

Development Permit Panel

Council Chambers, City Hall 6911 No. 3 Road

Wednesday, June 24, 2020 3:30 p.m.

MINUTES

Motion to adopt the	<mark>minutes</mark> of th	e Development	Permit Panel	meeting i	held on	June.	10
<i>2020</i> .							

1. GENERAL COMPLIANCE - REQUEST BY CHRISTOPHER BOZYK ARCHITECTS LTD. FOR A GENERAL COMPLIANCE RULING AT 4331 VANGUARD ROAD (FORMERLY 4331 AND 4431 VANGUARD ROAD)

(File Ref. No.: DP 17-782793) (REDMS No. 6463441)

APPLICANT: Christopher Bozyk Architects Ltd.

PROPERTY LOCATION: 4331 Vanguard Road (formerly 4331 and 4431 Vanguard

Road)

Director's Recommendations

That the attached plans to change the location of the proposed green wall feature and add new sustainability features be considered to be in General Compliance with the approved Development Permit (DP 17-782793).

2. **DEVELOPMENT PERMIT 18-797127**

(REDMS No. 6472575)

APPLICANT: Wensley Architecture Ltd.

PROPERTY LOCATION: 8131 Westminster Highway

ITEM

Director's Recommendations

That a Development Permit be issued which would permit the construction of a highrise mixed-use development containing approximately 436 m^2 (4,695 ft^2) of commercial space, 641 m^2 (6,904 ft^2) of office space, and 134 dwellings (including 13 affordable housing units) at 8131 Westminster Highway on a site zoned "Downtown Commercial (CDT1)".

3. DEVELOPMENT PERMIT 19-858597

(REDMS No. 6245695)

APPLICANT: 0855855 B.C. Ltd.

PROPERTY LOCATION: 9820 Alberta Road

Director's Recommendations

That a Development Permit be issued which would:

- 1. permit the construction of six townhouse units at 9820 Alberta Road on a site zoned "Town Housing (ZT60)- North McLennan (City Centre)"; and
- 2. vary the provision of Richmond Zoning Bylaw 8500 to reduce the minimum east side yard setback from 3.0 m to 2.25 m.
- 4. New Business
- 5. Date of Next Meeting: July 15, 2020

ADJOURNMENT





Development Permit Panel Wednesday, June 10, 2020

Time: 3:30 p.m.

Place: Council Chambers

Richmond City Hall

Present: Joe Erceg, Chair

Cecilia Achiam, General Manager, Community Safety

Milton Chan, Director, Engineering

The meeting was called to order at 3:30 p.m.

Minutes

It was moved and seconded

That the minutes of the meeting of the Development Permit Panel held on May 27, 2020 be adopted.

CARRIED

1. DEVELOPMENT PERMIT 19-876647

(REDMS No. 6473769)

APPLICANT: Easterbrook Milling Co. Ltd.

PROPERTY LOCATION: 17720 River Road

Development Permit Panel Wednesday, June 10, 2020

INTENT OF PERMIT:

- 1. Permit the construction of a single detached house at 17720 River Road on a site zoned "Agriculture (AG1)" and designated as an Environmentally Sensitive Area (ESA); and
- 2. Vary the provisions of Richmond Zoning Bylaw 8500 to increase the maximum farm house footprint from 60% to 72% of the maximum floor area to accommodate a secondary suite on the ground floor for farm workers and immediate family.

Gallery Comments

None.

Correspondence

John Roston, 12262 Ewen Avenue (Schedule 1)

Wayne Craig, Director, Development, noted that Mr. Roston provided background information on previous Council decisions regarding house size on Agricultural Land Reserve (ALR) areas and expressed his general support for the proposed variances in the applicant's original submission.

Richmond FarmWatch (Schedule 2)

Mr. Craig noted the organization's acknowledgement of the applicant as a long-term bona fide farmer in Richmond and their expression of support for the proposed variances in the applicant's original submission. He added that the organization expressed concern regarding the legal agreement that would restrict occupancy of the secondary suite to forcign farm workers. In response to this concern, he confirmed that the legal agreement that would be secured as a condition for approval of the subject application does not deal whatsoever with the immigration status of farm workers.

In reply to a query from the Panel, Mr. Craig confirmed that staff is recommending that the legal agreement allow occupancy of the secondary suite to either farm labourers working on a farm operation associated with the subject site or the immediate family of the property owner.

Panel Discussion

The Panel expressed support for the proposed changes to the applicant's original submission, noting that (i) there have been extensive discussions and debates in the community regarding farm house size where different views were expressed, and (ii) the application will move forward for Council consideration.

Development Permit Panel Wednesday, June 10, 2020

Panel Decision

It was moved and seconded

That a Development Permit be issued which would:

- 1. permit the construction of a single detached house at 17720 River Road on a site zoned "Agriculture (AGI)" and designated as an Environmentally Sensitive Area (ESA); and
- 2. vary the provisions of Richmond Zoning Bylaw 8500 to increase the maximum farm house footprint from 60% to 72% of the maximum floor area to accommodate a secondary suite on the ground floor for farm workers and immediate family.

CARRIED

- 2. Date of Next Meeting: June 24, 2020
- 3. Adjournment

It was moved and seconded That the meeting be adjourned at 3:36 p.m.

CARRIED

Certified a true and correct copy of the Minutes of the meeting of the Development Permit Panel of the Council of the City of Richmond held on Wednesday, June 10, 2020.

Joe Erceg	Rustico Agawin
Chair	Committee Clerk

Schedule 1 to the Minutes of the Development Permit Panel meeting held on Wednesday, June 10, 2020.

To De	evelopment Permit Panel
Date:	JUNE 10, 2020
Item	# .1
Re:_	DP 19-876647
i —	

From: CityClerk

Sent: Tuesday, 9 June 2020 09:01 **To:** Agawin,Rustico Romualdo

Subject: FW: Easterbrook Variance Application - Development Permit Panel

From: Powell, Jo Anne < JPowell@richmond.ca>

Sent: June 9, 2020 8:37 AM

To: CityClerk < CityClerk@richmond.ca>

Subject: FW: Easterbrook Variance Application - Development Permit Panel

FYI

From: Erceg, Joe < JErceg@richmond.ca>

Sent: June 5, 2020 12:28 PM

To: Craig, Wayne < WCraig@richmond.ca>; O'Halloran, Matthew < MOHalloran@richmond.ca>

Cc: Capuccinello Iraci, Tony < ACapuccinelloiraci@richmond.ca>; Powell, Jo Anne < JPowell@richmond.ca>

Subject: Fwd: Easterbrook Variance Application - Development Permit Panel

FYI.

Sent from my iPhone

Begin forwarded message:

From: "John Roston, Mr" < john.roston@mcgill.ca>

Date: June 5, 2020 at 11:50:22 AM PDT

To: "Brodie, Malcolm" < MBrodie@richmond.ca >, "McNulty,Bill" < BMcNulty@richmond.ca >,

"McPhail,Linda" <LMcPhail@richmond.ca>, "Loo,Alexa" <ALoo@richmond.ca>,

"Steves, Harold" hsteves@richmond.ca, "Au, Chak" <CAu@richmond.ca, "Day, Carol"

<<u>CDay@richmond.ca</u>>, "Greene,Kelly" <<u>kgreene@richmond.ca</u>>, "Wolfe,Michael"

<MWolfe@richmond.ca>

Cc: "Erceg,Joe" < <u>JErceg@richmond.ca</u>>, "Konkin,Barry" < <u>BKonkin@richmond.ca</u>>, Steve

Easterbrook < petrioche@gmail.com >

Subject: Easterbrook Variance Application - Development Permit Panel

Dear Mayor and Councillors,

As you will recall, one of the commitments made to genuine farmers during the great ALR house size debate was that every effort would be made to accommodate any reasonable variances they might request for residence construction and that those requests would be expedited. Stephen Easterbrook is one of those farmers who spoke against limiting ALR house size. He has now applied for two variances and it appears that the Development Permit Panel is not taking into consideration the fact that he is a genuine farmer and the Panel is rather applying a very strict interpretation of the bylaws.

The height restrictions were intended to ensure that additional living space was not added. In this

case, he appears to be requesting a variance for a chimney and a style of roof. The other variance is to accommodate a secondary suite, primarily for farm workers, on the ground floor which increases the ground floor ratio from 60% to 72% although the overall house size is within the 400m2 limit. Neither of these requests appears to be designed to increase the value of the property when it is sold, but rather to meet his needs while he continues farming for the foreseeable future.

While I didn't attend the Development Permit Panel meeting and can only rely on the minutes, it appears that the Panel's focus was on how to alter the house to eliminate the need for variances rather than to allow Mr. Easterbrook to build the house he wants and will best fit his needs. For instance, the Panel would like to limit use of the secondary suite to farm workers although the foreign farm workers in question are only permitted to be in the country for a maximum of eight months in the year.

If Council does not wish the Development Permit Panel to have the leeway of treating requests from genuine farmers differently than requests from developers then the Panel should suggest that the farmer take his case to Council and ask it to override the Panel's decision and grant the variances. It doesn't make sense to waste both the Panel's and Mr. Easterbrook's time on the current process.

John Roston 12262 Ewen Avenue Richmond, BC V7E 6S8 Phone: 604-274-2726



Schedule 2 to the Minutes of the Development Permit Panel meeting held on Wednesday, June 10, 2020.

To De	velop	ment	Permit	Panel
Date:	JUNE	10	2020	of management of the
Item :	#			
Re:	DP 19	1-87	6647	
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				And the section of the section

June 5, 2020

Your Worship, Mayor Brodie and Councillors,

Farmers throughout Richmond have learned that a local, long-term bona fide farmer of 17720 River Road has been asked by the Development Permit Panel to sign a restrictive covenant.

An email from Stephen Easterbrook states that this restrictive covenant is required as a condition of building a new home with a secondary suite to house foreign farmworkers.

We have significant concerns about this request and see it as unreasonable and as over-reach on the part of the Development Permit Panel.

The farmer is requesting two minor variances which will help facilitate the functioning and viability of his farm. It's clear that he has taken extensive efforts at significant costs to comply with all City requirements including keeping his proposed home, which includes farm worker housing in the home, within the 400m2 house size limit.

The glaring concern is the covenant being required to assure that the suite within the home only be occupied by foreign farm workers. In the case they may be seasonal workers, under the Federal Seasonal Agricultural Worker program, foreign farm workers are prohibited from staying in Canada more than eight months. https://www.canada.ca/en/immigration-refugees-citizenship/services/work-canada/permit/agricultural-workers-work-temporarily.html

A farmer, during these months may need to use the suite for other purposes that suit the farm. In the case of longer term non-seasonal farm workers, why only foreign workers? What if extended family wishes to work on the farm, or local farm workers or farm workers from another province? Also there are any number of reasons such as aging, disabilities or extended family circumstances that a farmer, or any homeowner, may need to use a suite in their home. Secondary permanent dwellings have been conditional to farm use, but never secondary suites in the primary residence.

We are asking that you review this very concerning matter and ensure that the Development Permit Panel understands that Council promised farmers, after extensive consultation including several public hearings, that farmers would be able to build to suit their needs.

Council implemented farm house size limits to stop speculators and investors. This was never intended to cause hardship to farmers in their living and farming activities. It is your responsibility to ensure the Development Permit Panel give farmers the flexibility they might need.

Yours sincerely, Richmond FarmWatch Richmondfarmwatch@gmail.com 604-723-3686



Report to Development Permit Panel

To:

Development Permit Panel

Date:

June 2, 2020

From:

Wayne Craig

File:

DP 17-782793

Director, Development

Re:

Application by Christopher Bozyk Architects Ltd. for a General Compliance to

Development Permit (DP 17-782793) at 4331 Vanguard Road (formerly 4331 and

4431 Vanguard Road)

Staff Recommendation

That the attached plans to change the location of the proposed green wall feature and add new sustainability features be considered to be in General Compliance with the approved Development Permit (DP 17-782793).

Wayne Craig

Director, Development

(604-247-4625)

JR:blg Att. 3

Staff Report

Origin

Christopher Bozyk Architects Ltd. has requested a General Compliance ruling regarding changes to the approved Development Permit (DP 17-782793) for a three-storey, 8,576 m² commercial industrial development at 4331 Vanguard Road (formerly 4331 and 4431 Vanguard Road) on a site zoned "Industrial Retail (IR1)" (Attachment 1). The project entails a vehicle storage and repair facility, showroom, and car wash. The Development Permit was endorsed by the Development Permit Panel on August 29, 2018, and was issued with the associated Zoning Text Amendment Bylaw (ZT 16-740866) adopted by Council on February 25, 2019.

The requested General Compliance ruling is related to the proposed relocation of a green wall feature on the south elevation of the building. The attached plans show the proposed relocation and the addition of new sustainability features.

Background

Development surrounding the subject site is as follows:

- To the North and East: Medium sized industrial lots (0.12 ha to 0.25 ha) (0.3 ac. to 0.6 ac.) all zoned "Industrial Retail (IR1)" and used for various general industrial purposes (auto repair, equipment rental shops, roofing and woodworking facilities, home interior products, etc.).
- To the South: An east-west leg of Vanguard Road and Highway 99.
- To the West: Shell Road, the Shell Road rail corridor and Highway 99.

Staff Comments

The proposed changes to the plans attached to this report are in general compliance with the original approved Development Permit (Attachment 2). In addition, the modified proposal (Attachment 3) complies with the intent of the applicable sections of the Official Community Plan (OCP) and is in compliance with the "Industrial Retail (IR1)" zone, except for the building height variance included in the original Development Permit.

Analysis

Proposed Changes to the Green Wall Feature

- The approved Development Permit includes a 90.6 m² (975 ft²) feature green wall on the south elevation of the building, which frames the building entrance. The planting material covers a portion of this wall, with the remainder clad in black metal panels.
- The proposed revisions would relocate the green wall to the west elevation and reduce the area to 54.8 m² (580 ft²). The proposed black metal panels would be extended across the entrance wall in place of the plantings. These changes to the entry are proposed to bring the development in line with the corporate branding standard of the occupant.

- No change to the planting material in the green wall is proposed. The applicant has confirmed that reduced area of the green wall continues to provide an environmental benefit to the site.
- The City is holding a \$148,500 Landscape Security for the installation of the original proposed green wall based on a cost estimate provided by the applicant. A new security is not required.

Environmental Sustainability

- The approved Development Permit for this site incorporated a number of sustainability initiatives in addition to the aforementioned green wall. A 586 m² (6,309 ft²) green roof composed of sedum tiles will be installed over the showroom roof to help reduce heat island effect. On-site storm water management will be used to collect and store surface storm water for use in on-site irrigation. New landscaping is provided on all three frontages and within the parking area, and includes 35 new trees. Finally, rooftop solar panels are included to help offset the electrical demand.
- To compensate for the reduction in area of the green wall, two new sustainability initiatives are proposed: an apiary and EV charging stations.
- An apiary consisting of two beehives is proposed in the landscaped area on the west side of the site. The applicant has indicated that additional hives may be added, and that the apiary will be maintained by the owner with honey harvesting performed annually.
- The approved landscape plan has an emphasis on flowering plant species appropriate for pollinators. The landscape design is intended to recreate a wildflower meadow, and the proposed apiary would be located in the largest landscaped area.
- The proposed apiary and pollinator-friendly landscaping advance the City's objectives of supporting urban agriculture and strengthening the local food system. The proposal also aligns with the recently launched "Richmond Nectar Trail," which encourages residents and businesses to plant pollen-rich plants enabling bees and other pollinators to traverse the city.
- The City is holding a \$268,172.26 Landscape Security for the on-site landscaping based on the landscape plan and cost estimate provided by the applicant. The proposed apiary has been added to the landscape plan, and a new security is not required.
- Two publicly accessible electric vehicle charging stations are proposed, which would provide Level 2 charging to a total of four vehicles. These charging stations are shown on the site plan next to the entry plaza.

Conclusions

Christopher Bozyk Architects Ltd. has requested a General Compliance ruling for proposed changes to a green wall feature and the addition of new sustainability features.

Staff have no objection to the proposed changes. Staff recommend support of this General Compliance request for the proposed changes to the approved Development Permit.

Jordan Rockerbie

Planner 1

(604-276-4092)

JR:blg

Attachments:


Attachment 1: Location Map

Attachment 2: Relevant Approved Development Permit Plans

Attachment 3: Proposed New Development Permit Plan

ATTACHMENT 1



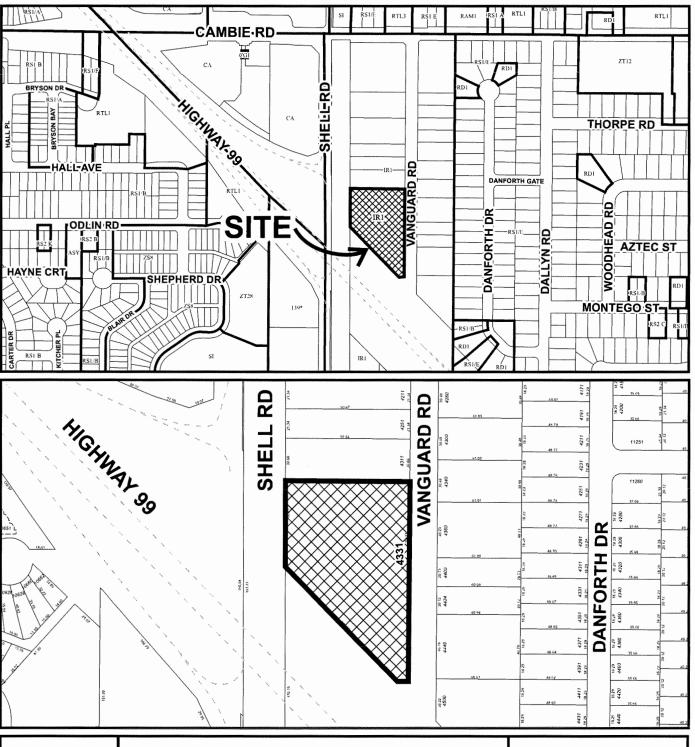


N

DP 17-782793

Original Date: 01/28/20

Revision Date:

Note: Dimensions are in METRES

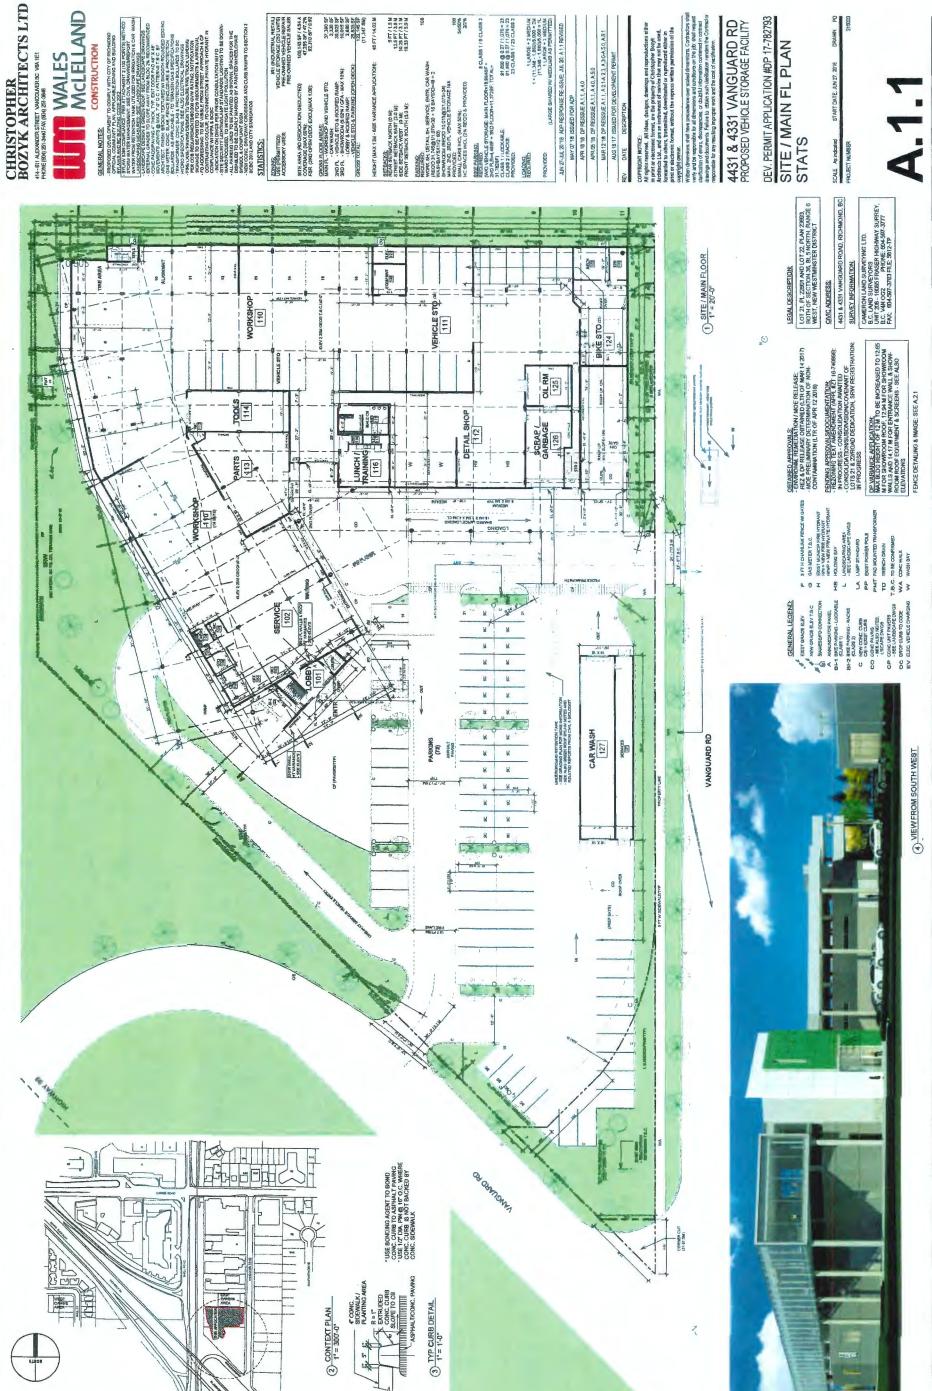

Plantl

Variances are cloud outlined

CHRISTOPHER BOZYK ARCHITECTS LTD MCLELLAND CONSTRUCTION 414-611 ALEXANDER STREET VANCOUVER BC VGA 1E? PHONE (604) 251-3846 FAX (604) 251-3848

JAN 27-AL (2018) AOP-RESPONSE PELSSUE, AL 27: A 1 PENSED

MAY 07:19 ISSUED FOR ADP

APR 18:19 ID PERSSUE A.11, A.41 A.50

APR 18:19 ID PERSSUE A.11, A.41 A.50

MAR 12:19 ID PERSSUE A.11, A.41 A.50

ALIG 19:17 SISSUE COFFICE/PRENT FERMIT

PEV DATE ID ESCRETCH

4431 & 4331 VANGUARD RD PROPOSED VEHICLE STORAGE FACILITY

DEV. PERMIT APPLICATION #DP 17.782793 PERSPECTIVES

A.5.0

Plan#7




3) VIEW FROM SHELL (WEST)




2) VIEW FROM VANGUARD EAST



(1) VIEW FROM VANGUARD SOUTH

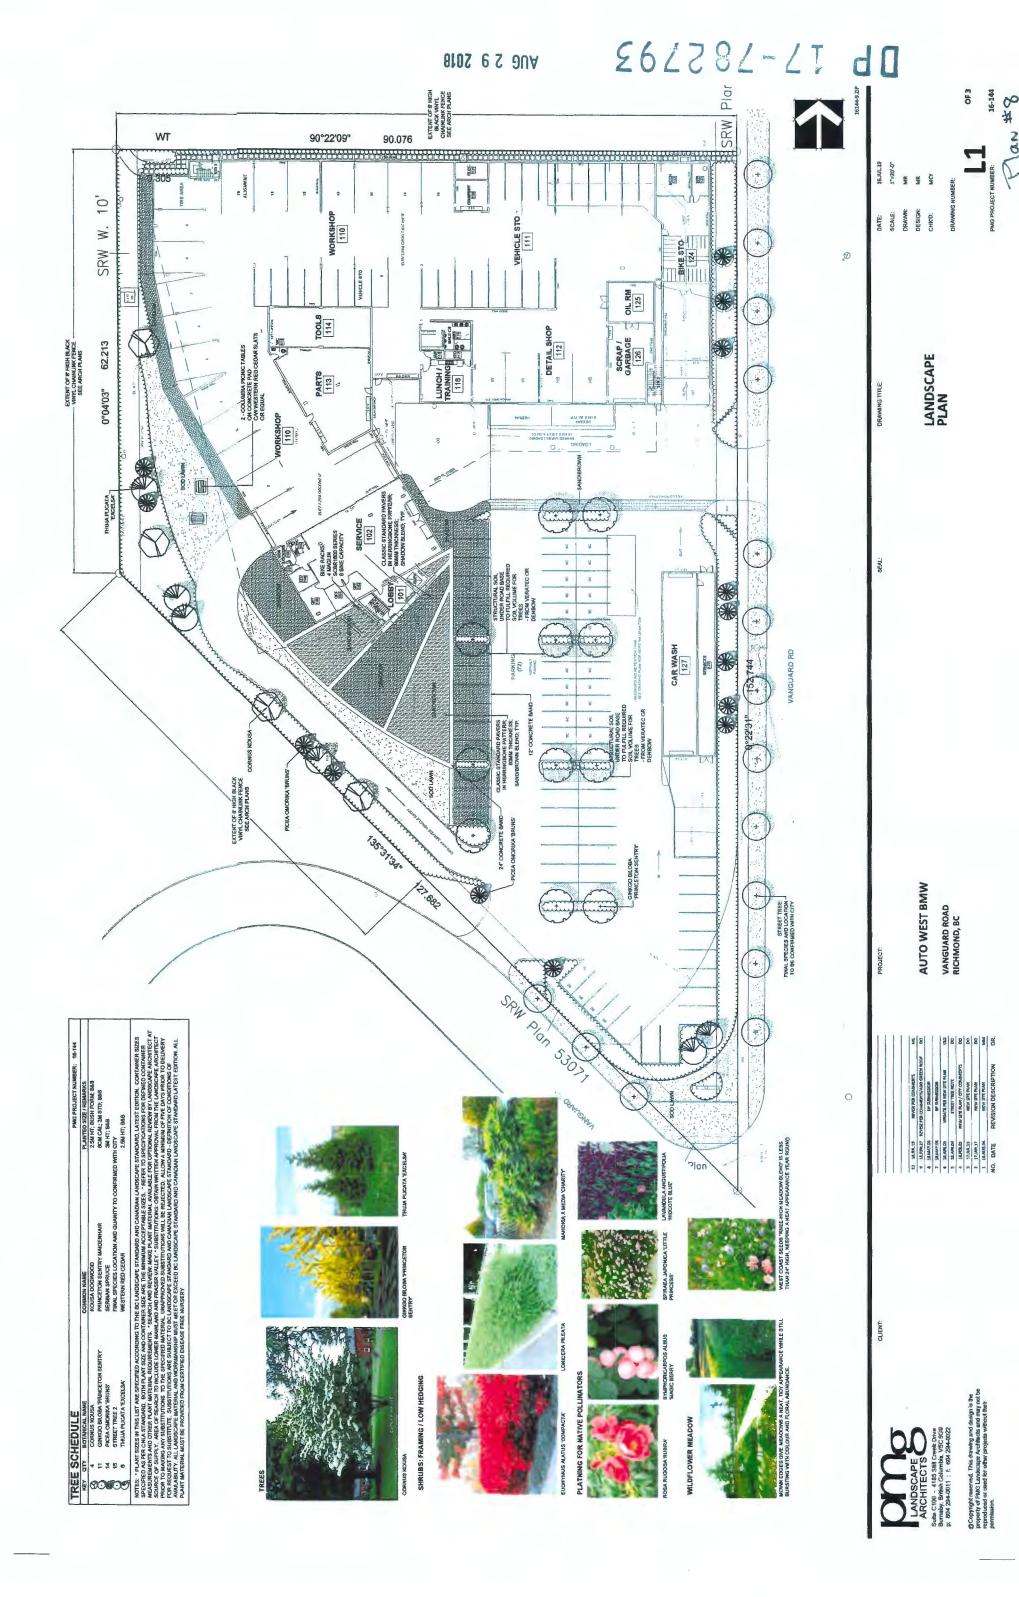

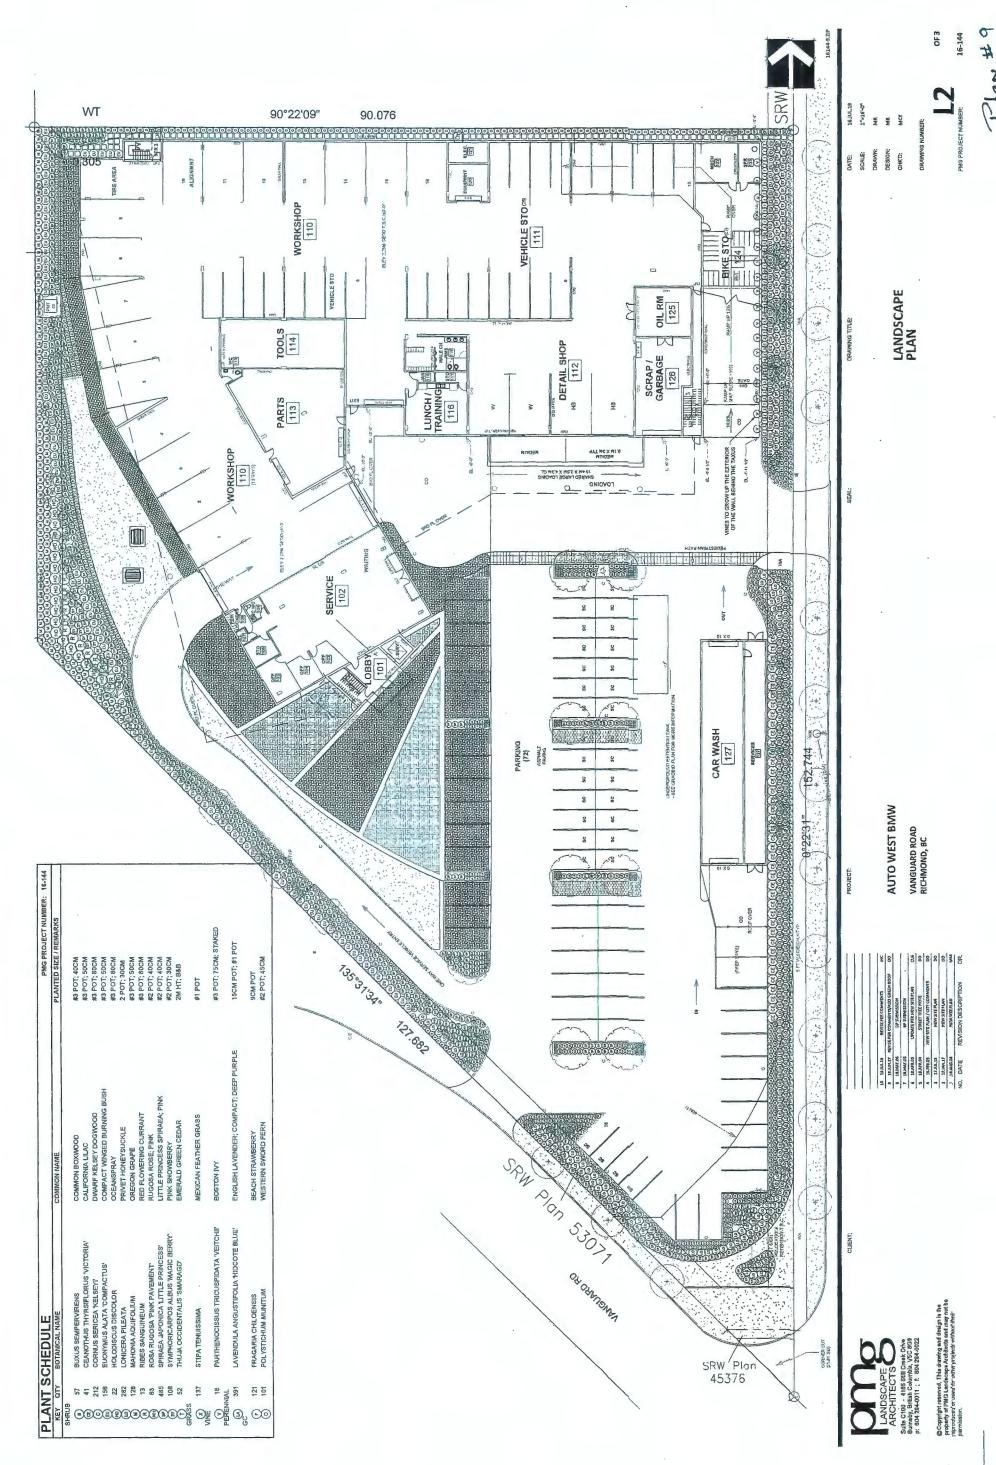

НТЯОИ

VANGUARD RD

1 SITE PLAN 1" = 40'-0"

51

EXIST SIGN - RELOCATION - RETENSION

DP GENERAL COMPLIANCE APPLICATION

CHRISTOPHER
BOZYK ARCHITECTS LTD
International Constitution of the **4331 VANGUARD RD**

PROPOSED GREEN WALL RELOCATION & APIARY ADDITION SCALE. MAY 26, 2020 PROJECT NUMBER: 215003



MAIN FLOOR 2ND FLOOR 16' - 11" 3RD FLOOR 26' - 10" 1 NEW GREEN WALL / S-W ELEVATION 3/32" = 1'-0" OUT, NE OF SHOWROOM BEHND

2 APPROX S-W VIEW FROM HIGHWAY 99

GREEN WALL SPECIFICATION:
SPECIFICATION PER APPROVED DP & PROVIDED PRODUCT
DATA: PATENT GREEN WALL SYSTEM "SEMPERGREENWALL"
OR SIM APPROVED


of Christopher Bozyk Architects Ltd., and are an instrument of ormat, without the express written permission of the copyright owner

PROPOSED GREEN WALL RELOCATION
DATE: MAY 25, 2020 PROJECT NUMBER: 215003

CHRISTOPHER
BOZYK ARCHITECTS LTD
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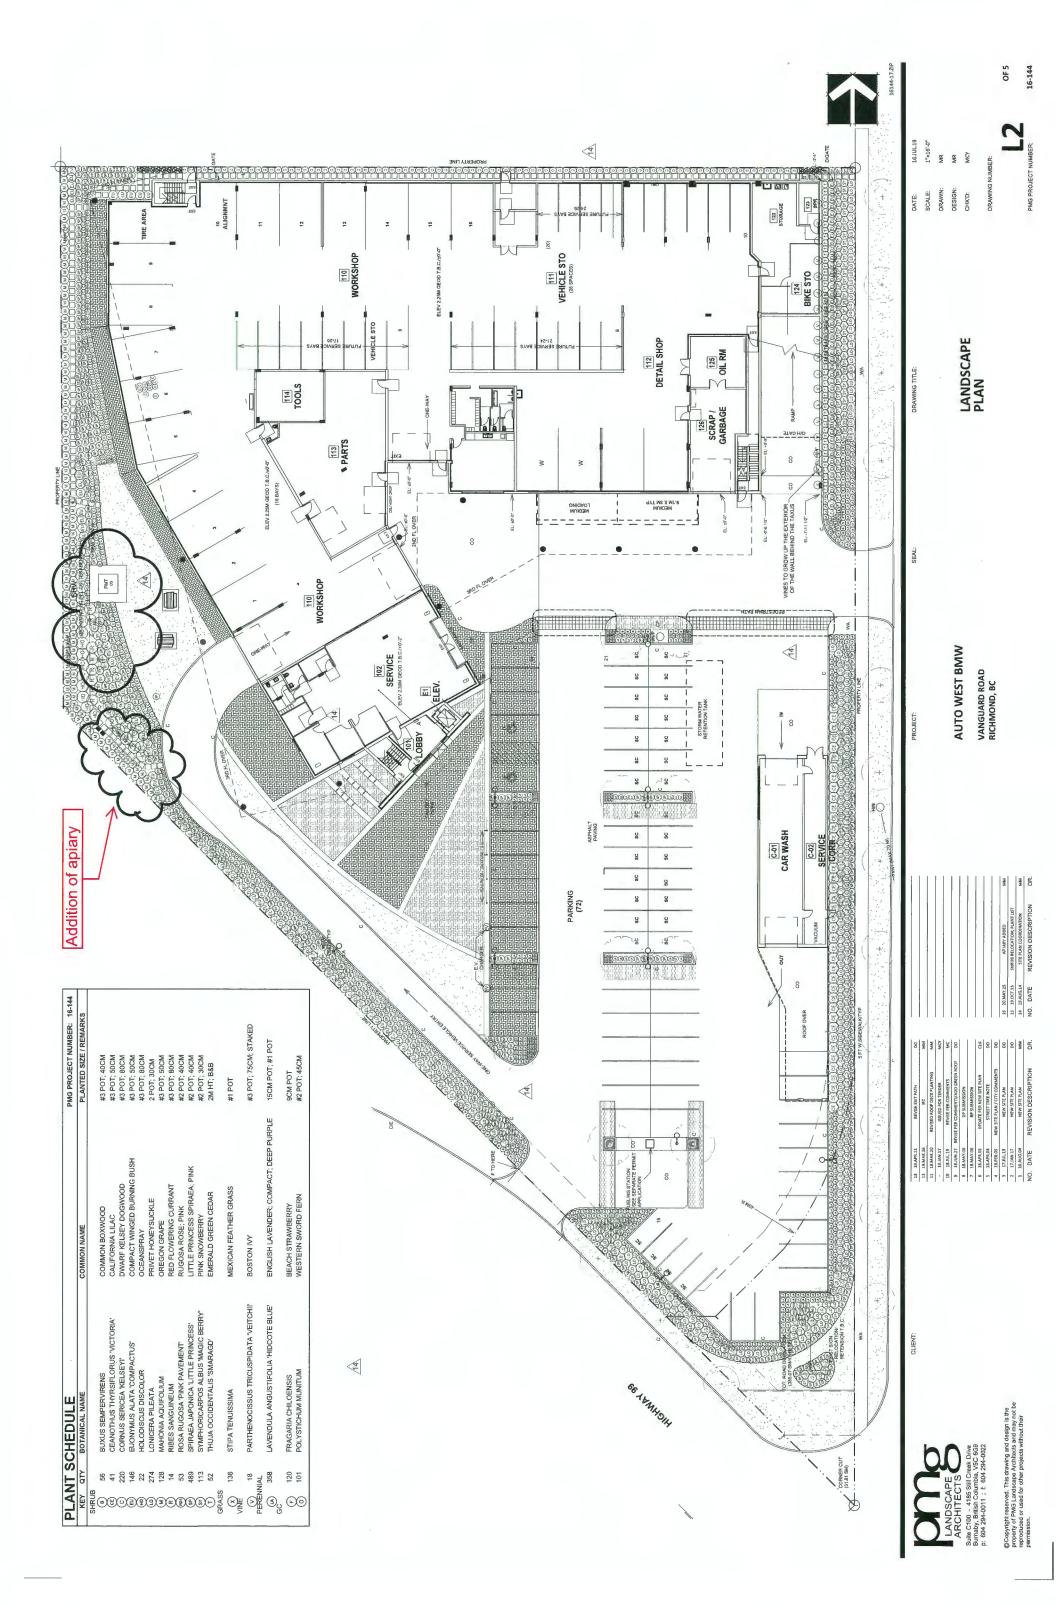
DP GENERAL COMPLIANCE APPLICATION

4331 VANGUARD RD

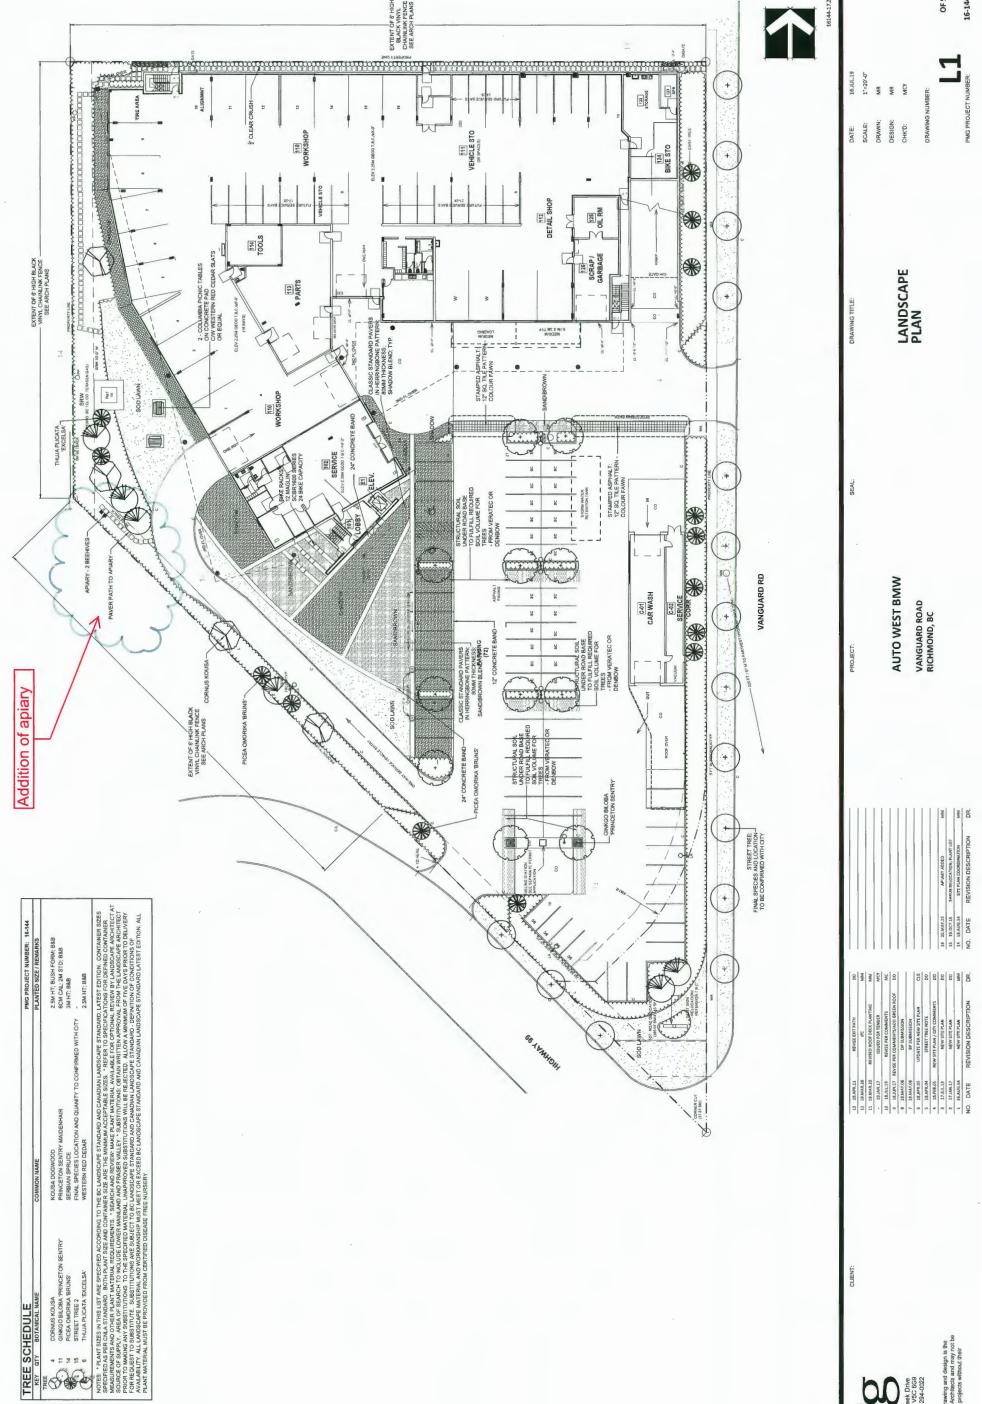

LANDSCAPE ARCHITECTS

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Report to Development Permit Panel

To: Development Permit Panel Date: June 2, 2020

From: Wayne Craig File: DP 18-797127

Director, Development

Re: Application by Wensley Architecture Ltd. for a Development Permit at

8131 Westminster Highway

Staff Recommendation

That a Development Permit be issued which would permit the construction of a high-rise mixed-use development containing approximately 436 m² (4,695 ft²) of commercial space, 641 m² (6,904 ft²) of office space, and 134 dwellings (including 13 affordable housing units) at 8131 Westminster Highway on a site zoned "Downtown Commercial (CDT1)".

Wayne Craig

Director, Development

(604-247-4625)

WC:sb Att. 4

Staff Report

Origin

Wensley Architecture Ltd. has applied to the City of Richmond for permission to develop a mixed-use high-rise residential, office and commercial development at 8131 Westminster Highway on a site zoned "Downtown Commercial (CDT1)". No rezoning application is associated with the subject Development Permit application. Key components of the proposal include:

- A single 14-storey tower with 11 floors of residential apartments over a three-storey podium containing a floor of office space above ground level commercial retail units, four levels of parking, resident indoor amenity and service spaces.
- A maximum floor area ratio (FAR) of 3.29 including affordable housing, additional floor area ratio (FAR) of 0.07 for resident indoor amenity space, and a maximum height of 47m geodetic.
- A total floor area of approximately 11,435 m² (123,085 ft²) comprised of approximately:
 - o 436 m² (4,696 ft²) of commercial space.
 - \circ 641 m² (6,904 ft²) of office space.
 - o 10,052 m² (108,202 ft²) of residential space.
 - o 235 m² (2,531 ft²) of indoor amenity space for residents.
 - o 305 m² (3,283 ft²) of circulation space in non-residential podium.
- Approximately 134 dwelling units, including:
 - o 121 market residential units.
 - o 13 affordable housing low-end-of-market rental (LEMR) units.
- Lane dedication and construction of a new City lane across the west (side) and north (rear) frontages of the site.

The site is comprised of one lot which is currently vacant and previously contained a two-storey commercial building.

Road and Engineering improvements required with respect to the subject development will be secured through the City's Standard Servicing Agreement process as a consideration of the Development Permit. Works include City lane and road works, frontage improvements, and utility upgrades.

Development Information

Please refer to attached Development Application Data Sheet (Attachment 1) for a comparison of the proposed development data with the relevant Bylaw requirements.

Background

Development surrounding the subject site is as follows:

To the north: Across the proposed rear lane, an existing large commercial centre with a large

grocery store that has the same designation under the City Centre Area Plan (CCAP) as the subject site, for high density high-rise commercial and mixed-use

development (Urban Core T6 (45 m) and Village Centre Bonus).

To the east: A small low-rise commercial development, also with the same designation under

the CCAP as the subject site.

To the south: Across Westminster Highway, small low-rise commercial developments, also

with the same designation under the CCAP as the subject site.

To the west: Across the proposed side lane, a high-rise mixed-use development facing

No. 3 Road and a small low-rise commercial development facing

Westminster Highway, also with the same designation under the CCAP as the

subject site.

Staff Comments

The proposed scheme attached to this report has satisfactorily addressed the significant urban design issues and other staff comments identified as part of the review of the subject Development Permit application. In addition, it complies with the intent of the applicable sections of the Official Community Plan (OCP) and is in compliance with the "Downtown Commercial (CDT1)" zone.

Advisory Design Panel Comments

On January 23, 2019, the Advisory Design Panel (ADP) supported the subject Development Permit application moving forward to the Development Permit Panel, subject to the applicant giving consideration to the ADP's comments. A copy of the relevant excerpt from the Advisory Design Panel Minutes is attached for reference (Attachment 2), together with the applicant's design response in 'bold italics'.

Analysis

Conditions of Adjacency

- The proposed development includes enhancement of the Westminster Highway streetscape with active commercial uses, office entry lobby and ramped covered walkway to the inset residential entry lobby.
- The interface with the proposed west (side) City lane is enhanced with the residential entry lobby and pedestrian walkways. This interface includes the main access to the parking structure, loading spaces and on-site parallel parking.
- The interface with the proposed north (rear) City lane includes a secondary access to the parking structure.
- A three-storey podium party wall is proposed along the east property line, which will be visible until future adjacent development occurs. In the interim, the party wall has been treated with a variety of colour and texture in a grid pattern for visual interest and to break down the wall visually.

- A tiered 14-storey building massing is provided along all sides of the site.
- The tower shape and placement on the subject site facilitates future development in the area achieving the minimum 24m tower spacing guideline in the CCAP through providing 12m to 19m setback from the future lane centreline and 12m setback from the east property line.

Urban Design and Site Planning

- The proposed tiered massing includes a single 14-storey tower consisting of a three-storey
 podium containing commercial, office, resident indoor amenity, service and parking uses,
 four-storey mid-level podium and seven-storey tower portion both containing residential and
 resident amenity uses.
- The site is designated Urban Core T6 (45 m) in the CCAP and zoned "Downtown Commercial (CDT1)", which permits 47m geodetic building height. The site is also designated Sub-Area B.4 Mixed Use High-Rise Commercial & Mixed Use in the CCAP. The proposed form of development takes advantage of the site's proximity to the Canada Line and provision of a new City lane to create a high-density urban environment that is consistent with CCAP objectives.
- The proposed building heights comply with NAV Canada building height restrictions.
- The proposed building includes commercial, office and residential uses. Registration of a legal agreement on title is a consideration of the Development Permit, addressing noise impacts generated by the internal uses from penetrating into residential areas that exceed noise levels allowed in the City's Noise Bylaw and that noise generated from rooftop equipment will comply with the City's Noise Bylaw.
- The site is located in an area impacted by traffic and Canada Line noise. Registration of a legal agreement on title is a consideration of the Development Permit, addressing noise impacts on residential uses, including those related to the Canada Line.
- The site is located in an area impacted by aircraft noise (Area 3) and registration of an aircraft noise sensitive use legal agreement on title is a consideration of the Development Permit. As part of the Building Permit (BP) process, the applicant is required to design and construct the building in a manner that mitigates potential aircraft noise to the proposed dwelling units. Submitted acoustic and mechanical engineering information indicate the proposal dwelling units will achieve the required:
 - a) CMHC guidelines for interior noise levels as indicated in the chart below:

Portions of Dwelling Units	Noise Levels (decibels)
Bedrooms	35 decibels
Living, dining, recreation rooms	40 decibels
Kitchen, bathrooms, hallways, and utility rooms	45 decibels

- b) The ASHRAE 55-2004 "Thermal Environmental Conditions for Human Occupancy" standard for interior living spaces.
- In accordance with the City's flood plain designation and protection Bylaw 8204, registration of a flood covenant is a consideration of the Development Permit. The proposal complies with the bylaw.
- Service uses, parking, loading and waste management are screened from public view.

Transportation

- The CCAP requires the expansion of rear lane and road networks. Road dedication is required along the south property line of 3 m width for future Westminster Highway road widening. Lane dedication is required along the west and north property lines of 6 m width to establish the new lane with interim width, which will be widened to ultimate 9 m lane width through future adjacent development. Lane and road dedication are considerations of the Development Permit.
- In accordance with the existing "Downtown Commercial (CDT1)" zoning, the density is calculated on the gross site area prior to road dedications being provided.
- All transportation improvements required with respect to the subject development will be
 designed and constructed at the owner's sole cost through the City's Standard Servicing
 Agreement processes as a consideration of the Development Permit. Key transportation
 improvements to be provided by the owner include:
 - O Along the Westminster Highway frontage, new 3 m wide concrete sidewalk at the new property line, street trees in tree grates and pavers behind existing curb and gutter, maintain existing westbound traffic lanes, and lengthen the existing raised median to the east by approximately 15 m.
 - Along the new City Lane frontage: along the entire west and north property lines, new laneway complete with roll-over curbs on both sides and between the roll-over curbs, asphalt driving surface.

Parking and Access

- Vehicle access is proposed to the site from the required City lane at the west and north sides of the development, which is accessed from Westminster Highway.
- The total number of parking spaces proposed to be provided on-site is 164, including 121 for the use of the residents, 12 for the use of the affordable housing unit residents and 31 for the shared use of residential visitors, commercial and office uses.
- Short term class 2 bicycle storage is accommodated with bicycle racks near the office and residential lobby entries. Longer term class 1 bicycle storage is accommodated in shared secure bicycle storage rooms located on all five levels of the parking structure.
- Two medium (SU-9) on-site loading spaces are provided adjacent to the waste management room and near the residential lobby entry.
- Registration of a legal agreement is required, ensuring the provision and shared use of the visitor/commercial/office parking spaces, loading spaces, and class 1 bicycle storage rooms.
- Registration of a legal agreement is required, ensuring the provision of energized electric vehicle (EV) charging outlets for 10% of the shared visitor/commercial parking spaces (208V 240V), and 10% of Class 1 secure bicycle storage spaces in all bicycle storage rooms (120V).

Architectural Form and Character

 The proposed development contributes towards contemporary architectural expression including a high level of architectural design, articulation and material quality. The design includes articulation along the building facades, terraced building massing and a substantial podium with commercial base to anchor the building. The penthouse units are two-level, providing roofline articulation opportunities as well as mechanical equipment screening opportunities.

- The proposed cladding materials (cement panel, metal panels, stainless steel perforated screens, aluminum fins, window wall, and glass guard rails) are consistent with the Official Community Plan (OCP) guidelines and contribute towards a distinct identity and urban environment.
- The palette of colours includes wood to dark grey tones, and white and orange tone accents. When used in combination with variations in massing and materials, helps break up the massing, reinforce the identity of the project and project a crisp, contemporary image.
- Rooftop equipment will be located at the top floor level and screened similar to adjacent two-level penthouse residential units.

Landscape Design and Open Space Design

- The CCAP encourages the provision of additional open space to enhance the urban environment. The subject development's public open space contributions are provided along Westminster Highway and the lane.
- 831 m² (8,945 ft²) of residential outdoor amenity space is provided, based on the OCP standard of 6 m² (65 ft²) per dwelling unit, comprising three consolidated, irrigated, landscaped multi-use outdoor spaces and accessed from interior corridors and the fourth floor indoor amenity room. The space on the east side of the development at the fourth floor level is designed as an active space with three items of play equipment for 5 to 13-year olds and older, a fitness deck for all ages and a patio area at the indoor amenity space. The space on the north side of the development at the eighth floor level features three items of play equipment for toddlers to 12-year olds, chalkboard area and family seating areas. On the same floor level, the space on the south side is designed for communal social activities and sun bathing with harvest table, BBQ, clustered outdoor seating and long chairs.
- Private outdoor patios or balconies are provided for all dwelling units.
- At the time of application, there were 11 trees located on the subject site. The arborist report identified these trees as being in poor to moderate condition. Subsequently, the applicant elected to demolish the existing building. In order to demolish the building, the trees needed to be removed and a tree removal permit was issued. Based on the 2:1 tree removal compensation ratio, the planting of 22 new trees on-site would be required. There are a total of 32 new trees included in the Development Permit plans.
- At grade, the overall landscape design approach is to provide an urban streetscape interface softened with planting to Westminster Highway. The plant palette at grade is colourful with Bowhall Red Maple and Columnar European Aspen trees, ornamental grasses and perennials.
- At the fourth floor level, the outdoor amenity design approach is to facilitate exercise with active play elements for older children, raised deck and patio area adjacent to indoor amenity space. Planting at the fourth level provides semi-private patios with screening in edge planters facing north, east and south with a plant palette of Vine Maple and Tall Stewartia trees, shrubs, ferns, ornamental grasses, perennials, and groundcover.
- At the eighth floor level, the outdoor amenity design approach is to provide a passive and social sundeck area facing south and a creative and active family play area for toddlers to preteens facing north. Planting at the eighth level surrounds, complements and softens the outdoor amenity areas with a plant palette of Japanese Maple, Serviceberry and Serbian Spruce trees, shrubs, ornamental grasses, perennials and groundcover.
- All landscaped areas will be serviced by an irrigation system.

Prior to forwarding the subject application to Council, the applicant is required to provide to
the City, a Letter of Credit for landscaping in the amount of \$387,783.18, as estimated by the
project Landscape Architect, to ensure that on-site landscape features are provided in
accordance with the Development Permit.

Shared Indoor Amenity Space

- The OCP requires that multi-family development comprising 40 units or more provide at least 100 m² (1,076 ft²) of indoor amenity space. The subject development exceeds the OCP minimum by more than double, providing 235 m² (2,531 ft²) of indoor amenity space.
- An open multi-purpose room with washroom facility is located on the fourth floor level adjacent to covered patio area in the outdoor amenity space, facilitating meetings and free form exercise such as Tai Chi or Yoga.
- A larger multi-purpose room is located on the third floor level with a washroom facility and a number of furnishings to facilitate a variety of social activities, including clustered lounge seating areas, kitchenette and table area, billiard and foosball table areas.

Crime Prevention Through Environmental Design

- CPTED measures enhance safety and personal security in and around the proposed building.
- Casual surveillance is provided through minimizing blind corners, prominent residential lobby and commercial entrances, locating visitor and shared visitor/commercial parking close to the entries in the parkade, clear sightlines to exits within the parkade (mirrors where needed), glazed vestibules, and lighting in all pedestrian areas.
- The streetscape and common area design is defined and visually permeable to establish a sense of territoriality that contributes toward overall safety.
- Target hardening security features are provided at all pedestrian and parking entrances.

Accessible Housing

- The 13 affordable housing units in the proposed development are all basic universal housing units that are designed to be easily renovated to accommodate a future resident in a wheelchair. These single-storey units are required to incorporate all of the accessibility provisions listed in the Basic Universal Housing Features section of the City's Zoning Bylaw, and are permitted a density exclusion of 1.86 m² (20 ft²) per unit.
- All of the proposed units incorporate aging in place features to accommodate mobility constraints associated with aging. These features include:
 - o Stairwell hand rails.
 - o Lever-type handles for plumbing fixtures and door handles.
 - Solid blocking in washroom walls to facilitate future grab bar installation beside toilets, bathtubs and showers.
- Wheelchair access is accommodated in all common areas and corridors to unit entries.

Sustainability Measures

• District Energy Utility (DEU) compatible building and mechanical system designed to facilitate a future connection to a City utility. Registration of a legal agreement on title is required, securing the owner's commitment to connect to a DEU that provides that no Building Permit will be issued unless the building is designed with the capability to connect to and be serviced by a DEU. The owner will also be required to provide mechanical

- drawings and energy modeling, which shall be reviewed by the City and LIEC for compliance with DEU requirements (i.e. capable of connecting to a future DEU system) prior to Building Permit issuance.
- The proposal has met all criteria to proceed under the LEED "Silver" equivalency grandfathering provisions as adopted by Council.

Dwelling Unit Mix

- The OCP and City Centre Area Plan (CCAP) encourage the development of a variety of unit types and sizes supportive of the diverse needs of Richmond's population including, but not limited to, households with children.
- The OCP encourages multiple family residential development to provide at least 40% of units with two or more bedrooms that are suitable for families with children. The proposed development complies, with 73% of units overall having two and three bedrooms.
- Staff support the applicant's proposal, which includes the following mix of affordable housing and market strata unit sizes:

	Tenure 1	Total		
Unit Type	Affordable Housing Units	Market Strata Units	% of Units	# of Units
Studio	1	22	17%	23
1-Bedroom	0	12	9%	12
2-Bedroom	8	77	63%	85
3-Bedroom	4	10	10%	14
Total	13	121	100%	134

Affordable Housing

- In compliance with the City's Affordable Housing Strategy, the owner proposes to design and construct 13 low-end-of-market rental units, comprising at least 1,019 m² (10,970 ft²) of habitable space, based on 10% of the development's total residential floor area. Occupants of these units will enjoy full use of all residential amenity spaces, parking, bicycle storage, and related features, at no additional charge to the affordable housing occupants.
- The Affordable Housing Strategy encourages at least 60% of affordable housing units to be provided with two or more bedrooms. The proposed development complies, with 92.3% of affordable housing units having two and three bedrooms.
- Prior to Development Permit issuance, a Housing Agreement and Housing Covenant will be registered on title requiring that the owner satisfies all City requirements in perpetuity.

	Affordable Housing Strategy Requirements				Project Targets	
Unit Type	Minimum Unit Area	Maximum Monthly Unit Rent (1)	Total Maximum Household Income(1)	Unit Mix	# of Units (2)	
Studio	37 m ² (400 ft ²)	\$811	\$34,650 or less	7.7%	1	
1-Bedroom	50 m ² (535 ft ²)	\$975	\$38,250 or less	0%	0	
2-Bedroom	69m² (741 ft²)	\$1,218	\$46,800 or less	61.5%	8	
3-Bedroom	91 m ² (980 ft ²)	\$1,480	\$58,050 or less	30.8%	4	
Total	1,019 m ² (10,970 ft ²)	N/A	N/A	100%	13	

- (1) Denotes the council-approved rates as of July 24, 2017. Rates may be adjusted periodically as provided for under adopted City policy.
- (2) 100% of affordable housing units meet Richmond Basic Universal Housing (BUH) standards.

City Centre Development

- The applicant will be providing a voluntary contribution in the amount of \$37,115.79 towards future City community planning studies, as set out in the City Centre Area Plan (i.e. 2020 rate of \$0.30 x 123,719.31 maximum buildable square feet).
- Registration of a legal agreement on title is required, ensuring that future owners are aware that the development is subject to potential impacts due to other development that may be approved within the City Centre (e.g., impacts on views).

Public Art

• The applicant will be providing a voluntary contribution in the amount of \$91,988.51 towards the City's Public Art Program (i.e. 2020 rate of \$0.89 x 97,674.67 residential square feet, excluding affordable housing and \$0.47 x 11,599.54 commercial/office square feet).

Servicing Agreement

• The developer is generally required to design and construct the new City lane, Westminster Highway frontage beautification, raised median and sanitary sewer improvements and related City road and City lane land dedication. The developer's design and construction of the required works and granting of statutory rights-of-way, as determined to the satisfaction of the City, shall be implemented through the City's Standard Servicing Agreement process (secured with legal agreement registered on title and provision of a Letter of Credit) prior to Development Permit issuance, as set out in the attached Development Permit considerations (Attachment 4).

Conclusions

The proposed development is consistent with Richmond's objectives for the subject site and Lansdowne Village as set out in the Official Community Plan (OCP), City Centre Area Plan (CCAP), and Zoning Bylaw. The project will enhance the Lansdowne Village urban community through its on-site pedestrian circulation works, street-fronting commercial space, articulated form, pedestrian-oriented streetscape, affordable housing and basic universal housing feature units. The proposed development will also enhance the community through the developer's concurrent construction of off-site pedestrian and road network improvements. The applicant has agreed to complete Development Permit considerations (Attachment 4). On this basis, staff recommend that the Development Permit be endorsed, and issuance by Council is recommended.

Sara Badyal

Planner 2

(604-276-4282)

Sara Badyal

SB:blg

Attachments:

Attachment 1: Development Application Data Sheet

Attachment 2: Advisory Design Panel Meeting Minutes Annotated Excerpt (January 23, 2019)

Attachment 3: Development Permit Considerations



Development Application Data Sheet

831 m²

None

Development Applications Department

DP 18-797127

Address: 8131 Westminster Highway

Applicant: Wensley Architecture Ltd. Owner: 1054824 BC Ltd., Inc. No BC1054824

Planning Area(s): Lansdowne Village (City Centre)

	Existing	Propose	ed	
Site Area	3,483 m²	,	Site 2,631 m ² Dedication 853 m ²	
Land Uses	Vacant	Mixed Use		
OCP Designation	Downtown Mixed Use	Complies		
Area Plan Designation	Urban Core T6 (45 m), Sub-area B	·····		
Zoning	Downtown Commercial (CDT1)	Complies		
Number of Units	Vacant	134 dwelling units, including 13 AH u 641 m² office space 436 m² commercial space		
	Bylaw Requirement	Proposed	Variance	
Floor Area Ratio	Max. 3.3, including AH (11,494 m²)	3.29, including AH (11,435 m²)	None permitted	
Lot Coverage	Max. 90%	86%	None	
Setback – Westminster Hwy	Min. 3 m	3 m	None	
Setback – West Side Yard	Min. 0 m	3 m	None	
Setback – East Side Yard	Min. 0 m	0 m	None	
Setback – Rear Yard	Min. 0 m	0 m	None	
Height	Max. 47 m geodetic	47 m geodetic	None	
Lot Size	None	34.3 m min. lot width 80.5 m min. lot depth 2,631 m ² lot area	None	
Parking Spaces: Residential Affordable Housing Shared VisitorOffice/Commercial Total	City Centre Zone 1 121 12 31 164	121 12 31 164	None	
Accessible Parking Spaces	Min. 2%	2.4% (4 spaces)	None	
Small Car Parking Spaces	Max. 50%	45% (73 spaces)	None	
Tandem Parking Spaces	Permitted	None	None	
Loading	2 medium truck (SU-9) spaces	2 medium truck (SU-9) spaces	None	
Bicycle Storage	168 class 1 secure bike spaces 27 class 2 bike rack spaces	169 class 1 secure bike spaces 27 class 2 bike rack spaces	None	
EV (Energized) Car Charging	100% resident parking spaces 10% shared parking spaces	100% resident parking spaces 10% shared parking spaces	None	
Amenity Space - Indoor:	Min. 100 m ²	235 m ²	None	
		224 0	.	

Min. 804 m²

Amenity Space - Outdoor:

Annotated Excerpt from the Minutes from Advisory Design Panel Meeting

January 23, 2019

DP 18-797127 – ONE-TOWER CITY CENTRE RESIDENTIAL MIXED USE DEVELOPMENT

ARCHITECT: Wensley Architecture Ltd.

LANDSCAPE ARCHITECT: P+A Landscape Architecture

PROPERTY LOCATION: 8131 Westminster Highway

Applicant's Presentation

Barry Weih, Wensley Architecture Ltd., and Michael Patterson, P+A Landscape Architecture, presented the project and answered queries from the Panel on behalf of the applicant.

Panel Discussion

Comments from Panel members were as follows:

- ensure that the indoor amenity room washroom is accessible *Incorporated*.
- applicant is advised for signage in the building or parking area to use instead the word "accessible" as it is more appropriate, e.g., "accessible parking" *Incorporated*.
- appreciate the presentation; understand that the site is difficult *Noted*.
- the model is more successful in representing the proposed colours than the renderings; more contrast in colours shown in the model is the right direction for the project *Noted*.
- the applicant has design leeway north and south of the top tower portion; could have potentially brought it forward or have a little bit of differentiation between the left and right sides, or balcony extensions West and east sides have different vocabularies with regards to deck treatments and framed residential units.
- proposed building massing with three different kinds of levels stepping back makes it
 difficult to see the lower podium; review the proportions Designed to comply with CCAP
 setback guidelines.
- there is blank façade on the tower portion facing Westminster Highway; consider incorporating some glazing on the tan-coloured wood-like panels considering that Westminster Highway is the project's frontage This described blank wall is a structural stair. Although adding glazing was not an option on the lower levels, two sides of these stairs were cut on the top floors to create a visually lighter top floor in this location.
- the two CRU storefronts are framed along Westminster Highway, then opening up with tall glazed façade adjacent to the main residential covered entrance along the lane appears odd Glazing reduced in this location to create a more private residential entry.
- proposed horizontal banding treatment detracts from the verticality of the building The DP guidelines for tall buildings requires that towers be more horizontal. These horizontal bands terminate in many locations to allow a more vertical expression to find its way to the ground.
- consider adding spandrel glazing to the office component, from the floor up to the desk height to allow desks along the window and concealing under desk areas **Reviewed. Floor**

- to ceiling glass is more desirable to tenants than having spandrel panels block the openness of the fenestration.
- slender columns at the front building entrance appear out of place in the bulky and large building; if the applicant intends to incorporate columns, consider installing more substantial columns to better complement the architecture and scale of the building It is our intent to have a slender column underneath the lightness of the glass office + amenity projection. Columns are doubled up to be more robust.
- appreciate the applicant's presentation of the project, especially the project's site context and how it fits into the neighbourhood *Noted*.
- consider installing weather protection for the barbeque area on the outdoor amenity space to make it more functional all year round *Design improved. Barbeque area relocated to the South deck. This mini kitchen will have coverage via the extended slab above.*
- appreciate the project design and the provision of lanes *Noted*.
- appreciate the use of amenity planting on the roof terraces; should be closely coordinated with the structural and mechanical engineer to ensure it works *Structural and Mechanical consultants have reviewed and approved all planter locations.*
- the children's play area currently appears bleak; consider installing a more stimulating equipment with livelier colours for the play area considering that it is located on the north side of the building *Design improved with livelier and more vibrant colours*.
- consider tree locations planted on the north amenity deck to only block some sunlight –
 Design improved to allow for more daylight.
- like the project; appreciate the perforated metal screening on the parkade; also appreciate that the affordable housing units are distributed throughout the market housing units *Noted*.
- the shadow study shows that the children's play area does not receive adequate sun exposure in the current location on the level 8 north amenity deck; consider installing poured in place surfacing or artificial turf in lieu of rubber tiles for the small sized children's play area; also consider providing an open play space with surface articulation with more imaginative play value than structured play elements; the small size of the play area is difficult to program Design improved. With increasing concerns for solar exposure, we feel that the children's play area receives an adequate amount of sun exposure during the day. An additional play area was incorporated at the fourth floor on the west side of the development. The children's play areas have a variety of play structures.
- would prefer a green roof than a gravel ballast on the tower rooftop to mitigate heat island effect *Not possible as the building height is at the maximum allowable.*
- consider installing an outdoor kitchen on level 8 south amenity deck *Design improved*, barbeque and outdoor kitchen added.
- rationale for the canopy that angles off to the northeast is not clear The canopy in this location follows the faceted façade and has continuous coverage of 6'-0" in door locations. The angled off area on the east end allows for a more robust tree to grow unhindered by the canopy.
- appreciate the presentation; understand that the subject site is challenging due to its proposed mixed uses; the applicant will have to deal with circulation and lobby location issues which are apparent on the floor plans Office and residential lobbies are separated due to uses.
- rationale for indoor parking lay-out is not clear; has created a condition where residents do not have internal direct access to the waste and recycling room *Due to the only parking*

- ramp location, residents do not have internal access to the waste and recycling but are covered when accessing this room.
- applicant needs to address the challenges of bicycle parking and circulation Bicycle rooms
 are located on every floor of the parkade and offer many locations for secure bicycle
 storage.
- consider having a consolidated lobby; separate lobby locations for different uses makes sense from an urban design point of view; however, the proposed circulation strategy needs to be reviewed The residential lobby is prominent from the lane. The offices have a lobby facing Westminster Highway and an internal lobby in the parkade.
- consider removing the column in front of the building that is farthest to the south in the sidewalk The columns are an architectural feature that frame the parkade entrance and terminate at the level 4 cornice. This noted column is central in the sidewalk and allows for movement on all sides.
- there is strong verticality of the expression and form of the building as it steps back on both sides and both ends; consider utilizing some of the horizontal and vertical fin expressions on the building to lace the two together *The architectural concept is to maintain a balance between horizontal expressions and vertical elements.*
- the mid-block parking entrance could be strengthened by having a podium horizontal fin expression on the top of the podium to break up the expression on the podium level at that point; will better integrate the facets of the building on the three layers together Orange is used to designate entry into the retail, offices, and parkade. Having them horizontal would only allow the user to see them when looking up. We want all users of the parkade to see the entrance when entering the lane. In this instance, vertical orange fins will work best.
- the chamfer on the podium at the lane appears awkward and out of context with respect to the form of the building *The chamfer is a result of required lane dedication*.
- appreciate the presentation and comprehensive package provided by the applicant to the Panel *Noted*.
- appreciate the proposed sustainability features of the project; e.g., targeting LEED silver equivalency and use of perforated metals to reduce energy use in the parkade *Noted*.
- consider installing a continuous band of louvers for retail spaces to accommodate potential ventilation strategy for retail spaces *Incorporated*.
- there is extensive use of glass in the office component; applicant is encouraged to use more spandrel panels, which could be at the top and bottom *Addressed above*.
- review proposed mechanical enclosure size as it appears too small *Reviewed*.
- the applicant is encouraged to use heat recovery system in the project due to its mixed uses;
- did not see vestibules on the floor plans; the applicant is reminded of the requirement to install a vestibule for retail space over 3,000 square feet in area *Noted*.
- overall, appreciate the project; however, the applicant is encouraged to involve a mechanical engineer at this stage of the project *Noted*.
- appreciate that the applicant is contributing to the City's Public Art Fund; the applicant is
 encouraged to incorporate public art into the project as it helps enhance the pedestrian
 experience along the ground plane *Noted*.
- overall, appreciate the project *Noted*.
- on the east elevation, consider (i) introducing different panel colours, (ii) adding more texture to the glass balconies, and (iii) adding smaller articulation to provide variation and help

reduce the single massing or colour – The east elevation has a varied façade and is very elegant via the use of white and charcoal windows and railings contrasting each other in different locations. The abundant use of cementitious panels also adds to this very textured façade.

- support the use of wood colour in the soffit on the ground level and on the top of the building as it adds warmth to the building character; consider using in other soffit areas, c.g. at the rear side of the building Design improved, also incorporated in soffits along the pedestrian sidewalk that access the main floor bike rooms.
- consider breaking down the horizontal massing of the wall on ground level along the west and rear sides of the building by adding different colours, patterning or texture to enhance pedestrian experience in the area We feel that the angled metal panels, with varying dimensions achieves this request.

Panel Decision

It was moved and seconded

That DP 18-797127 be supported to move forward to the Development Permit Panel subject to the applicant giving consideration to the comments of the Advisory Design Panel.

CARRIED



Development Permit Considerations

Development Applications Department

8131 Westminster Highway

DP 18-797127

Prior to forwarding this Development Permit application to Council for approval, the owner must complete the following requirements:

- 1. (*Voluntary Contributions*) City acceptance of the Owner's offer to provide the following voluntary contributions and should the contributions not be provided within one year of the application being presented to Development Permit Panel, the contribution rates will be increased annually to reflect current contribution rates.
 - a) \$37,115.79 towards future City community planning studies, as set out in the City Centre Area Plan (i.e. \$0.30 x 123,719.31 maximum buildable square feet).
 - b) \$91,988.51 towards the City's Public Art Program (i.e. \$0.89 x 97,674.67 residential square feet, excluding affordable housing and \$0.47 x 11,599.54 commercial/office square feet).
- 2. (*Landscape Security*) Submission of a Letter of Credit for landscaping in the amount of \$387,783.18 as specified on the landscape cost estimate provided and sealed by the project Landscape Architect (including materials, installation and 10% contingency).
- 3. (Road Dedication)
 - a) 3 m road dedication along the entire south property line for future Westminster Highway widening.
 - b) 6 m lane dedication along the entire west property line.
 - c) 6 m lane dedication along the entire north property line.
 - d) 7 m by 7 m lane dedication corner cut at the intersection of the new north-south and east-west lanes.
- 4. (Flood Construction Level) Registration of a flood indemnity restrictive covenant on Title (Area A).
- 5. (Aircraft Noise Sensitive Development) Registration of a legal agreement on title identifying that the proposed development must be designed and constructed in a manner that mitigates potential aircraft noise (Area 3) to the proposed dwelling units. Dwelling units must be designed and constructed to achieve:'
 - c) CMHC guidelines for interior noise levels as indicated in the chart below:

Portions of Dwelling Units	Noise Levels (decibels)
Bedrooms	35 decibels
Living, dining, recreation rooms	40 decibels
Kitchen, bathrooms, hallways, and utility rooms	45 decibels

- d) the ASHRAE 55-2004 "Thermal Environmental Conditions for Human Occupancy" standard for interior living spaces.
- 6. (*Commercial Noise*) Registration of a commercial noise restrictive covenant on title addressing noise impacts generated by the internal uses from penetrating into residential areas that exceed noise levels allowed in the City's Noise Bylaw and that noise generated from rooftop equipment will comply with the City's Noise Bylaw.
- 7. (*Canada Line Noise*) Registration of a mixed-use noise sensitive use covenant on title addressing noise impacts on residential uses, including those related to the Canada Line.
- 8. (City Centre Impacts) Registration of a legal agreement on title stipulating that the development is subject to potential impacts due to other development that may be approved within the City Centre including without limitation, loss of views in any direction, increased shading, increased overlook and reduced privacy, increased ambient noise and increased levels of night-time ambient light, and requiring that the owner provide written notification of this through the disclosure statement to all initial purchasers, and erect signage in the initial sales centre advising purchasers of the potential for these impacts.
- 9. (Parking, Loading and Bicycle Storage) Registration of a legal agreement on title, ensuring:
 - a) The provision of shared visitor/commercial/office parking spaces in accordance with the DP and such spaces will be identified and will not be sold, leased, assigned, designated or allocated in any other manner to individual unit

- owners/renters/occupants or any other person. The shared parking spaces are to be available for use by customers of commercial/office units within the subject development during business hours and available for use at all times by both visitors of residents of residential units; and owners, tenants and employees of commercial/office units.
- b) The provision of shared loading area in accordance with the DP and such area will be identified and will not be sold, leased, assigned, designated or allocated in any other manner to individual unit owners/renters/occupants or any other person.
- c) The provision of shared bicycle storage areas designated as common property for the sole purpose of bicycle storage by residents of residential units; and owners, tenants and employees of commercial/office units. The conversion of bicycle storage area into habitable space is prohibited (e.g., other storage uses).
- 10. (Electric Vehicle (EV) Charging Infrastructure for Vehicles & "Class 1" Bicycle Storage) Registration of a legal agreement on title, securing the owner's commitment to voluntarily provide, install, and maintain EV charging infrastructure within the buildings on the subject site. More specifically, the minimum required rates for EV charging infrastructure shall the greater of the following table or as per the Official Community Plan or Zoning Bylaw rates in effect at the time of Development Permit approval.

User/Use	Ener	gized Outlet – Minimum Permitted Rates
User/use	Vehicle Parking (1)	"Class 1" (Secured) Bike Storage (2)
Market Residential (i.e. resident parking & bike storage) Affordable Housing (i.e. resident parking & bike storage)	(1 per parking space as per Zoning Bylaw)	per each 10 bikes or portion thereof in a bike storage room or locker (which Energized Outlet shall be located to facilitate shared use with bikes in the room/locker)
Non-Residential (i.e. shared/tenant/employee parking & bike storage)	1 in 10 parking spaces	1 per each 10 bikes or portion thereof in a bike storage room or locker (which Energized Outlet shall be located to facilitate shared use by bikes when secured in the room/locker)

- (1) "Vehicle Parking" "Energized Outlet" shall mean all the wiring, electrical equipment, and related infrastructure necessary to provide Level 2 charging (as per SAE International's J1772 standard) or higher to an electric vehicle.
 - NOTE: Richmond's Electric Vehicle Charging Infrastructure Bylaw provides that, where an electric vehicle energy management system is implemented, the Director of Engineering may specify a minimum performance standard to ensure a sufficient rate of electric vehicle charging. For the purposes of the Bylaw, electric vehicle energy management system means a system to control electric vehicle supply equipment electrical loads comprised of monitor(s), communications equipment, controller(s), timer(s), and other applicable devices.
- (2) "Class 1 (Secured) Bike Storage" "Energized Outlet" shall mean an operational 120V duplex outlet for the charging of an electric bicycle and all the wiring, electrical equipment, and related infrastructure necessary to provide the required electricity for the operation of such an outlet.
- 11. (Housing Agreement) Registration of the City's standard Housing Agreement and Housing Covenant to secure 13 affordable housing units, the combined habitable floor area of which shall comprise at least 10% of the subject development's total residential building area. Occupants of the affordable housing units subject to the Housing Agreement shall enjoy full and unlimited access to and use of all on-site indoor and outdoor amenity spaces. No more than 50% of affordable housing parking spaces shall be small car size. Affordable Housing tenants shall not be charged any additional fees (e.g., parking fees, move in/move out fees). The terms of the Housing Agreements shall indicate that they apply in perpetuity and provide for the following:

	Affordab	Project Targets			
Unit Type	Minimum Unit Area	Maximum Monthly Unit Rent (1)	Total Maximum Household Income(1)	Unit Mix	# of Units (2)
Studio	37 m ² (400 ft ²)	\$811	\$34,650 or less	7.7%	1
1-Bedroom	50 m ² (535 ft ²)	\$975	\$38,250 or less	0%	0
2-Bedroom	69m² (741 ft²) \$1,218		\$46,800 or less	61.5%	8
3-Bedroom	91 m ² (980 ft ²)	\$1,480	\$58,050 or less	30.8%	4
Total	1,019 m² (10,970 ft²)	N/A	N/A	100%	13

- (1) Denotes the council-approved rates as of July 24, 2017. Rates may be adjusted periodically as provided for under adopted City policy.
- (2) 100% of affordable housing units meet Richmond Basic Universal Housing (BUH) standards.
- 12. (*District Energy Utility*) Registration of a restrictive covenant and/or alternative legal agreement(s), to the satisfaction of the City, securing the owner's commitment to connect to District Energy Utility (DEU), which covenant and/or legal agreement(s) will include, at minimum, the following terms and conditions:

- a) No building permit will be issued for a building on the subject site unless the building is designed with the capability to connect to and be serviced by a DEU and the owner has provided an energy modelling report satisfactory to the Director of Engineering;
- b) If a DEU is available for connection, no final building inspection permitting occupancy of a building will be granted until:
 - i. the building is connected to the DEU, which may include the owner's supplied and installed central energy plant to provide heating and cooling to the building, at no cost to the City, or the City's DEU service provider, Lulu Island Energy Company, on the subject site satisfactory to the City;
 - ii. if the City so elects, the owner transfers ownership of the central energy plant on the site, if any, at no cost to the City, or City's DEU service provider, Lulu Island Energy Company, to the City and/or the City's DEU service provider, Lulu Island Energy Company, on terms and conditions satisfactory to the City;
 - iii. the owner enters into a Service Provider Agreement with the City and/or the City's DEU service provider, Lulu Island Energy Company, on terms and conditions satisfactory to the City; and
 - iv. the owner grants or acquires the Statutory Right-of-Way(s) and/or easements necessary for supplying the DEU services to the building and the operation of the central energy plant, if any, by the City and/or the City's DEU service provider, Lulu Island Energy Company.
- c) If a DEU is not available for connection, no final building inspection permitting occupancy of a building will be granted until:
 - i. the City receives a professional engineer's certificate stating that the building has the capability to connect to and be serviced by a DEU;
 - ii. the owner enters into a covenant and/or other legal agreement to require that the building connect to a DEU when a DEU is in operation;
 - iii. the owner grants or acquires the Statutory Right-of-Way(s) and/or easements necessary for supplying DEU services to the building; and
 - iv. the owner provides to the City a letter of credit, in an amount satisfactory to the City, for costs associated with acquiring any further Statutory Right of Way(s) and/or easement(s) and preparing and registering legal agreements and other documents required to facilitate the building connecting to a DEU when it is in operation.
- 13. (*Servicing Agreement*) Enter into a Servicing Agreement* for the design and construction of Engineering and Transportation works in accordance with Transportation Association of Canada (TAC) Specifications, City Engineering Design Specifications and applicable Bylaws to the satisfaction of the City. A Letter of Credit or cash security for the value of the Service Agreement works, as determined by the City, will be required as part of entering into the Servicing Agreement. Works include, but may not be limited to, the following:

13.I. Road works:

- a) Westminster Highway Frontage Improvements: Works to include, from north to south, a 3.0 m wide concrete sidewalk at the new property line, hardscape boulevard (Min. 1.5 m width) with soil cells, street trees in 1.2 m x 1.8 m tree grates and 0.3 m x 0.6 m grey tone pavers running parallel behind existing curb and gutter, maintain existing westbound traffic lanes, and lengthen the existing raised median to the east by approximately 15.0 m.
- b) New City Lane: Works to include, along the entire west and north property lines, new laneway complete with roll-over curbs on both sides and between the roll-over curbs, asphalt driving surface.

13.II. Water Works

- a) Using the OCP Model, there is 733.0L/s of water available at a 20 psi residual at Westminster Highway frontage. Based on your proposed development, your site requires a minimum fire flow of 220 L/s.
- b) At the Owner's cost, the Owner is required to:
 - i. Submit Fire Underwriter Survey (FUS) or International Organization for Standardization (ISO) fire flow calculations to confirm the development has adequate fire flow for onsite fire protection. Calculations must be signed and sealed by a Professional Engineer and be based on Building Permit Stage and Building designs.
- c) At the Owner's cost, the City is to:
 - i. Abandon and cap at main the existing water service connection.

ii. Install a new water service connection at the Westminster Highway frontage, complete with meter, meter box, and right-of-way. Install a water service connection off of the existing water main at Westminster Highway, complete with water meter, which shall be part of the on-site Mechanical Works design.

13.III. Storm Sewer Works:

- a) At the Owner's cost, the Owner is required to:
 - i. Install approximately 122 m of lane drainage along the north and the west property lines. The lane drainage shall connect to the existing 300 mm storm sewer via a new manhole. The City, at the developer's cost, shall extend the tie-in from the new manhole towards south to ultimately connect to the 800 mm box culvert on Westminster Highway.
- b) At the Owner's cost, the City is to:
 - i. Cut and cap at main all existing storm sewer connections to the development site.
 - ii. Install a new storm service connection complete with inspection chamber at the east end of the south property line and tie-in to the existing 300 mm storm sewer at Westminster Highway into a new sump manhole. Extend the tie-in from the new manhole towards south to ultimately connect to the 800 mm box culvert on Westminster Highway.

13.IV. Sanitary Sewer Works:

- a) At the Owner's costs, the Owner is required to:
 - i. Through the servicing agreement process, remove the post-sinkhole sanitary lines along the entire west property line (including the 43 m replacement pipe) that may be damaged by the project's upcoming preload, soil densification (if required), foundation works and building construction and replace it with a new sanitary line (approximately 88 m) from existing sanitary manhole SMH3121 located at the southwest corner to SMH3122 located at the northwest corner of the site. Replacement works would be subject to the result of a video inspection of the post-sinkhole sanitary lines.
- b) At the Owner's cost, the City is to:
 - i. Cut and cap, at main, the existing sanitary sewer connection to the development site.
 - ii. Install a new sanitary service connection at the existing manhole SMH3123 located just north of the north east corner of the property.

13.V. Frontage Improvements:

- a) At the Owner's costs, the Owner is required to:
 - i. Provide frontage improvements as per Transportation's requirements.
 - ii. Construct a new walkway along the north and west property lines of the development site as per Planning and Transportation requirements.
 - iii. Review street lighting levels along Westminster Hwy frontage and provide lighting as per City standards using LED fixtures along the lane at the north and the west property lines of the development site.
 - iv. Coordinate with BC Hydro, Telus and other private communication service providers:
 - 1. Before relocating/modifying any of the existing power poles and/or guy wires within the property frontages.
 - 2. To locate/relocate all above ground utility cabinets and kiosks required to service the proposed development, and all above ground utility cabinets and kiosks located along the development's frontages, within the developments site (see list below for examples). A functional plan showing conceptual locations for such infrastructure shall be included in the development design review process. Please coordinate with the respective private utility companies and the project's lighting and traffic signal consultants to confirm the requirements (e.g., statutory right-of-way dimensions) and the locations for the aboveground structures. If a private utility company does not require an aboveground structure, that company shall confirm this via a letter to be submitted to the City. The following are examples of statutory right-of-ways that shall be shown on the architectural plans/functional plan, the servicing agreement drawings, and registered prior to SA design approval:

BC Hydro PMT	4.0 m x 5.0 m	Shaw cable kiosk	1.0 m x 1.0 m	Traffic signal UPS	1.0 m x 1.0 m
BC Hydro LPT	3.5 m x 3.5 m	Telus FDH cabinet	1.1 m x 1.0 m		
Street light kiosk	1.5 m x 1.5 m	Traffic signal kiosk	2.0 m x 1.5 m		

13.VI. General Items:

- a) At the Owner's cost, the Owner is required to:
 - i. Enter into, if required, additional legal agreements, as determined via the subject development's Servicing Agreement(s) and/or Development Permit(s), and/or Building Permit(s) to the satisfaction of the Director of Engineering, including, but not limited to, site investigation, testing, monitoring, site preparation, dewatering, drilling, underpinning, anchoring, shoring, piling, pre-loading, ground densification or other activities that may result in settlement, displacement, subsidence, damage or nuisance to City and private utility infrastructure.
 - ii. Provide, prior to first SA design submission, if preload is required, a geotechnical assessment of preload and soil preparation impacts on the existing 200mm PVC sanitary pipe along the west property line and the existing 250 PVC sanitary pipe along the north property line, and provide mitigation recommendations. The mitigation recommendations (if required) shall be incorporated into the first SA design submission or if necessary prior to pre-load.
 - iii. Not encroach into the existing SRW with proposed trees, non-removable fencing, or other structures.

Prior to Building Permit* Issuance, the owner must complete the following requirements:

- 1. (Legal Agreements) Confirmation of compliance with existing and Development Permit legal agreements.
- 2. (*Development Permit*) Incorporation of special features in Building Permit (BP) plans as determined via the Development Permit process.
- 3. (*Aircraft Noise Sensitive Development*) Confirmation that the proposed development is designed in a manner that mitigates potential aircraft noise to the proposed dwelling units, including submission of:
 - a. Acoustic report prepared by a registered professional confirming design achieves the following CMHC interior noise level guidelines:

Portions of Dwelling Units	Noise Levels (decibels)
Bedrooms	35 decibels
Living, dining, recreation rooms	40 decibels
Kitchen, bathrooms, hallways, and utility rooms	45 decibels

- b. Mechanical report prepared by a registered professional confirming design achieves the ASHRAE 55-2004 "Thermal Environmental Conditions for Human Occupancy" standard for interior living spaces.
- 4. (Construction Parking and Traffic Management Plan) Submission of a Construction Parking and Traffic Management Plan* to the Transportation Department. Management Plan shall include location for parking for services, deliveries, workers, loading, application for any lane closures, and proper construction traffic controls as per Traffic Control Manual for works on Roadways (by Ministry of Transportation) and MMCD Traffic Regulation Section 01570. (http://www.richmond.ca/services/ttp/special.htm).
- 5. (*Latecomer Works*) If applicable, payment of latecomer agreement charges, plus applicable interest associated with eligible latecomer works.
- 6. (*Construction Hoarding*) Obtain a Building Permit* (BP) for any construction hoarding associated with the proposed development. If construction hoarding is required to temporarily occupy a public street, the air space above a public street, or any part thereof, additional City approvals and associated fees may be required as part of the BP. For further information on the Building Permit, please contact the Building Approvals Department at 604-276-4285.

Note:

- This requires a separate application.
- Where the Director of Development deems appropriate, the preceding agreements are to be drawn not only as personal covenants of the property owner but also as covenants pursuant to Section 219 of the Land Title Act.
 - All agreements to be registered in the Land Title Office (LTO) shall have priority over all such liens, charges and encumbrances as is considered advisable by the Director of Development. All agreements to be registered in the LTO shall, unless the Director of Development determines otherwise, be fully registered in the Land Title Office prior to enactment of the appropriate bylaw.
 - The preceding agreements shall provide security to the City including indemnities, warranties, equitable/rent charges, letters of credit and withholding permits, as deemed necessary or advisable by the Director of Development. All agreements shall be in a form and content satisfactory to the Director of Development.

- Additional legal agreements, as determined via the subject development's Servicing Agreement(s) and/or Development Permit(s), and/or Building Permit(s) to the satisfaction of the Director of Engineering may be required including, but not limited to, site investigation, testing, monitoring, site preparation, de-watering, drilling, underpinning, anchoring, shoring, piling, pre-loading, ground densification or other activities that may result in settlement, displacement, subsidence, damage or nuisance to City and private utility infrastructure.
- Applicants for all City Permits are required to comply at all times with the conditions of the Provincial Wildlife Act and Federal
 Migratory Birds Convention Act, which contain prohibitions on the removal or disturbance of both birds and their nests. Issuance
 of Municipal permits does not give an individual authority to contravene these legislations. The City of Richmond recommends
 that where significant trees or vegetation exists on site, the services of a Qualified Environmental Professional (QEP) be secured
 to perform a survey and ensure that development activities are in compliance with all relevant legislation.

[signed copy on file]	
Signed	Date



Development Permit

No. DP 18-797127

To the Holder:

WENSLEY ARCHITECTURE LTD.

Property Address:

8131 WESTMINSTER HIGHWAY

Address:

C/O CARL HUMPHREY

1444 ALBERNI STREET, UNIT 301


VANCOUVER, BC V6G 2Z4

- 1. This Development Permit is issued subject to compliance with all of the Bylaws of the City applicable thereto, except as specifically varied or supplemented by this Permit.
- 2. This Development Permit applies to and only to those lands shown cross-hatched on the attached Schedule "A" and any and all buildings, structures and other development thereon.
- 3. Subject to Section 692 of the Local Government Act, R.S.B.C.: buildings and structures; off-street parking and loading facilities; roads and parking areas; and landscaping and screening shall be constructed generally in accordance with Plans #1 to #32 attached hereto.
- 4. Sanitary sewers, water, drainage, highways, street lighting, underground wiring, and sidewalks, shall be provided as required.
- 5. As a condition of the issuance of this Permit, the City is holding the security in the amount of \$387,783.18. to ensure that development is carried out in accordance with the terms and conditions of this Permit. Should any interest be earned upon the security, it shall accrue to the Holder if the security is returned. The condition of the posting of the security is that should the Holder fail to carry out the development hereby authorized, according to the terms and conditions of this Permit within the time provided, the City may use the security to carry out the work by its servants, agents or contractors, and any surplus shall be paid over to the Holder. Should the Holder carry out the development permitted by this permit within the time set out herein, the security shall be returned to the Holder. The City may retain the security for up to one year after inspection of the completed landscaping in order to ensure that plant material has survived.
- 6. If the Holder does not commence the construction permitted by this Permit within 24 months of the date of this Permit, this Permit shall lapse and the security shall be returned in full.

Development Permit No. DP 18-797127

To the Holder:	WENSLEY ARCHITE	CTURE LTD.
Property Address:	8131 WESTMINSTEI	RHIGHWAY
Address:	C/O CARL HUMPHR 1444 ALBERNI STRE VANCOUVER, BC V	EET, UNIT 301
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This Permit is not a Build	ling Permit.	
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MAVOR		



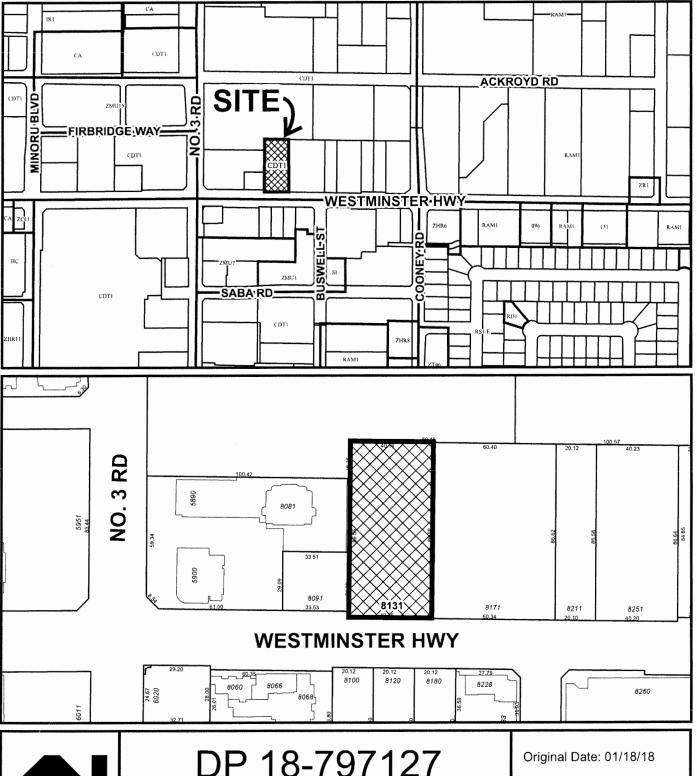



DP 18-797127 SCHEDULE "A"

Revision Date:

Note: Dimensions are in METRES

BOLD PROPERTIES GOSEN

DP 18-797127 Plan # 1 Jun 2, 2020

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PROJECT ADDRESS.

#131 WESTMINSTER HWY.

GTY OF RICHMOND, BC.

DRAWING TITLE.

SHEET

PROJECT NO. 7005 DRAWN BY. CSH

SCALE. NT. REVIEW BY. BW

NAKNO. A0001 WHOLDER

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STATISTICS:

TOTAL RESIDENTIAL TOTAL GROSS COMMERCIAL (LEASABLE: 4,898.27ft²) TOTAL GROSS OFFICE (LEASABLE: 5,175.48 ft²) TOTAL GROSS OFFICE (LEASABLE: 5,175.48 ft²) TOTAL PROJECT AREA - RESIDENTIAL + COMMERCIAL + OFFICE PARKING STATISTICS-7.0 STRUCTURED PARKING STALLS (INTERIOR) PARKING STALLS (EXTERIOR) TOTAL STALLS PROPOSED RESIDENTIAL PARKING (134 UNITS)								17C COT
TAL GROSS COMMERCIAL (LEASABLE: 4,898.27ft²) TAL GROSS OFFICE (LEASABLE: 5,175.48 ft²) TAL PROJECT AREA - RESIDENTIAL + COMMERCIAL + CAMERCIAL CAMERCI								10/,449
TAL GROSS OFFICE (LEASABLE: 5,175.48 ft²) TAL PROJECT AREA - RESIDENTIAL + COMMERCIAL + CAMERCIAL + CAMERICAL + CAMERCIAL + CAMERICAL CINTERIOR) SUCTURED PARKING STALLS (INTERIOR) FAL STALLS PROPOSED SIDENTIAL PARKING (134 UNITS)								4,914
RICTURED PARKING (134 UNITS)								5,189
RICTURED PARKING STALLS (INTERIOR) RING STALLS (EXTERIOR) FAL STALLS PROPOSED SIDENTIAL PARKING (134 UNITS)	OFFICE (4.5.1 - EXCLUSIONS)							123,080
KUCTURED PARKING STALLS (INTERIOR) KKING STALLS (EXTERIOR) FAL STALLS PROPOSED SIDENTIAL PARKING (134 UNITS)								PROPOSED
NGING STALLS (EXTERIOR) FAL STALLS PROPOSED SIDENTIAL PARKING (134 UNITS)								161
SIDENTIAL PARKING (134 UNITS)								3
SIDENTIAL PARKING (134 UNITS)								
			REQUIRED					PROPOSED
	S	1 STALL/UNIT = 121	121					121
DENTIAL		0.9/UNIT = 11.7	12					12
VISITOR PARKING		0.2/UNI! = 25.8	/7			SHARED WILL GEN	SHAKED WILL GENERAL RELAIL/OFFICE	(31 SHAKEU)
GENERAL RETAIL PARKING 3.75/1	3.75/100 m² L1	$3.75/433.2 \text{ m}^2 = 16.2$	16					
OFFICE PARKING 2.55/1	00 m² L2	$2.55/459.7 \text{ m}^2 = 11.7$	12					i
SHARED PARKING (VISITOR & GENERAL RETAIL/OFFICE)			28	(PREVIOUSLY REQUESTED 30)	UESTED 30)			164
TOTAL CTALLS CITES TE 44		DEDCENTAGE 0% CH	CHABER (B1 B2) BESTDENITAL B2	TOFNITAL D2	D3	D4	TOTALS	PERCENTAGE %
	5 5m × 2 5m (18 0' × 8 2')		15	9	18	12	54	32.93%
ARD SPACES	5.5m x 2.74m (18.0' × 9.0')		, ro	4	9	15	30	18.29%
	4.6m x 2.3m (15.1' x 7.54') - MAXIMUM 50%	45%	9	10	12	14	42	25.61%
PACES	4.6m x 2.74m (15.1' x 9.0')		0 (11	# 4	on (31	18.90%
ES	5.5m × 3./m (18.0° × 12.14°) - 2% OF OVERALL		7 (7 0	0 0	0 0	4 (4 630
PARALLEL SPACES 5.5m x	5.5m × 2.5m (18.0' × 8.2') 9.1m × 3.0m (29.85' × 9.8')		m c	•	0	0	2 LOADING	1.83%
		8	31 + 2 LOADING	36	47	20	164 + 2 LOADING	100.00%
BICYCLES STORAGE-7.14.10 @ 134	@ 134 UNITS		REQUIRED					PROPOSED
(1)	1.25 STALL/UNIT		168					169
	0.2 STALLS/UNIT		27					77
COMMERCIAL/OFFICE (CLASS 1) 0.2// 100 m ²	100 III		1 4					1 4
CLASS 1			170					171
			31				***	31
TOTAL BIKE STALLS - CLASS 1 TYPES: REGULAR TOTAL BIKE STALLS - CLASS 1 TYPES: VERTICAL							110	29.24%
TOTAL BIKE STALLS - CLASS 1 TYPES: LARGE							11	6.43%
							1/1	100.00%
AMENITY (@ 134	@ 134 UNITS	REQUIRED (m ²)						PROPOSED (m ²)
AMENITY	6.0 m²/UNIT (134)	804 m ² LE	LEVEL 04					359.77
		e l	LEVEL 08 (NORTH)					264.75
			TOTAL:					830.73
INDOOR AMENITY MIN. 1	MIN. 100 m ²	100 m ² AM	AMENITY 01:LEVEL 03					194
			AMENITY 02:LEVEL 04					41.1
		01	TOTAL:					235.1
MECHANICAL EXCLUSIONS 4.5.1 MAXIMUM 100.0 m ²		AREA (m²)						
WATER ENTRY ROOM		31.75						
TELECOM ROOM		22.04						
EM DISTRICT ENERGY ROOM		20.3						
		99.96						

BOLD PROPERTIES GOSIEN

DP 18-797127 Plan # 2 Jun 2, 2020


VAN 301 - 1444 Albarol Stratt Vancouver, V66 224
VIC 104 - 3212 Jackin Read Victoria, V98 0J5
604,885,3528 | office@waarch.cs | wararch.cs
PROJECT NAME:


PROJECT ADDRESS:
8131 WESTMINSTER HWY.
GITY OF RICHMOND, BC.
DRAWING TITLE:
STATISTICS
SHEET


 PROJECT NO.
 1705
 DRAWN BY:
 CSH


 SCALE
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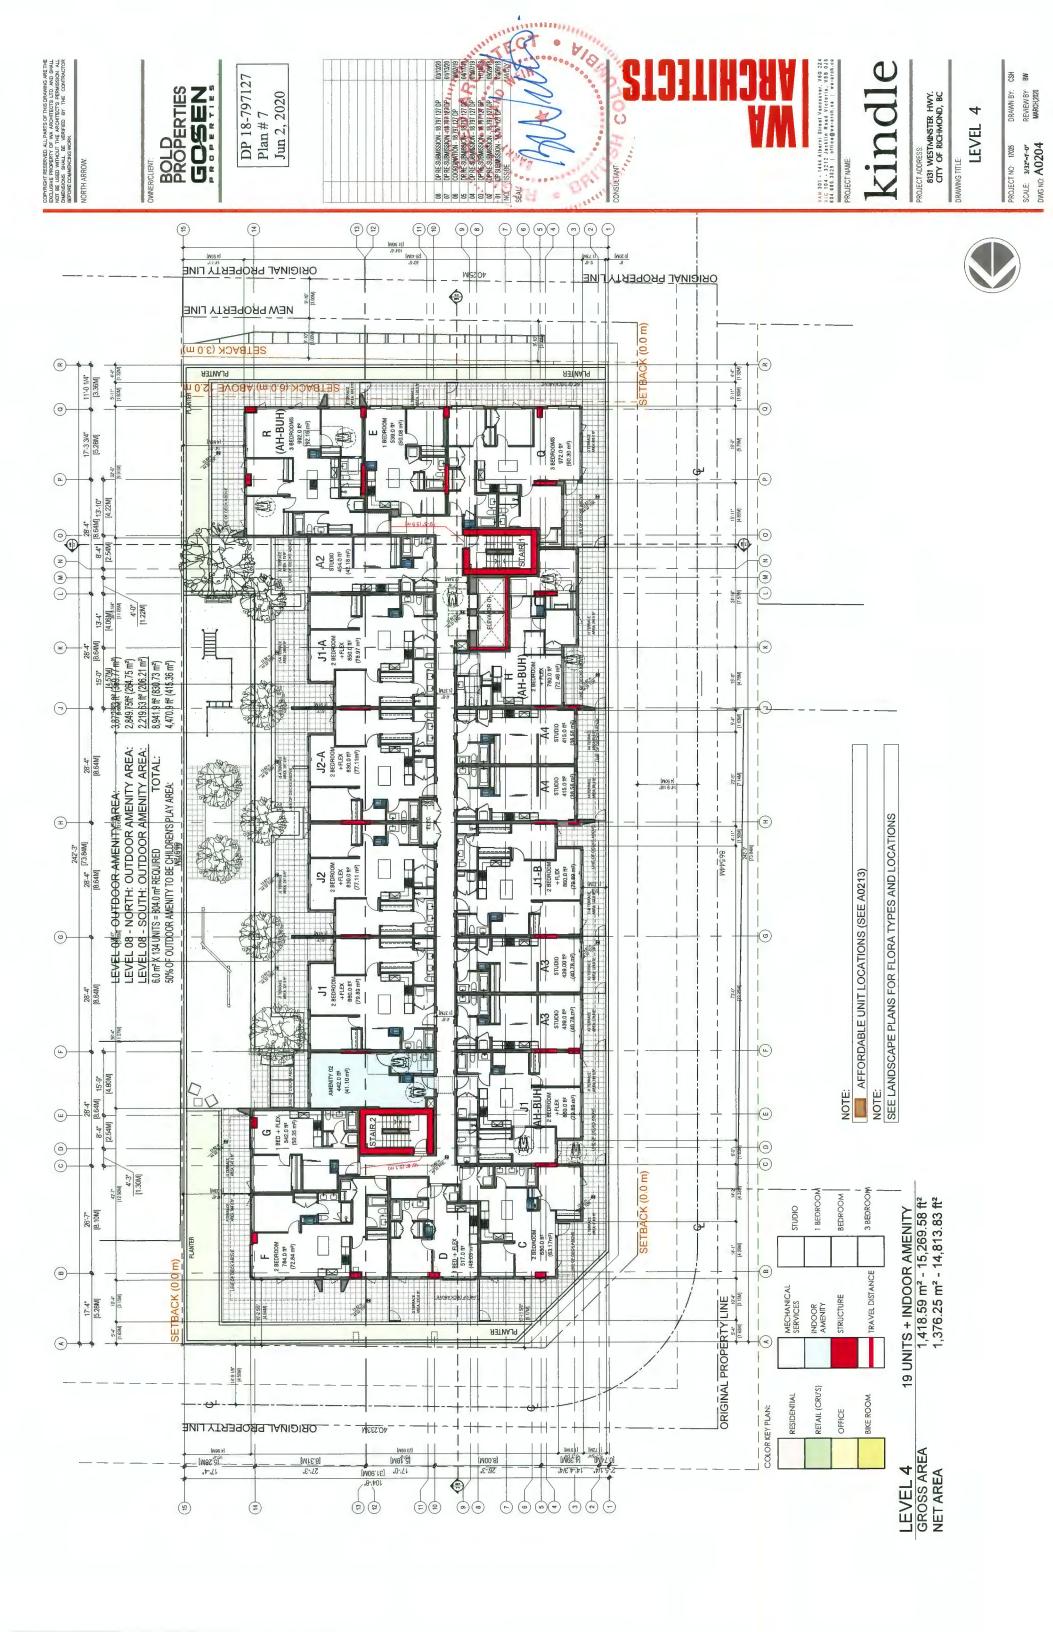
 DWG NO.
 A0002
 MARCH2020
 NA




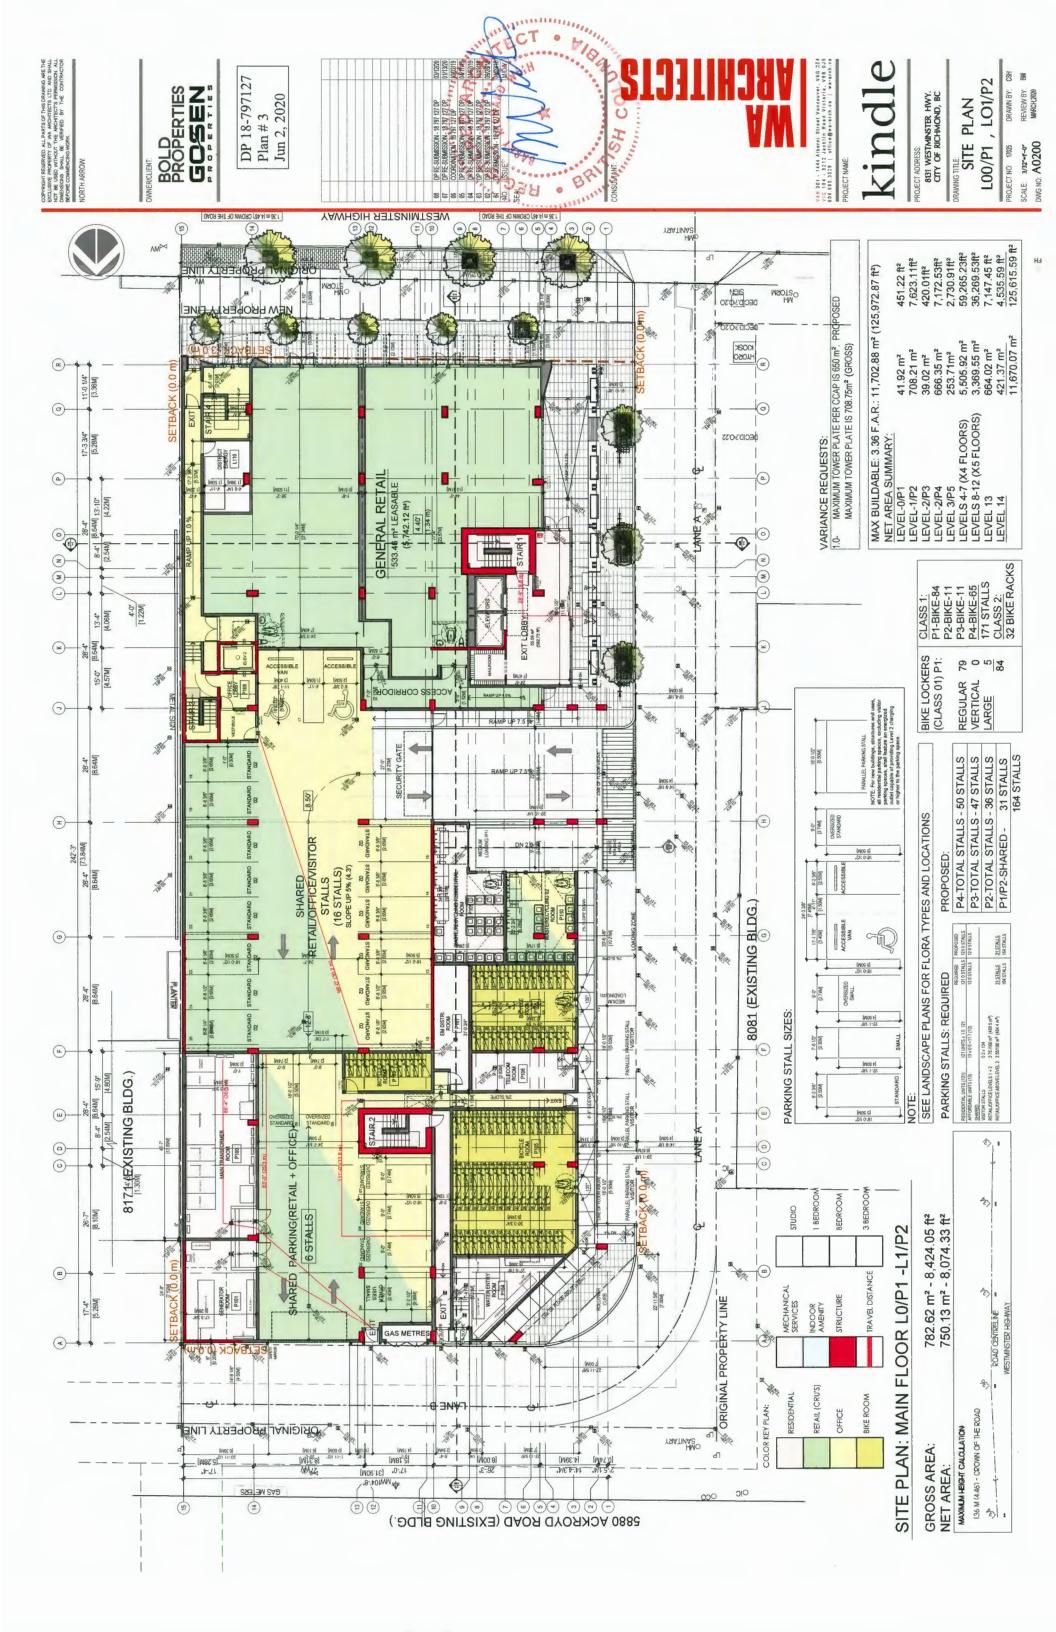


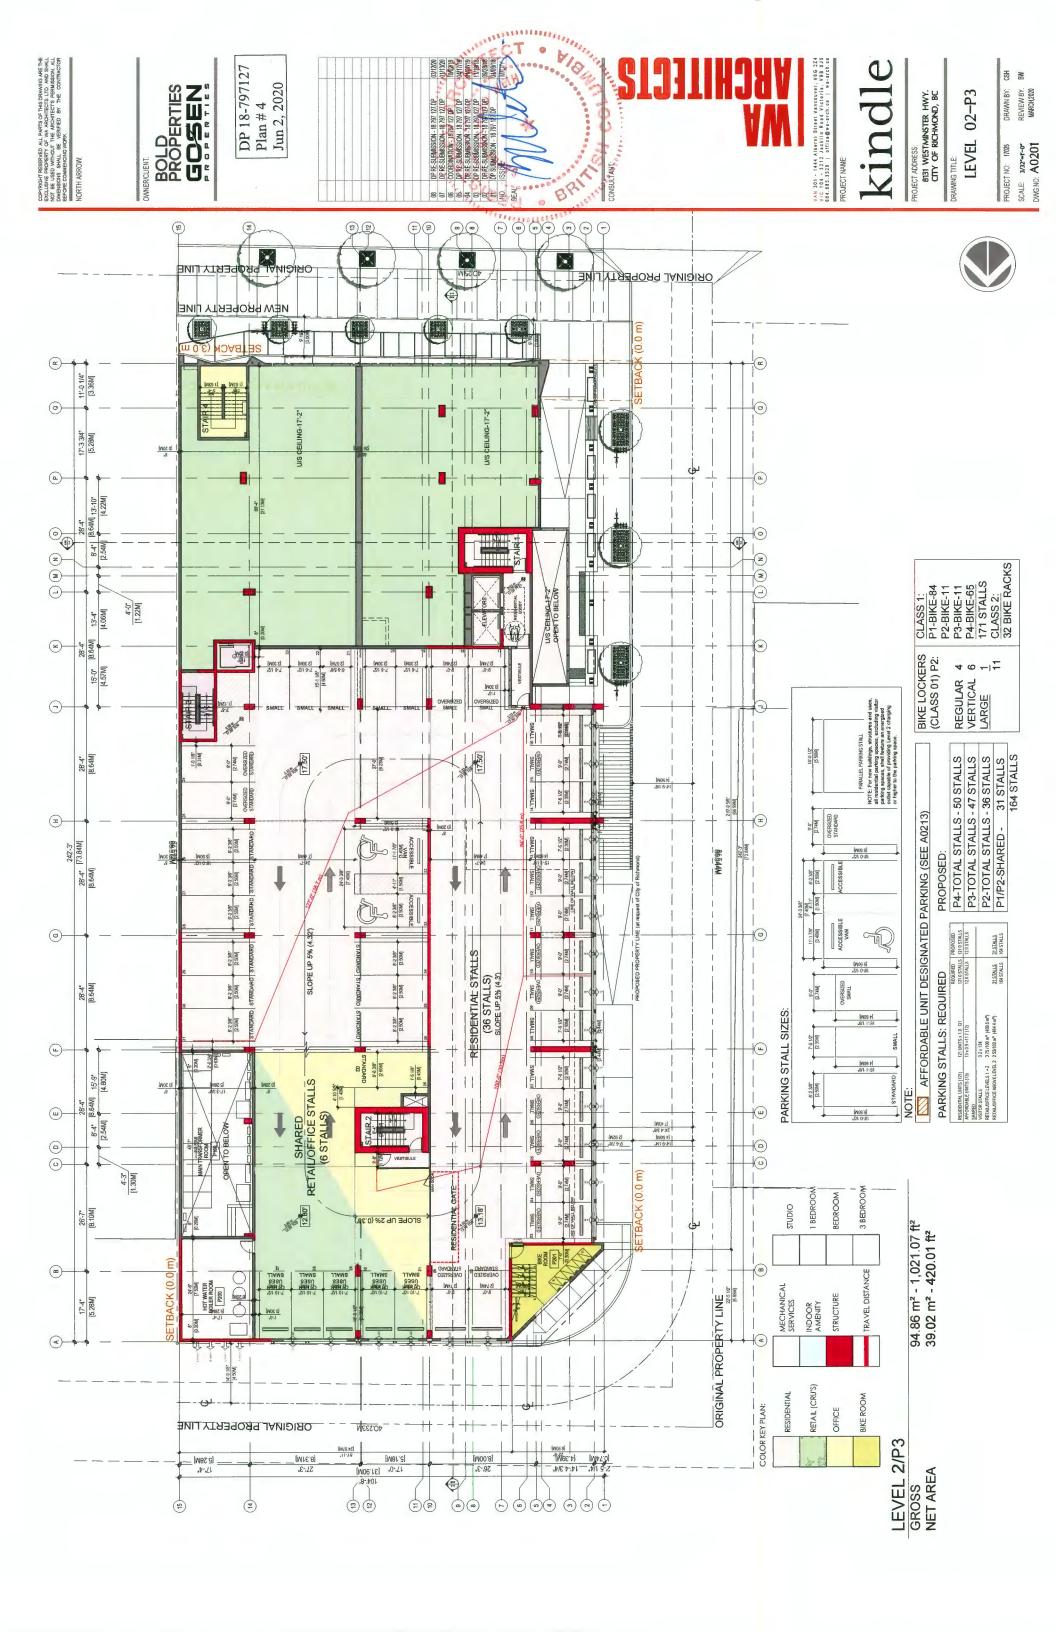


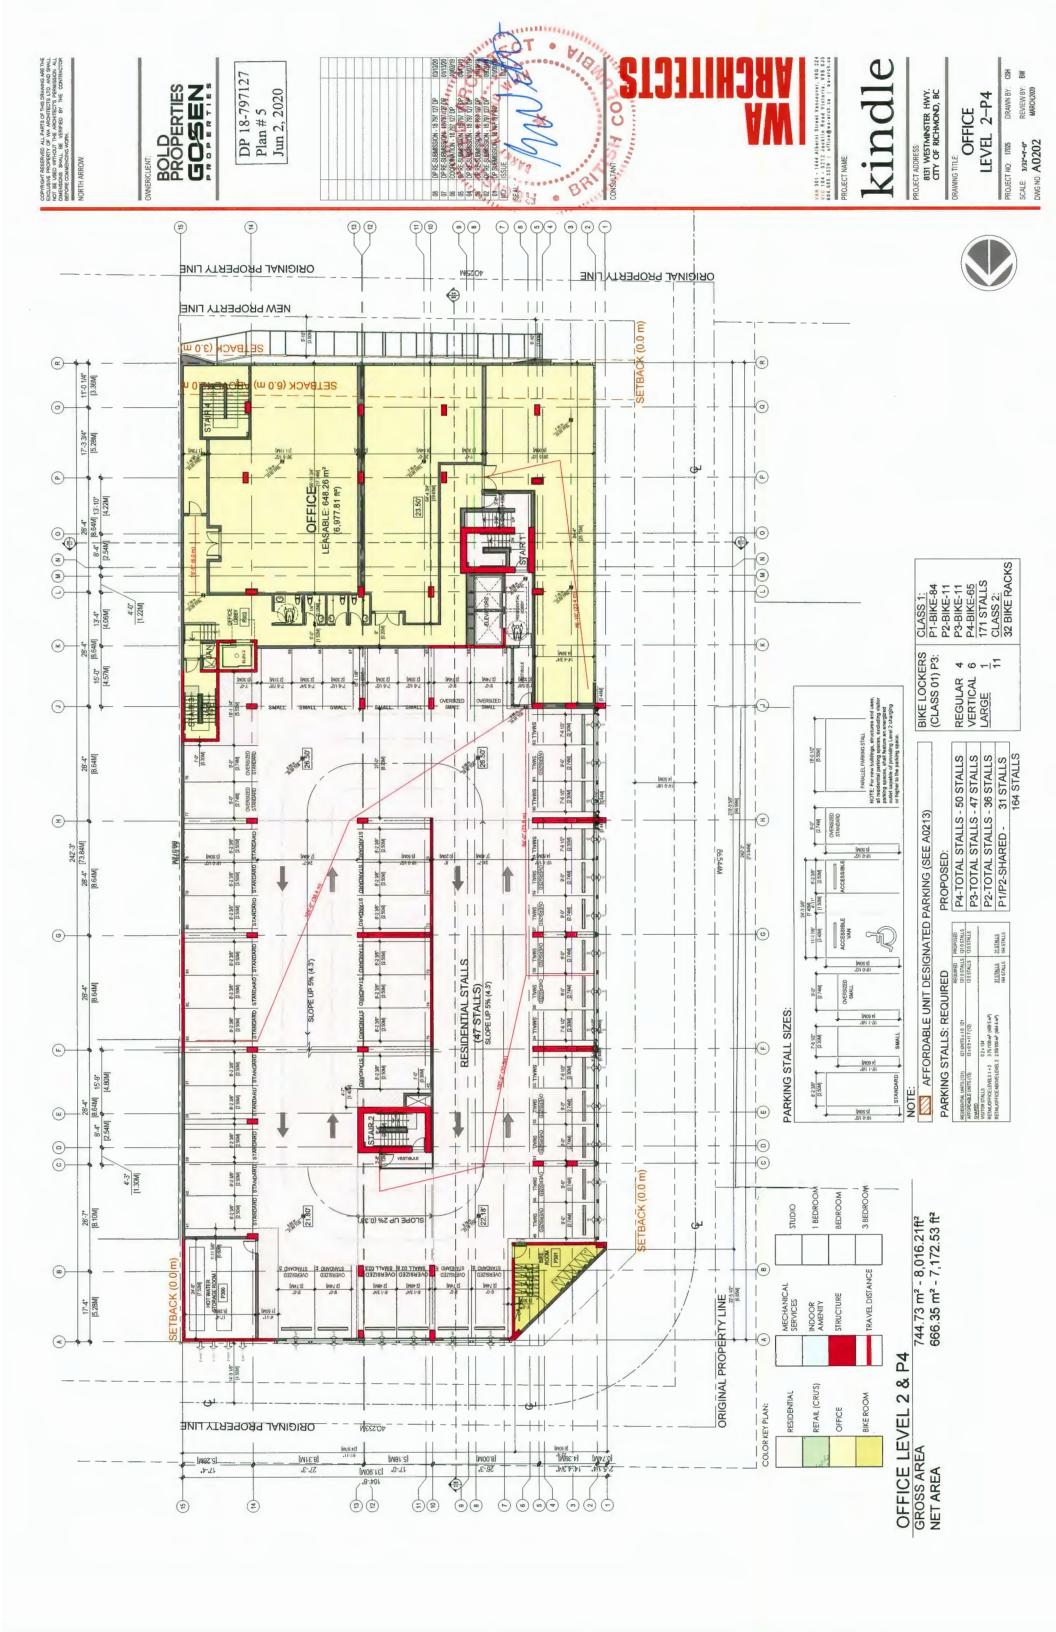


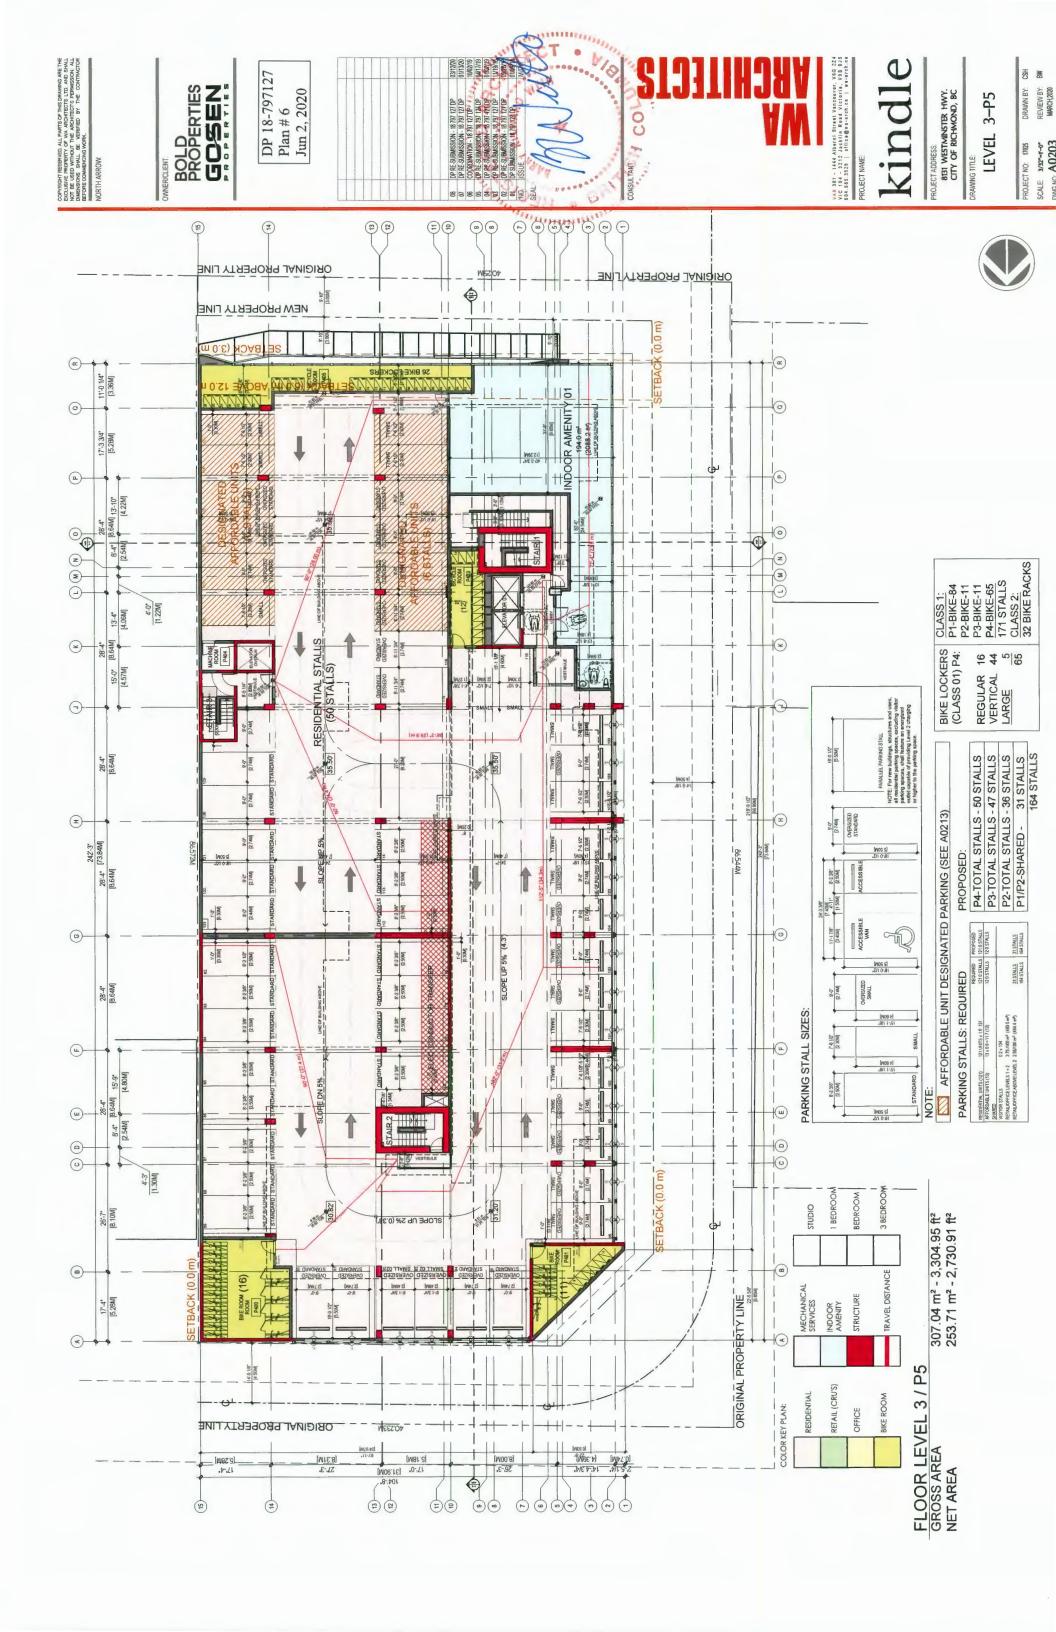


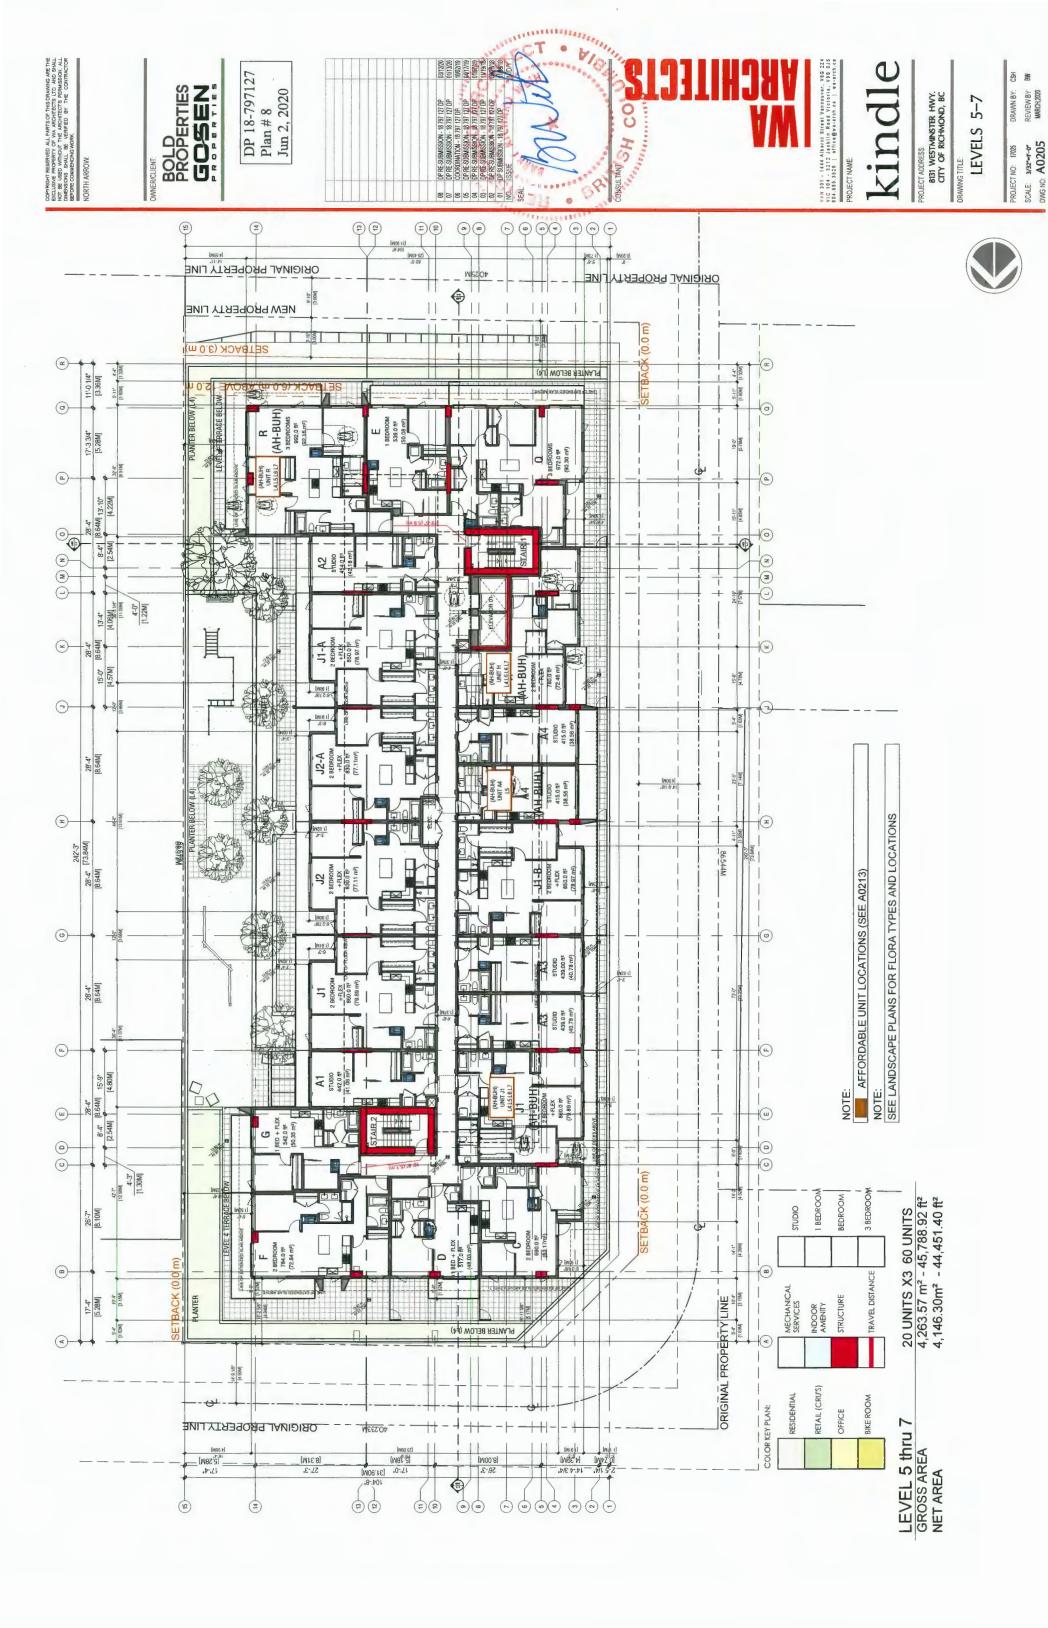


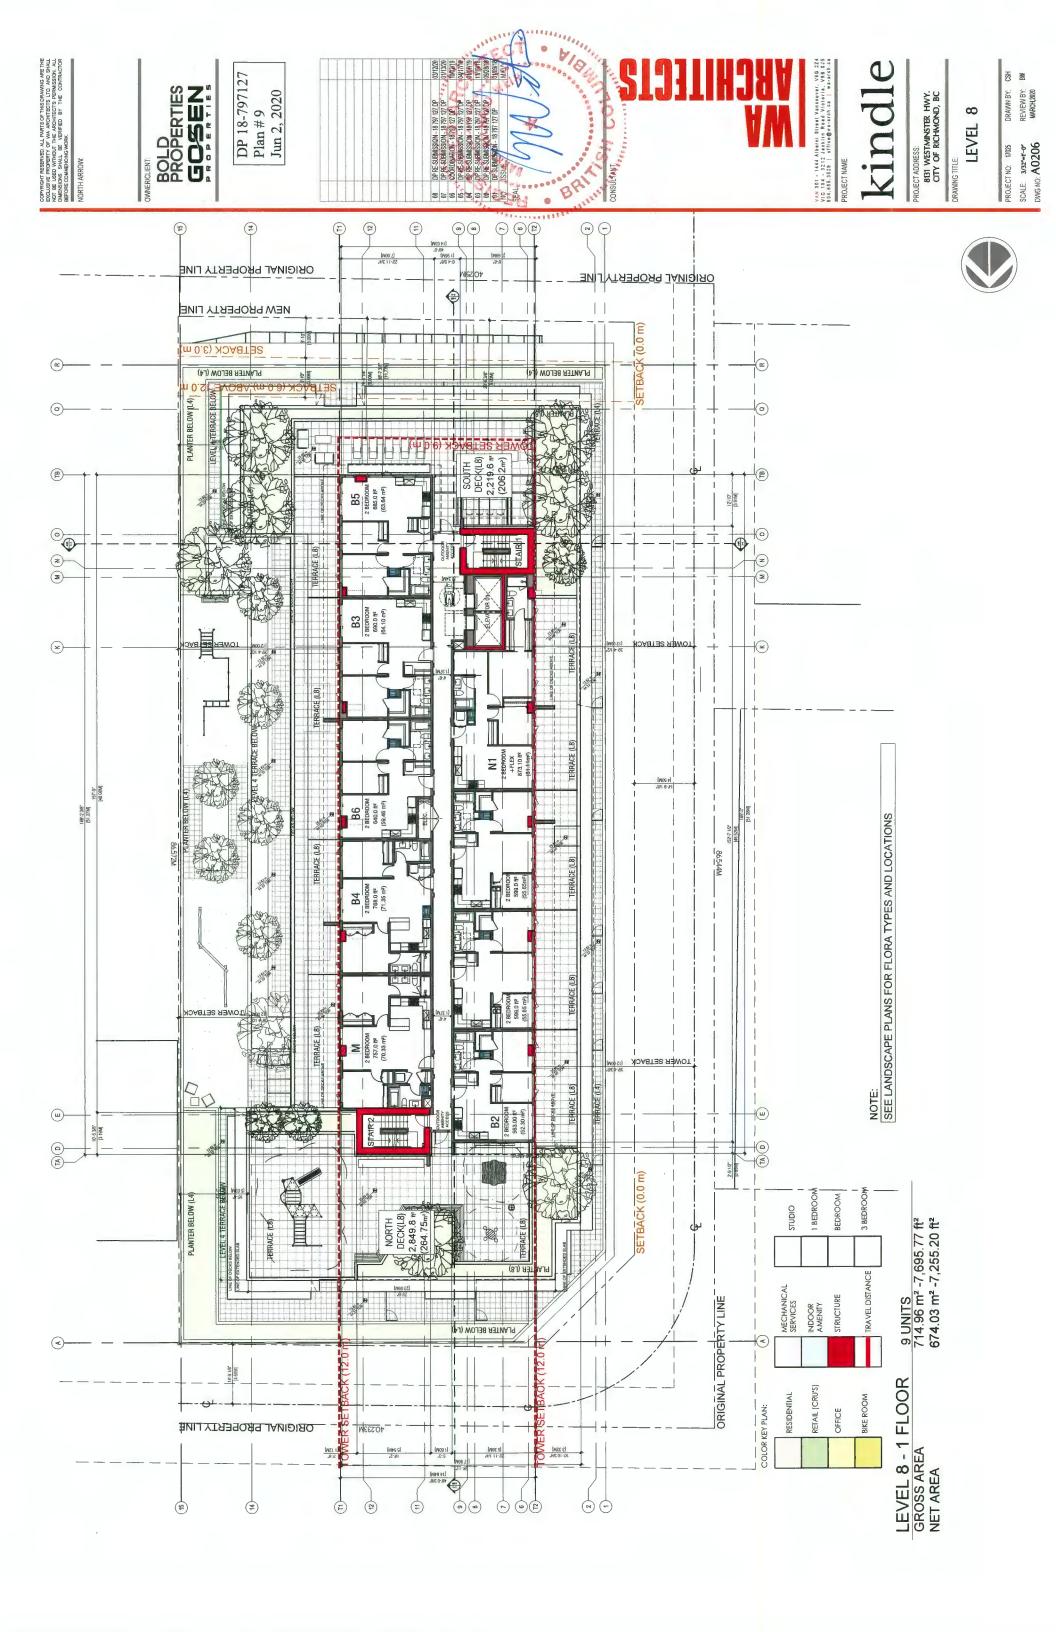

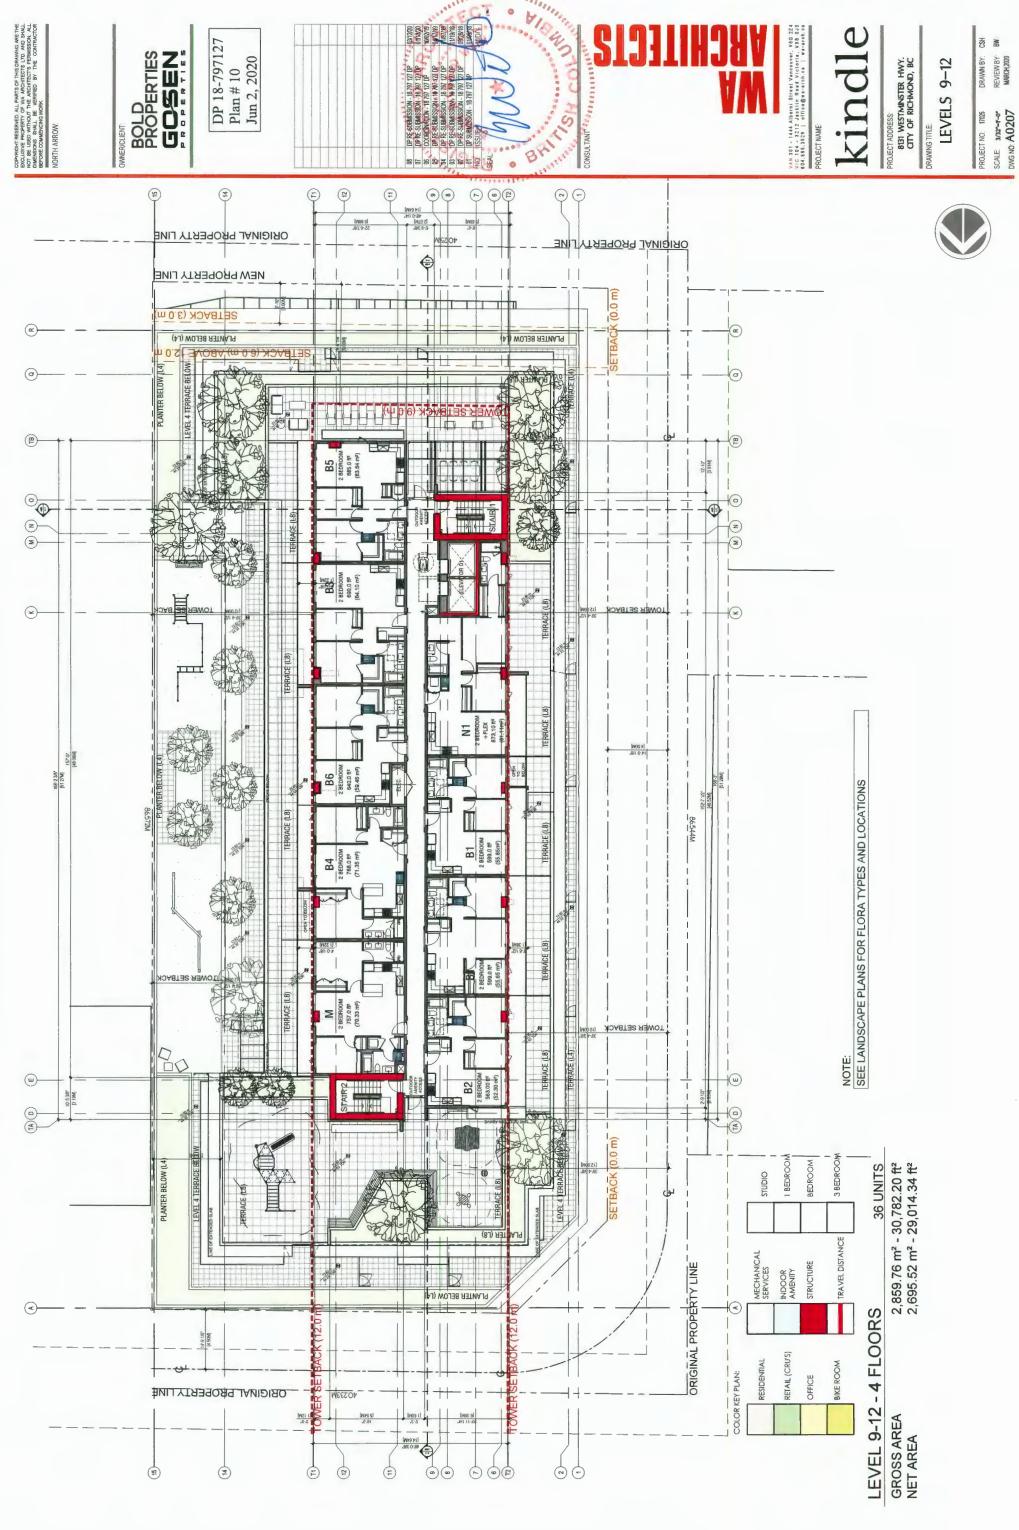

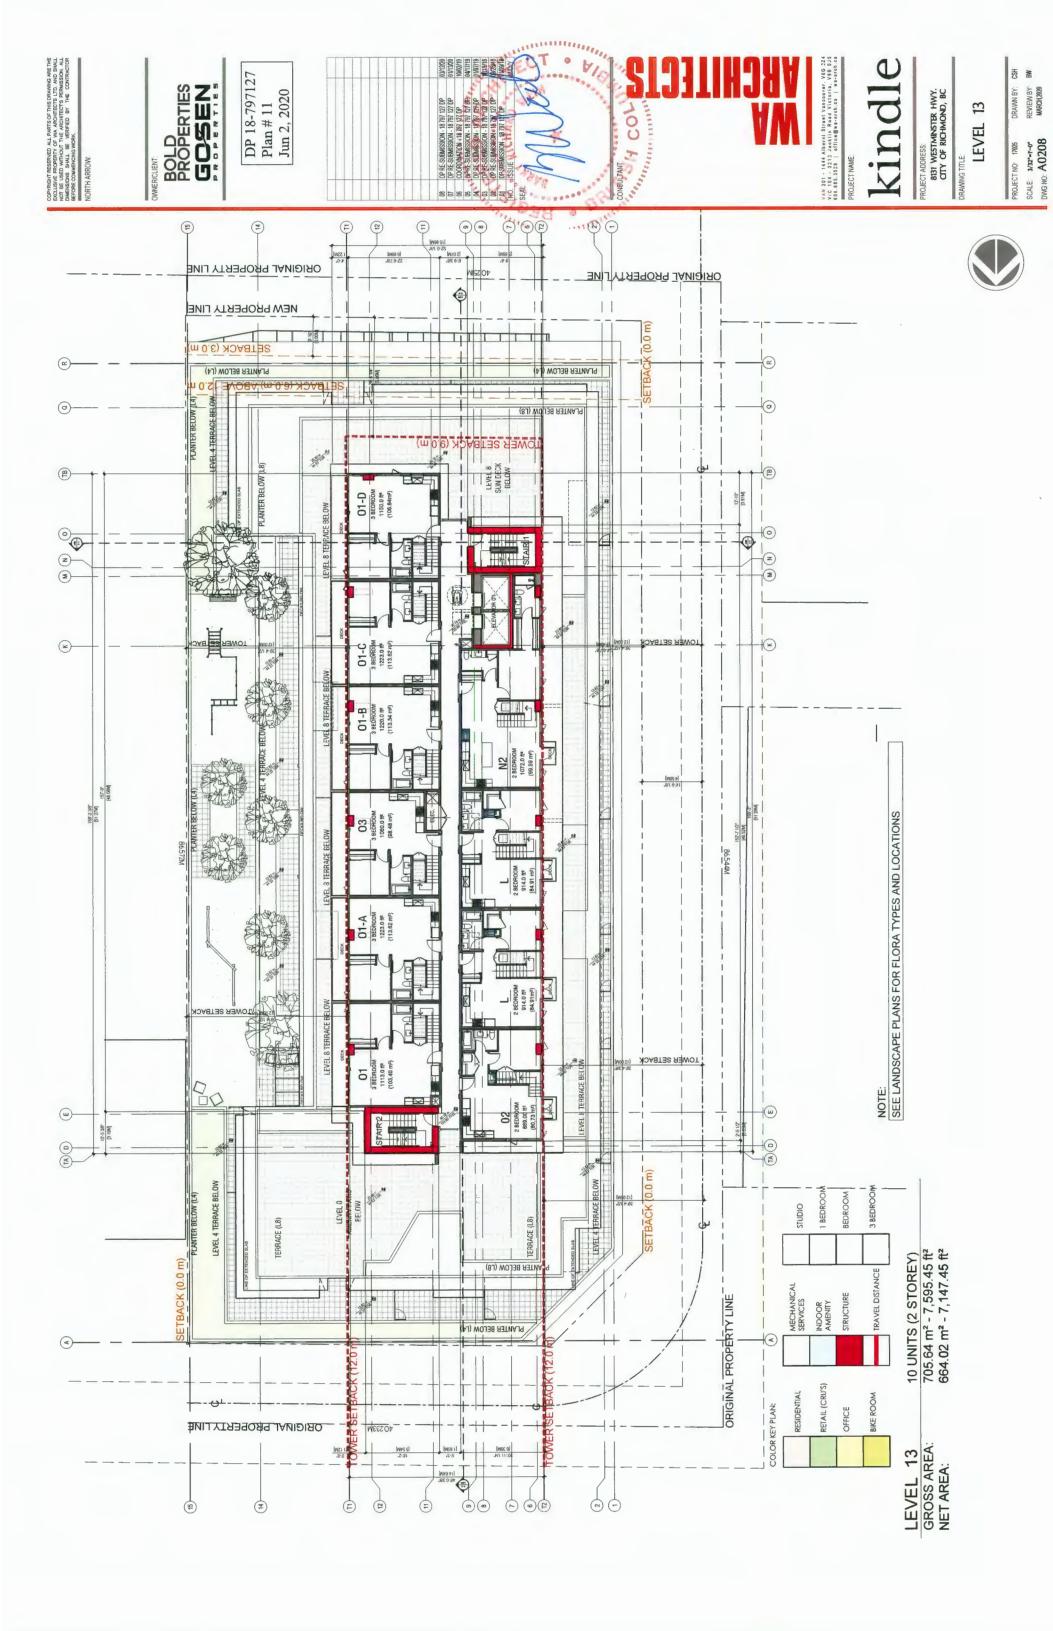

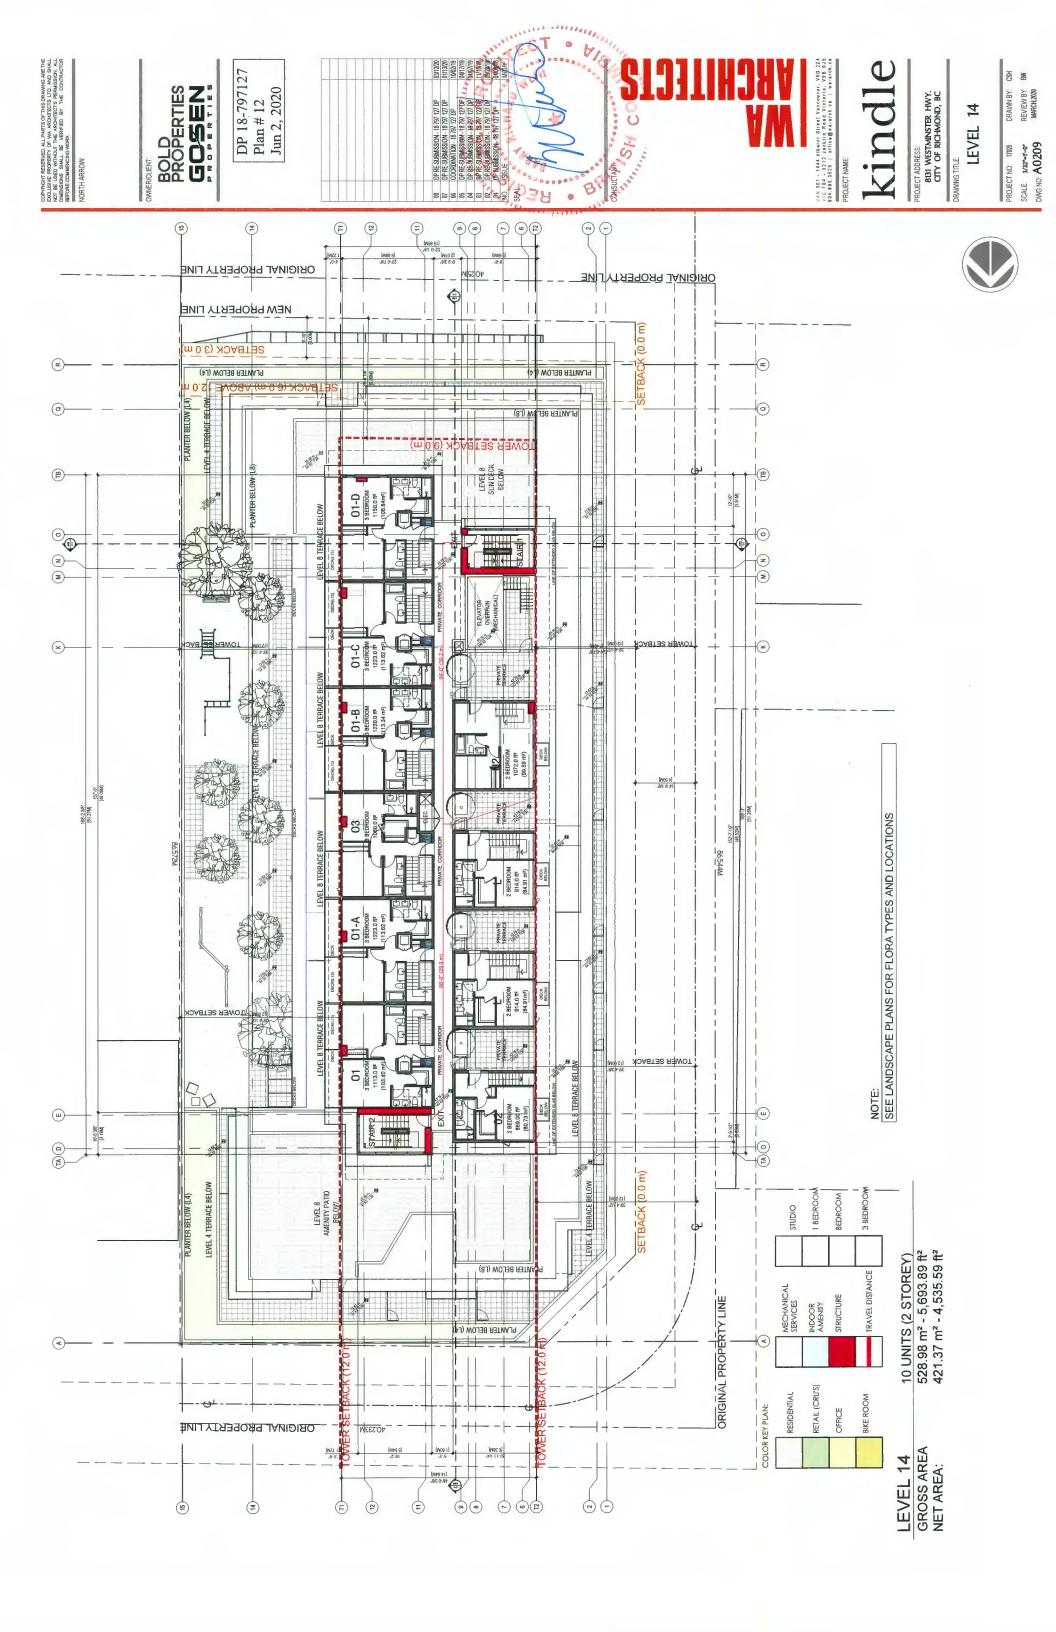

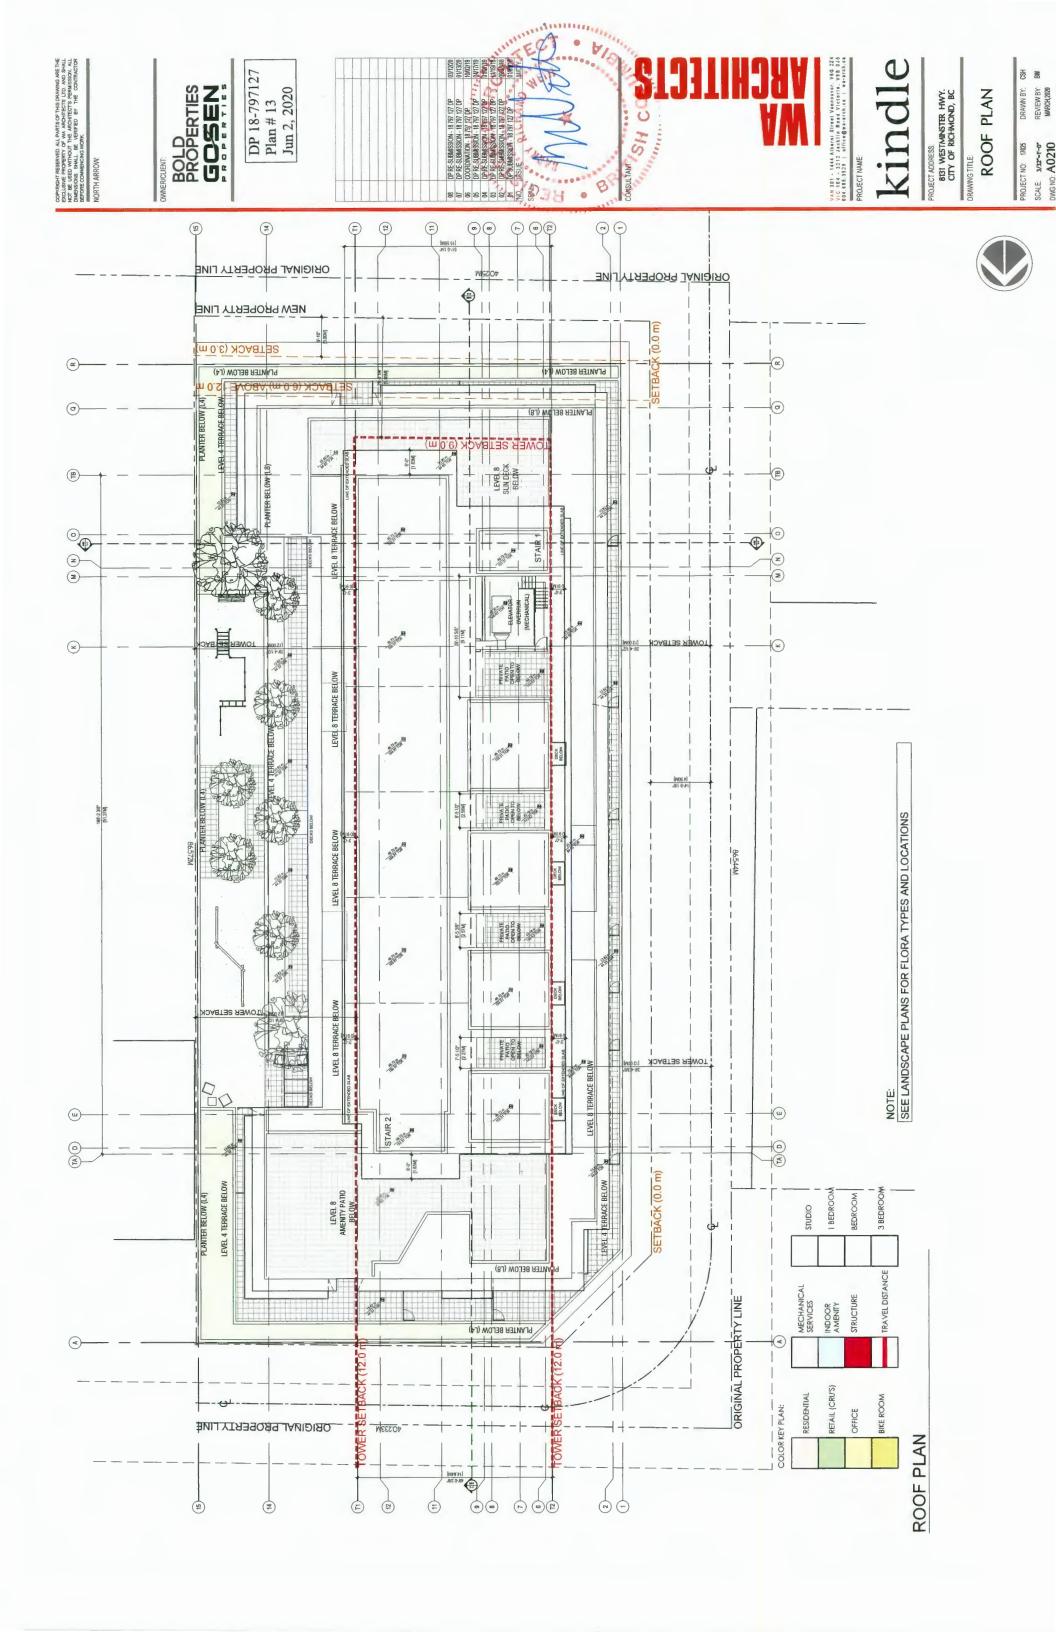

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ELEVATION
(NO SHADOWS) BOLD PROPERTIES GOSEN PROJECT ADDRESS.
BIRT WESTMINSTER HWY.
CITY OF RICHMOND, BC. ONSULTANT PROJECT NO: 17025 SCALE: 3/32"-1-0"



MATERIALS

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MACENACOL LONGOR

MACENACOL LONGOR

(B) ALUMENDA RALING SALT SCHECKING

(B) ALUMENDA RALING SALT SCHECKING

(B) CONTRINCAL SAWBER OW CALLER

(B) CONTRINCAL SAWBER OF CALZING FR

PREFINISHED WHITE, BLACK CHARCOAL PREFINISHED MATCH BACKGROUND FINISH COLORS

MATERIALS
SOCIETS FINE

(I) ALMANDA MACLON FINE

(II) STANLESS STEL, FEFFORMED

MISCELLANEOUS

PREFINISHED WHITE, BLACK CHARGOAL COLORS

> WHITE, BLACK CHARCOAL WHITE, BLACK CHARCOAL


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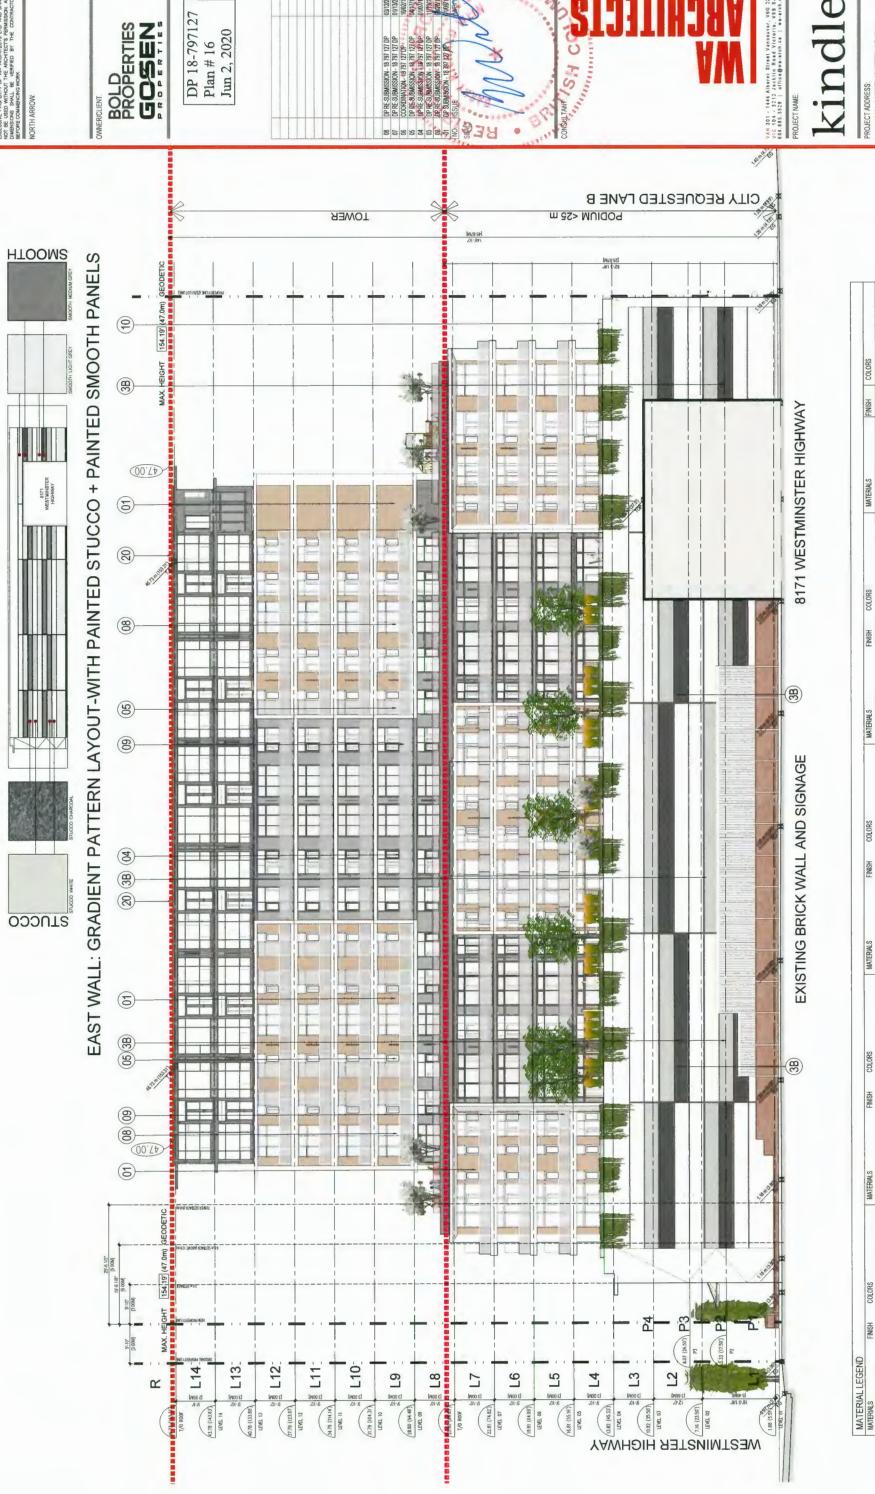
WEST ELEVATION

COLORS

FINISH COLORS

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-	MAX. HEIGHT (154.19] (47.0m) GEODETIC 7/6 NOS 7/6 NOS 8-8-8-8-8-8-8-8-8-8-8-8-8-8-8-8-8-8-8-	13 COM	L12 .	iwo cl	10 L	6	New Oil New		P P P P P P P P P P P P P P P P P P P	[2004]	4		[2004]	L2 (8.07 (26.50))	Tars .	*d
	1/0 ROOF 1/0 ROOF 1/0 ROOF 1/0 ROOF		13 00M] 9-10°	(3 00W) (3 00W) (4 28 (114.12	12 CON 12 CON 12 CON 13 CON 13 CON 13 CON 13 CON	(3 000M) 8-10.	LEVEL 09 97-10"	1/0 R00F 3-10° 3-10° 3-10°	300M 10 M 10 M	(3 00W) 3-10. ELVE 08	(20) (20) (20) (20) (20) (20) (20) (20)	(13.82 (45.33°)) LEVEL 04	10.82 (35.50°) LEVEL 03	7.16 (23.50) 12.0°	1991 C	SB (5.517)



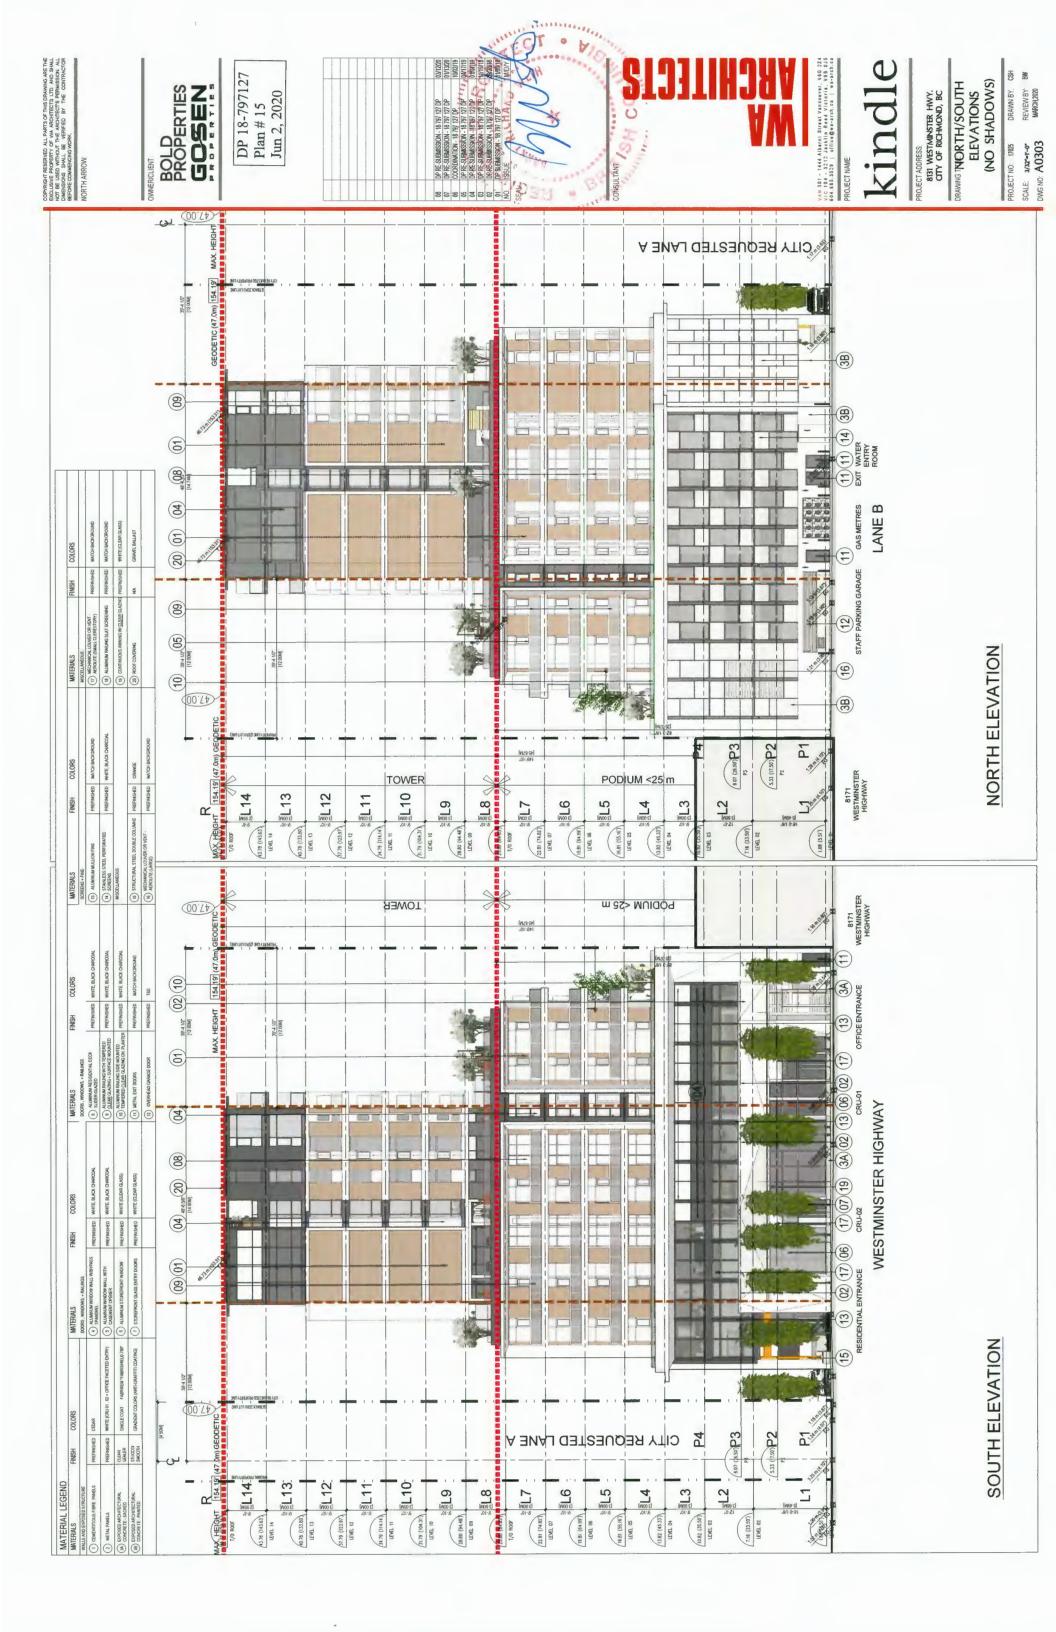

JECT ADDRESS:
8131 WESTMINSTER HWY.
CITY OF RICHMOND, BC

(B) CONTINUES ANNUES (B)

(C) CONTINUES ANNUES (B)

(D) CONTINUES ANNUES (B)


(E) CONTINUES (B)


(E

EAST ELEVATION

DRAWING TITLE: EAST
EEVATION
(NO SHADOWS)

SCALE: 3/32"-1"-0"
DWG NO: A0305

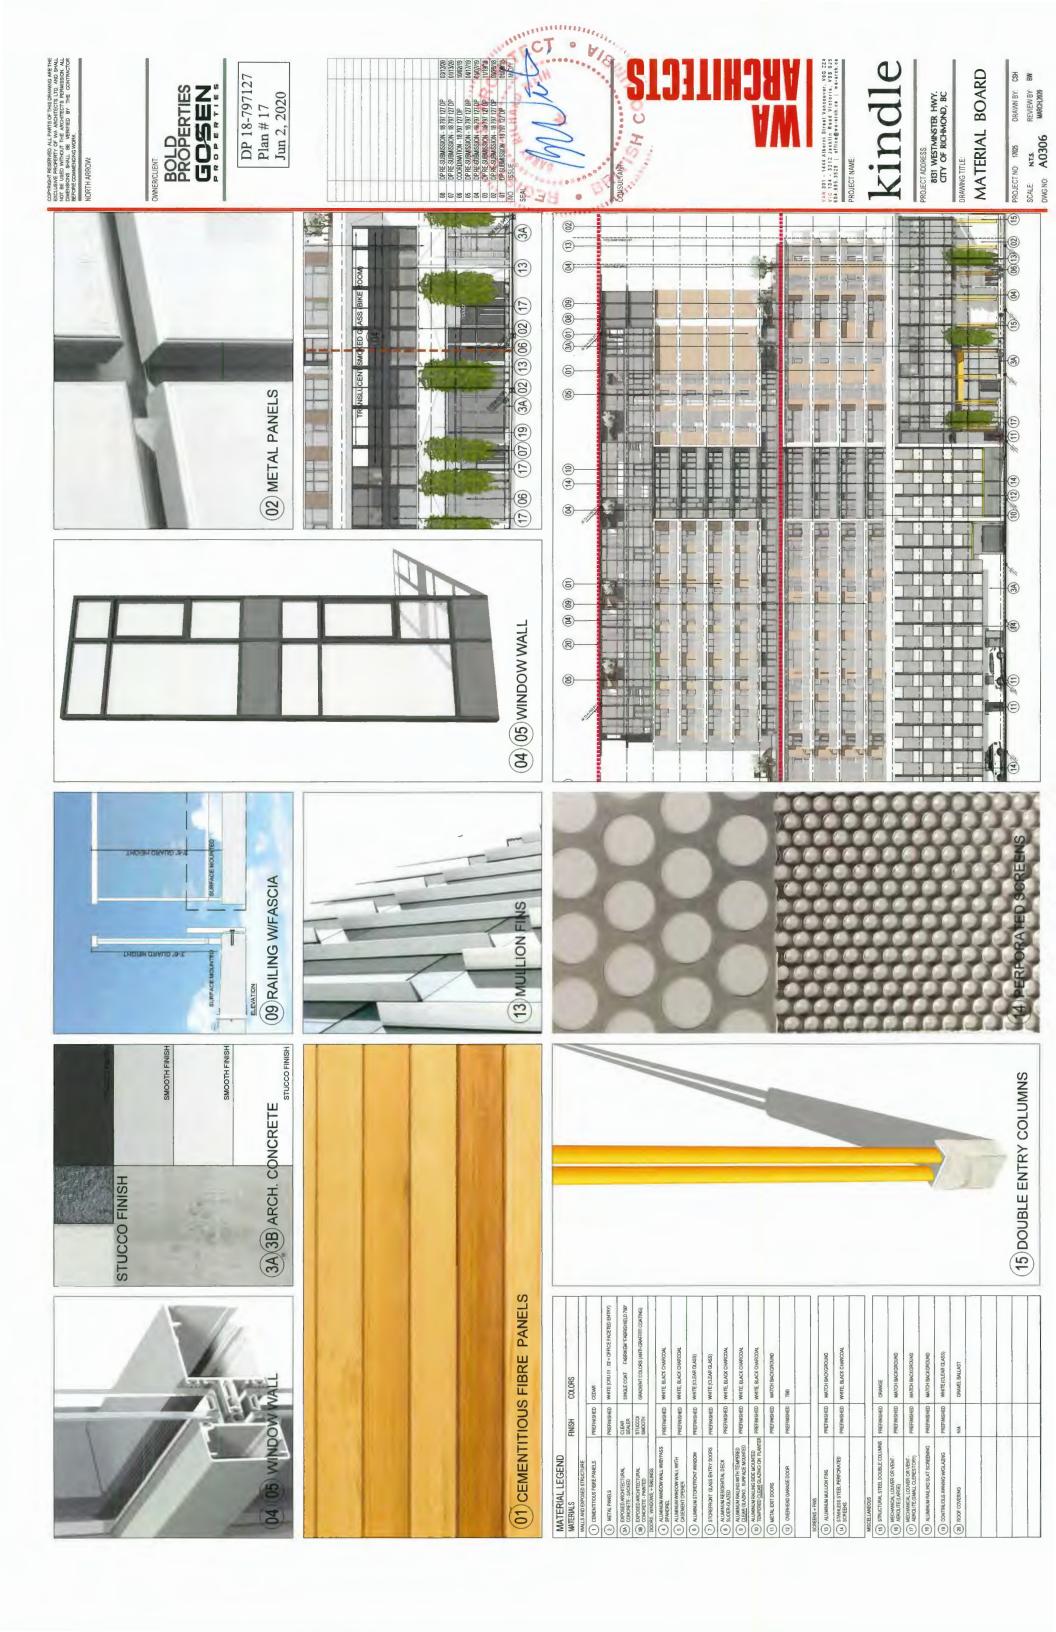

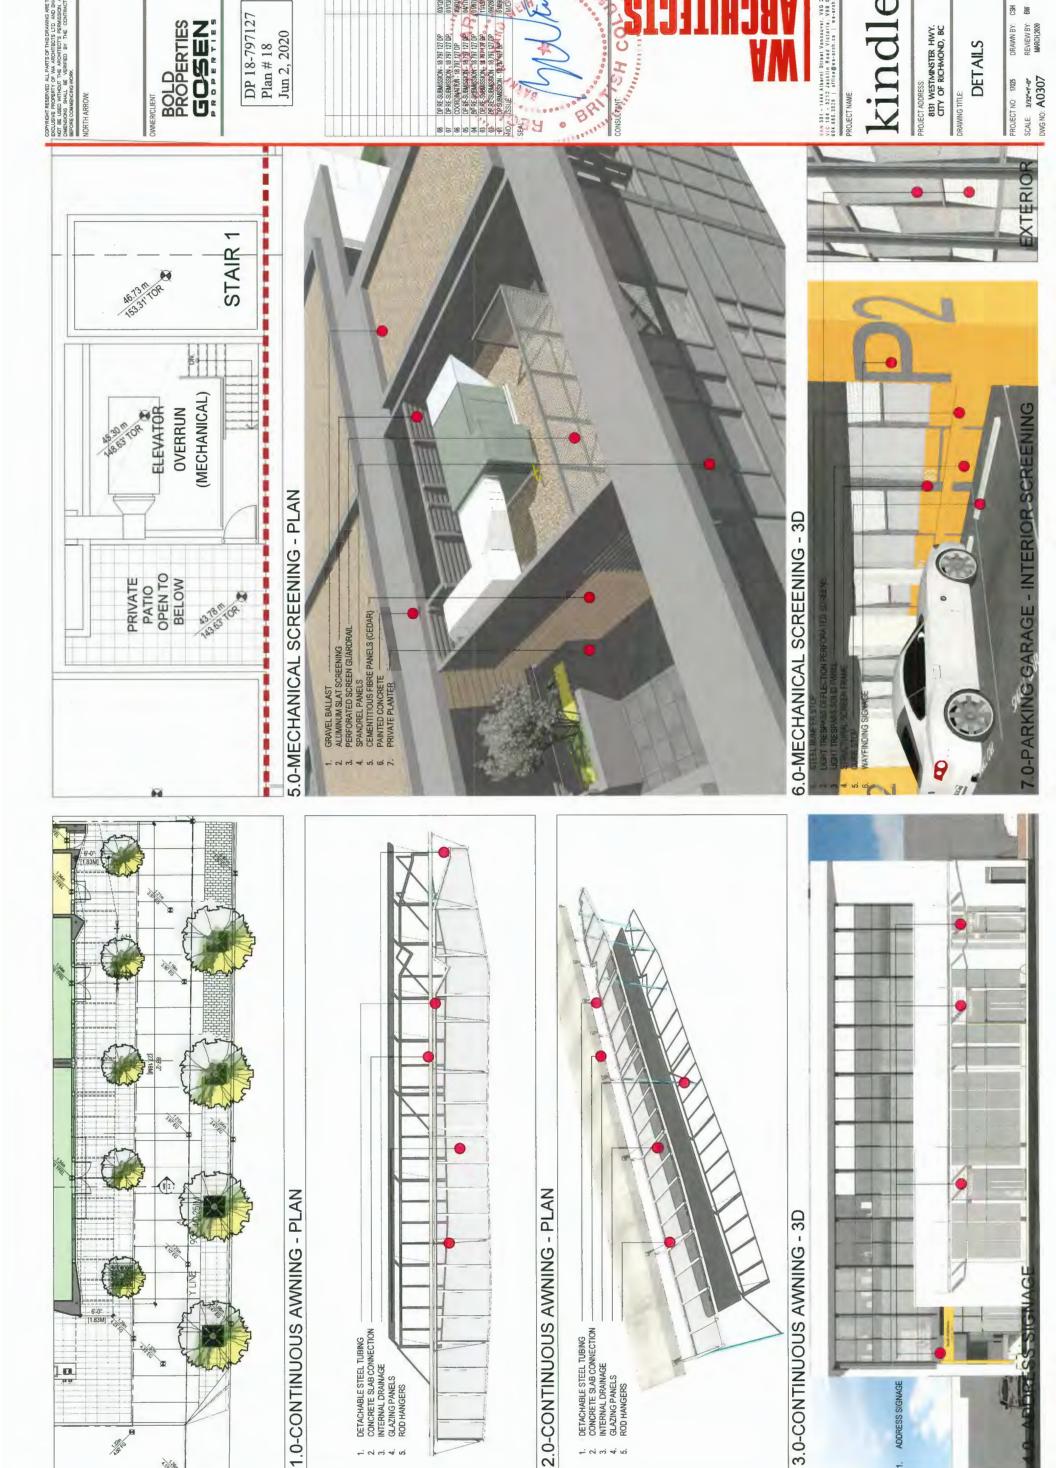

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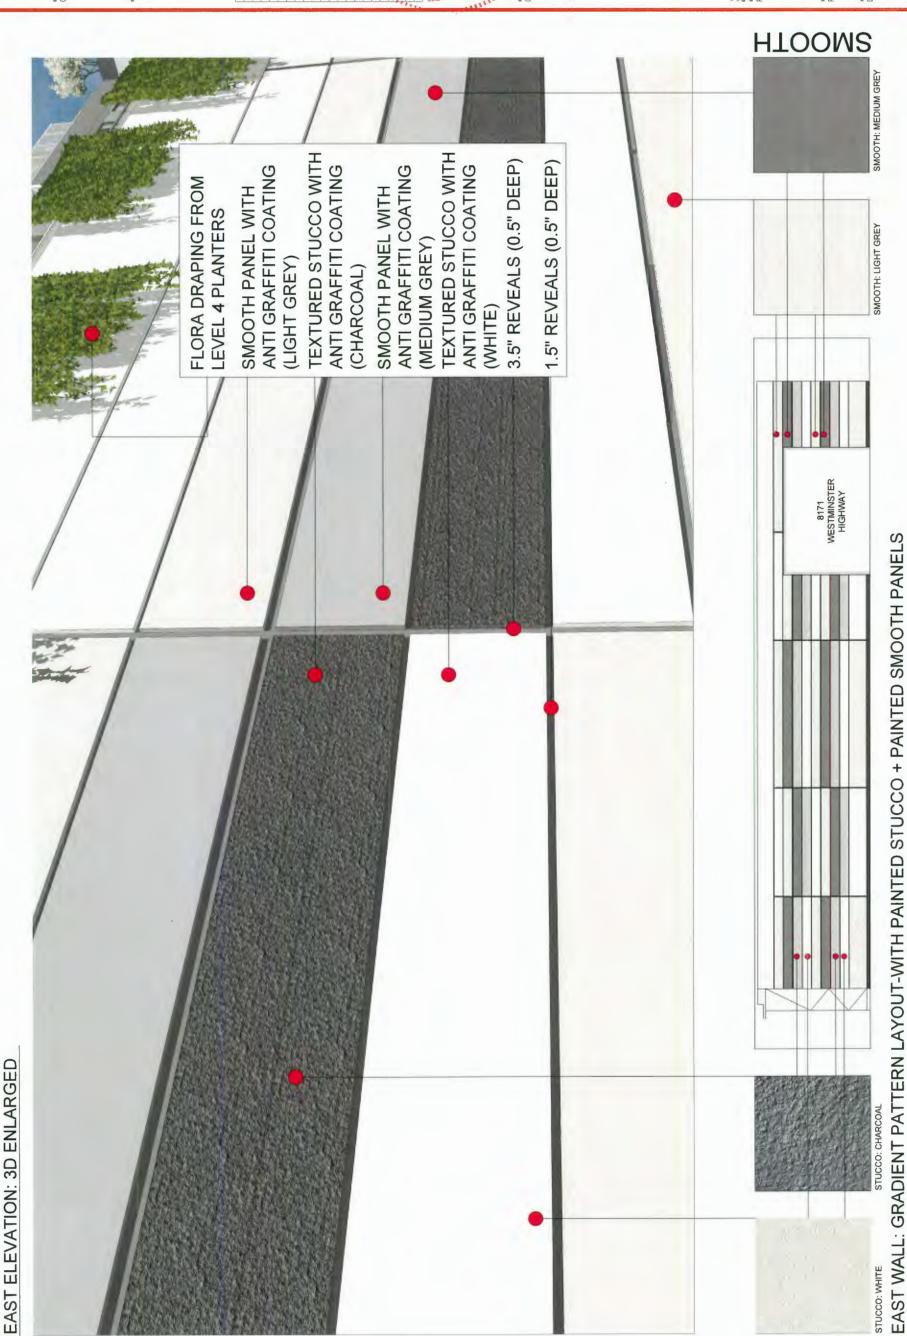
- 21 65 45 153

100

* 10 Kg

VIBIN EAST ELEVATION VAM 301 - 1444 Alberni Straet Vancouver, V6G 224 VIC 104 - 3212 Jacklin Road Victoria, V9B 0J5 604,685.3529 | office@wa-arch.ca | wa-arch.ca DRAWN BY: CSH REVIEW BY: BW MARCH,2020 DP 18-797127 Plan # 19 Jun 2, 2020 BOLD PROPERTIES GOSEN PROJECT ADDRESS:
8131 WESTMINSTER HWY.
CITY OF RICHMOND, BC BRITIS PROJECT NO: 17025

SCALE: 3/32~-r-o* DWG NO: A0310




1.0-ARCHITECTURAL LIGHTING: AMBIENT OUTDOOR LIGHTING


- LED AMBIENT INDOOR LIGHTING
 - LOBBY CHANDELIER
- **CEILING MOUNTED FIXTURES**
- RECESSED FIXTURES
- RETAIL DISPLAYS
- LED RECESSED SIDEWALK AND STAIR LIGHTING
- LED RECESSED SOFFIT LIGHTING
- LIGHTING (WASTE /RECYCLING ED AMBIENT CEILING WASH ROOMS)
- JP/DOWN FOR BIKE ROOMS AND EXIT DOOR LIGHTING (CPTED) **.ED WALL WASH LIGHTS:** Si
 - LED HANGING FIXTURE (3 FOOT CANDLES) - LANE LIGHTING AT 18'-0" (CPTED) ന
- ED RECESSED RAMP LIGHTING
- AMBIENT INDOOR LIGHTING
- SIDEWALK AND EXIT DOOR JP/DOWN FOR COVERED LED WALL WASH LIGHTS: -IGHTING (CPTED) 2
- LED HANGING FIXTURE (3 FOOT CANDLES)- LANE B LIGHTING AT 18'-0" (CPTED) ന
 - LED RECESSED CEILING LIGHT FOR WALLED EXITS (CPTED)



DP 18-797127 Plan # 20 Jun 2, 2020


BOLD PROPERTIES GOSETIES

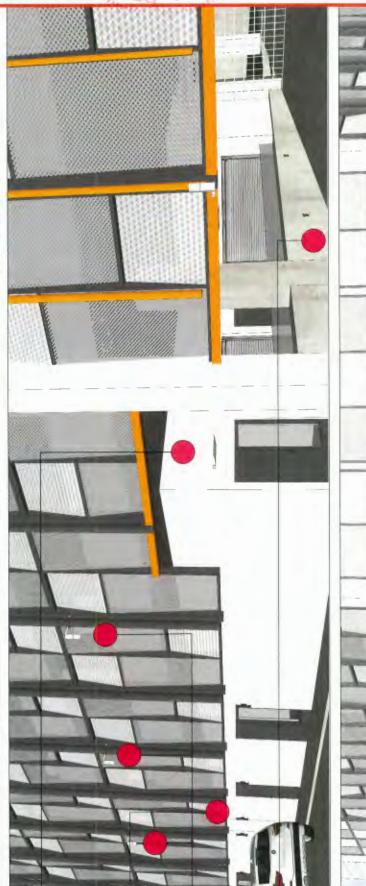

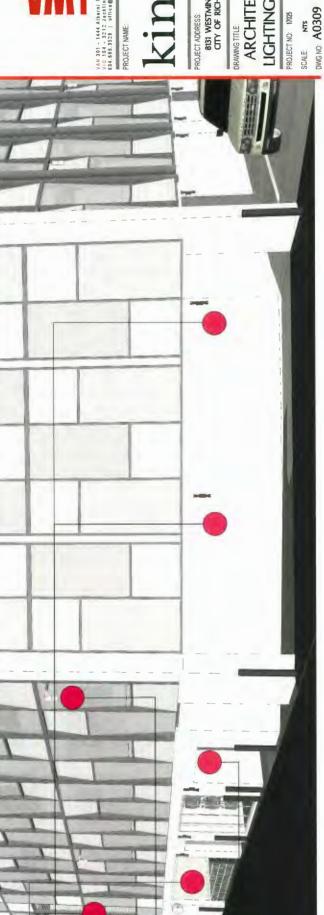

LIGHTING (CPTED) ARCHITECTURAL

PROJECT ADDRESS: 8131 WESTMINSTER HWY. CITY OF RICHMOND, BC

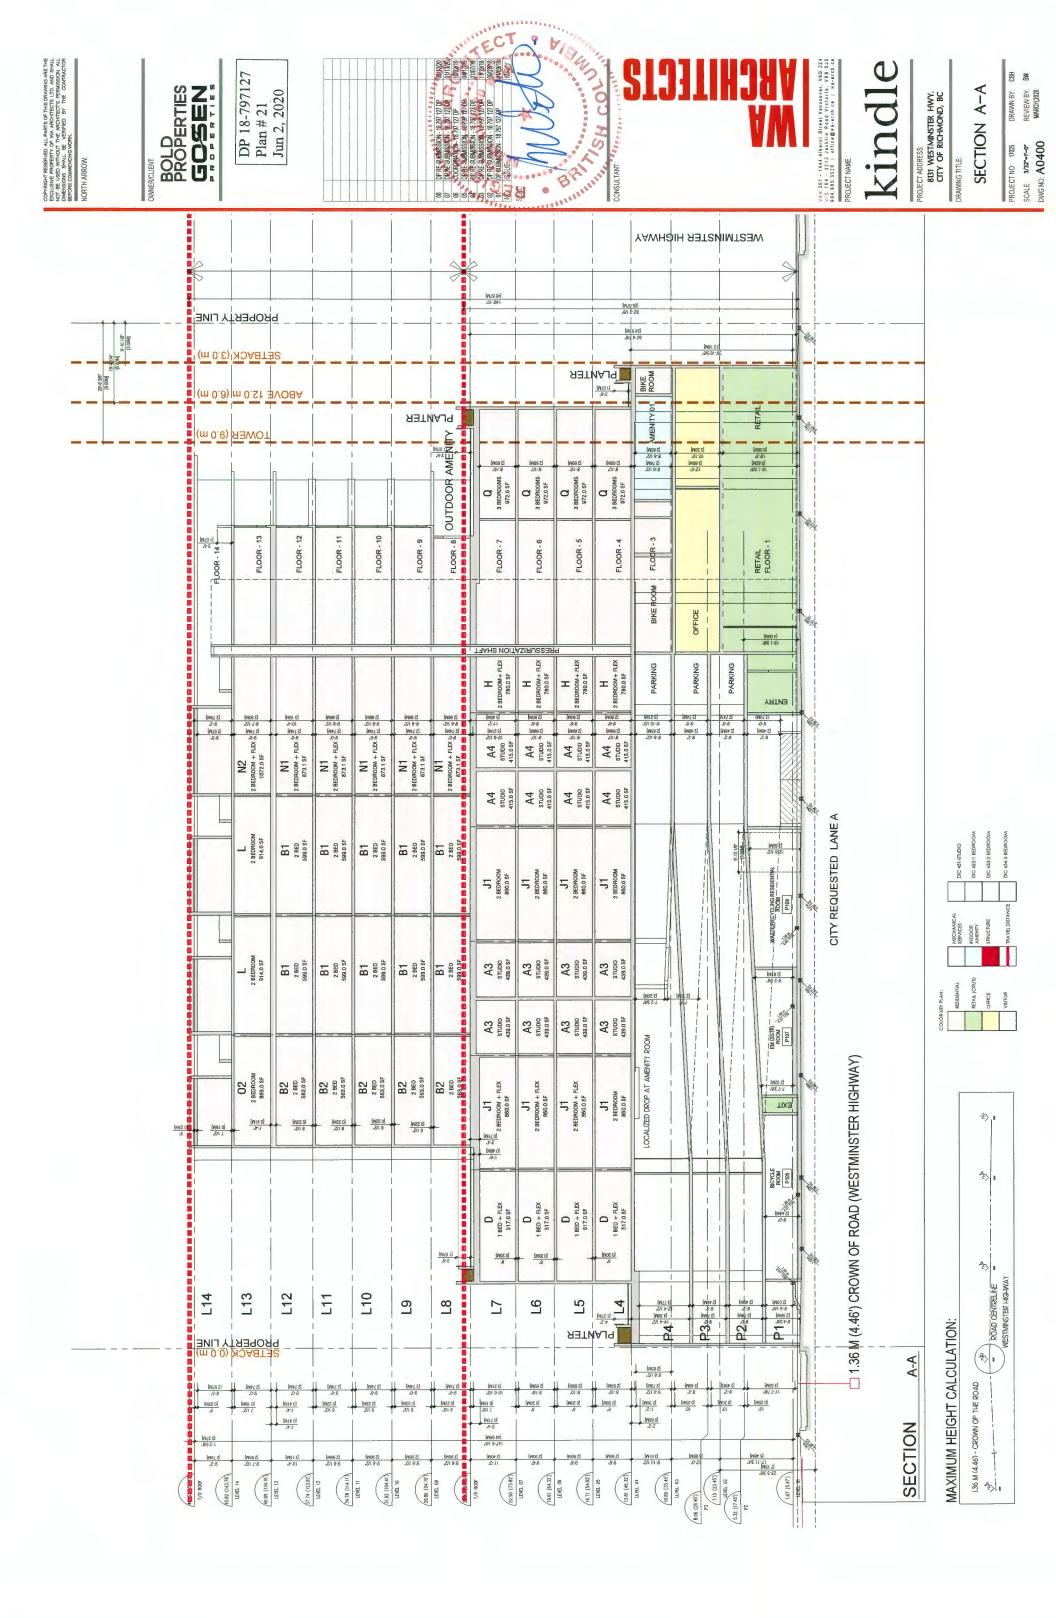

CONSEQUENCE CONSEQUENCES COPYROIT RESENED ALL PARTS OF THE DRAWNIG ARE THE DECLARES INTO AND SAULT ON OR USEN WITHOUT HE ARCHITECT'S PERSISSION, ALL BESTONE CONTRACTOR SAULT BESTONE OF THE CANTRACTOR BESTONE OF THE CONTRACTOR NORTH ARROW. VAM 301 - 1444 Albarni Street Vescouver, V6G 224 VC 104 - 3312 Jacklin Read Victoria, V9B 015 644.885.3529 | office@wa-erch.ca | wa-arch.ca | PROJECT NAME. DP 18-797127 Plan # 22 Jun 2, 2020 BOLD PROPERTIES GOSEN

PROJECT ADDRESS.

8131 WESTMINSTER HWY.
CITY OF RICHMOND, BC

SECTION 1-1

DRAWN BY: CSH REVIEW BY: BW MARCH,2020 PROJECT NO: 17025 SCALE: 3/32"-1"0" DWG NO: A0401

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						, 22		01:291			(N/20)	(W99 Z) - 1/2. 9.9				WESTMINSTER HIGHWAY
	- NTAL	ETBACK	d								TERRACE	PARKADE-P5	OFFICE SPACE	1	COMMERCIAL SPACE	
	" (m 0.S)	LBACK (NEB SE.	OT_			DECK					1	9	-	COMMER	*
74.2004)		01-D 2 BED 1150.0 SF	2 BED ROOM 665.0 SF	2 BED HOOM 665.0 SF	2 BED ROOM 685.0 SF	B5 2 BED ROOM 685.0 SF	2 BED ROOM 685.0 SF		STUDIO 454.0 SF	STUDIO 454.0 SF	STUDIO 454.0 SF	1		!		WESTMINSTER HIGHWAY (WESTMINSTER HIGHWAY)
* <u> </u>		To the state of th		No.	The state of the s	No.						- Andrews	I de la constant de l		The state of the s	1.36 M (4 46') CROWN OF ROAD (WESTMINSTER HIGHWAY)
	(<u>m 0.5</u>)	BACK (NEB SE.	OI			DECK	3 EDROWS	3 8EDROOMS (772.0 SF	3 BEDROOMS 872.0 SF	DECK SEDROOM	INDOOR	OFFICE			ROWN OF ROA
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	- BNIT Ā	BEODE	 -					NIEW	NIEW -	NIEW	VIEW		EXISTING BUILDING BUILDING			WESTMINSTER HIGHWAY

DP 18-797127 COPYRIGHT RESERVED

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ARCCARR

ARCCA 02/19/2020 12/09/2019 11/15/2019 10/30/2019 09/26/2019 04/17/2019 01/07/2019 11/19/2018 09/24/2018 01/05/2018 Kindle Ground Level Key Plan 3M/MP L-1.0 Plan # 23 Jun 2, 2020 BOLD PROPERTIES 17-059 8131 WESTMINSTER HWY. CITY OF RICHMOND, BC Checked By Orawn By Job No. 10 Re-Issued for DP
9 Issue for BP
18 Issued for BP
18 Issued for 90% Review
Coordination
6 Issued for DP
18 Re-Issued for DP
2 Re-Issued for DP
3 Re-Issued for DP
1 Issued for DP
1 Issued for DP
Revisor No 1:125 P. J. A. Bundscape Arr. Site Manning Scale - 4'X4' TREE GRATE TO CITY STANDARD (TYP.) DOWN LIGHT, IN SOFFITS ARCHITECTURAL LIGHT, ON COLUMNS CONTINUOUS AWNING (ABOVE) △ UP LIGHT, FROSTED LENS WITH TIMER LIGHTING KEY (REFER TO ELECTRICAL) STEP LIGHT, SHIELDED MAX RECEPTACLE LOCATION (GPC) IN EXTERIOR GRADE SOX) **WESTMINSTER HWY** .⊳ 🖸 🦪 3 (23) (5) (5) (15) (8) (15) (15) (15) PRIVACY SCREEN
(REFER TO ARCH)
STREETSCAPE PAVING
TO WET CITY STANDARDS
STREET TREE PLANTING
TO WEET CITY STANDARDS (B) (B) (B) (2) (T) 14 TRELLIS (REFER TO ARCH) (G) 18 TRELLIS (REFER TO ARCH) (G) 19 PLAY STRUCTURE TBD (Z) FITNESS STRUCTURE TBD **4**)⊥ (1 (4.0) GENERAL RETAIL FEATURE WALL DISTRICT (2) CRU 01 CUSTOM BUILT-IN PLANTERS PREFAB METAL PLANTER 3 STEPS L W/ HANDRAILS 88Q COUNTER (13) BIKE RACK
(14) PREFAB METAL
(15) TREE GRATE
(16) BBQ COUNTE ELEV. 2 TACTILE STRIP EXIT LOBSY HARVEST TABLE W/ BENCH ELEV.3 OUTDOOR FURNITURE LB CUSTOM BENCH STAR 3 OFFICE LOSSY LOUNGE CHAIR (£) (£) (£) MODULAR BLOCK RETAINING WALL L4 SEATING DECK ARTIFICIAL TURF (5) ARTIFICIAL TU (6) RETAINING W (7) L1 BENCH (8) L4 SEATING D PROPOSED LANEWAY CONCRETE PAVING
 HYDRAPRESED
 SLAB PAVING
 FEATURE UNIT PAVING
 RUBBER SAFETY
 SURFACING SACRAS 200000 2000000 2000000 SHORKE BICYCLE ROOM EM DISTRI. ROOM 300 10 75 MAIN TRANSFORMER ROOM STAIR 2

DP 18-797127 Plan # 24 Jun 2, 2020 OOP-RIGHT RESERVED

OOP-RIGHT RESERVED

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KIN Pary & Associated Reserved

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The Reserved Res Level One Grading Plan 09/26/2019 04/17/2019 01/07/2019 11/19/2018 09/24/2018 01/05/2018 R. K. m. Perry & Auton ares Inc.
112 East Brandway
Vancoure, 8G. VST 1V9
FEW 738 4118
FEW 758 4116
WWWEDPTAPPRESSAR 02/19/2020 12/09/2019 11/15/2019 10/30/2019 BOLD PROPERTIES Kindle Ħ 8131 WESTMINSTER HWY. L-1.1 Checked By Drawn By 10 Re-issued for DP
9 issue for BP
1 issued for BO's Review
1 issued for Model
Coordination
6 issued for Clert Review
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JM/MP 17-059

Level One Planting Plan ₽ JM/MP 17-059 Cnecked By Drawn By: Job No

Project North:

L-1.2

1:150

Sheet No. Scale

Kindle

Project Title:

8131 WESTMINSTER HWY.

Drawing Title:

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R. K. m. Plerry. B. Assoc. ares. Proc. 112. East Broadway.
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F. Four 738. 4716
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www.pernyamiassociales.ca P.f. A Lindscape Act Site Manning

DP 18-797127 Plan # 25 Jun 2, 2020

9) Contractor to submit a representative sample of the proposed topsoil for testing to Pedific Soil Analysis. Contractor is responsible for arranging and payment of soil analysis and amendments to growing medium as determined. Contractor shall instruct soil testing lab to submit results directly to the consultainst for approval prior to commencement of work.	1) Trees to be min. 6cm ca conform to City of Richmo standards and species list.	1) Trees to be min. 6cm caliper wire basket to conform to City of Richmond street tree standards and species list.				
 Contractor to provide landscape architect a copy of all packing slips received from nursely listing names and quantities of all plant stock propiled to site prior to planting 	Level 1	Level 1 - Plant List				
11) The contractor shall locate and verify the existence of all utilities prior to starting work.	Symbol Trees	Qty. Botanical Name	Common Name	Scheduled Size Mature Height	lature Height	Remarks
12) All nearing heds to have min 75 mm denth of 25mm minus screened	AcrB	3 Acer rubrum 'Bowhall'	Bowhail Red Maple	6cm cal., WB	12m Ht.	
composted bark mulch (not on groundcover areas).	PfE	4 Off-Site Street iree 5 Populus tremula 'Erecta'	Columnar European Aspen	6cm cal., WB	1.8.U.	species subject to city approval
13) All plants shall be watered thoroughly twice during the first 24-hour period after planting. All plants shall then be watered as necessary.	Shrubs					
14) The landscape contractor shall refer to the contract specifications for	HMA	HmA 25 Hakonechloa macra 'Aureola'	Japanese Forest Grass	#1 pot		
additional requirements.	¥	20 Heuchera 'Cherries Jubilee'	Coral Bells	#1 pot		

2) All planting and landscape installation to meet or exceed the BCSLA/BCLNA - CSLA landscape standards 1) Contractor is responsible to obtain and be familiar with the relevant project specifications

PLANTING NOTES:

NOTE

Remarks tr. Species subject to City approval tr.	Off-site street trees ST1 to City of Richmond standards RICHURAL SOIL WESTERT OF STRUCTURAL SOIL
Scheduled Size Mature Height 6cm cal., WB 12m Ht. 6cm cal., WB 12m Ht. 18.0. 6cm cal., WB 10m Ht. #1 pot #1 pot	S S S S S S S S S S S S S S S S S S S
Common Name Bowhall Red Maple Columnar European Aspen Japanese Forest Grass Coral Bells	DON CORPY The state of the sta
Level 1 - Plant List Symbol Qty. Botanical Name Trees 3 Acer rubrum Bowhall STI 4 Off-Site Street Tree PtE 5 Populus tremula 'Erecta' Shrubs Groundcovers, Vines, Perns, Perennials and Grasses HmA 25 Hakonechloa marra 'Aureola' HC 20 Heuchera 'Cherries Jubilee'	
Generic Mailysis is not acceptable. 10) Contractor to provide landscape architect a copy of all packing slips received from nursery listing names and quantities of all plant stock supplied to site prior to planting armses and quantities of all plant stock supplied to site prior to planting and verify the existence of all utilities prior to starting work. 12) All planting beds to have min 75 mm depth of 25mm minus screened composted bank mulch (not on groundcover areas). 13) All plants shall be watered thoroughly twice during the first 24-hour period after planting. All plants shall refer to the contract specifications for additional requirements. 14) The landscape contractor shall refer to the contract specifications for additional requirements. 15) All sod to be unnetted and grown on sand. 16) Plant Search area to include BC, WA, OR & CA.	TANASCONE TO THE PROPERTY OF T
Society of the standard of the	Coca Merries Properties of the Parish Properti

DP 18-797127 Plan # 26 Jun 2, 2020 COPPRIGHT RESERVED

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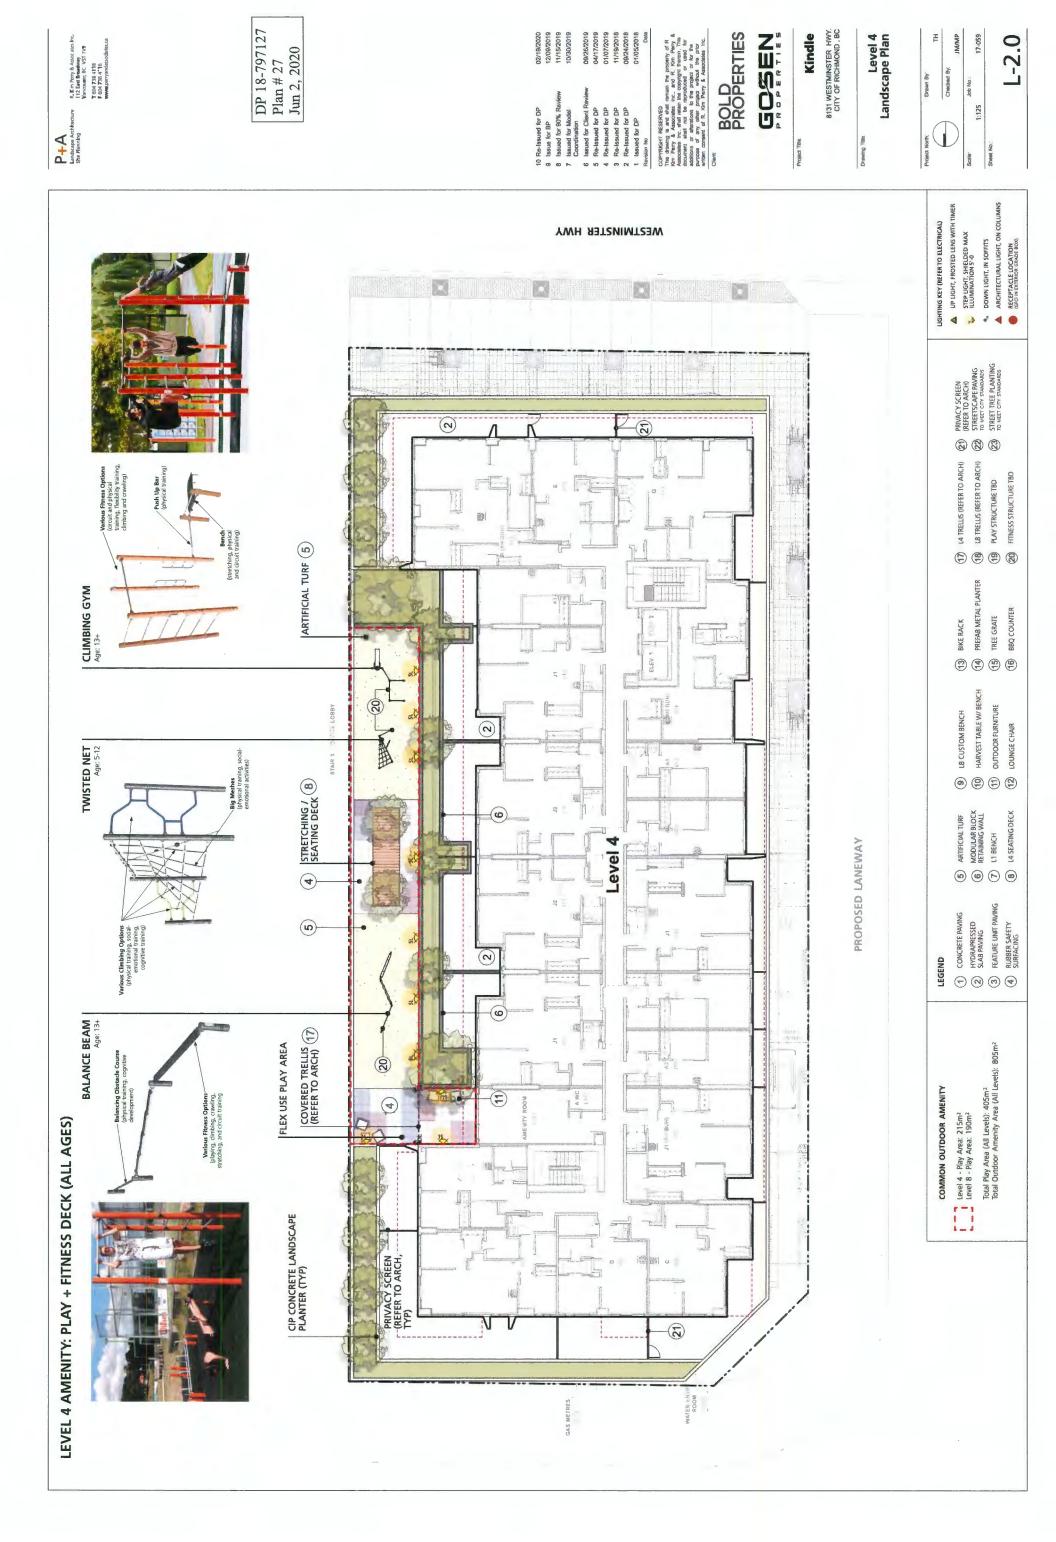
purpose of any other project without the prior

written consent of R. Kim Perny & Associates Inc.

Client. L-1.3 02/19/2020 12/09/2019 10/30/2019 09/26/2019 04/17/2019 01/07/2019 11/19/2018 09/24/2018 01/05/2018 BOLD PROPERTIES Kindle 17-059 R. K. m. Perry & Assoc attel Inc.
112 East Brandway
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WWWILDPROYNTASSOCIATES, CA H IMMI Ground Level Landscape Lighting Plan Checked By I Re-Issued for DP
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 ARCHITECTURAL LIGHT, ON COLUMNS GEGETACLE LOCATION (GEGINETTRION GEGINETTRION COLUMNS) LIGHTING KEY (REFER TO ELECTRICAL)

OP LIGHT, FROSTED LENS WITH TIMER STEP LIGHT, SHIELDED MAX WESTMINSTER HWY PROPOSED LANEWAY 24 BLOPE th THAMBFORDIER WDCIM P100 STAIR 2

P+A Landscape Ard Site Hanning



R. K. m. Perry & Assac ares for 112 East Broadway Vancouver, BC, VST 1V9 7504 738 4118 F 504 738 4116

P.g. A

Shrubs Symbol Trees

4) Contractor to ensure all plant material delivered to site is from nurseries certified to be free from the phytophthora ramorum virus (sudden oak death) removal and replacement of plant material found to contain the virus to be at the contractor's expense.

As a minimal acceptable standard:
 Sizes on the plant list shall be considered minimum sizes
 Root bails to be free of permicious weeds

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16) Plant Search area to include BC, WA, OR & CA 15) All sod to be unnetted and grown on sand.

B) Container grown stock, shall have the container removed and the rootball be cleanly scored in two vertical locations.

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DP 18-797127 Plan # 28 Jun 2, 2020

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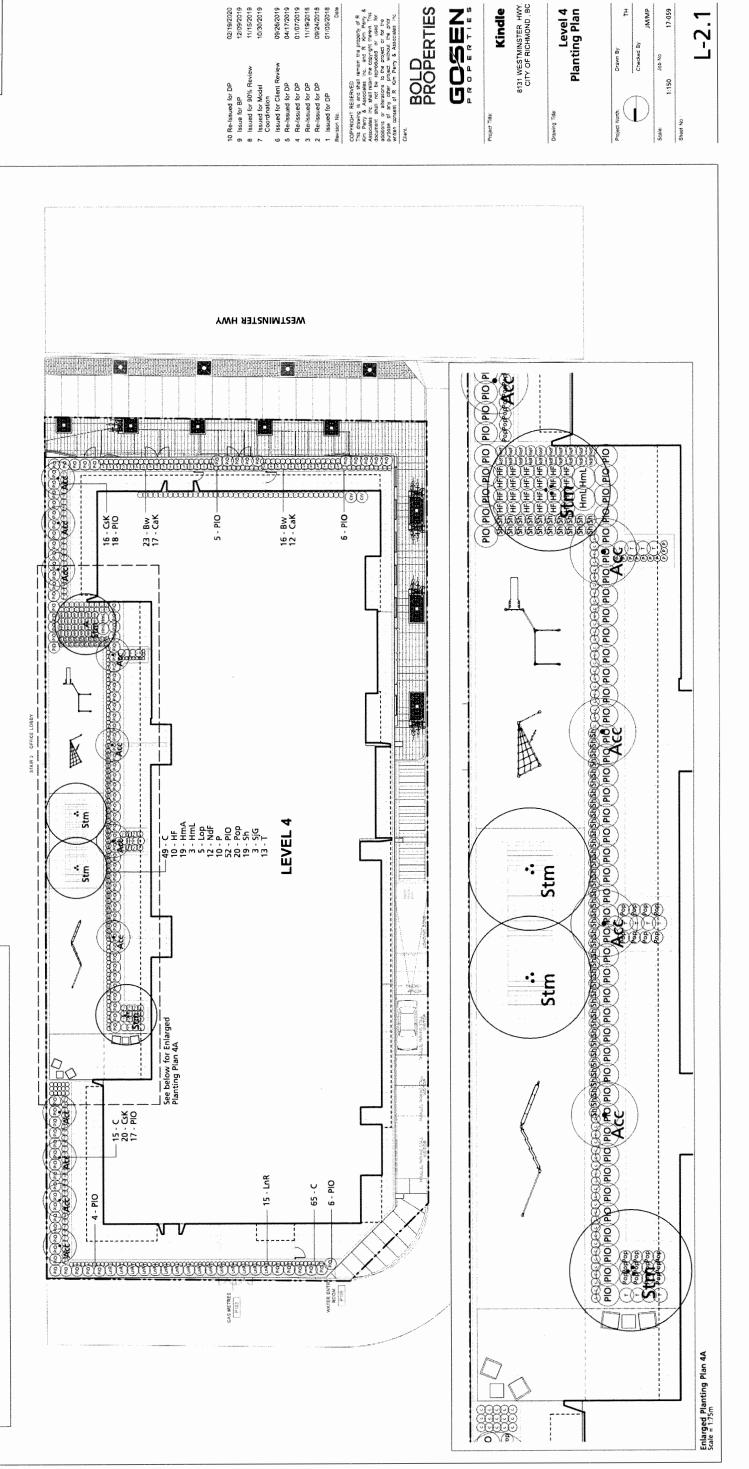
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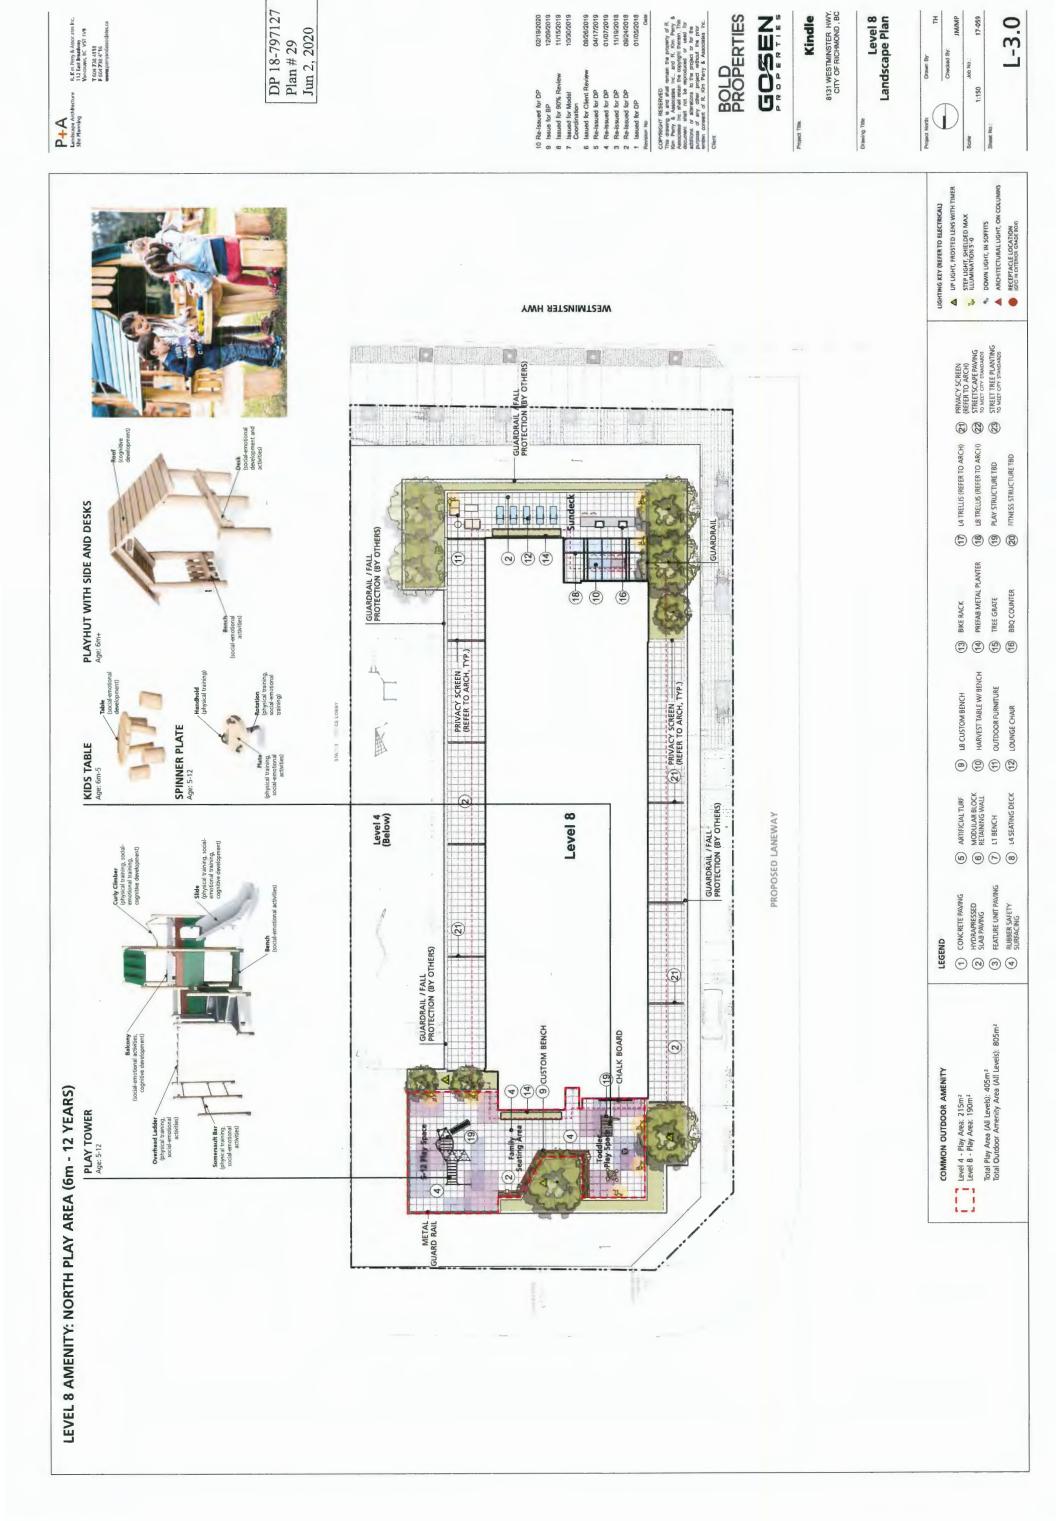
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Level 4 - Plant List	- Plar	nt List					
Symbol	Qty.	Qty. Botanical Name	Common Name	Scheduled Size Mature Height	Mature Height	Spacing	Remarks
Trees							
Acc	-	11 Acer circinatum	Vine Maple	2.5m ht.	4m	3m	Max. 3 stems
Stm	4	4 Stewartia monodelpha	Tall Stewartia	6cm cal., WB	7.5m	8 E	
Shrubs							
Bw	39	39 Buxus microphylla 'Winter Gem'	Winter Gem Boxwood	#2 pot	4' Ht.	450 mm	
HML	2	Hydrangea macrophylla 'Lanarth White'	Lanarth White Lacecap Hydranged	#5 pot	Height	Spread	
LIR	15	15 Lonicera nitida 'Red Tips'	Red Tips Boxleaf Honeysuckle	#3 pot	4. Ht.	E,	
NAF	20	20 Nandina domestica 'Fire Power'	Fire Power Heavenly Bamboo	#3 pot	Height	Spread	
임	103	103 Prunus laurocerasus 'Otto Luyken'	Otto Luyken Laurel	#3 pot	3' Ht.	E	
Sh	59	59 Sarcococca hookeriana var. humilis	Dwarf Sweet Box	#2 pot	2' Ht.	450 mm	
-	13	13 Taxus x media 'Hicksii' (male form)	Hicksii Yew (male form)	5' ht	6' Ht.	200 mm	Hedge
Groundcovers, Vines, Ferns,	ers, Vin	es, Ferns, Perennials and Grasses					
Cak	29	Calamagrostis x acutiflora 'Karl Foerster'	Feather Reed Grass	#1 pot	5. Ht.	mm 009	
J	129	129 Carex oshimensis 'Evergold'	Sedge	#1 pot		350 mm	
¥	24	24 Hosta 'Frances Williams'	Frances Williams Hosta	#1 pot	Height	Spread	
	22	22 Lavandula angustifolia 'Munstead'	English Lavender	#1 pot		400 mm	
۵.	10	10 Pachysandra terminalis	Japanese Spurge	#1 pot		300 mm	Groundcover
Pop	73	73 Polystichum polyblepharum	Japanese Tassel Fern	#1 pot	Height	Spread	





cates Inc. 1V9 F.K. m. Perry B. Assoc at 11.2 East Broadway.
Vancouses, BC. VST. 13V
T. 654 738 4118
F. 664 738 4146
www.perryandissocial

Remarks

Level 8 - Symbol Trees

9) Contractor to submit a representative sample of the proposed topsoil for testing to Padick Sol Analysis. Contractor, is responsible for arranging and payment of soil analysis and amendments to growing medium as determined. Contractor shall instruct soil testing lab to submit results directly to the consultant for approval prior to commencement of work. Generic Analysis is not acceptable.

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11) The contractor shall locate and verify the existence of all utilities prior to starting work.

4) Contractor to ensure all plant material delivered to site is from nurseries certified to be free from the phytophthora ramorum viros (sudden oak death) removal and replacement of plant material found to contain the virus to be at the contractor's expense.

As a minimal acceptable standard:
 a) Sizes on the plant list shall be considered minimum sizes
 b) Root bails to be free of pernicious weeds

2) All planting and landscape installation to meet or exceed the BCSLA/BCLNA - CSLA landscape standards 1) Contractor is responsible to obtain and be familiar with the relevant project specifications

PLANTING NOTES:

13) All plants shall be watered thoroughly twice during the first 24-hour period after planting . All plants shall then be watered as necessary.

14) The landscape contractor shall refer to the contract specifications for additional requirements.

and grown on sand.

15) All sod to be unnetted

7) No container grown stock will be accepted if it is root bound. All root wrapping material made of synthetics or plastics shall be removed at time of planting.

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B) Container grown stock, shall have the container removed and the rootball be cleanly scored in two vertical locations.

16) Plant Search area to include BC, WA, OR & CA


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Multi-stem to be selected by LA 3m Spread 5m 450 mm 750 mm 1.2m 900 mm Spread 450 mm Spread 500 mm 600 mm 350 mm 400 mm 300 mm Spread 4' Ht. 2.5' Ht. 4' Ht. 2' Ht. 2' Ht. 2' Ht. 6' Ht. 8' Ht. Max Height 6m 8m Scheduled Size Mature Height #1 pot 5' Ht. #1 pot #1 pot #1 pot Heigh 6cm cal., 3m ht., WB 4m ht., B&B 3m ht., WB 4m ht., B&B #3 pot #3 pot #3 pot #3 pot #3 pot #3 pot 5 pot Dwarf Japanese Maple Osakazuki Japanese Maple Autumn Brilliance Serviceber Serbian Spruce Winter Gem Boxwood
Victoria Lilac
Kelsey Dogwood
Annabelle Hydrangea
Privet Honeysuckle
Unigue Rhododendron
Dwarf Sweet Box
Goldmound Spirea
Hicksii Yew (male form) Common Name Feather Reed Grass Sedge English Lavender Japanese Spurge Autumn Joy Sedum Acer palmatum Acer palmatum 'Osakazuki' Amelanchier x grandiflora 'Autumn Brilliance' Picea omorika rough Spirococca hookeriana var. humilis
Sig 26 Spiraea japonica 'Goldmound'
68 Taxus x media "Hicksi" (male form)
Groundcovers, Vines, Ferras, Perennials and Grasses
Cak 31 Calamagrosis x acutifiora 'Karl Foerster
Cak 62 Carex oshimensis 'Evergold'
109 Lavandula angustifolia 'Munstead' 33 Buxus microphylla 'Winter Gem'
28 Ceanothus thyrsiflorus Victoria'
20 Cornus sericea 'Kelsey'
14 Vidrangea arborescens 'Annabelle'
21 Ionitera pileata
22 Rhododendron 'Unique' 9 Pachysandra terminalis 7 Sedum telephium 'Autumn Joy' 8 - Plant List
Oty, Botanical Name

DP 18-797127 Plan # 30

Hedge

2020		02/19/2020	12/09/2019	11/15/2019	10/30/2019	09/26/2019	04/17/2019	01/07/2019	11/19/2018	09/24/2018	01/05/2018	Date	
Fian # 50 Jun 2, 2020		10 Re-Issued for DP	9 Issue for BP	8 Issued for 90% Review	7 Issued for Model Coordination	6 Issued for Client Review	5 Re-Issued for DP	4 Re-Issued for DP	3 Re-Issued for DP	2 Re-Issued for DP	1 Issued for DP	Revision No.	COPYRIGHT RESERVED
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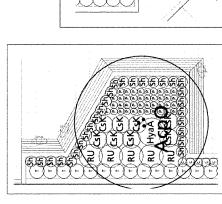
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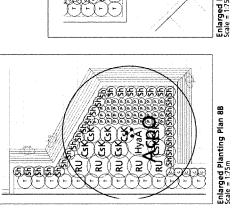
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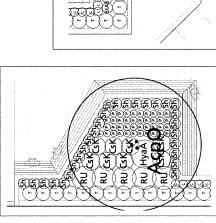
BOLD PROPERTIES

PROPOSED LANEWAY

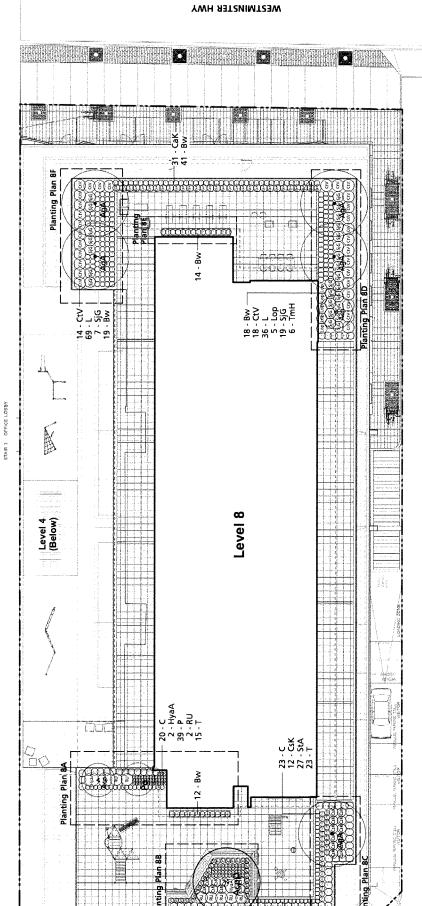Enlarged Planting Plan 8A Scale = 1.75m







Enlarged Planting Plan 8C Scale = 1:75m

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Ξ JM/MP 17-059 Checked By 1:150

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Drawn By


Level 8 Planting Plan

8131 WESTMINSTER HWY.

Kindle

Project Title:

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R. K. m. Penny S. Auson anns Inc.
112 East Broadway
Vancounes, BC. VST 1V9
TGOV 738 4118
F 504 728 4116
www.pennyandesondaes.ca

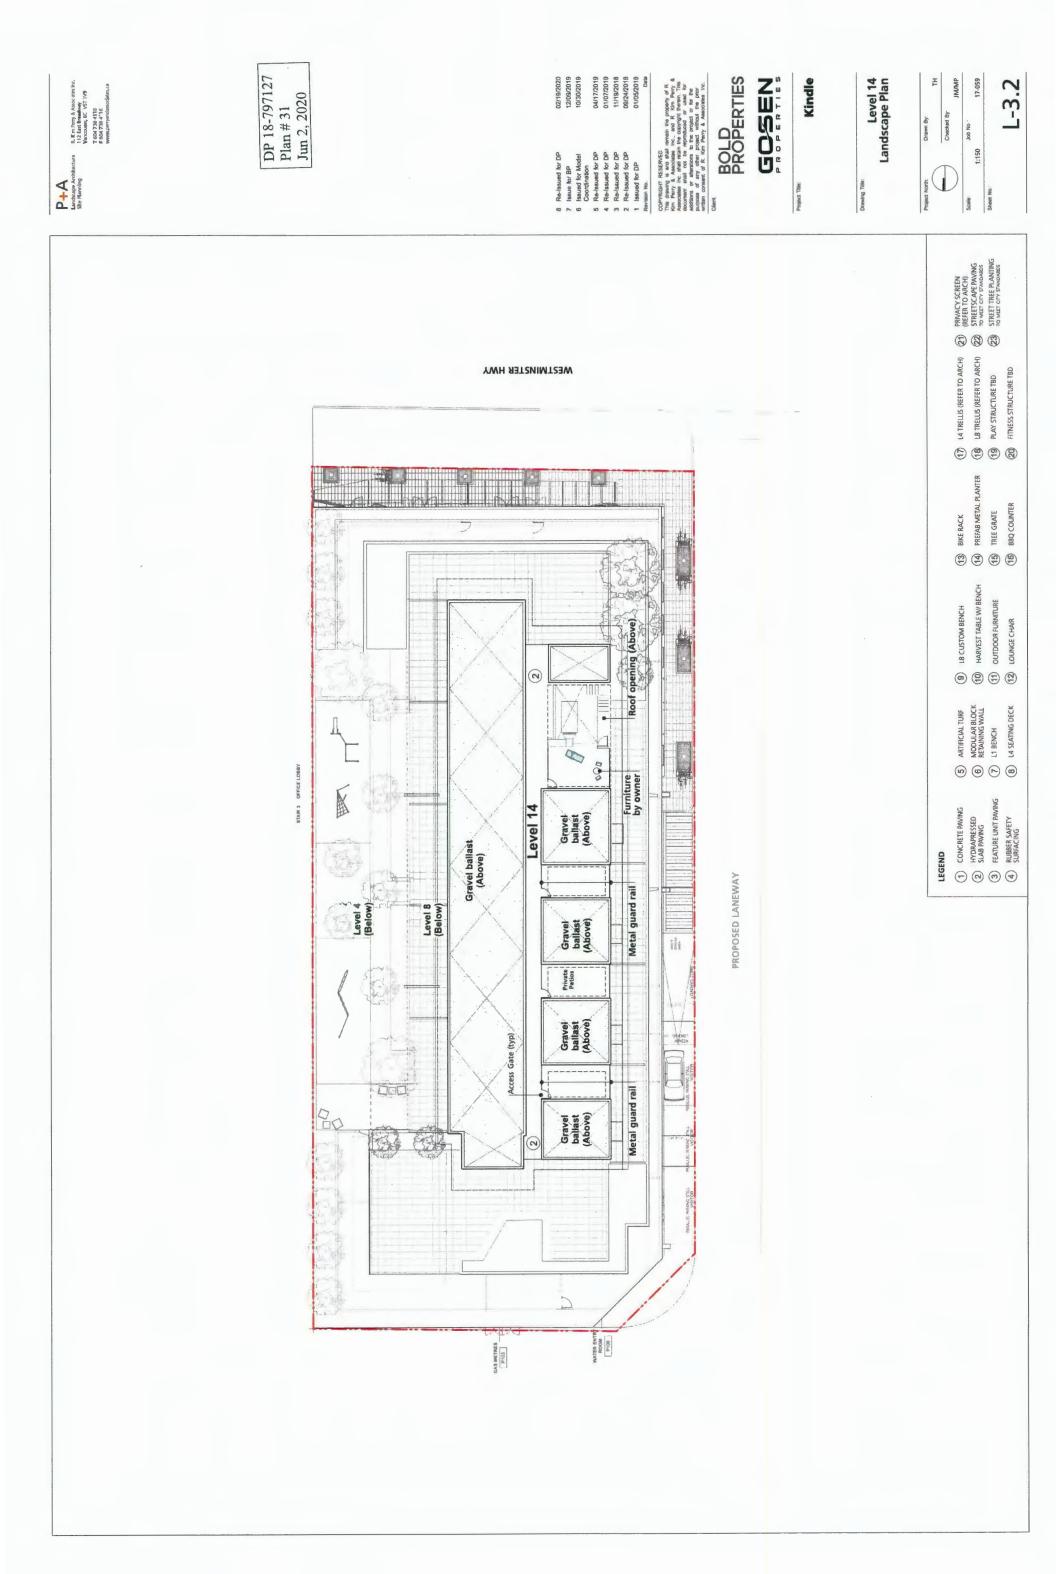P+A

Remarks Spacing

450 mm 4' Ht. 6-8' Ht. Scheduled Size Mature Size #2 pot #10 pot Winter Gem Boxwood Blue Satin Rose of Sharon Common Name

On Standard Groundcover DP 18-797127 Plan # 32 Jun 2, 2020

WESTMINSTER HWY 300 mm Gravel ballast ballast ballast ballast ballast (Above) #1 pot Japanese Spurge Bw 54 Buxus microphylla 'Winter Gem' HisB 4 Hibiscus syriacus 'Blue Satin' Groundcovers, Vines, Ferns, Perennials and Grasses 66 Pachysandra terminalis STAIR 3 OFFICE LOSEY M Level 14 - Plant List
Symbol Qty. Botanical Name
Trees
Trees
Shrubs Privato Level 4 (Below) 12) All planting beds to have min 75 mm depth of 25mm minus screened composted bark mulch (not on groundcover areas). contractor shall refer to the contract specifications for iments . 9) Contractor to submit a representative sample of the proposed topsoil for testing to Pacific Soil Analysis. Contractor is responsible for arranging and pagines of soil analysis and amendments to growing medium as determined. Contractor shall instruct soil testing lab to submit results directly to the consultant for approval prior to commencement of work. Generic Analysis is not acceptable. 13) All plants shall be watered thoroughly twice during the first 24 hour period after planting. All plants shall then be watered as necessary. 10) Contractor to provide landscape architect a copy of all packing slips received from nursery listing names and quantities of all plant stock supplied to site prior to planting 11) The contractor shall locate and verify the existence of all utilities prior to starting work. 16) Plant Search area to include BC, WA, OR & CA. 15) All sod to be unnetted and grown on sand. 20

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Action of the comparing the property of the comparing th GOSEN BOLD PROPERTIES

Furniture Roof opening (Above)

Metal guard rail

(Belo

GAS METRES

PROPOSED LANEWAY

02/19/2020 12/09/2019 10/30/2019

04/17/2019 01/07/2019 11/19/2018 09/24/2018 01/05/2018

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Project

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Project North:	\int		Scale:	

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Sheet No

Level 14 Planting Plan Drawing Title:

14) The landscape additional requires

 No container grown stock will be accepted if it is root bound.
 In oot wrapping material made of synthetics or plastics shall be removed at time of planting. 8) Container grown stock, shall have the container removed and the rootball be cleanly scored in two vertical locations.


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PLANTING NOTES:



A2 STUDIO 454.0 ft² 12.18 m²)

J1-A

J2-A 2 BEDROOM +FLEX 830.0 TP (77.11m²)

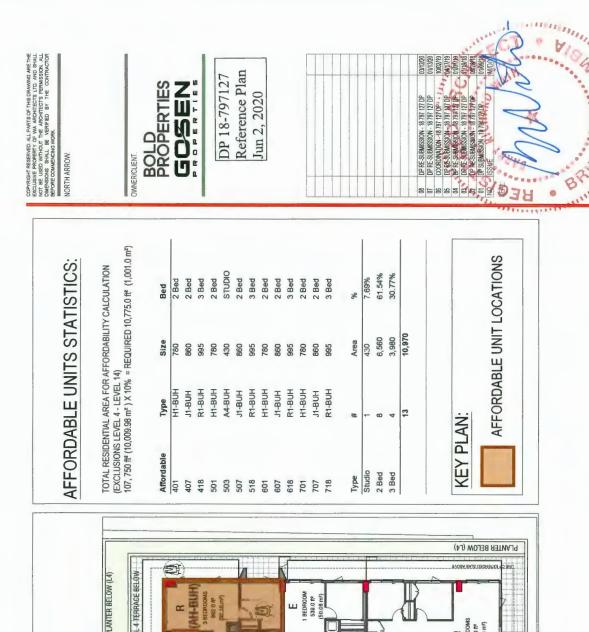J2 2 BEDROOM +FLEX 830.0 ft² (77.11 m²)

2 BEDROOM +FLEX 860.0 ff² UT (79.89 m²)

I

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AFFORDABLE UNITS LOCATION PLAN:

SETBACK (0.0 m) PLANTER

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G

AFFORDABLE UNITS PLANS: 100% OF AFFORDABLE UNITS (A4 ,H, J1, R) ALL CONFORM TO BASIC UNIVERSAL HOUSING REQUIREMENTS AS PER THE BY-LAW (4.16)

2 BEDROOM +FLEX 850.0 11² (78.97 m²) JI-B

A3 STUDIO 439.00 ft² (40.78 m²)

M

PLANTER BELOW (L4)





VAN 301 - 1444 Alberni Sireet Vancouver, VGG 22.viC 104 - 3212 Jacklin Road Victoria, V9B 0J5604.685.3529 | office@wa-arch.cs wa-arch.cs

PROJECT ADDRESS:
EB11 WESTAMNSTER HWY.
CITY OF RICHMOND, BC DRAWING TITLE:

UNITS A4,H,JI,R AFFORDABLE PROJECT NO: 17026

REVIEW BY: MARCH, 2020 DRAWN BY: SCALE: VARES
DWG NO: A0216

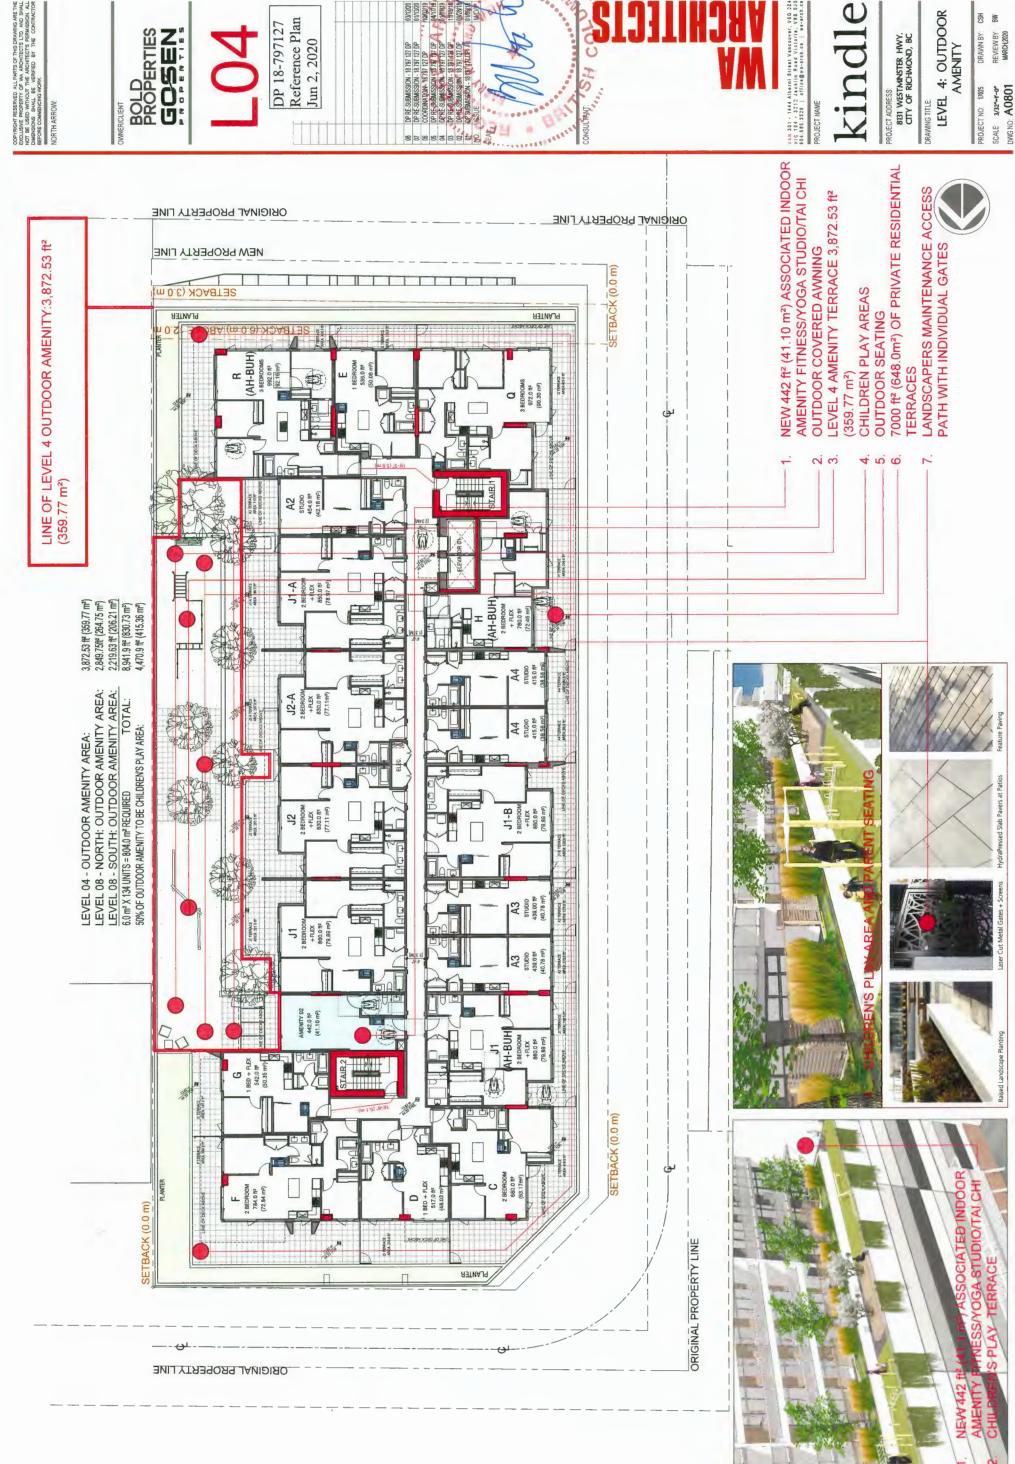


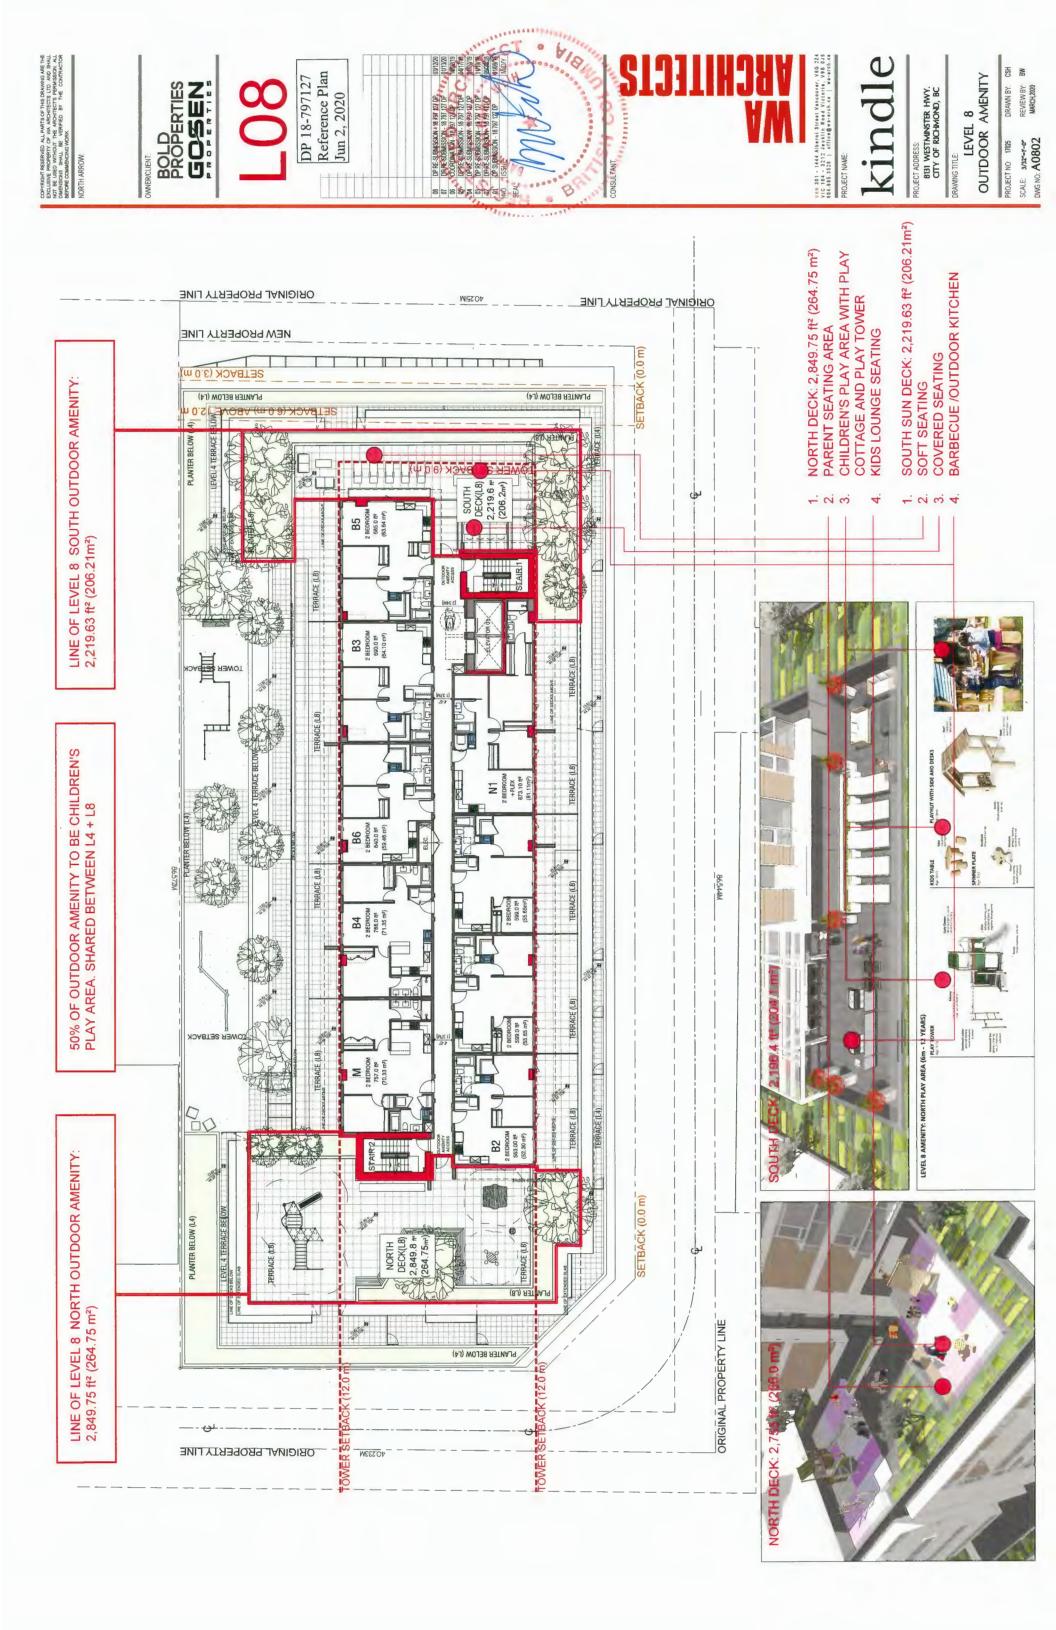

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SCALE:
DWG NO: A0507 PROJECT NO: 17025

PROJECT ADDRESS.
8131 WESTMINSTER HWY.
CITY OF RICHMOND, BC

DRAWING TITLE:
SHADOW
STUDY

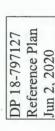











ER 21



SUMMER SOLSTICE - JUNE 21

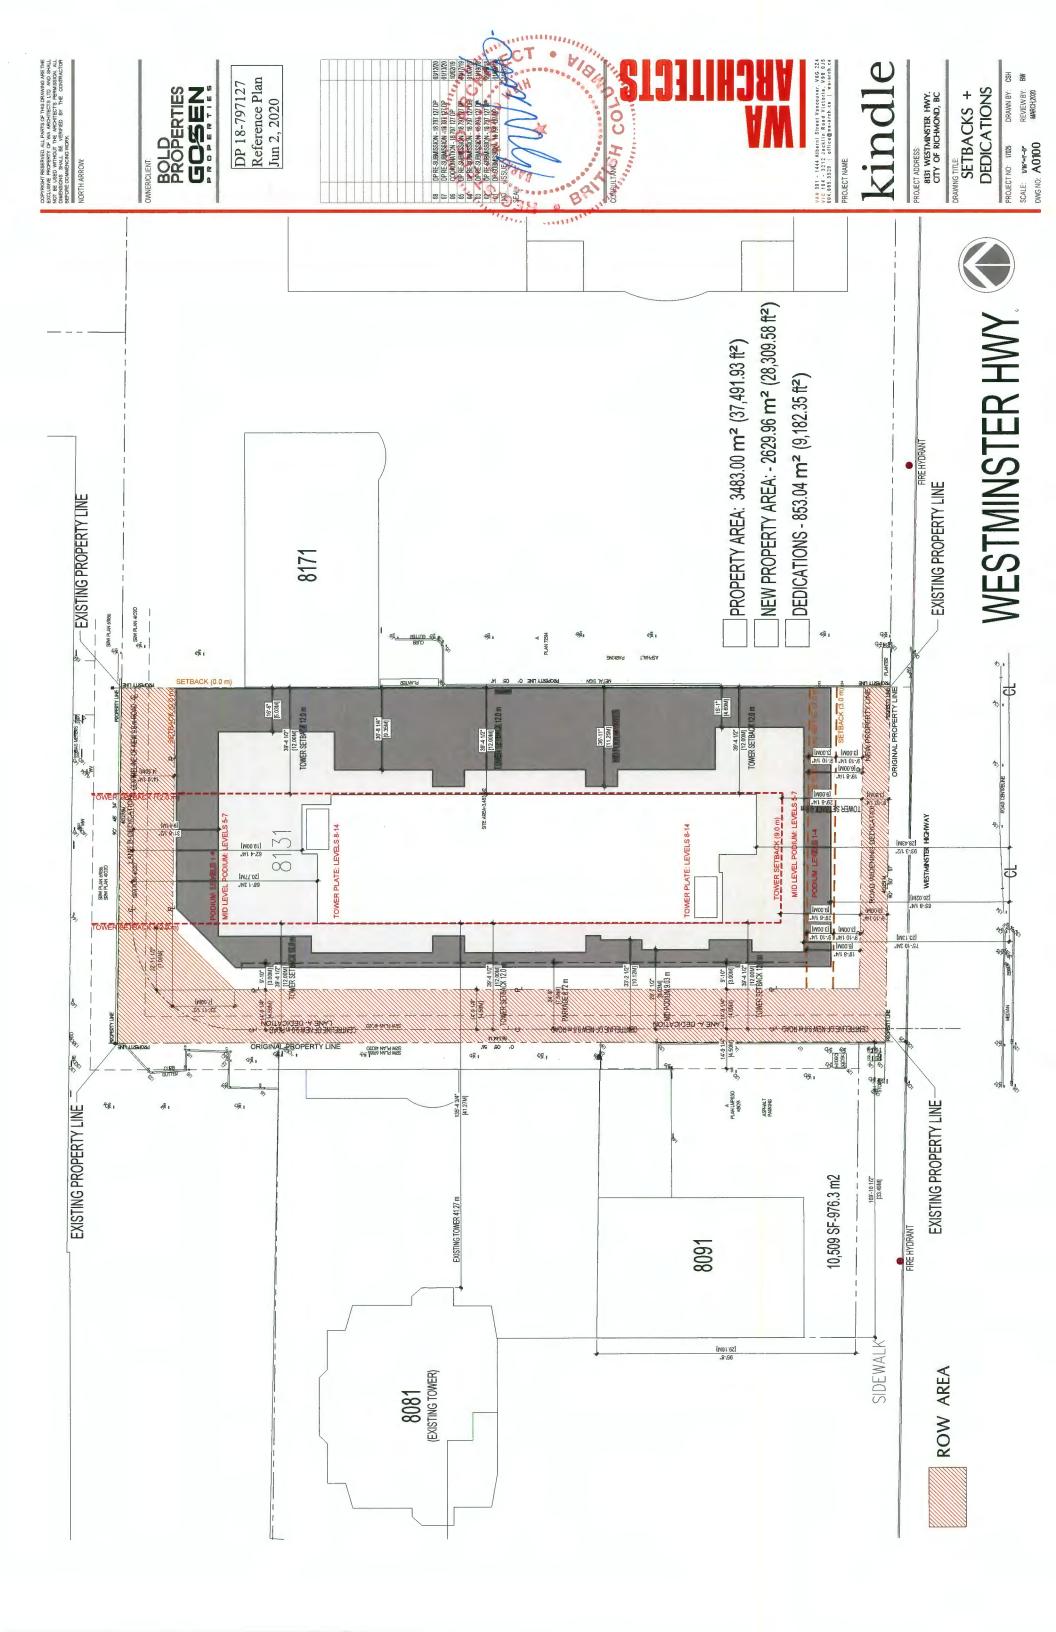

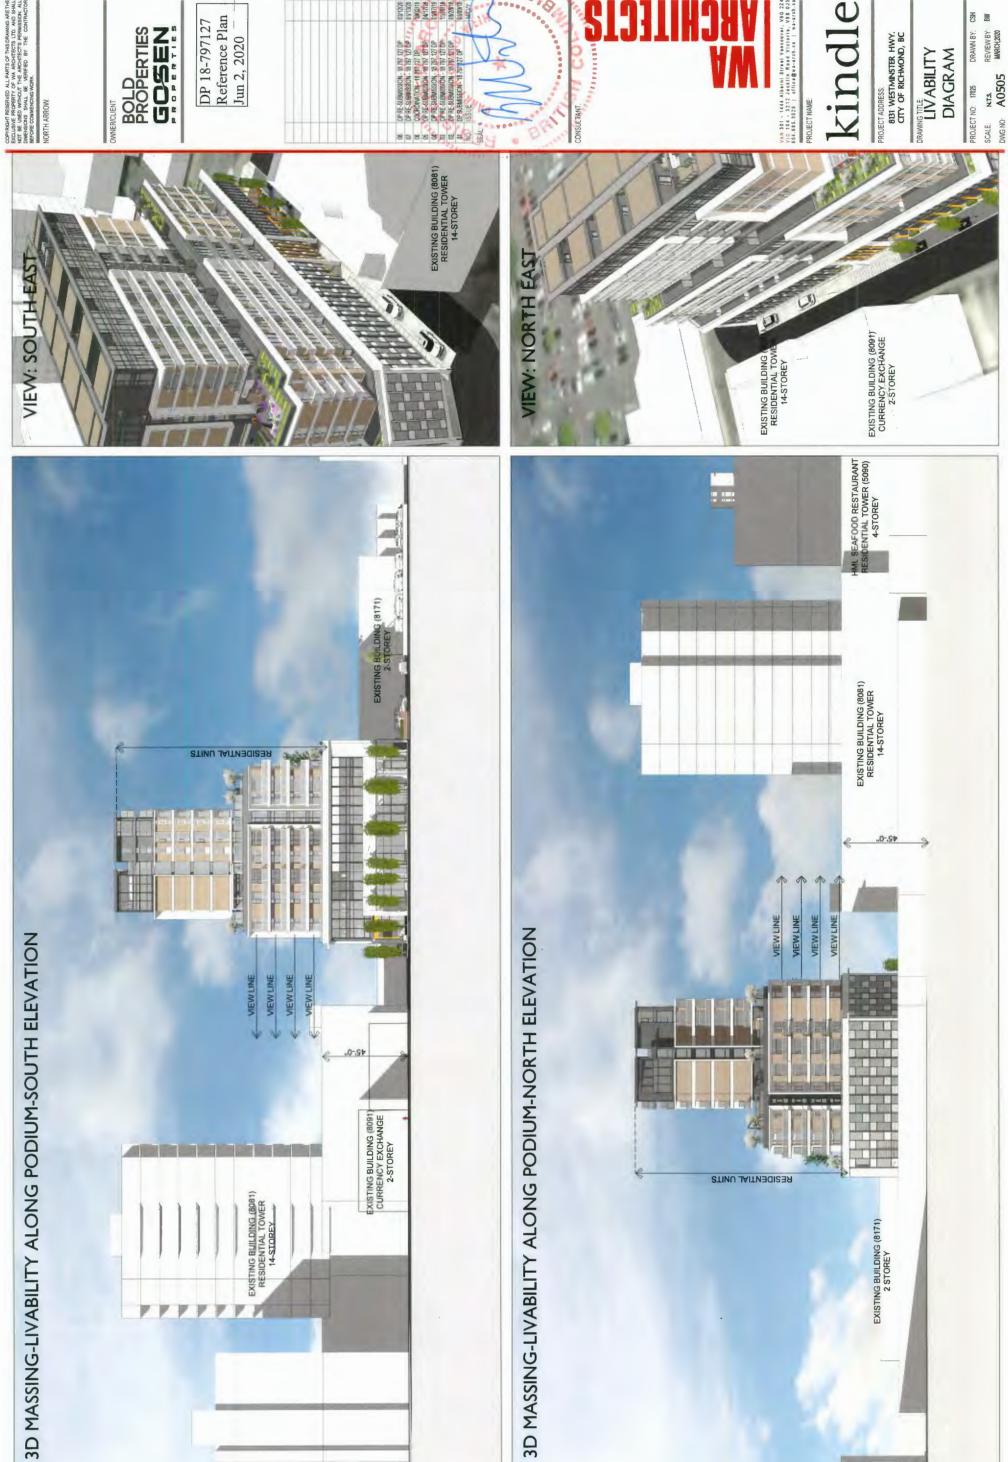

DP 18-797127

Reference Plan Jun 2, 2020

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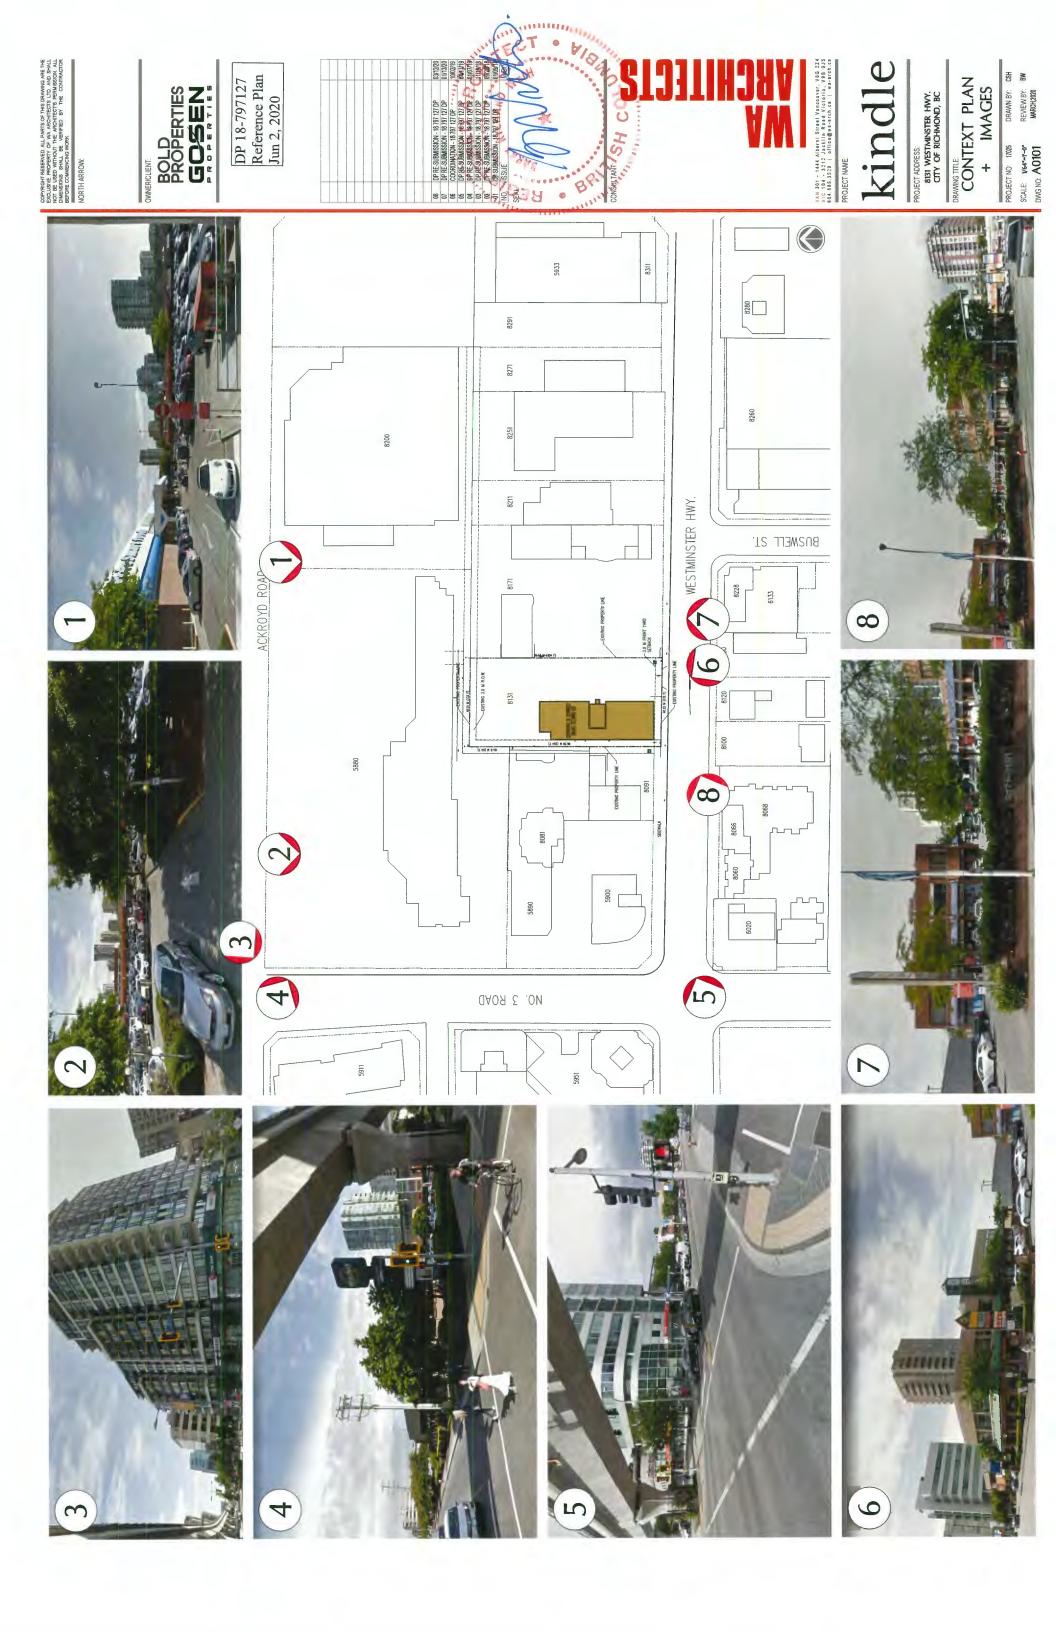
DRAWN 8Y: CSH REVIEW 8Y: 8W MARCH,2020

DP 18-797127 Reference Plan Jun 2, 2020

VAN 301 - 1444 Alberni Street Vancouver, V6G 224 VIC 104 - 3212 Jacklin Road Victoria, VSB 035 604.665.3529 | office@wa.mch.ca | wa-arch.ca

STREETSCAPE

DRAWN BY: CSH REVIEW BY: BW MARCH,2020 BOLD PROPERTIES GOSEN PROJECT ADDRESS.
8131 WESTAINSTER HWY.
CITY OF RICHMOND, BC 10 TP FE GLIMASSIAN - 18 TAY 17 OP THE GLIMASSIAN - 18 TAY 17 OP THE GLIMASSIAN - 18 TAY 17 OP THE FE GLIMASSIAN - 18 TAY 17 OP THE GLIMASSIAN - 18 TAY 18 SCALE: NTS.
DWG NO: A0506 PROJECT NO: 17025 MOS. 03 ROAD CANADA LINE WESTMINSTER HIGHWAY ACKROYD ROAD PROPOSED LANE A WESTMINSTER HIGHWAY PROPOSED LANE A ACKROYD ROAD NORTH STREETSCAPE SOUTH STREETSCAPE E CANADA LINE MOS. 03 ROAD



BOLD PROPERTIES GOSEN

DP 18-797127 Reference Plan Jun 2, 2020







3D CONTEXT

SCALE: NTS.
DWGNO: A0501


PROJECT ADDRESS:
8131 WESTMINSTER HWY.
CITY OF RICHMOND, BC



DP 18-797127 Reference Plan Jun 2, 2020

BOLD PROPERTIES GOSEN

RENDERING 01

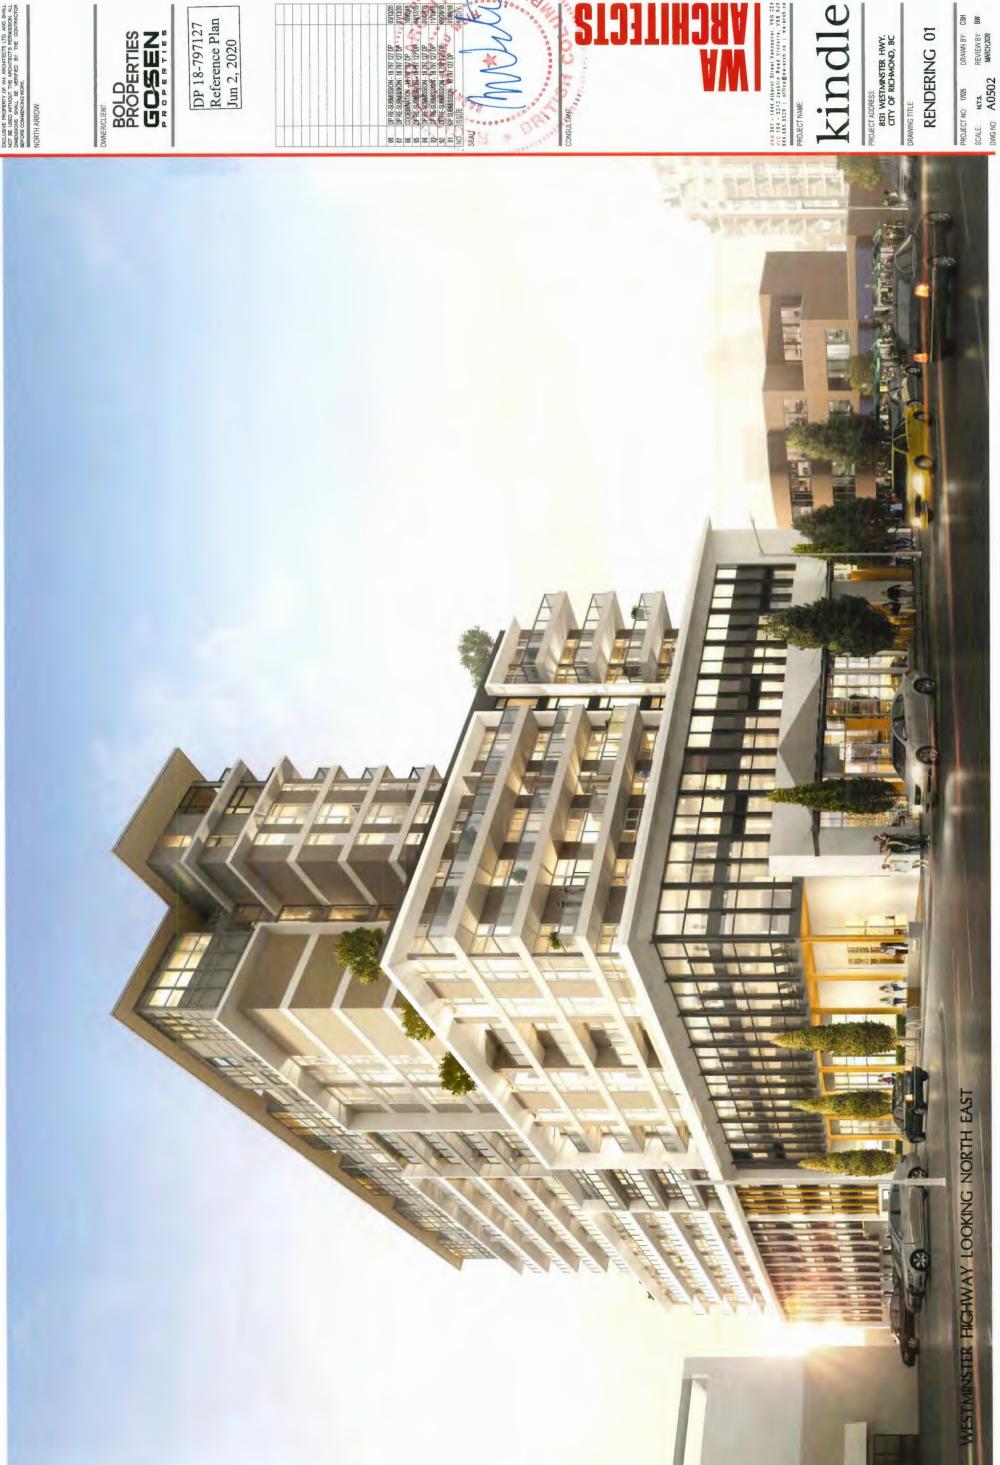



DP 18-797127 Reference Plan Jun 2, 2020

VAN 301 - 1444 Alberni Street Vancouver, V8G 224 VIC 104 - 3212 Jackin Read Victoria, V9B 045 644,685,3528 | office@wa-erch.ca | wa-erch.ca PROJECT NAME:

RENDERING 03

SCALE. NTS. REVIEWBY: CSH
SCALE. NTS. REVIEWBY BW
DWG NO: A0500 MARCH 2020

3D VIEWS

PROJECT ADDRESS.

8131 WESTMINSTER HWY.
CITY OF RICHMOND, BC

VAM 301 - 1444 Alberni Street Vancouver, VBG 224 VIC 104 - 3212 Jacklin Road Victoria, VBB 015 604,665,3528 | office@wa-erch.cs | wa-erch.cs PROJECT NAME:





DP 18-797127 Reference Plan Jun 2, 2020

BOLD PROPERTIES GOSEN





DP 18-797127 Reference Plan Jun 2, 2020 BOLD PROPERTIES GOSEN DRAWING TITLE PARKADE SCREENS PRECEDENCE PROJECT ADDRESS:
8131 WESTMINSTER HWY.
CITY OF RICHMOND, BC SCALE: 3/32"-T-0" DWG NO: A0803 EDOGAWA GARAGE CLUB RENOVATION AGEWALL: PERFORATED SCREENS ALS A STATE OF CHARACTER STREET, STREE gediecedeiseelddd EDEGAWA GARAGE CLUB RENOVATION

P+A

R, K m Perry ill Associates bro.
112 East Braunhaup.
Vancouney, BC V57 1V9
T 604 728 4118
F 604 728 4118

Seating + Amenity

Amenity Harvest Table

Hardscape

Soft Seating



Amenity Seating





Reference Plan Jun 2, 2020 DP 18-797127








Seating Deck with Tree



Amenity Area BBQ

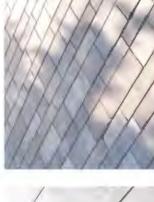

Feature Paving

02/19/2020 04/17/2019 01/07/2018 11/19/2018 09/24/2018

6 Re-Issued for DP 4 Re-Issued for DP 4 Re-Issued for DP 3 Re-Issued for DP 1 Issued for DP 1 Issued for DP Revision NO



HydraPressed Slab Pavers at Patios

Laser Cut Metal Gates + Screens

Raised Landscape Planting

Decorative Tree Grate

Planting





Precast Planters



Evergreen Hedges + Screening

Seasonal Interest

Mass Planting





Ornamental Flowering Trees



Kindle

8131 WESTMINSTER HWY. CITY OF RICHMOND, BC

BOLD PROPERTIES

GOSEN

Precedent Image Board

Drawn By:

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Report to Development Permit Panel

To: Development Permit Panel

Date: June 3, 2020

From: Wayne Craig

File: DP 19-858597

Director, Development

Re: Application by 0855855 B.C. Ltd. for a Development Permit at 9820 Alberta Road

Staff Recommendation

That a Development Permit be issued which would:

- 1. Permit the construction of six townhouse units at 9820 Alberta Road on a site zoned "Town Housing (ZT60) North McLennan (City Centre)"; and
- 2. Vary the provision of Richmond Zoning Bylaw 8500 to reduce the minimum east side yard setback from 3.0 m to 2.25 m.

Wayne Craig Director, Development (604-247-4625)

WC:na Att. 2

Staff Report

Origin

0855855 B.C Ltd. has applied to the City of Richmond for permission to develop six three-storey townhouse units at 9820 Alberta Road on a site zoned "Town Housing (ZT60) – North McLennan (City Centre)", with vehicle access from the adjacent property at 9840 Alberta Road. The site currently contains a single detached dwelling, which will be demolished. A location map is provided in Attachment 1.

The site is being rezoned from "Single Detached (RS1/F)" to "Town Housing (ZT60) – North McLennan (City Centre)" for this project under Bylaw 9960 (RZ 16-742260), which received third reading following the Public Hearing on February 19, 2019.

Removal of the existing driveway crossing and other frontage improvements including replacement of the street tree in front of the site, and service connections will be done through a City Work Order at the developer's cost prior to the issuance of a Building Permit.

Development Information

Please refer to attached Development Application Data Sheet (Attachment 2) for a comparison of the proposed development data with the relevant Bylaw requirements.

Background

Development surrounding the subject site is as follows:

To the North: Across Alberta Road, single detached dwellings zoned "Single Detached

(RS1/F)".

To the South: A three-storey townhouse development zoned "Town Housing (ZT60) – North

McLennan (City Centre)" and A.R. MacNeill Secondary School to the

southwest.

To the East: A three-storey townhouse development zoned "Town Housing (ZT60) – North

McLennan (City Centre)".

To the West: A three-storey townhouse development zoned "Town Housing (ZT60) – North

McLennan (City Centre)."

Rezoning and Public Hearing Results

During the rezoning process, staff identified the following design issues to be resolved at the Development Permit stage: [staff comments added in 'bold italics']

- Compliance with Development Permit Guidelines for multiple-family projects in the 2041 Official Community Plan Bylaw 9000 and the City Centre Area Plan.
 - The project provides quality form and character that follows the Development Permit Guidelines for townhouse development and compliments the established housing form in the immediate vicinity.

- Refinement of the character and form of building elevations including materials to create an interesting streetscape along Alberta Road and the internal drive aisle.
 - Articulation and a variety of materials and colours provide for well balanced building form and character.
- Review of the size and species of replacement trees, and landscape plan to ensure bylaw compliance and to achieve a mix of conifer and deciduous trees on-site and along the frontage.
 - A mix of conifer and deciduous replacement trees have been included as part of the landscape plan to ensure more local plant species are provided in the neighbourhood.
- Refinement of the outdoor amenity area design.
 - The shared outdoor amenity on-site is proposed to be combined with the existing amenity space for the adjacent townhouse development. This proposal incorporates an amenity design that compliments the design of the existing play amenities on the adjacent development site. A legal agreement was secured through the Rezoning application to ensure cross-access to the shared amenity space is provided for both properties.
- Review of aging-in-place features and the design of the convertible unit.
 - Future considerations for the convertible unit like the vertical lift are included in the design of Unit 3. Aging-in-place features have been implemented in each unit.
- Review of a sustainability strategy for the development including measures to achieve BC Energy Step Code and acoustical requirements.
 - A statement on meeting BC Energy Step Code Step 3 was provided, reviewed, and deemed acceptable by Sustainability Staff.
 - An Acoustic report and Thermal report was provided as per the Rezoning Considerations to ensure demonstration of the interior noise levels and noise mitigation standards comply with the OCP and Noise Bylaw requirements.

The Public Hearing for the rezoning of this site was held on February 19, 2019. No concerns regarding the rezoning application were expressed at the Public Hearing.

Staff Comments

The proposed scheme attached to this report has satisfactorily addressed the significant urban design issues and other staff comments identified as part of the review of the subject Development Permit application. In addition, it complies with the intent of the applicable sections of the Official Community Plan (OCP) and is generally in compliance with the "Town Housing (ZT60) – North McLennan (City Centre)" zone except for the zoning variances noted below.

Zoning Compliance/Variances (staff comments in bold italics)

The applicant requests to vary the provision of Richmond Zoning Bylaw 8500 to reduce the minimum east side yard setback from 3.0 m to 2.25 m.

The variance was identified at the time of the rezoning application. Staff supports the proposed variance which accommodates at grade private outdoor space along the western portion of the northern building cluster on the site. The separation between the northern building and the adjacent units on the neighbouring site across the north-south drive aisle remains adequate and there are no concerns of shadowing between the two developments.

Advisory Design Panel Comments

The application was not forwarded to the Advisory Design Panel for comments due to the relatively small scale of the project.

Analysis

Conditions of Adjacency

- The proposed height, building form, siting and orientation of the buildings respect the
 massing, and is similar in character with existing surrounding residential townhouse
 developments.
- The reduced east side yard setback from 3.0 m to 2.25 m provides adequate separation of approximately 10.7 m between the three-storey townhouse units across the shared drive aisle.
- The applicant has provided a shadow study demonstrating how the units and landscaped areas will be impacted by the placement of the buildings. The shared amenity area and neighbouring property to the east is provided with adequate lighting throughout the year.

Urban Design and Site Planning

- The six three-storey townhouse units proposed in two triplex clusters will be accessed via a shared driveway located on 9840 Alberta Road, which was secured via a statutory right-of-way (SRW) at the time of the rezoning of that property. This development incorporates a minor widening of the access to Alberta Road and the internal drive isle will facilitate vehicle turn around for both properties. Registration of an SRW is a requirement of rezoning adoption to ensure cross-access is provided to the subject property
- The applicant has an agreement with the neighbouring Strata regarding maintenance and cost sharing of the shared driveway.
- The common outdoor amenity area is proposed to be located in the southeast corner of the site and will act as an extension to the existing outdoor amenity area for the neighbouring development. The common outdoor amenity space will be in excess of the Official Community Plan (OCP) guidelines with approximately 67 m² of onsite amenity space and a combined total of 143 m² with the adjacent townhouse development.
- Registration of a cross-access agreement, including future removal of the fence through the outdoor amenity area, is required prior to rezoning adoption for the purpose of shared use of the proposed outdoor amenity space on the subject property between the two properties.
- The provision of private outdoor spaces exceeds the Development Guidelines of 30 m² per unit. All of the private outdoor spaces can be accessed either directly from the at grade living space or via balconies.

- Two parking spaces are provided per unit in tandem arrangement, which complies with the Town Housing (ZT60) North McLennan (City Centre) zone.
- A total of two visitor parking spaces are provided on site for the subject property.
- A total of 12 Class-1 (long-term) bicycle parking spaces are provided within the garages and two Class-2 (short-term) bicycle parking spaces are next to the garbage and recycling area.
- The garbage and recycling enclosure is located just off the main vehicle entry to the site for
 easy access. The bins are enclosed against the north building with a façade that matches well
 with the rest of the building.

Architectural Form and Character

- The overall appearance of the proposal conforms to the Design Guidelines of the North McLennan area and is consistent with the character of the surrounding area.
- The building forms are well articulated. Visual interest has been incorporated with gable roofs, bay windows, entry porches, hutches, and a mix of materials and colours.
- A pedestrian scale is provided at the ground floor level of the units along the internal drive aisle by the inclusion of windows, doors, balconies, and landscape features.
- Relationship to the Alberta Road frontage is enhanced by including an access to one of the units, and appropriate building massing, articulation and character for the 3 unit building,
- The proposed building materials (hardi-plank siding, wood trims, wood batten, double glazed vinyl framed window, and asphalt roof shingles) are generally consistent with the neighbourhood character and Design Guidelines.
- Articulation is added through the use of entry canopies and roof form. Colour choice is satisfactory with the use of warmer tones of the taupe and greys for the siding, along with some browns, to provide balance to the warmer tones.
- Accessibility features that allow for aging in place have been incorporated into all six units of
 this development (i.e., blocking in all bathrooms for grab-bars, level handle for all doors, and
 lever faucet in all bathrooms and powder rooms).
- One convertible unit has been incorporated into the design. Alternate floor plans, demonstrating simple conversion potential to accommodate a person in a wheelchair, are provided (see alternative floor plans for Unit #3 where a vertical lift may be installed).

Landscape Design and Open Space Design

- Tree retention and compensation was reviewed at the rezoning stage. Two bylaw-sized trees were identified on-site and one is proposed to be removed due to general poor health condition. A total of two replacement trees are required to compensate for the removal of the one on-site bylaw-sized tree. One bylaw-sized Lawson Cypress tree of 9.0 m in height and a 22 cm stem diameter will be retained in the northwest corner of the site.
- Tree protection fencing will be required prior to any construction activities occurring on-site. A contract with a certified arborist to oversee site preparation activities on-site and supervise any constructions and hard surface paving within the protection zone is required.
- The landscape design includes the planting of 10 new trees (including large calliper and ornamental species) and a variety of shrubs and ground covers, which meets the Official Community Plan (OCP) guidelines for tree replacement and landscaping.
- A lush landscape consisting of flowering trees, shrubs, and ground covers is proposed along the street frontages to provide seasonal changes.

- Drought tolerant and native planting materials are incorporated into the landscaping design.
- Permeable pavers are proposed to allow for higher storm water infiltration potential.
- Hard surfaced landscaping is also proposed through a mixture of asphalt and a permeable paving system to help soften the appearance of the internal drive-aisle and helps identify areas of interest such as the amenity area and visitor parking.
- The child's play area includes open space as well as a daisy desk and caterpillar for engaged learning. The neighbouring site's amenity space provides further open space, a sandbox, a bench, bicycle parking, trees and shrubs.
- An irrigation system is proposed for all landscaped areas for the purpose of maintaining healthy and long lasting live landscaping.
- Prior to issuance of the development permit the applicant is to provide security for landscaping in the amount of \$40,554.92 to ensure proposed landscaping and the survival of protected trees upon completion.

Crime Prevention Through Environmental Design

- The proposed plan provides good edge features along the site to separate public and private space, giving the site a good sense of territoriality to residents and visitors.
- Building orientation and landscaping features provide good sight lines and view angles throughout the site.
- All amenities, including the outdoor amenity area, the mailbox, and garbage/recycling enclosures, are located in highly visible area and will receive passive surveillance from the street and buildings.

Sustainability

- The applicant advises that the project will include sustainability features such as the use of energy efficient appliances, use Low-E glass, and insulation beneath entire ground floor slabs (not including garage).
- Step 3 of the BC Energy Step Code will be achieved for the proposed development and the sustainability strategy provided to City Staff has been deemed acceptable to meet requirements.

Conclusions

As the proposed development would meet applicable policies and Development Permit Guidelines, staff recommend that the Development Permit be endorsed, and issuance by Council be recommended.

Nathan Andrews Planning Technician (604-247-4911)

NA:ml/blg

Attachment 1: Location Map

Attachment 2: Development Application Data Sheet

The following are to be met prior to forwarding this application to Council for approval:

Receipt of a Letter-of-Credit for landscaping in the amount of \$40,554.92.
 NOTE: staff to ensure that landscape estimates include a 10% contingency cost.

Prior to a Demolition Permit issuance, the developer is required to complete the following:


 Installation of appropriate tree protection fencing around all trees to be retained as part of the development prior to any construction activities, including building demolition, occurring on-site.

Prior to future Building Permit issuance, the developer is required to complete the following:

- Submission of a Construction Parking and Traffic Management Plan to the Transportation Department.
 Management Plan shall include location for parking for services, deliveries, workers, loading, application for any lane closures, and proper construction traffic controls as per Traffic Control Manual for works on Roadways (by Ministry of Transportation) and MMCD Traffic Regulation Section 01570.
- Incorporation of CPTED, sustainability, and accessibility measures in Building Permit (BP) plans as determined via the Rezoning and/or Development Permit processes.
- A Servicing Agreement is not required. Removal of the existing driveway crossing and other frontage
 improvements including replacement of the street tree in front of the site, and service connections will be done
 through a work order at the developer's cost.



City of Richmond

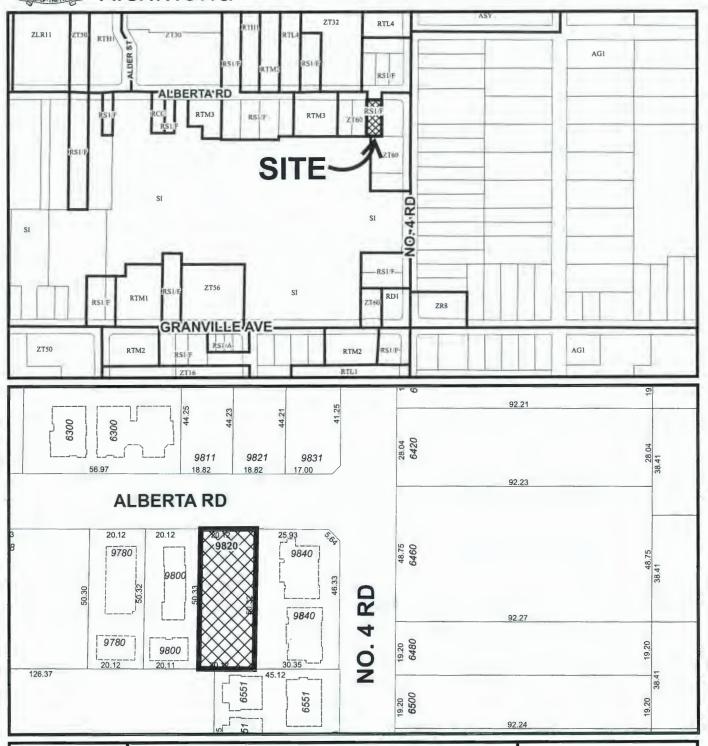



DP 19-858597

Original Date: 04/26/19

Revision Date:

Note: Dimensions are in METRES



Development Application Data Sheet

Development Applications Department

DP 19-858597 Attachment 2

Address: 9820 Alberta Road

Applicant: 0855855 B.C. Ltd. Owner: 0855855 B.C. Ltd.

Planning Area(s): North McLennan (City Centre)

	Existing	Proposed
Site Area:	1,012 m ²	1,012 m ²
Land Uses:	Single Detached Dwelling	Townhouses
OCP Designation:	Neighbourhood Residential	No Change
Zoning:	Single Detached (RS1/F)	Townhousing (ZT60)
Number of Units:	1	6

	Bylaw Requirement	Proposed	Variance
Floor Area Ratio:	Max. 0.65	0.65	none permitted
Lot Coverage:	Max. 40%	35%	none
Lot Size:	Min. 1,010 m ²	1,012 m ²	none
Setback - Front Yard:	Min. 6 m	6 m	none
Setback – Side Yard (East):	Min. 3 m	2.25 m	Variance required
Setback - Side Yard (West):	Min. 3 m	3.22 m	none
Setback – Rear Yard:	Min. 3 m	6.24 m	none
Height (m):	Max. 12 m and 3 storeys	11.85 m (3 storeys)	none
Off-street Parking Spaces – Regular/Commercial:	1.4 (R) and 0.2 (V) per unit	2 (R) per unit and 0.2 (V) per unit	none
Total off-street Spaces:	11	14	none
Tandem Parking Spaces	100% Permitted	100% 6 tandem (12 spaces)	none
Bicycle Parking	Class 1: 1.25 spaces/unit Class 2: 0.2 space/unit	Class 1: 2 spaces/unit Class 2: 0.2 space/unit	none
Amenity Space – Indoor:	Min. 50 m ²	Cash in lieu (\$6,000)	none
Amenity Space – Outdoor:	Shared: Min. 36 m ² Private: Min. 30 m ² /unit	Shared: Min. 67.5 m ² Private: Min. 30 m ² /unit	none



Development Permit

No. DP 19-858597

To the Holder:

0855855 BC LTD.

Property Address:

9820 ALBERTA ROAD

Address:

C/O 130 - 4471 NO. 6 ROAD RICHMOND, BC V6V 1P8

1. This Development Permit is issued subject to compliance with all of the Bylaws of the City applicable thereto, except as specifically varied or supplemented by this Permit.


- 2. This Development Permit applies to and only to those lands shown cross-hatched on the attached Schedule "A" and any and all buildings, structures and other development thereon.
- 3. The "Richmond Zoning Bylaw 8500" is hereby varied to:
 - a) Reduce the minimum east side yard setback from 3.0 m to 2.25 m.
- 4. Subject to Section 692 of the Local Government Act, R.S.B.C.: buildings and structures; off-street parking and loading facilities; roads and parking areas; and landscaping and screening shall be constructed generally in accordance with Plans #1 to #15 attached hereto.
- 5. Sanitary sewers, water, drainage, highways, street lighting, underground wiring, and sidewalks, shall be provided as required.
- 6. As a condition of the issuance of this Permit, the City is holding the security in the amount of \$40,554.92 to ensure that development is carried out in accordance with the terms and conditions of this Permit. Should any interest be earned upon the security, it shall accrue to the Holder if the security is returned. The condition of the posting of the security is that should the Holder fail to carry out the development hereby authorized, according to the terms and conditions of this Permit within the time provided, the City may use the security to carry out the work by its servants, agents or contractors, and any surplus shall be paid over to the Holder. Should the Holder carry out the development permitted by this permit within the time set out herein, the security shall be returned to the Holder. The City may retain the security for up to one year after inspection of the completed landscaping in order to ensure that plant material has survived.
- 7. If the Holder does not commence the construction permitted by this Permit within 24 months of the date of this Permit, this Permit shall lapse and the security shall be returned in full.

Development Permit No. DP 19-858597

То	the Holder:	0855855 BC LTD.	
Pro	operty Address:	9820 ALBERTA ROA	,D
Ad	dress:	C/O 130 - 4471 NO. RICHMOND, BC V6	
8.		of this Permit and an	enerally in accordance with the terms and y plans and specifications attached to this
	This Permit is not a Build	ling Permit.	
	UTHORIZING RESOLUT AY OF ,	ION NO.	ISSUED BY THE COUNCIL THE
DE	ELIVERED THIS D	DAY OF ,	
M	AYOR		



City of Richmond

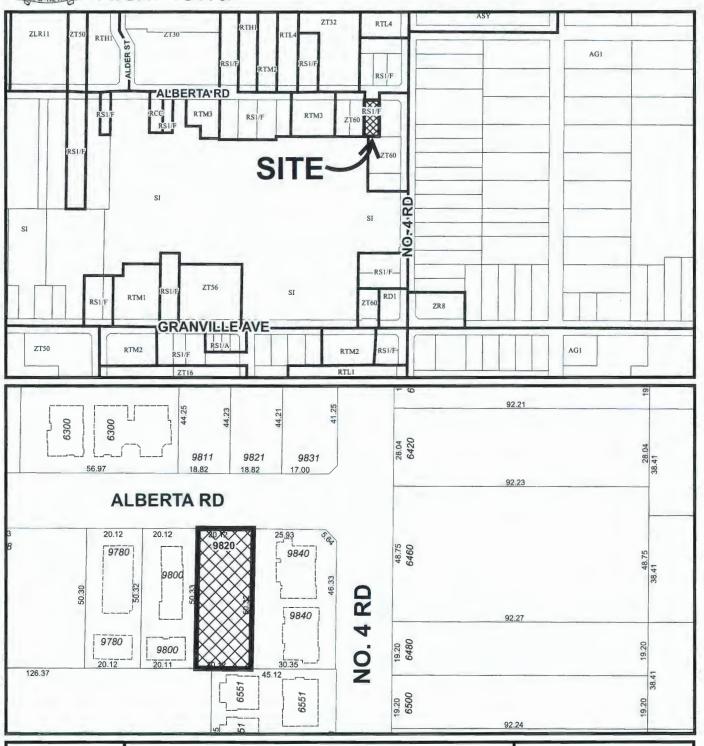



DP 19-858597 SCHEDULE "A"

Original Date: 04/26/19

Revision Date:

Note: Dimensions are in METRES

HOUSE DEVELOPMENT AT 9820 ALBERTA ROAD, RICHMOND, BC PROPOSED TOWN

DEVELOPMENT DATA

LOT 7, SECTION 10, BLOCK 4 NORTH, RANGE 6 WEST NEW WESTMINSTER DISTRICT PLAN 1712 9820 ALBERTA ROAD, RICHMOND, BC (A) CIVIC ADDRESS: (B) LEGAL DESCRIPTION:

1,012 SM (10,893 SF) (C) LOT AREA: (D) ZONING USE

PROPOSED REZONING CURRENT: RS1/F, (PROPOSED: ZT60) (ZT60) (UNDER RS1/F ZONING) CURRENT ZONING

 $0.65 \times 1,012 \text{ SM} = 657.8 \text{ SM}$ TOTAL FLOOR AREA (7,080 SF) 6 UNITS 0.3 TO REST OF SITE AREA 0.55 TO 454.5 SM 1 PER LOT (E) FLOOR AREA RATIO (F) NUMBER OF UNIT:

MAX - 45% (G) BUILDING COVERAGE:

MAX HEIGHT - 9M FRONTYARD - 6M REARYARD - 6M SIDEYARD - 2M (H) BUILDING HEIGHT: (I) SETBACK:

MAX MAIN BUILDING HEIGHT - 12M

LIVE PLANT MIN - 25%

MAX - 40%

NON-POROUS - 65%

- 3M

EAST AND WEST SIDEYARD

REAR YARD - 3M

2 PER DWELLING UNIT

(J) PARKING

0.2 VISITOR PARKING / UNIT X6 = 21.4 PER DWELLING UNITS X6 = 9

TOTAL = 11 REQUIRED ZT60 ZONING ALLOW TANDEM PARKING 0.2 PER DWELLING UNIT X6= 2 RESIDENTIAL BICYCLE STORAGE VISITOR BICYCLE

6SM PER UNIT X6= 36 SM (388SF) OUTDOOR AMENITY SPACE

(K) OUTDOOR SPACE

1.25 PER DWELLING UNIT X6=8

DRAWING LIST

ALBERTA ROAD

SITE PLAN (2/F, 3/F & ROOF) DEVELOPMENT SUMMARY SITE PLAN (1/F) PARKING PLAN A2A-

DAOR 4 .ON

UNIT PLANS UNIT PLANS ELEVATIONS A5-A6-

SCHOOL

ELEVATIONS

EXTERIOR COLOURS EXTERIOR COLOURS SHADOW STUDIES AREA DIAGRAM FAR DIAGRAM A10-A8-

LOCATION MAP

NTS

PROPOSED

657.5 SM (7077 SF) FAR FLOOR AREA

6 UNITS

35.5% (3864 SQ. FT.) 30.25% SEE LANDSCAPE DRAWINGS 65% SEE LANDSCAPE DRAWINGS

EAST SIDE YARD — 2.25M (7'5") [VARIANCE REQUIRED] WEST SIDE YARD — 3.22M (10'7") FRONT YARD FACING ALBERTA RD - 6.02M (19'9") BUILDING HEIGHT - 11.85M (38'11") FRONTYARD FACING ALBERTA RD - 6M

12 REGULAR IN TANDEM ARRANGEMENT VISITOR PARKING: 2 REGULAR

6.24M (20'6")

REAR YARD -

VISITOR BIKE RACK BICYCLE

12 (INSIDE GARAGE)

67.3 SM AMENITY SPACE PROVIDED: (725 SQ. FT.) THIS PROJECT SHALL MEET STEP CODE AS REQUIRED BY THE CITY OF RICHMOND



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RCHITEC **ERIC LAW**

ericiam.architect@gmail.com 216 288 WBTH AVENUE VANCOUVER BC VSY1N5







DEVELOPMENT SUMMARY

T NUMBER:16-03	6/1/2020	BY: EL	D BY: EL
PROJECT	ISSUED:	DRAWN BY:	CHECKED




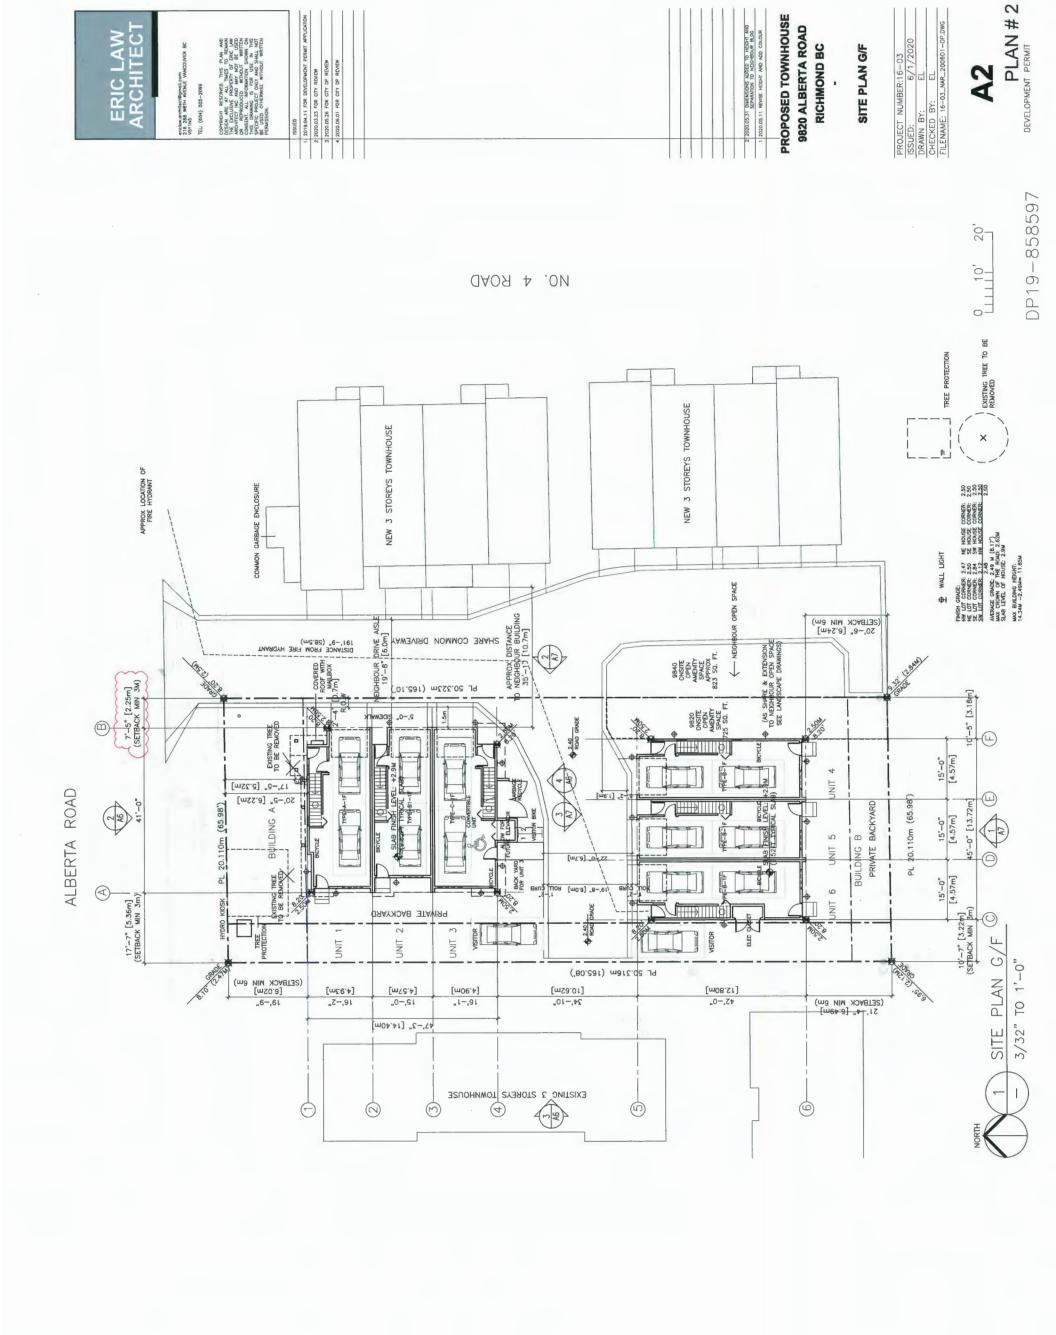

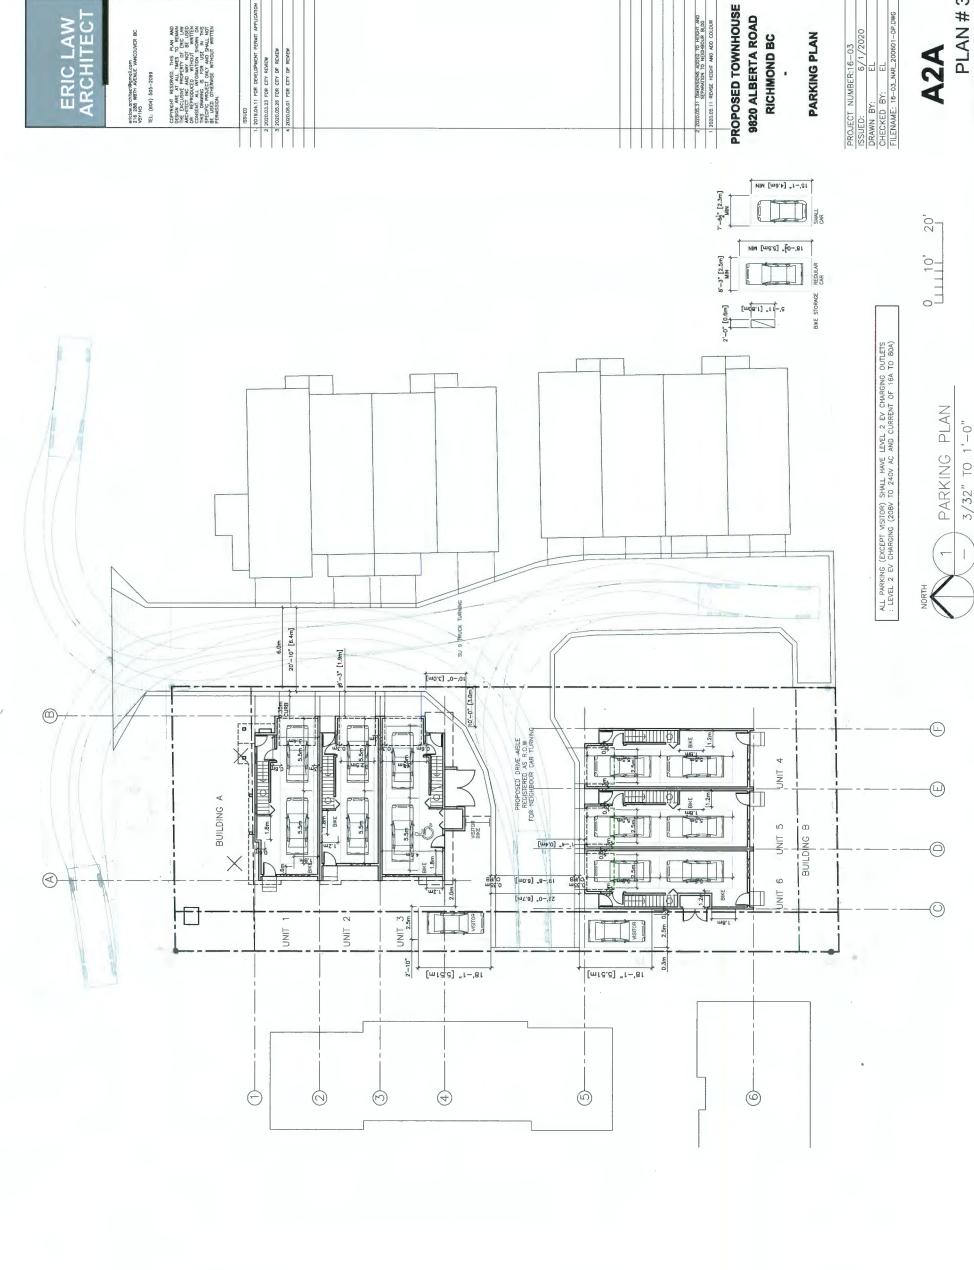


PLAN # 3
DEVELOPMENT PERMIT

DP19-858597

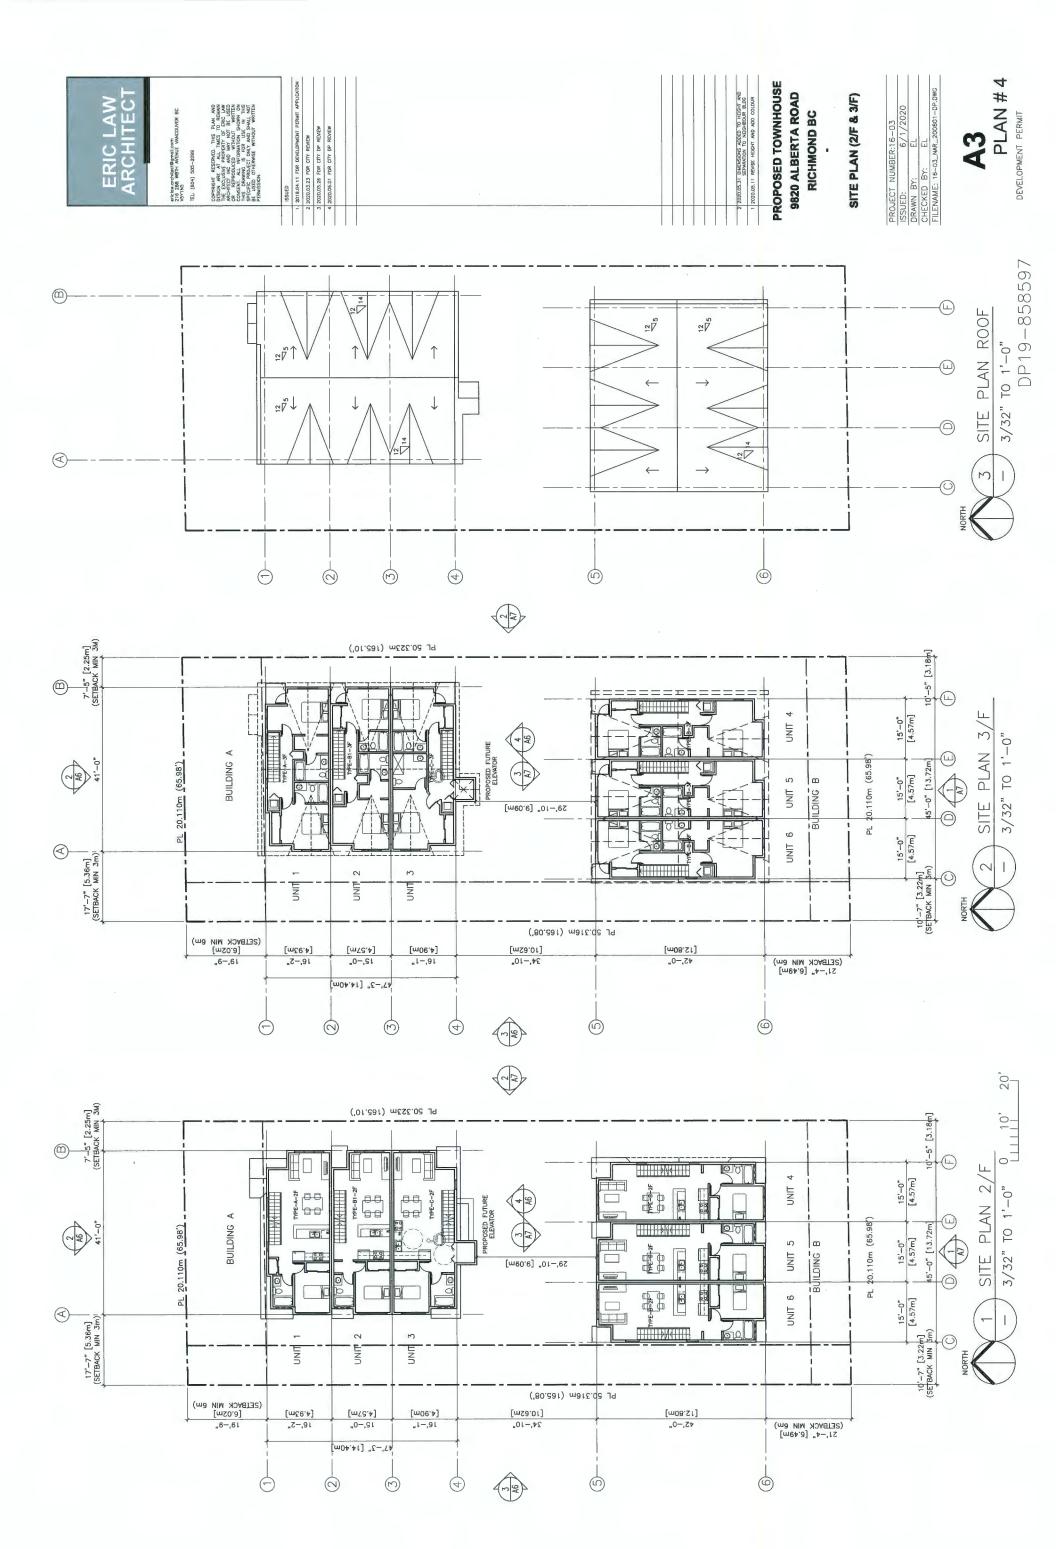

DP19-858597

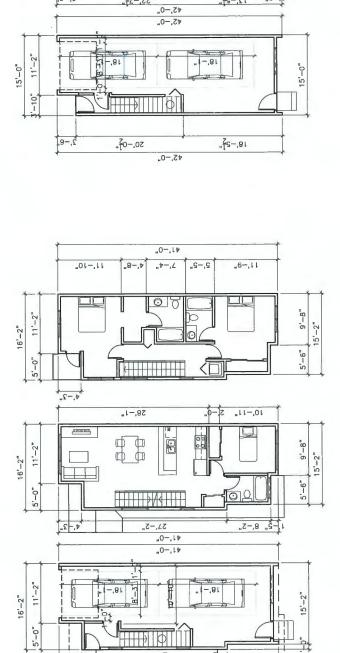

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27,-2"

"O-, l Þ

"Z-,6



3 LEVEL 3 - 1/8" TO 1'-0"

2 LEVEL 2 - 1/8" TO 1'-0"

1 LEVEL 1 - 1/8" TO 1'-0"

TYPE-A-1F


TYPE-A-3F

TYPE-A-2F

3 BEDROOM
3 BEDROOM
10 MINISTER & 1317 SO, FT. 0.1.15' 10'
10 MINISTER & 1317 SO, FT. 0.1.15' 10'

TOTAL UNIT AREA: ±1317 SQ. FT. INCLUDING STAIR AND G/F ENTRY

UNIT PLAN TOTAL UNIT AREA: ±1267 SQ. FT. INCLUDING STAIR AND G/F ENTRY TYPE B 3 BEROOM

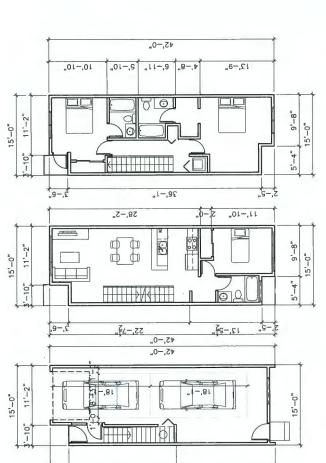



1. 2019.04.11 FOR DEVELOPMENT PERMIT AP
2 2020.03.23 FOR CITY RENEW
3 2020.05.26 FOR CITY OP RENEW
4 2020.06.01 FOR CITY OP RENEW

ERIC LAW ARCHITECT

ericlaw.architect@gmail.com 216 288 W8TH AVENUE VANI VSY1NS TEL: (604) 505-2099

6 LEVEL 3 - 1/8" TO 1'-0" TYPE-B-3F

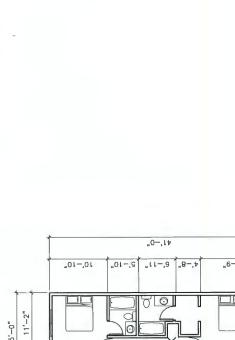

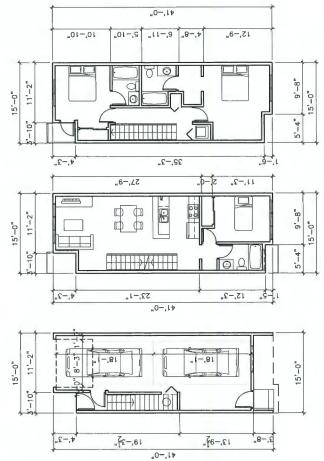

8 LEVEL 2 - 1/8" TO 1'-0"	TYPE-81-2F
7 LEVEL 1 - 1/8" TO 1"-0"	TYPE-81-1F

0 1111


TOTAL UNIT AREA: ±1242 SO. FT. INCLUDING STAIR AND G/F ENTRY

TYPE B1 UNIT PLAN

9 LEVEL 3 - 1/8" TO 1'-0"

TYPE-B1-3F

A4

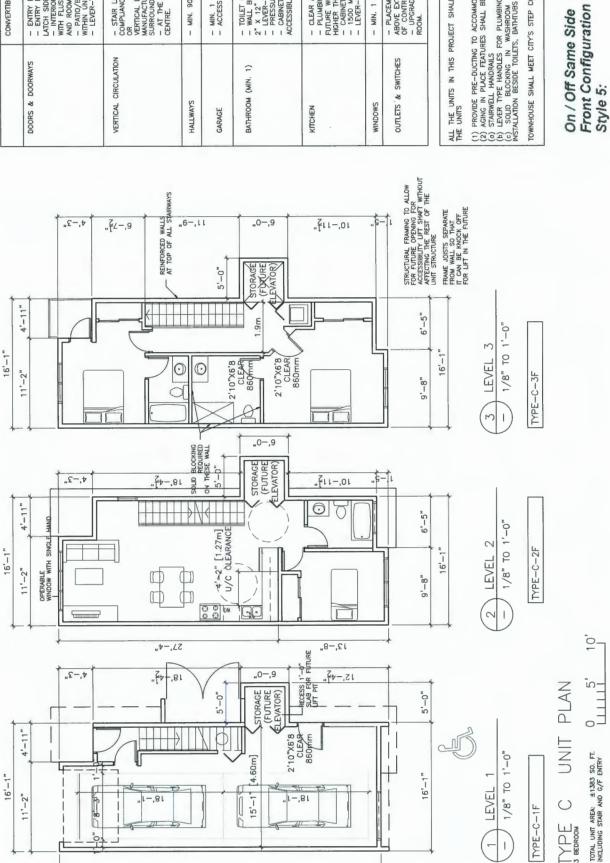

"O-,O>

CONVERTIBLE UNIT GUIDELINES	- ENTRY DOORS ARE A WINIMUM 863 MM BUT IDEALLY 914 MM AND HAVE CLEAR ACCESS ENTRY DOOR CLEAR EXTERIOR FLOOR SPACE MIN, 1220 MM DETH BY DOOR WIDTH PLUS. LATCH SIDE (NOT NEEDED IF ROUGH IN WIRING PROVIDED FOR FUTURE AUTOMATIC DOOR OPENER) INTERIOR DOORS TO AMIN LUMNG AREAS, 1 BATHROOM AND 1 BEDDOOM, MIN, 800 MM CLEAR OPENING WITH FLUSH THRESHOLDS MAX, 13 MM HEIGHT. DEMONSTRATE WHEELCHAIR ACCESS BETWEEN THE HALLWAY AND ROOMS AND WIDEN HALLWAY AND/OR DOORWAY(S) IF NECESSARY TO SECURE ACCESS PARIO/SALCOMPLY WITH SE GUILLING CORE LEVER-TYPE HANDLES FOR ALL DOORS.	- STAIR LIFT, STAIRCASE WIDTH, FRAMING SUPPORT, AND LANDINGS, AS NOTED ON FLOOR PLANS IN COMPLANCE WITH MANUFACTURER SPECIFICATIONS. OR VERTICAL LIFT, DEPRESSED SLAB AREA, AND LANDINGS, AS NOTED ON FLOOR PLANS IN COMPLIANCE WITH MANUFACTURER SPECIFICATIONS. FRAMING TO ACCOMMODATE SHAFT CONSTRUCTION WITHOUT IMPACT TO SURROUNDING STRUCTURE. - AT THE TOP OF ALL STAIRWAYS, WALLS ARE REINFORCED WITH 2" X 12" SOLID LUMBER AT 914 MM TO CENTRE.	- MIN. 900 MM WIDTH.	- MIN. 1 ACCESSIBLE PARKING SPACE WITH MIN. 4 M GARAGE WIDTH. - ACCESS FROM GARAGE TO LIVING AREA MIN. 800 MM CLEAR OPENING.	- TOILET CLEAR FLOOR SPACE MIN, 1020 MM AT SIDE AND IN FRONT WALL BLOCKING FOR FUTURE GRAB BAR INSTALLATION AT TOILET. TUB AND SHOWER. REINFORCED WITH 2. X, 12" SOLD LUMBER IN ALL BATHILES, SHOWER, AND TOILET LOCATIONS LEYER-TYPE HANDLES FOR PLUMBING FIXTHEES PRESSINER AND TEMPERATURE CONTROL VALVES ARE INSTALLED ON ALL SHOWER FAUCETS CABINETS UNDERWEATH SINKIG) ARE EASILY REMOVED. DEMONSTRATE BATH AND SHOWER CONTROLS ARE ACCESSIBLE (LAYOUT OR FIXTURE PLACEMENT).	- CLEAR AREA NEEDED UNDER FUTURE WORK SPACE PLUMBING AND GAS PIPES (IN-WALL AND IN-FLOOR) LOCATED CLEAR OF UNDER COUNTER AREA OF PUTURBING AND GAS PIPES (STOKE, SINK & WIN. 817 BM WE COUNTER), ALL PIPES ARE BROUGHT IN NO HIGHER THAN 304 MAI TO 355 MM TO THE CENTRE OF THE PIPE FROM FLOOR LEVEL CABINES UNDERSEACH SINK ARE EXSLY REMOVED 1500 MM TURNING DIAMETER OR TURNING PATH DIAGRAM LEVER-TYPE HANDLES FOR PLUMBING PATH DIAGRAM.	- MIN. 1 WINDOW THAT CAN BE OPENED WITH A SINGLE HAND (BATHROOM, KITCHEN, LIVING ROOM)	 PLACEMENT LOCATIONS OF ELECTRICAL OUTLETS: BESIDE WINDOW, BOTTOM OF STARWAYS, BESIDE TOILET, ABOVE EXTERNAL DOORS (UNISED AND INSIDE), ON FRONT FACE OF KITCHEN COUNTER, WITHIN PROXIMITY OF CONTROL CENTRE FOR SMART HOME OPPIONS. UPGRADE TO FOUR-PLEX OUTLETS IN MASTER BEDROOM, HOME OFFICE, GARAGE, AND RECREATION ROOM.
	DOORS & DOORWAYS	VERTICAL CIRCULATION	HALLWAYS	GAPAGE	BATHROOM (MIN. 1)	ктснем	WINDOWS	OUTLETS & SWITCHES

ERIC LAW ARCHITECT


COPPROFIT RESERVED THIS PLAN AND FESTIVATE TO RECEIVANT A TAKET THESE TO RECEIVANT AND THE LESS OF RESPONSED WHILD THE WEST THE CONSERT, ALL INFORMATION STOWN ON THIS DAWNED SE FOR USE IN THIS SECRED PROJECT DULY AND SALL HOT BE USED THE WINDER THE STRANGESTON. WHICH WILLIAMS WITHOUT WHITE PERMISSION.

ericlaw.orchitect@gmail.com 216 288 WBTH AVENUE VANC VSY1N5

12 2019.04.11 FOR DEVELOPMENT PER 2 2020.03.23 FOR CITY REVIEW 3 2020.05.25 FOR CITY DP REVIEW 4 2020.05.01 FOR CITY DP REVIEW

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ALL THE UNITS IN THIS PROJECT SHALL INCORPORATE THE FOLLOWING FEATURES IN THE UNITS	1) PROVIDE PRE-DUCTING TO ACCOMMODATE PUTURE SOLAR HOT WATER HEATING A SIGN IN PLACE FEATURES SHALL BE PROVIDED TO ALL UNITS:	b) SIGNERATE FRANCES. C) SOLID BLOCKING IN WASHROOM WALLS TO FACILITATE FUTURE GRAB (SOLID BLOCKING IN WASHROOM WALLS TO FACILITATE FUTURE GRAB (NSTALLATION BESIDE TOILETS, BATHTUBS AND SHOWERS	OWNHOUSE SHALL MEET CITY'S STEP CODE REQUIREMENTS
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크	F81	STS P	NO.

TOTAL UNIT AREA: ±1383 SO. FT. INCLUDING STAR AND G/F ENTRY

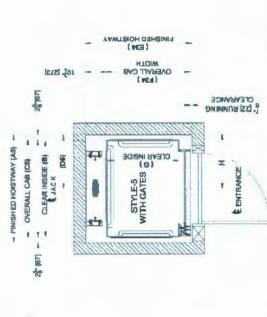

PROPOSED TOWNHOUSE

20.05.31 DIMENSIONS ADDED TO HEIGHT AND SEPARATION TO NEIGHBOUR BLDG 20.05.11 REVISE HDIGHT AND ADD COLOUR

9820 ALBERTA ROAD

RICHMOND BC

Cab Size	A5	മ	S	D2	E34	F34	9	H
"x 48"	54 1/4"	48"	49"	27 1/8"	53 7/8"	42 1/4"	36"	27 1/8"
36" x 54"	.74. 09	54"	55"	30 1/2"	53 7/8"	42 1/2"	36"	30 1/8"


Elvoron - Home Elevator - Design and Planning Guide, 37086-F-DP

DP19-858597


Page 9 of 20

7d



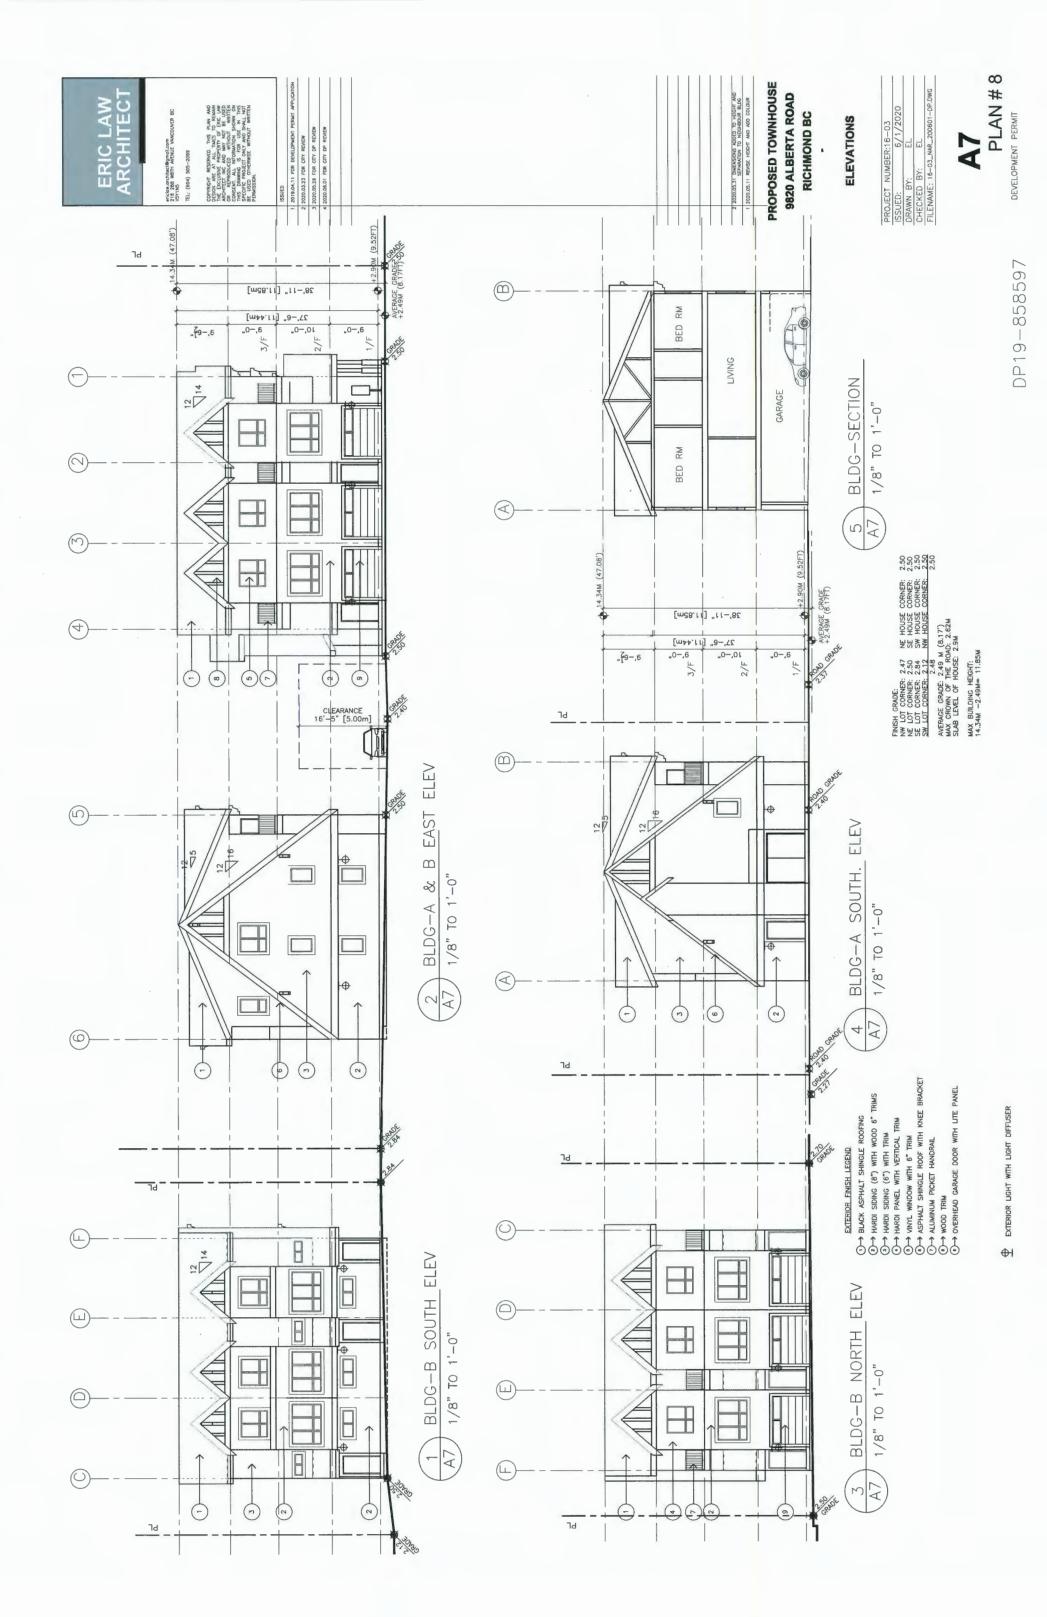

SITE COVERAGE AREA 3864 SQ. FT.

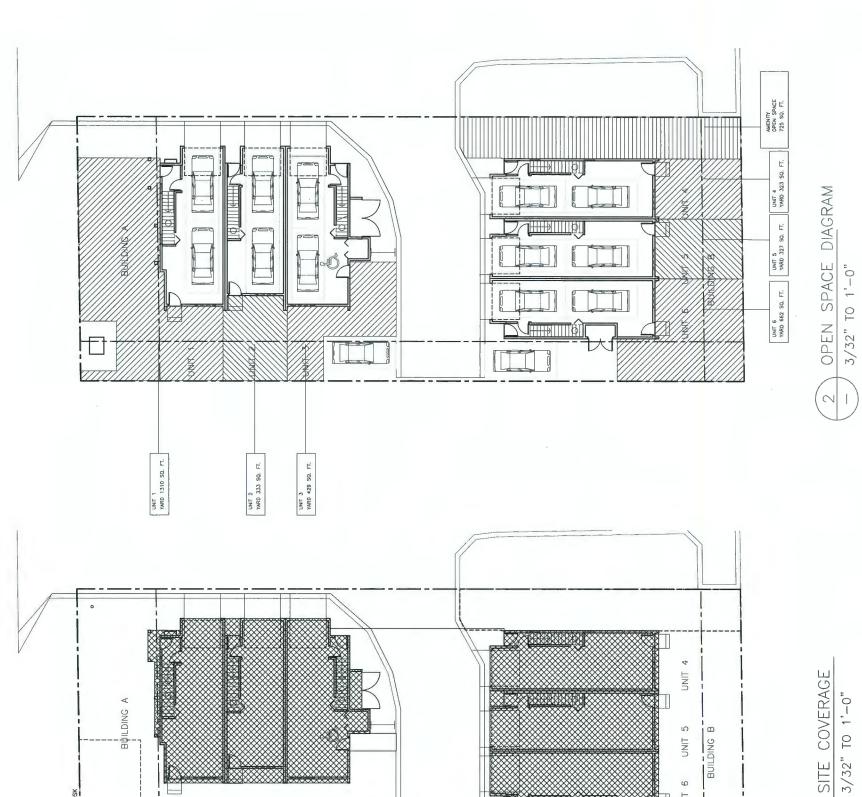

| ISSUED | 1.2019.04.31 FOR DEVELIDABLENT PERMIT APPLICATION | 2.2020.05.23 FOR DIT RENEW | 3.2020.05.25 FOR CITY DE RENEW | 4.2020.05.01 FOR CITY DE RENEW |

UNIT 1

UNIT 2

UNIT 3

ericlaw.orchitect@gmail.com 216 288 W8TH AVENUE VANCOLVER BC VSY1N5 TEL: (804) 505-2099

ERIC LAW ARCHITECT

PROPOSED TOWNHOUSE 9820 ALBERTA ROAD RICHMOND BC

020.05.31 DMENSIONS ADDED TO HEIGHT AND SEPARATION TO NEIGHBOUR BLDG 020.05.11 REVISE HEIGHT AND ADD COLOUR

UNIT 5 BUILDING B

UNIT 6

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C		
M		
2		

PROJECT NUMBER:16-03	:UED: 6/1/2020	DRAWN BY: EL	CHECKED BY: EL	FILENAME: 16-03_NAR_200601-DP.DWG	
PROJE	ISSUED:	DRAW	CHECI	FILEN	

A8

PLAN #9
DEVELOPMENT PERMIT



2 2020.05.31 DMENSIONS ADDED TO HEIGH AND SEPARATION TO NEIGHBOUR BLDG 1 2020.05.11 REVISE HEIGH AND ADD COLOUR

PROPOSED TOWNHOUSE 9820 ALBERTA ROAD RICHMOND BC

EXTERIOR COLOURS


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PROJECT N	ISSUED:	DRAWN BY:	CHECKED BY:	FILENAME:	

ERIC LAW ARCHITECT	ericke.gochherdigmol.com 216 286 WETH MFHUE VANCOLACIR BC YOYTHS TEL. (804) 505-2099	COPPRIOR RESIDENCE THE PLAN AND COPPRIOR RESIDENCE PROCESS. THE DELLISTER PROFESSIVE OF ENC. LAW THE DELLISTER PROFESSIVE OF THE LAW CONTROLLED WITHOUT WRITTEN CONTROLLED WITHOUT WRITTEN CONTROLLED WITHOUT WRITTEN CONTROLLED WITHOUT WRITTEN CONTROLLED CONTROLLED WITHOUT WRITTEN PROMESSION.	ISSUED 1, 2019.04.11 FOR DEVILIDADET PERMIT APPLICATION 2, 2020.05.23 FOR CITY REVIEW 3, 2020.05.25 FOR CITY REVIEW 3, 2020.05.25 FOR CITY REVIEW 4, 2020.05.25 FOR CITY REVIEW 5, 2020.05	3 2000.06.01 FOR CITY DP REVEW		
© — -		12 B B C C C C C C C C C C C C C C C C C	(m28.1		(E) → ⊕ • • • • • • • • •	AVERACE (8.17FT), +2.49W (8.17FT),
(D) (S) (A) (A)					m m constitution of the co	ALSO REFER TO 3 BLDG-A & B WEST ELEV
(A) — -		15 V				ALSO REFER TO BLDG—A NORTH ELEV

ALSO REFER TO BLDG-A & B WEST ELEV 1/8" TO 1'-0" A6

1/8" TO 1'-0"


ROOF ASPHALT ROOF SHINGLE CAMPACOAL	(B) FASCIA BOARD, BRACKET MATCH BENJAMIN MOORE CC-542 WILLOW	© → WINDOW TRIM MODRE HC—85 FAIRVIEW TAUPE	(D) MATCH BENJAMIN MOORE HC-172 REVERE PEWTER	(E)→HARDI SIDING COPLEY GRAY	(F)→MATCH BENJAMIN MOORE 2113—10 CHOCOLATE SUNDAE	GARAGE DOOR CHOCOLATE SUNDAE CHOCOLATE SUNDAE
					L] ,

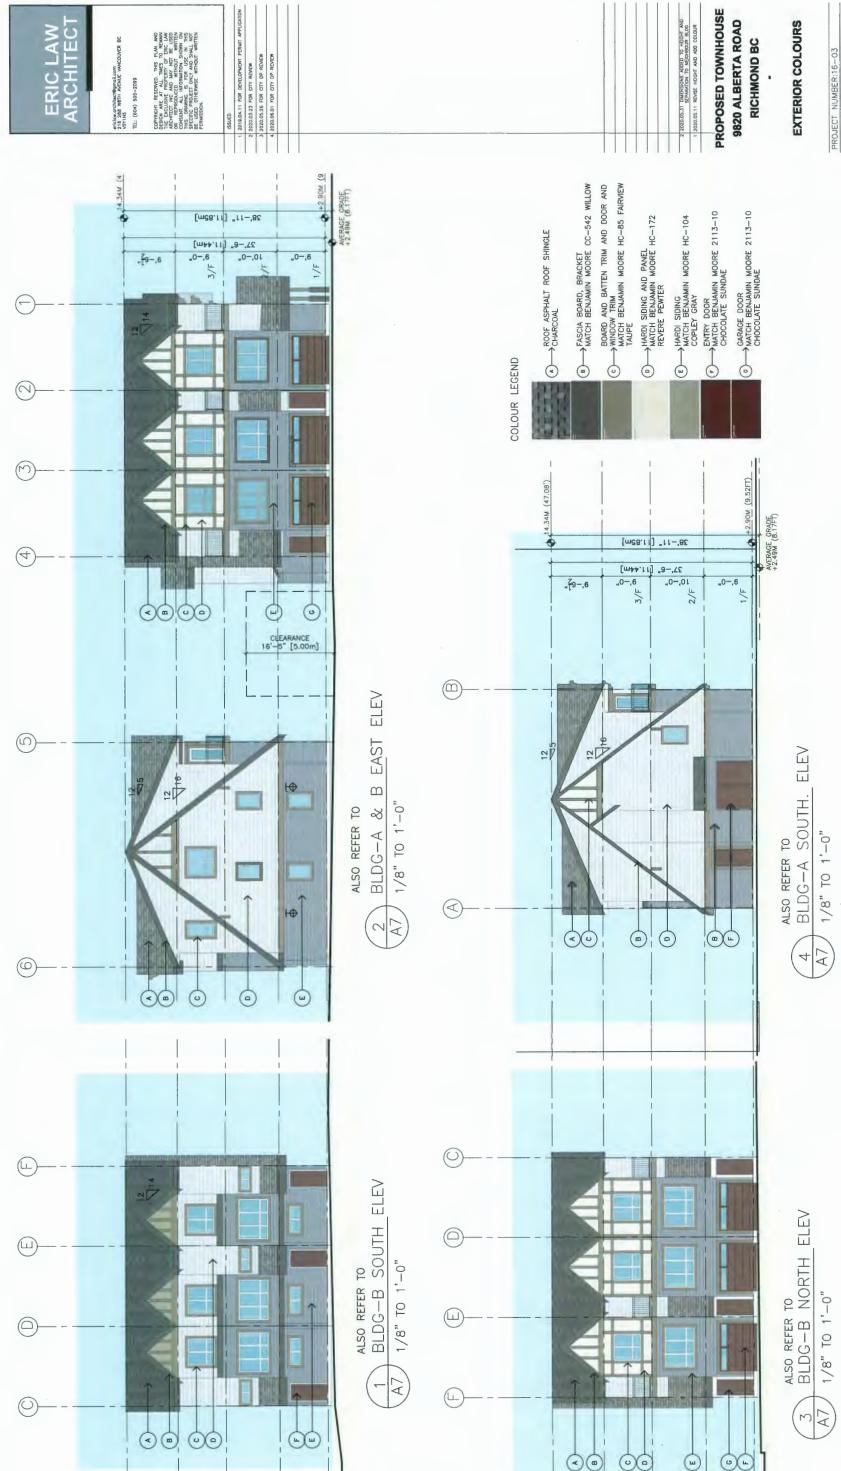


PROPOSED TOWNHOUSE 9820 ALBERTA ROAD 0.05.3) DIMENSIONS ADDED TO HEIGHT AND SEPARATION TO NEIGHBOUR BLDG 0.05.11 REVISE HEIGHT AND ADD COLDUR RICHMOND BC

EXTERIOR COLOURS

PROJECT N	PROJECT NUMBER:16-03
SSUED:	6/1/2020
DRAWN BY:	E
CHECKED B	BY: EL

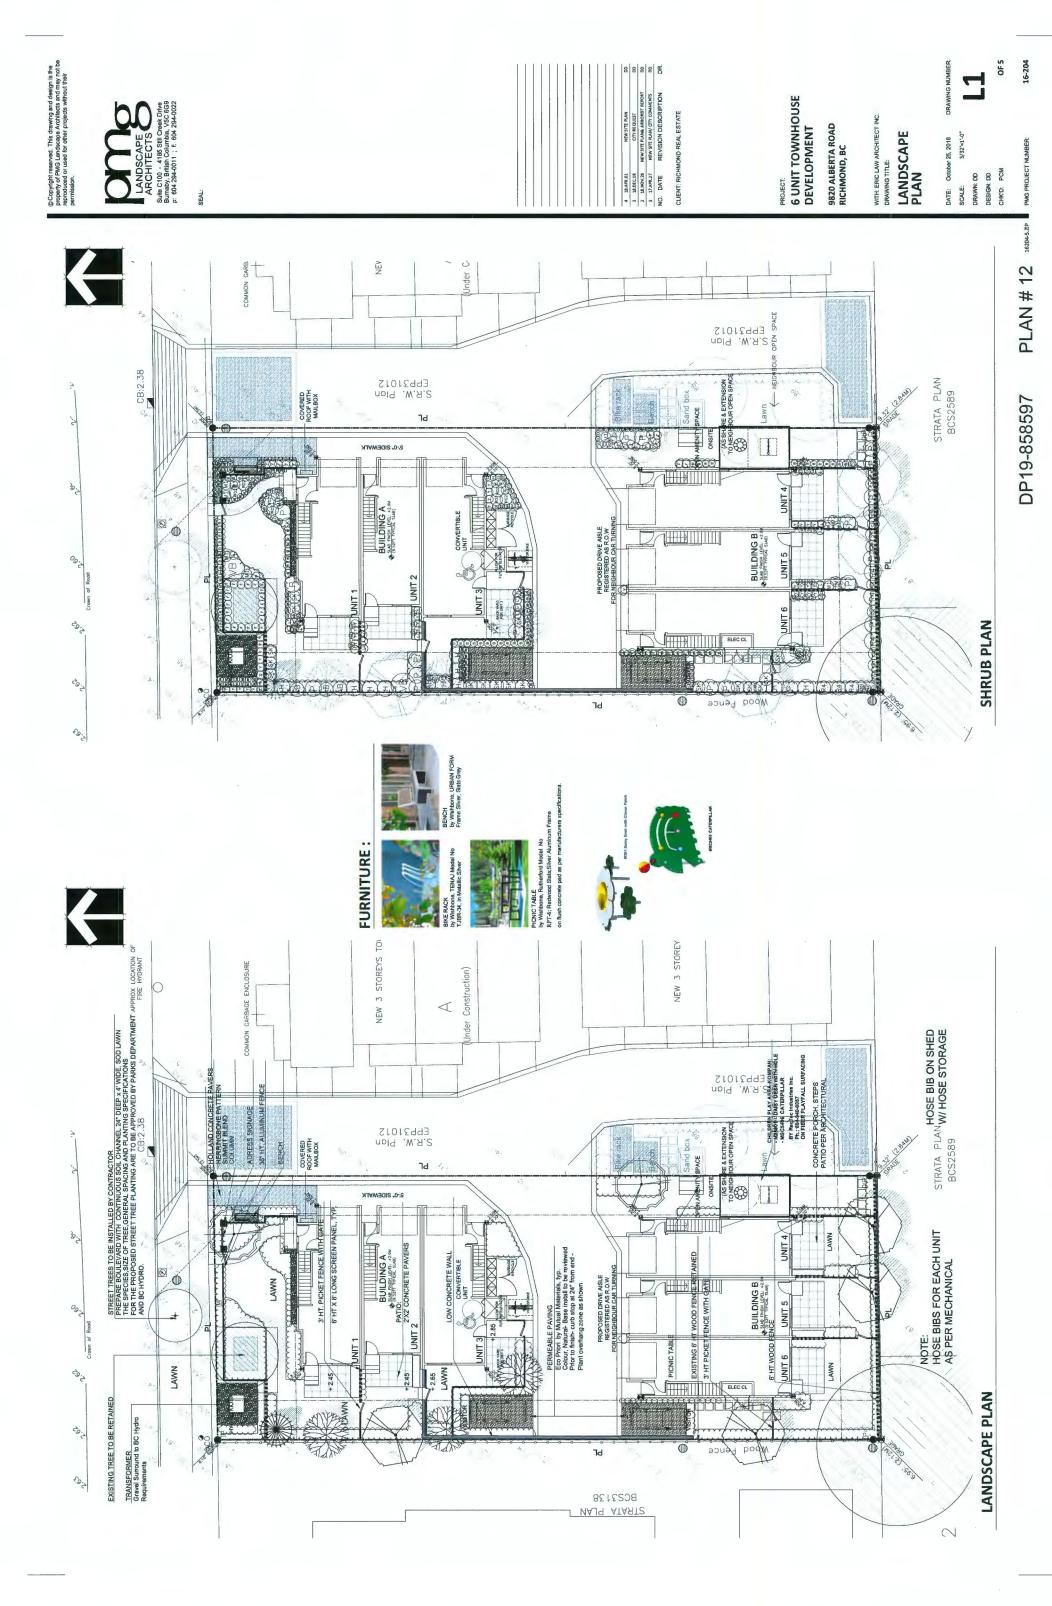

SEAL:

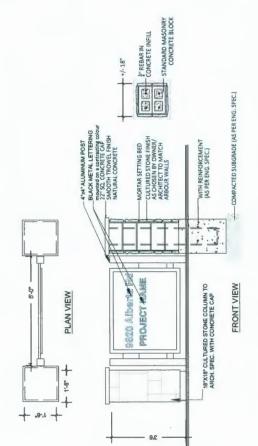

ENTRANCE SIGN

1/2" = 1'0"

6.0" HT WOOD FENCE WITH LATTICE

1. METAL MATERIAL: ALUMINUM TO BE POWDER COATED BLACK, TWO COATS.
2. ALL HARDWARE TO BE HOT DIPPED GALVANZED, MEDIUM GAUGE.
1. GATE HARDWARD TO BE CHOSEN BY OWNER.
118/TALL PER MANUFACUREYS INSTRUCTIONS.
4. ALUMINUM FENCE TO BE POWDERCOATED SEM-GLOSS BLACK.

2/12/

12×12×24* CONC. FOOTING — SLOPE TOP EDGE FOR DRAINAGE 3* DRAIN ROCK UNDER

COMPACTED SUBGRADE OR PATIO ON SLAB 8-0" MAX. O.C.

2x4 P.T. BOTTOM RAIL

-4x4 P.T. FIR POST 1x6 ROUGH CEDAR BOARDS


ALL FENCES TO BE LEVEL CHANGES IN GRADE TO BE IN 12-18" STEPS (MAX.), GAPS TO GRADE TO FOLLOW FINISH GRADE. GAP TO BE 3-6".
 All dark brown to matich the craftsman brown of the Heritage House and New House shingles.

2-1

4. AL DOSTS PRESSURE TREATED TO CSA STANDARD AND END CUTS
TREATED. WITH PRESERVITIVE.
2. ALL OTHER MEMBERS TO BE CEDAR, RZ (CONSTRUCTION) GRADE MINIMUM.
3. ALL HARDWARE HOT DIPPED GALVANIZED.
4. APRY 2. COATS EXTERIOR STANT OWNER, CAUGHERS SECIFICATION.
FINISHS SELECTION AS APPROVED BY PROJECT ARCHITECT.


2x6 NAILER — 1x6 NAILER

5-6

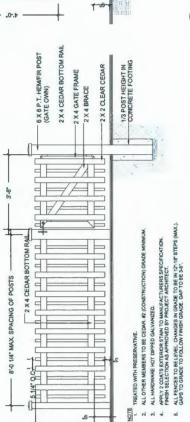

NOTE

POST PLAN

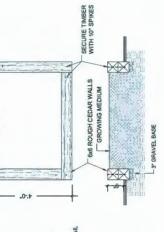

L'S' GRAVEL BASE	(S) GARDEN PLOT
CONCRETE FOOTING	

CLIENT: RICHMOND REAL ESTATE

1/2 = 1.0

	1/2" = 1-0"	
ENCE WITH GATE		
4 36" HT. PICKET FENCE WITH GATE		

PLANT SCHEDULE

1. REFER TO PLAN FOR GATE DIMENSIONS AND LAYOUT

(3) 36" HT. ALUMINUM FENCE WITH COLUMN

	Γ				
T NUMBER: 16204		Z	SIN	PLANT SCHEDULE - Street tree	
NEKS .	Г	KEY	OTY	KEY QTY BOTANICAL NAME	COMMON NAME
		TREE O	-	SYRINGA RETICULATA 'IVORY SILK	NORY SILK JAPANESE TREE LILAC
89		NOTES: SPECIFII MEASUR SOURCE PRIOR T FOR REC AVALAB PLANT M	PLANT ED AS PE EMENTS OF SUP O MAKIN DUEST TO MUTY. A	SAZES IN THIS LIST ARE SPECIFIED ACCORDING ROCK! STANDOOM, DENTANDIAND, DENTANDIAND, DENTANDIAND, DENTANDIAND, DENTANDIAND, DENTANDIAND, DENTANDIAND, DENTANDIAND, DENTANDIANDIANDIANDIANDIANDIANDIANDIANDIANDI	NOTES, E VANT GIZES IN THIS LIST, ANTE SECRETE DIS ACCORDING TO THE EL LANGESCAES ESTRAGACIO, ANCHOLA LANGESCAE SERVERE AND ACCOUNTING THE EL LANGESCAES ESTRAGACIO. AND ACCOUNTING THE LANGEST ACCOUNTING THE THE ANNUAL MACCENTALE SERVER AND ACCOUNTING THE ACCOUNTING THE THE ANNUAL MACCENTALE SERVER AND ACCOUNTING THE ACCOUNTING THE ACCOUNTING THE ACCOUNTING THE ACCOUNTING THE PROAD THE PROAD THE ACCOUNTING THE PROAD THE REFERE THE ACCOUNTING THE REPORT THE ACCOUNTING THE SERVER THE ACCOUNTING THE REPORT TO BE CHARGECAE STANDARD AND CAMADIA WHITE ACCOUNTING THE SERVER THE REFERE THE ACCOUNTING THE SERVER THE REFERE THE PROAD SERVER THE REFERE THE PROAD SERVER THE REFERE THE PROAD SERVER THE PROAD SERVICE THE PROAD SERVER SERVER SERVER SERVER THE PROAD SERVER SERVER SERVER SERVER SERVER SERVER THE SERVER SERV
	_	ARCHITECT.			

HEX BIT TAMPER RESISTANT SCREW WASHERS	CONCRETE PAD SIDEMALK SIDEMALK TO	NIS
GRADE GRADE	NOTE: SITE FURNISHINGS TO BE INSTALED TO MANUFACTURED SPECIFICATIONS (6) SITE FURNITURE MOUNTING	

NET GIT	4117	BUILMEALRAME	COMMON NAME	PLAMIED SIZE / REMARKS	1
唯					
5	4	ACER PALMATUM	JAPANESE MAPLE	6CM CAL: B&B	_
0	60	MAGNOLIA KOBUS STELLATA 'PINK STAR'	PINK STAR MAGNOLIA (LIGHT PINK)	2M HT; B&B	_
and the	, -	PICEA OMORIKA 'BRUNS'	BRUNS SERBIAN SPRUCE	3.5M HT; B&B	_
	. (4	STYRAX JAPONICUS 'ROSEA'	PINK FLOWERED JAPANESE SNOWBELL	BCM CAL, 1.2M STD; B8B	_
SHRUB			CASS INC. INC.		_
(88)	4	ABELLA 'EDWARD GOUCHER'	PINK ABELIA	#2 POT; 30CM	
X.	63	BUXUS MICROPHYLA WINTER GEN	LITTLE-LEAF BOX	#2 POT; 25CM	-
Œ	11	HYDRANGEA M. 'ENDLESS SUMMER'	ENDLESS SUMMER BIGLEAF HYDRANGEA	#S POT; BOCM	_
X	21	PIERIS JAPONICA VALLEY FIRE	VALLEY FIRE PIERIS	ILIS POT; SOCM	_
X	7	RHODODENDRON 'CHRISTMAS CHEER	CHRISTIMAS CHEER RHODODENDRON	IRS POT; SDCM	_
XI	80	ROSA SCARLET MEIDILAND	SCARLET MEIDILAND ROSE	#2 POT; 40CM	-
X	27	SKIMMIA JAPONICA (10% MALE)	JAPANESE SKIMMIA	#2 POT; 30CM	
Œ	45	TAXUS X MEDIA 'HICKSII'	HICK'S YEW	1M+POT	_
X	0	VIBURNUM X 'BURKWOODII'	BURKWOOD VIBURNUM	#3 POT, 50 CM	_
00	12	WEIGELA FLORIDA NANA VARIEGATA"	OWARF VARIEGATED WEIGELA	#2 POT; 30CM	_
RX38					_
0	83	CAREX ICE DANCE	FROSTED SEDGE	#1 POT	-
X	13	MISCANTHUS SINENSIS 'LITTLE KITTEN'	COMPACT MAJOEN GRASS	#1 POT	_
X3	75	PENNISETUM ALOPECUROIDES 'HAMLIN'	DWARF FOUNTAIN GRASS	#1 POT	_
ERENIE!	¥				_
(E	57	BERGENIA CORDIFOLIA	HEARTLEAF BERGENIA; ROSE PINK	15 CM POT	_
Q.	40	LAVENDULA ANGUSTIFOLIA 'HIDCOTE BLUE'	ENGLISH LAVENDER	#1 POT	-
(e)	48	POLYSTICHUM MUNITUM	WESTERN SWORD FERN:	#1 POT; 20CM	
				10000	
ASUREN NDSCAP	MENTS WENTS E ARC	SIZES IN THIS LIST ARE SPECIFIED ACCORDING TO S. BOTH PLANT SIZE AND CONTAINER SIZE ARE TH. AND OTHER PLANT MATERIAL BEACHIGEMENTS. 'S HITTECT AT SOURCE OF SUPPLY, AREA OF SEARCH THE LANDSCAPE ARCHITECT PROOR TO MANDRA AT	NOTES. PIANT SIZES IN THE LEST ARE SPECIFIED ACCROUNG TO THE BIC LANGGOLD, ESTAGN DIATEST EDITION. CONTANESS SPECIFIED AS PER METALES. FINENT OF SECRICIATIONS FOR FORTHELD CONTANES METALES, BOTH PLANT SIZE AND CONTANESS SECRICIATIONS FOR FORTHELD CONTANESS. BOTH PLANT SIZE AND CONTANESS SECRICIATIONS FOR FORTHELD CONTANESS. BOTH PLANT SIZE AND CONTANESS FOR SECRICIATIONS FOR SECRICIATIONS FOR SECRICIATIONS FOR SECRICIATIONS FOR SECRICIATIONS FOR SECRICIAL SECRICIATIONS FOR SECRICIAL SECRICIAL PROPRIOSES SECRICIATIONS FOR SECRICIAL SHAPPING SECRICIAL PROPRIOSES SECRICIALISMS WITH SECRICIAL PROPRIOSES SECRICIALISMS FOR	ANNER SUZES SPECIFIED AS PER CIONS FOR DEFINED CONTAINER FOR OPTIONAL REVIEW BY THOUSESTITUTIONS, OFF AN WRITTEN PROVED SUSSTITUTIONS WILL BE	
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PROJECT:
6 UNIT TOWNHOUSE
DEVELOPMENT

PMG PROJECT NUMBER: 16-204 PLANTED SIZE / REMARKS

WITH: ERIC LAW ARCHITECT INC. DRAWING TITLE: 9820 ALBERTA ROAD RICHMOND, BC LANDSCAPE DETAILS DATE: October 25, 2018 CHKD: PCM DRAWN: DD DESIGN: DD SCALE

DRAWING NUMBER

OF 5 16-204

PLAN # 13

DP 19-858597

OF 5 16-204

16204-5.ZIP

PLAN # 14

DP19-858597

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SCALE:
DRAWN: DD
DESIGN: DD
CHKD: PCM

LOT COVERAGE PLAN WITH: ERIC LAW ARCHITECT INC. DRAWING TITLE:


PROJECT:
6 UNIT TOWNHOUSE
DEVELOPMENT


9820 ALBERTA ROAD RICHMOND, BC

APPROX LOCATION OF FIRE HYDRANT


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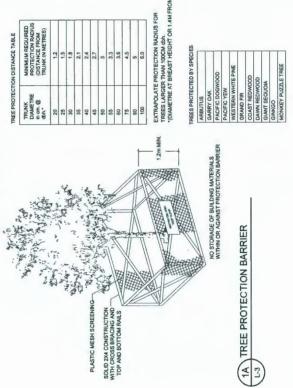
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J WAJA ATARTZ



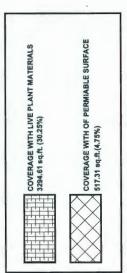

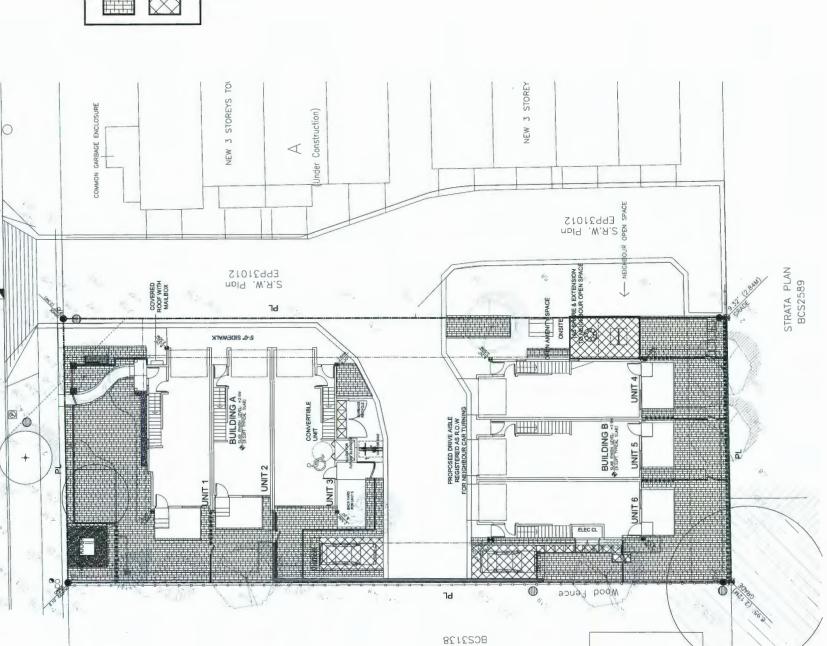NEW 3 STOREYS TOWNHOUSE

S.R.W. Plan EPP31012

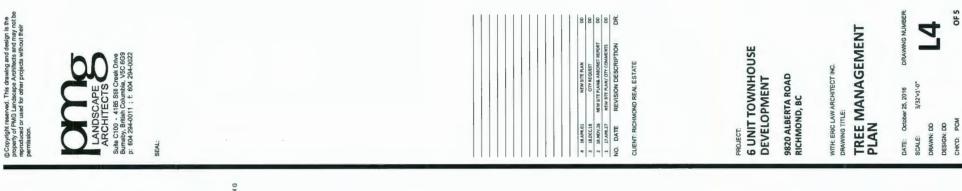2.-0. SIDEMALK

BUILDING A

THE PROJECT ARBORIST MUST BE ON-SITE DURING
THE DEMOLITION OF THE EXISTING DRIVEWAY TO SUPERVI
AND DIRECT LOW-IMPACT METHODS AND CONVERSION
TO SOFT LANDSCAPE CONDITIONS.

UNIT 2

COVERED ROOF WITH MALBOX

97

96

Inder Construction)

NOTE: ALL TREES REGARDLESS OF SIZE ARE PROTECTED IN HIGH ENVIRONMENTALLY SENSATIVE AREAS

APPROX LOCATION OF FIRE HYDRANT

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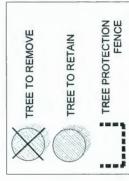
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NEW 3 STOREYS TOWNHOUSE

PEPP31012

UNIT 4

UNIT 5

V

BUILDING B

EXISTING TREE

PROTECTION FENCE

Wood

(AS SHARE & EXTENSION TO NEIGHBOUR OPEN SPACE


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BC22138

J NAJA ATARTZ

EXISTING 3 STOREYS TOWNHOUSE



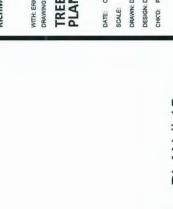

THE PROJECT ARBORIST MUST BE ON-SITE DURING
THE EXCAVATION FOR SEWER SERVICE CONNECTIONS TO
UNDERTAKE ROOT PRUNIUNG AND DIRECTI EWAINFACTAMETHODS.
IF IT EXISTING RETAINING WALL IS REMOVER 2.2588
AND REPLACED, THEN THE PROJECT ARBORIST MUS BE ON-SITE TO
DIRECT LOW IMPACT MATERIALS AND METHODS.

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PLAN #15 DP19-858597

16-204

PMG PROJECT NUMBER

16204-5.ZIP


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PROJECT	ISSUED:	DRAWN BY:	CHECKED BY:	FILENAME	

SHADOW STUDIES

COPPROTE RESERVED. THIS PLAN AND DESCUN ARK AT ALL THISS TO RELAME THE EDICUSTOR REPORT OF THE USED SHORTH AND ANY AND THE USED CORESTET. ALCOHOLOGY, SERVED AND ANY AND THE USED CORESTET. ALCOHOLOGY, SERVED OF THE USE AND THE SERVED OF THE SERVED THE SERVED OF THE SER Tree (UTC-07:00 E | 10:00 A | 10:00 NO 4 RD

ericles.archRect@mail.com 216 288 W5TH AVENUE VANC V5Y1N5 TEL: (604) 505—2089


SHADOW STUDY JUNE 21-10:00AM

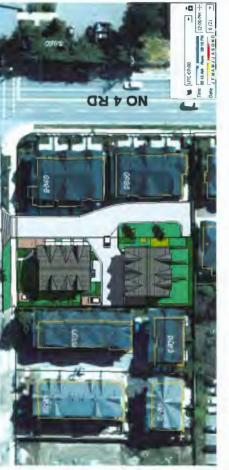

SHADOW STUDY JUNE 21-12:00PM

Time 07:44 At 3 A 5 0 M D 13

NO 4 RD

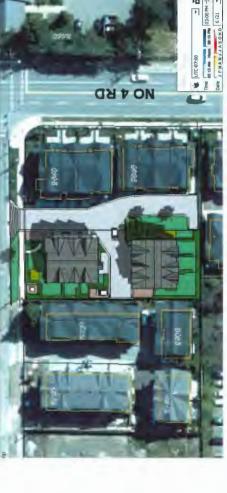

PROPOSED TOWNHOUSE 9820 ALBERTA ROAD RICHMOND BC

SEPARATION TO NEIGHBOUR BLDC SEPARATION TO NEIGHBOUR BLDC S5.11 REVISE HEIGHT AND AND COLOUR

SHADOW STUDY JUNE 21-3:00PM



SHADOW STUDY MARCH 21-10:00AM

