

Development Permit Panel Electronic Meeting

Council Chambers, City Hall 6911 No. 3 Road Wednesday, June 14, 2023 3:30 p.m.

MINUTES

| Motion to adopt the | <mark>minutes</mark> o | f the Development | Permit | Panel m | eeting l | held o | n May | 10 |
|---------------------|------------------------|-------------------|--------|---------|----------|--------|-------|----|
| 2023. | | | | | | | | |

1. DEVELOPMENT PERMIT 21-935984

(REDMS No. 7106166)

APPLICANT: Gordon Chan

PROPERTY LOCATION: 12551 No. 1 Road

Director's Recommendations

That a Development Permit be issued which would:

- 1. permit the replacement of all the existing single-glazed windows with new double-glazed windows, the replacement of two doors on the front (north) elevation and the removal of the overhead garage door on the rear (south) elevation at 12551 No. 1 Road; and
- 2. vary the provision of Richmond Zoning Bylaw 8500 to reduce the minimum front yard setback to the garbage and recycling enclosure from 3.0 m to 0 m.

ITEM

2. **DEVELOPMENT PERMIT 21-936149**

(REDMS No. 7049603)

APPLICANT: Gradual Architecture Inc.

PROPERTY LOCATION: 6520 Williams Road

Director's Recommendations

That a Development Permit be issued which would:

- 1. permit the construction of eight townhouse units at 6520 Williams Road on a site zoned "Low Density Townhouses (RTL4)"; and
- 2. vary the provision of Richmond Zoning Bylaw 8500 to reduce the minimum required lot width from 40.0 m to 36.6 m.
- 3. New Business
- 4. Date of Next Meeting: June 28, 2023

ADJOURNMENT

Minutes



Development Permit Panel Wednesday, May 10, 2023

Time:

3:30 p.m.

Place:

Remote (Zoom) Meeting

Present:

John Irving, General Manager, Engineering and Public Works, Acting Chair

Cecilia Achiam, General Manager, Community Safety Peter Russell, Director, Sustainability and District Energy

The meeting was called to order at 3:30 p.m.

MINUTES

It was moved and seconded

That the minutes of the meeting of the Development Permit Panel held on Wednesday, February 15, 2023, be adopted.

CARRIED

1. DEVELOPMENT PERMIT 21-932383

(REDMS No. 6913890)

APPLICANT:

Flat Architecture Inc.

PROPERTY LOCATION:

8951, 8971 Spires Road and 8991 Spires Gate

INTENT OF PERMIT:

- 1. Permit the construction of 22 townhouse units and two secondary suites at 8951, 8971 Spires Road and 8991 Spires Gate and the surplus portion of Spires Road on a site zoned "Parking Structure Townhouses (RTP4)" zone; and
- 2. Vary the provisions of Richmond Zoning Bylaw 8500 to:
 - (a) reduce the minimum lot width from 40 m to 33.5 m; and
 - (b) reduce the minimum lot area from 2,400 m² to 2,000 m².

Applicant's Comments

Rajinder Warraich, Flat Architecture Inc., with the aid of a visual presentation (attached to and forming part of these minutes as <u>Schedule 1</u>), provided background information on the proposed development, including its site context, site layout, architectural design, building elevations, and exterior cladding materials and colours, highlighting the following:

- 22 residential units and two secondary suites are proposed in three townhouse blocks;
- the proposal includes two Basic Universal Housing Units (BUH) units;
- a future lane will be provided along the west property line of the subject site and a pedestrian walkway is proposed along the site's south property line;
- the Tudor style architecture of the townhouse buildings is consistent with the recently completed townhouse development to the south;
- the entrance to the parking podium and the main pedestrian entrance to the building are located along Spires Road;
- the central courtyard on the podium level is surrounded by the three townhouse blocks;
- stairs are proposed on Spires Gate and Spires Road frontages to provide pedestrian access to the podium;
- two common outdoor amenity areas are provided on the podium level;
- private outdoor spaces will be provided for townhouse units at grade and on the podium level; and
- lighting will be provided along the future lane along the west property line and along the pedestrian walkway to the south of the subject site.

Ruchir Dhall, Architecture Panel Inc., added that the landscape design for ground-oriented units in the proposed development matches the landscaping of the recently completed neighbouring townhouse development. Also, he noted that other main landscape features of the project include distinct landscaping for semi-private and common outdoor amenity spaces to provide visual separation, separation between the picnic area and community gardens on the podium level outdoor amenity area, and flowering plants and ornamental shrubs will be installed at the site's pedestrian entrance near the intersection of Spires Gate and Spires Road.

Staff Comments

Wayne Craig, Director, Development, noted that (i) there are two technical variances proposed for the project relating to the site area and site geometry which were noted at the time of rezoning, (ii) there is a Servicing Agreement associated with the project which include, among others, frontage improvements and utility works along Spires Gate and Spires Road, (iii) two Basic Universal Housing (BUH) units are included in the project, and (iv) the project has been designed to achieve Step Code Level 3 of the BC Energy Step Code.

Panel Discussion

In reply to a query from the Panel regarding potential security concerns on the future lane along the west property line, Mr. Warraich noted that (i) there are no grade changes from the future lane to the subject site and adjacent developments, and (ii) proposed measures to address potential security and safety concerns include locating the children's play area overlooking the future lane, installing larger windows on the side of residential units adjacent to the future lane, installing lighting along the lane, and temporarily treating the future lane as a private space including installing a fence and gate until the lane will be fully developed in the future.

In reply to a query from the Panel regarding access from the parkade to the residential units, Mr. Warraich noted that (i) there is no direct access from the parkade to the residential units except for the two secondary suites, and (ii) an exit stair is provided in the parkade to provide access to residential units on the podium level.

In reply to a query from the Panel regarding how the project would achieve Step Code Level 3 of the BC Energy Step Code, Mr. Warraich stated that the project will be using a high efficiency condenser system in addition to other proposed sustainability measures.

In reply to a query from the Panel regarding the provision of parking in the proposed development, Mr. Warraich confirmed that some of the residential parking spaces will be in tandem arrangement.

In reply to a further query from the Panel, Mr. Craig confirmed that there is a restrictive covenant to prohibit the conversion of the tandem garage area into habitable or storage space and to ensure that both parking spaces are assigned to the same dwelling unit.

Correspondence

Jose Gonzalez, 8935 Cook Crescent (Schedule 2)

Mr. Craig noted that Mr. Gonzalez raised concerns regarding construction impacts to the neighbourhood including pedestrian safety, vehicle safety, overall access to the neighbourhood, and continuity of frontage treatments, landscaping and sidewalks.

In reply to Ms. Gonzalez's concerns, Mr. Craig noted that (i) should the project proceed, it would be required to provide a Construction Parking and Management Plan as a condition of Building Permit issuance, (ii) the plan will be reviewed and approved by the Transportation Department, (iii) the City is aware of construction related concerns in the area and is carefully monitoring the situation, (iv) residents could contact the City's Bylaw Department should they have any construction related concern in the area, (v) overall access to the neighbourhood would be addressed by the Construction Parking and Management Plan, (vi) the proposed development will be providing sidewalks along their frontages, (vii) the sidewalk along the Spires Road frontage of the proposed development will be connected to the recently installed sidewalk along the adjacent townhouse development to the south.

Gallery Comments

None.

Panel Discussion

The Panel expressed support for the project, noting that its design has addressed potential security and safety concerns.

Panel Decision

It was moved and seconded

That a Development Permit be issued which would:

- 1. permit the construction of 22 townhouse units and two secondary suites at 8951, 8971 Spires Road and 8991 Spires Gate and the surplus portion of Spires Road on a site zoned "Parking Structure Townhouses (RTP4)" zone; and
- 2. vary the provisions of Richmond Zoning Bylaw 8500 to:
 - (a) reduce the minimum lot width from 40 m to 33.5 m; and
 - (b) reduce the minimum lot area from $2,400 \text{ m}^2$ to $2,000 \text{ m}^2$.

CARRIED

2. DEVELOPMENT PERMIT 21-943565

(REDMS No. 7202148)

APPLICANT:

Orion Construction

PROPERTY LOCATION:

9800 Van Horne Way

INTENT OF PERMIT:

Permit the construction of two multi-tenant light industrial buildings at 9800 Van Horne Way on a site zoned "Light Industrial (IL)".

Applicant's Comments

Jeremy Paquin, Orion Construction, Ruchir Dhall, Architecture Panel Inc. and Darcy Forcier, D. Force Design Inc., with the aid of a visual presentation (attached to and forming part of these minutes as <u>Schedule 3</u>), introduced the project and provided background information on the proposed development including its site context, site layout, design rationale, architectural design, exterior cladding materials, and proposed sustainability measures, highlighting the following:

- the two proposed multi-tenant light industrial buildings will provide a total of 44 units as strata titled units;
- vehicular access to the site is provided on River Drive and Van Horne Way;
- outdoor amenity spaces for employees are distributed throughout the site; and
- design changes in response to Advisory Design Panel comments relating to pedestrian safety and accessibility, hard and soft landscaping, outdoor amenity spaces, location of amenities such as garbage enclosure, and number of electric vehicle (EV) charging stations to be provided have been incorporated in the project.

Jessica Thiessen, Krahn Group of Companies, with the aid of the same visual presentation, briefed the Panel on the main landscaping features of the project, noting that (i) planting along the perimeter of the site and pockets of planting throughout the parking area have been added, (ii) proposed planting materials are native and adapted species that will provide four season interest, and (iii) existing trees along the south property line will be retained.

Anabella Alfonzo Raffalli, Aartplace, with the aid of the same visual presentation, provided background information on the public art in the project, noting that (i) the proposed public art has gone through the City's public art process, (ii) public art will be installed on the plaza area at the northwest corner of the subject site, (iii) the public art concept references the history of Richmond and surrounding landmarks and natural elements, and (iv) sustainable painting materials will be used for the public art.

Staff Comments

Mr. Craig noted that (i) there will be a Servicing Agreement associated with the project for frontage works along Van Horne Way and River Drive and City utility works, (ii) out of a total of 21 existing trees on the site, seven trees along the south property line will be retained and 14 trees will be removed either due to poor health condition or due to being impacted by building demolition and construction, (iii) 40 new trees are proposed to be planted on the site, exceeding the City's required 2:1 replacement ratio, and (iv) a Statutory Right-of-Way over a portion of the south property line will be provided to help in the installation of a future City road on the CP Rail corridor.

Panel Discussion

In reply to queries from the Panel, the applicant noted that (i) there would be future rooftop mechanical units with improvements by future tenants, (ii) the high parapets on the buildings would screen the rooftop mechanical units from views from the street, (iii) the building rooftops in the subject site would be visible from Canada Line, (iv) proposed species of planting materials in the plaza area at the northeast corner of the site are small and grow vertically and would not interfere with the proposed seating in the area, (v) Building B has been designed with dock loading for large trucks while Building A has been designed to accommodate loading for smaller vehicles, (vi) maintenance of the public art surface painting will be addressed through the strata property management plan, (vii) overall, there is a smaller amount of glass in the proposed development compared to those of residential buildings, and (viii) there is provision for individual units in the two buildings to install their own EV charging stations for all their parking stalls.

Discussion ensued regarding the long-term maintenance of public art in the project and in reply to a query from the Panel, Mr. Craig confirmed that the project's development permit will be registered on title and staff will work with the strata to ensure that the landscape and public art will be maintained.

Correspondence

None.

Gallery Comments

None.

Panel Discussion

The Panel expressed support for the project, noting that it is well thought out and the proposed landscaping and public art would enhance pedestrian, cyclist and motorist experience in the area.

Panel Decision

It was moved and seconded

That a Development Permit be issued which would permit the construction of two multitenant light industrial buildings at 9800 Van Horne Way on a site zoned "Light Industrial (IL)".

CARRIED

3. DEVELOPMENT PERMIT 22-019430

(REDMS No. 7181149)

APPLICANT:

Talvinder Jagde

PROPERTY LOCATION:

10151 Ainsworth Crescent

INTENT OF PERMIT:

- 1. Permit the construction of a coach house at 10151 Ainsworth Crescent on a site zoned "Single Detached with Granny Flat or Coach House Edgemere (REI)"; and
- 2. Vary the provisions of Richmond Zoning Bylaw 8500 to:
 - (a) increase the maximum setback that a coach house is permitted to be located from the south property line from 2.0 m to 5.95 m; and
 - (b) decrease the minimum setback that a coach house is permitted to be located from the north property line from 2.0 m to 0.90 m.

Applicant's Comments

Talvinder Jagde, with the aid of a visual presentation (attached to and forming part of these minutes as <u>Schedule 4</u>), provided background information on the proposed development, including its site context, architectural design, unit layout, and exterior cladding materials, highlighting the following:

- the proposed variances are requested to locate the proposed coach house outside of
- the tree protection zone of a significant tree on the neighbouring property to the south;
- the proposed coach house has been designed to minimize impacts to neighbouring properties due to the requested setback variances;
- there are no windows proposed on the north and south sides of the coach house to address concerns of overlook into the neighbouring properties;
- the proposed coach house will complement the character of the principal dwelling through the use of similar materials, finishes and colours;
- the proposed location of the coach house will not overshadow neighbouring properties;
- landscaping will be installed to provide screening and privacy for the yards of neighbouring properties; and
- the proposed coach house will achieve Step Code 3 of the BC Energy Step Code.

Panel Discussion

Discussion ensued regarding the proposed landscaping under the dripline of the significant retained tree and as a result of the discussion, staff were directed to work with the applicant to ensure protection of the root zone and survivability of proposed plantings under the tree.

Correspondence

None.

Gallery Comments

None.

Panel Decision

It was moved and seconded

That a Development Permit be issued which would:

- 1. permit the construction of a coach house at 10151 Ainsworth Crescent on a site zoned "Single Detached with Granny Flat or Coach House Edgemere (REI)"; and
- 2. vary the provisions of Richmond Zoning Bylaw 8500 to:
 - (a) increase the maximum setback that a coach house is permitted to be located from the south property line from 2.0 m to 5.95 m; and
 - (b) decrease the minimum setback that a coach house is permitted to be located from the north property line from 2.0 m to 0.90 m.

CARRIED

4. New Business

It was moved and seconded

That the Development Permit Panel meeting tentatively scheduled on Thursday, May 25, 2023 be cancelled.

CARRIED

5. Date of Next Meeting: June 14, 2023

ADJOURNMENT

It was moved and seconded *That the meeting adjourn (4:35 p.m.).*

CARRIED

Certified a true and correct copy of the Minutes of the meeting of the Development Permit Panel of the Council of the City of Richmond held on Wednesday, May 10, 2023.

John Irving Acting Chair Rustico Agawin Committee Clerk



















Schedule 1 to th Development meeting held May 10, 2023


2 CONTEXT PLAN
Sale 315°41"



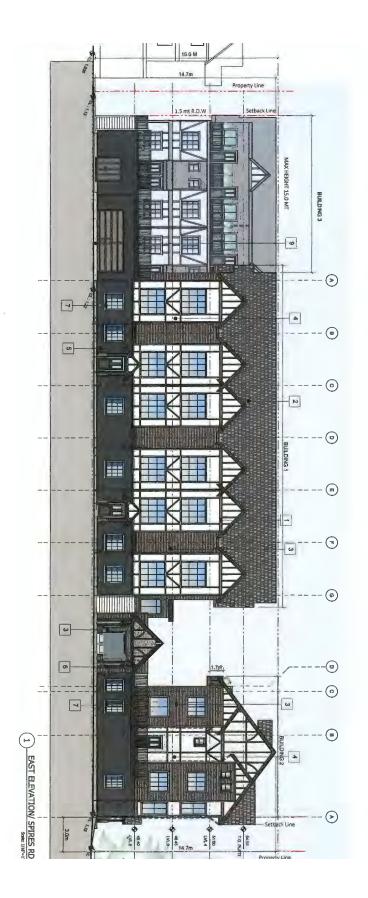



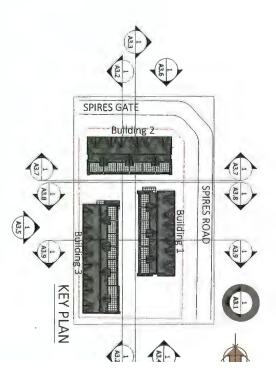

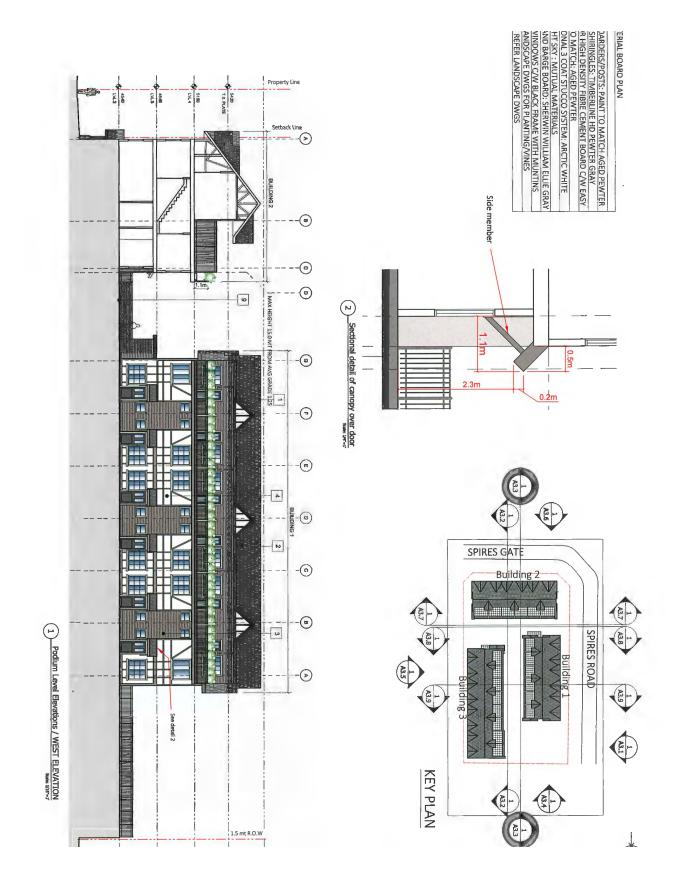




1 VIEW FROM SPIRES RD Sole: N.T.S.

23-Feb-23 PROJECT NO: 17-127 PROJECT INFO:

Townhouse Development at 8951, 8971 Spires Rd., 8991 Spires Gate, Richmond, BC CLIENT:

Juliana

ARCHITECTURE &

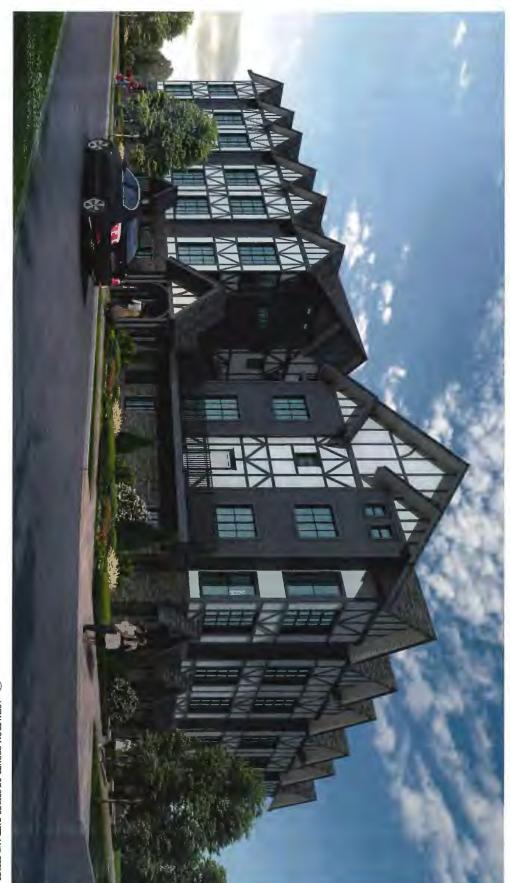

VIEW FROM CORNER OF SPIRES GATE AND SPIRES RD

and the contract of the contra

PROJECT NO.
17-127
17-127
As Noted R.W

PROJECT INFO:

Juliana

Townhouse Development at 8951, 8971 Spires Rd., 8991 Spires Gate, Richmond, BC CLIENT: Unit 209-5321 King George Surrey BC, VIX 1G1 www.faburshiechure.ca conlact@faburshiechure.ca






Juliana

Townhouse Development at 8951, 8971 Spires Rd., 8991 Spires Gate, Richmond, BC CLIENT:



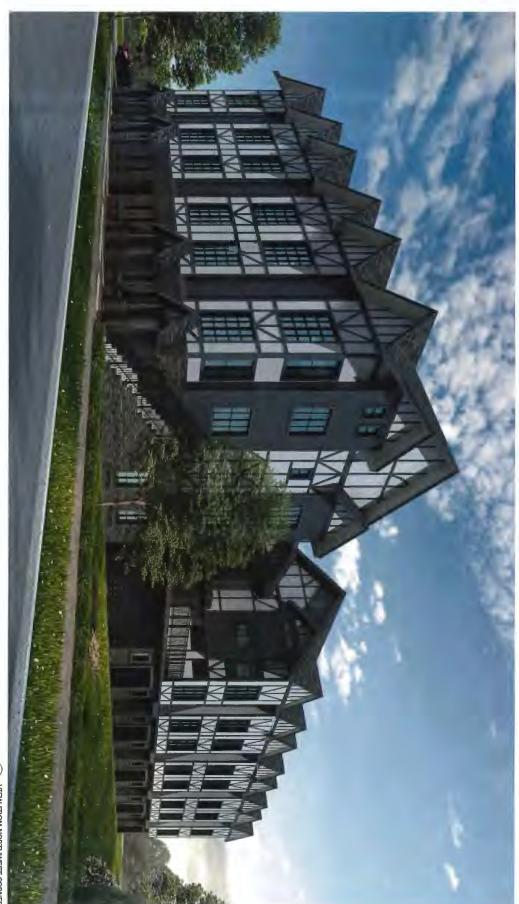

1) VIEW FROM NORTHWEST CORNER Scale N.T.S.

PROJECT INFO:

Juliana

23-Feb-23
PROJECT NO:
17-127 Townhouse Development at 8951, 8971 Spires Rd., 8991 Spires Gate, Richmond, BC CLIENT:











BIRDS VIEW FROM SPIRES RD / EAST SI


3 VIEW FROM LANE ALONG WEST SIDE





4 VIEW FROM SPIRES GATE / NORTH SIDE



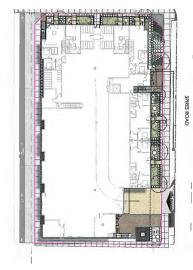



2 SOME PROPOSED PLANTS

LE AND SUMMARY

among a mix of other townhouse complexes and rapidly evolving residential lots, the contextual ly and appropriate placement of elements.

y simple mix of suffaces and their configuration owing to a very similar scale of such suffaces such as the advisorable. We have chosen to simil our selection to 2 or 3 cried limities and reserved a mote as for the decidency.

ord edges has been very carefully configured with some matching trees of the surrunding high the contextually appropriate with scale and available right of very. Simbarly, being cognizant or the deck level planting, we have chosen to fair the trees and place the bull typ plantes to the shuckural reasons. The trees selected for the internal layout are small and relatively less in number.

a rapidly changing area where a number of developments have sprung up in the past few years. Hes a senstitive scheme that merges with the general transformation of the area.

residential development demands privacy for the various units and their accessible spaces. The is spaces (private paths from one another) are entered a secon (thulp accidentate smanaga) and e plants are used in translem with smaller hedging material such as the Spirareo and the flowering te loyers of textural relief.

e site, and the area by main lobby are treated with multiple layers of ornamental grasses and are placed in a way that emphasizes the project signes and create a vectorning landscape for suisfulling some of the proposed plants are PENNISTEIN HAMBUR, BULLE OUT GRASS and Hemerocalis a Taxus buffer in the background to provide privacy for adjacent unit.


sed along the west side of the building providing additional visually appealing green elements to y pedestrians.

an designed with a finear two zone concept. The main constituents are the Social acceptand area of one has been outgraented with an outdoor likethen and subtlandie elements like the garden raised plantiess c/w spout and work bench for the residents use at the deck level.

4

ise of native plants requiring tower water intake and offering trees that encourage bird habitat such the lane.



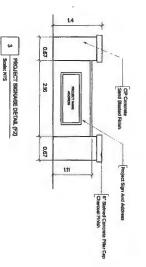

GENERAL NOTES

All materials and workmenship to CLS Standards, letest edition. Soil depths and subgrade exceed that standard.

Plant sizes in this list are specified according to the BC Landscape Standard's larest edition. Conf standards: both plant size and container size are the minimum acceptable sizes. The installers are a material evaluable to the Landscape Auchitect for optional review at the source of supply-fave of sear visiley. 'Substitution' must obtain written approval from the Landscape Auchitect prior to making Unapproved substitution' will be rejected Author a minimum of five worlding dips prior to delivery (subspects of the Landscape Standard.

All plant material must be provided from the cartified "Disease Free" nursery.All plant material must Landscape STandard.Provide cartification upon request.All landscaping and landscape materials to

Shrub Areas
Tree Pits Min, growing medium depths over prope Lawn eress Ground Cover Areas 450mm 300mm (around root bells)

Growing medium shall have physical and chemical properties as described in the standards for to structures where the medium shall conform to the requirements for level 1 applications. Processing on done of-late using a mechanized screening process. Proposed growing medium shall be tested by shall guarantee that the soil submitted for testing is a sample representative of the each to be used at it.

On-Site or imported soils shall satisfy the requirements of the standards for growing medium. Soils a including woody plant parts, weed or reproducive parts of the weeds, plant pathogenic organisms.

All plenting beds shall receive min. 50mm bark mulch.

The contractor shall maintain clean working conditions, remove all refuse and debris and present the completion of all works.

All the Plentors are fixed not removable.

Pant species and varieties may not be substituted without the approval of the Landscape architect. All plant material to be warmaked for one year from date of substantial completion. All wood finces to be code, with one cost of clear pendesting preservative. All planted areas to be equipped with automatic impation system.

omatic zoxud irrigation system to be provided with following primary zones,

Street level bouleverd areas including the ROW's, setbacks not part of private yards, driveway acc

Podium level public areas. This includes planting in plantar beds and on slab. Individual yards on site level. Mainly inground planting.

Individual yards on site level. Mainly inground planting. Individual yards on podium leval. Mainly planter. All amenty areas on podium level. Mainly planter beds.

These have been carefully chosen to address the varying volume of growing medium to be cate and discharge.

Landscape Plans are prepared based on latest drawings Revision

| EEE PAVING/STTE FURNISHING EGENDS ON LA. SEE LB FOR SOIL VOLUME CALCULATION AND PLANTER HEIGH DIFRODFTOP PLANTERS. |
|--|
|--|



ARCHITECTURE PANEL INC.

Unit 208, 1463 Foster Street, White Rock, BC | 8047831480 | ruckingsard ARCHITECTURE I LANDSCAPE ARCHITECTURE I URBAN DESIGN

These Drawlogs and the design are and at all times remain the exclusive properly of Drawlor Parent file. and cannot be used whost of the fundament properly of Drawlor Parent file. and cannot the test cannot for verification of all dimensions, always the and other datum on Carawlops. Any Carawpson the Assembly recorded inspections to the Landscape Architect and the design and the section and its who controlled a first production of the Architecture and the Architectur

Sheet Titlo

Rolewed By SD


| ä | | |
|-------|------------------|-----------------------|
| Owner | 8991 Spires Gate | 8951, 8971 Spires Rd, |


| | res Gate | 71 Spires Rd, | _ |
|------------|----------|---------------|-------------|
| Jawn By | | 18 | otal Sheets |
| Checked By | | 5 | Sheet No. |


| Status | | - | Checked by | | | 5 | Sheet No. |
|--------|----|--------------------|----------------------|---|---|------------------|-------------|
| | | ony or recentation | Charles and Blokmond | | | | Contractors |
| | | or opposition | DB Anglication | | | FLAI AICHTECUITE | Consullants |
| ۵ | ס | 0 | z | × | r | ~ | 8 |
| 8 | 23 | 20 | 27 | 8 | 8 | 8 | P |


| O | ٦ | 0 | Z | Z | | ~ | 8 |
|-----------------|-----------------|-----------------|-----------------|-----------------|------------------|-----------------|-------------|
| 03-04-23 | 21-03-23 | 20-01-23 | 27-10-22 | 03-10-22 | 06-07-22 | 06-04-22 | Date |
| DP Resubmission | DP Resubmission | DP Resubmission | DP Resubmission | DP Regubmission | DP Regulomission | DP Resubmission | lasue Notes |
| | | N | | | | | |




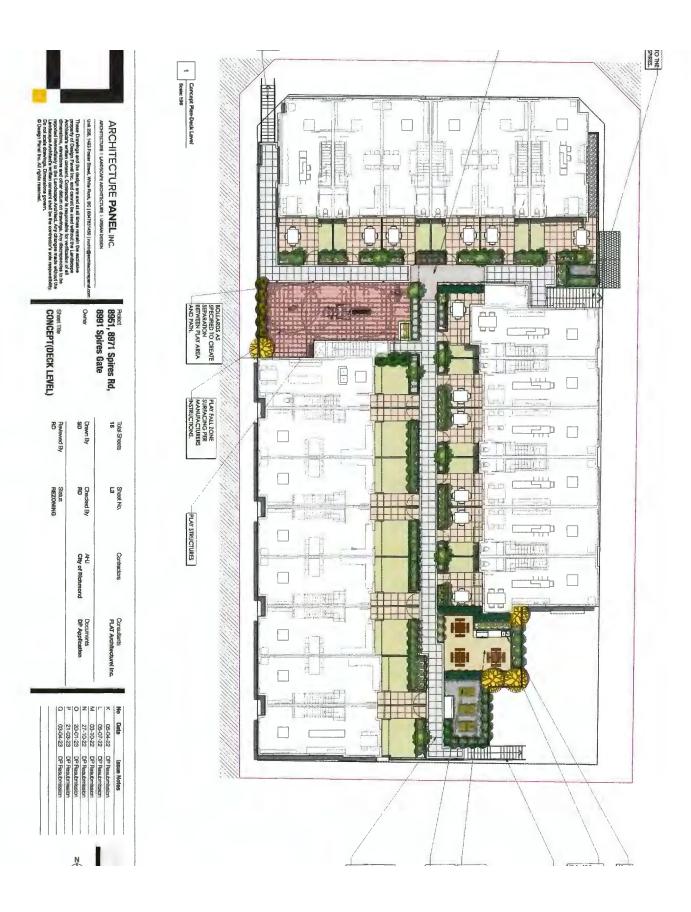


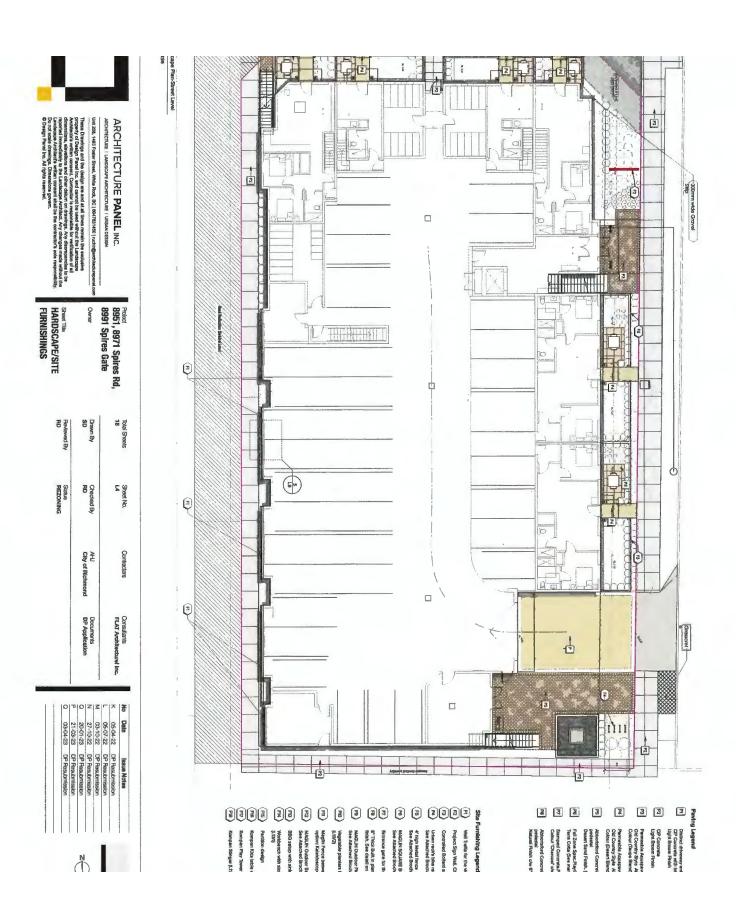


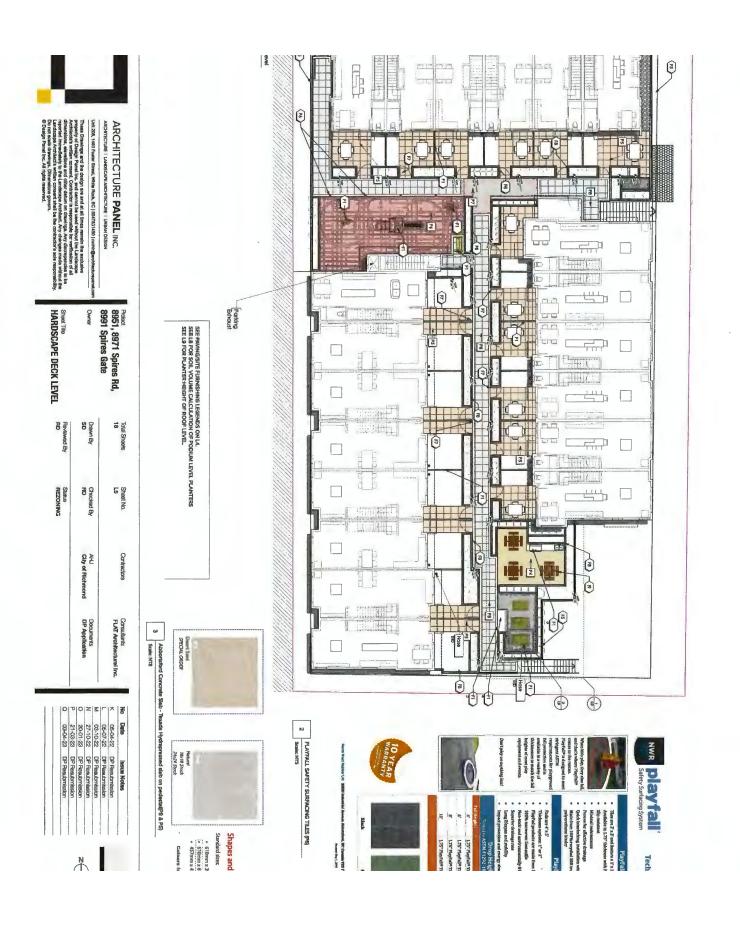

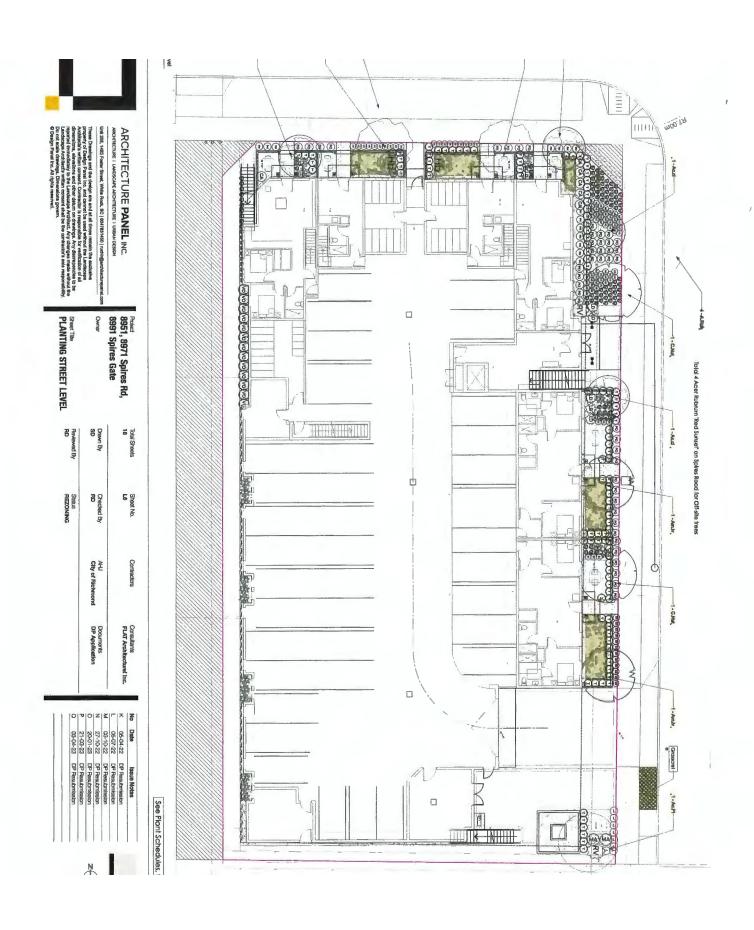

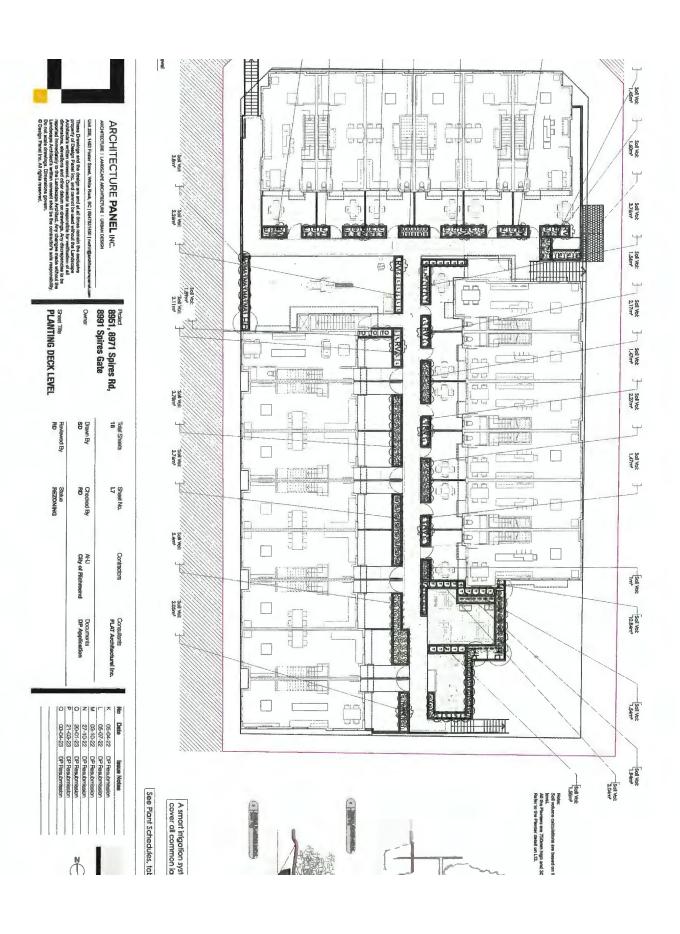

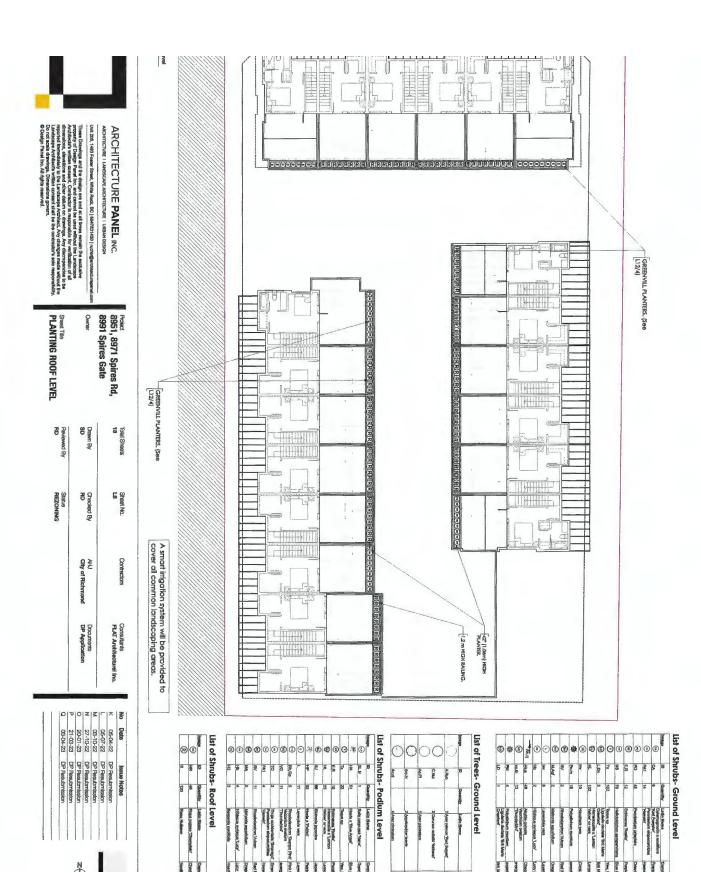

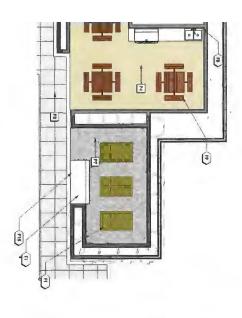



Abbotsford AquaPeve Teupe Bland (P3)
Scale: NTS

Abbotsfort
4 Scalar NTS


Length: 8 7/8" (226mm)
W4dth: 7 1/8" (84mm)
Ares: 2.3 stones /R2, 25
stones /m2
Thickness: 2 3/8"
(60mm)


Old Country Stone Type

AquaPara" Old County Stores Colone Thugas Bland





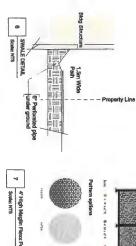

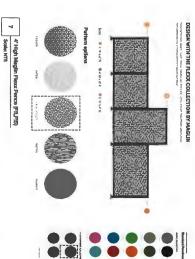

| | | | _ | - | | | | _ |
|--|-------------------------------|--|---|--|--|---------------|--------|---|
| - Pendamin Chr O'Rona - Eyt bels to dem SERTEAL | TO SPECIFIC Below 17070 Janes | The behalf or protected with C-Coalt and per Department of Coalt and Department of Coalt and Department of Coalt and Department of Coalt | WEIGHT TON OF THE PERMITTER AND WITE TO | Co-Ordina Negati Marindone Date (Date (Dat | HATCHALLS: The patient is commissed of \$7 (F2.7ms) as | MTB750 SERIES | MAGLIN | |

막라

Min width of the improper sub 15" (0.381m)

The first factor of the factor

URNISHING LEGENDS ON LA.



sentation of Planting (FI)

Traces Density and the design are and at all times ments the exclusive property of Delegal Piscell in userd denoted in social effects of the contributes Avoidabeats within consent. Contributes in expoputable for verification of all offerentiations, devertions and other deaths on the entiring. Any disappearders to be imported impediately to the Landscape Avoidated. Any disappearders and without the Landscape Avoidated. Any disappearments without the Landscape Avoidated. Any disappearments without the Contributed and develope, Dimensional operation.


Ob only the Avoidabeat's Within measured. Sheet Title
AMENITY/DETAILS-1


| 3 | |
|----------|---|
| Owner | 8951, 8971 Spires Rd, 8991 Spires Gate |
| Drawn By | Total Sheets |

| | | j <u>e</u> |
|-------------|-------------------------|-------------------------------------|
| Reviewed By | Drawn By SD | Total Sheets 18 |
| Status | Checked By RD | Sheet No. |
| | AHJ City of Richmond | Contractors |
| | Documents REZONING | Consultants Architecture Panel Inc. |


| OP Resubmission | 03-04-23 | 2 |
|------------------|----------|---|
| DP Resubmission | 21-03-23 | ס |
| DP Resubmission | 20-01-23 | 0 |
| DP Resubmission | 27-10-22 | z |
| DP Regubritssion | 03-10-22 | Z |
| DP Resubmission | 06-07-22 | ľ |
| DP Resubmission | 05-04-22 | _ |
| lasue Notes | Deathe | 중 |

B Scale: NTS

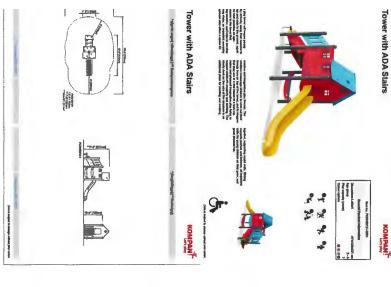

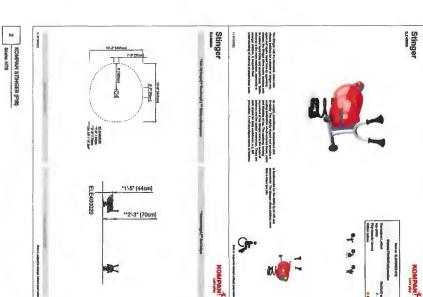

Kids Table with 4 Sitting Poles

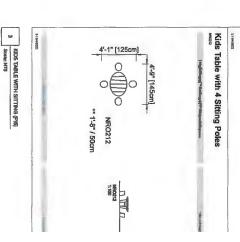




| RE PANEL INC. 8951, 8971 S RECEIVE I URBAN DESIGN 8991 Spires (| Owner | He Rock, BC 5047531450 ruchin@architecturepenel.com |
|--|--------------|---|
| | 8991 Spires | ARCHITECTURE URBAN DESIGN |
| | 8951, 8971 S | JRE PANEL INC. |


COMPAN PLAY TOWER WITH ADA STAIRS (FIT)


| Sheet Title DETAILS-2 | Owner | Protect 8951, 8971 Spires Rd, 8991 Spires Gate |
|-----------------------|--------------------------|--|
| Reviewed By | Drawn By SD | Total Sheets 18 |
| Status | Cheded By RD | Sheet No. |
| | AHJ City of Fichmond | Contractors |
| | Documents DP Application | Consultants FLAT Architecturel Inc. |

| Data Issue Notes 05-04-22 DP Resubmission 05-07-22 DP Resubmission 03-10-22 DP Resubmission 27-10-22 DP Resubmission 20-01-23 DP Resubmission 20-01-23 DP Resubmission 21-03-23 DP Resubmission 21-03-23 DP Resubmission | t | 0 | Z | Z | | ~ | 8 |
|--|-----------------|-----------------|-----------------|-----------------|-----------------|-----------------|-------------|
| DP Resubmission | 21-03-23 | 20-01-23 | 27-10-22 | 03-10-22 | 05-07-22 | 05-04-22 | Data |
| | DP Regubmission | DP Resubmission | Issue Notes |

03-04-23 DP Resubmission

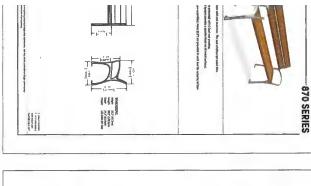

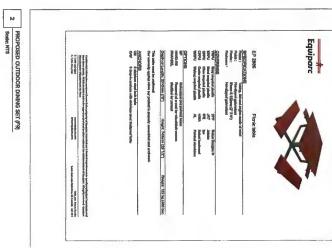

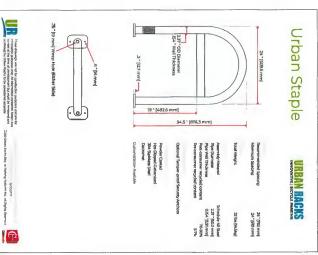

Perth



OR BENCH (FTZ)



| SEE | | |
|-------|--|--|
| PAVIN | | |

| n. | | | | | |
|--|-----------------|----------------------------------|--------------------------|------------|--|
| reported immediately to the L andscape Architects written Do not scale drawings. Dimer | wings Design | Unit 208, 1483 Faster Street, W. | ARCHITECTURE I LANDSCAPE | ARCHITECTL | |

ARCHITECTURE PANEL INC.

at (0.1, 402 Feather Bitter, White Reds, DC (947/20140) | nicht@profrischrepsenfl.com
as (2), and (2) and a be design are root at all times remain the occurate
opening of Design) areas in a root and extend the season of whole the Landscape
opening of Design) areas in a root and extend the season of whole the Landscape
opening of Design) areas in a root and extend the season of whole the Landscape
opening on the Company of the Company of

Sheet Title
DETAILS-3

8951, 8971 Spires Rd, 1

Total Streets Sheet No. Confectors Consultarits

18 L11 FAIT Confectors FAIT Architectural Inc.

Checked By Arti City of Richmond DP Application

RD REZONING

 No. Data
 Issue Notase

 K. GS-04-22
 DP React/mistion

 L. 056-07-22
 DP React/mission


 M. 03-10-22
 DP React/mission

 N. 27-10-22
 DP React/mission

 O 20-01-23
 DP React/mission

 P 21-03-23
 DP React/mission

 Q 03-04-23
 DP React/mission

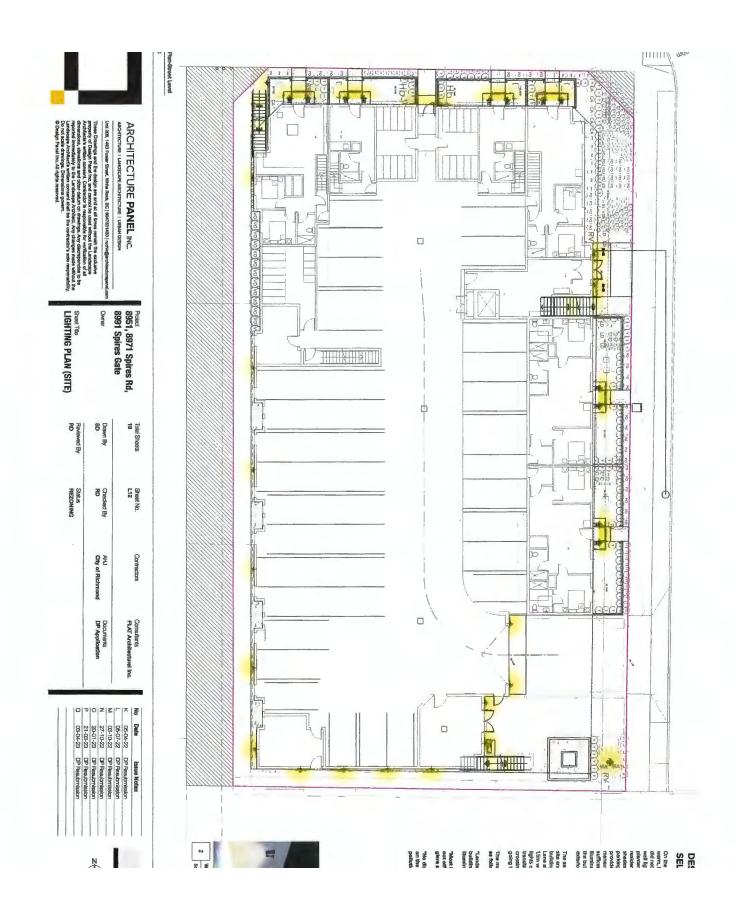

Schedule 2 to the Minutes of the Development Permit Panel meeting held on Wednesday, May 10, 2023

| To | Dev | qole | men | t Po | ermit | Pane |
|-----|------|------|-----|------|-------|------|
| Dat | te:/ | MAY | 10, | 20 | 23 | |
| | | 4 | • | | | |

item # 1

Re: DP 21-932383

8951, 8971 SPIRES ROAD & 8991 SPIRES GATE

Jose G <corvette_racer@hotmail.com> May 8, 2023 1:56 PM

To: CityClerk

From:

Sent:

Subject: Feedback for May 10 Development Permit Panel meeting

Attachments: 10.jpg; 20.jpg; 30.jpg; 40.jpg; 50.jpg

Follow Up Flag: Follow up **Flag Status:** Flagged

City of Richmond Security Warning: This email was sent from an external source outside the City. Please do not click or open attachments unless you recognize the source of this email and the content is safe.

Dear Mayor and Council, I am providing feedback for file DP 21-932383, Application by Flat Architecture Inc. for a Development Permit at 8951, 8971 Spires Road and 8991 Spires Gate.


As a long-term resident of the Spires Road area, I have previously provided input on rezoning and development applications in our neighbourhood. I am grateful that key concerns have been taken seriously by members of Council and City Staff. For this application, there are several concerns which continue to be a problem and a few new concerns specific to this application. This development is on one of the only 2 roads into our subdivision. Both of the 2 entry roads are active construction sites, at the preloading stage currently, so the key concerns which should be addressed before the application is approved are:


- 1) Safety of access for pedestrians, including school children. The proposed development and the traffic management plan requirements ignore that the area around the development is heavily used by pedestrians. School children walk to Cook School past the development. Residents walk to the Canada Line, to stores and around the neighbourhood past the development. This development should include a safe path for pedestrians during construction, particularly since this will be a construction site for well more than 2 years.
- 2) Safety for pedestrians and cars across existing construction sites. I'm attaching 4 photos showing the current dirty and dangerous damage from existing construction projects in our neighbourhood. Boulevards are turned into mud pits and construction fences extend to the very the edge of the road, leaving only the road for pedestrians to walk. Even City parking restriction signs are behind construction fencing so they're ignored. I've been told that City policy is that road boulevards that are turned into mud pits by construction vehicles will not be fixed by the developer until their project is finished, which in the case of one photographed site, has been **over 2 years** now. Meanwhile pedestrians and cyclists have to walk in the only lane of traffic, competing with cars for space. This is an accident in the making. Why are boulevards not repaired with crushed gravel to address continuing damage during construction?
- 3) Access to our homes. With both Cook Gate and Spires Gate being construction sites, I implore the City to coordinate construction blockages of roads. Currently, when the access from Cook Gate has been blocked due to delivery of construction materials, cement truck pours or crane operations, I've turned around to drive to Spires Gate, but now It will also

become a construction zone. Which City department is responsible for coordinating road access to ensure residents can get to their homes? Mornings are particularly bad for congestion. We do not want a reoccurence of the 2 situations where access to our subdivision was completely blocked so even emergency vehicles would be unable to enter.

4) Continuity of frontages and landscaping. As you can see in the final attached photo, there is a completed project next to the site for this application. There is also a largely-completed project on the other side. It's unclear if there will be continuity across the 3 sites. Will sidewalks join together without zig-zagging? Will there be similar green shrubs and plantings on the proposed development to be consistent with its neighbours? It's unclear in the requirements for the proposed development whether the variances being requested by the developer and their plans whether they are required to align with neighbours so that there will be continuity and some consistency for pedestrians and residents


... Jose Gonzalez 8935 Cook Crescent

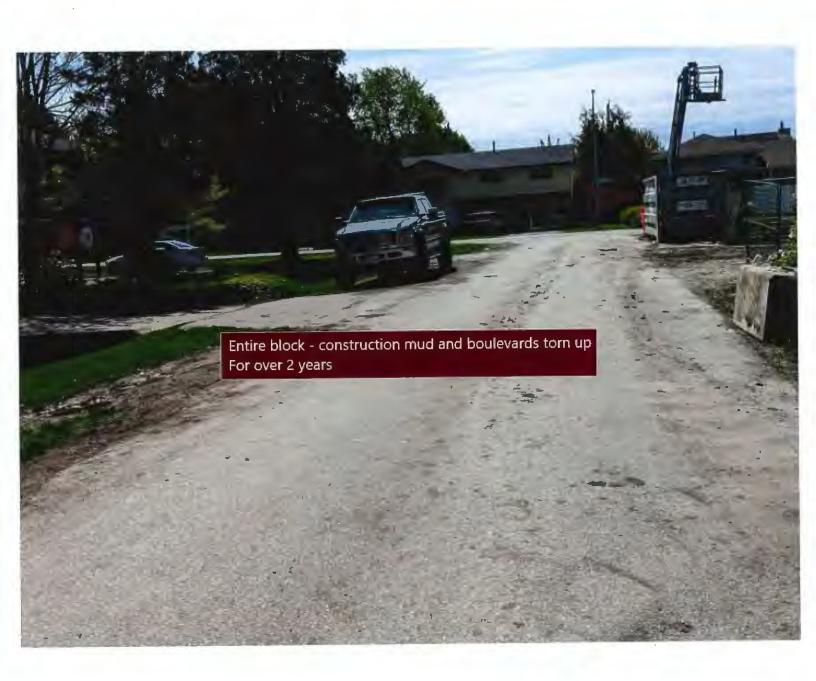

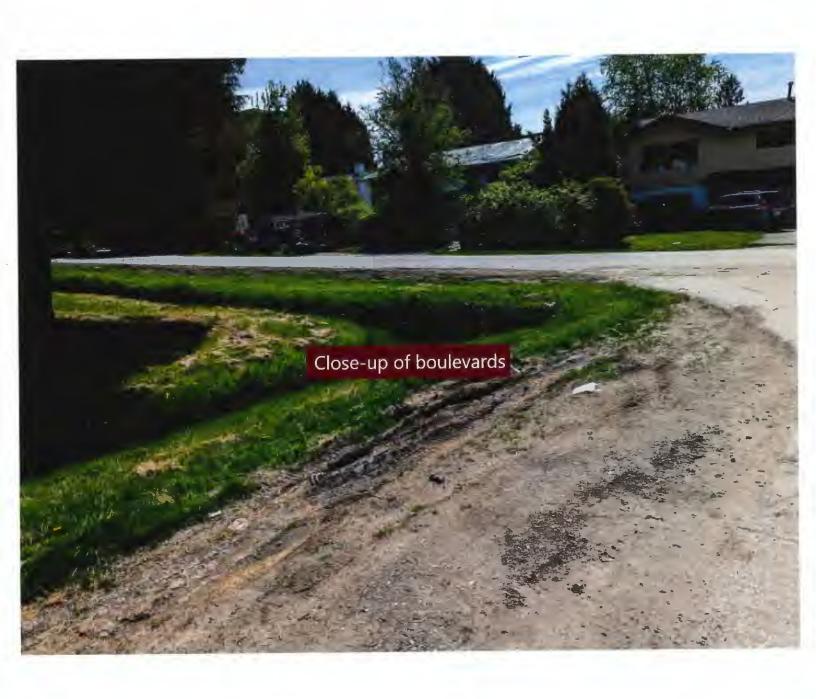





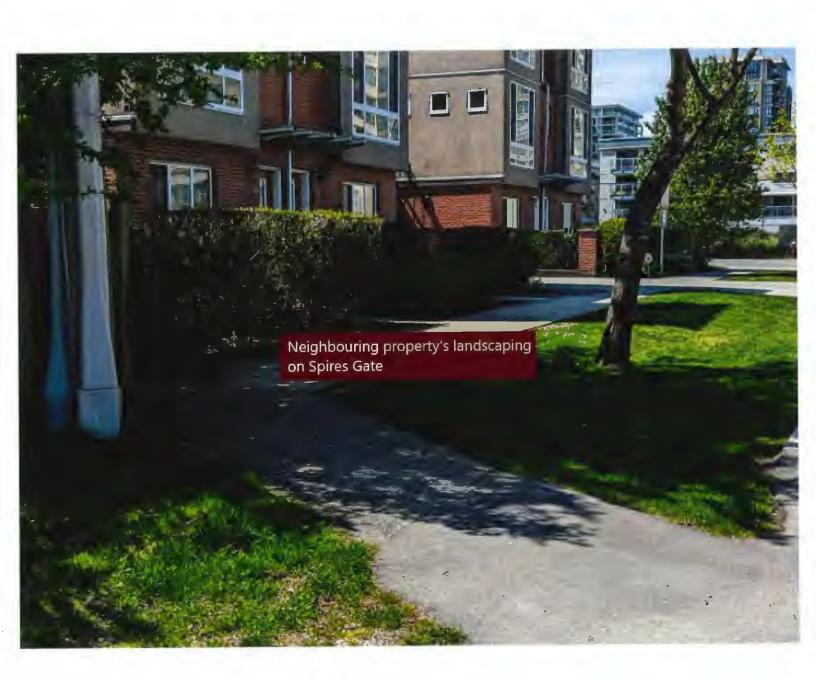




Development Permit Panel

9800 Van Horne Way, Richmond

May 10, 2023

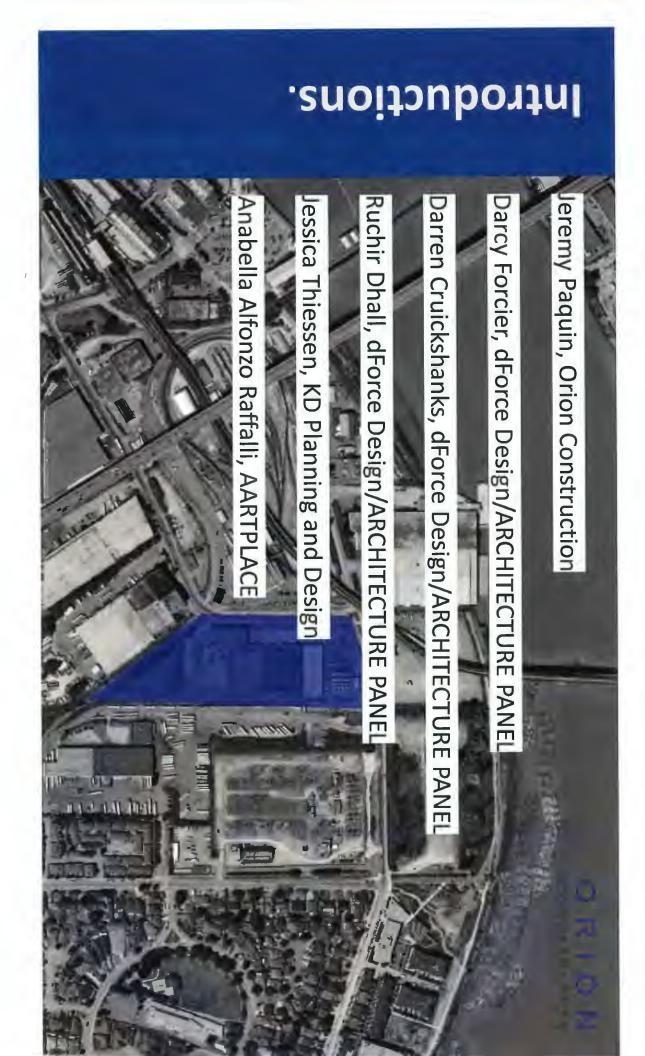

Two Buildings

Zoning: IL (Light Industrial)

Lot Size: 8.99 Acres

Site Coverage: 48.6% / FAR: 0.62

Building 1000:

34 ft tall; 26 Units;

58,936 sq ft of main floor; &

25,761 sq ft of upper floor.

Building 2000:

35 ft tall; 18 Units;

131,668 sq ft of main floor; &

27,418 sq ft of upper floor.

CONS

ORION CONSTRUCTION

Architectural

PROPOSED INDUSTRIAL BUILDINGS FOR:



9800 VAN HORNE WAY, RICHMOND, BC















2 BUILDING B FROM RIVER DRIVE

S BUILDING A ENTRANCE

CONSULTANTS LIST:

ARCHITECT
CHIP BARRETT
ARCHITECT

DEVELOPER ORION CONSTRUCTION

CENTRAS
CENTRAS
ENGINEERING LTD.

GEOPACIFIC
CONSULTANTS LTD. THE TETM AVENUE VALCOURS BC, VSP 6F2 TEL: 804-194-0523 CONTACT: HATT ANDHEAD

> KD PLANNING & DESIGN LTD ASSOTSFORD, SC V25 320 TILL SOM-085-0081 FAX: SOM-085-0081

ARBORIST

KD PLANNING &

DESIGN LTD


WADD-SAOTH GLADYS AVENUE
ASSOCIATION OF AND ASSOCIATION OF ASSOCIATION OF


AC-BOSS 20 AME, SURREY BC, V 400 TEL: 804-389-1372 CONTACT: CHP BARRETT


104 - 3450 YI STREET, SURREY BC, V22 OTE TBL: 604-863-3494 CONTACT: BRADEN SHITH




| NO ATTEMPT OF THE | AND SITE FLAN - SITE FLAN | THE STATE AND STATE OF STATE O | WAY SENDED HAT MERSENING IN THE MANAGEMENT OF TH | DOT PLAN & PURTOR - |
|-------------------|---------------------------|--|--|---------------------|
| | SECTION | 5-TC4 | GACHE U.M. | |

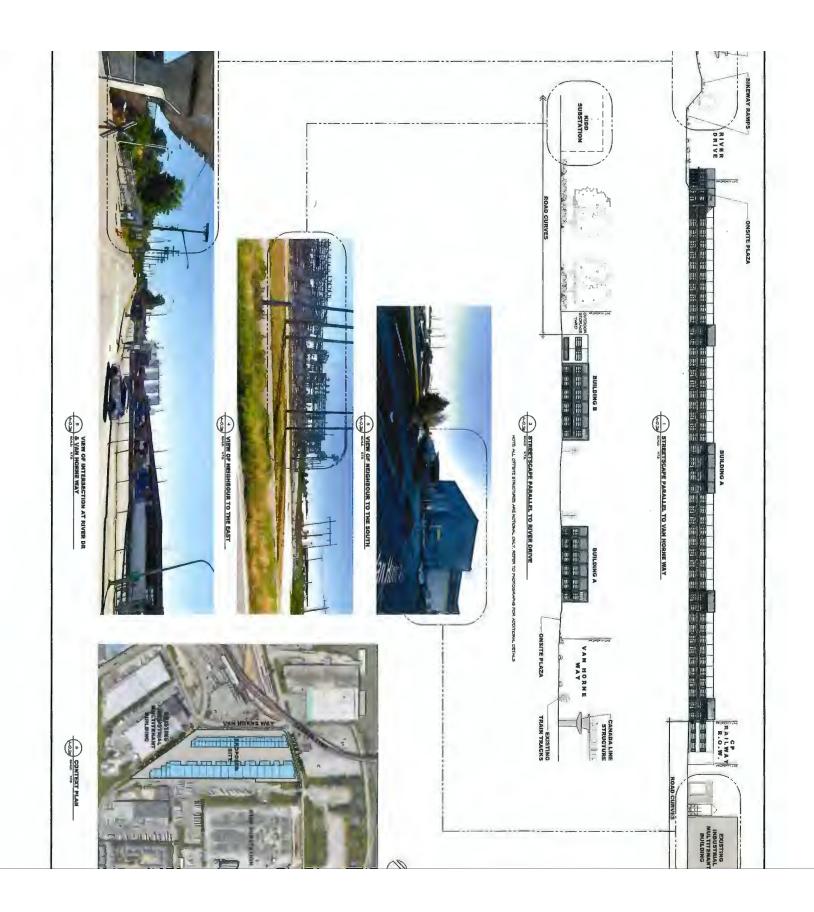


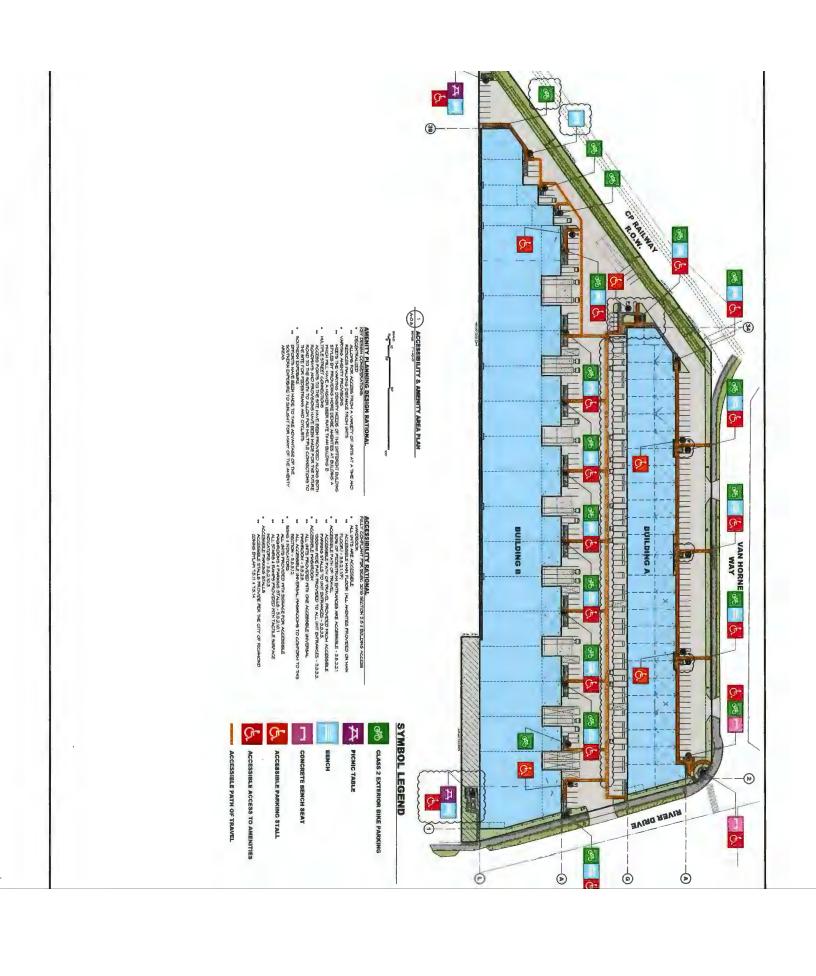

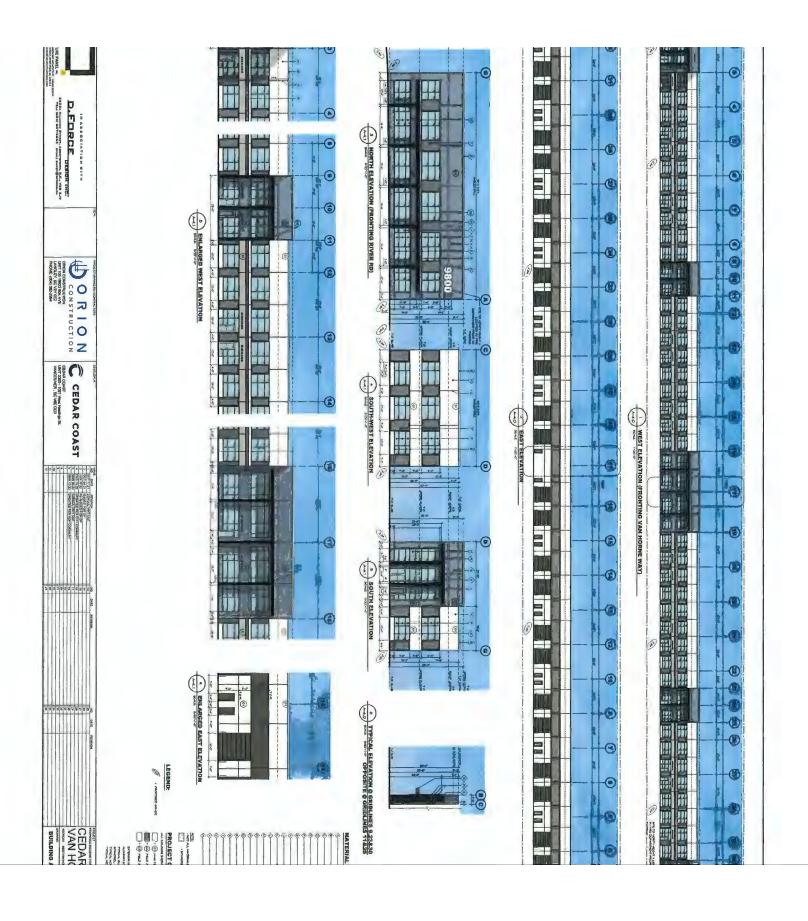

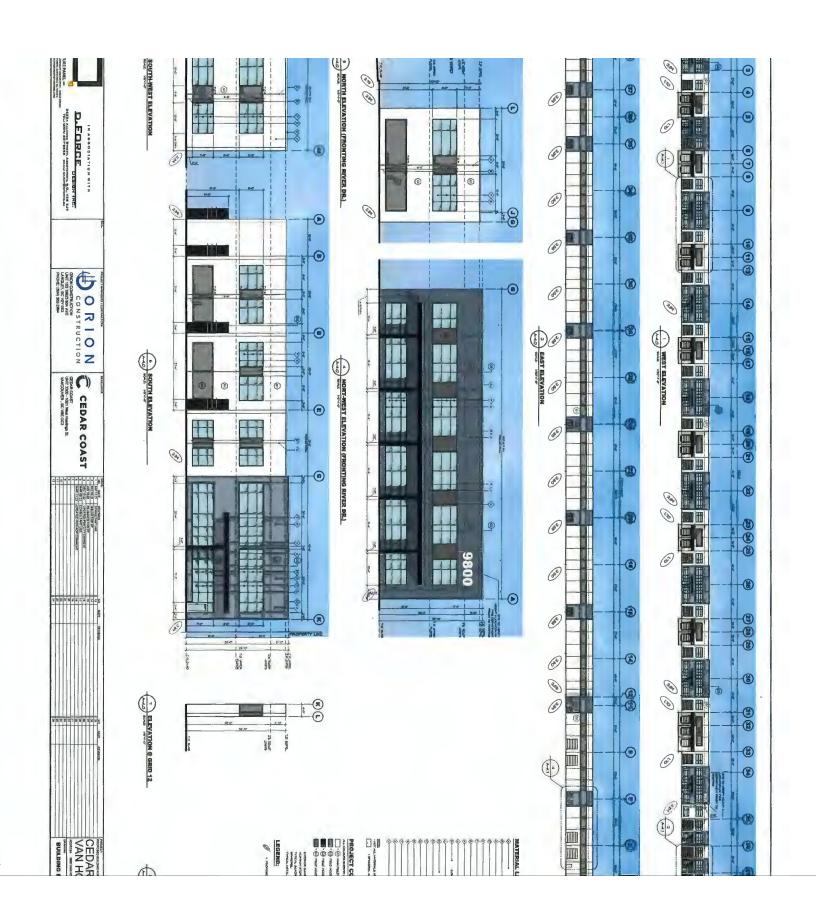

Landscape Architecture

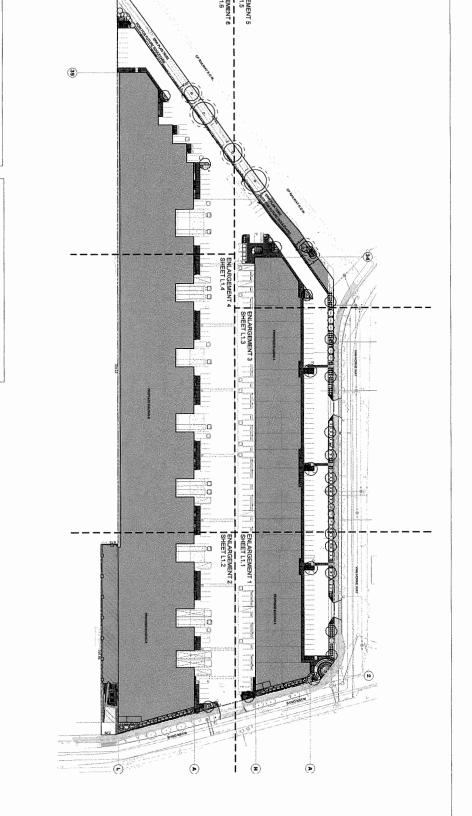

AT MENTAL SHAPE SH

O. DO NOT SPRAY WATER CATO THEE TRUNKS

CREAR UPULTY AND SERVICES LOCATES PRICE TO SECONMINIC CONCENTRATION ARROAD
 OF APPELLET PREJAMANCE AND LOCATES PRICES PRICES, SERVICES AND CONCENTRATION AND CONCENTRAT

et seering dies jaho bis vergest soder as denstall is its Highel blange dering combistion and its Theirb bild his velocid wither dibons of settles requel by the Cheek of Cherch I representative if Solvio to that that the disc best with being settlested by differs. The cost of this work shall be desicted from the local intelligence and difference received from the Collection. mall mend vil jeg compactiors own exhemit marienance metante bill on the total services of the compaction of the compact Damazed Brandher al frunka skall be febfobused in accordance with standard Ractices and attoantions, society absonstib (ib a) descriptations with appropriate Species PERCENDI PER NIGHTAGET MAL CONFORM TO THE CAMBINAL MADISSANE FLAGADOM OF THE THROUGH THE CAMBINATION OF THE PERCENDIAN O

The state is included an extent content to the content at a stream and the state of the stream of the state of the stream of the state of the stream of the state of the state




Non exhaustive list of sustainability measures:



- Level 2 EV charging for 10 parking stalls.
- 100% of units are roughed-in for EV charging.
- designs are finalized). Include electrical outlets near select bike parking locations to promote charging of e-bikes (locations TBD as
- Efficient parking, circulation, and bay design reduces the amount of idling and driving on site
- Design all outdoor lighting as high efficiency LED to maximise building efficiency.
- Base building electrical will support tenant installation of high efficiency LED interior lighting and mechanica
- Both buildings will be designed as solar ready to allow for future installations by tenants.
- Reduced water usage through selecting drought resistant species
- Select endemic flora and ensure alien or invasive species are not planted
- Limiting the removal of trees and planting new trees.
- Provide facilities to encourage three stream waste separation and recycling
- Limited window-to-wall ratio (WMR) to reduce solar heat gain.
- future obsolescence of building elements. Selecting materials that have long-life and low maintenance properties to extend the lifespan of the building
- only entrance beautified by public art, thus promoting commuting and visits by transit and by foot. The development is located within walking distance to bus stops and the Bridgeport SkyTrain and contains a



Thank You

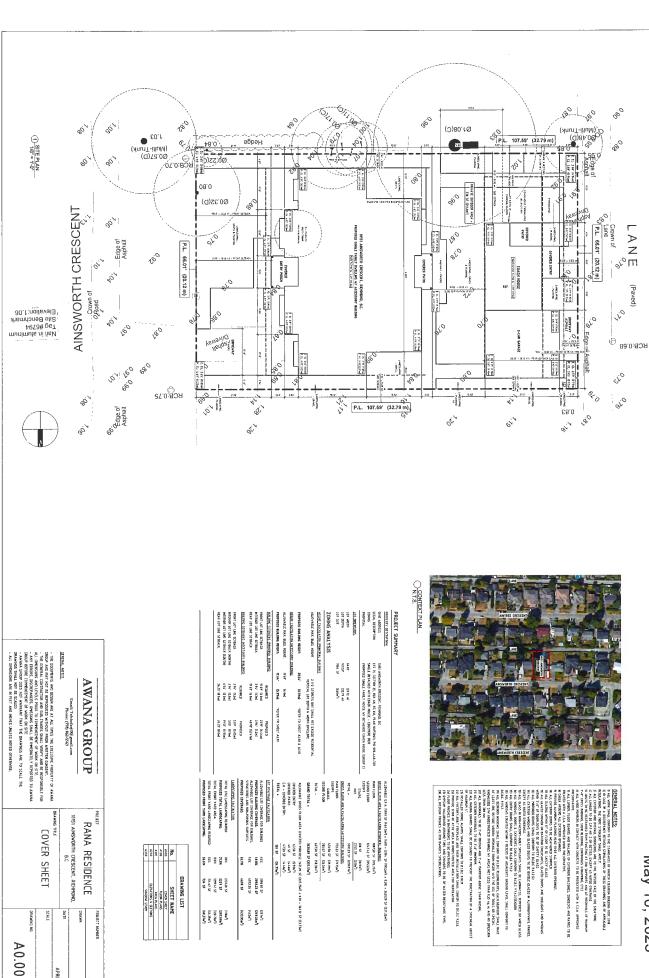

Schedule 4 to the Minutes of the meeting held on Wednesday, Development Permit Panel May 10, 2023

^or₀E B N U

(Paved)


vio.


cio


MATCHING THE CONTROL OF THE CONTROL


| CI SOUTHWAY | | | | | | | | |
|---|--------------|-------------------------------------|--|---|------------------------------------|-------------------------|------------------|----------------------------------|
| BLCCHLUNA | | | | ALLOWABLE G.F.A.: 5000 SF (444.5ml) = 0.001 - 12104 SF (1955.6ml) = 0.001 + 363120 SF (337.35ml) | 5 1412 - 101 | F (1955æ-) x | 93 0£1£46 + 10£0 | (37),35#71 |
| 223 | SOMEWHY 1988 | DESCRIPTION THEOREM IN TRANSPORT OF | REMEMBED, D.C. | SENSO SLOVE AREA CALCINATION FRANCE AS BUILDING | STRUTTER 19. | Jr. | | |
| 300 | FOL 3E SELLA | 34 25, BLX 44 | LOT 31, SECTION 25, BUX 44, RG 6H, PLAN SHPZOGIT, PID 006-446-320 | MAIN FLOOR. | 188756 St [175.35m ²] | (#8.35m ²) | | |
| | SWELL OLLYC | ETE LYHE'A IN HED MILH COM | PROPOSOD SWALE FAHEY NOUSE W/ DETACHED COACH HOUSE TOROUP OF SWALE OTTACHED STATE FOR THE FOREIGN FOR | 92 | desesses as every | (18532m ²) | | |
| Sines. | | | | STARS. | 5 1512 | (2 0m²) | ' | |
| - | 101 | 10 21 02 | | 10141 • | MATTER SE (SMIRH) | (278 07m ²) | | |
| - | 11759 | (22.79 e) | | CRESS FLOOR AREA CALCILIATION (ACCESSORY BIRLINGS) | HATTER ABU | jē. | | |
| | 25. 100, | (148m²) | | HAM FLOOR | TRAD SE DESM'S | D175m ²) | | |
| ANALYSIS | | | | EARAGE. | 13050 SF (31996) | (35.95% ²) | | |
| | | | | , | 28542.55 (265447) | (26.56m²) | | |
| CHINA THE REAL PROPERTY OF THE PARTY OF THE | | | | TOTAL . | 127.54 SF (SEJEN) | (51,35~2) | | |
| IN NAC BEEN HERMI | 4.5 | RICAL LOT DE | ADDITION TO DESIGN TO MEDIA CHARLES OF STREET, AND ADDITIONAL OF STREE | GRAND TOTAL . | 3628.09 SF ()37.17m ³) | 033.17m ⁵) | | |
| DULING KIGHT | nse | (E.76m) | HEER TO SHEET AZON A AZON | ALIGNARII ISROES PLOGRANIA (COVERTO PRINCIES) SALEO SE DISLEOÑ e e 18 - 363 E SE DELEM- | b POHOGS) | 155 eX109 C | model con . | 363 IZ SF (33,73 64) |
| LCINATION (ACCESSORY BUILDING | 594D RIV | | | COVERED ENTRY | - | (5 5 (m)) | | |
| THAX BUDG HUGHT: | 1567 | ž. | | CH - COVERED ENTRY. | 1752 58 | F 647 | | |
| DUALDING MERCHET | W.B | B.17m | WITH TABLE BY SAIDS. | 10141 - | 15.9 SF | (H.77m²) | | |
| EMBYON WASSELD SERVELD | CHE | 036(038 | PROPUS(D | HOLLY ROTH SEVELAGE TOT | | | | |
| T LINE SETBACK | | 19 69" (6 Dw) | 2177 (6.464) | ALLOWABLE LOT COVERAGE FOR BUILDINGS | X57 | | 3194 60 55 | (25)m ²] |
| LOT LIME SETBACK. | | 34C (12w) | 3.96° ff2ed | PROPOSED BUILDING COVERAGE | 2 | × | AS CURIAL | (269.26m ³) |
| ENC SCHRACK | | 15 65. (6 gm) | 40 95' (12 47m) | ALLOWABLE LOT COVERAGE FOR BUNGENESS | , 10x | | 497233 SF | (642m ²) |
| CONTROL VACCESCOPIES | A Court | 031900319 | DZSD4DB4 | PACPUSCO COVERAGE: | 8 | 65.7× | 1479 57 | (GERGE) |
| T LINE SCHOOLS. | | ME SAG | 569 (505ml | CANDSCAPHS CALCULATION | | | | |
| TOTAL SCIENCE (SOUTH) | | 656 (204) | 11 St (5 See) | GHERD'S SMARTSONY 2ND TALOL | 70(| | 15 62102 | [families] |
| TWE STEACK | | 24.25" H God | 24.25' III.0el | PROPOSED TOTAL LANDSCAPHG | жи | | 2239 15 | [287,8847] |
| | | | | TOTAL FROMT YARD AREA. | 24601 | | 2994158 | [120 7(w ²) |
| | | | | TOTAL FRONT YARD LANDSCAPING REQUIRED | 20 55% | | FH 67 SF | [16.38m ²] |
| | | | | PROPOSED FROM Y YARD LANSCAPING. | F | X | 35 74 | 6E 330 7 |


| | 100 Att | TOWNS STADE. | |
|--------------------------|-------------------------------------|--------------|------------------|
| וס | RANA RESIDENCE | FNOF | R ZZIF |
| 1 | 10151 AINSWORTH CRESCENT, RICHMOND, | , RICHMOND, | דו |
| | 8.0 | DATE | APRIL 16TH, 2023 |
| SENT. BE RESPONSIBLE FOR | COVER SHEET | ET SCALE | As indicated |
| 3116. | | | |

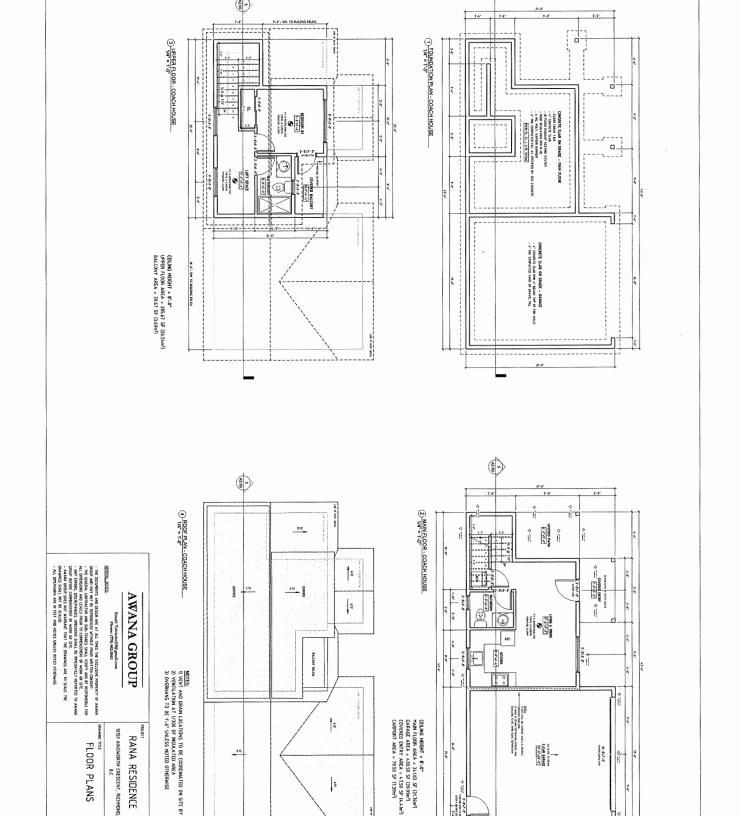


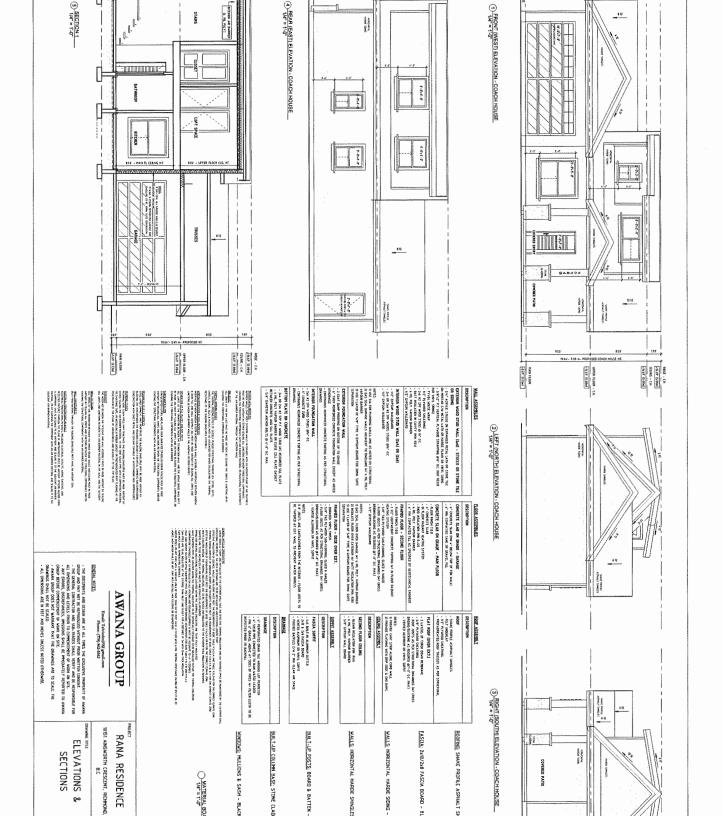

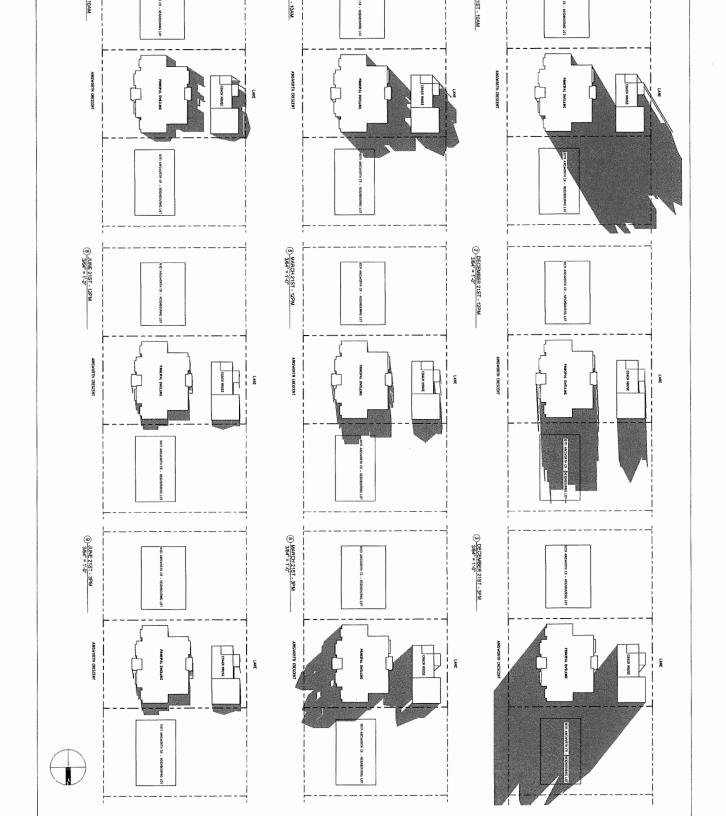


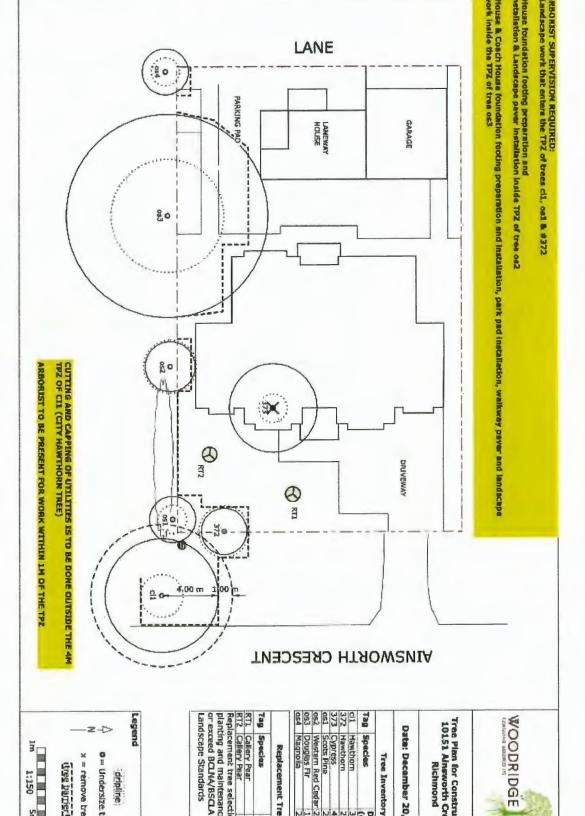

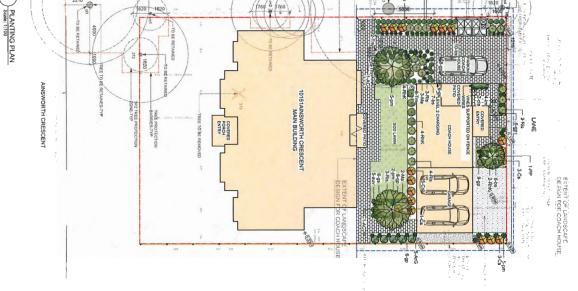

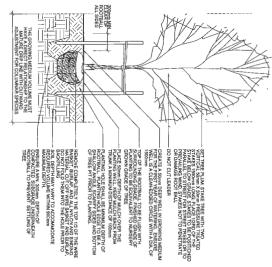

TREE PLANTING DETAIL Scale: N/A

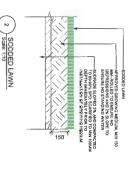


| 5 | |
|------------|---|
| z | |
| \exists | |
| _ | |
| S | 1 |
| ≃ i | |
| . : | |
| = | l |
| 2 | 1 |
| in | |
| Ë | |
| | |
| 2 | |
| Z | |
| SNI | |
| ٤ | |
| ≤ | |
| O | |
| ᄍ | |
| - | |

| PLANT LIST 10151 AINSWORTH CR., RMD | NSWORTH CF | L, R | S | | |
|--|--|--------|---------|-------------|----------|
| Botanical Name | Common Name | No. | Size | Spacing Sym | Syr |
| 33341 | | | T | | П |
| | | 1 | 1 | | T |
| Acer circinatum | Vine maple | 2 | 7 cm | as shown | AC |
| Parrotla persica 'Spire' | Parrotia | 1 | 7 cm | | dd |
| | | | | | |
| SBURHS | | | | | |
| | | | | | П |
| Azalea 'Girard Fuchsia' | Azalea | 5 | #2 pot | as shown | AZG |
| Cornus stolonifera | Redtwig dogwood | 16 | #2 pot | as shown | Ç. |
| Mahonia aquiufolium | Oregon grape | 60 | #2 pot | as shown | Ma |
| Rhododendron 'Kalinka' | Rhadadendran | 10 | #2 pot | as shown | 줐 |
| Ribes sangulnium | Red flowering current | 15 | #2 pot | as shown | RLs |
| 17 | Yew | 34 | 1.2 🖽 | as shown | 'n |
| | | | | | |
| VINES, GROUND COVERS AND HERBACEOUS PERENNIALS | PERENNIALS | | | | |
| | | | | | |
| Arctostaphylos uva-ursi | Klnnickinnick | 5 | #1 pot | as shown | 85 |
| Blechnum spicant | Deer fern | 27 | MI pot | as shown | 2 |
| Clematis armandii | Evergreen clematis | 2 | #1 pot | as shown | C!a |
| Gaultheria procumbens | Wintergreen | 43 | HI pot | as shown | gp d3 |
| Gaultheria shallon | Safal | 12 | #1 pot | as shown | ā |
| Uriope muscari "Big Biue" | Ully turf | 4 | #1 pat | as shown | ã |
| Polystichum munitum | Western sword fern | 122 | #1 pot | as shown | mg |
| | | | | | |
| Contractor to be certified by BCLNA | | | | | |
| All plants and installation to meet or exceed latest Canadian Landscape standard (CLS) #1 standards | l latest Canadian Landscape st | prepue | CLS) #1 | standards | |
| Contraction to Actual Missing Singularity of Practice and Actual Actual Contraction of Practice Contraction Contra | COLD THE INCH OL JOING SALE IN 10 10 1 | | | | |

 $\binom{N}{N}$

SCALE IS PROVIDED FOR CONVENIENCE DO NOT SCALE DRAWINGS FOR DIMENSIONS

GENERAL PLANTING N
GENVIRG MEDIUM: In according to the control of the control of

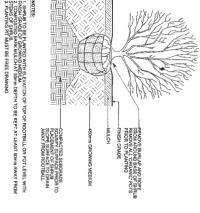

SHRUB PLANTING DETAIL

IRRIGATION: Supply and installation required for a complete automatic, inground inrigation system to provide supplemental water efficiently and uniformly. All components to be new and includes all pipes, stewers, valves, in-ground irrigation boxes, so privide reads; solarlow to controller and an answer and includes all pipes, stewers, valves, in-ground irrigation boxes, so privide reads; solarlow to controller and anii sensor. Hease bits and quick couplers to be on their separate zone, Controller on base 2 controllers and wrining secured in a lockable, weather proof relate but irrigation components to be Rainbird, Toro or Hunter, Irrigation design and inetallation per Condellar Landscape Standards, latest design are to be provided by controllers and to be approved by the landscape and relation providing a water service in the and connecting irrigation systems in water service in complete with handlow preventor, pressure reducing valve and solution valves. Contractor to delate irrigation complete, sprifted in seads and commission system in addition to providing as-built drawings and one year warrantly.



Report to Development Permit Panel

To: Development Permit Panel **Date:** May 24, 2023

From: Wayne Craig File: DP 21-935984

Director, Development

Re: Application by Gordon Chan for a Development Permit at 12551 No. 1 Road

Staff Recommendation

That a Development Permit be issued which would:

- 1. Permit the replacement of all the existing single-glazed windows with new double-glazed windows, the replacement of two doors on the front (north) elevation and the removal of the overhead garage door on the rear (south) elevation at 12551 No. 1 Road; and
- 2. Vary the provision of Richmond Zoning Bylaw 8500 to reduce the minimum front yard setback to the garbage and recycling enclosure from 3.0 m to 0 m.

Wayne Craig

Director, Development (604-247-4625)

WC:mp Att. 3

Staff Report

Origin

Gordon Chan has applied to the City of Richmond on behalf of Public Services and Procurement Canada for permission to replace all the existing 18 single-glazed windows with double-glazed windows of the existing office building for Fisheries and Oceans Canada at 12551 No. 1 Road. The applicant also proposes to replace two doors on the front (north) elevation and remove the existing overhead garage door on the rear (south) elevation.

The subject property is split-zoned: most of the site is zoned "Light Industrial (IL)", and the small triangular portion along Bayview Street is zoned "Steveston Commercial (CS2)". A location map is included in Attachment 1.

The subject property is located within the Steveston Village Heritage Conservation Area (SVHCA); it is not one of the identified heritage resources (i.e., protected heritage properties).

Both a Heritage Alteration Permit and Development Permit applications were submitted for the proposed exterior changes. However, with recent changes to the Heritage Procedures Bylaw approved by Council on May 15, 2023, only a Development Permit is required for exterior changes to non-heritage properties in the SVHCA. Therefore, the associated Heritage Alteration Permit application is no longer required and the Development Permit application will be used to consider the proposed changes.

Development Information

Please refer to attached Development Application Data Sheet (Attachment 2) for a comparison of the proposed development data with the relevant Bylaw requirements.

Background

Development surrounding the subject site is as follows:

To the north: Across Bayview Street is a vacant property at 12451 No. 1 Road on a site zoned

"Steveston Commercial (CS2)". The property is currently landscaped with trees and lawn. The property contains an identified heritage resource, the curved roadway pattern as a trace in the landscape of the original Canadian Pacific Railway track that extended along the waterfront to the Gulf of Georgia

Cannery.

To the east: Immediately to the east is the south end of No. 1 Road with a pier and boat dock

and the No. 1 Road South Discharge station, which is an identified heritage

resource.

To the south: South Arm Fraser River.

To the west: A one-storey, multi-tenant commercial building at 3900 Bayview Street on a site

zoned "Steveston Commercial (CS2)".

Staff Comments

The proposed scheme attached to this report has satisfactorily addressed the urban design issues and other staff comments identified as part of the review of the subject Development Permit application. In addition, it is generally in compliance with the "IL" zone, with the exception of the zoning variance noted below.

Zoning Compliance/Variance

The applicant requests to vary the provision of Richmond Zoning Bylaw 8500 to reduce the minimum front yard setback of 3.0 m from the IL zone boundary to 0 m to accommodate an enclosure to better screen the existing garbage and recycling containers adjacent to the public sidewalk. The enclosure must comply with the setbacks in the zone.

- In accordance with section 3.2.4 of Richmond Zoning Bylaw 8500, where a lot is located in more than one zone, siting regulations shall apply as if the zone boundary were a lot line. There is no minimum front yard, side yard or rear yard setback requirement in the "Steveston Commercial (CS2)" zone, but the "Light Industrial (IL)" zone requires a minimum of 3.0 m front yard setback.
- The applicant has noted that the rear yard of the subject site is currently used for a compound by various federal agencies with a security gate to restrict access, so the garbage and recycling containers cannot be located in the rear yard. The proposed location at the northwest corner of the property has been selected to minimize interference with pedestrian traffic and other vehicular access and to ensure compliance with the B.C. Building Code and Richmond Fire Bylaw (e.g. spatial separation requirement).
- Staff are supportive of this variance request as it allows the enclosure to be constructed to screen the garbage and recycling containers from public view and enhance the overall streetscape along Bayview Street.
- The front property line is located to the north of the IL zone boundary and is parallel to Bayview Street, so the front yard setback measured from the front property line is greater (2.0 m to the north east corner of the proposed enclosure).
- The design of the enclosure has been reviewed as part of the DP application process and will be discussed in detail in the "Analysis" section of this report.
- There are no changes to parking and access to the site as a result of this variance.

Richmond Heritage Commission Comments

The applications were reviewed by the Richmond Heritage Commission (RHC) on April 6, 2022 and the RHC adopted the following resolution:

That the Richmond Heritage Commission support the DP and HAP applications (DP 21-985984 & HA21-985982) for 12551 No. 1 Road subject to a future review of the encroachment issue to ensure the streetscape and urban design is compatible with the Steveston Village Heritage Conservation Area.

The RHC had no concerns regarding the proposal to replace the windows and remove the overhead garage door but expressed concerns regarding the overall streetscape and urban design of the site. The applicant considered the RHC's comments and revised the plans to provide an enclosure to fully house garbage and recycling bins to enhance the overall appearance of the site. The parking stalls along Bayview Street and No. 1 Road encroach onto City property. The representative of the property owner provided a letter noting that Public Services and Procurement Canada is committed to investigating the encroachment issues further and continuing the discussion with the City. The encroachment issue will be dealt with separately from the Development Permit application.

A copy of the relevant excerpt from the RHC minutes from April 6, 2022 is attached for reference (Attachment 3).

Analysis

Architectural Form and Character

- The existing office building is a one-storey structure with a flat roof. The building was constructed in the 1970s and is not one of the identified heritage resources within the Steveston Village Heritage Conservation Area.
- The existing windows are single-glazed aluminum framed windows and the frame colour is white. The proposed windows are double-glazed aluminum windows and the frame colour will be white to match the existing colour.
- The applicant also proposes to replace the two existing single-pane glass doors on the front (south) elevation with double-pane glass doors. The new door frames will match the existing colour brown.
- There are two overhead doors for the attached garage in the rear yard. Only the overhead door on the west elevation is currently in use. The overhead door on the south elevation is not being used and is proposed to be removed. The area will be infilled and cladded with vinyl siding to match the existing appearance. The proposed changes on the rear elevation will not be visible from Bayview Street.
- The proposed changes are minor in nature and would not alter the existing character of the building.

Landscaping and Open Space Design

- The building is set back 7.6 m from Bayview Street and is also screened by the existing parking and vehicle circulation area at front.
- The garbage and recycling containers are currently stored in the front yard. The applicant proposes a new enclosure to fully house the garage and recycling containers. Staff supports the proposed location considering the existing site layout, operational requirements of the federal agencies and space availability.
- The proposed enclosure is large enough to store all the required containers. The proposed material is metal siding, and the proposed colour is "Harris Grey" (from Vancouver Heritage Foundation's Historical True Colours paint palette), which is similar to the existing colour of the main building. The proposed material and colour are consistent with the Steveston Village Riverfront Sub-area Guidelines. The height of the proposed enclosure is 1.6 m.

• No other changes are proposed to the existing landscaping and open space design.

Conclusion

The applicant proposes to replace all the existing windows and two doors on the front (south) elevation, and remove the overhead garage door on the rear elevation of the existing office building for Fisheries and Oceans Canada at 12551 No. 1 Road. The applicant also proposes a new enclosure to fully house the garbage and recycling containers.

The proposed changes are minor in nature and would not alter the existing character of the building, and the proposed garbage and recycling enclosure would enhance the overall appearance of the site.

Staff recommend that the Development Permit be endorsed, and issuance of the Development Permit for 12551 No. 1 Road by Council be recommended.

Minhee Park Planner 2

(604-276-4188)

MP:cas


Att. 1: Location Map

Minher Rul

2: Development Application Data Sheet

3: Excerpt from the Richmond Heritage Commission April 6, 2022 Meeting Minutes



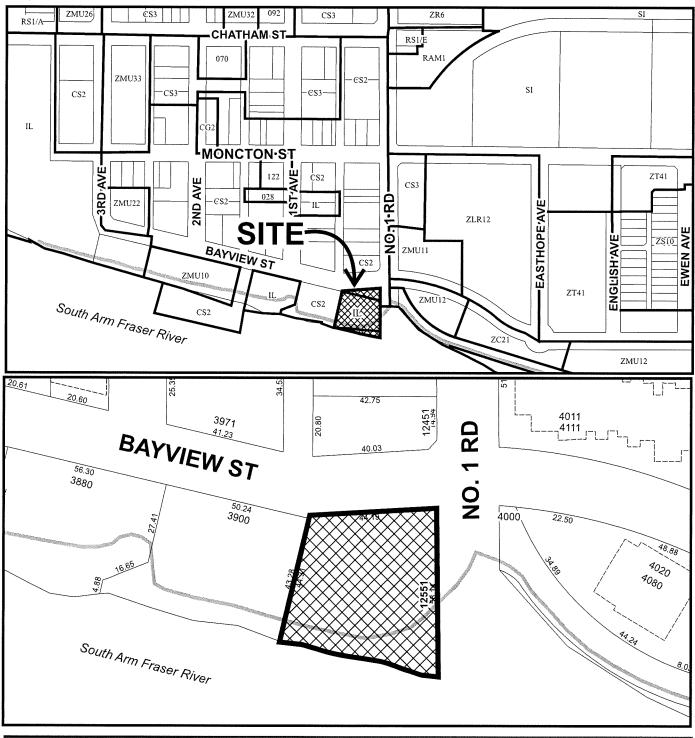



DP 21-935984

Original Date: 08/04/21

Revision Date:

Note: Dimensions are in METRES



Development Application Data Sheet

Development Applications Department

| DP 19-858887 | | | Attachment 2 |
|-----------------------------|--------|---------------|--------------|
| Address: 12551 No. 1 Road | | | |
| Applicant: Gordon Chan | Owner: | Crown Federal | |
| Planning Area(s): Steveston | | | |

| | Existing | Proposed | |
|------------------|--|-----------|--|
| Site Area: | 2,503 m ² | No Change | |
| Land Uses: | Office | No Change | |
| OCP Designation: | Heritage Mixed Use (Commercial Industrial with Residential and Office Above) | No Change | |
| Zoning: | Steveston Commercial (CS2) Light Industrial (IL) | No Change | |

| | Bylaw Requirement | Proposed | Variance |
|---------------------------|-------------------|---|------------------------------|
| Lot Coverage: | Max. 60 % | 20.35 % (no change) | None |
| Setback – Front Yard: | Min. 3 m | 7.6 m (to the main building, no change) 0 m (to garbage and recycling enclosure) | 0 m Variance requested |
| Setback – West Side Yard: | Min. 0 m | 10.4 m (no change) | None |
| Setback – East Side Yard: | Min. 0 m | 5.6 m (no change) | None |
| Setback – Rear Yard: | Min. 0 m | 16.3 m (no change) | None |

Excerpt from the Draft Minutes Richmond Heritage Commission Meeting

Wednesday, April 6, 2022 – 7:00 p.m. Webex Meeting

3.b) Development Permit and Heritage Alteration Permit Applications for 12551 No. 1 Road (HA21-935982 & DP21-935984)

Staff provided an overview of the Development Permit and Heritage Alteration Permit applications for 12551 No. 1 Road.

- The subject property is located in the Steveston Village Heritage Conservation Area. It is a federally-owned site which supports a number of federal agencies, such as Fisheries and Oceans Canada and Steveston Harbour Authority.
- The proposed work is to replace all the existing single-glazed windows with double glazed windows and remove the overhead garage door on the south elevation, which is not visible from the street.
- The new window frames will match the existing colours so there will be minimal changes to the look of the building.
- The existing parking area encroaches onto the City sidewalk and it will be dealt with separately through a separate Heritage Alteration Permit application which will be bought forward to the Heritage Commission for review at a later date.

In response to the Commission's questions, staff provided the following additional information:

- Staff have requested a letter from Public Services Procurement Canada confirming a separate Heritage Alteration Permit application will be submitted to address the encroachment issue.
- If the encroachment issue needs to be addressed as part of the current DP and HAP applications, there are funding implications as the approved funding for the window replacement and removal of the overhead garage door might not be available if it is not spent this year.

A comment was made that no sufficient information was provided regarding the materials and window design to complete a review of the proposal.

Commission acknowledged the funding implications and noted that it had no issue with the current proposal and support dealing with the encroachment issue at a later date as part of a separate Heritage Alteration Permit application, but would like to ensure that the encroachment issue is addressed to improve the overall streetscape and design of the site.

It was moved and seconded:

That the Richmond Heritage Commission support the DP and HAP applications (DP21-985984 & HA21-985982) for 12551 No. 1 Road subject to a future review of the encroachment issue to ensure the streetscape and urban design is compatible with the Steveston Village Heritage Conservation Area.

CARRIED

Opposed: Commissioner Kurnicki



Development Permit

No. DP 21-935984

To the Holder: Gordon Chan

Property Address: 12551 No. 1 Road

Address: Suite 200 - 3999 Henning Drive,

Burnaby, BC V5C 6P9


- 1. This Development Permit is issued subject to compliance with all of the Bylaws of the City applicable thereto.
- 2. This Development Permit applies to and only to those lands shown cross-hatched on the attached Schedule "A" and any and all buildings, structures and other development thereon.
- 3. The Richmond Zoning Bylaw 8500 is hereby varied to:
 - a) reduce the minimum front yard setback from the "Light Industrial (IL)" zone boundary from 3.0 m to 0 m.
- 4. Subject to Section 692 of the Local Government Act, R.S.B.C.: buildings and structures; off-street parking and loading facilities; roads and parking areas; and landscaping and screening shall be constructed generally in accordance with Plans #1 to #8 attached hereto.
- 5. If the Holder does not commence the construction permitted by this Permit within 24 months of the date of this Permit, this Permit shall lapse.
- 6. The land described herein shall be developed generally in accordance with the terms and conditions and provisions of this Permit and any plans and specifications attached to this Permit which shall form a part hereof.
- 7. This Permit is not a Building Permit.

| AUTHORIZING RESOLUTION NO. | <resolution no.=""></resolution> | · ISSUED B | BY THE | COUNCIL | THE |
|----------------------------|----------------------------------|------------|--------|---------|-----|
| DAY OF <date></date> | | | | | |

DELIVERED THIS <Day> DAY OF <Month>, <Year>

| MAYOR | | | |
|-------|--|--|--|



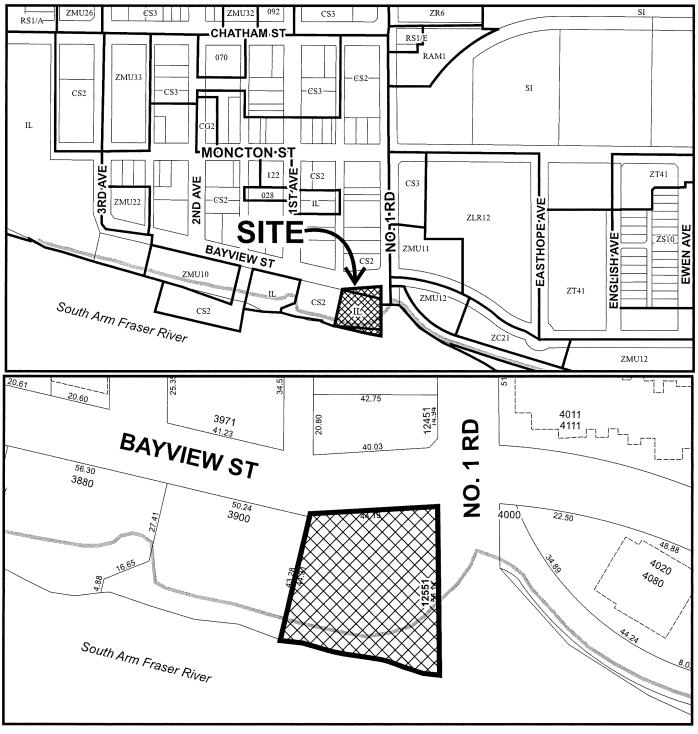





DP 21-935984 SCHEDULE "A"


Original Date: 08/04/21


Revision Date:


Note: Dimensions are in METRES

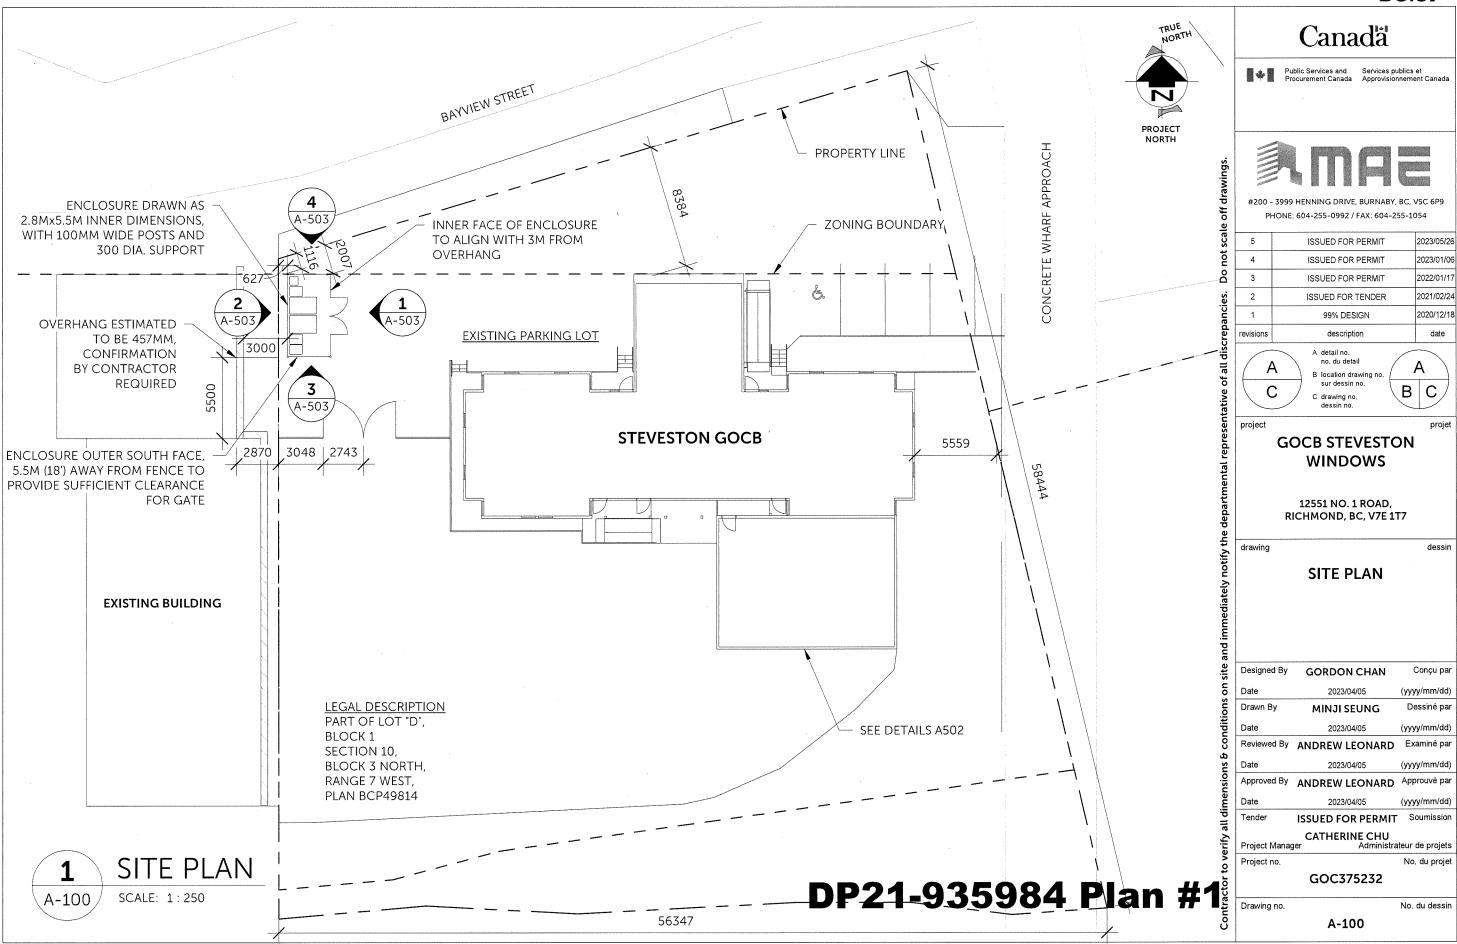


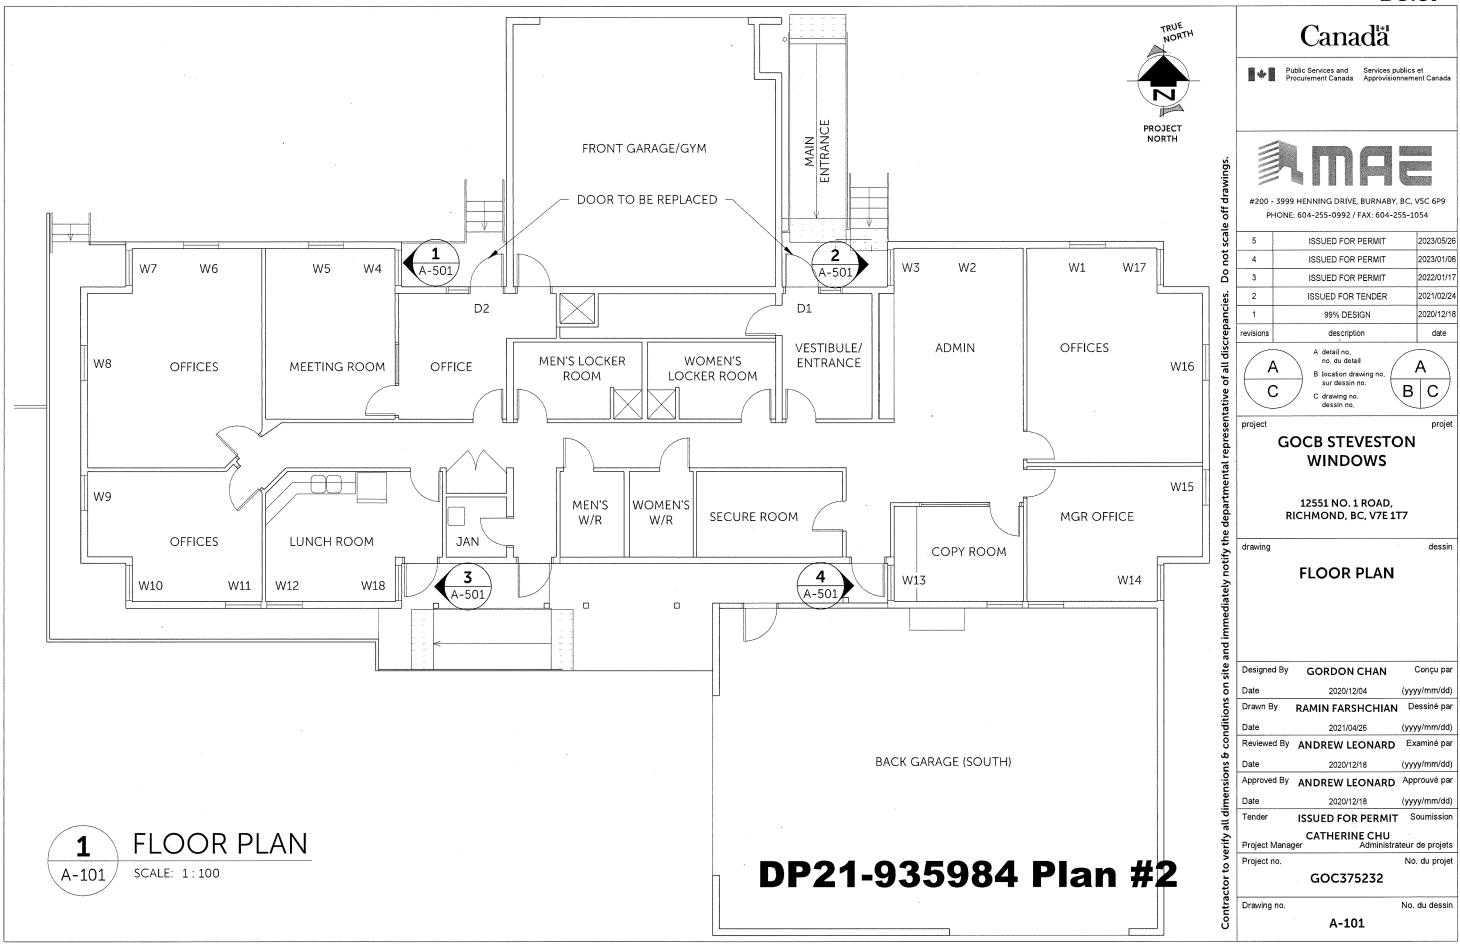


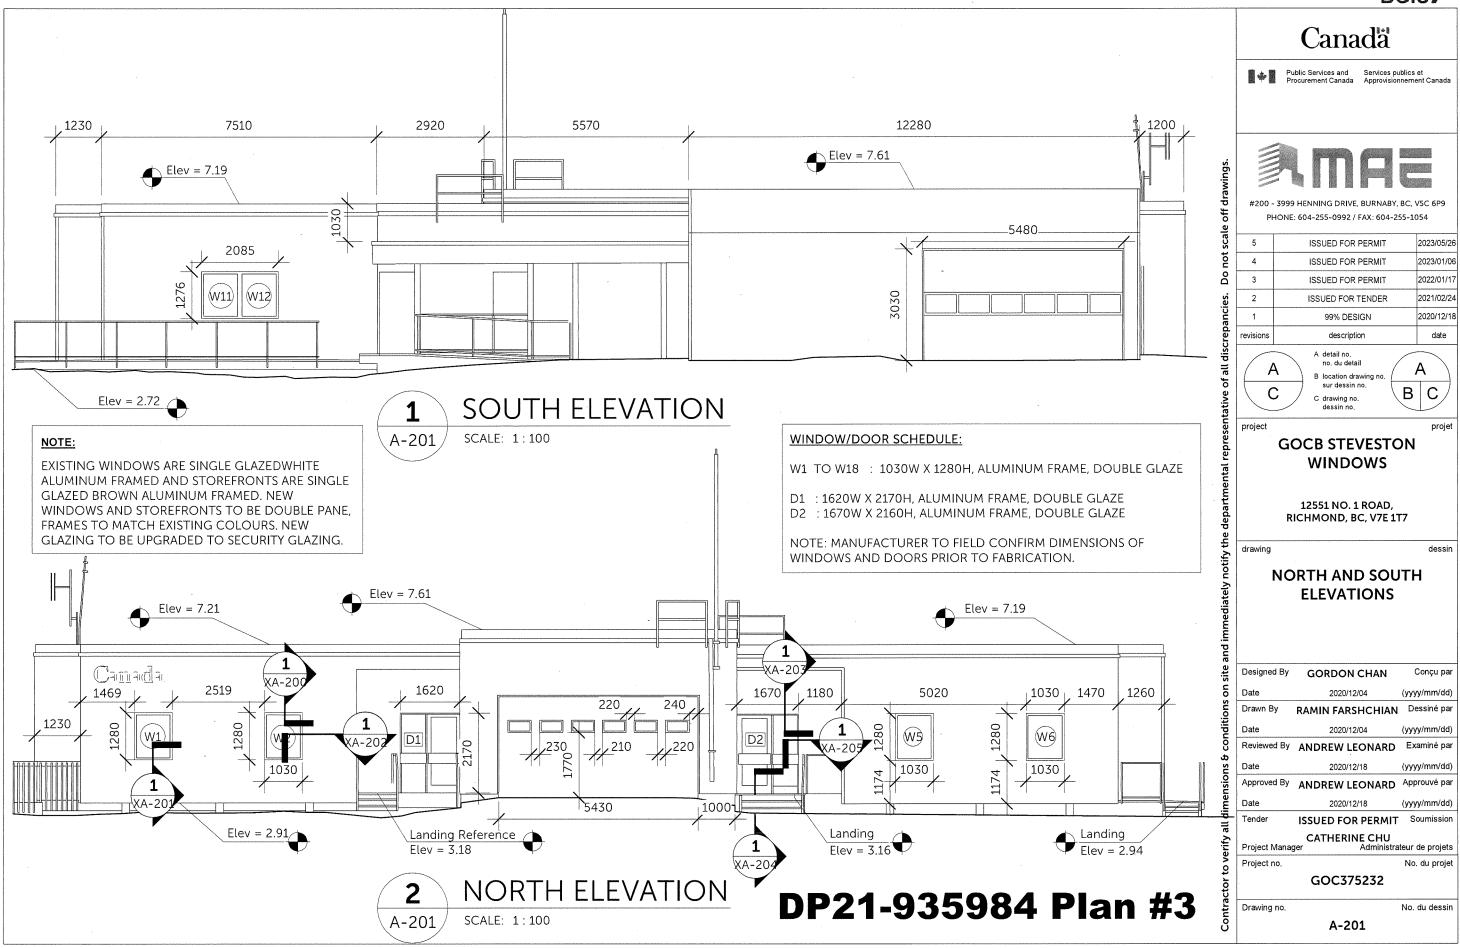

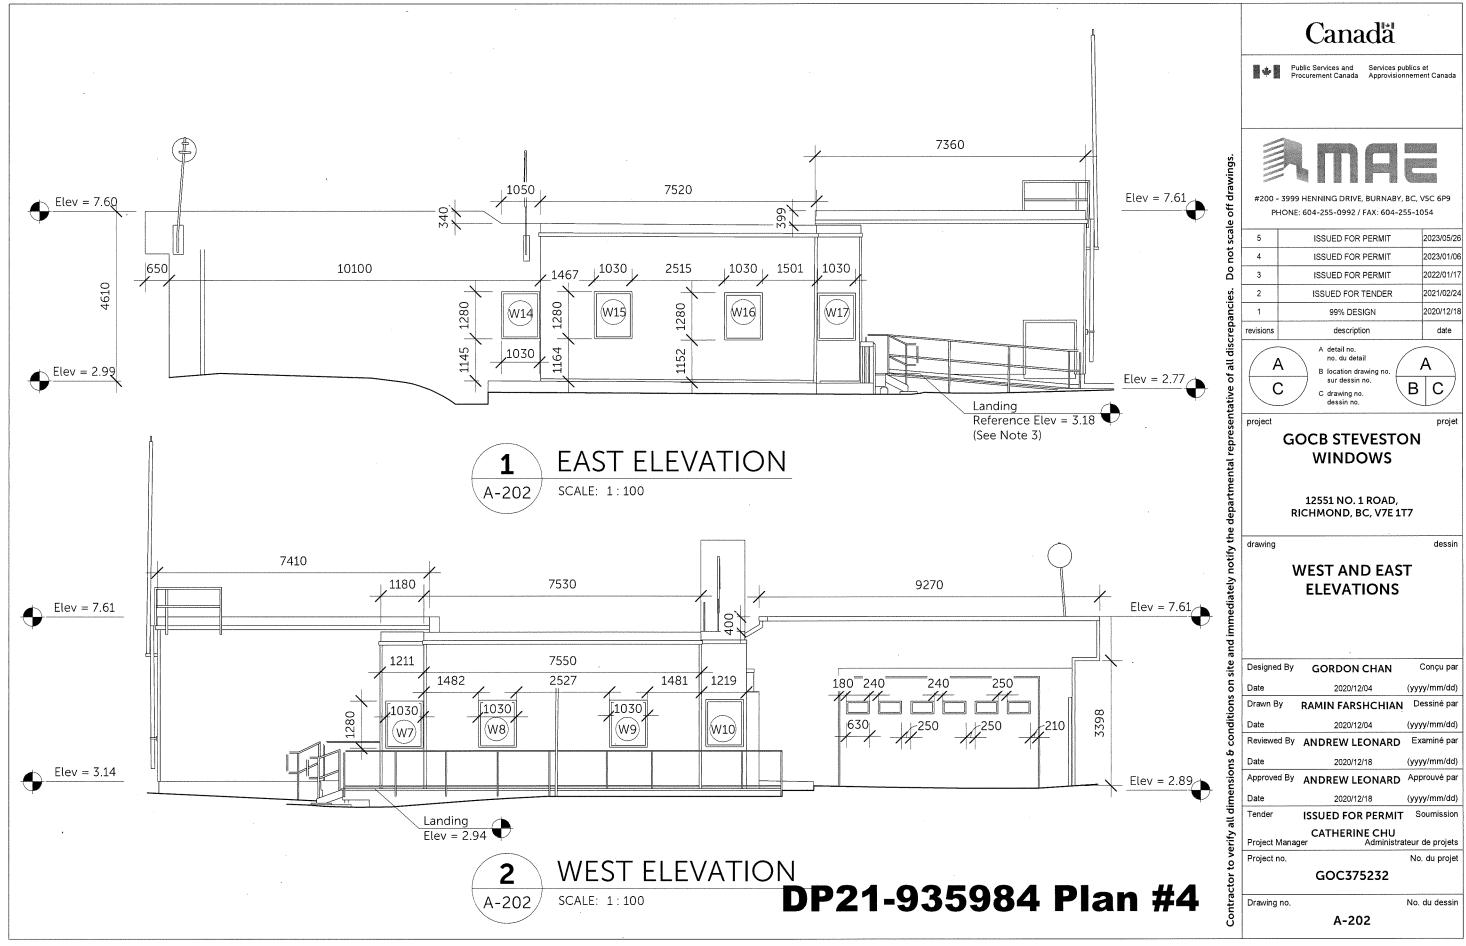

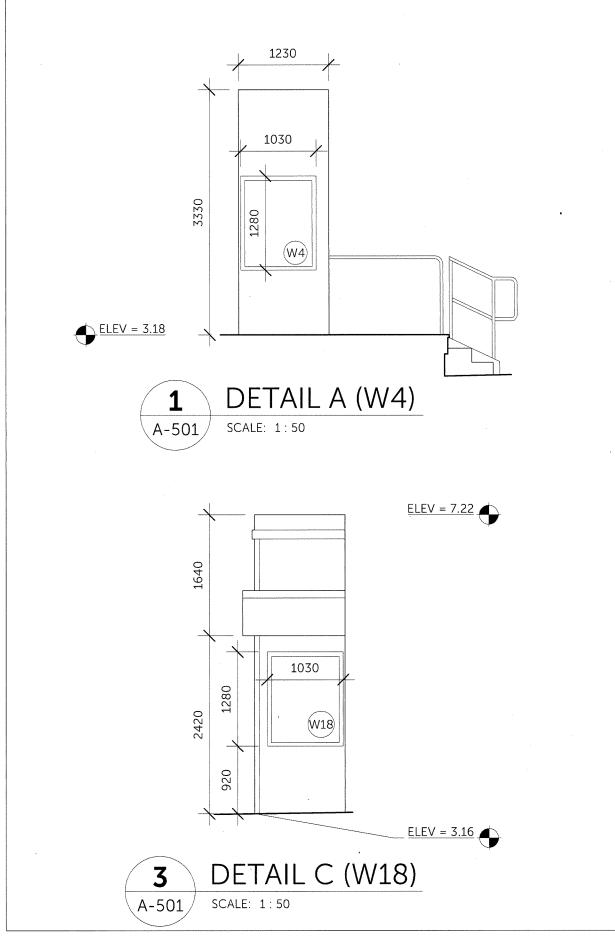

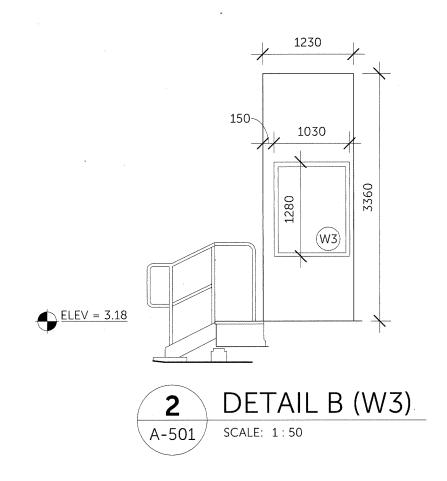

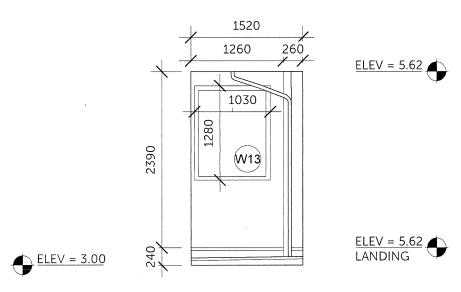

4 DETAIL E (W13)

A-501 SCALE: 1:50

DP21-935984 #5

Canada

•

Public Services and Procurement Canada

Services publics et Approvisionnement Cana



#200 - 3999 HENNING DRIVE, BURNABY, BC, V5C 6P: PHONE: 604-255-0992 / FAX: 604-255-1054

| | revisions | description | date |
|---|-----------|-------------------|------------|
| | 1 | 99% DESIGN | 2020/12/18 |
| | 2 | ISSUED FOR TENDER | 2021/02/24 |
| 3 | 3 | ISSUED FOR PERMIT | 2022/01/17 |
| | 4 | ISSUED FOR PERMIT | 2023/01/06 |
| | 5 | ISSUED FOR PERMIT | 2023/05/26 |
| | | | |

A

A detail no.
no. du detail

B location drawing no.
sur dessin no.



project

GOCB STEVESTON WINDOWS

12551 NO. 1 ROAD, RICHMOND, BC, V7E 1T7

drawing

dess

Conçu par

WINDOW DETAIL

Designed By GORDON CHAN

te 2020/12/04 (yyyy/mm/dd) awn By RAMIN FARSHCHIAN Dessiné par

Date 2020/12/04 (yyyy/mm/d

Reviewed By ANDREW LEONARD Examiné par

Date 2020/12/18 (yyyy/mm/dd)
Approved By ANDREW LEONARD Approuvé par

Date 2020/12/18 (yyyy/mm/dd)

Tender ISSUED FOR PERMIT Soumission


Project Manager CATHERINE CHU
Administrateur de projets


ect no. No. du projet

GOC375232

Drawing no. No. du dessin

A-501

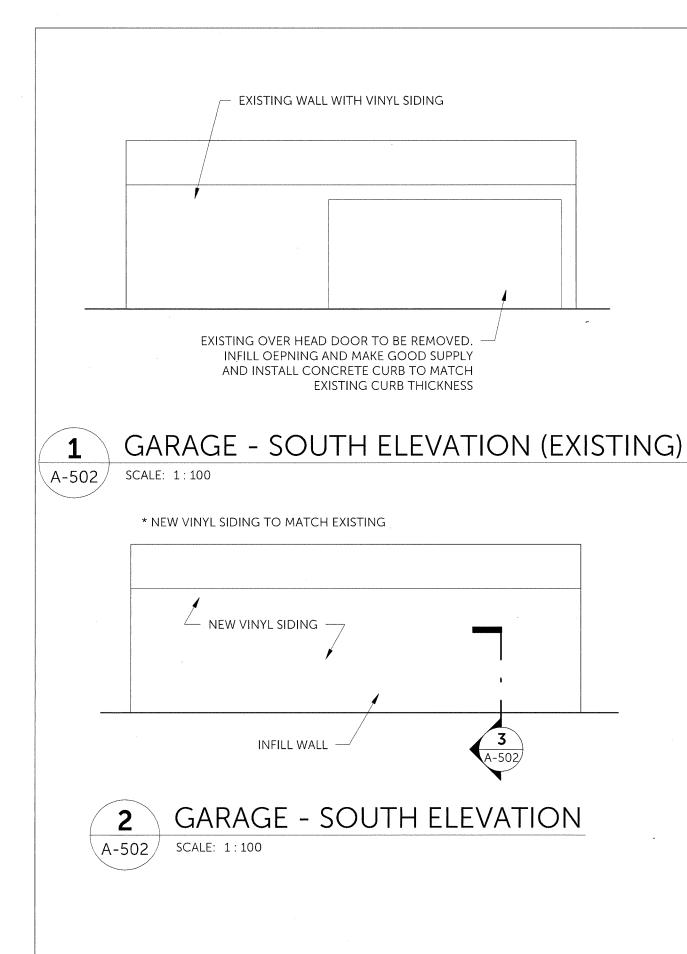

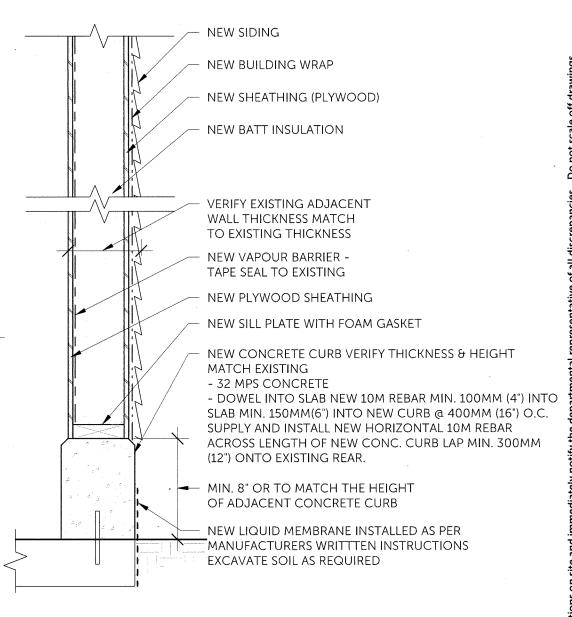

INFILL WALL SECTION 3 A-502 SCALE: 1:10

DP21-935984 Plan #6

Canada

Public Services and Services publics et Procurement Canada Approvisionnement



PHONE: 604-255-0992 / FAX: 604-255-1054

| , | 5 | ISSUED FOR PERMIT | 2023/05/26 |
|------|-----------|-------------------|------------|
| | 4 | ISSUED FOR PERMIT | 2023/01/06 |
| 1 | 3 | ISSUED FOR PERMIT | 2022/01/17 |
| 2000 | 2 | ISSUED FOR TENDER | 2021/02/24 |
| | 1 | 99% DESIGN | 2020/12/18 |
| | revisions | description | date |

B location drawing no



GOCB STEVESTON WINDOWS

12551 NO. 1 ROAD, RICHMOND, BC, V7E 1T7

GARAGE DETAIL AND ELEVATION

| ā | | | |
|------------|-------------|----------------|--------------|
| site | Designed By | GORDON CHAN | Conçu par |
| 5 | Date | 2023/05/26 | (yyyy/mm/dd) |
| ous | Drawn By | MINJI SEUNG | Dessiné par |
| conditions | Date | 2023/05/26 | (yyyy/mm/dd) |
| - | Reviewed By | ANDREW LEONARD | Examiné par |
| ns d | Date | 2023/05/26 | (yyyy/mm/dd) |
| nensions | Approved By | ANDREW LEONARD | Approuvé par |
| ner | Date | 2023/05/26 | (vvvv/mm/dd) |

ISSUED FOR PERMIT Soumission **CATHERINE CHU**


Project Manager Administrateur de projets No. du projet

GOC375232

No. du dessin


A-502

NOTE: NEW ENCLOSURE COLOUR TO BE HARRIS GREY FROM VANCOUVER HERITAGE FOUNDATION HISTORICAL TRUE COLOURS PAINT PALETTE.

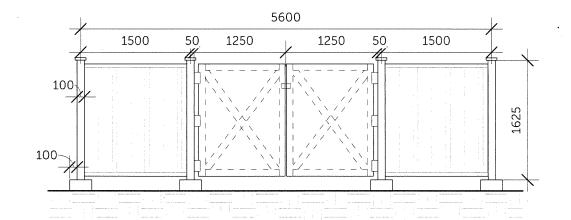


EAST ELEVATION SCALE: 1:50


A-503

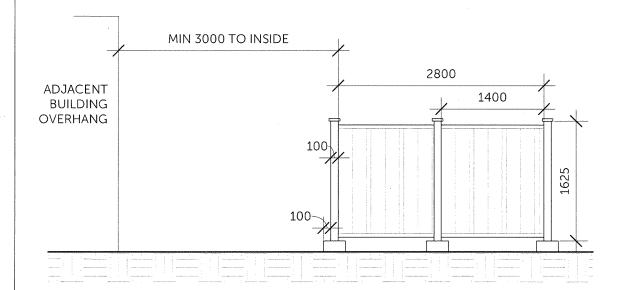

SOUTH ELEVATION A-503 SCALE: 1:50

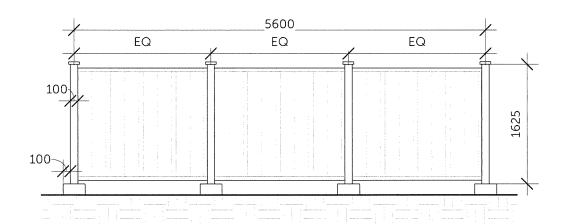

WEST ELEVATION SCALE: 1:50 A-503

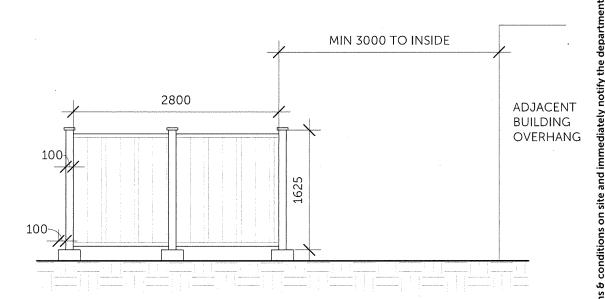

NORTH ELEVATION A-503 SCALE: 1:50

DP21-935984 Plan #7

Canada



#200 - 3999 HENNING DRIVE BURNARY, BC. V5C 6P9 PHONE: 604-255-0992 / FAX: 604-255-1054

| | 5 | ISSUED FOR PERMIT | 2023/05/26 |
|-----------|-----------|-------------------|------------|
| | 4 | ISSUED FOR PERMIT | 2023/01/06 |
| 3 | 3 | ISSUED FOR PERMIT | 2022/01/17 |
| chairers. | 2 | ISSUED FOR TENDER | 2021/02/24 |
| | 1 | 99% DESIGN | 2020/12/18 |
| | revisions | description | date |
| | | | |

B location drawing no



GOCB STEVESTON WINDOWS

12551 NO. 1 ROAD, RICHMOND, BC, V7E 1T7

dessin

No. du projet

No. du dessin

NEW GARBAGE ENCLOSURE ELEVATIONS


| ٠. | | | |
|----|-------------|-------------------|--------------|
| | Designed By | GORDON CHAN | Conçu par |
| | Date | 2023/05/26 | (yyyy/mm/dd) |
| | Drawn By | MINJI SEUNG | Dessiné par |
| | Date | 2023/05/26 | (yyyy/mm/dd) |
| | Reviewed By | ANDREW LEONARD | Examiné par |
| | Date | 2023/05/26 | (yyyy/mm/dd) |
| | Approved By | ANDREW LEONARD | Approuvé par |
| | Date | 2023/05/26 | (yyyy/mm/dd) |
| | Tender | ISSUED FOR PERMIT | Soumission |
| | | | |

CATHERINE CHU Administrateur de projets Project Manager

Drawing no.

GOC375232

A-503

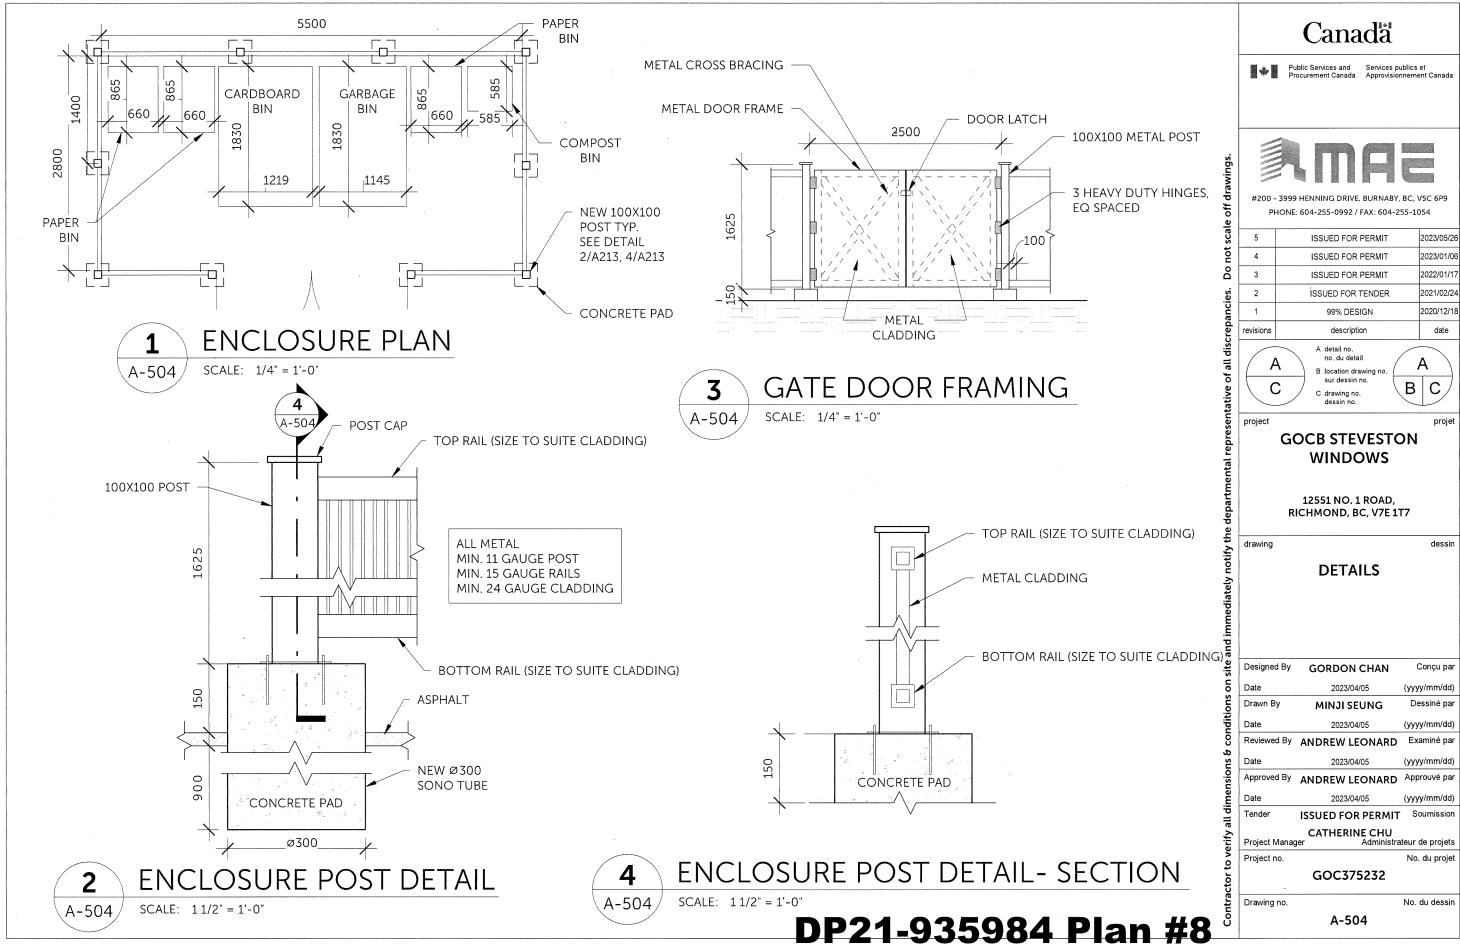



Report to Development Permit Panel

To:

Development Permit Panel

Date:

May 24, 2023

From:

Wayne Craig

File:

DP 21-936149

Director of Development

Re:

Application by Gradual Architecture Inc. for a Development Permit at 6520

Williams Road

Staff Recommendation

That a Development Permit be issued which would:

- 1. Permit the construction of eight townhouse units at 6520 Williams Road on a site zoned "Low Density Townhouses (RTL4)"; and
- 2. Vary the provision of Richmond Zoning Bylaw 8500 to reduce the minimum required lot width from 40.0 m to 36.6 m.

Wayne Craig

Director of Development

WC:mp Att. 2

Staff Report

Origin

Gradual Architecture Inc. has applied to the City of Richmond on behalf of Londonpark Holdings Ltd. (Director Long Fei Liu) for permission to develop eight (8) townhouse dwellings at 6520 Williams Road on a site zoned "Low Density Townhouses (RTL4)". The site currently contains a single detached dwelling which does not contain a secondary suite. The existing dwelling would be demolished. A location map is provided in Attachment 1.

The site is being rezoned from the "Single Detached (RS1/E)" zone to the "Low Density Townhouses (RTL4)" zone for this project under Bylaw 10224 (RZ 17-792242).

A Servicing Agreement is required as a condition of building permit issuance and includes, but is not limited to, the following improvements:

- 0.1 m road dedication along the entire Williams Road frontage; and
- Removal of the existing sidewalk and replacement with new 1.5 m concrete sidewalk at the property line, $1.5\ m$ landscaped boulevard with street trees and street lighting, and $0.15\ m$ curb and gutter.

Development Information

Please refer to attached Development Application Data Sheet (Attachment 2) for a comparison of the proposed development data with the relevant Bylaw requirements.

Background

To the north:

Development surrounding the subject site is as follows:

Across Williams Rd, a single detached dwelling on a property zoned "Single Detached (RS1/C)" with vehicle access from

Sheridan Road.

To the south and west: Steveston London Secondary School and Park on properties zoned

"School and Institutional Use (SI)".

To the east: A single detached dwelling on a property zoned "Single Detached

(RS1/E)" with vehicle access from Williams Road. This property

is part of a separate rezoning application including both the properties at 6560 and 6580 Williams Road (RZ 21-945388), which is currently under staff review. The proposed rezoning would permit development of townhouses with shared vehicle

access from the subject site.

Rezoning and Public Hearing Results

During the rezoning process, staff identified the following design issues to be resolved at the Development Permit stage:

Compliance with Development Permit Guidelines for the form and character of multiple-family projects provided in the Official Community Plan (OCP).

- Articulation of the west elevations adjacent to the park space to enhance the buildings' appearance and maximize sunlight and views.
- Review of the size and species of on-site trees to ensure bylaw compliance and to achieve an acceptable mix of coniferous and deciduous species on-site.
- Review of the proposed driveway design and requirement for a vehicle turn-around area, and possibility of retaining Tree #7 if the adjacent site to the east proceeds for redevelopment.
- Refinement of the shared outdoor amenity area design, including the choice of play equipment, to create a safe and vibrant environment for children's play and social interaction.
- Review the long-term design of the temporary turn-around area, such as future conversion to additional outdoor amenity space.
- Review of relevant accessibility features for the one proposed convertible unit and aging-in-place design features in all units.
- Review of a sustainability strategy for the development proposal.

The Public Hearing for the rezoning of this site was held on February 16, 2021. No public correspondence was received at the Public Hearing.

Staff worked with the applicant to address the above design issues in the following ways:

- Detailed architectural and landscape plans have been provided to demonstrate that the proposed development is generally consistent with the Development Permit guidelines for multi-family projects and Arterial Road Guidelines for Townhouses in the OCP.
- The applicant has refined the design while maintaining the general character presented to Council at the rezoning stage. The west elevations of the buildings have been modified by providing additional glazing and architectural details to add visual interest and take advantage of the natural sunlight and views to better orient end units to the adjacent park.
- Detailed landscape plans have been submitted to provide for a mix of coniferous and deciduous replacement trees, which meet the bylaw size requirements.
- The proposed driveway design has been reviewed and approved by the Transportation Department. The on-site vehicle turn-around area is required for the proposed development as the rezoning application for the proposed townhouse development on the adjacent sites at 6250 and 6280 Williams Road is still under staff review. Tree #7 would be removed to enable the construction of the required vehicle turn-around area.
- The design of the outdoor amenity area for this proposal includes two children's play structures and a bench to promote social interaction. A plan showing details of the conversion of the above-noted on-site turn-around area into expanded outdoor amenity, once the adjacent site access has been developed, is attached the DP.
- The proposed accessibility features include aging-in-place features in all units and one convertible unit.
- The applicant has provided a sustainability strategy and a letter from a Certified Energy Advisor indicating that the project will achieve Step 3 of the BC Energy Step Code consistent with current City regulations.

The above issues are discussed further in the "Analysis" section of this report.

Staff have not received any comments from the public in response to the placement of the DP application notification sign on the subject site.

Staff Comments

The proposed scheme attached to this report has satisfactorily addressed the significant urban design issues and other staff comments identified as part of the review of the subject Development Permit application (Plans #1 to #18). In addition, it complies with the intent of the applicable sections of the Official Community Plan and is generally in compliance with the "Low Density Townhouses (RTL4)" zone, except for the zoning variance noted below.

Zoning Compliance/Variances (staff comments in bold)

The applicant requests to vary the provision of Richmond Zoning Bylaw 8500 to reduce the minimum lot width from 40.0 m to 36.6 m.

• Staff supports the proposed variance as the proposal is generally consistent with the guiding principles of the Arterial Road Land Use Policy and guidelines, and does not result in the creation of an orphan development site. The two properties to the east meet the minimum assembly size for Arterial Road townhouses and would share the driveway access to Williams Road with the subject site. This variance was noted in the rezoning report and no concern was expressed at the rezoning stage and the Public Hearing.

Analysis

Conditions of Adjacency

- The proposed townhouses have been designed with consideration of the existing surrounding context. All of the units are three storeys with an open park space to the west and a larger setback of 7.65 m provided on the east side adjacent to the existing single family house.
- The subject site to the east is the subject of a proposed townhouse development application that is currently under staff review. The current site plan submitted for the proposed development to the east shows three-storey townhouses with wider west side yard setbacks ranging from 5.0 m to 6.5 m provided to three-storey portion of the buildings.
- The west elevations of the townhouses on the subject site have been refined by providing additional windows and architectural details to add visual interest and take advantage of the natural sunlight and views to the adjacent park.
- A statutory right-of-way allowing vehicle access to and from the adjacent future development site through the subject site has been secured at rezoning. Signage indicating that the driveway on the subject site is connected to the future adjacent townhouse development is proposed to be installed at the south end of the north-south portion of the drive aisle.

Urban Design and Site Planning

- The proposed development consists of eight (8) townhouse dwellings in two four-unit clusters arranged on either side of a central east-west drive aisle.
- Vehicular access to the proposed development is to be from Williams Road through a new driveway, with future connection to the neighbouring property to the east, secured by a statutory of right-of-way at the time of rezoning.

- The four units in the front building along Williams Road are proposed to have direct pedestrian access from the street through landscaped front yards. The four units at the rear of the property have pedestrian access from the drive aisle.
- All of the units are three-storeys, with living space primarily located on the second and third storeys, and have private outdoor space at grade in the form of a landscaped front or rear yard. For the four units fronting Williams Road, balconies facing the interior drive aisle are provided in addition to the front yards facing Williams Road. The four units facing the drive aisle include decks facing the park.
- All four end units have a rooftop deck recessed within the structure of the roof in addition to the front or rear yards.
- The common shared outdoor amenity area is proposed at the southeast corner of the site, where it can be expanded should the adjacent site to the east be redeveloped and the on-site vehicle turn-around area be no longer required. The amenity area on the subject site includes play structures for young children and bench seating.
- Cash-in-lieu of indoor amenity space was secured through rezoning (\$14,152) consistent with OCP policy.
- All townhouse units are proposed to have two enclosed vehicle parking spaces; four of the units have parking spaces in a side-by-side arrangement and four have parking spaces in a tandem arrangement. Level 2 EV charging is accommodated in each garage in accordance with the City requirements. Class 1 bicycle parking spaces are accommodated in the garages.
- Two visitor parking spaces are provided at the west end of the drive aisle and visitor bicycle parking is located at the entrance to the site.
- A garbage and recycling room and the mailbox kiosk are located at the site entrance.

Architectural Form and Character

- The proposed development presents a modern architectural approach with a simple colour scheme of white and grey. The apparent mass of the buildings is reduced through the use of projections, recesses, materials, colours and windows.
- Individuality of units is expressed through private landscaped yards with gates, covered entry
 porches for the street-fronting units, the use of vertical elements, and material and colour
 changes.
- The proposed main building materials include HardiPanel in white, ceramic-coated siding panels in grey for the first storey to provide a distinct bottom, cedar soffits, wood finish aluminum siding, and a metal roof.
- The proposed colour palette consists of a combination of white and grey with dark walnut color for accent walls, front doors and soffits to add warmth and visual interest.

Landscape Design and Open Space Design

- On-site tree retention and removal was assessed as part of the rezoning application, at which
 time it was determined that one tree on the subject site, one tree on the neighbouring property
 and four trees on City property are to be retained and protected. The Landscape Plan includes
 the proposed Tree Management Plan (Plan #16) showing the trees to be retained and
 removed.
- The Magnolia tree located within the proposed common outdoor amenity area will be retained and protected.

- Consistent with the 2:1 tree replacement ratio policy in the OCP, the Landscape Plan shows that eight deciduous and coniferous replacement trees are proposed to be planted. A variety of shrubs, perennials, grasses and groundcover is also proposed.
- The Landscape Plan notes that all soft landscaped areas are to be irrigated through installation of an automated system consistent with the industry standards.
- Common outdoor amenity space is located at the southeast corner of the site, and will benefit from solar exposure. The space contains children's play structures and bench seating. Bollards are proposed to separate the outdoor amenity space from the turn-around area to ensure safety.
- To define the street edge, 4' high fencing with pedestrian gates is proposed. Solid wood privacy fencing is proposed along the side property lines and the existing hedge along the south property line is proposed to be maintained.
- In future, the vehicle access on the subject site will be shared with the future development to the east. Upon completion, turning movement will be accommodated in the resulting T-shaped drive aisle, and the proposed vehicle turn-around area will no longer be required. This area could be used to expand the site's common outdoor amenity area. The applicant has provided a landscape plan to show the potential conversion of the vehicle turn-around area. The future plan consists of additional lawn area with a tree and relocation of the shrubs to the north to define the edge. The plan is attached to the Development Permit (Plan #18). Prior to issuance of the DP, a legal agreement is required to be registered on title to require conversion of the temporary turn-around area into additional outdoor amenity area in accordance with the plan attached to the DP once the adjacent site is redeveloped, and prohibit conversion of the area into additional parking spaces or any other uses.
- A landscape security in the amount of \$71,051.28 is required prior to Development Permit issuance to ensure that the agreed upon landscape works are installed.

Crime Prevention Through Environmental Design

- The applicant has identified that the proposal responds to the following principles of CPTED, as encouraged in the design guidelines contained within the OCP.
 - The edges are clearly defined by the existing hedge at the south property line and the proposed 6' fence on the east and west property lines. The proposed 4' fences at the north property line to provide unobstructed views of surrounding areas.
 - The outdoor amenity area is unobstructed by landscaping and is visible from the driveway and buildings.
 - Adequate lighting is provided to enhance security, particularly dark distant corners such as visitor parking areas.

Site Servicing and Off-site Improvements

- A Servicing Agreement is required as a condition of Building Permit issuance for the design and construction of the servicing upgrades and off-site improvements.
- The servicing requirements and off-site improvements identified during the rezoning application process include:
 - o 0.1 m road dedication along the entire Williams Road frontage.
 - o Removal of the existing sidewalk and replacement with 1.5 m concrete sidewalk at the property line, 1.5 m landscaped boulevard, and 0.15 m concrete curb and gutter.

o Removal of the existing driveway crossing and replacement with frontage works as described above.

Accessible Housing

- The proposed development includes one convertible unit that is designed with the potential to be easily renovated to accommodate a future resident in a wheelchair (Unit #8). The potential conversion of these units will require the installation of a stair lift. The list of convertible unit features and floor plans are included in Plan #13 attached to the DP.
- All of the proposed units incorporate aging in place features to accommodate mobility constraints associated with aging. These features include:
 - o stairwell hand rails;
 - o lever-type handles for plumbing fixtures and door handles; and
 - o solid blocking in washroom walls to facilitate future grab bar installation beside toilets, bathtubs and showers.

Sustainability

- The applicant has submitted written confirmation from a Certified Energy Advisor that the proposed design will meet the required BC Energy Step Code 3 requirements. The key technical elements include additional insulation in building assemblies (walls, roofs, floor, and slab), 1.20 U value or lower for windows, and air source heat pumps.
- A key component of achieving greater energy efficiency is the use of heat pumps. The heat pumps are proposed on the second-floor balconies facing the drive aisle for the units at the front of the property, and the rear patios for the units at the rear of the property. The applicant has submitted a report prepared by a qualified acoustic consultant noting that the proposed units can achieve compliance with the City's Noise Bylaw.
- Grasscrete is proposed for the temporary turn-around area to enhance permeability.
- 100% of the residential parking spaces are provided with Level 2 EV charging in the garage in accordance with Richmond Zoning Bylaw 8500.

Conclusions

As the proposed development would meet applicable policies and Development Permit Guidelines, staff recommend that the Development Permit be endorsed, and issuance by Council be recommended.

Minhee Park,

Planner 2

MP:cas

Attachment 1: Location Map

Minher Rul

Attachment 2: Development Application Data Sheet

The following are to be met prior to forwarding this application to Council for approval:

- Receipt of a Letter-of-Credit for landscaping in the amount of \$71,051.28.
- Registration of a legal agreement to require future conversion of the temporary turn-around area into additional
 outdoor amenity space in accordance with the plan attached to the Development Permit and prohibit conversion
 of the area into parking spaces once the adjacent property to the east is redeveloped and the turn-around area is
 no longer needed. This legal agreement can be combined with the legal agreement for SRW.


Prior to future Building Permit issuance, the developer is required to complete the following:

• Submission of an acoustic report and recommendations prepared by an appropriate registered professional to demonstrate that the interior noise levels and noise mitigation standards comply with the City's Official Community Plan and Noise Bylaw requirements. The report should address noise from proposed exterior mechanical systems (e.g., heat pumps). Maximum interior noise levels (decibels) within the dwelling units must achieve CMHC standards as follows:

| Portions of Dwelling Units | Noise Levels (decibels) | | |
|---|-------------------------|--|--|
| Bedrooms | 35 decibels | | |
| Living, dining, recreation rooms | 40 decibels | | |
| Kitchen, bathrooms, hallways, and utility rooms | 45 decibels | | |

- Incorporation of accessibility features in the Building Permit plans as determined via the Development Permit process.
- The applicant is required to obtain a Building Permit for any construction hoarding associated with the proposed development. If construction hoarding is required to temporarily occupy a street, or any part thereof, or occupy the air space above a street or any part thereof, additional City approvals and associated fees may be required as part of the Building Permit. For further information on the Building Permit, please contact Building Approvals Department at 604-276-4285.
- Submission of a construction traffic and parking management plan to the satisfaction of the City's Transportation Department (http://www.richmond.ca/services/ttp/special.htm).



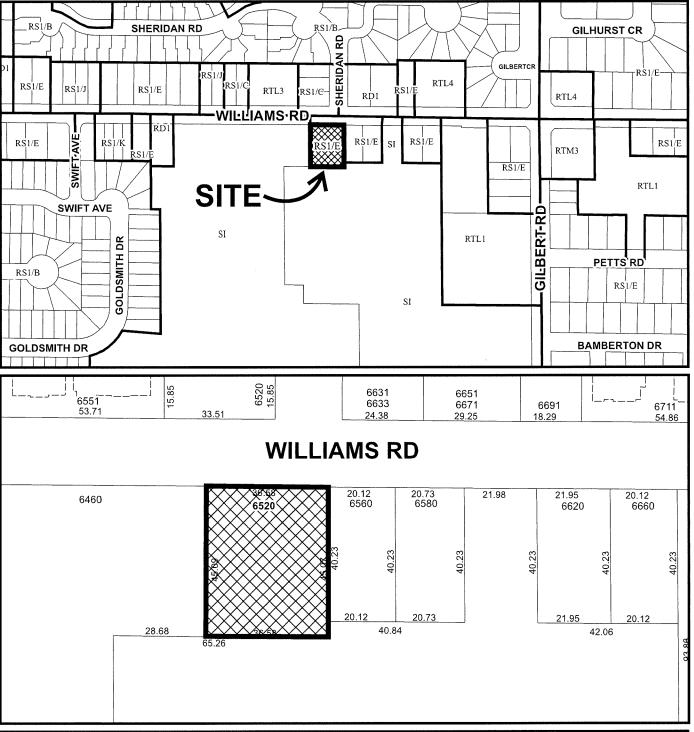



DP 21-936149

Original Date: 08/12/21

Revision Date:

Note: Dimensions are in METRES



Development Application Data Sheet

Development Applications Department

| DP 21-936149 | | | Attachment 2 |
|------------------|---------------------------|-----------------|--------------------------|
| Address: 6520 | Williams Road | | |
| Applicant: Grad | ual Architecture Inc. | Owner: | Londonpark Holdings Ltd. |
| Planning Area(s) | Blundell | | |
| Floor Area Gross | : 1,467.07 m ² | Floor Area Net: | 987.28 m ² |

| : | Existing | Proposed |
|------------------|------------------------------|-------------------------------|
| Site Area: | 1,648.1 m ² | 1,645.6 m ² |
| Land Uses: | Single Detached | Townhouses |
| OCP Designation: | Neighbourhood Residential | No Change |
| Zoning: | Single Detached (RS1/E) | Low Density Townhouses (RTL4) |
| Number of Units: | One Single Detached Dwelling | Eight Townhouse Dwellings |

| | Bylaw Requirement | Proposed | Variance |
|-----------------------------------|--|--|-----------------------------|
| Floor Area Ratio: | 0.6 | 0.6 | none permitted |
| Lot Coverage: | Max. 40 % | 35.1 % | None |
| Lot Width | Min. 40 m | 36.6 m | Vary the lot width by 3.4 m |
| Setback – Front Yard: | Min. 6.0 m | 6.2 m | None |
| Setback – East Side Yard: | Min. 3.0 m | 7.6 m | None |
| Setback – West Side Yard: | Min. 3.0 m | 3.8 m | None |
| Setback – Rear Yard: | Min. 3.0 m | 4.8 m | None |
| Height (m): | Max. 12 m | 11.2 m | None |
| Off-street Parking Spaces – Total | 18 regular stalls (including 2 visitor stalls) | 18 regular stalls (including 2 visitor stalls) | None |
| Tandem Parking Spaces | Max. 50% | 8 (50%) | None |



Development Permit

No. DP 21-936149

To the Holder:

Gradual Architecture

Property Address:

6520 Williams Road

Address:

Unit 205- 8168 Granville Street


Vancouver BC V6P 4Z4

- 1. This Development Permit is issued subject to compliance with all of the Bylaws of the City applicable thereto, except as specifically varied or supplemented by this Permit.
- 2. This Development Permit applies to and only to those lands shown cross-hatched on the attached Schedule "A" and any and all buildings, structures and other development thereon.
- 3. The "Richmond Zoning Bylaw 8500" is hereby varied to:
 - a) Reduce the minimum lot width from 40.0 m to 36.6 m.
- 4. Subject to Section 692 of the Local Government Act, R.S.B.C.: buildings and structures; off-street parking and loading facilities; roads and parking areas; and landscaping and screening shall be constructed generally in accordance with Plans #1 to #18 attached hereto.
- 5. Sanitary sewers, water, drainage, highways, street lighting, underground wiring, and sidewalks, shall be provided as required.
- 6. As a condition of the issuance of this Permit, the City is holding the security in the amount of \$71,051.28 to ensure that development is carried out in accordance with the terms and conditions of this Permit. Should any interest be earned upon the security, it shall accrue to the Holder if the security is returned. The condition of the posting of the security is that should the Holder fail to carry out the development hereby authorized, according to the terms and conditions of this Permit within the time provided, the City may use the security to carry out the work by its servants, agents or contractors, and any surplus shall be paid over to the Holder. Should the Holder carry out the development permitted by this permit within the time set out herein, the security shall be returned to the Holder. The City may retain the security for up to one year after inspection of the completed landscaping in order to ensure that plant material has survived.
- 7. If the Holder does not commence the construction permitted by this Permit within 24 months of the date of this Permit, this Permit shall lapse and the security shall be returned in full.

Development Permit No. DP 21-936149

| To the Holder: | Gradual Architecture | | |
|---------------------------------|--|--|--|
| Property Address: | 6520 Williams Road | | |
| Address: | Unit 205- 8168 Granville Street Vancouver BC V6P 4Z4 | | |
| | n shall be developed generally in accordance with the terms and sof this Permit and any plans and specifications attached to this a part hereof. | | |
| 9. This Permit is not a Build | ding Permit. | | |
| AUTHORIZING RESOLUT DAY OF , | TION NO. ISSUED BY THE COUNCIL THE . | | |
| DELIVERED THIS I | DAY OF . | | |
| | | | |
| MAYOR | | | |
| | | | |



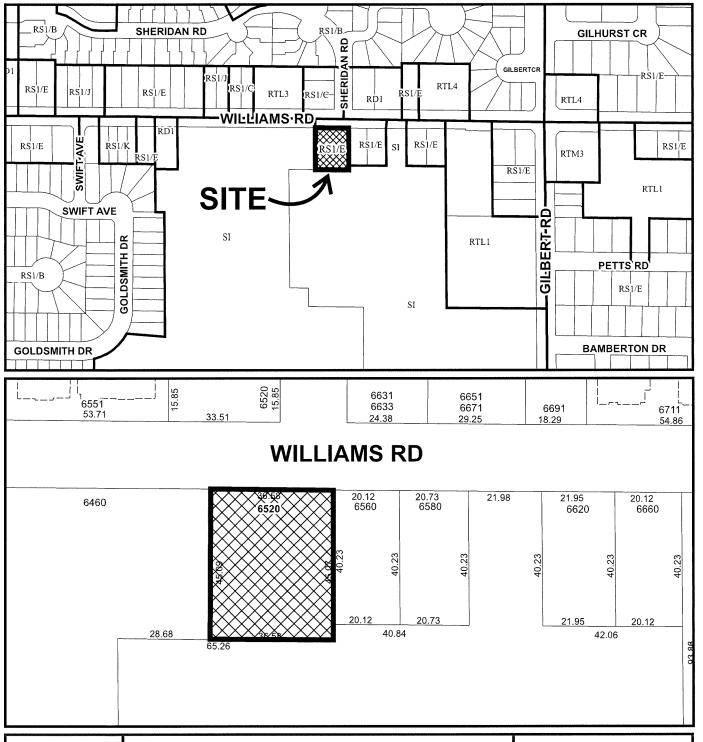



DP 21-936149 SCHEDULE "A"

Original Date: 08/12/21

Revision Date:

Note: Dimensions are in METRES

PROPOSED 3-STOREY TOWNHOUSE DEVELOPMENT (DP 21-936149)

6520 WILLIAMS ROAD, RICHMOND, BC

| PROJECT SUMMARY | | | | |
|--|---|----------------|------------------|--------------|
| CIVIC ADDRESS | 6520 WILLIAMS R | OAD, RICHMOI | ND, BC | |
| LEGAL DESCRIPTION | LOT A BLOCK 4N | PLAN LMP6445 | | |
| | SECTION 31 RAN | | | |
| | PID: 017-923-808 | | | |
| ZONING | RTL4 (PRO | POSEDI | | |
| LOT WIDTH - VARIANCE REQUIRED | 120.00 ft | 36.6 m | | |
| LOT DEPTH | 148.00 ft | 45.1 m | | |
| LOT AREA | 17740.77 sf | 1648.17 m2 | | |
| SITE AREA AFTER ROAD DEDICATION | 17713.71 sf | 1645.66 m2 | | |
| | PERMI | ITED | PROPO | SED. |
| LOT COVERAGE (FOR BUILDINGS) | 40.0% | TILED. | 35.3% | JED |
| BUILDING 'A' W/ ENTRY PORCH | | | 3147.89 sf | 292.45 m2 |
| BUILDING B' W/ ENTRY PORCH | | | 3108.41 sf | 288.78 m2 |
| IOTAL | | | 6256.30 sf | 581 23 m2 |
| TOTAL | | | 6236.30 31 | 301.231112 |
| •. | PERMI | ITED | PROPO | SED |
| NON-POROUS (IMPERMEABLE) SURFACE | 65.0% | | 64.7% | |
| BUILDING 'A' | | | 3147.89 sf | 293.02 m2 |
| BUILDING 'B' | | | 3108.41 sf | 288.78 m2 |
| WALKWAYS | | | 1409.85 sf | 130.98 m2 |
| ASPHALT DRIVEWAY | | | 3608.41 sf | 335.23 m2 |
| GRASSCRETE TURNAROUND | | | 190.46 sf | 17.69 m2 |
| | 11513.91 sf | 1069.68 m2 | 11465.02 sf | 1065.14 m2 |
| | PERMI | TTED | PROPO | SED |
| PLANTING AREA | 25.0% | | 25% | 11514 |
| | | | 4468.75 sf | 415.16 m2 |
| SETBACKS | PERMI | | PROPO | SED |
| FRONT YARD (N) | 19.69 ft | 6.00 m | 20.50 ft | 6.25 m |
| SIDE YARD (W) BLDG A | 9.84 ff | 3.00 m | 12.67 ft | 3.86 m |
| SIDE YARD (E) BLDG A | 9.84 ft | 3.00 m | 25.75 ft | 7.85 m |
| SIDE YARD (W) BLDG B | 9.84 ft | 3.00 m | 12.50 ft | 3.81 m |
| SIDE YARD (E) BLDG B | 9.84 ft | 3.00 m | 25.08 ft | 7.65 m |
| REAR YARD (S) | 9.84 ft | 3,00 m | 15.75 ff | 4.80 m |
| | PERMI | | PROPO | |
| DENSITY (FSR) | 0.60 | 10628.23 sf | 0.60 | 10582.58 sf |
| BUILDING HEIGHT (BOTH BUILDINGS) | PERM(12.00 m | TTED 39.37 ft | PROPO 11.20 m | SED 36.75 ft |
| | | 39.37 11 | 11.20 M | 36./3 11 |
| UNITS PROPOSED | 8 UNITS | | | |
| VEHICLE PARKING | REQUIRED | | PROPOSED | |
| STALLS/UNIT | 2 STALLS/UNIT | | 2 STALLS/UNIT | |
| STANDARD | 16 STALLS | | 8 STALLS | |
| TANDEM | 50% | | 8 STALLS | |
| VISITOR 2% | 1.6 | | 2 | |
| TOTAL | 18 | | 18 | (TO 040V (= |
| ALL RESIDENT PARKING SPACES (EXCLUDING VISITOR PARKING AND | NG) WILL PROVIDE LEVE 0 16A TO 80A). | EL 2 EV CHARGI | NG OUTLETS (2081 | / TO 240V AC |
| PARKING - CLEAR MIN. DIMENSIONS (TANDEM) | ft | m | | |
| WIDTH | 11.88 | 3.40 | | |
| LENGTH | 18.00 | 5.50 | | |
| BICYCLE PARKING | REQUIRED | | PROPOSED | |
| CLASS A (RESIDENT) - 1.25 BIKES/UNIT @ 8 UNITS | 10 STALLS | | 10 STALLS | |
| CLASS B (NON-RESIDENT) - 0.20 BIKES/UNIT ® 8 UNITS | 2 STALLS | | 2 STALLS | |
| | | | | |
| DWELLING COUNT | BUILDING 'A' | BUILDING 'B' | | |
| THREE BEDROOM | 2 UNITS | 2 UNITS | | |
| FOUR BEDROOM | 2 UNITS | 2 UNITS | | |
| EST. GARBAGE & RECYCLING SPACE REQUIREMENTS | | | | |
| WASTE STREAM | 80L | 240L | 360L | 3 YARD BIN |
| GARBAGE | | | 2 | |
| CARDBOARD & PAPER | | | 2 | |
| NON-GLASS CONTAINERS CART | | | 1 | |
| FOOD SCRAPS CART | | 1 | | |
| | | | | |

GLASS CONTAINERS CART

| PERMITTED FSR | 10628.23 | (9.27 O4.0) | |
|-------------------------|----------|---------------------|---------|
| PROPOSED FSR | 10582.58 | 0.597 | |
| STAIR EXCLUSION | 397.16 | | |
| ENT/STAIR EXCLUSION | 674.02 | | |
| THERMAL EXCLUSION | 185.06 | | |
| COVERED PORCH EXCLUSION | 583.65 | PERMITTED 10% FSR = | 1242.25 |
| GROSS FSR | 12422.47 | | |
| PORCHES | 648.15 | | |
| PROPOSED SALEABLE | 11774.32 | | |
| PROPOSED BUILDABLE | 15726.38 | (INCLUDING GARAGE) | |
| | | | |



DRAWING LIST

A.0.0 COVER SHEET
A.1.1 SITE PLAN
A.1.1 SITE PLAN PRIVATE OUTDOOR & AMENITY SPACE
A.1.2 SUN SHADE DIAGRAMS FOR MARCH & JUNE
A.1.3 SITE PLAN - EXTERIOR LIGHTING
A.1.4 STREETS CAPE
A.1.5 SITE COVERAGE & IMPERMEABLE
A.1.6 3D ORTHO YIERS
A.1.7 PERSPECTIVE VIEW
A.1.8 FREE FIGHTING PLAN
A.2.0 13T/2ND FLR PLANS
A.2.1 SROJATH FLR PLANS
A.2.2 ROOF PLANS
A.2.3 SIT/2ND FLR - FAR OVERLAY
A.2.4 SRO FLR - FAR OVERLAY
A.3.0 BLOG A - ELEVATIONS
A.3.1 BLOG & - ELEVATIONS
A.3.1 BLOG & - ELEVATIONS
A.3.2 MATERIAL BOARD
A.4.0 BLOG SECTIONS
A.5.0 UNIT #8 - ADAPTABLE DETAIL PLANS

info@gradualarchitecture.com 1. 205 - 8168 GranvIIIe St. Vancouver, BC Canada V6P 4Z4 www.gradualarchitecture.com


LONDON PARK TOWNHOUSE DEVELOPMENT DP 21-936149


6520 WILLIAMS ROAD RICHMOND, BC

| DRAWN BY: | # 3U22I |
|-----------|------------|
| NJ/DF/SW | 6 |
| SCALE: | PROJECT NO |
| AS SHOWN | GA-G118 |
| | |

COVER SHEET

A0.0

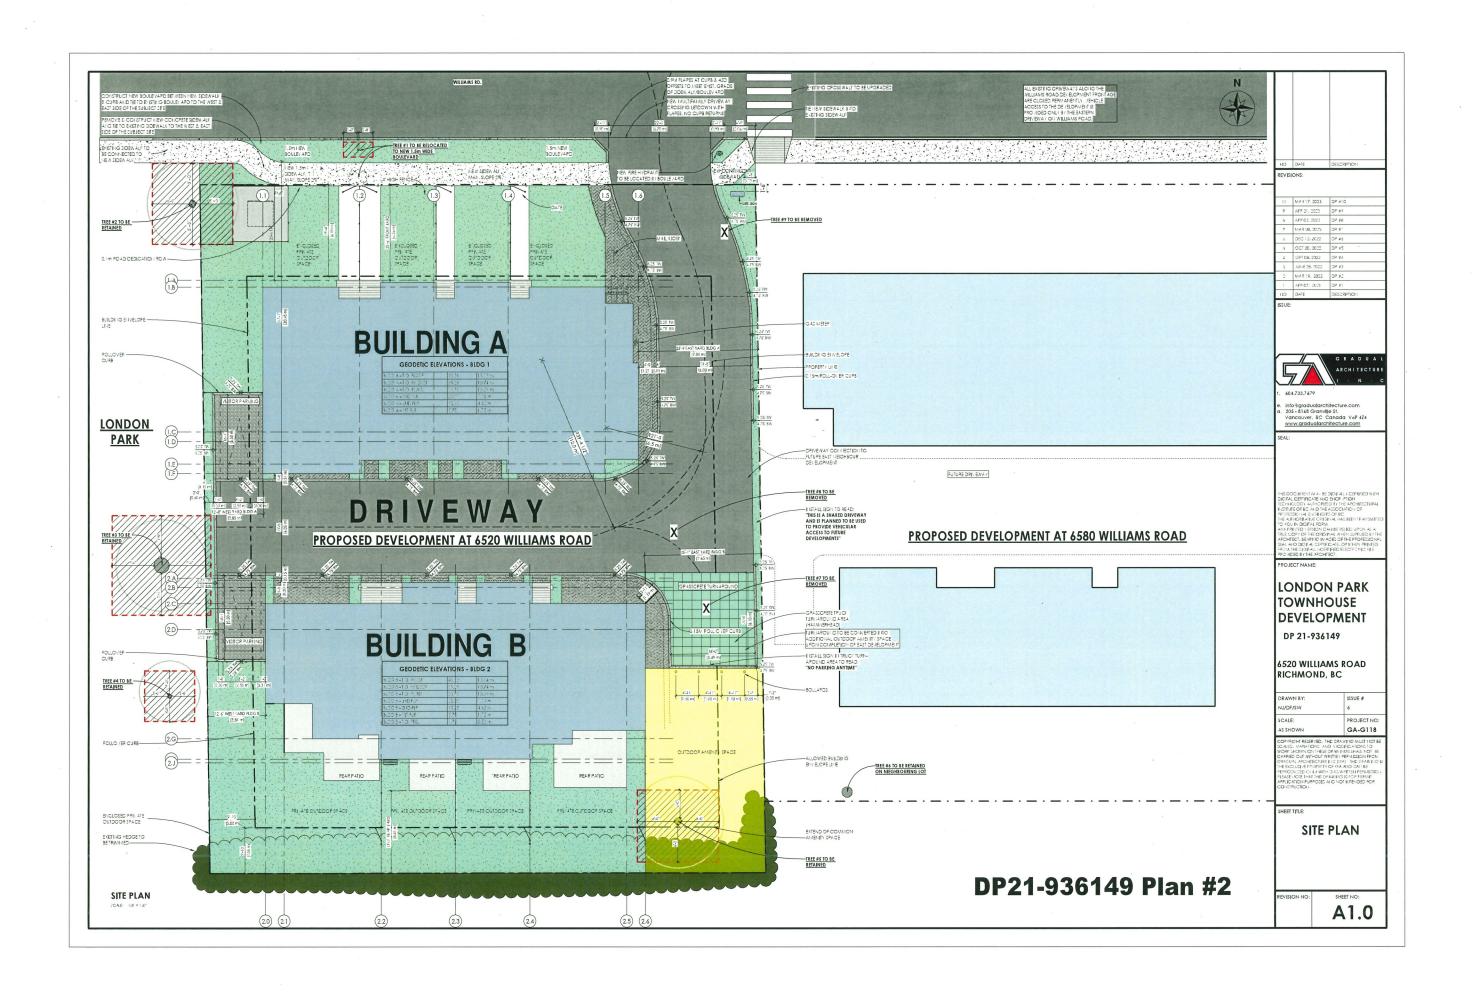

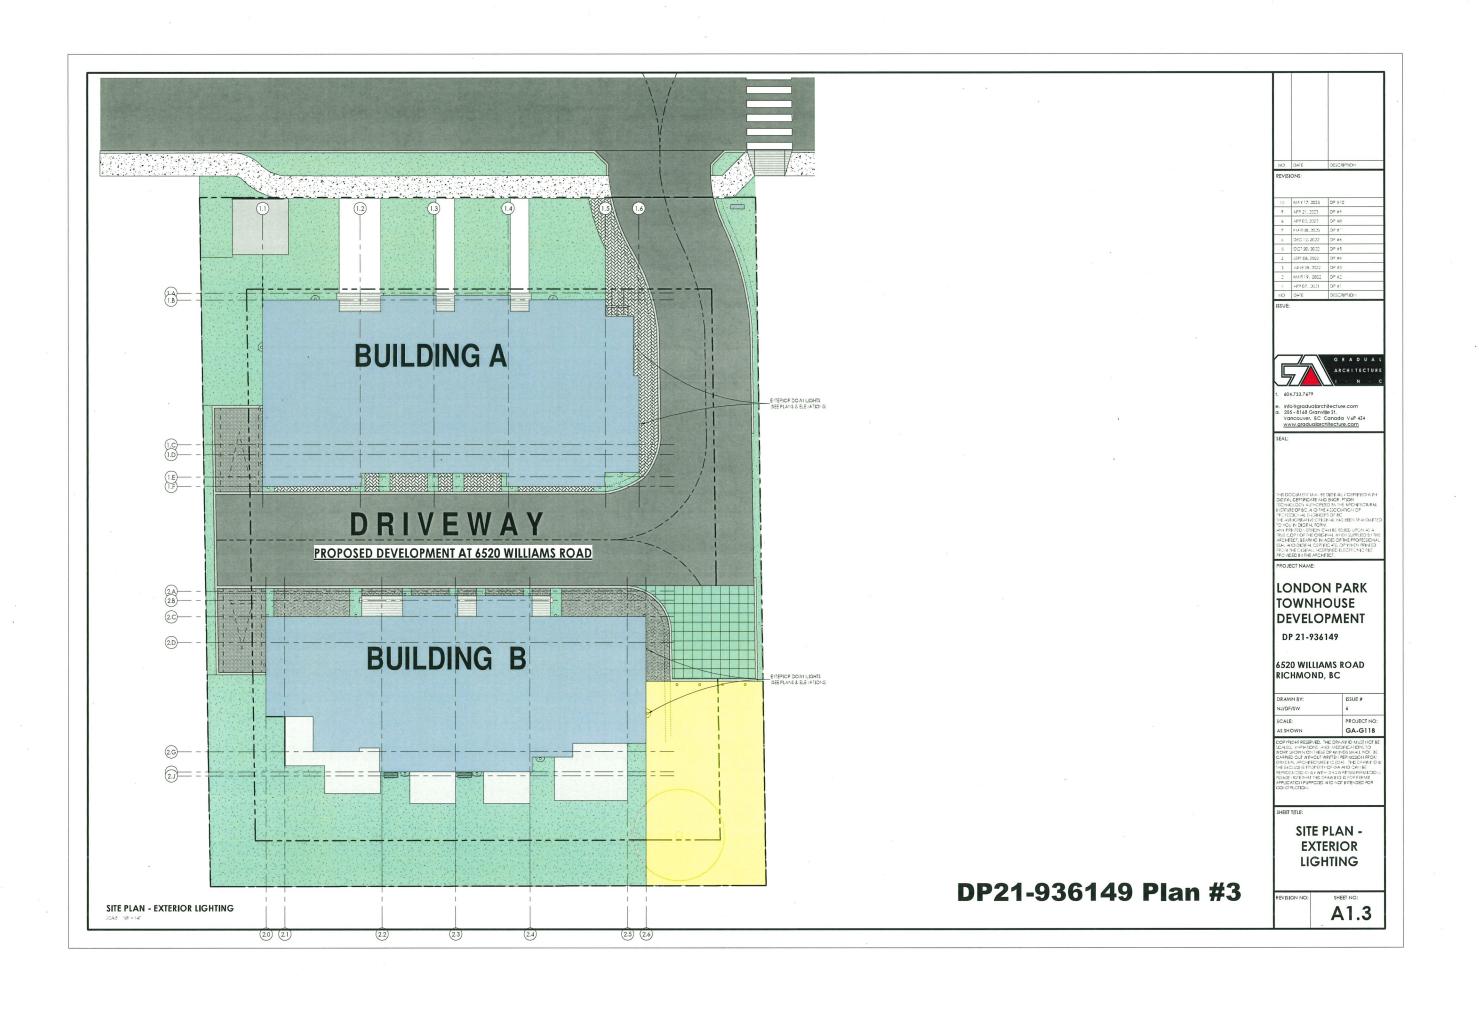





DA/E DESCRIPTION :

DA/E DESCRIPTION :

DESCRIPTION :

DESCRIPTION :

DESCRIPTION :

DESCRIPTION :

DESCRIPTION :

| REVISIONS: | | | | |
|------------|---------------|--------|--|--|
| 10 | MAY 17, 2023 | DP #10 | | |
| 9 | APP 21, 2023 | DP #9 | | |
| 8 | APR 03, 2023 | DP #8 | | |
| 7 | MAR 08, 2023 | DP #" | | |
| 6 | DEC 12, 2022 | DP #6 | | |
| 5 | OCT 20, 2022 | DP #5 | | |
| 4 | SEPT 08, 2022 | OP #4 | | |
| 3 | JUNE 28, 3022 | DP #3 | | |
| 2 | MAR 19. 2022 | DP #2 | | |
| 1) | APR 07, 2021 | DP #1 | | |

IS



. (0.1.722.7.770

e. info@gradualarchitecture.com a. 205 - 8168 Granville St. Vancouver, BC Canada V6P 474 www.gradualarchitecture.com

SEAL

HIS DOCUMENT MAIL SE DIGIPALL CEPTIED WIT-DIGIPAL CEPTIGNER HIS BLOCK PROMI TECHNOLOGY, AUTHORIZED BY THE PROHECURAL JUSTIME OF SEA JUST THE ACCOUNTING OF PEDEZGICH, BUSTIMERS OF THE AUTHORIZED THE AUTHORIZED CHIEF AND ACCOUNTING OF THE AUTHORIZED TO YOUN DIGIPAL FORM. BERRIED UPON ACCOUNTING OF THE OFFI AUTHORIZED FOR THE OWNERS AUTHORIZED BY THE ARCHITECT, SERVICE OF ACCOUNTING OF THE POPULATION.

PROJECT NAME

LONDON PARK TOWNHOUSE DEVELOPMENT

DP 21-936149

6520 WILLIAMS ROAD RICHMOND, BC

| AS SHOWN | GA-G118 |
|-----------|------------|
| SCALE: | PROJECT NO |
| NJ/DF/SW | 6 |
| DRAWN BY: | ISSUE # |

SHEET TIT

STREETSCAPE

REVISION NO:

A1.4



PERSPECTIVE VIEW - EAST (BOTH BLDGS)



PERSPECTIVE VIEW - WEST (BOTH BLDGS)

DP21-936149 Plan #5

| | DATE | DESCRIPTION |
|-----|------|-------------|
| ISI | ONS: | |

| 10 | MAY 17, 2023 | DP #10 |
|----|---------------|--------|
| 9 | AFR 21, 2023 | DP #9 |
| 8 | APP 03, 2023 | DP #8 |
| 7 | MAR 08, 2023 | DP #" |
| ó | DEC 12, 2022 | DP #6 |
| 5 | OCT 20, 2022 | DP #5 |
| 4 | SEPT 08, 2022 | DP #4 |
| 3 | JUNE 28, 3022 | DP #3 |
| 2 | MAR 19, 2022 | DP #2 |
| 1 | APR 07, 2021 | OP #1 |
| | | |




e. info@gradualarchitecture.com a. 205 - 8168 GranvIIIe St. Vancouver, 8C Canada V6P 4Z4 www.gradualarchitecture.com


LONDON PARK TOWNHOUSE DEVELOPMENT DP 21-936149


6520 WILLIAMS ROAD RICHMOND, BC

PERSPECTIVE VIEWS

A1.7

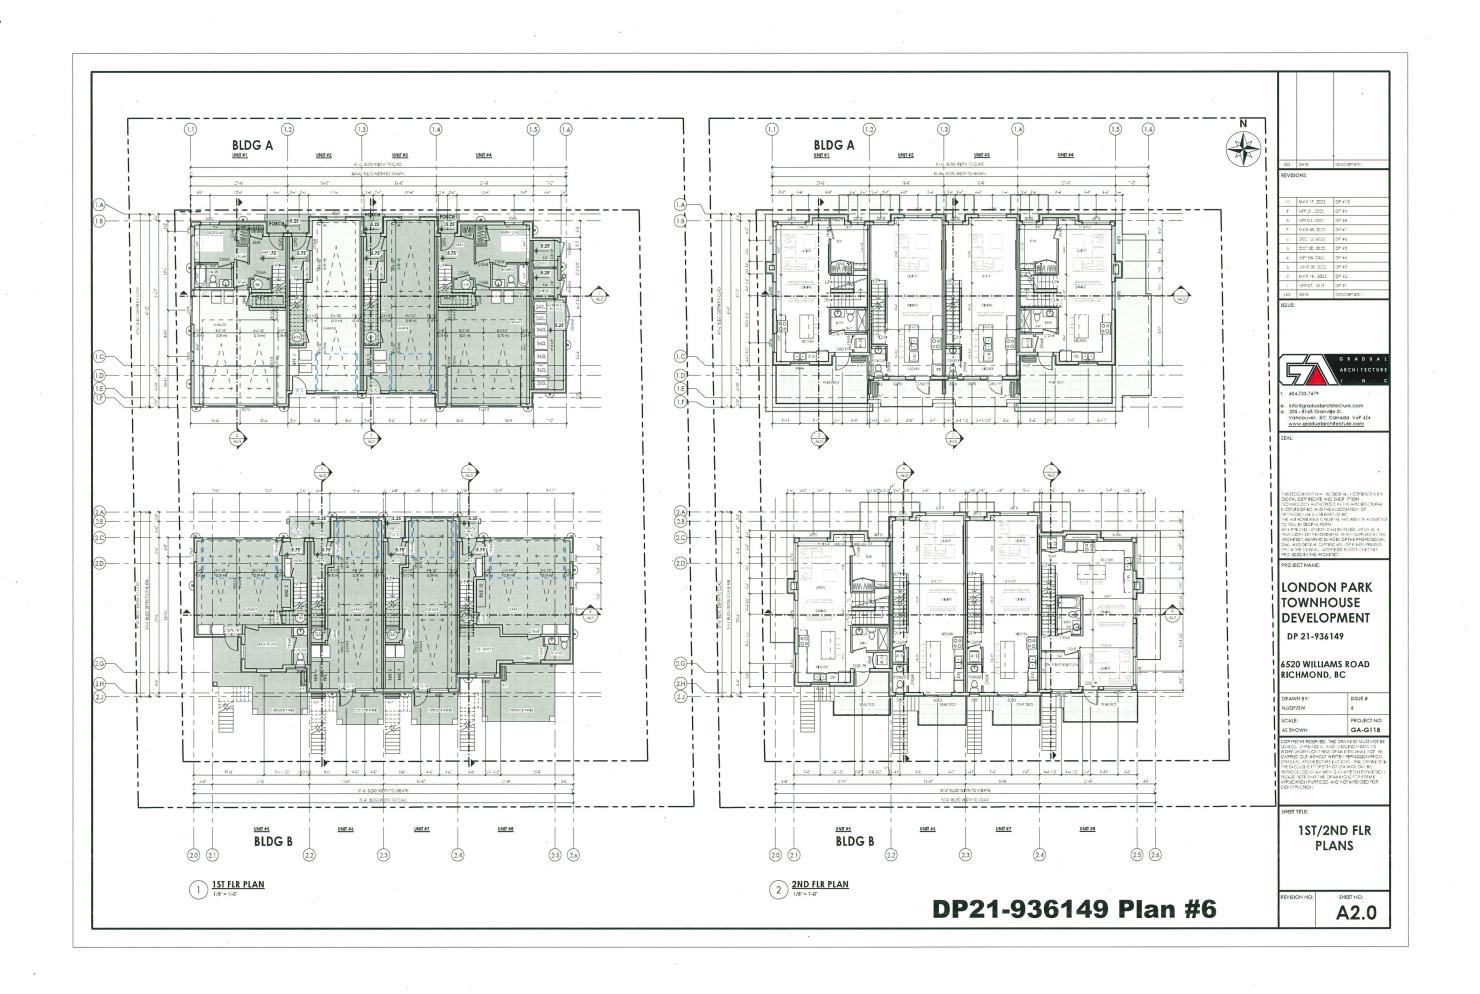

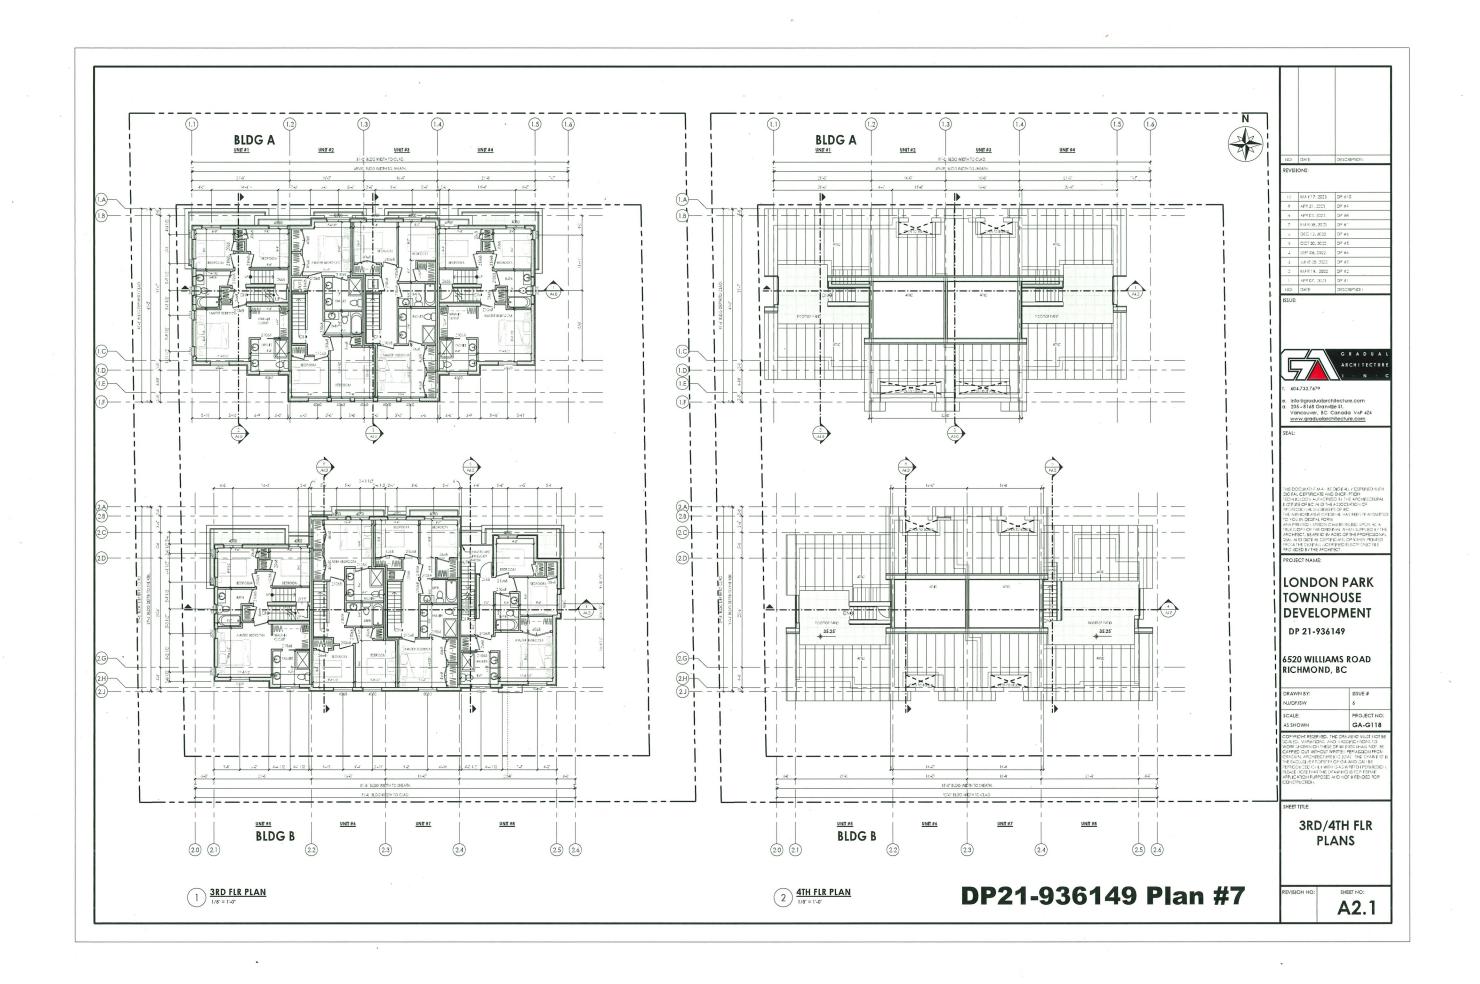

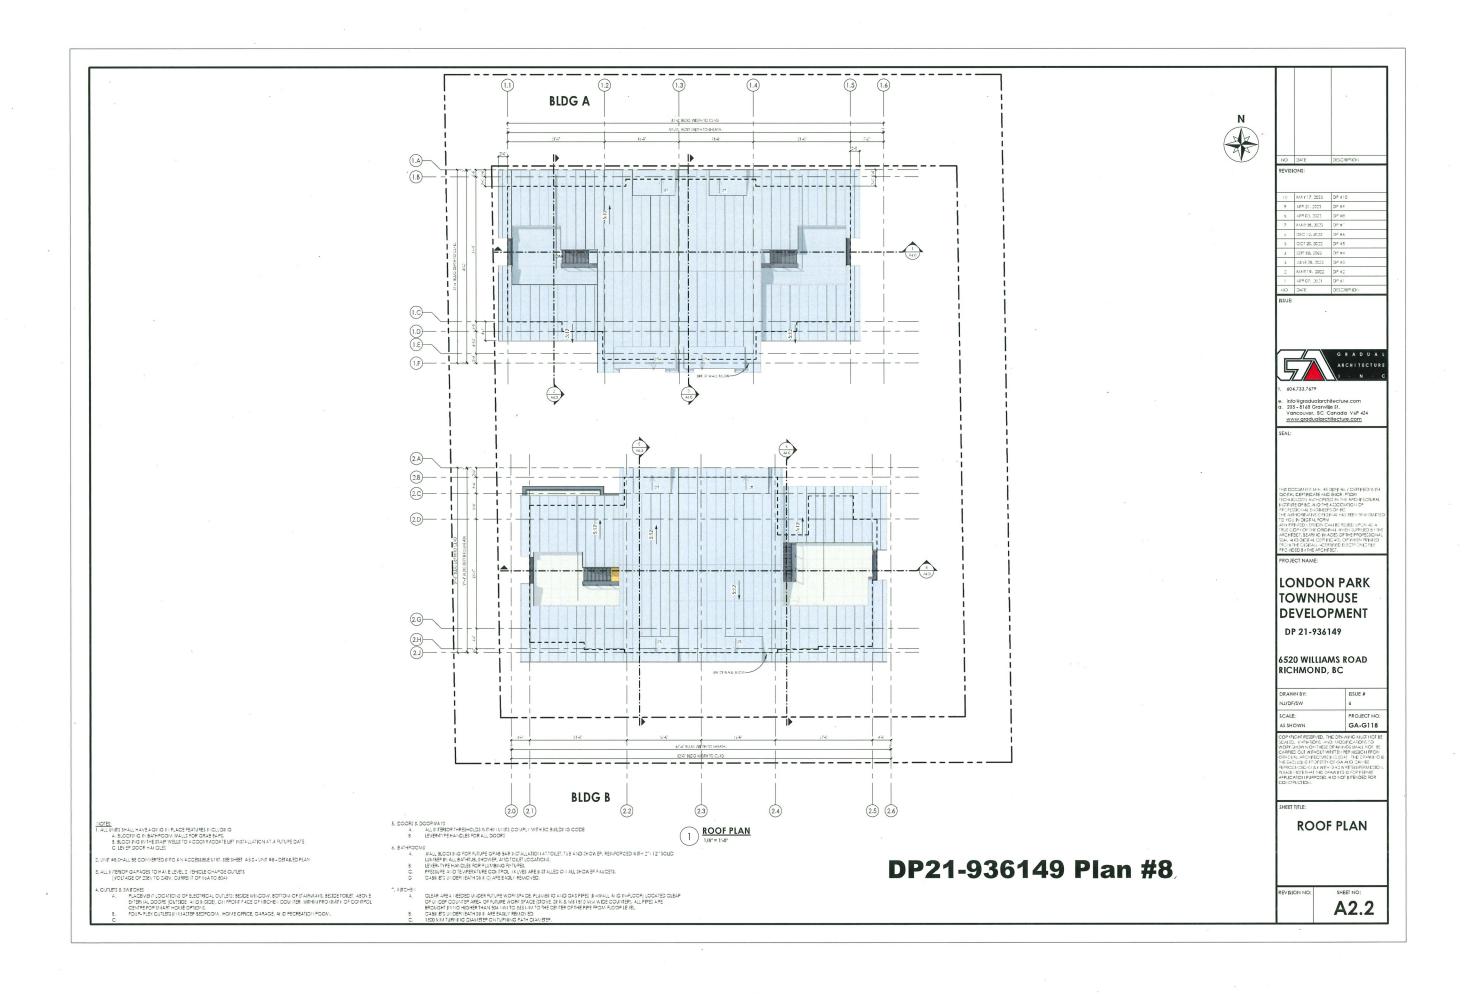









MATERIAL LIST

- FACCIA & TPIM (COLOURTO MATCH CLADDING) S. VIJIVLTHER MALLY SROKEN WINDOW PAINTED BM CALMA COL-22
 PAINTED BM CALMA COL-22
 PAINTED BM REIDALL CHAPCOAL HC-166
 PAINTED, DARI MATCHIAL WALLIUT

- CERACLAD CERAMIC COATED SIDING PANELS 5 REVEALS CHARCOAL

- 10. METAL GAPAGE DOOP & MAN-DOOR BM HEARTHSTOLIE CC-1-601
- - 12. GLASS GUARD W/ INSTAL PAILITIG GLASS GUARD TEMPERED TRAITISLEUCENT METAL PAILITIG PAINTED CHARGOAL
- 14. LONGBOARD LINIK & LOCK BATTEN W CODGRAIN FINISH DARN NATIONAL WALNUT

DP21-936149 Plan #9



604.733.7679

i. info®gradualarchilecture.com 3. 205 - 8168 Granville St. Vancouver, BC Canada VoP 4Z4 www.gradualarchilecture.com

LONDON PARK TOWNHOUSE DEVELOPMENT DP 21-936149

6520 WILLIAMS ROAD RICHMOND, BC

PROJECT NO

BLDG A -**ELEVATIONS**

A3.0









DP21-936149 Plan #10

MATERIAL LIST

- , FAZCIA & TPIM (COLOURTO MATCH CLADDING) 8. VIII Î/L THER JALLY SROKEN MI DOM PAINTED BIJ COLUN CO 22 PAINTED, BIJ LEVIDALL CHAPCOAL HOAG6 PAINTED, DARI: MATIONAL WALNUT

- CERACLAD CERAMIC COATED SIDING PANELS 5 REVEALS CHARCOAL

- 12. GLASS GUARD W/INSTAL PAILITIG GLASS GUARD TEMPERED TRAITISEUCENT METAL PAILITIG PAINTED CHARGOAL
- 14, LOHGBOAPD LINK & LOCK BATTEH W CODGRAIN FINISH DARK HATIOHAL WALHUT



604.733,7679

info@gradualarchitecture.com 205-8168 Granville St. Vancouver, BC Canada V6P 474 www.gradualarchitecture.com

MAR 19, 2022 DP # 4PP 07, 2021 DP #

LONDON PARK TOWNHOUSE DEVELOPMENT


DP 21-936149


6520 WILLIAMS ROAD RICHMOND, BC


| DRAWN BY: | ISSUE # |
|-----------|-------------|
| NJ/DF/SW | 6 |
| SCALE: | PROJECT NO: |
| AS SHOWN | GA-G118 |


BLDG B -**ELEVATIONS**


A3.1

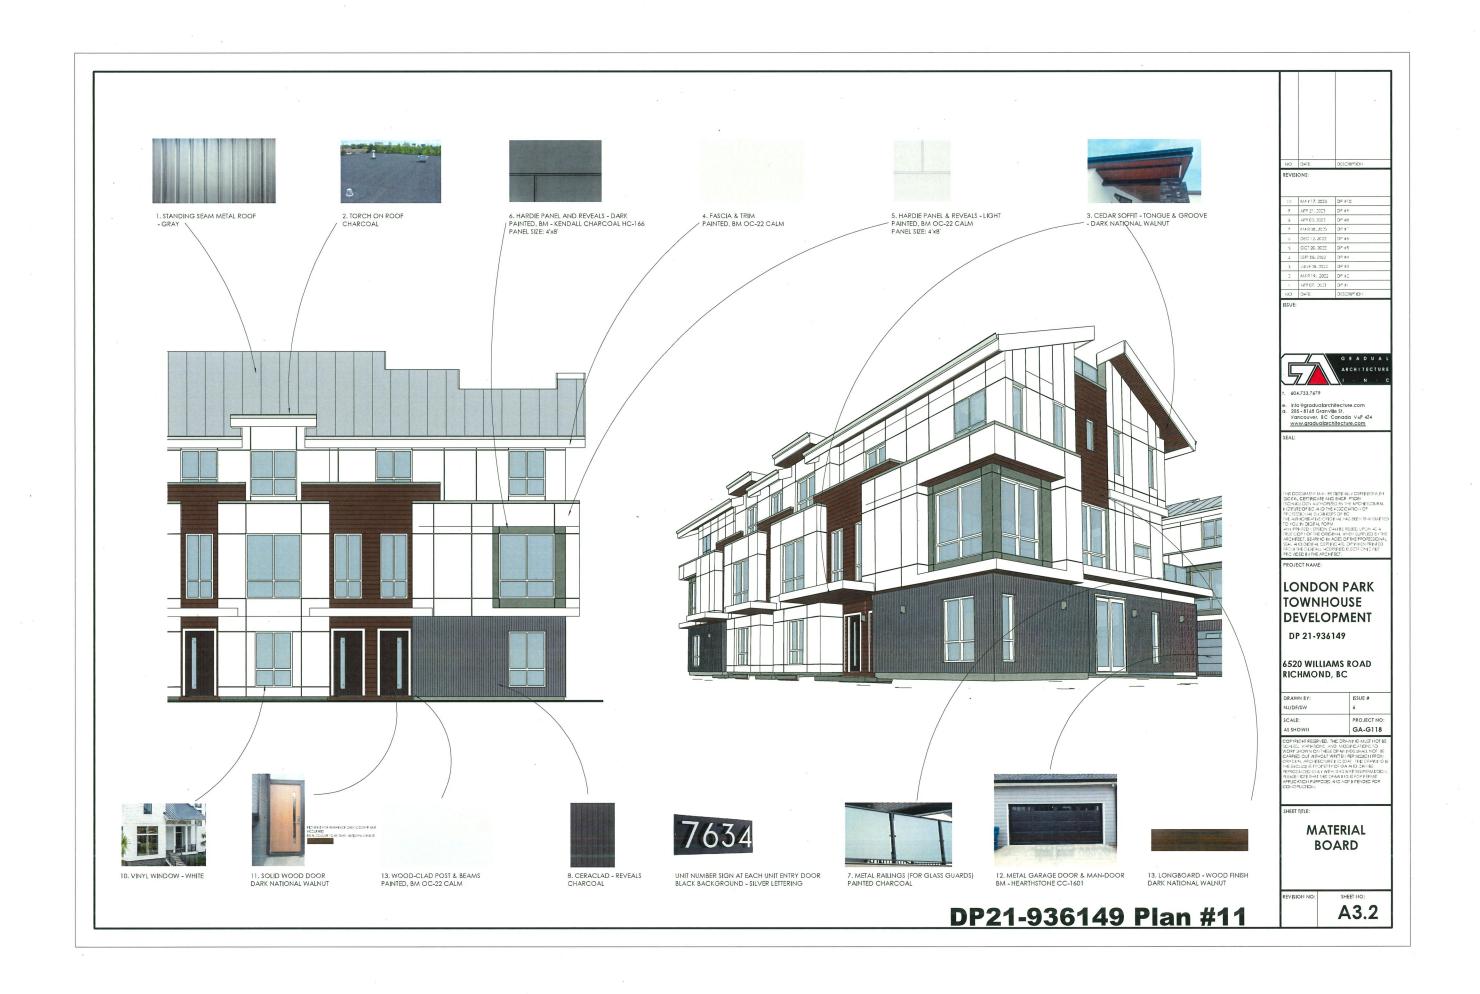

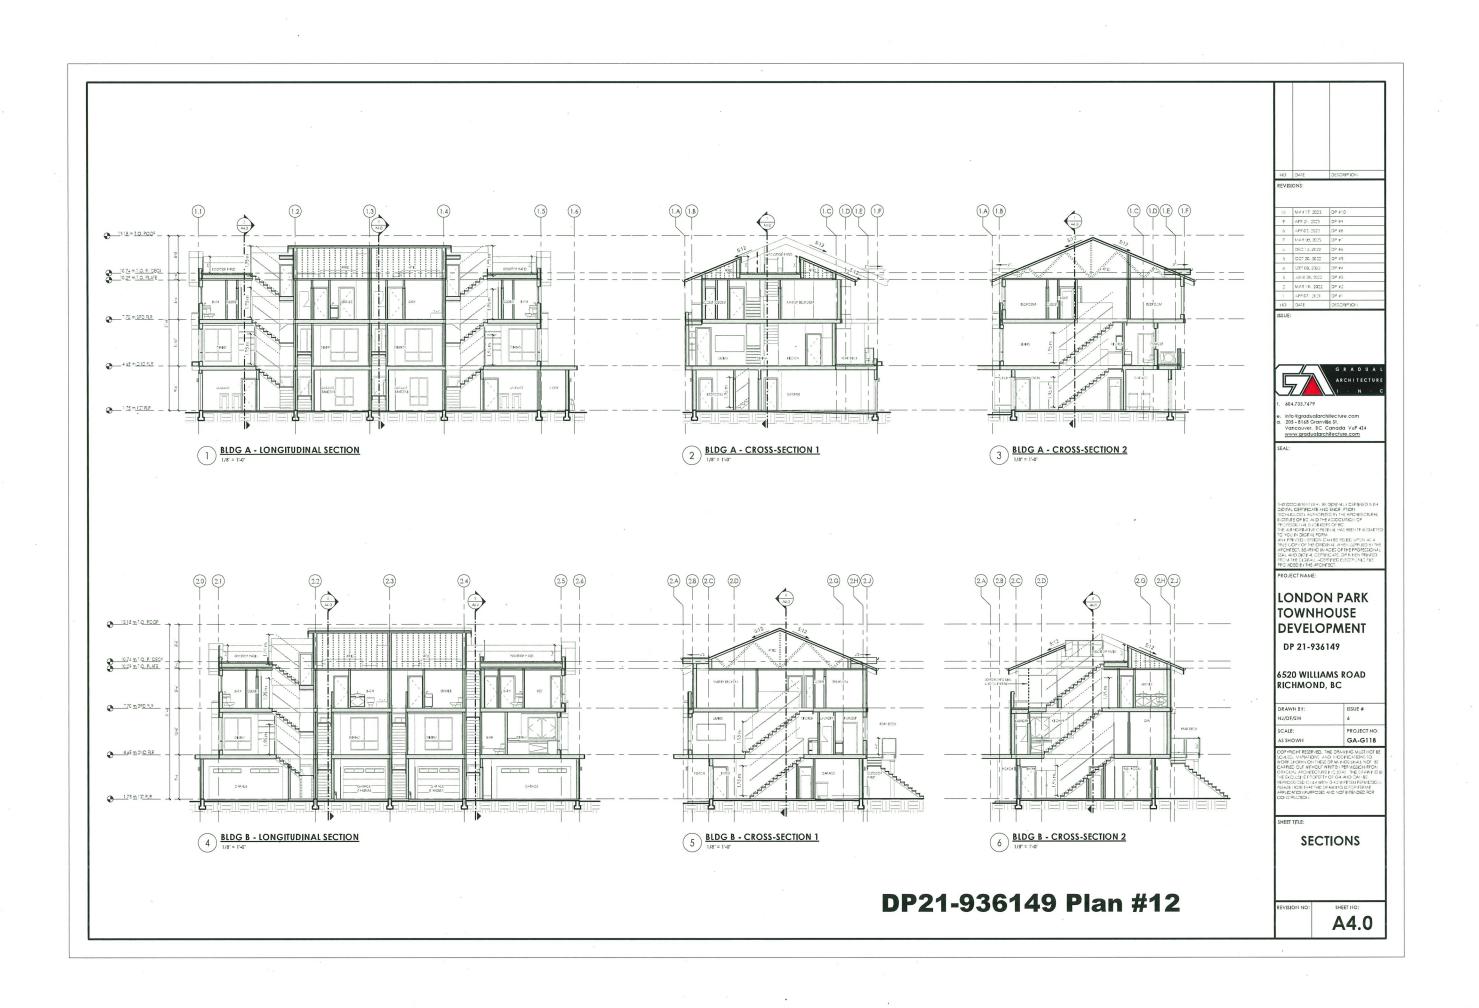

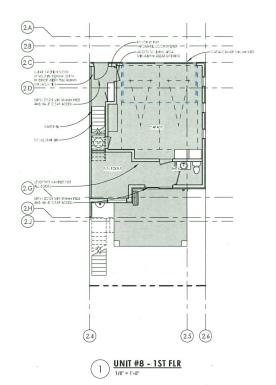

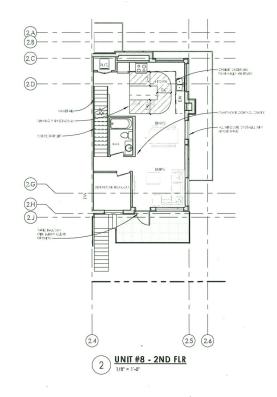

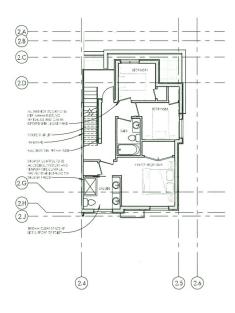

3 <u>UNIT #8 - 3RD FLR</u>

UNIT #8 SHALL BE CONVERTED INTO ALL ACCESSIBLE UNIT SEE SHEET A5.0 - UNIT #8 - DETAILED PLAN

ICHEN

CLEAP APEA HEEDED UIDER PLUVER W.OPKSPACE, PLUMBBYG ALD DAS PIPES (NAW ALL ALD IN-PLOOR) LOCATED CLEAP
OF UIDER COUNTER AREA OF FUTURE W.OPKSPACE, PLOVE, SINK IS A MILL BOOMM. WIDE COUNTER). ALL PIPES APE
BROUGHT IN NO INCIDENT PARK AS MAN TO THE CONTER OF THE PIPE PROVINT, OF EACH
CARE HEST WINDERS (EACH TIME). ARE EAST, PRINCYED.

CORD HEST WINDERS (EACH TIME). TO THE WINDERS OF THE PIPE PROVINT, OF EAST.

DP21-936149 Plan #13

| 10 | MAY 17, 2023 | DP #10 |
|----|----------------|--------|
| 9 | APR 21, 2023 | DP #9 |
| 8 | APR 03, 2023 | DP #8 |
| 7 | MAR 08, 2003 | DP #" |
| ó | DEC 12, 2022 | DP #6 |
| 5 | OCT 20, 2022 | DP #5 |
| 4 | SEPT 08, 2022 | DP #4 |
| 3 | JULIE 38, 3022 | DP #3 |
| 2 | MAR 19, 2022 | DP #2 |
| 1 | APR 07, 2021 | DP #1 |



604.733.7679

info@gradualarchilecture.com 1. 205-8168 Granville St. Vancouver, 8C Canada VoP 474 www.gradualarchilecture.com


LONDON PARK TOWNHOUSE DEVELOPMENT DP 21-936149

6520 WILLIAMS ROAD RICHMOND, BC

| DRAWN BY: | ISSUE # |
|-----------|---------|
| NJ/DF/SW | 6 |
| SCALE: | PROJECT |
| ÀS SHOWN | GA-G1 |

UNIT #8 -ADAPTABLE DETAILED PLANS

A5.0

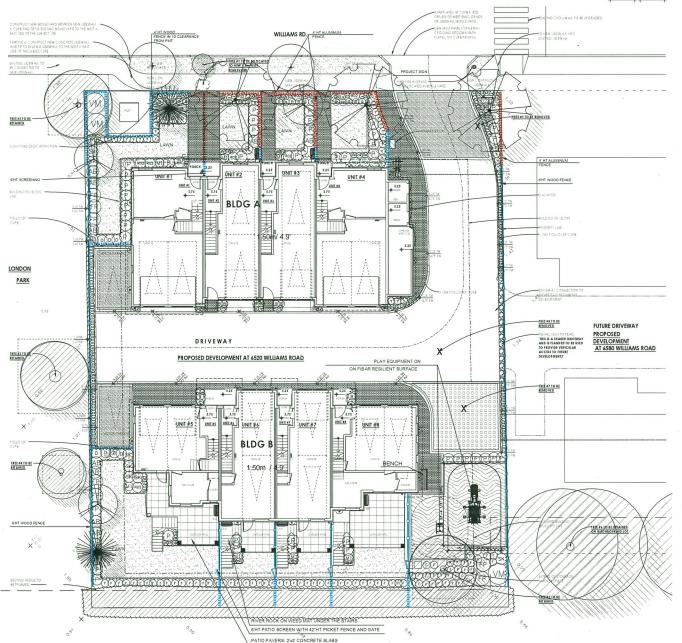





MAGLIN BIKE RACK -MBR500-S_3
BLACK COLOR-MATTE FINISH;
POWDER COATED

MAGLIN BENCH - MLB510-M Metal
BLACK COLOR-MATTE FINISH;
POWDER COATED

NOTE : ALL FURNITURE TO BE MOUNTED AS PER MANUFACTURER SPECIFICATIONS

Play equipment by Jambett





LA-16006_(Éco-mobile_sur_ressorts) L-16064_(Glissoire_classique_3')

NOTE: PLAY EQUIPMENT TO BE INSTALLED OVER EXISTING GRADE.

PAVING MATERIAL KEY

PATTERN A-DRIVEWAY AND VISITOR PARKING : PERMEABLE Concrete paver by Mutual Materials, typ. COLOR- Cascade Herringbone pattern
Base install to be reviewed prior to finish.
Installed per manufacturer's specification PATTERN B-WALKWAYS Holland pavers; Charchoal color; RUNNING BONE PATTERN

2'X2' CONCRETE SLAB

FENCE KEY



4'-0" HT WOOD FENCE

PLANT SCHEDULE PLANTED SIZE / REMARKS TYPE AND LOCATION BY CITY 7CM CAL; 2M STD; B&B

NOTES: "PLANT SIZES IN THIS LIST ARE SPECIFIED ACCORDING TO THE CANADIAN LANDSCAPE STANDARD, LATEST EDITION. CONTAINER SIZES SPECIFIED AS PER CINLA STANDARDS. BOTH FLANT SIZE AND CONTAINER MERCANDARD AS PER CINLA STANDARDS. BOTH FLANT SIZE AND CONTAINER MERCANDERWEST AND OTHER PLANT MERCANDERWEST. SEARCH AND REVIEW MARE PLANT MATERIAL MABLE FOR OFFICIAL REVIEW BY LANDSCAPE ARCHITECT AT SOURCE OF SUPPLY, AREA OF SEARCH TO INCLUDE LOWER MAINLAND AND FRASER VALLEY. SUBSTITUTIONS CONTAIN MERCANDER APPROVAL FROM THE LANDSCAPE ARCHITECT PROVIDED TO MAKING ANY SUBSTITUTIONS TO THE SPECIFIED TREATED, LINAPPROVOED SUBSTITUTIONS WILL BE REJECTED. ALLOW A MINIMUM OF FIVE DAYS PRIOR TO DELIVERY FOR REQUEST TO SUBSTITUTE. SUBSTITUTIONS ARE SUBJECT TO CANADIAN LANDSCAPE STANDARD. DEFINITION OF CONDITIONS OF AVAILABILITY, ALL LANDSCAPE MATERIAL AND WORMANDER MIST MEST OF EXCEED CANADIAN LANDSCAPE STANDARD. DEFINITION OF CONDITIONS OF AVAILABILITY, ALL LANDSCAPE MATERIAL AND WORMANDER MIST MEST OF THE CANADIAN LANDSCAPE STANDARD. SETS THE STANDARD SETS OF THE STANDARD SEARCH SETS OF THE STANDARD SETS

| PLA | NIS | SCHEDULE | | PMG PROJECT NUMBER: 17-236 | | |
|-------------|------------------|--|--|---|--|--|
| KEY | QTY | BOTANICAL NAME | COMMON NAME | PLANTED SIZE / REMARKS | | |
| | 3 3 2 2 | ACER CIRCINATUM ACER RUBRUM 'RED SUNSET' PINUS FLEXILIS 'VANDERWOLF'S PYRAMID' | VINE MAPLE RED SUNSET MAPLE VANDERWOLF'S PYRAMIDAL LIMBER PINE | 8CM CAL; B&B 8CM CAL; 2M STD; B&B 3.5M HT;B&B | | |
| SHRUB | | | | | | |
| (B) | 31 | BUXUS MICROPHYLLA 'WINTER GEM' | LITTLE-LEAF BOX | #3 POT; 50CM | | |
| 300 | 13 | MAHONIA NERVOSA | LONGLEAF MAHONIA | #2 POT; 25CM | | |
| 8 | 8 | PHOTINIA X FRASERI | FRASER PHOTINIA | #2 POT; 40CM | | |
| 8 | 47 | PIERIS JAPONICA 'VALLEY FIRE' | VALLEY FIRE PIERIS | #3 POT; 50CM | | |
| | 12 | ROSA 'SCARLET MEIDILAND' | SCARLET MEIDILAND ROSE | #2 POT; 40CM | | |
| S | 8 | SKIMMIA JAPONICA (10% MALE) | JAPANESE SKIMMIA | #2 POT; 30CM | | |
| 8 | 34 | TAXUS X MEDIA 'HICKSII' | HICK'S YEW | 1.2M B&B | | |
| XX | 11 | VACCINIUM OVATUM | EVERGREEN HUCKLEBERRY | #2 POT; 50CM | | |
| AB GRASS | 3 | VIBURNUM P.T. 'MARIESII' | MARIE'S DOUBLE FILE VIBURNUM | #3 POT; 50CM | | |
| (1) | 7 | MISCANTHUS SINENSIS 'LITTLE KITTEN' | COMPACT MAIDEN GRASS | #2 POT | | |
| (S) | 76 | PENNISETUM ALOPECUROIDES 'HAMLIN' | DWARF FOUNTAIN GRASS | #1 POT | | |
| PERENN | IAL | | | | | |
| | 70 | COREOPSIS V. 'MOONBEAM' | MOONBEAM TICKSEED | #1 POT | | |
| @ @ | 28 | NEPETA x WALKERS JR | DWARF BLUE CATMINT | 15CM POT | | |
| P | 84 | POLYSTICHUM MUNITUM | WESTERN SWORD FERN* | #1 POT; 20CM | | |
| | | | | | | |
| | | | | | | |

- PROVIDE DESIGNED BUILD HIGH EFFICIENCY AUTOMATIC IRRIGATION SYSTEM TO I.I.A B.C. STANDARDS TO ALL SOFT LANDSCAPE AREAS. SHOP DRAWINGS O BE REVIEWED AND APPROVED BY LANDSCAPE ARCHITECT PRIOR TO INSTALLATION.

DP21-936149 Plan #14

© Copyright reserved. This drawing and design is the property of PMG Landscape Architects and may not be reproduced or used for other projects without their



SEAL:

PROJECT:

8 UNIT TOWNHOUSE DEVELOPMENT

6520 WILLIAMS ROAD RICHMOND

DRAWING TITLE:

LANDSCAPE PLAN

DATE: November 22, 2017 DRAWING NUMBER SCALE: **3.**a DRAWN: DD


DESIGN: DD CHK'D: PCM

OF 4

17-236



- ALL POSTS PRESSURE TREATED TO CSA STANDARD AND END CUTS
 TREATED WITH PRESERVITIVE.
 ALL OTHER MEMBERS TO BE CEDAR. #2 (CONSTRUCTION) GRADE MINIMUM.
- 3. ALL HARDWARE HOT DIPPED GALVANIZED.
- APPLY 2 COATS EXTERIOR STAIN TO MANUFACTURERS SPECIFICATION.
 FINISH SELECTION AS APPROVED BY PROJECT ARCHITECT.
- ALL FENCES TO BE LEVEL. CHANGES IN GRADE TO BE IN 12"-18" STEPS (MAX.). GAPS TO GRADE TO FOLLOW FINISH GRADE. GAP TO BE 3-6".

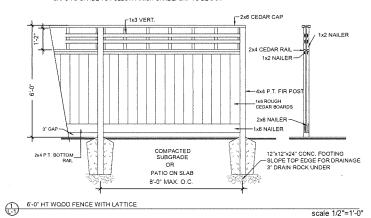


- NOTES:

 1. METAL MATERIAL: ALUMINUM TO BE POWDER COATED BLACK, TWO COATS.

 2. ALL HARDWARE TO BE HOT DIPPED GALVANIZED, MEDIUM GAUGE.

 3. GATE HARDWARD TO BE CHOSEN BY OWNER, INSTALL PER MANUFACURER'S INSTRUCTIONS.

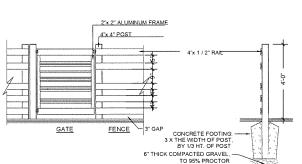


4' HT ALUMINUM FENCE WITH GATE scale 1/2"=1'-0"

-12" X 12" GRASSCRETE FORMERS LAID EDGE TO EDGE ALL WORK WITHIN THE PROTECTED ROOT ZONES OF TREES MUST BE UNDER THE SUPERVISION OF THE PROJECT ARBORIST REMOVE GRASS LAYER 50 MM MAX UNDISTURBED EXISTING SUBGRADE DO NOT CUT TREE ROOTS PAVER DETAIL THROUGH ROOT ZONE GRASSCRETE DETAIL

scale 1/2"=1'-0"

CONCRETE EDGE

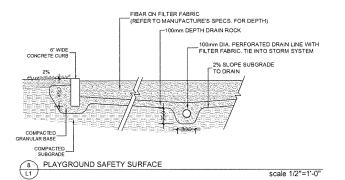

- NOLIES:

 1. ALL POSTS PRESSURE TREATED TO CSA STANDARD AND END CUTS
 TREATED WITH PRESERVITIVE.

 2. ALL OTHER MEMBERS TO BE CEDAR. #2 (CONSTRUCTION) GRADE MINIMUM.

 3. ALL HARDWARE HOT DIPPED GALVANIZED.

- APPLY 2 COATS EXTERIOR STAIN TO MANUFACTURERS SPECIFICATION.
 FINISH SELECTION AS APPROVED BY PROJECT ARCHITECT.
- 5. ALL FENCES TO BE LEVEL. CHANGES IN GRADE TO BE IN 12"-18" STEPS (MAX.). 5. ALL FENCES TO BE LEVEL. CHANGES IN GRADE TO BE IN 12"-18" STEPS (MAX.). GAPS TO GRADE TO FOLLOW FINISH GRADE. GAP TO BE 3-6". GAPS TO GRADE TO FOLLOW FINISH GRADE. GAP TO BE 3-6".

- ALL POSTS PRESSURE TREATED TO CSA STANDARD AND END CUTS
- TREATED WITH PRESERVITIVE.
 2. ALL OTHER MEMBERS TO BE CEDAR. #2 (CONSTRUCTION) GRADE MINIMUM.
- 3. ALL HARDWARE HOT DIPPED GALVANIZED.
- APPLY 2 COATS EXTERIOR STAIN TO MANUFACTURERS SPECIFICATION. FINISH SELECTION AS APPROVED BY PROJECT ARCHITECT.

3 X THE WIDTH OF POST BY 1/3 HT. OF POST 1x6 NAILER 4'HT SCREEN 6'HT PATIO SCREEN 3'-6" HT FENCE COMPATCTED SUBGRADE TO 95% PROCTOR SECTION GATE

3 4'HT WOOD SCREEN-FRONT YARDS

BACKYARDS FENCE LAYOUT

scale 1/2"=1'-0"

PLAN VIEW 3'-6" LETTERS TO BE GALVANIZED METAL AND POWDER COATED WILLIAMS WITH BLACK FINISH, USE HIDDEN MOUNTING TO AFFIX ROAD ARCHITECTURAL CONCRETE BASE WITH MOUNTED 1/ 2"x 2"/4" ALUMINUM SLATS FRONT VIEW 150mm GRANULAR SUBBASE -

5 PROJECT SIGN

DP21-936149 Plan #15

© Copyright reserved. This drawing and design is the property of PMG Landscape Architects and may not be reproduced or used for other projects without their



| | - | |
|-----|-----------|-------------------------------|
| | | |
| 14 | 23.MAY.18 | REVISION AS PER CITY COMMENTS |
| 13 | 23.APR.27 | REVISION AS PER CITY COMMENTS |
| 12 | 23.APR.26 | REVISION AS PER CITY COMMENTS |
| 11 | 23 APR.24 | REVISION AS PER CITY COMMENTS |
| 16 | 22.NOV.10 | NEW SITE PLANSICITY COMMENTS |
| 9 | 22.5EP.08 | NEW SITE PLAN |
| 8 | 22.JUL-13 | NEW SIFE PLAN |
| 7 | 22.MAR.01 | NEW SITE PLAN |
| 6 | 22.JAN.10 | NEW SITE PLANSCITY COMMENTS |
| 5 | 21.MAY.07 | REVISION AS PER CITY COMMENTS |
| 4 | 21.APR.14 | NEW SHE PLAN &CITY COMMENTS |
| 3 | 21.MAR.03 | REVISION AS PER CITY COMMENTS |
| 2 | 20.NOV.10 | NEW SITE PLAN |
| 1 | 20.JUN.29 | NEW SHE PLANSCITY COMMENTS |
| NO. | DATE | REVISION DESCRIPTION |

CLIENT:

PROJECT: **8 UNIT TOWNHOUSE** DEVELOPMENT

6520 WILLIAMS ROAD RICHMOND

DRAWING TITLE:

LANDSCAPE **DETAILS**


DATE: November 22, 2017

DRAWN: DD DESIGN: DD


3.b


CHKTD: PCM PMG PROJECT NUMBER

OF 4 17-236

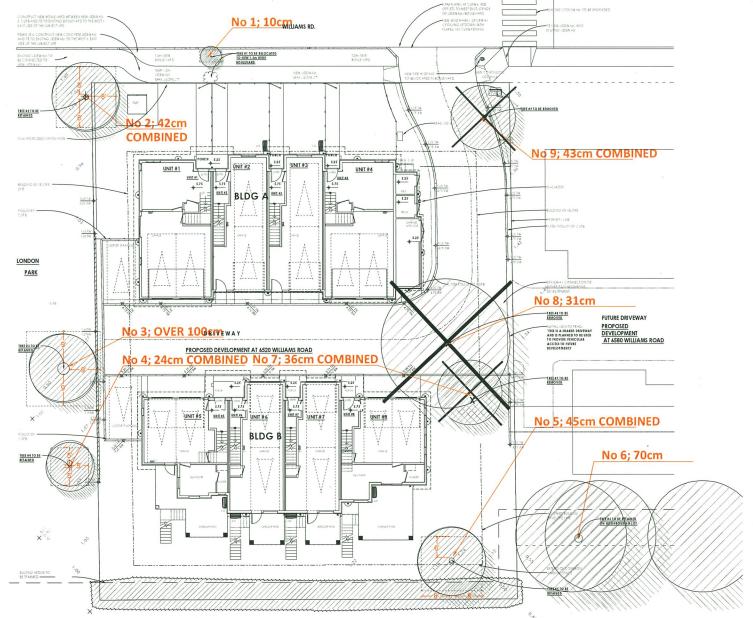



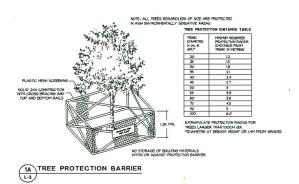

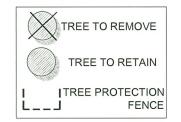

| TREE # | SPECIES | DBH (cm) | SPREAD (m) est. |
|-----------|---|-------------|--------------------|
| 1 | Golden chain (Laburnum sp.) | 10 | 1.9m |
| 2 | Threadleaf Cypress (Chamaecyparis pisifera sp.) | 42 | 6.1m |
| 3 | Hazelnut (Corylus sp.) | 100 | 6.1m |
| 4 | Magnolia <i>(Magnolia sp.)</i> | 25 | 4m |
| 5 . | Magnolia (Magnolia sp.) | 45 | 6.1m |
| 6 | Douglas fir (Pseudotsuga menziesii) | 70 | 12.2m |
| 7 | Japanese Maple (Acer palmatum sp.) | 36 | 6.1m |
| 8 | Dove tree (Davidia involucrata) | 31 | 11m |
| 9 | Magnolia (Magnolia sp.) | 43 | 6.1m |

© Copyright reserved. This drawing and design is the property of PMG Landscape Architects and may not be reproduced or used for other projects without their permission.



SEA

| | 23.MAY.18 | REVISION AS PER CITY COMMENTS | DD |
|----|-----------|-------------------------------|----|
| | 23.APR.27 | REVISION AS PER CITY COMMENTS | DD |
| Ī | 23.APR.26 | REVISION AS PER CITY COMMENTS | DD |
| | 23.APR.24 | REVISION AS PER CITY COMMENTS | DD |
| | 22.NOV.10 | NEW SITE PLAN&CITY COMMENTS | DD |
| Ī | 22.SEP.08 | NEW SITE PLAN | DD |
| | 22.JUL.13 | NEW SITE PLAN | DD |
| Ι | 22.MAR.01 | NEW SITE PLAN | 00 |
| Ī | 22.JAN.10 | NEW SITE PLANSCITY COMMENTS | DO |
| | 21.MAY.07 | REVISION AS PER CITY COMMENTS | 00 |
| Ī | 21.APR.14 | NEW SITE PLAN &CITY COMMENTS | DD |
| | 21.MAR.03 | REVISION AS PER CITY COMMENTS | DO |
| | 20.NOV.10 | NEW SITE PLAN | DO |
| | 20.JUN.29 | NEW SITE PLANSCITY COMMENTS | DO |
|). | DATE | REVISION DESCRIPTION | DF |
| | | | |

CLIE

8 UNIT TOWNHOUSE DEVELOPMENT

6520 WILLIAMS ROAD RICHMOND

DRAWING TITLE

TREE MANAGEMENT PLAN

DATE: November 22, 2017
SCALE: 3/32"=1"-0"
DRAWN: DD
DESIGN: DD
CHKD: PCM


DATE: November 22, 2017
DRAWN: GD
DRAWN: DD
OF

DP21-936149 Plan #16

17236-16.ZIP

6-16.ZIP PMG PROJECT NUMBER

17-236

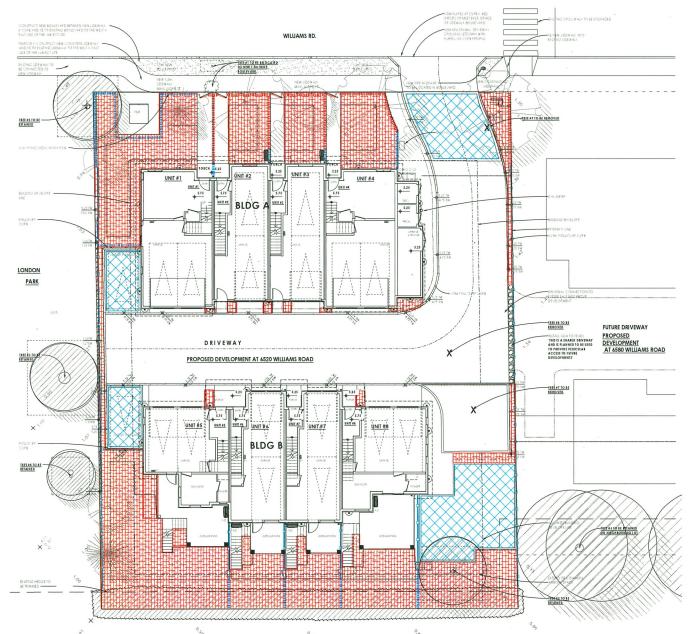







© Copyright reserved. This drawing and design is the property of PMG Landscape Architects and may not be reproduced or used for other projects without their permission.



| 14 | 23.MAY.18 | REVISION AS PER CITY COMMENTS | 0 |
|-----|-----------|-------------------------------|---|
| 13 | 23.APR.27 | REVISION AS PER CITY COMMENTS | 0 |
| 12 | 23.APR.26 | REVISION AS PER CITY COMMENTS | 0 |
| 11 | 23.APR.24 | REVISION AS PER CITY COMMENTS | 0 |
| 10 | 22.NOV.10 | NEW SITE PLANSCITY COMMENTS | 0 |
| 9 | 22.SEP.08 | NEW SITE PLAN | D |
| 8 | 22.JUL13 | NEW SITE PLAN | D |
| 7 | 22.MAR.01 | NEW SITE PLAN | 0 |
| 6 | 22.JAN.10 | NEW SITE PLAN&CITY COMMENTS | 0 |
| 5 | 21.MAY.07 | REVISION AS PER CITY COMMENTS | D |
| 4 | 21.APR.14 | NEW SITE PLAN &CITY COMMENTS | 0 |
| 3 | 21.MAR.03 | REVISION AS PER CITY COMMENTS | 0 |
| 2 | 20.NOV.10 | NEW SITE PLAN | D |
| 1 | 20.JUN.29 | NEW SITE PLANSCITY COMMENTS | D |
| 10. | DATE | REVISION DESCRIPTION | D |
| | | | |

CLIEN

8 UNIT TOWNHOUSE
DEVELOPMENT

6520 WILLIAMS ROAD RICHMOND

DRAWING TITLE:

LANDSCAPE PLAN

DATE: November 22, 2017 DRAWING NUMBER: SCALE: 3/32*=1*-0*
DRAWN: DD


DRAWN: DD

DESIGN: DD CHK'D: PCM

17236-16 7IP PMG PRO JECT NUMBER:

17-236

DP21-936149 Plan #17

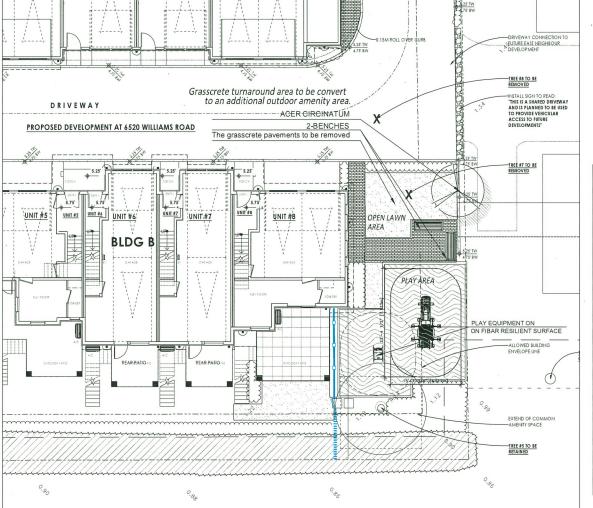





DP21-936149 Plan #18

© Copyright reserved. This drawing and design is the property of PMG Landscape Architects and may not be reproduced or used for other projects without their



,

| 14 | 23 MAY 18 | REVISION AS PER CITY COMMENTS | - |
|----|------------|-------------------------------|---|
| 13 | 23.NIA1.18 | REVISION AS PER CITY COMMENTS | - |
| 12 | 23.APR.26 | REVISION AS PER CITY COMMENTS | |
| 11 | 23.APR.24 | REVISION AS PER CITY COMMENTS | |
| 10 | 22.NOV.10 | NEW SITE PLAN&CITY COMMENTS | |
| 9 | 22.SEP.08 | NEW SITE PLAN | C |
| 8 | 22.JUL.13 | NEW SITE PLAN | C |
| 7 | 22.MAR.01 | NEW SITE PLAN | |
| 6 | 22.JAN.10 | NEW SITE PLANSCITY COMMENTS | 0 |
| 5 | 21.MAY.07 | REVISION AS PER CITY COMMENTS | C |
| 4 | 21.APR.14 | NEW SITE PLAN &CITY COMMENTS | |
| 3 | 21.MAR.03 | REVISION AS PER CITY COMMENTS | C |
| 2 | 20.NOV.10 | NEW SITE PLAN | C |
| 1 | 20.JUN.29 | NEW SITE PLAN&CITY COMMENTS | 0 |
| ın | DATE | DEVISION DESCRIPTION | п |

CLIENT:

PROJECT:

8 UNIT TOWNHOUSE DEVELOPMENT

6520 WILLIAMS ROAD RICHMOND

DRAWING TITLE:

FUTURE ADDITIONAL AMENITY SPACE


DATE: November 22, 2017 DRAWING NUMBER: SCALE: 1/8"=1'-0"

DRAWN: DD
DESIGN: DD
CHKTD: PCM

3.e

17236-16.ZIP PMG PROJECT NUMBER:

17-236

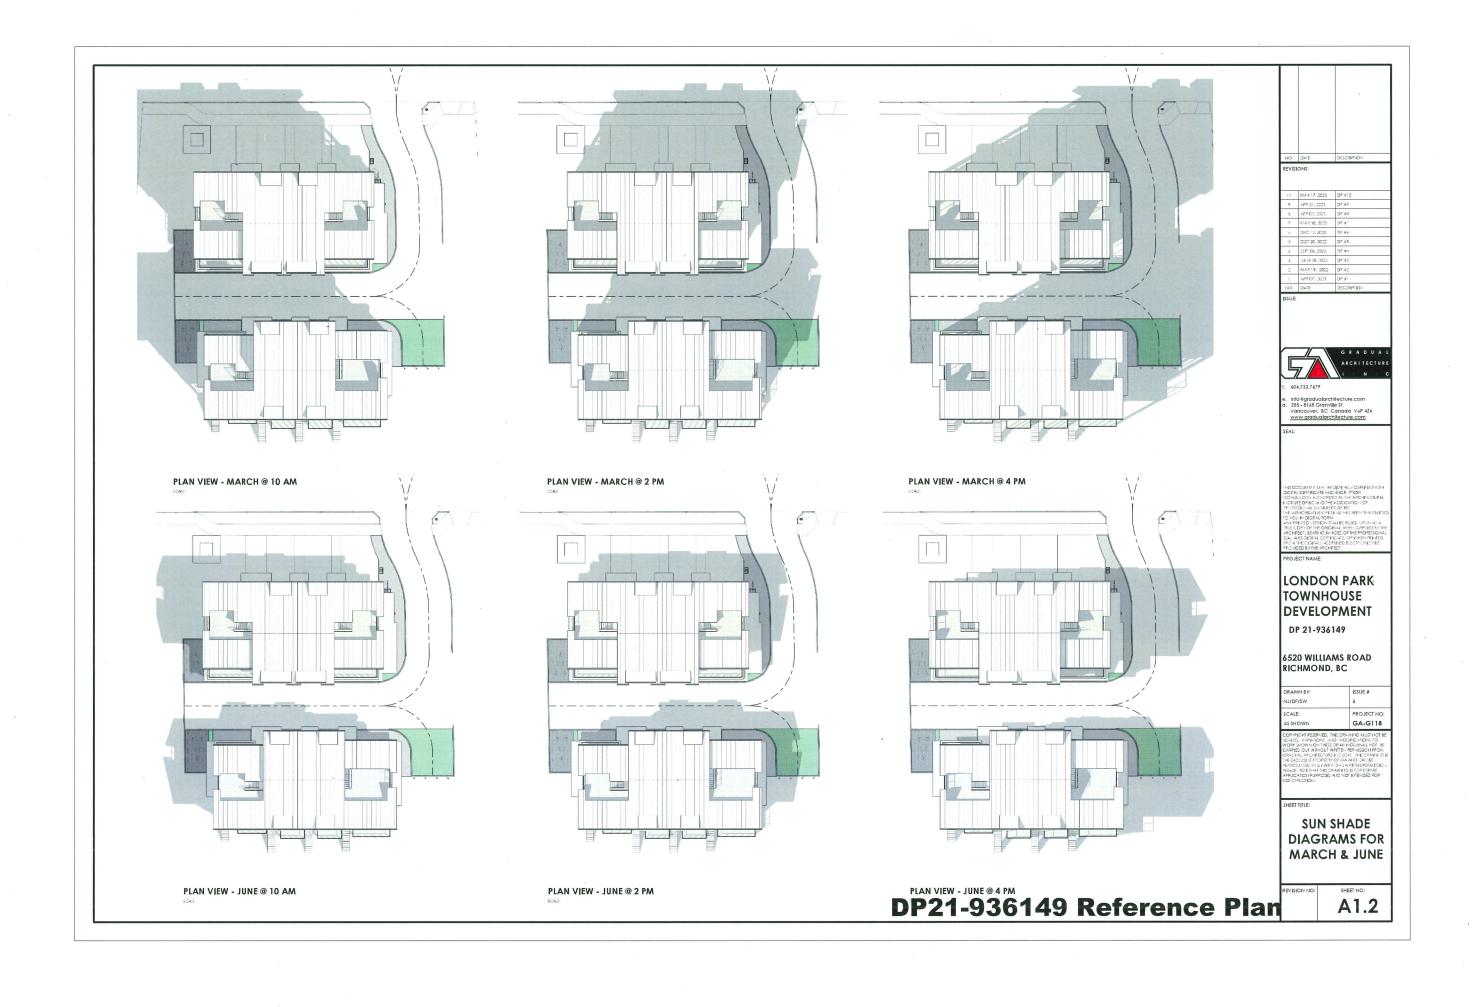



ORTHO VIEW - NORTHWEST

ORTHO VIEW - SOUTHWEST





ORTHO VIEW - NORTHEAST



ORTHO VIEW - SOUTHEAST

DP21-936149 Reference Plan

| O | DATE | DESCRIPTION |
|---|------|-------------|
| | | |
| | | |
| | | |
| | | |
| | | |

NO DATE

REVISION

| 10 | MAY 17, 2023 | DP #10 |
|----|---------------|--------|
| 9 | APR 21, 2023 | DP #9 |
| 9 | APR 03, 2023 | DP #8 |
| 7 | MAR 08, 2023 | DP #" |
| 6 | DEC 12, 2022 | DP #6 |
| 5 | OCT 20, 2022 | DP #5 |
| 4 | SEPT 08, 2022 | DP #4 |
| 3 | JUNE 28, 2022 | DP #3 |
| 2 | MAR 19. 2022 | DP #2 |
| 1 | 4PR 07, 2021 | DP #1 |
| | | |

ISSU



1017227

e. info@gradualarchitecture.com a. 205 - 8168 Granville St. Vancouver, BC Canada VoP 4Z4

SEAL

THIS DOCUMENT MAY BE DIGITALLY CEPTIFIED WITH DIGITAL CEPTIFICATE WID SIXES FROM TECHNICODES WITHORDED SIXE PROPERTIES INTUITED BE AN AIR DIGITAL PROPERTIES INTUITED BE AN AIR DIGITAL PROPERTIES THE AIR CONTROL OF THE PROPERTIES OF THE AIR SIXES CONTROL OF THE PROPERTIES OF THE AIR CONTROL TO THE ORIGINAL WITHOUGH THE OF THE AIR CONTROL THE ORIGINAL WITHOUGH THE OF THE AIR CONTROL THE AIR SIXES OF THE PROPERTIES OF THE AIR CONTROL THE AIR SIXES OF THE PROPERTIES OF THE AIR CONTROL THE AIR SIXES OF THE PROPERTIES OF THE AIR CONTROL THE AIR SIXES OF THE PROPERTIES OF THE AIR CONTROL THE AIR SIXES OF THE PROPERTIES OF THE AIR CONTROL THE PROPERTIES OF THE AIR CONTROL THE PROPERTIES OF THE PROPER

PROJECT NA

LONDON PARK TOWNHOUSE DEVELOPMENT

DP 21-936149

6520 WILLIAMS ROAD RICHMOND, BC

| NJ/DF/SW | 1 " |
|-----------|---------|
| DRAWN BY: | ISSUE # |

CCALED, VARRATONIC, AND MODIFICATIONS TO WORK THOWN ON THESE DRAWINGSHALL NOT SECOND THE CONTROL OF THE CONTROL

SHEET TIT

3D ORTHO VIEWS

REVISION NO:

A1.6