



Development Permit Panel Electronic Meeting

Council Chambers, City Hall 6911 No. 3 Road Wednesday, May 15, 2024 3:30 p.m.

MINUTES

Motion to adopt the <mark>minutes</mark> of the Development Permit Panel meeting held on April 24, 2024.

1. **DEVELOPMENT PERMIT 21-945917**

(REDMS No. 7658413)

APPLICANT: Arno Matis Architecture

PROPERTY LOCATION: 6851 and 6871 Elmbridge Way

Director's Recommendations

That a Development Permit be issued which would:

- 1. permit the construction of 376 residential units, hotel and accompanying commercial uses in a high-rise mixed use development containing three 15 storey towers at 6851 and 6871 Elmbridge Way on a site zoned "High-Density Mixed Use (ZMU52) – Oval Village (City Centre)"; and
- 2. vary the provisions of Richmond Zoning Bylaw 8500 to:
 - (a) reduce the minimum road setback of 3.0 m along River Road to 0.25 m to allow a projection on a small portion of the development's podium (Levels 3 to 6) for components of the building and residential balcony units; and
 - (b) not require a large size on-site loading space in the proposed development.

ITEM

2. DEVELOPMENT PERMIT 22-008932

(REDMS No. 7540972)

APPLICANT: Kenneth Kim (Kenneth Kim Architecture Inc.)

PROPERTY LOCATION: 6500 Cooney Road

Director's Recommendations

That a Development Permit be issued which would permit the construction of six townhouse units over a common parking structure at 6500 Cooney Road on a site zoned "Parking Structure Town Housing (ZT93) - Brighouse (City Centre)".

3. DEVELOPMENT PERMIT 23-034544

(REDMS No. 7643815)

APPLICANT: Maskeen (Hamilton) Properties Corp.

PROPERTY LOCATION: 4651, 4671, 4691 Smith Crescent and 23301, 23321, 23361, 23381 Gilley Road

Director's Recommendations

That a Development Permit be issued which would permit the construction of a mixeduse mid-rise development comprising commercial space, City-owned community amenity space and 186 residential units, including 19 low-end-of-market (LEMR) units at 4651, 4671, 4691 Smith Crescent and 23301, 23321, 23361, 23381 Gilley Road on a site zoned "Residential/Limited Commercial (ZMU53) - Neighbourhood Village Centre (Hamilton)".

- 4. New Business
- 5. Date of Next Meeting: May 29, 2024

ADJOURNMENT



Minutes

Development Permit Panel Wednesday, April 24, 2024

Time: 3:30 p.m.

Place: Remote (Zoom) Meeting

Present: Cecilia Achiam, General Manager, Community Safety, Chair Marie Fenwick, Director, Arts, Culture and Heritage Michael Allen, Acting Director, Real Estate Services

The meeting was called to order at 3:30 p.m.

MINUTES

It was moved and seconded That the minutes of the meeting of the Development Permit Panel held on March 27, 2024 be adopted.

CARRIED

1. DEVELOPMENT PERMIT 23-024119 (REDMS No. 7609062)

APPLICANT: Topstream Management Ltd.

PROPERTY LOCATION: 8635, 8655, 8675 and 8695 Cook Crescent

INTENT OF PERMIT:

Permit the construction of 28 townhouse units and fourteen secondary suites at 8635, 8655, 8675 and 8695 Cook Crescent on a site zoned "Town Housing (ZT103) – Parking Structure Townhouses (Spires Road – Cook Crescent)".

Applicant's Comments

Coby Xiao, Topstream Management Ltd., introduced the presenters for the application and Jeff Shen, J+S Architect, Inc., with the aid of a visual presentation (attached to and forming part of these minutes as <u>Schedule 1</u>), provided background information on the proposed development, highlighting the following:

- the form of the proposed development is consistent with neighbouring townhouse developments in the area;
 - due to the closure of Cook Crescent in the future, the entrances to the building's
- parkade and main lobby will be located off Spires Road on the south side of the proposed development;
- the project provides 28 dwelling units, including 27 multi-level townhouse units and one ground level flat in four building blocks;
- the proposed unit mix consists of two- to five-bedroom townhouse units and 14 townhouse units will contain a secondary suite on ground level;
- a central courtyard space is proposed on the podium level surrounded by the four building blocks;
- all townhouse units include a patio on the podium level and/or rooftop deck and all secondary suites will have a private outdoor space;
 - a three-metre wide north-south public walkway along the west property line and a
- 10-meter wide greenway, i.e. Pedestrian Linkage, along the north property line are proposed;
- the triangular area north of the 10-meter wide greenway will be dedicated by the developer to the City;
- a three-metre landscape strip around the perimeter of the site is proposed to provide a second layer of landscaping on the ground level;
- the proposed 34 residential parking spaces meet the minimum Zoning bylaw requirement;
- the proposed use of materials, colours and architectural elements visually reduce the height of the building and breaks down the building mass;
- two four-storey convertible units and one single-level Basic Universal Housing (BUH) unit are proposed; and
- the project has been designed to achieve Step Code 4 of the BC Energy Step Code.

Yiwen Ruan, PMG Landscape Architects, with the aid of the same visual presentation, briefed the Panel on the main landscape features of the project, noting that (i) each unit will be provided with a landscaped yard with a canopy tree to enhance the pedestrian experience around the site, (ii) multiple trees are proposed to be retained and protected along the west property line, (iii) the west public walkway is configured to protect the retained trees, (iv) street furniture is proposed at the northeast and southeast corner plazas to encourage their use, (v) the outdoor amenity area on the podium level includes two children's play areas in different locations and exercise and play equipment for adults, (vi) each unit will be provided with a landscaped yard on the podium level, (vii) wall mounted and bollard lighting are proposed for the project, (viii) drought tolerant species are proposed for all planted areas.

Staff Comments

Wayne Craig, General Manager, Planning and Development, clarified that the triangular area north of the proposed 10-metre wide greenway is not intended to be a City park as it is a future development lot and there is an expectation that a licence agreement will be entered into to allow the residents of the proposed development to use the area until the redevelopment of the lot occurs.

In addition, Mr. Craig noted that (i) there is a Servicing Agreement associated with the project for site services and frontage works, and (ii) the applicant is commended for their efforts to integrate the four existing trees on the walkway along the western edge of the subject site.

In reply to a query from the Panel, Mr. Craig stated that the title of the triangular property north of the 10-metre wide greenway will be transferred to the City and the City anticipates to enter into a licencing agreement to allow the residents of the proposed development to use the lot, which will be fenced to prohibit public access.

Panel Discussion

In reply to queries from the Panel, the applicant team noted that (i) the secondary suites can be accessed on the ground level either from the street or public walkways, (ii) the secondary suites are designed to be studio or one-bedroom units and have sizes ranging from approximately 300 square feet or larger, (iii) there is a tree in the triangular area north of the 10-metre wide greenway that will be retained, (iv) the sculptural pieces hanging down in between buildings are intended to fill the gap between buildings and are not part of public art, and (v) lighting will be installed along the public walkways and on adjacent buildings.

Correspondence

None.

Gallery Comments

The Chair advised staff to meet with the member of public present in Council Chambers wanting to delegate but unable to speak on the proposal due to the absence of her translator.

Panel Discussion

The Panel expressed support for the project, noting the design is well thought out and there is adequate separation from the future development to the west through the provision of the public walkway.

Panel Decision

It was moved and seconded

That a Development Permit be issued which would permit the construction of 28 townhouse units and fourteen secondary suites at 8635, 8655, 8675 and 8695 Cook Crescent on a site zoned "Town Housing (ZT103) – Parking Structure Townhouses (Spires Road – Cook Crescent)".

CARRIED

2. DEVELOPMENT PERMIT 23-029453 (REDMS No. 7623245)

APPLICANT: Fougere Architecture Inc.

PROPERTY LOCATION: 10611 and 10751 River Drive

INTENT OF PERMIT:

Permit the construction of a mid-rise residential development comprising 181 residential units, including 18 low-end-of-market-rental (LEMR) units and 13 market rental units at 10611 and 10751 River Drive on a site zoned "Low to Mid Rise Apartment (ZLR46) - Bridgeport"

Applicant's Comments

Wayne Fougere, Fougere Architecture Inc., with the aid of a visual presentation (attached to and forming part of these minutes as <u>Schedule 2</u>), provided background information on the proposed development, highlighting the following:

• the proposed development completes the multi-phase overall development on the north side of River Drive between No. 4 Road and Shell Road;

the lower two-storey amenity building and four-storey apartment building are located along River Drive and the higher two six-storey apartment buildings are sited at the rear, fronting the dike and the river;

- a total of 181 dwelling units are proposed including 150 market strata units, 13 market rental units and 18 Low-End-of-Market (LEMR) units;
- street-facing apartment buildings have lower living areas to provide better connection to the street;
- the central pedestrian entry to the proposed development is located on River Drive
 and provides pedestrian connection from River Drive to the dike through the central courtyard;
 - a wheelchair accessible widened public walkway is located along the edge of the
- west property line and provides pedestrian connection from River Drive to the dike walkway;
- the public multi-use path along Shell Road on the east side of the subject site is
 wheelchair accessible; however, the access from the pathway's northern terminus to the dike is not wheelchair accessible due to its steep slope;
- the central courtyard on the podium level is enclosed by the four buildings and can be accessed from the street, public walkways and the dike;
- public art is proposed at the corner of River Drive and Shell Road;
- the project provides 91 Basic Universal Housing (BUH) units, including 16 for LEMR units, 10 for market rental units, and 65 for market strata units;
- the contemporary architectural style of the buildings in the proposed development is consistent with the buildings in Phase 1 of the overall development; and
 - outdoor amenity space is provided on the podium level central courtyard and indoor
- amenity spaces are provided in the two-storey indoor amenity building and smaller multi-purpose rooms in the larger northeast and northwest apartment buildings.

Yiwen Ruan, PMG Landscape Architects, with the aid of the same visual presentation, briefed the Panel on the proposed landscaping for the project, noting that (i) the proposed landscape design is intended to provide pedestrian connectivity and interaction, (ii) semiprivate spaces along the edges of the site are separated from public spaces through grade change and landscaping, including installation of tiered planters, (iii) the proposed outdoor amenity area on the podium level central courtyard provides a variety of uses for adults and children, including among others, as gathering spaces and play areas, (iv) accessible pedestrian pathways are provided along the west and east edges of the site and through the courtyard at the centre of the site, (v) proposed on-site planting includes drought tolerant and pollinator friendly species, and (vi) a high-efficiency on-site irrigation system will be provided for all planted areas.

Staff Comments

Mr. Craig noted that (i) the rental units in the rental building fronting River Drive will be secured through housing agreements and the developer has entered into a memorandum of understanding with a non-profit organization for the management of the rental units, (ii) the Servicing Agreement associated with the project includes frontage works on River Drive and Shell Road and site services, among others, (iii) there will be a separate Servicing Agreement for the construction of the dike and dike pathways, (iv) there is an extensive Transportation Demand Management (TDM) package associated with the project which includes, among others, the provision of transit passes to 15 percent of the residents of market strata units, an increase of on-site bicycle storage facility, and the provision of a bicycle maintenance facility, and (v) more than 70 percent of the total number of units provided in the project are family-friendly units, i.e., two-to three-bedroom units.

In reply to queries from the Panel, staff advised that (i) aging-in-place features incorporated in all of the proposed units include the provision of stairwell handrails, lever-type handles for plumbing fixtures and door handles, and solid blocking in washroom walls to facilitate future grab bar installation beside toilets, bathtubs and showers, (ii) there are no fully accessible units provided in the project; however, the project provides 91 Basic Universal Housing (BUH) units which includes 16 out of 18 LEMR units, 10 out of 13 market rental and 65 out of 150 market strata units, (iii) the dike connection from the Shell Road terminus to the dike is intended for maintenance vehicles and public access for pedestrians; however, it is not suitable for people in wheelchairs due to its steep grade, (iv) the public walkway along the west edge of the site from River Drive to the dike walkway is wheelchair accessible, and (v) it is not feasible for the proposed development to connect to the privately-owned geo utility located in the earlier phase of the overall development.

Panel Discussion

In reply to queries from the Panel, the applicant team advised that (i) the proposed public art for the project has been presented to the City's Public Art Advisory Committee, (ii) a local artist will be commissioned for the proposed public art, and (iii) the project has been designed to achieve Step Code 3 of the BC Energy Step Code with a privately owned low-carbon energy system.

Correspondence

None.

Gallery Comments

Sandra Lindahl, 10766 River Drive, queried about (i) actions taken by the developer to put in place pest control to address rodent infestation as a result of building demolition as noted at the June 19, 2023 Public Hearing for the rezoning of the subject site, (ii) the exact number of residential units provided in the proposed development, (iii) how the City will ensure that the proposed number of rental housing units are actually built and used for their intended purpose, (iv) who should the neighbours contact if they are not satisfied with the measures taken by the developer to ensure roads are kept free from dust, nails and other construction debris, (v) whether the strata or the renters of LEMR units will shoulder the cost for the installation of grab bars and the conversion of the BUH units into accessible units, and (vi) the location of vehicle access to the underground parkade on River Drive.

In addition, Ms. Lindahl expressed disagreement with the Traffic Impact Assessment prepared by a qualified professional referenced in the staff report indicating that the existing road network can accommodate the additional traffic generated by the proposed development, as she noted that residents in the area are currently experiencing traffic concerns on River Drive.

In reply to Ms. Lindahl's queries, the applicant team advised that (i) a pest control company has been commissioned by the developer to undertake pest control and will soon commence their work, (ii) the project will provide a total of 181 units, including 150 market strata units, 13 market rental units and 18 LEMR units, (iii) the developer can be contacted for construction related concerns and will regularly monitor construction and dialogue with neighbours, (iv) the rental company/operator will shoulder the costs for the installation of grab bars in the market rental and LEMR units, and (v) vehicle access to the underground parkade is located at the southwest corner of the subject site.

In reply to the query regarding how the City will ensure that the proposed number of market rental and LEMR units will be constructed and used for their intended purpose, Mr. Craig noted that the City will be registering a housing agreement on title of the property which includes the obligation to provide statutory declarations to the City on a periodic basis to ensure that those units are rented and LEMR units are rented by qualified tenants under the City's Affordable Housing Strategy guidelines.

In reply to Ms. Lindahl's concern regarding the Traffic Impact Assessment at rezoning, Mr. Craig noted that an independent third party assessment was provided during the rezoning phase and it was reviewed and approved by the City's Transportation Department.

A resident of 2401 Shell Road queried about (i) the number of parking stalls provided in the project, (ii) measures to mitigate construction debris including dust and dirt in the subject site impacting neighbouring residential properties, and (iii) the timeline for project construction.

In reply to the query regarding the number of parking stalls proposed for the project, the applicant team noted that 274 parking stalls will be provided for 181 residential units. In addition, Mr. Craig stated that the proposed number of parking stalls to be provided is consistent with the City's Zoning Bylaw requirement.

In reply to queries regarding measures to mitigate the impact of dust and dirt during construction and project construction timeline, the applicant team advised that (i) appropriate equipment will be used as needed to clear dust, dirt and other construction debris that are above normal levels, and (ii) the developer intends to commence project construction in the later part of this year subject to the timing of required City approvals.

In reply to a further query, the applicant clarified that the developer will endeavor to keep the roads clean during construction.

In addition, the Chair advised that the City's Bylaws Department contact information will be posted on the subject site so neighbouring residents can contact the City for construction-related concerns.

Panel Decision

It was moved and seconded *That a Development Permit be issued which would:*

1. permit the construction of a mid-rise residential development comprising 181 residential units, including 18 low-end-of-market-rental (LEMR) units and 13 market rental units at 10611 and 10751 River Drive on a site zoned "Low to Mid Rise Apartment (ZLR46) - Bridgeport"

CARRIED

3. DEVELOPMENT PERMIT 23-035339 (REDMS No. 7603680)

APPLICANT: Gustavson Wylie Architects Inc.

PROPERTY LOCATION: 18399 Blundell Road

INTENT OF PERMIT:

Permit/the construction of two single-storey buildings with drive-through restaurant uses at 18399 Blundell Road on a site zoned "Industrial (I)".

Applicant's Comments

David Cheung, Gustavson Wylie Architects Inc., with the aid of a visual presentation (attached to and forming part of these minutes as <u>Schedule 3</u>), provided background information on the proposed development, highlighting the following:

the original Development Permit for the project was issued by Council around three years ago; however, due to unforeseen events, the permit lapsed as construction did not take place within the required period;

- two single-storey buildings are proposed for quick service restaurant and drivethrough uses with a central plaza located between the two buildings for outdoor eating area;
- a right-in/right-out vehicle entry/exit and left turn entry are provided on Blundell Road and a right-in/right-out only vehicle entry/exit is proposed on Nelson Road;
- 64 outdoor parking spaces are proposed including two accessible parking stalls near the entrances of the two buildings;
- nine of the 64 parking stalls will be provided with electric vehicle (EV) charging stations;
- bicycle parking will be provided on the site;
- canopies are proposed at restaurant entrances to provide weather protection;

tilt-up concrete was proposed to be used in the original design of the buildings but

- has been changed to insulated metal panel system to meet sustainability requirements;
- contrasting colours are proposed for the project to provide visual interest in the industrial neighbourhood; and
- the central plaza includes an awning feature and landscaped to animate the place and provide visual interest.

Christy Voelker, Prospect and Refuge Landscape Architects, with the aid of the same visual presentation, briefed the Panel on the main landscape features of the project, noting that (i) three pedestrian entries are proposed from the sidewalk to the subject site, (ii) areas of pedestrian walkways that cross the drive aisles and vehicle queuing areas are treated with a different colour of permeable pavers to enhance pedestrian safety, (iii) shading and a variety of seating opportunities are proposed in the central plaza, (iv) proposed planting includes species that are low-maintenance and provide all-season interest, (v) a row of canopy trees is proposed along the south edge of the site to provide shade in the parking lot, (vi) on-site irrigation will be provided for planted areas, and (vii) permeable pavers are proposed for the outdoor eating plaza and pedestrian walkways.

Staff Comments

Mr. Craig noted that (i) an Automatic Volume Control (AVC) system that adjusts speaker volume will be installed in the drive-through to ensure compliance with the City's Noise Bylaw, (ii) the project includes nine electric vehicle (EV) charging stations, and (iii) there was a Servicing Agreement entered into as part of the previous Development Permit approval for frontage works which have been completed.

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Panel Discussion

In reply to queries from the Panel, the applicant team noted that (i) the AVC system automatically adjusts the speaker volume based on ambient noise levels and has been successfully used by many drive-through restaurants, (ii) shower facilities for restaurant workers biking to work would be difficult to provide in the restaurant buildings due to their size, (iii) automatic irrigation will be provided on-site for all planted areas, and (iv) raised planters in the central plaza will have adequate soil volume for the size of trees to be planted.

Gallery Comments

None.

Correspondence

None.

Panel Discussion

The Panel expressed support for the project for restaurant uses, noting that it is a welcome addition to the industrial neighbourhood.

It was moved and seconded

That a Development Permit be issued which would permit the construction of two single-storey buildings with drive-through restaurant uses at 18399 Blundell Road on a site zoned "Industrial (I)".

CARRIED

4. New Business

None.

5. Date of Next Meeting: May 15, 2024

ADJOURNMENT

It was moved and seconded *That the meeting adjourn (5:02 p.m.).*

CARRIED

Certified a true and correct copy of the Minutes of the meeting of the Development Permit Panel of the Council of the City of Richmond held on Wednesday, April 24, 2024.

Cecilia Achiam Chair Rustico Agawin Committee Clerk

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Schedule 1 to the Minutes of the Development Permit Panel meeting held on Wednesday, April 24, 2024



2024-04-24 Development Permit Panel Presentation


A 28-unit Townhouse Development 8635-8695 COOK CRESCENT, CITY OF RICHMOND

PROJECT INFO

Site Context

<image>

SE Corner

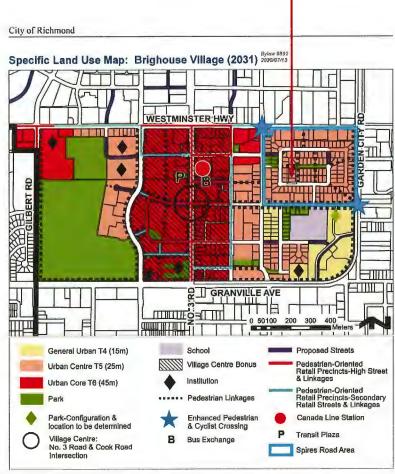

SITE LOCATION

Bylaw 10020 Maximum building height may be subject to established Airport Zoning Regulations in certain areas.

PROJECT INFO Neighboring Townhouse Developments

neighboring townhousing developments have received approvals in recent years



8888 Spires Road "Parking Structure Townhouses"



8800 Spires Road "Parking Structure Townhouses"





8951, 8971 Spires Road and 8991 Spires Gate "Parking Structure Townhouses"



8671, 8731 Spires Road "Parking Structure Townhouses"

PROJECT INFO Features to Fit Into Surrounding Neighborhood



8888 Spires Road "Parking Structure Townhouses"



8800 Spires Road "Parking Structure Townhouses"



- reflects a contemporary take on the traditional architectural style in the Neighborhood
- similar size and proportion of building blocks
- common features e.g., pitched roofs and atgrade yards with weather-protected entries
- traditional roof gables to downsize building scale
- same material language e.g., asphalt shingle on gable roof and siding on exterior





"Parking Structure Townhouses"





8671, 8731 Spires Road "Parking Structure Townhouses"


PROJECT INFO Recap from Rezoning: Pedestrian Linkage in the north and the west

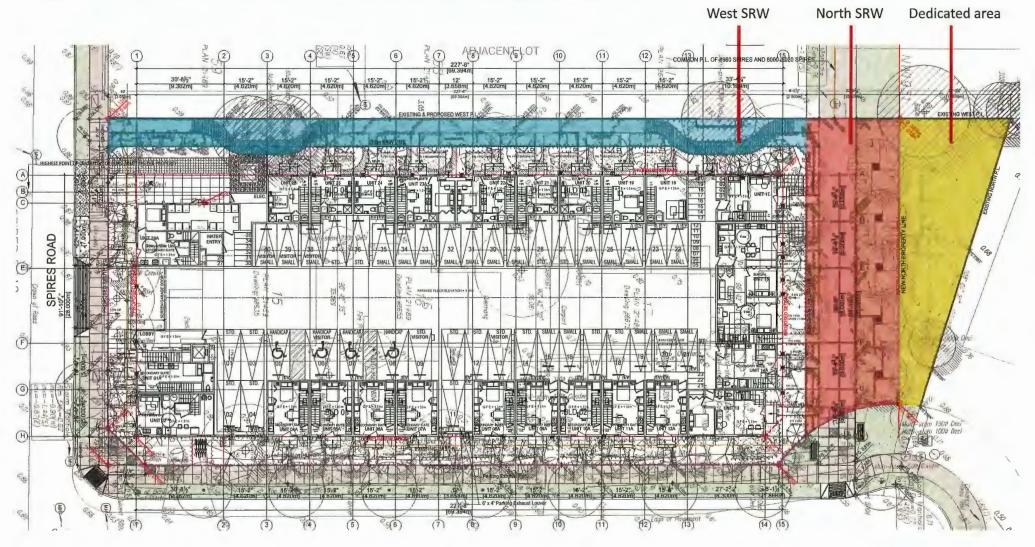


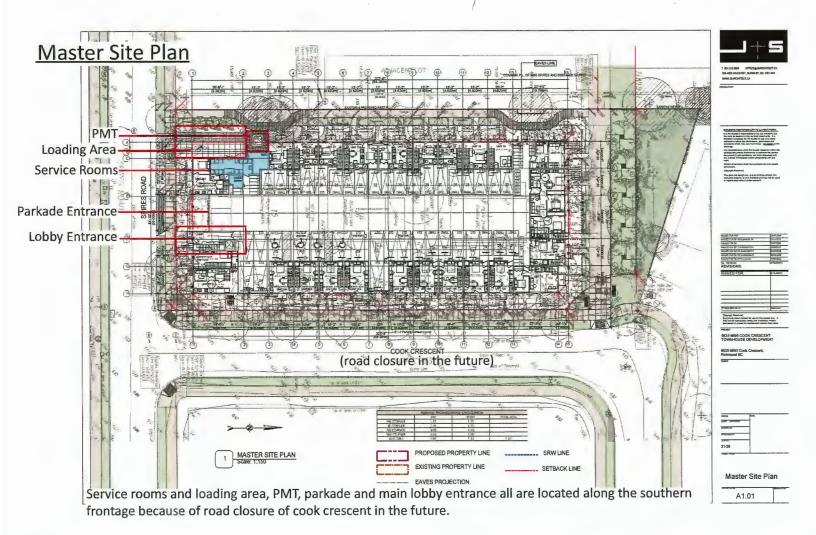


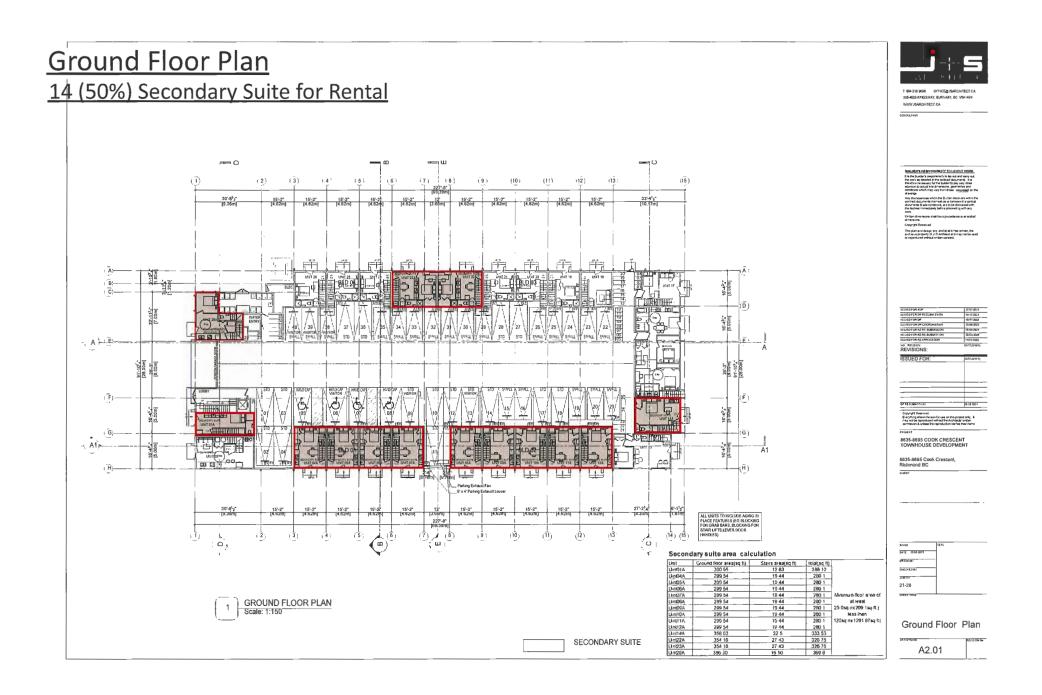

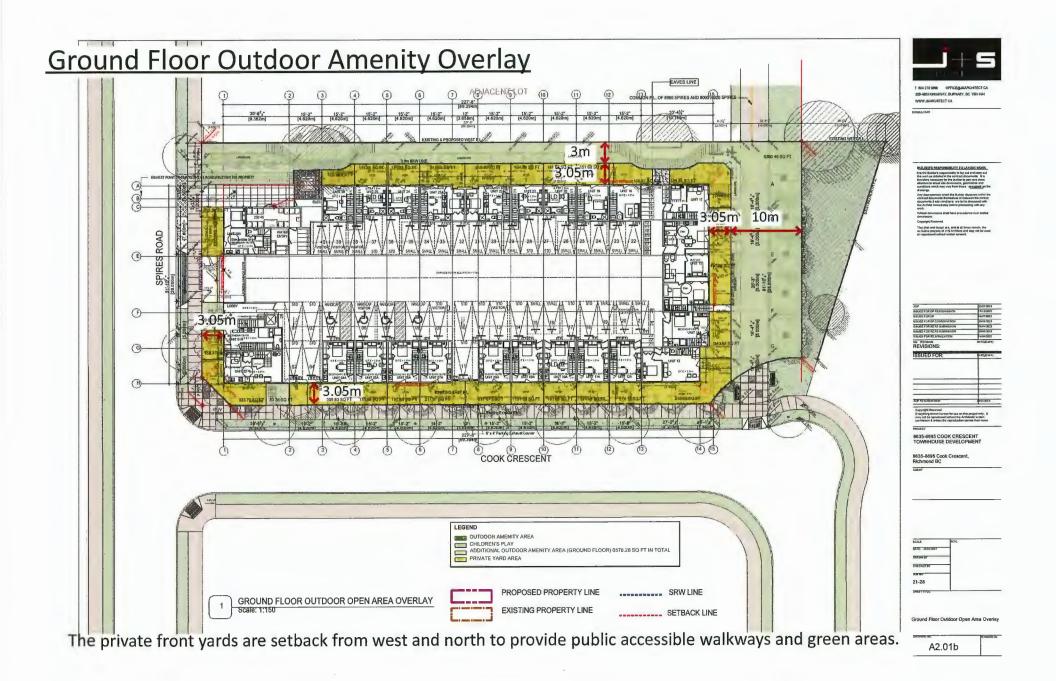

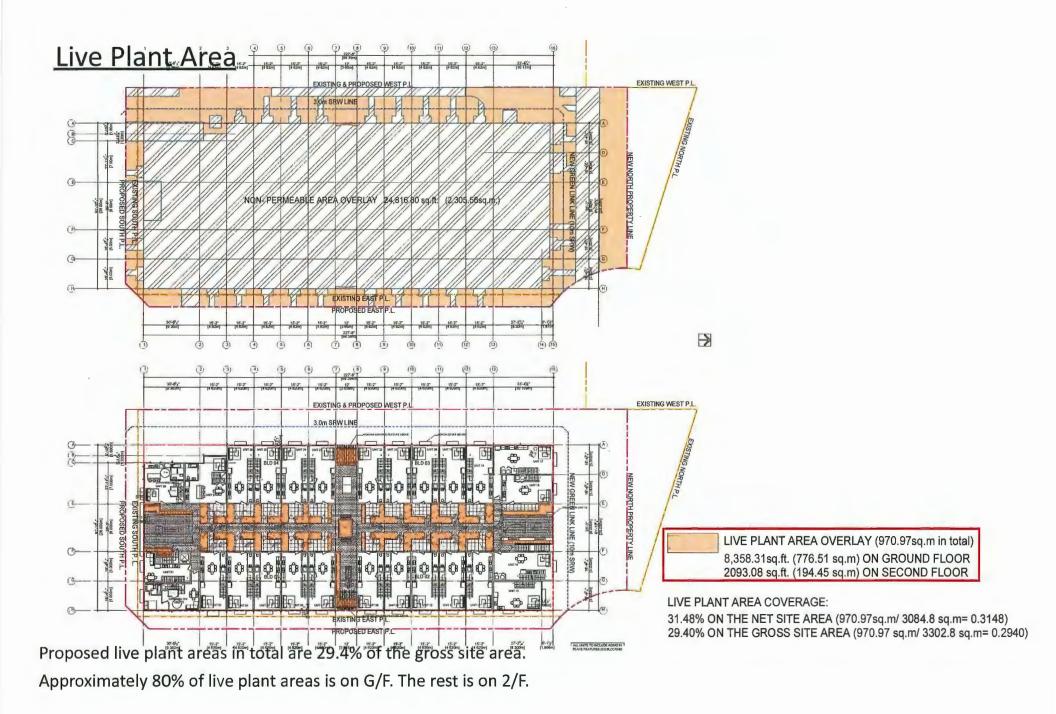


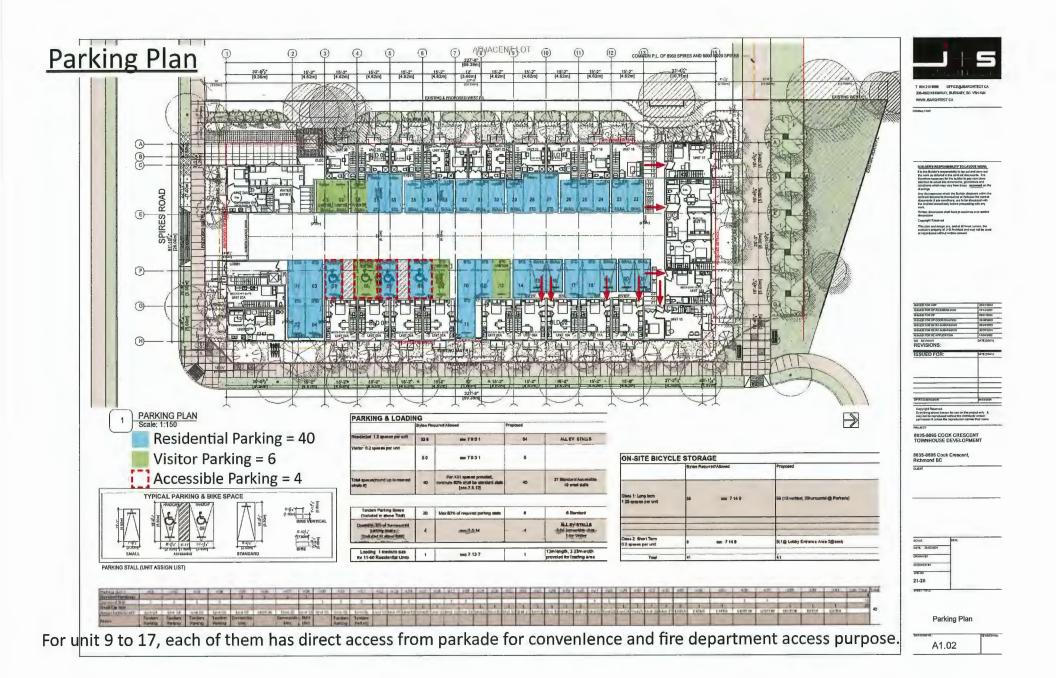


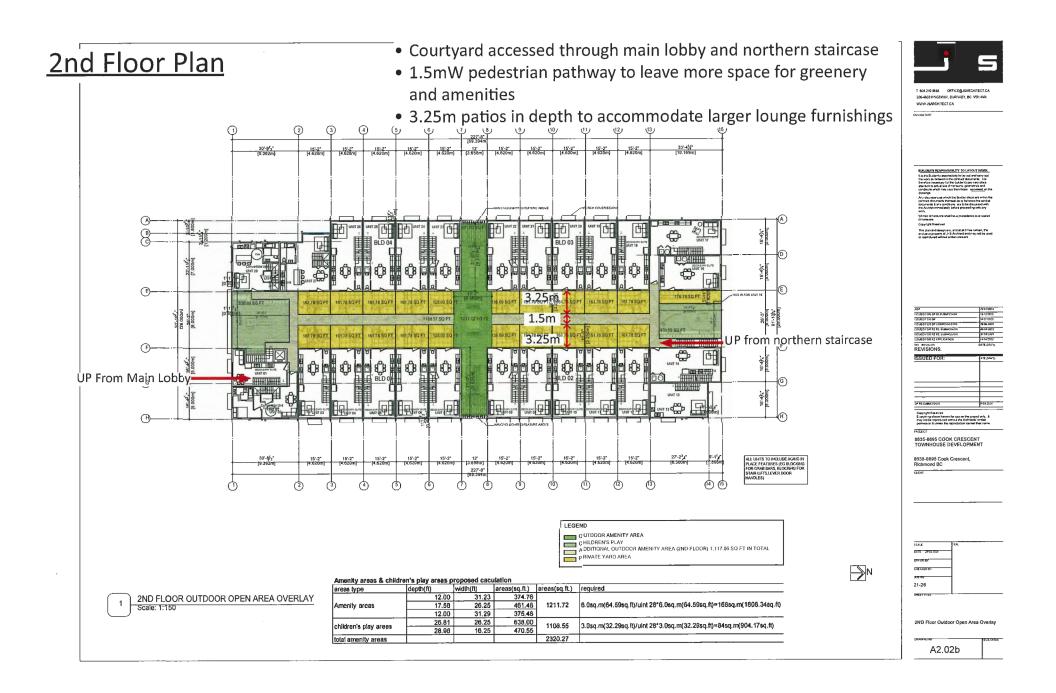

Connectivity with Ground Floor Green Spaces

- Connect the outdoor amenity with our North and West Side green belts.
- Outdoor spaces are integrated and achieve the functions as a system.

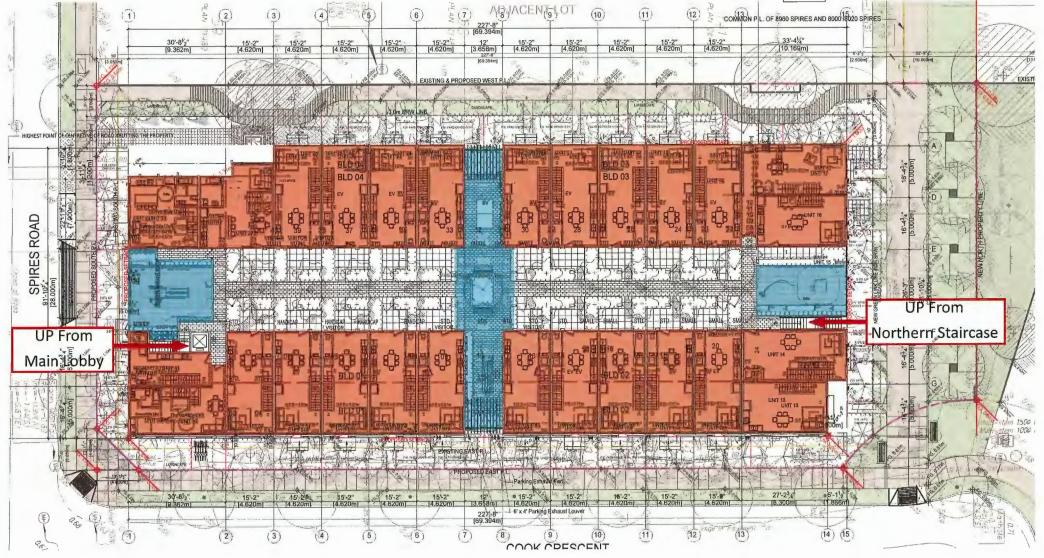

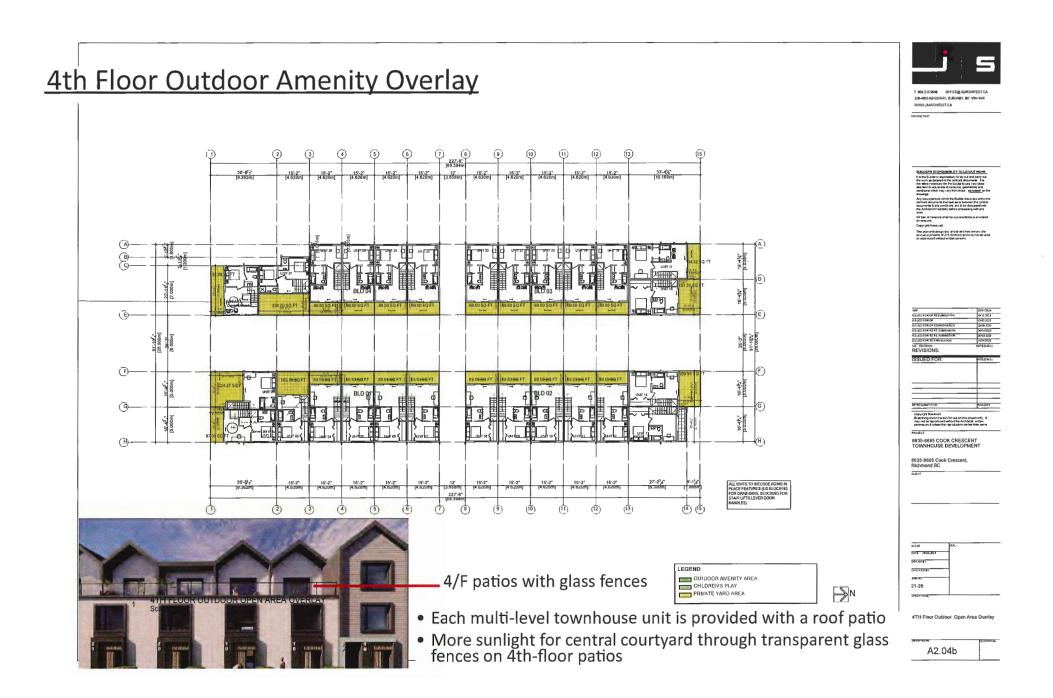






• Vertical metal tube elements hanging over the amenity areas to fill in spacing and activate building frontage further.

Street-Scape-02

A5.02

• Side facade of corner units is treated as the front facade.



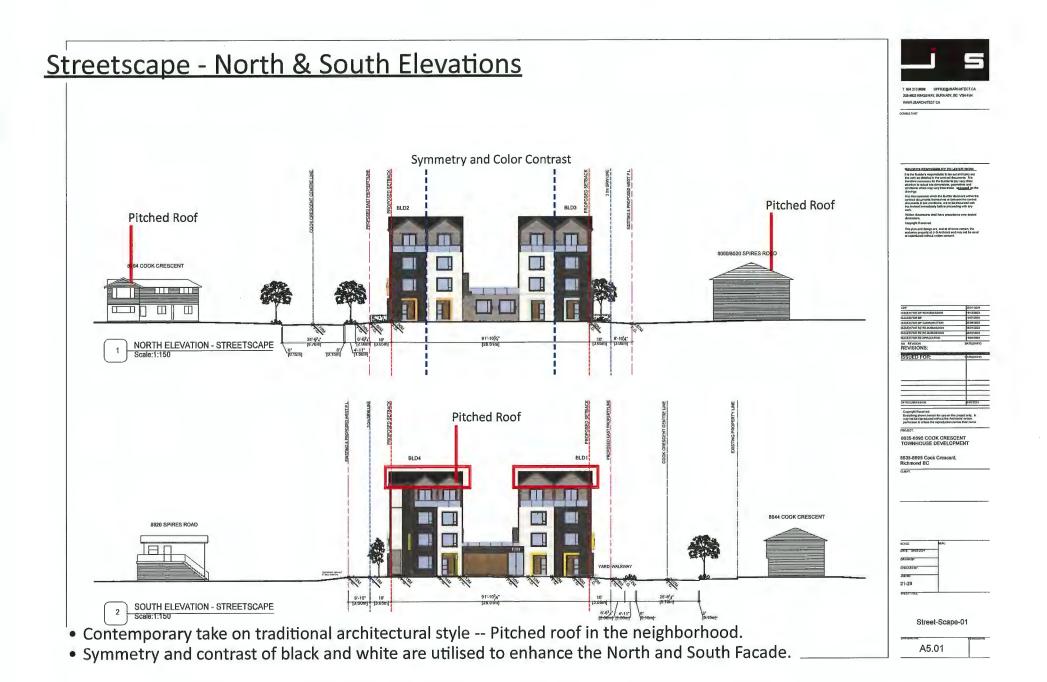


Further articulation to provide individuality to each block




- Different color to the individual entry frames to give identity to each individual block.
- A signboard for each building block is hung at the corner unit to draw pedestrian attention.

Highlighting The Main Entrance

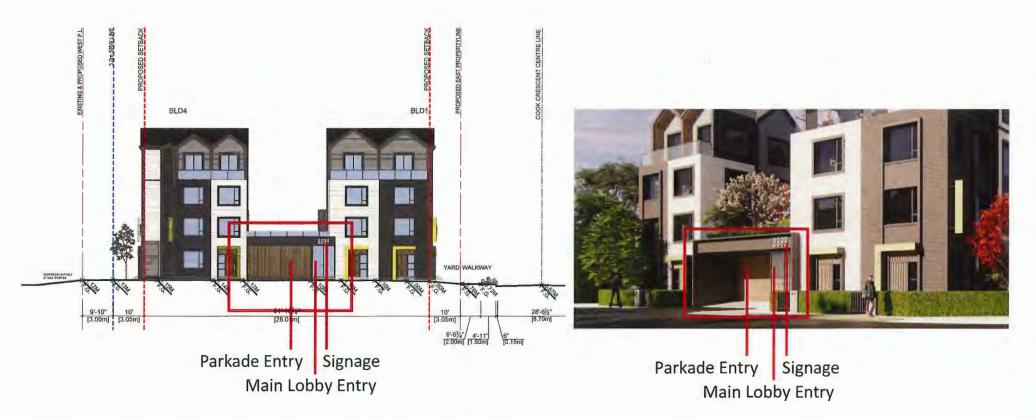


- The main lobby is under a large frame with the parkade entry.
- The architectural style of the frame is consistent with the overall contemporary style.
- Larger and higher than individual unit frames to be easily recognized.
- Features large glazing, which appears distinct from the individual unit entry with wood cladding.
- The address signage hung over lobby entry is for pedestrians to promptly notice its significance.

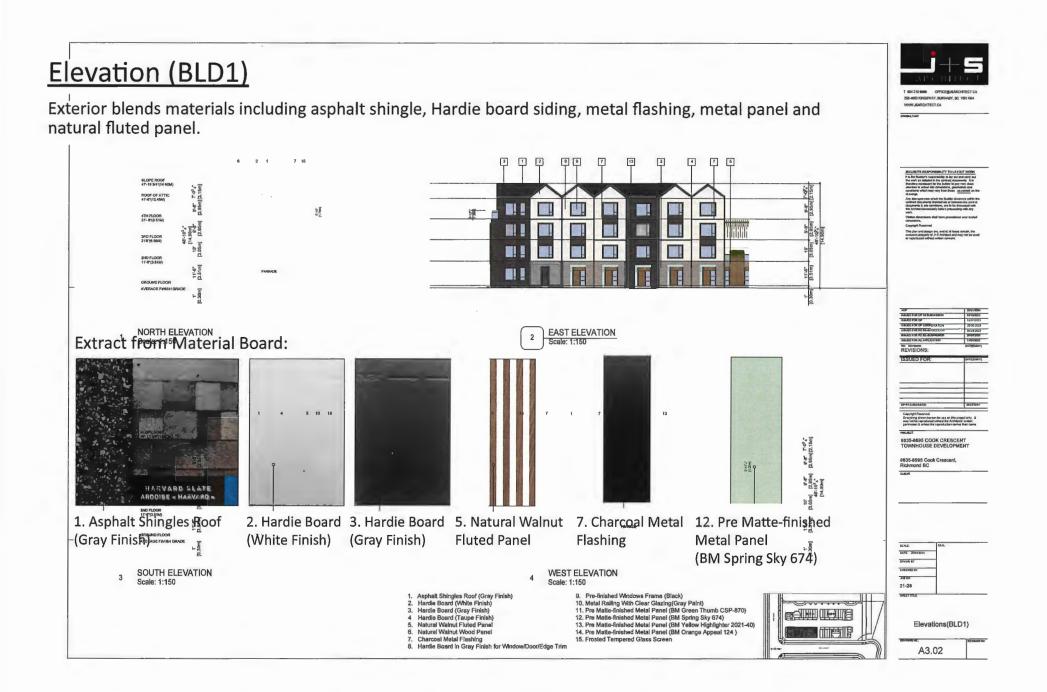


SUN & SHADOWS STUDIES WWW.JSARCHITECT CA Mar 21ST 12:00PM Mar 21ST 10:00AM Mar 21ST 2:00F Mar 21ST 4:00PM SPRING EQUINOX TIME 2/F Children's play area NO MEVIMON REVISIONS ISSUE 2/F Outdoor amenities 4/F patios open to the sky 2/F Children's play area 6635-8695 COOK CRESCENT TOWNHOUSE DEVELOPMENT June 21ST 12:00PM June 21ST 2:00PM June 21ST 4:00PM 8635-8895 Cook Crescent, Richmond BC June 21ST 10:00AM SUMMER SOLSTICE TIME IGALE DATE 26/03/202 DRAWN F CHECKEDBY JUS HO 21-28 TRACT THE Sun & Shadows Studies AUTUMNAL EQUINOX TIME September 21ST 10:00AM September 21ST 2:00PM September 21ST 12:00PM September 21ST 4:00PM A0.06

• 4/F patios are open to sky instead of being completely covered by pitched roof.

• Breaking the massing in the middle on the south and west sides to accommodate children's play areas and allow more sunlight to come through.

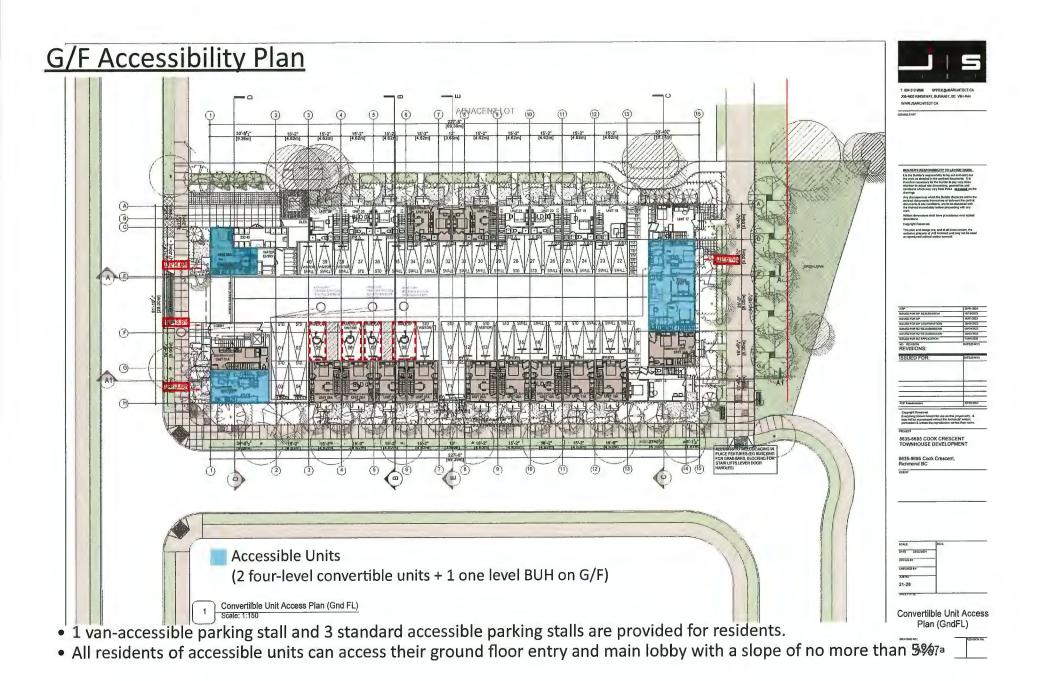

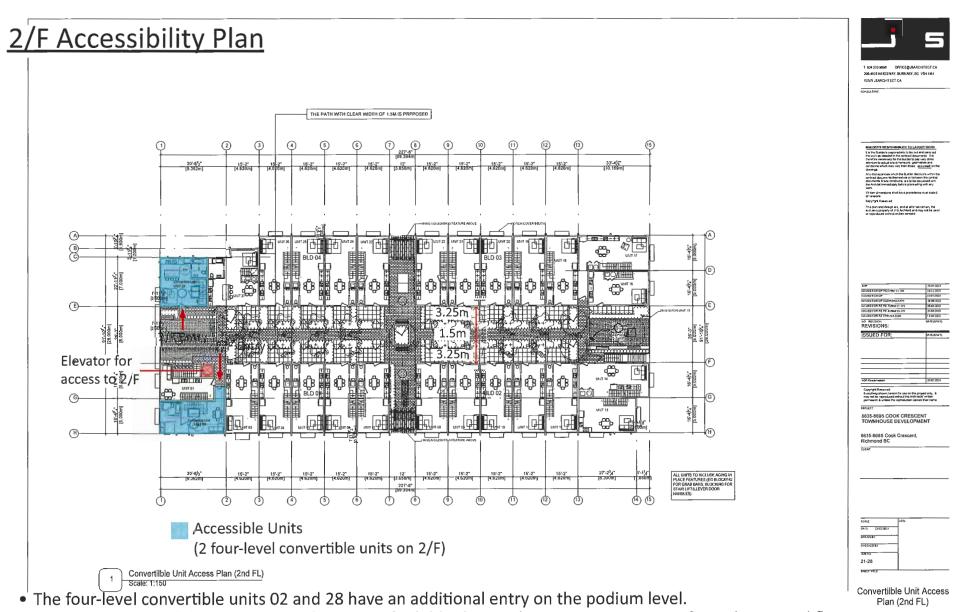

• To enhance accessibility, there is an elevator in the lobby for residents to move upstairs from the ground floor. The main pedestrian pathway is 1.50m wide.

Plan (2nd FL) A2.07b

Sustainability Strategy

The proposed building will comply with BC Energy Step Code Step 4 target, fulfilling the City's requirements.

Current Requirements

The table below outlines Richmond's BC Energy Step Code requirements for Part 3 buildings.

Building Type	Jul 1, 2022 to Oct 30, 2023	After Oct 31, 2023
Residential greater than 6 stories or non-combustible construction	Step 3 or Step 2 and LCES	Step 3 w/ EL-1 or Step 2 w/ EL-2
Residential 6 stories or less with combustible construction	Step 4 or Step 3 and LCES	Step 4 w/ EL-1 or Step 3 w/ EL-2
Office and Retail buildings	Step 3 or Step 2 and LCES	Step 3 W/ EL-1 O/ Step 2 W/ EL-2
Hotels and Motels	Step 3 or Step 2 and LCES	Step 4 w/ EL-1 or Step 3 w/ EL-2

The proposed building is a combustible construction and is required to meet Step 4 w/ EL-1 or Step 6 w/ EL-2. Emission Level (EL) information of EL-1 and EL-2 are listed in the BC Building Code Section 10.3.

Table 1 Modelling Results Summary		
TEUI	TEDI	
100.0	15.0	
94.3	13.34	
	TEUI 100.0	TEUI TEDI 100.0 15.0

Other highlighted features include:

- Operable panes for natural ventilation and light penetration.
- Light-colored roof pavers for roof decks to reduce heat absorption and cooling loads.
- LED lights to reduce electrical power demands.
- High-efficiency heat pumps.
- Double-glazed windows for energy efficiency.

Proposed energy conservation measures (ECMs) to help the project achieve the energy and emission performance requirements:

• High-performance building envelope considering the thermal bridging effect


Model Inputs	Proposed	
Glazing Information		
Window assembly U-value (including frame) (Btu/h.ft².*F) & SHGC	U 0.15 SHGC 0.38	
WWR	22.66%	
Envelope Information		
Overall wall effective R or U- value (ft ² .°F.h/ Btu)	Over all exterior wall R20.5 with TB: WF wall: effective R35 Wall between parkade and conditioned space: effective R24 Parkade exterior Wall: 8" reinforced concrete wall	
Overall roof effective R-value (ft².°F.h/ Btu)	EffectiveR40	

 Direct Ventilation with in-suite HRV (72% SRE) will be incorporated into the ventilation system design


 High-efficiency HVAC system with air source heat pump heating and cooling at suite level (heating COP of 3.5 and cooling SEER of 3.8




Landscape Design

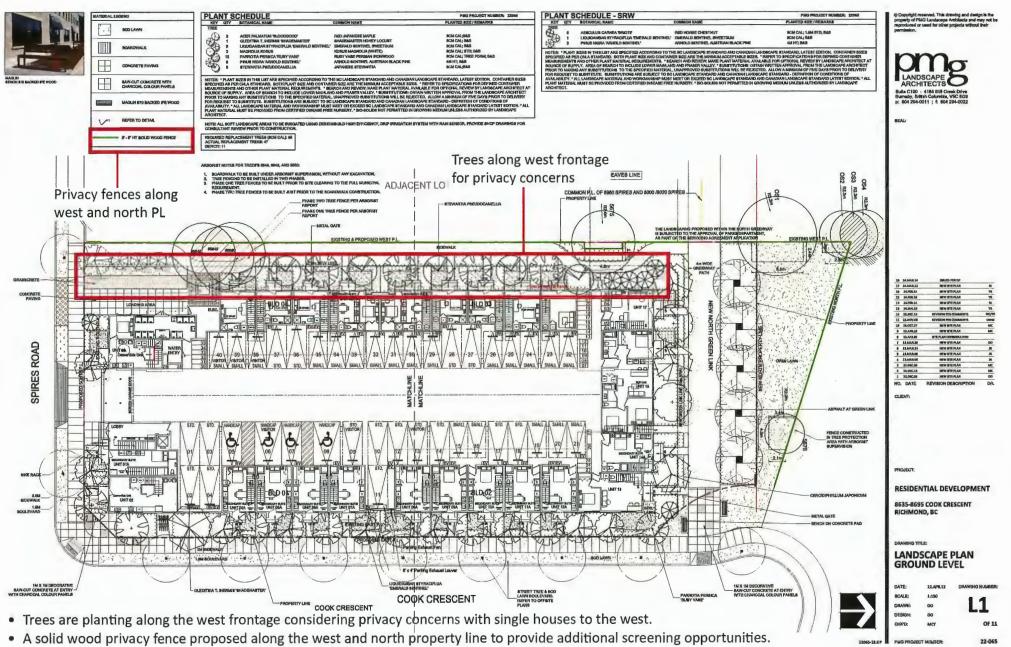


Multiple trees retained along the west PL.

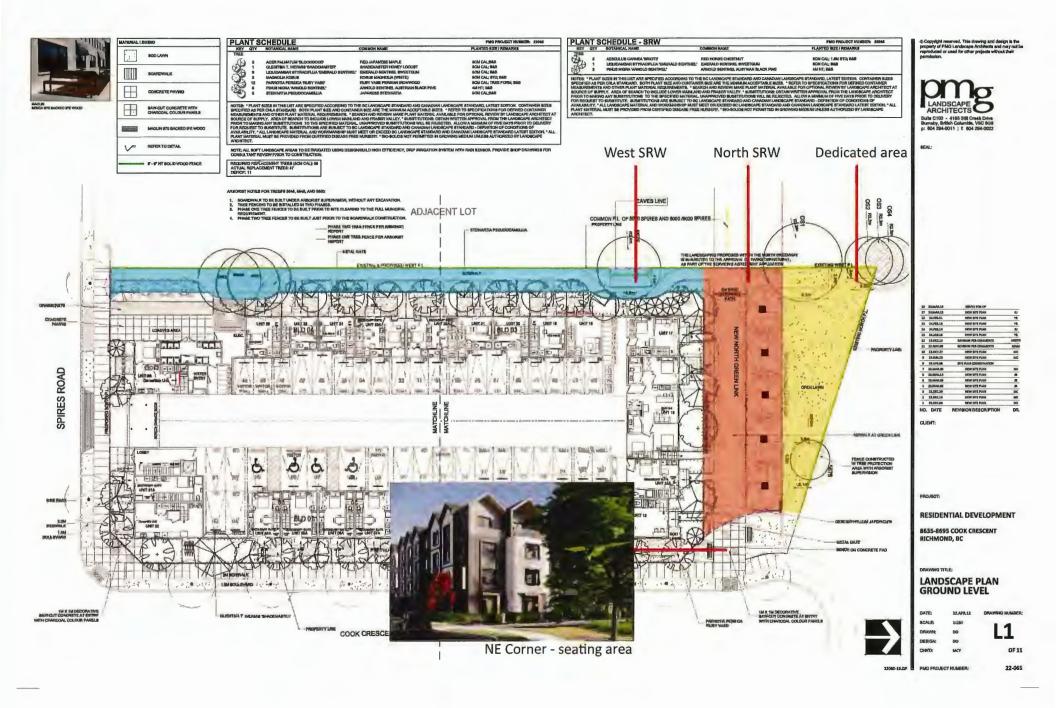

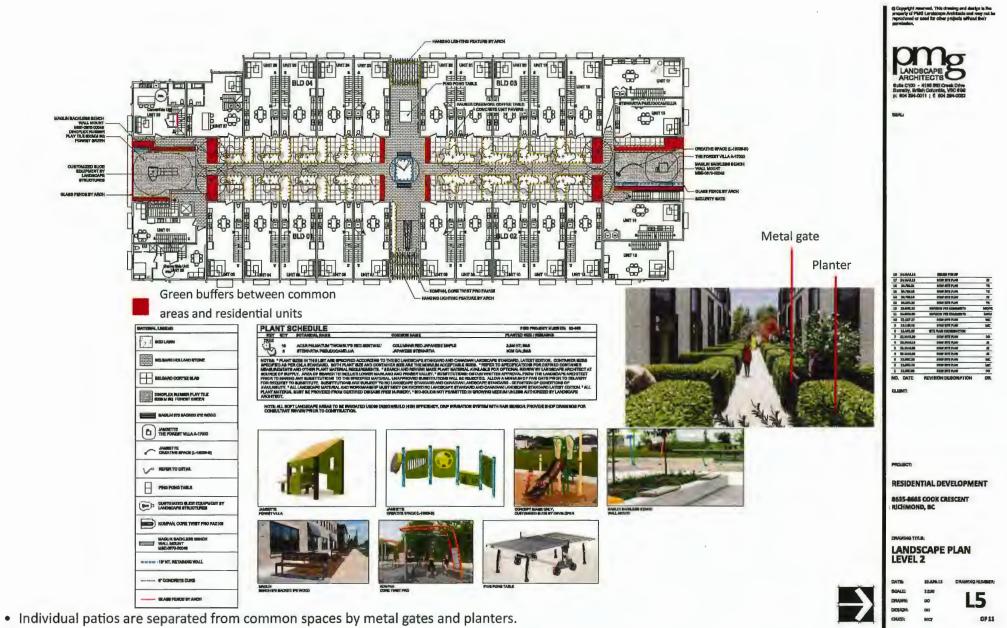



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• Green buffers between the play/amenity area and residential units for privacy and noise mitigation.

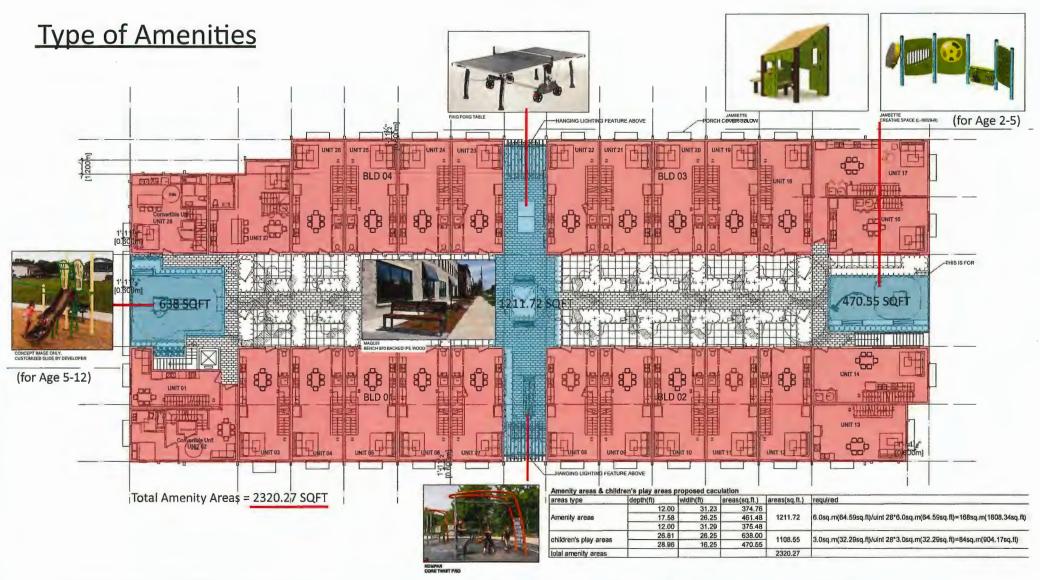


- The play areas are in the south and another in the north between buildings, each for a different age group (age 2 to 5 and age 5-12).
- A variety of play equipment for different play opportunities and benches for caregivers are provided in play areas, surrounded by appropriate shrub material as screens for privacy and noise mitigation.




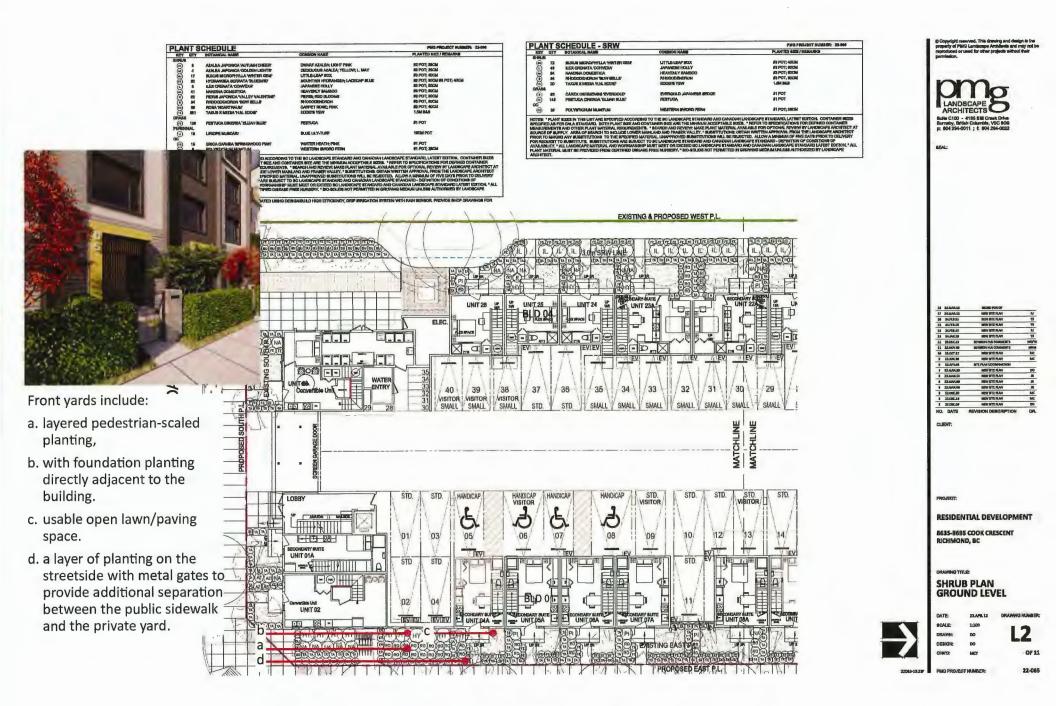

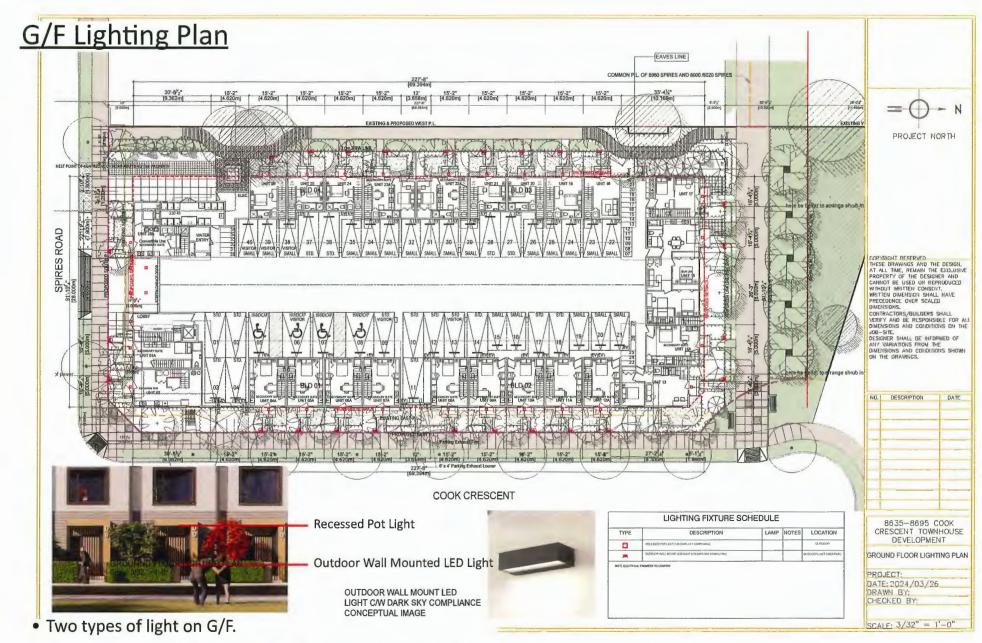• All proposed lighting fixtures are dark sky compliant lighting.

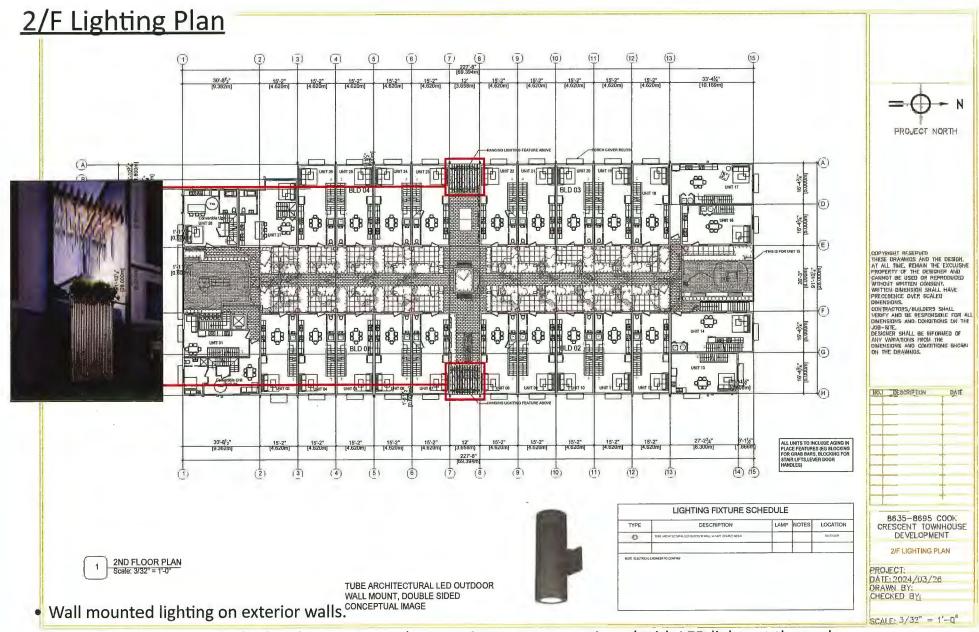

• Some of the vertical metal tube elements over the amenity areas are equipped with LED lights at the end.

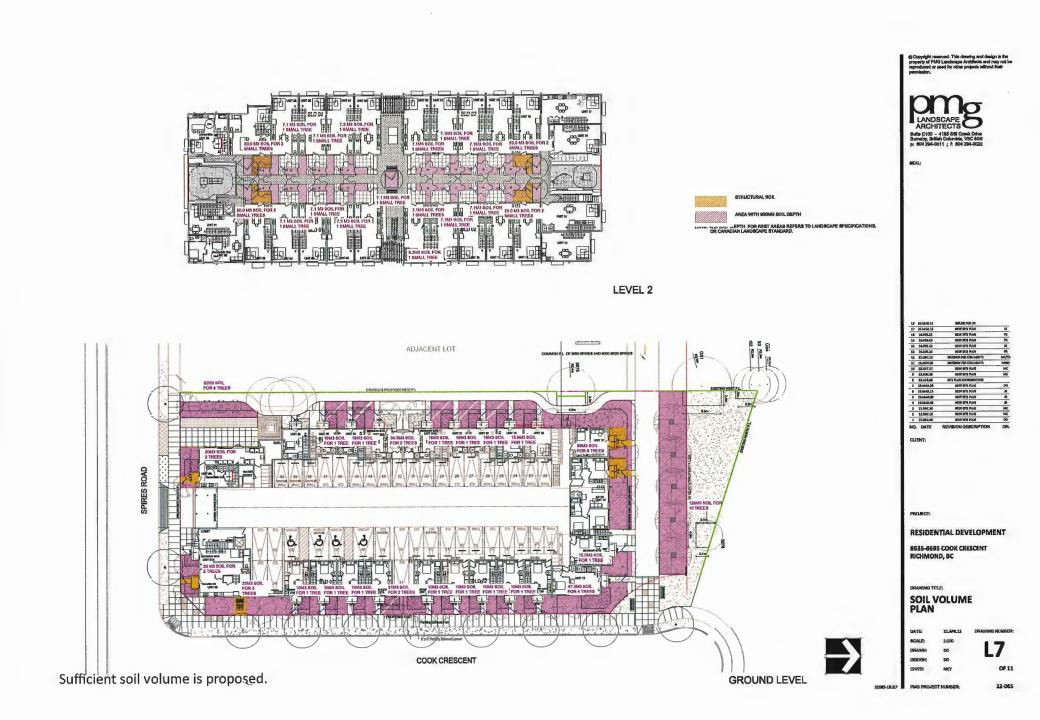


Schedule 2 to the Minutes of the Development Permit Panel meeting held on Wednesday, April 24, 2024


DEVELOPMENT PERMIT PANEL




CONTEXT

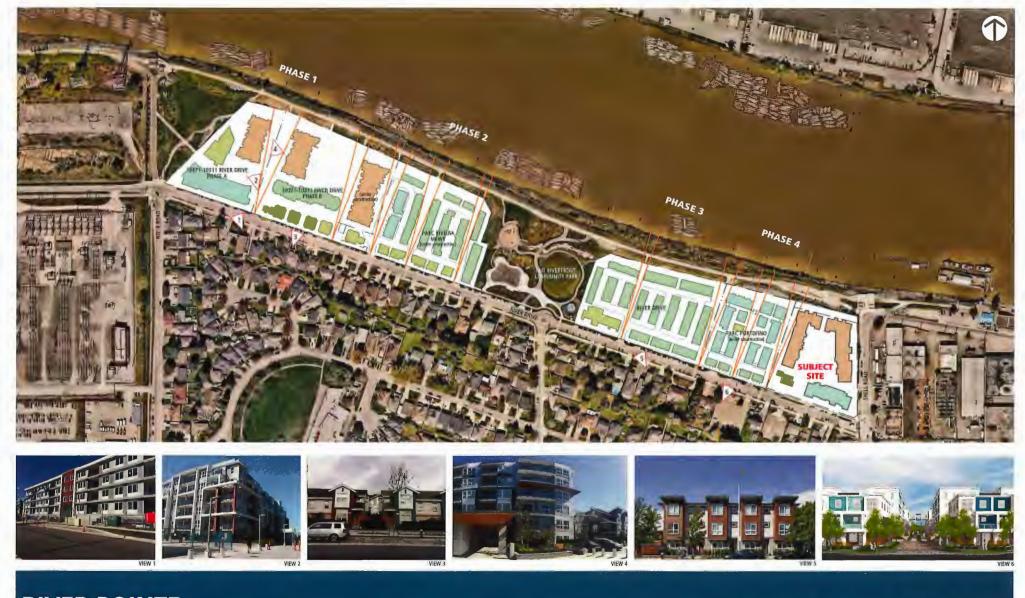


RIVER POINTE at #10611 and #10751 River Drive for Bains Properties Inc. by Fougere Architecture Inc. and PMG Landscape Architects on April 24, 2024

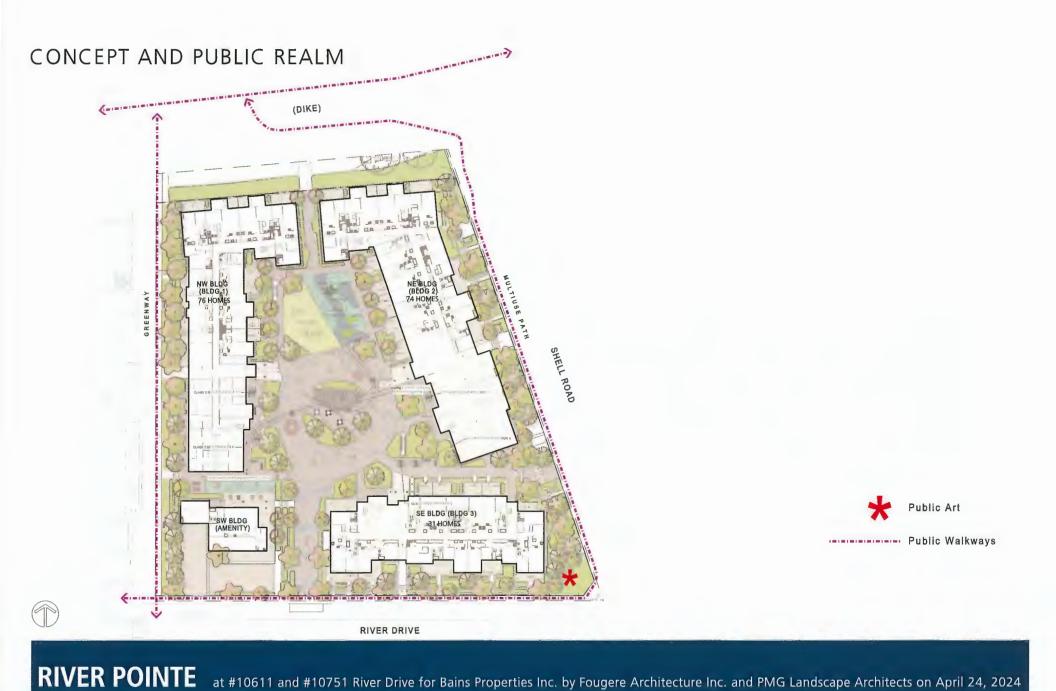

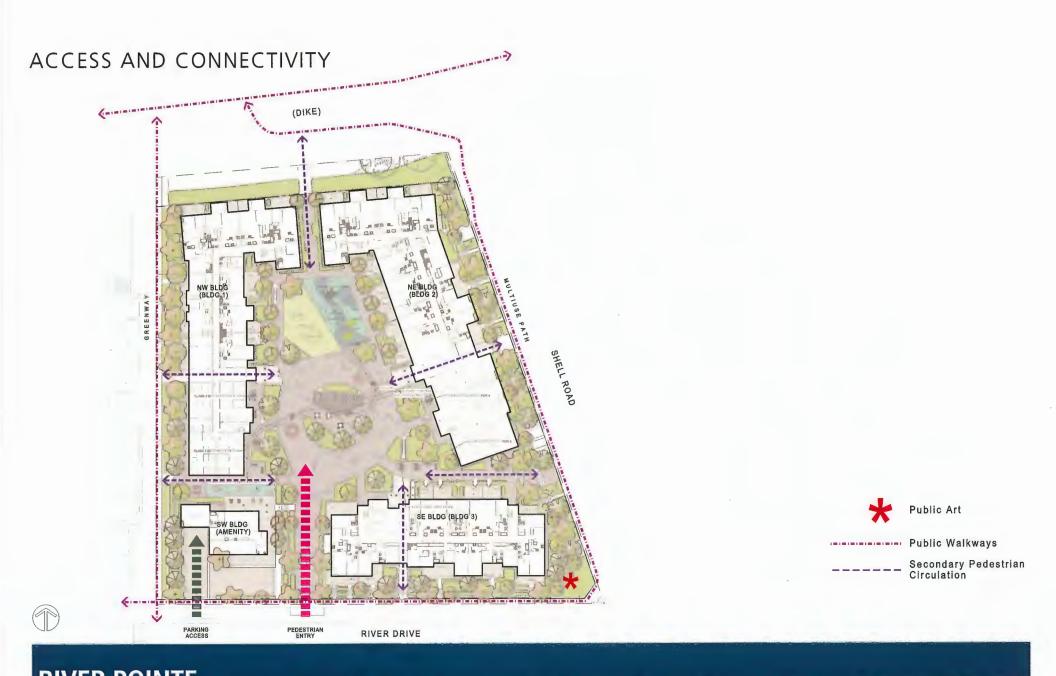





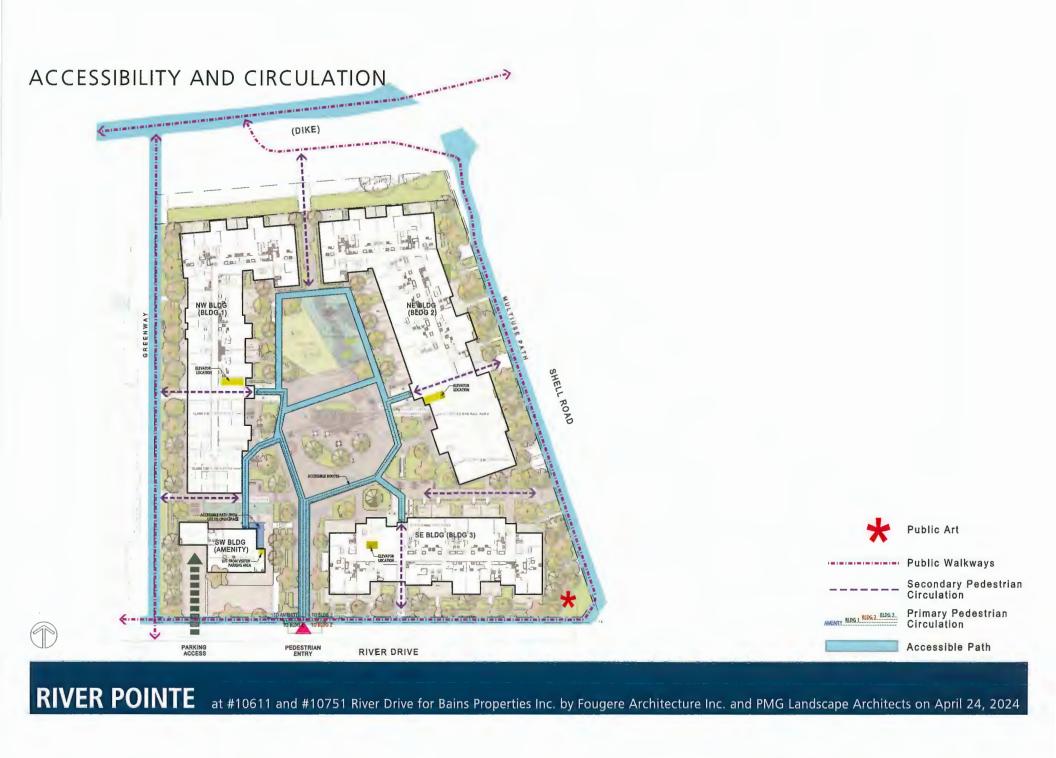

LOCATION OF HOMES WITH BUH (Basic Universal Housing) FEATURES









(DIKE)

GREENWAY

1

SHELL ROAD

RIVER DRIVE

ILTIUSE PATH

2








COMMON AMENITY



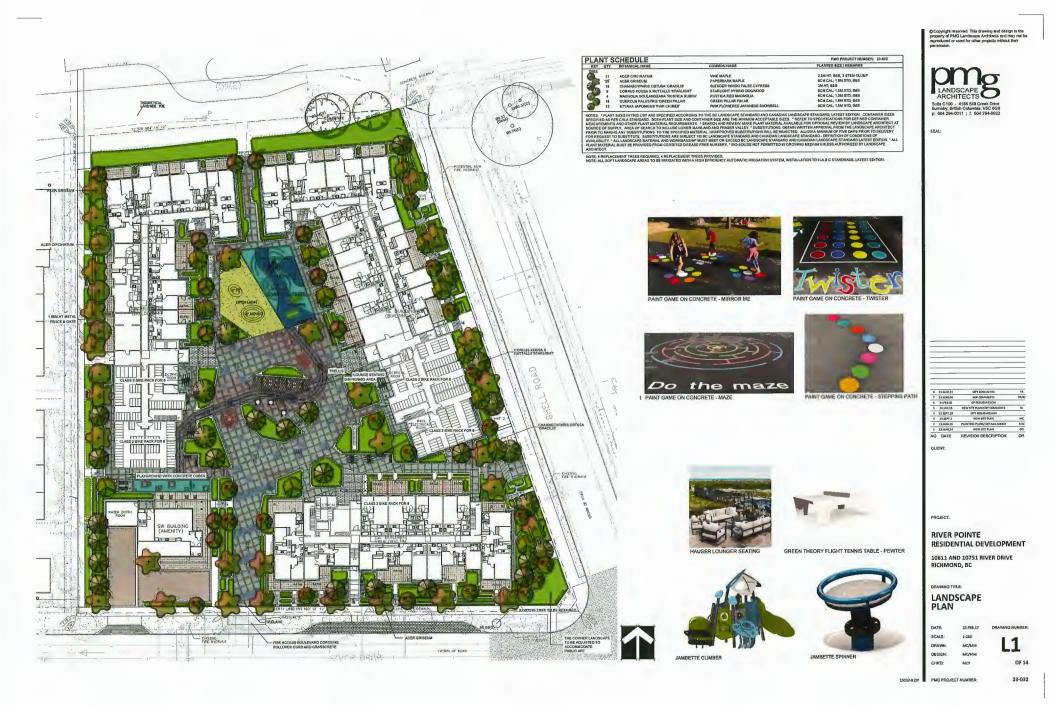

Schedule 3 to the Minutes of the Permit Panel Development meeting held on Wednesday, April 24, 2024



PROPOSED COMMERCIAL DEVELOPMENT

ISSUED FOR DEVELOPMENT PERMIT

18399 BLUNDELL ROAD, RICHMOND, B.C.







ARCHITECTURAL DRAWING LIST

- A0.0 COVER SHEET A0.1 CONTEXT PLAN
- SITE SURVEY PLAN
- A1.0 SITE PLAN
- A1.1 FIRE ACCESS PLAN
- A2.0 FLOOR PLAN
- A3.0 BUILDING A ELEVATIONS A3.1 BUILDING B ELEVATIONS
- A3.2 BUILDING A RENDERS
- A3.3 BUILDING B RENDERS
- A3.4 COURTYARD VIEWS
- A3.5 STREETSCAPE

LANDSCAPE DRAWING LIST

- LANDSCAPE COVER SHEET LO
- LANDSCAPE MATERIAL AND LAYOUT PLAN L1
- LANDSCAPE PLANTING PLAN L2 LANDSCAPE DETAIL L3




LOT GRADING PLAN



MARCH 22, 2024



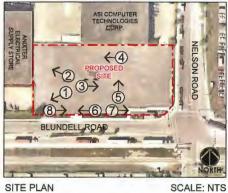

SITE PLAN



VIEW FROM THE SITE LOOKING TO SOUTH-WEST SITE CORNER



VIEW FROM THE SITE LOOKING TO NORTH-WEST SITE CORNER



VICINITY PLAN

SCALE: NTS

LEGEND:

R.

- a) PROPOSED SITE b) TUGBOAT ANNIE'S PUB & GRILLE c) NANAKSAR GURDWARA GURSIKH TEMPLE



UIEW FROM THE SITE LOOKING WEST TO NELSON ROAD



VIEW FROM THE SITE LOOKING EAST TO ANIXTER ELECTRICAL BUILDING



PROPOSED COMMERCIAL DEVELOPMENT

18399 BLUNDELL ROAD, RICHMOND, BC









SITE PLAN

SCALE: NTS



S VIEW FROM THE SITE LOOKING NORTH TO ASI COMPUTER BUILDING



O VIEW FROM BLUNDELL ROAD



VICINITY PLAN

LEGEND:

- a) PROPOSED SITE
- b) TUGBOAT ANNIE'S PUB & GRILLEc) NANAKSAR GURDWARA GURSIKH TEMPLE



VIEW FROM BLUNDELL ROAD




OVIEW FROM BLUNDELL ROAD









MARCH 22, 2024

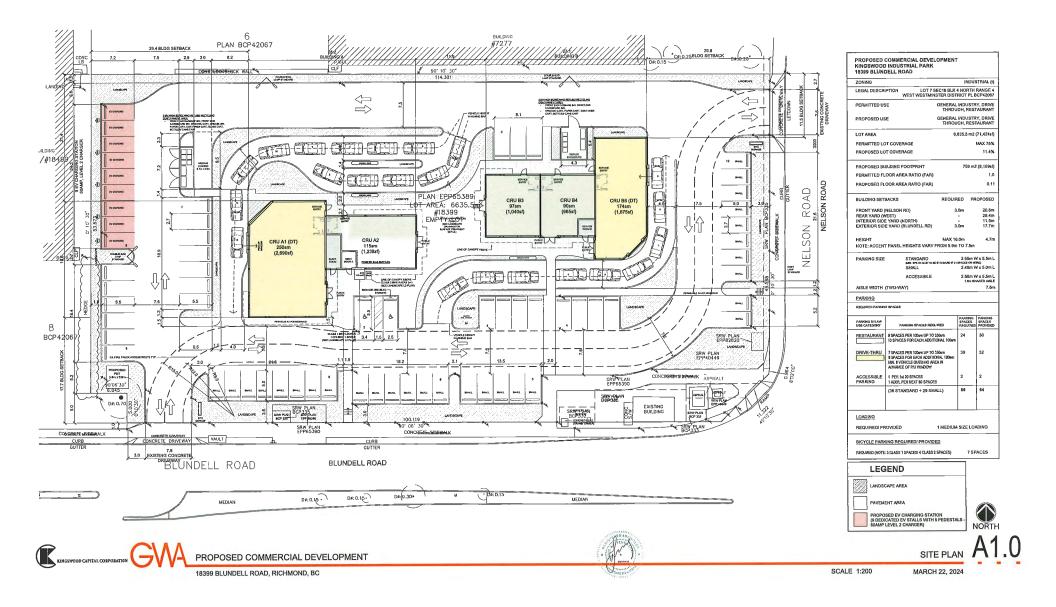

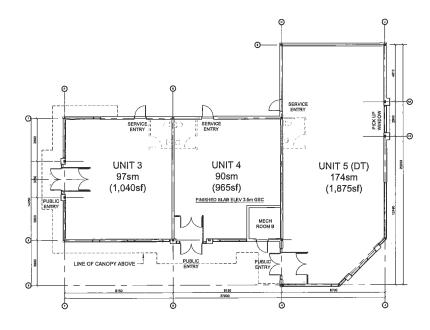

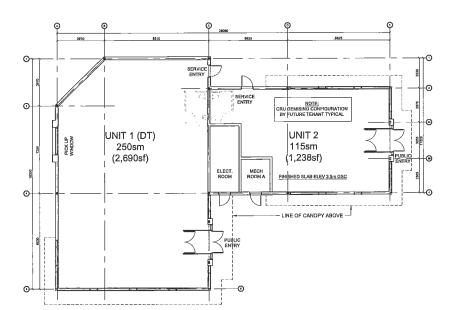



PROPOSED COMMERCIAL DEVELOPMENT

18399 BLUNDELL ROAD, RICHMOND, BC


Succes



Α SOUTH ELEVATION



в EAST ELEVATION

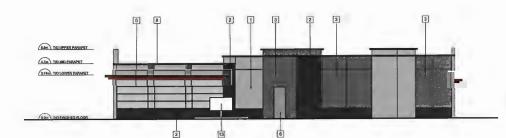


NORTH ELEVATION С







D WEST ELEVATION

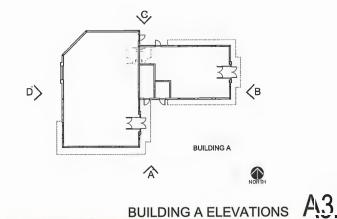


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MARCH 22, 2024

PROPOSED COMMERCIAL DEVELOPMENT

18399 BLUNDELL ROAD, RICHMOND, BC

KENGSWOOD CAPITAL CORPORATION




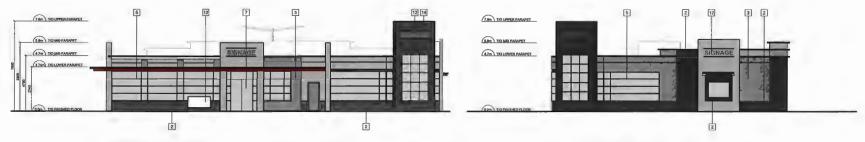

В EAST ELEVATION

WEST ELEVATION


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С NORTH ELEVATION

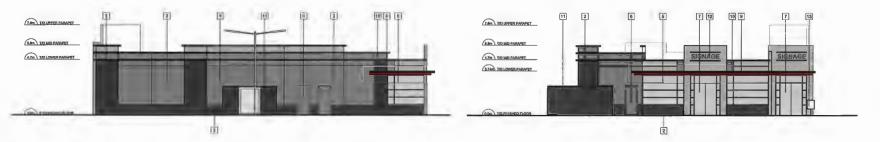





SCALE 1:100

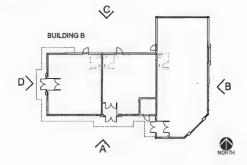BUILDING B ELEVATIONS

MARCH 22, 2024

A3.1

18399 BLUNDELL ROAD, RICHMOND, BC





NORTHEAST CORNER

SOUTHEAST CORNER



SOUTHWEST CORNER



PROPOSED COMMERCIAL DEVELOPMENT

18399 BLUNDELL ROAD, RICHMOND, BC



NORTHWEST CORNER







NORTHWEST CORNER

SOUTHWEST CORNER



PROPOSED COMMERCIAL DEVELOPMENT

18399 BLUNDELL ROAD, RICHMOND, BC



NORTHEAST CORNER



MARCH 22, 2024



COURTYARD VIEW A



COURTYARD VIEW B



PROPOSED COMMERCIAL DEVELOPMENT





18399 BLUNDELL ROAD, RICHMONO, BC



A STREETSCAPE VIEW FROM BLUNDELL ROAD



B STREETSCAPE VIEW FROM NELSON ROAD








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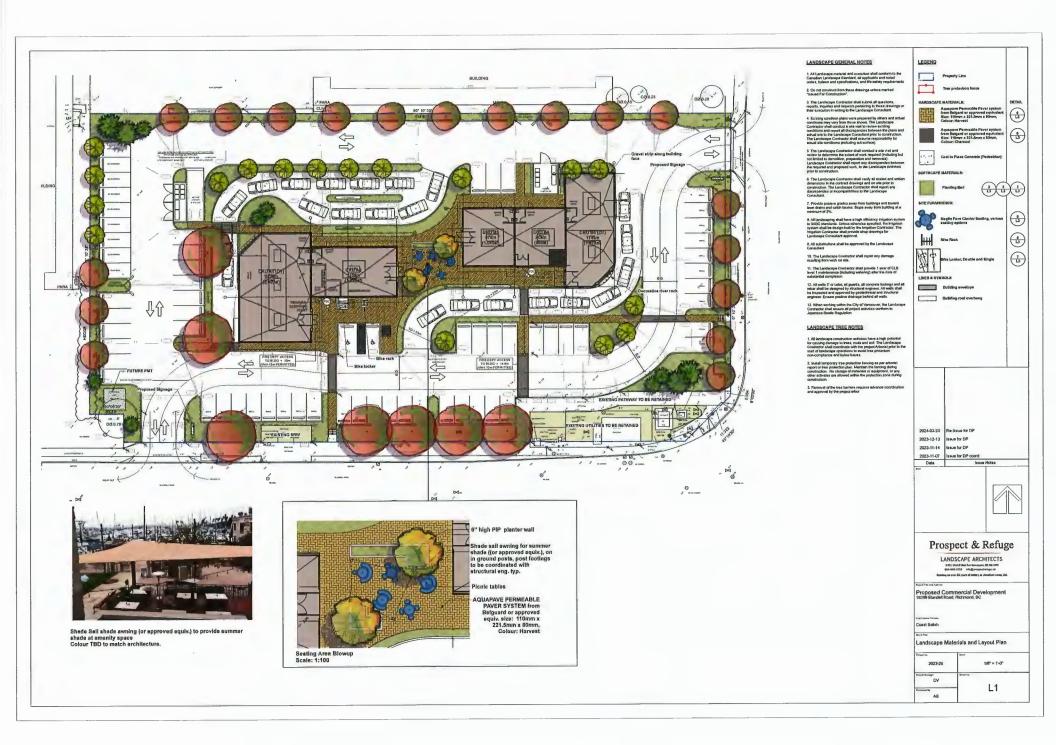
PROJECT NAME: Proposed Commercial PROJECT NO: 2023-26 Development


PROJECT ADDRESS: 18399 Blundell Road, Richmond, BC

DATE: 2024-03-20

ISSUED FOR: Re-Issue for DP



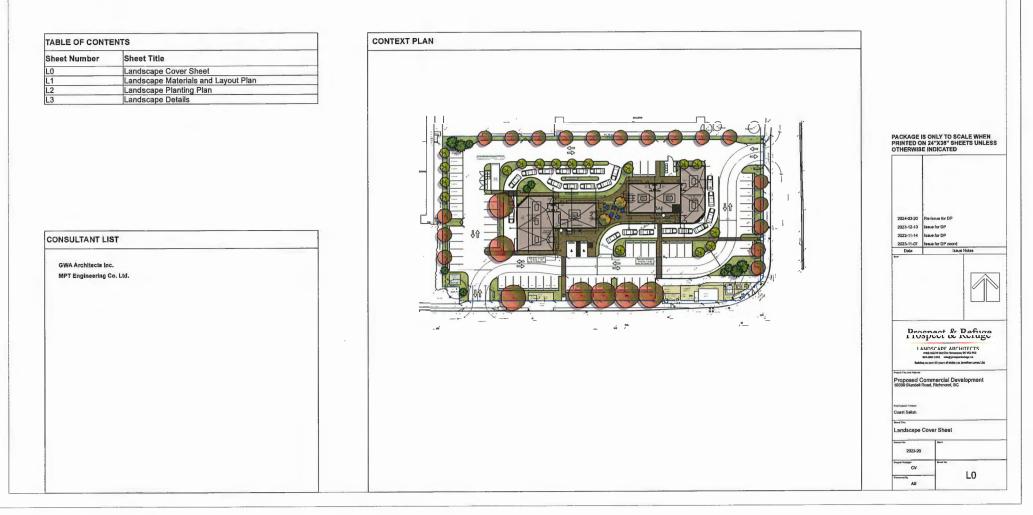

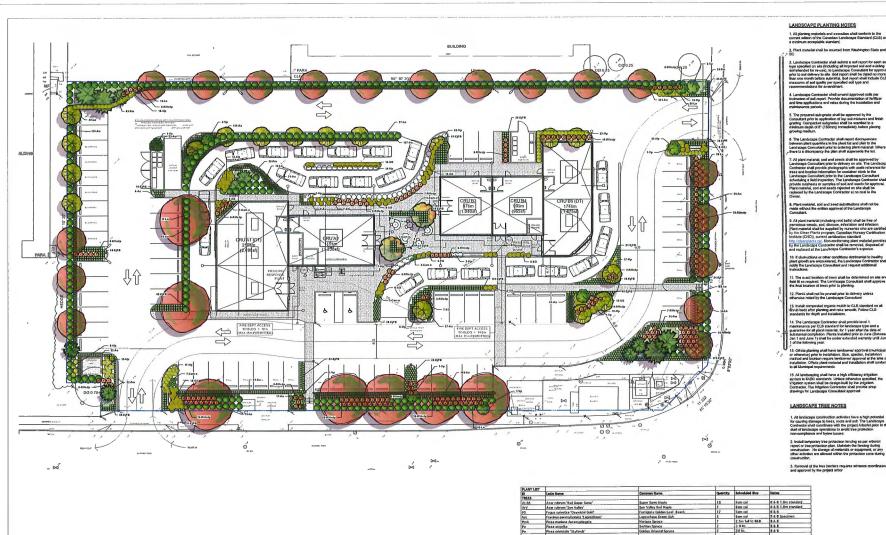

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Prospect & Refuge LANDSCAPE ARCHITECTS Mediate and memory in Friday Mediate unit of control of the second Mediate unit of control of the second






Landscape Planting Plan

AS



L2

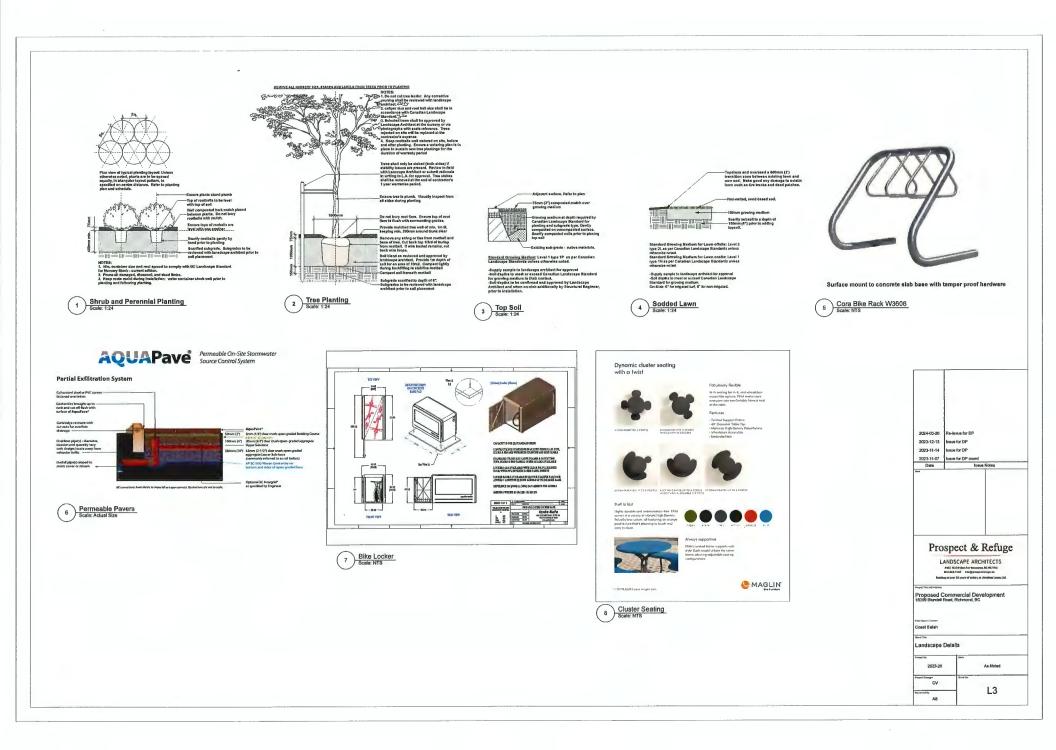



Re:	Application by Arno Matis Architecture for a Dev	velopme	ent Permit at 6851 and
From:	Suzanne Smith Program Manager, Development	File:	DP 21-945917
To:	Development Permit Panel	Date:	April 25, 2024

Staff Recommendation

That a Development Permit be issued which would:

6871 Elmbridge Way

- 1. Permit the construction of 376 residential units, hotel and accompanying commercial uses in a high-rise mixed use development containing three 15 storey towers at 6851 and 6871 Elmbridge Way on a site zoned "High-Density Mixed Use (ZMU52) - Oval Village (City Centre)"; and
- 2. Vary the provisions of Richmond Zoning Bylaw 8500 to:
 - a) Reduce the minimum road setback of 3.0 m along River Road to 0.25 m to allow a projection on a small portion of the development's podium (Levels 3 to 6) for components of the building and residential balcony units; and
 - b) Not require a large size on-site loading space in the proposed development.

Suzanne Smith Program Manager, Development

SS:ke Att. 4

Staff Report

Origin

Arno Matis Architecture has applied to the City of Richmond on behalf of Landa Oval Development Ltd. for permission to develop a high-rise mixed use development containing three 15 storey towers at 6851 and 6871 Elmbridge Way on a site zoned "High-Density Mixed Use (ZMU52) – Oval Village (City Centre)". The site currently contains multi-tenant light industrial buildings (Attachment 1 – Location Map).

Highlights of the proposed development include:

- 341 market residential units and 35 affordable housing units (Low End Market Rental LEMR).
 - Market residential units are located in the development podium and two towers at the north west and south west portions on the site.
 - LEMR units are dispersed throughout the development's podium, consistent with the Housing Agreement Bylaw and housing covenant secured through the rezoning for this development.
- Approximately13,854 m² (149,123 ft²) of floor area for:
 - A hotel tower at the north east portion of the site; and
 - Commercial floor space at-grade around the subject sites road frontages.
- Approximately 750 m² (8,073 ft²) of on-site indoor amenity space on Level 6 of the development's podium.
- Approximately 3,037 m² (32,690 ft²) of on-site outdoor amenity space on Level 6 and 9 of the development.
- A new City road (herein called the new west road) along the subject sites west edge that will connect Elmbridge Way and River Road and provide the primary vehicle access to the development's parkade. The name of this road will be determined by Council through the City's Road Naming Policy process.

The site is being rezoned from "Light Industrial (IL)" to "High-Density Mixed Use (ZMU52) – Oval Village (City Centre)" under Richmond Zoning Bylaw, Amendment Bylaw 10423 (RZ 17-782750).

A Servicing Agreement (SA 23-035702) is required as a rezoning consideration item and includes, but is not limited to, the design and construction of new and upgraded water mains, storm sewer and sanitary infrastructure (including new service connections) around the subject site. Frontage works, a public pathway, widening of the existing lane to the east and the new west road (including all tie-ins and transitions to existing road infrastructure) will also be completed through this Servicing Agreement.

Development Information

Please refer to attached Development Application Data Sheet (Attachment 2) for a comparison of the proposed development data with the relevant Bylaw requirements.

Background

Development surrounding the subject site is as follows:

To the north:	The Richmond Olympic Oval is located across River Road on a site zoned "High Rise Apartment and Olympic Oval (ZMU4) – Oval Village (City Centre)"
To the east:	Across an existing lane is the Onni 'Ora' high density mixed use development on a site zoned "Residential/Limited Commercial (RCL3)".
To the south:	Across Elmbridge Way is an existing building containing Worksafe BC offices on a site zoned "Downtown Commercial (CDT1)".
To the west:	A site zoned "Light Industrial Business Park (IB1)" containing existing light industrial buildings.

Rezoning and Public Hearing Results

The Public Hearing for the rezoning of this site was held on December 19, 2022. At the Public Hearing, concerns were noted from the neighbouring development to the east (Ora mixed use project) in relation to traffic impacts and concerns about the lane. The project was referred back to staff to address these matters with the developer and returned for a second Public Hearing. The applicant subsequently met with residents of the Ora development, and with City staff to review the issues and potential revisions in response.

A revised rezoning proposal was brought forward to the May 15, 2023 Public Hearing where the bylaw received 2nd and 3rd reading. This rezoning proposal made the following modifications to address traffic impacts and lane concerns raised at the previous Public Hearing that have been included and complied with as part of this Development Permit application:

- *Hotel Pick-up and Drop-Off* All hotel vehicle pick-up and drop-off functions were relocated on-site within the project parkade (level 1). No hotel vehicle pick-up or drop-off functions will occur in the lane. This was a significant change made from the original design in response to concerns.
- Lane Access As a result of concerns about impacts of traffic from the development proposal to the existing lane, the lane access to the proposed development's parkade will be restricted to hotel guests and on-site employees only (enter from the lane) and on-site employees (exit from the lane).
- *Main Site Access* The new west road vehicle access to the parkade will be the primary entrance/exit to the development and will accommodate a majority of the traffic for the development and minimize traffic impacts to the lane.
- *Vehicle Access Restrictions* Installations to facilitate vehicle access restrictions to the lane and ensuring that new west road vehicle access remains the primary vehicle access to the development have been incorporated (i.e., gate, security intercom/FOB access).
- Lane Width and Function Works to widen the lane by 3 m will accommodate 1.5 m of additional pavement widening to the existing lane and 1.5 m wide concrete transition area. This lane widening undertaken by the proposed development would result in a total 7.5 m wide drive-aisle plus 1.5 m wide concrete transition area that will be designed to enable access to the parkade and loading/service functions from the lane. Pedestrians can also utilize this transition area to facilitate safe movements through the lane as needed.

These lane works will be completed through the City's Servicing Agreement process, which is a rezoning consideration for the subject development.

• **On-site Loading** - On-site loading spaces are arranged to allow access from the lane to accommodate standard loading functions required for this development's non-residential and residential uses. In accordance with the rezoning, no on-site large loading space is provided as none of the proposed uses in the development would require service from these large trucks and the on-site loading facilitates (accommodating medium sized trucks) can adequately service the proposed development. A variance is included in this Development Permit application to not require a large size loading facility that is outlined in the Zoning Compliance/Variance section of the report below. This approach is supported by Transportation staff.

In addition to the above and in response to concerns about vehicles temporarily stopping in the lane and the resulting negative impacts to lane operations, regulatory revised "no stopping" signage was posted in the lane by the City at the time of the Public Hearing in May 2023, which would prohibit any vehicles from stopping or parking in the lane and require use of the on-site loading facilities in the Ora development.

Staff Comments

The proposed scheme attached to this report has satisfactorily addressed the significant urban design issues and other staff comments identified as part of the review of the subject Development Permit application. In addition, it complies with the intent of the applicable sections of the Official Community Plan and is generally in compliance with the "High-Density Mixed Use (ZMU52) – Oval Village (City Centre)" except for the zoning variances noted below.

Zoning Compliance/Variances (staff comments in bold)

The applicant requests to vary the provisions of Richmond Zoning Bylaw 8500 to:

1) Reduce the minimum road setback of 3.0 m along River Road to 0.25 m to allow a projection on a small portion of the development's podium (Levels 3 to 6) for components of the building and residential balcony units.

(Staff supports the proposed variance as the proposed setback reduction only applies to one small corner portion of the development's podium on levels 3 to 6 of the project. The proposed reduction in setback will have no impact to the pedestrian streetscape at-grade and does not result in any additional shadowing to adjacent areas. The proposed variance also enables the residential dwelling units at this corner portion of the podium adequate private outdoor space (i.e., balcony) and also maintains the project podiums' asymmetrical and angled design that is an element included in this development's design rationale.

2) Not require a large size on-site loading space in the proposed development.

(Staff supports the proposed variance as this matter was assessed through the processing of the rezoning application which confirmed that none of the proposed uses in the development would require service from larger trucks that would require a large size loading space. The current loading facilities accessed from the lane provide for medium size loading, which is adequate to service the development, has been reviewed and confirmed through the submitted Traffic Impact Assessment by the applicant's Transportation consultant and is supported by Transportation staff. In addition, a rezoning consideration item secures a legal agreement that specifies a maximum truck size (i.e., medium sized truck SU-9 or equivalent) aligned with the on-site loading being provided in the project and prohibits large size vehicles (i.e., WB-17 or equivalent).

Advisory Design Panel Comments

The Advisory Design Panel was supportive of project to move forward subject to the proposal giving consideration to ADP comments. A copy of the relevant excerpt from the Advisory Design Panel Minutes from December 6, 2023 is attached for reference (Attachment 3). The design response from the applicant has been included immediately following the specific Design Panel comments and is identified in *'bold italics'*.

Analysis

Conditions of Adjacency

- The proposal will have public roads along the north (River Road), south (Elmbridge Way) and west (new west road) frontages and an existing lane to the east.
- The design provides for a vibrant and pedestrian friendly streetscape along these public road frontages. At-grade commercial retail units (CRUs) wrap around the River Road, new west road and Elmbridge Way road frontages and provides for an activated streetscape on-site and provides continuity with adjacent at-grade retail developed on neighbouring developments to the east.
- Smaller open plaza spaces, situated between the frontage works (boulevards, sidewalks/multi-use pathways) and CRUs along the public roads provide additional opportunities for the development of a pedestrian friendly public realm.
- In response to elevation transitions, grade differences are addressed through the gradual sloping of the grade between the sidewalk and entrances to the CRU's and incorporating steps/risers were necessary along the north edge (River Road) of the development. Along the south edge (Elmbridge Way), the grade difference is managed through stairs and accessible ramps between the sidewalk and open spaces directly in front of the CRUs with landscape pockets incorporated into this area. This grade transition along Elmbridge Way generally aligns with the approach to managing a similar grade condition in the neighbouring development to the east.
- A lane exists between the subject site and neighbouring high-density mixed use development to the east (Ora development) that will be further widened by 3 m through this development. The new west road will be dedicated, designed and constructed through this project and will connect Elmbridge Way and River Road along the west edge of the site. The placement of the residential towers at the north west and south west portions of the site and hotel tower at the north east area responds to the surrounding adjacency conditions to minimize shadowing and to ensure compliance with minimum tower separation guidelines in the City Centre Area Plan (CCAP).
- Shadowing from the proposed development has been minimized to the public plaza area on the north side of River Road (Olympic Oval plaza area) by pushing the hotel tower location as far south as possible. Furthermore, residential tower locations have also been situated as far south as possible and separation between the residential towers has been reduced to allow the tower on the north west portion of the site to be pulled back from River Road while still complying with minimum tower separation distances. Upper levels of the residential tower

(north west tower levels 13 to 15) and hotel tower (north east tower levels 14 and 15) have been stepped back and terraced on the north side to reduce shadowing of surrounding areas.

Urban Design and Site Planning

- Residential lobby building entrances from the street are designed around open entrance plazas at the north west and south west portions of the development site. Entrances to the hotel lobby are situated at the north east portion of the site and the commercial/office lobby entrance is located at the south east corner. The overall placement and shaping of the development's podium creates plazas and open space at-grade adjacent to pedestrian entrances to the residential and/or hotel lobby and CRU's fronting the public roads around the project.
- The parkade for the development is located within the podium and consists of one level of parking below grade and five levels above grade. Access and egress to the development's parkade will be through the primary vehicle access from the new west road and restricted access from the lane as outlined previously in this report. Hotel pick-up and drop-off functions have been incorporated into the level 1 of the parkade with direct internal access from the pick-up/drop-off area being provided to the hotel lobby area.
- Indoor amenity space is provided on level 6 of the project podium. The indoor amenity area is required to be available for use by all residents and is 750 m² or 8,073 ft² in area and complies with City Centre Area Plan (CCAP) amenity space guidelines. Indoor amenity facilities will consist of a lounge, fitness centre and other resident recreation spaces (i.e., yoga, steam/sauna facilities). Access to the indoor amenity space is provided from the outdoor amenity area and the residential podium. It will be accessible to both market strata and residents of the LEMR units.
- Outdoor amenity space is provided on level 6 of the project podium and on level 9. On level 6, outdoor amenity space is provided in a consolidated courtyard area with a variety of features including seating and patio areas available to all residents, outdoor kitchen and dining areas and multi-purpose lawn/open space areas. An outdoor pool is also proposed as part of the outdoor amenity, which would be an amenity that would be available to residents and hotel guests. A small portion of the indoor amenity is also to be shared with the hotel. A legal agreement was secured through the rezoning to ensure the shared use of the outdoor pool amenity and small portion of the indoor amenity space containing the children's play area is provided in courtyard area between the residential towers. The outdoor amenity areas on level 6 and 9 is required to be available for use by all residents and is 3,037 m² (32,690 ft²) in area, which exceeds with City Centre Area Plan (CCAP) amenity space guidelines. Outdoor amenity features include:
 - A children's play area with climbing structure and landscaping to enable outdoor play and activities.
 - Access to the outdoor amenity on level 6 is provided from the residential podium. Access to the outdoor amenity on level 9 is provide from the residential towers.
 - The outdoor amenity areas are designed to have good natural light/sun exposure. The placement of the amenity areas in and shape and orientation of the residential towers helps to maximize sun exposure and minimize excessive shadowing.
- Service functions for the proposed development located on the subject site containing the residential and commercial loading areas, hotel shuttle loading and garbage/recycling

collection areas are located on-site and accessed from the lane. Garbage/recycling rooms for the residential and non-residential areas are located on level 1 and sized to accommodate all the necessary bins and equipment.

Architectural Form and Character

- The architectural form of the project podium and the application of asymmetrical plaza spaces at-grade are a design response to other similar shaped and oriented public spaces in the surrounding area (i.e., Richmond Olympic Oval plaza area on the north side of River Road opposite of the subject site and linear park to the east between the Ora project and Hollybridge Way).
- Frontage width of CRU's along River Road and Elmbridge Way is broken up through the use of varied setbacks and triangular plaza areas that integrate well with pedestrian-oriented commercial activities (i,e., retail, restaurants and cafes).
- Horizontal frame elements on the project podium wrap around the perimeter of all four frontages and differentiate and help break up the massing between the podium and tower components of the project. These horizontal frames are generally limited to levels 3 to 6 of the podium and provide another architectural response to break up the vertical massing of the building form at the lower levels by providing a strong horizontal building element between levels 2 and 3.
- The boomerang/wave footprint shape of the three towers is a consistent design element in this project that enables minimal direct tower to tower overlook within the development site as well as to existing neighbouring developments. This tower form also provides for maximum natural light exposure for residential units in the tower and hotel rooms while also ensuring natural sunlight exposure to the indoor and outdoor amenity spaces on levels 6 and 9 of the project.
- Although the shape of the three towers are similar, the application of balconies and metal/aluminum frames to the residential towers compared to the application of a generally contiguous glass curtain wall cladding for the hotel tower provides for a distinct architectural expression between the residential and hotel towers.
- The development's contemporary design and architecture is reflected in the proposed cladding, building materials and glazing proposed in the project that will consist of glazed curtain wall systems, aluminum frame/screen assemblies around balconies, podium and building parapets and glass guardrails around balconies.

Landscape Design and Open Space Design

- On-site landscaping in the subject development is located at-grade and on levels 6 and 9 associated with the outdoor courtyard amenity areas. Other landscape planting areas are proposed on the rooftops of the hotel/commercial mid-rise tower and rooftop of the two residential towers.
- At-grade, landscape design looks to enhance the pedestrian vibrant streetscape and integrate with the boulevard and sidewalk/pathway works being implemented on the public road frontages of the subject site. Pockets of landscaping are incorporated into the public plaza areas and consist of low level groundcovers and shrubs. Where larger plazas are situated generally around the corners of the development site, additional landscape plantings have been incorporated to provide varied surface treatment in the plaza areas directly in front of the CRUs.

- Where there is a grade transition between the sidewalk and entrance to the CRUs or building entrance areas, landscaping has been implemented in the form of concrete planters and terraces to reduce the presence of stairs and accessible ramps adjacent to the public road.
- The outdoor courtyard located on level 6 provides a significant planted landscape environment that include multi-purpose open spaces with trees, landscaped terraces around the edges and landscape buffers and screens provided between residential dwelling units, communal outdoor areas and outdoor patios to be used for the hotel. Benching, furniture (fixed and stationary tables and chairs), pathways and patios also have been integrated into the programing of the outdoor space area as a high-quality amenity for residents and guests of the hotel.
- The outdoor courtyard on level 9 provides the outdoor amenity area containing areas and installations to facilitate children's play and activities.
- The proposed landscaping plant lists include the incorporation of native plantings for landscaping throughout the project. A total of 83 on-site trees will be planted as part of this development, which will consist of a mix of both deciduous and coniferous tree species.
 - The proposed amount of trees to be planted (83) exceeds the Official Community Plan requirements of 2:1 tree replacement ratio (the rezoning identified the removal of 6 on-site trees requiring a minimum of 12 replacement trees at the OCP 2:1 replacement ratio).
- An on-site irrigation system will be provided for all planted and landscaped areas.
- In order to ensure that the proposed landscaping works are completed, the applicant is required to provide a landscape security of \$1,506,747 as a Development Permit consideration (Attachment 4).

Crime Prevention Through Environmental Design

- Crime Prevention Through Environmental Design (CPTED) principles have been considered throughout the design development of the subject project.
- Building entrances to the hotel, CRUs and residential lobby areas have clear and visible sight lines from the adjacent public sidewalks and roadways.
- Clear sight lines is provided along the existing lane with limited recesses located along the building edge adjacent to the lane.
- Active and passive surveillance is provided from the development to the public areas along the road and lane frontages and amenity areas located on level 6 and 9 of the project.

Accessible Housing and Unit Composition

- The proposed development includes 38 basic universal housing units that are designed to be easily renovated to accommodate a future resident in a wheelchair. These single-storey units are required to incorporate all of the accessibility provisions listed in the Basic Universal Housing Features section of the City's Zoning Bylaw, and are permitted a density exclusion of 1.86 m² (20 ft²) per unit.
- All of the proposed units incorporate aging in place features to accommodate mobility constraints associated with aging. These features include:
 - o stairwell hand rails;
 - o lever-type handles for plumbing fixtures and door handles; and
 - solid blocking in washroom walls to facilitate future grab bar installation beside toilets, bathtubs and showers.

- The residential unit mix is as follows:
 - Market residential units 341 total units consisting of 13 studios; 165 one bedroom (includes those with den); 135 two bedroom (includes those with den); 26 three bedroom (includes those with den) units.
 - Unit mix complies with the 40% family friendly unit target identified in the Official Community Plan (OCP).
 - Affordable LEMR Units 35 total units consisting of 3 studios; 10 one bedroom; 11 two bedroom; 11 three bedroom units.
 - Unit mix complies with the Affordable Housing Strategy targets for unit mix composition.

Public Art

- This development will install public art and the developer has been working with an independent public art consultant to prepare a Public Art Plan. Through the rezoning, a legal agreement will be registered on title to secure the implementation of a Public Art Plan and a financial security provided in accordance with the public art rezoning consideration item for this project.
- For public art contributions with a cumulative budget over \$250,000, the Public Art Plan is presented for Council approval prior to Building Permit issuance. The contribution amount is anticipated to be \$330,781, therefore, the Public Art Plan for this project will be brought forward for Council approval prior to issuance of the Building Permit.

Sustainability

- The proposed development will be connected to the City Centre District Energy Utility (DEU) for space and domestic hot water heating services. For cooling, an on-site low carbon energy plant will be required to be designed and constructed at the applicant's sole cost and transfer it to the City. Legal agreements for the connection to the City's DEU system and development of on-site low carbon energy system were secured through the rezoning.
- Based on the above provisions for connection to a City DEU system and provisions of an onsite low carbon energy system, the subject development will be subject to BC Energy Step Code – Step 2. The developer has confirmed that the project has been designed and modelled to comply with Step 2 performance targets.

Transportation

- Parking standards for the project are in compliance with Zoning Bylaw 8500 as they were secured through the associated rezoning (currently at third reading) prior to the introduction of the Provincial Bill 44 (limited residential parking requirements).
- The parkade is located within the project podium and contains a total of 675 parking spaces of which:
 - o 350 parking stalls are for residential uses.
 - 273 parking stalls are for non-residential uses.
 - 52 stalls allocated to Richmond Olympic Oval use during special events (when not reserved by the oval, these stalls can be used by the public). This was secured by legal agreement at rezoning.

- Through the rezoning, a package of Transportation Demand Management Measures were secured that have been incorporated into this Development Permit application submission, including:
 - Transit pass program available for the residential and non-residential uses in the development.
 - Additional on-site bicycle amenities and facilities:
 - Dedicated car-pool parking spaces (5 stalls)
 - Car share program and dedicated parking stalls for two car share vehicles
 - Electric Vehicle charging infrastructure (outlets to support level 2 EV charging infrastructure for a minimum of 10% of the non-residential parking stalls.
 - Interim off-site walkway connection along River Road that will be designed and constructed through the Servicing Agreement for this project.

Conclusions

As the proposed development would meet applicable policies and Development Permit Guidelines, staff recommend that the Development Permit be endorsed, and issuance by Council be recommended.

Kevin Eng

Planner 3


KE:cas

- Att. 1 Location Map
- Att. 2 Development Application Data Sheet
- Att. 3 Advisory Design Panel Excerpt of December 6, 2023 Meeting Minutes
- Att. 4 Development Permit Considerations





City of Richmond

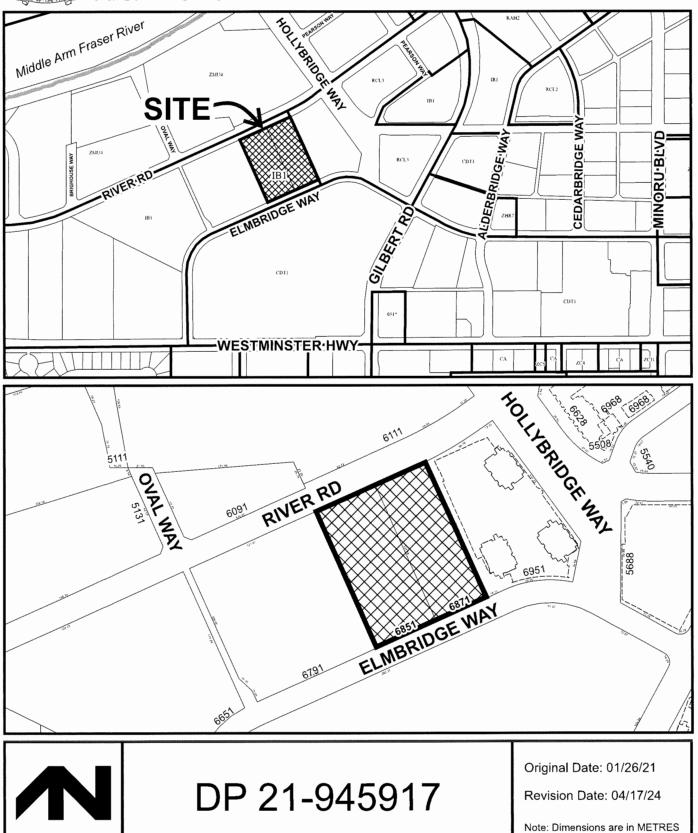



Development Application Data Sheet

Development Applications Department

376 residential dwelling units

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35 affordable LEMR units

341 strata residential units

DP 21-945917		Attachment 2
Address: 6851 and 6871 Elmbrid	ge Way	
Applicant: Arno Matis Architecture	Owner:	Landa Oval Holdings Ltd.
Planning Area(s): City Centre Are	a Plan – Oval Village	
Floor Area Gross: 72,561 m ²	Floor Area Net:	42,225 m ²
	Existing	Proposed
Site Area:	13,913 m ²	13,832 m²
Land Uses:	Light industrial business park uses	Residential (apartment housing) Hotel and supporting commercial services At-grade commercial Office
OCP Designation:	Mixed use	Mixed use – no change
City Centre Area Plan (CCAP) Designation	Urban Centre T5	No change – complies with OCP
Zoning:	Industrial Business Park (IB1)	High Density Mixed Use (ZMU52) – Oval Village (City Centre)

	<u> </u>		
	ZMU 52 Bylaw Requirement	Proposed	Variance
Floor Area Ratio:	 Max. 3.1 FAR including: Base (including AH): 2.0 FAR Village Centre Bonus: 1.0 FAR (non-residential use only) 0.1 FAR – indoor amenity space only 	 Max 3.1 FAR including: Base (including AH): 2.0 FAR Village Centre Bonus: 1.0 FAR (non-residential use only) 0.05 FAR – indoor amenity space only 	none permitted
Lot Coverage:	Max. 90% for buildings and landscaped roofs over parking spaces	Max. 90% for buildings and landscaped roofs over parking spaces	none

N/A

Number of Units:

	ZMU 52 Bylaw Requirement	Proposed	Variance
Setbacks (m)	Road: 3.0 m (9.84 ft.) Lane: 0.0 m (0.0 ft.)	Road: - River Road: 3.0 m (9.84 ft.) - New West Road: 3.0 m (9.84 ft.) - Elmbridge Way: 3.0 m (9.84 ft.) - Lane: 3.0 m (9.84 ft.)	Reduce River Road setback to 0.25 m to permit a minor encroachment for components of the building and balconies on levels 3 to 6
Height (m):	47 m (154 ft.) GSC	47 m (154 ft.) GSC	none
Lot Size:	Min. 10,000 m ²	13,832 m²	none
Parking	 Min. 675 stall Residential (AH and Mkt): 350 Shared pool (commercial/hotel, residential visitor): 273 Oval: 52 	 Min. 675 stall Residential (AH and Mkt): 350 Shared pool (commercial/hotel, residential visitor): 273 Oval: 52 	none
Bicycle Parking	Class 1 – 512 spaces Class 2 – 121 spaces	Class 1 – 644 spaces Class 2 – 138 spaces	none
Loading	Medium Size – 4 spaces Large Size – 1 space	Medium Size – 4 spaces	No large size loading space
Amenity Space – Indoor:	750 m ²	750 m²	n/a
Amenity Space – Outdoor:	2,256 m ²	3,037 m ²	n/a

04.24.2024

ADVISORY DESIGN PANEL COMMENTS:

December 6, 2023 Excerpt of Meeting Minutes DP 21-945917 – HIGH-RISE MIXED-USE PROJECT (356 DWELLING UNITS AND HOTEL) ARCHITECT: Arno Motis Architecture Inc./Arcadis LANDSCAPE ARCHITECT: PFS Studio PROPERTY LOCATION: 6851 ond 6871 Elmbridge Way

Applicant's Presentation

Arno Matis, Arno Matis Architecture, ond Londscope Architect Jeffrey Staotes, PFS Studio, presented the project ond together with Beth Deckert, Arcadis, answered queries from the Ponel.

Panel Discussion

Comments from Ponel members were as follows:

- Appreciate that the proposed 38 Bosic Universal Housing (BUH) units have varying numbers of bedrooms as it
 presents multiple opportunities for persons/fomily members with disabilities to live in the proposed development;
 APPLICANT RESPONSE: Noted with thanks.
- Also oppreciate that the proposed hotel will provide not only occessible rooms for people with mobility issues but
 also rooms that ore designed to accommodote people with hearing impairment; APPLICANT RESPONSE: Noted with
 thanks.
- Consider installing appropriate safety mirrors around the corners of the parkode ramp to enhance the sofety of cyclists accessing/exiting the parkade; RESPONSE FROM ARCHITECT: Project will install appropriate safety mirrors around the corners at the parkade ramp.
- Consider appropriate surface treatment for the elevotor flooring and walls to facilitate cleoning and mointenance for areas that are used to transport bicycles within the building; RESPONSE FROM ARCHITECT: Project will use appropriate surface treatment for elevator flooring/walls to facilitate cleaning and maintenance.
- The proposed development works very well; APPLICANT RESPONSE: Noted with thanks.
- Appreciate that a lot of thought and creative ideas have been put into the design of the proposed towers; the different design of the towers compared to other new developments in the nearby area is appreciated; APPLICANT RESPONSE: Noted with thanks.
- Overall, the proposed project is well presented; APPLICANT RESPONSE: Noted with thanks.
- Consider looking at how to reduce the retaining wall along the New West Road frontage at the transition slope to help soften the transition from the street; also consider further orchitectural articulation along the New West Road façade particularly above the vehicle access to improve the pedestrian experience; RESPONSE FROM LANDSCAPE ARCHITECT: The planters along New West Road have been terraced with the front planter along the sidewalk limited to max. 24" high.
- The north side ploza works well; however, the proposed stairs on the south plaza are long; look at the neighbouring
 Ora development on their approach to grade transition and investigate opportunities to reduce the scale of the stairs
 and incorporate additional landscaping to help soften the Elmbridge Way frontage; RESPONSE FROM LANDSCAPE
 ARCHITECT: The stairs along Elmbridge Way have been reduced in scale by doubling planted segments. Additional
 planting has been incorporated to soften the grading. Please refer to drawing L2.01 Ground Level Landscape Plan.
- Consider moving the location of the accessible ramp at the southeast corner onto the laneway to soften the grade transition from Elmbridge Way; RESPONSE FROM LANDSCAPE ARCHITECT: The accessible ramp has been relocated

to the laneway with the entry point facing the Elmbridge Way. Please refer to drawing L2.01 Ground Level Landscape Plan.

- CRUs along the New West Road appear to be narrow, particularly those near the corner plaza; look at their relationship to the corner plaza space in terms of size to ensure their viability as CRUs; RESPONSE FROM ARCHITECT: CRU depths along New West Road are 30 ft. Note that previous iterations did not include CRU on the New West Road. This has been added to animate the public realm.
- Ensure adequate weather protection along the south side of the building to provide opportunities for installing outdoor cafés; also investigate opportunities for additional planting along the south edge to create more intimate patio spaces adjacent to the CRUs; RESPONSE FROM LANDSCAPE ARCHITECT: Additional planting has been added to provide a soften CRU frontage and intimate patio spaces along Elmbridge way. Please refer to drawing L2.01 Ground Level Landscape Plan. Please note that overhangs are provided on all three street frontages to provide weather protection. Average overhang depths River Road = 6.6' New West St = 4' Elmbridge Way = 11.5'. Frames act as overhangs on all three street frontages as a stark design choice, providing ample rain protection. These frames are shown as dotted lines on architectural drawing A.201.
- Look at oppartunities to plant more trees along the New West Road right-of-way;
 - RESPONSE FROM LANDSCAPE ARCHITECT: Given the site's horizontal and vertical constraints, it's tricky to accommodate additional trees within the private property. The narrow planters between the city sidewalk and CRU patios are designed as terraces to soften the grading transition. High planters will be required for tree planting, which is not desired for pedestrians. Instead, we propose to extend landscape bulges with four additional street trees along the New West Road right-of-way with the understanding that this proposal will be subject to review and approval of the Servicing Agreement. Please refer to drawings L2.01 Ground Level Landscape Plan and L4.01 Ground Level Planting Plan.
- The design of the massing shades the central courtyard on Level 6 for some parts of the day; investigate opportunities to maximize sunlight exposure into the area, particularly at the outdoor swimming pool area;
 RESPONSE FROM ARCHITECT: Pool has been located on the southern end of the building, away from the 3 towers to maximize sunlight. The sun receives full sun from 9am-3pm during the summer (and partial sun thereafter). Further, boomerang massing curves to minimize shadowing on podium.
- Understond that security issues regarding access to and contral of some areas in the courtyard including the swimming pool by various users in the development will be resolved as the project moves forward; RESPONSE FROM LANDSCAPE ARCHITECT: Noted. Security issues and access control measures will be further studied and resolved as the project moves forward.
- Stepping stones are proposed for crossing the dry creek feature/pathway on the Level 6 central courtyard; ensure
 there are clear accessible routes for crossing the linear dry creek feature/pathway; RESPONSE FROM LANDSCAPE
 ARCHITECT: Stepping stones will be replaced with concrete bridges with integrated toe rail/curb to ensure clear
 accessible routes for crossing the dry creek feature. Please refer to drawing L2.02 Level 6 Landscape Plan.
- Look at how some of the central units within the interior corners af the residential buildings with small windows at the end relate to fire compartmentalization and separation; RESPONSE FROM ARCHITECT: Fire compartmentalization and separation will follow code requirements, unit adjustments to be resolved at the Building Permit stage.
- Appreciate the presentation package provided by the applicant especially its portrait format; APPLICANT RESPONSE: Noted with thanks.
- Appreciate the design team for bringing the river character into the design of the project; APPLICANT RESPONSE: Noted with thanks.
- Consider fine tuning the pockets of green spaces along River Road, Elmbridge Way and the New West Road including introducing permeability along these three sides; RESPONSE FROM LANDSCAPE ARCHITECT: Noted. Additional plantings have been added along Elmbridge Way CRU frontage and at the southwest corner plaza. The pockets of

green spaces will be refined further as the project moves forward to ensure the permeability from the sidewalk to the CRUs and residential entrances while optimizing plantings.

- Agree with the Panel comment that the grading treatment along Elmbridge Way looks busy: review the location of the stairs and introduce additional landscaping to improve the grading treatment; and RESPONSE FROM LANDSCAPE ARCHITECT: The stairs along Elmbridge Way have been reduced in scale by doubling planted segments. Additional planting have been incorporated to soften the grading. Please refer to drawing L2.01 Ground Level Landscape Plan.
- Support the Panel comment regarding using structural soil to increase the soil volume for planting on the ground level. RESPONSE FROM LANDSCAPE ARCHITECT: Structural soil has been extended under the boulevard, bike path and sidewalk along River Road and under sidewalk along Elmbridge Way. Please refer to drawing L4.01 Ground Level Planting Plan for structural soil extent and proposed soil volume for street trees.

The following written comments submitted by Panel member Nicci Theroux were reod into the record by the Chair:

- Appreciate the detail included in the presentation package; consider including north arrow on the landscope drawings; RESPONSE FROM LANDSCAPE ARCHITECT: Noted. North arrow has been placed on the landscape drawings.
- Support the vibrant connection of the street level with CRUs; RESPONSE FROM ARCHITECT: CRU spaces are required to be above the flood plane. A continuous plaza surrounding the project on all three sides provides a vibrant connection to the street.
- Soil volume appears inadequate on Level 6; RESPONSE FROM LANDSCAPE ARCHITECT: Proposed planters on Level 6 will ensure min. 450mm depth for shrub planting with the soil mound up to achieve min. 900mm of soil depth for trees. A minimum of 6 cubic meters of soil has been provided for each tree on level 6, but opportunities to increase soil provisions will be pursued. Please refer to drawing L4.02 for the proposed soil volume.
- Consider structural soil or soil cells under the sidewalk along River Road as the soil volume appears inadequate; RESPONSE FROM LANDSCAPE ARCHITECT: Structural soil has been extended under the boulevard, bike path and sidewalk along River Road. Please refer to drawing L4.01 Ground Level Planting Plan for structural soil extent and proposed soil volume for street trees.
- Planters ot Elmbridge Way and New West Road appear to be too small for trees indicated: consider aiming for a
 minimum of 6 cubic metres of soil volume even for smaller trees; and RESPONSE FROM LANDSCAPE ARCHITECT: A
 minimum of 6 cubic meters of soil has been provided for each on-site tree in planter at Elmbridge Way and New
 West Road. Please refer to drawing L4.01 Ground Level Planting Plan for the proposed soil volume for trees.
- The tree trench at Elmbridge Way appears narrow; consider structural soil or soil cells under the sidewolk_RESPONSE FROM LANDSCAPE ARCHITECT: Structural soil has been extended under sidewalk along Elmbridge Way. Please refer to drawing L4.01 Ground Level Planting Plan for structural soil extent and proposed soil volume for street trees.

Panel decision:

It was moved and seconded

That DP 21-945917 be supported to move forward to the Development Permit Panel subject to the applicant giving consideration to the comments of the Advisory Design Panel. CARRIED

Attachment 4



Development Permit Considerations

Development Applications Department 6911 No. 3 Road, Richmond, BC V6Y 2C1

Address: 6851 and 6871 Elmbridge Way File No.: DP 21-945917

Prior to Development Permit issuance, the following are to be met prior to forwarding this application to Council for approval:

1. Enter into a security agreement and receipt of a Letter-of-Credit for landscaping in the amount of \$1,506,747.00

Prior to Building Permit Issuance, the developer must complete the following requirements:

- 1. As part of the existing Servicing Agreement application (SA 23-035702), design approval and construction and installation of the new sanitary sewers and forcemain in Elmbridge Way and the removal of the existing sanitary system along the south property line of the proposed site is required to be undertaken in coordination with and ahead of the other Servicing Agreement works and to discharge the existing rights of ways along the south property line to the satisfaction of the City. This is required prior to issuance of any demolition permits for the existing buildings on the proposed site and/or prior to issuance of any building permits to ensure that the new sanitary sewers and forcemains in Elmbridge Way are installed and operational and the existing sanitary system are removed and the existing rights of ways are discharged at the south property line of the proposed site before the start of any site preparation works or release of future building permits.
- 2. Incorporation of accessibility measures in Building Permit (BP) plans as determined via the Rezoning and/or Development Permit processes.
- 3. Submission of a Construction Parking and Traffic Management Plan to the Transportation Department. Management Plan shall include location for parking for services, deliveries, workers, loading, application for any lane closures, and proper construction traffic controls as per Traffic Control Manual for works on Roadways (by Ministry of Transportation) and MMCD Traffic Regulation Section 01570.
- 4. Obtain a Building Permit (BP) for any construction hoarding. If construction hoarding is required to temporarily occupy a public street, the air space above a public street, or any part thereof, additional City approvals and associated fees may be required as part of the Building Permit. For additional information, contact the Building Approvals Department at 604-276-4285.

Note:

- * This requires a separate application.
- Where the Director of Development deems appropriate, the preceding agreements are to be drawn not only as personal covenants of the property owner but also as covenants pursuant to Section 219 of the Land Title Act.

All agreements to be registered in the Land Title Office shall have priority over all such liens, charges and encumbrances as is considered advisable by the Director of Development. All agreements to be registered in the Land Title Office shall, unless the Director of Development determines otherwise, be fully registered in the Land Title Office prior to enactment of the appropriate bylaw.

The preceding agreements shall provide security to the City including indemnities, warranties, equitable/rent charges, letters of credit and withholding permits, as deemed necessary or advisable by the Director of Development. All agreements shall be in a form and content satisfactory to the Director of Development.

- Additional legal agreements, as determined via the subject development's Servicing Agreement(s) and/or Development Permit(s), and/or Building Permit(s) to the satisfaction of the Director of Engineering may be required including, but not limited to, site investigation, testing, monitoring, site preparation, de-watering, drilling, underpinning, anchoring, shoring, piling, pre-loading, ground densification or other activities that may result in settlement, displacement, subsidence, damage or nuisance to City and private utility infrastructure.
- Applicants for all City Permits are required to comply at all times with the conditions of the Provincial *Wildlife Act* and Federal *Migratory Birds Convention Act*, which contain prohibitions on the removal or disturbance of both birds and their nests. Issuance of Municipal permits does not give an individual authority to contravene these legislations. The City of Richmond recommends that where significant trees or vegetation exists on site, the services of a Qualified Environmental Professional (QEP) be secured to perform a survey and ensure that development activities are in compliance with all relevant legislation.

- Signed Copy on File -

Signed

Date



No. DP 21-945917

To the Holder:	Arno Matis Architecture
Property Address:	6851 and 6871 Elmbridge Way
Address:	1540 West 2nd Ave Vancouver, BC V6J 1H2

- 1. This Development Permit is issued subject to compliance with all of the Bylaws of the City applicable thereto, except as specifically varied or supplemented by this Permit.
- 2. This Development Permit applies to and only to those lands shown cross-hatched on the attached Schedule "A" and any and all buildings, structures and other development thereon.
- 3. The "Richmond Zoning Bylaw 8500" is hereby varied to:
 - a) Reduce the minimum road setback of 3.0 m along River Road to 0.25 m to allow a projection on a small portion of the development's podium (Levels 3 to 6) for components of the building and residential balcony units.
 - b) Not require a large size on-site loading space in the proposed development.
- 4. Subject to Section 692 of the Local Government Act, R.S.B.C.: buildings and structures; off-street parking and loading facilities; roads and parking areas; and landscaping and screening shall be constructed generally in accordance with Plans #1 to #51 attached hereto.
- 5. Sanitary sewers, water, drainage, highways, street lighting, underground wiring, and sidewalks, shall be provided as required.
- 6. As a condition of the issuance of this Permit, the City is holding the security in the amount of \$1,506,747.00 to ensure that development is carried out in accordance with the terms and conditions of this Permit. Should any interest be earned upon the security, it shall accrue to the Holder if the security is returned. The condition of the posting of the security is that should the Holder fail to carry out the development hereby authorized, according to the terms and conditions of this Permit within the time provided, the City may use the security to carry out the work by its servants, agents or contractors, and any surplus shall be paid over to the Holder. Should the Holder carry out the development permitted by this permit within the time set out herein, the security shall be returned to the Holder. The City may retain the security for up to one year after inspection of the completed landscaping in order to ensure that plant material has survived.
- 7. If the Holder does not commence the construction permitted by this Permit within 24 months of the date of this Permit, this Permit shall lapse and the security shall be returned in full.

To the Holder:	Arno Matis Architecture
Property Address:	6851 and 6871 Elmbridge Way
Address:	1540 West 2nd Ave Vancouver, BC V6J 1H2

8. The land described herein shall be developed generally in accordance with the terms and conditions and provisions of this Permit and any plans and specifications attached to this Permit which shall form a part hereof.

, .

This Permit is not a Building Permit.


AUTHORIZING RESOLUTION NO. DAY OF , .

ISSUED BY THE COUNCIL THE

DELIVERED THIS DAY OF

MAYOR



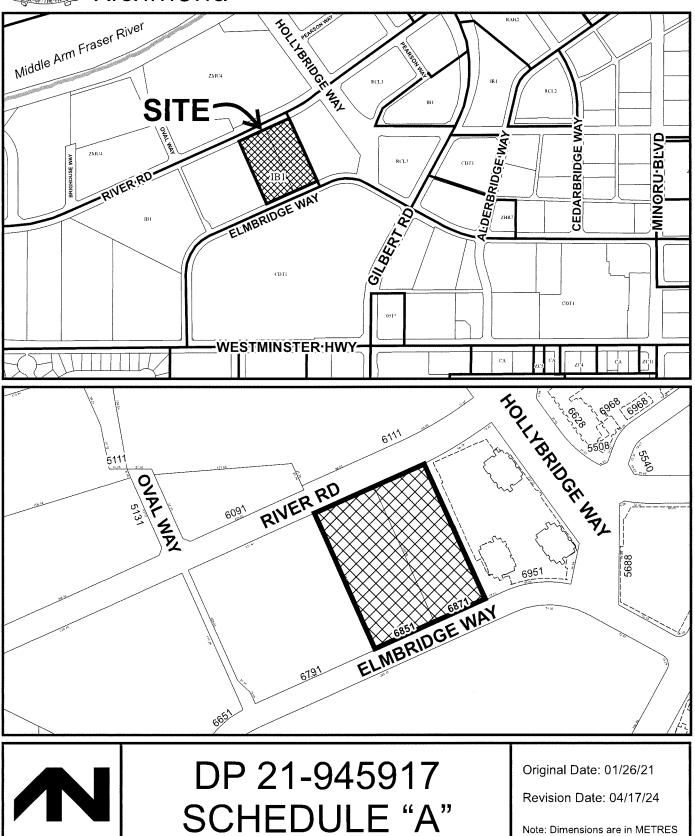

6851-6871 Elmbridge Way, Richmond, BC, CANADA MIXED USE HOTEL / RESIDENTIAL / COMMERCIAL/ OFFICE **DEVELOPMENT PERMIT**



	SHEETS - DP
SHEET #	SHEET NAME
AO	COVER SHEET DP
A000	LEVEL B1 AREA OVERLAY
A001	LEVEL L1 AREA OVERLAY
A002	LEVEL L2 AREA OVERLAY
A003	LEVEL L3 AREA OVERLAY
A004	LEVEL L4 AREA OVERLAY
A005	LEVEL L5 AREA OVERLAY
A006	LEVEL L6 AREA OVERLAY
A007	LEVEL L7 AREA OVERLAY
A008	LEVEL L8 AREA OVERLAY
A009	LEVEL L9 AREA OVERLAY
A010	LEVEL L10 AREA OVERLAY
A011	LEVEL L11 AREA OVERLAY
A012	LEVEL L12 AREA OVERLAY
A013	LEVEL L13 AREA OVERLAY
A014	LEVEL L14 AREA OVERLAY
A015	LEVEL L15 AREA OVERLAY
A016	ROOF AREA OVERLAY
A102a	SITE DATA / REQ.
A102b	STATISTICS
A102c	UNIT & PARKING MIX
A102d	DEVELOPMENT
	APPLICATION DATA
	SHEETS
A103	SURVEY PLAN
A104	BUILDING GRADE
A105	EXISTING STREETSCAPES
A106	CONTEXT PLAN
A107	CONTEXT ELEVATIONS
A108a	SHADOW STUDY
A108b	SHADOW STUDY
A109	SETBACK PLAN
A110	SITE PLAN
A111a	RENDERING
A111b	RENDERING
A111c	RENDERINNG
A111d	RENDERING
A200	LEVEL B1 PARKING
A201	LEVEL 1 PARKING
A202	LEVEL 2 PARKING
A203	LEVEL 3 PARKING
1001	I D (D) (D) I D (D) (I) (D)

LEVEL 4 PARKING

ARCHITECT (Design) Amo Matis Architecture Inc. 204 - 1540 West 2nd Avenue Vancouver, BC V6J 1H2 Tel. (604) 708 0188 ARCHITECT (of Record) INTERIOR DESIGNER IBI Suite 700 1285 West Pender Street Vancouver BC V6E 4B1 Tel. (604) 683-8797

LANDSCAPE
 Interior Destorer
 DataStudio

 Studio Munge
 PFS Studio

 25 Wingold Avenue
 1777 West 3rd Avenue,

 Toronto, Ontario M6B 1P8
 Vancouver, BC V6J 1K7

 Tel. (416) 588 1668
 Tel: (604) 736 5168

STRUCTURAL MECHANICAL MECHANICAL Integral #180 - 200 Granville Street Vancouver, B.C. V6C 1S4 Tel: (604) 687 1800 Holistic Engineering Ltd. #215-7131 17th Ave Burnaby, BC V3N 1K8 Tel: (604) 360 5221

ELECTRICAL Nemetz (S/A) & Associates Ltd 2009 W 4th Avenue Vancouver, BC V6J 1 Tel: (604) 736 6562 uver, BC V6J 1N3 CIVIL Aplin & Martin Consultants #1818 - 1177 West Hastings Street Vancouver, BC V6E 2K3 Tel: (604) 678 4496

GEOTECHNICAL Horizon Engineering #220 - 18 Gostick Place North Vancouver, BC V7M 3G3 Tel: (604) 990 0546

SURVEYOR Matson Peck & Topliss #320 - 11120 Horseshoe Way Richmond, BC V7A 5H7 Tel: (604) 270 9331

ARBORIST Radix Tree and Landscape Consulting Inc #264, 718-333 Brooksbank Ave, North Urancouver VZ 13/18 Vancouver V7J 3V8 Tel: (604) 770 1755

A204

BUILDING ENVELOPE BC Building Science 611 Bent Court 611 Bent Court New Westminster, BC V3M 1V3 Tel: (604) 520 6456

Landa Global Properties Ltd. 1550 - 200 BURRARD ST. VANCOUVER, BC. V6C 3L6 **PROJECT DRAWING LIST - DEVELOPMENT PERMIT** DP BOARD SUBMISSION 2024-04 SHEETS - DP SHEET # SHEET NAME LEVEL 5 PARKING A205 LEVEL 6 FLOOR PLAN A206 A207 LEVEL 7 FLOOR PLAN A208 LEVEL 8 FLOOR PLAN A209 LEVEL 9 FLOOR PLAN A210 LEVEL 10 FLOOR PLAN A211 LEVEL 11 FLOOR PLAN A212 LEVEL 12 FLOOR PLAN A213 LEVEL 13 FLOOR PLAN ΛM A214 LEVEL 14 FLOOR PLAN A215 LEVEL 15 FLOOR PLAN A216 LEVEL 16 ROOF PLAN A217 PARAPET FLOOR PLAN PNO MATIS ARCHITECTURE A301 BUILDING SECTION A-A 204-1540 W 2ND AVE, VANCOUVER, BC A302 BUILDING SECTION B-B V6J IH2 T. 604.708.0188 A303 BUILDING SECTION C-C A304 BUILDING SECTION D-D A401 BUILDING ELEVATION -WEST BUILDING ELEVATION -EAST A402 BUILDING ELEVATION -NORTH A403 BUILDING ELEVATION -A404 SOUTH WALL SECTION A801 A802 WALL SECTION A803 WALL SECTION WALL SECTION A804 A805 WALL SECTION A806 WALL SECTION A807 WALL SECTION A808 WALL SECTION A809 WALL SECTION A810 WALL SECTION A811 WALL SECTION A812 WALL SECTION A813 WALL SECTION TOTAL: 74 DP 21-945917 April 25, 2024 Plan # CODE CONSULTANT Camphora Engineering 2479 Kingsway Vancouver, BC V5R 5G8 Tel: (604) 800 9822 TRAFFIC CONSULTANT Bunt & Associates Engineering Ltd. #1550 - 1050 West The for an event state over signaling our first even prime of the area and employed in the state of the device of Pender Street Vancouver, BC V6E 3S7 Tel: (604) 685 6427 ARCADIS 1285 West Pender Street - Sute 100 Vancouver BC V6E 481 Carada tel 604 683 8797 Elmbridge Way 6851-6871 Elmbridge Way Richmond, BC CHECKED BY Checker APPROVED BY PROJECT MGR Approver COVER SHEET DP ISSUE 2 A0

SITE DATA

CIVIC ADDRESS: 6851 + 6871 Elmbridge Way, Richmond BC LEGAL ADDRESS:

LOT 125 SEC 6 BLK 4N RG 6W PL NWP85093 Lot 125, Block 4N. Plan NWP85093, Section 6, Range 6W, New Westminster Land District LOT 125 SEC 6 BLK 4N RG 6W PL NWP65093 Lot 126, Block 4N, Plan NWP65093, Section 6, Range 6W, New Westminster Land District



PROPOSED USES: Mixed Use: Residential / Affordable Housing / Hotel / CRU/ Office

PROPOSED REQUIREMENTS

NE CORNER

SE CORNER

BUILDING HEIGHT: NUMBER OF STORES : 15 PERMITTEDMAX HEIGHT: 47.00m / 154.20 PROPOSED HEIGHT: 47.00m / 154.20 Building Height= 7.0.NOTEL Elevator Overtur

	Building Height= T.C	0.HOTEL Elevelor Overruns	
SETBACKS:	STREET NAME	REQ.	PROPOSED
	RIVER ROAD	3m From Dedication	3m From Dedication
	RIVER ROAD	3.5m from PL	3.5m from PL
	ELMBRIDGE WAY	3m From Sidewalk Edge	3m From Sidewalk Edge L1-2 Matching East Neighbor Above
	NEW WEST STREET	3m From Dedication 21m From PL	3m From Dedication 21m From PL
	LANE	3m From PL	3m From PL
SRW:			
	STREET NAME	REQ.	PROPOSED
	RIVER ROAD	2.5m From PL 2m from Dedication	2.5m From PL 2m from Dedication
	ELMBRIDGE WAY	3.5m From PL	3.5m From PL
	NEW WEST STREET	18m From PL Om From Dedication	18m From PL Om From Dedication
	LANE	3m From PL	3m From PL
DEDICATIONS:	STREET NAME	REQ.	PROPOSED
	RIVER ROAD	.5m From PL	.5m From PL
	ELMBRIDGE WAY	D	0
	NEW WEST STREET	D	0
	LANE	18m From PL	18m From PL
	NW CORNER	4m x 4m From SRW	4m x 4m From SRW
	SW CORNER	4m x 4m From SRW	4m x 4m From SRW

3m x 3m From SRW

RESIDENTIAL UNIT MIX & HOTEL SUITE MIX

RESIDENTIAL AFFORDABLE HOUSING

HOTEL

L03	1	0	0	2	2	1	2	0	12
LOI	2	2	0	3	2	1	1	0	12
L95	2	1	0	1	2	2	0	0	8
L06	0	0	Q	0	0	٥	0	3	3
RESIDENTIAL UNITS SUB TOTAL	7	3	0	5	6	8	3	3	3.6
TOTAL PERCENTAGE PER UNIT TYPE	20%	9%	0%	14%	17%	23%	8%	8%	-
TOTAL % PER UNIT TYPE PROVIDED	2	1%		31%			\$1%	2%	1
COR TOTAL % PER UNIT TYPE REQUIRED				MIN 15%		M	N 5%		-

Purplet date (/ Appendix) and	1 100		- Jackson -	1000	CAUD-20-			 Contraction of the local division of the loc
(A)	3	17	0 1	2	1	0	1	24
_04	4	10	0	2	1	0	1	26
	5	24	0	4	1	0	1	 35
POOLUM RESIDENTIAL UNITS SUB TOTAL	12	59	0	8	3	0	3	 13

.08	6	3.	0	2	4	0			
07	6	2	0	3	4	0	0	3	18
.00	6	2	0	3	4	0	0	3	10
90	2	2	0		3	0	0	0	17
10	2	1	0	5	1	1	0	0	12
(11	2	2	0	5	2	1	0	0	17
.12	3	2	0	5	2	-1	Q	0	12
113	2	0	0	-4	1	1	2	0	340
14	0	2	0	4	1	1		0	9
L15	0	0	0	1	0	1		Q	5
WY TOWER RESIDENTIAL UNIT SUB TOTAL	26	17	0	37	23	6	6	7	124

State of the state	Contract of the local division of the local	Contraction of the		No.	A REAL PROPERTY AND A REAL		A NEW YORK	ALC: NO.	L BROG
L06	6	1	0	2	4	0	0	2	17
L06	6	2	0	3	4	0	0	3	11
106	6	1	0	3	4	0	0	3	18
109	2	2	0	5	3	8	0	¢.	12
10	2	2	0	5	2	1	0	9	12
01	2	2	0	5	2 1	1	0	0	12
L12	2	2	0	5	2	3	0	0	12
L13	2	2	G	5	1	1	0	đ	12
L14	2	1	0	5	2	1	0	0	12
L16	0	9	0	1	0 1	2	4	0	7
SW TOWER RESIDENTIAL UNIT SUB TOTAL	30	19	Q	39	25	7	4	8	132
									-
TOTAL REHIDENTIAL UNIT COUNT	70	95	0		51	13	13	15	341
TOTAL PERCENTAGE PER UNIT TYPE	21%	28%	0%	25%	15%	4%	-1%	4%	
TOTAL % FANKLY HOUSENIG UNITE PROVIDED*				36%			4%		
COR TOTAL % FAMILY HOUSING UNITS REQUIRED			1	MIN 15%		a.d.	N 5%		

SUITES											
Hotel Tower											
NONTH EAST STREET, TOMIER, SILLT'S COUNT	SCHOOL SCHOOL	ARCA DOM:	EXCELLATION.	THE REAL PROPERTY AND	THE PARTY OF	HINGS.	TOPA .				
LEI/GL	(1)(2)(2)	(5002.072	- COLO-1000 DV7		2008-000-000	1000					
L06	0	0	2	4	5	10	25				
L07	0	0	3	12	5	23	43				
108	0	0	3	7	2	2	14				
L09	0	0	4	10	2	4	20				
L10	0	0	6	9	2	3	20				
LII	0	0	5	7	2	6	20				
L12	0	0	5	10	1	4	20				
13	0	0	5	7	2	8	20				
L14	0	0	5	6	2	4	37				
L15	0	0	5	4	2	4	15				
TOTAL NOTEL UNIT COUNT	0	0	43	80	26		214				

VEHICLE PARKING & LOADING

Proposed Parking								Prop	ased Break	lown	Total Proposed	Total Required	
	<i>e1</i>	u	12	U	L4	LS	fotal.	Regular	Small	NC	-		1
Residential	0	a	0	68	157	136	fel	178	165	7	354	828	1
Residential attordable	0	0		28	0	0	26	14	14	0	28	22	1
Rest visitor	0	0	24	37	۵	0	61	30	31	0	63	61	* Shared with CBU
CitU-Matel	0	67	0	0	0	a .	67	10	34	3	67	67	"Designated for hotel guests
CRU UND	0	40	-	0	0	0	128	65	63	2	128	134	Shared with Oval & Matel Aman
Dlympic Ovel parking	51	1	0	0	0	0	52	22	30	0	32	52	"Shared with CRU & Hetal Amend
the first of the local data		304	10	1	200	106	-	000	1996	28.	690	664	1
and .					. *			49.46	1944	5.00			1
Care share	0	2	a	0	0	0	2	0	0	2	2	2	1
Carporel	0	5	0	0	0	ō	5	3	0	2	5	5	1
Loading [small size]*							9				6	1	1
Logding (modium size)		2					5	-			5	4	1
Loading (Targe size)		1					1				1	1	1
Total Inclusing Leading		1						1			709	682	1

BIKE PARKING

					Requi	red Bike(ba:	sed on TDM)											
		units/Area	Class 1	Gual	Cless 2	Class 3 TOM	Class 2	Class 1 Provided		Class 1 Provided	Total Class 1 Provided		Transforment Barrand	Class 2	Clase 1	Claus 2	Class 1 w/	Class 2 w/
		GRIG/ADER	CIRS I	COUNT	liner.	TDM Incr.	Norizontal	Vertical	Stacked	Provided		Required	Requirad	TOM Req	TDM Req			
	Rusidential	376	1.25	0.20	1-25	1.05	216	180	192	588	74	470	76	588	\$0			
Phase 1	Commercial	2,319 00	0.27pm100ml	0 fper 100m²	1.25	1.05	5	5	0	11	26	7	9	9	9			
Pingpe 1	Hotel	12,125.00	0.27pert30w ¹	0 78per320re*	1.25	t.05	-17	13	12	42	36	33	33	41	35			
	Office	00 4£8	0.27per100m²	0 Aper100vv*	1 25	1.05	2	1	0	3	10	2	3	3	3			
Test and					1	4	341	199	204	Diff.	340	517	122		228			

Netal (Closs 1: 0.27 pana per 100m2 preter don 100m2,Close 3: 0.27 space per 100 m3 preter Maa 100 m2 Offici: Class 1: 0.27 space per 100m2, present than 100m2, closes Class 3: 0.4 septor per 100 m3 gree Table Mahateman Sentitism required for each Rasilettical Torever Incades Manasent End el Trifo Facilitides required for Hotal and Converserial located at Lawel 1

LAND USE

Residential - Market	410		410
Residential - Affordable	28		28
Residential Visitor, Hotel Rooms, Amenity, Retall, Office		390	390
Sub-Total	438	390	828
20% TDM Reduction	-68	-78	-166
Reduction from Shared Parking		-40	-40
Olympic Oval Parking		+52	+52
TOTAL	350	325	675

Table 4.10: Shared Loading Bay

LAND USE	DAILY VEHICLE DEMAND							
-		LSU	M/HSU	WB				
Residential	12	3	4	0				
Hotel	8	4	4	Ð				
Retail	5	2	1	0				
Office	1	0	1	0				
Total	26	9	9	0				
		SHAR	ED USE	-				

Table 4.5: Bicycle Requirements

LAND USE	DENSITY	REQUIR	EMENT	CLASS I	CLASS /		
DENSITY		CLASS I LONG TERM	CLASS 2 SHORT TERM	CLASS I	CDGS /		
Residential	376 units	1.25 spaces per dwelling unit	0 2 spaces per dwelling unit	470	76		
Hotel	12.125 m	0.27 spaces per 100m2 of GLA greater than 100m2	0.27 spaces per 100m2 of GLA greater than 100m2	33	33		
Tetail	2,339 m²	0.27 spaces per 100m2 of GLA greater than 100m2	0.4 spaces per 100m2 of GLA greater than 100m2	7	9		
Office	834 m	0.27 spaces per 100m2 of GLA greater than 100m2	0.4 spaces per 100m2 of GLA greater than 100m2	2	3		
	SUB TOTAL						
	Addition	al for TDM 25% Class 1, 5% Cla	ass 2	128	7		
		OVERALL		640	128		

TABLES FROM TDM REPORT (FOR REFERENCE)

Landa Global Properties Ltd.

1550 - 200 BURRARD ST.

Table 4.4: Total Vehicle Parking (After TDM and Shared Parking)								
LAND USE	RESERVED	SHARED	TOTAL					

	SMALL LOADING DEMAND PER HOUR	MEDIUM LOADING DEMAND PER HOUR
TOTAL		SHARED LSU, M/HSU, WE
19	2	
16	2	1
8	2	1
2	1	1
45	7	4
		3

As can be seen above, using the shared use calculator and Loading Management Plan in place, the peak loading demand at any one time would be 4 small and 3 medium vehicles. Therefore, the provision of 6 small and 4 medium loading bays would be sufficient to accommodate the anticipated peak loading demand of the complete site.

DP 21-945 April 25, 2 Plan # 7_	
Plan # Z	
This is provide the supplication of the suppli	

		AREA SUMMAR	Y
COMMERCIAL WEEA TOTAL	COMMERCIAL EXCLUSION TOTAL	COMMERCIAL/ RETAIL	
LEVEL VI 10524 LE 2017 AL 10524 LE		FSR : 0.10	
HOTEL AREA TOTAL	HOTEL EXCLUSION TOTAL	FSR AREA : 15,538 SF (1,444 m2)	
Lond Area (EVEL 01 75%, 37	Lavel Area LEVEL 11 731 P	EXCLUSION : 0 SF (0m2)	
LEVEL D2 p+1 of LEVEL D2 2411 75	1.100 P	GFA : 15,538 SF (1,444 m2)	
15.6.8 149.7 15.6.8 149.7 15.6.9 1722.3 15.6.0 1722.3	LEVEL 5 1.46.3F LEVEL 5 1.45.3F LEVEL 7 1.07.1F		
		HOTEL	
(10日) (10日) (10日) (10H) (10日) (10H) (1	10100 III 100 IV	FSR : 0.84	
	位VEL 1. 112 デ 近VEL 12 102 第 近VEL 14 142 デ 157.E 541 143 デ	FSR AREA : 123,350 SF (11,460 m	
ERELEAR AVELY CONCEPTION	LEVEL F.M. P.H.F. T.T.R. PARACE	EXCLUSION : 14,968 SF (1,391 m)	2)
COMMERCIAL/RETAIL/HOTEL TOTAL	COMMERCIAL/RETAIL/HOTEL ENCLUMENTOTAL	GFA : 138,318 SF (12,850 m2)	
Local Area LD-51.01	Livel Area LEVEL 1 1.49 × F LEVEL 1 1.49 × F LEVEL 1 1.40 × F	TOTAL COMMERCIAL (RETAIL (HO	TE
181日か 第11.F 181日 24 F F 181日 25 1415 F	EpiE 13 1, 12, 15 EpiE 13 11% 11 EpiR, 15 1, 10, 15 EpiR, 15 1, 10, 15 EpiR, 16 11, 10, 15	TOTAL COMMERCIAL/RETAIL/HO	
	154E-7 1.57 F	FSR AREA : 138,888 SF (12,903 m	7)
15.51.79 Pro. 7 15.51.79 Pro. 7 16.51.79 Pro. 7 16.51.79 Pro. 7 15.51.79 Pro. 7	12.vh. =	EXCLUSION : 14,968 SF (1,391 m)	
15x51 11 1437 F 15x51 12 1447 F 15x51 12 1447 F 15x51 14 944 F	LEVEL 1. 1713 F	GFA : 153,856 SF (14,294 m2)	-1
LEVEL 14 0014 / F LEVEL 1944 02 / F TGTA, 1 mmg 2F	12992-15 203.05 12992-1544 203.05 12014(12995-05		
OFFICE AREA TOTAL	OFFICE AREA EXCLUSION FOTAL	OFFICE	
Lond Area	Laved Area	FSR : 0.06	
US-B-01 12-07 出行的の。 22-17 US-B-06 74-6.7	1548.1 // マ 1558.7 / ママ 1568.7 / ママ 1568.7 / ママ	FSR AREA : 8,973 SF (2,767 m2)	
total ports	LEVEL *6 /** * LEVEL * /* *F LEVEL * /* *F LEVEL * /* *7	EXCLUSION : 669 SF (0 m2)	
	1548.4 41.37 TuFA 540.75	GFA : 9,642 SF (896 m2)	
AFFORDABLE HOUTING AREA FOTAL	AFFORMARLE HOUSING EXCLUDION TOTAL	AFFORDABLE HOUSING	
Level Area LEVEL 2* 112/4.7 LEVEL 2* 112/4.7 LEVEL 2* 112/4.7	Lavel Aga	FSR : 0.20	
LEVEL NY ALEV.F LEVEL NY THY F TOTAL DIAL F		FSR AREA : 29,784 SF (2,636 m2) 29,784 SF REQUIRED	
MARKET HOUSING AREA TOTAL	MARKET HOUSEN EXCLUSION TOTAL	EXCLUSION : 0 SF (0 m2)	
	Lavel Area CECCETE EA C F LEVEL 1 155 F	GFA : 29,784 SF (2,638 m2)	
Lovel Area Erit El #1つ El El #1つ El			
10-05 10	(EVAL) 27日第 (EVAL) 27日第 (EVAL) 27日第 (EVAL) 27日第 (EVAL) 4 (EVAL)	MARKET HOUSING	
121日、12 2271年 15日、27 224年7年 15日、27 224年7年	LEVEL 6 21.0 P LEVEL 5 912 P LEVEL 7 990 P	FSR : 1.80	
		FSR AREA :268,760 SF (24,969 m) -760 SF (71 m2) BUH 8 268,000 SF (24,898 m	2) BONUS
LEVEL 12 PEVA 12 LEVEL 12 STOR 25	(금V점, 가 ())용 (? (금V점, C))3년 (? (금V점, 11) 13년 (? (금V점, 11) 13년 (?		
LEVEL 11 1124574 LEVEL 1244 12447-15 LOCAL 2014 2015	12/05.117 12/05 27 12/05.124 13/05 27 12/05.154 13/05 27 13/05.25	BUH EXCEMPTION: (38 UNITS X	
	()) Sg	EXCLUSION : 22,865 SF (2,124 m) GFA : 291,625 SF (27,093 m2)	23
AMENETY AREA TOTAL	AMEMITY EXCLURION TOTAL	OF # 1 201,020 OF (21,000 Hz)	
LEVEL D. PISH Y TUTAL MISH Y		AMENITY	
PARKING BIKSI LOASHKI MECH Garbiagi hecy cle exclusion TqTal		FSR : 0.05	
TQTAL Livel Ania ECCET, 24 22LD P		FSR AREA :8,104 SF (753 m2)	
ID FLOI		EXCLUSION : 0 SF (0 m2)	
1458.12 単元7章 正元日の 新元3章 1558.14 ジャッチ 位氏13 単元4章		GFA : 8,104 SF (753 m2)	
LEVEL 17 1159 LEVEL 17 1159 LEVEL 19 11117 LEVEL 19 111175 LEVEL 1 141175 LEVEL 1 141175		PARKING/BIKESPACE/LOADING/ MECHANICAL/SHAFTS/GARBAGI	
LEVEL CA TALLET		EXCLUSION : 288,031 SF (26,759	
EVEL 11 11117 LEVEL 1500 TUTT TITAL Devited		GFA : 288,031 SF (26,759 m2)	
COMMERCIAL/ RETAIL/ HOTEL/ OPTICE APPORTABLE (FER) TOTAL	EF MANINETE	TOTAL	
Covel Program	Arra 20241 E	FSR : 3.00 (Exclude Amenity)	
	11.40,F 11.407_F 1.60y_F	0.05 (Amenity)	
I OFFICE RELEPING TOTAL	prover Sportuger Hendel, P	FSR AREA :	445,405 SF (41,472 m2) -760 SF (71 m2) BUH Bons 445,645 SF (41,402 m2) 8,104 SF (753 m2) (Ameni
TOTAL, MEY ANEA	TOTAL GROSS AREA	ZMU 52 SITE AREA:	148,887 SF (13,832.06 m2)
Level Area LF CETL: F(4) 37 FF LF Eb 57 FF LFBE: M2 57 FF	Local Arm 20 CEPL, 196 27/06/07 10 BL 107/06/07	NET FL AREA (INCL AMENITY): EXCLUSION :	454,509 SF (42,225 m2) 329,532 SF (30,366 m2)
LEVEL "6 1979 3 CP	LEVEL 14 52-30 JF	GROSS FL AREA :	781,041 SF (72,561 m2)
(BR 5 +977) (BR * 610.7 (BR 7 610.7	123.21 1 1 1 1 1 1 1 1 1 1 1 1 1 1 1 1 1 1		
LEVEL T PERSON	Ent. 17 新市大」ド Ent. 17 新市大」ド Ent. 17 新市大」ド Ent. 17 新市大」ド Ent. 17 アイト Ent. 11 アクラルド Ent. 11 アクラル・ド		
	16/8/17 46/17		
LEVE 14 1/17	158.1 ASP 3 158.1 m.4 J 156.5 ASP 3		
ALERS A	1014C Re-1128		
Exclusion total			
Lond Mapp 10/10271.564 2+ 4/57 10/1027			
2010 11 84 97F 2010 11 84 97F 2010 12 579 17 2010 17			

RY	LEVEL	1 4		•	ε	FSR AREA		ε	. RI	+C+O+E)	n/(F+G)	G		H			P[G-H+)}	Gross Floc M(F+P)
	LEVEL 1 LEVEL 1 LEVEL 1	CRU	1 5,165 2 7,111 3 2,971	(277)	Circulation/Service - (0) - (0) - (0)	Elevator cor	0) 0) (0)	Stair 101 (0) {0}	5,54 2,11 2,91	Met FSR 15 (500) 16 (197) 16 (277)	Efficiency 100% 100%	(ievator shafts and Stair - (0) - (0) - (0)		Wall 0 (0) 0 (0) 0 (0)	Mechanical 0 (0) 0 (0) 0 (0) 0 (0)		Total Deductions - (0) - (0) - (0)	Gross Builds 5,385 (500 2,116 (19) 2,978 (27)
m2)	LEVEL 1 LEVEL 1 LEVEL 1 TOTAL		4 2,681 5 973 6 1.444 15,534		- (0) - (0) - (0)	-	0) 0) 0)	(0) (0) (0) - (0)	9) 1,44 15,51	18 (250) 13 (86) 18 (135) 18 (1,444)	100% 100% 100% 8.00	- (0) - (0) - (0) - (0)	-	0 (0) 0 (0) 0 (0) - (0)	0 (0) 0 (0) 0 (0) - (0)		- [0) [0] - [0] - [0]	2,688 (256 923 (86) 1,448 (13) 35,588 (1,4
	PER FSR AREA																	
	LEVEL	A SUITES TOTAL	нс	easable Area	C Circulation/Service	D Elevator cor		E Stair	,	I+C+D+E) let FSR	N/(F+G) Efficiency	G Elevator shafts and Scale		Wall	CLUSION Mechanical		P[G+H+) Total Oeductions	Great Floor M(F+P) Great Tolida
10 m2)	LÉVEL 2 LÉVEL 2 LÉVEL 3 LÉVEL 4		3.911 1.631	(531) (0) (549) (152)	819 (76) 502 (47) - (0) - (0)		0 B D	534 (50) 189 (18) ^ (0) (0)	66 5,91 1,63	12 (698) 01 (64) 11 (549) 18 (152)	76% 0% 85% 62%	(0) 835 (78) 1,015 (94) 1,015 (94)		0 (0) 0 (0) 0 (0) 0 (0)	233 (2) 231 (2) 226 (2) 149 (14) }	233 (22) 1.066 (99) 1.241 (115) 1.164 (108) 1.746 (116)	7,745 (720 1,757 (16) 7,152 (664 2,802 (260
(mz)	LEVEL 5 LEVEL 6 LEVEL 7 LEVEL 8	43	3ACC 10,580 3ACC 18,472 5.661	(1.716) (526)	(0) 2,652 (246) 3,110 (289) 1,301 (121)		0) 0)	· (0) · (0) · (0) · (0)	13,23	13 (133) 12 (1,229) 12 (2,005) 14 (647)	52% 59% 74% 82% 70%	1,016 (94) 1,016 (94) 1,018 (95) 1,144 (106)		0 (0) 0 (0) 0 (0) 0 (0)	230 (2) 125 (12 189 (16 89 (8)	13 14	1,145 (106) 1,207 (112) 1,233 (115)	2,679 (245 24,377 (2,3 22,789 (2,1 8,197 (76)
HOTEL	LEVEL 9 LEVEL LO LEVEL 11 LEVEL 12 LEVEL 13	20 20 20 20 20 20	8,024 8,024 8,024 8,024 8,024 8,024	(746)	1,464 (136) 1,464 (136) 1,464 (136) 1,464 (136) 1,464 (136)			(0) (0) (0) (0) - (0)	9,49 9,44 9,45	IC (842) IC (842) IC (847) IC (847)	78% 78% 78% 78% 78%	829 (77) 829 (77) 829 (77) 829 (77) 829 (77)		0 (0) 0 (0) 0 (0) 0 (0)	18) 08 18) 06 15) 06 18) 06		913 (85) 919 (85) 919 (85) 919 (85) 919 (85)	10,409 (96) 10,409 (96) 10,409 (96) 10,409 (96)
3 m2)	LEVEL 13 LEVEL 14 LEVEL 15 ROOF	20 17 15 214 113	7 584		1,288 (120) 1,288 (120) 1,299 (121) - (0) 18,297 (1,109)	-	0) (0) (0) (0)	- (0) - (0) - (0) (0) (7) (7)	8,00	IC (882) F6 (825) 51 (749) 0 (0) IC (31,480)	78% 78% 76% 76%	025 (77) 025 (77) 025 (77) 025 (77) 02,002 (1,195)		0 (0) 0 (0) 0 (0) 0 (0)	90 (8) 90 (8) 90 (8) 90 (8) 0 (0) 2,108 (31		919 (85) 919 (85) 919 (85) - 16,906 (8,393)	10,409 (967 9,795 (910 8,980 (834 - (0) 139,518 {12,
1 m2)	PSR *1 IN EVERY 40 H **1 IN EVERY 20	OTEL ROOMS ARE REQUIRE	D TO BE ACCESSIBLE - 4 RE LED TO BE HEADING IMPAIR ING IMPAIRED UNITS (HI) AL	QUINED	outrook (system)				0.1	1) 1)		adam (d'ada	1	- 100	1 4,400 (A3		10,000 (2,011)	Line, Star Hill
		DAL (CHL/ SICIL)		(11.096)	18,291 (1,699)	540	(4)	723 (67)	134,00	W (12,903)		12,862 (1,195)	1	- (0)	2,106 (15	(6)	14 964 [(1,391)	153,856 (14
12}	UPPICE LEVEL					PSR AAEA				₩C+D+E)	B/(F+G)			EX.	CLUSION		P(G+H+I)	Gross Floc M(F+P)
	LEVEL 1 LEVEL 2 LEVEL 3		Salaable/1 - 1,06	estable Ares	Circulation/Service 128 (12) (0) - (0)	54	(0)	Stair - (0) - (0)		4et FSR 94 (L19) - (0)	Efficiency 63%	Elevator shafts and State - (0) 99 (3) 58 (9)	-	W#9 0 (0) 0 (0) 0 (0)	Mechanical 0 (0) 0 (0) 0 (0) 0 (0)	_	Total Deductions [D] 99 [9] 94 [9]	Gross Builds 1,284 (11) 99 (9) 98 (9)
	LEVEL 6		-	(0) (0) (21)	- (0) - (0) - (0)		(0) (0) (0)	- (0) - (0) - (0)		(D) (0) (0) (3) (21)	100%	98 (9) 98 (9) 98 (9)		0 (0) 0 (0) 0 (0)	0 (0) 0 (0) 0 (0)		96 (9) 98 (5) 98 (9)	98 (9) 98 (9) 321 (30)
m2)	LEVEL 7 LEVEL 8 NOTAL FSR		7 46/ B,731	(0) (694) (013)	10) 129 (12)	2,434	(0) (110)	(C) - (C) 1,Lim (203)	7,40 8,97 8,5	(0) 66 (694) 73 (3041) 76	100%	96 (9) 80 (7) 808 (82)		0 (0) 0 (0) (0)	0 (0) 0 (0) - (3)		98 [9] 80 (7) 609 (4,234)	98 (9) 7,546 (70) 9,842 (89)
RED	APPORTANES NO FSR AREA	LARHOUT			c			E	1 0	H+C+D+E)	B/(F+G)			EXC.	CLUSION		- P[G+1++]	Gross Floor 64(F+P)
	LEVEL 1 LEVEL 2	SUITES		(0)	Circulation/Service (0) · (0)	Elavistor con		Stair (0) (0)		(et FSR - (0) - (0)	Efficiency	vetor shafts and Stair - (0) - (0)	Gro	0 (0) 0 (0)	6/techanical 0 (0) 0 (0)		Total Deductions	Gross Builds - (0) - (0)
9 m2)	LEVEL 3 LEVEL 4 LEVEL 5 LEVEL 6	12 12 8	12 10,72 8 6.44	(1,044) (1996) (599) (129)	(0) (0) (0)		(0) (0) (0)	(0) (0) (0) (0)	10,7	103 33 (1,044) 22 (996) 54 (599) 15 (129)	100% 100% 100% 100%	- 10) - 10) - 10) - 10] - 10]		0 (0) 0 (0) 0 (0) 0 (0)	0 (0) 0 (0) 0 (0) 0 (0) 0 (0)		(0) - (0) - (0) (0) (0)	11,233 (1,0 10,722 (99) 6,444 (59) 1,385
<u>UH BONUS</u> 8 m2) 5 X 20 SF) = 760 SF	FSR #5% OF AFFORD	35 ABLE HOUSING REQUIRED	32 29,784	0VIDED	- (9) 0% OF 376 IS 38 BUH UNITS.		(9)	- (0)	251,71 6.2 MAX29,781,42 FSB 0.20	14 (2,767)	100%	- [0]		- (0)	- (0)	1	- (0)	28,784 (2,6
4 m2)	FSR AREA	810,												D	CLUSION			Gross Ploor
	LEVEL	A SUITES TOTAL		eosable Area	C Circulation/Service 07 (8)	Elevitor con		E Stair (0)		H+C+D+E) Het FSR 17 (8)	B/(F+G) Efficiency 0%	G Elevator shafts and Stair 156 (14)		Wall	Mechanical 0 (0)	Shafts	(G+H+I) Total Deductions 156 [(T4)	Gross Rioor M(F+P) Gross Build 243 123
	LEVEL 1 LEVEL 2 LEVEL 3 LEVEL 4		14,61	(246) (0) (1,359) (1,268)	1,204 (112) (0) 5,421 (503) 7,550 (701)	Lini	169) (0) (0) (0)	(0) (0) (0) (0)	20,03	58 (527) - (0) 58 (1,462) 54 (1,970)	47% 0% 66% 59%	(0) 1,968 (183) 2,038 (189) 2,055 (191)		0 (0) 0 (0) 0 (0) 0 (0)	134 (1) 210 (20 137 (1) 78 (7)	13 19 11)	1.34 (12) 2.178 (202) 2.175 (102) 2.133 (198)	5.802 (55) 2.178 (20) 72.713 (2,0) 23.337 (2,1)
	LEVEL 5 LEVEL 6 LEVEL 7 LEVEL 8	33 36 36	5 22 471 19,731 21,36	(2.068) (1,834) (1,985) (1,985)	6.152 (572) 2.331 (217) 2.091 (294) 2.091 (194)	-	10 10 10 10	(0) (0) (0) (0)	28,61 22,01 23,41	80 (2,660) 89 (2,050) 57 (2,179) 57 (2,179)	59% 73% 84% 85% 85%	2,052 (191) 1,542 (143) 1,543 (143) 1,330 (124)		0 (0) 0 (0) 0 (0) 0 (0)	78 (7) 69 (6) 146 114 106 (10	47	2,130 (198) 1,611 (150) 1,649 (157) 1,436 (133)	30,750 [2,8 23,680 (2,2 25,146 [2,3 24,893 (2,3
	LEVEL 9 LEVEL 10 LEVEL 13 LEVEL 12	24 24 24 24 24 24	16,87 16,87 16,87	(1,568) (1,568) (1,568) (1,568)	1,642 (553) 1,494 (111) 1,194 (111) 1,194 (111)		(0) (0) (0) (0)	(0) (0) (0) (0)	18,0	71 (1,679) 72 (1,679) 73 (1,679) 73 (1,679)	85% 87% 87% 87%	1,248 (116) 1,248 (116) 1,248 (116) 1,248 (116)		0 (0) 0 (0) 0 (0) 0 (0)	69 (6) 69 (6) 69 (6) 69 (6) 69 (6)		1.317 (1.22) 1.317 (1.22) 1.317 (1.22) 1.318 (1.22)	19.368 (1.8 19.389 (1.8 19.390 (1.8 19.390 (1.8 19.391 (1.8
<u>NG/</u> AGE/RECYCLE 759 m2)	LEVEL 13 LEVEL 14 LEVEL 15 ROOF	22 21 12	16,09	(1,532) (1,495) (1,464) (0)	1,194 (111) 1,194 (111) 1,136 (106) - (0)		[0] {0] [0]	(0) (0) (0) (0)	17,21	P9 (1.642) 15 (1.606) 97 (1.570) - (0)	87% 87% 87% 90/V/01	1,249 (116) 1,249 (316) 1,249 (316) - (0)		0 (0) 0 (0) 0 (0) 0 (0)	69 (6) 69 (6) 69 (6) 0 (0)		1,318 (122) 1,318 (122) 1,318 (122) - (0)	18,997 (1,7 18,603 (1,7 18,215 (1,6 (0)
759 m2)	BUBTOTAL BER BONUS TOTAL PER	MS		(21,483)	16,673 (3,814)	1 1918	(188)	- (0)	74 268,00	10	80%	21,434 (1,980)		- (0)	1,441 (1)	<u> 1 (N</u>	22,983 (2,124)	291,625 (27)
	*BUH ALLOW FO	R A BONUS AREA OF 205F P	ier unit, 32 am + 6 Marke	5	05F 8EDUCTION.				MAX267,997 F3R 1.80									
445,405 SF (41,472 m2) -760 SF (71 m2) BUH Bonus	FSR AREA LEVEL	A Amenity	Suizable/	8 Leesable Area	C Circulation/Service	Elevator co	e and Stalr	E Stair	F(I	H+C+D+E} Net FSR	B/(F+G) Efficiency	6 Elevator shafts and Stair	-	N Wall	CLUSION I Mechanical	Shafes	(G+H+I) Total Deductions	Gross Floor M(F+P) Gross Buildable
445,645 SF (41,402 m2) 8,104 SF (753 m2) (Amenity) 148,887 SF (13,832.06 m2)	LEVEL 1 LEVEL 2 LEVEL 3 LEVEL 4			0 (0) 0 (0) 0 (0)	(6) (0) (0)	-	(0) (0) (0)	(0) (0) (0)		- (0) - (0) - (0)	•	- (0) - (0) - (0) (0)		0 (0) 0 (0) 0 (0) 0 (0)	0 (0) 0 (0) 0 (0) 0 (0)		- (0) (0) (0) - (0)	(0) (0) (0) (0)
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781,041 SF (72,561 m2)	PSR		6,19	5 (734)	- (0)			- (09	0.1	26 26	100%	- (0)	-	- (9)	- [0]		- (0)	6,104 [[73:
	EXCLUSION LEVEL	hierdigal Angli	A			c 1	D											Gross Roor M(F+P)
	LEVEL B1 LEVEL 1 LEVEL 2	Parking 25,575 49,992 42,761	(1,347) (4,644) (3,973)	8 the sp 7.902 { 2178 {	acs 341 (02)	Loading - (0) 4.731 (440)	Mechanic 65 (6) 2 405 (22)	31	fechanical Skafts - (0) - (0) - (0)	Garbag 3,365	(0) (313)	_					Total Deducations 23.542 (7,187) 62,671 (5,822) 47,567 (4,419)	Gross Build 23.542 (2.1 62.671 (5.8 47.567 (4.4
	LEVEL 1 LEVEL 5 LEVEL 6	46,039 50,983 43,834	(4,277) (4,277) (4,736) (4,072) (0)	0 (s 390 (2692 (1992 (S0}	0 (0) 0 (0) 0 (0) 0 (0)	4806 [44] 3173 [29] 1998 [14] 1818 [16] 172 [16]	6) 51 51 91	0101		2(0) 2(0) 2(0) 2(0)						49,602 (4,608) 55,673 (5,172) 47,644 (4,426)	49,602 (4,6 55,673 (5,1 47,644 (4,4
	LEVEL 0 LEVEL 0 LEVEL 0 LEVEL 10		(0) (0) (0) (0)	(1 (1) (1)	n N N	0 (0) 0 (0) 0 (0)	31 (3) 341 (13) 341 (13)		0 101 0 101 0 101 0 101		2(0) 2(0) 2(0)		-				172 (16) 31 (3) 141 (13) 141 (13) 141 (13)	172 (16) 31 141 141
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	LEVEL 15 YOYAL	345,184	(0) (0) (23,350)	15,154 ()	409)	010) 010) 4,731 (440)	141 (13) 141 (13) 15,865 (1,4		0(0) 0(0) - (0)	1.95	3(0) 3(0) (313)	· (N)		~ (U) FEA	- (0)	4	141 (13) 141 (13) 266,030 (26,759)	141 141 (13) 288,090 [[26]
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CARPOOL	_
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OVAL/ CRU/ HOTEL	-
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RESIDENTIAL VISITOR	
Grand total, 682	

COMMERCIAL SMALL ST COMMERCIAL STANDARI GEODETIC SEA LEVEL 3 COMMERCIAL ACCESSIE COMMERCIAL STALL ST COMMERCIAL STANDARI LEVEL 01 41

COMMERCIAL SMALL STA COMMERCIAL STANDARD LEVEL 02 61 COMMERCIAL SMALL ST. COMMERCIAL STANDARI LEVEL 03: 4 Grand total 145



OVAL/CRU/HOTEL ACCE OVAL/CRU/HOTEL LARG LEVEL 01: 2

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RESIDENTIAL SMALL CAR
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RESIDENTIAL ACCESSIBL RESIDENTIAL SMALL CAP RESIDENTIAL STANDARD LEVEL 04 154

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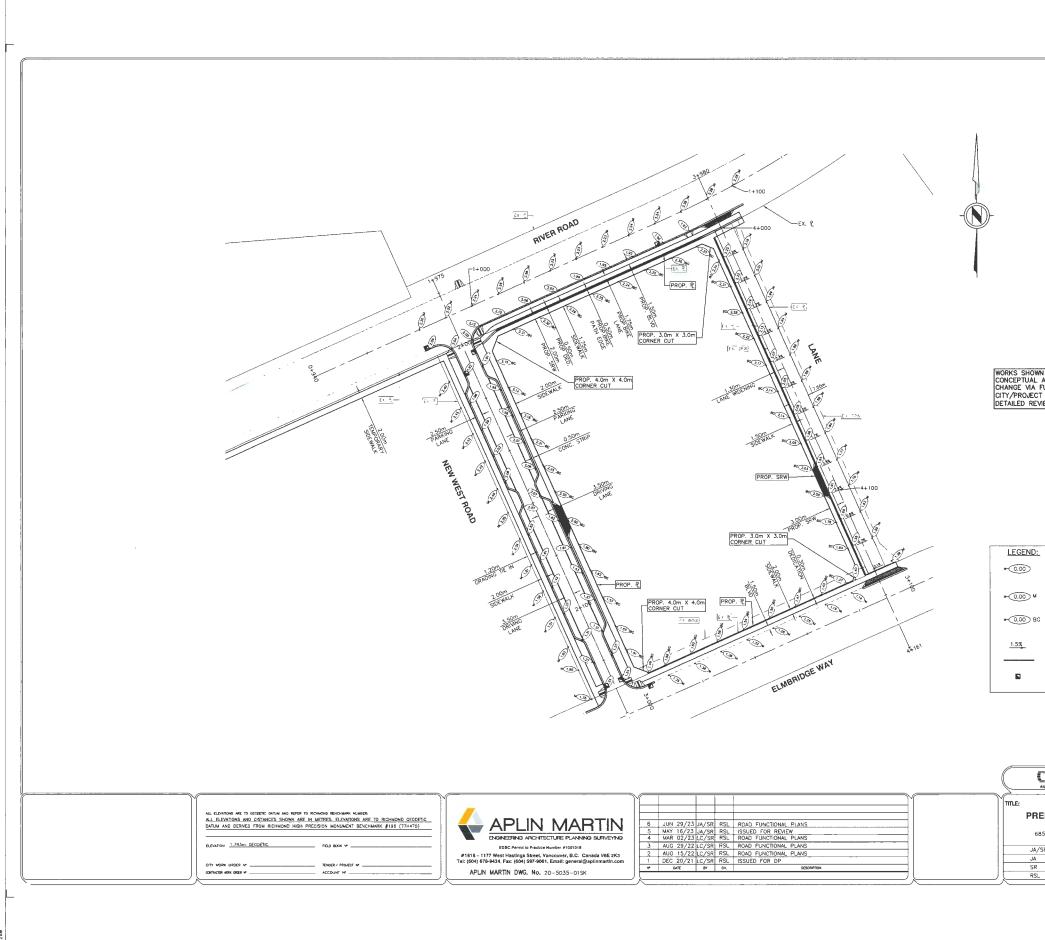
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MEDIUM SIZE LOADING MEDIUM GARBAGE LOA SMALL SIZE LOADING LEVEL 01: 12 Grand total 12

		Landa Global Properties
Parking Schedule - Summary		Ltd.
Comments Count		1550 - 200 BURRARD ST.
2		VANCOUVER, BC. V6C 3L6
5		COPYRIGHT This drawing has been prepared solely for the
[145		distribution for any purpose other than authorized by Arcadis is forbidden. Written dimensions shall
67		have precedence over scaled dimensions, Contractors shall verify and be responsible for all dimensions and conditions on the lob, and
52		COPPIOLT This drawing has been papared solely for the distribution for any purpose other data automated by Acada is forelables. Writing dimensions shall be acada is forelables. Writing dimensions shall be acada is forelable and consensus and the acada is forelable and any single of the dimensions. Shall be advanted any single on the dimension. Shall be advanted and any single on the dimension. Shall be advanted and any single on the dimension. Shall be advanted and any single on the dimension dimension. Shall be advanted and any single on the dimension of the dimension. Shall be advanted and any single on the dimension of the dimension. Shall be advanted and any single on the dimension of the dimension. Shall be advanted and advanted and advanted and advanted dimension. Shall be advanted and advanted and advanted advanted dimension. Shall be advanted adv
328		Arcadis for general conformance before proceeding with fabrication.
		Arcadis Professional Services (Canada) Inc. fementy Hi Group Professional Services (Canada) Inc.
22		ISSUES
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		2 DP BOARD SUBMISSION 2024-04-25
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Parking Schedule - Loading Type Comments Count		1285 West Pender Street - Suite 100 Varicoure: BC V8E 481 Canada tel 604 683 6797 www.coll.com
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6	1	6851-6871 Elmbridge Way Richmond, BC
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Ltd.		
1550 - 200 BURRARD ST. VANCOUVER, BC. V6C 3L0		
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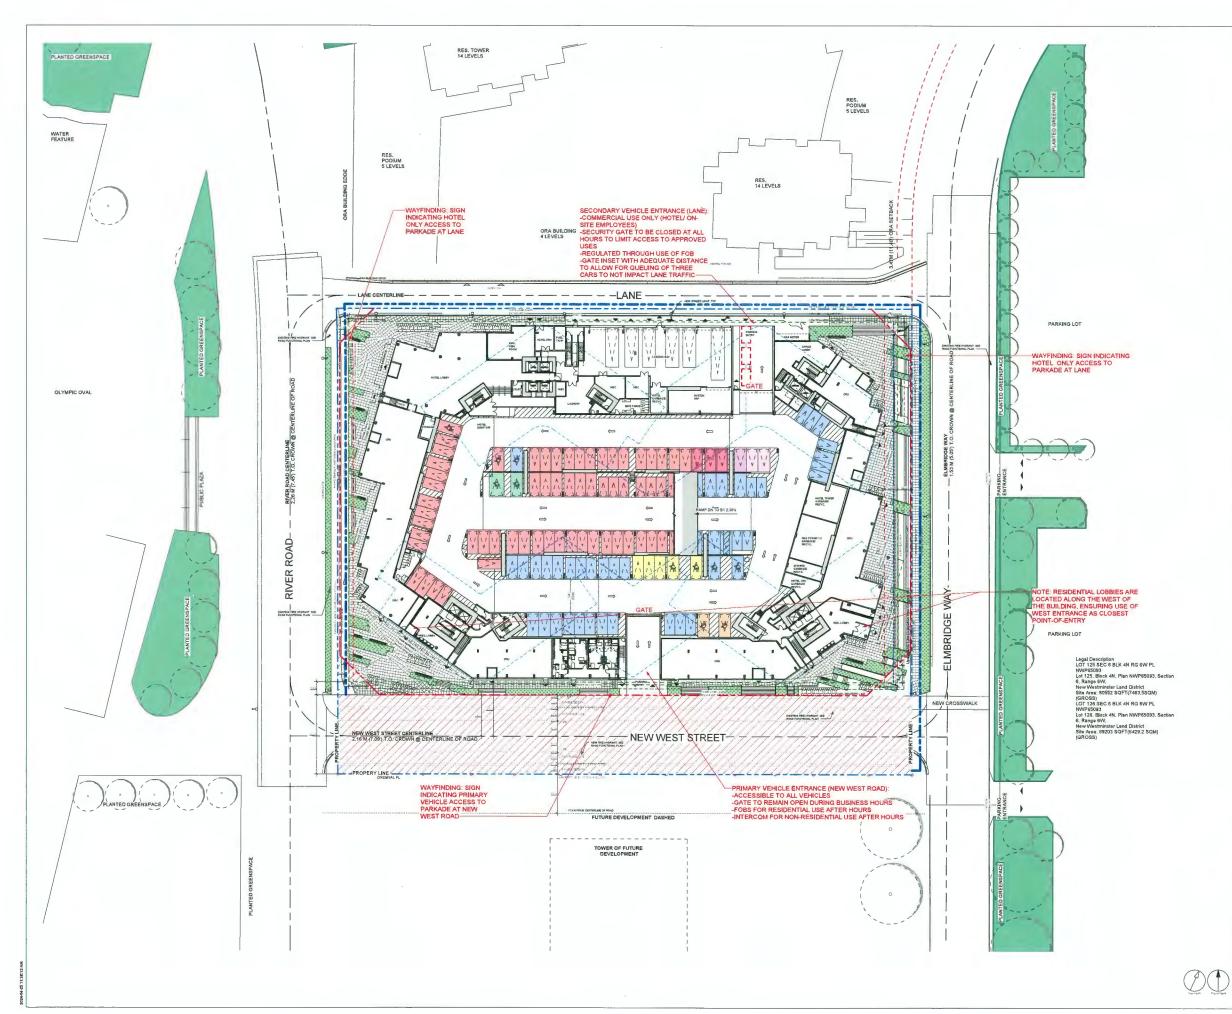


Landa Global Properties Ltd. 1550 - 200 BURRARD ST. VANCOUVER, BC, V6C 3L6
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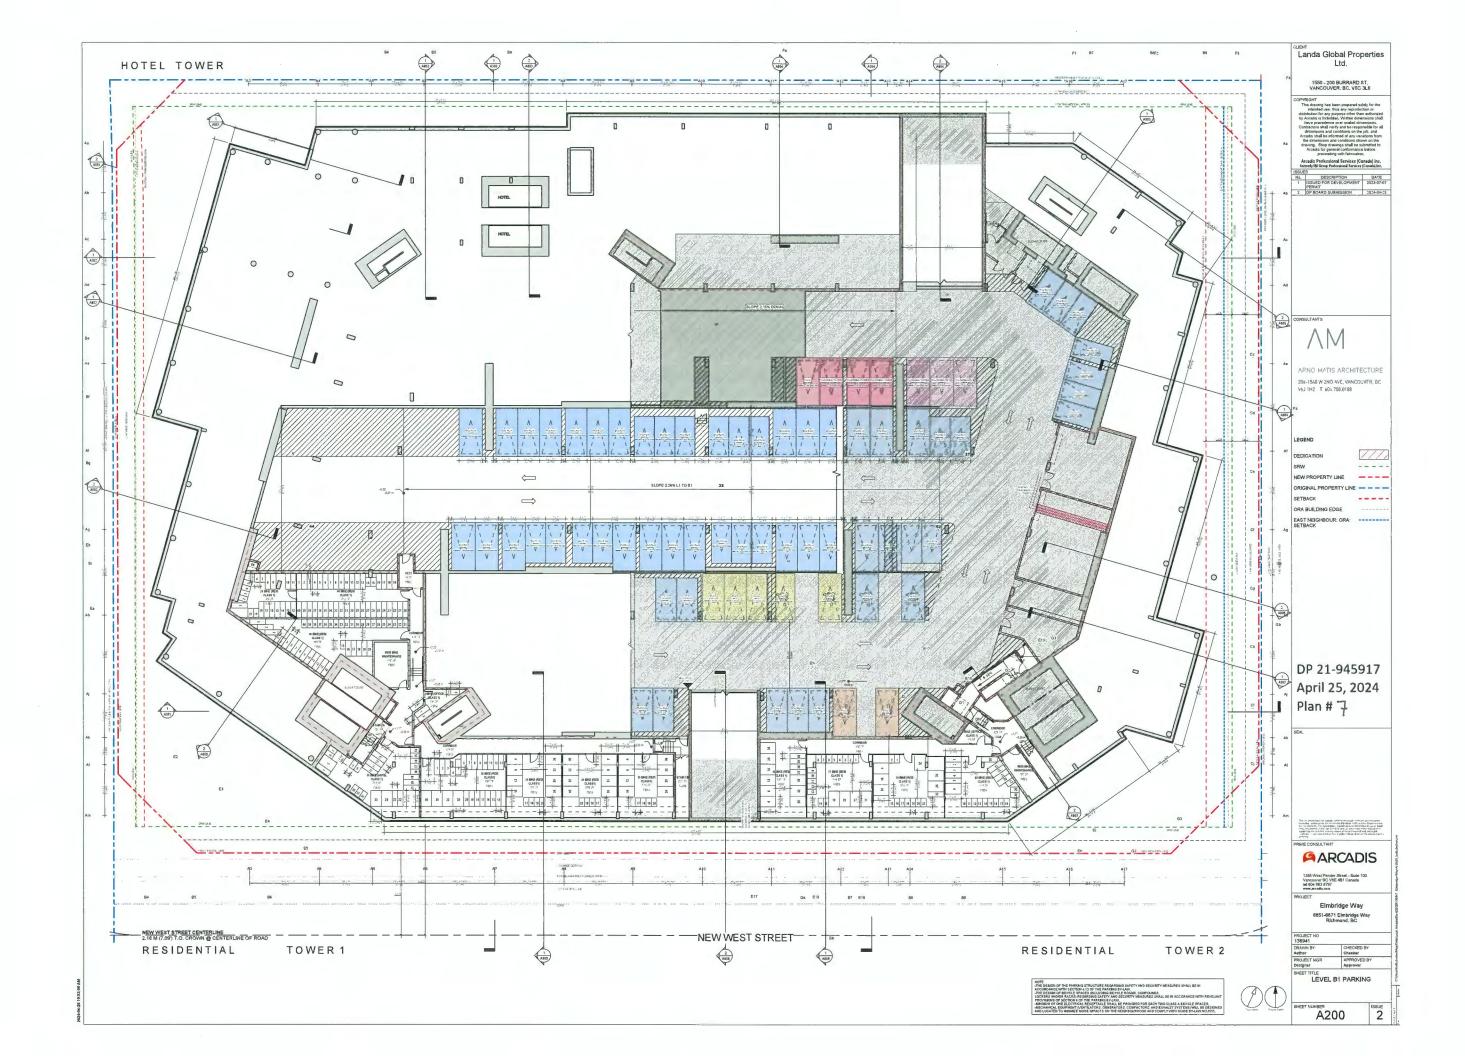
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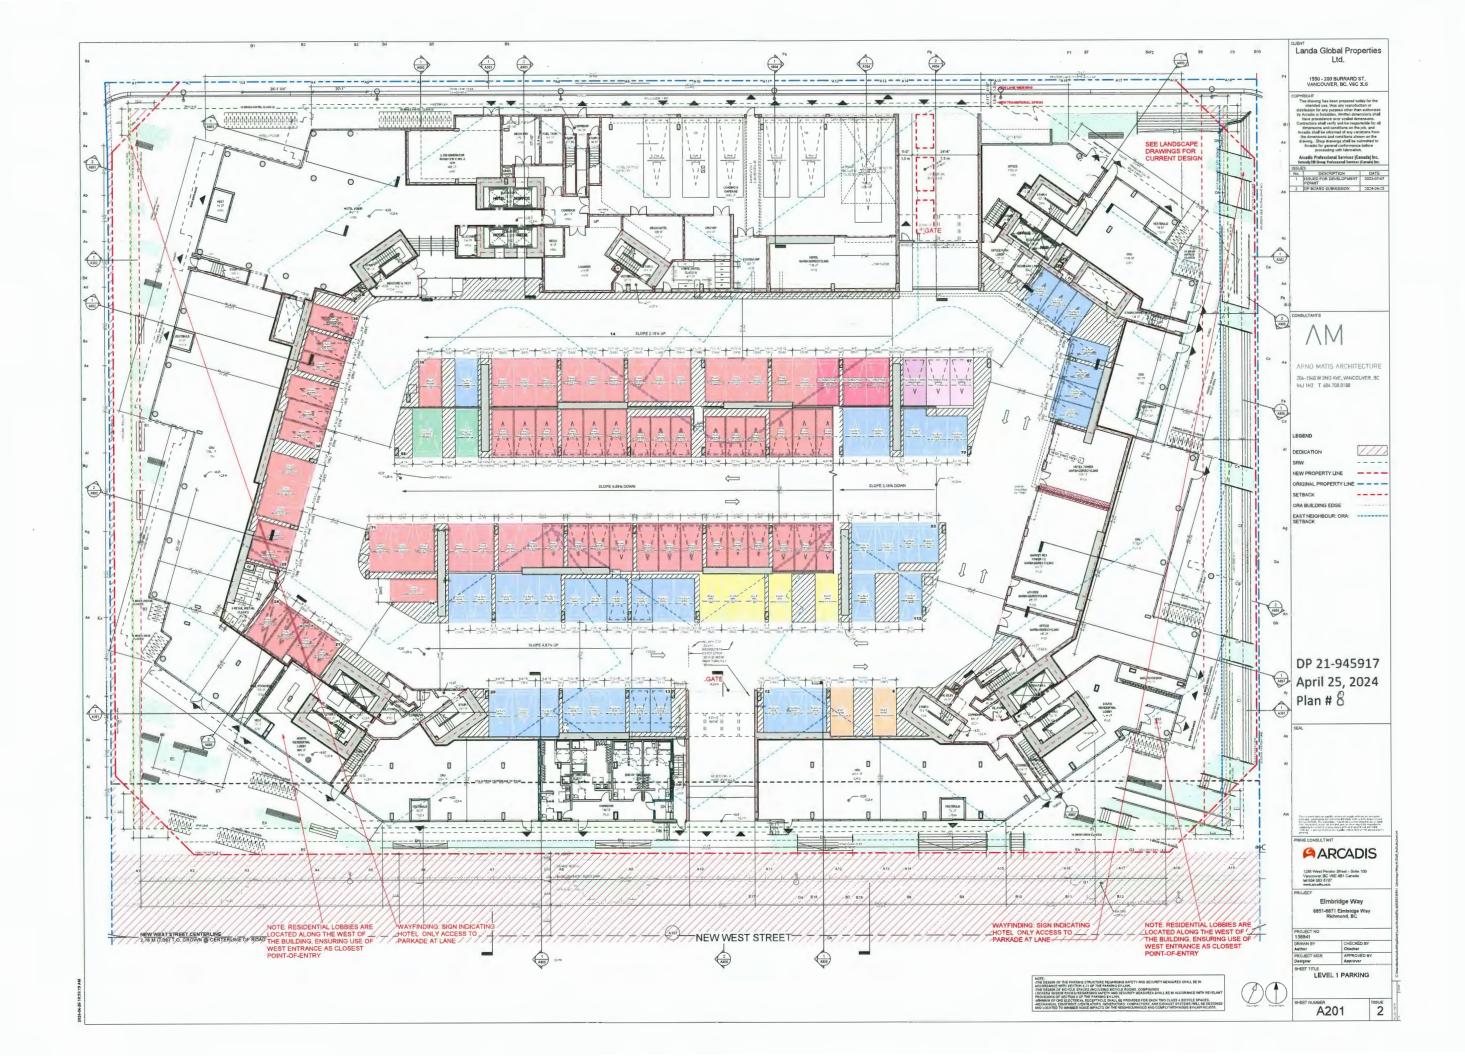
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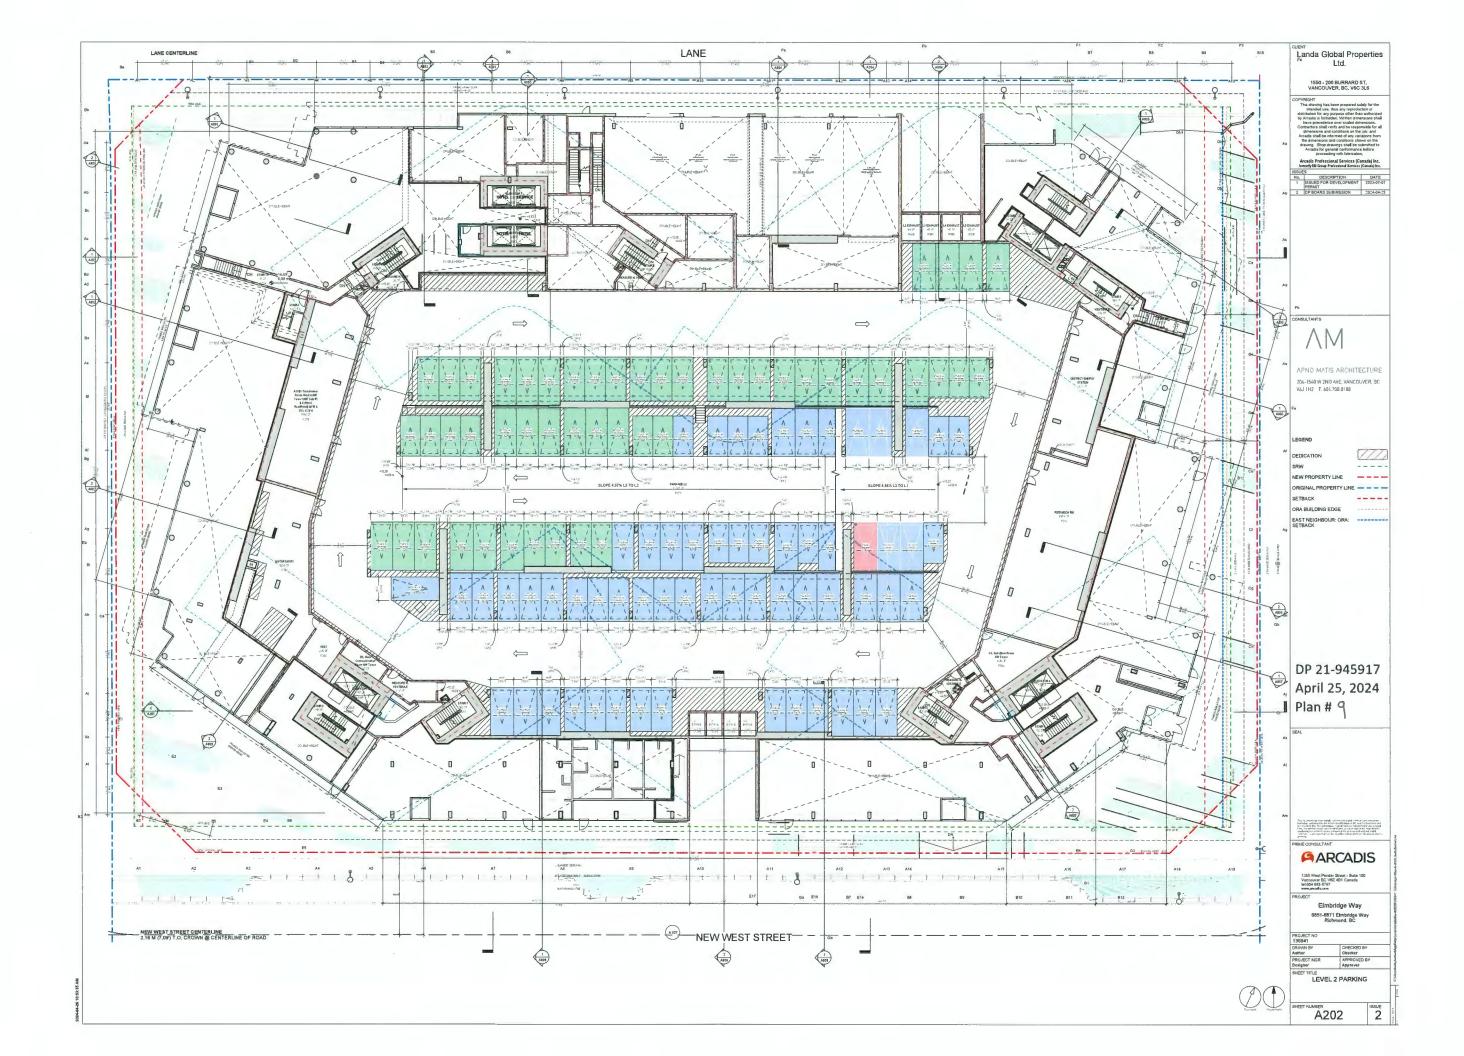
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 NSULTANTS ΛM 214-1540 W 2N 0 AVE, VANCOUVER, 30 Vol 182 - T-60-715-0188 WORKS SHOWN ON THIS DRAWING ARE CONCEPTUAL AND ARE SUBJECT TO CHANGE VIA FURTHER CONTRWATION OF CITY/PROJECT REQUIREMENTS AND DETAILED REVIEW/DESIGN PROCESS. PROPOSED ELEVATION (m) - BASED ON EXISTING ROADWAY CONDITIONS AND TYPICAL OFFSITE CITY STANDARDS + 0.00 M PROPOSED ELEVATION (m) - TO MATCH EXISTING ELEVATION * 0.00 BC BUILDING GRADES ELEVATION (m) - BUILDING ELEVATION AT PROPERTY LINE BASED ON TYPICAL OFFSITE GTY STANDARDS DP 21-945917 April 25, 2024 PROPOSED SLOPE Plan # 5 PROPOSED CONCRETE CURB PROPOSED CATCH BASIN C. S. Weitham and S. M. Harris, M. Harris, M. H. Wang, M. Wang, City of Richmond ARCADIS PRELIMINARY GRADING PLAN 1285 West Pender Street - Suite 100 Vancouver BC V6E 4B1 Canada tel d04 983 8797 www.acadis.com 6851 & 6871 ELMBRIDGE WAY DEVELOPWENT CITY FILE #: RZ-17-782750 JA/SR Elmbridge Way 1:500 JUNE 2023 1 OF 1 6851-6871 Elmbridge Way Richmond, BC CHECKED BY Checker APPROVED BY Approver ROJECT MGR BUILDING GRADE \bigcirc A104 155UE





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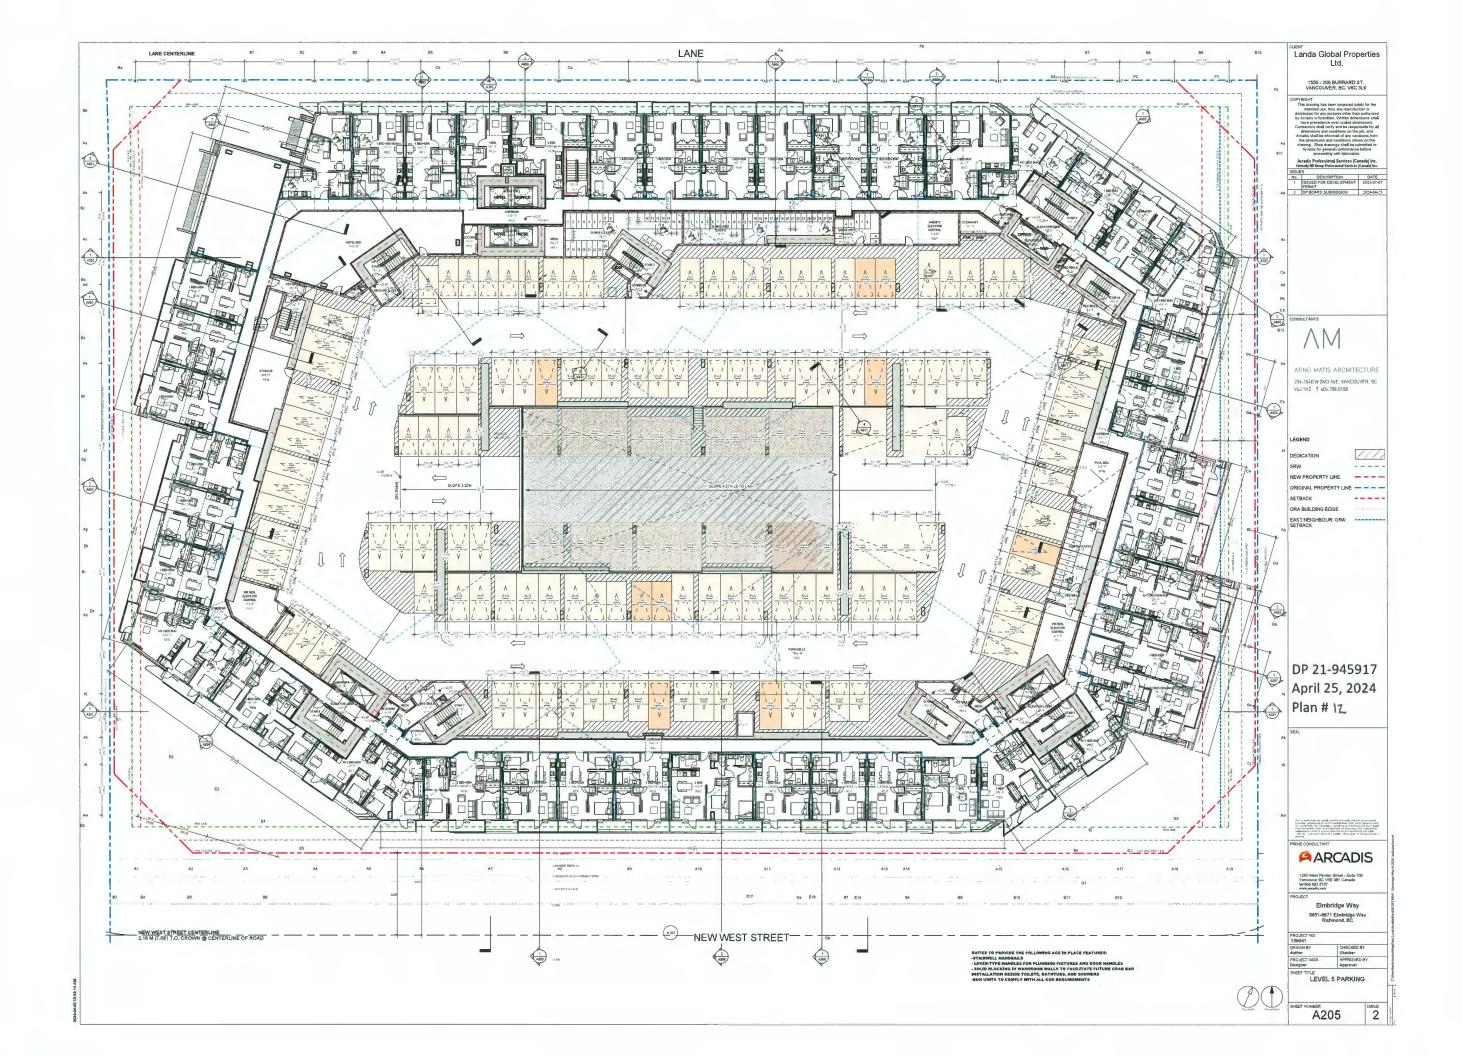











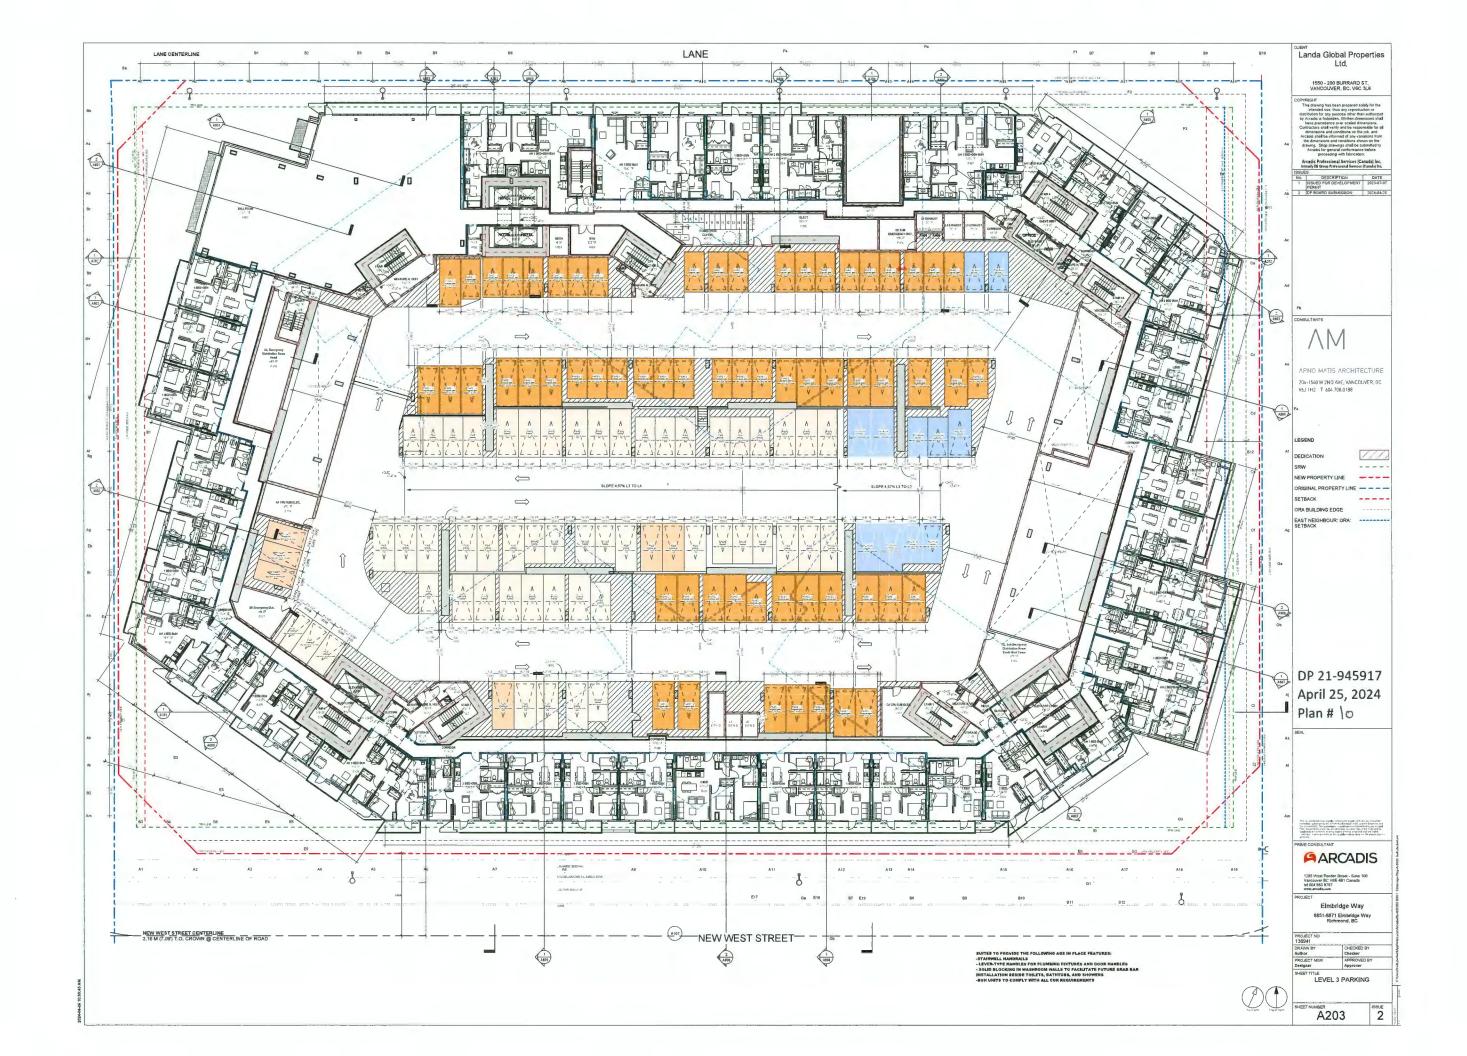


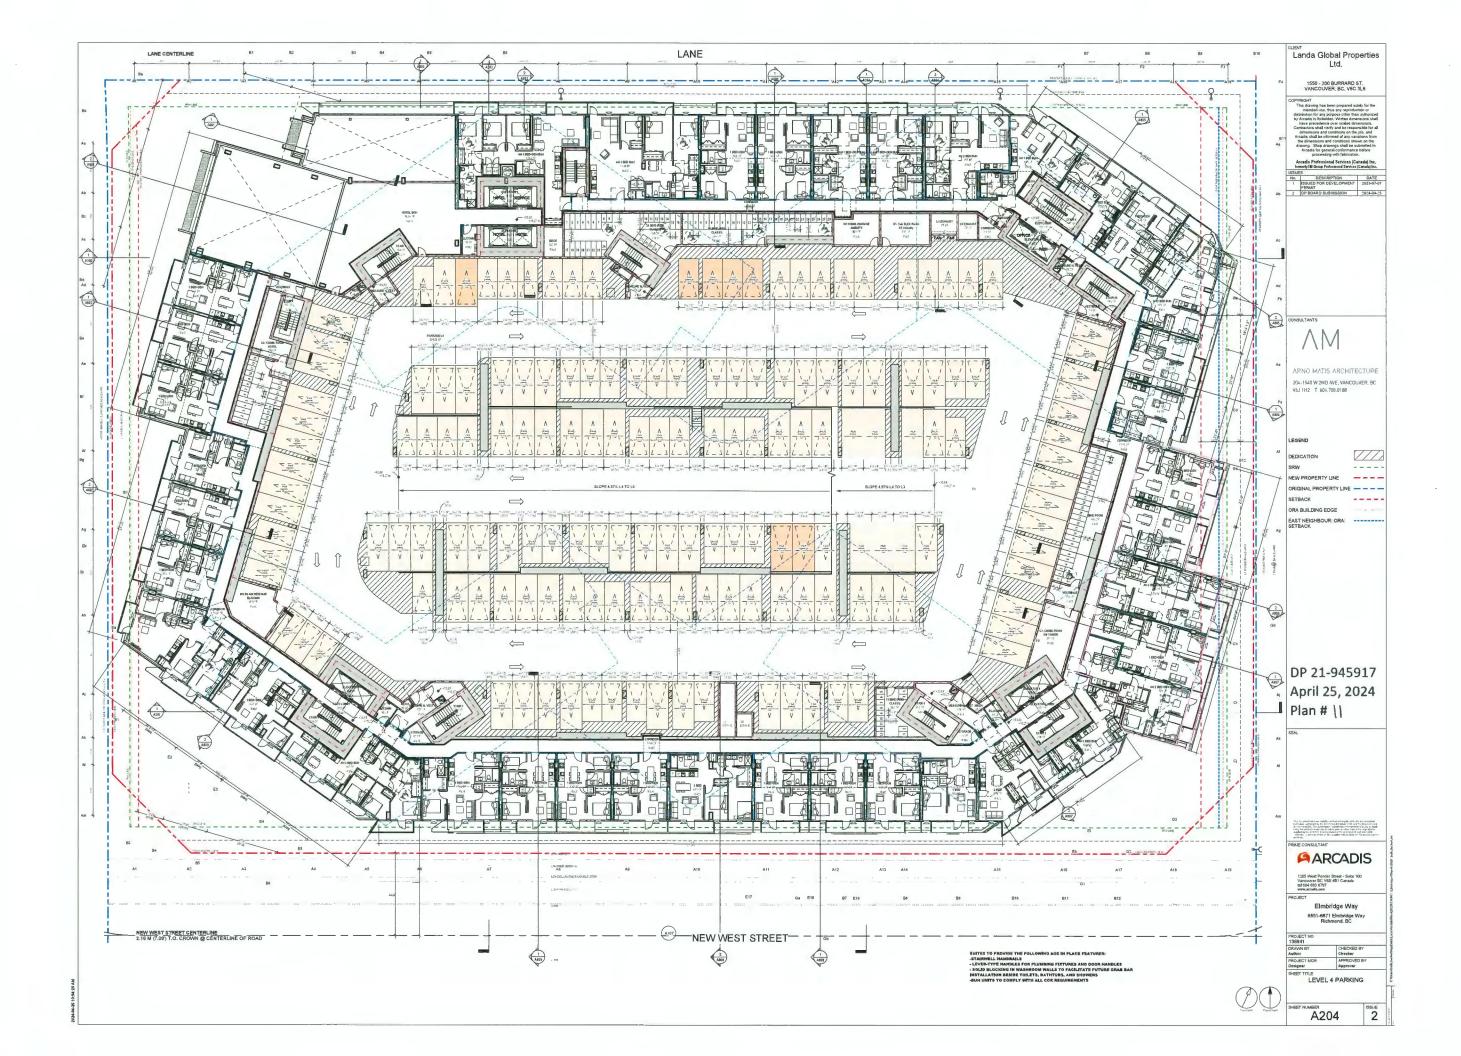


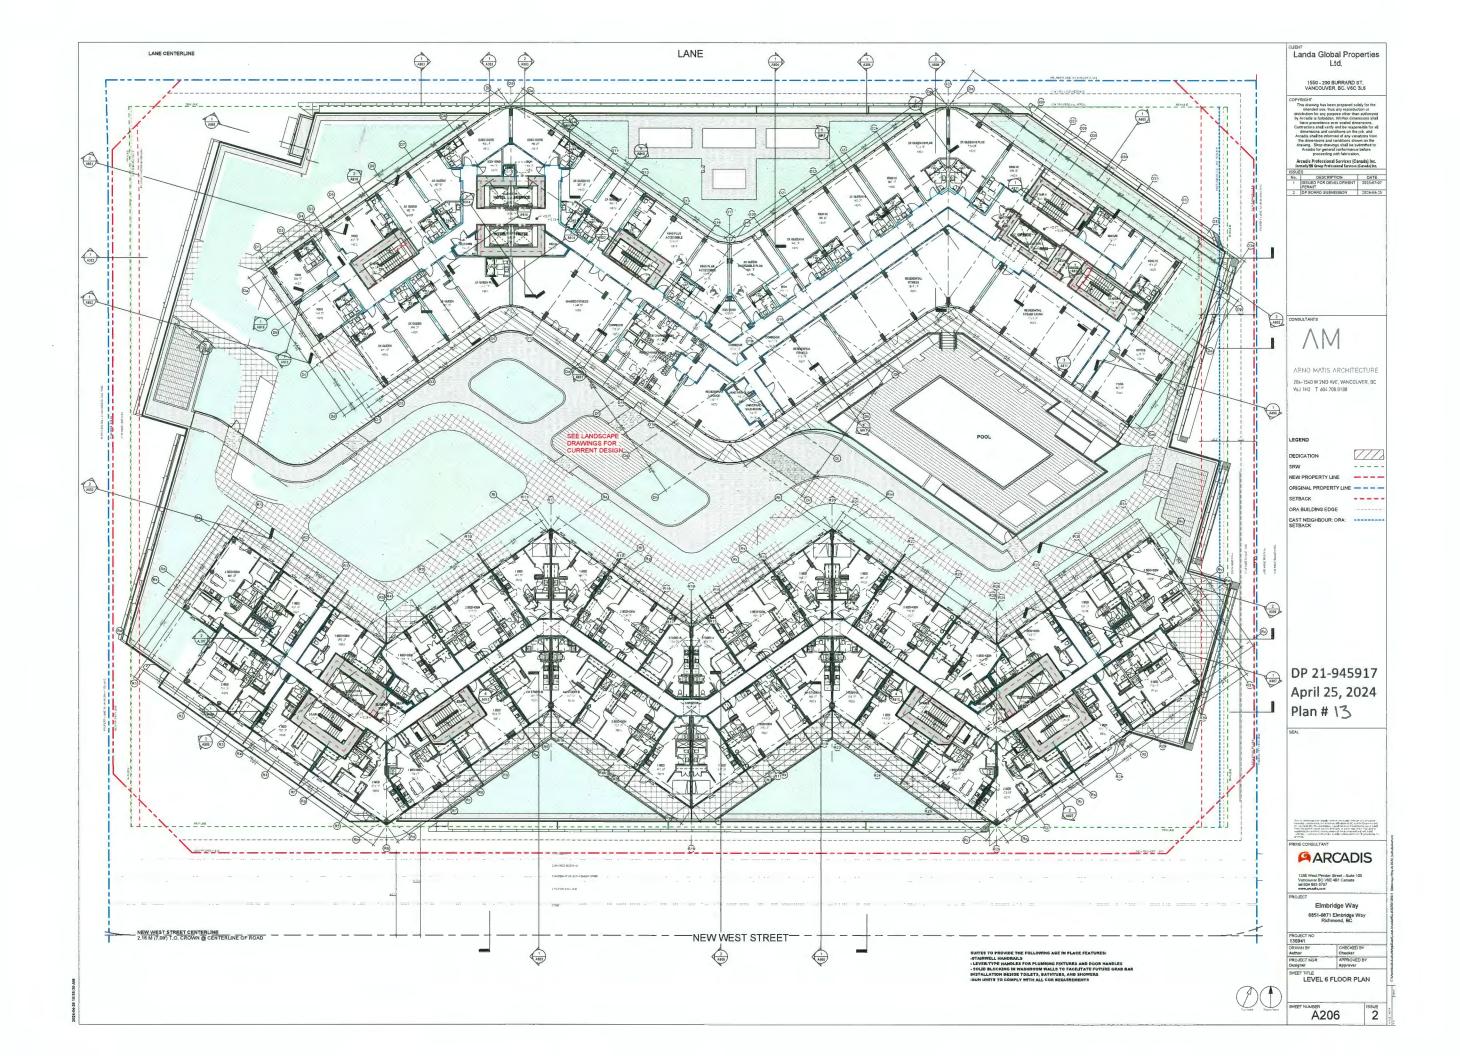


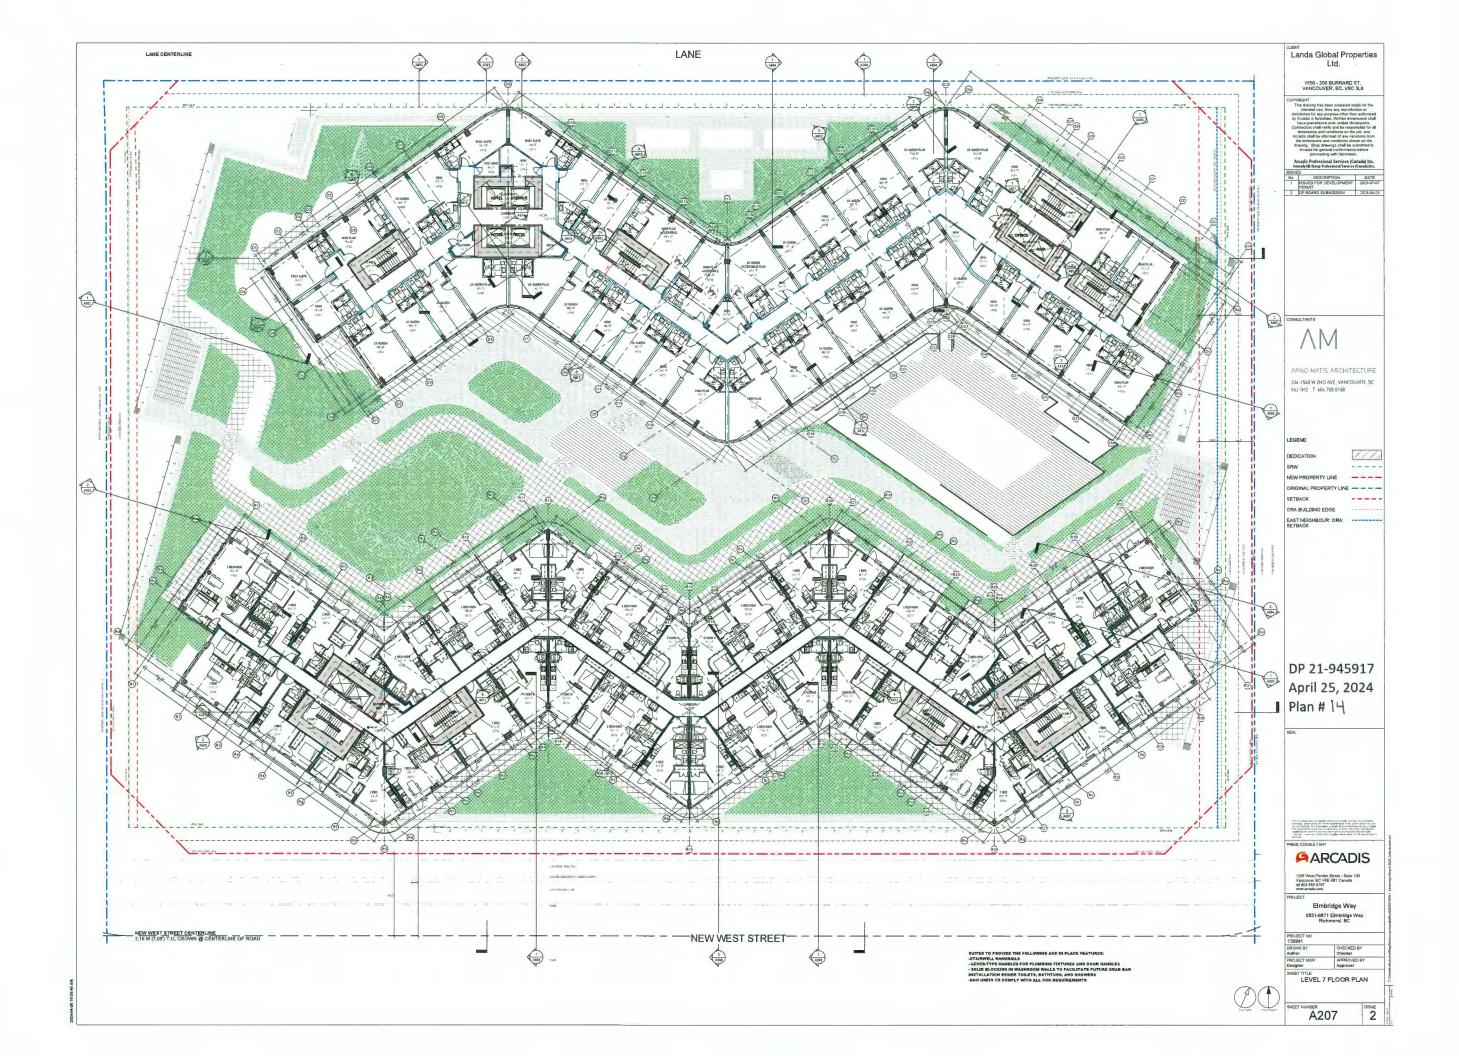


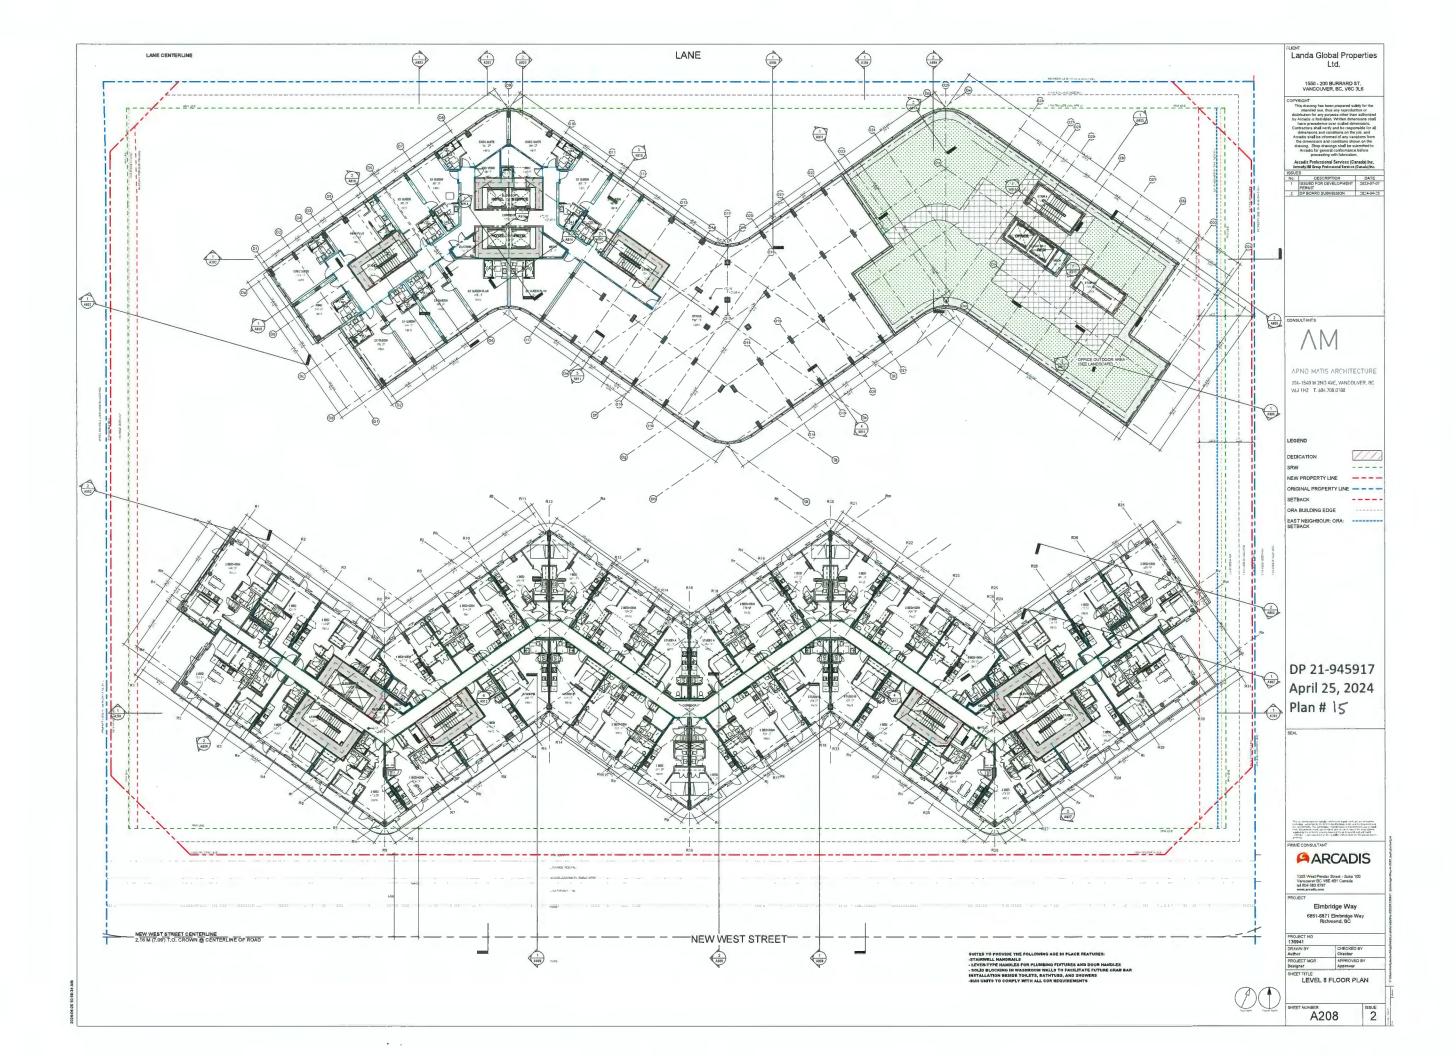


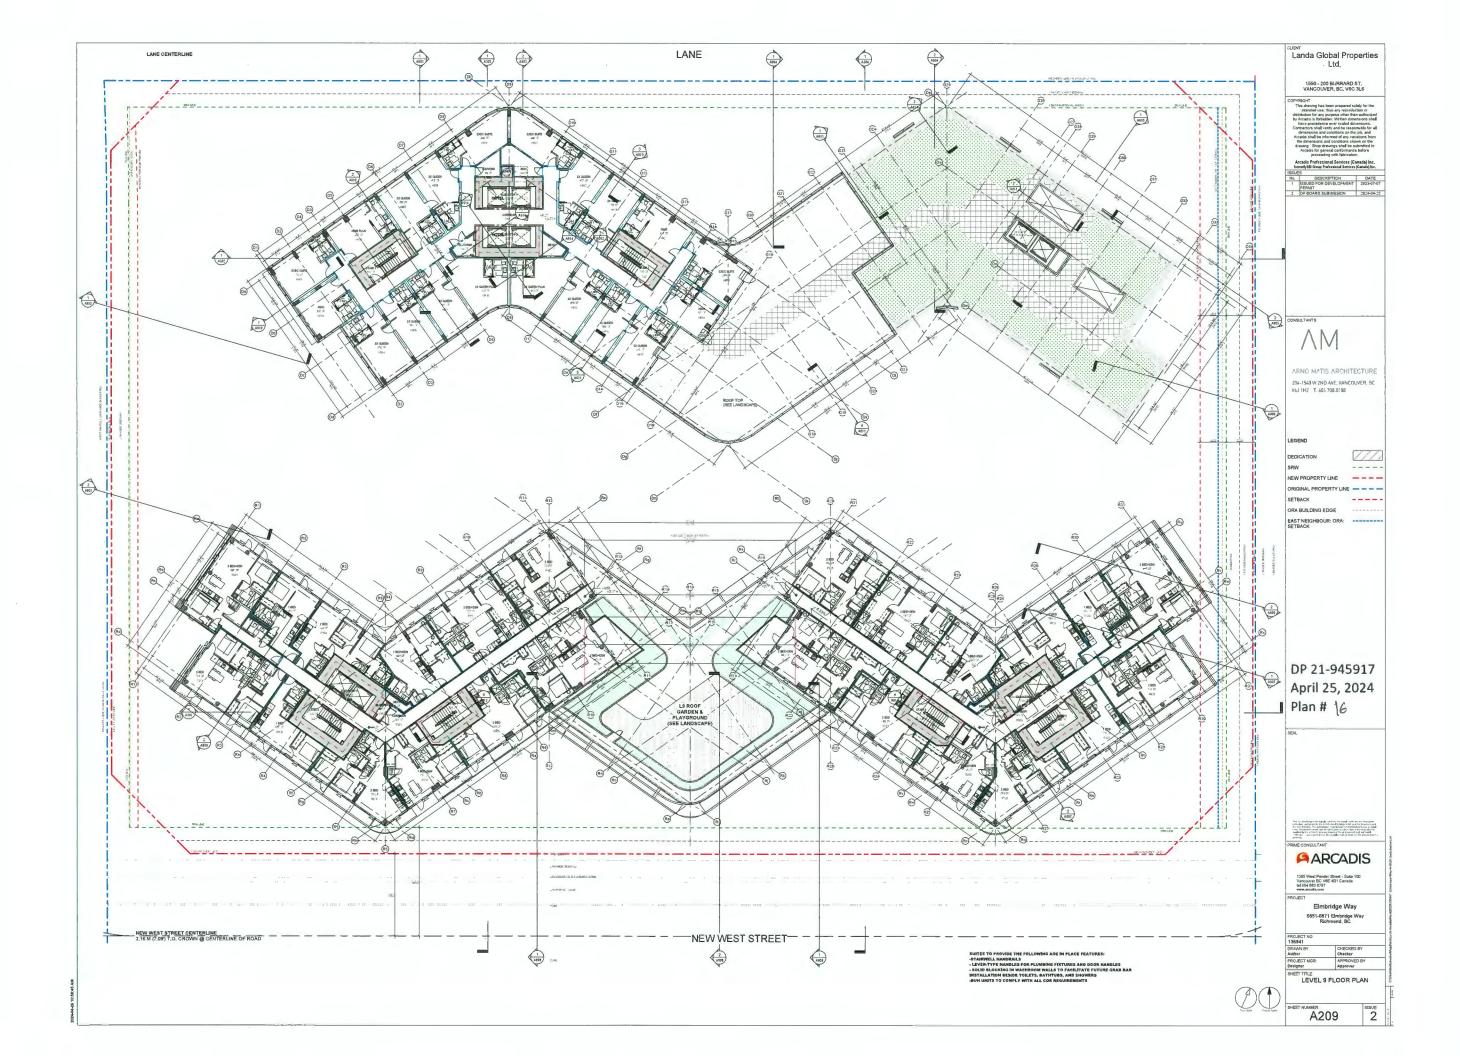


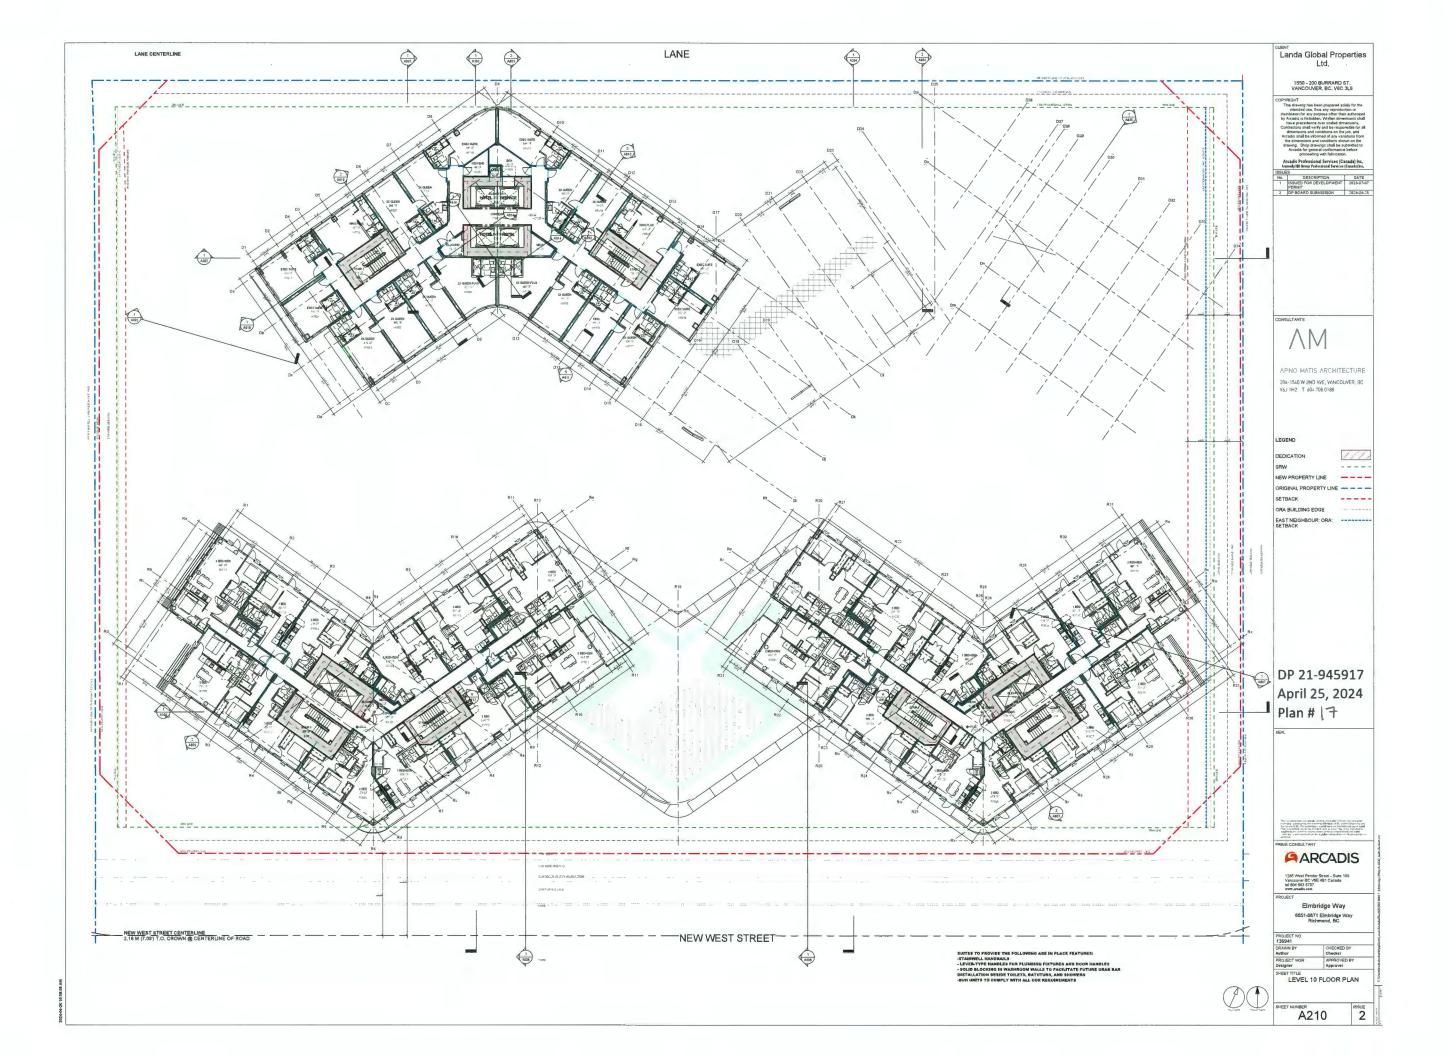


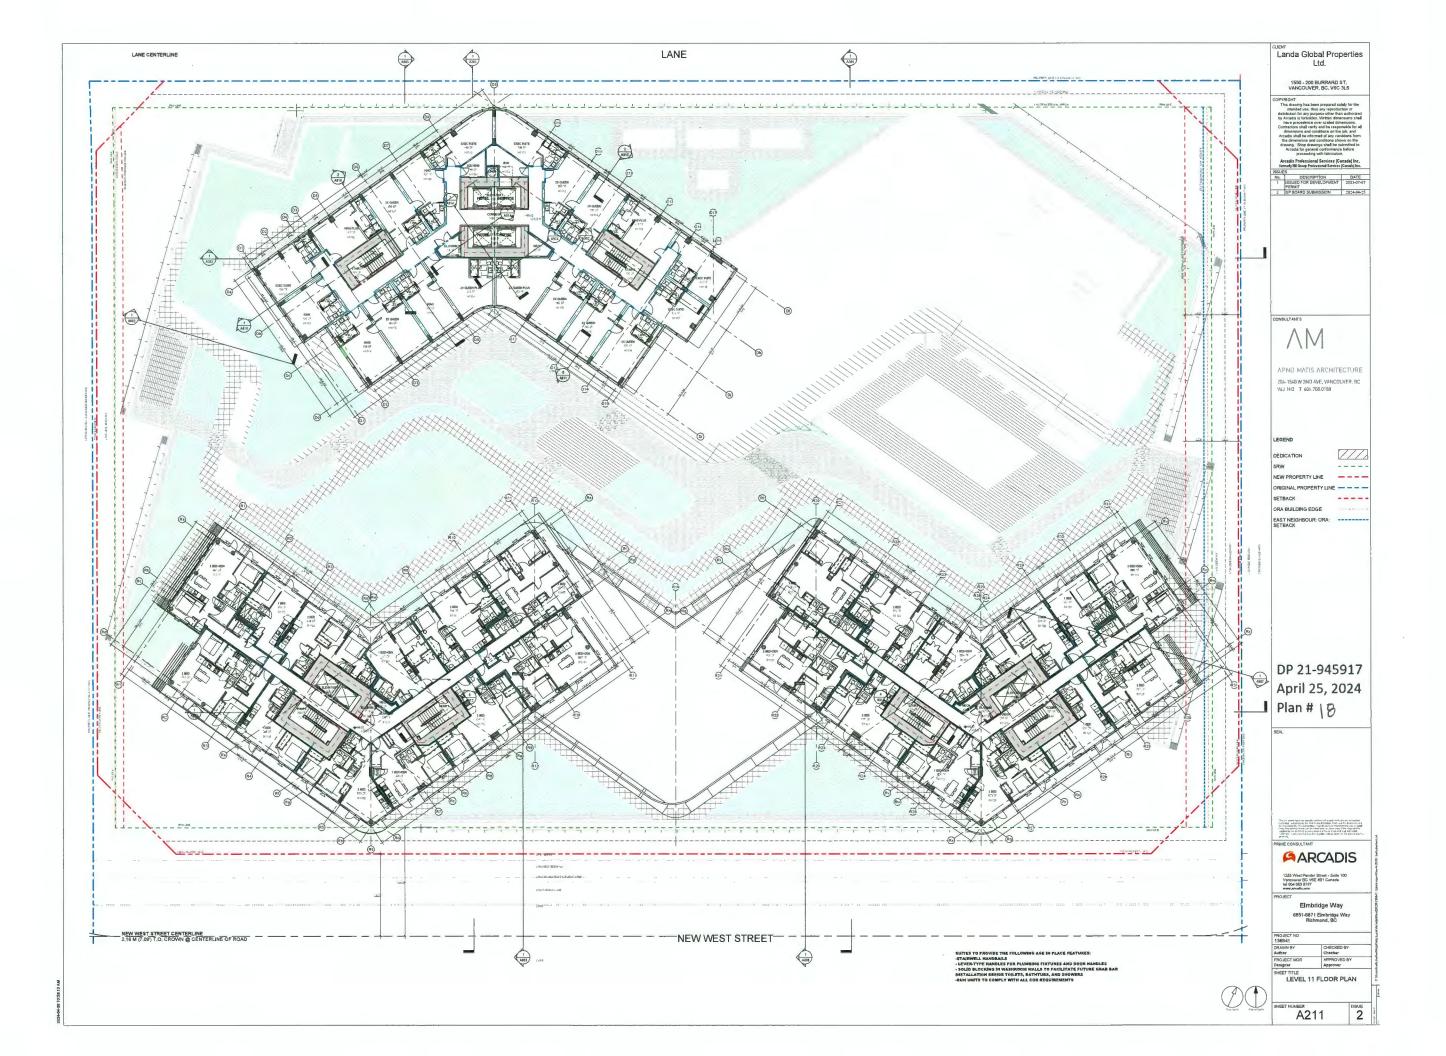


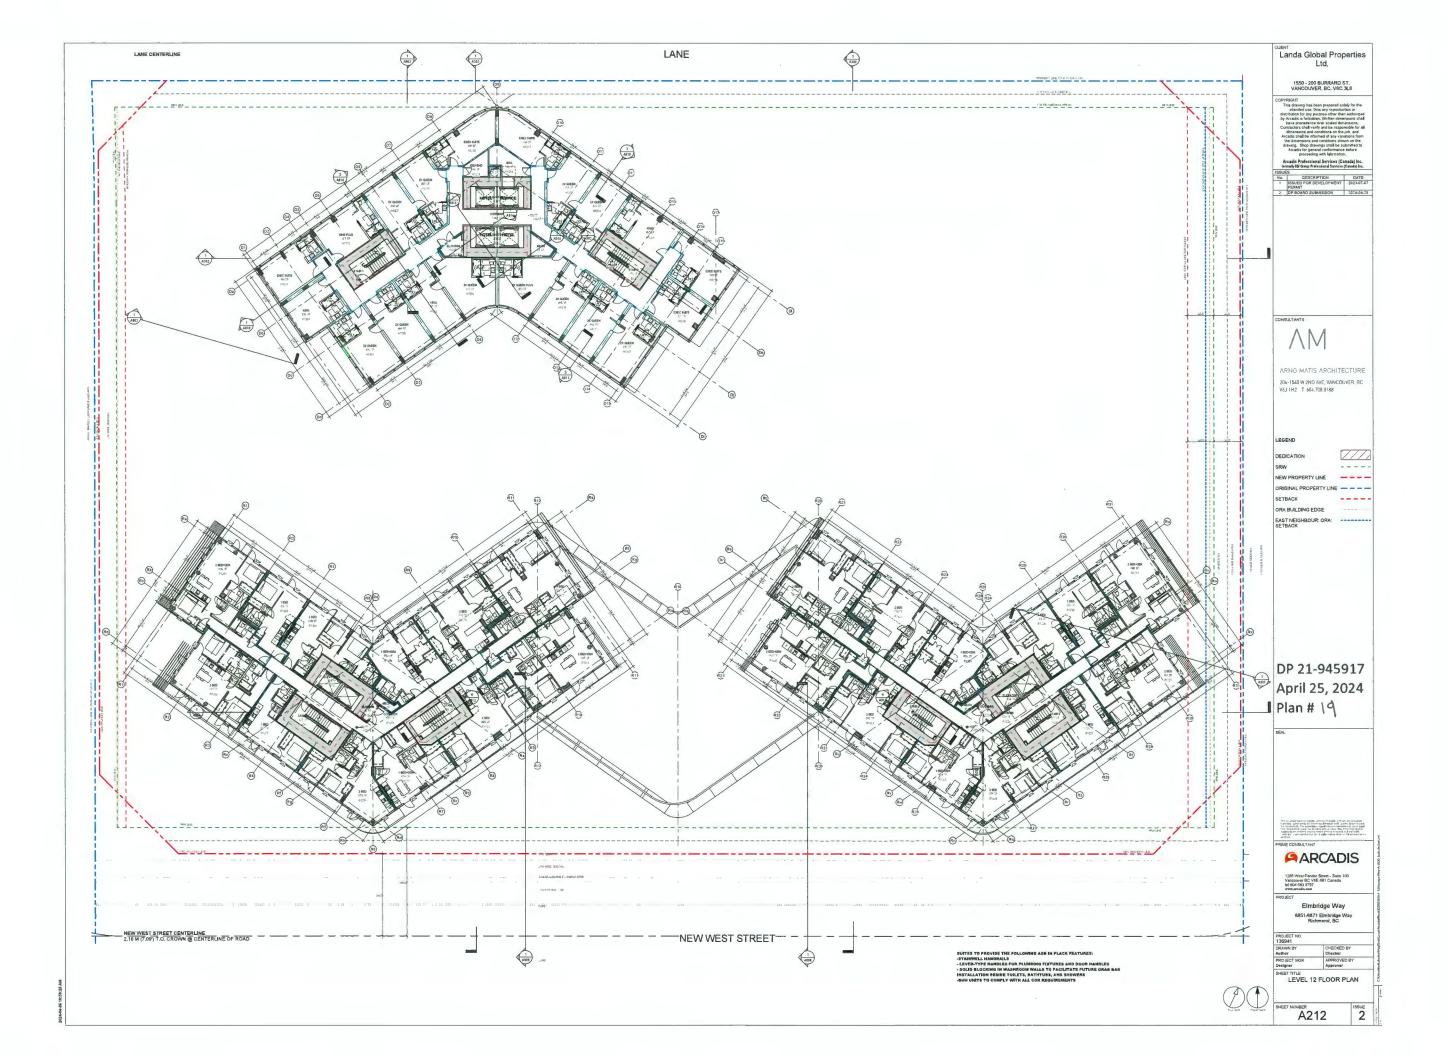


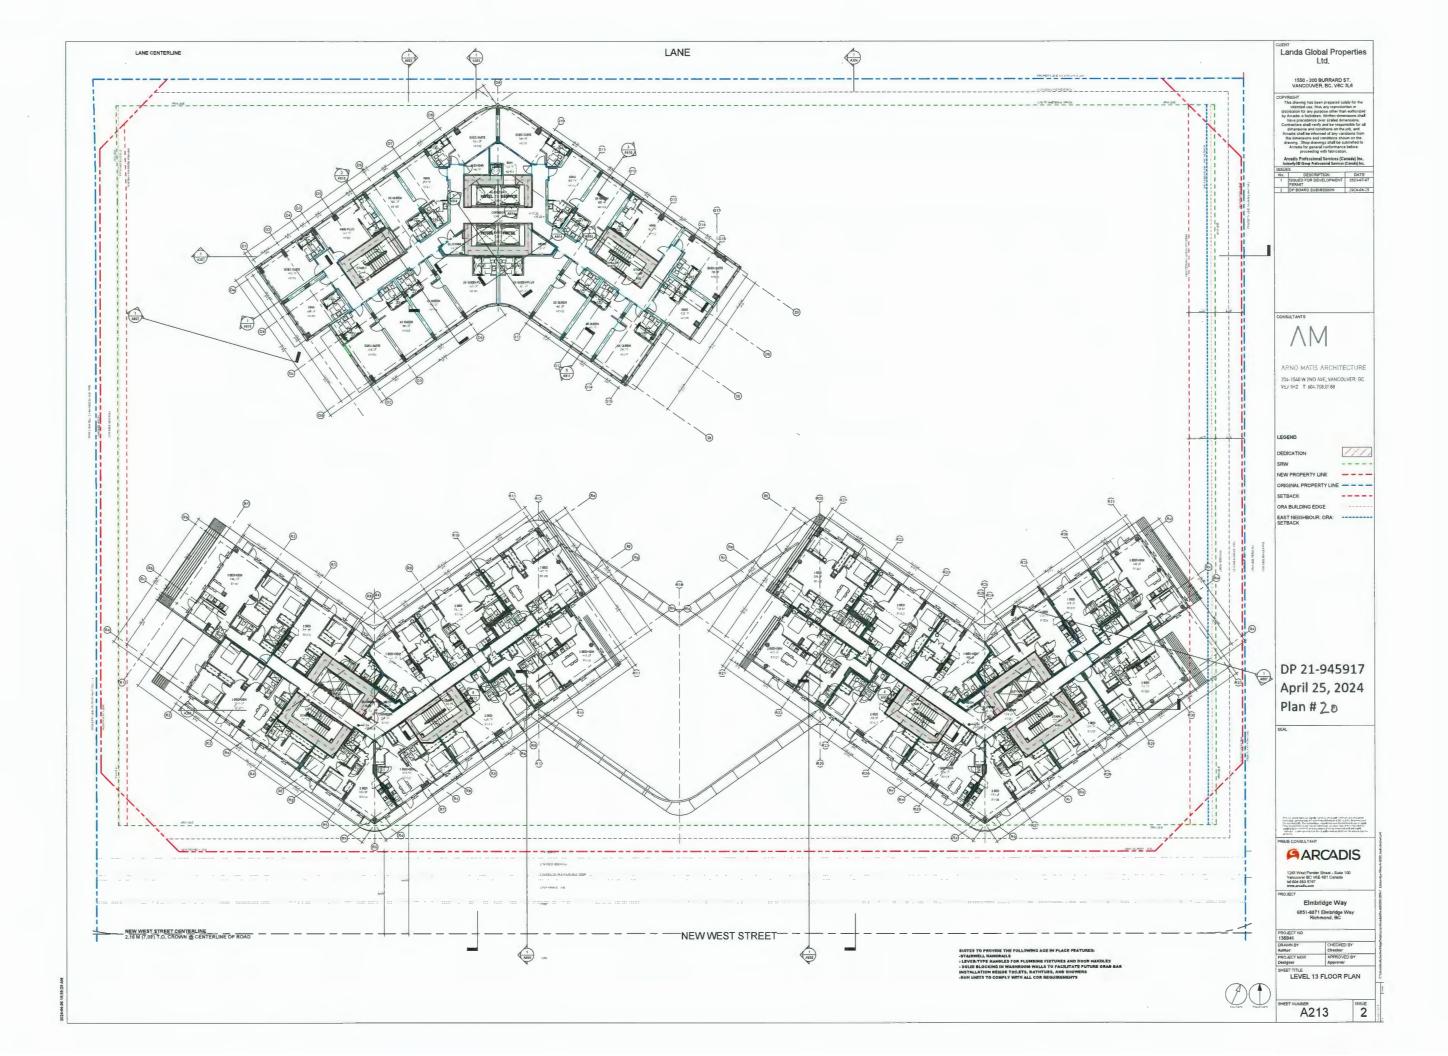


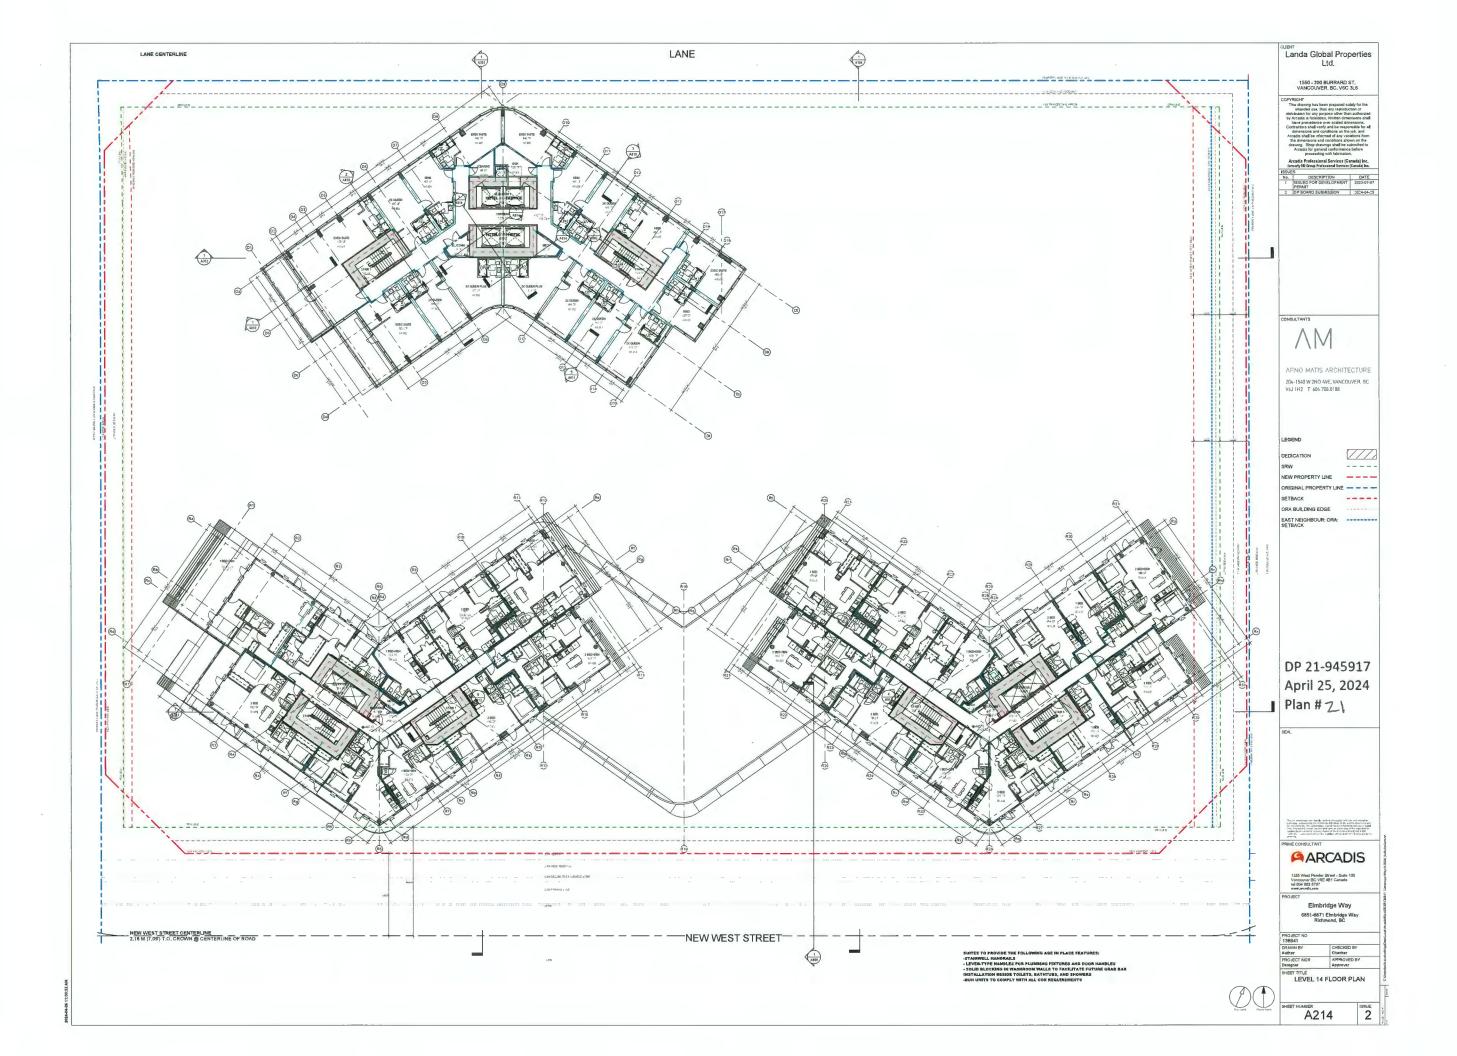


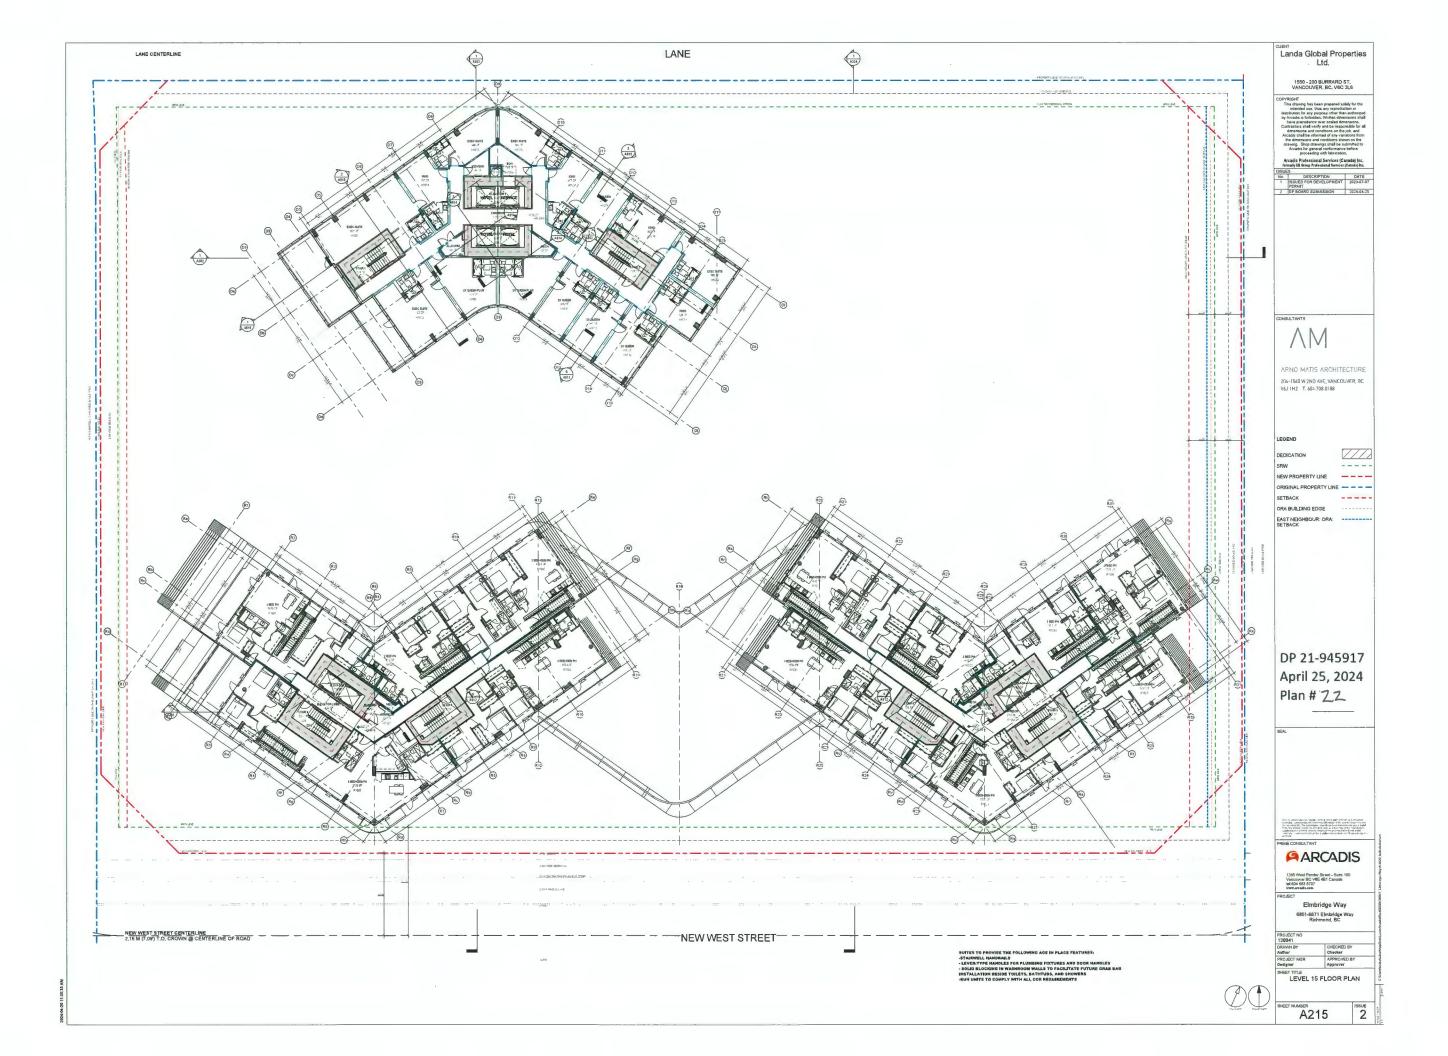

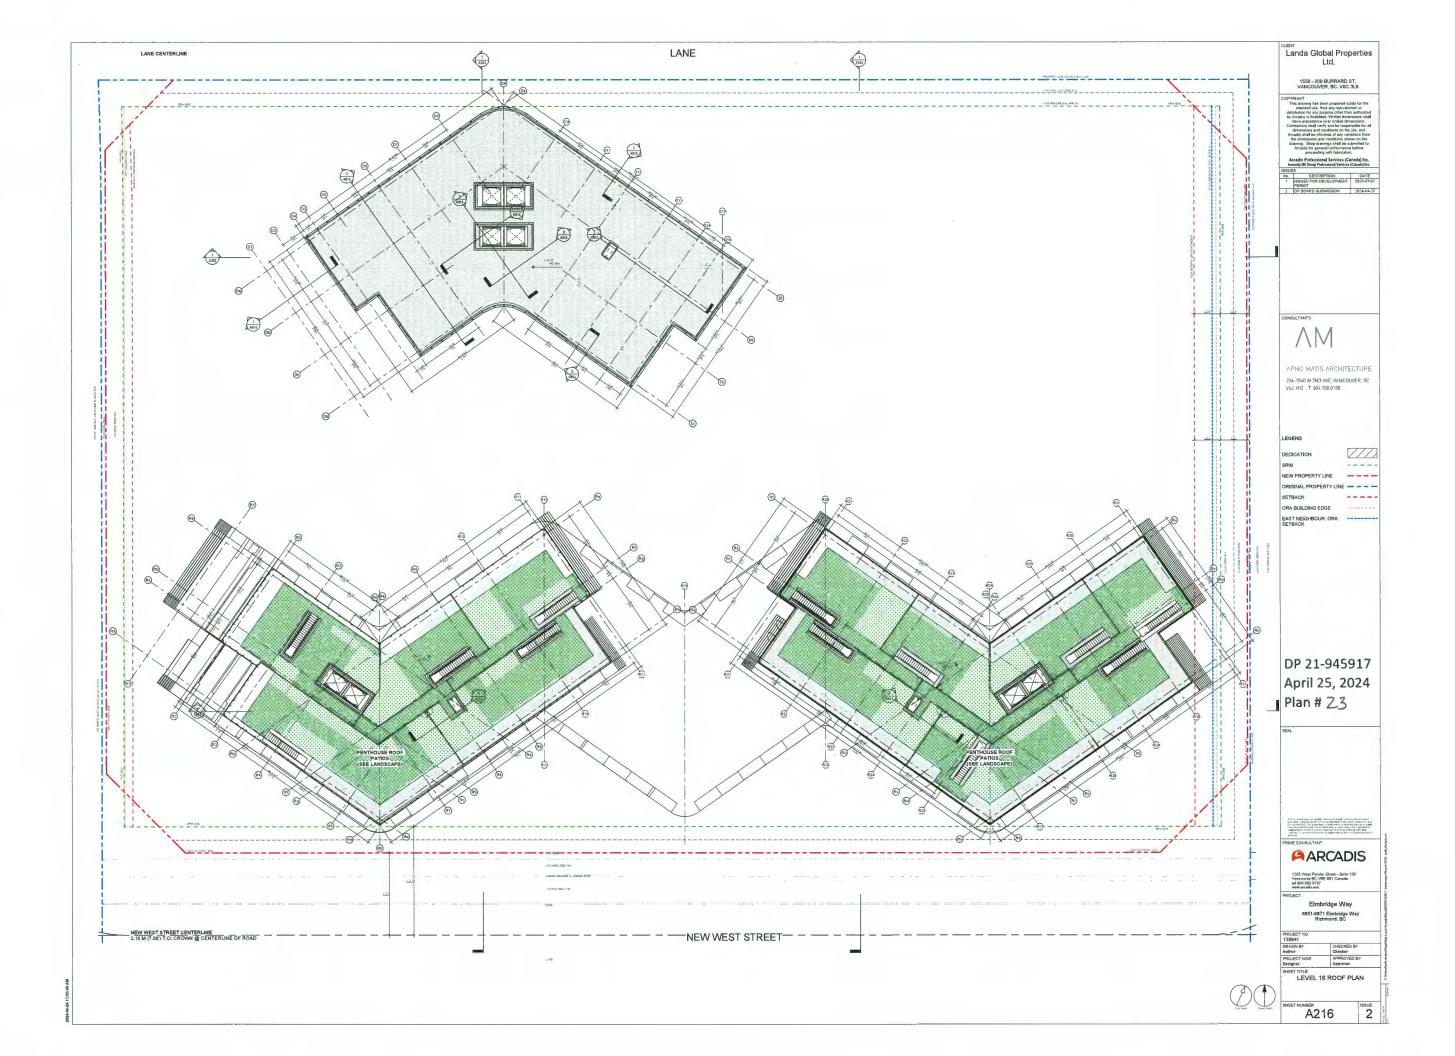

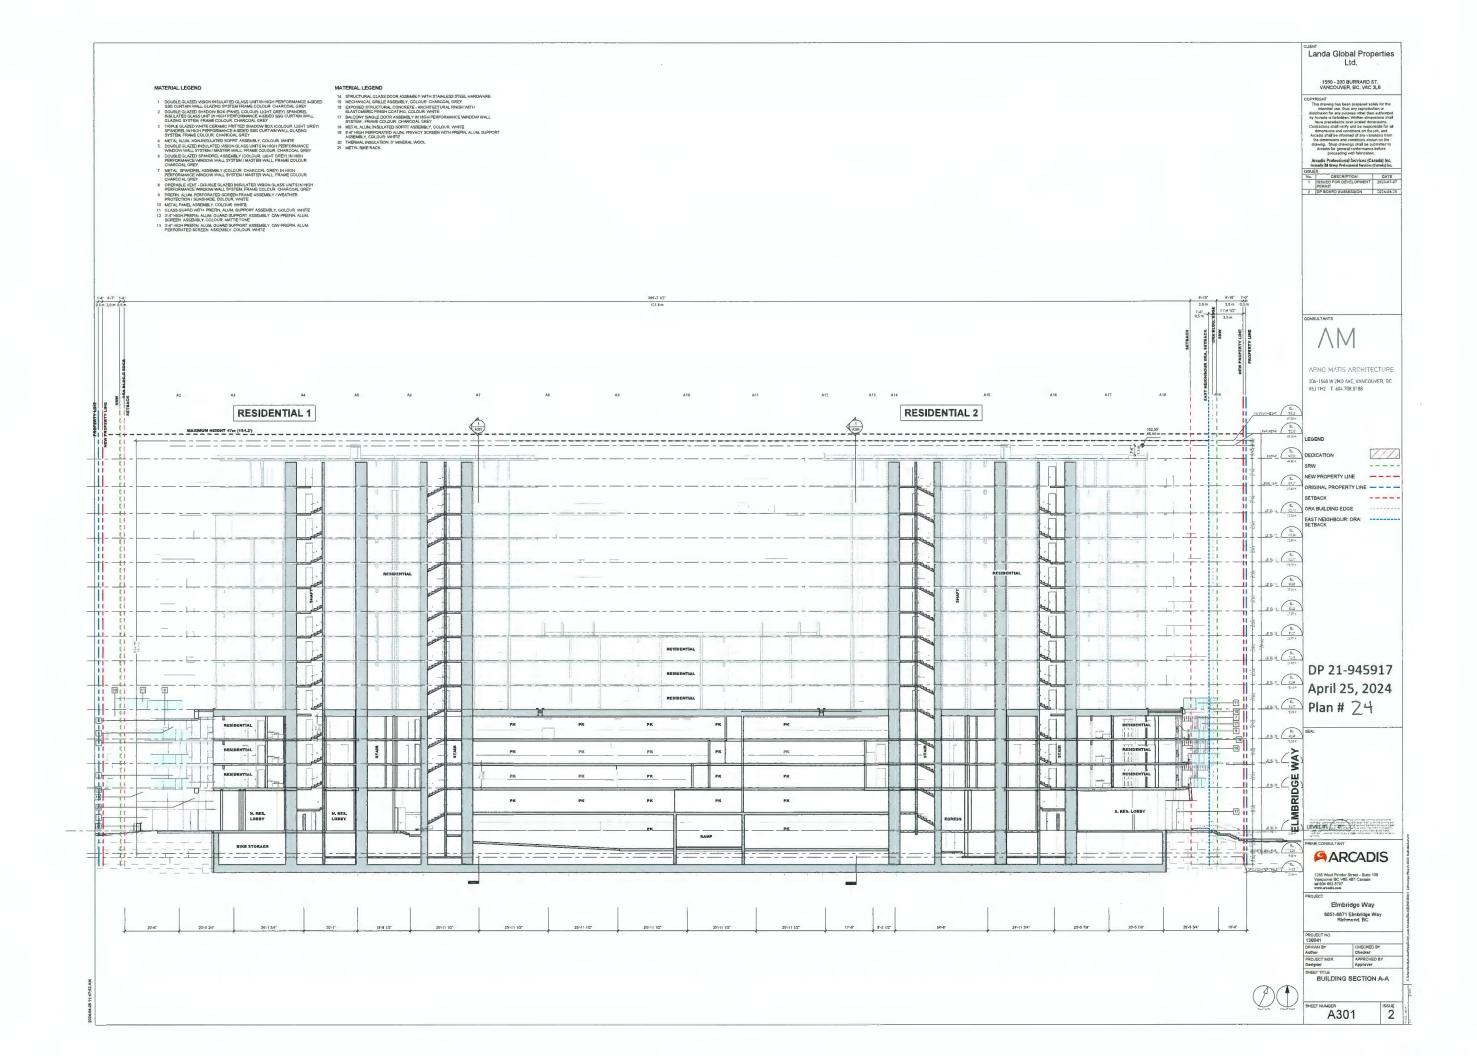

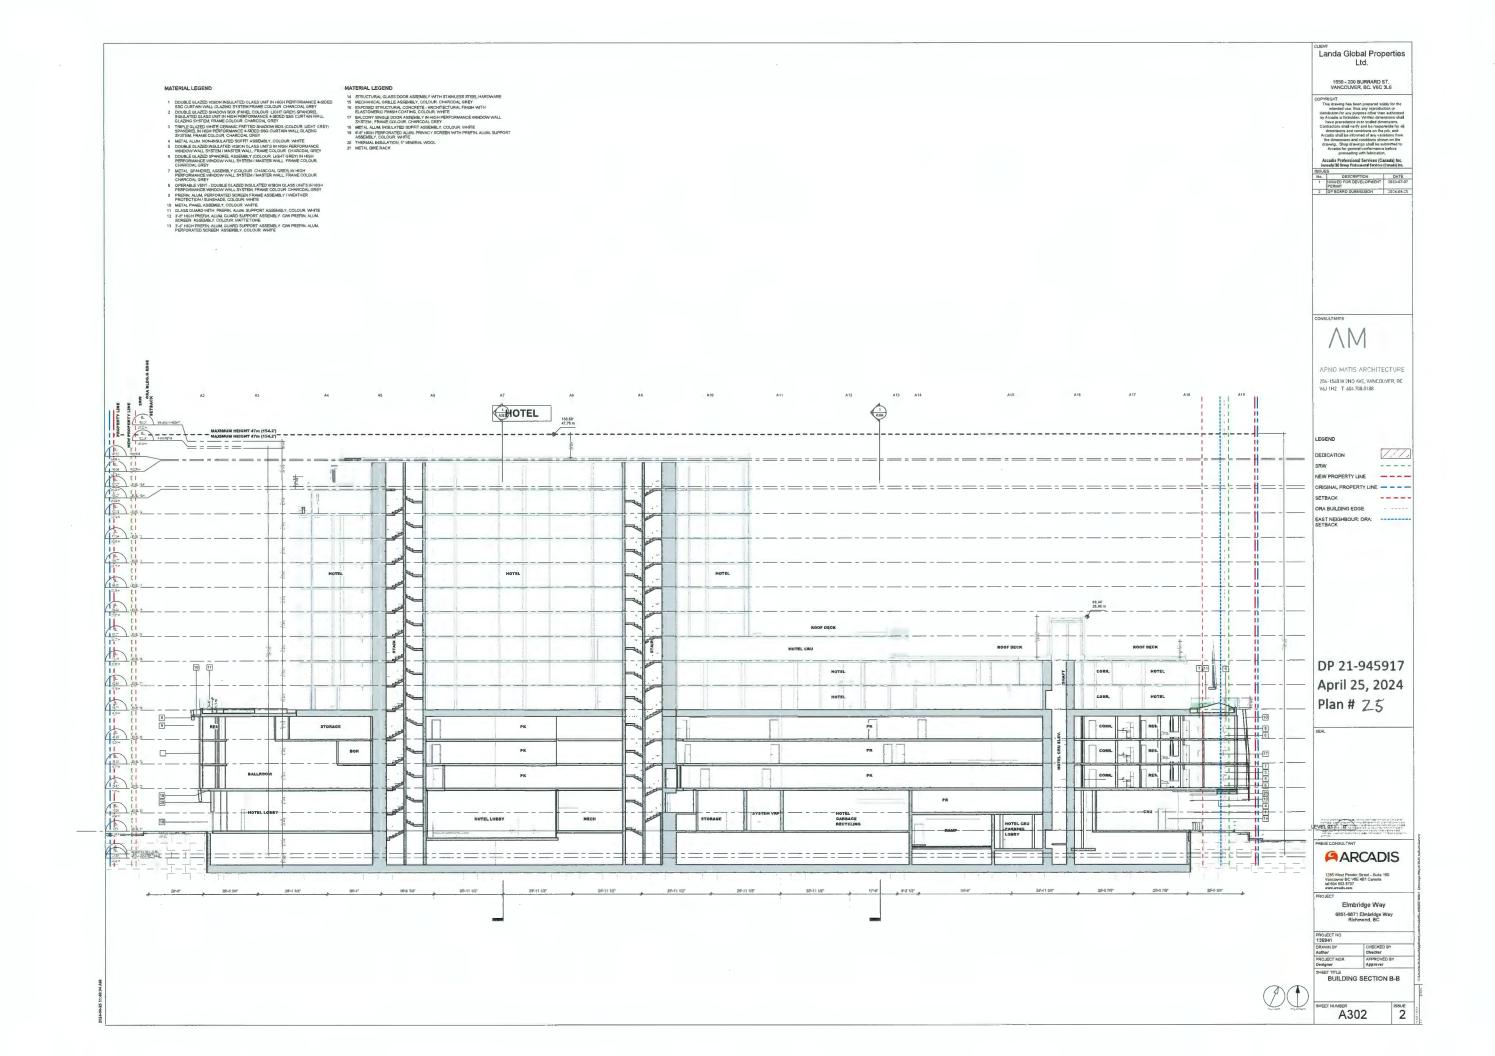

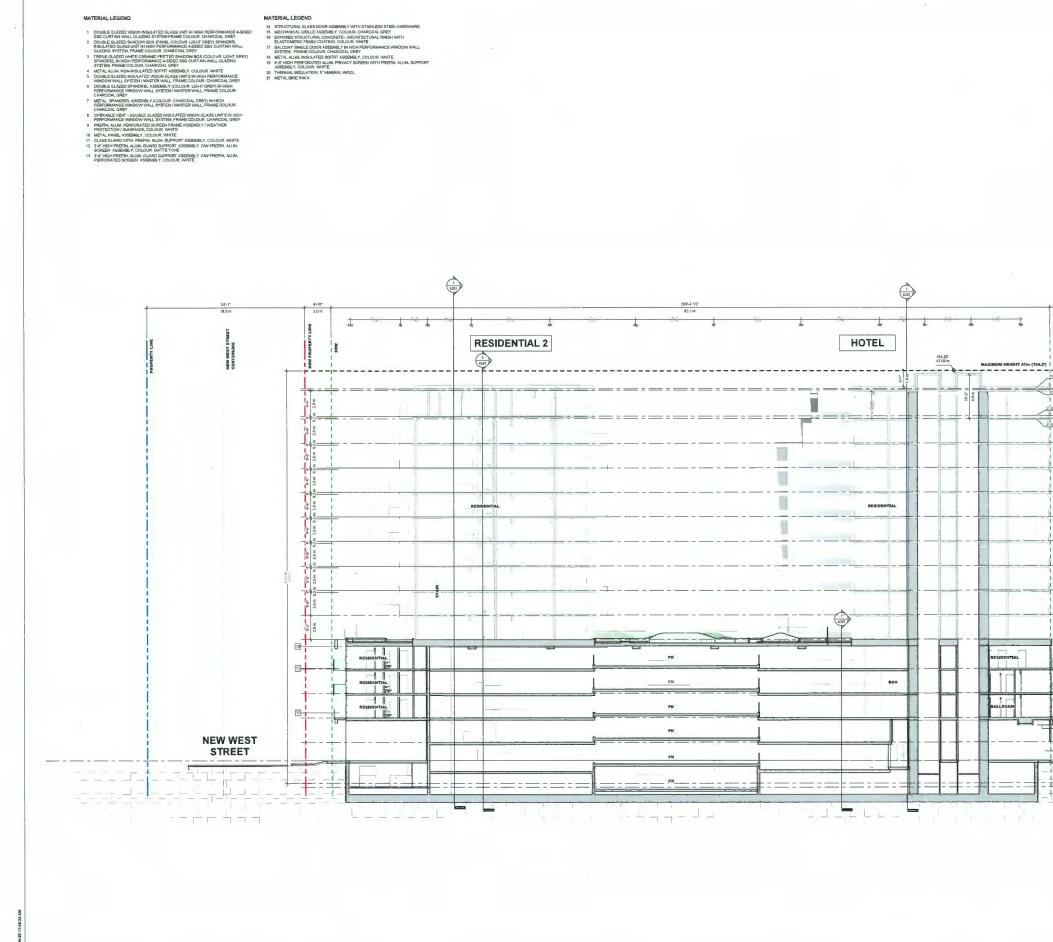


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MATERIAL LEGEND

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- DOUBLE GLAZED SPANDREL ASSEMELY (COLOUR: LIGHT GREY) IN HIGH PERFORMANCE WINDOW WALL SYSTEM / MASTER WALL FRAME COLOUR CHARCOAL GREY
- 7 METAL SPANDREL ASSEMBLY (COLOUR, CHARCOAL GREY) IN HIGH PERFORMANCE VIMIDOW WALL SYSTEM / MASTER WALL, FRAME COLOUR, CHARCOAL GREY
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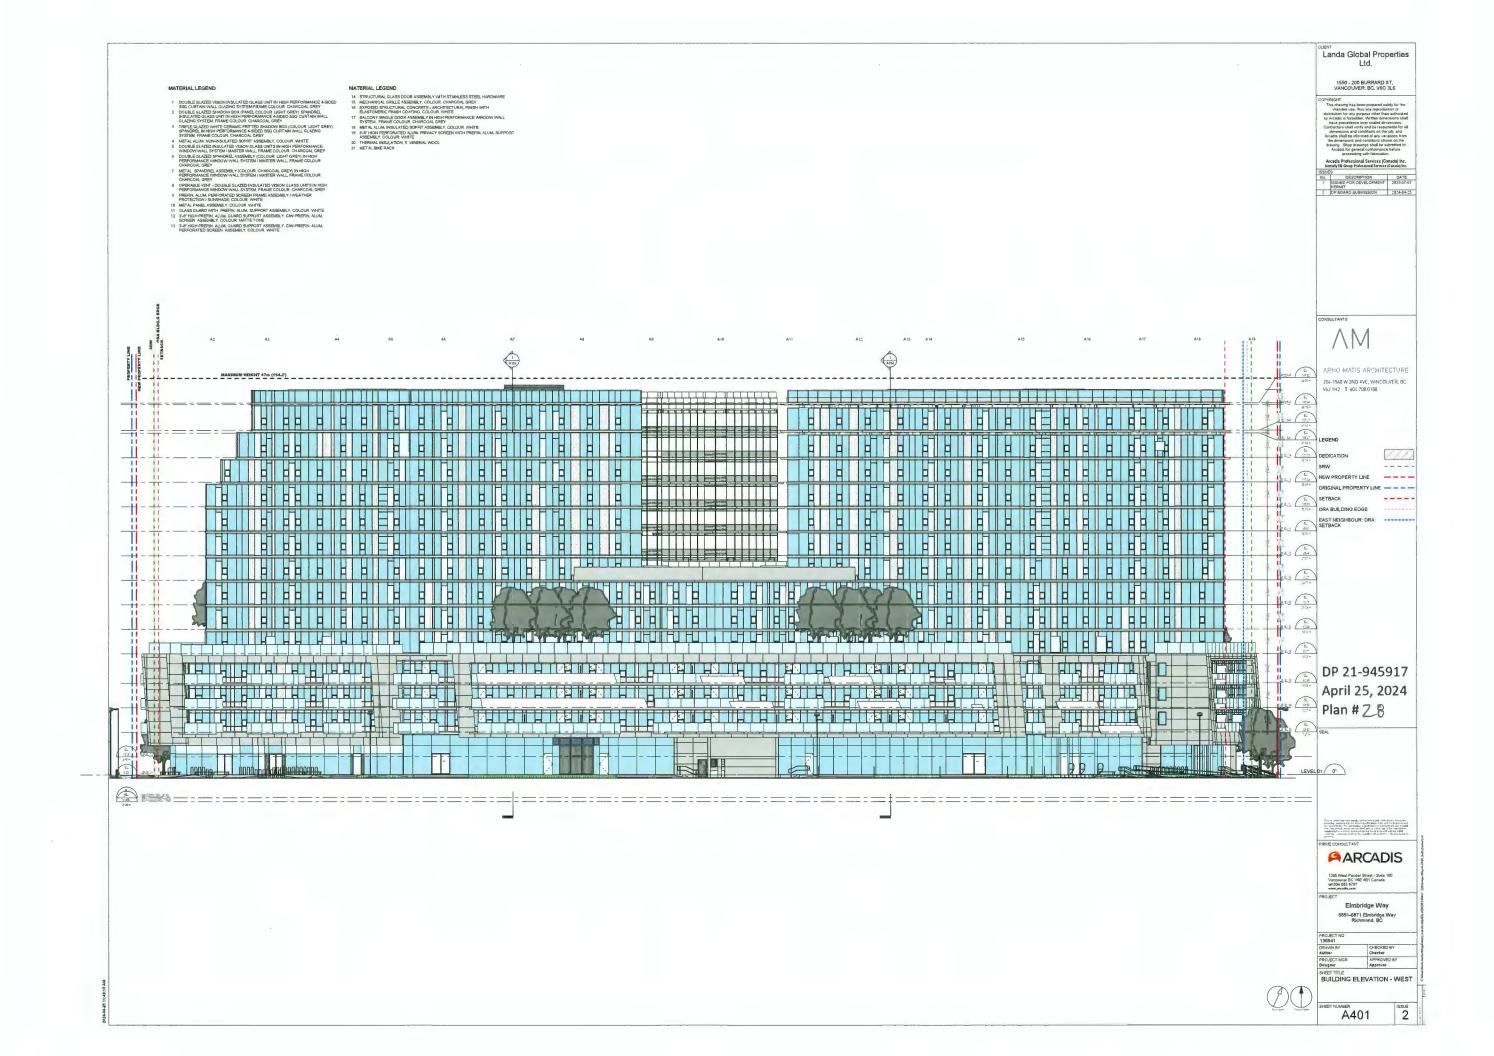
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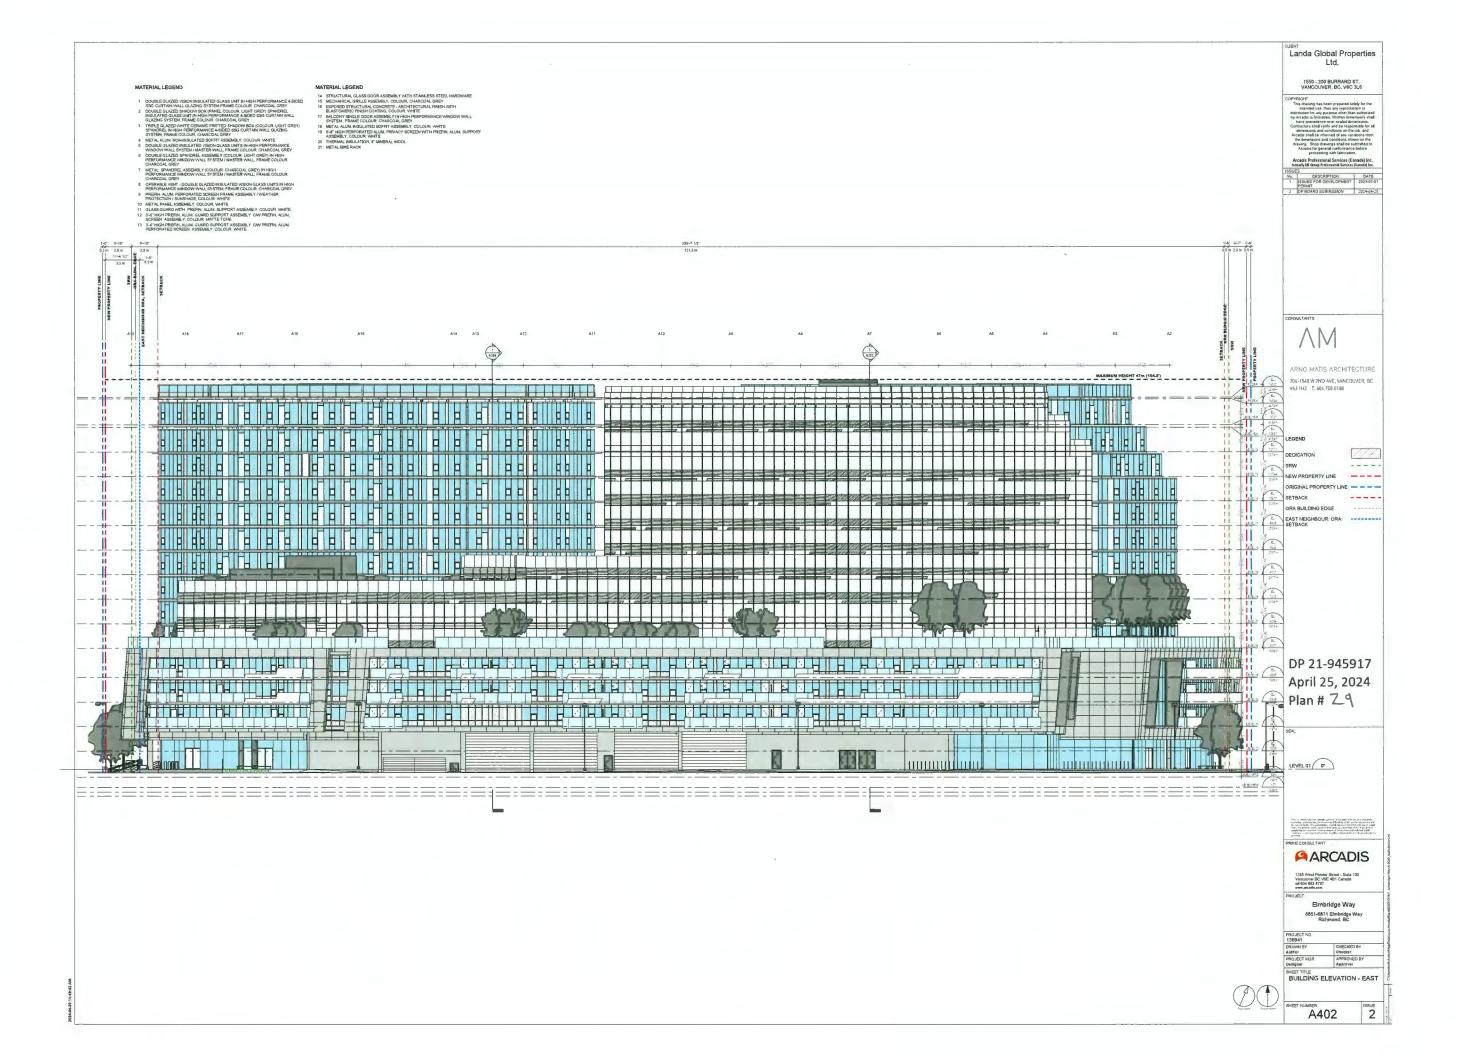



Landa Global Properties Ltd. 1550 - 200 BURRARD ST. VANCOUVER, BC. V6C 3L6 COPYRIGHT This drawing has been prepared solely for the relateded state, those any reproduction or the state of the state of the state of the how precedence our scaled dimensions that how preventions will really and the state of the how preventions will really and the state of the dimensions and accordings in the hold, and the dimensions and conditions shown on the the dimensions and conditions shown for the the dimensions and conditions is shown for the dimensions and conditions is shown for the dimensions and conditions shown for the dimensions and conditions the shown the dimensions and the shown the shown the dimension of the dimension of the shown the dimension of the dimension of the shown ady III Group Prof
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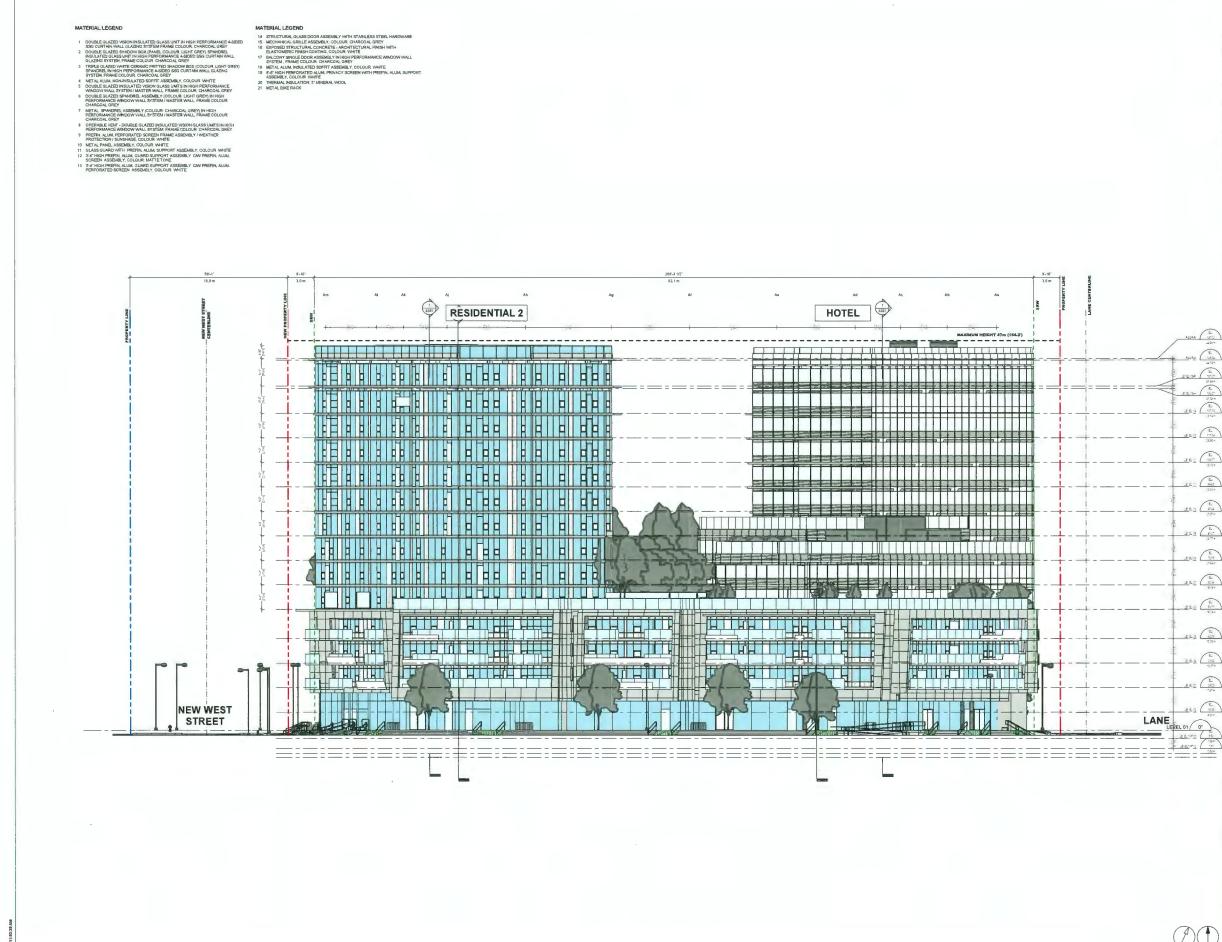
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 NSULTANTS ΛM ARNO MATIS ARCHITECTURE 204-1540 W 2NO AVE, VANCOUVER, BC V6J 1H2 T 604.708.0188 LEGEND ZIA DEDICATION SRW ----NEW PROPERTY LINE ORIGINAL PROPERTY LINE - - -SETBACK ----ORA BUILDING EDGE EAST NEIGHBOUR: ORA: ---DP 21-945917 April 25, 2024 Plan # Z7 This is a proving to an applicate of the parts of the transformation of the parts o INSID TANT ARCADIS 1285 West Pender Street - Sute 100 Vancouver BC V6E 4B1 Carada tel 604 683 8797 envranadiscem Elmbridge Way 6851-6871 Elmbridge Way Richmond, BC PROJECT NO 139841 ORAWN 8Y CHECKED BY Author Checker PROJECT MAR APPROVED BY Approver BHEET ITLE BUILDING SECTION D-D Ø 155UE A304





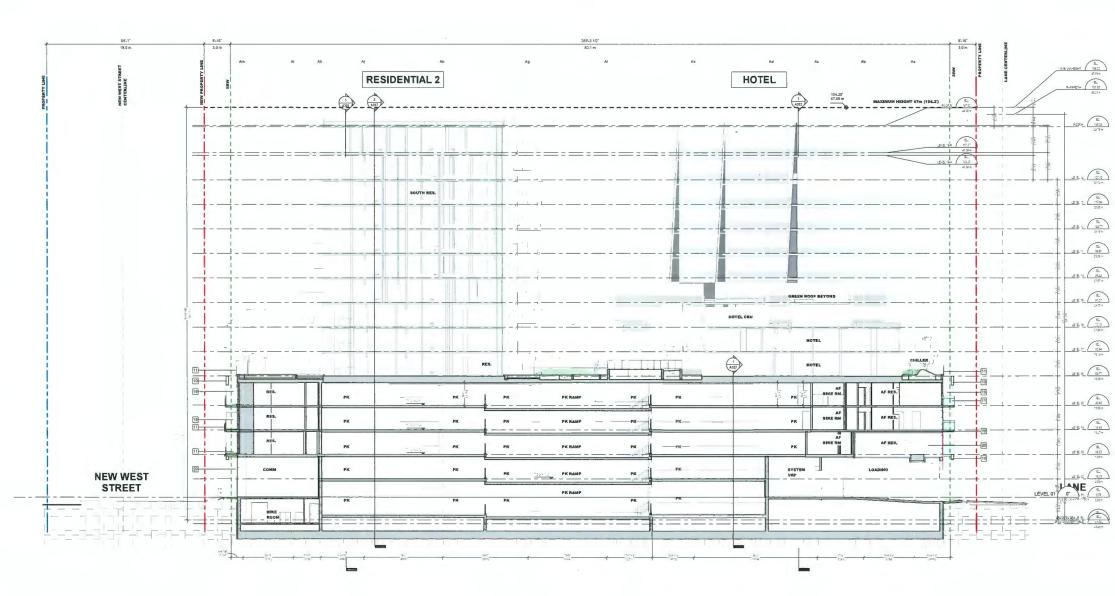

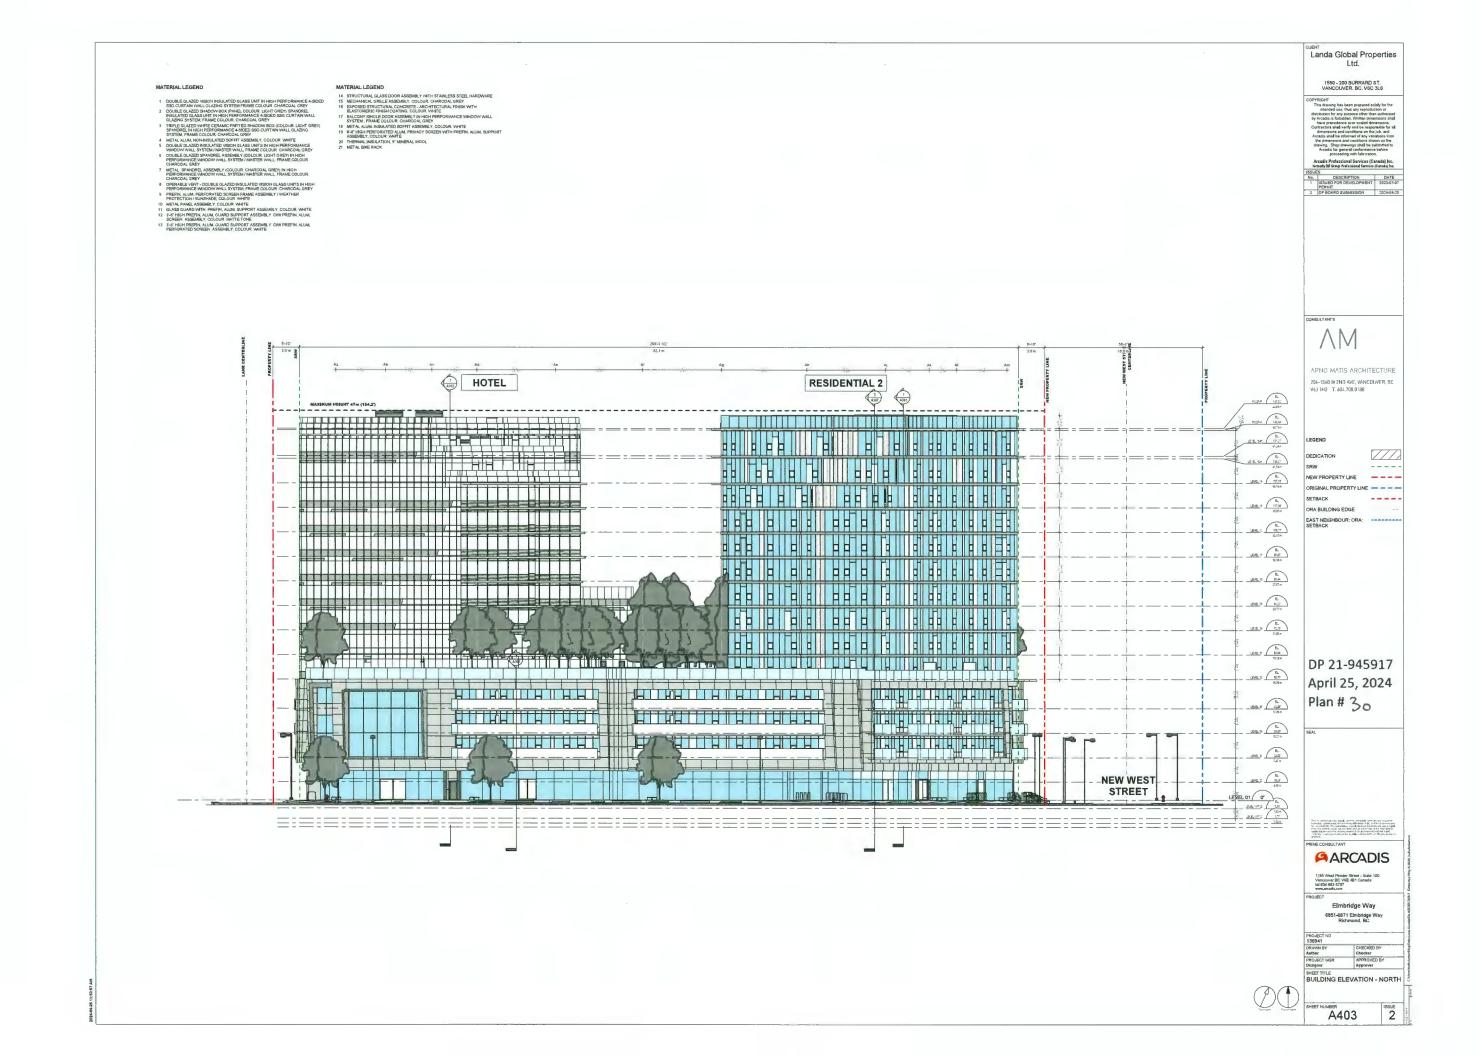

Landa Global Properties Ltd. 1550 - 200 BURRARD ST. VANCOUVER, BC. V6C 3L6 ES DESCRIPTION DATE ISSUED FOR DEVELOPMENT 2023-07-07 2 DP BOARD SUBMISSION 2024-04-25 ΛM APNO MATIS ARCHITECTURE 204-1540 W 2ND AVE, VANCOUVER, BC V6J 1H2 T. 604 708.0188 LEGEND ----____ CRIGINAL PROPERTY LINE - - - -ORA BUILDING EDGE LE CAR BUILDING EDGE CAR BUILDING EDGE EAST NEIGHBOUR: ORA: SETBACK 14.3 (P.) <u>100</u> DP 21-945917 April 25, 2024 ERE Plan # 31 <u>8 6 2</u> (10) 100 445 (L) LANE (a) I was explicitly ranked with a gain with any and weathing whether and a second ARCADIS 1265 West Pender Street - Suite 100 Vancouver BC V8E 4B1 Canada tel 604 663 6797 Elmbridge Way 6851-6871 Elmbridge Way Richmond, BC CHECKED BY Checker APPROVED BY Approver Author PROJECT MGR BUILDING ELEVATION - SOUTH ISSUE 2 A404

MATERIAL BOARD

PODIUM COMMERCIAL



- GLAZED VISION INSULATED GLASS UNIT IN HIGH PERFORMANCE 2-SIDED SSG STOREFRONT GLAZING SYSTEM, LOW-E GLASS, FRAME COLOUR: CHARCOAL GREY
- GLAZED SHADOW BOX (PANEL COLOUR: LIGHT GREY) SPANDREL INSULATED GLASS UNIT IN HIGH PERFORMANCE 4-SIDED SSG CURTAIN WALL GLAZING SYSTEM, FRAME COLOUR: CHARCOAL GREY
- STRUCTURAL GLASS DOOR ASSEMBLY WITH STAINLESS STEEL HARDWARE

RESIDENTIAL TOWERS & PODIUM RESIDENTIAL



- B GLAZED INSULATED VISION GLASS UNITS IN HIGH PERFORMANCE WINDOW WALL SYSTEM, LOW-E GLASS, FRAME COLOUR: CHAR-COAL GREY
- GLAZED SHADOW BOX (PANEL COLOUR: LIGHT GREY) SPANDREL INSULATED GLASS UNIT IN HIGH PERFORMANCE WINDOW WALL SYSTEM, FRAME COLOUR: CHARCOAL GREY
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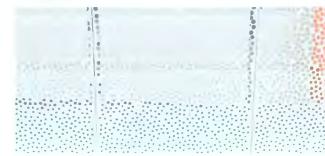
HOTEL TOWER



- GLAZED INSULATED VISION GLASS UNITS IN HIGH PERFORMANCE 4 SSG CURTAIN WALL SYSTEM, LOW-E GLASS, FRAME COLOUR: CHARCOAL GREY
- WHITE CERAMIC FRITTED GLAZED SHADOW BOX (IN COMBINATION WITH LIGHT GREY SPANDREL IN HIGH PERFORMANCE 4-SIDED SSG CURTAIN WALL GLAZING SYSTEM, FRAME COLOUR: CHAR-COAL GREY



EXPOSED CONCRETE - ARCHITECTURAL FINISH WITH ELASTOMER-IC FINISH COATING, COLOUR: WHITE, WITH TIE-HOLES AT PODIUM FRAMES



 PREFIN. ALUM. PERFORATED SCREEN / FRAME ASSEMBLY / WEATHER PROTECTION/ SUNSHADE, COLOUR: WHITE



- EXPOSED CONCRETE ARCHITECTURAL FINISH WITH ELASTOMER-IC FINISH COATING, COLOUR: WHITE, WITH TIE-HOLES AT PODIUM FRAMES
- EXPOSED CONCRETE SOFFITS ARCHITECTURAL FINISH WITH ELASTOMERIC FINISH COATING, COLOUR: WHITE (STUCCO RENDERED TO MATCH WHERE DROP FOR INSULATION IS RE-QUIRED, COLOUR TO MATCH)





- 3'-6" HIGH GLASS GUARD, FRAME COLOUR: CHARCOAL GREY
- FULL HEIGHT FRAMELESS FROSTED STRUCTURAL GLASS PRIVACY SCREEN WITH PREFIN. ALUM. CLIPS

M. BALCONY SINGLE DOOR ASSEMBLY IN HIGH PERFORMANCE WINDOW WALL SYSTEM, FRAME COLOUR: CHARCOAL GREY N. MECHANICAL GRILLE ASSEMBLY, COLOUR: CHARCOAL GREY

6851-6871 Elmbridge Way Richmond, BC Canada

PROJECT NO 202006 STATUS DE DATE ISSUED 2021-10-22 SCALE 12" = 1'-0" DRAWN BY IDS CHECKED BY SN

ISSUED FOR DEVELOPMENT PERMIT 2021-12-21 ISSUED FOR REZONING PERMIT 2021-06-04

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DP 21-945917

April 25, 2024

ARNO MATIS ARCHITECTURE


204-1540 W 2ND AVE, VANCOUVER, BC V6J 1H2 T, 604.708.0188

Plan # 32

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ARCHITECT Arno Matis Architecture 204 - 1540 West 2nd Ave Vancouver, BC V6J 1H2

ARCHITECT Arcadis IBI Group Suite 700 - 1285 West Pender Street Vancouver, BC CA V6E 4B1

LANDSCAPE ARCHITECT PFS Studio 1777 West 3rd Avenue Vancouver, BC V6J 1K7
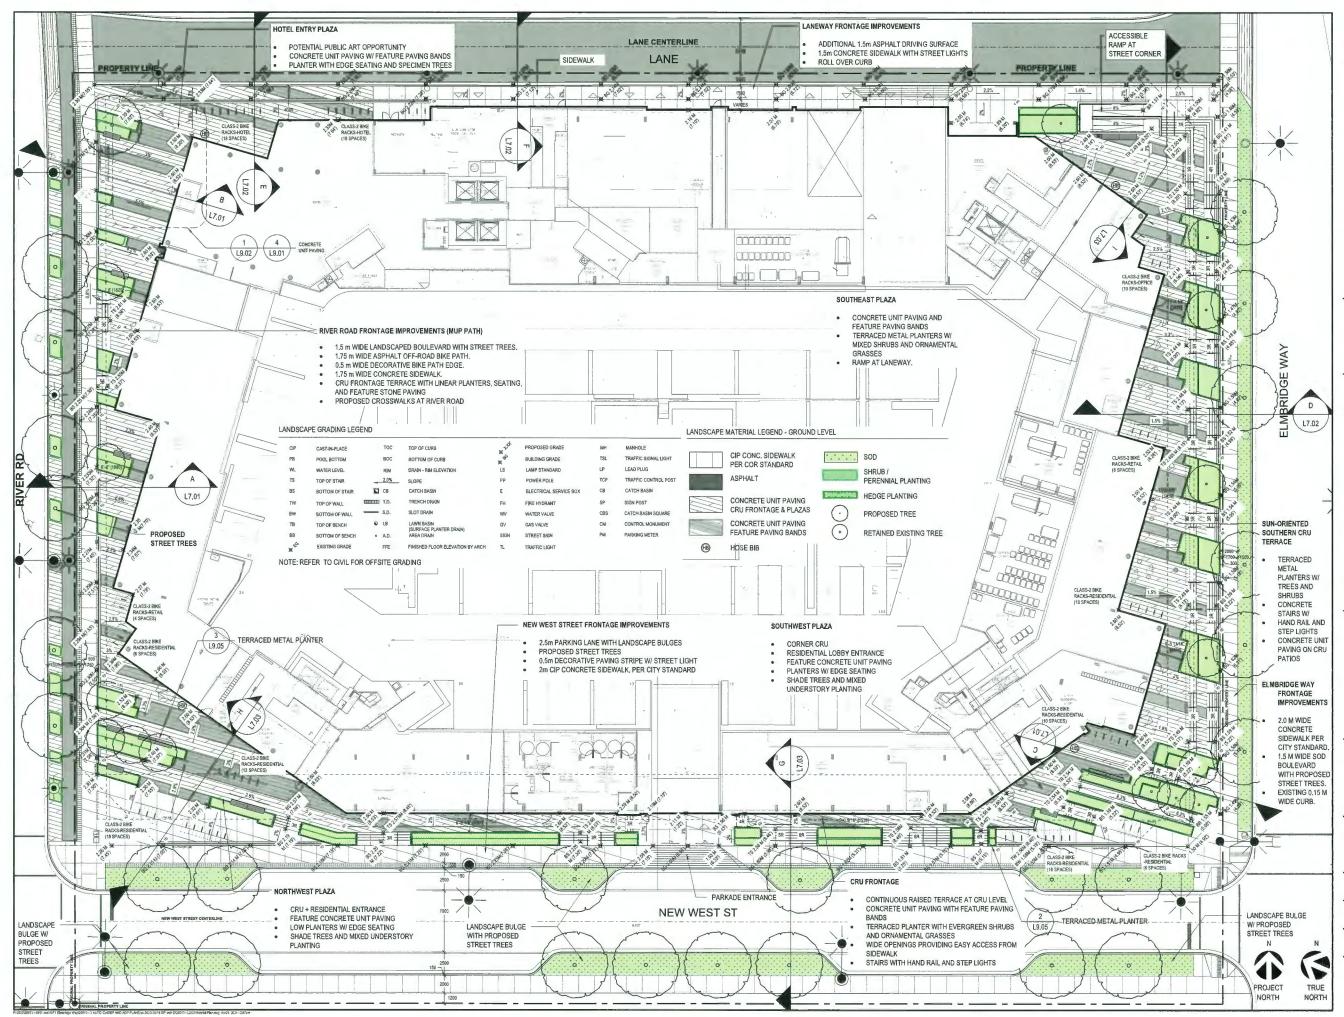
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ISSUANCE:

No,	Dale	Details
1	JUN 04, 2021	ISSUED FOR REZONING APPLICATION
2	DEC 21, 2021	ISSUED FOR DEVELOPING PERMIT
3	APR 8, 2021	ISSUED FOR 30% BP
4	AUG 29, 2022	ISSUED FOR REZONING APPLICATION
5	OCT 13, 2022	ISSUED FOR CITY REVIEW
6	JUN 30, 2023	ISSUED FOR DEVELOPING PERMIT
7	NOV 8, 2023	ISSUED FOR ADP
8	APR 25, 2024	ISSUED FOR DP BOARD SUBMISSION

PFS STUDIO

STAMP: DP 21-945917 April 25, 2024 Plan # 33

PROJECT NAME: 6851-6871 ELMBRIDGE WAY RICHMOND, BC CANADA

DATE:

JS

04/25/2024

CHECKED BY:


DRAWING TITLE: **GROUND LEVEL** LANDSCAPE PLAN

PFS PROJECT NUMBER: 20013 DRAWN BY:

JL/JR/JGC SCALE:

1/16" = 1'-0"

DWG, NO .: L2.01

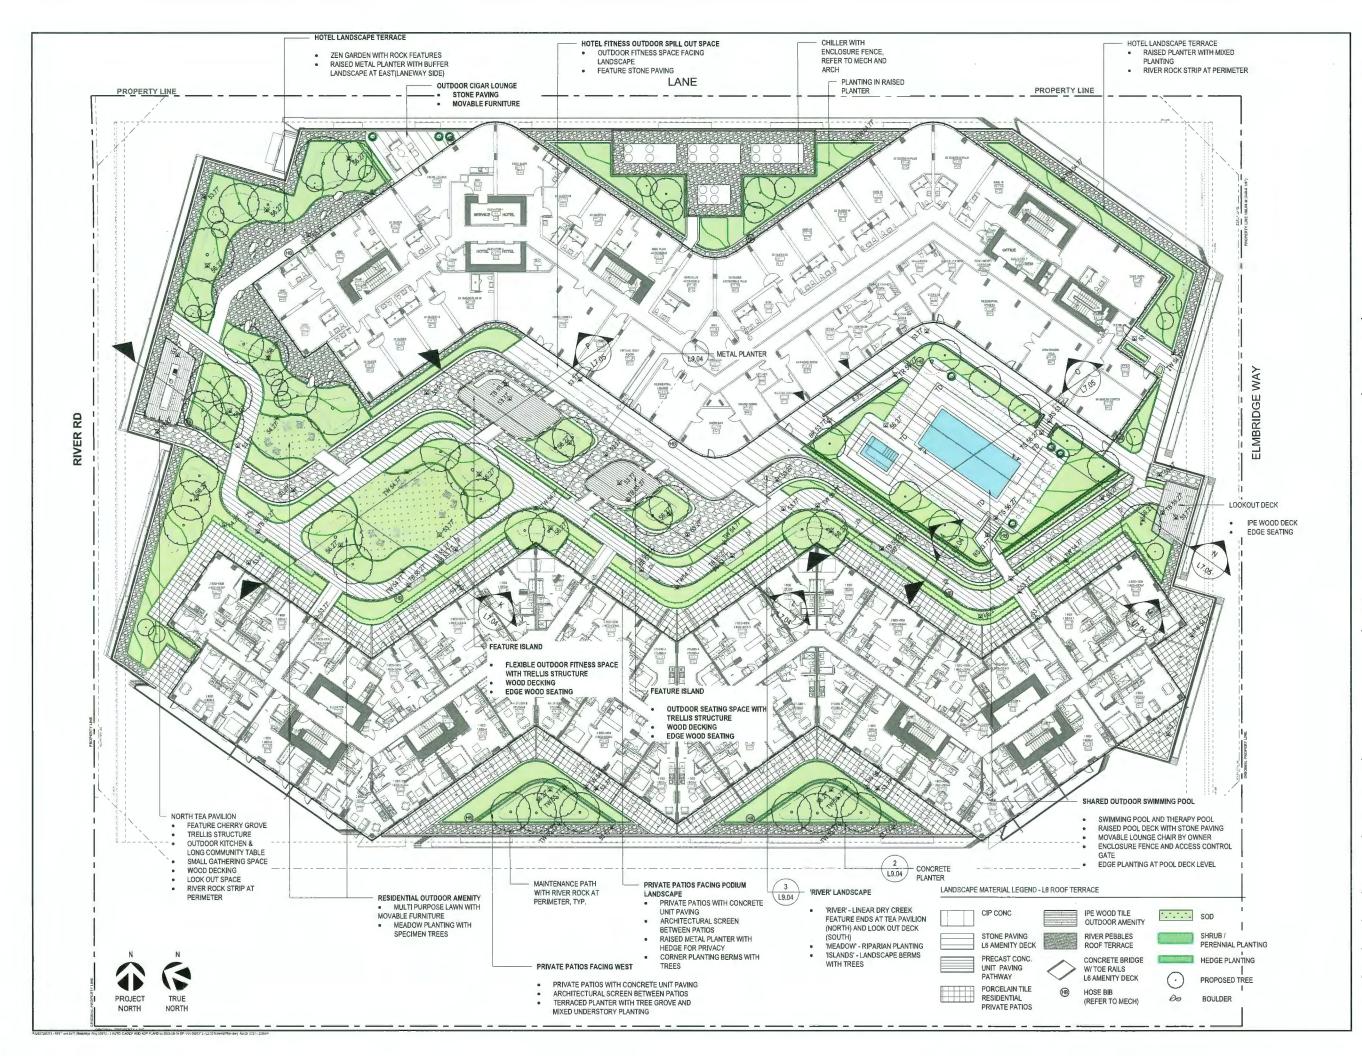



GLOBAL PROPERTIES

PROJECT TEAM:

ARCHITECT Arno Matis Architecture 204 - 1540 West 2nd Ave Vancouver, BC V6J 1H2

ARCHITECT Arcadis IBI Group Suite 700 - 1285 West Pender Street Vancouver, BC CA V6E 4B1

LANDSCAPE ARCHITECT PFS Studio 1777 West 3rd Avenue Vancouver, BC V6J 1K7

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No.	Data	Details
1	JUN 04, 2021	ISSUED FOR REZONING APPLICATION
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6	JUN 30, 2023	ISSUED FOR DEVELOPING PERMIT
7	NOV 8, 2023	ISSUED FOR ADP
8	APR 25. 2024	ISSUED FOR DP BOARD SUBMISSION



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FOR COORDINATION DP 21-945917 April 25, 2024 Plan # 34

PROJECT NAME:

6851-6871 ELMBRIDGE WAY RICHMOND, BC CANADA

DRAWING TITLE: LEVEL 6

LANDSCAPE PLAN

PFS PROJECT NUMBER:	DATE:
20013	04/25/2024
DRAWN BY:	CHECKED BY:
JL/JR/JGC	JS
SCALE: 1/16" = 1'-0"	

DWG. NO .:

L2.02







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ARCHITECT Arcadis IBI Group Suite 700 - 1285 West Pender Street Vancouver, BC CA V6E 4B1

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7	NOV 8, 2023	ISSUED FOR ADP
8	APR 25, 2024	ISSUED FOR OP BOARD SUBMISSION

PLANNING • URBAN DESIGH • LANDSCAPE ARCHITECTURE

DP 21-945917 April 25, 2024 Plan#35

PROJECT NAME:

6851-6871 ELMBRIDGE WAY RICHMOND, BC CANADA

DATE:

JS

04/25/2024

CHECKED BY:

DRAWING TITLE:

LEVEL 8

LANDSCAPE PLAN

PFS PROJECT NUMBER: 20013 DRAWN BY:

JL/JR/JGC SCALE:

1/16" = 1'-0"

DWG. NO .:

L2.03







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PLANNING + URBAN DESIGH + LANDSCAPE ARCHITECTURE Wards and a standard besign + LANDSCAPE ARCHITECTURE Weight Acca Weigh

DP 21-945917 April 25, 2024 Plan # 36

PROJECT NAME:

6851-6871 ELMBRIDGE WAY RICHMOND, BC CANADA


DRAWING TITLE: ROOFTOP

LANDSCAPE PLAN

PFS PROJECT NUMBER:	DATE:
20013	04/25/2024
DRAWN BY:	CHECKED BY:
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SCALE: 1/16" = 1'-0"	

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7	NOV 8, 2023	ISSUED FOR ADP
8	APR 25, 2024	ISSUED FOR OP BOARD SUBMISSION

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STAMP:

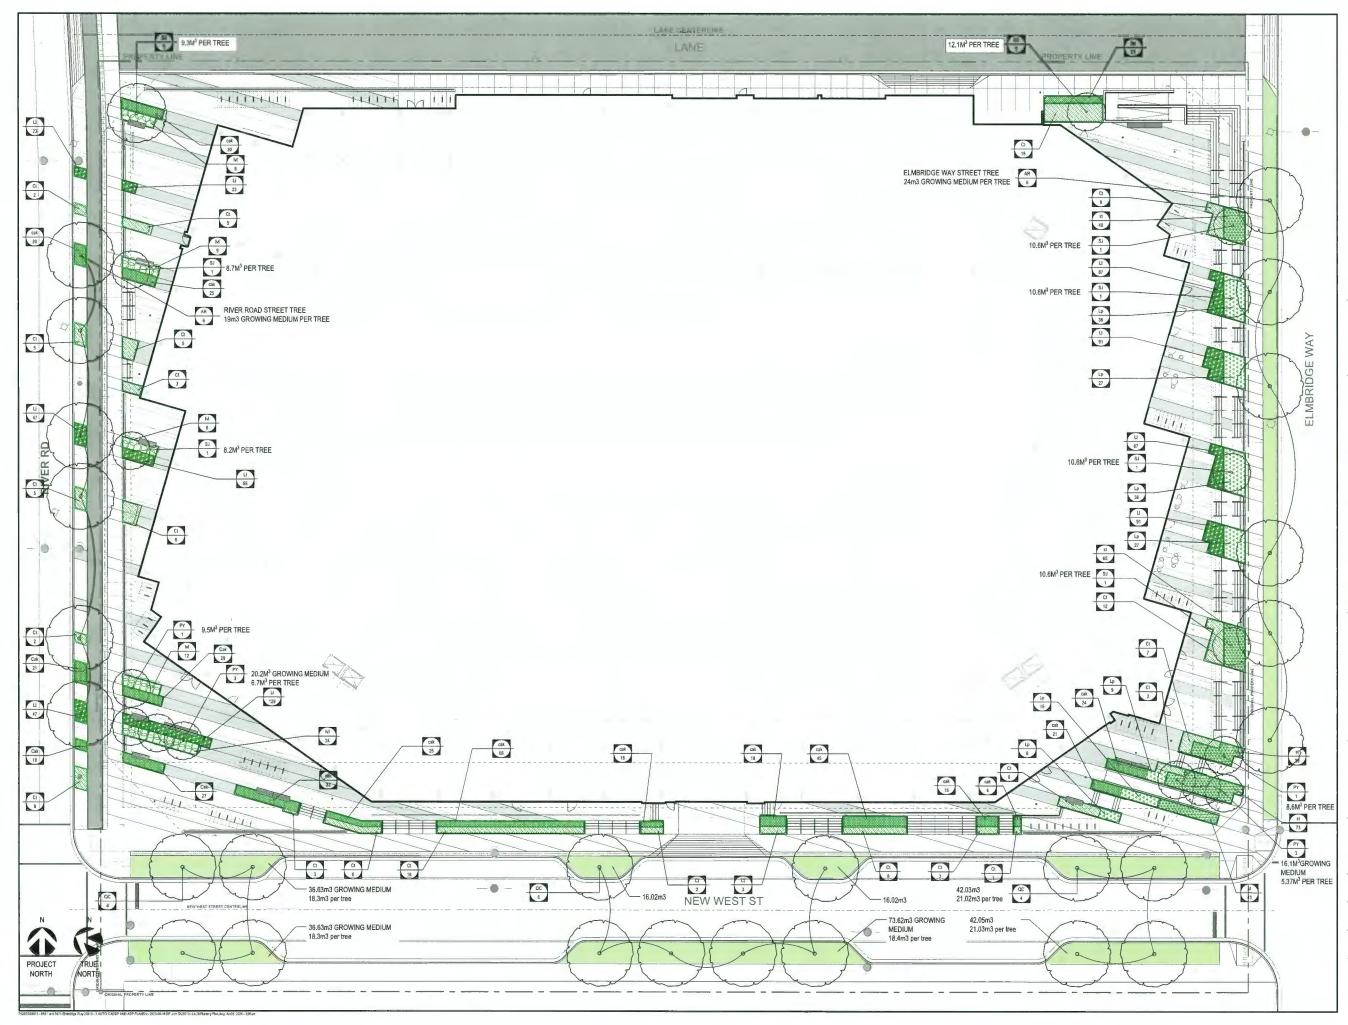DP 21-945917 April 25, 2024 Plan # 37

PROJECT NAME: 6851-6871 ELMBRIDGE WAY RICHMOND, BC CANADA

DATE:

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04/25/2024

CHECKED BY:


DRAWING TITLE: **GROUND LEVEL**

PLANTING PLAN

PFS PROJECT NUMBER: 20013 DRAWN BY: JL/JR/JGC

SCALE:

DWG. NO .:

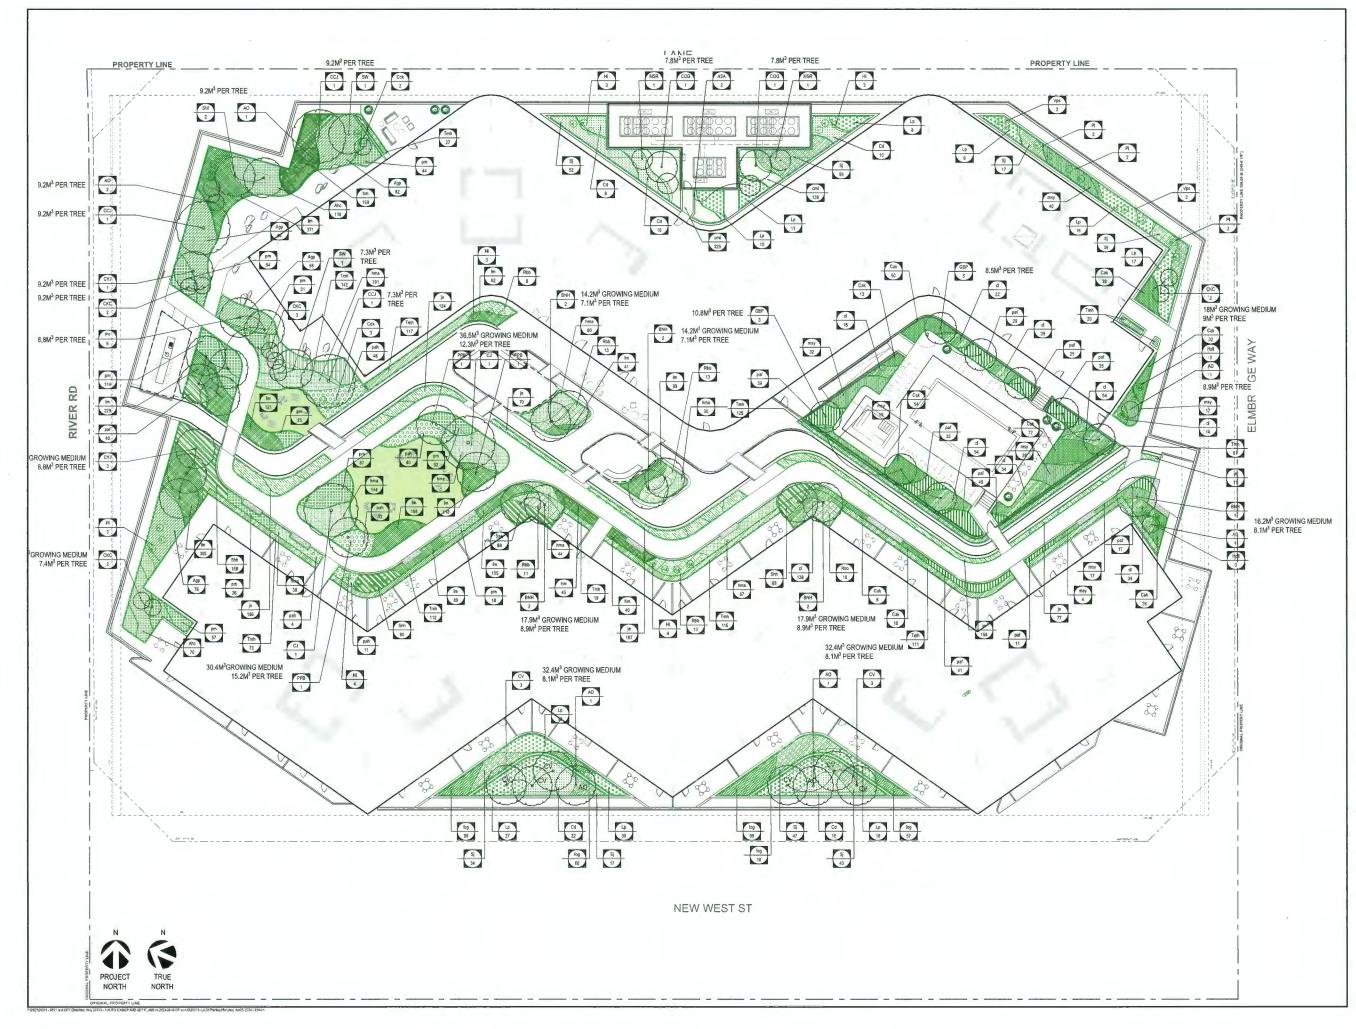





ARCHITECT Arno Matis Architecture 204 - 1540 West 2nd Ave Vancouver, BC V6J 1H2

ARCHITECT Arcadis IBI Group Suite 700 - 1285 West Pender Street Vancouver, BC CA V6E 4B1

LANDSCAPE ARCHITECT PFS Studio 1777 West 3rd Avenue Vancouver, BC V6J 1K7

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No.	Date	Detalls
1	JUN 04, 2021	ISSUED FOR REZONING APPLICATION
2	DEC 21, 2021	ISSUED FOR DEVELOPING PERMIT
3	APR 8. 2021	ISSUED FOR 30% BP
4	AUG 29, 2022	ISSUED FOR REZONING APPLICATION
5	OCT 13. 2022	ISSUED FOR CITY REVIEW
6	JUN 30, 2023	ISSUED FOR DEVELOPING PERMIT
7	NOV 8, 2023	ISSUED FOR ADP
8	APR 25, 2024	ISSUED FOR DP BOARD SUBMISSION

Reference Studio

STAMP: DP 21-945917 April 25, 2024 Plan # 38

PROJECT NAME:

6851-6871 ELMBRIDGE WAY RICHMOND, BC CANADA

DRAWING TITLE:

LEVEL 6 PLANTING PLAN

PFS PROJECT NUMBER: DATE; 04/25/2024 20013 DRAWN BY: CHECKED BY: JL/JR/JGC JS SCALE:

DWG. NO .:





PROJECT TEAM:

ARCHITECT Arno Matis Architecture 204 - 1540 West 2nd Ave Vancouver, BC V6J 1H2

ARCHITECT Arcadis IBI Group Suite 700 - 1285 West Pender Street Vancouver, BC CA V6E 4B1

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6	JUN 30, 2023	ISSUED FOR DEVELOPING PERMIT
7	NOV 8, 2023	ISSUED FOR ADP
8	APR 25, 2024	ISSUED FOR DP BOARD SUBMISSION

DP 21-945917 April 25, 2024 Plan # 39

PROJECT NAME:

STAMP:


6851-6871 ELMBRIDGE WAY RICHMOND, BC CANADA

DRAWING TITLE: LEVEL 8

PLANTING PLAN

PFS PROJECT NUMBER:	DATE:
20013	04/25/2024
DRAWN BY:	CHECKED BY:
JL/JR/JGC	JS
SCALE:	

DWG. NO.:

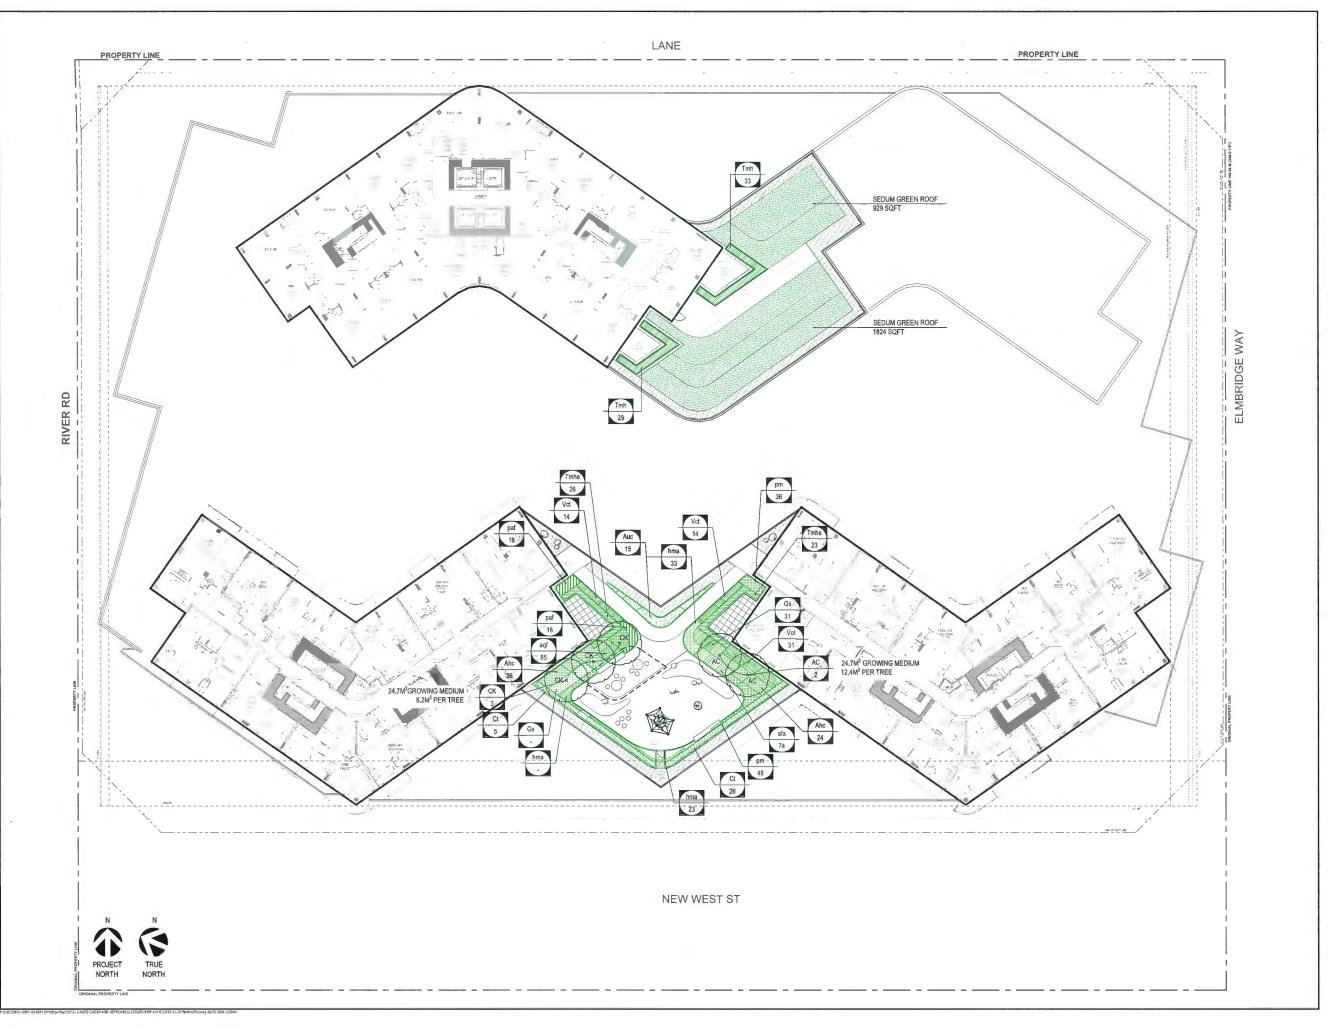





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7	NOV 8, 2023	ISSUED FOR ADP
8	APR 25, 2024	ISSUED FOR DP BOARD SUBMISSION

WEPFS STUDIO

STAMP:

DP 21-945917 April 25, 2024 Plan # 40

PROJECT NAME:

6851-6871 ELMBRIDGE WAY RICHMOND, BC CANADA

DRAWING TITLE:

PLANTING PLAN

PFS PROJECT NUMBER: 20013	DATE: 04/25/2024
DRAWN BY:	CHECKED BY:
JL/JR/JGC	JS

DWG. NO .:







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6	JUN 30, 2023	ISSUED FOR DEVELOPING PERMIT
7	NOV 8, 2023	ISSUED FOR ADP
8	APR 25, 2024	ISSUED FOR DP BOARD SUBMISSION

PLANNING - URBAN DESIGN - LANDSCAPE ARCHITECTURE

STAMP:

DP 21-945917 April 25, 2024 Plan # 41

PROJECT NAME:

6851-6871 ELMBRIDGE WAY RICHMOND, BC CANADA

DRAWING TITLE: ROOFTOP

PLANTING PLAN

PFS PROJECT NUMBER: 20013	DATE: 04/25/2024
DRAWN BY:	CHECKED BY:
JL/JR/JGC	JS
SCALE:	

DWG. NO .:

PLANT SCHEDULE KEY OTY BOTANICAL NAME

STRE	ET TREES			
AR	12	ACER RUBRUM ' OCTOBER GLORY'	OCTOBER GLORY RED MAPLE	7CM CAL. 8&8, UNIFORM SIZE AND OLTY
QC	14	QUERCUS COCCINEA	SCARLET OAK	7CM CAL. B&B, UNIFORM SIZE AND QLTY
ON SI	TE TREES	- EVERGREEN		
COG	2	CHAMAECYPARIS OBTUSA 'GRACILLIS'	GRACILLIS JAPANESE FALSE CYPRESS	2" HT, B&B SPECIMEN.
CYJ	4	CRYPTOMERIA JAPONICA BLACK DRAGON	BLACK DRAGON JAPANESE CEDAR	8' HT. B&B SPECIMEN.
PCC	2	PINUS CONTORTA VAR, CONTORTA	SHORE PINE	12' HT, 6' WIDTH (MIN.)
PPB	3	PINUS PARMFLORA BERGMANII	BERGMANII JAPANESE WHITE PINE	8' HT, WOOD CRATE, HAND-SCULPTED
ON SI	TE TREES	- DECIDUOUS		
àC	2	ACER CIRCINATUM	VINE MAPLE	8' HT B&B MULTI-STEMMED (3 MIN.) FULL
AO	10	ACER PALMATUM 'OSAKAZUKI'	OSAKAZUKI JAPANESE MAPLE	12' HT. B&B, MULTI-STEMMED (3 MIN) FULL.
ASA	2	ACER SHIRASAWANUAI AUREUM	GOLDEN FULL MOON MAPLE	5' HT, B&B, MULTI-STEMMED (3 MIM)
BNH	9	BETULA NIGRA 'HERITAGE'	HERITAGE RIVER BIRCH	12' HT, B&B, MULTI-STEMMED (3 MIN.) FULL
CKC	12	CORNUS KOUSA VAR, CHINENSIS	CHINESE FLOWERING DOGWOOD	7CM CAL, B&5, FULL UNIFORM SIZE & QUALITY
L C C J	3	CORNUS CONTROVERSA 'JUNE SNOW	JUNE SNOW DOGWOOD TREE	6CM CAL, B&B. SPECIMEN QUALITY, STRAIGHT CLEAR TRUNK.
CJ	2	CERCIDIPHYLLUM JAPONICA	KATSURA TREE	7CM CAL, B&B, UNIFORM SIZE AND OLTY
CV	6	CORNUS VENUS	DOGWOOD	7CM CAL B&B.
GBP	8	GINKGO BILOBA 'PRINCETON SENTRY'	PRINCETON SENTRY MAIDENHAIR TREE	6CM CAL 88B, UNIFORM SIZE, 6' HEIGHT CLEAR TRUNK
MSR	2	MAGNOLIA STELLATA 'ROYAL STAR'	STAR MAGNOLIA	5°HT, WB MULITISTEM, FULL
PΥ	14	PRUNUS X YEDGENSIS 'AKEBONO'	AKEBONO YOSHINO CHERRY	7cm CAL., W.B. FULL 6'HT CLEAR TRUNK
SJ	В	STYRAX JAPONICUS 'SNOW CONE:	SNOW CONE JAPANESE SNOWBELL	2CM CAL. B&B, SPECIMEN QUALITY, STRAIGHT CLEAR TRUNK.
SW	4	STEWARTIA PSEUDOCAMELLIA	JAPANESE STEWARTIA	7CM CAL. B&B E'MIN, STANDARD MATCHING, FULL

COMMON NAM

SIZE & DESCRIPTION

PLANTING NOTES:

- ALL PLANT MATERIAL SHALL BE IN ACCORDANCE WITH B.C.S.L.A./ B.C.N.T.A. STANDARDS. ALL TURN INVERTIGATION OF INTERCENT OF A DUBLICATION OF ADUBLICATION OF ADUBLICATION OF ADUBLICATION OF ADUBICATION O INSTALLATION OF STREETSCAPE SHALL BE UNDER SUPERVISION OF THE CITY OF RICHMONO 3. PARKS DEPARTMENT. SETBACKS FOR STREET TREE PLANTING. TREES SHALL NOT BE PLANTED WITHIN: 6,0m FROM STREET LIGHTS 2.0m FROM CATCH BASINS
 - 8.0m FROM STREET INTERSECTIONS 3,0m FROM HYDRANTS
 - 2.0m FROM MANHOLES 2.0m FROM DRIVEWAYS

LAUTO CARDO AND AND IN ALL A

C73-25-16 DP arcs D 20913 - L100 Plytern Plances Apr24 2824 - 1822b

- 2.0m FROM KJOSKS
- 22 MIT HOLE NOT MEETING AND LANTED AREAS SHALL BE TOP ORESSES WITH A MINILUM SOMM (2) ORGANIC MUCH LAYER, AS PER SPECIFICATIONS. AUTOMATIC IRRIGATION SHALL BE INSTALLED FOR ALL SOFT LANDSCAPING IN PROPERTY.
- ADEQUATE SUB-SURFACE ORANAGE SHALL BE INSTALLED FOR ALL PLANTED AREAS. THE LOCATION, SPACING, AND SPECIES OF THE PROPOSED STREET TREE ARE SUBJECT TO REVIEW AND APPROVAL IN THE SERVICING AGREEMENT PROCESS.

KEY QTY BOTANICAL NAME COMMON NAME SVERGREEN SHRUBS And 373 AZALEA JAPONICA 'HINO CRIMSON' EVERGRE #### 2000 Asp 3:3 AZALEA GUMPO PINK' Asc 15 ARBUTUS UNEDO COMPACTA Qd 72 CHOISYA - DEWITTEANA AZTEC PEARL' GUMPO PI DWARF S MEXICAN Cok 5 CHAMAECYPARIS OBTUSA KOSTERI Ci 264 CHOISYA TERNATA KOSTER MEXICAN SALA! WITCH HA VUINSTEA Lindope Muscari Big Blue Lindope Blue RIG RI UNI PRIVET H LOLITAP Rbb 68 RHODODENDRON BRUCE BRETCHBILL' BRUCE BR Shh 364 SARCOCOCCA HOOKERIANA v. HUMILIS SWEET BO Tan 142 TAXUS CUSPIDATA MONLOO EMERALD Timd 148 TAXUS X MEDIA DENSIFORMIS' 'Tmh 862 TAXUS X MEDIA HICXSI' 'Tmhs 49 TAXUS X MEDIA HICXDIE' DENSE YE HICK'S YEV HM EDDIE 8 Va 28 VACCINUM CORYMBOSUM TOP HAT TOP HAT S Vat 31 VACCINIUM OVATUM THUNDERBIRD'

DECIDUOUS SHRUBS

 Jackboolds Shrees
 Jackboolds Shrees

 ISN
 112
 BERERIS THUNBERGIK ROYAL EURGUNDY

 ISN
 HIP
 81

 HIP
 81
 HYDRANGEA PANCULATA LITTLE QUCK FREE

 Impli
 6
 HYDRANGEA PANCULATA LINE LIGHT

 Impli
 6
 HYDRANGEA PANCULATA LINE LIGHT

 Impli
 61
 HYDRANGEA PANCULATA LINE LIGHT

(va) Vps 4 VIBURNUAI PLICATUM SUMMER SNOWFLAKE

 Rsp
 43
 RDSA IMEIRACENA' PP 28,790

 Image: Signal State Sta

EVERGREEN AZALEA	#3 POT 24" O.C.
GUMPO PINK AZALEA	#3 POT 24" O.C.
DWARF STRAWBERRY TREE	#5 POT FULL 36" D.C.
MEXICAN ORANGE 'AZTEC PEARL'	\$3 PDT, FULL, 36" D.C.
KOSTER HINOKI CYPRESS	5' HT, B&B
MEXICAN ORANGE	\$3 POT. 36" O.C.
SALAL	#1 POT 18" O.C.
WITCH HAZEL	#3 POT
MUNSTEAD BLUE ENGLISH LAVENDER	#1 POT 18" O.C.
BIG BLUE LILY TURF	#1 POT, 12" 0.C.
PRIVET HONEYSUCKLE	#3 POT 24" 0.C
LOLITA PORTUGUESE LAUREL	47 POT 4'HT
BRUCE BRETCHBILL RHODODENDRON	#5 POT 35" O.C.
SWEET BOX	#3 POT FULL 16" O.C.
EMERALD CARPET SPREADING YEW	#3 POT FULL 16" O.C.
DENSE YEW	#3 PDT_FULL_24" O.C.
HICK'S YEW - MALE	5'HT, FIELD GROWN 15" O.C., FULL, PRIVACY HEDGE
HM EDDIE FASTIGIATE YEW	5' HT. B&B, 2' O.C.
TOP HAT EDIBLE BLUEBERRY	#2 POT. 24* O.C.
THUNDERBIRD EVERGREEN HUCKLEBERRY	#2 POT 24" O.C.

SIZE & DESCRIPTION

ROYAL BURGUNDY JAPANESE BARBERRY	#3 POT 24" O.C.
LITTLE QUICK FIRE PANICLE HYDRANGEA	#3 POT 36" O.C.
HYDRANGEA PANICULATA 'LIME LIGHT'	#3 POT_STANDARD
LITTLE HENRY SWEETSPIRE	#3 POT FULL 35" O.C.
ICECAP LANDSCAPE ROSE	#2 POT 24" O.C.
LITTLE PRINCESS JAPANESE SPIREA	\$3 POT FULL 24" O.C.
SUMMER SNOWFLAKE VIEURNUM	\$7 POT

GRUNSSES GROUNDCOVERS AND PERENNIALS 74 ASTILBE X ARENDSII 'FANAL' afa pocod aqf 85 ADULEGIA FORMOSANA cak 544 CALAMOGROSTIS ACUIFOLIA KARL FOERSTER' 422 CHASMANTHIUM LATIFOLIUM 818 CAREX MORROWELICE DANCE' 432 FESTUCA OVINA 'GLAUCA' tog 479 HAKONECHLOA MACRA hm hma⁴ 670 HAKONECHLOA MACRA 'AUREOLA' je 763 JUNCUS EFFUSUS 1770 LIRIOPE MUSCARE BIG BULE Im Im MISCANTHUS SINENSIS MALEPARTUS msrⁿ 69 MISCANTHUS SINENSIS 'YAKU JIMA' msy 135 PENNISETUM ALOPECUROIDES 'HAMELN' poo pah PERSICARIA AFFINE 'DIMITY' 334 Deg minin paf 357 PERSICARIA AMPLEXICAULE FIRETAIL POLYSTICHUM MUNITUM 811 st 258 STIPA TENUISSIMA

KEY QTY BOTANICAL NAME



GREEN ROOF PLANT SCHEDULE

SEDUM HYBRIDUM 'IMMERGRUNCHEN', SEDUM MIDDENDORF, DIFFUSUM. SEDUM TETRACTINUM 'CORAL REEF' SEDUM ALBUM 'GREEN ICE' SEDUM SPURIUM 'JOHN CREECH' SEDUM SPURIUM 'ALBUM SUPERBUM SEDUM SEXANGULARE SEDUM HYBRIDUM 'IMMERGRUNCHEN' SEDUM REFLEXUM 'BLUE SPRUCE' SEDUM SICHOTENSE

CLIENT:



PROJECT TEAM:

ARCHITECT Arno Matis Architecture 204 - 1540 West 2nd Ave Vancouver, BC V6J 1H2

ARCHITECT Arcadis IBI Group Suite 700 - 1285 West Pender Street Vancouver, BC CA V6E 4B1

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5	OCT 13, 2022	ISSUED FOR CITY REVIEW
6	JUN 30, 2023	ISSUED FOR DEVELOPING PERMIT
7	NOV 8. 2023	ISSUED FCR ADP
8	APR 25, 2024	ISSUED FOR OP BOARD SUBMISSION
		-

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DP 21-945917 April 25, 2024 Plan#42

PROJECT NAME:

STAMP:

6851-6871 ELMBRIDGE WAY RICHMOND, BC CANADA

DRAWING TITLE:

MASTER PLANT LIST


20013 CT NUMBER	04/25/2024
DRAWN BY: JL/JR/JGC	CHECKED BY: JS
SCALE:	

DWG. NO .:

L4.06

SIZE & DESCRIPTION

	#1 POT 12" O.C.
	10CM POT, 12" O.C.
	\$1 POT 18" O.C.
	#1 PQT_18" 0.C.
	\$1 POT 12" O.C.
	#1 POT, 12" O.C .
	#1 POT. FULL 16" O.C.
GRASS	#1 POT FULL 15" O.C.
	#1 POT 15" O.C.
	#1 POT 12" 0.C.
	#1 POT 24" O.C.
	#1 POT 24" O.C.
	#1 POT 24" O.C.
	10CM POT, 12" O.C.
.OWER	#1 POT 18" O.C
	#1 POT. 15" O.C.
	#2 POT FULL 3 18" O.C.

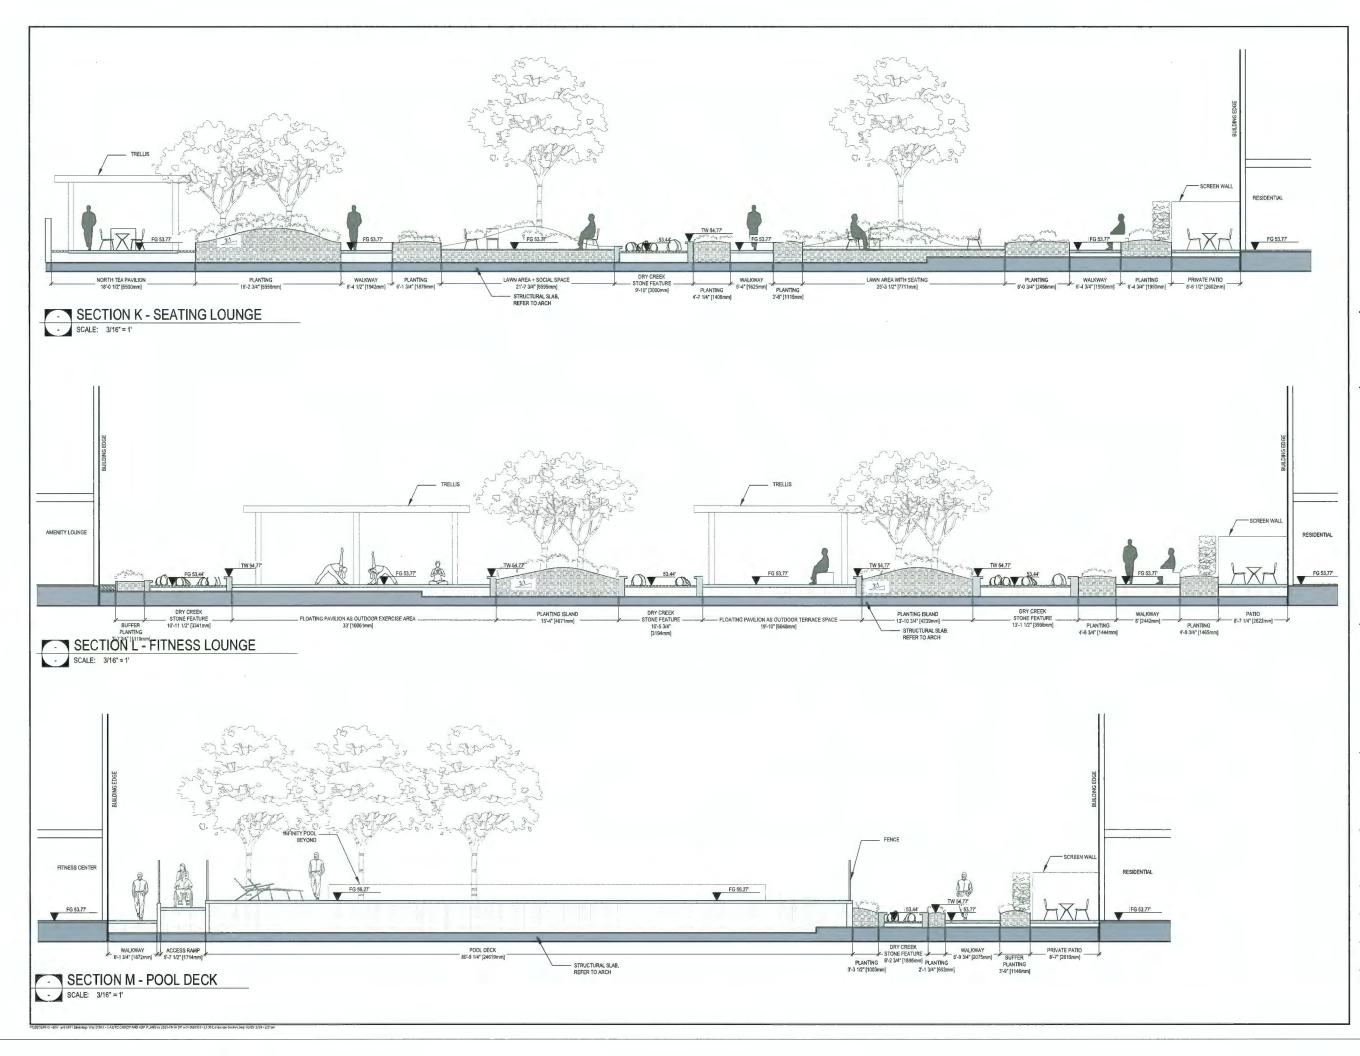



PROJECT TEAM:

ARCHITECT Arno Matis Architecture 204 - 1540 West 2nd Ave Vancouver, BC V6J 1H2

ARCHITECT Arcadis IBI Group Suite 700 - 1285 West Pender Street Vancouver, BC CA V6E 4B1

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8	APR 25, 2024	ISSUED FOR DP BOARD SUBMISSION

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STAMP:

DP 21-945917 April 25, 2024 Plan # 43

PROJECT NAME:

6851-6871 ELMBRIDGE WAY RICHMOND, BC CANADA


DRAWING TITLE:

PODIUM LANDSCAPE SECTIONS

PFS PROJECT NUMBER:	DATE:
20013	04/25/2024
DRAWN BY:	CHECKED BY:
JL/JR/JGC	JS
SCALE: 3/16" = 1'	

DWG. NO .:

L7.04

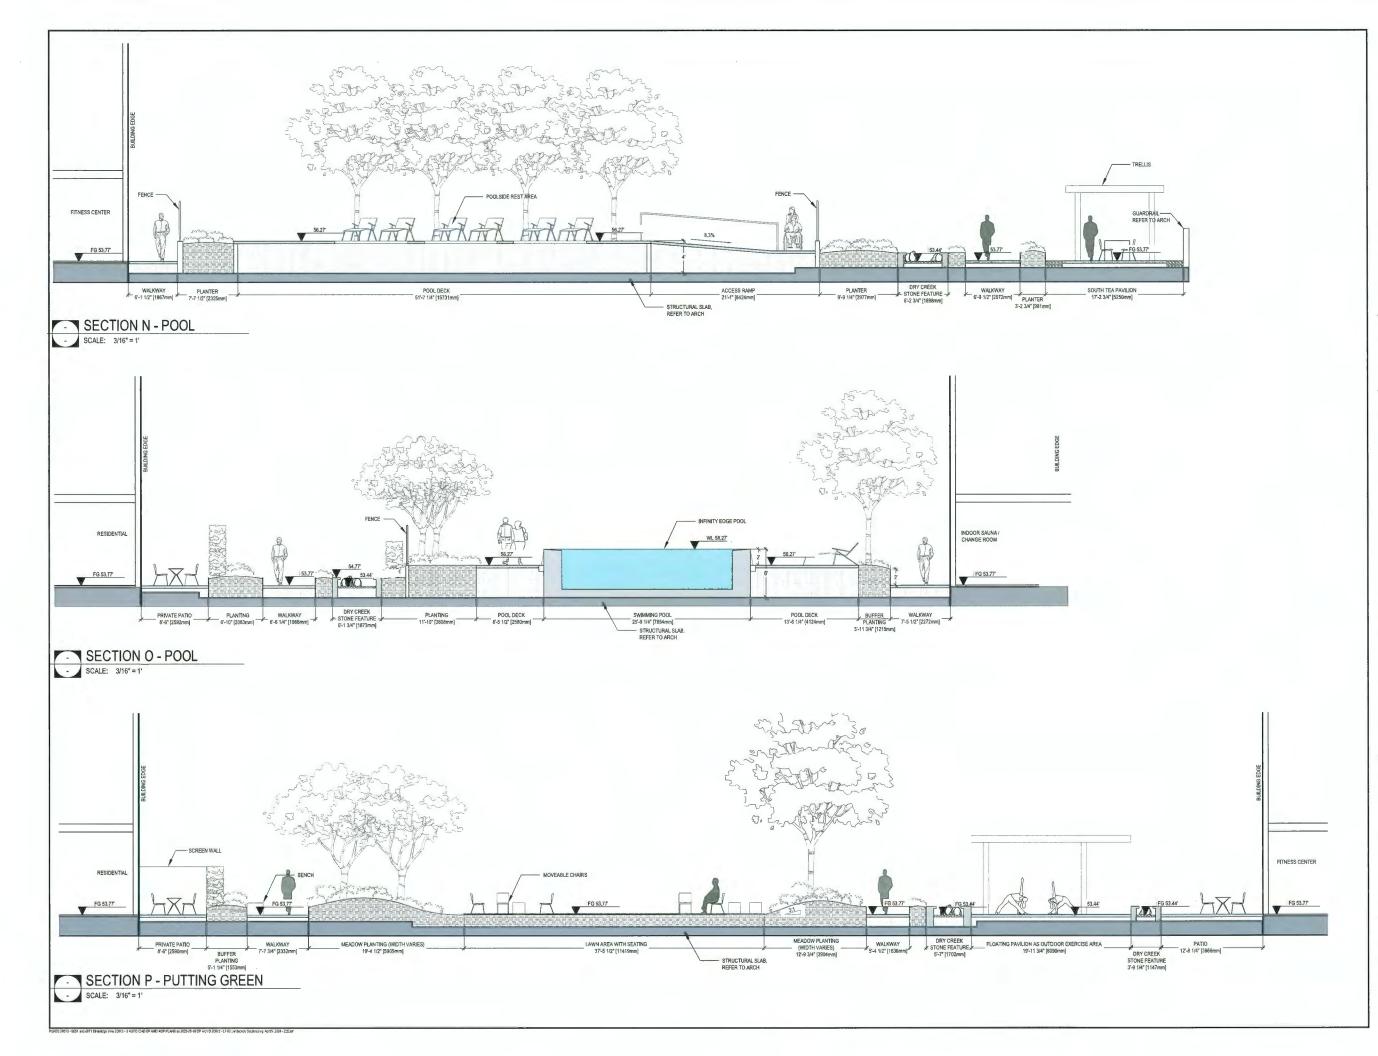



PROJECT TEAM:

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8	APR 25, 2024	ISSUED FOR DP BOARD SUBMISSION

STAMP:

DP 21-945917 April 25, 2024 Plan # 44

PROJECT NAME:

6851-6871 ELMBRIDGE WAY RICHMOND, BC CANADA


DRAWING TITLE:

PODIUM LANDSCAPE SECTIONS

PFS PROJECT NUMBER:	DATE:
20013	04/25/2024
DRAWN BY:	CHECKED BY:
JL/JR/JGC	JS
SCALE: 3/16" = 1'	

DWG, NO .:

L7.05

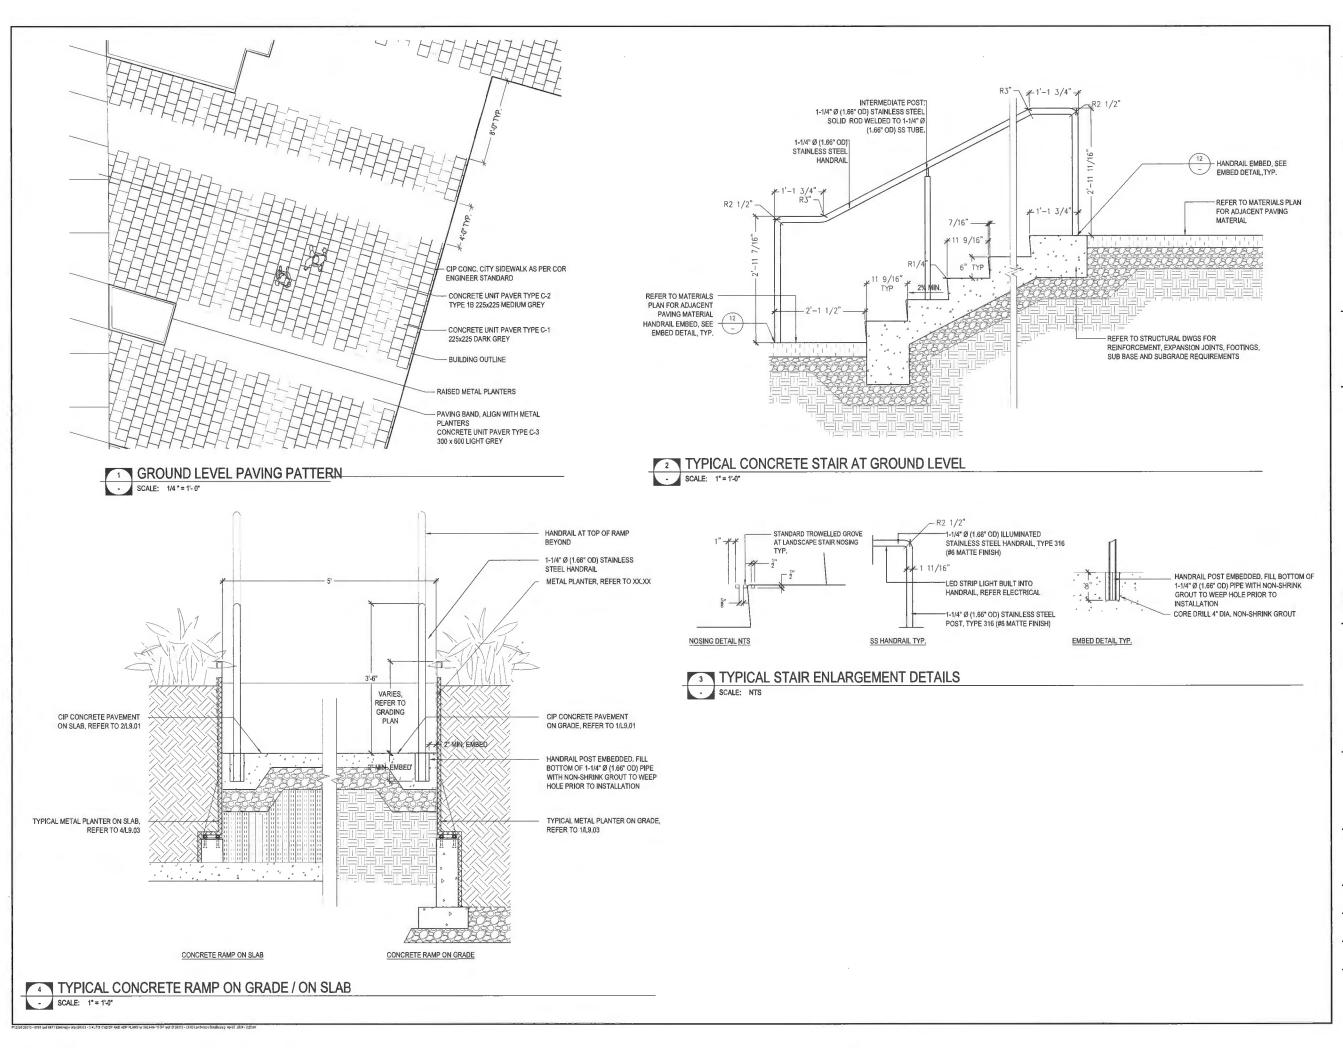



PROJECT TEAM:

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8	APR 25, 2024	ISSUED FOR DP BOARD SUBMISSION

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DP 21-945917 April 25, 2024 Plan # 45

PROJECT NAME:


6851-6871 ELMBRIDGE WAY RICHMOND, BC CANADA

DRAWING TITLE:

LANDSCAPE DETAILS STAIR & RAMP

PFS PROJECT NUMBER: DATE: 20013 DATE: 04/25/2024 DRAWN BY: CHECKED BY: JL/JR/JGC JS SCALE: AS SHOWN

DWG. NO .:

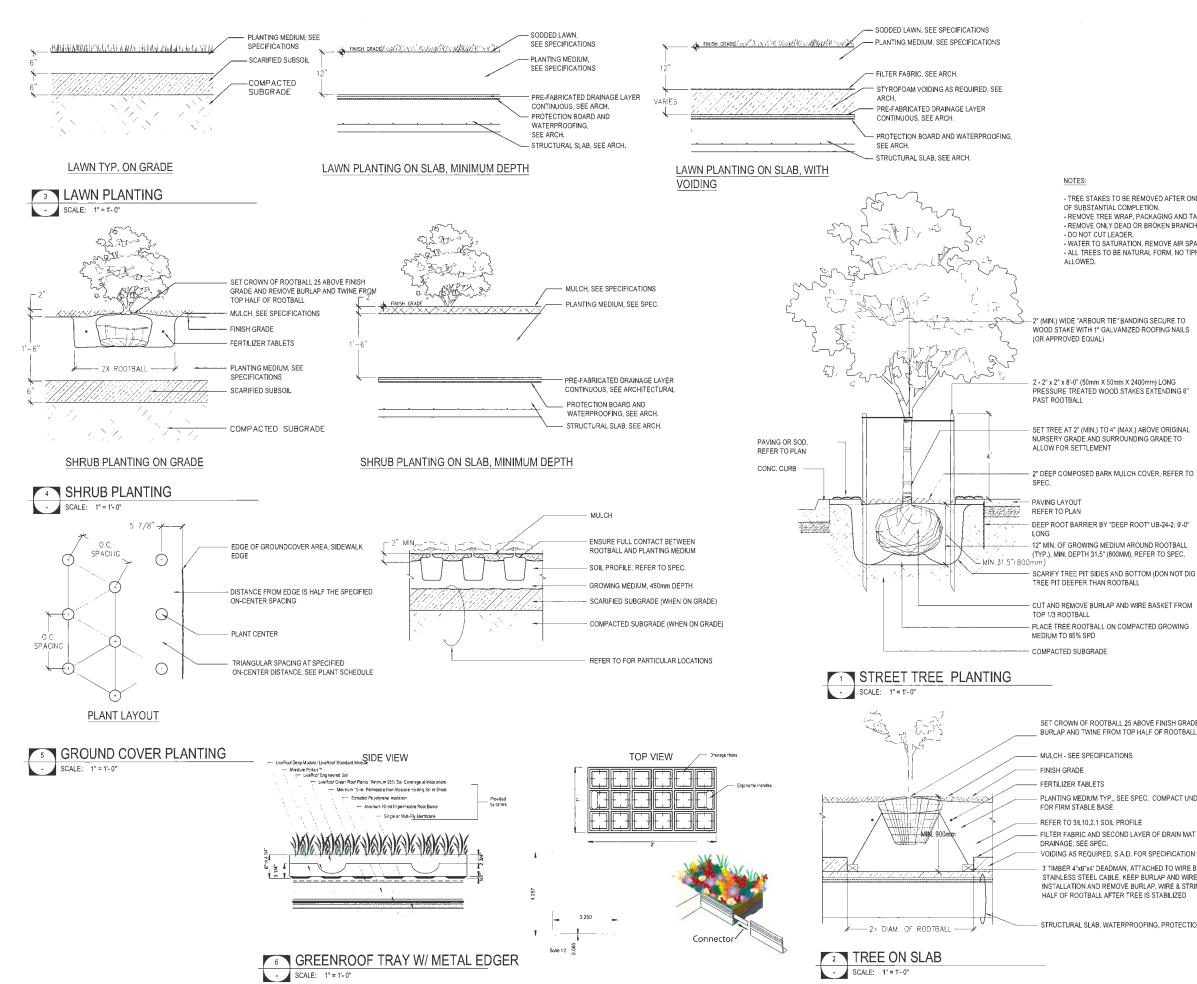

- TREE STAKES TO BE REMOVED AFTER ONE FULL YEAR FROM TIME OF SUBSTANTIAL COMPLETION.

REMOVE TREE WRAP, PACKAGING AND TAGS AT TIME OF STAKING.
 REMOVE ONLY DEAD OR BROKEN BRANCHES.

- WATER TO SATURATION, REMOVE AIR SPACE WITH SOIL PORES. - ALL TREES TO BE NATURAL FORM, NO TIPPING, SHEARING

SET CROWN OF ROOTBALL 25 ABOVE FINISH GRADE AND REMOVE BURLAP AND TWINE FROM TOP HALF OF ROOTBALL

PLANTING MEDIUM TYP., SEE SPEC. COMPACT UNDER ROOTBALL

FILTER FABRIC AND SECOND LAYER OF DRAIN MAT TO ENSURE

TIMBER 4"x6"x4' DEADMAN, ATTACHED TO WIRE BASKET W STAINLESS STEEL CABLE, KEEP BURLAP AND WIRE BASKET FOR INSTALLATION AND REMOVE BURLAP, WIRE & STRING FROM TOP

STRUCTURAL SLAB, WATERPROOFING, PROTECTION BOARD, S.A.D.

CLIENT:



PROJECT TEAM:

ARCHITECT Arno Matis Architecture 204 - 1540 West 2nd Ave Vancouver, BC V6J 1H2

ARCHITECT Arcadis IBI Group Suite 700 - 1285 West Pender Street Vancouver, BC CA V6E 4B1

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APR 25, 2024	ISSUED FOR DP BOARD SUBMISSION
	JUN 64, 2021 DEC 21, 2021 APR 8, 2021 AUG 29, 2022 OCT 13, 2022 JUN 30, 2023 NOV 8, 2023

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STAMP: DP 21-945917 April 25, 2024 Plan # 46

PROJECT NAME:


6851-6871 ELMBRIDGE WAY RICHMOND, BC CANADA

DRAWING TITLE:

LANDSCAPE DETAILS PLANTING

PFS PROJECT NUMBER:	DATE:
20013	04/25/2024
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JL/JR/JGC	JS
SCALE: AS SHOWN	

DWG. NO.:

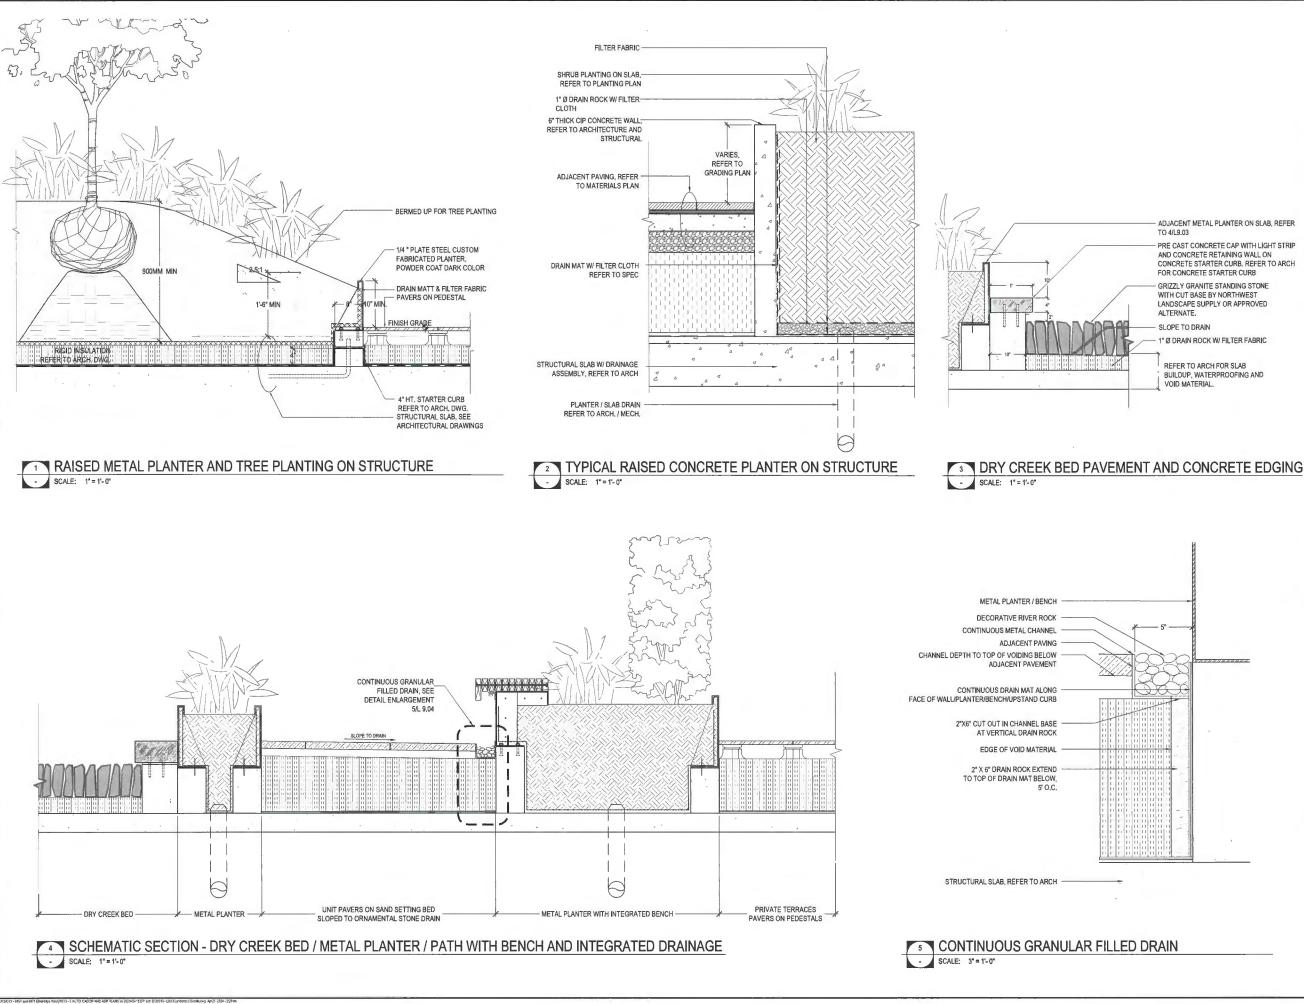



PROJECT TEAM:

ARCHITECT Arno Matis Architecture 204 - 1540 West 2nd Ave Vancouver, BC V6J 1H2

ARCHITECT Arcadis IBI Group Suite 700 - 1285 West Pender Street Vancouver, BC CA V6E 4B1

LANDSCAPE ARCHITECT PFS Studio 1777 West 3rd Avenue Vancouver, BC V6J 1K7

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8	APR 25, 2024	ISSUED FOR DP BOARD SUBMISSION

PLANNING - URBAN DESIGN - LANDSCAPE ARCHITECTURE

STAMP: DP 21-945917 April 25, 2024 Plan # 47

PROJECT NAME:


6851-6871 ELMBRIDGE WAY RICHMOND, BC CANADA

DRAWING TITLE:

LANDSCAPE DETAILS PLANTERS

PFS PROJECT NUMBER:	DATE:
20013	04/25/2024
DRAWN BY:	CHECKED BY:
JL/JR/JGC	JS
SCALE: AS SHOWN	

DWG. NO .:

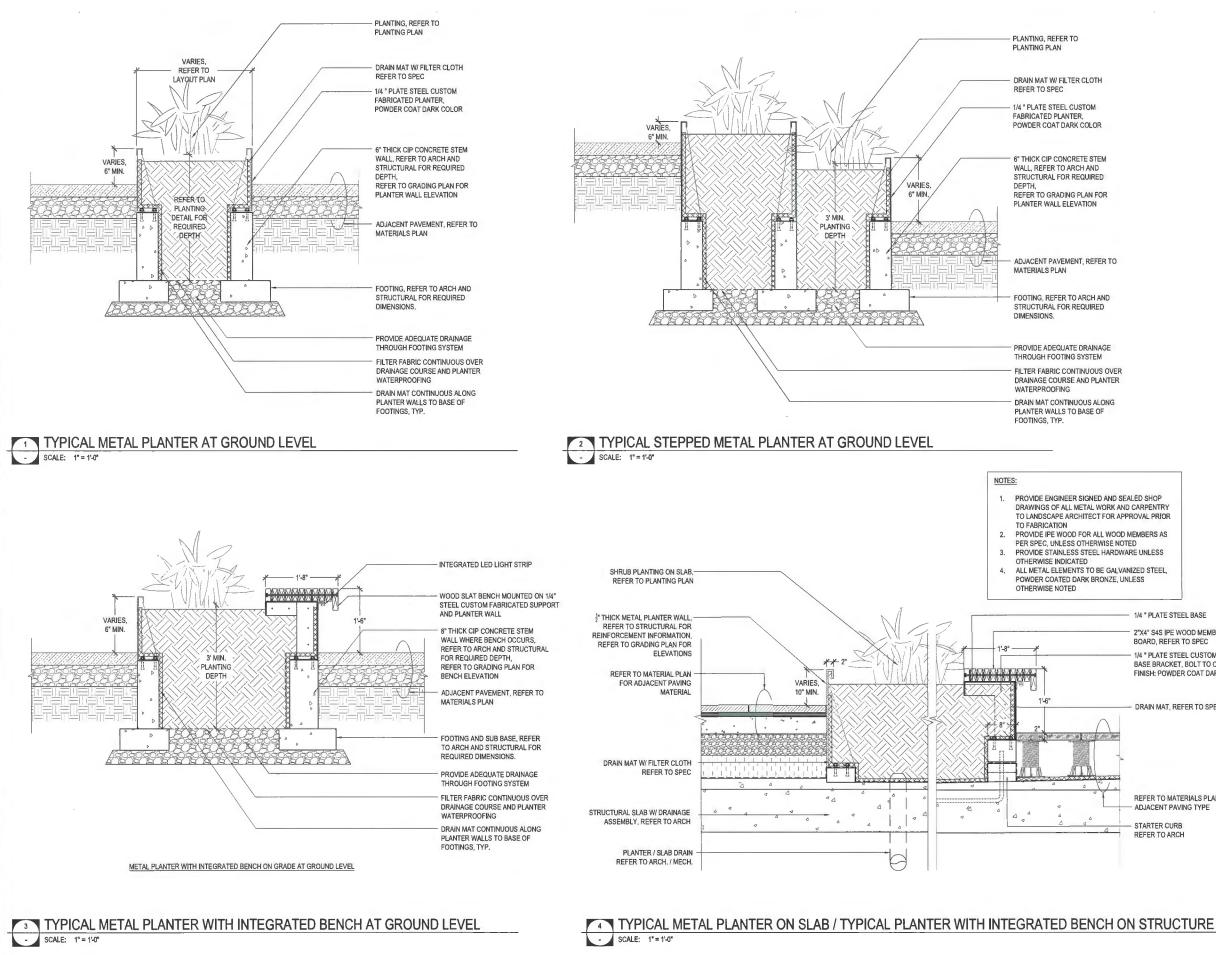

1/4 * PLATE STEEL BASE

2"X4" S4S IPE WOOD MEMBER, 2"X6" FRONT **BOARD, REFER TO SPEC**

1/4 " PLATE STEEL CUSTOM FABRICATED BASE BRACKET, BOLT TO CONC. CURB, FINISH: POWDER COAT DARK BRONZE COLOR

DRAIN MAT, REFER TO SPEC

REFER TO MATERIALS PLAN FOR ADJACENT PAVING TYPE

STARTER CURB REFER TO ARCH

CLIENT:



PROJECT TEAM:

ARCHITECT Arno Matis Architecture 204 - 1540 West 2nd Ave Vancouver, BC V6J 1H2

ARCHITECT Arcadis IBI Group Suite 700 - 1285 West Pender Street Vancouver, BC CA V6E 4B1

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DP 21-945917 April 25, 2024 Plan # 48

PROJECT NAME:

6851-6871 ELMBRIDGE WAY RICHMOND, BC CANADA


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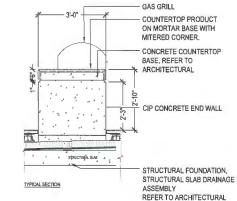
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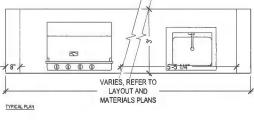
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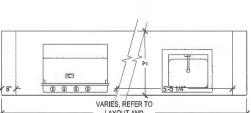







ROOF DETAILS




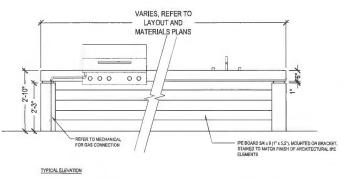

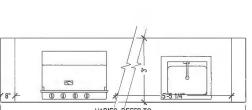


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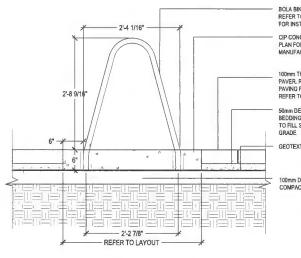


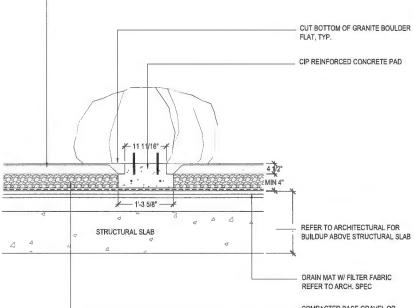


RUBBERIZED PLAYGROUND SURFACE BY LANDSAFE OR APPROVED EQUAL

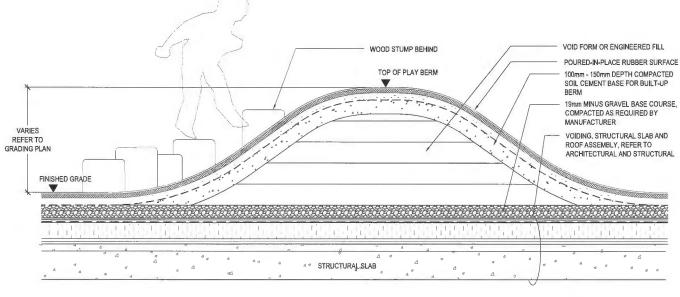


RUBBER BERM @ L9 PLAYGROUND - SCALE: 1"=1'-0"



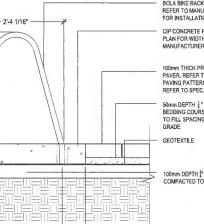



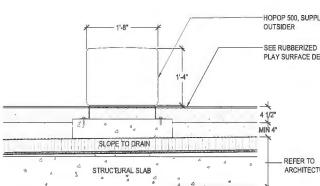


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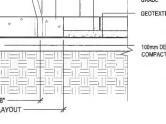
BIKE RACK









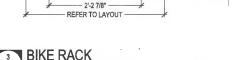





BOLA BIKE RACK. STAINLESS STEEL FINISH. REFER TO MANUFACTURER REQUIREMENTS FOR INSTALLATION

CIP CONCRETE PAD, REFER TO LAYOUT PLAN FOR WIDTH/LENGTH, REFER TO MANUFACTURER FOR REQUIRED DEPTH

100mm THICK PRE-CAST CONCRETE UNIT PAVER. REFER TO DWG 2/L9.02 FOR PAVING PATTERN

50mm DEPTH 1/2 * CLEAR CRUSH OPEN-GRADED BEDDING COURSE TO FILL SPACING TO MIN. 30mm BELOW FINISHED GRADE

100mm DEPTH \$ CLEAR CRUSH SUB-BASE COMPACTED TO 95% MPD

HOPOP 500, SUPPLIED BY

PLAY SURFACE DETAILS

REFER TO ARCHITECTURAL CLIENT:



PROJECT TEAM:

ARCHITECT Arno Matis Architecture 204 - 1540 West 2nd Ave Vancouver, BC V6J 1H2

ARCHITECT Arcadis IBI Group Suite 700 - 1285 West Pender Street Vancouver, BC CA V6E 4B1

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DP 21-945917 April 25, 2024 Plan #49

PROJECT NAME:

6851-6871 ELMBRIDGE WAY RICHMOND, BC CANADA


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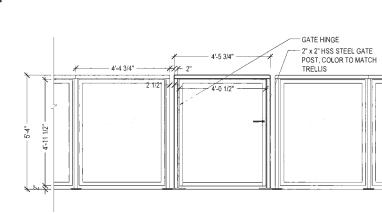
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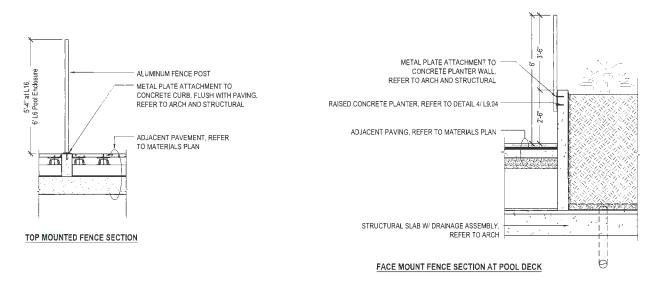




TYPICAL FENCE AND GATE ELEVATION - L16 SCALE: 1/2" = 1'- 0"



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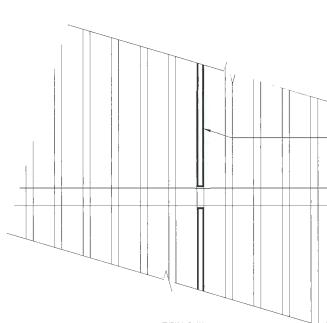
NOTES:

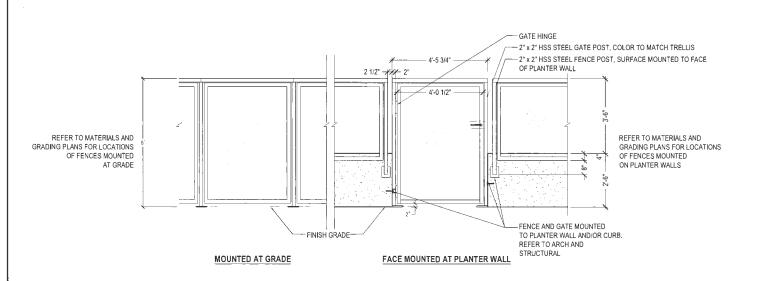1, REFER TO ARCHITECTURAL AND STRUCTURAL FOR REINFORCING DETAILS AND FOOTING DESIGN.


2. FENCE, GATE AND TRELLIS FABRICATOR TO PROVIDE ENGINEER STAMPED SHOP DRAWINGS FOR TRELLIS AND FENCE DETAILS FOR CONSULTANTS APPROVAL PRIOR TO FABRICATION.

3. FENCE AND GATE COLOR TO MATCH TRELLIS, RAL COLOR TO BE DETERMINED. PROVIDE COLOR SAMPLE FOR CONSULTANT'S APPROVAL PRIOR TO FABRICATION

4. SITE MEASURE DIMENSIONS OF EXISTING SITE CONDITIONS INCLUDING GLASS RAILING, SITE GRADING AND PLANTER WALL DIMENSIONS PRIOR TO FABRICATION. ADJUST FENCING AND TRELLIS DESIGN WHERE REQUIRED IN SHOP DRAWINGS TO FIT STRUCTURES TO EXISTING SITE CONDITIONS.





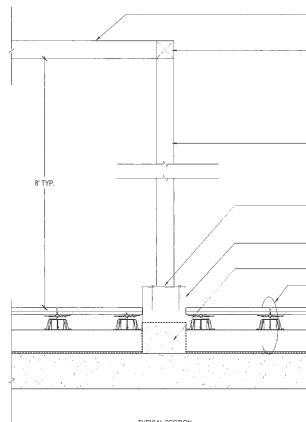

TYPICAL SECTION

4 TYPICAL TRELLIS STRUCTURE SECTION AND PLAN - L6 TEA PAVILLION - SCALE: 1" = 1-0"



TRELLIS BEAM W/ LED LIGHT STRIP HOUSING, REFER TO ENLARGEMENT A

5 x 5" ALUMINUM TRELLIS MID RAIL

REFER TO LAYOUT PLANS FOR LOCATIONS AND EXTENTS OF TRELLIS STRUCTURE

2" X 5" POWDER COATED HSS TRELLIS

5" X 5" POWDER COATED ALUMINUM EDGE BEAM

5" X 5" POWDER COATED ALUMINUM POST

POWDER COATED STEEL PLATE, REFER TO ARCH AND STRUCTURAL

CONCRETE BASE FOR TRELLIS POSTS. REFER TO ARCH AND STRUCTURAL

STARTER CURB, REFER TO ARCH

ADJACENT PAVING, REFER TO MATERIALS PLAN

REFER TO ARCHITECTURAL FOR ROOF ASSEMBLY AND STRUCTURAL SLAB

CLIENT:



PROJECT TEAM:

ARCHITECT Arno Matis Architecture 204 - 1540 West 2nd Ave Vancouver, BC V6J 1H2

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PLANNING - URBAN DESIGN - LANDSCAPE ARCHITECTURE WINDOWS & URBAN DESIGN - LANDSCAPE ARCHITECTURE WWEPKbcca

STAMP: DP 21-945917 April 25, 2024 Plan # 50

PROJECT NAME:

6851-6871 ELMBRIDGE WAY RICHMOND, BC CANADA


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LANDSCAPE DETAILS **FENCE & TRELLIS**

PFS PROJECT NUMBER:	DATE:
20013	04/25/2024
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JL/JR/JGC	JS
SCALE: AS SHOWN	

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CLIENT:



PROJECT TEAM:
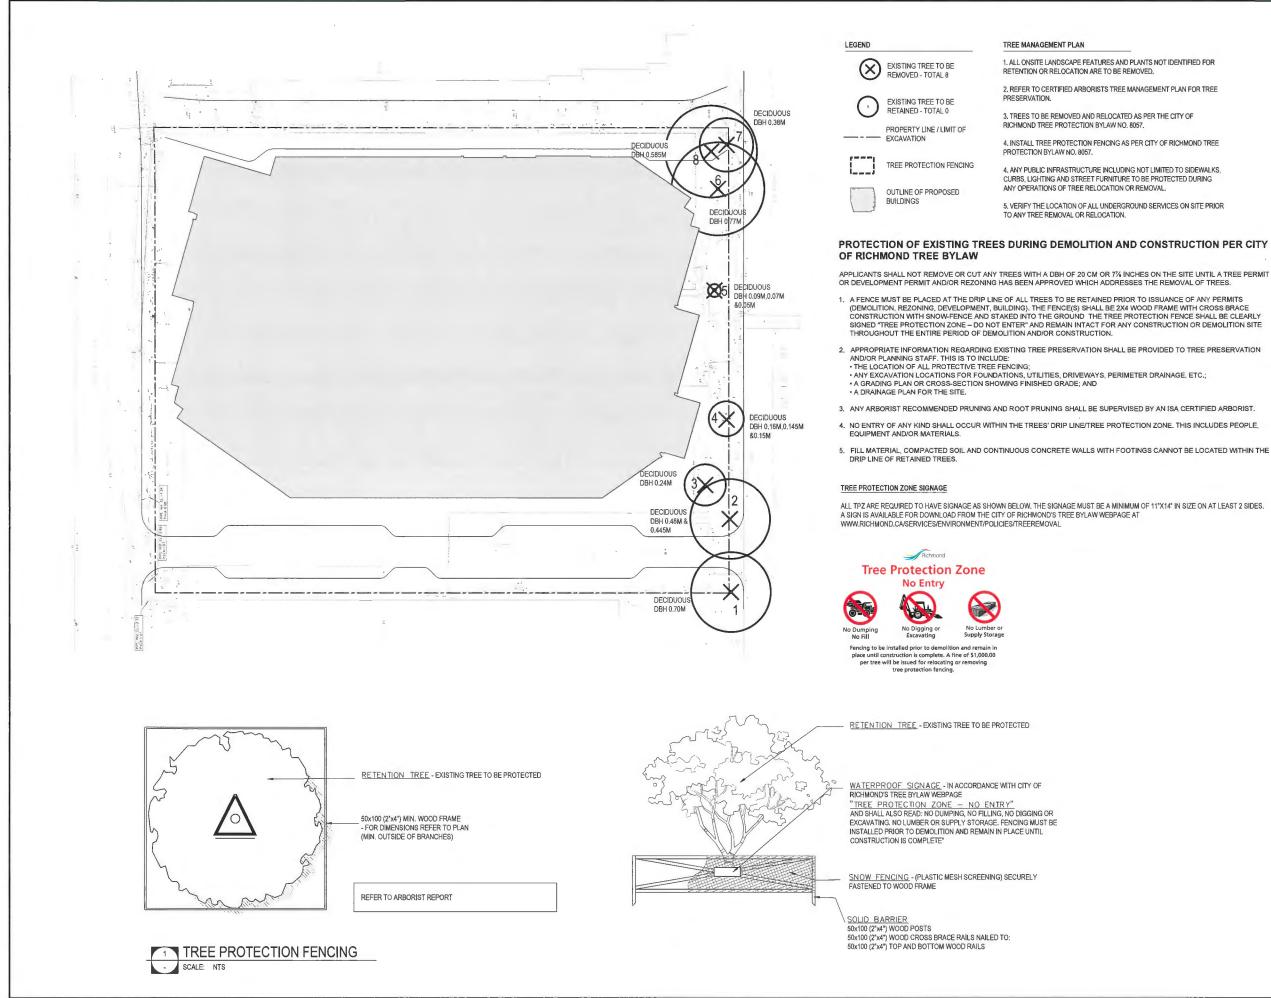
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STAMP DP 21-945917 April 25, 2024 Plan # 5

PROJECT NAME: 6851-6871 ELMBRIDGE WAY RICHMOND, BC CANADA

DRAWING TITLE: TREE MANAGEMENT

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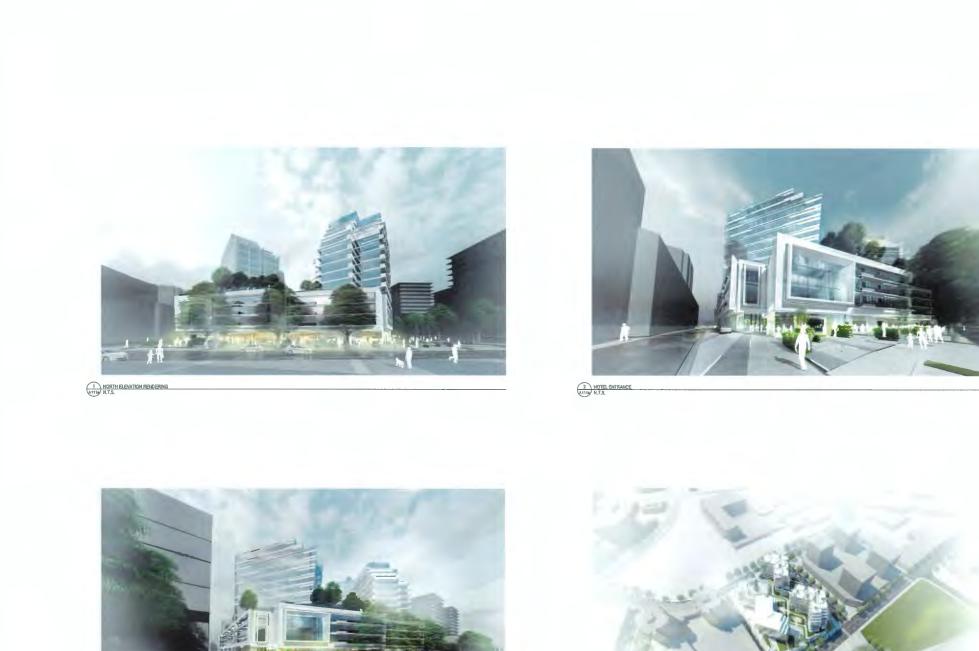
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4 SE PLAZA LOOKING NORTH


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1 PODIUM LANDSCAPE LOOKING NORTH

2 SW FLAZA LOOKING SOUTH



3 NORTH ELEVATION LOOKING EAST

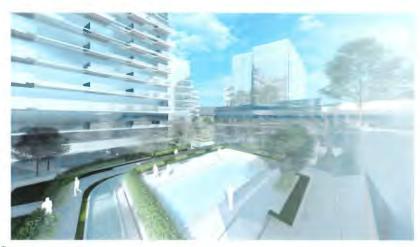

HOTEL ENTRANCE

Landa Global Properties Ltd. 1550 - 200 BURRARD ST, VANCOUVER, BC, V6C 3L6 DP BOARD SUBMISSION 2024-04-25 ΛM ARNO MATIS ARCHITECTURE 204-1540 W 2NO AVE, VANCOUVER, BC V6J 1H2 T 604.708.0188 - ML 1 KEY PLAN DP 21-945917 April 25, 2024 **Reference Plan** sensing to be a part of the sense of the balance of the part of the former of the exceeded BC. The determinance equipalities in our transmitted to part of a sense of the part of the sense of the sense of the part of the million in pro-sension is sense of the sense of the part of the sense of the part of the part of the part of the part of the sense of the part CONSIL ARCADIS 1285 West Pender Street - Sute 100 Vancouver BC V6E 181 Cenade tel 604 683 8797 www.anade.cem Elmbridge Way 6851-6871 Elmbridge Way Richmond, BC Checker APPROVED BY Approver RENDERING $\bigotimes_{F_{2r} \in F_{2r}} \bigotimes_{F_{2r} \in F_{2r}}$ ISSUE 2 A111d







Report to Development Permit Panel

To:	Development Permit Panel	
From:	Suzanne Smith Program Manager, Development	

Date: April 26, 2024 File: DP 22-008932

Re: Application by Kenneth Kim (Kenneth Kim Architecture Inc.) for a Development Permit at 6500 Cooney Road

Staff Recommendation

That a Development Permit be issued which would permit the construction of six townhouse units over a common parking structure at 6500 Cooney Road on a site zoned "Parking Structure Town Housing (ZT93) - Brighouse (City Centre)".

Suzanne Smith Program Manager, Development (604-276-4138)

SS:ta Att. 2

Staff Report

Origin

Kenneth Kim (Kenneth Kim Architecture Inc.) has applied on behalf of 1319414 B.C. Ltd., Inc. No. BC1319414 (Directors: Lei Yue and Songyun Lou) to the City of Richmond for permission to develop six townhouse units over a common parking structure at 6500 Cooney Road on a site zoned "Parking Structure Town Housing (ZT93) - Brighouse (City Centre)". The site is currently vacant.

The site is being rezoned from the "Low Density Townhouses (RTL1)" zone to "Parking Structure Town Housing (ZT93) - Brighouse (City Centre)" zone under Bylaw 10265 (RZ 08-429600) which received third reading following the Public Hearing on July 19, 2021. The subject site is located on the outer edge of the Spires Road Rental Tenure Policy Area however it is subject to instream provisions which enable it to proceed as outlined in this report.

A Servicing Agreement (SA 11-587092) is required as a condition of rezoning adoption. The Servicing Agreement includes, but is not limited to, the following improvements:

- Frontage improvement work on the site's Cooney Road and Cook Road frontage.
- The construction of a new 6.0 m public lane along the site's east property line.
- Related water, storm sewer and sanitary sewer connections to the subject site, along with public and private utility improvements.

Development Information

Please refer to attached Development Application Data Sheet (Attachment 1) for a comparison of the proposed development data with the relevant Bylaw requirements.

Background

Development surrounding the subject site is as follows:

To the North:	A 20-unit townhouse development fronting Cooney Road on property zoned "Town Housing (ZT53) – Cooney Road (Brighouse Village of City Centre)".
To the East:	A 24-unit townhouse development fronting Cook Road on property zoned "Low Density Townhouses (RTL1)".
To the South:	Across Cook Road, a single-family home on a lot zoned "Low Density Townhouses (RTL1)" which is the subject of an application to rezone to permit the development of a four storey mixed use building with office space at grade and 15 townhouse units over a parking structure. To the South East there is a 28- unit townhouse development on property zoned "Town Housing (ZT66) – Cooney Road (Brighouse Village of City Centre)".
To the West:	Across Cooney Road, a 13-unit townhouse development on property zoned "Low Density Townhouses (RTL1)".

Rezoning and Public Hearing Results

During the rezoning process, staff identified the following design issues to be resolved at the Development Permit stage:

- Compliance with Development Permit guidelines for the form and character of multiple family projects provided in the 2041 Official Community Plan (OCP) and City Centre Area Plan (CCAP), including the provision of an attractive pedestrian-oriented streetscape building design along Cooney Road.
- Review of tree replacement and protection features for the development proposal.
- Review of the shared outdoor amenity area design, including the choice of children's play equipment, to create a safe and vibrant environment for children's play and social interaction.
- Review of relevant accessibility features for the one proposed convertible unit and aging-inplace design features in all units.
- Review of sustainability strategy for the development proposal.

The Public Hearing for the rezoning of this site was held on July 19, 2021. No concerns regarding the rezoning application were expressed at the Public Hearing.

Staff Comments

The proposed scheme attached to this report has satisfactorily addressed the urban design issues and other staff comments identified as part of the review of the subject Development Permit application. In addition, it complies with the intent of the applicable sections of the Official Community Plan and is generally in compliance with the "Parking Structure Town Housing (ZT93) - Brighouse (City Centre)" zone.

Analysis

Conditions of Adjacency

- The subject site is located in the Spires Road Neighbourhood as identified in the City Centre Area Plan (CCAP). The subject site is designed for grade-oriented housing in the form of low-density townhouses with common parking structures concealed from public view. This is consistent with newer developments approved to date in the area. Future developments in the Spires neighbourhood will permit a larger height and massing under new guidelines associated with the Spires Rental Tenure Policy and OCP guidelines.
- The subject site is a small isolated site at the northeast corner of the Cooney Road and Cook Road intersection. The frontages have been designed to provide an animated interaction with both the Cooney Road and Cook Road frontages.
- A 6.0 m wide north-south rear lane dedication along the entire east property line has been secured at rezoning for the construction of an interim lane. The lane is to be widened through future development to the east and is proposed to allow for the long-term plan to provide a connection from Cook Road north to Spires Gate.
- A 1.8 m wide road dedication along the entire south property line and a 2.4 m wide road dedication along the entire west property line have been secured at rezoning.

- A 5.0 m x 5.0 m corner cut dedication at the southwest corner of the subject development site to accommodate future north-south and east-west lane intersection improvements has also been secured at rezoning.
- Additional Statuary Right-of-Ways (SRWs) have also been secured at rezoning along the Cook Road frontage and adjacent to the lane to allow the areas to be used as if it were a City street sidewalk and street respectively. The City will be responsible for the maintenance of the SRW areas.
- The building setbacks are consistent with the requirements for low-density townhouses. The existing conditions of the neighbouring properties have also been reviewed, and the setbacks from the lane and neighbouring properties have been specified accordingly.
- The development is setback 3.0 m from Cooney Road, 4.4 m from Cook Road, 0.0 m from the rear lane, and 1.5 m from the interior property line to the north.
- A low retaining wall (approximately 0.5 m in height) with a 1.52 m fence on top will be installed on the subject site along the north property line to enhance the landscaped edge of the property.
- The building's massing has been designed to minimize shadowing and overlook on neighbouring properties.
- The bulk of the top floor of the townhouse units are stepped back to minimize overlook into adjacent developments.
- The location and orientation of windows have been carefully considered to maintain privacy in the units and minimize the opportunity of overlook into adjacent developments.

Urban Design and Site Planning

- The applicant proposes to build a compact townhouse development comprising of six townhouse units at 1.2 FAR on the northeast corner of Cook Road and Cooney Road in the CCAP's Brighouse Village.
- The proposal includes individual, south-facing entries and yards along Cook Road, northfacing decks on the second floor and south-facing decks at the building's uppermost floor.
- All units have direct access to the partially enclosed parking structure, which has vehicle access to the public lane proposed along the east edge of the site.
- A 6.0 m road dedication along the entire east property line is to provide an interim lane aligned north-south parallel to Cooney Road which will be widened with future redevelopment to the east.
- Vehicle access to this townhouse project is from Cook Road. It is in the southeastern portion of the site via the proposed lane.
- Along the Cooney Road frontage, a 2.0 m sidewalk is proposed with a treed and grass boulevard designed to allow for the widening of Cooney Road to accommodate a bicycle path infrastructure in the future.

- Along Cook road, significant effort was made by staff to retain two existing trees on the City boulevard and adjacent to the lane. This includes two SRW's on portions of the site to secure movement around the trees. In addition, the 1.5 m wide sidewalk initially secured at rezoning has been increased to a 2.18 m. The sidewalk has also been relocated away from the curb, and instead, a 0.76 m grass boulevard will be located adjacent to the curb. These revisions aim to improve the accessibility of the sidewalk and safety for pedestrians.
- The proposed habitable floor elevation for the first floor is 0.3 m above the highest elevation of the highest crown of the road adjacent to the site.
- The buildings provide a well-defined street edge along both frontages.
- Along the Cook Road frontage, the proposal provides an attractive streetscape with an individual unit entry and a landscaped front yard to each of the townhouse units.
- Along the Cooney Road frontage, an entry gate with direct access to the garage level is provided, along with an accessible pathway that leads to the outdoor amenity space and another access point to garage level.
- A mailbox is proposed on the garage level by the east side entrance of the parking area.
- Parking standards for the project are in compliance with Zoning Bylaw 8500 as they were secured through the associated rezoning (currently at third reading) prior to the introduction of the Provincial Bill 44 (limited residential parking requirements).
- The proposal will feature a total of ten parking spaces (eight resident parking spaces and two visitor parking spaces). The number of parking spaces proposed is in compliance with the minimum Zoning Bylaw 8500 requirement.
- Four resident parking spaces will be in a tandem arrangement (50 per cent of the total required residential parking spaces), which is consistent with the provisions of Richmond Zoning Bylaw 8500. A restrictive covenant has been secured at rezoning to ensure that where two parking spaces are provided in a tandem arrangement, both parking spaces are assigned to the same dwelling unit.
- Eight Class 1 bicycle parking spaces are proposed in a secure location within the bicycle storage room in the garage level. Two Class 2 bicycle parking spaces are located outdoors at the south west corner of the site. The bicycle parking spaces are in compliance with the provisions of Richmond Zoning Bylaw 8500.
- The garbage, recycling and organics storage bins are proposed to be located in a room on the garage level. For collection, the garbage, recycling and organic storage bins are proposed to be staged for pick up along Cook Road.
- The outdoor amenity area is located in the northwest corner of the site. The overall size of the proposed outdoor amenity space (36.0 m²) complies with the Official Community Plan (OCP) requirement (i.e., 6.0 m² per unit).
- The applicant is proposing to provide cash-in-lieu of providing indoor amenity space on site. The total cash contribution required for the six-unit townhouse development is \$12,396.00 (\$2,066/unit).

• All the townhouse units will have private outdoor spaces consisting of a front yard on the street level and a deck on the fourth floor both fronting Cook Road. Five of the units will also have a private outdoor space on the second floor facing the north property line.

Architectural Form and Character

- The project's six townhouse units are designed as a single three-storey building over a singlelevel common parking structure.
- All dwelling units have direct entrances from Cook Road. The entrances feature private front yards.
- The proposed development has varying façade treatments at key points, a sloped roof, proportionate windows set symmetrically into the building and architectural details such as decorative wood slats and white wood trims.
- Larger setbacks on the fourth floor have been incorporated to provide a reduced massing expression to the streets.
- Stucco finish and horizontal siding are the two dominant materials used on the elevations. Façade details and trim contrast the background colours of the elevations to distinguish each level.
- Windows and entry roofs are used to accentuate each townhouse unit. Road fronting elevations have light brown horizontal siding as accent material on the ground and fourth levels.

Tree Preservation

- Three on-site trees were identified for removal in the original rezoning staff report. They have since been removed under T3 Permit as is permitted following the first Public Hearing in 2011. The Official Community Plan (OCP) requires a 2:1 replacement ratio for the trees removed, therefore requiring a total of six replacement trees. At the rezoning stage, the applicant committed to providing ten trees on site. As part of the development permit review, changes were made to the site plan to accommodate utilities required on site. As a result, four of the ten trees proposed at rezoning could no longer be accommodated on site.
- The applicant will plant a total of six trees on-site, which complies with the 2:1 replacement requirement established in the OCP. The applicant has also agreed to provide a \$3,000.00 (\$750/tree) voluntary contribution to the City's Tree Compensation Fund in lieu of the four trees that cannot be accommodated on site.
- Two City trees (tag# 1 and 2) adjacent to the site in the City's Cook Road boulevard are to be retained and protected as per City of Richmond Tree Protection Information Bulletin Tree-03.
- Staff ensured a Public Right-of-Passage Statutory Right-of-Ways (PROP SRW), approximately 5.4 m², was secured at rezoning to enable the Cook Road sidewalk to meander around the tree (tag# 2) in the City boulevard to ensure its retention.

• An additional Public Right-of-Passage Statutory Right-of-Ways (PROP SRW), approximately 2.6 m², was secured by staff at rezoning to allow the City lane to encroach into the site to allow for tree (tag# 1) retention in the City boulevard adjacent to the new lane.

Landscape Design and Open Space Design

- The proposed landscape plan includes a mix of six deciduous and coniferous trees on site, as well as a variety of shrubs, perennials and groundcovers.
- Landscaping with trees is proposed along the Cook Road and Cooney Road frontages creating a visually appealing frontage and screening the proposed front yard and outdoor amenity space from the sidewalk.
- Private deck planters are proposed in the second floor balcony for five of the units and in the fourth floor balcony of each townhouse unit.
- An outdoor amenity area is proposed in the north-west corner of the site.
- Wood play features and a playhouse are proposed on multicolor resilient flooring for two to five age groups.
- Permeable pavers are proposed to create a pathway that provides accessible circulation between the garage, outdoor play area and the Cooney Road sidewalk.
- A bench in the west side yard is also proposed for informal use of the residents.

Crime Prevention Through Environmental Design

- Street lighting are proposed in the rear lane to illuminate the lane and provide unobstructed views of the surrounding area.
- The pathway providing accessible circulation between the garage, outdoor play area and the Cooney Road sidewalk is illuminated with recessed and wall sconce light fixtures.
- Plantings adjacent to residential entries are low to maximize views and casual surveillance.
- Glazing and balcony access for each unit increases visual presence and provides opportunities for the passive surveillance of Cook Road, Cooney Road, the future back lane and the outdoor amenity space.

Sustainability

- The proposed development consists of six townhouses above a parking garage. This development is required to achieve Step 3 of the BC Energy Step Code for Part 3 construction. As part of a future Building Permit application, the applicant will be required to provide a report prepared by a Certified Energy Advisory which demonstrates that the proposed design and construction will meet or exceed the required standard.
- In compliance with Zoning Bylaw 8500, all eight resident parking spaces will be provided with energized outlets capable of providing Level 2 charging. The two visitor vehicle parking spaces will also be provided with energized outlets capable of providing Level 2 charging.

Accessible Housing

- The proposed development includes one convertible unit (Unit 1) that is designed with the potential to be easily renovated to accommodate a future resident in a wheelchair. The potential conversion of this unit in the future will require the installation of a vertical lift in the stacked storage space if desired.
- All of the proposed units incorporate aging-in-place features to accommodate mobility constraints associated with aging. These features include:
 - o stairwell hand rails;
 - o lever-type handles for plumbing fixtures and door handles; and
 - solid blocking in washroom walls to facilitate future grab bar installation beside toilets, bathtubs and showers.

Site Servicing and Off-site Improvements

Servicing and off-site improvements to support the proposed development were identified during the Rezoning Application review process and will be addressed under a Servicing Agreement prior to rezoning bylaw adoption. To address a discrepancy in the rezoning requirements through this Development Permit and its associated considerations, the \$9,000.00 cash contribution towards the Accessible Pedestrian Signals (APS) upgrade secured through the rezoning considerations is being waived as the applicant will be providing the upgrade directly. This will occur as part of the agreed upon requirement for the design and construction of the APS upgrade outlined in the Servicing Agreement.

Conclusions

As the proposed development would meet applicable policies and Development Permit Guidelines, and the applicant has agreed to the list of Development Permit Considerations (signed concurrence on file) outlined in Attachment 2, staff recommend that the Development Permit be endorsed, and issuance by Council be recommended.

Vidadi

Tolu Alabi Planner 1 (604-276-4092)

TA:js

Att. 1: Development Application Data Sheet 2: Development Permit Considerations



Development Application Data Sheet Development Applications Department

DP 22-00	8932					
Address:	6500 Cooney Road					
Applicant:	Kenneth Kim (Kenne	th Kim Architecture Inc.)				
Owner:	1319414 B.C. Ltd. (In	ncorporation No. BC 1319414)				
Planning A	Area(s): City Centre A	Area (Brighouse Village)				
Floor Area	Gross: <u>1111.33 m²</u>	Floor	Area Ne	t: 756.24 m ²		
		Existing		Propo	sed	
Site Area		870.9 m²		632.8 m ²		
Land Uses		Vacant		Multiple-Family	/ Residential	
OCP Desig	Ination	Neighbourhood Residentia	al	No Cha	ange	
CCAP Des	ignation	General Urban T4 / 1.2 FA	R	No Cha	-	
Developm	ent Permit Sub-Area	B2 Mixed-Use - Mid-Rise Residential & Limited Comme		B2 Mixed-Use Residential & Limi		
Zoning	Residential & Limited (Residential & Limited Commercial Parking Structure Town Housing (ZT93) Brighouse (City Centre)		
Number of	Units	0		6 townhouse units		
		Bylaw Requirement		Proposed	Variance	
Floor Area	Ratio	Max. 1.2 (759.36 m ²)		1.2 (756.24 m ²)	None Permitted	
	Building	Max. 56.0 %		52.5 %		
Lot Coverage	Non-porous Surfaces	Max. 80.0 %		74.2 %	None	
ooverage	Live Landscaping	Min. 20.0 %	20.0 %			
Setback – (Cooney Road	Min. 3.0 m		3.1 m	None	
Setback - 0	Cook Road	Min. 3.0 m		4.4 m	None	
Setback - S	Side Yard	Min. 1.5 m	1.5 m		None	
Setback - I	Rear Lane	Min. 0.0 m	0.1 m		None	
Building He	eight	Max. 15.0 m (4 storeys)	13.43 m (4 storeys)		None	
	Width	Min. 20.0 m		Min. 20.3 m		
Lot Size	Depth	Min. 30.0 m		Min. 31.6 m	None	
	Area	Min. 600.0 m ²		Min. 632.8 m ²		
Parking Spaces	Resident (1.2/unit)	8		8		
(City	Visitors (0.2/unit)	2		2	None	
Centre Zone 2)	Total	10		10		
	aces – Accessible	Not required		0	None	

Tandem Parking Spaces		Max. 50% of resident spaces 50% of resident spaces		None	
Bicycle Class 1 (1.25/unit)		8	8	None	
Parking	Class 2 (0.20/unit)	2	2	None	
EV (Energized) Car Charging		100% of resident parking spaces	100% of resident parking spaces	None	
Amenity Space – Indoor		Min. 50.0 m ²	Cash-in-lieu	None	
Amenity Space – Outdoor		Min. 36.0 m ²	36.0 m ²	None	



Development Permit Considerations Development Applications Department 6911 No. 3 Road, Richmond, BC V6Y 2C1

Address: 6500 Cooney Road

File No.: DP 22-008932

Prior to approval of the Development Permit*, the developer is required to complete the following:

- 1. [Zoning Amendment] Final adoption of the Zoning Amendment Bylaw 10265.
- 2. [Aircraft Noise Sensitive Development] Confirmation that the proposed development is designed in a manner that mitigates potential aircraft noise to the proposed dwelling units, including submission of:
 - a) Acoustic report prepared a registered professional confirming design achieves the following CMHC interior noise level guidelines:

Portions of Dwelling Units	Noise Levels (decibels)
Bedrooms	35 decibels
Living, dining, recreation rooms	40 decibels
Kitchen, bathrooms, hallways, and utility rooms	45 decibels

- b) Mechanical report prepared a registered professional confirming design achieves the ASHRAE 55-2004 "Thermal Environmental Conditions for Human Occupancy" standard for interior living spaces.
- 3. [Energy Step Code] Submissions from the Coordinating Registered Professional, including:
 - a) A statement identifying the applicable Energy Step Code performance target, confirmation that the required target has been considered in design, and that a Qualified Energy Modeller has been engaged to ensure that the proposed design can achieve the applicable performance targets.
 - b) A summary (e.g., one page) of the envelope energy upgrades and other energy efficiency measures (e.g. effective R-values of typical wall assemblies, U-values and solar heat gain coefficients of fenestration, window-to-wall ratios, thermal breaks in balconies and similar features) must be presented in the DP application such that the passive energy performance of the building can be assessed and discussed by the Advisory Design Panel.
- 4. **[Landscape Security]** Submission of a Letter of Credit for landscaping in the amount of \$74,750.00 (based on the cost estimate prepared by a registered landscape architect including a 10% contingency). A Legal Agreement is required to accompany the Landscaping Security to set the terms for the use and release of the security.
- 5. **[Tree Compensation]** City acceptance of the developer's offer to voluntarily contribute \$3,000.00 (\$750/tree) to the City's Tree Compensation Fund for the planting of replacement trees within the City.
- 6. [Servicing Agreement*] Revisions to the requirement to enter into a Servicing Agreement* (secured through RZ 08-429600) for the design and construction of frontage improvements and utility works have been agreed to and are included in the following:

a) **Functional Road Plan:**

A functional road plan is to be prepared and submitted as part of the Servicing Agreement to the satisfaction of the Director of Transportation for the interim and ultimate design of the roadworks described below and infrastructure works as developed through the functional design process to current City standards and policies and to confirm the SRW areas (amounts and geometry) described above, as noted in these considerations.

b) Cooney Road:

Frontage works are required behind the existing curb, along the subject site's frontage and extending northwards to include tie-in to the existing sidewalk to the north. Frontage works shall include removal of the existing sidewalk and installation of the following from east to west:

- (i) Minimum 2.00 m wide concrete sidewalk along the subject site's new property line, including tie-in to the existing sidewalk to the north
- (ii) 1.50 m treed boulevard
 - Treed portion to be planted at 9.00 m on centre (including reinstatement of the boulevard north of the subject site where the sidewalk must be removed)
 - City Centre streetlights in the boulevard (Type 3, powder coated blue, 9.14 m pole, and 250w MH lamp, except without pedestrian luminaires, banner arms, flowerpot holders, receptacles, or irrigation). All utility poles to be underground.

(iii) 1.80 m grassed boulevard with no above-grade utilities.

(iv) 0.15 m curb and gutter.

c) Cook Road:

Construction of frontage works including removal of the existing on street walkway and extruded curb and installation of the following from south to north:

(i) 0.15 m curb and gutter. The face of curb shall be approximately 11.85 m north of the existing south curb face.

- (ii) 0.76 m wide grassed boulevard with street lighting
 - City Centre streetlights (Type 3, powder coated blue, 9.14 m pole, and 250w MH lamp, except without pedestrian luminaires, banner arms, flowerpot holders, receptacles, or irrigation)
- (iii) Minimum 2.18 m wide concrete sidewalk between the grassed boulevard and the subject site's property line. Local reduction of this sidewalk width is permitted for the retention of one existing tree (tag# 2).

d) Cooney Road and Cook Road Intersection Improvements:

A traffic signal design will be required as part of the Servicing Agreement process. The exact scope of traffic signal upgrades shall be confirmed upon completion of the traffic signal design; however, a minimum of the following will be required at the Cooney Road and Cook Road intersection:

- (i) Replacement of the existing traffic signal at the NE corner of the intersection with a new City Centre decorative traffic pole complete with new traffic signal hardware
- (ii) New APS and LED streetlights on the new traffic pole. Intersection lighting design and drawings will be required to confirm lighting requirements.
- (iii) New communications conduit along the development frontage
- (iv) All new curb ramps are to have accessible tactile warning strips.

e) Public Lane:

Construction of a new 6.0 m wide lane is required, including, but not limited to, City Centre lighting along the lane's east side, the extension and repair or replacement of the existing fence along the entire property line of 8491 Cook Road (i.e. immediately east of the proposed lane), and special measures aimed at mitigating impacts on the existing significant tree east of the proposed lane as determined by an arborist (e.g., permeable paving, light weight fill), to the satisfaction of the City. Any grade differential between the lane and adjacent sites must be resolved via the design review/approval process. The functional road plan required for the public lane is to illustrate the swept path for two-way vehicle movements at the new lane/6468 Cooney Road easement intersection and any additional traffic control measures or devices to support the design.

(i) Driveway letdown for lane access shall be designed to facilitate safe, convenient pedestrian movement between the new sidewalk at the subject site and the on-street walkway east of the subject site.

f) Water Service:

Using the OCP Model, there is 861 L/s of water available at a 20 psi residual at the Cooney Rd frontage and 844 L/s of water available at a 20 psi residual at the Cook Road frontage. Based on the proposed development, the site requires a minimum fire flow of 220 L/s.

At owner's cost, the owner is to:

- (i) Submit Fire Underwriter Survey (FUS) or International Organization for Standardization (ISO) fire flow calculations to confirm development has adequate fire flow for onsite fire protection. Calculations must be signed and sealed by a Professional Engineer and be based on Building Permit Stage Building designs.
- (ii) Review hydrant spacing on all road frontages and install new fire hydrants as required to meet City spacing requirements for the proposed land use.
- (iii) Provide a right-of-way for the water meter. Minimum right-of-way dimensions to be the size of the meter box (from the City of Richmond supplementary specifications) + any appurtenances (for example, the bypass on W2n-SD) + 0.5 m on all sides. Exact right-of-way dimensions to be finalized via the servicing agreement process).

At owner's cost, the City is to:

- (i) Complete all tie-ins for the proposed works to existing City infrastructure.
- (ii) Cut and cap all existing water service connections and remove all existing water meters.
- (iii) Install a new water service connection, complete with water meter and water meter box as per City specifications to service the site.

g) Storm Sewer:

At owner's cost, the owner is to:

- (i) Provide a 300 mm storm sewer for drainage along the newly proposed lane.
- (ii) Provide an erosion and sediment control plan for all on-site and off-site works, to be reviewed as part of the servicing agreement design.
- At owner's cost, the City is to:
- (i) Install a new storm service connection complete with inspection chamber as per City specifications for the proposed site. The location and size of the required storm sewer service connection shall be determined through the servicing agreement design process. Inspection chamber to be located in a right-of-way onsite.
- (ii) Cut and cap all existing storm service connections to the development site and remove inspection chambers.
- (iii) Complete all tie-ins for the proposed works to existing City infrastructure.

h) Sanitary Sewer:

At owner's cost, the owner is to:

- (i) Replace the existing sanitary connection and inspection chamber serving the development site with approximately 31 m of new 200 mm sanitary sewer from manhole SMH1022 to a new manhole at the adjoining property line of 6468 Cooney Road and the development site.
- (ii) Install one new rear-yard sanitary service connection complete with an inspection chamber off of the new manhole to serve the development site. The size of the required sanitary sewer service connection shall be determined through the servicing agreement design process.
- (iii) Reconnect the existing sanitary connection to 8431 Cook Road to the new sanitary sewer.
- (iv) Not start onsite excavation or foundation construction prior to completion of rear-yard sanitary works by City.

At owner's cost, the City is to:

(i) Complete all tie-ins for the proposed works to existing City infrastructure.

i) Frontage Improvements:

At owner's cost, the owner is to:

- (i) Review street lighting levels along all road and lane frontages, and upgrade as required.
- (ii) Coordinate with BC Hydro, Telus and other private communication service providers:
 - To underground overhead service lines.
 - To pre-duct for future hydro, telephone and cable utilities along all road frontages.
 - To locate all proposed underground structures (e.g. junction boxes, pull boxes, service boxes, etc.) outside of bike paths and sidewalks.
 - Before relocating/modifying any of the existing power poles and/or guy wires within the property frontages.
 - To locate/relocate all above ground utility cabinets and kiosks required to service the proposed development, and all above ground utility cabinets and kiosks located along the development's frontages, within the developments site (see list below for examples). A functional plan showing conceptual locations for such infrastructure shall be included in the development process design review. Please coordinate with the respective private utility companies and the project's lighting and traffic signal consultants to confirm the requirements (e.g., statutory right-of-way dimensions) and the locations for the aboveground structures. If a private utility company does not require an aboveground structure, that company shall confirm this via a letter to be submitted to the City. The following are examples of statutory right-of-ways that shall be shown on the functional plan and registered prior to SA design approval:

uppiovui.	
BC Hydro LPT	Confirm size with BC Hydro, approximately 3.5 m x 3.5 m
BC Hydro PMT	Confirm size with BC Hydro, approximately 4.0 m x 5.0 m
BC Hydro Vista	Confirm size with BC Hydro
Street light kiosk	Approximately 2.0 m x 1.5 m
Traffic signal controller cabinet	Approximately 3.2 m x 1.8 m
Traffic signal UPS cabinet	Approximately 1.8 m x 2.2 m
Show possible locations in function	al plan of the following:
Shaw cable kiosk	Confirm size with Shaw, approximately 1.0 m x 1.0 m
Telus FDH cabinet	Confirm size with Telus, approximately 1.1 m x 1.0 m

j) General Items:

At owner's cost, the owner is to:

- (i) Not encroach into City rights-of-ways with any proposed trees, retaining walls, or other non-removable structures. Retaining walls proposed to encroach into rights-of-ways must be reviewed by the City's Engineering Department.
- (ii) Not encroach into the rear-yard sanitary right-of-way with proposed trees, retaining walls, non-removable fences, or other non-removable structures. No fill may be placed within the right-of-way without the City's review and approval.
- (iii) Provide, prior to start of site preparation works or within the first servicing agreement submission, whichever comes first, a geotechnical assessment of preload and soil preparation impacts on the existing utilities fronting the development site and provide mitigation recommendations.
- (iv) Provide a video inspection report of the existing storm and sanitary sewers along the development's frontages prior to start of site preparation works or within the first servicing agreement submission, whichever comes first. A follow-up video inspection report after site preparation works are complete (i.e. pre-load removal, completion of dewatering, etc.) is required to assess the condition of the existing utilities and provide recommendations. Any utilities damaged by the pre-load, de-watering, or other development-related activity shall be replaced at the Developer's cost.
- (v) Monitor the settlement at the adjacent utilities and structures during pre-loading, dewatering, and soil preparation works per a geotechnical engineer's recommendations, and report the settlement amounts to the City for approval.
- (vi) Enter into, if required, additional legal agreements, as determined via the subject development's Servicing Agreement(s) and/or Development Permit(s), and/or Building Permit(s) to the satisfaction of the Director of Engineering, including, but not limited to, site investigation, testing, monitoring, site preparation, dewatering, drilling, underpinning, anchoring, shoring, piling, pre-loading, ground densification or other activities that may result in settlement, displacement, subsidence, damage or nuisance to City and private utility infrastructure.

Prior to Building Permit* Issuance, the developer is required to complete the following:

- 1. [Legal Agreements] Confirmation of compliance with existing, Rezoning and Development Permit legal agreements.
- 2. [Rezoning/Development Permit] Incorporation of features in Building Permit (BP) plans as determined via the Rezoning and/or Development Permit processes, including accessibility, sustainability, amenity and landscape design measures. All landscaped areas are to be provided with an irrigation system.
- 3. [Accessibility] Incorporation of accessibility measures in Building Permit (BP) plans as determined via the Rezoning and/or Development Permit processes.
- 4. [Aircraft Noise Sensitive Development] Submission of an Acoustics Report by a registered professional confirming that the building design incorporates all the noise mitigation features necessary to ensure compliance with the standards set out in the OCP.
- 5. [Construction Parking and Traffic Management Plan] Submission of a Construction Parking and Traffic Management Plan to the Transportation Department. Management Plan shall include location for parking for services, deliveries, workers, loading, application for any lane closures, and proper construction traffic controls as per Traffic Control Manual for works on Roadways (by Ministry of Transportation) and MMCD Traffic Regulation Section 01570.
- 6. [Latecomer Works] If applicable, payment of latecomer agreement charges, plus applicable interest associated with latecomer works.
- 7. [Construction Hoarding*] Obtain a Building Permit (BP)* for any construction hoarding. If construction hoarding is required to temporarily occupy a public street, the air space above a public street, or any part thereof, additional City approvals and associated fees may be required as part of the Building Permit.

Note:

- * This requires a separate application.
- Where the Director of Development deems appropriate, the preceding agreements are to be drawn not only as personal covenants of the property owner but also as covenants pursuant to Section 219 of the Land Title Act.

All agreements to be registered in the Land Title Office shall have priority over all such liens, charges and encumbrances as is considered advisable by the Director of Development. All agreements to be registered in the Land Title Office shall, unless the Director of Development determines otherwise, be fully registered in the Land Title Office prior to enactment of the appropriate bylaw.

The preceding agreements shall provide security to the City including indemnities, warranties, equitable/rent charges, letters of credit and withholding permits, as deemed necessary or advisable by the Director of Development. All agreements shall be in a form and content satisfactory to the Director of Development.

- Additional legal agreements, as determined via the subject development's Servicing Agreement(s) and/or Development Permit(s), and/or Building Permit(s) to the satisfaction of the Director of Engineering may be required including, but not limited to, site investigation, testing, monitoring, site preparation, de-watering, drilling, underpinning, anchoring, shoring, piling, pre-loading, ground densification or other activities that may result in settlement, displacement, subsidence, damage or nuisance to City and private utility infrastructure.
- Applicants for all City Permits are required to comply at all times with the conditions of the Provincial *Wildlife Act* and Federal *Migratory Birds Convention Act*, which contain prohibitions on the removal or disturbance of both birds and their nests. Issuance of Municipal permits does not give an individual authority to contravene these legislations. The City of Richmond recommends that where significant trees or vegetation exists on site, the services of a Qualified Environmental Professional (QEP) be secured to perform a survey and ensure that development activities are in compliance with all relevant legislation.

[Signed copy on file]

Signed

Date



Development Permit

No. DP 22-008932

To the Holder:	1319414 B.C. Ltd. Incorporation No. BC 1319414
Property Address:	6500 Cooney Road
Address:	C/O: Kenneth Kim (Kenneth Kim Architecture Inc.) 2223 West Broadway Unit 221, Vancouver, BC V6K 2E4 Canada

- 1. This Development Permit is issued subject to compliance with all of the Bylaws of the City applicable thereto, except as specifically varied or supplemented by this Permit.
- 2. This Development Permit applies to and only to those lands shown cross-hatched on the attached Schedule "A" and any and all buildings, structures and other development thereon.
- 3. Subject to Section 692 of the Local Government Act, R.S.B.C.: buildings and structures; off-street parking and loading facilities; roads and parking areas; and landscaping and screening shall be constructed generally in accordance with Plans #1 to #17 attached hereto.
- 4. Sanitary sewers, water, drainage, highways, street lighting, underground wiring, and sidewalks, shall be provided as required.
- 5. As a condition of the issuance of this Permit, the City is holding the security in the amount of \$74,750 to ensure that development is carried out in accordance with the terms and conditions of this Permit. Should any interest be earned upon the security, it shall accrue to the Holder if the security is returned. The condition of the posting of the security is that should the Holder fail to carry out the development hereby authorized, according to the terms and conditions of this Permit within the time provided, the City may use the security to carry out the work by its servants, agents or contractors, and any surplus shall be paid over to the Holder. Should the Holder carry out the development permitted by this permit within the time set out herein, the security shall be returned to the Holder. The City may retain the security for up to one year after inspection of the completed landscaping in order to ensure that plant material has survived.
- 6. If the Holder does not commence the construction permitted by this Permit within 24 months of the date of this Permit, this Permit shall lapse and the security shall be returned in full.

Development Permit No. DP 22-008932

To the Holder:	1319414 B.C. Ltd. Incorporation No. BC 1319414
Property Address:	6500 Cooney Road
Address:	C/O: Kenneth Kim (Kenneth Kim Architecture Inc.) 2223 West Broadway Unit 221, Vancouver, BC V6K 2E4 Canada

7. The land described herein shall be developed generally in accordance with the terms and conditions and provisions of this Permit and any plans and specifications attached to this Permit which shall form a part hereof.

,

This Permit is not a Building Permit.

AUTHORIZING RESOLUTION NO. DAY OF , .


ISSUED BY THE COUNCIL THE

DELIVERED THIS DAY OF

MAYOR



City of Richmond

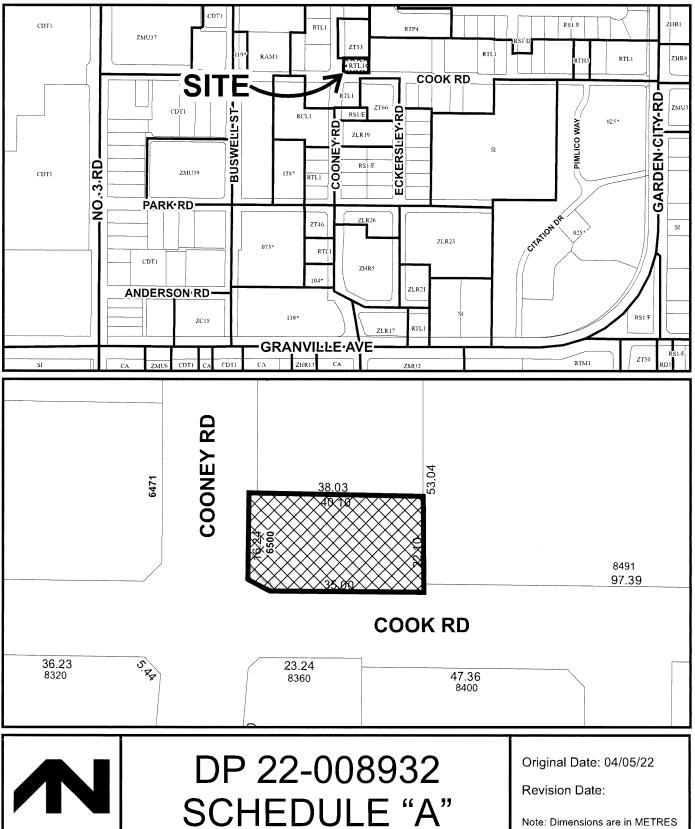

DP 22-008932 6500 COONEY RD - 6 UNIT TOWNHOUSE DEVELOPMENT



VIEW FROM LANE AT COOK ROAD

APRIL 26, 2024

PROJECT SUMMARY

CIVIC ADDRESS: LEGAL DESCRIPTION:	6500 COONEY ROAD, RICHMOND, BC. LOT 20 SECTION 9, BLOCK 4N RANGE 6W NWD PLAN 15292	FAR DENSITY
LOT SIZE:	870 0 544 10 274 2 55	LOT COVERAGE - BUILDI
ORIGINAL SITE: ROAD DEDICATIONS:	870.9 SM [9,374.3 SF] 2.4M ALONG CONNEY ROAD; 1.8M Along CDDK ROAD; 5M X 5M AT SW CORNER	LOT COVERAGE – NON-P
LANE DEDICATIONS:	6M ALONG EAST PROPERTY LINE	SETBACK - COONEY
NET SITE AREA:	632.8 SM [6811.4 SF] (UPDATED SUBDIVISION PLAN APR 2024)	SETBACK - COOK
		SETBACK - CORNER CUT
		SETBACK - LANE
		SETBACK - NORTH INTER
Illin		BUILDING HEIGHT
		LOT WIDTH
		LOT DEPTH
		LUTANEA
		PARKING REQUIRED
		TANDEM PARKING
		BICYCLE PARKING
A COLORADO		ACCESSIBLE PARKING
		EV CHARGING
		AMENITY - INDOOR

AR DENSITY AR DENSITY OT COVERAGE – BUILDING OT COVERAGE – PLANTING ETBACK – COONEY ETBACK – COOK ETBACK – COOK ETBACK – CORNER CUT ETBACK – LANE ETBACK – NORTH INTERIOR SIDE YARD UILDING HEIGHT OT WIDTH	Current Proposal (2021) 1.2 52.4% 74.1% 20% 3.19 m 4.45 m 3.03 m 0.08 m 1.51 m 1.2.48 m & 4-storeys 20.34 m 2.49 m	Bylaw Requirement (2193) 1.2 Max. 55 % Max. 55 % Max. 20 % Min. 3 m Min. 3 m Min. 3 m Min. 0 m Min. 1.5.0 m Min. 15.0 m & 4-storeys Max. 20 m Min.	t: 778-379-8918 / f: 604-800-0775 e. kennethæjkkalca 211-2223 West Broadway Vancouver, B.C. V6K 2E4
IT DEPTH JT AREA ARKING REQUIRED WOEM PARKING CYCLE PARKING CYCLE PARKING CYCLARGING MENITY – UNDOOR MENITY – UNDOOR APA ADDITIONAL OUTDOOR AMENITY INVATE OUTDOOR SPACE	31.62 m 632.8 m2 PARKING 10 (8 Residents + 2 Visitors) 25% (2 and 0 8) 8 Class 1 + 2 Class 2 0 100% of resident parking spaces 0 0CP/CCAP Cashi-In-lieu 36.0 m2 64.9 m2 39.28 - 40.54 m2	30 m Min. 600 m 2 min 10 (1.2/Unit Residents + 0.2/Unit Visitor) 50 % Max. 8 Class 1 (1.25/Unit) + 2 Class 2 (0.2/Unit) Not required 10 Level 2, 12kw EV Charging outlets 50 m 2 Min. 36 m 2 Min. 63.1 m 2 Min. (10% of Net Site Area) 37 m 2 Min.	THIS DRAWING MUST NOT BE SCALED, THE GENERAL CONTRACTOR SHALL VERIFY ALL DIMENSIONS AND LEVELS PRIOR TO COMMENCEMENT OF WORK, ALL ERRORS AND OMISSIONS SHALL BE REPORTED IMMEDIATELY TO THE ARCHITECT. COPYRIGHT RESERVED. THIS PLAY AND DESIGN ARE AND SHALL REMAIN AT ALL TIMES THE EXCLUSIVE PROPERTY OF KENNETH KIM ARCHITECTURE INC. AND MAY NOT BE USED OR REPRODUCED WITHOUT PRIOR WRITTEN CONSENT.
SITOR 2 24	PENCE WI D AROUND SI LANE AS PER BOLLOVER C	8431 Cook Road Existing 2-Storey Townhouses Ensty Banner A. And Faith And OF Conv. Ensurement Conv. Ensurement	Project Title 6-UNIT TOWNHOUSE 6500 Conney Rd (Existing) 8399 Cooney Rd (Proposed) Richmond, BC Sign & Seal
	n ATTON ATTON OR US I IN LAN CARL HARNE US I IN LAN CARL HARNE O O DOT 150 LANE IS LANE IS LAN	EP WIDER THAM 5 III. TOR RARAGE. SSPER CITY. BEQUIREMENTS 0 MAILBOX VIEW BY VIEW BY WISH WISH VIEW PANEL 4 AFF. WALL	No. Date Revision 13 Apr 23 2024 DP Revision 2 Updates 12 Apr 17 2024 DP Revision 2 Updates 11 Apr 17 2024 DP Revision 2 Updates 11 Apr 10 2024 DP Revision 2 10 Jun 12 2023 DP Revision 1 9 Jun 5 2023 BP Revision 1 8 Aug 19 2022 Fire fighting update 7 Jul 29 2022 Aborist update 6 Jul 5 2022 BP Submission 5 Jun 21 2022 DP Dubdated Set 13 Jun 9 2021 Traffic Revision) 1 Jan 13 2020 Proposal w/ New Parking Layout Sheet Title PROJECT DATA & SITE PLAN
EXISTING SIDEWALK/LETDOWN EXISTING SIDEWALK/LET			Drawn: CL Checked: KK Scale: Print date: Apr 23, 2024

AERIAL VIEW OF THE SUBJECT PROPOSAL




LOCATION PLAN





SITE AERIAL PHOTO




Existing Storm Service Proposed Storm Service Existing Sanitary Service Proposed Sanitary Service Existing Water Service Proposed Water Service Existing Gas Line Existing Street Light Duct Proposed recessed light Proposed wall sconce light

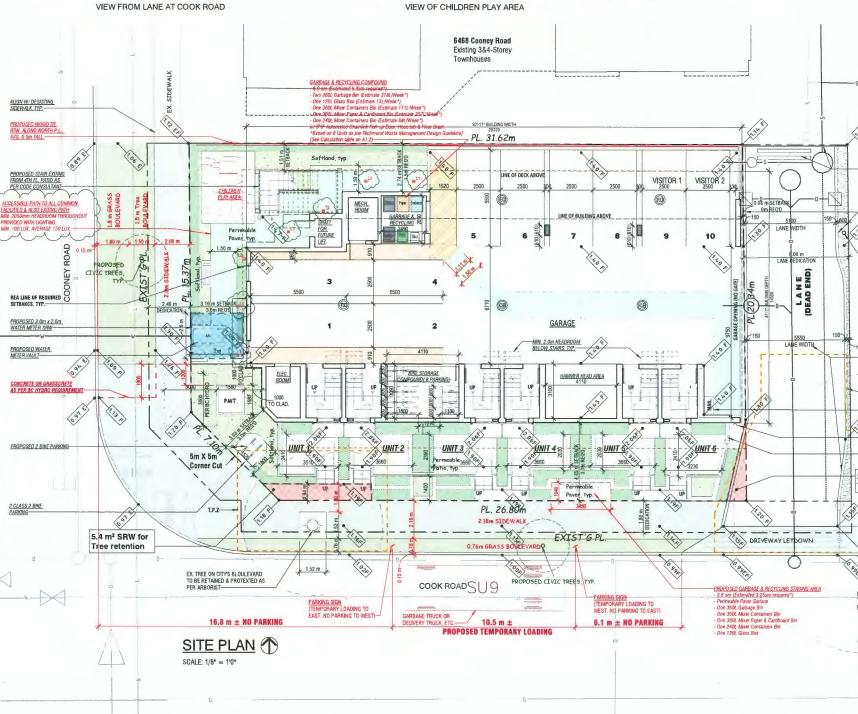


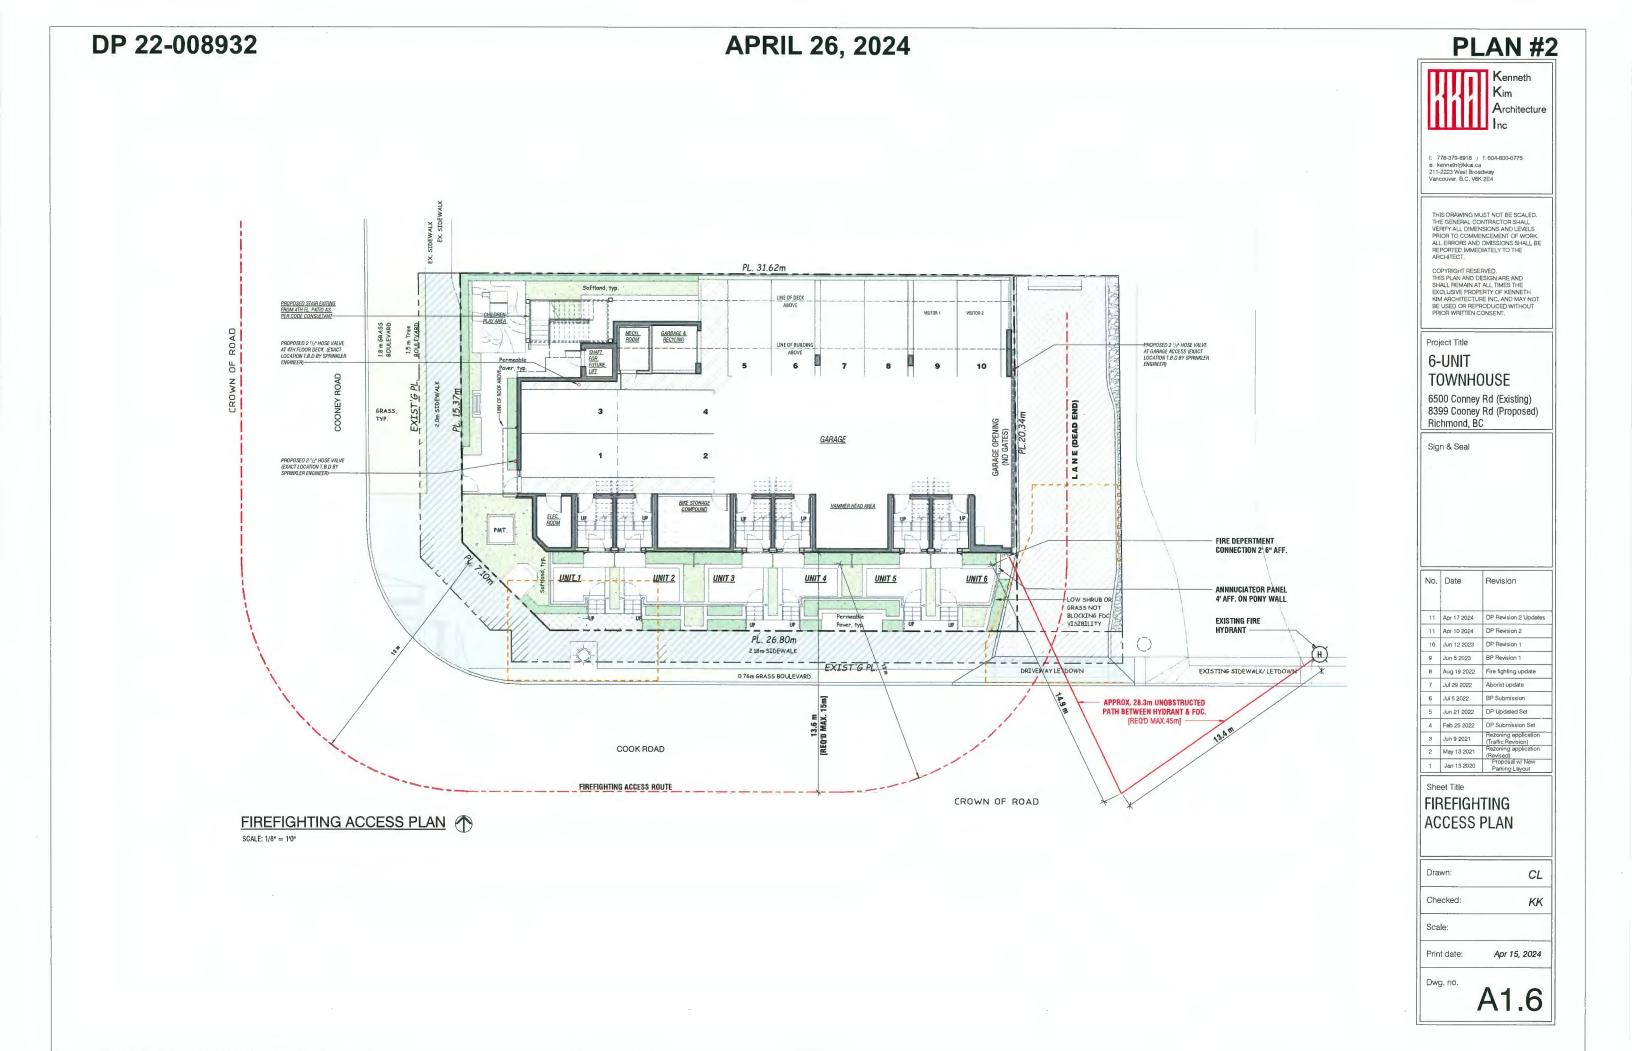


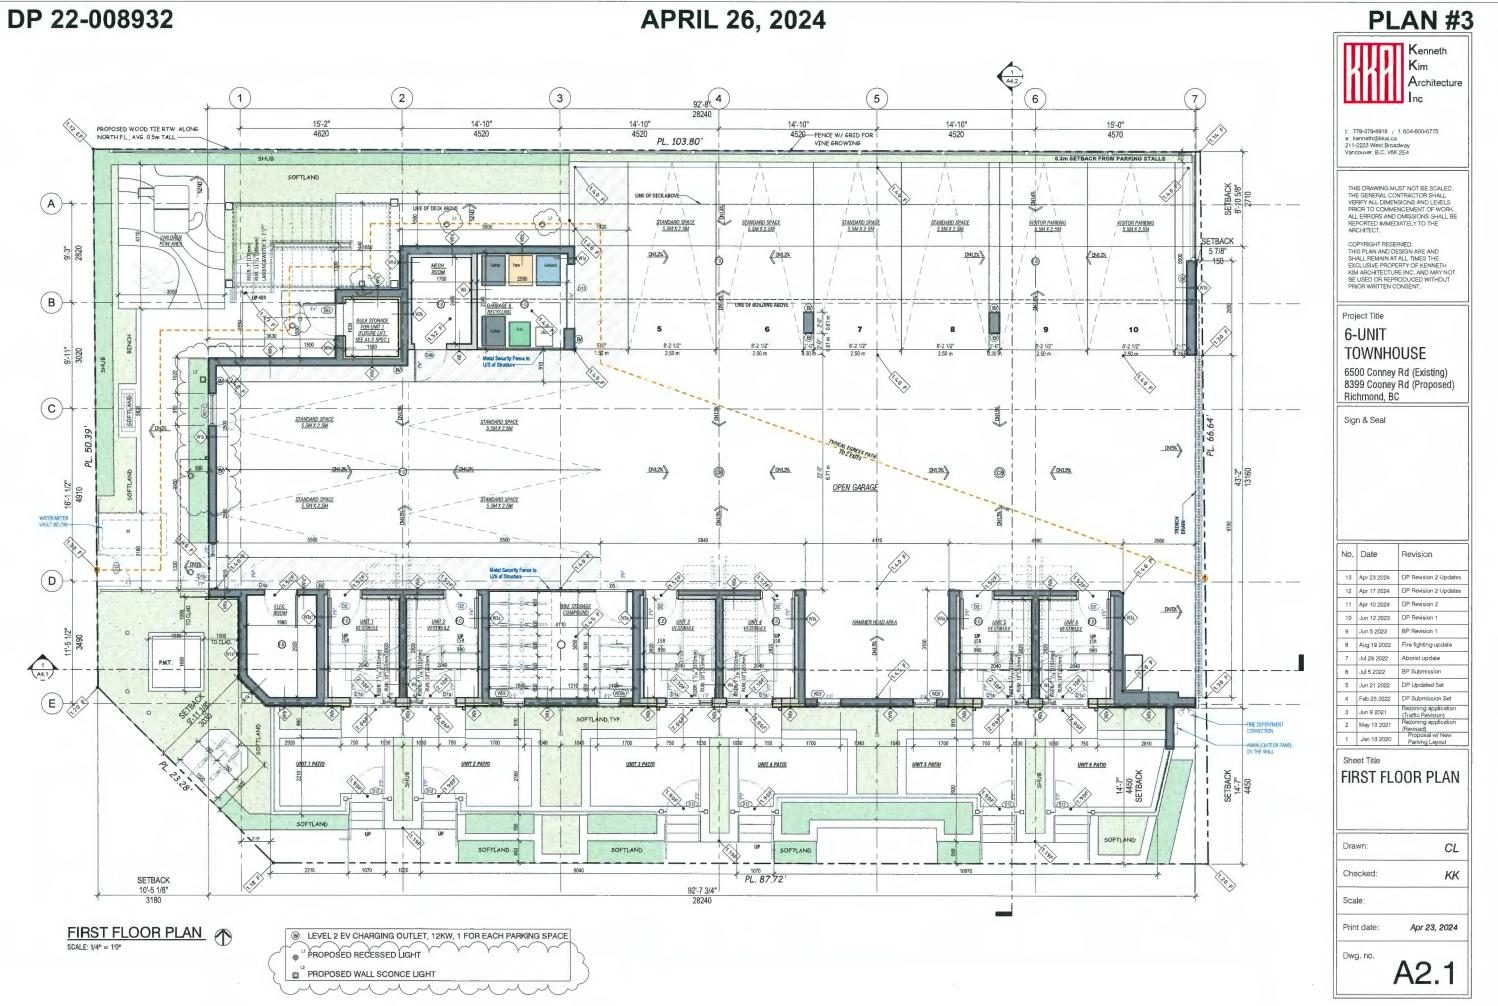


DP 22-008932

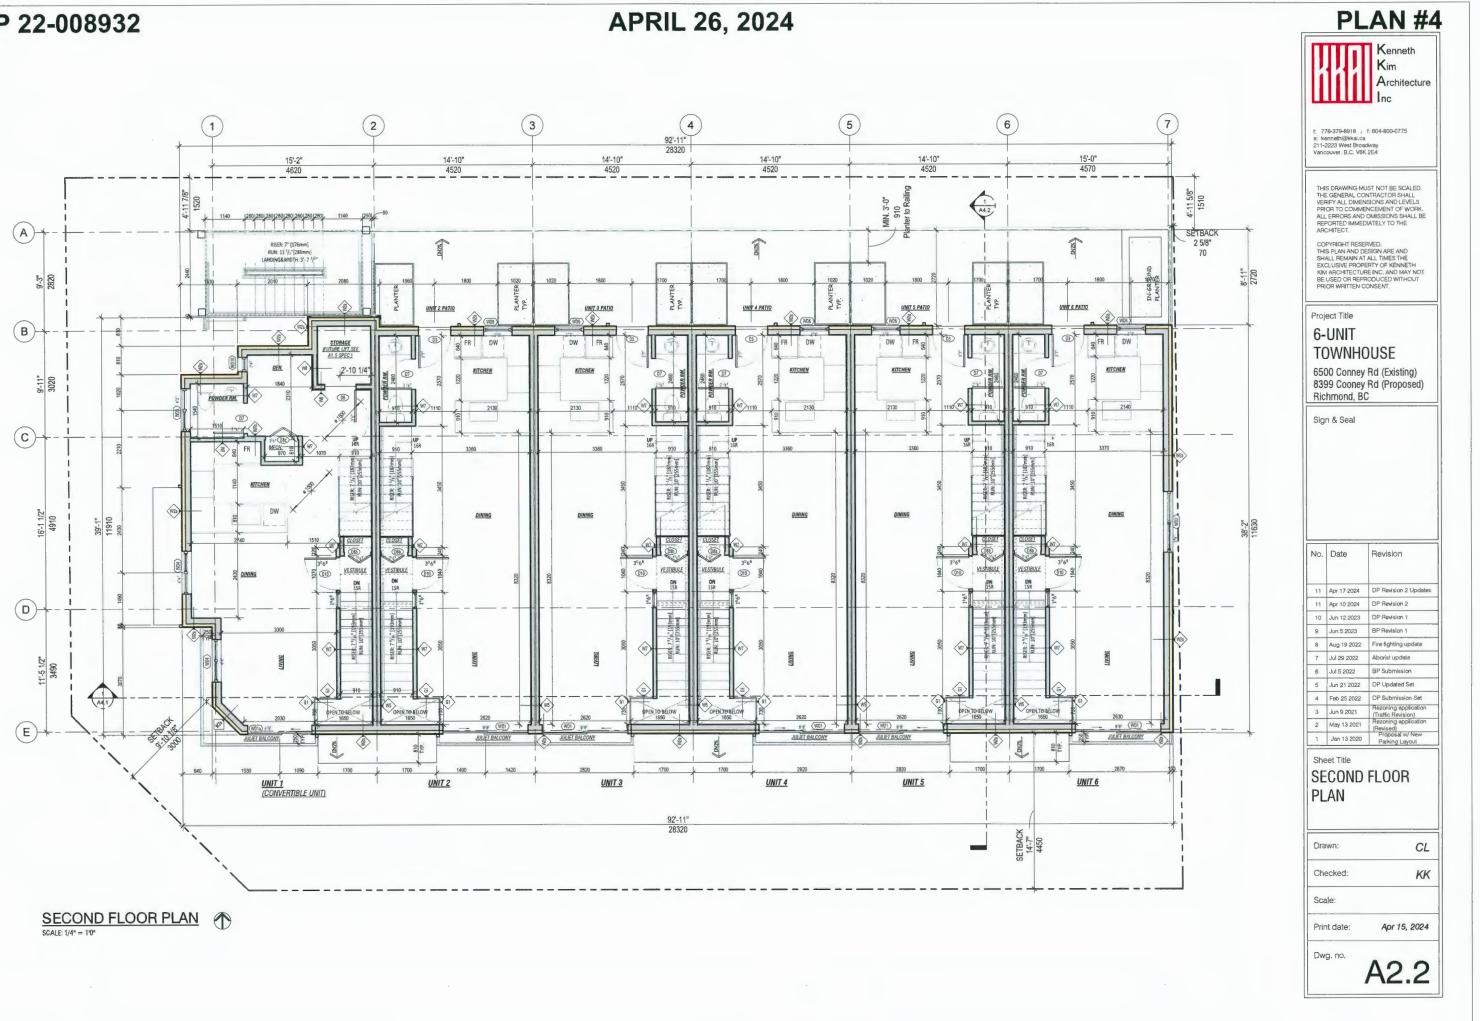

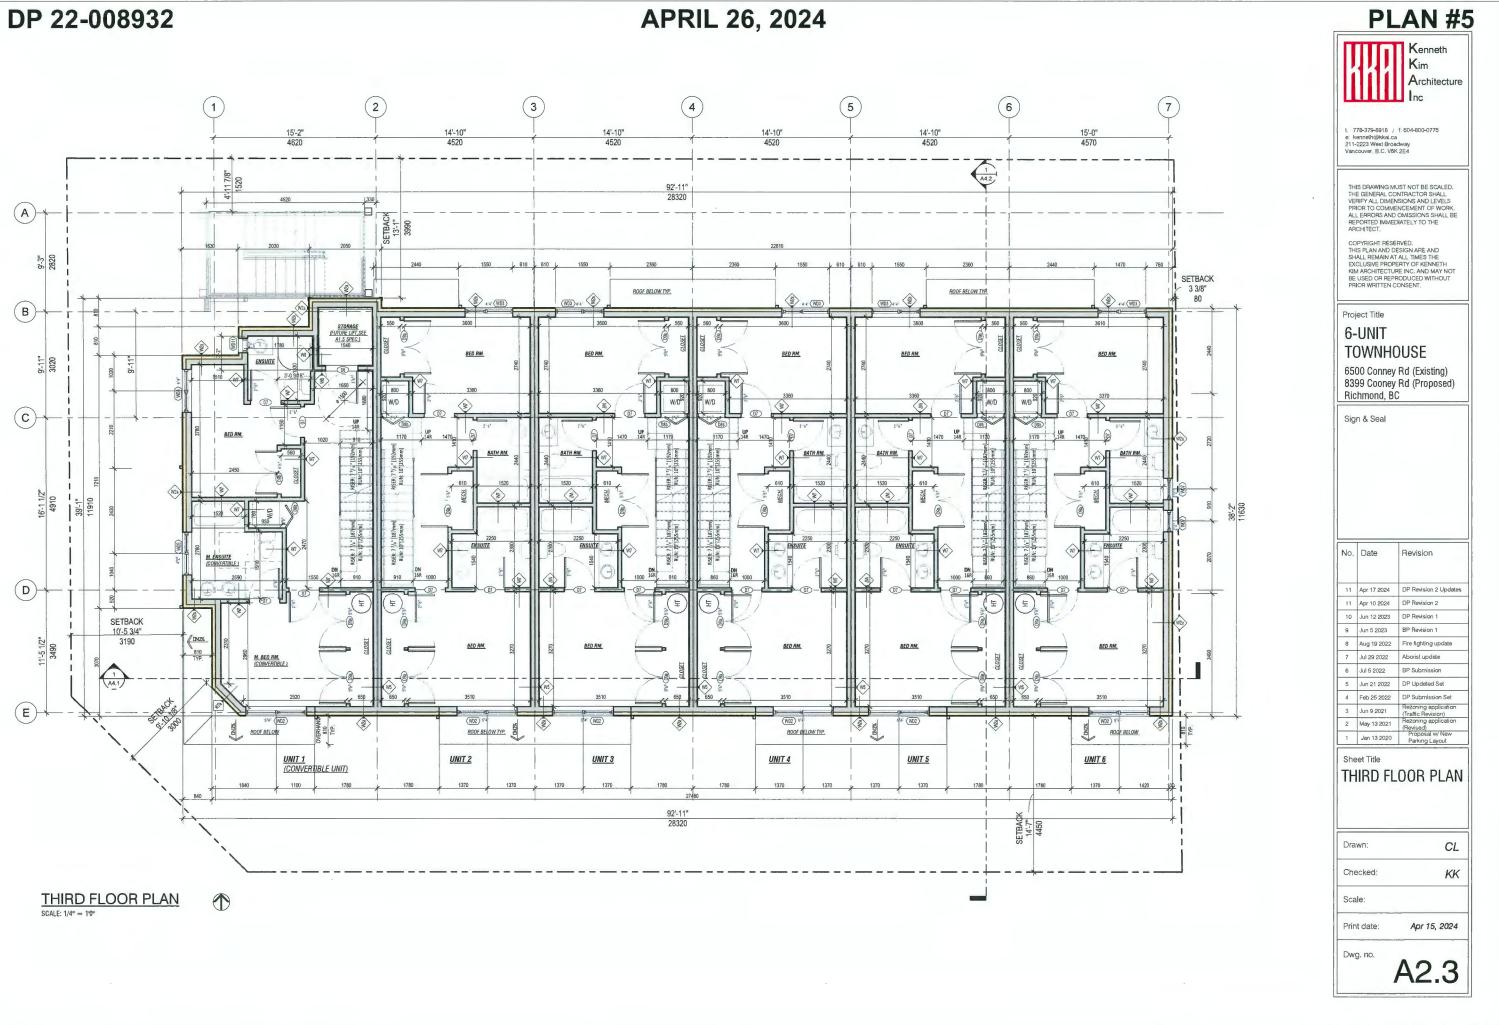

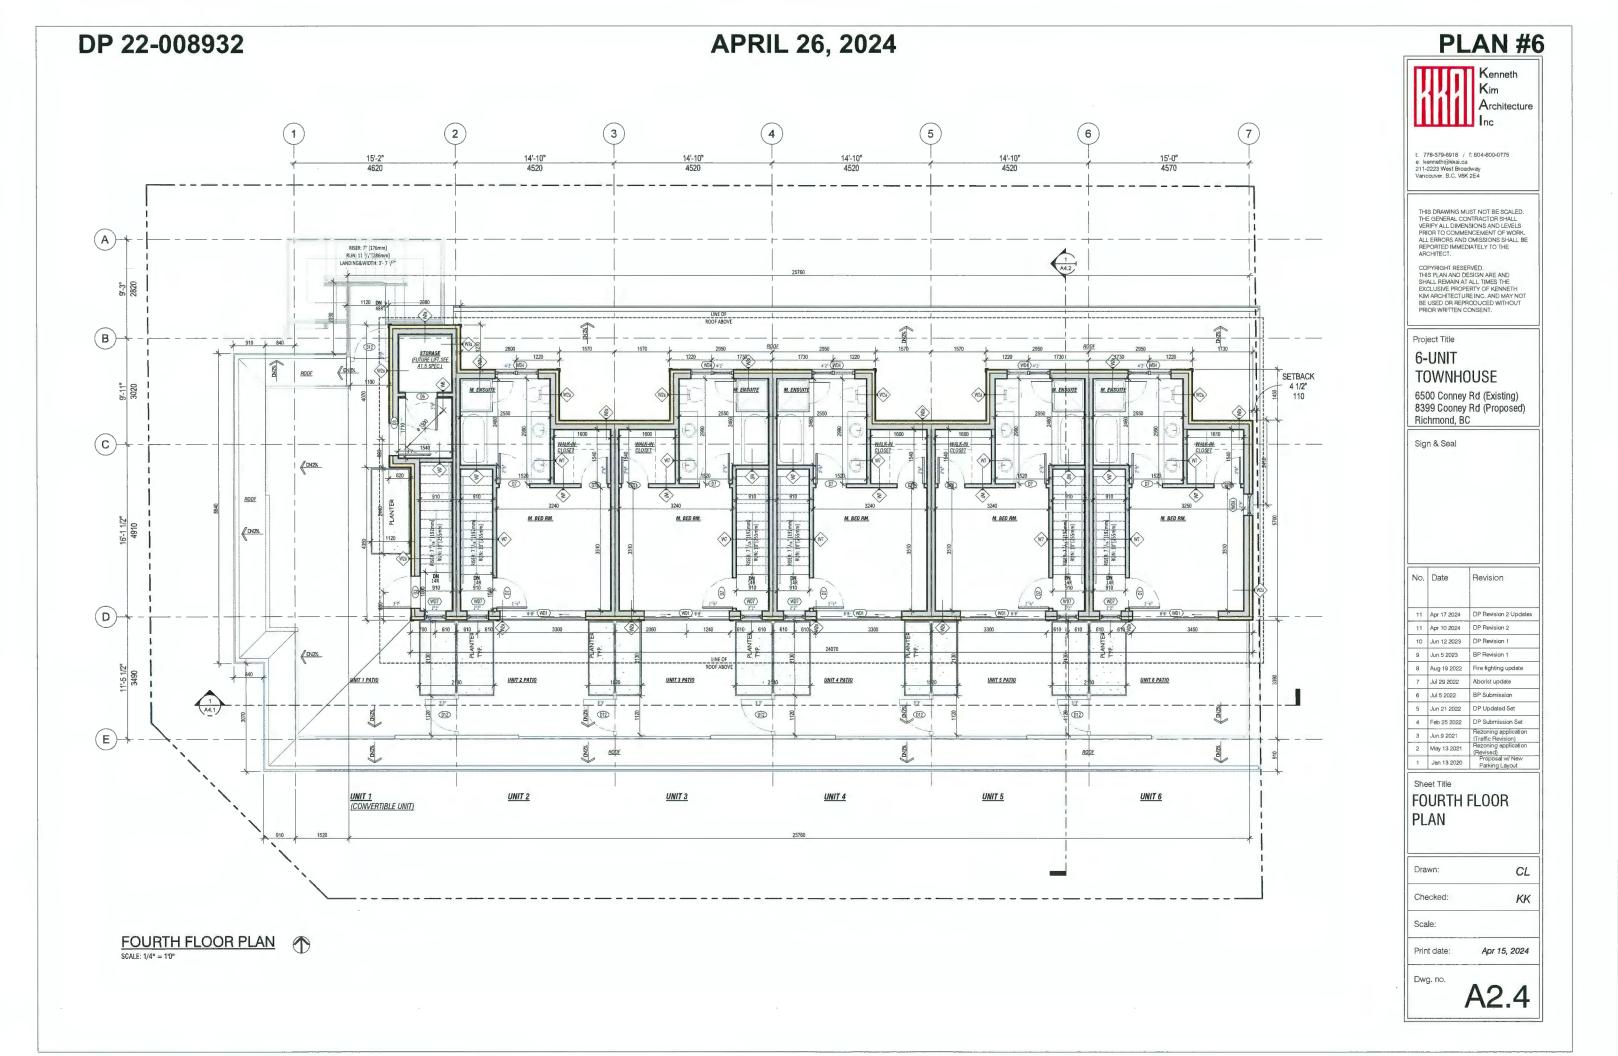



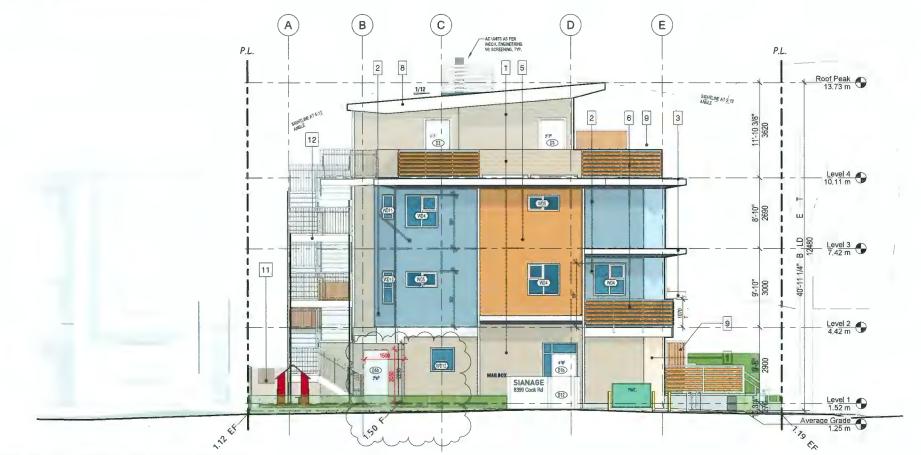

MATERIALS LEGEND

- Horizontal HardiePlank Siding

 COLOUR:Light Brown
- 2 Slapdash Stucco Finish COLOUR:Slate Gray
- 3 Metal Flashing COLOUR:Silver/light gray
- 4 Slapdash Stucco Finish COLOUR:Light Gray
- 5 Horizontal Siding (Aluminum, Steel or Composite) (e.g. Longboard® Tongue & Groove) COLOUR:Simulated Wood
- 6 Alum/Glass Balcony Guards w/ Decorative Wood Slats (Painted) @ Outside of Glass COLOUR: Medium Brown
- 7 Concrete- Painted COLOUR: Light Gray
- B Wood Trim/Fascia/Downspout- painted COLOUR: Ivory White
 - 9 Open Trellis Privacy Screen Between Units COLOUR: Medium Brown
 - 11 Wood Painted Privacy Fencing to Neighbour COLOUR: Medium Brown
 - 12 Exit Stairs Steel Structure: Silver/light gray **Bailing: Light Brown** Tread & Landing: Light Gray

WEST ELEVATION (COONEY RD) SCALE: 3/16" = 1'0"

PLAN #7

Kenneth Kim Inc

Architecture

778-379-8918 / f: 604-800-0775 e. kenneth@kkai.ca 211-2223 West Broadway Vancouver, B.C. V6K 2E4

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Project Title

6-UNIT TOWNHOUSE

6500 Conney Rd (Existing) 8399 Cooney Rd (Proposed) Richmond, BC

Sign & Seal

No. Date Revision 13 Apr 23 2024 DP Revision 2 Updates 12 Apr 17 2024 DP Revision 2 Updates 11 Apr 10 2024 DP Revision 2 10 Jun 12 2023 DP Revision 1 9 Jun 5 2023 BP Revision 1 8 Aug 19 2022 Fire fighting update 7 Jul 29 2022 Aborist update 6 Jul 5 2022 BP Submission 5 Jun 21 2022 DP Updated Set 4 Feb 25 2022 DP Submission Set A 100 22 2022 Di Costmando Cit.
 A 100 22 2021 (Prafic Revision)
 May 13 2021 (Revised)
 May 13 2021 (Revised)
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Sheet Title

SOUTH & WEST ELEVATION

Drawn:

CL

KK

Apr 23, 2024


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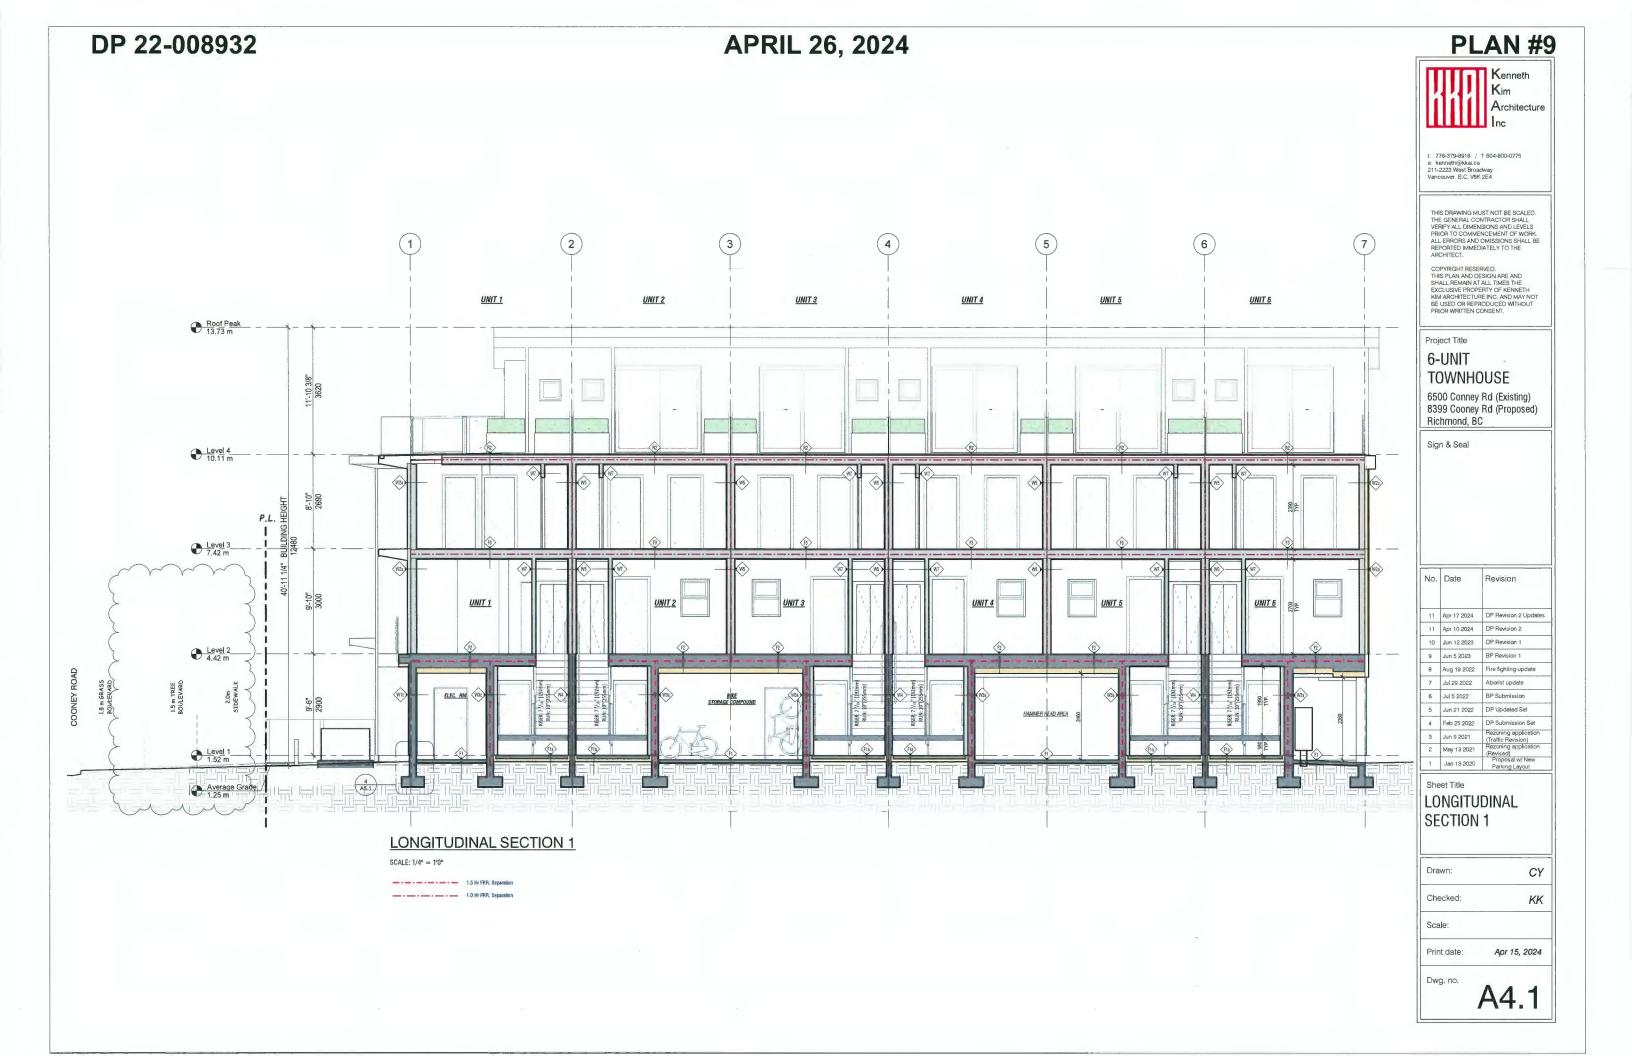
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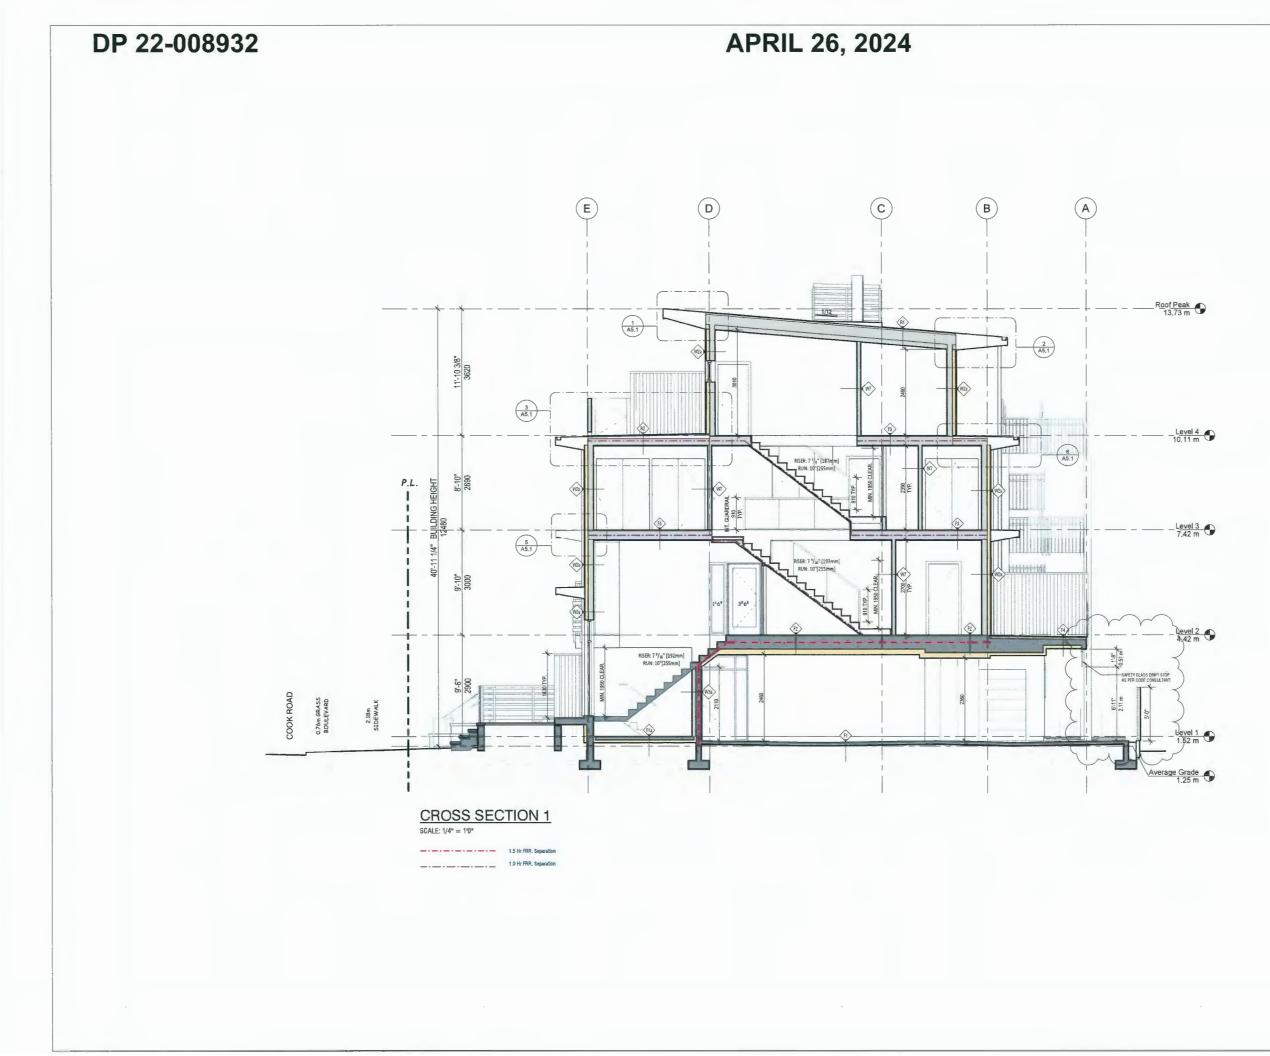
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Print date:

Dwg. no.





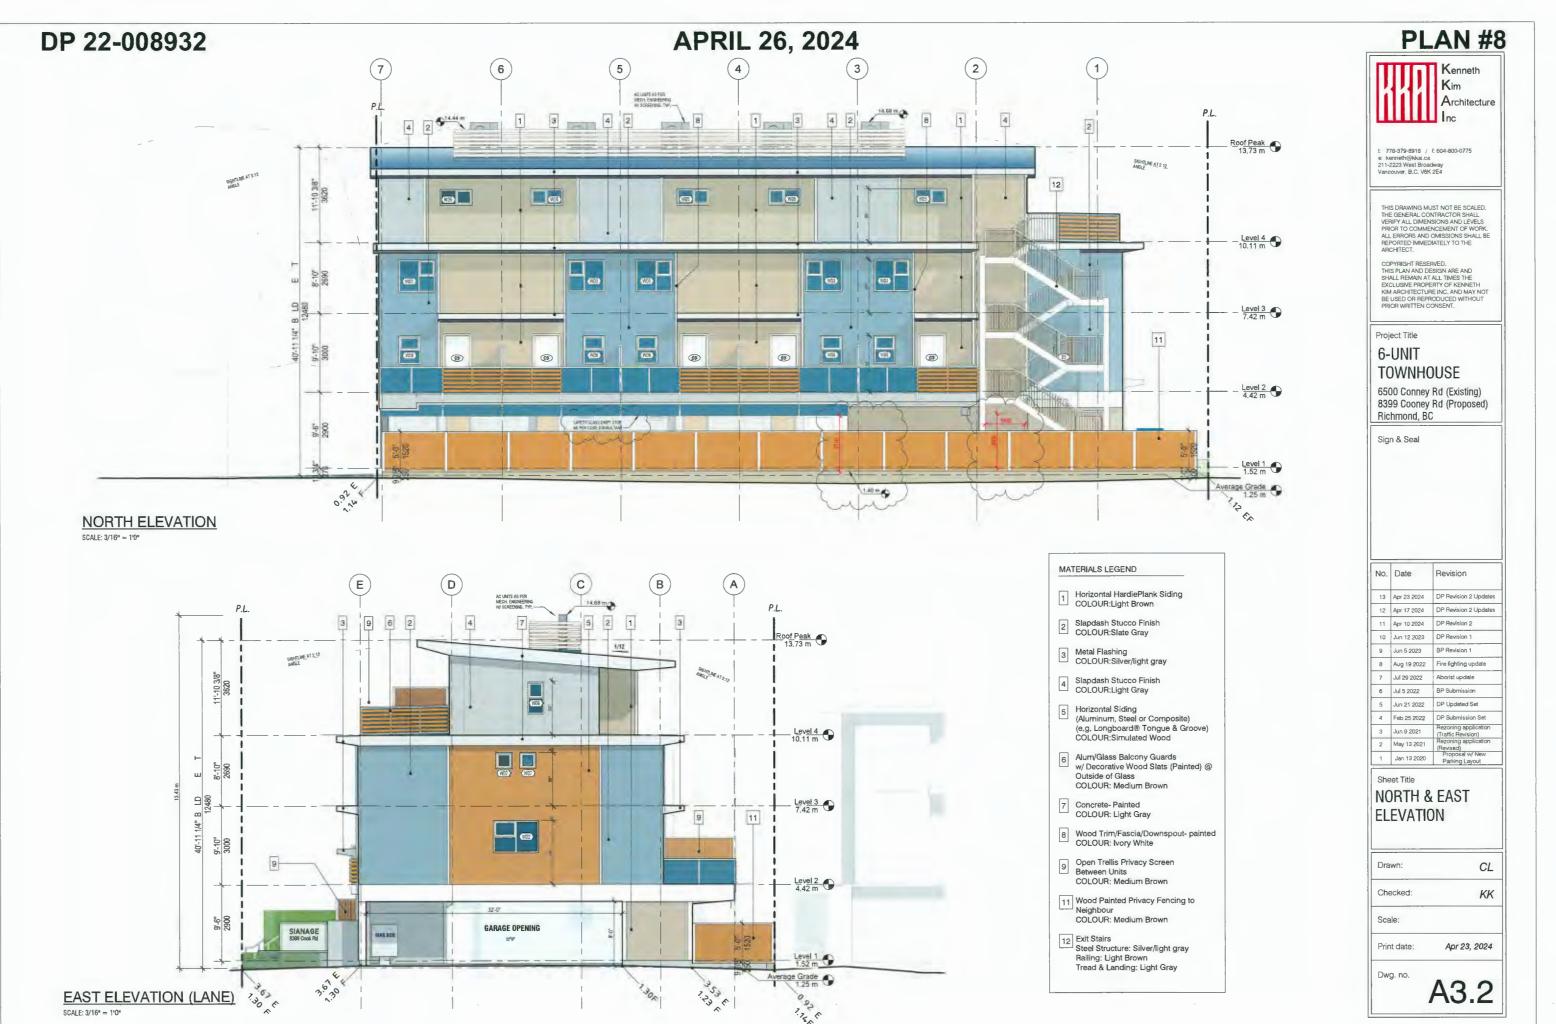

PLAN #10

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Project Title

6-UNIT TOWNHOUSE

6500 Conney Rd (Existing) 8399 Cooney Rd (Proposed) Richmond, BC

Sign & Seal

No. Date Revision Apr 17 2024 DP Revision 2 Updates 11 Apr 10 2024 DP Revision 2 10 Jun 12 2023 DP Revision 1 9 Jun 5 2023 BP Revision 1 B Aug 19 2022 Fire lighting update 7 Jul 29 2022 Aborist update 6 Jul 5 2022 BP Submission 5 Jun 21 2022 DP Updated Set 4 Feb 25 2022 DP Submission Set
 4
 Feb 25 2022
 DP Submission Set

 3
 Jun 9 2021
 Rezoning application (Traffic Revision)

 2
 May 13 2021
 Rezoning application (Revised)

 1
 Jan 13 2020
 Proposal w/ New Parking Layout
 Sheet Title **CROSS SECTION 1**


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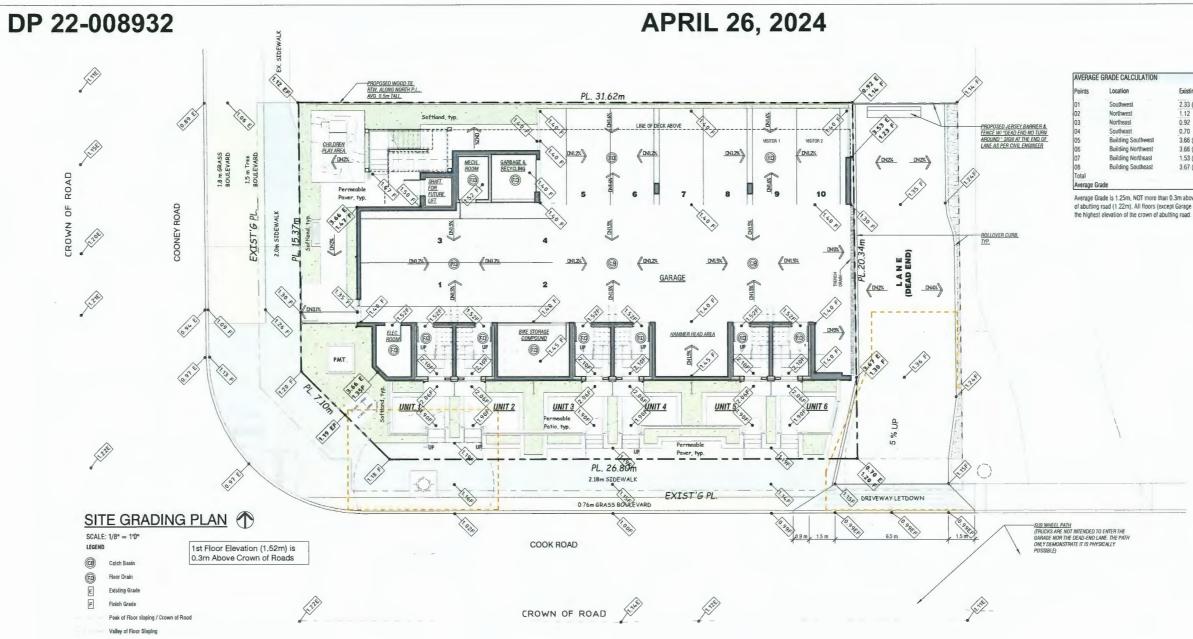
Print date: Apr 15, 2024

A4.2

Dwg. no.

DP 22-008932



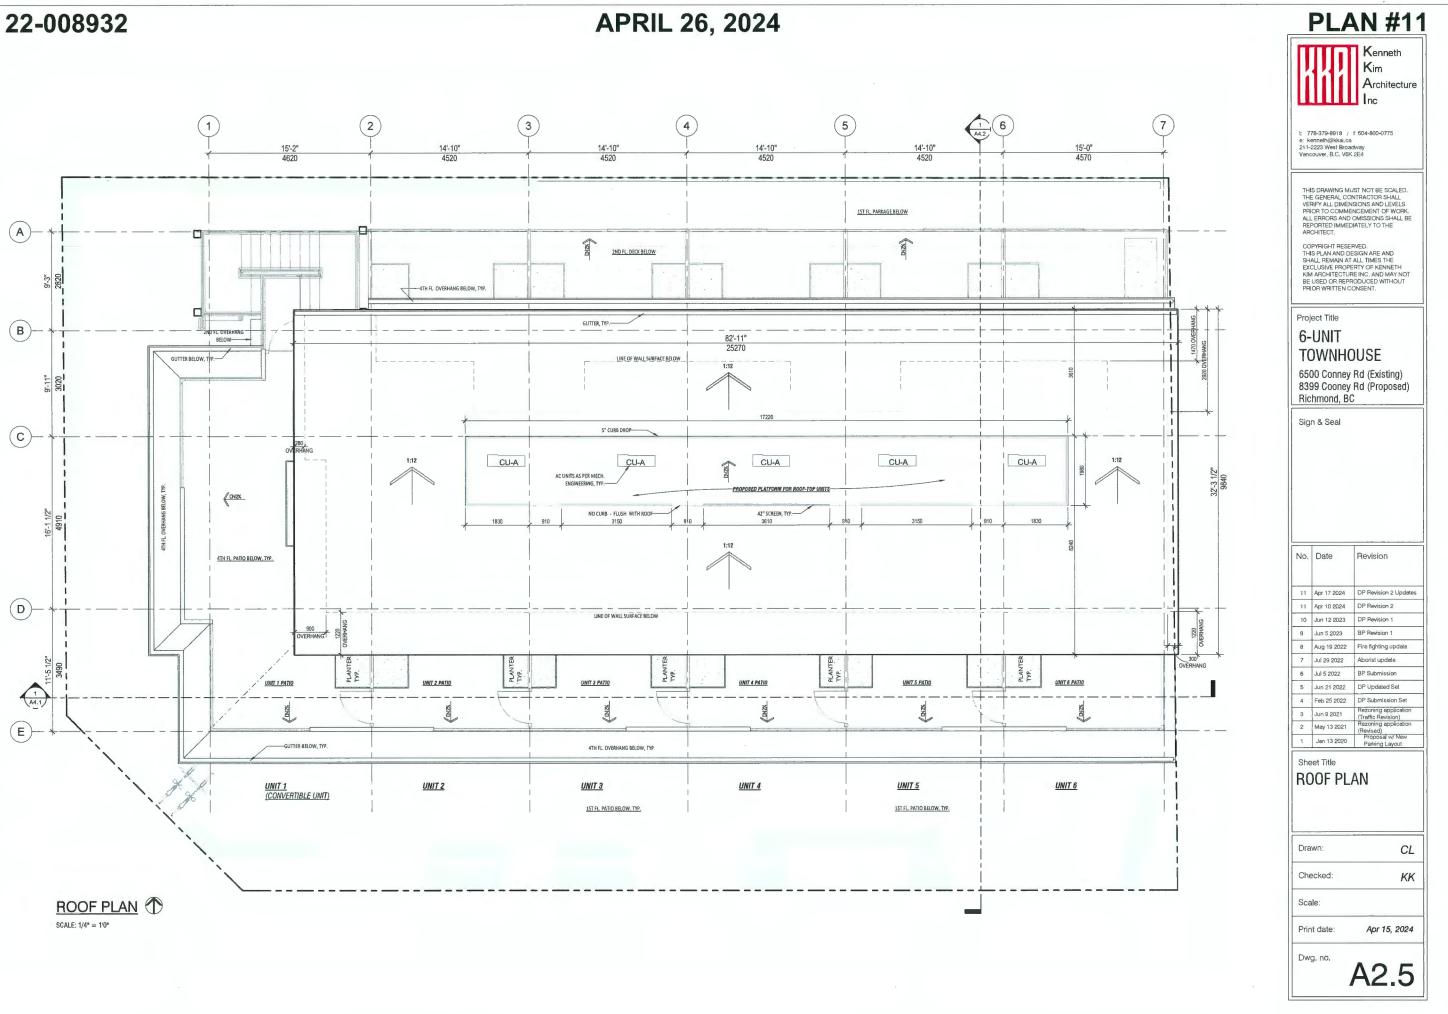

AGING-IN-PLA	ACE FEATURES (ALL UNITS)	CONVER	TIBLE UNIT FEATURES CHECKLIST								
ALL ROOMS	LARGE TOGGLE-TYPE ELECTRICAL SWITCHES		ENTRY DOORS MIN. 863 MM BUT IDEALLY 914MM AND HAVE CLEAR ACCESS	1	CIRCULATION	ELEVATOR LIFT: STAIRCASE WIDTH, FRAMING SUPPORT, AND LANDINGS, AS NOTED ON FLOOR PLANS IN COMPLIANCE WITH MANUFACTURER SPEC		OUTLETS &	PLACEMENT LOCATIONS OF ELECTRICAL OUTLETS: BESIDE WINDOW, BOTTOM CF STAIRWAYS, BESIDE TOILET ABOVE EXTERNAL DOORS	1	
	MINIMIZE THRESHOLD HEIGHTS (LESS THAN 1/2')	DOORS & DOORWAYS	ENTRY DOOR CLEAR EXTERIOR FLOOR SPACE MIN 1220 MM DEPTH BY DOOR WIDTH FLUS 500 MM LATCH SIDE (NOT NEEDED IF ROUGH-	1	(FUTURE)	SPEC NOTE: GARAVENTA HOME ELEVATOR (STYLE 3 40'x54" CAB SIZE) MAX. LOAD. 1,000LBS, 50FT MAS. TRAVEL, 6" MIN PIT	1	SWITCHES	(OUTSIDE AND INSIDE), ON FRONT FACE OF KITCHEN COUNTER WITHIN PROXIMITY OF CONTROL CENTRE FOR SMART HOME OPTIONS		
	WHERE POSSIBLE		IN WIRING PROVIDED FOR FUTURE AUTOMATIC DOOR OPENER) - SEE WWW.GARAVENTA.COM [OR APPROVED EQUAL]			UPGRADE TO FOUR-PLEX OUTLETS IN MASTER BEDROOM, HOME	1				
	MINIMIZE CONTRAST IN COLDURS OF FLOOR FINISHES WHERE POSSIBLE	INTERIOR DOORS TO MANU LINIKA AREAS, 1 BATHROOM AND 1 BEDROOM - MINI, BOLMAN CLEAR OPENING WITH FLUSH THRESHOLDS MAX 13 MM HEIGHT, DEMONSTRATE WHEELCHAIR ACCESS BETWEEN HALLWAY AND ROOMS. WIDEN HALLWAY ANDOR DOORWAYS IF NECESSARY TO PROVIDE ACCESS PATIOBALCONY MINI, BIO MIN CLEAR OPENING, NOTE HOW ACCESSED. ALL INTERD THRESHOLDS WITHIN LIVITS COMPLY WITH REGIC.		1		VERTICAL LIFT: DEPRESSED SLAB AREA, AND LANDINGS, AS NOTED ON FLOOR PLANS IN COMPLIANCE WITH MANUFACTURER SPEC. FRAMING TO ACCOMMODATE SHAFT CONSTRUCTION WIO IMPACT TO SURE. STRUCTURE	1		OFFICE, GARAGE, AND RECREATION ROOM. CLEAR AREA NEEDED UNDER FUTURE WORKSPACE. PLUMBING AND		
1	WALL BLOCKING FOR FUTURE ADDITIONAL HANDRAIL		DEMONSTRATE WHEELCHAIR ACCESS BETWEEN HALLWAY AND ROOMS.		1			KITCHEN	GAS PIPES (IN-WALL AND IN FLOOR) LOCATED CLEAR OF UNDER COUNTER AREA OF FUTURE WORKSPACE (STOVE, SINK & MIN, 810 MM WIDE COUNTER) ALL PIPES ARE BROUGHT IN NO HIGHER THAN 304 MM TO THE CENTRE OF THE PIPE FROM FLOOR LEVEL	1	
	INSTALLATION			-	-						
	INTERMEDIATE STAIR LANDINGS WHENEVER POSSIBLE					AT THE TOP OF ALL STAIRWAYS, WALLS ARE REINFORCED WITH 2'X12' SOLID LUMBER AT 914 MM TO CENTRE.					
	LESS STEEP RISE/RUN DIMENSIONS WHERE POSSIBLE			TOILET CLEAR FLOOR SPACE MIN. 1020 MM AT SIDE AND IN FRONT	V	1	CABINETS UNDERNEATH SINK ARE EASILY REMOVED.				
BATHROOMS	WALL BLOCKING FOR FUTURE GRAB BAR INSTALLATION		LEVER-TYPE HANDLES FOR ALL DOORS		BATHROOMS	WALL BLOCKING FOR FUTURE GRAB BARS AT TOILETS TUBS. AND SHOWERS	V	1	1500 MM TURNING DIAMETER OR TURNING PATH DIAGRAM	DIAGRAM V	
	(AT BATHTUB, TOILET)			1	(MIN 1/UNIT)	LEVER-TYPE HANDLES FOR PLUMBING FIXTURES	17	1	LEVER TYPE HANDLES FOR PLUMBING FIXTURES		
	LEVER HANDLE TAPS AND FAUCETS	HALLWAYS	MIN 900 MM WIDTH	V	i	PRESSURE AND TEMPERATURE CONTROL VALVES ARE INSTALLED	1	WINDOWS	MIN 1 WINDOW THAT CAN BE OPENED WITH A SINGLE HAND	1	
	2'-10" DOORS WHERE POSSIBLE	HALLWATS	MIN. SUD MM WID IN	17	-	ON ALL SHOWER FAUCETS	V		(BATHROOM, KITCHEN, LIVING ROOM)		
KITCHEN	LEVER HANDLE TAPS AND FAUCETS	GARAGE	GARAGE	MIN 1 ACCESSIBLE PARKING SPACE WITH MIN. 4M GARAGE WIDTH	V		CABINETS UNDERNEATH SINK ARE EASILY REMOVED.	V	1		
HALLWAYS	MIN 900 MM WIDTH		ACCESS FROM GARAGE TO LIVING AREA MIN 800 MM CLEAR OPENING	1		DEMONSTRATE BATH AND SHOWER CONTROLS ARE ACCESSIBLE (LAYOUT OR FIXTURE PLACEMENT)	1				


SUSTAINABIL	ITY FEATURES (ALL UNITS)			CRIME PREVE
LOW VEHICLE USE	LOCATED IN PEDESTRIAN-ORIENTED AREA (CITY CENTRE)	TREE RETENTION	IMPLEMENT ARBOURIST MEASURES TO RETAIN EXISTING 0 5M DIA ELM TREE (OFFSITE SW CORNER)	ENTRY DOORS
	ONLY 3 BLOCKS WALK FROM RICHMOND-BRIGHOUSE SKYTRAIN STATION		INPLEMENT ARBOURIST SPECIAL MEASURES TO RETAIN EXISTING 1 15M DIA EUM TREE (OFFSITE SE CORNER)	
	ONLY 2 BLOCKS FROM RICHMOND CENTER MALL			
	ONLY 2 BLOCKS FROM WILLIAM COOK ELEMENTARY SCHOOL			
	ONLY 3 BLOCKS FROM GARDEN CITY PARK & BRIGHOUSE PARK	MATERIALS	LOW VOC-EMITTING MATERIALS	
BUILDING STTING	SOUTH ORIENTATION MAXIMIZES DAYLIGHT PENETRATION AND MINIMIZES WEST LOW SUN EXPOSURE		LOW FLOW TOILETS, SHOWERS AND LAVATORIES	COMMON AREAS
	DEVELOPED ORPHANED LOT RESULTS IN HIGHER DENSITY & MORE EFFICIENT USE OF CITY INFRASTRUCTURE		ALL EXTERIOR GLAZING TO HAVE LOW-E COATINGS	
BUILDING DRIENTATION	VENTED WINDOWS ALLOW NATURAL THROUGH-UNIT VENTILATION			PARKING & LAHE
AND DESIGN	LARGE PRIVATE ROOF DECKS ENCOURAGE OUTDOOR ACTIVITIES (I.E. LESS USE OF APPLIANCES & LIGHTING)	LANDSCAPING	USE LOW MAINTENANCE PLANTING MATERIAL TO REDUCE WATER CONSUMPTION	
	VERTICAL LIFT PROVIDES ACCESSIBILITY TO ROOFTOP ACTIVITIES INCLUDING URBAN GARDENING (UNIT #1)		USE IRRIGATION SYSTEM TO MAINTAIN HEALTH OF LANDSCAPING	
	ROOFTOP DECK AREAS (WITH CONC PAVERS) ADDS INSULATION VALUE AND SHOULD REDUCE ENERGY LOSS		EXISTING AND NEW TREES ALONG SOUTH PROPERTY LINE PROVIDE SEASONAL SOLAR SHADING	
LOW ENERGY USE	STEP 3 WITH LOW CARBON ENERGY SYSTEM			
	USE ENERGY STAR APPLIANCES IN ALL UNITS			
	WILL CONSIDER LED LIGHTING THROUGHOUT (PENDING ELECTRICAL CONSULTANT REVIEW)			

ENTRY DOORS	FRONT ENTRIES DIRECTLY ACCESSED FROM PUBLIC STREET, WITH VIEWS FROM LARGE LIVING ROOM WINDOWS
	FRONT YARD PRIVATE SPACES ON RAISED PATIOS. FENCED AND GATED TO SEPARATE FROM PUBLIC REALM
	USE OF FRONT YARD PATIOS HELP STREET MONITOR PUBLIC STREETFRONT AREAS
	ALL EXTERIOR UNIT DOORS TO HAVE DOOR VIEWERS & AREA LIGHTING
	2NF FLOOR REAR EXTERIOR PRIVATE SPACES TO BE GATED
COMMON AREAS	LANDSCAPING DESIGNED TO ELIMINATE HIDING PLACES BUT PROVIDE LINES OF SIGHT WHERE APPROPRIATE
	COMMON OUTDOOR AMENITY AREAS, FENCED & GATED, ARE OVERLOOKED BY WINDOWS AT 2ND & 3RD FLOORS
PARKING & LANE	PARKADE PROVIDED LARGE OPENINGS FOR VISUAL/AURAL SURVEILLANCE OPPORTUNITIES
	PARKADE INTERIOR PAINTED LIGHT GRAY OR WHITE TO INCREASE VISIBILITY
	PARKADE MAN-DOORS TO HAVE GLAZED PANELS FOR TWO-WAY VISIBILITY
	BIKE STORAGE ROOMS IN PARKADE TO BE OPEN METAL SCREEN/GRILLE (NOTHING HIDDEN)
	GARBAGE & RECYCLING ROOMS IN PARKADE TO HAVE OPEN METAL SCREEN/GRILLE (NOTHING HIDDEN)
	PARKADE AND LANE LIGHTING "O BE AUTOMATICALLY ACTIVATED BY LIGHT LEVEL SENSOR

ocation	Existing Grade (m)	Proposed Grade (m)
outhwest	2.33 (T.O. Pre-loading)	1.19
orthwest	1.12	1.12
ortheast	0.92	1.14
outheast	0.70	1.20
uilding Southwest	3.66 (T.O. Pre-loading)	1.35
uilding Northwest	3.66 (T.O. Pre-loading)	1.47
uilding Northeast	1.53 (T.O. Pre-loading)	1.23
uilding Southeast	3.67 (T.O. Pre-loading)	1.30
		10.00


Average Grade is 1.25m, NOT more than 0.3m above the highest elevation of the crown of abutting road (1.22m). All floors (except Garage & Garbage room) are Min.0.3m above



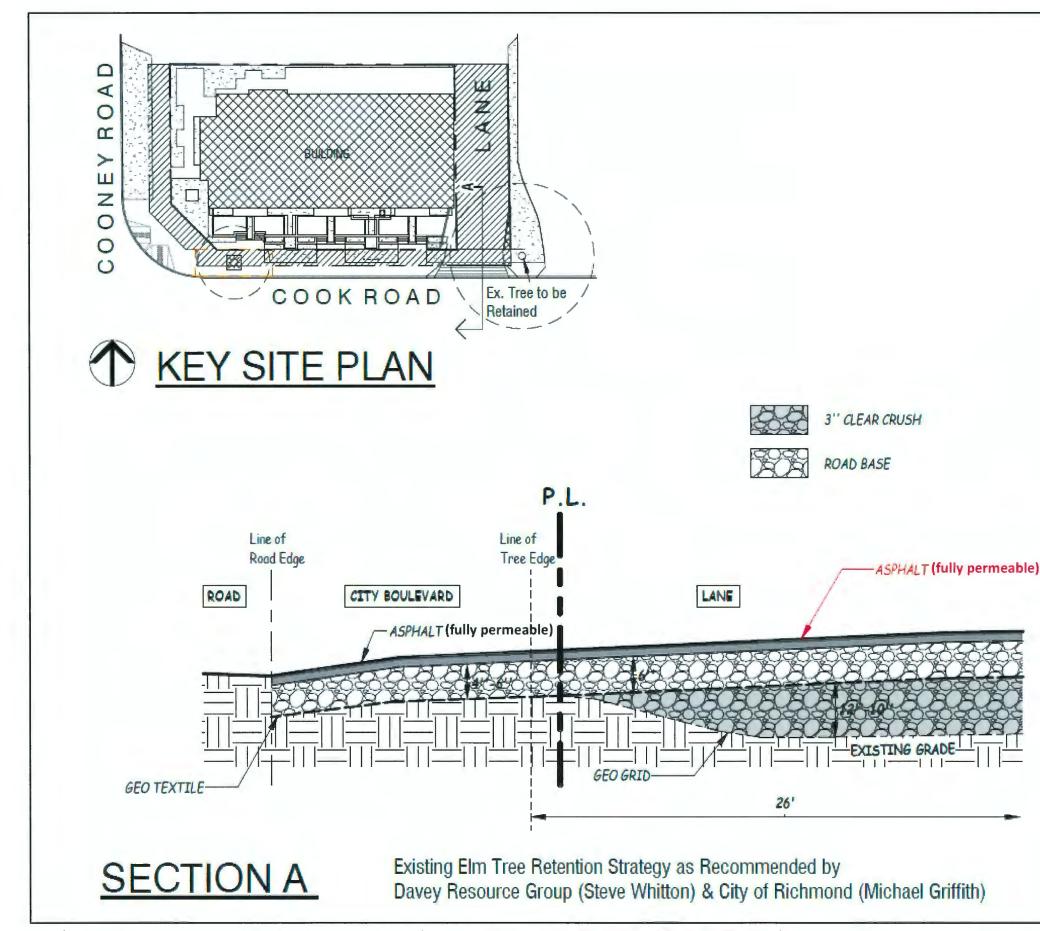


Driveway Details – Not to Scale

PLAN #13

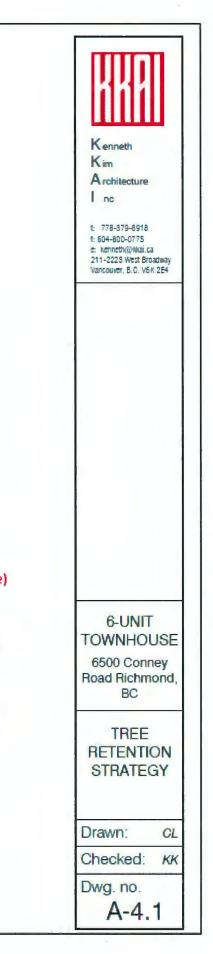


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APRIL 26, 2024

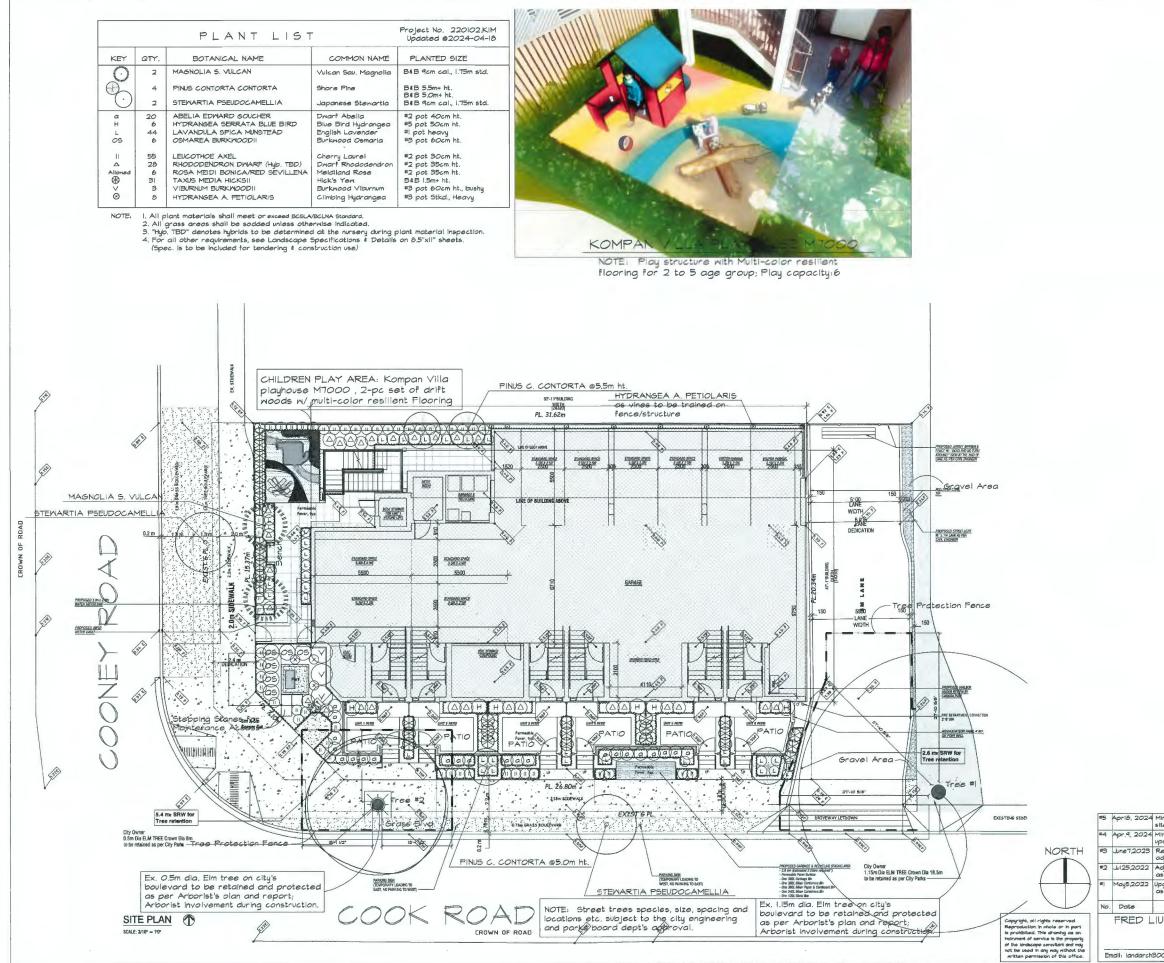


	PLAN #1
	Kenneth Kim Architecture Inc.
	211-2223 West Broadway Vancouver, BC, V8K 2E4 Tel: (776) 379-8918 Fax: (604) 800-9775 Kennelin@tkki.com
	COPYRIGHT RESERVED: This design and drawing are exclusive property of Kenneth Kim Architecture Inc. and cannot be used for any purpose without the written consent of the Architect. This drawing is not be used for construction until issued for that purpose by the Architect.
	Prior to commencement of the Work, the Contractor shall review and verify drawing dimensions, datums and levels to kently any discrepancies between information in this drawing and 1) actual site conditions: and: 2) the remaining Contractor Documents. The Contractor shall bring all discrepancies. If any, to the attention of the Architect for clarification before proceeding with work.
	PROJECT: Proposed 6-UNIT Residential Devt. 8399 Cook Rd (Ex. 6500 Cooney Rd.) Richmond, BC
	DEVELOPER:
	CONSULTANTS:
	FRED LIU & ASSOCIATES Landscape Consultant
	REVISION No. Date Revision
	DRAWING: File:
	LANDSCAPE SITE / PLANTING PLAN
nor revision as per arch revised site plan; ie alm changes, boulevard layout, plant list. nor revision as per arch new site plan; genera dating incl. jologground area, Plant List. evised as per arch new site plan with overall djustments; updated P ant List. Justed tree protection fences	DRAWN BY: M.S. CHECKED BY: F.L. SCALE:
s per current arborist's report. grading to full planting plan with plant list s per architect's instruction for cost estimate.	I/B"=1'-0" PRINT DATE: January 2022
REVISIONS J & ASSOCIATES, INC. Landscape Consultant Vancauver BC. V5P 2L3	PROJECT NO. SHEET NO. 220102.KIM Issue date: L1 of 1
00egmail.com TEL:(604)327.7541	2024-04-18

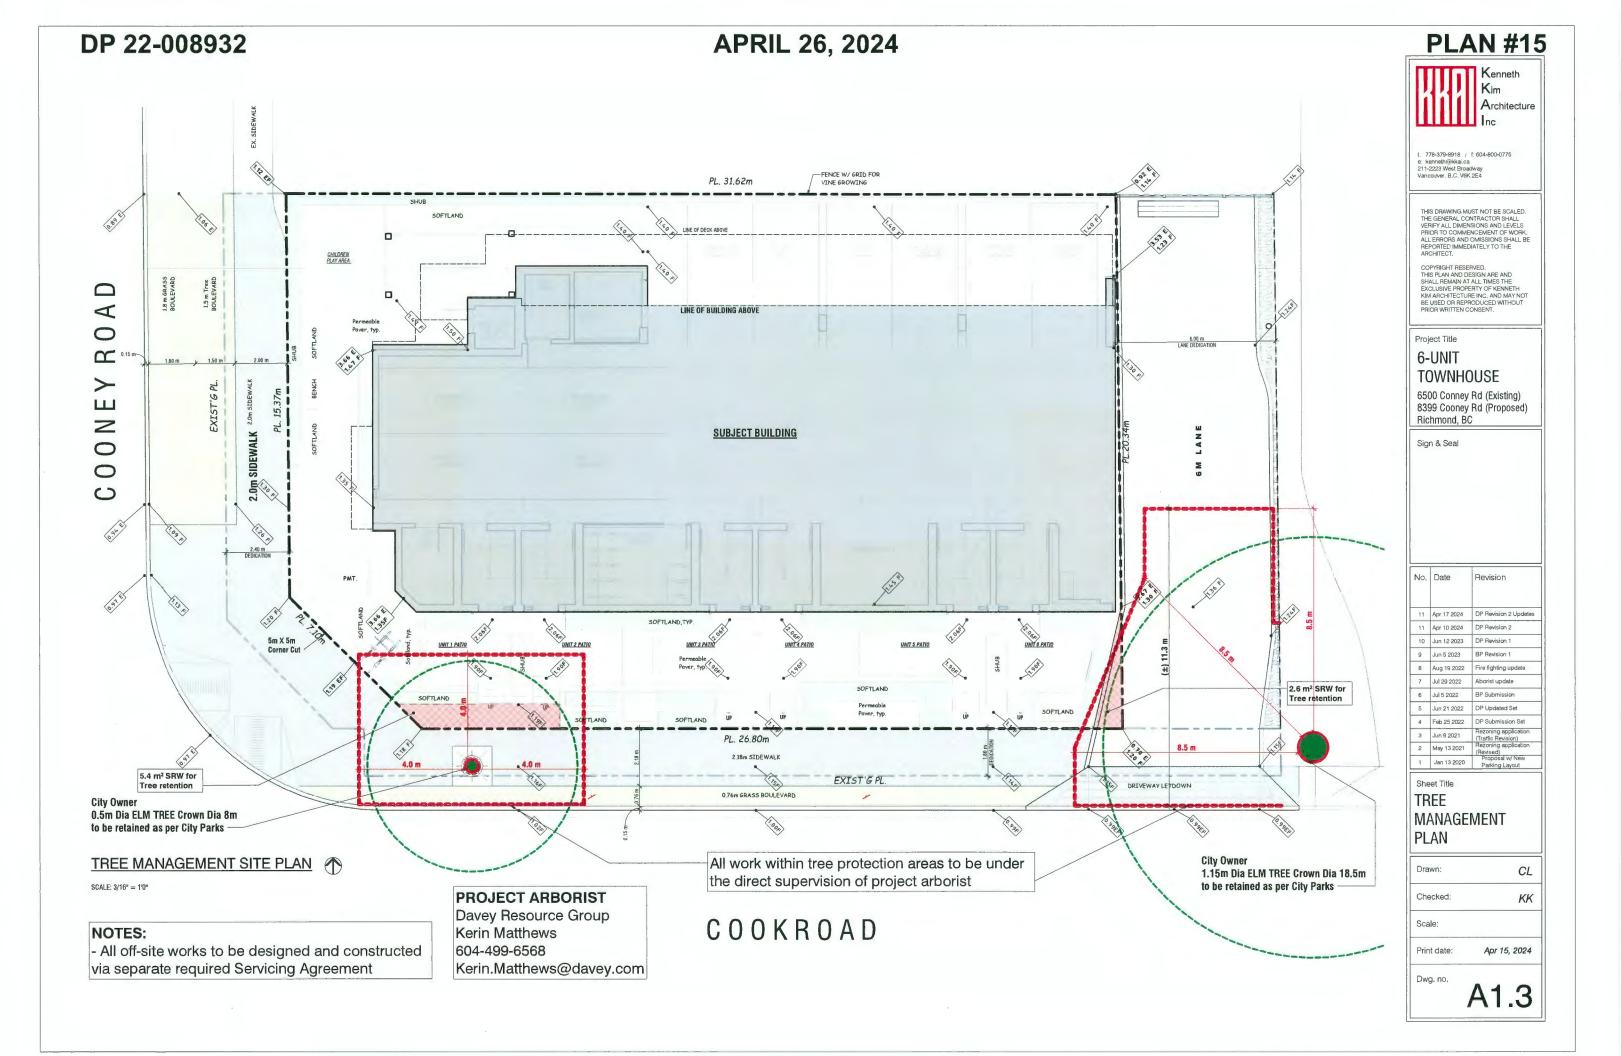


DP 22-008932

APRIL 26, 2024

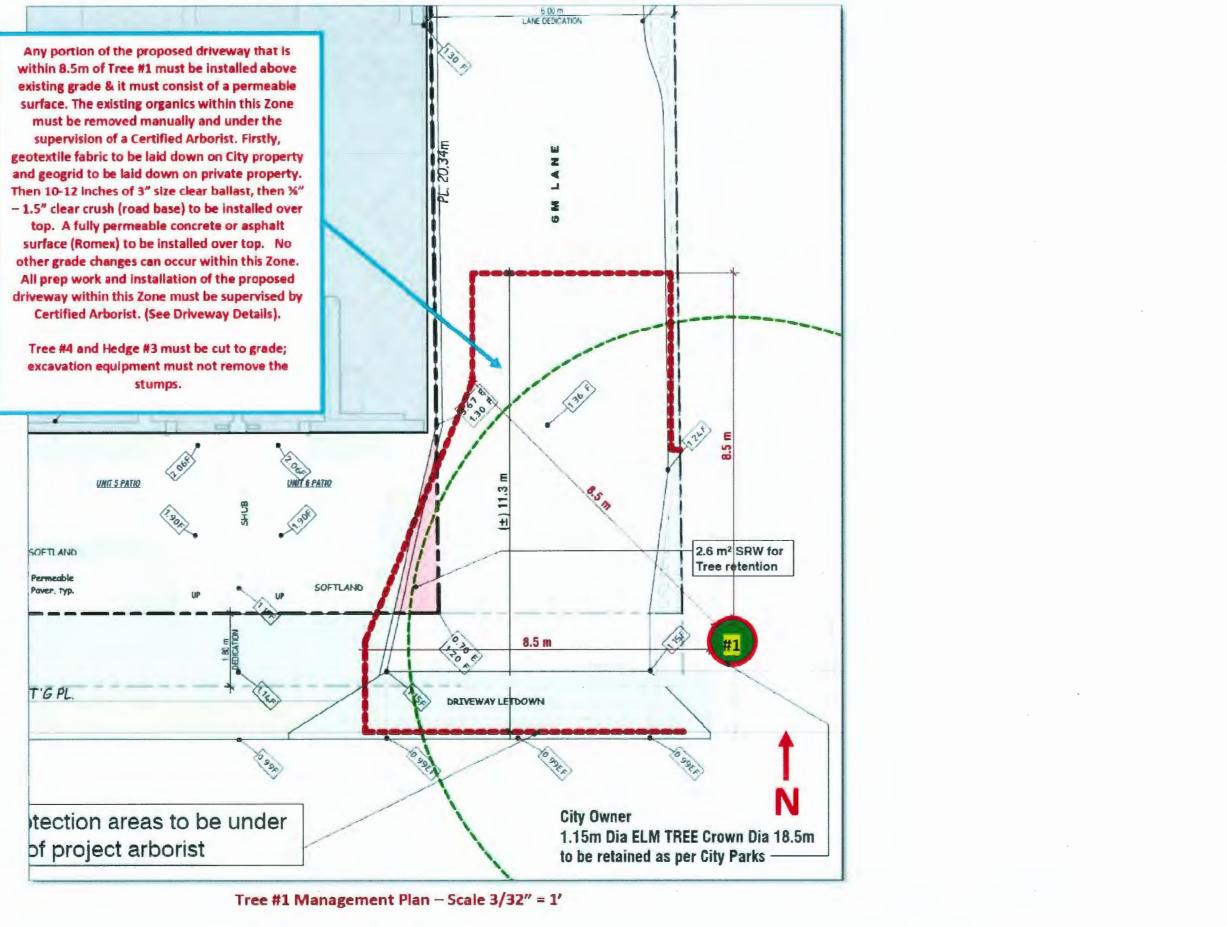

PLAN #16

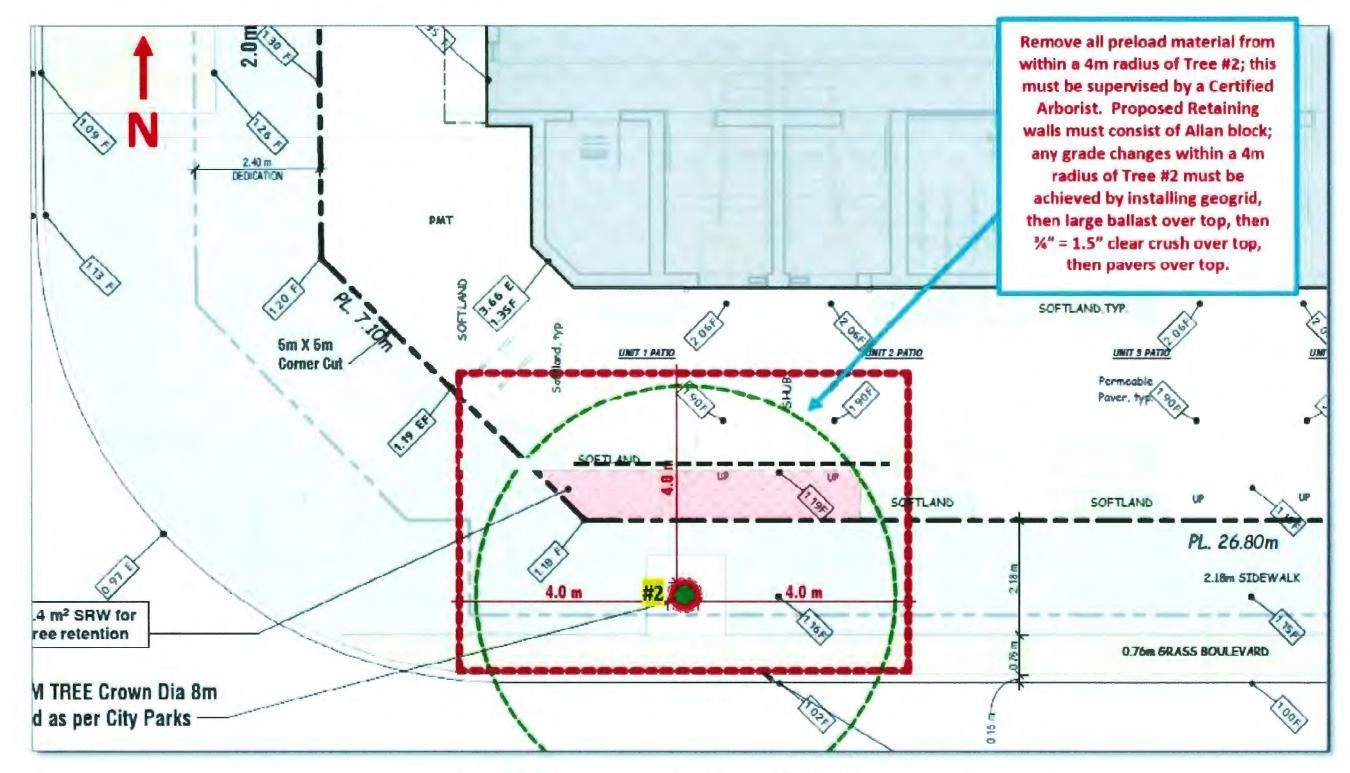

Tree #2 Management Plan, Scale 3/32" = 1'

PLAN #17

DP 22-008932

APRIL 26, 2024



SPRING/FALL EQUINOX 10AM



SPRING/FALL EQUINOX 2PM



SUMMER SOLSTICE 10AM



SUMMER SOLSTICE 2PM





REFERENCE



Architecture

t: 778-379-8918 / f 604-800-0775 e: kenneth@kkai.ca 211-2223 West Broadway Vancouver, B.C. V6K 2E4

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Project Title

6-UNIT TOWNHOUSE

6500 Conney Rd (Existing) 8399 Cooney Rd (Proposed) Richmond, BC


Sign & Seal


No. Date Revision 11 Apr 10 2024 DP Revision 2 1D Jun 12 2023 DP Revision 1 9 Jun 5 2023 BP Revision 1 8 Aug 19 2022 Fire fighting update 7 Jul 29 2022 Aborist update 6 Jul 5 2022 BP Submission 5 Jun 21 2022 DP Updated Set 4 Feb 25 2022 DP Submission Set 4 Peo 25 2022 DP Submission Set
 Jun 9 2021 Recoring application
 (Traffer Revision)
 May 13 2021 Recoring application
 (Revised)
 Jan 13 2020 Proposal W New
 Parking Layout

Sheet Title

SHADOW ANALYSIS Drawn: CL Checked: KK Scale: Print date: Apr 10, 2024 Dwg. no. A1.4



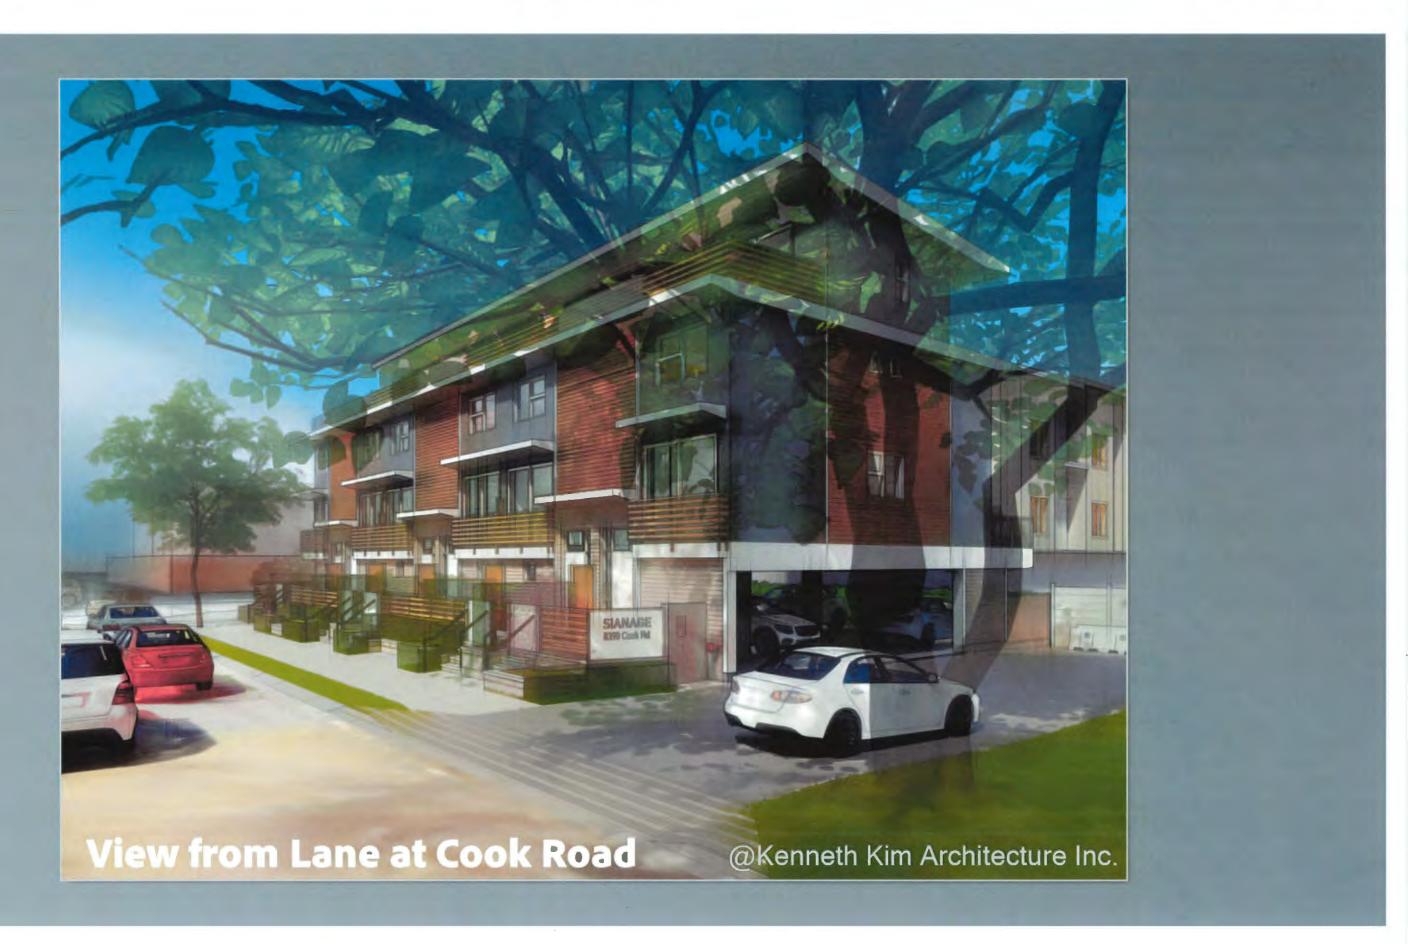

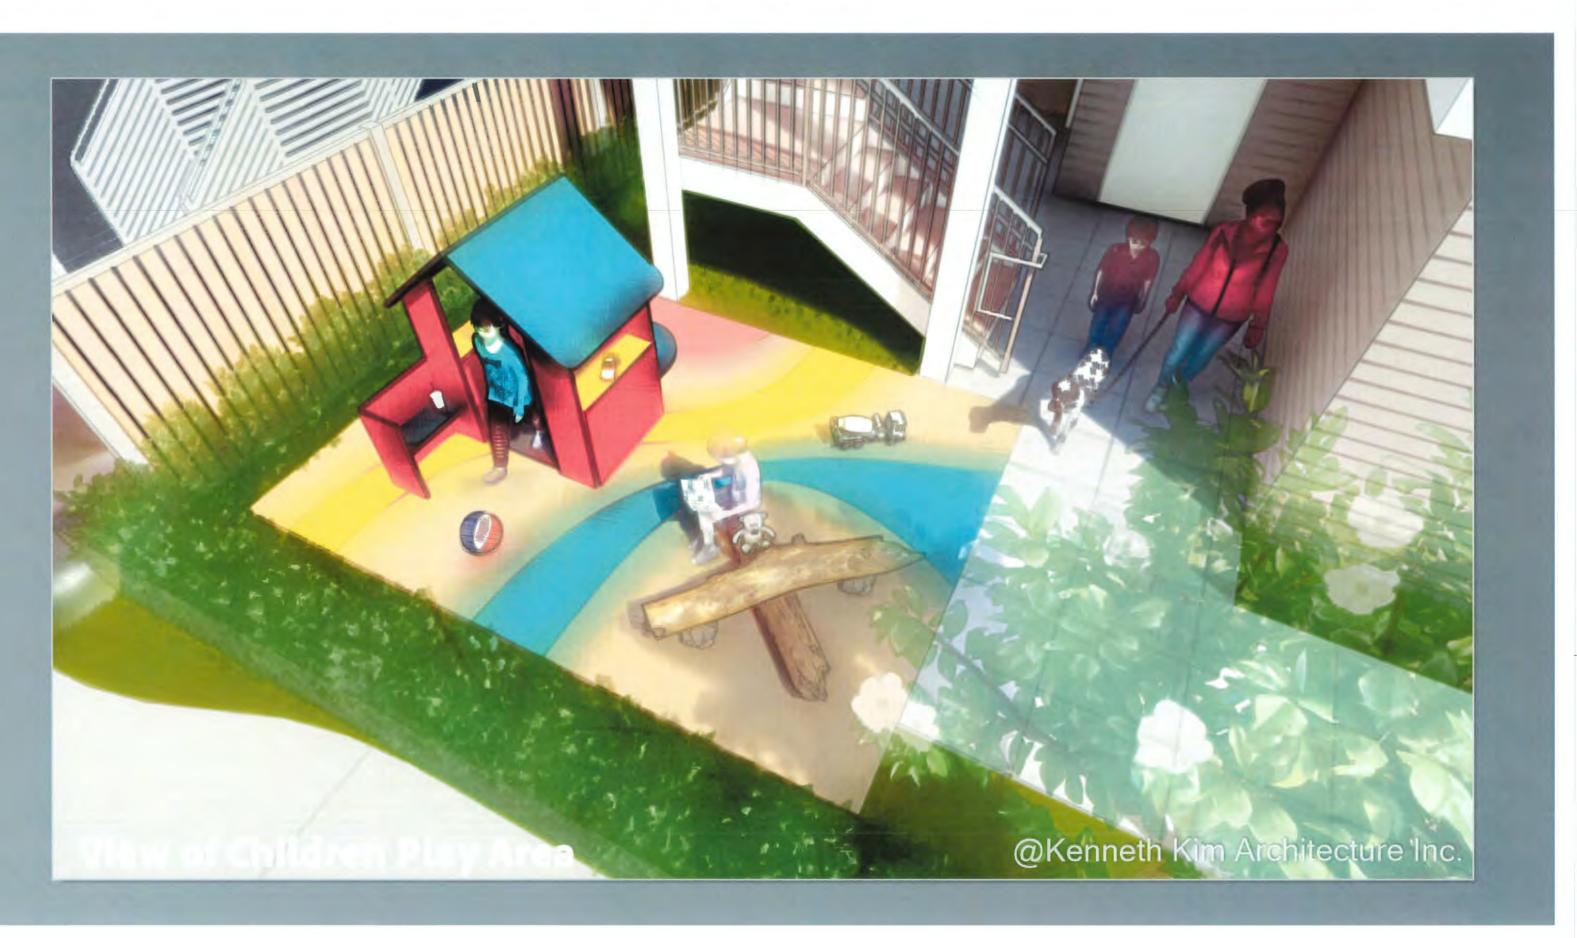



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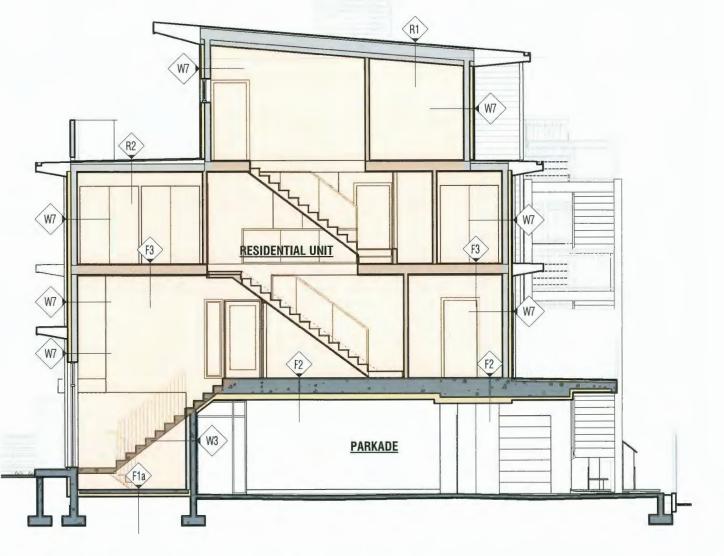
APRIL 26, 2024

ENERGY EFFICIENT MEASU	IRES SUMMARY (AS PER BULLETIN BUILING-40)
Buidling Type	Part 3, 4 Storeys Residential Townhouse
Building Area	Approx. 756 sm [8142 sf]
Required Energy Step Code	Step 3
Proposed Energy Step Code	Step 3 with Low Carbon Energy System
Primary Heating System	High-efficency Heat Pump

Table 1 Thermal Resistance of Building Envelope Assemblies

Architectural Reference	Nominal R_ Value ²
R1 - Main roof	R45 R45 batt insulation in cavity
R2 - Roof deck above living space	R32 R32 batt insulation in cavity
F1a – Typical ground floor slab	R15 ci 3" rigid insulation
F2 - Suspended slab floor.	R14 ci R14 Monofoam spray insulation or rigid insulation
W3 – Concrete fur-out wall	R14 3.5"(R14) batt insulation in cavity
W7 – Typical exterior wall	R10 ci + R22 2" R10 rigid insulation + 5.5"(R22) batt insulation in cavity
	Reference R1 - Main roof R2 - Roof deck above living space F1a - Typical ground floor slab F2 - Suspended slab floor. W3 - Concrete fur-out wall

Note: Table 1 is quoted from Certified Energy Adviser's *Thermal Bridging Calculation Report* (JRG Building Engineering). The R-value above will be optimized to meet Step 3 during BP stage.



TYPICAL CROSS SECTION

TTTT.T	Kenneth Kim	THIS DRAWING MUST NOT BE SCALED, THE GENERAL CONTRACTOR SHALL VERIFY ALL	Project Title	Consultants	No. Date	Revision	Sheet Title	File number:	- Scale:	1/8" = 1'-0"
ЦИЦИ	t: 778-379-8918	DIMENSIONS AND LEVELS PRIOR TO COMMENCEMENT OF WORK, ALL ERRORS AND OMISSIONS SHALL BE REPORTED IMMEDIATELY TO THE ARCHITECT.	6-UNIT TOWNHOUSE				ENERGY EFFICIENT MEASURES SUMMARY	Drawn:	CL Dwg. no.	
	f: 604-800-0775 e: kenneth@kkai.ca 211-2223 West Broadway Vancouver, B.C. V6K 2E4	COPYRIGHT RESERVED. THIS PLAN AND DESIGN ARE AND SHALL REMAIN AT ALL TIMES THE EXCLUSIVE PROPERTY OF KENNETH KIM ARCHITECTURE INC, AND MAY NOT BE USED OR REPRODUCED WITHOUT PRIOR WRITTEN CONSENT.	6500 Conney Rd (Existing) 8399 Cooney Rd (Proposed) Richmond, BC		1 Jul 15 20	022 ENERGY MEASURES SUMMARY	_	Print date: Jun 22,	KK 2022	A7.1



To:Development Permit PanelFrom:Josh Reis
Program Manager, Development

Date: April 24, 2024 File: DP 23-034544

Re: Application by Maskeen (Hamilton) Properties Corp. for a Development Permit at 4651, 4671, 4691 Smith Crescent and 23301, 23321, 23361, 23381 Gilley Road

Staff Recommendation

That a Development Permit be issued which would permit the construction of a mixed-use midrise development comprising commercial space, City-owned community amenity space and 186 residential units, including 19 low-end-of-market (LEMR) units at 4651, 4671, 4691 Smith Crescent and 23301, 23321, 23361, 23381 Gilley Road on a site zoned "Residential/Limited Commercial (ZMU53) - Neighbourhood Village Centre (Hamilton)".

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Josh Reis, MCIP, RPP, AICP Program Manager, Development

JR:sb

Att. 2

Staff Report

Origin

Maskeen (Hamilton) Properties Corp. (Directors: Jatinderpal Gill and Jagdip Sivia) has applied to the City of Richmond for permission to develop a mixed-use mid-rise development at 4651, 4671, 4691 Smith Crescent and 23301, 23321, 23361, 23381 Gilley Road on a site zoned "Residential/Limited Commercial (ZMU53) - Neighbourhood Village Centre (Hamilton)".

The site is being rezoned from the "Single Detached (RS1/F)" zone to the "Residential/Limited Commercial (ZMU53) - Neighbourhood Village Centre (Hamilton)" zone for this project under Richmond Zoning Bylaw 8500, Amendment Bylaw 10453 (RZ 21-942276). The site is also subject to associated amendments to the Hamilton Area Plan and City's Official Community Plan (OCP) City of Richmond 2041 OCP Land Use Map under Official Community Plan Bylaw 9000, Amendment Bylaw 10452. The rezoning bylaw and OCP amendment bylaws were given third reading at the Public Hearing held on June 19, 2023.

Highlights of the proposed development include:

- 186 dwelling units, including 167 strata units and 19 low-end-of-market (LEMR) units.
- The design and construction of a Community Policing Office in a grade-level unit fronting Gilley Road, which will be transferred to the City and was secured through the rezoning.
- Commercial spaces at grade level and fronting Gilley Road.
- One four-storey apartment building, one five-storey mixed-use building and a two-storey amenity building over a one-level shared parking structure.
- A total floor area of approximately 15,570.6 m² (167,600 ft²) comprised of:
 - \circ Approximately 132.7 m² (1,429 ft²) of Community Policing Office space.
 - \circ Approximately 604 m² (6,501 ft²) of Commercial space.
 - Approximately 13,105.8 m² (141,070 ft²) of market strata housing units and common circulation space provided over both buildings.
 - Approximately 1,490 m² (16,040 ft²) of LEMR housing units distributed over all floors of both buildings.
 - \circ Approximately 237.8 m² (2,560 ft²) of indoor amenity spaces for residents.
- The developer is intending to phase construction of the development. The first phase would consist of the southern building fronting Gilley Road and Smith Crescent, including the City facility, the residential amenity space and the parking structure. The second phase would consist of the northern building as shown in the DP plans. Each phase complies with the City's affordable housing requirements.

A Servicing Agreement is required as a condition of rezoning adoption and includes, but is not limited to, extending Garripie Avenue, Smith Crescent widening, frontage improvements to Gilley Road and Smith Crescent, utility connections and public plaza and walkway widening along the western edge of the site.

Development Information

Please refer to attached Development Application Data Sheet (Attachment 1) for a comparison of the proposed development data with the relevant Bylaw requirements.

Background

Development surrounding the subject site is as follows:

- To the North: Across the future Garripie Avenue extension, are single-detached homes on lots zoned "Single Detached (RS1/F)", which the Hamilton Area Plan designates for stacked townhouse development.
- To the South: Across Gilley Road, a mixed-use village centre development is under construction (DP 18-829286) on a lot zoned "Residential/Limited Commercial (ZMU35) Neighbourhood Village Centre (Hamilton)".
- To the East: Across Smith Crescent, are single-detached homes and a duplex on lots zoned "Single Detached (RS1/F)" and "Two-Unit Dwellings (RD1)", which the Hamilton Area Plan designates for stacked townhouse development.
- To the West: Across a public walkway connection from Gilley Road to Garripie Avenue, are a mixed-use low-rise development and a low-rise senior housing and care facility on lots zoned "Residential/Limited Commercial (ZMU29) Neighbourhood Village Centre (Hamilton)" and "Low Rise Apartment (ZLR27) Neighbourhood Village Centre (Hamilton)".

Rezoning and Public Hearing Results

The Public Hearing for the rezoning of this site was held on June 19, 2023. At the Public Hearing, no concerns about rezoning the property were expressed by the public.

Staff Comments

The proposed scheme attached to this report has satisfactorily addressed the significant urban design issues and other staff comments identified as part of the review of the subject Development Permit application. In addition, it complies with the intent of the applicable sections of the Official Community Plan and is generally in compliance with the "Residential/Limited Commercial (ZMU53) - Neighbourhood Village Centre (Hamilton)".

Advisory Design Panel Comments

The Advisory Design Panel was supportive of the application. An annotated copy of the relevant excerpt from the Advisory Design Panel Minutes from March 6, 2024 is attached for reference (Attachment 2). The design response from the applicant has been included immediately following the specific Design Panel comments and is identified in '*bold italics*'.

Analysis

Housing

• The following table indicates the proposed unit mix of LEMR and Market Strata units, with the overall number of units remaining the same as noted at rezoning.

The LEMR unit mix includes one additional two-bedroom unit and one fewer three-bedroom unit. The Market Strata unit mix includes one additional studio unit, two fewer one-bedroom units and one additional two-bedroom unit.

- 4 -

Unit Type	LEMR	Market Strata	Total
Studio	-	9.0% (15 units)	8.1% (15 units)
1-bedroom	10.5% (2 units)	43.7% (73 units)	40.3% (75 units)
2-bedroom	57.9% (11 units)	46.7% (78 units)	47.8% (89 units)
3-bedroom	31.6% (6 units)	0.6% (1 unit)	3.8% (7 units)
Total	19 Units	167 Units	186 Units

- The proposed development includes 22 basic universal housing units that are designed to be easily renovated to accommodate a future resident in a wheelchair. These include all 19 LEMR units and three Market Strata units. These single-storey units are required to incorporate all of the accessibility provisions listed in the Basic Universal Housing Features section of the City's Zoning Bylaw, and are permitted a density exclusion of 1.86 m² (20 ft²) per unit.
- All of the proposed units incorporate aging-in-place features to accommodate mobility constraints associated with aging. These features include:
 - o stairwell handrails;
 - lever-type handles for plumbing fixtures and door handles; and solid blocking in washroom walls to facilitate future grab bar installation beside toilets, bathtubs and showers.
- The building lobbies are accessed from the grade-level central courtyard as well as from the fronting sidewalks.

Conditions of Adjacency

- Commercial space and a Community Policing Office are proposed with shared connections to the sidewalk along Gilley Road along the south edge of the site, providing a pedestrian-friendly streetscape and commercial character compatible with the neighbouring development to the west.
- Courtyard level units are proposed with raised semi-private balconies and grade change screening with landscape buffer facing the Smith Crescent and Garripie Avenue fronting roads.
- Long frontages are visually broken up with articulation provided with vertically stacked balconies and colour changes for visual interest and a more pedestrian-compatible scale and form.

- The massing of the development is broken down into two main buildings arranged surrounding a central open space and smaller central amenity building, providing porosity through the site and open space pedestrian connections to Gilley Road, Garripie Avenue, a podium stair connection to Smith Crescent and the public walkway along the west edge of the site.
- There is a public high street plaza fronting onto Gilley Road and a public walkway providing a connection between Gilley Road and Garripie Avenue located within Statutory-Rights-of-Way (SRW) on the adjacent development to the west. This development will enlarge the public plaza from the interim approximately 7.5 m width and 238.6 m² (2,568 ft²) area to an ultimate approximately 17.8 m width and 535.7 m² (5,766 ft²) area. The public walkway will be widened from the interim 3 m width in a 3 m wide SRW to an ultimate 6 m wide in a 6 m wide SRW. The owner constructed and owner maintained public plaza and walkway was secured through the rezoning with registration of PROP/SRWs together with the design and construction through a Servicing Agreement.

Urban Design and Site Planning

- The proposed building height is five-storeys along the southern portion of the site and fronting onto Gilley Road high street, and steps down in height to four-storeys toward Garripie Avenue and the stacked townhouse development designated area to the north, and steps down to a two-storey amenity building toward the public walkway along the west edge of the site. All of the buildings are located on top of a shared enclosed one-level parking structure.
- The podium level central courtyard accommodates grade-level pedestrian access to all buildings, parking reserved for the Community Policing Office, shared parking for visitors and non-residential uses and two loading spaces.
- A five-storey building anchors the intersection of Gilley Road and Smith Crescent.
- A lower four-storey building anchors the intersection of Smith Crescent and Garripie Avenue and provides a transition to future potential stacked townhouse development to the north.
- A lower two-storey building provides a transition to neighbouring development to the west.
- The southern mixed-use building has an entry lobby facing the public sidewalk on Smith Crescent, a second entry lobby facing the central courtyard, and the commercial units and Community Policing Office along the sloping Gilley Road are accessed from an onsite walkway connecting at grade to the City sidewalk at the west end of the building and stairs and elevator access to Smith Crescent at the east end of the building. The north apartment building has an entry lobby facing the central courtyard. Both buildings and the western amenity building have access at grade from the central courtyard with an accessible pathway connection to the Gilley Road and Garripie Avenue sidewalks and public walkway along the west edge of the subject site.
- Indoor amenity space proposed in this development complies with Official Community Plan (OCP) requirements. Approximately 237.8 m² (2,560 ft²) of indoor amenity space is provided in the two-storey amenity building for the shared use of all residents in the development.

- Outdoor amenity space proposed in this development complies with Official Community Plan (OCP) requirements. Approximately 1,226 m² (13,197 ft²) of outdoor amenity space is provided in the central courtyard for the shared use of all residents in the development. Further details are provided in the Landscape Design and Open Space Design section of this report.
- Vehicle access to the one-level underground parking structure will be provided from Garripie Avenue. Vehicle access to the central courtyard surface parking area and residential and non-residential loading spaces will also be provided from Garripie Avenue. Garbage/recycling storage is located inside the parking structure and collection will be accommodated in a lay-by along Smith Crescent.
- The proposed development meets the requirements of the Richmond Flood Plain Designation and Protection Bylaw 8204. Registration of a flood plain indemnity covenant on Title was secured through the rezoning.

Architectural Form and Character

- The project proposes a contemporary architectural style featuring articulations provided through vertical balcony stacks separating different materials and colours, and a projecting framing element at the high street intersection. The scale of the building design elements on the low-rise and mid-rise buildings is pedestrian-friendly and provides visual interest.
- The exterior cladding is a combination of fibre cement panel, metal panel, metal horizontal plank, architectural concrete and accent stone cladding materials.
- Entry lobbies are identified with columns and covered areas framing entries with clearglazing and generous interiors.
- The colour palette of white and light grey with accents of medium grey and wood-tone provides visual interest.

Transportation

- Two vehicle accesses will be provided off Garripie Avenue, one providing access to the parking structure, and the second providing access to the two reserved Community Policing Office parking spaces, 32 shared parking spaces for visitors and non-residential uses and two loading spaces for residential and non-residential uses in the surface central courtyard area. Garbage/recycling collection is accommodated along Smith Crescent.
- Fire fighting access was further addressed by the project Architect and a code consultant.
- The proposed number of parking spaces is consistent with the Richmond Zoning Bylaw parking requirements, subject to the provision of the Transportation Demand Management measures (TDMs) secured through the rezoning, including:
 - Transit Pass Program with monthly bus pass (two-zone) offered to 16 per cent of the strata units (27 units) for a period of one year.
 - Additional Class 1 Bicycle Parking provision of Class 1 bicycle spaces at the rate of 1.5 spaces for each strata residential dwelling (instead of 1.25 spaces per dwelling). Bike storage rooms will have outlets for bicycle charging.
 - E-bike and e-scooter storage area.

- Bicycle Maintenance Facility provision of a bicycle maintenance room for shared use by all residents, including a bike stand, repair tools and bike washing area.
- The proposed number of bicycle storage spaces is consistent with Richmond Zoning Bylaw requirements.
 - There is a total of 285 Class 1 bicycle storage spaces provided within secure rooms or lockers in the amenity building and the parking structure.
 - There is a total of 50 Class 2 bicycle storage spaces provided in the central courtyard, public plaza and outside the Smith Crescent building entry lobby.

Tree Management

- Tree management was addressed at rezoning. There are 59 existing trees being removed from the development site. One off-site City tree and two hedges are being removed from the City boulevard. Three off-site neighbouring trees are required to be protected.
- Consistent with the rezoning staff report, in compensation for the on-site tree removal, 118 replacement trees are required either to be planted on-site or the provision of a voluntary contribution in the amount of \$768.00 for each replacement tree that is not able to be accommodated on-site. At the time of rezoning, preliminary plans identified 60 replacement trees. The applicant in working with staff has found additional on-site planting opportunities resulting in 84 replacement trees being provided for on-site. A voluntary contribution in the amount of \$26,112.00 to the City's City Compensation Fund for tree planting elsewhere in the City is required prior to Development Permit issuance.
- In compensation for off-site City tree and hedge removal, the provision of a contribution in the amount of \$4,500.00 to the City's City Compensation Fund for tree planting elsewhere in the City was secured through the rezoning.
- To ensure the protection of the existing trees on the adjacent property to the north, the provision of a contract with a Certified Arborist for the supervision of all works conducted within or in close proximity to tree protection zones was secured through the rezoning.

Landscape Design and Open Space Design

- Along Gilley Road, grade and stair connections are provided to street-fronting commercial space and the Community Policing Office.
- Along Garripie Avenue, raised semi-private patios are buffered with planting at grade.
- Along Smith Crescent, raised semi-private patios are buffered with tiered planters, including planting at grade.
- Along the west edge of the subject site, a public walkway is provided in Statutory-Right-of-Way, as secured through the rezoning, providing a pedestrian connection between Gilley Road and Garripie Avenue. Along the public walkway frontage, planting provides screening to the central courtyard surface parking area, with breaks for pedestrian connection.
- Class 2 bicycle racks are located throughout the central courtyard in close proximity to building entry lobbies and outside the building entry lobby fronting Smith Crescent.

- Outdoor amenity space is provided in the central courtyard for the shared use of all residents in the development. A variety of seating areas, including one with a fire pit are provided. Shrub and tree planting is provided throughout the central courtyard and provides screening along the edges of the courtyard to surrounding semi-private patios.
- Children's play is accommodated in the central courtyard with four play structures, three climbing poles, open play turf and lawn areas as well as a ground checkers/chess board. The children's play structures include climbing, sliding and social and imaginative play activities.
- The plant palette selection includes native and non-native, deciduous and coniferous species with a variety of textures and colours, providing all-season interest. The landscape design includes planting of 84 trees of ten species, including coniferous species of spruce and fir, and deciduous species of maple, hornbeam, beech, ginkgo biloba, locust, pear and oak.
- A lighting plan is included in the DP plans. Downward focussed bollard lighting will be provided throughout the courtyard.
- On-site irrigation will be provided for all planted areas.
- To ensure the provision of landscaping, a legal agreement and associated landscape security in the amount of \$573,699.34 is required prior to Development Permit issuance.

Public Art

• The developer is providing a cash contribution towards the City's Public Art Fund. This contribution was secured through the rezoning.

Crime Prevention Through Environmental Design

- Crime Prevention Through Environmental Design (CPTED) principles have been considered throughout the proposed development.
- Public areas, pedestrian pathways and resident private/semi-private areas are designed to be well-defined by soft landscaping to clearly delineate boundaries of uses.
- The entry lobbies are designed to be visually open from the central courtyard and the south building also has an entry lobby that is visually open from the Smith Crescent sidewalk.
- The parkade entry (overhead gate) is designed with clear sight lines.
- Views from interior spaces provide passive surveillance opportunities to outdoor amenity areas and patios. Views from upper units provide passive surveillance opportunities of grade-level public pathways.

Sustainability and Renewable Energy

- The developer has committed to design the subject development to meet the City's application Step Code requirement of Step 3 with a privately owned low-carbon energy system.
- The project includes the installation of an extensive green roof on the amenity building roof and planting on the parking podium, reducing urban heat island effect and improving air quality.

Servicing

• The developer is providing a cash contribution in the amount of \$ 13,540.57 as a cash-in-lieu of construction contribution towards the Hamilton Area Sanitary Pump Station as 4651, 4671, 4691 Smith Crescent belong to the Hamilton Area Sanitary Pump Station catchment. This contribution is in keeping with the Subdivision and Development Bylaw No. 8751 and is required.

Conclusions

As the proposed development would meet applicable policies and Development Permit Guidelines, staff recommend that the Development Permit be endorsed, and issuance by Council be recommended.

Sara Badyal

Sara Badyal Planner 3 (604-276-4282)

SB: js

- Att. 1: Development Application Data Sheet
 - 2: Advisory Design Panel Minutes (Annotated Excerpt from March 6, 2024)

The following are to be met prior to forwarding this application to Council for approval:

- 1. (DP Panel Notification Fee) Payment of all fees in full for the cost associated with the Development Permit Panel Notices, consistent with the City's Consolidated Fees Bylaw No 8636, as amended.
- (Tree Compensation) The City's acceptance of the developer's voluntary contribution in the amount of \$26,112.00 towards the City's tree compensation fund for tree planting elsewhere in the City in compensation for 34 replacement trees not accommodated on-site.
- 3. (Hamilton Sanitary Pump Station Contribution) At Developer's cost, the Developer is required to:
 - i) Pay, in keeping with the Subdivision and Development Bylaw No. 8751, a \$ 13,540.57 cash-in-lieu of construction contribution towards the Hamilton Area Sanitary Pump Station as 4651, 4671, 4691 Smith Cr belong to the Hamilton Area Sanitary Pump Station catchment.
- 4. (Landscape Security) Entering into a legal agreement and submission of a Landscaping security in the amount of \$573,699.34.

Prior to future Building Permit issuance, the developer is required to complete the following:

- Compliance with legal agreements secured via the Rezoning and/or Development Permit processes.
- Entering into a construction agreement for the Community Policing Office.
- Incorporation of accessibility measures in Building Permit as determined via the Rezoning and/or Development Permit processes.
- The applicant is required to obtain a Building Permit for any construction hoarding associated with the proposed development. If construction hoarding is required to temporarily occupy a street, or any part thereof, or occupy the air space above a street or any part thereof, additional City approvals and associated fees may be required as part of the Building Permit. *For further information on the Building Permit, please contact Building Approvals Department at 604-276-4285.*
- Submission of a construction traffic and parking management plan to the satisfaction of the City's Transportation Department (<u>https://www.richmond.ca/services/transportation/special.htm#TrafficPlan</u>).
- If applicable, payment of latecomer agreement charges, plus applicable interest associated with eligible latecomer works.



Development Application Data Sheet Development Applications Department

DP 23-034544			At	tachment	
Address:	4651, 46	671, 4691 Smith Crescent, 23301, 2332	1, 23361, and 23381 Gilley Road		
Applicant:	Maskee	n (Hamilton) Properties Corp.			
Owner	Maskee	n (Hamilton) Properties Corp., 1164822	BC Ltd., and Davinder Mander		
Planning Area(s)	Hamilto				
		Existing	Proposed		
Site Area		10,300 m²	10,300 m ²		
Land Uses		Vacant and Single-family residential	Mixed use		
OCP Designation		Mixed Use	Complies		
Area Plan Designa	ation	Neighbourhood Village Centre (Retail and Office with Residential above 4 Storey 1.50 FAR)	Complies		
Zoning		Residential/Limited Commercial (ZMU53) – Neighbourhood Village Centre (Hamilton)	Complies		
Number of Units		2 single-detached houses	19 LEMR units 167 strata units 604 m ² (6,501 ft ²) CRU 132.7 m ² (1,429 ft ²) Community faci	lity	
		Bylaw Requirement	Proposed	Variance	
Floor Area Ratio		Max. 1.5 FAR (including affordable housing), and Max 0.1 FAR community amenity space, and Max 0.1 FAR amenity space	1.48 FAR (including affordable housing), and 0.01 FAR community amenity space, and 0.02 FAR amenity space	None permitted	
Buildable Floor Ar	ea	Approx. Max. 15,450 m ² including strata residential, LEMR and commercial, and Min. 130 m ² community facility, and Min. 100 m ² amenity space	13,105.8 m ² strata residential 1,490.1 m ² LEMR 604 m ² commercial 132.7 m ² community facility 237.8 m ² amenity space	None permitted	
Lot Coverage		Max. 55 %	41 %	None	
Setbacks		Gilley Rd: Min 1.5 m Smith Cr: Min. 3 m North property line: Min. 3 m West Side Yard: Min. 6 m	Gilley Rd: Min. 2.8 m Smith Cr: Min. 3 m North property line: Min. 12.3 m West Side Yard: Min. 7.7 m	None	
Building Height		Max. 17 m & 4-storey, 20 m & 5-storey fronting Gilley	17 m & 4-storey, 20 m & 5-storey fronting Gilley	None	
Lot Dimensions		Width: Min. 40 m Depth: Min. 40 m Area: Min. 4,000 m²	Width: 91 m Depth: 117.5 m Area: 10,300 m ²	None	
Parking Spaces		Total: 293 with TDMs: LEMR: 19 Market Strata: 234 Community facility: 2 Shared visitor/non-residential:38	Total: 293 with TDMs: LEMR: 19 Market Strata: 234 Community facility: 2 Shared visitor/non-residential:32 Visitor: 6	None	
Accessible Parking Spaces	g	Min. 2%	2.4%	None	

	Bylaw Requirement	Proposed	Variance
Small Car Parking Spaces	Max. 50%	2.4%	None
Tandem Parking Spaces	Permitted	8.9%	None
Loading Spaces	2 medium spaces	2 medium spaces	None
Bicycle Storage	Class 1: 275 residential 2 non-residential Class 2: 38 visitor and 3 non-residential	Class 1: 283 residential 2 non-residential Class 2: 8 visitor and 42 shared visitor/non-residential	None
Amenity Space – Indoor	Min. 100 m ²	237.8 m ²	None
Amenity Space – Outdoor	Min. 1,116 m ²	1,226 m ²	None

Annotated Excerpt from the Minutes from Advisory Design Panel Meeting

Wednesday, March 6, 2024 – 4:00 p.m.

Remote (Webex) Meeting

Panel Discussion

Comments from Panel members were as follows:

- Consider providing a soil depth plan in the next stage of the project to ensure adequate soil volume is provided for planting in the outdoor amenity area *Considered. Appropriate soils volumes will be provided.*
- Consider adding structural soil under the sidewalk along Gilley Road to ensure the survivability of the street trees *Off-site design reviewed through required Servicing Agreement.*
- Consider showing the slopes on the plans to ensure that accessibility has been achieved in the outdoor amenity area *Considered. All amenity areas are accessible with minimal slopes.*
- Consider providing stair access to the green roof on the amenity building *Incorporated for maintenance purposes only.*
- Consider providing a landscape lighting plan due to the mixed uses of the courtyard and in order to address potential CPTED concerns *Provided in DP plans.*
- A few landscape details including fencing are missing *Provided in DP plans*.
- Consider redesigning the children's play area on the northeast between Building A and Building B, taking into consideration that it will be in shade most of the time – Design improved, secondary children's play area relocated close to central children's play area, play equipment revised and improved, and nearby seating improved.
- The trees on the north of Building A between the building and the parking area will also be in full shade; ensure that appropriate tree species will be installed in this area *Considered. Appropriate tree species selected.*
- Consider enhancing the planting along Garripie Avenue to screen the exposed blank walls *Design improved, shrubs provided.*
- Reconsider the use of Allan Block for the retaining wall and consider using concrete retaining wall to reduce costs and long-term maintenance *Considered. Textured Allan Block provides visual interest to the planter retaining wall along Smith Crescent. With proper installation there should be no long-term maintenance issues.*
- Consider consolidating the children's play area on the north side between Building A and Building B with the children's play area adjacent to the amenity building; consider installing a bigger or additional play equipment to the consolidated play area; consider a passive outdoor amenity space between Building A and Building B *Addressed above*.

- Consider relocating commercial garbage room close to the CRUs; on garbage collection days, the contractor can move the commercial garbage to the collection area; also consider removing the elevator that provides access from the parkade to the CRUs to reduce costs *Considered. Elevator retained and adjacent garbage/recycling rooms and loading area retained.*
- Review functionality of parcel delivery areas in the building lobbies to ensure they are designed to meet the needs of residents; consider engaging the services of a company that provides parcel delivery boxes and also help design the parcel delivery area *Considered. Sufficient room provided.*
- Consider redesigning the exterior design of the lobbies of the two buildings to make them more welcoming and prominent, e.g. redesign the columns and windows; also ensure that the bench near the Building A lobby entrance is of proper depth and width to comfortably seat people *Design improved. All lobbies feature covered area and glazing.*
- Overall, the project is well designed and integrated with the neighbouring buildings; however, consider redesigning the amenity building to make it the heart/focal point of the project; consider not to mimic the design of the two buildings in order to create something iconic that is separate and distinct from the two buildings; also consider enlarging the amenity building to integrate the staircase from the parkade to come up into amenity building; the redesign may result in additional parking spaces – *Design improved in a manner that provides design continuity with overall development, stair access added to roof level for maintenance purposes, interior elevator added for accessibility, second floor deck added, skylight added over bicycle storage room and additional accent stone cladding provided. Design change to integrate exit stair access to parkade level was considered, but was not able to be accommodated without losing required parking spaces.*
- Reconsider the installation of green roof on the amenity building rooftop due to long-term maintenance concerns; in lieu of the green roof, consider installing a usable amenity space on the amenity building rooftop, install a staircase to access the rooftop; irrigation and electric outlets would be needed for green roof maintenance *Addressed above. Green roof provided and appropriate irrigation and electrical outlets will be provided.*
- Appreciate the clean and functional design of the mixed-use and apartment buildings considering their scale and size; consider installing rooftop decks on the two buildings to take advantage of the views surrounding the two buildings; also consider creating some units with rooftop access *Considered. Roof top decks not incorporated due to costs and long-term management and maintenance concerns were not implemented.*
- Appreciate that the affordable housing units are distributed throughout the two buildings and not segregated in one area *Noted*.
- Consider providing more accessible parking stalls in the residential rental parking to match the number of accessible parking stalls provided in the residential owner parking to accommodate low-income people with disabilities *Considered. Parking provision meets zoning bylaw requirements.*
- Consider improving the accessibility of the two-storey amenity building by installing an elevator and making the office space on the ground floor accessible; also consider making the entire amenity building accessible *Incorporated*.
- The project is interesting and well considered *Noted*.
- Allan Block retaining walls are cheaper to build than concrete, but long-term maintenance could be a concern *Addressed above*.

- Support the installation of a green roof on the amenity building, but should be done properly; consider a deeper soil volume to accommodate a wider range of plant species; ensure long-term survivability and maintenance of planting *Considered. Additional construction details will be provided through the required Building Permit application.*
- Architectural renderings should incorporate and reflect the landscape design to enable the Panel to better appreciate the overall design of the project, especially in areas where there are large exposed concrete walls, areas near the PMT and the corner areas *Renderings updated*.
- Support the location of the children's play areas in different locations as it would allow separation of play areas for different age groups and mitigate noise that would result from one larger play area; however, address the shading concern and consider more seating opportunities for parents and visitors *Addressed above*.
- Agree with the Panel comment that the amenity building should be treated as the heart of the project and redesigned to provide a more welcoming experience *Addressed above*.
- The lobbies for the residential and commercial spaces at the southeast corner on Gilley Road and Smith Crescent appears secondary and uninviting; the landscaped area adjacent to the residential plaza could be integrated into one plaza space, e.g. increase the tree grates and install more landscape elements to make the corner more welcoming and useful to CRU users and the public and mitigate the hardscape in the adjacent residential plaza *Design Improved. Entry lobby expression improved, requested exterior stair connection added, and seating added at raised planter similar to what has been proposed along the public walkway along the west edge of the site.*
- Understand the intent for flexible use of the large paved plaza on the west side of the site along Gilley Road; however, consider enhancing its landscape, e.g. by incorporating green spaces and a water feature to provide more visual interest and improve user experience; the enhanced landscape of the two plazas on both ends of Gilley Road could provide more identity to the project *Considered. Public plaza expands existing interim plaza provided on neighbouring property to the west and is designed as a hard paved plaza for continuity with added checkers/chess board paving. The design meets the Hamilton Area Plan objective of a hard paved plaza intended for pedestrian movement large group gathering.*
- Consider softening the expression around the PMT area along Smith Crescent; consider changing the paving material, minimizing its "throat" and changing the visual sightlines but ensuring adequate access for maintenance *PMTs surrounded on three sides with raised planters and clearances kept to minimum required by BC Hydro.*
- Portions of the concrete walls along the Gilley Road and Garripie Avenue elevations adjacent to the sidewalks are exposed; consider installing plantings with appropriate height in terraced/stepped planters and provide more articulation to the concrete walls, e.g. adding texture to mitigate the blank wall effect; also consider adjusting the structure above the parking garage to provide better transition *Landscape screening provided Yew hedge and ornamental grass provided along Gilley Road. Bamboo, broadleaf evergreen hedging, ferns, ornamental grass and trees provided along Garripie Avenue.*
- Look at ways to ensure that pedestrian circulation is not impeded along the upper walkway when the outward swinging doors of adjacent CRUs are opened *Design improved with partially recessing most doors. The walkway is wide enough to accommodate out-swinging doors without impeding pedestrian circulation.*

- Investigate opportunities to provide more access points to the upper walkway adjacent to CRUs from the sidewalk along Gilley Road *Design improved with additional stair access immediately east of the community amenity Community Policing Office. Continuous access provided west of the community amenity Community Policing Office and both elevator and stair access provided at east end of commercial units.*
- Consider reorienting the stairs to the CRUs at the corner to land at the street level residential plaza and more adjacent to the elevator *Incorporated*.
- Does not support the Panel comment of removing CRU lobby elevator providing access to CRUs *Noted*.
- Investigate opportunities to better identify the residential and commercial lobbies at the street level corner plaza as it would also improve wayfinding *Addressed above*.
- Agree with Panel comments that the amenity building should be the heart of the project; ensure accessibility to the second floor for all users *Incorporated*.
- The garage exit stairwells are awkwardly located in the courtyard and could be better related and integrated with adjacent building masses; consider relocating the garage exit adjacent to the amenity building to create more usable spaces; also consider relocating the garage exit on the northeast between Building A and Building B as it blocks the space between the two buildings *Considered. Parking exit stairs provided adjacent to walkways and located to meet building code requirements.*
- Ensure that wheelchair turning provides accommodated in the BUH unit plans *Incorporated.*
- Garbage collection across the bicycle lanes are challenging; consider installing signage to warn cyclists of potential collisions along the bicycle lanes *Signage is reviewed through the required Servicing Agreement process.*
- Overall, appreciate the applicant for a well handled project and presentation Noted.
- Support the Panel comment to provide an elevator in the amenity building to enhance its accessibility; consider providing access to the amenity building from the parkade underneath the building through the elevator *Addressed above*.
- Consider increasing the height of the bicycle room on the ground floor of the amenity building to provide a usable deck for the second floor of the amenity building *Incorporated.*
- Consider removing the elevator access from the underground parkade to the CRUs for security reasons; consider locating commercial visitor parking spaces in the courtyard surface parking area; consider providing some visitor parking spaces in the parkade outside a separately gated area for residents to enhance security for the residents *Considered. Elevator access retained for accessibility. Resident and limited visitor parking spaces as well as class 1 bicycle storage and garbage/recycling for all uses are provided in the parking structure. Community Policing Office and shared visitor/commercial/Community Policing Office parking spaces are provided in the central courtyard.*
- Does not support the Panel comment to remove the elevator access from the underground parkade and CRU lobby to the CRUs as the elevator would be useful to provide accessibility to people in wheelchairs *Noted*.

Panel Decision

It was moved and seconded

That DP 23-034544 be supported to move forward to the Development Permit Panel subject to the applicant giving consideration to the comments of the Advisory Design Panel.

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CARRIED



Development Permit

No. DP 23-034544

To the Holder:	Maskeen (Hamilton) Properties Corp. 308-6321 King George Boulevard Surrey, BC V3X 1G1
Property Address:	4651, 4671, 4691 Smith Crescent and 23301, 23321, 23361, 23381 Gilley Road
Address:	Ajit Thaliwal and Grant Copland Maskeen (Hamilton) Properties Corp. 308-6321 King George Boulevard Surrey, BC V3X 1G1

- 1. This Development Permit is issued subject to compliance with all of the Bylaws of the City applicable thereto, except as specifically varied or supplemented by this Permit.
- 2. This Development Permit applies to and only to those lands shown cross-hatched on the attached Schedule "A" and any and all buildings, structures and other development thereon.
- 3. Subject to Section 692 of the Local Government Act, R.S.B.C.: buildings and structures; off-street parking and loading facilities; roads and parking areas; and landscaping and screening shall be constructed generally in accordance with Plans #1 to #31 attached hereto.
- 4. Sanitary sewers, water, drainage, highways, street lighting, underground wiring, and sidewalks, shall be provided as required.
- 5. As a condition of the issuance of this Permit, the City is holding the security in the amount of \$573,699.34 to ensure that development is carried out in accordance with the terms and conditions of this Permit. Should any interest be earned upon the security, it shall accrue to the Holder if the security is returned. The condition of the posting of the security is that should the Holder fail to carry out the development hereby authorized, according to the terms and conditions of this Permit within the time provided, the City may use the security to carry out the work by its servants, agents or contractors, and any surplus shall be paid over to the Holder. Should the Holder carry out the development permitted by this permit within the time set out herein, the security shall be returned to the Holder. The City may retain the security for up to one year after inspection of the completed landscaping in order to ensure that plant material has survived.
- 6. If the Holder does not commence the construction permitted by this Permit within 24 months of the date of this Permit, this Permit shall lapse and the security shall be returned in full.

To the Holder:	Maskeen (Hamilton) Properties Corp. 308-6321 King George Boulevard Surrey, BC V3X 1G1
Property Address:	4651, 4671, 4691 Smith Crescent and 23301, 23321, 23361, 23381 Gilley Road
Address:	Ajit Thaliwal and Grant Copland Maskeen (Hamilton) Properties Corp. 308-6321 King George Boulevard Surrey, BC V3X 1G1

7. The land described herein shall be developed generally in accordance with the terms and conditions and provisions of this Permit and any plans and specifications attached to this Permit which shall form a part hereof.

, .

This Permit is not a Building Permit.


AUTHORIZING RESOLUTION NO. DAY OF , .


ISSUED BY THE COUNCIL THE

DELIVERED THIS DAY OF

MAYOR



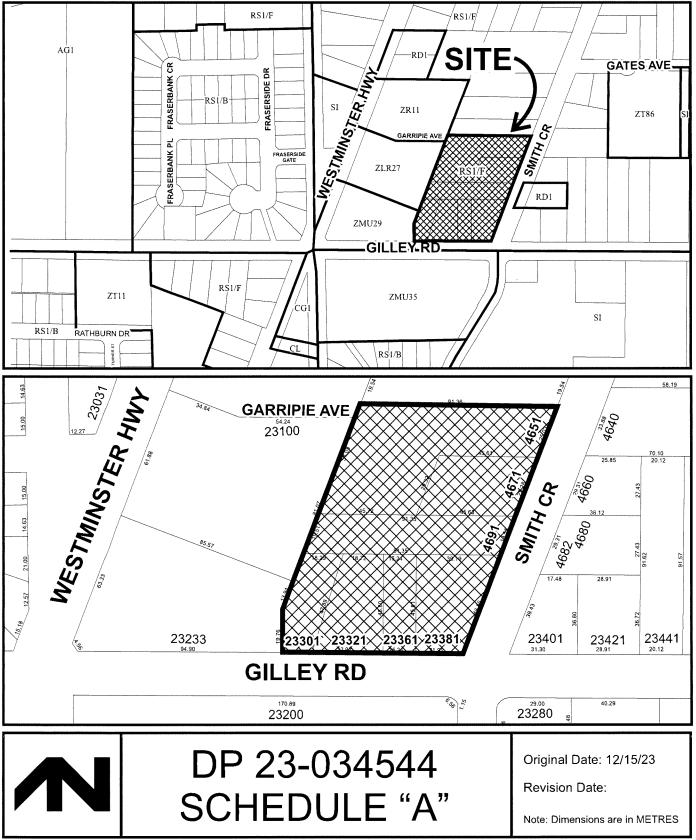

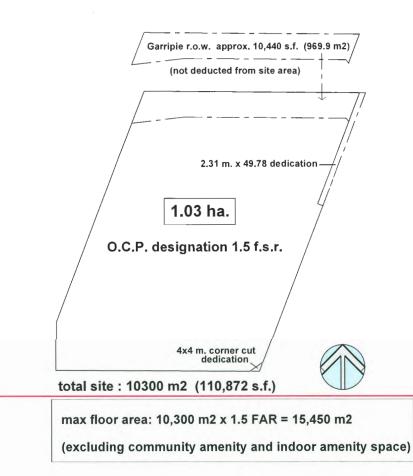

Notes:

- Bicycle maintenance facility, charging outlets for min. 10% of class 1 bicycle storage spaces, and other TDMs as per legal agreements.

Community amenity City facility in south building, 2 dedicated parking spaces in courtyard. 19 LEMR units

22 BUH units required to comply with section 4.16 of Richmond Zoning Bylaw 8500.


- Aging in place features to be provided in all units including stairwell handrails, lever-type handles for doors and plumbing fixtures, and solid wall blocking in washrooms at all toilets, bathtubs and showers to facilitate future grab bar installation.

- Automatic irrigation system for all planted areas.


Public access road PROP SRW along north edge of site, public walkway and public plaza PROP SRW along west edge of site.

Off-site works, public access road SRW works, public walkway and plaza SRW works via Servicing Agreement

Phases include first parkade, south building and amenity building, then north building.

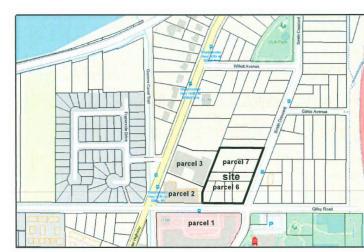

location plan detail

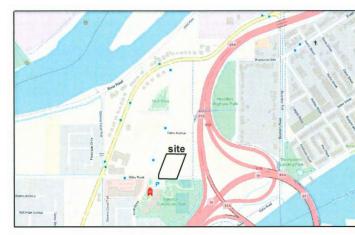

location plan

affordable h	ousing data :							
minimum unit areas per AH Strategy :								
studio unit	400 s.f. 37 m2							
1-bedroom unit	535 s.f. 50 m2							
2-bedroom unit	741 s.f. 69 m2							
3-bedroom unit	980 s.f. 91 m2							
affordable units p	rovided :							
studio units	none							
1-bedroom B5	2 x 552 = 1104 s.f.							
2-bedroom C3	1 x 974 = 974 s.f.							
2-bedroom C4	9 x 748 = 6732 s.f.							
2-bedroom C6	1 x 954 = 954 s.f.							
3-bedroom D1	3 x 1072 = 3216 s.f.							
3-bedroom D2	3 x 1020 = 3060 s.f.							
19	units total - 16,040 s.f.							
(min. required are	ea:15,695 s.f see 10e)							
affordable unit per	rcentages :							
2/19 = 10.5%	1-bedroom units							
11/19 = 57.9%	2-bedroom units							
6/19 = <u>31.6%</u> 3	3-bedroom units							
100%								

. . . .

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project data :

110,872 s.f. (10300 m2 = 1.03ha) (after road dedications) 96 s.f. 374 s.f. 74 s.f. 74 s.f. 74 s.f. 192 s.f. (10,608.4 m2) 802 s.f. 82 s.f. 82 s.f. 12,682 s.f. 4th floor total - 50,848 s.f. (4723.8 m2) total buildings A & B - 165,040 s.f. (15,332.2 m2) (above areas exclude elevators, stairs, mech./elec. rooms as permitted by zoning bylaw - refer to dwg. 10e) total bldg. B 15 76 87 7.5% 23 41.4% 28 46.8% 4 8 4.3% 55 186 100% required per bylaw : standard apt. - 167 x 1.4* = 234 (*TDM rate) affordable apt. - 19 x 1 = 19 + visitor - 186 x .2 = 38 notes : CPO requires 2 on-site spaces, per RCMP CPO - (132.8 m2) -2. program, plus 2 dedicated street spaces commercial - (743 m2) per bylaw commercial parking is shared with residential visitor parking total req'd - 293 spaces provided - 34 surface spaces 259 parkade spaces *293 spaces (*TDMs to support 1.4 residential parking ratio - refer to CTS report) bicycle parking required : residential spaces required : 186 x 1.5 = 279 spaces 186 x .2 37 spaces total - 316 spaces provided : parkade - 279 spaces surface- 40 spaces total - 319 spaces commercial spaces required : 5 spaces total provided : 2 class 1. bike lockers in parkade 3 class 2, surface spaces next to plaza (2 spaces within CPO not counted) required : 1,076 s.f. (100 m2) provided : 2,560 s.f. (238 m2)

proposed zoning : ZMU53 Neighbourhood Village Centre (Lamilton) site area : building areas : F.A.R.: 114,401 + 50,476 = 164,877 / 110,872 = 1.487 site coverage : 4223 m2 41% unit types : parking provision : indoor amenity :

bldg. A -	
ground floor -	24,6
2nd floor -	22,3
3rd floor -	22,3
4th floor -	22,3
5th floor -	22,3
total -	114,1
bldg. B -	
ground floor -	12,8
2nd floor -	12,6
3rd floor -	12,6

	type :		bldg. A
-	studio -		15
	1-bedroom	-	53
	2-bedroom	-	59
	3-bedroom	-	4
			131

outdoor amenity : required : 186 x 6 = 1116 m2 (12,013 s.f.)

building height :

max. allowed per bylaw : 4-storey & 17.0 m. (55.77 ft.) 5- storey & 20.0 m. (65.61 ft.) fronting Gilley proposed height : 4-storey & 16.95 m. (55.61 ft.) bldg. B 5-storey & 19.95 m. (65.45 ft.) bldg. A

parcels 6 & 7 - proposed residential - commercial development

Richmond B.C.


April 24, 2024 DP 23-034544 Plan #1


provided : approx. 13,200 s.f. = 1226 m2



ADP submission Feb. 26, 2024 revised to April 12, 2024



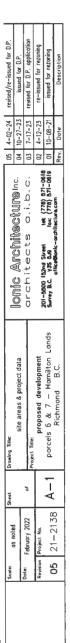

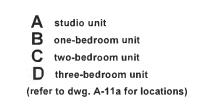

saleable/rentable floor areas :

comn	<u>commercial area</u> :								
	7,930 s.f. including CPO (includes mech. & elec. spaces)								
salea	ble resid	ential are	<u>a</u> :						
unit type	area	no. units	total area -						
A A1	444 s.f. 460 s.f.	14 1	6,216 s.f. 460 s.f.						
В В1	572 s.f. 656 s.f.	26 7	14,872 s.f. 4,592 s.f.						
B2 B3 B4	695 s.f. 686 s.f. 695 s.f.	5 18 4	3,475 s.f. 12,348 s.f. 2,780 s.f,						
B4 B5 B6	539 s.f. 827 s.f.	11	5,929 s.f. 827 s.f.						
В7 С	742 s.f. 846 s.f.	1	742 s.f. 30,456 s.f.						
C1 C2	872 s.f. 846 s.f.	36 6 4	5,232 s.f. 3,384.f.						
C3 C5	975 s.f. 754 s.f.	27 5	26,325 s.f. 3,770 s.f.						
D2	1,020 s.f.	1	1,020 s.f.						
	totals -	167 units	122,571 s.f. (11387 m2)						
renta	ble reside	ential are	<u>a :</u>						
uniy type	area	no. units	total area -						
B5	552 s.f.	2	1,104 s.f.						
C3	974 s.f. 748 s.f.	1	974 s.f. 6,732 s.f.						
C4 C6	748 s.f. 954 s.f.	9 1	6,732 s.f. 954 s.f.						
D1	1.072 s.f.	3	3.216 s.f.						

ì	totals -	19 units	16,040 s.f. (1490.1 m2)
D1 D2	1,072 s.f. 1,020 s.f.	3 3	3,216 s.f. 3,060 s.f.
C6	954 s.f.	1	954 s.f.

residential summary :

total units - 167 + 19 = 186 units								
total unit area- 122,571 + 16,158 = 138,729 s.f.								
(12,887.9 m2)								



bylaw floor area calculation (net area for density calculation) :

floor -	actual gros	actual gross area -		deductions per zoning bylaw -						bylaw net floor area -			
		elevators s		stairs		mech. / elec.		- Sylaw net noor area					
ground	25,150 s.f. 2	2336.4 m2					454 s.f.		24,696 s.f.	2294,3 m2			
second	22,848 s.f. 2	2122.6 m2	158 s.f.		316 s.f.				22,374 s.f.	2078.5 m2			
third	22,848 s.f.	14	158 s.f.		316 s.f.				22,374 s.f.				
fourth	22,848 s.f.		158 s.f.		316 s.f.				22,374 s.f.	11			
fifth	22,848 s.f.		158 s.f.		316 s.f.				22,374 s.f.				

building B :


floor -	actual gross area -	deductions per zoning bylaw -					bylaw net floor area -		
1001 -	actual gross area -	elevators	stairs		mech. / el	ec.			
ground	13,012 s.f. 1208.8 m2				210 s.f.		12,802 s.f.	1189.3 m2	- 1
second	13,072 s.f. 1214.4 m2	74 s.f	316 s.f.				12,682 s.f.	1178.2 m2	
third	13,072 s.f. "	74 s.f	316 s.f.				12,682 s.f.	н	
fourth	13,072 s.f. "	74 s.f	316 s.f.				12,682 s.f.	11	
totals -	52,228 s.f. 4852 m2	222 s.f. 20.6m2	948 s.f.	88.1 m2	210 s.f.	19.5 m2	50,848 s.f.	4723.8 m2	


total bylaw floor area for site density calculation : 114,192 + 50,848 = 165,040 - (22 x 20*) = 164,620 s.f. (*20 s.f./unit deduction for units with BUH features)


bylaw residential area for affordable housing provision requirement :


bylaw total area : 114,192 + 50,848 = 165,040 s.f. bylaw residential area : 165,040 - 7,930 = 157,110 s.f. x 10% = 15,711 s.f. required

parcels 6 & 7 - proposed residential - commercial development

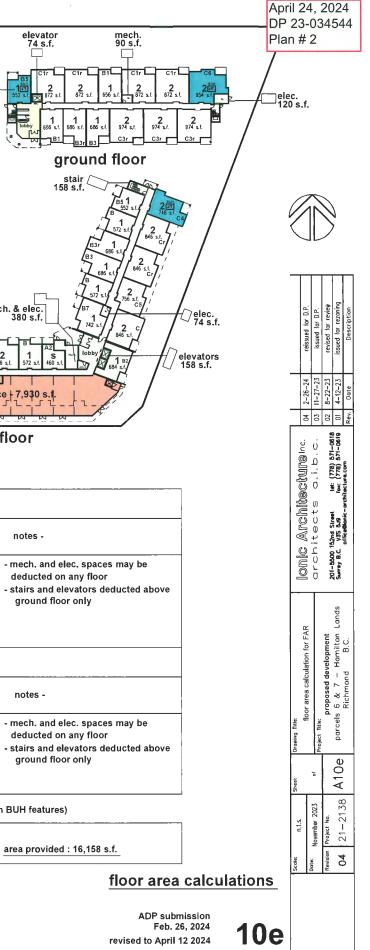

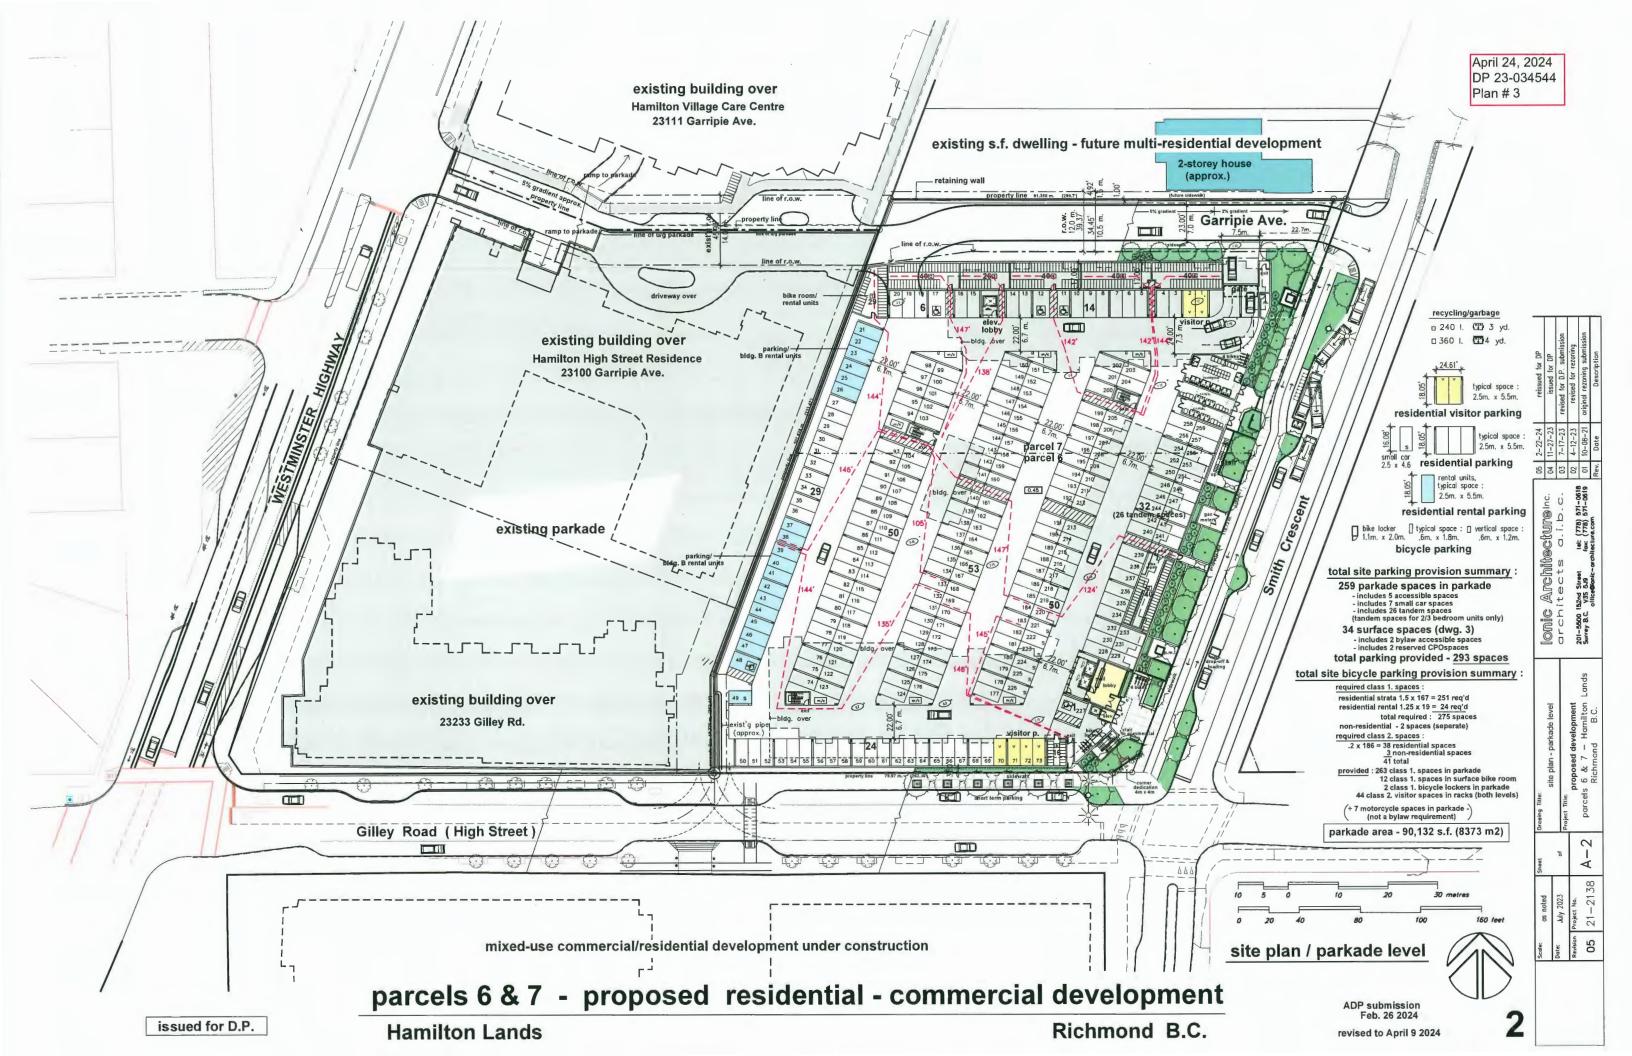

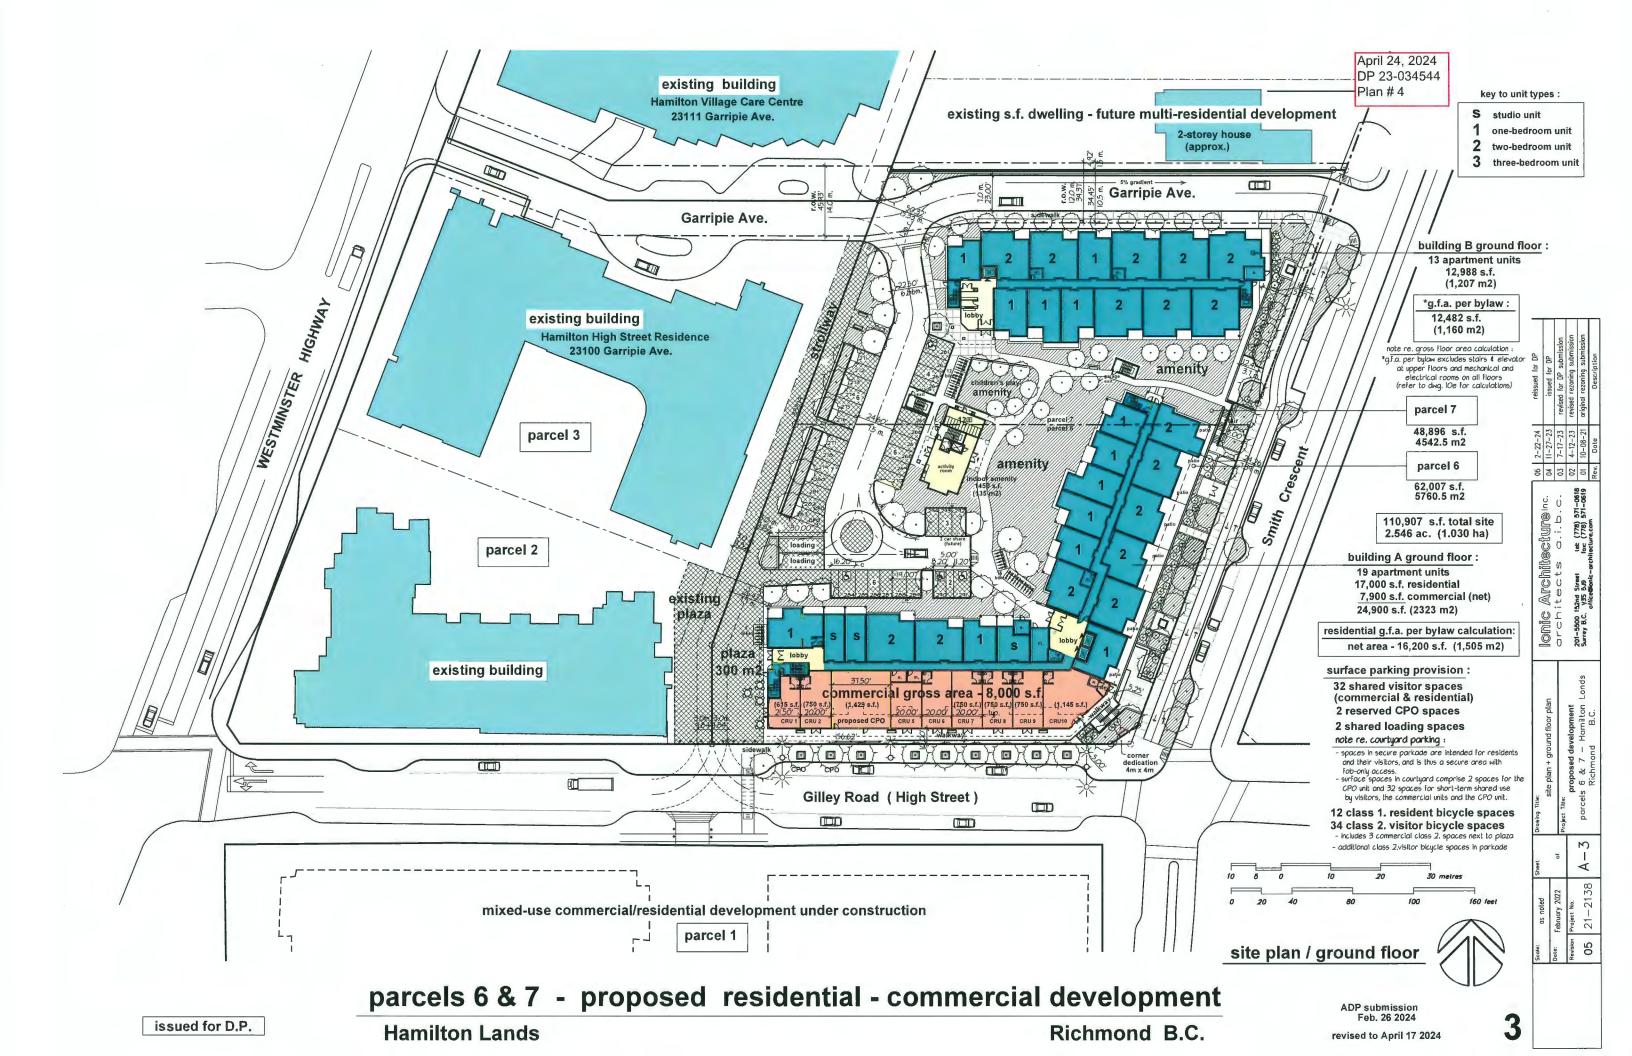

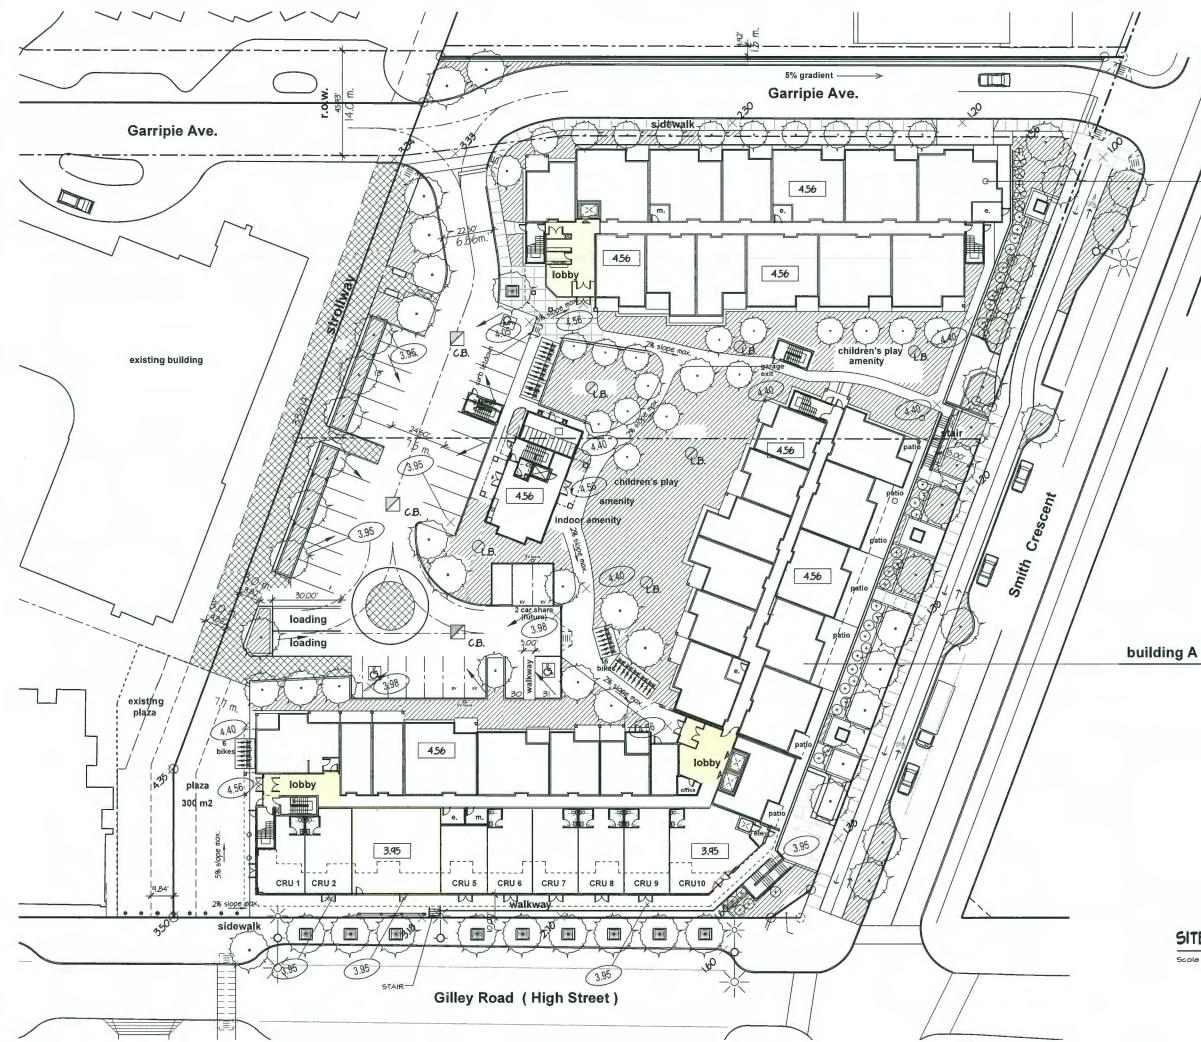



building B ground floor :

GRADING KEY :

(ELEVATIO	ONS IN METRES)	
× 1,50	EXISTING GRADE	
×	EX. GRADE (interpolated)	
× 3.95	PROPOSED ORADE	
4.56	FINISH FLOOR ELEVATION	
	SURFACE DRAINAGE	
🖉 L.B.	LAWN BASIN	
🖊 с.в.	CATCH BASIN	
S Ø	3" SLAB DRAIN BELOW ROAD FINISHED	
O PD	PLANTER DRAIN	

REFER TO CIVIL ENG. DRAWINGS FOR FINAL ORADING


building A ground floor :

_				01	Rev. Date
lonic Architecturenc.			Alan-ITA (ATT) -tel Steers becal mode-inc	S Surrey B.C. V35 549 fox; (778) 571-0619	
Drowing Title:	SILE GRADING	Project Title:	proposed development	parcels 6 & 7 - Hamilton Land	Richmond B.C.
Sheet	ĩ	5		S-2	
as noted	Coherent 2000	reuruury 2022	Project Na.	21-21 ZB S-2	
Scole:	Date:	-	Revision		

SITE GRADING - ACCESSIBILITY STRATEGY

1"=20'



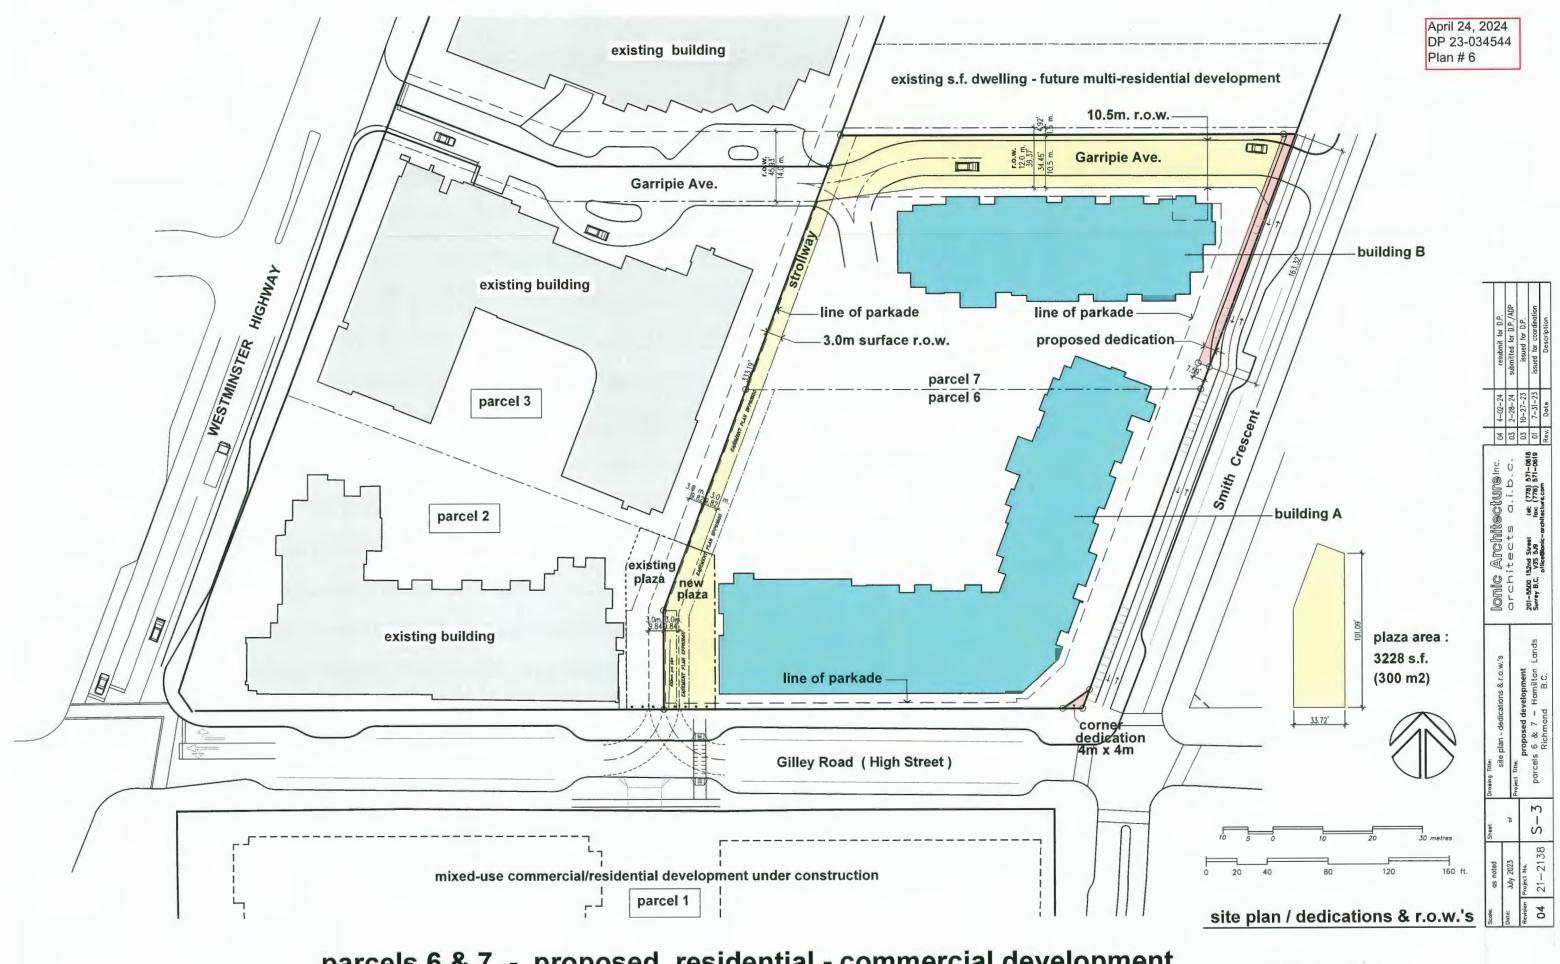



parcels 6 & 7 - proposed residential - commercial development

Hamilton Lands

Richmond B.C.


ADP submission for review Feb. 21 2024 revised to April 2 2024

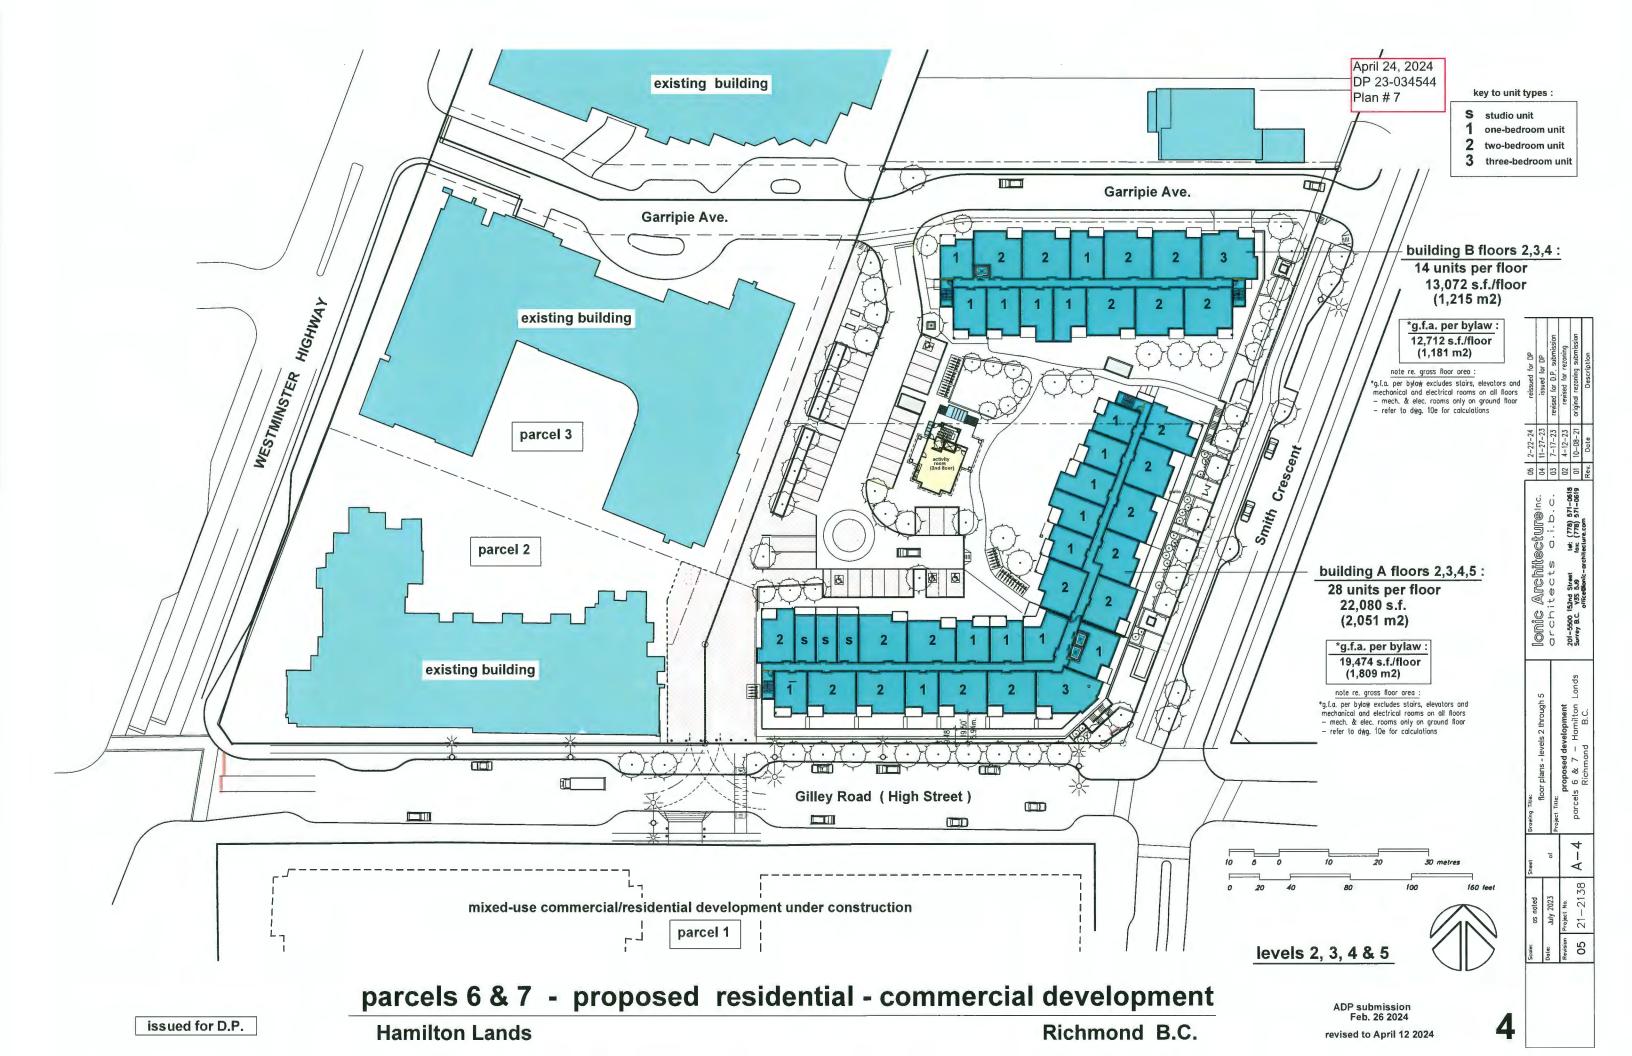


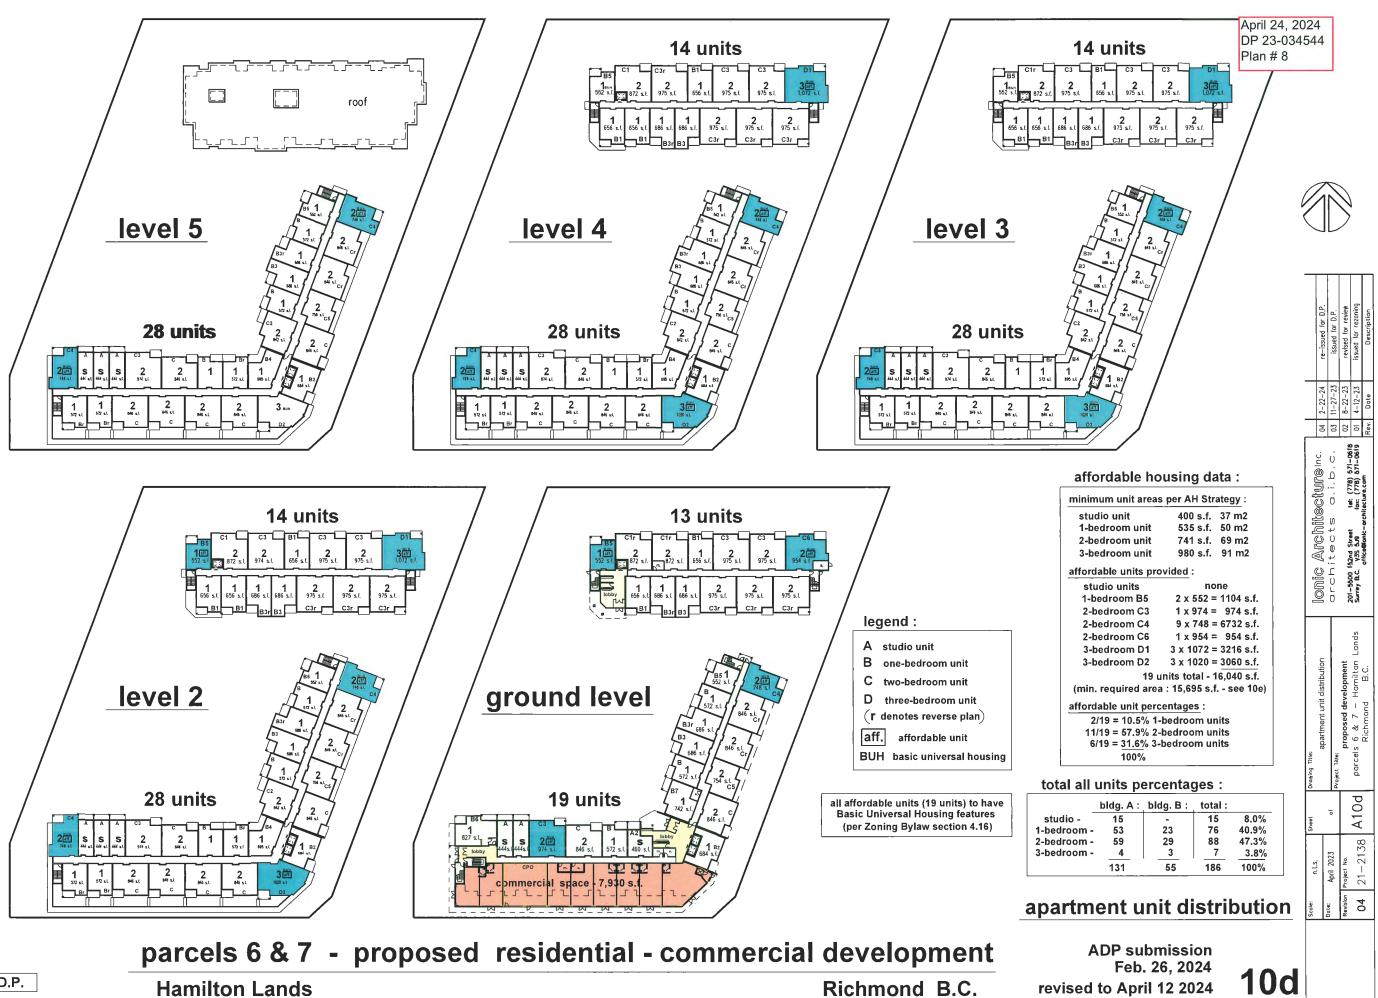




issued for D.P.

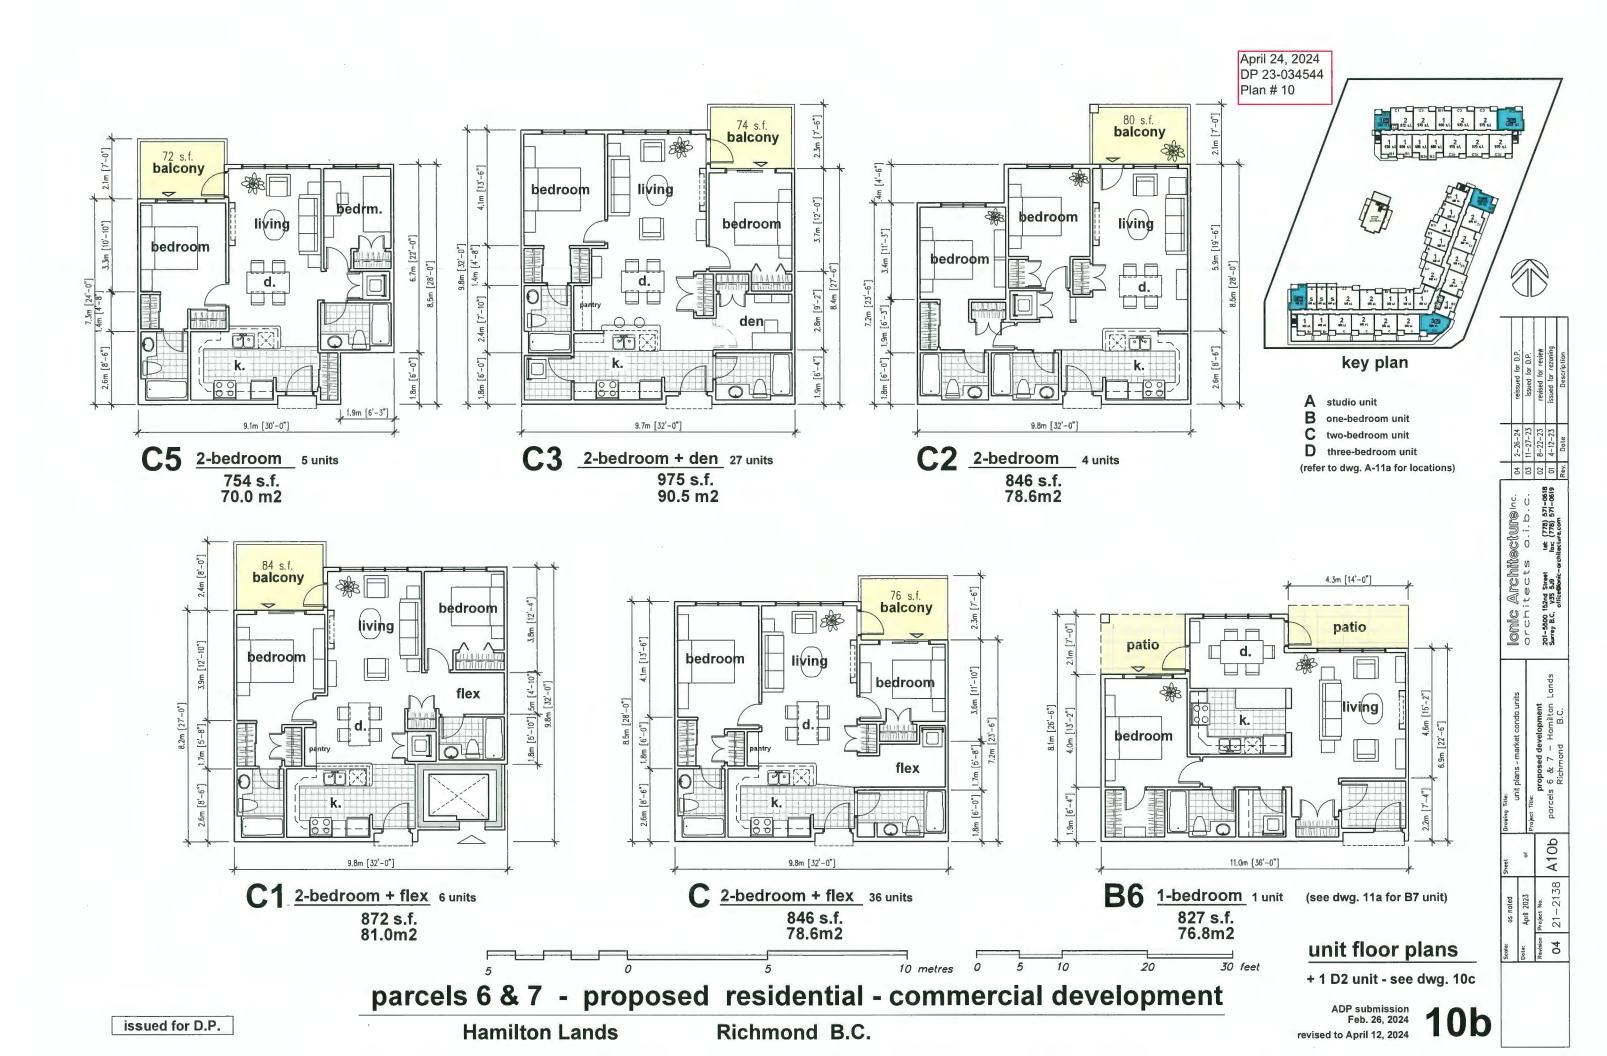

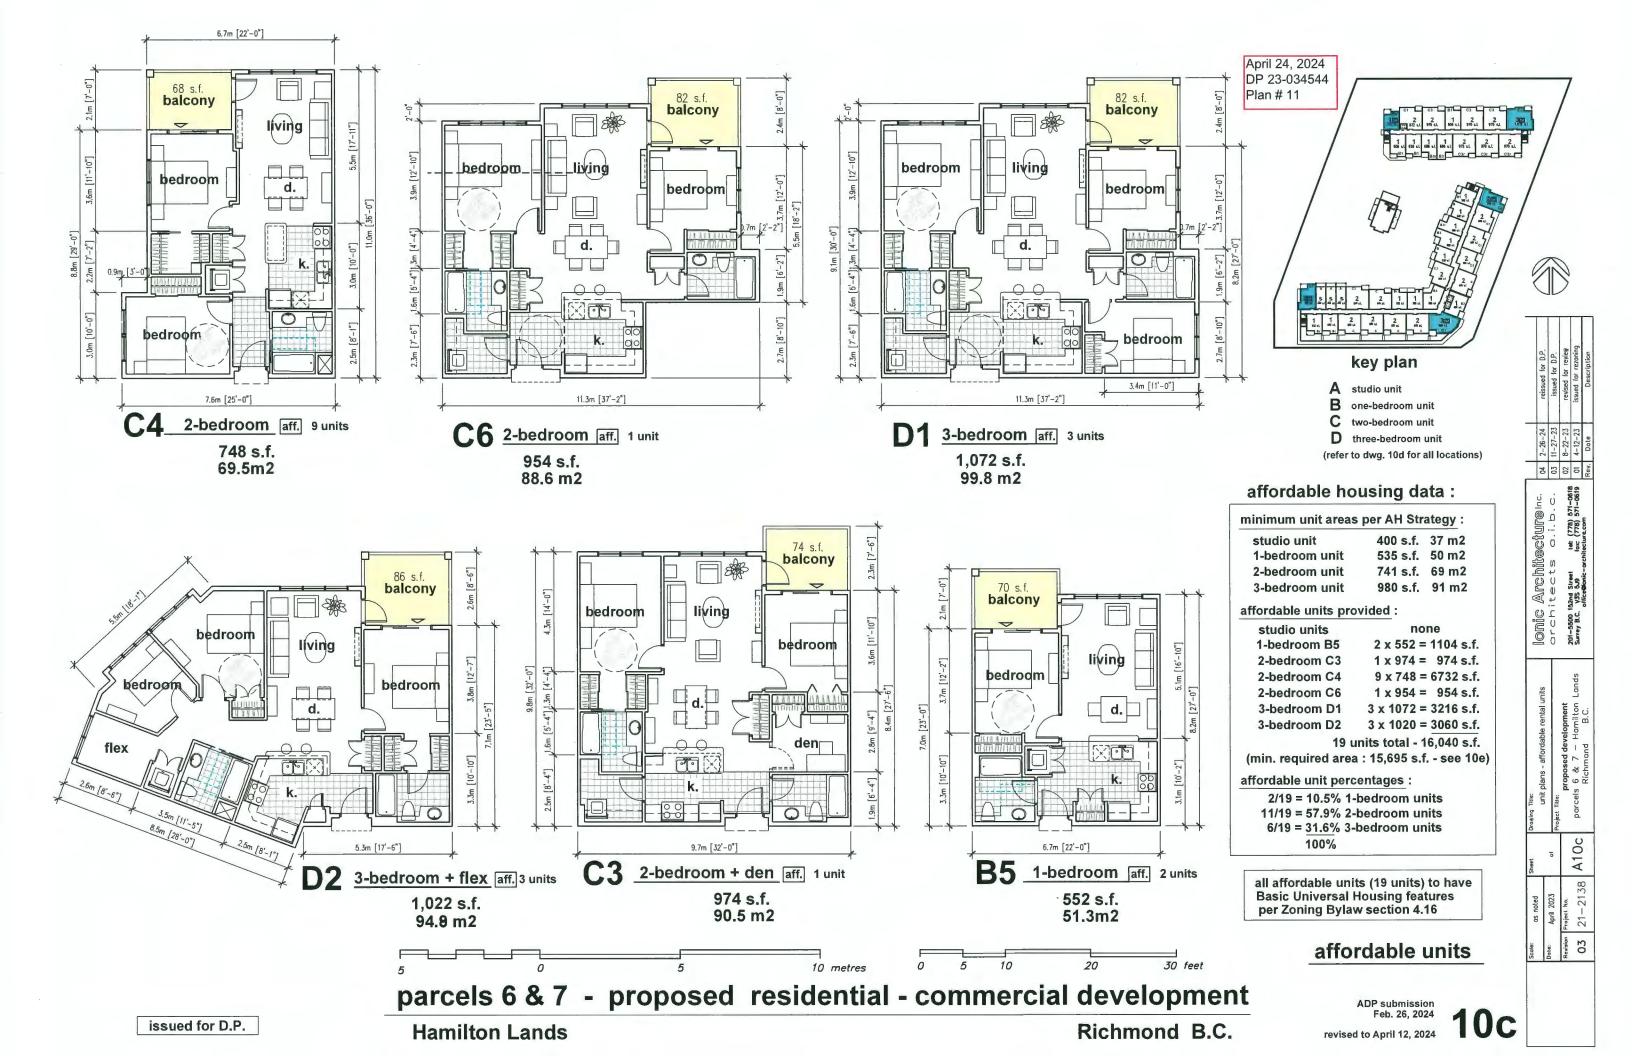

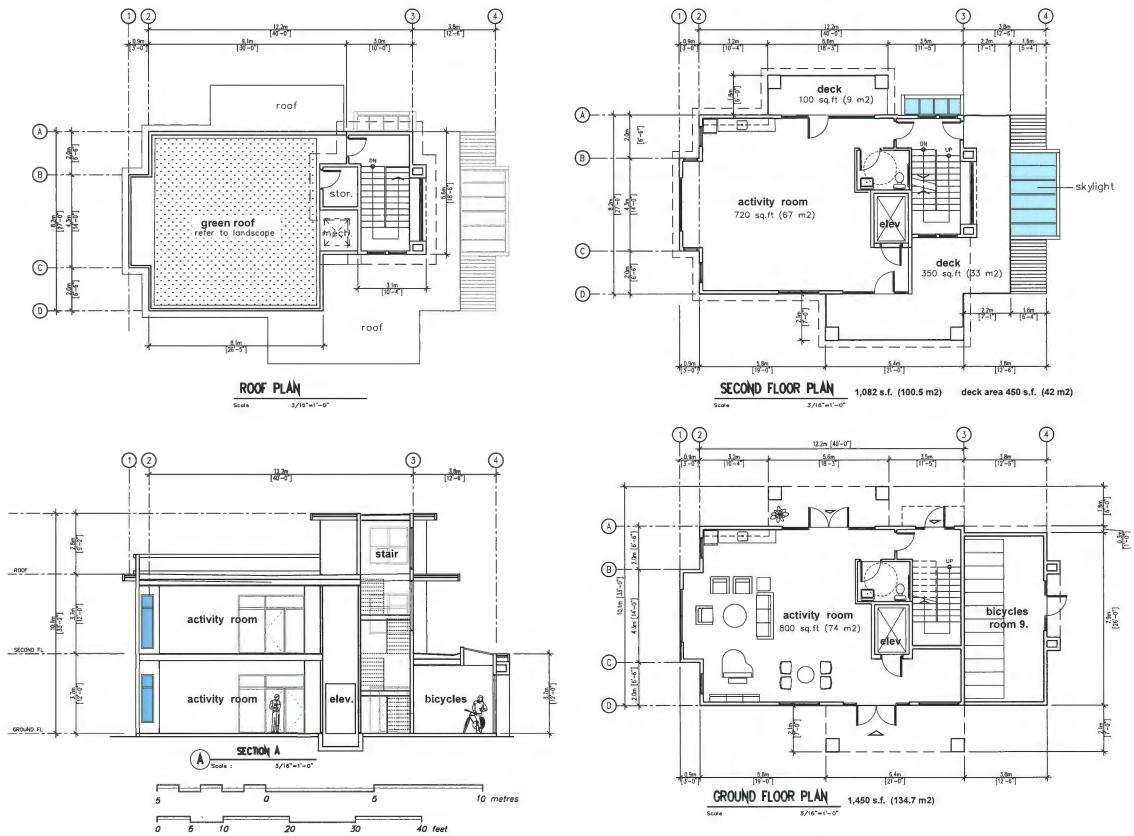


parcels 6 & 7 - proposed residential - commercial development

Hamilton Lands

Richmond B.C.

April 24, 2024 DP 23-034544 Plan # 12



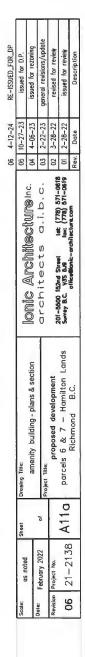

11a

ADP submission Feb. 26 2024 revised to April 12 2024



EXTERIOR MATERIALS & FINISHES			
MATERIAL / FINISH	COLOUR	MATERIAL / FINISH	COLOUR
() STONE	IXL - WIARTON ESTATE STONE	(9) WINDOWS & DOORS :	
2) JAMES HARDIE PANELS VERTICAL SIDING STYLE	SMOOTH - PRIME - NIGHT GRAY	COMMERCIAL UNITS -	BLACK ALUMINUM FRAMES CLEAR GLASS BLACK VINYL & CLEAR GLASS
3 JAMES HARDIE PANELS	SMOOTH - PRIME - NIGHT GRAY	(A) AMENITY BUILDING	WHITE ENAMEL FRAMES & CLEAR GLASS
(4) JAMES HARDIE PANELS	SMOOTH - PRIME - COBBLE STONE	-	TIMBER BARK
5 JAMES HARDIE PANELS	SMOOTH - PRIME - ARCTIC WHITE	() CONCRETE	NATURAL CONCRETE
6 JAMES HARDIE SOFFIT	SMOOTH - PRIME - ARCTIC WHITE	(2) ALUM, AND GLASS RAILING	BLACK ENAMEL ALUM, & CLEAR GLASS
T) FAST PLANK SYSTEM	DARK WALNUT	(B) GLASS CANOPY	CLEAR GLASS
© ALI3 METAL PANEL SOLUTION	PEWTER METALLIC	(4) COMMERCIAL SIGNAGE / SIGN BACKING SUPPORT	B. COMPOSITE WOOD PLASTIC DARK WALNUT (I 1/2 1N+ 41N)






revised to April 12 2024

11b



EXTERIOR MATERIALS & FINISHE MATERIAL / FINISH	COLOUR	MATERIAL / FINISH	COLOUR
 STONE JAMES HARDIE PANELS VERTICAL SIDING STYLE JAMES HARDIE PANELS JAMES HARDIE PANELS JAMES HARDIE PANELS JAMES HARDIE SOFFIT FAST PLANK SYSTEM ALI3 METAL PANEL SOLUTION 	IXL - WIARTON ESTATE STONE SMOOTH - PRIME - NIGHT GRAY SMOOTH - PRIME - NIGHT GRAY SMOOTH - PRIME - COBBLE STONE SMOOTH - PRIME - ARCTIC WHITE SMOOTH - PRIME - ARCTIC WHITE DARK WALNUT PEWTER METALLIC	 (1) WINDOWS & DOORS : COMMERCIAL UNITS - RESIDENTIAL UNITS - (2) AMENITY BUILDING (2) HARDIE FASCIA (1) CONCRETE (2) ALUM, AND GLASS RAILING (3) GLASS CANOPY (4) COMMERCIAL SIGNAGE / SIGN BACKING SUPPORT 	BLACK ALUMINUM FRAMES CLEAR GLASS BLACK VINYL & CLEAR GLASS WHITE ENAMEL FRAMES & CLEAR GLASS TIMBER BARK NATURAL CONCRETE BLACK ENAMEL ALUM. & CLEAR GLASS CLEAR GLASS B. COMPOSITE WOOD PLASTIC DARK WALNUT (1 1/2 IN+ 41N)



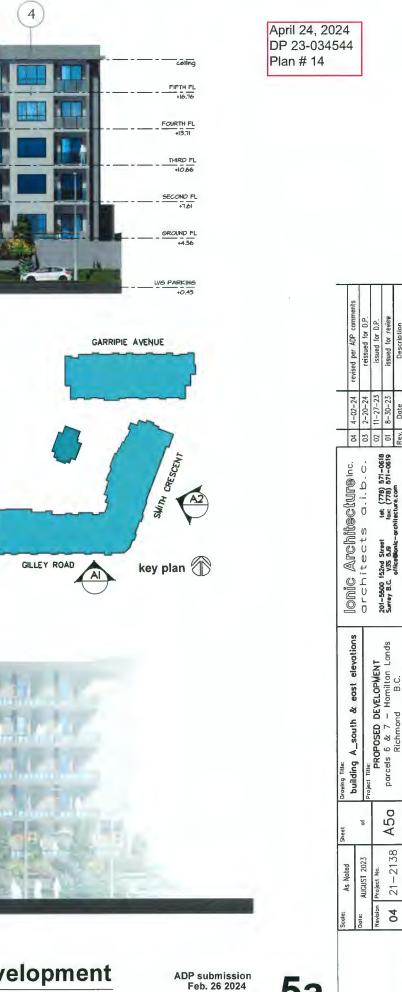

Richmond B.C.

Feb. 26 2024 revised to April 17 2024



		revised per ADP comments	reissued for D.P.	issued for review
	K	4-02-24	2-20-24	8-30-23
		8	50	01
obby ion to plaza		Ionic Architecturenc	architects a.i.b.c	201-5500 152nd Street tet: (778) 571-0618 Surrey B.C. V35 5.99 (arx (778) 571-0619
EXTERIOR MATERIALS & F		2 2	Г	м
MATERIAL / FINISH	COLOUR IXL - WARTON ESTATE STONE SMOOTH - PRIME - NIGHT GRAY SMOOTH - PRIME - NIGHT GRAY SMOOTH - PRIME - ARCTIC WHITE SMOOTH - PRIME - COBBLE STONE SMOOTH - PRIME - ARCTIC WHITE DARK WALNUT	Drowing Title: browing Title: building A_north & west elevations	Project Title:	parcels 6 & 7 - Hamilton Lands
(8) AL13 METAL PANEL SOLUTION	N PEWTER METALLIC	ă		5a
(9) WINDOWS & DOORS -	BLACK ALUMINUM FRAMES	aet	ğ	45 A
WINDOWS & DOORS – COMMERCIAL UNITS	CLEAR GLASS	Sheet		_
COMMERCIAL UNITS RESIDENTIAL UNITS	CLEAR GLASS BLACK VINYL & CLEAR GLASS		023	1 3,8
COMMERCIAL UNITS RESIDENTIAL UNITS DAMES HARDIE FASCIA CONCRETE	CLEAR GLASS		GUST 2023	1
COMMERCIAL UNITS RESIDENTIAL UNITS D JAMES HARDIE FASCIA	CLEAR GLASS BLACK VINYL & CLEAR GLASS PRIME COLOR – PEWTER METALLIC	Scole: As Noted She		DA 01-01 ZR





EXTERIOR MATERIALS & FIN	COLOUR
T STONE	IXL - WIARTON ESTATE STONE
(2) JAMES HARDIE PANELS VERTICAL SIDING STYLE	SMOOTH - PRIME - NIGHT GRAY
(3) JAMES HARDIE PANELS	SMOOTH - PRIME - NIGHT GRAY
JAMES HARDIE PANELS	SMOOTH - PRIME - ARCTIC WHITE
5 JAMES HARDIE PANELS	SMOOTH - PRIME - COBBLE STONE
6 JAMES HARDIE SOFFIT	SMOOTH - PRIME - ARCTIC WHITE
() FAST PLANK SYSTEM	DARK WALNUT
(8) AL13 METAL PANEL SOLUTION	PEWTER METALLIC
(9) WINDOWS & DODRS -	
COMMERCIAL UNITS	BLACK ALUMINUM FRAMES
RESIDENTIAL UNITS	BLACK VINYL & CLEAR GLASS
10 JAMES HARDIE FASCIA	PRIME COLOR - PEWTER METALLIC
1) CONCRETE	NATURAL CONCRETE
D METAL AND GLASS RAILING	BLACK / NATURAL ANOD. ALUM.
3 METAL & GLASS CANOPY	PATTERNED GLASS
COMMERCIAL SIGNAGE	(VARIES, 3D ILLUMINATED)
🚯 SIGN BACKING SUPPORT	B. COMPOSITE WOOD PLASTIC DARK WALNUT (1/2" X 4")









streetscape to Gilley Road 'High Street'


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parcels 6 & 7 - proposed residential - commercial development

Hamilton Lands


Richmond B.C.


April 24, 2024 DP 23-034544 Plan # 17




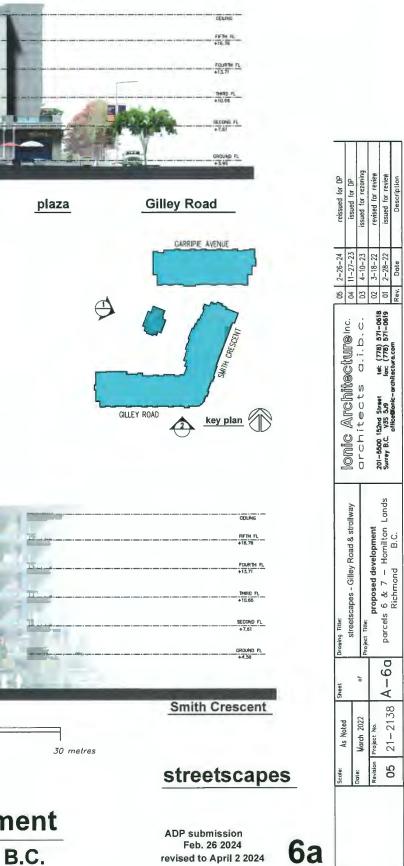

April 24, 2024 DP 23-034544

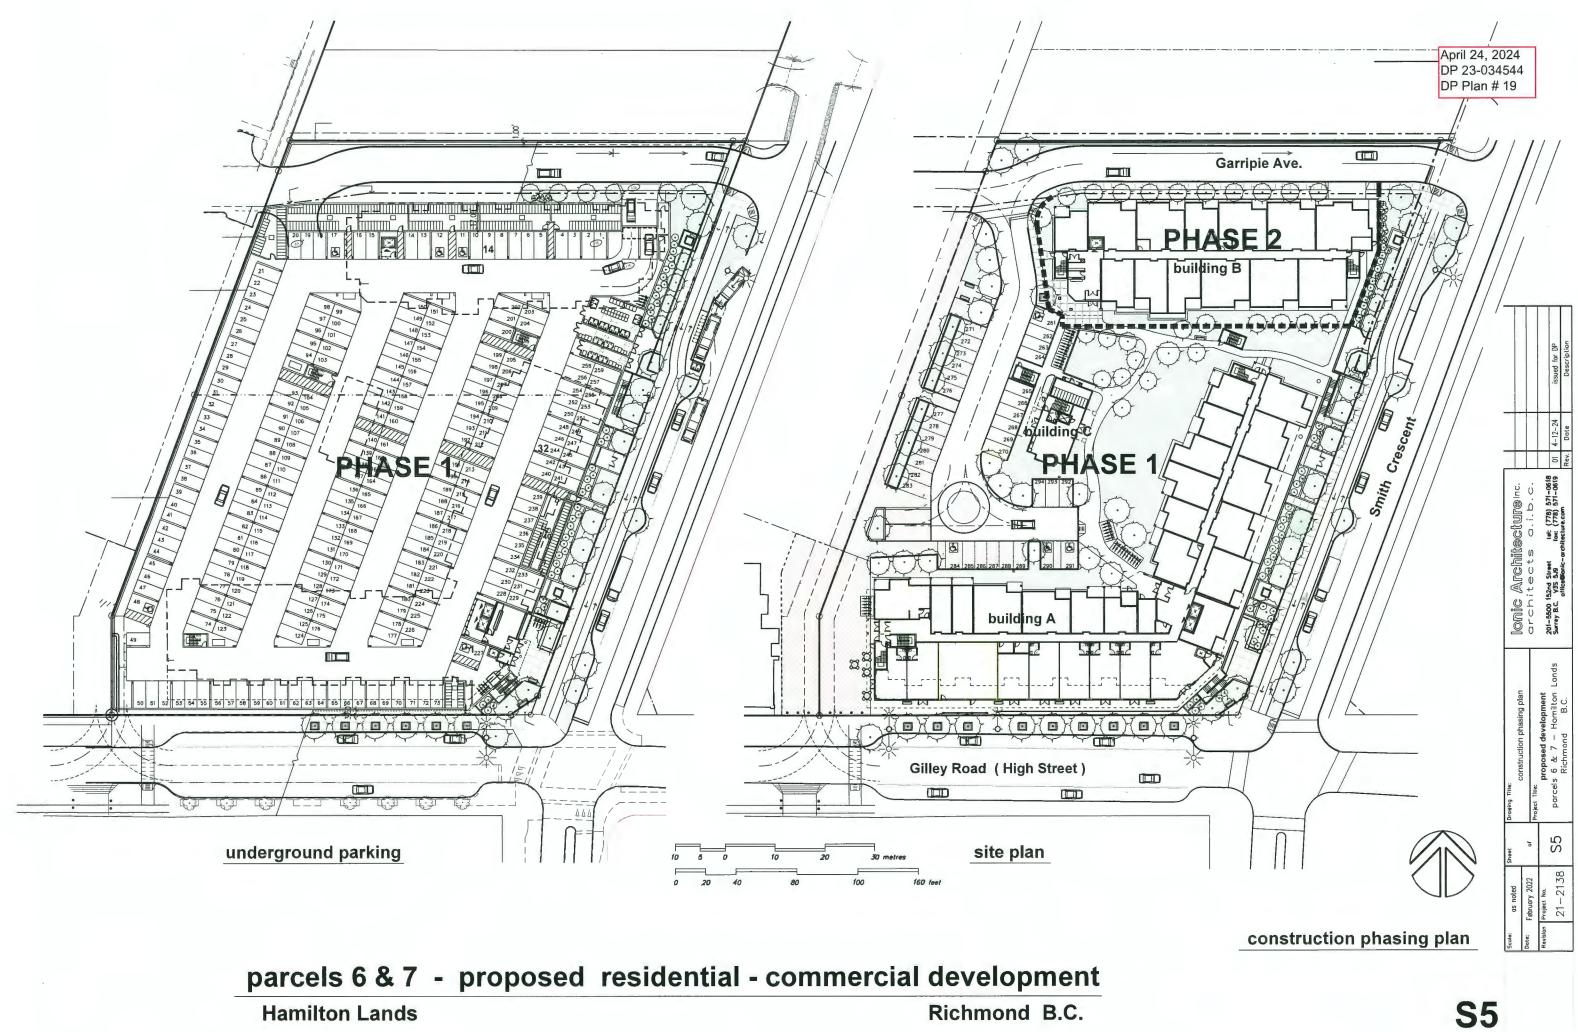

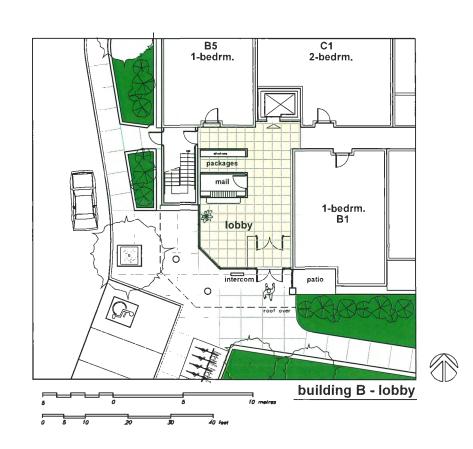

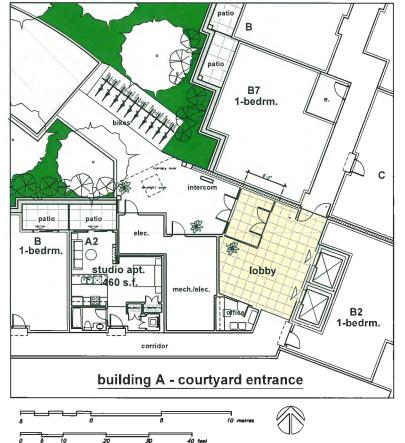






parcels 6 & 7 - proposed residential - commercial development


Richmond B.C.


revised to 4/02/2024

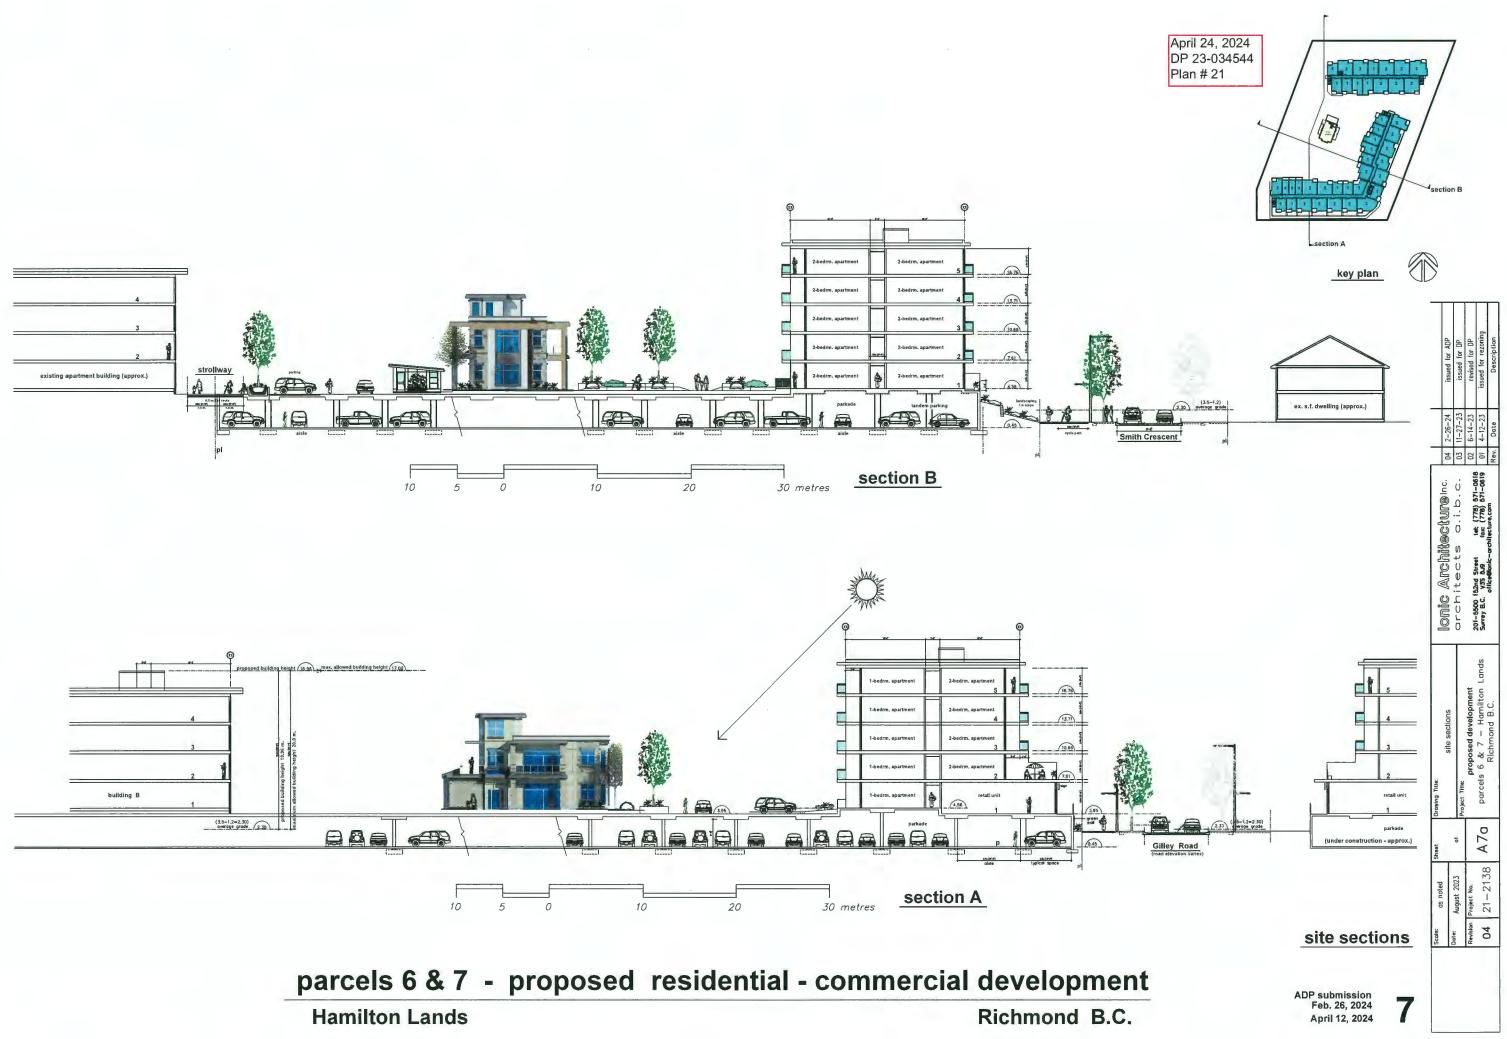

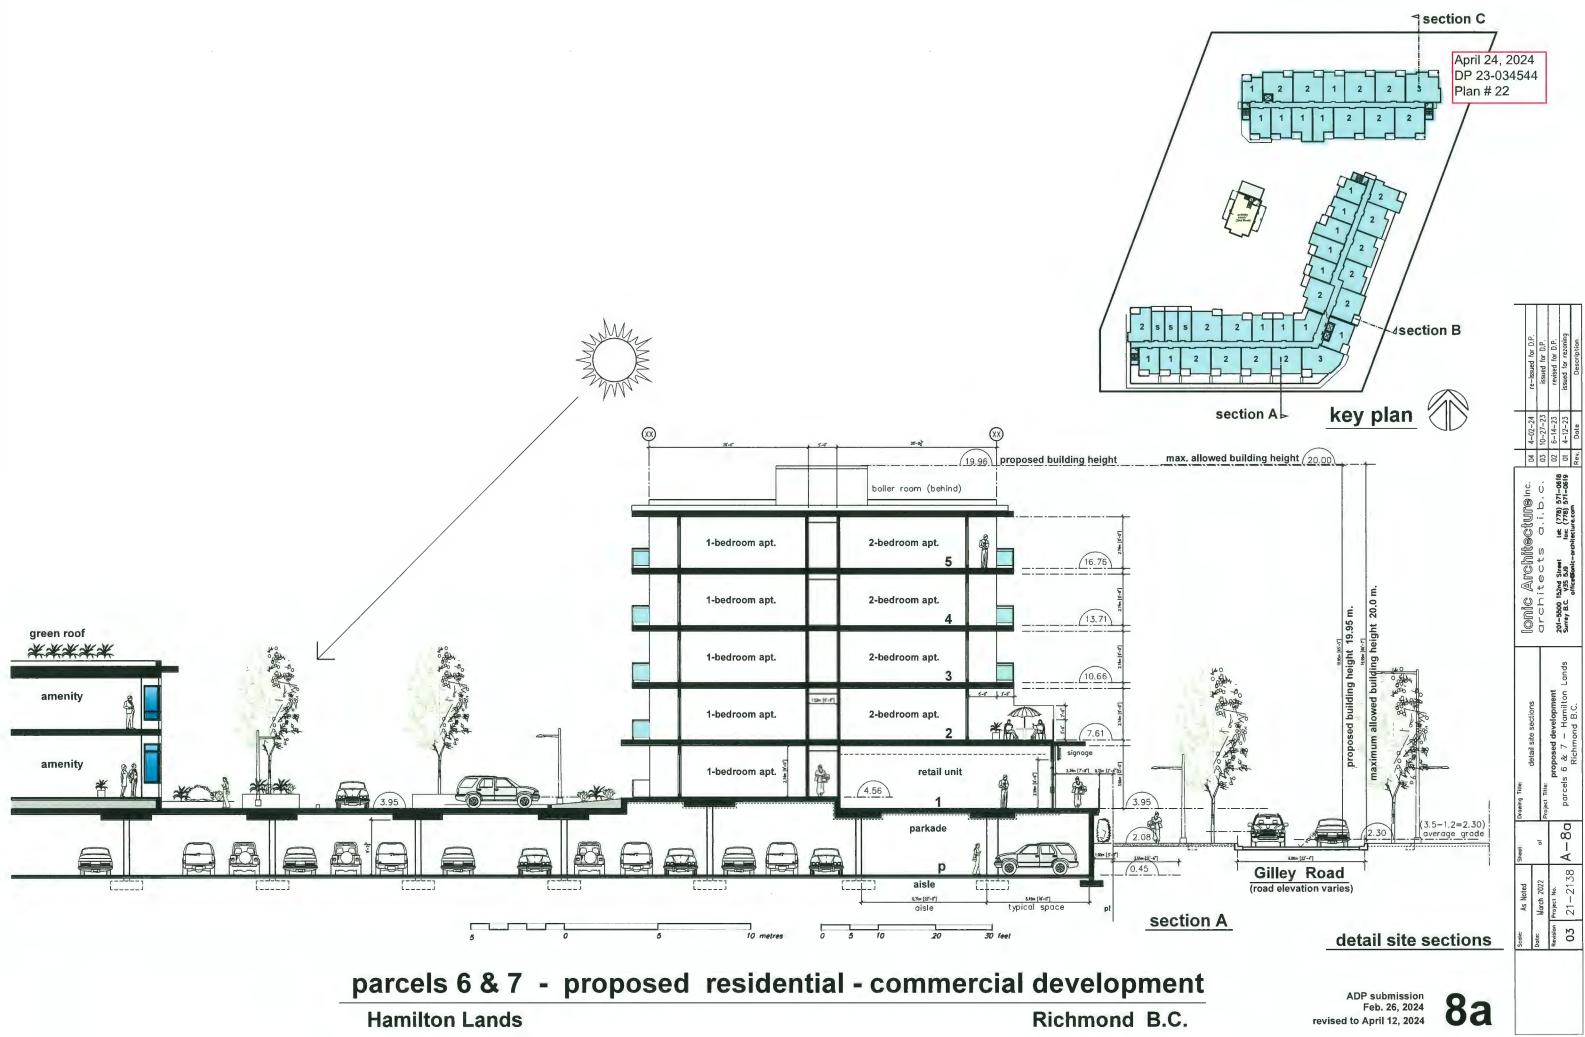

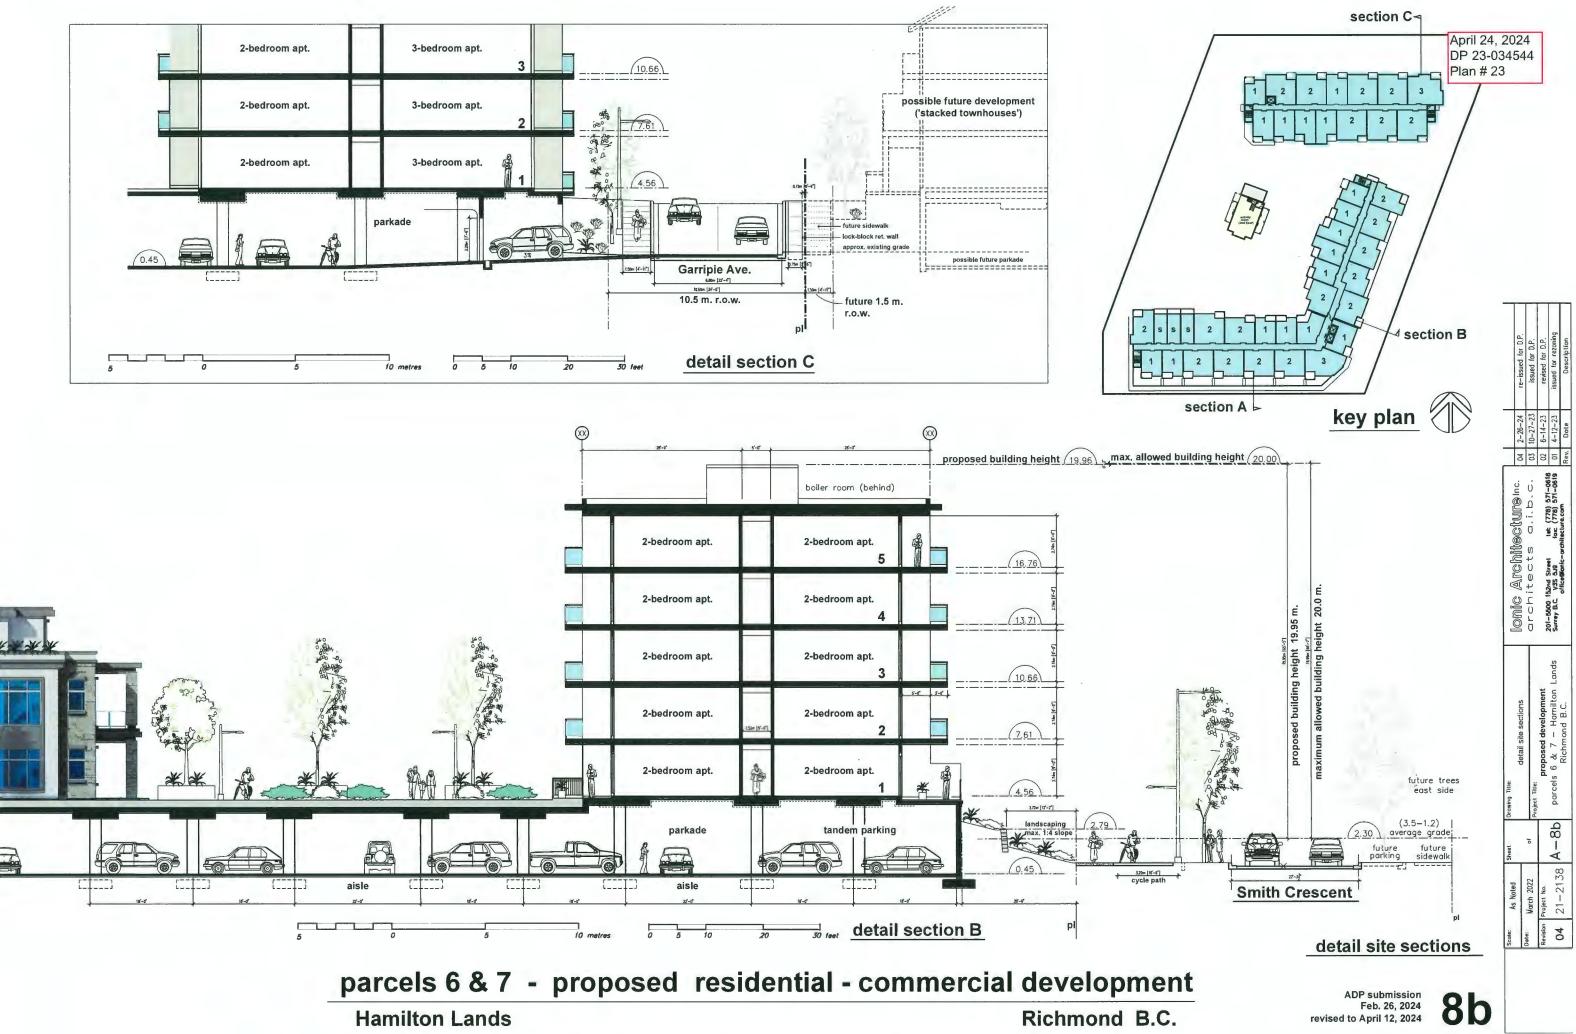


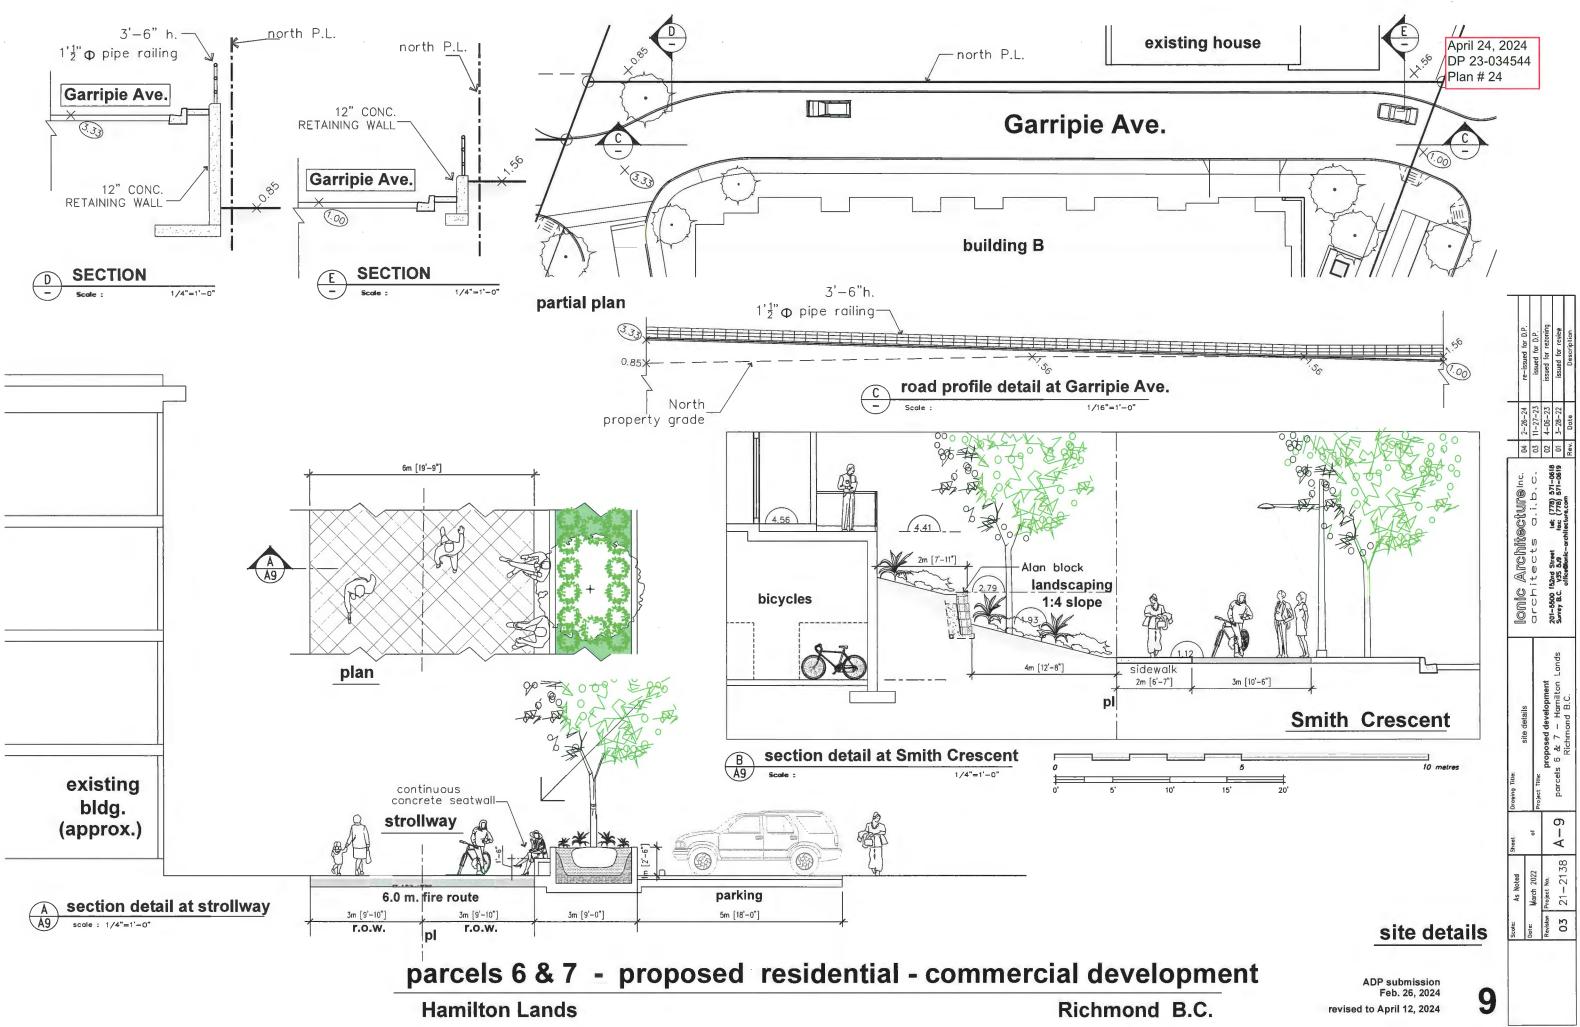

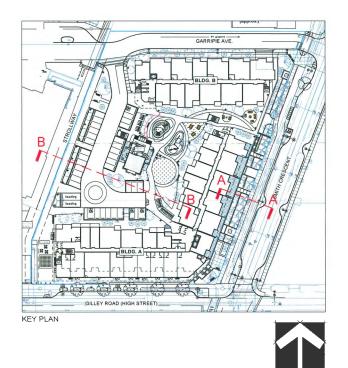



SECTION A - A (NOTE: REFER TO ARCHITECTURAL DRAWINGS FOR SIDEWALK AND PATIO ELEVATIONS) SCALE = $1/4^{-1}-0^{-1}$

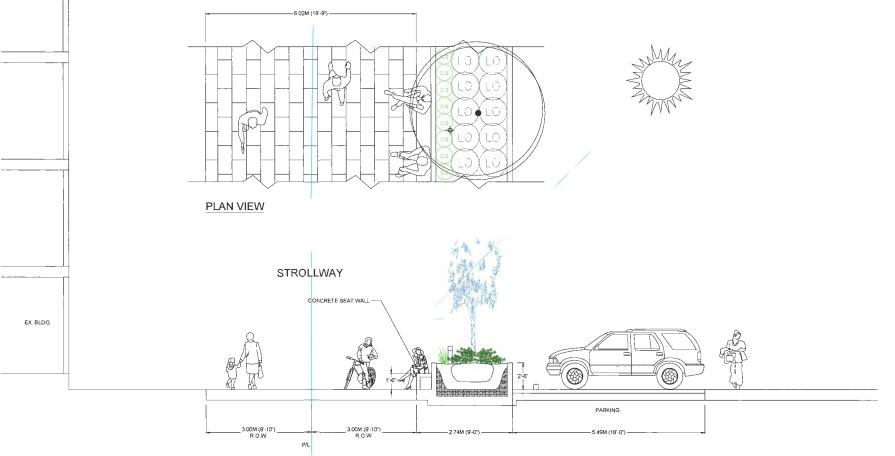

SECTION B - B SCALE = 1/4"=1'-0"

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SEAL:

April 24, 2024 DP 23-034544 DP Plan # 25

s	24 APR 18	COMMENTS	JR
4	24 APR.15	COMMENTS	JR
3	24.APR.03	NEW SITE PLAN / COMMENTS	JR
2	24 FEB 29	ISSUED FOR BP	JR.
1	23.APR.13	NEW SITE PLAN / COMMENTS	JR
NO.	DATE	REVISION DESCRIPTION	DR

CLIENT.

PROJECT:

CORNERSTONE

23301, 23321, 23361, 23381 GILLEY RD & 4691, 4671 AND 4651 SMITH CRESCENT, RICHMOND, BC

DRAWING TITLE

LANDSCAPE SECTIONS


DATE: 23.MAR.28 SCALE: AS NOTED DRAWN: DESIGN: IR CHK'D: BA

DRAWING NUMBER:

L6

OF 7


23053-6.ZIP PMG PROJECT NUMBER:

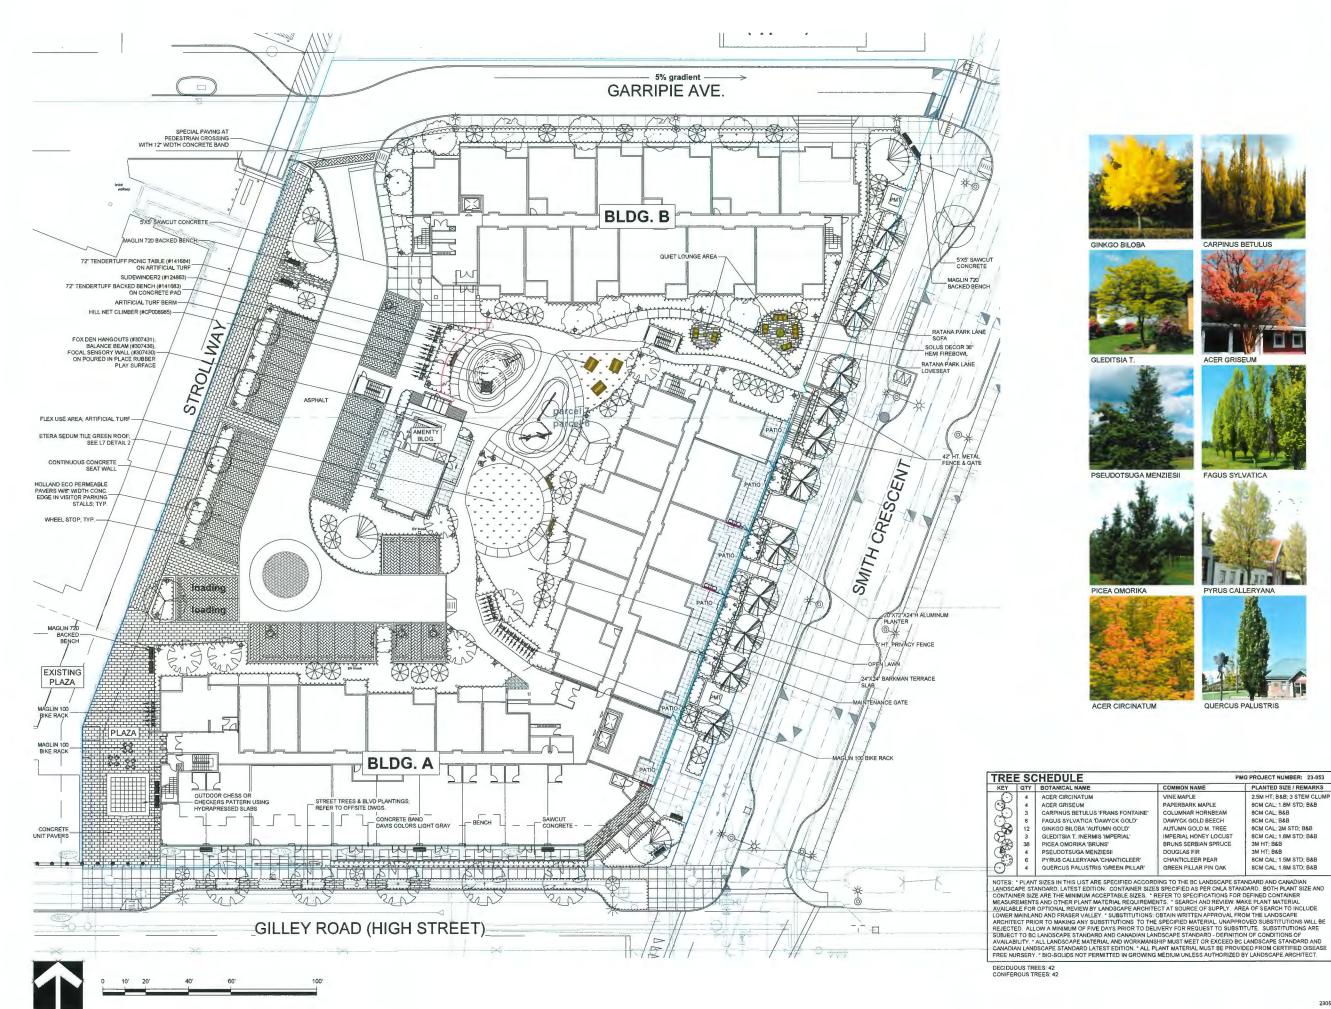

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SEAL:



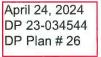

CLIENT:

PROJECT

CORNERSTONE

23301, 23321, 23361, 23381 GILLEY RD & 4691, 4671 AND 4651 SMITH CRESCENT, RICHMOND, BC

DRAWING TITLE:

LANDSCAPE PLAN

DATE:	23.MAR.28
SCALE:	1"=20'-0"
ORAWN:	JR
DESIGN:	JR
CHK'D:	BA

DRAWING NUMBER



CARPINUS BETULUS







FAGUS SYLVATICA





QUERCUS PALUSTRIS

	PI	IG PROJECT NUMBER: 23-053
_	COMMON NAME	PLANTED SIZE / REMARKS
	VINE MAPLE	2.5M HT; B&B 3 STEM CLUMP
	PAPERBARK MAPLE	BCM CAL; 1.8M STD; B&B
	COLUMNAR HORNBEAM	8CM CAL; B&B
	DAWYCK GOLD BEECH	BCM CAL; B&B
	AUTUMN GOLD M. TREE	BCM CAL; 2M STD; B&B
	IMPERIAL HONEY LOCUST	BCM CAL; 1.8M STD; B&B
	BRUNS SERBIAN SPRUCE	3M HT; B&B
	DOUGLAS FIR	3M HT; B&B
	CHANTICLEER PEAR	8CM CAL; 1.5M STD; B&B
	GREEN PILLAR PIN OAK	8CM CAL; 1.8M STD; B&B

PMG PROJECT NUMBER





AHONI

SPIRAEA



IRIOPE



FRAGARIA



PRUNUS



MPERATA



BUXUS



POLYSTICHUM

PM	G PROJECT NUMBER: 21-140
NAME	PLANTED SIZE / REMARKS
STRAWBERRY BUSH	#3 POT; 80CM
THED JAPANESE AUCUBA	#3 POT; 50CM
AF BOX	#3 POT; 40CM
IIA LILAC	#3 POT; 50CM
DOGWOOD	#3 POT; 80CM
HYDRANGEA	#3 POT; 80CM
EAVENLY BAMBOO	#3 POT; 50CM
KEN LAUREL	#3 POT; 50CM
ENDRON; BLUE	#3 POT, 50CM 1M B&B
ENDRON; LIGHT PURPLE; E. MAY	#3 POT; 50CM
D ROSE; RED	#2 POT; 40CM
E SKIMMIA	#2 POT; 30CM
INCESS SPIRAEA; PINK	#2 POT; 40CM
V	1.5M B&B
VEIGELA	#3 POT; 60CM
D JAPANESE SEDGE	#1 POT
RASS	#2 POT
DUNTAIN GRASS	#1 POT
FEATHER GRASS	#1 POT
LAVENDER; COMPACT; VIOLET-BLUE	#1 POT
STAR: PURPLE	15CM POT
OP	#1 POT
ONEYSUCKLE	#2 POT;40CM
SWORD FERN	#1 POT; 25CM

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SEAL:

April 24, 2024 DP 23-034544 DP Plan # 27

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			JR
4	24.APR.15	COMMENTS	RL RL
4	24.APR.15 24.APR.03	COMMENTS NEW SITE PLAN / COMMENTS	JR JR JR JR JR

CLIENT:

PROJECT:

CORNERSTONE

23301, 23321, 23361, 23381 GILLEY RD & 4691, 4671 AND 4651 SMITH CRESCENT, RICHMOND, BC

DRAWING TITLE:

SHRUB PLAN


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DRAWING NUMBER

L2

QF 7

23053-6.ZIP PMG PROJECT NUMBER:

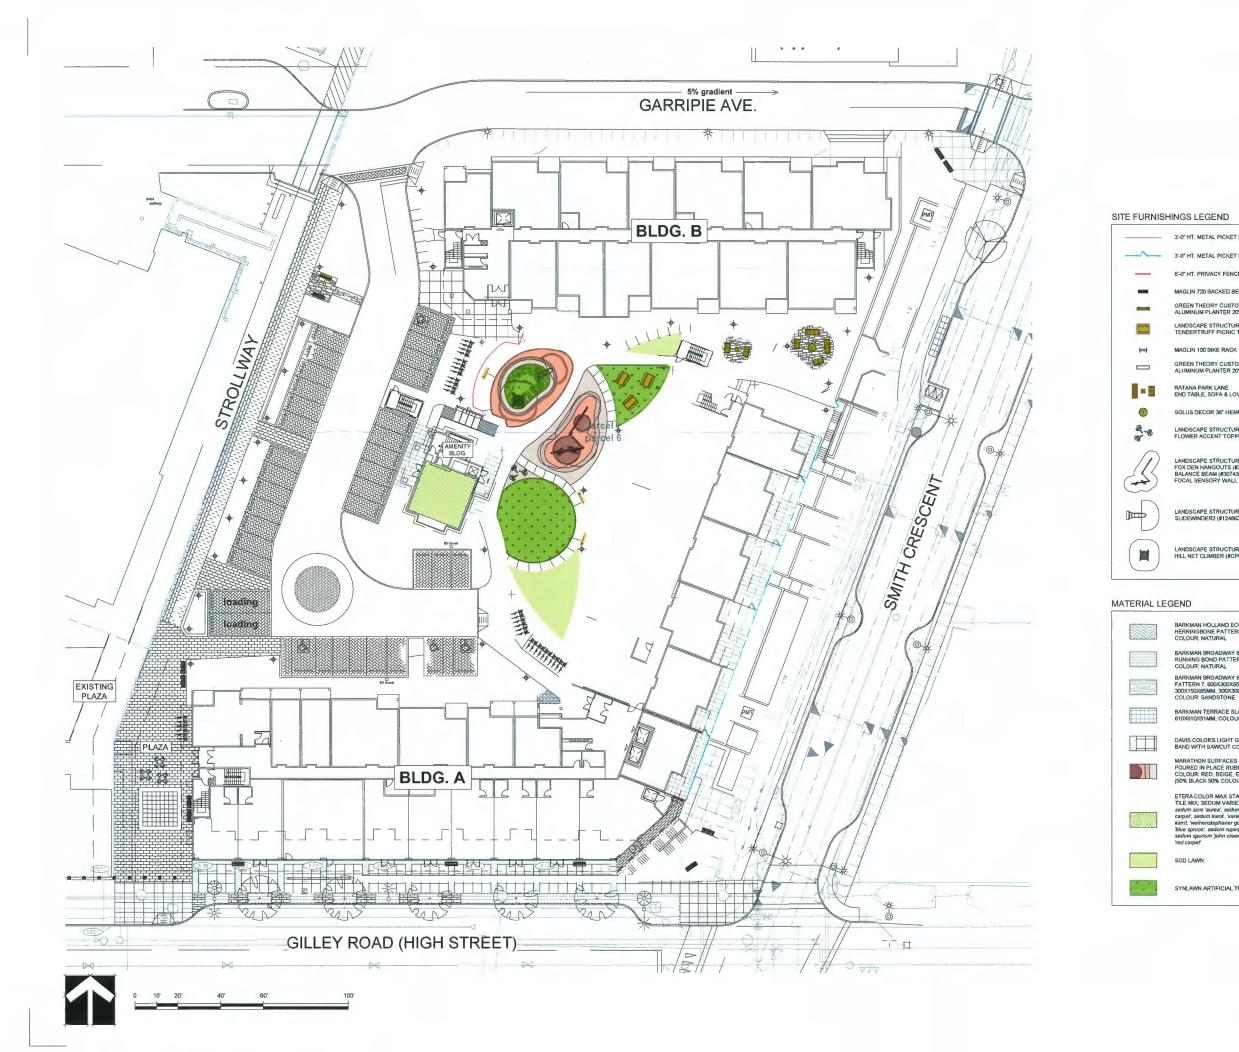

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SEAL:

April 24, 2024 DP 23-034544 DP Plan # 28

5 24,APR.18 COMIN 4 24.APR.15 3 24.APR.03 COMMENTS NEW SITE PLAN / COM ISSUED FOR BP 2 24.FEB.29 1 23.APR.13 NEW SITE PLAN / COMMENTS NO. DATE REVISION DESCRIPTION DR.

CLIENT:

PROJECT:

CORNERSTONE

23301, 23321, 23361, 23381 GILLEY RD & 4691, 4671 AND 4651 SMITH CRESCENT, RICHMOND, BC

DRAWING TITLE:

MATERIALS PLAN

DATE:	23.MAR.28
SCALE:	1"=20'-0"
DRAWN:	JR
DESIGN:	JR
CHK'D:	BA

DRAWING NUMBER

L3

OF 7

3'-0" HT. METAL PICKET FENCE (PLAY AREA)

3'-6" HT. METAL PICKET FENCE & GATE

6'-0" HT. PRIVACY FENCE

MAGLIN 720 BACKED BENCH

GREEN THEORY CUSTOM ALUMINUM PLANTER 20"X72"X24"H

LANDSCAPE STRUCTURES TENDERTRUFF PICNIC TABLE (#141684)

GREEN THEORY CUSTOM ALUMINUM PLANTER 20"X72"X24"H

RATANA PARK LANE END TABLE, SOFA & LOVESEAT

SOLUS DECOR 36" HEMI FIREBOWL

LANDSCAPE STRUCTURES FLOWER ACCENT TOPPER (#212256)

LANDSCAPE STRUCTURES FOX DEN HANGOUTS (#307431), BALANCE BEAM (#307436), FOCAL SENSORY WALL (#307430)

LANDSCAPE STRUCTURES SLIDEWINDER2 (#124863)

LANDSCAPE STRUCTURES HILL NET CLIMBER (#CP0089

BARKMAN HOLLAND ECO PERMEABLE HERRINGBONE PATTERN, 210X105X80M COLOUR: NATURAL

BARKMAN BROADWAY 65MM RUNNING BOND PATTERN, 300X150X65MM COLOUR: NATURAL

BARKMAN BROADWAY 65MM PATTERN 7, 600X300X65MM, 300X150X65MM, 300X300X65MM COLOUR: SANDSTONE

BARKMAN TERRACE SLAB 610X610X51MM, COLOUR: NATURAL


DAVIS COLORS LIGHT GRAY CONCRETE BAND WITH SAWCUT CONCRETE

MARATHON SURFACES LANDSAFE POURED IN PLACE RUBBER COLOUR: RED, BEIGE, EGGSHELL, BROWN (50% BLACK 50% COLOUR)

ETERA COLOR MAX STANDARD SEDUM TILE MIX: SEDUM VARIETIES: sedum acre 'aurea': sedum album 'coral carpet'; sedum kamt'.variegatimi'; sedum kamt. 'weihenstephaner gold', sedum reflaxum Öbue spruce: sadum rupestre 'angelina'; sedum spurkum 'john creech'; sedum squrkum 'red cancel red came

SOD LAWN

SYNLAWN ARTIFICIAL TURF

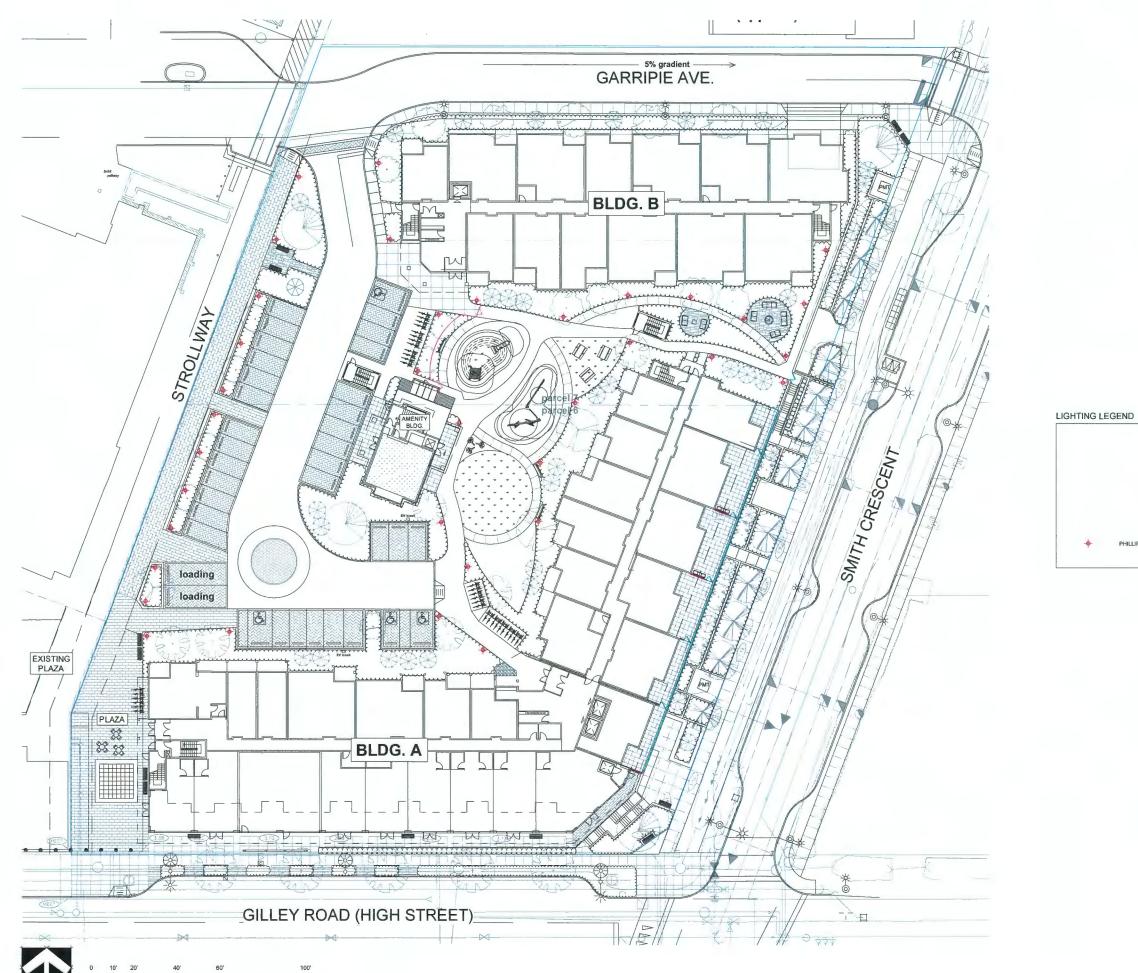


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SEAL:





PHILLIPS LED BOLLARD LIGHT II; BCP150/151

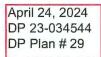	5	24.APR.19	COMMENTS	JR
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CLIENT:

PROJECT:

CORNERSTONE

23301, 23321, 23361, 23381 GILLEY RD & 4691, 4671 AND 4651 SMITH CRESCENT, RICHMOND, BC

DRAWING TITLE:

LIGHTING PLAN

DATE:	23.MAR.28	DRAWING NUMBER
SCALE:	1"=20'-0"	1.4
DRAWN:	JR	14
DESIGN:	JR	
CHK'D:	BA	OF 7

23053-6.ZIP PMG PROJECT NUMBER:

23-053

OF 7



TENDERTUFF PICNIC TABLE (#141684) & BACKED BENCH (#141683)


SYNLAWN ARTIFICIAL TURF

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Suite C100 - 4185 Still Creek Drive Burnaby, British Columbia, V5C 6G9 p: 604 294-0011 ; f: 604 294-0022

SEAL:



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4	24.APR.15	COMMENTS	成
3	24.APR.03	NEW SITE PLAN / COMMENTS	求
2	24.FEB.29	ISSUED FOR 8P	18
1	23.APR.13	NEW SITE PLAN / COMMENTS	床

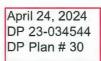CLIENT:

PROJECT:

CORNERSTONE

23301, 23321, 23361, 23381 GILLEY RD & 4691, 4671 AND 4651 SMITH CRESCENT, RICHMOND, BC

DRAWING TITLE:


AMENITY ENLARGEMENT

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DESIGN:	JR	
CHK'D:	BA	OF 7



23053-6.ZIP PMG PROJECT NUMBER:

23-053

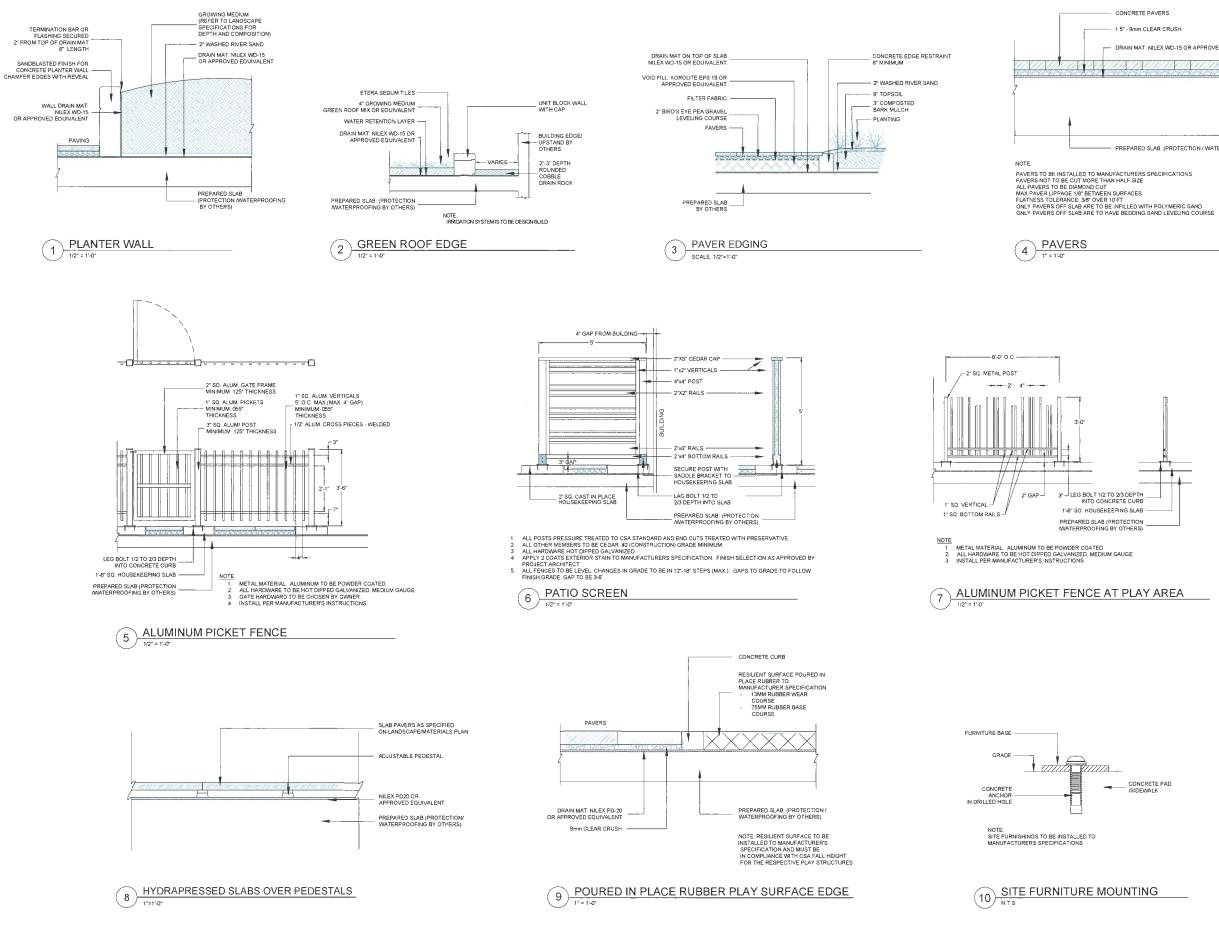


DRAIN MAT: NILEX WD-15 OR APPROVED EQUIVALENT PREPARED SLAB: (PROTECTION / WATERPROOFING BY OTHERS)

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SEAL:



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5	24 APR.18	COMMENTS	JR
4	24 APR.15	COMMENTS	JR
3	24 APR.03	NEW SITE PLAN / COMMENTS	JR
2	24 FEB 29	ISSUED FOR BP	IR
1	23 APR.13	NEW SITE PLAN / COMMENTS	jR
NO	DATE	REVISION DESCRIPTION	DR.

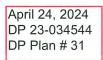CLIENT.

PROJECT:

CORNERSTONE

23301, 23321, 23361, 23381 GILLEY RD & 4691, 4671 AND 4651 SMITH CRESCENT, RICHMOND, BC

DRAWING TITLE:

LANDSCAPE DETAILS


DATE:	23.MAR.28	DRAWING NUMBER
SCALE:	AS NOTED	
DRAWN:	JR	
DESIGN	JR	
CHK'D	BA	OF 7

23-053

OF 7

consultants :

OWNER :	MASKEEN (HAMILTON) PROPERTIES CORP.
	TEL: (604) 502-9096 fax: (604) 502-9035 email info@maskeen.ca
SURVEYOR :	ONDERWATER LAND SURVEYING LTD. TEL: (604) 574-7311 fax: (604) 574-3018 email matt@onderwater.ca
CIVIL ENGINEER :	H.Y. ENGINEERING/SURVEYING TEL: (604) 583-1616 fax: (604) 583-1737 email hyengineering.com
TRAFFIC ENGINEER :	CTS TRAFFIC ENGINEERING TEL: (604) 936-6190 fax: (604) xxx-xxxx email gvlieg@cts-bc.com
ARBORIST :	ARBORTECH CONSULTING TEL: (604) 275-3484 fax: (604) 275-9554 email norm@arbortechbc.ca
LANDSCAPE ARCH. :	PMG LANDSCAPE ARCHITECTS TEL: (604) 294-0011 fax: (604) 294-0022 email Ben@pmglandscape.com
CODE CONSULTANT :	PONTEM GROUP TEL: (604) 363-7329 email echen@pontemgrp.com

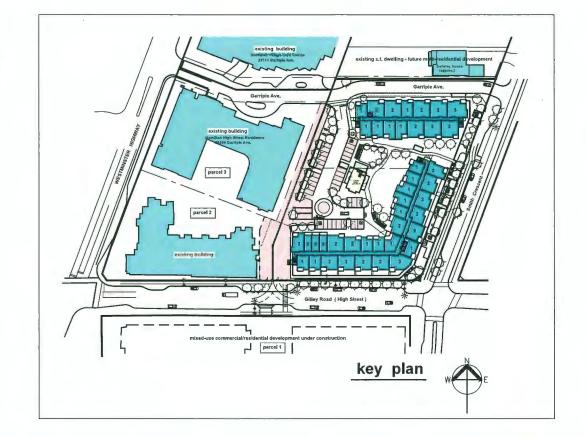







view from south-east

parcels 6 & 7 - proposed residential - commercial development

Hamilton Lands

Richmond B.C.

drawing list :

 A-0 cover sheet A-1 project data A-2 parkade plan A-3 site plan/ground floor plan A-4 plans - levels 2 through 5 A-5a-A5b building A elevations A-5c building B elevations A-6a streetscapes A-6b streetscapes A-7 site sections A-8a-8b detail site sections A-9 site details A-10a-10b apartment unit plans A-10d apt. unit distribution A-10d bylaw floor areo calculation A-10d detail floor plans - lobbies A-11a amenity building plans A-12 community police office A-13 shadow casts A-14a model views
A-14b model views A-14c model views A-14d model views
A-15 site study - adjacent site
 S-1 topographic survey S-2 site grading plan S-3 dedications & R.O.W.s S-4 fire department access plan S-5 construction phasing plan

cover sheet

ADP submission Feb. 26, 2024 revised to April 12, 2024



April 24, 2024 DP 23-034544 Reference Plan


04 04 03 04 01

IONIC Architecturainc. architects a.i.b.c. 201-2000 12200 51001 14 (773) 571-0019 201-2000 12200 51001 14 (773) 571-0019 54000 12200 51001 14 (773) 571-0019

A-0

38

evision 04

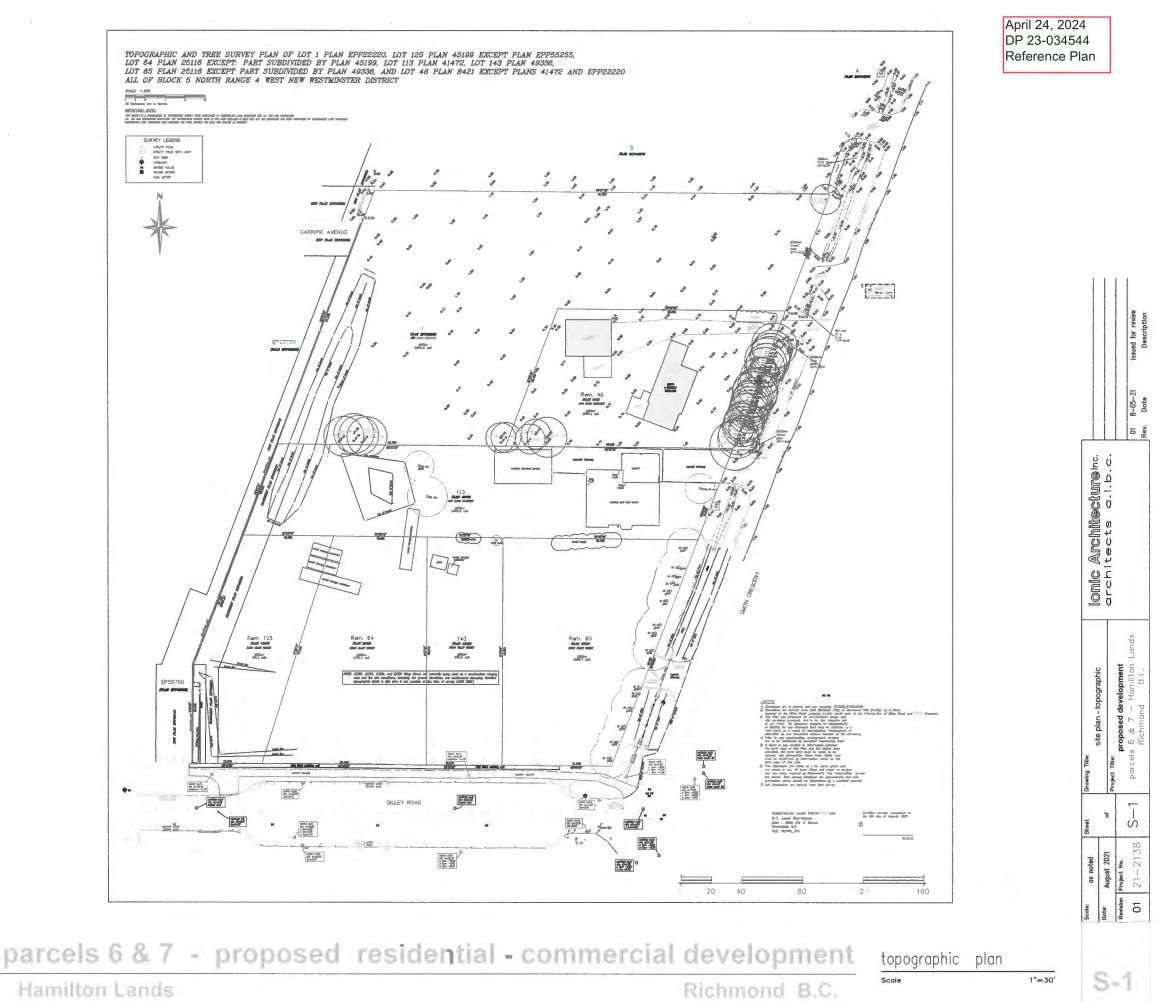





building A - Smith Crescent entrance



parcels 6 & 7 - proposed residential - commercial developm

Richmond

	April 24, 2024 DP 23-034544 Reference Plan	4-02-24 revised per ADP comments 2-20-24 reissued for DP 11-27-23 issued for DP 8-50-23 issued for review Dote Description
		©Mic Architects a.i.b.c. architects a.i.b.c. 201-500 1508 teet teet teet (778) 571-0619 2010-500 1508 teet teet teet (778) 571-0619 01 1 Rev.
		Drowing Title: perspective views - building A Project Title: PROPOSED DEVELOPMENT Parcels 6 & 7 - Hamilton Lands RICHMOND BC
		Scole: As Noted Street Date: AuGuST 2023 of Revision Project No. 04 21-2138 140
ment B.C.	ADP submission Feb. 26, 2024 revised to April 2, 2024	





Richmond B.C.

Feb. 26, 2024 revised to April 2, 2024 **14b**



courtyard view



amenity building & bldg. A







parcels 6 & 7 - proposed residential - commercial development

Hamilton Lands

Richmond B.C.

ADP submission Feb. 26, 2024 revised to April 2, 2024 **14C**




21 JUN 0900



21 JUN 1200



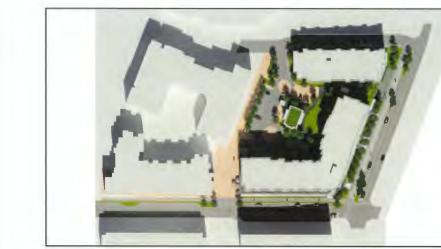

21 MAR 1200







21 DEC 1200



21 MAR 0900

21 DEC 0900

parcels 6 & 7 - proposed residential - commercial development

Hamilton Lands

Richmond B.C.

April 24, 2024 DP 23-034544 Reference Plan

21 JUN 1500

21 MAR 1500

[Onlic Architects a.i.b.c. architects a.i.b.c. 201-200 lized stat lat(778) 571-0615 Survey BC. VSS 550 alter@ont-architecture.com A13 21-2138 Revision 04

ADP submission Feb. 26, 2024

shadow casts

13