

#### Development Permit Panel Electronic Meeting

Council Chambers, City Hall 6911 No. 3 Road Wednesday, March 16, 2022 3:30 p.m.

MIN	UT	ES
-----	----	----

Motion to adopt the	<mark>minutes</mark> of	the Development	Permit Par	nel meeting	held on	January
<i>12, 2022.</i>						

#### 1. **DEVELOPMENT PERMIT 19-858783**

(REDMS No. 6834373)

APPLICANT: Zhao XD Architect Ltd.

PROPERTY LOCATION: 8231 and 8251 Williams Road

#### **Director's Recommendations**

That a Development Permit be issued which would:

- 1. permit the construction of ten townhouse dwellings at 8231 and 8251 Williams Road with vehicle access from 8299 Williams Road on a site zoned "Low Density Townhouses (RTL4)"; and
- 2. vary the provisions of Richmond Zoning Bylaw 8500 to increase the permitted small parking spaces from 0 to 6 (i.e. 30%).

#### 2. DEVELOPMENT VARIANCE PERMIT 21-930451

(REDMS No. 6837842)

APPLICANT: Speera Ventures Incorporated

ITEM

PROPERTY LOCATION: 10620 Williams Road

#### **Director's Recommendations**

That a Development Variance Permit be issued which would vary the provisions of Richmond Zoning Bylaw 8500 on proposed Lot 2 to:

- 1. reduce the rear yard setback requirement from 6.0 m to 3.1 m to facilitate on-site tree retention.
- 2. permit the required private outdoor space to be located in the front yard instead of the rear yard.
- 3. New Business
- 4. Date of Next Meeting: March 30, 2022

**ADJOURNMENT** 

#### **Minutes**



# Development Permit Panel Wednesday, January 12, 2022

Time:

3:30 p.m.

Place:

Remote (Zoom) Meeting

Present:

John Irving, General Manager, Engineering and Public Works, Acting Chair

Cecilia Achiam, General Manager, Community Safety

Milton Chan, Director, Engineering

The meeting was called to order at 3:30 p.m.

#### **Minutes**

It was moved and seconded

That the minutes of the meeting of the Development Permit Panel held on November 24, 2021 be adopted.

**CARRIED** 

#### 1. DEVELOPMENT PERMIT 20-910008

(REDMS No. 6784725)

APPLICANT:

1058085 BC Ltd.

PROPERTY LOCATION:

10431 No. 5 Road

#### INTENT OF DEVELOPMENT PERMIT:

Permit the construction of two duplexes at 10431 No. 5 Road on a site zoned "Arterial Road Compact Two-Unit Dwellings (RCD)".

### Development Permit Panel Wednesday, January 12, 2022

#### **Applicant's Comments**

Eric Law, Eric Law Architect, with the aid of a visual presentation (attached to and forming part of these Minutes as <u>Schedule 1</u>), provided background information on the proposed development, including its site context, site layout, floor plan, and architectural form and character, highlighting the following:

- the proposed development consists of two two-storey front-to-back duplexes on a lot subdivided into two for a total of 4 dwelling units overall;
- a landscaped central pedestrian pathway is proposed between the two duplex buildings and provides access to all the units;
- the form and character of the proposed development is consistent with the low-rise residential character of the surrounding neighbourhood;
- the proposal includes two convertible units located at the rear;
- each unit will be provided with a single-car garage and one outdoor parking stall in tandem configuration which are accessed from the rear laneway; and
- the project has been designed to achieve Step 3 of the BC Energy Step Code.

Donald Duncan, Donald V.S. Duncan Landscape Architect, provided an overview of the main landscaping features of the project, noting that (i) a diverse selection of plant materials are proposed along the frontage to provide visual interest, screening and privacy, with preference given to native species, (ii) the central pedestrian pathway will be treated with permeable pavers and planting along the edges to soften its character, (iii) hard and soft landscaping is proposed for the private outdoor space of the rear units, (iv) the permeable paving surface treatment for the outdoor private space of convertible units would enhance the accessibility of users, (v) planting is proposed at the rear to soften the look of the garages and the rear lane, and (vi) the retention of two existing City trees at the rear of the subject site and the reconfiguration of the driveway had been considered; however, the retention of these trees is not possible due to vehicles accessing/exiting the driveway.

#### **Staff Comments**

Wayne Craig, Director, Development, noted that (i) the applicant's efforts to retain one on-site tree along the No. 5 Road frontage and undertake special mitigation measures for tree retention are appreciated, (ii) laneway improvements including driveway orientation and landscaping opportunities will be further reviewed through the Servicing Agreement associated with the project, and (iii) opportunities for tree planting will be considered in addition to the proposed lawns between the drive aisles.

## Development Permit Panel Wednesday, January 12, 2022

#### **Panel Discussion**

In reply to queries from the Panel, Mr. Duncan acknowledged that (i) the project's tree replacement ratio meets the City's requirement, (ii) the quality and survivability of trees were considered in the choice of tree species proposed to be planted on the site, (iii) majority of proposed paving materials on the site are pervious, (iv) the driveway adjacent to the rear lane will be treated with asphalt, (v) permeable paving treatment is proposed for the resident outdoor parking space at the back of the single car garage for each unit, and (vi) hard and soft landscape elements are proposed for the private outdoor space for each unit.

Discussion ensued regarding the possibility of retaining the two existing City trees at the rear of the site and the proposed configuration of the driveway that results in significant concrete paving on the driveway.

As a result of the discussion, staff were directed to work with the applicant to investigate opportunities to reconfigure the proposed driveway in order to preserve the existing trees or provide new tree planting and maximize opportunities for soft landscaping.

#### **Gallery Comments**

None.

#### Correspondence

None.

#### **Panel Discussion**

The Panel expressed support for the project, noting that (i) the project has some good landscape elements, (ii) the project fits well into the character of the neighbourhood, and (iii) the driveway access from the rear lane would result in an enhanced pedestrian experience along the No. 5 Road frontage.

#### **Panel Decision**

It was moved and seconded

That a Development Permit be issued which would permit the construction of two duplexes at 10431 No. 5 Road on a site zoned "Arterial Road Compact Two-Unit Dwellings (RCD)"

**CARRIED** 

# Development Permit Panel Wednesday, January 12, 2022

#### 2. New Business

It was moved and seconded

That the Development Permit Panel meeting tentatively scheduled on Wednesday, January 26, 2022 be cancelled.

**CARRIED** 

#### 3. Adjournment

It was moved and seconded *That the meeting be adjourned at 3:52 p.m.* 

**CARRIED** 

Certified a true and correct copy of the Minutes of the meeting of the Development Permit Panel of the Council of the City of Richmond held on Wednesday, January 12, 2022.

John Irving	Rustico Agawin	
Acting Chair	Committee Clerk	

meeting held on Wednesday, January 12, 2022. Schedule 1 to the Minutes of the Development Permit Panel Development

ericlas.architect@gmail.com 216 288 WETH ANDHUE VANCOUNER BC VSYINS TEL: (604) 505–2099

ERIC LAW ARCHITECT





ADJACENT HOUSE





VIEW ACROSS NO. 5 ROAD



AERIAL CONTEXT VIEW

	-	2		,	,	
REVISION	2021.05.11 BLDG CLEVATION ACCED	2021.05.27 GARAGE CLEVATION ADDED	2021.08.23 REVISED PER ADP COMMENTS	2021.12.08 ADDED EXTERIOR UGHT	2021.12.13 SPECIFY EXTERIOR DOMNUISHT	

2	CHECKED BY:
E	DRAWN BY:
1/10/2022	ISSUED:
3ER:18-08	PROJECT NUMBE

COMPACT DUPLEX 10431 NO. 5 RD RICHMOND BC

CONTEXT

DP 20-910008

CONTEXT

AERIAL IMAGE NO 5 RD

COPRIOR RESEARCH, THE PLAN AND DECORRECT RESEARCH TO RETURN THE CONTROL OF REPORTED AND ANY PART OF REPORT OF REPORT

Pricipe orchitect@mail.com 216 238 WSTH AFENUE VANCOUMER BC VSYTHS TEL: (604) 505-2099

ERIC LAW ARCHITECT

IMAGE ALONG NO. 5 ROAD

IMAGE ALONG NO. 5 ROAD DP 20-910008

PROPOSED
COMPACT DUPLEX
10431 NO. 5 RD
RICHMOND BC IMAGES

DEVELOPMENT PERMIT

IMAGE

# PROPOSED DUPLEX AT 10431 NO. 5 ROAD, RICHMOND, BC

COPRESE RILLEGIA THE FLAM AND RECORD AND, AF SHALLEGIA OF RELIANS AND ADDRESS OF RECORD AND ADDRESS OF REPORTANCE AND AND ADDRESS OF REPORTANCE AND AND ADDRESS OF REPORTANCE AND ADDRESS OF REPORTANCE

erkfor architet@gredi.com 216 288 WETH ANDRUC VANDOUNER OC VSY1145

(604) 505-2099

ERIC LAW ARCHITECT

(A) CIVIC ADDRESS:
(B) LEGAL DESCRIPTION:
(C) LOT AREA:
(D) ZONING USE (F) NUMBER OF UNIT: (G) BUILDING COVERAGE (J) PARKING: (i) SETBACK: (H) BUILDING (E) FLOOR AREA RATIO DEVELOPMENT DATA FRONT YARD — 6M SIDE YARD — 2M REAR YARD — 6M 1 PER LOT MAX - 45% 10431 NO 5 ROAD, RICHMOND, BC
"\*\* LOT 336 SECTION 36 BLOCK 4 NORTH RANGE 6 WEST, NWD 44778
390.5 SN (4,200.5 F) FOR EACH LOT AFTER SUBDIVISION INTO 2 LOTS, ORIGINAL LOT SIZE 781 SM CURRENT; RS1/F, PROPOSED: RCD 2 PER DWELLING UNIT 0.3 TO REST OF SITE AREA 0.55 TO 454.5 SM CURRENT ZONING (UNDER RS1/E ZONING) MAX HEIGHT - 9M 0.5 PER LOT
(WITH AFFORDABLE HOUSING CONTRIBUTION)
1 TOTAL FAR FLOOR AREA PER LOT
2:
0.50 X390.5 SM = 234.3 SM (2.521 SF)
1(TOTAL FAR AREA = 468.6 SM FOR 2 LOTS) 2 PER LOT
SITE COVER - MAX 50% (2101 SF)
POROUS AREA-MIN 30%
LIVE PLANT-MIN 20%
LIVE PLANT AT FRONTYARD - MIN 5 GARAGE BETWEEN 1.2 TO 12.5M FROM REAR YARD GARAGE SIDE YARD — 1.2M 2 PER DWELLING UNITS VISITOR — NO REQUIREMENT MAX MAIN BUILDING HEIGHT – 9M MAX CARACE HEIGHT – 4M FRONT YARD – 6M SIDE YARD – 1.2M REAR YARD – 10M PROPOSED REZONING (RCD) COVERED PORCH 10% = 23.4 SM (252 SF) 15.8SM (170.5 SO, FT.) 7% COVERED PORCH GARAGE 25 SM PER UNIT (289 SF) 19.4 SM (209 SO, FT.) GARAGE PER UNIT SF 50% FRONT (APD — 6.3M (2016\*)


NORTH SIDE YARD — 1.27M (4'2")

SOUTH SIDE YARD — 1.27M (4'2")

SOUTH SIDE YARD — 1.28M (4'8")

GABAGE — BETEREN 5.5M TO 11.8M FROM REAR YARD

GABAGE — 1.2M SIDE YARD 2 UNITS PER LOT 46% (1935 SO. FT. / 4203 SO. FT PER LOT) 47% REFER TO LANDSCAPE 25% REFER TO LANDSCAPE 234.2SM (2521 SQ. FT.) PER LOT TOTAL FAR AREA 468.4SM (5042 SQ. FT) FOR 2 LOTS 0.6 2 REGULAR PARKING IN TANDEM ARRANGEMENT PER UNIT PROPOSED BUILDING HEIGHT - 8.05M GARAGE HEIGHT - 3.97M

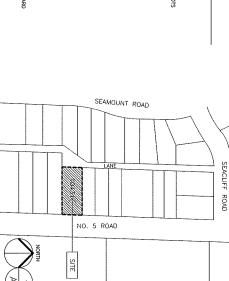



PROPOSED

1/8" TO 1'-0" CONTEXT ELEVATION ALONG NO. ഗ ROAD

D D

D D

/

THE

⊞ **|** 

H

Ħ

NEIGHBOUR HOUSES

PL

LOT 2 BLDG B


SITE

LOCATION MAP



DP 20-910008

2

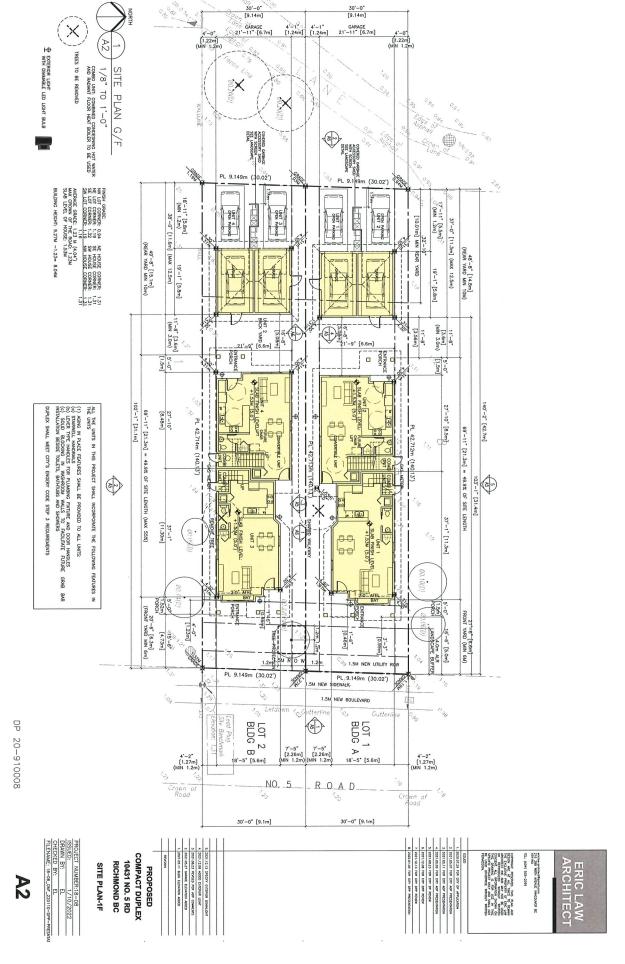

DEVELOPMENT PERMIT



A3

DP 20-910008



PROPOSED COMPACT DUPLEX 10431 NO. 5 RD RICHMOND BC SITE PLAN-2F

PL 9.149m (30.02') 20'-7" [6.3m]

LOT 1 BLDG A

30'-0" [9.1m]

ROAD

COPRESENT RECEIVED. THE FLAM AND DEPOSIT OF THE AND THE SECOND OF THE SE

22'-7" [6.9m] (FRONT YARD MIN 10M)

6.0m MIN SETBACK

4'-2" [1.27m] (MIN 1.2m)

ericlos archiect@psol.com 216 250 NBTH ANDAUE VANDOUNTR DC VEYING TDL: (604) 505-2079 ERIC LAW ARCHITECT

PL 42.712m (140,13') 65'-1" [19.8m] (46.6% OF LOT LENGTH) 36'-0" [10.97m]

29'-1" [8.86m]

PL 42.714m (140.13") PL 42.713m (140.13') 

PL 9.149m (30.02')

1/8" TO 1'-0" SITE PLAN 2/F

53'-5" [16.3m] (REAR YARD MIN 10m)

140'-2" [42.7m]

(F)

29'-1" [8.9m]

36'-0" [11.0m]

65'-1" [19.8m] (46.6% OF TOTAL SITE LENGTH MAX 55%)

21'-7" [6.6m] (FRONTYARD MIN 6m)

4'-2" [1.27m] (MIN 1.2m)

£1'−9" [6.62m]

PL 9.149m (30.02')

20'-7" [6.3m]

LOT 2 BLDG B

30'-0" [9.1m]

2;"-0" [7.32m]

5'-3" [1.60m] (MIN 1.2m)

NO. 5


5'-3" [1.60m] (MIN 1.2m)

(S)

PL 9.149m (30.02')

(Z)

52'-5" [16.0m] (REAR YARD MIN 10M)

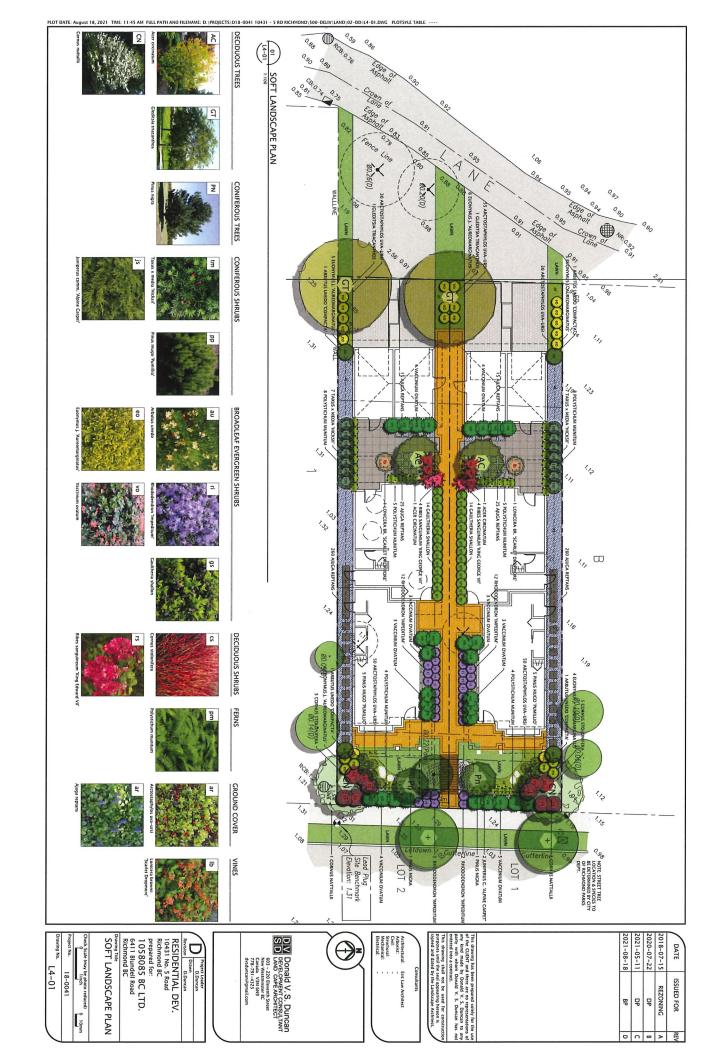



#### **Report to Development Permit Panel**

To: Development Permit Panel

Date:

February 24, 2022

From:

Wayne Craig

File:

DP 19-858783

Director of Development

Re:

Application by Zhao XD Architect Ltd. for a Development Permit at 8231 and 8251

Williams Road

#### Staff Recommendation

That a Development Permit be issued which would:

- 1. Permit the construction of ten townhouse dwellings at 8231 and 8251 Williams Road with vehicle access from 8299 Williams Road on a site zoned "Low Density Townhouses (RTL4)"; and
- 2. Vary the provisions of Richmond Zoning Bylaw 8500 to increase the permitted small parking spaces from 0 to 6 (i.e. 30%).

Wayne Craig

Director, Development

(604-247-4625)

WC:jr Att. 3

#### Staff Report

#### Origin

Zhao XD Architect Ltd. has applied on behalf of Y&W Development Ltd. (Directors Jing Long Yuan and Xia Wang) to the City of Richmond for permission to develop ten (10) townhouse dwellings at 8231 and 8251 Williams Road on a site zoned "Low Density Townhouses (RTL4)," with vehicle access from 8299 Williams Road. The site currently contains two single detached dwellings, which would be demolished. A location map is provided in Attachment 1.

The site is being rezoned from "Single Detached (RS1/E)" to "Low Density Townhouses (RTL4)" under Richmond Zoning Bylaw 8500, Amendment Bylaw 10173 (RZ 18-824503).

A Servicing Agreement is required as a condition of building permit issuance and includes, but is not limited to, the following improvements:

- Removal of the existing sidewalk and replacement with new 2.0 m wide sidewalk and 1.5 m landscaped boulevard behind the existing curb; and.
- removal of the existing driveway crossings and replacement with the above frontage improvements.

#### **Development Information**

Please refer to attached Development Application Data Sheet (Attachment 2) for a comparison of the proposed development data with the relevant Bylaw requirements.

#### **Background**

Development surrounding the subject site is as follows:

To the North: Single detached dwellings on properties zoned "Single Detached (RS1/E)" with vehicle access from Pigott Road.

To the South: Single detached dwellings on properties zoned "Single Detached (RS1/E)" with vehicle access from Williams Road. One of the properties is included in an active rezoning application (RZ 21-934592). 8240 Williams Road is proposed to be rezoned for a three-unit townhouse development. The application is currently under review, and a staff report will be submitted to the Planning Committee following completion of the staff review process.

To the East: A vacant property recently rezoned to "Low Density Townhouses (RTL4)" in

order to develop ten (10) townhouse units (RZ 17-788945, DP 18-829083). The building permit application for this development is currently under review. Driveway access to the subject site is provided through a Statutory Right-of-Way

registered on this property secured as a condition of rezoning approval.

Single detached dwellings on properties zoned "Single Detached (RS1/E)" with To the West:

vehicle access from Williams Road.

#### Rezoning and Public Hearing Results

During the rezoning process, staff identified the following design issues to be resolved at the Development Permit stage:

- Compliance with Development Permit Guidelines for the form and character of multiple-family projects provided in the 2041 Official Community Plan (OCP).
- Review of the size and species of on-site trees to ensure bylaw compliance and to achieve an acceptable mix of coniferous and deciduous species on-site.
- Refinement of the shared outdoor amenity area design, including the choice of play equipment, to create a safe and vibrant environment for children's play and social interaction.
- Review of relevant accessibility features for the four proposed convertible units and aging-inplace design features in all units.
- Review of a sustainability strategy for the development proposal.

The Public Hearing for the rezoning of this site was held on July 20, 2020. No public correspondence was received at the Public Hearing.

Staff worked with the applicant to address the above design issues in the following ways:

- The architectural and landscape drawings have been reviewed by staff and presented to the Advisory Design Panel for comment. The applicant has refined the design while retaining the general character presented to Council at rezoning stage.
- The proposed size and location of the shared outdoor amenity area is the same, however it has been redesigned with a greater focus on structured play opportunities.
- An accessibility strategy including detailed design of the four convertible units was reviewed by staff and presented to the Advisory Design Panel.
- The applicant has provided a sustainability strategy and a letter from a Certified Energy Advisor indicating that the project will achieve Step 3 of the BC Energy Step Code consistent with current City regulations.

The above issues are discussed further in the "Analysis" section of this report.

#### Staff Comments

The proposed scheme attached to this report has satisfactorily addressed the significant urban design issues and other staff comments identified as part of the review of the subject Development Permit application (Plans 1-15). In addition, it complies with the intent of the applicable sections of the OCP and is generally in compliance with the "Low Density Townhouses (RTL4)" zone except for the zoning variance noted below.

#### Zoning Compliance/Variances (staff comments in bold italics)

The applicant requests to vary the provisions of Richmond Zoning Bylaw 8500 to:

1) Increase the permitted small parking spaces from 0 to 6 (i.e. 30%).

The applicant proposes a small parking space in each of the six garages with a side-by-side parking arrangement. Richmond Zoning Bylaw 8500 permits up to 50% small parking spaces where more than 31 spaces are required. This development would require 21 parking spaces. Staff support the proposed variance as it applies only to the side-by-side garages and is consistent with similar townhouse developments, including the approved development to the east (RZ 17-788945).

#### **Advisory Design Panel Comments**

The Advisory Design Panel reviewed the proposed development on July 7, 2021, and recommended support for the proposal subject to consideration of the Panel's comments. A copy of the relevant excerpt from the Advisory Design Panel Minutes is attached for reference (Attachment 3). The design response from the applicant has been included immediately following the specific Design Panel comments and is identified in 'bold italics'.

#### **Analysis**

#### Conditions of Adjacency

- The site grade is proposed to meet the existing grade of adjacent properties. Perimeter retaining walls are not proposed.
- The subject site abuts existing single detached dwellings to the north and west. These sensitive interfaces have been given special design consideration:
  - O Rear units are two storeys and have a variable rear yard setback consistent with the guidelines for arterial road townhouses. The minimum setback is generally 6.0 m, with up to 50% of the ground floor set back 4.5 m. New trees and hedges are proposed in the rear yard.
  - o The westernmost units are two storeys and have a 3.0 m side yard setback. New trees and hedges are proposed in the side yard.
- The subject site abuts a recently approved townhouse development to the east that has not yet been constructed. The adjacent development consists of two- and three-storey townhouses, with two-storey massing immediately adjacent to the subject site. The proposed development would also provide two-storey massing adjacent to the future development consistent with the guidelines for arterial road townhouses.

#### Urban Design and Site Planning

• The proposed development consists of ten (10) townhouse dwellings arranged on a central drive aisle, which would be an extension to the drive aisle to be constructed on 8299 Williams Road. A pedestrian access is provided in the middle of the site adjacent to an existing Magnolia tree, which is proposed to be retained. Retention of this tree strongly informed the proposed layout and building massing. The pathway would be constructed with permeable pavers with supervision by the project arborist within the tree protection zone.

- The two front buildings contain a total of six dwellings and would have direct access to the sidewalk along Williams Road. Front yards are landscaped and include a covered patio for weather protection. Three of the dwellings would have some living space at grade.
- The three dwellings with no living space at grade include a Juliet balcony on the second storey accessed from the living room. These balconies would overlook the internal drive aisle.
- The two rear buildings contain a total of four dwellings and would have access from the drive
  aisle. The front doors are set back from the drive aisle to allow space for a roof overhang
  providing weather protection. Rear yards are landscaped and accessed directly from the
  living room.
- Each dwelling has a garage containing two vehicle parking spaces and two Class 1 bicycle
  parking spaces. Two visitor vehicle parking spaces are proposed at the east end of the site,
  and two Class 2 bicycle parking spaces are proposed near the front of the site beside the
  central pathway.
- A garbage and recycling room is proposed in the middle of the site beside the central pathway. A small loading area is provided across from the garbage and recycling room, which also functions as a turn-around location.

#### Architectural Form and Character

- The proposed architectural form and character draws from traditional single detached designs. The material palette consists of Hardie Board siding in three colours, painted wood trim, cultured stone, and black asphalt shingles.
- A band of cultured stone is provided along the base of the street-fronting elevations. Grey and taupe Hardie Board siding is used on the first and second storeys, and yellow Hardie Board siding is used on the third storey and as an accent. Colour and articulation are used to visually distinguish individual dwelling units.
- Gable roofs reinforce the low-rise residential character of the development. The rear units immediately adjacent to single detached dwellings have a simple roof form, whereas the front units have more complex roof lines incorporating projecting gable ends.
- An archway feature is proposed between the two front buildings framing the pathway and the
  retained Magnolia. The archway is designed as an extension of the building massing and
  would be clad in gray Hardie Board siding with cultured stone footings.

#### Landscape Design and Open Space Design

- Two on-site trees are proposed to be retained. These are a Magnolia in the middle of the site and a Cherry tree in the southeast corner of the site. On-site building layout and landscaping have been designed to retain these trees, and the off-site sidewalk will need to be designed to avoid impacting the Cherry tree. A \$20,000 tree survival security is to be provided prior to rezoning bylaw adoption.
- At rezoning stage, staff supported the applicant's proposal to remove and replace one on-site tree due to its poor condition, which would require two replacement trees based on the 2:1 replacement ratio contained in the OCP. A total of 15 trees are proposed in the development, which includes 11 deciduous and four (4) coniferous trees.
- Each dwelling unit has a private outdoor space at grade that includes a small lawn, patio, shade tree, and planted area.

- A central pathway is proposed providing a connection to the Williams Road sidewalk.
   Permeable pavers are proposed for the entirety of the pathway, and landscaping would be provided on both sides. The retained Magnolia tree is integrated into the landscaped area, which also includes the mailbox, bench seating, and bike racks for visitors. A trellis structure would mark the entry and further distinguish the on-site pathway from the public sidewalk.
- The shared outdoor amenity area is at the rear of the site between the two buildings, and immediately across from the pathway to Williams Road. The programming of the outdoor amenity area includes bench seating and a play structure allowing for climbing, jumping, and sliding.
- The drive aisle is predominantly asphalt with concrete curbs. Permeable pavers are proposed at the east and west extents of the drive aisle, and in the centre where the pathway crosses to the outdoor amenity area.
- All soft landscaped areas would be provided with automatic irrigation.
- A Landscape Security in the amount of \$117,881.23 is required prior to Development Permit issuance to ensure that the agreed upon landscaping works are installed.

#### Crime Prevention Through Environmental Design

- A 1.8 m (6 ft.) wood fence is proposed around the perimeter of the property for privacy and security. The fence within the front yard will be 1.0 m (3.5 ft.) tall to provide clear sightlines from the units to the sidewalk while maintaining separation of the public and private realms.
- Front yards are landscaped with low shrubs and deciduous trees to maintain clear sightlines.
- Pedestrian site access is controlled via gates at each of the walkways to the unit entries.
- The mailbox is proposed beside the central pathway and is covered but not enclosed, maintaining visibility.
- Building-mounted sconce lighting is proposed beside each garage door, and pot lights are
  proposed in the soffits above each unit entrance. Bollard lighting is proposed along the
  central pathway and the shared amenity area.

#### Accessible Housing

- The proposed development includes four (4) convertible units that are designed with the potential to be easily renovated to accommodate a future resident in a wheelchair. The potential conversion of these units will require installation of a chair lift. All four (4) of these units are two storeys.
- All of the proposed units incorporate aging in place features to accommodate mobility constraints associated with aging. These features include:
  - o stairwell hand rails;
  - o lever-type handles for plumbing fixtures and door handles; and,
  - o solid blocking in washroom walls to facilitate future grab bar installation beside toilets, bathtubs and showers.
- The central pathway, which provides access to the garbage enclosure, mailboxes, and Williams Road sidewalk, is typically 2.0 m wide but narrows to 1.5 m wide within the tree protection zone. This width is sufficient to accommodate a person using a wheelchair or other mobility aid.

#### Sustainability

- This development is expected to achieve Step 3 of the BC Energy Step Code for Part 9 buildings or Step 2 with a low carbon energy system. The applicant has provided a letter from a Certified Energy Advisor confirming that the buildings have been designed to achieve Step 3 of the BC Energy Step Code.
- Each dwelling would have an air source heat pump for heating and cooling. Heat pumps have generally been located away from living areas to minimize noise impacts on residents. The proposed locations of the heat pumps are shown on the site plan. The applicant must provide an acoustical report confirming that the noise generated by the heat pumps complies with Richmond Noise Regulation Bylaw 8856.
- 100% of the residential parking spaces are provided with Class 2 EV charging in the garage, as per Richmond Zoning Bylaw 8500.

#### **Conclusions**

As the proposed development would meet applicable policies and Development Permit Guidelines, staff recommend that the Development Permit be endorsed, and issuance by Council be recommended.



Planner 1

(604-276-4092)

JR:js

#### Attachments:

Attachment 1: Location Map

Attachment 2: Development Application Data Sheet


Attachment 3: Excerpt of the Minutes from the July 7, 2021 Advisory Design Panel Meeting

The following are to be met prior to forwarding this application to Council for approval:

- 1. Receipt of a Letter-of-Credit for landscaping in the amount of \$117,881.23. NOTE: staff to ensure that landscape estimates include a 10% contingency cost.
- 2. Complete an acoustical report and recommendations prepared by an appropriate registered professional, which demonstrates that the interior noise levels and noise mitigation standards comply with the City's Official Community Plan and Noise Bylaw requirements. The report should address noise from proposed exterior mechanical systems (e.g. heat pumps). Maximum interior noise levels (decibels) within the dwelling units must achieve CMHC standards follows:

Portions of Dwelling Units	Noise Levels (decibels)
Bedrooms	35 decibels
Living, dining, recreation rooms	40 decibels
Kitchen, bathrooms, hallways, and utility rooms	45 decibels



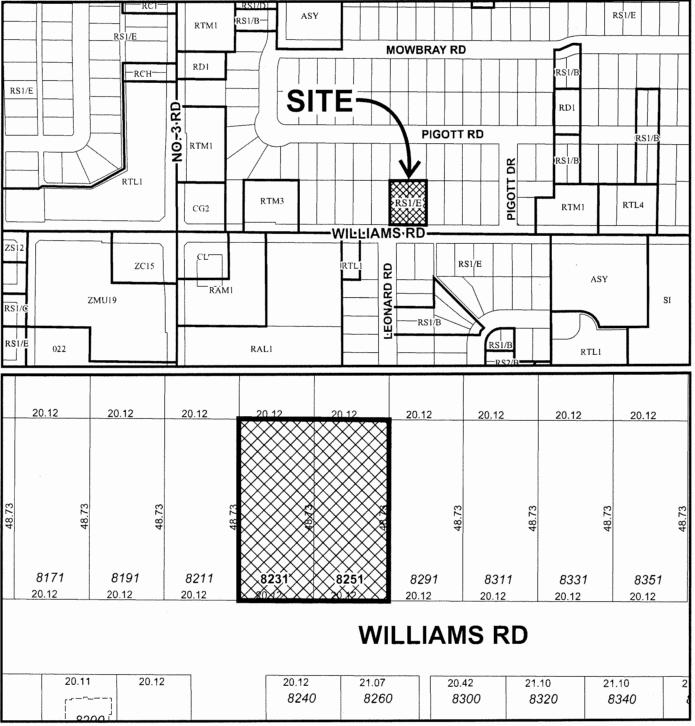



DP 19-858783

Original Date: 04/29/19

**Revision Date:** 

Note: Dimensions are in METRES



#### **Development Application Data Sheet**

**Development Applications Department** 

DP 19-858783 **Attachment 2** 

Address: 8231 and 8251 Williams Road

Y&W Development Ltd. (Directors

Applicant: Zhao XD Architect Ltd.

Owner: Jing Long Yuan and Xia Wang)

Planning Area(s): Broadmoor

Floor Area Gross: 1,660 m<sup>2</sup> (17,870 ft<sup>2</sup>) Floor Area Net: 1,151.7 m<sup>2</sup> (12,397 ft<sup>2</sup>)

	Existing	Proposed
Site Area:	1,959.8 m <sup>2</sup>	1,919.5 m <sup>2</sup>
Land Uses:	Single detached dwellings	Townhouse dwellings
OCP Designation:	Neighbourhood Residential	No change
Zoning:	Single Detached (RS1/E)	Low Density Townhouses (RTL4)
Number of Units:	Two single detached dwellings	Ten (10) townhouse dwellings

	Bylaw Requirement	Proposed	Variance
Floor Area Ratio:	Max. 0.6 FAR	0.6 FAR	None permitted
Lot Coverage:	Building: Max. 40% Non-porous Surfaces: Max. 65% Live Landscaping: Min. 25%	Building: 40% Non-porous Surfaces: 65% Live Landscaping: 29%	None
Setback – Front Yard:	Min. 6.0 m	6.0 m	None
Setback – West Side Yard:	Min. 3.0 m	3.0 m	None
Setback – East Side Yard:	Min. 3.0 m	3.0 m	None
Setback – Rear Yard:	Min. 3.0 m	4.5 m	None
Height (m):	Max. 12.0 m	12.0 m	None
Lot Size:	No minimum	1,919.5 m²	None
Lot Dimensions (m):	Width: Min. 40 m Depth: Min. 35 m	Width: 40.2 m Depth: 47.7 m	None
Off-street Parking Spaces – Resident/Visitor:	Min. 2 R and 0.2 V per unit	2 R and 0.2 V per unit	None
Off-street Parking Spaces – Accessible:	Zero if fewer than 3 visitor parking spaces are required	0	None
Off-street Parking Spaces - Small:	Not permitted if fewer than 31 spaces are required	6 (i.e. 30%)	Vary

Off-street Spaces - Total:	Min. 20 R and 2 V	20 R and 2 V	None
Tandem Parking Spaces	Permitted – Maximum of 50% of required spaces	8 (40%)	None
Bicycle Parking Spaces – Class 1	Min. 1.25 per unit	20 (2 per unit)	None
Bicycle Parking Spaces – Class 2	Min. 0.2 per unit	2 (i.e. 0.2 per unit)	None
Amenity Space – Indoor:	Min. 50 m <sup>2</sup> or cash-in-lieu	Cash-in-lieu	None
Amenity Space – Outdoor:	Min. 6.0 m² per unit	60 m² (i.e. 6.0 m² per unit)	None

# Excerpt from the Minutes from The Design Panel Meeting

Wednesday, July 7, 2021 – 4:00 p.m. Remote (Webex) Meeting

#### DP 19-858783 – ARTERIAL ROAD TOWNHOUSE DEVELOPMENT

ARCHITECT:

Zhao XD Architect Ltd.

LANDSCAPE

PMG Landscape Architects

ARCHITECT:

**PROPERTY** 

8231 and 8251 Williams Road

LOCATION:

#### Applicant's Presentation

Architect Xuedong Zhao, Zhao XD Architect Ltd., and Landscape Designer Denitsa Dimitrova, PMG Landscape Architects, presented the project and answered queries from the Panel.

#### **Panel Discussion**

Comments from Panel members were as follows:

- appreciate the densification of the subject site which includes 10 townhouse units;
- appreciate the retention of the Magnolia tree which is the focal point of the proposed development; however, consider increasing the width of the pedestrian pathway to enhance its accessibility considering that it provides the only direct pedestrian access to the subject site from Williams Road;

#### 1.5 m minimum width is provided for accessible path (see updated plans).

consider either relocating the four Western Red Cedar trees or consider replacing them with another tree species due to the tight growing space when these trees mature in the future;

#### See updated landscape plans.

• consider consolidating the small planting areas fronting both sides of the driveway into larger patches of planting;

#### See updated landscape plans.

overall, the choice of landscaping materials is appropriate;

• consider using less trim on some of the Hardie materials (e.g., using 7/8- inch thickness) on the south elevation as it would provide a thinner effect particularly on the underside of the proposed archway;

The suggestions are considered. The arch is reduced 1'-0" in height thickness. Thinner cladding will be used on the underside of the arch.

- appreciate the provision of exterior insulation on the townhouse buildings that will not reduce the setbacks; the energy model should reflect this and guide the applicant towards achieving compliance with Step 3 of the BC Energy Step Code;
- understand the rationale for the location of most of the windows along the south elevation facing Williams Road from an architectural perspective; however, consider installing sun shading outside of the building envelope to reduce the impact of sun exposure to the windows; should be included in the energy modeling to ensure achieving Step Code compliance;

Sun shading projection would increase the bulkiness of the buildings. The selection of windows addresses the energy saving strategies which is included in the effort to comply Step Code requirements.

• the proposed wood trellis in front of the Magnolia tree and the archway is not reflected in any of the architectural drawings and may not be appropriate as it appears heavy and may draw more attention than originally intended; consider an alternate approach to provide shading;

#### See updated landscape plans.

- overall, appreciate the site layout and presentation of the project by the applicant;
- consider incorporating exterior fixed shading into the architecture of the buildings to minimize solar heat gain and in order to ensure the achievement of BC Energy Step Code 3 rating requirements;

#### See the response above for the shading devices.

 consider improving the solar heat gain coefficient (SHGC) of 0.43 for windows considering that the window-to-wall ratio along the south elevation is very high;

#### SHGC 0.43 or higher will be used. One window for Unit F is removed.

 appreciate the project conforming to the new airtightness standard; however, consider including a heat recovery ventilation (HRV) system which is included in the applicant's sustainability strategy but not in the energy model;

Sustainability strategy indicates that "Reductions of air leakage will reduce heating and cooling costs, with heat recovery ventilators (HRV) or equivalent providing fresh air to each townhome unit."

- appreciate the details provided on the project's firefighting plan, e.g. fire truck access and location of fire hydrants; however, include information on the distance required from the fire hydrant to the fire truck;
  - As a new fire hydrant is proposed in the middle of the site, the required distance from fire hydrant to the fire truck can be easily achieved.
- the project's mechanical system needs to be outlined as it will impact the project's final energy modeling and compliance with BC Energy Step Code 3;
  - "Mechanical Components" are included in the CEA's letter/documents for the Step Code compliance.
- review the floor plans of convertible units D and C1 and confirm whether the washrooms would be wheelchair accessible when converted to fully accessible units in the future; recommend that washrooms on both the ground and second floors should be accessible;
  - Per City's "Convertible Unit Guidelines for Townhouses", minimum one bathroom should be designed as convertible.
- like the building design and the stepping down in height to provide an appropriate interface with adjacent residential developments;
- look at the existing elevation of the Magnolia tree and its proposed grade in the future as it may impact the usable space for the proposed pedestrian pathway;
  - See previous responses that address the improvements.
- consider a different and more special material and/or colour for the archway than Hardie panel that better reflects an idea of a background to the Magnolia tree;
  - Contrast with building can also enhance the importance of expressions that tree/vegetation provides. Even if a distinct building material background for the tree may possibly be proposed to provide some benefits to show the tree, but extra cladding materials/colors may not be proper for the building design, since we should limit the number of different materials/colors for the building design composition.
- appreciate the retention of the Magnolia tree; however, consider modifying the tree, e.g. through root pruning or relocating it to provide an appropriate width for the pedestrian pathway considering that vehicular access to the subject site is provided in the adjacent site and therefore a direct pedestrian access to the site from Williams Road would be important;
  - Relocating the tree is not supported by arborist for best interest for the tree to survive. The width of the walkway is increased for better use and visual prominence.
- support the Panel comment that the proposed trellis could overwhelm the visual scale of the space which includes the archway and the Magnolia tree;

 proposed site signage is simple and low key; consider echoing this character (i.e. concrete board and cedar trim detail) along the frontage as individual entries into the separate units to enhance their character;

The distinct appearance is intended for its visibility with the limited scale (see landscape plan).

 consider more variability in terms of materials and colours between units to make them more visually distinct and not read as a single large apartment complex;

As mentioned earlier, the units at street front are designed with expressions in both massing recess and color differentiation. With the distinctive front doors and porches as well as the massing and color as mentioned, the individuality of the townhouse units is well expressed, while the unity of the townhouse building that these units belong to can also be maintained and expressed with a consistency of the color scheme as shown.

- support the Panel comment regarding the tightness of the growing space for the Western Red Cedar trees as they mature; consider managing the growth of these trees (e.g., trimming) to avoid overwhelming the ancillary spaces to the side; and
- concerned about the proposed location of concrete patios and bollard lights within the SRW for the sanitary sewer in the rear yard; the applicant should work with City staff as the project moves forward to ensure that Engineering guidelines for SRWs are complied with.

Removable concrete pads should be more maneuverable than other paving materials so that patios can be more easily reconstructed for any events for City to service the SRW though it would happen not so often in term of years.

The following written comments submitted by Panel member Patrick Schilling were read into the record by Jordan Rockerbie:

- vehicular access from within the property is an interesting approach, removing traffic from Williams Road and issues with vehicles pulling in and out of garages;
- overall massing fits well within the context; each building is relatively similar in size to the neighbouring single-family dwellings;
- each building is also broken down into smaller elements; multiple articulations create a human scale and minimize what could be perceived as a large mass; however, there might be too many articulations, when looking at the ground floor plan one can wonder if there would be a way to reduce the number of articulations, while maintaining the successful overall massing breakdown;

#### A "chimney" is removed for the suggested improvement.

incorporation of 10 residential units into this design is to be commended;

- ground floors of Building 1 and Building 2 are primarily occupied by parking; unfortunate that the City could not have relaxed the parking requirements here to allow for more active uses on the ground floor; the split between parking and residential is well done on Building 3 and Building 4;
- the separation between Building 3 and Building 4 works well, but the separation between Building 1 and Building 2 is tight; wondering if there is a way to increase that separation;
  - Elevation drawing shows many portions of buildings in-between are merely the projections of rear portions of the buildings, while the spacing near the street frontage is more opened up. The introduction of arch minimizes the impression of tall "gap" for the rear portion of the buildings.
- removing the connecting arch element between these two buildings would create a visual separation that may help to increase the perceived separation;
   and
  - As mentioned, the arch can not only provide better articulations for the walkway and tree but also minimize the impression of tall and narrow gap impression between the buildings.
- concerned with the functionality of units B, B1 and E as they have no residential area on the ground floor and livable area only begins on the second floor.

Upper floors are often seen as a more desirable living space than on ground level for street facing units.

#### **Panel Decision**

It was moved and seconded

That DP 19-858783 be supported to move forward to the Development Permit Panel subject to the applicant giving consideration to the comments of the Advisory Design Panel.

CARRIED



#### **Development Permit**

No. DP 19-858783

To the Holder:

ZHAO XD ARCHITECT LTD.

Property Address:

8231 AND 8251 WILLIAMS ROAD

Address:

11181 VOYAGEUR WAY SUITE 255

RICHMOND, BC V6X 3N9


- 1. This Development Permit is issued subject to compliance with all of the Bylaws of the City applicable thereto, except as specifically varied or supplemented by this Permit.
- 2. This Development Permit applies to and only to those lands shown cross-hatched on the attached Schedule "A" and any and all buildings, structures and other development thereon.
- 3. The "Richmond Zoning Bylaw 8500" is hereby varied to increase the permitted small parking spaces from 0 to 6 (i.e. 30%).
- 4. Subject to Section 692 of the Local Government Act, R.S.B.C.: buildings and structures; off-street parking and loading facilities; roads and parking areas; and landscaping and screening shall be constructed generally in accordance with Plans 1 to 15 attached hereto.
- 5. Sanitary sewers, water, drainage, highways, street lighting, underground wiring, and sidewalks, shall be provided as required.
- 6. As a condition of the issuance of this Permit, the City is holding the security in the amount of \$117,881.23 to ensure that development is carried out in accordance with the terms and conditions of this Permit. Should any interest be earned upon the security, it shall accrue to the Holder if the security is returned. The condition of the posting of the security is that should the Holder fail to carry out the development hereby authorized, according to the terms and conditions of this Permit within the time provided, the City may use the security to carry out the work by its servants, agents or contractors, and any surplus shall be paid over to the Holder. Should the Holder carry out the development permitted by this permit within the time set out herein, the security shall be returned to the Holder. The City may retain the security for up to one year after inspection of the completed landscaping in order to ensure that plant material has survived.
- 7. If the Holder does not commence the construction permitted by this Permit within 24 months of the date of this Permit, this Permit shall lapse and the security shall be returned in full.

#### Development Permit No. DP 19-858783

To the Holder:	ZHAO XD ARCHITECT LTD.		
Property Address: 8231 AND 8251 WILLIAMS ROAD			
Address: 11181 VOYAGEUR WAY SUITE 255 RICHMOND, BC V6X 3N9			
8. The land described herein conditions and provisions Permit which shall form a	shall be developed generally in accordance with the terms and of this Permit and any plans and specifications attached to this part hereof.		
This Permit is not a Build	ing Permit.		
AUTHORIZING RESOLUTE DAY OF ,	ION NO. ISSUED BY THE COUNCIL THE		
DELIVERED THIS D	AY OF , .		
MAYOR			



# City of Richmond

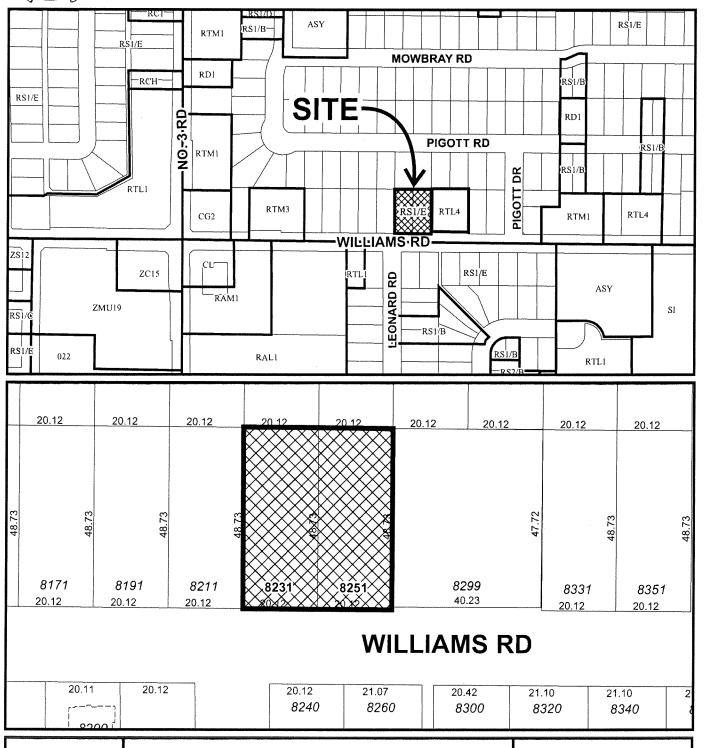



DP 19-858783 SCHEDULE "A"

Original Date: 04/29/19

Revision Date: 02/07/22

Note: Dimensions are in METRES





\$255-11181 Voyageur Way, Richmond, BC V6X 3N9 Tel. (604) 275-8882 Fax (604) 909-1736

Email: Info@zhaoarch.com Web: zhaoarch.com

This drawing small mot be used for construction

ZHAO XD ARCHITECT LTD. www.zhaoarch.com Tel: 604 275-8882

10-UNIT TOWNHOUSE DEVELOPMENT 8231 & 8251 WILLIAMS ROAD, RICHMOND, BC







	CITY FD COMMENTS
DEC 30/21	CITY FO COMMENTS
NOV 29/21	FOR ADP COMMENTS
WAR 11/20	FOR CITY COMMENTS
APR 1/19	DP APPLICATION
DEC19/18	FOR CITY COMMENTS
MAY31/18	REZONING APP
Date	Issued For:

B C C DETAIL NUMBER

documents are the copyright assembly of the CONSULTANT or shall be retained again featured against the artistes permission of the CONSULTANT. The confractor and is these and verify or gettinest difference and verify or gettinest difference and verify or acrepansions to the CONSULTANT before proceeding with the work

TOWNHOUSE DEVELOPMENT

8231-51 Williams Road RICHMOND, BC

Drawing Title:

COVER


Date Scale:


Checked By:

Project No -

Drawing No.:

Α1

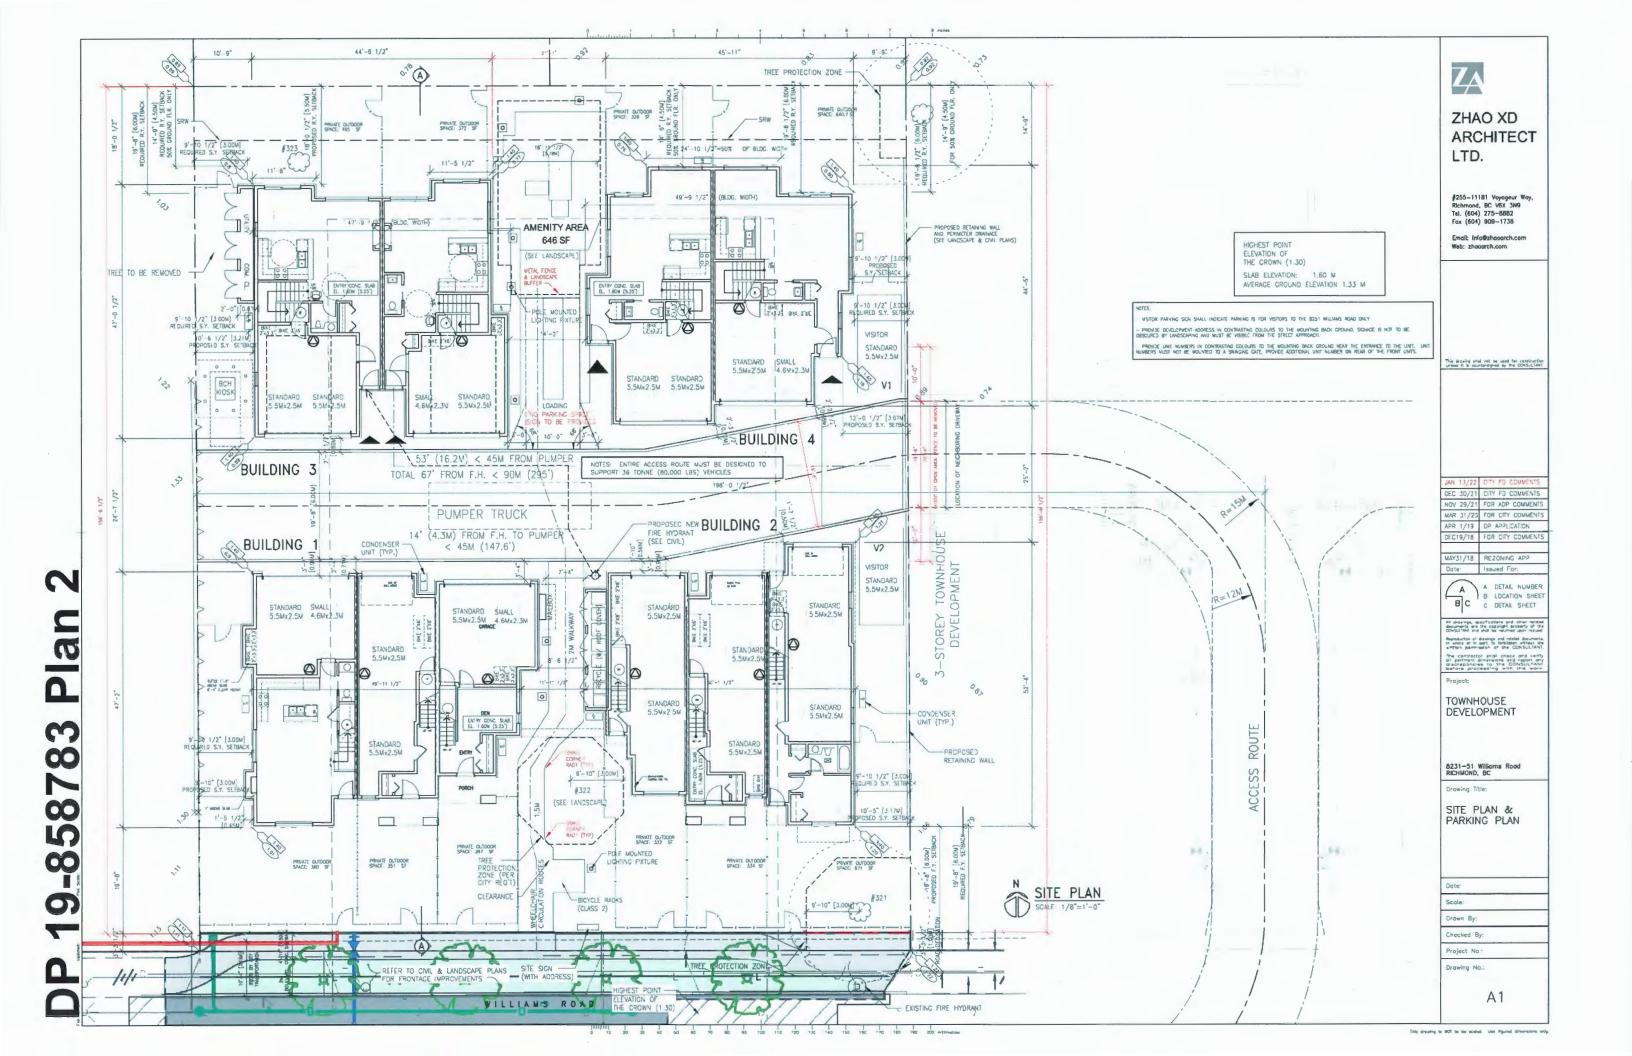

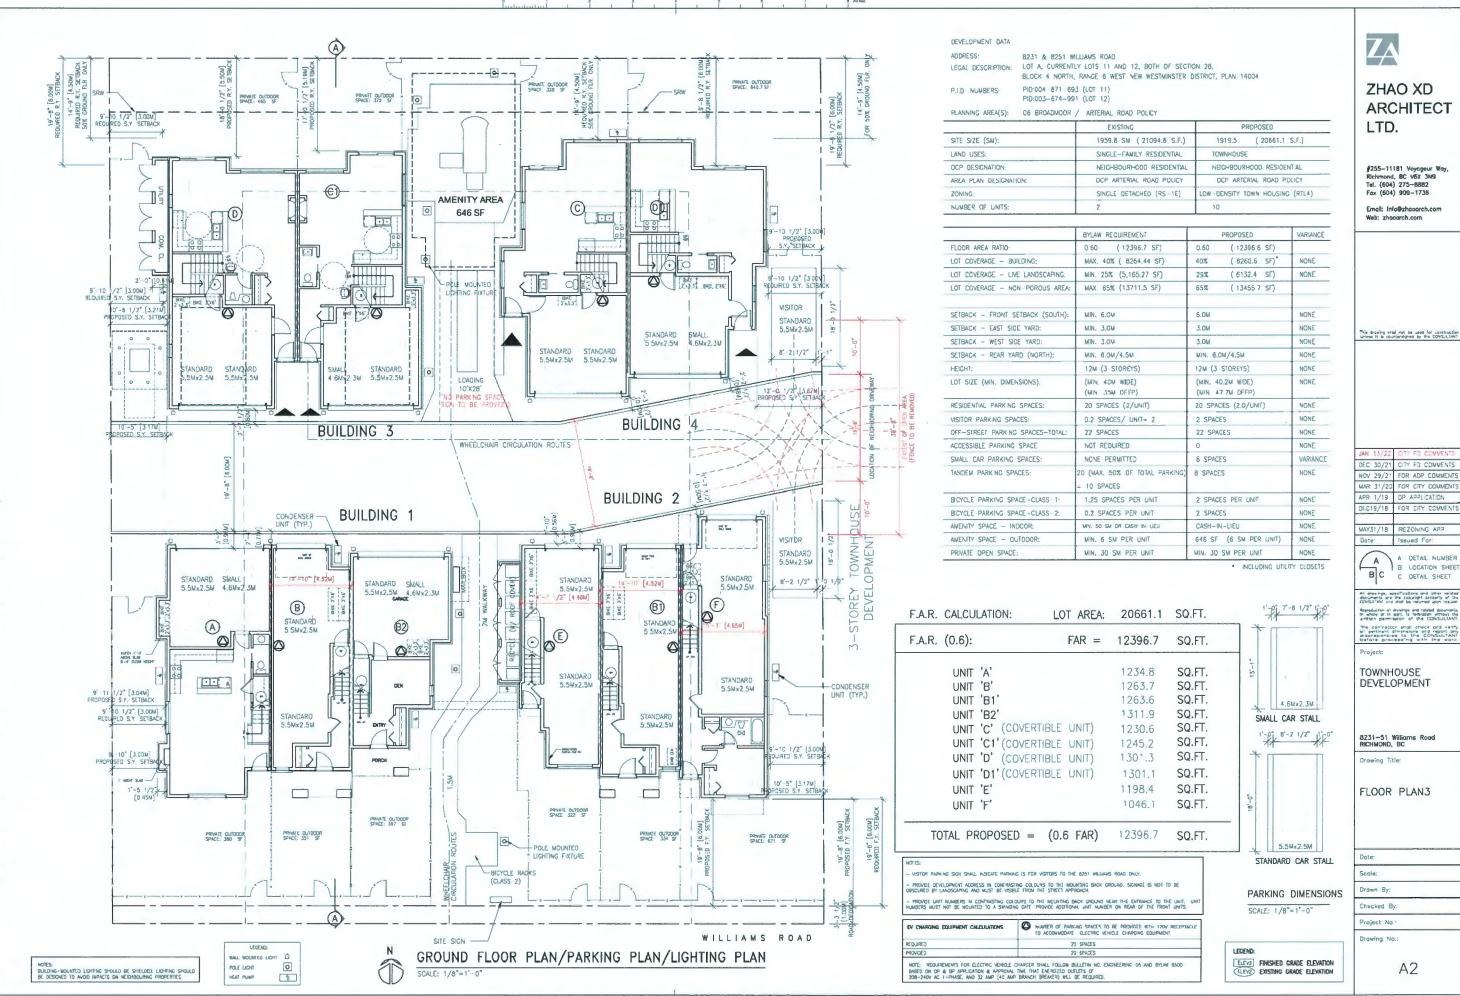

783

9-858

# 19-858783 Plan

ALL INDOOR PARKING SPACES WILL BE PROMOTED WITH LEVEL 2 EV CHARGING OUTLETS (208V TO 240V AC AND CURRENT OF 15A TO 80A).

SITE

CONTEXT PLAN

AGING IN PLACE FEATURES FOR ALL UNITS: -SOLID BLOCKING IN WASHROOM WALLS FOR FUTURE GRAB BARS; -LEVER-TYPE HANDLES FOR PLUMBING AND DOOR HANDLES

**ZHAO XD ARCHITECT** LTD.

#255-11181 Voyageur Way, Richmond, BC V6x 3N9 Tel. (604) 275-8882 Fax (604) 909-1736

Email: info@zhaoarch.com Web: zhaoarch.com

A DETAIL NUMBER B LOCATION SHEET C DETAIL SHEET

TOWNHOUSE DEVELOPMENT

8231-51 Williams Road RICHMOND, BC


FLOOR PLANS


Drawn By:


Checked By:

Project No · Drawing No.:

A3

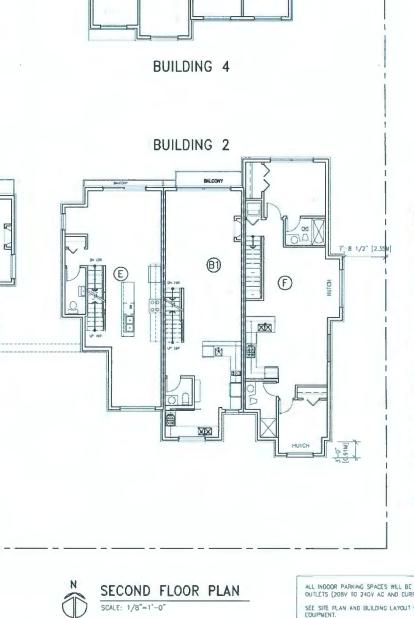


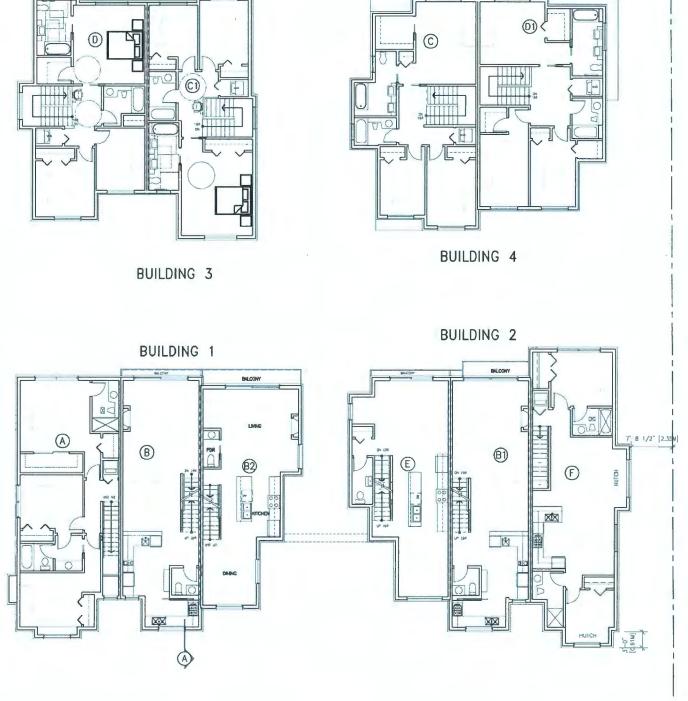

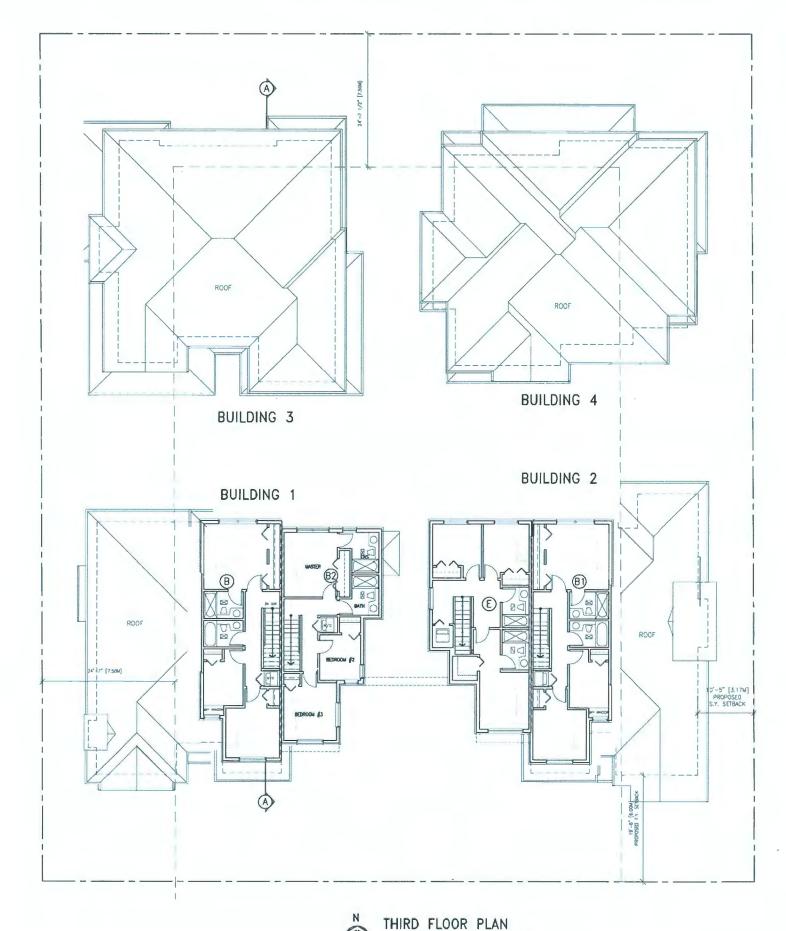

SCALE: 1/8"=1'-0"

AGING IN PLACE FEATURES FOR ALL UNITS: -SOLID BLOCKING IN WASHROOM WALLS FOR FUTURE GRAB BARS.
-LEVER-TYPE HANDLES FOR PLUMBING AND DOOR HANDLES

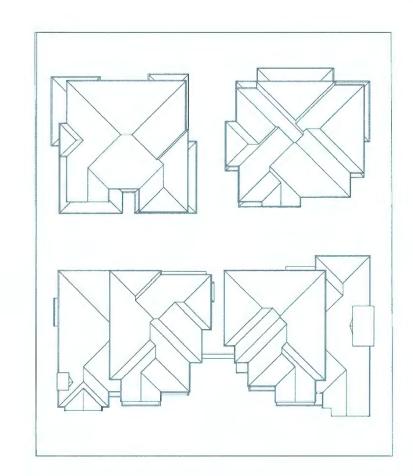



ROOF PLAN
SCALE: 1/8"=1'-0"

**ZHAO XD** 

7,

**ARCHITECT** LTD.

#255-11181 Voyageur Way, Richmond, BC V6X 3N9 Tel. (604) 275-8882 Fax (604) 909-1738

Email: Info@zhaoarch.com Web: zhaoarch.com

JAN 13/2"	CITY FD COMMENTS
DEC 30/21	CITY FO COMMENTS
NOV 29/21	FOR ADP COMMENTS
MAR 51/20	FOR CITY COMMENTS
APR 1/19	DP APPLICATION
OEC19/18	FOR CITY COMMENTS
WAY31/18	REZONING APP
Date	Issued For:

A DETAIL NUMBER B LOCATION SHEET C DETAIL SHEET

Project:

TOWNHOUSE DEVELOPMENT

8231-51 Williams Road RICHMOND, BC

Drawing Title:

FLOOR PLANS

Scale:

Drawn By: Checked By:

Project No -

Drawing No.:

A4



74 (1772) ZHAO XD 10.33 0 10.08 CEL. ARCHITECT LTD. THE WE IL 100 #255-11181 Voyageur Way, Richmond, BC V6X 3N9 Tel. (604) 275-8882 Fax (604) 909-1736 30 -4 1/2" [13.00m] MAL. PERMITE 0'-11" [3.00M] 15 2014 Email: Info@zhaoarch.com Web: zhaoarch.com WEST ELEVATIONS AVG. PAL CRADE BUILDING 2 SCALE: 1/8"=1" 0" BUILDING 4 3 (4) (8) (13.13) This decoring shall not be used for construction unless it is counterelighed by the CONSULTANT (2) 10.08 00.01 -(4) Free Section (140 ) cm 4.62 200 4.57 240 1 DEC 30/21 CTY FO CONVENTS NOV 29/21 FOR ADP COMMENTS MAR 3" /20 FOR CITY COMMENTS 18 91 EAST ELEVATIONS APR 1/19 DP APPLICATION DEC19/18 FOR CITY COMMENTS BUILDING 3 SCALE: 1/8"-1" 0" BUILDING 1 (13.33) MAYJ'/18 REZONING APP 0 2 A DETAIL NUMBER B LOCATION SHEET C DETAIL SHEET 19-858783 Plan Till at (111 )00 10"-4 1/2"
[12.00w]
MAX. PERMITID -(8) EXTERIOR FINISH & COLOR TOWNHOUSE DEVELOPMENT 3 1) ASPHALT SHINGLES - DUAL BLACK - IKO 5" ALUM, GUTTER ON 2X6 WOOD FASCH BOARD PAINTED (TYP.)
MATCH COLOR IRON GRAY 3 HARDIE SIDING (7") MONTEREY TAUPE 8231-51 Williams Road RICHMOND, BC NORTH ELEVATIONS /181 \181 I (4) HARDIE SIDING (7") - TUSCAN GOLD (13) AC UN BUILDING 2 BUILDING 1 5 HARDIE SIDING (7") - IRON GRAY SCALE: 1/8" 1"-0" Drawing Title: (3)(11) 7,64645 6 2X10 WOOD TRIM MATCH COLOR IRON GRAY **ELEVATIONS** 7 ALUNM, GUARDRAIL (BLACK) 10.11 COUBLE-GLAZED WINDOWS IN VINYL FRAMES
 C/W 2x4 SILL (SLOPE 15%) & 2x4 SIDE & TOP TRIM
 C/W FLASHING OVER
 TRIM PAINTED: COLOR MATCH MONTEREY TALIPE 9 LIGHT FIXTURE 7.33 002 10 SOLID CORE WOOD DOOR - BJ 1231 WYNWOOD Scole: (11) CARAGE DOOR: BM: AF-380 COSTAL PATH Drawn By: 12 POT LIGHTS AT EACH ENTRY (412 YEAR 13 2X10 HOR ZONTAL TRIM BOARD C/W FLASHING OVER Checked By: MONTEREY TAUPE Project No · CULTURE STONE BY BORAL (A BLEND OF 65% ASPEN DRESSD FIRELDSTONE Drawing No.: SOUTH ELEVATIONS ( a) (B) 35% ASPEN COUNTRY LEDGESTONE BUILDING 4 SCALE: 1/8"=1"-0" BUILDING 3 Α6 10 9

This drawing is 1007 to be scaled. Use Figured dimensions only.





STREET SCAPE (WILLIAMMS ROAD)

SCALE: 1"=20"-0"



# ZHAO XD ARCHITECT LTD.

#255-11181 Voyageur Way, Richmond, 8C V6X 3N9 Tel. (604) 275-8882 Fax (604) 909-1736

Email: Info@zhaoarch.com Web: zhaoarch.com

This drawing shall not be used for Lenstruction unless it is ocurboralgness by the CONSLITANT

100	^
DEC 30/21	CITY FO COMMENTS
NOV 29/21	FOR ADP COMMENTS
MAR 31/20	FOR CITY COMMENTS
APR 1/19	DP APPLICATION
OFC19/18	FOR CITY COMMENTS
WAY31/18	REZONING APP
Date	Issued For:



orwangs, specifications and other nested occurrents are the copyright property of the CROSITANT each between some report specification of develops and related documents, and or in our LB tombotion primate the reference of the CROSILLIANT. The connector and these and wanty persons of the CROSILLIANT.

Denineh

TOWNHOUSE DEVELOPMENT

8231-51 Williams Road RICHMOND, BC

Drawing Title:

STREETSCAPE ELEVATIONS


Date:
Scale:
Drawn By:
Checked By:

Project No : Drawing No.:

Α7

This drawing is NOT to be socied. Use Figured dimensions only.

SUN SHADING DIAGRAMS ZHAO XD **ARCHITECT** LTD. #255-11181 Voyageur Way, Richmond, BC V6X 3N9 Tel. (604) 275-8882 Fox (604) 909-1736 MARCH 21 Email: info@zhaoarch.com Web: zhaoarch.com This drawing shall not be used for construction unless it is vocarboral grown by the COMSULTANT 10:00 am 12:00 pm 4:00 pm 0 A DETAIL NUMBER
B LOCATION SHEET
C DETAIL SHEET JUNE 21 19-858783 Plan TOWNHOUSE DEVELOPMENT 4:00 pm 10:00 am 12:00 pm 8231-51 Williams Road RICHMOND, BC (ULI) Drawing Title: SUN SHADING DIAGRAMES & SECTIONS 10.33 1000 CEL 7.E3 CEL. 7.33 380 R Scale: Drawn By: 4.52 70 TL Checked By: Project No -Drawing No.: SECTIONS SCALE: 1/8"=1"-0" 8A BUILDING 3 **BUILDING 1** 

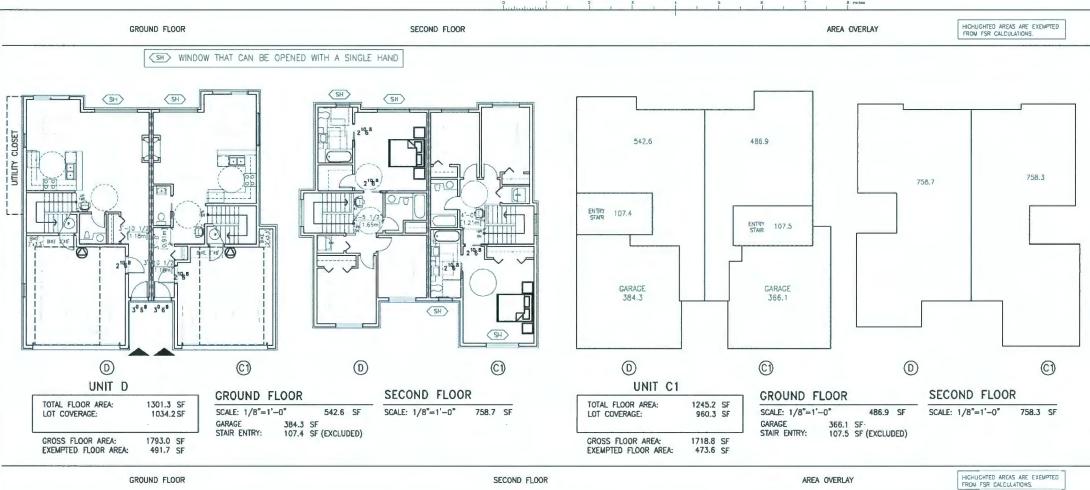

100

0

TOTAL FLOOR AREA:

CROSS FLOOR AREA-

EXEMPTED FLOOR AREA:

UNIT C

(C)

465.6 SF

(01)

1230.6 SF

1692.5 SF

461.9 SF

GROUND FLOOR

GARAGE 354.3 SF STAIR ENTRY: 107.6 SF (EXCLUDED)

SCALE: 1/8"-1'-0"

01

SECOND FLOOR

SCALE: 1/8"=1'-0" 765.0 SF

9-858

CHECKLIST - CONVERTIBLE UNIT FEATURES

entry door min. 863 mm but opally 914mm and have clear access. Differ door clear extende floor space min. 1220 mm depth by door width Alus Boo ma on lator 150 erot meded if rough in wring provided for Tuture automatic door dyemer)

LEVER-TYPE HUNGLES FOR ALL DOORS.

MERICAL LIFT, DEPRESSED SLAB AREA, AND LANDINGS, AS NOTED ON FLOOR PLANS IN COMPULANCE WITH MANUFACTURER SPECE FAITONS, FRANKIN TO ACCOMMODIST SHAFT CONSTRUCTION METHOUIL MARKET TO SURRECUMENT, STRUCTURES, AT THE TOP OF ALL STARWAYS, MALLS ARE RENTORCED WITH ZX12 SOLVO LUMBER AT 144M TO CONTINUE.

HISH WW GOD HIS

### CARACE

MN. I ACCESSIBLE PARKING SPACE WITH MN. 4 W CARACE VIDITH ICCESS FROM CARACE TO LYMIC AREA WITH MIN. 800 MM CLEAR DOOR OPENING 2"-B" SLIDING OR 2"-10" SWINGING DOOR SPEC.) AND PLUSH THRESHOLDS MAX. 13 WM

### OUTLETS & SWITCHES

PLACEMENT LOCATIONS OF ELECTRICAL OUTLETS BESDE WINDOW, BOTTOM OF S'ARBAYS, BESDE TOLET, ABOVE DIFERRIAL DOCAS (OUTSDE AND NOSIS), ON FRONT FACE OF INTERNAL COLAMIEN, WITH PROXIMITY OF CONTROL CENTER FOR SAMET HOME OPPICIES. UPGRADE TO FOUR-PLEX OUTLETS IN MASTER BEDROOM, HOME OFFICE, GARACE, AND RECREATION ROOM.

### DOORS & DOORWAYS

INTEROR DOORS TO MAIN LAING AREAS, I BATHROOM AND I BEDROOM, MIN. 800 MM CLEAR OPENING WITH FLUSH THRESHOUSS MAIL I JAME HEIGHT DEMONSTRATE WHELCHMIR ACCESS BETIEVEN THE MALLMAY AND ROCKS AND WIDEN HALLWAY AND/OR DOORWAY(S) IF MECESSARY TO SECURE ACCESS

ATTO/BALCONY MIN. 86CMM CLEAR OPENING NOTE HOW ACCESSED. LL INTERIOR THRESHOLDS WITHIN UNITS COMPLY BC BUILDING CODE

### VERTICAL CIRCULATION

### HALLWAYS

### BATHROOMS (MIN. 1)

TOLET CLEAP FLOOR SPACE MIN. 1020 VAN AT SOE AND IN FROMT.

WALL BLOCKUS FOR FUTURE GRAB BAR INSTALLATIONS TOLET, TUB AND SHOWER RENFORCED

WHI 272 SOLD LIMBER IN ALL BANTHUS, SHOWER, AND TOLET LOCATIONS.

LEVEN-TIPE HANGLES FOR PLANBING PRIVATES.

PERSLAPER, AND TOLET LOCATIONS TOLET FOR THE LOCATIONS.

CHEVEN-TIPE HANGLES FOR PLANBING PRIVATES.

CHEVEN-TIPE HANGLES FOR THE PLANBING PRIVATES.

WHITH HANGLES FOR FOR THE PLANBING PRIVATES.

WHITH HANGLES FOR FOR THE PLANBING FOR THE STANDING DOOR SPECE)

WHITH LUSH PRESENCES MIN. 13 WE REGIT!

7915

01

SECOND FLOOR

SCALE: 1/8"=1'-0" 791.5 SF

765.0

(C)

509.6 SF

MIN. 1 WINDOW THAT CAN BE OFENED WITH A SINCLE HAND (BATHROOM, MITCHEN, LIVING ROOM

BAY WINDOW SEAT MIN. 2' ABOVE FINISHED FLOOR IS STRUCTURALLY PROTITUDED FROM THE WALL NO FLOORING JOIST EXTENDS BEYOND THE WALL TO PREVENT A CONVERSION TO USABLE FLOOR SPACE.

### SUSTAINABILITY FEATURES (TO BE PROVIDED IN ALL UNITS): DOUBLE GLAZED VINYL FRAMED WINDOW W/LOW E GLASS (TYP.):

FNERGY STAR APPLIANCES AND LOW FLOW FIXTURES: LOW EMITTING SEALANTS, PAINTS, ADHESIVES, CARPETS & CONPOSITE WOOD

SH WINDOW THAT CAN BE OPENED WITH A SINGLE HAND

AGING IN PLACE FEATURES FOR ALL UNITS:

### BAY WINDOW NOTES:

-SOLID BLOCKING IN WASHROOM WALLS FOR FUTURE GRAB BARS; -LEVER-TYPE HANDLES FOR PLUMBING AND DOOR HANDLES



ZHAO XD **ARCHITECT** LTD.

#255-11181 Voyageur Way, Richmond, BC V6X 3N9 Tel. (604) 275-5882 Fax (604) 909-1736

Email: Info@zhqoarch.com Web: zhoogrch.com

DEC 30/21 CITY FO CONVENTS NOV 29/21 FOR ADP COMMENTS MAR 31/20 FOR CITY COMMENTS APR 1/19 DP APPLICATION DEC19/18 FOR CITY COMMENTS MAY31/18 REZONING APP Date: Issued For:

A DETAIL NUMBER B LOCATION SHEET B C C DETAIL SHEET

At arowings, specifications and other related documents are the copyright brokerty of the CONSULANT and shall be returned upon request Reproduction at drawings and related documents in whole or in part, is forbidden without the written permission of the CONSULTANT

TOWNHOUSE DEVELOPMENT

8231-51 Williams Road RICHMOND, BC

Drawing Title:

UNIT FLOOR PLANS

Drawn By

ecked By:

Project No awing No.:

A10

This drawing in 1607 to be social. Use floured dimensions only.

1301.1 SF

974.7 SF

1789.3 SF

48B.2 SF

509.6

23.0

GROUND FLOOR

SCALE: 1/8"=1' 0"

(01)

GARAGE

COVERED AREA

357.7 SF

STAIR ENTRY: 107.5 SF (EXCLUDED)

COVERED AREA: 23.0 SF (EXCLUDED)

ENTRY 107.5

465.6

354.3

(C)

TOTAL FLOOR AREA:


CROSS FLOOR AREA-


EXEMPTED FLOOR AREA:

LOT COVERAGE:

UNIT D1

107.6

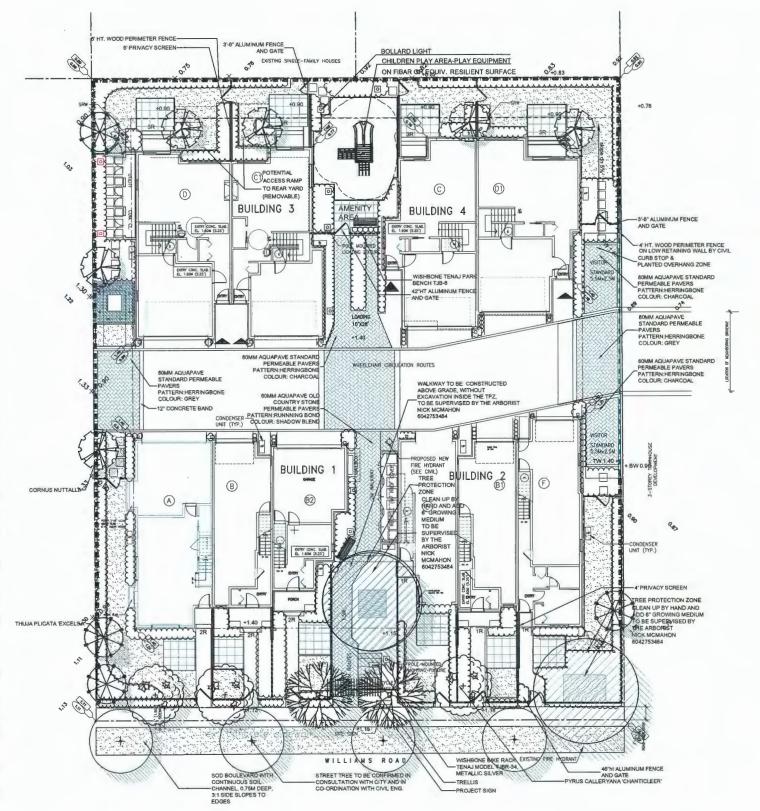

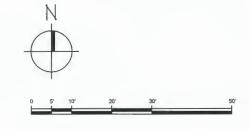







Cabana-mec650 by BigToys BY RecTec Industries Ph.: 604-940-0067

PLANT SCHEDULE
KEY QTY BOTANICAL NAME
TREE PMG PROJECT NUMBER: 19-028 LANTED SIZE / REMARKS 4 STREET TREE

NOTES: "PLANT SIZES IN THIS LIST ARE SPECIFIED ACCORDING TO THE BC LANDSCAPE STANDARD AND CANADIAN LANDSCAPE STANDARD, LATEST EDITION. CONTAINER SIZES SPECIFIED AS PER CINA. STANDARD. BOTH PLANT SIZE AND CONTAINER SIZE ARE THE MINIMUM ACCEPTABLE SIZES. REFER TO SPECIFICATIONS FOR DEFINED CONTAINER MEASUREMENTS AND OTHER PLANT MATERIAL. REQUIREMENTS. SEARCH AND REVIEW. MAKE PLANT MATERIAL AVAILABLE FOR OPTIONAL REVIEW BY LANDSCAPE ARCHITECT AT SOURCE OF SUPPLY. AREA OF SEARCH TO INCLUDE LOVER MAINLAND AND FRASER VALLEY, "SUBSTITUTIONS: OBTAIN WRITTEN APPROVAL FROM THE LANDSCAPE ARCHITECT AT SOURCE OF SUPPLY. AREA OF SEARCH THE LANDSCAPE ARCHITECT FRIOR TO MAKING ANY SUBSTITUTIONS TO THE SPECIFIED MATERIAL. UNAPPROVED SUBSTITUTIONS: WILL BE REJECTED. ALLOW A MINIMUM OF FIVE DAYS PRIOR TO DELIVERY FOR REQUEST TO SUBSTITUTIONS ARE SUBJECT TO SE CHANDSCAPE STANDARD AND CANADIAN LANDSCAPE STANDARD. DEFINITION OF CONDITIONS OF AVAILABILITY." ALL LANDSCAPE MATERIAL. AND WORKMANSHIP MUST MEET OR EXCEED BC LANDSCAPE STANDARD AND CANADIAN LANDSCAPE STANDARD LATEST EDITION. "ALL PLANT MATERIAL MUST BE PROVIDED FROM CERTIFIED DISEASE FREE NURSERY." BIO-SOLIDS NOT PERMITTED IN GROWING MEDIUM UNLESS AUTHORIZED BY LANDSCAPE ARCHITECT.

PLAN	NT S	CHEDULE		PMG PROJECT NUMBER: 19-028
KEY	QTY	BOTANICAL NAME	COMMON NAME	PLANTED SIZE / REMARKS
TREE				
-622	2	CERCIDIPHYLLUM JAPONICUM	KATSURA TREE	9CM CAL; 1.8M STD; B&B
	6	MAGNOLIA KOBUS STELLATA	STAR MAGNOLIA (WHITE)	6CM CAL; 1.5M STD; B&B
1	3	PYRUS CALLERYANA 'CHANTICLEER'	CHANTICLEER PEAR	6CM CAL; 1.5M STD; B&B
DIS	4	THUJA PLICATA 'EXCELSA'	WESTERN RED CEDAR	3M HT; B&B

NOTES: \* PLANT SIZES IN THIS LIST ARE SPECIFIED ACCORDING TO THE BC LANDSCAPE STANDARD AND CANADIAN LANDSCAPE STANDARD, LATEST EDITION. CONTAINER SIZES SPECIFIED AS PER CINA. STANDARD. BOTH PLANT SIZE AND CONTAINER SIZES SPECIFIED AS PER CINA STANDARD. BOTH PLANT SIZES SPECIFIED AS PER CINA STANDARD. BOTH PLANT SIZES SPECIFIED AS PER CINA STANDARD AND STANDARD STANDARD STANDARD STANDARD STANDARD STANDARD AND STANDARD STAND

NOTE:

- All soft tandscape areas to be irrigated with automatically installation to I.I.A.B.C. Standards, latest edition.

©Copyright reserved. This drawing and design is the property of PMG Landscape Architects and may not be reproduced or used for other projects without their



Suite C100 - 4185 Still Creek Drive Burnaby, British Columbia, V5C 6G9 p: 604 294-0011 ; f: 604 294-0022

SEAL:

10	DATE	DO (ICION DECODIDITION	-
1	19.MAR.07	ISSUED FOR DP	A
2	20JAN.21	NEW SITE PLAN/CITY COMMENTS	R
3	20.MAR.06	NEW SITE PLAN	P
4	21JAN.08	NEW SITE PLAN & CITY COMMENTS	D
5	21.MAR.15	NEW SITE PLAN	D
6	21.DEC.01	NEW SITE PLAN & CITY COMMENTS	D
7	22.JAN.10	REVISION AS PER CITY COMMENTS	D

CLIENT:

PROJECT:

### **10 UNIT TOWNHOUSE** DEVELOPMENT

8231 - 8251 WILLIAMS ROAD RICHMOND

DRAWING TITLE:

### LANDSCAPE **PLAN**

DATE:	19.FEB.26	DRAWING NUMBER:
SCALE:	3/32"=1'-0"	
DRAWN:	RJ	3.a
DESIGN:	RJ	910
CHK'D:	PCM	OF 5

203

1.40

EXISTING SINGLE-FAMILY HOUSES

(C)

BUILDING 3

0

250

01

EXISTING FIRE HYDRANT

0

**BUILDING 4** 

LOADING 10'X28'



NOTES: \*PLANT SIZES IN THIS LIST ARE SPECIFIED ACCORDING TO THE BC LANDSCAPE STANDARD AND CANADIAN LANDSCAPE STANDARD, LATEST EDITION. CONTAINER SIZES SPECIFIED AS PER CNIA STANDARD, BOTH PLANT SIZE AND CONTAINER SIZE ARE THE MINIMUM ACCEPTABLE SIZES. \*REFER TO SPECIFICATIONS FOR DEFINIED CONTAINER MEASUREMENTS AND OTHER PLANT MATERIAL REQUIREMENTS. \*S EARCH HOT DITIONS FOR THE PLANT MATERIAL AVAILABLE FOR OPTIONAL REVIEW BY LANDSCAPE ARCHITECT TA SOURCE OF SUPPLY. AREA OF SEARCH TO INCLUDE LOWER MAINLAND AND FRASER VAILLEY. \*SUBSTITUTIONS SO BEAIN WRITTEN APPROVAL FROM THE LANDSCAPE ARCHITECT PRIOR TO MAKING ANY SUBSTITUTIONS TO THE SPECIFIED MATERIAL LANDAPPROVED SUBSTITUTIONS SO BTAIN WRITTEN APPROVAL FROM THE LANDSCAPE ARCHITECT FOR REQUEST TO SUBSTITUTION SO TO THE SPECIFIED MATERIAL UNAPPROVED SUBSTITUTIONS OF ALLOW A MINIMUM OF FIVE ONS PRIOR TO DELIVERY FOR REQUEST TO SUBSTITUTION STO TO THE SPECIFIED MATERIAL UNAPPROVED SUBSTITUTIONS OF A CANADIAN LANDSCAPE STANDARD -DEFINITION OF CONDITIONS OF AVAILABLE TO THE PLANT OF THE PLANT OF



©Copyright reserved. This drawing and design is the property of PMG Landscape Architects and may not be reproduced or used for other projects without their



Suite C100 - 4185 Still Creek Drive Burnaby, British Columbia, V5C 6G9 p: 604 294-0011 ; f: 604 294-0022

SEAL:

22.JAN.10	REVISION AS PER CITY COMMENTS	DD
21.DEC.01	NEW SITE PLANSCITY COMMENTS	DD
21.MAR.15	NEW SITE PLAN	DD
21_JAN.08	NEW SITE PLAN & CITY COMMENTS	DD
20.MAR.06	NEW SITE PLAN	IU
20.JAN.21	NEW SITE PLAN/CITY COMMENTS	RJ
19.MAR.07	ISSUED FOR DP	RJ
. DATE	REVISION DESCRIPTION	DF

CLIENT:

PROJECT:


# **10 UNIT TOWNHOUSE** DEVELOPMENT

8231 - 8251 WILLIAMS ROAD RICHMOND

DRAWING TITLE:


## **LANDSCAPE SHRUB PLAN**

ı	DATE:	19.FEB.26	DRAWING NUMBE
	SCALE:	3/32"=1'-0"	0.1
	DRAWN:	RJ	3.b
	DESIGN:	RJ	0110
	CHK'D:	PCM	OF

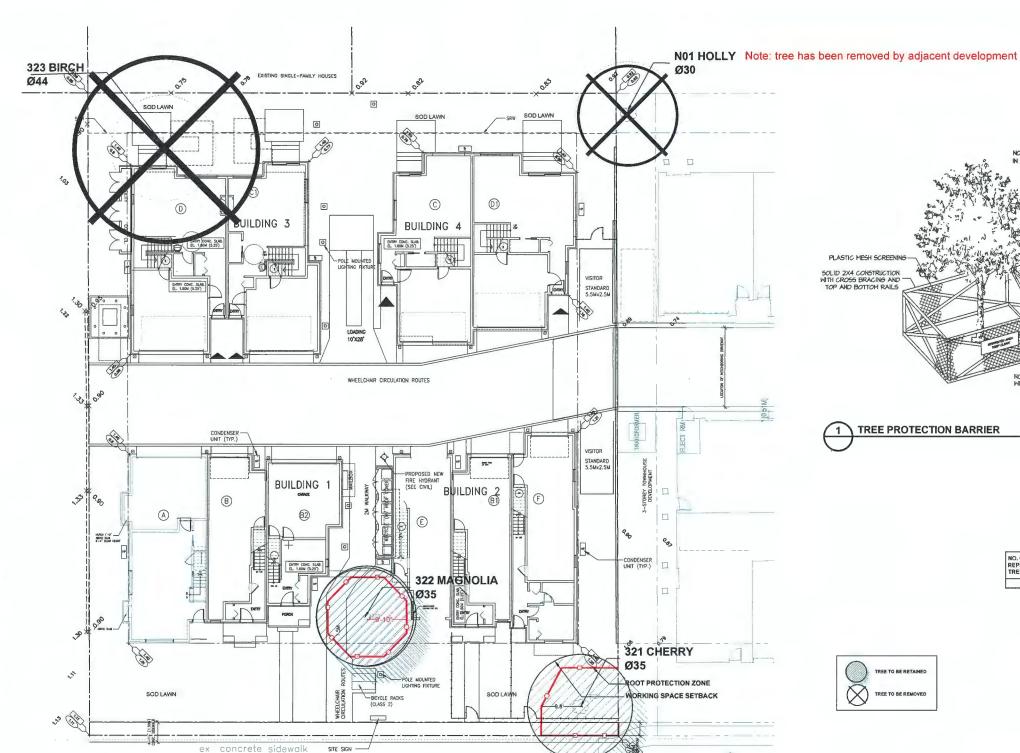

WILLIAMS ROAD

EXISTING FIRE HYDRANT

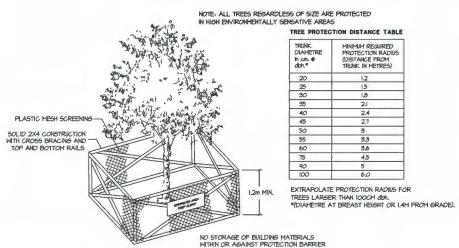

1 TREE PROTECTION BARRIER

NO. OF REPLACEMENT	SUITABLE REPI	LACEMENT TREES
TREES	BOTANICAL NAME	SIZE
2	CERCIDIPHYLLUM JAPONICUM	9CM CAL; 1.8M STD; B&B





© Copyright reserved. This drawing and design is the property of PMG Landscape Architects and may not be reproduced or used for other projects without their



Suite C100 - 4185 Still Creek Drive Burnaby, British Columbia, V5C 6G9 p: 604 294-0011 ; f: 604 294-0022

7 22.IAN.10 REVISION AS PER CITY COMMENTS DO 6 21.DEC.01 NEW SITE PLANKSTIF PAAN DO 5 21.MAR.15 NEW SITE PAAN DO 3 21.MAR.06 NEW SITE PAAN CITY COMMENTS DO 3 20.MAR.06 NEW SITE PAAN L 2 20.JAN.21 NEW SITE PAAN CITY COMMENTS BU 1 20.MAR.06 NEW SITE PAAN CITY COMMENTS BU 1 30.MAR.07 NEW SITE PAAN CITY COMMENTS BU 1 30.MAR.07 NEW SITE PAAN CITY COMMENTS BU 1 30.MAR.07 NEW SITE PAAN CITY COMMENTS BU	10.	DATE	REVISION DESCRIPTION	DR.
6 21.0EC.01 NEW SITE PLAN BCITY COMMENTS DD 5 21.MAR.15 NEW SITE PLAN DD 4 21.JAN.08 NEW SITE PLAN & CITY COMMENTS DD 3 20.MAR.06 NEW SITE PLAN RJ	1	19.MAR.07	ISSUED FOR DP	RJ
6 21.DEC.01 NEW SITE PLANB.CITY COMMENTS DD 5 21.MAR.15 NEW SITE PLAN DD 4 21.JAN.08 NEW SITE PLAN & CITY COMMENTS DD	2	20JAN.21	NEW SITE PLAN/CITY COMMENTS	RJ.
6 21.DEC.01 NEW SITE PLANE/CITY COMMENTS DD 5 21.MAR.15 NEW SITE PLAN DD	3	20.MAR.06	NEW SITE PLAN	RU-
6 21.DEC.01 NEW SITE PLANBICITY COMMENTS DD	4	21.JAN.08	NEW SITE PLAN & CITY COMMENTS	DD
	5	21.MAR.15	NEW SITE PLAN	DD
7 22.IAN.10 REVISION AS PER CITY COMMENTS DO	6	21.DEC.01	NEW SITE PLANBICITY COMMENTS	DD
	7	22JAN,10	REVISION AS PER CITY COMMENTS	DD

CLIENT:

PROJECT:

### **10 UNIT TOWNHOUSE** DEVELOPMENT

8231 – 8251 WILLIAMS ROAD RICHMOND

### TREE MANAGEMENT **PLAN**

- 1			
1	DATE:	19.FEB.26	DRAWING NUMBER:
-	SCALE:	3/32"=1'-0"	
-	DRAWN:	RJ	3.C
- 1	DESIGN:	RJ	0.0
1	CHK'D:	PCM	OF 5

PMG PROJECT NUMBER:

19-028

- ALL POSTS PRESSURE TREATED TO CSA STANDARD AND END CUTS TREATED WITH PRESERVITIVE.
- 2. ALL OTHER MEMBERS TO BE CEDAR. #2 (CONSTRUCTION) GRADE MINIMUM.
- 3. ALL HARDWARE HOT DIPPED GALVANIZED.
- APPLY 2 COATS EXTERIOR STAIN TO MANUFACTURERS SPECIFICATION. FINISH SELECTION AS APPROVED BY PROJECT ARCHITECT.
- ALL FENCES TO BE LEVEL. CHANGES IN GRADE TO BE IN 12"-18" STEPS (MAX.). GAPS TO GRADE TO FOLLOW FINISH GRADE. GAP TO BE 3-6".

rdx3 VERT


-2x6 CEDAR CAP

\_1x6 ROUGH

2x6 NAILER

1x6 NAILER

- 1. ALL WOOD P.T. HEM/FIR
- 2. ALL FASTENERS HOTDIPPED GALVANIZED
- 3. STAIN ALL EXPOSED SURFACES WITH TWO
- COATS PREMIUM WEATHERPROOFING STAIN, COLOUR
- TO MATCH ARCH.; PROVIDE SAMPLE TO OWNER FOR
- PREAPPROVAL PRIOR TO APPLICATION
- 4. STEP FENCE IN EQUAL SEGMENTS TO FOLLOW

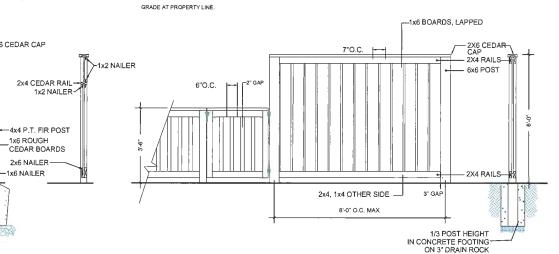



COMPACTED SUBGRADE

PATIO ON SLAB


8'-0" MAX. O.C.





3" GAP-

2x4 P.T. BOTTOM

- METAL MATERIAL: ALUMINUM TO BE POWDER COATED BLACK, TWO COATS.
- 2. ALL HARDWARE TO BE HOT DIPPED GALVANIZED, MEDIUM GAUGE
- 2. ALL PROVINCE TO BE CHOSEN BY OWNER.
  INSTALL PER MANUFACURERS INSTRUCTIONS.
  4. ALUMINUM FENCE TO BE POWDER COATED SEM-GLOSS BLACK.

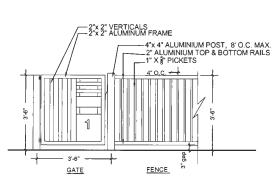

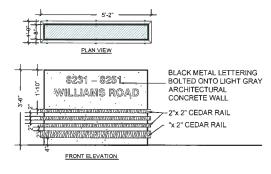


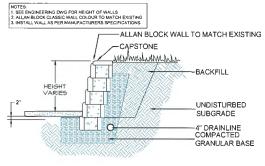







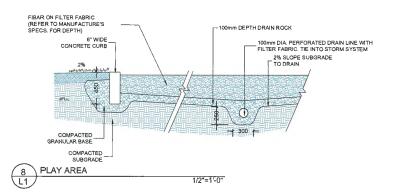





GEOGRID PLACEMENT TO FOLLOW THE LAYOUT AS INDICATED ON THE CIVIL PLANS AS REQUIRED TO PROTECT THE ROOTS OF THE RETAINED TREES.

MICHAEL J MILLS CONSULTING

1, IN THE EVENT ROOTS ARE EXPOSED, CONTACT PROJECT ARBORIST FOR ASSISTANCE PRIOR TO PROCEEDING, NICK MCMAHON 6042753484 2. PAVERS TO BE INSTALLED TO MANUFACTURERS SPECIFICATIONS



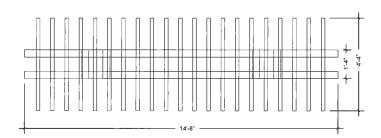

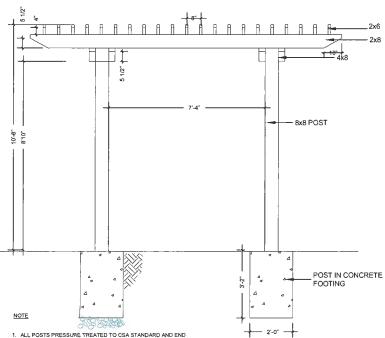

- ALL POSTS PRESSURE TREATED TO CSA STANDARD AND END CUTS TREATED WITH PRESERVATIVE.
- ALL OTHER MEMBERS TO BE CEDAR. #2 (CONSTRUCTION) GRADE MINIMUM.
- 3. ALL HARDWARE HOT DOUBLE DIPPED GALVANIZEO.
- 4. APPLY 2 COATS APPLY 2 COATS OF BENJAMIN MOORE GRAPHITE 1603.



© Copyright reserved. This drawing and design is the property of PMG Landscape Architects and may not be reproduced or used for other projects without their



Suite C100 - 4185 Still Creek Drive Burnaby, British Columbia, V5C 6G9 p: 604 294-0011; f: 604 294-0022



PROJECT:

### **10 UNIT TOWNHOUSE** DEVELOPMENT

8231 - 8251 WILLIAMS ROAD RICHMOND

DRAWING TITLE:

## LANDSCAPE **DETAILS**

DATE:	19.FEB.26	DRAWING NUMBER:
SCALE:	3/32"=1'-0"	<b>a</b> I
DRAWN:	RJ	3.a
DESIGN:	RJ	0.0
CHK'D:	PCM	OF 5

# PART ONE GENERAL REQUIREMENTS 1 CCDC Doc 2 2008 Comply with all articles 2 Canadian Landscape Standard, talest edition, prepared by the Canadian Society of Landscape Architects and the Canadian Landscape & Horsery Association, jointly. All vort and malerials shall meel standards as set out in the Canadian Landscape Standard unless superseded by this specification or as directed by Landscape Architect with written 3 HASTER HERREPAL SPECEFICATIONS & STANDARD DETAILS, 2000 edition, prepared by the Consultans, and the Municipal Engineers Division. 4 STANDARD FOR LANDSCAPE IRRIGATION SYSTEM, 2008: Prepared by the Irrigation Industry Association of Britis 5 MUNICIPAL BYLAWS AND ENGINEERING SPECIFICATIONS WHERE NOTED 2 Owner reserves the right to lest or re-test materials. Contractor responsible to pay for testing if materials 1. Any alternate products differing from that contained in the contract documents must be pre-approved by the 2 Submittals to consist of product sample or manufacturer's product description. ALL SETTLE 1. They it he grow of the Landsupe Architect's Content with the Ower and when the Landsupe Architect is the created from an accessing a three opening to conform conformance in the plans and specifications. Content to many programatic haza. Marke to depty orders. Overview to be depth of which the finder for the Follows. 1.1 Shall by Side Needing, descript Conformation State States and produced with with the thing of the Pollows. 1.2 Shall by Side Needing, General Conford Privar to vary side disturbance, a weeking with the general contractor it and manying deprivation. and munisipal requirements. 12. Start lip Sile Meeting, Landscape Confract Of separatel. At the start of work with Owner's Representative, S to held to review expected work and to verify the acceptability of the subgrade and general site conditions to the 13. Mart by Sid Hesting, Leutrage contrast or separate to make the leaf is review appealed with all to include the leaf is review appealed with all to sharply the acceptability of the subgrade and general rule conditions to the Law for this needing. 13. Progress Side Visita: In-observe advantage and werk-anothy as necessary through the course of the work. Deal any period social elements was accided. Side Lyand, Mining Gender, Corway Seldon-vessilla, depths, Lond grade Systems, Park Gengeless. Side Fordinary, and alter determine of the elements where the Landange Architect Fraction, Bus-structural walls and sides, leaf Parkop. 15. Seldon-lated Selformance Review of all level actions of all substitutions, development where the Landange Architect Fractions, Selformance Review of all level actions, and action of the Certificate of Completion Upon the desiration of the behavior, selformance and deficiency. But contributed the Certificate of Completion Upon the Architecture Selforman of the Certificate of Completion of the Certificate of Certificate of Certificate Selforman of Certificate Self .1 Unless otherwise instructed in the Contract Documents, the preparation of the subgrade shall be the response constitutes acceptance of the subgrade by the Landscape Contractor. Any subsequent corrections to the subgrade 2 All work and superintendence shall be performed by personnel skilled in tandscape contracting. In addition, all curroll license issued by the appropriate additionlies. 3 A site visit is required to become familiar with site conditions before bidding and before start of work A Continu location of all services before proceeding with any work. 5 Hotify Landscape Architect of any discrepancies. Obtain approval from Landscape Architect prior to deviating .6 Take appropriate measures to avoid environmental damage. Do not dump any waste materials into water bodies 8. Where now work cooperts with existing and where existing work is aftered, make good to match existing undist 1. Guarantee all materials and workmorship for a minimum period of one full year from the date of Certificate of 2 Refer to individual sections for specific warranties. PART TWO SCOPE OF WORK Other conditions of Contract may apply. Confirm Scope of Work at time of fender Work includes supply of all related items and performing all operations necessary to complete the work in accommunity. counts in the transluting. 2.1 Enterlaim of Exicing Treas, where thom on drawings. 2.2 Finals forcing and sandstage Drawings. 2.3 Singly and prisement of growing medium. 2.4 Examing of expected growing medium and/or site logicals. 2.5 Singly and expected site of site in the east of requirements at site list and Tall Conference of the east of the e 1 Growing Medium: Conform to Canadian Landscape Standard for definitions of imported and on-site lopsoid. Refe TABLE ONE: PROPERTIES OF GROWING MEDIUM FOR LEVEL 2 GROUNED AND LEVEL 3 HIDDERATE AREAS (whaten System of Soil Classification Tentural Class: "Loany Sand" to "Sandy Loan". Trees and Large Shrubs Percent Of Dry Weight of To 0 - 1% 0 - 5X 0 - 5% larger than 2mm ercent Of Dry Weight of Growing 0 - 15% 10 - 25% larger than 0.002mm smaller than 0.05mm 4 - 25× 0 - 5X smaller than 0 002mm naximum 35% basinus 15 Acidity (pH): Fertilizer. An organic and/or inorganic compound containing hitrogen (NI, Phosphate (25), and Potash (solut Line: Ground agricultural linestone. Meet requirements of the Canadian Landscape Standard i – Organic Additive. Commercial compost product to the requirements of the Canadian Landscape Standard, falles lecommonded suppliers: The Ansver Garden Products, Franer Richmond Soils & Fibre, Stream Organics Hanagement 5 Sand: Clean, washed pump sand to meet requirements of the Canadian Landscape Standard i (Imposted Bath Molch: None 13/8") minus Fir/Henlock bath chips and lines, free of chunks and sticks, dath bro xtraneous natter: Fresh orange in colour bath will be rejected

Methicides and Pesticides: If used, must conform to all federal, provincial and local statutes. Appliers must hold current licenses issued by the appropriate authorities in
the area.

1) Plant Material. To the reguments of the Caudian Landscape Standard. Refer to 3.9, Plants and Pizating. All plant material must be provided from a tertified of free markey. Provide proof of certification.

.13 Supplier and installers of segmental bleck walls to provide engineered drawings for all walls, signed and sealed drawings for all walls, individually, in excess of 12m, or combinations of walls collectively in excess of 12m. Installations must be reviewed and signed off by Certified Professional Engineer; initude cost of angineering services in

10 Drain Rock: Clean, round, iter1, derable, and have a maximum size of 19nm and containing no material smaller than 19nm

.14 Hiscellaneous: Any other material necessary to complete the project as shown on the drawings and described herein.

9 Brainage Piping if required Schedule L& PVC nominal sizes.

.12 Sed: Refer to individual sections in this specification

		11
s of British Celumbia, Readbuilders and Heavy Construction		4. On not stockpile soil, construction materials, or excavaled materials within vegetation retention areas
itish Columbia		Do not park, fuel or service vehicles within vegetation relention areas     Be debris fires, clearing fires or trash burning shall be permitted within vegetation relention areas.
		3 No excavations, drain or service trenches nor any other disruption shall be permitted within vegetation retention areas without a review of the pro-
and any for faction	by an independent testing facility	the Landscape Architect.  3. Do not cut branches or roots of relained trees without the approval of the Landscape Architect.
v and approval prior to placement. Refer to Section 3.4 Growing		9 Any damage to existing vegetation intended for preservation will be subject to evaluation by an LS.A. Certified Arborist using the "Guide for Plant
s de not meet speci	ficulion.	1992. 31. Replacement planning of equivalent value to the distorbance will be required. The cost of the evaluation and of the replacement planning will be II General Contractor and or the personals desponsible for the distortance.
l anderane Archite		.9 In nurricipalities with specific free refention/replacement bytaws ensure compliance to bytaws
t Lansscape Archite	ξ1.	.11 In situations where required construction may disturb existing vegetation intended for preservation, contact Landscape Architect for review prior
		construction.  3.2 GRADES
ers Representative	iewer, the Landscape Architect will observe to arrange for site observation at the	.1 Ensure subgrade is prepared to conform to depths specified in Section 35, Growing Medium Supply, below. Where planting is indicated close to exist suitable planting pockets for material indicated on the planting plan. Shage subgrade to eliminate free standing water and conform to the site grading.
9: r to review tree pro	eservation issues, general landscape issues	2. On stopes in excess of 31 french subgrade across stope to 150m (61) nivinum at 15m (6 ft.) intervals minimum.
, Sil e Superintender e Landscape Contra	of and Landscape Contractor; a needing is to ctor. Provide growing medium test results	3 Scarify the entire subgrade inneciately pour to placing growing medica. Re-cultivate where vehicular traffic results in compaction during the constructed that all planting areas are smoothly confound after light compaction to finished grades.
Review of differen	of aspects of the work may be dealt with on and Drainage Materials; Lawns or Grass areas;	4. Eliminally standing water from all finished grades. Provide a smooth, firm and even surface and conform to grades shown on the Landscape Drawing maximum and minimum gradests defined by the Condision Landscape Standard.
planding practice an	d tayrul, Tree support; Mulch; Irrigation ed reviewer such as: Pedestrian Paving.	3. Construct swales true to line and grade, smooth and free of sags or high points. Minimum slope ZX, maximum side stopes 10%. Assure positive dra
rations of deficienc	y list, and recommendations for completion. te of Completion will be made to the Payment	.6 Slope not to exceed the tollowing maximums: Rough Grass 3-1, Lawn 4-1, Landscape plantings 2-1.
	se of Lonpletion will be made to the rayment fule 'C' will be issed where required.	.7 Finished soll/notch elevation at building to comply with municipal requirements
	, review all waranty material and report	8 Inform Landscape Architect of completion of finish grade prior to placement of seed, and, plants or mulch
		3.3 LANDSCAPE DRAINAGE. 1. Related Mark. Growing medium and Finish Grading, Grass areas, Trees Shrubs and Groundcovers, Planters, (nb Walls
	al Contractor. Placement at growing medium responsibility of the Landscape Contractor	<ol> <li>Work Included: Site finish grading and surface drainage, Installation of any drainage systems defailed on landscape plans. Note: Earth basins show coordination only, confirm scope of work prior to bid.</li> </ol>
il personnel applym	g herboides and/or pesticides shall hold a	2.1 Coordinate all landscape drainage work with rest of site drainage, Refer to engineering drawings and specifications for connections and other drainage. Refer to engineering drawings and specifications for connections and other drainage. Refer to engineering drawings and specifications for connections and other drainage.
		so as to prevent interruption at service or damage to them. Protect existing structures and utility services and be responsible for damage caused 23. Planter drains on slab. Refer to Section 3.30, installing Landscapes on Structures
		Streenlan     Do Trenting and buckfilling in accordance with engineering defails and specifications.
g from the plans		32 Lay drains on prepared bed, I rue to line and grade with inverts smooth and free of sags or high points. Ensure barrel of each pipe is in contact with length.
ies. Conform with a	# lederal, provincial and local statutes and	33 Comences laying give at outlat and proceed in upstream direction. 34 Lay perforated pipes with perforations at Ripm and Eym positions. 35 Make joints high in accordance with neurolacturer's directions.
ean and repair dama	ge resulting from landscape work. Repairs	36. Do not allow water to flow through the pipes during construction except as approved by Engineer.  37. Make watertight connections to existing drains, new or existing expholes or catchbasins where indicated or as directed by Landscape Architect
sturbed condition		38 Plug-upstream ends of pipe with waterlight clean out caps. 39 Surround and cover pipe with drain rock in waifern Stenn layers to various depths as shown in details, ninimum 190nm. 39 Cover frain rock with hon-overen filler footbla pail diedes and seans minimum 190nm.
		3.10 Assure positive of sinege. 3.22 Back (4) remainder of Iranch as indicated.
f Completion		3.0 Protect subdrains from floatalism during installation. 3.4 GROWING HERRING TESTING
		Submit representative sample of growing nedium proposed for use on this project to an independent laboratory. Provide test results to Landscapi placing. Test results in include:
		11 Physical properties, X content of gravel, sand, silt, city and organics 12 Action PH and quantiles of lime or sighter required in Strong withou specified range 13 Boliveine levels as fromisple and frame elements and recommodifications for required soil amendments.
		.14 Carbon/Mirogen level.
cordance with the drawings and specifications and generally		<ol> <li>GROWING HEIDRH SUPPLY AND PLACEHORT</li> <li>Supply all growing medium required for like performance of the Endract. Do not load, transport or spread growing medium when it is so well that it diseases.</li> </ol>
		2. Supply all proving medium administures as required by the soil test. Amended growing medium must meet the specification for growing nedium as de-
		various areas. 2.1 Throughly mix required awendments into the full depth of the growing medium.
		Special mises may be required for various situations. Refer to drawing notes for instructions     Flace the amended growing medium in all grass and planting areas. Spread growing medium in unform layers not accreding 6" (550mm), over unforced.
		standing water
		Himmun depths of growing medium placed and compacted to 80%.     Li On-grade     Li Seeded and sodded favor
		LLI Seeces and someon team.  LLI Mass planted shripes 1 groundovers
		L.E.S. Tree & large shrub jits
fer to Table One be	lov.	A 2 0n-554b A 21 hrigated lawn
	Planting Areas	A.22 Considerer area  A.23 Lavo without automatic irrigation
	and Planters 2P	125 Trees and specimen shrubs:
Total Growing Medic	ıh.	.4.2.7 Havinum M* depth growing medium except where mounded for trees over column points     .5 Hanually spread growing medium/planting and around existing frees, shrubs and obstacles.
	0 - 1%	.6 In permeter seeded grass areas, feather growing nedium out to nothing at edges and briend into existing grades.
4	0 - 5%	.7 Finished grades shall conform to the elevations shown on landscape and site plans.
ng Hedium Excluding	; Gravel	3.6. ROUGH GRASS AREA - SELDING 1. General: Rough grass areas are noted on the drawings as "Rough Grass". Treat all areas defined as rough grass between all property lines of the
1%	10 - 80%	boulevards to edge of roads and lanes.
x	10 - 25%	2. Preparation of Surfaces: To Canadian Landscape Standard Class 3 Areas Rhough grasts Section 7.1.13 2.1. Clean existing soldly wenthum lenses of debris ever 50mm in any density. 2.2. Rhoughly grads our lateas to silieve for mantenance specified and for positive drainage.
x	0 - 25X	.3 Time of Seeding: Seed from early spring (generally April tol) to tate fall (September 18th) of each year. Further extensions may be obtained on co-
15%	maximum 35X	Architect  L. Seed Supply & Testing: All seed must be obtained from a recognized seed supplier and shall be No. 1 grass mixture delivered in containers bearing
x .	10 - 20%	Seed Supply & Testling: All seed must be obtained from a recognized seed supplier and shall be No. 1 griss niesture delivered in containers bearing     1.3 Analysis of the seed mixture     1.2 Percentage of each seed type
to to	15 - 20% 4.5 - 6.5	5 Seed Micture. All varieties shall be rated as strong performers in the Pacific Horthwest and are subject to client approval
fler at least 10 nin	ules of moderate to heavy rain or irrigation.	70% Creeping Red Fescus 20% Annual Rye 5% Salurn Percennial Rye
e 21 in proportions r	equired by sail test.	53 Saturn Perennal Nye 53 Kenlucky Bloograss For Widthover Areas use a mixture of Widthovers, with Hard Foscues (Torratinh Coastal Widthovers) with Hard Foscue or pre-approved atterna
et adding sed ar-	approved by the Labdacone deshibard	.6 Fertilizer: Methanical seeding Apply a complete synthetic slow-release fertilizer with maximum 35% water soluble nitrogen and a formulation ratio
st earlinn and pre-i nl.	approved by the Landscape Architect.	sulphur urea coaled, 112 kg/ha(NOBhs/acre) using a mechanical spreader.  7. Seeting: Apply seed at a rate of 112k/H (NOBhs/acre) with a mechanical spreader, bicorporate seed into the top 114* (firm) of soil and lightly con
	f	3. Acceptance Provide adequate protection of the seeded areas until conditions of acceptance have been met. (emply with Section 3.7 Hydroseeding.
brown in colour and free of all soil, stones, roots or other		3,7 Propageeding

Test results to include: sical properties, X: ceol ent of gravel, sand, sill, clay and organics. clily PN and quantillies of line or sulptur required to bring within specified range richt levels of principle and trace elements and recommendations for required soil amendments. how/Allicome. Incl. G HEDRIH SUPPLY AND PLACEHENT pply all growing medium admixtures as required by the soil test. Amended proving medium must meet the specification for growing medium as d heroughly his required amendments into the full depth of the growing medium.

Interpolate may be required for various situations. Refer to drawing notes for instructions. nimum depths of growing medium placed and compacted to 88%: mually spread growing medium/planting soil around existing trees, shrubs and obstacles. permeter seeded grass areas, feather growing medium out to nothing at edges and blend into existing grades nished grades shall conform to the elevations shown on landscape and site plans. neral: Rough years areas are noted on the drawings as "Rough Grass". Treat all areas defined as rough grass between all property lines of the project including all rolls longing of reads and laws. reparation of Surfaces: To Canadian Landscape Standard Class 3 Areas (Rough grass) Section 7.1.1.3 Team existing soil by mechanical means of debris over Some in any dimension. Roughly grade surfaces to allow for maintenance specified and for positive drainage. ne of Seeding Seed from early spring (senerally April (s.1) to late fall (September 18th) of each year. Further extensions may be obtained on eed Micture. All varieties shall be rated as strong performers in the Pacific Northwest and are subject to client approval TOX Compaigh But Section
2024 Aurerial Fig.
5% Salarm Ferenail Fig.
5% Salarm Ferenail Fig.
5% Salarm Ferenail Fig.
5% Resolutify Regions
Fig. Wildlineer Areas use a malure of Midflowers with Hard Fescors (Terrainh Coastal Midflower)
Fig. Wildlineer Areas use a malure of Midflowers with Hard Fescors (Terrainh Coastal Midflower) persons: Apply seed at a nate of 112k/H (100lbs /acre) with a mechanical spreader, bicorpor at e seed into the top 1/4" (firm) of soil and lightly compac

PART THREE SOFT LANDSCAPE DEVELOPMENT ention or existent rocks. Prior to any work on site - protect individual frees or plant groupings indicated as retained on landscape plans as vegetation retention areas. In some instances the Landscape Architect will had trans or areas to renam. Discups tree retention areas at a start-up meeting with the Landscape Architect. 7. A physical harrier must be included to delineate clearing houndaries. Refer to physical harrier detail. If detail not provided comply with local sourcitinal requirements 3 No machine travel through or within vegetation retention areas or under crowns of trees to be relained is allowed not stockoile sail, construction materials, or excavaled materials within vegetation retention areas and nork flui or tervire vehicles wilhin venetation retention areas debris fires, clearing fires or trash burning shall be permitted within vegetation relection areas excavations, drain or service frenches nor any other disruption shall be permitted within vegetation reduced adscape Architect. o not cut branches or roots of retained trees without the approval of the Landscape Architect. or danage to existing regelation intended for preservation will be subject to evaluation by an I.S.A. (entitled Arborist using the "Guide for Plant Appraisal", Eighth Edition eplacement planting of equivalent value to the distorbance will be required. The cost of the evaluation and of the replacement planting will be the responsibility of the it Contractor and or the personals responsible for the distorbance. nuricipalities with specific tree refention/replacement bytaws ensure compliance to bytaws sil valions where required construction may disturb existing vegetation intended for preservation, contact Landscape Architect for review prior to commencing o Loure subgrade is prepared to conform to depths specified in Section 35, Groving Medium Supply, below. Where planking is indicated close to existing frees, prepare is dualing activate for material indicated on the planking plan. Shape subgrade to eliminate free standing water and conform to the site or action and drainage plan. times in access of 31 branch subgrade access since to Silves 62 minimum at 15m S H i intervals minimum. urify the entire subgrade innectiately pour to placing growing medizm. Re-cultivate where vehicular traffic result That all planting areas are smoothly contoured after light compaction to finished grades. inhate standing water from all finished grades. Provide a smooth, firm and even surface and conform to grades shown on the Landscape Grawings. Do not exceed on and minimum gradents defined by the Conadian Landscape Standard. (APE DRAINAGE Lated Work: Growing medium and Finish Grading, Grass areas, Trees Shrubs and Groundcovers, Planters, (nb Walls urk koludet. Sie finish prading und surface draininge, best alfalton of any drainings systems debalded on landscape plans. Hele Catch bases drown on landscape plans for sulface alfa, custom suspec of warry part or bid.

The constitute of landscape and such parts of sile drainings, before is explorating draining and specifications for connections and other drainings work.

The constitute of landscape and such parts of sile drainings, before is explorated pointing and secondaring sould be such parts of the sile of sile and a secondaring sould be sile and secondaring which which and a factorist and development delines parts of secondaring which which are also secondaries and a factorist of sile and secondaries a rousen D freating and bushfilling in accordance with engineering details and specifications. Ay drains on prepared bed, true to line and grade with inverts smooth and free of sags or high points. Ensure barrel of each pipe is in contact with bed throughout full immence laying pipe at insiliet and prissed in agritisan direction.

In grafinal depter will perfur allows at these most yet presidence,

In grafinal depter will perfur allows at these most yet presidence are grafinal and an advantage of the control of the cont NG HEDRUH TESTING of representative sample of growing medium proposed for use on this project to an independent laboratory. Provide test results to Landscape Architect princ to test results to include:

thruseEterna May be used as an alternale to mechanical seeding in rough grass areas

2 May not be used in areas of lawn unless pre-approved by the Landscape Architect prior to bidding

.6 Water: Shall be free of any inpurities that may have an injurious effect on the success of seeding or may be harmful to the

2. Nay not be note on the control before the contro

J. Equipment: Use industry standard hydraufic seeder/indiciner equipment with the Lark volume certified by an identification plate or sticker affised in place on the equipment. The hydraufic seeder/indiciner shall be capable of selficient application to mix the material into a himspecons story and to maintain the storry in a hottle-process until at its applied. The discharge press and go nonzertes shall be capable of applications are maintained in applied. The materials unforther over the designated are made to applie and a story and the story of the designated area.

ii or the nertormance of the Centract. Do not load transport or coread proving medium when it is so wet that its structure is likely to b

5 Specified Turigrass by area: Refer to Table 2 below. TABLE 2 SPECIFIED TURFGRASS BY AREA | TARLE 379 TERED | 1000 Cells S.5 Y AREA
| Area | Description
| CLASS | Laws, all reservation for Gravings as favor in urban
| Class | Laws, all reservations for inclining benderand grass
| CLASS | Grass - public parks, industrial and notiful virous sites
| SPECIAL | Specific parks, industrial and notiful virous sites
| SPECIAL | Specific parks, industrial and notiful virous sites
| SPECIAL | Specific parks, industrial and notiful virous sites
| SPECIAL | Specific parks | Spec Hajor Species
Kentucky Blue for sun, Fescues for shade .6 Line: The line shall be as defined in Settlion 2.23, Materials: Apply at rates recommended in required soil text. Refer to Section 3.4 for method Ferfilszer: Refer to Section 222 Materials. Apply specified ferfilizer at rates shown in the required soil test. Apply with a mechanical spreader. Cultival medium 48 hours prior to scoding. Apply separately from time.

tes: If the line of Tender provide a complete chart of all components of the min proposed including mulch, tackiller, water etc. Stoped sides require tackiller

.N. Distribute slurry uniformly over the surface of the area to be hydroseeded. Blend application into previous applications and existing grass areas to form uniform surface

13. Heat-source Bigs in advances mentality after sensing and unless for 6 days after Solutionial Competition Angulity secretary by the foreign Received after premise that settlements in self-affected seed from designable frequency service time forces complete sharpages will speak see to be time forces complete sharpages will speak see to be time forces complete sharpages will speak see to be time ever by the Owner Maller in settlement by the Owner Maller in Solution seems of the Owne

33 Acceptance of the Sough Crass Areas. Proper germanium of all specified grass species in the responsibility of the Landscape Centractor. The probability research will established with on apparent deader have species and with a reasonably free or week that Canadam Landscape Standard, Section Di Maintenance Level C. Those species for Section Sectio

Growing Medium. Comply with Section 221 Growing Medium. Prior to sodding, request an inspection of the limithed grade, and depth and condition of growing mediu.

3 Time of Soddings. Sod from April 1st to October 1st. Further extensions may be obtained on concurrence of the Landscape Architect 4 Sed Supply. Conform to all conditions of Canadian Landscape Standard, Section 8, 8 C. Standard for Torfgrass Sed.

3. Acturately measure the quantities of each of the naturals in Pendharged risk the lank either by mass or by a commonly accepted system of mass-calibr measurements. The naturants shall be added to the test while it is being Princip with water, in the following sequence, seed, fertilizer. Thoroughly nic into a lattle chappe, add on water or other material is the mortrier. On natives silvening, the layer form the foot of the locus of the chapter of the chapter.

8. Sodding Pregure a smooth, firm, even surface for laying and Lay and staggered with sections circely bulled, without overtapping or gaps, annels and even with adjining areas and reliability. Water to obtain mixture generated on it? I to 4.17 - Ideal. Copyly with requirements of Canadam Ladiscage Standard Section 8, EC Standard for Turyless Sod.

9. Hentmuce. Byon melessace mendality after undergood continue for 66 pays after Solutionial Conjection and accepted by the flower. Protest sudded areas from dange with frequency with or interest complete with Sprage well favor in their work y the Source Visited in continue protection of 3" for 1" Microb at a section of 3" fo

Acceptance of Lann Areas: The hart shall be rescended well established, with mapparent dead spots or bare spots and shall be reasonably free of weeks the Canadan.
Landscape Standard, Section Difficulties and the Canadan Canadan in messary for weed removal orders other moditions of contract foreid their size. After the Lanns take not all early two-pures weeding the conditions been sent all early two-pures weeding the conditions down with the Flaten very by the Vietnam extent of the Vietnam extends of the Vietna

1 Conform to planting layout as shown on Landscape Plans. 2. Obtain approval of Landscape Architect for layout and preparation of planning prior to commencement of planting operation 3 Make edge of beds with smooth clean defined lines

9 PLANTS AND PLANTING

LAWN AREAS - SODDING

PART THREE SOFT LANDSCAPE DEVELOPMENT - CONT

8.6.2 Fertilizer: 8.6.2.1 Rough Grass: If a soil analysis is available comply with results. 8.6.2.2 Lawn: Where bydroseeding is approved, compravilly and analysis recommendations.

.11 Clean up. Remove all materials and other debris resulting from seeding operations from the job site.

5. Standards
5. St

Review: 1.1 Review at the source of supply and/or collection point does not prevent subsequent rejection of any or all planting stock at the site. Availability

A rea of search includes the Lower Hainland and Fraser Valley. Refer to Plant Schedule for any extension of area.

Supply proof of the availability of the specified plant material within 30 days of the award of the Confract.

8 Substitution
81 Obtain written approval of the Lundscape Architect prior or making any substitutions to the specified material. Hon-approved substitutions will be rejected
82 Adva a minimum of Supy prior to delivery for request to substitution
83 Substitutions are subject to Canadian Lundscape Standard - definition of Canadians of Availability

 Plant Species & Location
 Plants shall be true to same and of the height, caliper and size of root ball as shown on the landscapersole plan schedule. Caliper of trees is to be halen 6" (Sciol above grade.
3.2 Plant all specified species in the location as shown on the landscape drawings. Notify Landscape Architect if conflicting rock or underground/overhead services are

entrumbered.

93 Deviation of given planting location, will only be allowed after review of the proposed deviation by the Landscape Architect. Exercision
 These addings studied Exercise a source shaped free pit to the depth of the real-ball and to all least twee the width of the real-ball. Assure that flowbed grade is at the original grade life time was grown all.

10 Consuge of Flashing Holes:
11. Provide drivings of planting piles where required is an shaped conditions, break not the side of the planting pile to allow drawings from shape, and in Ital conditions, mound in receive the related and respected piles of planting below is labeled. ? Plusting and Fertiling Procedures.
2.7 Plus all arces and bridge with the roots plused in their natural growing position. If puritage, toosen around the log of the ball and cut away or field under. Do not pull ling from order the bulk Carefully resource containers, without algoing the roots and it.

vice.
27. Filling planting bies by goolly finning the growing netion around the rest system in 5° (Social Sysys, Settle the soil with valer. Add sad as required in neel finish goods. Leave no air mids. When 27° of the Insposit has been planed, upply fertilizer as recommended by the required soil test at the specified rates.
28.3 Where planting is indicated adjacent to existing times, are special care to a root distribution of the cord system or natural grades of such frees.
28.4 Where Instal are natural around values of midstall below of this development enterior on the Trees.

12. Likes the line cardidy vertical.

3. Line high-regived connectial, fail were polypropiene labric hell, minimus width films DV-1. Approved product. Achor file - available from Despition.

3. Conference Trees over 5.11 highly. Gay with here 2-transd wires 10 papel. Drive blees trakes equidated across the recompletely below grade.

5. Trees 5.11. - a whose of Except Section 5 par a dree using three duadree from 2-27-54 buried to the maximum possible depth instead of slakes.

10. Mark all pay wires with violde fragging naterial.

II. Proving
III. (In proving to the nicionum necessary to remove dead or injured branches. Preserve the natural character of the glasts, do not not the leader. Use only clean, sharp tends. What is not not not be branch order tenony on into. Shape affected areas to a not for retain valer. Person disregate makerial. Michael S. Michael Spatial parts with an even layer of multin 12-127-17 (85 - 78 and dayth. Confern placement of multin nursus labeled "Groundsweer Area" on Groungs: Multin all July (Shinhal Gazeller critic around items in man, larner of item edge.
 10 (Shinhal Gazeller critic around items).

10 Plant Material Mantesance
111 Testian all plant material for 69 days offer bedicage with his received a Certificate of Completion.
112 Material plant material for 69 days offer bedicage with his received a Certificate of Completion.
113.1 Material is usually control to the control to be plant to 50% to 60% of 10% of 10%

38 Plast Valurally.
31 Reptice all unsalidatory yield salerial except these designated "Specimen" for a partial of the ES year after the Certificate of (impletion. Reptice of impletion and interest of impletion and impletion and improved as a second interest of impletion and interest of impletion and implet

ART THREE SOFT LANDSCAPE DEVELOPMENT - CONT

18.4 For all joint material, this Loudisepe Architect reserves the right to extend the Contractor's responsibility for waither graving season if, in this opinion, that disverting many departments on the season of the contractor's responsibility of waither graving season if, in this opinion, that disverting which is the contractor of the contract map be desicred with the landscape activated and distressors where mentioneess has been estimated undersors behavior and the contractor of the contractor of the page. The reserved manufactors standards a minimum of cereb There-Produces Refer to Section 311, Castaloniest Humbrauce.

3.6 The Lindiags operation is on proceeded for repision and part of page of the reserved of the contract that is designed or siden with the associated and the contract of the contract

the Certificate of Congletion

38.7 Deviation from the specifications may require extension of the Warranty Period as determined by the Landscape Architect.

1. Verify that drawage and protection material is completely installed and acceptable before beginning work. Contact Landscape Architect for instructions if not in place

Z. Coordinate work with construction of planters and planter drawage.
Z.1. Verify that planter drains are in place althysistive drawage to roof drains is present prior to placing any drain rock or sail

Provide clean rul at all through-slab drain locations . Use 300ms ain. dia. PVC Pipe filled with drain rock unless specific drawing detail shown.

Install drain rock evenly to a ninimum depth of 4" 1100mmfor alternate sheet drain it specified. Install sheet drain as per manufacturer's recommendations

5 Cover drain rock for alternale sheet drain it specified on drawing detals) with filter fabric Lapping M-(Monn) at all edges. Obtain approval of drainage system prior to placing growing nedium.

.6 Place an even layer of 25 - 50nm clean washed pump sand over filter fabric

Plate graving nedick to depths specified in Section 35 down for various sorface treatments. Befor to traveling delate for any light verified to Section 35 down from the specified or section of the specified source of the specified source of the specified source.

ESTABLISHMENT MAINTENANCE (Provide a separate price for this section)

I hales. The ideal of "relabilisment" maniferation is improvide sofficed user in early installed pilot destript for a replaintly but he prod of the feet some increase. He trappiers more contributions of the public pilot in the public transition is required that is the device field for the trappier and the respect in a result failure and uncertainty work actionally engage relabilisment. Establishment of numbers procedures apply to all new and relationed regulation moleday collocated for the progress areas and more rease and during a result of the public process and th

B. Related Standards and Logistation: Canadian Landscape Standard, latest edition, Fertilizer Code, B.C. Pesticide Control Act.

6 Haintenance Level: Comply with B. C. Landscape Standard, Section 14, Table 14.2, Haintenance Level 2 "Groomed".

7 Haterials: Conply with Part Two of this specification. 2.1 Fertilizers: To the requirements of the Canadian Landscape Standard Formulations and rates as required by soil testing

11 Ferfaligne: To the experiences of the Caudact Louistice Stocked Formalistics are copied by so testing
12 Vallering Dazing The Feed primary season, water now pleats at least every local Did app between April 10 and My 3 Mil. and every locally QiB days between April 10 and My 3 Mil. and every locally QiB days between April 1 and My 3 Mil. and every locally QiB days between April 1 and My 3 Mil. and every locally QiB days between April 1 and My 3 Mil. and every locally QiB days between April 1 and My 3 Mil. and every locally 1 and more between April 1 and My 3 Mil. and every locally 1 and more between April 1 and My 3 Mil. and every locally 1 and more between April 1 and My 3 Mil. and every locally 1 and more between April 1 and My 3 Mil. and every locally 1 and more between April 1 and My 3 Mil. and every locally 1 and more between April 1 and My 3 Mil. and every locally 1 and more locally 1 and 1 a

9. Grass Case & Linkstromen.
3.1 Mariering User has not deprivately represented the properties of a pulse of the control of the con

Ne west expediate to zero.

3 Fertilizery Excellent pass audyin.

6 Limon Excellent pass audyin.

6 Limon Excellent pass audyin.

6 Limon Excellent pass audyin.

8 Limon Excellent pass audyin.

8 Limon Excellent pass audyin.

8 Limon Excellent passes when the gross reaches a height of Som. You be a height of Com. (Spe with a mechanical wirting officing edger once per year in Murch.

8 Limon Excellent passes when the gross reaches a height of Som. You be a height of Com. (Spe with a mechanical wirting officing edger once per year in Murch.

8 Arxillan Arxillan not requered in the first growing season. If necessary, in the second growing season, availar in early May with a solidable methanical correr. (over to a gibb) of Som. (Exp. otherwise correct correct correct.)

egin on room, is 1, and remove core. 27. Repairs. Re-grade, re-seed or re-sed when necessary to restore damaged or faling grass areas. Halch the grass varieties in the surrounding area. Re-sed, if required, troubled the moving season. Re-seed between April 1st and April 15th or between September 1st and September 15th. Protect re-seeded areas and keep most until the firs

Copyright reserved. This drawing and design is the property of PMG Landscape Architects and may not b reproduced or used for other projects without their



Suite C100 - 4185 Still Creek Drive Burnaby, British Columbia, V5C 6G : 604 294-0011 ; f: 604 294-002

SEAL:

6 21.DEC.01 NEW SITE PLANSCITY COMMENTS 5 21 MAR 15 NEW SITE OLAN 4 21JAN.08 NEW SITE PLAN & CITY COMMENTS 3 20.MAR.06 NEW SITE PLAN 2 20.JAN.21 NEW SITE PLAN/CITY COMMENTS 1 19.MAR.07 NO. DATE REVISION DESCRIPTION

CLIENT

PROJECT:

**10 UNIT TOWNHOUSE** DEVELOPMENT

8231 - 8251 WILLIAM5 ROAD RICHMOND

DRAWING TITLE:

LANDSCAPE **SPECIFICATIONS** 

DRAWING NUMBER DATE: 19.FEB.26 SCALE: DRAWN: DESIGN: CHK'D:

19-028

19028-6.ZIP PMG PROJECT NUMBER:



# **Report to Development Permit Panel**

To:

Development Permit Panel

Date:

February 22, 2022

From:

Wayne Craig

File:

DV 21-930451

Director, Development

Re:

Application by Speera Ventures Incorporated for a Development Variance Permit

at 10620 Williams Road

### Staff Recommendation

That a Development Variance Permit be issued which would vary the provisions of Richmond Zoning Bylaw 8500 on proposed Lot 2 to:

- 1. Reduce the rear yard setback requirement from 6.0 m to 3.1 m to facilitate on-site tree retention.
- 2. Permit the required private outdoor space to be located in the front yard instead of the rear yard.

Wayne Craig

Director, Development

(604-247-4625)

WC:blg

Att. 2

### Staff Report

## Origin

Speera Ventures Incorporated has applied to the City of Richmond, on behalf of the owner, AJM Ventures Ltd. (Jeffery Wu), for permission to reduce the minimum rear yard requirement under the "Compact Single Detached (RC2)" zone from 6.0 m to 3.1 m and permit the required private outdoor space to be located in the front yard to facilitate the retention of an existing significant tree in the front yard of the future Lot 2 of the proposed development at 10620 Williams Road (Attachment 1).

The subject property is being rezoned from the "Single Detached (RS1/E)" zone to the "Compact Single Detached (RC2)" as part of rezoning application RZ 20-891369 which has received third reading. The rezoning application would facilitate the subdivision of the existing lot into two new lots and the Development Variance Permit applies only to proposed Lot 2 of the development.

### **Development Information**

Please refer to attached Development Application Data Sheet (Attachment 2) for a comparison of the proposed development data with the relevant Bylaw requirements.

## **Background**

Development surrounding the subject site is as follows:

To the North: Across Williams Road, single-family dwellings on lots zoned "Single Detached (RS1/E)", "Compact Single Detached (RC1)" and "Compact Single Detached

(RC2)", fronting Williams Road.

To the South: Across the lane, single-family dwellings on lots zoned "Single Detached with

Granny Flat or Coach House – Edgemere (RE1)", fronting Aintree Place.

To the East: Single-family dwellings on a lots zoned "Compact Single Detached (RC1)",

fronting Williams Road.

To the West: Single-family dwellings on a lots zoned "Compact Single Detached (RC1)",

fronting Williams Road.

### Rezoning and Public Hearing Results

During the rezoning process, staff had identified two variances to Zoning Bylaw 8500 that are required to facilitate the retention of a significant tree in the front yard of proposed Lot 2:

- To reduce the minimum rear yard setback from 6.0 m to 3.1 m.
- To permit the required private outdoor space to be located in the front yard instead of the rear yard.

The Public Hearing for the rezoning of this site was held on April 19, 2021. At the Public Hearing, no concerns about rezoning the property were expressed.

### Staff Comments

The proposed development is generally in compliance with the "Compact Single Detached (RC2)" zone in Richmond Zoning Bylaw 8500, except for the two variances that are the subject of this application. These variances are proposed in order to retain an existing healthy significant tree (Tree tag #001 97 cm caliper Cedar) in the front yard of 10620 Williams Road (Plan #2), which results in shifting the footprint of the future single-family home on the proposed Lot 2 southward to accommodate the required 4.8 m tree protection zone. As part of the rezoning application, staff secured the developer's commitment to retain the significant tree and a \$10,000.00 security and a legal agreement has been provided and registered on title.

The proposed scheme attached to this report has satisfactorily addressed the staff comments identified as part of the review of the subject Development Variance Permit application. In addition, it complies with the intent of the applicable sections of the Official Community Plan (OCP) and is generally in compliance with the "Compact Single Detached (RC2)" zone except for the zoning variances noted below.

# Zoning Compliance/Variances (staff comments in bold italics)

The applicant requests to vary the provisions of Richmond Zoning Bylaw 8500 as follows:

- 1) That the minimum rear yard setback requirement of the "Compact Single Detached (RC2)" zone be reduced from 6.0 m to 3.1 m on the future Lot 2, as shown on the attached permit plans. Staff support the requested variance because the reduction of the rear yard setback allows for retention of the existing significant 97 cm caliper Cedar tree (tag #001) in the front yard. In addition, the proposed setback would facilitate a home design that includes an attached rear lane accessed garage, consistent with neighbouring developments. Furthermore, the rear yard abuts a 6.0 m wide lane which limits added impact to the neighbour across the lane.
- 2) Permit the required private outdoor space for Lot 2 to be located in the front yard instead of the rear yard. Staff support the requested variance as the required tree protection area in the front yard, the shifting of the building footprint towards the rear of the property while continuing to provide an attached lane accessed garage and secondary suite parking, eliminates the opportunity for the required private outdoor space to be located in the rear yard. Careful consideration of the existing grade within the Tree Protection Zone (TPZ) surrounding tree tag #001 is required. Existing site grade is lower than the sidewalk therefore, in order to save tree tag #001, the grade within the TPZ cannot be manipulated. The private outdoor space in the front yard would consist of a raised wooden deck that provides for retention of the existing grade surrounding the significant tree and provides for improved use of the front yard, accessibility and functionality. As a consideration of the associated rezoning, a Certified Arborist is required to oversee the construction of the deck footings to ensure the trees roots are not impacted and ground drainage is addressed.

## **Analysis**

## Conditions of Adjacency

- The proposed building footprint of Lot 2 would project approximately 2.8 m into the required rear yard setback of 6.0 m, providing a 3.1 m separation from the property line to the south and the lane. Living space on the second storey above the garage is stepped back to alleviate any shadowing concerns for the neighbours.
- A 1.2 m side yard setback is provided to the east and west; consistent with the minimum requirement in the zone.
- To the north, the interfaces are single-family front yards along Williams Road. The Lot 2 front yard is proposed to have additional landscaping treatment in order to accommodate requirements for private outdoor space. The 10.2 m front yard setback on Lot 2 will be utilized to enhance the space around the retained tree.

## Landscaping

- Tree retention and protection was assessed at the time of rezoning.
- One on-site tree (tag #001) and three street trees (tag #CT001, CT002, CT003) were assessed and all are to be retained.
- Through the rezoning the applicant is required to provide a Tree Survival Security of \$40,000.00 to ensure all four trees are retained and protected.
- The developer has also provided a landscape plan (Plan #5-6) and Landscape Security of \$27,068.85 to ensure the landscaping treatment is incorporated.
- Included in the landscape plan for Lot 2, is the planting of one new tree in the rear, a variety of shrubs, permeable pavers, and low-lying vegetation and grass. Specifically for Lot 2, the proposal prioritizes a raised decking system that would be level with the sidewalk in the front yard to create less impact on the roots of the retained Cedar tree and to enhance low valued green space beneath the tree. Enhancements around the decking area would primarily be a variety of shrubs to help with privacy of the front yard space and to create a more functional outdoor green space for the user.
- A new 1.2 m (4 ft.) high fence along a portion of the front yard and a new 1.8 m (6 ft.) high fence along the rear yard are proposed to provide further screening between neighbours.

### Conclusions

As the proposed development would meet applicable policies and Development Permit Guidelines, staff recommend that the Development Variance Permit be endorsed, and issuance by Council be recommended.

Nathan Andrews Planning Technician (604-247-4911)

NA:blg

## Attachments:

Attachment 1: Location Map


Attachment 2: Development Application Data Sheet

The following are to be met prior to forwarding this application to Council for approval: Prior to future Building Permit issuance, the developer is required to complete the following:

- The applicant is required to obtain a Building Permit for any construction hoarding associated with the proposed development. If construction hoarding is required to temporarily occupy a street, or any part thereof, or occupy the air space above a street or any part thereof, additional City approvals and associated fees may be required as part of the Building Permit. For further information on the Building Permit, please contact Building Approvals Department at 604-276-4285.
- Submission of a construction traffic and parking management plan to the satisfaction of the City's Transportation Department (<a href="http://www.richmond.ca/services/ttp/special.htm">http://www.richmond.ca/services/ttp/special.htm</a>).



# **ATTACHMENT 1**

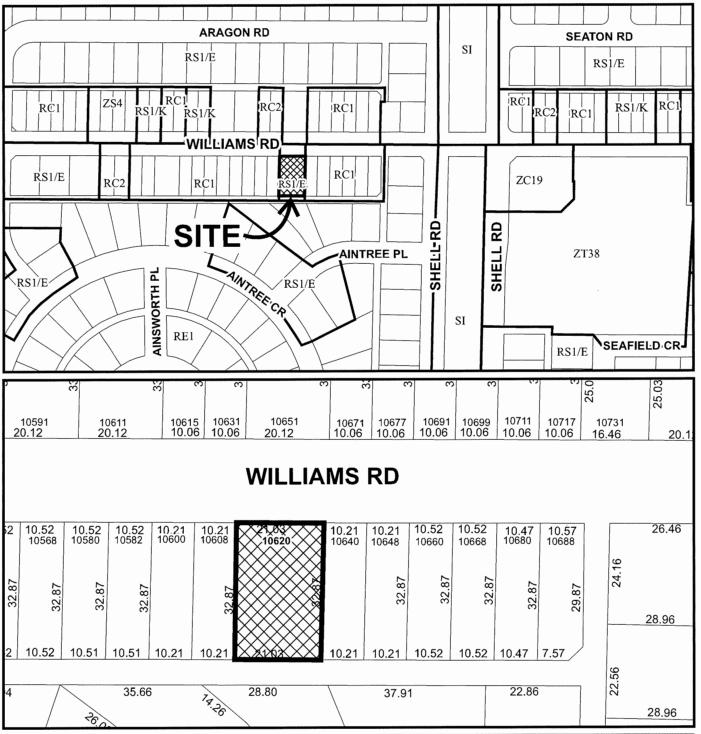



DV 21-930451

Original Date: 04/14/21

Revision Date:

Note: Dimensions are in METRES



# **Development Application Data Sheet**

**Development Applications Division** 

DV 21-930451 Attachment 2

Address: 10620 Williams Road

Applicant: Speera Ventures Incorporated Owner: AJM Ventures Ltd.

Planning Area(s): Shellmont

	Existing	Proposed
Site Area:	692 m <sup>2</sup>	Lot 2: 346 m²
Land Uses:	One single detached dwelling	Two single detached dwellings
OCP Designation:	Neighbourhood Residential	No change
Zoning:	Single Detached (RS1/E)	Compact Single Detached (RC2)

On Future Subdivided Lots	Bylaw Requirement	Proposed	Variance
Floor Area Ratio:	Max. 0.6	Max. 0.6	none permitted
Buildable Floor Area (m²):*	Lot 2: Max. 207.60 m² (2235 ft²)	Lot 2: Max. 207.54 m <sup>2</sup> (2234 ft <sup>2</sup> )	none permitted
Lot Coverage (% of lot area):	Building: Max. 50% Non-porous Surfaces: Max. 70% Lot Landscaping with live plant material: Min. 20%	Building: Max. 50% Non-porous Surfaces: Max. 70% Lot Landscaping with live plant material: Min. 20%	none
Lot Size:	Min. 270 m²	346 m²	none
Lot Dimensions (m):	Width: 9.0 m Depth: 24.0 m	Width: 10.52 m Depth: 32.88 m	none
Setback – Front Yard Lot 2:	Min. 6.0 m	10.2 m	none
Setback – Side Yard:	Min. 1.2 m	1.2 m	none
Setback – Rear Yard Lot 2:	Min. 6.0 m	3.1 m	Variance requested for Lot 2 rear yard only
Height (m):	Max. 2 ½ Storeys (9.0 m)	9.0 m	none
On-site Vehicle Parking with Secondary Suite:	Min. 3 per lot	Lot 2: Min. 3	none
Private Outdoor Space (m²):	Min. 20 m² (min.3.0 width and depth) provided on the lot outside front yard	Min. 20 m <sup>2</sup> in the front yard	Variance on Lot 2 only



# **Development Variance Permit**

No. DV 21-930451

To the Holder:

SPEERA VENTURES INCORPORATED

Property Address:


10620 WILLIAMS ROAD


Address:


C/O JEFFREY WU AJM VENTURES LTD. 9791 HERBERT ROAD RICHMOND, BC V7A 1T6

- 1. This Development Variance Permit is issued subject to compliance with all of the Bylaws of the City applicable thereto, except as specifically varied by this Permit.
- 2. This Development Variance Permit applies to and only to those lands shown cross-hatched on the attached Schedule "A" and any and all buildings, structures and other development thereon.
- 3. The "Richmond Zoning Bylaw 8500" is hereby varied as follows:
  - a) The minimum required rear yard setback for Lot 2 only is reduced from 6.0 m to 3.1 m, as shown on Plans #1-7 attached hereto.
  - b) The required private outdoor space for Lot 2 only to be permitted in the front yard instead of the rear yard, as shown on Plans #1-7 attached hereto.
- 4. The land described herein shall be developed generally in accordance with the terms and conditions and provisions of this Permit and any plans and specifications attached to this Permit which shall form a part hereof.
- 5. If the Holder does not commence the construction permitted by this Permit within 24 months of the date of this Permit, this Permit shall lapse.


This Permit is not a Building Permit.				
AUTHORIZING RESOLUDAY OF ,	JTION NO.		ISSUED BY THE COUNCIL THE	
DELIVERED THIS	DAY OF	,		
MAYOR				

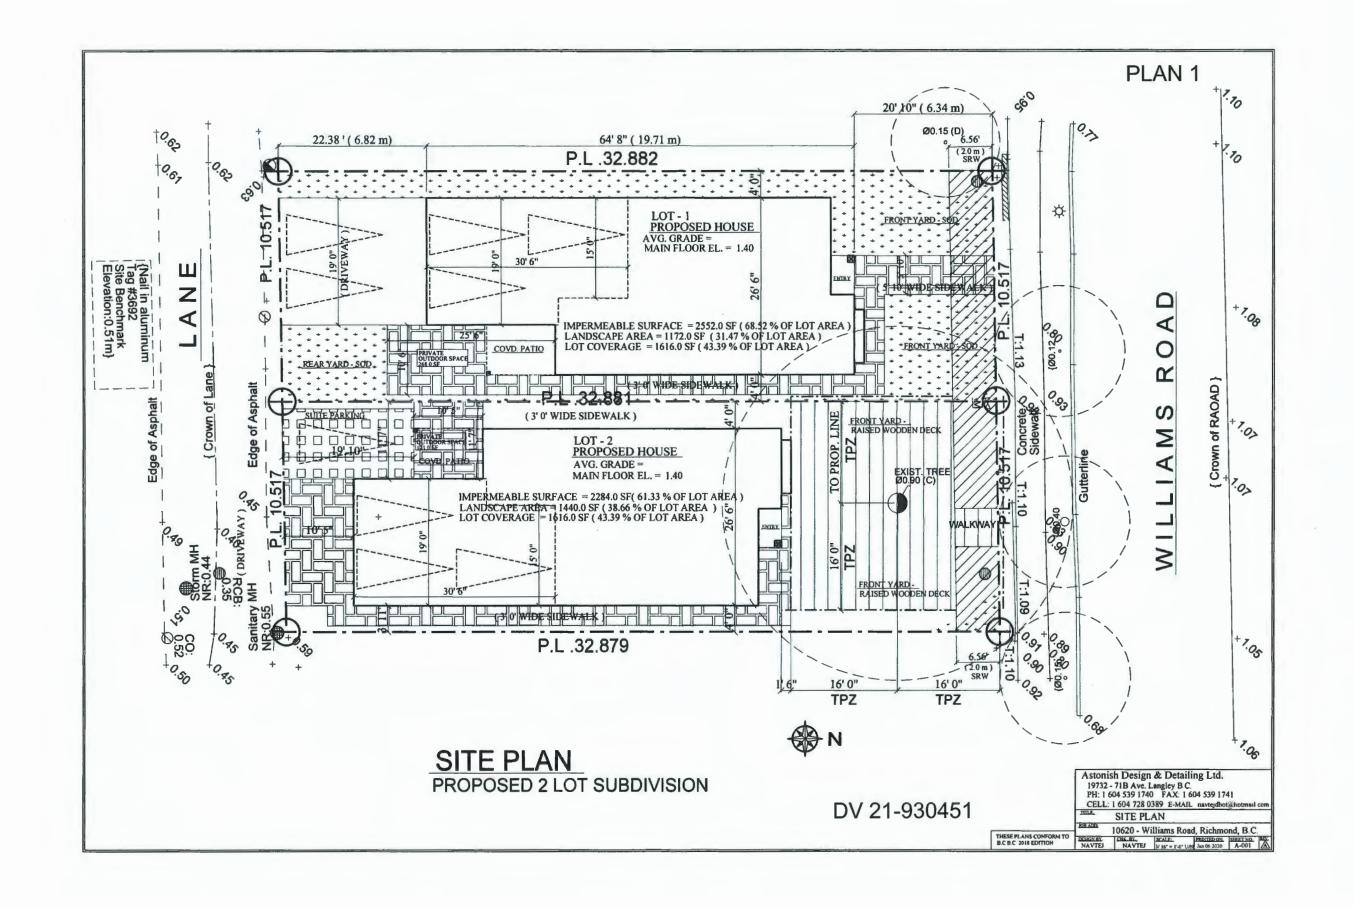

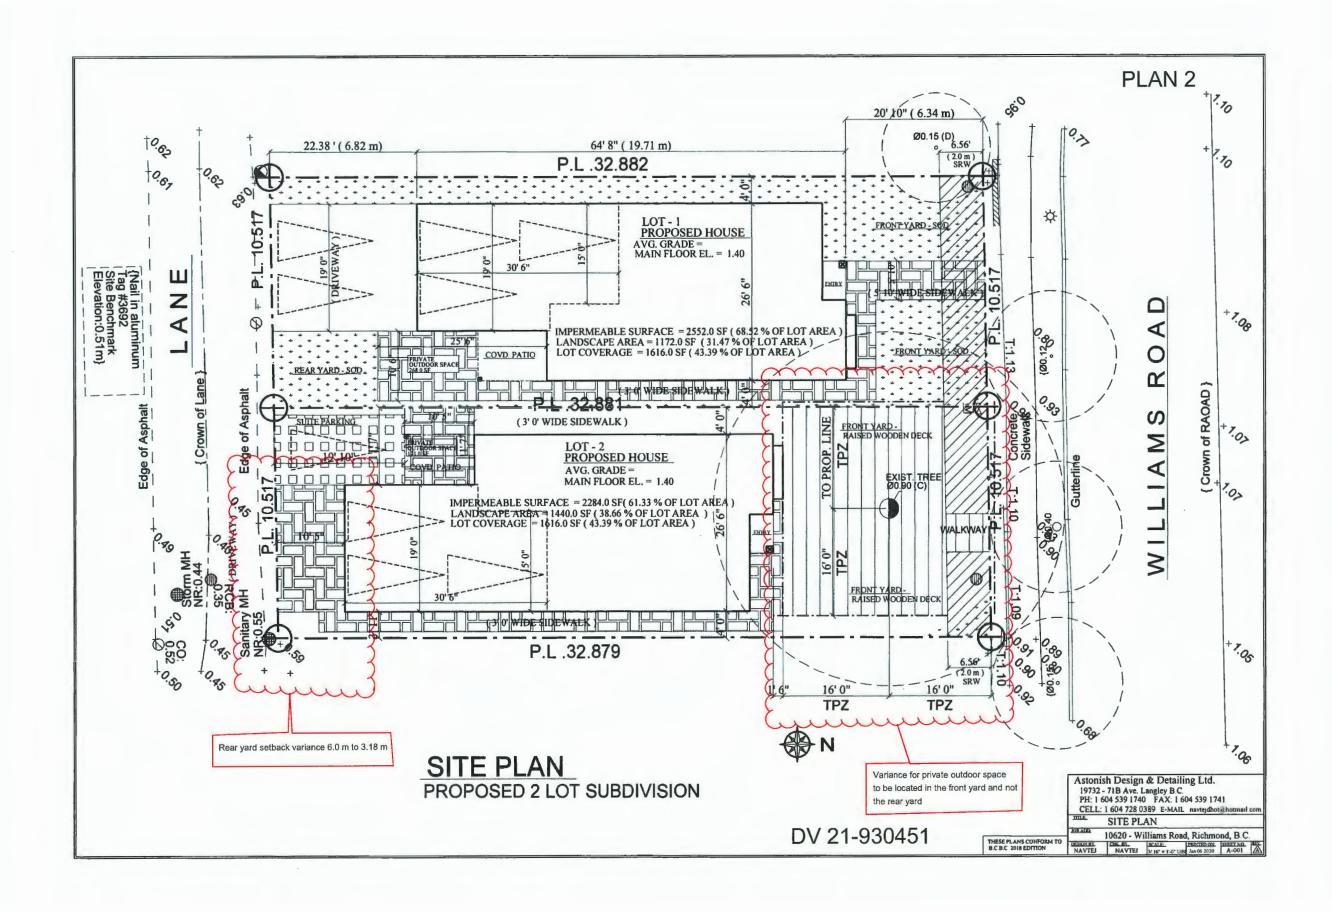


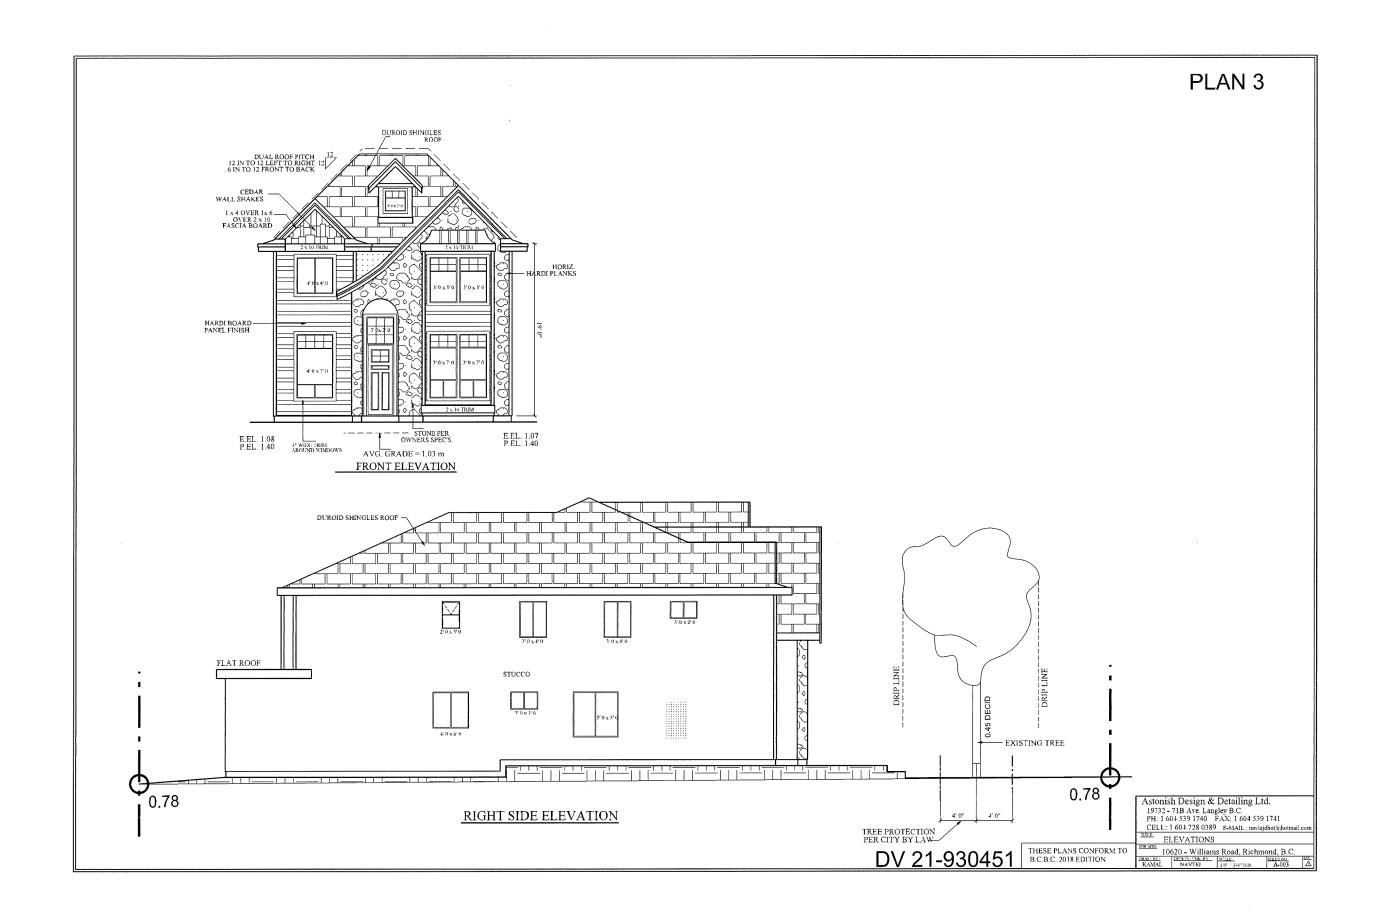

# PLAN 4

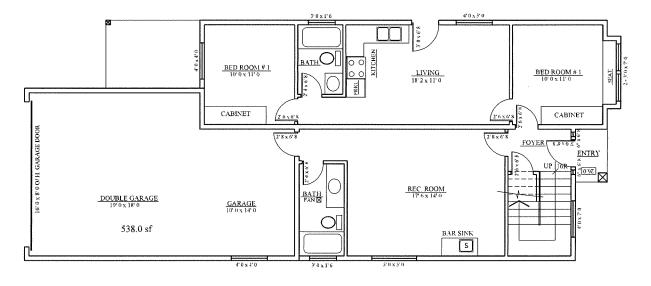

MAIN FLOOR PLAN - AREA = 1517.0 SF INCL, GARAGE

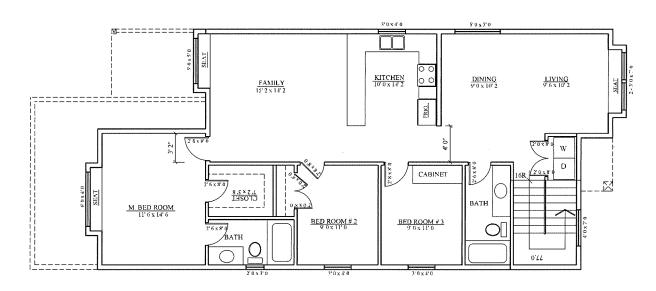

SECOND FLOOR PLAN - AREA = 1255.0 SF

Astonish Design & Detailing Ltd.
19732 - 71B Ave Langley B.C.
PH: 1 604 539 1740 FAX: 1 604 539 1741
CELL: 1 604 728 0389 E-MAIL: navlejdhot@hotn

# PLAN 5

Copyright reserved. This drawing and design is the reperty of PMG Landscape Architects and may not be eproduced or used for other projects without their



ARCHITECTS

Suite C100 - 4185 Still Creek Drive
Burnaby, British Columbia, V5C 669
p: 604 294-0011 ; f: 604 294-0022

	***************************************	
1 21 f(8 89	MUSE COMMESTES	
NO, DATE	REVISION DESCRIPTION	
OLUTAIT.		


**2 LOT SUBDIVISION** 

10620 WILLIAMS ROAD RICHMOND, B.C.

DRAWING TITLE:

LANDSCAPE PLAN

DATE:	21.JAN.05	DRAWING NUMBER:
SCALE:	1/8*=1'-0*	1.4
DRAWN:	мм	11
DESIGN:	мм	
CHK'D:	MCY	OF 2

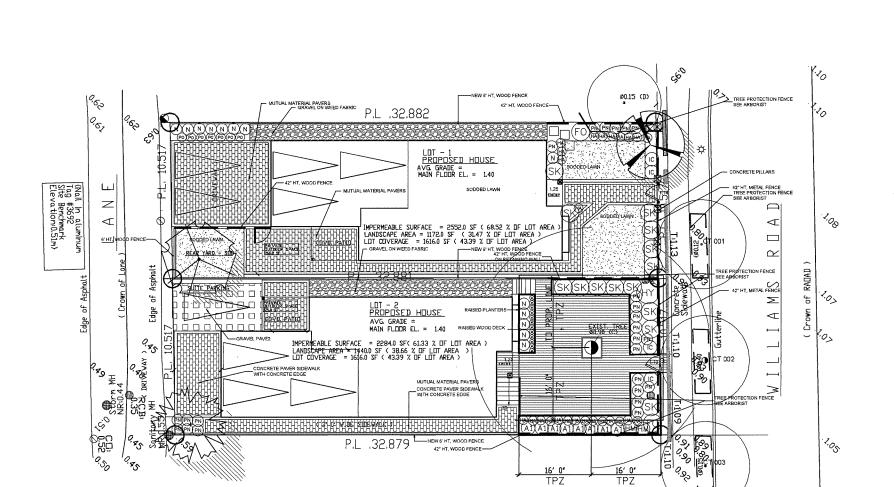

PMG PROJECT NUMBER: 20-159

PLANTED SIZE / REMARKS

6CM CAL; 1,8M STD; B&B 6CM CAL; 1,5M STD; B&B 5CM CAL; B&B

#2 POT; 25CM #2 POT; 40CM #2 POT; 30CM #3 POT; 50CM #3 POT; 50CM #2 POT; 40CM #3 POT; 50CM

#1 POT #1 POT #1 POT

#1 POT; 25CM

PAPERBARK MAPLE FOREST PANSY REDBUD PINK FLOWERING DOGWOOD

AZALEA, SINGLE DEEP CRIMSON MOUNT AIRY FOTHERGILLA DOUBLE DELIGHTS WEDDING GOWN OAKLEAF HYDRANGEA JAPANESE HOLLY FIREPOWER HEAVENLY BAMBOO JAPANESE SKIMMIA

BLACK MONDO GRASS ORIENTAL FOUNTAIN GRASS

(PS)

NOTES: "PLANT SIZES IN THIS LIST ARE SPECIFIED ACCORDING TO THE BCLANDSCAPE STANDARD AND CANADIAN LANDSCAPE STANDARD, LATEST EDITION, CONTAINER SIZES
SPECIFIED AS FER CYLL STANDARD, BOTH PLANT SIZE AND CONTAINER SIZES ARE THE MINIMUM ACCEPTABLE SIZES. "REFER TO SPECIFICATIONS FOR DEBINED CONTAINER
SIZES SPECIFIED AS FER CYLL STANDARD, BOTH PLANT SIZE AND CONTAINER SIZES ARE THE MINIMUM ACCEPTABLE SIZES. "REFER TO SPECIFICATIONS FOR DEBINED CONTAINER
SOURCE OF SUPPLY, AREA OF SEARCH TO INCLUDE LONGER WAINLAND, AND FRASER VALLEY." SUBSTITUTIONS OFTAN WEITTEN APPROVAL FROM THE ANDSCAPE ARCHITECT AT
SOURCE OF SUPPLY, AREA OF SEARCH TO INCLUDE LONGER WAINLAND, AND FRASER VALLEY. SUBSTITUTIONS OFTAN WEITTEN APPROVAL FROM THE ANDSCAPE ARCHITECT AND ADDRESS OFTAN WEITTEN APPROVAL FROM THE ANDSCAPE ARCHITECT AND ADDRESS OFTAN ARCHITE

WESTERN SWORD FERN

GOLD VARIEGATED JAPANESE FOREST GRASS

PLANT SCHEDULE

ACER GRISEUM CERCIS CANADENSIS 'FOREST PANS' CORNUS FLORIDA 'RUBRA'

AZALEA JAPONICA 'HINO CRIMSON FOTHERGILLA MAJOR 'NOUNT AIR'' HYDRANGEA MAC, 'DANGING SNOW HYDRANGEA OURCRIFOLIA 'RUBY SLIPPERS' ILEX CRENATA 'CONVEX' NANDINA DOMESTICA 'RIFEPOWER' SKIMMIA JAPONICA (10% MALE)

OPHIOPOGON PLANISCAPUS "NIGRESCENS" PENNISETUM ORIENTALE

HAKONECHLOA MACRA 'AUREOLA

POLYSTICHUM MUNITUM


DV 21-930451


10-


20159-2.ZIP PMG PROJECT NUMBER:

20-159

# PLAN 6

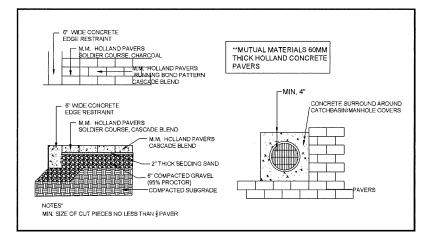

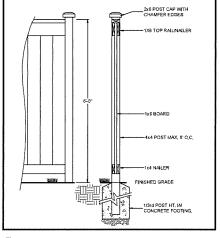

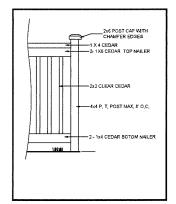









3 4' HT, WOOD FENCE

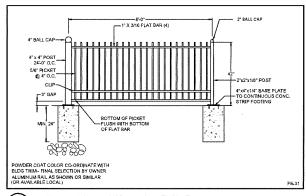

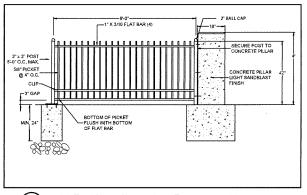

42" HT. ALUMINIUM PICKET FENCE

5 42" HT. ALUMINIUM PICKET FENCE W/ PILLARS

©Copyright reserved. This drawing and design is the property of PMG Landscape Architects and may not be reproduced or used for other projects without their permission.



SFAL:

NO, DATE REVISION DESCRIPTION C

PROJECT:

2 LOT SUBDIVISION

10620 WILLIAMS ROAD RICHMOND, B.C.

DRAWING TITLE:

LANDSCAPE
DETAILS

DATE: 21JAN.65 DRAWNIG NUMBER
SCALE: AS NOTED
DRAWA: MM
DESIGN: MM
CHKTD: MCY OF 2

DV 21-930451

20159-1.ZIP PMG PROJECT NUMBER:

20-159

