



# Development Permit Panel Electronic Meeting

Council Chambers, City Hall 6911 No. 3 Road Wednesday, March 13, 2024 3:30 p.m.

# **MINUTES**

Motion to adopt the minutes of the Development Permit Panel meeting held on January 17, 2024.

#### 1. DEVELOPMENT PERMIT 21-941827 (REDMS No. 7582619)

APPLICANT: Vivid Green Architecture Inc.

PROPERTY LOCATION: 6740 and 6780 Francis Road

#### **Director's Recommendations**

That a Development Permit be issued which would permit the construction of a total of four front-to-back duplexes at 6740 and 6780 Francis Road (one duplex on each new lot created after subdivision), on lots zoned "Two-Unit Dwellings (ZD7) – Francis Road (Blundell)"

#### 2. DEVELOPMENT VARIANCE PERMIT 22-011004 (REDMS No. 7536504)

APPLICANT: Danny Wong

PROPERTY LOCATION: 8451 No. 5 Road

ITEM

### Director's Recommendations

That a Development Variance Permit be issued that would vary the provisions of Richmond Zoning Bylaw 8500 to reduce the minimum size of a farm operation associated with a roadside stand in the "Roadside Stand (CR)" zone from 8.0 ha to 1.77 ha, to permit the construction of a roadside stand at 8451 No. 5 Road.

# 3. DEVELOPMENT PERMIT 23-014121

(REDMS No. 7521612)

APPLICANT: 1166225 BC Ltd.

PROPERTY LOCATION: 8880 Cook Road and 8751 Citation Drive

### **Director's Recommendations**

That a Development Permit be issued which would:

- 1. permit the construction of two six-storey buildings containing 339 rental units at 8880 Cook Road and 8751 Citation Drive on a site zoned "Low Rise Rental Apartment (ZLR44) – Brighouse Village (City Centre)"; and
- 2. vary the provisions of Richmond Zoning Bylaw 8500 to reduce the road setback to projecting balconies above the second floor from 3.0 m to 1.2 m.

# 4. New Business

5. Date of Next Meeting: March 27, 2024

# ADJOURNMENT



**Minutes** 

# Development Permit Panel Wednesday, January 17, 2024

Time: 3:30 p.m.

Place: Remote (Zoom) Meeting

Present: Cecilia Achiam, General Manager, Community Safety, Chair John Irving, General Manager, Engineering and Public Works Peter Russell, Director, Sustainability and District Energy

The meeting was called to order at 3:30 p.m.

### MINUTES

It was moved and seconded That the minutes of the meeting of the Development Permit Panel held on December 13, 2023 be adopted.

#### CARRIED

#### 1. DEVELOPMENT PERMIT 20-919145 (REDMS No. 7317348)

APPLICANT: Jonathan King

PROPERTY LOCATION: 4571, 4591 and 4611/4631 Steveston Highway

#### INTENT OF PERMIT:

- 1. Permit the construction of 16 townhouse units at 4571, 4591 and 4611/4631 Steveston Highway on a site zoned "Low Density Townhouses (RTL4)".
- 2. Vary the provisions of Richmond Zoning Bylaw 8500 to reduce the front yard setback along Steveston Highway from 6.0 m to 4.50 m.

### Applicant's Comments

Jiang Zhu, Imperial Architecture Ltd., with the aid of a visual presentation (attached to and forming part of these minutes as <u>Schedule 1</u>), provided background information on the proposed development, highlighting the following:

- the proposed form, massing, and architectural design of the townhouse buildings are compatible with adjacent residential developments;
- a north-south entry driveway off Steveston Highway is proposed along the west
   property line and the proposed east-west internal drive aisle will provide shared access to future developments to the east and west;
- the development's proposed common outdoor amenity space will be available for shared use with the future development to the west;
- two electric vehicle (EV) charging will be provided for each garage;
- the unit entries and the proposed common outdoor amenity area are fully accessible; and
- the development includes two convertible units.

Zhipin Li, Homing Landscape Architecture, Corp., with the aid of the same visual presentation, briefed the Panel on the main landscape features of the project, noting that (i) existing landscape conditions such as existing trees and hedges will be retained as much as possible and additional trees are proposed to be planted to provide privacy, (ii) changes to existing site grade will be minimized for landscaping, (iii) a significant amount of native plant species is proposed for landscaping, (iv) the proposed common outdoor amenity space exceeds the required size and provides for a variety of uses, and (v) the proposed on-site turnaround area will be landscaped and used as an additional outdoor amenity space when the adjacent property to the west will redevelop in the future.

#### Staff Comments

Wayne Craig, Director, Development, noted that (i) the shared use of the proposed common outdoor amenity between the proposed development and the future development to the west is just a design intent and there is no formal sharing arrangement between the two developments, (ii) the project has been designed to achieve Level 3 of the BC Energy Step Code with on-site Low-Carbon Energy Systems, (iii) there is a Servicing Agreement associated with the project for frontage works and site services, (iv) the Servicing Agreement includes a provision for turning restriction within the driveway to ensure right-in/right-out turning movements, (v) the proposed front yard setback was identified at the time of rezoning, (vi) an acoustical report was provided by the applicant confirming that the units will meet Canada Mortgage and Home Corporation (CMHC) internal noise standards, and (vii) there will be future cross access over the east-west internal drive aisle with adjacent properties to the west and east of the subject site secured by a Statutory Right-of-Way.

#### Panel Discussion

In reply to a query from the Panel regarding the design of the two buildings fronting Steveston Highway, the applicant noted that (i) the two buildings are not identical as they have different roof forms to provide some variation in building design, and (ii) permeable pavers will be installed on the entry driveway, visitor parking stalls, internal pedestrian walkways and entries to common areas.

In reply to queries from the Panel, Mr. Craig noted that (i) there are other developments along Steveston Highway that have right-in/right-out turning restrictions for vehicle access, and (ii) all required replacement trees will be accommodated on the subject site.

#### Correspondence

None.

#### **Gallery Comments**

None.

#### **Panel Discussion**

The Panel expressed support for the project, noting that (i) the design of the proposed development has taken into consideration the existing adjacent developments as well as the future redevelopment of neighbouring properties, and (ii) the provision of low-carbon energy systems for the project is appreciated.

#### Panel Decision

It was moved and seconded *That a Development Permit be issued which would:* 

- 1. permit the construction of 16 townhouse units at 4571, 4591 and 4611/4631 Steveston Highway on a site zoned "Low Density Townhouses (RTL4)"; and
- 2. vary the provisions of Richmond Zoning Bylaw 8500 to reduce the front yard setback along Steveston Highway from 6.0 m to 4.50 m.

#### CARRIED

#### 2. DEVELOPMENT PERMIT 21-943418 (REDMS No. 7451673)

APPLICANT: Karla Castellanos Architect

PROPERTY LOCATION: 13888 Wireless Way

#### INTENT OF PERMIT:

- Permit the construction of a three-storey light industrial and ancillary office building on a new lot created through subdivision of the west portion (proposed Lot 1) of the subject site at 13888 Wireless Way, on a site zoned "Industrial Business Park (ZI3) – Crestwood Area (East Cambie)".
- 2. Vary the provisions of Richmond Zoning Bylaw 8500 to:
  - (a) reduce the required number of parking spaces from 2.8 spaces to 0.75 spaces for each 100 m<sup>2</sup> of gross leasable floor area of building on Lot 1;
  - (b) reduce the minimum required number of large-sized on-site designated loading spaces on Lot 1 from 1 space to 0 spaces; and
  - (c) reduce the minimum percentage of standard parking spaces on Lot 2 from 50 per cent to 30 per cent.

#### **Applicant's Comments**

Karla Castellanos, KCC Architecture, with the aid of a visual presentation (attached to and forming part of these minutes as <u>Schedule 2</u>), provided background information on the proposed development, highlighting the following:

- the proposal is a redevelopment of an existing site through subdivision of the lot to create a new lot;
- pedestrian access to the two buildings will be from the existing sidewalk along Wireless Way;
- a three-storey building for light industrial and ancillary office use is proposed on the new Lot 1 which has been designed to allow flexibility of use by future tenants;
- the proposed building mimics the form and character of the existing building;
- each unit will have a separate entry and a common lobby and corridor will also be provided for access to the individual units;
- high performance building materials are proposed to provide more efficient energy performance for the building;
- the Riparian Management Area (RMA) along the south edge of the site will be fully restored on new Lot 1 and partially restored on Lot 2;
- parking for Lot 1 is provided in front of the units;
- screening will be provided for the proposed rooftop mechanical equipment;
- architectural treatment, i.e. different wall textures with interesting patterns and colours, is proposed for the flat west façade of the new building to provide visual interest; and
- there are three proposed variances related to parking and loading.

Clark Kavolinas, C. Kavolinas and Associates Inc., with the aid of the same visual presentation, briefed the Panel on the main landscape features of the project, noting that (i) landscaped and treed islands are proposed to break up the surface parking area in front of the proposed building on Lot 1, (ii) native plant species are proposed to be installed within the RMA setback along the south property line, (iii) a row of trees will be planted along the east side of Lot 2 and three additional trees will be incorporated into the existing surface parking area on Lot 2, and (iv) bicycle racks will be installed near the pedestrian access to the new building off Wireless Way.

#### Staff Comments

Mr. Craig noted that (i) there is a Servicing Agreement associated with the project for frontage works, (ii) there will be invasive plant removal within the RMA along the southern edge of the site and a three-year monitoring period over the planting within the RMA, (iii) an Agricultural Land Reserve (ALR) buffer covenant will be registered as a condition of the subject application, and (iv) the provision of rooftop solar panels is included in the project for on-site electricity generation approximately 40% of the roof area.

In reply to a query from the Panel, Mr. Craig noted that (i) the three proposed parking variances associated with the project were reviewed and accepted by the City's Transportation Department, (ii) the project's proposed Transportation Demand Management (TDM) package includes the provision of a three-year transit pass program for tenants or owners of the new building and a shuttle service to bring employees between the site and the Bridgeport Canada Line station, and (iii) the proposed TDM measures are secured by a legal agreement and will run for a minimum of three years.

In reply to a further query from the Panel, Mr. Craig noted that there will be improvements on the RMA along the southern edge of Lot 2 which include the removal of invasive species and additional planting within the planting area which require the removal of some parking stalls in Lot 2.

#### **Panel Discussion**

In reply to queries from the Panel, the applicant noted that (i) there will be 11 stratified units, (ii) each unit consists of three-storeys and have its own rooftop solar panels, and (iii) one roughed-in electric vehicle (EV) charging infrastructure will be allocated for each unit to accommodate future installation of an EV charging station.

The Panel then advised that the applicant clarify during the Building Permit stage the location and percentage of parking stalls that will be provided with roughed-in EV charging infrastructure.

#### Correspondence

None.

#### **Gallery Comments**

None.

#### Panel Discussion

The Panel expressed support for the project, noting that the applicant has put a lot of thought into the design of the project.

#### Panel Decision

It was moved and seconded That a Development Permit be issued which would:

- 1. permit the construction of a three-storey light industrial and ancillary office building on a new lot created through subdivision of the west portion (proposed Lot 1) of the subject site at 13888 Wireless Way, on a site zoned "Industrial Business Park (ZI3) – Crestwood Area (East Cambie)"; and
- 2. vary the provisions of Richmond Zoning Bylaw 8500 to:
  - (a) reduce the required number of parking spaces from 2.8 spaces to 0.75 spaces for each 100  $m^2$  of gross leasable floor area of building on Lot 1;
  - (b) reduce the minimum required number of large-sized on-site designated loading spaces on Lot 1 from 1 space to 0 spaces; and
  - (c) reduce the minimum percentage of standard parking spaces on Lot 2 from 50 per cent to 30 per cent.

#### CARRIED

#### 3. DEVELOPMENT PERMIT 22-021165 (REDMS No. 7501936)

APPLICANT: 0853803 BC Ltd. and 1121648 BC Ltd.

PROPERTY LOCATION: 6571 and 6591 No. 1 Road

#### INTENT OF PERMIT:

- 1. Permit the construction of eight townhouse units at 6571 and 6591 No. 1 Road on a site zoned "Low Density Townhouses (RTL4)".
- 2. Vary the provisions of Richmond Zoning Bylaw 8500 to reduce the minimum required lot width on major arterial roads from 50.0 m to 40.2 m.

#### Applicant's Comments

Eric Law, Eric Law Architect, with the aid of a visual presentation (attached to and forming part of these minutes as <u>Schedule 3</u>), provided background information on the proposed development, highlighting the following:

• the project has been designed in consideration of its site context;

a new driveway is proposed along the north side adjacent to the existing singlefamily home to the north (6551 No. 1 Road) and secured by a Statutory-Right-of-

Way (SRW) to provide more separation and shared access to the neighbouring property when it redevelops in the future;

the site grade along the west property line will be raised to provide an appropriate

- interface with the adjacent townhouse development to the west and enhance the usability of the backyards of the rear units of the proposed development;
- the proposal includes one convertible unit;
- the project has been designed to achieve Level 3 of the BC Energy Step Code with Low Carbon Emission Systems; and
- the proposed landscaping for the three-storey front units along No. 1 Road includes installation of berms to reduce their apparent height to read like two-storey units.

Yiwen Ruan, PMG Landscape Architects, with the aid of the same visual presentation, briefed the Panel on the main landscape features of the project, noting that (i) permeable pavers are proposed to identify key points on the driveway and internal drive aisle, (ii) the common outdoor amenity area includes a children's play equipment and bench seating, (iii) nine trees are proposed to be planted on-site, and (iv) on-site irrigation will be provided for soft landscaping.

In addition, Mr. Law noted that one on-site and one off-site tree will be removed and four replacement trees will be installed.

#### Panel Discussion

In reply to a query from the Panel, Mr. Law noted that mechanical equipment for the townhouse units will be installed on the second floor of the units.

#### Staff Comments

Mr. Craig noted that (i) there is a Servicing Agreement associated with the project for frontage works and site services, and (ii) the proposed lot width variance is a technical variance and was identified at rezoning.

#### Correspondence

Shiraz and Almas Mohamed, 6551 No. 1 Road (Schedule 4)

Mr. Craig noted that the letter of Mr. Shiraz Mohamed and his wife, owners of the adjacent single-family home to the north (6551 No. 1 Road), pertains to land use which is outside of the purview of the Panel.

#### **Gallery Comments**

None.

#### Panel Discussion

The Panel expressed concern regarding the site grade, in particular the elevations of the driveway, internal drive aisle and ground floor/garage of the townhouse units which meet the bylaw requirements but are below the street level and potentially at risk of flooding.

Mr. Craig noted one option would be to refer the application back to staff to increase the site grade and provide time for the applicant to consider how that would be accomplished and address any architectural changes before returning. The other option for the Panel would be to endorse the Permit with direction that site grading be amended prior to the application being presented to City Council for consideration; however, the application would not then return to the Panel and would limit any changes the applicant could make to the application.

In reply to a query from the Panel, Mr. Law noted that the heating system includes an electrical hot water tank, located on second level. It was noted the equipment could be potentially located at grade once overall site grade is raised.

Discussion ensued regarding the need for the applicant to address this concern, and as a result of the discussion, the following **referral motion** was introduced:

It was moved and seconded

That DP 22-021165 be referred back to staff in order for the applicant to work with staff to increase the site grade and introduce necessary changes to the project design in order to mitigate the risk of flooding in the proposed development.

CARRIED

#### 4. New Business

It was moved and seconded

That the Development Permit Panel meeting tentatively scheduled on Wednesday, January 31, 2024 be cancelled.

CARRIED

# 5. Date of Next Meeting: February 14, 2024

### ADJOURNMENT

It was moved and seconded *That the meeting adjourn (4:59 p.m.).* 

#### CARRIED

Certified a true and correct copy of the Minutes of the meeting of the Development Permit Panel of the Council of the City of Richmond held on Wednesday, January 17, 2024.


Cecilia Achiam Chair Rustico Agawin Committee Clerk


Schedule 1 to the Minutes of the Development Permit Panel meeting held on Wednesday, January 17, 2024



16 UNIT TOWNHOUSE DEVELOPMENT (DP 20-919145) AT 4571, 4591, 4611 STEVESTON HIGHWAY, RICHMOND, BC ISSUED DDP REVIEW 2024-01-17



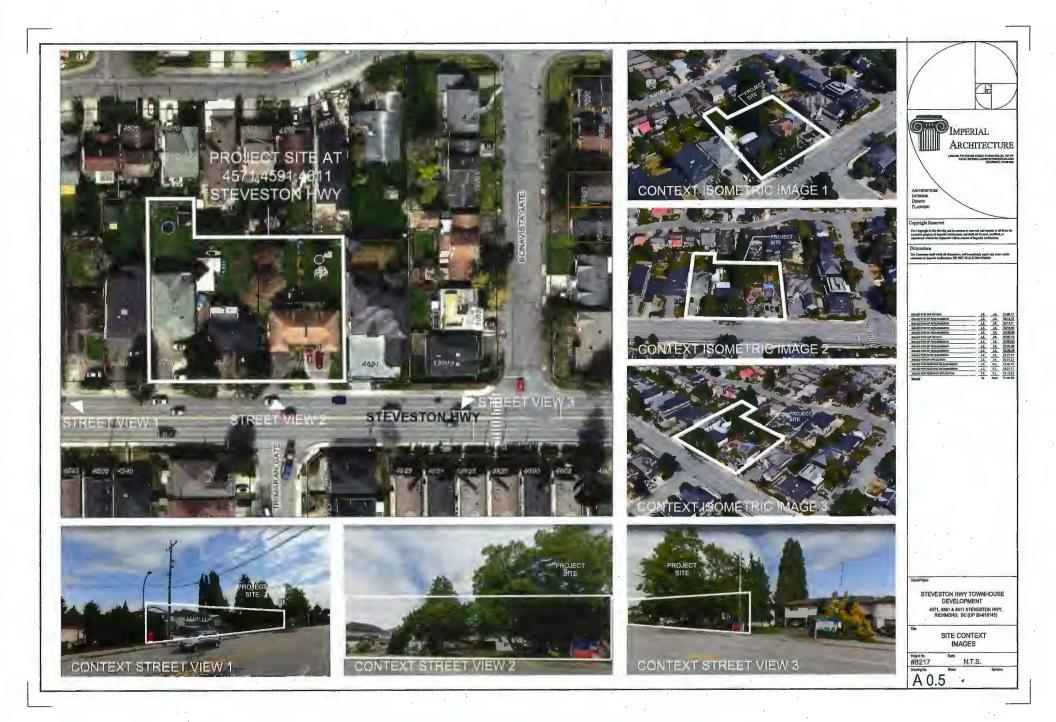

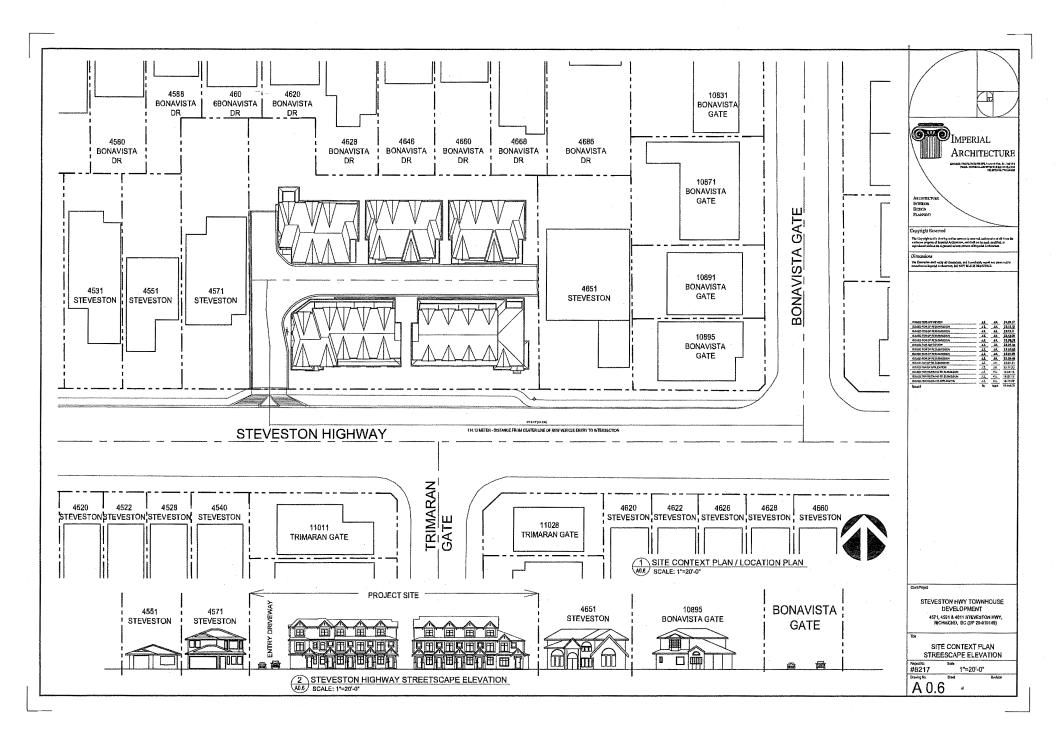


			1		
Project Data           Let         Cols Addras         Let         Let <th colspa="&lt;/th"><th>Pathafangs (Dalcar)</th><th>31/bab  <th <<="" th=""><th></th></th></th></th>	<th>Pathafangs (Dalcar)</th> <th>31/bab  <th <<="" th=""><th></th></th></th>	Pathafangs (Dalcar)	31/bab <th <<="" th=""><th></th></th>	<th></th>	
Project Statistics         Project Statistics           Data         Bit/1         Bit/2           Jandim         Bit/2         Bit/3           Jandim         Bit/2         Bit/3           Jandim         Bit/2         Bit/3           Jandim         Bit/3         Bit/3           Jandim         Bit/3         Bit/3	Transmit Funding Mannis Levine Punding Mannis Levine Punding Mannis Punder Schwarz,	I 6 Gañ     IIIIIIIIIIIIIIIIIIIIIIIIIIIIIIIIIIII			
Raginal Jaborat         Program         Program         Program           Garc Aras Ends         0.3         0.5	Construction of the construction         1.9 (Specific and the construction)           Construction of the construction         1.9 (Specific and the construction)           Construction of the construction         1.9 (Specific and the construction)           Construction of the construction         1.9 (Specific and the construction)           Construction of the construction         1.9 (Specific and the construction)           Construction of the construction         1.9 (Specific and the construction)           Construction of the construction         1.9 (Specific and the construction)           Construction of the construction         1.9 (Specific and the construction)           Construction of the construction         1.9 (Specific and the construction)           Construction of the construction         1.9 (Specific and the construction)           Construction of the construction         1.9 (Specific and the construction)           Construction of the construction         1.9 (Specific and the construction)           Construction of the construction         1.9 (Specific and the construction)           Construction of the construction         1.9 (Specific and the construction)           Construction of the construction         1.9 (Specific and the construction)           Construction of the construction         1.9 (Specific and the construction)	Bland         All         All </td <td>Database PLANERO Copyright Reserved The Cryptright Reserved and the Cryptright Reserved regulated after the sequence interact of the set of the set regulated after the sequence interact of the set o</td>	Database PLANERO Copyright Reserved The Cryptright Reserved and the Cryptright Reserved regulated after the sequence interact of the set of the set regulated after the sequence interact of the set o		
Average Grading Calculation         Institute         Institute         Preposed Grain         Prefit           104         Scolvest         1.00/Lett	Unit State S	Line is         Unit is <t< td=""><td></td></t<>			
Idit         Website         100 Mate	Link 3 Link Link Link Link 4 L	Units         Indicate         Indicate <t< td=""><td>Analysis         J.J.         J.K.         H.         Margin           Margin Corp.         J.K.         A.         Margin         Margin</td></t<>	Analysis         J.J.         J.K.         H.         Margin           Margin Corp.         J.K.         A.         Margin		
21         Maring & Territoria         137/Jatur         0           8         Maring & Territoria         132/Jatur         0151/25           Aurory Gold         Other State           Floor Area Calculation           Bable of State	ин и и и и и и и и и и и и и и и и и и	Building 5         Building C         Buildin			
Bit Mark         TextOre A         TextOre A         TextOre B         TextOre B <thtextore b<="" th="">         TextOre B         <thtextore <thtextore="" b<="" th="" thr=""> <thtex< th=""><th>Company         Data         Data         Data         Data           Company         Table 2         Main of (and 2)         Main of (and 2)         Main of (and 2)           Processing         Table 2         Main of (and 2)         Main of (and 2)</th><th>International         International         Internat</th><th></th></thtex<></thtextore></thtextore>	Company         Data         Data         Data         Data           Company         Table 2         Main of (and 2)         Main of (and 2)         Main of (and 2)           Processing         Table 2         Main of (and 2)	International         Internat			
Outdoor Amenity Area Calculation           Test Among drive         Tables         Tables           Test Among drive         105-6         Filling           Test Among drive         0.00 Muser         600 Muser           Address drivery branch staget         100-10 Muser         103.30 M           Address drivery branch staget         100-10 Muser         103.30 M           Address drivery branch staget         100-10 Muser         100-10 Muser           Address drivery branch staget         100-10 Muser         100-10 Muser           Dadder drivery branch staget         100-10 Muser         100-10 Muser	UNTE. 2. Unit 10.8 m Arz Competities Lante. 2. Unit 14 Commer Alockaff unt. 4. The Project Mill Information for that purch and unter him here also and a void a to achieve eithe	na na natalation name tolet, matana mo nonce mo "long" the indelegeor readen pather no door invelor will be provided in all			
	NE SCALAR IN THAT REACT ASSUMPTION BE INSTRUCT AN ADVISOR OF A SUBJECT OF A SUBJECT OF A SUBJECT AND	· · · · · · · · · · · · · · · · · · ·	Covernaud STEVESTON HWY TOWNHOUSE DEVELOPMENT 4571, 4591 & 4491 & TEVESTON HWY, RICHMOND, &C (DP 20-419145) Teve		
			PROJECT DATA & STATISTICS           Problem         Setting           #8217         Setting           N.T.S.         Denning No.           Denning No.         West		
			A 0.3		

· · · · ·







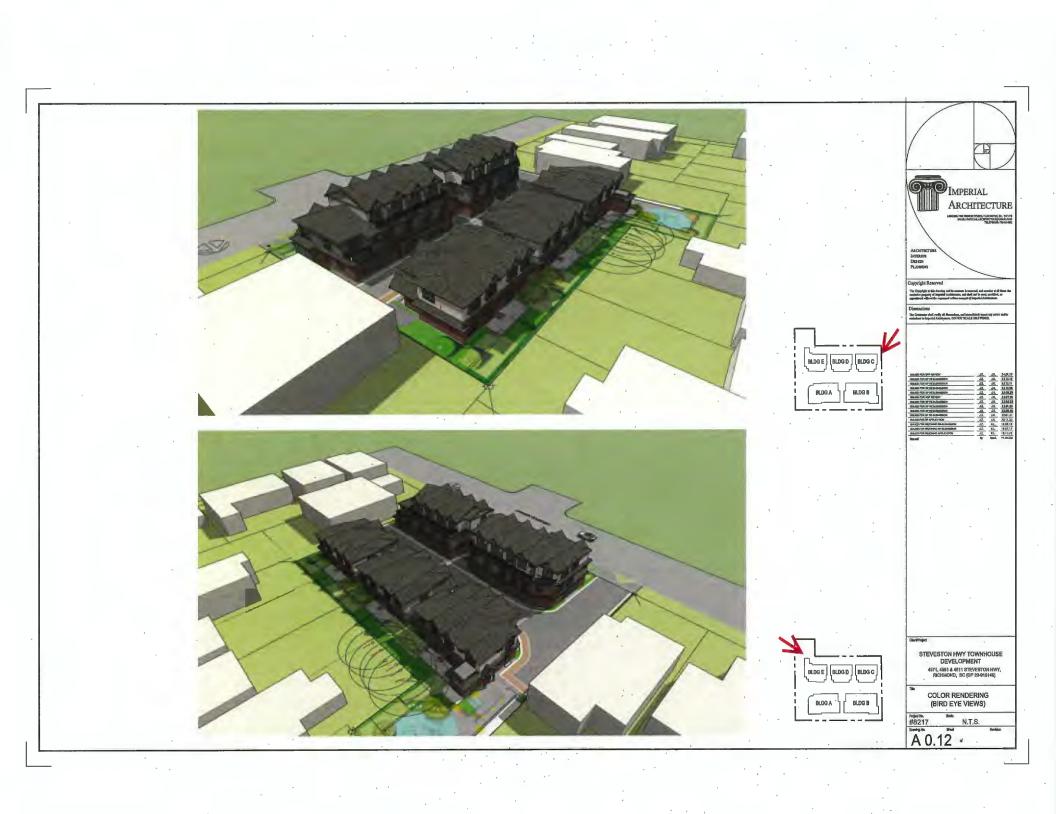







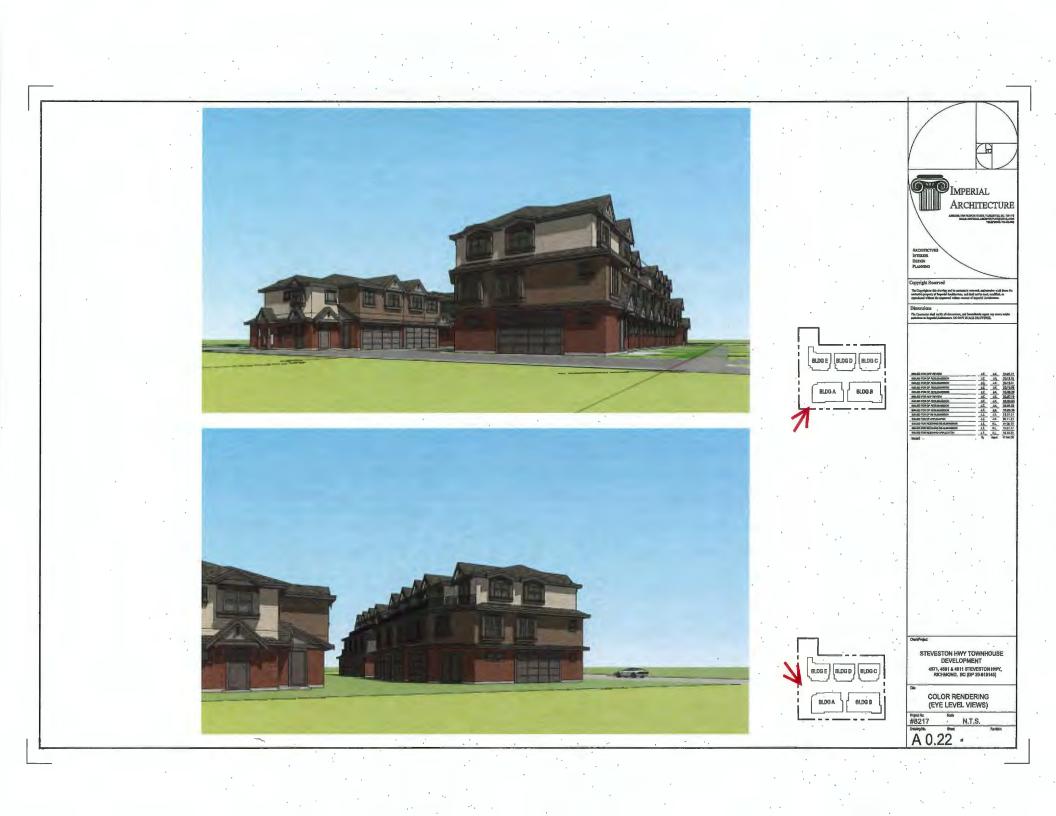


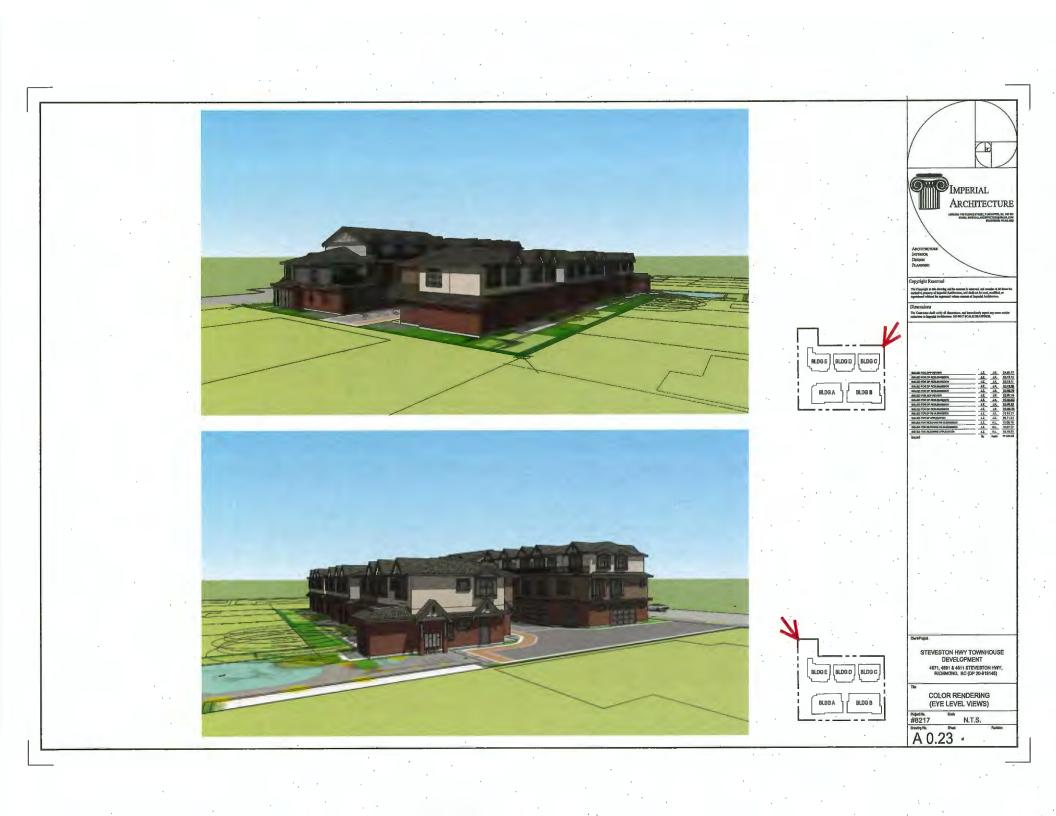


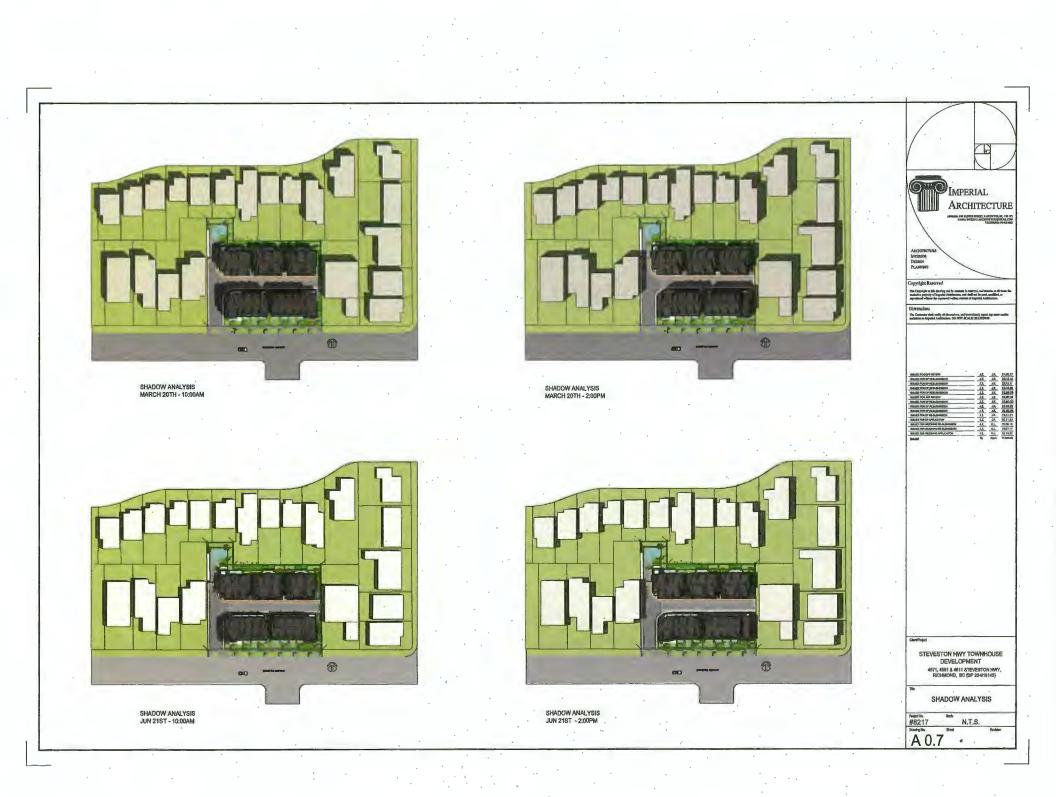




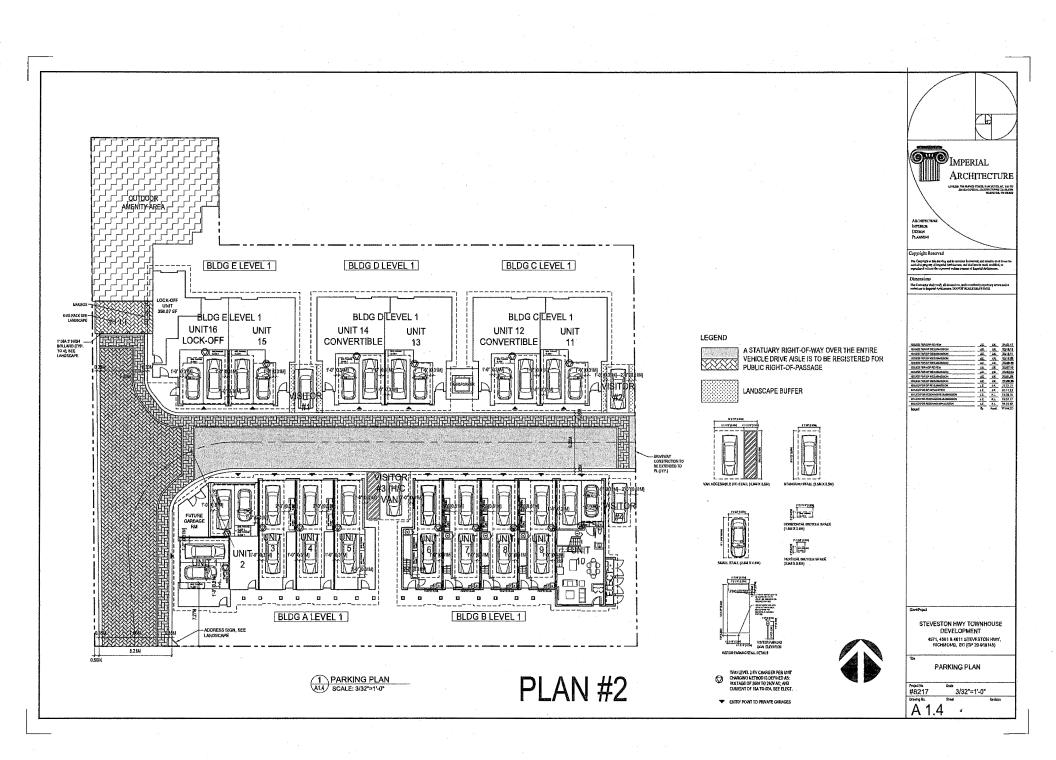


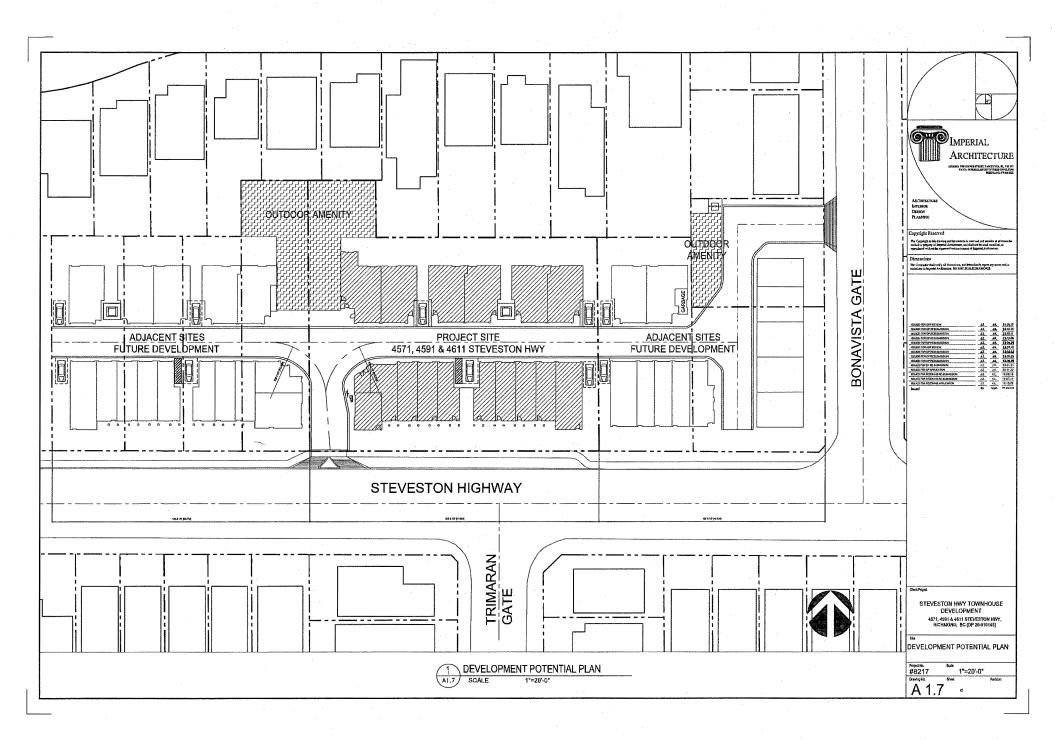

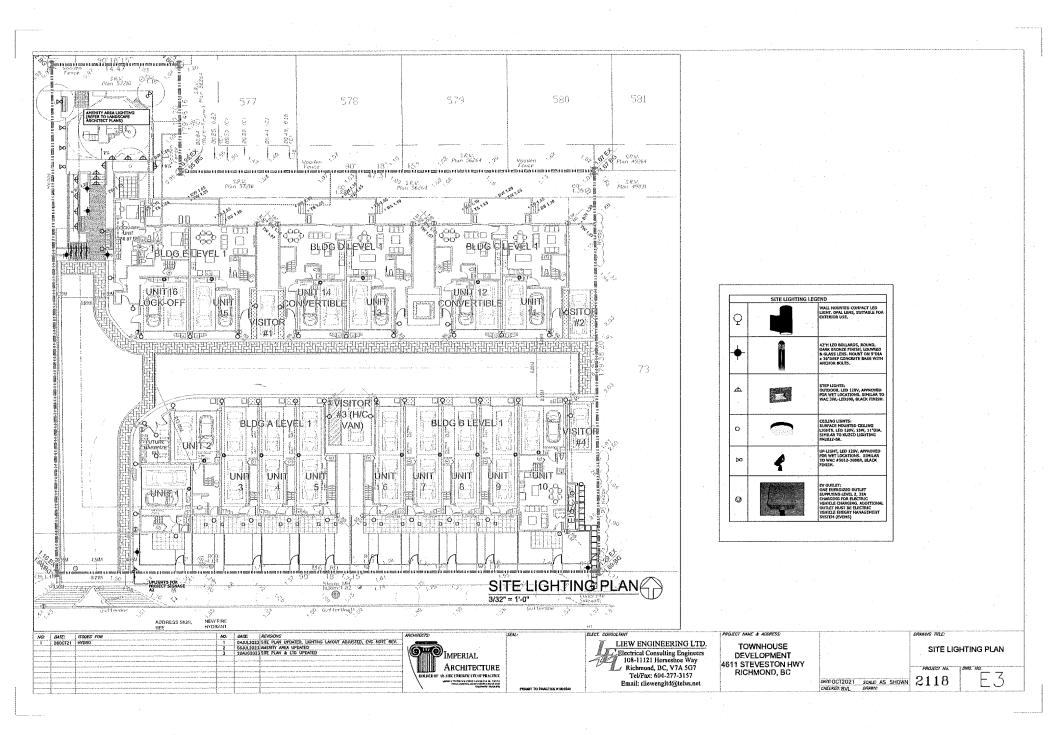

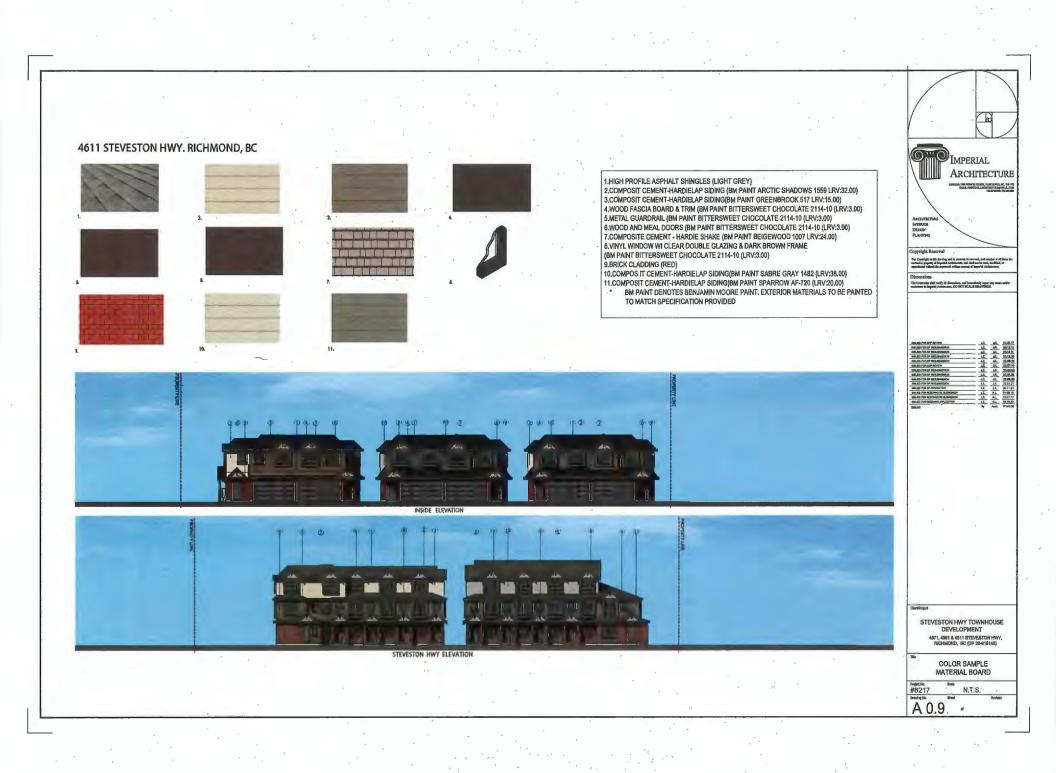



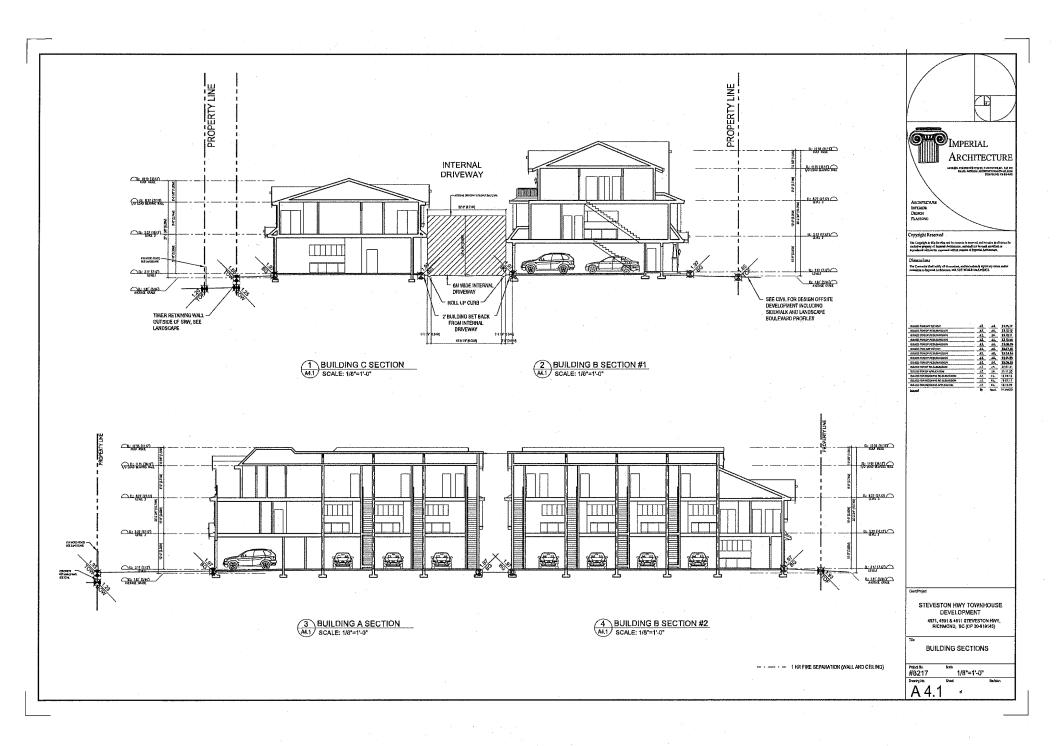



Imperial Architecture Itd. Architecture, INTERIOR DESIGN & PLANNING 7705 FRENCH STREET, VANCOUVER, BC, V6P 4V5, 778-938-8552, IMPERIAL ARCHITECTURE@GMAIL.COM


July 20, 2023

#### **Accessibility Strategy**

#### 16 Unit Townhouse Development at 4571, 4591, 4611 Steveston Highway, Richmond, BC


The design of project is in compliance with relevant Aging-In-Place and accessibility requirements in various city documents such as OCP, Townhouse Design Guidelines etc.


- 1. Wheelchair access and circulation
  - 1.1 All units in front buildings (Buildings A, & B) expect unit 2 have their main unit entries facing Steveston Highway. Direct paved pathway between unit entry and public sidewalk for each front unit was proposed. The width and slope of each pathway were designed in consideration of the wheelchair usage and access.
  - 1.2 All units in back buildings (Building C, D & E) and Unit 2 in Building A have their main unit entries from internal driveway. The width and slope of the pathway were designed in consideration of the wheelchair usage and access.
- 2. Coverable Unit design and Aging-In-Place features for all units
  - 2.1 Unit 12 and 14 in Buildings C and D were designed to meet requirements in City of Richmond's Coverable Unit design guideline. Detailed Convertible Unit plans demonstrated compliance with each requirement in the guideline. Refer to the attached convertible unit floor plans, manufacturer's specifications on future elevator for more information.
  - 2.2 Aging-In-Place features as listed in the OCP will be Incorporated into design of all units.
- 3. Accessibility to outdoor amenity area and H/C visitor parking stall
  - 3.1 Main access to outdoor amenity area is at the end of the internal driveway at northwest corner of the site which is connected to all unit entries. Residents from all units can get access to the outdoor amenity area through share pedestrian walkway on internal driveway as demonstrated on the attached wheelchair circulation route diagram.
  - 3.2 The Van access H/C visitor stall is located centrally between building A and B in the development beside the internal driveway. H/C visitor stall users can get access to all unit entries through the internal driveway as demonstrated on the attached wheelchair circulation route diagram.
- 4. Accessibility to private yards for convertible units
  - 4.1 Grading design for both convertible units' private yards complied with accessibility design standards. Maximum slope proposed is no greater than 5%.

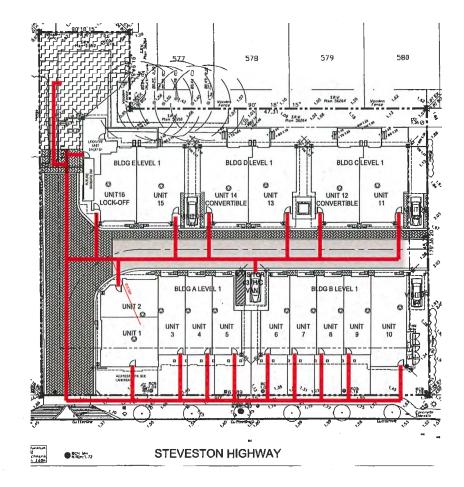

IMPERIAL ARCHITECTURE LTD. 1-8

IMPERIAL ARCHITECTURE LTD. 2-8

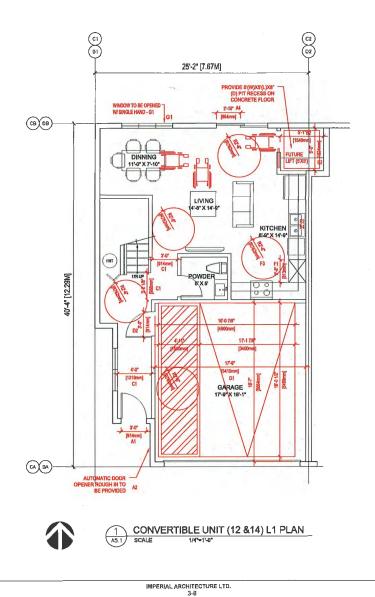

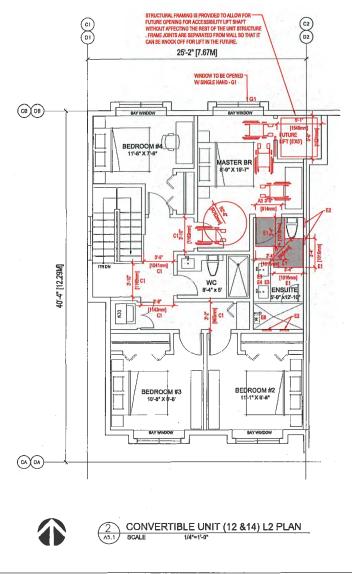


IMPERIAL ARCHITECTURE LTD. 4-8

	DOORS & DOORWAYS	A1	ENTRY DOORS ARE A MINIMUM 863 MM BUT IDEALLY 814 MM AND HAVE CLEAR ACCESS.			
٨		A2	ENTRY DOOR CLEAR EXTERIOR FLOOR SPACE MIN, 1220 MM DEPTH BY DOOR WIDTH PLUS 600 MM ON LATCH SIDE (NOT NEEDED IF ROUGH IN WIRING PROVIDED FOR FUTURE AUTOMATIC DOOR OPENER).			
		A3	INTERIOR DOORS TO MAIN LIVING AREAS, 1 BATHROOM AND 1 BEDROOM, MIN. 800 MM CLEAR OPENING WITH FLUSH THRESHOLDS MAX. 13 MM HEIGHT, DEMONSTRATE WHEELCHAIR ACCESS BETWEEN THE HALLWAY AND ROOMS AND WIDEN HALLWAY AND / OR DOORWAY(S) /F MECESSARY TO SECURE ACCESS.			
		Aá	PATIO / BALCONY MIN. 880 MM CLEAR OPENING. SMALL REMOVABLE WOOD RAMP WILL BE USEO TO ADAPT 2" HEIGHT OIFFERENCE BETWEEN FINISHED SURFACES WHEN THE UNIT IS CONVERTED TO ACCESSIBLE UNIT (I.E. WHEN THE ELEVATOR IS INSTALLED)			
		A5	ALL INTERIOR THRESHOLDS WITHIN UNITS COMPLY WITH BC BUILDING CODE.			
		A6	LEVER-TYPE HANOLES FOR ALL DOORS			
В	VERTICAL CIRCULATION	B2	VERTICAL LIFT, DEPRESSED SLAB AREA, AND LANDINGS, AS NOTED ON FLOOR PLANS IN COMPLIANCE WITH MANUFACTURER SPEDS, FRAMING TO ACCOMMODATE SHAFT CONSTRUCTION WITHOUT IMPACT TO SURROUNDING STRUCTURE.			
		B3	AT THE TOP OF ALL STARWAYS, WALLS ARE REINFORCED WITH 2* X 12* SOLID LUMBER AT 914 MM TO CENTRE.			
	HALLWAYS	C1	MIN, 900 MM WIDTH.			
D	GARAGE	01	MIN. 1 ACCESSIBLE PARKING SPACE WITH MIN. 4 M GARAGE WIDTH,			
	GARAGE	D2	ACCESS FROM GARAGE TO LIVING AREA MIN. 800 MM CLEAR OPENING.			
E		Eí	TOILET CLEAR FLOOR SPACE MIN, 1020 MM AT SIDE AND IN FRONT.			
	BATHROOM (MIN.1)	E2	WALL BLOCKING FOR FUTURE GRAB BAR INSTALLATION AT TOILET, TUB AND SHOWER. REINFORCED WITH 2" X 12" SOLID LUWBER IN ALL BATHTUB, SHOWER, AND TOILET LOCATIONS,			
		E3	LEVER-TYPE HANDLES FOR PLUMBING FIXTURES.			
		E4	PRESSURE AND TEMPERATURE CONTROL VALVES ARE INSTALLED ON ALL SHOWER FAUCETS.			
		E5	CABINETS UNDERNEATH SINK(S) ARE EASILY REMOVED.			
		Eð	DEMONSTRATE BATH AND SHOWER CONTROLS ARE ACCESSIBLE (LAYOUT OR FIXTURE PLACEMENT)			
F	KITCHEN	F1	CLEAR AREA NEEDED UNDER FUTURE WORK SPACE, PLUMBING AND GAS PIPES (IN-WALL AND IN-FLOOR) LOCATED CLEAR OF UNDER COUNTER AREA OF FUTURE WORK SPACE (STOVE, SINK & MIN, B10 MM WIDE COUNTER), ALL PIPES ARE BROUGHT IN NO HIGHER THAN 304 MM TO 355 MM TO THE CENTRE OF THE PIPE FROM FLOOR LEVEL.			
		F2	CABINETS UNDERNEATH SINK ARE EASILY REMOVED.			
		F3	1500 MM TURNING DIAMETER OR TURNING PATH DIAGRAM.			
		F4	LEVER-TYPE HANDLES FOR PLUMBING FIXTURES.			
	WINDOWS	G1	MIN. 1 WINDOW THAT CAN BE OPENED WITH A SINGLE HAND (BATHROOM, KITCHEN & LIVING ROOM)			
н	OUTLETS &	кı	PLACEMENT LOCATIONS OF ELECTRICAL OUTLETS: BESIDE WINDOW, BOTTOM OF STAIRWAYS, BESIDE SWITCHES TOILET, ABOVE EXTERNAL DOORS (OUTSIDE AND MSIDE),ON FRONT FACE OF KATCHEN COUNTER, WITHIN PROXIMITY OF CONTROL CENTRE FOR SMART HOUSE OPTIDNS.			

clear cab size	hoistway width	hoistway length	jack centerline	entrance centerline
40" x 50"	60-1/2"	59-1/2"	29-3/4"	35-3/4"
40" x 54"	60-1/2"	63-1/2"	31-3/4"	39-3/4"
42" x 60"	62-1/2"	69-1/2"	34-3/4"	45-3/4"
48" x 60"	68-1/2"	69-1/2"	34-3/4"	45-3/4"
minimum*	54-1/2"	59-1/2"		





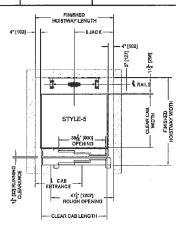


IMPERIAL ARCHITECTURE LTD. 6-8

IMPERIAL ARCHITECTURE LTD. 5-8

Specifications			In-Line
Overhead Clearances Required:	Hydraulic Drive	In-Line Drive	Drive w/Controller at top of holstway
84" Cab height - standard door pkg. 84" Cab height - upgrade / premium door pkg.	96" (2438 mm) 96" (2438 mm)	96" (2438 mm) 96" (2438 mm)	108" (2743 mm) 114" (2896 mm)
96° Cab height - standard door pkg. 96° Cab height - upgrade / premium door pkg.	108" (2743 mm) N/A	108" (2743 mm) N/A	120" (3048 mm) N/A
Rated Load: Standard 750 lbs (340 kg) or 1,000 lbs (45	55 kg)		
Speed: 40 ft/min (12.2 meters/min) nominal speed			· · · · · · · · · · · · · · · · · · ·
Travel Range: Up to 50 feet (15.2 m)			1. A.
Stops: Up to 6 stops			
Standard Controls: Fully automatic push button oper Illuminated push buttons	ation   Digital floor indicat	or in car   Automatic	car lighting upon entry
Standard Safety Features: Battery-powered emerger monitoring system   Emergency stop and alarm	ncy lowering   Safety brake	system   Car door ar	nd hall door safety
Hydraulic Drive System : 1:2 cable hydraulic drive   Qu for smooth start and stop	uiet submersed pump and	motor   Two-speed v	alve
In-Line Drive System : Geared direct drive motor   Vari	iable frequency drive for s	mooth start and stop	Speed monitor
Power Requirements: 230 VAC single phase   Optiona	al 208 VAC 3 phase (Hydra	ulic Drive only)	
Popular Options: Premium fixtures   Integral emerger	ncy telephone   3-speed sl	iding doors	and the or an according to succeed.
Flooring: By others to match the home decor   Minim	um 1/8" thick   Maximum 3	3/4" thick	

Warranty: 2 year standard warranty | Optional additional 5 year extended warranty to 7 years (North America Only)

PRIVATE YARD GRADING DESIGN FOR CONVERTIBLE UNITS ON SHOWN ON LANDCAPE DRAWINGS

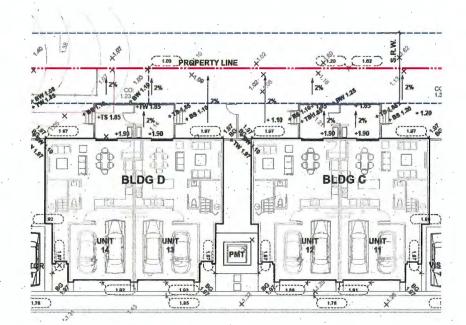

IMPERIAL ARCHITECTURE LTD. 8-8

IMPERIAL ARCHITECTURE LTD. 7-8



Imperial Architecture Atd. Architecture, Interior Design & Planning 7705 FRENCH STREET, VANCOUVER, BC, VEP 4V5, 778-938-8552, IMPERIAL ARCHITECTURE ACMAIL.COM

July 20, 2023

Building Approval Department City of Richmond 6911 No. 3 Road, Richmond, British Columbia

To whom it may concern,

#### Re: DP 20-919145 - 4571, 4591, 4611 Steveston Hwy, Richmond

I, Jiang Zhu Architect AIBC, am the architect for the Development Permit Application for DP 20-919145 – the 16-unit townhouse development at 4571, 4591, 4611 Steveston Hwy, Richmond.

On behalf the design consultant team, we hereby confirm that:

The applicable Energy Step Code performance targets have been considered in design, and that a Qualified Energy Modeler has been engaged to ensure that the proposed design can achieve the applicable performance targets.

For reference and record, below is the contact information of the Qualified Energy Modeler for this project:

Jack Cui, M.Sc. P.Eng., LEED AP Senior Energy Modelling Specialist | Division Manager JRS ENGINEERING 300 – 4595 Canada Way, Burnaby BC V5G 1J9 jcui@jrsengineering.com

Please refer to the attached letter from JRS dated July 7<sup>th</sup>, 2023 outlining details and pathways chosen by the consultant team for achieving the city's step code requirements.



Jlang Zhu, Architect AIBC, CP, MRAIC, LEED AP BD+C Principal Imperial Architecture Ltd. Tei: 778-938-8552 Imperial.architecture@gmail.com

> IMPERIAL ARCHITECTURE LTD. 1-1



#### SUSTAINABILITY STRATEGY 4611 STEVESTON

#### July 7, 2023

Development Permit Document Drawing Requirements Development Applications Department City of Richmond 6911 No. 3 Road, Richmond, BC VóY 2C1

Re: 4611 Steveston – Development Permit Application DP 20-919145 - 4571, 4591, 4611 Steveston Hwy Sustainability Strategy

As a part of the Development Permit Application for 4611 Steveston JRS Engineering (JRS) hereby commits to assisting the project team in Implementing sustainability strategies. The proposed project is located at 4611 Steveston Highway, Richmond, BC, and the project will be developed as a 16-unit townhouse complex with a total of five buildings.

The following sustainability strategies have been analysed and included in the building designs in order to reduce energy consumption and reduce greenhouse gas emissions, and thus achieve the BC Energy Step Code compliance:

 Step 3 with Low Carbon Energy System. Effective July 1, 2022, Energy Step Code requirements for Part 9 Residential Buildings in Richmond include Step 5<sup>(6)</sup>, Step 4<sup>(b)</sup>, or Step 3<sup>(b)</sup> + Low Carbon Energy System\*\*. The project will target a low carbon energy system and thus Step 3 applies.

(a) Building envelope performance requirements can be achieved using all campliance pathways defined in BCBC.

(b) Building performance requirements must be achieved using adjusted TEDI and MEUI compliance pathways. \*\* Annual limit of  $\leq$  500 kg CO2e per housing unit, or  $\leq$  2.5 kg CO2e/ m2 of conditioned floor area and  $\leq$  1000 kg CO2e per housing unit.

- The proposed building skin is listed in the Appendix A
- Air source heat pump to reduce heating and cooling energy
- HRV/ERV to reduce heating/cooling energy for conditioning ventilation air
- Energy Star appliances to reduce energy consumption
- Electric hot water tank to further reduce the greenhouse gas emissions

The project team will coordinate to incorporate the measures required to meet all requirements of the Richmond's BC Energy Step Code for Part 9 Townhames.

Please contact the undersigned if you should require any additional information.

JRS ENGINEERING EGBC Permit to Practice #1002484

Per:

Jack Cui, MSc, PEng, LEED AP Sr Energy Modelling Specialist I Division Manager

www.JRSENGINEERING.com

VANCOUVER 300 - 4595 Canada Way 115 - 1923 Burnaby, British Columbia VSG 119 Calgary, TELi (404) 320 1999 TELi

CALGARY 115 - 1925 18th Avenue NE Calgary, Atberta T2E 778 TEL: (403) 452 3377



Appendix A

Proposed Building Skin

 $\square$ JRS ENGINEERING LTD. APPENDIX A - PROPOSED BUILDING SKIN

PAGE 1 OF 1

#### **PROPOSED BUILDING SKIN**

The following building skin performance has been proposed to achieve Step 3 + Low Carbon Energy System:

- R17.8 Wall
- R31.3 Roof
- Window Performance: U=0.25, SHGC=0.35
- Window to wall ratios:

  - o Building A: 14.2% o Building B: 13.4% o Building C: 13.5% o Building D: 13.5%
  - o Building E: 12.4%
- Airtight air barrier system

4611 STEVESTON TOWNHOUSE DEVELOPMENT

## STEVESTON HWY TOWNHOUSE DEVELOPMENT LANDSCAPE SET: ISSUED FOR ADP COMMENTS DECEMBED 2, 2022

DECEMBER 3, 2023

#### LANDSCAPE DRAWING INDEX

DRAWING INDEX			
SHEET Na.	SHEET NAME		
L 0.0	LANDSCAPE COVER SHEET AND DESIGN RATIONALE		
L01	LANDSCAPE TREE MANAGEMENT PLAN		
L02	LANDSCAPE REPLACEMENT TREE PLAN		
L 1.0	LANDSCAPE LAYOUT AND MATERIALS PLAN		
L 1.1	LANDSCAPE GRADING PLAN		
L 1.2	POROUS SURFACE DIAGRAM		
L 1.3	OUTDOOR AMENITY AREA ENLARGEMENT PLAN		
L 1.4	LANDSCAPE SECTIONS		
L 1.5	FUTURE OUTDOOR AMENITY & TURNAROUND AREA PLAN		
L 2.0	LANDSCAPE PLANTING PLAN - NORTH AREA		
L 2.1	LANDSCAPE PLANTING PLAN - SOUTH AREA		
L 2.2	LANDSCAPE PLANT LIST		
L 2.3	DESIGN-BUILD IRRIGATION PLAN		
L 3.0	HARDSCAPE DETAILS		
L 3,1	FURNISHING DETAILS		
L 3.2	FURNISHING DETAILS		
L 3,3	FURNISHING DETAILS		
L 3,4	SOFTSCAPE DETAILS		

#### GENERAL NOTES

ALL LANDSCAPE ARCHITECTURAL DRAWINGS IN THIS PACKAGE SHALL BE READ IN CONJUNCTION WITH ALL OTHER LANDSCAPE ARCHITECTURAL DRAWINGS, DETAILS, SPECIFICATIONS, AND OTHER CORRESPONDANCE THAT MAY BE ISSUED DURING THE COURSE OF THE CONTRACT.

IF A DISCREPANCY OCCURS BETWEEN THE DWAMINGS AND THE SPECIFICATIONS OR ANY OTHER DOCLIMENT ASSOCIATED WITH THE PROJECT THE CONFLICT SHALL BE REPORTED IN WRITING TO THE LANDSCAPE ARCHITECT TO DBTAIN CLARIFICATION AND APPROVAL BEFORE PROCEEDING WITH WORKS.

THE CONTRACTOR SHALL VISIT THE SITE TO VERIFY THE TRUE EXISTING CONDITIONS ANY UNCLEAR ISSUES SHALL BE CLARIFED WITH THE LANDSCAPE ARCHITECT NO CLAIM SHALL BE ALLOWED FOR EXTRAS WHICH MAY ARISE THROUGH NEGLECT OF THIS ADVICE.

ALL EXISTING INFORMATION IS BASED ON AVAILABLE RECORDS AND SHALL NOT BE CONSTRUED TO BE COMPLETE OR ACCURATE.

LAYOUT OF HARDSCAPE, SITE FURNITURE, SOIL, FLANTING, AND ALL OTHER MATERIALS IS TO BE STAKED OUT AND APPROVED BY THE LANDSCAPE ARCHITECT PRIOR TO INSTALLATION.

ALL PLANTING SHALL BE IN ACCORDANCE WITH CSLA LANDSCAPE STANDARD, LATEST EDITION

THE CONTRACTOR IS RESPONSIBLE FOR DETERMINING THE EXISTENCE, LOCATION, AND ELEVATION OF ALL UTILITIES AND CONCELED STRUCTURES, AND IS RESPONSIBLE FOR NOTIFYING THE APPROPRIATE COMPANY, DEPARTMENT OR PERSON(S) OF ITS INTENTION TO CARRY QUIT IS OPERATIONS.

HOMING LANDSCAPE ARCHITECTURE INC. DOES NOT GUARANTEE THE EXISTENCE, LOCATION, AND ELEVATION OF UTILITIES OR CONCEALED STRUCTURES AT THE PROJECT SITE.


FINAL SELECTION AND APPROVAL OF ALL STREET TREES TO BE DONE BY THE CITY OF RICHMOND.


#### LANDSCAPE DESIGN RATIONALE


The site is surrounded by single family houters on the north, west and east sides, and the landscape design intends to ensure the privacy of the adjacent neighbors. Existing hedges along the east property line will be rotained and evergreen tress are proposed there to create a dense lendscape buffer which addresses any potential privacy and overfook concerns. Evergreen hedges are proposed along the north property line, and a solid 6' high privacy fance with vines is proposed along the west property line. All the landscape elements and design strategies mentioned above will help to protect the privacy of adjacent neighbors.

The landscape decign inlends to bring nature close to the local residents. Lawn, flower bads, native shrubs, and a mixed of deciduous and evergreen trees are proposed in the front yards along the Stavesion Highway, which crades a green buffer between the private houses and the public sidewalk. The ratset plantars with wood trells and vines are provided to maximize the planting opportunities in the limited spaces along the internal drive axis. The rated planters also work as green dividers between the adjacent garages. There are large patios, lawn, planting beds and trees in the backyards of the Units 11 to 16, and the green background of the houses.


A large outdoor amenity space is located at the northwestern corner of the site which is highly visible from the driveway entry. Three removable bollards are designed at the entry of the outdoor amenity erea to stop vehicles and ensure pedestrian's safety. Bike racks and mailbox are elso located there for easy access for everyone including the disable. The key program of the outdoor amonity space is a playground with various play elements for children at various ages. A large play structure is proposed in the center of playground to provide ective play opportunities such as climbing, jumping, running and sliding for older kids. Stepping stones in planting bed creates a nature play zone where children at various ages can access nature to improve their creetivity. Sandbox and mud kitchen are provided to help the children to develop their social and communication skills while they are playing. An existing evergreen hedge is retained on the west and a couple of farge trees will be planted on the wast and south sides of the playaround to provide enough shade for the children and their parents. Two benches are provided for parents to sit and observe their children. pley, A 6' high privacy fence will be installed around the playaround to ensure the children's safety, A multi-functional lawn is provided at the north and of the outdoor amenity space for flexible programs. The playground is designed at the existing grades, and a maximum 10% slope remp and stair are used to connect the playground with the amanity space entrance. A pedastrian path in different color of pavers is proposed along the north side of internal drive aiste to provide a safe pedestrian access to the outdoor amonity entrance.

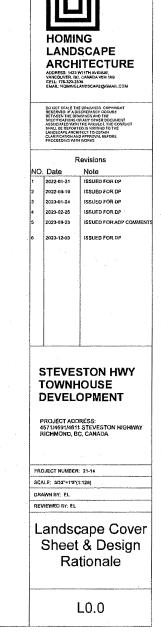


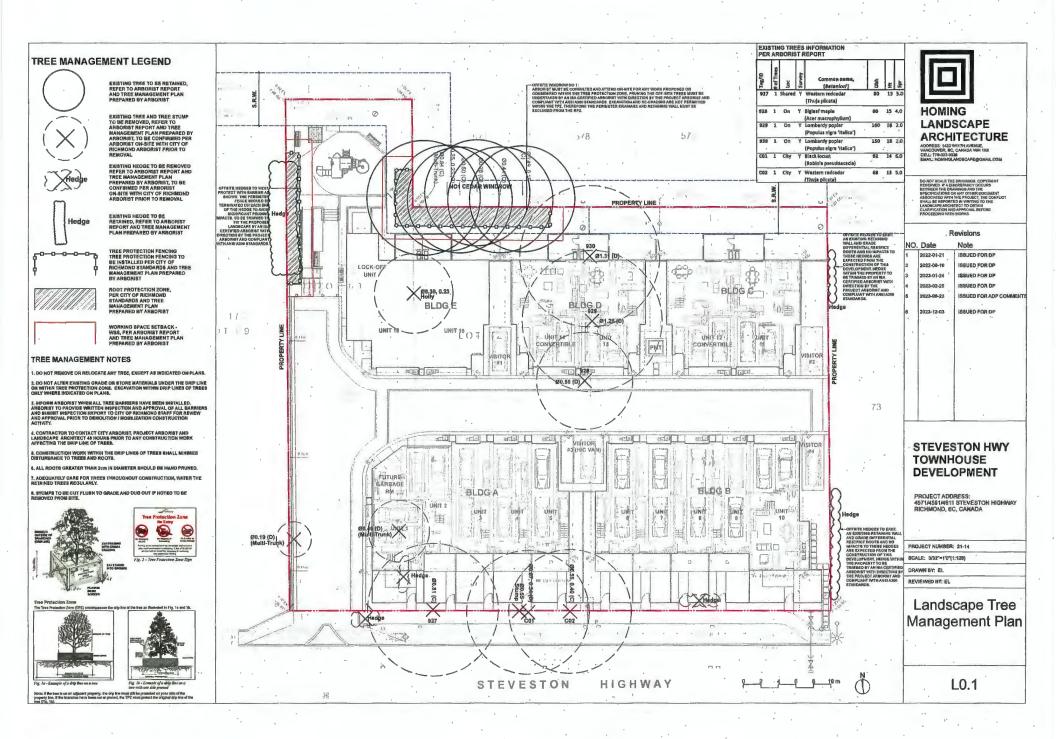

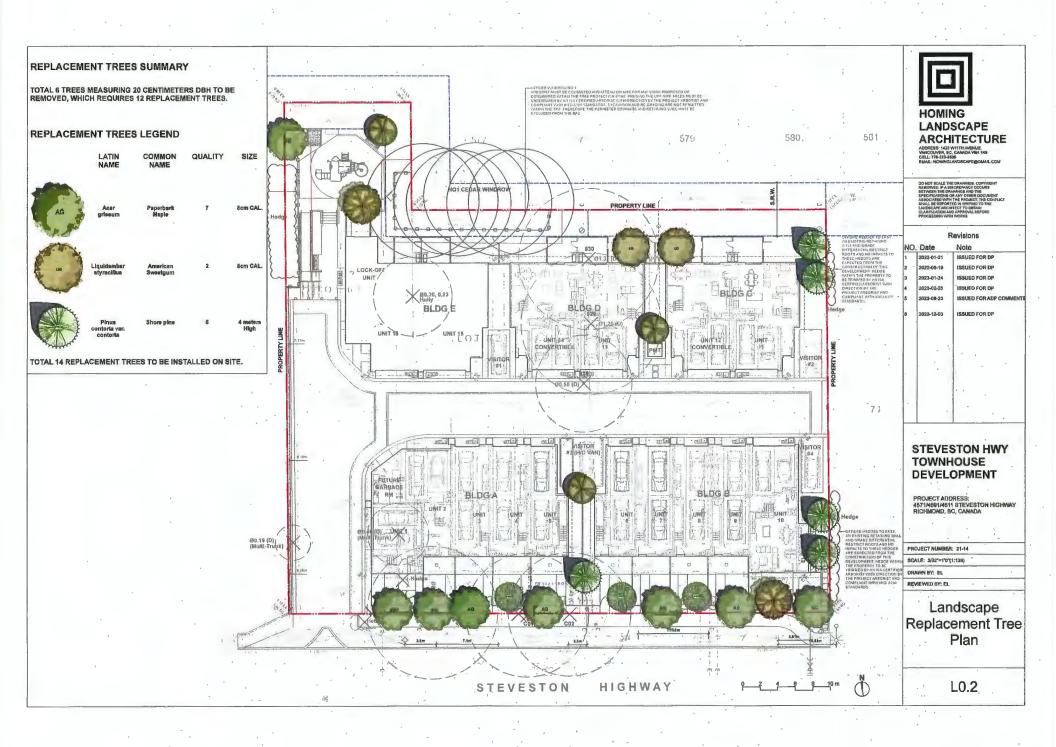




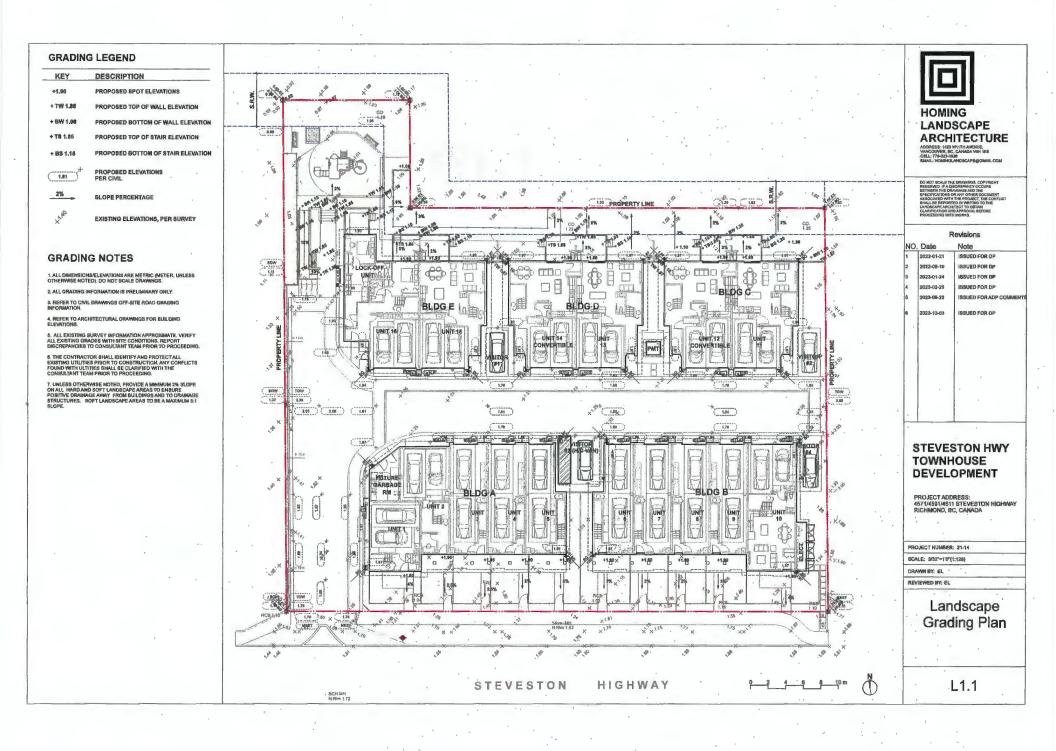


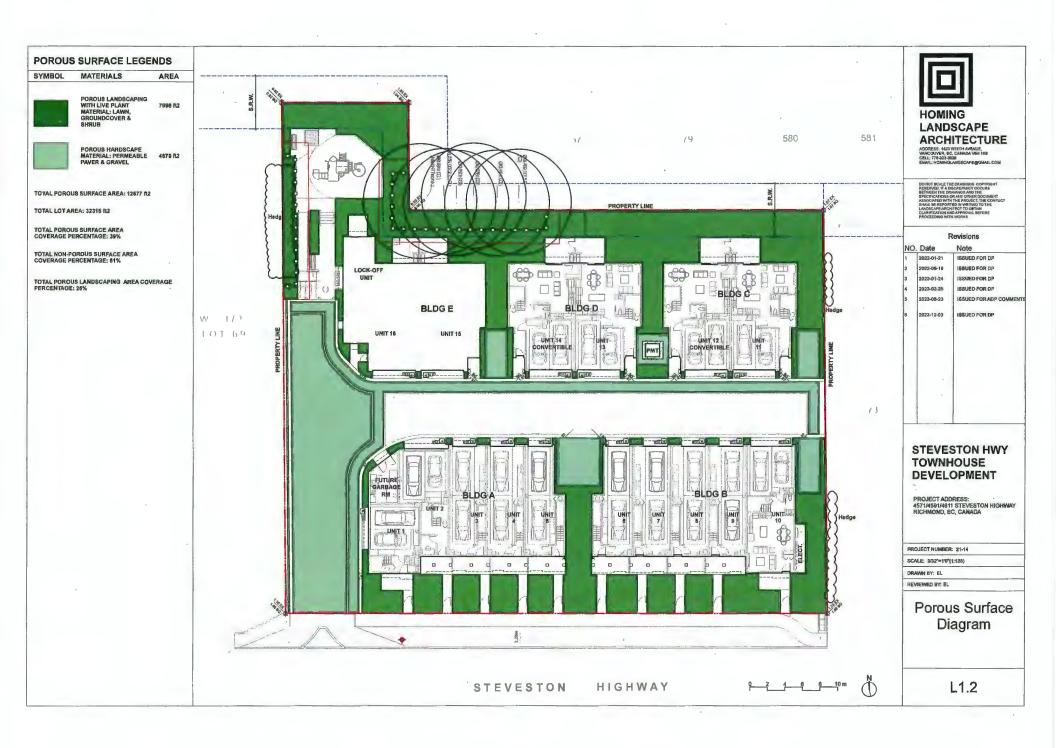




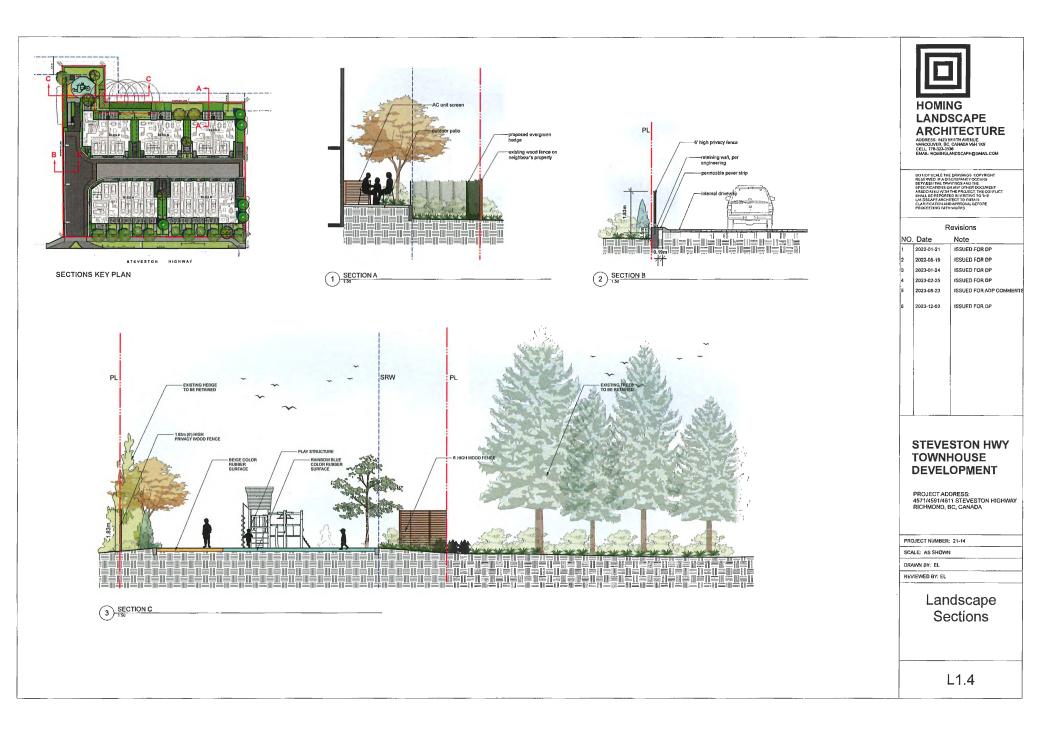



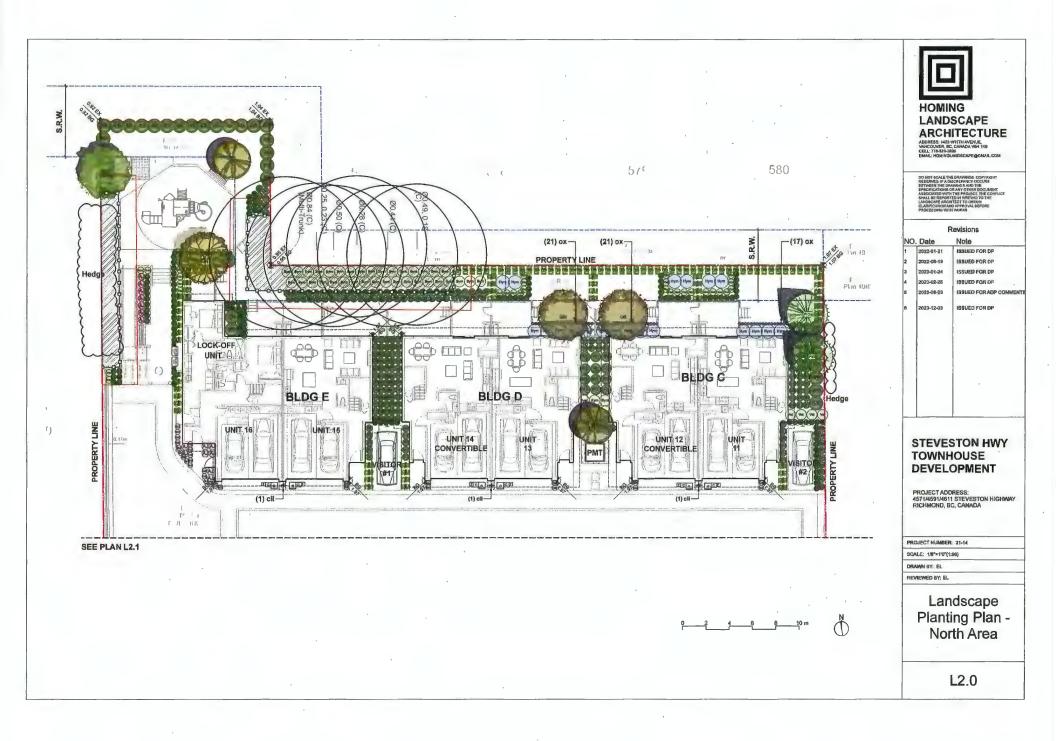

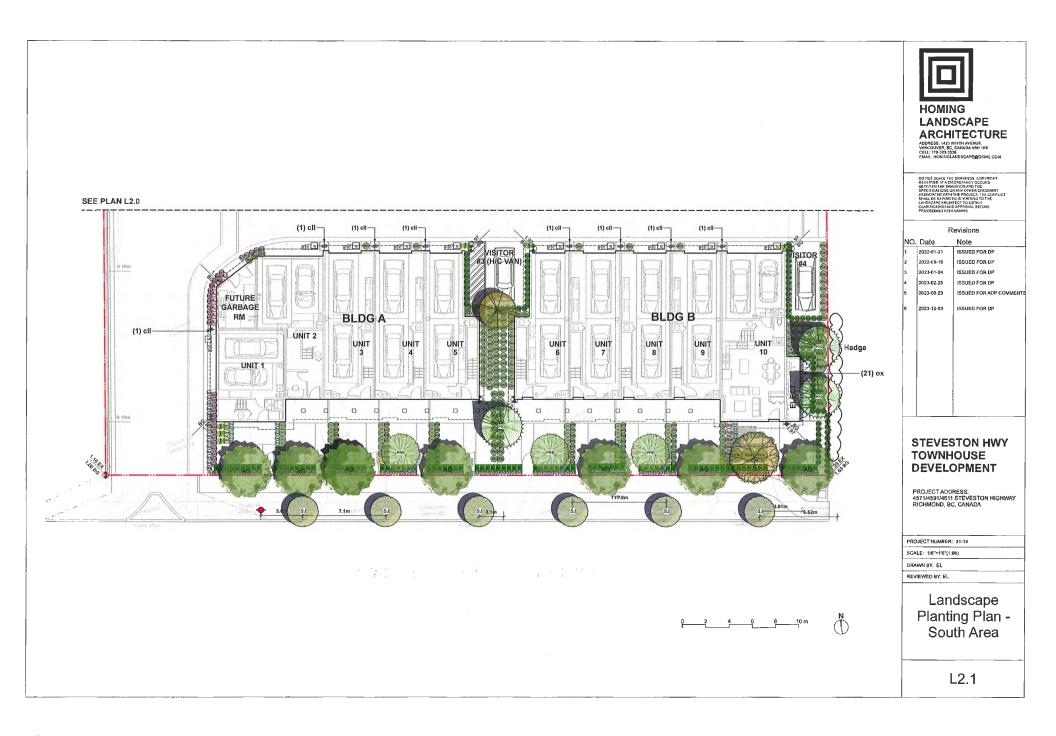

ONSITE PLANT LIST					
ID	Latin Name	Common Name	Quantity	Scheduled Size	No
TREES (DECIDUOUS & CONIFEROUS)					
AG	Acer ariseum	Paperbark Maple	9	8cm cal.	
BEP	Betula papyrifera	Paper Birch	3	6cm cal.	-
CN	Cornus nuttallii 'Eddie's White Wonder'		2	6cm cal.	
LIO	Liquidambar styraciflua	American Sweetgum	2	8cm cal.	1
PIO	Pinus contorta var. contorta	Shore Pine	5	4m high.	-
PRE	Prunus emarginata	Bitter Cherry	3	6cm cal.	
SHRUBS	· · · · · · · · · · · · · · · · · · ·				+
Arb	Arbutus unedo 'Compacta'	Compact Strawberry Bush	14	#3 pot	-
LA	Azalea japonica 'Kent's Pride'	Kent's Pride Azalea	23	#2 pot	+
Bx	Buxus microphylla	Littleleaf Boxwood	91	#2 pot	1
ec1	Erica carnea	Spring Heath	30	#1 pot	1
Gs	Gaultheria shallon	Salal	109	#2 pot	-
Hym	Hydrangea macrophylla	Bigleaf Hydrangea	20	#3 pot	
Ma	Mahonia aquifolium	Oregon Grape Holly	12	#2 pot	1
Nad	Nandina domestica	Heavenly Bamboo	32	#2 pot	
Rh4	Rhododendron 'PJM'	PJM Rhododendron	32	#3 pot	+
Shh	Sarcococca hookeriana var. humilis	Sweet Box	8	#2 pot	1
Ski	Skimmia japonica	Japanese Skimmia	25	#3 pot	
Spg	Spiraea x bumalda 'Goldflame'	Goldflame Spirea	6	#2 pot	
Svm	Symphoricarpos alba	Snowberry	42	#2 pot	
Tmh	Taxus x media 'Hicksii'	Hick's Yew	110	4' High	-
Th	Thuja occidentalis 'Smaragd'	Emerald Cedar	40	#2 pot	
Vot	Vaccinium ovatum 'Thunderbird'	Thunderbird Evergreen Huckleberry	4	#3 pot	1
PERENNIALS & GROUNDCOVERS					+
em	Euphorbia x martinii	Martin's Spurge	8	#1 pot	1
lsa	Lavandula angustifolia	English Spike Lavender	136	#2 pot	1
OX	Oxalis oregana	Oregon Oxalis	80	#1 pot	1
pol	Polystichum munitum	Western sword fern	190	#1 pot	-
					╈
cmi	Carex morrowii 'Ice Dance'	Ice Dance Japanese Sedge	48	#1 pot	
fes	Festuca glauca	Boulder Blue Fescue	26	#1 pot	1
ha	Hakonechloa macra `Aureola`	Golden Japanese Forest Grass	206	#1 pot	
VINES					+
cłł	Clematis ligusticifolia	Western White Clematis	11	#1 pot	
					+

	HOMING COMPOSED TO THE DATA OF							
			evisions					
	NO.	Date	Note					
		2022-01-21	ISSUED FOR DP					
		2022-08-19	ISSUED FOR DP					
	э	2023-01-24	ISSUED FOR DP					
	4	2023-02-25	ISSUED FOR DP					
	5	2023-08-23	ISSUED FOR ADP COMMENTS					
	8	2023-12-03	ISSUED FOR DP					
I	STEVESTON HWY TOWNHOUSE DEVELOPMENT PROJECT ADDRESS: 4571/4591/4611 STEVESTON HIGHWAY RICHMOND, BC, CANADA							
	PROJECT NUMBER: 21-14							
	SCALE: 3/32"=1'0"(1:128)							
	DRAWN BY: EL							
	REVIEWED BY: EL							
	Landscape Plant List							
	L2.2							

3 				
Latin Name	Common Name	Quantity	Scheduled Size	Notes
Styrax japonicus	Japanese Snowbell Tree	6	6cm cal,	·
2040D				

### PLANTING NOTES:


In case of discrepancy between plant numbers on this list and on the plan, the latter shall prevail.


2) All planting shall be in accordance with CSLA Landscape Standard, latest adition,

3) The Landscape Contractor shall ensure that the on-site planting medium/soil meets the specification & recommendations of the soil analysis shale has executed prior to Final Acceptance of the sila analysis shall be accurated for the Final Acceptance of the landscape works by the Consultant and the municipal authorities.

4) Minimum planting medium depths: lawn - 67/150mm groundcover - 127/300mm shrubs - 137/450mm traes - 247/600mm (around & beneath rootbell)

5) All plant material to be supplied on the job site must be obtained from a nursery participating in the BCLNA Phytophthora ramorum Cartification Program,

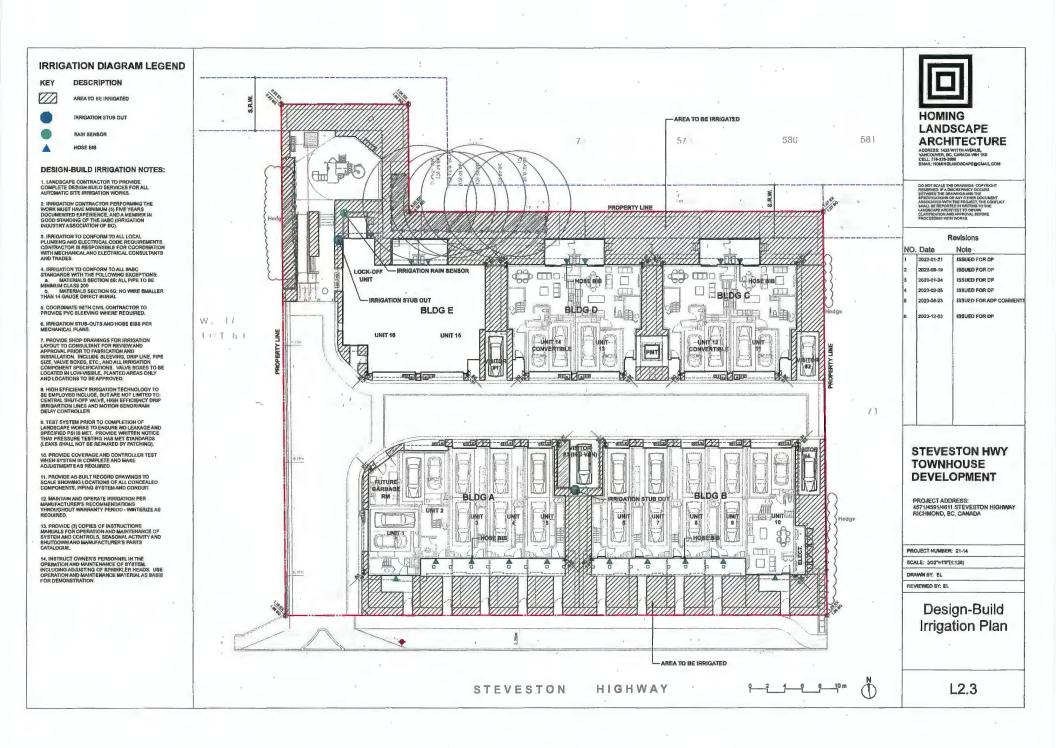


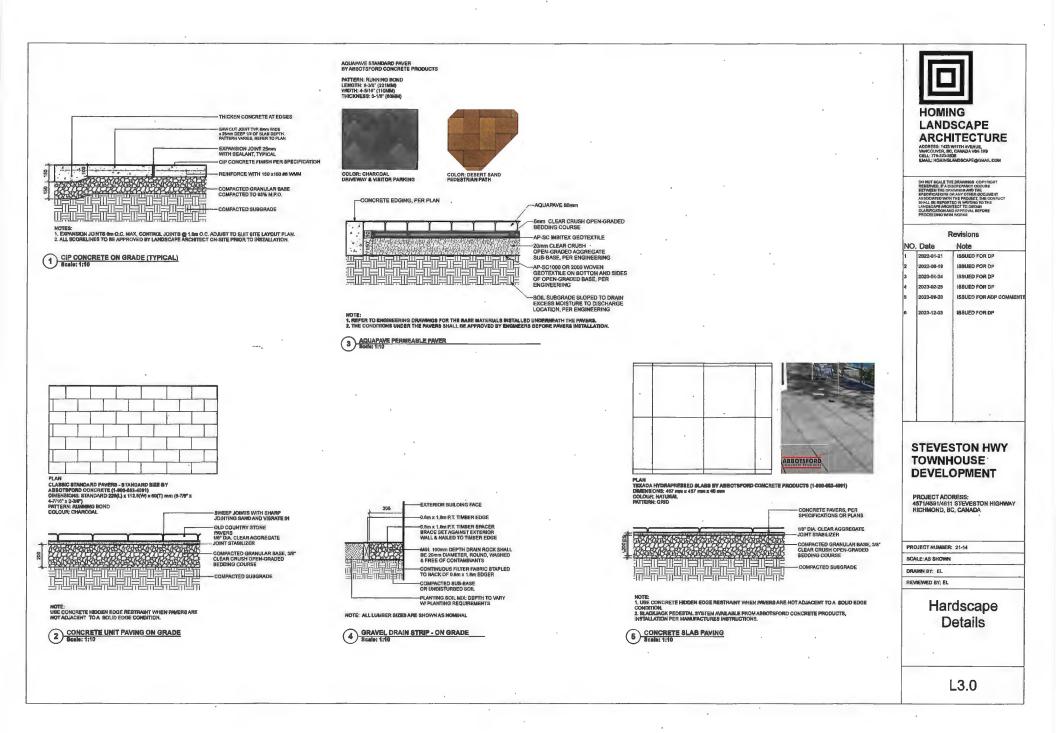





2 BIKE RACK Boale: 1:10

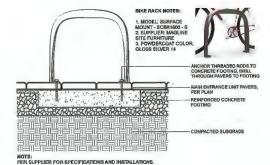






2309 ICDNIC BACKED BENCH BY MAGLIN SIYE FLIRINITURE (1-880-718-6508) MODEL: MBE-3305-60017 LEMIRIT: 717 (177 Sen) DEFIN: 5357 (FA300) SEAT HEIGHT: 518 (45,60) WEIGHT: 122.588 (58,60) WEIGHT: 122.588 (58,60) R à. (6) BENCH





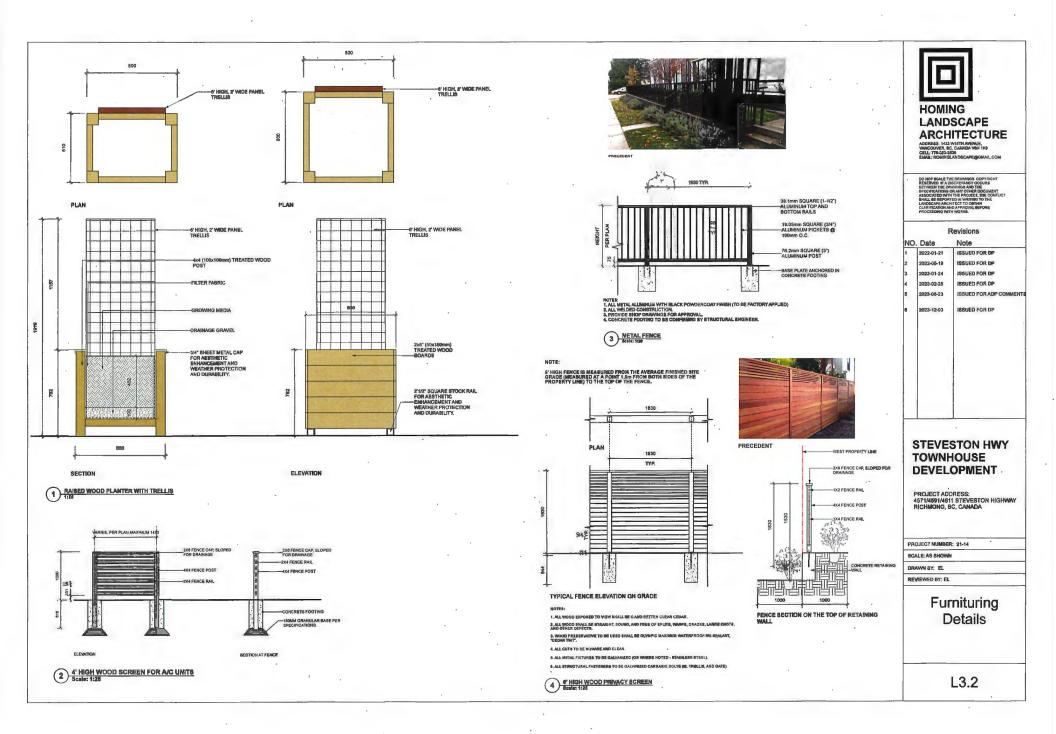

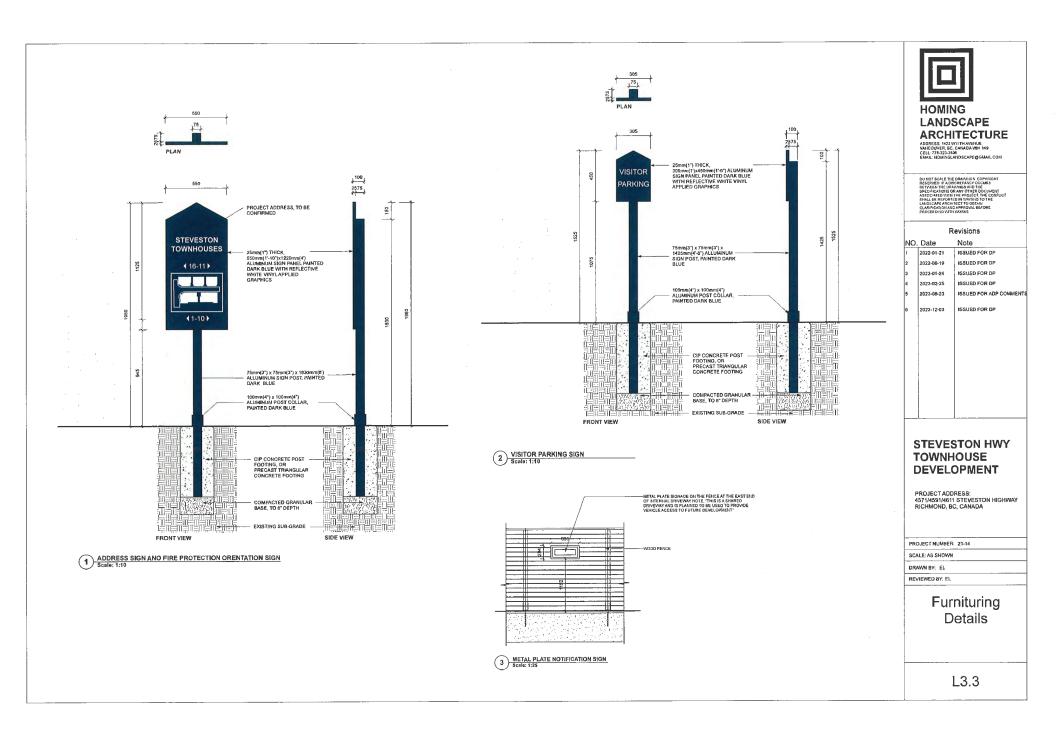

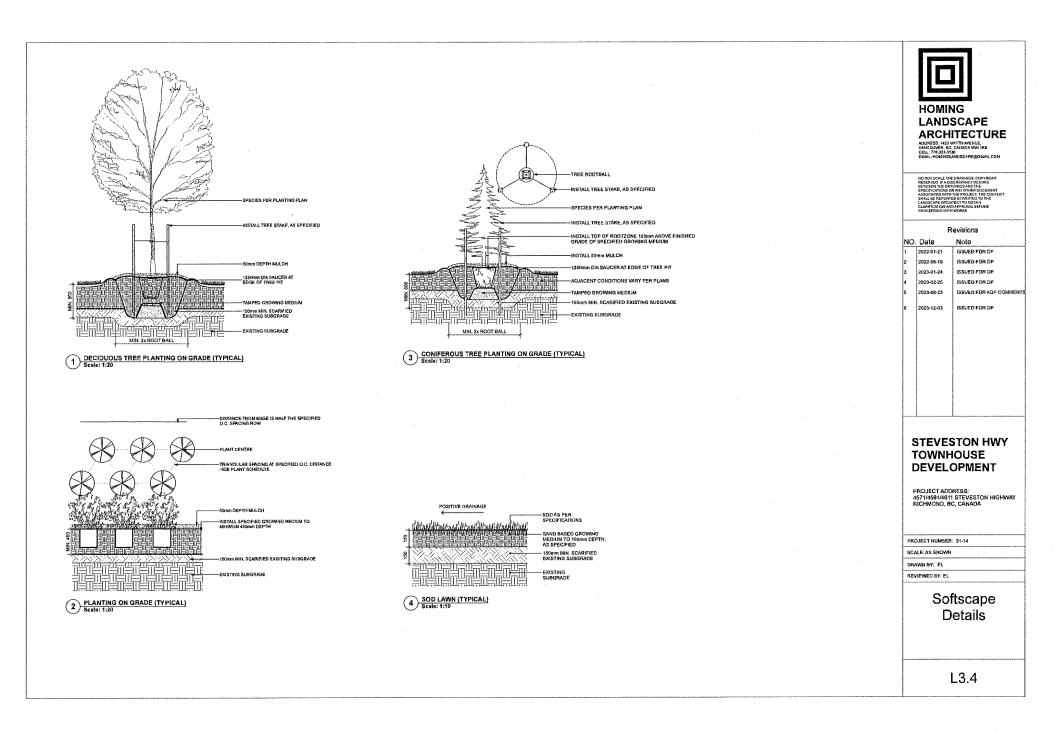

Schedule 2 to the Minutes of the Development Permit Panel meeting held on Wednesday, January 17, 2024

# **SYMPHONY HILL TECH CENTRE 2**

13888 WIRELESS WAY RICHMOND BC

DEVELOPMENT PERMIT PANEL PRESENTATION





# **TABLE OF CONTENTS**

~\_

1.0 INTRODUCTION

2.0 PROJECT CONTEXT

3.0 DESIGN PROPOSAL

4.0 LANDSCAPE

5.0 RENDERINGS



## to the second

# **1.0 INTRODUCTION**

protocol de la

so that the serve

5 AR05-AP1

114024463

KCC ARCHITECTURE

# **1.1** PROJECT INTRODUCTION

# The property is situated between Wireless Way and Westminster Highway,

west of Sparwood Place, encompassing a total area of 20,088,73 square meters. Currently zoned as 13 industrial Business Park in the Crestwood Area, the site hosts a three-story building at its centre. The proposed development aims to subdivide the western portion of the property, aligning with the city's initiative to enhance industrial land density.

Benefiting from its strategic location, the site boasts convenient access to major transportation routes such as Westminster Highway, Knight Street, and No. 6 Road, connecting to key highways in the lower mainland.

Surrounded by operational industrial developments to the north, east, and west, the property faces Westminster Highway to the south, featuring a statutory right of way along its southern boundary. Notably, this right of way is Intended to extend Sparwood Place, providing secondary access to the adjacent western property.

In response to preliminary comments received on August 12, 2021, the City initially requested a separate site access for the new parcel. However, following a thorough review with the client, it was determined that sharing site access with the existing building would be preferred. This arrangement allows for the creation of a welcoming pedestrian plaza in front of the new building, enhancing the overall design and functionality of the development.

SYMPHONY HILL TECH CENTRE 2 | 13888 WIRELESS WAY RICHMOND BC



KCC ARCHITECTURE

[51] (010) [01103]

## **2.0 PROJECT CONTEXT**

DES GEPPOROSAE

1 diar chiti

AP AR JHGS



# 2.1 SITE CONTEXT



AG | Agriculture & Golf CV | Vehicle Sales IB | Industrial Business Park IL | Light Industrial SI | School & Institutional ZI | Industrial Business Park - Crestwood Area (East Cambie)

6 SYMPHONY HILL TECH CENTRE 2 13888 WIRELESS WAY RICHMOND BC

KCC ARCHITECTURE

# **2.2** APPLICABLE POLICIES & GUIDELINES







Community Energy De and Emissions Plan

2050



Flood Protection Management Strategy 2019







Waste Management Design Guidelines



KCC ARCHITECTURE

# CAREPORT MAGE.

DARKS AR

## **3.0 DESIGN PROPOSAL**

+ PROTECT CONTENT

化振动化制油

# **3.1** DESIGN RATIONALE

### 3.1.1 Building Layout

The proposed new development comprises a three-story building, with the first two levels designated for multitenant industrial units. The third level is allocated for additional office space, either for the units below or for new tenants. All units will be offered as strata properties.

Assuming that the primary service connections are available along Wireless Way, service rooms have been strategically positioned to face North, specifically towards Wireless Way. To ensure a visually unobtrusive appearance, the illumination of the building will be confined within the property boundaries. Rooftop units will be carefully situated to remain out of sight from the street; where visibility is unavoidable, aesthetic screening will be implemented.

In response to the City's preliminary comments, parking has been meticulously provided. The parking spaces for the existing building adhere to the zoning requirements outlined in the original submission, ensuring compliance with city regulations.

### 3.1.2 Building Form and Character

The architectural design incorporates **prominent featured walls to seamlessly mirror and integrate with the existing building, maintaining a cohesive aesthetic.** The proposed building height is meticulously set at 14.3 meters.

The strategically positioned canopies introduce strong lines, highlighting and defining the entrances to each unit. Varied parapet heights, reveals, and painted stripes contribute to the nuanced articulation evident throughout the building elevations.

A judicious combination of materials and colours has been selected to accentuate both individuality and a harmonious overall design. In addition, the maximization of windows serves the dual purpose of allowing ample natural light to permeate interior spaces, enhancing the overall functionality and aesthetic appeal of the structure.



# **3.1** DESIGN RATIONALE

### 3.1.3 Accessibility Strategy

The accessible path leading to each building aligns with public accessibility standards, ensuring uniformity. Positioned in front of each building, the path runs parallel to the entire length of the structure. This layout **allows individuals using** wheelchairs to easily navigate, providing sufficient space to turn around and maneuver at the entrance door of each unit.

Internally, the design and finishing of the proposed building are intentionally structured for future stratification upon completion. As a result, we are currently adhering to the minimum code requirements per unit. This approach affords flexibility to prospective tenants, enabling them to tailor their spaces according to specific needs and preferences once they assume occupancy.

### 3.1.4 Sustainability Statement

The buildings incorporate **high-performance building materials**, including insulated tilt-up panels, double glass units with e-coating, and insulated overhead doors, rellecting a commitment to energy efficiency and sustainability. Specifically, windows in office/mezzanine areas feature canopies to mitigate direct sunlight, while strategically positioned **skylights** enhance natural light within the warehouse, contributing to reduced energy consumption.

To promote the use of electric vehicles, the new industrial facility will be equipped with one charging station for each unit. Thoughtful landscape design, encompassing both soft and hard elements, has been implemented to elevate common areas, minimize water consumption, and utilize native plants to reduce irrigation requirements.

In alignment with water conservation practices, all toilets within the facility will adhere to water-efficient standards. Complying with the latest British Columbia Building Code (BCBC) requirements during the Building Permit coordination process, we will develop a comprehensive building energy model. This model will ensure the **optimization of the building's energy performance, achieving a harmonious balance among mechanical, electrical, and building envelope components to enhance overall efficiency and effectiveness.** 



# **3.3** LEGAL & SETBACKS



#### SITE DATA LOT 1

 $\left( \begin{array}{c} 1 \\ 1 \end{array} \right)$ 

### CIVIC ADDRESS

13886 WIRELESS WAY RICHMOND BC

#### LEGAL DESCRIPTION

LDT B SECTION 5 BLOCK 4 NORTH RANGE 5 WEST NEW WESTMINSTER DISTRICT PLAN BCP24407 PID 026-714-604

#### ZONING

INDUSTRIAL BUSINESS PARK (ZI3) - CRESTWOOD AREA (EAST CAMBIE)

#### SITE AREA

SETBACKS

SYMPHONY HILL CORPORATE LOT 1 (PROPOSED BUILDING)

TOTAL SITE AREA 41,568.45 SF (3,861.83 SM)

### BUILDING FOOTPRINT

PROPOSED BUILDING 15,891.49 SF (1,476.37 SM)

FRONT YARD (WIRELESS WAY) 6.0 M PERMITTED 7.3 M PROVIDED

REAR & INTERIOR SIDES YARDS NO MINIMUM REQUIRED

#### SITE DATA LOT 2

#### CIVIC ADDRESS

13888 WIRELESS WAY RICHMOND BC

#### LEGAL DESCRIPTION

LOT B SECTION 5 BLOCK 4 NORTH RANGE 5 WEST NEW WESTMINSTER DISTRICT PLAN BCP24407 PID 026-714-604

#### ZONING

INDUSTRIAL BUSINESS PARK (ZI3) - CRESTWOOD AREA (EAST CAMBIE)

#### SITE AREA

SYMPHONY HILL CORPORATE LOT 2 (EXISTING BUILDING)

### TOTAL SITE AREA 174,671.86 SF (16,227.54 SM)

BUILDING FOOTPRINT

EXISTING BUILDING FOOTPRINT 42,231.13 SF (3,923.40 SM)

#### SETBACKS

FRONT YARD (WIRELESS WAY) 6.0 M

REAR & INTERIOR SIDES YARDS

NO MINIMUM REQUIRED

PERMITTED PROVIDED



# **3.4 PROJECT STATISTICS**





	SHEDANALOTA						
	BUILDING FOOTPRINT						
	PROPOSED BUILDING	15,891.49 SF (1,476.37 SM)					
	GROSS FLOOR AREA						
-	LEVEL 1 LEVEL 2 LEVEL 3	15,891.49 SF (1,476.37 SM) 9,166.10 SF (851.56 SM) 15,295.71 SF (1,421.01 SM)					
	TOTAL GFA	40,353.30 SF (3,748.94 SM)					
	DENSITY (FAR)						
	PERMITTED PROPOSED	1.00 0.97					
	LOT COVERAGE						
	PERMITTED PROPOSED	60% 38%					
	BUILDING HEIGHT						
Ş	ALLOWED	13,00 M (42.65') TO THE ROOF DECK 15,00 M (49.21') FOR MECHANICAL EQUIPMENT &					
	PROPOSED	12.83 M (42.09') 13.90 M (45.60') ARCHITECTURAL FEATURES W					
	AVERAGE FINISHED GRADE						
1	PROPOSED	2.40 M					
	PARKING REQUIREMENT						
	INDUSTRIAL, WAREHOUSE	2.80 spaces per 100.0 m² of gross leasable floor a					
-	REQUIRED	The gross leasable floor area for the warehouse, including the ancillary office space: 3,436.87 SM 3,436.87 / 100 x 2.80 = 96.23 (96)					
-	PROPOSED	Variance requested to use the Industrial General parking rate of 0.75 spaces per 100.0 m² 3,436.87 / 100 × 0.75 = 25.77 (26)					
198.	STANDARD PROVIDED SMALL PROVIDED TOTAL PROVIDED	16 16 32					
	ACCESSIBLE PARKING						
	REQUIRED	If required more than 11 spaces 2% are required					
	PROVIDED	2 x 26 / 100 = 0.52 1 (Van Accessible)					
	LOADING SPACE						
-2	REQUIRED	1 every 1,861 SM GFA, + 1 every 5,000 SM above 1 2					
	PROVIDED	2 (One medium loading space shared with					
	BIKE STORAGE						
	CLASS 1	REQUIRED 3,436.87 / 100 x 0.27 = 9.27 (9) PROVIDED 10					
D 8C	CLASS 2	REQUIRED 3,436.87 / 100 x 0.40 = 13.74 (14) PROVIDED 16					

SITE DATA LOT 1

#### 12 SYMPHONY HILL TECH CENTRE 2 | 13888 WIRELESS WAY RICHMOND BC


	15,891.49 SF (1,476.37 SM)
	15,891.49 SF (1,476.37 SM) 9.165.10 SF (851.56 SM) 15,295.71 SF (1,421.01 SM)
	40,353.30 SF (3,748.94 SM)
	1.00 0,97
	60% 38%
	13.00 M (42.65) TO THE ROOF DECK 15.00 M (49.21) FOR MECHANICAL EQUIPMENT & ARCHITECTURAL FEATURES ONLY
	12.83 M (42.09') 13.90 M (45.60') ARCHITECTURAL FEATURES WALLS
DE	
_	2.40 M
E	2.80 spaces per 100.0 m² of gross leasable floor area
	The gross leasable floor area for the warehouse, including the ancillary office space: 3,436.87 SM 3,436.87 / 100 × 2.80 = 96.23 (95)
	Variance requested to use the Industrial General parking rate of 0.75 spaces per 100,0 m² of gross leasable floor area: 3,436,87 / 100 x 0.75 = 25.77 (26)
	16 16 32
	If required more than 11 spaces 2% are required accessible 2 × 26 / 100 = 0.52 1 (Van Accessible)
	1 every 1,861 SM GFA, + 1 every 5,000 SM above 1,861 SM 2
	2 (One medium loading space shared with the garbage truck space)
	REQUIRED 3,436,87 / 100 x 0.27 = 9.27 (9) PROVIDED 10

#### SITE DATA LOT 2 BUILDING FOOTPRINT EXISTING BUILDING FOOTPRINT 42,231.13 SF (3,923.40 SM) GROSS FLOOR AREA EXISTING TOTAL BUILDING AREA 126,693.39 SF (11,770.20 SM) DENSITY (FAR) PERMITTED PROPOSED 1.00 0.72 LOT COVERAGE PERMITTED PROPOSED 60% 24% BUILDING HEIGHT 13.00 M (42.65') TO THE ROOF DECK 5.00 M (49.21') FOR MECHANICAL EQUIPMENT & ARCHITECTURAL FEATURES ONLY ALLOWED BUILDING HEIGHT REMAINS AS ORIGINALLY APPROVED BY THE CITY EXISTING AVERAGE FINISHED GRADE EXISTING 3.00 M PARKING REQUIREMENT 2.80 spaces per 100.0 m<sup>2</sup> of gross leasable floor area 10,826.09 / 100 x 2.80 = 303.13 (304) REQUIRED STANDARD PROVIDED SMALL PROVIDED TOTAL PROVIDED 111 256 367 ACCESSIBLE PARKING If required more than 11 spaces 2% are required accessible 2 x 303 / 100 = 6.06 (6) 11 REQUIRED

PROVIDED




# **3.4 PROJECT STATISTICS**

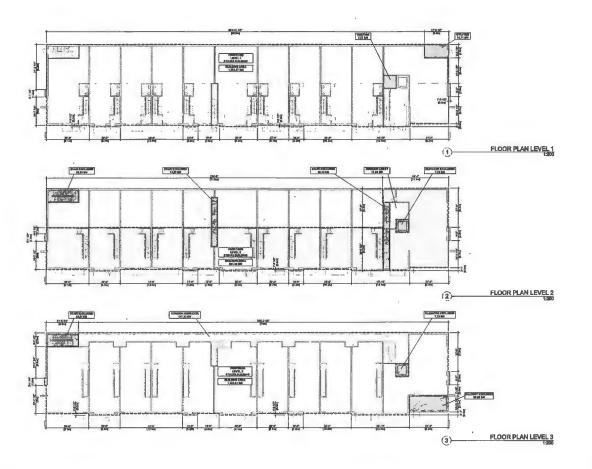


13 SYMPHONY HILL TECH CENTRE 2 | 13888 WIRELESS WAY RICHMOND BC


KCC ARCHITECTURE

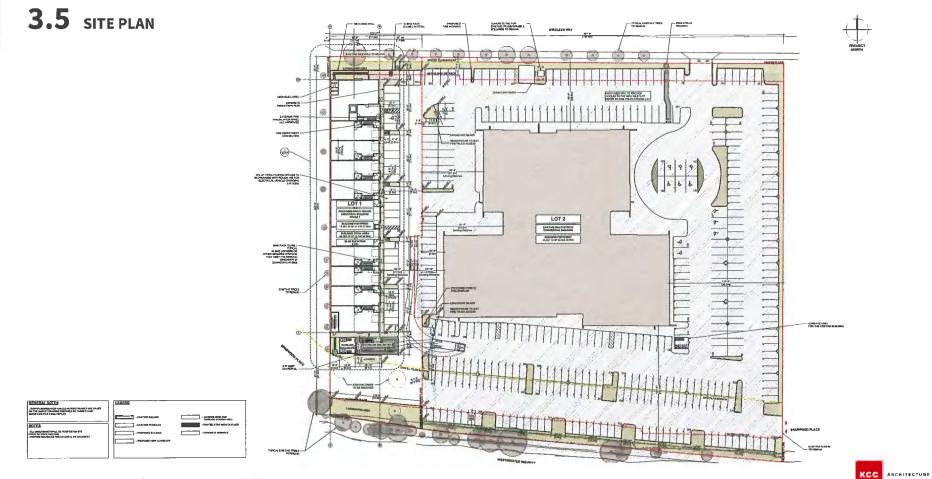



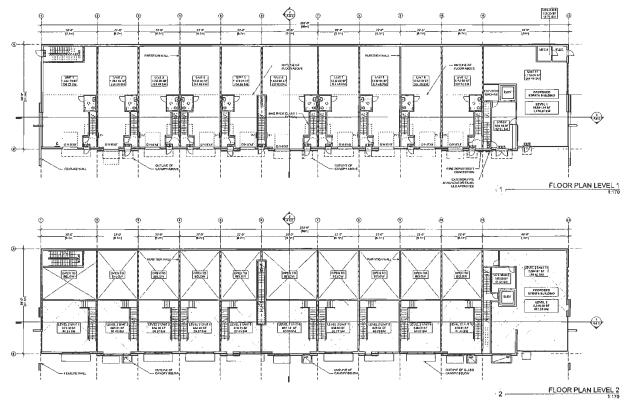




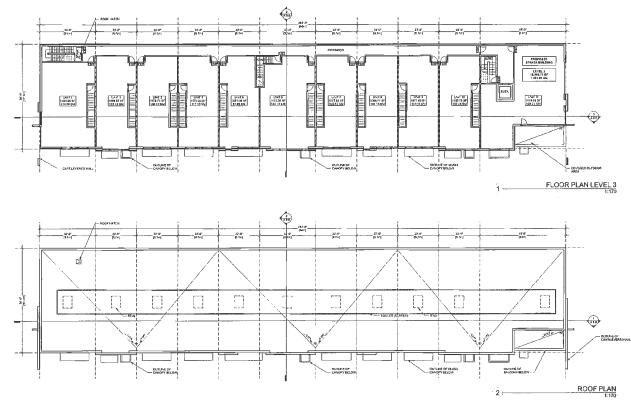



3.7 ELEVATIONS

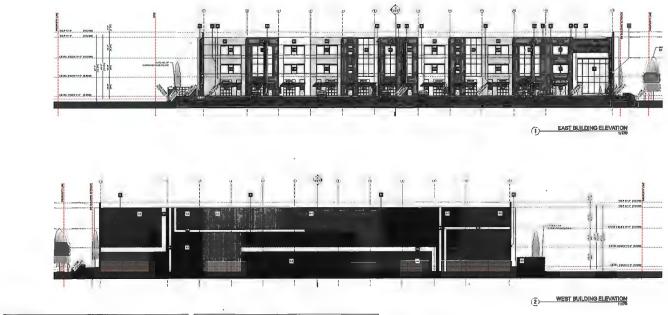



AND YEAR - ALL protocology and the second s	MATTENIA LEGEND		COLONE L POPUL		
-Prior Constraint and Region for (1600) PLane	E BELLANE TA GAR BOLOGER MARL Dan Carl Paymer and . Carl Layers and . Barts (Annel Action Level Lane		Distriction access     Distriction acces	And Anticipation (Active Activ	Construction States     Construction     Constructio



#### SYMPHONY HILL TECH CENTRE 2 13888 WIRELESS WAY RICHMOND BC 18

ALL BRIDERING (MALL OF TENTION ON AND	Infrant Linking		SCI. On all Linkson		
-PAR Control ( particular ACTUAL TO ( 1997) ( home	CONTRACTOR DECISION OF ADVANCES PROM	Tanga January 🔤	In success become	C Harton warm	Version and a statement
	CANTURNED INCL	TLANSID ONLOT	El de Later lacolo	STORAGE METOTE	HONESTEEN VERALAND
	Currie mi L		Barranten include	E Ingelations Column	States and a state of the state
	The Property and the second second	Carlos al Carlos an Anna an Ann	District and a second second	The second process and the second	

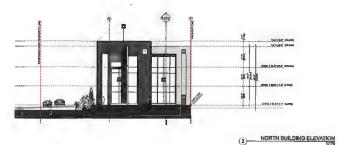

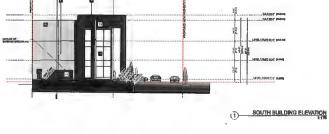


# 3.7 ELEVATIONS

KCC ANCHITECTURE

**3.8** SECTIONS



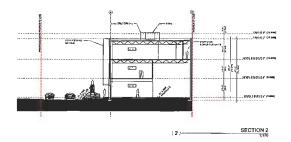

19 SYMPHONY HILL TECH CENTRE 2 | 13888 WIRELESS WAY RICHMOND BC



## **3.9** VARIANCES

#### 3.9.1 Variance Rationale

We seek the City's consideration of the following variances, along with accompanying rationale for each:

(A) reduce the required number of parking spaces from 2.8 spaces to 0.75 spaces for each 100 square meter of gross leasable floor area of building on Lot 1

1. The primary purpose of the proposal is for warehouse and storage, requiring minimal utilization of parking spaces.

(B) reduce the minimum required number of large-sized on-site designated loading spaces on Lot 1 from 1 space to 0 spaces

 The industrial units are intentionally designed to accommodate smaller operations, unsuitable for large-scale production, manufacturing, or extensive storage activities. The envisioned use primarily involves vans and pick-up trucks.


2. Each unit features an overhead door that opens directly to an adjacent parking space. This layout is purposefully designed to facilitate the loading and unloading of small to medium-sized packages, with the expectation that vans or pick-up trucks can park in close proximity to the overhead door.

3. Moreover, the proximity of the site to the existing office building on Lot 2 necessitates careful consideration in the size of trucks accommodated. The cohesive design of the new building is intended to seamlessly integrate with the existing structure, making larger trucks incongruent with the overall aesthetic. Therefore, accommodating larger trucks on this site would not be harmonious with the design intent and visual cohesion of the surrounding area.

(C) reduce the minimum percentage of standard parking spaces on Lot 2 from 50 percent to 30 percent


 The existing building on Lot 2 included more parking spaces than required. Despite the reduction in standard parking spaces, the project still complies with Zoning requirements.

20 SYMPHONY HILL TECH CENTRE 2 | 13888 WIRELESS WAY RICHMOND BC

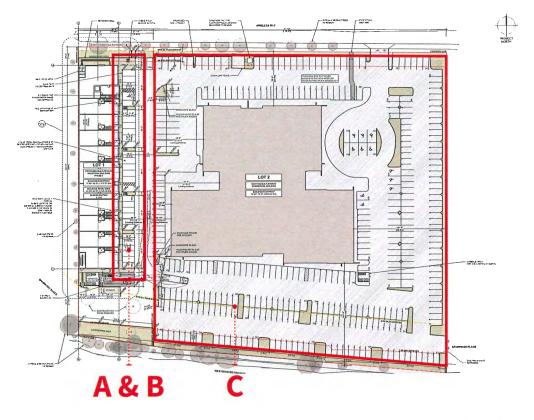

KCC ARCHITECTURE




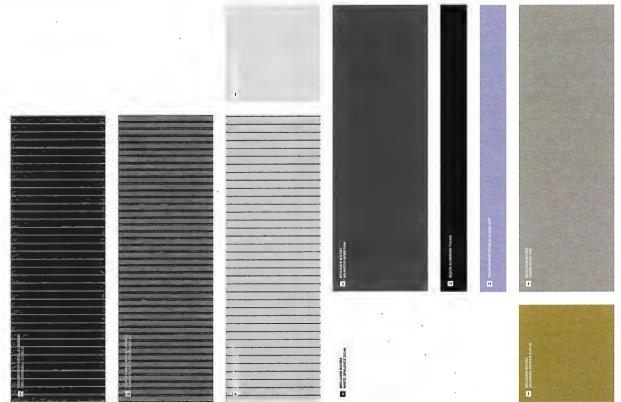

KCC ARCHITECTURE

21 SYMPHONY HILL TECH CENTRE 2 | 13888 WIRELESS WAY RICHMOND BC

## 3.11 SHADOW ANALYSIS

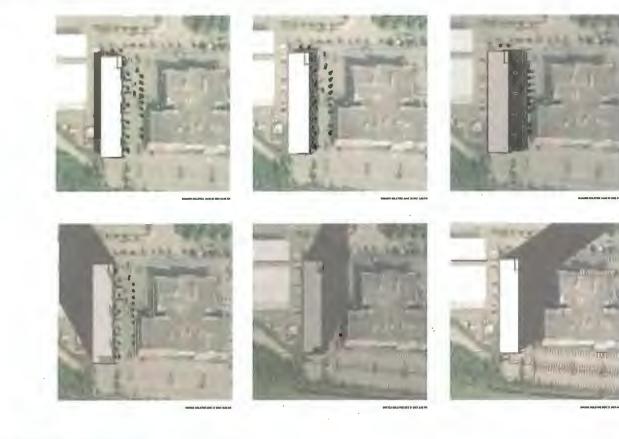

22 SYMPHONY HILL TECH CENTRE 2 | 13888 WIRELESS WAY RICHMOND BC





P DOLLARS.




DESIGN/PROPERTY

ali of choilt a

CIERCORE done

1 P. 14

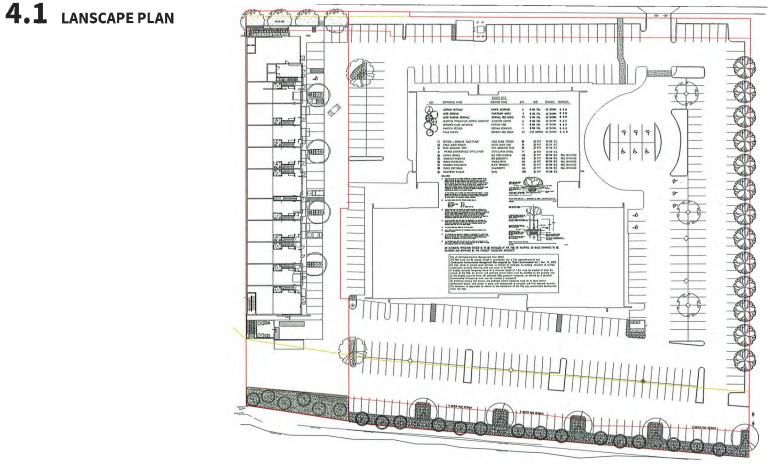

KCC ARCHITECTURE


24 SYMPHONY HILL TECH CENTRE 2 | 13888 WIRELESS WAY RICHMOND BC



## **5.0 RENDERINGS**

- A PADPA APE
- FL PROFILE (NEW)
- 四句书(中)(何月第
- 파티국이하나다 이하
- $(0, \varepsilon_1, \ldots, \varepsilon_n) \in (0, \varepsilon_1, \varepsilon_1, \ldots, \varepsilon_n)$



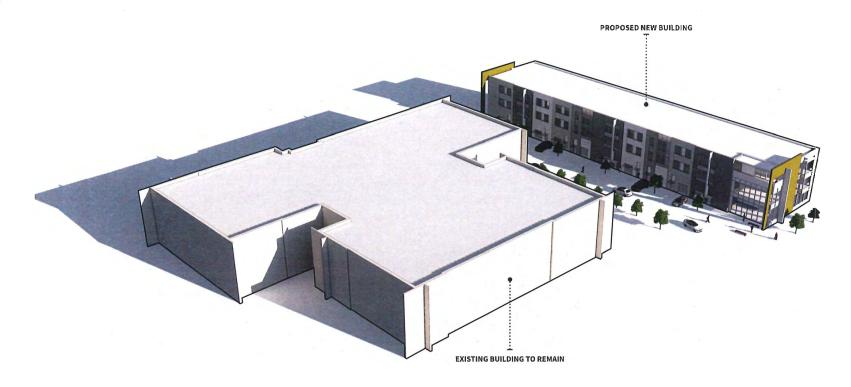

26 SYMPHONY HILL TECH CENTRE 2 | 13888 WIRELESS WAY RICHMOND BC



5.1 RENDERINGS



-----


27 SYMPHONY HILL TECH CENTRE 2 13888 WIRELESS WAY RICHMOND BC



28 SYMPHONY HILL TECH CENTRE 2 | 13888 WIRELESS WAY RICHMOND BC



Schedule 3 to the Minutes of the Development Permit Panel meeting held on Wednesday, January 17, 2024

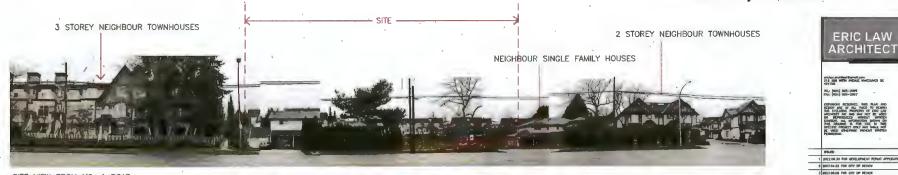

SITE VIEW FROM NO. 1 ROAD



SITE VIEW TOWARD NEIGHBOUR TOWNHOUSE AT THE REAR



AERIAL CONTEXT VIEW





SITE VIEW ACROSS NO 1 ROAD



NEIGHBOUR SINGLE FAMILY HOUSE





2013 10.03 TOR OTY DP REACH 2023 11 23 TOR OTY DP REACH 2023 12 14 FOR CITY DP REACH 2024 01.12 TOR CITY DP PRODUCT

PROPOSED TOWNHOUSE 6571-6591 NO, 1 ROAD RICHMOND BC

NEIGHBOUR SINGLE FAMILY HOUSE OPPOSE NO. 1 ROAD

DP 22-021165

PROJECT NUMBE	ER:16-03
ISSUED:	1/5/2024
DRAWN BY:	EL
CHECKED BY:	EL


CONTEXT

CONTEXT



DP 22-021165



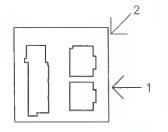

2. VIEW ALONG NO 1 ROAD SIDEWALK

 PROJECT NUMBER:16-03

 ISSUED:
 1/5/2024

 DRAWN 8Y:
 EL

 CHECKED BY:
 EL

 FILENAME:
 10-04\_SH0\_240108-DPP-PRESEND


I BILLASS BROOM FOR ALL CONCEPTS ROOM SEED TOWNHOUSE 8571-8591 NO, 1 ROAD RICHMOND BC

DP 22-021165

IMAGE (1)



1. AERIAL VIEW ALONG NO 1 ROAD

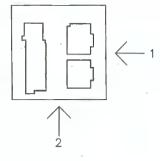



#### 2. AERIAL SOUTH VIEW

IMAGE (2)

PROJECT NUMBER:16-03 ISSUED: 1/8/2024 DRAWN BY: EL CHECKED BY: EL FILENAME: 10-04\_SHOL:R0108-DPP-PRESDA

11.23 PENDED POIL OFT EAML

PROPOSED TOWNHOUSE 6571-8591 NO, 1 ROAD RICHMOND BC

ERIC LAW

 2022.08.30 FOR DEVELOPMENT

 2022.08.30 FOR DEVELOPMENT

 2023.04.38 FOR DEVELOPMENT

 32023.06.08 FOR OTY DP REVEN

 42023.10.03 FOR OTY DP REVEN

 8003.11.25 FOR ETY DP REVEN

 2023.04.07 FOR ETY DP REVEN

 8003.11.25 FOR ETY DP REVEN

 7004.01.77 FOR ETY DP REVEN





2. AERIAL WEST VIEW

DEVELOPMENT PERMIT


DP 22-021165

IMAGE (3)

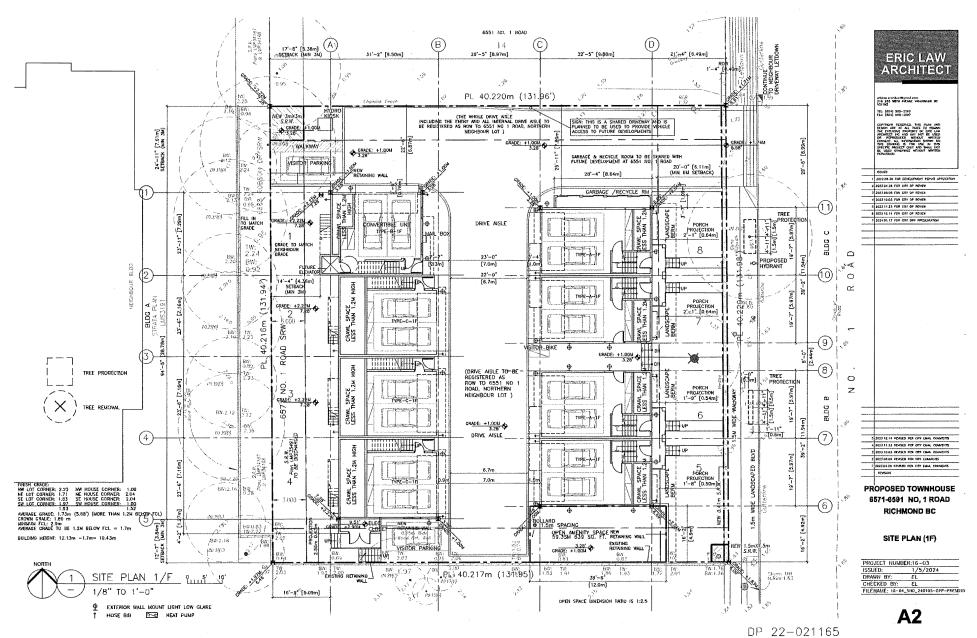


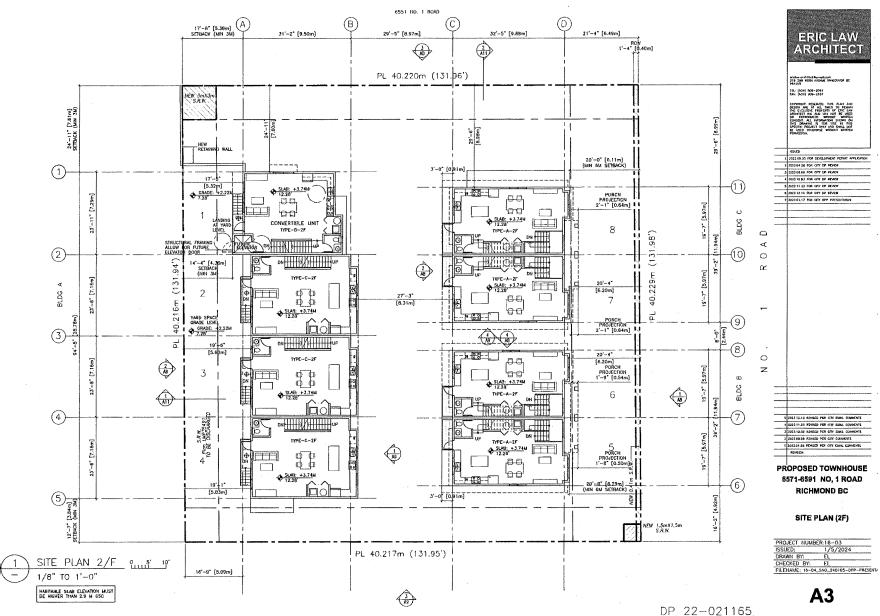

NORTH

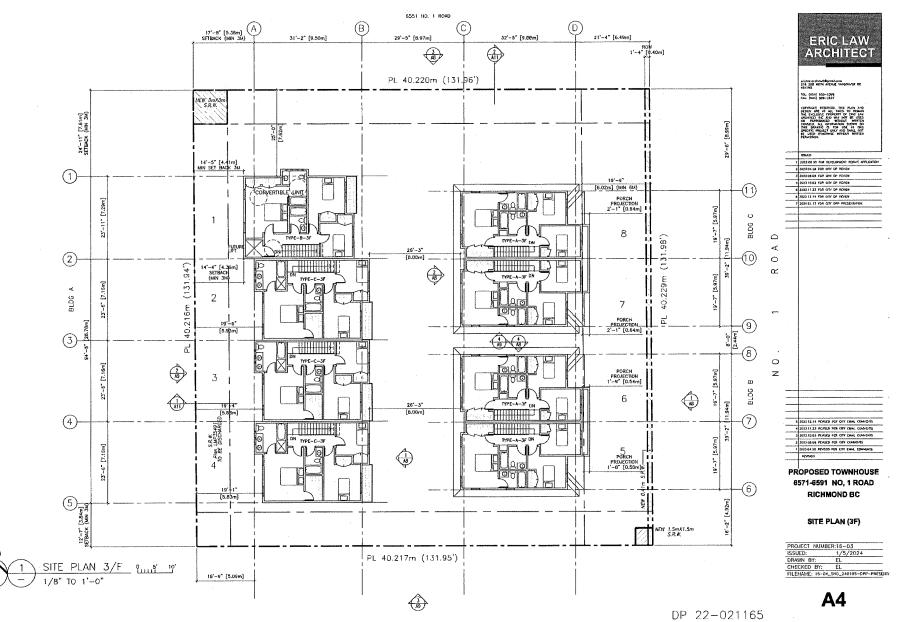


NORTH

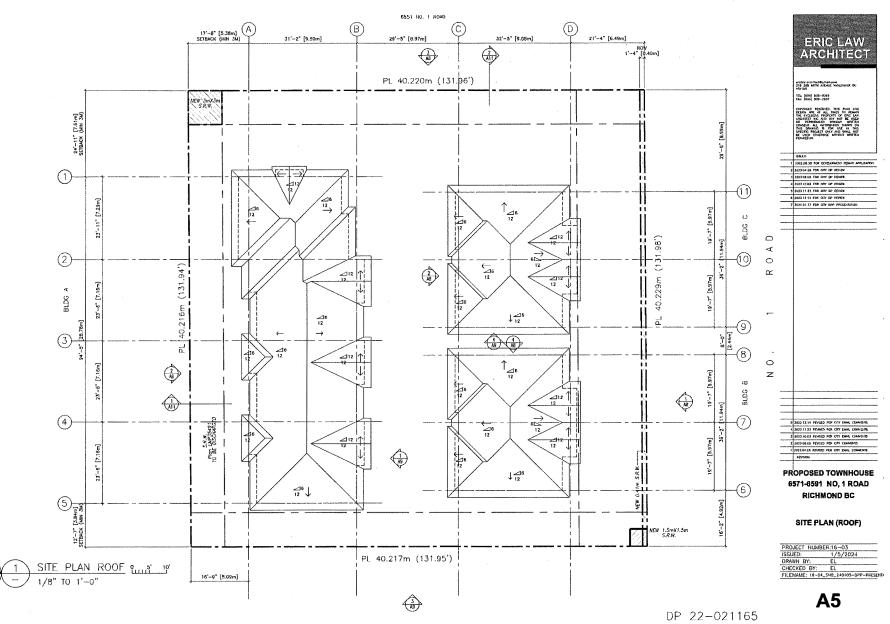


NORTH



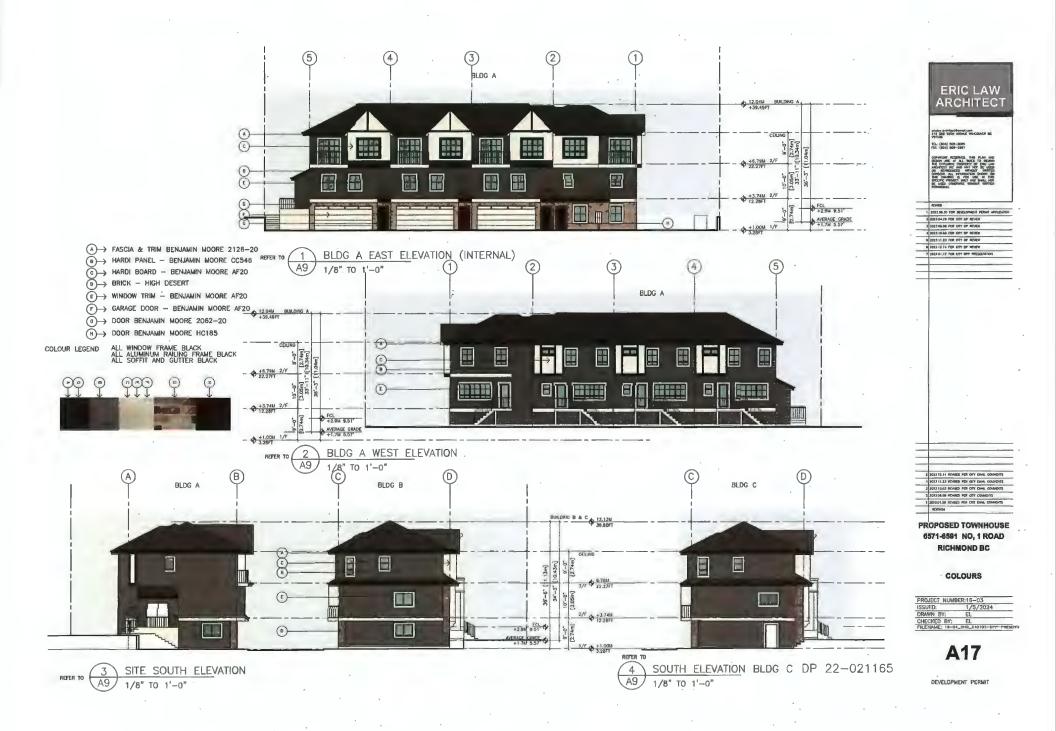






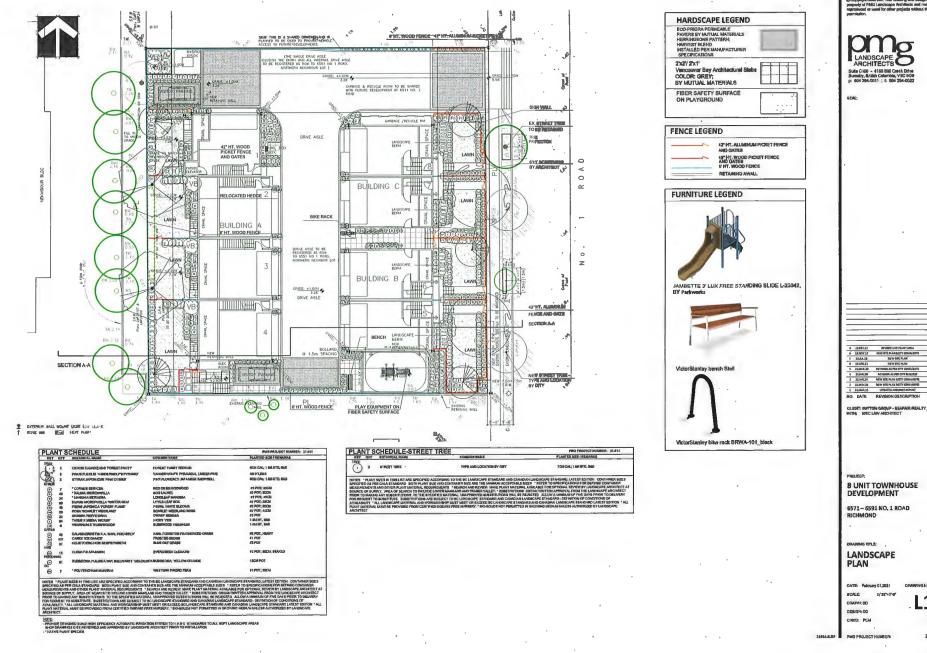

L1 OF4 21-014

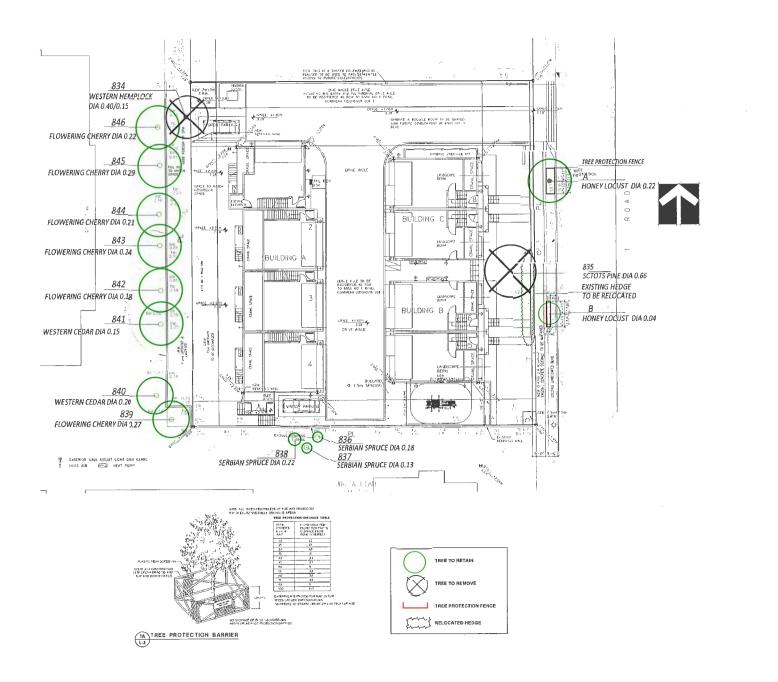

Copyright reserved. This drawing and design is the property of PMG Landscape Architects and may not be reproduced or used for other projects without their parmission.



SEAL

2136.11 ROMEONTANTOR
 2136.11 ROMEONTANTOR
 326.11 ROMEONTANTOR
 336.11 ROMEONTANTOR

NO. DATE REVISION DESCRIPTION CLIMIT: SUTTON GROUP - SEAFAIR REALTY WITK: ERIC LAW ARCHITECT

DR.

PROJECT 8 UNIT TOWNHOUSE DEVELOPMENT 6571 - 6591 NO. 1 ROAD RICHMOND

DRAWING TITLE: TREE MANAGEMENT PLAN

DATE: February 03,2021 CRAWING NUMBER SCALE: 3/ 32\*=1'-0\* DRAW(): DD

L3 OF 4

OESIGN: DD CHKID; PCM 21014-8.20 PMG PROJECT NUMBER

21-014

Schedule 4 to the Minutes of the Development Permit Panel meeting held on Wednesday, January 17, 2024

To Development Parmit Panel

	January 17, 2024	Item # (3			
From:	Shiraz Mohamed <shirazmohamed@hotmail.com></shirazmohamed@hotmail.com>	Ro: DP 22-021165			
Sent:	January 17, 2024 10:24 AM				
То:	CityClerk				
Subject:	Development Permit Panel Meeting for File 22-021165 Applicant 0853803 BC Ltd				
Follow Up Flag:	Follow up				
Flag Status:	Flagged				

City of Richmond Security Warning: This email was sent from an external source outside the City. Please do not click or open attachments unless you recognize the source of this email and the content is safe.

## Hi Ashley Kwan,

My name is Shiraz Mohamed & my wife & I own the adjoining property # 6551 on No 1 Road.

Due to critical weather condition I am unable to attend the above meeting and am resorting to email to put forward my concerns that this permit should not be issued as I have addressed previously to the City the reasons for my concerns. We have lodged our objection to have the two lots developed since the start of this application and the City Planning and Development Division must have all my prior emails and communications.

If the Rezoning Application were to be approved, this would have very negative on both my wife and I:

- The Rezoning would immediately devalue our property causing unnecessary financial duress and hardship
- The Rezoning would make it very difficult to sell our property, once approved
- The Rezoning would greatly limit the redevelopment opportunities of our property and go against the City's development plan
- The Rezoning would interrupt the enjoyment of our property as we would now be sandwiched between two different townhouse developments.

Based on the points above, I strongly urge the City to reconsider and deny this application for Rezoning.

Thank you for your time. Shiraz & Almas With regards

Sent from my iPad



To: Development Permit Panel From: Wayne Craig Director, Development Date: February 23, 2024 File: DP 21-941827

Re: Application by Vivid Green Architecture Inc. for a Development Permit at 6740, 6780 Francis Road

## **Staff Recommendation**

That a Development Permit be issued which would permit the construction of a total of four front-to-back duplexes at 6740 and 6780 Francis Road (one duplex on each new lot created after subdivision), on lots zoned "Two-Unit Dwellings (ZD7) – Francis Road (Blundell)".

Wayne Co

Wayne Craig Director, Development (604-247-4625)

WC:cl

Att. 2

## Staff Report

## Origin

Vivid Green Architecture Inc. has applied to the City of Richmond [on behalf of the owner Ding City Development Inc. (Directors: Guo Qing Yao, Guo Hui Yao, Ji Ting Yang, Heng Henry Li)] for permission to develop a total of four front-to-back duplexes at 6740 and 6780 Francis Road (Attachment 1) on a site zoned "Two Unit Dwellings (ZD7) – Francis Road (Blundell)". The site currently contains two vacant lots. Subdivision of the site to create four lots is required prior to the construction of each duplex.

The site is being rezoned from the "Single Detached (RS1/E)" zone to the "Two-Unit Dwellings (ZD7) – Francis Road (Blundell)" zone for this project under Richmond Zoning Bylaw 8500, Amendment Bylaw 10277 (RZ 17-775025). The Bylaw was given third reading at the Public Hearing held July 19, 2021 and the applicant is working to complete all of the rezoning requirements.

A Servicing Agreement is required to be entered into prior to subdivision approval and includes, but is not limited to, the following improvements:

- Design and construction of a new 1.5 m wide concrete sidewalk and wide treed/grass boulevard after land dedication to accommodate the works and future road widening along Francis Road.
- Provision of water, storm sewer and sanitary sewer service connections, water meters and inspection chambers as required for each lot. A new 1.5 m wide Statutory Right-of-Way (SRW) is required to be registered on Title to accommodate the servicing infrastructure located along the north property lines of the lots.

Additional road improvements associated with rezoning include the submission of a \$45,600.00 contribution towards the construction of a special crosswalk at the Francis Road/Minler Road intersection.

### **Development Information**

Please refer to the attached Development Application Data Sheet for a comparison of the proposed development data with the relevant Bylaw requirements (Attachment 2).

## **Existing Site Description and Surrounding Context**

The subject site is located on the south side of Francis Road, just west of Gilbert Road. The site is currently vacant, with two driveway crossings to Francis Road.

Existing development immediately surrounding the subject site is as follows:

To the north: Directly across Francis Road are two-storey townhouses on a lot governed by Land Use Contract 047 (with underlying zoning "Town Housing (ZT101) – Francis Road & Lucas Road (Blundell)").

To the east:	Are three lots at 6800 Francis Road, 9071 and 9091 Gilbert Road, that are the subject of an active application to develop 14 townhouses (RZ 22-011696/ DP 23-028754). The application is in circulation and will be subject to a separate staff report to be presented to Council for consideration upon completion of the staff review.
To the south:	Are single-family dwellings on lots zoned "Single Detached (RS1/B)" fronting Maple Place.
To the west:	Is a vacant lot at 6700 Francis Road that was recently rezoned to "Two Unit Dwellings (ZD7) – Francis Road (Blundell)" and a Development Permit issued to facilitate the construction of two duplexes (RZ 19-867880/ DP 21-934726). The site is currently the subject of an active subdivision application to create two lots, each to contain a front-to-back duplex (SD 19- 867901).

## **Rezoning and Public Hearing Results**

During the rezoning application review process, staff identified the following design issues to be further examined at the Development Permit (DP) stage:

- Compliance with the DP Guidelines for Arterial Road Duplex projects in the Official Community Plan (OCP).
- Review of the proposed architectural character, scale and massing to ensure that the duplexes are well designed, fit well into the neighbourhood and are sensitive to the existing surrounding single-family housing.
- Confirming that aging-in-place features are provided in all units, as well as the provision of a Convertible Unit.
- Refinement of lot grading to ensure tree protection and an appropriate transition to existing neighbouring development.
- Refinement of the landscape design to finalize the provision of a staging area for waste bin collection, and ensuring a mix of conifer and deciduous replacement trees of the required size.

Through the review of this DP application, staff worked with the applicant to address the design issues to staff's satisfaction. The applicant has made the following revisions to their proposal to address the design issues previously identified:

- Refinements to the design of the duplexes to ensure they are consistent with the DP guidelines for Arterial Road Duplexes and fit well into the neighbourhood, and that adjacency impacts are minimized. Revisions made to the design include:
  - Further differentiating the appearance of each duplex to avoid substantially similar designs side-by-side.
  - Widening the front portion of the shared drive-aisles slightly and emphasizing the rear unit entry design so that they are more visible from the street.
  - Improving the appearance of side elevations through varied cladding and reducing the size of window openings on side elevations along existing adjacent housing.

- Breaking up the roofline and building mass on the upper level to clearly define the front from the back unit in each duplex.
- Accessibility features have been finalized and verified, with aging-in-place features provided in all units and the provision of a Convertible Unit in "Duplex C" on "Lot 3".
- Lot grading has been refined to maintain the existing elevation in the tree protection areas in the rear yards and to maintain an appropriate transition to the existing neighbouring development to the south. Proposed lot grading along the far west property line of the subject site is to match that of the duplex that is to be constructed at 6700 Francis Road as part of a separate development application, while proposed lot grading along the far east property line of the subject site is to be addressed through a small retaining wall (ranging from 13 cm to 23 cm high).
- The Landscape Plan has been revised to increase the amount of soft landscaping and improve visual interest in the front yards, and the plant list has been updated to provide a mix of conifer and deciduous replacement trees of the required sizes.
- The short-term staging area for waste bin collection has been finalized and is easily accessible to service providers.

The Public Hearing for the rezoning of this site was held on July 19, 2021. At the Public Hearing, no concerns about the proposal were expressed by members of the public. Bylaw 10277 for the rezoning of the subject site was given third reading following the Public Hearing.

## Public Input During the DP Application Review Process

Staff has not received any comments from the public in response to the placement of the DP Application Notification Sign on the subject site.

## Staff Comments

The proposed scheme attached to this report (Plans # 1.a to 3.g, and Reference Plans) has satisfactorily addressed the significant urban design issues and other staff comments identified as part of the review of the subject DP application. In addition, it is consistent with the intent of the applicable sections of the OCP and complies with all aspects of the "ZD7" zone.

## Analysis

## **Conditions of Adjacency**

- The proposed two-storey duplexes at the subject site have been designed with consideration of the existing surrounding context of low-density two-storey single-family housing, as well as with the future context of Arterial Road Duplexes proposed immediately to the west and Arterial Road Townhouses to the east.
- The apparent building mass of each duplex has been minimized through the use of building recesses and physical breaks in the rooflines that assist with clearly defining each unit in the cluster.

- The architectural expression of the buildings along the streetscape is visually interesting, well articulated, sufficiently distinct from one another to provide variety and follows that of the residential character in the neighbourhood.
- Upper-level private outdoor spaces are oriented towards either the arterial road and or the central shared drive-aisles (with the side open to existing neighbouring lots recessed and screened with planters containing trees).
- The number and size of window openings are minimized along side yard elevations to avoid overlook into adjacent dwellings.

## Site Planning, Access, and Parking

- The proposed site layout on each new lot after subdivision consists of a duplex containing one unit at the front and one unit at the back. The front and back units are separated by paired carports that each accommodate two side-by-side resident parking spaces (i.e., a total of four resident parking spaces per lot). Each duplex is located on either side of a shared drive-aisle that runs through the center of each pair of lots. A visitor parking space is proposed at the south end of each of the drive-aisles, which is to be shared between each pair of duplexes (i.e., a total of two visitor parking spaces for the proposed development).
- Vehicle access to the site was examined as part of the rezoning application review process and supported by the City's Transportation Department. A single shared driveway crossing to each pair of lots is proposed from Francis Road and the drive-aisles on each pair of lots are to be shared. A legal agreement is required to be registered on Title prior to rezoning bylaw adoption to ensure that upon subdivision of the property, a reciprocal cross-access easement is registered on Title for the area of the shared drive-aisles and the shared visitor parking spaces.
- Pedestrian access from the public sidewalk to each of the front units is provided by a pathway treated with permeable pavers. Pedestrian access to each of the back units is provided via the shared drive-aisles. The use of the drive-aisles by both vehicles and pedestrians is highlighted by the proposed decorative surface treatment with permeable pavers. The entries to each of the eight units are visible from Francis Road.

### **Open Space and Landscape Design**

- Private outdoor space is provided on-site for each of the units as follows, consistent with the guidelines in the OCP:
  - The front units have access to the front yards as well as to upper-level decks that are oriented towards Francis Road and the central shared drive-aisles (with landscape screening provided on sides open to existing adjacent lots).
  - The back units have access to rear yards at grade with patios.

- Tree retention and removal was assessed as part of the Rezoning Application review process, at which time it was determined that:
  - A hedgerow consisting of 10 cedar trees along the south property line of 6740 Francis Road, a small hedgerow on neighbouring property near the northeast corner of 6780 Francis Road, four trees on neighbouring properties (Tag # 901-904), and one street tree in the boulevard on City-owned property (Tag # 905) are to be retained and protected;
  - Two trees and two shrubs in tree form are to be removed due to poor condition and conflict with the proposed development (Tag # 885-888).

The Landscape Plan includes the proposed Tree Management Plan (Plan #2.b) showing the trees to be retained and removed.

- The Landscape Plan illustrates that a total of 11 trees are proposed to be planted and maintained on-site in the front and rear yards, which exceeds the 2:1 tree replacement ratio requirement in the OCP. This includes a mix of deciduous and coniferous trees of various sizes and species (i.e., Black Hills spruce, Vine maple, Maidenhair tree, Columnar English oak, and Black Hawthorne).
- A variety of shrubs, perennials and grasses are proposed in the Landscape Plan, including (but not limited to): Azalea, Oregon Grape, Mock Orange, Skimmia, Spiraea, David's Viburnum, Bergenia, Blue Lily Turf, Salal, Wester Sword Fern.
- The Landscape Plan requires that all soft landscaped areas be maintained with the installation of an automatic irrigation system.
- A variety of decorative paving treatments is proposed on-site to differentiate between hardsurface area uses, to provide visual interest and to assist with site permeability. Specifically, two colours and patterns of permeable pavers are proposed for the entrance pathways, shared drive-aisles and visitor parking spaces (i.e., natural and charcoal colours, and running bond and herringbone patterns), standard large square pavers are proposed for patios and broomfinished concrete paving is proposed within the carports and for maintenance pathways.
- To define the street edge and clearly distinguish between public and private open space along Francis Road, low aluminum picket fencing, with staggered pilasters and gates, is to be slightly set back from the front property line and to surround the front yards.
- Horizontal cedar privacy fencing is proposed along the side yards not abutting the shared drive-aisles and around the rear yards (not to exceed 1.8 m high).
- A preliminary exterior lighting concept is proposed, which does not cause spill over onto adjacent properties. The lighting concept includes downward-facing building-mounted lighting along building facades and at unit entries. Proposed light fixture locations are illustrated on Plan # 1.c. The Landscape Plan also shows the location of pilaster-mounted and bollard lighting (Plan # 2.d).
- To ensure that the Landscape Plan is adhered to, the applicant is required to submit a Landscaping Security in the amount of \$219,247.50 (100 per cent of a cost estimate prepared by the Registered Landscape Architect, including all materials, installation, and a 10 per cent contingency), prior to DP issuance. A legal agreement is also required to set the terms for use and release of the Landscaping Security.

## Architectural Form and Character

- The design is modern with low sloping roofs and massing articulation. Small-scale elements such as covered front porches and rear unit entry canopies help to highlight main entrances and reinforce the residential character of development.
- A combination of contemporary composite lap siding and panels in a variety of muted tones with vertical wood-grained accent siding is used to provide subtle differentiation between units and duplex clusters. Specifically, the proposed colour palette consists of taupe, white, gray, burnt red, creamy yellow, black and two tones of grey.

## Accessible Housing

- Each of the units in the duplexes incorporates aging-in-place features to accommodate mobility constraints associated with aging. These features include:
  - stairwell hand rails;
  - lever-type handles for plumbing fixtures and door handles; and
  - solid blocking in washroom walls to facilitate future grab bar installation beside toilets, bathtubs and showers.
- One Convertible Unit is proposed in the front unit of "Duplex C" on "Lot 3", which is designed with the potential to be easily renovated to accommodate a future resident in a wheelchair. The potential conversion of these units will require installation of a stair lift, as proposed on the drawings. The list of Convertible Unit features and floor plans are included in the Reference Plans to the DP.

## **Sustainability**

- The applicant has submitted written confirmation from their Certified Energy Advisor that the proposed design will meet the required Energy Step Code 3 with a Low Carbon Energy System. The key technical elements that enable this performance target to be achieved include:
  - Primary air source heat pump for heating and cooling, and secondary natural gas condensing boiler for radiant heating.
  - Additional insulation in building assemblies (ceiling, exterior walls, floor, slab).
  - Triple glazed windows and doors.
  - Electric domestic hot water heating.
  - Heat recovery ventilation system.

The heat pumps for each of the front units are proposed to be located on the second-floor deck above carports near the common drive-aisles, and the heat pumps for the rear units are proposed to be tucked into a notch in the rear walls of the buildings. The project architect has submitted written confirmation that the proposed heat pumps will comply with the City's Noise Regulation Bylaw 8856. Prior to Building Permit issuance, the applicant is required to submit written confirmation of the same from a registered acoustic consultant.

• Consistent with Zoning Bylaw requirements, an energized outlet capable of providing Level 2 Electric Vehicle charging is proposed for each of the resident vehicle parking spaces.

## Crime Prevention Through Environmental Design (CPTED)

- The applicant has identified that the following principles of CPTED are incorporated into the proposed design:
  - The street edge is defined with low aluminum picket fencing and low planting in the front yards to provide an appropriate separation and transition from the public to private realm while maintaining visual porosity into the site
  - Extensive windows and private outdoor spaces at ground levels and upper levels along Francis Road act as "eyes on the street", providing a sense of natural surveillance.
  - The shared drive-aisles, visitor parking areas, and unit entrances contain pedestrian-level lighting for visibility. Lighting in rear yards also provides a sense of safety and security for residents using their private outdoor spaces at night
  - Surveillance equipment will be located in the front and rear yards, providing an added layer of security.

#### Site Servicing & Off-Site Improvements

- Servicing requirements and off-site improvements to support the proposed development were identified during the Rezoning Application review process and include (but are not limited to):
  - Land dedication as well as design and construction of a new 1.5 m wide concrete sidewalk and wide treed/grass boulevard to accommodate future road widening along Francis Road.
  - Provision of water, storm sewer and sanitary sewer service connections, water meters and inspection chambers as required for each lot. A new 1.5 m wide SRW is required to be registered on Title prior to rezoning, to accommodate the servicing infrastructure located along the north property lines of the lots.
  - Additional road improvements associated with rezoning include the submission of a \$45,600.00 contribution towards the construction of a special crosswalk at the Francis Road/Minler Road intersection.
- A Servicing Agreement is required to be entered into prior to subdivision approval for the design and construction of the servicing requirements and frontage improvements.

## Conclusion

This proposal is to develop four front-to-back duplexes on the subject site after subdivision, with vehicle access from Francis Road via shared driveway crossings.

The applicant has addressed the design issues identified through the Rezoning Application review process, as well as additional staff comments regarding site planning, urban design, architectural form and character, and landscape design identified as part of the DP application review process. The proposal as designed meets the applicable policies and design guidelines contained within the OCP, and complies with the requirements of the "ZD7" zone.

On this basis, staff recommend that the DP be endorsed, and issuance by Council be recommended.

Cynthia Lussier Planner 2 (604-276-4108)

CL: js

## Att. 1: Location Map 2: Development Application Data Sheet

The following requirements are to be completed prior to forwarding this DP application to Council for approval:

1. Receipt of a cash security or Letter-of-Credit for landscaping in the amount of \$219,247.50 (100% of a cost estimate prepared by the Registered Landscape Architect, including all materials, installation, and a 10% contingency). The applicant must enter into a legal agreement with the City that sets the terms for use and release of the landscaping security.

Prior to Subdivision<sup>\*</sup>, the applicant is required to complete the following:

- Register on title of the proposed new lots a cross-access easement for the shared driveway crossing, shared drive-aisles, and shared visitor parking spaces.
- Pay Development Cost Charges (DCCs)(City & GVS&DD), Translink DCCs, School Site Acquisition Charge, and Address Assignment Fees. The design and construction of service connections are to be dealt with through the Servicing Agreement (SA) process.
- Enter into a SA\* for the design and construction of servicing and off-site improvements, to include (but not limited to):

Water Works

- Using the OCP Model, there is 541 L/s of water available at 20 psi residual at the hydrant located at the north east corner of 6780 Francis Road. Based on your proposed development, your site requires a minimum fire flow of 95 L/s.
- At the applicant's cost, the applicant is required to submit Fire Underwriter Survey (FUS) or International Organization for Standardization (ISO) fire flow calculations to confirm the development has adequate fire flow for onsite fire protection. Calculations must be signed and sealed by a Professional Engineer and be based on Building Permit designs at Building Permit stage.
- At the applicant's cost, the City will install eight (8) new water service connections (two for each duplex) off of the 300 mm AC watermain on Francis Road, complete with water meters.
- Through rezoning, the applicant must provide a 1.5 m wide SRW along the north property line of the subject properties to accommodate the new water meters.

Storm Sewer Works

- At the applicant's cost, the applicant is required to:
  - Inspect and confirm the condition of the storm connection lead and inspection chamber (STIC61047) located at the adjoining property line of 6740 and 6780 Francis Road using video inspection. Use the existing service connection if video inspection shows that the existing leads are in good condition.
  - Inspect and confirm the condition of the storm connection lead and inspection chamber (STIC50515) located at the north east corner of 6780 Francis Road using video inspection. Use the existing service connection if video inspection shows that the existing leads are in good condition.
  - Inspect and confirm the condition of the storm connection lead and inspection chamber (STIC61048) located at the north west corner of 6740 Francis Road using video inspection. Use the existing service connection if video inspection shows that the existing leads are in good condition.

- At the applicant's cost, the City will:
  - Cut and cap the existing south west storm service connection located at the adjoining property line of 6740 and 6780 Francis Road (STIC61047).
  - Cut and cap the south east storm service connection located at the north east corner of 6780 Francis Road (STIC50515).
  - If the existing storm service leads (STIC61047, STIC61048 & STIC50515) are found to be inadequate, install new service connections. Details shall be finalized via the SA process.
  - Through rezoning, the applicant must provide a 1.5 m wide SRW along the north property line of the subject properties to accommodate the existing storm inspection chambers.

#### Sanitary Sewer Works

- At the applicant's cost, the applicant is required to:
  - Not start onsite excavation or foundation construction prior to completion of rear yard sanitary works by City crews.
  - Confirm the condition of the existing sanitary service, sanitary connection lead and inspection chamber at the south east corner of 6780 Francis Road (SIC17008) using video inspection. Use the existing service connections if video inspection shows that the existing leads are in good condition.
  - Confirm the condition of the existing sanitary service, sanitary connection lead and inspection chamber at the south west corner of 6740 Francis Road (SIC3966) using video inspection. Use the existing service connections if video inspection shows that the existing leads are in good condition.
  - Additional sanitary service connection may be required at the common property line of 6740 and 6780 Francis Rd.
  - The details of the sanitary servicing shall be finalized via the SA process.
- At the applicant's cost, the City will:
  - Install new service connections as per the approved SA design.
- Frontage Improvements
- The applicant is required to coordinate with BC Hydro, Telus, and other private communication service and utility providers:
  - When relocating/modifying any of the existing power poles and/or guy wires within the property frontages.
  - To determine if above-ground structures are required and coordinate their locations (e.g. Vista, PMT, LPT, Shaw cabinets, Telus Kiosks, etc.). These should be located on-site.
  - To underground overhead service lines
- The applicant is required to review street lighting levels along all frontages, and upgrade as required.
- The applicant is required to complete other frontage improvements as per the following City Transportation Department requirements:
  - Remove the existing sidewalk and construct a new 1.5 m wide concrete sidewalk next to the new property line.
  - Construct a new grass/tree boulevard over the remaining width between the new sidewalk and the existing south curb of Francis Road. The cross-section of the frontage improvements, measuring from north to south, are to include:
    - Existing south curb of Francis road.
    - 2.0 m wide grass boulevard with no tree planting (this area is slated for future road widening).
    - 1.5 m wide landscaped boulevard with street trees.
    - 1.5 m wide concrete sidewalk.
    - New north property line of the subject site.
    - 1.5 m wide utility SRW.

Note that, through rezoning, a 2.0 m wide road dedication is required for future road widening and an additional 0.1 m wide dedication is required to meet the required frontage improvements.

- o Account for the following other frontage improvements:
  - Tree planting is to be restricted to the 1.5 m wide strip of the boulevard immediately next to the new sidewalk. The 2.0 m wide boulevard behind the fronting Francis Road south curb is to be kept free of any tree planting.
  - The new sidewalk and boulevard are to transition to meet the existing frontage treatments to the east and west of the subject site. The transition sections are to be placed beyond the subject site's east and west frontages and are not to be constructed with angular turns.
  - All existing driveway crossings along Francis Road are to be closed permanently. The applicant is responsible for the removal of the existing driveway letdowns and the replacement with barrier curb/gutter, boulevard and concrete sidewalk per standards described under in this *Frontage Improvements* section.
  - New driveway crossings to the site must be constructed to City design standards.
  - Consult City Parks Department on the requirements for tree protection/placement including tree species and spacing as part of the frontage works.
  - All above-ground hydro/telephone kiosks and other third party equipment must not be placed within any frontage works area including sidewalk and boulevard.

### General Items

- The applicant is required to:
  - Provide, prior to start of site preparation works, a preload plan and geotechnical assessment of preload, dewatering, and soil preparation impacts on the existing utilities fronting the development site and provide mitigation recommendations.
  - Provide a video inspection report of the existing storm sewers along the Francis Road frontage and the
    existing sanitary lines along the south property line prior to start of site preparation works. A follow-up
    video inspection, complete with a civil engineer's signed and sealed recommendation letter, is required
    after site preparation works are complete (i.e. pre-load removal, completion of dewatering, etc.) to
    assess the condition of the existing utilities and provide recommendations to retain, replace, or repair.
    Any utilities damaged by the pre-load, de-watering, or other ground preparation shall be replaced or
    repaired at the applicant's cost.
  - Conduct pre/post-preload elevation surveys of all surrounding roads, utilities, and structures. Any damage, nuisance, or other impact to be repaired at the applicant's cost. The post-preload elevation survey shall be incorporated within the SA design.
  - Monitor the settlement at the adjacent utilities and structures during pre-loading, dewatering, and soil
    preparation works per a geotechnical engineer's recommendations, and report the settlement amounts
    to the City for approval.
  - Not encroach into City SRWs with any proposed trees, retaining walls, or other non-removable structures.
  - Enter into, if required, additional legal agreements, as determined via the subject development's SAs and/or DPs and/or Building Permit(s) to the satisfaction of the Director of Engineering, including, but not limited to, site investigation, testing, monitoring, site preparation, de-watering, drilling, underpinning, anchoring, shoring, piling, pre-loading, ground densification or other activities that may result in settlement, displacement, subsidence, damage or nuisance to City and private utility infrastructure.

Prior to Building Permit<sup>\*</sup> issuance, the applicant is required to complete the following:

- Submission of written confirmation (signed and sealed) from a registered acoustic consultant that noise associated with heat pump operation will comply with the City's Noise Regulation Bylaw.
- Incorporation of accessibility measures in Building Permit (BP) plans as determined via the Rezoning and/or DP Application processes.
- Installation of appropriate tree protection fencing around all trees to be retained as part of the development prior to any construction activities, including building demolition, occurring on-site. Tree protection fencing must be

installed to City standard as per the City's Tree Protection Information Bulletin Tree-03, and must remain in place until construction and landscaping on-site is completed.

- Submission of a Construction Parking and Traffic Management Plan to the Transportation Department. Management Plan shall include location for parking for services, deliveries, workers, loading, application for any lane closures, and proper construction traffic controls as per Traffic Control Manual for works on Roadways (by Ministry of Transportation) and MMCD Traffic Regulation Section 01570.
- If applicable, payment of latecomer agreement charges, plus applicable interest associated with eligible latecomer works.
- Obtain a Building Permit (BP) for any construction hoarding. If construction hoarding is required to temporarily occupy a public street, the air space above a public street, or any part thereof, additional City approvals and associated fees may be required as part of the Building Permit. For additional information, contact the Building Approvals Department at 604-276-4285.


\* This requires a separate application.

• Where the Director of Development deems appropriate, the preceding agreements are to be drawn not only as personal covenants of the property owner but also as covenants pursuant to Section 219 of the Land Title Act.

All agreements to be registered in the Land Title Office shall have priority over all such liens, charges and encumbrances as is considered advisable by the Director of Development. All agreements to be registered in the Land Title Office shall, unless the Director of Development determines otherwise, be fully registered in the Land Title Office prior to enactment of the appropriate bylaw.

The preceding agreements shall provide security to the City including indemnities, warranties, equitable/rent charges, letters of credit and withholding permits, as deemed necessary or advisable by the Director of Development. All agreements shall be in a form and content satisfactory to the Director of Development.

Applicants for all City Permits are required to comply at all times with the conditions of the Provincial Wildlife Act and
Federal Migratory Birds Convention Act, which contain prohibitions on the removal or disturbance of both birds and their
nests. Issuance of Municipal permits does not give an individual authority to contravene these legislations. The City of
Richmond recommends that where significant trees or vegetation exists on site, the services of a Qualified Environmental
Professional (QEP) be secured to perform a survey and ensure that development activities are in compliance with all
relevant legislation.

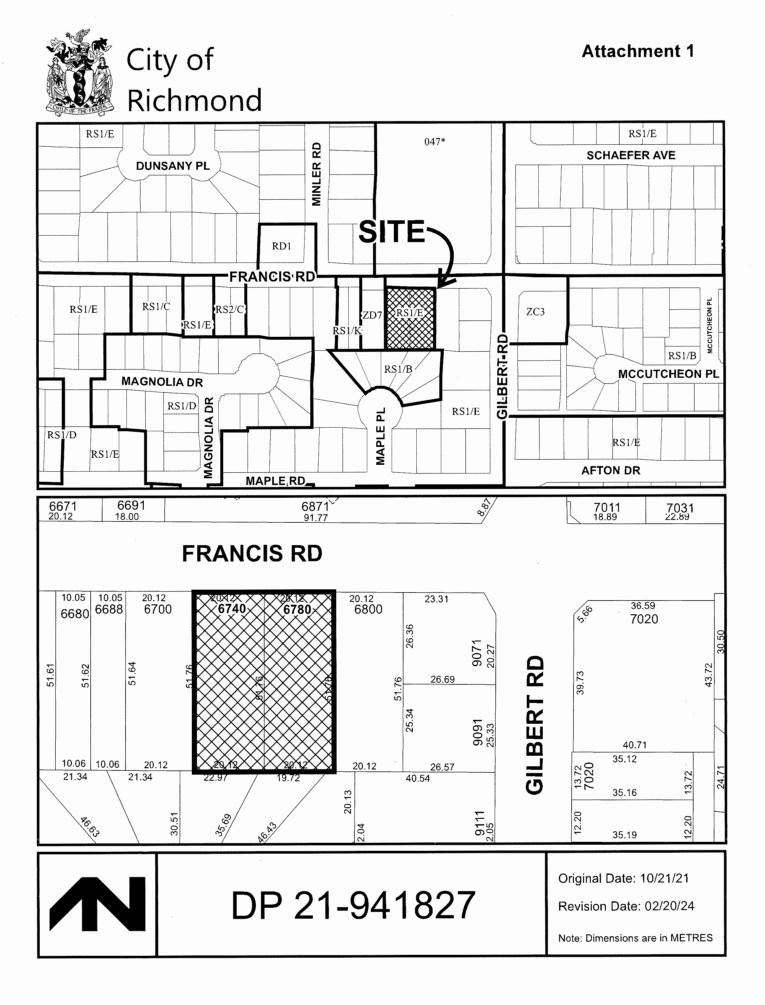





# **Development Application Data Sheet**

**Development Applications Department** 

## DP 21-941827

Address: 6740, 6780 Francis Road

Applicant: Vivid Green Architecture Inc.

Owner: Ding City Development Inc.

Planning Area(s): Blundell

	Existing	Proposed
Site Area:	Approximately 2,080 m <sup>2</sup>	Lot 1: Approximately 499 m <sup>2</sup> Lot 2: Approximately 499 m <sup>2</sup> Lot 3: Approximately 499 m <sup>2</sup> Lot 4: Approximately 499 m <sup>2</sup> after road dedication
Land Uses:	Vacant Lots	Four Duplexes (one per lot)
OCP Designation:	Neighbourhood Residential	No change
Zoning:	Single Detached (RS1/E)	Two-Unit Dwellings (ZD7) – Francis Road (Blundell)
Number of Units:	Vacant Lots	Eight

	Bylaw Requirement	Proposed Lot 1	Variance
Floor Area Ratio:	The lesser of 0.60 or 334.5 m <sup>2</sup> per lot	0.60	None Permitted
Buildable Floor Area (Net):	299 m <sup>2</sup>	299 m <sup>2</sup>	
Lot Coverage – Buildings:	Max. 45%	41%	None
Lot Coverage – Buildings, structures, and non-porous surfaces:	Max. 70%	55%	None
Lot Coverage – Live Landscaping:	Min. 20%	22%	None
Setback – Front Yard:	Min. 6.0 m	6.0 m	None
Setback – Side Yard (west):	Min. 1.2 m	1.2 m	None
Setback – Side Yard (east):	Min. 1.2 m	1.55 m	None
Setback – Rear Yard:	The greater of: • 6.0 m; or • 20% of total lot depth (9.9134 m) for max 60% of first storey rear wall and 25% of total lot depth for min 40% of first storey rear wall and all of the upper storey; to a max of 10.70 m.	<ul> <li>9.92 m for 60% of first storey wall; and</li> <li>10.70 m for 40% of first storey wall and all of the upper storey</li> </ul>	None

Building Height (m):	9.0 m (pitched roof) 7.5 m (flat roof)	6.9 m	None	
Minimum Lot Size:	464.5 m <sup>2</sup>	Approximately 499 m <sup>2</sup>	None	
Vehicle Parking Spaces – Resident:	2 spaces/unit (4 per lot; 16 total for the development)	2 spaces/unit	None	
Vehicle Parking Spaces – Visitor:	0.2 spaces/unit (1 per lot; which can be shared between more than two dwelling units on an arterial road)	1 space (shared with Lot 2)	None	
Vehicle Parking Space Size:	Min. 50% Standard Spaces as per dimensions in ZC7 zone (2 per lot; 8 Standard Spaces total for the development)	50% Standard Spaces (2 per lot)	None	

	Bylaw Requirement	Proposed Lot 2	Variance	
Floor Area Ratio:	The lesser of 0.60 or 334.5 m <sup>2</sup> per lot	0.60	- None Permitted	
Buildable Floor Area (Net):	299 m <sup>2</sup>	299 m <sup>2</sup>		
Lot Coverage – Buildings:	Max. 45%	42%	None	
Lot Coverage – Buildings, structures, and non-porous surfaces:	Max. 70%	54%	None	
Lot Coverage – Live Landscaping:	Min. 20%	23%	None	
Setback – Front Yard:	Min. 6.0 m	6.0 m	None	
Setback – Side Yard (west):	Min. 1.2 m	1.55 m	None	
Setback – Side Yard (east):	Min. 1.2 m	1.2 m	None	
Setback – Rear Yard:	The greater of: • 6.0 m; or • 20% of total lot depth (9.9134 m) for max 60% of first storey rear wall and 25% of total lot depth for min 40% of first storey rear wall and all of the upper storey; to a max of 10.70 m.	<ul> <li>9.92 m for 60% of first storey wall; and</li> <li>10.70 m for 40% of first storey wall and all of the upper storey</li> </ul>	None	
Building Height (m):	9.0 m (pitched roof) 7.5 m (flat roof)	7.0 m	None	
Minimum Lot Size:	464.5 m <sup>2</sup>	Approximately 499 m <sup>2</sup>	None	
Vehicle Parking Spaces – Resident:	2 spaces/unit (4 per lot; 16 total for the development)	2 spaces/unit	None	

Vehicle Parking Spaces – Visitor:	0.2 spaces/unit (1 per lot; which can be shared between more than two dwelling units on an arterial road)	1 space (shared with Lot 1)	None
Vehicle Parking Space Size:	Min. 50% Standard Spaces as per dimensions in ZC7 zone (2 per lot; 8 Standard Spaces total for the development)	50% Standard Spaces (2 per lot)	None


	Bylaw Requirement	Proposed Lot 3	Variance	
Floor Area Ratio:	The lesser of 0.60 or 334.5 m <sup>2</sup> per lot	0.60	- None Permitted	
Buildable Floor Area (Net):	299 m²	299 m²		
Lot Coverage – Buildings:	Max. 45%	42%	None	
Lot Coverage – Buildings, structures, and non-porous surfaces:	Max. 70%	54%	None	
Lot Coverage – Live Landscaping:	Min. 20%	23%	None	
Setback – Front Yard:	Min. 6.0 m	6.0 m	None	
Setback – Side Yard (west):	Min. 1.2 m	1.2 m	None	
Setback – Side Yard (east):	Min. 1.2 m	1.55 m	None	
Setback – Rear Yard:	The greater of: • 6.0 m; or • 20% of total lot depth (9.9134 m) for max 60% of first storey rear wall and 25% of total lot depth for min 40% of first storey rear wall and all of the upper storey; to a max of 10.70 m.	<ul> <li>9.92 m for 60% of first storey wall; and</li> <li>10.70 m for 40% of first storey wall and all of the upper storey</li> </ul>	None	
Building Height (m):	9.0 m (pitched roof) 7.5 m (flat roof)	6.9 m	None	
Minimum Lot Size:	464.5 m <sup>2</sup>	Approximately 499 m <sup>2</sup>	None	
Vehicle Parking Spaces – Resident:	2 spaces/unit (4 per lot; 16 total for the development)	2 spaces/unit	None	
Vehicle Parking Spaces – Visitor:	0.2 spaces/unit (1 per lot; which can be shared between more than two dwelling units on an arterial road)	1 space (shared with Lot 4)	None	

Vehicle Parking Space Size:	Min. 50% Standard		
	Spaces as per		
	dimensions in ZC7 zone	50% Standard Spaces	Nono
	(2 per lot; 8 Standard	(2 per lot)	None
	Spaces total for the		
	development)		

	Bylaw Requirement	Proposed Lot 4	Variance
Floor Area Ratio:	The lesser of 0.60 or 334.5 m <sup>2</sup> per lot	0.60	None Permitted
Buildable Floor Area (Net):	299 m <sup>2</sup>	299 m <sup>2</sup>	
Lot Coverage – Buildings:	Max. 45%	42%	None
Lot Coverage – Buildings, structures, and non-porous surfaces:	Max. 70%	55%	None
Lot Coverage – Live Landscaping:	Min. 20%	22%	None
Setback – Front Yard:	Min. 6.0 m	6.0 m	None
Setback – Side Yard (west):	Min. 1.2 m	1.55 m	None
Setback – Side Yard (east):	Min. 1.2 m	1.2 m	None
Setback – Rear Yard:	The greater of: • 6.0 m; or • 20% of total lot depth (9.9134 m) for max 60% of first storey rear wall and 25% of total lot depth for min 40% of first storey rear wall and all of the upper storey; to a max of 10.70 m.	<ul> <li>9.92 m for 60% of first storey wall; and</li> <li>10.70 m for 40% of first storey wall and all of the upper storey</li> </ul>	None
Building Height (m):	9.0 m (pitched roof) 7.5 m (flat roof)	6.9 m	None
Minimum Lot Size:	464.5 m <sup>2</sup>	Approximately 499 m <sup>2</sup>	None
Vehicle Parking Spaces – Resident:	2 spaces/unit (4 per lot; 16 total for the development)	2 spaces/unit	None
Vehicle Parking Spaces – Visitor:	0.2 spaces/unit (1 per lot; which can be shared between more than two dwelling units on an arterial road)	1 space (shared with Lot 3)	None
Vehicle Parking Space Size:	Min. 50% Standard Spaces as per dimensions in ZC7 zone (2 per lot; 8 Standard Spaces total for the development)	50% Standard Spaces (2 per lot)	None



City of Richmond

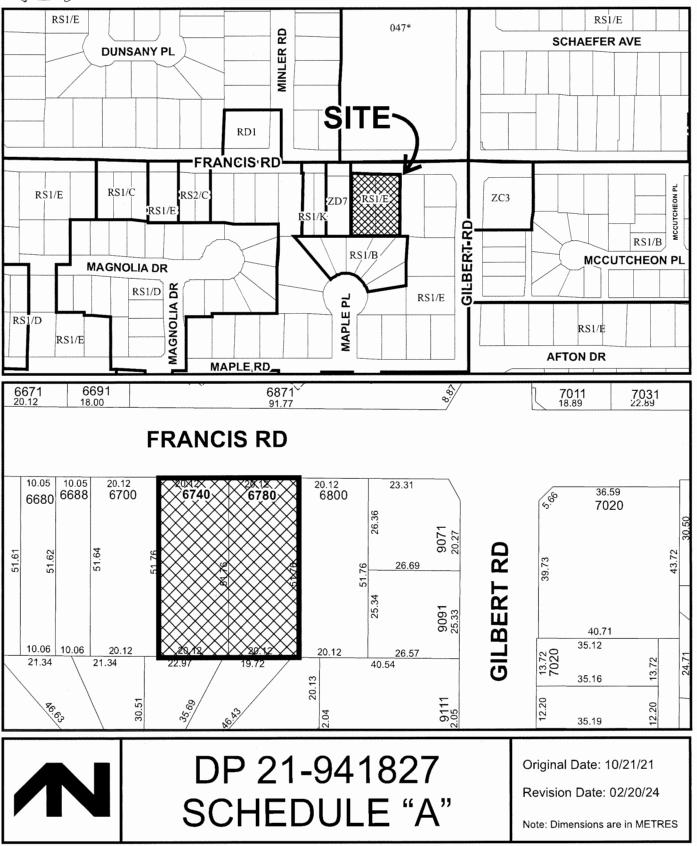



# **Development Permit**

### No. DP 21-941827

To the Holder:	Vivid Green Architecture Inc. (on behalf of Ding City Development Inc.)
Property Address:	6740, 6780 Francis Road
Address:	# 1141-11871 Horseshoe Way Richmond BC V7A 5H5

- 1. This Development Permit is issued subject to compliance with all of the Bylaws of the City applicable thereto, except as specifically varied or supplemented by this Permit.
- 2. This Development Permit applies to and only to those lands shown cross-hatched on the attached Schedule "A" and any and all buildings, structures and other development thereon.
- 3. Subject to Section 692 of the Local Government Act, R.S.B.C.: buildings and structures; off-street parking and loading facilities; roads and parking areas; and landscaping and screening shall be constructed generally in accordance with Plans #1.a to #3.g attached hereto.
- 4. Sanitary sewers, water, drainage, highways, street lighting, underground wiring, and sidewalks, shall be provided as required.
- 5. As a condition of the issuance of this Permit, the City is holding the security in the amount of \$219,247.50 to ensure that development is carried out in accordance with the terms and conditions of this Permit. Should any interest be earned upon the security, it shall accrue to the Holder if the security is returned. The condition of the posting of the security is that should the Holder fail to carry out the development hereby authorized, according to the terms and conditions of this Permit within the time provided, the City may use the security to carry out the work by its servants, agents or contractors, and any surplus shall be paid over to the Holder. Should the Holder carry out the development permitted by this permit within the time set out herein, the security shall be returned to the Holder. The City may retain the security for up to one year after inspection of the completed landscaping in order to ensure that plant material has survived.
- 6. If the Holder does not commence the construction permitted by this Permit within 24 months of the date of this Permit, this Permit shall lapse and the security shall be returned in full.

## Development Permit No. DP 21-941827

To the Holder:	Vivid Green Architecture Inc. (on behalf of Ding City Development Inc.)
Property Address:	6740, 6780 Francis Road
Address:	# 1141-11871 Horseshoe Way Richmond BC V7A 5H5

7. The land described herein shall be developed generally in accordance with the terms and conditions and provisions of this Permit and any plans and specifications attached to this Permit which shall form a part hereof.

,


This Permit is not a Building Permit.

AUTHORIZING RESOLUTION NO. DAY OF , .

ISSUED BY THE COUNCIL THE


DELIVERED THIS DAY OF

MAYOR

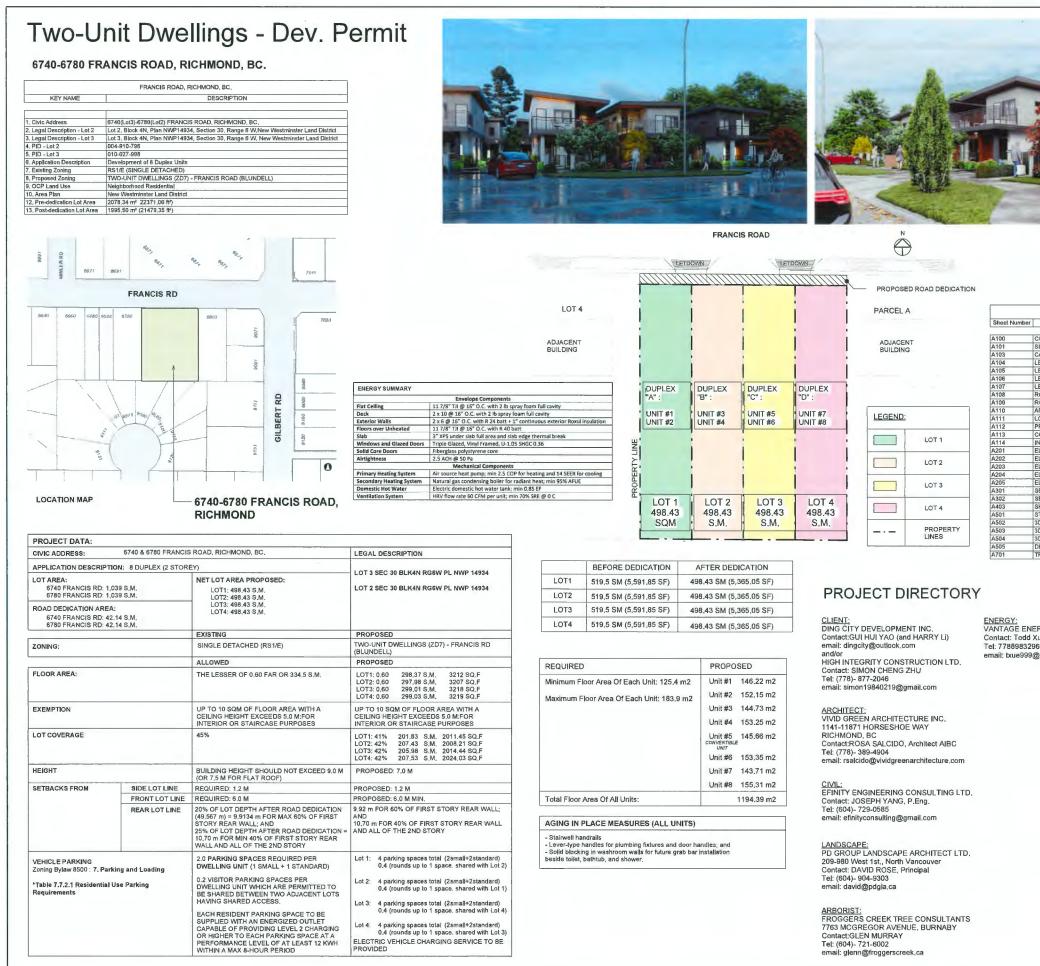



	L II-1197 [Brosshes No. Ref: and, RC 73 -96 te 778-98-90 architecture inc. www.Surficested/idencom	- 1.1 2.060.1 40.8 10.5 MG
DRAWING LIST Sheet Name OVER PAGE TTE PLAN, SETBACKS AR TURNING PATH EVEL, J. DUPLEX AAB EVEL, 2, DUPLEX CAD EVEL, 2, DUPLEX CAD COOP PLAN, DUPLEX CAD EVEL, 2, DUPLEX CAD COOP PLAN, DUPLEX CAD EVEL, 2, DUPLEX CAD OOP PLAN, DUPLEX CAD TO COVERAGE PLAN OVERTIBLE UNIT TIAL LIGHTING CONCEPT LEVATIONS EVEL STONS ECTIONS E	DP 21-941827 PLAN # 1.a FEB 23 2024	
RGY SOLUTIONS INC. ue jgmail.com	20.         10-0-00-00         24.00-00         24.00-00           21.         10-0-00-00         24.00-00         24.00-00         24.00-00           22.         10-0-00-00         10-0-00-00         10-0-00-00         10-0-00-00           22.         10-0-00-00         10-0-00-00         10-0-00-00         10-0-00-00           23.         10-0-00-00         10-0-00-00         10-0-00-00         10-0-00-00           23.         10-0-00-00         10-0-00-00         10-0-00-00         10-0-00-00           24.         10-0-00-00         10-0-00-00         10-0-00-00         10-0-00-00           24.         10-0-00-00-00-00-00-00-00-00-00-00-00-00	144-miles (J. 1976). 1. M. Jahling Ukura Vasumuri Vasumuri VAB-PRL_274m-1748. Frankle AssL_164-mun_Costul. 1p. 2824_164.Listel.vd



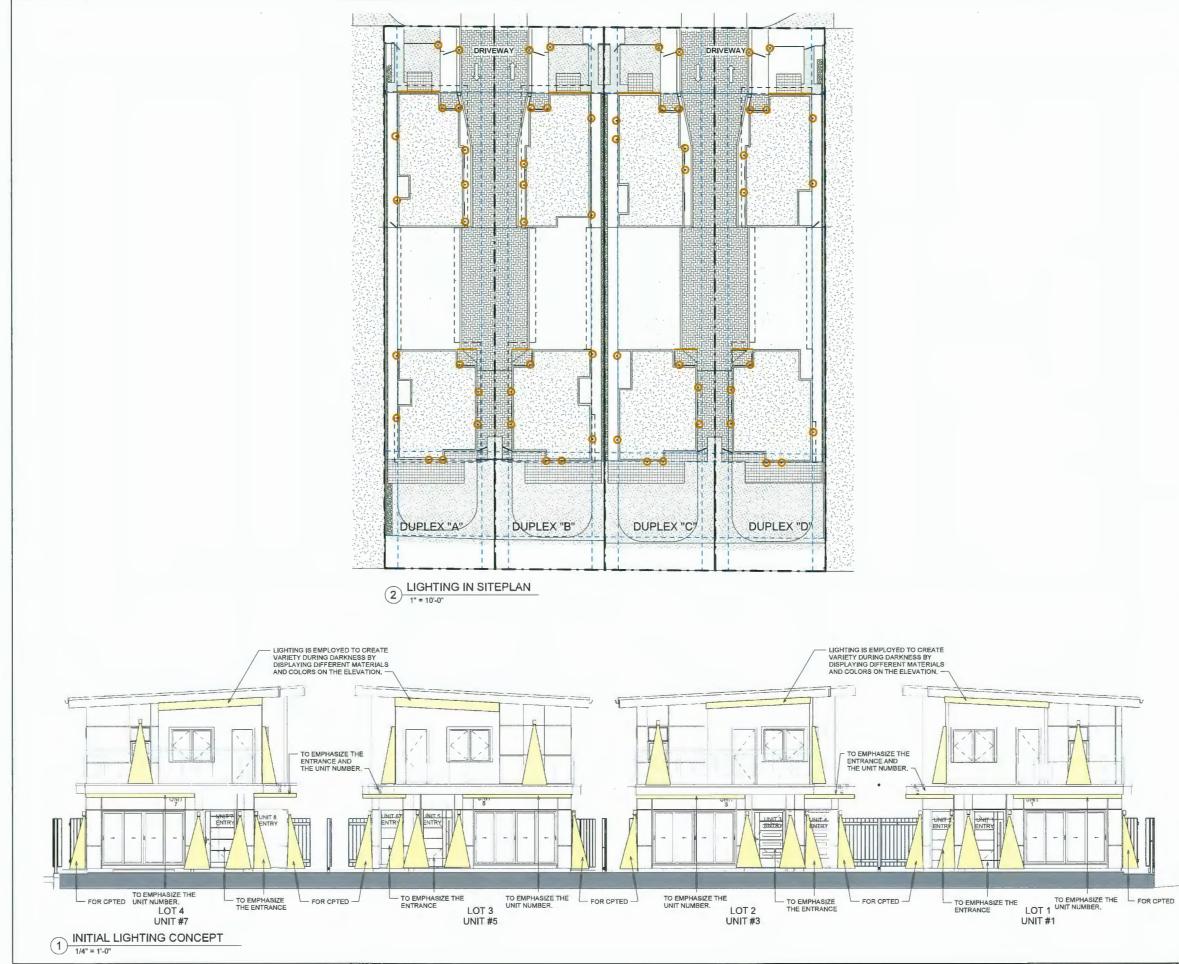




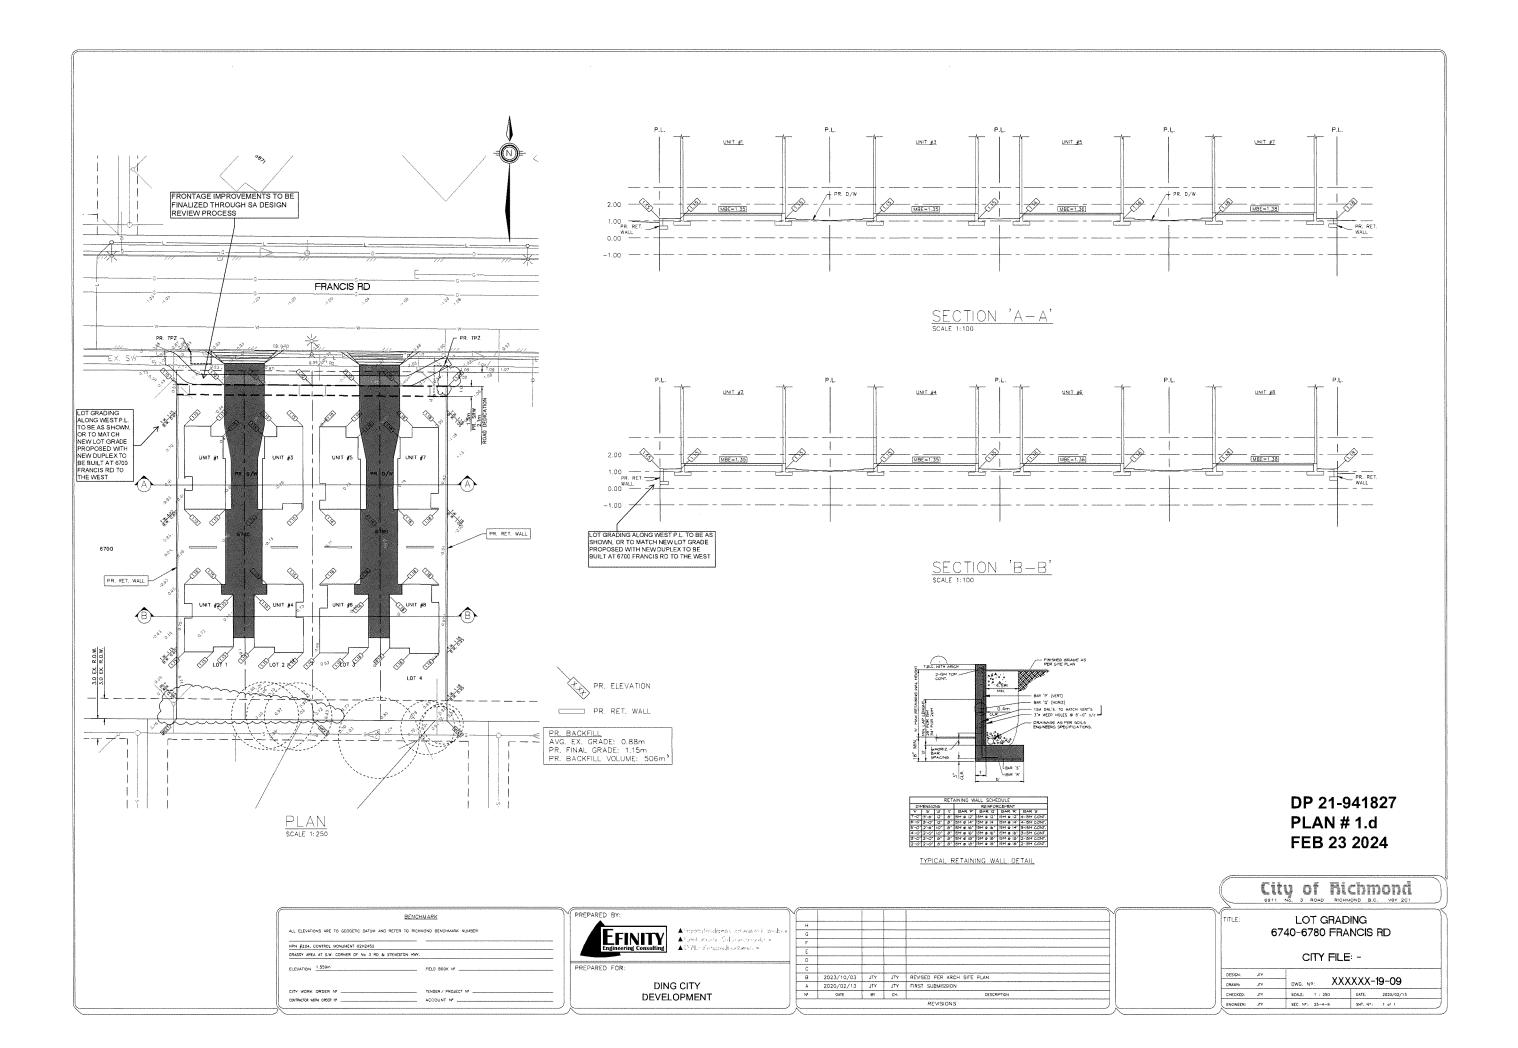

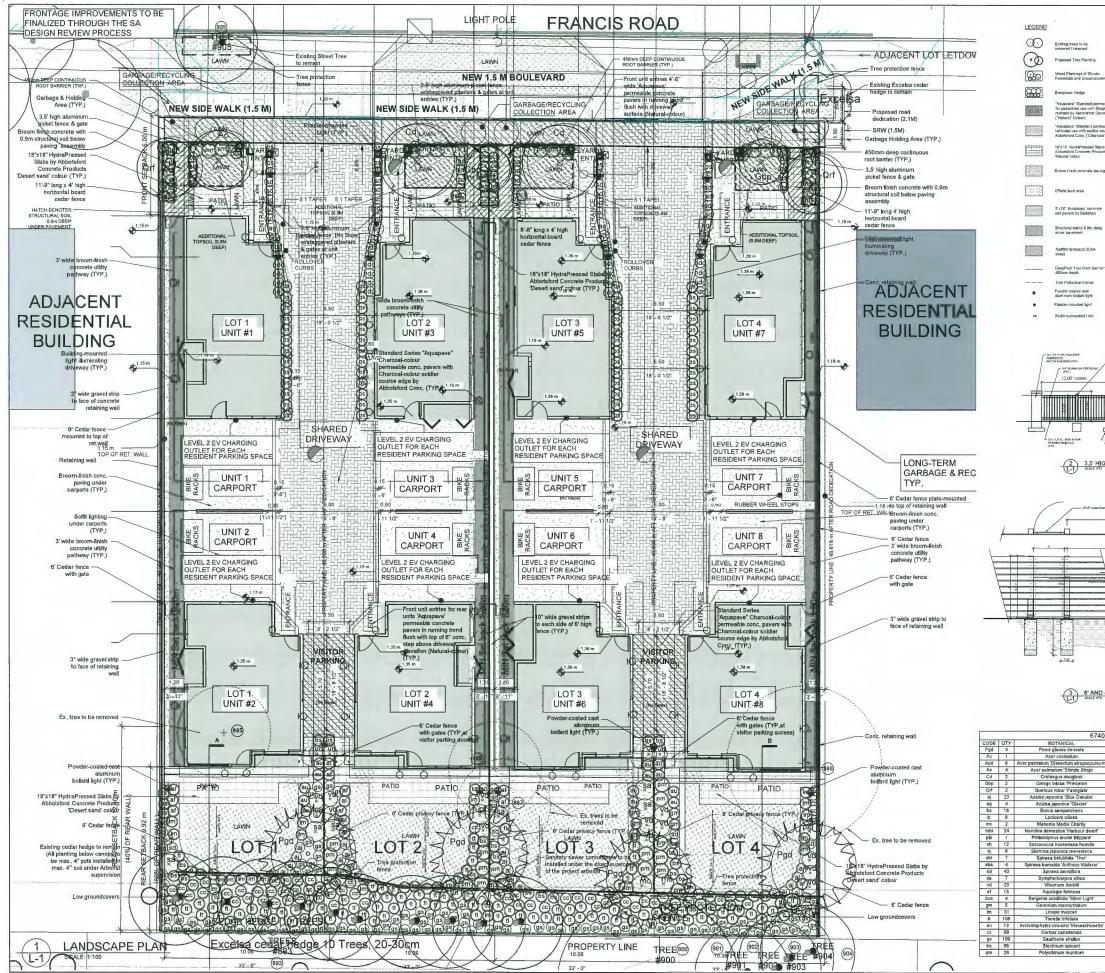

						FOR ANY FOR ANY PO GROU	N AND DESIGN IS P PUKPOSE WIGHOUT PUKPOSE WIGHOUT PUKPOSE ARC	NOTECTED BY COPYR VWRITEN FEHMLOS HITECTURE LTO	IO-T AND SHALL	NCT BE
		NOTES 1. All Indecape v with the current in Standard publishe standard publishe	vork shaji be carmer dition of the Caresti ed by CSLA/CNTA a	fort in accorda an Landscape and the contract	nce	No. 2		COORDIN		NGES
overs s		2. Growing mediu of the Canadian L provided to the fol Grass Areas - 300 Shrucs Grounded	m in accordance wi avdscape Standard lowing minimum de Jrimi (1) overs. Vines & Pers 300 mm (1) of tops d to 85% Std. Proct	th the outrent e I shall be pthe/oumension nrials - 450 mm	altion 5: 1 (181)	4	05/05/21 18/11/22 25/11/22 25/01/23	REVS, PER LA REVS, PER C REVS, PER C REVS, PER C	ITY COMME	ENT
rmetable p InapEige Concrete P	edge	3. Ensure excevel	on or fill adjacent t			8	03/02/23 R	EVS, PER OCI	REQUIREN	MENTS
	ione paveni for		fence shall be inst rté project complete			10 11 12	09/02/24 R	EVS, PER CIT EVS, PER CIT EVS, PER CIT	REQUIREN	MENTS
lats by	u;	5. The project sits high efficiency rej	al) ba migatad by a pation syntem,	fully automatic I	iou-flow			ISSUE		
×ing						1 No 2 3	DATE 10/02/20 17/03/20	ISSUED	FOR RZ/DP	P
						4	20/04/21 05/05/21	RE-ISSUE	FOR RZ/D/	Ρ
te-						6	25/11/22		D FOR DP	KORD.
eb						8 9 10	25/01/23 03/02/23 06/10/23	RE-ISSUE	D FOR DP	_
						10	06/02/23	RE-ISSUE	D FOR DP	_
merto						13	15/02/23	RE-(SSUE	D FOR DP	
							(		)	
								NORTH	1	
						-			4.04	
1	* 5" 44 UMB/LISH H35 16 THAL DO 15 - 15 - 16" CCTLD TO 15 - 15 - 16" CCT, FCO 11 MUST (179",							1-94		21
/:	CHC FCOINUS (149)	CONC CAPITY	ECALT					1 # 2		4
T		1	WHEREAR WHICHLON ATTROC. VIRIALISA V	MLS A DOT 2 CEOF CEOF			ER 3	23 2	024	ł
2.2.2.2		\$ <u>.</u>				s	EAL			
HIGH F	ICKET FENCE W/ GATE	& PILASTE	RS							
e franse E-E	<u></u> †	r				-				
5.4	/			fT			0	-		
4				j-	1		/			
-		1'25' cefar rater Beforern deutig lep e ro.8	VI 11 cadaraama m				/			
			n gab, deal I drae orant son-bolled no, trundations rivees lease scards (Th						7	N
- 21		iert bage set m C' w fe t	2 934.94 9411 19 14							,
		- 14' \$4%-der card \$ deap elpest to	2 gaves steel in an let, gather could after fold is top of our c. Soundation traisfolian 1 need					-	-	4
	\$200°	Conta unde	ooled gracular on Marzed vangrade		4			Cre		_
		CATE						Gro pe Archite		
T	IGH CEDAR FENCE W/ OTAL FENCE HEIGHT I OT TO EXCEED 1.8 M A	ICL RETAIN	IING WALL NG BYLAW				Kejowne	515 Houghton a BC, Conada p: 604 904 980	VIX BE9	
40-67	80 Francis Road Plant COMMON Black Hills Spruce Vine maple	SPACING as shown as shown	TYPE tree tree	NATIVE nonnative native	SIZE Ht, 5m Ht 4m	Viv 114		n Archite I Horses		
um'	Purple Japanese maple Shindo Shojo Japanese maple	as shown as shown	tree tree	nonnative nonnative	6', #25 pot 6', #25 pot		LIENT	nih Can	truction	
F	Black Hawthorn Innceton Sentry Maidenhair Tre Columnar English Oak	as shown	tree tree tree	native nonnative nonnative	10', #25 pol 6cm Cal 8cm Cal	7		grityCons Isay Roa		n Li
	Japanese azalea Japanese azalea Boxwood	as shown as shown as shown	shrub shrub shrub	nonnative nonnative	#2 pot #2 pot #2 pot	_	ROJECT:	_		
,	Wild honeysuckle Charity Oregon grape Heavenly bamboo	as shown as shown as shown	shrub shrub shrub	nonnative nonnative nonnative	#3 pot #5 pot #2 pot	6		/elopmen ) Francis		
-	Mock orange Sarcococca Japanese skimmia	as shown as shown as shown	shrub shrub shrub	native nonnative nonnative	#3 pot #2 pot #3 pot	-	WG, TITLE			
,	Tor Birchleaf spirea Japanese spirea Mountain Spiraea	as shown as shown as shown	shrub shrub shrub	nonnative nonnative native	#2 pot #2 pot #2 pot	L	andsca	pe Plan		
-	Common Snowberry David's viburnum Western Columbine	as shown as shown as shown	shrub shrub perennial	native nonnative native	#2 pot #3 pot # 1 pot		DESIGNED	DR		
	Bergenis Hardy geranium Blue lity turf	as shown as shown as shown	perennial perennial perennial	nonnative nonnative nonnative	# 1 pot # 1 pot # 1 pot	_	CHECKED	SK DR		
tts'	Foamfjower Kinnikinnick	as shown as shown	perennial ground cover	native nonnative	# 1 pot # 2 pot	-	SCALE	1/100		
	Bunchberry Salal Deer fern	as shown as shown as shown	ground cover ground cover fern	native native	# 2 pot # 1 pot # 2 pot		PROJECT No.	29 Jan,2020	VG No.	RE
	Western sword fern	as shown	fern	native	# 1 pot		1816		-1 of 4	1

L-1 of 4 12

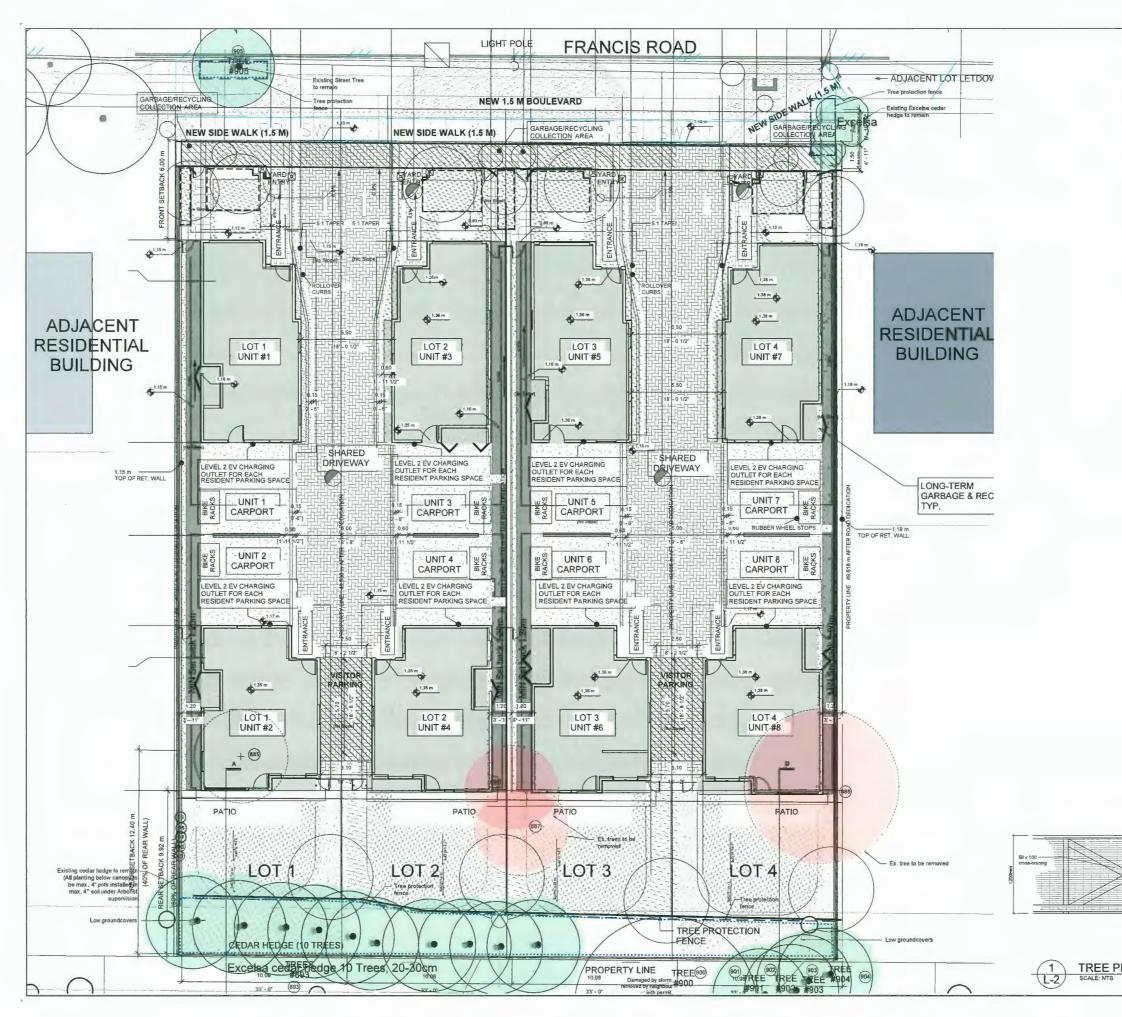

#### LEGEND




Existing trees to be removed Existing trees to be retained

FUK WAY PURPOSE WITHOUT VARITELY FERRICION FROM PO GROUP LANDSCAPE ARCHITECTURE UTD
REVISIONS
1 06/10/23 REVS. PER CITY REQUIREMENTS 2 06/02/24 REVS. PER CITY REQUIREMENTS
ISSUE
No DATE DESCRIPTION
1 25/11/22 ISSUED FOR DP 2 25/01/23 RE455UED FOR DP
3 03/02/23 RE-ISSUED FOR DP 4 06/10/23 RE-ISSUED FOR DP
5 05/02/24 RE-ISSUED FOR DP
6 15/02/24 RE-ISSUED FOR DP
NORTH
DP 21-941827
PLAN # 2.b
FEB 23 2024
SEAL
PD Croup
PD Group
115 - 515 Mar olden Pared
315 - 515 Houghton Road Kejawna BC, Canada, V1X 889 p: 404 904 9803
AACHITECT:
Vivid Green Architecture Inc.
1141-11871 Horseshoe Way
CLIENT. High IntegrityConstruction Ltd.
7180 Lindsay Road
RICHMOND BC
PROJECT: 8-Unit Development
6740-6780 Francis Road
OWG, TITLE-
Tree Retention Plan
DESIGNED DR DRAWN SK
CHECKED DR
SCALE 1 100 DATE 29 Jan.2020
PROJECT No. DWG No. REV
1816 L-2 of 4 2


Snowlence mesh fixed to top and bottom rails and posts

- 75 x 75 pointed posts driven un firm, Confirm locations of utility lines prior to installing posts.

TREE PROTECTION FENCE

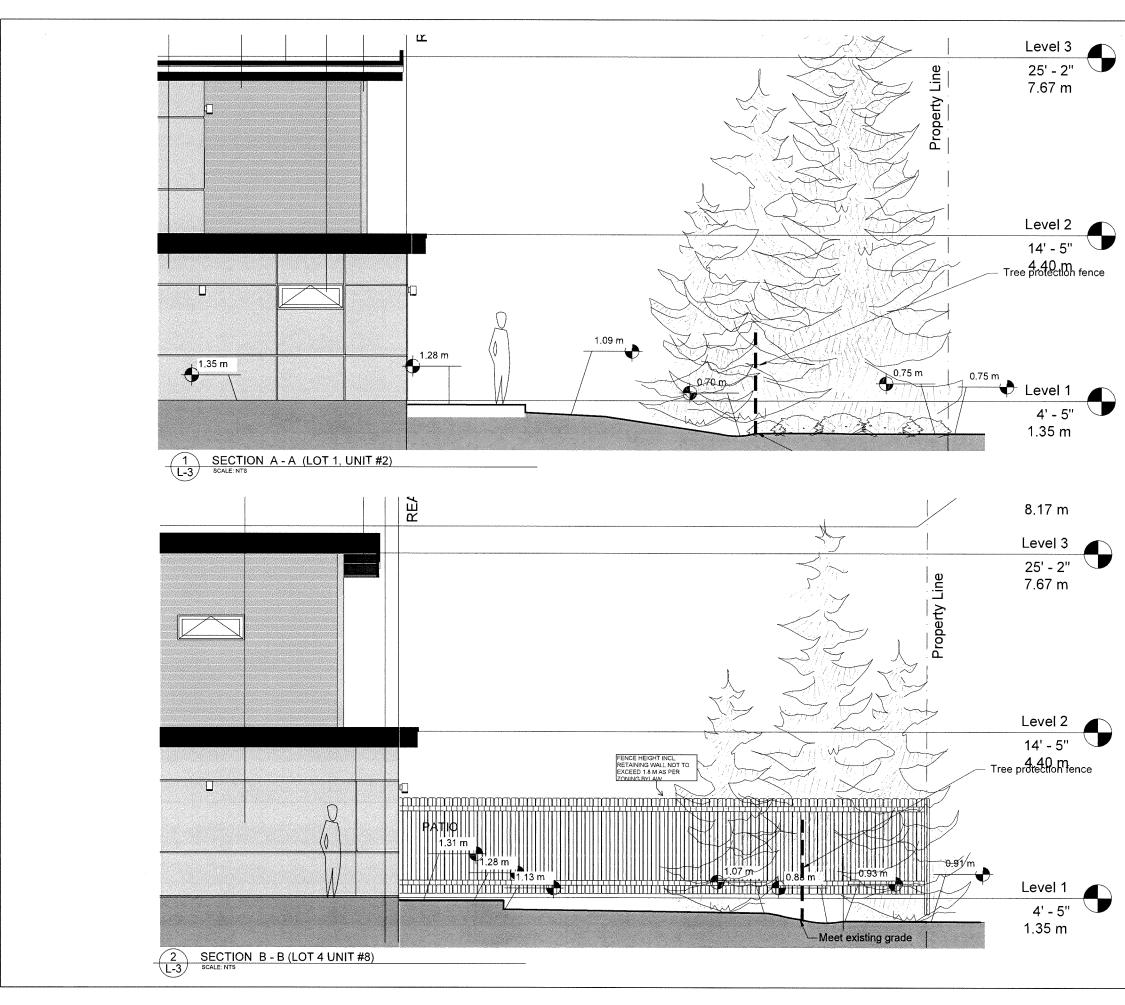



IS PROTECTES BY COPARISHT AND SHALLINGT BEWZED ROUT VARINGN REAMELED FROM ARCHTSCTURE LTD.	KON 65 PR M(ZHOL) 2F ANCH	N IND DESKA
ANDHI-DUIDHE CIU.		PURPOSE WIT
REVISIONS	-	- LANDSCAPE
DESCRIPTION	Т	DATE
REVS, PER CITY REQUIREMENTS		06/10/23
REVS, PER CITY REQUIREMENTS		15/02/24
	+	
	+-	
	1	
	T	
	+-	
^	+-	
······································	+	
ISSUE		h
ISSUE	<b>—</b>	
DESCRIPTION ISSUED FOR DP		DATE 25/11/22
RE-ISSUED FOR DP		25/11/22 25/01/23
RE-ISSUED FOR DP		03/02/23
RE-ISSUED FOR DP		05/10/23
RE-ISSUED FOR DP	4	15/02/24
	T	
1-941827	21	Р2
N # 2.c	١N	LA
23 2024	5 2	=В
	_	
		u.
		,
		Contraction of the second
	Y	
	/	
	/	
		Y
		Pr
) Group		
Group	scat	Lands
S - 515 houghten Road	3:5 -	Lands
Broup	3:5 -	Lands
S - 515 Houghton Road on R - Consta - 1/1 / 839 p. 504 F04 F805	3:2 - 3:2 -	Lands 3 Kolo
S-513 Houghton Road ps 64-504 7805	3:5- Jowne T:	Lands 3 Kolo RCHITECT
S-515 heighten Road ne BC. Conda, Y1X 892 p. 544 704 7003	3:5- Jowne ct: CE	Lands 3 5012 RCHITECT
S-513 Houghton Road ps 64-504 7805	з:5- з:5- ююло ст: тееп 871	Lands 3 5 old RCHITECT id Gre 1-118
S-515 heighten 83ad p. 564 "94 #805 p. 564 "94 #805	з:5- з:5- ююло ст: тееп 871	Lands stals RCHITECT Id Gre 1-118
s-513 Foughton Road on BC Consta VIX 819 b. 545 - 94 - 94 - 953 en Architecture Inc. 71 Horseshoe Way	з:5- Iscar з:5- Isono ст: тееп 871	Lands stals RCHITECT Id Gre 1-118
s-515 heuphon 85ad one 8C. Conada (V) 899 pt: 504 704 7005 en Architecture Inc. 71 Horseshoe Way ergrityConstruction Ltd.	scar з:5- dexno cт: тееп 871	Lands 3 800 CONTECT d Gre 1-118 OND BC JENT. JENT. JENT.
eqrityConstruction Ltd.	scor 3:5- devno cr: een 871	3 Fold CHIMECT d Gre 1-118 SHD BC IENT. gh In 80 Li
eqrityConstruction Ltd.	scor 3:5- devno cr: een 871	Lands 3 tols RCHITECT id Gre 1-118 10HD BC UENT. igh In
eqrityConstruction Ltd.	3:5- 3:5- siowner siow	Lands 3 Kels RCHITECT Id Gre 1-118 LIENT Igh In 180 Li
S-319 benchilecture Ltd S-319 benchilecture Ltd S-319 benchilecture Ltd s-319 benchilecture Ltd en Architecture Inc. 71 Horseshoe Way egrityConstruction Ltd. ndsay Road	3:5- 3:5- cr: reen 871 	Lands RCHITECT Id Gre 1-118 IDHD BC UENT. Igh In 180 Li CHIZON, B ROJECT:
Construction     Section	3:5- 3:5- siborne reen 871 siborne reen 871 siborne Treen 0 ec re Dev 780	RCHITECT Id Gree 1-118 ISHO BC UENT ISO LI CHIZOND BC ROJECT: Unit D 740-67
Construction     Section	3:5- 3:5- siborne reen 871 siborne reen 871 siborne Treen 0 ec re Dev 780	Lands 3 tola RCHITECTI id Gree 1-118 toho BC LIENT. igh In 180 Li CHIVON: E ROJECT: Unit D
Construction     Section	3:5- 3:5- siborne reen 871 siborne reen 871 siborne Treen 0 ec re Dev 780	RCHITECT Id Gree 1-118 ISHO BC UENT ISO LI CHIZOND BC ROJECT: Unit D 740-67
evelopment 80 Francis Road	3:5- albonne cr: reen 871 cr: tind 0ec r: Dev 780 sc	Rohmedda Rohmedda I - 118 Roho ed Llent Roho ed Rohedda Robett Roho ed Roho Roho Roho Roho Roho Roho Roho Roh
s-513 Foughton Road one & Conda, VIX 889 p. 64-94-9603 en Architecture Inc. 71 Horseshoe Way egrityConstruction Ltd. ndsay Road evelopment 80 Francis Road	a:s- sis- cr: reen 871 Lind ac tr: Dev 780 s.c	a since the second seco
evelopment 80 Francis Road	a:s- sis- cr: reen 871 Lind ac tr: Dev 780 s.c	a since the second seco
Construction Ltd     S-313 Headhon Road     S-313 Headhon Roadhon Roadhon     S-313 Headhon Roadhon Roadhon     S-313 Headhon Roadhon Roadhon     S-313 Headhon Roadhon Roadhon     S-313 Headhon	a:s-a biowner cr: reen 871 : Lind .ec tr: Dev 0780 Ec scar	CHITECT CHITECT J Gree I-118 HID BC EENT. Gh In D HO-05 HIT D HO-07 HO-07 HIT D HO-07 HIT D HIT
s-513 Foughton Road one & Conda, VIX 889 p. 64-94-9603 en Architecture Inc. 71 Horseshoe Way egrityConstruction Ltd. ndsay Road evelopment 80 Francis Road	a:s-a biowner cr: reen 871 : Lind .ec tr: Dev 0780 Ec scar	Rentrect Rectification definition in the second second definition definita definition definition definition definition definition de
Construction     S-313 Houghton Road     S-314 Ho	a:s-a biowner cr: reen 871 : Lind .ec tr: Dev 0780 Ec	a since the second seco
en Architecture Inc. 71 Horseshoe Way egrityConstruction Ltd. degrityConstruction Ltd. evelopment 80 Francis Road ape Sections	Iscar 3:5- Iscar Iscar reen 871 Scar Dev 780 Scar Iscar	Lands: 3 Fold RCHITECT Id Gree LI-118 KOND EC LIENT. IGN IN AOJECT: Unit D 40-67 400-67 4
Construction Ltd     Sa 35 Percent Ltd	Iscar 3:5- Iscar Iscar reen 871 Scar Dev 780 Scar Iscar	Landss relations and the second and the sec
Construction Ltd     Sa 35 Percent Ltd	Iscar 3:5- Iscar Iscar reen 871 Scar Dev 780 Scar Iscar	Landss relations and the second and the sec
Construction Ltd     Sa 35 Percent Ltd	Iscar 3:5- Iscar Iscar reen 871 Scar Dev 780 Scar Iscar	Lands: rolo rolo ac uent. ligh In 180 Li ligh In 180 Li 180 Li
Construction Ltd     Sa 35 Percent Ltd	Iscar 3:5- Iscar Iscar reen 871 Scar Dev 780 Scar Iscar	Landss relations and the second and the sec
evelopment	Iscap 3:5- cr: reen 871 cr: cr: cr: cr	andsi 3 3 Fold 1 Gree -118 10 80 ENT. 9h In 80 Li 100-67 ENT.
evelopment Bo Francis Road	3:5- 3:5- 15-mnc cr: cr: cr: creen 871 5 cr: creen 871 5 cr: creen 871 5 cr: creen 871 5 cr: creen 871 5 cr: creen 871 5 creen	

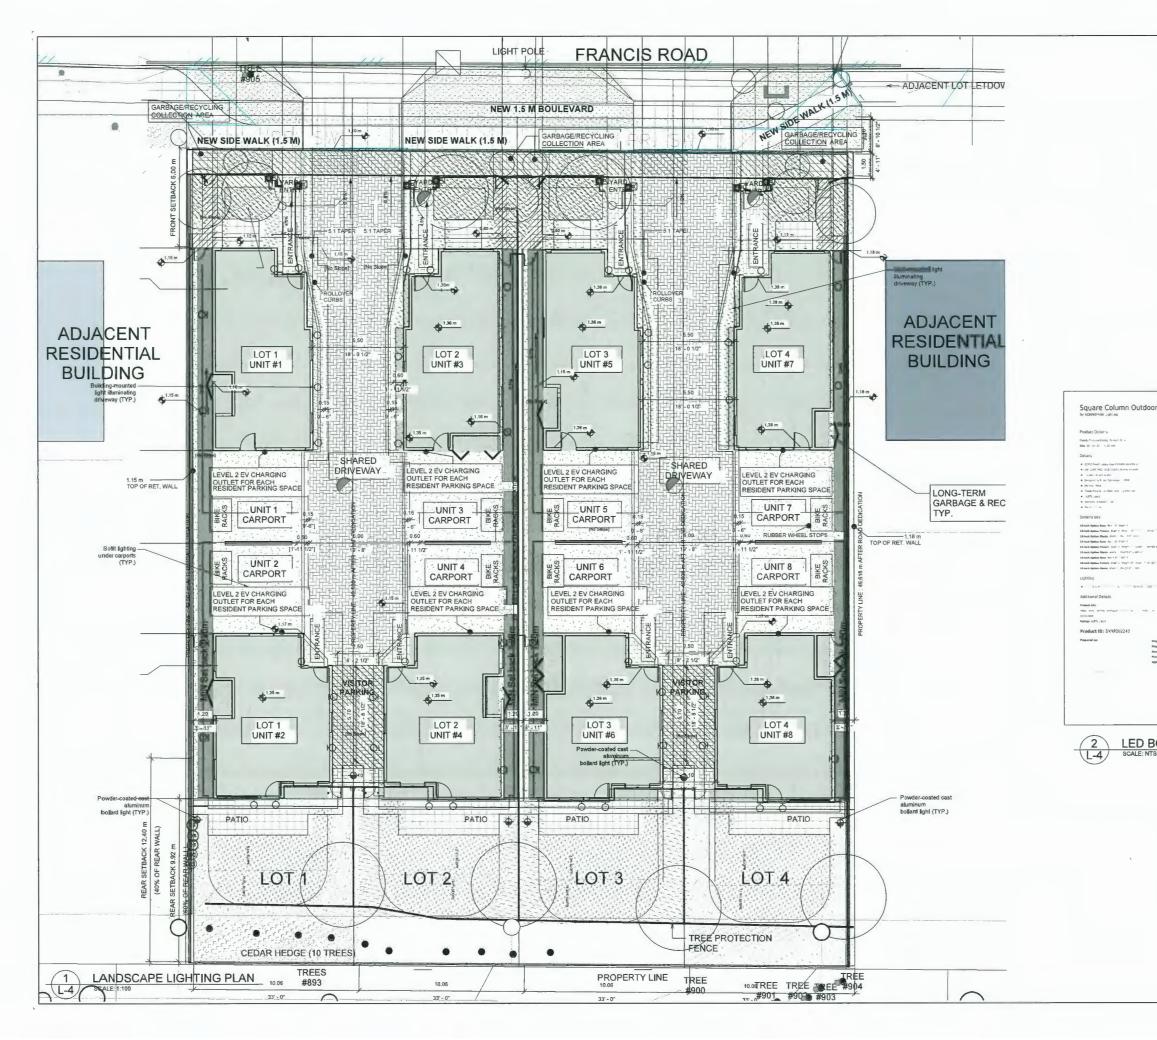







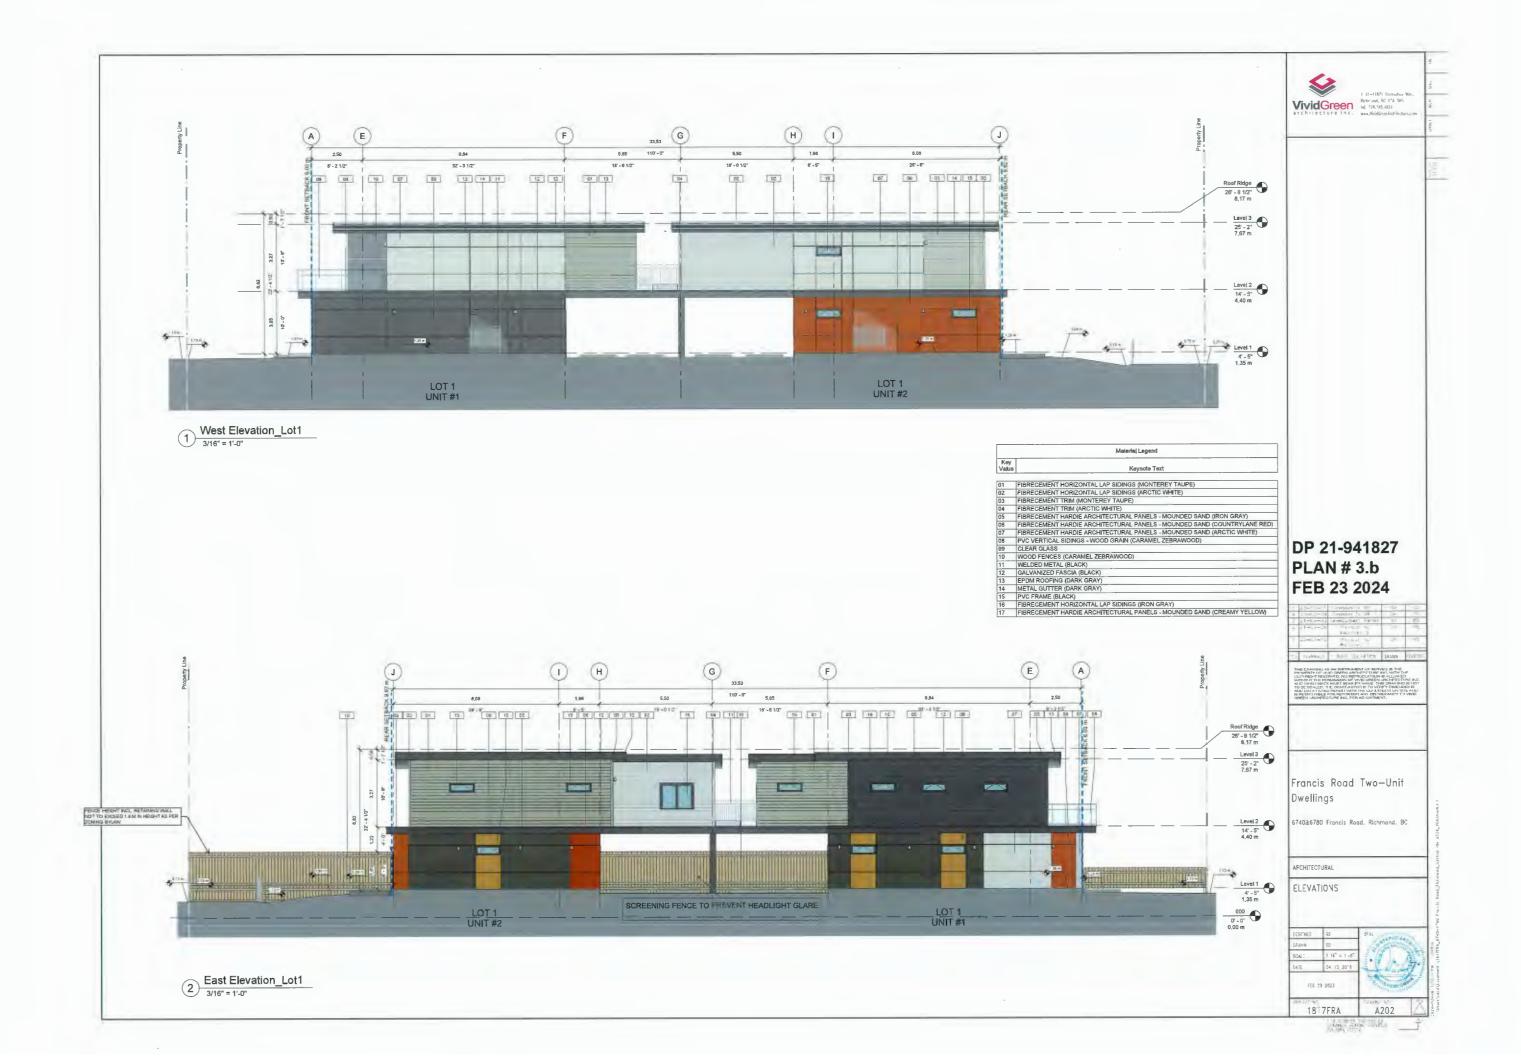


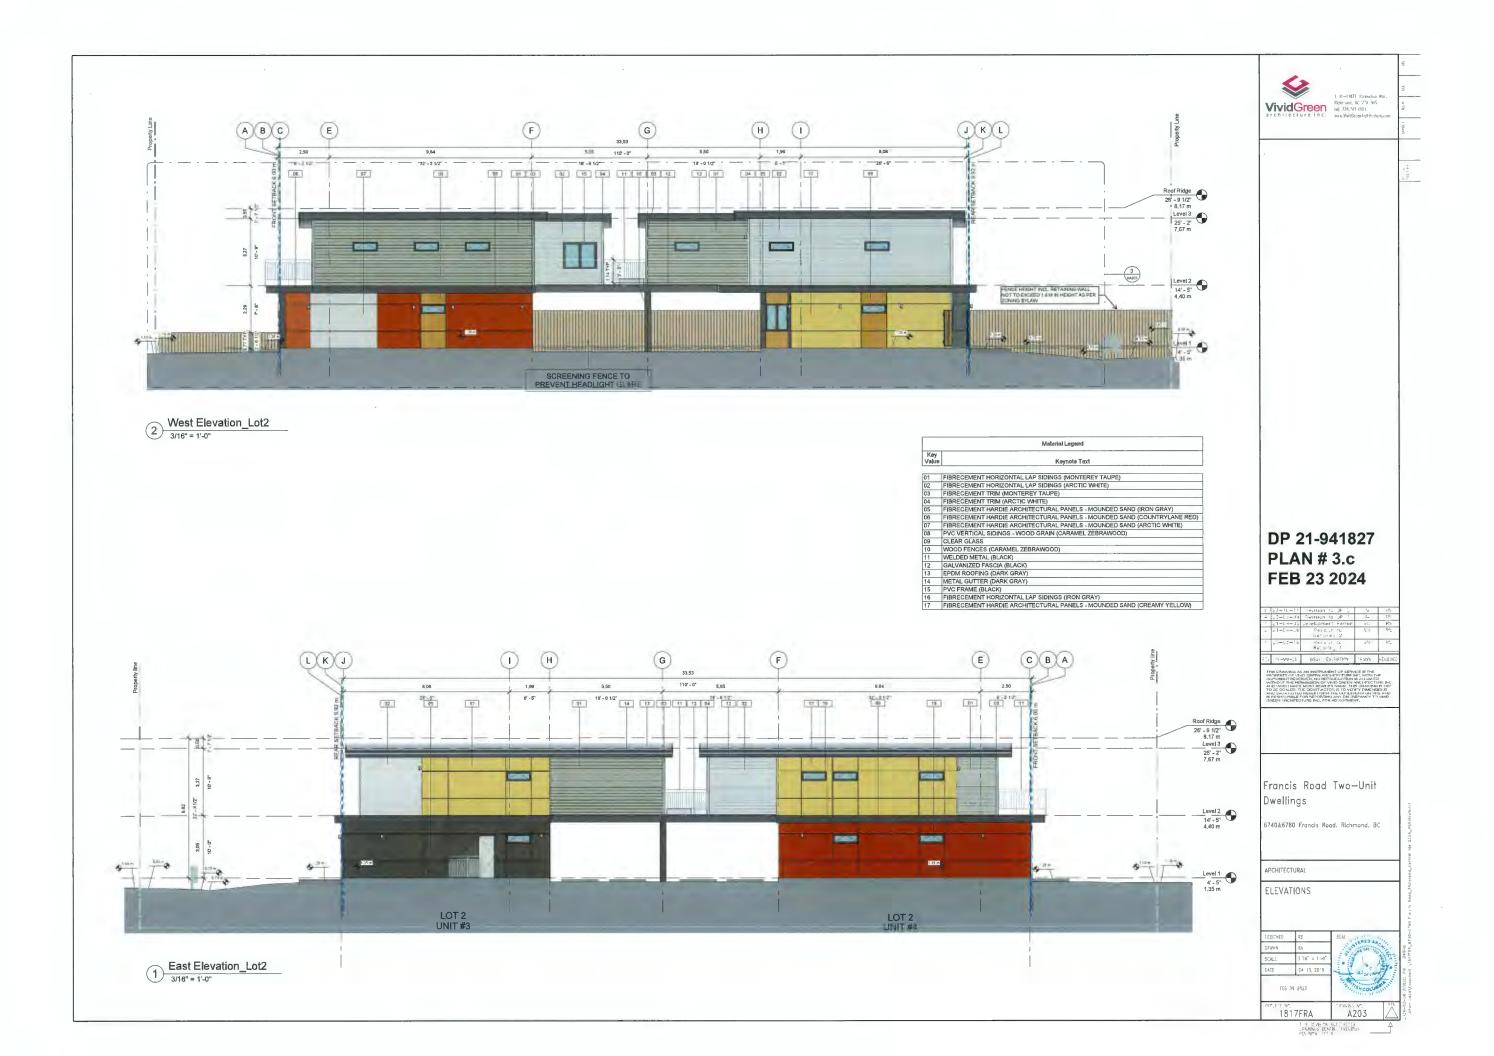




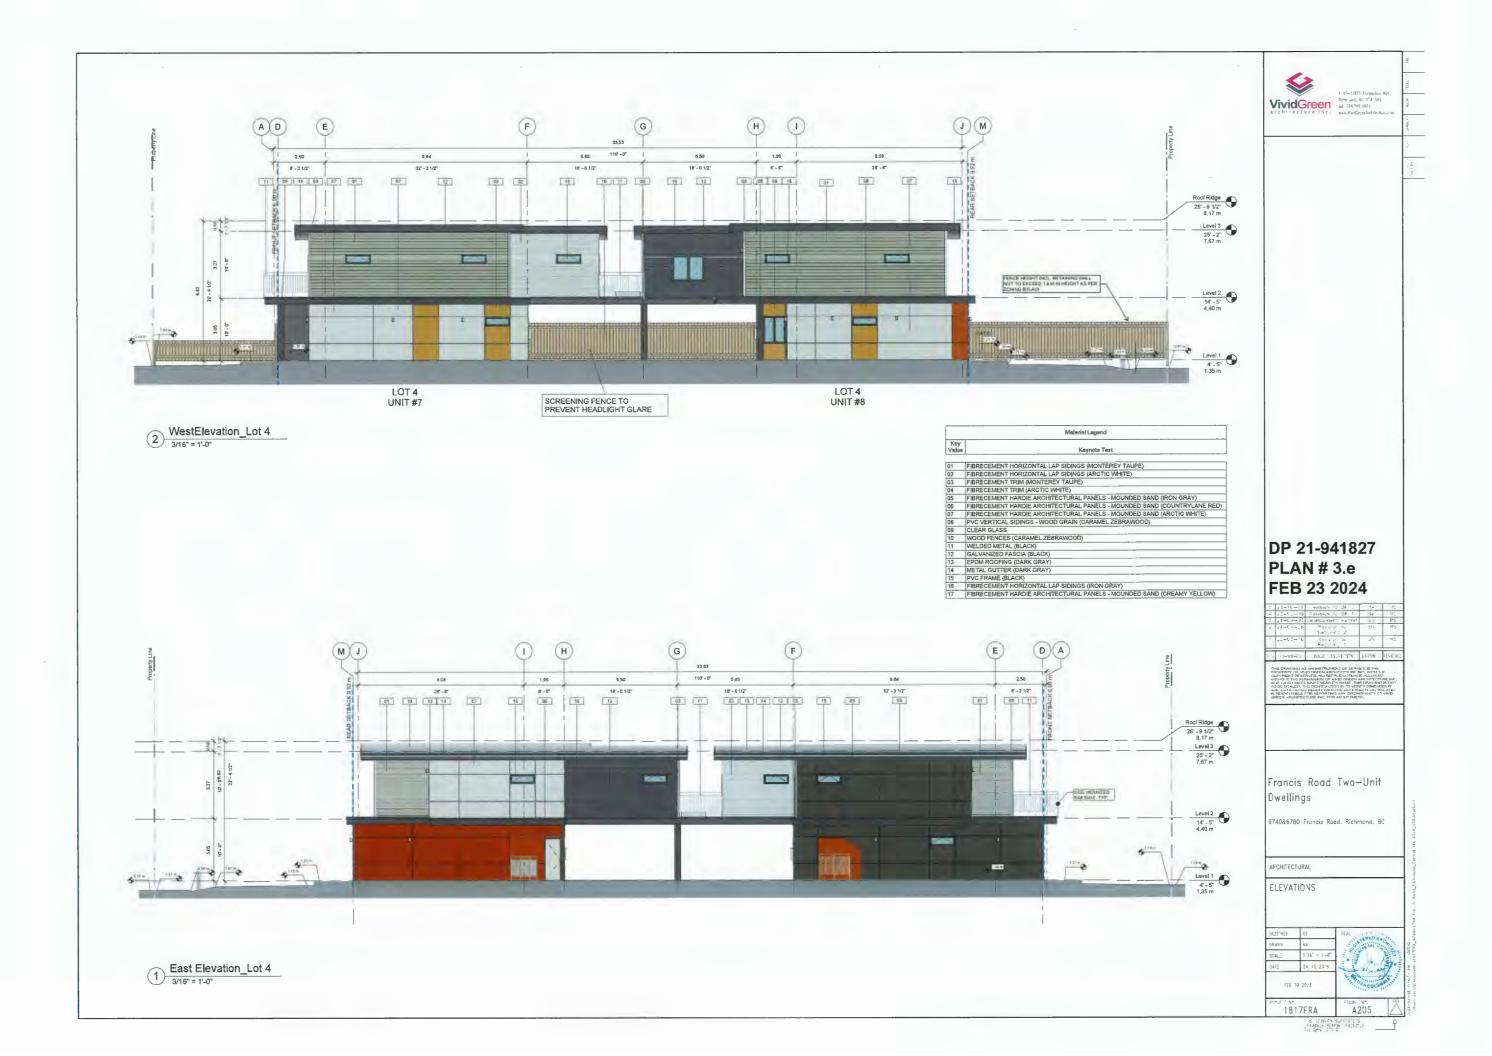

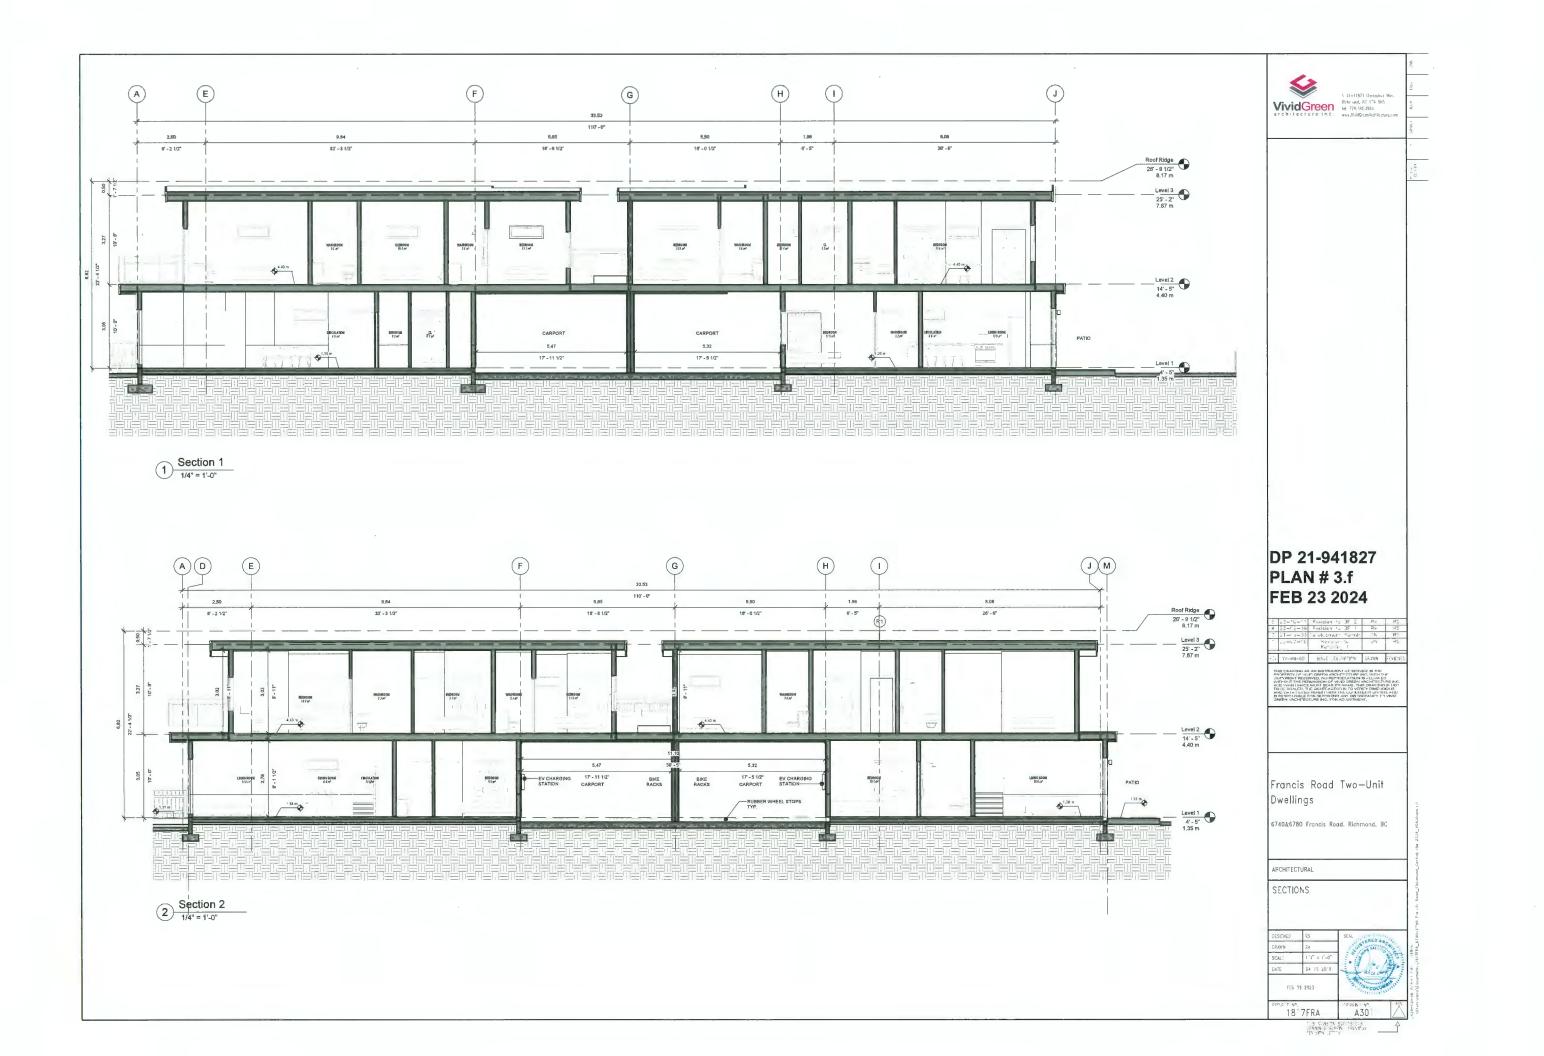


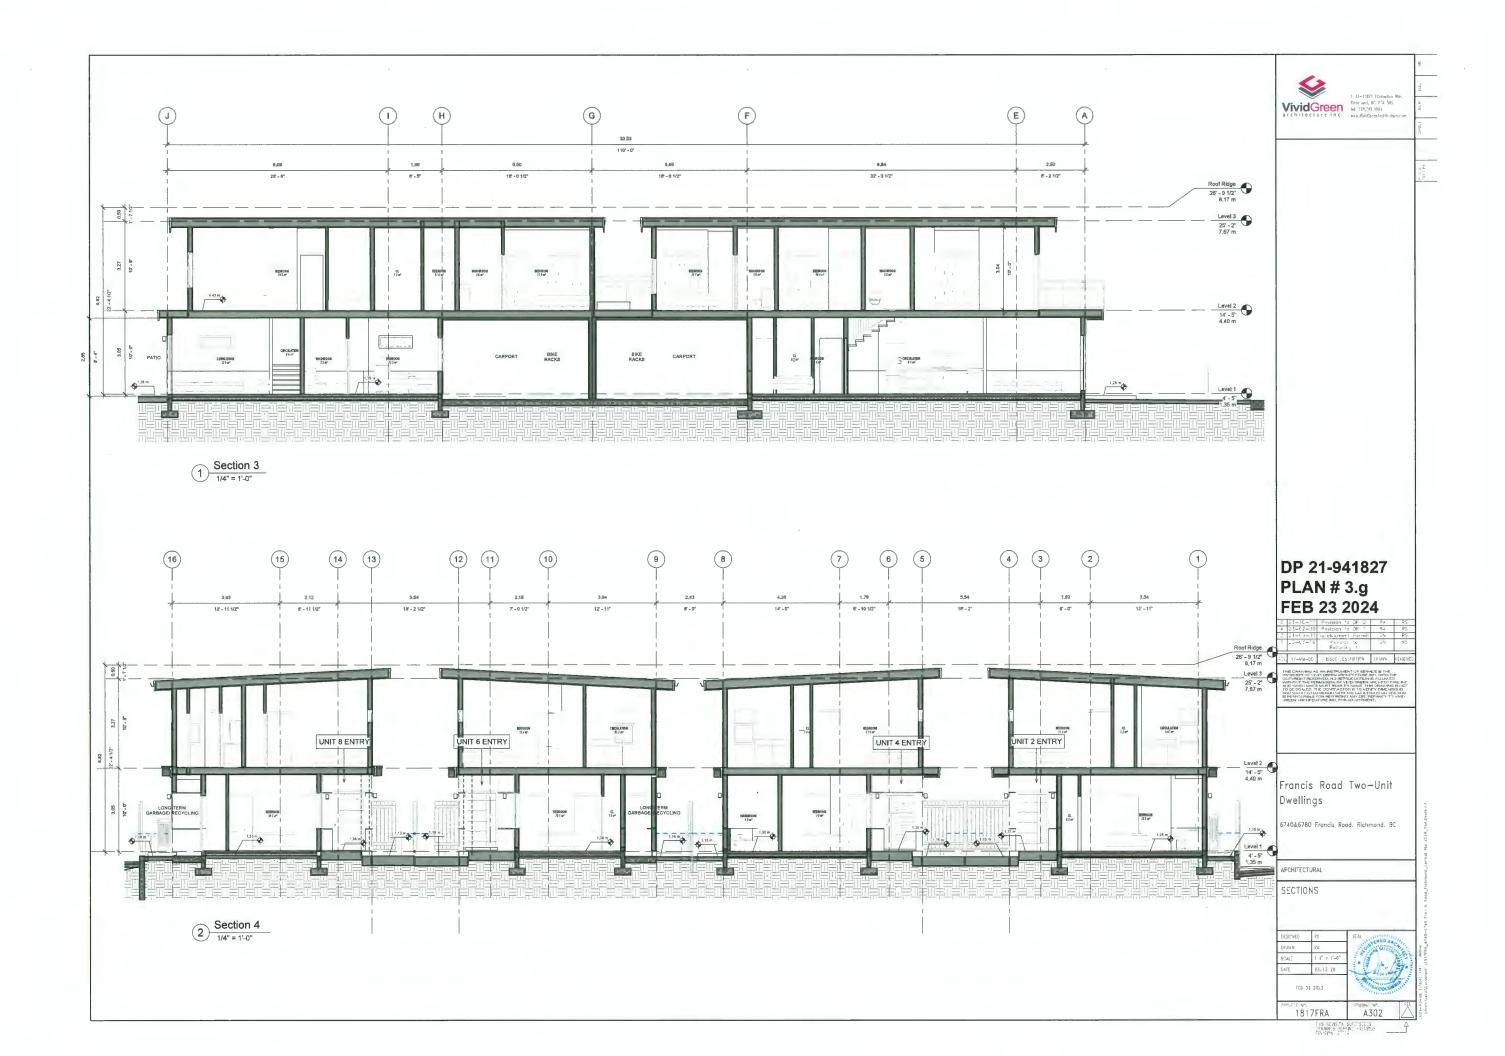


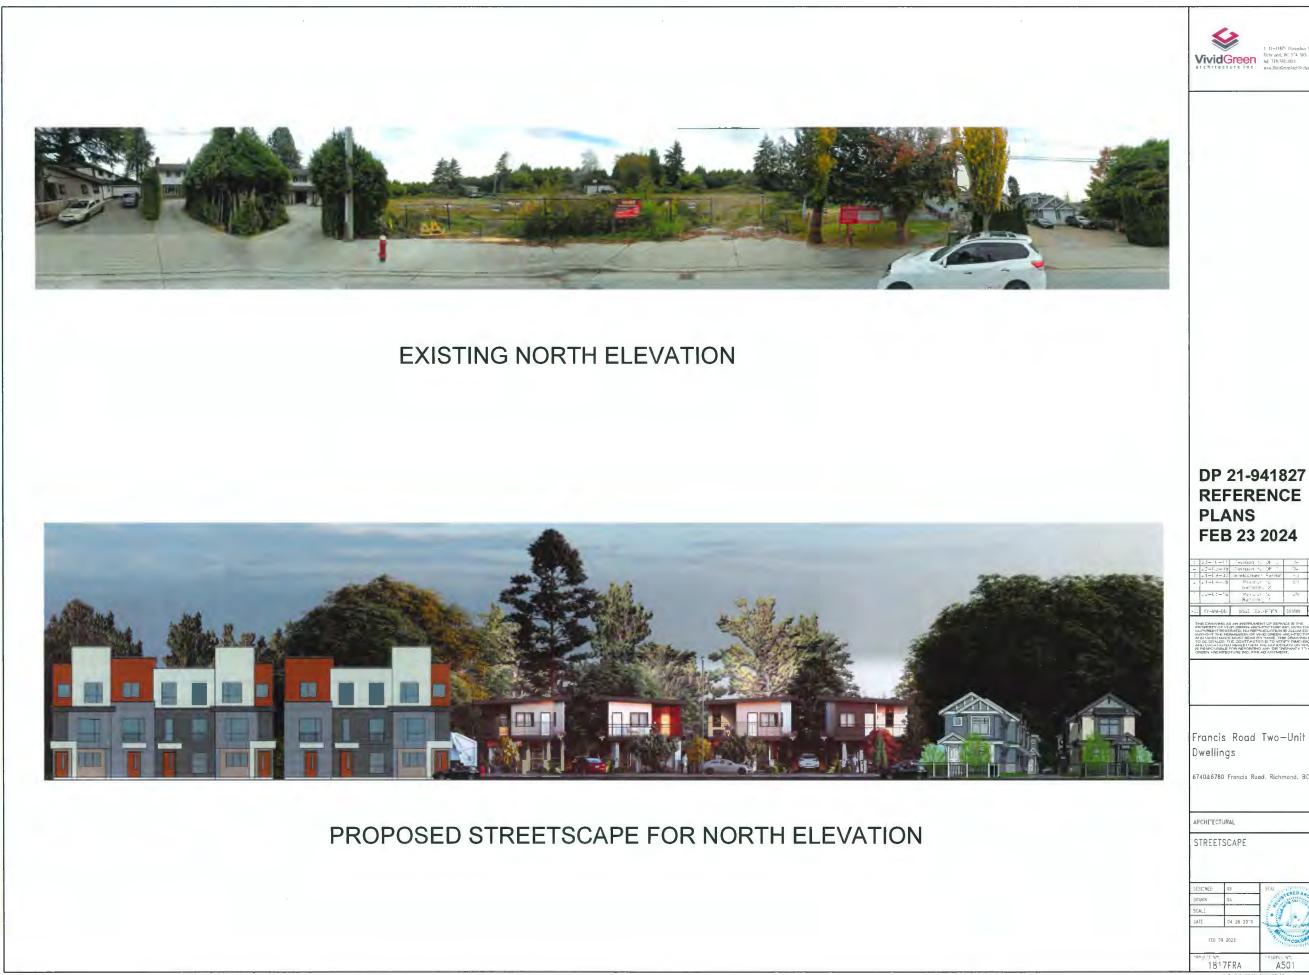


v. IM MATAL Xummark √1517564\_5740-5764 fra-14 Rood\_Flatmand\_Certist 14e 2334\_VGAMinet r.1

SUNNIS BEATN STELLS

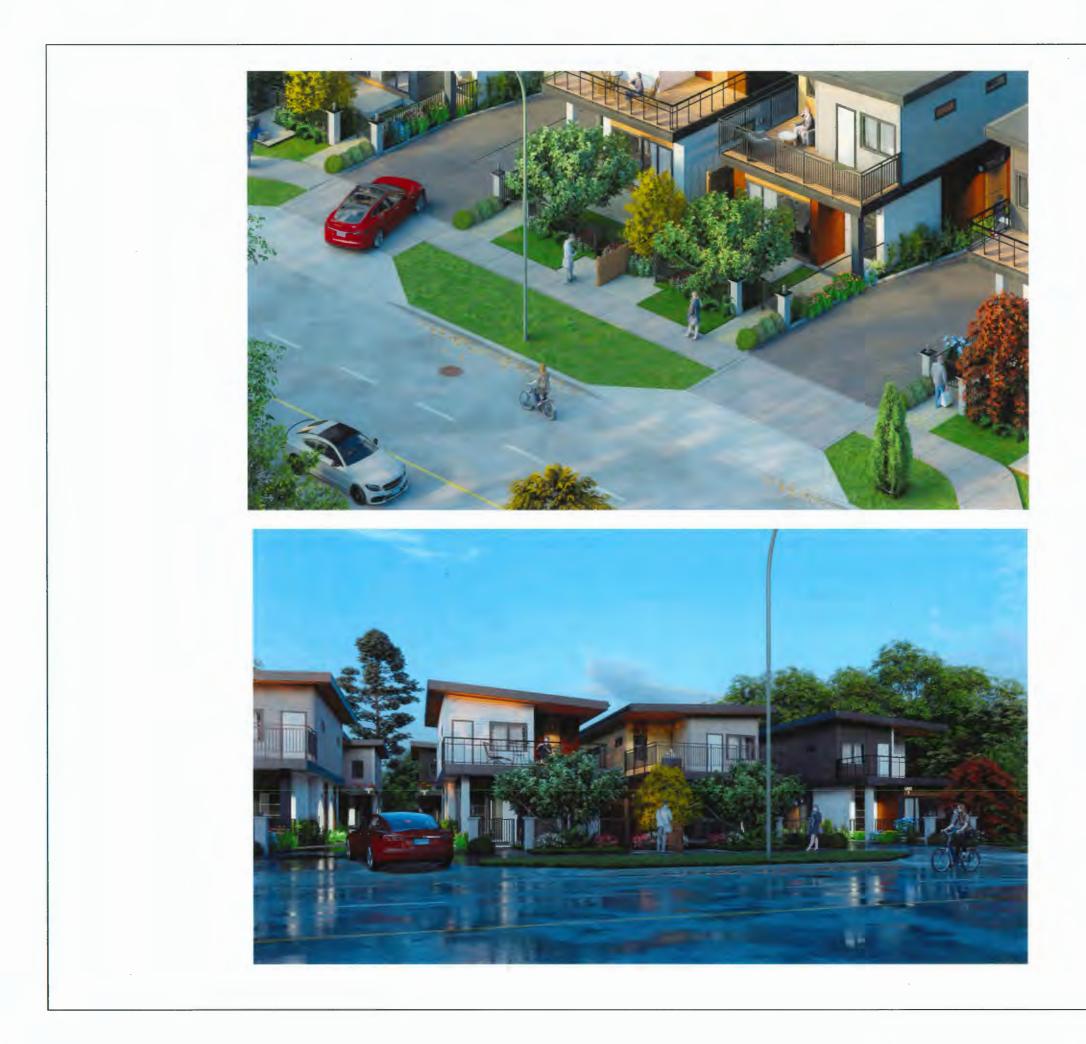

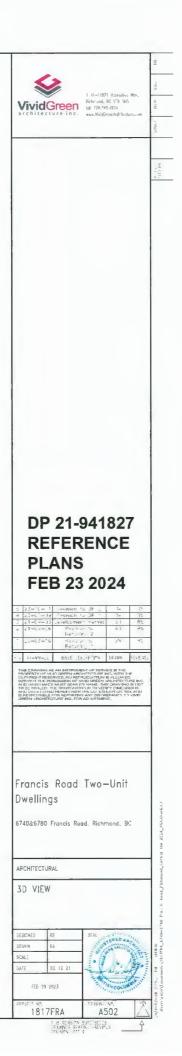



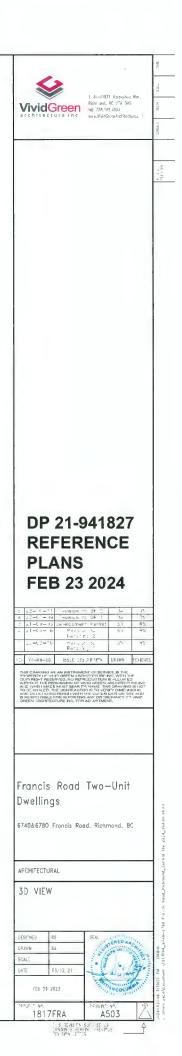















DP 21-941827 REFERENCE PLANS FEB 23 2024

-	∠1-t→6 _>-t:-'6	Meyson to Recording 2 Maybor to Ret. 1 g 1	57 211	RS
-1-	11-44-11	ISSUE ESURIETION	1 KAWN	E VIE NEL
		AN INSTRUMENT OF BERY	NO R THE	


Francis Road Two-Unit Dwellings


6740&6780 Froncis Road. Richmond, BC

APCHITECTURAL


3D VIEW



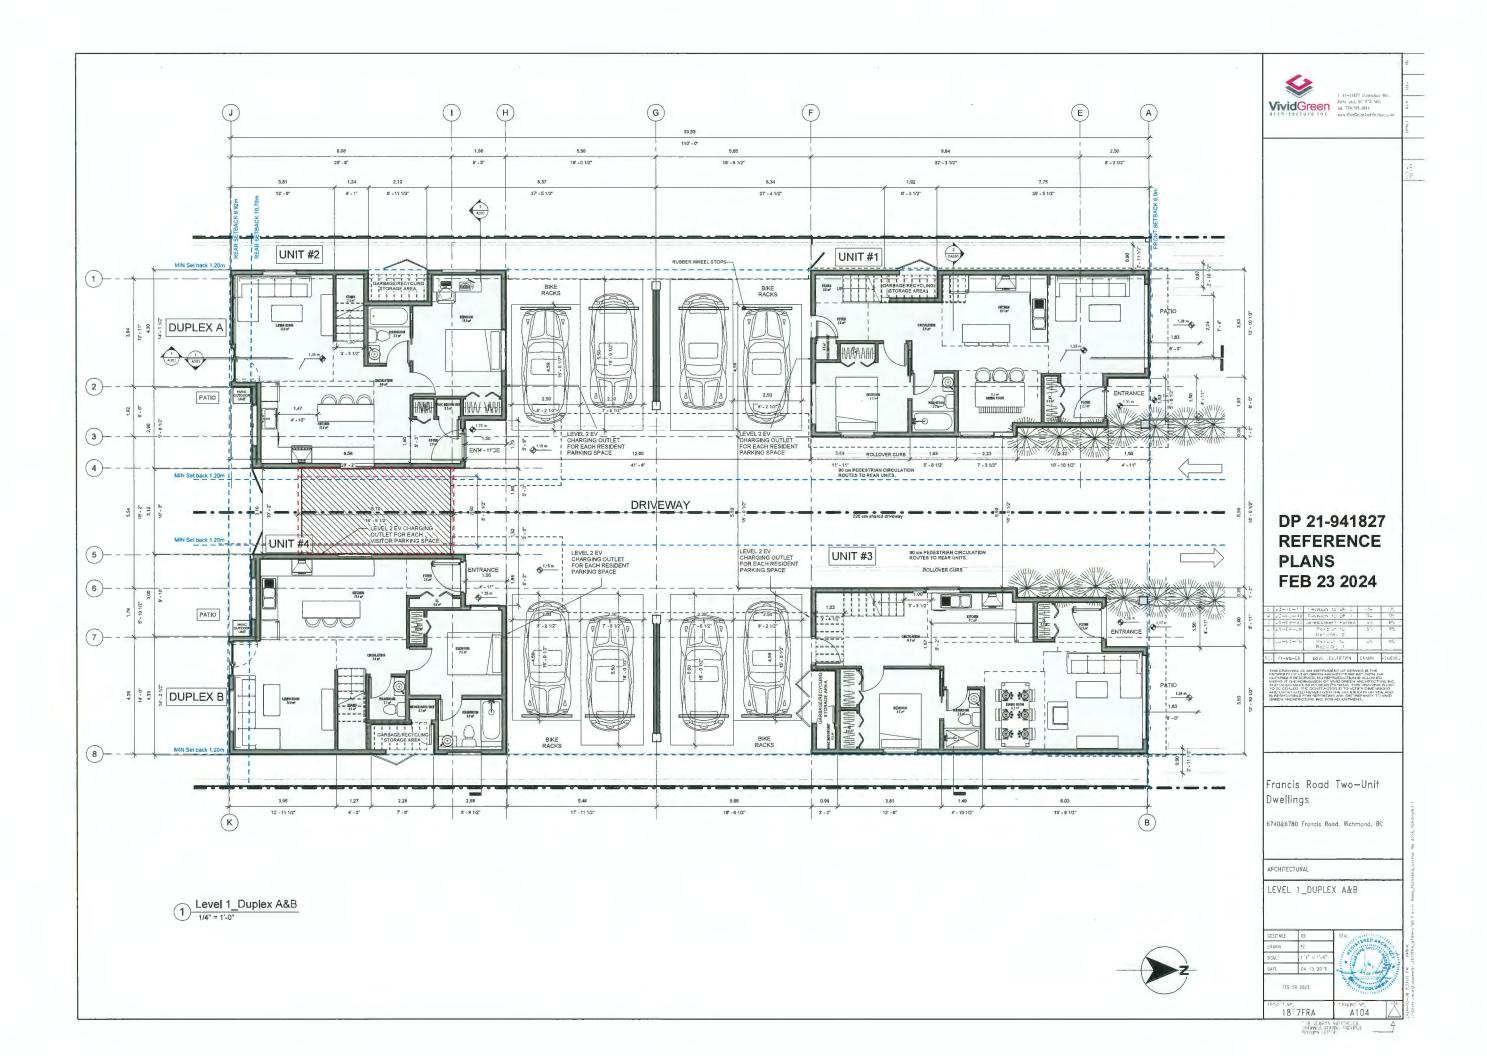

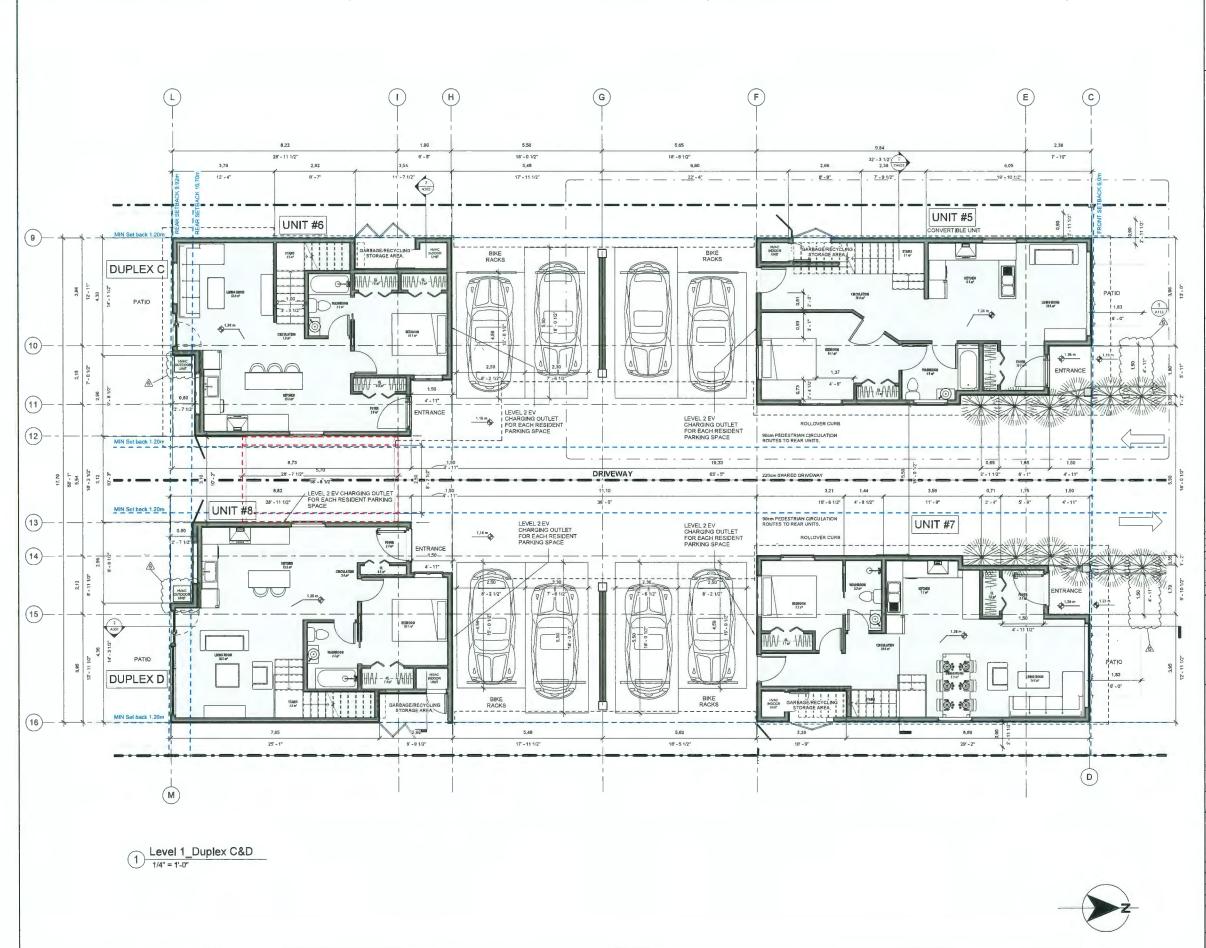



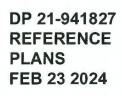

~	23-10-11	evision to DF 1	in .	15
4	23-01-09	Fevision to DF 1	R-	75
2	21-03-03	vereicoment Hermit	511	RS
e	21-64-6	Revision to Nettorint 12	S I	25
1	_1-07-10	Record to Record 1	274	×5
-11	YI-WW-ED	BSLE .ESLEFTIMN	<b>L</b> RAWN	e EMIEME E
_				_


Francis Road Two-Unit Dwellings


6740&6780 Francis Road, Richmond, BC


APCHITECTURAL

LEVEL 1\_DUPLEX C&D FE6 03 2023 18 7FRA A105

TUS SCASCN SU E SECES

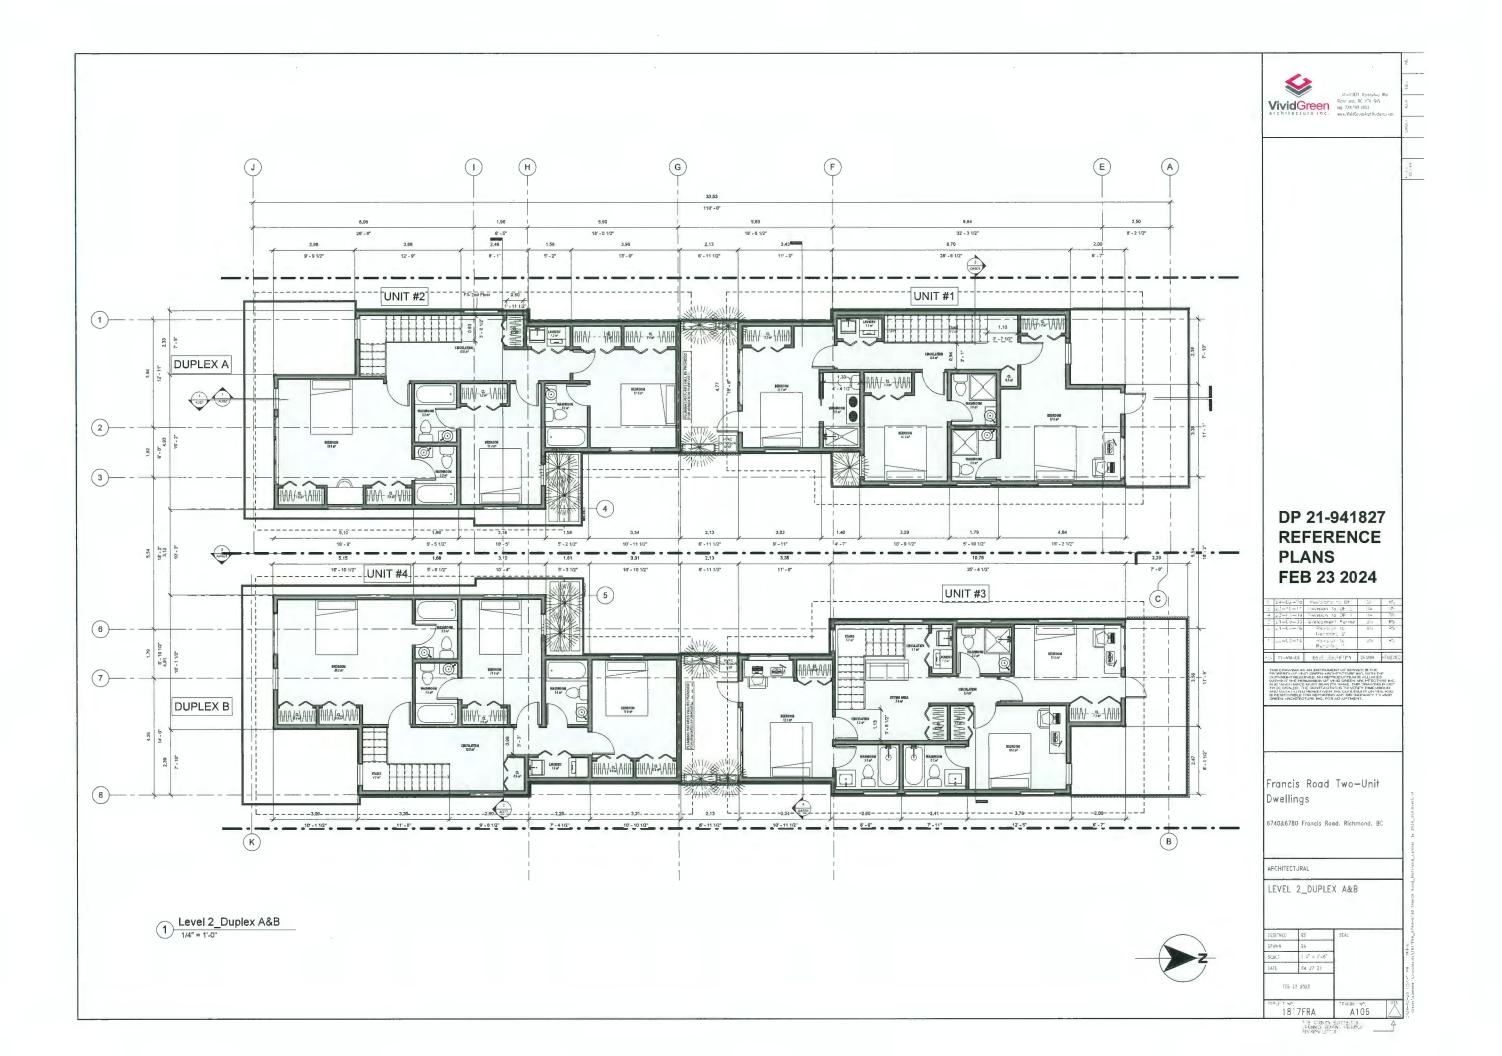

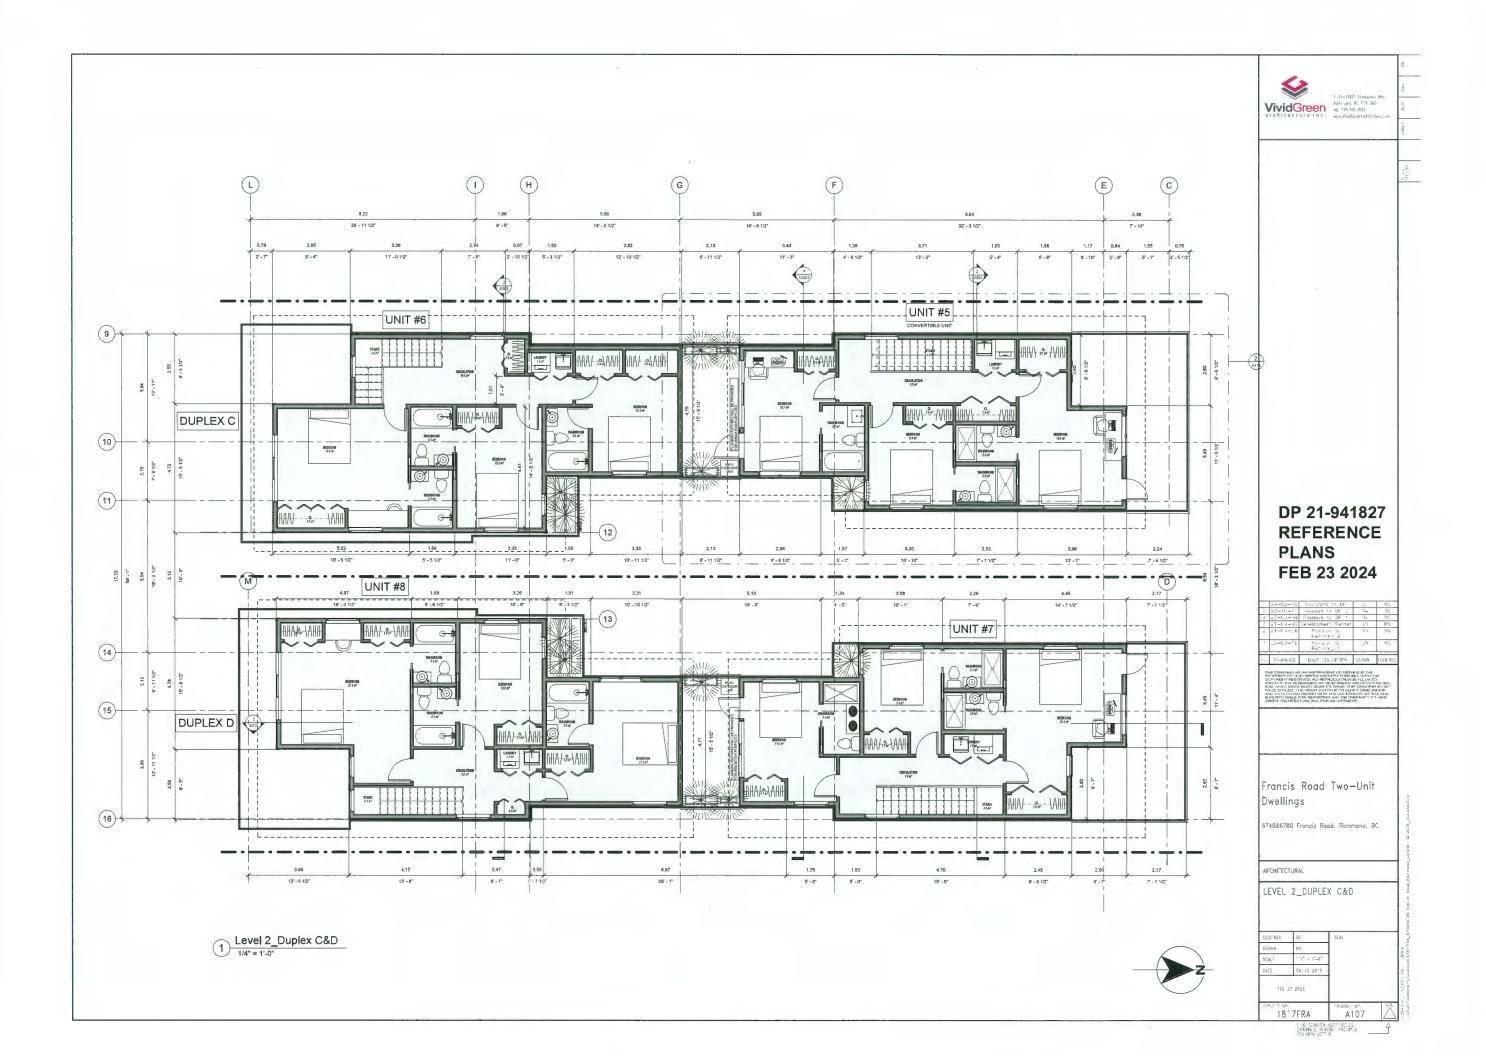

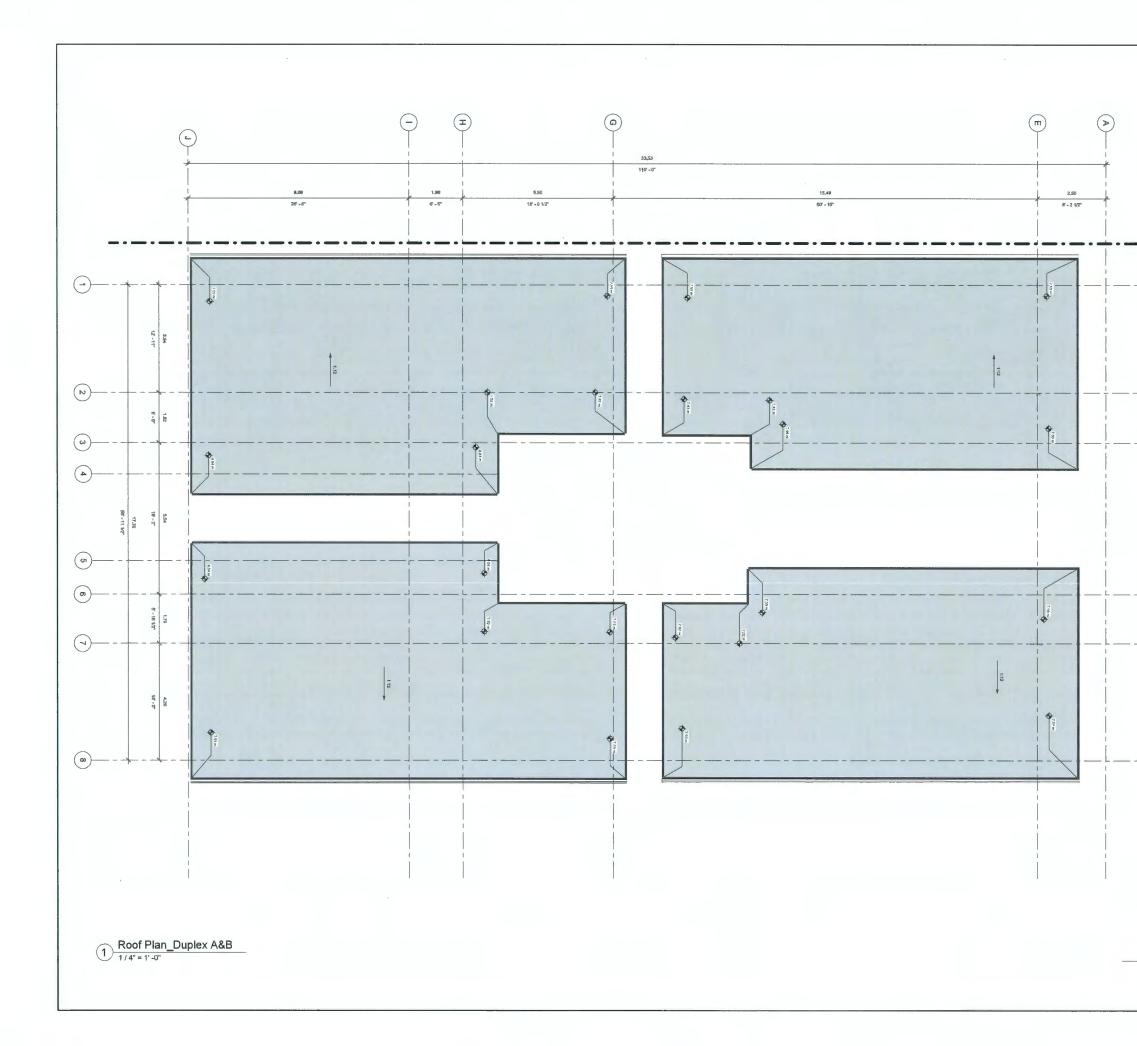



DP 21-941827 REFERENCE PLANS FEB 23 2024

	21-04-16	Person to Nettoint 2 Herbor to	51	RS
	_3-03-10	Record	274	H.F.
121	$\gamma(-hh-1)$	ISSUE ESCRIPTION	L F 71/N	REVIEWE.

TO DE SOALED, THE DENTRACION IN TO VEHITY DIMENSION AND DATA (101ED REMEIT) WITH THE CARTURITORS ON SITE AND IS RESPONSIBLE FOR REPORTING AND DISCREPANCY TO VID DREEN ARCHITECTURE INC, FOR ADJUSTMENT,

### Francis Road Two-Unit Dwellings

5740&6780 Francis Road. Richmond, BC

APCHITECTURAL

FE6 39 2023 18 7FRA








ANNALS FLAFIN, HENRUS

A108

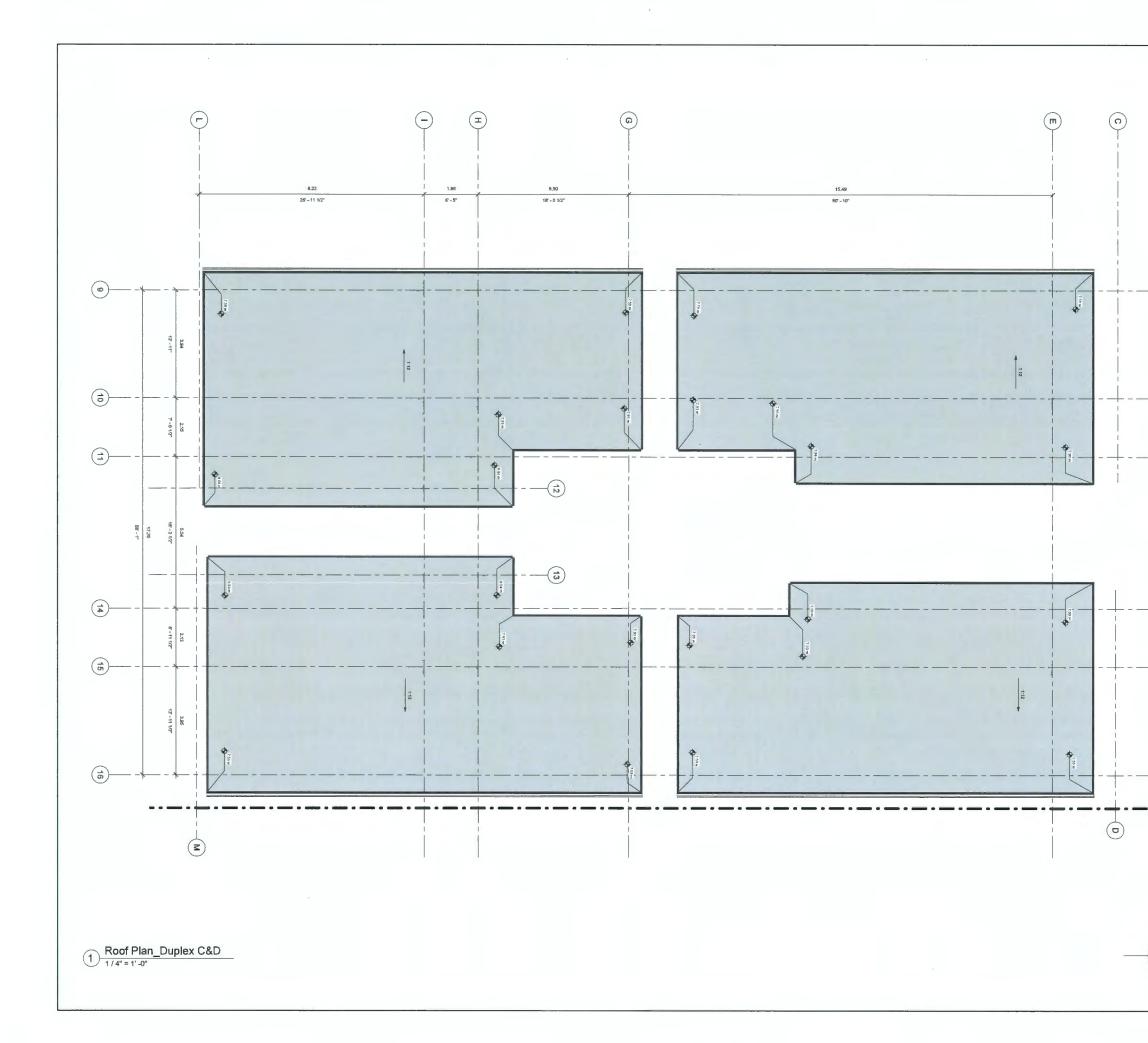







4-b2-08 1:30:15 EM \_\_JERUAL Unerstream (1517584\_5740-5780 F at h Road\_ERcimond\_Central file 42:24\_Y

1817FRA A109

Doors & Doorways	Entry doors are a minimum 863 mm but ideally 914 mm and have clear access.
Doornajo	Entry door clear exterior floor space min. 1220 mm depth by door width plus 600 mm on latch side (not needed if rough in wiring provided for future automatic door opener)
	Interior doors to main living areas, 1 bathroom and 1 bedroom, min. 800 mm clear opening with flush thresholds max. 13 mm height. Demonstrate wheelchair access between the hallway and rooms and widen hallway and/or doorway(s) if necessary to secure access.
	Patio/balcony min. 860 mm clear opening. Note how accessed.
	All interior thresholds within units comply with BC Building Code.
	Lever-type handles for all doors.
Vertical Circulation	Stair lift, staircase width, framing support, and landings, as noted on floor plans in compliance with manufacturer specifications.
	At the top of all stairways, walls are reinforced with 2" x 12" solid lumber at 914 mm to centrc.
Hallways	Min. 900 mm width.
Garage	Min. 1 accessible parking space with min. 4 m garage width.
	Access from garage to living area min. 800 mm clear opening.
Bathroom (Min, 1)	Toilet clear floor space min. 1020 mm at side and in front.
	Wall blocking for future grab bar installation at toilet, tub and shower. Reinforced with 2" x 12" solid lumber in all bathtub, shower, and toilet locations.
	Lever-type handles for plumbing fixtures.
	Pressure and temperature control valves are installed on all shower faucets.
	Cabinets underneath sink(s) are easily removed.
	Demonstrate bath and shower controls are accessible (layout or fixture placement).
Kitchen	Clear area needed under future work space. Plumbing and gas pipes (in-wall and in- floor) located clear of under counter area of future work space (stove, sink & min. 810 mm wide counter). All pipes are brought in no higher than 304 mm to 355 mm to the centre of the pipe from floor level.
	Cabinets underneath sink are easily removed.
	1500 mm turning diameter or turning path diagram.
	Lever-type handles for plumbing fixtures.
Windows	Min. 1 window that can be opened with a single hand (bathroom, kitchen, living room)
Outlets & Switches	Placement locations of electrical outlets: beside window, bottom of stairways, beside toilet, above external doors (outside and inside), on front face of kitchen counter, within proximity of control centre for smart home options.
	Upgrade to four-plex outlets in master bedroom, home office, garage, and recreation room.

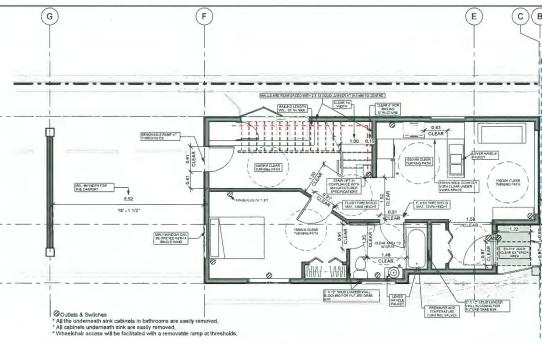

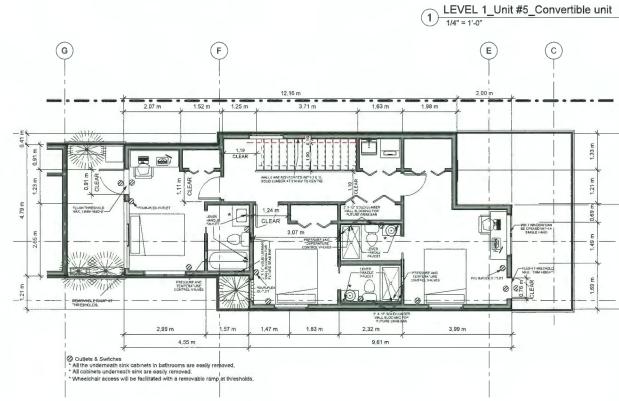


F

### CONVERTIBLE UNIT FEATURES

1-1-0		Maximum Rail Le	
		10 metres	394 methes
Dim	nensions	mm	inch
A	Floar to top of footnest.	9.5	3.75
в	top of footnest to top of seat (Short) (Tall)	445 (410) (505)	17.5 (16.25) (19.75
С	Iop of seat to top of arms	250	9.75
b	lop of arms to top of seat back	190	17. 5
Ł	Width between arminests (Wide arm version)	445 (495)	17,a (19.5)
Ł	Overall width	605	23.13
G	Overall height to floor	980	38.5
н	Length of arms from seat back	4+0	18.5
ł	Length of seat base from seat back	435	17
J	Length of footrest	320	12.75
Y	Width of foourest	310	12.25
L	Front of footrest to stringer	o/0	22.5
м	Back of seat to stringer	13	0.5
N	Folded width	310	12.2a
0	Minimum width required to swivel at top	670	26.25
μ	Distance from from of rail to stringer (Wide arm version)	21a (240)	8.5 (9.5)

STAIRLIFT BC MANUFACTURER

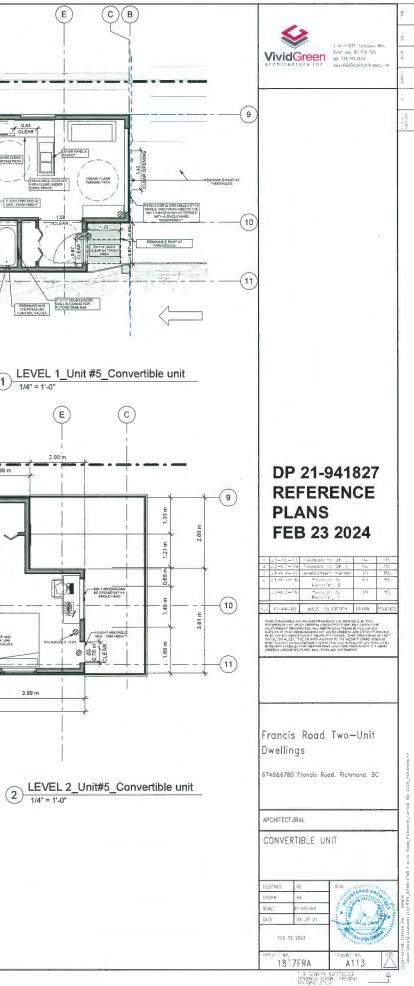




1 Shadow Study-21 March-10 AM



2 Shadow Study-21 March-12 PM



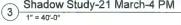



4 Shadow Study-21 June-10 AM 1" = 40'-0"



5 Shadow Study-21 June-12 PM







8 Shadow Study-21 September-12 PM





То:	Development Permit Panel	Date:	February 22, 2024
From:	Wayne Craig Director of Development	File:	DV 22-011004
Re:	Application by Danny Wong for a Development V 8451 No. 5 Road	Variance	e Permit at

### **Staff Recommendation**

That a Development Variance Permit be issued that would vary the provisions of Richmond Zoning Bylaw 8500 to reduce the minimum size of a farm operation associated with a roadside stand in the "Roadside Stand (CR)" zone from 8.0 ha to 1.77 ha, to permit the construction of a roadside stand at 8451 No. 5 Road.

Wayne Co

Wayne Craig Director of Development

WC:ys Att. 4

### Staff Report

### Origin

Danny Wong, on behalf of Da Xing Investment Ltd. (Director: Da Xing), has applied to the City of Richmond for permission to reduce the minimum size of a farm operation associated with a roadside stand in the "Roadside Stand (CR)" zone from 8.0 ha to 1.77 ha, to permit the construction of a roadside stand at 8451 No. 5 Road (also known as the Dajue Art Garden Centre).

The subject property is split-zoned "Roadside Stand (CR)" and "Agriculture (AG1)" (Attachment 1). The roadside stand is proposed to be located within the "Roadside Stand (CR)" zoned portion of the subject property, which requires the requested variance. While "roadside stand" is a permitted use in both the "Roadside Stand (CR)" and "Agriculture (AG1)" zones, the roadside stand must be incidental and supported by a farm operation of at least 8.0 ha in size in the "Roadside Stand (CR)" zone and 0.8 ha in the "Agriculture (AG1)" zone. The existing farm operation is approximately 1.77 ha in size and the applicant has requested a variance to allow a roadside stand to be located within the "Roadside Stand (CR)" portion of the lot, in order to locate the building closer to No. 5 Road.

The purpose of the roadside stand building is to store and showcase plant and nursery products from the existing nursery operation located on the property. The proposed roadside stand building includes  $189.80 \text{ m}^2 (2,043 \text{ ft}^2)$  of indoor floor area and  $110.18 \text{ m}^2 (1,186 \text{ ft}^2)$  of outdoor area – for a total of approximately  $300 \text{ m}^2 (3,229 \text{ ft}^2)$ . Other than the requested variance, the proposed use and size of the roadside stand is consistent with Zoning Bylaw 8500 and the Agricultural Land Reserve (ALR) Use Regulation.

### Background

The subject property previously contained a non-conforming roadside stand building in the "Roadside Stand (CR)" zoned portion of the lot, which was demolished in 2021 in order to construct the proposed new roadside stand building. The subject site currently contains a nursery farm operation, an agricultural building (barn) for storage/ processing farm products, and a single-family dwelling.

### **Development Information**

Please refer to the attached Development Application Data Sheet (Attachment 2) for a comparison of the proposed development data with the relevant Bylaw requirements.

### Surrounding Development

- To the North: Single-family dwelling and farm operation on an approximately 4.62 acres (1.87 hectares) lot zoned "Agriculture (AG1)".
- To the South: Single-family dwelling and farm operation on an approximately 2.17 acres (0.88 hectares) lot zoned "Agriculture (AG1)".

To the East:	Across No. 5 Road, Buddhist temple on an approximately 0.84 acres (0.34 hectares) lot zoned "Assembly (ASY)".
To the West:	No access property on an approximately 10.18 acres (4.12 hectares) lot zoned "Agriculture (AG1)".

### Consultation

### Food Security and Agricultural Advisory Committee (FSAAC)

The Food Security and Agricultural Advisory Committee (FSAAC) reviewed the proposal on September 28, 2023. The Committee unanimously supported the proposal. A copy of the relevant excerpt from the FSAAC meeting minutes is attached for reference (Attachment 3).

Informational signage has been installed on the property and no correspondence has been received regarding the proposal.

### Staff Comments

### Roadside Stand (CR) Zone

On February 9<sup>th</sup>, 1987, Council created the Roadside Stand zone as part of a comprehensive rezoning bylaw, which rezoned 21 existing roadside stand businesses to the new Roadside Stand zone, including the subject property. "Roadside stand" was also a permitted use in Agricultural zones, but was limited by the type of roadside stand based on the licensing classes identified in the "Roadside Stand Bylaw" (now located in the Business Regulation Bylaw):

- Class A: be farming a minimum of not less than 0.2 hectares (half-acre) of land and provide a portable building of a maximum 93 m<sup>2</sup> (1,001 ft<sup>2</sup>) in floor area;
- Class B: be farming a minimum of not less than 0.8 hectares (2 acres) of land and provide a permanent building of a maximum 93 m<sup>2</sup> (1,001 ft<sup>2</sup>) in floor area; and
- Class C: be farming a minimum of not less than 8.0 hectares (20 acres) of land and provide a permanent building of a maximum 190 m<sup>2</sup> (2,045 ft<sup>2</sup>) in floor area.

Class A & B were permitted in Agricultural zones and Class C was permitted in the dedicated Roadside Stand zone. The current Zoning Bylaw 8500 allows "roadside stand" in both the "Roadside Stand (CR)" zone and the "Agriculture (AG1)"zone, but contains the following restrictions (based on sizes in the historical "Roadside Stand Bylaw", and now located in the Business License Bylaw):

- Roadside Stand (CR): roadside stand must be incidental to and supported by a farm operation of at least 8.0 ha (20 acres) and a maximum 190 m<sup>2</sup> (2,045 ft<sup>2</sup>) in floor area.
- Agriculture (AG1): roadside stand must be incidental to and supported by a farm operation of at least 0.8 ha (2 acres) and a maximum 93 m<sup>2</sup> (1,001 ft<sup>2</sup>) in floor area.

Although the proposed roadside stand would be Class B, the "Roadside Stand (CR)" zone only allows for a roadside stand if the farm operation is at least 8.0 ha (20 acres). The existing farm operation is approximately 1.77 ha in size. As such, the applicant has requested a variance to allow the roadside stand to be located within the "Roadside Stand (CR)" portion of the lot, in order to locate the building closer to No. 5 Road, utilize previously disturbed area of the property while not encroaching into the Environmentally Sensitive Area (ESA) located on the west side of the property, and allow more area for the farm operation in the "Agriculture (AG1)" portion of the property.

### Environmentally Sensitive Area (ESA)

- The west side of the property is designated Environmentally Sensitive Area (ESA), which is currently actively farmed.
- In accordance with Provincial Legislation and Regulations, farming activities are not subject to the City's ESA Development Permit process or guidelines.
- According to the applicant's agrologist report, there will be no changes/ impacts to the existing farming operation within the ESA designated area as a result of the proposed variance to permit a roadside stand in the "Roadside Stand (CR)" zoned portion of the property.

### Previous & Current Farm Business

- The subject property has held a business license for nursery since 1974.
- According to the agrologist report submitted by the applicant, the east side of the property has been used for greenhouse crop for many years and is proposed to continue. There is currently greenhouse crop production on the east side of the property, which facilitates production of potted plants.
- The purpose of the proposed roadside stand building would be to sell the products from the nursery operation.
- Based on the property's farm plan, the Agrologist Report indicates that the applicant is proposing to sell products from the nursery operation in the roadside stand building as per Zoning Bylaw 8500 and the Agricultural Land Reserve (ALR) Use Regulation, which requires at least 50% of the retail sales must be farm products produced on the farm on which the retail sales are taking place.
- The applicant has provided evidence that the land has farm class as per BC Assessment.

### Zoning Compliance/ Variances (staff comments in bold italics)

The applicant requests to vary the provision of Richmond Zoning Bylaw 8500 to reduce the minimum size of a farm operation associated with a roadside stand in the "Roadside Stand (CR)" zone from 8.0 ha to 1.77 ha.

### Staff supports the proposed variance due to the following:

• The proposed variance allows the roadside building to be located in the "Roadside Stand (CR)" zoned portion of the lot along No. 5 Road frontage, reserves more area for

the farm in the "Agriculture (AG1)" zoned portion of the lot, and utilizes the existing disturbed area of the previous roadside stand.

- The proposal could proceed in the "Agriculture (AG1)" zoned portion of the lot without a variance, but would impact the existing farm operation and Environmentally Sensitive Area and would need to be reduced in size to not more than 93 m<sup>2</sup>.
- There is an existing farm with farm status.
- The submitted Agrologist Report has confirmed that the land is suitable for the existing farm operation, and the nursery products produced onsite will support the proposed road side stand.
- The proposed size and siting of the roadside stand building are consistent with Zoning Bylaw 8500, other than the requested variance.

### Analysis

### **Conditions of Adjacency**

- The subject site is bordered by agricultural operations to the north and south. The proposed roadside stand would support the existing farm operation on-site and is considered an agricultural use.
- The proposed roadside stand building complies with all setback requirements of the zoning bylaw.

### Site Planning

- The subject property is approximately 5 acres (2.02 hectares) and is split-zoned "Roadside Stand (CR)" (0.62 acres/ 0.25 hectares) and "Agriculture (AG1)" (4.37 acres/ 1.77 hectares).
- The property currently contains an existing plant nursery farm operation, an agricultural building (barn) for storage/ processing farm products, and a single-family dwelling.
- The proposed floor area of the roadside stand building includes 189.80 m<sup>2</sup> (2,043 ft<sup>2</sup>) of indoor floor area and 110.18 m<sup>2</sup> (1,186 ft<sup>2</sup>) of outdoor area.
- The proposed roadside stand will be situated in generally the same location of the previous non-conforming building that was demolished in 2021, utilizing the existing paved area adjacent to the parking lot.
- The size and siting of the building is consistent with Zoning Bylaw 8500, other than the requested variance.
- Proposed parking is consistent with the minimum required number of vehicle parking spaces as per Zoning Bylaw 8500.
- The existing parking area and driveway surface will remain as asphalt.
- Vehicle access to the roadside stand building, as well as farm access to the existing farming operation, will be provided via an existing driveway off of No. 5 Road. Transportation staff have reviewed the proposed access and have no concerns.

### Architectural Form and Character

• The proposed design of the roadside stand building is compatible with the general farm building design, and features low pitched metal roof and siding, stone footing, and glazing on the front façade.

### Landscape Design and Open Space Design

- The proposed landscape plan includes a 3 m wide planting strip along No. 5 Road frontage. This landscaped planting area includes a variety of shrubs as well as five vine maple trees. At maturity the shrubs and trees in the landscape strip would provide screening of the parking area and blend in with the existing chain link fence, which is to remain in place for security reasons.
- No existing trees are proposed to be removed.
- Pedestrian access is being provided via a 1.5 m asphalt pathway and clearly marked connecting the City sidewalk to the entrance of the roadside stand building.
- In order to ensure the proposed landscaping works will be completed, the applicant is required to provide a landscape security of \$10,389 in association with the Development Variance Permit.

### Conclusion

The proposed plans attached to this report have satisfactorily addressed staff comments identified as part of the review of the subject Development Variance Permit application. In addition, the development is consistent with the intent of the applicable sections of the Official Community Plan and is in compliance with the "Roadside Stand (CR)" zone except for the variance being sought.

Staff recommend that the Development Variance Permit be endorsed, and issuance by Council be recommended.

The list of Development Permit Considerations is included in Attachment 4, which has been agreed to by the applicant.


1 Hain

Yuli Siao Planner 2

YS:cas

Attachment 1: Location Map
Attachment 2: Development Application Data Sheet
Attachment 3: Excerpt from minutes of FSAAC meeting (September 28, 2023)
Attachment 4: Development Permit Considerations



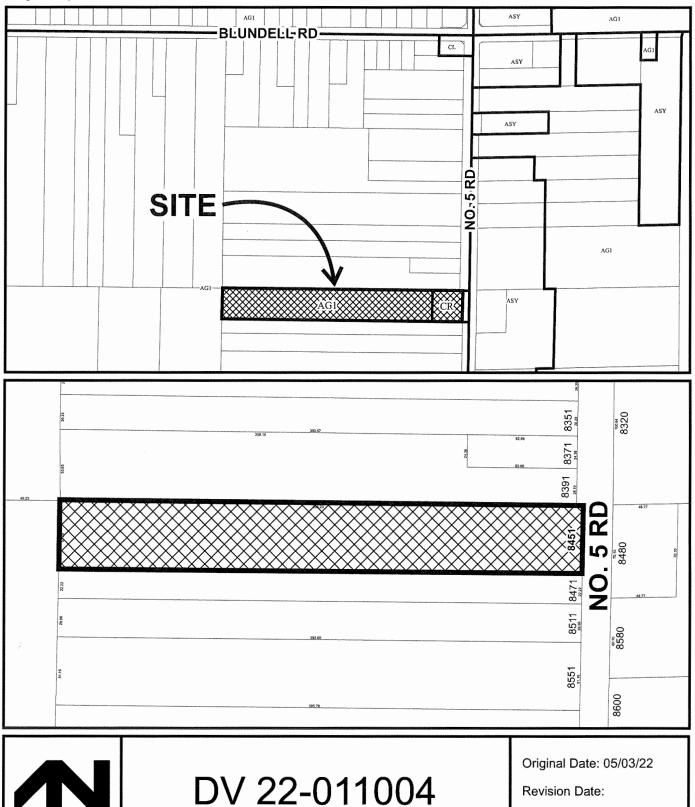

Note: Dimensions are in METRES



### **Development Application Data Sheet**

Development Applications Division

#### DV 22-011004 Attachment 2 8451 No. 5 Road Address: Applicant: Danny Wong Owner: Da Xing Investment Ltd. Planning Area(s): East Richmond Existing Proposed Site Area: Total: 20,223 m<sup>2</sup> (5 ac / 2.02 ha) No change Single-family residential, agriculture and Land Uses: No change roadside stand **OCP** Designation: Agriculture (AGR) No change Roadside Stand (CR) and No change Zoning: Agriculture (AG1)

	Bylaw Requirement (CR)	Proposed	Variance
Floor Area Ratio:	Max. 0.50	0.075	None
Density:	Max. 1 roadside stand per lot	1 roadside stand	None
Floor Area:	Max. 190.0 m <sup>2</sup> (2,045 ft <sup>2</sup> )	189.80 m² (2,043 ft²)	None
Retail Sales Area	Max. indoor and outdoor area: 300 m <sup>2</sup> (3,229 ft <sup>2</sup> )	300 m² (3,229 ft²)	None
Lot Coverage:	Max. 35%	7.41%	None
Setback – Front Yard:	Min. 3.0 m	23.5 m	None
Setback – Side Yard north:	N/A	26 m	None
Setback – Side Yard south:	NA	3.38 m	None
Setback – Rear Yard:	N/A	33.5 m	None
Height (m):	Max. 10.5 m	5.5 m	None
Lot Size:	Roadside stand must be incidental and supported by a farm operation of at least 8.0 ha	1.77 ha	Variance required
Off-street Parking Spaces:	1 space per 20.0 m <sup>2</sup> = 15	15	None
Off-street Parking Spaces – Accessible:	Min. 2% = 1	2	None

### Excerpt from Minutes of Food Security and Agricultural Advisory Committee (FSAAC) September 28, 2023

### **Development Variance Permit Application at 8451 No. 5 Road**

Liyang Wan, Planner 1, Policy Planning, introduced the Development Variance Permit application at 8451 No. 5 Road and provided the following comments:

- The subject property is split-zoned "Roadside Stand (CR)" and "Agriculture (AG1)";
- The purpose of the application is to request a variance to the "Roadside Stand (CR)" zone to allow a roadside stand incidental to a farm operation of 1.77 ha in size;
- There was a previous roadside stand building on the property which was demolished in 2021 in order to construct the new proposed roadside stand building;
- The west side of the property is designated Environmentally Sensitive Area (ESA), which is actively farmed and there is no changes to the farm operation within this area as a result of the proposed variance; and
- Other than the requested variance, the proposed use, size and siting of the roadside stand are consistent with the City's Zoning Bylaw.

The applicant provided the following additional comments:

- In addition to the proposed new roadside stand building, a number of improvements have been made to the farm including a new farm road, drainage system and greenhouses;
- The nursery operation consists primarily of trees and shrubs, roses, annual plants, and hanging baskets;
- Over 50% of the product sold through the nursery operation is grown on the farm, with plans to expand on-site production;
- The proposed new roadside stand building will provide interior space to showcase and sell nursery products; and
- The nursery operation is a family-owned farm business with experience in growing nursery stock.

In response to questions from the Committee, the applicant provided the following additional comments:

• Since the previous roadside stand building was demolished, the nursery operation has been selling products outside, which presents challenges related to storage and showcasing of nursery product;

- The total size of the proposed roadside stand building is approximately 190 m2 of indoor area and 110 m2 of outdoor area, for a total of 300 m2; and
- Improvements to the farm also include a rainwater storage system to utilize rainwater for irrigation purposes.

The Committee passed the following motion:

That the Food Security and Agricultural Advisory Committee support the Development Variance Permit at 8451 No. 5 Road (DV 22-011004).

Carried Unanimously

### **ATTACHMENT 4**



### **Development Variance Permit Considerations**

Development Applications Department 6911 No. 3 Road, Richmond, BC V6Y 2C1

### Address: 8451 No. 5 Road

File No.: DV 22-011004

### Prior to forwarding the application to Council for approval, the developer is required to complete the following:

- 1. Submission of a landscaping security in the amount of \$10,389. The Applicant must also enter into a legal agreement to accompany the landscaping security, which sets the terms for use and release of the security.
- 2. Registration of a flood plain covenant on title identifying a minimum habitable elevation of 2.9 m GSC.

### Prior to Building Permit Issuance, the developer must complete the following requirements:

 Submission of a Construction Parking and Traffic Management Plan to the Transportation Department. Management Plan shall include location for parking for services, deliveries, workers, loading, application for any lane closures, and proper construction traffic controls as per Traffic Control Manual for works on Roadways (by Ministry of Transportation) and MMCD Traffic Regulation Section 01570.

### Note:

- \* This requires a separate application.
- Where the Director of Development deems appropriate, the preceding agreements are to be drawn not only as personal covenants of the property owner but also as covenants pursuant to Section 219 of the Land Title Act.

All agreements to be registered in the Land Title Office shall have priority over all such liens, charges and encumbrances as is considered advisable by the Director of Development. All agreements to be registered in the Land Title Office shall, unless the Director of Development determines otherwise, be fully registered in the Land Title Office prior to enactment of the appropriate bylaw.

The preceding agreements shall provide security to the City including indemnities, warranties, equitable/rent charges, letters of credit and withholding permits, as deemed necessary or advisable by the Director of Development. All agreements shall be in a form and content satisfactory to the Director of Development.

- Additional legal agreements, as determined via the subject development's Servicing Agreement(s) and/or Development Permit(s), and/or Building Permit(s) to the satisfaction of the Director of Engineering may be required including, but not limited to, site investigation, testing, monitoring, site preparation, de-watering, drilling, underpinning, anchoring, shoring, piling, pre-loading, ground densification or other activities that may result in settlement, displacement, subsidence, damage or nuisance to City and private utility infrastructure.
- Applicants for all City Permits are required to comply at all times with the conditions of the Provincial *Wildlife Act* and Federal *Migratory Birds Convention Act*, which contain prohibitions on the removal or disturbance of both birds and their nests. Issuance of Municipal permits does not give an individual authority to contravene these legislations. The City of Richmond recommends that where significant trees or vegetation exists on site, the services of a Qualified Environmental Professional (QEP) be secured to perform a survey and ensure that development activities are in compliance with all relevant legislation.

Signed Date



### **Development Variance Permit**

# No. DV 22-011004 To the Holder: Da Xing Investment Ltd. Property Address: 8451 No. 5 Road Address: 120 – 2899 No. 3 Road Richmond, BC V6X 2B2

- 1. This Development Variance Permit is issued subject to compliance with all of the Bylaws of the City applicable thereto, except as specifically varied by this Permit.
- 2. This Development Variance Permit applies to and only to those lands shown cross-hatched on the attached Schedule "A" and any and all buildings, structures and other development thereon.
- 3. The "Richmond Zoning Bylaw 8500" is hereby varied to:
  - a) Reduce the minimum size of a farm operation associated with a roadside stand in the "Roadside Stand (CR)" zone from 8.0 ha to 1.77 ha.
- 4. The land described herein, and any buildings, structures, off-street parking facilities, landscaping and screening shall be developed generally in accordance with the terms and conditions and provisions of this Permit and any plans and specifications attached to this Permit which shall form a part hereof (Plan #1-4).
- 5. As a condition of the issuance of this Permit, the City is holding the security in the amount of \$10,389 to ensure that development is carried out in accordance with the terms and conditions of this Permit. Should any interest be earned upon the security, it shall accrue to the Holder if the security is returned. The condition of the posting of the security is that should the Holder fail to carry out the development hereby authorized, according to the terms and conditions of this Permit within the time provided, the City may use the security to carry out the work by its servants, agents or contractors, and any surplus shall be paid over to the Holder. Should the Holder carry out the development permitted by this permit within the time set out herein, the security shall be returned to the Holder. The City may retain the security for up to one year after inspection of the completed landscaping in order to ensure that plant material has survived.
- 6. If the Holder does not commence the construction permitted by this Permit within 24 months of the date of this Permit, this Permit shall lapse.

This Permit is not a Building Permit.

To the Holder: Da Xing Investment Ltd.

Property Address: 8451 No. 5 Road

Address: 120 – 2899 No. 3 Road Richmond, BC V6X 2B2

AUTHORIZING RESOLUTION NO. DAY OF , .


ISSUED BY THE COUNCIL THE

, .

DELIVERED THIS DAY OF

MAYOR

## 8451 NO. 5 ROAD, RICHMOND DV 22-011004

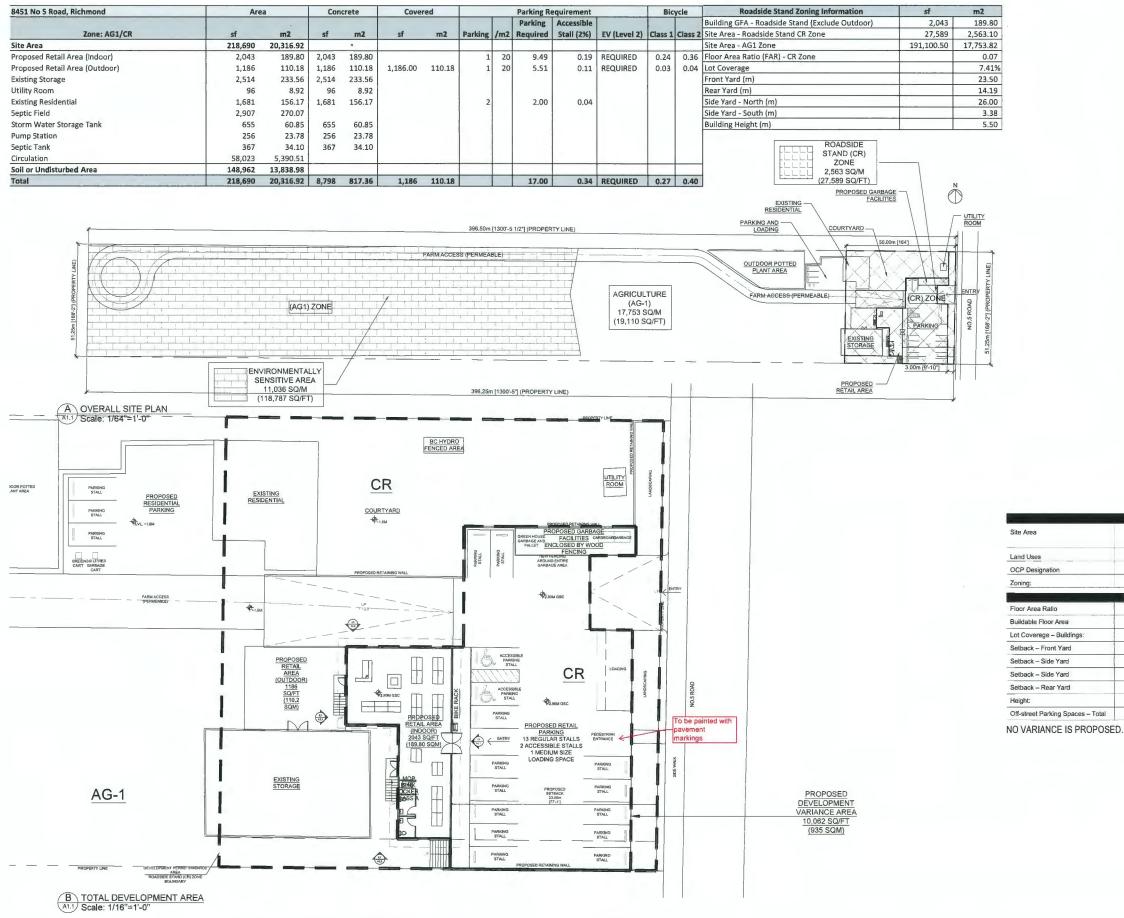

### DRAWING LIST A1.1 TITLE PAGE / SITE PLAN / AREA AND PARKING CALCULATION A1.2 SITE PLAN A1.3 SITE PLAN A3.1 PROPOSED ELEVATION A3.2 PROPOSED ELEVATION / SECTION Architelier SCOPE OF WORK BUILD 1 ROADSIDE COVERED RETAIL STAND BUILD 4 GREENHOUSES BUILD 2 STORAGE BUILDINGS BUILD 1 UTILITY ROOM UPGRADE SEPTIC FIELD, STORMWATER STORAGE TANK, PUMP STATION & SEPTIC TANK MAINTAIN EXISTING RESIDENTIAL LEGAL DESCRIPTION LOT 1 SEC 24 BLK 4N RG 6W PL NWP4105 LOT 1, BLOCK 4N, PLAN NWP4105, SECTION 24, RANGE 6W NEW WESTMINSTER LAND DISTRICT PROJECT DIRECTORY DANNY WONG ARCHITECT AIBC, MRAIC, RI, B.ARCH., LEED AP ARCHITELIER ARCHITECTURE, INTERIOR DESIGN & REAL ESTATE CONSULTING 680 - 838 WEST HASTINGS STREET, VANCOUVER, BC V6C 0A6 / #3-11240 BRIDGEPORT ROAD RICHMOND · BC · CANADA · V6X 1T2 (604) 773-2068 WWW.ARCHITELIER.COM GENERAL NOTES DISCLAIMER AWING MUST NOT BE SCALED. TH TOTAL AREA OF FARM RETAIL SHALL NOT EXCEED 300 M2. AT LEAST 50% OF THAT AREA IS LIMITED TO THE SALE OF FARM PRODUCTS PRODUCED EITHER ON THAT AGRICULTURAL AND OR BY AN ASSOCIATION TO WHICH THE OWNER OF THE AGRICULTURAL LAND BELONGS. 2. FLOOD CONSTRUCTION LEVEL (FCL) FOR ALL NEW CONSTRUCTIONS ON THIS SITE SHALL BE MINIMUM 2.9 M GSC DRAWING ISSUES CONNECT PROPOSED ALL BUILDINGS TO

EXISTING SEPTIC SYSTEM

Existing	Proposed
AG1 - 20,316.92 m <sup>2</sup>	CR - 2,563.10 m <sup>2</sup>
	AG1 - 17,753.82 m <sup>2</sup>
AGR	AGR & CR
2.13A - AGR	2.13A - AGR
AG1	AG1 & CR

Bylaw Requirement		Proposed Variance	
	300 m2	0.074	None permitted
T	300 m2	189.80 m2	None permitted
1	Max. 50 %	7.41 %	
1	Min. 3 m	23.5 m	
T	Min. 0 m	26 m	
T	Min. 0 m	3.38 m	
T	Min. 0 m	14.19 m	
T	Max. 10.5 m	5.50 m	
T	15	15	

### PLAN #1A

680-638 WEST HASTINGS STREET VANCOUVER, BC V6C 0A6 WWW.ARCHITELIER.COM 604.773.2068

2022-02-22 ISSUED FOR DVP 2022-10-02 ISSUED FOR DVP R

PROJECT

ADDRESS

8451 NO, 5 ROAD, RICHMOND DV 22-011004

PROPERTY INFORMATION


SHEET TITLE

SITE PLAN - PROPOSED

A012123
AS NOTED
SA
DKW
December 3, 2023

A1.1

# 8451 NO. 5 ROAD, RICHMOND DV 22-011004

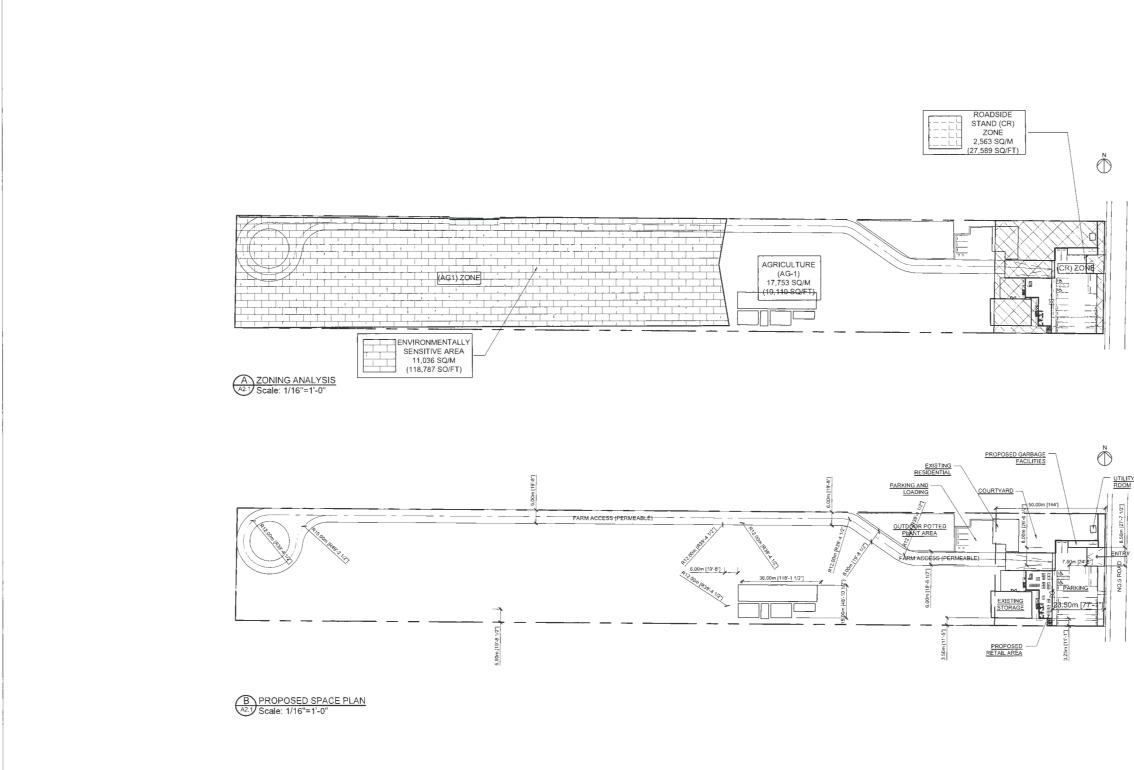



680-838 WEST HASTINGS STREET VANCOUVER, BC V6C 0A6 WWW.ARCHITELIER.COM 604,773,2068

#### DISCLAIMER

HIS DRAWING MUST NOT BE SCALED. T

DRAWING ISSUES 2022-02-22 ISSUED FOR DVP 2022-10-02 ISSUED FOR DVP i

PROJECT

ADDRESS

8451 NO. 5 ROAD, RICHMOND DV 22-011004

PROPERTY INFORMATION


SHEET TITLE

PROPOSED SPACE PLAN

#### Job No. A012123 Scale AS NOTED Drawn By SA Checked By DKW Date December 3, 2023

A2.1

PLAN #1B

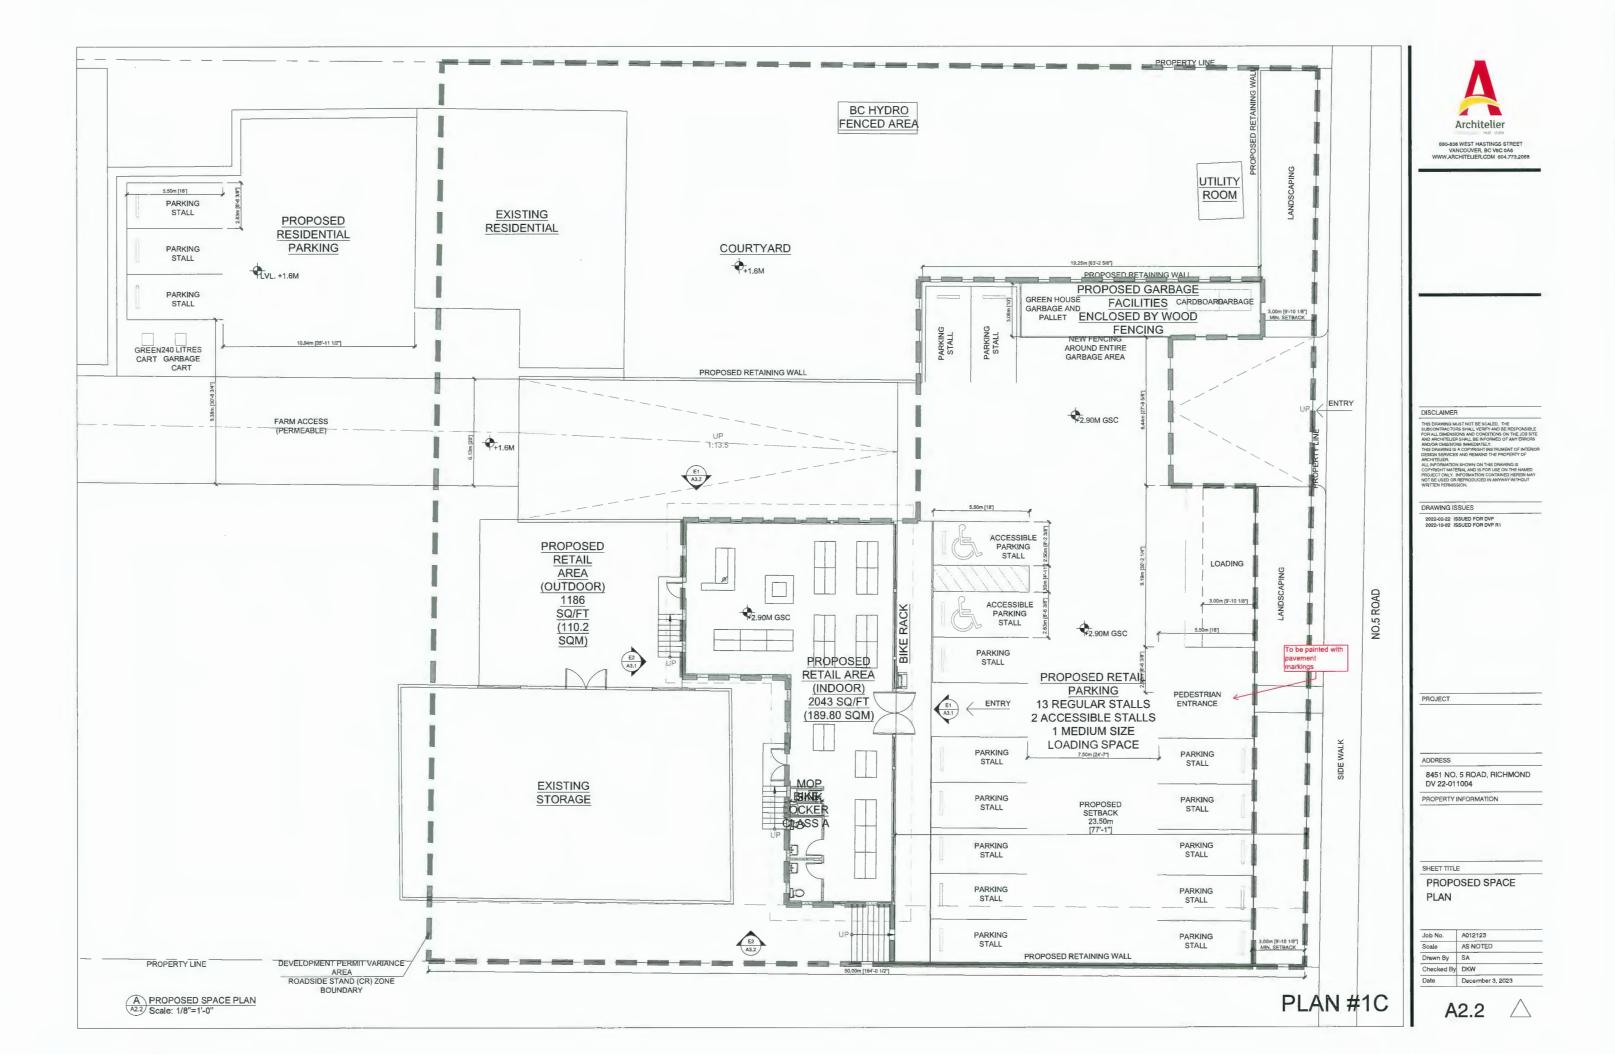

PROPERTY LINE BC HYDRO FENCED AREA T TRASL UTILITY ROOM -HCI 5.50m [18] L PARKING OUTDOOR POTTED PLANT AREA EXISTING RESIDENTIAL PROPOSED RESIDENTIAL PARISING PARKING STALL COURTYARD +1.6M PROPOSED RETAINING WALL PROPOSED RETAINING WALL PROPOSED GARBAGE GREEN HOUSE GARBAGE AND PALLET ENCLOSED BY WOOD FENCING PARKING STALL GREEN240 LITRES CART GARBAGE CART STALL PARKIN NEW FENCING AROUND ENTIRE GARBAGE AREA PROPOSED RETAINING WALL ALBERTA INFTRA-HGDG 1999 (CA) ¥2.90M15 and the second division of the second divisio ALBERTA NETRA-HEDG 1999 (CA) \_\_\_\_ +1.6M ALBERTA IFTRA-HODG 1999 (CA) E1 A32 ACCESSIBLE PARKING STALL PROPOSED AREA LOADING (OUTDOOR) <u>1186</u> <u>SQ/FT</u> (110.2 <u>SQM</u>) 3,00m (9'-10 1/8" 2.90M GSC Π PARKING STALL E2 A3,1 ALB To be painted with PROPOSED RETAIL AREA ement  $\square$ PROPOSED RETAIL þ arkings (INDOOR) 2043 SQ/FT 13 REGULAR STALLS 2 ACCESSIBLE STALLS PEDESTRIAN (189.80 SQM) 1 MEDIUN SIZE LOADING SPACE PARKING STALL PARKING STALL EXISTING STORAGE PARKING STALL PROPOSED PARKING STALL 23.50 PARKING STALL D PARKING STALL PARKING STALL PARKING STALL p PARKING E2 A32 PARKING STALL


PROPOSED RETAINING WALL


AREA ROADSIDE STAND (CR) ZONE BOUNDARY


DEVELOPMENT PERMIT VARIA


PROPERTY LINE


A TRAFFIC OVERLAY A2.2 Scale: 3/32"=1'-0"

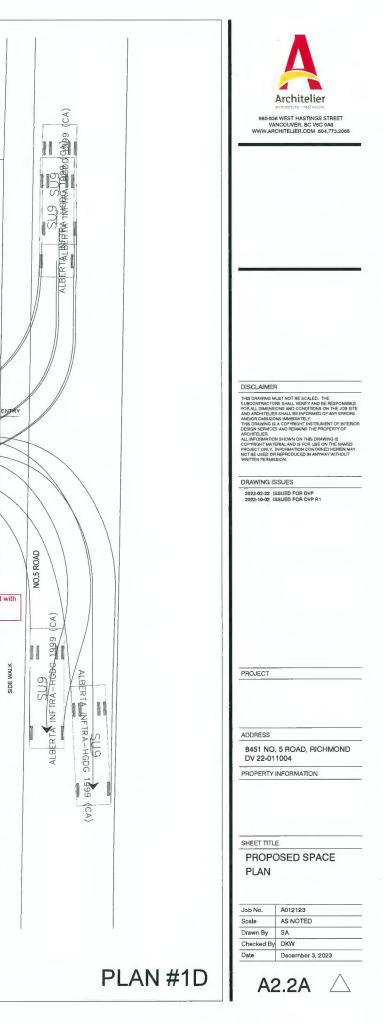

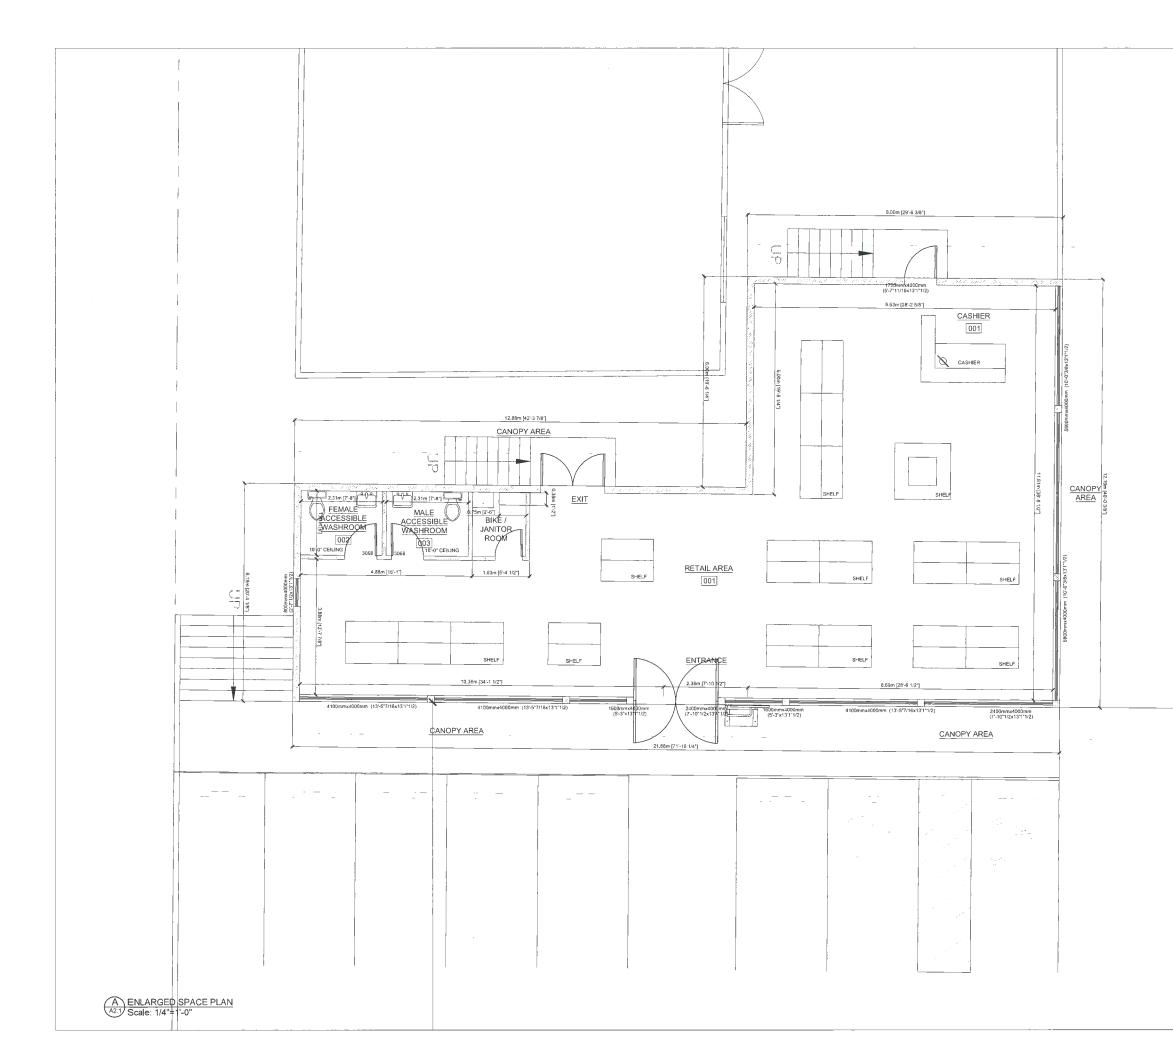

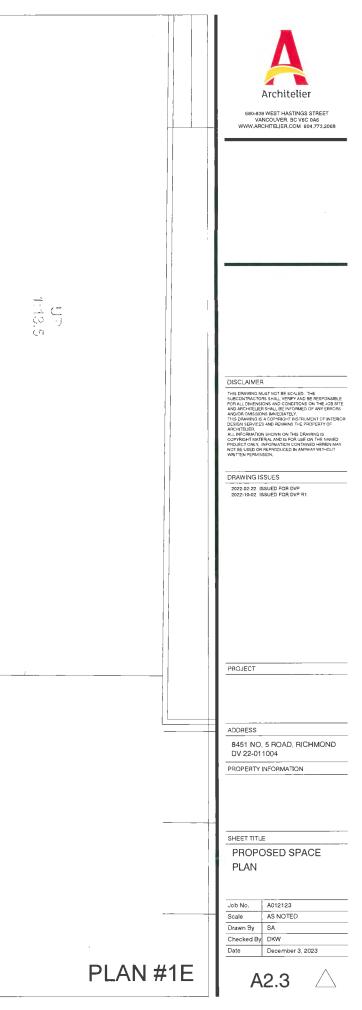

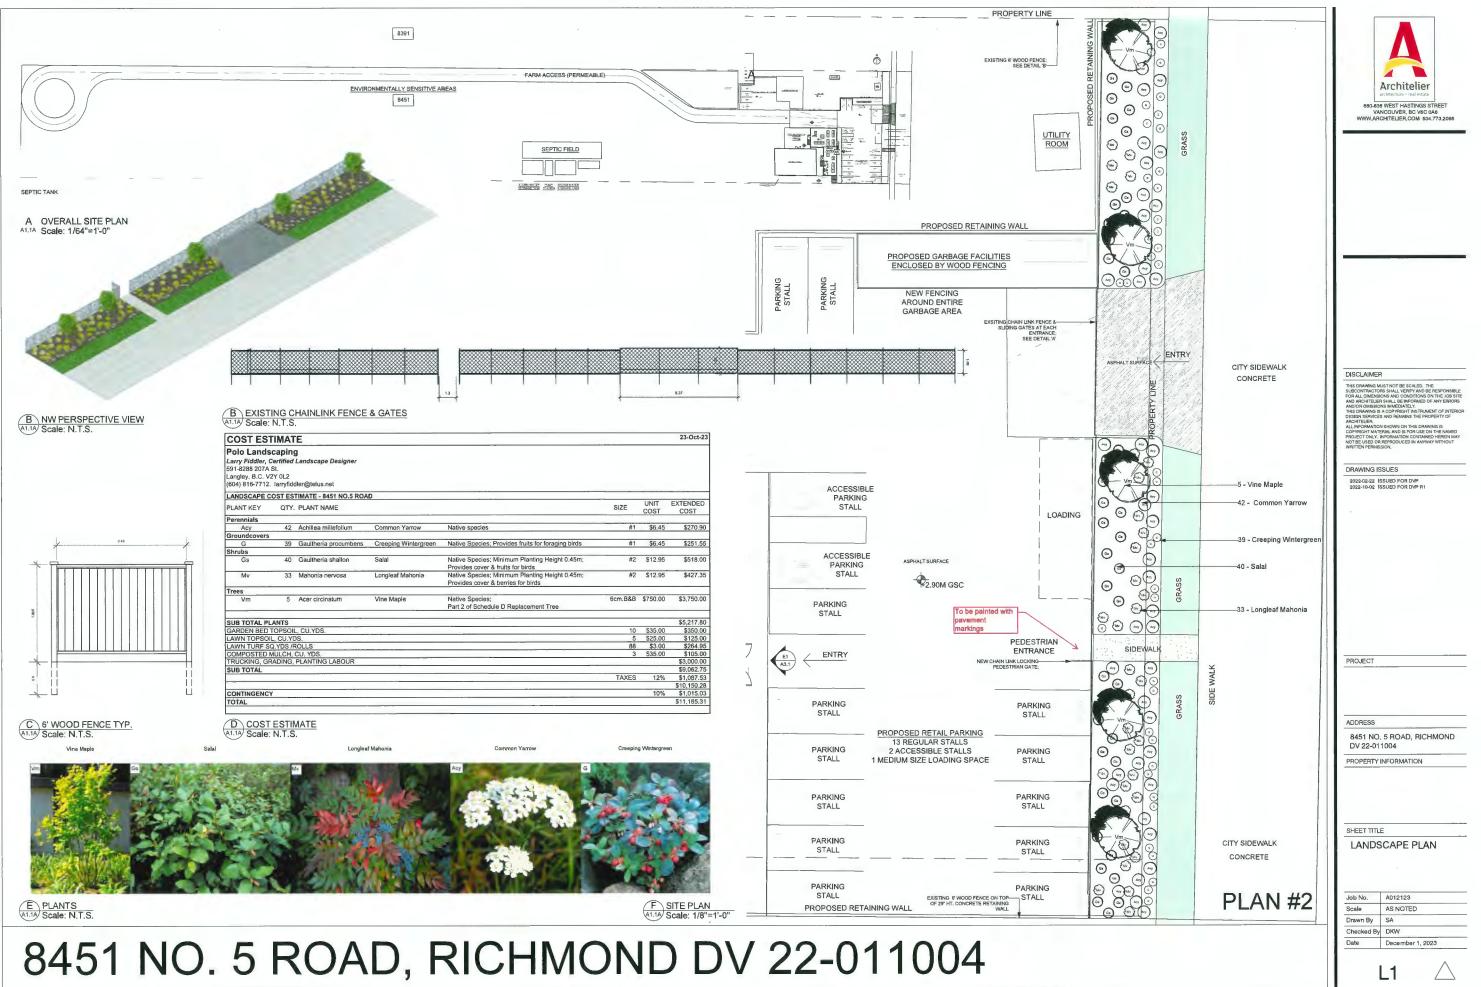

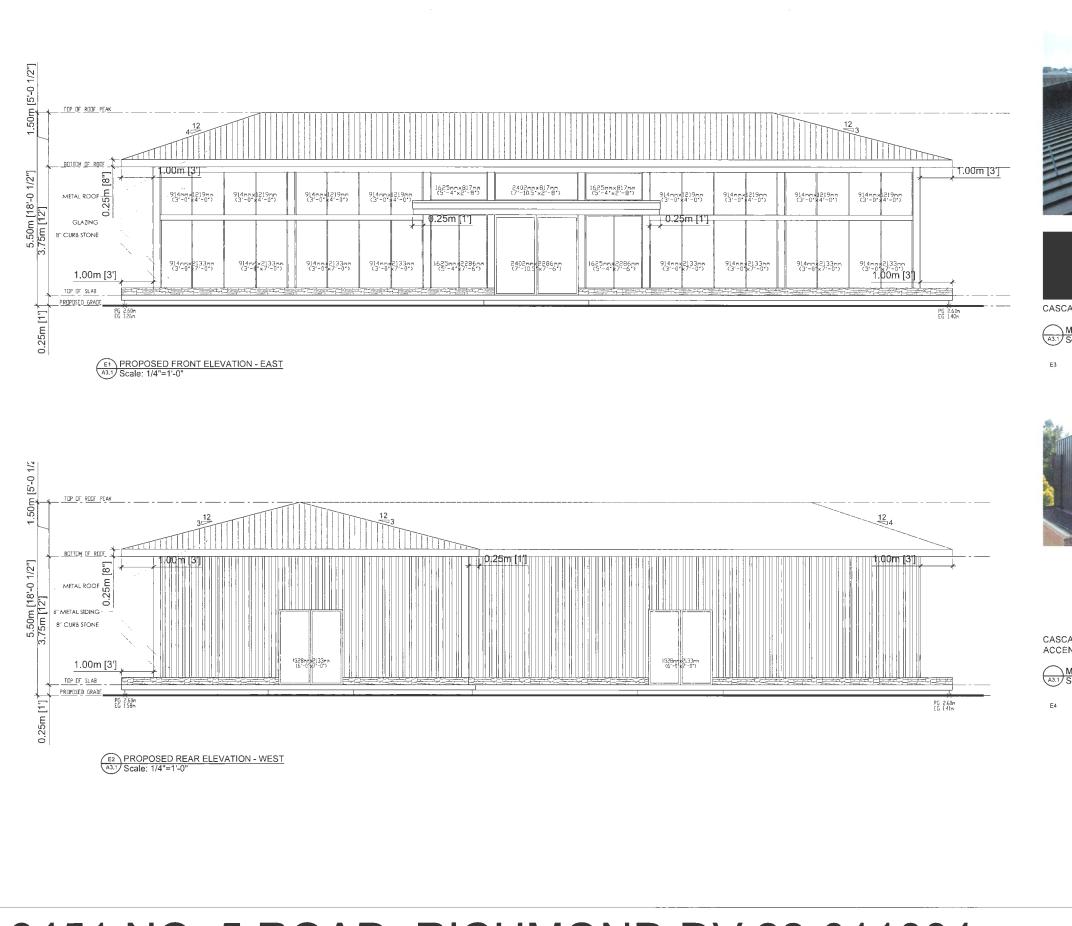

# 8451 NO. 5 ROAD, RICHMOND DV 22-011004





CASCADIA PREFINISHED METAL ROOFING - DARK BRONZE

MATERIAL SAMPLE: METAL ROOF





PLAN #3

CASCADIA PREFINISHED METAL SIDING - POLAR WHITE ACCENT COLOUR - ESPRESSO

MATERIAL SAMPLE: METAL CLADDING



680-838 WEST HASTINGS STREET VANCOUVER, BC VEC 0A6 WWW,ARCHITELIER,COM 604,773,2068

#### DISCLAIMER

THIS DRAWING MUST NOT BE SCALED. THE SUBCONTRACTORS SHALL VERIFY AND BE RESPONSIBLE FOR ALL DIRHONIONS AND CONDITIONS ON THE JOB SITE AND ARCHITELIER SHALL BE INFORMED OF ANY ERRORS AND/OR OMISSIOS IMMEDIATELY. THIS DRAWING IS A COPYRIGHT INSTRUMENT OF INTERFOR

ACHITEUER ALL INFORMATION SHOWN ON THIS DRAWING IS COPYRIGHT MATERIAL AND IS FOR USE ON THE NAMED PROJECT ONLY, INFORMATION CONTAINED HEREIN MAY

DRAWING ISSUES 2022-02-22 ISSUED FOR DVP 2022-10-02 ISSUED FOR DVP R1

PROJECT

ADDRESS

8451 NO. 5 ROAD, RICHMOND DV 22-011004

PROPERTY INFORMATION


SHEET TITLE


ELEVATION

A012123	
AS NOTED	
SA	
DKW	
December 3, 2023	
	AS NOTED SA DKW

A3.1

# 8451 NO. 5 ROAD, RICHMOND DV 22-011004

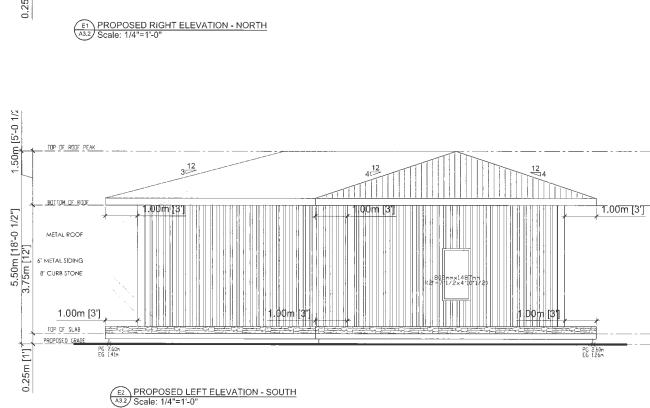

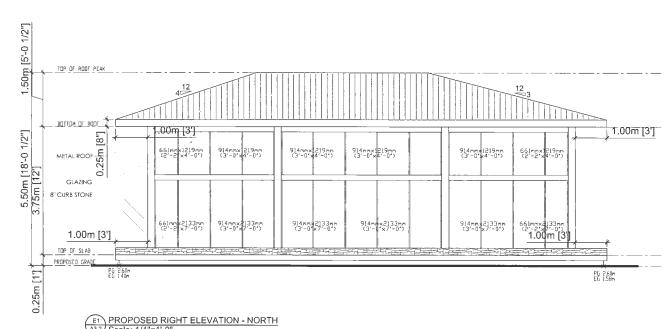



580-838 WEST HASTINGS STREET VANCOLVER, BC V6C 0A6 WWW.ARCHITELIER.COM 504.773.2068

#### DISCLAIMER

THIS DRAWING MUST AND THE SCALED. THE SUBCONTRACTORS SHALL VERIFY AND BE RESPONSIBLE FOR ALL DIMENSIONS AND CONDITIONS ON THE JOB SITE AND ARCHTELES SHALL BE WORKED OF ANY ERRORS ANDIOR OMISSIONS IMMEDIATELY. THIS DRAWING IS A COPYRIGHT INSTRUMENT OF INTERION DESIGN SERVICES AND REMAINS THE PROPERTY OF ARCHTELES.

ALL INFORMATION SHOWN ON THIS DRAWING IS COPYRIGHT MATERIAL AND IS FOR USE ON THE NAMED PROJECT ONLY, INFORMATION CONTAINED HEREIN MAY NOT BE USED OR REPRODUCED IN ANYWAY WITHOUT WRITTEN PERMISSION.

DRAWING ISSUES

2022-02-22 ISSUED FOR DVP 2022-10-02 ISSUED FOR DVP R1

PROJECT

ADDRESS

8451 NO, 5 ROAD, RICHMOND DV 22-011004

PROPERTY INFORMATION

SHEET TITLE

PLAN #4

ELEVATION / SECTION

Job No.	A012123
Scale	AS NOTED
Drawn By	SA
Checked By	DKW
Date	December 3, 2023

 $\triangle$ 

A3.2



То:	Development Permit Panel
From:	Wayne Craig Director, Development

Date: February 20, 2024 File: DP 23-014121

### Re: Application by 1166225 BC Ltd. for a Development Permit at 8880 Cook Road and 8751 Citation Drive

### Staff Recommendation

That a Development Permit be issued which would:

- Permit the construction of two six-storey buildings containing 339 rental units at 8880 Cook Road and 8751 Citation Drive on a site zoned "Low Rise Rental Apartment (ZLR44) – Brighouse Village (City Centre)"; and
- 2. Vary the provisions of Richmond Zoning Bylaw 8500 to reduce the road setback to projecting balconies above the second floor from 3.0 m to 1.2 m.

Wayne Co

Wayne Craig Director, Development (604-247-4625)

WC:el Att. 3

### Staff Report

### Origin

1166225 BC Ltd. (Incorporation number: BC1165225; Directors: Yechuan Wu and Hongda Wu) has applied to the City of Richmond for permission to develop two six-storey buildings containing 339 rental units at 8880 Cook Road and 8751 Citation Drive on a site zoned "Low Rise Rental Apartment (ZLR44) – Brighouse Village (City Centre)".

The site is being rezoned from "Low Rise Apartment and Town Housing (ZLR32) – Brighouse Village (City Centre)" to "Low Rise Rental Apartment (ZLR44) – Brighouse Village (City Centre)" for this project under Bylaw 10396 (RZ 21-932698) which received third reading on October 17, 2022.

The site currently contains two apartment buildings with a total of 102 units, which will be demolished. The subject property was a strata owner-occupied apartment condo development that completed a "strata windup" process in July 2018 and then sold to the developer for redevelopment.

Key components of the proposal include:

- Approximately 20,107 m<sup>2</sup> (216,430 ft<sup>2</sup>) of purpose-built market rental housing consisting of 271 market rental housing units.
- Approximately 3,755 m<sup>2</sup> (40,427 ft<sup>2</sup>) of purpose-built moderate-income rental housing based on BC Housing's Housing Income Limits (HILs) consisting of 68 moderate-income rental units.
- A range of unit types from studio to three-bedroom apartment units, as well as two to three-bedroom townhouse units. All moderate-income rental housing units meet the minimum size requirements under the Low End Market Rental Program.
- Six accessible units (including two studios, two one-bedroom units and two two-bedroom units); all accessible units will be designed to meet the accessibility requirements under the BC Building Code.
- 296 Basic Universal Housing (BUH) units. 100 per cent of the apartment units proposed will be designed to meet BUH provisions or the accessibility requirements.
- Indoor amenity space of approximately 698 m<sup>2</sup> (7,508 ft<sup>2</sup>) in area, including a fitness centre, casual seating lounges, piano rooms, shared and private work spaces, meeting rooms, kitchens, washrooms and guest suites.
- Outdoor amenity space of approximately 3,355 m<sup>2</sup> (36,113 ft<sup>2</sup>) in area, including a central courtyard, a children's play area, outdoor seating areas, open turf area and garden pots throughout the development.
- Retention of a central grove of ten maple trees and oak trees.
- An on-site low carbon energy plant designed to connect to the future off-site City Centre district energy utility (DEU) system. The building design will also meet Energy Step Code Step 3.

• Five publicly accessible open spaces (mini-pocket parks) at strategic locations along the periphery of the development with a total area of 379.7 m<sup>2</sup> (4,087 ft<sup>2</sup>).

An associated Servicing Agreement (SA 23-021998) was secured through the Rezoning (RZ 21-932698) for the design and construction of the publicly accessible open spaces (mini-pocket parks). An associated Servicing Agreement (SA 22-025603) was also secured at Rezoning for road and engineering improvement works required with respect to the subject development. Works include road widening, traffic signal improvements, frontage improvements along all road frontages and utility upgrades.

### **Development Information**

Please refer to attached Development Application Data Sheet (Attachment 1) for a comparison of the proposed development data with the relevant Bylaw requirements.

### Background

Development surrounding the subject site is as follows:

To the North:	Across Cook Road, a number of two-storey townhouses on properties zoned "Low Density Townhouses (RTL1)".
To the South:	Across Citation Drive, a four-storey apartment condo on a property on "Land Use Contract (LUC 025)", with the underlying "Low Rise Apartment and Town Housing (ZLR32) – Brighouse Village (City Centre)" zone.
To the East:	Across Garden City Road, a 16-storey apartment condo on Cook Road zoned "Residential/Limited Commercial (ZMU3) – North McLennan (City Centre)" zone, and Garden City Park located to the south of Alberta Road.
To the West:	Across Pimlico Way, a number of two-storey townhouses on a property on "Land Use Contract (LUC 025)", with the underlying "Low Rise Apartment and Town Housing (ZLR32) – Brighouse Village (City Centre)" zone.

### **Rezoning and Public Hearing Results**

The Public Hearing for the rezoning of this site was held on October 17, 2022. At the Public Hearing, concerns regarding the potential impact to neighouring developments, traffic, parking and tenant relocation support were expressed. Staff have also received similar inputs to the subject Development Permit application from an area resident. Responses to the concerns raised are provided below in *italics*.

1. Potential impact to the adjacent properties including shadowing

The proposed buildings are a maximum of six-storeys. With its ample building setbacks, the project will have minimal overshadowing impacts to adjacent properties, each of which is separated by a road or drive aisle in addition to the setbacks. The retention of trees and planting of new trees plus the provision of numerous pocket parks will create social gathering spaces and variety in the building massing while contributing to the pedestrian realm.

2. Traffic congestion and pedestrian safety

A Transportation Impact Assessment report prepared by Bunt & Associates was submitted and reviewed by the Transportation Department at the Rezoning stage. All potential future traffic generated from the project has been taken into account. The results of the future traffic operations analysis confirm that key intersections will remain well within capacity to accommodate the forecast increase in future peak period traffic projected to the Year 2036 without any road capacity improvements on either Garden City Road or Cook Road.

In addition, the proposed road and intersection design, including internal and external roads, and pedestrian circulation and movements, have all been designed and accommodated in compliance with the City's technical regulations and design criteria.

Furthermore, the developers have committed to upgrading the northbound Pimlico Way approach to the Cook Street intersection, incorporating separate left-turn and right-turn lanes.

### 3. Parking and delivery

This new proposed project will provide multiple dedicated parking stalls on site for temporary deliveries and drop off and will provide clear wayfinding and signage for deliveries. This way deliveries will avoid parking off-site when making deliveries to the lobby of the proposed building fronting Cook Road and not use the neighbour's parking stalls, thus making it safer for young families in the neighbouring townhouse complex.

4. Tenant relocation

The developer will comply with the forms of communication, commitment and assistance provided to their tenants in accordance with the City's required Tenant Relocation Plan secured at the Rezoning stage.

### **Staff Comments**

The proposed scheme attached to this report has satisfactorily addressed the significant urban design issues and other staff comments identified as part of the review of the subject Development Permit application. In addition, it complies with the intent of the applicable sections of the Official Community Plan (OCP) and is generally in compliance with the "Low Rise Rental Apartment (ZLR44) – Brighouse Village (City Centre)" zone, except for the zoning variances noted below.

### Zoning Compliance/Variances (staff comments in bold)

The applicant requests to vary the provisions of Richmond Zoning Bylaw 8500 to reduce the road setback to projecting balconies above the second floor from 3.0 m to 1.2 m.

Staff supports the proposed variance as the building envelope is limited by the significant road dedications along all fronting streets and retention of the tree grove in the centre of the site. Along the perimeter of the site, road dedications are required for road widening and frontage improvements, and dedications ranging from 5.07 m to 6.34 m. Surrounding the central courtyard, the building footprint must be located outside of the critical root zones of the protected tree grove and therefore pushed to the minimum setbacks from the new exterior property lines after road dedications.

The projecting balconies are proposed to meet the private outdoor space requirements under the Development Permit Guidelines and to provide additional visual interest of the buildings. The projecting balconies are proposed on level 3 or above and will not be encroaching into any SRW or common open spaces.)

### **Advisory Design Panel Comments**

The Advisory Design Panel (ADP) was supportive of the application subject to consideration of the Panel's comments. A copy of the relevant excerpt from the Advisory Design Panel Minutes from December 6, 2023 is attached for reference (Attachment 2). The design response from the applicant has been included immediately following the specific Design Panel comments and is identified in '*bold italics*'.

### Analysis

### Conditions of Adjacency

- Significant road dedications ranging from 5.07 m to 6.34 m are required for road widening and frontage improvements along all fronting roads of the site. The parking podium and residential buildings are pushed to the minimum road setbacks to allow for a larger central courtyard, to facilitate the preservation of a tree grove of ten trees in the middle of the site.
- Ground-oriented units are proposed along all fronting roads to screen the partially sunken, two-level parkade, and to provide a streetscape and residential character compatible with the adjacent townhouse developments across Cook Road and Pimlico Way.
- The proposed building height is six-storeys. Along the fronting streets, the proposal features four levels of apartment units on top of two levels of ground-oriented townhouse units. The proposal provides a transition between the apartment towers east of Garden City Road and the two-storey townhouse clusters west of Pimlico Way.
- Long frontages are broken into different building forms, and massing is broken into smaller vertical components to reinforce a stronger urban character that is more compatible in scale and form with the adjacent existing low-rise apartments and townhouse developments.
- The massing of the buildings is further broken down along Pimlico Way and Garden City Road to increase neighbourhood porosity through the site.
- The proposed design (including building height, setbacks, frontage treatments and built form, etc.) is consistent with the design guidelines under "Sub-Area B.2 Mixed Use Mid-Rise Residential & Limited Commercial" in the City Centre Area Plan, which is intended for medium-density, mid-rise (four-eight storeys) housing.

### Urban Design and Site Planning

- Designing around the minimum road setbacks and critical root zones of the protected trees on site, a concrete podium containing one level of residential spaces oriented towards the fronting roads and two levels of parking surrounding the central courtyard is proposed.
- Two five-storey residential buildings are proposed on top of the podium. The buildings are placed towards the outermost extremes of the podium to allow for the inner courtyard to be maximized.

- The parkade will have direct openings around the courtyard to provide natural ventilation and natural light into the space.
- The use of a metal screen with planted vines will create a green wall and screen between the parkade and the open courtyard.
- Ground-oriented units along all sides of the site are set further away from the street, as compared to the upper levels, and set above the sidewalk elevation with individual unit access, stepped planters, large open patios spaces and gated entries to create more pedestrian-friendly streetscape.
- Two lobby entries, set at sidewalk elevation for a friendly, accessible approach to the building are provided at the northeast side of the site (Cook Road) and the southwest side of the site (Citation Drive) respectively.
- A vehicle access service area will be provided off Pimlico Way. This area is designed to provide parkade access, as well as a central pickup/drop off, garbage/recycling collection and loading area.
- While the introduction of new Provincial legislation under Bill 47 has come into effect, as this application received first reading prior to January 1, 2024, the City's current parking regulations under Richmond Zoning Bylaw No 8500 are still in effect.
- There is a total of 223 parking spaces provided in the parkade, including:
  - o 140 stalls for market rental units, including three accessible spaces.
  - o 28 stalls for moderate-income rental units, including one accessible space.
  - 55 visitor parking stalls, including two accessible parking spaces and two car share spaces.
- The proposed number of parking spaces is consistent with the parking requirements under the ZLR44 zone subject to the provision of Transportation Demand Measures (TDM) to the satisfaction of the City. The TDM includes:
  - Car Share Vehicles and Designated Parking Spaces provision of two car share vehicles and designated car share parking spaces.
  - Car Share Membership provision of a car share membership for each dwelling unit.
  - Subsidized Transit Passes provision of a Transit Pass Program offering a monthly two-zone pass for each dwelling unit, for one year.
  - Additional Class 1 Bicycle Parking Provision of Class 1 bicycle parking at a rate of 1.9 spaces per unit (instead of 1.25 spaces per unit) for units that are one-bedroom or larger. The net increase of secured bike storage spaces for the project is 163 spaces. Bike storage rooms will have outlets for bicycle charging.
  - Bicycle Maintenance Facility provision of a bicycle maintenance room for resident use to include a bike stand, repair tools, bike washing area and opportunities for charging of e-devices.
  - Shared Bike and Micro Mobility Station provision of a SRW and access to an area for a future shared e-bike and e-scooter parking corral on the site.
  - Implementation of cycling facilities and enhancements along the site's frontage to be secured through the associated site Servicing Agreement for the application.

- Unassigned Parking registration of a restrictive covenant on Title to ensure that all residential parking spaces are unassigned and assignment is managed by the property manager.
- Delivery vehicle parking provision of additional delivery vehicle parking for e-commerce vans (Amazon, etc.), food delivery vehicles and registration of a legal agreement on Title to outline the operation of the parkade gate to provide access to the delivery vehicle parking and to encourage the use of visitor parking on-site during daytime hours (i.e., from 8:00 a.m. to 7:00 p.m.).
- There is a total of 588 Class 1 (residential) bicycle parking spaces provided within bike storage rooms in the parkade. In which, 106 spaces are provided for moderate-income housing units and 482 spaces are provided for market rental housing units. The proposed number of Class 1 bicycle parking spaces is consistent with the requirements under the ZLR44 zone.
- There is a total of 68 Class 2 (visitor) bicycle parking spaces provided on-site. In which, 27 spaces are provided in the open area by each of the two residential lobbies, 25 spaces are provided within the parkade and 16 spaces are provided along the perimeter of the site, within the public pocket park areas. The proposed number of Class 2 bicycle parking spaces is consistent with the requirements under the zoning bylaw.
- The CCAP requires that multi-family developments comprising 200 units or more provide indoor amenity space at a standard of 2 m<sup>2</sup> (21.5 ft<sup>2</sup>) per dwelling unit. The subject development exceeds the CCAP minimum and provides for 698 m<sup>2</sup> (7,508 ft<sup>2</sup>) of indoor amenity spaces. Features include two guest suites on P2, a fitness centre on level two, as well as casual seating lounges, piano rooms, shared and private workspaces, meeting rooms, kitchens and washrooms on levels three and four.
- Outdoor amenity spaces proposed in this development also exceed the minimum OCP requirements. Outdoor amenity spaces proposed on-site include:
  - a 1,888 m<sup>2</sup> (20,325 ft<sup>2</sup>) central courtyard on the ground level, featuring open lawn space beneath mature trees, various outdoor seating areas, planting areas and a children's play area;
  - 1,149 m<sup>2</sup> (12,371 ft<sup>2</sup>) of open space on level two, featuring an open artificial turf, plating pods and outdoor walkways; and
  - 317 m<sup>2</sup> (3,416 ft<sup>2</sup>) of outdoor space on level three, between two indoor amenity rooms, connected through exterior stairs to the second-level amenity deck and fourth-level indoor amenity room, featuring outdoor dining and lounging areas.

### Architectural Form and Character

- The overall design intent is to introduce a low-rise building form in a manner that maintains a pedestrian-oriented building massing that, in turn, respects the scale of the immediate neighborhood to the north, west and south.
- The form and configuration of the building were dictated by the retention of trees in the central courtyard. A variety of building heights with breaks in architectural shapes, along with changes in massing, forms and character across the entire site has been implemented.

A wide range of architectural design elements have been incorporated into the design of the project.

- A combination of suspended balconies and inset balconies have been provided to create rhythm and pattern for each elevation; balcony alignment has also been used to differentiate between fronting facades to create visual interest.
- The exterior cladding is a combination of fibre cement panel and brick with metal slats. The choice of materials and colour palettes reflect the residential nature of the project. A unique blend of materials and colours is selected for each mass and building to break up the long façade, provide individual character and help integrating the project into its surrounding context.

### **Tree Management**

- Tree preservation was reviewed at the rezoning stage and reconfirmed during the Development Permit review process.
- 15 bylaw-sized trees located on site are to be retained and protected:
  - Ten trees (tag# 1887, 1888, 1889, 1890, 1891, 1892, 1893, 1894, 1895 and 1896) located in the central courtyard;
  - Four trees (tag# 1956, 1957, 1958 and 1959) located at the southwest corner of the site; and
  - One tree (tag# 1852) located at the northeast corner of the site.
- A Tree Survival Security in the amount of \$150,000.00 for the 15 trees has been secured at Rezoning stage.
- Significant discussion and effort by City staff and the applicant went into consideration of tree removal on site. The approach taken and supported by the City's Tree Preservation group was to retain the stands of trees in the centre and in key locations.
  - In order to support this form of development and to accommodate the number of rental units proposed on the site; 19 trees that are in good to fair conditions but in conflicts with the building envelope, are identified for removal.
  - Another 112 trees that are in poor condition will also be removed.
- 263 replacement trees are required for the removal of 131 trees on site.
- While the proposed development would occupy a significant amount of the site, the applicant is proposing to plant 135 replacement trees on site, including eight conifers and 127 deciduous trees.
- The applicant has agreed to provide a voluntary contribution of \$98,304.00 (\$768.00/tree) to the City's Tree Compensation Fund, in lieu of planting the remaining 128 replacement trees, prior to DP issuance.

### Landscape Design and Open Space Design

• The overall landscape concept satisfactorily enhances the interface between the proposed development and the public realm.

- Building lobbies and private patios are proposed along the road frontages to animate the public realm.
- Private patios for the ground-oriented units along all of the site's four road frontages feature raised planters with layered shrubs, privacy hedging and individual gated accesses to enhance the residential character of the proposal and to provide a pedestrian-oriented streetscape.
- A series of publicly accessible open spaces (mini-pocket parks) are proposed in strategic locations along the periphery of the development:
  - At the northwest corner: A drinking fountain, two feature benches in a striking blue hue and ten designated bike parking spaces are proposed to engage the intersection of Cook and Pimlico; distinctive paving will also be introduced to clearly define the space.
  - At the northeast corner: One mature tree will be preserved, providing shade and natural beauty amidst a spacious open lawn accessible to the public. Additionally, two distinctive benches in a vibrant yellow hue are planned to enhance public enjoyment and relaxation within the area.
  - At the southeast corner: Two feature benches in dark blue color and eight designated bike parking spaces are proposed to encourage individuals to rest in this area; distinctive paving will be implemented to delineate the space, enhancing its visual appeal and functionality.
  - At the southwest corner: Four existing trees will be preserved, offering both shade and a natural view. An open lawn with two distinctively designed benches, adorned in a vibrant red hue, is envisioned to elevate public enjoyment and relaxation within the area.
  - By the vehicle access to the site: A grove of specimen conifers that meet the minimum size of replacement trees as well as drought tolerant ground covers and shrubs are proposed to screen and soften the view of the service area/parkade entrances while enhancing the public realm. Along the sidewalk frontage, 14 visitor bike parking and three bench seating will be provided.
- The developer worked with the project arborist to retain the existing trees in the middle of the site while enhancing the central courtyard with amenity features for future residents. The space includes:
  - Open lawn space beneath mature trees;
  - An adventurous kid's place space for a range of ages with features such as a see-saw, a climbing net, two springers and a play-hut with a slide; and
  - Wood platform seating, deck seating, and amphitheatre seating areas.
- The developers are providing as much children's play area as possible in one place, based on the ADP comments, given tree retention. On the second level, an artificial turf is proposed at the south end of the podium for active play.
- Elevated planters, trellis screening, shrubs and trees are proposed along the perimeter of the courtyard to screen the parkade walls and exposed concrete of the building base.
- A grand staircase with integrated planters and a hanging ramp system are also proposed in the courtyard to connect the outdoor amenity space on the ground-level and the second-level.

- Five garden pots are proposed at the northwest and southwest wings of the podium, on the second level, to provide urban agricultural opportunities on site.
- An amenity deck is proposed on the third floor between the two indoor amenity rooms. It features outdoor dining and lounging areas with fire pit and barbeque, perimeter planting pockets and raised planters with trees.
- A lighting plan is included in the DP plans, which indicates lighting provided throughout the site:
  - Various types of lighting, including low planter wall lights, bollard lights, pedestrianscaled pole lights and wall sconce lights, have been proposed for different locations. Each light has been thoughtfully chosen to ensure that they are oriented downward, specifically designed to illuminate ground surfaces, building entrances and stairways effectively.
  - Shielded and downward-facing lights were selected.
  - Low planter wall lights and wall sconce lights were proposed at the parking courtyard to provide a safe walking experience, meanwhile, these lights were selected as non-glared.
  - The lighting fixtures have been chosen to guarantee that the illumination level at the property line does not exceed three foot-candles.
- An irrigation system is proposed to ensure continued maintenance of live landscaping on site.
- In order to ensure that the proposed landscaping works are completed, the applicant is required to provide a landscape security of \$ 858,573.29 in association with the Development Permit.

### Crime Prevention Through Environmental Design

- Crime Prevention Through Environmental Design (CPTED) principles have been considered throughout the proposed development.
- Public areas, pedestrian pathways and resident private/semi-private areas are designed to be well-defined by soft landscaping and hard fencing/gates to clearly delineate boundaries of uses.
- Entry lobbies are designed to be visually open from the sidewalk.
- The service area and parkade entry is designed with clear sight lines, clear signage and good lighting for both entry and exit.

### Sustainability and Renewable Energy

- The subject site is within the City Centre District Energy Utility catchment area and connection to the utility will be required for this development. The developer is required to design, construct and transfer ownership to the City of a Low Carbon Energy Plant (LCEP) and related infrastructure on-site to facilitate a future connection to a City Centre District Energy Utility (DEU) system.
- The developer has committed to design the subject development to meet the City's Step Code requirements (i.e., Step 3). Details on how all units are to be built and maintained to this commitment will be reviewed at Building Permit stage.

- The architect advised that the following features will be specified in the development:
  - Air Source Feat Pumps (ASHPs).
  - o Heat Recovery Ventilators (HRVs).
  - High efficiency LED.
  - Electrified cooking in suites.

### Accessible Housing

- The proposed development includes 296 basic universal housing units that are designed to be easily renovated to accommodate a future resident in a wheelchair. These single-storey units are required to incorporate all of the accessibility provisions listed in the Basic Universal Housing Features section of the City's Zoning Bylaw, and are permitted a density exclusion of 1.86 m<sup>2</sup> (20 ft<sup>2</sup>) per unit. The proposed development includes six accessible units that are designed to be fully accessible at the time of construction for a resident in a wheelchair. These units are required to incorporate all of the accessibility provisions listed in the Basic Universal Housing Features section of the City's Zoning Bylaw and in the BC Building Codes.
  - Four of the accessible units will be designated as moderate-income housing units, and two of the accessible units will be designated as market rental units
  - These accessible units will be secured in perpetuity with the Market Rental Agreement and the Moderate Income Housing Agreement registered on Title.
- All of the proposed units incorporate aging-in-place features to accommodate mobility constraints associated with aging. These features include:
  - o stairwell hand rails;
  - o lever-type handles for plumbing fixtures and door handles; and
  - solid blocking in washroom walls to facilitate future grab bar installation beside toilets, bathtubs and showers.

### Conclusions

As the proposed development would meet applicable policies and Development Permit Guidelines, staff recommend that the Development Permit be endorsed, and issuance by Council be recommended.

Edwin Lee Planner 2 (604-276-4121)

EL:js

- Att. 1: Development Application Data Sheet
  - 2: Excerpt from the Meeting Notes of Advisory Design Panel Meeting (December 6, 2023)
  - 3: Development Permit Considerations



# Development Application Data Sheet Development Applications Department

DP 23-014121		Attachment 1			
Address: 8880 Cook Road and 8751 Citation Drive					
Applicant: 1166225 BC Ltd.	Owner:	1166225 BC Ltd.			
Planning Area(s): Brighouse Village (City Centre)					
Floor Area Gross: 26,351 m <sup>2</sup> (283	B,640 ft <sup>2</sup> ) Floor Area Net:	23,862 m² (256,857 ft²)			
$= \sum_{\substack{i=1,\dots,n\\i\neq j\neq i}}^{i+1} \sum_{\substack{j=1,\dots,n\\i\neq i}}^{i+1} \sum_{\substack{j=1,\dots,n\\i\neq i}}^{i+1} \sum_{\substack{j=1,\dots,n\\i\neq i}}^{i+1} \sum_{\substack{j=1,\dots,n\\i\neq i}}^{i+1} \sum_{\substack{j=1,\dots,n}}^{i+1} \sum_{\substack{j=1,\dots,n\\i\neq i}}^{i+1} \sum_{\substack{j=1,\dots,n}}^{i+1} \sum_{\substack{j=1,\dots,n\\i\neq i}}^{i+1} \sum_{\substack{j=1,\dots,n}}^{i+1} \sum_{\substack{j=1,\dots,n\\i\neq i}}^{i+1} \sum_{\substack{j=1,\dots,n}}^{i+1} \sum_$	Existing	Proposed			
Site Area:	13,879 m²	11,392 m²			
Land Uses:	Apartment Residential	No Change			
OCP Designation:	Apartment Residential	No Change			
Area Plan Designation:	City Centre Area Plan: General Urban T4 – High Density Townhouses	No Change			
Zoning:	Low Rise Apartment and Town Housing (ZLR32) – Brighouse Village (City Centre)	Low Rise Rental Apartment (ZLR44) – Brighouse Village (City Centre)			
Land Use Contracts:	Land Use Contract (LUC 025)	Discharge			
Number of Units:	102	339			

	Bylaw Requirement	Proposed	Variance
Floor Area Ratio:	<ul> <li>Max. 1.8 FAR Market Rentals</li> <li>Min. 0.3 FAR Moderate Income Rentals</li> </ul>	<ul> <li>Market Rentals: 1.765 FAR</li> <li>Moderate Income Rentals: 0.33 FAR</li> </ul>	none permitted
Buildable Floor Area (m <sup>2</sup> ):*	<ul> <li>Market Rental: Max. 20,505.6 m<sup>2</sup> (220,720 ft<sup>2</sup>)</li> <li>Moderate Income Rental: Min. 3,417.6 m<sup>2</sup> (36,786 ft<sup>2</sup>)</li> </ul>	<ul> <li>Market Rental: 20,107.0 m<sup>2</sup> (216,430 ft<sup>2</sup>)</li> <li>Moderate Income Rental: 3,755.8 m<sup>2</sup> (40,427 ft<sup>2</sup>)</li> </ul>	none permitted
Lot Coverage (% of lot area):	<ul> <li>Building: Max. 60%</li> <li>Non-porous Surfaces: Max. 80%</li> <li>Landscaping with Live Plant Material: Min. 20%</li> </ul>	<ul> <li>Building: 45.5%</li> <li>Non-porous Surfaces: 78.3%</li> <li>Landscaping with Live Plant Material: 22.7%</li> </ul>	none
Lot Size:	Min. 11,000 m²	11,391 m²	none
Setbacks (m):	Road: Min.3.0 m	Cook Road: 3.0 m Garden City Road: 3.0 m Citation Drive: 3.0 m Pimlico Way: 3.0 m	none
Height (m):	Max. 25.0 m	24.04 m	none

Off-street Parking Spaces – Regular (R):	<ul> <li>Total: 164 (R), including:</li> <li>Market Rental Unit: 271 x 0.5 space/unit with TDM Reduction = 136 (R)</li> <li>Moderate Income Rental: 68 units x 0.4 space/unit with TDM Reduction = 28 (R)</li> </ul>	168	none
Off-street Parking Spaces – Visitor (V):	339 units x 0.16 space/unit with TDM Reduction = 55 (V)	55	none
Small Car Parking Spaces	Max. 50% when 31 or more spaces are provided on-site (225 x Max. 50% = 112)	96	none
Accessible Parking Spaces (Residential):	Min. 2% when 11 or more spaces are required: - Market Rental Unit: 136 x 2% = 3 - Moderate Income Rental: 28 x 2% = 1	5	none
Accessible Parking Spaces (Visitor):	Min. 2% when 11 or more spaces are required (55 x 2% = 2 spaces)	2	none
Bicycle Parking Spaces – Class 1	<ul> <li>Total: 588, including:</li> <li>Studio: 1.25 spaces per unit x 87 = 109 spaces</li> <li>All other unit types: 1.9 spaces per unit x 252 = 479 spaces</li> </ul>	588	none
Bicycle Parking Spaces – Class 2	339 units x 0.2 = 68 spaces	68	none
Amenity Space – Indoor:	Min. 2 m <sup>2</sup> per unit = 339 x 2 m <sup>2</sup> = 678 m <sup>2</sup>	698 m²	none
Amenity Space – Outdoor:	Min. 6 m <sup>2</sup> per unit + 10% of the net development site area = 339 units 6 m <sup>2</sup> + 1,139.2 m <sup>2</sup> = 3,173.2 m <sup>2</sup>	3,355 m²	none

# Excerpt from the Minutes from The Design Panel Meeting

# Wednesday, Wednesday December 6, 2023 – 4:00 p.m. Remote (WebEx) Meeting

#### 2. DP 23-014121 - TWO 6-STOREY RESIDENTIAL BUILDINGS CONTAINING 339 RENTAL UNITS

ARCHITECT:	GBL Architects Inc.
LANDSCAPE ARCHITECT:	Durante Kreuk Landscape Architects
PROPERTY LOCATION:	8880 Cook Road and 8751 Citation Drive

### Applicant's Presentation

Amela Brudar, GBL Architects Inc., introduced the project and Alejandro Martinez, GBL Architects, Inc., and Landscape Architect Alexa Gonzalez, Durante Kreuk Ltd., presented the project and answered queries from the Panel.

# Panel Discussion

Comments from Panel members were as follows:

appreciate the provision of six fully accessible units among the 296 Basic . Universal Housing (BUH) units; also appreciate the variety of sizes of the accessible units which include studio and one-to three-bedroom units;

Applicant's response: acknowledged.

concerned about access to parking for drivers with disabilities as after 10 pm . the driver would have to get out of the vehicle to access the parkade and get back to the vehicle prior to proceeding to the parkade; consider other options to access the parkade after 10 pm, especially for drivers with disabilities;

Applicant's response: No change has been made. After a thorough examination and exhaustive technical analysis in collaboration with our traffic consultant, Bunt & Associates, we have explored various options, incorporating detailed turn radius assessments and Crime Prevention Through Environmental Design (CPTED) considerations. Our comprehensive investigation has led us to the determination that the most viable solution is to position the intercom system outside the entry gate of each building. Upon occupancy, these structures will leverage cutting-edge smart technology to facilitate seamless and secure access to the parkade and building, ensuring the convenience and safety of all residents and visitors, particularly when accessed from within their vehicles. For example, a smart intercom and security system would enable visitors to receive a time-limited barcode on their smartphone, which grants access to specific floors, units, and the parking area of the building.

 concerned about visitor access after hours; consider moving the parkade gates one car length down into the tunnel and putting the interphone on the left side on the pilaster to better facilitate the visitor parking process after hours;

Applicant's response: We are complying with CPTED guidelines, creating an alcove in the parkade entryway would regrettably be perceived as a potential area of shelter or refuge for individuals experiencing homelessness.

 the building design at the Garden City and Cook Road intersection needs more work to provide architectural and visual interest; consider incorporating cedar coloured metal planks at this building corner;

Applicant's response: Thank you for your insightful comment. We conducted a comprehensive review of the design, placing particular emphasis on the visual hierarchy of the corner. Our primary focus has been on showcasing the prominent tree that has been preserved at the site's corner, adhering to the City's directives for safeguarding its root zone. In our reassessment, we have strategically directed visual interest towards the main gateway entry, specifically the lobby entrance, and highlighted the distinctive suspended balconies featured on only these two building facades. We believe that the existing design effectively emphasizes these key elements, contributing to a compelling street view. Upon careful consideration, we've concluded that introducing additional architectural features may not enhance the overall design. In fact, it could potentially detract from the established visual hierarchy we've worked to achieve. We remain committed to preserving the balance and aesthetic appeal of the project, ensuring that each element contributes harmoniously to the overall composition.

 appreciate the unique design of the project which has turned its site constraint into the highlight of the project; the building design is straightforward and economical and achieves the intended purpose of the building; also appreciate the design of the central courtyard and the parkade;

Applicant's response: acknowledged.

review the proposed screening of the parkade wall from the central courtyard; in addition to the proposed trellis screen with climbing plants, consider introducing further treatment to the parkade wall, e.g. adding texture and colour to the parkade wall to break up and reduce the apparent height of the parkade wall surrounding the central courtyard;

Applicant's response: we have extensively investigated and tried to find a proper balance when it comes to the economic feasibility of wall treatments for a rental project. We have introduced additional planters at selected locations, with shrubs and trees to soften the parkade wall.

- For the north side of the West Parkade wall, the planter at the northwest corner has been expanded to partially cover the parkade wall. The planter is 3' high and hosts shade-tolerant shrubs and trees, enhancing the aesthetic appeal of the area. Additionally, the incorporation of hanging plants, specifically Cotoneaster, along the edge of the planter, serves to further soften the appearance of the wall.

In addition, another planter has been added between the social decking areas, positioned at curb height. This newly added planter also incorporates shrubs and trees, strategically placed to break up the parkade wall.

- For the south side of the West Parkade Wall, the planter along the wall has been widened, providing more space for denser planting and tree growth.
- For the North and East Parkade walls, we proposed hanging plants such as contoneater along the edge of parkade walls to allow green coverage from top to bottom. This complements the green trellises, which feature climbers growing from the bottom up, thereby enhancing the overall greenery and aesthetic appeal of the walls.
- support the Panel comment regarding further building treatment at the Garden City and Cook Road intersection to make the corner more visually interesting;

Applicant's response: see response above.

• consider introducing accent colours to the neutral colours of the buildings, especially around the lower level of the townhouses to make the building features stand out more;

Applicant's response: we have reviewed the design and have incorporated additional copper spandrel panels.

 support the concept of pocket parks; however, there are few landscape elements present in the proposed pocket parks in the project; consider adding more landscape elements in the pocket parks to make them more usable and enjoyable to users;

### Applicant's response:

Drinking fountains have been added in both northwest and southeast plazas to improve the pedestrian experience by offering a convenient source of refreshment for both people and their companions.

The Seating benches have been transformed into distinctive, colorful variations. Each park now has its own unique palette, allowing for easy differentiation and enhancing the overall pedestrian experience. • understand the constraints of the site and appreciate the applicant for coming up with an attractive building design;

### Applicant's response: acknowledged.

 concerned about how the public realm dedications have been allocated in the subject site; the design of the mid-block pocket park along Pimlico Way is problematic as it appears closed off and functions more as a landscaped buffer than a public space; consider reallocating this pocket park to consolidate with smaller pocket parks along the periphery of the site to allow for larger pocket parks that are more publicly accessible with additional public amenities;

# Applicant's response: Pimlico Way pocket park has been revised to have a more welcoming use and improved programming/equipment.

 not convinced on the proposed variance to the balcony projection setback to fronting roads; investigate opportunities to introduce design changes to the building in order to meet the required balcony projection setback;

# Applicant's response: We are unable to setback the building further due to setback constraints from the central courtyard tree root zone and the reduced site size resulting from road dedications on all four frontages.

 concerned about the depth of the central courtyard and its relationship with the parkade wall surrounding it; investigate opportunities to better address this concern; as the central courtyard location will be fairly shaded, ensure that the appropriate species of climbing plants on the parkade wall will be selected to ensure their long-term survivability;

### Applicant's response: We have extensively investigated and tried to find a proper balance when it comes to the economic feasibility of wall treatments for a rental project. New Planters and specimens have been added to soften down the wall expression.

 identified pedestrian routes from the building to the courtyard appear circuitous and challenging to persons with mobility issues and families with children; an accessible path from the elevator lobby at P1 to the courtyard would be a more realistic accessible route; consider making it more attractive and usable, e.g. ensuring it is well lighted and having adequate width to facilitate pedestrian circulation;

Applicant's response: All design considerations have been implemented and they provide a clear path of travel to anyone with mobility challenges. Path to the courtyard from the elevator lobby has been widened and clearly marked. We have also incorporated weather protection for pedestrians at the door access to the courtyard.

• consider consolidating the two children's play areas on the ground level and on Level 2 into one larger play area for easier supervision of children;

Applicant's response: we've successfully merged two play areas into a single space, expanding it slightly while carefully coordinating with existing tree protection measures.

• investigate opportunities to directly activate the central courtyard and make it more accessible to residents and directly link with the daily life of the residents;

Applicant's response: We have proposed a variety of programs to enhance daily use, including deck seating, playground, and great open reserved lawn areas covered with large mature trees. There is plenty of space for relaxing, kids playing, gathering, exercising, etc. On Level 2, we proposed urban agriculture to encourage residents to do gardening. As well as a big open artificial turf lawn to provide opportunity for gathering, games, and sports opportunities.

• proposed form and character of the building is reasonable, attractive, and appropriate for its site context;

Applicant's response: acknowledged.

 agree with the Panel comment that the site constraint has been turned into an opportunity to design a building courtyard typology;

### Applicant's response: acknowledged.

• the building design is modest, well executed, and appropriate for its intended use for affordable and market rental housing;

### Applicant's response: acknowledged.

• the central courtyard has been successfully designed to create a park-like experience for users;

### Applicant's response: acknowledged.

investigate opportunities for incorporating public art at the pocket parks; and

Applicant's response: The incorporation of public art is not mandated for 100% rental projects within the City, and as such, the proposed project is exempt from the obligation to integrate public art.

• climbing plants for the proposed trellis on the parkade wall surrounding the central courtyard may take a long time to be established due to the height of the parkade wall; consider alternate treatments to screen the parkade wall; due to its shady location, consider incorporating architectural in lieu of landscape treatment to the parkade wall around the courtyard.

Applicant's response: we proposed two ways to mitigate the tall trellis. Firstly by raising the planters 3 feet high from the finished grade and adding hanging plants to soften the planter wall. Secondly we added hanging plants from level 2 edge planters.

Hanging plants are proposed in locations where planters are located along the parapet edge of level 2 as shown on planting plan sheet L-2.05. The guardrail location has been shifted from the parapet to the pathway side of these planters to allow for these cascading plants to grow uninterrupted. These cascading plants can be expected to cover up to 6' to 8' or more within 3 to 5 growing seasons, typically.

The following written comments submitted by Panel member Nicci Theroux were read into the record by the Chair:

 consider the inclusion of deciduous trees at the central pocket park on Pimlico Way for shade; the large landscape area provides a nice buffer to the road;

Applicant's response: Thank you for this comment. Trees were changed to 6 deciduous trees and 3 conifer trees instead of all conifer trees.

• consider including a pattern in the paving where pedestrians may cross the service area to indicate that this is a potentially a shared pathway;

Applicant's response: Thank you for this comment. A different pattern and color have been applied to the service area.

• the northern half of the play on Level 2 will be in shade at the solstice; consider what might be more appropriate in a shadier spot or combine the play to the south on Level 1 at the same time keeping some separation for age groups;

Applicant's response: We have consolidated the level 2 play area to Level 1 to make a larger playground.

 consider soil cells or structural soil under the sidewalk at Citation Drive as the tree trench does not appear to provide adequate soil volume for street trees; consider the same approach for Garden City Road and Pimlico Way;

Applicant's response: Structural soil has been proposed under the sidewalk along Citation Drive. For Garden City Road and Pimlico Road, the planted boulevard is 1.5m wide which allows approximately 15m<sup>3</sup> soil volume per tree.

soil volume for *acer griseum* in the courtyard appears inadequate; and

Applicant's response: we limited the acer griseum in the courtyard to where it can provide a minimum of  $10m^3$  soil volume per tree.

• remainder of the trees are smaller in the courtyard; consider aiming for a minimum of 6 cubic metres of soil volume even for smaller trees.

Applicant's response: Thank you for this commnet. We have increased soil volume for trees in the courtyard by either increasing the planting area or raising up the planter heights.

### **Panel Decision**

It was moved and seconded

That DP 23-014121 be supported to move forward to the Development Permit Panel subject to the applicant giving consideration to the comments of the Advisory Design Panel.

Opposed: Alan Tse

CARRIED

# **ATTACHMENT 3**



Development Applications Department 6911 No. 3 Road, Richmond, BC V6Y 2C1

## Address: 8880 Cook Road and 8751 Citation Drive

### Prior to approval of the Development Permit, the developer is required to complete the following:

- 1. (OCP Amendment) Final adoption of OCP Amendment Bylaw 10395.
- 2. (Zoning Amendment) Final adoption of the Zoning Amendment Bylaw 10396.
- 3. (Tree Compensation) City acceptance of the developer's offer to voluntarily contribute \$98,304.00 (\$768.00/tree) to the City's Tree Compensation Fund for the planting of replacement trees within the City.
- 4. (Landscaping Security) Receipt of a Letter of Credit for landscaping in the amount of \$858,573.29 (based on the costs estimate provided by a CSLA registered landscape Architect including 10% contingency). A legal agreement is required to accompany the Landscape Security to set the terms for its use and release.
- 5. (Accessible Units) Registration of Market Rental Agreement and Moderate Income Housing Agreement on title securing the developer's offer to voluntarily provide four accessible, moderate income housing units, and two accessible market rental units. Languages should be included in the agreements that these units are required to incorporate all of the accessibility provisions listed in the Basic Universal Housing Features section of the City's Zoning Bylaw and in the BC Building Codes.

### Prior to Demolition Permit Issuance, the developer must complete the following requirements:

- 1. Provide written confirmation and supporting documents to demonstrate that the proposed Tenant Relocation Plan has been implemented.
- 2. Installation of appropriate tree protection fencing around all trees to be retained as part of the development prior to any construction activities, including building demolition, occurring on-site.

### Prior to Building Permit Issuance, the developer must complete the following requirements:

- 1. Confirm that "Land Use Contract (LUC 025)" has been discharged from the subject site.
- Submission of a Construction Parking and Traffic Management Plan to the Transportation Department Management Plan shall include location for parking for services, deliveries, workers, loading, application for any lane closures, and proper construction traffic controls as per Traffic Control Manual for works on Roadways (by Ministry of Transportation) and MMCD Traffic Regulation Section 01570.
- 3. Incorporation of accessibility measures in Building Permit (BP) plans as determined via the Rezoning and/or Development Permit processes.
- 4. If applicable, payment of latecomer agreement charges, plus applicable interest associated with eligible latecomer works.
- 5. Obtain a Building Permit (BP) for any construction hoarding. If construction hoarding is required to temporarily occupy a public street, the air space above a public street, or any part thereof, additional City approvals and associated fees may be required as part of the Building Permit. For additional information, contact the Building Approvals Department at 604-276-4285.

### Note:

- \* This requires a separate application.
- Where the Director of Development deems appropriate, the preceding agreements are to be drawn not only as personal covenants of the property owner but also as covenants pursuant to Section 219 of the Land Title Act.

All agreements to be registered in the Land Title Office shall have priority over all such liens, charges and encumbrances as is considered advisable by the Director of Development. All agreements to be registered in the Land Title Office shall, unless the Director of Development determines otherwise, be fully registered in the Land Title Office prior to enactment of the appropriate bylaw.

Initial: \_\_\_\_\_



# File No.: DP 23-014121

The preceding agreements shall provide security to the City including indemnities, warranties, equitable/rent charges, letters of credit and withholding permits, as deemed necessary or advisable by the Director of Development. All agreements shall be in a form and content satisfactory to the Director of Development.

- Additional legal agreements, as determined via the subject development's Servicing Agreement(s) and/or Development Permit(s), and/or Building Permit(s) to the satisfaction of the Director of Engineering may be required including, but not limited to, site investigation, testing, monitoring, site preparation, de-watering, drilling, underpinning, anchoring, shoring, piling, pre-loading, ground densification or other activities that may result in settlement, displacement, subsidence, damage or nuisance to City and private utility infrastructure.
- Applicants for all City Permits are required to comply at all times with the conditions of the Provincial *Wildlife Act* and Federal *Migratory Birds Convention Act*, which contains prohibitions on the removal or disturbance of both birds and their nests. Issuance of Municipal permits does not give an individual authority to contravene these legislations. The City of Richmond recommends that where significant trees or vegetation exists on site, the services of a Qualified Environmental Professional (QEP) be secured to perform a survey and ensure that development activities are in compliance with all relevant legislation.

Signed

Date



# **Development Permit**

# No. DP DP 23-014121

To the Holder:	1166225 BC Ltd.
Property Address:	8880 Cook Road and 8751 Citation Drive
Address:	c/o GBL Architects 224 W 8th Avenue Unit 300, Vancouver, British Columbia, V5Y 1N5

- 1. This Development Permit is issued subject to compliance with all of the Bylaws of the City applicable thereto, except as specifically varied or supplemented by this Permit.
- 2. This Development Permit applies to and only to those lands shown cross-hatched on the attached Schedule "A" and any and all buildings, structures and other development thereon.
- 3. The "Richmond Zoning Bylaw 8500" is hereby varied to reduce the road setback to projecting balconies above the second floor from 3.0 m to 1.2 m.
- 4. Subject to Section 692 of the Local Government Act, R.S.B.C.: buildings and structures; off-street parking and loading facilities; roads and parking areas; and landscaping and screening shall be constructed generally in accordance with Plans #1 to #76 attached hereto.
- 5. Sanitary sewers, water, drainage, highways, street lighting, underground wiring, and sidewalks, shall be provided as required.
- 6. As a condition of the issuance of this Permit, the City is holding the security in the amount of \$858,573.29 to ensure that development is carried out in accordance with the terms and conditions of this Permit. Should any interest be earned upon the security, it shall accrue to the Holder if the security is returned. The condition of the posting of the security is that should the Holder fail to carry out the development hereby authorized, according to the terms and conditions of this Permit within the time provided, the City may use the security to carry out the work by its servants, agents or contractors, and any surplus shall be paid over to the Holder. Should the Holder carry out the development permitted by this permit within the time set out herein, the security shall be returned to the Holder. The City may retain the security for up to one year after inspection of the completed landscaping in order to ensure that plant material has survived.
- 7. If the Holder does not commence the construction permitted by this Permit within 24 months of the date of this Permit, this Permit shall lapse and the security shall be returned in full.

To the Holder:	1166225 BC Ltd.
Address:	8880 Cook Road and 8751 Citation Drive c/o GBL Architects
	224 W 8th Avenue Unit 300, Vancouver, British Columbia, V5Y 1N5

8. The land described herein shall be developed generally in accordance with the terms and conditions and provisions of this Permit and any plans and specifications attached to this Permit which shall form a part hereof.

This Permit is not a Building Permit.

AUTHORIZING RESOLUTION NO. DAY OF , .


ISSUED BY THE COUNCIL THE

.


DELIVERED THIS DAY OF ,

MAYOR



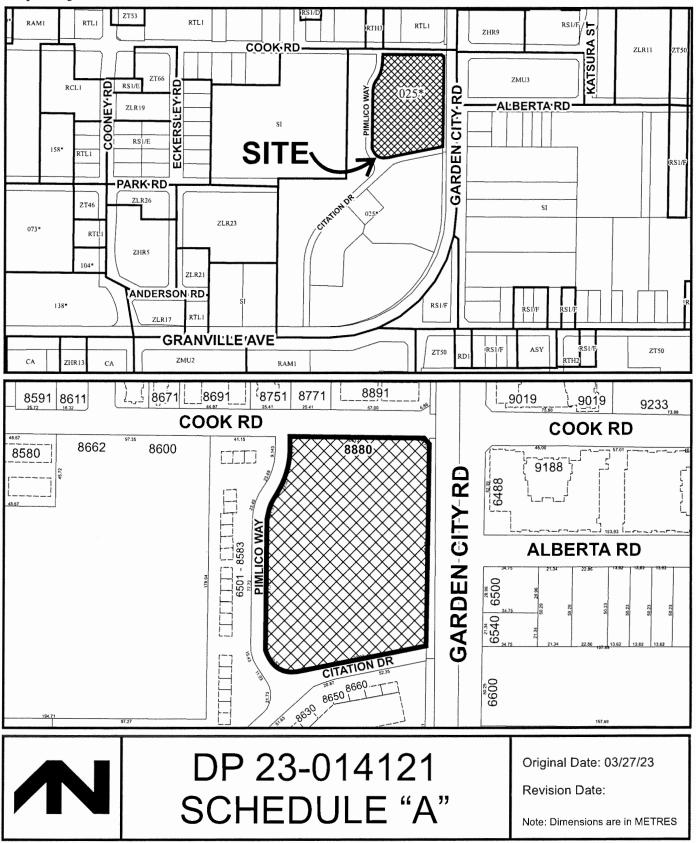



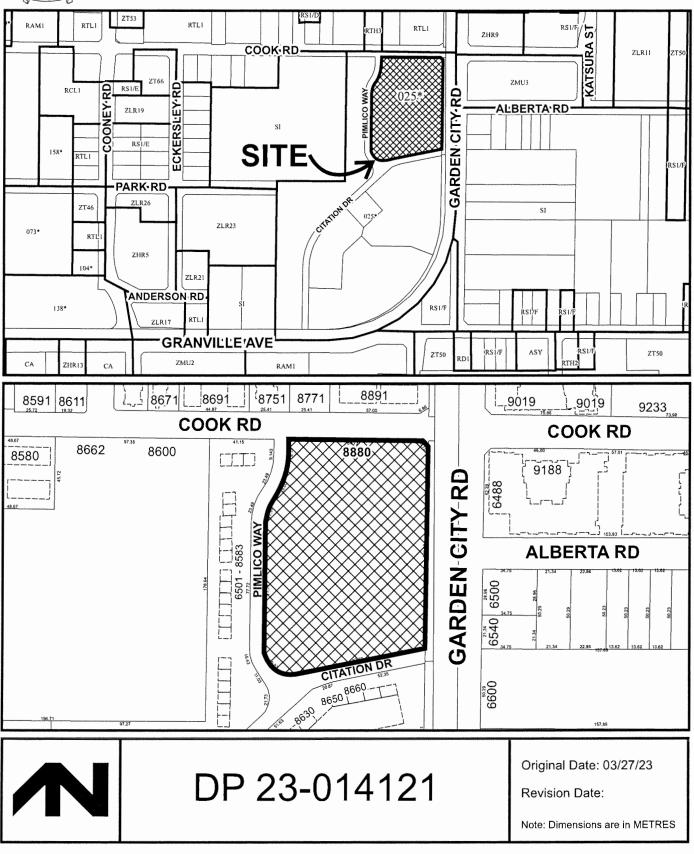

# 8880 COOK RD. & 8751 CITATION DRIVE

RICHMOND, BC

**DEVELOPMENT PERMIT APPLICATION DP 23-014121** 



DP 23-014121 PLAN #1

February 20, 2024



#### **PROJECT TEAM:**

#### OWNER

AARON WU 684.620.9199

### ARCHITECT

AMELA BRUDAR

#### CODE

BILL MAY

#### STRUCTURAL

DARRYL BOWERS 604 294 3753

#### MECHANICAL

CAREN SPOELSTRA 504 687.1821 EXT. 77150

#### LANDSCAPE + ARBORIST

ALEXA GONZAL

FLORIAN FISC 778 988 4403

ELECTRICAL GARY GEISSINGER

#### TRAFFIC + TRANSPORTATION

PFTFR JOYCF 604 685 6427 ext. 2 pjoyce@bunteng.co

#### CIVIL

JEFF CRAWFORD 604.270.9331 jeff@mgt.bc.ca

DANIEL WONG 604.270.9331 daniel.wong@mpt.bc.ca

#### GEOTECHNICAL

JONAH SCHWAE PHONE EMAIL

#### ENVELOPE

CONTACT NAME PHONE EMAIL

#### SUSTAINABILITY

DANIEL ROBERTS 604.924.0094

#### INTERIOR DESIGN

CONTACT NAI

PHONE

#### DEVELOPMENT STRATEGIST

ALEJANDRO MARTIN 604.736.1156 axt. 203

# 8880 COOK RD. & 8751 CITATION DRIVE RICHMOND, BC

	DRAWING LIST	
Number	Name	Number
A-0.01	STATS	A-2.06
A-0.01a	STATS II	A-2.07
A-0.02	SURVEY	A-2.08
A-0.04	CONTEXT PLAN	A-2.09
A-0.05	STREETSCAPE	A-2.10
A-0.06	STREETSCAPE	A-3.01
A-0.08	SHADOW STUDIES	A-3.02
A-0.09	DESIGN RATIONAL/ MASSING	A-3.03
A-0.10	NOTES & LEGENDS I	A-4.00
A-0.11	GENERAL NOTES, SYMBOLS & LEGENDS	A-4.01
A-0.12	MATERIALS I	A-4.02
A-0.13	MATERIALS II	A-4.03
A-0.14	SUSTAINABILITY RATIONALE	A-4.04
A-0.15	WALL ASSEMBLIES	A-4.05
A-0.16	FLOOR ASSEMBLIES	A-4.06
A-0,21	SITE PLAN	A-4.07
A-0.22	SITE AREA PLAN	A-4.08
A-0.23	LOT COVERAGE	A-4.09
A-0.24	SITE POROSITY	A-4.10
A-0.25	SITE S.R.W.	A-4.11
A-0.26	OUTDOOR AMENITY	A-4.12
A-0.27	LDT GRADING	A-4.13
A-0.28	LOT GRADING I	A-4.14
A-1.01	FLOOR PLANS - KEY LEGEND	A-4.15
A-1.02	FLOOR PLANS - PARKING LEGEND	A-4.16
A-1.03	FLOOR PLAN - P1	A-4.17
A-1.04	FLOOR PLAN - P2	A-4.18
A-1.05	FLOOR PLAN - L1	A-4.19
A-1.06	FLOOR PLAN - L2	A-4.20
A-1.07	FLOOR PLAN - L3	A-5.01
A-1.08	FLOOR PLAN - L4	A-5.02
A-1.09	FLOOR PLAN - L5	A-5.03
A-1.10	FLOOR PLAN - L6	A-5.04
A-1.11	FLOOR PLAN - ROOF	A-5.05
A-1.12	ENLARGED FLOOR PLANS	A-5.06
A-1.13	ENLARGED FLOOR PLANS	A-5.07
A-1.14	ENLARGED FLOOR PLANS	A-5.08
A-1.15	ENLARGED FLOOR PLANS	A-6.01
A-2,01	ELEVATIONS	A-6.02
A-2.02	ELEVATIONS	A-6.03
A-2,03	ELEVATIONS	A-6.04
A-2,04	ELEVATIONS	A-6.05
A-2.05	ELEVATIONS	A-6.06

Number	Name
A-2.06	ELEVATIONS
A-2.07	ELEVATIONS
A-2.08	ENLARGED ELEVATIONS
A-2.09	ENLARGED ELEVATIONS
A-2.10	ENLARGED ELEVATIONS
A-3.01	BUILDING SECTIONS I
A-3.02	BUILDING SECTIONS II
A-3.03	BUILDING SECTIONS III
A-4.00	UNIT NOTES
A-4.01	TYP. ACCESSIBLE UNITS
A-4.02	UNIT PLANS - STUDIO
A-4.03	UNIT PLANS - STUDIO
A-4.04	UNIT PLANS - 1BD
A-4.05	UNIT PLANS - 1BD
A-4.06	UNIT PLANS - 2BD
A-4.07	UNIT PLANS - 2BD
A-4.08	UNIT PLANS - 2BD
A-4.09	UNIT PLANS - 2BD
A-4.10	UNIT PLANS - 3BD
A-4.11	UNIT PLANS - 3BD
A-4.12	UNIT PLANS - TH - 2BD
A-4.12	UNIT PLANS - TH - 2BD
A-4.14	UNIT PLANS - TH - 2BD
A-4.15	UNIT PLANS - TH - 2BD
A-4,16	UNIT PLANS - TH - 2BD
A-4.17	UNIT PLANS - TH - 2BD
A-4.17 A-4.18	UNIT PLANS - TH - 3BD
A-4.19	UNIT PLANS - TH - 3BD
A-4.17 A-4.20	UNIT PLANS - TH - 3BD
A-4.20 A-5.01	FAR - P1
A-5.02	FAR - P2
A-5.03	FAR - L1
A-5.04	FAR - L2
A-5.05	FAR - L3
A-5.06	FAR - L3
A-5.08	_
A-5.08	FAR - L5
A-6.01	FAR - L6 3D VIEWS
A-6.01 A-6.02	3D VIEWS 3D VIEWS
	3D VIEWS
A-6.03	
A-6.04	3D VIEWS
A-6.05 A-6.06	3D VIEWS 3D VIEWS

	DRAWING LIST
Number	Name
A-6.07	3D VIEWS
A-6.08	3D VIEWS
A-7.01	TRAFFIC & TRANSPORTATION
A-7.02	TRAFFIC & TRANSPORTATION
A-8.00	PRIVACY SCREEN DETAILS
A-8.01	METAL PLANKS DETAILS
A-8.02	ROOF SCREENING DETAILS
A-8.03	BALCONY DETAILS
A-8.04	PARKADE AND STAIR SCREEN
A-8.05	TH PRIVACY SCREEN DETAILS
A-9.01	WASTE MANAGEMENT PLAN
A-9.03	WASTE MANAGEMENT ROOMS
A-9.04	WASTE MANAGEMENT ROOMS CALCULATION
A-10.01	CIRCULATION PLAN - P1
A-10.02	CIRCULATION PLAN - P2
A-10.03	CIRCULATION PLAN - L1
A-10.04	CIRCULATION PLAN - L2
A-10.05	CIRCULATION PLAN - L3
A-10.06	CIRCULATION PLAN - L4
A-10.07	CIRCULATION PLAN - L5
A-10.08	CIRCULATION PLAN - L6
A-11.01	SIGNAGE AND WAYFINDING
A-11.02	SIGNAGE AND WAYFINDING
A-11.03	SIGNAGE AND WAYFINDING
A-11.05	SIGNAGE AND WAYFINDING
A-11.08	SIGNAGE AND WAYFINDING
A-11.09	SIGNAGE AND WAYFINDING
A-11.10	SIGNAGE AND WAYFINDING
A-11.11	SIGNAGE AND WAYFINDING
A-11.12	SIGNAGE AND WAYFINDING

# DP 23-014121 PLAN #2

February 20, 2024

# gbl

# PROJECT STATISTICS GENERAL INFORMATION

	SF	m2		
NET SITE AREA USED FOR FAR CALCULATIONS	122,620	11392		
BLDG. HEIGHT	VARIES	10.36	16.43	22.48
AVERAGE BLDG. HEIGHT (meters)	18	10.50	10.45	22.40
SETBACKS	3.00m			

#### FAR ALLOWED

	NEW SITE AREA ALLOWED				
DESCRIPTION	NET FAR	AREA [SF]			
MARKET RENTAL	1.79	219,489			
NON-MARKET RENTAL	0.31	38,171			
TOTAL MAX	2.10	257,660			

#### AREA BREAKDOWN - PROPOSED

		CIRCULATION	RENTABLE			EXCLUSIONS+		TOTAL		1
DESCRIPTION	GFA (SF)	(SF)	(SF)	EFFICIENCY	SERVICE	BUH	AMENITY	EXCLUSIONS	FAR AREA	FAR
TOTAL	283,640	27,890	234,999	82.9%	3,499	15,776	7,508	26,783	256,857	2.09

23.39

**PLAN #3** 

#### PARKING REQUIREMENTS

DESCRIPTION	BYLAW	REQUIRED RATIO [PER UNIT]	TOTAL UNITS PROVIDED	VISITORS STALLS REQUIRED (0.16/UNIT)	RES. STALLS REQUIRED	TOTAL REQUIRED
MARKET RENTAL	Bylaw 10393 and Parking By Law 7.9.3 Table 7.9.3.1 Zone 2	0.5	271	44	136	180
MODERATE INCOME RENTAL	Bylaw 10396 and Parking By Law 7.9.3 Table 7.9.3.1 Zone 2	0.4	68	11	28	39
TOTAL REQUIRED			339	55	164	219
TOTAL PROVIDED				55	168	223

- CESU SUE FARMING REQUIRED 2º UR ST-	
ACCESSIBLE PARKING PROVIDED	5
S ALL CARS LLOWED	1
SMALL CARS PROVIDED	96
CLASS A LOADING	2
MEDIUM SIZE LOADING	1

#### BICYCLE STALL REQUIREMENTS

REQUIREMENTS/UNIT		1.25	1.90	0.2		
UNIT COUNT TOTAL REQUIRED	TOTAL UNITS	CLASS 1 (STUDIOS)	CLASS 1 (ALL OTHER UNITSI	CLA55 2	PROPORTION	
	339	87 109	252 479			
	588					
CLASS-1 HOR (STANDARD,					1	
OVERSIZED, LOCKERSI	303		-	68	51.5%	N/A
CLASS-1 HOR STACKED	194				33.0%	33.0%
CLASS-1 VER	91				15.5%	33.0%
TOTAL PROVIDED	588		1	68		

#### AMENITY REQUIREMENTS

INDOOR AMENINTY	m2	SF
MINIMUM INDOOR AMENITY REQ'D PER UNIT	2	21.52782
TOTAL UNITS	339	
TOTAL INDOOR AMENITY AREA REQ'O	678	7,298
PROVIDED INDOOR AMENITY AREA	698	7,508
OVER/UNDER AMENITY	20	210

OUTDOOR AMENITY	m2	SF	
OUTDOOR SHARED AREA REQ'D PER UNIT	6	64.58346	
TOTAL UNITS	339		
MIN. OUTDOOR AREA REQ'D	2034	21,894	
10% SITE AREA REQ'D*	1139	12262	
TOTAL OUTDOOR AREA REQUIRED	3173	34,156	
PROVIDED OUTDOOR AMENITY AREA	3355	_36,113	-
OVER/UNDE DUT DO ARE	n A	A 0 4	

#### UNIT MIX REQUIREMENTS

FAMILY UNIT BREAKDOWN				
RENT TYPE	BY-LAW MIN. FAMILY REQ'D (%)	UNITS PROVIDED	FAMILY UNITS PROVIDED	FAMILY UNITS PROVIDED (%)
MODERATE INCOME RENTAL (MIR)	15%	68	16	24%
MARKET RENTAL (MR)	40%	271	120	44%
TOTAL		339	136	40%

# UNIT TYPE COUNTS

RENT TYPE	STUDIO	1BD	2BD	3BD	TH	TOTAL	BUH BY- LAW (%) REQUIRED	BUH REQUIRED	BUH PROVIDED
MODERATE INCOME RENTAL (MIR)	36	16	7	4	5	68	100%	63	63
MARKET RENTAL (MR)	51	100	75	13	32	271	100%	239	239
TOTAL	87	116	82	17	37	339		302	302
UNIT PERCENTAGE [%]	26%	34%	24%	5%	11%	100%			

MARKET RENTAL (MR)					
UNIT TYPE	NO. OF UNITS	MIN. SIZE (SF)	% FAMILY UNITS	% BUH UNITS	
STUDIO	51		N/A	19%	
1 BED	100		N/A	37%	
2 BED	75		28%	28%	
3 BED	13		5%	5%	
TOWNHOUSE (2 BED)	26		10%	N/A	
TOWNHOUSE (3 BED)	6		2%	N/A	
TOTAL	271		44%	88%	

Note: Townhouse design will not meet BUH provision. All apartment units will provide BUH requirements.

MODERATE INCOME RENTAL (MIR)					
UNIT TYPE	NO. OF UNITS	MIN. SIZE (SF)	% FAMILY UNITS	% BUH UNITS	
STUDIO	36	400	0%	57%	
1 BED	16	535	0%	24%	
2 BED	7	741	10%	10%	
3 BED	4	980	6%	6%	
TOWNHOUSE (2 BED)	5	741	7%	0%	
TOWNHOUSE (3 BED)	0	980	0%	N/A	
TOTAL	68		24%	97%	

Note: Townhouse design will not meet BUH provision. All apartment units to meeet BUH requirements.

# February 20, 2024



#### BL ARCHITECTS INC.

300-224 WEST 8TH AVENUE VANCOUVER, BC CANADA VSY INS TEL +04 73+ 1156 FAX +04 73t 5279

NOTES

#### ABBREVIATIONS

MR- MARKET RENTAL MIR - MODERATE INCOME RENTAL FAR - FLOOR AREA RATIO

REV	ISIONS	
NO.	DATE	DESCRIPTION
4	MAR 10 2023	ISSUED FOR DP
5	OCT 06 2023	RE-ISSED FOR DP
6	JAN 19 2024	RE-ISSUED FOR DP
7	CED 15 202/	DE ISSUED EAD OD

8880 COOK RD. & 8751 CITATION DRIVE

### RICHMOND, BC

# STATS

DATE DRAWN BY CHECKED BY SCALE

2/14/2024 4:07:30 PM GBL 1/2" = 1'-0" 20039

JOB NUMBER

A-0.01

# **GROSS AREA**

TOTAL - GFA		
USE	AREA	
AMENITY	7508 SF	
BUH EXCLUSION	6032 SF	
CIRCULATION	27890 SF	
EXCLUSIONS	9744 SF	
RESIDENTIAL	228967 SF	
SERVICE	3499 SF	
TOTAL	283640 SF	
TOTAL - REN	TABLE	
USE	AREA	
1BD	64907 SF	
280	65518 SF	
3BD	18855 SF	
BUH	6032 SF	
STUDIO	38693 SF	
TH	40995 SP	
TOTAL	234999 5	
TDTAL - EXCL	USIONS	
USE	AREA	
AMENITY	7508 SF	
BUH	6032 SF	
ELECTRICAL ROOM	1259 SF	
EXCLUSION	8570 SF	
MECH, SHAFT	1174 SF	
MECHANICAL	2240 SF	
TOTAL	26783 SF	

#### OUTDOOR AREA

OUTDOOR AMENITY AREA			
USE	LEVEL	AREA	
OUTDOOR AMENITY	LI	20325 SF	
OUTDOOR AMENITY	L2	1830 SF	
OUTDOOR AREA	L2	10542 SF	
OUTDOOR AMENITY	L3	3416 SF	
TOTAL: 4		36113 SF	

# PARKADE

CARS

#### BICYCLE

TOTAL CLASS 1 BIKES

 BICYCLE - HOR. CLASS 1
 285

 BICYCLE - HOR. STACKED CLASS 1
 194

 BICYCLE - LOCKER
 11

 BICYCLE - OVERSIZE
 6

TOTAL CLASS 2 BIKES

TYPE

ICYCLE - VERT, CLASS 1

CLE - HOR. - CLASS 2

PARKING - TOTAL CAR		
TYPE	COUNT	
RESIDENTIAL - H/C STALL	3	
RESIDENTIAL - H/C VAN STALL	2	
RESIDENTIAL - REGULAR STALL	91	
RESIDENTIAL - SMALL STALL	72	
VISITOR - REGULAR	30	
VISITOR - SMALL CAR STALL	23	
VISITOR H/C STALL	2	
TOTAL	223	

#### PARKING - RESIDENTIAL

TYPE	COUN
RESIDENTIAL - H/C STALL	3
RESIDENTIAL - H/C VAN STALL	2
RESIDENTIAL - REGULAR STALL	91
RESIDENTIAL - SMALL STALL	72
TOTAL	168

#### PARKING - VISITORS

TYPE	COUNT
VISITOR - REGULAR	30
VISITOR - SMALL CAR STALL	23
VISITOR H/C STALL	2
TOTAL	55

PARKING - OTH	IER
TYPE	COUNT
CAR SHARE	2
CLASS A LOADING STALL	2
GARBAGE TRUCK	1
MEDIUM SIZE LOADING	1

#### MECHANICAL SHAFT AREA

MECHANICAL L2-L6		L6	
_EVEL	TYPE	AREA (SFI	AREA [m2]
L2	MECH, SHAFT	260	24.14
L3	MECH, SHAFT	256	23.76
L4	MECH. SHAFT	252	23.41
L.5	MECH, SHAFT	248	23.00
1.6	MECH, SHAFT	259	24.09
		1274	118.40

# FAR SUMMARY

LEVEL	AREA	FAR
P1	295 SF	0.00
LI	24727 SF	0.20
P2	281 SF	0.00
L2	47003 SF	0.38
L3	44792 SF	0.37
L4	46559 SF	0.38
L5	46737 SF	0.38
Ló	46463 SF	0.38
TOTAL	256857 SF	2,09

#### NET FAR - MARKET RENTAL

LEVEL	AREA	FAR
LI	18063 SF	0.1
L2	33172 SF	0.2
13	22676 SF	0.1
L4	31388 SF	0.2
L5	41276 SF	0,3
L6	42015 SF	0.3
TOTAL	188541 SF	1.5

#### NET FAR - MODERATE INCOME RENTAL LEVE AREA FAR 2508

# 1048 SF 40427 SF

8383 SF

27890 SE

0.009

NET FA	R - CIRCULATIO	N
LEVEL	AREA	FAR
P1	295 SF	0.0
LI	4156 SF	0.0
P2	231 SF	0.0
L2	5448 SF	0.0
L3	4433 SF	0.0
L4	4416 SF	0.0
L5	4414 SF	0.0
Ló	4448 SF	0,0

COUN

COUNT

# FAR SUMMARY BY LEVEL

TYPE	AREA (SF)	FAR
BIKE LOCKERS	2924	0.02
DOG WASH	321	0.00
EXCLUSION	246	0.00
GARBAGE	2098	0.02
MECHANICAL	594	0.00
PARKADE	41143	0.29
RESIDENTIAL	295	0.00
TOTAL AREA	47621	0.34

#### GROSS AREA - EXCLUSION = NET AREA 47621-(2924-321-246-2098-594-41143) = 295 SF

TYPE	AREA (SF)	FAR
AMENITY	1033	0.01
BIKE LOCKERS	8218	0.06
ELECTRICAL RDOM	1259	0.01
EXCLUSION	873	0.01
MECHANICAL	1646	0.01
PARKADE	35300	0.25
CIRCULATION	281	0.00
IQTAL AREA	48610	0.35

48610- (1033-8218-1259-873-1646-35300) 281 SF

#### FAR BREAK DOWN L1 AREA ISF 0.00 EMENT OUTD00R 20325 0.15 0.11 15037

0.15 TOTAL AREA GROSS AREA - EXCLUSION = NET AREA

RESIDENTIAL CIRCULATION

60090 - (20325-15037) = 24,728 SF

FAR	BREAK DOWN	L2
TYPE	AREA (SF)	FAR
1BD	4670	0.03
2BD	5033	0.04
3BD	2081	0.01
AMENITY	1596	0.01
BALCONY	1872	0.01
BUH	720	0.01
EXCLUSION	1713	D.01
MECH. SHAFT	260	0.00
OUTDOOR AMENITY	1830	0.01
OUTDOOR AREA	10542	0.08
PATIO	6433	0.05
RESIDENTIAL CIRCULATION	5448	0.04
STUDIO	9347	0.07
тн	20424	0.15
TOTAL ARTA	71968	0.52

TOTAL AREA GROSS AREA - EXCLUSION = NET AREA

71968 -(1596-1872-720-1713-260-1830-10542-6433) = 47,0025F

FAR BREAK DOWN L3		
TYPE	AREA (SF)	FAR
18D	15643	0.11
2BD	12911	0.09
3BD	3414	0.02
AMENITY	3269	0.02
BALCONY	5558	0.64
BUH	1320	0.01
EXCLUSION	1521	0,01
MECH. SHAFT	256	0.00
OUTDOOR AMENITY	3416	0.02
RESIDENTIAL CIRCULATION	4433	0.03
STUDIO	8392	0.06
TOTAL AREA	60133	0.43

GROSS AREA - EXCLUSION = NET AREA 60133-[3269-5558-1320-1521-256-3416] = 44,793 SF

"YPE	AREA (SF)	FAR
18D	14861	0.11
2BC	15254	0,11
3BC	4455	0.03
AMENITY	1609	0.01
BALCONY	5602	0.04
BUH	1340	0.01
EXCLUSION	1526	0.01
MECH, SHAFT	252	0.00
RESIDENTIAL	4416	0.03
STUDIO	7573	D,05
IOTAL AREA	56888	0.41

#### GROSS AREA - EXCLUSION = NET AREA 56888 - (1609-5602-1340-1526-252) = 46,559 SF

TYPE	AREA [SF]	FAR
1BD	14875	0.11
2BC	16304	0.12
3BC	4454	0.03
BALCONY	5587	0.04
BUH	1333	0.01
EXCLUSION	1527	0.01
MECH. SHAFT	248	0.00
RESIDENTIAL	4414	0.03
STUDIO	6691	0.05
TOTAL AREA	55432	0.40

GROSS AREA - EXCLUSION = NET AREA 55432- (5587-1333 -1527-248) = 46,737 SF

TYPE	AREA [SF]	FAR
IBC	14859	0.11
2BC	16017	0.11
380	4450	0.03
BALCONY	5494	0.04
BUH	1320	0.01
EXCLUSION	1528	0.01
MECH. SHAFT	259	0.00
RESIDENTIAL	4448	0.03
ROOF DECK	255	0.00
STUDIO	6690	0.05
TOTAL AREA	55313	0.40

GROSS AREA - EXCLUSION = NET AREA 55318 - (5494-1320-1528-259-255) = 46,462 SF

# **UNIT SUMMARY**

ALL UNITS

NAME	COUNT	%
IBD	100	29%
BD - MIR	16	5%
280	75	22%
80 - MIR	7	2%
BO	13	4%
BD - MIR	4	1%
TUDIO	51	15%
STUDIO - MIR	36	11%
TH	32	9%
		1%
TH-MIR	5	
OTAL	339	100%
UNITS BY	EVEL -	MIR
NAME	COUNT	%
MIR		
.1		
H-MIR	5	7%
	5	7%
.2		
BD - MIR	2	3%
BD - MIR	1	1%
RD - MIR	1	1%
BD - MIR		
TUDIO ~ MIR	6	9%
2	10	15%
3 BD - MIR	10	15%
BD - MIR	4	6%
BD - MIR		1%
BU - MIK	1	
TUDIO - MIR	17	25%
4	32	47%
4 BD - MIR	4	6%
BD - MIR	2	3%
		1%
BD - MIR	1	
TUDIO - MIR	13	19%
	20	29%
	1	1%
	1	1% 1%
IBD - MIR		
.5 DBD - MIR TOTAL: 68	1	1%
BD - MIR	1 68	1% 100%
BD - MIR OTAL: 68	1 68	1% 100%
BD - MIR OTAL: 68 UNITS BY NAME IR	1 68 LEVEL -	1% 100%
BD - MIR OTAL: 68 UNITS BY NAME IR	1 68 LEVEL -	1% 100%
BD - MIR OTAL: 68 UNITS BY NAME AR	1 68 LEVEL -	1% 100%
BD - MIR OTAL: 68 UNITS BY NAME AR	1 68 LEVEL - COUNT	1% 100% MR %
BD - MIR TOTAL: 68 UNITS BY NAME AR II II	1 68 LEVEL -	1% 100% MR %
BD - MIR OTAL: 68 UNITS BY NAME AR .1 H H	1 68 LEVEL - COUNT 32 32	1% 100% MR % 12%
BD - MIR OTAL: 58 UNITS BY NAME AR 1 H H 2 BD	1 68 LEVEL - COUNT 32 32 6	1% 100% MR % 12% 12% 2%
BD - MIR OTAL: 58 UNITS BY NAME 4R -1 -1 -1 -2 BD -2 -2 -2 -2 -2 -2 -2 -2 -2 -2 -2 -2 -2	1 68 <b>LEVEL -</b> COUNT 32 32 6 5	1% 100% MR % 12% 12% 2% 2%
BD - MIR OTAL: 68 UNITS BY NAME AR .1 H H 2 BD BD BD BD	1 68 LEVEL - COUNT 32 32 32 6 5 1	1% 100% MR % 12% 12% 2% 2% 0%
BD - MIR TOTAL: 68 UNITS BY NAME I. I. I. I. I. I. I. I. I. I. I. I. I.	1 68 <b>LEVEL -</b> COUNT 32 32 6 6 5 1 1 15	1% 100% MR % 12% 12% 2% 2% 0% 6%
BD - MIR OTAL: 68 UNITS BY NAME AR 1 1 H H BD 10 100 TUDIO	1 68 LEVEL - COUNT 32 32 32 6 5 1	1% 100% MR % 12% 12% 2% 2% 0%
BD - MIR OTAL: 68 UNITS BY NAME AR J. H 2 2 80 TUDIO 3	1 68 <b>LEVEL -</b> COUNT 32 32 32 6 5 1 1 15 27	1% 100% MR % 12% 12% 2% 2% 0% 6% 10%
BD - MIR OTAL: 68 UNITS BY NAME AR .1 'H 'H 22 BD CBD CBD CBD CTUDIO 3	1 68 <b>LEVEL -</b> COUNT 32 32 6 6 5 1 1 15	1% 100% MR % 12% 12% 2% 2% 0% 6%
BD - MIR OTAL: 68 UNITS BY NAME NAME 1 1 1 1 2 80 0 50 50 50 50 50 50 50 50 50	1 68 <b>LEVEL -</b> COUNT 32 32 32 6 5 1 1 5 27	1% 100% MR % 12% 12% 2% 2% 2% 0% 6% 10%
BD - MIR OTAL: 68 UNITS BY NAME AR 1 1 1 1 1 1 1 1 1 1 1 1 1	1 68 <b>LEVEL -</b> COUNT 32 32 6 5 1 15 27 17 13	1% 100% MR % 12% 12% 2% 2% 2% 0% 6% 5%
BD - MIR OTAL: 68 UNITS BY NAME AR .1 1 H BD CBD CBD CBD CBD CBD CBD CBD CBD CBD	1 68 COUNT 32 32 6 5 1 1 5 27 27 17 13 2	1% 100% MR % 12% 12% 2% 2% 2% 0% 6% 6% 5% 10%
BD - MIR OTAL: 68 UNITS BY NAME AR .1 .1 .1 .2 .2 .2 .0 .0 .0 .3 .3 .0 .0 .0 .0 .0 .0 .0 .0 .0 .0 .0 .0 .0	1 68 <b>LEVEL -</b> COUNT 32 32 6 5 1 15 27 17 13	1% 100% MR % 12% 12% 2% 2% 2% 0% 6% 5%
IBD - MIR           TOTAL: 68           UNITS BY           NAME           NAME           II           II           HBD           100           STUDIO           3           IBD           IBD           IBD           SBO           STUDIO           3           IBD           IBD           SBO           STUDIO           JBD           SBO           STUDIO	1 68 <b>LEVEL -</b> COUNT 32 32 32 32 32 32 32 32 32 32 32 32 32	1% 100% MR % 12% 12% 2% 2% 2% 0% 6% 6% 5% 5% 10%
BD - MIR OTAL: 68 UNITS BY NAME I I BD C BD STUDIO SJ STUDIO L 4	1 68 <b>LEVEL -</b> COUNT 32 32 32 32 32 32 32 32 32 32 32 32 32	1% 100% MR % 12% 12% 2% 2% 2% 2% 0% 6% 6% 5% 5% 10%
BD - MIR OTAL: 68 UNITS BY NAME AR 1 1 H BD 50 100 100 100 100 100 100 100	1 68 <b>LEVEL -</b> COUNT 32 32 32 6 5 1 1 15 27 17 13 2 2 34 23	1% 100% MR % 12% 12% 12% 2% 2% 2% 2% 0% 6% 6% 10% 10% 10% 13%
BD - MIR OTAL: 68 UNITS BY NAME AR 1 H 2 2 BD 0 0 0 0 0 0 0 0 0 0 0 0 0	1 68 <b>LEVEL -</b> 32 32 6 5 1 1 15 27 17 13 2 2 34 23 17	1% 100% MR % 12% 12% 2% 2% 2% 2% 2% 2% 5% 6% 10% 6% 10% 13%
BD - MIR OTAL: 68 UNITS BY NAME AR 1 1 1 1 2 BD 60 51000 3 80 51000 51	1 68 <b>LEVEL -</b> COUNT 32 32 6 5 1 15 27 17 13 2 2 34 23 4 23 32 32 32 32 32 32 32 32 32	1% 100% MR % 12% 12% 2% 0% 6% 10% 6% 10% 6% 10% 8% 5% 13% 13%
BD - MIR OTAL: 68 UNITS BY NAME AR 1 1 1 1 2 BD 60 51000 3 80 51000 51	1 68 <b>LEVEL -</b> COUNT 32 32 6 5 1 15 27 17 13 2 27 17 13 2 34 23 4	1%, 100% % 12% 12% 12% 2% 2% 2% 2% 6% 6% 10% 6% 10% 10% 10% 10% 10% 10% 9% 6% 6% 5% 6% 6% 6% 9% 6% 9% 9%
BD - MIR OTAL: 68 UNITS BY NAME I I BD C BD C BD C BD C BD C BD C BD C BD C BD C BD C BD C BD C BD C BD C BD C BD C C BD C C BD C C BD C C C C C C C C C C C C C	1 68 <b>LEVEL -</b> COUNT 32 32 6 5 1 15 27 17 13 2 2 34 23 4 23 32 32 32 32 32 32 32 32 32	1% 100% MR % 12% 12% 2% 0% 6% 10% 6% 10% 6% 10% 8% 5% 13% 13%
BD - MIR OTAL: 68 UNITS BY NAME I I H 2 BD 5 UNITS BY NAME 3 BD 5 1 1 1 1 4 2 8D 5 1 1 1 1 1 1 1 1 1 1 1 1 1	1 68 LEVEL - COUNT 32 32 32 6 5 5 1 15 27 17 13 2 27 13 27 34 23 4 4 47	1% 10% <b>MR</b> 12% 12% 2% 0% 6% 10% 6% 10% 6% 10% 8% 1% 1% 1% 1% 1%
BD - MIR OTAL: 68 UNITS BY NAME AR 1 1 H 2 2 BD 5 100 5 100 5 100 100 100 100	1 68 COUNT 32 32 32 6 5 1 1 15 27 17 13 2 2 2 34 2 34 47 27	1%, 100%, 100%, % 12%, 12%, 12%, 2%, 2%, 2%, 0%, 6%, 6%, 10%, 8%, 13%, 13%, 13%, 13%, 13%, 13%, 10%, 10%, 10%, 10%, 10%, 10%, 10%, 10
BD - MIR OTAL: 68 UNITS BY NAME AR 1 1 1 2 BD 1 1 1 2 BD 1 1 1 1 1 2 BD 1 1 1 1 1 1 1 1 1 1 1 1 1	1 68 LEVEL - COUNT 32 32 6 5 1 15 27 17 13 2 2 34 47 27 20	1%, 100% MR 12% 12% 2% 2% 2% 2% 2% 2% 2% 6% 10% 6% 10% 1% 1% 1% 1% 1% 7% 2% 7%
BD - MIR TOTAL: 58 UNITS BY NAME MR 1 1 TH 2 BD 5 TUDIO 3 3 BD 3 BD 5 TUDIO 5 TUDIO 5 5 BD 5 5 BD 5 5 5 5 5 5 5 5 5 5 5 5 5	1 68 LEVEL - COUNT 32 32 6 5 1 15 27 27 3 4 4 47 27 20 3 3	1%, 100% <b>MR</b> 12% 12% 12% 2% 2% 2% 6% 12% 6% 10% 6% 13% 8% 6% 13% 13% 13% 13% 13% 13% 13% 13
BD - MIR OTAL: 68 UNITS BY NAME AR 1 1 1 1 2 BD 5 100 5 100 5 100 100 100 100	1 68 LEVEL - COUNT 32 32 6 5 1 15 27 17 13 2 2 34 47 27 20	1%, 100% MR 12% 12% 2% 2% 2% 2% 2% 2% 2% 6% 10% 6% 10% 1% 1% 1% 1% 1% 7% 2% 7%
BD - MIR OTAL: 68 UNITS BY NAME AR 1 1 1 1 2 BD 5 100 5 100 100 100 100 100 10	1 68 LEVEL - COUNT 32 32 6 5 1 15 27 27 3 4 4 47 27 20 3 3	1%, 100% <b>MR</b> 12% 12% 12% 2% 2% 2% 6% 12% 6% 10% 6% 13% 8% 6% 13% 13% 13% 13% 13% 13% 13% 13
BD - MIR OTAL: 68 UNITS BY NAME AR 1 1 1 1 2 BD 5 100 100 100 100 100 100 100	1 68 <b>LEVEL</b> - COUNT 32 32 6 5 1 15 27 17 13 2 2 34 23 4 47 27 20 3 15 65 5 65	1%, 100% <b>MR</b> 12% 12% 12% 2% 2% 6% 10% 6% 10% 6% 10% 6% 10% 10% 10% 10% 10% 2% 2% 2%
BD - MIR TOTAL: 48 UNITS BY NAME I I I I I I I I I I I I I	1 68 <b>LEVEL -</b> COUNT 32 32 6 5 1 15 27 17 13 2 2 2 34 34 47 27 20 3 15 65 27	1%, 10% <b>MR</b> 3% 12% 12% 2% 2% 2% 2% 6% 6% 6% 5% 6% 10% 6% 13% 13% 13% 13% 13% 13% 13% 13% 13% 10% 2% 2% 2% 10% 2% 10% 2% 10% 10% 10% 10% 10% 10% 10% 10% 10% 10
BD - MIR OTAL: 68 UNITS BY NAME AR 1 1 H 2 BD 5 100 100 100 100 100 100 100	1 68 LEVEL - COUNT 32 32 6 5 1 15 27 27 20 17 13 2 2 3 4 4 7 27 20	1%, 100% MR % 12% % 2% % 2% % 2% % 0% % 6% % 10% % 1% 11% 1
BD - MIR OTAL: 68 UNITS BY NAME AR 1 1 H 2 BD 5 100 100 100 100 100 100 100	1 68 LEVEL - COUNT 32 32 32 6 5 1 15 27 17 3 2 2 3 4 47 27 20 3 15 65 27 20 4	1%, 10% <b>MR</b> 12% 12% 12% 2% 2% 2% 6% 12% 6% 6% 10% 6% 10% 7% 11% 11% 7% 2% 2% 6% 2% 6% 10% 7% 7% 10% 7% 10% 7% 10% 7% 10% 7% 10% 10% 10% 10% 10% 10% 10% 10% 10% 10
BD - MIR OTAL: 68 UNITS BY NAME AR 1. 1: 1: 1: 1: 1: 1: 1: 1: 1: 1:	1 68 LEVEL - COUNT 32 32 6 5 1 15 27 27 20 17 13 2 2 3 4 4 7 27 20	1%, 100% MR % 12% % 2% % 2% % 2% % 0% % 6% % 10% % 1% 11% 1
BBD - MIR TOTAL: 68 UNITS BY NAME AR 1 1 1 1 1 1 1 1 1 1 1 1 1	1 68 LEVEL - COUNT 32 32 32 6 5 1 15 27 17 3 2 2 3 4 47 27 20 3 15 65 27 20 4	1%, 10% <b>MR</b> 12% 12% 12% 2% 2% 2% 6% 12% 6% 6% 10% 6% 10% 7% 11% 11% 7% 2% 2% 6% 2% 6% 10% 7% 7% 10% 7% 10% 7% 10% 7% 10% 7% 10% 10% 10% 10% 10% 10% 10% 10% 10% 10

AV	ERAGE UN	IT SIZ	E
NAME	AREA	%	AV. UNIT
1BD	54726 SF	29%	563.98
18D - MIR	9457 SF	5%	593.88
280	60483 SF	22%	811.42
2BD - MIR	5759 SF	2%	816.84
3BD	14654 SF	4%	1051.82
3BD - MIR	4201 SF	1%	1017.00
STUDIO	22632 5F	15%	437.79
STUDIO - MIR	16061 SF	11%	437.79
TH	36046 SF	9%	1049.83
TH-MIR	4949 SF	1%	925.00
TOTAL	228967 SF	100%	

II         TH         I3         4.6           11         TH-MIR         4         198           1.1         TH-MIR         4         198           1.2         118D         5         198           1.2         118D         5         198           1.2         118D         5         198           1.2         128D         38         198           1.2         38D         1         0%           1.2         38D         1         0%           1.2         38D         1         0%           1.2         37UDIO         3         1%           1.2         STUDIO         3         1%           1.3         18D         10         3%           1.3         18D         10         3%           1.3         38D         1         0%           1.3         38D         1         0%           1.3         38D         18         0%           1.3         38D         1         0%           1.4         18D         15         4%           1.4         18D         15         18	~	LL UNITS B	LEVEL	
11         TH         13         4.5           1.1         TH-MIR         4         15%           1.2         TRJ-MIR         4         15%           1.2         18D         5         1%           1.2         18D         5         1%           1.2         18D         3         1%           1.2         28D         3         1%           1.2         38D         1         0%           1.2         38D         1         0%           1.2         38D         1         0%           1.2         37D010         10         3%           1.3         18D         10         3%           1.3         18D         10         3%           1.3         28D         18         10%           1.3         28D         11         0%           1.3         37D010         1         0%           1.3         57U010         1         0%           1.4         18D         15         4%           1.4         18D         16         3%           1.4         18D         16         5%		NAME	COUNT	%
TH-MIR         4         19           11         17         5%           180         5         1%           12         180         5           12         180         5         1%           12         280         3         1%           12         280         3         1%           12         280         3         1%           12         380         1         0%           12         380         1         0%           12         380         1         0%           12         STUDIO         10         3%           13         180         10         3%           13         280         11         0%           13         380         1         0%           13         380         1         0%           13         380         1         0%           13         380         1         0%           14         180         15         4%           15         380         1         0%           14         280         18         16           15	NORTH			
I.1         TH-MIR         4         19           12         1BD         17         5%           12         1BD         17         5%           12         1BD         17         5%           12         1BD         18         2         1%           12         2BD         MR         1         0%           12         3BD         1         0%         1         0%           12         3BD         MIR         1         0%         1         0%           12         3BD         MIR         1         0%         1         0%           12         STUDIO         10         3%         1         1         0%           13         1BD<-MIR	L1	TH	13	4%
1         17         5%           12         18D         5         1%           12         18D         MR         2         1%           12         28D         3         1%           12         28D         MR         1         0%           12         38D         1         0%           12         38D         1         0%           12         37DDi0         10         3%           12         STUDi0         3         1%           12         STUDi0         3         1%           12         STUDi0         3         1%           13         18D         10         3%           13         18D         10         3%           13         38D         1         0%           13         38D         1         0%           13         38D         1         0%           13         38D         1         0%           14         18D         18         18           14         18D         18         18           14         18D         18         18           14 <td>L1</td> <td></td> <td></td> <td>1%</td>	L1			1%
12         18D         5         1%           1         18D - MIR         2         1%           2         18D - MIR         2         1%           2         28D - MIR         1         0%           12         28D - MIR         1         0%           12         38D - MIR         1         0%           12         38D - MIR         1         0%           12         STUDIO         10         3%           13         18D - MIR         8         2%           13         18D - MIR         8         2%           13         28D - MIR         1         0%           13         28D - MIR         1         0%           13         STUDIO         1         0%           13         STUDIO         1         0%           14         18D - MIR         3         1%           14         18D - MIR         1         0%           14         28D - MIR <t< td=""><td>L1</td><td></td><td>17</td><td>5%</td></t<>	L1		17	5%
12         18D - MIR         2         1%           2         280         3         1%           12         280 - MIR         1         0%           12         38D         1         0%           12         38D         1         0%           12         38D         10         3%           12         38D         10         3%           12         STUDIO         10         3%           13         18D - MIR         8         2%           13         18D - MIR         8         2%           13         28D - MIR         1         0%           13         38D - MIR         1         0%           13         38D - MIR         1         0%           13         STUDIO -         5         1%           14         18D         15         4%           14         18D         1         0%           14         38D - MIR         1         0%           14         38D - MIR         1         0%           14         38D - MIR         1         0%           15         28D         14         4%		180	5	1%
2         28D         3         1%           12         28D - MIR         1         0%           12         38D - MIR         1         0%           12         38D - MIR         1         0%           12         37D00         10         3%           12         STUDIO -         3         1%           12         STUDIO -         3         1%           13         18D - MIR         8         2%           13         18D - MIR         3         1%           13         28D - MIR         1         0%           13         38D - MIR         1         0%           13         38D - MIR         1         0%           13         STUDIO -         5         1%           13         STUDIO -         5         1%           14         18D - MIR         1         0%           14         28D - MIR         1         0%           14         38D - 1         <			2	
12         280 - MR         1         9%           12         380 - MIR         1         0%           12         380 - MIR         1         0%           12         380 - MIR         1         0%           12         STUDIO         10         3%           142         STUDIO         10         3%           13         180 - MIR         10         3%           13         180 - MIR         6         2%           13         280 - MIR         3         1%           13         380 - MIR         1         0%           13         380 - MIR         1         0%           13         STUDIO         1         0%           13         STUDIO         1         0%           14         180 - MIR         1         0%           14         280 - MIR         1         0%           14         380 - MIR         1         0%           14         380 - MIR         1         0%           14         280 - MIR         1         0%           15         280 - MIR         1         0%           15         380 - MIR			+ +	
12         3BD         1         0%           12         3BD -MIR         1         0%           12         STUDIO         10         3%           12         STUDIO         3         1%           12         STUDIO         3         1%           12         STUDIO         3         1%           12         STUDIO         3         1%           13         18D         10         3%           13         28D         10         3%           13         38D         1         0%           14         18D         15         4%           14         18D         15         1%           14         28D         14         4%           14         38D         1         0%           14         38D         1         0%           15         38D         18         1%           15				
12         280 - MR         1         0%           L2         STUDIO         10         3%           L2         STUDIO         10         3%           L2         STUDIO         10         3%           L3         18D         10         3%           L3         18D         10         3%           L3         18D         10         3%           L3         280         10         3%           L3         280         10         3%           L3         280         10         3%           L3         280         10         9%           L3         380         1         9%           L3         STUDIO         5         1%           L4         180         15         4%           L4         280         12         4%           L4         280         12         4%           L4         280         16         9%           L4         280         16         9%           L4         280         16         9%           L5         380         14         4%           L5				
12         STUDIO         10         3%           12         STUDIO         3         1%           12         STUDIO         3         1%           12         STUDIO         3         1%           12         26         6%           13         18D         10         3%           13         18D         10         3%           13         28D         10         3%           13         28D         1         0%           13         38D         1         0%           13         STUDIO         1         0%           13         STUDIO         1         0%           14         18D         15         4%           14         18D         15         16%           14         18D         12         16%           14         38D         1         0%           14         38D         1         0%           15         28D         14         4%           15         28D         14         4%           15         38D         1         0%           15         28D				
L2         STUDIO - MIR         3         1%           L2         26         6%           L3         18D         10         3%           L3         18D         10         3%           L3         18D         10         3%           L3         18D         10         3%           L3         28D         10         3%           L3         38D         1         0%           L3         38D         1         0%           L3         38D         1         0%           L3         38D         1         0%           L3         STUDIO         1         0%           L4         18D         15         4%           L4         18D         13         3%           L4         28D         12         4%           L4         28D         1         0%           L4         38D         1         0%           L4         38D         1         0%           L5         18D         18         5%           L5         18D         18         5%           L5         38D				
MIR         10           22         26         5%           12         18D - MIR         10         3%           13         18D - MIR         6         2%           13         28D - MIR         3         19%           13         38D - MIR         1         0%           13         38D - MIR         1         0%           13         38D - MIR         1         0%           13         STUDIO         1         0%           13         STUDIO         1         0%           14         18D - MIR         1         0%           14         18D - MIR         1         0%           14         28D - MIR         1         0%           14         38D - MIR         1         0%           14         38D - MIR         1         0%           14         38D - MIR         1         0%           15         28D - MIR         1         0%           15         38D - MIR         1         0%           15         38D - MIR         1         0%           15         38D - MIR         1         0%           <	L2			3%
MIR         2           2         26         5%           13         18D         10         3%           13         18D         10         3%           13         18D         10         3%           13         280         10         3%           13         280         10         3%           13         280         10         3%           13         380         1         0%           13         380         1         0%           13         STUDIO         1         0%           13         STUDIO         5         1%           14         180         15         4%           14         180         12         4%           14         280         12         4%           14         280         17         6%           14         380         1         0%           15         380         1         0%           15         380         1         0%           15         380         1         0%           15         380         1         10%	L2		3	1%
L3         18D         10         3           L3         18D<-MIR		MIR		
L3         1BD - MIR         8         2%           L3         2B0         10         3%           L3         2B0 - MIR         3         1%           L3         3BD         1         9%           L3         3BD         1         9%           L3         3BD         1         9%           L3         3BD         1         9%           L3         STUDIO         1         0%           L3         STUDIO         5         1%           L4         1BD - MIR         3         1%           L4         1BD - MIR         3         1%           L4         3BD - MIR         1         0%           L5         3BD - MIR         1         0%           L6         3BD - 1         0% <t< td=""><td>L2</td><td></td><td></td><td></td></t<>	L2			
IBD - MR         8         22           IZ         28D         10         3%           IZ         28D         10         3%           IZ         28D         MR         3         15%           IZ         38D         1         0%           IZ         38D         1         0%           IZ         38D         1         0%           IZ         37000         1         0%           IZ         STUDIO         1         0%           IZ         18D         15         4%           IA         18D         15         4%           IA         18D         15         4%           IA         18D         MR         1         0%           IA         28D         MR         1         0%           IA         38D         1         0%         16         5%           IA         38D         1         0%         15         5%           IA         38D         1         0%         16         10         16           IA         38D         1         0%         15         17%         5%	L3	1BD	10	3%
13         28D         10         5%           L3         28D         HIR         3         19%           L3         3B0         1         0%           L3         3B0         1         0%           L3         3B0         1         0%           L3         3B0         1         0%           L3         STUDIO         1         0%           L3         STUDIO         5         1%           L4         18D         15         4%           L4         18D         15         4%           L4         28D         12         2%           L4         28D         12         5%           L4         28D         14         0%           L4         38D         1         0%           L4         38D         1         0%           L4         STUDIO         5         1%           L5         38D         14         4%           L5         38D         1         0%           L5         38D         1         1%           L6         38D         1         1%           L6 <td>L3</td> <td>18D - MIR</td> <td>8</td> <td>2%</td>	L3	18D - MIR	8	2%
3         280 - MR         3         1         9%           L3         380 - MIR         1         0%           L3         380 - MIR         1         0%           L3         STUDIO         1         0%           L3         STUDIO         1         0%           L3         STUDIO         1         0%           L3         STUDIO         5         1%           L4         180 - MIR         3         1%           L4         180 - MIR         1         0%           L4         280 - MIR         1         0%           L4         380 - MIR         1         0%           L4         380 - MIR         1         0%           L4         380 - MIR         1         0%           L5         280 - MIR         1         0%           L5         380 - MIR         1         0%           L6         280	L3	ZBD	10	3%
3         3BD         1         0%           13         3BD - MIR         1         0%           13         3BD - MIR         1         0%           13         STUDIO         1         0%           13         STUDIO         5         1%           13         STUDIO         5         1%           14         1BD         15         4%           14         1BD         15         4%           14         2BD         12         4%           14         2BD         12         4%           14         2BD         14         0%           14         2BD         14         0%           14         3BD         1         0%           14         3BD         1         0%           14         STUDIO         5         1%           15         3BD         180         10           15         3BD         180         15           15         3BD         14         4%           15         3BD         14         4%           16         3BD         1         10%           16				
L3         3BD - MIR         1         0%           L3         STUDIO         1         0%           L3         STUDIO - MIR         5         1%           L3         STUDIO - MIR         3         9%         129           L4         1BD - MIR         3         12         4%           L4         1BD - MIR         3         10%           L4         2BD - MIR         1         0%           L4         2BD - MIR         1         0%           L4         3BD - MIR         1         0%           L4         3BD - MIR         1         0%           L4         STUDIO - STUDIO         1         0%           L4         STUDIO - STUDIO         1         0%           L5         2BD         14         4%           L5         3BD - MIR         1         0%           L5         3BD - MIR         1         0%           L5         3BD - MIR         1         0%           L6         3BD - MIR         1         0%           L6         3BD - MIR         1         0%           L6         3BD - MIR         1         0% <td></td> <td></td> <td></td> <td></td>				
L3         STUDIO         1         0%           L3         STUDIO         1         0%           L3         STUDIO         5         1%           L4         18D         15         4%           L4         18D         15         4%           L4         18D         15         4%           L4         18D         15         4%           L4         28D         12         4%           L4         28D         12         4%           L4         38D         1         0%           L4         38D         1         0%           L4         38D         1         0%           L4         38D         1         0%           L4         38D         18         0%           L5         28D         14         4%           L5         38D         1         0%           L5         28D         14         4%           L6         28D         14         4%           L6         28D         14         4%           L6         38D         1         1%           L6         38D		000		
L3         STUDIO - MIR         5         I%           L3         39         129           L4         119D         15         4%           L4         119D         15         4%           L4         119D         15         4%           L4         119D         12         4%           L4         28D         12         4%           L4         28D         12         4%           L4         28D         11         6%           L4         38D         1         0%           L4         38D         1         0%           L4         38D         1         0%           L4         38D         1         0%           L5         18D         18         5%           L5         28D         14         4%           L5         38D         1         0%           L5         38D         1         0%           L5         38D         14         4%           L6         28D         14         4%           L6         38D         1         0%           L6         STUDIO				
MIR         IP           13         39         123           14         1BD         155         4%           14         1BD         15         4%           14         1BD         15         4%           14         1BD         15         4%           14         2BD         12         4%           14         2BD         12         4%           14         2BD         11         0%           14         3BD         1         0%           14         3BD         1         0%           14         STUDIO         1         0%           15         2BD         14         4%           15         3BD<-MR				0%
MIR         3         30         12           13         30         12         44           18D         15         4%           144         18D         15         4%           144         28D         12         4%           144         28D         12         4%           14         28D         10         0%           14         380         1         0%           14         380         1         0%           14         380         1         0%           14         STUDIO         1         0%           15         18D         18         5%           15         380         1         0%           15         380         1         0%           15         380         1         0%           16         280         14         4%           16         380         1         10%           16         280         14         4%           16         380         1         10%           16         380         1         10%           16         280         2 <td>L3</td> <td></td> <td>5</td> <td>1%</td>	L3		5	1%
L4         18D         15         4%           L4         18D -MIR         3         1%           L4         18D -MIR         3         1%           L4         28D -MIR         1         0%           L4         28D -MIR         1         0%           L4         38D -MIR         1         0%           L4         38D -MIR         1         0%           L4         STUDIO         1         0%           L4         STUDIO         1         0%           L5         18D         18         5%           L5         28D         14         4%           L5         38D -MIR         1         0%           L6         18D         18         5%           L6         38D         111         197           L6         38D         1         10%           L6         38D         1         10%           L1         TH-MIR         1         0% </td <td></td> <td>MIR</td> <td></td> <td></td>		MIR		
L4         18D - MIR         3         1%           L4         28D - MIR         12         4%           L4         28D - MIR         1         0%           L4         38D - MIR         1         0%           L5         18D         18         5%           L5         28D         1.4         4%           L5         38D - MIR         1         0%           L5         38D - MIR         1         0%           L5         38D - MIR         1         0%           L6         28D - MIR         1         0%           L6         38D - MIR         1         0%           L6         38D - MIR         1         0%           L6         38D - 2         1%         1%           L6         38D - 2         1%         1%           L6         38D - 2         1%         1%           L6         38D - 2	L3		39	12%
L4         18D - MIR         3         1%           L4         28D - MIR         12         4%           L4         28D - MIR         1         0%           L4         38D - MIR         1         0%           L5         18D         18         5%           L5         28D         1.4         4%           L5         38D - MIR         1         0%           L5         38D - MIR         1         0%           L5         38D - MIR         1         0%           L6         28D - MIR         1         0%           L6         38D - MIR         1         0%           L6         38D - MIR         1         0%           L6         38D - 2         1%         1%           L6         38D - 2         1%         1%           L6         38D - 2         1%         1%           L6         38D - 2	L4	1BD	15	4%
L4 28D 12 4% L4 28D -MIR 1 0% L4 38D -MIR 1 0% L4 38D -MIR 1 0% L4 38D -MIR 1 0% L4 5TUDIO 1 0% L4 5TUDIO 1 0% L4 5TUDIO 1 0% L5 38D 14 4% L5 38D 18D 18 5% L6 38D 18 19 L6 38D 18 19 L6 38D 18 19 L6 38D 18 19 L6 38D 18 5% L6 38D 18 19 L6 38D 19 L6 48 L1 17 11 19 L6 18D 19 L2 18D 19 L2 18D 19 L2 28D 2 19 L2 18D 19 L2 18D 19 L2 18D 4% L2 18D 4% L3 28D 4% L3 28D 4% L3 28D 4% L3 38D 2 19 L4 18D 8 22 L4 18D 8 20 L4 18D 8 21 L6 38D 2 19 L6 51000 7 28 L6 38D 2 19 L6 38D 2 19 10 10 38 10 10 10 10 10 10 10 10 10 10				
L4         28D - MIR         1         0%           L4         38D - MIR         1         0%           L4         38D - MIR         1         0%           L4         STUDIO         1         0%           L4         STUDIO         1         0%           L4         STUDIO         1         0%           L5         18D         18         5%           L5         28D         14         4%           L5         28D         14         4%           L5         38D - MIR         1         0%           L5         38D - MIR         1         0%           L5         38D - MIR         1         0%           L6         18D         18         5%           L6         28D         14         4%           L6         38D         2         1%           L2         18D         1         0%				
L4         38D         1         0%           L4         38D         1         0%           L4         38D         1         0%           L4         STUDIO         1         0%           L4         STUDIO         1         0%           L4         STUDIO         1         0%           L4         STUDIO         5         1%           L4         STUDIO         5         1%           L5         18D         18         5%           L5         38D         1         0%           L5         38D         1         0%           L5         STUDIO         4         1%           L5         STUDIO         4         1%           L6         28D         14         4%           L6         38D         2         1%           L6         38D         2         1%           L6         38D         2         1%           L6         38D         1         0%           L1         TH-MIR         1         0%           L2         18D         1         0%           L2         <				
L4         38D - MIR         1         0%           L4         STUDIO         1         0%           L4         STUDIO - MIR         5         1%           L4         STUDIO - STUDIO - STUDIO - L5         18         5%           L5         18D         18         5%           L5         38D         1         0%           L6         18D         18         5%           L6         28D         14         4%           L6         39D         2         1%           L6         39D         2         1%           L6         38D         1         10%           L6         STUDIO         4         19           L6         STUDIO         1         10%           L2         18D         1         0%           L2         28D         2         1%				
Li         STUDIO         1         0%           L4         STUDIO - MIR         5         1%           L4         STUDIO - MIR         5         1%           L4         STUDIO - MIR         5         1%           L5         18D         16         5%           L5         28D         14         6%           L5         28D         14         6%           L5         38D         1         0%           L5         38D         1         0%           L5         STUDIO         4         1%           L6         18D         18         5%           L6         28D         14         4%           L6         28D         14         4%           L6         28D         14         4%           L6         38D         11         10%           L6         STUDIO         4         1%           L6         STUDIO         3         11           L2         18D         1         0%           L2         18D         1         1%           L3         18D         17         2%	L4			
L4         STUDIO - MIR         S         I%           L4         39         122           L5         18D         18         5%           L5         28D         14         4%           L5         28D         14         4%           L5         38D - MIR         1         0%           L5         38D - MIR         1         0%           L5         38D - MIR         1         0%           L5         38D         14         4%           L6         28D         14         4%           L6         28D         14         4%           L6         28D         14         4%           L6         38D         2         1%           L6         38D         2         1%           L6         37DIO         4         1%           L6         37UOIO         3         19           L2         28D         2         1%           L2         28D         2         1%           L2         28D         3         19           L2         28D         3         19           L3         18D	L4	3BD - MIR	1	0%
MIR         IP           Lá         39         123           L5         18D         18         5%           L5         28D         14         4%           L5         38D         1         0%           L5         38D         1         0%           L5         38D         1         0%           L5         38D         11         0%           L5         STUDIO         4         1%           L6         18D         18         5%           L6         28D         14         4%           L6         38D         2         1%           L6         37DDIO         4         1%           L6         37DDIO         4         1%           L6         37DDIO         38         111           197         5%         38         111           SOUTH         2         10         0%           L2         18D         1         0%           L2         28D         2         1%           L2         28D         2         1%           L3         18D         7         2%	L4	STUDIO	1	0%
MIR         IP           Lá         39         123           L5         18D         18         5%           L5         28D         14         4%           L5         38D         1         0%           L5         38D         1         0%           L5         38D         1         0%           L5         38D         11         0%           L5         STUDIO         4         1%           L6         18D         18         5%           L6         28D         14         4%           L6         38D         2         1%           L6         37DDIO         4         1%           L6         37DDIO         4         1%           L6         37DDIO         38         111           197         5%         38         111           SOUTH         2         10         0%           L2         18D         1         0%           L2         28D         2         1%           L2         28D         2         1%           L3         18D         7         2%	L4	STUDIO -	5	
L4         39         125           LS         180         18         58           LS         280         14         4%           LS         380         1         0%           LS         STUDIO         4         1%           L6         280         14         6%           L6         380         2         1%           L6         380         1         0%           L1         TH-MIR         1         0%           L2         180         1         0%           L2         280         2         1%           L3         180         1         0%           L3         180         1				1%
LS         18D         18         5%           L5         28D         14         4%           L5         38D         1         0%           L5         38D         1         0%           L5         38D         1         0%           L5         38D         1         0%           L5         38D         18         0%           L5         38D         18         5%           L6         18D         18         5%           L6         39D         2         1%           L6         39D         2         1%           L6         STUDIO         4         1%           L6         STUDIO         4         1%           L6         STUDIO         4         1%           L6         STUDIO         3%         11           10         10%         1         0%           L1         TH-MIR         1         0%           L2         28D         2         1%           L2         STUDIO         3         1%           L2         28D         3         1%           L3 <td< td=""><td>1.4</td><td></td><td>10</td><td>12%</td></td<>	1.4		10	12%
LS         28D         14         4%           LS         38D         1         0%           LS         38D         1         0%           LS         38D         1         0%           LS         STUDIO         4         1%           LS         STUDIO         4         1%           LS         STUDIO         4         1%           L6         18D         18         5%           L6         28D         14         4%           L4         28D         1         1%           L4         57UDIO         4         1%           L4         STUDIO         4         1%           L4         STUDIO         4         1%           L6         STUDIO         4         1%           L1         TH-MIR         1         0%           L2         18D         1         0%           L2         28D         2         1%           L2         STUDIO -         3         1%           L3         18D         7         2%           L3         18D         1         0%           L3		100		
LS         38D         1         0%           LS         3BD - MIR         1         0%           LS         3BD         18         1%           LS         2BD         14         4%           L6         3BD         2         1%           L6         3BD         2         1%           L6         3BD         2         1%           L6         3FUDIO         4         1%           L6         STUDIO         4         1%           L1         TH - MIR         1         0%           L2         2BD         1         1%           L2         2BD         2         1%           L2         STUDIO -         3         1%           L3         18D         7         2%           L3         2BD - MIR         1         0%           L3         2BD - MIR         1         0%           L3         3BD - 1         1%           L4 </td <td></td> <td></td> <td></td> <td></td>				
L5         38D - MIR         1         0%           L5         STUDIO         4         1%           L5         STUDIO         4         1%           L5         SBD - MIR         1         0%           L5         STUDIO         4         1%           L6         18D         18         5%           L6         28D         14         4%           L6         370         2         1%           L6         STUDIO         4         1%           L6         STUDIO         4         1%           L6         STUDIO         4         1%           L6         STUDIO         4         1%           L6         STUDIO         1         0%           L1         TH-MIR         1         0%           L2         18D         1         0%           L2         STUDIO         3         1%           L2         STUDIO         3         1%           L3         28D         3         1%           L3         28D         3         1%           L3         28D         3         1%				
LS         STUDIO         4         19           L5         38         119         38         118           L6         28D         14         6%         14         6%           L6         28D         14         6%         15%         14         6%           L6         38D         2         1%         14         6%         180         18         197           L6         STUDIO         4         1%         14         6%         11         197         58           SOUTH         1         7         28         18         197         58         11         197         58           L1         TH-MIR         1         0%         11         20         6%         11         12         280         2         18         11         197         12         11         3%         11         19         12         12         180         1         19         12         19         12         19         13         19         13         13         10         14         13         14         10         14         13         10         14         13         10         14				
L5         38         111           L6         1BD         18         58           L6         28D         14         4%           L6         39D         2         1%           L6         37D010         4         1%           L6         TH         197         5%           SOUTH         -         20         6%           L1         TH-MIR         1         0%           L2         18D         1         0%           L2         280         2         1%           L2         280         2         1%           L3         18D         7         2%           L3         18D         7         2%           L3         18D         1         0%           L3         STUDIO -         12         4%           L4         18D         1         0%           L4         28D         1 <td>L5</td> <td></td> <td></td> <td>0%</td>	L5			0%
L6         18D         18         5%           L6         28D         1.4         4.8           L6         28D         1.4         4.8           L6         39D         2.1%         1.8           L6         STUDIO         4         1.9           L1         TH-MIR         1         0.0%           L1         TH-MIR         1         0.0%           L2         18D         1         0.9           L2         28D         2         1.9           L2         STUDIO -         3         1.9           L2         STUDIO -         3         1.9           L3         18D         7         2.9           L3         28D         3         1.9           L3         28D         3         1.9           L3         28D         3         1.9           L3         28D         1         0.9	L5	STUDIO		1%
L6         18D         18         5%           L6         28D         1.4         4.8           L6         28D         1.4         4.8           L6         39D         2.1%         1.8           L6         STUDIO         4         1.9           L1         TH-MIR         1         0.0%           L1         TH-MIR         1         0.0%           L2         18D         1         0.9           L2         28D         2         1.9           L2         STUDIO -         3         1.9           L2         STUDIO -         3         1.9           L3         18D         7         2.9           L3         28D         3         1.9           L3         28D         3         1.9           L3         28D         3         1.9           L3         28D         1         0.9	L5		38	119
L6         28D         14         4%           L6         38D         2         1%           L6         38D         2         1%           L6         STUDIO         4         1%           L6         STUDIO         4         1%           L6         STUDIO         4         1%           L6         STUDIO         1%         1%           L6         38         111         197         5%           SOUTH         1         0%         1         0%           L1         TH-MIR         1         0%         1         1           L2         28D         2         1%         1         1         0%           L2         28D         2         1%         1		180	18	5%
Lé         39D         2         1%           Lé         STUDIO         4         1%           Lé         STUDIO         4         1%           Lé         STUDIO         4         1%           SOUTH         197         5%           L'         TH-MIR         1         0%           L1         TH-MIR         1         0%           L2         18D         1         0%           L2         28D         2         1%           L2         28D         2         1%           L2         28D         2         1%           L3         TBD - MIR         2         1%           L3         28D - MIR         1         0%           L3         28D - MIR         1         0%           L3         37UDIO -         12         4%           L3         5TUDIO -         12         4%           L4         18D - MIR         1         0%           L4         18D - MIR         1         0%           L4         18D - MIR         1         0%           L4         38D         2         1%				
Lé         STUDIO         4         19           Lé         38         111           197         58'           SOUTH         19         6%           L'         TH         19         6%           L1         TH-MIR         1         0%           L2         18D         1         0%           L2         18D         1         0%           L2         280         2         1%           L2         STUDIO -         3         1%           L2         STUDIO -         3         1%           L2         STUDIO -         3         1%           L3         18D         7         2%           L3         18D         7         2%           L3         28D         3         1%           L3         28D         1         0%           L3         38D         1         0%           L3         STUDIO -         8         2%           L4         18D         1         0%           L4         18D         1         0%           L4         18D         1%         16				
L6         38         111           197         581           SOUTH         197         581           L1         TH         19         681           L1         TH-MIR         1         0%           L1         TH-MIR         1         0%           L1         TH-MIR         1         0%           L2         18D         1         0%           L2         280         2         1%           L2         280         2         1%           L2         STUDIO -         3         1%           L2         STUDIO -         3         1%           L3         18D - MIR         2         1%           L3         28D - MIR         1         0%           L3         STUDIO -         12         4%           L4         18D - MIR         1         0%           L4         28D - MIR         1         0%           L4         38D         2				
197         Set           SOUTH         1         9         64           L1         TH         19         64           L1         TH-MIR         1         09           L1         TH-MIR         1         09           L2         16D         1         07           L2         16D         1         07           L2         STUDIO         5         19           L2         STUDIO -         3         19           L2         STUDIO -         3         19           L3         18D         7         29           L3         28D         3         19           L3         28D - MIR         1         09           L3         STUDIO -         12         49           L3         STUDIO -         12         49           L3         18D - MIR         1         09           L4         18D - MIR         1         09           L4         28D - MIR         1         09           L4         28D - MIR         1         09           L4         28D - MIR         1         09           L4		1510010		
L'         TH         19         6%           L1         TH-MIR         1         0%           L1         TH-MIR         1         0%           L2         18D         1         0%           L2         18D         1         0%           L2         280         2         1%           L2         STUDIO         5         1%           L2         STUDIO         3         1%           L2         STUDIO         3         1%           L3         18D         7         2%           L3         28D         3         1%           L3         28D         3         1%           L3         28D         3         1%           L3         28D         1         0%           L3         35D         1         0%           L3         STUDIO -         12         6%           L4         18D         16         0%           L4         18D         1         0%           L4         28D         2         1%           L4         28D         1         1%           L4         2	L6			11% 58%
L'         TH         19         6%           L1         TH-MIR         1         0%           L1         TH-MIR         1         0%           L2         18D         1         0%           L2         18D         1         0%           L2         280         2         1%           L2         STUDIO         5         1%           L2         STUDIO         3         1%           L2         STUDIO         3         1%           L3         18D         7         2%           L3         28D         3         1%           L3         28D         3         1%           L3         28D         3         1%           L3         28D         1         0%           L3         35D         1         0%           L3         STUDIO -         12         6%           L4         18D         16         0%           L4         18D         1         0%           L4         28D         2         1%           L4         28D         1         1%           L4         2	SOUTH			
L1         TH-MIR         1         0%           L1         20         6%           L2         18D         1         0%           L2         280         2         1%           L2         280         2         1%           L2         280         2         1%           L2         57000         3         1%           L2         57000         3         1%           L2         57000         3         1%           L3         180         7         22           L3         180         3         1%           L3         280         3         1%           L3         280         3         1%           L3         280         1         0%           L3         570010         1         0%           L4         180         8         2           L4         180         8         2           L4         280         5         1%           L4         280         4         2           L4         180         9         2           L4         380         2		TH	19	6%
L1         20         6%           L2         1BD         1         0%           L2         280         2         1%           L2         280         2         1%           L2         STUDIO         5         1%           L2         STUDIO -         3         1%           L2         STUDIO -         3         1%           L3         18D         7         2%           L3         18D         7         2%           L3         18D         MIR         2         1%           L3         28D         3         1%         10%           L3         STUDIO -         1         0%         1           L3         STUDIO -         12         6%         1           L3         STUDIO -         12         6%         1           L4         18D         8         2%         14         14           L4         28D         5         19         1         4           L4         28D         19         1         19           L4         STUDIO -         8         22         15           L4				0%
L2         1BD         1         0%           L2         280         2         1%           L2         STUDIO         5         1%           L2         STUDIO         3         1%           L2         STUDIO         3         1%           L2         STUDIO         3         1%           L2         STUDIO         3         1%           L2         118D         7         2%           L3         18D         7         2%           L3         28D         3         1%           L3         28D         3         1%           L3         28D         3         1%           L3         28D         MIR         1           L3         STUDIO         1         0%           L3         STUDIO         12         4%           L4         18D         MR         1         0%           L4         18D         1         1%         1%           L4         28D         1         1%         1%           L4         38D         2         1%         1%           L4         38D         <	-	T.t. Mark		
L2         280         2         1%           L2         STUDIO         5         1%           L2         STUDIO - MIR         3         19           L2         STUDIO - MIR         3         19           L3         18D         7         2%           L3         18D         7         2%           L3         28D         3         1%           L3         28D         3         1%           L3         28D         4M         1         0%           L3         STUDIO - MIR         1         0%         1           L3         STUDIO - MIR         1         0%         4           L3         STUDIO - MIR         1         0%         4           L4         18D - MIR         1         0%         1           L4         28D         S         1         10           L4         28D         S         1         10           L4         3BD         2         1         1           L4         STUDIO - MIR         2         2         1           L5         18D         7         3         1		100	1	
L2         STUDIO         5         19           L2         STUDIO -         3         19           L2         STUDIO -         3         19           L2         TI1         53         19           L3         18D         7         28           L3         18D         7         28           L3         18D         3         19           L3         28D         3         19           L3         28D         3         19           L3         28D         1         09           L3         STUDIO         1         09           L3         STUDIO         12         49           L3         STUDIO         12         49           L4         18D         8         29           L4         18D         9         3         19           L4         28D         2         19         14           STUDIO         8         29         14           L4         28D         3         19           L4         STUDIO -         8         29           L4         SED         18D         9		- COMPANY		
L2 STUDIO - 3   19 MIR 11 39 L3 18D - MIR 2 19 L3 18D - MIR 2 19 L3 28D - MIR 1 09 L3 28D - MIR 1 09 L3 5TUDIO - 12 60 MIR 200 5 19 L4 18D - MIR 1 09 L4 18D - MIR 1 09 L4 28D 5 19 L4 28D 5 19 L4 28D 5 19 L4 28D - MIR 1 09 L4 28D - MIR 2 19 L4 28D - MIR 1 09 L4 28D - MIR 1 09 L4 28D - MIR 2 19 L4 28D - MIR 1 09 L4 28D - MIR 1 09 L4 28D - MIR 2 19 L4 28D - MIR 1 09 L4 38D 2 19 L5 18D 9 3 L5 28D 6 22 19 L5 38D 2 19 L5 38D 38 L5				
MIR         11           13         18D         7         2%           1.3         18D         7         2%           1.3         18D         7         2%           1.3         18D         7         2%           1.3         28D         3         19           1.3         28D         3         19           1.3         28D         1         0%           1.3         38D         1         0%           1.3         38D         1         0%           1.3         STUDIO         1         0%           1.3         STUDIO         12         4%           1.4         18D         6         22           1.4         18D         6         22           1.4         28D         2         19           1.4         28D         2         19           1.4         28D         2         19           1.4         28D         11         39           1.4         28D         2         19           1.4         STUDIO         8         22           1.5         18D         9				1%
IMR         I           12         11         3%           L3         18D         7         2%           L3         18D         7         2%           L3         18D         4%         1%           L3         28D         3         1%           L3         28D         4%         1         0%           L3         38D         1         0%         1         0%           L3         38D         1         0%         1         0%           L3         STUDIO         1         0%         1         0%           L4         18D         MR         1         0%         1         1         0%           L4         18D         5         1%         1         1%         1         1%         1         1%         1         1%         1         1%         1         1%         1	L2		3	19/
L3         18D         7         2           L3         18D - MIR         2         19           L3         28D - MIR         2         19           L3         28D - MIR         1         0%           L3         28D - MIR         1         0%           L3         STUDIO         1         0%           L3         STUDIO         1         0%           L3         STUDIO         1         0%           L3         STUDIO         1         0%           L4         18D - MIR         1         0%           L4         18D - MIR         1         0%           L4         28D - MIR         1         0%           L4         28D - MIR         1         0%           L4         28D - MIR         1         0%           L4         5TUDIO - 3         19         11           L4         STUDIO - 8         22         1%           L4         7200 - 8         22         1%           L4         38D         2         1%           L5         18D         9         37           L5         38D         2		MIR		
L3         18D         7         2           L3         18D - MIR         2         19           L3         28D - MIR         2         19           L3         28D - MIR         1         0%           L3         28D - MIR         1         0%           L3         STUDIO         1         0%           L3         STUDIO         1         0%           L3         STUDIO         1         0%           L3         STUDIO         1         0%           L4         18D - MIR         1         0%           L4         18D - MIR         1         0%           L4         28D - MIR         1         0%           L4         28D - MIR         1         0%           L4         28D - MIR         1         0%           L4         5TUDIO - 3         19         11           L4         STUDIO - 8         22         1%           L4         7200 - 8         22         1%           L4         38D         2         1%           L5         18D         9         37           L5         38D         2	L2		11	3%
L3         18D - MIR         2         19           28D         3         11         00           13         28D - MIR         1         09           L3         38D         1         00           L3         STUDIO - MIR         12         49           L3         STUDIO - MIR         12         49           L4         18D - MIR         1         09           L4         28D - S         19         14         28D           L4         28D - MIR         1         09         14           28D - MIR         1         09         14         36D         2           L4         28D - MIR         1         09         3         19           L4         STUDIO - MIR         8         22         22           L4         STUDIO - MIR         9         3         19           L5         28D         6         22         19           L5         28D         2         19 </td <td></td> <td>18D</td> <td>7</td> <td>2%</td>		18D	7	2%
L3         28D         3         11           28D - MIR         1         09           L3         28D - MIR         1         09           L3         STUDIO         1         09           L3         STUDIO - MIR         12         4           L3         STUDIO - MIR         12         4           L4         18D         8         23           L4         18D         MIR         1         09           L4         28D         5         19           L4         28D         2         19           L4         38D         2         19           L4         STUDIO - MIR         8         22           L4         38D         2         19           L4         STUDIO - MIR         8         23           L4         STUDIO - MIR         8         23           L5         18D         9         35				1%
L3         28D - MIR         1         0%           L3         38D         1         0%           L3         STUDIO         1         0%           L3         STUDIO         12         4%           L3         STUDIO         12         4%           L3         STUDIO         12         4%           L4         18D         8         27           L4         18D - MIR         1         0%           L4         28D         MR         1           L4         28D         2         19           L4         38D         2         19           L4         STUDIO         3         19           L4         STUDIO         3         19           L4         STUDIO         3         19           L4         STUDIO         8         23           L4         STUDIO         2         19           L5         38D         2         19           L5         38D         2         11           L5         STUDIO         11         13			-	
L3         38D         1         00           L3         STUDIO         1         0%           L3         STUDIO - MIR         12         4%           L3         TBD - MIR         1         0%           L4         18D - MIR         1         0%           L4         18D - MIR         1         0%           L4         28D - S         1%         1%           L4         28D - MIR         1         0%           L4         28D - MIR         3         1%           L4         STUDIO - MIR         8         22%           L4         STUDIO - MIR         8         22%           L5         18D - STUDIO - STUDIO         11         3%           L5         28         6%				
L3         STUDIO         1         0%           L3         STUDIO - MIR         12         49           L3         EVIDIO - MIR         12         49           L4         18D         8         27           L4         18D         8         29           L4         18D         9         1         09           L4         28D         5         19         1           L4         28D         2         19         1           L4         28D         2         19         2           L4         STUDIO - MIR         8         22         19           L4         STUDIO - MIR         9         5         28           L5         18D         9         5         25           L5         38D         2         19         11         35           L5         7200         11         38         38         36         36				_
L3         STUDIO         1         0%           L3         STUDIO - MIR         12         49           L3         EVIDIO - MIR         12         49           L4         18D         8         27           L4         18D         8         29           L4         18D         9         1         09           L4         28D         5         19         1           L4         28D         2         19         1           L4         28D         2         19         2           L4         STUDIO - MIR         8         22         19           L4         STUDIO - MIR         9         5         28           L5         18D         9         5         25           L5         38D         2         19         11         35           L5         7200         11         38         38         36         36	L3			0%
L3 STUDIO - 12 49 MIR 2 99 L4 18D 8 27 L4 18D MIR 1 09 L4 28D MIR 1 09 L4 28D MIR 1 09 L4 28D MIR 1 09 L4 5TUDIO 3 19 L4 STUDIO - 8 29 L4 STUDIO - 8 29 L4 5TUDIO - 8 29 L5 18D 9 39 L5 28D 6 24 L5 38D 2 19 L5 28 5TUDIO 11		STUDIO		0%
MIR         47           L3         27         69           L4         18D         8         29           L4         18D         8         29           L4         18D         98         29           L4         28D         5         19           L4         28D         2         19           L4         28D         2         19           L4         STUDIO         8         22           L4         STUDIO         8         23           L5         18D         9         5           L5         38D         2         19           L5         38D         2         19           L5         5TUDIO         11         35		STUDIO -	12	
L1         27         69           L4         1BD         8         29           L4         1BD - MIR         1         09           L4         2BD - MIR         1         09           L4         STUDIO -         8         29           L5         3BD         9         39           L5         STUDIO         11         39				
L4         1BD         8         29           L4         1BD - MIR         1         00           L4         2BD         5         19           L4         2BD - MIR         1         00           L4         STUDIO         3         19           L4         STUDIO -         8         22           L4         STUDIO -         8         23           L5         1BD         9         37           L5         2BD         2         19           L5         3BD         2         11           L5         2BD         2         19           L5         28         89         25	L3		27	8%
L4         18D - MIR         1         0°           L4         28D         5         19           L4         28D - MIR         1         0°           L4         38D         2         19           L4         38D         2         19           L4         STUDIO - MIR         8         2           L4         STUDIO - MIR         8         2           L5         18D         9         37           L5         18D         9         23           L5         38D         2         19           L5         3FUDIO         11         33           L5         STUDIO         11         33		1BD		
L4         28D         5         19           L4         28D - MIR         1         00           L4         28D - 2         19           L4         STUDIO - 3         19           L4         STUDIO - 8         29           L4         STUDIO - 8         29           L4         STUDIO - 18         29           L5         18D         9         39           L5         38D         2         19           L5         7000         11         39				
L4         28D - MR         1         00           L4         38D         2         19           L4         STUDIO -         3         19           L4         STUDIO -         8         25           L4         STUDIO -         8         25           L4         STUDIO -         8         25           L5         18D         9         37           L5         28D         6         22           L5         38D         2         19           L5         STUDIO 111         33         12           L5         Z8D         6         26				
L4         38D         2         19           L4         STUDIO         3         19           L4         STUDIO-         8         29           L4         STUDIO-         8         29           L4         STUDIO-         8         29           L5         18D         9         69           L5         280         6         26           L5         3BD         2         10           L5         3BD         2         11           L5         STUDIO         11         39           L5         28         80         2				
L4         STUDIO         3         19           L4         STUDIO -         8         29           L4         STUDIO -         8         29           L4         28         89         29           L5         18D         9         39           L5         38D         2         11           L5         38D         2         11           L5         STUDIO         11         39           L5         Z8         89         2		28D - MIR		
L4         STUDIO         3         19           L4         STUDIO -         8         29           L4         STUDIO -         8         29           L4         28         89         29           L5         18D         9         39           L5         38D         2         11           L5         38D         2         11           L5         STUDIO         11         39           L5         Z8         89         2	L4		1 0	1%
L4 STUDIO- 8 22 L4 28 99 L5 1BD 7 37 L5 28D 6 22 L5 38D 2 19 L5 5TUDIO 11 33 L5 28 68	L4		2	
MIR         28         69           L4         28         60         33           L5         18D         9         33           L5         28D         6         24           L5         3BD         2         19           L5         STUDIO         11         33           L5         28         89	L4 L4	3BD		
L4         28         89           L5         18D         9         39           L5         28D         6         29           L5         38D         2         19           L5         STUDIO         11         59           L5         28         89	L4 L4 L4	3BD STUDIO	3	1%
L5 1BD 9 39 L5 2BD 6 29 L5 3BD 2 19 L5 STUDIO 11 39 L5 28 89	L4 L4 L4	3BD STUDIO STUDIO -	3	1%
LS 280 6 29 LS 380 2 19 LS STUDIO 11 39 LS 28 89	L4 L4 L4 L4	3BD STUDIO STUDIO -	3	1%
L5 3BD 2 19 L5 STUDIO 11 39 L5 28 89	L4 L4 L4 L4 L4	3BD STUDIO STUDIO - MIR	3 8 28	1% 2% 8%
L5 38D 2 19 L5 STUDIO 11 39 L5 28 89	L4 L4 L4 L4 L4 L5	3BD STUDIO STUDIO - MIR 1BD	3 8 28 9	1% 2% 8% 3%
L5 STUDIO 11 39 L5 28 89	L4 L4 L4 L4 L4 L5	3BD STUDIO STUDIO - MIR 1BD	3 8 28 9	1% 2% 8%
L5 28 89	L4 L4 L4 L4 L4 L5 L5	3BD STUDIO STUDIO - MIR 1BD 2BD	3 8 28 9 6	1% 2% 8% 3%
	L4 L4 L4 L4 L5 L5 L5	3BD STUDIO STUDIO - MIR 1BD 2BD 3BD	3 8 28 9 6 2	1% 2% 8% 3% 2% 1%
L0 100 7 37	L4 L4 L4 L4 L5 L5 L5 L5 L5 L5	3BD STUDIO STUDIO - MIR 1BD 2BD 3BD	3 8 28 9 6 2 11	1% 2% 8% 3% 2% 1% 3%
	L4 L4 L4 L4 L5 L5 L5 L5 L5 L5	38D STUDIO STUDIO - MIR 18D 28D 38D STUDIO	3 8 9 6 2 11 28	1% 2% 8% 3% 2% 1% 3% 8%

MA	RKE	RENTA	LI
	NAN	E	CO
1BD			
2BD			
38D		_	
STUD	10		
TH			
TOTA			_
Tom	-		
TOTA			
		AGE UN	IT :
	AVER		11 :
NA		AREA	
NA 18D	AVER	AREA 54726 S	SF.
NA 18D	AVER	AREA	SF.
NA	AVER	AREA 54726 S	SF SF
NA 18D 28D	ME	AREA 54726 S 60483 S	SF SF SF
NA 180 280 380	ME	AREA 54726 S 60483 S 14654 S	SF SF SF

	NAME	COUNT	%	
NORTH				
L1	TH	13	4%	
L1	TH-MIR	6	1%	
L1		17	5%	
L2	1BD	5	1%	
L2	1BD - MIR	2	1%	
LZ		3	1%	
L2	28D			
L2	2BD - MIR	1	0%	
LZ	3BD	3	0%	
12	3BD - MIR	1	0%	
L2	STUDIO	10	3%	
L2	STUDIO -	3		
-	MIR		1%	
L2		26	8%	
	180	10	3%	
L3		8	2%	
L3	1BD - MIR			
L3	ZBD	10	3%	
L3	280 - MIR	3	1%	
L3	3BD	1	0%	
L3	3BD - MIR	1	0%	
L3	STUDIO	1	0%	
L3	STUDIO -	5		
	MIR		1%	
L3	in the second se	39	12%	
	100	15		
L4	1BD		4%	
L4	1BD - MIR	3	1%	
L4	2BD	12	4%	
L4	2BD - MIR	1	0%	
L4	3BD	1	0%	
L4	3BD - MIR	1	0%	
		1		
L4	STUDIO		0%	
L4	STUDIO -	5	1%	
	MIR			
L4		39	12%	
LS	1BD	18	5%	
1.5	2BD	14	4%	
L5	380	1	0%	
L5	3BD - MIR	1 1	0%	
			1%	
L5	STUDIO	4		
L5		38	11%	
L6	180	18	5%	
L6	280	14	4%	
L6	3BD	2	1%	
L6	STUDIO	4	1%	
Ló		38	11%	ĺ
		197	58%	
		177	30 70	
SOUTH	1			
L*	TH		-	
		19	6%	
L1	TH-MIR	19	0%	
L1				
L1	TH-MIR	1 20	0% 6%	
L1	TH-MIR 18D	1 20 1	0% 6% 0%	
L1 L2 L2	TH-MIR 1BD 2BD	1 20 1 2	0% 6% 0% 1%	
L1 L2 L2 L2	TH-MIR 1BD 280 STUDIO	1 20 1 2 5	0% 6% 0% 1%	
L1 L2 L2	TH-MIR 1BD 280 STUDIO STUDIO -	1 20 1 2	0% 6% 0% 1%	
L1 L2 L2 L2 L2 L2	TH-MIR 1BD 280 STUDIO	1 20 1 2 5 3	0% 6% 0% 1% 1%	
L1 L2 L2 L2 L2 L2	TH-MIR 1BD 280 STUDIO STUDIO - MIR	1 20 1 2 5 3 11	0% 6% 0% 1% 1% 1% 3%	
L1 L2 L2 L2 L2 L2 L2 L2 L2 L2 L2	TH-MIR 1BD 280 STUDIO STUDIO - MIR 1BD	1 20 1 2 5 3	0% 6% 0% 1% 1% 1% 3% 2%	
L1 L2 L2 L2 L2 L2 L2	TH-MIR 1BD 280 STUDIO STUDIO - MIR 1BD	1 20 1 2 5 3 11	0% 6% 0% 1% 1% 1% 3%	
L1 L2 L2 L2 L2 L2 L2 L2 L2 L2 L3 L3	TH-MIR 18D 280 STUDIO STUDIO - MIR 18D 18D - MIR	1 20 1 2 5 3 11 7 2	0% 6% 0% 1% 1% 1% 3% 2% 1%	
L1 L2 L2 L2 L2 L2 L2 L2 L3 L3 L3	TH-MIR 18D 28D STUDIO STUDIO - MIR 18D 18D - MIR 28D	1 20 1 2 5 3 11 7 2 3	0% 6% 0% 1% 1% 1% 3% 2% 1%	
L1 L2 L2 L2 L2 L3 L3 L3 L3	TH-MIR 18D 280 STUDIO - MIR 18D 18D - MIR 28D 28D - MIR	1 20 1 2 5 3 11 7 2 3 1	0% 6% 0% 1% 1% 1% 2% 1% 1% 1%	
L1 L2 L2 L2 L2 L2 L2 L3 L3 L3 L3 L3 L3	TH-MIR 18D 280 STUDIO - MIR 18D 18D - MIR 28D 28D - MIR 38D	1 20 1 2 5 3 3 11 7 2 3 1 1 1	0% 6% 0% 1% 1% 3% 2% 1% 1% 0% 0%	
L1 L2 L2 L2 L2 L3 L3 L3 L3 L3 L3 L3 L3 L3	TH-MIR           1BD           280           STUDIO           STUDIO -           MIR           18D           18D - MIR           28D - MIR           28D - MIR           38D - MIR           38D - STUDIO	1 20 1 2 5 3 11 7 2 3 1 1 1 1 1	0% 6% 0% 1% 1% 1% 2% 1% 1% 1%	
L1 L2 L2 L2 L2 L2 L2 L3 L3 L3 L3 L3 L3	TH-MIR           18D           280           STUDIO -           MIR           18D           18D           18D           18D           280           STUDIO -           MIR           38D           STUDIO -           STUDIO -           STUDIO -	1 20 1 2 5 3 3 11 7 2 3 1 1 1	0% 6% 0% 1% 1% 3% 2% 1% 1% 0% 0% 0%	
L1 L2 L2 L2 L2 L3 L3 L3 L3 L3 L3 L3 L3 L3	TH-MIR           1BD           280           STUDIO           STUDIO -           MIR           18D           18D - MIR           28D - MIR           28D - MIR           38D - MIR           38D - STUDIO	1 20 1 2 5 3 11 7 2 3 1 1 1 1 12	0% 6% 0% 1% 1% 1% 2% 2% 1% 1% 0% 0% 0% 0% 0%	
L1 L2 L2 L2 L2 L3 L3 L3 L3 L3 L3 L3 L3 L3 L3	TH-MIR           18D           280           STUDIO -           MIR           18D           18D           18D           18D           280           STUDIO -           MIR           38D           STUDIO -           STUDIO -           STUDIO -	1 20 1 2 5 3 11 7 2 3 1 1 1 1 1	0% 6% 0% 1% 1% 3% 2% 1% 1% 0% 0% 0%	
L1 L2 L2 L2 L3 L3 L3 L3 L3 L3 L3 L3 L3 L3	TH-MIR           18D           280           STUDIO -           MIR           18D           18D - MIR           28D - MIR           38D           STUDIO -           MIR	1 20 1 2 5 3 11 7 2 3 1 1 1 1 1 1 2 2 7	0% 6% 0% 1% 1% 1% 2% 	
L1 L2 L2 L2 L3 L3 L3 L3 L3 L3 L3 L3 L3 L3	TH-MIR           18D           280           STUDIO -           MIR           18D           18D           18D           18D           28D           28D           28D           28D           STUDIO           MIR           38D           STUDIO           MIR           18D	1 20 1 2 5 3 11 7 2 3 1 1 1 1 1 1 2 27 8	0% 6% 0% 1% 1% 1% 2% 2% 1% 0% 0% 0% 0% 0% 8% 2%	
L1 L2 L2 L2 L2 L3 L3 L3 L3 L3 L3 L3 L4 L4	TH-MIR           18D           280           STUDIO           STUDIO           MIR           18D           18D           280           280           38D           STUDIO           STUDIO           MIR           18D - MIR           38D           STUDIO           MIR           18D           18D           18D           18D           18D           18D           18D	1 20 1 2 5 3 1 1 7 2 3 1 1 1 1 1 1 2 7 8 8	0% 6% 0% 1% 1% 3% 2% 1% 1% 0% 0% 0% 8% 2% 0%	
L1 L2 L2 L2 L2 L3 L3 L3 L3 L3 L3 L4 L4 L4	TH-MIR           1BD           280           STUDIO           STUDIO           MIR           1BD           280           280           STUDIO           MIR           280           280           280           280           380           STUDIO           STUDIO           MIR           180           STUDIO           180           STUDIO           180           280           180           180           180	1 20 1 2 5 3 3 11 7 2 2 3 1 1 1 1 1 2 7 8 8 1 5 5	0% 6% 0% 1% 1% 1% 2% 1% 1% 1% 0% 0% 0% 0% 4% 8% 8% 2% 0% 1%	
L1 L2 L2 L2 L2 L3 L3 L3 L3 L3 L3 L3 L3 L3 L4 L4 L4 L4	TH-MIR           1BD           280           STUDIO           STUDIO           MIR           1BD - MIR           280           280           STUDIO           MIR           1BD - MIR           380           STUDIO           MIR           1BD - MIR           1BD - MIR           1BD - MIR           2BD - MIR	1 20 1 2 5 3 3 11 7 2 3 3 11 7 2 3 3 1 1 1 1 1 1 27 8 8 1 5 5 1	0% 6% 0% 1% 1% 1% 2% 2% 1% 1% 0% 0% 0% 8% 2% 0% 8% 2% 0%	
L1 L2 L2 L2 L2 L3 L3 L3 L3 L3 L3 L3 L3 L3 L4 L4 L4 L4	TH-MIR           1BD           280           STUDIO           STUDIO           MIR           1BD           280           280           STUDIO           MIR           280           280           280           280           380           STUDIO           STUDIO           MIR           180           STUDIO           180           STUDIO           180           280           180           180           180	1 20 1 2 5 3 3 11 7 2 2 3 1 1 1 1 1 2 7 8 8 1 5 5	0% 6% 0% 1% 1% 1% 2% 1% 1% 1% 0% 0% 0% 0% 4% 8% 8% 2% 0% 1%	
L1 L2 L2 L2 L2 L3 L3 L3 L3 L3 L3 L4 L4 L4	TH-MIR           1BD           280           STUDIO           STUDIO           MIR           1BD - MIR           280           280           STUDIO           MIR           1BD - MIR           380           STUDIO           MIR           1BD - MIR           1BD - MIR           1BD - MIR           2BD - MIR	1 20 1 2 5 3 3 11 7 2 3 3 11 7 2 3 3 1 1 1 1 1 1 27 8 8 1 5 5 1	0% 6% 0% 1% 1% 1% 2% 2% 1% 1% 0% 0% 0% 8% 2% 0% 8% 2% 0%	
L1 L2 L2 L2 L3 L3 L3 L3 L3 L3 L4 L4 L4 L4	TH-MIR           1BD           280           STUDIO           MR           1BD           280           280           280           280           280           280           280           380           STUDIO           MIR           1B0           1B0           1B0           1B0           1B0           1B0           280           280           STUDIO      MIR	1 20 1 2 5 3 11 7 2 3 1 1 1 1 2 27 8 1 5 1 2 27 8 1 2	0% 6% 0% 1% 1% 1% 2% 2% 2% 0% 0% 0% 0% 0% 0% 0% 0% 0% 1% 1%	
L1 L2 L2 L2 L2 L3 L3 L3 L3 L3 L3 L3 L3 L4 L4 L4 L4	TH-MIR           1BD           280           STUDIO           STUDIO           MR           1BD           280           280           280           380           STUDIO           MR           1BD - MIR           1BD - MIR           1BD - MIR           28D           STUDIO           MIR           28D           28D - MIR           28D           28D - MIR           38D           STUDIO	1 20 1 2 5 3 1 1 7 2 3 1 1 1 2 7 8 1 1 2 27 8 1 1 2 2 3 3	0% 6% 0% 1% 1% 1% 2% 2% 0% 0% 0% 0% 6% 0% 8% 2% 0% 1%	
L1 L2 L2 L2 L2 L3 L3 L3 L3 L3 L3 L3 L4 L4 L4 L4 L4 L4	TH-MIR           18D           280           STUDIO -           MR           18D           18D           28D           28D - MIR           28D           28D - MIR           28D           28D - MIR           28D           28D - MIR           28D           38D           STUDIO	1 20 1 2 5 3 3 11 7 2 3 3 1 1 1 1 1 1 1 2 7 8 1 1 1 1 2 27 8 1 1 2 2 3 8	0% 6% 0% 1% 1% 1% 2% 1% 1% 0% 0% 0% 0% 0% 0% 0% 0% 0% 1% 1% 1% 2%	
L1 L2 L2 L2 L3 L3 L3 L3 L3 L3 L4 L4 L4 L4	TH-MIR           18D           280           STUDIO -           MR           18D           18D           28D           28D - MIR           28D           28D - MIR           28D           28D - MIR           28D           28D - MIR           28D           38D           STUDIO	1 20 1 2 5 3 1 1 7 2 3 1 1 1 2 7 8 1 1 2 27 8 1 1 2 2 3 3	0% 6% 0% 1% 1% 1% 2% 2% 2% 0% 0% 0% 0% 0% 0% 0% 0% 0% 1% 1%	

# DP 23-014121 PLAN #4

# 

# L UNIT TOTAL COUNT % 100 37% 75 28% 13 5% 51 19% 12 12% 71 100%

	_		
SIZE - MR			
%	AV. UNIT SIZE (SF)		
37%	563.98		
28%	810.88		
5%	1056.47		
19%	436.82		
12%	1069.93		
100%			

MODERATE I	NCOME REP	NTAL
NAME	COUNT	%
1BD - MIR	16	24%
2BD - MIR	7	10%
3BD - MIR	4	6%
STUDIO - MIR	36	53%
TH-MIR	5	7%
TOTAL	68	100%

AVER	GE UNIT	SIZE -	MIR
NAME	AREA	%	AV. UNIT SIZE (SF)
1BD - MIR	9457 SF	24%	593.88
2BD - MIR	5759 SF	10%	816.84
3BD - MIR	4201 SF	6%	1017.00
STUDIO - MIR	16C61 SF	53%	438.90
TH-MIR	4949 SF	7%	925.00
TOTAL	40427 SF	100%	



BEL ARCHITECTS INC.

300-224 WEST 9TH AVENUE VANCOUVER, BC CANADA VSY INS TEL e04 73+ 1156 FAX a04 731 5279 IT RESERVED: THIS PLAN AND DE COPYRIGHT RESE REMAIN THE EXCL NOT BE USED DR NOTES

#### ABBREVIATIONS

MR- MARKET RENTAL MIR - MODERATE INCOME RENTAL FAR - FLOOR AREA RATIO

REVISIONS				
NO.	DATE	DESCRIPTION		
6	JAN 19 2024	RE-ISSUED FOR DP		
7	FEB 15 2024	RE- ISSUED FOR DP		

# 8880 COOK RD. & 8751 CITATION DRIVE

RICHMOND, BC

### STATS II

DATE DRAWN BY CHECKED BY SCALE

2/14/2024 4:08:14 PM Author Checker 1/2" = 1'-0" 20039

JOB NUMBER





SOUTH WEST VIEW





300-224 WEST 8TH AVENUE	TE_ #04 73# 1156
VANCOUVER, BC CANADA V5Y 1N5	FAX 684 731 5271
FORVERSUT RECEIPTED. THIS DI AN AND DES	CION ARE AND AT ALL TIMES
COPYRIGHT RESERVED. THIS PLAN AND DE REMAIN THE EXCLUSIVE PROPERTY OF GRU	

REVISIONS				
NO.	DATE	DESCRIPTION		
4	MAR 10 2023	ISSUED FOR DP		
5	OCT 06 2023	RE-ISSED FOR DP		
6	JAN 19 2024	RE-ISSUED FOR DP		
7	FEB 15 2024	RE- ISSUED FOR DP		

# 8880 COOK RD. & 8751 CITATION DRIVE

RICHMOND, BC

# MATERIALS I

DATE DRAWN BY CHECKED BY SCALE

2/14/2024 4:13:19 PM AM & GT GBL

JOB NUMBER 20039



MICROPERFORATED PANEL, PAINTED

A-0.12



NORTH WEST VIEW





BBL ARCHITECTS INC. 308-224 WEST 8TH AVENUE VANCOUVER, BC CANADA VSY IN TEL x84 73# 1156 FAX x84 731 5279 NOTES

REVISIONS				
NO.	DATE	DESCRIPTION		
5	OCT 06 2023	RE-ISSED FOR DP		
4	IAN 10 2024	PE-ICCIIED END D		

•	001 00 0000	112 120201 01101
6	JAN 19 2024	RE-ISSUED FOR DP
7	FEB 15 2024	RE- ISSUED FOR DP

# 8880 COOK RD. & 8751 CITATION DRIVE

RICHMOND, BC

### MATERIALS II

DATE DRAWN BY CHECKED BY SCALE


2/14/2024 4:13:22 PM Author

JOB NUMBER 20039

A-0.13



MICROPERFORATED PANEL, PAINTED

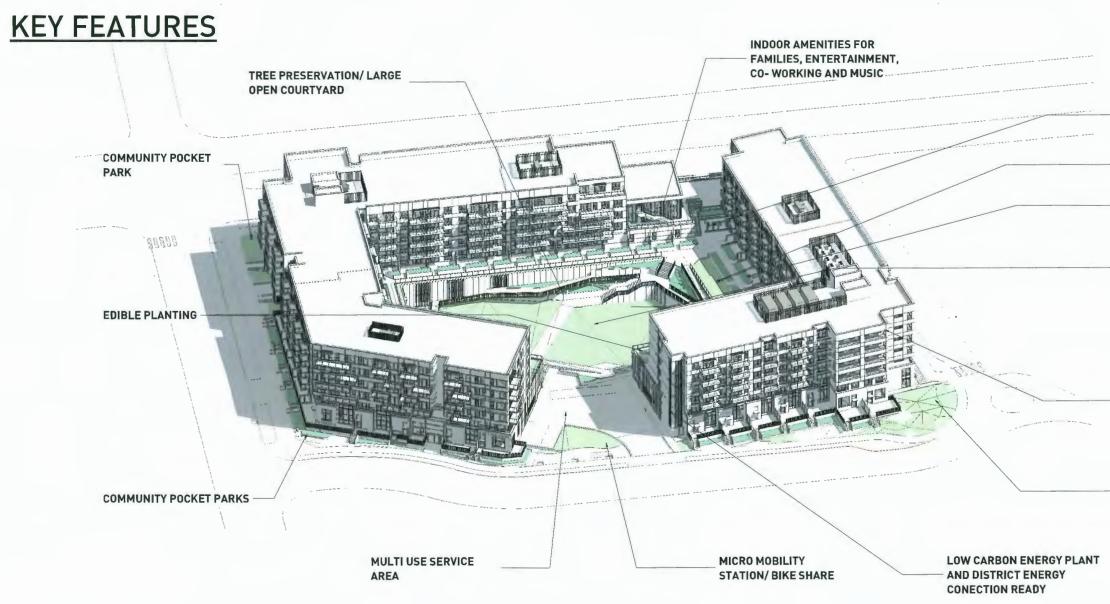

#### HIGH-PERFORMANCE BUILDING DESIGN

Using a measured approach of building envelope, mechanical and electrical efficiency to deliver a low energy consuming and GHG emitting building

#### EMISSIONS CONSCIOUS DESIGN

• Using modeling to establish the amount of embodied carbon and energy associated with its construction and identifying ways to reduce the building's impact through construction

#### **RESILIENT CONSTRUCTION**

- Considering extreme heat events, power outages, extreme precipitation and resulting local flooding events, poor air quality, as well as earthquakes In-suite four-pipe fancoil offering both heating and cooling to maintain comfortable indoor conditions and address the issues of higher future average temperatures, higher extreme temperatures and longer and more frequent heatwaves and droughts
- Description: Building heating and cooling will be provided by hot and chilled water from a central plant utilizing air source heat pumps (ASHPs). Suites, amenities rooms and management office will have four-pipe fan coil units and heat recovery ventilators (HRVs). Domestic hot water will be provided by ASHPs in the central plant.
- High performance envelope design and durable building construction
- Strategic window placement minimizing overheating and heat-loss and enhancing occupant comfort
- Air-source heat pump technology
- Low-carbon system
- Heat recovery technology for suite ventilation
- Dominantly electrified service water heating
- High efficiency LED
- Electrified cooking in suites
- Window to Wall ratio 33%

# DP 23-014121 PLAN #7

#### RAINWATER MANAGEMENT

- Transforming the site to a more biodiverse green environment and helping to reduce the flow of peak stormwater volumes to sensitive habitats through vegetated roof and planters
  - Alignment with the City of Richmonds's rainwater management strategy

#### **GREEN MOBILITY**

- · Providing residents with the best opportunity to live car-free with convenient location for bicycle parking
- Walking distance to many shops, restaurants, services, office etc.
- Access to frequent transit networks along Cook Rd and Garden City corridor.

#### LANDSCAPE

- Preference for native and adaptive plants
- High efficiency irrigation
- Bird-friendly fruit bearing trees .
- . Edible planting
- Outdoor amenity spaces provide a balance of shaded, covered, and sunlit areas to promote year-round use during various weather conditions .
- Providing universal access to diversity of social/gathering spaces for all ages and abilities

#### AMENITIES

- Variety of generous indoor and outdoor amenities shared between all residents
- Family-friendly amenities including play gym, yoga, guest suites, music rooms, co working and private working rooms, entertainment and gathering, edible planting and plenty of common outdoor space.
- Pet-friendly amenities including dog-run and dog-wash
- On-site bike repair rooms
- EV charging for all residents.

# February 20, 2024

g	bĮ
GBL ARCHITECTS INC.	

 $\in$ 

**GREEN ROOF** 

FITNESS /GYM FACILITIES AND DECK

URBAN AGRICULTURE

FOUR SEASON **OUTDOOR AMENITY** 

**HIGH-PERFORMANCE ENVELOPE,** LOW WINDOW TO WALL RATIO; SUNSHADES AND WEATHER PROTECTION

**COMMUNITY POCKET** PARKS

R	REVIS	SIONS	
N	NÔ,	DATE	DESCRIPTION
	5	OCT 06 2023	RE-ISSED FOR DP
	6	JAN 19 2024	RE-ISSUED FOR OP
	7	FEB 15 2024	RE- ISSUED FOR DP

# 8880 COOK RD. & 8751 CITATION DRIVE

RICHMOND, BC

# SUSTAINABILITY RATIONALE


DATE DRAWN BY CHECKED BY SCALE


2/14/2024 4:13:55 PM Checker

JOB NUMBER

20039


A-0.14

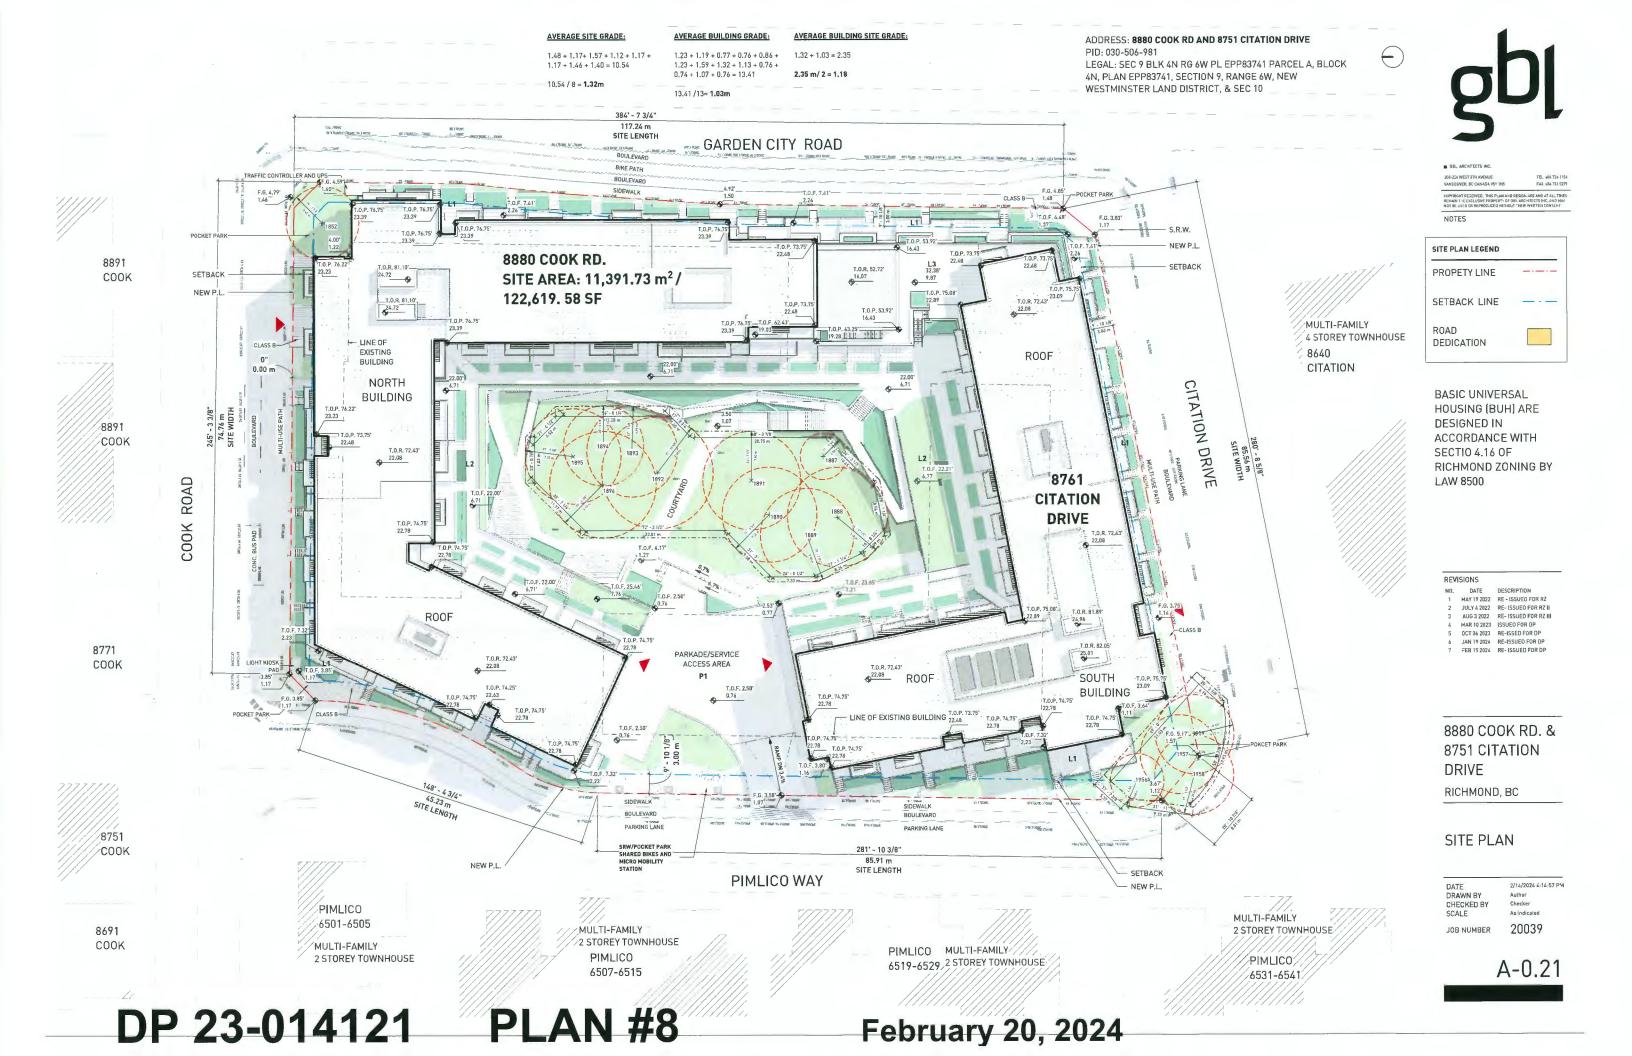

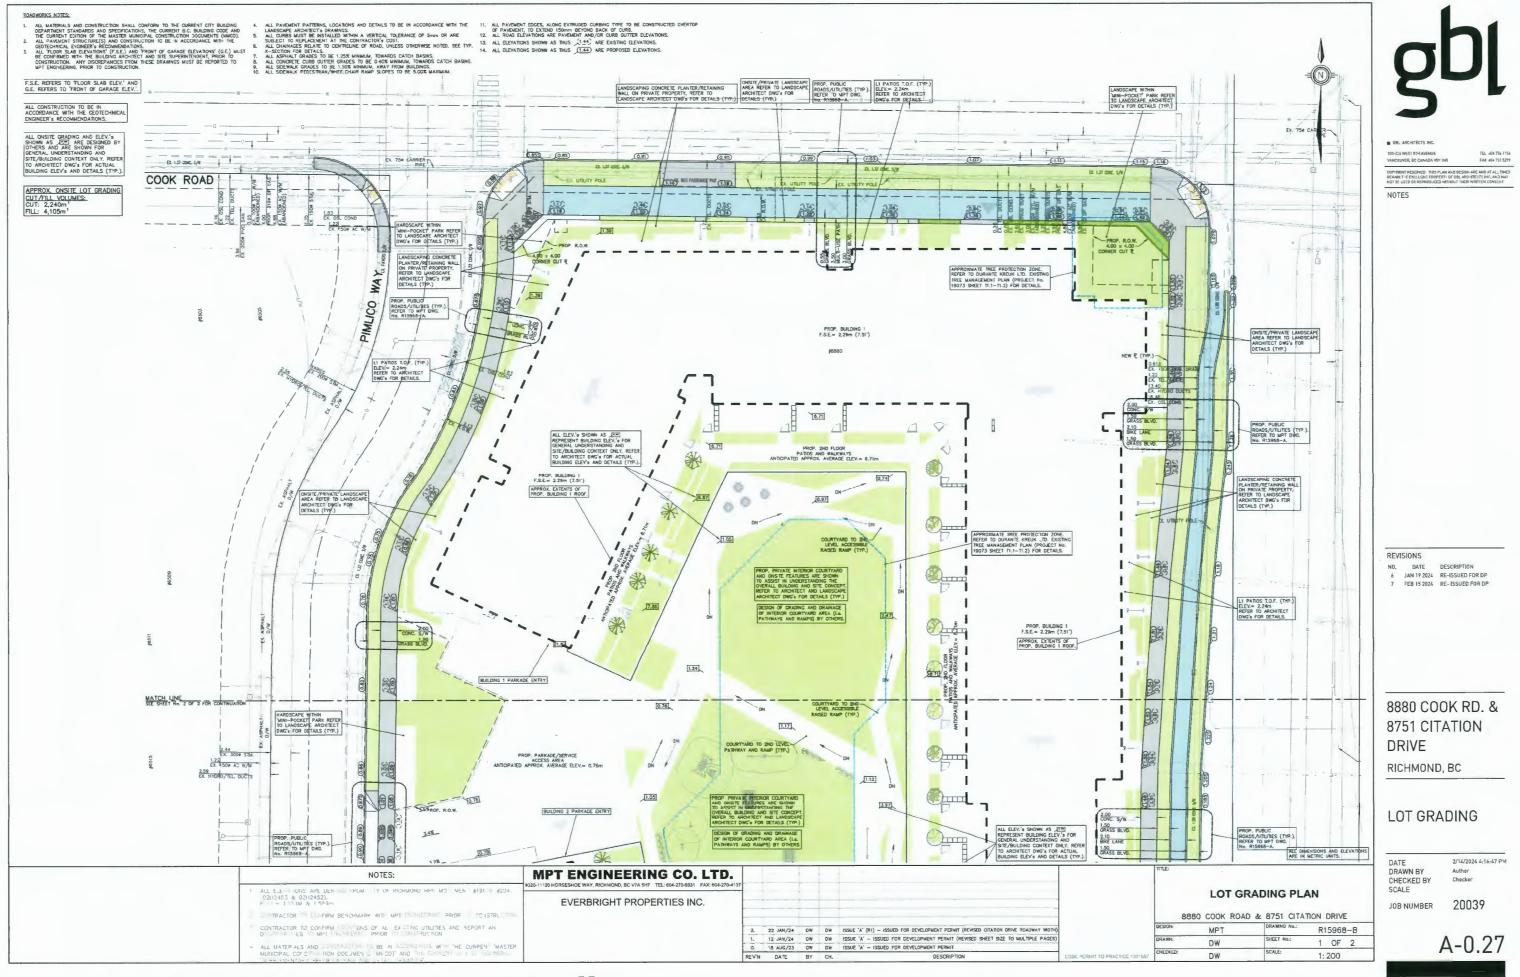


# DP 23-014121 PLAN #9

# February 20, 2024

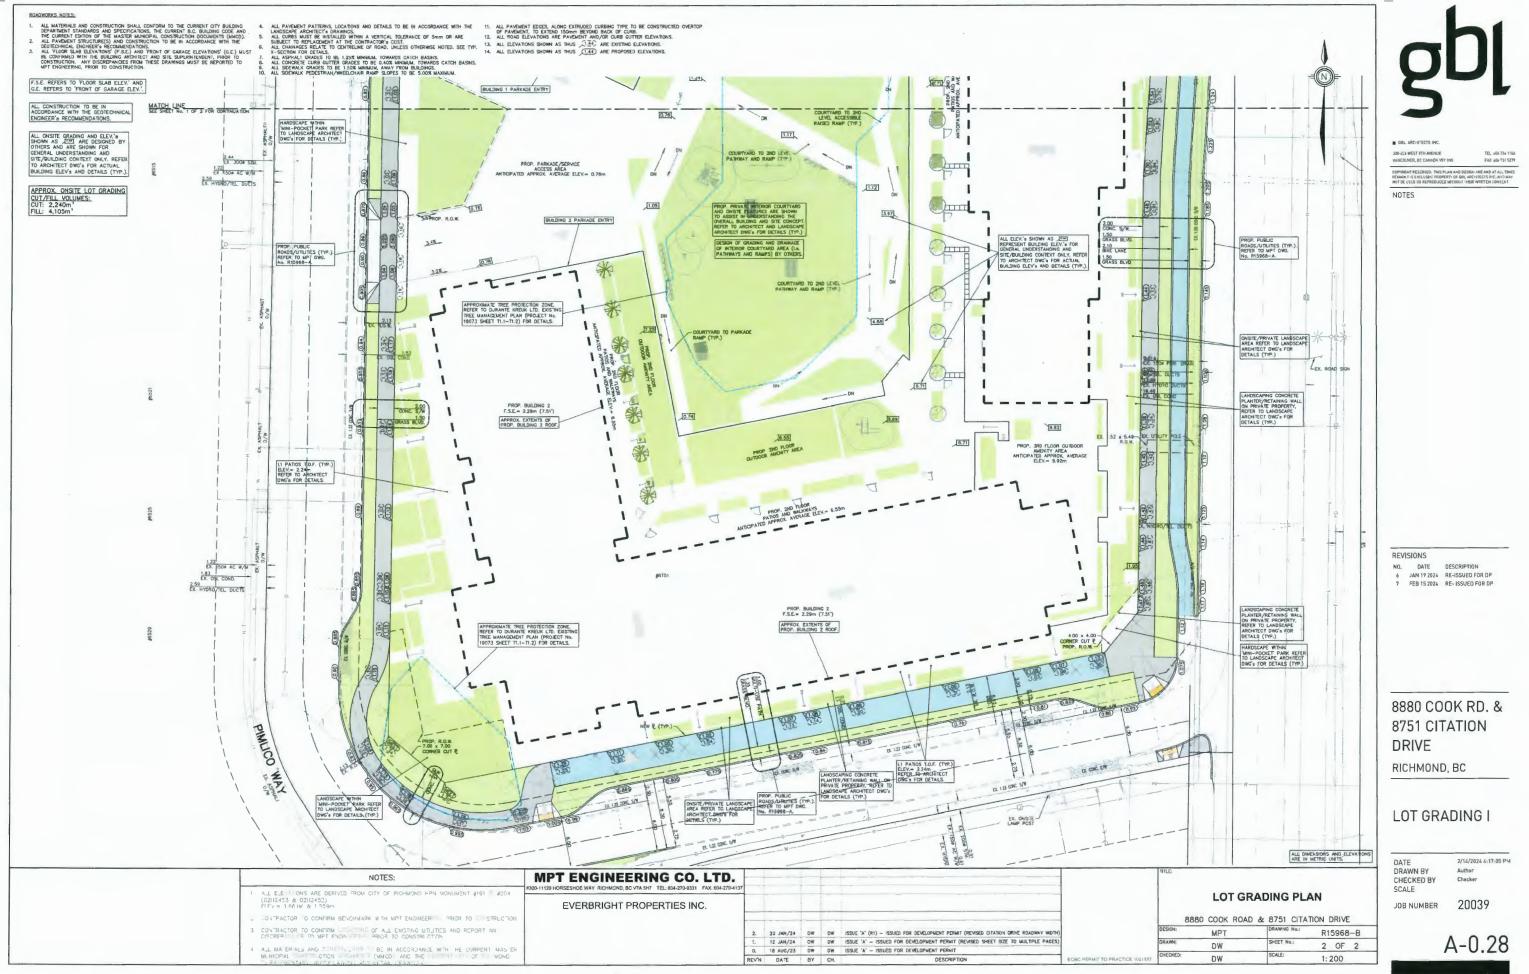

# DP 23-014121 PLAN #10

# February 20, 2024

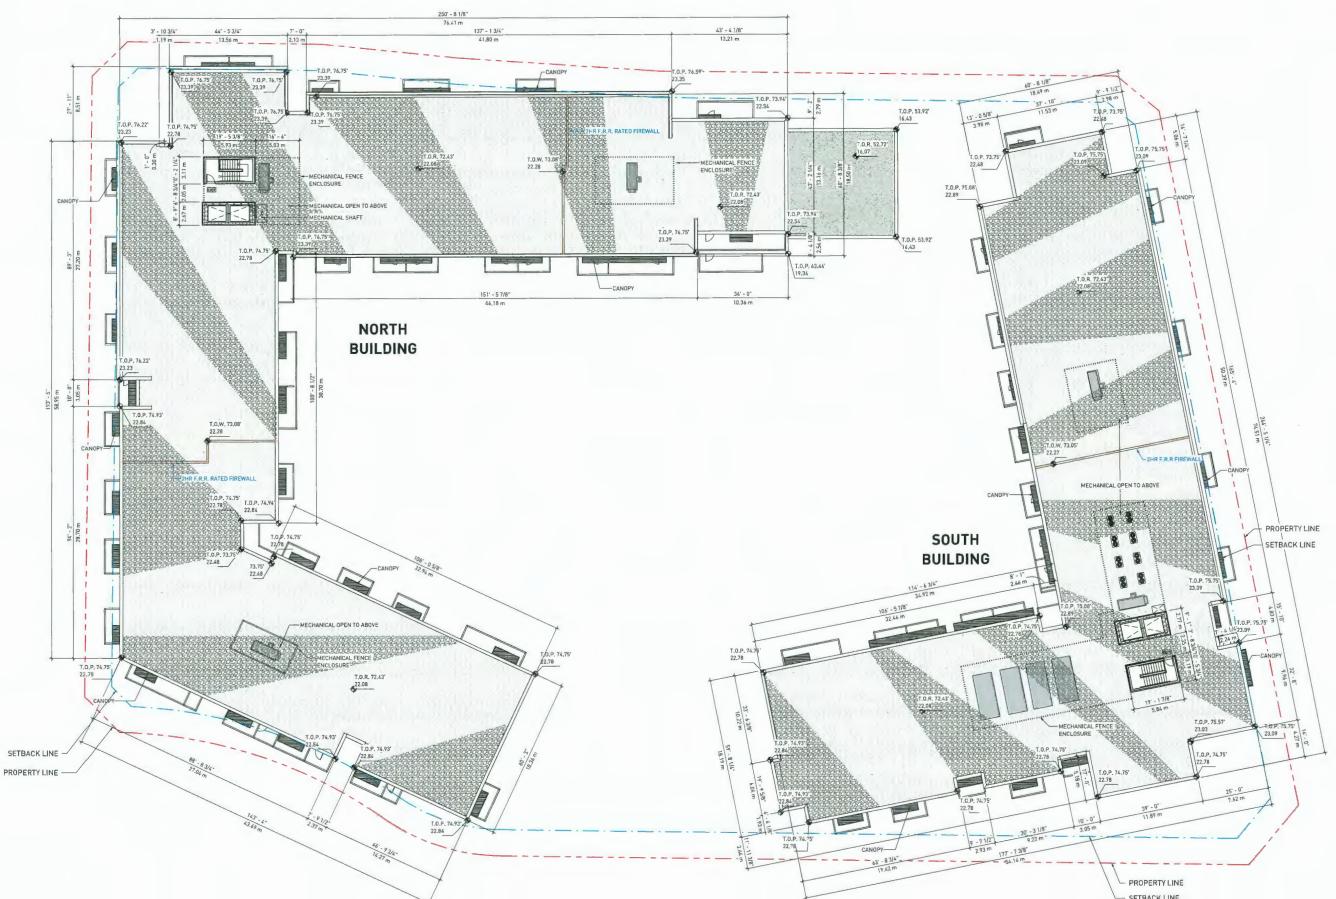

DP 23-014121 **PLAN #11** 

February 20, 2024

SETBACK LINE



300-224 WEST 8TH AVENUE	TEL a04 73 a 115
VANCOUVER, BC CANADA V5Y INS	FAX 6DA 731 527
COPYRIGHT RESERVED: THIS PLAN AND DE REMAIN THE EXCLUSIVE PROPERTY OF GBU	

 $\bigcirc$ 

REV	ISIONS	
NO.	DATE	DESCRIPTION
1	MAY 19 2022	RE - ISSUED FOR RZ
2	JULY 4 2022	RE- ISSUED FOR RZ II
3	AUG 3 2022	RE- ISSUED FOR RZ III
4	MAR 10 2023	1SSUED FOR DP
5	OCT 06 2023	<b>RE-ISSED FOR DP</b>
6	JAN 19 2024	RE-ISSUED FOR DP
7	FEB 15 2024	<b>RE-ISSUED FOR DP</b>

# 8880 COOK RD. & 8751 CITATION DRIVE

### RICHMOND, BC

# FLOOR PLAN -ROOF

DATE DRAWN BY CHECKED BY SCALE JOB NUMBER

2/14/2024 4:19:34 PM Author Checker 1/16" = 1'-0" 20039





# DP 23-014121 PLAN #12

# February 20, 2024



 $\odot$ 

BBL ARCHITECTS INC. 300-224 WEST 8TH AVENUE VANCOUVER, BC CANADA VSY INS TEL 004 730 1156 FAX 004 731 5279 NOTES

# MICROPERFORATED

MICROPERFORATED PANEL SYSTEM • ALLOWS FOR LIGHT AND VENTILATION TO PARKADE • CREATES PRIVACY BETWEEN AREAS

REV	ISIONS	
NO.	DATE	DESCRIPTION
4	MAR 10 2023	ISSUED FOR OP
5	OCT 06 2023	RE-ISSED FOR DP
6	JAN 19 2024	RE-ISSUED FOR DP
7	FEB 15 2024	RE- ISSUED FOR DP

# 8880 COOK RD. & 8751 CITATION DRIVE

### RICHMOND, BC

# ENLARGED FLOOR PLANS

DATE DRAWN BY CHECKED BY SCALE JOB NUMBER

2/14/2024 4:19:45 PM Auth Checker 3/32" = 1'-0" 20039





2 DP-BUILDING ELEVATION - NORTH DP 23-014121 **PLAN<sup>®</sup>#13** 

February 20, 2024

B GBL ARCHITECTS INC.

308-224 WEST 8TH AVENUE VANCOUVER, BC CANADA VSY INS TEL 004 73+ 1156 FAX 004 731 5279 COPYRIGHT RESERVED. THIS PLAN AND DESIGN ARE AND AT ALL TIMES REMAIN 1 'SE EXCLUSIVE FROMERTY OF GBU, ARCHITECTS INC, AND MAY NOT BE USED OR REPRODUCED WITHOUT THEIR WRITTEN CONSENT

NOTES

#	DESCRIPTION	COLOR
01	FIBRECEMENT PANEL	WHITE
02	FIBRECEMENT PANEL	GREY
03	FIBRECEMENT PANEL	DARK GREY
0.4	FIBRECEMENT PANEL	COPPER
05	BRICK - Norman - Running Bond	WHITE
05a	BRICK - Norman - Running Bond	GREY
06	GLASS GUARDRAIL	TRANSPARENT
07	<varies></varies>	<varies></varies>
08	ALUMINUM FINS	CEDAR
09	GLASS	TRANSPARENT
10	SPANDREL GLASS	CHARCOAL
11	SPANDREL GLASS	COPPER
12	ALUMINUM SUNSHADE	BLACK
13	VINYL MULLION	BLACK
14	FRITZ GUARDRAIL	WHITE
15	ALUMINUM GUARDRAIL	BLACK
16	ALUMINUM FLASHING	WHITE
17	ALUMINUM FLASHING	CHARCOAL
18	ALUMINUM OVERHEAD DOOR	NATURAL ALUMN
19	ALUMINUM MULLION	BLACK
20	EXTERIOR TREATED	CEDAR
21	MICROPERFORATED STAINLESS STEEL MESH	WHITE
22	MICROPERFORATED STAINLESS STEEL MESH	BLACK

#### REVISIONS

N0.	DATE	DESCRIPTION
1	MAY 19 2022	RE - ISSUED FOR RZ
2	JULY 4 Z022	RE- ISSUED FOR RZ 1
З	AUG 3 2022	RE- ISSUED FOR RZ III
4	MAR 10 2023	ISSUED FOR OP
5	OCT 06 2023	RE-ISSED FOR DP
6	JAN 19 2024	RE-ISSUED FDR DP
7	FEB 15 2024	RE- ISSUED FOR DP

# 8880 COOK RD. & 8751 CITATION DRIVE

RICHMOND, BC

### ELEVATIONS

DATE DRAWN BY CHECKED BY SCALE JOB NUMBER

2/14/2024 4:20:42 PM GBL As indicaled 20039





10.54 / 8 = 1.32m


DP 23-014121

13.41/13= 1.03m

PLAN #14

February 20, 2024

2L

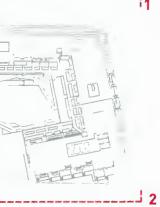

B GBL ARCHITECTS INC.

RENLAN	THE EXCLUSIVE FROPERTY OF OBL & USED OR REPRODUCED WITHOUT TH	RCHITECTS INC. AND MAY
NOT	ES	
	MATERIAL LE	GEND
Ħ	DESCRIPTION	COLOR
01	FIBRECEMENT PANEL	WHITE
02	FIBRECEMENT PANEL	GREY
03	FIBRECEMENT PANEL	DARK GREY
84	FIBRECEMENT PANEL	COPPER
05	BRICK - Norman - Running Bond	WHITE
05a	BRICK - Norman - Running Bond	GREY
06	GLASS GUARDRAIL	TRANSPARENT
07	<varies></varies>	<varies></varies>
08	ALUMINUM FINS	CEDAR
09	GLASS	TRANSPARENT
10	SPANDREL GLASS	CHARCOAL
11	SPANDREL GLASS	COPPER
12	ALUMINUM SUNSHADE	BLACK
13	VINYL MULLION	BLACK
14	FRITZ GUARDRAIL	WHITE
15	ALUMINUM GUARDRAIL	BLACK
16	ALUMINUM FLASHING	WHITE
17	ALUMINUM FLASHING	CHARCOAL
18	ALUMINUM OVERHEAD DOOR	NATURAL ALUMN
19	ALUMINUM MULLION	BLACK
20	EXTERIOR TREATED WOOD	CEDAR
21	MICROPERFORATED STAINLESS STEEL MESH	WHITE
22	MICROPERFORATED STAINLESS STEEL MESH	BLACK

-		
REV	ISIONS	
N0,	DATE	DESCRIPTION
1	MAY 19 2022	RE - ISSUED FOR RZ
2	JULY 4 2022	RE- ISSUED FOR RZ II
3	AUG 3 2022	RE- ISSUED FOR RZ III
4	MAR 10 2023	ISSUED FOR DP
5	OCT 06 2023	RE-ISSED FOR DP
6	JAN 19 2024	RE-ISSUED FOR DP
7	⊏EB 15 2024	RE- ISSUED FOR DP

# 8880 COOK RD. & 8751 CITATION DRIVE

RICHMOND, BC

# **ELEVATIONS**

DATE DRAWN BY CHECKED BY SCALE JOB NUMBER

2/14/2024 4:22:02 PM As indicated 20039




**KEY PLAN** 



**PLAN #15** 

GARDEN CITY RD.

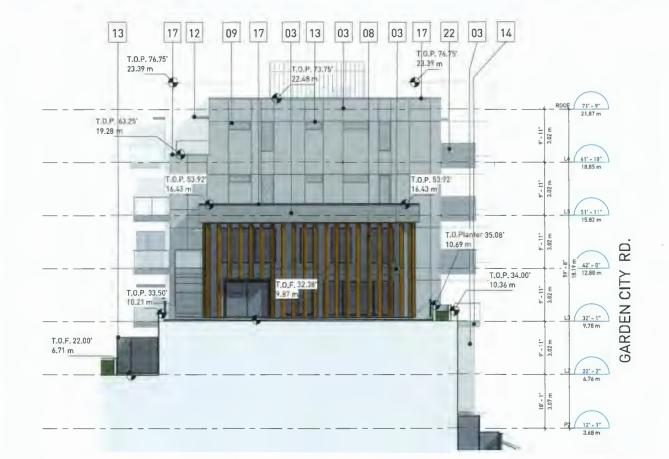


DP-BUILDING ELEVATION - AMENITY DP 23-014121

1 DP - BUILDING ELEVATION - EAST. 3/32" = 1"-0"

AVERAGE SITE GRADE:	AVERAGE BUILDING GRADE:	AVERAGE BUILDING SITE GRADE:
1.48 + 1.17+ 1.57 + 1.12 + 1.17 + 1.17 + 1.46 + 1.40 = 10.54	1.23 + 1.19 + 0.77 + 0.76 + 0.86 + 1.23 + 1.59 + 1.32 + 1.13 + 0.76 +	1.32 + 1.03 = 2.35
	0.74 + 1.07 + 0.76 = 13.41	2.35 m/ 2 = 1.18
10.54 / 8 = <b>1.32m</b>	13.41 /13= <b>1.03m</b>	

# February 20, 2024

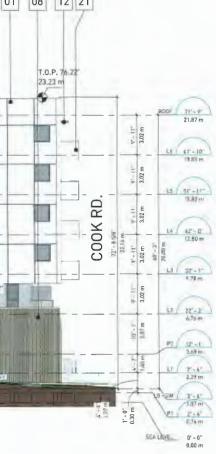



300-224 WES	ST BTH AVENUE	TEL e04.73+ 1156
VANCOUVER	L BC CANADA V5Y INS	FAX 604 731 5279
COPYRIGHT	ESERVED: THIS PLAN AND DE	SIGN ARE AND AT ALL TIMES
	EXCLUSIVE PROPERTY OF BBL	

MATERIAL LEGEND		
#	DESCRIPTION	COLOR
01	FIBRECEMENT PANEL	WHITE
02	FIBRECEMENT PANEL	GREY
03	FIBRECEMENT PANEL	DARK GREY
04	FIBRECEMENT PANEL	COPPER
05	BRICK - Norman - Running Bond	WHITE
05a	BRICK - Norman - Running Bond	GREY
06	GLASS GUARDRAIL	TRANSPARENT
07	<varies></varies>	<varies></varies>
08	ALUMINUM FINS	CEDAR
09	GLAS5	TRANSPAREN <sup>-</sup>
10	SPANDREL GLASS	CHARCOAL
11	SPANDREL GLASS	COPPER
12	ALUMINUM	BLACK
13 VINYL MULLION		BLACK
14	FRITZ GUARDRAIL	WHITE
15	ALUMINUM	BLACK
16	ALUMINUM FLASHING	WHITE
17	ALUMINUM FLASHING	CHARCOAL
18	ALUMINUM OVERHEAD DOOR	NATURAL ALUM
19	ALUMINUM MULLION	BLACK
20	EXTERIOR TREATED	CEDAR
21	MICROPERFORATED STAINLESS STEEL MESH	WHITE
22	MICROPERFORATED STAINLESS STEEL	BLACK

#### REVISIONS

ICC I DIONO				
NO.	DATE	DESCRIPTION		
1	MAY 19 2022	RE - ISSUED FOR RZ		
2	JULY 4 2022	RE- ISSUED FOR RZ II		
3	AUG 3 2022	RE- ISSUED FOR RZ III		
4	MAR 10 2023	ISSUED FOR DP		
5	OCT 06 2023	RE-ISSED FOR OP		
6	JAN 19 2024	RE-ISSUED FOR DP		
7	FEB 15 2024	RE- ISSUED FOR DP		

8880 COOK RD. & 8751 CITATION DRIVE

RICHMOND, BC

# ELEVATIONS

DATE DRAWN BY CHECKED BY SCALE JOB NUMBER

2/14/2024 4:22:37 PM AM AM As indicated 20039




KEY PLAN

A-2.03

# DP 23-014121 PLAN #16

# February 20, 2024



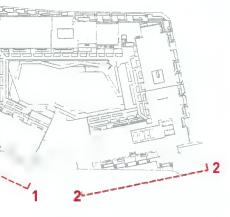



#### AVERAGE BUILDING GRADE:

#### AVERAGE BUILDING SITE GRADE:

1.23 + 1.19 + 0.77 + 0.76 + 0.86 + 1.23 + 1.59 + 1.32 + 1.13 + 0.76 + 0.74 + 1.07 + 0.76 = 13.41 1.32 + 1.03 = 2.35 2.35 m/ 2 = 1.18

13.41 /13= **1.03m** 

# gbl

 BBL ARCHITETS INC.

 300-214 WEST RITH AVENUE
 TEL INF.75 H 156

 VANCOURCE RE CONVARIA Y INS
 FAX INF.75 H 157

 Dommark Treasweb, THE DAW AND BELIN ARCHING IN TALL 101437
 FAX INF.75 H 156

 Dommark Treasweb, THE DAW AND BELIN ARCHING IN TALL 101437
 FAX INF.75 H 156

 Dommark Treasweb, THE DAW AND BELIN ARCHING IN TALL 101437
 FAX INF.75 H 156

 DOM BELING IN THE DAW AND BELING IN THE DAW AN

NOTES

#	DECODIDITION	001.07
	DESCRIPTION	COLOR
01	FIBRECEMENT PANEL	
02	FIBRECEMENT PANEL	
03	FIBRECEMENT PANEL	DARK GREY
04	FIBRECEMENT PANEL	COPPER
05	BRICK - Norman - Running Bond	WHITE
05a	BRICK - Norman - Running Bond	GREY
06	GLASS GUARDRAIL	TRANSPARENT
07	«varies»	<varies></varies>
08	ALUMINUM FINS	CEDAR
09	GLASS	TRANSPARENT
10	SPANDREL GLASS	CHARCOAL
11	SPANDREL GLASS	COPPER
12	ALUMINUM	BLACK
13	VINYL MULLION	BLACK
14	FRITZ GUARDRAIL	WHITE
15	ALUMINUM GUARDRAIL	BLACK
16	ALUMINUM FLASHING	WHITE
17	ALUMINUM FLASHING	CHARCOAL
18	ALUMINUM OVERHEAD DOOR	NATURAL ALUMN
19	ALUMINUM MULLION	BLACK
20	EXTERIOR TREATED WOOD	CEDAR
21	MICROPERFORATED STAINLESS STEEL MESH	WHITE
22	MICROPERFORATED STAINLESS STEEL MESH	BLACK

REVISIONS			
N0.	DATE	DESCRIPTION	
1	MAY 19 2022	RE - ISSUED FOR RZ	
2	JULY 4 2022	RE- ISSUED FOR RZ II	
3	AUG 3 2022	RE- ISSUED FOR RZ III	
4	MAR 10 2023	ISSUED FOR DP	
5	DCT 06 2023	RE-ISSED FOR DP	
6	JAN 19 2024	RE-ISSUED FOR DP	
-	FCD 16 2027	DE LECUED FOO DD	

# 8880 COOK RD. & 8751 CITATION DRIVE


RICHMOND, BC

# ELEVATIONS

DATE DRAWN BY CHECKED BY SCALE JOB NUMBER 2/14/2024 4:23:15 PM AM & GT GBL As indicated 20039





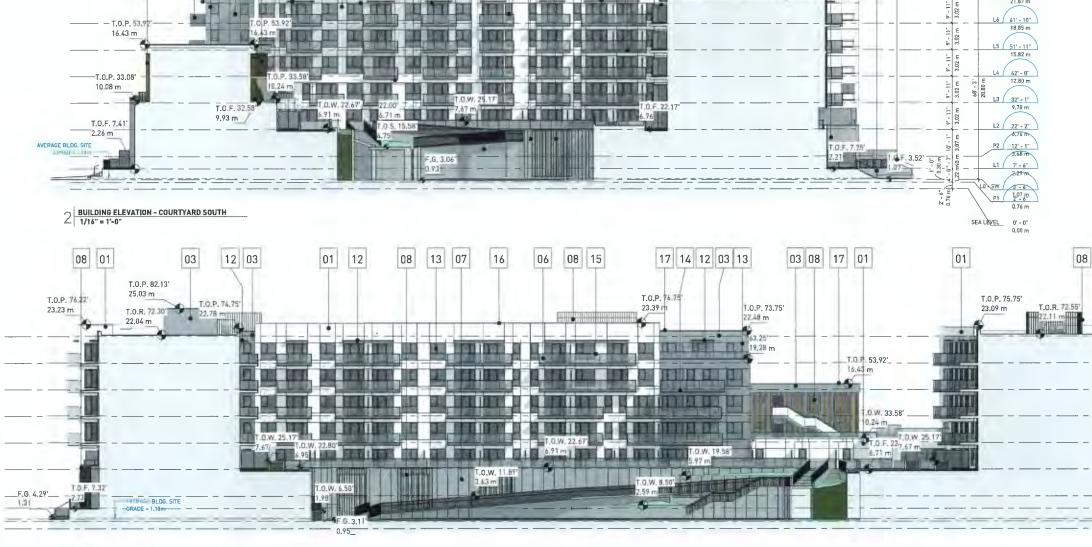



01 15 13 08 07 15 07 15 01 12 14

88

19

22.78 m

T.O.P. 74.75' T.O.P. 75.08'

1022.89 milt

05a 01 07 15

T.0.P.74.75 22,79 m 22.79 m

-


.O.R. 72.55

08 22 12 13 03 08

T.0.8, 73 15 22.48 m

- T.O.P. 53 16.43 m 12 01 02 13

T.O.P. 75.08 22.89 m

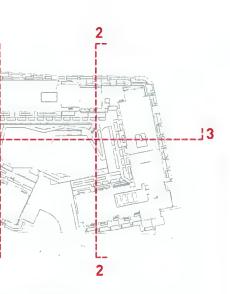

# **KEY PLAN**

1

R00F 71' - 9" 21.87 m

L6 61' - 10" 18.85 m

L5 51' - 11"



#### BU ARCHITECTS INC.

COLVER, BC CANADA VSY IN

TEL 684 73+ 1156 FAX 684 731 5279

COPYRIGHT RESERV REMAIN THE EXCLU: NOT BE USED OR RE

NOTES

	MATERIAL LE	GEND
#	DESCRIPTION	COLOR
01	FIBRECEMENT PANEL	WHITE
02	FIBRECEMENT PANEL	GREY
03	FIBRECEMENT PANEL	DARK GREY
04	FIBRECEMENT PANEL	COPPER
05	BRICK - Norman - Running Bond	WHITE .
05a	BRICK - Norman - Running Bond	GREY
Q6	GLASS GUARDRAIL	TRANSPARENT
07	<varies></varies>	<varies></varies>
80	ALUMINUM FINS	CEDAR
09	GLASS	TRANSPARENT
10	SPANDREL GLASS	CHARCOAL
11	SPANDREL GLASS	COPPER
12	ALUMINUM SUNSHADE	BLACK
13	VINYL MULLION	BLACK
14	FRITZ GUARDRAIL	WHITE
15	ALUMINUM GUARDRAIL	BLACK
16	ALUMINUM FLASHING	WHITE
17	ALUMINUM FLASHING	CHARCOAL
18	ALUMINUM OVERHEAD DOOR	NATURAL ALUM
19	ALUMINUM MULLION	BLACK
20	EXTERIOR TREATED WOOD	CEDAR
21	MICROPERFORATED STAINLESS STEEL MESH	WHITE
22	MICROPERFORATED STAINLESS STEEL MESH	BLACK

REVISIONS			
NO.	DATE	DESCRIPTION	
1	MAY 19 2022	RE - ISSUED FOR RZ	
2	JULY 4 2022	RE- ISSUED FOR RZ II	
3	AUG 3 2022	RE- ISSUED FOR RZ III	
4	MAR 10 2023	ISSUED FOR DP	
5	OCT 06 2023	RE-ISSED FOR DP	
6	JAN 19 2024	RE-ISSUED FOR DP	
7	FE8 15 2024	RE~ ISSUED FOR DP	

# 8880 COOK RD. & 8751 CITATION DRIVE

RICHMOND, BC

# **ELEVATIONS**

DATE DRAWN BY CHECKED BY SCALE JOB NUMBER


2/14/2024 4:24:01 PM As indicated 20039



A-2.05






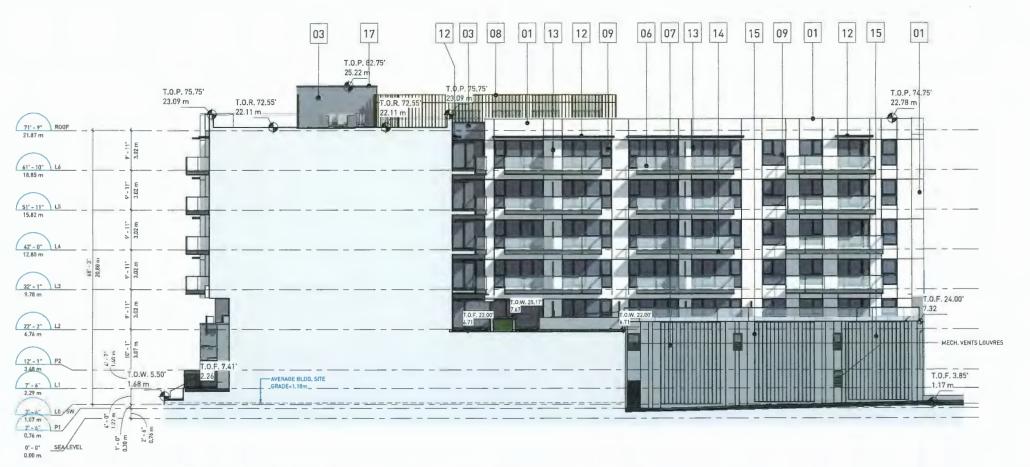

ELEVATION - COURTYARD NORTH WEST



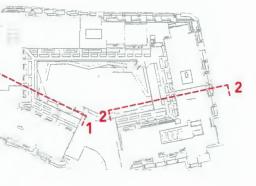

# KEY PLAN



NOTES

	MATERIAL LE	GEND
#	DESCRIPTION	COLOR
01	FIBRECEMENT PANEL	WHITE
02	FIBRECEMENT PANEL	GREY
03	FIBRECEMENT PANEL	DARK GREY
04	FIBRECEMENT PANEL	COPPER
05	BRICK - Norman - Running Bond	WHITE
05a	BRICK - Norman - Running Bond	GREY
0.6	GLASS GUARDRAIL	TRANSPARENT
07	<varies></varies>	«varies»
08	ALUMINUM FINS	CEDAR
09	GLASS	TRANSPARENT
10	SPANDREL GLASS	CHARCOAL
11	SPANDREL GLASS	COPPER
12	ALUMINUM SUNSHADE	BLACK
13	VINYL MULLION	BLACK
14	FRITZ GUARDRAIL	WHITE
15	ALUMINUM GUARDRAIL	BLACK
16	ALUMINUM FLASHING	WHITE
17	ALUMINUM FLASHING	CHARCOAL
18	ALUMINUM OVERHEAD DOOR	NATURAL ALUM
19	ALUMINUM MULLION	BLACK
20	EXTERIOR TREATED	CEDAR
21	MICROPERFORATED STAINLESS STEEL MESH	WHITE
22	MICROPERFORATED STAINLESS STEEL MESH	BLACK

#### REVISIONS

N0.	DATE	DESCRIPTION
1	MAY 19 2022	RE - ISSUED FOR RZ
2	JULY 4 2022	RE- ISSUED FOR RZ II
3	AUG 3 2022	RE- ISSUED FOR RZ 111
4	MAR 10 2023	ISSUED FOR DP
5	DCT 06 2023	RE-ISSED FOR DP
6	JAN 19 2024	RE-ISSUED FOR DP
7	FEB 15 2024	RE-ISSUED FOR DP


# 8880 COOK RD. & 8751 CITATION DRIVE

RICHMOND, BC

# ELEVATIONS

DATE DRAWN BY CHECKED BY SCALE JOB NUMBER 2/14/2024 4:24:39 PM AM As indicated 20039



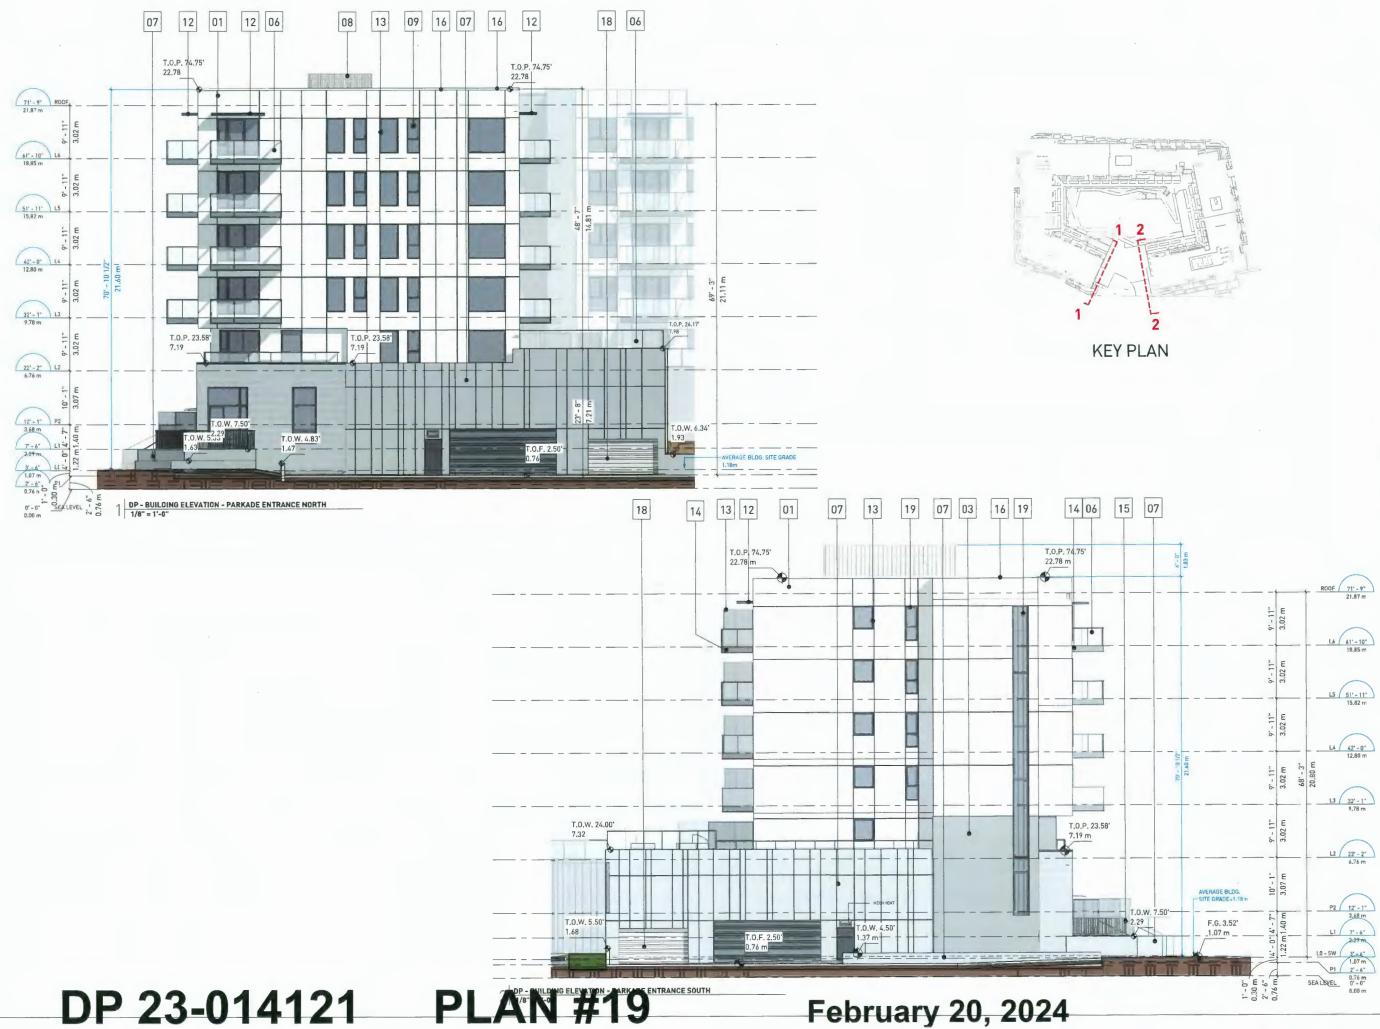



BE ARCHITECTS INC. 308-224 WEST 3TH AVENUE VANCOUVER, BC CANADA VSY 1N5

TEL #04 73e 1156 FAX 604 731 5279

COPYRIGHT RESERVE REMAIN THE EXCLUSION OF BEUSED OR REP THIS PLAN

NOTES

MATERIAL LEGEND		
Ħ	DESCRIPTION	COLOR
01	FIBRECEMENT PANEL	WHITE
02	FIBRECEMENT PANEL	GREY
03	FIBRECEMENT PANEL	DARK GREY
04	FIBRECEMENT PANEL	COPPER
05	BRICK - Norman - Running Bond	WHITE
05a	BRICK - Norman - Running Bond	GREY
06	GLASS GUARDRAIL	TRANSPARENT
07	<varies></varies>	<varies></varies>
08	ALUMINUM FINS	CEDAR
09	GLASS	TRANSPARENT
10	SPANDREL GLASS	CHARCOAL
11	SPANDREL GLASS	COPPER
12	ALUMINUM SUNSHADE	BLACK
13	VINYL MULLION	BLACK
14	FRITZ GUARDRAIL	WHITE
15	ALUMINUM GUARDRAIL	BLACK
16	ALUMINUM FLASHING	WHITE
17	ALUMINUM FLASHING	CHARCOAL
18	ALUMINUM OVERHEAD DOOR	NATURAL ALUMN
19	ALUMINUM MULLION	BLACK
20	EXTERIOR TREATED	CEDAR
21	MICROPERFORATED STAINLESS STEEL MESH	WHITE
22	MICROPERFORATED STAINLESS STEEL MESH	BLACK

#### REVISIONS

N0.	DATE	DESCRIPTION
4	MAR 10 2023	ISSUED FOR DP
5	OCT 06 2023	RE-ISSED FOR DP
6	JAN 19 2024	RE-ISSUED FOR DI
7	FEB 15 2024	RE- ISSUED FOR D

# 8880 COOK RD. & 8751 CITATION DRIVE

RICHMOND, BC

# ELEVATIONS

DATE DRAWN BY CHECKED BY SCALE JOB NUMBER 2/14/2024 4:25:13 PM Author Checker As indicated 20039





<sup>2</sup> DP 23-014121 **PLAN #20** 

# February 20, 2024



BBL ARCHITECTS INC.

300-224 WEST 8TH AVENUE VANCOUVER, BC CANADA VSY INS TEL 404 736 1156 FAX 604 731 5279 N ARE AND AT ALL TIME

NOTES

	MATERIAL LEGEND		
#	DESCRIPTION	COLOR	
01	FIBRECEMENT PANEL	WHITE	
02	FIBRECEMENT PANEL	GREY	
03	FIBRECEMENT PANEL	DARK GREY	
04	FIBRECEMENT PANEL	COPPER	
05	BRICK - Norman - Running Bond	WHITE	
05a	BRICK - Norman - Running Bond	GREY	
06	GLASS GUARDRAIL	TRANSPAREN"	
07	«varies»	<varies></varies>	
08	ALUMINUM FINS	CEDAR	
09	GLASS	TRANSPARENT	
10	SPANDREL GLASS	CHARCOAL	
11	SPANDREL GLASS	COPPER	
12	ALUMINUM	BLACK	
13	VINYL MULLION	BLACK	
14	FRITZ GUARDRAIL	WHITE	
15	ALUMINUM GUARDRAIL	BLACK	
16	ALUMINUM FLASHING	WHITE	
17	ALUMINUM FLASHING	CHARCOAL	
18	ALUMINUM OVERHEAD DOOR	NATURAL ALUMN	
19	ALUMINUM MULLION	BLACK	
20	EXTERIOR TREATED	CEDAR	
21	MICROPERFORATED STAINLESS STEEL MESH	WHITE	
22	MICROPERFORATED STAINLESS STEEL MESH	BLACK	

#### REVISIONS

	NO.	DATE	DESCRIPTION
	4	MAR 10 2023	ISSUED FOR DP
	5	OCT 06 2023	RE-ISSED FOR DP
			OF LEGISTE COD DO

6 JAN 19 2024 RE-ISSUED FOR DP 7 FEB 15 2024 RE- ISSUED FOR DP

# 8880 COOK RD. & 8751 CITATION DRIVE

### RICHMOND, BC

# ENLARGED ELEVATIONS

DATE DRAWN BY CHECKED BY SCALE

2/14/2024 4:25:35 PM Author Checker As indicated 20039

JOB NUMBER

A-2.08

# DP 23-014121 **PLAN #21**

# February 20, 2024

1 ELEVATION - COURTYARD - NORTH WEST





gU

BBL ARCHITECTS INC. 305-224 WEST 8TH AVENUE VANCOUVER, BC CANADA YSY 1N5 TEL 604.736 1156 FAX 604.736 5279 COPYRIGHT RESE REMAIN THE EXCL NOT BE USED OR

NOTES

	MATERIAL LE	GEND	
#	DESCRIPTION	COLOR	
01	FIBRECEMENT PANEL	WHITE	
02	FIBRECEMENT PANEL	GREY	
03	FIBRECEMENT PANEL	DARK GREY	
04	FIBRECEMENT PANEL	COPPER	
05	BRICK - Norman - WHITE Running Bond		
05a	BRICK - Norman - Running Bond	GREY	
06	GLASS GUARDRAIL	TRANSPAREN <sup>®</sup>	
07 «varies» «varies»		<varies></varies>	
08			
09 GLASS TRANSPARE		TRANSPAREN"	
10	SPANDREL GLASS	CHARCOAL	
11	SPANDREL GLASS	COPPER	
12	ALUMINUM SUNSHADE	BLACK	
13	VINYL MULLION	BLACK	
14	FRITZ GUARDRAIL	WHITE	
15	ALUMINUM GUARDRAIL	BLACK	
16	ALUMINUM FLASHING	WHITE	
17	ALUMINUM FLASHING	CHARCOAL	
18	ALUMINUM OVERHEAD DOOR	NATURAL ALUMN	
19	ALUMINUM MULLION BLACK		
20	EXTERIOR TREATED WOOD	CEDAR	
21	MICROPERFORATED STAINLESS STEEL MESH	WHITE	
22	MICROPERFORATED STAINLESS STEEL MESH	BLACK	

#### REVISIONS

NO.	DATE	DESCRIPTION

- 5
   OCT 06 2023
   RE-ISSED FOR DP

   6
   JAN 19 2024
   RE-ISSUED FOR DP

   7
   FEB 15 2024
   RE-ISSUED FOR DP

8880 COOK RD. & 8751 CITATION DRIVE

RICHMOND, BC

# ENLARGED ELEVATIONS

DATE DRAWN BY CHECKED BY SCALE JOB NUMBER


2/14/2024 4:25:58 PM Author Checker As indicated 20039




# 2 ELEVATION - COURTYARD - EAST DP 23-014121 **PLAN #22**

February 20, 2024



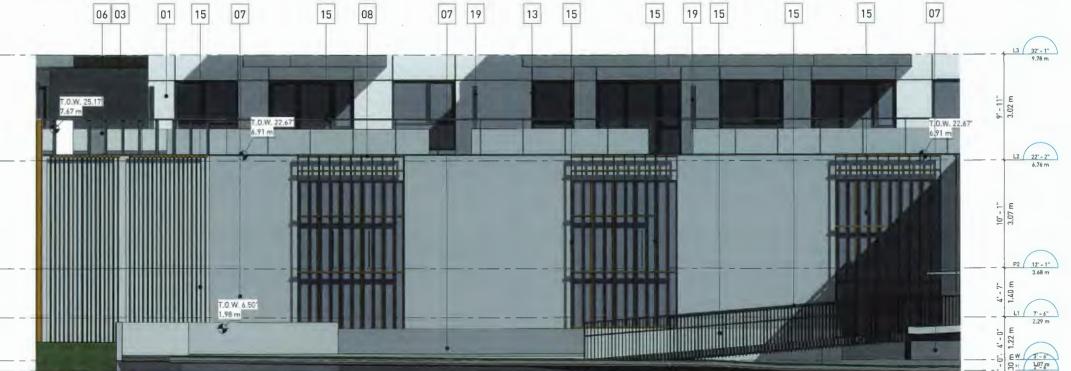

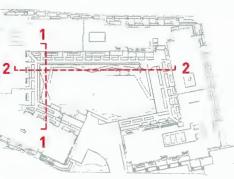



300-224 WEST &TH AVENUE	TEL 004.730 1156
VANCOUVER, BC CANADA VSY INS	FAX ±04 731 5279
COPYRIGHT RESERVED. THIS PLAN AND DES	IGN ARE AND AT ALL TIMES
REMAIN THE EXCLUSIVE PROPERTY OF GRUA	
NOT BE USED OR REPRODUCED WITHOUT TH	

1-1-1-1-0-		-		
	1 (A-3.0) (A-8.04)			
		າມາກ	B PL	[2
		Call Difference Caller	NAME AND ADDRESS	
TR.45 m				
12 - 7 - 14 - 19 - 19 - 19 - 19 - 19 - 19 - 19	BRU PARKATE BIKE BIKE	547 14 5 5 5 5 5 5 5 5 5 5 5 5 5 5 5 5 5 5		and a second and a
2010 - 102 - 10 - 10 - 10 - 10 - 10 - 10	REPAR ROOM PARKADE BIKE BIKE LOCKERS BIKE LOCKERS		2	2
0.76 m 0'-0" INLEYED BUILDING SECTION - NORTH				K
0.00 m 4 1/16" = 1'-0"	3			
PL 58	e(380)	Lamma Aur		SB
1.00m (TLA)	EURPRENT SORTEN 2 HR F.R.R. // P			1 10 1 1 1 1 1 1 1 1 1 1 1 1 1 1 1 1 1
18.65 m 51'-11' L5 220-	180-A2 180-A1 180-A1	CLUSET	The second secon	aller and a superior
15.82 m 42'-0" L4 12.80 m 42'-0" L4 12.80 m 42'-0" L4 12.80 m 12.80 m 42'-0" L4 12.80 m 12.80 m 12.8	STELLIS-STeam         18D-A9         18D-A2         18D-A7         18D-A3           VIII.III.S. 17 Auto         18D-A2         18D-A3         18D-A3         18D-A3	CLOSEY		Manager 1 and 1 an
12 - 5 - 12         12 - 5 - 12           2.71m         12 - 5 - 12           12 - 5 - 12         12 - 5 - 12           4.75m         12 - 5 - 12		CLUBET	I I MALL I MALL	1 4 4 1 TH-1
RES.	H-280	TH-280	10	
DP 23-014	121 PLĀN	#23	February 20, 202	24

PL 56 1-101/8-1-101/8-and the p OUN And a second sec 100 280-82 18D A7 280-82 1000 280-82 6+ 11-10 1.4 11.00m 2BD-82 0.00 4 . . 28D-82 280-82 Canal County COMPANY STREET 18D-A9 51'-11 112 15:82-m 100 **FEIDE** Contraction of Contraction 100.00.0 Н 18D-A9 28D-82 Contraction of Street of S . 28D-82 210-03-008 12.01 m 11204 18D-A9 > 0.00 Ĥ CORE INCOME Ser. 240-42-468 # 28D-82 2BD-B2-MIR 11" - 1" 9.78 m m.lis THE R. LEW. (10) 280-81 H-380 280-82 TH-280 - 74:-T 14 Pitenade -794200 BIKE PZ 17-11 F2 тн-зво 明石田市 Es circin THE OWNER OF Citra Li ..... PARKADE \_\_\_\_ PARKAD PARKADE


(1) (A-3.03)

2 A-3.01





	BBL ARCHITECTS INC.	
COPYRIGHT RESERVED. THIS PLAN AND DESIGN ARE AND AT ALL TIME	300-224 WEST 8TH AVENUE	TEL e64 73e 1156
	VANCOUVER, BC CANADA VSY (N5	FAX 684 731 5279
NOT BE USED OR REPRODUCED WITHOUT THEIF WRITTEN CONSENT		F GBL ARCHITECIS INC. AND MAY

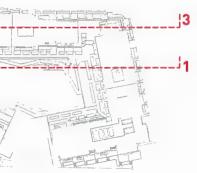

REV	ISIONS		
NO.	DATE	DESCRIPTION	
4	MAR 10 2023	ISSUED FOR DP	
5	OCT 06 2023	RE-ISSED FOR DP	
6	JAN 19 2024	RE-ISSUED FOR DP	
7	FEB 15 2024	RE- ISSUED FOR DP	

# 8880 COOK RD. & 8751 CITATION DRIVE RICHMOND, BC

# BUILDING SECTIONS I


DATE DRAWN BY CHECKED BY SCALE

2/14/2024 4:26:57 PM Author Checker As indicated JOB NUMBER 20039



# KEY PLAN



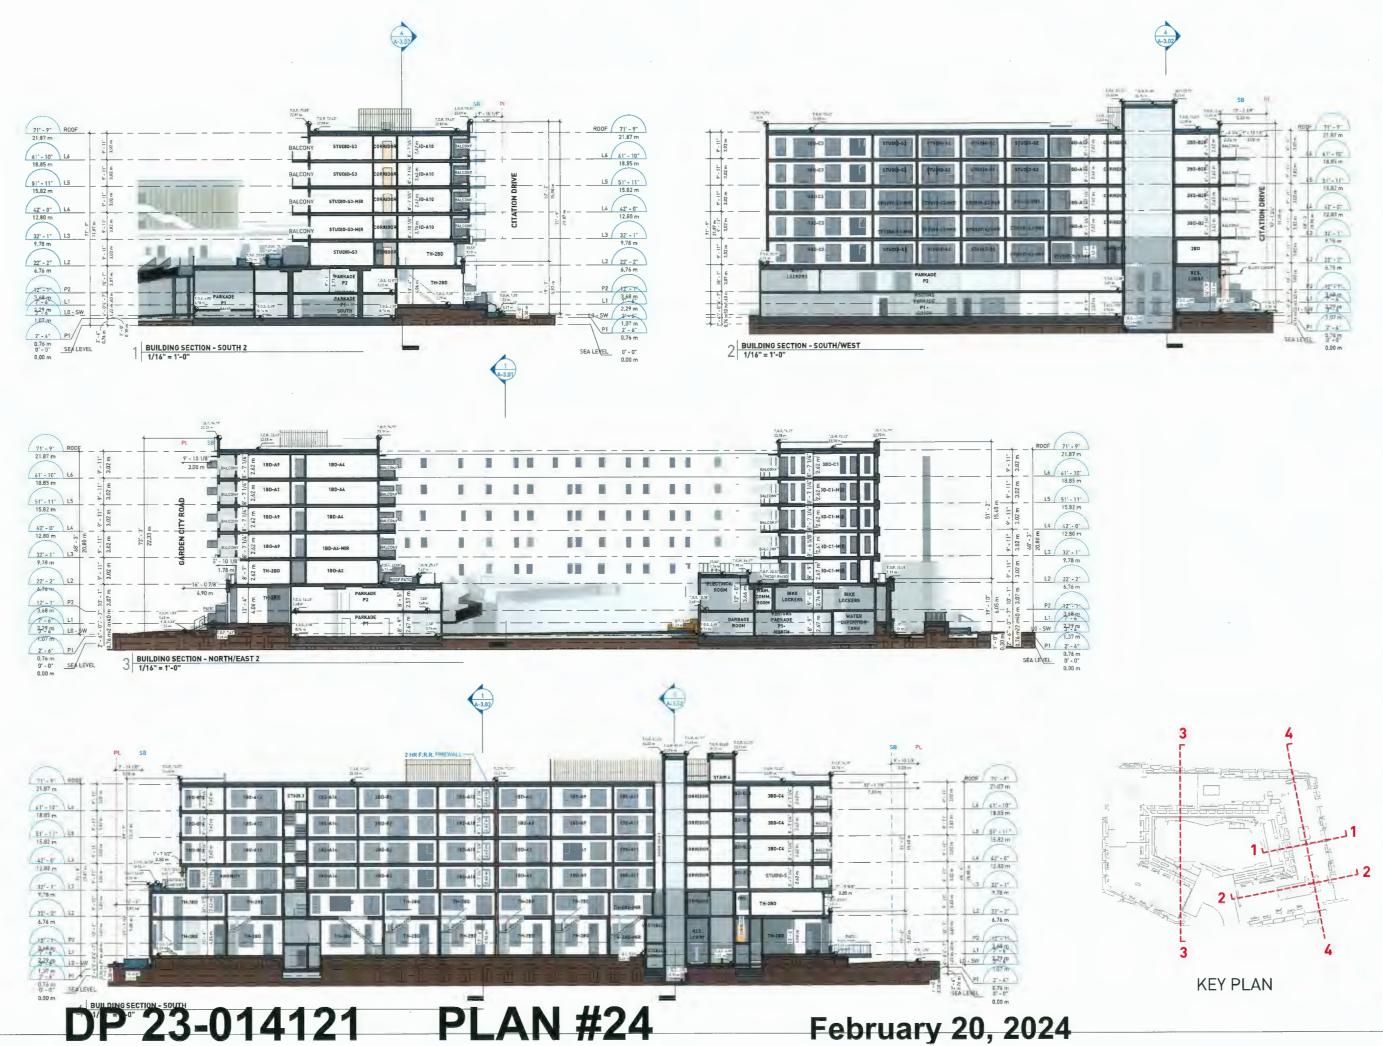





BIL ARCHITECTS INC.	
300-224 WEST #TH AVENUE	TEL e64.73e 1156
VANCOUVER, BC CANADA V5Y 1N5	FAX ±04 731 5279
COPYRIGHT RESERVED: THIS PLAN AND DES REMAIN THE EXCLUSIVE FROPERTY OF GBL NOT BE USED OR REPRODUCED WITHOUT TO	ARCHITECTS INC. AND HAY
NOTES	

REVISIONS			
ND,	DATE	DESCRIPTION	
4	MAR 10 2023	ISSUED FOR DP	
5	OCT 06 2023	RE-ISSED FOR DP	
6	JAN 19 2024	RE-ISSUED FOR DP	
7	FEB 15 2024	RE- ISSUED FOR DP	

# 8880 COOK RD. & 8751 CITATION DRIVE

### RICHMOND, BC

# BUILDING SECTIONS II

DATE DRAWN BY CHECKED BY SCALE JOB NUMBER 2/14/2024 4:27:30 PM Author Checker As indicated

20039





DP 23-014121

**PLAN #25** 

2 BUILDING SECTION - SOUTH 2 - ENLARGED February 20, 2024



TEL 604 73e 1156 FAX 604 731 5279 COPYRIGHT RESERVED. THIS PLAN AND DESIGN ARE AND AT ALL THES REMAIN 1'-E EXCLUSIVE PROPERTY OF DIRL ARCHITECTS INC. AND MAY NOT BE USED DR REPRODUCED WITHOUT "HER WRITTEN CONSENT



**1 - NORTH EAST PERSPECTIVE** 

**PLAN #26** DP 23-014121

February 20, 2024

#### B GBL ARCHITECTS INC. 300-224 WEST RTH AVENU NEDWER, BC CANADA VSY

TEL 604 73e 1156 FAX 604 731 5279

NOTES

DISCLAIMER: RENDERING IMAGES ARE CONCEPTUAL REPRESENTATIONS, MATERIALS AND FINISHES ARE APPROXIMATE AND SUBJECT TO CHANGE THROUGHOUT THE PERMITTING PROCESS.

# REVISIONS NO. DATE DESCRIPTION 4 MAR 10 2023 ISSUED FOR OP 5 DCT 06 2023 RE-ISSED FOR DP 6 JAN 19 2024 RE-ISSUED FOR DP 7 FEB 15 2024 RE-ISSUED FOR DP

# 8880 COOK RD. & 8751 CITATION DRIVE

RICHMOND, BC

#### **3D VIEWS**

DATE DRAWN BY CHECKED BY SCALE

2/14/2024 4:49:27 PM Author Checker As indicated 20039

JOB NUMBER

A-6.01



DP 23-014121 **PLAN #27** February 20, 2024



#### BI GBL ARCHITECTS INC. WER, BC CANADA Y

#### TEL 404 73e 1156 FAX e04 731 5279

NOTES

#### DISCLAIMER:

DISLICAIMER: RENDERING IMAGES ARE CONCEPTUAL REPRESENTATIONS, MATERIALS AND FINISHES ARE APPROXIMATE AND SUBJECT TO CHANGE THROUGHOUT THE DEPONUTION DEPONOE PERMITTING PROCESS.

#### REVISIONS

NO,	DATE	0
4	MAR 10 2023	15
5	OCT D6 2023	R
6	JAN 19 2024	R
7	FEB 15 2024	R

DESCRIPTION ISSUED FOR OP RE-ISSED FOR DP RE-ISSUED FOR DP RE- ISSUED FOR DP

# 8880 COOK RD. & 8751 CITATION DRIVE

RICHMOND, BC

#### **3D VIEWS**

DATE DRAWN BY CHECKED BY SCALE JOB NUMBER


2/14/2024 4:49:35 PM Author Checker As indicated 20039



1 - SOUTH EAST - CORNER BETWEEN GARDEN CITY ROAD AND CITATION DRIVE DP 23-014121 PLAN #28

February 20, 2024



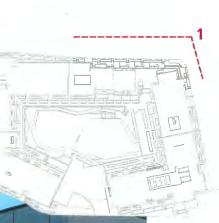

# gbl

TEL =84 73+ 1156 FAX ±84 731 5279 10-224 WEST 8TH AVENUE ANCOUVER, BC CANADA 1 D DESIGN ARE AND AT ALL TIMES THE ARCHITECTS INC. AND MAY T THEIR WRITTEN PARTY

NOTES

DISCLAIMER: RENDERING IMAGES ARE CONCEPTUAL REPRESENTATIONS, MATERIALS AND FINISHES ARE APPROXIMATE AND SUBJECT TO CHANGE THROUGHOUT THE PERMITTING PROCESS.

R	EVI	S	01	٧S	

110.	Division in the
4	MAR 10 202
5	OCT 06 2023
6	JAN 19 202
7	FEB 15 2024

DESCRIPTION 
 DESCRIPTION

 223
 ISSUED FOR DP

 223
 RE-ISSED FOR DP

 124
 RE-ISSUED FOR DP

 124
 RE-ISSUED FOR DP

 124
 RE-ISSUED FOR DP

#### 8880 COOK RD. & 8751 CITATION DRIVE

RICHMOND, BC

#### **3D VIEWS**

DATE DRAWN BY CHECKED BY SCALE JOB NUMBER

2/14/2024 4:49:43 PM Author Checker As indicated 20039







**PLAN #29** 

**1 - AERIAL PARKADE ENTRY** DP 23-014121

February 20, 2024

# gbl

#### BBL ARCHITECTS INC. 00-224 WEST STH AVENUE

UVER, BC CANADA VSY

NOTES

DISCLAIMER: RENDERING IMAGES ARE CONCEPTUAL REPRESENTATIONS, MATERIALS AND FINISHES ARE APPROXIMATE AND SUBJECT TO CHANGE THROUGHOUT THE PERMITTING PROCESS.

REVISIONS			
NO.	DATE	DESCRIPTION	
5	OCT 06 2023	RE-ISSED FOR DP	
6	JAN 19 2024	RE-ISSUED FOR DP	
7	FEB 15 2024	RE- ISSUED FOR DP	

#### 8880 COOK RD. & 8751 CITATION DRIVE RICHMOND, BC

#### 3D VIEWS

DATE DRAWN BY CHECKED BY SCALE

2/14/2024 4:49:51 PM Author Checker As indicated 20039

JOB NUMBER

A-6.04



2 - TOWNHOUSE ENTRANCE DP 23-014121 **PLAN #30** 

February 20, 2024

# gbl

#### BBL ARCHITECTS INC.

300-224 WEST ITH AVENUE VANCOUVER, BC CANADA VSY INS TEL q04 736 1156 FAX x84 731 5279 NOTES

DISCLAIMER: RENDERING IMAGES ARE CONCEPTUAL REPRESENTATIONS, MATERIALS AND FINISHES ARE APPROXIMATE AND SUBJECT TO CHANGE THROUGHOUT THE DEDINITION DROCES PERMITTING PROCESS.

#### REVISIONS

NO.	DATE	DESCRIPTION
4	MAR 10 2023	ISSUED FOR DP
5	OCT 06 2023	RE-ISSED FOR DP
6	JAN 19 2024	RE-ISSUED FOR DP
7	FEB 15 2024	RE-1SSUED FOR OF

## 8880 COOK RD. & 8751 CITATION DRIVE

RICHMOND, BC

#### **3D VIEWS**

DATE DRAWN BY CHECKED BY SCALE JOB NUMBER

2/14/2024 4:50:00 PM Author Checker As indicated 20039



#### 1 - VIEW OF COURTYARD LOOKING SOUTH DP 23-014121 **PLAN #31** February 20, 2024



# gbl

# BBL ARCHITECTS INC.

NOTES

DISCLAIMER: RENDERING IMAGES ARE CONCEPTUAL REPRESENTATIONS, MATERIALS AND FINISHES ARE APPROXIMATE AND SUBJECT TO CHANGE THROUGHOUT THE PERMITTING PROCESS.

#### REVISIONS

NO.	DATE
	MAR 10 202
	DCT 06 202
	JAN 19 202
7	FEB 15 202

DESCRIPTION 023 ISSUED FOR DP 023 RE-ISSED FOR DP 024 RE-ISSUED FOR DP 24 RE- ISSUED FOR DP

## 8880 COOK RD. & 8751 CITATION DRIVE


RICHMOND, BC

# **3D VIEWS**

DATE DRAWN BY CHECKED BY SCALE JOB NUMBER

2/14/2024 4:50:08 PM Author Checker As indicated 20039



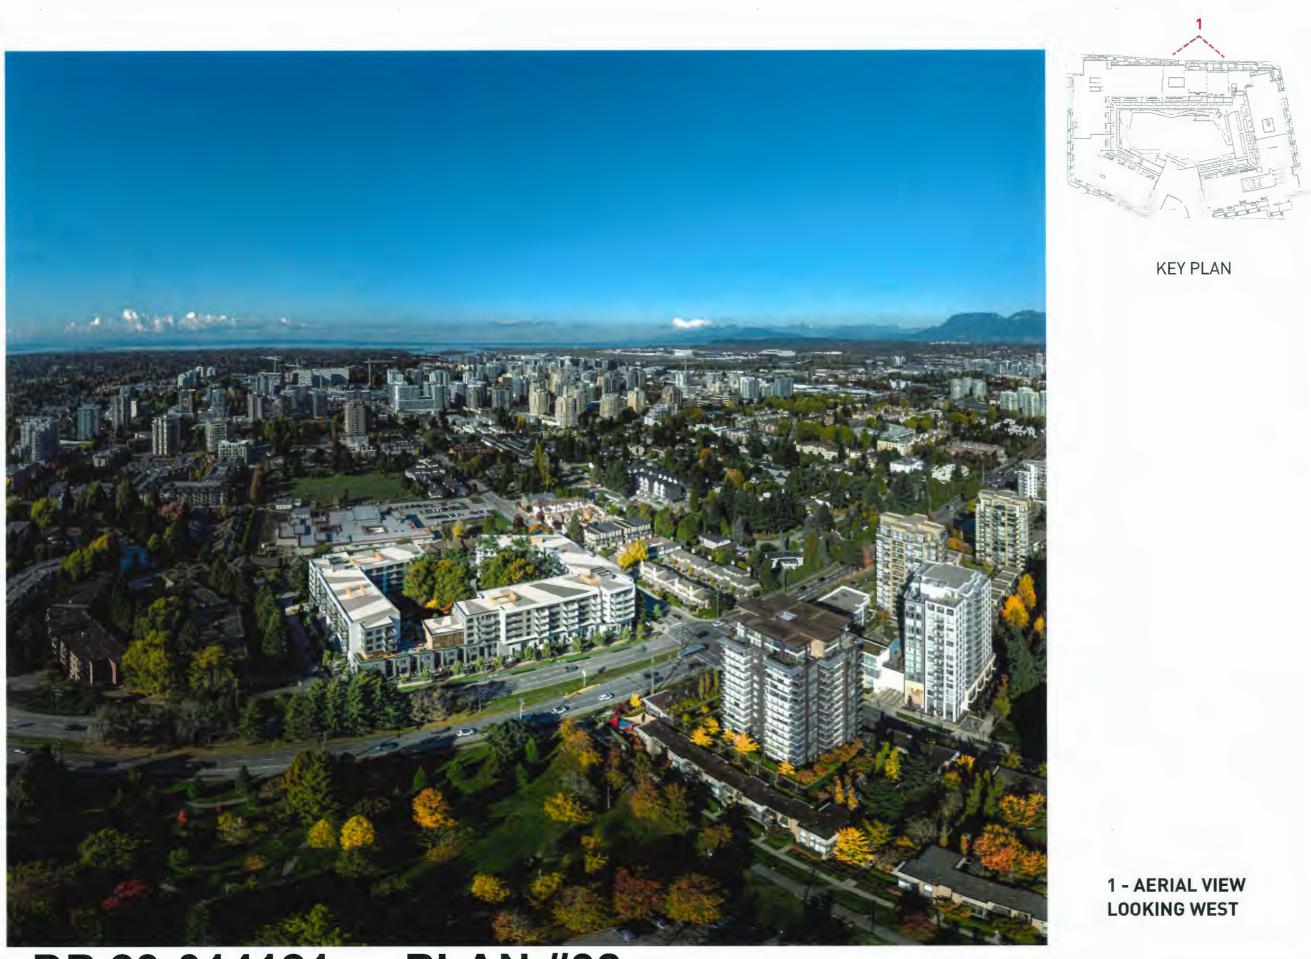

# **PLAN #32** DP 23-014121

February 20, 2024



0-224 WEST 8TH AVENUE ANCOUVER, BC CANADA VS TEL 664.73a 1156 FAX 664.731 5275 NOTES

DISCLAIMER: RENDERING IMAGES ARE CONCEPTUAL REPRESENTATIONS, MATERIALS AND FINISHES ARE APPROXIMATE AND SUBJECT TO CHANGE THROUGHOUT THE PERMITTING PROCESS.

2	E\/I	CL	OBI	C

NO.	DATE	DESCRIPTION
5	DCT 06 2023	RE-ISSED FOR OP
6	JAN 19 2024	<b>RE-ISSUED FOR DP</b>
7	FEB 15 2026	RE- ISSUED FOR DP

#### 8880 COOK RD. & 8751 CITATION DRIVE

RICHMOND, BC

#### **3D VIEWS**

DATE DRAWN BY CHECKED BY SCALE

2/14/2024 4:50:16 PM Author Checker As indicated 20039



A-6.07



1 - SOUTH EAST




2 - COOK RD. ENTRY **PLAN #33** DP 23-014121



**3 - CITATION DR. ENTRY** 

February 20, 2024

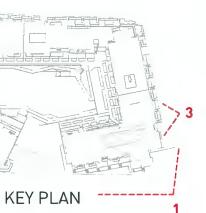



#### BBL ARCHITECTS INC. 309-224 WEST 8TH AVENUE VANCOUVER, BC CANADA VSY 1N5

TEL, 004.730 1156 FAX 604.731 5279

NOTES

DISCLAIMER: RENDERING IMAGES ARE CONCEPTUAL REPRESENTATIONS, MATERIALS AND FINISHES ARE APPROXIMATE AND SUBJECT TO CHANGE THROUGHOUT THE BERMITING DROCES PERMITTING PROCESS.

100 M
and and
2 1 7
「 注意 「 ドー 」
The second

#### REVISIONS

NO.	DATE	DESCRIPTION
5	OCT 06 2023	RE-ISSED FOR DP
6	JAN 19 2024	RE-ISSUED FOR DP
7	FEB 15 2024	RE- ISSUED FOR DP

# 8880 COOK RD. & 8751 CITATION DRIVE


RICHMOND, BC

#### **3D VIEWS**

DATE DRAWN BY CHECKED BY SCALE JOB NUMBER

2/14/2024 4:50:25 PM Author Checker As indicated 20039



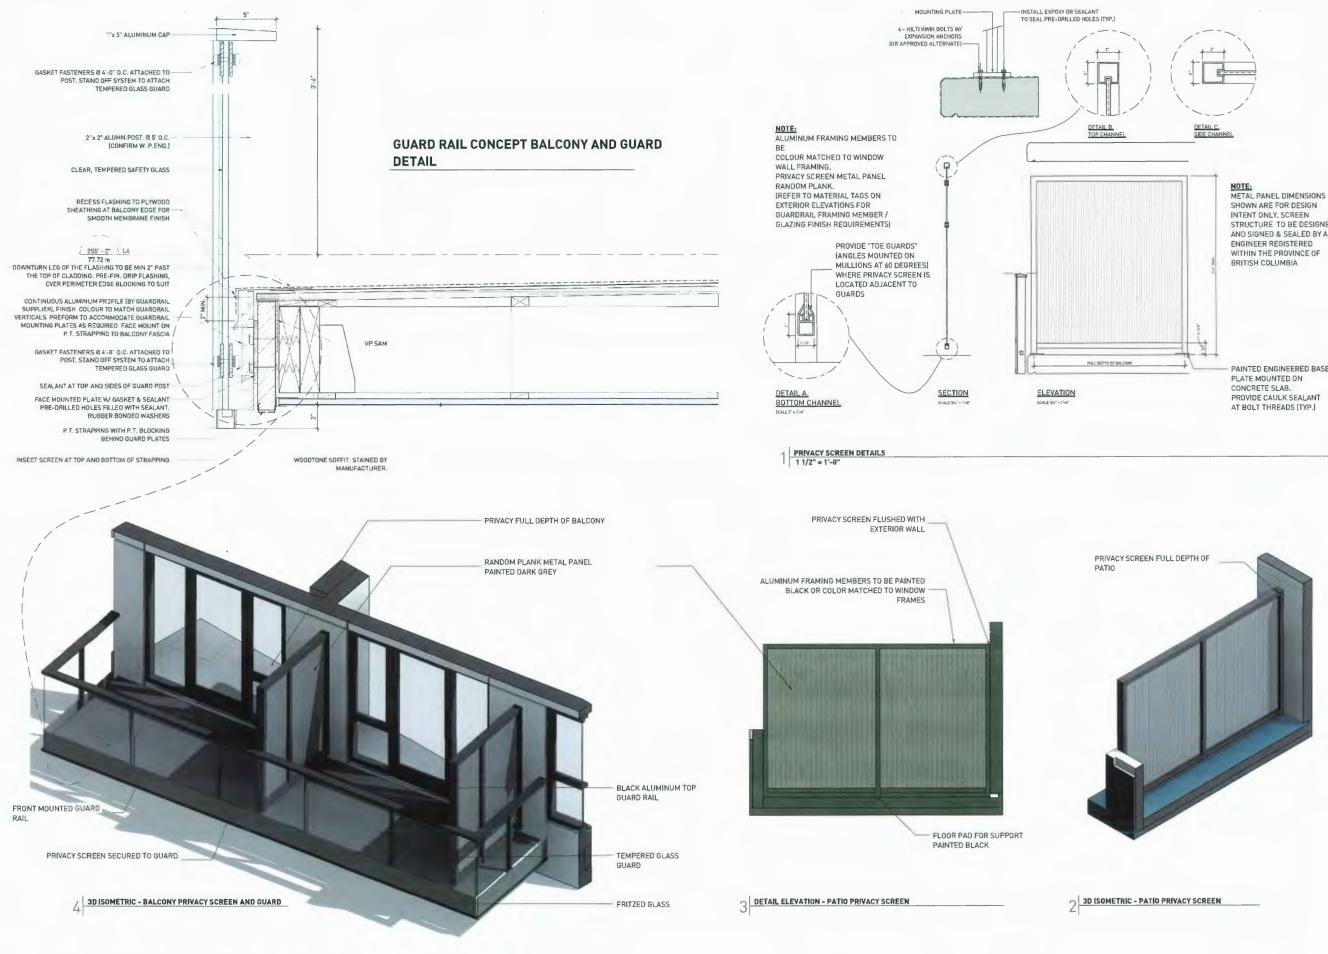

PLAN #34 DP 23-014121

February 20, 2024



TEL all4.73a 1156 FAX all4.731 5279 300-224 WEST 8TH AVENUE ANCOUVER, BC CANADA VSY 1N5 COPYRIGHT RESERVED: THIS PUAN AND DESI REMAIN THE EXCLUSIVE PROPERTY OF OBLIA NOT BE USED OR REPRODUCED WITHOUT IN RE AND AT ALL TIME NOTES

BBL ARCHITECTS INC.

SHOWN ARE FOR DESIGN INTENT ONLY. SCREEN STRUCTURE TO BE DESIGNED AND SIGNED & SEALED BY AN

PAINTED ENGINEERED BASE

#### REVISIONS NO. DATE

5	OCT 06 2023	RE-ISSED FOR DP
6	JAN 19 2024	RE-ISSUED FOR DF
7	FEB 15 2024	RE- ISSUED FOR D

DESCRIPTION

## 8880 COOK RD. & 8751 CITATION DRIVE

RICHMOND, BC


#### **PRIVACY SCREEN** DETAILS

DATE DRAWN BY CHECKED BY SCALE

2/16/2026 4:50:35 PM Checker 1 1/2" = 1'-0" 20039

JOB NUMBER

A-8.00

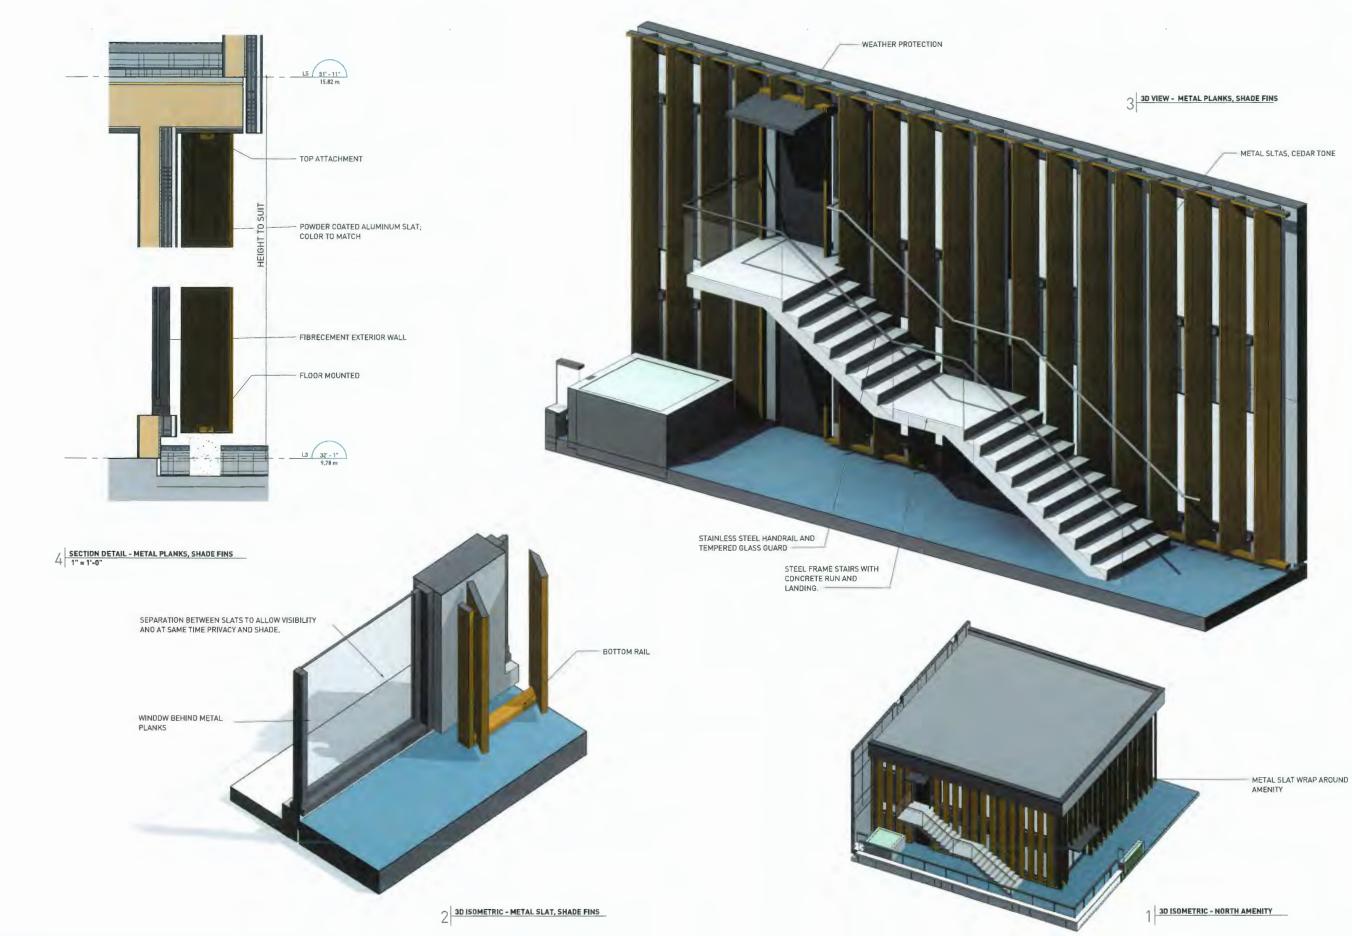

DP 23-014121 **PLAN #35** 

February 20, 2024

#### BBL ARCHITECTS INC. 300-224 WEST 8TH AVENUE

TEL 604 736 1°56 FAX 604 731 5279 ANCOUVER, BC CANADA VSY 11

NOTES

REVISIONS			
NO.	DATE	DESCRIPTION	
5	OCT 06 2023	RE-ISSED FOR DP	
6	JAN 19 2024	RE-ISSUED FOR DP	
7	FEB 15 2024	RE- ISSUED FOR DP	

# 8880 COOK RD. & 8751 CITATION DRIVE

RICHMOND, BC

#### METAL PLANKS DETAILS


DATE DRAWN BY CHECKED BY SCALE

2/14/2024 4:50:42 PM Author Checker 1" = 1'-0"

JOB NUMBER 20039

A-8.01



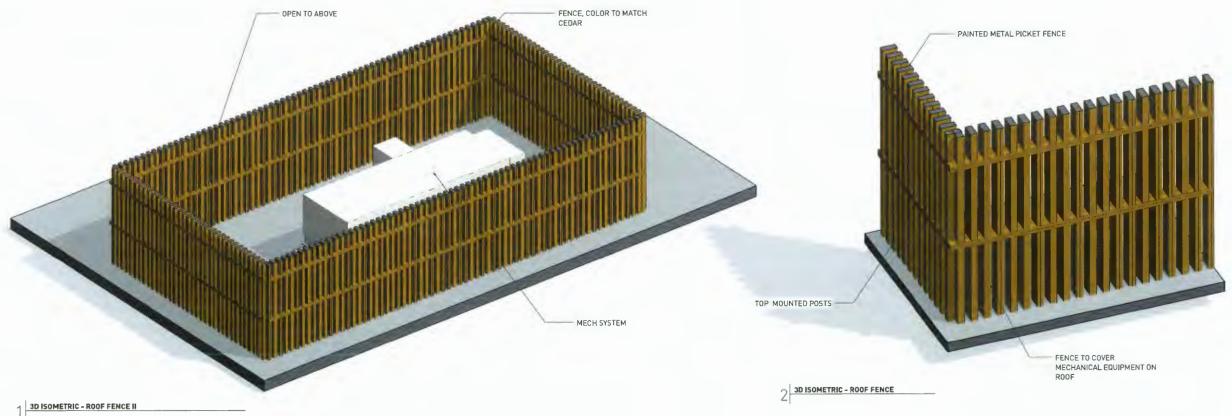

# DP 23-014121 **PLAN #36**

# February 20, 2024



TEL 004 730 1156 FAX 604 731 5279 300-224 WEST &TH AVENUE VANCOUVER, BC CARADA VSY IN N ARE AND AT ALL TIMES CHITEOIS INC. AND MAY RESERVED. THIS PLA NOTES

#### REVISIONS

NO.	DATE	DESCRIPTION
5	DCT 06 2023	RE-ISSED FOR DP
6	JAN 19 2024	RE-ISSUED FOR DP
7	FEB 15 2024	<b>RE-ISSUED FOR DP</b>

## 8880 COOK RD. & 8751 CITATION DRIVE

RICHMOND, BC

#### **ROOF SCREENING** DETAILS

DATE DRAWN BY CHECKED BY SCALE

2/14/2024 4:51:15 PM Author Checker


JOB NUMBER

20039



# DP 23-014121 PLAN #37

# February 20, 2024

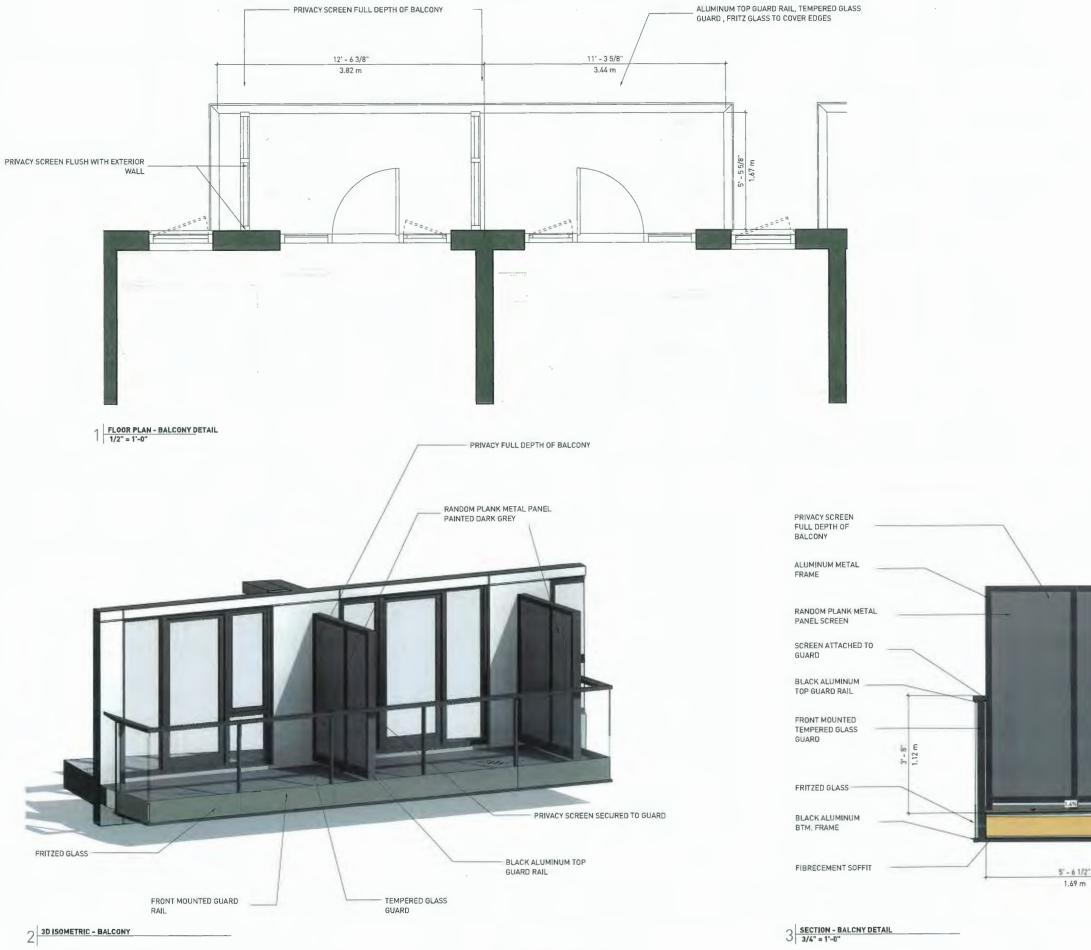



#### GBL ARCHITECTS INC.

 
 305-224 WEST ETH AVENUE
 TEL. 64/27 Ja 136

 VANCOUVER, BC CANADA VOY INS
 FAX. 66/33 5279

 COPYRISHT RESORNED, THIS PLAN AND BESIGN AK AND AT ALL TIMES REMAINT-LE DECLIGHT REPORT OF ORLANCHTEETS INCLINNER AND MAN TOT EL LISC ON MERIOLUSIEN (INCUI THEIR WATTER LOWERHY

NOTES



7' - 0" 2.13 m

#### 8880 COOK RD. & 8751 CITATION DRIVE

DATE DESCRIPTION

 S
 OCT 06 2023
 RE-ISSED FOR DP

 6
 JAN 19 2024
 RE-ISSUED FOR DP

 7
 FEB 15 2024
 RE- ISSUED FOR DP

RICHMOND, BC

REVISIONS


NO.

#### BALCONY DETAILS

DATE DRAWN BY CHECKEO BY SCALE 2/14/2024 4:51:20 PM Author Checker As indicated 20039

JOB NUMBER

A-8.03

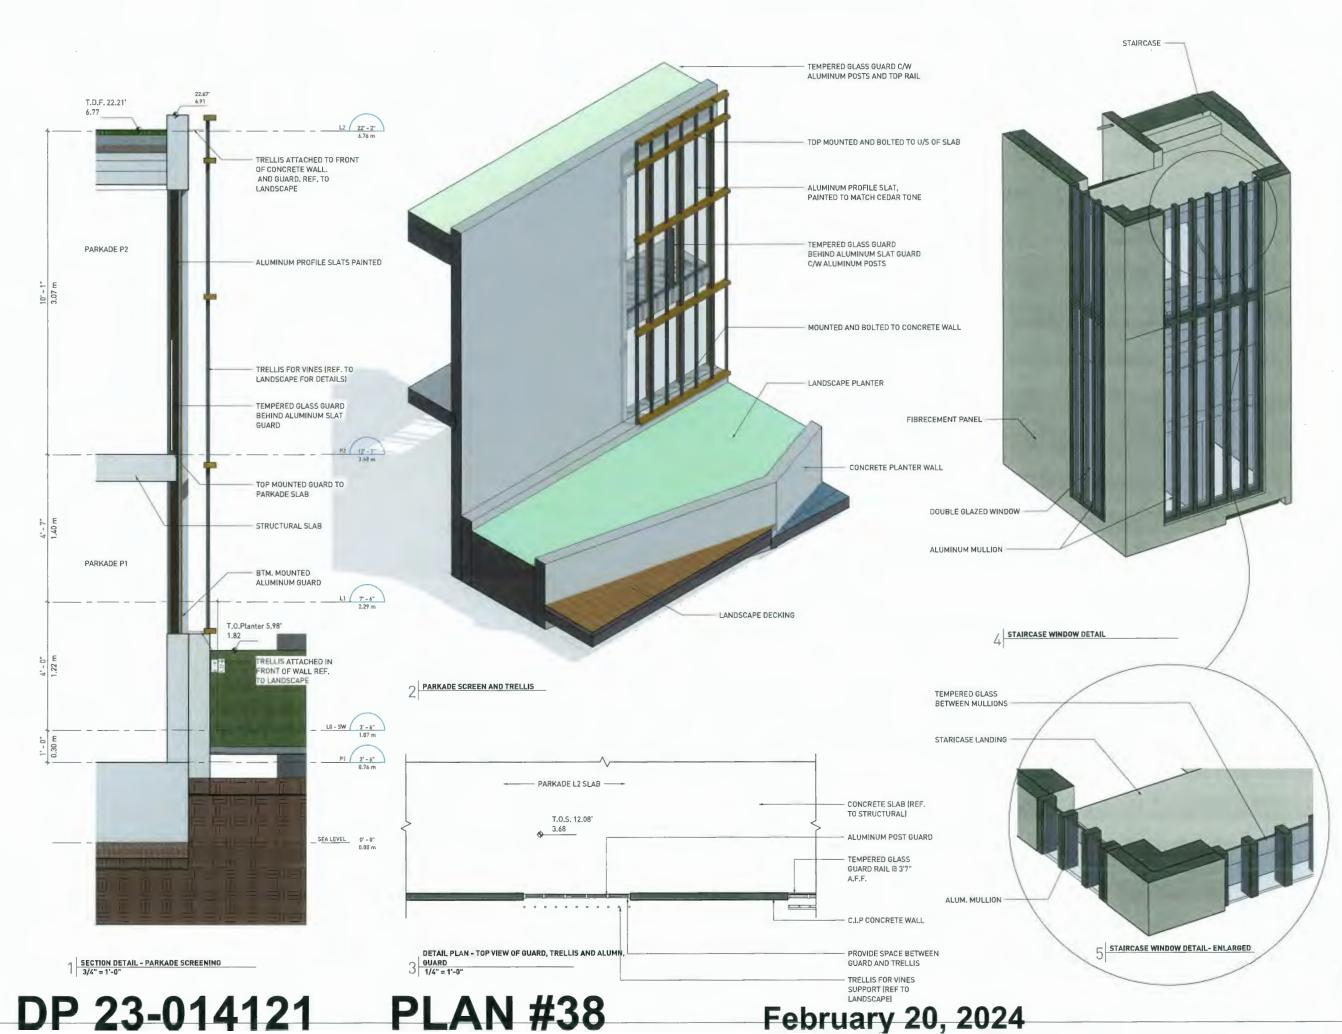

gbl

BBL ARCHITECTS INC.

 200-224 WEST STH AIYENUE
 TEL. 404 73h 1156

 VANCOUVER, BC CANADA YSY INS
 FAX 404 731 5279

 COPYRIGHT RESERVED. THIS PLAN AND DESIGN ARE AND AT ALL THESS
 REMAIN 1-6 EXCLUSIVE FROMEWON OF ULL AND HAST

 NO 78 0.4200 TREPOLOCIES INFORMATION THAN WRITER CONSEMI
 NO 78 0.4200 TREPOLOCIES INFORMATION THAN WRITER CONSEMI

NOTES

REV	SIONS	
NO.	DATE	DESCRIPTION
5	OCT 06 2023	RE-ISSED FOR D
6	JAN 19 2024	RE-ISSUED FOR
7	FEB 15 2024	RE- ISSUED FOR

# 8880 COOK RD. & 8751 CITATION DRIVE


RICHMOND, BC

#### PARKADE AND STAIR SCREEN

DATE DRAWN BY CHECKED BY SCALE 2/14/2024 4:51:26 PM Author Checker As indicated


JOB NUMBER 20039

A-8.04

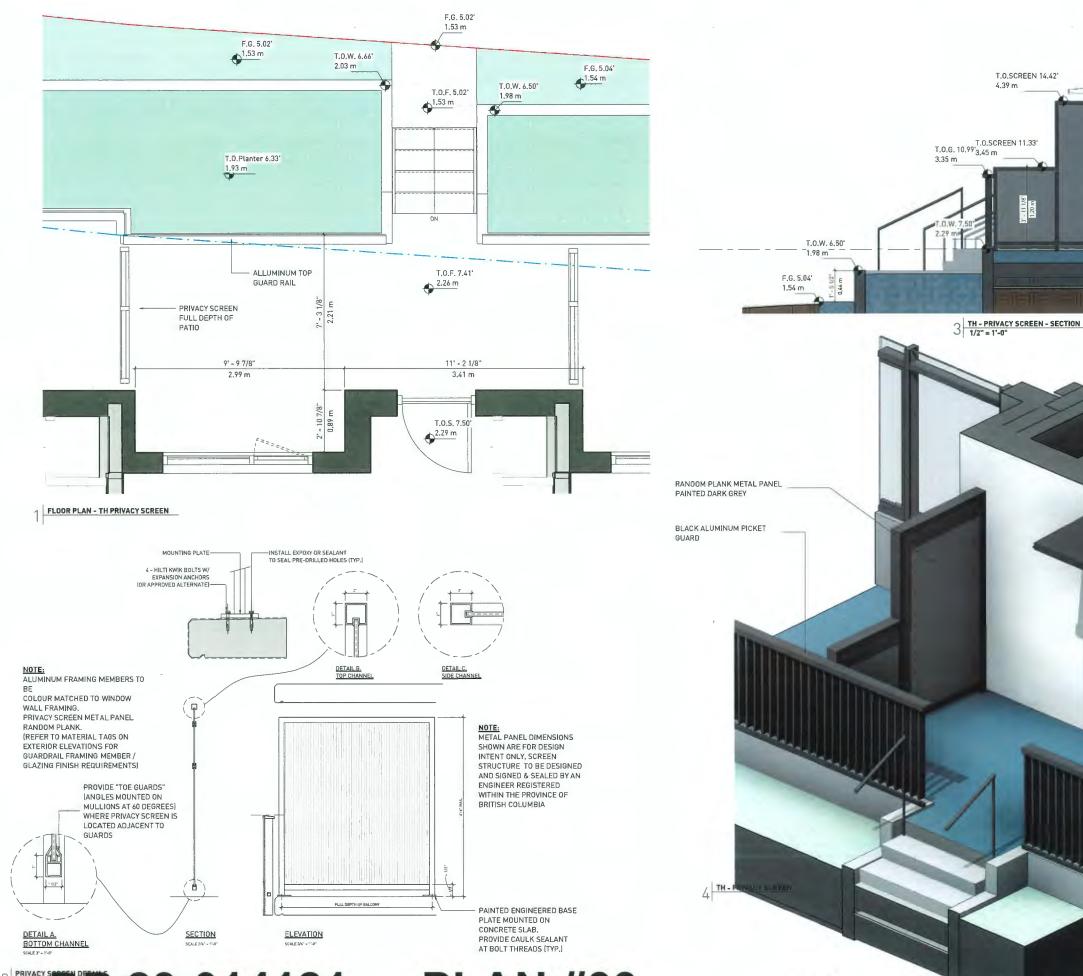

2 PRIVACY SIDE 23-014121 **PLAN #39** 

February 20, 2024

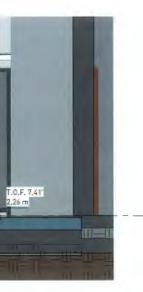

T.O.SCREEN 14.42' 4.39 m

r' - 0 1/8" 2.14 m

BBL ARCHITECTS INC. 300-224 WEST 8TH AVENUE TEL e04.73e 1156 FAX e04.73i 5279 VANCOUVER, BC CANADA VSY INS HT RESERVED. THIS PLAN AND DESIGN ARE AND AT ALL TIMES THE EXCLUSIVE PROPERTY OF GBU ARCHITECTS INC. AND MAY COPYRIGHT RESER REMAIN 1 HE EXCL NOT BE USED OR I NOTES

L1 <u>7' - 6"</u> 2.29 m



REVIS	IONS

NO.	DATE	DESCRIPTION
5	OCT 06 2023	RE-ISSED FOR DP
6	JAN 19 2024	RE-ISSUED FOR D
7	FFB 15 2024	RE- ISSUED FOR D

## 8880 COOK RD. & 8751 CITATION DRIVE


#### RICHMOND, BC

#### TH PRIVACY SCREEN DETAILS

DATE DRAWN BY CHECKEO BY SCALE JOB NUMBER

2/14/2024 4:51:31 PM Author Checker As indicated 20039



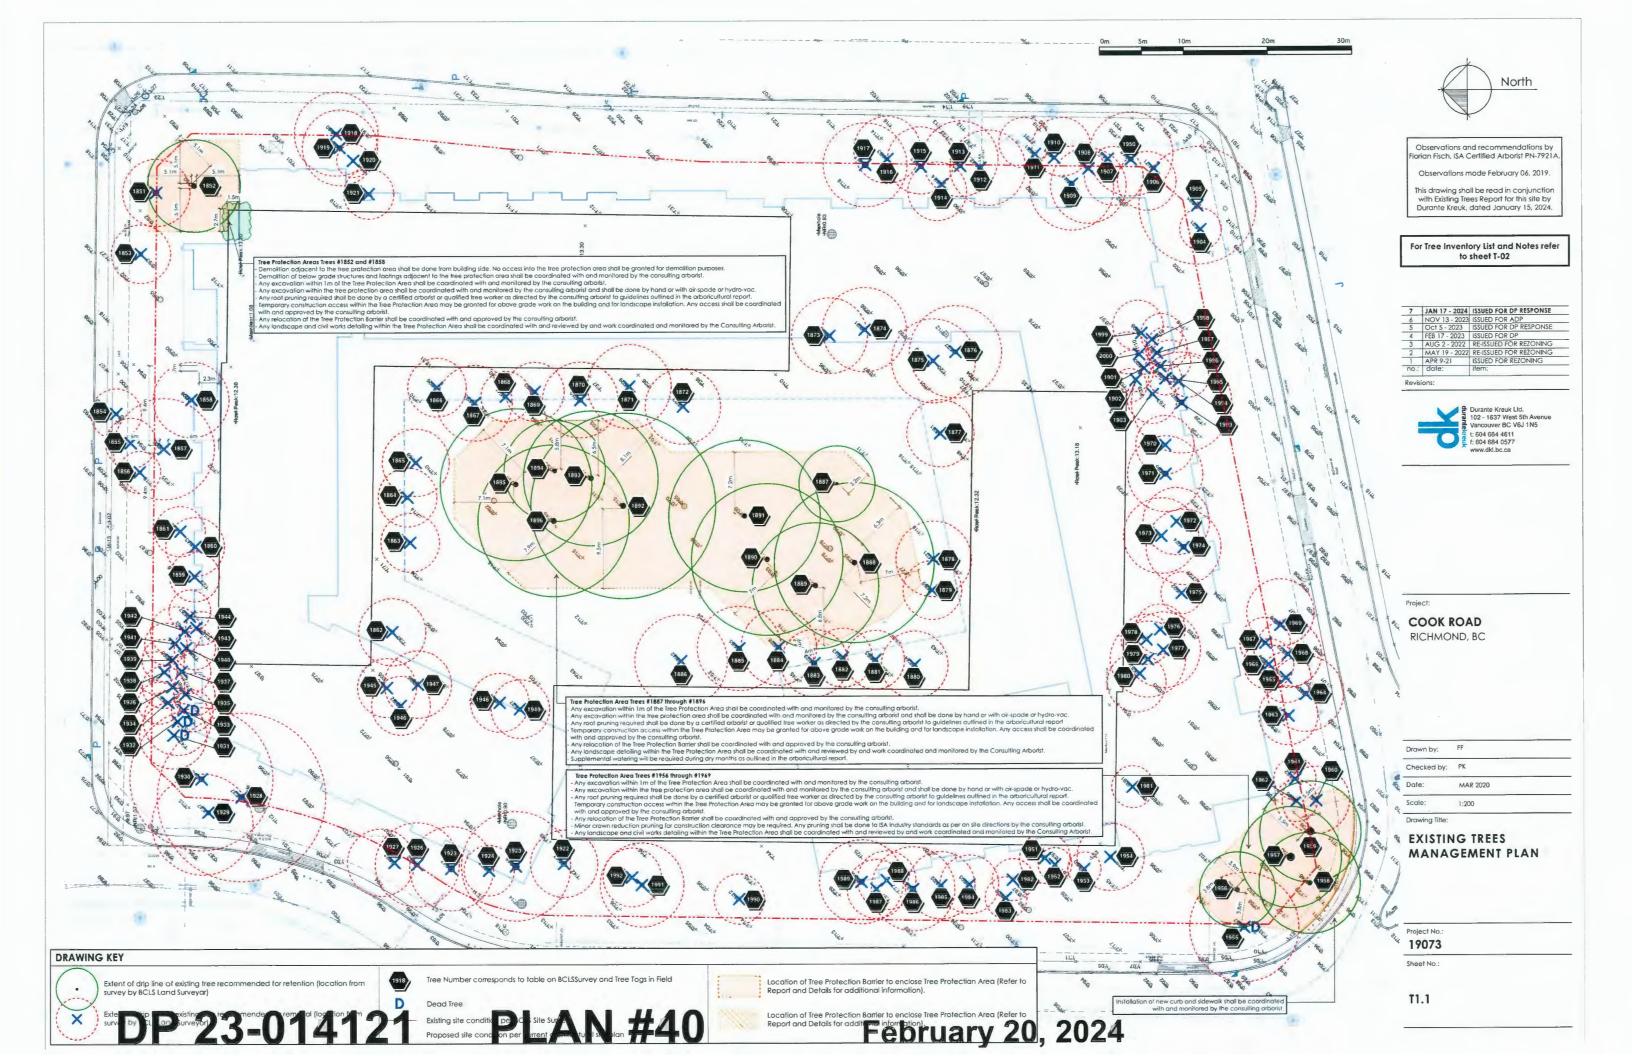

-	The No.	Nate .	Killerin	THEOCOM	ana na	Disad	1	-	Diado	Raild Observations ON SITE	Fieldsh-	New ad	E. H-am	Sild Hen	ecies	Apre	Number of
Quero	1892	c)								Co-dominant leades.	B		65			Prunus var.	1851
Querc				-	1								~			(cherry) Champecyp	
North	1893		٠			•	•			8 Reduced vigor. 60 % LCR.	18	в	64			(false cypress	1852
Querc	1894	c}								Multiple Ganademia canks al lower		7	4			Prunus var.	853
North		7			1					frunk, Watersprouts, Dieback from top.	8	1	~			(cherry)	853
North	1895									Othersterns 10, 10, 9, 1 stern dead. Poor		?	34		ed deciduous	unidentified	
Quero	1896	c)					ľ.		s.	3 structure. Suppressed by adjacent trees. Next to power pole.		6	34	6	ied]	(unidentilied	854
North									- 1	Suppressed by adjacent trees.						liex vor.	
(wesh	1901	4		•	1	•	4			Asymmetrical crown, 2 Co-dominant leaders,		6	27	2		(holly)	855
Thuja	1902									loiot crown Asymmetrical crown.			Ŧ	1	dentalis	Thuja occide	
(west Thuja		0		۰.						Phototropic (ean 100 % LCR.		4	3/	2		(white cedar	1856
(west	1903			•		•				2 Co dominant leaders. Reduced vigar, Joint crown, 95 % LCR.		13	94			Thuja plicato	857
Pinus										Joint crown 90 % LCR. Dieback				-		(western red Pseudotsugo	
	1904			•	• •	٠				6 (minimal) lower crown. 3m from	26	9	31				1858
(lodge										retaining wall. Suppressed by adjacent trees.						(Douglas fir) Acer palmat	
Pinus	1905			•		•				Asymmetrical crown. Surface root(s).	D	6	28	3		(Japanese m	1859
(lodge Pinus				•						Surface root(s). Along retaining wall. Heavily pruned. Poor structure.	7	7	28			Prunus var.	1860
(lodgi	1906		-	÷						Surface motifs! Herwily onuned Poor					alum)	(cherry a piu Prunus var.	
				•		•	•			structure. Asymmetrical crown.	6	6	22		plum)	(cherry or plu	1861
Pinus	1907									Corrected lean. 2m from building. 3 Dieback (minimal). Asymmetrical	3	8	40		arta	Pinus contar	1862
{lodg										CTOWTL B5 % LCR.	Ť.	Ĩ			e pinej	(lodgeocle p	
Pinus	1908									Asymmetrical crown. Limbed up on building side. Woundwood					antico	Cedrus aflan	
(lodg				1	1	"	1			development is moderate. Poor	3	7	63		or)	(atlas cedar)	1863
Pinus	1909									structure. Reduced vigor. 80% LCR. Asymmetricat crown. Limbed up on							
(lodg	1.07			•						buldingside. Woundwood	3	7	33		antica	Cedrus atlan	1864
Pinus	1910									development is moderate. Poor structure. Reduced vigor. 65% LCR.					ar)	(atlas cedar)	-
(lodge	1410									Asymmetrical crown. Limbed up on					anlica	Cedrus atlan	
Pinus	1911			•	1	•				3 building side. Woundwood development is moderate. Poor	3	8	45				1865
flodg	1911			+						structure, Reduced vigor, 65% LCR.						(atlas cedar)	
Pinus	1912			<b>♦</b> <sup>1</sup>	1	•			0	Heavily pruned. Poor structure. Close to building. Surface root(s).	10	7	21			Prunus var. (cherry)	1866
(lodg										0 Heavily pruned. Poor structure.		9	30			Prunus var.	1867
(lodg	1913			-	-						10	í	~			(cherry) Prunus var.	
Pinus	1914			•	1	Þ				0 Heavily pruned. Poor structure.	10	6	21			(cherry)	1868
[lodg	1914			•	-					Ram's hom from base to 2n above	11	7	40	2		Acer vor.	1869
Pinus	1915									ground. Asymmetrical crown.				-		(maple) Acervar	
(lodg	1713			•	1	Þ	•			Asymmetrical crown, 10cm a stem dead middle crown,	10	9	52	3		(maple)	1870
Pinus				1						Asymmetrical crown. Histroically						Acer var.	
(lodg	1916			•		Þ				dropped structural limbs. Potential decay calumn mid crown. Close to	10	10	38			(magie)	1871
Pinus										building. Limbed up to 65% LC.R. Dieback lower							
	1917			•		•				3 crown. Pruning wound(s). Woundwood	з	9	41			Cedrus atlan	1872
(lodg										development is good. Jaint crown. Surface root(s), Heaving						(attas cedar)	
Caryl	1918			•		•				5 pavement 80% LCR. Deadwood in	15	9	36			Pinus contor	1873
(haze										Joint crown. Surface root(s). Heaving						(lodgepcle p	
Caryl	1919			•		•				5 povement. 80% LCR. Deadwood in	15	10	40			Pinus contan	1674
(haze									-	Joint crown. Surface root(s), Heaving						flodgepcle p	
Pierts (Japa	1920			•		•				5 povement. 80 % LCR. Deadwood in	15	10	35			Pinus cantan	1875
Acer	1921									Joint crown. Surface root (s). Henving					and the second s	(lodgepcle p	
(map	1921			•		•				5 povement. 80 % LCR. Deadwood in	15	11	40			Pinus contor	1876
Pinus (lodg	1922									Jower crown. Joint crown. Surface rool (s). Heaving						(lodgepcle p	
Pinus				•		•				5 poveman1.80% LCR. Deadwood in	15	8	30			Pinus contor	1677
(lodg	1923									Surface root(s). Poor structure.						(lodgepole p Prunus var.	
Pinus				•		Þ	4			Watersprou's from roots.	10	9	28			(cherry)	1678
(lodg	1924			•	-					Surface rool (s). Poor structure.	10	7	25		:	Prunus var.	1579
Pinus	1925								-	Watersprouts from roots. Surface root(s). Poor structure.			_			(cheny)	
(lodg Pinus				٠	1					9 Watesprouts from roots.	9	В	23		-	Prunus var. (cherry)	1880
flodg	1926								n.	Phototropic lean. Asymmetrical crown	10	-	39	2		Acer var.	1581
Pinus	1927		-	•						Included bark.	10	'	37	- 2		(maple)	1001
flodg										Included bark. Other stems 10cm e. 12cm e Pruning wound(s) 1m above						Acervor.	
Cedh	1928			•	1	•	1			ground. Woundwood development is	10	7	38	4		(maple)	1882
{deod Cedh									-	poor, Girdling rool (s). Carected lean. Close to building.							
(deor	1929									Asymmetrical crown, Limbed up on	22		51		odarc	Cedrus dieoc	1883
Cedh	1930			•						building side. Poor structure. Joint crown. 60% LCR.		•	51		edat	(deodar ced	1883
(deor	1930		~							Corrected lean. Close to building.							
Thuja	1931									Asymmetrical crown. Limbed up on	22	9	a		cdara	Cedrus deco	1384
(west Thuja										<sup>22</sup> building side. Poor structure. Joint crown, 90 % LCR.	-	í			edar)	(deodar ced	1004
west	1932									Carecled lean. Close to building							
Thuja	1933			•		•				Asymmetrical crown. Limbed up an building side. Poor structure. Joint	22	10	52		6000	Ceditus deco	1685
(west Thuja										crown, 85 % LCR.					edar)	(deodar ced	
fwest	1934									Girding root(s). Asymmetrical trunk.						Acer vor.	
Thuja	1935			•		•				<ul> <li>Included bark, Asymmetrical crown.</li> <li>Pruning wound(s), Woundwood</li> </ul>	9	31	35				1886
(west Thuja										development is poor. Surface root(s).						(maple)	
	1936	b)	٠		•					Carected lean. Sub-dominant. Deadwood lower crown.	12	9	28			Acer platana	1887
(west	1937								af	Surface root(s). Asymmetrical hunk. Ha						(Norway ma	
(west Thuja	100	b)							-	an north side. Corected lean. Joint crown, Asymmetrical crown. Dieback	24	19	41		vbra	Quercus rub	1888
(west Thuja (west		-1	ľ		1					crown, Asymmetrical crown. Dieback lower crown.	20		01		ed udk	Northem red	-000
(west Thuja (west Thuja	1938									Surface root(s). Corrected teon, Joint						Quercus rub	
(west Thuja (west Thuja (west					17					B crown, Asymmetrical crown, Dieback	29	1.5	57			avercus rubi	1687
(west Thuja (west Thuja	1938 1939	ы			•							14	37		and a set	all a state	
(west Thujo (west Thujo (west Thujo	1939	Ы	•		•	•				lower crown.		(2	3/			Northern red	
(west Thuja (west Thuja (west Thuja (west Thuja (west			•		•	•			_		27				ubra	Quercus rub	1590
(west Thuja (west Thuja (west Thuja (west Thuja (west Thuja	1939				•	•			_	lower crown. Surface root(s). Corrected lean. Jaint	27				ubra		1890
(west Thuja (west Thuja (west Thuja (west Thuja (west	1939 1940	b)			•	•				Surface icot(s). Carected lean. Jaint 27 crown. Asymmetrical crown. Diebock		18			vbra Rd ook	Quercus rub	1990

The Mo		8 of Beers	WWW/cm	Principal - M	Helight - m	Reld Observations	These	Pear.	Fuile	Gund	Renave	Lebuh	Number of Street, or other
1892	Quercus rubra		66	2	2 37	Jaint crown. Dieback lower crown.	T	1	1	•	1	•	b
1.993	Northern red ook Quercus rubra	~	55		6 41	Joint crown, Asymmetrical crown.					t		1
1843	Northern red ook		30	1	0 41	Diebock lower crown. Hanger.				Τ.		1	Ĩ
1894	Quercus rubra Northern red oak		48	R	2 43	Joint crown, Asymmetrical crown. Dieback lower crown Hanger				٠		٠	k
1895	Output a school		58	H	. 4	Joint crown, Asymmetrical crown,					1	1.	
IQUS	Northern red oak	-	-			Diebock lower crown. Hanger.					+	Ľ	1
1896	Quercus rubra Northern red calk		65		8 44	Joint crown, Asymmetrical crown. Dieback lower crown, Hanger,				٠		+	Ł
1903	Phuja plicata		21		12	Joint crown. Asymmetrical crown.					+		
	(western red cedar) Thuia picata					Deadwoodinner crown, 100 % LCR. Joint crown, Asymmetrical crown.				-			
1902	(western red cedar)		26	3	12	Deadwood inner crown. 100 % LCR.				٠	٠		
1903	Thujaplicato		25		12	Joint crown, Asymmetrical crown, Deadwood inner crown, 100% LCR,				+	•		
	(western red cedar)					Main leader previously removed.							
1904	Pinus contarta		23		5 6	Woundwood development is poor.					•		
	(lodgepole pine)					Suppressed by adjacent trees 80 % LCR of Im abovo ground.							
1905	Pinus contarta		72		4 15	Subdominant leader leaning on street				+	•		
	(lodgepole pine)					ight. 70% LCR.						÷	
1906			29		15	Jaint crown Asymmetrical crown. Deadwood Jower crown. 80 % LCR.			٠		•		•
	(lodgepole pine)												
1907	Pinus contorta		26	7	15	Joint crown Asymmetrical crown. Deadwood Jower crown. 85 % LCR.			•		•		
	{lodgepole pine}					Photoleopic lean.					-		
1908	Pinus contorta		34	5	15	Joint crown Asymmetrical crown. Deadwood lower crown. 80 % LCR.			•				
	(lodgepole pine)	- 1				Phototropic lean.							
1909		2	56	1	0 15	Jaint crown Asymmetrical crown. Deadwood lawer crown. 90 % LCR.			•		+		
	(lodgepole pine)	-				Pholotropic lean.					+	-	
1910	Pinus contorta		30		15	Joint crown Asymmetrical crown. Deadwood lower crown. 85% LCR.							
	(lodgepole pine)					Phototopic lean.							
1911	Pinus conforta (lodgepole pine)		21	1	5 15	Photohopic lean. Asymmetrical crown Deadwood lower crown. Joint crown.			٠		•		
	Pinut conforta					Photobanic loop Anomenabical conven						-	•
1913	(lodgepole pine)		40	9 5	15	Deadwood lower crown, Joint crown.			•		•		
1913	Pinus cantotta		41	4	15	Phototropic lean. Asymmetrical crown.							
	(lodgepole pine)					Deadwood lower crown, Joini crown,					-		
1914	Pinus contarta (lodgepole pine)		30	1	7 15	Phototropic lean. Asymmetrical arown. Deadwood lower crown, Joint arown.			٠		٠		
	Pinus contarta	- 1				Deadwood lower crown, Reduced							
1915	(lodgepale pine)		50	1 8	8 15	vigor Joint crown. Hanger. Heavily pruned.			+		•		1
	Pinus contorta					Deadword Jowar crown. Reduced							1
1914			29		8 15	vigor. Joint crown, Hanger. Heavily pruned.			٠		•		
						Deathroad lower cown Reduced							
1917		2	67		0 15	vigor Jaint crown. Hanger. Heavily			+		٠		1
	(lodgepole pine)					limb dropped.							
1918	Carylus var.	3	4		0 7	Deadwood substantial. Dead co- dominant leades. Decay column.							
	(hazel ond filbert)	_				Reduced vigor.							
1915		5	52		. 7	Otherstems 10cm a. One co-dominant leaderis deod. Decay column.							
	(hazet and filbert)	-				Reduced vigor.					1		
1920	Piens japanica (Japanese pieris)	2	24		9 5	Deadwood inner crown Reduced vigor			٠		٠		
1921	A CAR HOR	3	34		6 7	Previously heavily pruned. Poor							
174	(maple)	_	-			structure.					+		
192	Pinus contarta (todgepale pine)	2	57		5 14	Joint crown, Decdwood minimal lawer arown, Asymmetrical arown.				٠	+		
	Pinus contarta	-				Included bark. Joint crown. Deadwood							
192	(lodgepole pine)	2	80	2 1	3 18	inner crown. Ivy on lower trunk.				•	•		
192	Pinus contarto		35	5	6 14	Sweep. Asymmetrical crown, Joint					•		
	(lodgepole pine) Pinus contorto					crown. Deadwood innner crown.			-		-		
192	(lodgepole pine)	2	75	5 1	0 14	Included bark. Joint crown, Deadwood in crown,				٠	٠		
192	Pinus contorta					Phototropic lean Joint crown.							
	(lodgepole pine)									1	-		
192	(lodgepole pine)		33	5 4	B 9	Heavy phototropic lean, Joint crown.			+		•		1
192	Cecius deocioro				0 2	Corrected tean. Asymmetrical crown. Joint crown. 2 subdominant leaden	-						
174	(deodar cedar)		A		- 21	Suiface root(s).					-		
192	Cechus deodara		2		2 21	Asymmetrical crown, Joint crown, Deadwood in crown, Surface root(s),				٠	٠		,
	(deodor cedor) Cedrus deodoro											-	-
1930	(deodar cedar)		60	1	7 21	Joint crown. Surface root [s]. Deadwood in crown.				•	٠		
193	Thuja plicata		з			Part of hedge.	+				٠		
	(western red cedar) Thuja plicata												
193	(western red cedar)		3	1	8 7	Part of hedge.	1				*		
	Thuja plicata		2	1.	4 7	Part of hedge. Asymmetrical crown.	4				٩		
193	(western red cedar) Thuja plicata					Port of hedge. Asymmetrical crown							
	(western red cedar)		3	2	5 7	80% dead		•	1		•		
193	Thuja plicata		3		4 8	Part of hedge. Asymmetrical crown. 90% dead.					٠		
						Not of hades Assessed cours					-		
193	(western red cedar)		2 2	1	5 8	60% dead. Reduced vigor.		•	1		٠		
193	(western red cedar)	2				Part of hedge. Asymmetrical crown Reduced vigar, 100% LCR.							
193	(western red cedar) Thuja plicata (western red cedar) Thuja plicata	2	2	5	5 8								
193 193 193	(western red cedar) Thuja plicata (western red cedar) Thuja plicata (western red cedar) Thuja plicata (western red cedar)					Red at bodge. As we matri and armun							
193 193 193	(western red cedar) Thuja plicata (western red cedar) Thuja plicata (western red cedar) Thuja plicata (western red cedar)		2		58	Red at bodge. As we matri and armun					•		
193 193 193	(vestem red cedar) Truja plicata (vestem red cedar) Truja plicata (vestem red cedar) Truja plicata (vestem red cedar) Truja plicata (vestem red cedar)			•		Part of hedge. Asymmetrical crown. Reduced vigar. 100% LCR. Part of hedge. Asymmetrical crown.		•			•		
193 193 193 193 193	(western red cedar) Thuja plicata (western red cedar) Thuja plicata (western red cedar) Thuja plicata (western red cedar) Thuja plicata (western red cedar)		2 3	•	5 8	Part of hedge. Asymmetrical crawn. Reduced vigar. 100% LCR. Part of hedge. Asymmetrical arown. 100% LCR.		•	•		•		
193 193 193 193 193	(western red cedar) Thuja plicata (western red cedar) Thuja plicata (western red cedar) Thuja plicata (western red cedar) Thuja plicata (western red cedar) Thuja plicata		2 3		5 8	Part of hedge. Asymmetrical crown. Reduced vigar. 100% LCR. Part of hedge. Asymmetrical crown.		•	*		•		
193 193 193 193 193 193 193 194	(western red ceckar) Thuja pilcarla (western red ceckar) Thuja pilcarla	2	2 3 1- 2	4	58 59 59	Port of hedge. Asymmetrical crown. Reduced vigor. 100% LCR. Port of hedge. Asymmetrical crown. 100% LCR. Part of hedge. Asymmetrical crown. 100% LCR.		•	*				
193 193 193 193 193 193	(western red ceckar) Thuja pilcarla (western red ceckar) Thuja pilcarla		2 3 1- 2	4	58 59 59	Part of hedge. Asymmetrical crown. Reduced Agar. 100% LCR. Part of hedge. Asymmetrical arown. 100% LCR. Part of hedge. Asymmetrical arown. 100% LCR.		•	•				

Tree No.	Species	# of Planna	Dilli-em	Rpressi - m	Helight - m	Reid Observations ON SITE	Distant I	Toor	12	Leritaria	Paultaneedin
1943	Thuja plicata	T	20	J.	ų,	Part of hedge Asymmetrical crown		1			l
	(western red cedar) Thuja pfical a	-	-			100% ECR. Part of hedge. Asymmetrical crown.				-	
1944	(western red cedar)		36	5	9	100% LCR.			٠	•	1
	Pinus contorta					Girdling root(s). Asymmetrical crown. Joint crown. Previously heavyly pruned.			U		
1945	(lodgepole pine)		30	7	15	Deadwood 'ower crown. Surface			•	•	
	Pinus contarto					root(s). 80 % LCR. Asymmetrical crown, Joint crown,					
1946	(lodgepole pine)		29	7	13	Connected lean Deadwood lower crown, Surface root(s), 80 % LCR,			٠	1	•
1947	Pinus contorta		30	8	ы	Inint crown deadwood Inwar crown					
	(lodgepole pine) Pirus contorta					Surface rool(s). 80% LCR.					
1948	(lodgepole pine)		34	7	14	vigar. Surface root(s). 75 % LC R.			•	1	
1949	Pinus contorta		31	7	13	Joint crown. Deadwood. Reduced vigor. Surface root(s).60% LCR.			٠	4	×.
1950	(lodgepole pine) Pinus contorta			10	14	Included bark, Joint crown,					
17.30	(lodgepole pine)		~							-	1
1951	Thuja plicata (western red cedar)		29	4	12	Reduced vigor. Corrected tean. Base near building.			٠		
	Thuja plicata		-			Heavly pruned, Decay calumn.					
1952	(western red cedar)	2	23	4	5	Suppressed by adjacent trees. Poor structure.			Τ.		1
1953	Acer var.	3	29	4	5	Heavily pruned. Suppressed by adjacent trees. Poor structure.			+		
	(maple) Acervar	- 5				Reduced vices 2 Co-dominant leader					t
1954	(maple)	2	43	8	12	Base near building. Included bark.			•	1	
1955	Pinus contorto		54	13	9	Diebock (minimal). Phototropic lean. Ivy an lower trunk 70% LCR Joint	+				
	(lodgepole pine)					crown.					
1956	Pinus conforta		45	9	20	Dieback (minimal). Phototropic lean. Ivy an lower trunk. 70% LCR. Joint			•		
	(lodgepole pine)					crown.					
1957	Pinus contorta		86	12	10	2 Co-dominant leaders at 2m above ground. Ivy an Icwer trunk, 85 % LCR.				•	
	(lodgepole pine)					Joint crown. 3 Co-dominant leaders at 2m above					
1958	Pinus contorta		49	12	23	ground ivy on lower trunk, 85 % LCR.			٠		
	(lodgepale pine) Pinus cantorla					Joint crown, Asymmetrical crown. Deadwood minimal. Ivy on lower trunk.					
1959	(lodgepole pine)	2	82	12	20	85% LCR. Joint crown.			٠		
1960	Belulo var.		21	8	8	Dieback from top.		•			•
	(birch) Comus var.										t
1961	{dogwood]	3	30	5	8	Deadwood minimal.					1
1962	Pinus cantoria (todgepole pine)	4	27	5	6	Deadwood minimal Phototropic lean. Other stems 7cm ø.				+ •	ł
1963	Pinus contana	-	40	7	14	Joint crown. Deadwood lower crown.					J.
	(lodgepole pine) Pinus contorto										
1964	(lodgepole pine)		T	9	13	Jaint crown. Dendwood Jower crown			•	1	
1965	Pinus conforta (lodgepole pine)		28	6	14	Joint crown. Deadwood lower crown.			٠		e.
1966	Pinus contorta		25	6	1.4	Joint crown, Deadwood lower crown.					t
1766	(lodgepole pine)		2	•	54	Joint Down, Deabwood lower clown,			•		1
1967	Pinus contorta (lodgepole pine)		30	á	13	Joint crawn. Deadwood lower crown.			٠	1	•
1968	Pinus cantarta		37	8	15	Joint crown. Deadwood lower crown.			+		
	(lodgepole pine) Pinus contorta			0		loint crown Deadwood lower crown				-	÷
1969	{lodgepole pine}		36	8	10	Heavy phototropic lean east			•		
1970	Betula var. (birch)		21	7	18	Main leader dropped at 13m above ground.			٠		•
1971	Belula var.	2	57	9	20						
	(blinch)	-	-		-						1
1972	Pinus contorta (lodgepole pine)		31	8	11	Deadwood minimal.			٠		•
1973	Belula var.		30	9	20						•
	(birch) Betulo var.	1									
1974	4	2	54	9	21	Included bark.			*	-	"
1975	Prunus var. (cherry or pium)		21	4	5	Previously heavily pruned. Poor structure. Sput bork.		٠			٠
1.000	Prunus var.		20			Previously heavily pruned. Poor					
1976	(cherry or plum)		a	0	0	structure. Woundwood development is poor.			*		1
1977	Champecyparis		27	9	18	Joint crown. Reduced vigor,		+			
	(false cypress) Prunus var.			1		Previously heavily pruned. Poor				1	t
1978	(cherry or plum)		20	6		structure. Woundwood development is poor.			+	1	•
1979	Chamaecypails	2	37	9	10	Joint crown. Included balk. 2 Co-					•
	(false cypress)	-	-			dorringrifieddes, keduced vigor.					1
1980	Chamaecyparis		20	7	18	Reduced vigor. Subdominant leader		•			•
	(( alse cypress)					development is poor.					
1981	Prunus var.		25	5	6	Previously havily pruned. Woundwood development is poor. Split bark. Poor					•
	(cherry or pium)					structure.					
1982	Thuja plicato (western red cedar)	2	23	5	4	Shaped. Joint crown			٠	•	٠
1983	Thujaplicata	2	21	5	4	Shaped. Joint crown.					
	(western red cedar) Pinus contorto										
1984	(lodgepole pine)		IJ	7	6	Stunted top. Joint crown.			•	•	•
1985	Pinus canlorta (lodgepole pine)		25	7	10	Stunted lap. Joint crown. Suppressed by adjacent trees. Phototropic lean.			+		•
1986	Pinus conforta	2	60	10		Joint crown.					
1700	(lodgepole pine)	-									1
1987	Betula var. (birch)	2	29	7	18	Joint crown.				• •	•
1988	Befula var.		25	7	18	Joint crown. Suppressed by adjacent trees,					•
	(birch) Betula var.					_					
1989	(birch)	2	.58	10	18	Joint crown.				•	•
1990	Comus var.	2	22	6	5	Asymmetrical arown. Lean west. Pruning wound(s), Woundwood				• •	•
_	(dogwood)		-		_	development is poor.			_		1

Dies No.	Species	# of Bears	Dittem	April - fit	Hetudint - ris	Reld Observations	Dent
						ON SITE	
1991	Pinus contorto (Todgepole pine)		46	10	11	Deadwood in crown.	
1992	Prunus lustanica (Portuguese (gurel)		24	7	7	Asymmetrical arown. Suppressed by adjacent trees.	
1993	Pinus contarta Rodaepole pinet		56	12	18	Main leader dropped at 14m above ground. Deadwood. Girdling root(s).	
1994	Thuja přicata (western red cedar)		IJ	12	12	Asymmetrical crown. Part of hedge. 100% LCR. Deadwood inner crown. Prevously topped at 10m above ground.	
1995	Thuja plicara (westem red cedar)	2	28		12	Part of hedge, 40% LCR. Deadwood lower arown. Previously topped of 10m above ground.	
1996	Thuja plicata		22		12	Asymmetrical crown, Part al hedge, 100 % LCR, Deadwood inner crown, Previously topped at 10m above	
1997	(western red cedar) Thuja plicata (western red cedar)		28			ground. Asymmetrical crown, Part of nedge. 100 % LCR, Deadwood inner crown. Previously lopped at 10m above	
1998	Thuja plicalo (western red cedar)		24		12	Previously topped of 10m above	
1999	Thujo plicato (western red cedar)		30		12	ground. Asymmetrical crown. Part of hedge. 100 %, LCR. Deadwood inner crown. Previously topped at 10m obove around.	
2000	Thujo plicata (western red cedar)	-	25		12	Asymmetrical crown. Part al hedge. 100% LCR Deadwood inner arown. Previously topped at 10m above ground.	
			-		-	TREE NOTES	
+	Nan- bylaw trees unde	0.20	DBH	and	dec	ad frees listed on shaded background.	
٠	Byfow trees over 0.20 D	8H are	e liste	d or	101	white background.	
a	Considered on invasive	e spec	ies p	er IS	Clr	waive Species Council of BC. Removal	rex
b	Crown cleaning be rea	cquire	dwp	uld	this	tree beretained.	
d	have fulfing a local star of the					tine but outside of the adjusted property	tie


#### ARBORICULTURAL NOTES

Exert Post Post Doced Loncor Loncor Loncor Loncor Loncor • • . . • • . . . . . . . . . . . . . . • • . . . .

.

+ c) + .

1. Install tree protection barriers to City of Richmond requirements (see detail on this sheet) and maintain throughout construction. 2. Trees, their environment, and their health and stability change with time. Our recommendations to protect and retain trees are based on observations made on the date noted, and on a visual assessment of the trees using normal visual assessment procedures. Durante Kreuk Ltd. cannot guaranly that trees recommended for retention will remain whole or stable. Durante Kreuk Ltd. assumes no responsibility for tree protection unless we have been contracted to provide services in that regard, and provided appropriate notice when work on or near the trees is to be done. 3. Tree protection measures and all work on trees on City of Richmond Parks Land shall be pre-approved by City of Richmond arborist.

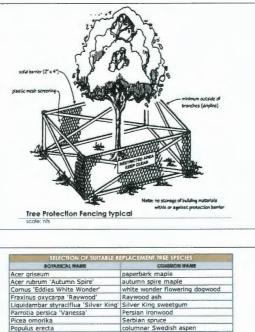

Kwanzan flowering

Douglas fir Regal Prince Englis

Selection of Suitable Replacement Tree Sp

# **PLAN #41** DP 23-014121

# February 20, 2024

Prunus serrulata 'Kwanzan

Pseudotsuga menziesii Quercus robur 'Regal Prince'

	Deed	Phon	Fab	Event	Rupperva	<b>Notauto</b>	Reditor	-
	Ĩ	1	Ī	•	•			Ī
				•	٠			
			٠		٠			
				•	+			
2			•		•			
				•	•			
				•	•			
				•	•			
				•	•			
				•	•			
1	line		mer	nda	d			0.6.0

IES KAME	
ing dogwood	
TT	
spen	
herry	
oak	
ecles	

7	JAN 17 - 2024	ISSUED FOR DP RESPONSE
6	NOV 13 - 2023	ISSUED FOR ADP
5	Oct 5 - 2023	ISSUED FOR DP RESPONSE
4	FEB 17 - 2023	ISSUED FOR DP
3	AUG 2 - 2022	<b>RE-ISSUED FOR REZONING</b>
2	MAY 19 - 2022	RE-ISSUED FOR REZONING
1	APR 9-21	ISSUED FOR REZONING
no.:	date:	item:



Durante Kreuk Ltd. 102 - 1637 West 5th Avenue Vancouver BC V&J 1N5 1: 604 684 4611 1: 604 684 0577 w.dkl.bc.ca

Project:

COOK ROAD RICHMOND, BC

Drawn by:	FF	
Checked by:	РК	
Date:	MAR 2020	
Scale:	NTS	

Drawing Title:

#### EXISTING TREES INVENTORY AND ARBORICULTURAL DETAILS

Project No.: 19073

Sheet No .:

T1.2

#### **DRAWING LIST**

L-0.00 LANDSCAPE COVER SHEET L-1.01 LANDSCAPE OVERALL SITEPLAN L-1.02 LANDSCAPE PORCKT PARKS PLAN L-1.03 NON POROUS AND LIVE PLANTING J L-1.1 MATERIALS & GRADING PLAN L-1.2 MATERIALS & GRADING PLAN L-1.3 MATERIALS & GRADING PLAN L-1.4 MATERIALS & GRADING PLAN L-1.5 MATERIALS & GRADING PLAN L-1.6 LEVEL 3 AMENITY DECK L-2.1 LIGHTING PLAN L-2.2 LIGHTING PLAN L-2.3 LIGHTING PLAN L-2.3 LIGHTING PLAN L-2.4 LIGHTING PLAN L-2.5 LIGHTING PLAN L-3.1 IRRIGATION COORDINATION PLAN L-3.2 IRRIGATION COORDINATION PLAN L-3.3 IRRIGATION COORDINATION PLAN L-3.4 IRRIGATION COORDINATION PLAN L-3.5 IRRIGATION COORDINATION PLAN L-3.5 IRRIGATION COORDINATION PLAN L-4.1 PLANTING PLAN L-4.2 PLANTING PLAN L-4.2 PLANTING PLAN L-4.3 PLANTING PLAN L-4.4 PLANTING PLAN L-4.4 PLANTING PLAN L-4.5 PLANTING PLAN L-4.5 PLANTING PLAN L-4.6 SOIL VOLUME PLAN L-4.6 SOIL VOLUME PLAN L-5.1 LANDSCAPE SECTIONS L-5.1 LANDSCAPE SECTIONS L-5.1 LANDSCAPE SECTIONS L-5.1 LANDSCAPE DETAILS L-6.1 LANDSCAPE DETAILS L-6.1 LANDSCAPE DETAILS L-6.1 LANDSCAPE DETAILS	AREAS
L-1.02LANDSCAPE PORCKT PARKS PLANL-1.03NON POROUS AND LIVE PLANTING JL-1.1MATERIALS & GRADING PLANL-1.2MATERIALS & GRADING PLANL-1.3MATERIALS & GRADING PLANL-1.4MATERIALS & GRADING PLANL-1.5MATERIALS & GRADING PLANL-1.6LEVEL 3 AMENITY DECKL-2.1LIGHTING PLANL-2.2LIGHTING PLANL-2.3LIGHTING PLANL-2.4LIGHTING PLANL-2.5LIGHTING PLANL-3.1IRRIGATION COORDINATION PLANL-3.2IRRIGATION COORDINATION PLANL-3.3IRRIGATION COORDINATION PLANL-3.4IRRIGATION COORDINATION PLANL-3.5IRRIGATION COORDINATION PLANL-3.4IRRIGATION COORDINATION PLANL-3.5IRRIGATION COORDINATION PLANL-4.1PLANTING PLANL-4.2PLANTING PLANL-4.3PLANTING PLANL-4.4PLANTING PLANL-4.5PLANTING PLANL-4.6SOIL VOLUME PLANL-5.1LANDSCAPE SECTIONSL-5.3LANDSCAPE SECTIONSL-6.1LANDSCAPE DETAILS	AREAS
L-1.03       NON POROUS AND LIVE PLANTING A         L-1.1       MATERIALS & GRADING PLAN         L-1.2       MATERIALS & GRADING PLAN         L-1.3       MATERIALS & GRADING PLAN         L-1.4       MATERIALS & GRADING PLAN         L-1.5       MATERIALS & GRADING PLAN         L-1.4       MATERIALS & GRADING PLAN         L-1.5       MATERIALS & GRADING PLAN         L-1.6       LEVEL 3 AMENITY DECK         L-2.1       LIGHTING PLAN         L-2.2       LIGHTING PLAN         L-2.3       LIGHTING PLAN         L-2.4       LIGHTING PLAN         L-2.5       LIGHTING PLAN         L-3.1       IRRIGATION COORDINATION PLAN         L-3.2       IRRIGATION COORDINATION PLAN         L-3.3       IRRIGATION COORDINATION PLAN         L-3.4       IRRIGATION COORDINATION PLAN         L-3.5       IRRIGATION COORDINATION PLAN         L-3.4       IRRIGATION COORDINATION PLAN         L-3.5       IRRIGATION COORDINATION PLAN         L-4.1       PLANTING PLAN         L-4.2       PLANTING PLAN         L-4.3       PLANTING PLAN         L-4.4       PLANTING PLAN         L-4.5       PLANTING PLAN         L-4.4	AREAS
<ul> <li>L-1.1 MATERIALS &amp; GRADING PLAN</li> <li>L-1.2 MATERIALS &amp; GRADING PLAN</li> <li>L-1.3 MATERIALS &amp; GRADING PLAN</li> <li>L-1.4 MATERIALS &amp; GRADING PLAN</li> <li>L-1.4 MATERIALS &amp; GRADING PLAN</li> <li>L-1.5 MATERIALS &amp; GRADING PLAN</li> <li>L-1.6 LEVEL 3 AMENITY DECK</li> <li>L-2.1 LIGHTING PLAN</li> <li>L-2.2 LIGHTING PLAN</li> <li>L-2.3 LIGHTING PLAN</li> <li>L-2.4 LIGHTING PLAN</li> <li>L-2.5 LIGHTING PLAN</li> <li>L-3.1 IRRIGATION COORDINATION PLAN</li> <li>L-3.2 IRRIGATION COORDINATION PLAN</li> <li>L-3.3 IRRIGATION COORDINATION PLAN</li> <li>L-3.4 IRRIGATION COORDINATION PLAN</li> <li>L-3.5 IRRIGATION COORDINATION PLAN</li> <li>L-3.4 IRRIGATION COORDINATION PLAN</li> <li>L-3.5 IRRIGATION COORDINATION PLAN</li> <li>L-4.1 PLANTING PLAN</li> <li>L-4.2 PLANTING PLAN</li> <li>L-4.3 PLANTING PLAN</li> <li>L-4.4 PLANTING PLAN</li> <li>L-4.5 PLANTING PLAN</li> <li>L-4.6 SOIL VOLUME PLAN</li> <li>L-5.1 LANDSCAPE SECTIONS</li> <li>L-5.1 LANDSCAPE SECTIONS</li> <li>L-5.1 LANDSCAPE DETAILS</li> </ul>	AREAS
<ul> <li>L-1.2 MATERIALS &amp; GRADING PLAN</li> <li>L-1.3 MATERIALS &amp; GRADING PLAN</li> <li>L-1.4 MATERIALS &amp; GRADING PLAN</li> <li>L-1.4 MATERIALS &amp; GRADING PLAN</li> <li>L-1.5 MATERIALS &amp; GRADING PLAN</li> <li>L-1.6 LEVEL 3 AMENITY DECK</li> <li>L-2.1 LIGHTING PLAN</li> <li>L-2.2 LIGHTING PLAN</li> <li>L-2.3 LIGHTING PLAN</li> <li>L-2.4 LIGHTING PLAN</li> <li>L-2.5 LIGHTING PLAN</li> <li>L-3.1 IRRIGATION COORDINATION PLAN</li> <li>L-3.2 IRRIGATION COORDINATION PLAN</li> <li>L-3.3 IRRIGATION COORDINATION PLAN</li> <li>L-3.4 IRRIGATION COORDINATION PLAN</li> <li>L-3.5 IRRIGATION COORDINATION PLAN</li> <li>L-3.4 IRRIGATION COORDINATION PLAN</li> <li>L-3.5 IRRIGATION COORDINATION PLAN</li> <li>L-4.1 PLANTING PLAN</li> <li>L-4.2 PLANTING PLAN</li> <li>L-4.3 PLANTING PLAN</li> <li>L-4.4 PLANTING PLAN</li> <li>L-4.5 PLANTING PLAN</li> <li>L-4.6 SOIL VOLUME PLAN</li> <li>L-5.1 LANDSCAPE SECTIONS</li> <li>L-5.3 LANDSCAPE SECTIONS</li> <li>L-6.1 LANDSCAPE DETAILS</li> </ul>	
<ul> <li>L-1.3 MATERIALS &amp; GRADING PLAN</li> <li>L-1.4 MATERIALS &amp; GRADING PLAN</li> <li>L-1.5 MATERIALS &amp; GRADING PLAN</li> <li>L-1.6 LEVEL 3 AMENITY DECK</li> <li>L-2.1 LIGHTING PLAN</li> <li>L-2.2 LIGHTING PLAN</li> <li>L-2.3 LIGHTING PLAN</li> <li>L-2.4 LIGHTING PLAN</li> <li>L-2.5 LIGHTING PLAN</li> <li>L-3.1 IRRIGATION COORDINATION PLAN</li> <li>L-3.2 IRRIGATION COORDINATION PLAN</li> <li>L-3.3 IRRIGATION COORDINATION PLAN</li> <li>L-3.4 IRRIGATION COORDINATION PLAN</li> <li>L-3.5 IRRIGATION COORDINATION PLAN</li> <li>L-3.4 IRRIGATION COORDINATION PLAN</li> <li>L-3.5 IRRIGATION COORDINATION PLAN</li> <li>L-4.1 PLANTING PLAN</li> <li>L-4.2 PLANTING PLAN</li> <li>L-4.3 PLANTING PLAN</li> <li>L-4.4 PLANTING PLAN</li> <li>L-4.5 PLANTING PLAN</li> <li>L-4.6 SOIL VOLUME PLAN</li> <li>L-5.1 LANDSCAPE SECTIONS</li> <li>L-5.3 LANDSCAPE SECTIONS</li> <li>L-6.1 LANDSCAPE DETAILS</li> </ul>	
L-1.4       MATERIALS & GRADING PLAN         L-1.5       MATERIALS & GRADING PLAN         L-1.6       LEVEL 3 AMENITY DECK         L-2.1       LIGHTING PLAN         L-2.2       LIGHTING PLAN         L-2.3       LIGHTING PLAN         L-2.4       LIGHTING PLAN         L-2.5       LIGHTING PLAN         L-3.1       IRRIGATION COORDINATION PLAN         L-3.2       IRRIGATION COORDINATION PLAN         L-3.3       IRRIGATION COORDINATION PLAN         L-3.4       IRRIGATION COORDINATION PLAN         L-3.5       IRRIGATION COORDINATION PLAN         L-3.4       IRRIGATION COORDINATION PLAN         L-3.5       IRRIGATION COORDINATION PLAN         L-3.4       IRRIGATION COORDINATION PLAN         L-3.5       IRRIGATION COORDINATION PLAN         L-4.1       PLANTING PLAN         L-4.2       PLANTING PLAN         L-4.3       PLANTING PLAN         L-4.4       PLANTING PLAN         L-4.5       PLANTING PLAN         L-4.6       SOIL VOLUME PLAN         L-5.1       LANDSCAPE SECTIONS         L-5.2       LANDSCAPE SECTIONS         L-5.3       LANDSCAPE DETAILS	
L-1.5       MATERIALS & GRADING PLAN         L-1.6       LEVEL 3 AMENITY DECK         L-2.1       LIGHTING PLAN         L-2.2       LIGHTING PLAN         L-2.3       LIGHTING PLAN         L-2.4       LIGHTING PLAN         L-2.5       LIGHTING PLAN         L-2.4       LIGHTING PLAN         L-2.5       LIGHTING PLAN         L-3.1       IRRIGATION COORDINATION PLAN         L-3.2       IRRIGATION COORDINATION PLAN         L-3.3       IRRIGATION COORDINATION PLAN         L-3.4       IRRIGATION COORDINATION PLAN         L-3.5       IRRIGATION COORDINATION PLAN         L-3.4       IRRIGATION COORDINATION PLAN         L-3.5       IRRIGATION COORDINATION PLAN         L-4.1       PLANTING PLAN         L-4.2       PLANTING PLAN         L-4.3       PLANTING PLAN         L-4.4       PLANTING PLAN         L-4.5       PLANTING PLAN         L-4.4       PLANTING PLAN         L-5.1       LANDSCAPE SECTIONS         L-5.2       LANDSCAPE SECTIONS         L-5.3       LANDSCAPE SECTIONS         L-5.1       LANDSCAPE SECTIONS	
L-1.6       LEVEL 3 AMENITY DECK         L-2.1       LIGHTING PLAN         L-2.2       LIGHTING PLAN         L-2.3       LIGHTING PLAN         L-2.4       LIGHTING PLAN         L-2.5       LIGHTING PLAN         L-3.1       IRRIGATION COORDINATION PLAN         L-3.2       IRRIGATION COORDINATION PLAN         L-3.3       IRRIGATION COORDINATION PLAN         L-3.4       IRRIGATION COORDINATION PLAN         L-3.5       IRRIGATION COORDINATION PLAN         L-3.4       IRRIGATION COORDINATION PLAN         L-3.5       IRRIGATION COORDINATION PLAN         L-3.4       IRRIGATION COORDINATION PLAN         L-3.5       IRRIGATION COORDINATION PLAN         L-4.1       PLANTING PLAN         L-4.2       PLANTING PLAN         L-4.3       PLANTING PLAN         L-4.4       PLANTING PLAN         L-4.5       PLANTING PLAN         L-4.4       PLANTING PLAN         L-5.1       LANDSCAPE SECTIONS         L-5.2       LANDSCAPE SECTIONS         L-5.3       LANDSCAPE SECTIONS         L-5.1       LANDSCAPE SECTIONS	
L-2.1       LIGHTING PLAN         L-2.2       LIGHTING PLAN         L-2.3       LIGHTING PLAN         L-2.4       LIGHTING PLAN         L-2.5       LIGHTING PLAN         L-3.1       IRRIGATION COORDINATION PLAN         L-3.2       IRRIGATION COORDINATION PLAN         L-3.3       IRRIGATION COORDINATION PLAN         L-3.4       IRRIGATION COORDINATION PLAN         L-3.5       IRRIGATION COORDINATION PLAN         L-3.4       IRRIGATION COORDINATION PLAN         L-3.5       IRRIGATION COORDINATION PLAN         L-3.4       IRRIGATION COORDINATION PLAN         L-4.1       PLANTING PLAN         L-4.2       PLANTING PLAN         L-4.3       PLANTING PLAN         L-4.4       PLANTING PLAN         L-4.5       PLANTING PLAN         L-4.4       PLANTING PLAN         L-5.1       LANDSCAPE SECTIONS         L-5.1       LANDSCAPE SECTIONS         L-5.3       LANDSCAPE SECTIONS         L-5.1       LANDSCAPE SECTIONS	
L-2.2LIGHTING PLANL-2.3LIGHTING PLANL-2.4LIGHTING PLANL-2.5LIGHTING PLANL-2.5LIGHTING PLANL-3.1IRRIGATION COORDINATION PLANL-3.2IRRIGATION COORDINATION PLANL-3.3IRRIGATION COORDINATION PLANL-3.4IRRIGATION COORDINATION PLANL-3.5IRRIGATION COORDINATION PLANL-3.4IRRIGATION COORDINATION PLANL-3.5IRRIGATION COORDINATION PLANL-4.1PLANTING PLANL-4.2PLANTING PLANL-4.4PLANTING PLANL-4.4PLANTING PLANL-4.5PLANTING PLANL-4.6SOIL VOLUME PLANL-5.1LANDSCAPE SECTIONSL-5.3LANDSCAPE SECTIONSL-5.4LANDSCAPE DETAILS	
L-2.3LIGHTING PLANL-2.4LIGHTING PLANL-2.5LIGHTING PLANL-3.1IRRIGATION COORDINATION PLANL-3.2IRRIGATION COORDINATION PLANL-3.3IRRIGATION COORDINATION PLANL-3.4IRRIGATION COORDINATION PLANL-3.5IRRIGATION COORDINATION PLANL-3.5IRRIGATION COORDINATION PLANL-4.1PLANTING PLANL-4.2PLANTING PLANL-4.3PLANTING PLANL-4.4PLANTING PLANL-4.5PLANTING PLANL-4.6SOIL VOLUME PLANL-5.1LANDSCAPE SECTIONSL-5.3LANDSCAPE SECTIONSL-5.4LANDSCAPE DETAILS	
L-2.4LIGHTING PLANL-2.5LIGHTING PLANL-3.1IRRIGATION COORDINATION PLANL-3.2IRRIGATION COORDINATION PLANL-3.3IRRIGATION COORDINATION PLANL-3.4IRRIGATION COORDINATION PLANL-3.5IRRIGATION COORDINATION PLANL-4.1PLANTING PLANL-4.2PLANTING PLANL-4.3PLANTING PLANL-4.4PLANTING PLANL-4.5PLANTING PLANL-4.6SOIL VOLUME PLANL-5.1LANDSCAPE SECTIONSL-5.3LANDSCAPE SECTIONSL-5.4LANDSCAPE DETAILS	
L-2.5LIGHTING PLANL-3.1IRRIGATION COORDINATION PLANL-3.2IRRIGATION COORDINATION PLANL-3.3IRRIGATION COORDINATION PLANL-3.4IRRIGATION COORDINATION PLANL-3.5IRRIGATION COORDINATION PLANL-4.1PLANTING PLANL-4.2PLANTING PLANL-4.3PLANTING PLANL-4.4PLANTING PLANL-4.5PLANTING PLANL-4.6SOIL VOLUME PLANL-5.1LANDSCAPE SECTIONSL-5.3LANDSCAPE SECTIONSL-5.4LANDSCAPE DETAILS	
L-3.1IRRIGATION COORDINATION PLANL-3.2IRRIGATION COORDINATION PLANL-3.3IRRIGATION COORDINATION PLANL-3.4IRRIGATION COORDINATION PLANL-3.5IRRIGATION COORDINATION PLANL-4.1PLANTING PLANL-4.2PLANTING PLANL-4.3PLANTING PLANL-4.4PLANTING PLANL-4.5PLANTING PLANL-4.6SOIL VOLUME PLANL-5.1LANDSCAPE SECTIONSL-5.3LANDSCAPE SECTIONSL-5.4LANDSCAPE DETAILS	
L-3.2IRRIGATION COORDINATION PLANL-3.3IRRIGATION COORDINATION PLANL-3.4IRRIGATION COORDINATION PLANL-3.5IRRIGATION COORDINATION PLANL-4.1PLANTING PLANL-4.2PLANTING PLANL-4.3PLANTING PLANL-4.4PLANTING PLANL-4.5PLANTING PLANL-4.6SOIL VOLUME PLANL-5.1LANDSCAPE SECTIONSL-5.3LANDSCAPE SECTIONSL-5.1LANDSCAPE DETAILS	
L-3.3IRRIGATION COORDINATION PLANL-3.4IRRIGATION COORDINATION PLANL-3.5IRRIGATION COORDINATION PLANL-4.1PLANTING PLANL-4.2PLANTING PLANL-4.3PLANTING PLANL-4.4PLANTING PLANL-4.5PLANTING PLANL-4.6SOIL VOLUME PLANL-5.1LANDSCAPE SECTIONSL-5.3LANDSCAPE SECTIONSL-5.4LANDSCAPE DETAILS	
L-3.4IRRIGATION COORDINATION PLANL-3.5IRRIGATION COORDINATION PLANL-4.1PLANTING PLANL-4.2PLANTING PLANL-4.3PLANTING PLANL-4.4PLANTING PLANL-4.5PLANTING PLANL-4.6SOIL VOLUME PLANL-5.1LANDSCAPE SECTIONSL-5.3LANDSCAPE SECTIONSL-5.3LANDSCAPE DETAILS	
L-3.5IRRIGATION COORDINATION PLANL-4.1PLANTING PLANL-4.2PLANTING PLANL-4.3PLANTING PLANL-4.4PLANTING PLANL-4.5PLANTING PLANL-4.6SOIL VOLUME PLANL-5.1LANDSCAPE SECTIONSL-5.2LANDSCAPE SECTIONSL-5.3LANDSCAPE SECTIONSL-6.1LANDSCAPE DETAILS	
L-4.1 PLANTING PLAN L-4.2 PLANTING PLAN L-4.3 PLANTING PLAN L-4.4 PLANTING PLAN L-4.5 PLANTING PLAN L-4.6 SOIL VOLUME PLAN L-5.1 LANDSCAPE SECTIONS L-5.2 LANDSCAPE SECTIONS L-5.3 LANDSCAPE SECTIONS L-6.1 LANDSCAPE DETAILS	
L-4.2PLANTING PLANL-4.3PLANTING PLANL-4.4PLANTING PLANL-4.5PLANTING PLANL-4.6SOIL VOLUME PLANL-5.1LANDSCAPE SECTIONSL-5.2LANDSCAPE SECTIONSL-5.3LANDSCAPE SECTIONSL-6.1LANDSCAPE DETAILS	
L-4.3       PLANTING PLAN         L-4.4       PLANTING PLAN         L-4.5       PLANTING PLAN         L-4.6       SOIL VOLUME PLAN         L-5.1       LANDSCAPE SECTIONS         L-5.2       LANDSCAPE SECTIONS         L-5.3       LANDSCAPE SECTIONS         L-5.4       LANDSCAPE DETAILS	
L-4.4       PLANTING PLAN         L-4.5       PLANTING PLAN         L-4.6       SOIL VOLUME PLAN         L-5.1       LANDSCAPE SECTIONS         L-5.2       LANDSCAPE SECTIONS         L-5.3       LANDSCAPE SECTIONS         L-5.4       LANDSCAPE DETAILS	
L-4.5       PLANTING PLAN         L-4.6       SOIL VOLUME PLAN         L-5.1       LANDSCAPE SECTIONS         L-5.2       LANDSCAPE SECTIONS         L-5.3       LANDSCAPE SECTIONS         L-6.1       LANDSCAPE DETAILS	
L-4.6       SOIL VOLUME PLAN         L-5.1       LANDSCAPE SECTIONS         L-5.2       LANDSCAPE SECTIONS         L-5.3       LANDSCAPE SECTIONS         L-6.1       LANDSCAPE DETAILS	
L-5.1 LANDSCAPE SECTIONS L-5.2 LANDSCAPE SECTIONS L-5.3 LANDSCAPE SECTIONS L-6.1 LANDSCAPE DETAILS	
L-5.2 LANDSCAPE SECTIONS L-5.3 LANDSCAPE SECTIONS L-6.1 LANDSCAPE DETAILS	
L-5.3 LANDSCAPE SECTIONS L-6.1 LANDSCAPE DETAILS	
L-6.1 LANDSCAPE DETAILS	
L-6.2 LANDSCAPE DETAILS	
L-6.3 LANDSCAPE DETAILS	
L-6.4 LANDSCAPE DETAILS	
L-6.5 LANDSCAPE DETAILS	
L-6.6 LANDSCAPE DETAILS	
L-6.7 LANDSCAPE DETAILS	
T1.1 EXISTING TREES MANAGEMENT PLA	N
T1.2 EXISTING TREES INVENTORY	

#### **MATERIALS KEY**

SURFACING			SITE FURNISHING		
PI	CIP CONCRETE PAVING (PEDESTRIAN ONLY) BROOM FINISHED PATHWAYS 100MM THICK, SAWCUT AS PER PLAN	Ld 01 Ld 02 L-6.1 L-6.1		METAL VISITOR BIKE PARKING Model: Bola Supplier: LandscapeForms Installation: Surlace Mount	Ld 01 L-6.4
(P2)	CIP STAMPED CONCRETE PAVING COLOR: CHARCOAL PATTERN: RUNNING BOND	Refer to Arch. Drowing for Detailing	F2	PRE-FABRICATED BENCH Model: Neoliviano - 118" backed w/ center arms Supplier: LandscapeForms Installation: Surface Mount	Ld 02 L-6.4
P3	CIP STAMPED CONCRETE PAVING (POCKET PARKS) THICKNESS: 100MM THICK: COLOR: NATURAL PATTERN: DIAGONAL BASKET WEAVE	Ld 01 L-6.1	F3	CUSTUMIZED BENCH	Ld 05 L-6.4
P4	FEATURE CONCRETE PAVING HOLLAND PAVER SIZE: 4" X 8"; COLOUR: CHARCOAL GREY PATTERI: EINNING BOND Locations: Building Entries and Exits	(Ld 06) (L-6.1)	F4 💥	FEATURE BENCH Model: Air Collection Color: Five Different Colors for Each Park, Mixed Colors for Central Lawn Areo Supplier: LandscaoeForms	Ld 03 L-6.4
P5	HYDRAPRESSED CONCRETE PAVERS SIZE: 24%24" COLOUR: NATURAL GREY	Ld 03 Ld 04 L-61 L6.1 L-6.1	ES \	CLIMBING NET	
<b>1</b>	HYDRAPRESSED CONCRETE PAVERS SIZE. 24%24" COLOUR: CHARCOAL GREY	Ld 03/Ld 04 L4.01/L4.01 L4.01		Model: NRO813 Supplier: Kompon	(La 01) L-6.5
	COMPOSITE WOOD DECKING	Ld 08 Ld 09 L-6.1 L-6.1	F6 &	SEA-SAW, 2 PEOPLE Model: NRO015 Supplier: Kompan	Ld 02 L-6.5
PB	FIBAR PLAY SURFACING	(1d 10) (1-6.1)	F7 ¥	SPRINGER - BEE Model: NRO118 Supplier: Kompan	Ld 03 L-6.5
P9	ARTIFICIAL TURF	Ld 07 L-6.1	FB 🚩	SPRINGER - SNAIL Model: NRO115 Supplier: Kompan	Ld 04 L-6.5
	GRAVEL/RIVER ROCK DRAINAGE STRIP	Ld 11 Ld 12 L-6.1 L-6.1	(F)	PLAY HUT w/ SLIDE •KOMPAN PLAY HUT AND SLIDE	100
<b>(1)</b>	SAND BASED SODDED LAWN	Ld 02 L-6.2			L-6.5
	URBAN AGRICULTURE		FID	DECK SEATING	Ld 04 L-6.6
WALLS & FENCES	HARDSCAPE		(F1) <b>P</b>	DRINKING FOUNTAIN - Pocket Park	(Ld 04)
	CIP CONCRETE RETAINING WALL		GRADING		L-6.4
	CIP CONCRETE STAIRS		TW	TOP OF WALL	
			BW	BOTTOM OF WALL	
$\square$	METAL GATE	Ld 01 L-6.3	+3.21	SPOT ELEVATION (METERS)	
	METAL GUARDRAIL	(Ld 02)	FFE	FINISHED FLOOR ELEVATION	
		Refer to Arch. Drowing for	Lemma	SLOPE DIRECTION	
	• VARYING HEIGHTS	Detoiling	LIGHTING		
	METAL EDGER (RETAINING) •SHEET PANELS, 12" HT RETAINING		<u>_</u>	RECESSED STEP LIGHTING	Ld 01 L-6.7
AL AL			<b>#</b>	LANDSCAPE BOLLARD LIGHTING	Ld 02 L-6.7
	•SITE SALVAGED WHERE POSSIBLE			PEDESTIRAN SCALE POLE LIGHT	Ld 03 L-6.7
			ð	WALL SCONCE LIGHT	Ld 04 L-6.7
			IRRIGATION & HO	DSE BIB	
			•	IRRIGATION STUB-OUT (CONNECTION PAREFER TO MECHANICAL AND ELECTRICAL FOR	OINT) FURTHER DETAIL
			Φ	FROST FREE HOSE BIB REFER TO MECHANICAL AND ELECTRICAL FOR A	URTHER DETAIL

# <sup>3</sup>ark, Areo Park

ES					
SYM	QTY	BOTANICAL NAME	COMMON NAME		SIZE/COMMENT
	- 25	Acer palmatum 'Blood Good'	Boodgood Jopanese Maple	9	6cm cal., B&B
A	- 18	Acer palmatum 'Sangu Koku'	Coral Bark Japanese Maple		6cm cal., B&B
DA					
- CD	- 28	Acer griseum	Paperbark Maple		6cm cal., B&B
•	- 8	Acer rubrum 'Autumn Spire'	Autumn Spire Maple		8cm cal., B&B
~ (-)-	- 14	Cornus 'Eddies White Wonder'	White Wonder Flowering Do	gwood	6cm cal., B&B
A.	- 3	Fraxinus oxycarpa 'Raywood'	Roywood Ash		8cm cal., B&B
non	- 2	Porrotia persica 'Vanessa'	Persion Ironwood		6cm cal., B&8
	- 8	Picea omorika	Serbion Spruce		4m Ht., B&B
	- 9				
SV		Populus erecta	Columnar Swedish Aspen		8cm cal., B&B
30	- 17	Prunus semulata 'Kwanzan'	Kwanzan Flowering Cherry		8cm cal., B&B
21.7	- 3	Quercus robur 'Regal Prince'	Regal Prince English Oak		8cm cal., 8&B
•	- 34	Street Tree	Species TBD		7cm cal., Min. 1.8m Std., B&B
UBS/FERNS					
SYM	QTY	BOTANICAL NAME	COMMON NAME	SIZE/C	COMMENT
az	110	Azalea 'Hino White'	Hino White Azalea		ot, 18" o.c.
AZ Bx	19 14	Azalea 'Hino Pink' Buxus m. Wintergem	Hino Pink Azalea Winter Gem 80xwood		ot, 18" o.c. ot, 15" o.c.
Ct	187	Choisya ternata	Mexican Mock Oronge		ot, 24" o.c.
CS	21	Cornus sericea 'Arctic Fire'	Arctic Fire Red-Osier Dogwood	#2 pc	ot, 30" o.c.
De	69	Dryopteris erythrosara	Autum Fern	#2 pc	ot, 18" o.c.
G	107	Gaultherio Shallon	Salal		ot, 15" o.c.
HS	12	Hydrangea serrata 'Blue Bird'	Blue Bird Hydrangea		ot, 30" o.c.
LP	225	Lonicera pileata	Privet Honeysuckle		ot, 18" o.c.
MA	12 239	Mahonia aquifolium Mahonia repens	Oregon Grape Holly Creeping Oregon Grape Holly		ot, 24" o.c.
Pm	214	Polystichum munitum	Sword Fern		ot, 18" o.c. ot, 18" o.c.
R	47	Rhododendron 'Unique'	Unique Rhododendron		of, 24" o.c.
Rh	108	Rhododendron 'PJM'	PJM Rhadodendron		of, 24" o.c.
R1	84	Rhododendron 'Anna Krushke'	Anno Krushke Rhododendron		ot, 24" o.c.
Sh	81	Sarcococco nookeriana 'Humilis'	Dwarf Sweet 8ox		ot, 18" o.c.
SR	87	Sarcococca ruscifolia	Sweet Box		ot, 30" o.c.
Vd	175	Vibumum davidii	David's Viburnum		ot, 24" o.c.
ENNIALS/GRASS	_	BOTANICAL NAME	COMMON NAME	SIZE/C	COMMENT
со	288	Carex oshimensis 'Evergald'		#1 pot, 1	
	66	Clemotis armandii			8" o.c., min 3 trailers
c	488	Catoneoster dammeri	Bearberry Coloneaster	#1 pol, 1	5" o.c.
e	149	Erica carnea 'December Red'	Winter Heath	#1 pot, 1	2° o.c.
f	60	Festuca glauca 'Elijah Blue'	Blue Fescue	#1 pol, 1	
н	8	Hemerocallis Stella D'oro	Stella D'oro Daylily	#1 pot, 1	5" o.c.
ha	173	Heuchera 'Amber Waves'		#1 pol, 1	2" o.c.
hg	180	Heuchera 'Green Sprice'	Green Spice Coral Bells	#1 pot, 1	2" o.c.
hl	260	Heuchera 'Lime Richy'	Lime Corol Bells	#1 pol, 1	2" o.c.
hp	32	Heuchera 'Shanghai Purple'	Purple Coral Bells	#1 pot, 1	2" o.c.
	182	Lavandula angustifolia 'Hidcote Blue	'Hidcote Blue Lavender	#1 pol, 1	4" O.C.
La	609	Liriope muscari 'Big Blue'	Lily Turf	#1 pot, 1	2" o.c.
	153	Lithodora diffusa 'Grace Ward'	Groce Word Lithodora	#1 pol, 1	4" o.c.
La				#2 pot, 1	8" o.c.
La li	46	Miscanthus sinensis 'Maleportus'			
La li L		Ophiapogan japonicus 'Nana'		7cm pot	, 12" o.c.
La li L Ms	46		Dwarf Mondo Gross		, 12" o.c. 8" o.c. min 3 trailers
La li Ms a pt	46 384 61 289	Ophiapogan japonicus 'Nana' Porthenocissus quinquefolio Pachysandra terminalis	Dwarf Mondo Grass Virginia Creeper Pachysandra	#2 pot. 1 9cm pot	8" o.c. min 3 trailers , 12" o.c.
La li L Ms a	46 384 61 289 88	Ophiapogan japonicus 'Nana' Porthenocissus quinquefolio Pachysondra terminalis Phlox subulata 'Scarlet Flame'	Dwarf Mondo Gross Virginia Creeper Pachysandra Scarlet Flame Creeping Phlox	#2 pot, 1 9cm pot #1 pot, 1	8" o.c. min 3 trailers , 12" o.c. 4" o.c.
La li Ms a pt	46 384 61 289	Ophiapogan japonicus 'Nana' Porthenocissus quinquefolio Pachysandra terminalis	Dwarf Mondo Grass Virginia Creeper Pachysandra Scarlet Flame Creeping Phlox Black-eyed Susan	#2 pot. 1 9cm pot	8" o.c. min 3 trailers , 12" o.c. 4" o.c. 5" o.c.

#### LANDSCAPE NOTES

. All work shall meet or exceed the requirements as outlined in the current Standard.

- current Edition. For container classes #3 and smaller, plant sizes shall be as shown in the plant list and the Standard; for all other plants, bothplant size and container class shall be as shown in the plant list. Specifically, when the plant list call for #5 class containers, these shall be as defined in the BCNTA (ANSI) Standard.
- 3. All trees to be staked in accordance with BCNTA Standards. 4. ALL STREET TREES Install 8' x 24" Deep Root Barrier centred on each tree between tree pit and sidewalk (ON
- BOTH SIDES: CURB AND SIDEWALK). 5. For all existing on site services and survey symbols refer to survey drawings. 6. All landscaping and treatment of the open portions of the site shall be campleted in accordance with the appraved drawings within six (6) months of the date of issuance of any required occupancy permit, or any use
- or occupancy of the proposed develop ment not requiring an occupancy permit, and thereafter permanently maintained in good conditions.
- 7. All Patios shall be equipped with hose bibs.
- All irrigation valve boxes equipped with quick-couplers.
   Coniferous replacement trees shall be 4m height and deciduous replacement trees shall be 8cm caliper per City of Richmond. February 20, 2024

# **PLAN #42** DP 23-014121

_	 		
 - 11A	 the Ca	 L es e els	

2. Plant sizes and related container classes are specified according to the Canadian Landscape Standard

7	Feb 19 - 2024	ISSUED FOR DP RESPONSE
-		
5	Oct 5 - 2023	RE-ISSUED FOR DP
4	FEB 17 - 2023	ISSUED FOR DP
3	AUG 2 - 2022	<b>RE-ISSUED FOR REZONING</b>
2	MAY 19 - 2022	RE-ISSUED FOR REZONING
1	APR 9-21	ISSUED FOR REZONING
no.;	date:	item:



Durante Kreuk Ltd. 102 - 1637 West 5th Avenue Vancouver BC V6J 1N5 t: 604 684 4611 f: 604 684 0577 www.dkl.bc.ca

Project:

COOK ROAD RICHMOND, BC

AG Drown by:

Checked by: PK

Date: MAR 2020

Scale: NTS


Drowing Title:

#### LANDSCAPE COVER SHEET


Project No.: 19073

Sheet No.:

L-0.00

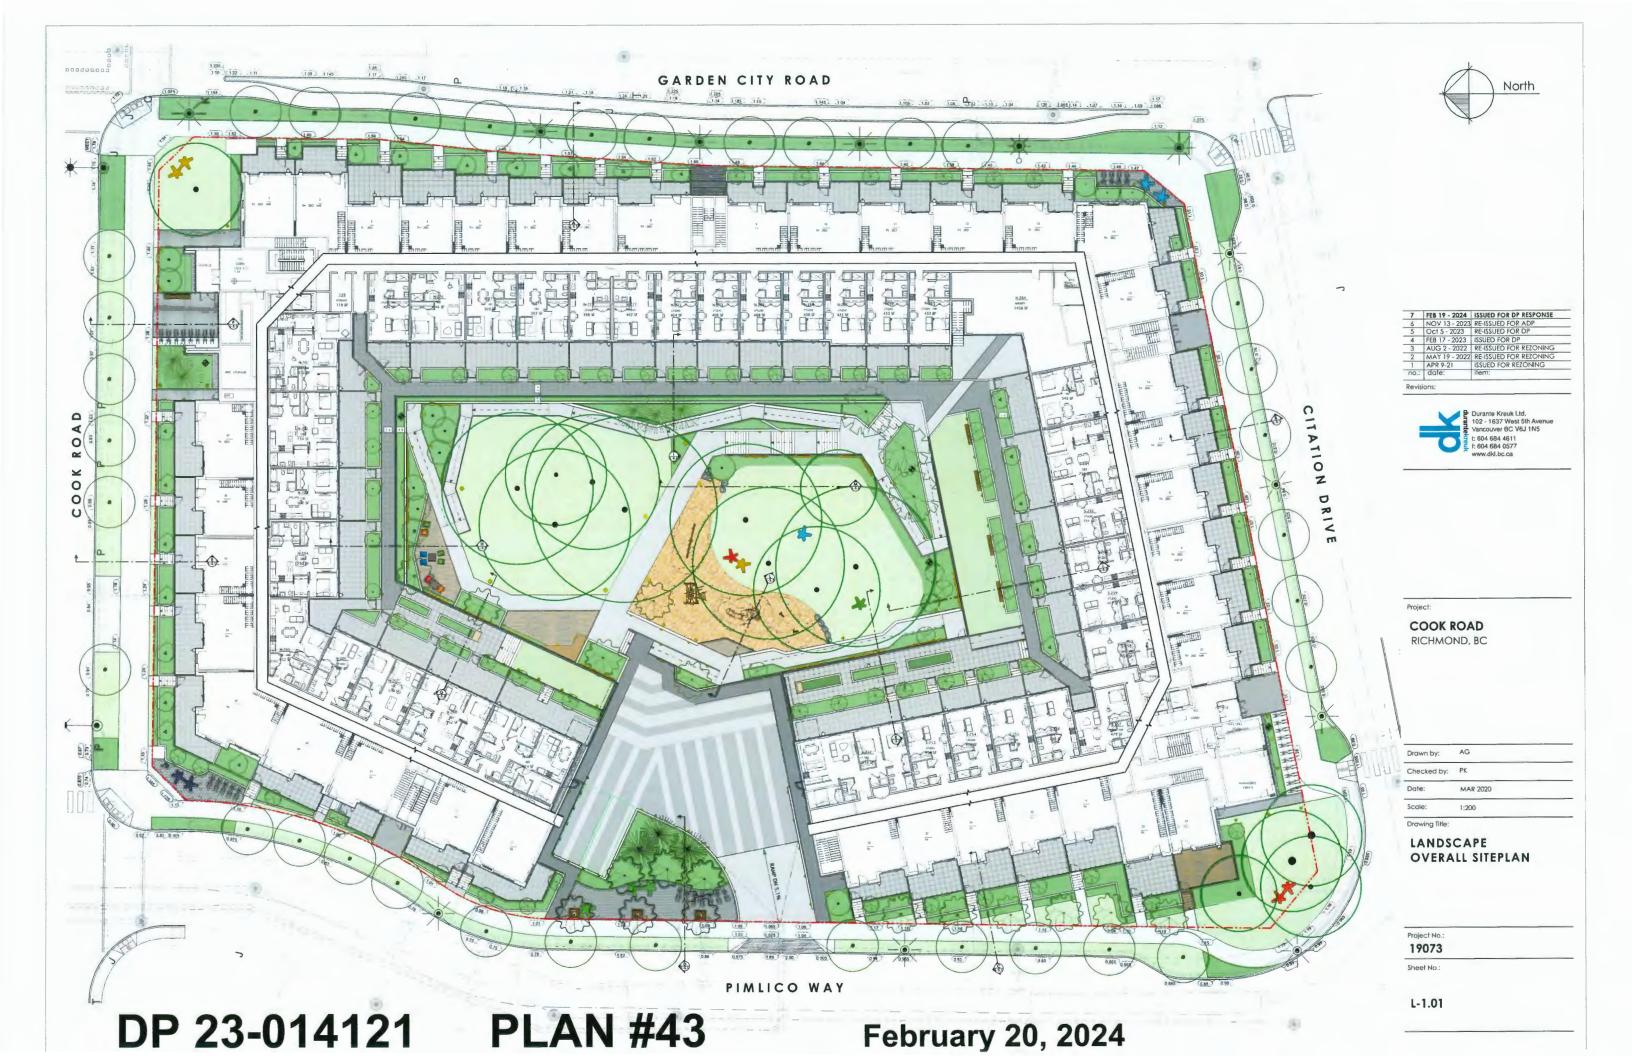


#### GARDEN CITY ROAD

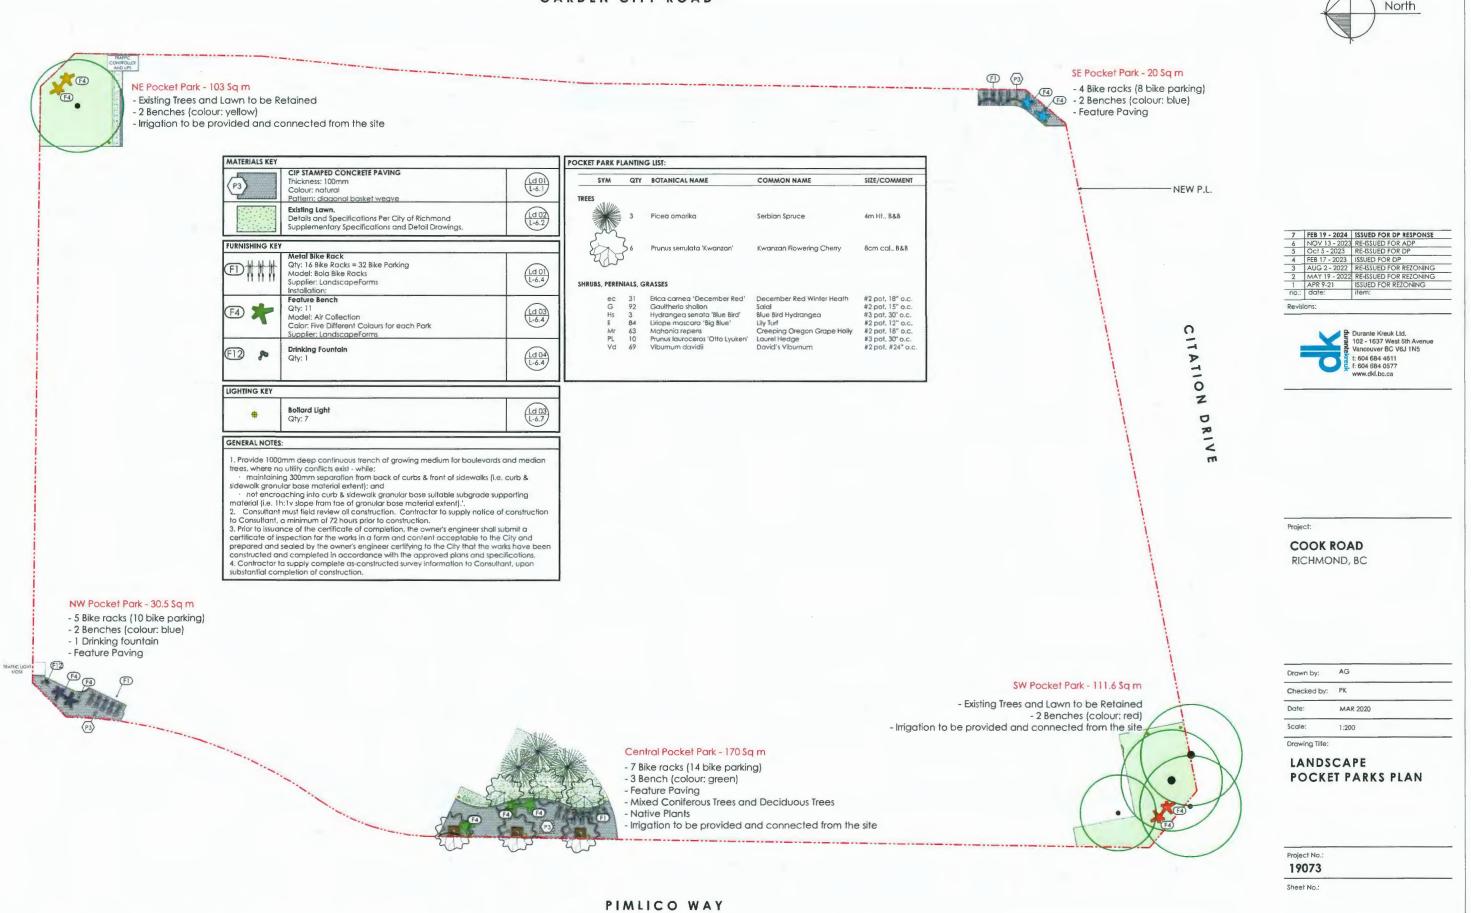


# DP 23-014121 PLAN #44

February 20, 2024

L-1.02

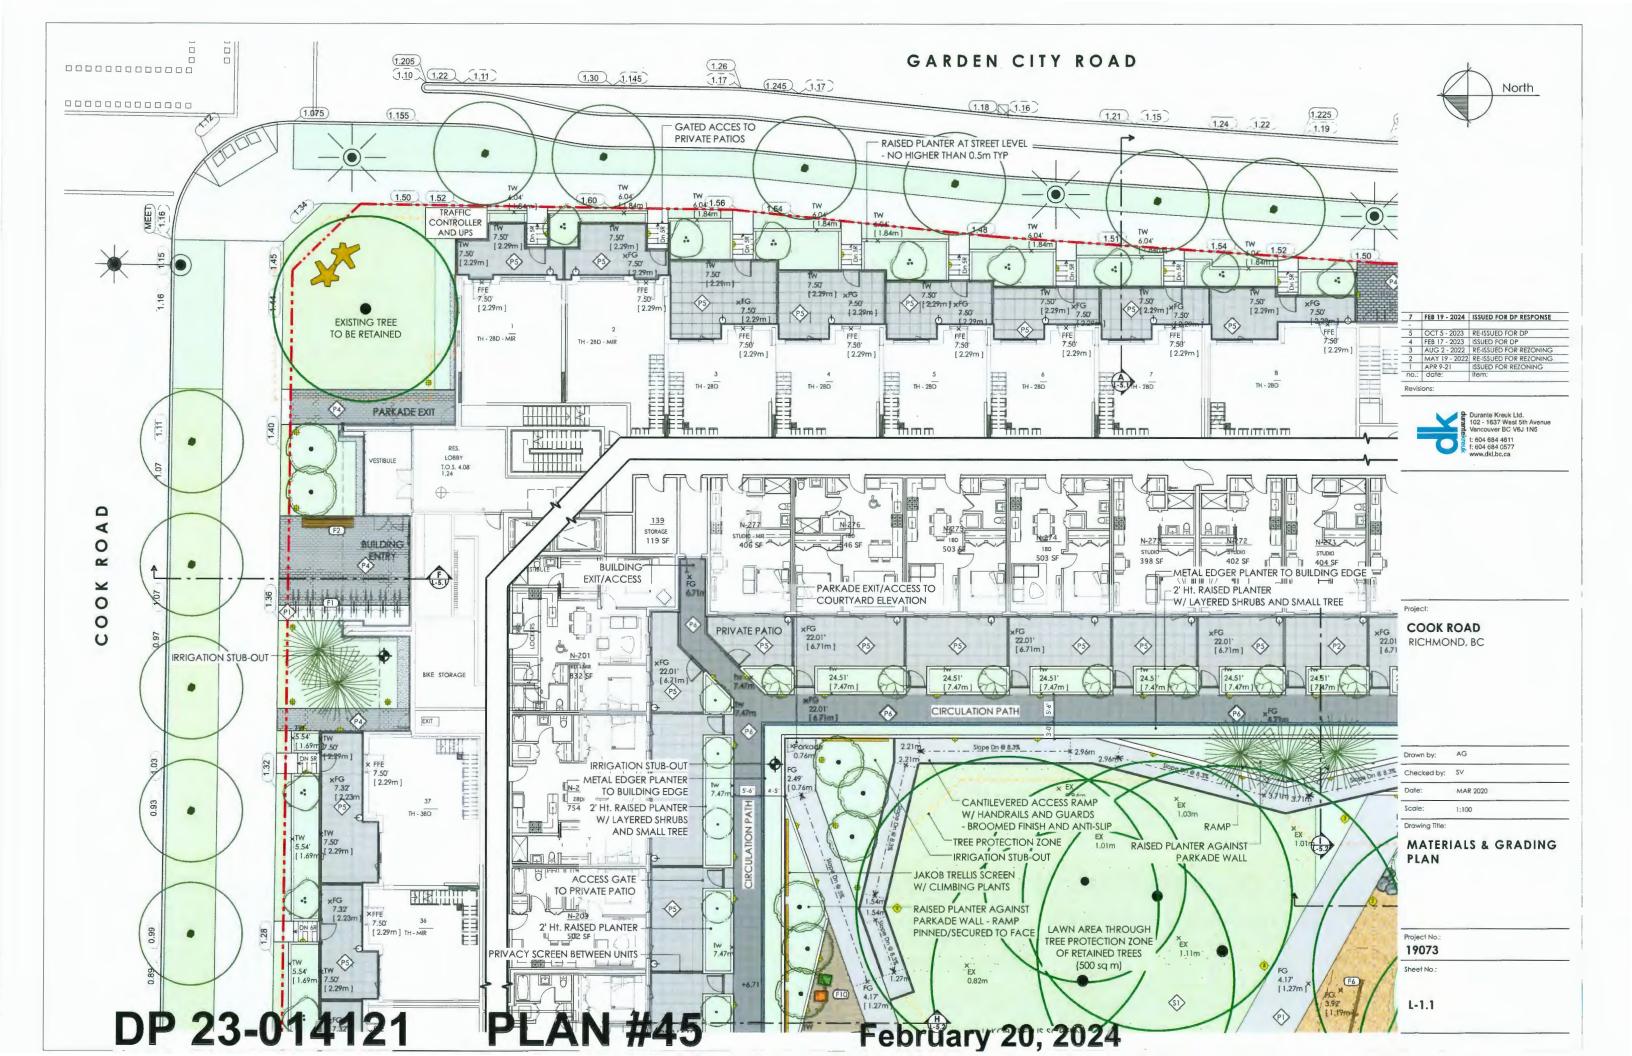

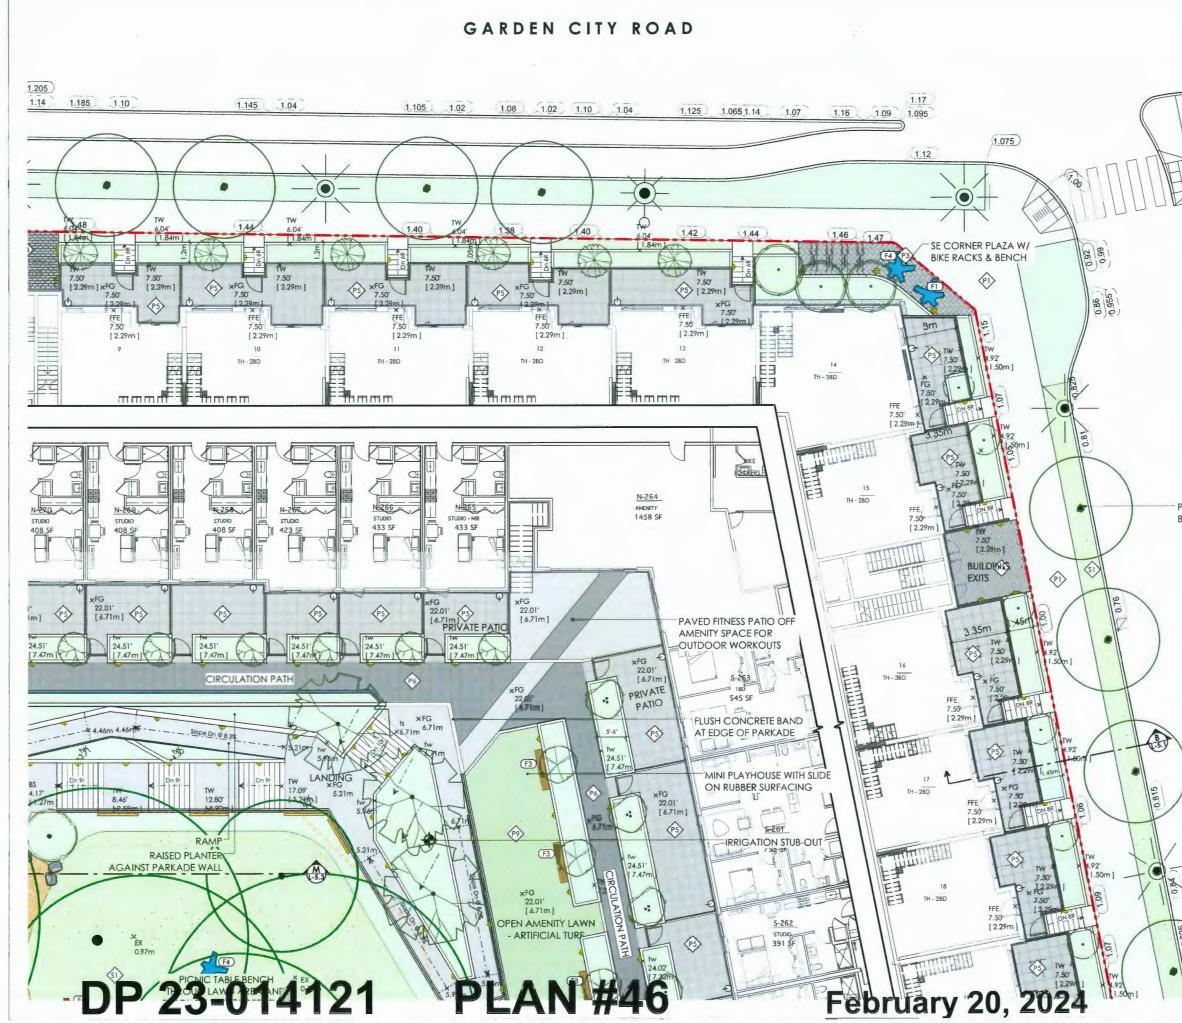



Durante Kreuk Ltd. 102 - 1637 West 5th Avenue Vancouver BC V6J 1N5 1: 604 684 4611 1: 604 684 0577 www.dkl.bc.ca

North

PROVIDE STRUCTURAL SOIL BELOW SIDEWALK

0

ITA

-

0

Z

D

RIV

m

Project:

COOK ROAD RICHMOND, BC

Drawn by:	AG	
Checked by:	SV	
Date:	MAR 2020	
Scale:	1:100	

Drawing Title:


#### MATERIALS & GRADING PLAN


Project No.: 19073


17073


Sheet No.:

L-1.2

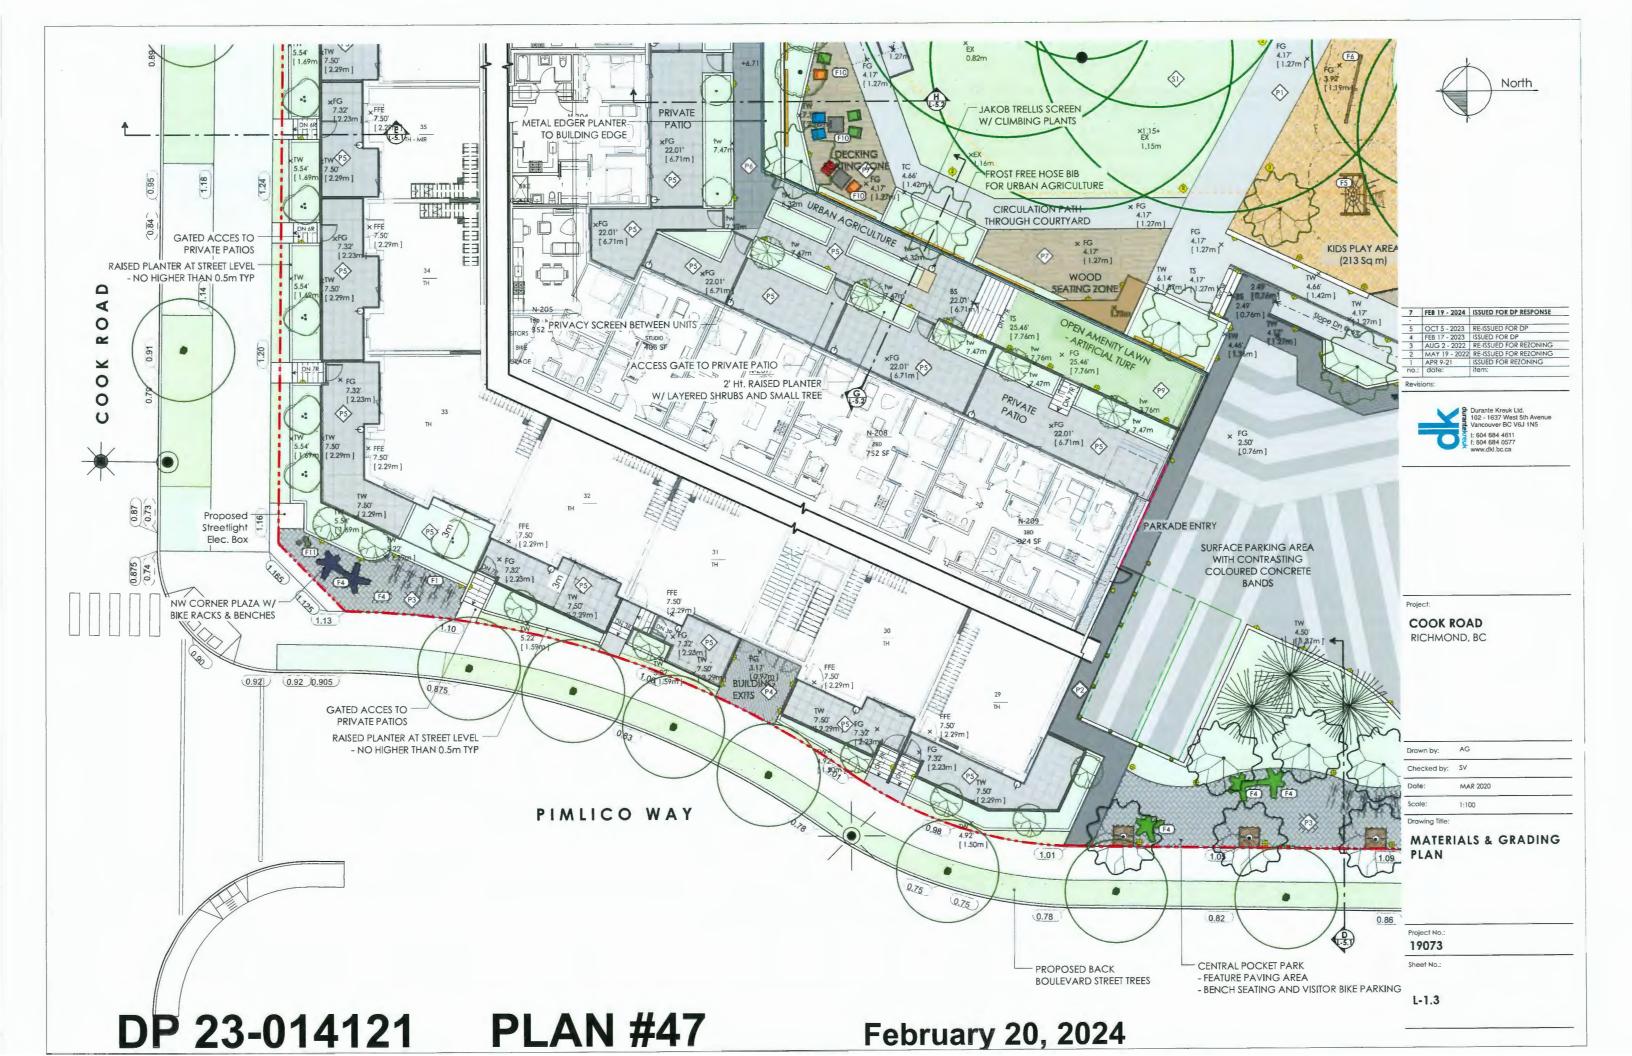

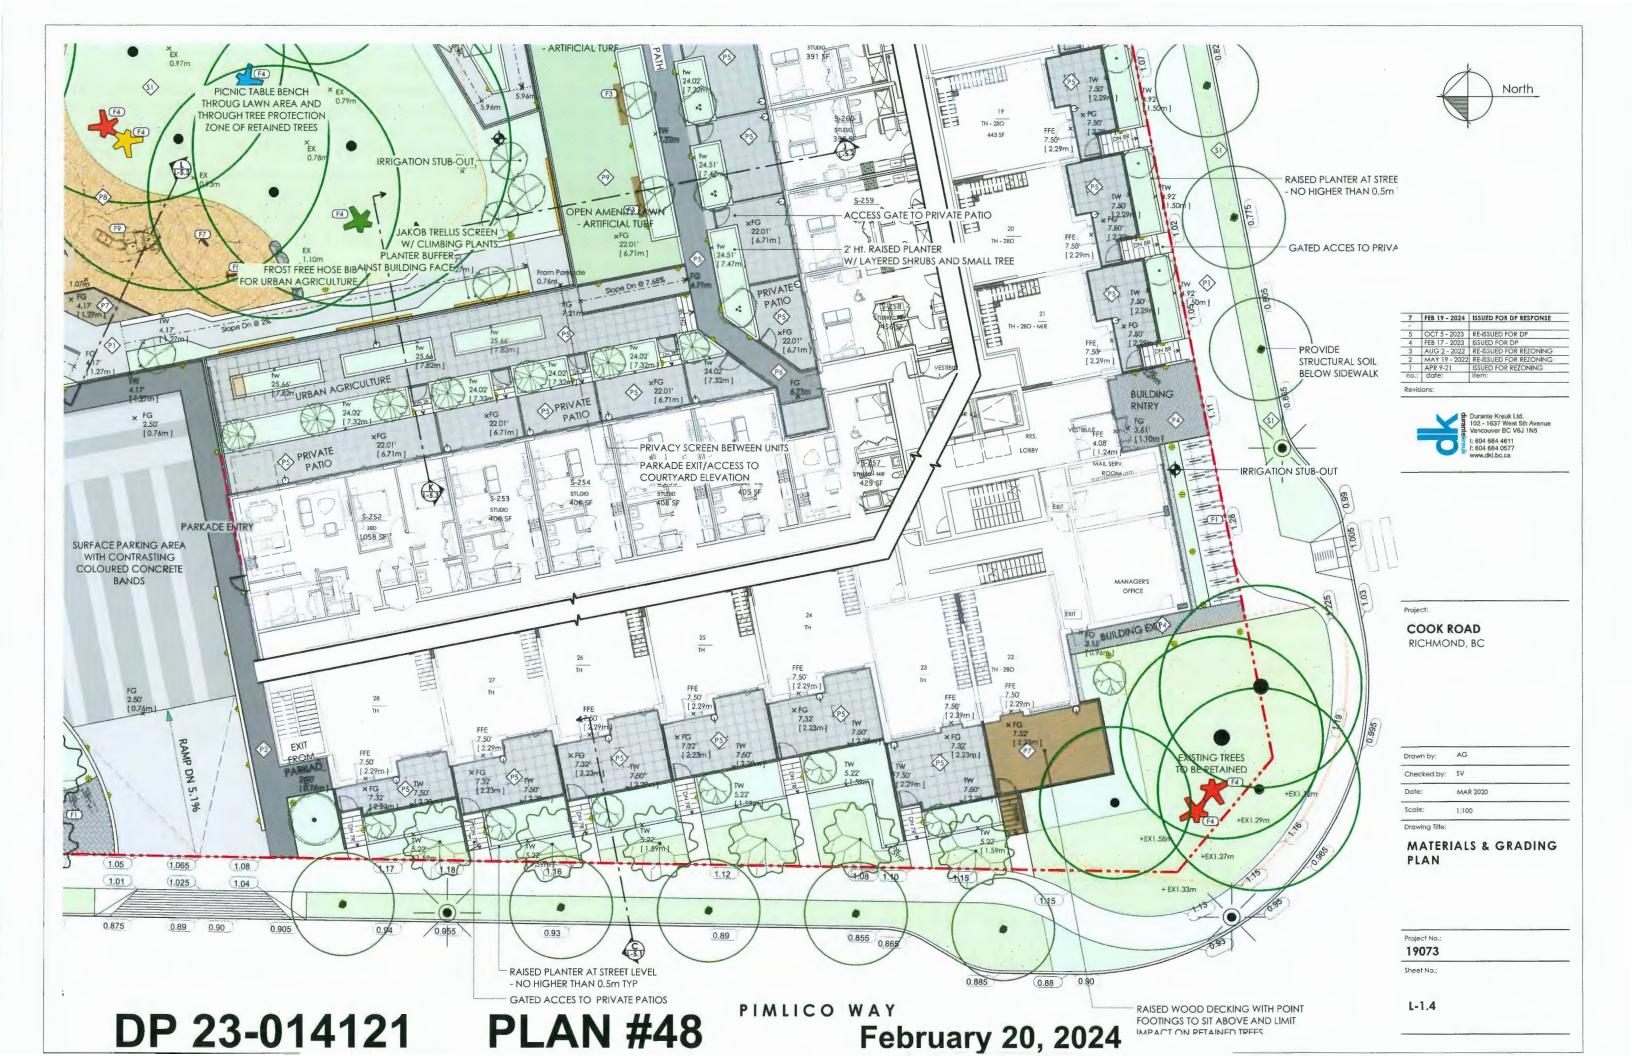

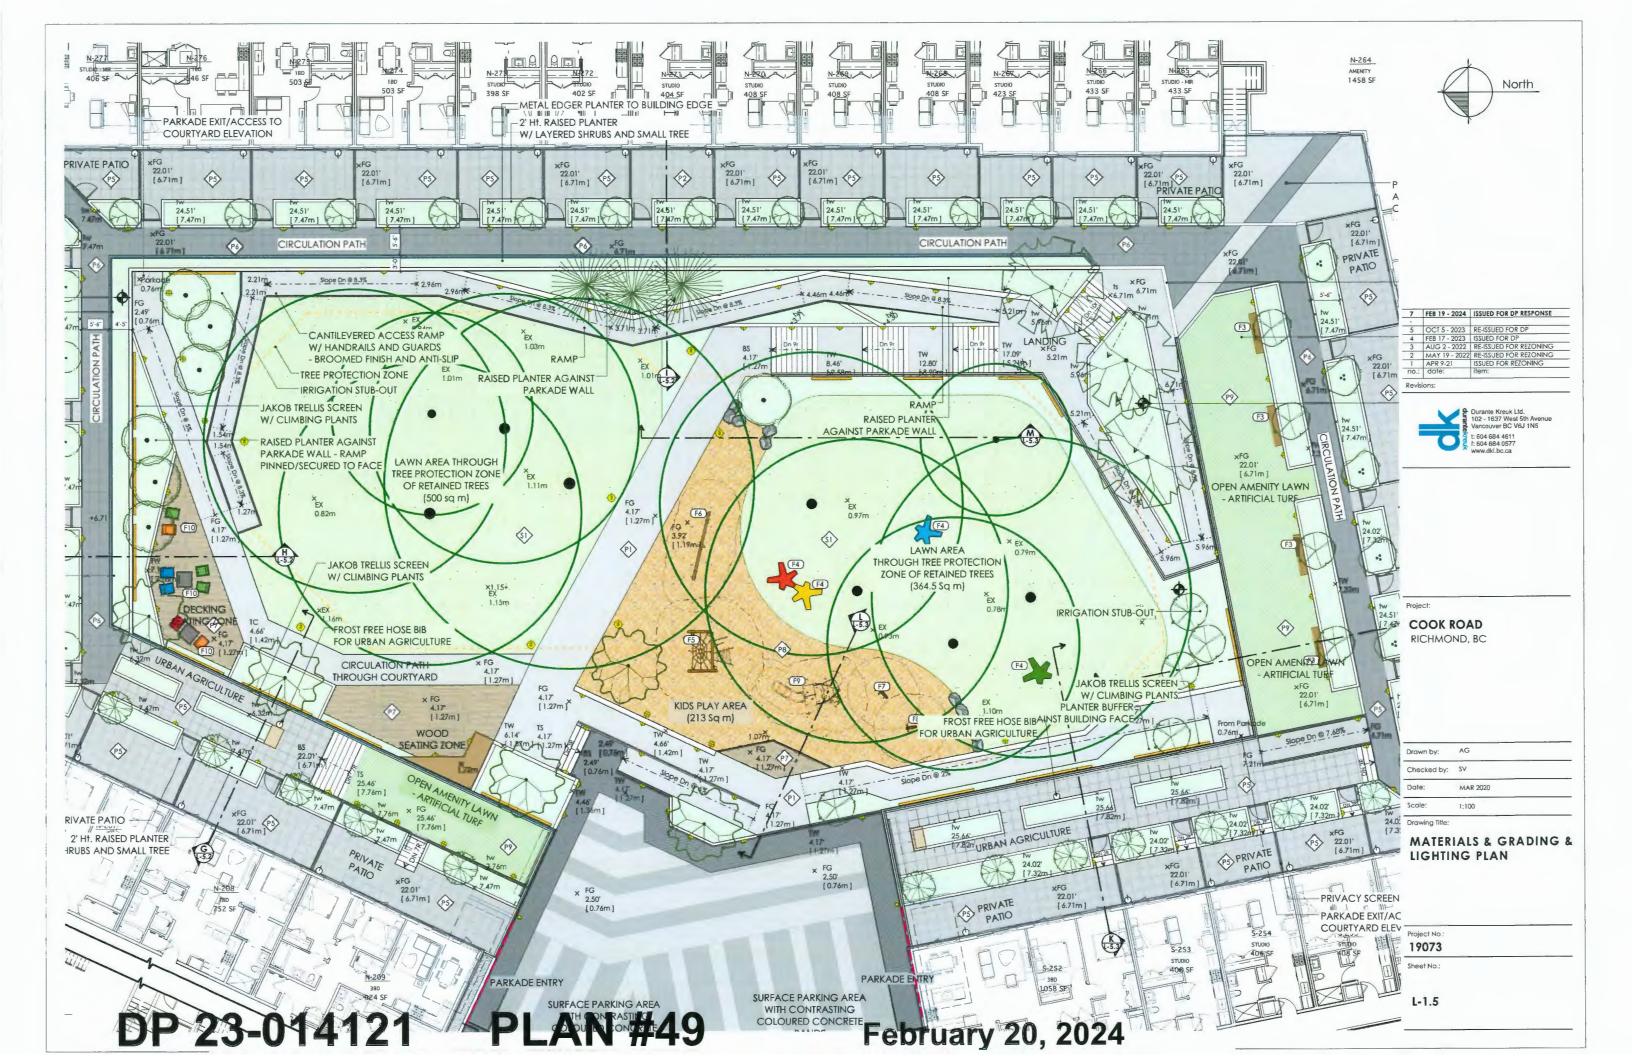

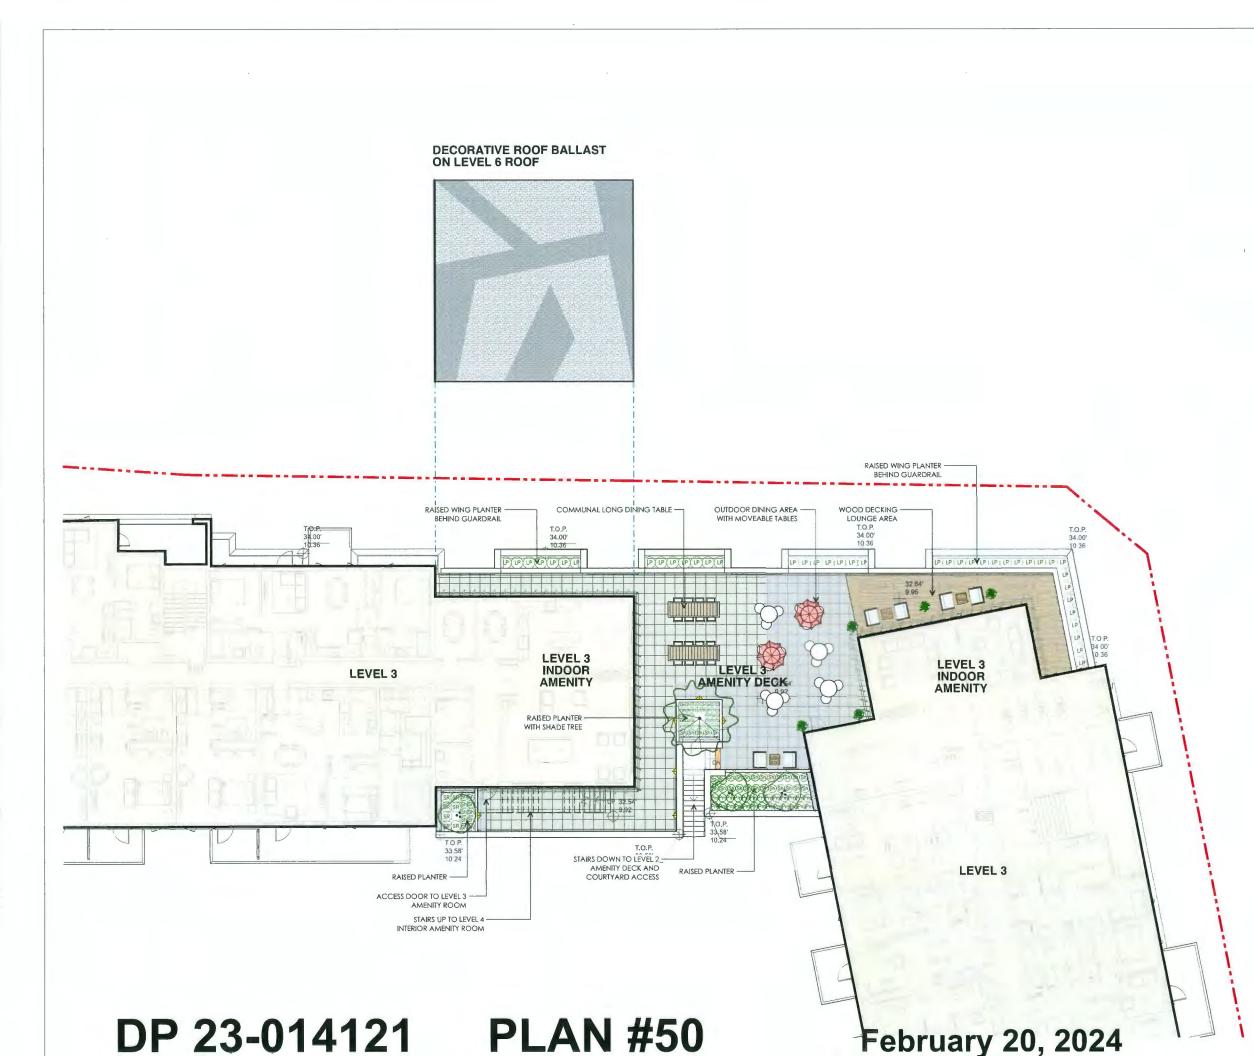

North

- 5 C	CT 6 0000	
5 C	OT C 0000	
	OCT 5 - 2023	RE-ISSUED FOR DP
4 F	EB 17 - 2023	ISSUED FOR DP
3 A	UG 2 - 2022	RE-ISSUED FOR REZONING
2 N	1AY 19 - 2022	RE-ISSUED FOR REZONING
1 A	PR 9-21	ISSUED FOR REZONING
no.: c	date:	item:



Project:

COOK ROAD RICHMOND, BC

Drawn by:	AG	
Checked by:	РК	
Date:	AUG 2023	
Scale:	1:100	
Drawing Title:		


#### LANDSCAPE -LEVEL 3 AMENITY DECK


Project No.:

19073

Sheet No.:

L-1.6

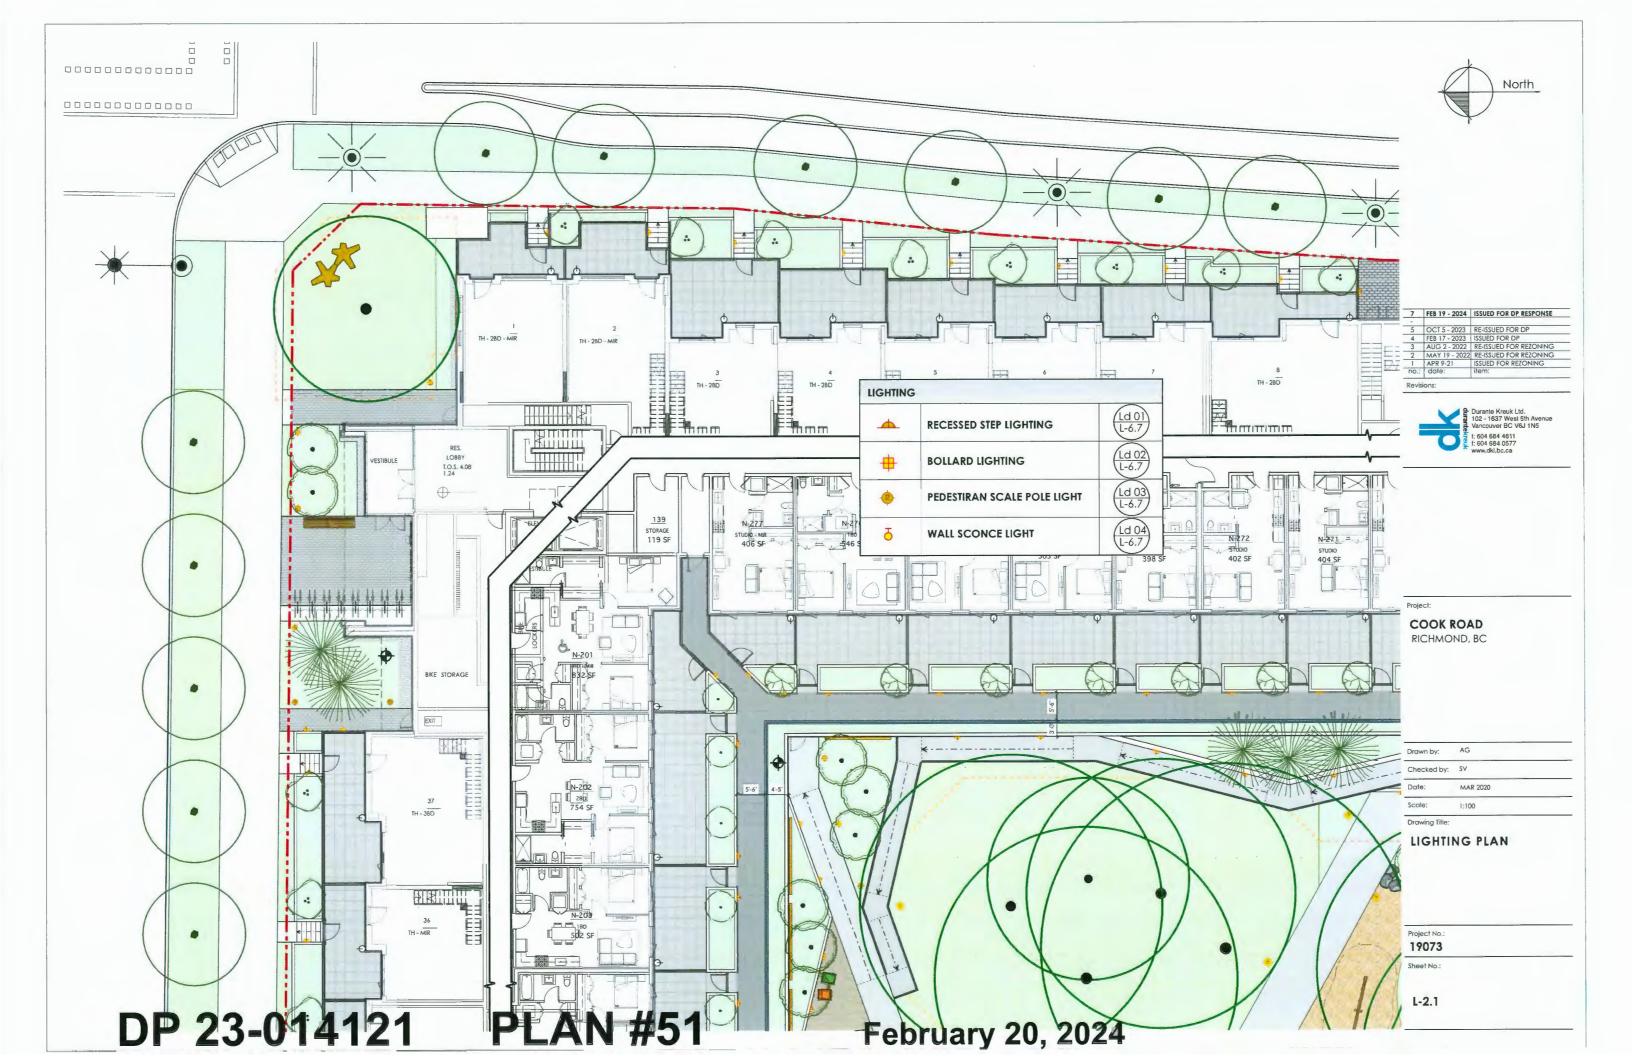

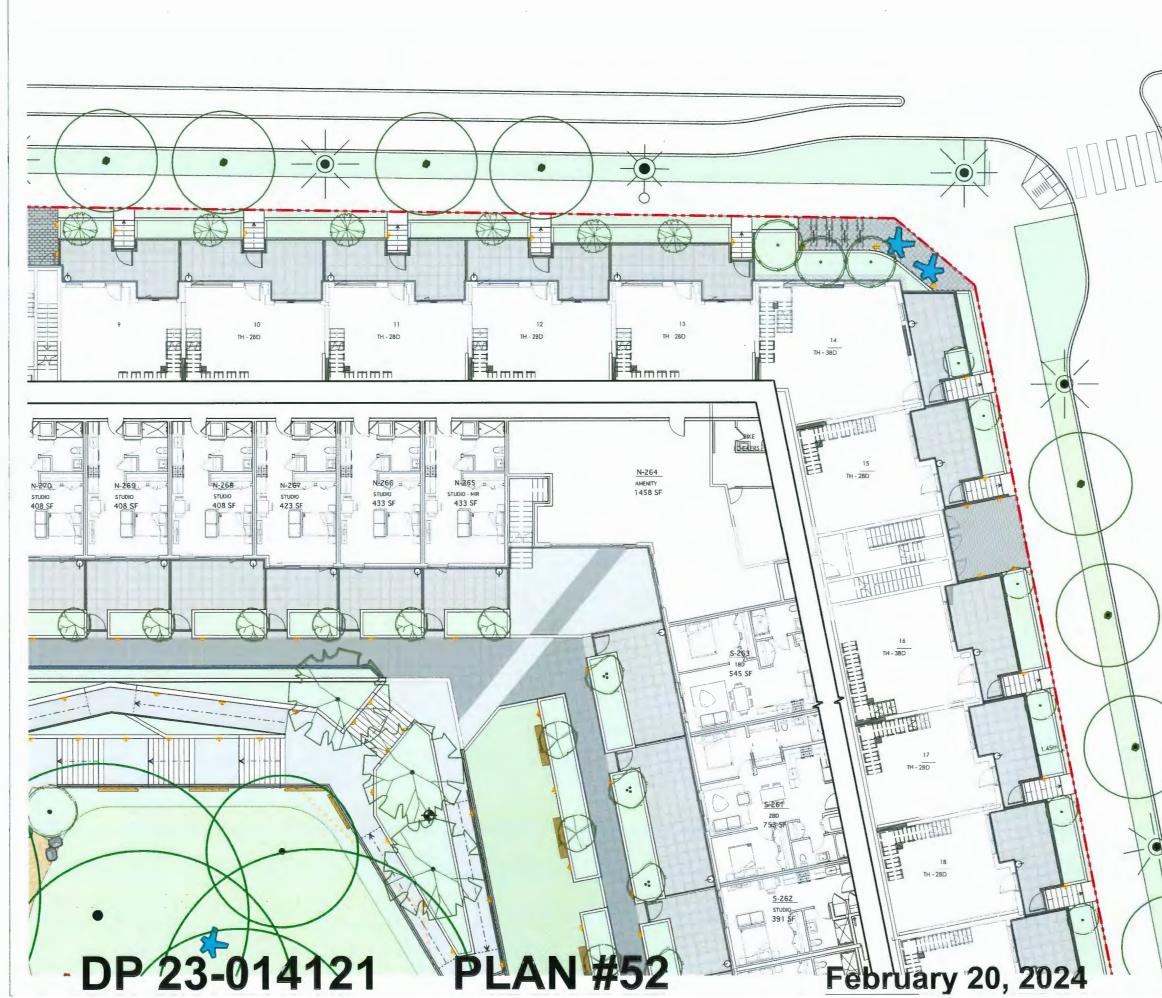





7	FEB 19 - 2024	ISSUED FOR DP RESPONSE
-		
5	OCT 5 - 2023	RE-ISSUED FOR DP
4	FEB 17 - 2023	ISSUED FOR DP
3	AUG 2 - 2022	RE-ISSUED FOR REZONING
2	MAY 19 - 2022	RE-ISSUED FOR REZONING
1	APR 9-21	ISSUED FOR REZONING
no.:	date:	item:

Revisions:



Durante Kreuk Ltd. 102 - 1637 West 5th Avenue Vancouver BC V6J 1N5 1: 604 684 4811 1: 604 684 0577 www.dkl.bc.ca

Project:

COOK ROAD RICHMOND, BC


Drawn by:	AG	
Checked by:	SA	
Date:	MAR 2020	
Scale:	1:100	_
Drawing Title:		_


#### LIGHTING PLAN


Project No.: 19073


Sheet No.:


L-2.2

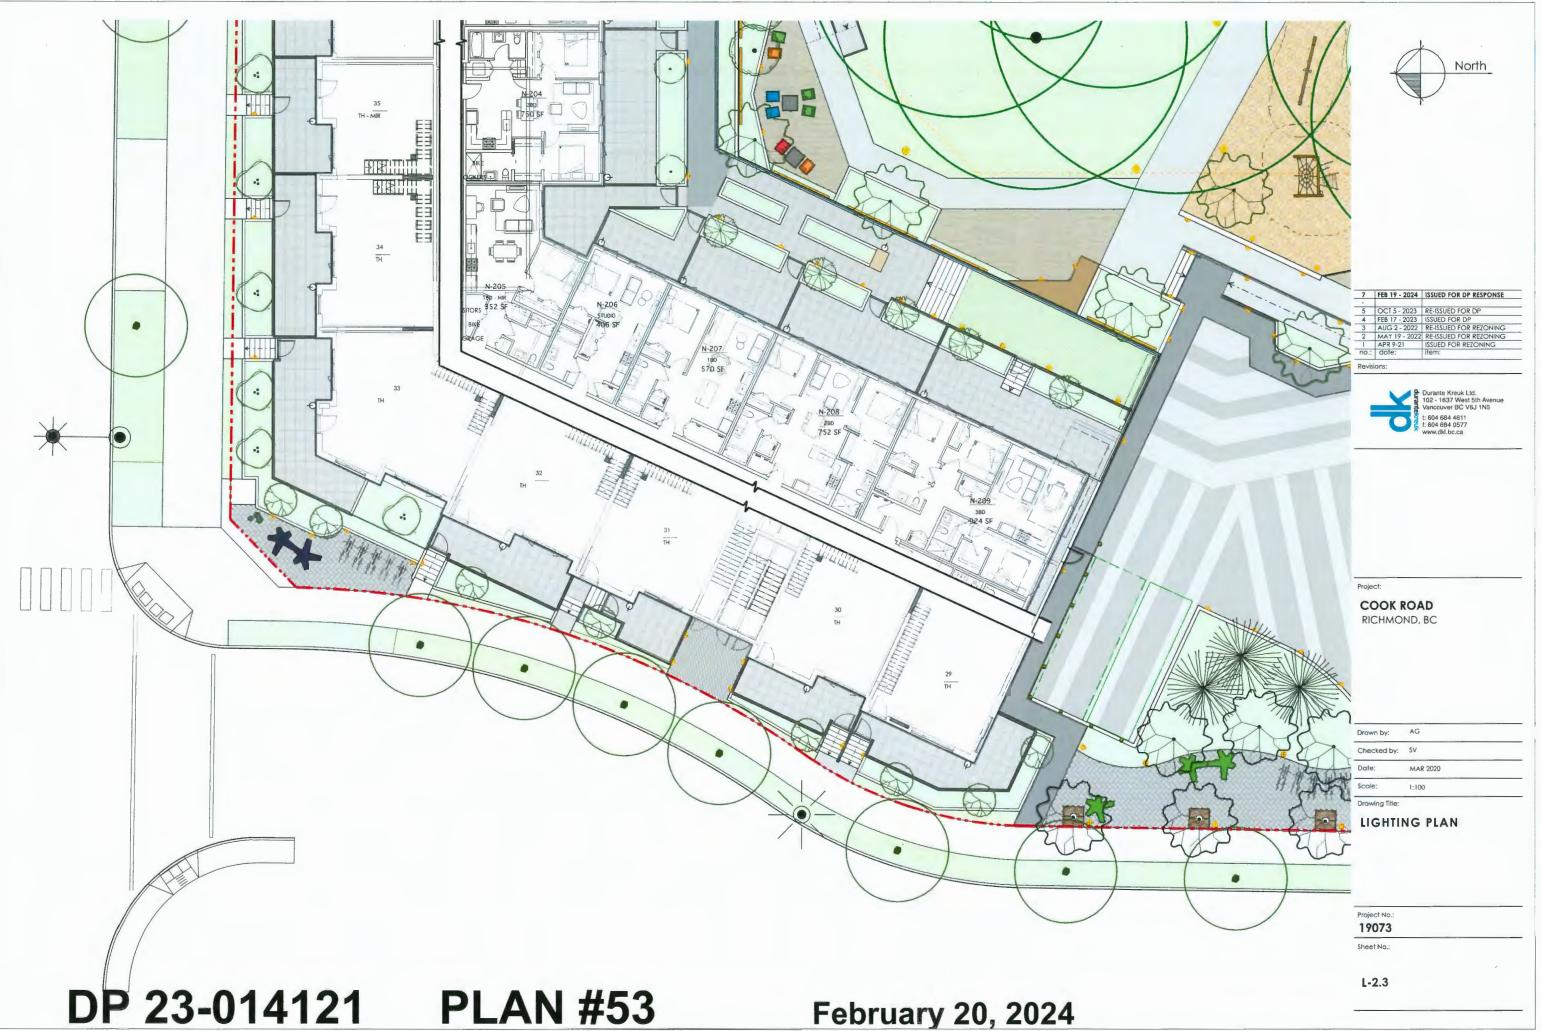

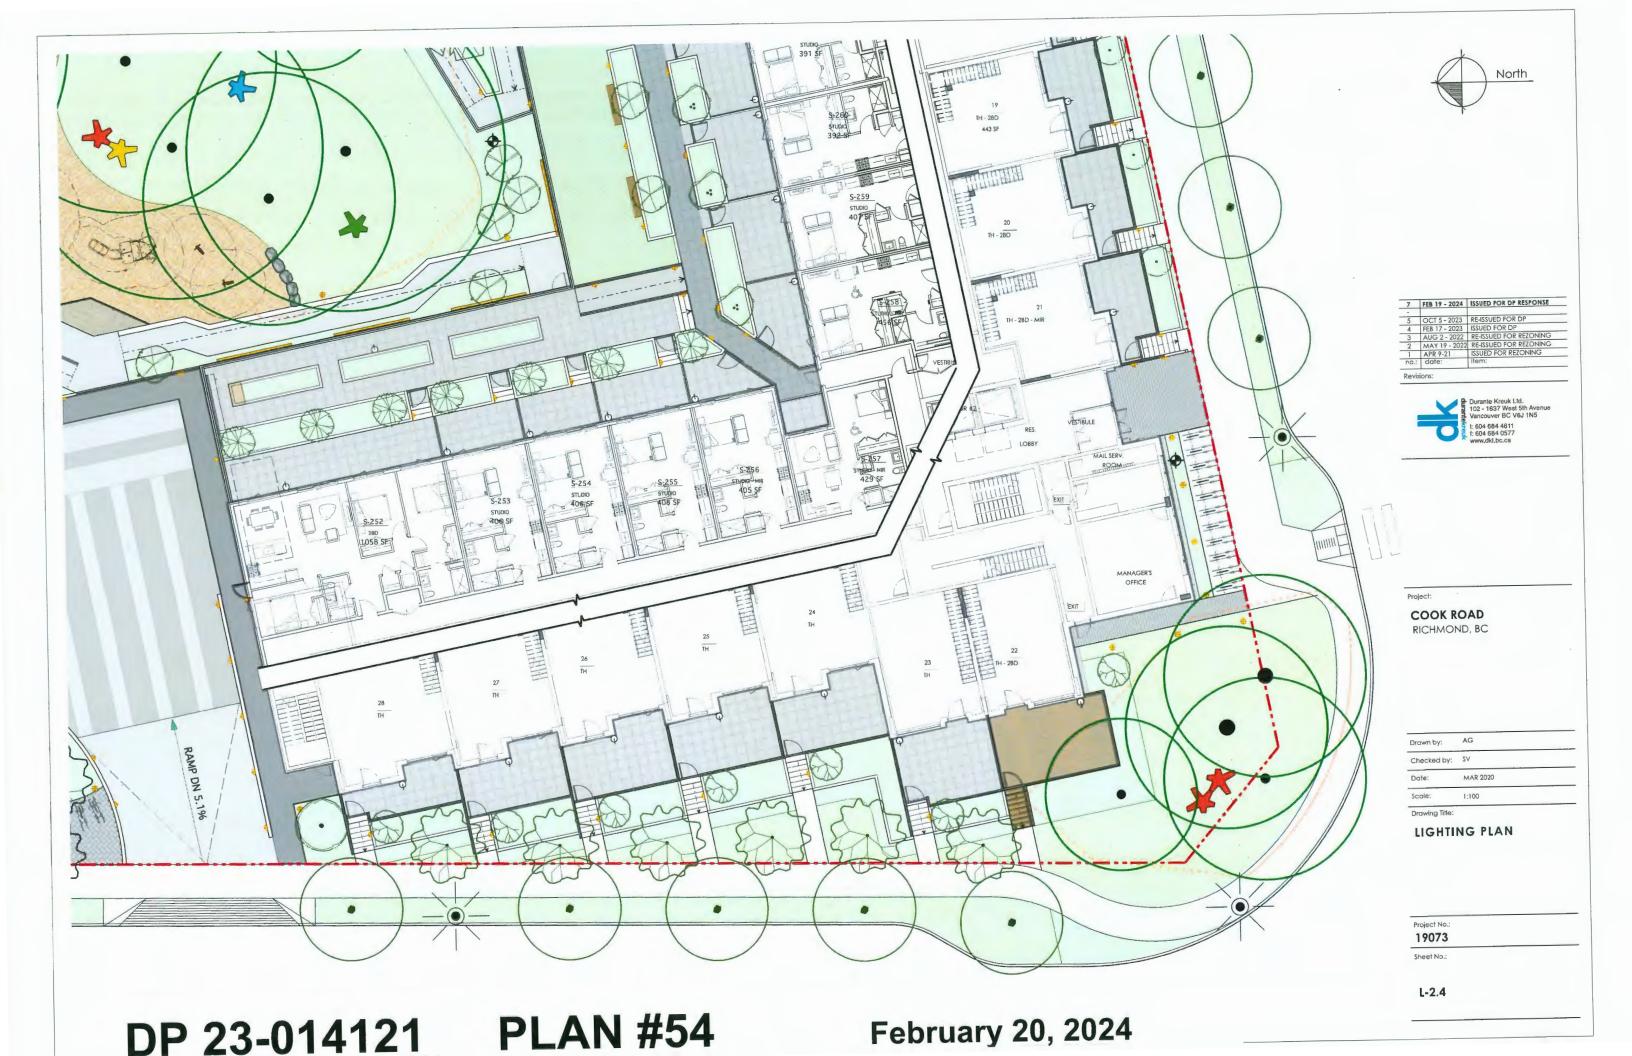

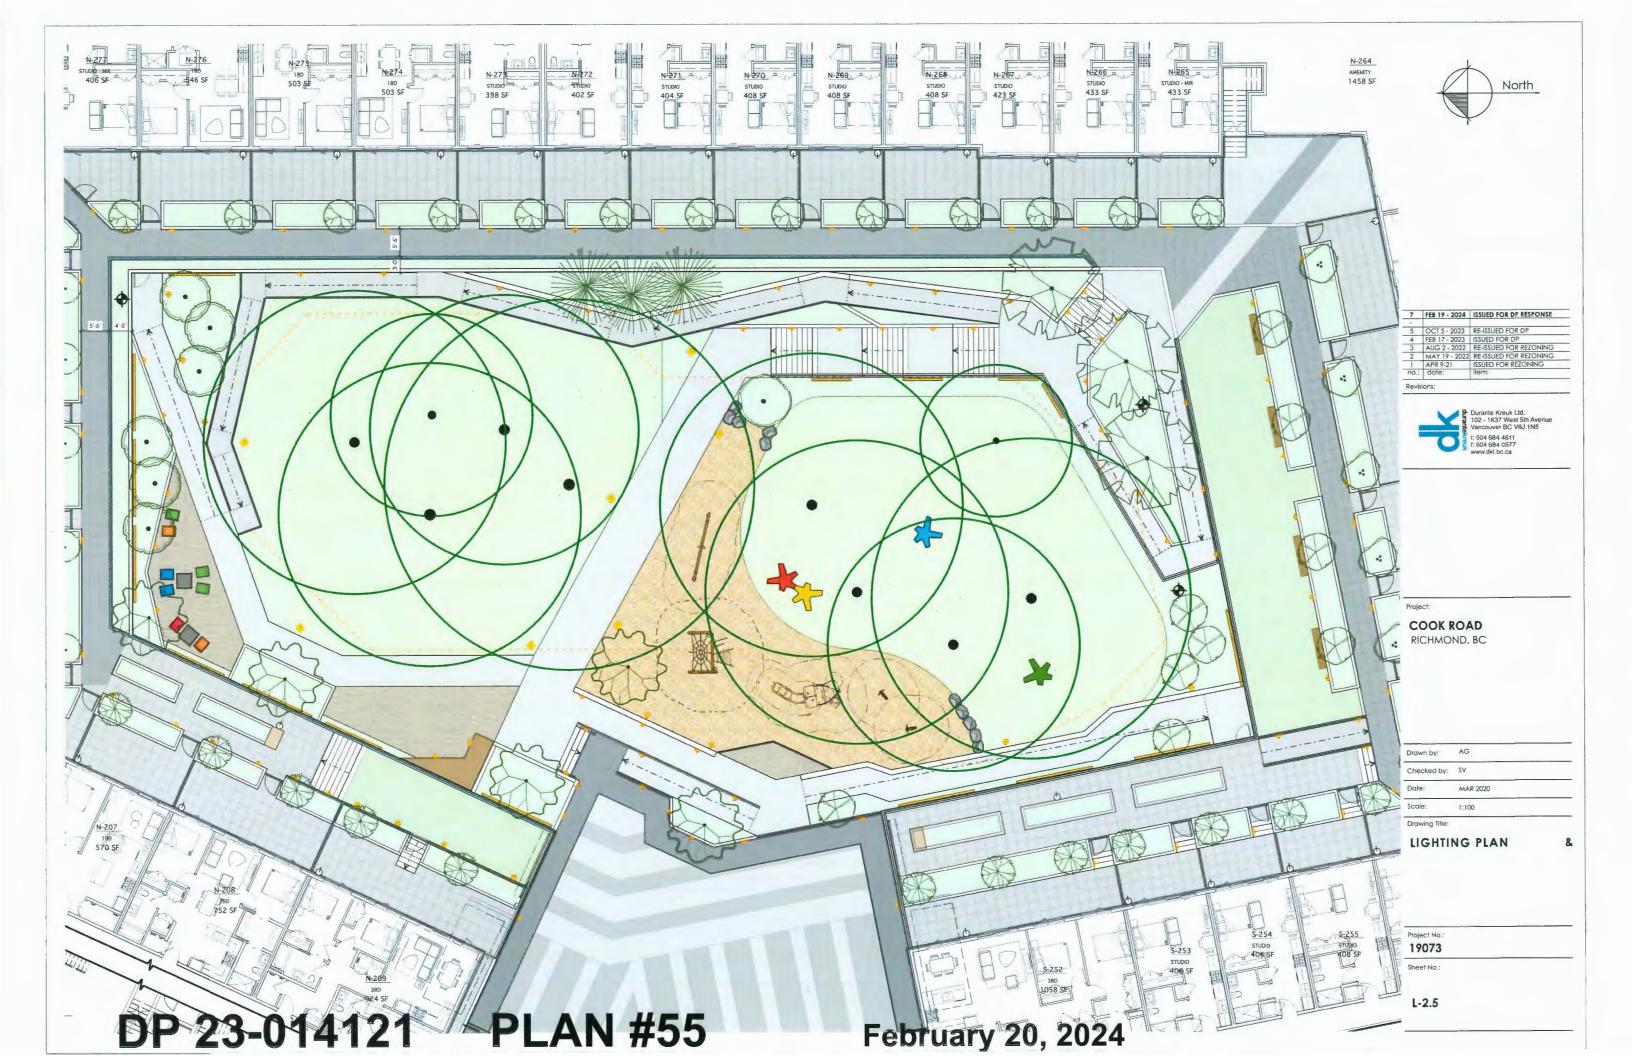

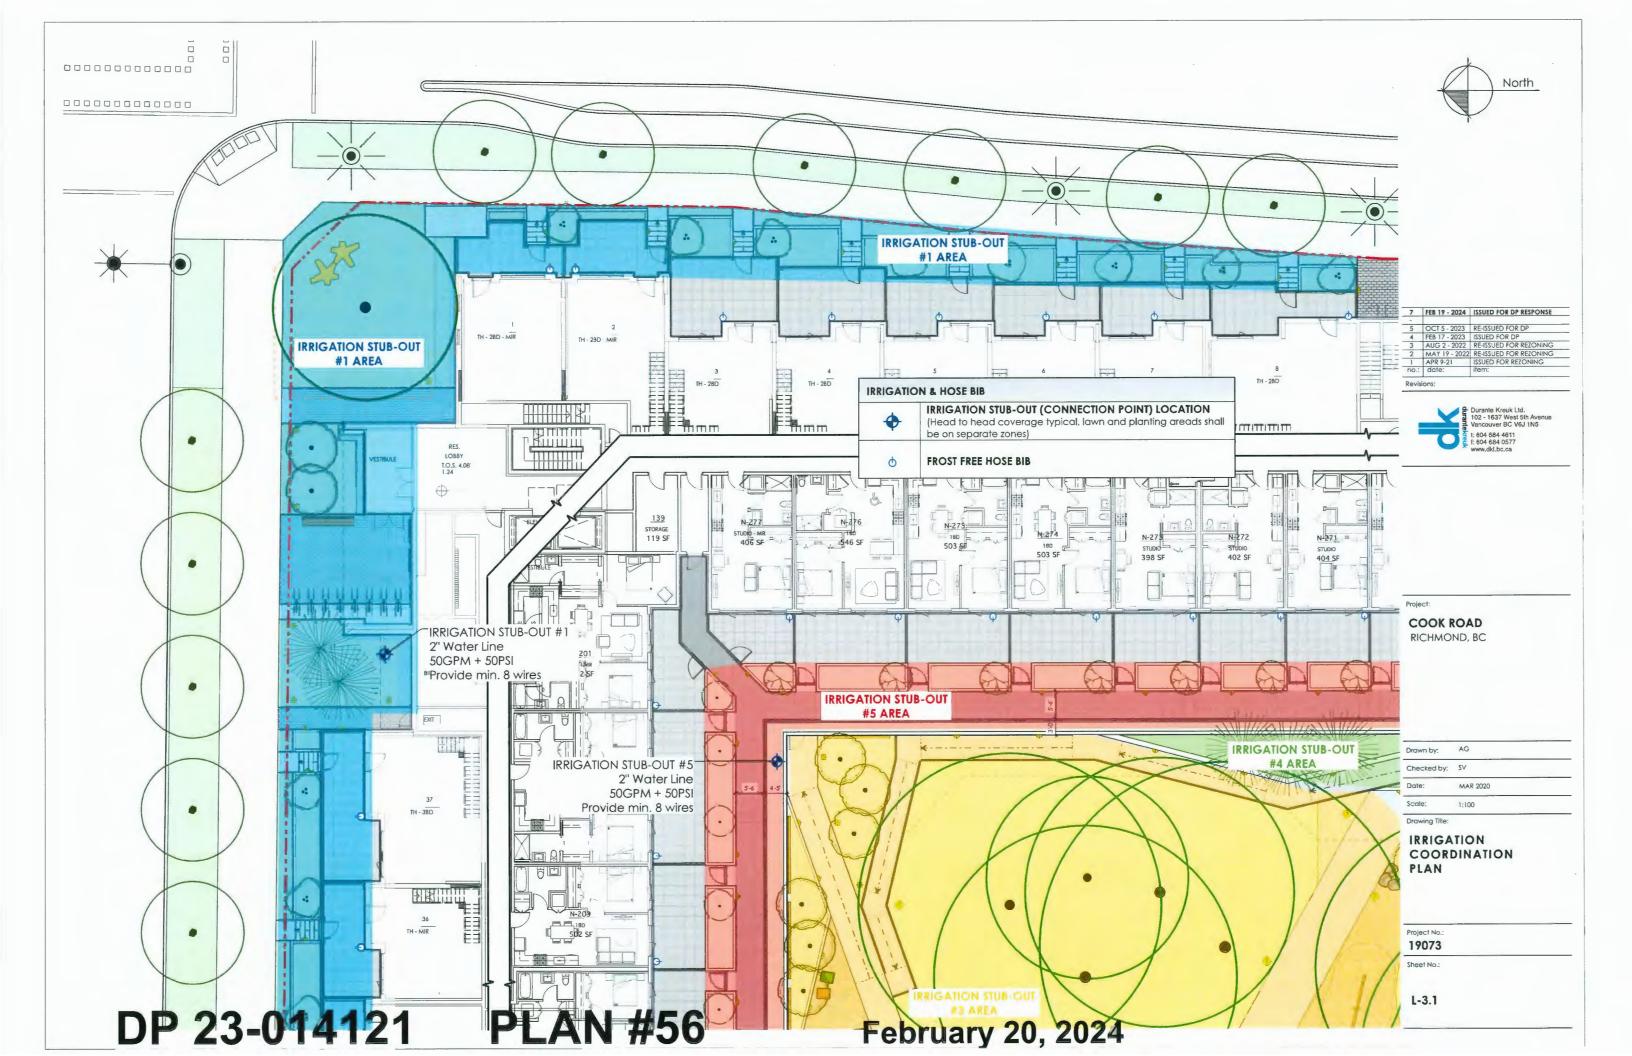

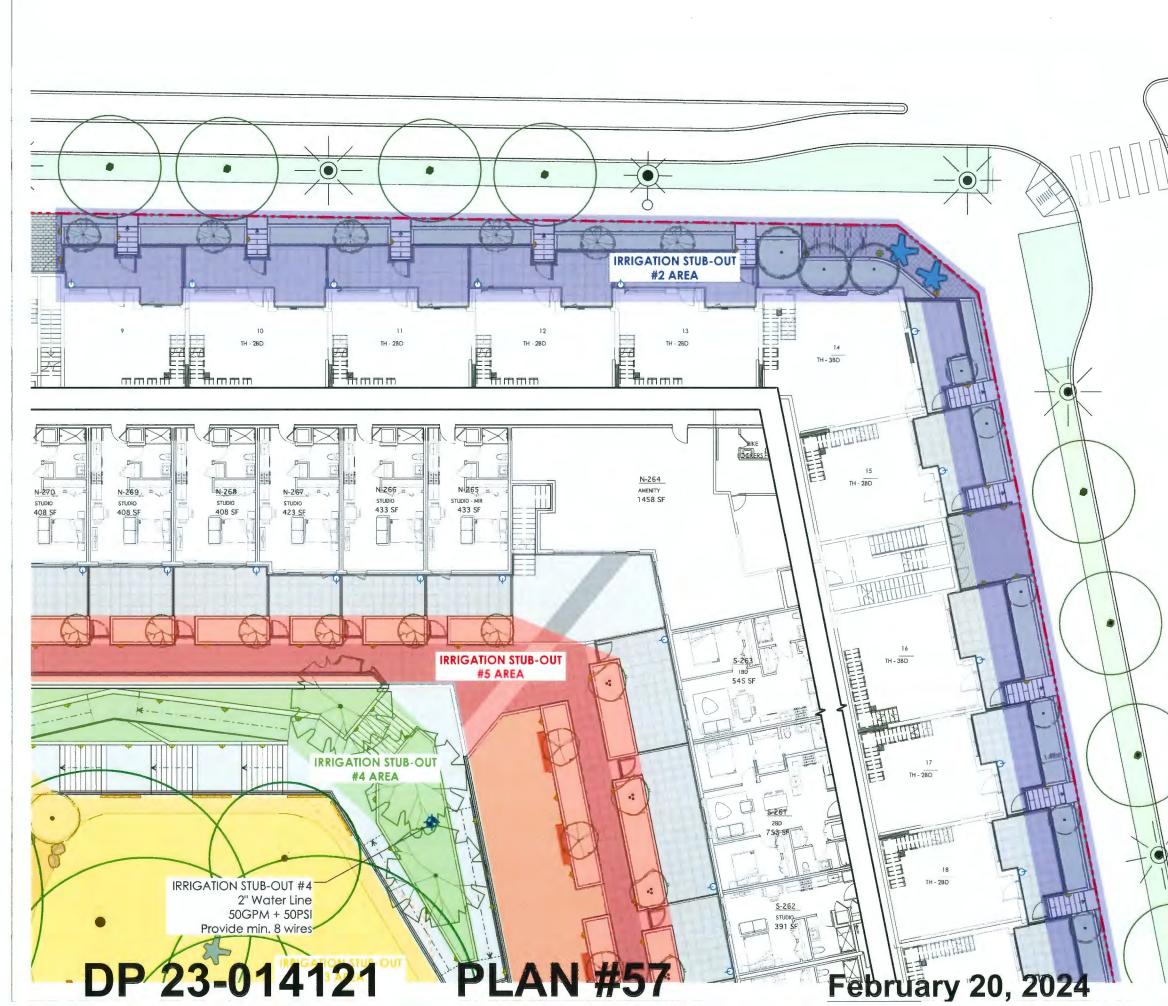



7	FEB 19 - 2024	<b>ISSUED FOR DP RESPONSE</b>
5	OCT 5 - 2023	RE-ISSUED FOR DP
4	FEB 17 - 2023	ISSUED FOR DP
3	AUG 2 - 2022	RE-ISSUED FOR REZONING
2	MAY 19 - 2022	RE-ISSUED FOR REZONING
1	APR 9-21	ISSUED FOR REZONING
no.:	date:	item:



Durante Kreuk Ltd. 102 - 1637 West 5th Avenue Vancouver BC V6J 1N5 1: 604 684 4611 1: 604 684 0577 www.dkl.bc.ca

North

Project:

COOK ROAD RICHMOND, BC

Drawn by:	AG	
Checked by:	SV	
Date:	MAR 2020	
Scole:	1.100	


Drawing Title:


#### IRRIGATION COORDINATION PLAN

Project No.: 19073


Sheet No.:


L-3.2

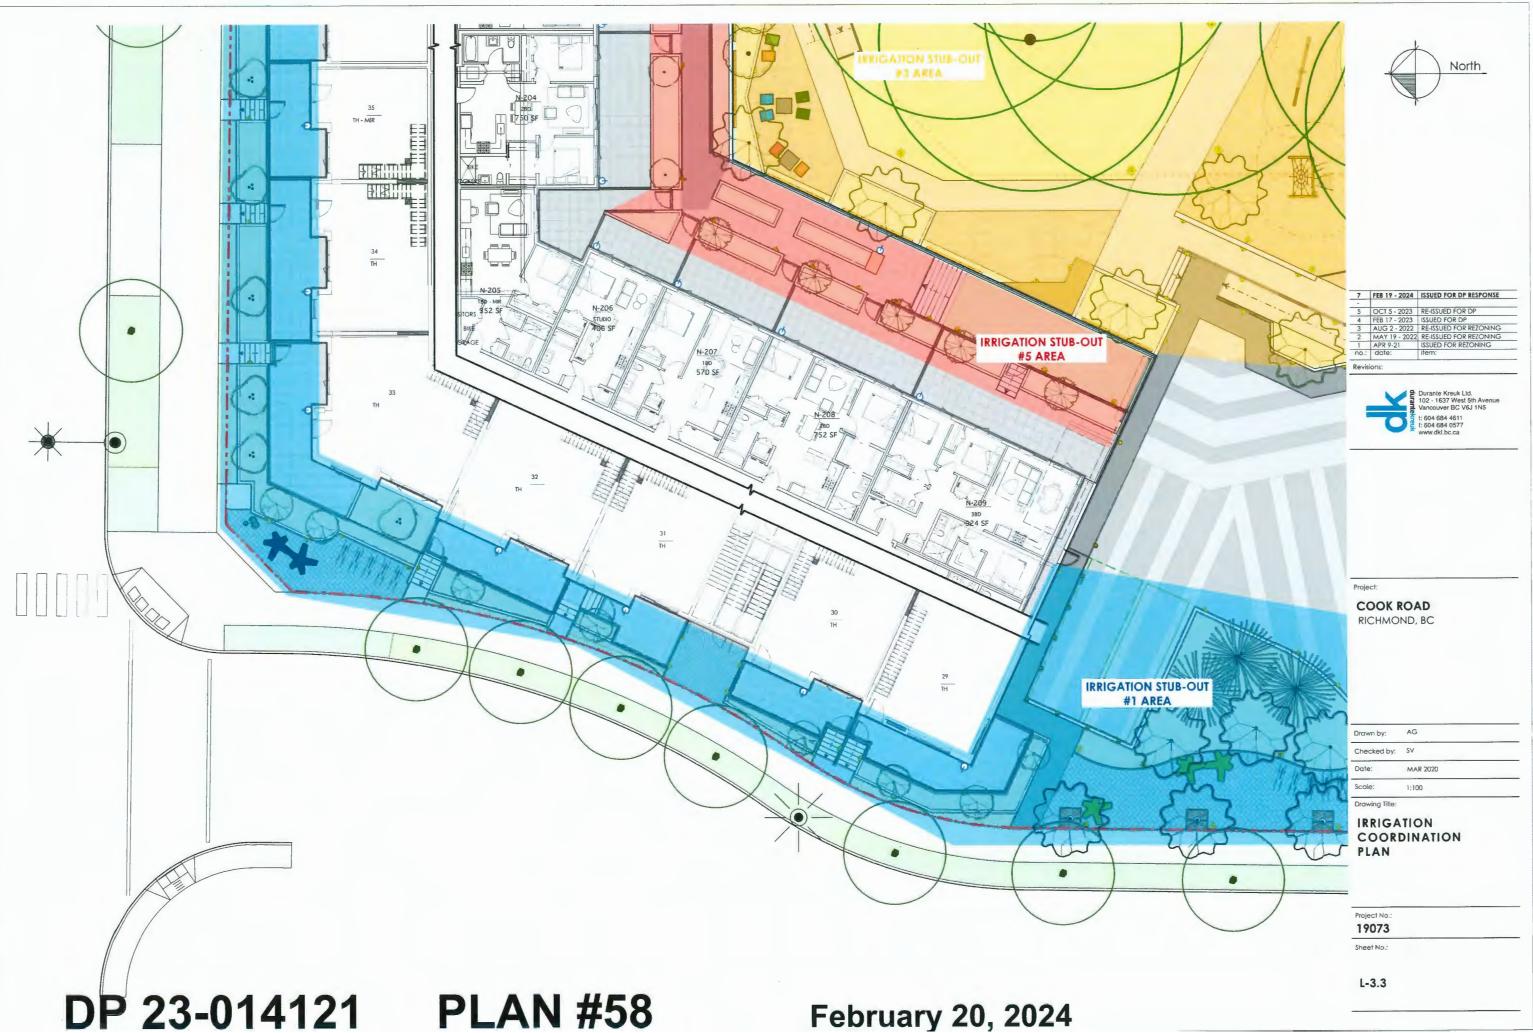


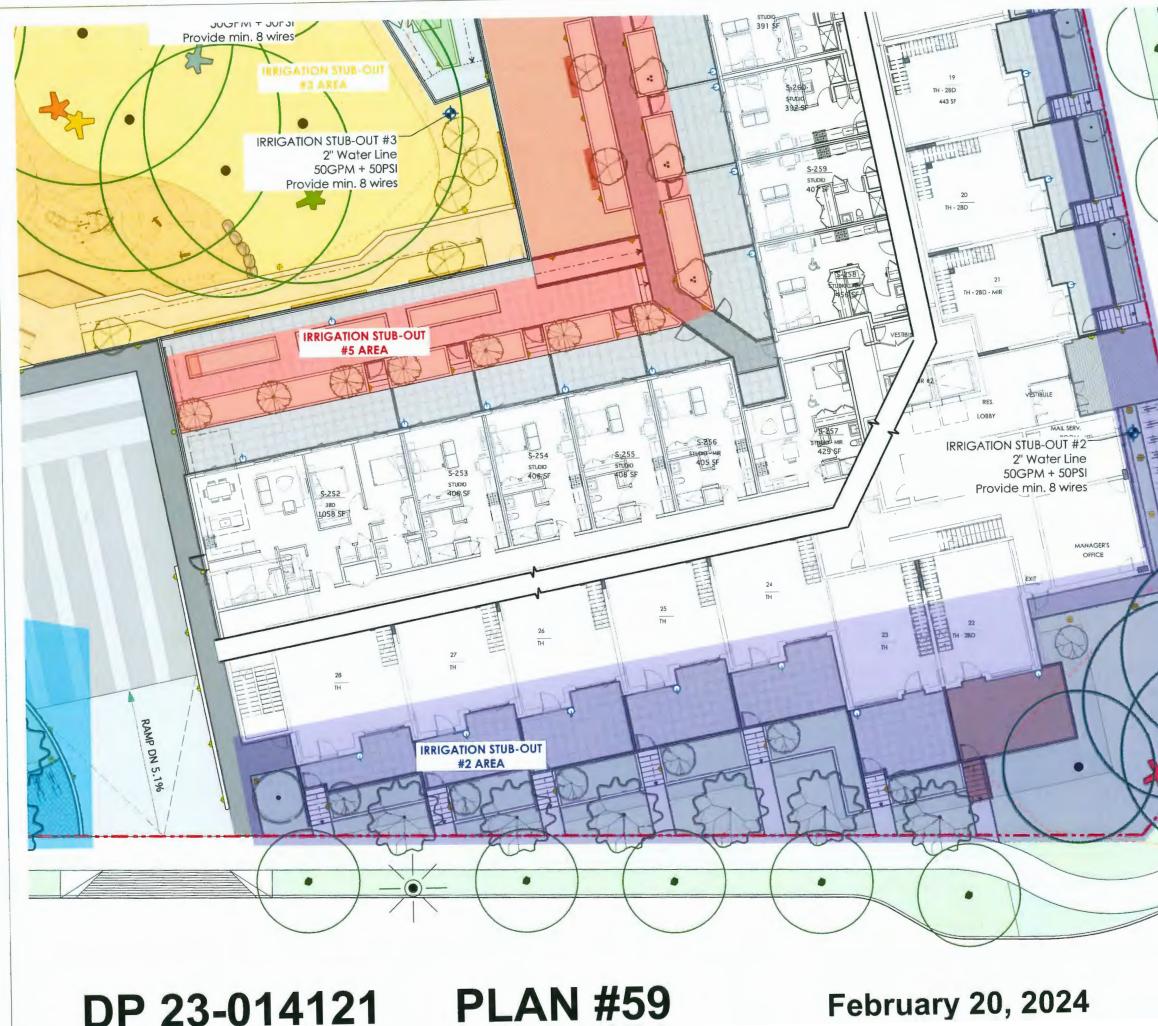

North
7         FEB 19 - 2024         ISSUED FOR DP RESPONSE           -         -         -           -
3       AUG 2 - 2022       RE-ISSUED FOR REZONING         2       MAY 19 - 2022       RE-ISSUED FOR REZONING         1       APR 9-21       ISSUED FOR REZONING         no.:       date:       Item:         Revisions:       Durante Kreuk Ltd.         102 - 1637 West 5th Avenue Vancouver BC V6J 1N5       : 604 684 4611         1:       604 684 4611         1:       : 604 684 4611         1:       : 604 684 4611         ::       : 604 684 4611         ::       : 604 684 4611         ::       : 604 684 4611         ::       :<
Project: COOK ROAD RICHMOND, BC
Drawn by: AG Checked by: SV Date: MAR 2020 Scole: 1:100 Drawing Title: IRRIGATION
COORDINATION PLAN

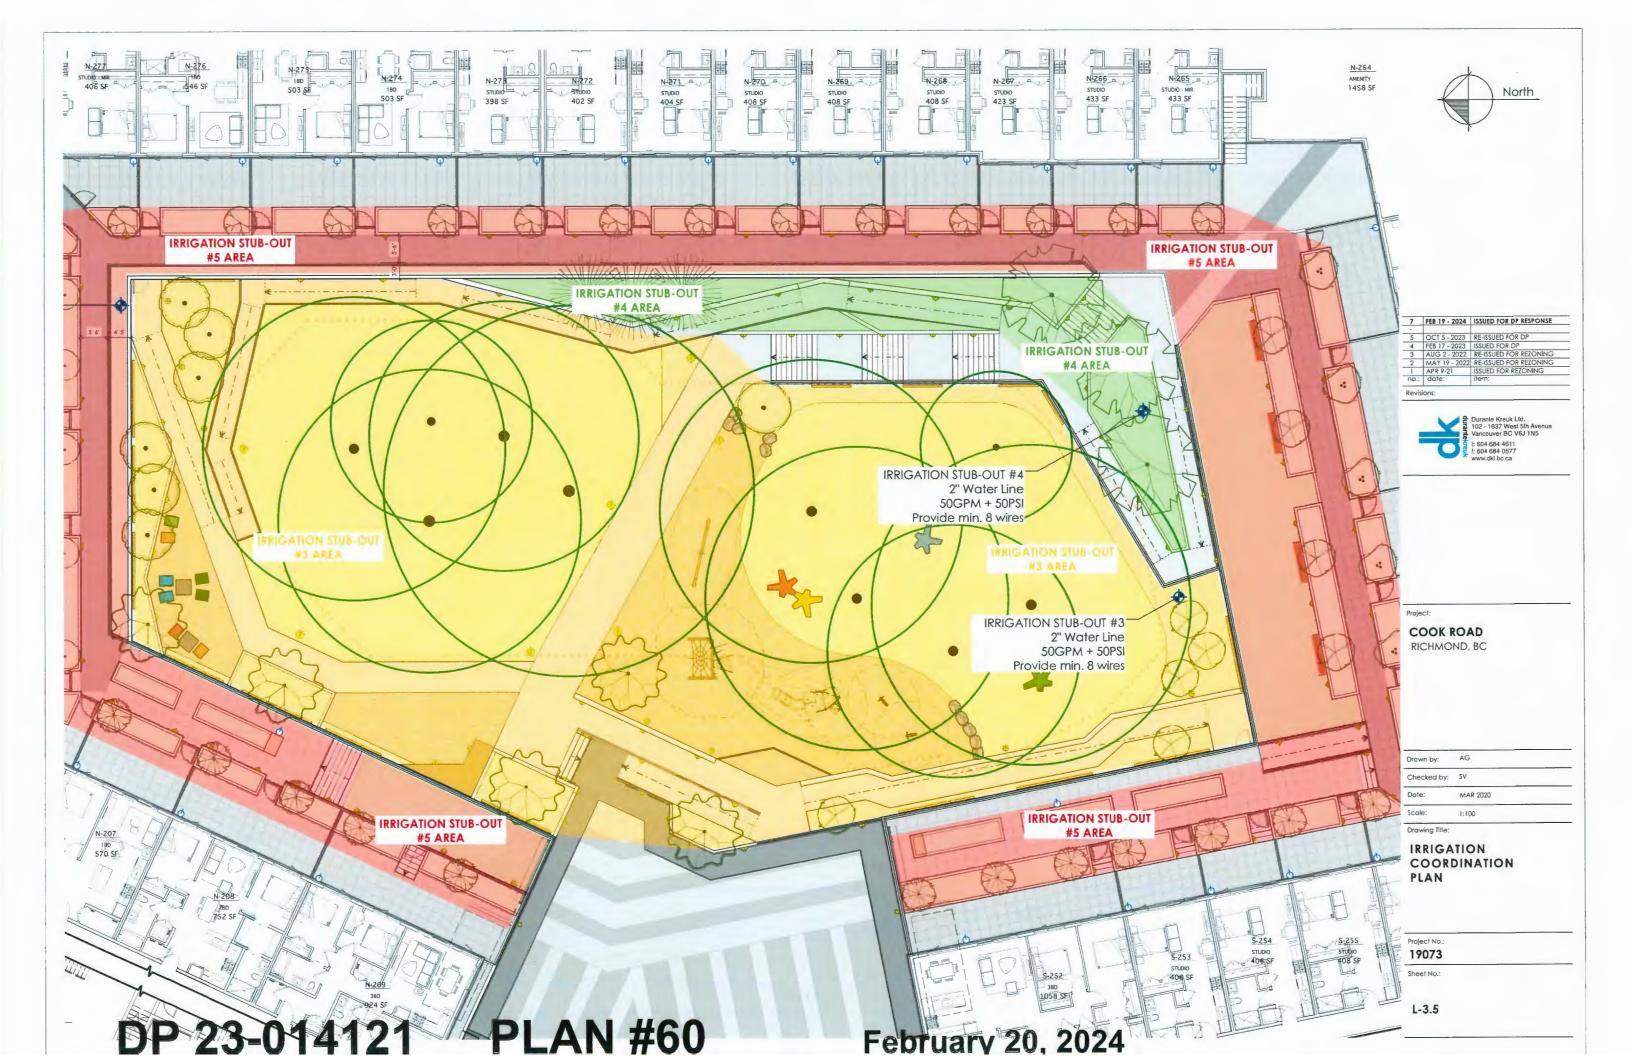

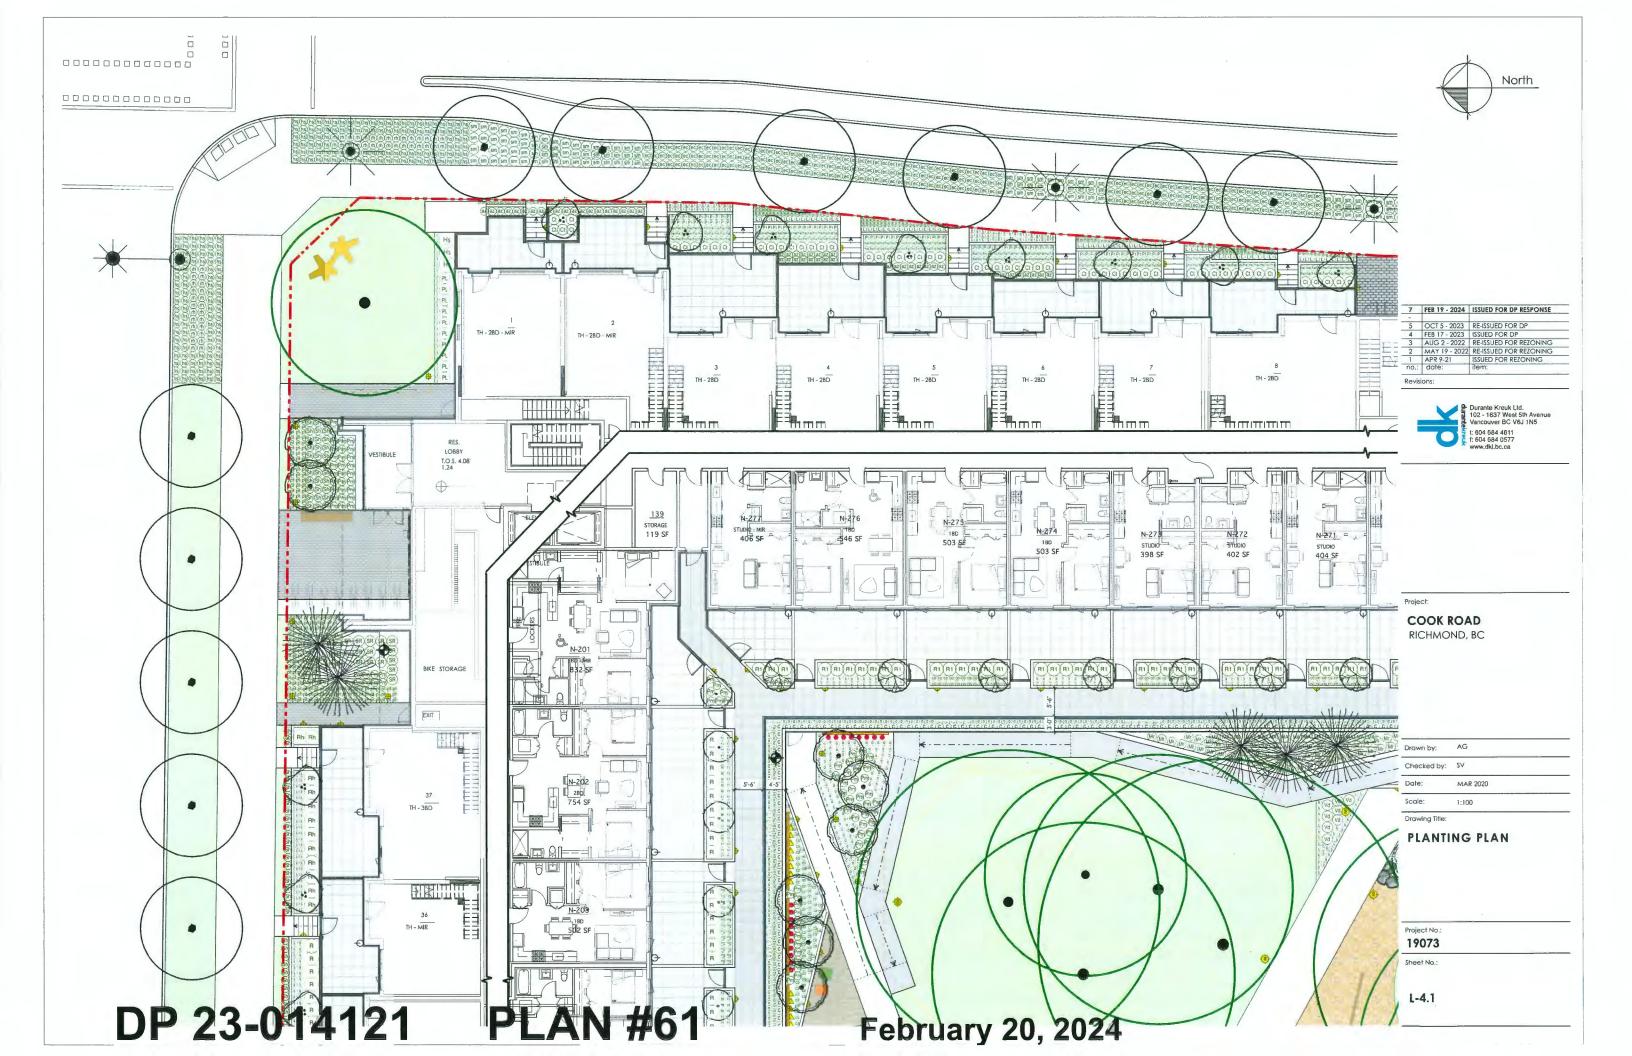

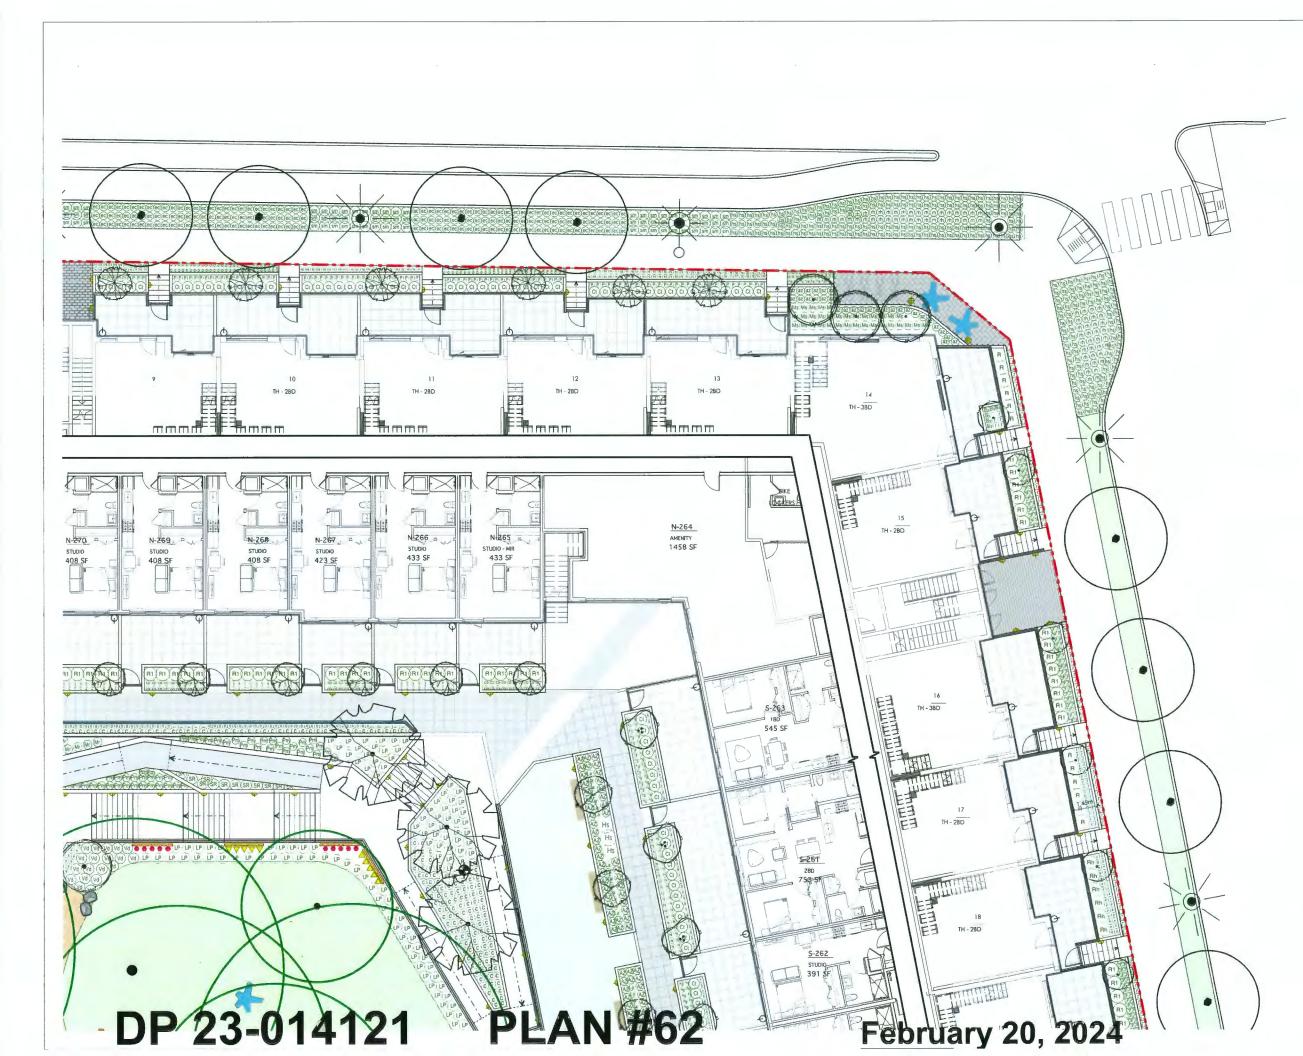

North

7	FEB 19 - 2024	<b>ISSUED FOR DP RESPONSE</b>
-		
5	OCT 5 - 2023	RE-ISSUED FOR DP
4	FEB 17 - 2023	ISSUED FOR DP
3	AUG 2 - 2022	RE-ISSUED FOR REZONING
2	MAY 19 - 2022	RE-ISSUED FOR REZONING
1	APR 9-21	ISSUED FOR REZONING
no.:	date:	item:



Durante Kreuk Ltd. 102 - 1637 West 5th Avenue Vancouver BC V6J 1N5 t: 604 684 4811 f: 604 684 0577 www.dkl.bc.ca

Project:

COOK ROAD RICHMOND, BC


Drawn by:	AG	
Checked by:	SV	
Date:	MAR 2020	
Scale:	1:100	
Drawing Title:		

#### PLANTING PLAN

Project No.: 19073

Sheet No.:


L-4.2

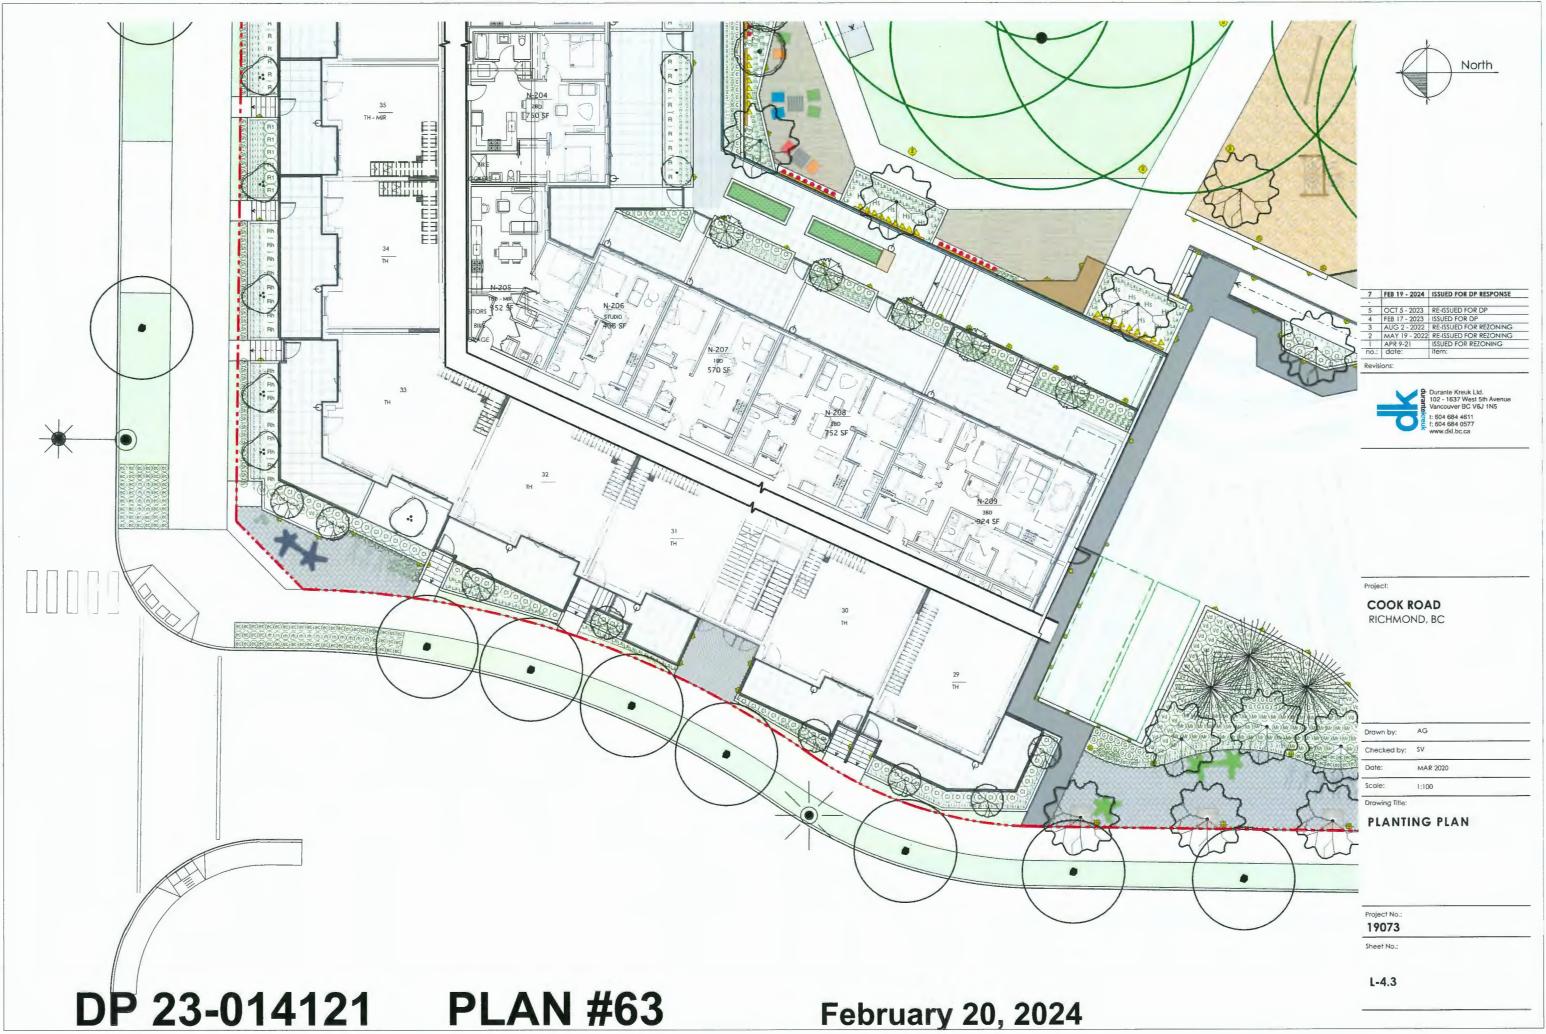





DP 23-014121 PLAN #64

February 20, 2024

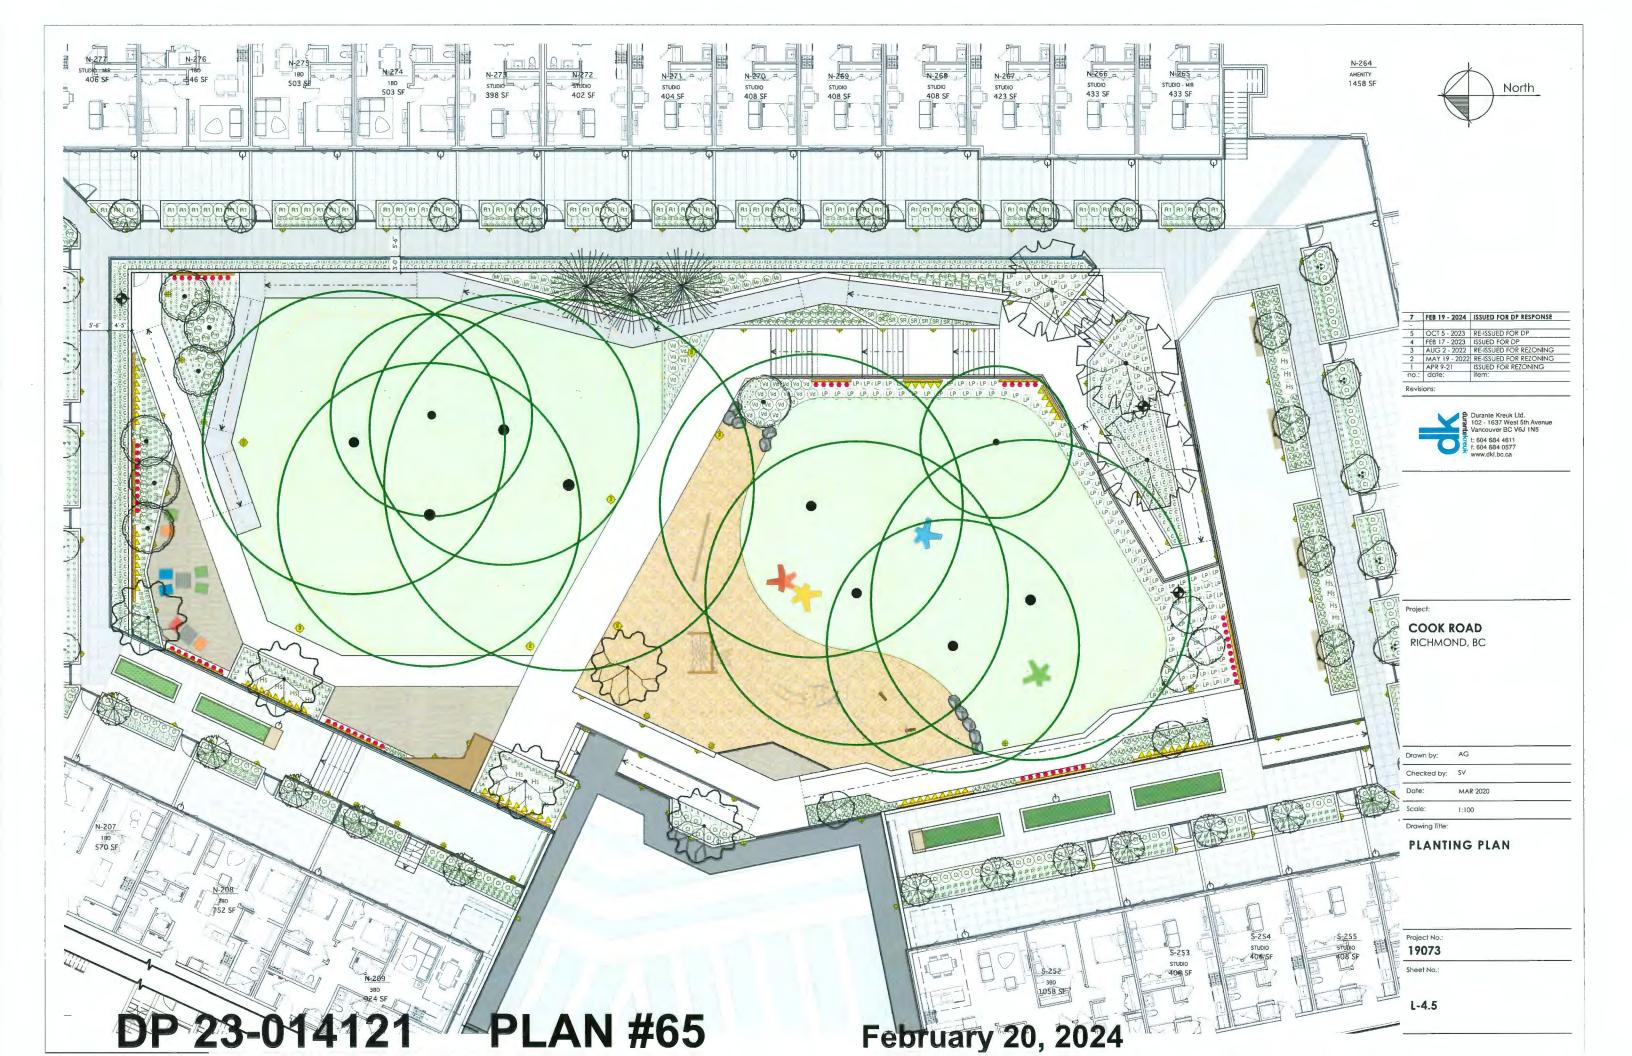

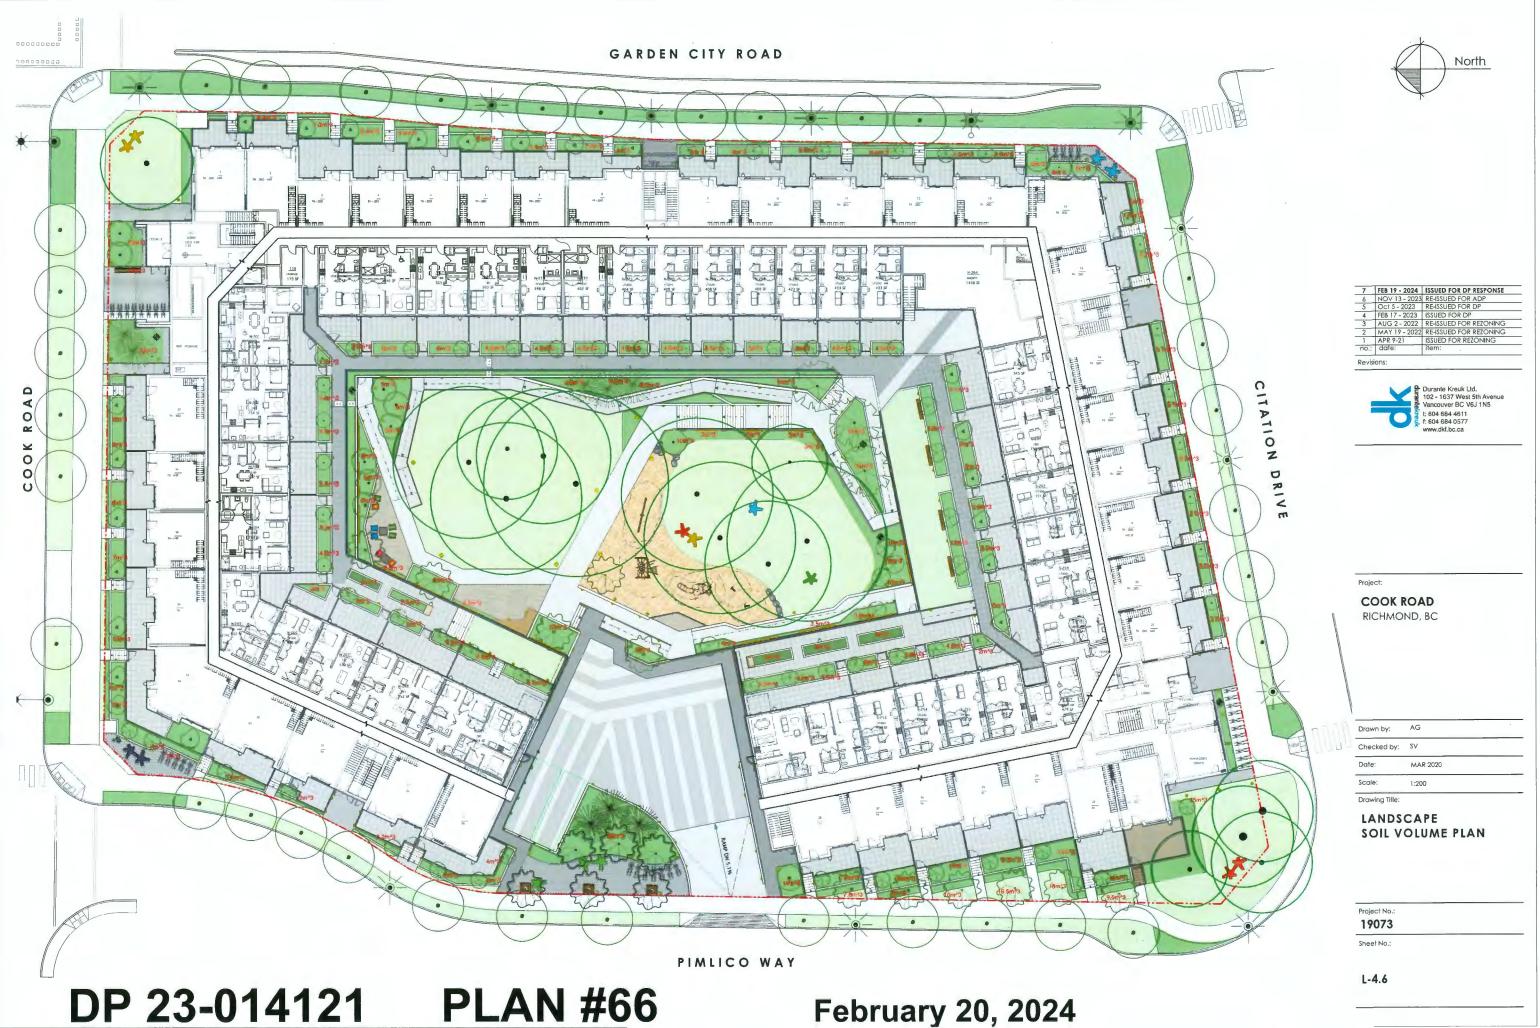

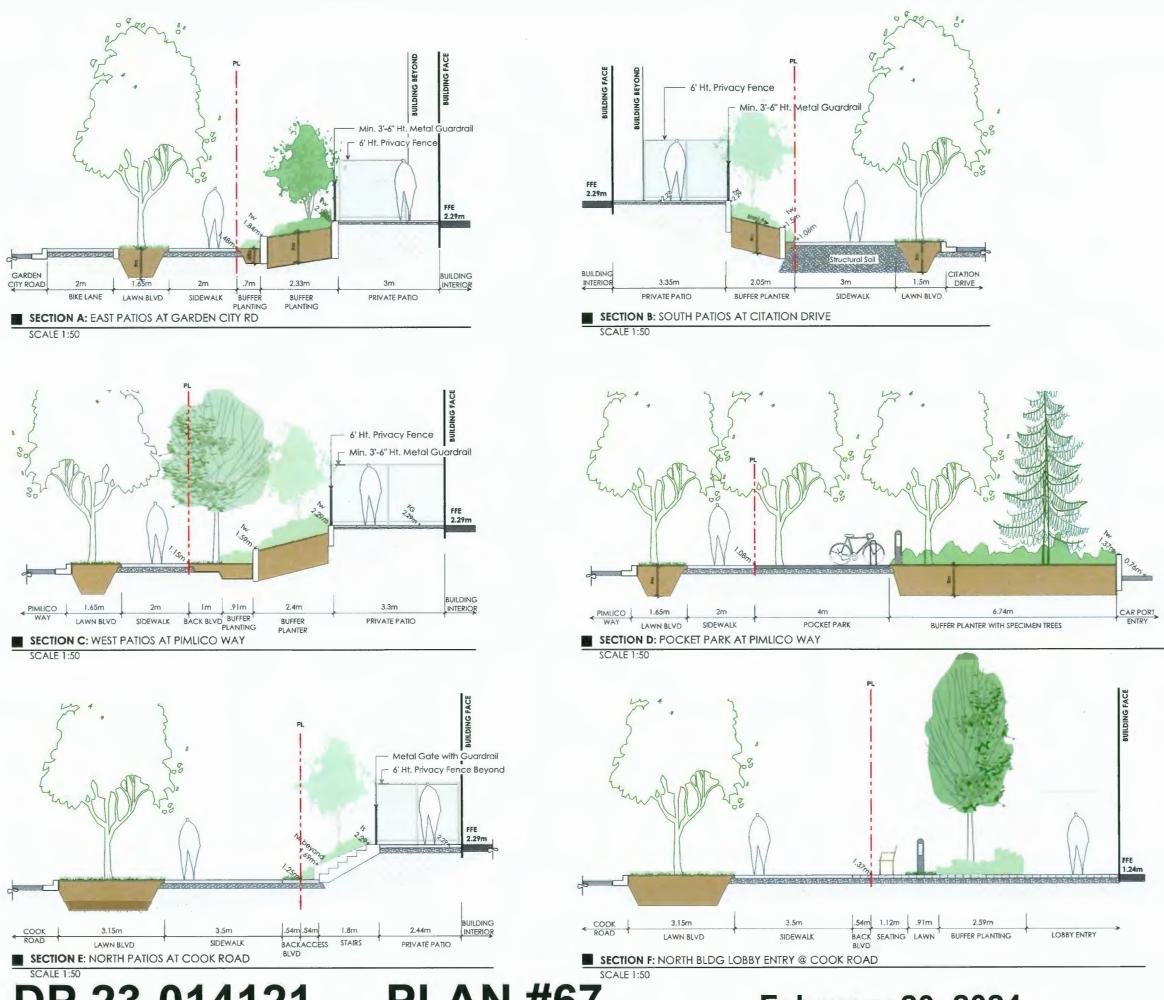

DP 23-014121 PLAN #67

February 20, 2024

6	Feb 5 - 2024	<b>ISSUED FOR DP RESPONSE</b>
5	Oct 5 - 2023	RE-ISSUED FOR DP
4	FEB 17 - 2023	ISSUED FOR DP
3	AUG 2 - 2022	RE-ISSUED FOR REZONING
2	MAY 19 - 2022	<b>RE-ISSUED FOR REZONING</b>
1	APR 9-21	ISSUED FOR REZONING
no.:	date:	item:



Durante Kreuk Ltd. 102 - 1637 West 5th Avenue Vancouver BC V6J 1N5 t: 604 684 4611 f: 604 684 0577 www.dkl.bc.ca

Project:

COOK ROAD RICHMOND, BC


Drawn by:	AG/LF	
Checked by:	РК	_
Date:	JAN 2024	
Scale:	Ad Shown	
Drawing Title:		

#### LANDSCAPE SECTIONS

Project No.: 19073

Sheet No.:

L-5.1

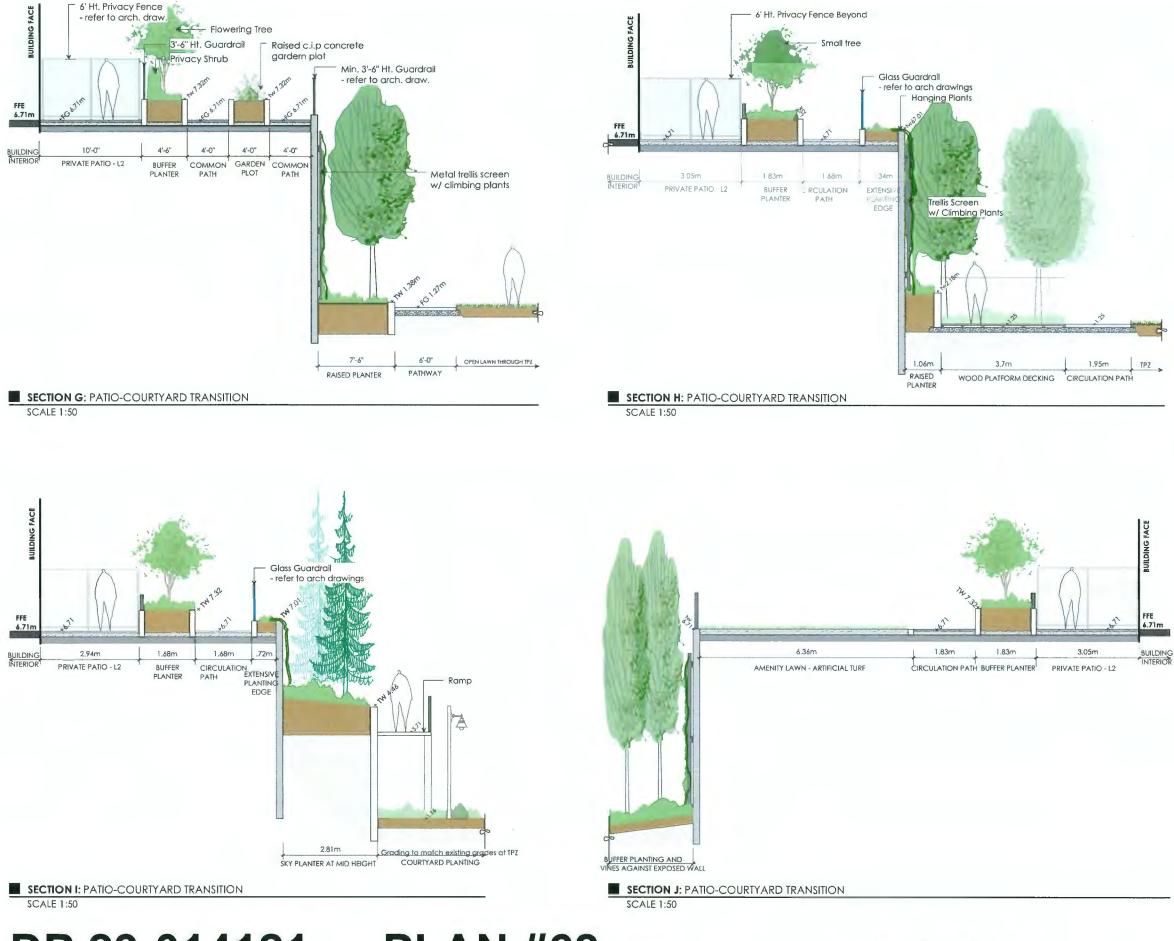

DP 23-014121

**PLAN #68** 

February 20, 2024

6	Feb 5 - 2024	<b>ISSUED FOR DP RESPONSE</b>
5	Oct 5 - 2023	RE-ISSUED FOR DP
4	FEB 17 - 2023	ISSUED FOR DP
3	AUG 2 - 2022	<b>RE-ISSUED FOR REZONING</b>
2	MAY 19 - 2022	<b>RE-ISSUED FOR REZONING</b>
T	APR 9-21	ISSUED FOR REZONING
10.:	date:	item:

Durante Kreuk Ltd. 102 - 1637 West 5th Avenue Vancouver BC V6J 1N5 t: 604 684 4611 f: 604 684 0577 www.dkl.bc.ca

Project:

COOK ROAD RICHMOND, BC

Drawn by:	AG/LF
Checked by:	РК
Date:	JAN 2024
Scale:	As Shown
Drawing Title:	And


#### LANDSCAPE SECTIONS


Project No.:


19073

Sheet No .:

L-5.2

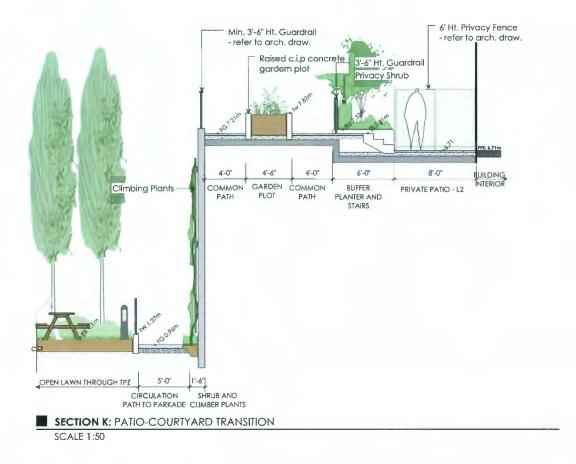

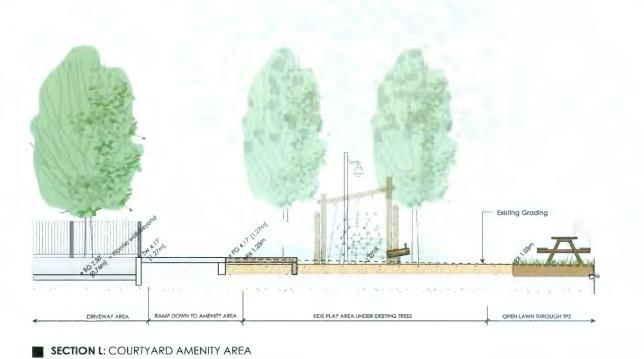

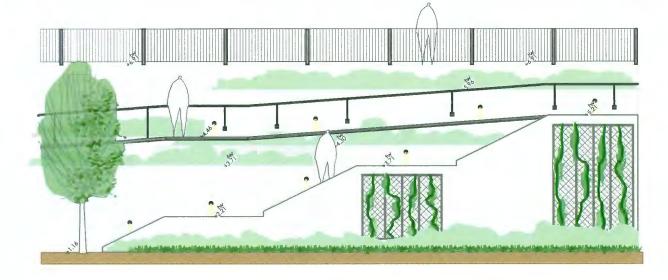

SECTION M: COURTYARD GRAND ACCESS STAIR SCALE 1:50

SCALE 1:50

# DP 23-014121 PLAN #69

## February 20, 2024

6	Feb 5 - 2024	<b>ISSUED FOR DP RESPONSE</b>
5	Oct 5 - 2023	RE-ISSUED FOR DP
4	FEB 17 - 2023	ISSUED FOR DP
3	AUG 2 - 2022	RE-ISSUED FOR REZONING
2	MAY 19 - 2022	
1	APR 9-21	ISSUED FOR REZONING
10.:	date:	item:



Durante Kreuk Ltd. 102 - 1637 West 5th Avenue Vancouver BC V6J 1N5 1: 604 684 4611 f: 604 684 0577 www.dkl.bc.ca

Project:

COOK ROAD RICHMOND, BC


Drawn by:	AG/LF	
Checked by:	PK	
Date:	JAN 2024	
Scale:	As Shown	

#### LANDSCAPE SECTIONS

Praject No.: 19073

Sheel No.:

L-5.3

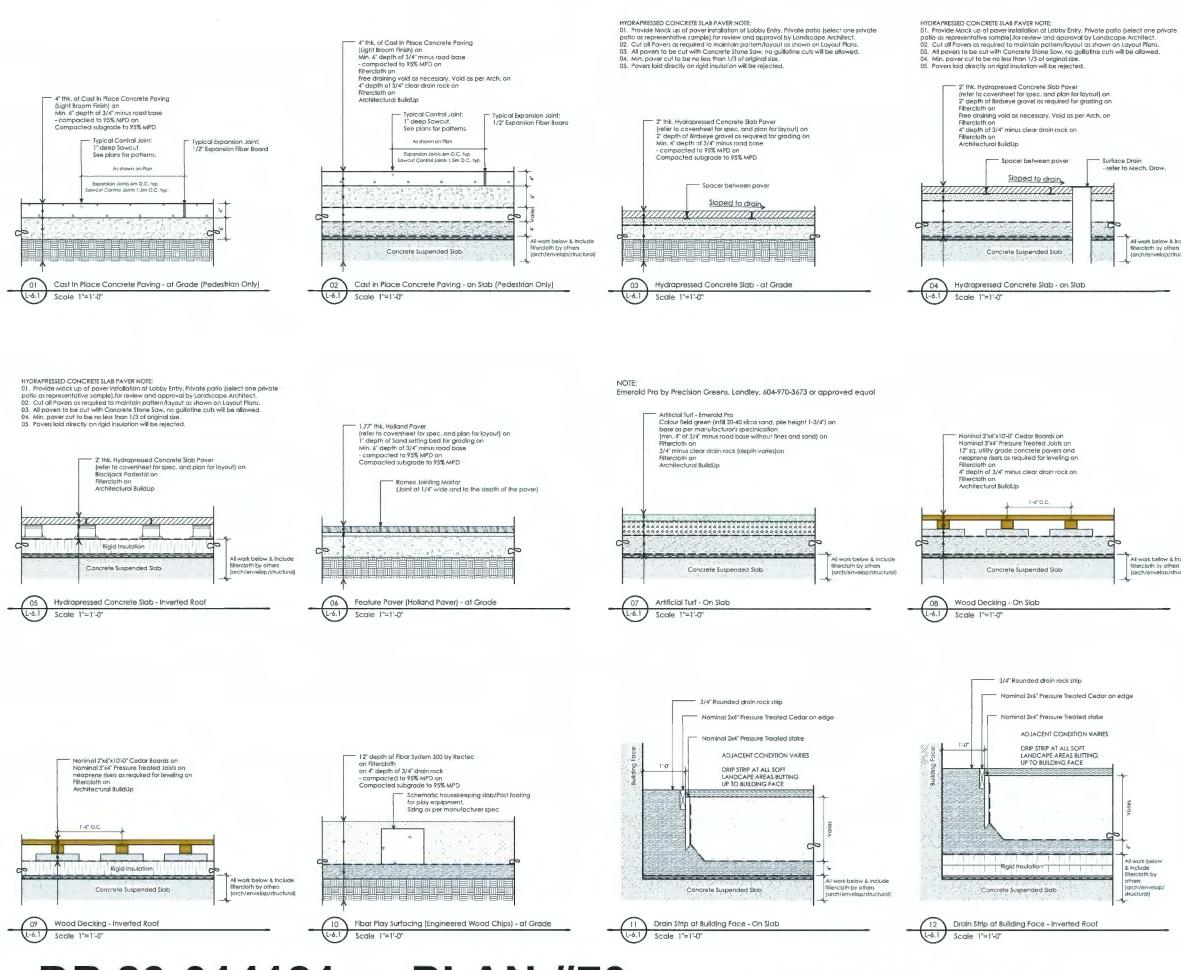

#### **DP 23-014121 PLAN #70**

## February 20, 2024

- refer to Mech. Drow

All work below & Include filtercloth oy others forch/envelop/structural}

6	Jan 17 - 2024	ISSUED FOR DP RESPONSE
5	Oct 5 - 2023	RE-ISSUED FOR DP
4	FEB 17 - 2023	ISSUED FOR DP
-		
-		
-		
no.:	date:	item:
Revis	ions:	



Durante Kreuk Ltd. 102 - 1637 West 5th Avenue Vancouver BC V6J 1N5 t: 604 684 4611 f: 604 684 0577 w.dkl.bc.ca

All work below & Include filtercloth by others (arch/envelop/structural)

Project:


COOK ROAD RICHMOND, BC

Drawn by:	AG	
Checked by:	РК	
Date:	MAR 2020	
Scale:	As Indicated	


#### LANDSCAPE DETAILS


Project No.: 19073

Sheet No .:

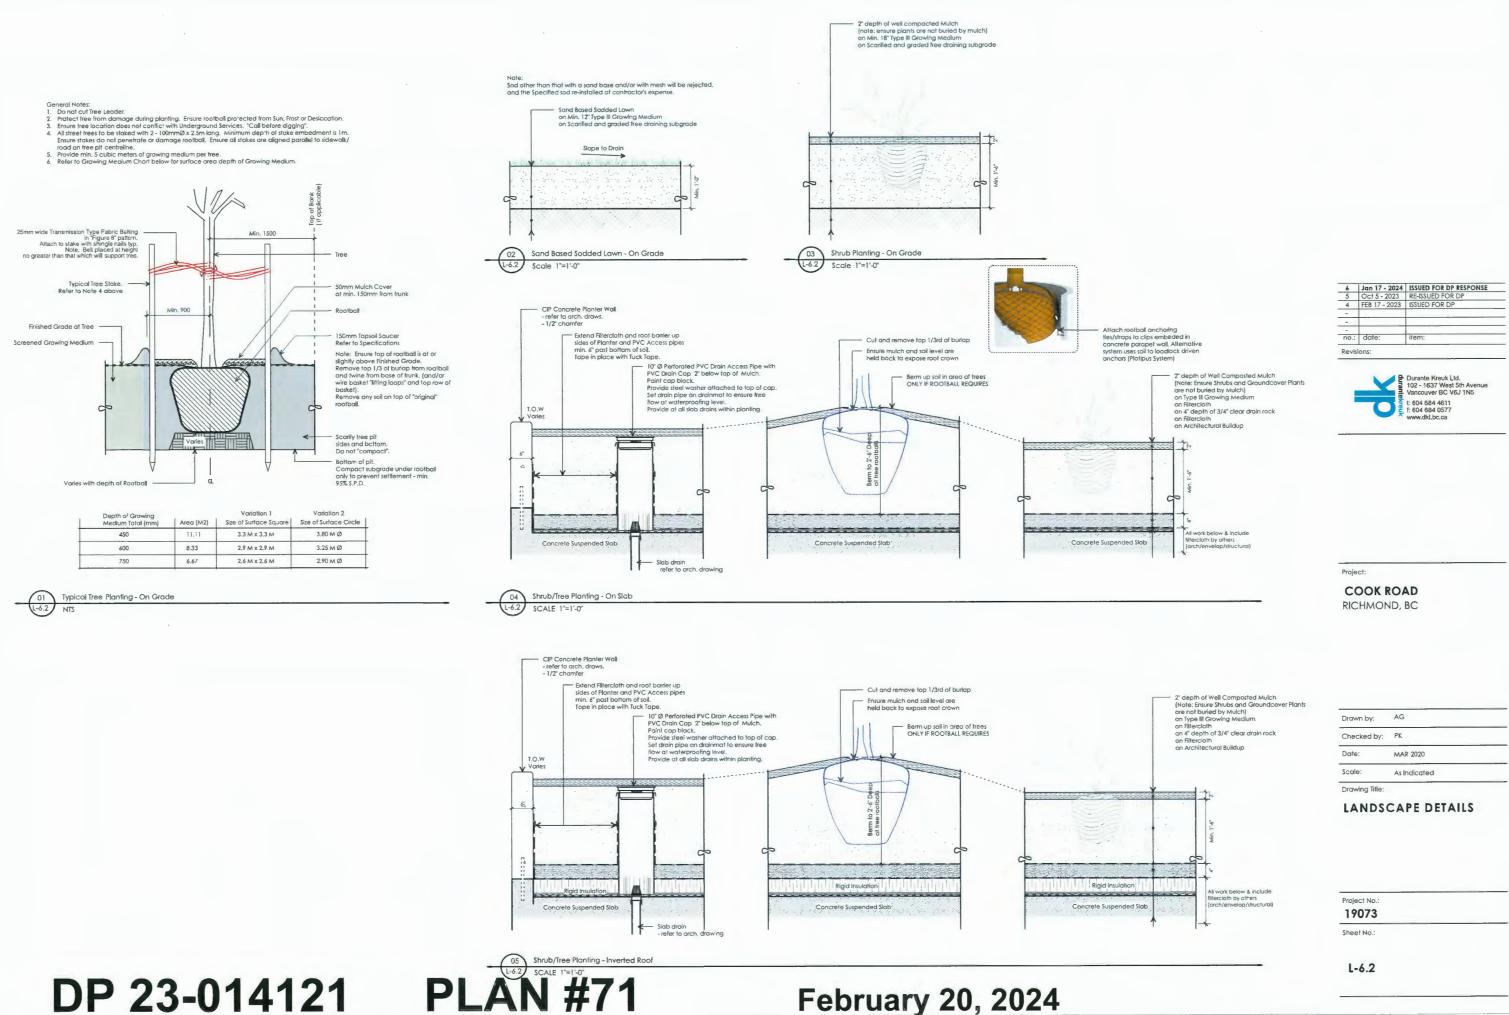

plann by.		
Checked by:	PK	
Date:	MAR 2020	
Scale:	As Indicated	
Drawing Title:		

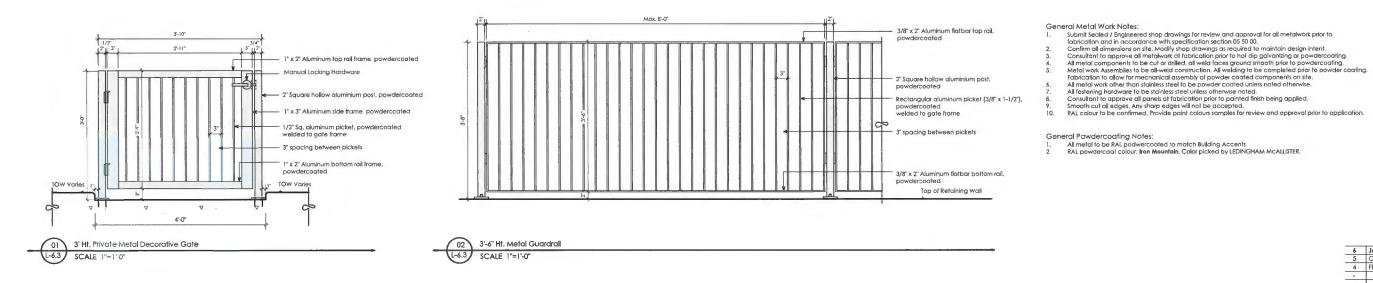

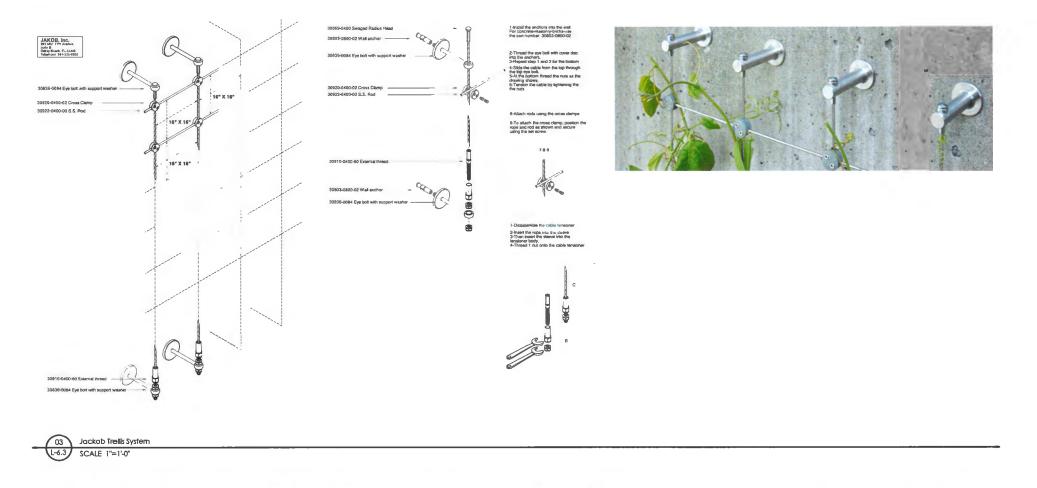

#### **PLAN #72** DP 23-014121

February 20, 2024

6	Jan 17 - 2024	ISSUED FOR DP RESPONSE
5	Oct 5 - 2023	RE-ISSUED FOR DP
4	FEB 17 - 2023	ISSUED FOR DP
-		
-		
-		
10.:	date:	item:



Project:

COOK ROAD RICHMOND, BC


Drawn by:	AG	
Checked by:	РК	
Date:	MAR 2020	
Scale:	As Indicated	
Drawing Title:		

#### LANDSCAPE DETAILS

Project No.: 19073

Sheet No.:

#### **FGP** Collection Product Data Sheet

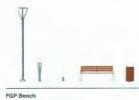

Binches snabble scense of toockes
 Binches snabble scense of toockes
 Supports and Laherum in signatures
 Supports and Laherum in signatures
 Binches snabble in ether an anotaced first to providence i
 Binches and and in 70° or 120° introl
 Binches are snabble as threats-dring, sortice mount, or orthodised
 Supports dir a" Lahert "mounting system
 Anotable in bare and Junch mood for enters use
 Anotable in bare and Junch wood with Life-Billing for Inference use
 FGM bench shots fully ssemable

#### FGP Bike Rack

L-6.4 NTS

The bake rack can be powdercoated or c wer plate has a durable dark grey anoticed finsh. Is bicycle support with capability for attachment at two to meet APBP (Association of Pedestrian and Bicycle se to meet APBP (Association of Pedestrian and Bicycle essenais) guidenes. Immediates a venety of commonly used locke including ishoe stype enhanded to concrete surface ike Rack stress fully and



Inc. 1 800 521 2545 F 299 381 3455 1 7800 F Michael Ave. Kale

Metal Bike Rack and Prefabricated Bench - or Similar Desigh/Quality

mag Paz, Part of Lat based designer Francesco Gernez Paz, Part of Landacape Forms Obb-indianve, RGP ware designed for it ranciousal peopleciation and appeal. The FGP Collection includes fine elements: a bench, lister recetticle, belie rack and padcathrun and pathway LED lights, The design language is elegant and light. Dements have a Bidd isrepticity atth sublity curved Starfish Air Staffsh Ark Submodphic experimenter, radial design ellower for filmidite groupped or individual uses, Johned as softenet ends or exattemed biroughout en amit, Staffsch Aki unates a constellation of metating that westcomes groups, pairs and individuals with suble differences in banch Designer Emilio Tutión

• Starthin Ar uses its biomorphic, sayaminter indeal desays to cruain fishel-waving for grouped in indexted, ins. • Startink Are subwind hands with indexted IDPC payamylawi analog to group and index index (Startink Are subwind indexted). • Quincin lamma LB mice barries photos (Startink Are subwind indexted) indexted index Material • High-density polyethylene (HDPE) rotational motiong -s is plane transformation process that parmits the manufacturing of hollow or

**Air Collection** 

Product Data Sheet

# Barlen Av 12.3" 81" 18" 124 20 1118 Note: refer to Plan for color selection

for each pocket park.

HCP-is signive-gril, colorAu, sustein-gril, durate and samp to markate.
 HDPE du Vissolitzed so the color west fade.
 B moduced in mathetiat of colors, which are all "00%" recyclable at the end of their Missoer.
 HDPE is non-portug and requires Hile mantenance. It is samp to wash

double-walled parts. HCPE is lightweight, colorful, susteinable, durable and easy to

using press inzerd water and a degreating detergent that contain surfactants

Revised April 27 2022 | Landscape Perms Inc. | 300.521.25-16 | F 269.381.3455 | 7800 E. Michigan Awe., Kalamaroo, MI 49348





ELKAY SPECIFICATIONS

Elkay Outdoor Bi-Level Pedestal Fountain with Pet Station Non-Filtered Non-Refri Model LK4420DB






ADA & ICC A117.1 ASME A112.19.3/CSA 845.4 Buy American Act NSF/ANSI 61 & 372 (lead free) 1000

Warranty pertains to drinking water applications only. Non-drinking water applications are not covered under warranty.

PART:	QTY;	
PROJECT:		
CONTACT:		
DATE		
NOTES:		
APPROVAL:		

In keeping with our policy o the most current version of 8 When making a component the right to change product specifications without notice. Please visit allay.com for in describes an Bitay product with design, quelity and kunctional benefits to the user Elkay REV 061 © 2023 Page 1



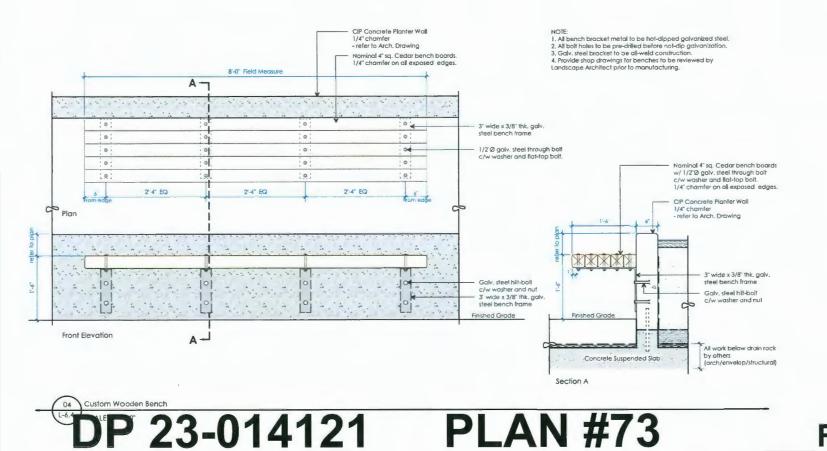

February 20, 2024

6	Jan 17 - 2024	ISSUED FOR DP RESPONSE
5	Oci 5 - 2023	RE-ISSUED FOR DP
4	FEB 17 - 2023	ISSUED FOR DP
-		
-		
-		
no.:	date:	item:



Durante Kreuk Ltd. 102 - 1637 West 5th Avenue Vancouver BC V6J 1N5 t; 604 684 4611 f: 604 684 0577 www.dkl.bc.ca

Project:

COOK ROAD RICHMOND, BC


Drawn by:	AG	
Checked by:	РК	
Date:	MAR 2020	
Scale:	As Indicated	
Drawina Title:		


#### LANDSCAPE DETAILS

Project No.: 19073

Sheet No.:

L-6.4

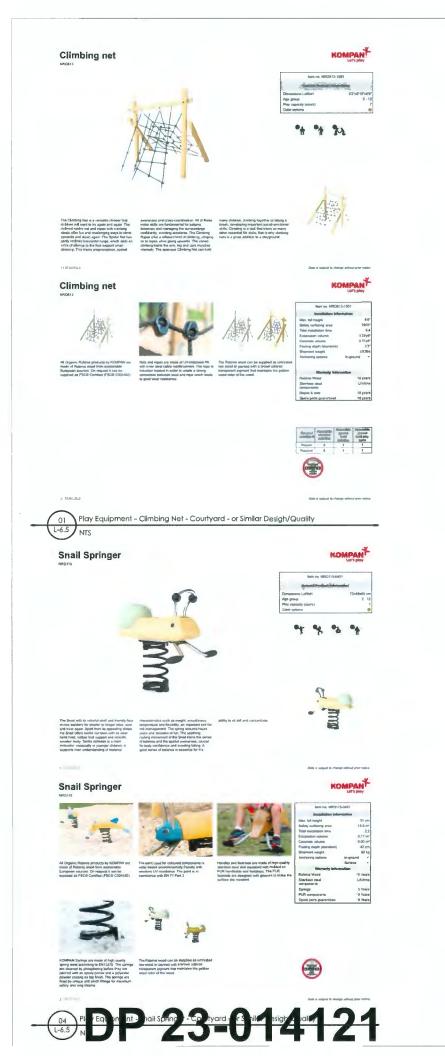

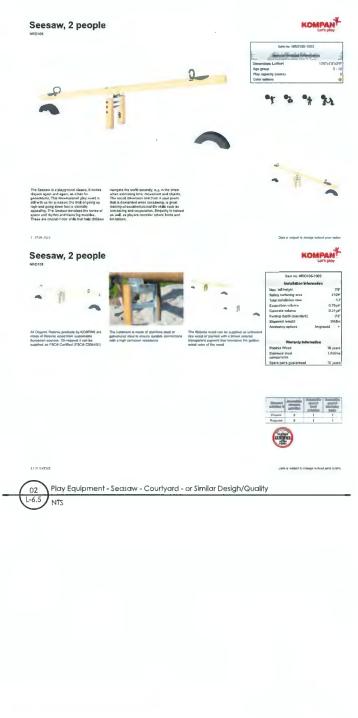





lar Desigh/Quality

vel ?

February 20, 2024

tern no. NRD115-	0421	
nstallation Islam	natan	
ingle i		110-
lacing areas	1	6584
fuller tree		1.3
velume	0,2	244'
of large		Oye*
(bradenate) rila		1.44
regina -	1	ribs.
optimus	in-ground	*
	Bartson	
Discosity inform	n eile	
wat	10 1	eara
final in	Lde	true
10		
		ears
	2 1	wars
s gueranieed	10 1	98/5

6	Jan 17 - 2024	ISSUED FOR DP RESPONSE
5	Oct 5 - 2023	RE-ISSUED FOR DP
4	FEB 17 - 2023	ISSUED FOR DP
-		
-		
-		
no.:	date:	item:



Durante Kreuk Ltd. 102 - 1637 West 5th Avenue Vancouver BC V6J 1N5 t: 604 684 4611 f: 604 684 0577 www.dkl.bc.ca

Project:


COOK ROAD RICHMOND, BC

Drawn by:	AG	
Checked by:	РК	
Date:	MAR 2020	
Scale:	As Indicated	
Drawing Title:		

#### LANDSCAPE DETAILS

Project No.: 19073

Sheet No.:

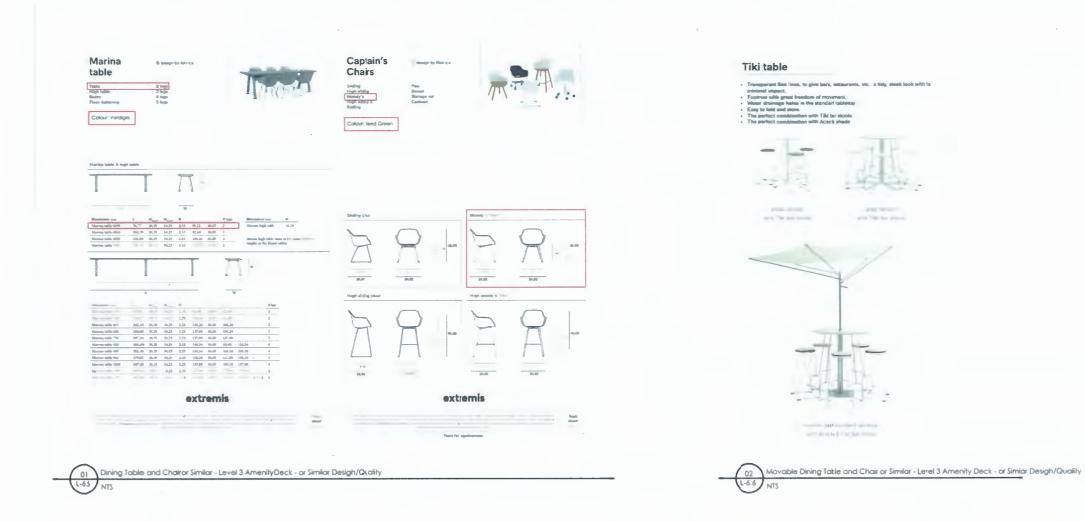



**PLAN #75** 



04 Outdoor Lounge Fumiture x Similar - Deck Seating at Courtyard - or Smilar Design/Quality L-6.6 NTS

### February 20, 2024

Outdoor Lounge Finitue or Similar - Level 3 Antienijy Deck - or Similar Desigh/Qual

1 П

alfresco square &

round table

AG MAR 2020 As indicated Draving Title

Dravn by: Checked by: Ph Date: Scale:

LANDSCAPE DETAILS

Project: COOK ROAD RICHMOND, BC



Durante KreukLtd 102 1637 Weit 5th Avenue Vancouver BCV6J 1N5


6	Jan 17 - 2024	ISSUED FOR EP RESPONSE
5	Oct 5 - 2023	RE-ISSUED FCR DP
4	FEB 17 - 2023	ISSUED FOR DP
-		
-		
-		
no.:	date:	item:

L-6.6

Project No :

19073

Sheet No.:

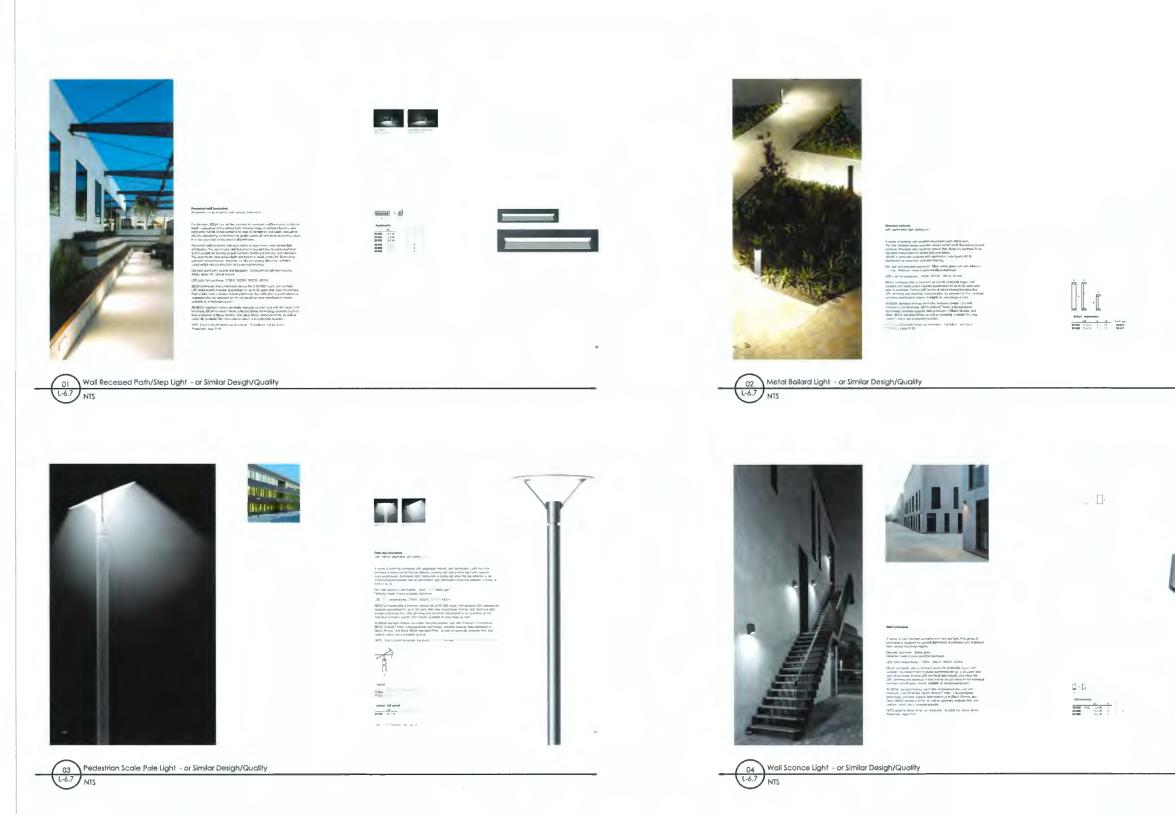

## DP 23-014121 PLAN #76

### February 20, 2024





6	Jan 17 - 2024	ISSUED FOR DP RESPONSE
5	Oct 5 - 2023	RE-ISSUED FOR DP
4	FEB 17 - 2023	ISSUED FOR DP
-		
-		
no.:	date:	item:



Durante Kreuk Ltd. 102 - 1637 West 5th Avenue Vancouver BC V6J 1N5 t: 604 684 0577 www.dkl.bc.ca



COOK ROAD RICHMOND, BC


Project:

Drawn by:	AG	
Checked by:	РК	
Date:	MAR 2020	
Scale:	As Indicated	

#### LANDSCAPE DETAILS

Project No.: **19073** 

Sheet No.:

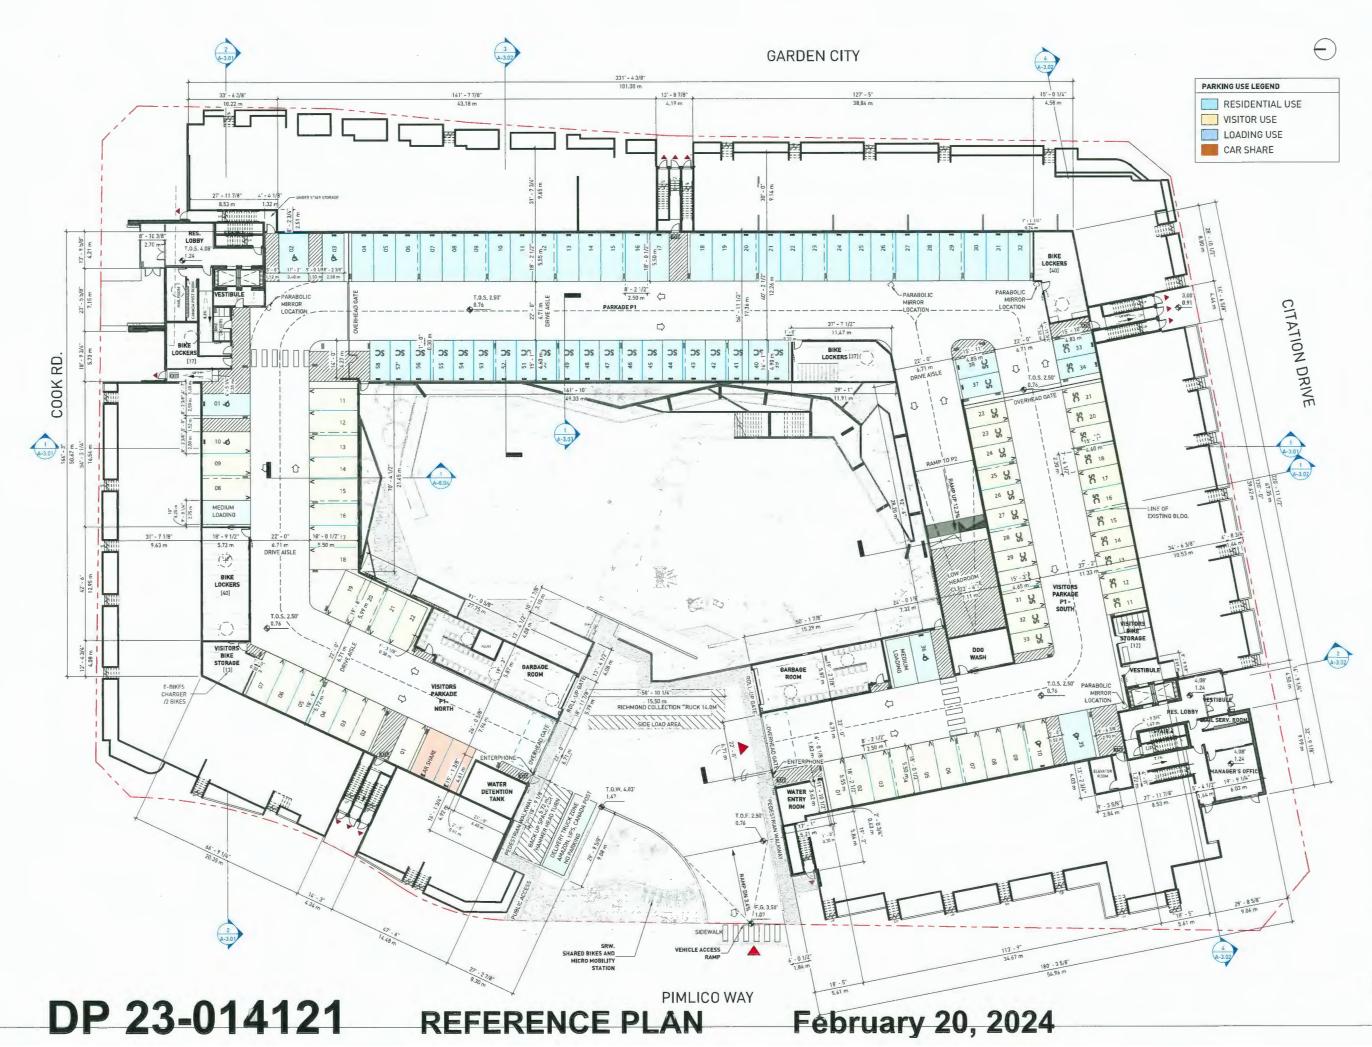

#### BBL ARCHITECTS INC 300-224 WEST #TH AVENUE ANCOUNER, BC CANADA VSY IN

TEL 604.73e 1158 FAX 606.731 5279

NOTES EV OUTLETS WILL NEED TO BE SUPPLIED WITH ENERGIZED OUTLETS IN ORDER TO SUPPORT EV CHARGING, WITH EACH PARKING SPACE CAPABLE OF RECEIVING "LEVEL 2" CHARGING AT A PERFORMANCE LEVEL OF AT LEAST 12 KWH WITHIN A MAX 8-HOUR PERIOD

PARKING - P1		
TYPE		COUNT
CAR SHARE		2
CLASS A LOADING STALL		2
GARBAGE TRUCK	Г	1
MEDIUM SIZE LOADING		1
RESIDENTIAL - H/C STALL		3
RESIDENTIAL - H/C VAN STALL		2
RESIDENTIAL - REGULAR STALL		29
RESIDENTIAL - SMALL STALL		24
VISITOR - REGULAR		30
VISITOR - SMALL CAR STALL	L	23
VISITOR H/C STALL	ľ	2
TOTAL		119
PARKING - BIKES	21	
TYPE		COUNT
BICYCLE - HOR, CLASS 1		57
BICYCLE - HOR. STACKED CLASS 1		56
BICYCLE - VERT. CLASS 1		27
TOTAL		140
P1 - GROSS AREA SUM	M	
USE	M	AREA
USE BIKE LOCKERS	M	AREA 2924 5
USE BIKE LOCKERS DOG WASH	M	AREA 2924 5 321 5
USE BIKE LOCKERS DOG WASH EXCLUSION	M	AREA 2924 5 321 5 246 5
USE BIKE LOCKERS DOG WASH EXCLUSION GARBAGE	M	AREA 2924 5 321 S 246 S 2099 S
USE BIKE LOCKERS DOG WASH EXCLUSION GARBAGE MECHANICAL	M	AREA 2924 5 321 S 246 S 2099 S 594 S
USE BIKE LOCKERS DOG WASH EXCLUSION GARBAGE	M	AREA 2924 5 321 S 246 S 2099 S

#### REVISIONS

NO.	DATE	DESCRIPTION
1	MAY 19 2022	RE - ISSUED FOR RZ
2	JULY 4 2022	RE- ISSUED FOR RZ []
3	AUG 3 2022	RE- ISSUED FOR RZ III
4	MAR 10 2023	ISSUED FOR DP
5	OCT 06 2023	RE-ISSED FOR DP
6	JAN 19 2024	RE-ISSUED FOR DP
7	FEB 15 2024	RE- ISSUED FOR DP

#### 8880 COOK RD. & 8751 CITATION DRIVE


RICHMOND, BC

#### FLOOR PLAN - P1

DATE DRAWN BY CHECKED BY SCALE JOB NUMBER

2/14/2024 4:17:56 PM AM GBL As indicated 20039



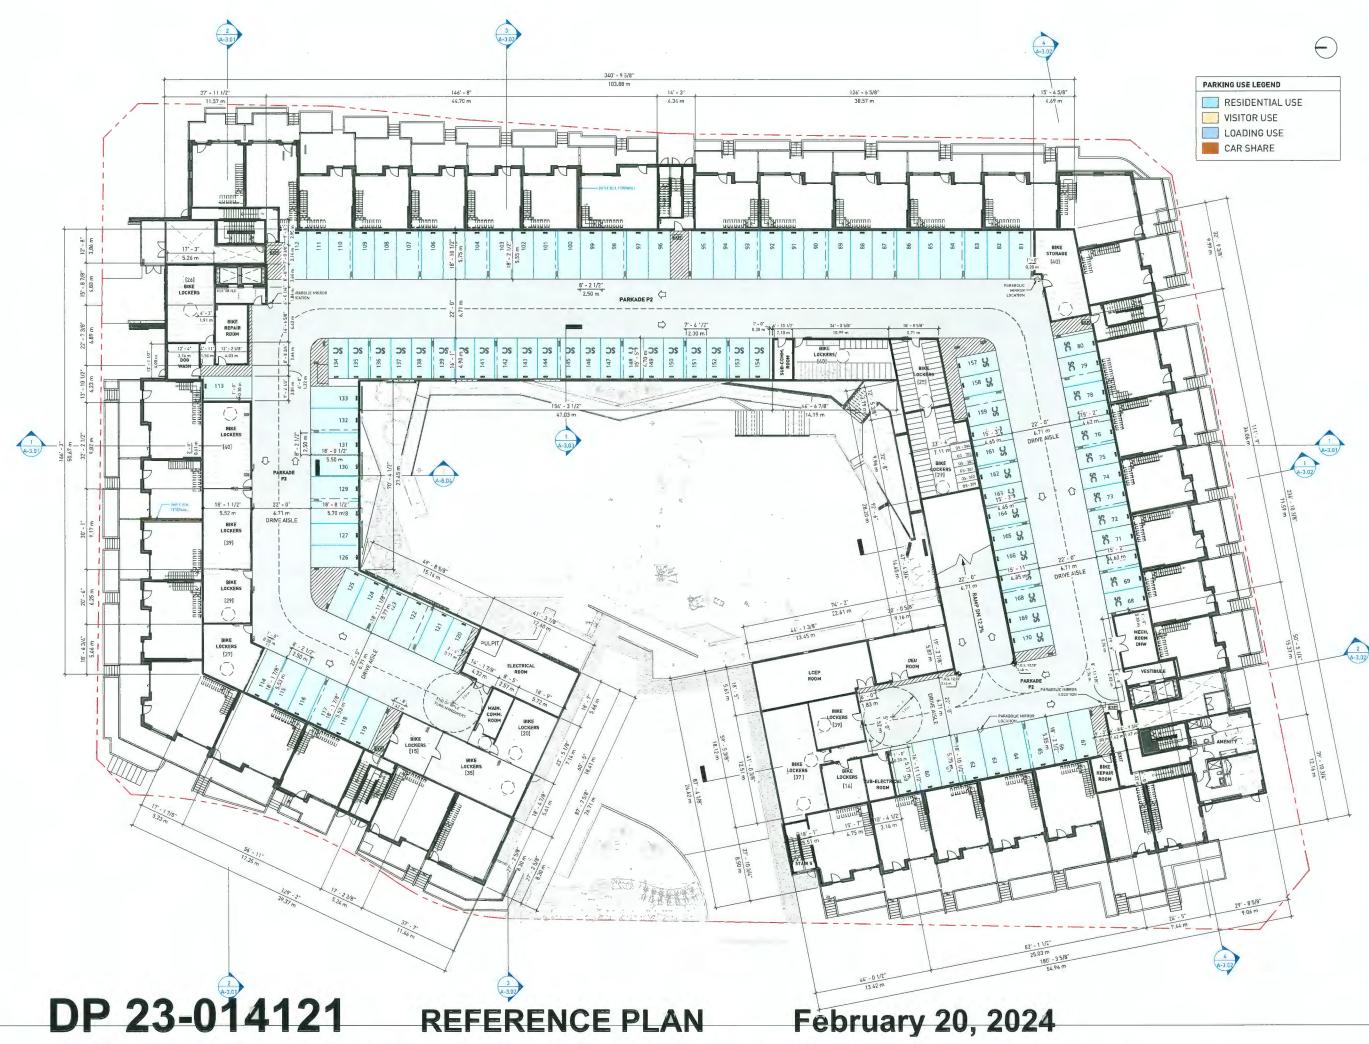





#### GBL ARCHITECTS INC.

TEL	6DL	730	1156
17 A.W.		-	F 3 100

300-224 WEST 9TH AVENUE VANCOUVER, BC CANADA VSY IN COPYRIGHT RESERVED. THIS PLAN AND DESIGH ARE AND AT ALL TIMES REMAIN 1-1E EXCLUSIVE PROPERTY OF OBL ANC-TIECTS INC. AND MAY NOT BE USED OR REPRODUCED WITHOUT THEIR WRITTEN CONSENT

#### NOTES

EV DUTLETS WILL NEED TO BE SUPPLIED WITH ENERGIZED OUTLETS IN ORDER TO SUPPORT EV CHARGING, WITH EACH PARKING SPACE CAPABLE OF RECEIVING "LEVEL 2" CHARGING TA PERFORMANCE LEVEL OF AT LEAST 12 KWH WITHIN A MAX B-HOUR PERIOD

PARKING - P2	
TYPE	COUNT
RESIDENTIAL - REGULAR STALL	62
RESIDENTIAL - SMALL STALL	48
TOTAL	110

PARKING - BIKES P2	
TYPE	COUNT
BICYCLE - HOR, CLASS 1	228
BICYCLE - HOR, STACKED CLASS 1	138
BICYCLE - LOCKER	11
BICYCLE - OVERSIZE	6
BICYCLE - VERT. CLASS 1	64
TOTAL	447

P2 - GROSS AREA SUMMARY	
USE	AREA
AMENITY	1033 SF
BIKE LOCKERS	8218 SF
ELECTRICAL ROOM	1259 SF
EXCLUSION	873 SF
MECHANICAL	1646 SF
PARKADE	35300 SF
RESIDENTIAL CIRCULATION	281 SF
TOTAL	48610 SF

#### REVISIONS

NO.	DATE	DESCRIPTION
4	MAR 10 2023	<b>ISSUED FOR OP</b>
5	OCT 06 2023	RE-ISSED FOR DP

- 6 JAN 19 2024 RE-ISSUED FOR DP 7 FEB 15 2024 RE- ISSUED FOR DP

#### 8880 COOK RD. & 8751 CITATION DRIVE


RICHMOND, BC


#### FLOOR PLAN - P2

DATE DRAWN BY CHECKED BY SCALE JOB NUMBER

2/14/2024 4:18:12 PM ۵M GBL As indicated 20039



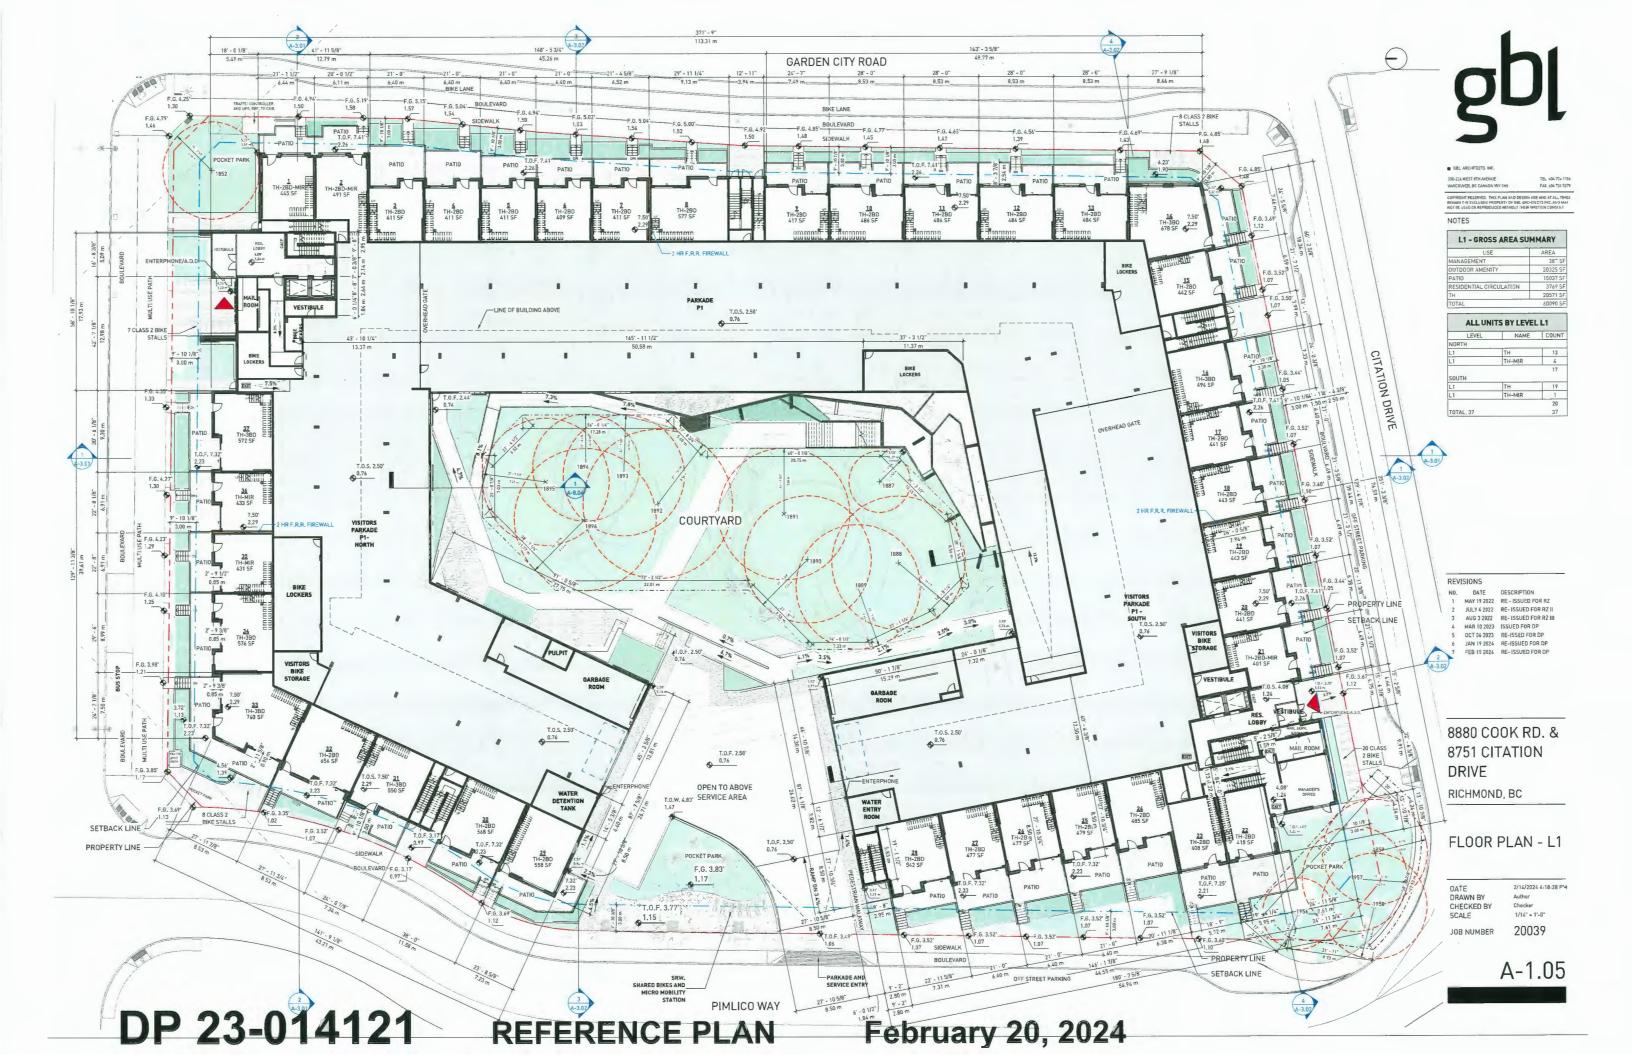

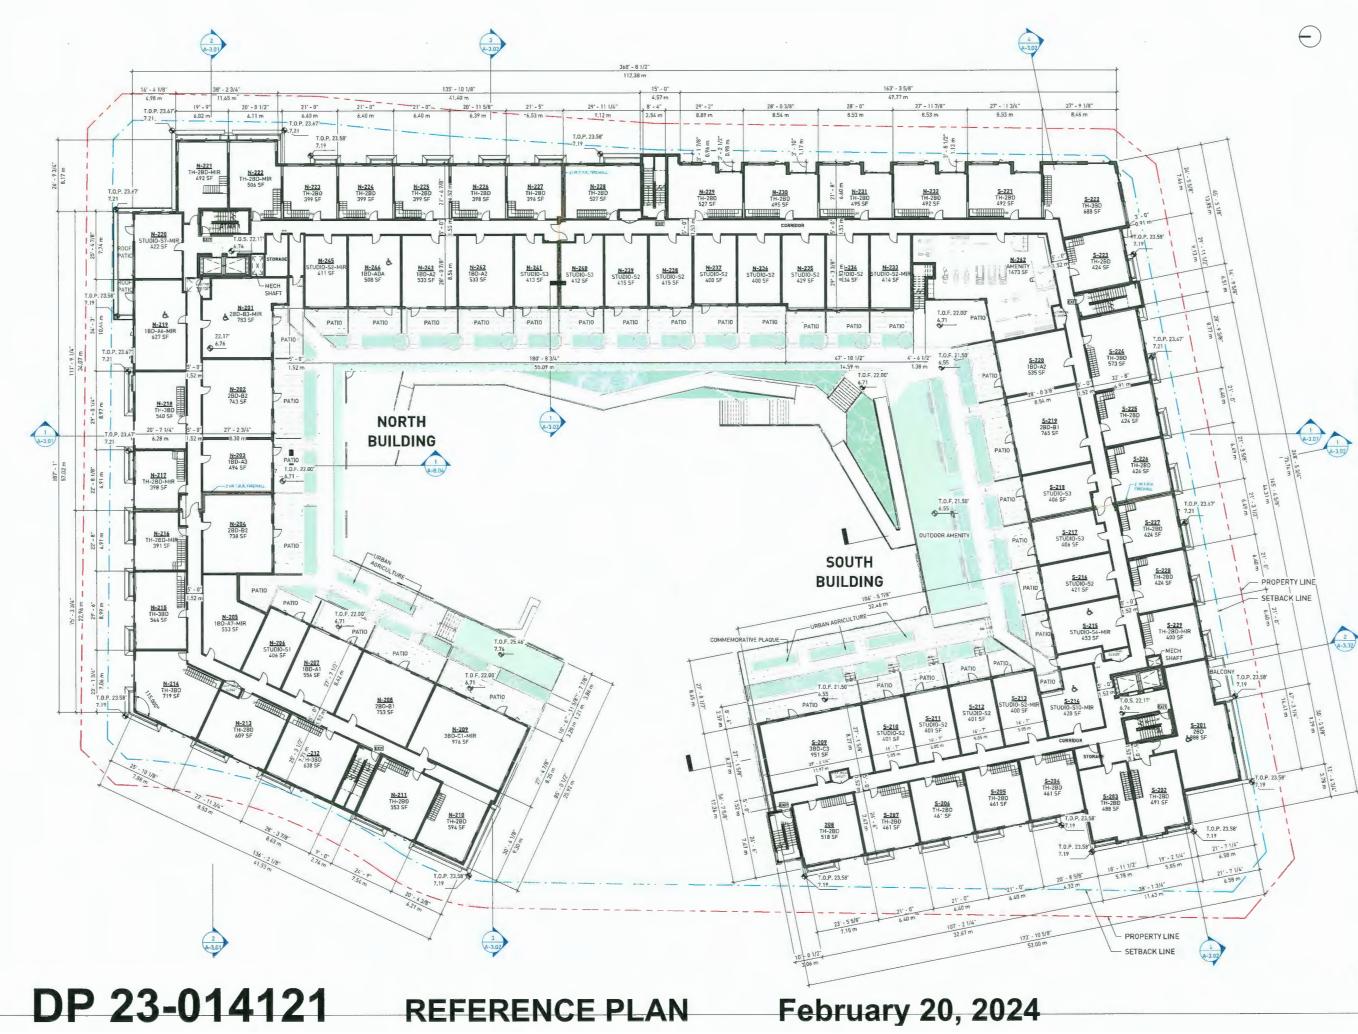



300-204 WEST 8TH AVENUE	TEL 004730 1156
VANCOUVER, BC CANADA V5Y IN5	FAX 684 731 5279
THEORET DE CHINDRETS, THS	
	THEN ARE AND AT ALL TIMES
COP*RIGHT RESERVED: THIS PLAN AND DE REMAIN THE EXCLUSIVE FROPERIO OF GRU	ARCHITECTS INC. AND MAY

USE	AREA
AMENITY	1596 SF
BUH	720 SF
RESIDENTIAL CIRCULATION	5449 SP
EXCLUSION	1713 SF
MECH, SHAFT	260 SF
BALCONY	1872 SF
OUTDOOR AMENITY	1830 SF
OUTDOOR AREA	0542 SP
PATIO	6433 SF
16D	4670 SF
2ED	5033 SF
360	2081 SF
STUDIO	9347 SF
тн	20424 SF
TOTAL	71963 SF

LEVEL	NAME	COUNT
NORTH		
L2	18D	5
L2	1BD - MiR	2
L2	2BD	3
L2	2BD - MIR	1
L2	3BD	1
L2	3BD - MIR	1
L2	STUDIO	10
L2	STUDIO - MIR	3
SOUTH		26
L2	1BD	1
L2	2BD	2
L2	STUDIO	5
L2	STUDIC - MIR	3
		11
TOTAL: 37		37

#### REVISIONS

	1010110	
NO.	DATE	DESCRIPTION
1	MAY 19 2022	RE - ISSUED FOR RZ
2	JULY 4 2022	RE- ISSUED FOR RZ II
3	AUG 3 2022	RE- ISSUED FOR RZ III
4	MAR 10 2023	ISSUED FOR OP
5	OCT 06 2023	RE-ISSED FOR DP
6	JAN 19 2024	RE-ISSUED FOR DP
7	FEB 15 2024	RE- ISSUED FOR DP

#### 8880 COOK RD. & 8751 CITATION DRIVE

RICHMOND, BC

#### FLOOR PLAN - L2

DATE DRAWN BY CHECKED BY SCALE JOB NUMBER

2/14/2024 4:18:39 PM Author Checker 1/16" = 1'-0" 20039

A-1.06



DP 23-014121 REFERENCE PLAN February

February 20, 2024

# gbl

BBL ARCHITECTS INC.

00-224 WEST 8TH AVENUE TEL 804 738 1156 YANCOLIVER, BC CANADA VSY 1N5 FAX 404 731 5279

COPYRIGHT RESERVED THIS PLAN AND DESIGN ARE AND AT ALL THIS REMANT 1-E EXCLLSME FROPENTO OF BBL AR-THEFTS INC, AND MAY NOT BE USED DR REPRODUCED WITHOUT THEIR WRITTEN CONSELIT

NOTES

USE	AREA
1BD	15643 SF
28D	12911 SF
3BD	3414 SF
AMENITY	3269 SF
BALCONY	5558 SF
BUH	1320 SF
EXC_USION	'521 SF
MECH. SHAFT	256 SF
OUTDOOR AMENITY	3416 SF
RESIDENTIAL CIRCULATION	4433 SF
STUDIO	8392 SF
TOTAL	60133 SF

LEVEL	NAME	COUNT
NORTH		
L3	1BD	10
L3	1BD - MIR	8
L3	2BD	10
L3	2BD - MIR	3
L3	3BD	1
L3	3BD - MIR	1
L3	STUDIO	1
L3	STUDIO - MIR	5
SOUTH		39
L3	180	7
L3	1BD - MIR	2
L3	280	3
L3	2BD - MIR	1
L3	3BD	1
L3	STUDIO	1
L3	STUDIO - MIR	12
		27

#### REVISIONS

NQ.	DATE	DESCRIPTION
1	MAY 19 2022	RE - ISSUED FOR RZ
2	JULY 4 202Z	RE- ISSUED FOR RZ II
3	AUG 3 2022	RE- ISSUED FOR RZ III
4	MAR 10 2023	ISSUED FOR DP
5	OCT 06 2023	RE-ISSED FOR DP
6	JAN 19 2024	<b>RE-ISSUED FOR DP</b>
7	FEB 15 2024	RE- ISSUED FOR DP

#### 8880 COOK RD. & 8751 CITATION DRIVE


RICHMOND, BC

#### FLOOR PLAN - L3

DATE DRAWN BY CHECKED BY SCALE JOB NUMBER

2/14/2024 4:18:53 PM Author Checker 1/16" = 1'-0" 20039



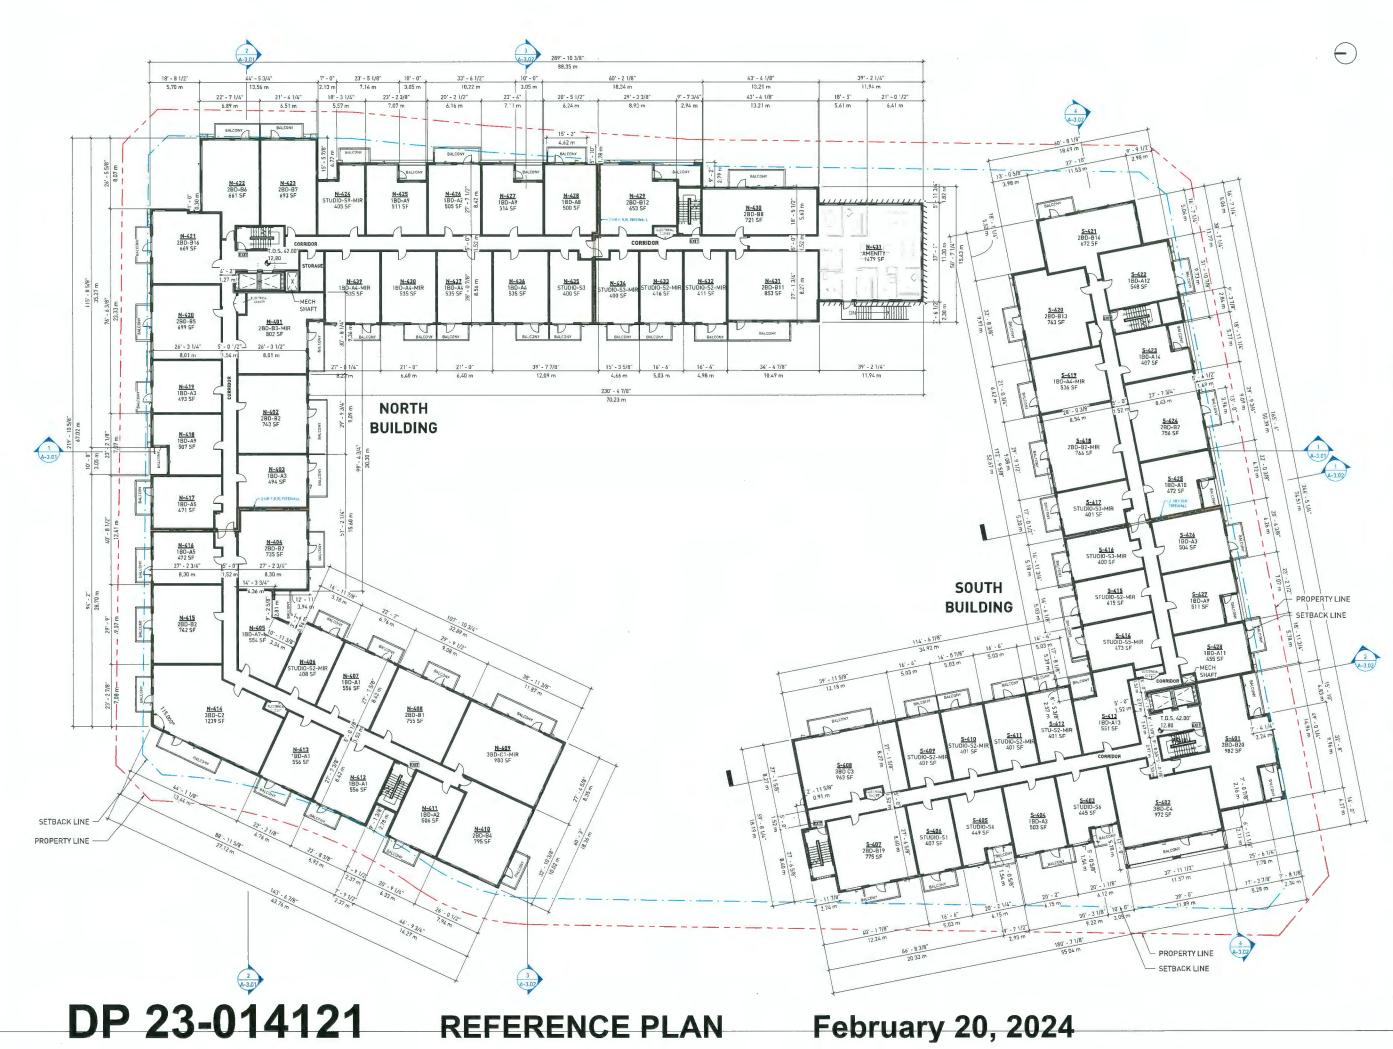

# gbl

GBL	ARCHITECTS	INC.	

300-224 WEST OTH AVENUE	TEL 604 736 1156
VANCOUVER, BC CANADA VSY INS	FAX 606 731 5279
COPYRIGHT RESERVED: THIS PLAN AND DESIGN REMAIN THE EXCLUSIVE PROPERTY OF GBL AND	

NOTES

USE	AREA
1BD	14861 SF
2BD	15254 SF
3BD	4455 SF
AMENITY	1609 SF
BALCONY	5602 SF
BUH	1340 SF
EXC_USION	1526 SF
MECH. SHAFT	252 SF
RESIDENTIA_ CIRCULATION	4416 SF
STUDIO	7573 SF
TOTAL	56888 SF

LEVEL	NAME	COUNT
NORTH		
L4	180	15
L4	1BD - MIR	3
L4	2BD	12
L4	2BD - MIR	1
L4	3BD	1
L4	3BD - MIR	1
LL	STUDIO	1
L4	STUDIO - MIR	5
SOUTH		39
L4	1BD	8
L4	1BD - MIR	1
L4	280	5
L4	2BD - MIR	1
L4	380	2
L4	STUDIO	3
L4	STUDIO - MIR	8
		28

#### REVISIONS

NO.	DATE	DESCRIPTION
1	MAY 19 2022	RE - ISSUED FOR RZ
2	JULY 4 2022	RE- ISSUED FOR RZ II
3	AUG 3 2022	RE- ISSUED FOR RZ III
4	MAR 10 2023	ISSUED FOR DP
5	OCT 06 2023	RE-ISSED FOR DP
6	JAN 19 2024	RE-ISSUED FOR DP
7	FEB 15 2024	RE- ISSUED FOR DP


#### 8880 COOK RD. & 8751 CITATION DRIVE

RICHMOND, BC

#### FLOOR PLAN - L4

DATE DRAWN BY CHECKED BY SCALE JOB NUMBER 2/14/2024 4:19:02 PM Author Checker 1/16" = 1'-0" 20039

A-1.08

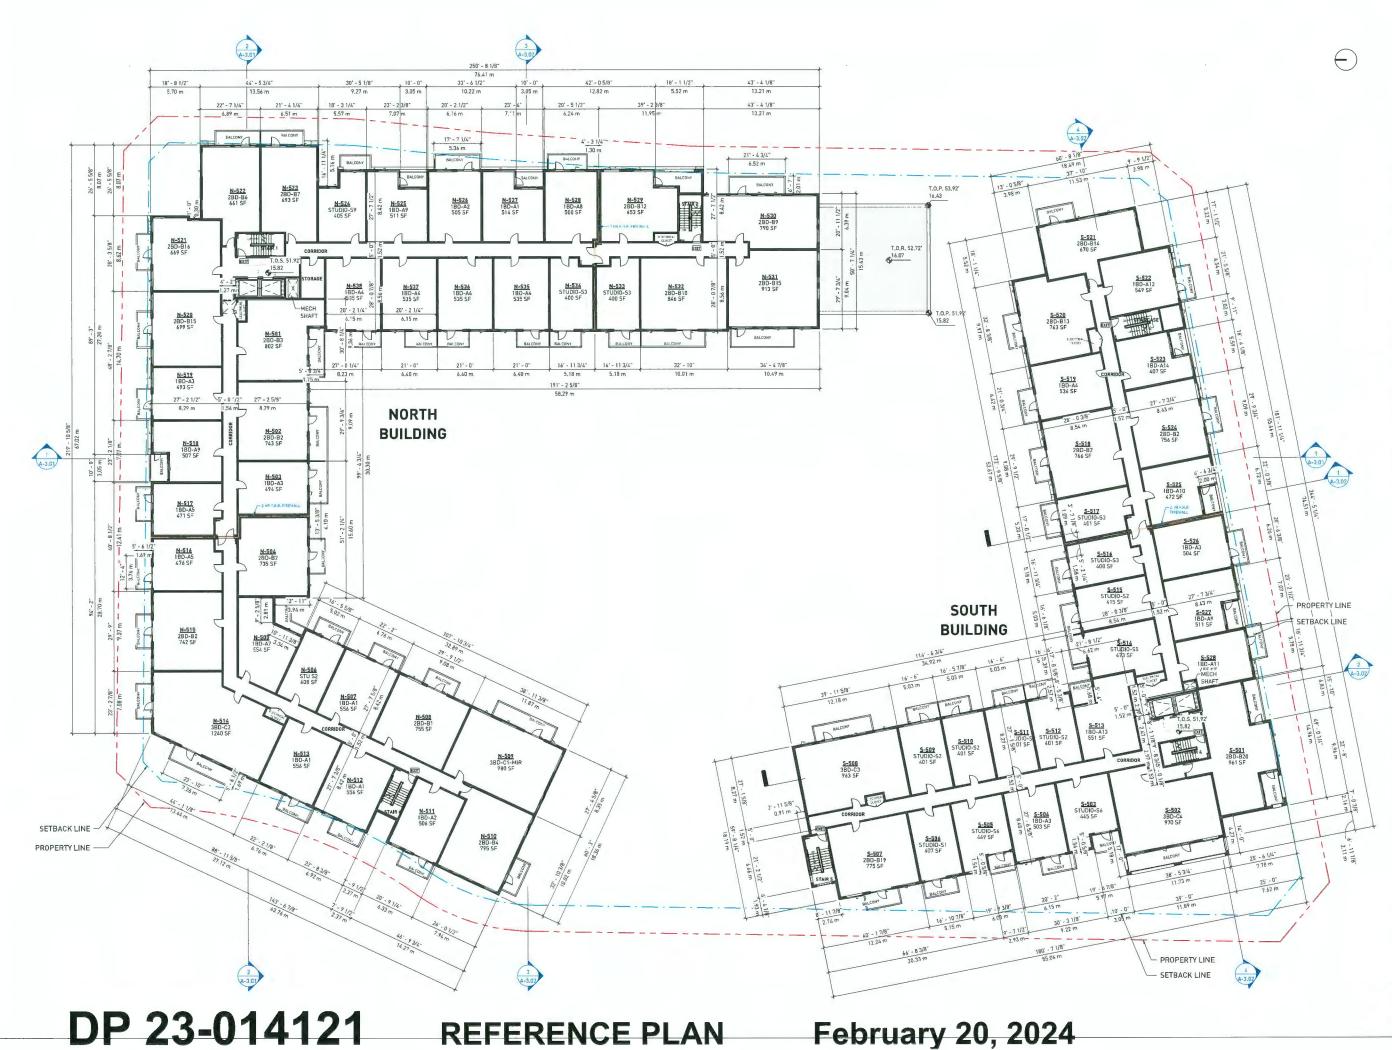



#### BBL ARCHITECTS INC

300-224 WEST 3TH AVENUE	TEL 004 730 1156
VANCOUVER, BC CANADA V5Y INS	FAX ±06 731 5279

COPYRIGHT RESERVED: THIS PLAN AND DESIGN AN REMAIN THE EXCLUSIVE PROPERTY OF GBL ARCHIT ROT BE USED DR REPRODUCED WITHOUT THEIR W NOTES

USE	AREA
1BD	148"5 SF
2BD	16304 SF
38D	4454 SF
BALCONY	5587 SF
BUH	1333 SF
EXCLUSION	1527 SF
MECH. SHAFT	248 SF
RESIDENTIAL CIRCULATION	4414 SF
STUDIO	6691 SF
TOTAL	55432 SP

LEVEL	NAME	COUNT
NORTH		
L5	1BD	18
L5	28D	14
L5	3BD	1
L5	3BD - MIR	1
L5	STUDIO	4
SOUTH		38
L5	1BD	9
L5	2BD	6
L5	3BD	2
L5	STUDIO	11
OTAL: 66		66

REV	ISIONS	
NO.	DATE	DESCRIPTION
1	MAY 19 2022	RE - ISSUED FOR RZ
2	JULY 4 2022	RE- ISSUED FOR RZ II
З	AUG 3 2022	RE- ISSUED FOR RZ III
4	MAR 10 2023	ISSUED FOR DP
5	OCT 06 2023	RE-ISSED FOR DP
6	JAN 17 2024	RE-ISSUED FOR DP
7	FEB 15 2024	RE- ISSUED FOR DP

#### 8880 COOK RD. & 8751 CITATION DRIVE


#### RICHMOND, BC

#### FLOOR PLAN - L5

DATE DRAWN BY CHECKED BY SCALE JOB NUMBER

2/14/2024 4:19:11 PM Author Checker 1/16" = 1"-0" 20039



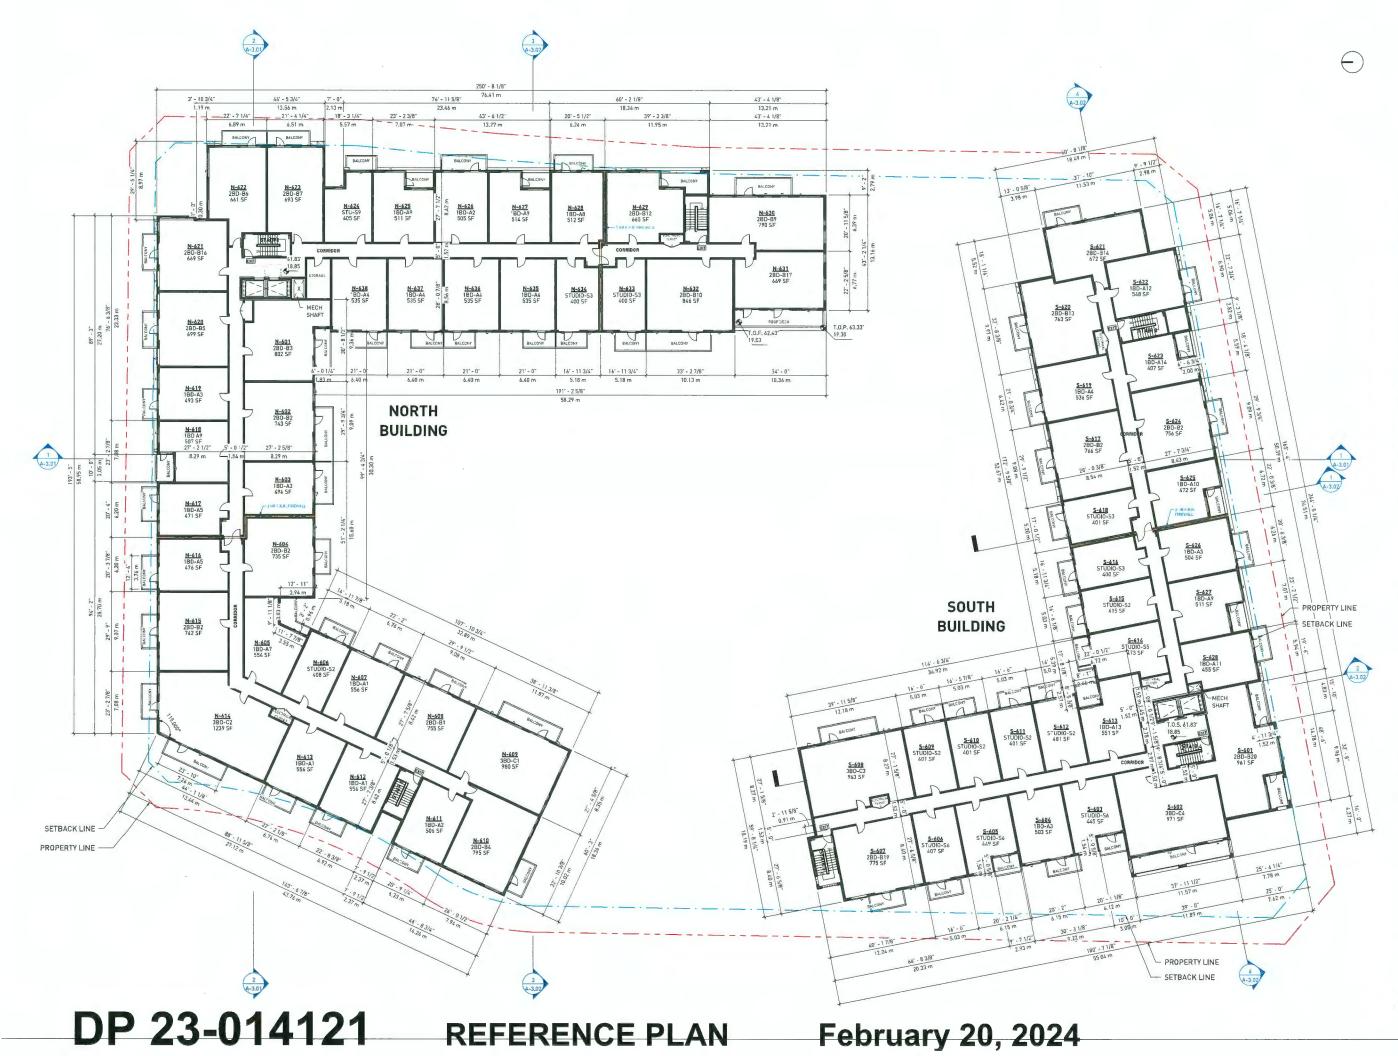

# gbl

BBL ARCHITECTS INC.

ILE-J24 WEST OTH AMENUE TEL. 40C 73x 1154 VARIOURCE BC CANADA YO 1155 DE VARIOURCE BC CANADA YO 1155 DE VARIOURCE BC CANADA YO 1155 BCMART FE SEX USES FERDERED OF DEL ARCHITECTS INC. AN UNK TO BE VASID DE REPRODUCED INTPOLIT HER WATTER CONSENT NOTES

 L6 - GROSS AREA SUMMARY

 USE
 AREA

 180
 1689 SF

 280
 16017 SF

 380
 4490 SF

 380
 4490 SF

 390
 4490 SF

 390
 16017 SF

 390
 4490 SF

 SUH
 1320 SF

 EXCLUSION
 1528 SF

 MECH, SHAFT
 259 SF

 RODF DECK
 255 SF

 STUDIO
 6600 SF

 TOTAL
 S5318 SF

LEVEL	NAME	COUNT
NORTH		
L6	18D	18
L6	2BD	14
L6	3BD	2
L6	STUDIO	4
SOUTH		38
L6	1BD	9
L6	2BD	6
L6	3BD	2
L6	STUDIO	11
		28
TOTAL: 66		66

REV	REVISIONS				
NO,	DATE	DESCRIPTION			
1	MAY 19 2022	RE - ISSUED FOR RZ			
2	JULY 4 2022	RE- ISSUED FOR RZ II			
3	AUG 3 2022	RE- ISSUED FOR RZ III			
4	MAR 10 2023	ISSUED FOR DP			
5	OCT 06 2023	RE-ISSED FOR DP			
6	JAN 19 2024	RE-ISSVED FOR DP			
7	FEB 15 2024	RE- ISSUED FOR DP			

#### 8880 COOK RD. & 8751 CITATION DRIVE

RICHMOND, BC

#### FLOOR PLAN - L6

DATE DRAWN BY CHECKED BY SCALE JOB NUMBER

2/14/2024 4:19:25 PM Author Checker 1/16" = 1'-0" 20039

A-1.10


## DP 23-014121

**REFERENCE PLAN** 

### February 20, 2024

5 18ED - ACCESIBLE UNIT - TYPE A6



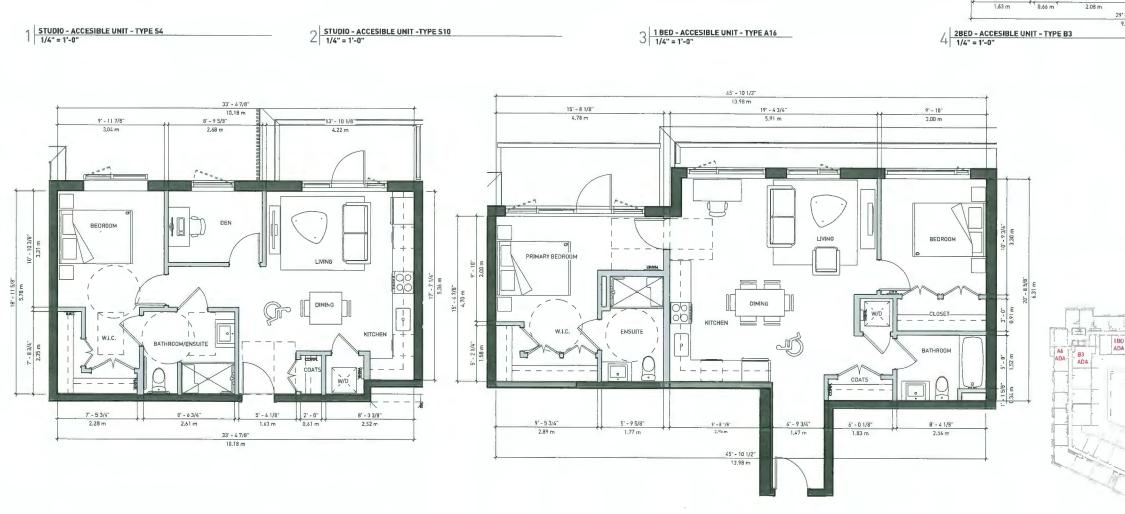





DIN

6' - 10



BBL ARCHITECTS WC. 300-224 WEST 3TH AVENUE VANCOUVER, 8C CANADA VSY INS TEL 604.73e 1156 FAX 604.731 5279 NOTES

**BASIC UNIVERSAL** HOUSING (BUH) ARE DESIGNED IN ACCORDANCE WITH SECTION 4.16 OF RICHMOND ZONING BY LAW 8500

REVISIONS				
NO.	DATE	DESCRIPTION		
4	MAR 10 2023	ISSUED FOR OP		
5	OCT 06 2023	RE-ISSED FOR DP		
6	JAN 19 2024	RE-ISSUED FOR DP		
7	FEB 15 2024	RE- ISSUED FOR DP		


8880 COOK RD. & 8751 CITATION DRIVE RICHMOND, BC

#### TYP. ACCESSIBLE UNITS

DATE DRAWN BY CHECKED BY SCALE

2/14/2024 4:41:21 PM Author Checker As indicated JOB NUMBER 20039



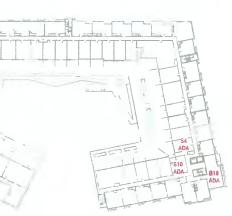

**KEY PLAN**