

Development Permit Panel Electronic Meeting

Council Chambers, City Hall 6911 No. 3 Road

Wednesday, February 15, 2023 3:30 p.m.

MINUTES

Motion to adopt the minutes of the Development Permit Panel meeting held on December 14, 2022.

1. DEVELOPMENT PERMIT 21-933765

(REDMS No. 6862789)

APPLICANT: Interface Architecture Inc.

PROPERTY LOCATION: 9300 and 9320 Cambie Road

Director's Recommendations

That a Development Permit be issued which would:

- 1. permit the construction of 126 residential units in a five-storey multi-family apartment building over a common parkade at 9300 and 9320 Cambie Road on a site zoned "Low Rise Apartment (ZLR43) Alexandra Neighbourhood (West Cambie)".
- 2. vary the provisions of Richmond Zoning Bylaw 8500 to:
 - (a) increase the maximum lot coverage of buildings from 40 to 43 per cent; and
 - (b) reduce the minimum width of one manoeuvring aisle in the parkade from 6.7 m to 6.4 m.

ITEM

- 2. New Business
- 3. Date of Next Meeting: March 1, 2023

ADJOURNMENT





Time:

3:30 p.m.

Place:

Remote (Zoom) Meeting

Present:

Cecilia Achiam, General Manager, Community Safety, Acting Chair

Peter Russell, Director, Sustainability and District Energy

James Cooper, Director, Building Approvals

The meeting was called to order at 3:30 p.m.

MINUTES

It was moved and seconded

That the minutes of the meeting of the Development Permit Panel held on November 16, 2022 be adopted.

CARRIED

1. GENERAL COMPLIANCE - REQUEST BY SYSTEMOS DEVELOPMENT LTD. (PARAMJIT KAHLON) FOR A GENERAL COMPLIANCE RULING AT 5500, 5502, 5506 and 5508 WILLIAMS ROAD (FORMERLY 5500 WILLIAMS ROAD) (File Ref. No.: DP 20-890821) (REDMS No. 7035867)

APPLICANT:

Systemos Development Ltd. (Paramjit Kahlon)

PROPERTY LOCATION:

5500, 5502, 5506 and 5508 Williams Road

(formerly 5500 Williams Road)

INTENT OF PERMIT:

To consider the attached plans involving changes to the proposed Tree Management Plan and Landscape Plan to be in General Compliance with the approved Development Permit (DP 20-890821).

Applicant's Comments

Rosa Salcido, Architect, Vivid Green Architecture Inc., with the aid of a visual presentation (attached to and forming part of these minutes as <u>Schedule 1</u>), provided background information on the subject request for a General Compliance Ruling for plans involving changes to the proposed Tree Management Plan and Landscape Plan associated with DP 20-890821, highlighting the following:

- the original Tree Management Plan associated with the previously approved DP 20-
- 890821 indicated that three trees located at the southwest corner and along the south side of Lot A were to be removed;
- during demolition of the detached garage, a plum tree (tag #593) located in the west side yard of Lot A and identified for retention in the original Tree Management Plan was accidentally damaged and subsequently removed;
- the applicant is proposing that the removed plum tree be replaced with a Quercus Robur Crimson Spire tree and planted slightly farther away from the building; and
- the applicant is proposing that the replacement tree be slightly moved in order to provide more space for the growth of the replacement tree at maturity.

In addition, Denitsa Dimitrova, PMG Landscape Architects, noted that (i) a 10 cm caliper Quercos Robur Crimson Spire tree is proposed to be planted in lieu of the removed plum tree, (ii) the size of the other replacement trees for the entire site as provided in the original landscape plan will be increased from 6 cm to 8 cm caliper, and (iii) the replacement trees will be planted two to three meters from the property line.

Staff Comments

Wayne Craig, Director, Development, noted that (i) the upsizing of replacement trees that were part of the original Development Permit would provide further compensation for the removal of the plum tree and provide immediate impact at the time of development, and (ii) the Tree Survival Security provided at the time of the original Development Permit will be retained by the City and as a result of the removal of the tree, \$10,000 will be forfeited and turned into a cash in lieu contribution to the City's Tree Compensation Fund.

Panel Discussion

In reply to queries from the Panel, Mr. Craig confirmed that (i) an arborist was required for the project and was to be on-site during any construction activities within the tree protection zones, (ii) for the damage and removal of the plum tree, the applicant would be forfeiting \$10,000 out of the \$45,000 security for all of the trees to be retained, (iii) to ensure long-term survivability of trees to be planted on-site, the Tree Survival Security will not be released until such time that the trees have been installed and inspected, (iv) there is a 10 percent holdback to ensure that trees survive for a minimum of one year, and (v) the maintenance period could be extended from one year to two years or more should there be concerns relating to the survivability of the trees.

In reply to a query from the Panel, Terry Thrale, Woodridge Tree Consulting Arborists Ltd., acknowledged that they were not informed about the demolition on the day that the plum tree identified for retention was accidentally damaged and were therefore not present on-site on that day to oversee construction activities within the tree protection zones.

In reply to further queries from the Panel, Ms. Dimitrova and Mr. Thrale noted that (i) available space for planting of additional trees on-site is insufficient, (ii) the type and size of replacement trees were suggested in consultation with the City, (iii) a replacement tree with a bigger caliper would generally have a lesser chance of success in terms of survivability, (iv) there are proposed measures to ensure the survivability of the replacement trees, including but not limited to appropriate timing for planting of trees, installation of tree barriers and provision for irrigation, (v) when mature, the replacement tree (i.e., Quercus Robur Crimson Spire) which is an oak tree, would be taller than the replaced tree (i.e., plum tree), and (vi) generally, replacement trees are installed after the buildings have been constructed.

Correspondence

None.

Gallery Comments

None.

Panel Discussion

In order to ensure the long-term survivability of trees to be planted on-site, staff were directed to (i) require the project arborist to be present on-site during planting of trees, (ii) require the project arborist to conduct regular site inspections to monitor the condition of the trees and provide progress reports for a period of two years or more, and (iii) include a condition that the maintenance security will not be released until the end of monitoring period following planting.

In reply to the Panel's direction, Mr. Craig noted that the arborist contract would be revised to reflect the Panel's direction.

Panel Decision

It was moved and seconded

That the attached plans involving changes to the proposed Tree Management Plan and Landscape Plan be considered to be in General Compliance with the approved Development Permit (DP 20-890821).

CARRIED

2. New Business

It was moved and seconded That the Development Permit Panel meeting tentatively scheduled on Wednesday, January 18, 2023 be cancelled.

CARRIED

3. Date of Next Meeting: February 1, 2023

ADJOURNMENT

It was moved and seconded *That the meeting adjourn (4:00 p.m.).*

CARRIED

Certified a true and correct copy of the Minutes of the meeting of the Development Permit Panel of the Council of the City of Richmond held on Wednesday, December 14, 2022.

| Cecilia Achiam | Rustico Agawin | |
|----------------|----------------|--|

Cecilia Achiam Acting Chair

Rustico Agawin Committee Clerk

DUPLEX RESIDENTIAL 5500-5502 Williams Rd.

DUPLEX RESIDENTIAL 5506-5508 Williams Rd.

Schedule 1 to the Minutes of t Development Permit Par meeting held on Wednesda December 14, 2022

December 14, 2022







DEVELOPMENT PERMIT 20-890821






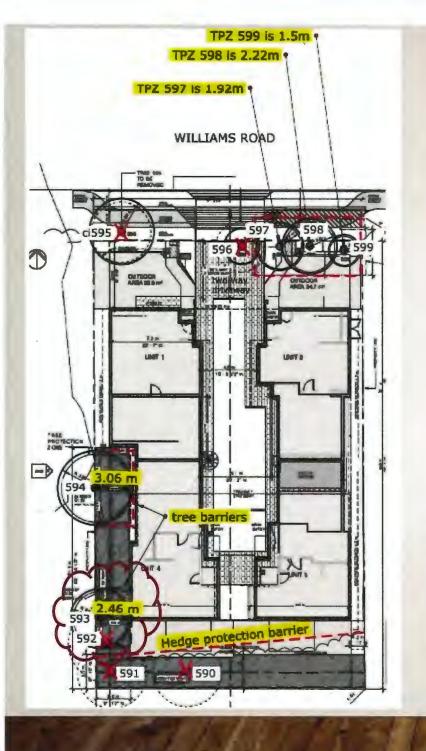


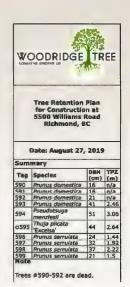




| Summary | | | | |
|---------|----------------------------|-------------|------------|--|
| Tag | Species | DBH (cm) | TPZ (m) | |
| 590 | Prunus domestica | 16 | n/a | |
| 591 | Prunus domestica | 16 | n/a | |
| 592 | Prunus domestica | 21 | n/a | |
| 593 | Prunus domestica | 41 | 2.46 | |
| 594 | Pseudotsuga menziesii | 51 | 3.06 | |
| cl595 | Thuja plicata 'Excelsa' | 44 | 2.64 | |
| 596 | Prunus serrulata | 24 | 1.44 | |
| 597 | Prunus serrulata | 32 | 1.92 | |
| 598 | Prunus serrulata | 37 | 2.22 | |
| 599 | Prunus serrulata | 21 | 1.5 | |

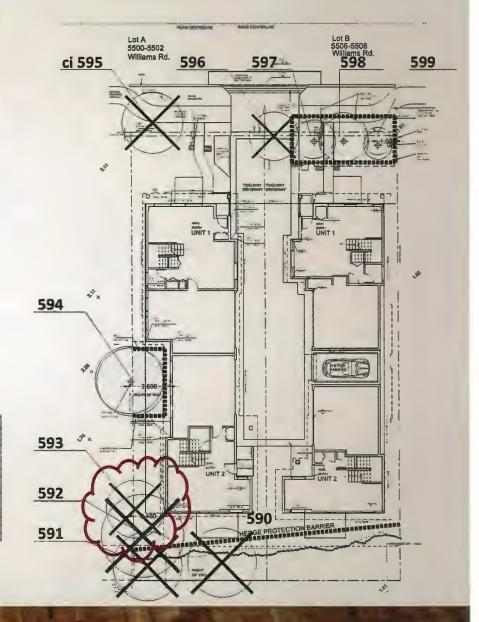

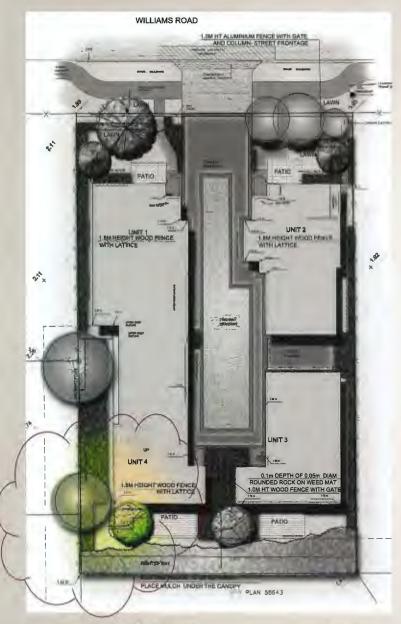

Initially approved plan

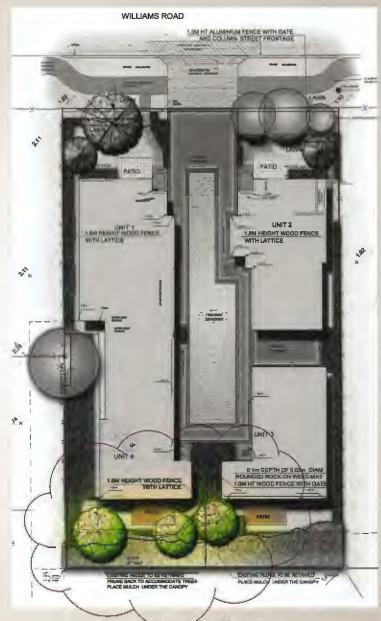

Proposed plan













IMAGE 6 - Tree #593 and dead trees #592, 591 and 590









Report to Development Permit Panel

To:

Re:

Development Permit Panel

Date:

January 23, 2023

From:

Wayne Craig

File:

DP 21-933765

Director, Development

Application by Interface Architecture Inc. for a Development Permit at

9300 and 9320 Cambie Road

Staff Recommendation

That a Development Permit be issued which would:

- 1. Permit the construction of 126 residential units in a five-storey multi-family apartment building over a common parkade at 9300 and 9320 Cambie Road on a site zoned "Low Rise Apartment (ZLR43) - Alexandra Neighbourhood (West Cambie)".
- 2. Vary the provisions of Richmond Zoning Bylaw 8500 to:
 - a) Increase the maximum lot coverage of buildings from 40 to 43 per cent; and
 - b) Reduce the minimum width of one manoeuvring aisle in the parkade from 6.7 m to 6.4 m.

Wayne Craig

Director, Development

(604-247-4625)

WC:el Att. 3

Staff Report

Origin

Interface Architecture Inc. has applied to the City of Richmond on the behalf of Westmark Developments (Camosun) Ltd. (Directors: Harmel Singh Bains and Ravjot Singh Bains) for permission to develop 126 residential units in a five-storey multi-family apartment building over a common parkade at 9300 and 9320 Cambie Road on a site zoned "Low Rise Apartment (ZLR43) – Alexandra Neighbourhood (West Cambie)". The development proposal provides five affordable housing units distributed throughout the building, consistent with the West Cambie Area Plan. The site is currently vacant.

The site is being rezoned from "Single Detached (RS1/F)" to "Low Rise Apartment (ZLR43) – Alexandra Neighbourhood (West Cambie)" for this project under Bylaw 10219 (RZ 18-835042) which received third reading on January 18, 2021.

Highlights of the proposed development include:

- The development site is split into two parts due to the required dedication of McKim Way east-west through the lots.
 - The northern portion of the site will have a residential building containing 126 apartment units.
 - o The southern portion of the site will have an outdoor amenity space with garden plots for the exclusive use of the residents in the apartment block.
- The development provides a range of unit types from one bedroom to three-bedroom plus den; thereby providing homes for a broad range of family sizes.
 - O Unit areas are proposed to range from 58.9 m² to 152.3 m² (634 ft² to 1,639 ft²).
 - o All the units will be connected to the Alexandra District Energy Utility.
- The indoor amenity space encompass approximately 548.5 m² (5,904 ft²) and will include a fitness centre and a multipurpose room on the first floor, as well as a common amenity room (for study, music, dance, play, movies, etc.) on each resident floor.
- The outdoor amenity space will be approximately 1,147 m² (12,347 ft²) in area, including a community garden on the south side of McKim Way and three programmed areas on top of the parking podium.

A Servicing Agreement will be required for this development, and includes the following:

- New fire hydrants, watermain and storm sewer upgrades.
- Frontage improvements along Cambie Road.
- Full road construction of McKim Way.
- Greenway extension south side of McKim Way.

Development Information

Please refer to attached Development Application Data Sheet (Attachment 1) for a comparison of the proposed development data with the relevant Bylaw requirements.

Background

The subject site is located on the south side of Cambie Road approximately centred between Dubbert Street to the west and Stolberg Street to the east. The site is in the Alexandra Neighbourhood of the West Cambie Planning Area. After road dedications of approximately 1,281.9 m² (13,798 ft²), the net site will be approximately 6,735.6 m² (72,501 ft²) in area.

Development surrounding the subject site is as follows:

To the North: Across Cambie Road, lots zoned "Single Detached (RS1/B)" that back onto Cambie Road.

To the East: A six-storey residential apartment block with a day care centre on a site specific zone. This development at 4033, 4099, 4133 Stolberg Street and 9388 Cambie Road is referred to as REMY.

To the South: Across McKim Way, two low-rise residential apartment complexes (four to six storeys) on site specific zones.

To the West: A three-storey townhouse development on a site specific zone.

Rezoning and Public Hearing Results

The Public Hearing for the rezoning of this site was held on January 18, 2021. At the Public Hearing, the following concerns were expressed; the responses to the concerns are provided in *italics*.

1. Impact of the massing and orientation of the proposed building on the adjacent apartment building to the east (REMY).

The applicant worked with staff to review the massing (i.e. height, width, and footprint of the building). The proposal is designed to respond to the site context in the following ways:

- Set the building height at a maximum 5-storeys, an intermediate height between the 6-storey REMY building to the east and 3-storey townhouses to the west.
- Position the central mass away from both the east side (REMY) and west (townhouses) to best balance considerations of shadowing, overlook, privacy and screening.
- Pull back the north and south 'ends' at the top Level 5 to create 4-storey north & south 'ends'.
- Taper the building's south-east corner to permit more direct sunlight to REMY's west building face.

2. The proposed courtyard on top of the parking podium should be relocated from the west side to the east side of the site in order to provide more building separation between the proposed apartment building and the *REMY* building to the east.

The applicant has reviewed the design and propose to keep the primary outdoor amenity areas at the west side. Shifting the main outdoor amenity areas to the east side would:

- Increase the potential for sound reverberation between the two taller buildings.
- Potentially create more shadow impact on the townhouses.
- 3. Loss of Privacy for residents in the REMY building.

The project complies with the Official Community Plan (OCP) and setback requirements. The main central massing is 10.34 m (34 ft.) from the common property line, whereas the REMY Building is 6.3 m (20.6 ft.) from the common property line. That is, other than at the wider sections at the north and south ends, the main building is set much farther away from the common property line than the existing REMY Building.

4. Sunlight blockage.

Shadow analyses illustrate that the proposed building will not block sunlight all day. The shadow simulations at both the south and north ends show plenty of sunshine on the REMY building during June (summer) from 1 p.m. to 6 p.m. In March (spring), the REMY building is in direct sunlight from 2 p.m. to 3 p.m.

The south end of the project has been refined to improve the impact on the REMY project. The balconies have been pushed with no projection into minimum side yard setback.

Staff Comments

The proposed scheme attached to this report has satisfactorily addressed the significant urban design issues and other staff comments identified as part of the review of the subject Development Permit application. In addition, it complies with the intent of the applicable sections of the Official Community Plan and is generally in compliance with the "Low Rise Apartment (ZLR43) – Alexandra Neighbourhood (West Cambie)" zone except for the zoning variances noted below.

Zoning Compliance/Variances (staff comments in bold)

The applicant requests to vary the provisions of Richmond Zoning Bylaw 8500 to:

1) Increase maximum lot coverage of buildings from 40 to 43 per cent.

This variance is to accommodate the proposed balcony alcoves (i.e., floor plan indentations that support balconies) and balcony projections (i.e., areas extend from the building face to the supporting columns). While this variance was not noted at time of rezoning, staff consider this to be a minor variance and support it based on the following:

 The balconies are located within the permitted building envelope and do not decrease the setback between the proposed building and the REMY building to the east.

- The projections help providing appropriate building articulation and establishing the architectural character of the development proposal.
- These balconies will enhance passive surveillance opportunity along the public roads as well as the outdoor amenity areas on site.
- The proposed balconies will provide residents with access to weather protected private outdoor spaces.
- Balcony design with columns supporting the structure facilitate inclusion of thermal break between balconies and interior building spaces to help enhancing energy efficiency.
- 2) Reduce minimum width of one manoeuvring aisle in the parkade from 6.7 m to 6.4 m.
 - This variance is to accommodate the storm and sanitary drainage pipes within the parkade, which were identified during the detailed design/servicing for the project. While this variance was not noted at time of rezoning, staff consider this to be a minor variance and support it based on the following:
 - The civil and mechanical consultants confirmed that the storm and sanitary drainage pipes could not be installed within the 1.2 m wide strip between the parkade and the east property line.
 - The best option is to install the storm and sanitary drainage pipes inside the parkade along east parkade wall.
 - To accommodate the storm and sanitary drainage pipes, the parking spaces along the eastern parkade wall would need to be shifted 0.3 m westwards, which resulted in a reduction of the drive aisle width to be 0.3 m less than the minimum drive aisle width required as per the City's Zoning Bylaw.
 - A memorandum prepared by the project traffic consultant has been submitted to confirm that two-way vehicle movements can be maintained with the narrowed drive aisle, and that the 90-degree parking spaces (all sized for small cars) fronting the drive aisle can be accessed without any issues, has been submitted.
 - Transportation staff have reviewed the proposal and support the proposed reduced drive aisle width.

Advisory Design Panel Comments

The Advisory Design Panel was supportive of the application subject to consideration of the Panel's comments. A copy of the relevant excerpt from the Advisory Design Panel Minutes from March 23, 2022 is attached for reference (Attachment 2). The design response from the applicant has been included immediately following the specific Design Panel comments and is identified in 'bold italics'.

Analysis

Conditions of Adjacency

- The proposal provides a transition between the six-storey apartment block to the east (REMY) and the three-storey townhouse complex to the west. The proposed design (including height and building massing) is consistent with West Cambie Area Plan's Medium Density Housing (Character Area 4), with increased open space, and no additional overshadowing of neighbouring properties. The main (central) mass of the building is shifted away from the west property line to provide outdoor amenity space adjacent to the townhouse development to the west.
- The central mass is also shifted away from the east property line to provide more physical and visual separation with the apartment building to the east. The proposed building setback to the common property line (i.e., approximately 10.4 m) is larger than the building setback provided on the REMY site (i.e., approximately 6.3 m).
- The southeast part of the building is also tapered to create more space for direct sunlight penetration between buildings.
- The location and orientation of windows and balconies have been carefully considered to minimize overlook issues.
 - O At the north and south ends of the proposed building, while the proposed building setback is 4.0 m (13.1 ft.) from the east property line, the minimum distance between facing windows of the proposed building and the existing building to the east, above the first level, is approximately 9 m (30 ft.), across the common property line.
 - O At the central mass of the building, the proposed building setback is 10.4 m (34.0 ft.) from the east property line, and the minimum distance between facing windows of the proposed building and the existing building to the east, above the first level, is approximately 16.7 m (54.8 ft.), across the common property line.
- The landscaped parkade podium surface elevation is set to match the townhouse rear yards and the top of the *REMY* parkade podium to create an appropriate transition to the neighbouring properties.

Urban Design and Site Planning

- The required McKim Way road dedication divides the development into two parts.
- The northern portion of the site, located between Cambie Road and McKim Way, will be developed into a residential building.
- The southern portion of the site will developed into a community garden for the exclusive use of the residents in the apartment block. A crosswalk is proposed at the entrances to the building and the community garden to provide a safer connection between the two portions of the site.
- A single vehicle access to the parkade will be provided from McKim Way at the southwest corner of the apartment block. Vehicle access is not provided to/from Cambie Road.

- Loading spaces and the garbage/recycling area are located adjacent to the vehicle access, and this area is screened from street view by terraced planting wall and live planting.
- The main entry lobby is located at McKim Way; a secondary entry lobby is also provided at Cambie Road. Both are designed to be accessible and clearly visible from the sidewalk.
- Landscaped terraces are proposed to screen the parking structure from street view and soften the grade transitions between the street level and the podium level.
- The interior courtyards on top of the parking podium may be accessed from the building as well as the stairways connecting to both McKim Way and Cambie Road.

Architectural Form and Character

- The project proposes a contemporary architectural style featuring strong horizontal floor and roof lines with stacked balconies creating a vertical visual rhythm. Some portion of the roof are raised to add ceiling height to the top floor living areas, while creating visually interesting roof lines. The architectural vocabulary serves to transition from the simple rectilinear lines of the six-storey *REMY* project (to the east) to the finer-scaled elements at the townhouses (to the west).
- Facades are planned with a distinct, 'heavier' first floor, a main building superstructure
 that is visually tied together with balcony 'frames', and a stepped back top floor with
 vertically articulated roof line. North and south penthouse roofs are curved to recall the
 curved McKim Way frontage.
- The exterior cladding is a combination of smooth and textured fibre-cement board with metal reveals. Other exterior cladding materials such as brick, cedar soffits, and metal cladding are used to provide accent and visual interest. Further accents and articulation are provided by high contrasting metal guardrails at the balconies, as well as taller glazed walls at the entry lobbies and interior amenity areas.
- The choice of materials and colours reflect the residential nature of the project and provide good contrast in colour (white Hardie vs. charcoal gray brick) and texture (masonry vs. cement board panels).

Tree Management

- At Rezoning stage, it had been determined that no on-site trees were in suitable condition or location to facilitate retention in context to the proposed development. Subsequent to third reading on the associated zoning bylaw amendment, all trees have been removed via approved Tree Permits to accommodate site preparation and pre-loading.
- The Official Community Plan 2:1 replacement ratio requires that a minimum of 44 replacement trees be provided for the removal of 22 bylaw sized trees on-site. The applicant has agreed to plant approximately 79 trees on the lot.
- Four City trees located along the Cambie Road frontage are identified for removal as the result of the required frontage improvement works; a cash compensation in the amount of \$4,550.00 to Parks Division's Tree Compensation Fund has been secured at Rezoning stage.

Landscape Design and Open Space Design

- Along McKim Way, pedestrian entrances will be marked by decorative pavers, step lights and furniture. An architectural trellis at the parkade entry is proposed, and loading area will be screened by raised planters from McKim Way.
- Along Cambie Road, terraced planters are proposed to transition the elevation difference between Cambie road and the first floor of the building. The two pedestrian entrances will be marked by decorative pavers and step lights. The pedestrian entrance next to the building lobby will also be enhanced by a landscape boulder feature, seating and bike rack in front.
- Along the west property line, the proposed site grade will match with the existing site grade of the neighbouring townhouse development. Tall shrubs with trees plus neighbour's existing 1.8 m high fence ensure the privacy of both properties.
- Along the east property line, the outdoor spaces are designed as a quiet and resting zone with lounge seats. To respect neighbouring property, planters on the podium level will be terraced down to the property line, which mirrors neighbour's spatial character. One row of trees will be provided to create the sense of privacy for the residents.
- Outdoor amenity spaces proposed in this development exceeds the minimum OCP requirements. Outdoor amenity spaces proposed on the podium include a 384 m² (4,137 ft²) children's play area, an outdoor dining area adjacent to the children's play area, a covered patio space outside of the multipurpose room, and a lounge area at the northeast portion of the podium. The children's play area includes a large open lawn area as well as four play structures catered to children from age 0.5 12 and one outdoor table tennis table.
- In addition, a community garden for the exclusive use of the residents in the apartment building is proposed on the south side of McKim Way. The garden plots in the community garden will be organized in a radial configuration pointing towards the lobby entry to tie in with the overall landscape design. The entry of the community garden will be marked by an open seating space and trellis. Fruit trees will be planted on the north edge of the community garden to enhance pedestrian experience along the sidewalk. This community garden will be managed by the future strata corporation.
- A lighting plan is included in the DP plans, which indicates lighting provided throughout the site that is directed downwards and into the site.
 - o Bollard lights proposed are approximately 1.1 m high, and are to light some of the outdoor amenity areas and seating areas.
 - O Step lights proposed are approximate 0.3 m above ground, and are proposed along pathways, unit entries, and stairs, to ensure safe pedestrian traffic.
 - O Unit entry downward lights are proposed to light the unit numbers on the entry column. On site irrigation for all soft landscape will be installed.
- In order to ensure that the proposed landscaping works are completed, the applicant is required to provide a landscape security of \$483,881.36 in association with the Development Permit.

Crime Prevention Through Environmental Design

- Crime Prevention Through Environmental Design (CPTED) principles have been considered throughout the proposed development.
- Public areas, pedestrian pathways and resident private/semi-private areas are designed to be well-defined by soft landscaping and hard fencing/gates to clearly delineate boundaries of uses.
- Entry lobbies are designed to be visually open from the sidewalk.
- The parkade entry (overhead gate and fob console) is designed with clear sight lines, weather protection, adequate car queuing, clear signage and good lighting for both entry and exiting.
- View from interior spaces to provide passive surveillance were carefully considered to all
 key areas such as outdoor activity areas, grade level patios, building and pathway corners
 and lower visibility side yards.
- Garden plots in the residents' community garden are angled for better visibility from the entry point.

Sustainability and Renewable Energy

- The subject site is within the Alexandra District Energy Utility catchment area and connection to the utility will be required for this development. The Rezoning Considerations include requirements for the registration of legal agreements ensuring that the building will be capable of accommodating the ADEU connection and ensuring that the service connection will be made prior to occupancy.
- The developer has committed to design the subject development to meet the City's Step Code requirements (i.e., Step 3). Details on how all units are to be built and maintained to this commitment will be reviewed at Building Permit stage.
- The architect advised that low-flow toilets, showers and lavatories as well as Energy Star appliances will be specified in all units.

Transportation

- There is a total of 193 parking spaces including 164 stalls for market residential units, five stalls for affordable residential units, 22 visitor parking spaces and two car share spaces. A total of four accessible parking stalls (three residential and one visitor parking) will be provided.
- The proposed number of parking spaces is consistent with the parking requirements under the ZLR43 zone subject to the provision of Transportation Demand Measures (TDM) to the satisfaction of the City. The TDM includes:
 - o Provision of a bicycling maintenance and repair room in the development.
 - o Provision of 120V electric plug-ins for electric bikes; one for every 40 bicycle storage racks (if there are fewer than 40 bicycle racks in a storage compound, one 120V electric plug-in will be provided for each compound).

- Allocate a minimum of two parking spaces within the residential visitor pool of parking for car-share vehicles, with SROW registered in perpetuity to ensure such a space is publicly accessible. The car-share space is to be equipped with an electric vehicle (EV) quick-charge (240 V) charging station for the exclusive use of car-share vehicles parked in the required car-share space.
- O Provision of monthly transit passes (2-zone for one year) to 25 per cent of the market units and 100 per cent of affordable units.
- o Provision of a bench along each of the two street frontages of the development (or equivalent cash contribution of \$4,000.00 in total).
- Voluntary cash contribution of \$15,000.00 toward the construction of multimodal wayfinding signs in the West Cambie area.
- O Voluntary cash contribution of \$2,500.00 towards cycling-related infrastructures in the West Cambie area.
- The proposal will feature 24 parking spaces in a tandem arrangement. Registration of a restrictive covenant to prohibit the conversion of the tandem garage area into habitable space, and to ensure that both parking spaces be assigned to the same dwelling unit where two parking spaces are provided in a tandem arrangement, has been secured at Rezoning stage.
- The applicant has agreed not to assign/sell the three residential accessible parking spaces to any particular unit and the future strata will ensure these spaces will be available to all residents on an on-demand basis. A legal document to secure this arrangement will be registered on Title prior to Development Permit issuance.
- There is a total of 214 bicycle parking spaces provided throughout the site (188 Class 1 and 26 Class 2 spaces).
 - o All the Class 1 spaces are contained in rooms with a maximum of 40 bicycle spaces in compliance with provisions of Zoning Bylaw 8500.
 - 18 Class 2 spaces are proposed along the McKim Way frontage, and eight Class 2 spaces are proposed along the Cambie Road frontage.

Affordable Housing

• In accordance with the "Character Area 4 – Medium Density Housing" designation under the West Cambie Plan, the permitted base density at the subject site is 1.50 floor area ratio (FAR), and the density may be increased to a maximum of 1.70 FAR provided that built affordable housing units with a total floor area equals to 1/3 of the density bonus are included in the development. This development must provide a minimum of 449 m² (4,833.4 ft²) of affordable housing.

• The development proposal provides approximately 452 m² (4,873.1 ft²) of floor space in a total of five affordable housing units. The proposed unit types are shown in the table below:

| Unit Type | Number of Units | Minimum Unit Area | Proposed Unit Area | Maximum Monthly Unit Rent** | Total Maximum Household Income** |
|------------------|--------------------|---|---|--------------------------------------|---|
| Two Bedroom | 2 | 69 m² (795 ft²) | 74.88 m ² (806 ft ²) | \$1,218 | \$46,800 or less |
| Three Bedroom | 3 | 91 m ² (938 ft ²) | 100.99 m ² (1,087 ft ²) | \$1,480 | \$58,050 or less |

^{**}May be adjusted periodically as provided for under adopted City policy.

- Rent and income controls will be applied to these units via an agreement on Title as outlined under the rezoning application (RZ 18-835042).
- All five units are designed as universal housing units. The affordable housing unit locations are indicated on the development plans. The unit sizes and locations have been reviewed and accepted by the City's Affordable Housing staff.

Accessible Housing

- The proposed development includes 36 basic universal housing units that are designed to be easily renovated to accommodate a future resident in a wheelchair. These single-storey units are required to incorporate all of the accessibility provisions listed in the Basic Universal Housing Features section of the City's Zoning Bylaw, and are permitted a density exclusion of 1.86 m² (20 ft²) per unit.
- All of the proposed units incorporate aging in place features to accommodate mobility constraints associated with aging. These features include:
 - Stairwell hand rails.
 - o Lever-type handles for plumbing fixtures and door handles.
 - Solid blocking in washroom walls to facilitate future grab bar installation beside toilets, bathtubs and showers.
- Two building entries are provided for this double-fronting development site. The primary entry (at McKim Way) is served by a 3-segment ramp, with integrated bench rest areas at the intermediate landings, between the sidewalk and the lobby.
- At the secondary Cambie Road entry lobby, a wheelchair platform lift is provided for access from the lobby at grade up to the main (podium) level.
- A pedestrian walkway/ramp (at approximately 4.6 per cent gradient) is provided adjacent and separate from the vehicle ramp for direct access from street level to the parkade level.
- A wheel platform lift in the garbage room will provide functionality for both resident wheelchairs and the transport of refuse.

Conclusions

As the proposed development would meet applicable policies and Development Permit Guidelines, staff recommend that the Development Permit be endorsed and issuance by Council be recommended.

Edwin Lee

Planner 2

(604-276-4121)

EL:js

Att.

- 1: Development Application Data Sheet
- 2: Excerpt from the Minutes of Advisory Design Panel Meeting (February 7, 2018)
- 3: Development Permit Considerations



Development Application Data Sheet

Development Applications Department

DP 21-933765 Attachment 1

Address: 9300 and 9320 Cambie Road

Westmark Developments

Applicant: Interface Architecture

Owner: _(Camosun) Ltd.

Planning Area(s): West Cambie (2.11A)

Floor Area Gross: 12,326.7 m²

Floor Area Net: 11,422.2 m²

| | Existing | Proposed | |
|------------------------|---|---|--|
| Site Area: | 8,019 m² | 6,736 m ² | |
| Land Uses: | Single Detached | Multi-Family Residential | |
| OCP Designation: | Apartment Residential | No Change | |
| Area Plan Designation: | Residential Area 1: 1.50 base FAR (Max. 1.7 FAR with density bonusing for affordable housing). Townhouse, low-rise Apartments (4-storey typical). | No Change | |
| Zoning: | Single Detached (RS1/F) | "Low Rise Apartment (ZLR43) – Alexandra Neighbourhood (West Cambie)" | |
| Number of Units: | 0 (demolished) | 126 | |

| | Bylaw Requirement | Proposed | Variance |
|---|---|---|----------------------|
| Floor Area Ratio: | Max 1.7 FAR with affordable housing plus up to 0.1 FAR for amenity. | 1.7 FAR with five affordable housing units plus 0.08 FAR for amenity | None permitted |
| Lot Coverage (% of lot area): | Max. 40% | 42.2% | Variance required |
| Setback – Cambie Road: (Building/Parking structure) | Min. 4.0 m / 2.0 m | 4.0 m / 2.0 m | None |
| Setback – McKim Way: (Building/Parking structure) | Min. 7.5 m / 7.5 m | 7.5 m / 7.5 m | None |
| Setback – Side Yard (east): (Building/Parking structure) | Min. 4.0 m / 1.2 m | 4.0 m / 1.2 m | None |
| Setback – Side Yard (west): (Building/Parking structure) | Min. 4.0m / 0.9 m | 4.0m / 0.9 m | None |
| Height (m): | Max. 19.5 m (5 storeys) | 19.5 m (5 storeys) | None |
| Lot Size: | Min. 6,700 m ² | 6,736 m² | None |
| Off-street Parking Spaces – Residential: | 1.5 (Apartment Housing) + 1.0 (Affordable Housing) = 169 with TDM | 169 with TDM | None |

| Off-street Parking Spaces – Visitor: | 0.2 (V) per unit = 23 with TDM | 24 | None |
|--|---|---|----------------------|
| Off-street Parking Spaces – Total: | 192 | 193 | None |
| Tandem Parking Spaces: | Permitted | 24 | None |
| Small Car Parking Spaces: | Max. 50% when 31 or more spaces are provided on-site (192 x Max. 50% = 96) | 93 | None |
| Accessible Parking Spaces: | Min. 2% when 11 or more spaces are required (192 x 2% = 4 spaces) | 4 | None |
| Manoeuvring Aisle Width (90° Parking Angle) | Min. 6.7 m | 6.7 m min. except for the easternmost drive aisle in the parkade at 6.4 m | Variance required |
| Bicycle Parking Spaces - Class 1: | 1.25/unit = 158 | 188 | None |
| Bicycle Parking Spaces - Class 2: | 0.2/unit = 26 | 26 | None |
| Bicycle Spaces (totals) | 184 | 214 | None |
| Amenity Space – Indoor: | Min. 100 m² | 548.5 m² | None |
| Amenity Space – Outdoor: | Min. 6 m ² x 126 units = 756 m ² (8,137 ft ²) | 1,147 m² (12,347 ft²) | None |

Excerpt from the Minutes from The Design Panel Meeting

Wednesday, March 23, 2022 – 4:00 p.m. Remote (Webex) Meeting

Panel Discussion

Comments from Panel members were as follows:

- a shadow study of the four-storey versus five-storey building would have been useful to confirm that no additional overshadowing of adjacent developments would occur as a result of the increased height in accordance with the Area Plan; A 4-storey building would obviously cast lower shadows, but the current 5-storey building complies with the OCP (West Cambie, Alexandra Neighbourhood) and was carefully designed to minimize shadowing impacts. In addition, the massing & density was achieved on a footprint that was reduced by the new McKim Way street ROW and the orphaned remnant site area.
- understand the rationale for the proposed massing of the subject building to achieve the desired density; however, investigate opportunities for adjustment to the east-west length of the building to provide greater separation from adjacent developments to the east and west and allow more solar exposure and privacy for the subject development and adjacent buildings;
 - The final E-W positioning of the main body of the building was deemed the best balance of the anticipated impacts on the E & W neighbours. The analyses considered: (i) types of neighbouring interior and exterior spaces, (ii) overlook potential in both directions across the PL's, (iii) the daily solar path, and (iv) location and uses of the proposed outdoor amenity areas.
- residential units at the southeast corner of the building (i.e., Units 227, 228, 327, 328, 427 and 428) are in close proximity to the adjacent 6-storey building to the east; investigate opportunities for turning the windows of these units away from the windows of residential units in the adjacent building to provide privacy and avoid overlook concerns;

There is no overlook issue from Level 1 looking east (L1 is indoor amenity area). At Level 2, the distance between windows is approx. 34 ft. At levels 3-6, the REMY project has 1 window facing west (ranging 41-50 ft. apart). We have other residential projects that typically have a minimum of about 26 ft. apart (i.e. townhouses at both sides of a common drive aisle), the proximity of the windows do not present significant privacy/overlook concerns.

 consider bringing down the grade of the main lobby on the south side of the building to improve its relationship with the sidewalk; reducing the amount of ramps would improve the accessibility of the entrance lobby;

The main south entry lobby FFE - lowered to 3.90m from the main floor 4.20 FFE - allows the outdoor accessible ramp to be efficiently laid out in only three 6m ramp segments.

 consider improving the grade relationship of residential units facing Cambie Road to the public sidewalk to activate the sidewalk;

Due to the similar design parameters with the 6-storey REMY project (i.e. stacked condos over u/g sunken concrete parkade close to the Cambie PL), the grade relationship of the L1 residential units to the Cambie sidewalk is handled the same way. The landscape screening has been given a more dynamic layered treatment than at the adjacent REMY project. This project features a prominent entry lobby at Cambie Road.

• support the proposed location and landscape screening of the two pad-mounted transformers (PMTs) along the site's Cambie Road frontage;

Noted. This solution was arrived at after an intensive review of optional locations.

proposed landscaping treatment for the space between the subject building and the adjacent six-storey building to the east gives rise to CPTED concerns; consider enhancing the visual openness of the space through appropriate choice of planting materials and other landscaping strategies; also consider investigating opportunities for stormwater detention;

The gap between the parkade podiums is to be landscaped with a continuous strip of shrub planting ('CC' Mexican mock orange, 'OD' false holly, see L4) on 2 tiers. There is a high degree of passive surveillance along the entire length of this gap that should alleviate CPTED concerns. Additional fencing/gating do not seem like appropriate measures but could easily be implemented by the incoming strata council. The gap between podiums does allow extensive rainwater percolation.

 consider replacing the proposed play equipment in the children's play area to also provide play opportunities for children of other age groups, especially for younger children; also consider a more durable surface and not just bare lawn for areas where the table tennis tables are located in the common outdoor amenity space;

The children's play area has been enlarged while decreasing the lawn area. Larger play equipment is now proposed (i.e. added a 2-swing structure and a balance ring) while creating 3 distinct play zones. The 4 table tennis tables have been reduced to just 1, and now installed permanently on a resilient surface.

 consider improving the sightlines from the residential units into the indoor amenity room on each floor, e.g. through maximizing the use of glazing on the indoor amenity room;

The small indoor amenity rooms on each floor are planned to be enclosed opaquely, except for a vision panel in the each room door. Extensive glazing was considered but opaque framed walls (STC 50 minimum) will be provided for noise control& privacy.

 appreciate the well-designed building considering the challenges and constraints of a long and narrow infill site;

Noted.

 appreciate the provision of extra indoor amenity spaces which are above the minimum requirement;

It was a good way to handle the awkward interior spaces at the elbows.

support the five-storey building height to compensate for road dedication and in order to achieve the desired density for the project;

Noted.

 consider enhancing the screening for the garbage loading area to avoid being used for other purposes;

The current layout and screening has been thoroughly vetted by many consultants and planners. Most importantly, the layout meets the requirements for truck movement and sightlines.

• the project is well-thought out; appreciate the use of renderings and pictures of the model in the presentation to better understand the project;

Noted, and thanks.

appreciate the extensive green space being proposed; however, the applicant should ensure (i) the effectiveness of the irrigation system and the choice of planting materials, (ii) the provision of water access to the community garden for residents, and (iii) successful programming of the space for community garden;

The podium is designed with appropriate drought-resistant and varied planting materials, and an irrigation system will be provided. The common garden at the south remnant site area (complete with water access and tool storage) will eventually be programmed by the strata council.

• consider including a wheelchair-accessible planting box in the community garden for residents;

Accessibility has been incorporated (i.e. level access from the sidewalk, planter boxes with various heights, navigable surface treatment).

• the design and materials for the trellis on top of the parkade entrance/outdoor amenity area appear heavy; consider a scaled down and lighter design for the trellis considering its adjacency to the existing townhouse development to the west:

The butterfly trellis structure has been reduced in size and made less 'monumental'. The wingspan has been reduced from 40'-8" to 29'-4" which lowers the canopy by about 16". Its function as a cover for the bbq area and weather protection for the parkade keypad entry is maintained.

• consider installing a formalized cross walk to connect the main development to the community garden for residents across McKim Way;

We are proposing a road narrowing to facilitate a shorter crosswalk, but this will need to be vetted by Fire and Engineering.

• overall, support the choice of planting, play equipment and programming of the outdoor amenity space;

Noted.

appreciate the applicant's presentation of the project, especially the use of the
 3D model which was useful in understanding some areas in the building;

Noted.

• support the five storeys instead of the four storeys building height as the building has been moved as far as possible to the east to provide adequate separation from the townhouse development to west (26 meters separation) and the adjacent six-storey building to the east (10.4 meters separation);

Noted.

• not concerned with potential overlook to adjacent developments due to matching of grade levels across property lines of adjacent developments;

Noted.

 proposed landscaping for the project is well-considered, particularly along the east side;

Noted.

appreciate the chamfer at the southeast corner of the building;

Noted.

• support the proposed location of the two PMTs along the site's Cambie Road frontage;

Noted.

appreciate the butterfly-shaped roof of the trellis on top of the parkade entrance; however, it appears heavy; the trellis in the residents' community garden also appears bulky; consider echoing the expression of the building, e.g. its colours and materials, to the expressions of the trellises on the site and the parkade entry fence to create a lighter feel;

The main butterfly trellis canopy has been scaled down & now less monumental.

 support the proposed grade changes from the public sidewalk to the entrance lobby on McKim Way;

Noted.

 appreciate the provision of an indoor amenity space on every floor of the building;

Noted.

• support the distribution of the affordable housing and Basic Universal Housing (BUH) units throughout the building;

Noted.

consider enhancing the accessibility of balconies in BUH units;

The 3'0 balcony doors in all units will easily meet the required 800mm horizontal clearance. The door sill & threshold must sit on a two 2x6 sill plates, creating a drop of about 3" on one or both sides of the door to maintain a positive lip for envelope reasons. However, for the BUH units (and indeed all units with balconies) there are many lightweight temporary door curb ramps available on the market that will allow wheelchairs to navigate over the curbs over various heights (from 1.5" to 4").

• ensure that all BUH standards are achieved in all BUH units including those relating to the toilet area;

BUH requirements are currently met, and they will be reviewed on an ongoing basis throughout the BP process.

• ensure that the doorways to the library and fitness amenity rooms have double doorways or have a clear opening that meets the City's BUH standards;

Complies. Will continue to review throughout the BP process.

the proposed three resident accessible parking stalls may not be adequate considering the number of BUH units being provided in the project; consider providing additional accessible resident parking stalls near the elevator;

The BUH units do not require accessible stalls, so the current complement complies with the bylaw. The owner will consider assigning standard sized stalls to all BUH units.

appreciate the applicant's commitment to meet the City's Step Code requirements (i.e., BC Energy Step Code 3) and connect to the City district energy utility; consider installing CO₂heatpumps for domestic hot water heating in lieu of gas; also consider using electric fire pits in lieu of gas fire pits in the common outdoor amenity area to reduce fossil fuel use on the site;

Per the mechanical consultant, this project uses a water-source heat pump to preheat the DHW and gas-fired boilers to supplement and backup the heat pump. He added that "I have not seen CO2 heat pumps being used on any project as the cost is so much higher that it is not being considered." Regarding the gas fire pit on the east side of the podium, it has been deleted.

 appreciate the applicant for showing the fire hydrant and Fire Department connections on the site; however, the applicant should ensure that the fire hydrant is in the right location and distance from the building;

The FH location will be reviewed again and finalized via the Servicing Agreement process.

 appreciate the low percentage of the building's window-to-wall ratio, however, consider installing solar shading on the building's south and west sides to further mitigate energy loss and minimize energy cost;

Solar shading devices are effective at those locations but their potential architectural expression will not suit the current design vocabulary. The curtain wall glazing at the lobby sections of the elevations will be substantially 'non-vision': large portions will be opaque or translucent, with high low-e (thermal resistance) ratings. Interior blinds will be installed at all windows.

 appreciate the building's height and massing and their relationship with respect to adjacent developments;

Noted.

• consider providing a direct connection from the main development to the residents' community garden across McKim Way to address CPTED concerns;

We are proposing to narrow the curbs at the crossing to improve traffic safety. Will be finalized via the SA.

• consider introducing additional pedestrian scale lighting appropriate to the size and space of the residents' community garden including cut-offs and glare screens to avoid light pollution to adjacent developments;

Street lighting in the area is sufficient, (ii) height of hedges at garden perimeter is low enough to see into and through the garden areas.

• support the Panel comment that some or all of those planting boxes should be completely accessible to people in wheelchairs;

Planting boxes are at 2 heights (12" & 24", see sheet L8).

- support the proposed grade transition from the public sidewalk to the lobby entrance facing McKim Way; however, concerned about the "canyon" effect of the space between the garbage loading area and the street which creates a blind corner; consider looking at ways to make the space more open and accessible;
 - The layout and screening of the loading has been painstakingly designed to: (i) satisfy truck movements and sightlines, (ii) visually screen the hard surfaces, (iii) clearly delineate pedestrian and vehicle areas, and (iv) provide a dynamic urban edge along the sidewalk. Bollard lighting is proposed at the edges of the loading bay surface; also, narrow cone floodlighting is to be installed at the top of the decorative trellis columns for general illumination of the loading area.
- review the size of the planting strip for the trellis treatment to ensure appropriate maintenance and survivability of planting; consider widening and deepening the strip and include provision for irrigation;
 - The landscape architect confirmed that the planting strips have adequate width and depth for planting and irrigation.
- appreciate the form of the trellis structure on top of the parkade entrance/outdoor amenity area; however, it appears heavy; review the programming of the trellis area, e.g. whether it should include a barbeque and/or outdoor kitchen;
 - As mentioned, the butterfly trellis over the parkade entrance has the wingspan substantially reduced. For CPTED reasons, the gas BBQ connection has been removed.
- the programming of the trellis area in the common outdoor amenity area on the west side should also be reflected on the on the outdoor amenity area at the northeast corner of the podium; consider incorporating a wood deck seating area that integrates screening or shade structure; also review whether the fire pit is necessary and consider the option of installing an electric barbeque to reduce fossil fuel usage;
 - The general concept for the outdoor amenity areas was to accommodate more active & diverse programming at the larger brighter west side podium. The east side would be for passive seating for mature residents (esp. nearer to REMY 's property line). For safety reasons, the fire pit has been deleted.
- overall, support the potential uses for the common outdoor amenity space; however, consider installing a play equipment that provides play opportunities for younger children; note that the lawn area provides a much better play amenity than a single stand alone play equipment;
 - New play equipment has been specified (previous model now not available). The play area is part of the range of potential activities on the podium.

 support the Panel comment to install hard surface for the table tennis areas to reduce maintenance requirements for the lawn and allow the use of the space for other outdoor activities, e.g. a picnic spot;

Noted. A durable resilient surface is specified for this area.

• overall, appreciate the grade transition from the public sidewalk to the first habitable level through the use of retaining walls; however, the applicant needs to clarify how the fence and exhaust louvers above the PMTs located along the site's Cambie Way frontage will work within the landscape and impact the planting; planting materials should be carefully selected to avoid a dead patch of planting behind the PMTs;

The louvres behind the twin PMT's at the Cambie frontage have now been carefully designed and coordinated with the mechanical & landscape consultants.

• consider enhancing the exterior cladding treatment of retaining walls closest to the street using materials that reflect the architecture of the building, e.g. brick, to make the transition more pleasant;

The retaining wall planters at the sidewalk are intended to have an architectural finished concrete (i.e. grind smooth & sealed) rather than be cladded with masonry or tiled veneer. We prefer the cleaner, more contemporary, bare concrete look, softened by an abundance of soft landscaping.

appreciate the well-designed project;

Noted.

• the proposed five-storey building works well with the adjacent six-storey building to the east and the townhouse development to the west;

Appreciate the comment.

appreciate the proposed landscaping, e.g. the use of stepped planters, to create a
pedestrian-friendly transition from the sidewalk to the entrance lobby along
McKim Way;

Appreciate the comment.

 concerned about the livability of residential units that are located far from the elevators; and

Always a concern, but these distances are not extreme; having lobbies at both the McKim and Cambie frontages help (but elevators are only at the McKim end).

• consider installing an additional elevator on the north side of the parkade or relocating one of the elevators from the south side to the north side considering the distance of the north residential parking stalls from the south elevators.

The current floor plan layout best optimizes resident security, accessibility, wayfinding, and construction efficiency.

Panel Decision

It was moved and seconded

That DP 21-933765be supported to move forward to the Development Permit Panel subject to the applicant giving consideration to the comments of the Advisory Design Panel.

CARRIED

ATTACHMENT 3



Development Permit Considerations

Development Applications Department 6911 No. 3 Road, Richmond, BC V6Y 2C1

File No.: DP 21-933765

Address: 9300 and 9320 Cambie Road

Prior to approval of the Development Permit, the developer is required to complete the following:

- 1. Final adoption of the Zoning Amendment Bylaw 10219.
- 2. Registration of a legal agreement on title ensuring that:
 - the number of accessible parking stalls per the Development Permit will be maintained in perpetuity;
 - the owners (including the future strata corporation) may not lease, assign, sell, or otherwise designate the accessible visitor parking spaces to the owners/tenants/occupants of any unit in the development nor to any other persons, other than to a parking tenant where all of the visitor parking stalls are subject to the parking lease and may not be assigned;
 - the bylaws of the future strata corporation, the parking lease which applies to the residential parking, and/or any other such legal documents which apply to the administration and management of the parking stalls in the development must require that if any of the three accessible residential parking stalls is leased to, assigned to, sold to, or designated for the use of the owners/tenants/occupants of a particular unit who does not require the use of such a stall, if another owner/tenant/occupant of the development requires such a stall but has been leased/assigned/sold/designated a regular residential stall the owners/tenants/occupants must execute the required documents to exchange such stalls. The requirement for the use of an accessible stall will be evidenced by the possession of a accessible parking permit issues pursuant to the Motor Vehicle Act (BC);
 - all of the four accessible parking stalls must be designated as common property or common residential property, as applicable, on the strata plan which contains those parking stalls; and
 - prior to occupancy of the development, the owner must execute and deliver to the City a statutory declaration confirming that the legal documents which apply to the administration of the parking stalls in the development and the strata plan for the development comply with this covenant.
- 3. Receipt of a Letter-of-Credit for landscaping in the amount of \$483,881.36. No Landscape Letter of Credit will be returned until the Letter of Assurance, confirming the landscaping are installed as per the Development Permit, prepared by the Landscape Architect, is reviewed by staff.

Prior to Building Permit Issuance, the developer must complete the following requirements:

- Submission of a Construction Parking and Traffic Management Plan to the Transportation Department.
 Management Plan shall include location for parking for services, deliveries, workers, loading, application for any lane closures, and proper construction traffic controls as per Traffic Control Manual for works on Roadways (by Ministry of Transportation) and MMCD Traffic Regulation Section 01570.
- 2. Incorporation of accessibility measures in Building Permit (BP) plans as determined via the Rezoning and/or Development Permit processes.
- 3. Payment of the Supplementary Local Area DCC for the Alexandra Neighbourhood based on \$7.56 per ft².
- 4. Obtain a Building Permit (BP) for any construction hoarding. If construction hoarding is required to temporarily occupy a public street, the air space above a public street, or any part thereof, additional City approvals and associated fees may be required as part of the Building Permit. For additional information, contact the Building Approvals Department at 604-276-4285.

Note:

- * This requires a separate application.
- Where the Director of Development deems appropriate, the preceding agreements are to be drawn not only as personal covenants
 of the property owner but also as covenants pursuant to Section 219 of the Land Title Act.

| Ĭ'n | iti | al |
|-----|-----|----|
| | | |

All agreements to be registered in the Land Title Office shall have priority over all such liens, charges and encumbrances as is considered advisable by the Director of Development. All agreements to be registered in the Land Title Office shall, unless the Director of Development determines otherwise, be fully registered in the Land Title Office prior to enactment of the appropriate bylaw.

The preceding agreements shall provide security to the City including indemnities, warranties, equitable/rent charges, letters of credit and withholding permits, as deemed necessary or advisable by the Director of Development. All agreements shall be in a form and content satisfactory to the Director of Development.

- Additional legal agreements, as determined via the subject development's Servicing Agreement(s) and/or Development Permit(s), and/or Building Permit(s) to the satisfaction of the Director of Engineering may be required including, but not limited to, site investigation, testing, monitoring, site preparation, de-watering, drilling, underpinning, anchoring, shoring, piling, pre-loading, ground densification or other activities that may result in settlement, displacement, subsidence, damage or nuisance to City and private utility infrastructure.
- Applicants for all City Permits are required to comply at all times with the conditions of the Provincial Wildlife Act and Federal Migratory Birds Convention Act, which contains prohibitions on the removal or disturbance of both birds and their nests. Issuance of Municipal permits does not give an individual authority to contravene these legislations. The City of Richmond recommends that where significant trees or vegetation exists on site, the services of a Qualified Environmental Professional (QEP) be secured to perform a survey and ensure that development activities are in compliance with all relevant legislation.

| Signed | Date |
|--------|------|



Development Permit

No. DP 21-933765

To the Holder:

Interface Architecture Inc.

Property Address:

9300 and 9320 Cambie Road

Address:

11590 Cambie Road Unit 230,


Richmond, British Columbia V6X 3Z5

- 1. This Development Permit is issued subject to compliance with all of the Bylaws of the City applicable thereto, except as specifically varied or supplemented by this Permit.
- 2. This Development Permit applies to and only to those lands shown cross-hatched on the attached Schedule "A" and any and all buildings, structures and other development thereon.
- 3. The "Richmond Zoning Bylaw 8500" is hereby varied to:
 - a) Increase maximum lot coverage of buildings from 40% to 43%; and
 - b) Reduce minimum width of one manoeuvring aisle in the parkade from 6.7 m to 6.4 m.
- 4. Subject to Section 692 of the Local Government Act, R.S.B.C.: buildings and structures; off-street parking and loading facilities; roads and parking areas; and landscaping and screening shall be constructed generally in accordance with Plans #1 to #50 attached hereto.
- 5. Sanitary sewers, water, drainage, highways, street lighting, underground wiring, and sidewalks, shall be provided as required.
- 6. As a condition of the issuance of this Permit, the City is holding the security in the amount of \$483,881.36 to ensure that development is carried out in accordance with the terms and conditions of this Permit. Should any interest be earned upon the security, it shall accrue to the Holder if the security is returned. The condition of the posting of the security is that should the Holder fail to carry out the development hereby authorized, according to the terms and conditions of this Permit within the time provided, the City may use the security to carry out the work by its servants, agents or contractors, and any surplus shall be paid over to the Holder. Should the Holder carry out the development permitted by this permit within the time set out herein, the security shall be returned to the Holder. The City may retain the security for up to one year after inspection of the completed landscaping in order to ensure that plant material has survived.
- 7. If the Holder does not commence the construction permitted by this Permit within 24 months of the date of this Permit, this Permit shall lapse and the security shall be returned in full.

Development Permit No. DP 21-933765

| To the Holder: | Interface Architecture Inc. 9300 and 9320 Cambie Road 11590 Cambie Road Unit 230, Richmond, British Columbia, V6X 3Z5 | | | | | |
|---|---|--|--|--|--|--|
| Property Address: | | | | | | |
| Address: | | | | | | |
| 3. The land described herein shall be developed generally in accordance with the terms and conditions and provisions of this Permit and any plans and specifications attached to this Permit which shall form a part hereof. This Permit is not a Building Permit. | | | | | | |
| AUTHORIZING RESOLUT DAY OF , | ION NO. ISSUED BY THE COUNCIL THE | | | | | |
| DELIVERED THIS D | AY OF , . | | | | | |
| MAYOR | | | | | | |



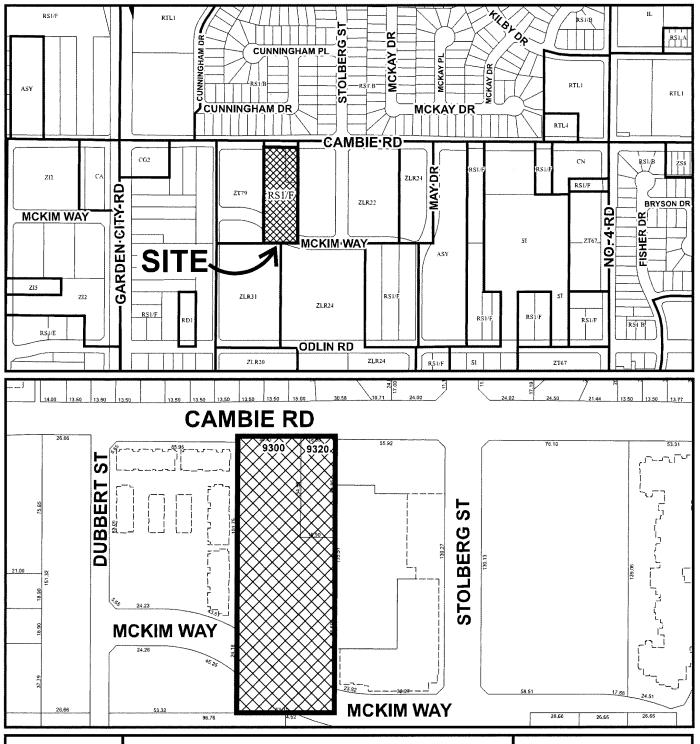




DP 21-933765 SCHEDULE "A"

Original Date: 06/02/21

Revision Date:

Note: Dimensions are in METRES



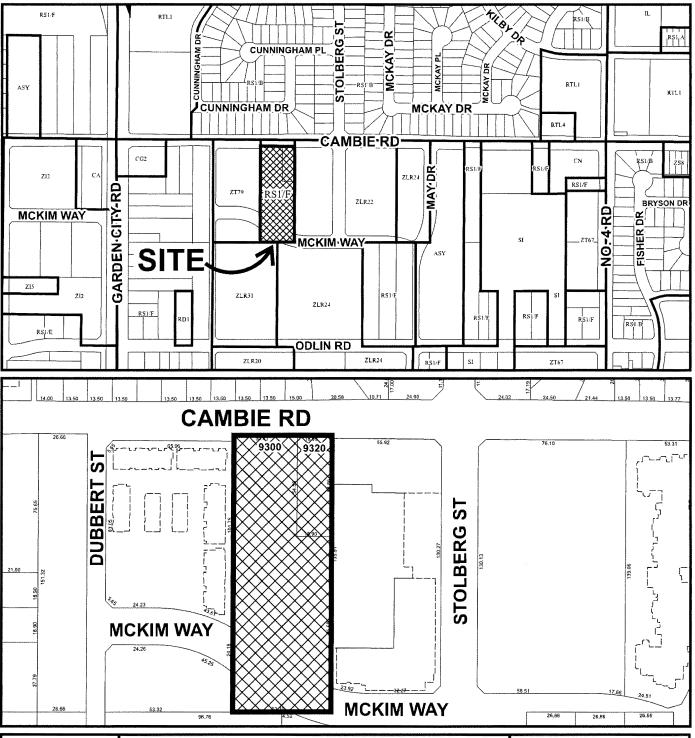



DP 21-933765

Original Date: 06/02/21

Revision Date:

Note: Dimensions are in METRES

DEVELOPMENT PERMIT [DP-21-933765]

JANUARY 3, 2023

IAN 3, 2023 Issue for DP 7

MAR 4 2022 Issue for ADP

FEB 18, 2022 |ssue for DP 4 FEB 16, 2022 Issue for DP 4

OCT 21, 2021 Issue for DP 3 (REV1

NOV 11, 2022 ADP response (DP6 JUL 8, 2022 ADP response (DP 5)

126-UNIT MULTI-FAMILY DEVELOPMENT

9300 & 9320 CAMBIE ROAD, RICHMOND BC



DRAWING LIST

ARCHITECTURAL

- A1.00 COVER SHEET
 A1.01 PROJECT INFORMATION
 A1.02 SITE SURVEY
 A1.03 CONTEXT PLAN
 A1.04 EXISTING SITE CONTEXT
 A1.05 LOT GRADING PLAN & OFFSITE SERVICES
 A1.06 SITE PLAN
 A1.07 FIREF IGHTING
 A1.08 ACCESSIBILITY DIAGRAMS

- A2.06 FLOOR PLAN L5 A2.07 ROOF PLAN

- A2.08 OVERLAY-L1 FLOOR AREA RATIO
 A2.09 OVERLAY-L2 FLOOR AREA RATIO
 A2.10 OVERLAY-L3 FLOOR AREA RATIO
 A2.11 OVERLAY-L3 FLOOR AREA RATIO
 A2.12 OVERLAY-L5 FLOOR AREA RATIO
 A2.13 OVERLAY-L1 GLOOVERAGE
 A2.14 OVERLAY-L1 GLO

- A3.01 BLDG ELEVATIONS
 A3.02 BLDG ELEVATIONS
 A3.03 BLDG PERSPECTIVE W/ MATERIAL
 A3.04 BLDG ELEVATION NORTH
- A3.05 BLDG ELEVATION SOUTH

- A4.01 SECTION A
 A4.02 SECTION B
 A4.03 SECTION E
 A4.04 SECTIONS F,G, H & I
 A4.05 SECTION J
- A4.06 SECTION 6.1, 6.2 & 6.3 A4.07 SECTION K & L

- A5.01 UNIT PLANS TYPE A1 & A2-L
- A5.02 UNIT PLANS TYPE B1 & 82
 A5.03 UNIT PLANS TYPE B3 & B4
 A5.04 UNIT PLANS TYPE B3 & B6
 A5.05 UNIT PLANS TYPE C2.1 & C2.2
 A5.07 UNIT PLANS TYPE C3.1 & C3.2
 A5.08 UNIT PLANS TYPE C3.1 & C3.2
 A5.09 UNIT PLANS TYPE C4
 A5.09 UNIT PLANS TYPE C4
 A5.09 UNIT PLANS TYPE C4
 A5.10 UNIT PLANS TYPE D3
 A5.11 UNIT PLANS TYPE D3
 A5.12 UNIT PLANS TYPE B1 UNIT PLANS TYPE B1 UNIT PLANS TYPE B1 UNIT PLANS TYPE B3 UNIT PLANS TYPE B3 UNIT PLANS TYPE B3 UNIT PLANS TYPE B3 UNIT PLANS TYPE B1 UNIT PLANS TY

- ASO SO RENDENNO ABRIA VIEW CAMBIE ROAD

 10 SO ENDENNO ABRIA VIEW CAMBIE ROAD

 10 SO ENDENNO ABRIA VIEW CAMBIE ROAD

 10 SO ENTRY MANGES LETALS DAY

 3765

PLAN #1

A8.01 SHADOW STUDY MARCH & JUNE
A8.02 SHADOW STUDY SEPT
A8.03 SHADOWING ON REMY WEST FACE (SOUTH END)
A8.04 SHADOWING ON REMY WEST FACE (NORTH END) LANDSCAPE LANDSCAPE PILAN (COLOURED)
LANDSCAPE PILAN
GRADING PILAN
SIRRUB PILAN
SIRRUB PILAN
SIRRUB PILAN
FENCING & MATERIAL PILAN
LIGHTING PILAN
SECTIONS
DETAILS
AFAA CALCULATION
AREA CALCULATION
COST ESTIMATE
JUNE JUNE 15, 2022 CIVIL ARBORIST TREE MANAGEMENT REPORT REV #4 NOVEMBER 22, 2022 ACOUSTIC

MECHANICAL

SURVEY

TRANSPORTATION



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January 23, 2023

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126 - UNIT MID-RISE DEVELOPMENT

9300 & 9320 CAMBIE ROAD RICHMOND, B.C.

1804MCK2

JAN 3. 2023

DRAWN BY

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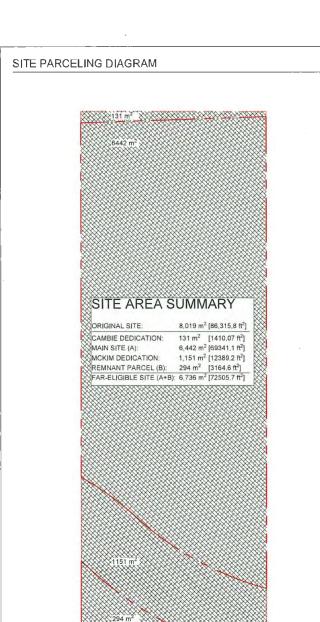
KYC

SHEET TITLE

COVER SHEET

SCALE

NA





ENGINEERING ISSUES

Acoustic

RECOMMENDATIONS TO ADDRESS AIRCRAFT AND ROAD TRAFFIC NOISE:

WINDOWS / DOORS

> AT BEDROOMS. MEETS OR EXCEEDS STC 37 AND OITC 31

> RECOMMEND GLAZED AREA AT EACH BEDROOM TO NOT EXCEED 2.8 M2 (APPROX 5' X 8')

> FOR BEDROOM WALLS HIGHLIGHTED IN GREEN INSTALL ADDITIONAL LAYER OF GWB > FOR BEORDOM WALLS HIGHLIGHTED IN RED. INSTALL ADDITIONAL LAYER OF GWB & RESILIENT CHANNELS

* ROOF / CEILINGS > AT LIVING ROOMS HIGHLIGHTED IN YELLOW, INSTALL BATT INSULATION & RESILIENT METAL CHANNELS > AT BEDROOMS HIGHLIGHTED IN RED. INSTALL BATT INSULATION & RESILIENT METAL CHANNELS, AND AN ACDITIONAL LAYER OF GWB (TOTAL 2 LAYERS)

REVIEW OF OUTDOOR TRANSFORMERS FOR COMPLIANCE WITH NOISE BYLAW NO. 8858

* TWO PROPOSED DISTRIBUTION LPT'S ON THE PODIUM EAST SIDE

> MAXIMUM PREDICTED NOISE LEVEL IS WELL BELOW THE NOISE LEVEL LIMITS STIPULATED IN NOISE BYLAW

BE PART OF THE ALEXANDRA DISTRICT UTILITY NETWORK FOR HEATING, COOLING, AND COMESTIC HOT WATER

OUTLETS APABLE OF PROVIDING LEVEL 2 EV-CHARGING
IN AD LIFE THE GARSHED AN ISSUED TO THE CHARGING
LEVEL 2 F VICET BE 209 V OF V . 11 TO 80

SITE INFORMATION / PROJECT DESCRIPTION

9300, 9320 CAMBIE ROAD RICHMOND BO (1) LOT 5 EXCEPT: PL 45079 BLK 'A' SECT 34 BLK 5N RNG 6W NWO PLAN 1224

(2) LOT 55 SECT 34 BLK 5N RNG 6W NWP PLAN 45079 8019 m² [86.321.8 ft²] = 1.982 AC LOT SIZE ORIGINAL SITE: CAMBIE DEDIGATION. 131 m² [1 410.07 [12]

MAIN SITE 'A' 6 442 m² [69,341,1 ft²] MCKIM DEDICATION: 1,151 m² [12,389,2 ff²] 294 m² [3,164,6 ft²] REMNANT SITE B'. FAR-ELIGIBLE 'A' + 'B' 6 736 m² [72,505.7 ft²]

NC / NO / NO / YES AREA 2 (ANSD POLICY)

WEST CAMBIE 11 / APARTMENT RESIDENTIAL (ALEXANDRA

SITE CONTEXT

A 126-UNIT MULTI-FAMILY RESIDENTIAL DEVELOPMENT IS PROPOSED FOR THIS 8 019.5 M2 AGGREGATE SITE IN A 123-UNT MULTIFAMLY RESIDENTIAL DEVELOPMENT IS PROPOSED FOR THIS \$0.95.802 AGGREGATE SITE IN THE ALEXANDRA REIGHBOURHOOD OF THE WEST CAMBE RAEQ. (2.11a). IT IS ESSENTIALLY AN INFILL SITE AMID EXISTING OR NEARLY COMPLETED MULTIFAMLY DEVELOPMENTS. A SP-UNIT TOWNHOUSE PROJECT IS CURRENTLY UNDER CONSTRUCTION IMMEDIATE. YOT THE WEST, THE 8-STORY MULTIFAMLY REMY PROJECT IS ADJACENT TO THE EAST SIDE. TO THE SOUTHWEST IS POLYGONS 25-UNIT, 8-STOREY BERKELEY POLYGON SENSINING. SSEUNIT, 4-STOREY MEMOLET (DEVALUE) DEVELOPMENT, NOW HOUSE CONSTRUCTION AND NEARLY COMPLETED. TO THE SOUTHEAST IS POLYGONS EXISTING SSEUNIT, 4-STOREY MEMOLET OF MARCE APARTMENTS. NORTH OF CAMBIE IS THE DAKE SINGLEFAMLY NEIGHBOURHOOD. THE NORTH CAMBIE FROM THE AST SIDE TO THE SOUTHER AS IS THE OAKS SINGLEFAMLY NEIGHBOURHOOD. THE NORTH CAMBIE FROM THE SITE, WILL REQUIRE A 11 IN ZOAD DEDICATION. ROAG DEDICATION ISO, ATING A TRIANGULAR REMNANT PARCEL DE 294 MZ. TOGETHER WITH THIS SMA PIECE THE OVERALL FAR-ELIGIBLE SITE AREA IS 6736 M2. THE SITE IS IN CHARACTER AREA 4 - MEDIUM

THE BUILDING MASSING IS CARGELY INFLUENCED BY THE ADJACENT VULTI-FAMILY PROJECTS AND THE TWO THE BUILDING MASSING IS CARGE. YI NEFUENCED BY THE ADJACENT YULTH-FAMILY PROJECTS AND THE TWO ROAD FRONTAGES. THE PROPOSED 5 STOREYS, OVER A SINGLE-LEVEL HALF-STOREY SUMKEN CONCRETE PARKAGE EASE THE TRANS.TION FROM THE 6-STOREY APARTMENT ELOCK DOWN TO THE 5-STOREY TOWNHOUSES, ALSO THE TOP (STH) FLOOR IS STEPPED BACK AT BOTH THE MORTH AND BOJ. THE HOB TO LOWER AND ARTICULATE THE BUILDING FRONTAGE STREETWALLS THE MAIN (CENTRAL), MASS IS SHIFTED AWAY FROM WEST PLITO CREATE AN INTERESTING, USEFUL OUTDOOR AMENITY AREA ON THE WEST SIDE OF THE PARKADE PODIUV. THE CENTRAL MASS IS ALISC SHIFTED AWAY FROM THE EAST PL. SUCH THAT THE REMY UNITS FACING WEST ARE GIVEN MORE PHYSICAL AND VISUAL SEPARATION

THE SE PART OF THE BUILDING IS TAPERED TO CREATE MORE SPACE FOR DIRECT SUNLIGHT PENETRATION BETWEEN BUILDING SOME OF THE BUILDING SOME OF THE SEARCH SOME OF THE SEARCH SOUTH FOR BETTER DIRECT SUNLIGHT EXPOSURE. AT THE SOUTH FOR THE MASSING IS RUBBLED BACK TO ACCOMMODATE A WIDER FRIENDLER MAIN ENTRY PLAZA TERRACED PLANTERS WITH INTEGRATED RAMPS AND A GRAND DUTTOON STATE.

DENSITY AND HOUSING MIX

THE OCP IDENTIFIES THE SUBJECT SITE AS RESIDENTIAL AREA 1 PERMITTING A BASE 1.50 FAR TO A MAX 1.70 'AR (TOWNHOUSE: LOW-RISE APARTMENTS) WITH DENSITY BONUSING FOR AFFORDABLE HOUSING. THE PERMITTED 0.2 FAR BONUS DENSITY WILL BE APPORTIONED 2/3 FOR MARKET UNITS & 1/3 FOR AHU UNITS (). 0.0557 FAR - 449,1 M2 MINIMUM FOR 5 UNITS IN THIS PROJECT), THE 5 AHU UNITS COMPRISE 452,1 M2. THE 126-UNITS ARE COMPRISED OF THE FOLLOWING UNIT MIX:

1 BEDROOM (5%) | 1-BR + DEN (13%) | 2-BR (51%) | 2-BR + DEN (20%) | 3-BR (10%) 3-BR + DEN (1%) FIXE UNITS ARE SET TO BE AFFORMABLE HOUSING RENTAL UNITS (AHU) TO BE MARAGED BY A CITY-APPROVED THIRD PARTY CONTRACT. THE TWO SER UNITS ARE ON LEVEL. IT HE HARRE SBY UNITS ARE DISTRIBUTED ON 19VF. S. 73.1. THIRTY-SEVEN BASIC UNIVERSAL HOUSING UNITS (BITH ARE DISTRIBUTED ON 19VF.) S. 73.1. THIRTY-SEVEN BASIC UNIVERSAL HOUSING UNITS (BITH ARE DISTRIBUTED OVER ALL FIVE FLOORS, THE VINICIDE & BALANCED BOOM WIN OF ONE, TWO, AND THREE-BEDROOM UNIT TYPES, AND TOTAL ABOUT 20% OF THE PROPOSED. "SEAHING COUNT." THE OPEN EXCEMPINED S AMINIMUM OF THE AREA OF THE PROPOSED. "SEAHING COUNT." THE OPEN EXCEMPINED S AMINIMUM OF THE PROPOSED. "SEAHING COUNT." THE OPEN EXCEMPINED S AMINIMUM OF THE PROPOSED. "SEAHING COUNT." THE OPEN EXCEMPINED S AMINIMUM OF THE OPEN EXCEMPINED.

ARCHITECTURAL CHARACTER THE PROJECT WILL HAVE A CONTEMPORARY ARCHITECTURAL STYLE FEATURING STAGGERED GROUPS OF STACKED BALCONIES CREATING A PLAYFUL VISIAL RHYTHM ACROSS THE LOW-SLING WID-RISE BUILDING. A STRONG TRIPARTITE DESIGNO FITHE ELEVATIONS ARE EMPHASIZED BY THE GRAY BRICK (PASSE) GROUPED BALCONIES (BOOY), AND STEPPED BACK TOP FLOOR WITH ARTICULATED ROOF LINE (TOP), THE ARCHITECTURAL VCCABULARY SERVES TO TRANSITION FROM THE SIMPLE RECTILE HEAR LINES OF THE 6-STOREY REMY PROJECT TO THE TRADITIONAL PINER-SCALED ELEMENTS AT THE TOWN-HOUSES.

6-STARET REMIT PROJECT TO THE TRADITIONAL PRIEST-SCALED ELEMENTS AT THE TOWNHOUSES.
THE EXTERIOR CLADDING IS A COMBINATION OF SMOOTH AND "EXTURED FIRIR-CEMENT BOARD WITH META
REVEALS. EXTERIOR ACCENT CLADDING MATERIALS SLOTH AS BRICK, CEDAR SOFFITS OR METAL CLADDING
OTHER ARCHITECTURA. ACCENTS INCILIDE HIGH CONTRASTION METAL RELOGNY GLADRANGLES AS MELLA SKY. SOME FULL-HEIGHT GLAZED WALLS AT BOTH ENTRY LOBBIES AND THE INTERIOR AMENITY AREAS

TOTALS

225, 325 425. 103, 120. 101, 107 116 122, 202, 208 217, 223, 302, 308 317, 323, 402, 408 417, 423, 502, 608 512, 618, 115, 216, 318, 416, 214, 314, 414.

224, 324, 424,

THE PROJECT SISTE PLANNING STRIVES TO MEET THE WEST CAMBIE AREA PLAN'S ALEXANDRA LIVABILITY CUIDELINES (8.1). THE PROJECT'S LOCATION AND OVERALL DESIGN ADDRESSES THE VARIOJS ASPECTS OF SOCIAL INFRADICUTAE IN THE FOLLOWING WAYS

INFIGURE OF THE DEVELOPMENT WILL COMPLETE THE LOCAL FRONTAGE AND BEAUTIFICATION PUBLIC WORKS (I.E. SIDEWALKS, BOULEVARDS, LANDSCAPING, LIGHTING, ETC).

2,031,7 m² (21,869 SF) 97,6 m² (1,050 ft²)

12.326,7 m² (132.684 ft²) 904,5 m² (9,737 ft²)

AFFORDABLE LEMR HOUSING UNITS (AHU) / BASIC UNIVERSAL HOUSING UNITS (BUH) *ALL AHU ARE BUH

PROXIMITY TO AMENITIES: THE PROJECT HAS CONVENIENT ACCESS TO ARTERIAL ROADS. HWYS 91 A 99, AS WELL AS TO PUBLIC TRANSIT, SCHOOLS, PARKS, AND SHOPPING AMENITIES.

EXEMPTIONS

422.6 m² (4.S50 ft²)

128.1 m² (1,379 ft²)

128.1 m² (1,379 ft²)

128.1 m² (1,379 ft²)

SIZE REQ

NET (FAR)

2.147.4 m² (23.114 f²)

2,446,9 m² (26,338 ft²)

2,446.9 m² (26.338 ft²)

2,446.9 m² (26,338 ft²)

1,934.1 m² (20,819 ft²)

11 422 2 m² / 122 947 ft² 1

TOTAL AREA REQ (m²)

CITY DIRECTED PRIORITIES AFFORDABLE/UNIVERSAL HOUSING, DEU.

FLOOR AREA BREAKDOWN SUMMARY

GROSS (m² & ft²

2.570.0 m² (27.664 ft²)

2,575.0 m² (27,717 h²)

2.575.0 m² (27.717 ft²)

3

WASTE MANAGEMENT SUMMARY

D2-U E1-U

AHU & BUH SUMMARY

2,575.0 m² (27,717 ft²)

ACCESSIBILITY AS A DOUBLE-FRONTING SITE (FACING BOTH MCKIM WAY AND CAMBLE ROAD), THE BUILDING IS DESIGNED TO FACILITATE ENTRY ACCESSIBILITY FROM BOTH ROADS AS WELL AS PROVIDE ACCESS TO THE COMMON OUTDOOR AMENITY AREAS.

NEIGHBOURLINESS: SMOOTH TRANSITIONS TO ADJACENT PROPERTIES ARE CREATED BY SETTING
THE TOP OF THE PARKADE PODIUM SURFACE TO MATCH THE ADJACENT FINISHED GRADES (I.E. AVOID OVERLOOK ISSUES). AT THE PUBLIC SIDEWALKS LEVEL OR EASY CHANGES OF GRADE, AND DIRECT VISUAL CONNECTIONS ARE PROVIDED TO THE ENTRY LOBBIES. THE LANDSCAPING! GNAGE/LIGHTING IS DESIGNED TO: (i) MEET CPTED OBJECTIVES, (ii) DENTIFY AND ENHANC

PUBLIC VS PRIVATE OUTDOOR SPACES, AND (III) HIDE ONSITE PARKING AND LOADING ACTIVITIES. DAYLIGHT & VIEWS: THE MASSING IS DESIGNED TO CREATE APPROPRIATE PHYSICAL SEPARATION FROV THE ACJACENT PROJECTS TO IMPROVE DAYLIGHT PENETRATION AND VISUAL PRIVACY. FROVE THE ADMINIST FROUDT IS TO IMPROVE ON LIGHT PRESENTING AND VISION THE RESIDENTS. THIS FEATURE ATTHE TRANSOLAR REMNANT SITE ALSO SERVES TO VISIOLAL OPEN UP THE NORTH END OF THE ALEXANDRA WAY FEODWAY SETWEEN THE BERKELEY HOUSE AND MAPFAIR PLACE PROJECTS.

LANDSCAPING AND OPEN SPACE DESIGN

LANDSCAPING AND OPEN SPACE DESIGN
THE LANDSCAPING AND OPEN SPACE DESIGN
THE LANDSCAPING AND GREE SPACE DESIGN ACHIEVES A NUMBER OF IMPORTANT OUTDOOR FUNCTIONS.
FIRST IT FACILITATES AN ACCESSIBLE, WELL LT PEDESTRIAN CIRCLATION AND BUILDING EXTING THROUGH
THE SITE, OVER THE PRANCAD PODIUM. SECOND THE MALOR PATHWAYS DEFINE ZONES OF COMMON
RESIDENT ACTIVITY A REAS FROM ZONES OF PRIVATE RESIDENTIAL DUTDOOR SPACE. THE LANDSCAPED
ARRAS ON THE BUILDING SIDE OF THE PATHS WILL FEATURE OF ENSER LANDSCAPING THAT SERVE AS VISUAL
PRIVACY SCREENING TO THE MAIN FLOOR RESIDENT PATIOS AND BEDROOMS. THE LANDSCAPE DESIGN ON
THE OTHER SED OF THE PATHWAYS WILL FEATURE OF CONTROL PROPRIED IN TERRACTION AND
COMMUNAL NEIGHBOURLY ADTIVITES IN VARIOUS SIZE GROUPINGS AND ACTIVITY PYES. THERE WILL BE
SEVERAL SWALL OUTDOOR PHORTURE GROUPINGS, PATHSIGE BENCHES FOR RESTING, AN ACTIVE KIDS! PLAY
AREA ZONE, AND A LARGER WELL DEFINED PLAZA AREA FOR RESIDENT EVENTS SUCH AS OUTDOOR NOVIES
MEETINGS ON INFORMALE INTERTAINMENT. THESE ACTIVE OUTDOOR AREAS ON THE WEST SIDE OF THE
BUILDING, CIRC INFORMATION BE AN EXTENSION OF THE LOSD BY AND AMENTY SPACES AT THE SOLTH END OF THE
BUILDING ARE MEANT TO BE AN EXTENSION OF THE LOSD SY ISSUALLY CUED TO EXTEND FROM THE WORLD. SULDING, ORE MEAN TO BE FAVE KENDOOR AND THE COBSTAND AMEN'T SPACES AT THE SOCI IT END OF THE MEAN THE SOCIAL PROPERTY OF THE MEAN THE MEA

INTERIOR AMENITIES FOR RESIDENTS

IN ADDITION TO THE OUTDOOR LANDSCAPED AMENITY AREAS. THIS PROJECT ALSO FEATURES INDOOR AMENITY AREAS FOR THE RESIDENTS. ON THE MAIN FLOOR, THE AMENITY SPACES ARE LABELED FITNESS AMENITY AREAS FOR THE RESIDENTS, ON THE MAIN FLOOR, THE AMENITY SPACES ARE LABELED FITNESS; LIBRARY, MERITMON AND MULTIPIERPOSE: THEIR LOCATION AT THE MAIN FLOOR ADJACENT TO THE ENTRY LOBBY SHOULD ENCOURAGE RESIDENT INTERACTION AND ACHIEVE SOME LEVEL OF SEPARATION HOUSE SECURITY; FAREA AT EACH RESIDENT FLOOR A COMMON AMENITY ROCK IS AVAILABLE FOR MESIDENT USES SUCH AS MUSIC LESSONS SITH TOWN A COMMON AMENITY ROCK IS AVAILABLE FOR MESIDENT USES SUCH AS MUSIC LESSONS SITH TOWN A COMMON AMENITY ROCK IS AVAILABLE FOR THE STATE OF THE STATE OF

SHADOWING IMPACT ON THE EAST NEIGHBOUR (REMY PROJECT)

STADDWING MYACL ON THE EAST REIGHDOWN INSEMT PROJECT!

TO ADDRESS OUR STIONS ABOUT DALK'S HADDWING ON THE ADJACENT REMY BUILDING. ADDITIONAL 3D IMAGES ARE PROVIDED - LOOKING BOTH NOR'T HAND SOUTH BETWEEN THE BUILDINGS. S - SHOWING SHADOW PROLECTIONS ON THE \$ STOREY BUILDING. THIS GAP IS ORIENTED NORTH-SOUTH, SO THERE IS DIRECT SUNLICHT PENETRATION EVERY DAY BETWEEN THE BUILDINGS. THE AVALYSES SHOWS HOURLY SHADOWING DURING THE IRM-GPM PERIOS ON IT HE MARCH. S SEPTEMBER SOLAR EQUINOKES, AND THE JUVE SOLSTICE.

ZONING BYLAW COMPLIANCE

THE PROPOSED DEVELOPMENT WILL ABIDE WITH A CUSTOM ZONING DISTRICT SCHEDULE, BUT THE PROJECT IS EXPECTED TO FULLY COMPLY WITH THE CORRENT ZONING SYLWI IN TERMS OF THE TYPICAL ZONING PARAMETERS SUCH AS DENSITY, PARKINGLOADING, SITE COVERAGE ENERGY CONSERVATION, AND CARRAGERECYCLE PACILITIES. MINIMUM BULLONG SETBACKS AND IMAXIMUM SULLION GENOT WILL BE ESTABLISHED DURING THE APPROVALS PROCESS, NO ZONING VARIANCES ARE BEING REQUESTED.

THE PROJECT PROVIDES 5 AHJI'S (AFFORDABLE HOUSING UNITS) TOTALING 452.1 MZ (0.67 FAR = 3/3 OF 0.2 BONUS DENSITY), PER THE AFFORDABLE HOUSING STRATEGY, THESE JNITS WILL BE REGISTERED ON TITLE AND REGULATED BY A HOUSING AGREEMENT WITH THE CITY, OF THESE, 2 ARE 2-BR AND 3 ARE 3-BR.

AND RESULTING BY A HOUSING MARKEMENT WITH THE LITT, UP THESE, ZAME JOB AND JAME JOB.

THE PARKING REQUIREMENT LOOM/LANCE STRATEGY IS OUTLINED IN THE TRANSPORTATION DEMAND

MANAGEMENT PLAN, IT PROPOSES A REDUCTION OF THE GENERAL REQUIREMENT OF 1,7 SPACESHUNT

OZYTO 1,35 TALI SLIVINIT. THE PROJECT PROPOSES 193 SPACES (164 VARKET RESIDENTIAL STALLS - 24

AFFORDABLE RESIDENTIAL STALLS - 24 VISITOR STALLS OF WHICH 2 ARE CAR SHARE STALLS, THE TOM

MEASURES TO SUPPORT THIS PARKING REQUIREMENT REDUCTION IS AS FOLLOWS

- PROVISION OF 120V ELECTRIC PLUG-INS FOR ELECTRIC BIKES, ONE FOR EVERY 40 BICYCLE STORAGE RACKS (IF THERE ARE FEWER THAN 40 BICYCLE RACKS IN A STORAGE COMPOUND, ONE 120V ELECTRIC PLUG-IN IS REQUIRED FOR EACH COMPOUND)
- VOLUNTARY CASH CONTRIBUTION OF \$15,000 TOWARD THE CONSTRUCTION OF MULTI-MODAL
- WAYFINDING SIGNS IN THE WEST CAMBIE AREA, AND VOLUNTARY CASH CONTRIBUTION OF \$2,500 TOWARDS CYCLING-RELATED INFRASTRUCTURES IN THE WEST CAMBIE AREA.

THE TRANSPORTATION CONSULTANT WILL ALSO ADVISE ON THE VEHICLE C RCULATION BOTH WITHIN AND OUTSIDE THE PARKADE, THE REQUIREVENT TO HAVE SERVICE VEHIDLES BACK INTO THE LOADING -AND NOT

BACK OUT ONTO THE STREET - HAS BEEN NOTED.

THE PROJECT WITH. BE CONSERT NO FEL.

THE PROJECT WITH. BE CONSECTED TO THE ALEXANDRA DISTRICT ENERGY LITLITY INFRASTRUCTURE. THE
DEU WILL BE EXPECTED TO DELIVER ENERGY FOR SPACE HEATING, CCOLING, AND DOMESTIC HOT WATER IN
COMPLIANCE WITH A LEXANDRA DISTRICT ENERGY LITLITY BY LAW NO, 8841. IN ADDITION, TO MEET THE
ELECTRIC VEHICLE CHARGING INFRASTRUCTURE REQUIREMENTS, EACH RESPONTIAL. PARKING STALL
EXCLUDING VISITOR PARKING MUST FEATURE AN ENERGIZED CUTLET CAPABLE OF PROVIDING. EVEL 2
CHARGING, PER ENGINEERING SE BULLETIN DATED 2018-3018. TWO STRATEGIES MAY BE USED TO MEET THE
REQUIREMENTS. (I) DEDICATED CIRCUITS, AND (II) EV WANAGEMENT SYSTEMS.

IN TERMS OF BUILDING SETBACK REDUIREMENTS, 4 DW MINIMUM SIDE YARD AND CAMBIE ROAD SETBACKS ARE PROPOSED FOR THE UPPER FRAMED BUILDING, AND 7 3M AT MCKIM WAY. FOR THE HALF-STOREY SUNKEN PARKADE, SIDEYARD SETBACKS ARE PROPOSED AT 0.9 M (WEST) AND 1.2 M (EAST), 2.0 U AT CAMBIE ROAD, AND 7.5 M AT VICKIM WAY. AT THE STREET FRONTAGES, THE DUITDOOR STAIRS AND RAMP ARE PROPOSED TO NOT EXCEED A MAXIMUM 2,5M PROJECTION INTO ROAD SETBACKS.

ACCESSIBILITY STRATEGY

ACCESSIBILITY IS LARGELY ADDRESSED BY THE REQUIREMENTS OF THE BC BUILDING CODE, BEYOND THIS THE STRATEGY IS TO PROVIDE ACCESSIBILITY TO ALL THE COMMON RESIDENT AREAS AND EXCEED THE MINIMUM CITY EXPECTATIONS FOR UNIVERSAL HOUSING UNITS,

- a) 2018 BC BULDING CODE, THE LATEST ACCESSIBILITY REQUIREMENTS HAVE BEEN RECENTLY UPDATED AND ILLUSTRATED IN THE "BUILDING ACCESSIBILITY HANDBOOK 2020", THERE ARE REQUIREMENTS FOR ACCESSIBLE WASHROOMS, IMPOOR AMENITY SPACES, POWER DOOR OPENERS (AT BUILDING ENTRIES). RAMP DESIGN LEVEL PATHWAYS FROM ACCESSIBLE SPACES TO RESIDENT UNIT DOOR
- b) BASIC UNIVERAL HOUSING. THE CITY OR RICHMOND PROVIDES FAR BONUSING (I.E.) 85M2 [20 SF] PER BUH UNIT). THESE FEATURES ARE DESCRIBED IN SECTION 1, 16 (I.E. DIMENSIONS AND CLEARANCES FOR KEY ACTIVE AREAS EASY-TO-USE FEATURES LIKE ROCKER LIGHT SWITCHES, EASE OF REACH, SUP-RESISTANT FLOOR SURFACES ETC.). FOR THIS PROJECT, THE OCP GUIDELINES CALL FOR 10% BUH; 36 OF THE '26 UNITS ARE PROPOSED (29%).
- CIENHANCED ACCESS AT STREET ENTRIES TWO BUILDING ENTRIES ARE PROVIDED FOR THIS DOUBLE-FRONTING DEVELOPMENT SITE. THE PRIMARY ENTRY (MCKIM) IS SERVED BY A 3-SEGMENT RAMP WITH INTEGRATED BENCH REST AREAS AT THE INTERMEDIATE LANDINGS. AT THE SECONDARY ENTRY LOBBY (CAMBIE), A WHEELCHAIR PLATFORM LIFT IS AVAILABLE TO PROVIDE ACCESS TO THE MAIN RESIDENT. LEVEL (I.E. TO THE ELEVATORS) AND TO THE PODICY OUTDOOR RESIDENT AMENITY AREAS.
- a) AGING-IN-PLACE MEASURES. THESE MEASURES INC. JDE (!) LEVER-TYPE HANDLES TO PLUMBING FIXTURES AND DOOR HANDLES. (!) SOLID BLOCKING WITHIN WALLS FOR FUTURE INSTALLATION OF GRAB BARS AT TOLLETS TUBS AND SHOWER. THEY WILL GE SPECIFIED FOR ALL 126 RESIDENT UNITS.
- e) <u>ELEVATING DEVICES</u> TWO FULL-SIZE ELEVATORS ARE PROVIDED AT THE MAIN MCKIM ENTRY, ELEVATOR REQUIRES SERVICING, THE OTHER ELEVATOR WILL BE AVAILABLE FOR RESIDENT U GARBAGERECYCLE ROOM. IT HE PARKADE. THE WHEEL CHAIR PLATFORM HET WILL PROVIDE FUNCT ONALITY FOR BOTH RESIDENT WHEELCHAIRS AND THE TRANSPORT OF REFUSE.
- f) <u>RESIDENT AMENITY AREAS</u>: ACCESSIBILITY IS PROVIDED AT THE MULTIPURPOSE, FITNESS, KITCHENETTE, AND LIBRARY AREAS. THE RESIDENT COMMUNITY GARDEN IS DESIGNED WITH PLANTERS OF VARYING SILL. HEIGHTS TO ENCOURAGE USE BY RESIDENTS OF VARYING PHYSICAL ABILITY.

SUSTAINABILITY STRATEGY

SUSTAINABILITY IS ADDRESSED BY COMPLYING WITH THE REQUIREMENTS FOR THE ENERGY STEP CODE 3 (2018 BC BUILDING CODE) AND THE DISTRICT ENERGY UTILITY, THEN EXCEEDING THEM WHERE POSSIBLE:

- a) <u>EMERGY STEP CODE LEVEL 3</u>. THESE CODE REQUIREMENTS PROVIDE TARGET METRICS FOR EMERGY USAGE COMP. ANCE DURING THE DESIGN AND CONSTRUCTION OF THE BUILDING. DESIGNED TO PROACTIVELY OPTIMIZE EMERGY USE AND REQUEC CARBON EMISSIONS, THESE METRICS WILL REGULATE AIRTIGHTNESS (MINIMIZE EMERGY LEAKAGE, EMERGY USE BY EQUIPMENT AND SYSTEMS, AND THERMAL RESISTANCE (ENVELOPE ASSEMBLIES).
- b) <u>DISTRICT ENERGY UTILITY</u>. THE ALEXANDRA DISTRICT ENERGY UTILITY IS A GEOTHERMAL-BASED SYSTEM THAT CENTRALIZES ENERGY PRODUCTION FOR HEATING COOLING AND DOMESTIC HOT WATER, THE BENEFITS OF BEING PART OF THE ADEU INCLUDE: (I) AVAILABLE HEAT NO S. COOLING FOR RESIDENT COMFORT, III) SMALLER-SIZED DONSTIE MECHANICAL EQUIPMENT, (II) INCREASED ENERGY EFFICIENCY BY MATCHING ENERGY SUPPLY WITH ENERGY DEMAND. (IV) REDUCES USE OF FOSSIL FLELS AND SUBSEQUENT GREENHOUSE GASES.
- E) <u>CENTRAL LOCATION.</u> THE SUBJECT SITE IS CENTRALLY LOCATED WITH VERY GOOD WALKABILITY TO PUBJIC TRANSIT, SHOPPING, SCHOOLS AND RECREATION FACILITIES, BIRISGIN RICHMORID IS ALWAYS A CONVENIENT OPTION. SO THE BIRE STORAGE ROOMS PROVIDE ABOUT 9'A MORE THAN THE MINIMUM REOT).
- B) ORIENTATION TO DIRECT SUNLIGHT: THE RESIDENT BALCONIES, SOME LARGER THAN OTHERS, ALL EXCEED MINIMUM SPACES REQUIREVESTS AND SHOULD ENCOURAGE SNOWENT OUTSIDE OF THE UNITS INTERNAL CLUSTER AND SHOULD ENCOURAGE SNOWENT OUTSIDE OF THE UNITS INTERNAL CLUSTER OF BALCONIES ARCHITECTURALLY BRACKETED FOR PRIVACY; ARE ORIENTED TO THE SOUTHER CONTROL OF THE UNITS.
- e) <u>FENESTRATION</u>: THE EXTERIOR WALLS ARE CONSERVATIVELY FENESTRATED TO PROVIDE AN ENERGY-EFFICIENT BALANCE OF ENERGY-SAVING DAY IGHT (LARGE? WINDOWS) AND ENERGY LOSS (MORE SOLIC WALLS), ALTHOUGH ALL UNITS HAVE AVAILABLE COLLING (DEU), ALL WINDOWS ARE OPENABLE FOR NATURAL VENTILATION FOR ENERGY CONSERVATION
- LOW ENERGY-WATER USE. THE PROJECT WILL SPECIFY THE FOLLOWING ENERGY-EFFICIENT DEVICES: LOW WATER FLOW TOILETS, ENERGY STAR APPLIANCES LED LIGHTING HIGH-EFFICIENCY MECHANICAL UNITS.
- g) ELECTRIC VEHICLES EVICHARGING IS PROVIDED TO BYLAW REQUIREMENTS FOR ALL RESIDENT PARKING STALLS, IN ADDITION, THE TOM MEASURES INCLUDE PROVISION OF 120VELECTRIC PLUG-INS FOR ELECTRIC SMACES ARE ON EVER EVERY 40 BICYCLE STORAGE RACKS (OR ONE PER COMPOUND), TWO CAR-SHARE VISITOR SPACES ARE IN THE PARKADE.
- IN <u>LANDSCAPING</u> THE LANDSCAPING DESIGN WILL FEATURE. (I) DROUGHT-RESISTANT NATIVE SPECIES. (II) PERMEABLE SURFACES AND LIVE P_ARTING TO INCREASE WATER RETERTION AND REDUCE STORMWARE ACQUAIN, INCREASE WATER RETERTION AND REDUCE STORMWARE ACQUAINT (INCREASE WATER RETERTION AND REDUCE STORMWARE ACQUAINT).

ZONING SUMMARY

BASIC UNIVERSAL

HOUSING (BUH) UNITS

Zoning Bylaw No. 8500

= 36 UNITS OUT OF 126 UNITS TOTAL

PERMITTED / REQUIRED PROJECT SPECIFICS (PROPOSED: RS1/F (EXISTING) LOT ZONING USES MEDIUM DENSITY HOUSING (OCP. PARTMENT HOUSING 50 FAR (BASE MKT HSG) = 10 104 m² .50 FAR (BASE MKT HSG) = 10,104 m² 0,057 ALH (452,7 m²) + 0.2 (1/3 ALH = 0.067 = 449,06 m² M(N) & (2/3 MKT = 0,133 = 898,13 m² MAX) • 0.131 MKT (880.25 m²) OTAL ALLOWABLE MAX FAR: OTAL PROPOSED FAR >>1.7 FAR - 11,451 2 m2 [123,259 ft] >1,695 FAR = 11,422.2 m² [122,947 ft²] 0,0814 INTERIOR AMENITY= 548,5 m² + 0.1 INTERIOR AMENITY = 673,6 m² MAX LOT COVERAGE 40% MAXIMUM 12.2% [2.842 M² / 6 736 m²] .5 m (MCKIM WAY), 4.0 m (CAMBIE ROAD MIN BUILDING SETBACKS 7.5 m (MCK,M WAY); 4.0 m (CAMBIE ROAD 4.0 m MIN AT INTER OR LOT LINES 4 0 m M N AT INTERIOR LOT LINES MIN PARKADE SETRACKS 7.5 m (MCK₁M WAY), 2.0 m (CAMBIE ROAD .5 m (MCKIM WAY), 2.0 m (CAMBIE ROAD 0,9 m (WEST) 0,9 m (EAST) STAIR SETBACKS 1.5 m MINIMUM AT PUBLIC ROAD 5 m AT PUBLIC ROAD BUILDING HEIGHT MAX 5 STOREYS 19.5 m 9,5 m 5 STOREYS OVER BSMT PARKADI 2.6 m GSC (PER OCP WEST CAMBIE) FARKING 192 SPACES (AFTER 10% TDM REDUX) 193 SPACES = 1.523 SP/UNIT *R. 164 SP - 1.5 PER 121 MKT UNITS * 164 RES D MARKET UNITS *R 5 SP = 1 0 PER 5 AHU UNITS * 5 RESID AFFORDABLE UNITS * V 23 SP - 0.2 PER 126 RESID UNITS *24 VISITOR (INCLUDE 2 CAR SHARE MIN. 100 m: (INDOOR) 548,5 m2 = 0,0814 FAR (INDOOR) 853 1 m² COMMON OUTDOOR (USABLE) (14.4.5.D) 6 m²/UNIT /758 m²/ COMMON OUTDOOR 3 m²/UNIT (378 m²) CHILDREN'S PLAY 384,3 m² CHILDREN'S PLAY 6 m2 PRIVATE OUTDOOR SPACE MIN. 6.3 m² PER UNIT MECHANICAL SPACE 100 m² MAX AFFORDABLE LEMB 449.06 m² MINIMUM* 452.7 m² (5 UNITS .2 x 2BR .3 x 3BR)* - ONE THIRD OF 0.2 BONUS FAR * SEE SUMMARY TABLE HOUSING (AHU) UNITS = 0.0666667 FAR ALL AHU UNITS ARE ALSO BUH UNITS * TO BE BUILT # UNITS EXCEED 60 10% (PER OCP GUIDELINES)

TARGET 85% OF ALL LEMR UNITS

| | MAR 11 2022 issue for ADP |
|---|------------------------------------|
| | MAR 4 2022 Issue for ADP |
| | FEB 18, 2022 (saue for DP 4 |
| | FEB 16, 2022 Issue for DP 4 |
| | OCT 21, 2021 Issue for DP 3 (REV1) |
| | CONSULTANTS |
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INTERFACE:

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PROJECT 126 - UNIT MID-RISE MULTI-FAMILY

DEVELOPMENT 9300 & 9320 CAMBIE ROAD

PROJECT NO 1804MCK2

SCALE As Noted

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CHECKED BY SHEET TITLE


PROJECT INFORMATION


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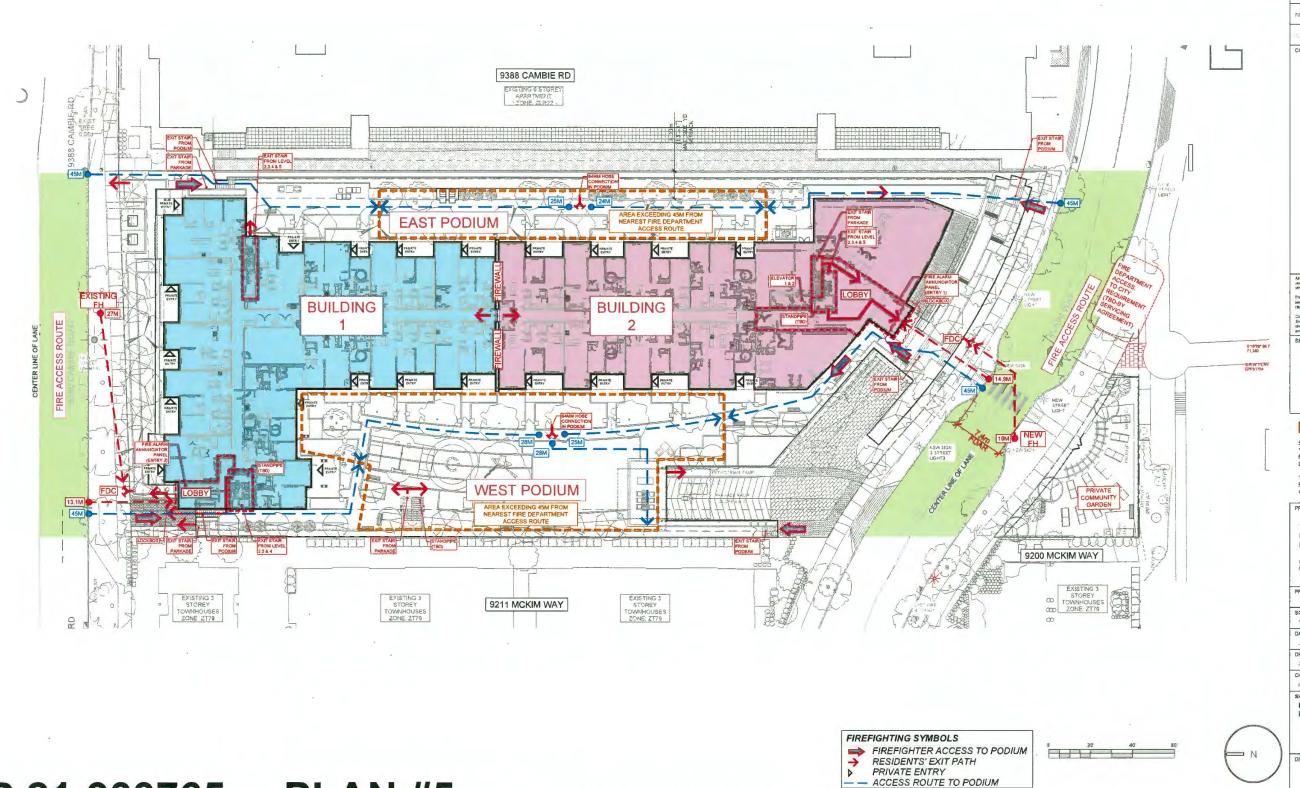
MIXED CONTAINERS REFUNDABLES MIXED PAPER V CHARGING MIKED PAPER GLASS FOOR SCRIPS CAFE OA D GAF LE H 2

UNIT MIX SUMMARY 1,049 1,087 1,163 3B+D F1 1.639

| | | | | | | | SUBTOTAL | | 1 1,639 | | 1% |
|--------------------------------|---|------------------|------------|------------------------|-----|-----|----------|------|---------|--------|------|
| 1 | | TOTAL | | 22 | 28 | 28 | 28 | 20 | 126 | 96,378 | 100% |
| | | | | | | | | | | | |
| AVERAGE SITE GRADE CALCULATION | | | | | | | | OIT | N | | |
| | | | NE | N | W | SE | | SW | | AVER | AGE |
| | | SITE A (MAIN) | 1.93 | 1. | 96 | 2.1 | 3 | 2.08 | | 2.025 | m |
| | 2 | SITE B MNANT | 2,35 | 7 | .15 | - | | 2.47 | | 2.323 | m |
|] | 4 | J , ∡ | <u>Z</u> , | AVERAGE FINISHED GRADE | | | | | 2,17 m | | |
| | | | | | | | | | | | |



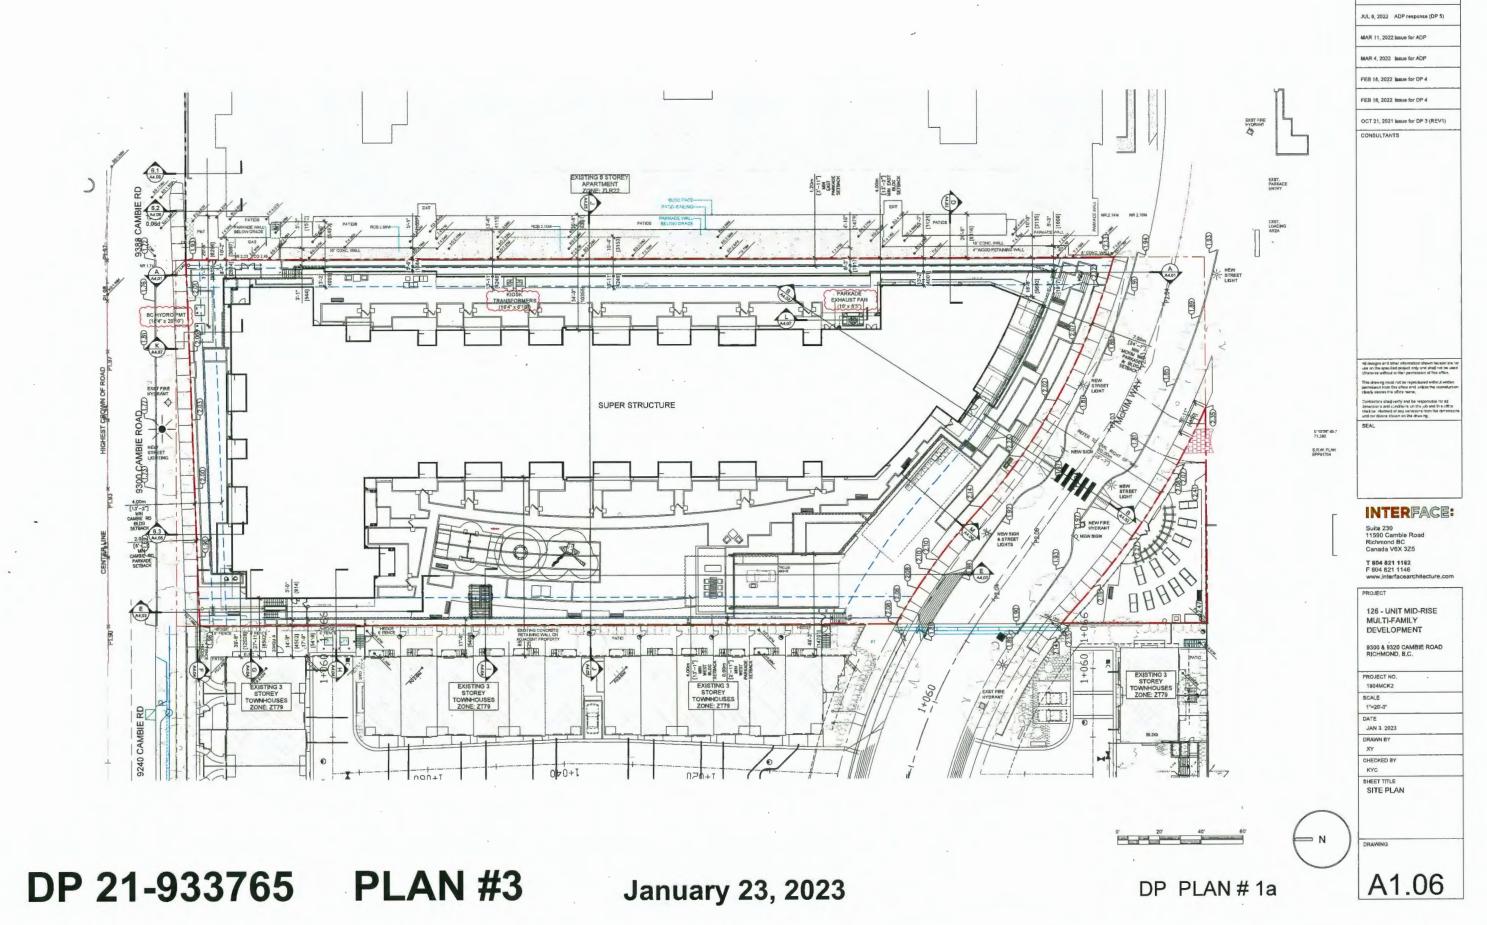

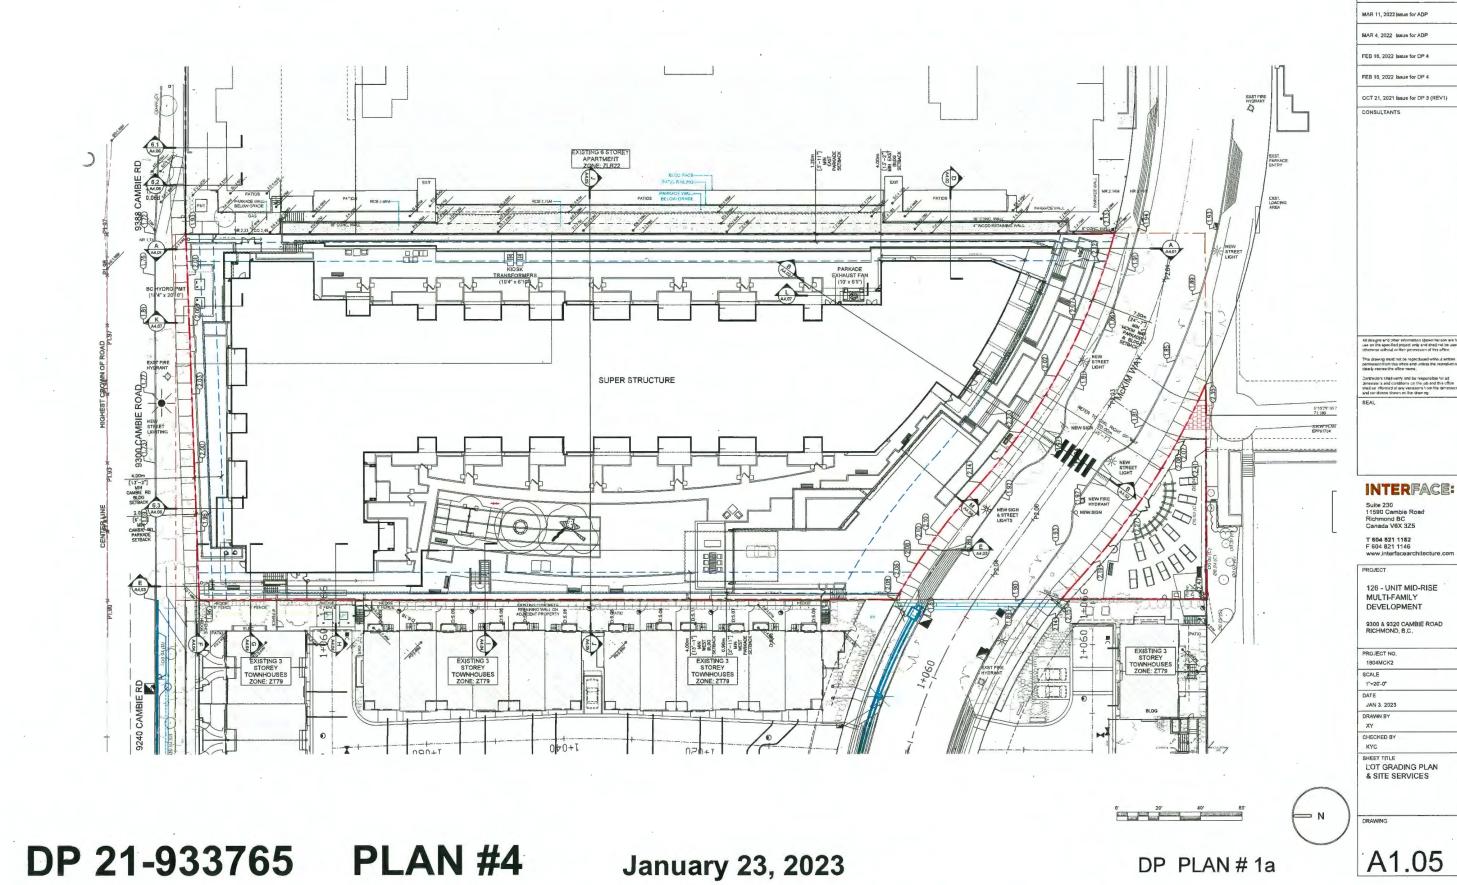

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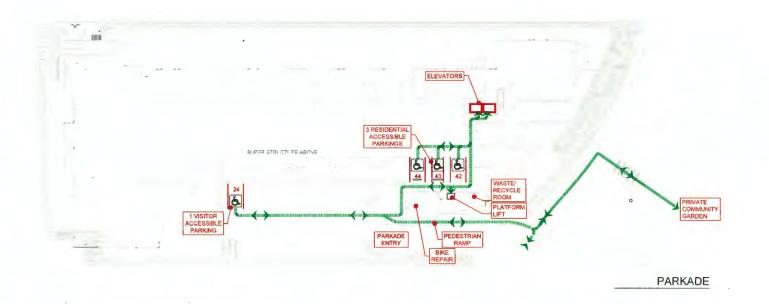
INTERFACE:

126 - UNIT MID-PISE MULTI-FAMILY DEVELOPMENT

SCALE 1"=20'0"

SHEET TITLE FIREFIGHTING PLAN

A1.07



ACCESSIBLE WASHROOM

120A

WEST

ACCESSIBILITY PATH
ACCESSIBLE TRAVEL PATH

DP 21-933765

2-WAY TRAFFIC ACCESS ARROWS

ACCESSIBLE SPACES & AREAS

()

ELEVATORS

101


122

VESTIBULE

RAMP

FITNESS

LEVEL 1

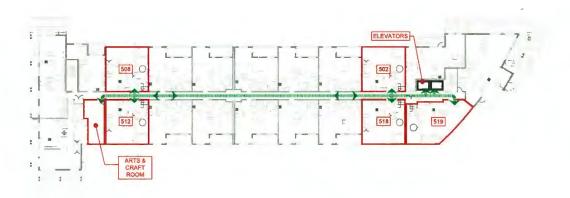

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REVISIONS

LEVEL 5

LEVEL 2,3 & 4

214 314 414 AHU & BUH SUMMARY AFFORDABLE LEMR HOUSING UNITS (AHU) / BASIC UNIVERSAL HOUSING UNITS (BUH) *ALL AHU ARE BUH UNIT 225, 325, 425, 103, 120, 101, 107, 116, 122,

202, 208, 217, 223, 302, 308, 317, 323, 402, 408, 417, 423

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PROJECT NO.

1"=30'-0" DATE

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PROPOSED & REQUIRED BUH COMPONENTS DWELLING UNIT ENTRY DOOR VACADODA CLOSET VERTICAL PLATFORM LIFT AT CAMBIE LOBBY & WASTERCOM V-1504 VERTICAL PLATFORM LIFT -----(4.7) (2004) \$10 (M* [1206mm] M(N, 1200mm)

PLAN #6


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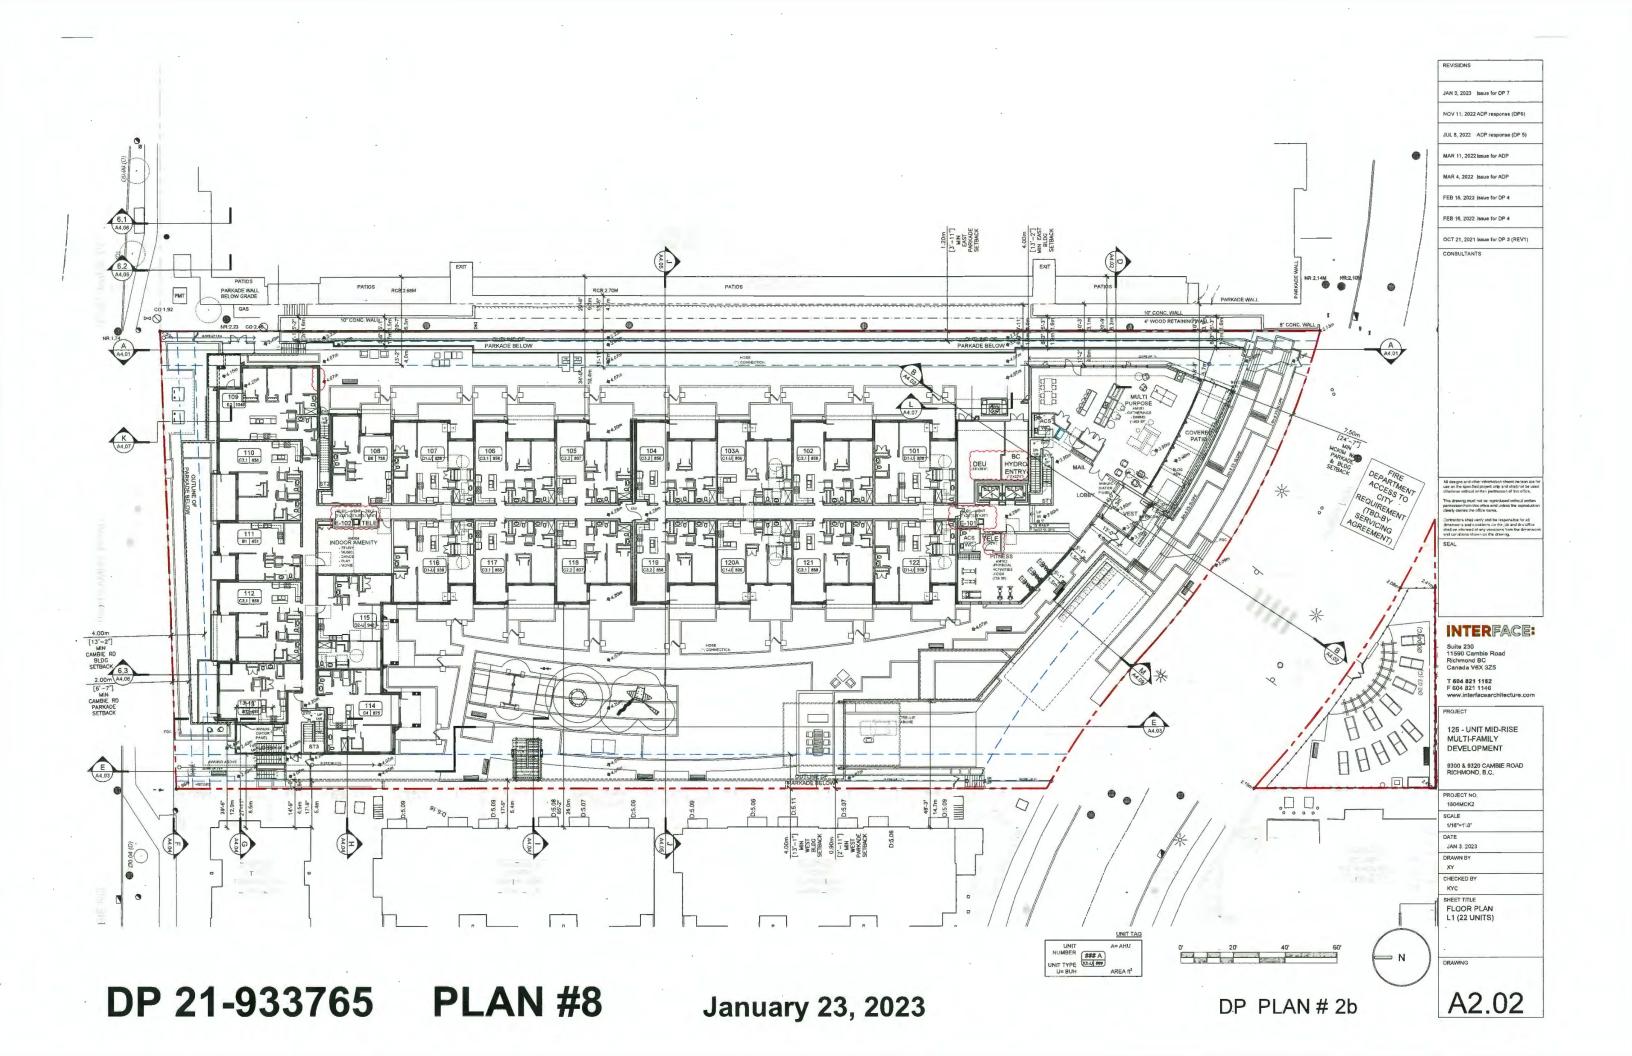
SHEET TITLE
ACCESSIBILITY . DIAGRAM


BASIC UNIVERSAL HOUSING FEATURES (Richmond Zoning Bylaw 8500)


BUILDING ACCESS: ACCESS DWELLING UNIT AND AMENITY FROM ROAD AND ON-SITE PARKING; ELEVATOR ACCESS FROM ROAD AND ENTRY TO ON-SITE PARKING; AUTOMATIC DOOR OPENER TO MAI ENTRY.


January 23, 2023




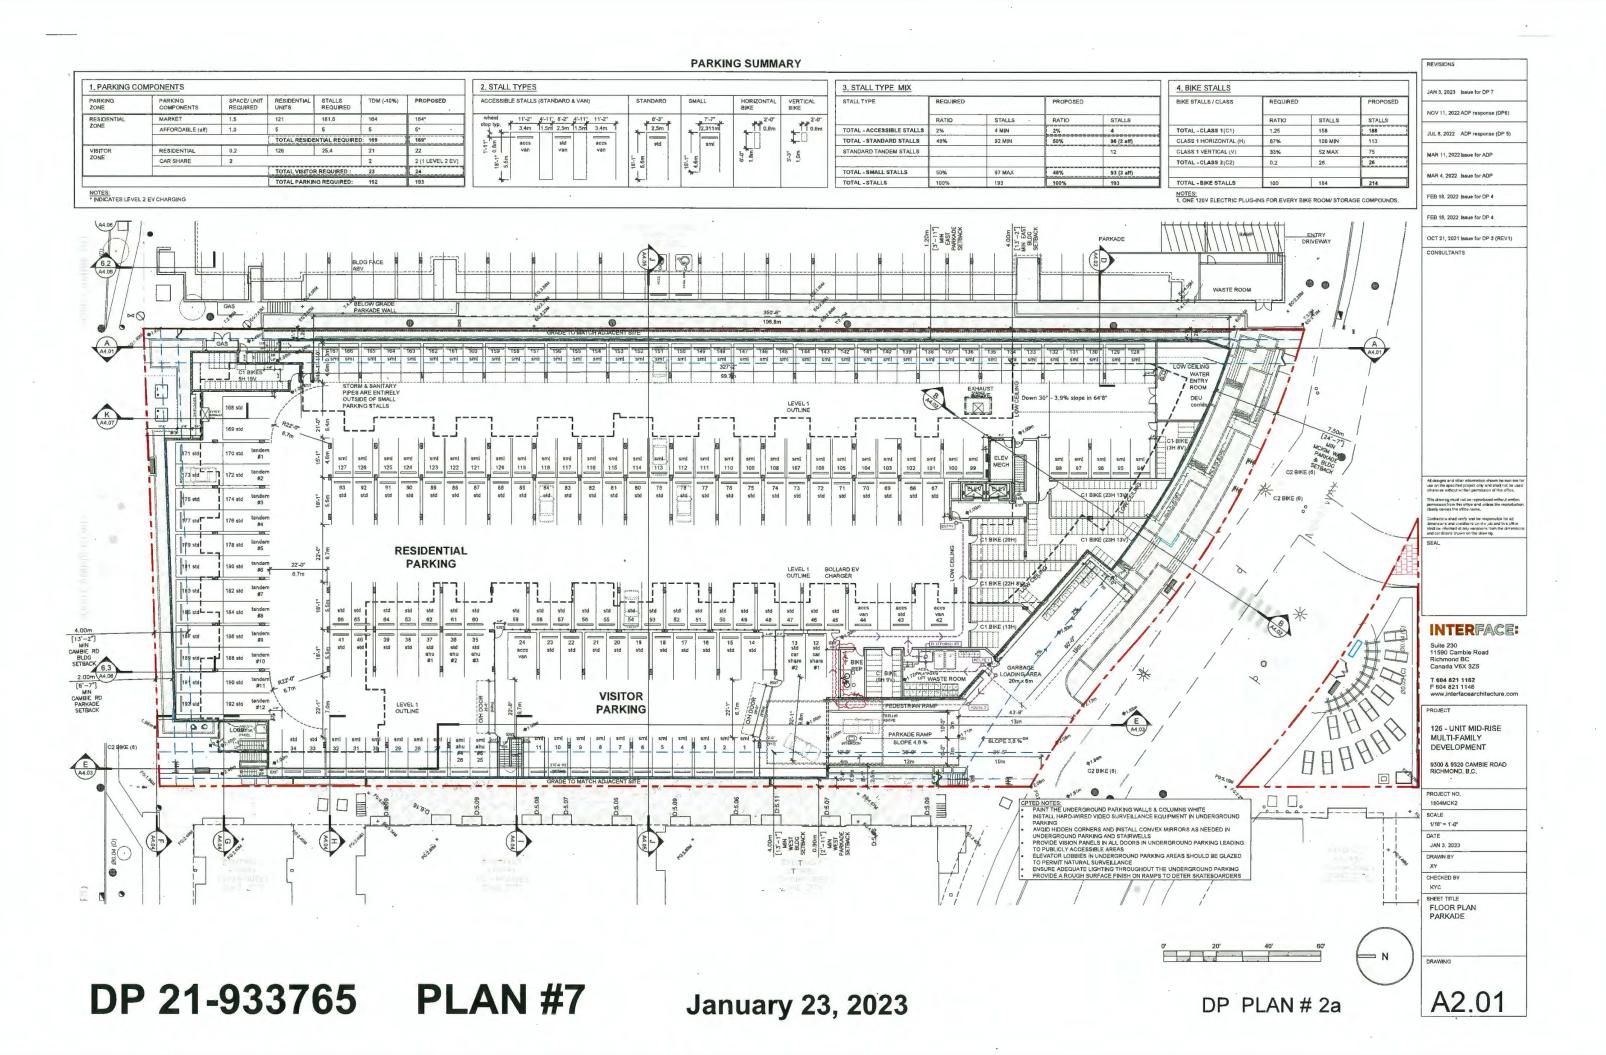


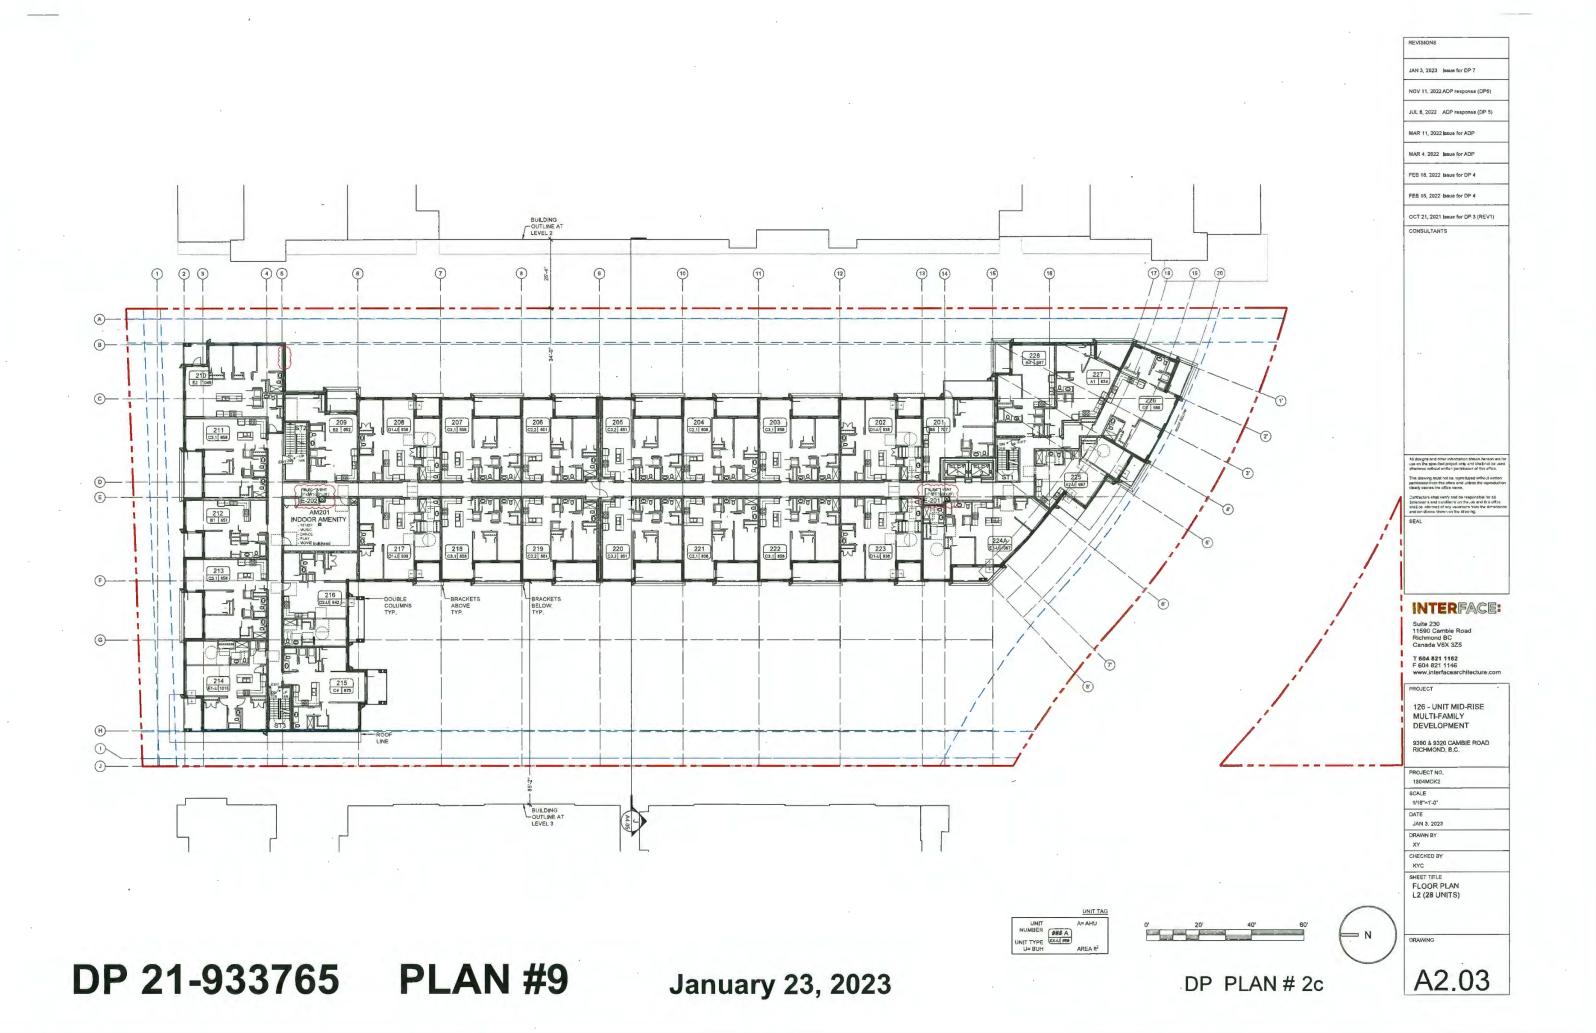

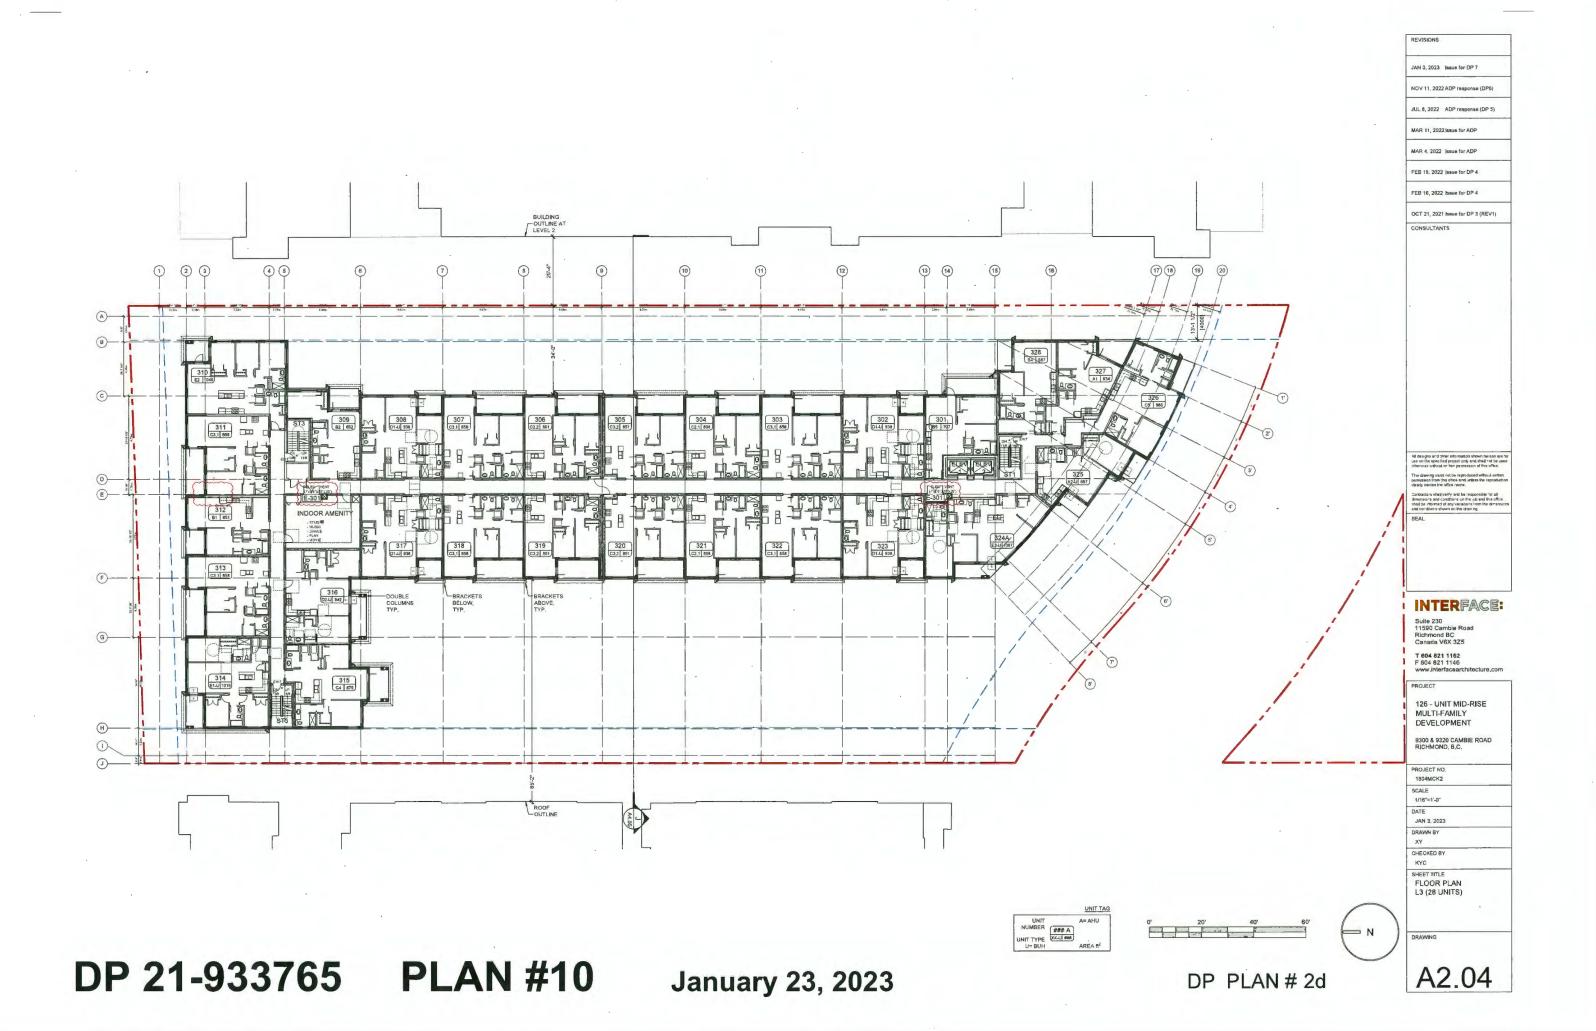

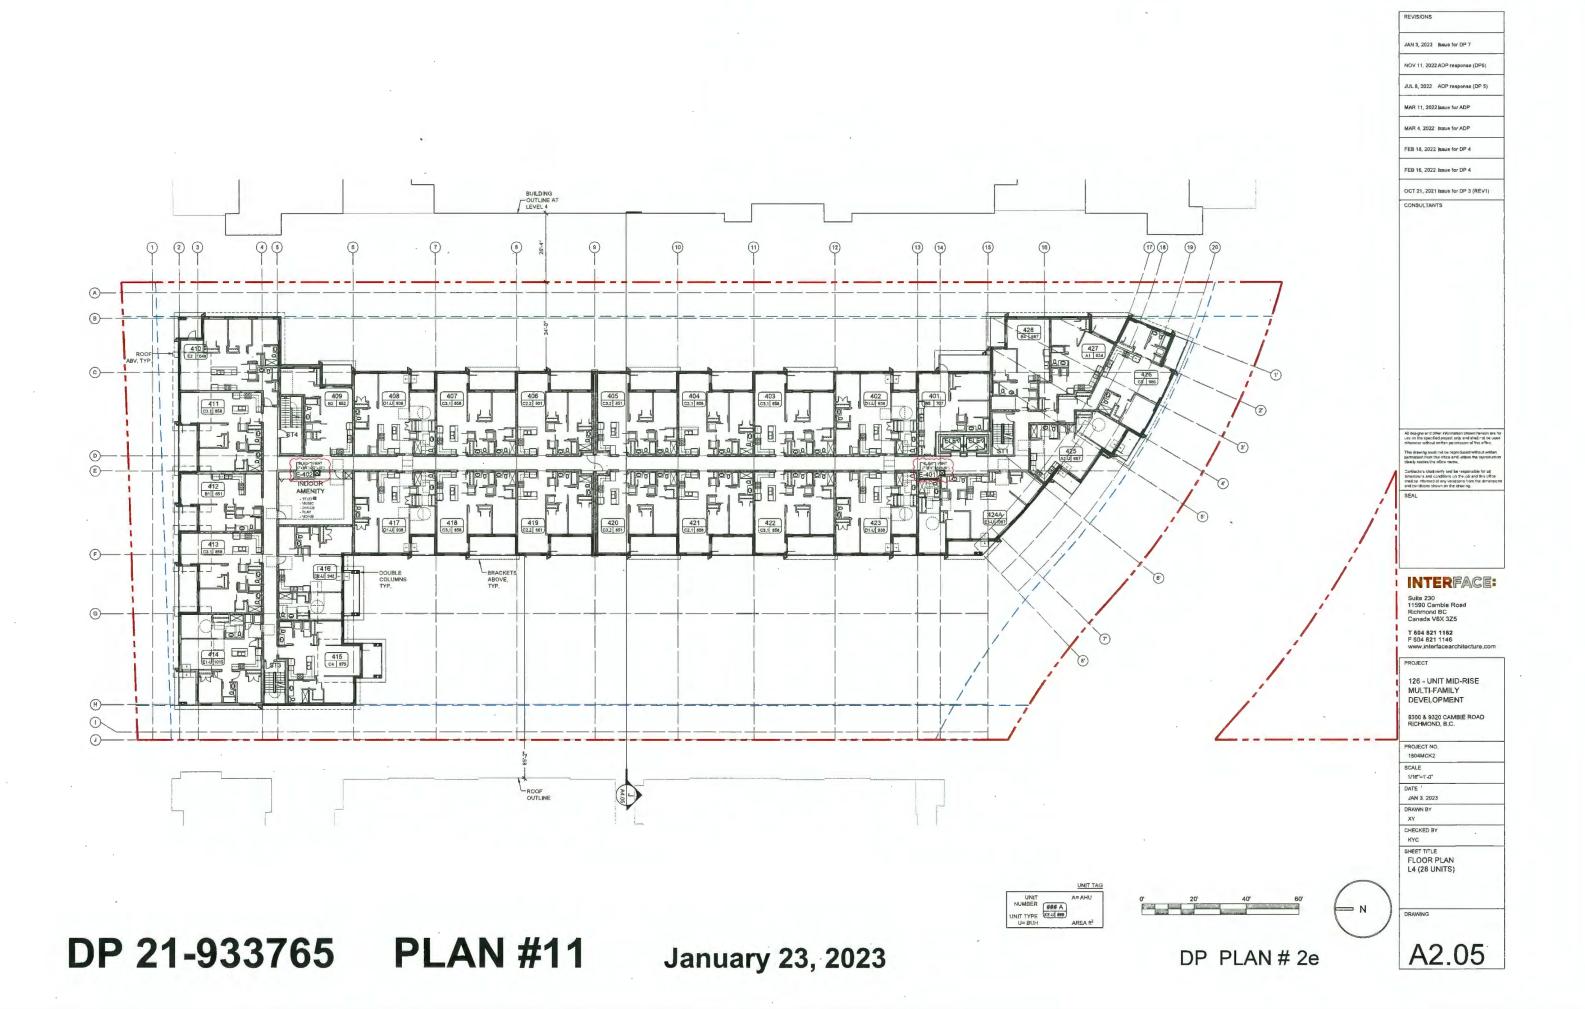

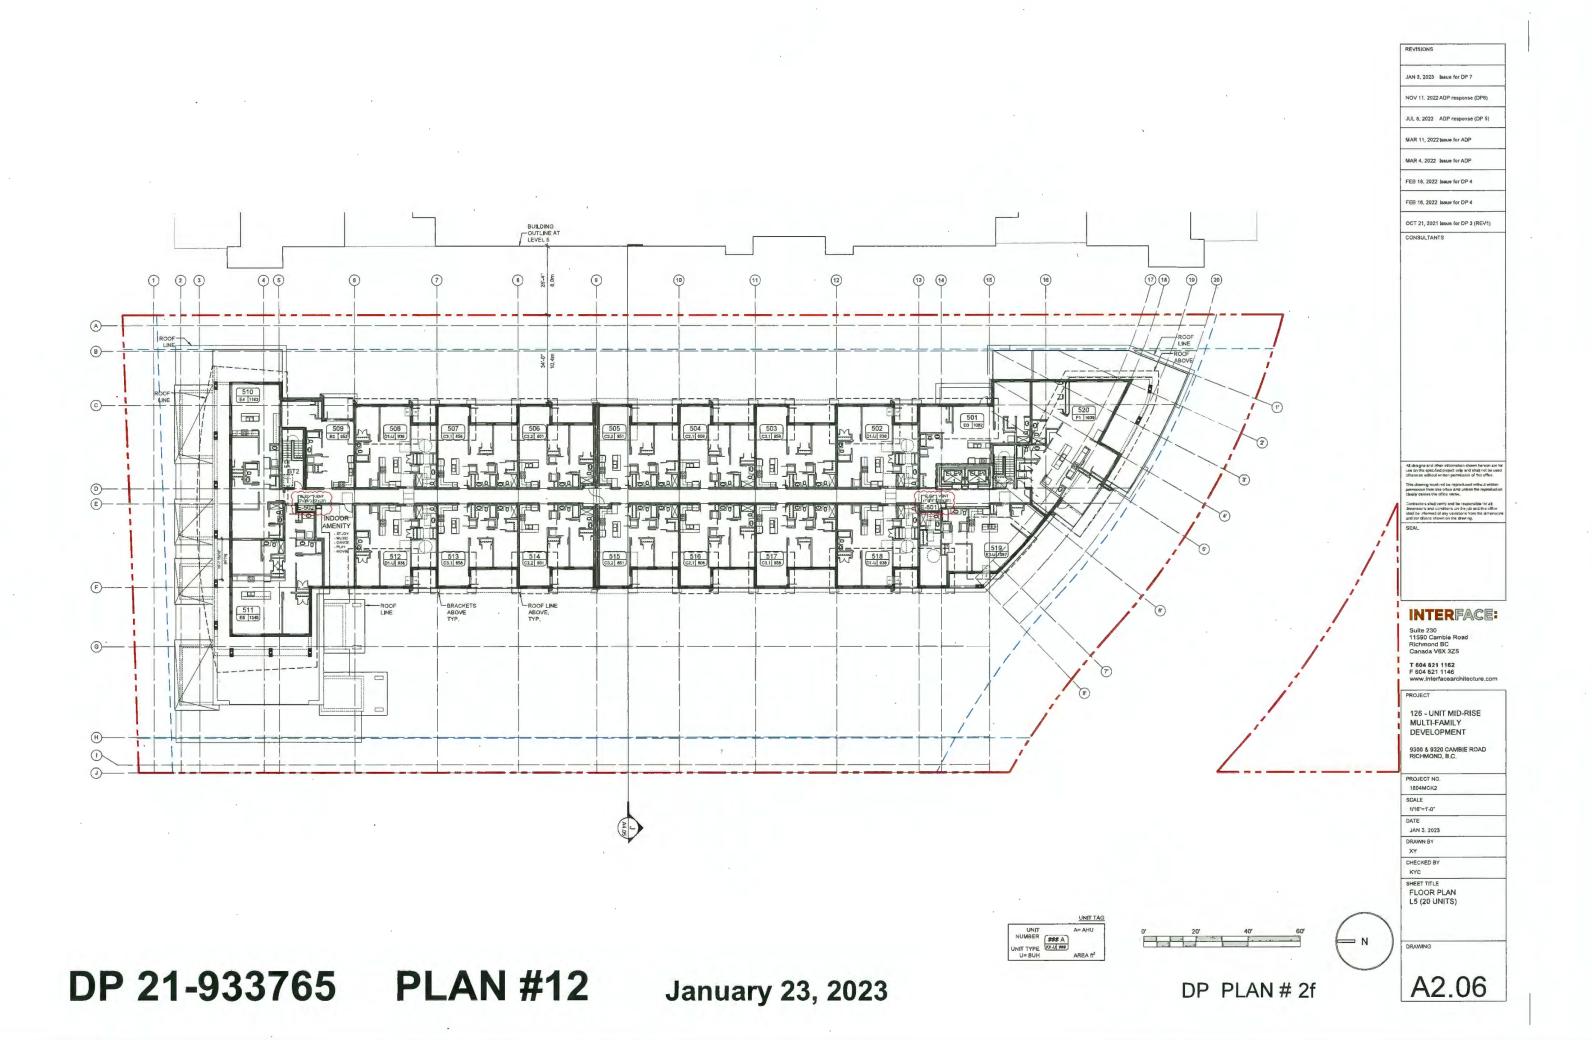

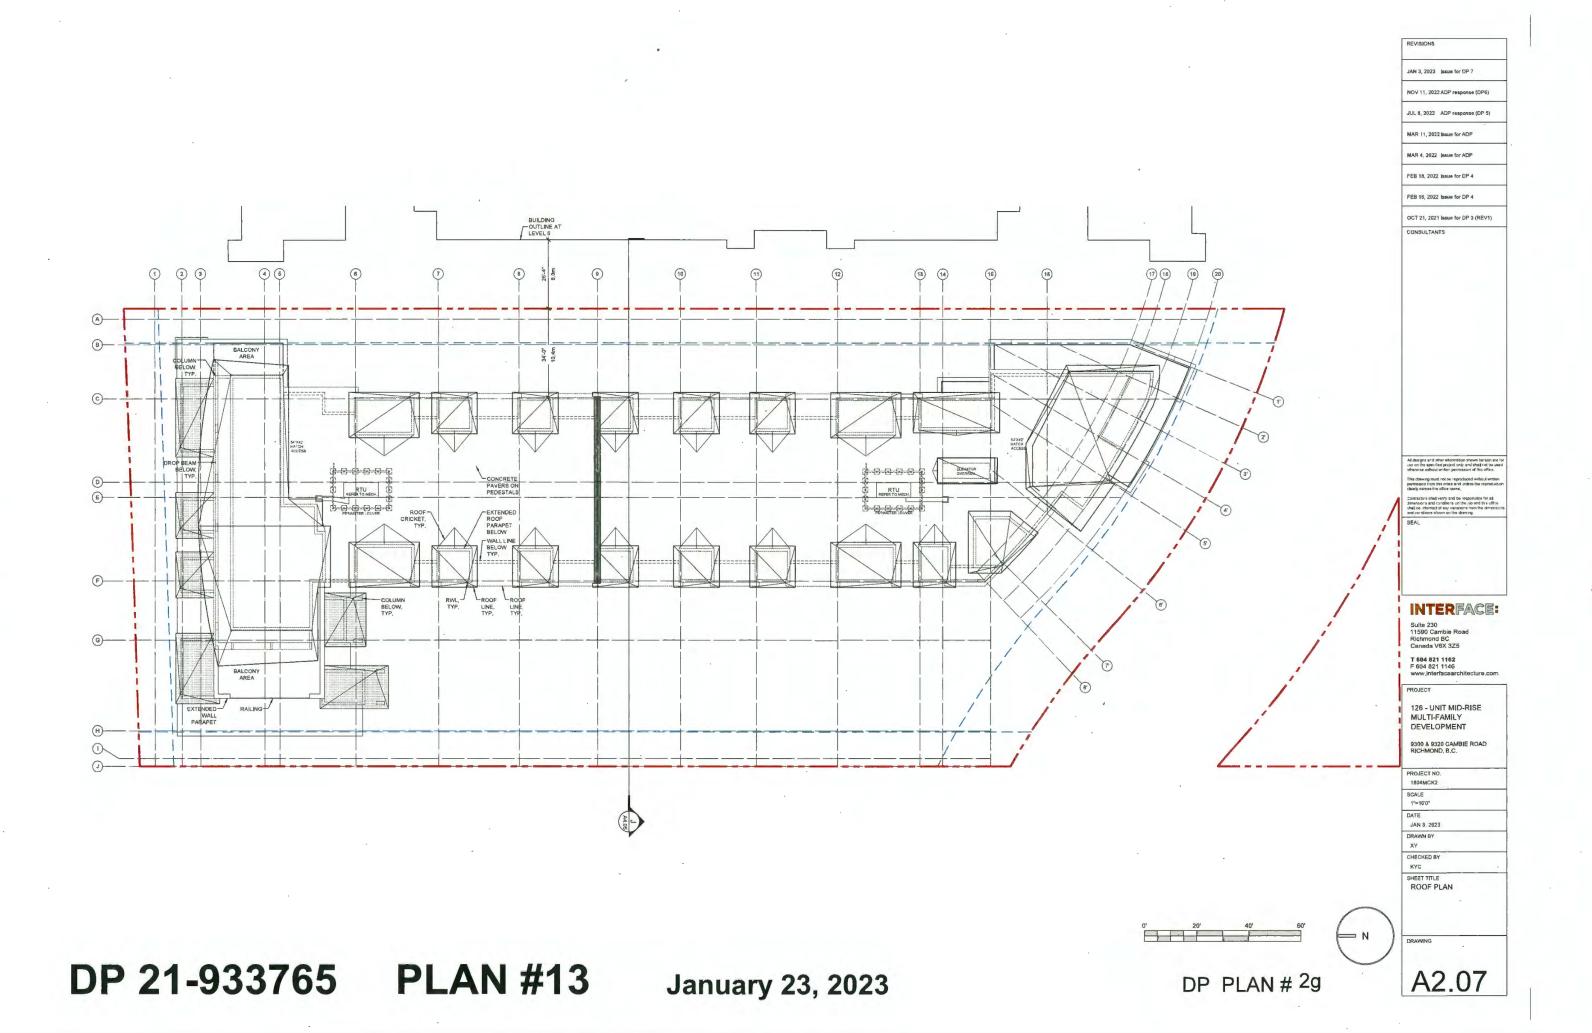



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PROJEC

126 - UNIT MID-RISE MULTI-FAMILY DEVELOPMENT

9300 & 9320 CAMBIE ROA RICHMOND, B.C.

1804MCK2

SCALE

DATE JAN 3 2023

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KYC SHEET TITLE

SHEET TITLE
RENDERING
AERIAL VIEW ON
MCKIM WAY

DRAWING



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PROJEC

126 - UNIT MID-RISE MULTI-FAMILY DEVELOPMENT

9300 & 9320 CAMBIE ROAL RICHMOND, B.C.

PROJECT NO

1804MCK2 SCALE

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JAN 3. 2023

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SHEET TITLE
RENDERING
STREET VIEW ON
MCKIM WAY



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RENDERING
AERIAL VIEW ON
CAMBIE RD

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PROJECT

126 - UNIT MID-RISE MULTI-FAMILY DEVELOPMENT

9300 & 9320 CAMBIE RO RICHMOND, B.C.

1804MCH

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DATE JAN 3, 20

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SHEET TITLE
RENDERING
STREET VIEW ON
CAMBIE RD

DRAWING

TYPICAL ROOF FASCIAS
FIBER CEMENT TRIM BOARDS
COLOUR: ARCTIC WHITE



4 LOBBY/ AMENITY ROOF CANOPY FIBER CEMENT TRIM BOARDS CAPPED WI PRE-PINISHED ALUMINUM FLASHING COLOR: TO MATCH IRON GRAY



BALCONY RAILINGS & GLAZING
ALUMNUM FRAME
POMDER COATED TO MATCH ADJACENT WALL
SEE NOTE 8*
GLAZING: TEMPERED GLASS VITRIUM GLASS
PEWTER



ROOF/ BALCONY SOFFIT
FIBER CEMENT HORIZONTAL PLANK SIDING,
6" EXPOSURE (NONE-VENTED & VENTED)
SEE NOTE #"

10 EXTERIOR WALL PANEL SYSTEM
SMOOTH FIBER CEMENT REVEAL PANEL SYSTEM
COLOUB: ARCTIC WHITE



EXTERIOR WALL VERTICAL PLANK SIDING
FIBER CEMENT VERTICAL PLANK SIDINGS,
6" EXPOSURE
CEDARTONE TRUGRAIN



9 EXTERIOR WALL PANEL SYSTEM
SMOOTH FIBER CEMENT REVEAL PANELS SYSTEMS
COLOUR; IRON GRAY



EXTERIOR BRICK VENEER WALL
ECON BRICK (11 127 X 3 1/27 X 3 1/27);
RUNNING BOND
IRON SPOT OR COAL CREEK OR SIMILAR
(DEPENDING ON AVAILABILITY)

20 PLANTERS & CONCRETE COPING CAST-IN-PLACE CONCRETE GRIND SMOOTH



SCHEDULE OF FINISHES

1 PENTHOUSE ROOF SURFACE 2-PLY SBS MEMBRANE ARTIC WHITE CAPSHEET

2 TYPICAL ROOF FASCIAS

3 ROOF SOFFITS

4 GUTTER & RWL
PRE-FINISHED ALUMINUM,
COLOUR, SEE NOTE #1

5 BALCONY POST & BEAMS
SOLID WOOD OR WOOD CLADDING OR FIBER
CEMENT WRAP
COLOUR: SEE NOTE #1

6 BALCONY RAILING & GLAZING

7 BALCONY SOFFIT

8 EXTERIOR WALL VERTICAL PLANK SIDIR

9 EXTERIOR WALL PANEL SYSTEM

10 EXTERIOR WALL PANEL SYSTEM

11 RESIDENTIAL DOORS/ WINDOWS LOW"E" DOUBLE GLAZED DOORS &

VINYL FRAMES COLOUR: SEE NOTE #1 ALUMINUM FLASHING COLOUR: SEE NOTE #1

12 CONCRETE COPINGS

13 BRICK VENEER WALL

14 LOSBY/ AMENITY ROOF CANOPIES

3 CANOPY SOFFITS

15 TYPICAL EXIT/ SERVICE DOORS
HOLLOW METAL DOOR.

16 LOBBY, AMENITY GLAZING SYSTEM GLAZING SYSTEMS POUBLE GLAZEL ANOBIZE ALUMINUM FRAME DARK GRAY ANODIZED FINISH.

17 LOBBY/ AMENITY DOOR

DOUBLE GLAZED ANODIZED ALUMINUM FRA
GRAY ANODIZED FINISH
W/ TEMPERED GLASS CLEAR FINISH.

18 EXTERIOR HANDRAIL/GUARDRAIL

INTERCOM

IN CONCRETE: ARCHITECTURAL FINISHED

20 PLANTER WALLS

NOTE:

1. FINISHED SIMILAR TO ARCTIC WHITE IF FINISH ON ADJACENT WALL IS.
CEDARTONE OR ARTIC WHITE.
FINISHED SIMILAR TO IRON GRAY IF FINISH ON ADJACENT WALL IS.
IRON GRAY OR BRICK VENEER.

JAN 3, 2023 | Issue for DP 7

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PROJECT

126 - UNIT MID-RISE MULTI-FAMILY DEVELOPMENT

9300 & 9320 CAMBIE ROA

PROJECT NO.
1804MCK2
SCALE
NTS
DATE
JAN 3. 2023
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MATERIAL BOARD

DRAWING

A3.03

DP 21-933765 PLAN #18

January 23, 2023

DP PLAN # 4c



DP 21-933765 PLAN #19

9 January 23, 2023

DP PLAN # 4a

A3.01

SHEET TITLE
BUILDING ELEVATIONS:
EAST & WEST

1/16" = 1'-0" DATE JAN 3, 2023

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NORTH FRONTAGE - ALONG CAMBIÉ ROAD



SOUTH FRONTAGE - ALONG MCKIM WAY

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PROJECT

126 - UNIT MID-RISE MULTI-FAMILY DEVELOPMENT

9300 & 9320 CAMBIE ROAD R(CHMOND, 8,C,

PRGJECT NO. 1804MGK2

SCALE 1/16" = 1'-0"

DATE JAN 3 2023

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SHEET TITLE
BUILDING ELEVATIONS:
NORTH & SOUTH

DRAWIN

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126 - UNIT MID-RISE MULTI-FAMILY DEVELOPMENT

9300 & 9320 CAMBIE ROAD RICHMOND, B.C.

PROJECT NO. 1804MCK2

SCALE 1/8" = 1'-0"

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SHEET TITLE
BUILDING ELEVATION:
(ENLARGED W/O
LANDSCAPING)
NORTH

DRAWING

A3.04



INTERFACE:


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126 - UNIT MID-RISE MULTI-FAMILY DEVELOPMENT


SCALE 1/16" = 1'-0"


SHEET TITLE
BUILDING ELEVATION:
(ENLARGED W/O
LANDSCAPING)
SOUTH


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Suite 230 11590 Cambie Road Richmond BC Canada V6X 3Z5 DEVELOPMENT

DP 21-933765 PLAN #26

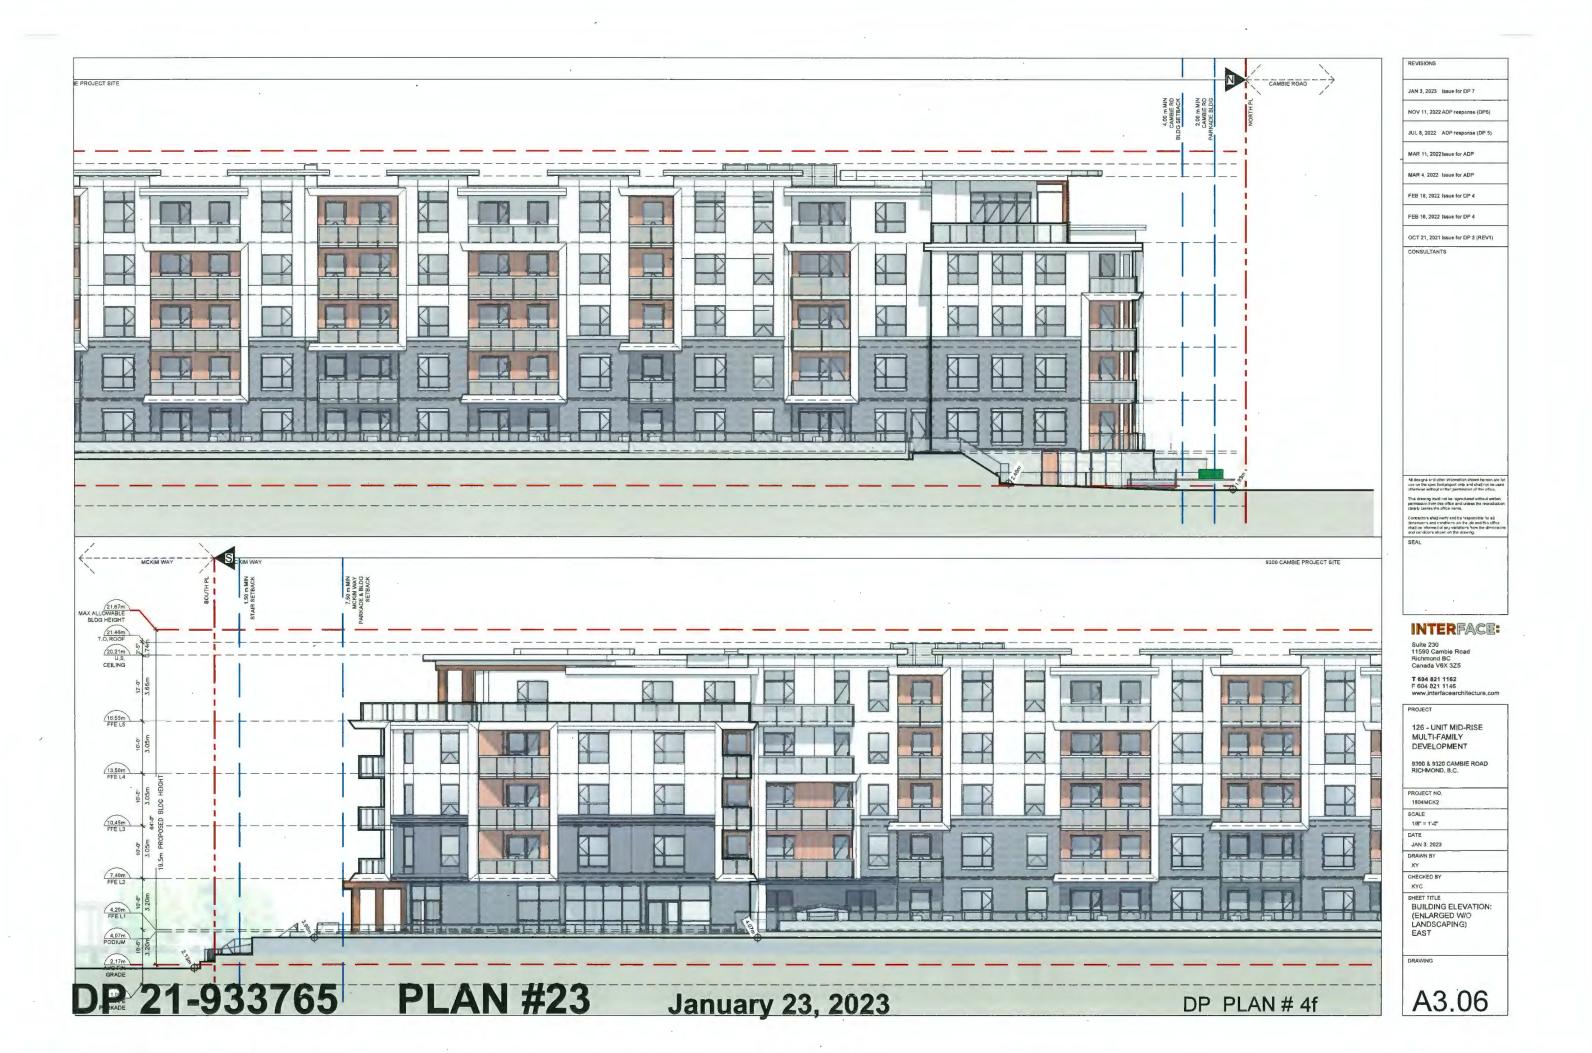January 23, 2023

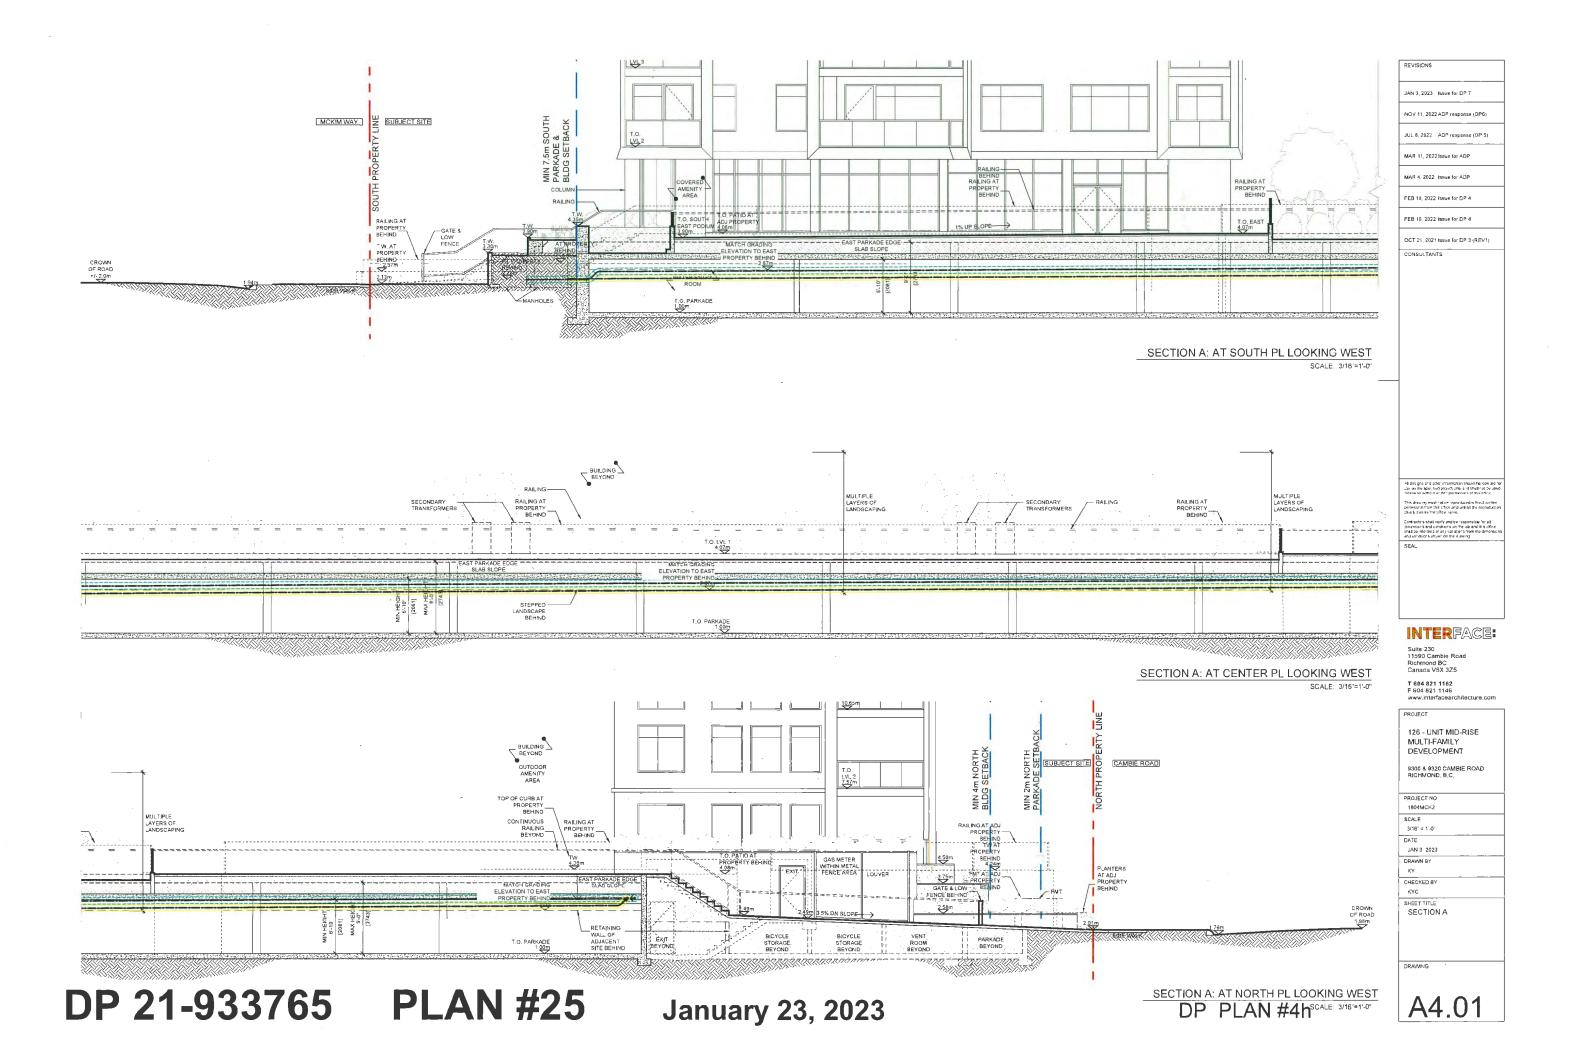
DP PLAN#4i

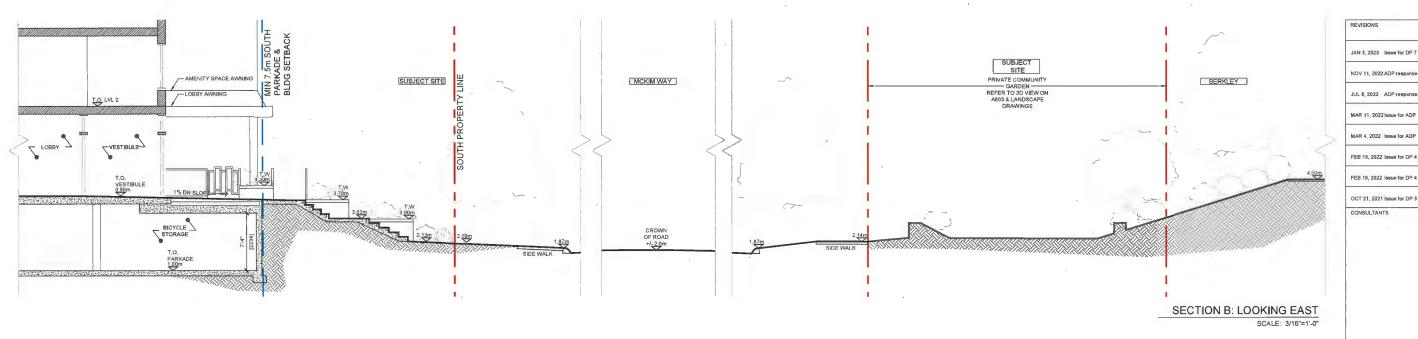
INTERFACE:

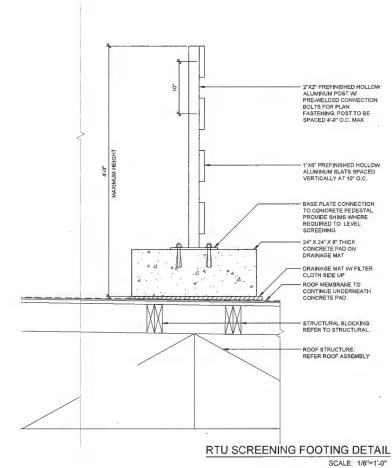
126 - UNIT MID-RISE MULTI-FAMILY


1804MCK2 SCALE SEE DWG DATE JAN 3 2023 CHECKED BY SHEET TITLE SECTION B


A4.02

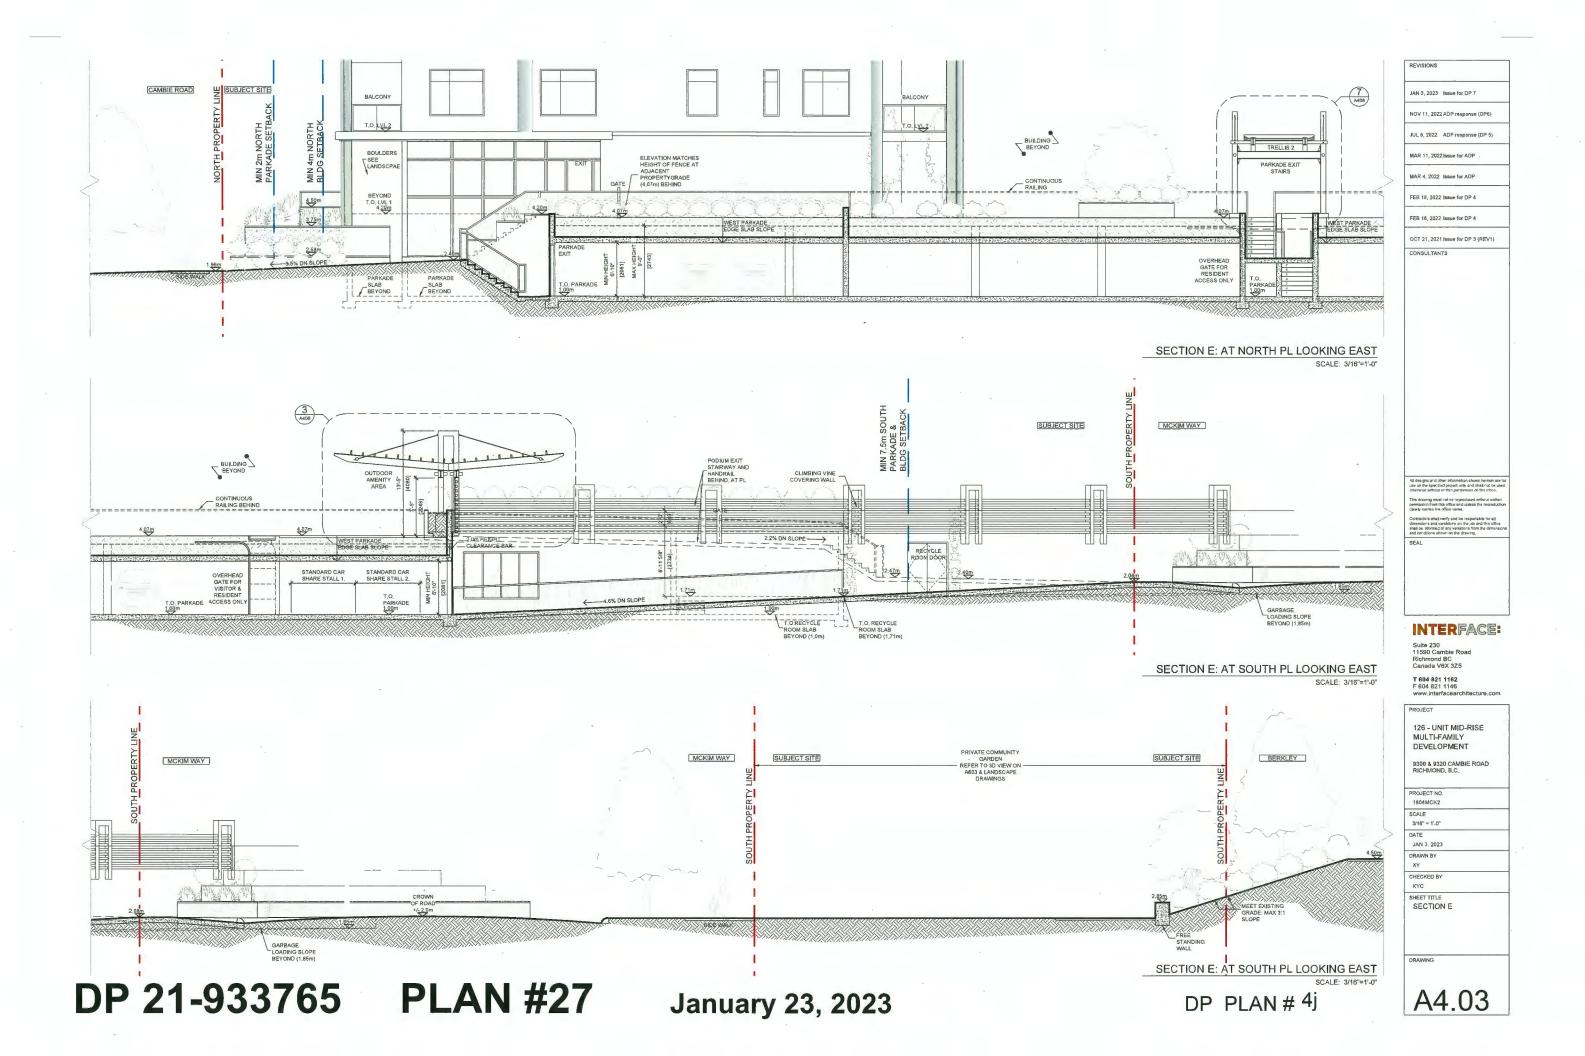


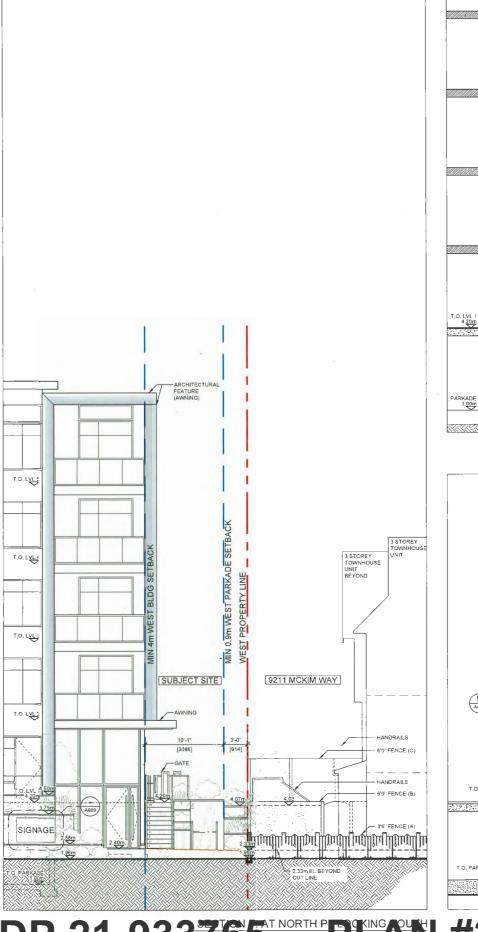

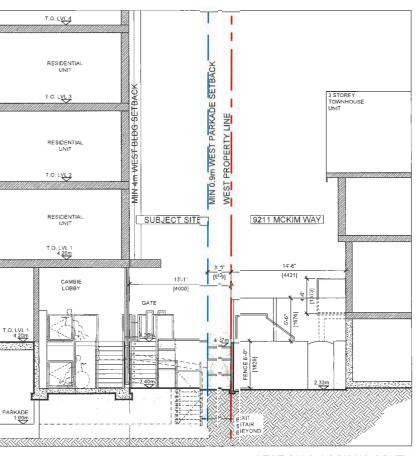

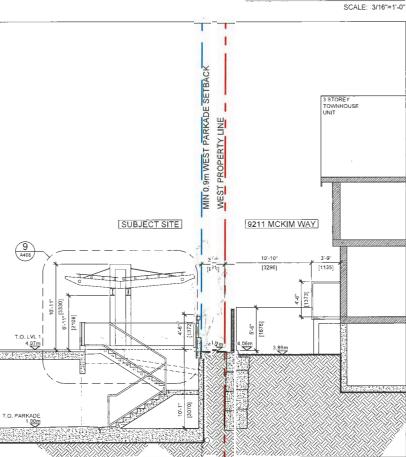

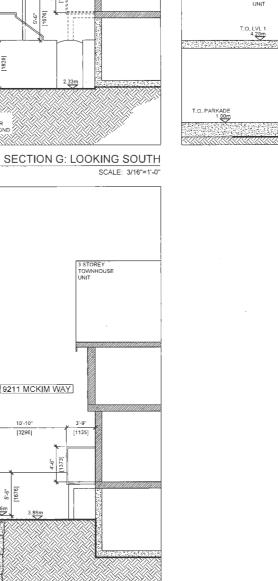

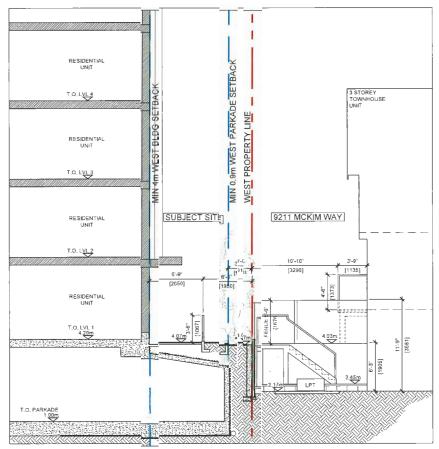

JAN 3, 2023 Issue for DP 7

INTERFACE:

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T 604 821 1162 F 604 821 1146 www.interfacearc

126 - UNIT MID-RISE MULTI-FAMILY DEVELOPMENT 9300 & 9320 CAMBIE ROAD RICHMOND, B.C. PROJECT NO. 1804MCK2 SHEET TITLE SECTION F, G, H & I


A4.04


DP 21-933765 PLAN #28


January 23, 2023 1/16-11-0"

SECTION H: LOOKING SOUTH

SCALE: 3/16"=1'-0"

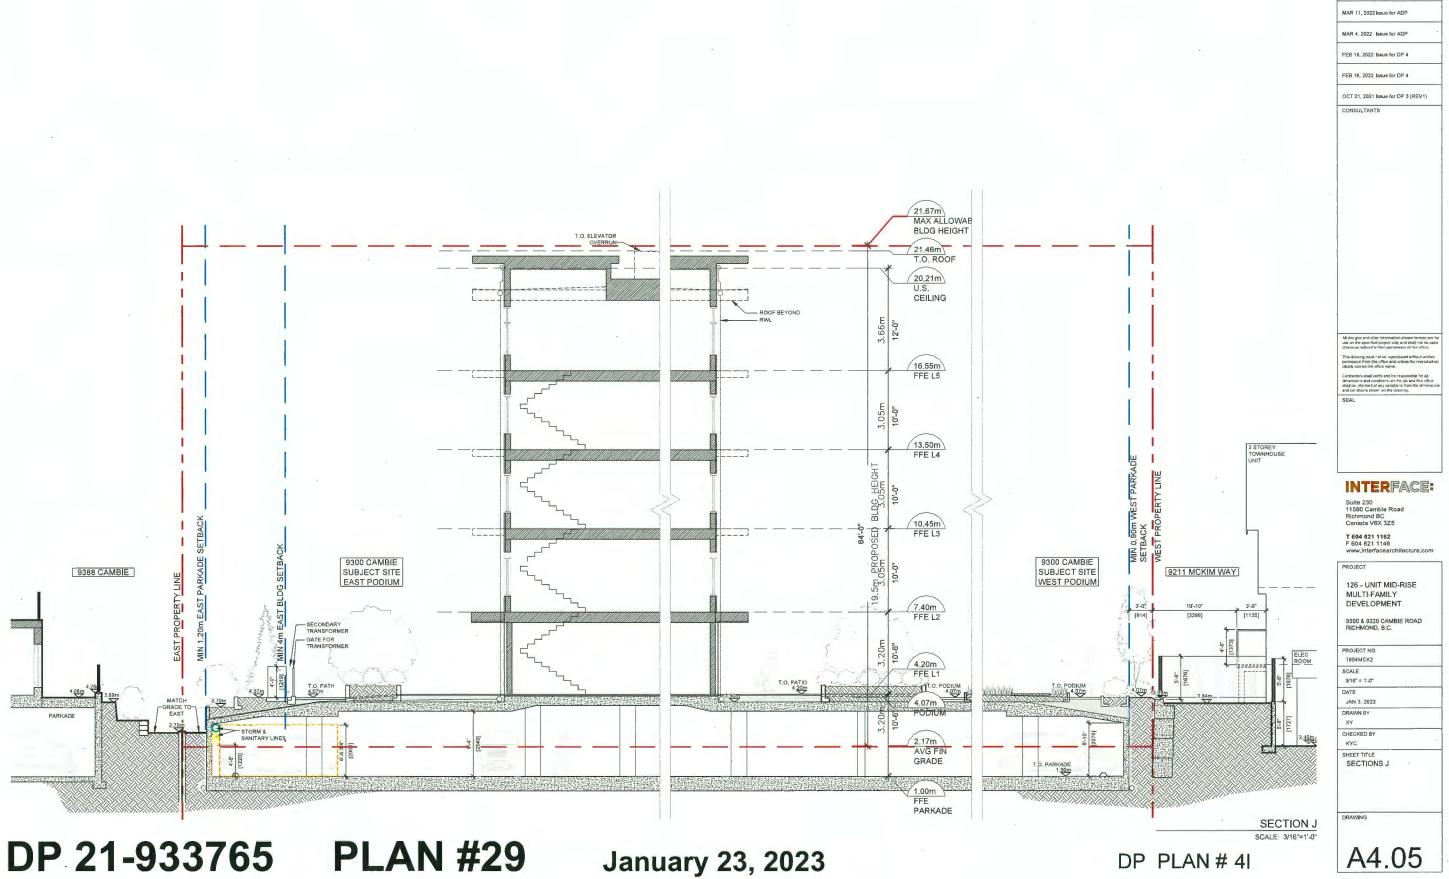

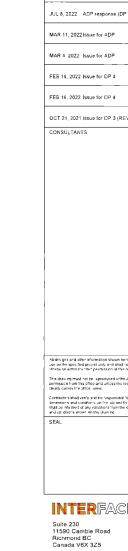

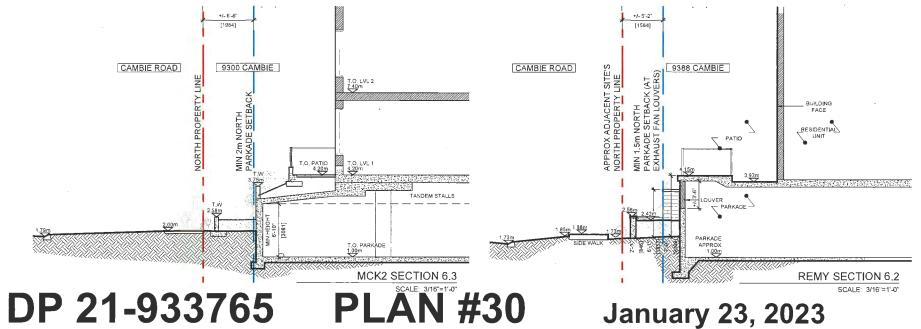

January 23, 2023

CAMBIE ROAD REMY SECTION 6.1


DP PLAN # 4m

INTERFACE:

126 - UNIT MID-RISE MULTI-FAMILY DEVELOPMENT

PROJECT NO. 1804MGK2 SCALE 3/16" = 1'-0" SHEET TITLE SECTIONS 6.1, 6.2 & 6.3

A4.06

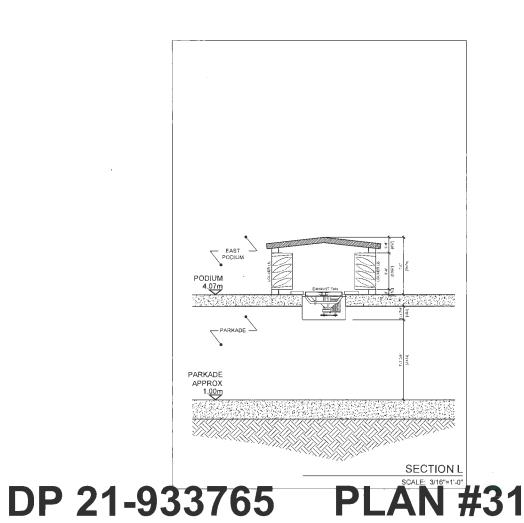

BUILDING SETBACK CAMBIE ROAD SECTION K SCALE: 3/16"=1'-0" **January 23, 2023** DP PLAN # 4n


INTERFACE: Suite 230 11590 Cambie Road Richmond BC Canada V6X 3Z5 T 604 821 1162 F 604 821 1146 www.interfacearc 126 - UNIT MID-RISE MULTI-FAMILY DEVELOPMENT


PROJECT NO. 1804MCK2


DATE JAN 3 2023


CHECKED BY SHEET TITLE SECTIONS K & L

A4.07

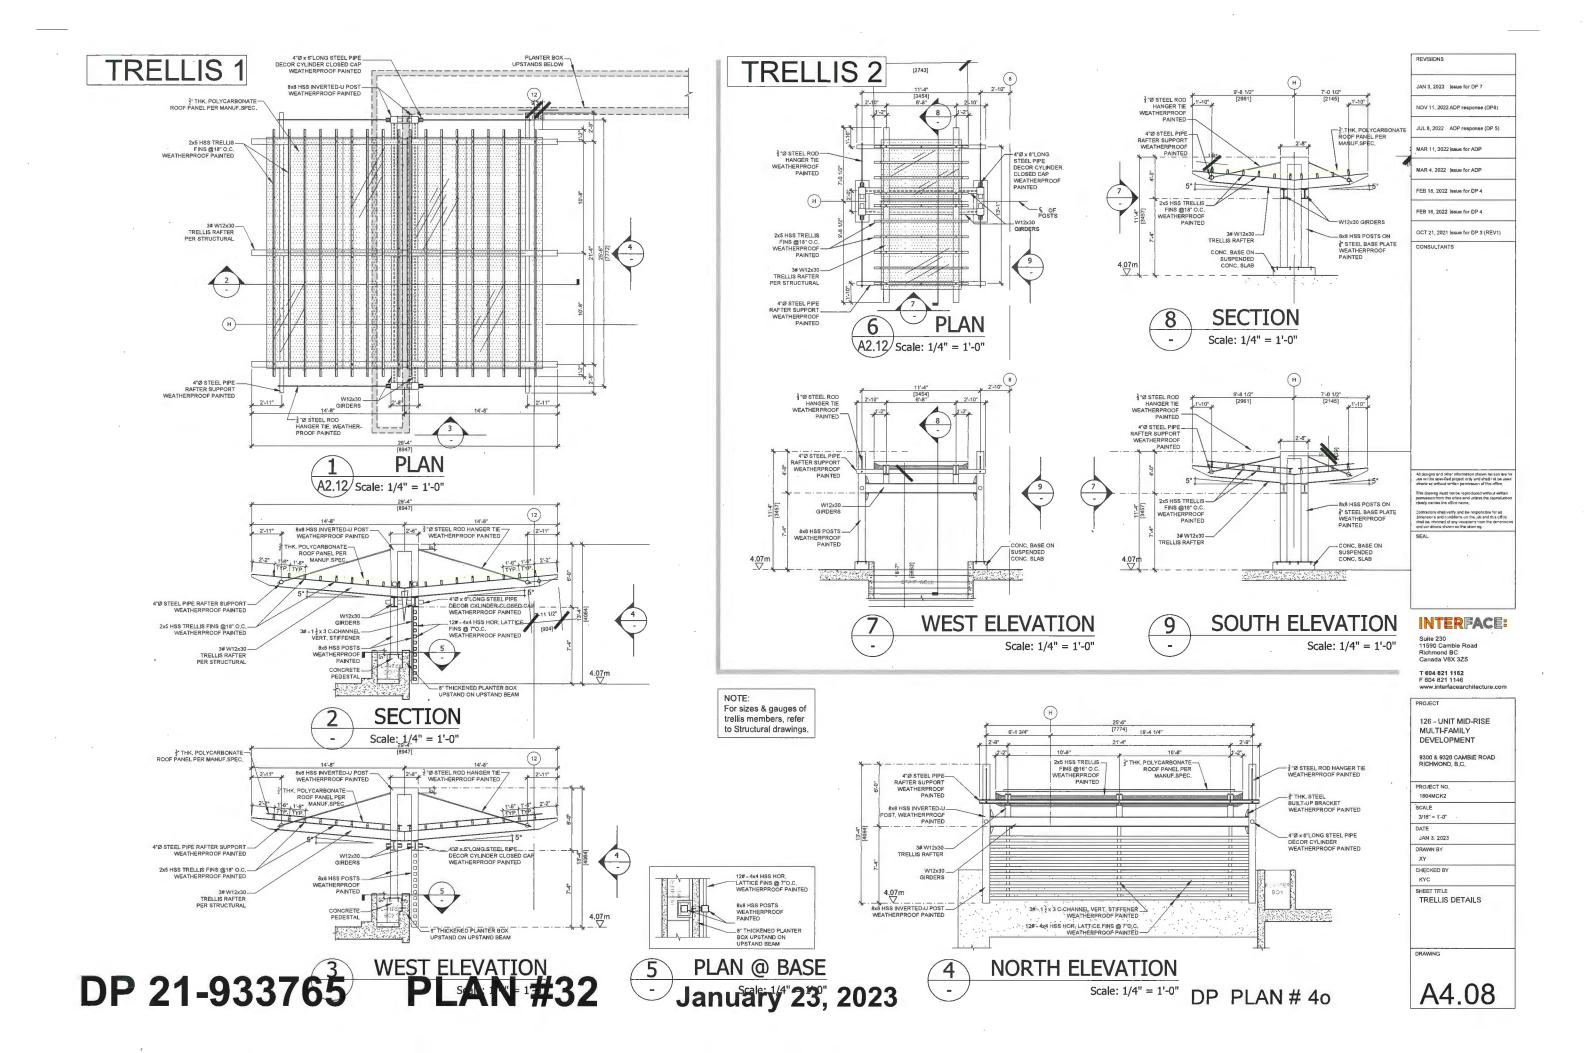

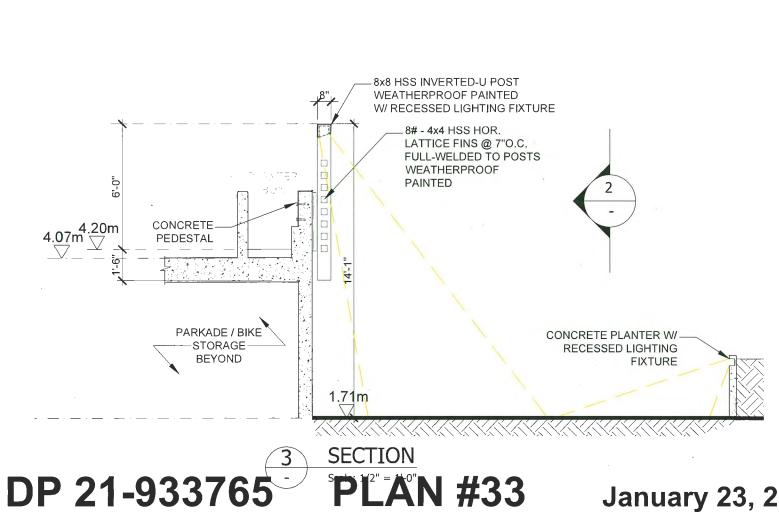

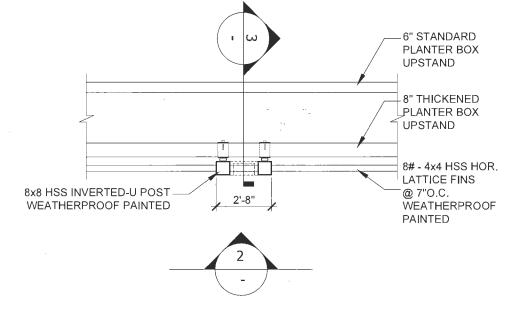

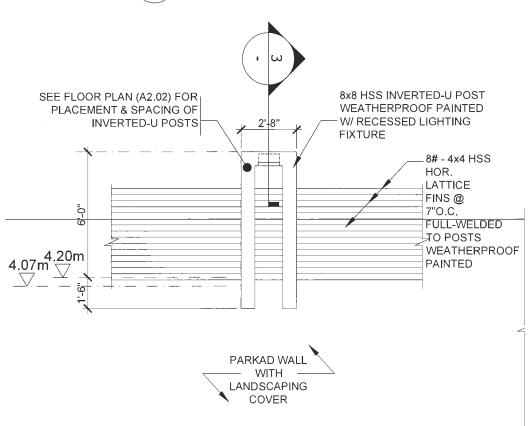

PLAN

Scale: 1/2'' = 1'-0''

ELEVATION Scale: 1/2" = 1'-0"

DP PLAN#40

JAN 3, 2023 | Issue for DP 7 NOV 11 2022 ADP response (DP6) JUL 8, 2022 ADP response (DP 5 MAR 11, 2022 Issue for ADP MAR 4 2022 Issue for ADP FEB 18, 2022 (ssue for DP 4 FEB 16, 2022 Issue for DP 4

REVISIONS

INTERFACE:

Suite 230 11590 Cambie Road Richmond BC Canada V6X 3Z5

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126 - UNIT MID-RISE MULTI-FAMILY DEVELOPMENT 1804MCK2 SCALE 3/16" = 1'-0" JAN 3 2023 CHECKED BY TRELLIS POST LIGHTING

A4.09

January 23, 2023



MCKIM WAY SOUTH WEST FRONTAGE



MCKIM WAY SOUTH EAST FRONTAGE



CAMBIE ROAD NORTH EAST FRONTAGE




CAMBIE ROAD NORTH WEST FRONTAGE



DP 21-933765 **PLAN #34**



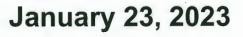



EAST PROPERTY LINE INTERFACE

DP PLAN#6b

JAN 3, 2023 Issue for DP 7

NTERFACE:

Suite 230 11590 Cambie Road Richmond BC Canada V6X 3Z5

126 - UNIT MID-RISE MULTI-FAMILY DEVELOPMENT

CHECKED BY

SHEET TITLE
3D STREET VIEWS




COMMUNITY PARK FRONTAGE



COMMUNITY GARDEN LOOKING FROM NORTH WEST



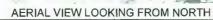



AERIAL VIEW LOOKING FROM EAST



DP 21-933765





AERIAL VIEW LOOKING FROM WEST

DP PLAN # 6c

FEB 18, 2022 (ssue for DP 4

INTERFACE:

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126 - UNIT MID-RISE MULTI-FAMILY DEVELOPMENT

JAN 3, 2023

PRIVATE COMMUNITY GARDEN 3D STREET VIEWS & AERIAL VIEWS






SIGNAGE AT CAMBIE ROAD



SIGNAGE AT MCKIM WAY

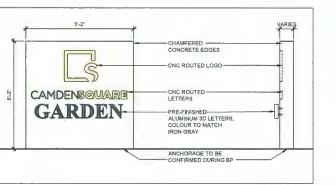

TYPICAL SIGNAGE DETAIL

January 23, 2023

INTERFACE:

126 - UNIT MID-RISE MULTI-FAMILY DEVELOPMENT

SHEET TITLE
ENTRY SIGNAGES
& DETAILS









AERIAL VIEW - LOOKING FROM NORTH EAST

AERIAL VIEW - LOOKING FROM NORTH WEST

AERIAL VIEW - LOOKING FROM SOUTH WEST

DP 21-933765 PLAN #37

January 23, 2023

DP PLAN#6a

REVISIONS

NOT II, 2022 ADI TESPUISE (DI

MAD 44 20231--- - 4-- ADD

....

OCT 21, 2021 Issue for DP 3 (REV1

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& SEAL

INTERFACE:

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PROJECT

126 - UNIT MID-RISE MULTI-FAMILY DEVELOPMENT

9300 & 9320 CAMBIE RO

1804MCK2

SCALE

DATE

DRAMBI BY


XY

KYC

3D AERIAL VIEWS

3D ALKIAL VILVO

DRAWING

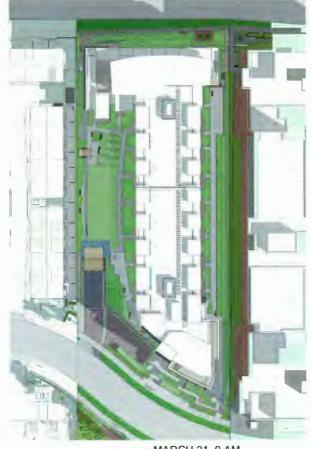

MARCH 21, 9 AM









MARCH 21, 3 PM

JUNE 21, 3 PM



JAN 3, 2023 Issue for DP 7

MAR 4, 2022 Issue for ADP FEB 18, 2022 Issue for DP 4

INTERFACE:

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126 - UNIT MID-RISE MULTI-FAMILY DEVELOPMENT

SHEET TITLE SHADOW STUDY: MARCH & JUNE

A8.01

DP 21-933765

SPRING EQUINOX

PLAN #381,9 AM







AUTUMN EQUINOX

SEPTEMBER 21, 12 PM

SEPTEMBER 21, 3 PM

INTERFACE:

126 - UNIT MID-RISE MULTI-FAMILY DEVELOPMENT

DATE JAN 3. 2023

SHEET TITLE
SHADOW STUDY:
SEPTEMBER

A8.02













MARCH 21 6PM

SHADOWING ON REMY WEST FACE (SOUTH END, MCKIM WAY) - SPRING EQUINOX (1PM TO 6PM)













JUNE 21 6PM

SHADOWING ON REMY WEST FACE (SOUTH END, MCKIM WAY) - SUMMER SOLSTICE (1PM TO 6PM)













SEPT 21 6PM

SHADOWING ON REMY WEST FACE (SOUTH END, MCKIM WAY) - AUTUMN EQUINOX (1PM TO 6PM)

DP 21-933765 **PLAN #40**

January 23, 2023

JAN 3, 2023 Issue for DP 7

MAR 4, 2022 Issue for ADF FEB 18, 2022 Issue for DP 4 FEB 16, 2022 Issue for DP 4

INTERFACE:

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126 - UNIT MID-RISE MULTI-FAMILY DEVELOPMENT

9300 & 9320 CAMBIE ROAD RICHMOND, B.C.

SCALE

CHECKED BY

SHEET TITLE SHADOWING ON REMY WEST FACE (SOUTH END)

A8.03













MARCH 21 6PM

SHADOWING ON REMY WEST FACE (NORTH END, CAMBIE ROAD) - SPRING EQUINOX (1PM TO 6PM)













SHADOWING ON REMY WEST FACE (NORTH END, CAMBIE ROAD) - SUMMER SOLSTICE (1PM TO 6PM)













SEPT 21 6PM

SHADOWING ON REMY WEST FACE (NORTH END, CAMBIE ROAD) - AUTUMN EQUINOX (1PM TO 6PM)

DP 21-933765 **PLAN #41**

January 23, 2023

INTERFACE:

Suite 230 11590 Cambie Road Richmond BC Canada V6X 3Z5

REVISIONS

JAN 3, 2023 Issue for DP 7

126 - UNIT MID-RISE MULTI-FAMILY DEVELOPMENT

9300 & 9320 CAMBIE ROAD RICHMOND, B.C.

PROJECT NO. 1804MCK2

SCALE

JAN 3. 2023

CHECKED BY

SHEET TITLE SHADOWING ON REMY WEST FACE (NORTH END)

A8.04

| LANT S | CHEDULE - ONSITE | PMG PROJECT NUMBER: 19-151 | |
|---------|--------------------------------|----------------------------|-------------------------|
| KEY QTY | BOTANICAL NAME | COMMON NAME | PLANTED SIZE / REMARKS |
| 6 | ACER CIRCINATUM | VINE MAPLE | 4M HT; B&B 3 STEM CLUMP |
| 15 | ACER PALMATUM | JAPANESE MAPLE | 4M HT; B&B |
| 8 | ACER RUBRUM 'ARMSTRONG' | COLUMNAR ARMSTRONG MAPLE | 8CM CAL; 2M STD; B&B |
| 6 | CERCIDIPHYLLUM JAPONICUM | KATSURA TREE | BCM CAL; 1.8M STD; B&B |
| 10 | FAGUS SYLVATICA 'DAWYCK GOLD' | DAWYCK GOLD BEECH | 8CM CAL; B&B |
| 6 | GLEDITSIA T. INERMIS 'SKYLINE' | SKYLINE HONEY LOCUST | 8CM CAL; 1.8M STD; B&B |
| 10 | AMELANCHIER X GRANDIFLORA | SERVICEBERRY | 8CM CAL; 1.5M STD; B&B |
| 13 | PICEA GLAUCA | WHITE SPRUCE | 4M HT; B&B |

NOTES: *PLANT SIZES IN THIS LIST ARE SPECIFIED ACCORDING TO THE BC LANDSCAPE STANDARD AND CANADIAN LANDSCAPE STANDARD, LATEST EDITION. CONTAINER SIZES SPECIFIED AS PER CNLA STANDARD. BOTH PLANT SIZE AND CONTAINER SIZE ARE THE MINIMUM ACCEPTABLE SIZES. * REFER TO SPECIFICATIONS FOR DEFINED CONTAINER MEASUREMENTS AND OTHER PLANT MATERIAL REQUIREMENTS. * SEARCH AND REVIEW: MAKE PLANT MATERIAL AVAILABLE FOR OPTIONAL REVIEW BY LANDSCAPE ARCHITECT AT SOURCE OF SUPPLY. AREA OF SEARCH TO INCLUDE LOWER MAINLAND AND FRASER VALLEY, * SUBSTITUTIONS: OBTAIN WRITTEN APPROVAL FROM THE LANDSCAPE ARCHITECT PRIOR TO MAKING ANY SUBSTITUTIONS TO THE SPECIFIED MATERIAL. UNAPPROVED SUBSTITUTIONS WILL BE REJECTED. ALLOW A MINIMUM OF FIVE DAYS PRIOR TO DELIVERY FOR REQUEST TO SUBSTITUTE. SUBSTITUTIONS ARE SUBJECT TO BC LANDSCAPE STANDARD AND CANADIAN LANDSCAPE STANDARD - DEFINITION OF CONDITIONS OF AVAILABILITY. * ALL LANDSCAPE MATERIAL AND WORKMANSHIP MUST MEET OR EXCEED BC LANDSCAPE STANDARD AND CANADIAN LANDSCAPE STANDARD LATEST EDITION. * ALL PLANT MATERIAL MUST BE PROVIDED FROM CERTIFIED DISEASE FREE NURSERY. * BIO-SOLIDS NOT PERMITTED IN

NOTE: ONSITE IRRIGATION FOR ALL SOFT LANDSCAPE WILL BE INSTALLED

| PLANT SCHEDULE- COMMUNITY GARDEN PMG PROJECT NUMBER: 19-15 | | | | | | |
|--|-----|------------------------|-------------|------------------------|--|--|
| KEY | QTY | BOTANICAL NAME | COMMON NAME | PLANTED SIZE / REMARKS | | |
| TREE | | | | | | |
| | 3 | FICUS CARICA | COMMON FIG | 8CM CAL; 1.5M STD; B&B | | |
| 8 | 2 | MALUS DOMESTICA 'FUJI' | FUJI APPLE | 8CM CAL; 1.5M STD; B&B | | |

NOTES: * PLANT SIZES IN THIS LIST ARE SPECIFIED ACCORDING TO THE BC LANDSCAPE STANDARD AND CANADIAN LANDSCAPE STANDARD, LATEST EDITION. CONTAINER SIZES SPECIFIED AS PER CNLA STANDARD. BOTH PLANT SIZE AND CONTAINER SIZE ARE THE MINIMUM ACCEPTABLE SIZES. * REFER TO SPECIFICATIONS FOR DEFINED CONTAINER MEASUREMENTS AND OTHER PLANT MATERIAL OF SUPPLY. AREA OF SEARCH TO INCLUDE LOWER MAINLAND AND FRASER VALLEY. * SUBSTITUTIONS: OBTAIN WRITTEN APPROVAL FROM THE LANDSCAPE ARCHITECT PRIOR TO MAKING ANY SUBSTITUTIONS TO THE SPECIFIED MATERIAL. UNAPPROVED SUBSTITUTIONS WILL BE REJECTED. ALLOW A MINIMUM OF FIVE DAYS PRIOR TO DELIVERY FOR REQUEST TO SUBSTITUTE. SUBSTITUTIONS ARE SUBJECT TO BC LANDSCAPE STANDARD AND CANADIAN LANDSCAPE STANDARD - DEFINITION OF CONDITIONS OF AVAILABILITY. * ALL LANDSCAPE MATERIAL AND WORKMANSHIP MUST MEET OR EXCEED BC LANDSCAPE STANDARD AND CANADIAN LANDSCAPE STANDARD LATEST EDITION. * ALL PLANT MATERIAL MUST BE PROVIDED FROM CERTIFIED DISEASE FREE NURSERY. * BIO-SOLIDS NOT PERMITTED IN GROWING MEDIUM UNLESS AUTHORIZED BY LANDSCAPE ARCHITECT.

DP PLAN#3

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REVISION DESCRIPTION

RESIDENTIAL DEV.

9300 & 9320 CAMBIE RD. RICHMOND, BC

LANDSCAPE **PLAN**

19-151

| PLANT S | PMG PROJECT NUMBER: 19-151 | | |
|-------------------|--------------------------------|--------------------------|-------------------------|
| KEY QTY | BOTANICAL NAME | COMMON NAME | PLANTED SIZE / REMARKS |
| 6 | ACER CIRCINATUM | VINE MAPLE | 4M HT; B&B 3 STEM CLUMP |
| 15 | ACER PALMATUM | JAPANESE MAPLE | 4M HT; B&B |
| 8 | ACER RUBRUM 'ARMSTRONG' | COLUMNAR ARMSTRONG MAPLE | 8CM CAL; 2M STD; B&B |
| - 20 6 | CERCIDIPHYLLUM JAPONICUM | KATSURA TREE | 8CM CAL; 1.8M STD; B&B |
| 10 | FAGUS SYLVATICA 'DAWYCK GOLD' | DAWYCK GOLD BEECH | 8CM CAL; B&B |
| 6 | GLEDITSIA T. INERMIS 'SKYLINE' | SKYLINE HONEY LOCUST | 8CM CAL; 1.8M STD; B&B |
| 10 | AMELANCHIER X GRANDIFLORA | SERVICEBERRY | 8CM CAL; 1.5M STD; B&B |
| 13 | PICEA GLAUCA | WHITE SPRUCE | 4M HT; B&B |

NOTES: *PLANT SIZES IN THIS LIST ARE SPECIFIED ACCORDING TO THE BC LANDSCAPE STANDARD AND CANADIAN LANDSCAPE STANDARD, LATEST EDITION. CONTAINER SIZES SPECIFIED AS PER CNLA STANDARD. BOTH PLANT SIZE AND CONTAINER SIZE ARE THE MINIMUM ACCEPTABLE SIZES. *REFER TO SPECIFICATIONS FOR DEFINED CONTAINER MEASUREMENTS AND OTHER PLANT MATERIAL REQUIREMENTS. * SEARCH AND REVIEW: MAKE PLANT MATERIAL AVAILABLE FOR OPTIONAL REVIEW BY LANDSCAPE ARCHITECT AT SOURCE OF SUPPLY. AREA OF SEARCH TO INCLUDE LOWER MAINLAND AND FRASER VALLEY. * SUBSTITUTIONS: OBTAIN WRITTEN APPROVAL FROM THE LANDSCAPE ARCHITECT PRIOR TO MAKING ANY SUBSTITUTIONS TO THE SPECIFIED MATERIAL. UNAPPROVED SUBSTITUTIONS WILL BE REJECTED. ALLOW A MINIMUM OF FIVE DAYS PRIOR TO DELIVERY FOR REQUEST TO SUBSTITUTE. SUBSTITUTIONS ARE SUBJECT TO BC LANDSCAPE STANDARD AND CANADIAN LANDSCAPE STANDARD - DEFINITION OF CONDITIONS OF AVAILABILITY. * ALL LANDSCAPE MATERIAL AND WORKMANSHIP MUST MEET OR EXCEED BC LANDSCAPE STANDARD AND CANADIAN LANDSCAPE STANDARD LATEST EDITION. * ALL PLANT MATERIAL MUST BE PROVIDED FROM CERTIFIED DISEASE FREE NURSERY. * BIO-SOLIDS NOT PERMITTED IN GROWING MEDIUM UNLESS AUTHORIZED BY LANDSCAPE ARCHITECT.

NOTE: ONSITÉ IRRIGATION FOR ALL SOFT LANDSCAPE WILL BE INSTALLED

| PLANT SCHEDULE- COMMUNITY GARDEN PMG PROJECT NUMBER: 19-15 | | | | | | |
|--|-----|------------------------|-------------|------------------------|--|--|
| KEY | QTY | BOTANICAL NAME | COMMON NAME | PLANTED SIZE / REMARKS | | |
| TREE | | | | | | |
| | 3 | FICUS CARICA | COMMON FIG | 8CM CAL; 1.5M STD; B&B | | |
| ₹\$ | 2 | MALUS DOMESTICA 'FUJI' | FUJI APPLE | 8CM CAL; 1.5M STD; B&B | | |

NOTES: *PLANT SIZES IN THIS LIST ARE SPECIFIED ACCORDING TO THE BC LANDSCAPE STANDARD AND CANADIAN LANDSCAPE STANDARD, LATEST EDITION. CONTAINER SIZES SPECIFIED AS PER CNLA STANDARD. BOTH PLANT SIZE AND CONTAINER SIZE ARE THE MINIMUM ACCEPTABLE SIZES. * REFER TO SPECIFICATIONS FOR DEFINED CONTAINER MEASUREMENTS AND OTHER PLANT MATERIAL REQUIREMENTS. * SEARCH AND REVIEW: MAKE PLANT MATERIAL AVAILABLE FOR OPTIONAL REVIEW BY LANDSCAPE ARCHITECT AT SOURCE OF SUPPLY. AREA OF SEARCH TO INCLUDE LOWER MAINLAND AND FRASER VALLEY. * SUBSTITUTIONS: OBTAIN WRITTEN APPROVAL FROM THE LANDSCAPE ARCHITECT PRIOR TO MAKING ANY SUBSTITUTIONS TO THE SPECIFIED MATERIAL. UNAPPROVED SUBSTITUTIONS WILL BE REJECTED. ALLOW A MINIMUM OF FIVE DAYS PRIOR TO DELIVERY FOR REQUEST TO SUBSTITUTE. SUBSTITUTIONS ARE SUBJECT TO BC LANDSCAPE STANDARD AND CANADIAN LANDSCAPE STANDARD - DEFINITION OF CONDITIONS OF AVAILABILITY. * ALL LANDSCAPE MATERIAL AND WORKMANSHIP MUST MEET OR EXCEED BC LANDSCAPE STANDARD AND CANADIAN LANDSCAPE STANDARD LATEST EDITION. * ALL PLANT MATERIAL MUST BE PROVIDED FROM CERTIFIED DISEASE FREE NURSERY. * BIO-SOLIDS NOT PERMITTED IN GROWING MEDIUM UNLESS AUTHORIZED BY LANDSCAPE ARCHITECT.

HAUSER
HARVEST 118" EXTENSION TABLE.
-PICNIC TABLE & BBQ UNDER THE
TRELLIS INCORPORATED WITH
PARKING ENTRY STRUCTURE. TRELLIS WITH LIGHTING
BY ARCH.
JBBER PLAY AREA

PLAN #43 DP 21-933765

January 23, 2023



p: 604 294-0011 ; f: 604 294-002

| | | _ | |
|----|-------------|-----------------------------------|---|
| | | _ | - |
| 13 | 2022/NOV/14 | CITY COMMENTS/NEW SITE PLAN | _ |
| 12 | 2022/JUN/22 | NEW SITE PLAN | |
| 11 | 2022/APR/30 | ADP COMMENTS | |
| 10 | 2022/APR/20 | PARKADE EXHAUST | |
| 9 | 2022/MAR/09 | ISSUE FOR ADP | _ |
| 8 | 2022/FEB/16 | NEW SITE PLAN | |
| 7 | 2021/OCT/25 | CITY COMMENTS & NEW SITE PLAN | |
| 6 | 2021/SEP/14 | EAST PARKADE LINE | |
| 5 | 2021/JUL/29 | NEW SITE PLAN | |
| 4 | 2021/MAY/17 | NEW SITE PLAN | Τ |
| 3 | 2020/OCT/29 | NEW SITE PLAN- COMMUNITY GARDEN | _ |
| 2 | 2020/SEP/25 | NEW SITE PLAN AND CITY COMMENTS | _ |
| 1 | 2020/MAR/06 | CLIENT COMMENTS AND NEW SITE PLAN | _ |
| NO | DATE | REVISION DESCRIPTION | Τ |

CLIENT:


PROJECT


RESIDENTIAL DEV.

9300 & 9320 CAMBIE RD. RICHMOND, BC

LANDSCAPE **PLAN**

| 1 | DATE: | 20.FEB.27 | DRAWING NUMBER: |
|--------------|---------------------|-------------|-----------------|
| 100ft | SCALE: | 1/20"=1'-0" | 1.4 |
| | DRAWN: | YR | L1 |
| | DESIGN: | YR | |
| DD DLAN // 6 | CHK'D: | MCY | OF 10 |
| DP PLAN # 3a | PMG PROJECT NUMBER: | | 19-151 |

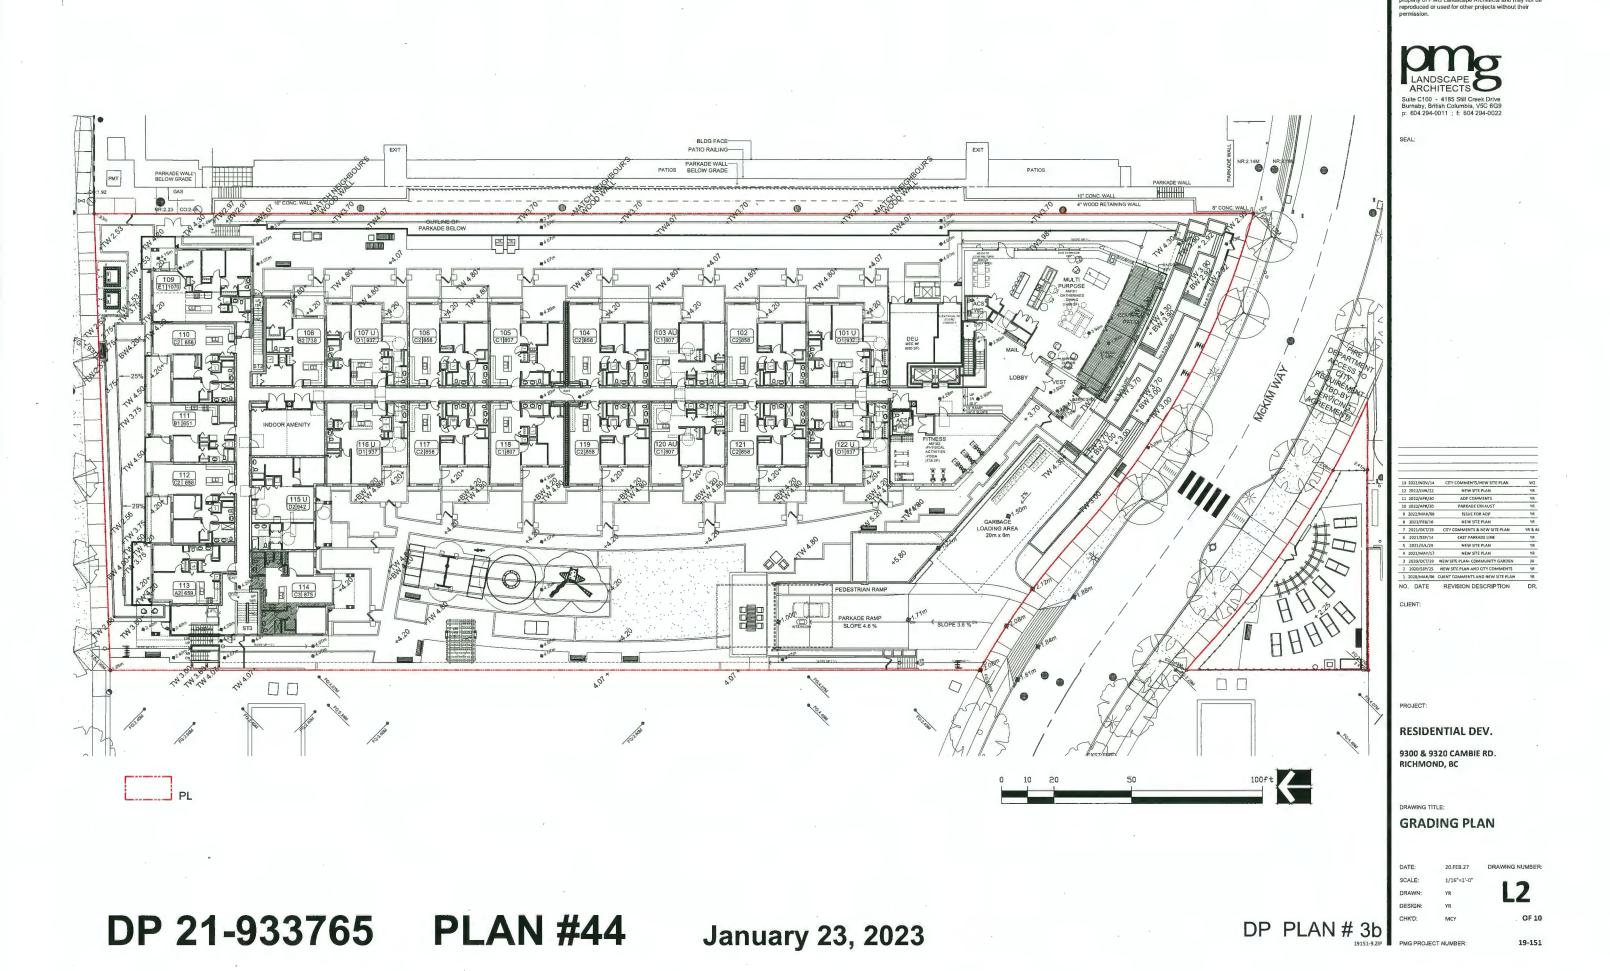

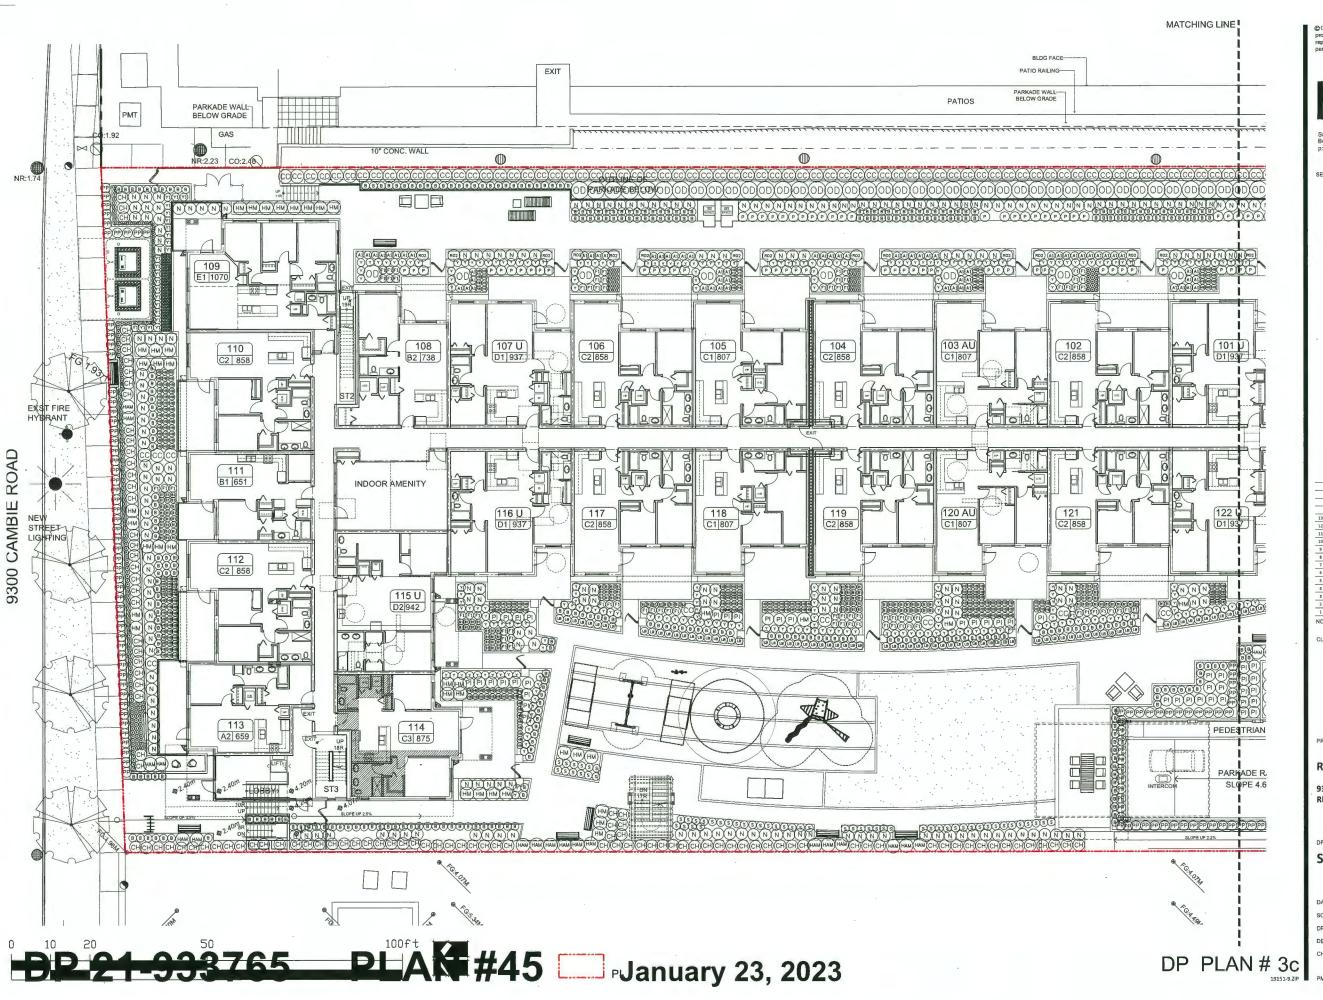

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SEAL:

| - | | | |
|----|-------------|-----------------------------------|------|
| 13 | 2022/NOV/14 | CITY COMMENTS/NEW SITE PLAN | W. |
| 12 | 2022/JUN/22 | NEW SITE PLAN | YF |
| 11 | 2022/APR/30 | ADP COMMENTS | YE |
| 10 | 2022/APR/20 | PARKADE EXHAUST | YR |
| 9 | 2022/MAR/09 | ISSUE FOR ADP | YR |
| 8 | 2022/FE8/16 | NEW SITE PLAN | YB |
| 7 | 2021/OCT/25 | CITY COMMENTS & NEW SITE PLAN | YR & |
| 6 | 2021/SEP/14 | EAST PARKADE LINE | YR |
| 5 | 2021/JUL/29 | NEW SITE PLAN | YR |
| 4 | 2021/MAY/17 | NEW SITE PLAN | YR |
| 3 | 2020/OCT/29 | NEW SITE PLAN- COMMUNITY GARDEN | JH |
| 2 | 2020/SEP/25 | NEW SITE PLAN AND CITY COMMENTS | YR |
| 1 | 2020/MAR/06 | CLIENT COMMENTS AND NEW SITE PLAN | YF |
| 10 | DATE | REVISION DESCRIPTION | DE |

CLIENT

PROJECT


RESIDENTIAL DEV.

9300 & 9320 CAMBIE RD. RICHMOND, BC

RAWING TITLE:

SHRUB PLAN

| - 1 | | | |
|-------|------------|-------------|-----------------|
| | DATE: | 20.FEB.27 | DRAWING NUMBER: |
| | SCALE: | 3/32"=1'-0" | 1.3 |
| | DRAWN: | YR | L3 |
| | DESIGN: | YR | |
| | CHK'D: | MCY | OF 10 |
| C | | | |
| 9.ZIP | PMG PROJEC | CT NUMBER: | 19-151 |

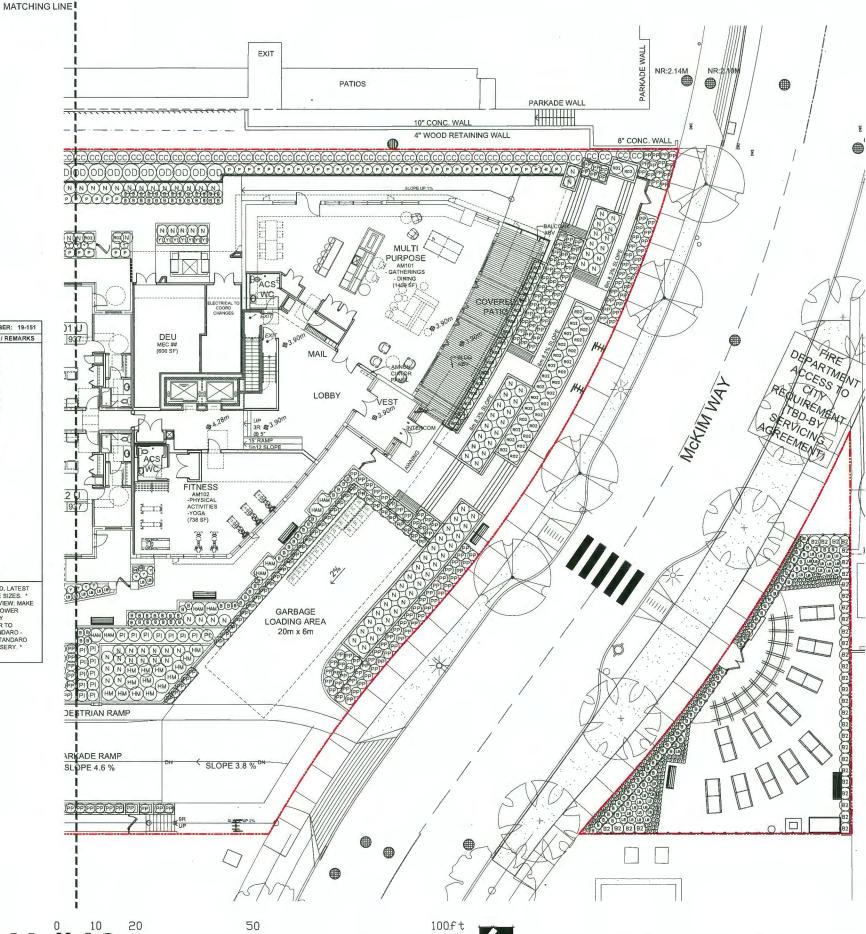

PLANT SCHEDULE PMG PROJECT NUMBER: 19-151 PLANTED SIZE / REMARKS LITTLE-LEAF BOX CHOISYA TERNATA SUNDANCE #3 POT; 50CM MEXICAN MOCK ORANGE CORNUS SERICEA 'KELSEY!'
HEBE PINGUIFOLIA 'SUTHERLANDII' DWARF KELSEY DOGWOOD SUTHERLAND HEBE #3 POT; 80CM #2 POT; 40CM HYDRANGEA MACROPHYLLA 'ENDLESS SUMMER' ENDLESS SUMMER BIGLEAF HYDRANGEA #3 POT: 80CM #3 POT; 80CM HYDRANGEA PANICULATA 'LIMELIGHT' LIMELIGHT HYDRANGEA; LIMEGREEN-PINK NANDINA DOMESTICA MOONBAY OSMANTHUS DELAVAYI DWARF HEAVENLY BAMBOO FALSE HOLLY #3 POT: 50CM #3 POT; 50CM PRUNUS LAUROCERASUS 'OTTO LUYKEN' OTTO LUYKEN LAUREL #3 POT: 50CM HYBRID RHODODENDRON; PALE YELLOW TAXUS X MEDIA 'HICKSII' HICK'S YEW 1.0M B&B VACCINIUM 'POLARIS' POLARIS BLUEBERRY #3 POT; 60CM BOWLE'S GOLDEN SEOGE BLUE OAT GRASS BLACK MONDO GRASS #1 POT #1 POT HELICTOTRICHON SEMPERVIRENS OPHIOPOGON PLANISCAPUS NIGRESCENS CHARACIAS SPURGE LAVENDULA ANGUSTIFOLIA 'HIDCOTE BLUE' PEROVSKIA ATRIPLICIFOLIA 'BLUE SPIRE' ENGLISH LAVENDER; COMPACT; DEEP PURPLE 15CM POT RUSSIAN SAGE RUBUS CALYCINOIDES CREEPING RASPBERRY #1 POT AUTUM JOY STONECROP PACHYSANDRA TERMINALIS JAPANESE SPURGE #1 POT: 15CM NOTES: * PLANT SIZES IN THIS LIST ARE SPECIFIED ACCORDING TO THE BC LANDSCAPE STANDARD AND CANADIAN LANDSCAPE STANDARD, LATEST EDITION, CONTAINER SIZES SPECIFIED AS PER CNLA STANDARD, BOTH PLANT SIZE AND CONTAINER SIZE ARE THE MINIMUM ACCEPTABLE SIZES. REFER TO SPECIFICATIONS FOR DEFINED CONTAINER MEASUREMENTS AND OTHER PLANT MATERIAL REQUIREMENTS. * SEARCH AND REVIEW: MAKE REFER TO SPECIFICATIONS FOR DEFINED CONTAINER MEASUREMENTS AND OTHER PLANT MATERIAL REQUIREMENTS. * SEARCH AND REVIEW ME PLANT MATERIAL PAVALUBLE FOR OPTIONAL REVIEW BY LANDSCAPE ARCHITECT AT SOURCE OF SUPPLY. AREA OF SEARCH TO INCLUDE LOWER MAINLAND AND FRASER VALLEY. * SUBSTITUTIONS: OSTAIN WRITTEN APPROVAL FROM THE LANDSCAPE ARCHITECT PRIOR TO MAKING ANY SUBSTITUTIONS TO THE SPECIFIED MATERIAL. UNAPPROVEO SUBSTITUTIONS WILL BE REJECTED. ALLOW A MINIMUM OF FIVE DAYS PRIOR TO DELIVERY FOR REQUEST TO SUBSTITUTE. SUBSTITUTIONS ARE SUBJECT TO BE LANDSCAPE STANDARD AND CANADIAN LANDSCAPE STANDARD ADD CANADIAN LANDSCAPE STANDARD AND CANADIAN LANDSCAPE STANDARD LATEST EDITION. * ALL PLANT MATERIAL AND WORKMANSHIP MUST MEET OR EXCEED BC LANDSCAPE STANDARD AND CANADIAN LANDSCAPE STANDARD LATEST EDITION. * ALL PLANT MATERIAL MUST BE PROVIDED FROM CERTIFIED DISEASE FREE NURSERY. * BIO-SOLIDS NOT PERMITTED IN GROWING MEDIUM UNLESS AUTHORIZED BY LANDSCAPE ARCHITECT. NOTE: ONSITE IRRIGATION FOR ALL SOFT LANDSCAPE WILL BE INSTALLED

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Burnaby, British Columbia, V5C 6G9 p: 604 294-0011; f: 604 294-0022

NO. DATE REVISION DESCRIPTION

PROJECT:

RESIDENTIAL DEV.


9300 & 9320 CAMBIE RD. RICHMOND, BC

DRAWING TITLE:

SHRUB PLAN

| - | | | |
|------|-------------|-------------|---------------|
| | DATE: | 20.FEB.27 | DRAWING NUMBE |
| | SCALE: | 3/32"=1'-0" | |
| 10 | DRAWN: | YR | L4 |
| | DESIGN: | YR | |
| . 1 | CHKD: | MCY | OF 1 |
| | | | |
| IP I | PMG PROJECT | T NUMBER: | 19-15 |



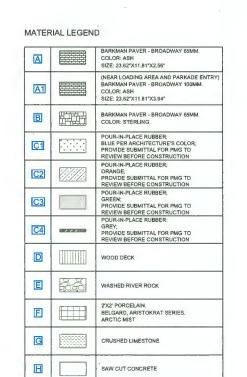

| FENCE LEGEND | | | | | | |
|------------------------------|--------------------------|--|--|--|--|--|
| | 42" HIGH METAL FENCE | | | | | |
| Annual S Reports H.S. Report | 6' HIGH SOLID WOOD FENCE | | | | | |
| | 42" WOOD FENCE | | | | | |

Suite C100 - 4185 Still Creek Drive Burnaby, British Columbia, V5C 6G9 p: 604 294-0011 ; f: 604 294-0022

| NR223 | CO2. 16° CONC. WALL | | • | • | 4° WOOD RETAINING WALL | B' CONC. WALL J |
|------------|-----------------------------------|--------------------------|----------------------------|---|---|--|
| | | OUTLINE OF PARKADE BELOW | 3) A | | A | |
| 109 (1107) | | | | | MULTI- PURPOSE Authorized Authorized Contemporary | |
| | 110 100 8277 | | 05 (104 (103 AU) (1807) | 102 C2(856) 101 U DEU | Transport of the state of the s | |
| | | | | 2288 DEC MINISTER OF STATE OF | MAIL | my Section of American |
| 2:: | 111 111 1051 INDOOR AMENITY | | | | | A CESS ON THE STREET OF THE ST |
| | INDOOR AMENITY | | 18 119 120 AU 11807 120 AU | 121 122 U | NESS Mage and the second secon | |
| | 112 | | | | | |
| | 115 U | | | | GARBAGE LOADING AREA 20m x fim | |
| | | | | | | |
| | 113 | | (A) | PEDESTRIAN RAMP | A | |
| | H1000M ST3 | IA I | | PARKADE RAMP SLOPE 4.6 % | SLOPE 38 W | HABBA |
| | | | | | | |
| | | | | | | |
| P | | | NI 447 | | 0 10 20 50 | 100ft |

DP 21-933765 PLAN #47

January 23, 2023

| 1 | 2020/MAR/06 DATE | REVISION DESCRIPTION | DR. |
|----|---------------------|---------------------------------------|--------|
| 2 | 2020/SEP/25 | · · · · · · · · · · · · · · · · · · · | YR |
| 3 | 2020/OCT/29 | NEW SITE PLAN- COMMUNITY GARDEN | JH. |
| 4 | 2021/MAY/17 | NEW SITE PLAN | YR |
| 5 | 2021/JUL/29 | NEW SITE PLAN | YR |
| 6 | 2021/SEP/14 | EAST PARKADE LINE | YA |
| 7 | 2021/OCT/25 | CITY COMMENTS & NEW SITE PLAN | YR & R |
| 8 | 2022/FEB/16 | NEW SITE PLAN | YR |
| 9 | 2022/MAR/09 | ISSUE FOR ADP | YR |
| 10 | 2022/APR/20 | PARKADE EXHAUST | YR |
| 11 | 2022/APR/30 | ADP COMMENTS | YR |
| 12 | 2022/JUN/22 | NEW SITE PLAN | YR |
| 13 | 2022/NOV/14 | CITY COMMENTS/NEW SITE PLAN | WZ |

PROJECT:


RESIDENTIAL DEV.


9300 & 9320 CAMBIE RD. RICHMOND, BC


DRAWING TITLE:

FENCING & MATERIAL PLAN


| - 11 | | DATE: | 20.FEB.27 | DRAWING NUMBER: |
|-------|-------------|---------------------|-------------|-----------------|
| 100ft | | SCALE: | 1/16"=1'-0" | |
| | | DRAWN: | YR | L5 |
| | | DESIGN: | YR | |
| - | DI ANI 11 6 | CHKD: | MCY | OF 10 |
| DP | PLAN # 3e | | | |
| | | PMG PROJECT NUMBER: | | 19-151 |

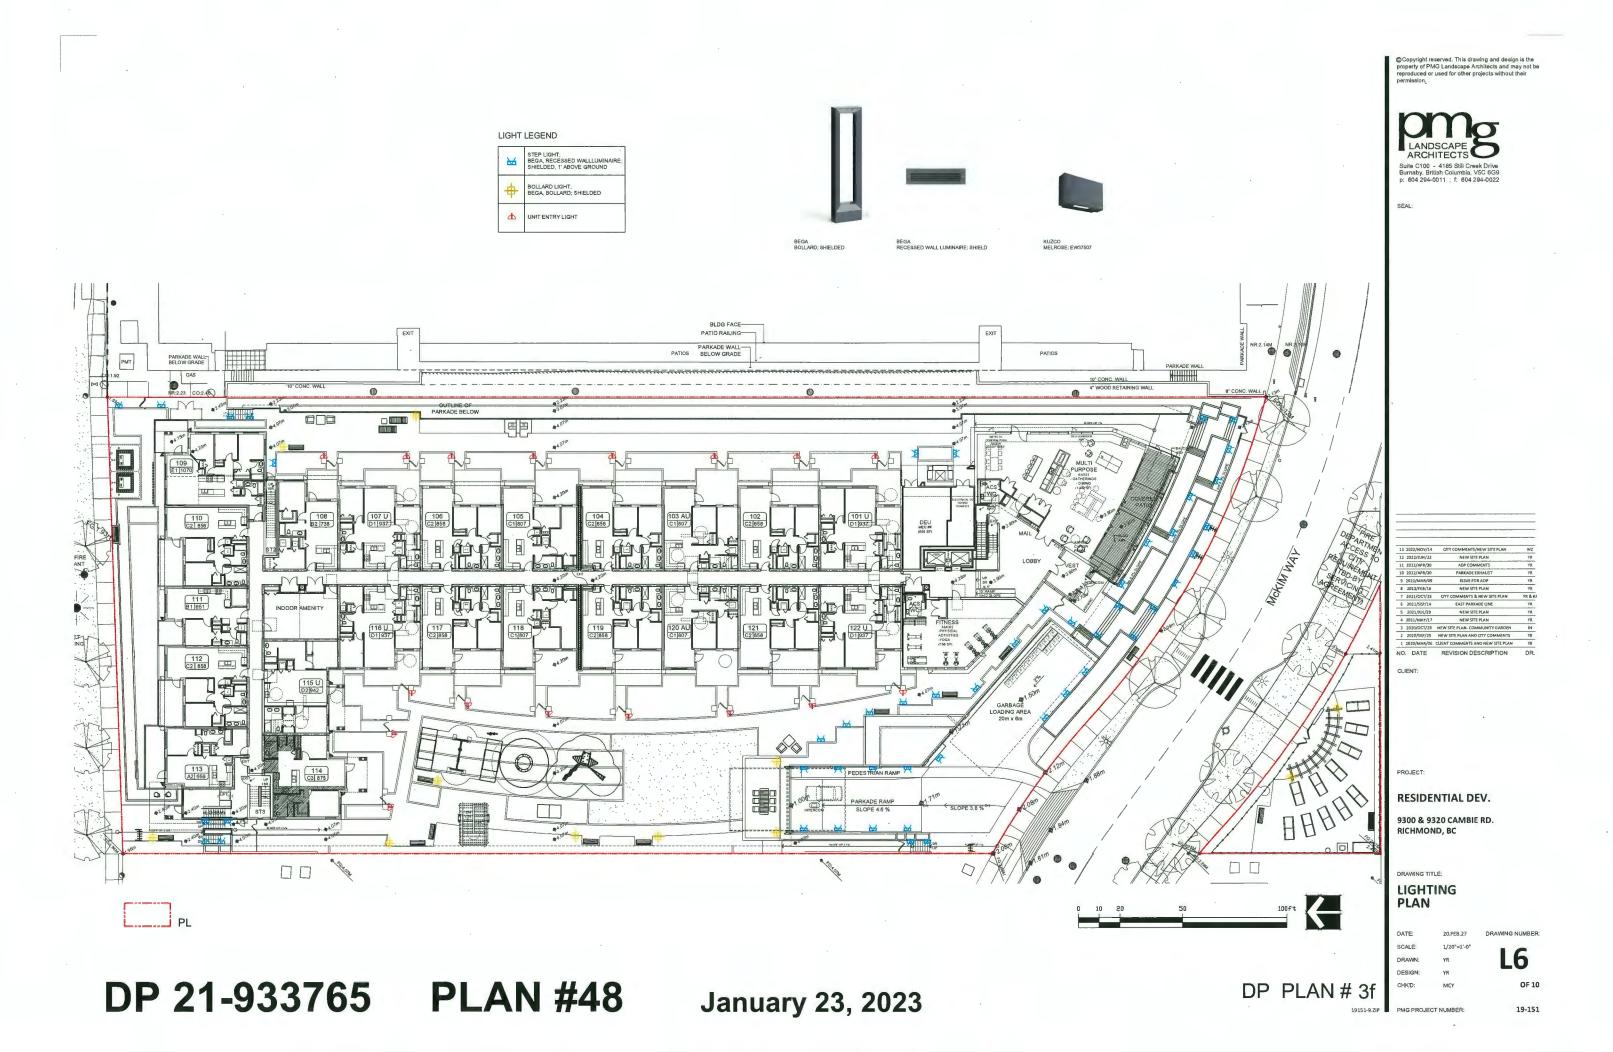

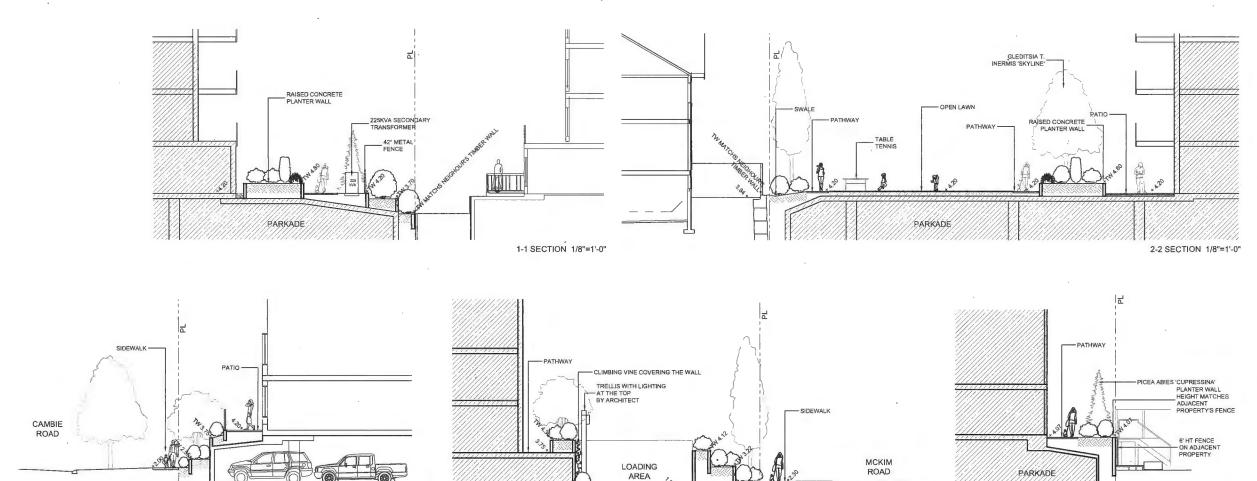


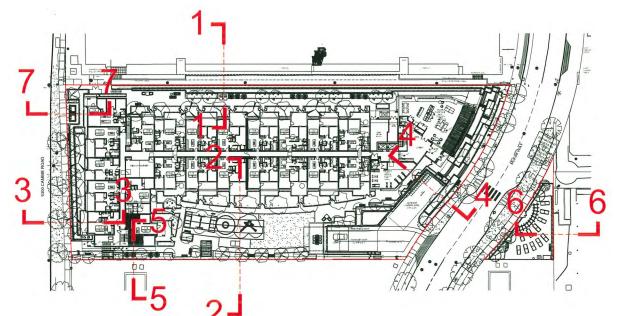

3-3 SECTION 1/8"=1'-0"

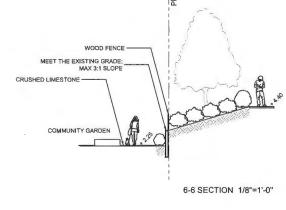

4-4 SECTION 1/8"=1'-0"

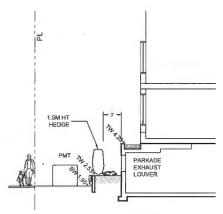

7-7 SECTION 1/8"=1'-0"

DP 21-933765 PLAN #49

January 23, 2023



| 13 | 2022/NOV/14 | CITY COMMENTS/NEW SITE PLAN | wz |
|----|-------------|-----------------------------------|--------|
| 12 | 2022/JUN/22 | NEW SITE PLAN | YR |
| 11 | 2022/APR/30 | ADP COMMENTS | YR |
| 10 | 2022/APR/20 | PARKADE EXHAUST | YR |
| 9 | 2022/MAR/09 | ISSUE FOR ADP | YR |
| 8 | 2022/FEB/16 | NEW SITE PLAN | YR |
| 7 | 2021/OCT/25 | CITY COMMENTS & NEW SITE PLAN | YR 5 P |
| 6 | 2021/SEP/14 | EAST PARKADE LINE | YR |
| 5 | 2021/JUL/29 | NEW SITE PLAN | YR |
| 4 | 2021/MAY/17 | NEW SITE PLAN | YR |
| 3 | 2020/OCT/29 | NEW SITE PLAN- COMMUNITY GARDEN | JH |
| 2 | 2020/SEP/25 | NEW SITE PLAN AND CITY COMMENTS | YR |
| 1 | 2020/MAR/06 | CLIENT COMMENTS AND NEW SITE PLAN | YR |
| 10 | DATE | REVISION DESCRIPTION | DR. |

PROJECT:

RESIDENTIAL DEV.

9300 & 9320 CAMBIE RD. RICHMOND, BC


DRAWING TITLE:

SECTIONS


| DATE: | 20.FEB.27 | DRAWING NUMBER: |
|---------|------------|-----------------|
| SCALE: | 1/8"=1'-0" | |
| DRAWN: | YR | L/ |
| DESIGN: | YR | |
| CHK'D: | MCY | OF 10 |
| | | |

DP PLAN # 3g

5-5 SECTION 1/8"=1'-0"

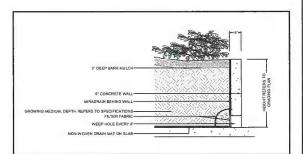





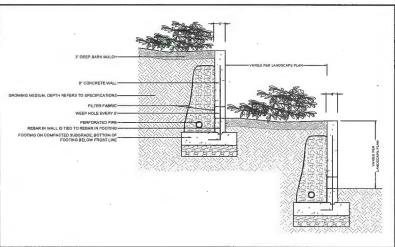


1-2 CONCRETE RETAINING WALL ON GRADE

SCALE: 1/2*=1*-0*

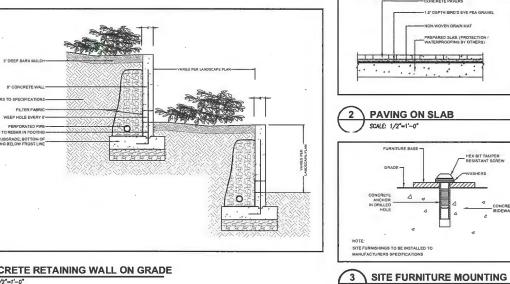


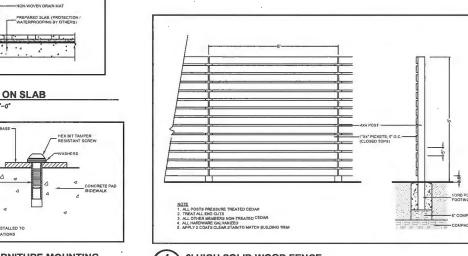


6' HIGH SOLID WOOD FENCE

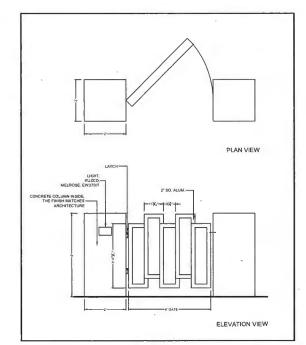


5 42" HIGH METAL GATE WITH COLUMNS

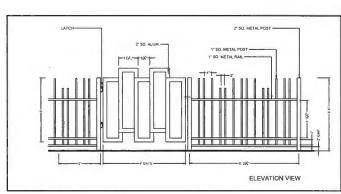

6 42" HIGH METAL GATE WITH FENCE

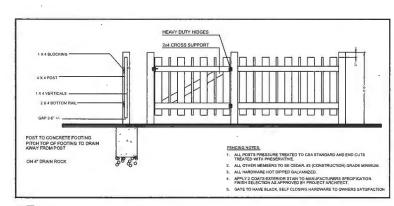

7 42" WOOD FENCE SCALE: 1/2*=1'-0*

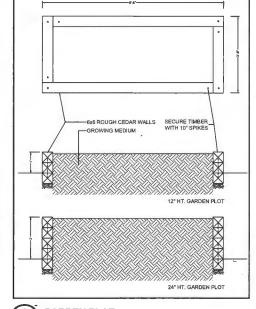

SCALE: 1/2"=1'-0"



KOMPAN SUPERNOVA GREEN LINE KOMPAN TWO SETTING SWING (AGE 5-12) CAGE 5-12) CA









WOOLSEY OUTDOOR PING PONG TABLE

DP PLAN # 3h

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PROJECT:

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9300 & 9320 CAMBIE RD. RICHMOND, BC

DRAWING TITLE:

DETAILS

DRAWING NUMBER: SCALE: **L8**

19-151