



Development Permit Panel

**Council Chambers, City Hall
6911 No. 3 Road**

**Wednesday, December 11, 2019
3:30 p.m.**

MINUTES

Motion to adopt the minutes of the Development Permit Panel meeting held on November 26, 2019.

1. DEVELOPMENT PERMIT 17-791045
(REDMS No. 6288179)

APPLICANT: BOLD Properties (Cooney) Limited Partnership

PROPERTY LOCATION: 6333 Cooney Road

Director's Recommendations

That a Development Permit be issued which would permit the construction of a high-rise building containing approximately 83 dwelling units at 6333 Cooney Road on a site zoned "High Rise Apartment (ZHR8) Brighouse Village".

2. DEVELOPMENT PERMIT 18-797785
(REDMS No. 6342646)

APPLICANT: by Sian Group Investments Inc.

PROPERTY LOCATION: 9680 Williams Road (formerly 9620, 9640, 9660 & 9680 Williams Road)

Development Permit Panel – Wednesday, December 11, 2019

ITEM

Director's Recommendations

That a Development Permit be issued which would permit the construction of 28 townhouse units, including six affordable housing units, at 9680 Williams Road (formerly 9620, 9640, 9660 & 9680 Williams Road) on a site zoned “Medium Density Town Housing (ZT82) – Williams Road”.



3. DEVELOPMENT PERMIT 18-818671

(REDMS No. 5856972)

APPLICANT: Christopher Bozyk Architects Ltd.

PROPERTY LOCATION: 4693, 4720, 4740 Vanguard Road and Road Parcel Richmond Key 20909

Director's Recommendations

That a Development Permit be issued which would:

1. *permit the construction of two industrial buildings on the consolidated parcel including 4693, 4720, 4740 Vanguard Road and Road Parcel Richmond Key 20909 on a site zoned “Industrial Retail (IR1)”; and*
2. *vary the provisions of Richmond Zoning Bylaw 8500 to:*
 - (a) *Increase the maximum height for buildings from 12.0 m to 16.15 m; and*
 - (b) *Reduce the minimum vehicle manoeuvring aisle width from 7.5 m to 6.7 m.*



4. GENERAL COMPLIANCE – REQUEST BY GBL ARCHITECTS FOR A GENERAL COMPLIANCE RULING AT 6340 NO. 3 ROAD

(File Ref. No.: DP 18-822743) (REDMS No. 6337388)

APPLICANT: GBL Architects

PROPERTY LOCATION: 6340 No. 3 Road

Development Permit Panel – Wednesday, December 11, 2019

ITEM

Director's Recommendations

That the attached plans to apply a public art element to the glazing of the southwest corner of the project facing No. 3 Road and Cook Road, to change the glazing on the second floor west and south elevations of the office building facing No. 3 Road and Cook Road, and include painted design elements on the east elevation of the parkade podium wall facing the lane/pedestrian mews be considered to be in General Compliance with Development Permit (DP 18-822743).



5. New Business

6. Date of Next Meeting: January 15, 2020 (Tentative)

ADJOURNMENT



City of Richmond

Minutes

Development Permit Panel Tuesday, November 26, 2019

Time: 3:30 p.m.

Place: Council Chambers
Richmond City Hall

Present: Peter Russell, Chair
Laurie Bachynski, Director, Corporate Business Service Solutions
Milton Chan, Acting Director, Engineering

The meeting was called to order at 3:30 p.m.

Minutes

It was moved and seconded

That the minutes of the meeting of the Development Permit Panel held on November 14, 2019 be adopted.

CARRIED

1. DEVELOPMENT VARIANCE 19-863864

(REDMS No. 6256436)

APPLICANT: Tuung Dih Chu

PROPERTY LOCATION: 8460 Steveston Highway

INTENT OF PERMIT:

Vary the provisions of Richmond Zoning Bylaw 8500 to reduce the minimum size of a farm operation associated with a roadside stand in the “Roadside Stand (CR)” zone from 8.0 ha to 3.0 ha, to permit the construction of a roadside stand at 8460 Steveston Highway.

Applicant's Comments

Michelle Wu, Manager, Lavender Rich Farm, accompanied by Tuung Dih Chu, applicant, with the aid of a PowerPoint presentation (attached to and forming part of these Minutes as Schedule 1) provided background information on the subject Development Variance application, highlighting the following:

Development Permit Panel

Tuesday, November 26, 2019

- the existing lavender farm has been in operation since 2017 and the applicant intends to construct a roadside stand building with an indoor floor area of 93 square meters in the “Roadside Stand (CR)” zoned portion of the split-zoned subject property;
- the proposed siting of the roadside stand building will allow the roadside stand to be located closer to Steveston Highway and not impact the existing farm operation in the “Agriculture (AG1)” zoned portion of the subject property;
- a significant amount of natural wood materials will be used for the proposed roadside stand building;
- there is an existing barn structure in the subject property currently used for storage and processing of lavender products;
- gravel material is proposed for surface treatment of the outdoor parking area;
- the existing driveway in the middle of the site will provide vehicle access to the roadside stand building;
- the existing farm access along the west property line will be maintained to provide access only to the farm;
- a three-meter wide planting strip along Steveston Highway will be installed to provide visual interest along the street frontage; and
- a pedestrian pathway will be constructed to provide pedestrian connection from the City sidewalk to the entrance of the roadside stand building.

In addition, Ms. Wu reviewed the elevations of the proposed roadside stand building, existing farm operations, processing method, and the high-value lavender products from the farm to be sold in the roadside stand building.

Staff Comments

Wayne Craig, Director, Development, noted that (i) the applicant is seeking a variance to the required size of farm operation to allow the proposed roadside stand building to be constructed in the “Roadside Stand (CR)” zoned portion of the subject site, (ii) the proposed roadside stand building could be located in the “Agriculture (AG1)” zoned portion of the site without requesting any variances; however, it would reduce the area used for farm operation and reduce the visibility of the building from the street, (iii) the proposed variance is specific to the building design attached to the subject Development Variance Permit application, and (iv) any further expansion of the proposed roadside stand building will be subject to Council approval.

In reply to a query from the Panel, Mr. Craig confirmed that (i) the subject property is split-zoned, consisting of “Roadside Stand (CR)” zone and “Agriculture (AG1)” zone, (ii) for a roadside stand to be located in “Roadside Stand (CR)” zone, it must be supported by a farm operation of at least 8.0 hectares, (iii) the requested variance is required since the existing farm operation in the subject property is approximately 3.0 hectares in size, and (iv) the building design and proposed landscaping are specific to the proposal.

Development Permit Panel

Tuesday, November 26, 2019

Panel Discussion

In reply to queries from the Panel, Ms. Wu acknowledged that (i) the proposed materials for the building include natural logs, (ii) the proposed planting strip along the Steveston Highway frontage includes two trees and shrubs, majority of which are lavenders, and (iii) lavenders grow well in Richmond.

Gallery Comments

None.

Correspondence

None.

Panel Discussion

The Panel expressed support for the application, noting that (i) the proposal is well thought out and supported by the City's Food Security and Agricultural Advisory Committee (FSAAC), (ii) the siting of the roadside stand along Steveston Highway is supported as it will not impact the existing farm operation, and (iii) the site frontage is well landscaped.

Panel Decision

It was moved and seconded

That a Development Variance Permit be issued that would vary the provisions of Richmond Zoning Bylaw 8500 to reduce the minimum size of a farm operation associated with a roadside stand in the "Roadside Stand (CR)" zone from 8.0 ha to 3.0 ha, to permit the construction of a roadside stand at 8460 Steveston Highway.

CARRIED

2. Date of Next Meeting: December 11, 2019

3. Adjournment

It was moved and seconded

That the meeting be adjourned at 3:43 p.m.

CARRIED

Development Permit Panel
Tuesday, November 26, 2019

Certified a true and correct copy of the Minutes of the meeting of the Development Permit Panel of the Council of the City of Richmond held on November 26, 2019.

Peter Russell
Chair


Rustico Agawin
Committee Clerk

Schedule 1 to the Minutes of the
Development Permit Panel
meeting held on Tuesday,
November 26, 2019.


Lavender Rich Farm

8460 Steveston Hwy


Site Plan

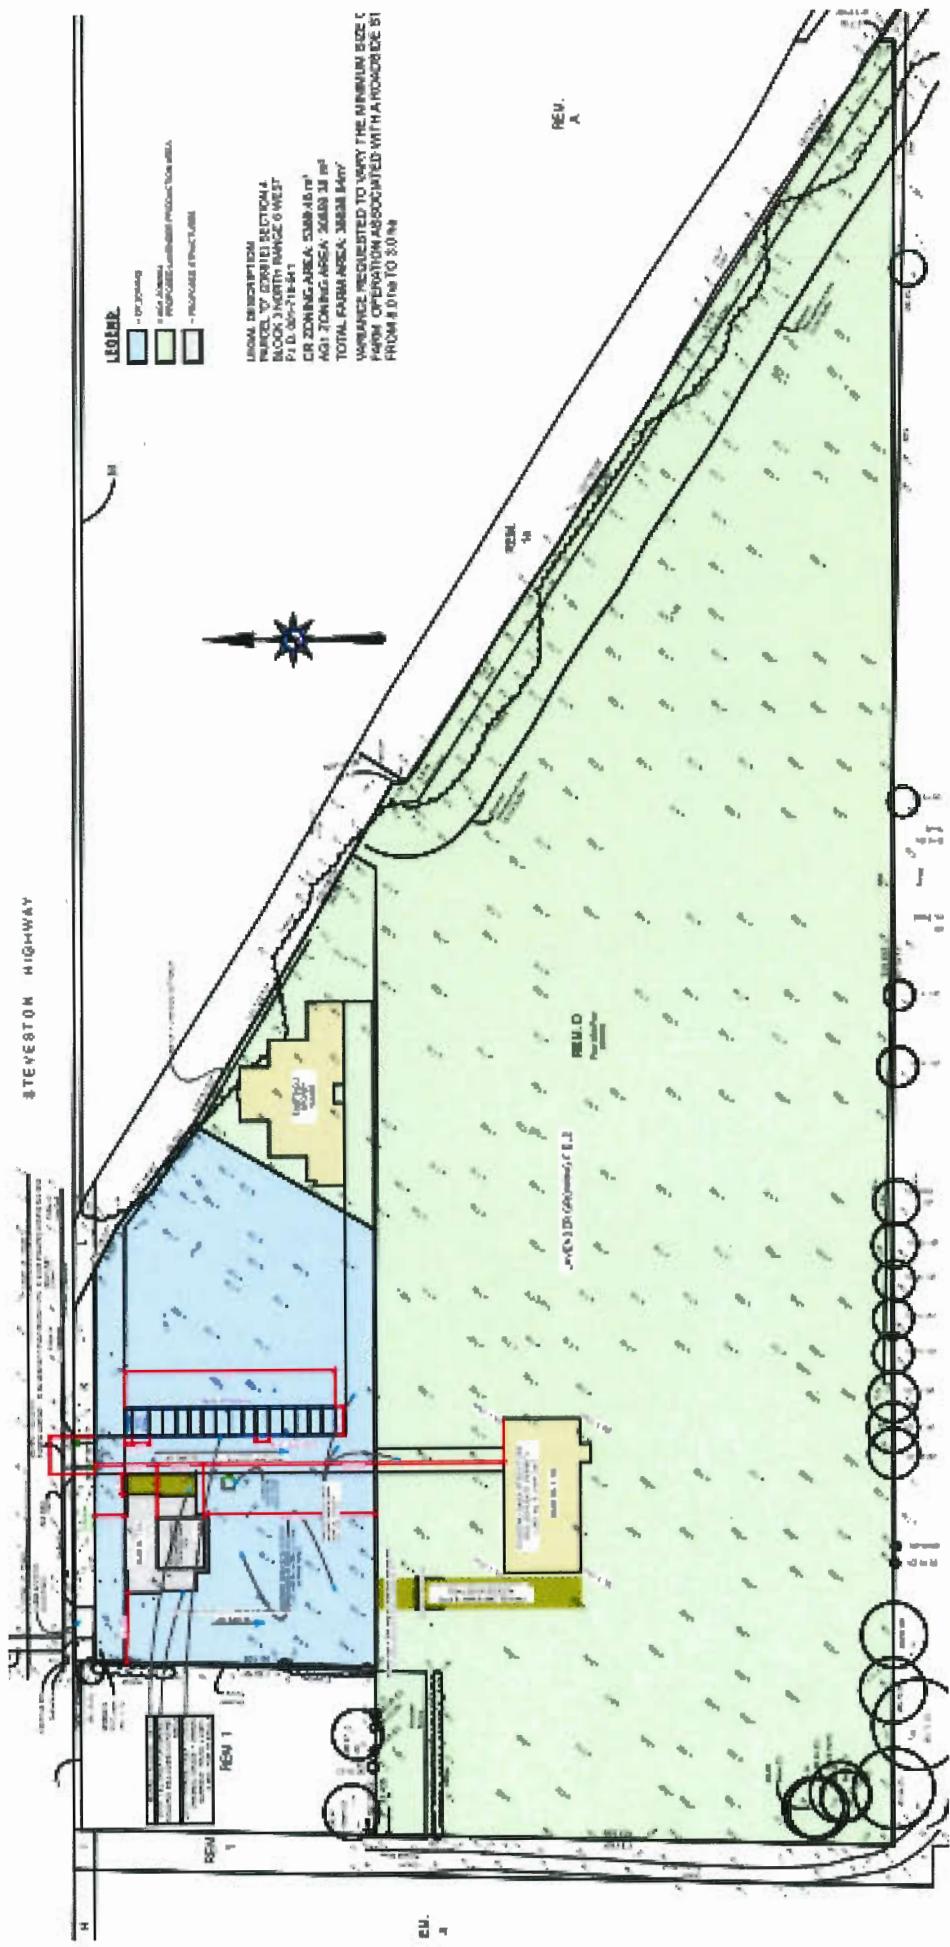

Landscaping plan

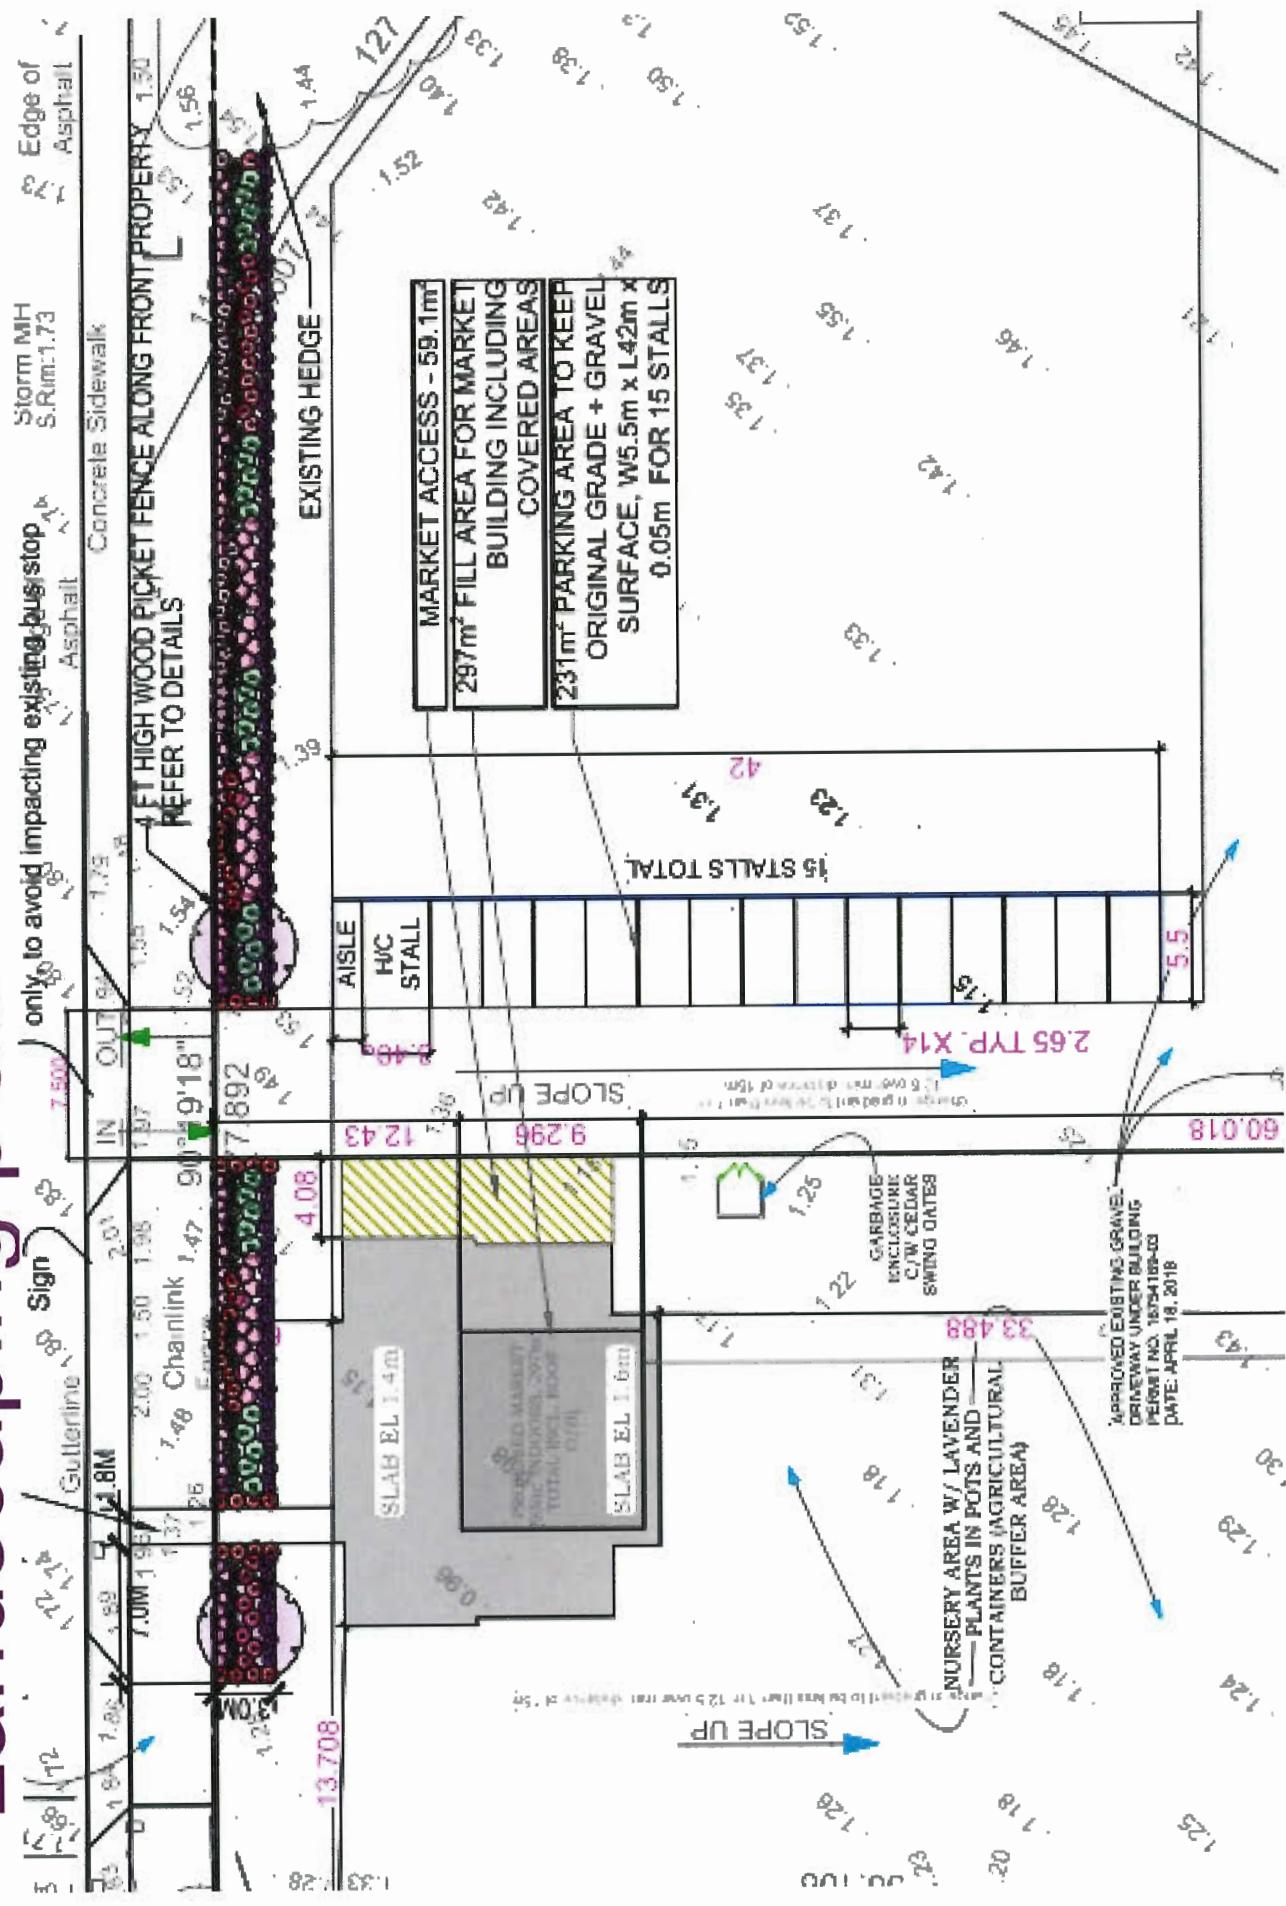

Proposed Roadside Stand

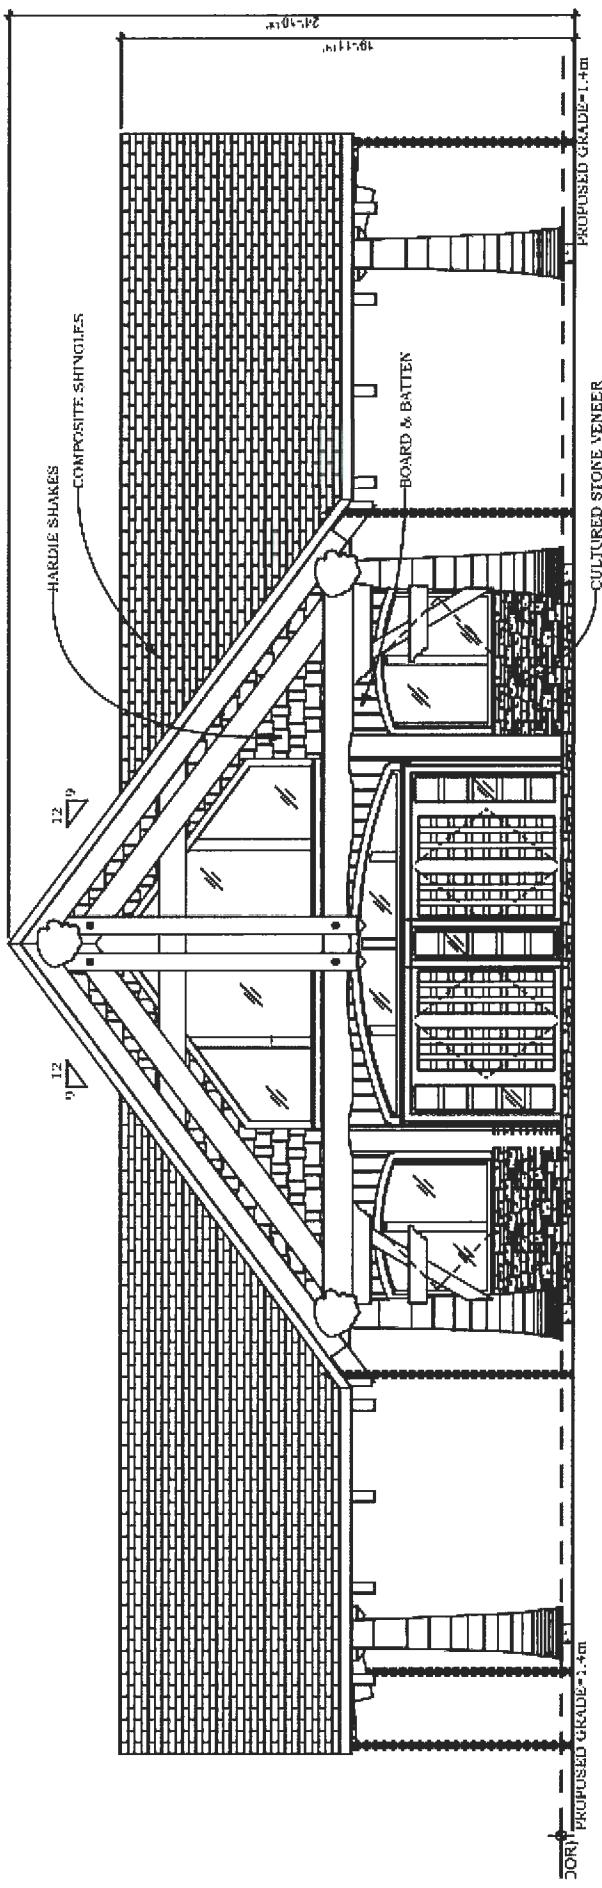

Lavender Field in Spring 2018



Lavender Field in Spring 2019



Lavender Field in Summer 2019



Harvesting




Air Dry in the Barn



Distill Lavender Oil



Value-added lavender products

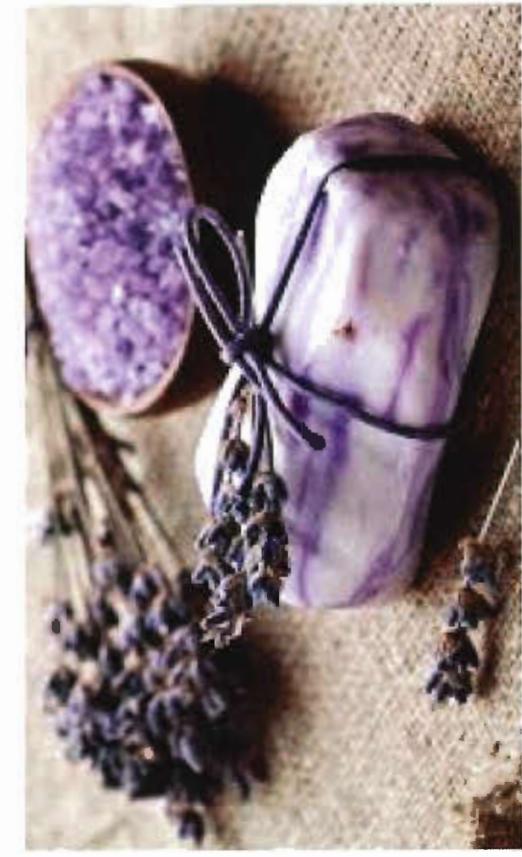



City of Richmond

Report to Development Permit Panel

To: Development Permit Panel

Date: November 14, 2019

From: Wayne Craig
Director, Development

File: DP 17-791045

Re: **Application by BOLD Properties (Cooney) Limited Partnership for a Development Permit at 6333 Cooney Road**

Staff Recommendation

That a Development Permit be issued which would permit the construction of a high-rise building containing approximately 83 dwelling units at 6333 Cooney Road on a site zoned "High Rise Apartment (ZHR8) Brighouse Village".


Wayne Craig
Director, Development
(604-247-4625)

WC:sb
Att. 5

Staff Report

Origin

BOLD Properties (Cooney) Limited Partnership has applied to the City of Richmond for permission to develop a high-rise residential development at 6333 Cooney Road on a site zoned “High Rise Apartment (ZHR8) Brighouse Village”. The developer’s proposal includes a total of 6,559 m² (70,597 ft²) floor area in a 14-storey tower development with approximately 83 dwelling units. The site is currently vacant.

The site is zoned “High Rise Apartment (ZHR8) – Brighouse Village (City Centre)”. Zoning Bylaw 8500, Amendment Bylaw 8738 (RZ 09-506908) and an associated Development Permit (DP 09-506909) were approved by Council on April 10, 2012 and Building Permits issued in 2013. In 2014, the Development Permit and Building Permits expired and the Servicing Agreement (SA 11-583906) was closed. The applicant is required to enter into a new Servicing Agreement and provide a new Letter of Credit security.

Like the original Development Permit, the subject Development Permit application proposes a tower and podium, although with a lower three-storey podium, increased separation of the tower from the west property line, more contemporary architectural design, and more generous residential lobby courtyard and lane sidewalk.

Development Information

Please refer to the attached Development Application Data Sheet (Attachment 1) for a comparison of the proposed development data with the relevant Bylaw requirements.

Background

Development surrounding the subject site is as follows:

To the north: A 14-storey residential tower that is designated under the City Centre Area Plan (CCAP) for high density high-rise mixed-use development (Urban Core T6 (45m)).

To the east: Across Cooney Road, a three-storey townhouse development that is designated under the CCAP for low density low-rise mixed-use development (General Urban T4 (15m)).

To the south: An older split-level house on an orphan lot designated under the CCAP for medium density mid-rise mixed use development (Urban Centre T5 (25m)). The City is reviewing a rezoning application (RZ 19-861646) from GUD GROUP to rezone 6371 Cooney Road from Low Density Townhouse (RTL1) to a Site Specific zone as per the CCAP in order to develop 14 apartment units.

To the west: Two older four-storey wood frame apartment buildings fronting Buswell Street in an area designated under the CCAP for medium density mid-rise mixed use development (Urban Centre T5 (25m)).

Staff Comments

The proposed scheme attached to this report has satisfactorily addressed the significant urban design issues and other staff comments identified as part of the review of the subject Development Permit application. In addition, it complies with the intent of the applicable sections of the Official Community Plan (OCP) and is in compliance with the “High Rise Apartment (ZHR8) Brighouse Village” zone.

Advisory Design Panel Comments

On February 21, 2019, the Advisory Design Panel (ADP) supported the subject Development Permit application moving forward to the Development Permit Panel, subject to the applicant giving consideration to the ADP’s comments. A copy of the relevant excerpt from the Advisory Design Panel Minutes is attached for reference (Attachment 2), together with the applicant’s design response in ‘***bold italics***’.

Analysis

Conditions of Adjacency

- The Cooney Road streetscape is enhanced with two residential unit entries, the residential tower lobby and entry courtyard. The residential tower and three-storey podium massing are provided along this frontage.
- The subject development will be accessed from a new interim City lane required to be constructed along the south edge of the subject site. The original rezoning secured public Rights-of-Way along the south edge of the site for a new City lane and along the Cooney Road frontage for future road widening. These Rights-of-Way areas will be designed and constructed via Servicing Agreement as secured by legal agreement registered on Title. Due to the passage of time, change in engineering requirements, change in ownership and additional lane widening for enhanced pedestrian passage, the applicant is required to enter into a new Servicing Agreement. The lane will be widened to ultimate width through the redevelopment of the site to the south.
- The development is setback along the north and west property lines, due to utility Right-of-Ways. The setback areas provide landscape buffers to the neighbouring residential developments. Shrubs, vines and low planting are proposed in front of the three-storey parking podium, and the walls treated with a relief pattern and inset panels to provide visual interest.
- The development is accommodated within a single tower, located at the southeast corner of the site facing the new lane and Cooney Road to maximize distance from existing neighbouring residential development, and minimize overlook.

Urban Design and Site Planning

- The proposed form of development takes advantage of the site’s proximity to the Canada Line and provision of a new City lane to create a high-density urban environment that is consistent with CCAP objectives.
- The distinctive tower is articulated with stepped roofline resulting from inset penthouse level, and stacked balconies.

- The three-storey podium includes a pedestrian-oriented residential frontage which could accommodate home based business uses, contributing towards local liveability. The podium also accommodates four levels of parking, including a level underground.
- Resident-shared amenity space is provided on the podium roof, including outdoor amenity space and an indoor amenity room pavilion at the north-west corner of the podium roof.
- Service uses, parking, loading and waste management are screened from public view.

Parking and Access

- The proposal includes 101 parking spaces within the parkade in compliance with Zoning Bylaw 8500.
- Parking, loading and waste management are accessed from the new City lane required to be constructed along the south edge of the subject development site. The proposed development will provide additional public Rights-of-Way (0.35 m width) along the north edge of the City lane Right-of-Way (ROW) to accommodate a wider sidewalk along the lane for enhanced pedestrian passage, ultimately to the future bus mall and Brighouse Canada Line Station when the properties to the west redevelop in the future. The interim 7.85 m lane width will be widened to ultimate 9.35 m lane width through the redevelopment of the site to the south.
- One medium (SU9) on-site loading space is provided adjacent to the new lane. The use of the loading space will be shared with the adjacent site to the south at 6371 Cooney Road and the applicant will provide a public Right-of-Way over the loading space for the shared use.
- Most of the utility Right-of-Way along the west property line is also covered by public Right-of-Way. The proposed development will provide Public Rights of Passage (PROP) over the remainder of the utility Right-of-Way along the west property line to accommodate potential future lane network construction.

Architectural Form and Character

- The proposed development contributes towards a modern architectural expression including:
 - Maximizing active transparent residential uses on the ground floor.
 - Three storey podium incorporates repeated vertical design treatment to break down the horizontal massing.
 - A distinct tower along the site's Cooney Road frontage, stepped back from the street-fronting podium and articulated with inset and projecting balconies, cladding incorporating strong graphic patterning in white, grey and black, together providing rhythm, variety and visual interest.
- Quality materials (e.g. cementitious panel, spandrel panels, aluminum frames, and glass guardrails) contribute towards a distinct identity and urban environment.
- A strong white-grey-black colour palette that, when used in combination with variations in massing and materials, helps break up the massing, reinforce the identity of the project and project a crisp, contemporary image.

Landscape Design and Open Space Design

- The CCAP encourages the provision of additional open space to enhance the urban environment. The subject development's public open space contributions are provided through public Rights-of-Way secured through the original rezoning and proposed additional public Right-of-Way to accommodate a wider sidewalk lane.

- 552 m² (5,942 ft²) of residential outdoor amenity space is provided, based on the OCP standard of 6 m² (65 ft²) per dwelling unit, comprising a consolidated, irrigated landscaped, multi-use, outdoor space at the podium roof level (co-located with required indoor residential amenity space), designed to provide for children's play, strolling, socializing, relaxing, and outdoor dining.
- Additional landscaping is provided at the residential lobby entrance, green roof on the indoor amenity pavilion, and landscape buffers along the north and west property lines.
- All landscaped areas will be irrigated and drought tolerant plants are incorporated in green roof and vegetated outdoor areas to reduce reliance on irrigation.
- Private outdoor patios and balconies are provided for all dwelling units in the tower.
- Prior to forwarding the subject application to Council, the applicant is required to provide to the City a Letter of Credit for landscaping in the amount of \$305,277.00, as estimated by the project Landscape Architect, to ensure that on-site landscape features are provided in accordance with the Development Permit.

Shared Indoor Amenity Space

- The OCP requires that multi-family development comprising 40 units or more provide at least 100 m² (1,076 ft²) of indoor amenity space. The subject development meets the OCP minimum and provides for attractive indoor amenity space located adjacent to the outdoor amenity space in the form of a 108 m² (1,161 ft²) enclosed pavilion at the podium roof level.

Crime Prevention Through Environmental Design

- CPTED measures enhance safety and personal security in and around the proposed building.

Casual surveillance is provided through minimizing blind corners, a prominent residential lobby entrance, locating visitor parking uses on the ground floor of the parkade, clear sightlines to exits within the parkade (mirrors where needed), glazed vestibules, street-oriented residential entries and lighting in all ***pedestrian*** areas.

- Territoriality is identified through landscape treatment.
- Target hardening security features are provided at all pedestrian and parking entrances.

Accessible Housing

- The proposed development includes 20 two-bedroom adaptable units that are designed with the potential to be easily renovated to accommodate a future resident in a wheelchair. These single-storey units are required to comply with the BC Building Code requirements for adaptable housing.
- All of the proposed units incorporate aging in place features to accommodate mobility constraints associated with aging. These features include:
 - Lever-type handles for plumbing fixtures and door handles.
 - Solid blocking in washroom walls to facilitate future grab bar installation beside toilets, bathtubs and showers.

Sustainability Measures

- The project will achieve the City standard of LEED "Silver" equivalent as per the attached LEED checklist (Attachment 3).
- District Energy Utility (DEU) compatible building and mechanical system designed to facilitate a future connection to a City utility. The applicant will be required to register a

legal agreement on Title securing the owner's commitment to connect to a District Energy Utility (DEU) that provides that no Building Permit will be issued unless the building is designed with the capability to connect to and be serviced by a DEU. The developer will also be required to provide mechanical drawings and energy modeling, which shall be reviewed by the City and LIEC for compliance with DEU requirements (i.e. capable of connecting to a future DEU system) prior to Building Permit issuance.

- Energized electric vehicle (EV) charging outlets for 100% of resident vehicle parking spaces (208V – 240V) and 10% of Class 1 secure bicycle storage spaces (120V).

Tree Management

- There are six trees (tag# 86, 87, 88, 89, 90, 91) located within the lane public Right-of-Way along the south edge of the subject development site as shown on the proposed tree management plan (DP Plan 40). These trees are in fair to poor condition and are in conflict with the required City lane construction.
- There are seven trees located on neighbouring property as follows:
 - Five trees (tag# OS2, OS3, OS4, OS5, and OS7) located on the neighbouring property to the south (6371 Cooney Road) will need to be removed to facilitate the required lane construction. The City has received a rezoning application for 6371 Cooney Road (RZ 19-861646) and the applicant has received written permission from the neighbouring property owner for the removal of these trees (Attachment 4). The applicant is required to obtain a tree removal permit for these trees.
 - Two trees (tag# OS1 and OS6) located on neighbouring property will not be impacted by the proposed development and are required to be protected. Installation of appropriate tree protection fencing is required as part of the development prior to any construction activities, including building demolition, occurring on-site. The applicant is also required to enter into a contract with a Certified Arborist for supervision of any on-site works conducted within the tree protection zone of the trees, monitor the trees and submit a post-construction assessment report to the City for review.
- There are a total of 19 new trees included in the Development Permit plans.

Affordable Housing

- The ZHR8 zone does not require the provision of built affordable housing units and voluntary cash contributions were provided through previous rezoning applications regarding the subject development site. In response to the need for affordable housing in the City, the applicant will be providing a voluntary contribution in the amount of \$100,000 towards the City's Affordable Housing Strategy (i.e. \$100,000 in addition previous contributions of \$30,545.00 via RZ 03-238768 and \$251,611.00 via RZ 09-506808).

City Centre Development

- The applicant will be providing a voluntary contribution in the amount of \$2,144.77 towards future City community planning studies, as set out in the City Centre Area Plan (i.e. \$19,779.77 at 2019 rate of \$0.28 per buildable square foot, less \$17,635 previously contributed via RZ 09-506808).
- Registration of a legal agreement on Title is required, ensuring that future owners are aware that the development is subject to potential impacts due to other development that may be approved within the City Centre.

Public Art

- The applicant will be providing a voluntary contribution in the amount of \$17,919.95 towards the City's Public Art Program (i.e. \$60,242.95 at 2019 rate of \$0.87 per residential square foot, less \$42,323 previously contributed via RZ 09-506808).

Servicing Agreement

- The applicant is generally required to design and construct the new City lane, Cooney Road frontage beatification, and sanitary sewer improvements. Further details are included in the attached Development Permit considerations (Attachment 5).

Discharges

The following legal agreements are obsolete and will be discharged from Title:

- SRW City utilities (1961 charge 300009C), which is now obsolete as all active City engineering utilities on/near the site are contained within other subsequent SRWs.
- Aircraft noise sensitive development covenant (2005 charge BX288986), which is now obsolete as a replacement covenant with SRW is also registered on Title (2012 charges BB4039857 and BB4039858).
- Servicing Agreement covenant (2012 charge BB4039865), which is now obsolete. Prior to discharge, the new Servicing Agreement and new Letter of Credit are required.
- Building Code equivalency covenant (2013 charge CA3162692), which is now obsolete as the proposed building design has changed.

Conclusions

The proposed development is consistent with Richmond's objectives for the subject property and Brighouse Village as set out in the Official Community Plan (OCP), City Centre Area Plan (CCAP), and Zoning Bylaw. The project will enhance the Brighouse Village urban community through its articulated form, pedestrian-oriented streetscape, adaptable housing, landscaping, widened lane public Right-of-Way, and sustainable development measures, including making provision for future connection to a City District Energy Utility system. The proposed development will also enhance the community through contributions towards Affordable Housing, community planning and Public Art, together with the developer's concurrent construction of off-site improvements secured through the original rezoning and updated through the subject Development Permit and Servicing Agreement applications. The applicant has agreed to complete DP considerations (Attachment 5). On this basis, staff recommend that the Development Permit be endorsed, and issuance by Council is recommended



Sara Badyal
Planner 2
(604-276-4282)

SB:blg

Attachment 1: Development Application Data Sheet

Attachment 2: Advisory Design Panel Meeting Minutes Annotated Excerpt (February 21, 2019)

Attachment 3: LEED Checklist

Attachment 4: Letter of permission for tree removal from owner of 6371 Cooney Road

Attachment 5: Development Permit Considerations



City of Richmond

Development Application Data Sheet

Development Applications Department

DP 17-791045

Attachment 1

Address:	6333 Cooney Road	BOLD Properties (Cooney) Limited	BOLD Properties (Cooney) Nominee Inc., Inc. No. BC1120735
Applicant:	Partnership	Owner:	
Planning Area(s):	City Centre (Brighouse Village)		

	Existing	Proposed
Site Area	2,458 m ²	No Change
Land Uses	Vacant	Multi-Family Residential
OCP Designation	Mixed-Use	Complies
Zoning	High Rise Apartment (ZHR8) - Brighouse Village	Complies
Number of Units	None	83 dwelling units, including: • 1 studio, 15 1-bedroom, 64 2-bedroom & 3 3-bedroom units • 81% family friendly units (2 & 3 bedroom) • 20 adaptable units

	Bylaw Requirement	Proposed	Variance
Floor Area Ratio	Max. 2.67	2.67	None permitted
Lot Coverage	Max. 70%	70%	None
Setback – Cooney Road	Min. 3 m	3 m	None
Setback – North Side Yard	Min. 2.7 m	2.7 m	None
Setback – South Side Yard	Min. 7.5 m	8.19 m	None
Setback – Rear Yard	Min. 1.5 m	1.5 m	None
Height	Max. 41 m	41 m	None
Lot Size	N/A	61 m lot width 39.6 Min. lot depth 2,458 m ² lot area	None
Parking Spaces	100 total spaces, including: 83 resident spaces 17 visitor spaces	101 total spaces, including: 84 resident spaces 17 visitor spaces	None
Parking – Accessible Spaces	2%	3.6% (3 spaces)	None
Parking – Small Car Spaces	Max. 50%	49% (49 spaces)	None
Parking – Tandem Spaces	Permitted	None	None
Off-Street Loading	1 medium truck (SU-9) space	1 medium truck (SU-9) space	None
Bicycle Storage	104 class 1 secure bike spaces 17 class 2 bike rack spaces	105 class 1 secure bike spaces 17 class 2 bike rack spaces	None
EV (Energized) Charging for Cars	100% Resident parking spaces	100% Resident parking spaces	None
Amenity Space – Indoor	Min. 100 m ² (1,076 ft ²)	108 m ² (1,161 ft ²)	None
Amenity Space – Outdoor	Min. 498 m ² (5,360 ft ²)	552 m ² (5,942 ft ²)	None

**Excerpt from the Minutes from
Advisory Design Panel Meeting
February 21, 2019**

DP 17-791045 – CITY CENTRE MIXED USE DEVELOPMENT

ARCHITECT:	Norr Architects Planners.
LANDSCAPE ARCHITECT:	Connect Landscape Architecture
PROPERTY LOCATION:	6333 Cooney Road

Applicant's Presentation

Simon Ho, Norr Architects Planners, and David Stoyko, Connect Landscape Architecture, presented the project and answered queries from the Panel on behalf of the applicant.

Panel Discussion

Comments from Panel members were as follows:

- extending the live-work units across the blank façade would be positive to energize the streetscape – **Improved.** *Additional dwelling unit added, increasing unit street frontage and reducing blank façade.*
- the tower design concept is strong; the podium is not as conceptually strong; language of the live-work units and the podium blank façade along Cooney Road need to be either unified or set these apart more from the rest of the development to provide a clear relationship; the roof form is an important component to achieve this – **Improved as noted above and design further refined, including podium and roof forms.**
- consider installing extensive green roof treatments for the lower roofs to improve views from the upper levels of the development and surrounding existing and future developments – **Improved.** *Extensive green roof treatment added to indoor amenity roof.*
- appreciate the proposed tower roofline treatment; support the angling of the roofline; however, the applicant could introduce a bolder approach subject to the height restrictions – **Improved and incorporated on all four elevations.**
- consider locating three-bedroom units close to the outdoor amenity area on Level 4 to provide a more direct adjacency for families with children to the amenity area – **Considered.** *Access for all units is provided through interior corridor from the elevator and stair lobby.*
- appreciate the proposed canopies on the indoor amenity space; consider providing weather protection from the indoor amenity space to the tower – **Considered.** *Maintaining an open outdoor amenity area is sought instead of visually splitting the amenity area into two separate areas.*
- appreciate the design of the bicycle racks – **Noted.**
- consider increasing the depth and area of balconies which have limited depths and sizes – **Considered.**
- appreciate the project's proposed mechanical systems and sustainability features – **Noted.**
- note that a vestibule is not provided at the main pedestrian entrance to the building – **Incorporated.**
- review the size of water entry room, which appears too small and may need to be increased – **Size of mechanical rooms on 1st and 2nd floors reviewed and confirmed by project Engineer.**
- the proposed location of the air cooled chiller plant at the southwest corner of the podium roof may not be appropriate due to potential noise issues to adjacent residential units in the subject development and neighbouring properties – **Reviewed by project Engineer, air-cooled chiller plant located on central spine area of tower roof, and equipment will be located on vibration isolators to mitigate any vibration and noise that could be produced.**
- a gas meter enclosure is not provided in the plans; location should be determined at this stage of the project as it affects the planning and design of other service rooms – **Incorporated.**
- review the location of the proposed generator room as it is under residential floor area and has potential noise, vibration and ceiling space plumbing issues; also look at the spacing requirement for louvers – **Reviewed. All**

adjacent residential units will incorporate acoustical enhancements to floor, wall and ceiling assemblies. Louvers spacing meets requirements.

- applicant needs to address parking ventilation at this stage of the project as there are no louvers provided in the plans; provision of shafts in the parkade may only be possible if one parking stall is removed – **Incorporated**.
- consider installing a canopy over the recessed entrances to the live-work unit along Cooney Road; will enhance the character and improve the weather protection for the live-work unit entries – **Incorporated**.
- appreciate the shift in the geometry of the paving near the tower entrance; also appreciate the lantern expression at the southeast corner of the building; all tower faces have a nice proportion to the articulation of the balconies except for the one corner at the tower entry; consider design development of the entry canopy to the tower, which could relate to the skewed geometry of the paving to provide a more dynamic character to the tower expression – **Incorporated**.

Entry canopy geometry mimics landscape paving geometry and corner glazing pattern improved to emphasize corner and entry expression.

- appreciate the model which expresses well the design intent of the building – **Noted**.
- appreciate the articulation on the podium – **Noted**.
- difficult to comment as the package provided by the applicant is incomplete – **Noted**.
- consider punctuating the landscaping on the north side of the building with higher shrubs or small trees – **Considered**.
The area is a PROP and utility SRW area, in which tree planting is not permitted.
- consider adding more soft landscaping on the outdoor amenity area on Level 4; the applicant could install planters on the edge with trailing plants to meet the vines that will be growing up from the ground level; additional shrub planting is also needed to better define and provide separation between various areas on the outdoor amenity area – **Improved**.
Design intent and functionality of the outdoor amenity area was reviewed and planting area was intensified adjacent to play lawn.
- appreciate the applicant contributing to the City's Public Art Fund; however, the applicant is encouraged to incorporate public art into the project as it improves the public realm – **Considered**.
- setbacks along the building façade on Cooney Road help break down the massing; however, consider pushing it more – **Considered**.
- consider using an intentional pattern for the accents on the residential podium façade along Cooney Road – **Improved**.
Design further refined.
- consider using different materials for the base and upper levels of the residential podium to provide a more pedestrian-oriented scale and character; will help articulate the base as a more public area due to the location of the live-work unit – **Considered**.
Design further refined, but additional materials were not incorporated as façade design and materiality is currently fairly complex.
- consider opening up the area near the entrance to the live-work unit to emphasize that it is a work area; consider introducing a different paving to differentiate the space as a work area rather than a sidewalk/pedestrian area – **Considered**.
- consider using a different language for the architecture of the live-work unit through the use of different materials on the front facade – **Improved**.
Design further refined, additional glazing and canopy provided.
- ensure that an appropriate space will be provided for installation of signage for the live-work unit – **Incorporated**.
- consider integrating more the District Energy Utility (DEU) room into the building façade; a different colour could be used to make these elements more of a feature – **Improved**.
Panel configuration and grille pattern revised for further integration.
- appreciate the random pattern on the north and west façades as it helps visually break down the massing and provides an appropriate interface with adjacent residential developments – **Noted**.
- consider a more prominent tower entry on the ground floor to emphasize it as an entrance – **Incorporated**.
Entry glazing expanded and canopy enlarged.
- appreciate the provision for bicycle storage; consider allocating a storage space for a hand bicycle – **Considered**.

- accessible parking spaces are proposed adjacent to the ramp; consider relocating or installing safety features – ***Improved by relocating spaces.***
- appreciate the provision of two-bedroom and three-bedroom accessible units; also consider providing one-bedroom accessible units – ***Considered. The one-bedroom unit compact size does not accommodate the required clearances.***
- appreciate the open kitchen concept; would be useful to a person using a mobility device – ***Noted.***
- clarify whether steps are proposed in the children’s play area which could pose accessibility issues – ***Improved. A ramp provides access to the children’s play structure area.***

Panel Decision

It was moved and seconded

That DP 17-791045 be supported to move forward to the Development Permit Panel subject to the applicant giving consideration to the comments of the Advisory Design Panel.

CARRIED

Opposed: Charan Sethi


KANE CONSULTING
Sustainability v4 for Building Design and Construction: Multifamily Midrise

Project Checklist
 Project Name: 6333 Cooney Road
 Date: Feb 19th, 2019




Y	?	N	Credit	Integrative Process	2
2	0	0	Credit	Location and Transportation	14
Y			Preq	Floodplain Avoidance	1
0	0	15	Credit	PERFORMANCE PATH	1
				LEED for Neighborhood Development Location	15
				PRESCRIPTIVE PATH	1
7	0	1	Credit	Site Selection	7
3	0	0	Credit	Compact Development	3
2	0	0	Credit	Community Resources	2
2	0	0	Credit	Access to Transit	2
0	2	5	Sustainable Sites	15	
Y			Preq	Construction Activity Pollution Prevention	1
Y			Preq	No Invasive Plants	1
0	1	1	Credit	Heat Island Reduction	2
0	0	3	Credit	Rainwater Management	3
0	1	1	Credit	Non-Toxic Pest Control	2
6	3	3	Water Efficiency	15	
Y			Preq	Water Metering	1
0	0	2	Credit	PERFORMANCE PATH	1
0	1	0	Credit	Total Water Use	12
				PRESCRIPTIVE PATH	1
3	2	1	Credit	Indoor Water Use	3
3	1	0	Credit	Outdoor Water Use	4
16	9	12	Energy and Atmosphere	37	
Y			Preq	Minimum Energy Performance	1
Y			Preq	Energy Metering	1
16	9	5	Credit	Education of the Homeowner, Tenant or Building Manager	30
0	0	5	Credit	Annual Energy Use	5
0	0	2	Credit	Efficient Hot Water Distribution	2
				Advanced Utility Tracking	2
4	1	4	Materials and Resources	9	
Y			Preq	Certified Tropical Wood	1
Y			Preq	Durability Management	1
1	0	0	Credit	Durability Management Verification	5
1	0.5	3.5	Credit	Environmentally Preferable Products	3
2	0.5	0.5	Credit	Construction Waste Management	2
TOTALS				56.5 23.5 30 TOTALS 110	
Certified: 40 to 49 points, Silver: 50 to 59 points, Gold: 60 to 79 points, Platinum: 80 to 110 Possible Points:					
Regional Priority: Community Resources Required Credit					
Regional Priority: Compact Development Required Credit					
Regional Priority: Annual Energy Usage Required Credit					
Regional Priority: Durability management verification Required Credit					

Attachment 4

Dear City of Richmond,

My name is Mao Wei Zhang and I am a director of the company (1111407 B.C. LTD.) that owns 6371 Cooney Road in Richmond. Following a conversation with Bold Properties in regards to their development at 6333 Cooney Road, I give permission for Bold Properties to remove the trees on 6371 Cooney Road at the time of construction as per the City's Staff Comments Letter dated November 9, 2018 stating "5 trees (tag# OS2, OS3, OS4, OS5, and OS7) located on neighbouring property will be severely impacted by the construction of the proposed access driveway on the development site. These trees are in poor condition but require written approval from the neighbouring property owner prior to removal."

Thanks for your cooperation and please contact me if you have more questions.

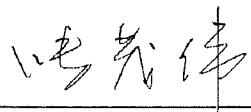

Mao Wei Zhang

1111407 B.C. LTD.

ycgimw@gmail.com

778 999 9516



**City of
Richmond**

Attachment 5

Development Permit Considerations

Development Applications Department
6911 No. 3 Road, Richmond, BC V6Y 2C1

Address: 6333 Cooney Road

File: DP 17-791045

Prior to forwarding this Development Permit application to Council for approval, the owner must complete the following requirements:

1. (*Voluntary Contributions*) City acceptance of the Owner's voluntarily contributions in the following amounts:
 - a) \$2,144.77 towards future City community planning studies, as set out in the City Centre Area Plan (i.e. \$19,779.77 at 2019 rate of \$0.28 per buildable square foot, less \$17,635 previously contributed via RZ 09-506808).
 - b) \$17,919.95 towards the City's Public Art Program (i.e. \$60,242.95 at 2019 rate of \$0.87 per residential square foot, less \$42,323 previously contributed via RZ 09-506808).
 - c) \$100,000 towards the City's Affordable Housing Strategy (Owner's offer in addition previous contributions of \$30,545.00 via RZ 03-238768 and \$251,611.00 via RZ 09-506808).
2. (*Landscape Security*) Submission of a Letter of Credit for landscaping in the amount of \$305,277 as specified on the landscape cost estimate provided and sealed by the project Landscape Architect (including materials, installation and 10% contingency).
3. (*Side Lane Enhanced Sidewalk Statutory Right of Way*) Granting approximately 15.4 m² (165.8 ft²) 0.35m wide statutory Right-of-Way for the purposes of Public Rights of Passage and utilities to accommodate an enhanced 1.85m wide sidewalk in the new lane along the south edge of the site and 2m x 2m corner cut at the southwest corner of the site. The works are to be built by the owner and maintained by the owner with the exception of City infrastructure, which is to be maintained by the City. Any works essential for public access within the required statutory Right-of-Way (SRW) are to be included in the Servicing Agreement (SA) and the maintenance & liability responsibility is to be clearly noted. The design must be prepared in accordance with City specifications and good engineering practice with the objective to optimize public safety.
4. (*Future Rear Lane Statutory Right of Way*) Granting approximately 17.5 m² (188.4 ft²) 1.5m wide statutory Right-of-Way for the purposes of Public Rights of Passage and utilities to accommodate future potential rear lane extension from north boundary of existing SRW plan BCP50328 to south boundary of existing SRW plan BCP20901 along the south edge of the site. The works are to be built by the owner and maintained by the owner with the exception of City infrastructure, which is to be maintained by the City. Any works essential for public access within the required statutory Right-of-Way (SRW) are to be included in the Servicing Agreement (SA) and the maintenance & liability responsibility is to be clearly noted. The design must be prepared in accordance with City specifications and good engineering practice with the objective to optimize public safety.
5. (*Shared Loading Bay Statutory Right of Way*) Granting of an approximately 56.1 m² (603.9 ft²) statutory Right-of-Way for the purposes of Public Rights of Passage for the shared use at all times of the loading bay with the proposed development and future development on the neighbouring property at 6371 Cooney Road. Any gates are to remain open from 7am to 7pm 7 days a week, and may only be secured if means are provided for the neighbouring property at 6371 Cooney Road to access the loading bay at all other times. The works are to be built by the owner and are to be maintained by the owner. Any works essential for public access within the required statutory Right-of-Way (SRW) are to be included in the Servicing Agreement (SA) and the maintenance & liability responsibility is to be clearly noted. The design must be prepared in accordance with good engineering practice with the objective to optimize public safety and after completion of the works, the owner is required to provide a certificate of inspection for the works, prepared and sealed by the owner's Engineer in a form and content acceptable to the City, certifying that the works have been constructed and completed in accordance with the accepted design.

6. (***Discharges***) Discharge the following obsolete charges from title:
 - a) SRW City utilities (1961 charge 300009C), which is now obsolete as all active City engineering utilities on/near the site are contained within other subsequent SRWs.
 - b) Aircraft noise sensitive development covenant (2005 charge BX288986), which is now obsolete as a replacement covenant with SRW is also registered on title (2012 charges BB4039857 and BB4039858).
 - c) Servicing agreement covenant (2012 charge BB4039865), which is now obsolete due to the passage of time. Prior to discharge, as noted below, a new servicing agreement and new letter of credit are required.
 - d) Building code equivalency covenant (2013 charge CA3162692), which is now obsolete as the proposed building design has changed.
7. (***City Centre Impacts***) Registration of a legal agreement on title stipulating that the development is subject to potential impacts due to other development that may be approved within the City Centre including without limitation, loss of views in any direction, increased shading, increased overlook and reduced privacy, increased ambient noise and increased levels of night-time ambient light, and requiring that the owner provide written notification of this through the disclosure statement to all initial purchasers, and erect signage in the initial sales centre advising purchasers of the potential for these impacts.
8. (***District Energy Utility***) Registration of a restrictive covenant and/or alternative legal agreement(s), to the satisfaction of the City, securing the owner's commitment to connect to District Energy Utility (DEU), which covenant and/or legal agreement(s) will include, at minimum, the following terms and conditions:
 - a) No building permit will be issued for a building on the subject site unless the building is designed with the capability to connect to and be serviced by a DEU and the owner has provided an energy modelling report satisfactory to the Director of Engineering;
 - b) If a DEU is available for connection, no final building inspection permitting occupancy of a building will be granted until:
 - i. the building is connected to the DEU, which may include the owner's supplied and installed central energy plant to provide heating and cooling to the building, at no cost to the City, or the City's DEU service provider, Lulu Island Energy Company, on the subject site satisfactory to the City;
 - ii. if the City so elects, the owner transfers ownership of the central energy plant on the site, if any, at no cost to the City, or City's DEU service provider, Lulu Island Energy Company, to the City and/or the City's DEU service provider, Lulu Island Energy Company, on terms and conditions satisfactory to the City;
 - iii. the owner enters into a Service Provider Agreement with the City and/or the City's DEU service provider, Lulu Island Energy Company, on terms and conditions satisfactory to the City; and
 - iv. the owner grants or acquires the Statutory Right-of-Way(s) and/or easements necessary for supplying the DEU services to the building and the operation of the central energy plant, if any, by the City and/or the City's DEU service provider, Lulu Island Energy Company.
 - c) If a DEU is not available for connection, no final building inspection permitting occupancy of a building will be granted until:
 - i. the City receives a professional engineer's certificate stating that the building has the capability to connect to and be serviced by a DEU;
 - ii. the owner enters into a covenant and/or other legal agreement to require that the building connect to a DEU when a DEU is in operation ;
 - iii. the owner grants or acquires the Statutory Right-of-Way(s) and/or easements necessary for supplying DEU services to the building; and
 - iv. the owner provides to the City a letter of credit, in an amount satisfactory to the City, for costs associated with acquiring any further Statutory Right of Way(s) and/or easement(s) and preparing and registering legal agreements and other documents required to facilitate the building connecting to a DEU when it is in operation.

9. (*Existing Tree Management*) The owner shall protect adjacent neighbouring trees, including:
 - a) (*Arborist Supervision*) Submission of a Contract entered into between the applicant and a Certified Arborist for supervision of any on-site works conducted within the tree protection zone of all trees to be protected. The Contract should include the scope of work to be undertaken, including: the proposed number of site monitoring inspections, and a provision for the Arborist to submit a post-construction assessment report to the City for review.
 - b) (*Tree Removal Permit*) 5 trees (tag# OS2, OS3, OS4, OS5, and OS7) located on neighbouring property will be severely impacted by the construction of the proposed access driveway on the development site. These trees are in poor condition. The neighbouring property owner has provided written approval and a tree removal permit is required to be obtained prior to removal.
 - c) (*Tree Protection*) 2 trees (tag# OS1 and OS6) located on neighbouring property to be protected require installation of appropriate tree protection fencing as part of the development prior to any construction activities, including building demolition, occurring on-site.
10. (*Servicing Agreement*) Enter into a Servicing Agreement* for the design and construction of Engineering and Transportation works in accordance with Transportation Association of Canada (TAC) Specifications, City Engineering Design Specifications and applicable Bylaws to the satisfaction of the City. A Letter of Credit or cash security for the value of the Service Agreement works, as determined by the City, will be required as part of entering into the Servicing Agreement. Works include, but may not be limited to, the following:
 - 10.I Road works:
 - a) Road Functional Design Works: Submission of a functional design (road works, interim and ultimate lane works), prepared to the satisfaction of the City, is required. Design to accommodate: Cooney Road frontage improvements and new lane. Works also include street lighting, traffic signage, boulevard landscaping, and street trees. The functional design is to indicate clearly all existing and proposed SRW PROPS, and include the frontage improvements listed below. Unless otherwise specified, all road works are to be designed as per bylaw, TAC Standards and the City's Engineering Design Specifications.
 - b) Cooney Road Frontage Improvements: Works to include, from east to west behind existing curb and gutter, grass boulevard (Min. 1.5 m) with street trees and new 2 m wide concrete sidewalk. The new sidewalk and boulevard are to transition to meet the existing frontage treatments to the north and south of the subject site. Sidewalk alignment with smooth transitions to north and south to be detailed on required road functional plan for City review in order to confirm interim frontage cross section. All existing driveways along the Cooney Road frontage are to be closed permanently. The Owner is responsible for the removal of the existing driveway let-downs and the replacement with sidewalk, boulevard and barrier curb and gutter to match frontage improvements. There are existing utility poles and junction boxes that will need to be relocated at the owner's cost.
 - c) New Lane: Interim lane to City Centre standard with additional sidewalk width. Works to include, from north to south, 1.85 m wide concrete sidewalk with street lighting located to maintain a 1.5 m width of sidewalk free and clear of obstruction, roll-over curb and remaining 6 m to be roadway driving surface approved by the City. Through the Servicing Agreement, decorative pavement treatment may be required to create a more pedestrian friendly environment in the lane.
 - 10.II Water Works:
 - a) Using the OCP Model, there is 659.0 L/s of water available at a 20 psi residual at Cooney Road. Based on the proposed development, site requires a minimum fire flow of 220 L/s.
 - b) At the Owner's cost, the Owner is required to:
 - i. Submit Fire Underwriter Survey (FUS) or International Organization for Standardization (ISO) fire flow calculations to confirm development has adequate fire flow for onsite fire protection. Calculations must be signed and sealed by a Professional Engineer and be based on Building Permit Stage building designs.
 - ii. Review hydrant spacing on all road frontages and install new fire hydrants as required to meet City spacing requirements for commercial land use.
 - iii. Obtain approval from Richmond Fire Rescue for all fire hydrant locations, relocations, and removals, as required.

- iv. Provide a Right-of-Way for water meter. Exact Right-of-Way dimensions to be finalized during the servicing agreement process.
 - c) At Owner's cost, the City is to:
 - i. Cut, cap, and remove the existing water service connections servicing 6333 Cooney Road.
 - ii. Install a new water service connection, complete with meter and meter box, to serve the proposed development.
- 10.III Storm Sewer Works:
- a) At the Owner's cost, the Owner is required to:
 - i. Provide an erosion and sediment control plan for all on-site and off-site works, to be reviewed as part of the servicing agreement design.
 - ii. Ensure trees are not placed on top of the storm sewer main and, follow offset and alignment similar to the existing trees at the Cooney frontage of the property to the north.
 - b) At Owner's cost, the City is to:
 - i. Cut, cap, and remove the existing storm service connections and inspection chambers servicing the subject site.
 - ii. Install a new storm service connection and type III inspection chamber. If required, the Owner shall provide a statutory Right-of-Way for the inspection chamber at their cost.
 - iii. Complete all tie-ins for the potential works to existing City infrastructure, to be determined by the pipe sizing calculations at the servicing agreement stage.
- 10.IV Sanitary Sewer Works:
- a) At the Owner's cost, the Owner is required to:
 - i. Install new sanitary sewer along Cook Road from existing manhole SMH58685 at the intersection of Cook Road and Buswell Street to a new manhole at the intersection of Cook Road and Cooney Road (approximately 165 m of 300 mm PVC sanitary sewer).
 - ii. Remove, or abandon and cut and cap, as per MMCD existing sanitary sewer between SMH57073 and SMH57072 in the SRW located along the south property line of 6333 Cooney Road (approximately 52 m of 300 mm PVC sanitary sewer).
 - iii. Remove existing and install new sanitary sewer from manhole SMH57091 to SMH57073 along the west property line of 6333 Cooney Road (approximately 53 m of 200 mm PVC sanitary sewer).
 - iv. Remove manhole SMH57093 located just south of the northwest corner of 6333 Cooney Road.
 - v. Ensure that the existing sanitary sewer along the west property line remains operational during any preload and/or construction phase. If the existing sanitary line is impacted during site preparation or construction of the proposed development then the owner shall be responsible to make the damaged sanitary system operational during the duration of the onsite works (i.e., temporary bypass via pumping, etc.). The damaged sanitary system shall be replaced at the same alignment through the servicing agreement, at the owner's costs, after completion of the site preparation and/or building construction works.
 - vi. Ensure no soil fill or building encroaches into the existing sanitary right of way along the west property line.
 - vii. Owner/Developer of the subject site has agreed to provide an engineering solution certified by a structural engineer stipulating that the footing and foundation design of the parkade will permit excavation to the bottom of the adjacent sanitary line without undermining the parkade structure. The purpose is to facilitate the removal of the existing sanitary sewer along west side and the installation of the new sanitary sewer.
 - b) Subject to available funding through the Development Coordinated Works budget, the city will provide funding for the construction of the following works. The owner is required to:
 - i. Install new sanitary sewer along Cooney Road from existing manhole SMH57072 to the new manhole (as noted above) at the intersection of Cook Road and Cooney Road (approximately 160 m of 300 mm PVC sanitary sewer). The developer is required to include the design of City funded sanitary main into the servicing agreement design.

- ii. Prior to commencing City funded sanitary main work on the Cooney Road frontage the developer must provide the City with a minimum 1 year notice of their intended start date, along with a cost estimate for the works to be reviewed by and approved by City staff.
- c) At Owner's cost, the City is to:
 - i. Complete all tie-ins for the proposed works to existing City infrastructure.
 - ii. Cut, cap, and remove the existing sanitary service connection and inspection chamber servicing the subject site.
 - iii. Install a new service connection off of the existing 300mm PVC sanitary sewer on Cooney Road, complete with inspection chamber. If required, the Owner shall provide a statutory Right-of-Way for the inspection chamber at their cost.

10.V Frontage Improvement Works:

- a) At the Owner's cost, the Owner is required to:
 - i. Coordinate with BC Hydro, Telus and other private communication service providers:
 1. To pre-duct for future hydro, telephone and cable utilities along all road frontages.
 2. Before relocating/modifying any of the existing power poles and/or guy wires within the property frontages.
 3. To underground overhead service lines.
 4. To locate/relocate all above ground utility cabinets and kiosks required to service the proposed development, and all above ground utility cabinets and kiosks located along the development's frontages, within the developments site (see list below for examples). A functional plan showing conceptual locations for such infrastructure shall be included in the development design review process. Please coordinate with the respective private utility companies and the project's lighting and traffic signal consultants to confirm the requirements (e.g., statutory Right-of-Way dimensions) and the locations for the aboveground structures. If a private utility company does not require an aboveground structure, that company shall confirm this via a letter to be submitted to the City. The following are examples of statutory Right-of-Ways that shall be shown on the architectural plans/functional plan, the servicing agreement drawings, and registered prior to SA design approval:

BC Hydro PMT	4.0 x 5.0 m
BC Hydro LPT	3.5 x 3.5 m
Street light kiosk	1.5 x 1.5 m
Traffic signal kiosk	2.0 x 1.5 m
Traffic signal UPS	1.0 x 1.0 m
Shaw cable kiosk	1.0 x 1.0 m
Telus FDH cabinet	1.1 x 1.0 m

- ii. Review street lighting levels along all road and lane frontages, and upgrade as required. Refer to drawings L12.3, complete with banner and without pedestrian light, flowerpot holder, and receptacle. The street light pole shall be painted RAL 5007 with a gloss, smooth-finish.

10.VI General Items:

- a) At the Owner's cost, the Owner is required to:
 - i. Provide, prior to start of site preparation works or within the first servicing agreement submission, whichever comes first, a preload plan and geotechnical assessment of preload, dewatering, and soil preparation impacts on the existing utilities fronting the entire development site and provide mitigation recommendations.
 - ii. Provide a video inspection report of the existing rear-yard sanitary sewers and storm sewer along the Cooney Road frontages prior to start of site preparation works or within the first servicing agreement submission, whichever comes first. A follow-up video inspection after site preparation works are complete (i.e. pre-load removal, completion of dewatering, etc.) to assess the condition of the existing utilities is required. Any utilities damaged by the pre-load, de-watering, or other ground preparation shall be replaced at the owner's cost.

- iii. Monitor the settlement at the adjacent utilities and structures during pre-loading, dewatering, and soil preparation works per a geotechnical engineer's recommendations, and report the settlement amounts to the City for review.
- iv. Submit a proposed strategy at the building permit stage for managing excavation de-watering. Note that the City's preference is to manage construction water onsite or by removing and disposing at an appropriate facility. If this is not feasible due to volume of de-watering, the owner will be required to apply to Metro Vancouver for a permit to discharge into the sanitary sewer system. If the sanitary sewer does not have adequate capacity to receive the volume of construction water, the owner will be required to enter into a de-watering agreement with the City to discharge treated construction water to the storm sewer system.
- v. Not encroach into City Rights-of-Way with any proposed trees, retaining walls, or other non-removable structures.
- vi. Coordinate the servicing agreement design for this development with the servicing agreement(s) for the adjacent development(s), both existing and in-stream. The owner's civil engineer shall submit a signed and sealed letter with each servicing agreement submission confirming that they have coordinated with civil engineer(s) of the adjacent project(s) and that the servicing agreement designs are consistent. The City will not accept the 1st submission if it is not coordinated with the adjacent developments. The coordination letter should cover, but not be limited to, the following:
 1. Corridors for City utilities (existing and proposed water, storm sewer, sanitary and DEU) and private utilities.
 2. Pipe sizes, material and slopes.
 3. Location of manholes and fire hydrants.
 4. Road grades, high points and low points.
 5. Alignment of ultimate and interim curbs.
 6. Proposed street lights design.
- vii. Enter into, if required, additional legal agreements, as determined via the subject development's Servicing Agreement(s) and/or Development Permit(s), and/or Building Permit(s) to the satisfaction of the Director of Engineering, including, but not limited to, site investigation, testing, monitoring, site preparation, de-watering, drilling, underpinning, anchoring, shoring, piling, pre-loading, ground densification or other activities that may result in settlement, displacement, subsidence, damage or nuisance to City and private utility infrastructure.

Prior to Building Permit* Issuance, the owner must complete the following requirements:

1. (*Legal Agreements*) Confirmation of compliance with existing and Development Permit legal agreements.
2. (*Accessibility and Sustainability*) Incorporation of special features in Building Permit (BP) plans as determined via the Development Permit process.
3. (*Aircraft Noise Sensitive Development*) Confirmation that the proposed development is designed in a manner that mitigates potential aircraft noise to the proposed dwelling units, including submission of:
 - a. Acoustic report prepared by a registered professional confirming design achieves the following CMHC interior noise level guidelines:

Portions of Dwelling Units	Noise Levels (decibels)
Bedrooms	35 decibels
Living, dining, recreation rooms	40 decibels
Kitchen, bathrooms, hallways, and utility rooms	45 decibels

- b. Mechanical report prepared by a registered professional confirming design achieves the ASHRAE 55-2004 "Thermal Environmental Conditions for Human Occupancy" standard for interior living spaces.

4. (**Construction Parking and Traffic Management Plan**) Submission of a Construction Parking and Traffic Management Plan* to the Transportation Department. Management Plan shall include location for parking for services, deliveries, workers, loading, application for any lane closures, and proper construction traffic controls as per Traffic Control Manual for works on Roadways (by Ministry of Transportation) and MMCD Traffic Regulation Section 01570. (<http://www.richmond.ca/services/ttp/special.htm>).
5. (**Latecomer works**) If applicable, payment of latecomer agreement charges, plus applicable interest associated with eligible latecomer works.
6. (**Construction Hoarding**) Obtain a Building Permit* (BP) for any construction hoarding associated with the proposed development. If construction hoarding is required to temporarily occupy a public street, the air space above a public street, or any part thereof, additional City approvals and associated fees may be required as part of the Building Permit. *For further information on the Building Permit, please contact the Building Approvals Department at 604-276-4285.*

Note:

- * This requires a separate application.
- Where the Director of Development deems appropriate, the preceding agreements are to be drawn not only as personal covenants of the property owner but also as covenants pursuant to Section 219 of the Land Title Act.
All agreements to be registered in the Land Title Office shall have priority over all such liens, charges and encumbrances as is considered advisable by the Director of Development. All agreements to be registered in the Land Title Office shall, unless the Director of Development determines otherwise, be fully registered in the Land Title Office prior to enactment of the appropriate bylaw.
The preceding agreements shall provide security to the City including indemnities, warranties, equitable/rent charges, letters of credit and withholding permits, as deemed necessary or advisable by the Director of Development. All agreements shall be in a form and content satisfactory to the Director of Development.
- Additional legal agreements, as determined via the subject development's Servicing Agreement(s) and/or Development Permit(s), and/or Building Permit(s) to the satisfaction of the Director of Engineering may be required including, but not limited to, site investigation, testing, monitoring, site preparation, de-watering, drilling, underpinning, anchoring, shoring, piling, pre-loading, ground densification or other activities that may result in settlement, displacement, subsidence, damage or nuisance to City and private utility infrastructure.
- Applicants for all City Permits are required to comply at all times with the conditions of the Provincial Wildlife Act and Federal Migratory Birds Convention Act, which contain prohibitions on the removal or disturbance of both birds and their nests. Issuance of Municipal permits does not give an individual authority to contravene these legislations. The City of Richmond recommends that where significant trees or vegetation exists on site, the services of a Qualified Environmental Professional (QEP) be secured to perform a survey and ensure that development activities are in compliance with all relevant legislation.

[signed copy on file]

Signed

Date

Initial:



City of Richmond

Development Permit

No. DP 17-791045

To the Holder: BOLD PROPERTIES (COONEY) LIMITED PARTNERSHIP

Property Address: 6333 COONEY ROAD

Address: C/O TOMMY HE, BOLD PROPERTIES
668 WEST HASTINGS STREET, UNIT 600
VANCOUVER, BC V6B 1P1

1. This Development Permit is issued subject to compliance with all of the Bylaws of the City applicable thereto, except as specifically varied or supplemented by this Permit.
2. This Development Permit applies to and only to those lands shown cross-hatched on the attached Schedule "A" and any and all buildings, structures and other development thereon.
3. Subject to Section 692 of the Local Government Act, R.S.B.C.: buildings and structures; off-street parking and loading facilities; roads and parking areas; and landscaping and screening shall be constructed generally in accordance with Plans #1 to #40 attached hereto.
4. Sanitary sewers, water, drainage, highways, street lighting, underground wiring, and sidewalks, shall be provided as required.
5. As a condition of the issuance of this Permit, the City is holding the security in the amount of \$305,277.00 to ensure that development is carried out in accordance with the terms and conditions of this Permit. Should any interest be earned upon the security, it shall accrue to the Holder if the security is returned. The condition of the posting of the security is that should the Holder fail to carry out the development hereby authorized, according to the terms and conditions of this Permit within the time provided, the City may use the security to carry out the work by its servants, agents or contractors, and any surplus shall be paid over to the Holder. Should the Holder carry out the development permitted by this permit within the time set out herein, the security shall be returned to the Holder. The City may retain the security for up to one year after inspection of the completed landscaping in order to ensure that plant material has survived.
6. If the Holder does not commence the construction permitted by this Permit within 24 months of the date of this Permit, this Permit shall lapse and the security shall be returned in full.

Development Permit
No. DP 17-791045

To the Holder: **BOLD PROPERTIES (COONEY) LIMITED PARTNERSHIP**

Property Address: **6333 COONEY ROAD**

Address: **C/O TOMMY HE, BOLD PROPERTIES
668 WEST HASTINGS STREET, UNIT 600
VANCOUVER, BC V6B 1P1**

7. The land described herein shall be developed generally in accordance with the terms and conditions and provisions of this Permit and any plans and specifications attached to this Permit which shall form a part hereof.

This Permit is not a Building Permit.

AUTHORIZING RESOLUTION NO.
DAY OF , .


ISSUED BY THE COUNCIL THE

DELIVERED THIS DAY OF , .

MAYOR



City of Richmond

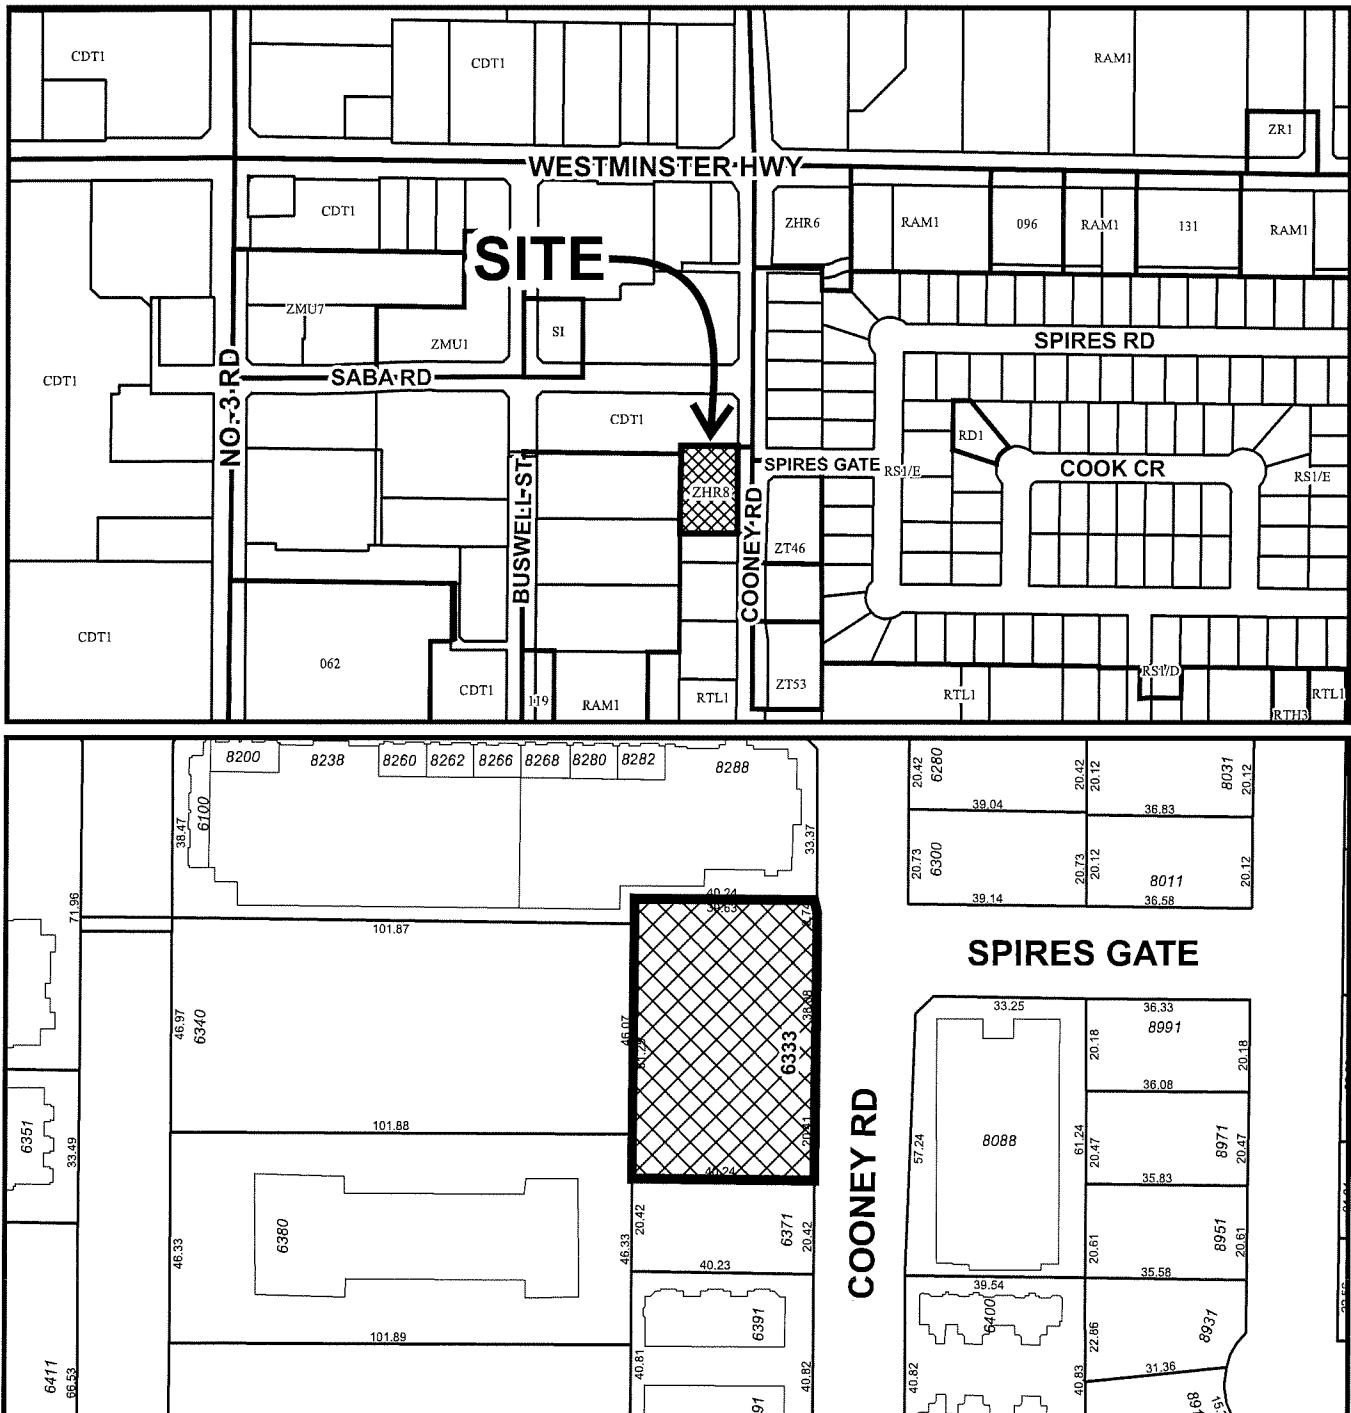

N

DP 17-791045
SCHEDULE "A"

Original Date: 11/16/17

Revision Date: 06/28/18

Note: Dimensions are in METRES



CONSULTANT INFORMATION

Civil, Landscape: CONNECT LANDSCAPE ARCHITECTURE LTD
 Architect: ST ARCHITECTURE LTD
 Structural: GLOTHAM SAMPSON GROUP OF COMPANIES LTD
 Mechanical: AME GROUP LTD
 Electrical: NEARLT & ASSOCIATES LTD.
www.starchitecture.com

- 20 Adaptable units provided and required to comply with BC Building Code adaptable unit standards.
 - Aging in place features provided in all units (level-style door handles and faucets, LED strip task lighting below washroom vanity mirrors, grab bar blocking at toilets, showers and bathtubs)
 - Indoor Amenity space to be provided for the shared use of all residents on level 4.
 - Building required to demonstrate LEED silver equivalent standard.
 - District Energy Utility requirements as per legal agreement.
 - Development is required to be designed and constructed to meet indoor acoustic and thermal criteria as per legal agreement.
 - Widened sidewalk SRW to be provided along north edge of lane SRW as per legal agreement.
 - Servicing Agreement required. Off-site and SRW works to be provided via separate required Servicing Agreement for City lane and frontage improvements as per legal agreement.
 - This Development Permit does not include signage. All signage required to comply with Sign Regulation bylaw 9700, including submitting separate sign permit applications as needed.

THE COMMENCEMENT

PROJECT OVERALL SITE SUMMARY						
Legal Address		Project Details				
Site Area		Area Statistics				
4 NORTH, RANGE 6 WEST, NEW WESTMINSTER DISTRICT		LOT A, PLAN BCP 28690 AND LOT 132 (EXCEPT PART SUBDIVIDED BY PLAN 38672), PLAN BCP 28692, BOTH OF SECTION 9, BLOCK 19(B) OF THE CIVIC ROAD, RICHMOND, BC				
Land Use Type	Area (m²)	GROSS AREA	DEDUCTIONS	NET AREA	AREA (SF)	AREA (SF)
Permitted Building Height (per 19.8.7.1)	Area (m²)	Area (sf)	Area (m²)	Area (sf)	Area (m²)	Area (sf)
1d) Permitted Building Height (per 19.8.7.1)	41.0 m	134.51 ft	24.66 sq.m	264.60 sqft	266.99 m²	2,873.90 ft²
1d) Permitted Building Height (Cooley Road); (per 19.8.5.1)	3.0 m	9.84 ft	57.68 sq.m	41.96 sqft	41.96 m²	452.63 ft²
1d) Permitted Building Height (per 19.8.5.4)	1.5 m	4.92 ft	60.88 sq.m	42.00 sqft	60.88 m²	635.08 ft²
Seibehack (Adjacent Neighbouring Tower); (per 19.8.6.2)	2.7 m	8.86 ft	57.62 sq.m	41.56 sqft	57.62 m²	628.72 ft²
Seibehack (Adjacent Lane Dedication); (per 19.8.6.3)	7.5 m	24.61 ft	57.62 sq.m	41.56 sqft	57.62 m²	628.72 ft²
Permitted Building Height (per 19.8.4)	Area (m²)	Area (sf)	Area (m²)	Area (sf)	Area (m²)	Area (sf)
Permitted Building Height (per 19.8.4)	2.67	6,563 sq.m	70,648 sqft	6,556 sq.m	70,597 sq. ft	2,873.90 ft²
Permitted Building Height (per 19.8.5)	70% Max	1,721 sq.m	18,522 sqft	1,711 sq. m	18,420 sq. ft	452.63 ft²
PERMITTED FLOOR AREA / FAR (per 19.8.4)	Permitted Building Height (per 19.8.4)	Permitted Building Height (per 19.8.5)	Permitted Building Height (per 19.8.5)	Permitted Building Height (per 19.8.4)	Permitted Building Height (per 19.8.5)	Permitted Building Height (per 19.8.5)
LEVEL	PERMITTED FLOOR AREA (m²) / FLOOR AREA (ft²)	PERMITTED FLOOR AREA (m²) / FLOOR AREA (ft²)	PERMITTED FLOOR AREA (m²) / FLOOR AREA (ft²)	PERMITTED FLOOR AREA (m²) / FLOOR AREA (ft²)	PERMITTED FLOOR AREA (m²) / FLOOR AREA (ft²)	PERMITTED FLOOR AREA (m²) / FLOOR AREA (ft²)
1	513.58 m²	5,528.27 ft²	246.80 m²	2,654.37 ft²	266.99 m²	2,873.90 ft²
2	579.68 m²	6,196.52 ft²	398.54 m²	4,265.29 ft²	379.14 m²	4,192.38 ft²
3	390.83 m²	4,205.66 ft²	63.72 m²	685.83 ft²	327.11 m²	3,522.08 ft²
4	692.88 m²	7,458.15 ft²	63.92 m²	687.99 ft²	628.97 m²	6,770.16 ft²
5	576.62 m²	6,206.66 ft²	47.56 m²	511.94 ft²	529.06 m²	5,694.72 ft²
6	576.62 m²	6,206.66 ft²	47.56 m²	511.94 ft²	529.06 m²	5,694.72 ft²
7	576.62 m²	6,206.66 ft²	47.56 m²	511.94 ft²	529.06 m²	5,694.72 ft²
8	576.62 m²	6,206.66 ft²	47.56 m²	511.94 ft²	529.06 m²	5,694.72 ft²
9	576.62 m²	6,206.66 ft²	47.56 m²	511.94 ft²	529.06 m²	5,694.72 ft²
10	576.62 m²	6,206.66 ft²	47.56 m²	511.94 ft²	529.06 m²	5,694.72 ft²
11	576.62 m²	6,206.66 ft²	47.56 m²	511.94 ft²	529.06 m²	5,694.72 ft²
12	576.62 m²	6,206.66 ft²	47.56 m²	511.94 ft²	529.06 m²	5,694.72 ft²
13	576.62 m²	6,206.66 ft²	47.56 m²	511.94 ft²	529.06 m²	5,694.72 ft²
14	442.34 m²	4,761.28 ft²	47.40 m²	510.23 ft²	384.94 m²	4,251.05 ft²
	7,004.88 m²	7,841.09 ft²		1,246.21 m²	13,414.13 ft²	13,596.86 m²

M MEGATRACK UNIT A1

FACILITY SUMMARY		TYPE	COUNT	PERCENTAGE
M + DEN UNIT	MEDIUM WORK UNIT			
1 M + DEN UNIT B1				
2	41.54 m ²	447.15 ft ²	83.00 m ²	884.30 ft ²
1	48.83 m ²	525.00 ft ²	48.83 m ²	525.59 ft ²
9	52.95 m ²	569.89 ft ²	476.59 m ²	526.55 ft ²
2	43.53 m ²	468.56 ft ²	87.06 m ²	937.12 ft ²
1	78.34 m ²	844.33 ft ²	78.34 m ²	843.23 ft ²
1	64.85 m ²	688.93 ft ²	64.85 m ²	688.93 ft ²
10	75.93 m ²	817.35 ft ²	759.34 m ²	817.35 ft ²
10	75.63 m ²	814.88 ft ²	756.31 m ²	814.85 ft ²
9	75.20 m ²	809.07 ft ²	676.82 m ²	7,285.23 ft ²
1	71.52 m ²	769.13 ft ²	71.52 m ²	769.13 ft ²
10	75.17 m ²	809.66 ft ²	75.17 m ²	809.66 ft ²
10	75.29 m ²	810.45 ft ²	752.94 m ²	810.45 ft ²
1	80.82 m ²	869.83 m ²	80.82 m ²	869.83 m ²
1	72.03 m ²	775.36 ft ²	72.03 m ²	775.36 ft ²
10	59.90 m ²	644.76 ft ²	598.00 m ²	6,447.57 ft ²
1	100.07 m ²	1,071.13 ft ²	100.07 m ²	1,071.13 ft ²
1	111.97 m ²	1,205.26 ft ²	111.97 m ²	1,205.26 ft ²
1	101.65 m ²	1,094.11 ft ²	101.65 m ²	1,094.11 ft ²
1	37.17 m ²	400.10 ft ²	37.17 m ²	400.10 ft ²
83			5,779.72 m ²	62,150.12 ft ²

UNIT ADAPT.

TOTAL PARKING REQUIREMENT - 2011		Required	Proposed	Actual Max.	Proposed
Initial @ Min. 1.0 Stall / Unit	83		84		
@ Min. 1.2 Stall / Unit	17		17		
On-site Vehicular Parking (combined)	100				
Free Accessible Stall @ Min. 2% Total Stalls	2		3		
Mobile Car Stalls @ 50% Total Stalls				50	
OFF-SITE PARKING REQUIREMENT					48
Space 1 / Unit (Class 1)	104				105
Space 2 / Unit (Class 2)	17				18
OFF-SITE PARKING (combined)	121				123



architecture
2023 - 2029 W Cordova Street
Vancouver, BC, Canada V6H 1E5
778.875.4979 | 778.875.4976
www.eighteenarchitects.com

CONSULTANT INFORMATION

DWML Landscape: CONNECT LANDSCAPE ARCHITECTURE
Architect: \$2 ARCHITECTURE
GLUTON-SIMPSON GROUP
NAE Group: NAE GROUP
Hennett & Associates L.
Mechanical: Hennett & Associates L.
Electrical: Imhofe.

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CONSULTANT INFORMATION

CME: CONNECT LANDSCAPE ARCHITECTURE
Landscape: SZ ARCHITECTURE
Architectural: GLOTMAN-SWIPSON GROUP OF COMPANIES
Structural: AME GROUP
Mechanical: HEMNETZ & ASSOCIATES LTD.
Electrical: IMBROUS

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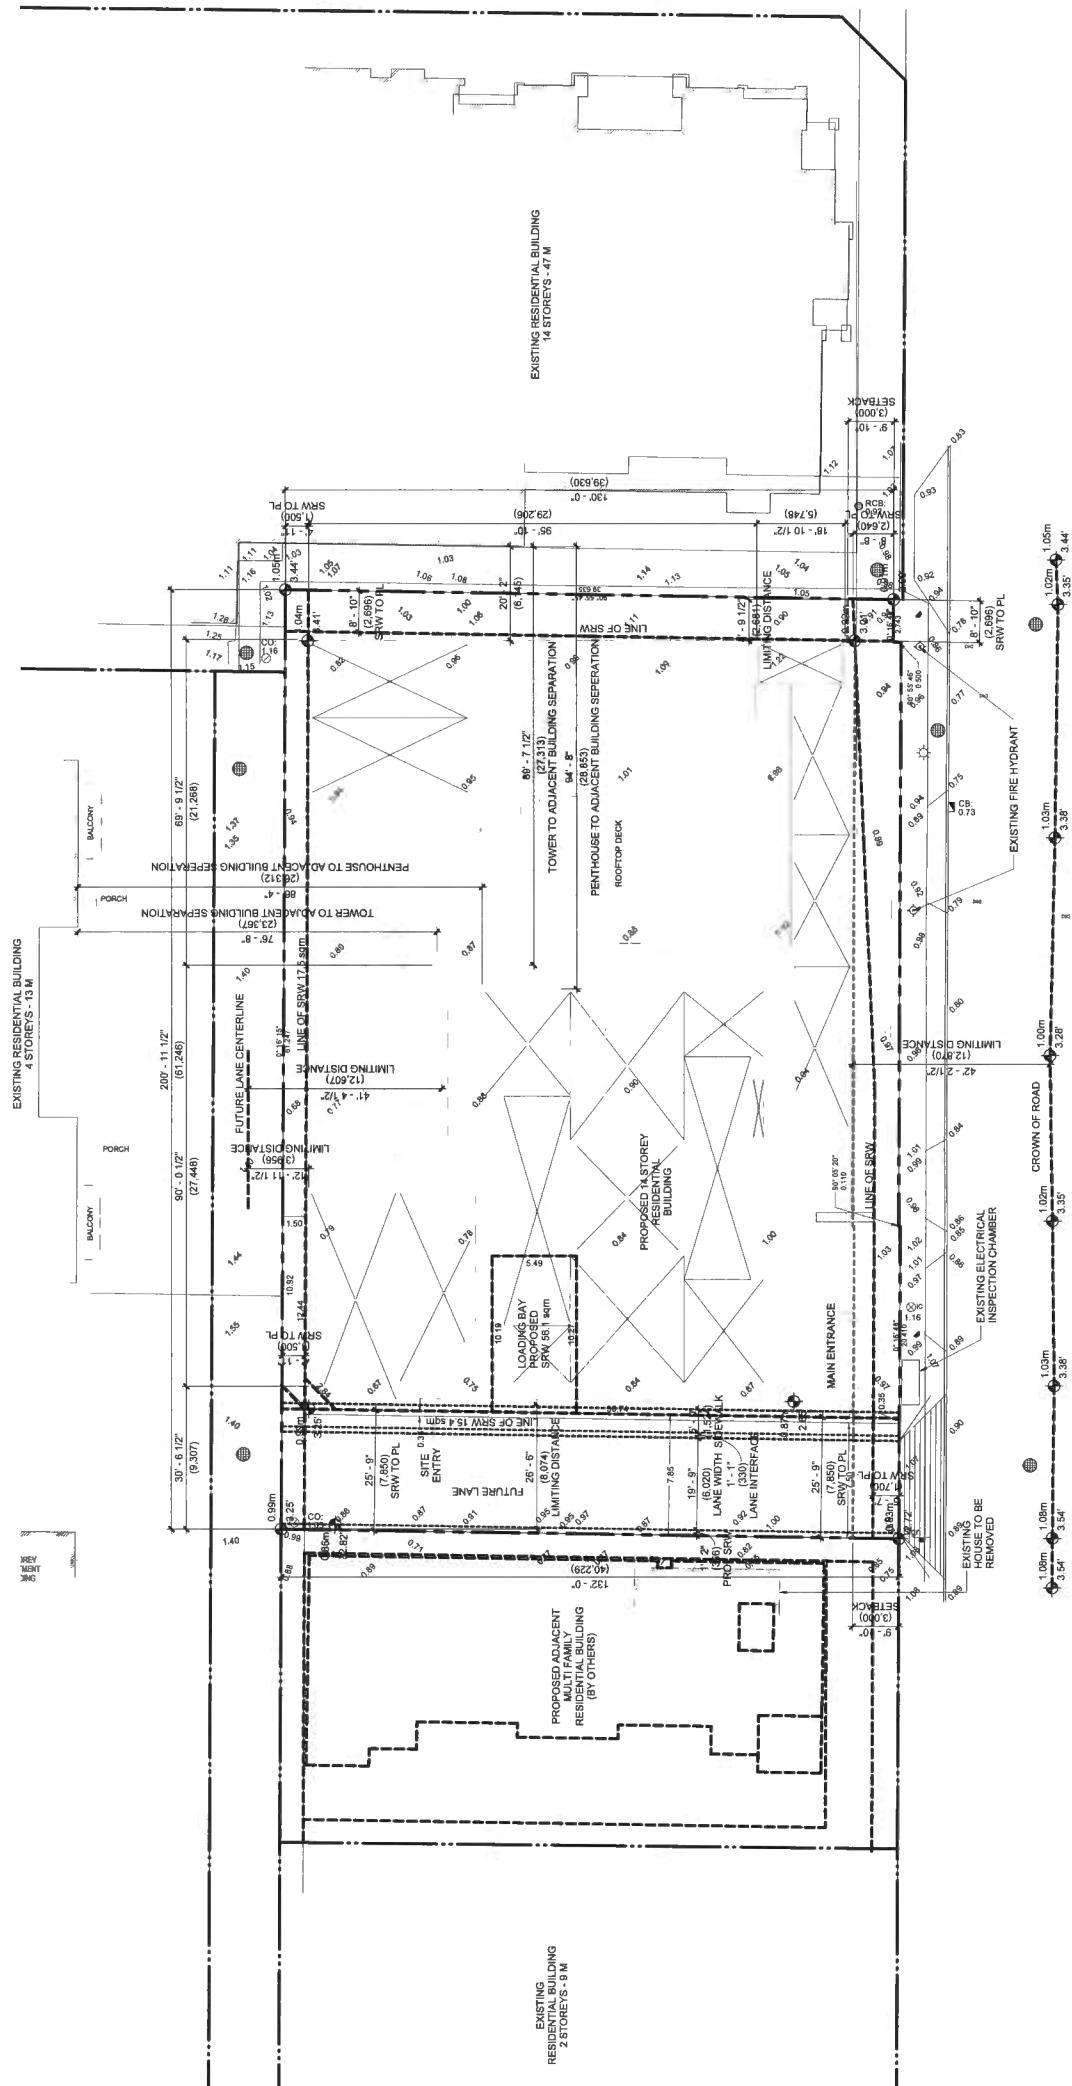
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TOWER

3333 COONEY ROAD
BIRCHMOND BC

Plan 2

NOV 20, 2019

SABA ROAD



Verify all dimensions, elevations and claims, and report any discrepancies to the Architect prior to construction. Dimensions are taken in feet of interior partitions, as of concrete block walls or of similar partitions, and are exclusive of doorway widths, unless otherwise indicated on the drawing.

The Contract Documents (Drawings and Specifications) are considered to be required by law that it be a binding instrument.

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ISSUED	DATE
DEVELOPMENT PERMIT APPLICATION	2017-11-03
DP APPLICATION RE-SUBMISSION	2018-09-28
AUD SUBMISSION	2019-02-01
DP RESUBMISSION	2019-10-31
DP RESUBMISSION	2019-11-08

SCALE 1/16" = 1'-0"
DATE 11/14/2019 4:27:50 PM
DRAWN BY JH
CHECKED BY SH
PROJECT NO 219171

SITE PLAN
DRAWING NO.
DP10-01-00

EXISTING SINGLE FAMILY RESIDENCE

2 STOREYS - 9 M

SPIRES GA

**EXISTING
RESIDENTIAL BUILDING**

EXISTING RESIDENTIAL BUILDING

EXISTING RESIDENTIAL BUILDINGS

SITE PLAN
10-01-00 SCALE: 1/16" = 1'-0"



CONSULTANT INFORMATION
S2 ARCHITECTURE INC.
Landscape Architectural Group of Companies
Mechanical Air Group
Structural Hilti & Associates LTD.
Interiors

CPTED PRINCIPLES

- LIGHT COLOURED PAINTED RISERS TO WALLS, COLUMNS AS NEEDED
- PROVIDE VISION PANELS IN DOORS LEADING TO PUBLICLY VISIBLE AREAS
- PROVIDE GLAZING TO ELEVATOR LOBBIES
- ENSURE ADEQUATE LIGHTING THROUGHOUT PARKING AREA
- INSTALL HARDWARE VIDEO SURVEILLANCE EQUIPMENT TO PARKING AREAS
- INSTALL ROADS SURFACE FINISH TO RAMPS TO DECK SKATEBOARDERS

NOT FOR
CONSTRUCTION

PROJECT INFORMATION

COONEY ROAD
TOWER

6333 COONEY ROAD
RICHMOND, BC

SWAP
SIGNED
BY
BRITISH COLUMBIA
REGISTERED ARCHITECT
NOV 20, 2019

This drawing supersedes previous sheets. Do not reuse these sheets.

Verbal demands, interrogatories and claims, and reports by experts, made in any action or proceeding, shall be based upon this drawing. It is the responsibility of the claimant to furnish a copy of this drawing to the defense party, and certifying of delivery well, dated, and initialled, and countersigned by one of the following:

The Company Directors, Officers, and Technicians who signed this drawing, or by one of the following:

All officers named on the drawing of the architect.

All officers named on the drawing of the architect. These drawings are copyright 2019 S2 Architecture. These drawings may not be reproduced without the permission of the architect.

DATE: NOV 20, 2019
POST AD RESPONSE: 2019-05-16
OP REQUESTION: 2019-10-31
DP REQUESTION: 2019-11-06


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CHECKED BY: SW
PROJECT NO: 219171

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CHECKED BY: SW
PROJECT NO: 219171

LEVEL P1 FLOOR PLAN

DRAWING NO: DP20-00-00

NOTE: SHOWN IN TRUE
ANGLED VIEW FROM ABOVE

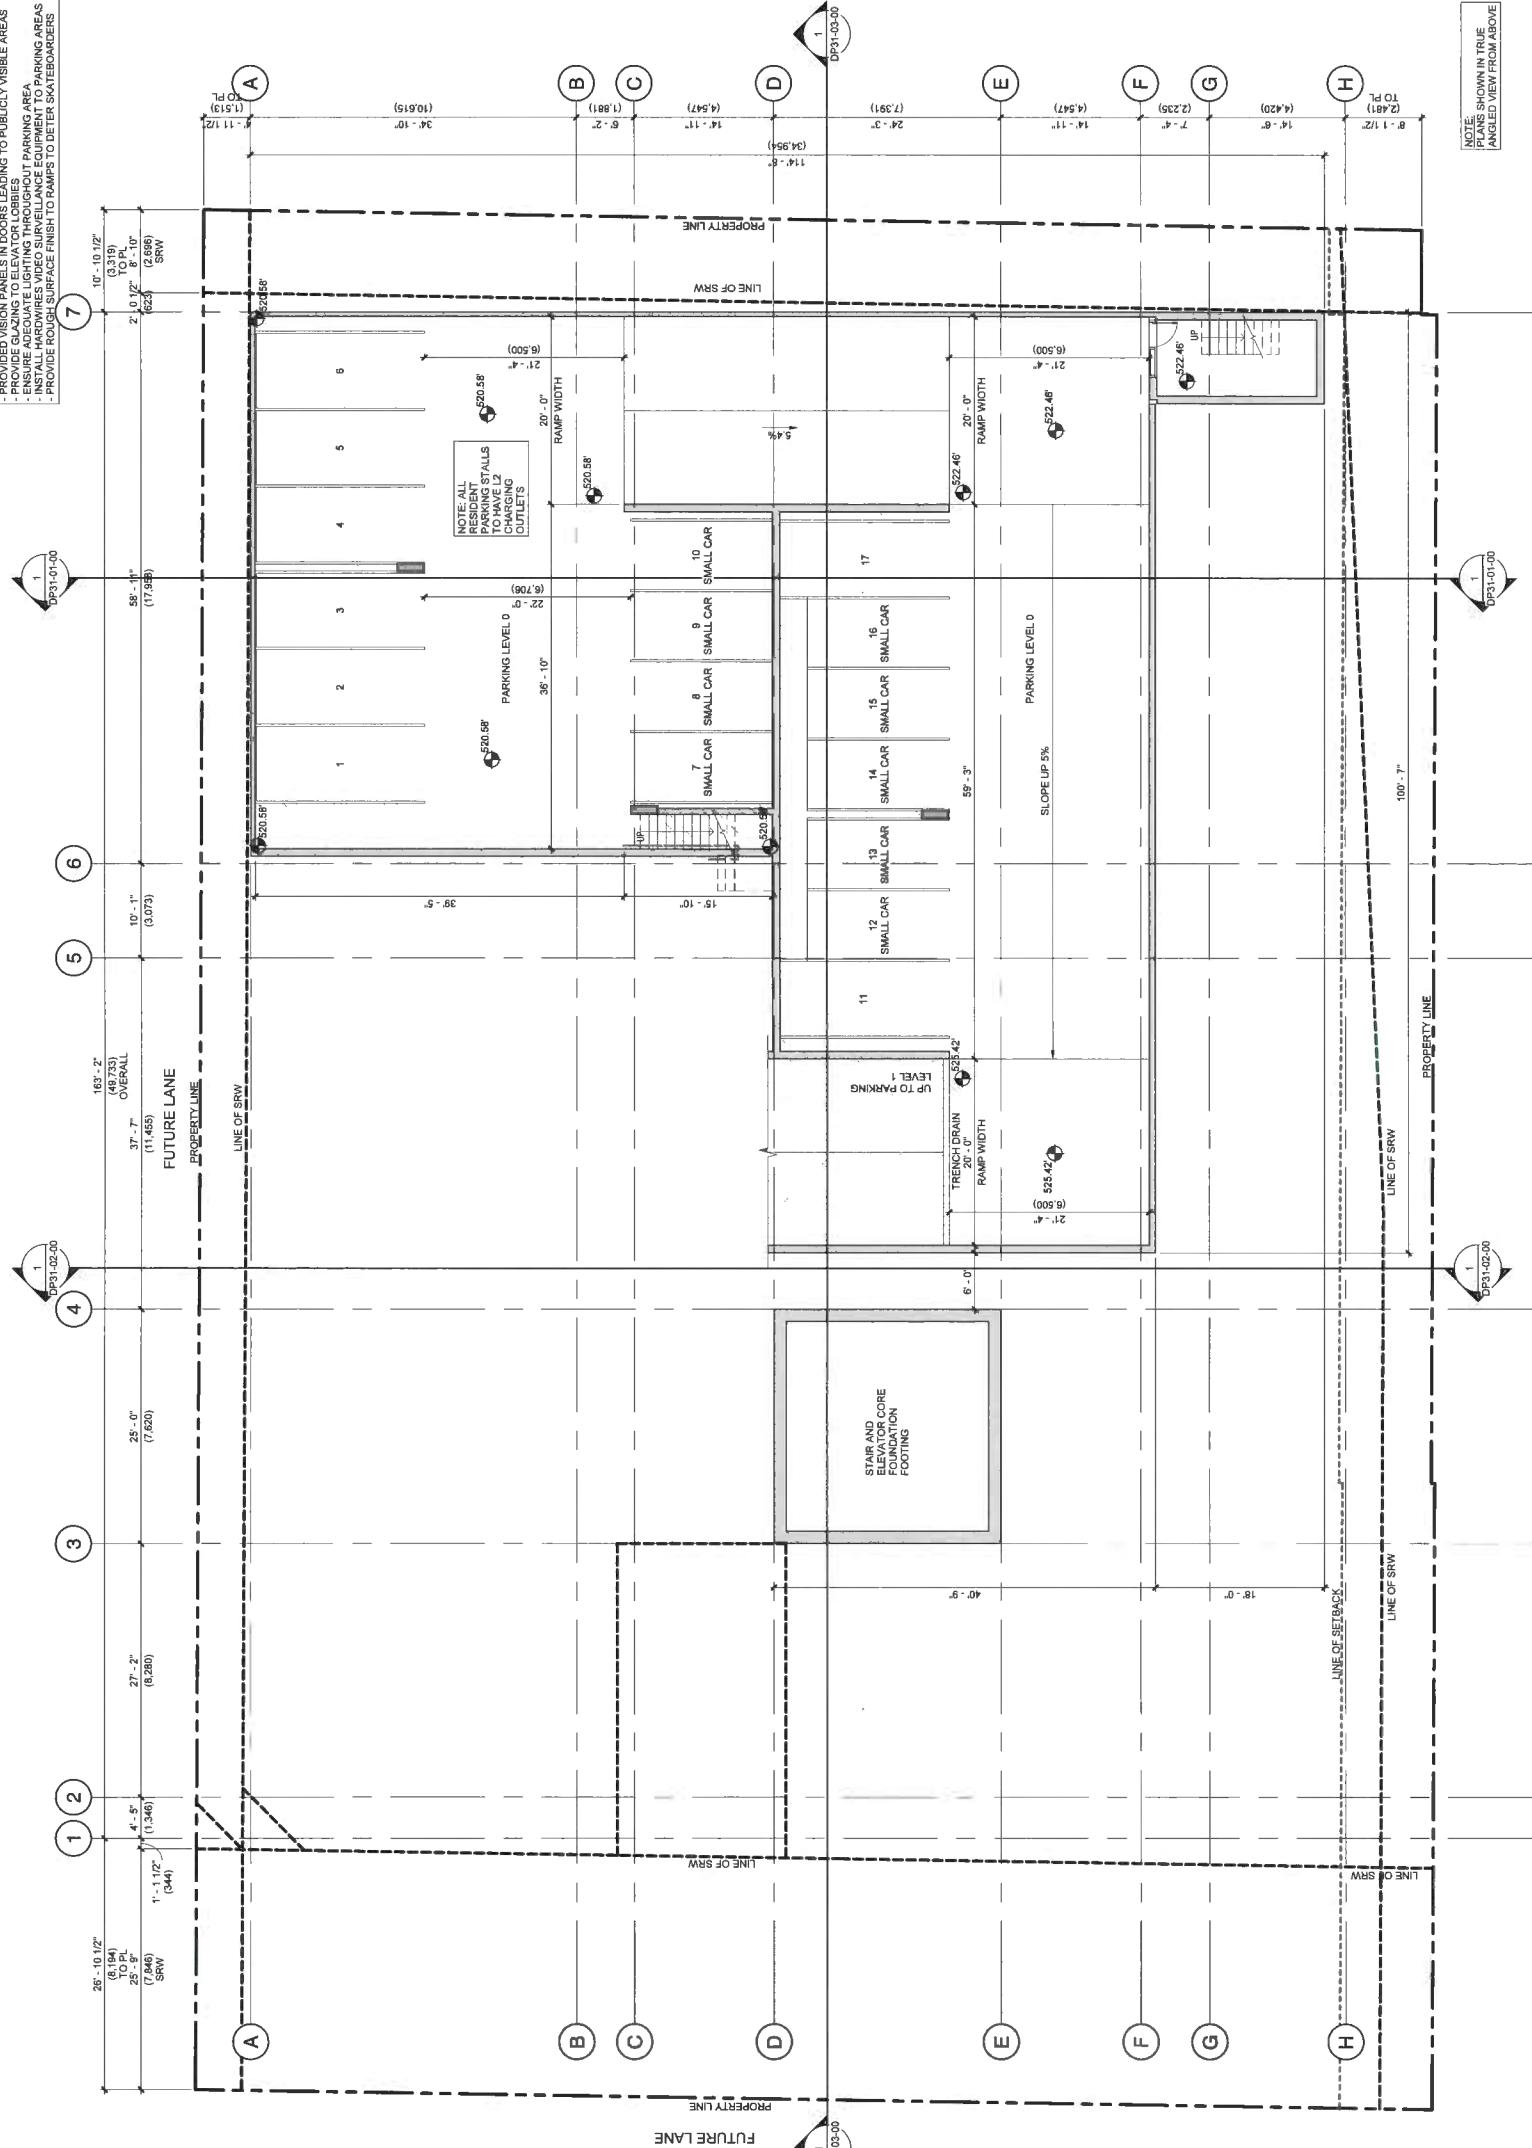



CONSULTANT INFORMATION
Cof. DANECKI LANDSCAPE ARCHITECTURE
Landscape Architectural Services Ltd.
Architectural Services Ltd.
Mechanic, MIE GROUP
Electrical, NICHET & ASSOCIATES LTD.

CEPTED PRINCIPLES
- AVOID HIDDEN CORNERS AND INSTALL CONVEY MIRRORS AS NEEDED
- PROVIDE 12' ZONE TO ELEVATE LOBBIES
- ENSURE ADEQUATE LIGHTING THROUGHOUT PARKING AREA
- INSTALL HARDWIRES VIDEO SURVEILLANCE EQUIPMENT TO PARKING AREAS
- PROVIDE ROUGH SURFACE FINISH TO RAMPS TO DEFER SKATEBOARDERS

NOT FOR
CONSTRUCTION

PROJECT INFORMATION

COONEY ROAD
TOWER


6333 COONEY ROAD
RICHMOND, BC

SWEDISH ARCHITECT
BY TJS INC.

10/15/19

Plan 5

DP 17-791045
NOV 20, 2019

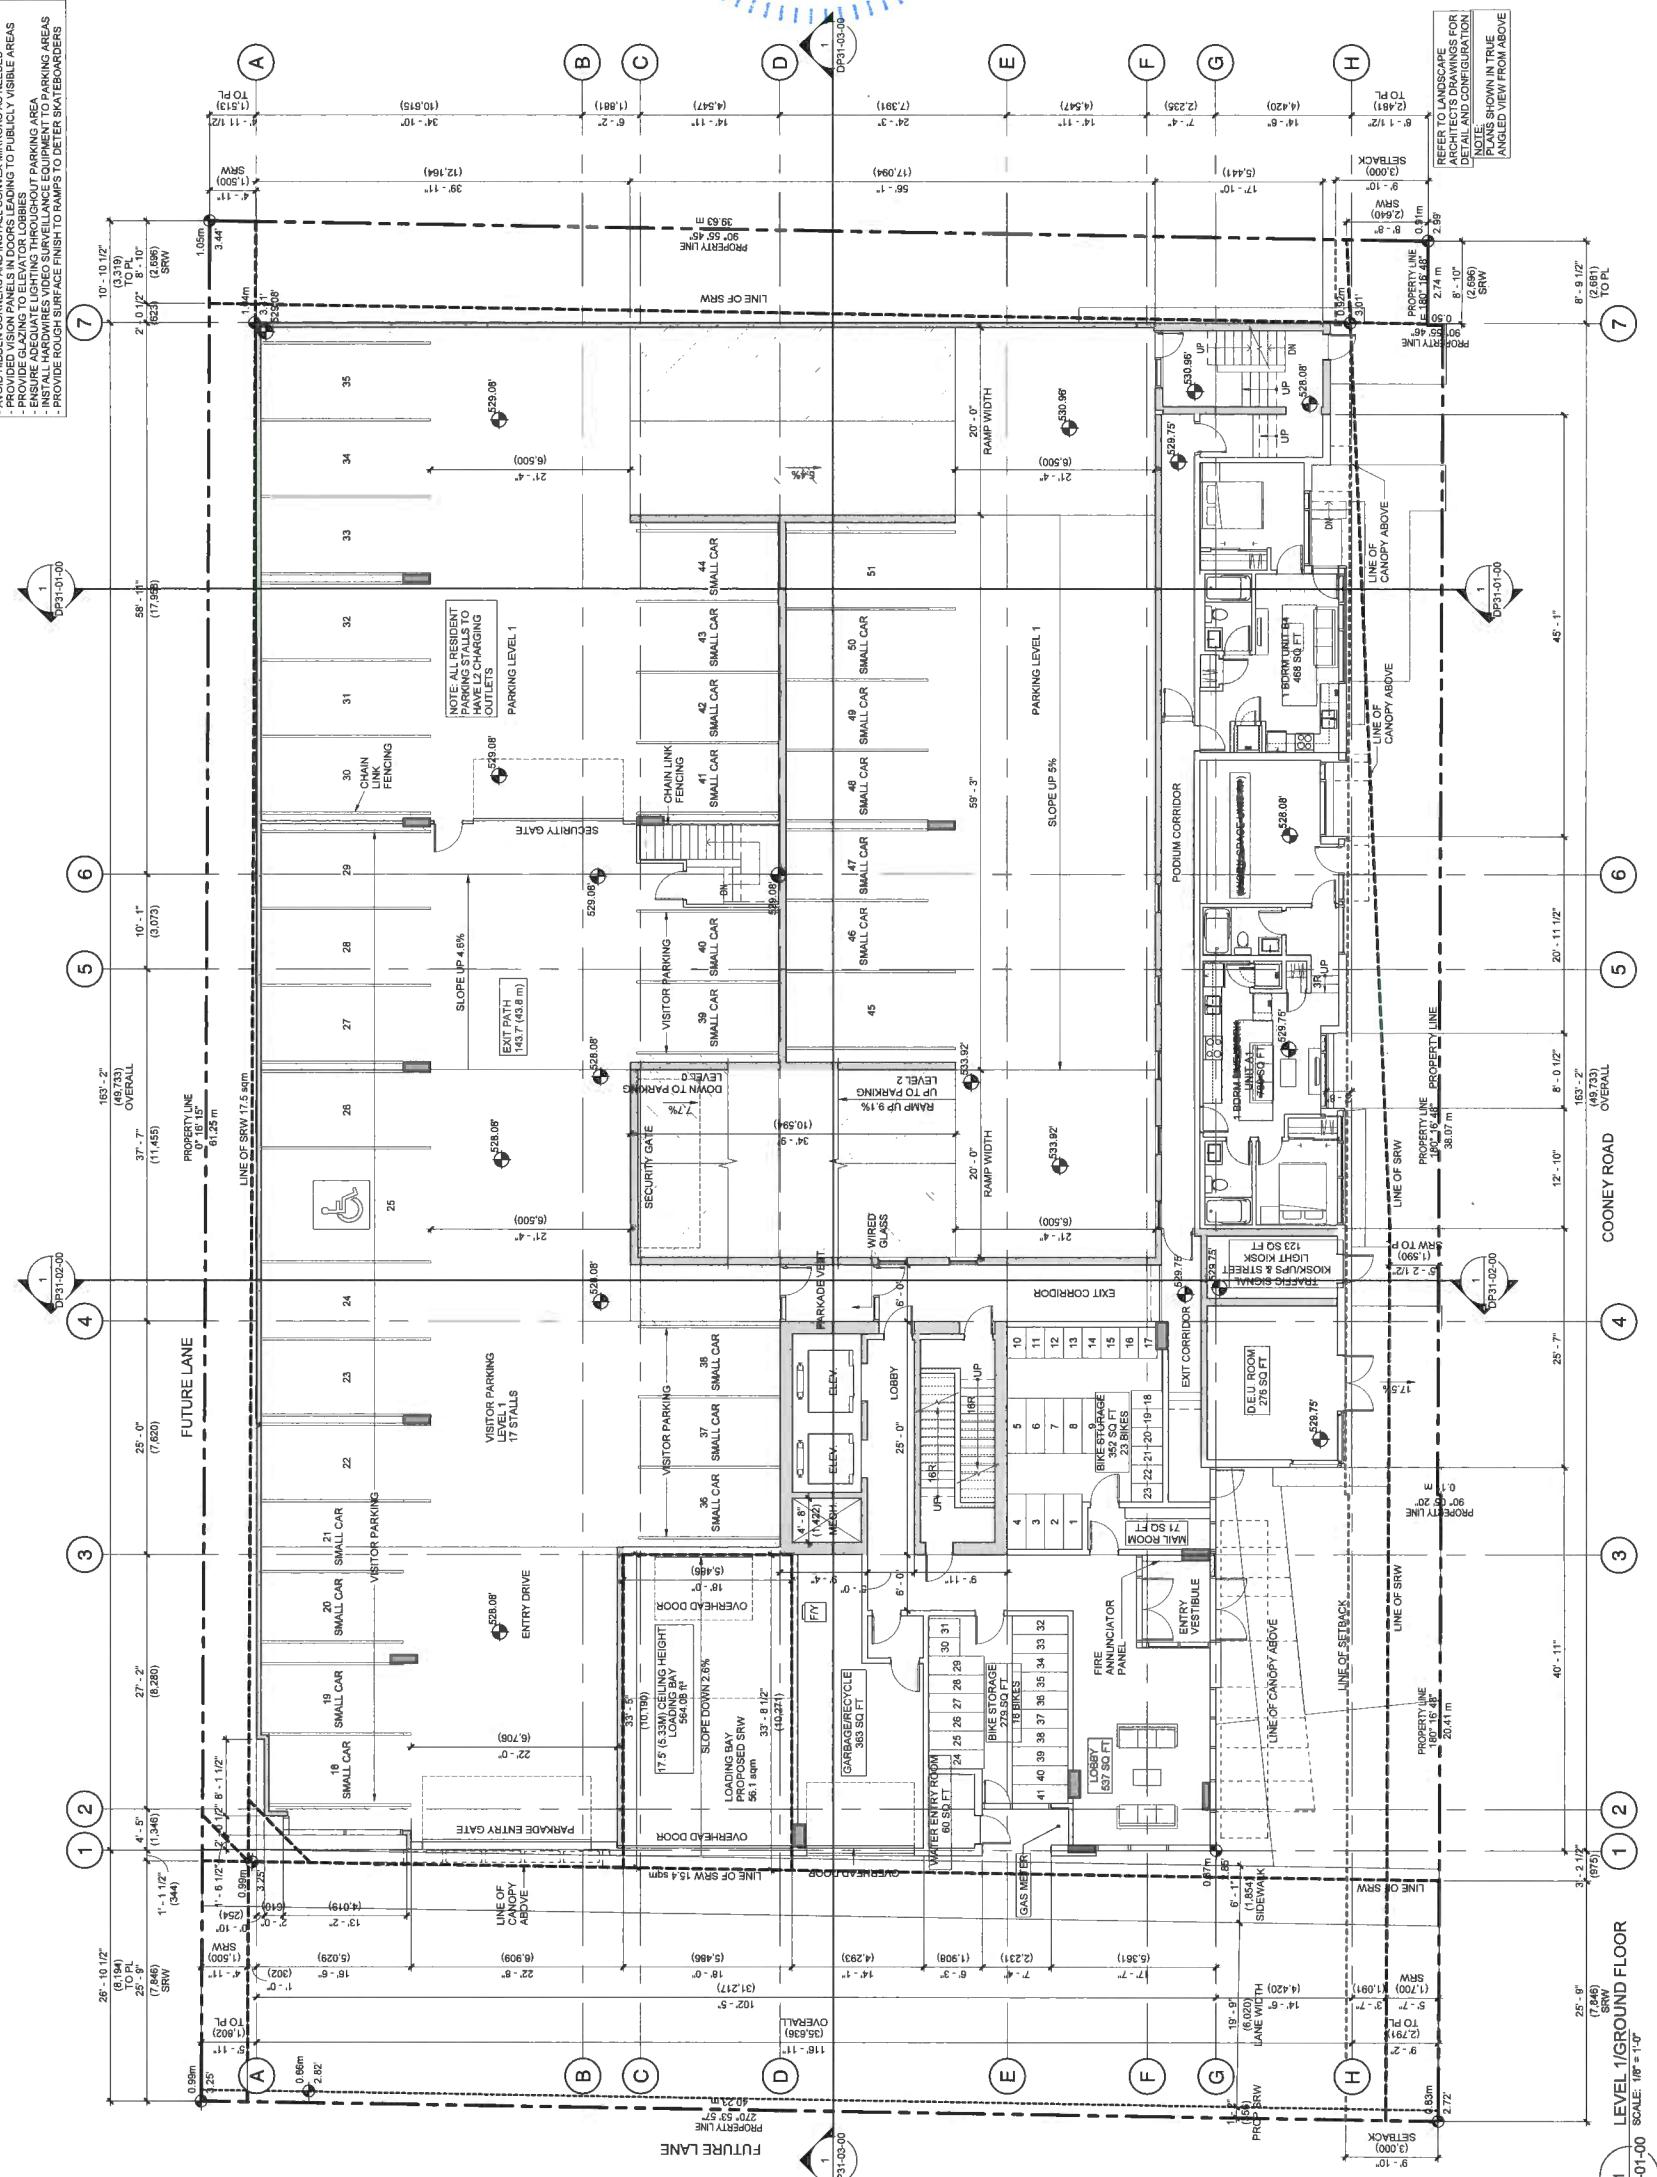

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LEVEL 1 FLOOR PLAN

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LEVEL 1 FLOOR PLAN

DRAWING NO.

DP20-01-00

DRAWING NO.



CONSULTANT INFORMATION

Arch: CONNECT LANDSCAPE ARCH
Landscape:
Architecture: SZ ARCHITECTURE
Structural: GLOTHMAN-SIMPSON GROUP
Mechanical: AME GROUP
Electrical: NEMET & ASSOCIATES LTD.
Interiors: INTERKIT.

Structural: GLÜTHMANN-SIMPSON GROUP OF COMPANIES
Mechanical: AME GROUP
Electrical: NEINETZ & ASSOCIATES LTD

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CPTED PRINCIPLES

- LIGHT COLOURED PAINTED FINISH TO WALLS, COLUMNS
- AVOID HIDDEN CORNERS AND INSTALL CONVEX MIRRORS AS NEEDED
- PROVIDE VISION PANELS IN DOORS LEADING TO PUBLICLY VISIBLE AREAS
- PROVIDE GLAZING TO ELEVATOR LOBBIES
- ENSURE ADEQUATE LIGHTING THROUGHOUT PARKING AREA
- INSTALL HARDWARE VIDEO SURVEILLANCE EQUIPMENT TO PARKING AREAS
- PROVIDE TOUGHER/FACED FINISH TO RAMPS TO DETER SKATEBOARDERS

NOT FOR
CONSTRUCTION

PROJECT INFORMATION

COONEY ROAD
TOWER

6333 COONEY ROAD
RICHMOND, BC

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Plan 7

NOV 20, 2019
DP 17-791045

DP 17-791045

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219171

BY
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EL 3 H
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SCALE DATE DRAWN CHECKED PROJECT DRAWING LEVEL DRAWING



architecture

CONSULTANT INFORMATION	
Chef:	Landscape: CONNECT LANDSCAPE ARCHITECTURE
Architect:	STRUCTURE: SE ARCHITECTURE
Structural:	Mechanical: GILMOUR-SIMPSON GROUP OF COMPANIES
Mechanical:	AEI: GROUP
Electrical:	NETTLETT & ASSOCIATES LTD.
Electronics:	


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CONSTRUCTION

6333 COONEY ROAD
RICHMOND, BC

Plan 8

DP 17-791045 Nov 20, 2019

DRAWING NO.
DP20-04-00

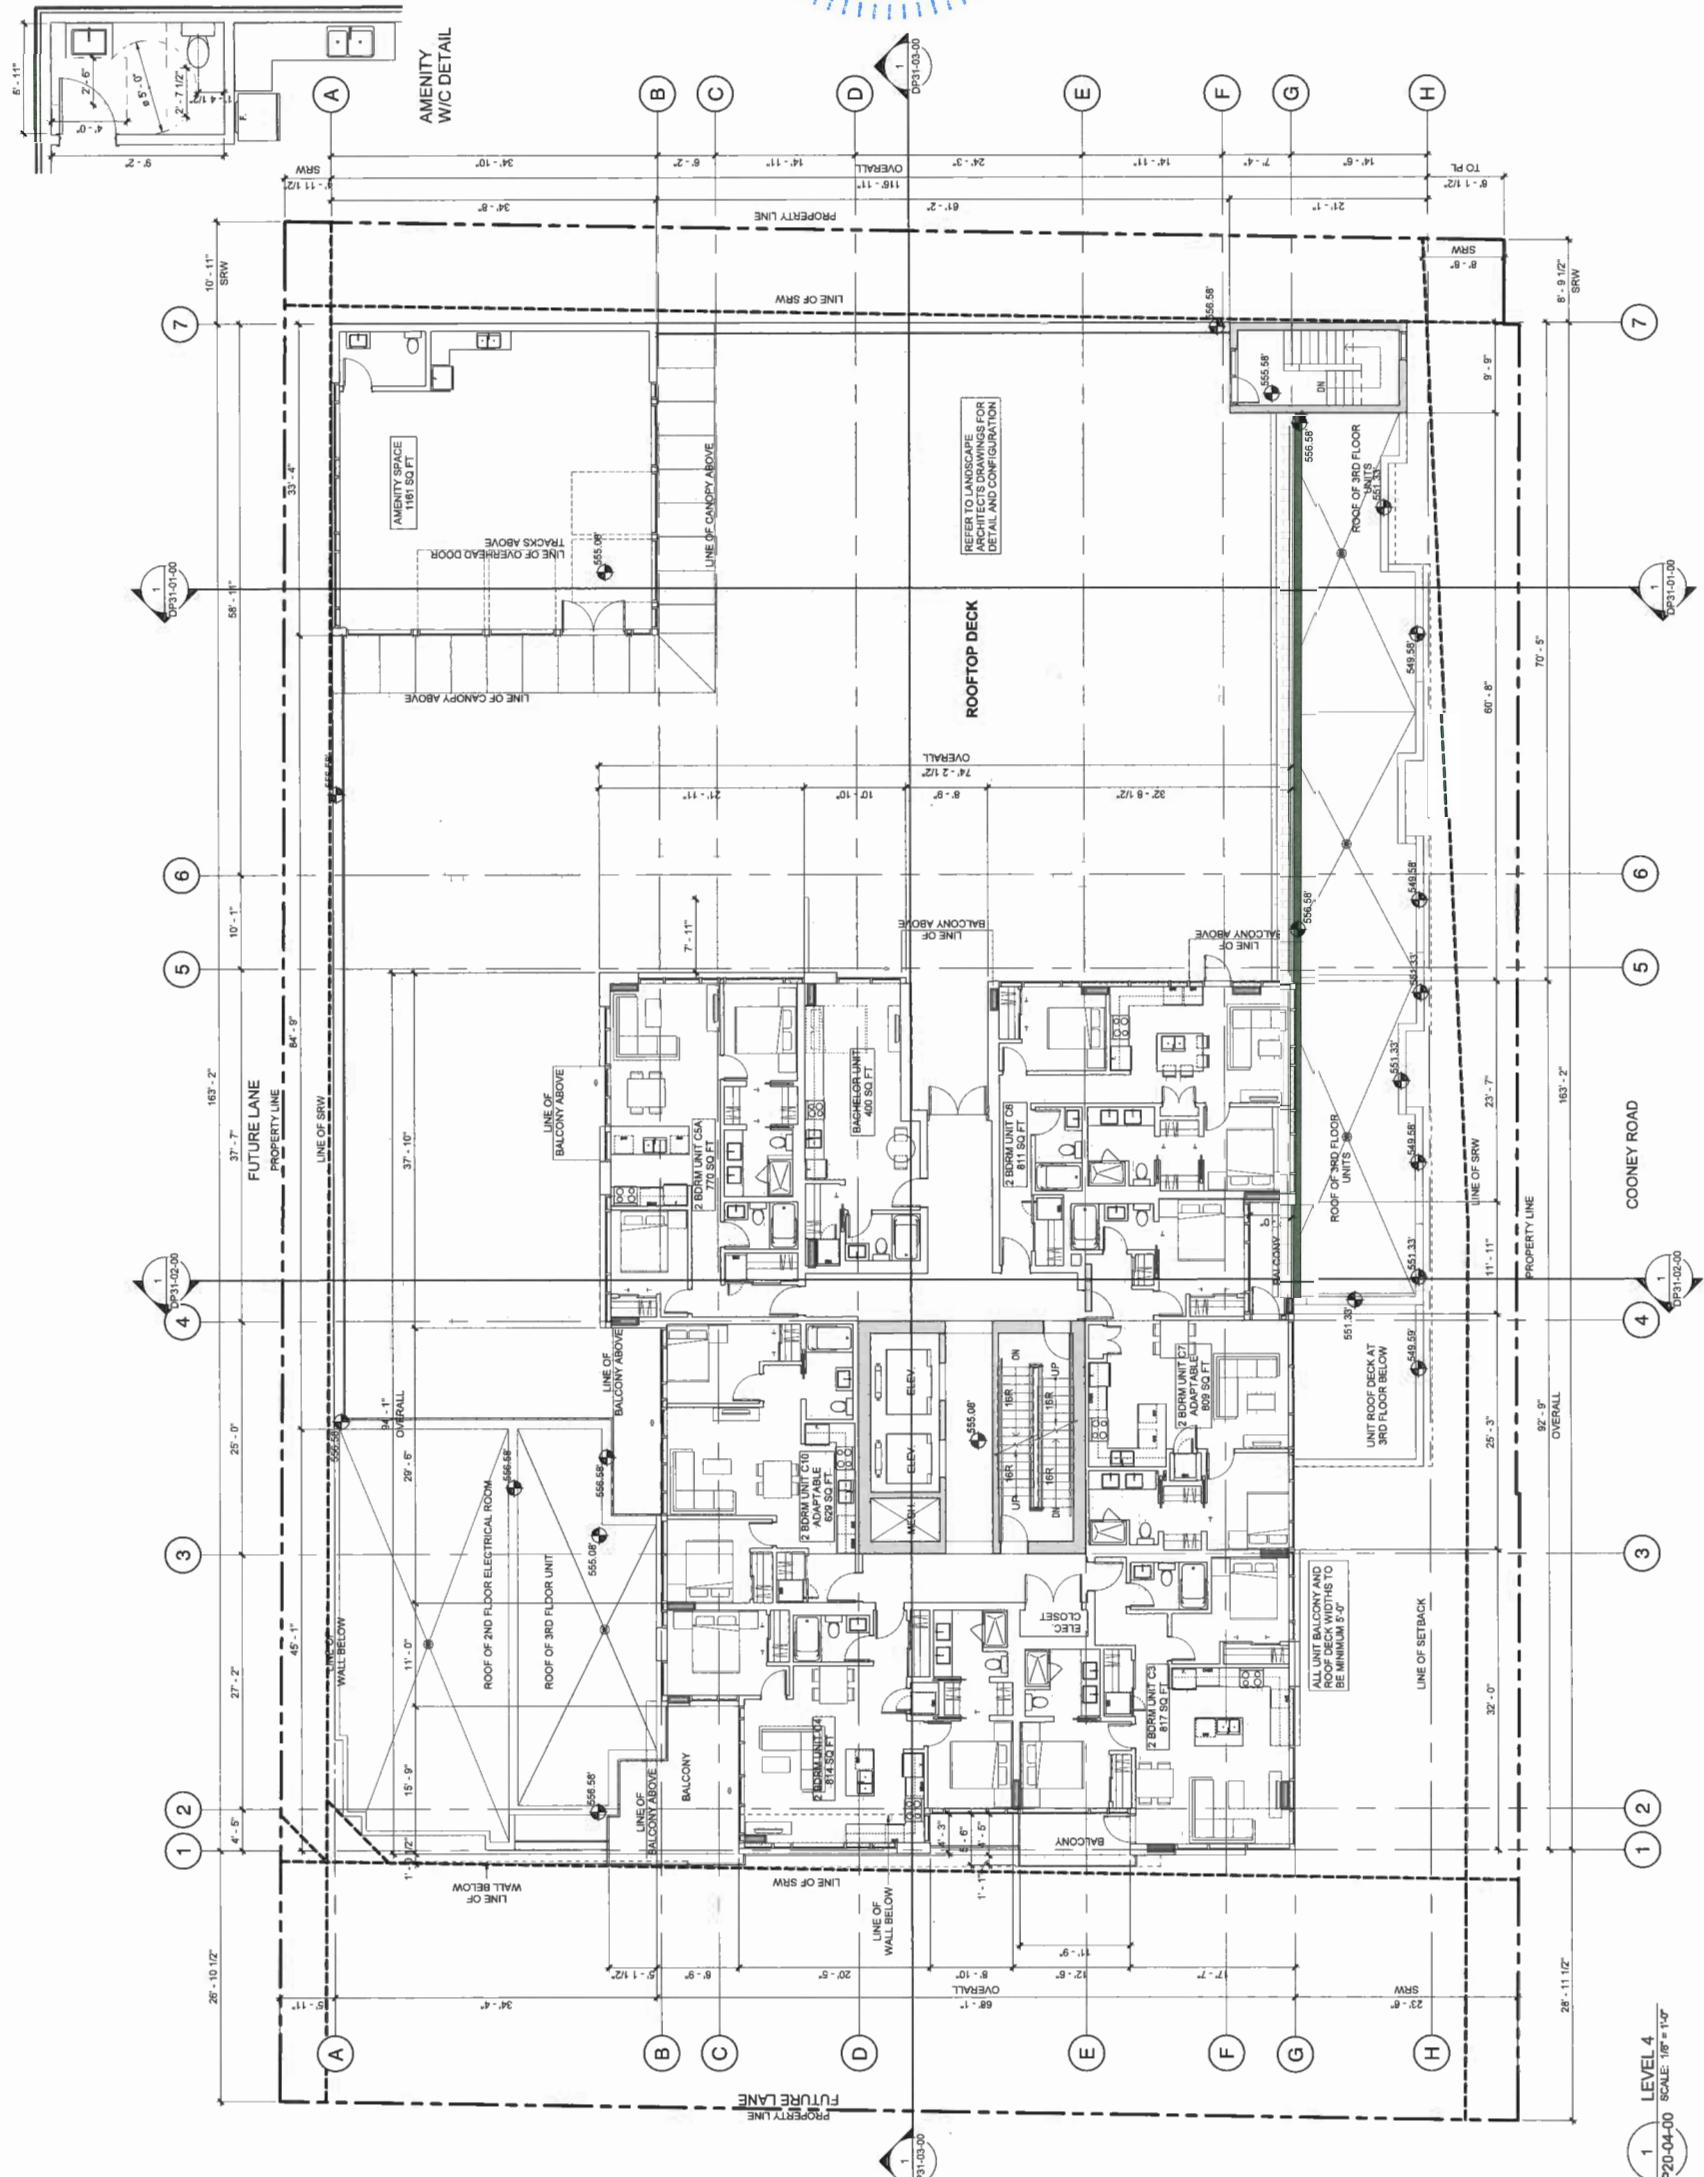



CONSULTANT INFORMATION
Cof.: CONNECT LANDSCAPE ARCHITECTURE
Landscape Architect: GUY CHAPMAN
Architect: TREVOR K. LANCE
Group: GROUP OF COMPANIES
Member:
Design: HENNET & ASSOCIATES LTD.

NOT FOR
CONSTRUCTION

PROJECT INFORMATION


COONEY ROAD
TOWER

6333 COONEY ROAD
RICHMOND, BC

REGISTERED ARCHITECT
TREVOR K. LANCE
B.C. PROFESSIONAL
PRACTICE
REGISTRATION
NO. DP313120

Plan 9

NOV 20, 2019
DP 17-791045

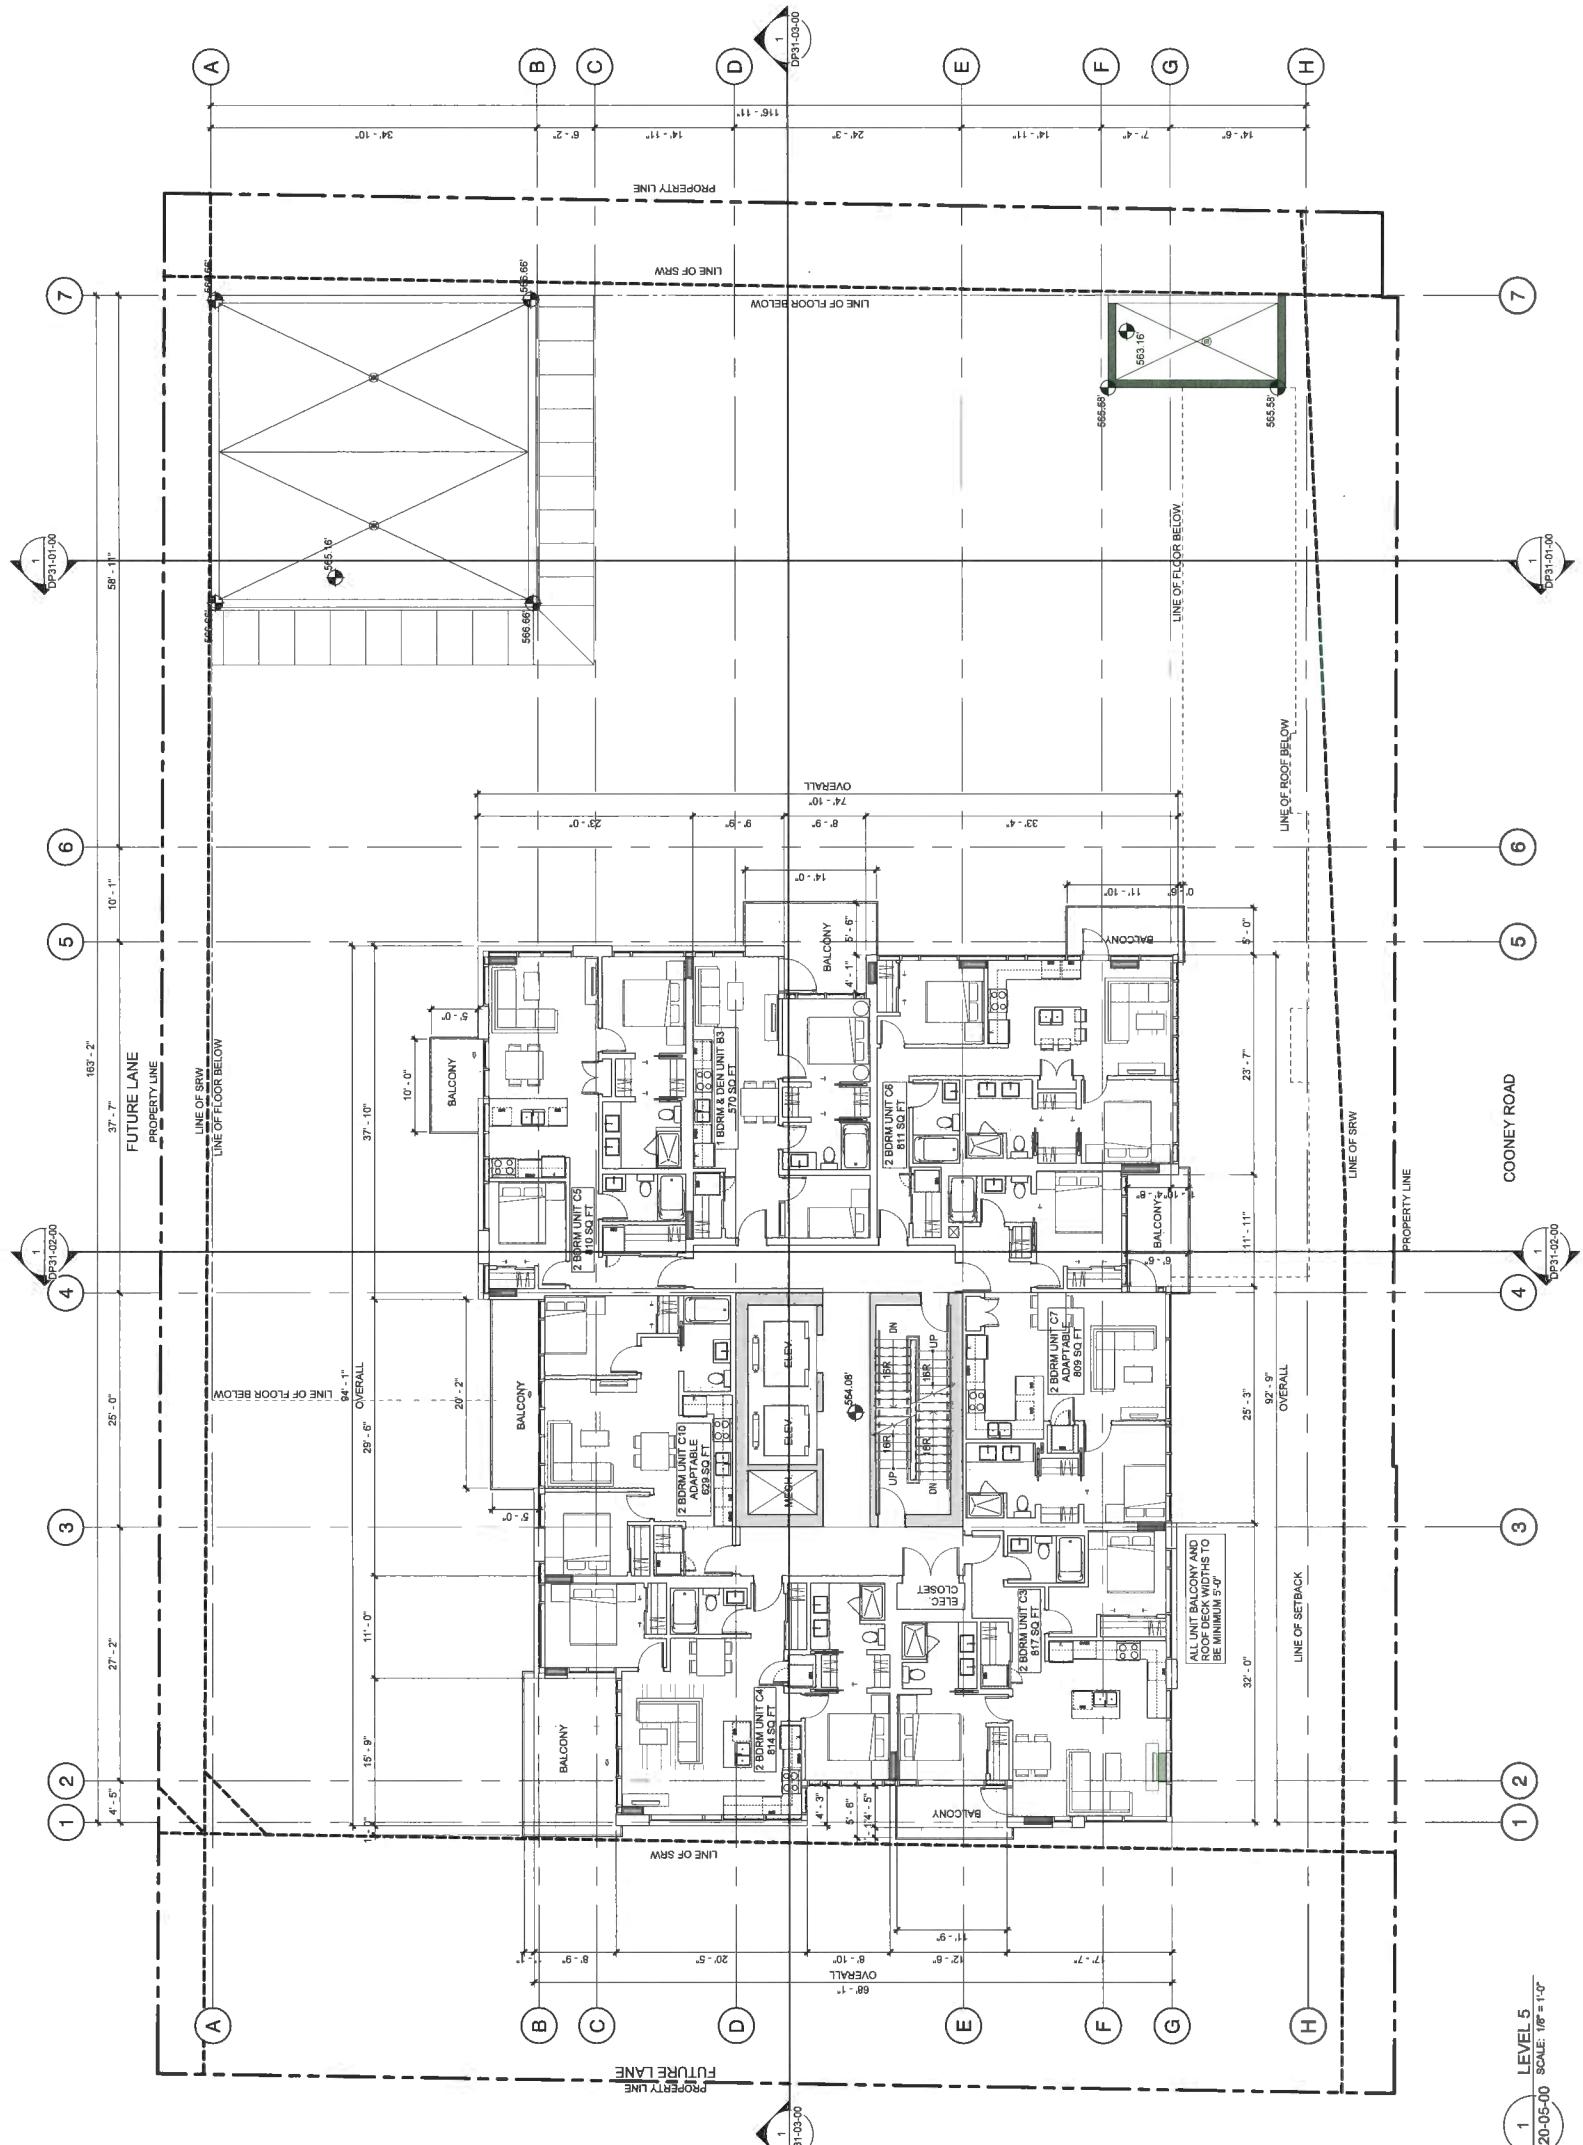

LEVEL 5
DP20-05-00
SCALE: 1/8" = 1'-0"

DP20-05-00
DRAWING NO.
LEVEL 5 FLOOR PLAN
DRAWING TITLE
LEVEL 5 FLOOR PLAN
DRAWING NO.



CONSULTANT INFORMATION

Che: CONNECT LANDSCAPE ARCHITECTURE
 Landscape: CONNECT LANDSCAPE ARCHITECTURE
 Architect: COASTAL BUILD & COMPANIES
 Structural: COASTAL BUILD & COMPANIES
 Mechanical: AFE GROUP
 Electrical: HANNAH & ASSOCIATES LTD.
 Interiors:

NOT FOR CONSTRUCTION

PROJECT INFORMATION

COONEY ROAD TOWER

6333 COONEY ROAD
 RICHMOND, BC

[Handwritten signature]
REGISTERED ARCHITECT
B.C. PROFESSIONAL REGISTRATION NO. K. LANGE
BRITISH COLUMBIA

The drawing represents property lines. Do not include trees, shrubs, or other vegetation, structures and elements, and include my drawings as they appear on the ground surface. Drawings are to be used for the purpose of construction only. They do not represent the final building, floor or roof levels, or exterior or interior finishes, unless otherwise indicated. The original documents, Drawings and Specifications, are controlled by the architect and are to be used in conjunction with the original documents. All drawings are the property of the architect. These drawings may not be reproduced without the permission of the architect.


ISSUED.....

DATE 2017-11-03
 DEVELOPMENT PERMIT
 APPROVAL
 SUBMISSION 2018-09-26
 RE-SUBMISSION 2019-02-01
 APP RESPONSE 2019-05-16
 DP RESUBMISSION 2019-10-31
 DP RESUBMISSION 2019-11-06

SCALE 1/8" = 1'-0"

DRAWN BY JH
 CHECKED BY SH
 PROJECT NO. 201711
 DRAWING NO. 10

DRAWING TITLE LEVEL 6 FLOOR PLAN

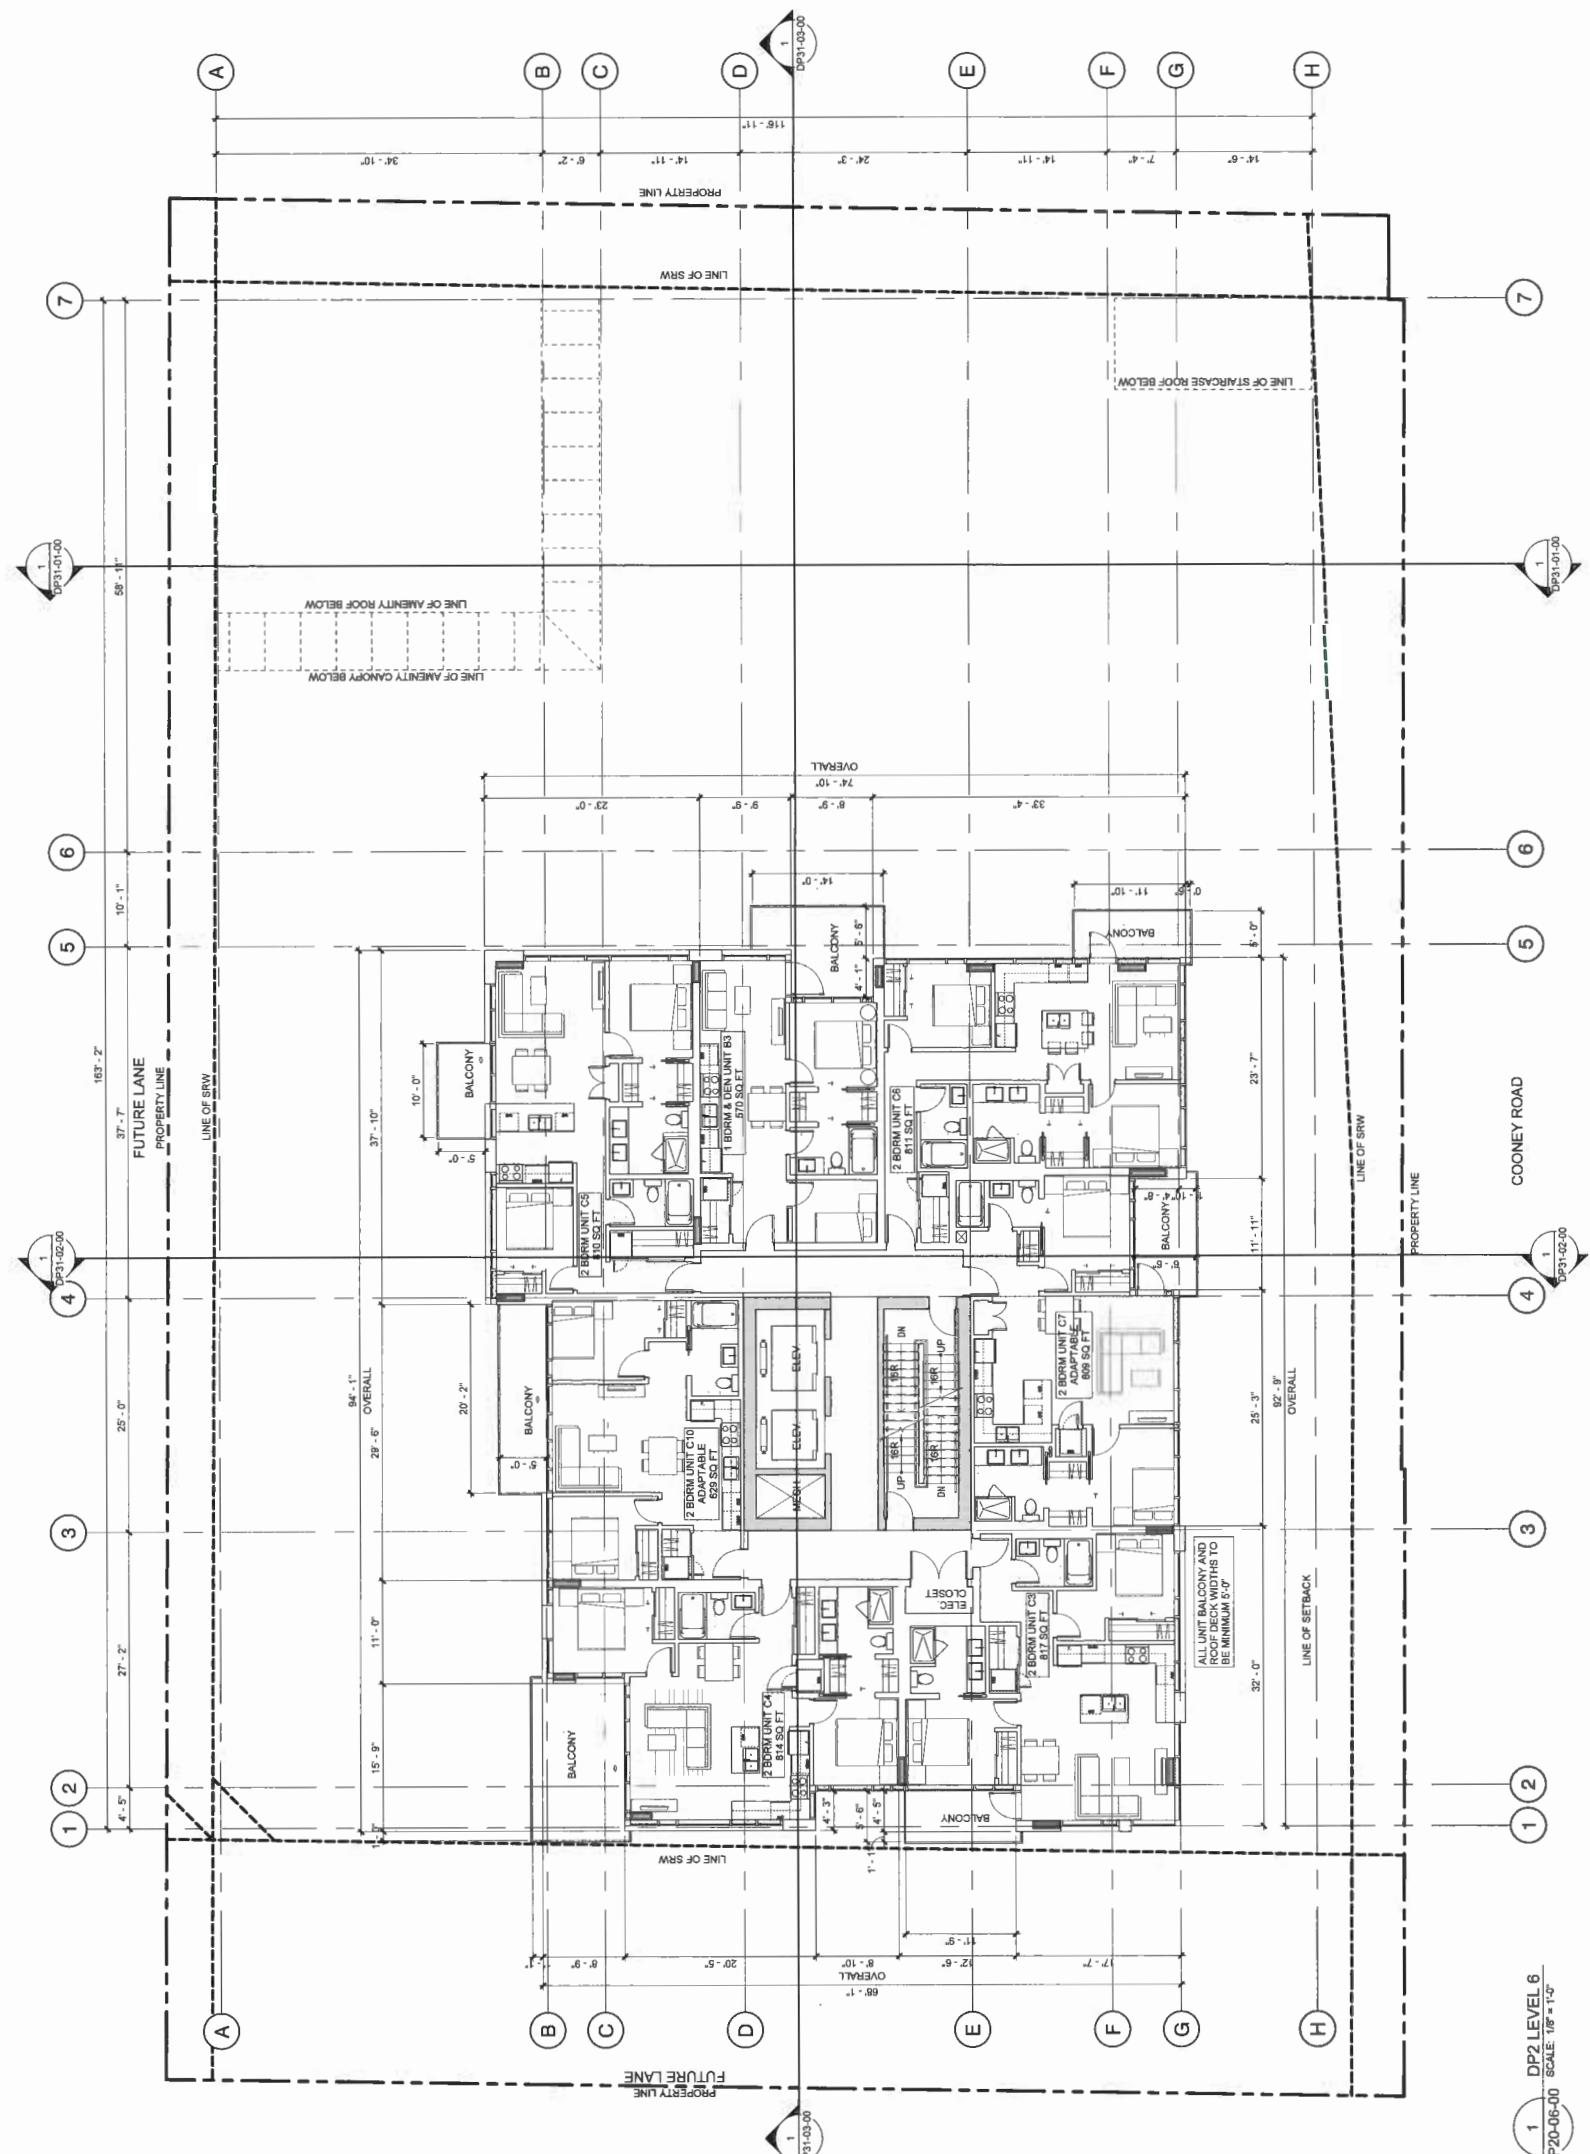



CONSULTANT INFORMATION
Dale Connect Landscape Architecture
Landscape Architectural Services Group / Cushman
Malouf, Inc. / NAE Group
Designs / Kmetz & Associates Ltd.
Inventor

NOT FOR
CONSTRUCTION

PROJECT INFORMATION

COONEY ROAD
TOWER

6333 COONEY ROAD
RICHMOND, BC


SWEDDLED ARCHITECTURE
DESIGN STUDIO LTD.
BRITISH COLUMBIA
REGISTERED PROFESSIONAL

This drawing supersedes previous issues. Do not use these drawings.
Verify all dimensions, elevations and details, and report any discrepancies to the architect prior to use. These drawings are to be used for construction purposes only. They are not to be used for insurance, legal or other purposes. All rights reserved by the architect. Any unauthorized copying or distribution of these drawings is prohibited by law.

DATE: NOV 20, 2019
DRAWING NO.: DP 17-791045
PLAN NO.: Plan 11
APPROVAL DATE: 2019-09-26
RE-SUBMISSION: 2019-09-26
POST APP RESPONSE: 2019-09-16
DP RESUBMISSION: 2019-10-31
DP RESUBMISSION: 2019-11-08

SCALE: 1'0" = 1'-0"
DATE: 11/14/2019 4:25:10 PM
DRAWN BY: JH
CHECKED BY: SH
PROJECT NO: 219171
DRAWING TITLE: LEVEL 7 FLOOR PLAN
LEVEL: 7 FLOOR PLAN

C DRAWING NO.: DP20-07-00
DRAFTER: SP
DATE: 11/14/2019 4:25:10 PM
PROJECT NO: 219171
DRAWING TITLE: LEVEL 7 FLOOR PLAN
LEVEL: 7 FLOOR PLAN

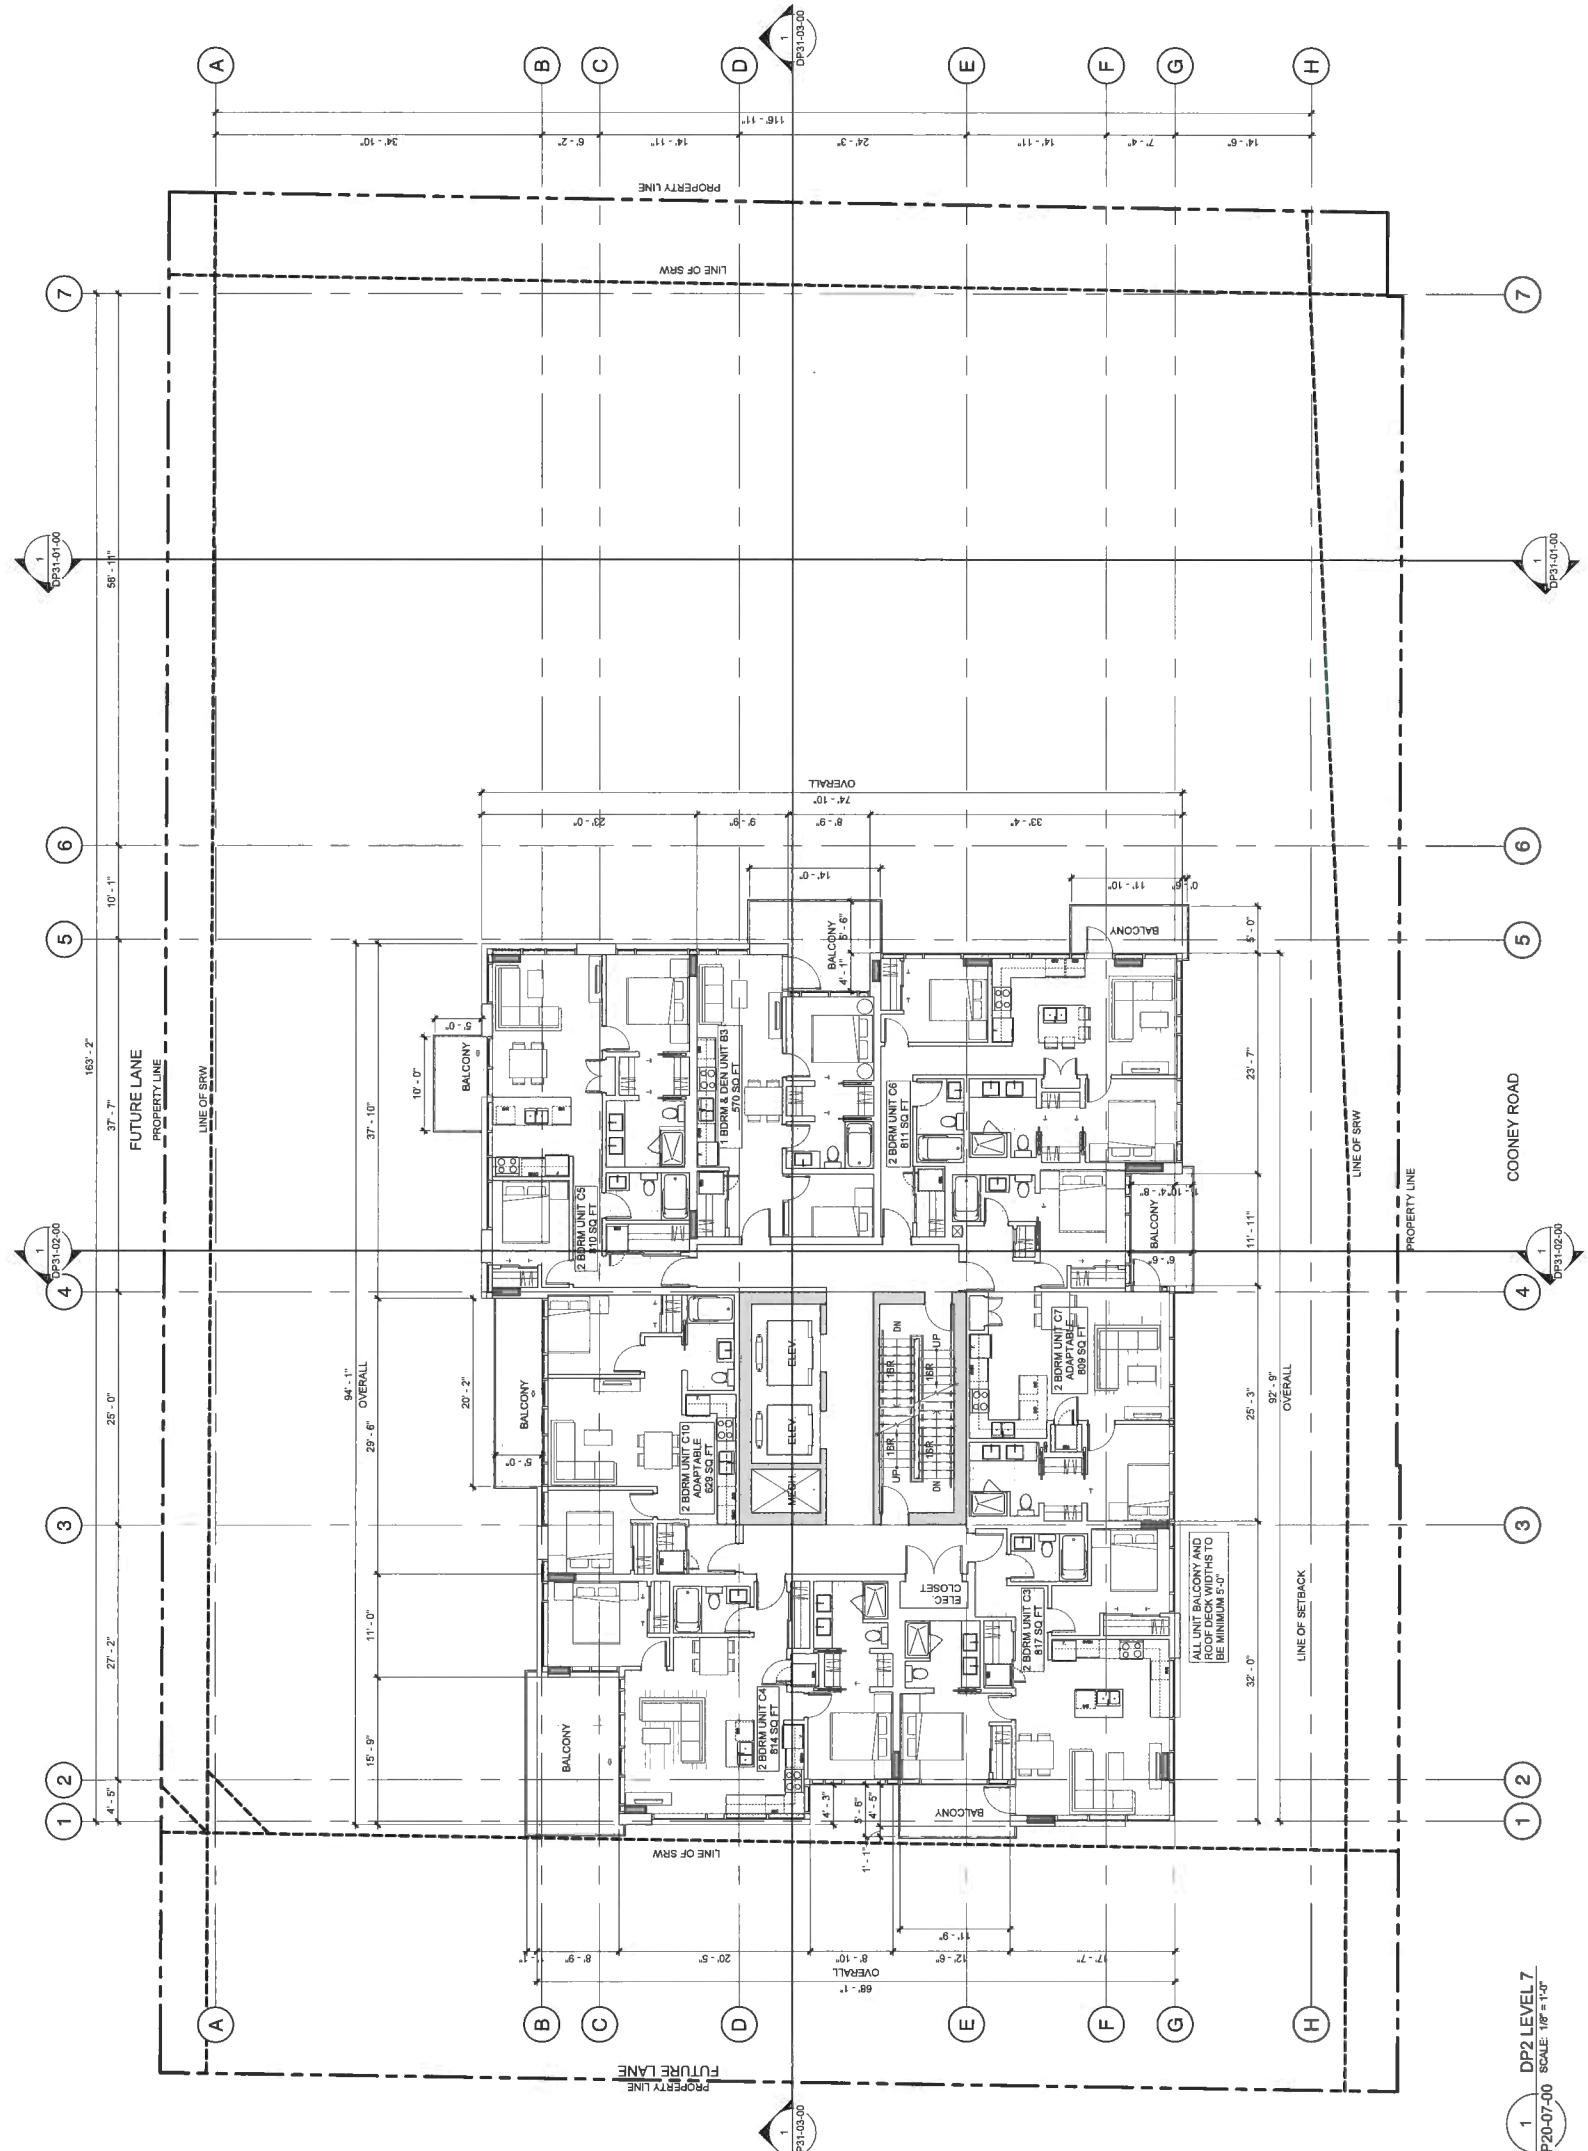



architecture

CONSULTANT INFORMATION

CNL Architecture	CONNECT LANDSCAPE ARCHITECTURE
Structural:	GUTHMANN GROUP OF COMPANIES
Mechanical:	AME GROUP
Electrical:	HENNET & ASSOCIATES LTD.
Interior:	INTERIOR

NOT FOR
CONSTRUCTION


COONEY ROAD
TOWER

6333 COONEY ROAD
RICHMOND, BC

REDACTED

Plan 12

DP 17-91043
NOV 20, 2019

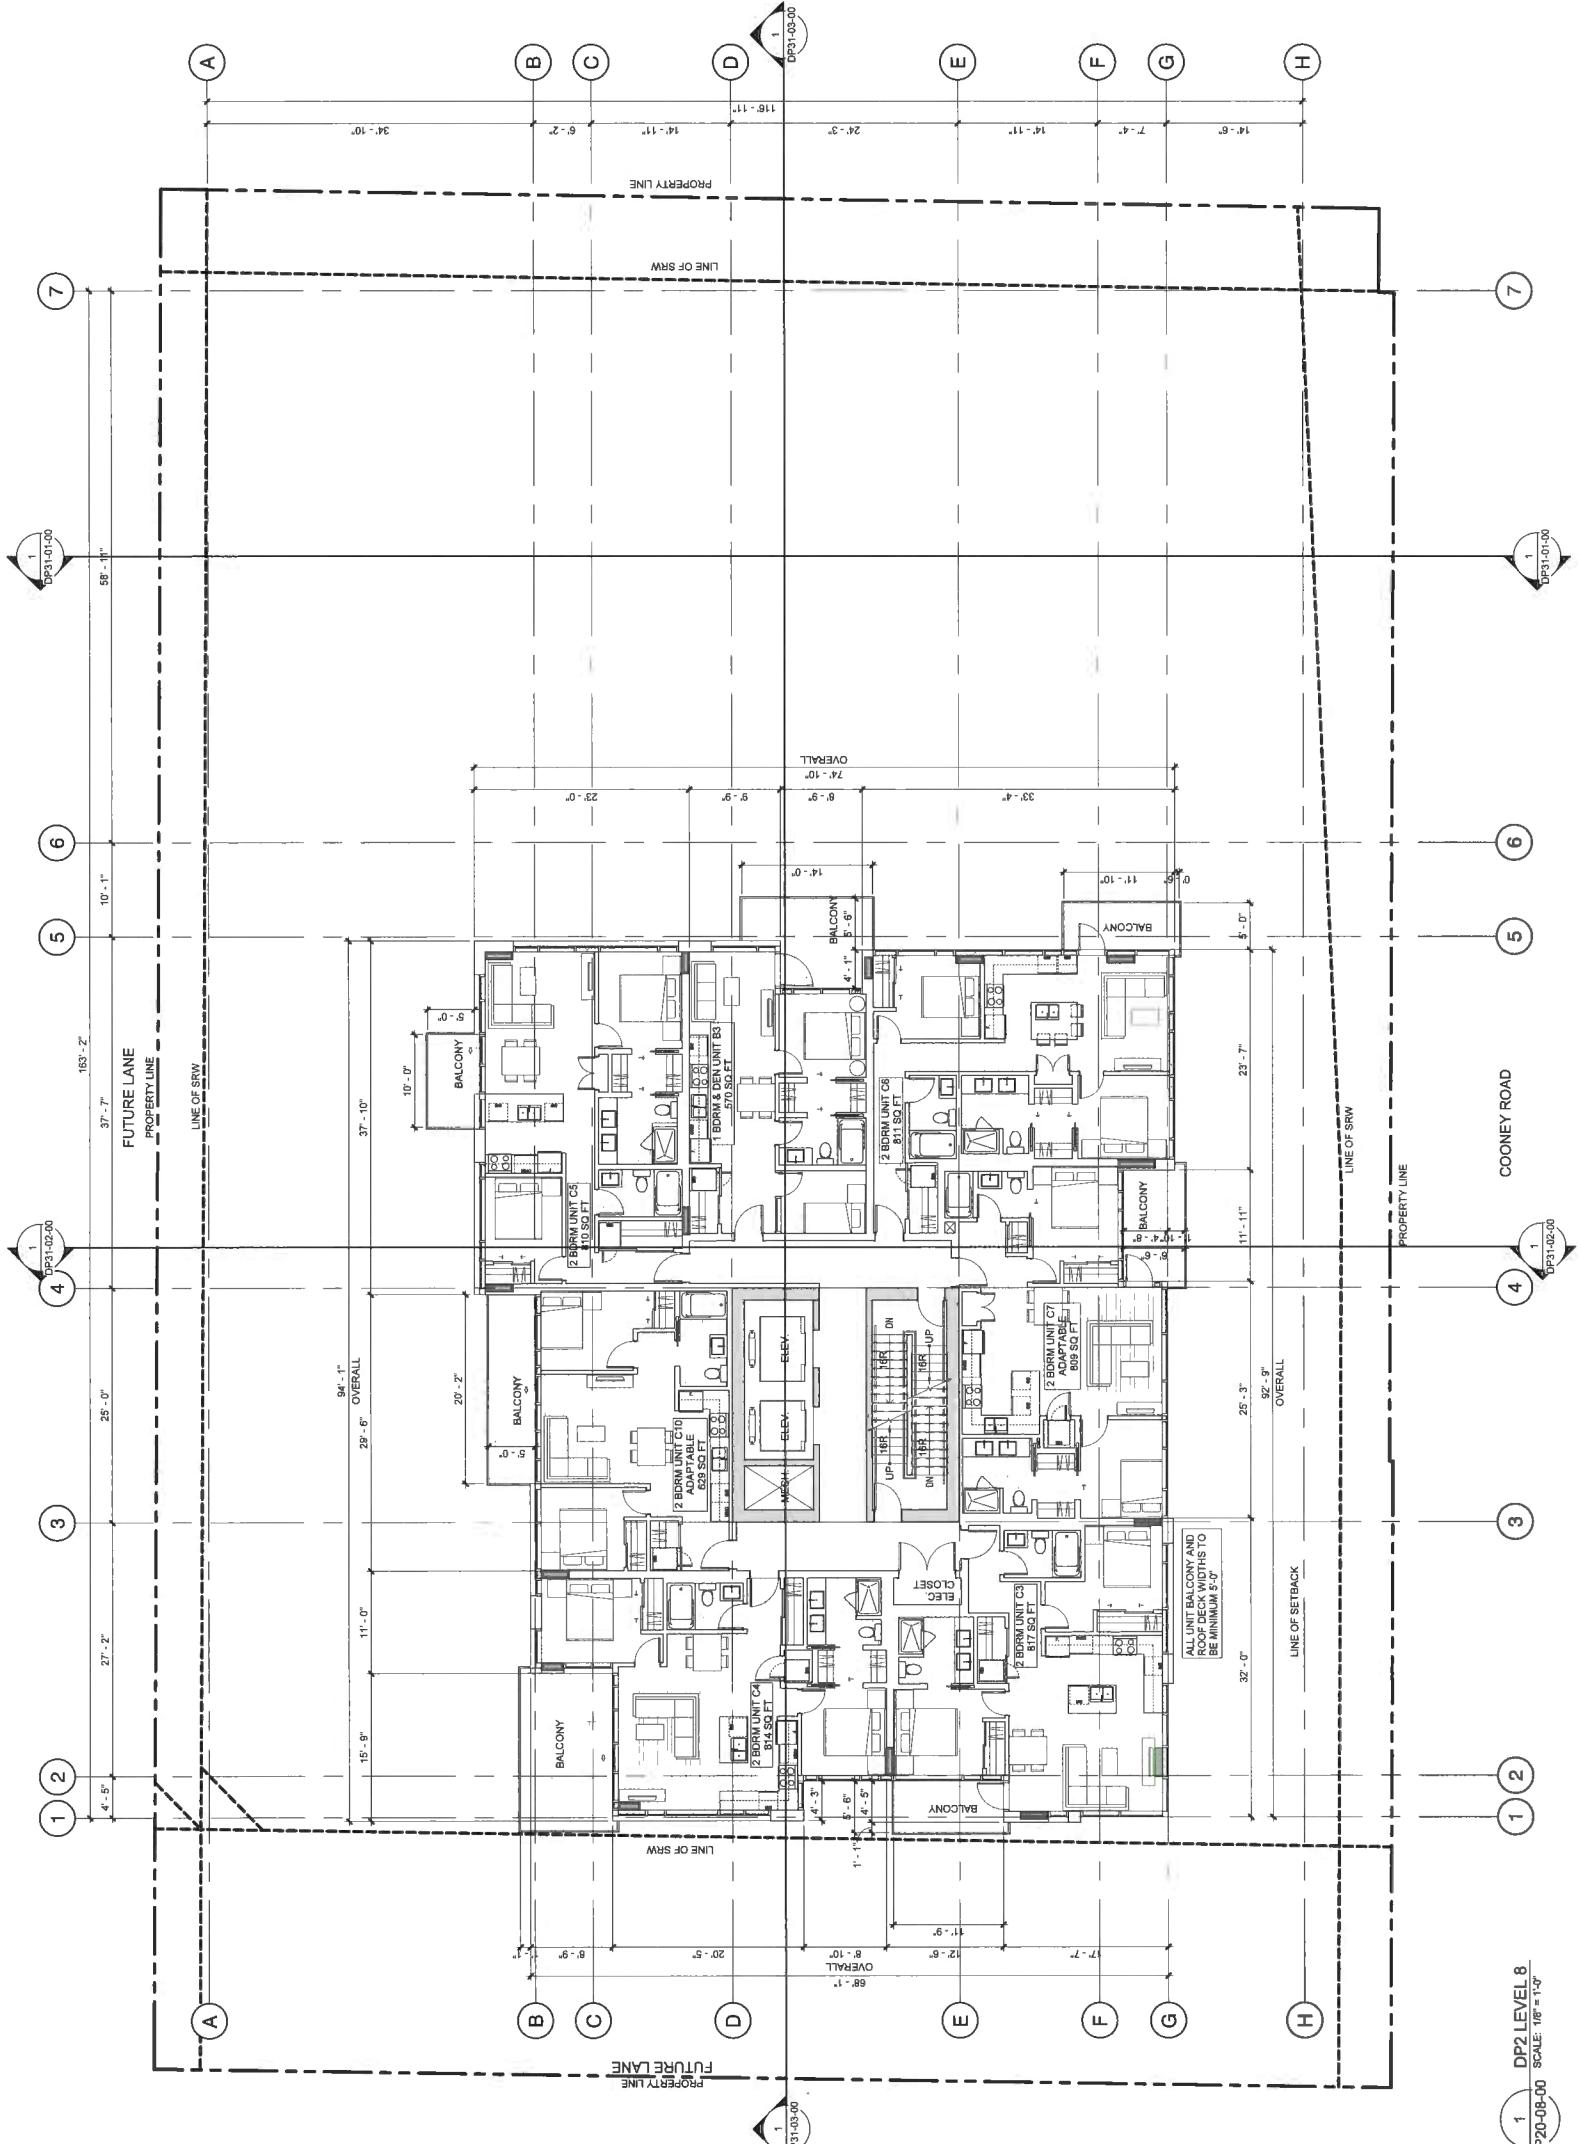



architecture

CONSULTANT INFORMATION

CHIEF LANDSCAPE ARCHITECTURE
Architectural: GLOTHMAN-SIMPSON GROUP OF COMPANIES
Naturalistic: AME GROUP
Design: HENETZ & ASSOCIATES LTD.

327-309 W Cordova Street
Vancouver, BC V6B 1E5
Telephone: (604) 685-1000
Telex: 720-222-1000

MCD

Landscape: CONNECT LANDSCAPE ARCHITECTURE
Architect: S2 ARCHITECTURE
Structural: GLOTHMAN-SIMPSON GROUP OF COMPANIES
MEP: AME GROUP
MEP: HEMNETZ & ASSOCIATES LTD.
Electrical: DUNN & CO. LTD.

NOT FOR
CONSTRUCTION

DOCUMENTATION

COONEY ROAD
TOWER

6333 COONEY ROAD
RICHMOND, BC


A circular blue stamp with a decorative border. The outer ring contains the words 'CHARTERED ARCHITECT' at the top and 'COUNCIL OF BRITAIN' at the bottom. The inner circle contains the word 'COUNCIL' at the top and 'CHARTERED' at the bottom. In the center, there is a large, dark, handwritten-style signature that appears to read 'J. M. L. COOPER'.

Plan 13

NOV 20, 2019
DB 17-791045

DP20-09-00

200

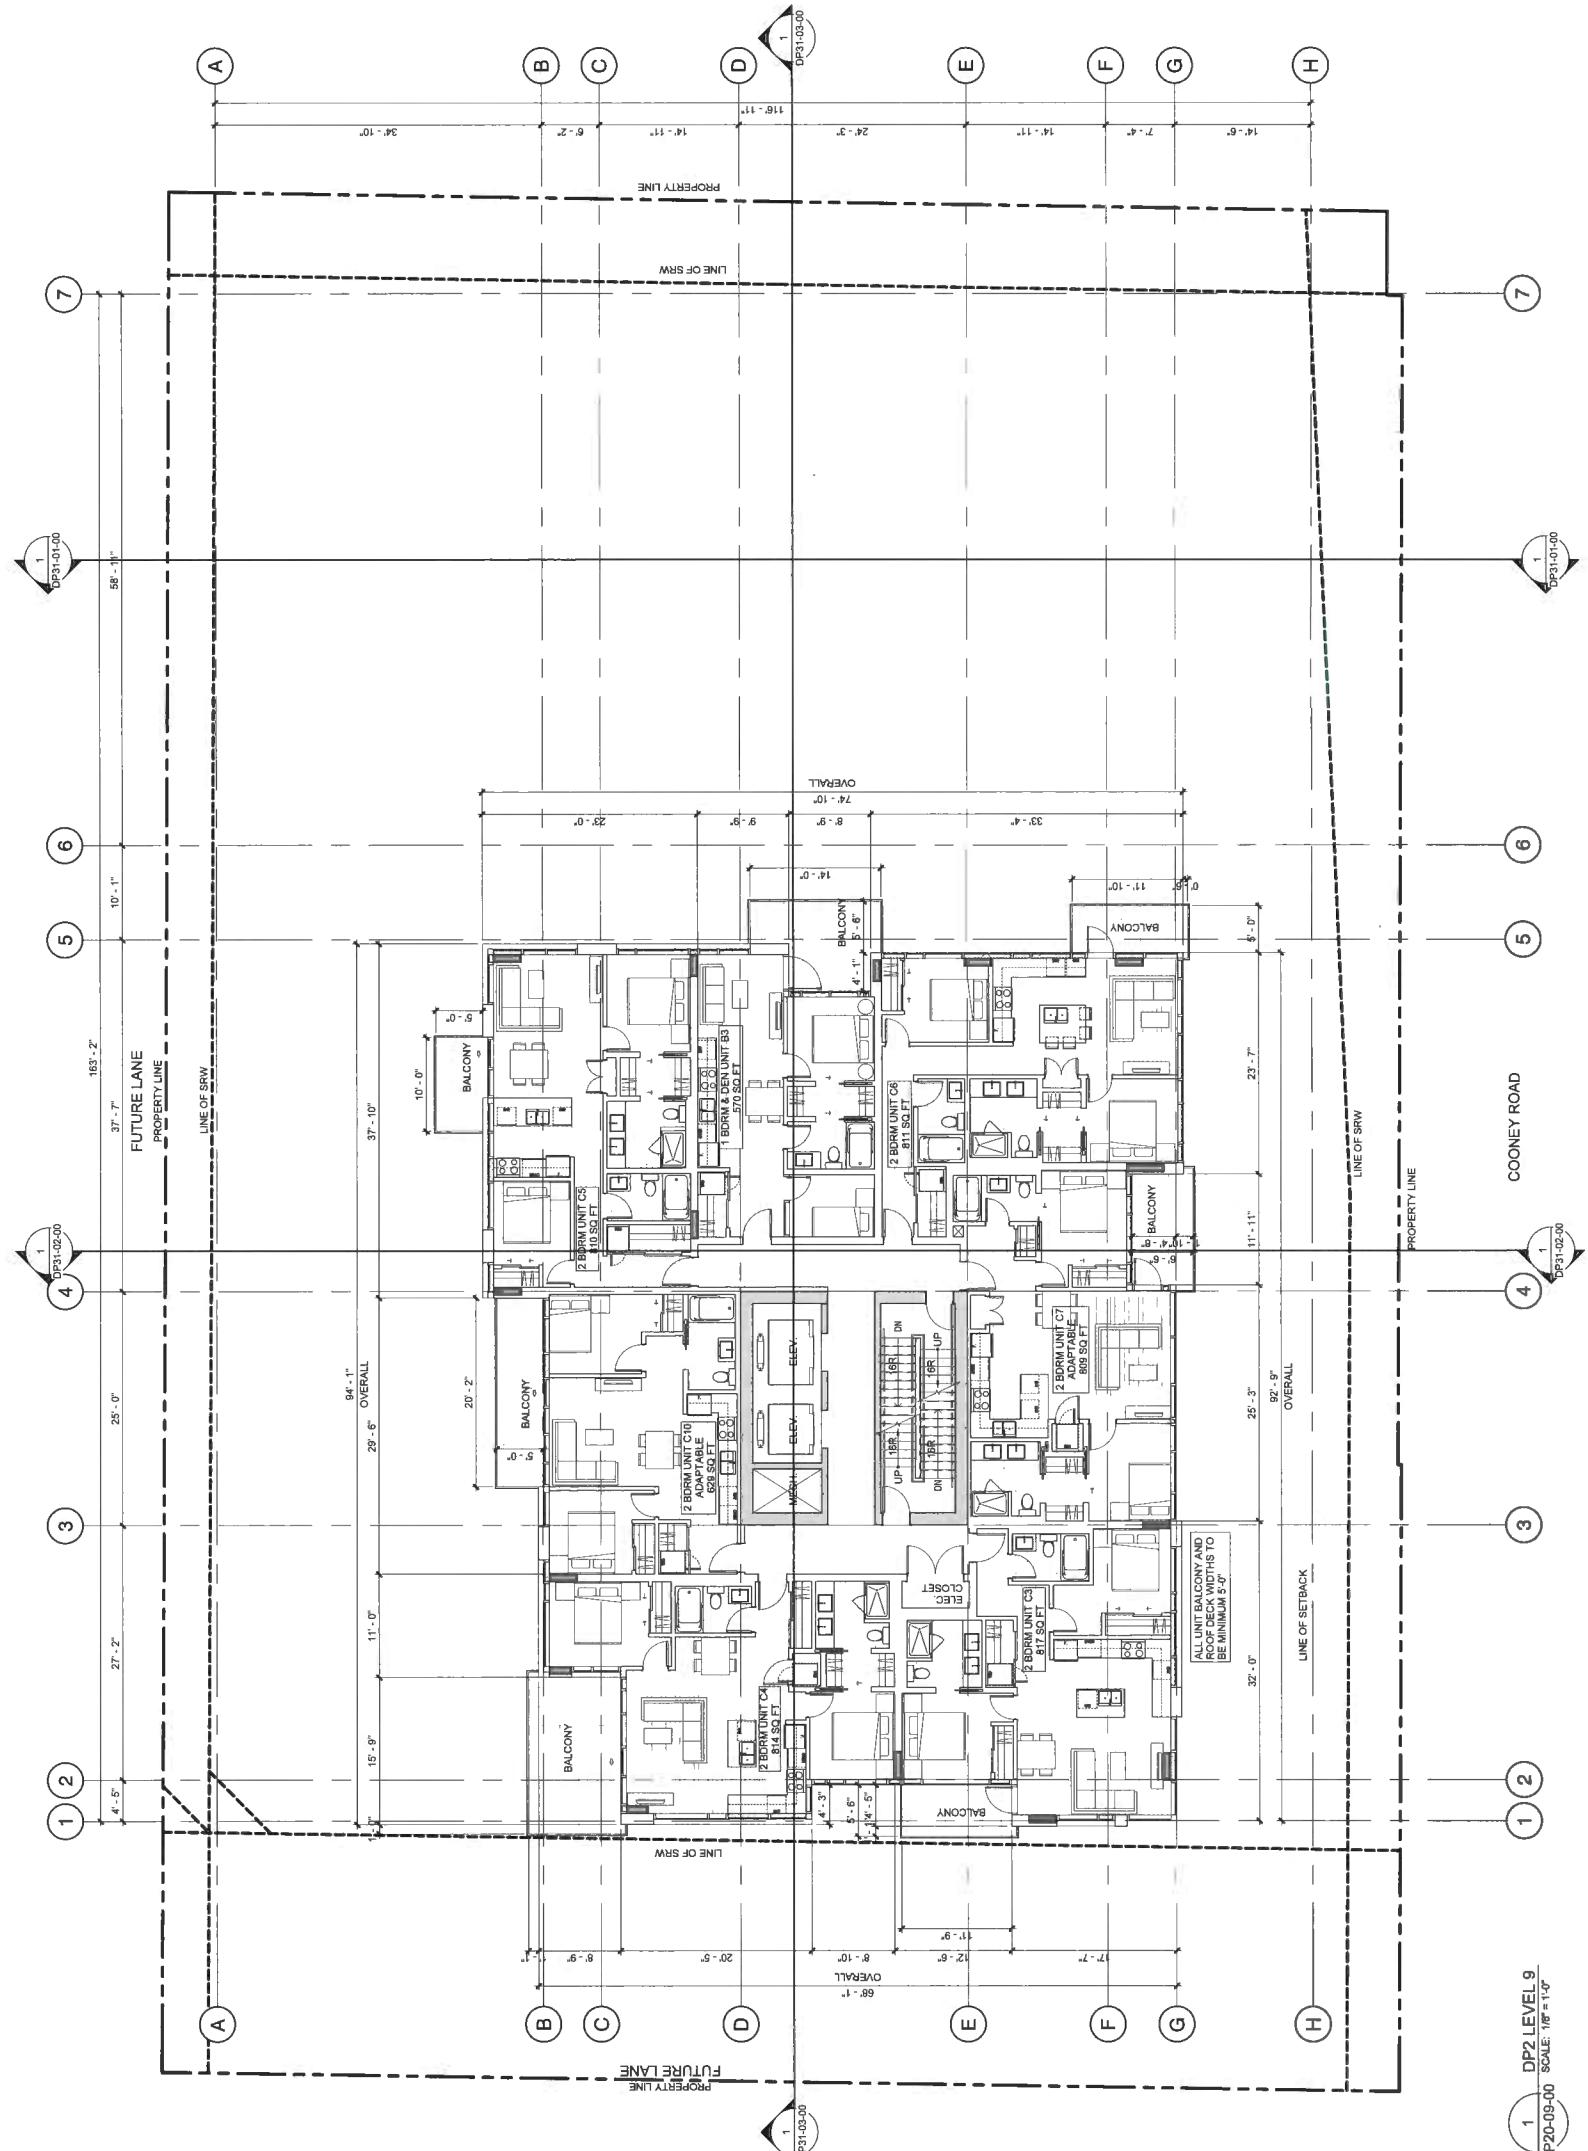



architecture
222-228 W. Gardner Street
Vancouver, BC, Canada V6B 1E9
† 604.541.3828

CONSULTANT INFORMATION

CML	CONNECT LANDSCAPE ARCHITECTURE
Landscape:	52 ARCHITECTURE LTD.
Architecture:	GLOTMAN-SIMPSON GROUP OF COMPANIES
Structure:	AME GROUP
Mechanical:	HEMNETZ & ASSOCIATES LTD.
Electrical:	BRUNNEN CONSULTING LTD.

THEATRE WORKS

CONNECT LANDSCAPE ARCHITECTURE
BY: S2 ARCHITECTURE
GLOAT-SIMPSON GROUP OF COMPANIES
AMT GROUP
NEMETZ & ASSOCIATES LTD.

NOT FOR
CONSTRUCTION

113

COONEY ROAD
TOWER

6333 COONEY ROAD
RICHMOND BC


ROBERT KLAASSEN

This drawing represents previous work. Do not make final decisions.

•Jan 14

DP 17-791045 NOV 20, 2019

DP20-10-00

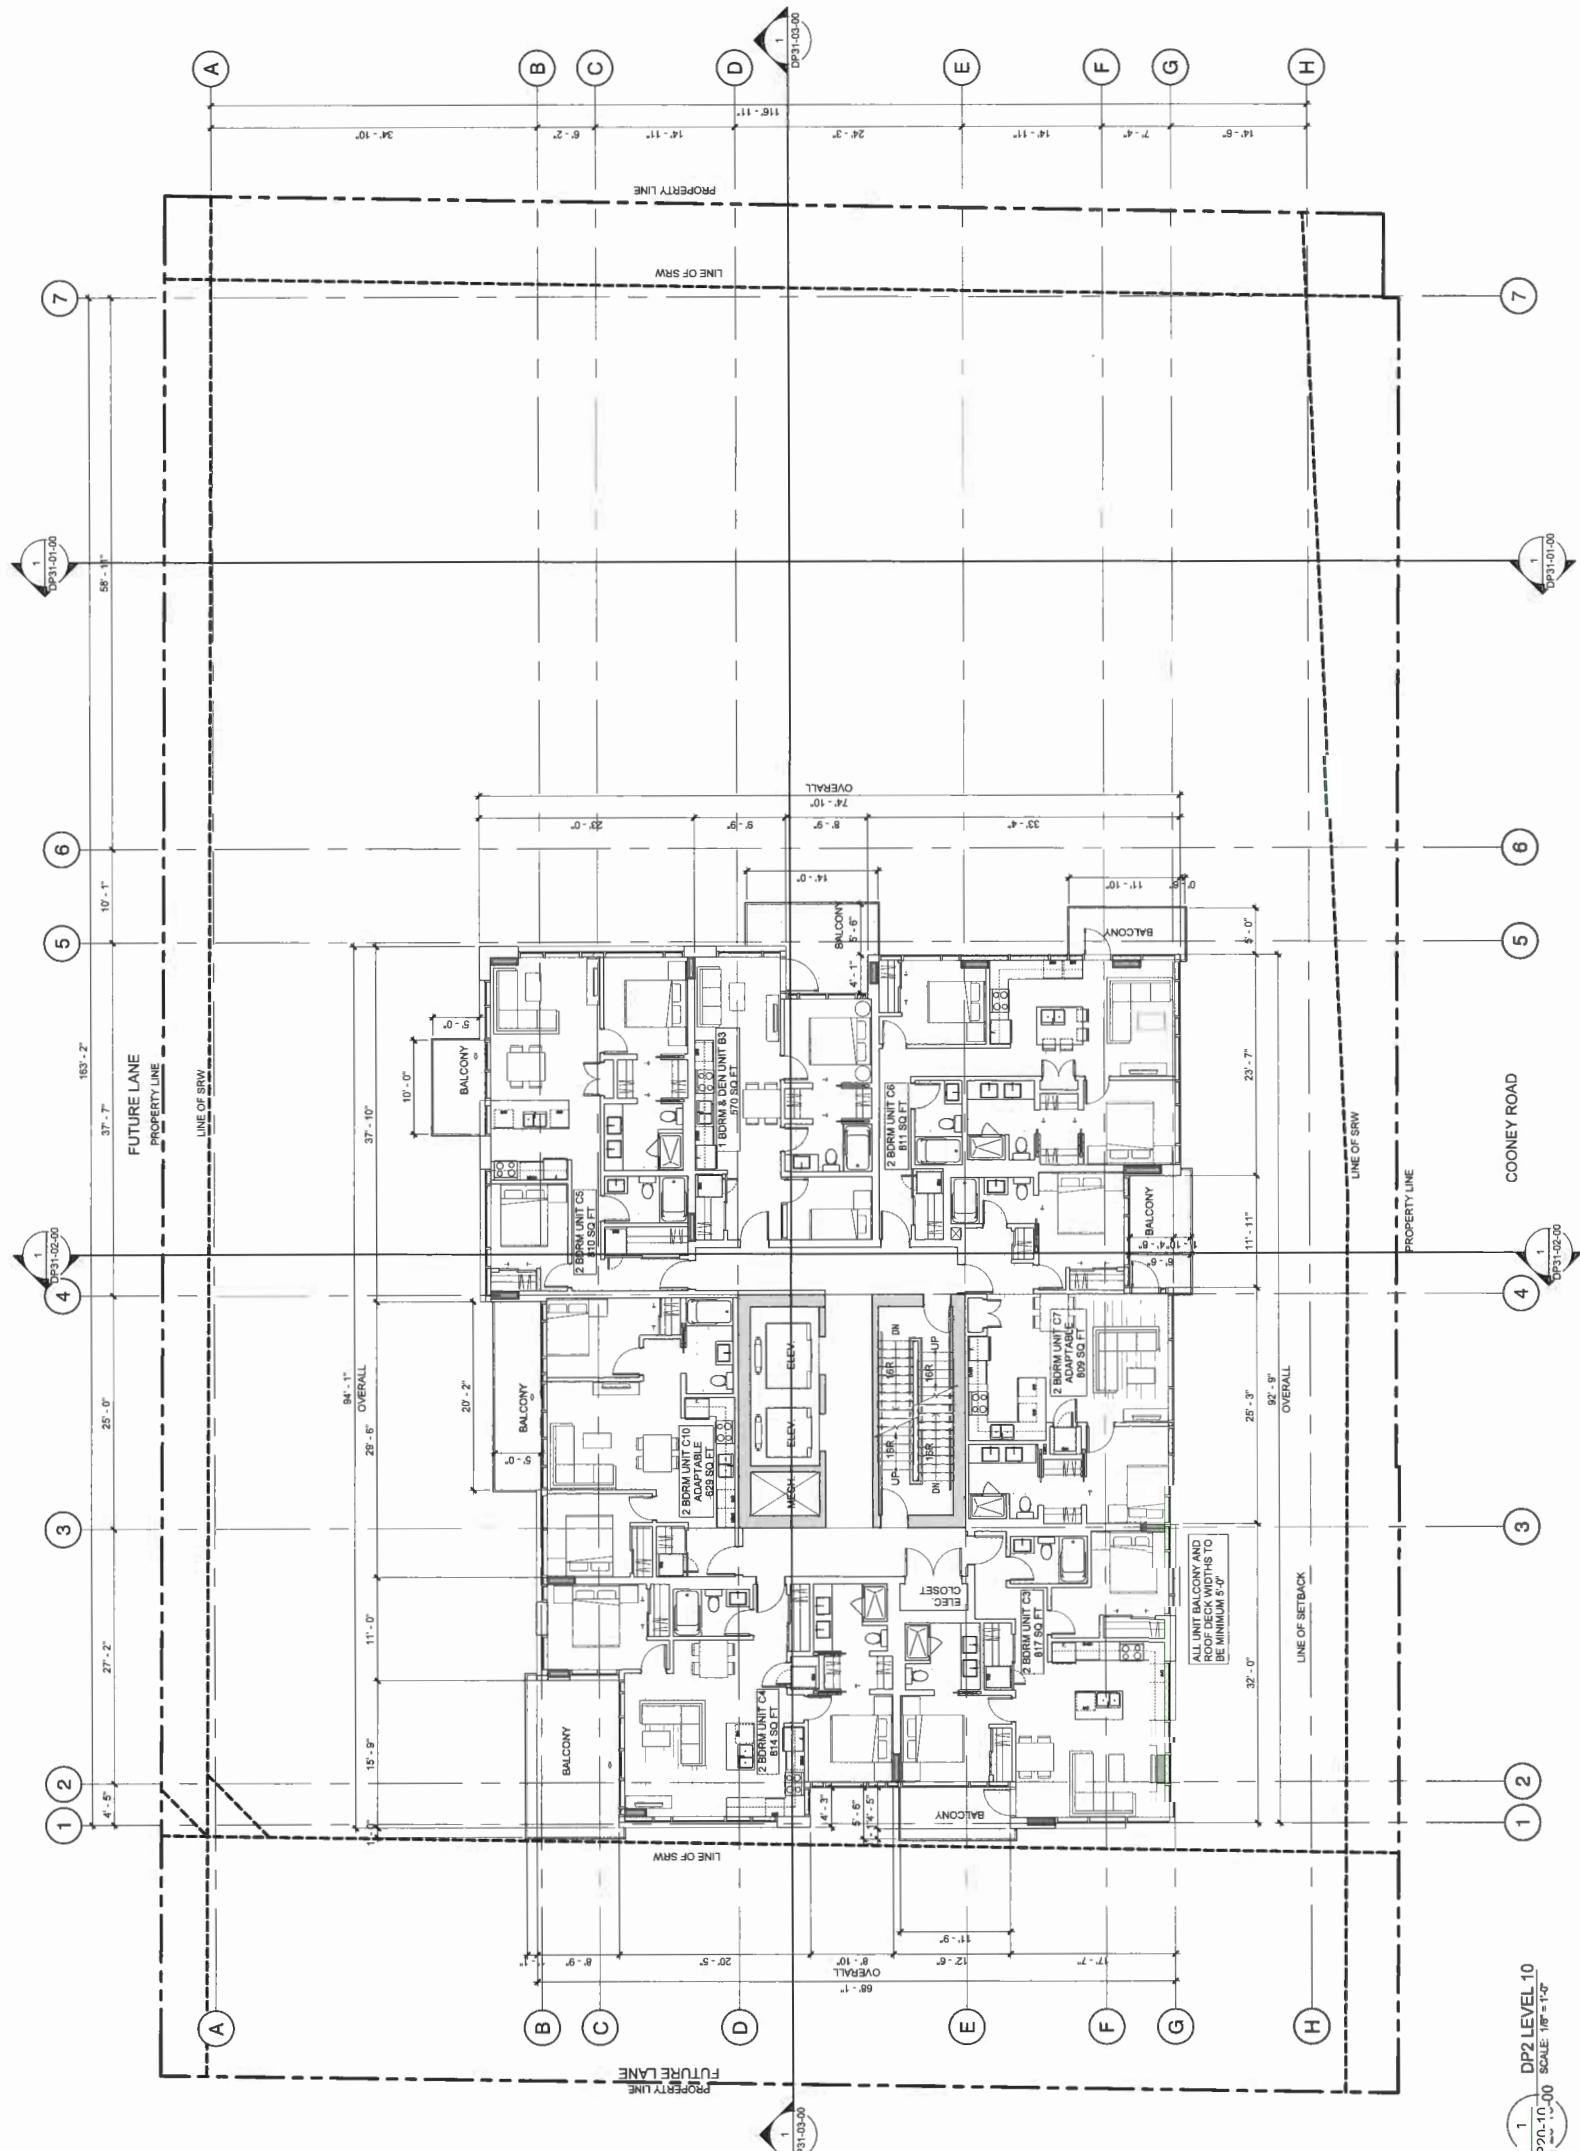



CONSULTANT INFORMATION

Client:	CONNECT LANDSCAPE ARCHITECTURE
Architect:	SZ ARCHITECTURE
Structural:	GLOTHMAN-SIMPSON GROUP
Mechanical:	AME GROUP
Electrical:	HENNETZ & ASSOCIATES LTD.
Interior:	

NOT FOR
CONSTRUCTION

PROJECT INFORMATION


DONNEY ROAD
TOWER

6333 COONEY ROAD
RICHMOND, BC

Plan 15

DP 17-791045
Nov 20, 2019

DP20-11-00

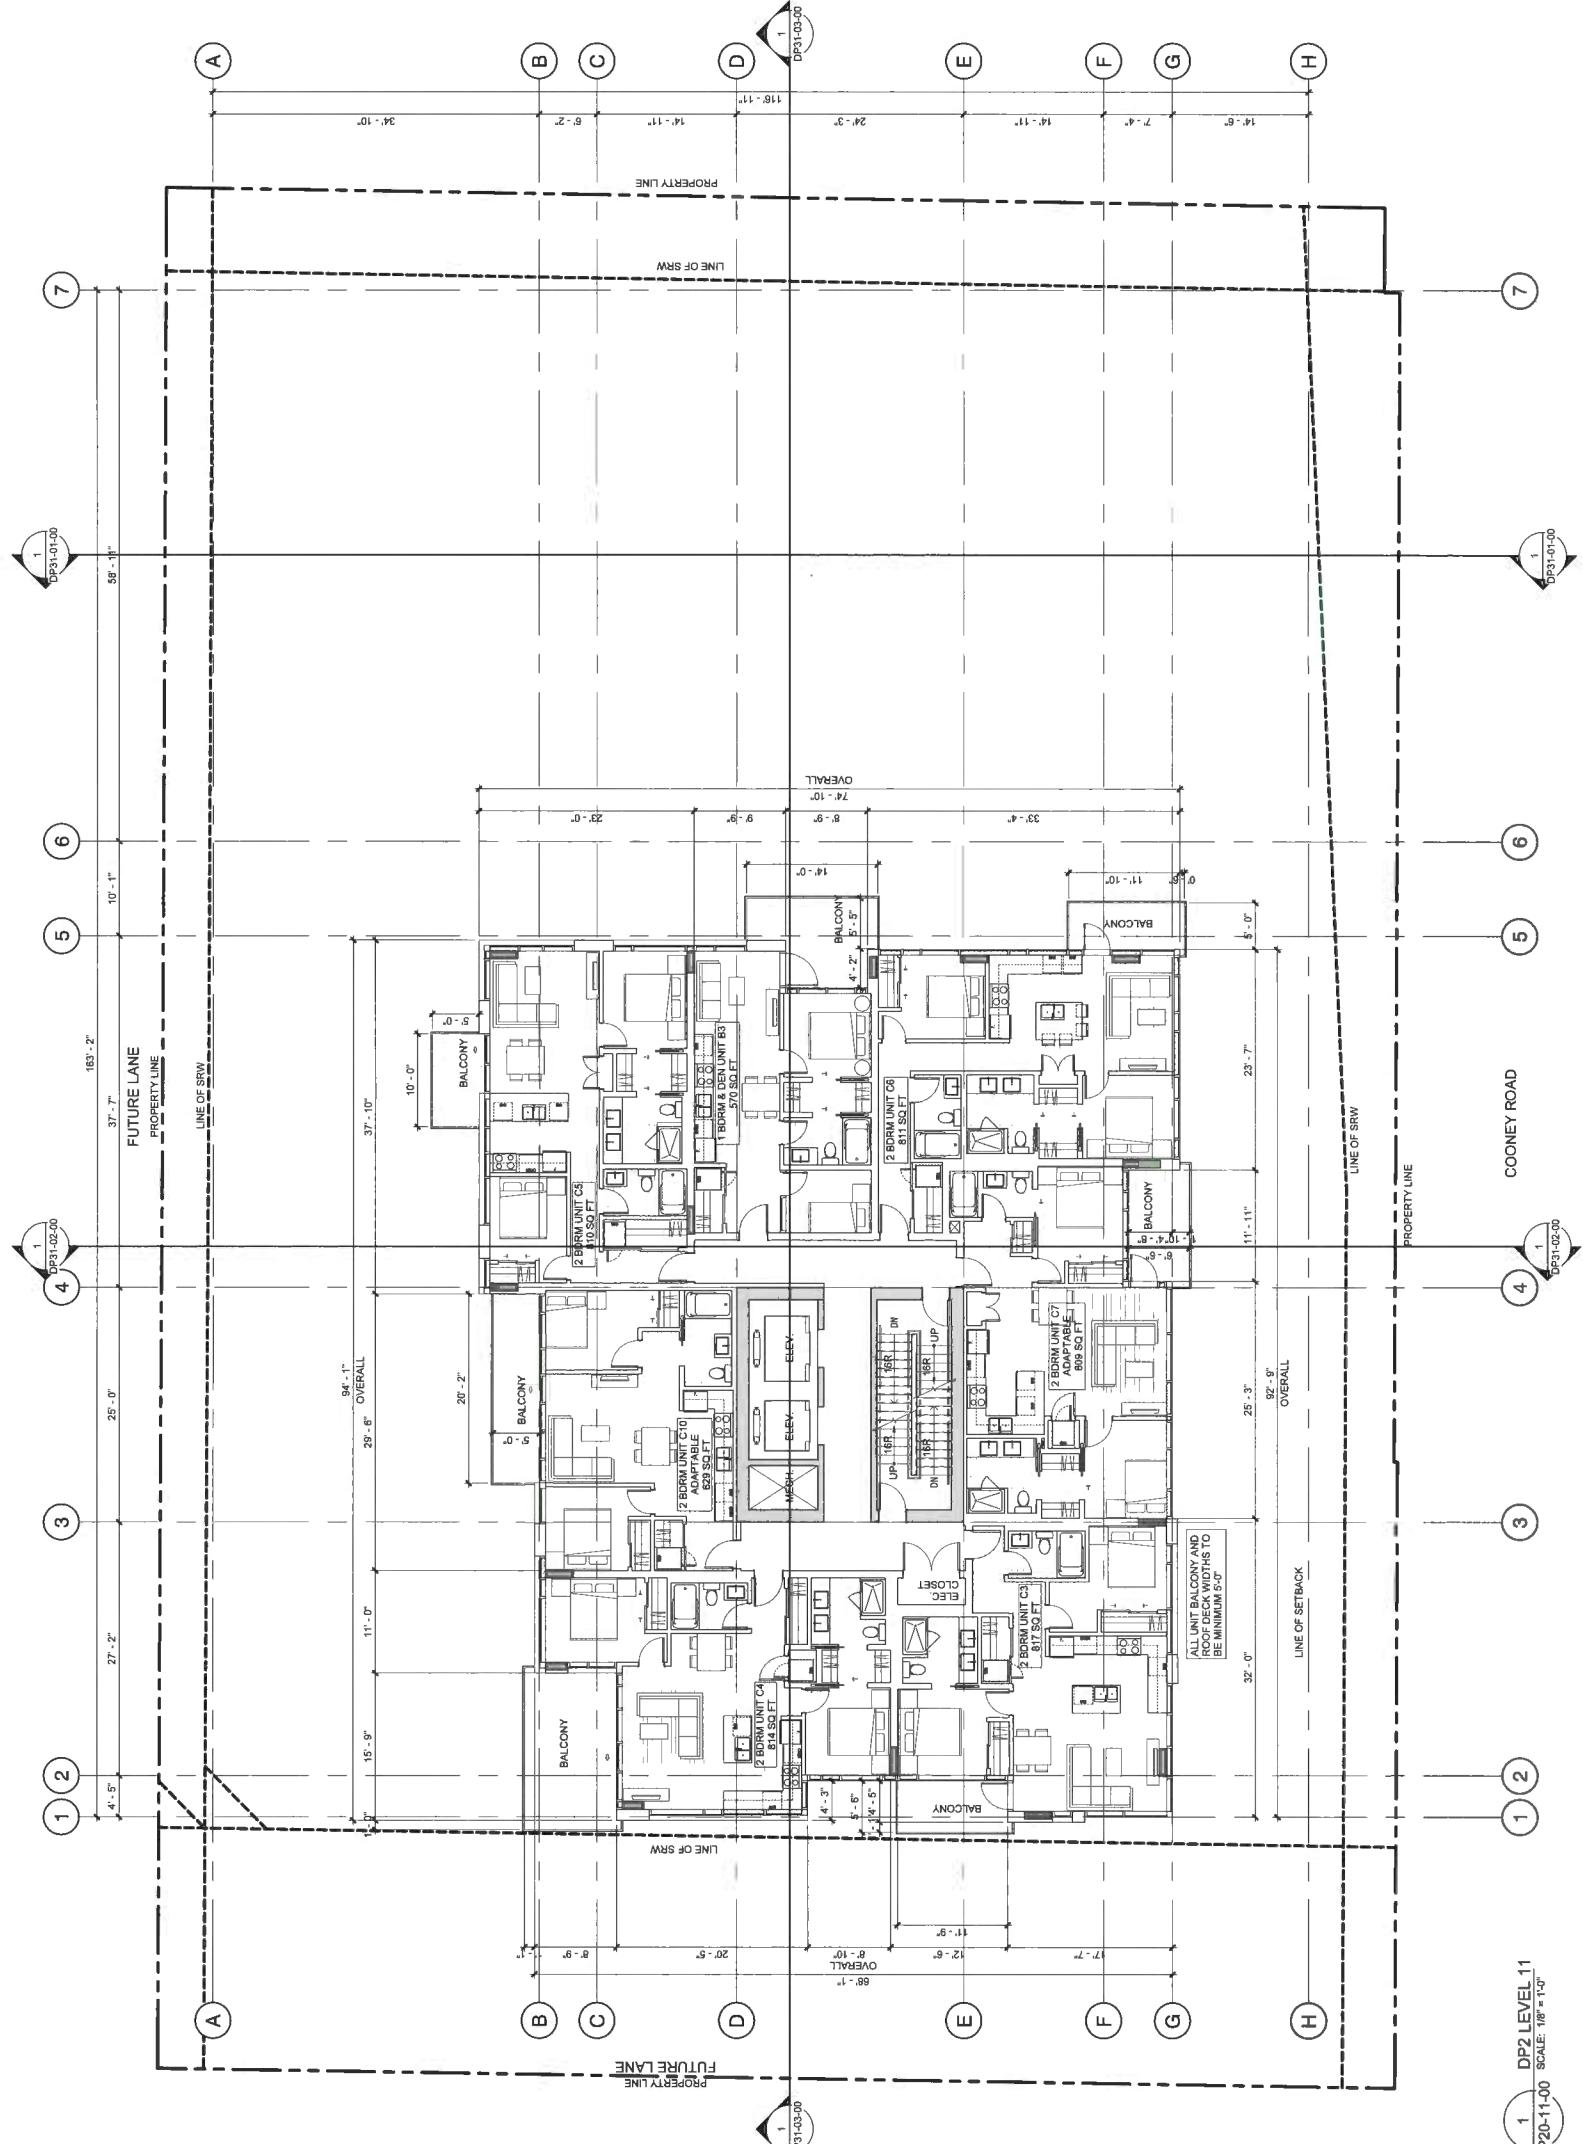



CONSULTANT INFORMATION

Chl. Landscape ARCHITECTURE
Landscape S ARCHITECTURE
Architectural Group of COMPANIES
Marinace A/E GROUP
Schele NAME & ASSOCIATES LTD.
Shore NAME & ASSOCIATES LTD.

NOT FOR CONSTRUCTION

PROJECT INFORMATION

COONEY ROAD
TOWER

6333 COONEY ROAD
RICHMOND, BC




This drawing is intended for review purposes. Do not include this drawing.
Verify all dimensions, distances and features, and inspect any construction details shown in the drawings. The architect or engineer has the final authority to determine the exact dimensions and features of the building. This drawing is not to be used for building permits, and requires a detailed set of plans and specifications to be submitted to the appropriate authority for review. All drawings remain the property of the architect. These drawings may not be reproduced without the permission of the architect.

DATE: 2019-09-26
DEVELOPMENT PERMIT NO: 2019-09-26
APPLICATION NO: 2019-09-26
RE-SUBMISSION NO: 2019-09-26
POST APPROVAL NO: 2019-09-26
DP RESUBMISSION NO: 2019-09-26
DP RESUBMISSION NO: 2019-09-26

SCALE: 1'0" = 1'-0"
DRAWN BY: JH
CHECKED BY: SH
PROJECT NO: 21977
DRAWING NO: 1
LEVEL: LEVEL 12 FLOOR PLAN

DP20-12-00
DRAWING NO: 1
LEVEL: LEVEL 12 FLOOR PLAN

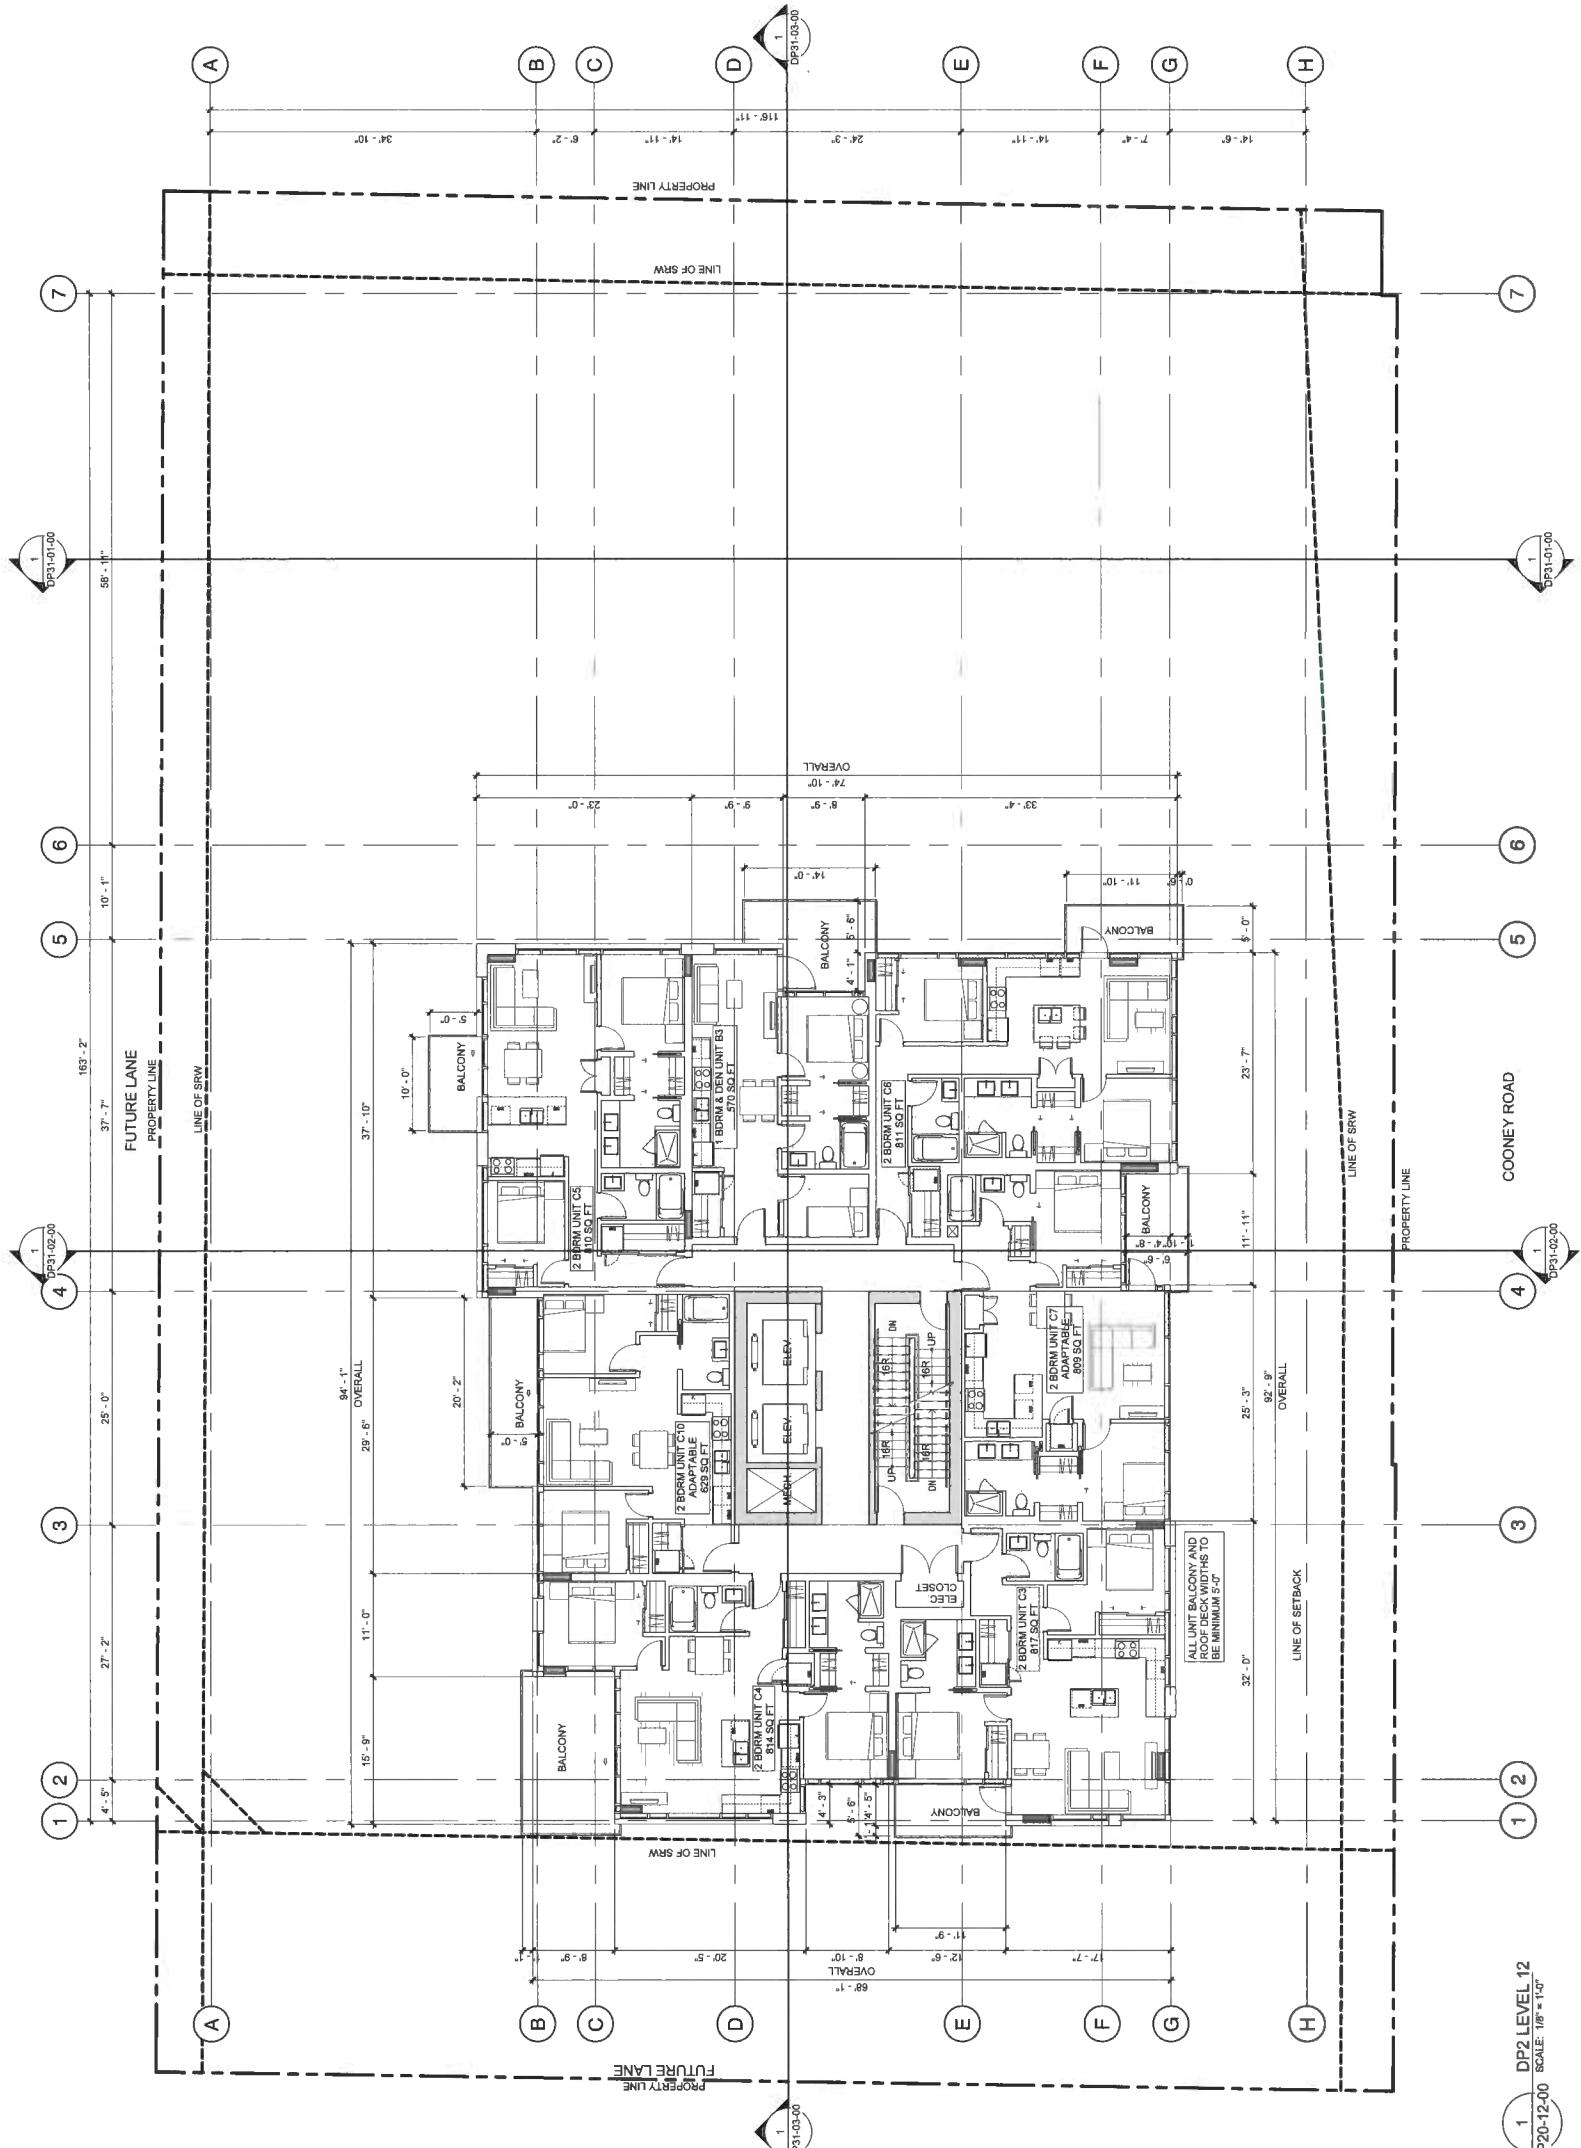

1 DP2 LEVEL 12
SCALE: 1'0" = 1'-0"
DP20-12-00



CONSULTANT INFORMATION

Client:	CONNECT LANDSCAPE ARCHITECTURE
Landscape:	SE 140TH STREET
Architect:	GLOTHAM-SIMPSON GROUP OF COMPANIES
Structure:	AME GROUP
Mechanical:	MEINETZ & ASSOCIATES LTD.
Electrical:	WILHELM

NOT FOR
CONSTRUCTION

66333 COONEY ROAD
ELCHMONT, BC

A circular blue ink stamp. The outer ring contains the words "REGISTERED ARCHITECT" at the top and "LONDON" at the bottom, separated by dots. In the center, there is a handwritten signature that appears to read "J. H. Jeffs". A small five-pointed star is positioned to the right of the signature.

Plan 17

DP 17-791045
Nov 20, 2019

This architectural floor plan illustrates the layout of a building across multiple levels. The plan includes several units, each with its own dimensions and features. Key elements include:

- Overall Dimensions:** The building's overall width is 94'-11" and depth is 163'-2".
- Units:**
 - Unit C6: 2 BDRM & KITCHEN, 510 SQFT
 - Unit C7: 2 BDRM & KITCHEN, 609 SQFT
 - Unit C8: 2 BDRM & KITCHEN, 614 SQFT
 - Unit C9: 2 BDRM & KITCHEN, 623 SQFT
 - Unit C10: ADAPTABLE, 623 SQFT
- Balconies:** Numerous balconies are shown, including a central balcony spanning multiple units.
- Rooms:** Each unit contains bedrooms, bathrooms, and other rooms typical of residential units.
- Exterior Features:** The plan shows property lines, future lanes, and service lines (LINE OF SRW).
- Dimensions:** Detailed dimensions are provided for each unit and the overall building footprint.
- Labels:** Labels such as "PROPERTY LINE", "FUTURE LANE", "LINE OF SRW", and "COONEY ROAD" are used to identify specific boundaries and external features.



CONSULTANT INFORMATION

Civil:	Landscape: CONNECT LANDSCAPE ARCHITECTURE
Architectural:	sz ARCHITECTURE
Structural:	GUTHMAN-SAURON GROUP OF COMPANIES
Mechanical:	HASE GROUP
Electrical:	HEMETZ & ASSOCIATES LTD.
Infras:	

NOT FOR
CONSTRUCTION


66333 COONEY ROAD
RICHMOND BC

This drawing supersedes previous issues. Do not scale these drawings.

Plan 18

DP 17-791045
Nov 20, 2019

DRAWING NO.
DP20-14-00

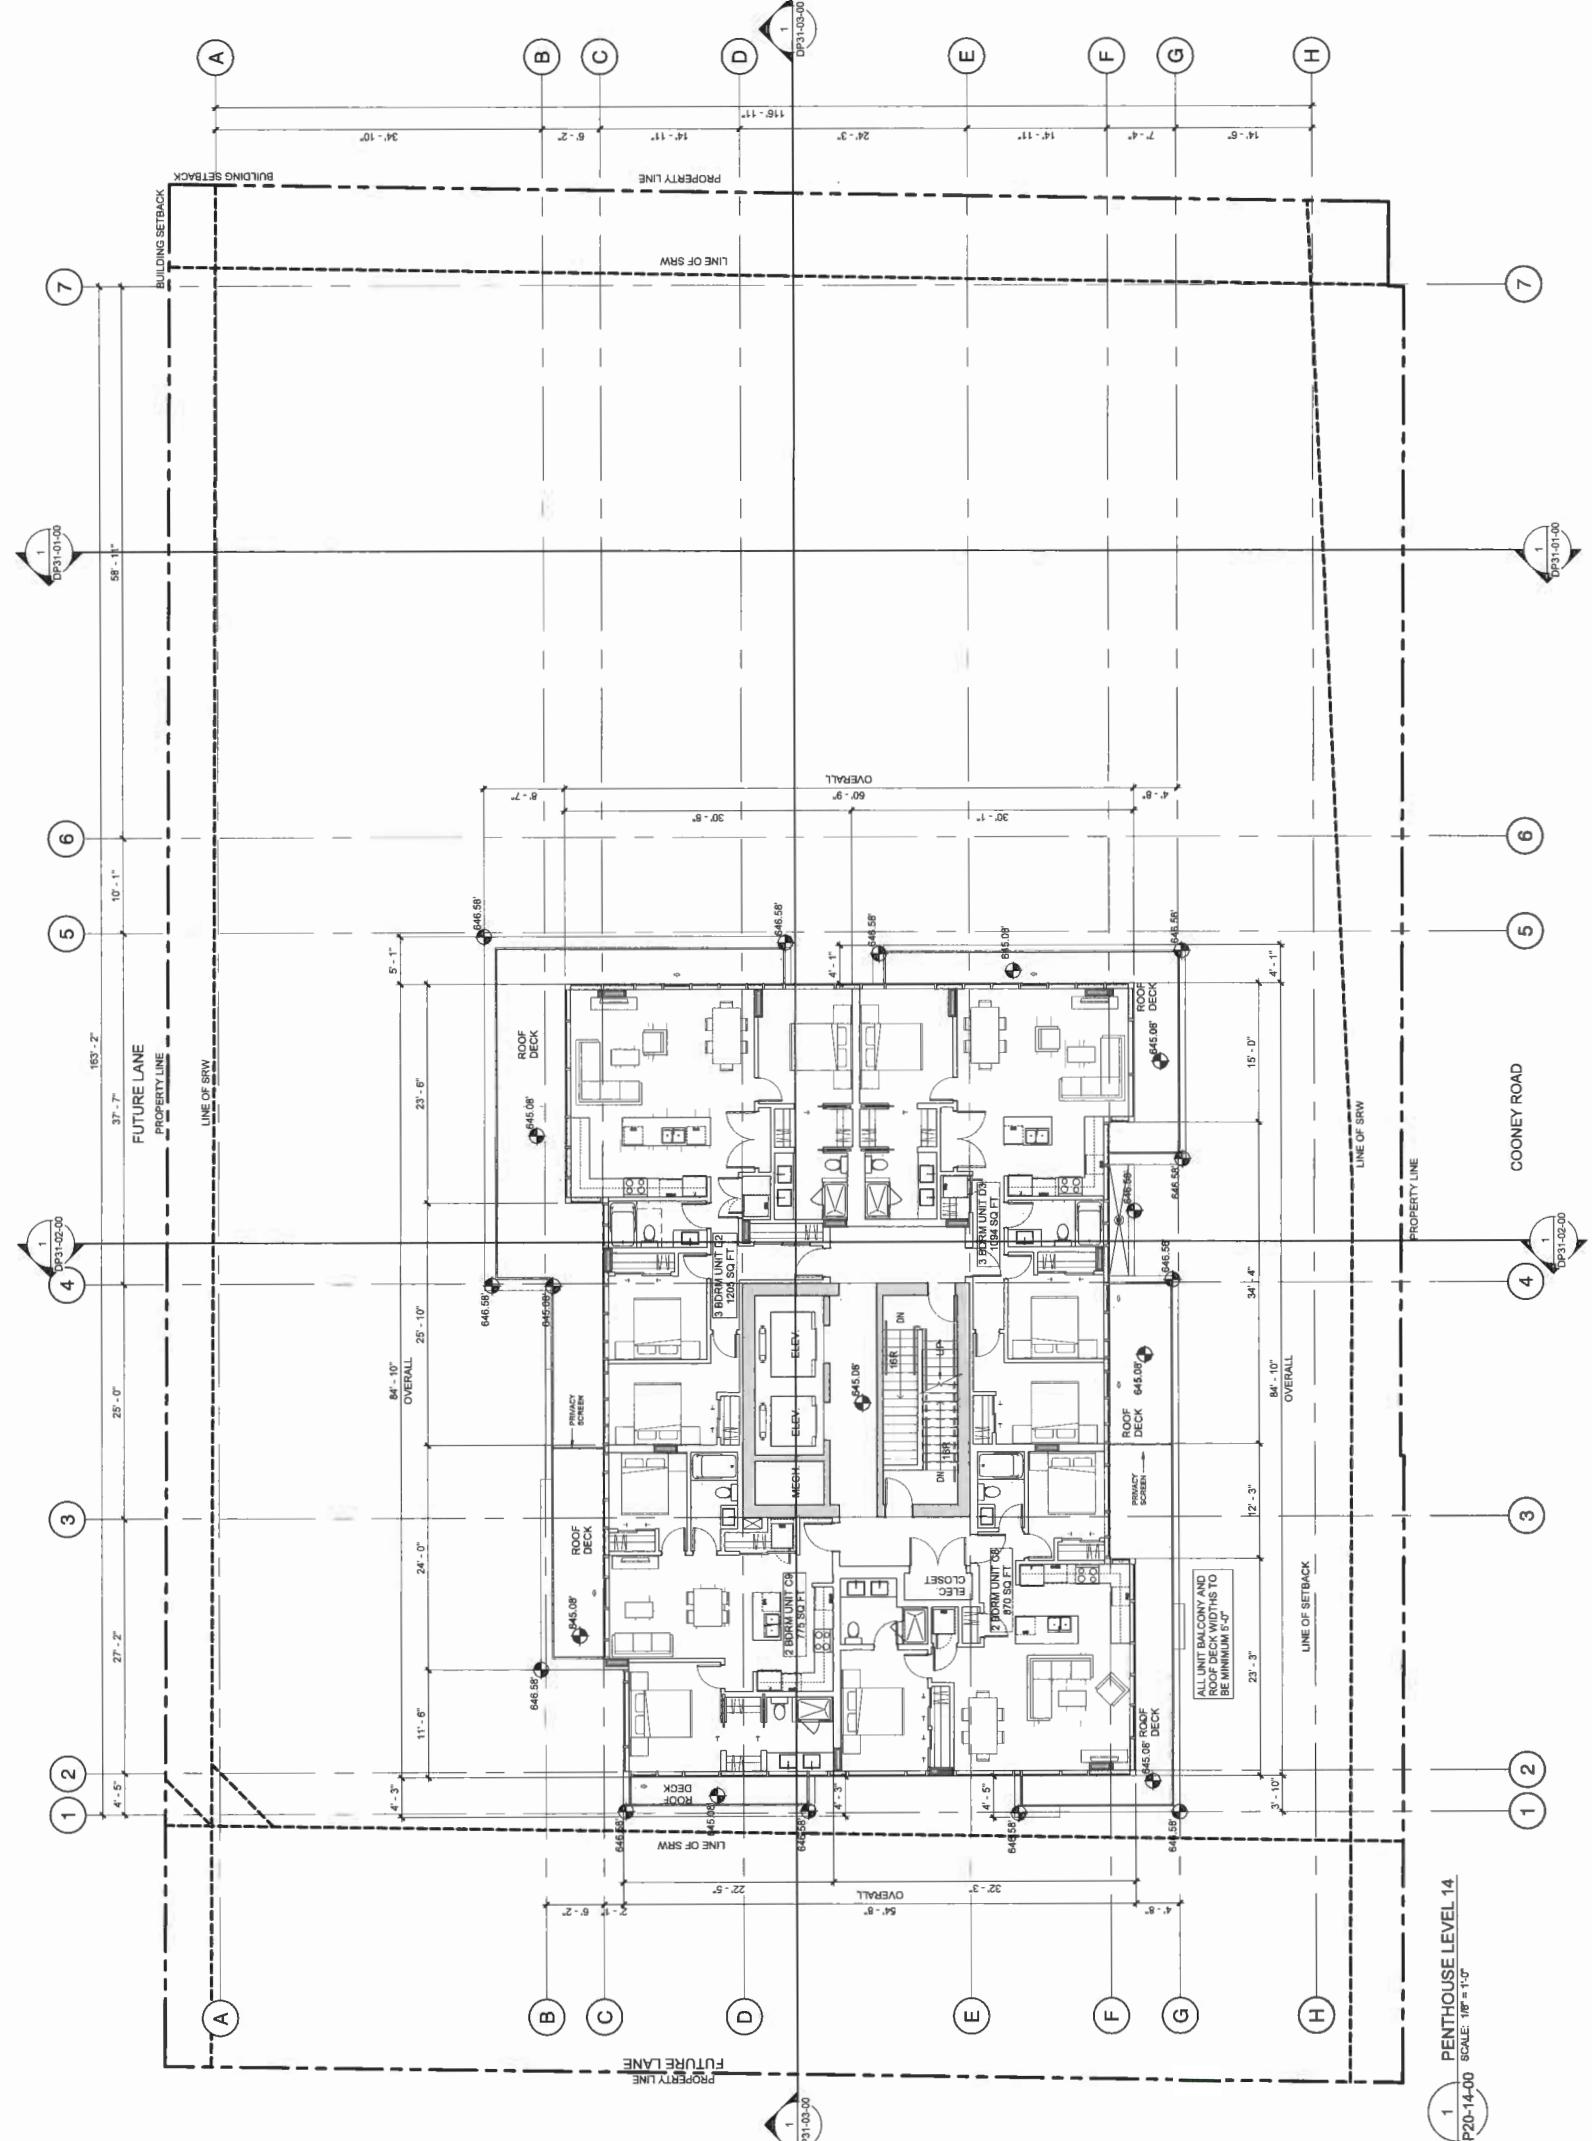



CONSULTANT INFORMATION

CML:	CONNECT LANDSCAPE ARCHITECTURE
Landscaping:	ES ARCHITECTURE
Architectural:	GOLD BAMA-SARFON GROUP OF COMPANIES
Structural:	AME GROUP
Mechanical:	HENNETZ & ASSOCIATES LTD.
Electrical:	Immerovics

NOT FOR
CONSTRUCTION


6333 COONEY ROAD
RICHMOND, BC

A circular blue stamp with a decorative border of vertical lines and dots. The text "REGISTERED ARCHITECT" is repeated twice around the inner circle, once in a clockwise direction and once in a counter-clockwise direction. In the center of the stamp is a small blue five-pointed star.

Plan 19

DP 17-791045 Nov 20, 2019

DP20-15-00

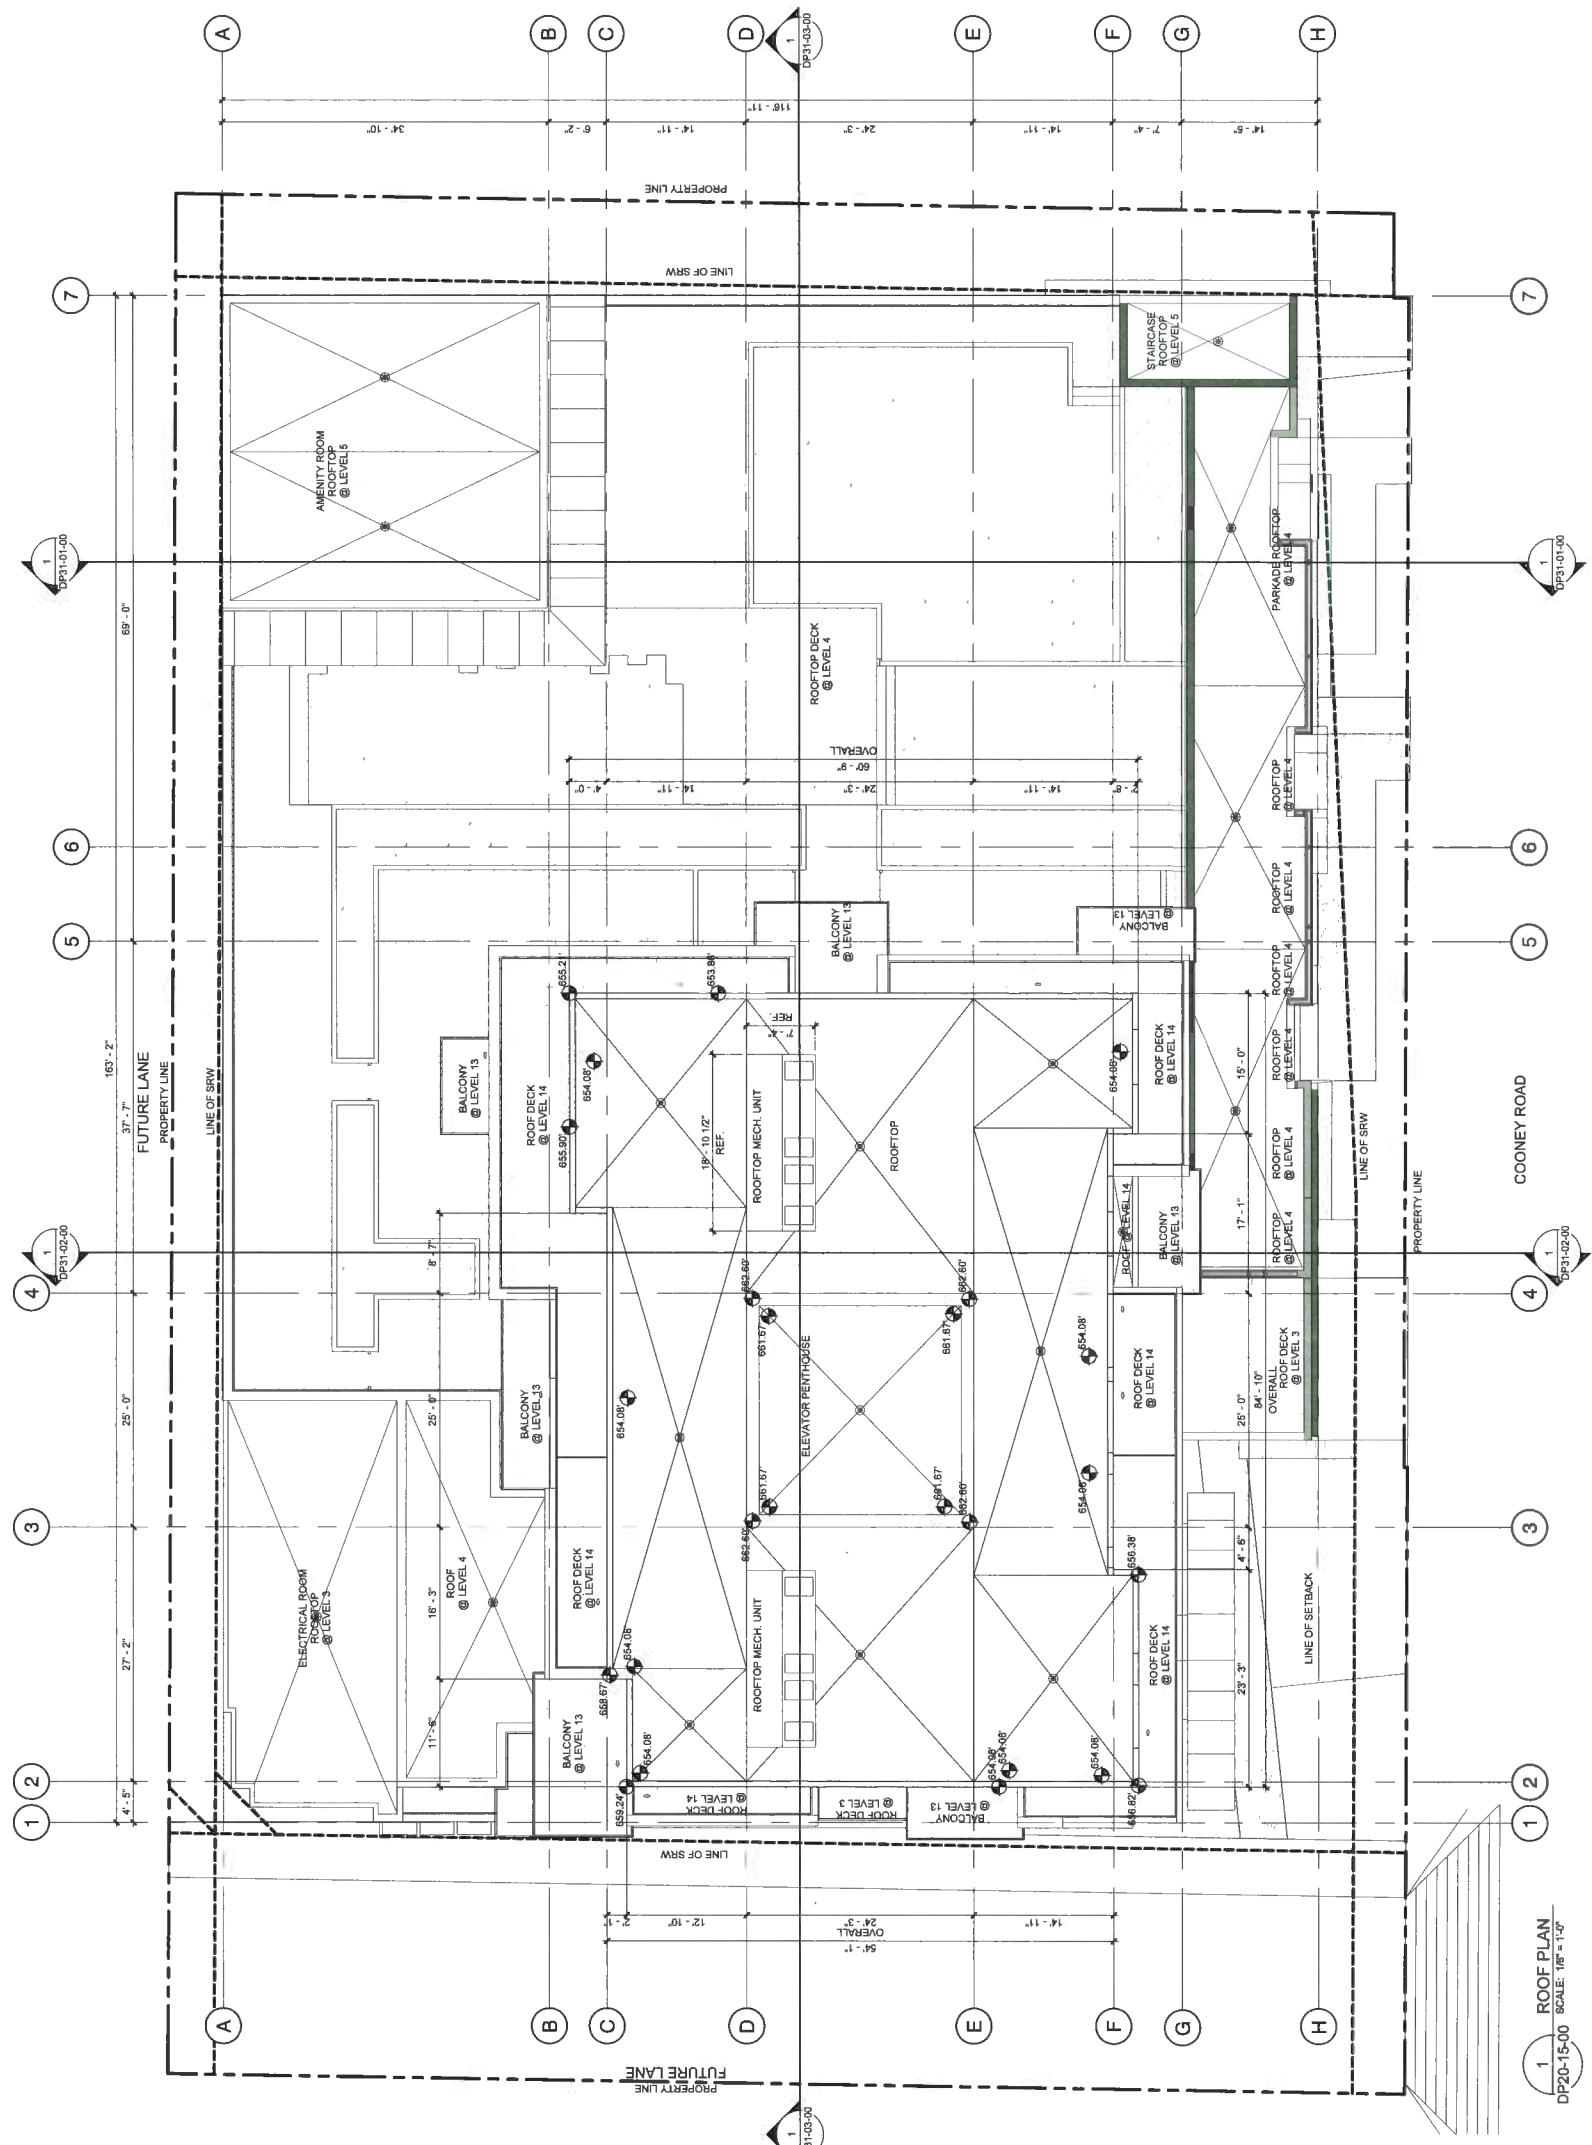



CONSULTANT INFORMATION

Cold. Landscap: CONNECT LANDSCAPE ARCHITECTURE
Architecte: S2 ARCHITECTURE
Structural: GLODANSON+SIMPSON GROUP OF COMPANIES
Mechanical: DAIRY GROUP
Electrical: HEMNETZ & ASSOCIATES LTD.
Interior: KARLSEN

CONSULTANT INFORMATION

Civil:
Landscape: CONNECT LANDSCAPE ARCHITECTURE
Architecture: S2 ARCHITECTURE
Structural: GLOTMAN SAMSON GROUP OF COMPANIES LTD.
Mechanical:
Electrical: HEMET & ASSOCIATES LTD.
Environmental:

BUILDING FINISH SCHEDULE

- | BUILDING FINISH SCHEDULE |
|--|
| 1 VISION GLASS WINDOW WALL 1 - CLEAR |
| 2 INSULATED SPANDEL GLASS WINDOW
WALL 2 - BLACK |
| 3 INSULATED SPANDEL GLASS WINDOW
WALL 3 - WHITE |
| 4 INSULATED SPANDEL GLASS WINDOW
WALL 4 - GREY |
| 5 PREFINISHED ALUMINUM MULLION 1 - BLA
ANDIZED |
| 6 PREFINISHED ALUMINUM MULLION 2 - CLE
ANDIZED |
| 7 GUARDRAIL - CLEAR GLAZED |
| 8 ROOFTOP RTU SCREENING - TBD |
| 9 LOUVERS - PREFINISHED EXTRUDED
ANODIZED ALUMINUM |
| 10 GRILLES - PREFINISHED EXTRUDED
ANODIZED ALUMINUM |
| 11 CEMENTITIOUS PANEL 1 - DARK GREY |
| 12 CEMENTITIOUS PANEL 2 - GREY |
| 13 CEMENTITIOUS PANEL 3 - WHITE |
| 14 OVERHEAD DOOR - SECTIONAL GLAZED |
| 15 PLANTING SCREENS |
| 16 GLASS AND STRUCTURAL STEEL CANOPY |
| 17 PRIVACY SCREEN - OPAQUE GLAZED |
| 18 STRUCTURAL STEEL FRAMING |
| 19 CEMENTITIOUS PANEL 4 - ACCENT |
| 20 CEMENTITIOUS PANEL 5 - LIGHT GREY |
| NOTE: OPEN AND REFERENCED CAVITY (PER
EFFECTIVE DATE) TYPICAL AT ALL PANEL EDGES
CLADDING LOCATIONS. |

NOT FOR
CONSTRUCTION

NOT FOR
CONSTRUCTION

COONEY ROAD
TOWER

6333 COONEY ROAD
RICHMOND, BC


104

A circular blue stamp with a decorative border containing the text "REGISTERED ARCHITECT" and "RIBA". The center of the stamp features a five-pointed star.

Plan 20

DP 17-791045
NOV 20, 2019

CJREWIT PRO

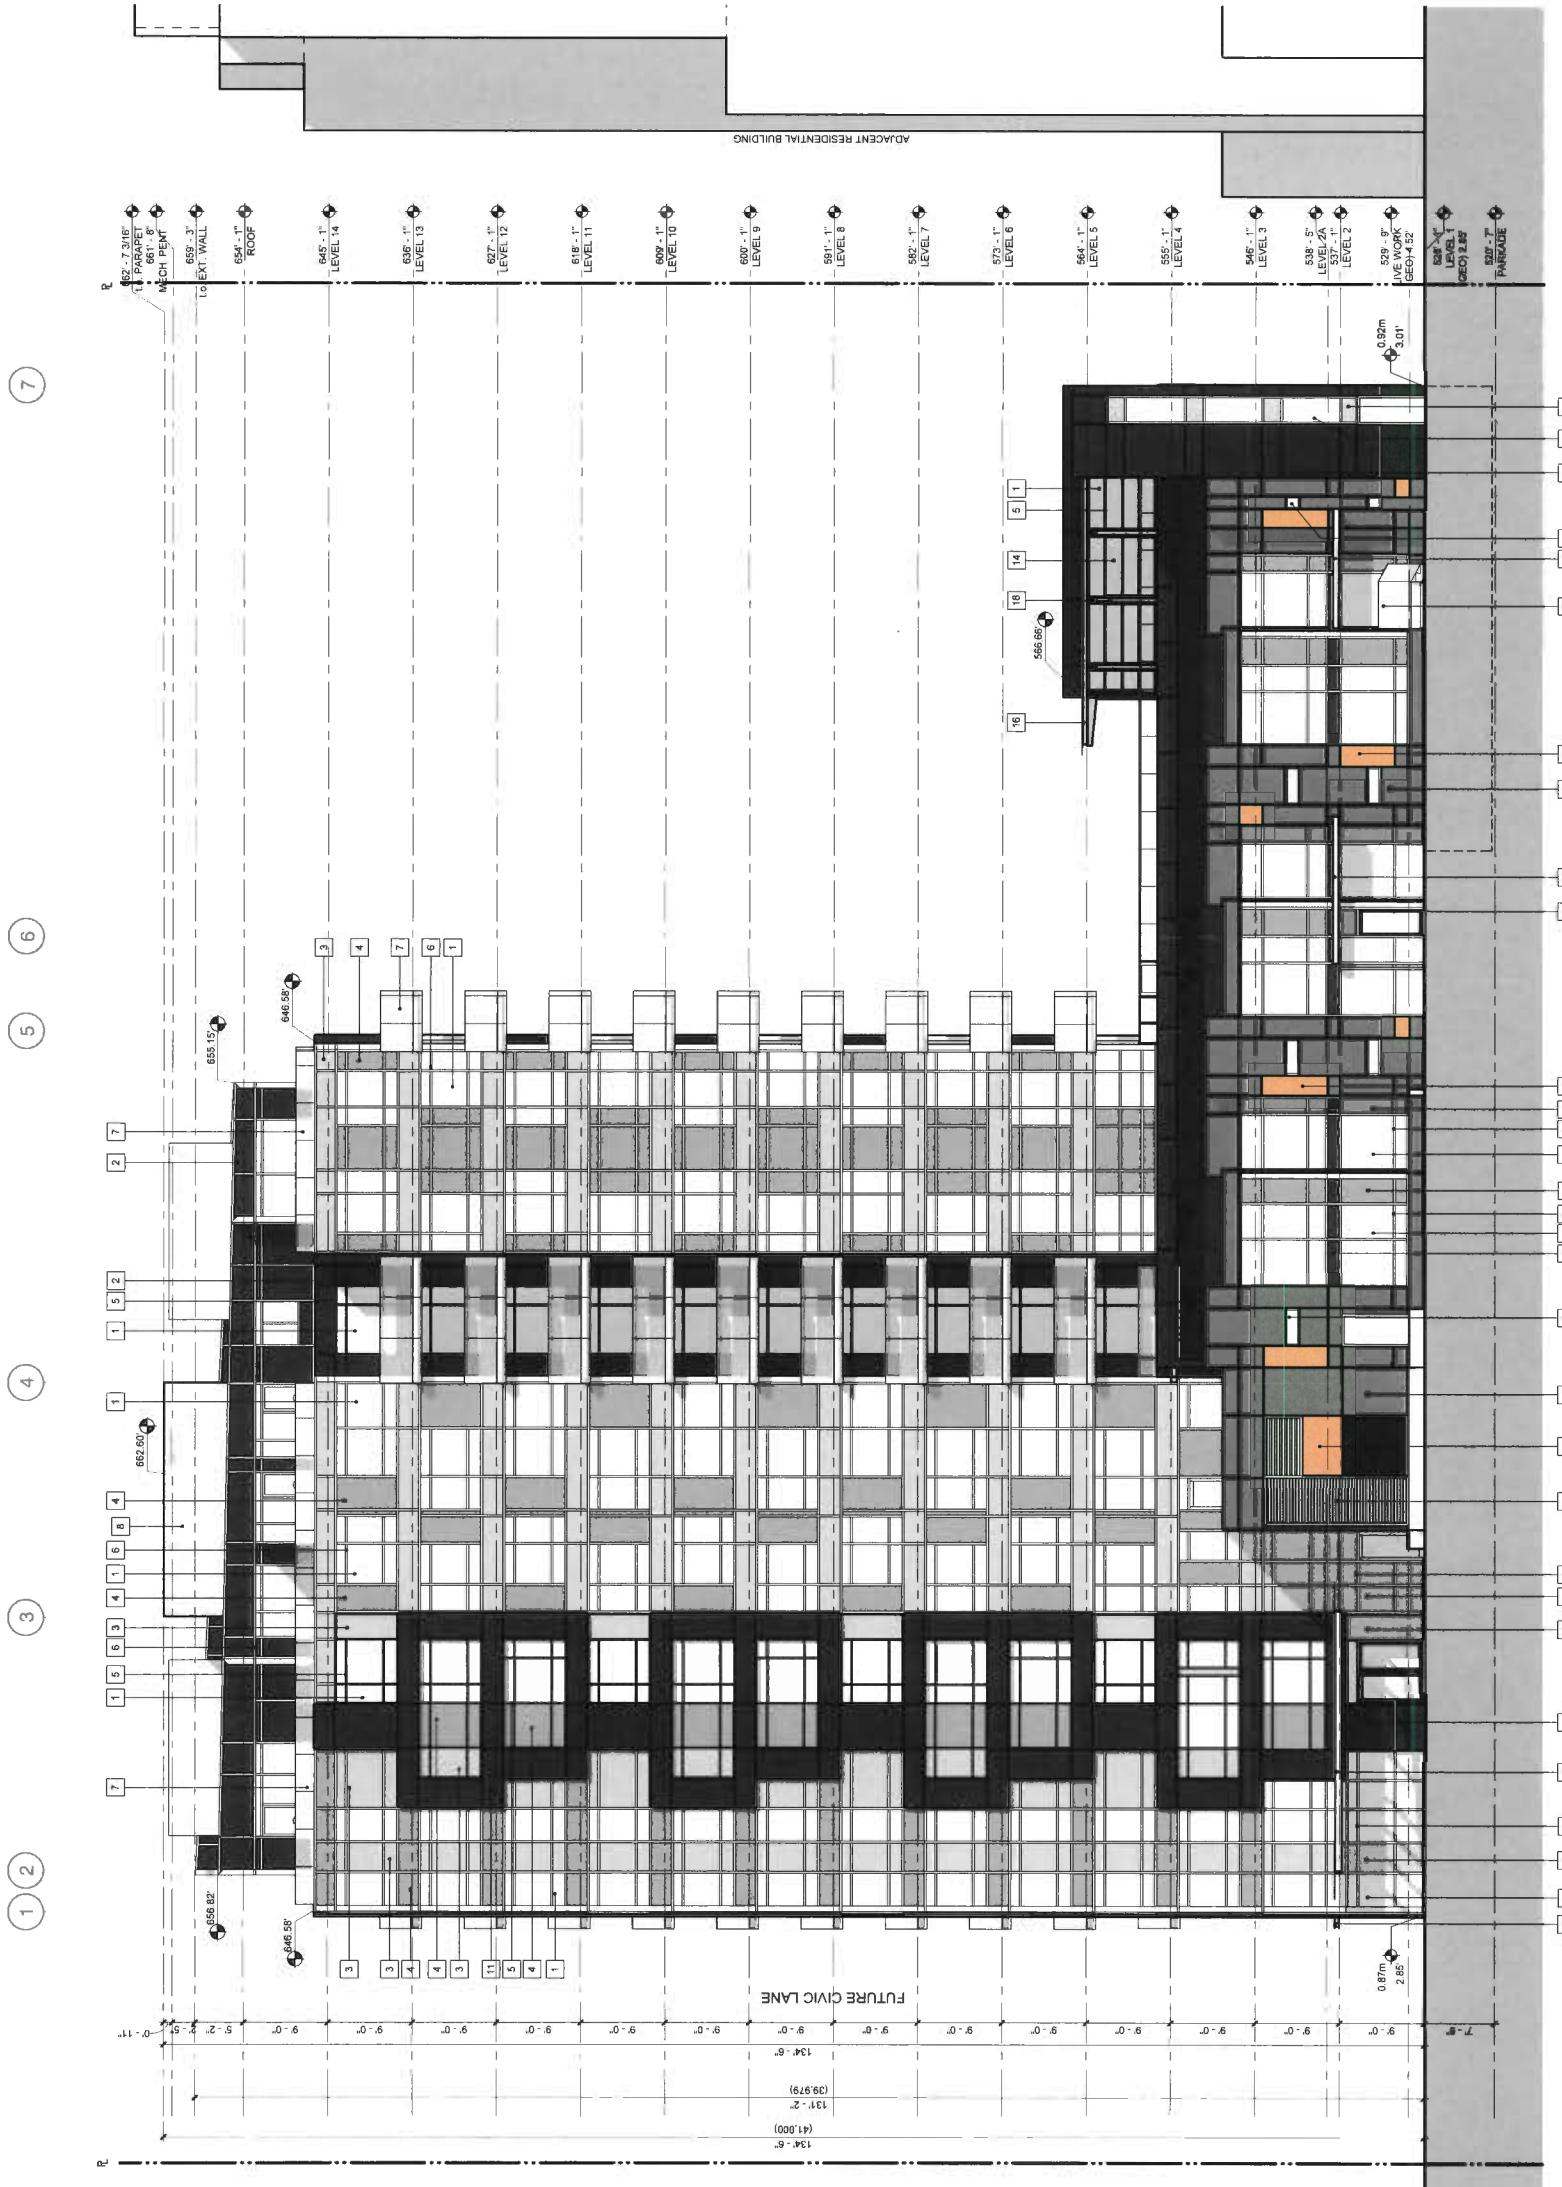

EAST ELEVATION
1
DP30-01-00 SCALE: 1/8" = 1'-0"

1

DRAFT PRO



CONSULTANT INFORMATION
CHEC
CONNECT LANDSCAPE ARCHITECTURE
Landscape
Structural
Mechanical
Electrical
INTERIOR

BRUNNEN INC., Chemainus 985 139
Structural Engineers
Mechanical & Electrical Group
INTERIOR
INTERIOR

BUILDING FINISH SCHEDULE


1	VISION GLASS WINDOW/WALL 1 - CLEAR
2	INSULATED SPANDREL GLASS WINDOW WALL 2 - BLACK
3	INSULATED SPANDREL GLASS WINDOW WALL 3 - WHITE
4	INSULATED SPANDREL GLASS WINDOW WALL 4 - GREY
5	PREFINISHED ALUMINUM/MULLION 1 - BLACK ANODIZED
6	PREFINISHED ALUMINUM/MULLION 2 - CLEAR ANODIZED
7	Mech. Pent
8	ROOFTOP RIB SCREENING - TBD
9	LOUVERS - PREFINISHED EXTRUDED ANODIZED ALUMINUM
10	GRILLES - PREFINISHED EXTRUDED ANODIZED ALUMINUM
11	CEMENTITIOUS PANEL 1 - DARK GREY
12	CEMENTITIOUS PANEL 2 - GREY
13	CEMENTITIOUS PANEL 3 - WHITE
14	OVERHEAD DOOR - SECTIONAL GLAZED
15	PLANTING SCREENS
16	Glass and Structural Steel Canopy
17	Privacy Screen - OPAQUE GLAZED
18	STRUCTURAL STEEL FRAMING
19	CEMENTITIOUS PANEL 4 - ACCENT
20	CEMENTITIOUS PANEL 5 - LIGHT GREY NOTE: OPEN AIR VENTED CAVITY (PER EQUITE SPEC) TYPICAL AT ALL PANEL EDGE CLADDING LOCATIONS

NOT FOR
CONSTRUCTION

PROJECT INFORMATION

COONEY ROAD
TOWER
RICHMOND, BC
6333 COONEY ROAD

6333 COONEY ROAD

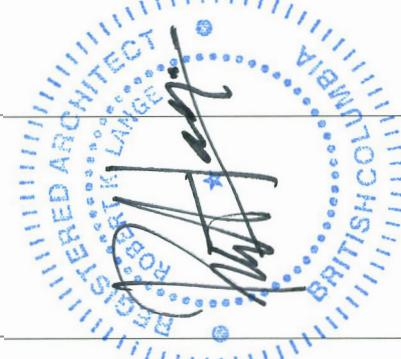

Plan 21

DP 17-791045 Nov 20, 2019



ISSUED
DATE
2011-11-23
APPLICATION
2011-09-28
RE-SUBMISSION
2011-05-16
POST APP RESPONSE
2011-10-31
DP RESUBMISSION
2011-11-08

SCALE
As indicated
DATE
11/11/2019 4:53:01 PM
DRAWN BY
JH
CHECKED BY
SH
PROJECT NO.
Z19771

DRAFTER
S2

BUILDING ELEVATIONS
- SOUTH

DRAWING NO.
DP30-02-00

1 SOUTH ELEVATION
DP30-02-00 SCALE 1'-0"



architecture
227, 309 W Condado Street
Wichita, KS 67202 USA 113

CONSULTANT INFORMATION

GME CONSULTANT LANDSCAPE ARCHITECTURE
 1000 University Street, Suite 1000
 Seattle, WA 98101-3143
 (206) 467-1000
www.gmeconsultant.com

COLLECT LANDSCAPE ARCHITECTURE
 55 S. Architecture
 Glendale-Tucson Group of Companies
 Nine Design & Associates LTD.
 (480) 941-1000

CONSTITUTIVAN

CHIEF LANDSCAPE ARCHITECTURE
Architectural: CONNECT LANDSCAPE ARCHITECTURE
Structural: SE ARCHITECTURE
Mechanical: GLUTMAN-SIMPSON GROUP OF COMPANIES
Electrical: AME GROUP
Landscaping: NEIMET & ASSOCIATES LTD.


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CONSTRUCTION

COONEY ROAD
TOWER

6333 COONEY ROAD
RICHMOND, BC

Plan 23

DP 17-791045 Nov 20, 2019

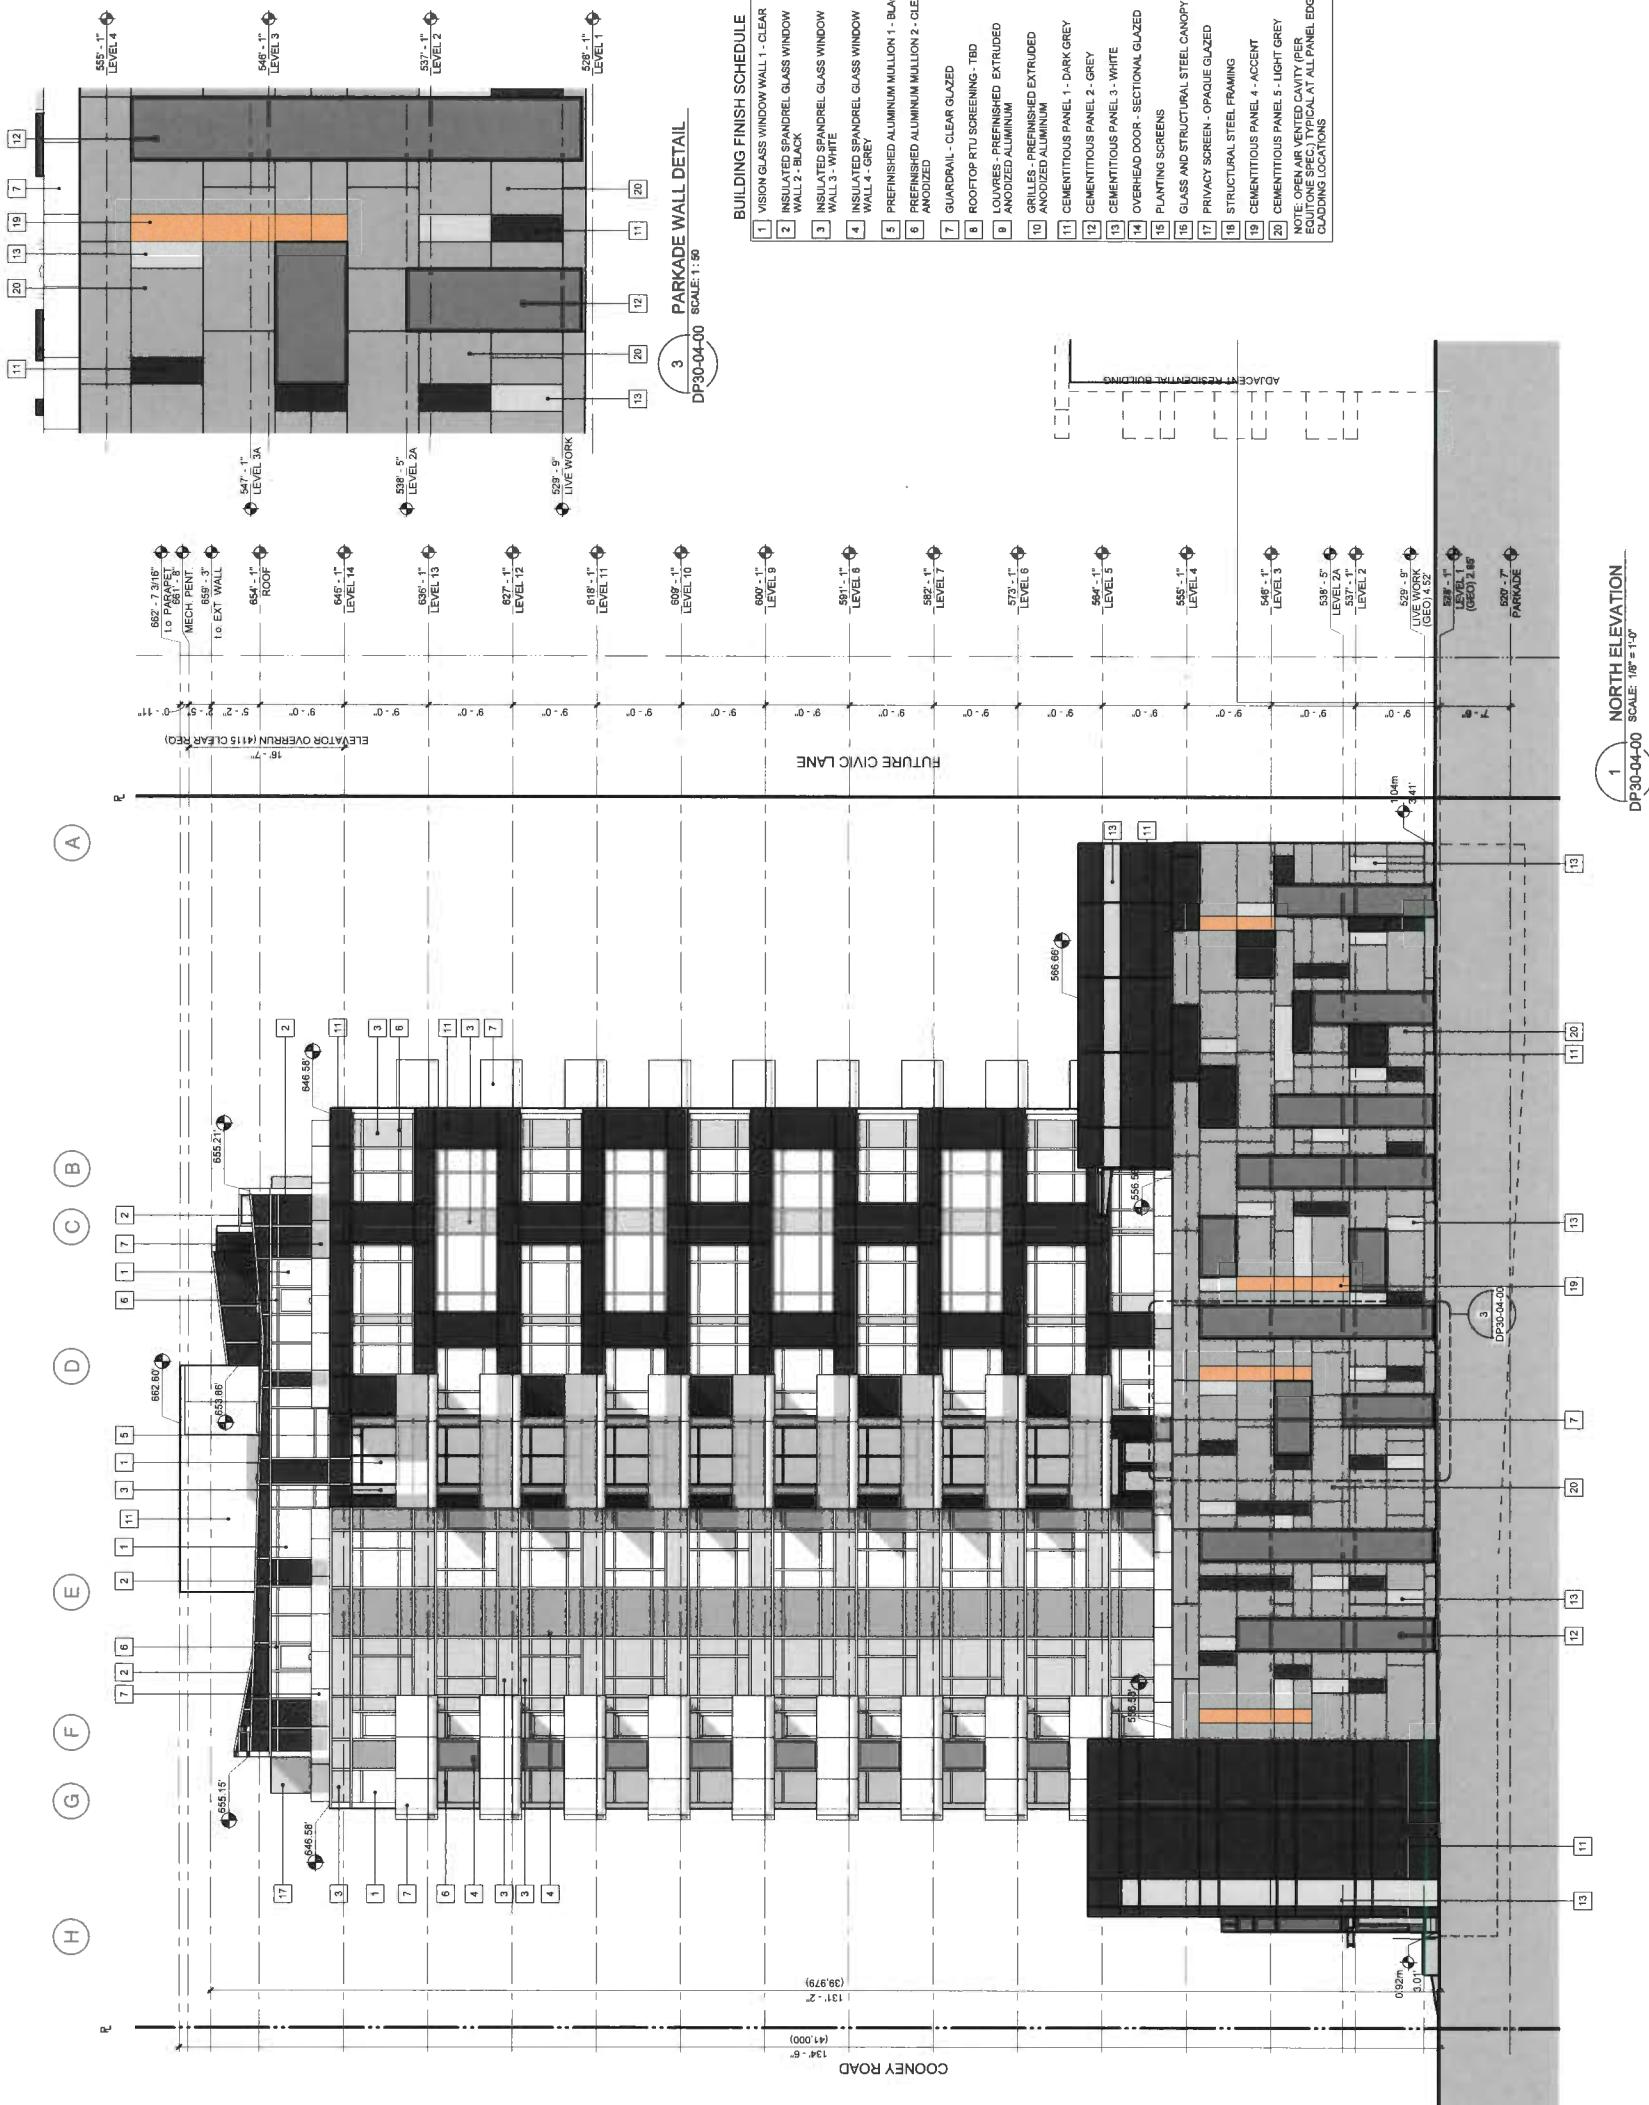



CONSULTANT INFORMATION
CNE: COENET LANDSCAPE ARCHITECTURE
Landscape Architect
Structure: GUTHMANN & SONS LTD OF CANADA INC.
Mechanical: AER INDUSTRIAL
Electrical: HARRIS & ASSOCIATES LTD.
Interior: None

BUILDING FINISH SCHEDULE	
[1]	VISION GLASS WINDOW WALL 1 - CLEAR
[2]	INSULATED SPANDREL GLASS WINDOW WALL 2 - BLACK
[3]	INSULATED SPANDREL GLASS WINDOW WALL 3 - WHITE
[4]	INSULATED SPANDREL GLASS WINDOW WALL 4 - GREY
[5]	PREFINISHED ALUMINUM MILLION 1 - BLACK
[6]	PREFINISHED ALUMINUM MILLION 2 - CLEAR ANODIZED
[7]	GUARDRAIL - CLEAR GLAZED
[8]	ROOFTOP RTU SCREENING - 180°
[9]	LOUVERS - PREFINISHED EXTRUDED ANODIZED ALUMINUM
[10]	GRILLER - PREFINISHED EXTRUDED ANODIZED ALUMINUM
[11]	CEMENTITIOUS PANEL 1 - DARK GREY
[12]	CEMENTITIOUS PANEL 2 - GREY
[13]	CEMENTITIOUS PANEL 3 - WHITE
[14]	OVERHEAD DOOR SECTIONAL GLAZED
[15]	PLANTING SCREENS
[16]	GLASS AND STRUCTURAL STEEL CANOPY
[17]	PRIVACY SCREEN - CERAMIC BAUCETTE
[18]	STRUCTURAL STEEL FRAMING
[19]	CEMENTITIOUS PANEL 4 - ACCENT
[20]	CEMENTITIOUS PANEL 5 - LIGHT GREY
	NOTE: OPEN AIR VENTED CAVITY PER EQUATION SPEC. TYPICAL AT ALL PANEL EDGE CLADDING LOCATIONS

JH

COONEY ROAD
TOWER
RICHMOND, BC

6333 COONEY ROAD

RICHMOND, BC

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architecture

200-1000 Columbia Street

Vancouver, BC, Canada V6E 1E6


www.s2architecture.com

CONSULTANT INFORMATION

CHIEF CONSULTANT ARCHITECTURE
Architect: S2 ARCHITECTURE
Structural: GUTMAN & SONS GROUP OF COMPANIES
Mechanical: REED & ASSOCIATES LTD.
Electrical: REED & ASSOCIATES LTD.
Interior: REED & ASSOCIATES LTD.

NOT FOR CONSTRUCTION

PROJECT INFORMATION

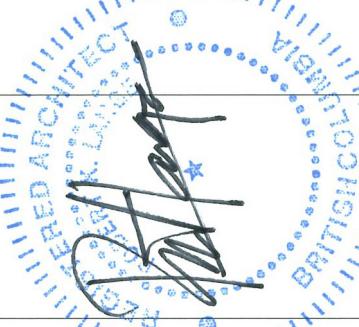COONEY ROAD TOWER6333 COONEY ROAD
RICHMOND, BC

The architect approves previous issues. Do not increase dimensions or add new features to the building. When changes are required, they must be made by the architect. No changes may be made to the exterior, interior, or structural elements of the building without the written consent of the architect. The architect reserves the right to require any changes to be made by the architect. All drawings remain the property of the architect. These drawings are to be used only for the construction of the building and are not to be reproduced or copied in whole or in part. Any unauthorized copying or reproduction of these drawings will result in legal action being taken against the individual or company responsible.

Plan 25

NOV 20, 2019


DP 17-791045

DP31-02-00





CONSULTANT INFORMATION
CNC: CONNECT LANDSCAPE ARCHITECTURE
Location: 1000 Columbia Street
Architectural: GILBERTSON GROUP OF COMPANIES
Structural: ALLEN ENGINEERING LTD.
Mechanical: KELLY & ASSOCIATES LTD.
Electrical: E&I CONSULTING LTD.
Interior:

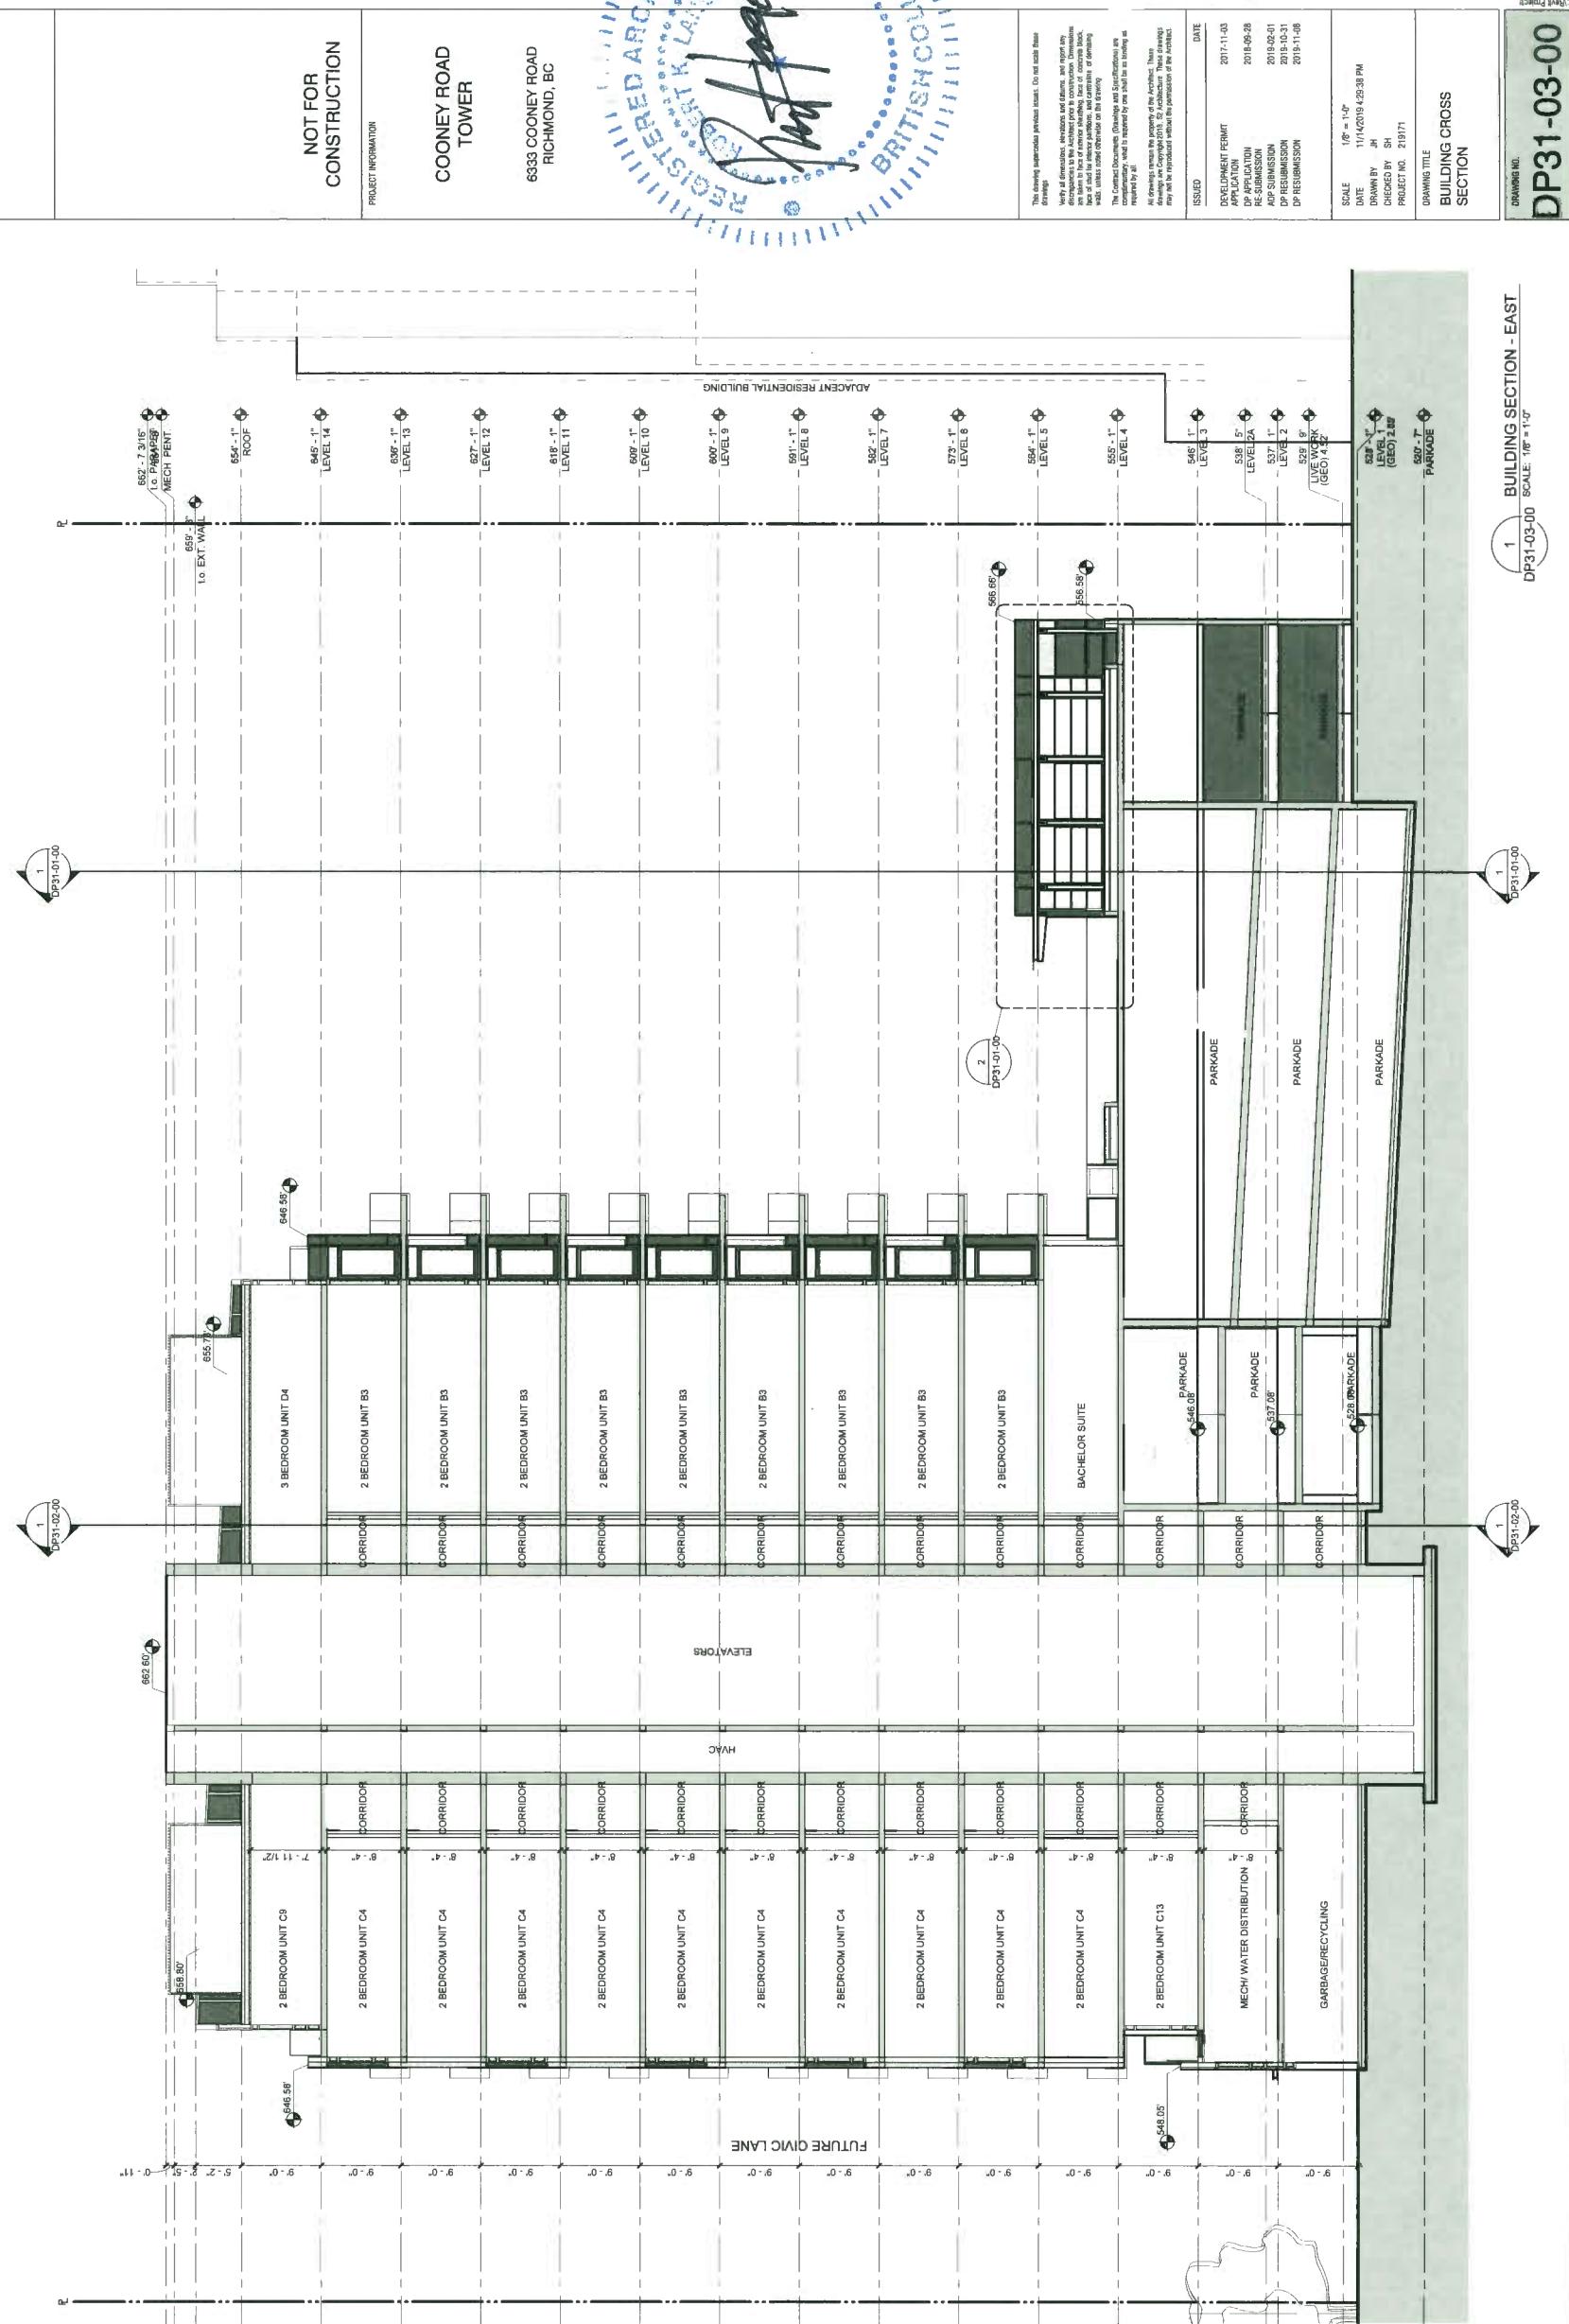

COONEY ROAD TOWER

6333 COONEY ROAD, RICHMOND, BRITISH COLUMBIA

RE-ISSUED FOR CITY COMMENTS

LANDSCAPE DRAWING INDEX

SHEET No.	SHEET NAME
L0.0	COVER SHEET & DRAWING LIST
L1.0	LANDSCAPE PLAN GROUND LEVEL
L1.1	LANDSCAPE PLAN FOURTH LEVEL
L1.2	LANDSCAPE PLAN ROOF LEVEL
L1.3	PRECEDENTS AND MATERIALS
L1.4	LANDSCAPE PERMEABILITY
L1.5	LANDSCAPE OPEN SPACE
L2.0	PLANT LIST AND PLANT MATERIALS
L2.1	GROUND LEVEL PLANTING PLAN
L2.2	FOURTH LEVEL PLANTING PLAN
L2.3	ROOF LEVEL PLANTING PLAN
L3.0	DETAILS - SOFTSCAPE
L3.1	DETAILS - HARDCAPE
L3.2	DETAILS - FURNISHINGS
L3.2	DETAILS - PLAY AREA

GENERAL NOTES

ALL LANDSCAPE ARCHITECTURAL DRAWINGS IN THIS PACKAGE SHALL BE READ IN CONJUNCTION WITH ALL OTHER DRAWINGS, DETAILS, SPECIFICATIONS, AND/OR OTHER CORRESPONDANCE THAT MAY BE ISSUED DURING THE COURSE OF THE CONTRACT.

IF A DISCREPANCY OCCURS BETWEEN THE DRAWINGS AND THE SPECIFICATIONS OR ANY OTHER DOCUMENT ASSOCIATED WITH THE PROJECT, THE CONFLICT SHALL BE REPORTED IN WRITING TO THE OWNER OR OWNERS REPRESENTATIVE TO OBTAIN CLARIFICATION AND APPROVAL BEFORE PROCEEDING WITH WORKS.

ALL EXISTING INFORMATION IS BASED ON AVAILABLE RECORDS AND SHALL NOT BE CONSTRUED TO BE COMPLETE OR ACCURATE. THE CONTRACTOR SHALL VISIT THE SITE TO VERIFY THE TRUE EXISTING CONDITIONS. ANY UNCLEAR ISSUES SHALL BE CLARIFIED WITH THE OWNER OR OWNERS REPRESENTATIVE. NO CLAIM SHALL BE ALLOWED FOR EXTRAS WHICH MAY ARISE THROUGH NEGLECT OF THIS ADVICE.

THE CONTRACTOR IS RESPONSIBLE FOR DETERMINING THE EXISTENCE, LOCATION, AND ELEVATION OF ALL UTILITIES AND CONCEALED STRUCTURES, AND IS RESPONSIBLE FOR NOTIFYING THE APPROPRIATE COMPANY, DEPARTMENT OR PERSON(S) OF ITS INTENTION TO CARRY OUT ITS OPERATIONS.

LAYOUT OF HARDCAPE, SITE FURNITURE, GROWING MEDIA, TREES, PLANTING, AND ALL OTHER MATERIALS IS TO BE STAKED OUT AND APPROVED BY OWNER OR OWNERS REPRESENTATIVE.

ALL PLANTING SHALL BE IN ACCORDANCE WITH THE CANADIAN LANDSCAPE STANDARD, LATEST EDITION.



DP 17-791045	Nov 20, 2019
Plan 27	
7 RE-ISSUED FOR CITY COMMENTS 19-11-06	
6 RE-ISSUED FOR DP APPLICATION 19-10-31	
5 ISSUED FOR PRIOR TO RESPONSE	
4 RE-ISSUED FOR DP APPLICATION	
3 RE-ISSUED FOR DP APPLICATION	
2 ISSUED FOR DP APPLICATION	
1 ISSUED FOR CLIENT REVIEW	
REVISIONS	

COONEY ROAD TOWER
6333 Cooney Road
Richmond, British Columbia
Scale: 1:200
Drawn: VGDS
Reviewed: DS
Project No. 06-561

COVER SHEET &
DRAWING LIST

LO.0

CONNECT LANDSCAPE ARCHITECTURE INC. DOES
NOT GUARANTEE THE EXISTENCE, LOCATION,
AND ELEVATION OF UTILITIES AND / OR
CONCEALED STRUCTURES AT THE PROJECT SITE.
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DETERMINING THE EXISTENCE, LOCATION, AND
ELEVATION OF ALL UTILITIES AND / OR
CONCEALED STRUCTURES, AND IS RESPONSIBLE
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DEPARTMENT OR PERSON(S) OF ITS INTENTION
TO CARRY OUT ITS OPERATIONS.

DP 17-791045
NOV 20, 2019
Plan 28

7 RE-ISSUED FOR CITY COMMENTS 19-11-06
6 RE-ISSUED FOR DP APPLICATION 19-10-31
5 ISSUED FOR PRIOR TO RESPON
4 RE-ISSUED FOR DP APPLICAT
3 RE-ISSUED FOR DP APPLICAT
2 ISSUED FOR DP APPLICATION
1 ISSUED FOR CLIENT REVIEW
REVISIONS

COONEY ROAD TOWER
6333 Cooney Road
Richmond, British Columbia
Scale: 1:100
Drawn: DS
Reviewed: DS
Project No. 06-581

LANDSCAPE PLAN
GROUND LEVEL

L1.0



CONNECT LANDSCAPE ARCHITECTURE INC. DOES NOT GUARANTEE THE EXISTENCE, LOCATION, AND ELEVATION OF UTILITIES AND / OR CONCEALED STRUCTURES AT THE PROJECT SITE.

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DP 17-791045 Plan 29 Nov 20, 2019

Plan 29

4	RE-ISSUED FOR DP APPLICATION
3	RE-ISSUED FOR DP APPLICATION
2	ISSUED FOR DP APPLICATION
1	ISSUED FOR CLIENT REVIEW

REVISIONS

COONEY ROAD TOWER

6333 Cooney Road
Richmond, British Columbia

Scale: 1:100 DS DS
Drawn: Reviewed: 06-581
Project No.

LANDSCAPE PLAN
LEVEL 4

L1.



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DP 17-791045 Plan 30 Nov 20, 2019

COONEY ROAD TOWER

6333 Cooney Road
Richmond, British Columbia

Scale: _____ 1:100
Drawn: _____ DS
Reviewed: _____ DS
Project No.: _____ 06-581

LANDSCAPE PLAN ROOF LEVEL

1

20 m

1

1

COONEY ROAD

LANDSCAPE INFLUENCES AND CONTEXT



ANGLED LINES TO MATCH BUILDING GEOMETRY AND OVERLAPPING PAVING PATTERNS



CONNECTED AMENITY ZONES



LANDSCAPE FEATURES AND MATERIALS



"COURTYARD" SPACE VISIBLE FROM AMENITY ROOM



NATURAL LOOK PLAY STRUCTURES




SMALL BEACH PEBBLE



TIMBER AND CONCRETE DETAILS



TIMBER AND CONCRETE DETAILING

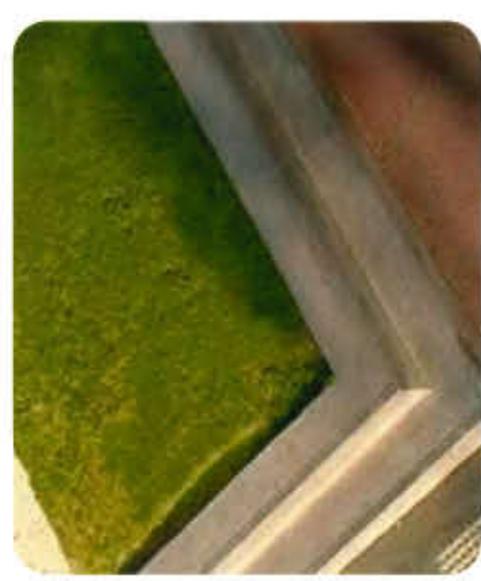

LANDSCAPE PAVING TYPES



CHARCOAL PATIO SLAB PRIVATE PATIOS



CHARCOAL PATIO SLAB PAVING



NATURAL 'STANDARD' PAVING



CHARCOAL 'STANDARD' PAVING



SAWCUT CONCRETE

DP 17-791045		Nov 20, 2019
Plan 31		
7 RE-ISSUED FOR CITY COMMENTS	19-11-06	
6 RE-ISSUED FOR DP APPLICATION	19-10-31	
5 ISSUED FOR PRIOR TO RESPONSIBILITY		
4 RE-ISSUED FOR DP APPLICATION		
3 RE-ISSUED FOR DP APPLICATION		
2 ISSUED FOR DP APPLICATION		
1 ISSUED FOR CLIENT REVIEW		
REVISIONS		

COONEY ROAD TOWER

6333 Cooney Road
Richmond, British Columbia
Scale: N/A
Drawn: DS
Reviewed: DS
Project No. 06-581

PRECEDENTS AND MATERIALS

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LEVEL 1 PERMEABILITY


LEGEND PERMEABILITY		GROUND LEVEL		LEVEL 4		ROOF	
		AREA	%	AREA	%	AREA	%
	PERMEABLE GRAVEL AREA	25.1m ²	1.0%	52m ²	2.1%		
	LAWN - MINIMUM 12" SOIL ON SLAB OR ON GRADE	234.6m ²	9.5%	42m ²	1.7%		
	EXTENSIVE GREEN ROOF 150mm GROWING MEDIUM DEPTH PERMEABLE					80m ²	3.3%
	INTENSIVE GREEN ROOF-PLANTER 450MM MIN GROWING MEDIUM DEPTH PERMEABLE					95m ²	3.9%
	PLANTING ON GRADE 450mm - 900mm GROWING MEDIUM DEPTH PERMEABLE						
	HARDSCAPE AREA IMPERMEABLE					487.6m ²	19.8%
						864m ²	30.4%
						80m ²	2.9%
						747.3m ²	28.2%
							3.3%
TOTAL							

NOTE: AREAS ARE DIRECT MEASUREMENTS. PERCENTAGES ARE BASED ON THE OVERALL SITE AREA OF 2,458 SQM INSIDE THE PROPERTY LINES.

DP 17-791045	Nov 20, 2019
Plan 31	
7 RE-ISSUED FOR CITY COMMENTS 6 RE-ISSUED FOR DP APPLICATION 5 ISSUED FOR PRIOR TO RESPONSE 4 RE-ISSUED FOR DP APPLICATION 3 RE-ISSUED FOR DP APPLICATION 2 ISSUED FOR DP APPLICATION 1 ISSUED FOR CLIENT REVIEW	REVISIONS

COONEY ROAD TOWER	
6333 Cooney Road	
Richmond, British Columbia	
Scale:	1:200
Drawn:	DS
Reviewed:	DS
Project No.	06-581

LANDSCAPE
PERMEABILITY

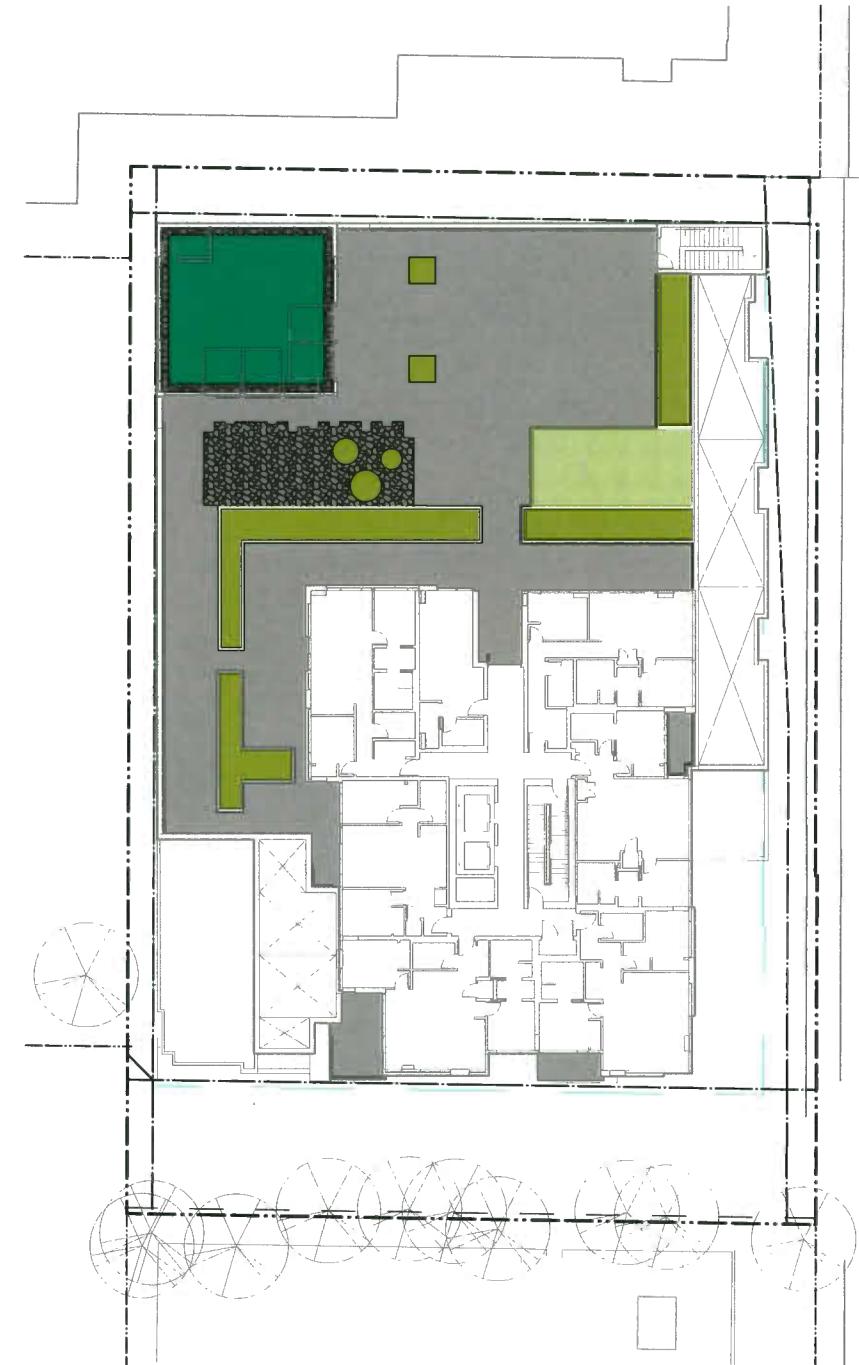


LEVEL 4 AND ROOF PERMEABILITY

A step function graph representing a signal over time. The vertical axis ranges from 0 to 20 m, and the horizontal axis represents time. The signal starts at 0 m, remains constant until time 0, then jumps to 10 m. It remains at 10 m until time 5, then jumps to 15 m. It remains at 15 m until time 10, then jumps to 20 m and stays there. An arrow at the top right indicates the direction of increasing time.

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PLANT LIST

TREES

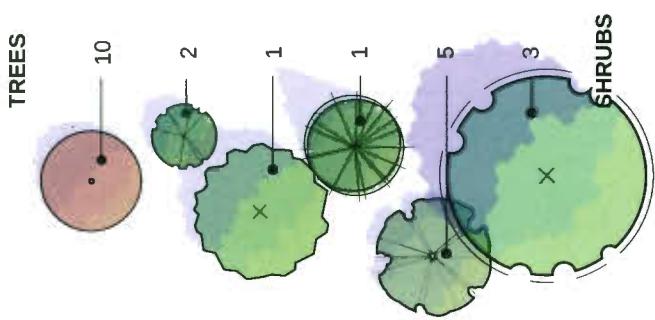

SHRUBS



COLOURS AND GRASSES

Cistus incanus
Rock Rose



EVERGREEN LAYERS



COMMON NAME

SIZE

SPACING

QTY.	BOTANICAL NAME	COMMON NAME	SIZE	SPACING
10	Acer Palmatum Aka kawa hime	Dwarf Japanese Maple	5cm cal., B&B	as shown
2	Liquidambar styraciflua 'Slender Silhouette'	Sweetgum	5cm cal., B&B	as shown
1	Malus x zumi 'Calocarpa'	Zumi Flowering Apple	6cm cal., B&B	as shown
1	Pinus engelmannii	Engelmann Spruce	3M height, B&B	as shown

QTY.	BOTANICAL NAME	COMMON NAME	SIZE	SPACING
23	Cistus incanus	Rock Rose	#2 pot	18" o.c.
23	Cotoneaster dammerii	Little-Leaf Cotoneaster	#2 pot	24" o.c.
21	Forsythia x intermedia	Forsythia	#5 pot	36" o.c.
10	Lavandula angustifolia 'Hidcote'	English Lavender	#2 pot	18" o.c.
74	Prunus laurocerasus 'Otto Luyken'	Cherry Laurel	#5 pot	24" o.c.
66	Polystichum munitum	Western Sword Fern	#2 pot	24" o.c.
48	Rhododendron 'Crete'	Pink Rhododendron	#5 pot	36" o.c.
30	Rhododendron 'Hotel'	Yellow Rhododendron	#5 pot	36" o.c.
36	Spiraea bumuloides 'Goldflame'	Goldflame Spirea	#2 pot	24" o.c.
78	Sarcococca hookerana humilis	Himalayan Sweet Box	#2 pot	24" o.c.
33	Skimmia japonica	Japanese Skimmia	#3 pot	30" o.c.
168	Taxus X Media 'Hicksii'	Hick's Yew - 1.5M height	#3 pot	20" o.c.

QTY.	BOTANICAL NAME	COMMON NAME	SIZE	SPACING
44	Akebia quinata	Chocolate Vine	#2 pot	18" o.c.
32	Arctostaphylos uva-ursi	Kinnikinnick	4'(10cm) pot	15" o.c.
190	Ceanothus griseus horizontalis	Creeping California Lilac	4'(10cm) pot	15" o.c.
392	Oxalis oreganum	Redwood Sorrel	4'(10cm) pot	15" o.c.
36	Parthenocissus quinquefolia	Virginia Creeper	#2 pot	18" o.c.
80	SQ.M. Eterna Colour Max Sedum Tile			

GROUND COVERS AND VINES

QTY.	BOTANICAL NAME	COMMON NAME	SIZE	SPACING
44	Akebia quinata	Chocolate Vine	#2 pot	18" o.c.
32	Arctostaphylos uva-ursi	Kinnikinnick	4'(10cm) pot	15" o.c.
190	Ceanothus griseus horizontalis	Creeping California Lilac	4'(10cm) pot	15" o.c.
392	Oxalis oreganum	Redwood Sorrel	4'(10cm) pot	15" o.c.
36	Parthenocissus quinquefolia	Virginia Creeper	#2 pot	18" o.c.
80	SQ.M. Eterna Colour Max Sedum Tile			

GRASSES, PERENNIALS, BULBS, AND ANNUALS

QTY.	BOTANICAL NAME	COMMON NAME	SIZE	SPACING
12	Allium giganteum	Persian Onion	#1 pot	18" o.c.
60	Carex eburnea	Bristleleaf Sedge	#1 pot	18" o.c.
77	Hakonechloa macra	Japanese Forest Grass	#1 pot	18" o.c.
17	Iris tenax	Oregon Iris	#1 pot	18" o.c.
7	Liriope muscari	Lily Turf	#1 pot	18" o.c.
12	Stipa tenuissima	Mexican Feather Grass	#1 pot	18" o.c.

NOTES:

- 1) In case of discrepancy between plant numbers on this list and on the plan, the latter shall prevail.
- 2) All planting shall be in accordance with BC Landscape Standard, latest edition.
- 3) All planting beds to be mulched with 2" (50mm) of Answer Garden Products 'Humus builder' or approved equal.

PLANT LIST & MATERIALS

NOV 20, 2019

DP 17-791045

Plan 32

REVISIONS

7 RE-ISSUED FOR CITY COMMENTS 19-11-06

6 RE-ISSUED FOR DP APPLICATION 19-10-31

5 ISSUED FOR PRIOR-TO-RESPONSE

4 RE-ISSUED FOR DP APPLICATION

3 RE-ISSUED FOR DP APPLICATION

2 ISSUED FOR DP APPLICATION

1 ISSUED FOR CLIENT REVIEW

REVISIONS

6333 Cooney Road

Richmond, British Columbia

Scale:

N/A

Drawn:

KDIDS

Reviewed:

DS

Project No.:

06-581

CONNECT LANDSCAPE ARCHITECTURE INC. DOES NOT GUARANTEE THE EXISTENCE, LOCATION, AND ELEVATION OF UTILITIES AND / OR CONCEALED STRUCTURES AT THE PROJECT SITE.

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DP 17-791045 Plan 33 Nov 20, 2019

Plan 33

4 RE-ISSUED FOR DP APPLICATION
3 RE-ISSUED FOR DP APPLICATION
2 ISSUED FOR DP APPLICATION
1 ISSUED FOR CLIENT REVIEW

REVISIONS


COONEY ROAD TOWER

6333 Cooney Road
Richmond, British Columbia
Scale: 1:100

Drawn: _____ DS
Reviewed: _____ DS
Project No. _____ 06-581

LANDSCAPE PLANTING GROUND LEVEL

L2:1

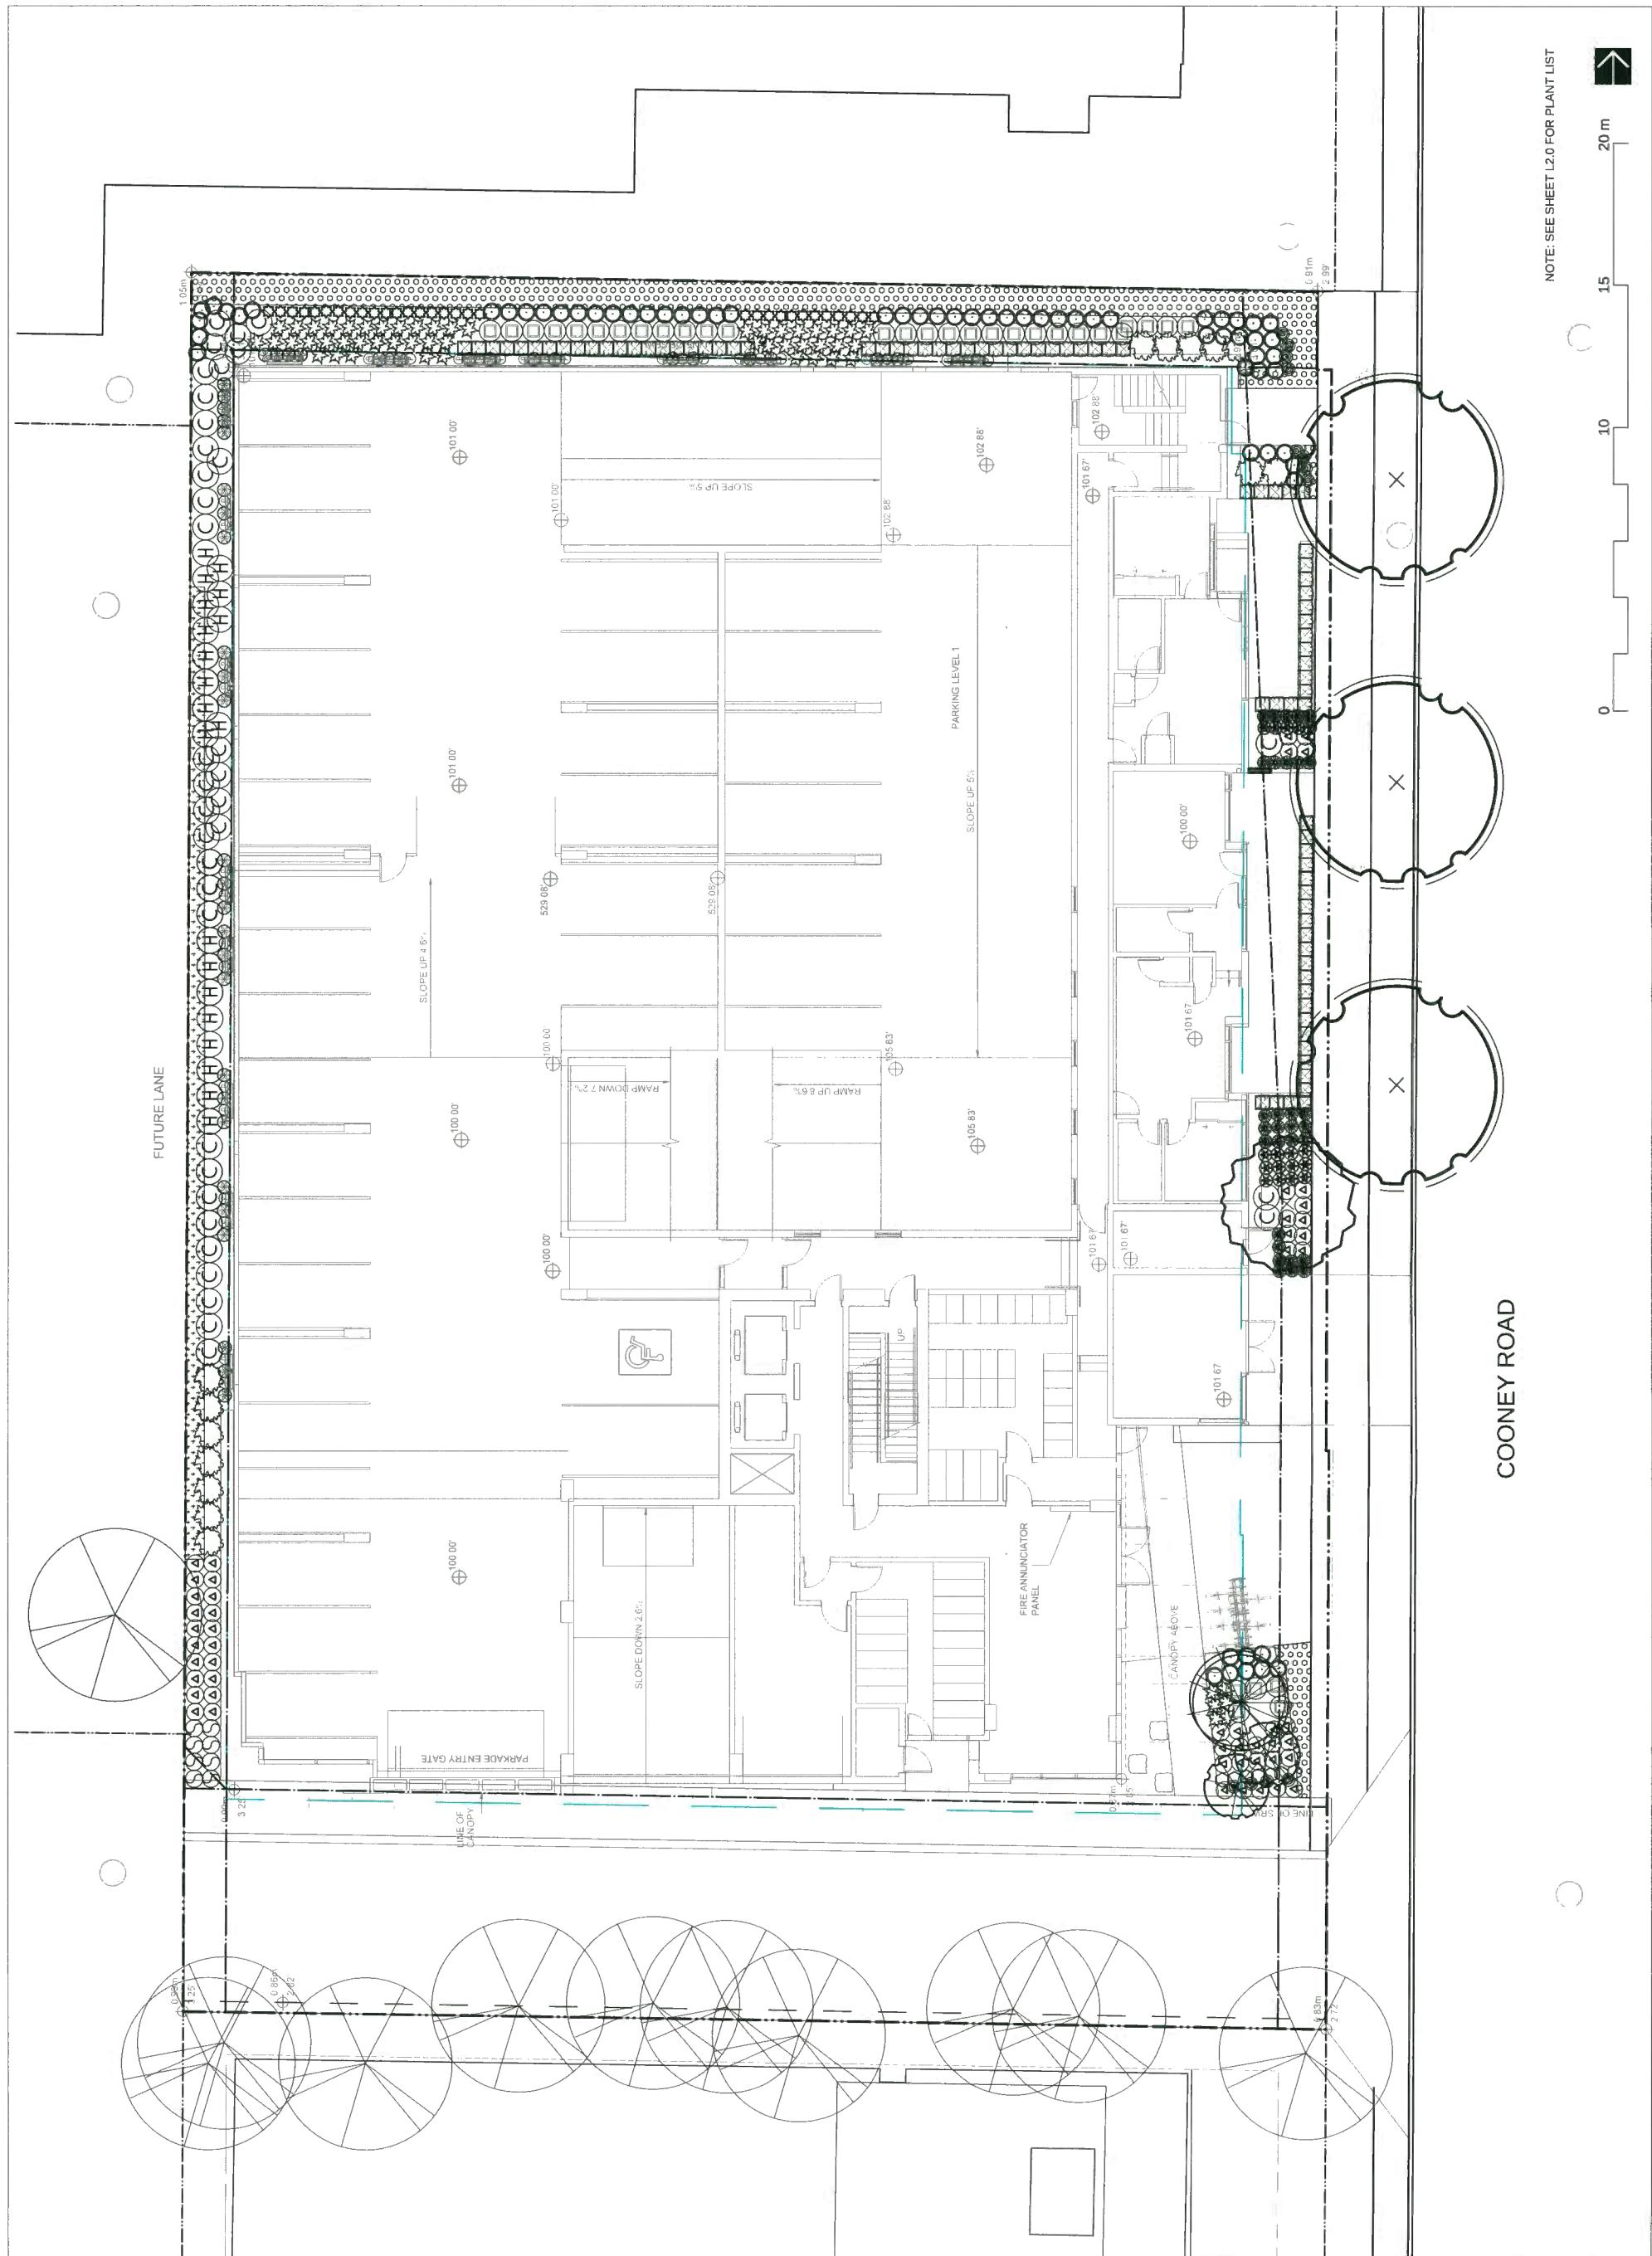

CONNECT LANDSCAPE ARCHITECTURE INC. DOES NOT GUARANTEE THE EXISTENCE, LOCATION, AND ELEVATION OF UTILITIES AND / OR CONCEALED STRUCTURES AT THE PROJECT SITE.
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DP 17-791045 Plan 34 Nov 20, 2019
 7 RE-ISSUED FOR CITY COMMENTS 19-1106
 6 RE-ISSUED FOR DP APPLICATION 19-10-31
 5 ISSUED FOR PRIOR TO RESPONSE
 4 RE-ISSUED FOR DP APPLICATION
 3 RE-ISSUED FOR DP APPLICATION
 2 ISSUED FOR DP APPLICATION
 1 ISSUED FOR CLIENT REVIEW
 REVISIONS

COONEY ROAD TOWER

6333 Cooney Road
Richmond, British Columbia

Scale: 1:100
Drawn: DS
Reviewed: DS
Project No. 06-581

LANDSCAPE PLANTING LEVEL 4


NOTE: SEE SHEET L2.0 FOR PLANT LIST



15 20 m

0 10

COONEY ROAD

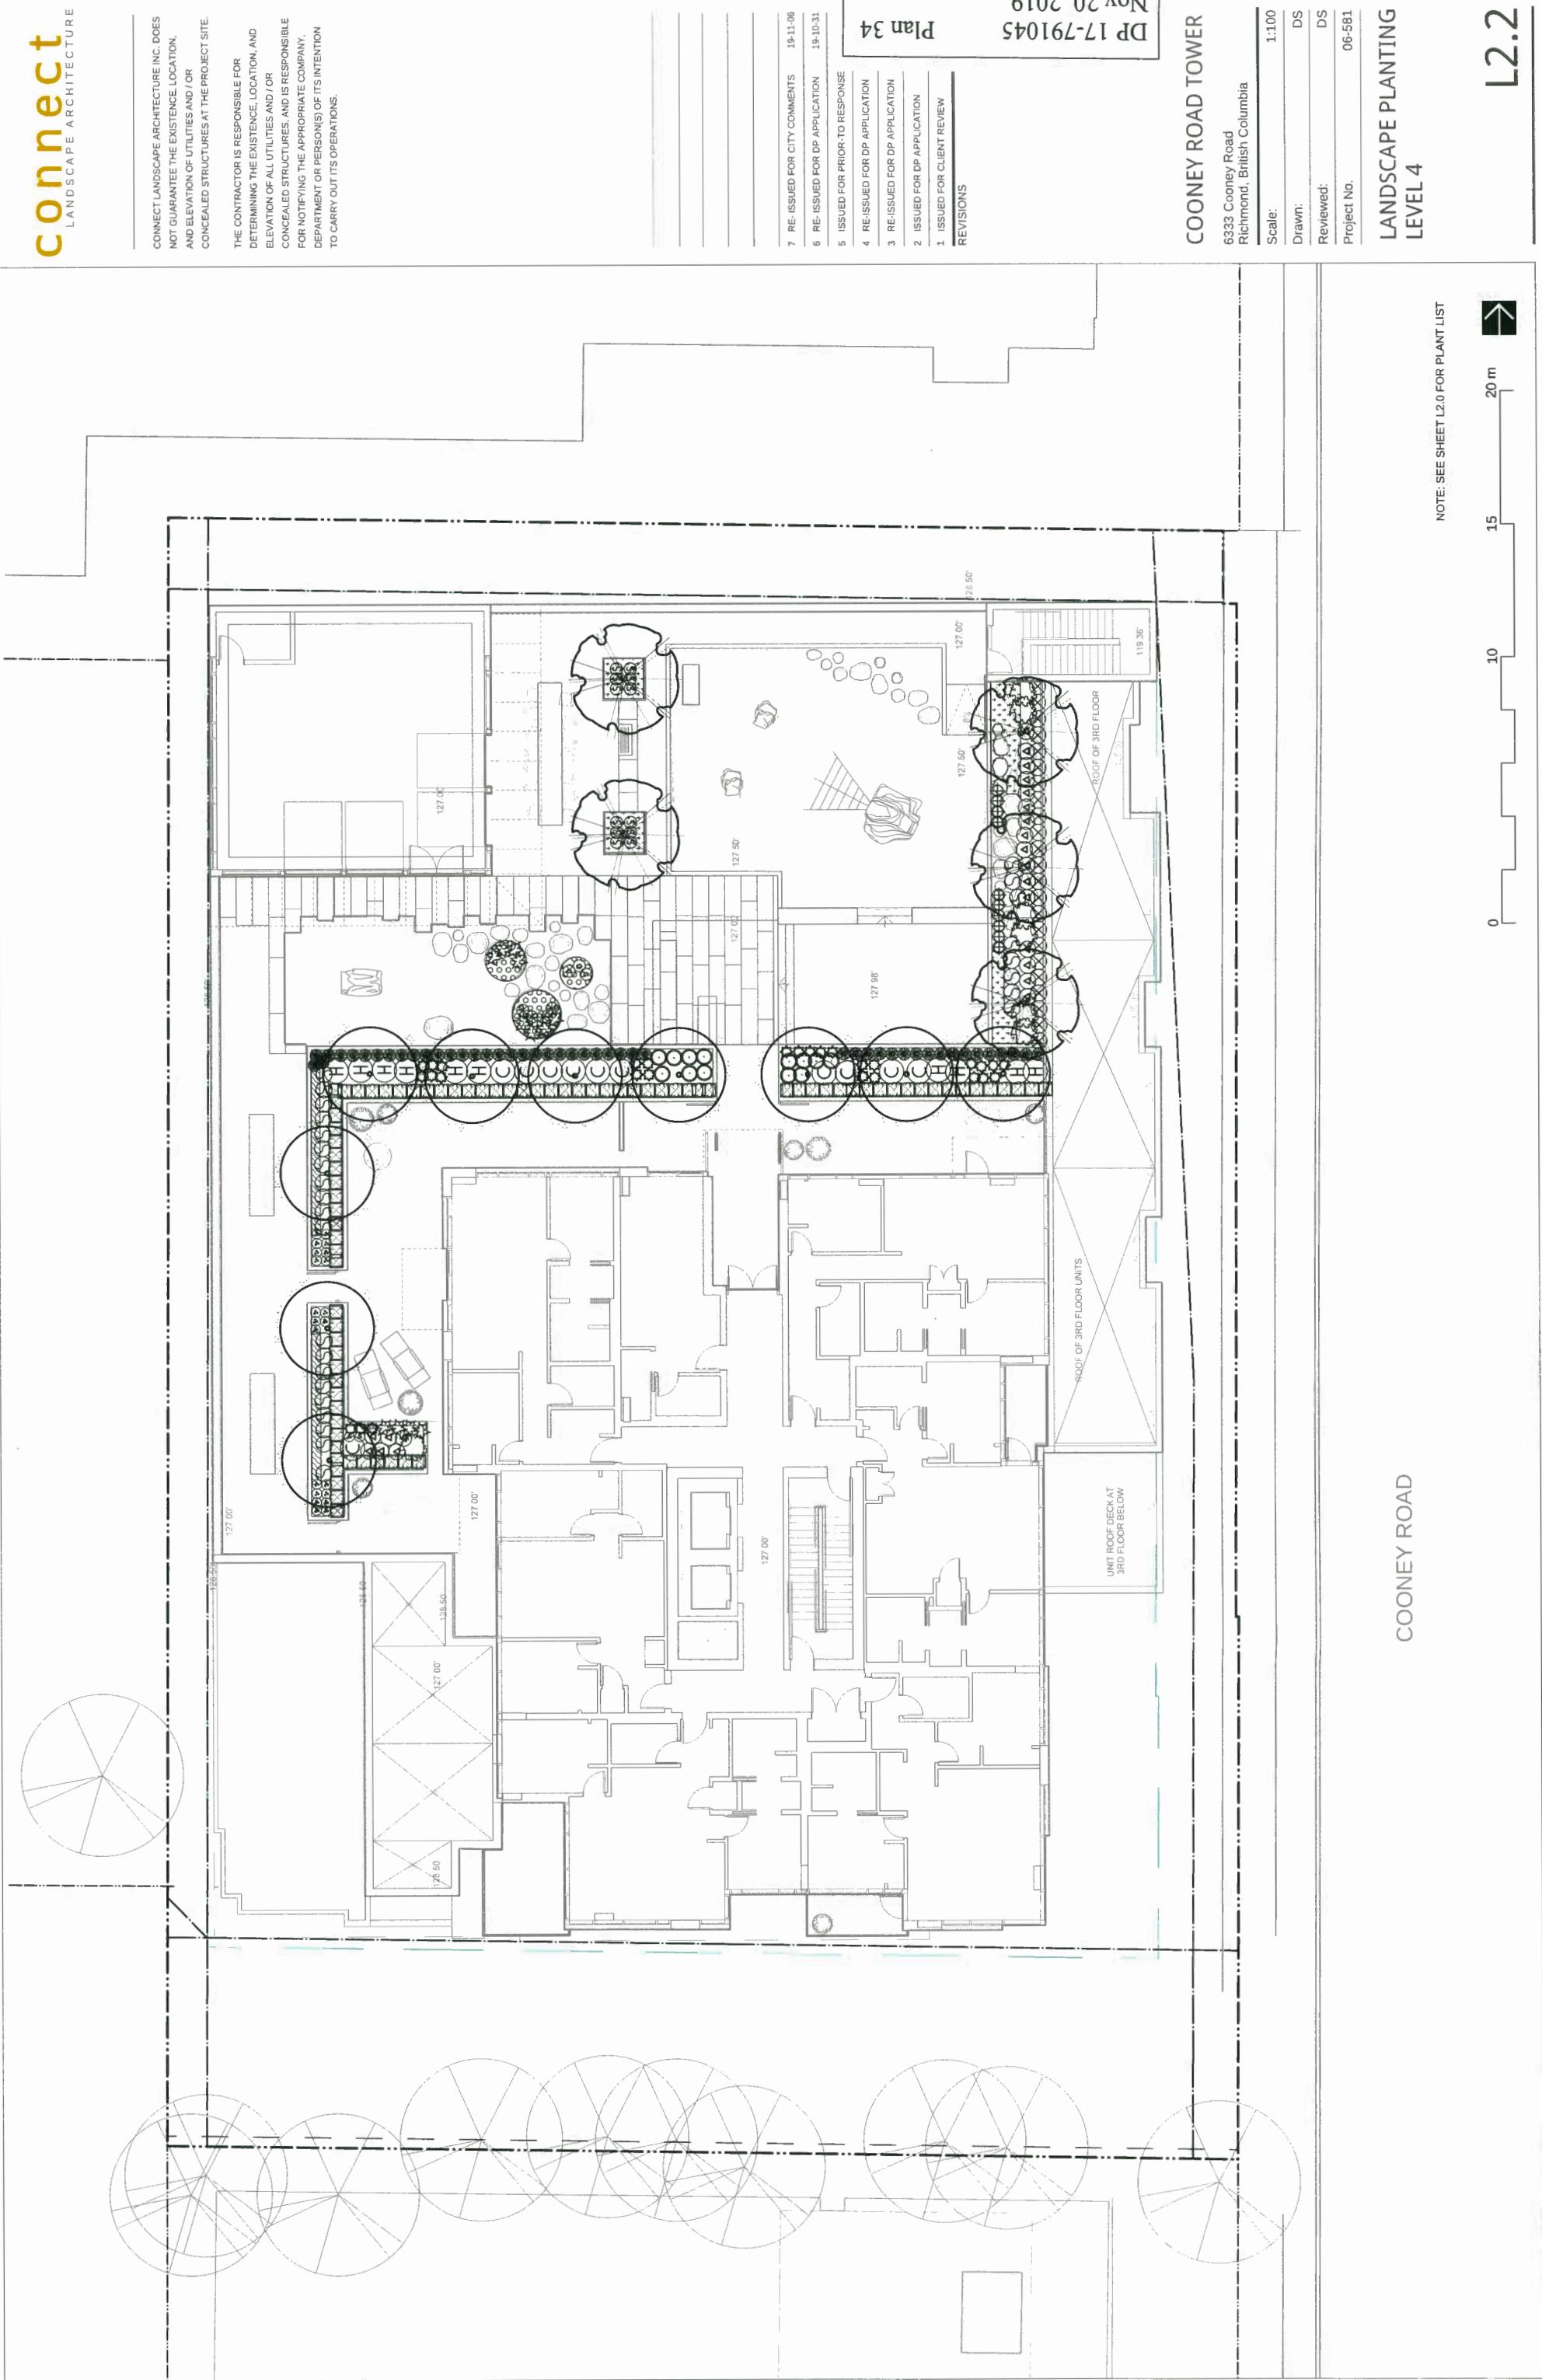

L2.2

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DP 17-791045 Plan 35 Nov 20, 2019

- 7 RE-ISSUED FOR CITY COMMENTS 19-11-06
- 6 RE-ISSUED FOR DP APPLICATION 19-10-31
- 5 ISSUED FOR PRIOR TO RESPONSE
- 4 RE-ISSUED FOR DP APPLICATION
- 3 RE-ISSUED FOR DP APPLICATION
- 2 ISSUED FOR DP APPLICATION
- 1 ISSUED FOR CLIENT REVIEW
- REVISIONS

COONEY ROAD TOWER

6333 Cooney Road
Richmond, British Columbia

Scale: 1:100
Drawn: DS
Reviewed: DS
Project No. 06-581

LANDSCAPE PLANTING ROOF LEVEL

NOTE: SEE SHEET L2.0 FOR PLANT LIST



20 m


15 m

10 m

0 m


COONEY ROAD

L2.3

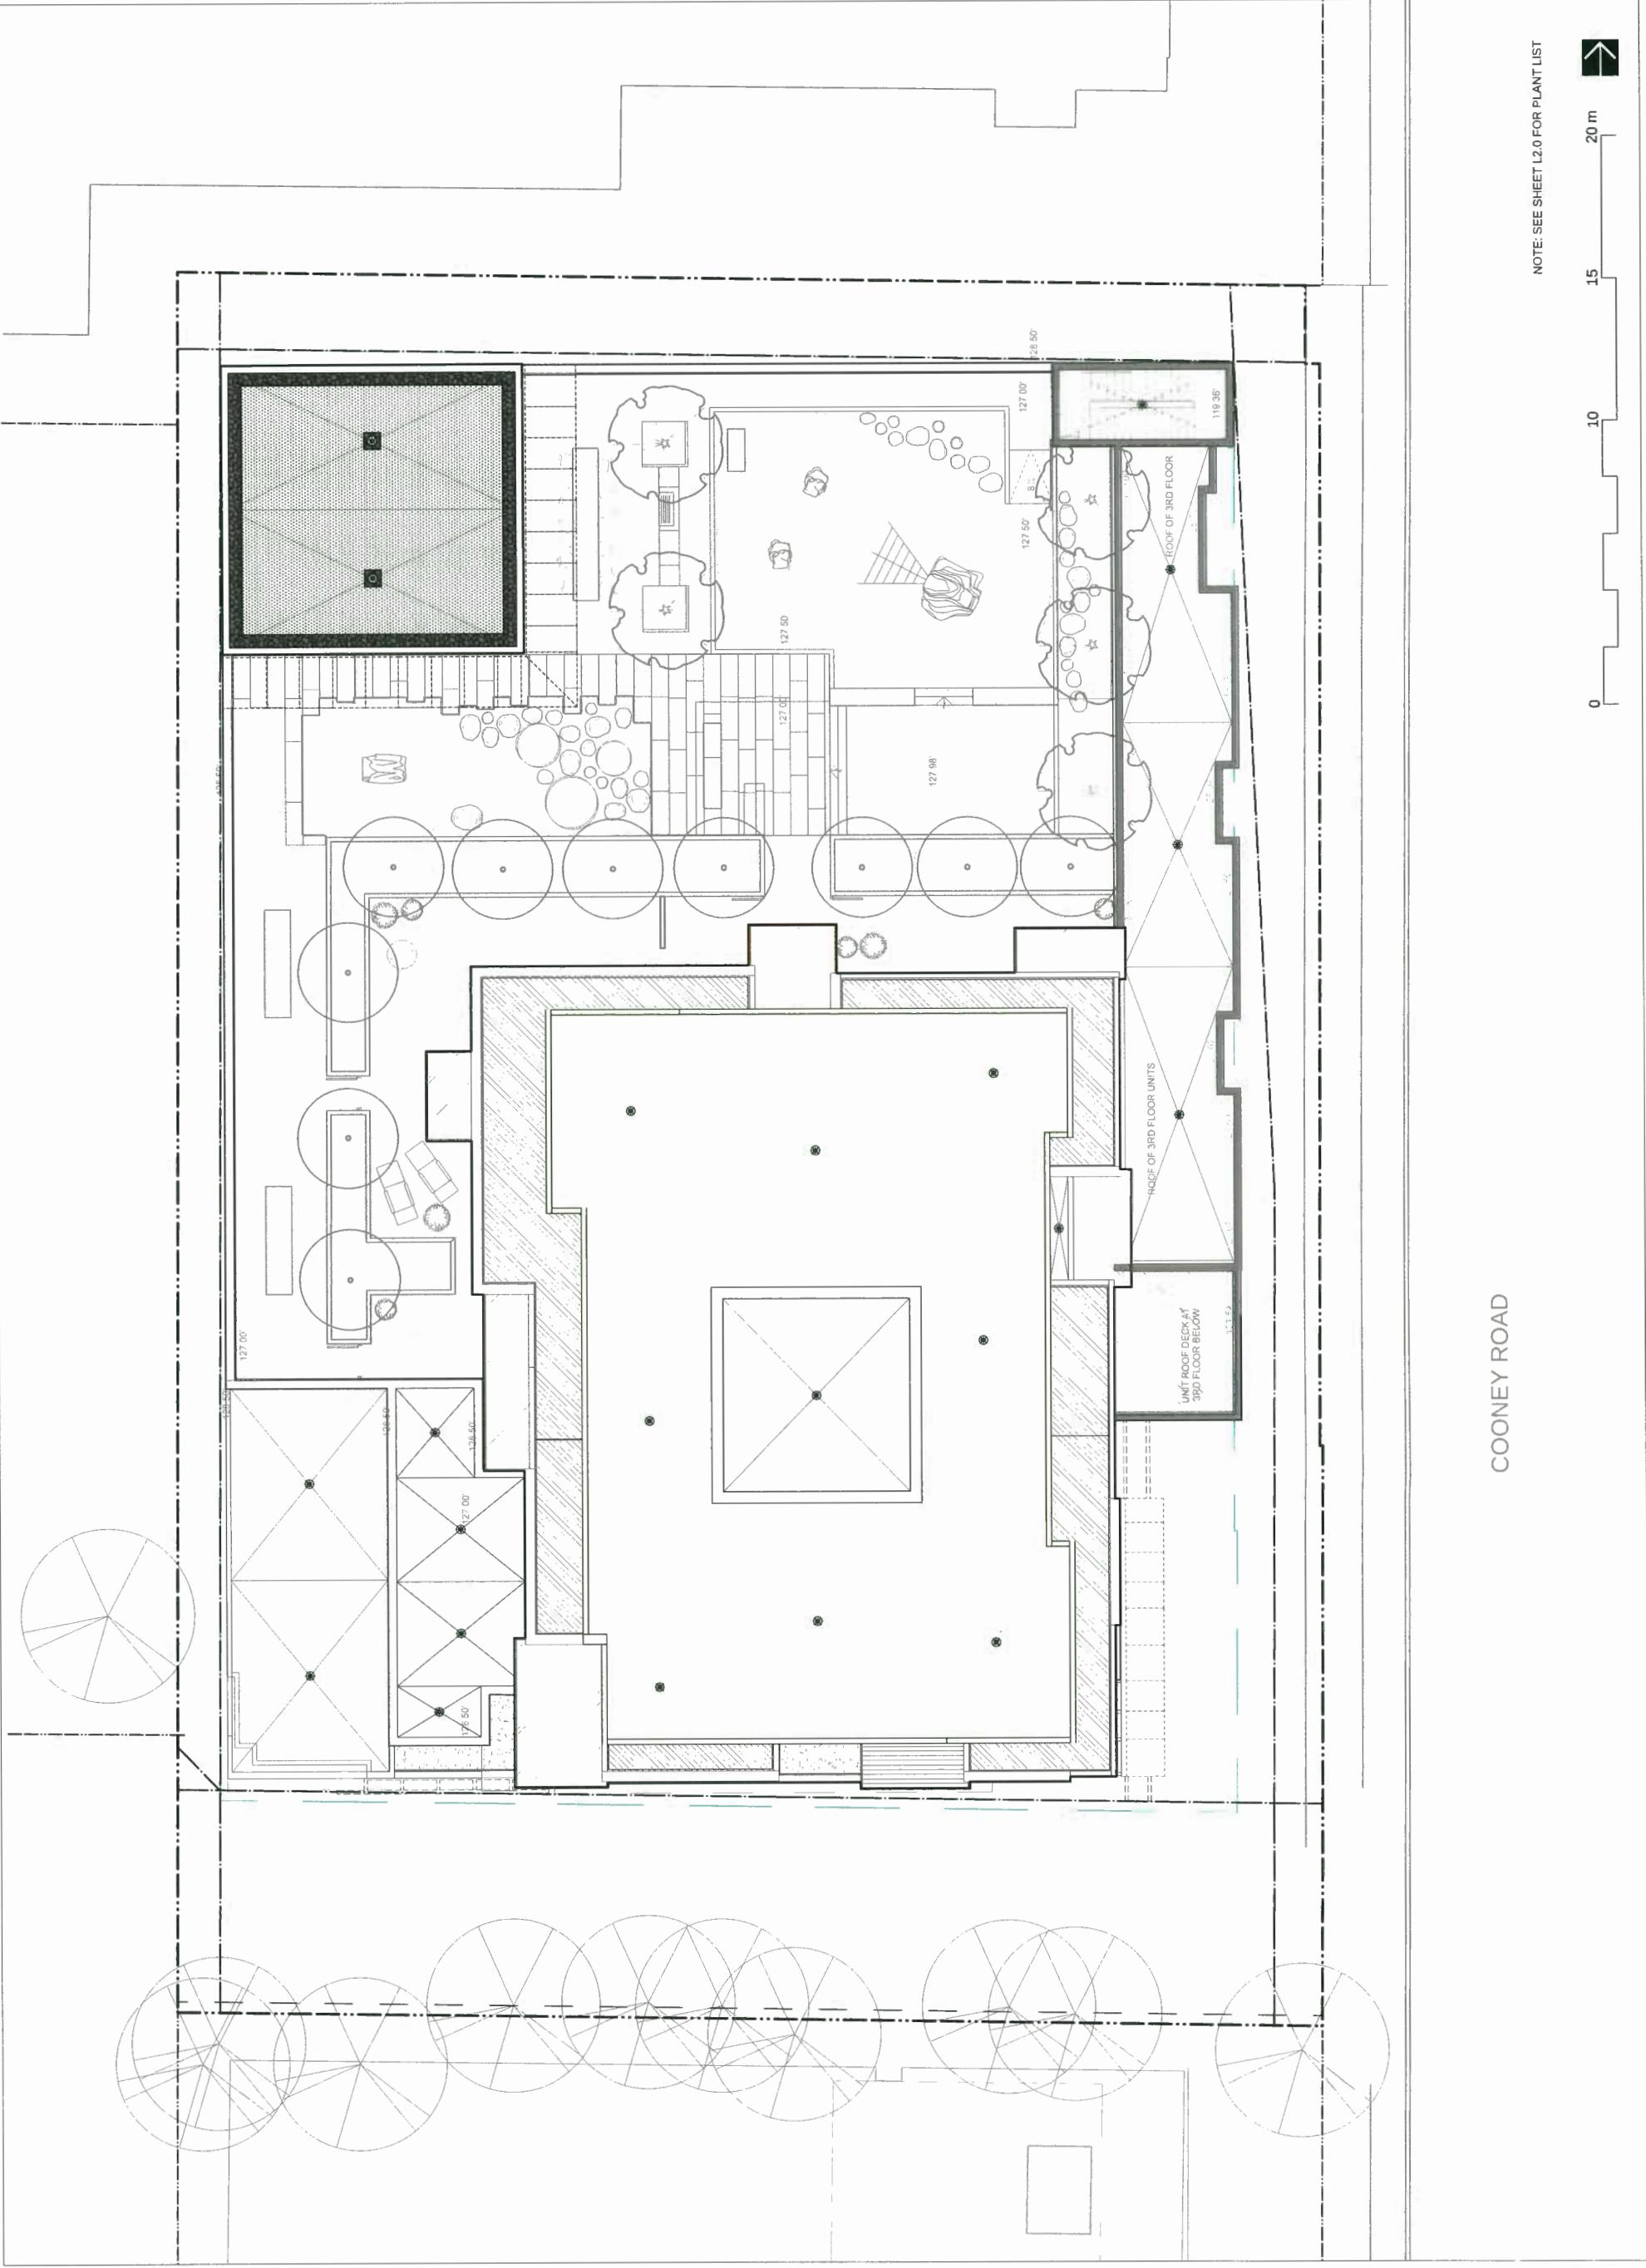


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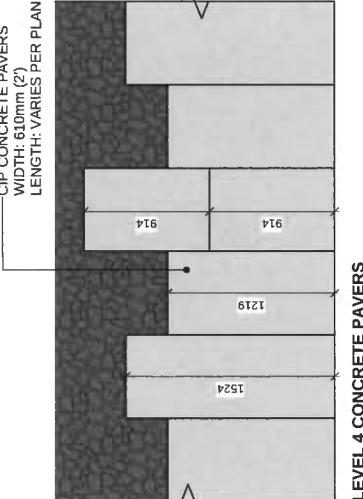
CIP CONCRETE PAVING NOTES:

1. SANDBLAST FINISH
2. SEE LAYOUT PLAN FOR SAWCUT JOINT PATTERN AND BAND WIDTH
3. EXP. JOINTS @ 6M O.C. MAX (PLUMB, STRAIGHT AND SQUARE)
- (AT CHANGES IN MATERIALS, FURNISHINGS, CURB EDGES - SPACING TO COINCIDE WITH PATTERN)
4. CONTROL JOINTS @ 1.5M O.C. (50°) O.C. MAX (PLUMB, STRAIGHT AND SQUARE)
5. FINAL LOCATION FOR JOINTS AND SAW CUTS TO BE CONFIRMED ON SITE WITH LANDSCAPE ARCHITECT
6. REFER TO CIVIL PLANS FOR VEHICULAR CONCRETE PAVING
7. FOR ALL HC ACCESSIBLE ROUTES ENSURE SAW CUT JOINTS RATHER THAN CONVEX TOOLED JOINTS
8. ALL OFF-SITE WORKS TO MEET CITY STANDARDS AND SPECIFICATIONS

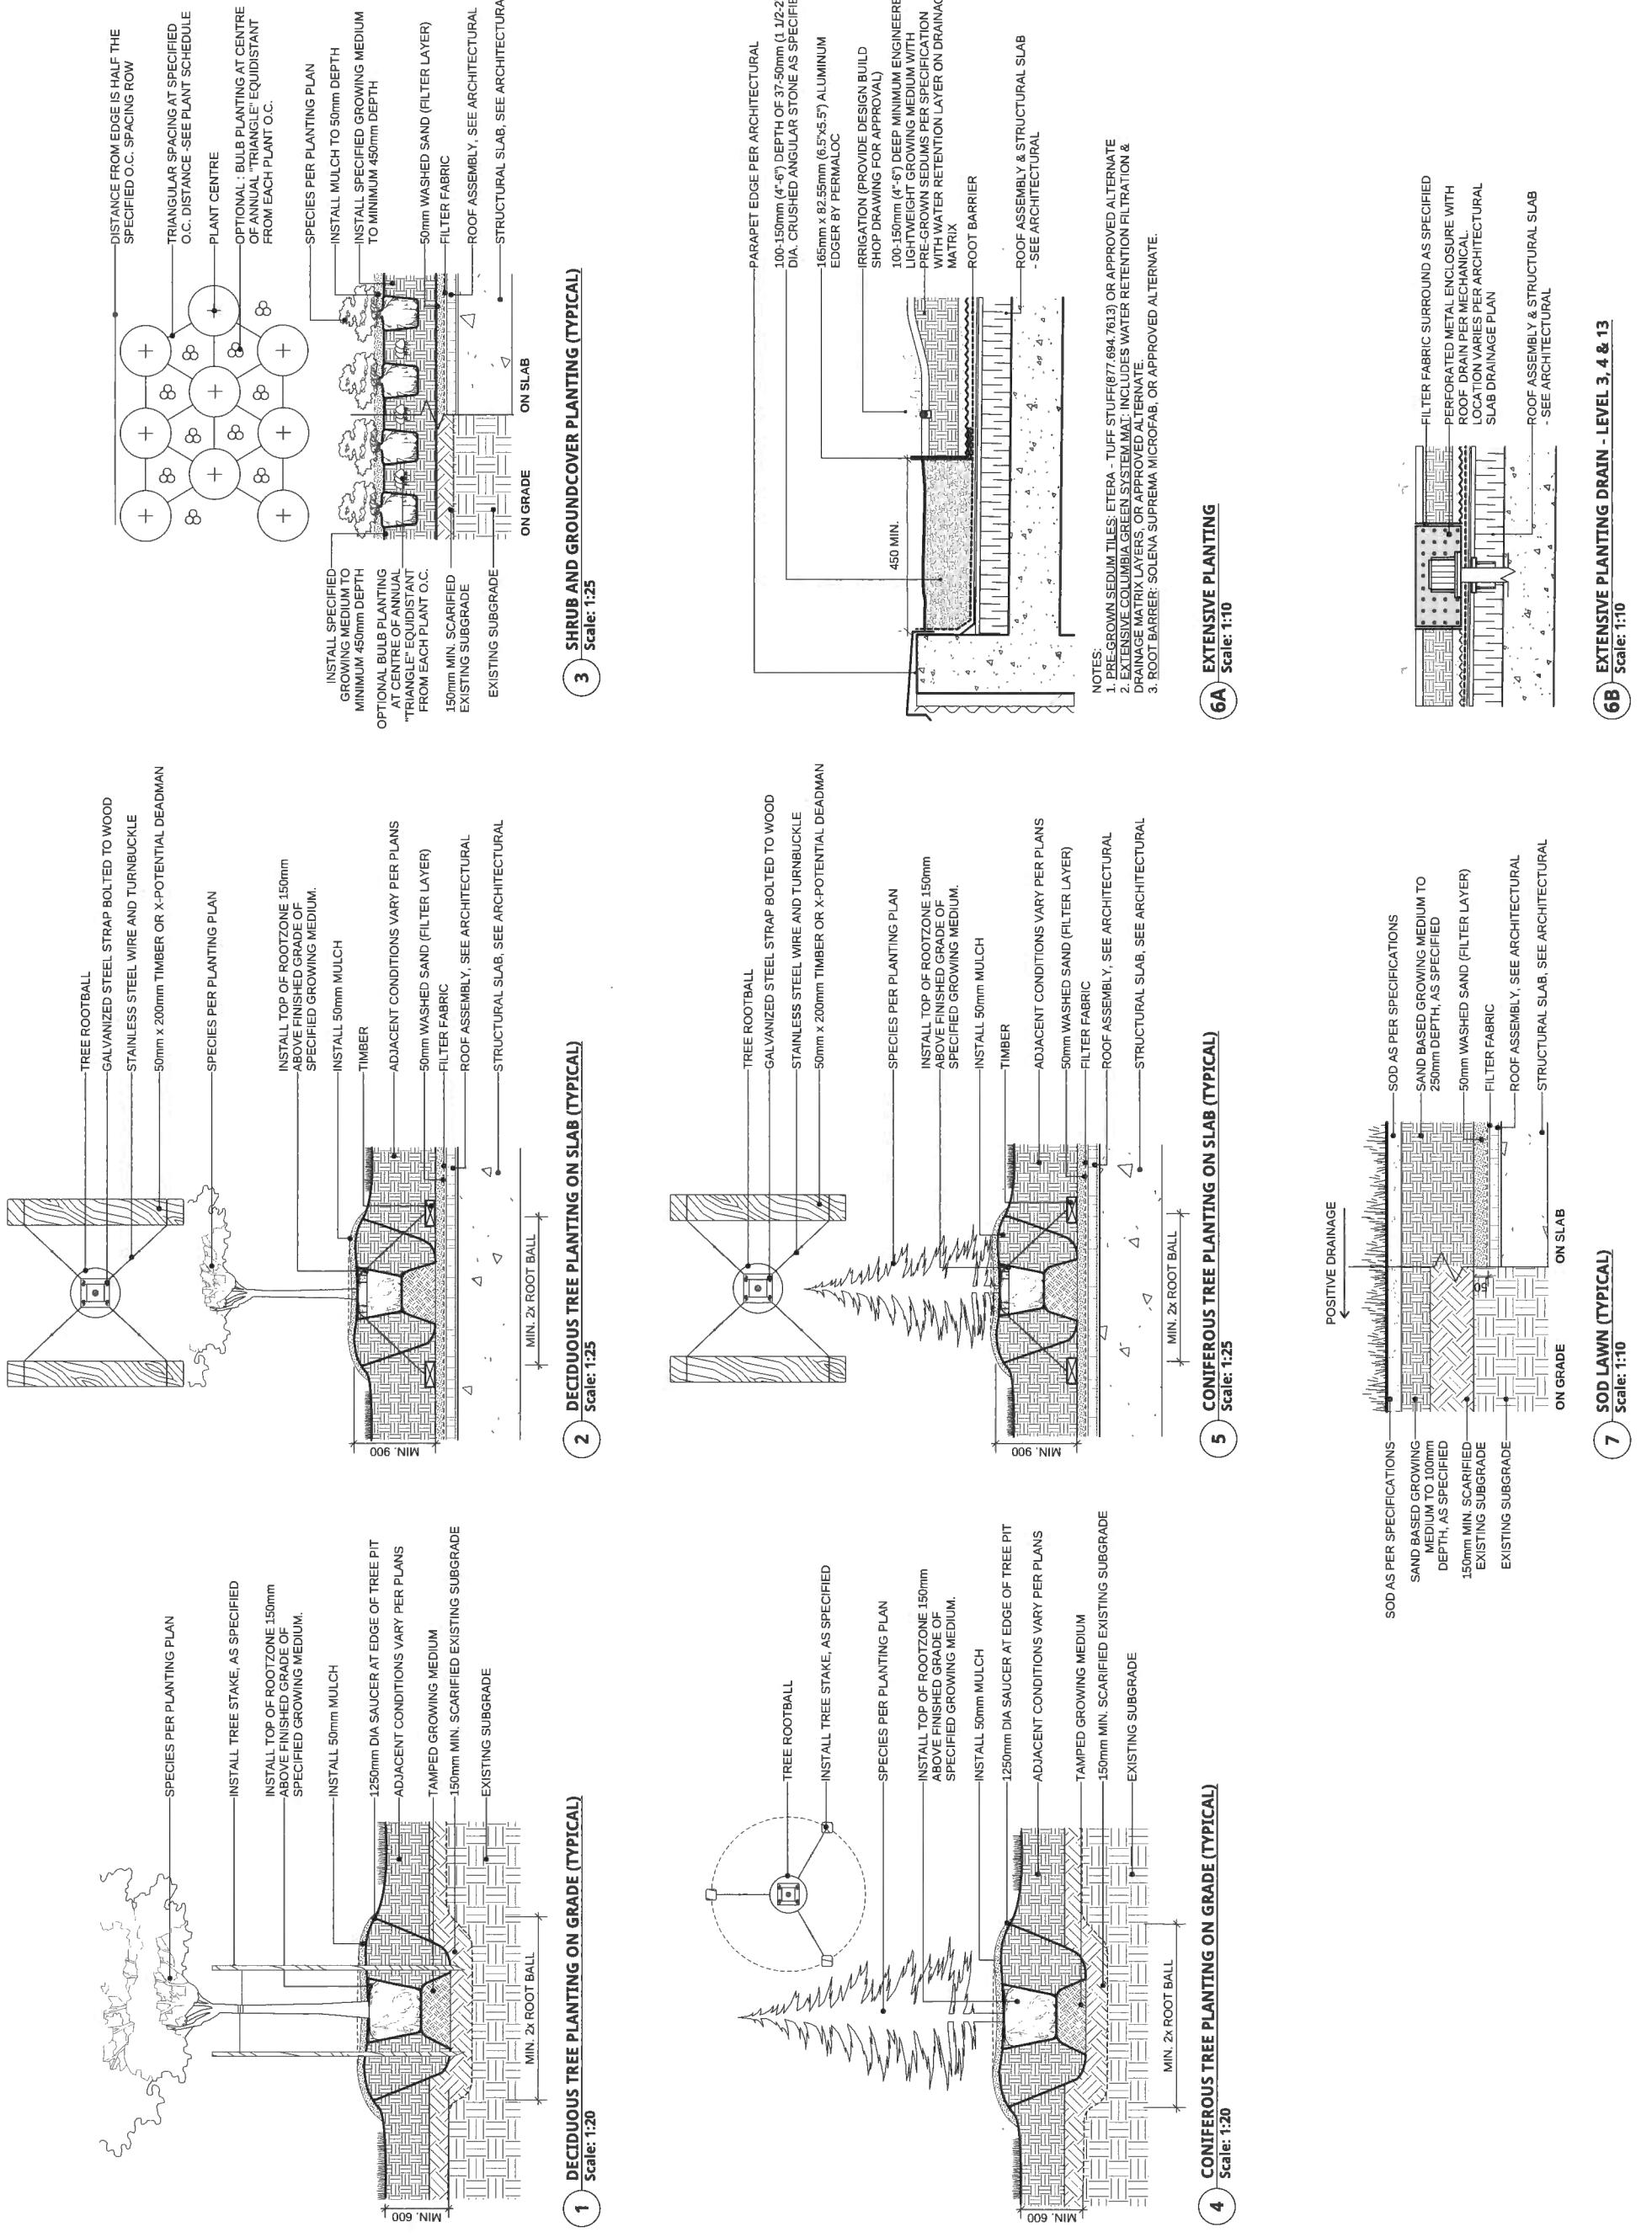


1 CIP CONCRETE ON GRADE / ON SLAB (TYPICAL)
Scale: 1:10

1. EXPANSION JOINTS 6m O.C. MAX CONTROL JOINTS @ 1.5m O.C. ADJUST TO SUIT SITE LAYOUT PLAN.
2. ALL SCORELINES TO BE APPROVED BY LANDSCAPE ARCHITECT ON-SITE PRIOR TO INSTALLATION.

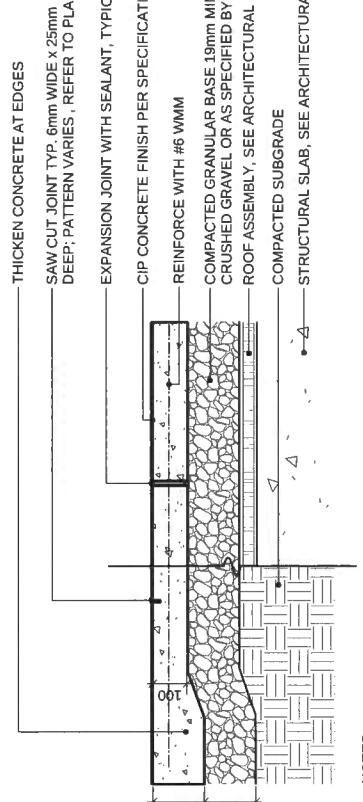


1 CIP CONCRETE ON GRADE / ON SLAB (TYPICAL)
Scale: 1:10

1. EXPANSION JOINTS 6m O.C. MAX CONTROL JOINTS @ 1.5m O.C. ADJUST TO SUIT SITE LAYOUT PLAN.
2. ALL SCORELINES TO BE APPROVED BY LANDSCAPE ARCHITECT ON-SITE PRIOR TO INSTALLATION.

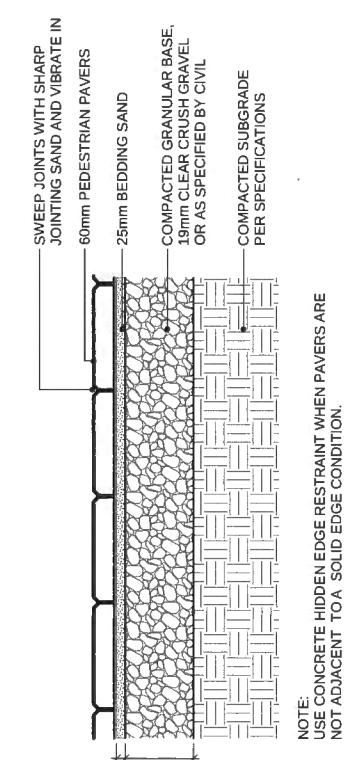


2 PEDESTRIAN UNIT PAVERS ON GRADE (TYPICAL)
Scale: 1:10

NOTE: USE CONCRETE HIDDEN EDGE RESTRAINT WHEN PAVERS ARE NOT ADJACENT TO A SOLID EDGE CONDITION.

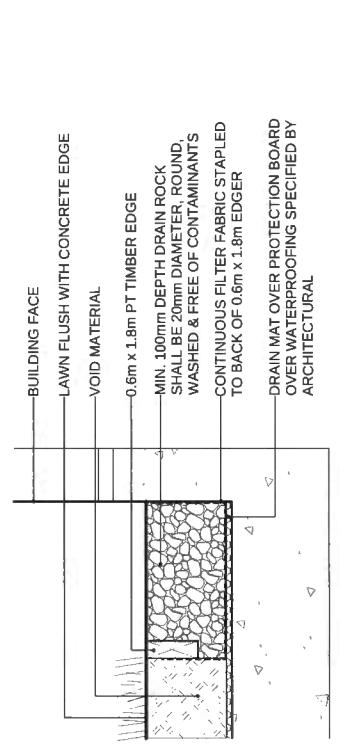


6 CIP CONCRETE STEPS
Scale: 1:10

NOTES: BOTTOM OF STAIR GRADES VARY, REFER TO GRADING PLAN FOR HEIGHTS.

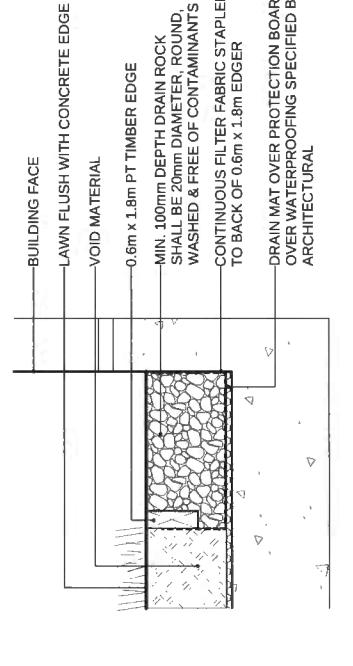


7 GRAVEL DRAIN STRIP - ON SLAB
Scale: 1:10

NOTES: 1. GUARDRAIL REQUIRED FOR ALL WALLS ABOVE 610mm (2').
2. ALL SCORELINES TO BE APPROVED BY LANDSCAPE ARCHITECT ON-SITE PRIOR TO INSTALLATION.

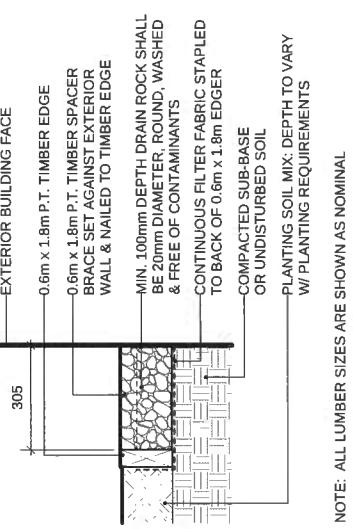


8 CIP CONCRETE RETAINING WALL (ON SLAB)
Scale: 1:20

NOTES: 1. GUARDRAIL REQUIRED FOR ALL WALLS ABOVE 610mm (2').
2. ALL SCORELINES TO BE APPROVED BY LANDSCAPE ARCHITECT ON-SITE PRIOR TO INSTALLATION.

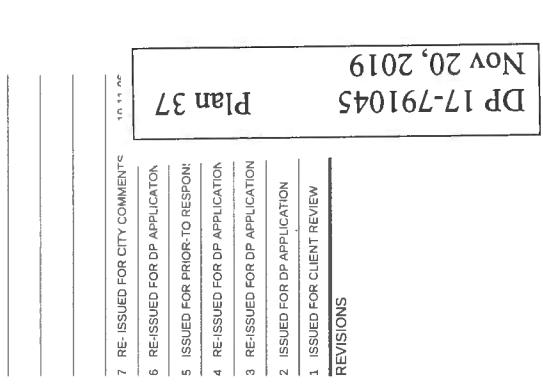

PROPOSED RESIDENTIAL DEVELOPMENT
Port Moody, British Columbia
Scale: As Shown
Drawn: K/D/S
Reviewed: DS
Project No.: 06-581
LANDSCAPE DETAILS
HARDSCAPE

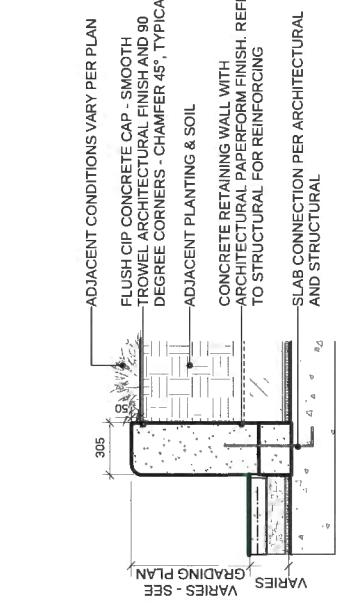

PROPOSED RESIDENTIAL DEVELOPMENT
Port Moody, British Columbia
Scale: As Shown
Drawn: K/D/S
Reviewed: DS
Project No.: 06-581
LANDSCAPE DETAILS
HARDSCAPE



PROPOSED RESIDENTIAL DEVELOPMENT
Port Moody, British Columbia
Scale: As Shown
Drawn: K/D/S
Reviewed: DS
Project No.: 06-581
LANDSCAPE DETAILS
HARDSCAPE




PROPOSED RESIDENTIAL DEVELOPMENT
Port Moody, British Columbia
Scale: As Shown
Drawn: K/D/S
Reviewed: DS
Project No.: 06-581
LANDSCAPE DETAILS
HARDSCAPE

CONNECT LANDSCAPE ARCHITECTURE INC. DOES NOT GUARANTEE THE EXISTENCE, LOCATION, AND ELEVATION OF UTILITIES AND / OR CONCEALED STRUCTURES AT THE PROJECT SITE.


THE CONTRACTOR IS RESPONSIBLE FOR DETERMINING THE EXISTENCE, LOCATION, AND ELEVATION OF ALL UTILITIES AND / OR CONCEALED STRUCTURES, AND IS RESPONSIBLE FOR NOTIFYING THE APPROPRIATE COMPANY, DEPARTMENT OR PERSON(S) OF ITS INTENTION TO CARRY OUT ITS OPERATIONS.



MODEL: MBR350 - 5 BIKE RACK
FINISH: STANDARD POWDERCOATED SILVER 14
BY: MAGLIN SITE FURNISHINGS
(1.800.716.5506)

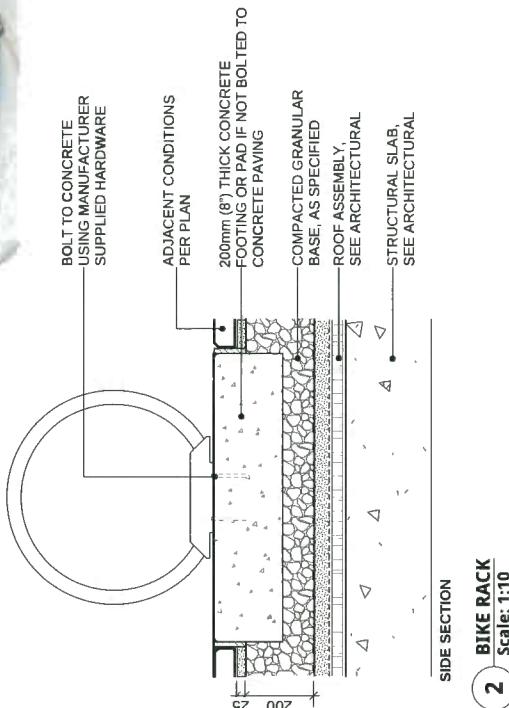

② BIKE RACK
Scale: 1:10

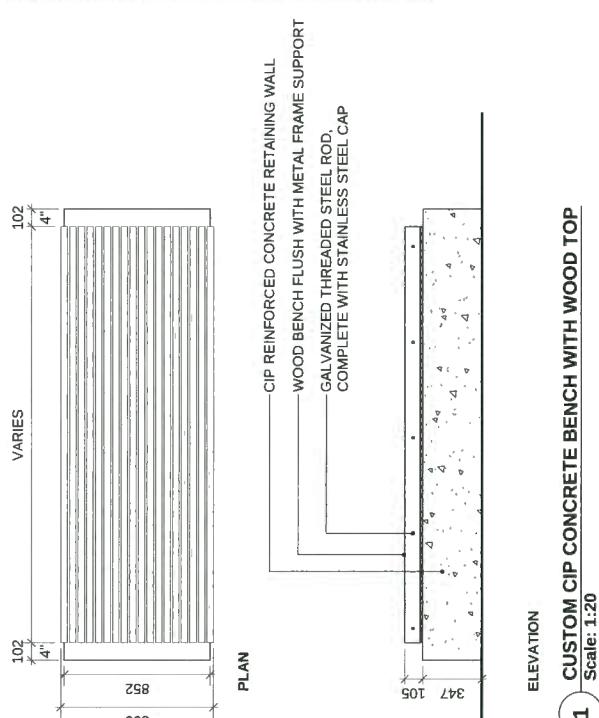

DP 17-791045	Nov 20, 2019
Plan 38	
7 RE-ISSUED FOR CITY COMMENTS	
6 RE-ISSUED FOR DP APPLICATION	
5 ISSUED FOR PRIOR TO RESPONSE	
4 RE-ISSUED FOR DP APPLICATION	
3 RE-ISSUED FOR DP APPLICATION	
2 ISSUED FOR DP APPLICATION	
1 ISSUED FOR CLIENT REVIEW	
REVISIONS	

PROPOSED RESIDENTIAL DEVELOPMENT

Port Moody, British Columbia
Scale: As Shown
Drawn: KDD/S
Reviewed: DS
Project No. 06-581

LANDSCAPE DETAILS FURNISHINGS



CUSTOM SELECTED BASALT COLUMN BENCHES



MODEL: HARVEST GROVE BBQ GRILL
AND COUNTERTOP KIT
FINISH: CHARCOAL BLOCK AND
POLISHED GRANULAR CONCRETE FINISH
BY: BARKMAN CONCRETE
778.689.7670

CONNECT LANDSCAPE ARCHITECTURE INC. DOES NOT GUARANTEE THE EXISTENCE, LOCATION, AND ELEVATION OF ALL UTILITIES AND/OR CONCEALED STRUCTURES AT THE PROJECT SITE.

THE CONTRACTOR IS RESPONSIBLE FOR DETERMINING THE EXISTENCE, LOCATION, AND ELEVATION OF ALL UTILITIES AND/OR CONCEALED STRUCTURES, AND IS RESPONSIBLE FOR NOTIFYING THE APPROPRIATE COMPANY, DEPARTMENT OR PERSON(S) OF ITS INTENTION TO CARRY OUT ITS OPERATIONS.

Plan 39

DP 17-791045
Nov 20, 2019

PROPOSED RESIDENTIAL DEVELOPMENT

Port Moody, British Columbia

Scale: As Shown


Drawn: K/D/S

Reviewed: D/S


Project No.: 06-581

LANDSCAPE DETAILS
PLAY AREA


L3.3

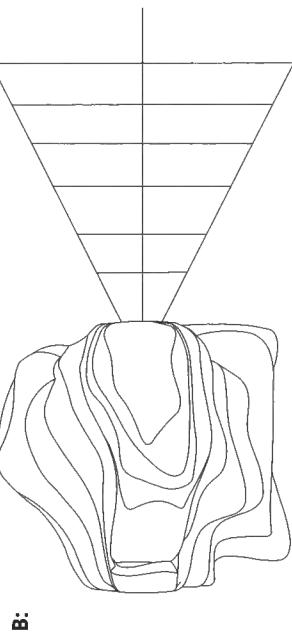

B:

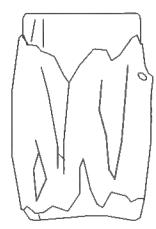


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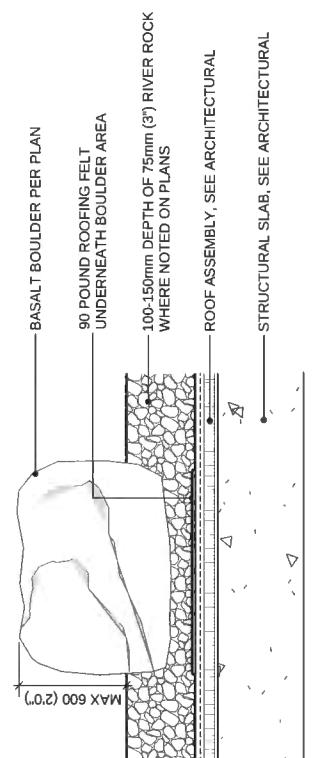
ADVENTURESCAPE DESIGN #4 (168367)
A: LOG CRAWL TUNNEL (173594)
B: THE POINTE (166355) WITH OUTRIGGER
FINISH & COLOUR: TBD BY BOLD
BY: LANDSCAPE STRUCTURES
(1.800.328.0035)

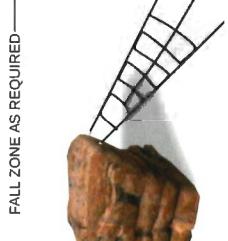PLAY EQUIPMENT


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Scale: 1:25



2 TURF SURFACING
Scale: 1:10

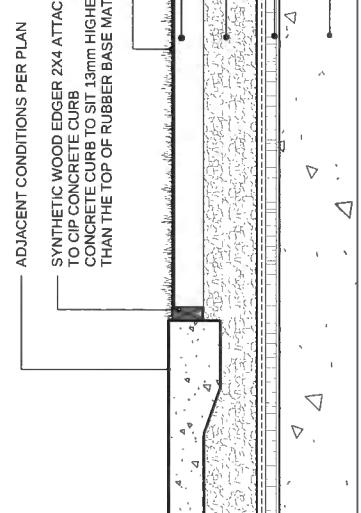

3 BASALT BOULDER
Scale: 1:10

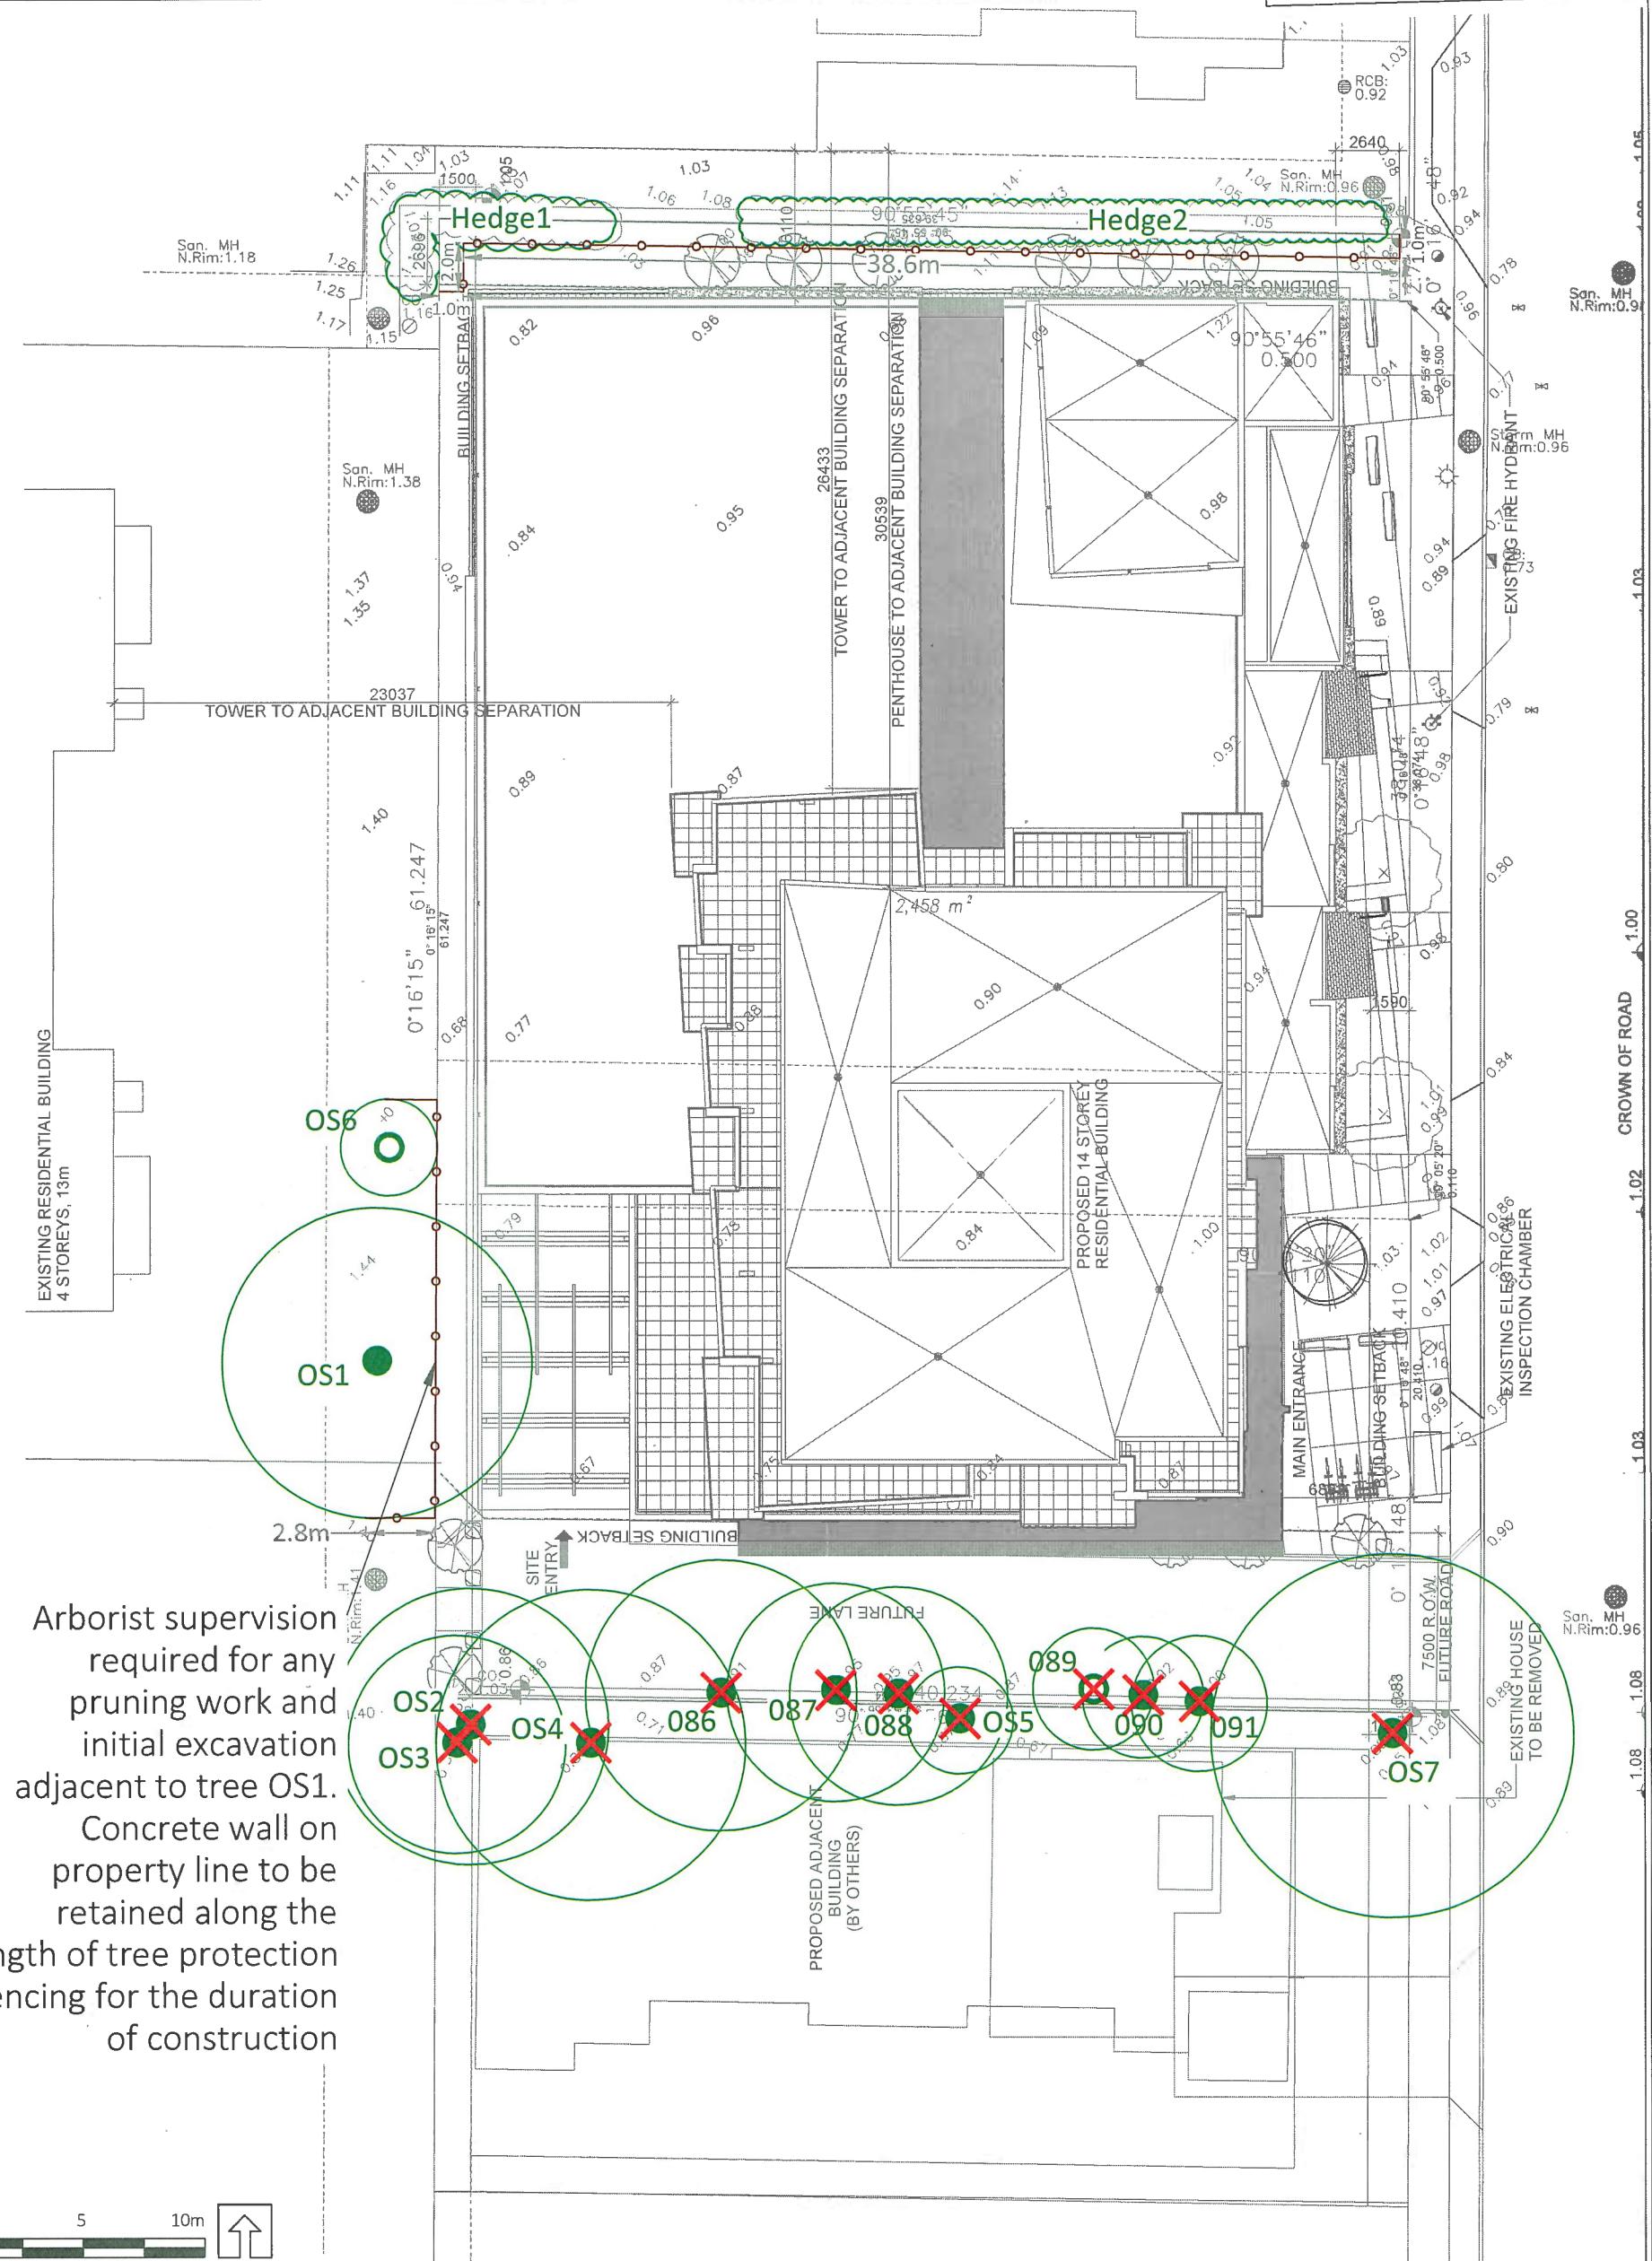




CONSULTANT INFORMATION
Cabi: DIRECT LANDSCAPE ARCHITECTURE
Landscape Architectural Services Group of Companies
Specialist: GUTHRIE-SIMPSON GROUP OF COMPANIES
Mechanical: KME GROUP
Electrical & Associates LTD.
Timber:

NOT FOR
CONSTRUCTION

PROJECT INFORMATION

COONEY ROAD
TOWER

6333 COONEY ROAD
RICHMOND, BC

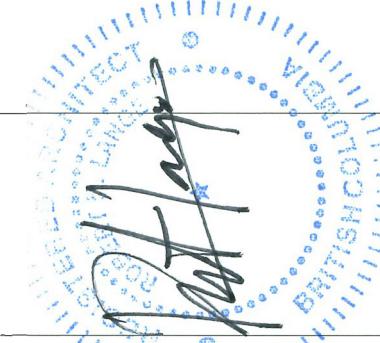

DP 17-791045 Reference Plan
Nov 20, 2019

This drawing represents previous levels. Do not issue these drawings. Only dimensions, elevations and elevations, and property lines are taken to be true to scale. Shaded areas of concrete blocks and/or stonework are not drawn to scale. The architect shall be advised of the actual performance and dimensions of these walls. All dimensions are in inches. Drawing and dimensioning are required by all. Alterations must be signed off by the architect. These drawings may be reproduced within the permission of the architect.

ISSUED

DATE

2019-10-31

DRAWN BY

JH

CHEKED BY

SH


PROJECT NO.

21971


SCALE 1/4" = 1'-0"
DATE 11/19/2019 4:33:00 PM
DRAWN BY SH
PROJECT NO. 21971

DRAWING TITLE
ENLARGED PLANS -
ADAPTABLE UNITS


DP20-16-00

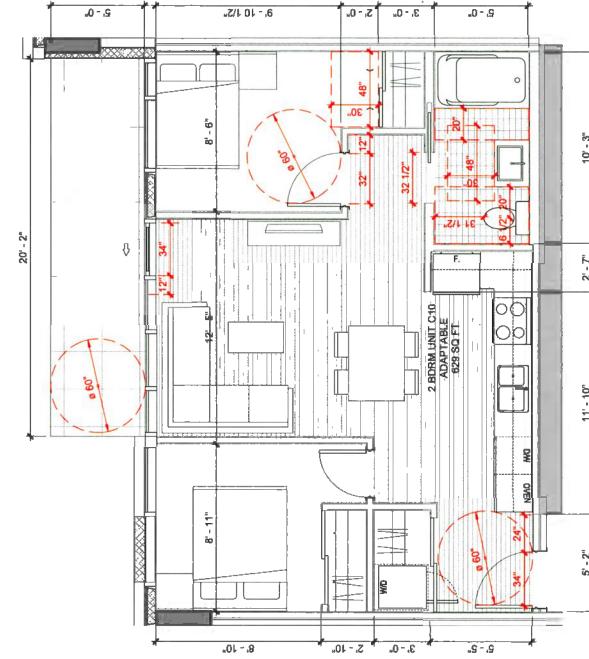

2 BDRM UNIT C10 ADAPTABLE - LEVEL 4-13
DP30-01-00 SCALE: 1/4" = 1'-0"

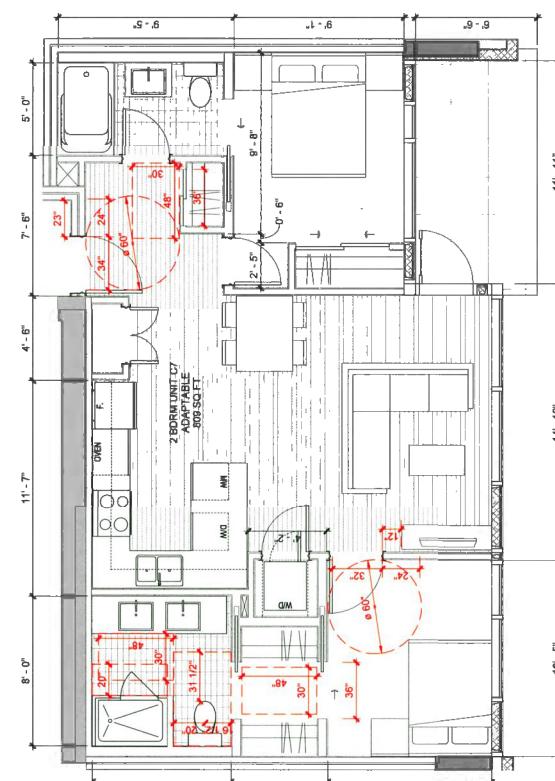

2 BDRM UNIT C7 ADAPTABLE - LEVEL 4-13
DP30-01-00 SCALE: 1/4" = 1'-0"

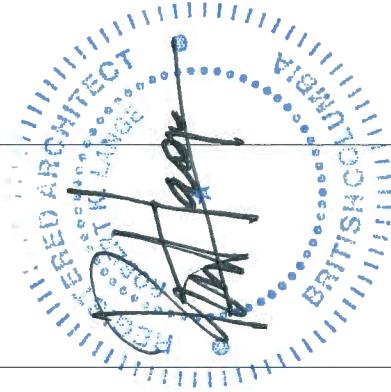

6633 COONEY ROAD
RICHMOND, BC

NOT FOR
CONSTRUCTION

PROJECT INFORMATION

DONEY ROAD
TOWER

CONSULTANT INFORMATION

CONNECT LANDSCAPE ARCHITECTURE: S2 ARCHITECTURE: GLOTMAN-SIMPSON GROUP: AME GROUP: NEIMETZ & ASSOCIATES LTD.

Architectural: Michaelson: Engineers: Inman:

S2
architecture

307-3040 • 2004 6000
Vernon, BC, Canada V6B 5A
T 604 545 2808
www.scarfteam.com

CONSULTANT INFORMATION

Cat#: CONNECT LANDSCAPE ARCHITECTURE
Architecture: 62 ARCHITECTURE
Design: GLENDA SIMPSON GROUP OF COMPANIES
AIE Group:
Architectural: NEMETZ & ASSOCIATES LTD.
Environ-
mentals:

The diagram illustrates a proposed urban layout. At the top, a rectangular area is labeled "PROPOSED RESIDENTIAL BUILDING". Below it, a larger rectangular area is labeled "PROPOSED ADJACENT FARMLAND (BY OTHERS)". To the right of these areas, a dashed line boundary is labeled "FUTURE LINE". A small rectangular area at the bottom is labeled "PROPOSED DESTINITY HOUSE". The entire plan is bounded by a thick black line, with the label "SABA ROAD" positioned above the top boundary.

This architectural site plan illustrates the layout of a building complex relative to surrounding structures and property boundaries. The plan features several distinct sections:

- LEVEL 4-14 TOWER IN DISTANCE**: Located at the top right, this section shows a tall, rectangular tower footprint.
- NEIGHBOURING TOWER**: Located below the main building, this section shows a smaller tower footprint.
- LEVEL 4 AMENITY SPACE**: Located to the right of the main building, this section shows a green-colored area representing amenities.
- NEIGHBOURING PARKING STRUCTURE**: Located at the top left, this section shows a parking structure footprint.
- LEVELS 1-3 PARKING**: Located at the far top right, this section shows a parking structure footprint.
- PROPERTY LINE**: Two horizontal lines running across the top and bottom of the plan indicate the property boundary.
- LEVELS 1-4**: A vertical label on the right side indicates the four levels of the main building.
- STAIRS**: A vertical label on the right side indicates the location of stairs.
- CORE**: A vertical label on the right side indicates the location of the core.

The main building itself is a large, multi-story structure with numerous windows and a grid-like pattern. It is surrounded by various green and grey shaded areas representing different zones or spaces.

**NORTH ELEVATION WITH MIRRORED
ELEVATION OF NEIGHBOURING TOWER**

This architectural site plan illustrates the proposed footprint of a building relative to surrounding property boundaries. The building's footprint is outlined in black, with a hatched pattern indicating the interior structure. The plan includes several labels:

- PROPERLY LINE**: A dashed line running horizontally across the top of the site.
- FUTURE LANE**: A dashed line running vertically down the center of the site.
- PROPOSED ADJACENT
MULTI-FAMILY
(BY OTHERS)**: A label positioned near the bottom center, identifying an adjacent building.

The plan also shows a detailed elevation view of a corner of the building's exterior wall on the right side.

This drawing supersedes previous issues. Do not retain those drawings.

any discrepancies to the Architect prior to construction. Dimensions are taken to face of exterior sheathing, face of concrete block, center of stud for interior partitions, and centerline of demising wall, unless noted otherwise on the drawing.

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004711
DODGE COUNTY ATTORNEY

2018-09-20

2019-10-0
2019-11-0
DP RESUBMISSION

卷之三

DATE 11/14/2019 4:27:45 PM
DRAWN BY JH

PROJECT NO. 219171

COONEY ROAD
STREETSCAPE

卷之三

0000000000

1 COONEY ROAD STREETSCAPE
DP00-04-00 SCALE: 1/16" = 1'-0"

1
DP00-C




CONSULTANT INFORMATION
CML CONNECT LANDSCAPE ARCHITECTURE
Landscape Architectural Services
GORDON & SONS GROUP OF COMPANIES
Metzler Associates Ltd.
Metzler & Associates Ltd.
Toronto

NOT FOR
CONSTRUCTION

PROJECT INFORMATION

COONEY ROAD
TOWER

6333 COONEY ROAD
RICHMOND, BC

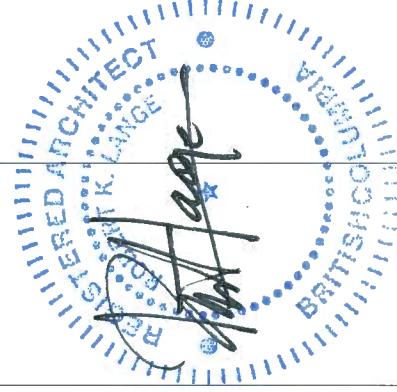

DP 17-791045 Reference Plan
Nov 20, 2019



SCALE	DATE	11/14/2019 4:32:56 PM
ISSUED	DRAWN BY	JH
DEVELOPMENT PERMIT	CHESTERBY	SH
APPLICATION	PROJECT NO.	21971
RE-SUBMISSION		
OP-RESUBMISSION		
OP-RESUBMISSION		
OP-RESUBMISSION		

DP000-03-00
DRAWING NO.

DP 17-791045 Reference Plan
Nov 20, 2019



City of Richmond

Report to Development Permit Panel

To: Development Permit Panel

Date: November 19, 2019


From: Wayne Craig
Director of Development

File: DP 18-797785

Re: **Application by Sian Group Investments Inc. for a Development Permit at 9680 Williams Road (formerly 9620, 9640, 9660 & 9680 Williams Road)**

Staff Recommendation

That a Development Permit be issued which would permit the construction of 28 townhouse units, including six affordable housing units, at 9680 Williams Road (formerly 9620, 9640, 9660 & 9680 Williams Road) on a site zoned “Medium Density Town Housing (ZT82) – Williams Road”.

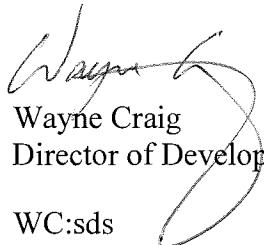
Wayne Craig
Director of Development

WC:sds
Att. 3

Staff Report

Origin

Sian Group Investments Inc. has applied to the City of Richmond for permission to develop 28 townhouse units, including six affordable housing units, at 9680 Williams Road (formerly 9620, 9640, 9660 & 9680 Williams Road). The subject site is being rezoned from “Single Detached (RS1/E)” to “Medium Density Town Housing (ZT82) – Williams Road” under Bylaw 9731 (RZ 15-715406), which received third reading following the Public Hearing on July 17, 2017. The site currently contains four single-family dwellings, which will be demolished.

A Servicing Agreement (SA 18-813841) is also associated with the proposal, which is a condition of Building Permit issuance and includes, but is not limited to, the following improvements:

- new concrete sidewalk and grassed and treed boulevard along the Williams Road frontage; and
- upgrades to the public walkway along the east property line, including new concrete sidewalk, boulevard and lighting.

Development Information

Please refer to attached Development Application Data Sheet (Attachment 1) for a comparison of the proposed development data with the relevant Bylaw requirements.

Background

Development surrounding the subject site is as follows:

To the North: Across Williams Road, single-family dwellings on lots zoned “Single Detached (RS1/E)” and “Single Detached (RS1/K)”.

To the East: Across an approximately 3.0 m wide City-owned public walkway, the site of a rezoning (RZ 15-700431) and a Development Permit application (DP 17-792931) to develop 18 townhouse units. The rezoning bylaw received third reading on February 20, 2017.

To the South: Duplex and single-family dwellings on lots zoned “Single Detached (RS1/E)” fronting Swansea Drive.

To the West: Fraserview Intermediate Care Lodge on a lot zoned “Health Care (HC)”.

Rezoning and Public Hearing Results

The Public Hearing for the rezoning of this site was held on July 17, 2017. No concerns regarding the rezoning application were expressed at the Public Hearing and the rezoning bylaw received second and third readings.

Informational signage has been installed on the property and no correspondence has been received regarding the proposal.

Staff Comments

The proposed scheme attached to this report has satisfactorily addressed the staff comments identified as part of the review of the subject Development Permit application. In addition, it complies with the intent of the applicable sections of the Official Community Plan (OCP) and is generally in compliance with the “Medium Density Town Housing (ZT82) – Williams Road” (no zoning variances are requested).

Advisory Design Panel Comments

The Advisory Design Panel (ADP) reviewed the proposal on August 22, 2018. A copy of the relevant excerpt from the Advisory Design Panel Minutes from August 22, 2018 is attached for reference (Attachment 2). The design response from the applicant has been included immediately following the specific Design Panel comments and is identified in ‘***bold italics***’.

Analysis

Conditions of Adjacency

- The building height of the rear units is 8.8 m (two storeys) in response to the single-family rear yard adjacency to the south. In addition, a 4.5 m rear yard setback to the ground floors and a 6.0 m rear yard setback to the second floors of the rear units are proposed to provide an improved interface.
- Along the east property line there is an approximately 3.0 m wide City-owned public walkway. The units along this interface, including all of the affordable housing units, are setback 4.0 m from the east property line, oriented towards the public walkway and contain individual entries for pedestrian access.
- In order to accommodate required improvements to the public walkway (i.e. new pedestrian lighting, widened sidewalk and grassed boulevard), a 1 m wide statutory right-of-way (SRW) along the east property line has been secured at rezoning.
- To the west is a community care facility, significantly setback from Williams Road. The proposed interior side yard setback is 4.5 m to the ground and second floors of the units. In addition, an approximately 7.5 m setback from the west property line to the third floor of the townhouse building along Williams Road is proposed, in order to address the interface and provide a transition from the adjacent property.
- Windows have been located carefully to avoid adjacent overlook and privacy concerns.
- Retaining walls will be provided along the south property line in order to provide usable yard space for the proposed units (up to 0.7 m in height). A lower 1.0 m high wood fence will be provided on top of the retaining wall to reduce the apparent height of the grade for the properties to the south, but also maintain privacy.
- Perimeter drainage will be required as part of the Building Permit to ensure storm water is managed and addressed through the development and will not impact neighbouring properties.
- The proposal includes two units with rooftop decks to provide private outdoor space. The visual impact of the rooftop decks is minimized by the location of the units. The units are located in the middle of the site, behind the units fronting Williams Road and in front of the units with single-family adjacency, oriented towards the internal drive-aisle and a significant distance from adjacent properties and the street, addressing potential overlook and privacy concerns.

- A statutory right-of-way (SRW) allowing access to/from the adjacent future development sites through the subject site (over the entry driveway and internal drive aisle) has been secured at rezoning.

Urban Design and Site Planning

- Vehicular access to the proposed development is to be from Williams Road through a new driveway at the northeast corner of the site, with future connections to the neighbouring properties to the west, secured by a SRW.
- The layout of the townhouse buildings is oriented around two north-south internal maneuvering aisles and an east-west internal maneuvering aisle, providing access to the unit garages.
- Units along Williams Road will have direct pedestrian access from the street, units along the public walkway will have access from the walkway, and the internal units will have access from the drive-aisle.
- Six stacked affordable housing units are provided in one townhouse building located in the northeast portion of the site. As per the Housing Agreement secured at rezoning, the required affordable housing units include four two-bedroom units with a minimum floor area of 90 m² (980 ft²) and two studio units with a minimum floor area of 37 m² (400 ft²). The applicant is proposing to provide two one-bedroom units (approximately 45 m² (480 ft²)) on one level located on the ground floor and four three-bedroom units (approximately 109 m² (1,175 ft²)) on two levels located on the second and third floors, which will be reflected in the Housing Agreement to be brought forward to Council.
- Each affordable housing unit is allocated one vehicle parking space as per Zoning Bylaw 8500, located in an enclosed garage, for a total of six vehicle parking spaces.
- The market townhouse units all have two vehicle parking spaces in a double car garage. Vehicle parking spaces for eight units are proposed in tandem arrangement, for a total of 16 parking spaces (36% of the total required residential parking spaces), which is consistent with Zoning Bylaw 8500 maximum of 50%. A restrictive covenant to prohibit the conversion of the tandem garage area into habitable space has been secured at rezoning.
- A total of six visitor parking spaces will be provided, including an accessible parking space. The number of parking spaces proposed is in compliance with the minimum Zoning Bylaw 8500 requirement.
- Both internal and external bicycle parking spaces have been incorporated into the proposal and are in compliance with Zoning Bylaw 8500 requirements.
- The shared outdoor amenity area is located in a central location along the City-owned public walkway to provide direct pedestrian access to/from the walkway, maximize sunlight penetration and offer casual surveillance from the walkway and adjacent units. The size of the outdoor amenity area is consistent with the OCP requirement (min. 6.0 m² per unit).
- Cash-in-lieu of indoor amenity space was secured through rezoning (\$28,000) consistent with OCP policy.
- The required waste management enclosures, as well as the covered mailbox kiosk, have been incorporated into the design of the buildings to minimize visual impact and are of an appropriate size.

Architectural Form and Character

- The proposed building form contains window bays, entrance porches, gable roofs and balconies to provide articulation to the building façade and establish a residential scale.
- The street fronting units will have individual canopies with doors of alternating colour. A pedestrian scale is generally achieved along the public street and walkway, and internal drive-aisle, through the inclusion of variation in building form, projections, recesses, materials/colours and landscape features.
- The proposed building materials include hardi siding and hardi panel with different colours (incl. grey, brown and blue) to give each building or portion of the building a distinct top, middle and base.
- Trim and secondary roof elements are used to reduce the apparent height of the buildings.

Landscape Design and Open Space Design

- Tree preservation was reviewed at rezoning stage where 23 on-site trees were identified for removal. Based on a 2:1 compensation ratio stated in the OCP, 46 replacement trees are required. At rezoning stage, tree compensation was secured in the amount of \$11,500 in lieu of planting 23 replacement trees. An additional \$1,300 was secured through rezoning for tree compensation to replace one City tree identified for removal. The remaining 23 replacement trees are required to be planted as part of this Development Permit. The applicant is proposing to plant 32 replacement trees.
- Two off-site trees (tag# A & B) located on neighbouring properties were identified for protection. A tree survival security of \$2,000 was secured through rezoning for the retention of these trees.
- The proposal provides a pedestrian-oriented streetscape fronting Williams Road and the public walkway with a landscaped edge treatment, including trees, lawn, patio areas, low transparent fencing, and a gate to each individual unit.
- Private outdoor space is provided for all units, typically with a patio, lawn area and landscaping. Various hedges, shrubs and ground covers have been selected to ensure the landscape treatment remains interesting throughout the year. The private outdoor space for two units is provided on individual rooftop decks of approximately 51 m^2 (550 ft^2) in area. Private outdoor space in the form of yard space or balconies is provided for the affordable housing units.
- Pockets of landscaping will be provided along the drive-aisle to soften the internal streetscape. Pedestrian access, tree planting, a variety of shrubs, and fencing will be provided at the north end of the internal drive-aisle to provide visual interest at the terminus along Williams Road.
- An irrigation system will be provided for the proposed landscaping on-site.
- The units with the rooftop decks will include a hose bib for irrigation and the potential for roof top urban agriculture.
- A children's play area is proposed in the shared outdoor amenity area, and play equipment has been chosen to provide different play opportunities (i.e. climbing, balance, motor skills) that can be used by different age groups and for multiple purposes. Seating is provided nearby for caregivers.
- The vehicle entrance, area in front of the shared outdoor amenity, end of the drive-aisle, and surface parking spaces will be treated with permeable pavers for better water infiltration and variety in paving surfaces.

- In order to ensure that the proposed landscaping works are completed, the applicant is required to provide a landscape security of \$113,843.95 in association with the Development Permit.

Crime Prevention Through Environmental Design

- Windows and balconies are located to increase the visual presence and surveillance along Williams Road, the public walkway, the amenity area, as well as the internal drive aisle. All entrances are visible and overlooked by pedestrians or by neighbour's windows.
- Low permeable fencing and low landscaping are provided to maximum clear unobstructed views and casual surveillance opportunities.
- Landscaping and fencing is provided along the street edge to distinguish the public realm and private space.
- Good neighbour fencing (approximately 1 m high) is provided around the perimeter of the site to encourage interaction between neighbours and foster a sense of community.
- Security lighting will be installed including wall mounted lighting and bollard lighting to provide adequate outdoor security illumination.

Sustainability

- As the application was submitted prior to the introduction of the Step Code requirement, the applicant has provided a report produced by a Certified Energy Advisory to confirm that the proposed townhouse units will be designed to achieve an EnerGuide rating of 82. The report prepared by the Energy Advisor is on file and will be utilized through the Building Permit review process to ensure these measures are incorporated in the Building Permit drawings. The applicant must submit an acceptable Building Permit application prior to December 31, 2019 to continue to be grandfathered.
- An air source heat pump system will be used for this development. The heat pump units have been located away from the street and will be screened by a low wood lattice fence.
- The architect advised that the following design/features are incorporated into the proposal:
 - Energy star windows to alleviate heating and cooling energy consumption;
 - The use of low-flow water fixtures, low-energy lighting and high energy efficiency appliances;
 - Durable and long-lasting materials that can reduce building maintenance;
 - Permeable ground cover and planting to absorb rainwater runoff and reduce load on municipal sewers; and
 - Interior paint with low VOC content.

Accessible Housing

- The proposed development includes two convertible units that are designed with the potential to be easily renovated to accommodate a future resident in a wheelchair. The potential conversion of these units will require installation of a chair lift in the staircase of Units 21 & 22.
- All of the proposed units incorporate aging in place features to accommodate mobility constraints associated with aging. These features include:
 - stairwell hand rails;
 - lever-type handles for plumbing fixtures and door handles; and

- solid blocking in washroom walls to facilitate future grab bar installation beside toilets, bathtubs and showers.

Conclusions

As the proposed development would meet applicable policies and Development Permit Guidelines, staff recommend that the Development Permit be endorsed, and issuance by Council be recommended.

The list of Development Permit Considerations is included in Attachment 3, which has been agreed to by the applicant (signed concurrence on file).



Steven De Sousa
Planner 1

SDS:cas

Attachment 1: Development Application Data Sheet

Attachment 2: Excerpt from the Meeting Minutes of the ADP (August 22, 2018)

Attachment 3: Development Permit Considerations



City of Richmond

Development Application Data Sheet

Development Applications Department

DP 18-797785

Attachment 1

Address: 9680 Williams Road (formerly 9620, 9640, 9660 & 9680 Williams Road)

Applicant: Sian Group Investments Inc. Owner: Sian Group Investments Inc.

Planning Area(s): Broadmoor

Floor Area Gross: 4,404 m² (47,400 ft²) Floor Area Net: 3,207 m² (34,520 ft²)

	Existing	Proposed
Site Area:	4,393.5 m ² (47,291 ft ²)	No change
Land Uses:	Single-family residential	Multiple-family residential
OCP Designation:	Neighbourhood Residential (NRES)	No change
Zoning:	Single Detached (RS1/E)	Medium Density Town Housing (ZT82) – Williams Road
Number of Units:	4	28

	Bylaw Requirement	Proposed	Variance
Floor Area Ratio:	Max. 0.73	0.73	None permitted
Lot Coverage – Buildings:	Max. 45%	44%	None
Lot Coverage – Non-porous:	Max. 65%	63%	None
Lot Coverage – Live Landscaping:	Min. 25%	25%	None
Setback – Front Yard (North):	Min. 4.5 m	4.5 m	None
Setback – Side Yard (East):	Min. 3.0 m	4.0 m	None
Setback – Side Yard (West):	Min. 3.0 m	3.0 m	None
Setback – Rear Yard (South):	First storey: Min. 4.5 m Second storey: Min. 6.0 m	First storey: 4.5 m Second storey: 6.0 m	None
Height:	Max. 12.0 m (3 storeys)	Front buildings: 11.5 m (3 storeys) Rear buildings: 8.8 m (2 storeys)	None
Lot Width:	Min. 40.0 m	80.5 m	None
Lot Depth:	Min. 35.0 m	54.8 m	None
Lot Size:	N/A	4,393.5 m ²	None

Off-street Parking Spaces – Regular (R) / Visitor (V):	Min. 2 (R) and 0.2 (V) per unit	2 (R) and 0.2 (V)	None
Off-street Parking Spaces – Affordable Housing (A):	Min. 1 per unit = 6	6	None
Off-street Parking Spaces – Accessible:	Min 2% when three or more visitor stalls required = 1	1	None
Total off-street Spaces:	Min. 44 (R), 6 (V) and 6 (A) = Min. 56	44 (R), 6 (V) and 6 (A) = 56	None
Tandem Parking Spaces:	Permitted – Max 50% of required spaces	36%	None
Small Car Parking Spaces:	Max. 50%	34%	None
Bicycle Parking Spaces – Class 1:	Min. 1.25 per unit	1.35 per unit	None
Bicycle Parking Spaces – Class 2:	Min. 0.2 per unit	0.2 per unit	None
Bicycle Parking Spaces – Total:	Min. 35 (Class 1) and 6 (Class 2)	38 (Class 1) and 6 (Class 2)	None
Amenity Space – Indoor:	Min. 70 m ² or cash-in-lieu	Cash-in-lieu	None
Amenity Space – Outdoor:	Min. 6 m ² per unit = 168 m ²	173 m ²	None

**Excerpt from the Minutes from
The Design Panel Meeting**

**Wednesday, August 22, 2018 – 4:00 p.m.
Rm. M.1.003
Richmond City Hall**

DP 18-797785 - 28-UNIT TOWNHOUSE DEVELOPMENT

ARCHITECT: Eric Law Architect

PROPERTY LOCATION: 9620, 9640, 9660 and 9680 Williams Road

Applicant's Presentation

Eric Law, Eric Law Architect, and Denitsa Dimitrova, PMG Landscape Architects, presented the project and answered queries from the Panel on behalf of the applicant.

Panel Discussion

Comments from Panel members were as follows:

- understand the constraints on the tight site; however, concerned that Buildings A and B are in close proximity to each other, specifically on the upper floors; consider increasing the distance between these two buildings to at least 25 to 30 feet;

The distances between Buildings A and B at 2/F and 3/F have been increased to 27'-2" (8.28 m) to 28'-9" (8.92 m). Windows on Unit 5 and 6 are re-oriented to face the drive-aisle to avoid overlook.

- consider installing garage doors for the carport to enhance its appearance as it is close to the site entry; the open carport could also pose a potential CPTED issue at night;

Garage doors are added to Building A to address CPTED issues.

- consider introducing a clerestory strip of glazing along the top band of each garage door to mitigate the appearance of the long row of garage doors; would soften the elevational treatment along the internal drive aisles; also consider allowing natural lighting into the garages;

Garage door glazing added.

- the dark, long and ambiguous spaces between Buildings D, E and F could pose potential CPTED concerns; consider relocating the entry gates for these spaces along the internal drive aisle;

An entry gate is provided near the drive aisle to stop public entry to the space.

- relationship of the buildings in the subject development with the neighbouring buildings is nicely resolved, e.g. height changes and variation in roof treatments are appropriate;

Noted.

- consider introducing an access point immediately adjacent to the Hydro kiosk to enhance pedestrian circulation and accessibility for residents on the west side of the subject development;

The Hydro kiosk location is slightly adjusted to allow for a pedestrian path to the west side of the development.

- consider consolidating the garbage and recycling spaces in one location for the convenience of residents;

The garbage and recycling areas are intentionally separate to avoid mix-up.

- support the proposed location of the outdoor amenity space as it will get good sun exposure in the afternoon;

Noted.

- consider installing textured pavers adjacent to the outdoor amenity space to enhance the safety of children playing in the area; will serve as a traffic calming measure and demarcate the outdoor amenity space;

Permeable pavers have been installed on the drive aisle adjacent to the outdoor amenity area to enhance the safety of children playing in the area.

- review the need for flat roofs at the back of Buildings A and B;

Flat roofs are to provide private outdoor space for the units.

- support the proposed colour palette which are clean and harmonious; however, consider introducing variation of colours to the front doors to provide individual identity to units;

Variation of front door colours is provided to the units.

- ensure adequate buffering to the units immediately adjacent to the outdoor amenity area;

Landscape buffer provided to the units adjacent to the outdoor amenity area.

- appreciate the pedestrian-friendly approach for the site and unit entries in Building A; consider a similar approach for Buildings B and C; consider relocating the Hydro kiosk to the electrical room; also consider change of texture on the internal drive aisle adjacent to the front doors of units in Buildings B and C to create a sidewalk feel on the edges and enhance the front door entry to the units;

The paving pattern of the sidewalk has been adjusted. The Hydro kiosk cannot be relocated due to requirements from BC Hydro.

- site coverage feels tight; amount of hard surface treatment is significant; two end units with flat roofs feel like special units; eliminating these units could provide Buildings A and B some breathing room;

Keeping more units will provide compact and denser living in this area. Eliminating two units will have significant adverse financial implications.

- the five-foot high wood fence is too high as the site is already dense; a three-foot high fence is adequate as it will provide opportunities for social interaction with neighbours;

3' high fence is now proposed along the property line.

- consider differentiating the texture of paving for the sidewalks along the internal drive aisle and for the portion of the drive aisle adjacent to the outdoor amenity area;

The paving pattern of the sidewalk has been adjusted.

- concerned on the potential CPTED concerns posed by the design of the carport;
Garage door added to Building A.
- provision of sliding doors for Building G convertible units could be problematic;

Sliding doors are now provided for wheelchair access.

- appreciate the proposed site lay-out given the constraints of the site;
Noted.

- the 3-storey building heights are tall in proportion to their width; investigate opportunities for improving daylight penetration into the area, e.g. through changes in the scale and design of the dormer to improve daylight penetration into the courtyard;

The 3 storey building is in the north-south orientation, and the gap in the north-south orientation allows daylight penetration into the courtyard from the south.

- concerned with the symmetry of unit plans for Buildings A and B; consider offsetting some alignments, e.g. bedrooms, living rooms and balconies, to improve privacy and livability of units;

The location of windows and balconies at the 3/F are now offset to improve privacy.

- consider installing an outward-swinging door in lieu of an inward-opening door for the powder room on level 2 of the affordable housing units to increase usable floor space; also consider installing a pocket door on the ground floor across the wall at the back of the closet to provide more floor space;

The door swings are adjusted. Pocket door provided on G/F.

- consider installing a pocket door for the powder room on the ground floor of the convertible units;

Pocket door adjusted in convertible units.

- considering widening the opening for the pocket door in the powder room on level 1 of type B3 convertible unit to enhance its accessibility; the applicant is also advised not to install an inward-swinging door for the washroom on level 2 of the same unit type;

Pocket doors are provided in the unit.

- appreciate the provision for Garaventa lift in the convertible units;

Noted.

- consider using low-flow fixtures and EnerGuide-rated appliances to enhance sustainability in the project;

Low flow fixtures and Energuide appliances noted on Drawing A1.

- concerned on the proposed location of the outdoor air source heat pumps particularly for the middle townhouse units; locating them around the entrances would not be visually appealing and could pose noise concerns; consider a louvered enclosure to mitigate noise concerns and improve their appearance;

The outdoor heat pump will be located in the private yard. Wood louvered enclosure proposed on Drawing A2A.

- gable and shed is the predominant roof form in the subject development; however, the 2 ½ storey-townhouse units along Williams Road introduce a hip roof; consider a gable and shed form for these units to be consistent with the rest of the development;

Building C roof adjusted to have a shed roof form.

- shed roofs coming together almost on the same ridge line creates visual tension; consider dropping the lower pitched roof from 5/12 to 4/12; also consider enlarging the two-foot overhang for the shed roofs to enhance the overall roof form;

The main roof pitch is 5/12 on elevation and 2 ft. overhang is noted on section.

- consider flipping the triplex building (Building F) with the duplex building (Building E) to align the gap between these two buildings closer to the centre of the space between Buildings A and B;

Building E and F are flipped.

- hope that City could relax the requirement for duplexes and a triplex on the south side of the development to better utilize space and resources; the three separate buildings on the south side could be consolidated into one building block;

Duplex and triplex forms are in accordance with City policy.

- agree with Panel comment that the five-foot high fence be lowered to three feet;
This comment has been addressed as described above.
- not concerned with the slope on the outdoor amenity area as it is not too steep;
Noted.
- the area occupied by the central visitor parking space, recycling and garbage could be the best location for the outdoor amenity area in terms of solar exposure; if the outdoor amenity area could not be relocated, consider changing the configuration of the outdoor amenity space in order to shift the mail box to the south (i.e., shady) side;

The mail box has been moved to the south side of the amenity space.

- consider installing patios or decks in lieu of lawns for units in Buildings G and H as the small lawns would be difficult to maintain;

Lawn for these units have been removed, patios have been enlarged.

- tree management plan does not provide information on the condition of trees to be removed; better accounting of existing trees is needed; suggest that the cash-in-lieu for trees to be planted in Richmond should ensure that replacement trees be planted close to the site losing the trees;

Tree management plan has been revised to address this comment.

- consider softening the transition between the visitor parking space and the entrances to the convertible units; applicant could consider installing a small tree, public art or trellis feature to soften the transition;

Small tree has been proposed between the visitor parking space and the entrances to the convertible units.

- building transition to the single-family homes to the south is sufficient;
Noted.
- consider varying the colours for each townhouse unit to visually break down the horizontal massing;

Variations of colours are proposed to break down the massing. See Drawings A17-A20.

- agree with Panel comment to install an additional pedestrian walkway from Williams Road to the internal drive aisle to enhance pedestrian access to Buildings B and C;

Pedestrian walkway has been provided.

- applicant is encouraged to incorporate public art into the project as it would benefit the project; proposed walkway on the east side of the site could be a potential location for public art;

Client prefers to contribute to the public art fund.

- agree with Panel comments that the applicant has done a decent job on the site lay-out given the site constraints; applicant could have provided more legible landscape plans to help the Panel review the project;

This comment has been addressed.

- concerned on the carports in Building H which is close to the site entry; consider flipping Building H with Building C and relocating the outdoor amenity area to the west side;

The current location of the outdoor amenity is more centralized at the east and visually connected to the public walkway.

- review the need for the slope in the outdoor amenity area; consider eliminating it; also support the Panel comment to move the slope to the south side and locate the seating on the north side;

The slope is moved to the south side and the bench moved to the north side.

- support the comment to introduce glass to the garage doors;

Glazing added to the garage doors.

- consider eliminating the rooftop decks on Type A2 units at the south end of Buildings A and B to make the roofline of these units consistent with the rest of the units in the development and to mitigate their impact to the courtyard;

The roof top decks are for the private open space for the units.

- consider differentiating the architecture of buildings along Williams Road, i.e. Buildings A, B, C and H;

The intent is to have a more cohesive architectural language, but with some variation in details.

- support Panel comments on reducing the fence height;

This comment has been addressed.

- also support Panel comments that the City consider relaxing the requirements for duplexes and a triplex along the south side; could open up opportunities for increased on-site planting; and

Duplex and triplex forms are in accordance with City policy.

- agree with Panel comment regarding the provision of an additional pedestrian access point between Buildings B and C from the internal drive aisle to Williams Road.

Pedestrian access point provided.

Panel Decision

It was moved and seconded

That 18-797785 be supported to move forward to the Development Permit Panel subject to the applicant giving consideration to the comments of the Advisory Design Panel.

CARRIED



City of Richmond

ATTACHMENT 3

Development Permit Considerations

Development Applications Department
6911 No. 3 Road, Richmond, BC V6Y 2C1

Address: 9620, 9640, 9660 & 9680 Williams Road

File No.: DP 18-797785

Prior to forwarding the application to Council for approval, the developer is required to complete the following:

1. Final Adoption of Zoning Amendment Bylaw 9731.
2. Receipt of a Letter-of-Credit for landscaping in the amount of \$113,843.95. The letter-of-credit will not be returned until the Letter of Assurance, confirming the landscaping is installed as per the Development Permit, prepared by the Landscape Architect, is reviewed by staff.

Prior to Building Permit Issuance, the developer must complete the following requirements:

1. Installation of appropriate tree protection fencing around all trees to be retained as part of the development prior to any construction activities, including building demolition, occurring on-site. Tree protection fencing must be installed to City standard in accordance with the City's Tree Protection Information Bulletin TREE-03, and must remain in place until construction and landscaping on-site is completed.
2. Submission of a Construction Parking and Traffic Management Plan to the Transportation Department. Management Plan shall include location for parking for services, deliveries, workers, loading, application for any lane closures, and proper construction traffic controls as per Traffic Control Manual for works on Roadways (by Ministry of Transportation) and MMCD Traffic Regulation Section 01570.
3. Incorporation of energy efficiency, CPTED, sustainability and accessibility measures in Building Permit (BP) plans as determined via the Rezoning and/or Development Permit processes.
4. Enter into a Servicing Agreement* for the design and construction of engineering infrastructure improvements. Works include, but may not be limited to:

Water Works:

- Using the OCP Model, there is 652.0 L/s of water available at a 20 psi residual at the Williams Road frontage. Based on your proposed development, your site requires a minimum fire flow of 220.0 L/s.
- The Developer is required to:
 - Submit Fire Underwriter Survey (FUS) or International Organization for Standardization (ISO) fire flow calculations to confirm the development has adequate fire flow for onsite fire protection. Calculations must be signed and sealed by a Professional Engineer and be based on Building Permit Stage and Building designs.
 - Install a new fire hydrant at the south side of Williams Road as required to meet City requirement of 75mm spacing between hydrants for townhouse developments.
 - Provide a utility right of way for the required water meter chamber. The sizing of the required right of way shall be determined via the servicing agreement review process.
- At Developer's cost, the City will:
 - Cut and cap all existing water service connections along the Williams Road frontage.
 - Install one (1) new water service connection complete with meter and meter box (to be placed on-site) along Williams Road frontage.

Storm Sewer Works:

- The Developer is required to:
 - Provide a 3 m x 1.5 m SRW for future storm IC within development site.
 - Provide walkway drainage between Williams Rd and south property line.
- At Developer's cost, the City will:
 - Cut and cap all existing service connections and remove all existing IC's along Williams Road frontage.

Initial: _____

- Cut and cap the existing storm sewer service connections at the northwest and northeast corners of the development site.
- Install one new storm service connection complete with IC at the Williams Road frontage.

Sanitary Sewer Works:

- The Developer is required to:
 - Not start onsite excavation and/or foundation works until the City has completed the proposed rear yard sanitary connections. Also indicate this as a note on the site plan and SA design plans.
- Provide walkway At Developers cost, the City will:
 - Cut and cap the existing sanitary service connections and remove the existing ICs located at the south property line of the development site.
 - Upgrade the existing sanitary service connection and install a new IC at MH2162 located on the west property line, 8 metres north of the south property line. IC to be located within existing Statutory Right-of-Way.
 - All sanitary works to be completed prior to any onsite construction.

Frontage improvements:

- Williams Road
 - Remove existing driveways and replace with barrier curb.
 - Green bike paint with bike stencil along the bike lane in front of the driveway.
 - Construct new 1.5m wide concrete sidewalk next to the existing property line along the north side of the development site. This must be along the entire frontage of the development site from the most westerly point of 9620 Williams Road, to the most easterly point of 9680 Williams Road.
 - Provide remainder width to existing curb, with landscaped/treed boulevard between the proposed concrete sidewalk and existing road curb.
 - Provide transition to connect the existing sidewalks east and west of the development site.
- East side of the walkway, along the east property line of the development
 - Provide pedestrian lighting from Williams Road to Swansea Drive to a standard that is satisfactory to the City.
 - Provide 2.0 m wide concrete sidewalk and 1.0 m wide grassed boulevard.
 - Allow a wider access for the existing walkway on Williams Road - 1m x 1m SRW corner cut.
- The Developer is also required to coordinate with BC Hydro, Telus and other private communication service providers in order to:
 - Underground Hydro service lines.
 - Relocate or modify any existing power poles and/or guy wires within the property frontages.
 - To determine if above ground structures are required and coordinate locations onsite (Vista, PMT, LPT, Shaw cabinets, Telus Kiosks, etc) prior to a Development Permit Application submission.
 - Review street lighting levels along east frontage of the development site and upgrade lighting using LED fixtures.

General Comments:

- Additional legal agreements, as determined via the subject development's Servicing Agreement(s) and/or Development Permit(s), and/or Building Permit(s) to the satisfaction of the Director of Engineering may be required, including, but not limited to, site investigation, testing, monitoring, site preparation, de-watering, drilling, underpinning, anchoring, shoring, piling, pre-loading, ground densification or other activities that may result in settlement, displacement, subsidence, damage or nuisance to City and private utility infrastructure.
- Provide, prior to first SA design submission, a geotechnical assessment of preload and soil preparation impacts on the existing utilities fronting or within the development site, proposed utility installations, the adjacent developments and provide mitigation recommendations. Any mitigation recommendations shall be incorporated into the first SA design submission or if necessary prior to pre-load.
- The fill and retaining wall system that are proposed within the existing utility right of way along the south property line of the proposed site require an encroachment agreement. An encroachment agreement between the property owner and the City shall be required and finalized prior to the servicing agreement being approved.

5. If applicable, payment of latecomer agreement charges, plus applicable interest associated with eligible latecomer works.
6. If applicable, obtain a Building Permit (BP) for any construction hoarding. If construction hoarding is required to temporarily occupy a public street, the air space above a public street, or any part thereof, additional City approvals and associated fees may be required as part of the Building Permit. For additional information, contact the Building Approvals Department at 604-276-4285.

Note:

- * This requires a separate application.
- Where the Director of Development deems appropriate, the preceding agreements are to be drawn not only as personal covenants of the property owner but also as covenants pursuant to Section 219 of the Land Title Act.

All agreements to be registered in the Land Title Office shall have priority over all such liens, charges and encumbrances as is considered advisable by the Director of Development. All agreements to be registered in the Land Title Office shall, unless the Director of Development determines otherwise, be fully registered in the Land Title Office prior to enactment of the appropriate bylaw.

The preceding agreements shall provide security to the City including indemnities, warranties, equitable/rent charges, letters of credit and withholding permits, as deemed necessary or advisable by the Director of Development. All agreements shall be in a form and content satisfactory to the Director of Development.

- Additional legal agreements, as determined via the subject development's Servicing Agreement(s) and/or Development Permit(s), and/or Building Permit(s) to the satisfaction of the Director of Engineering may be required including, but not limited to, site investigation, testing, monitoring, site preparation, de-watering, drilling, underpinning, anchoring, shoring, piling, pre-loading, ground densification or other activities that may result in settlement, displacement, subsidence, damage or nuisance to City and private utility infrastructure.
- Applicants for all City Permits are required to comply at all times with the conditions of the Provincial *Wildlife Act* and Federal *Migratory Birds Convention Act*, which contain prohibitions on the removal or disturbance of both birds and their nests. Issuance of Municipal permits does not give an individual authority to contravene these legislations. The City of Richmond recommends that where significant trees or vegetation exists on site, the services of a Qualified Environmental Professional (QEP) be secured to perform a survey and ensure that development activities are in compliance with all relevant legislation.

Signed

Date



City of Richmond

Development Permit

No. DP 18-797785

To the Holder: Sian Group Investments Inc.

Property Address: 9680 Williams Road (formerly 9620, 9640, 9660 & 9680 Williams Road)

Address: c/o Eric Law
Law Architect Inc.
216 – 288 W. 8th Avenue
Vancouver, BC V5Y 1N5

1. This Development Permit is issued subject to compliance with all of the Bylaws of the City applicable thereto, except as specifically varied or supplemented by this Permit.
2. This Development Permit applies to and only to those lands shown cross-hatched on the attached Schedule "A" and any and all buildings, structures and other development thereon.
3. Subject to Section 692 of the Local Government Act, R.S.B.C.: buildings and structures; off-street parking and loading facilities; roads and parking areas; and landscaping and screening shall be constructed generally in accordance with Plans #1 to #3 attached hereto.
4. Sanitary sewers, water, drainage, highways, street lighting, underground wiring, and sidewalks, shall be provided as required.
5. As a condition of the issuance of this Permit, the City is holding the security in the amount of \$113,843.95. to ensure that development is carried out in accordance with the terms and conditions of this Permit. Should any interest be earned upon the security, it shall accrue to the Holder if the security is returned. The condition of the posting of the security is that should the Holder fail to carry out the development hereby authorized, according to the terms and conditions of this Permit within the time provided, the City may use the security to carry out the work by its servants, agents or contractors, and any surplus shall be paid over to the Holder. Should the Holder carry out the development permitted by this permit within the time set out herein, the security shall be returned to the Holder. The City may retain the security for up to one year after inspection of the completed landscaping in order to ensure that plant material has survived.
6. If the Holder does not commence the construction permitted by this Permit within 24 months of the date of this Permit, this Permit shall lapse and the security shall be returned in full.

Development Permit
No. DP 18-797785

To the Holder: Sian Group Investments Inc.

Property Address: 9680 Williams Road (formerly 9620, 9640, 9660 & 9680 Williams Road)

Address: c/o Eric Law
Law Architect Inc.
216 – 288 W. 8th Avenue
Vancouver, BC V5Y 1N5

7. The land described herein shall be developed generally in accordance with the terms and conditions and provisions of this Permit and any plans and specifications attached to this Permit which shall form a part hereof.

This Permit is not a Building Permit.

AUTHORIZING RESOLUTION NO.
DAY OF , .


ISSUED BY THE COUNCIL THE

DELIVERED THIS DAY OF , .

MAYOR




City of Richmond

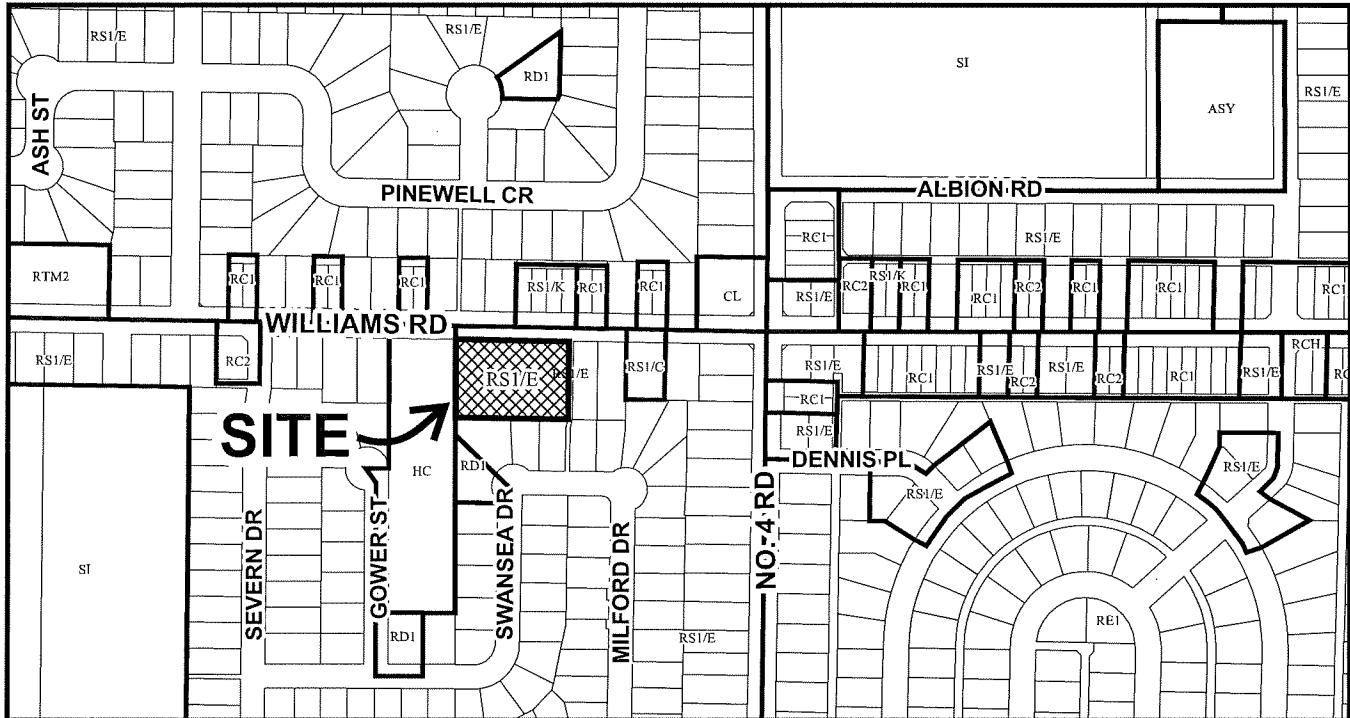

1	3	3	3	3	36	36	36	36	30	30	30	30	30	30	30	30	30	30	30
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WILLIAMS RD

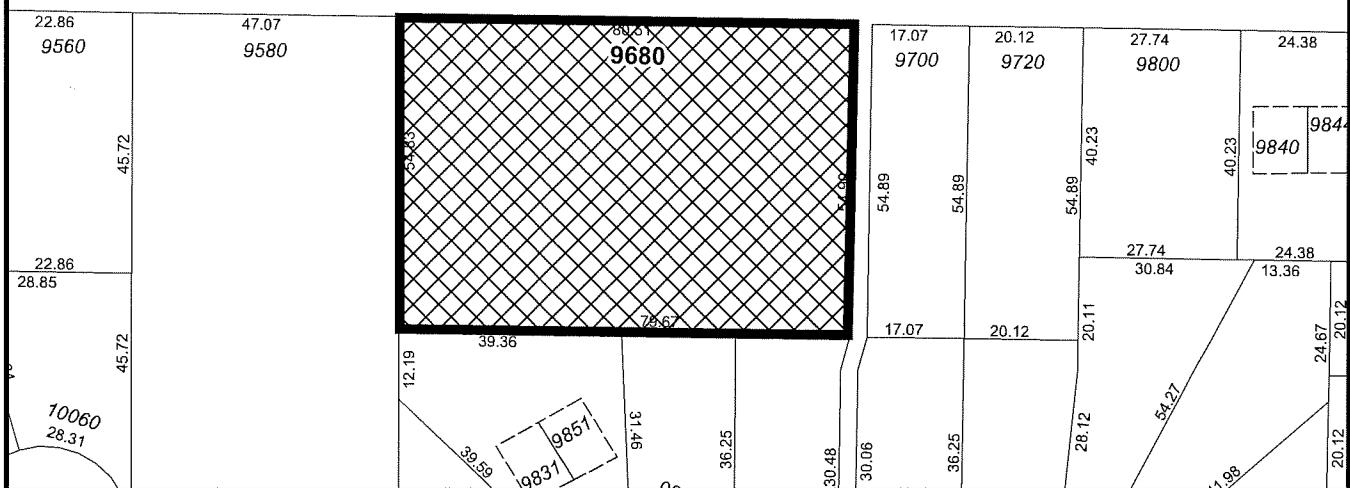

2	DP 18-797785 SCHEDULE "A"	Original Date: 01/19/18 Revision Date: 11/19/19 Note: Dimensions are in METRES
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ERIC LAW
ARCHITECT

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V7T 1N5
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FAX: (604) 505-2857

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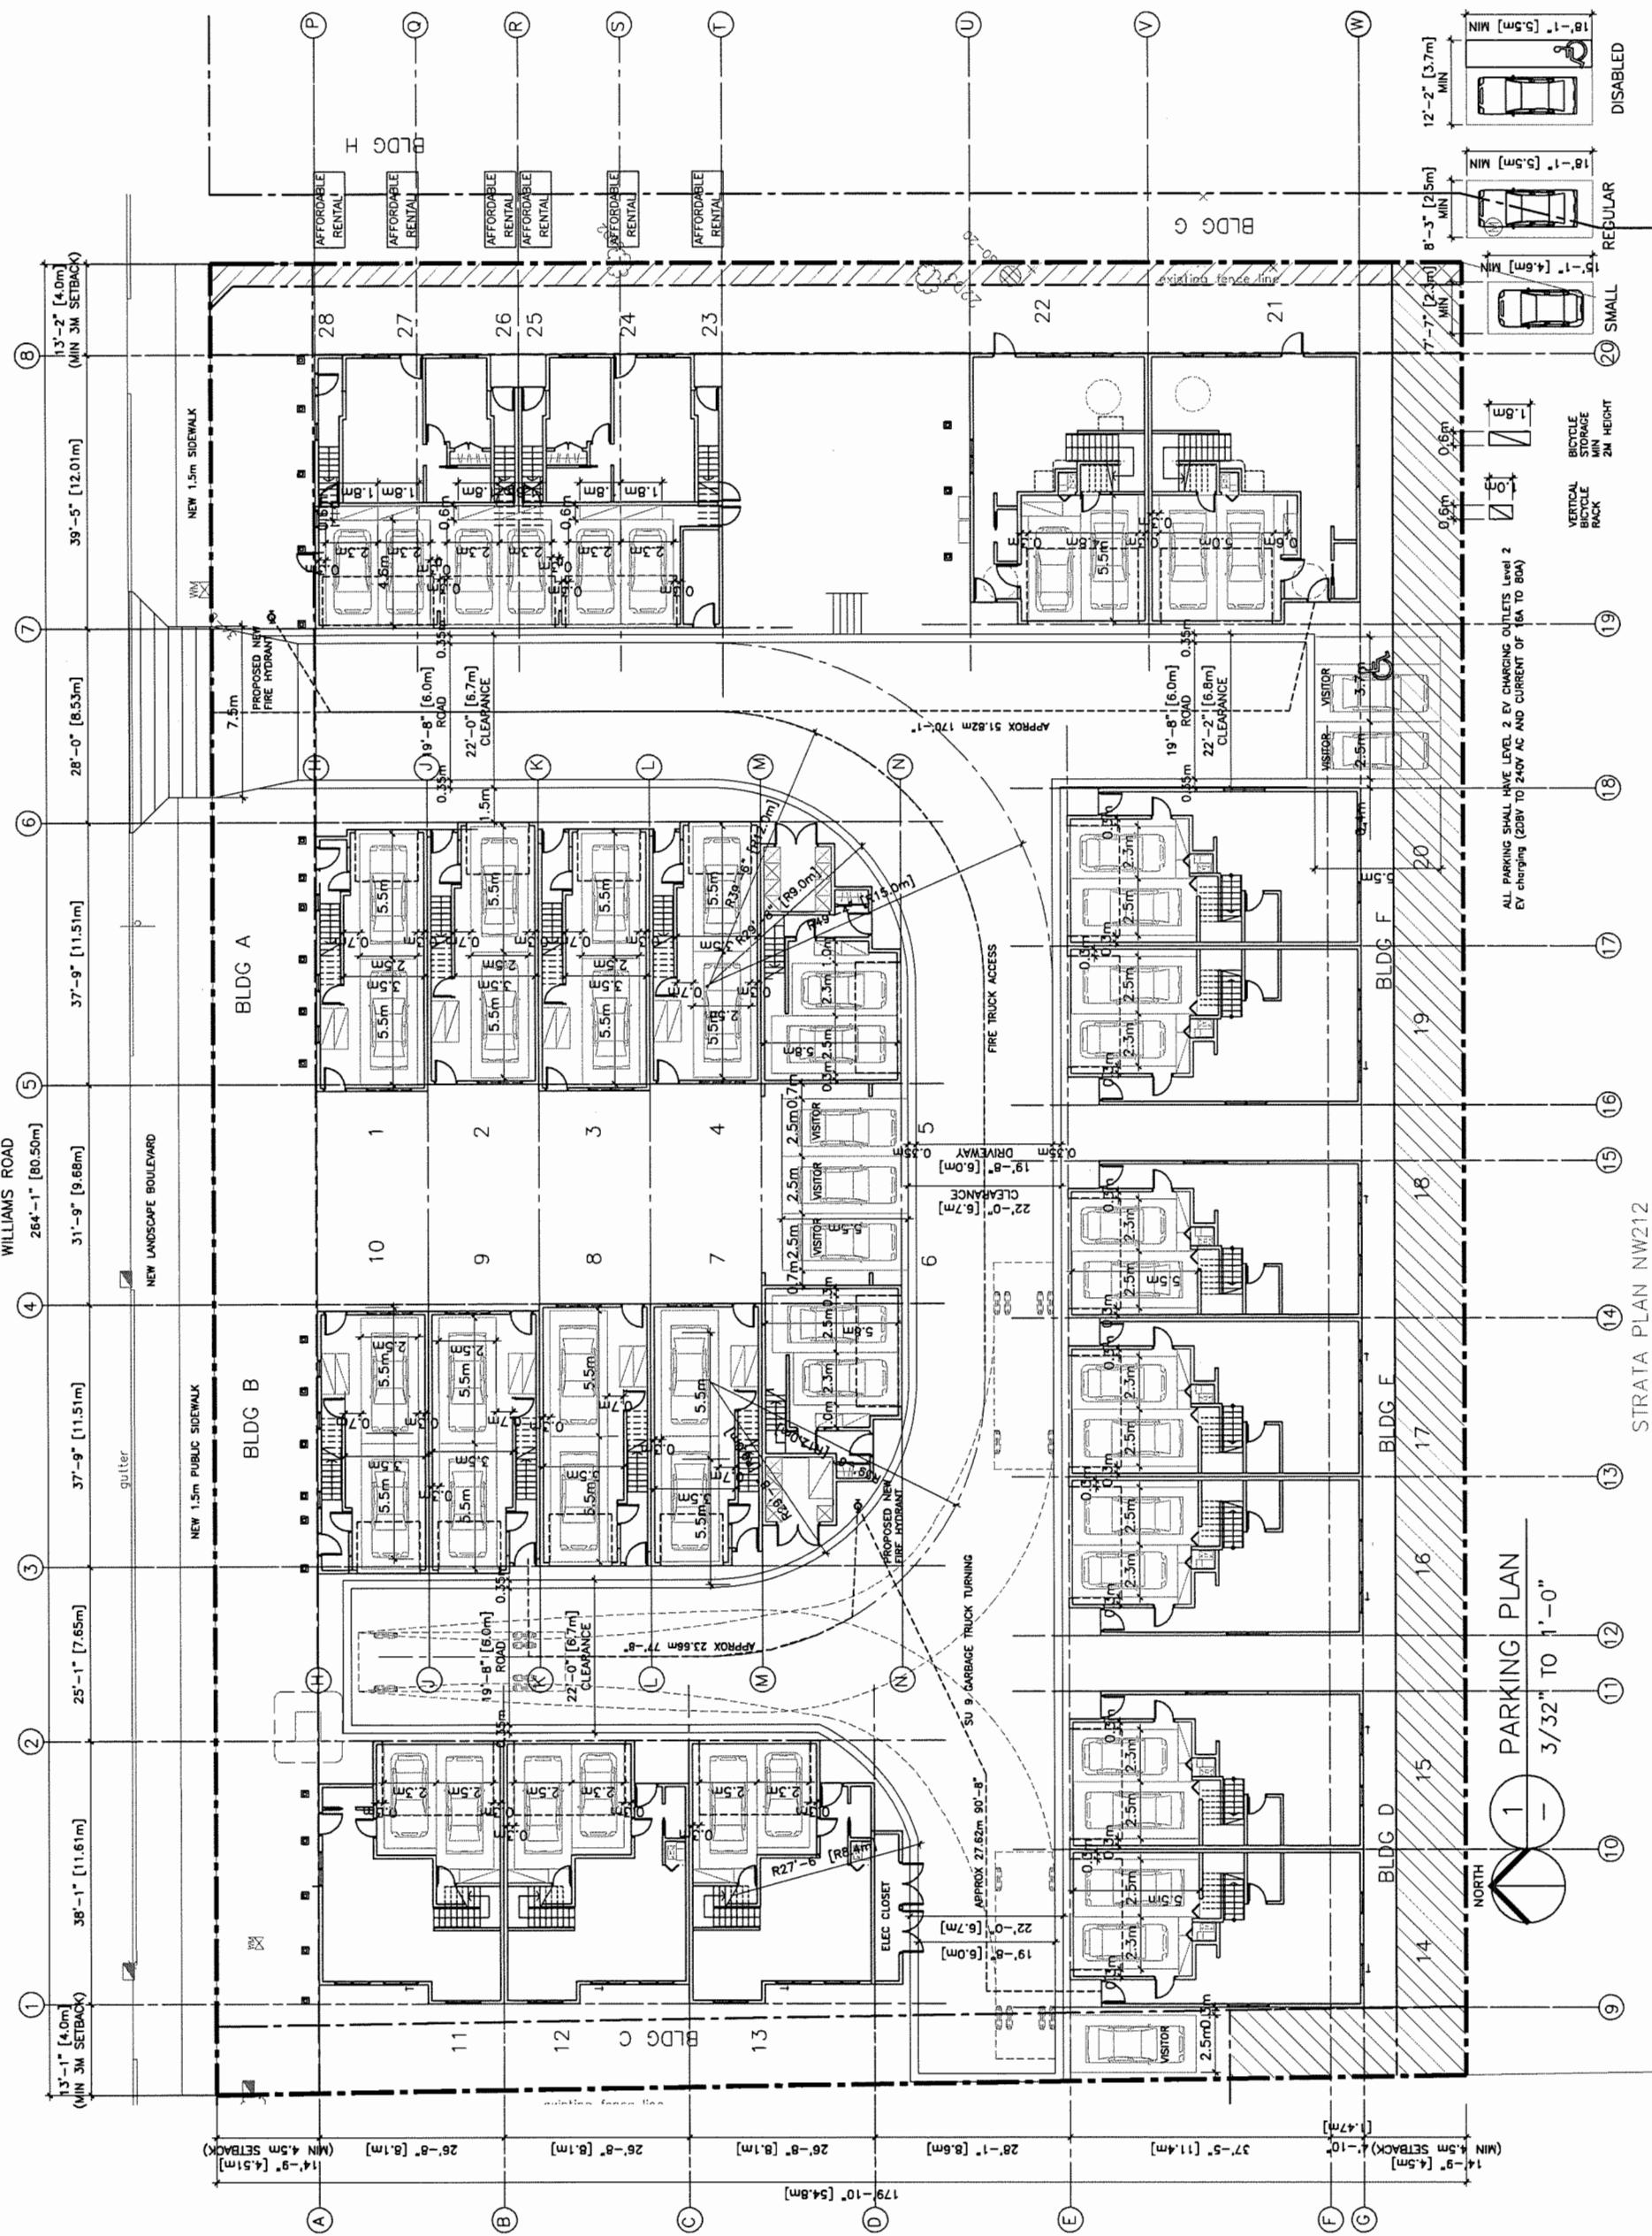
APPLICATION	
1.	2018.01.11 FOR DEVELOPMENT PERMIT
2.	2018.06.04 FOR CITY DP REVIEW
3.	2018.06.03 FOR CITY ADP REVIEW
4.	2019.10.19 FOR CITY REVIEW
5.	2019.11.19 FOR CITY REVIEW

PROPOSED TOWNHOUSE
AT
9620-9800

1. 201804 REVERSE PER CITY DP COMMENTS
REVISION

PROJECT NUMBER:	12-25
ISSUED:	11/18/2019
DRAWN BY:	EL
CHECKED BY:	EL
FILE NAME:	12-25_HAUL_001110.DWG

FILENAME: 13-12_MH_R_13-113-0FF.DRQ





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ISSUED
1. 2018.01.11 FOR DEVELOPMENT PERMIT APPLICATION
2. 2018.06.04 FOR CITY DP REVIEW
3. 2018.08.03 FOR CITY ADP REVIEW
4. 2019.10.19 FOR CITY REVIEW
5. 2019.11.19 FOR CITY REVIEW



**PROPOSED TOWNHOUSE
AT
9620-9800
WILLIAMS RD RICHMOND**

SITE PLAN 2/F

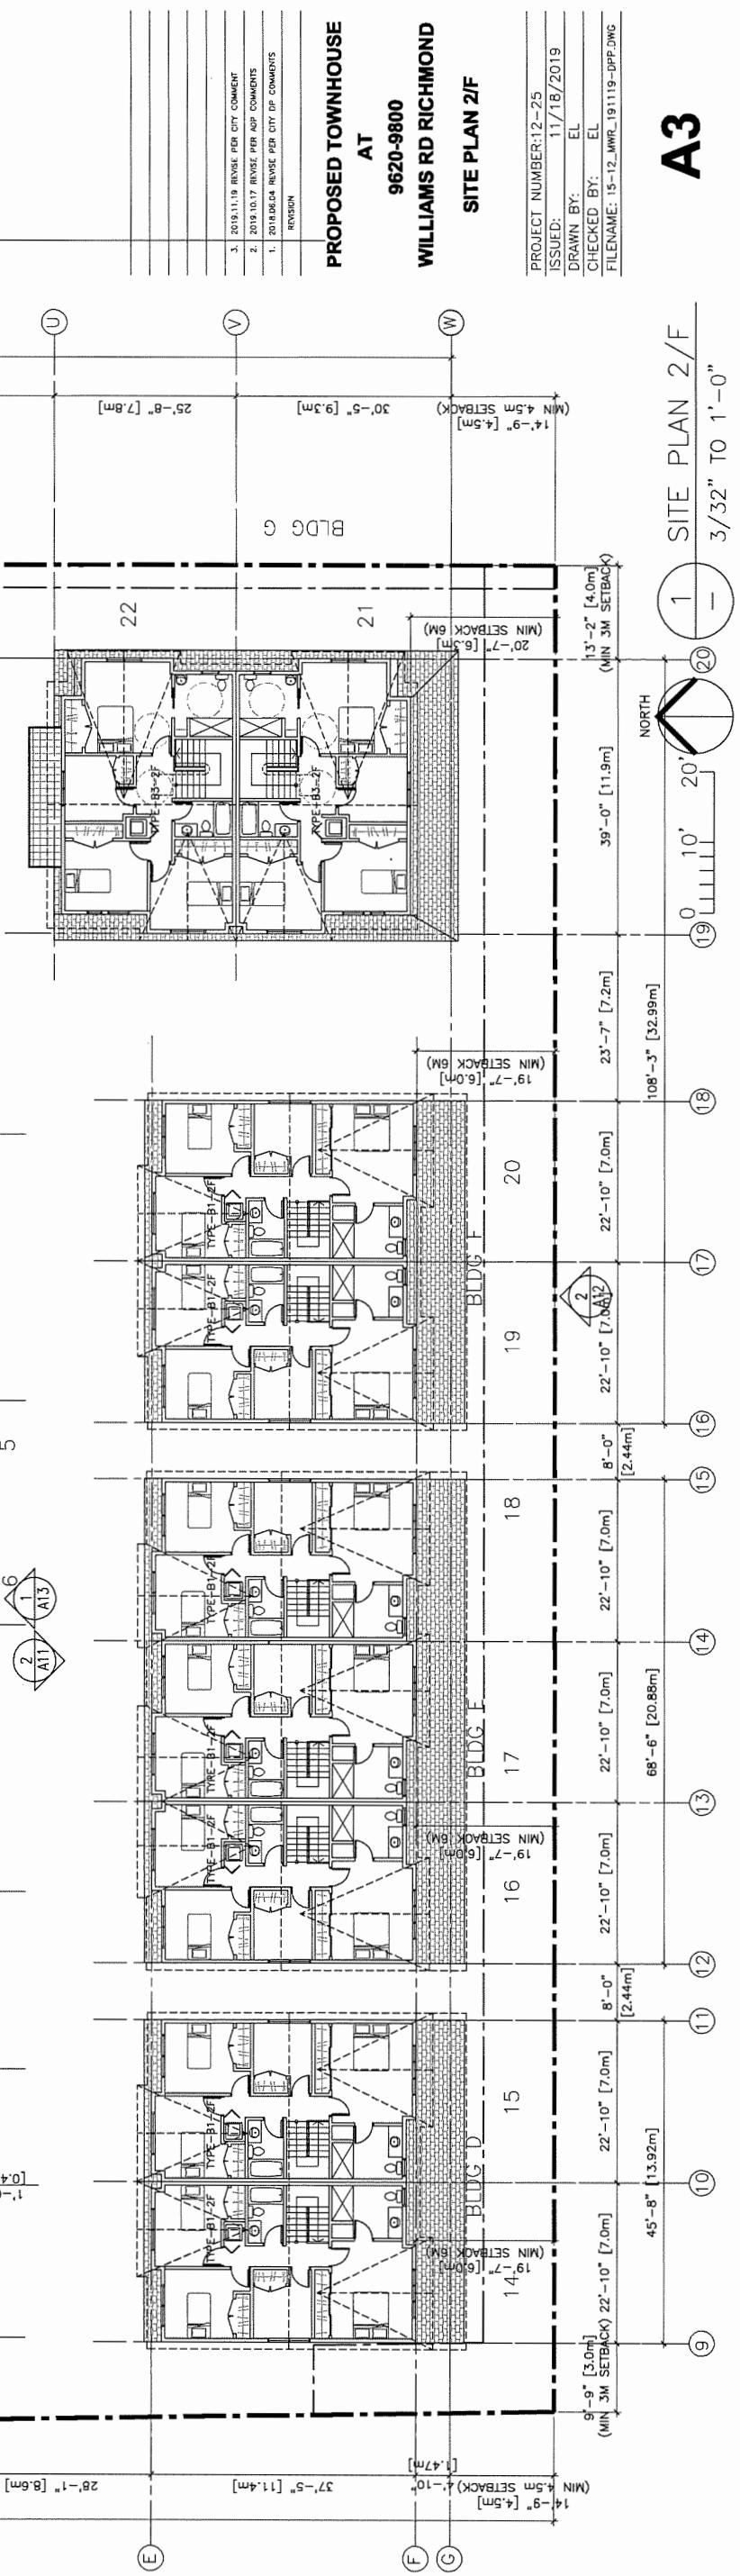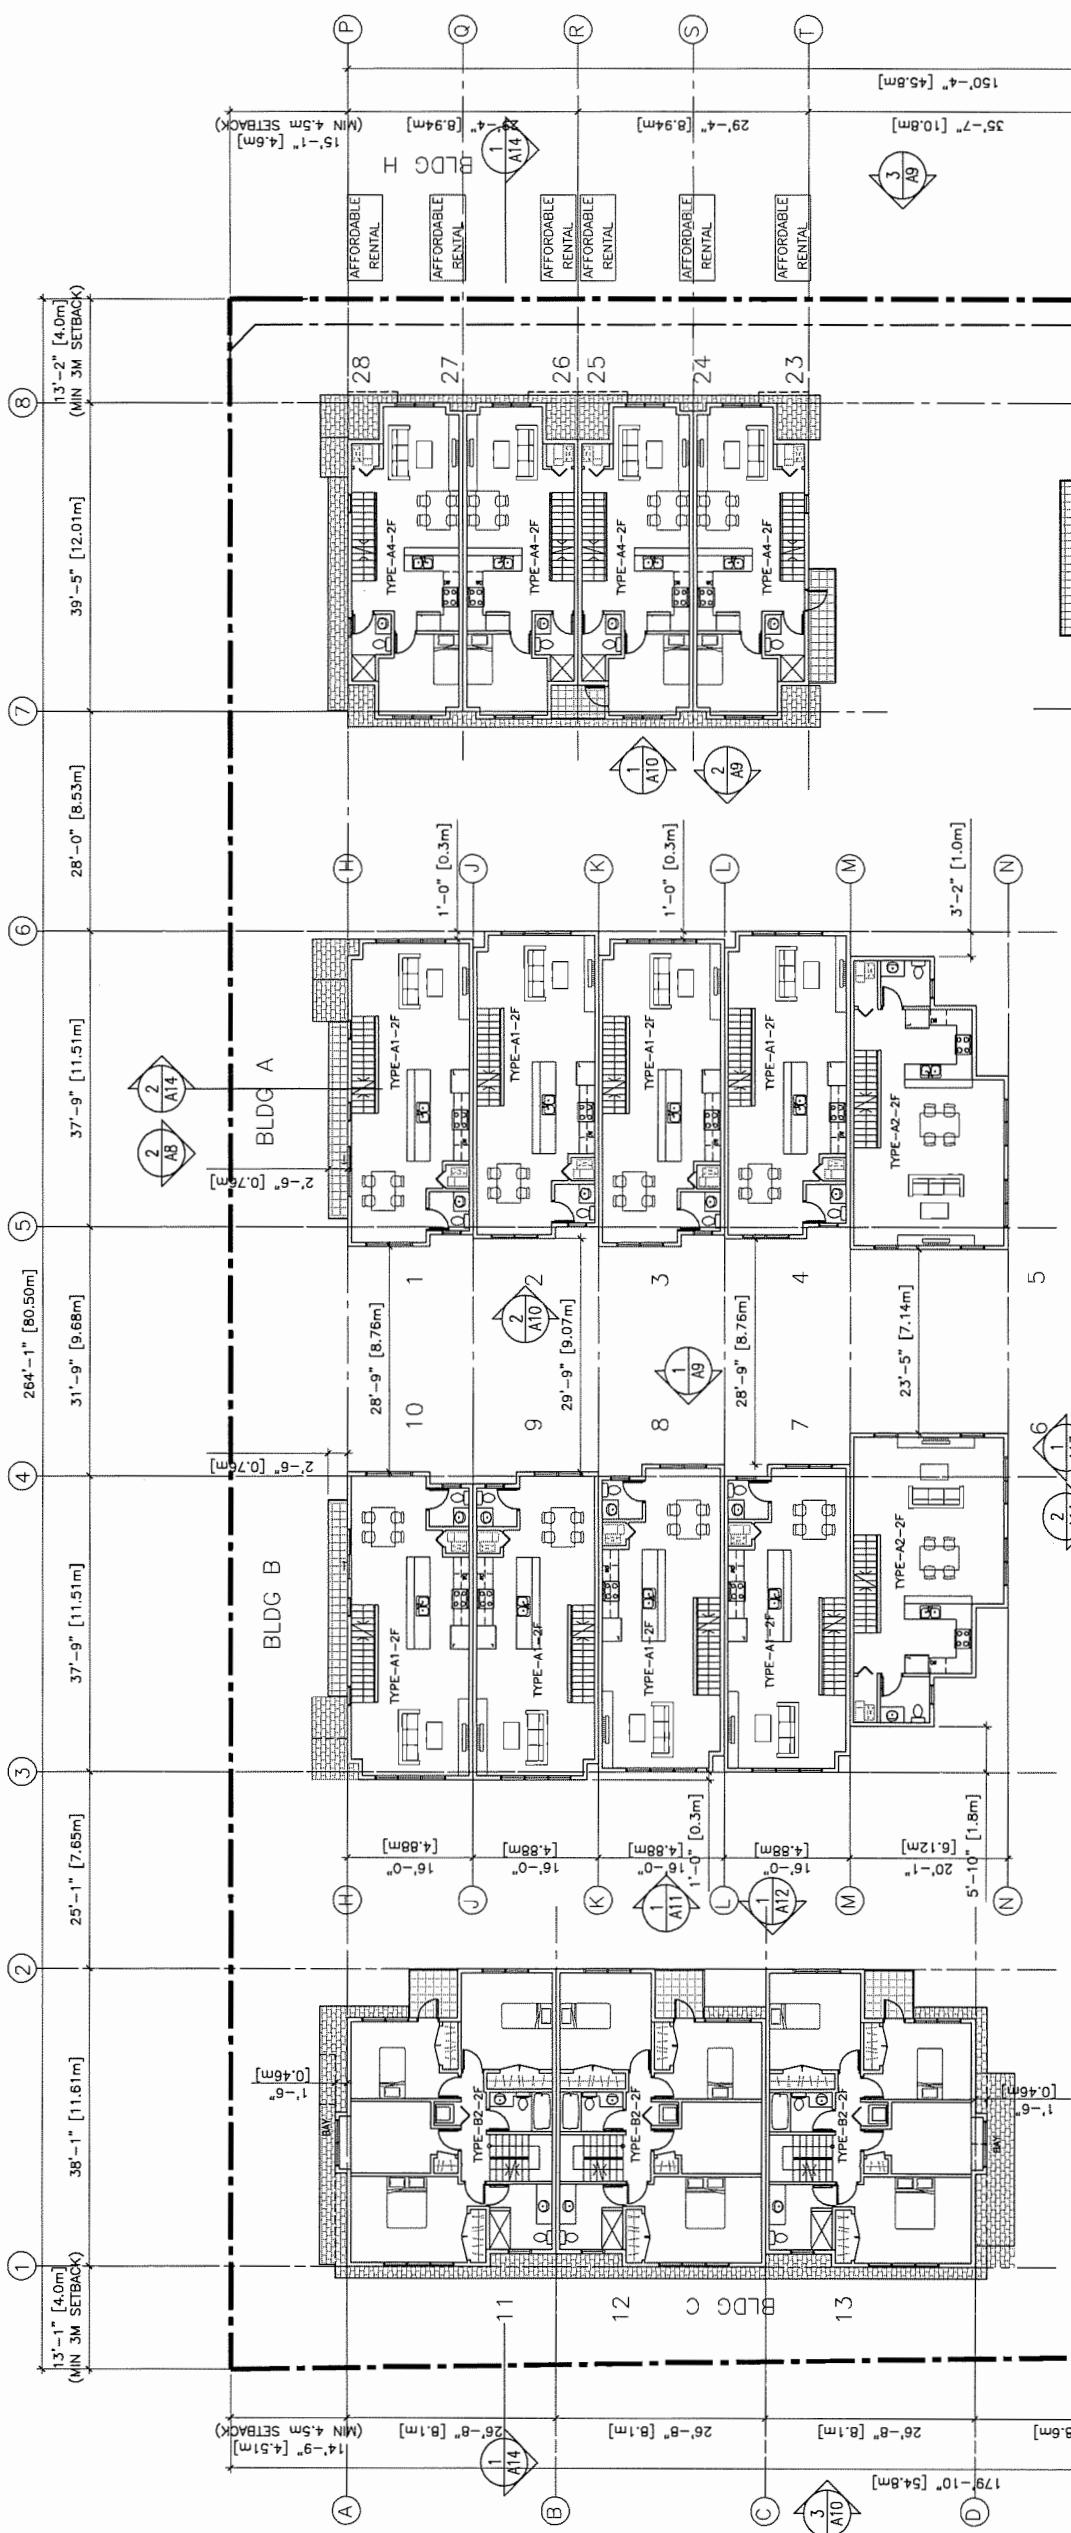PROJECT NUMBER: 12-25
ISSUED: 11/18/2019
DRAWN BY: EL
CHECKED BY: EL
REVISION: FILENAME: 15-12_MWR_191119-DPP.DWG

A3


DP 18-797785 DEVELOPMENT PERMIT
PLAN #1.C

**ERIC LAW
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ISSUED

1. 2018.01.11 FOR DEVELOPMENT PERMIT APPLICATION
2. 2018.06.04 FOR CITY DP REVIEW
3. 2018.08.03 FOR CITY ADP REVIEW
4. 2019.10.19 FOR CITY REVIEW
5. 2019.11.19 FOR CITY REVIEW




**PROPOSED TOWNSHOUSE
AT
9620-9800
WILLIAMS RD RICHMOND**

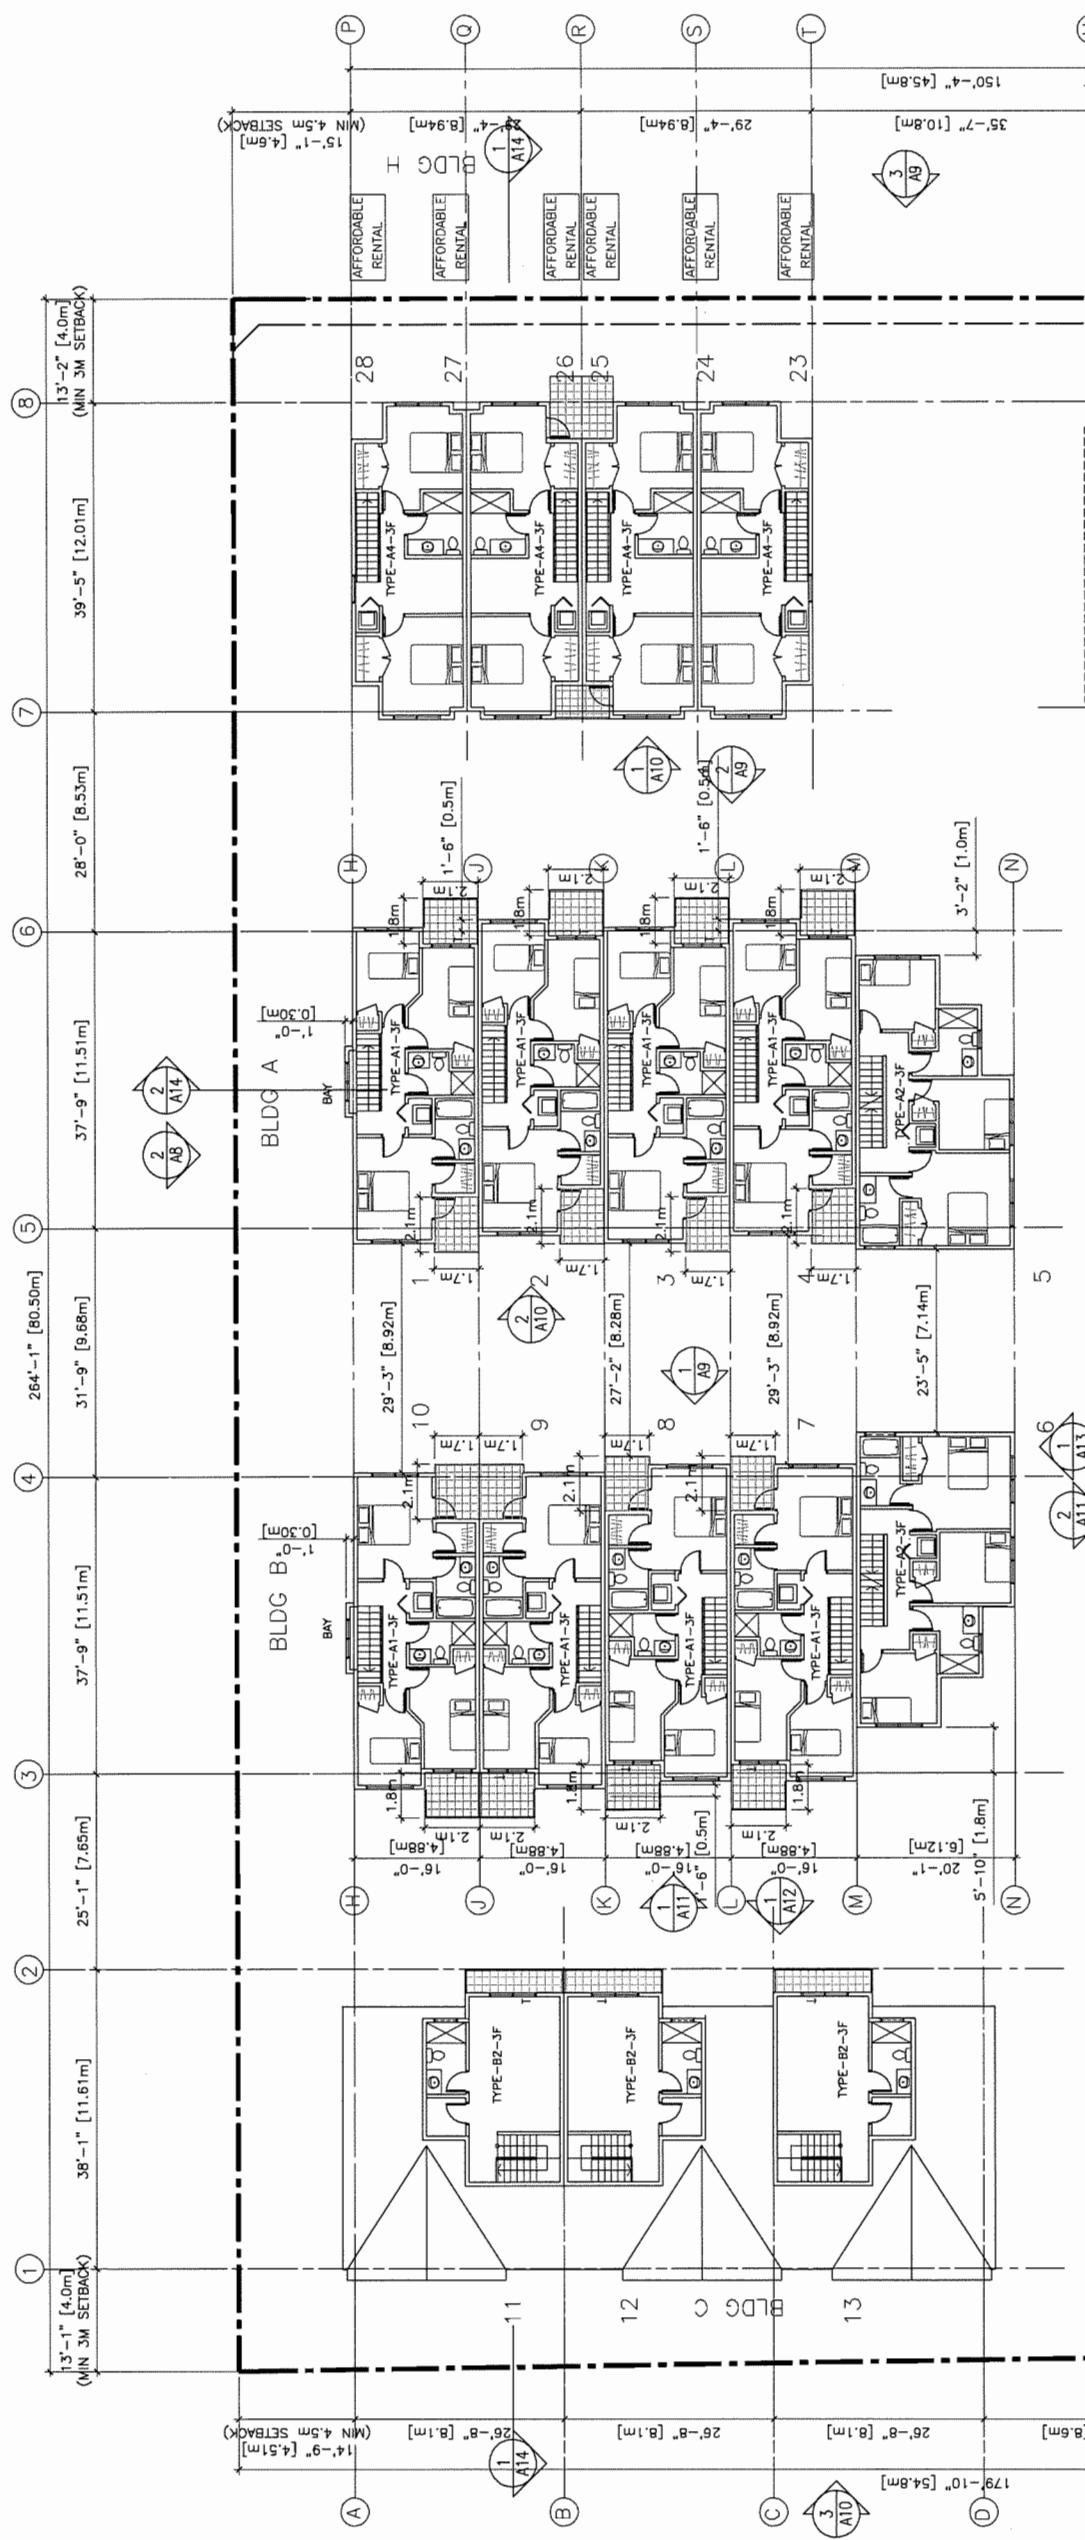SITE PLAN 3/F

PROJECT NUMBER: 12-25
ISSUED: 11/18/2019
DRAWN BY: EL
CHECKED BY: EL
REVISION: 1
FILENAME: 15-12_MWR_191119-DPP.DWG

A4

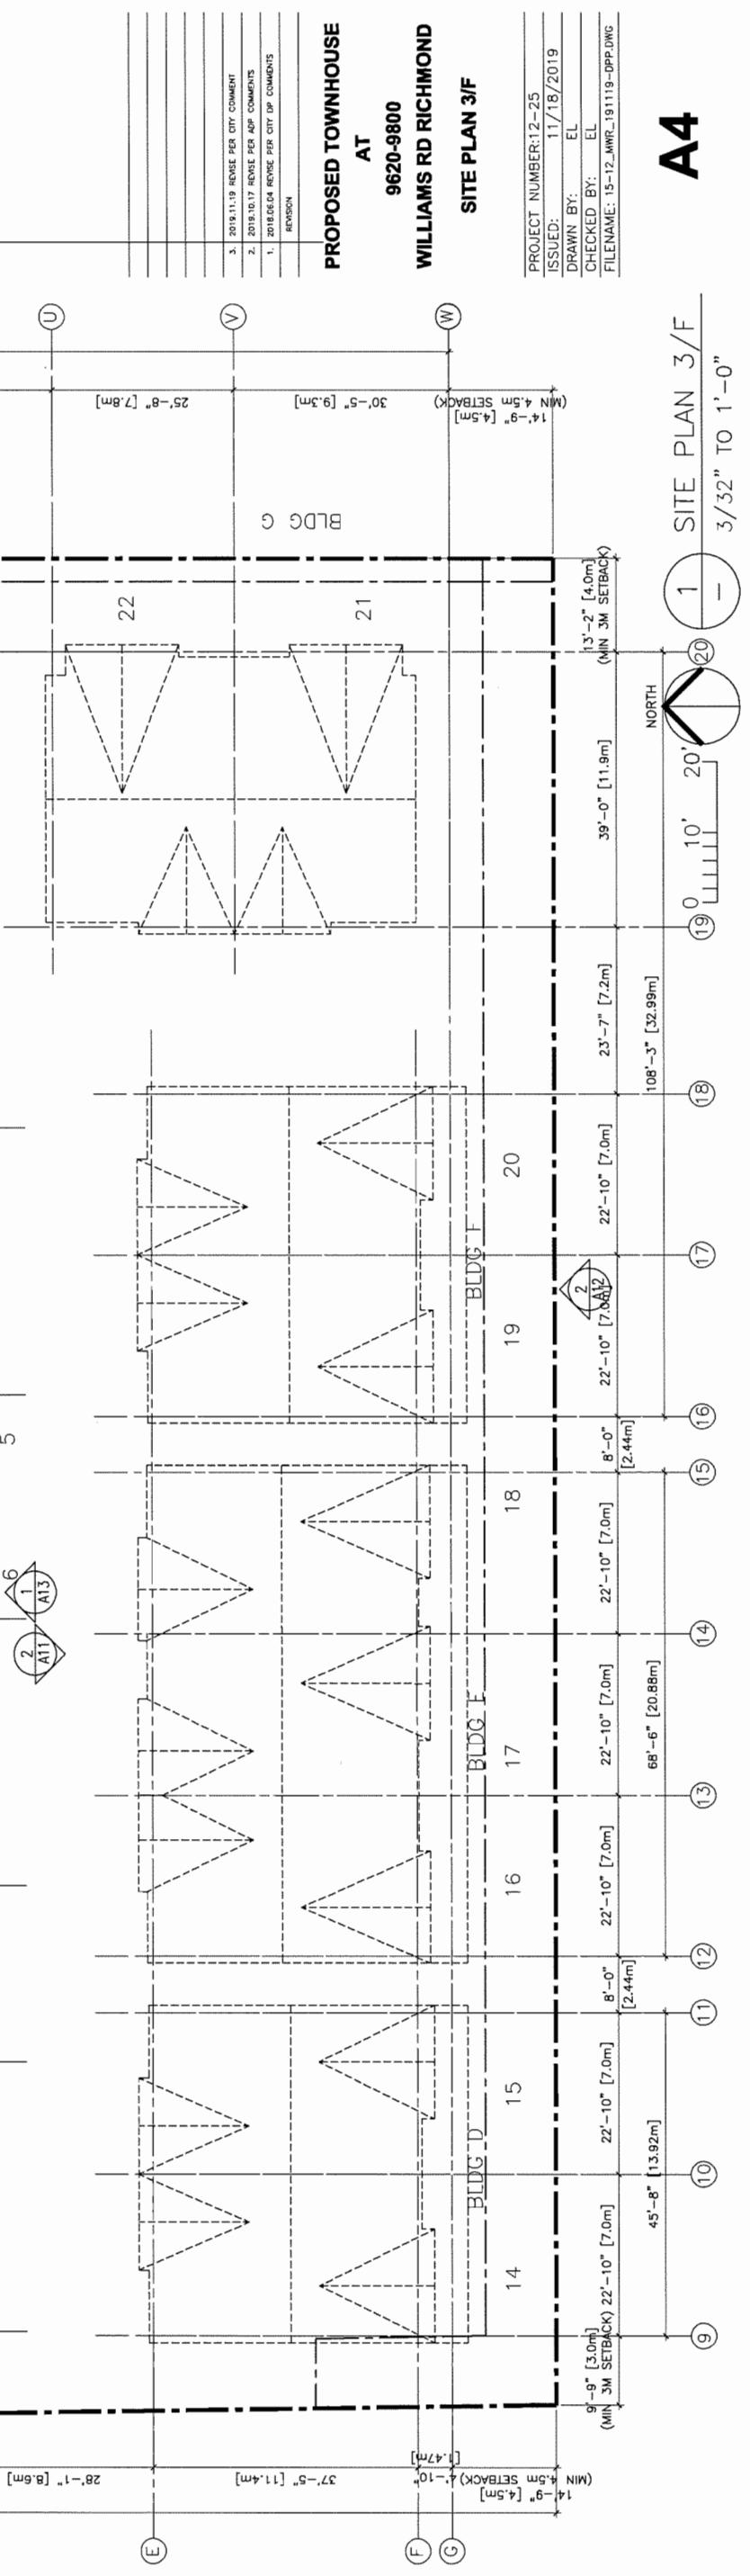



DP 18-797785 DEVELOPMENT PERMIT
PLAN 3/F

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ISSUED



1. 2018.01.11 FOR DEVELOPMENT PERMIT APPLICATION
2. 2018.06.04 FOR CITY DP REVIEW
3. 2018.08.03 FOR CITY ADP REVIEW
4. 2019.10.19 FOR CITY REVIEW
5. 2019.11.19 FOR CITY REVIEW




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ISSUED: 11/18/2019
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2. 2019.10.17 REVISE FOR ADP COMMENTS
3. 2019.11.19 REVISE FOR CITY COMMENT
FILENAME: 15-12_WMR_191119-DPP.DWG

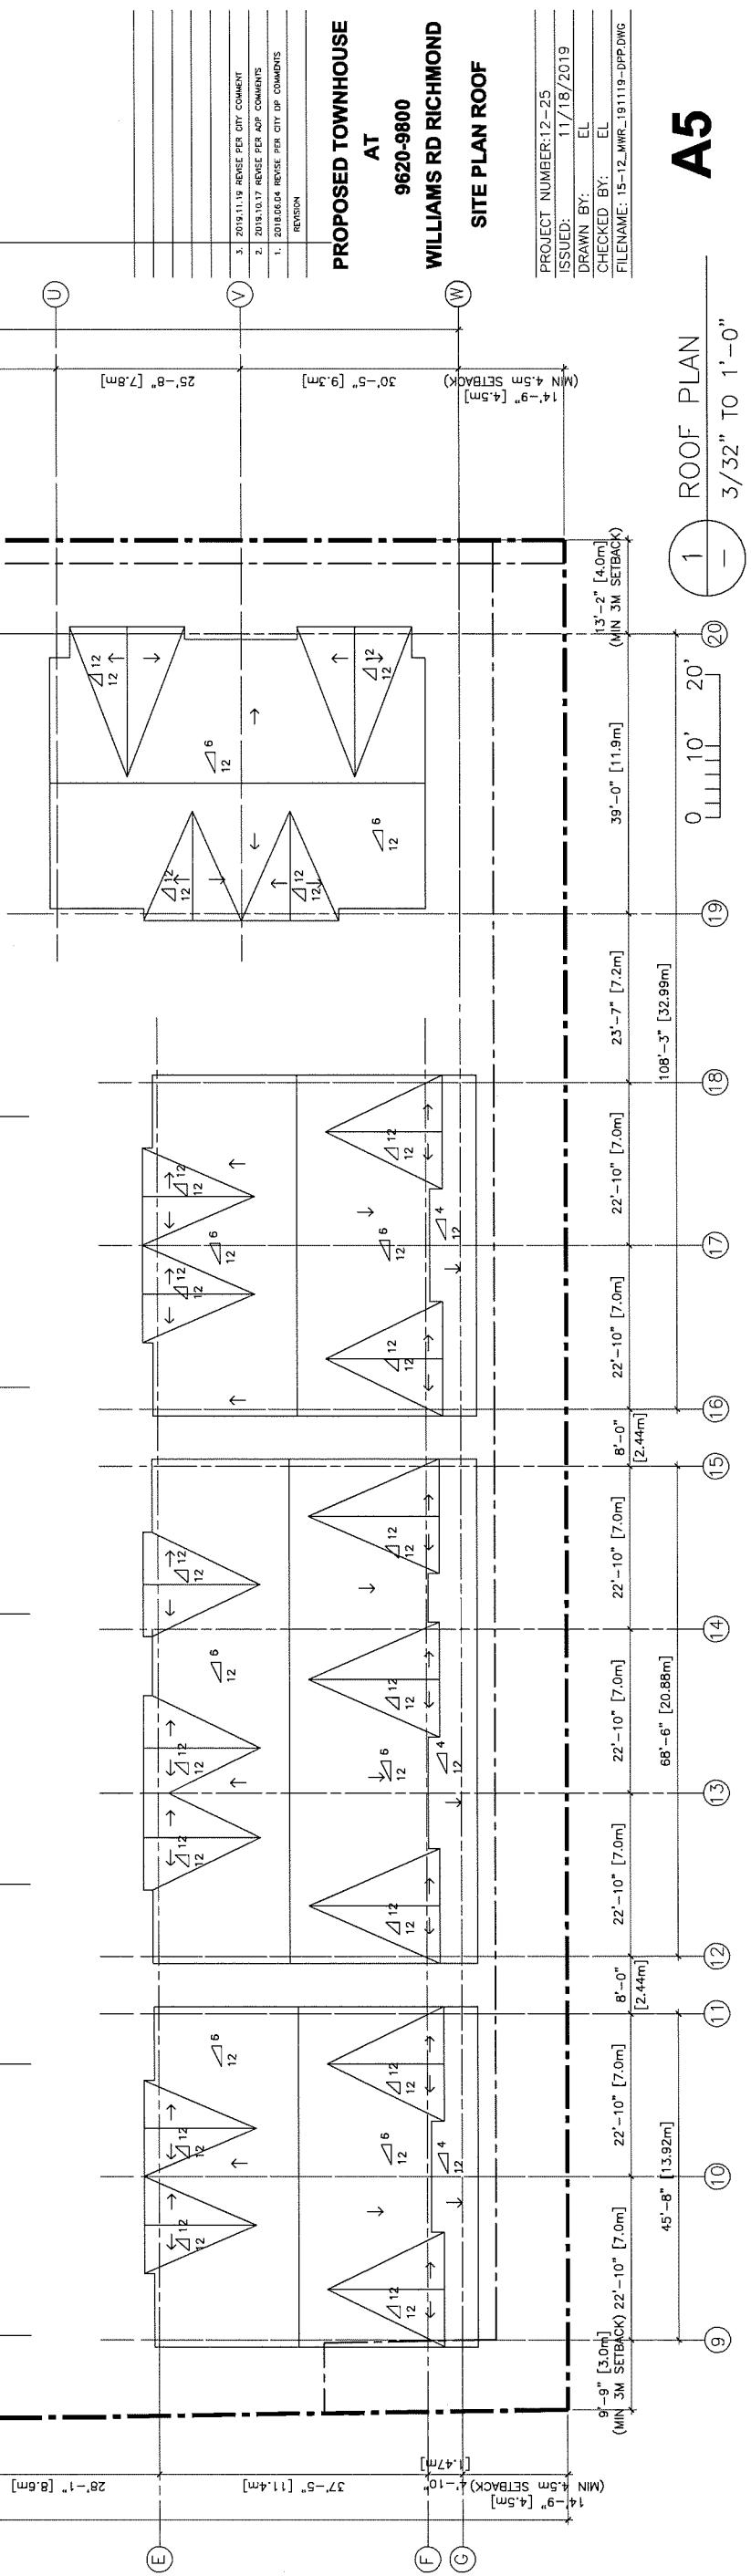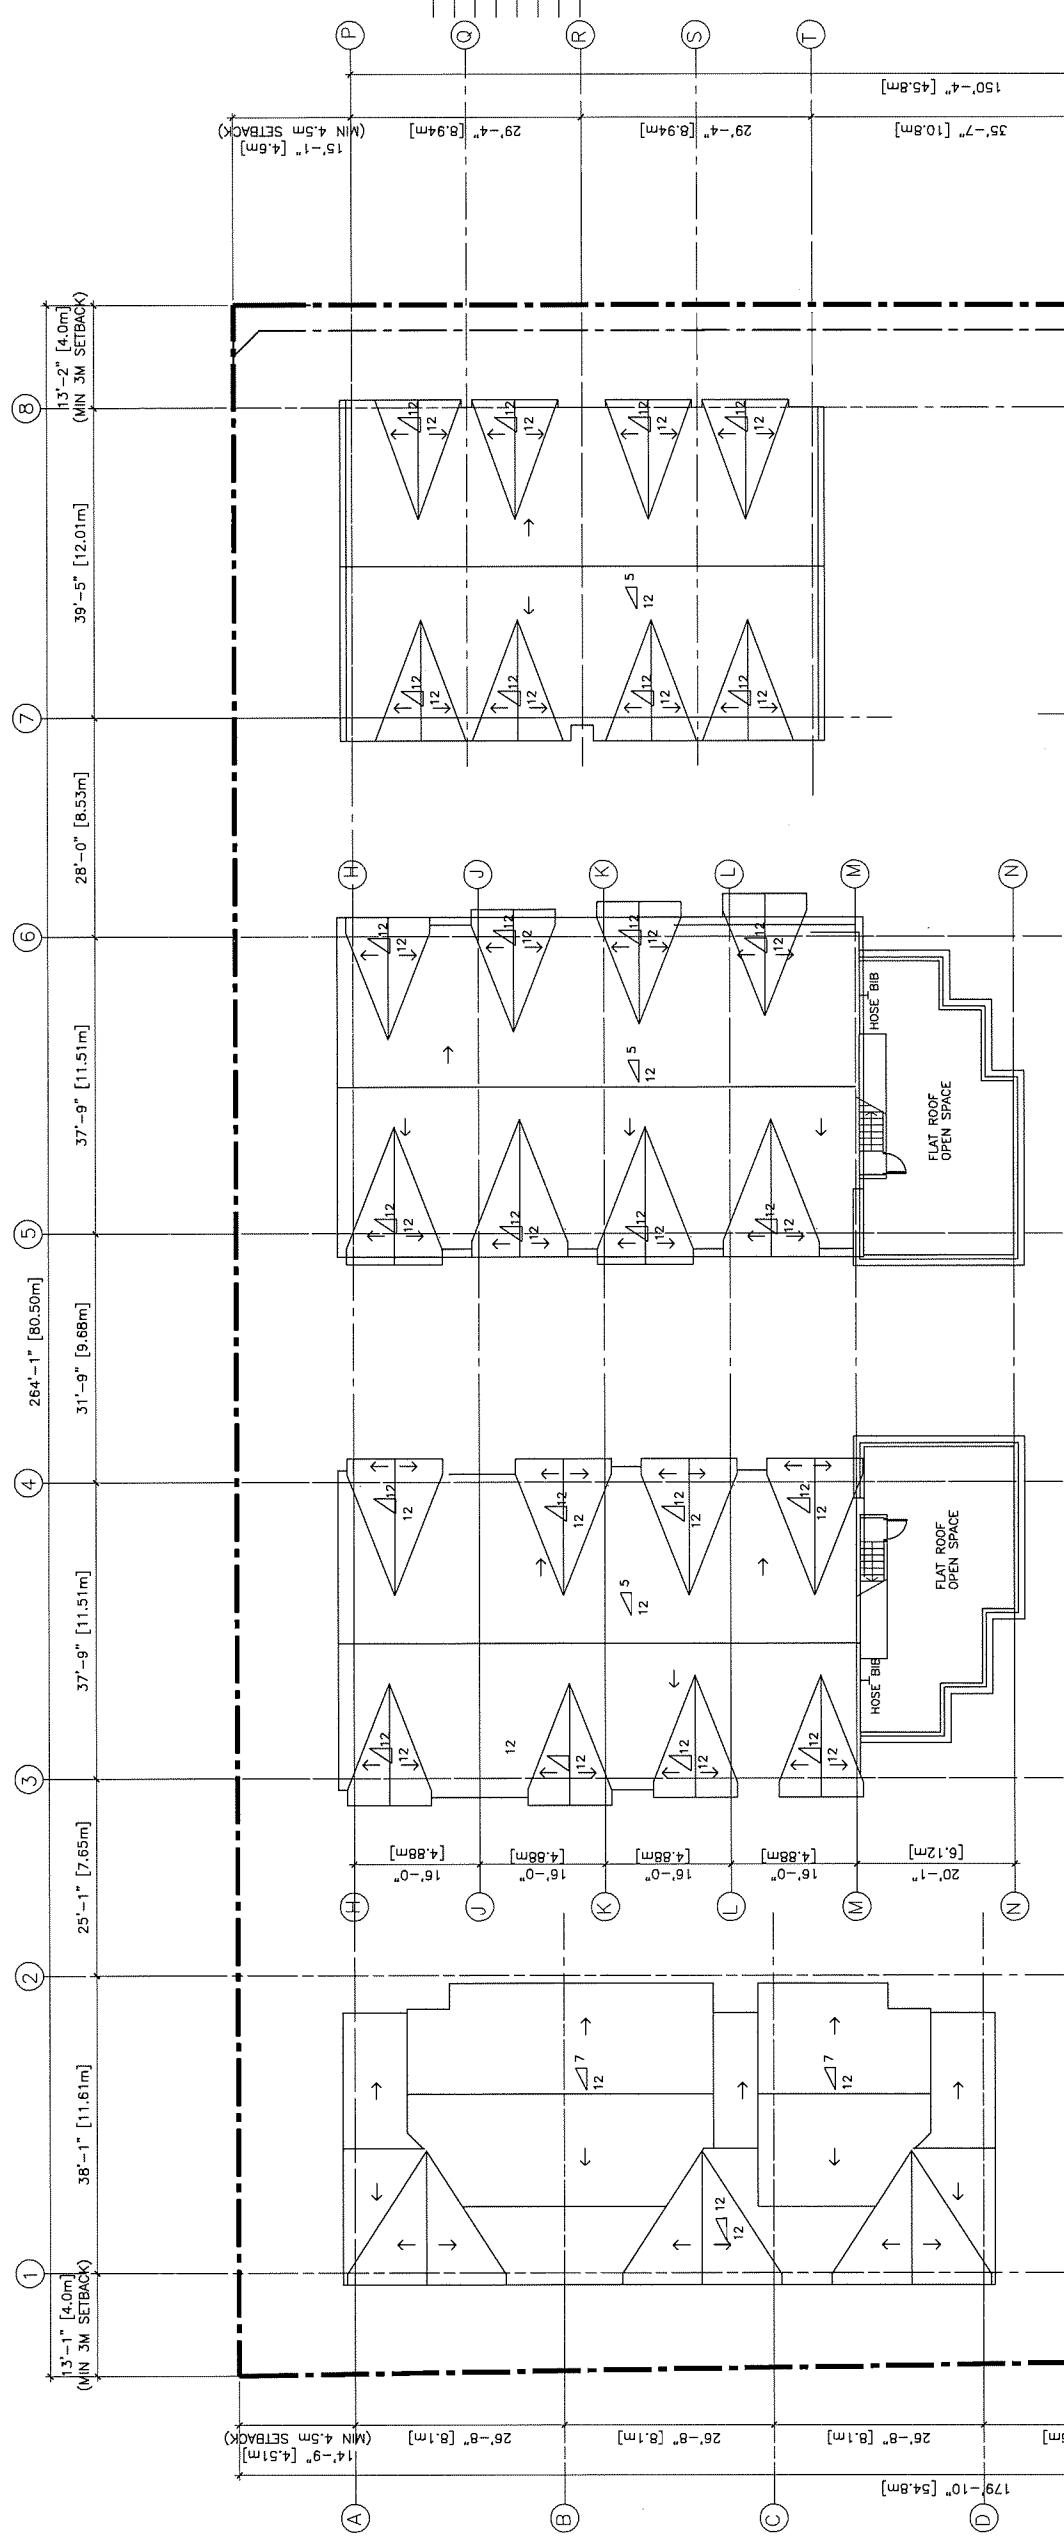A5


DP 18-797785 DEVELOPMENT PERMIT
PLAN # 1.E

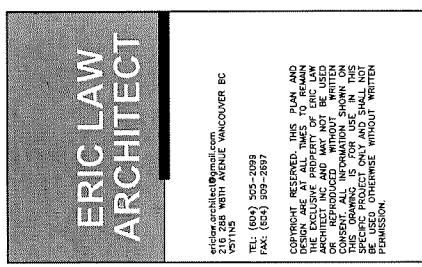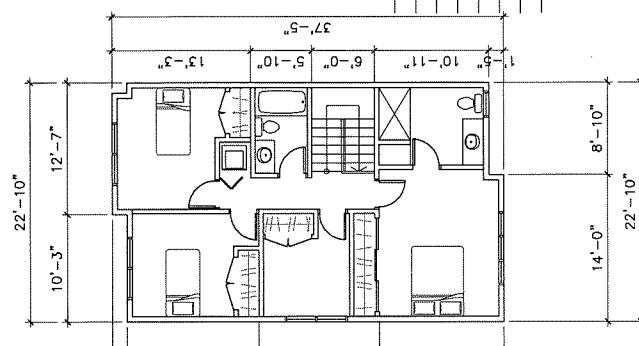A6DP 18-797785 DEVELOPMENT PERMIT
PLAN FISSUED
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2. 2018.06.04 FOR CITY DP REVIEW
3. 2018.08.03 FOR CITY AOP REVIEW
4. 2019.10.19 FOR CITY REVIEW
5. 2019.11.19 FOR CITY REVIEW


TYPE A1
3 BEDROOM
1 LEVEL 1
- 1/8" TO 1'-0"
TYPE-A1-1F
TOTAL UNIT AREA: ±1300 SQ. FT.
INCLUDING STAIR

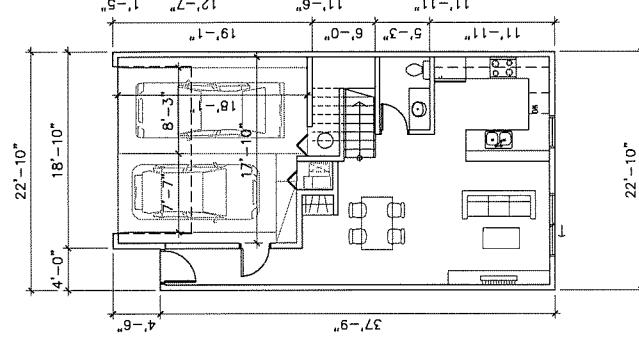


TYPE A2
3 BEDROOM
5 LEVEL 1
- 1/8" TO 1'-0"
TYPE-A2-1F
TOTAL UNIT AREA: ±1441 SQ. FT.
INCLUDING STAIR

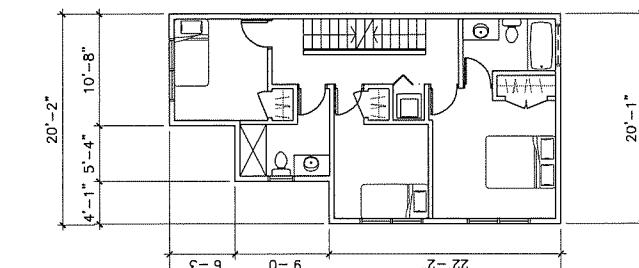


TYPE A3
3 BEDROOM
6 LEVEL 1
- 1/8" TO 1'-0"
TYPE-A3-1F
TOTAL UNIT AREA: ±1300 SQ. FT.
INCLUDING STAIR

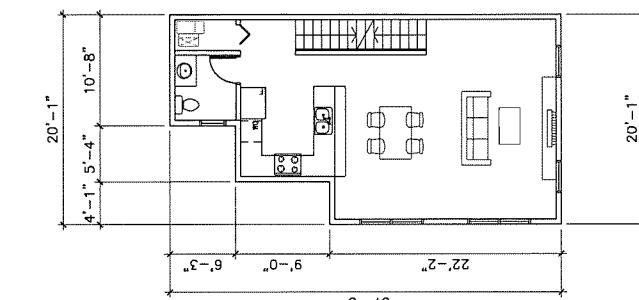


TYPE A4
3 BEDROOM
10 LEVEL 1
- 1/8" TO 1'-0"
TYPE-A4-1F
TOTAL UNIT AREA: ±1174 SQ. FT.
INCLUDING STAIR

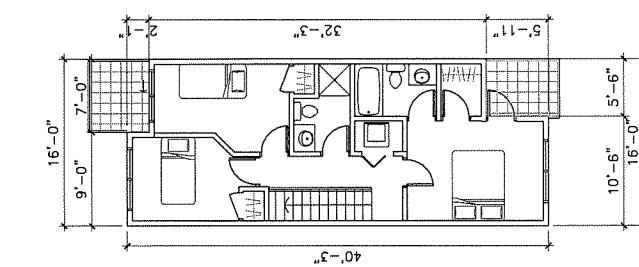


TYPE B1
3 BEDROOM + DEN
8 LEVEL 1
- 1/8" TO 1'-0"
TYPE-B1-1F
TOTAL UNIT AREA: ±1438 SQ. FT.
INCLUDING STAIR

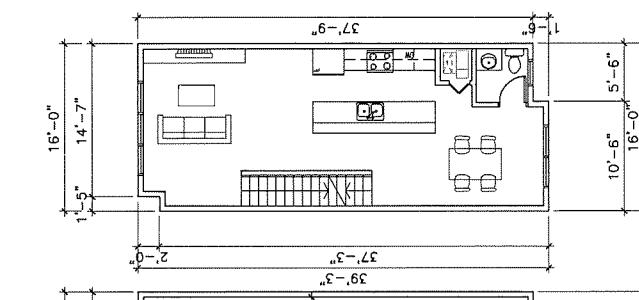

TYPE B2
3 BEDROOM + DEN
13 LEVEL 1
- 1/8" TO 1'-0"
TYPE-B2-1F
TOTAL UNIT AREA: ±1083 SQ. FT.
INCLUDING STAIR

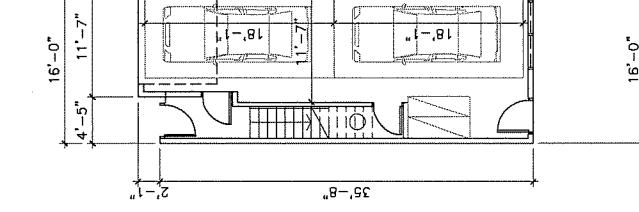

TYPE B3
3 BEDROOM
14 LEVEL 1
- 1/8" TO 1'-0"
TYPE-B3-1F
TOTAL UNIT AREA: ±1174 SQ. FT.
INCLUDING STAIR

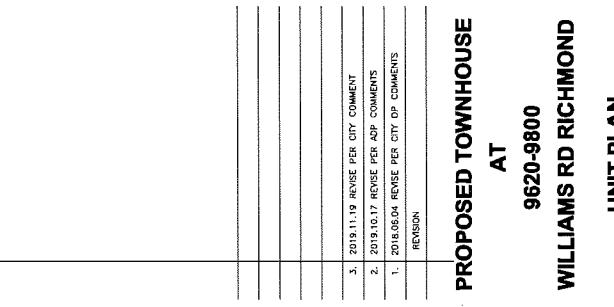

**PROPOSED TOWNHOUSE
AT
WILLIAMS RD RICHMOND**
UNIT PLAN

PROJECT NUMBER: 12-25
ISSUED: 11/18/2019
DRAWN BY: EL
CHECKED BY: EL
FILENAME: 15-12-WMR_191119-DP.DWG

14 LEVEL 3
- 1/8" TO 1'-0"
TYPE-B3-3F

13 LEVEL 2
- 1/8" TO 1'-0"
TYPE-B2-2F

12 LEVEL 1
- 1/8" TO 1'-0"
TYPE-B2-1F
TOTAL UNIT AREA: ±1083 SQ. FT.
INCLUDING STAIR

**AFFORDABLE
RENTAL**

11 LEVEL 3
- 1/8" TO 1'-0"
TYPE-A4-3F

10 LEVEL 2
- 1/8" TO 1'-0"
TYPE-A4-2F
TOTAL UNIT AREA: ±1174 SQ. FT.
INCLUDING STAIR

**AFFORDABLE
RENTAL**

14 LEVEL 3
- 1/8" TO 1'-0"
TYPE-B4-3F

12 LEVEL 1
- 1/8" TO 1'-0"
TYPE-B4-1F
TOTAL UNIT AREA: ±1174 SQ. FT.
INCLUDING STAIR

13 LEVEL 2
- 1/8" TO 1'-0"
TYPE-A3-3F

11 LEVEL 1
- 1/8" TO 1'-0"
TYPE-A3-1F
TOTAL UNIT AREA: ±1174 SQ. FT.
INCLUDING STAIR

12 LEVEL 1
- 1/8" TO 1'-0"
TYPE-A4-2F
TOTAL UNIT AREA: ±1174 SQ. FT.
INCLUDING STAIR

13 LEVEL 2
- 1/8" TO 1'-0"
TYPE-A4-3F
TOTAL UNIT AREA: ±1174 SQ. FT.
INCLUDING STAIR


**ERIC LAW
ARCHITECT**

eric.law@ericlawarchitect.com
216 288 MAIN AVENUE, VANCOUVER BC,
V6A 5G5
TEL: (604) 505-2088
FAX: (604) 599-2687

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3. 2018.09.03 FOR CITY APP REVIEW
4. 2018.10.19 FOR CITY REVIEW
5. 2019.11.19 FOR CITY REVIEW



CONVERTIBLE UNIT GUIDELINES

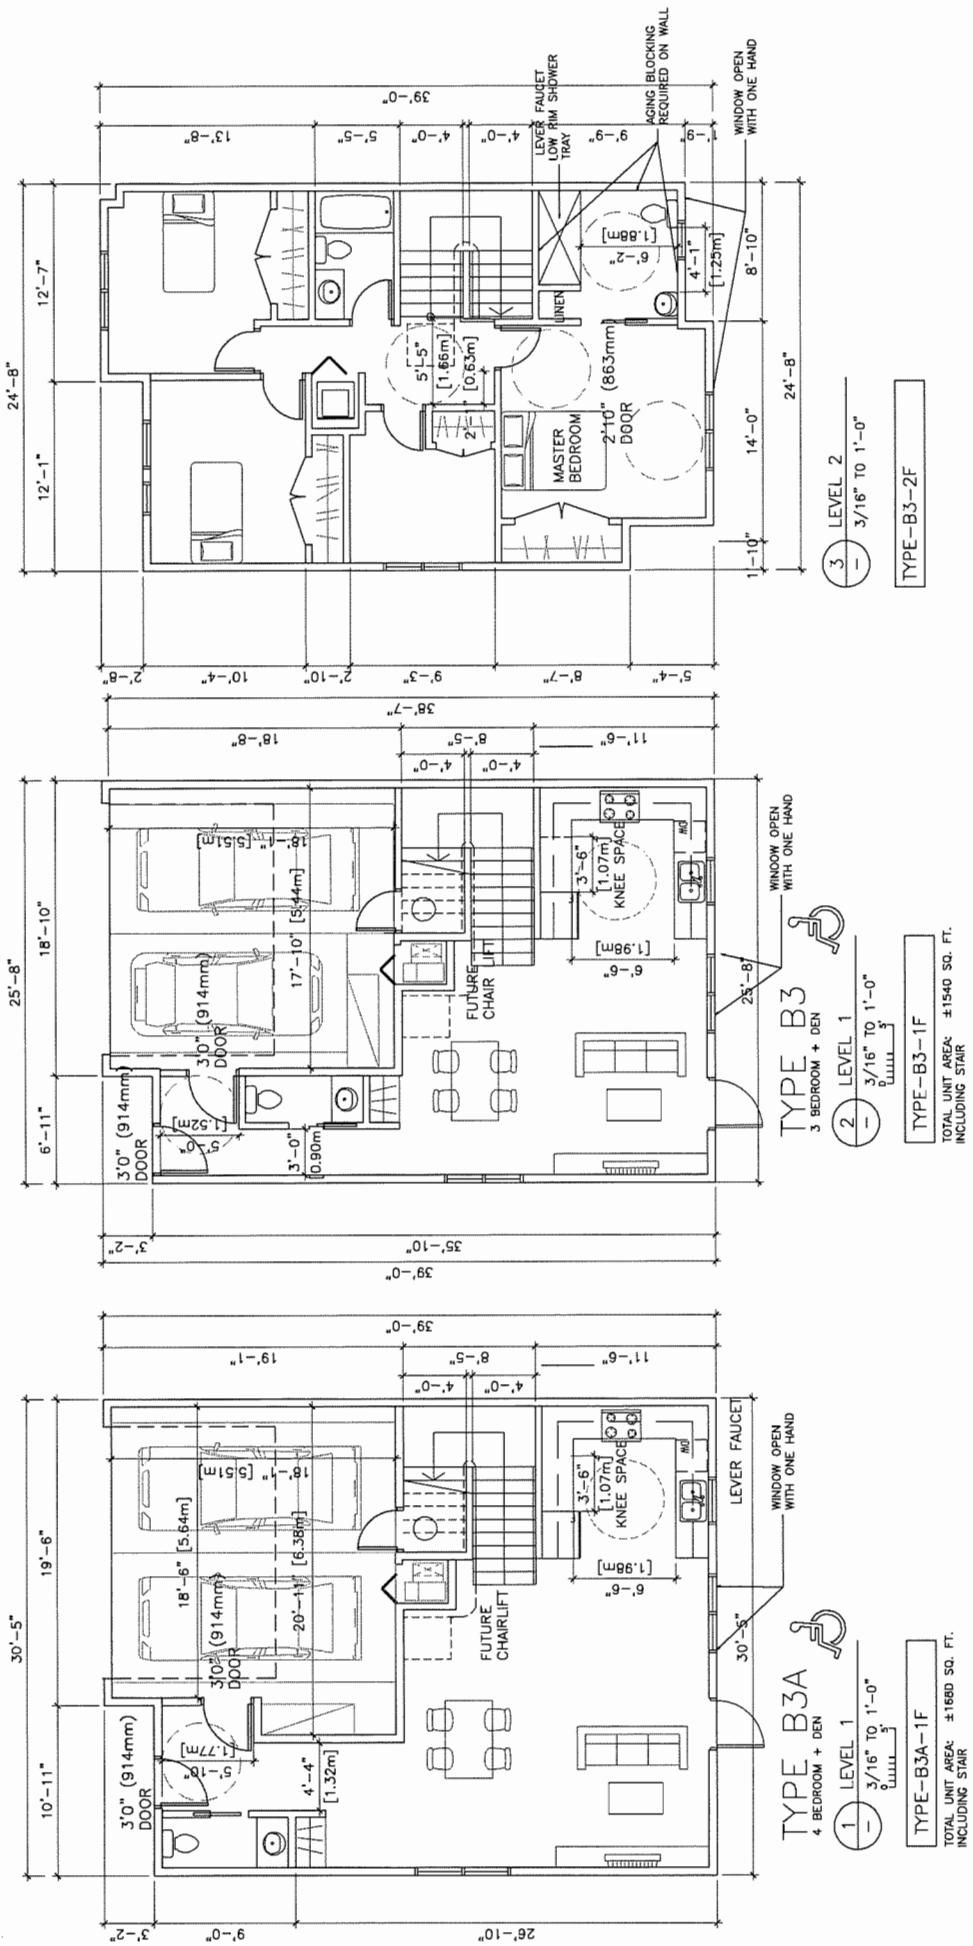
- DOORS & DOORWAYS**
 - ENTRY DOORS ARE A MINIMUM 914 MM BUT IDEALLY 1220 MM DEPTH BY DOOR WIDTH PLUS 600 MM ON LATCH SIDE (NOT NEEDED IF ROUGH IN WIRING PROVIDED FOR FUTURE AUTOMATIC DOOR OPERATOR).
 - INTERIOR DOORS TO MAIN LIVING AREAS, 1 BATHROOM AND 1 BEDROOM, MIN. 863 MM CLEAR OPENING WITH FLUSH THRESHOLDS MAX. 13 MM HEIGHT. DEMONSTRATE WHEELCHAIR ACCESS BETWEEN THE HALLWAY AND ROOMS AND WIDEN HALLWAY AND/OR DOORWAY(S) IF NECESSARY TO SECURE ACCESS.
 - PATIO/BALCONY MIN. 860 MM CLEAR OPENING. NOTE HOW ACCESSED. - ALL INTERIOR THRESHOLDS WITHIN UNITS COMPLY WITH BC BUILDING CODE.
 - LEVER-TYPE HANDLES FOR ALL DOORS.
- VERTICAL CIRCULATION**
 - STAIR LIFT, STAIRCASE WIDTH, FRAMING SUPPORT, AND LANDINGS, AS NOTED ON FLOOR PLANS IN COMPLIANCE WITH MANUFACTURER SPECIFICATIONS.
 - VERTICAL LIFT, DEPRESSED SLAB AREA, AND LANDINGS, AS NOTED ON FLOOR PLANS IN COMPLIANCE WITH MANUFACTURER SPECIFICATIONS, FRAMING TO ACCOMMODATE SHAFT CONSTRUCTION WITHOUT IMPACT TO SURROUNDING STRUCTURE.
 - AT THE TOP OF ALL STAIRWAYS, WALLS ARE REINFORCED WITH 2" X 12" SOLID LUMBER AT 914 MM TO CENTRE.
- HALLWAYS**
 - MIN. 900 MM WIDTH.
 - MIN. 1 ACCESSIBLE PARKING SPACE WITH MIN. 4 M GARAGE WIDTH.
 - ACCESS FROM GARAGE TO LIVING AREA MIN. 800 MM CLEAR OPENING.
- BATHROOM (MIN. 1)**
 - TOILET CLEAR FLOOR SPACE MIN. 1020 MM AT SIDE AND IN FRONT, 2" X 12" SOLID LUMBER BAR REINFORCED WITH 2" X 12" SOLID LUMBER IN ALL BATHTUB, SHOWER, AND TOILET LOCATIONS.
 - LEVER-TYPE HANDLES FOR PLUMBING FIXTURES.
 - PRESSURE AND TEMPERATURE CONTROL VALVES ARE INSTALLED ON ALL SHOWER FAUCETS.
 - CABINETS UNDERNEATH SINK(S) ARE EASILY REMOVED. DEMONSTRATE BATH AND SHOWER CONTROLS ARE ACCESSIBLE (LAYOUT OR FIXTURE PLACEMENT).
- KITCHEN**
 - CLEAR AREA NEEDED UNDER FUTURE WORK SPACE
 - PLUMBING AND GAS PIPES (IN-WALL AND IN-FLOOR) LOCATED CLEAR OF UNDER COUNTER AREA OF FUTURE WORK SPACE (STOVE, SINK & MIN. 810 MM WIDE COUNTER). ALL PIPES ARE BROUGHT IN NO HIGHER THAN 304 MM TO 355 MM TO THE CENTRE OF THE PIPE FROM FLOOR LEVEL. - CABINET'S UNDERNEATH SINK ARE EASILY REMOVED.
 - 1500 MM TURNING DIAMETER OR TURNING PATH DIAGRAM.
 - LEVER-TYPE HANDLES FOR PLUMBING FIXTURES.
- WINDOWS**
 - MIN. 1 WINDOW THAT CAN BE OPENED WITH A SINGLE HAND (BATHROOM, KITCHEN, LIVING ROOM)
 - PLACEMENT LOCATIONS OF ELECTRICAL OUTLETS, BESIDE WINDOW, BOTTOM OF STAIRWAYS, BESIDE TOILET, ABOVE EXTERNAL DOORS (OUTSIDE AND INSIDE), ON FRONT FACE OF KITCHEN COUNTER, WITHIN PROXIMITY OF CONTROL CENTRE FOR SMART HOME OPTIONS.
 - UPGRADE TO FOUR-PLEX OUTLETS IN MASTER BEDROOM, HOME OFFICE, GARAGE, AND RECREATION ROOM.

Turning Clearance Chart

The space requirements of the GSL Chairlift are affected by how the tube system is supported. The lift can either be mounted directly to the wall, **Direct Mount**, or structural support posts can be supplied **Tower mount**.

Platform Sizes	
Dim	Attachment Method
600 x 900 mm (31 1/2 x 35 3/8")	
mm	in
A	Direct Mount 125 4 7/8
	Tower Mount 150 5 7/8
B	Direct Mount 320 12 5/8
	Tower Mount 345 13 5/8
C	Direct Mount 1015 40
	Tower Mount 1040 41
D	Direct Mount 1230 48 3/8
	Tower Mount 1255 49 3/8
E	Direct Mount 1035 40 3/4
	Tower Mount 1060 41 3/4
F	Direct Mount 1145 45 7/16
	Tower Mount 1170 46 1/8

Note:
• Dimensions E and F includes 20mm (3/4") turning clearance and include standard ramps. Ramp extensions will increase the clearances required. Contact your local Gravienta Design Hot Line for more information.
• For towers mounted to 2" x 6" wood boards on walls (see page 26) add 38mm (1 1/2") to the above tower mount dimensions.

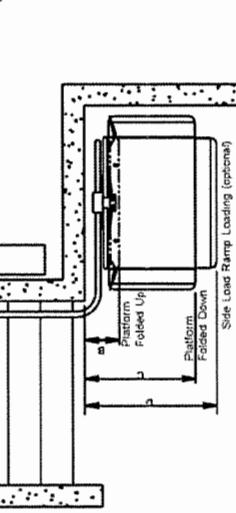

PROPOSED TOWNHOUSE

AT

9620-9800

WILLIAMS RD RICHMOND

UNIT PLAN

PROJECT NUMBER: 12-25
ISSUED: 11/18/2019
DRAWN BY: EL
CHECKED BY: EL
FILENAME: 15-12_WMR_191119-DPR.DWG

A7


ERIC LAW
ARCHITECT

RECORDED IN THE OFFICE OF THE LAND TITLE AND SURVEYOR FOR THE
RECORDS OF THE CITY OF VANCOUVER ON THIS 11TH DAY OF NOVEMBER, 1985
FOR THE USE OF THE B.C. LAND TITLE DEPARTMENT.
RECORDED

ISSUED	
	1. 2018.01.11 FOR DEVELOPMENT PERMIT APPLICATION
	2. 2018.06.04 FOR CITY DP REVIEW
	3. 2018.06.03 FOR CITY AIP REVIEW
	4. 2018.10.19 FOR CITY REVIEW
	5. 2019.11.19 FOR CITY REVIEW



N HEAT PUMP WITH WOOD OUTDOOR UNIT COVER

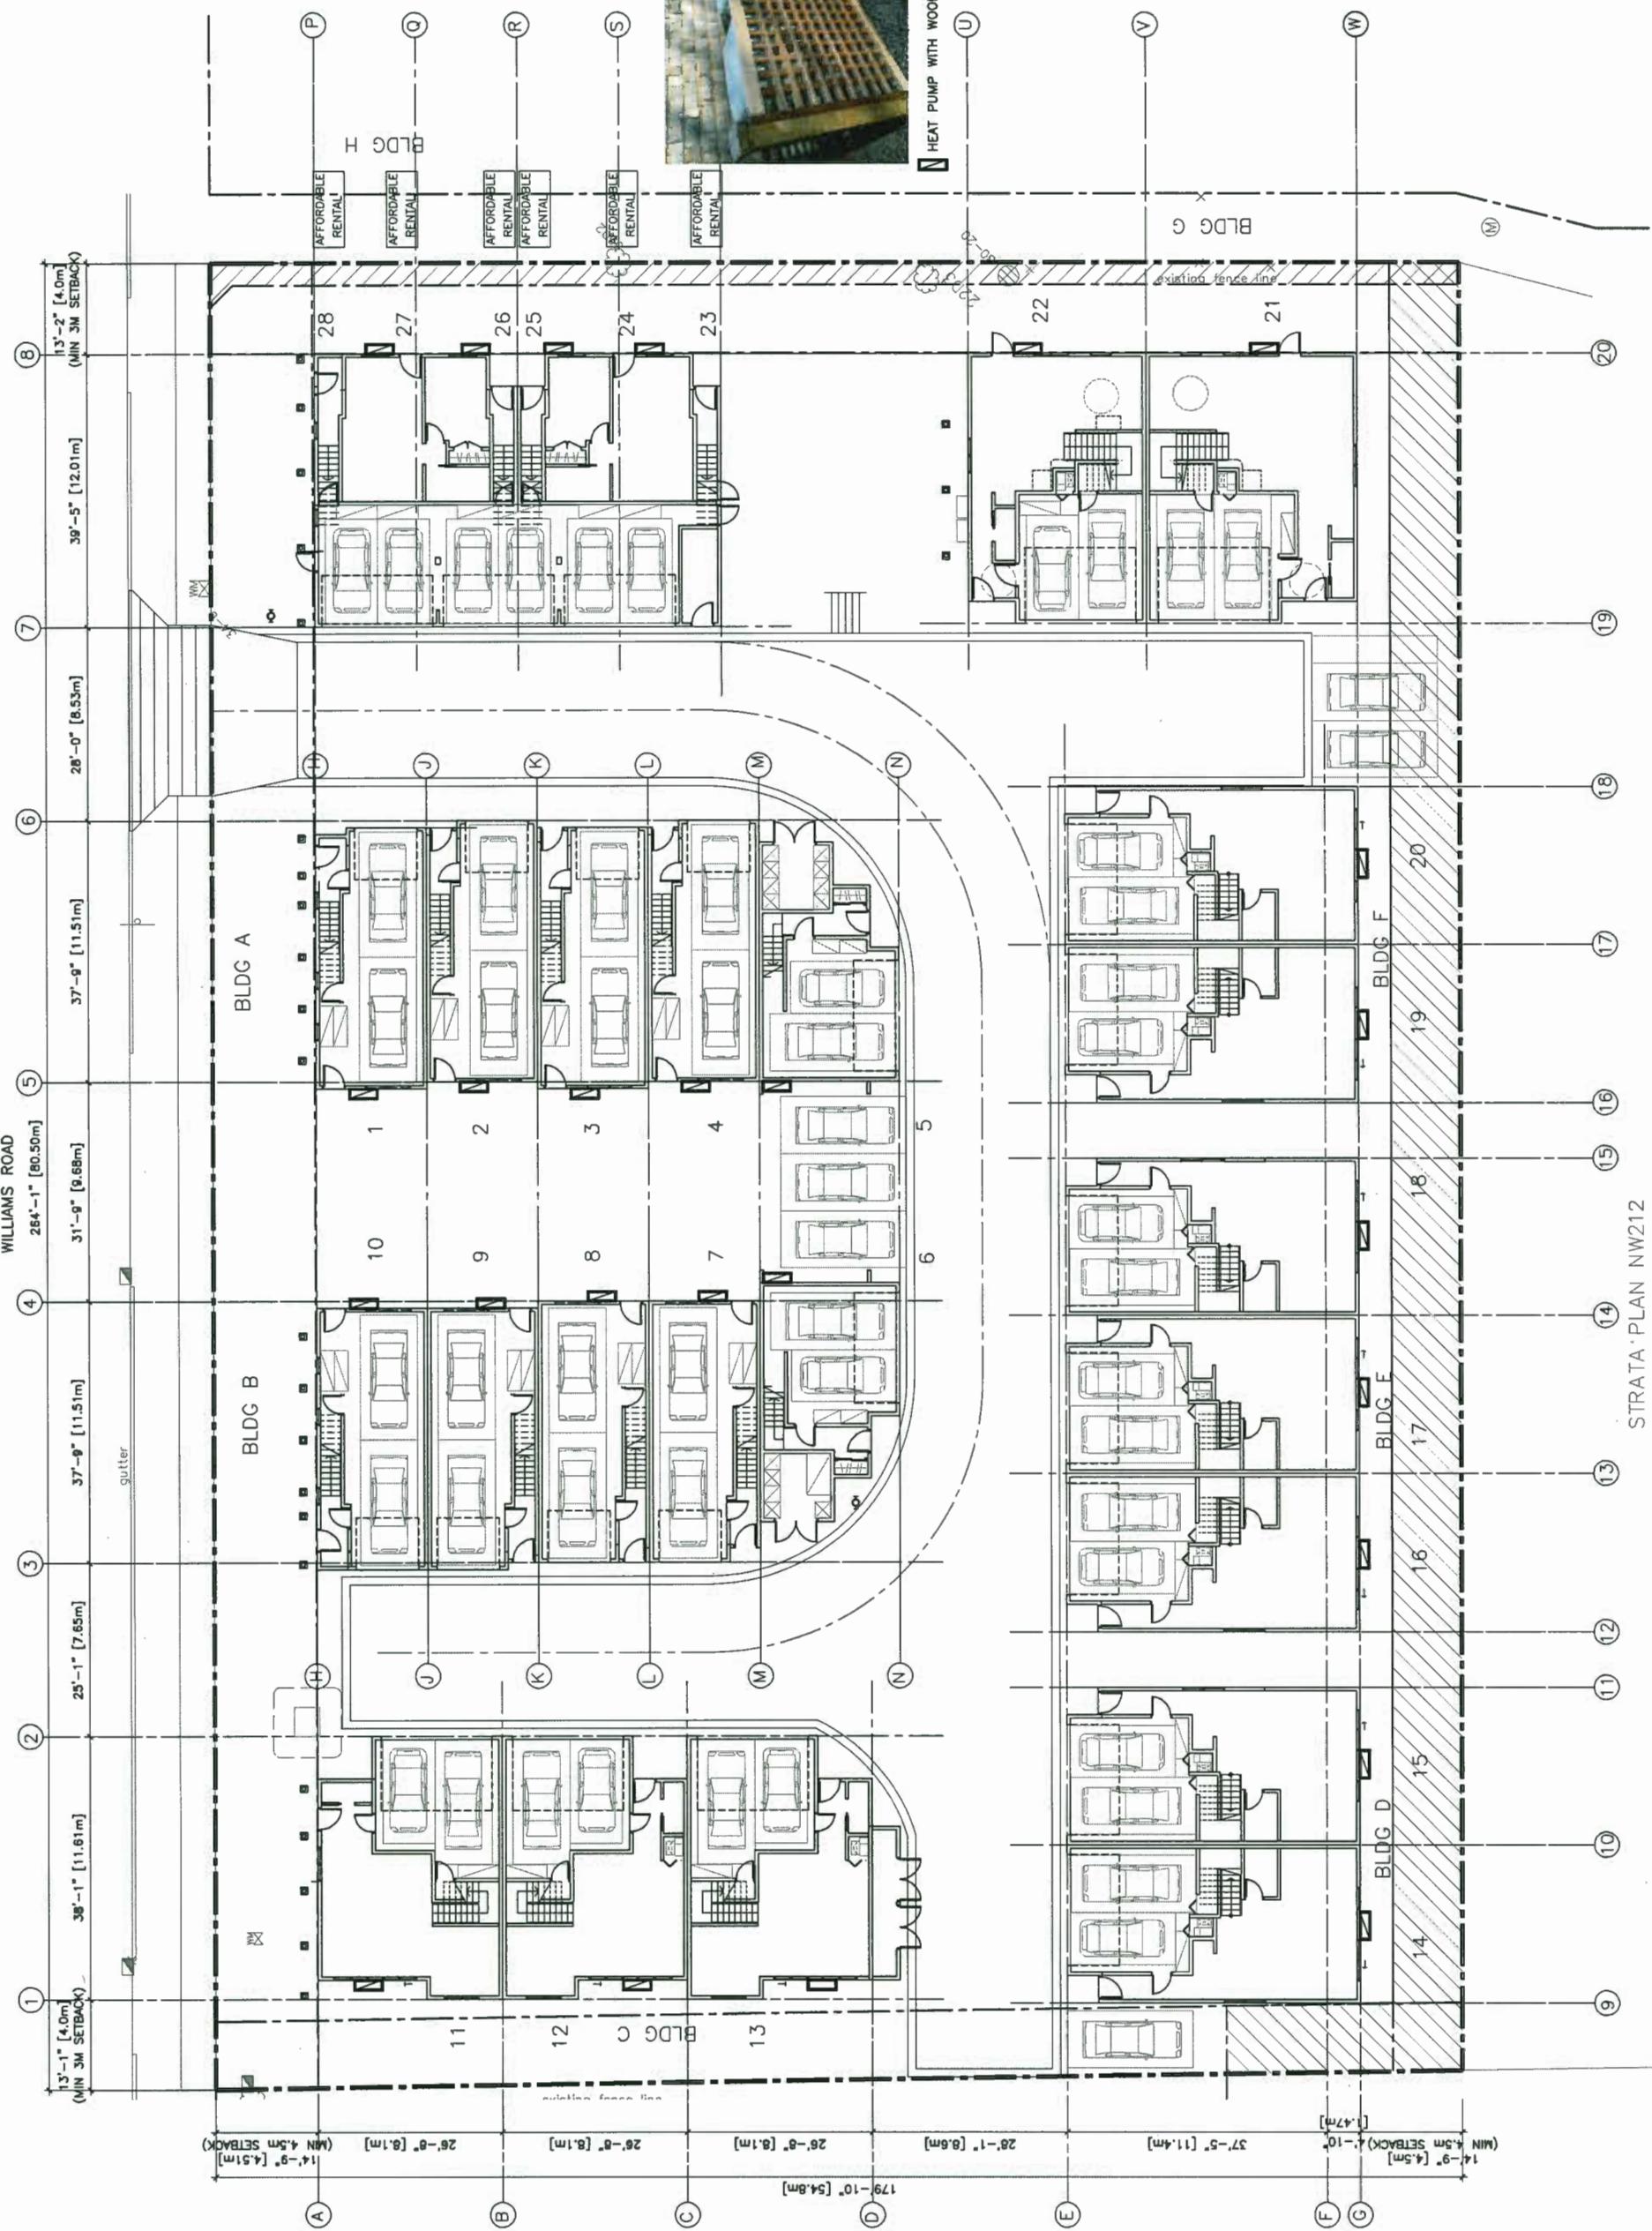

PROPOSED TOWNHOUSE

WILLIAMS RD RICHMOND
9620-9800

HEAT PUMP LOCATION

PROJECT NUMBER:12-25
ISSUED: 11/18/2019
DRAWN BY: EL
CHECKED BY: EL
FILENAME: 15-12_WHRP_191119-DPP.DWG

B-797785 DEVELOPMENT PERMIT


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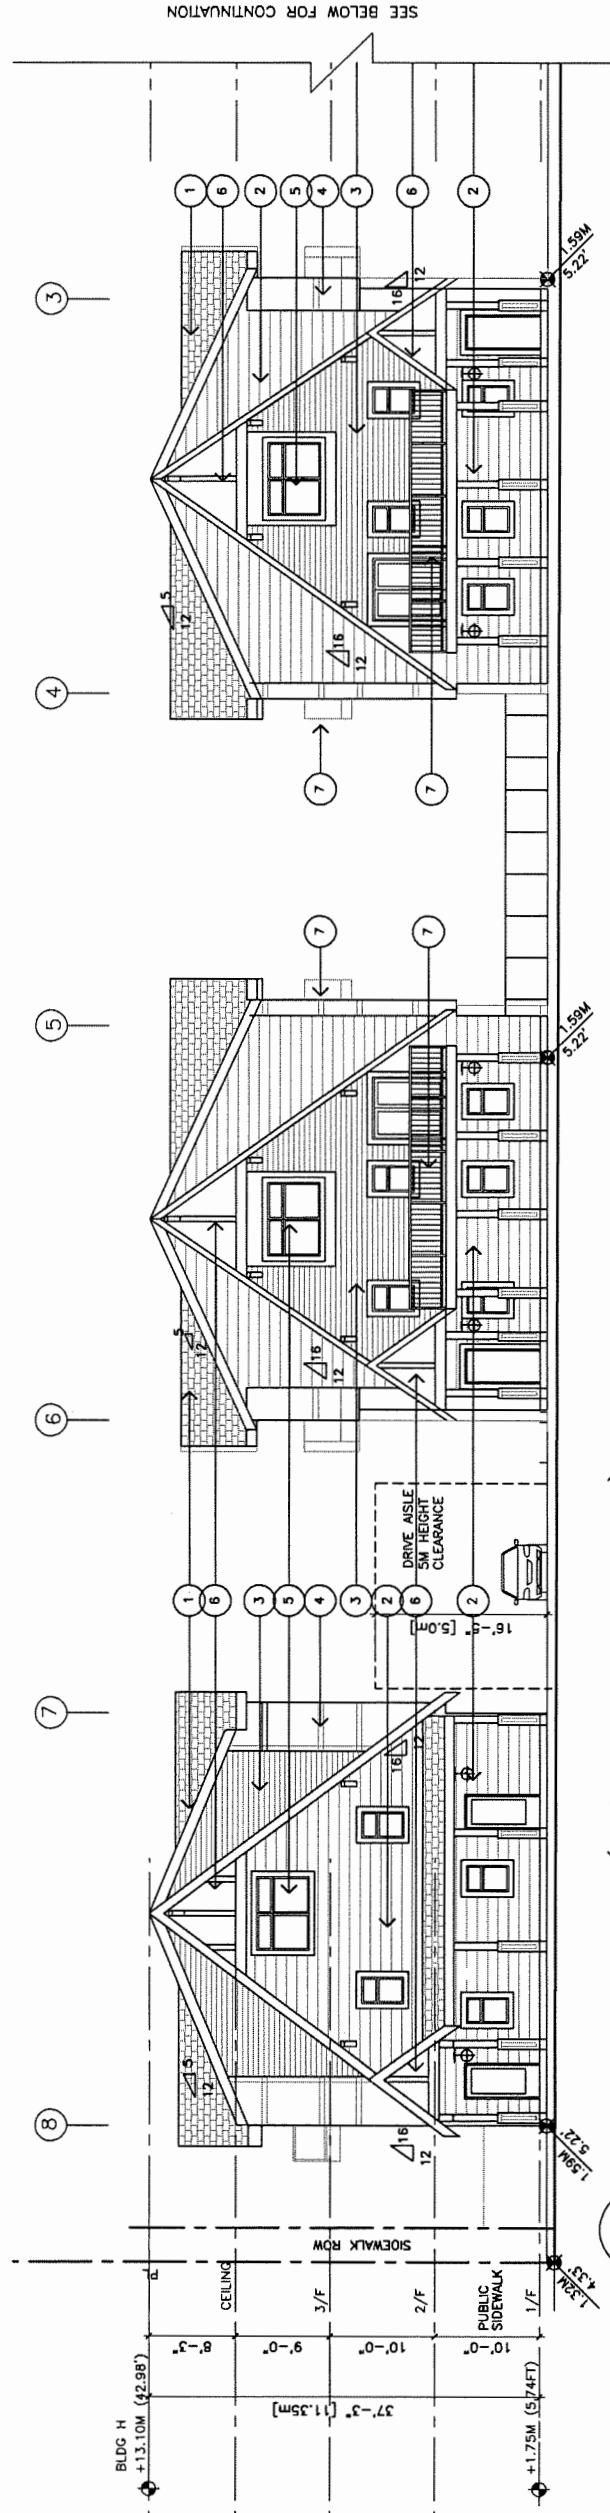
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V8T 1S8
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2. 2018.06.04 FOR CITY OF REVIEW
3. 2018.06.03 FOR CITY ADP REVIEW
4. 2018.10.18 FOR CITY REVIEW
5. 2019.11.19 FOR CITY REVIEW



1 NORTH ELEVATION ALONG WILLIAMS ROAD (CONTEXT)
A8 1/16" TO 1'-0"



2 NORTH ELEVATION (FACING WILLIAMS ROAD)
A8 1/8" TO 1'-0"

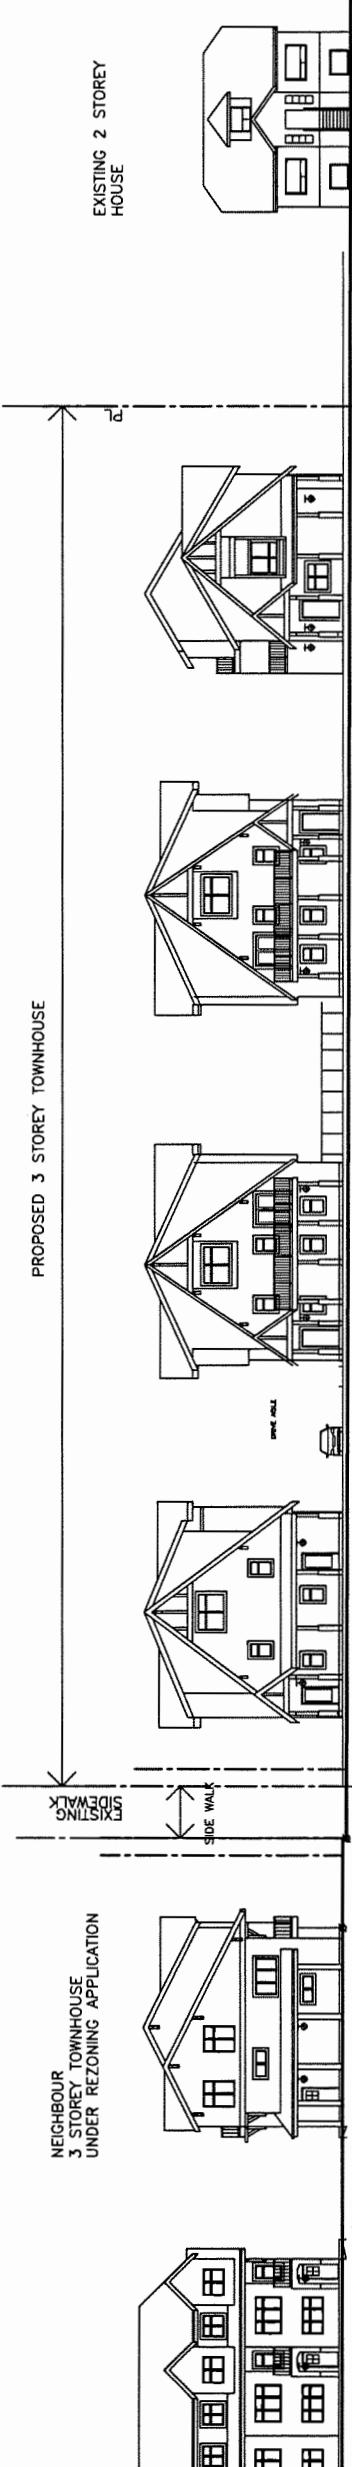EXTERIOR FINISH LEGEND


- ① → BLACK ASPHALT SHINGLE ROOFING
- ② → HARDI SIDING (8") WITH TRIM
- ③ → HARDI PANEL WITH TRIM
- ④ → VINYL WINDOW WITH 6" TRIM
- ⑤ → DECORATIVE TRIM
- ⑥ → ALUMINUM PICKET HANDRAIL
- ⑦ → WOOD TRIM
- ⑧ → OVERHEAD GARAGE DOOR WITH TOP LITE
- ⑨ → WOOD FENCE - SEE LANDSCAPE
- ⑩ → WOOD FENCE ON WOOD RETAINING WALL

EXTERIOR LIGHT

PROPOSED TOWNHOUSE
AT
9620-9800
WILLIAMS RD RICHMOND

ELEVATIONS

PROJECT NUMBER: 12-25
ISSUED: 11/18/2019
DRAWN BY: EL
CHECKED BY: EL
FILENAME: 15-12_MWR_191119-GPP.DWG

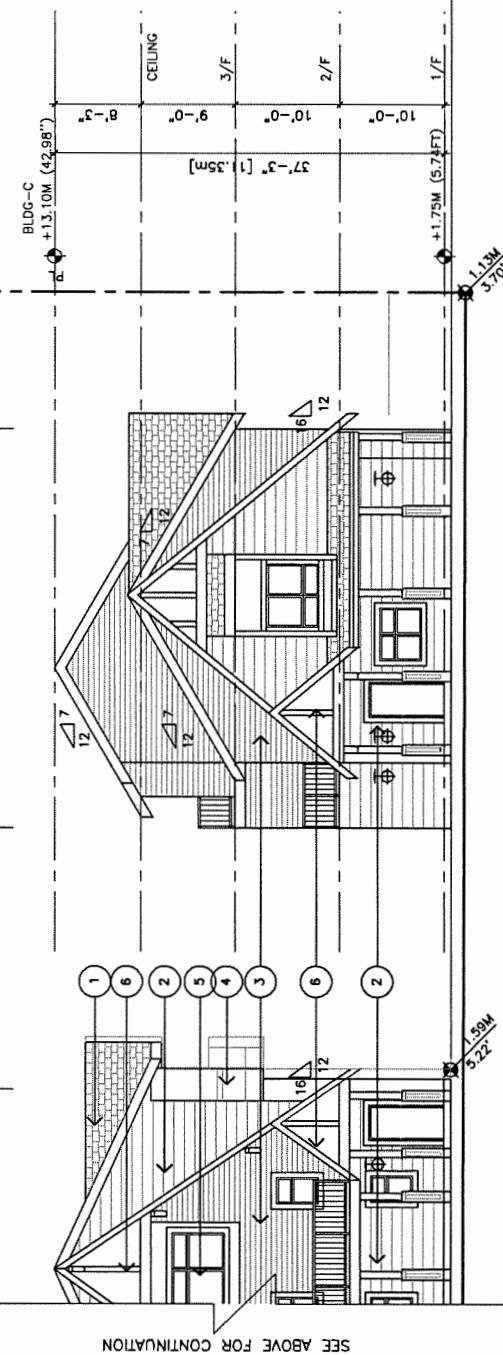

SEE ABOVE FOR CONTINUATION


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ERIC LAW
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ericarchitect@gmail.com
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ISSUED	FOR DEVELOPMENT / PERMIT APPLICATION
1.	2018.06.04 FOR CITY DP REVIEW
2.	2018.08.03 FOR CITY ADP REVIEW
3.	2019.10.19 FOR CITY REVIEW
4.	2019.11.19 FOR CITY REVIEW




DP 18-797785 DEVELOPMENT PERMIT
PLAN # 2.B

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4.	2019.10.19 FOR CITY REVIEW
5.	2019.11.19 FOR CITY REVIEW

PROPOSED TOWNHOUSE AT 9620-9800 WILLIAMS RD RICHMOND ELEVATIONS	PROJECT NUMBER: 12-25 ISSUED: 11/19/2019 DRAWN BY: EL CHECKED BY: EL FILENAME: 15-12-WMR-191119-DPP.DWG
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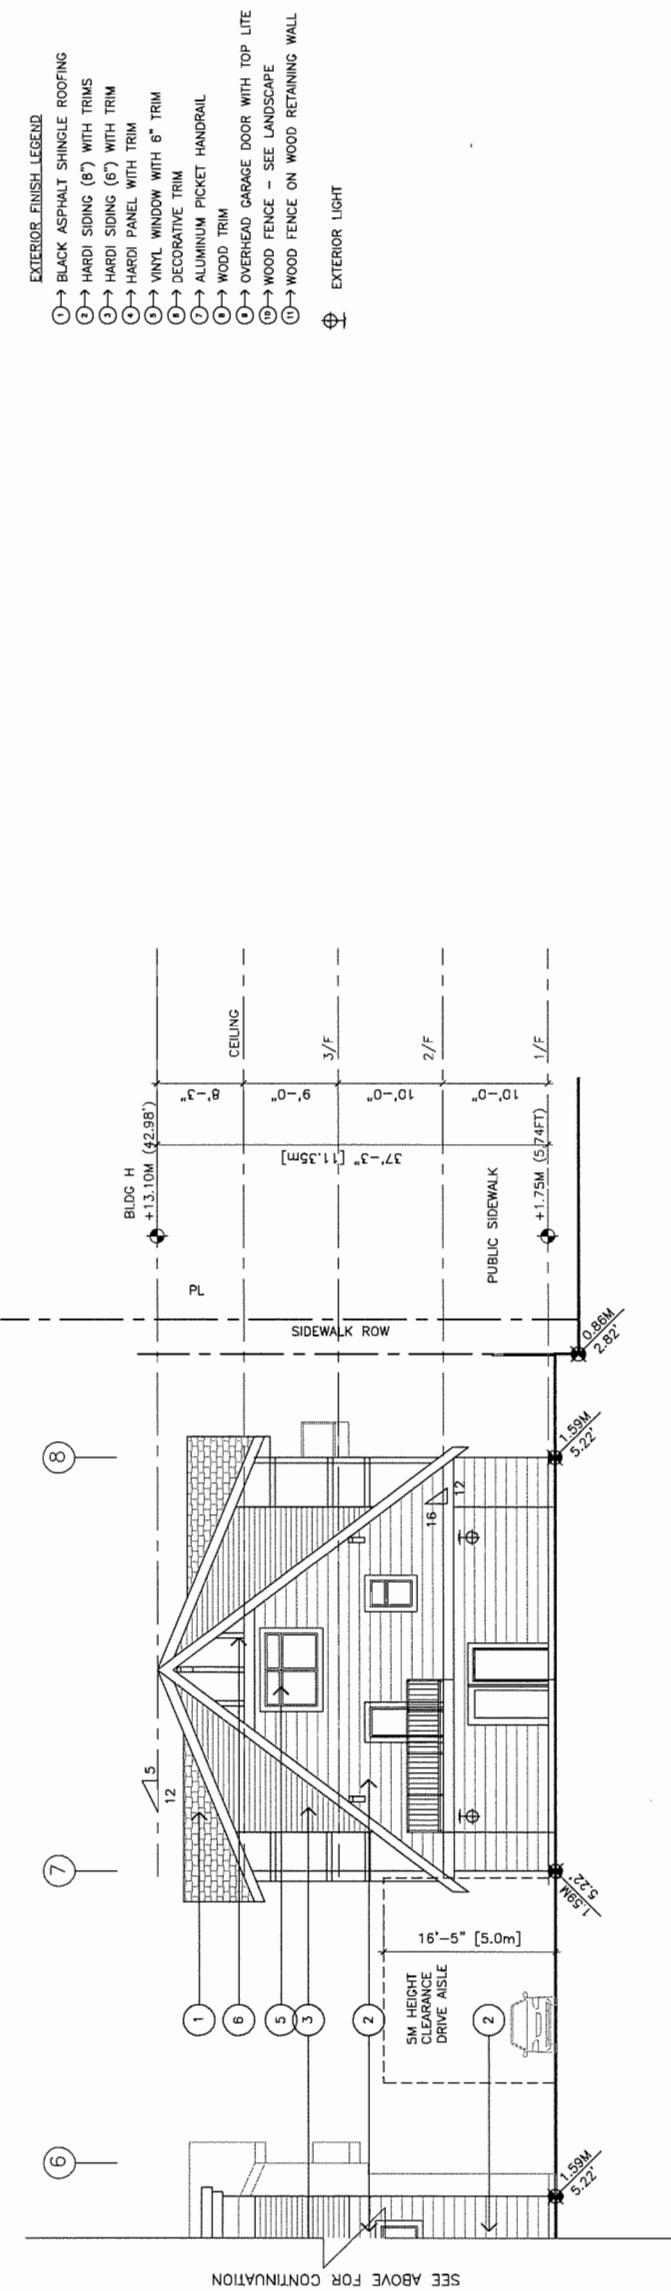
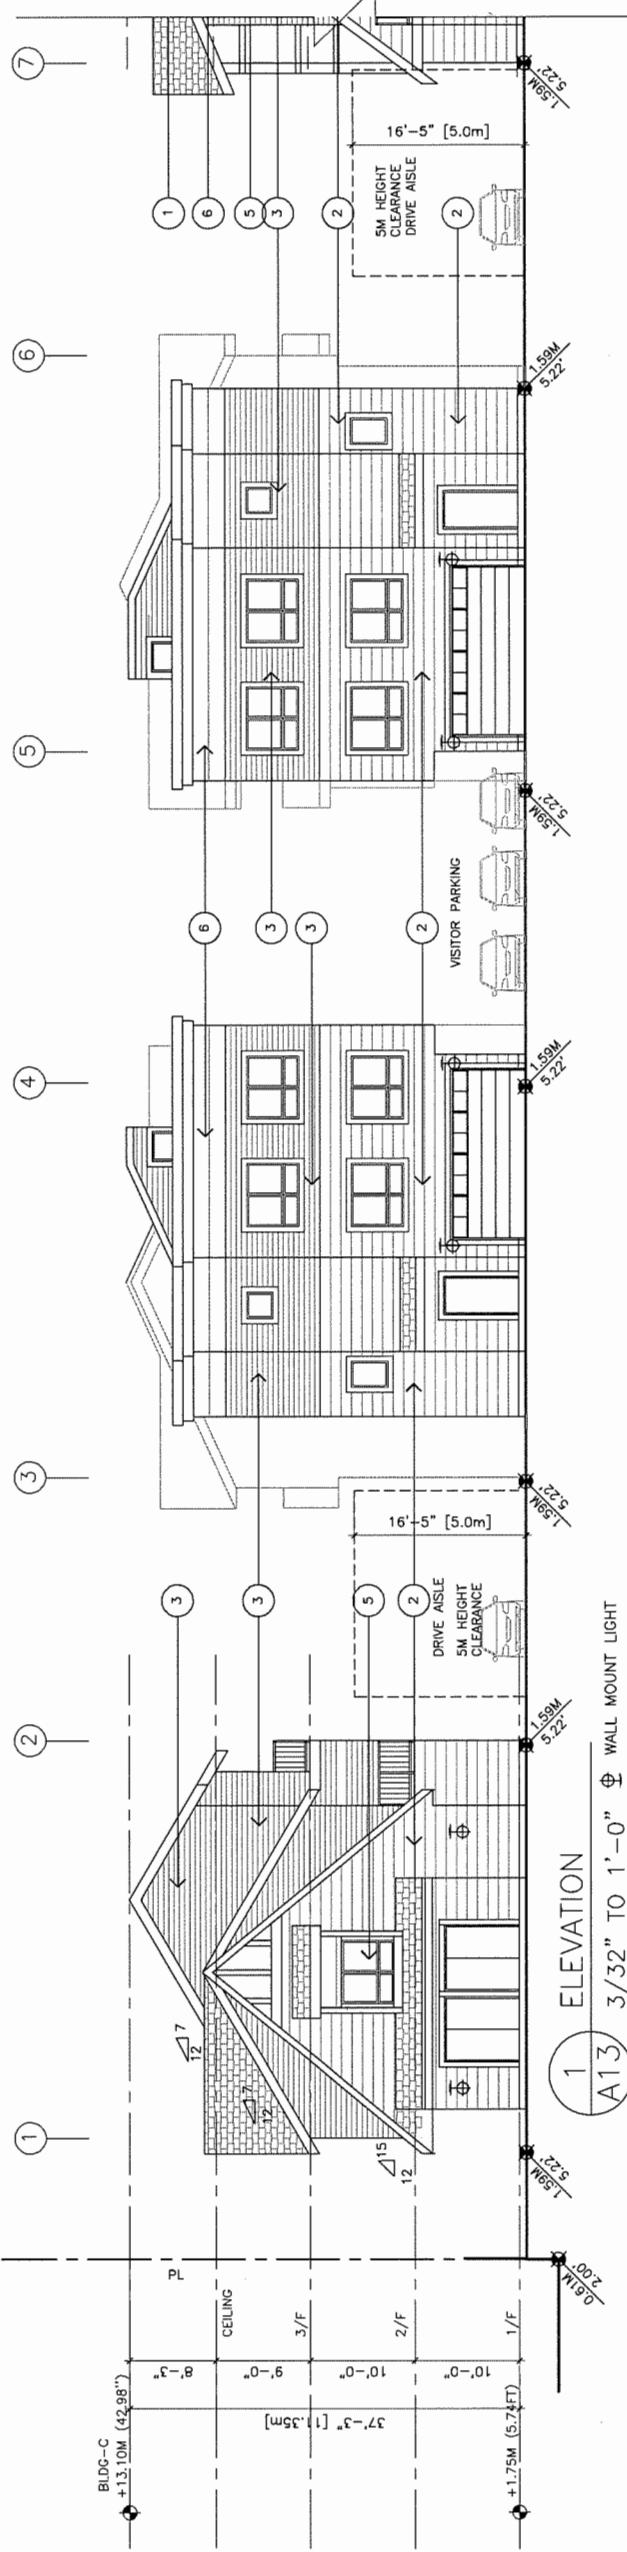


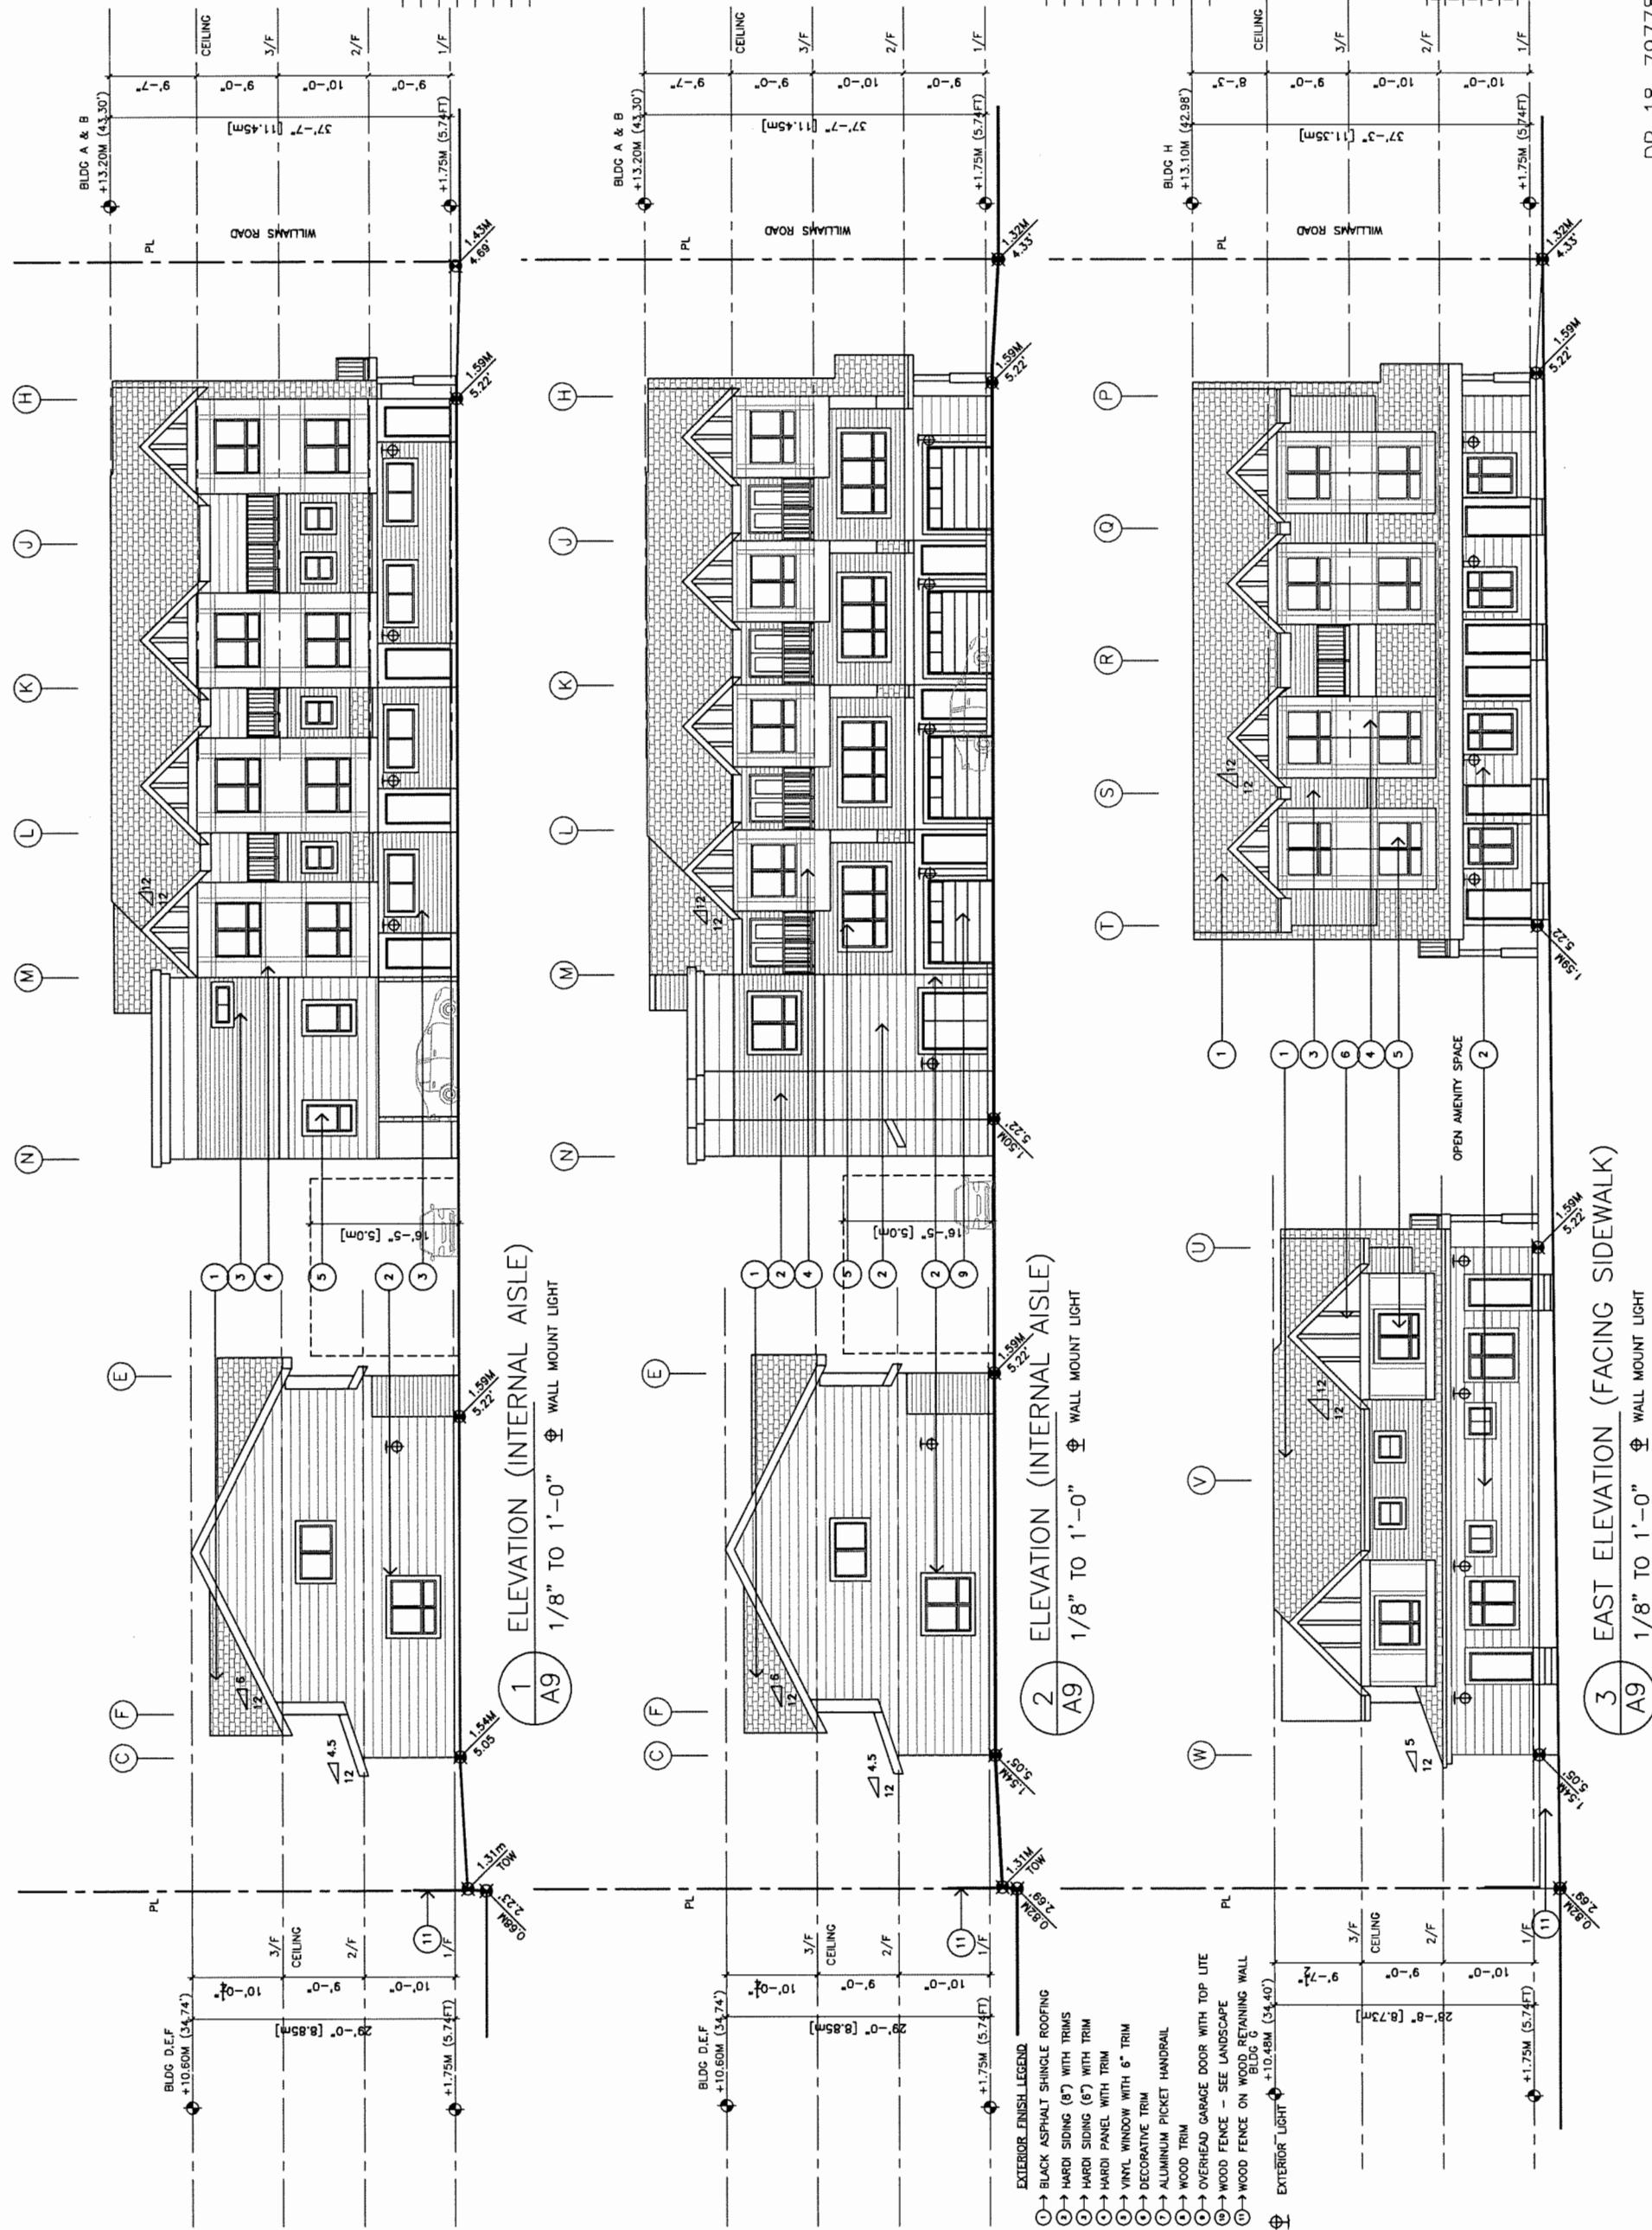DP 18-797785 DEVELOPMENT PERMIT
PLAN #2.C

**ERIC LAW
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ISSUED
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3. 2018.08.03 FOR CITY DPP REVIEW
4. 2018.10.19 FOR CITY REVIEW
5. 2019.11.19 FOR CITY REVIEW

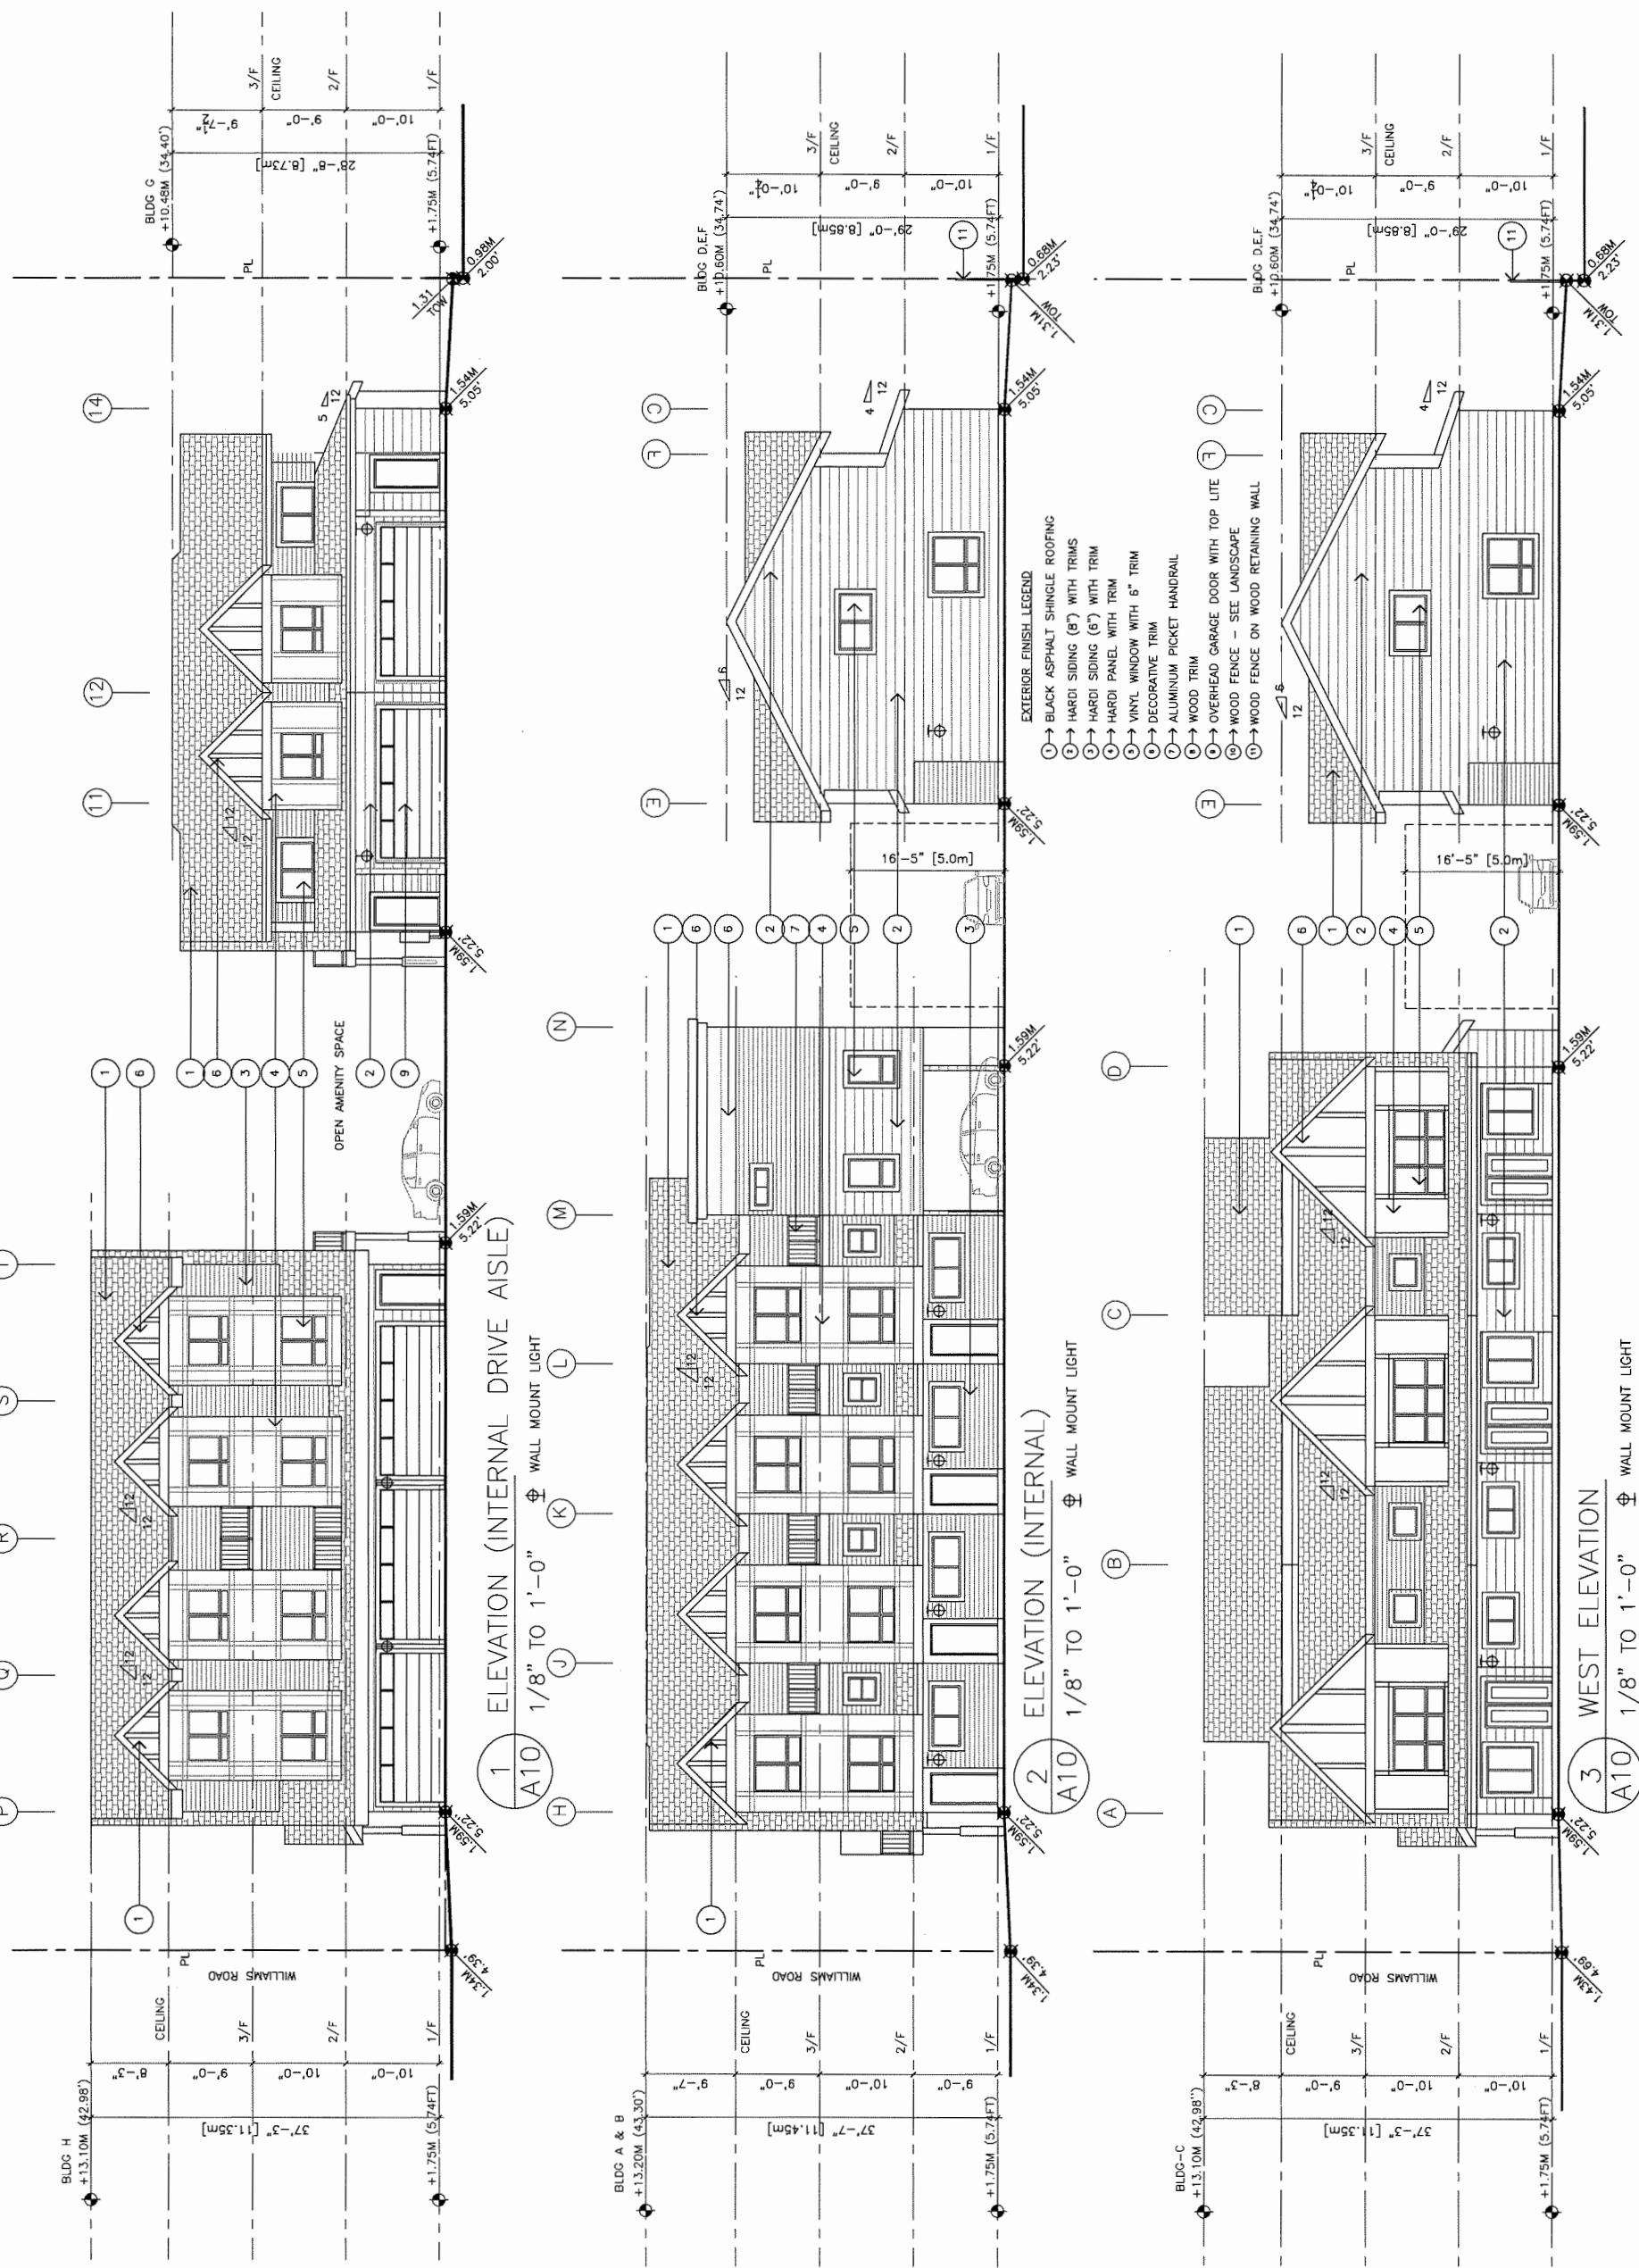

**PROPOSED TOWNHOUSE
AT
9620-9800
WILLIAMS RD RICHMOND**

ELEVATIONS

PROJECT NUMBER: 12-25
ISSUED: 11/18/2019
DRAWN BY: EL
CHECKED BY: EL
REVISION
FILENAME: 15-12_MNR_191119-DPP.DWG

A13

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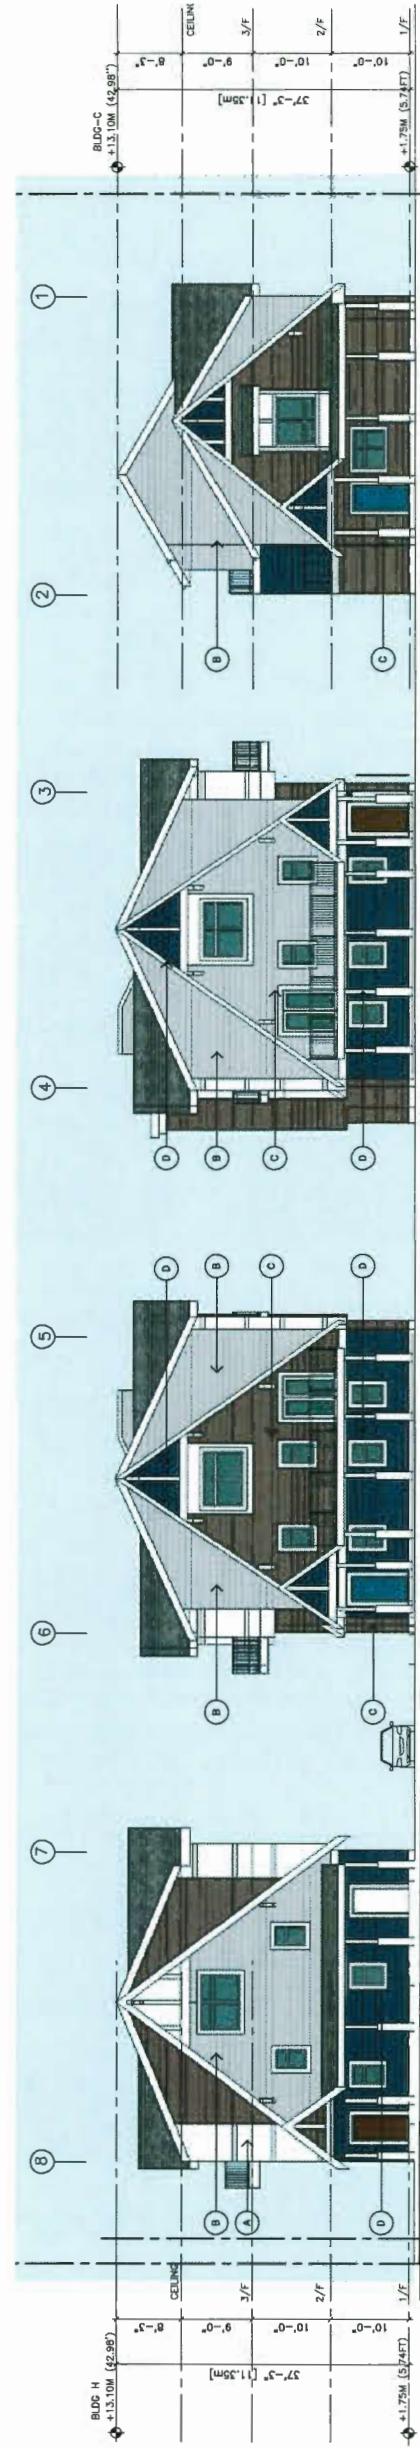
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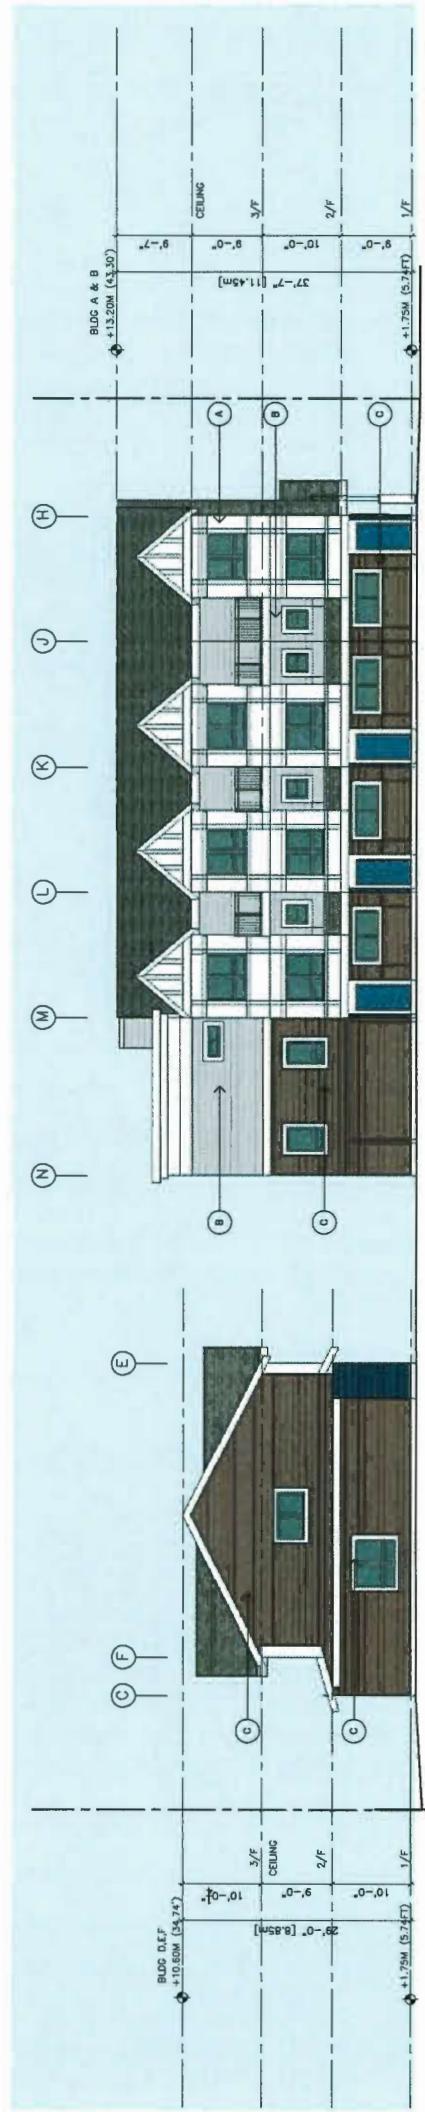
3. 2018.08.03 FOR CITY ADP REVIEW

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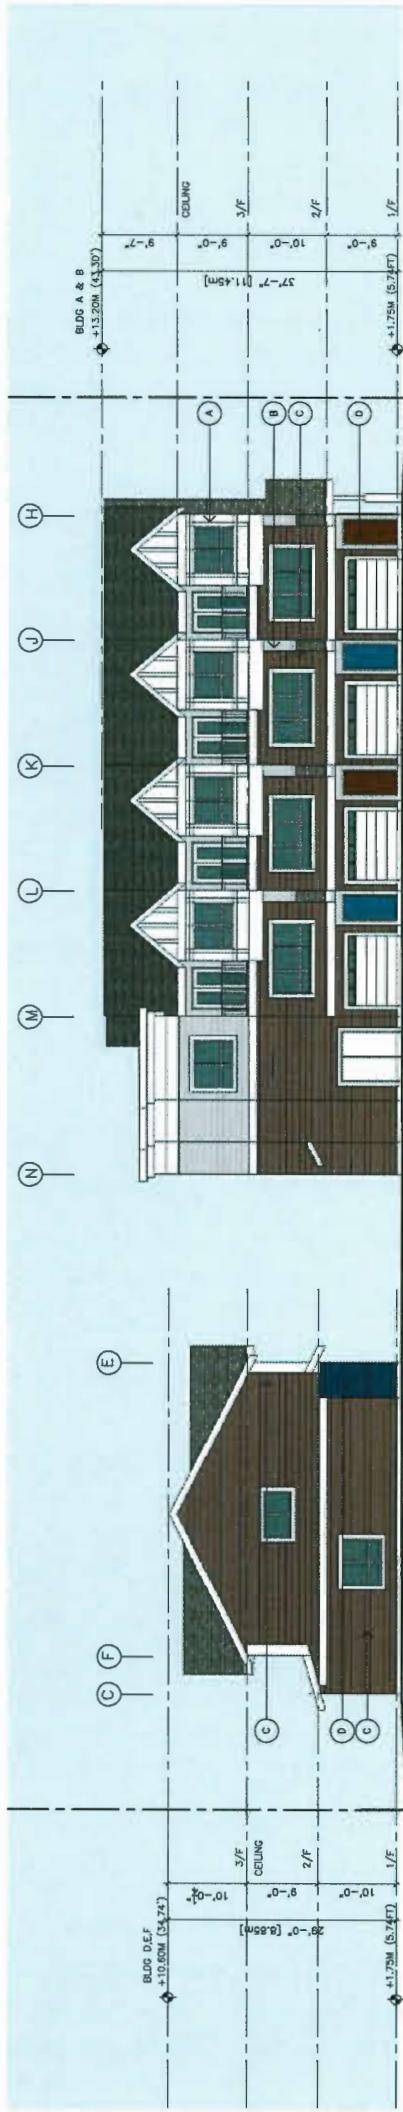
5. 2019.11.19 FOR CITY REVIEW



2 NORTH ELEVATION (FACING WILLIAMS ROAD)
A8 3/16" TO 1'-0"




1 ELEVATION (INTERNAL AISLE)
A9 3/16" TO 1'-0"



2 ELEVATION (INTERNAL AISLE)
A9 3/16" TO 1'-0"

HARDI SIDING COLOUR LEGEND
ALL HARDI TRIM OR CORNER TRIM SHALL MATCH THE ADJACENT HARDI PANEL COLOUR

EXTERIOR COLOUR
 A → HARDI PLUS ARCTIC WHITE
 B → HARDI PLUS PEARL GREY
 C → HARDI PLUS TIMBER BARK
 D → HARDI PLUS EVENING BLUE

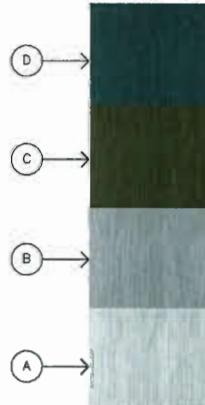

**PROPOSED TOWNHOUSE
AT
9620-9800
WILLIAMS RD RICHMOND**

COLOUR

PROJECT NUMBER: 12-25
ISSUED: 11/18/2019
DRAWN BY: EL
CHECKED BY: EL
FILENAME: 15-12_MNR_191119-DPP.DWG

A17

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3.	2018.06.04 FOR CITY AIP REVIEW

4. 2019.10.19 FOR CITY REVIEW
5. 2019.11.19 FOR CITY REVIEW

1

4

1

104

1

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1

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100

- 3. 2019.11.19 REVISE PER CITY COMMENT
- 2. 2019.10.17 REVISE PER ADP COMMENTS

1. 2018.06.04 REVISE PER CITY DP COMMENTS
REVISION

**PROPOSED TOWNHOUSE
AT**

9620-9800
WILLIAMS RD RICHMOND

COLOUR

PROJECT NUMBER:12-25
ISSUED: 11/19/2010

FILENAME: 10110-00000
DRAWN BY: EL
CHECKED BY: EL
ISSUED: 10/2010




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A18

35 DEVELOPMENT PERMIT


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18-797785 DEVELOPMENT PERMIT




ERIC LAW
ARCHITECT

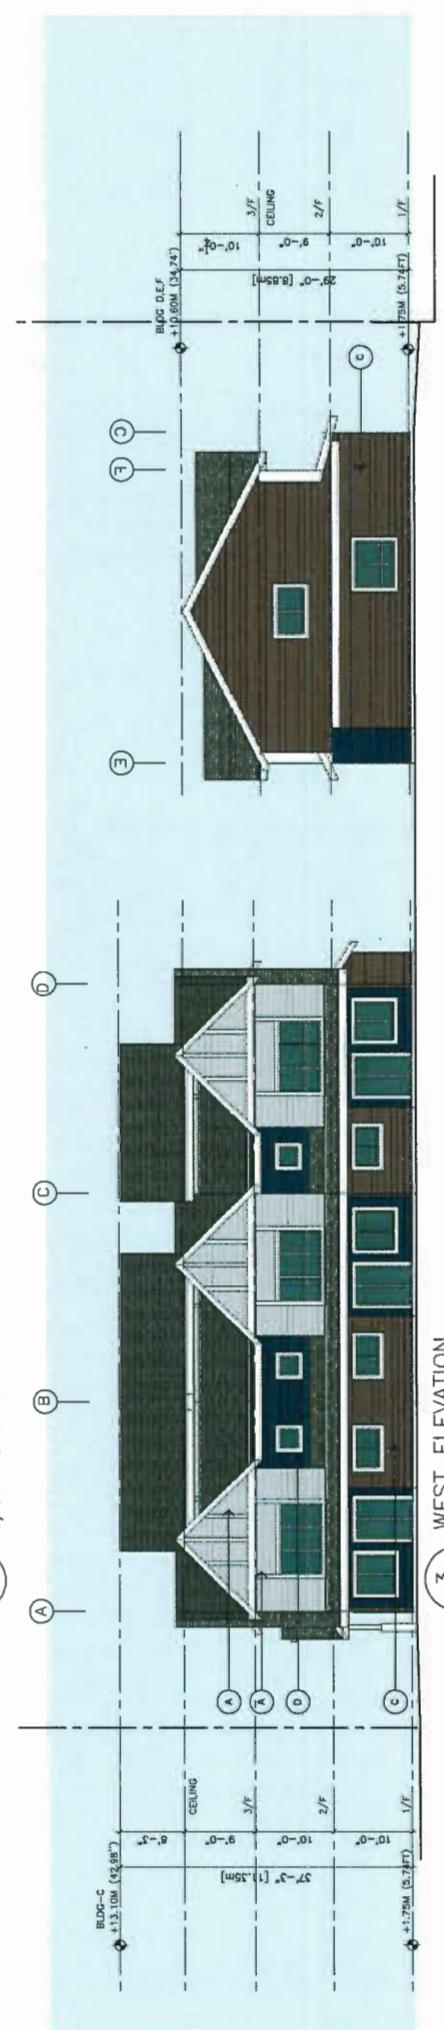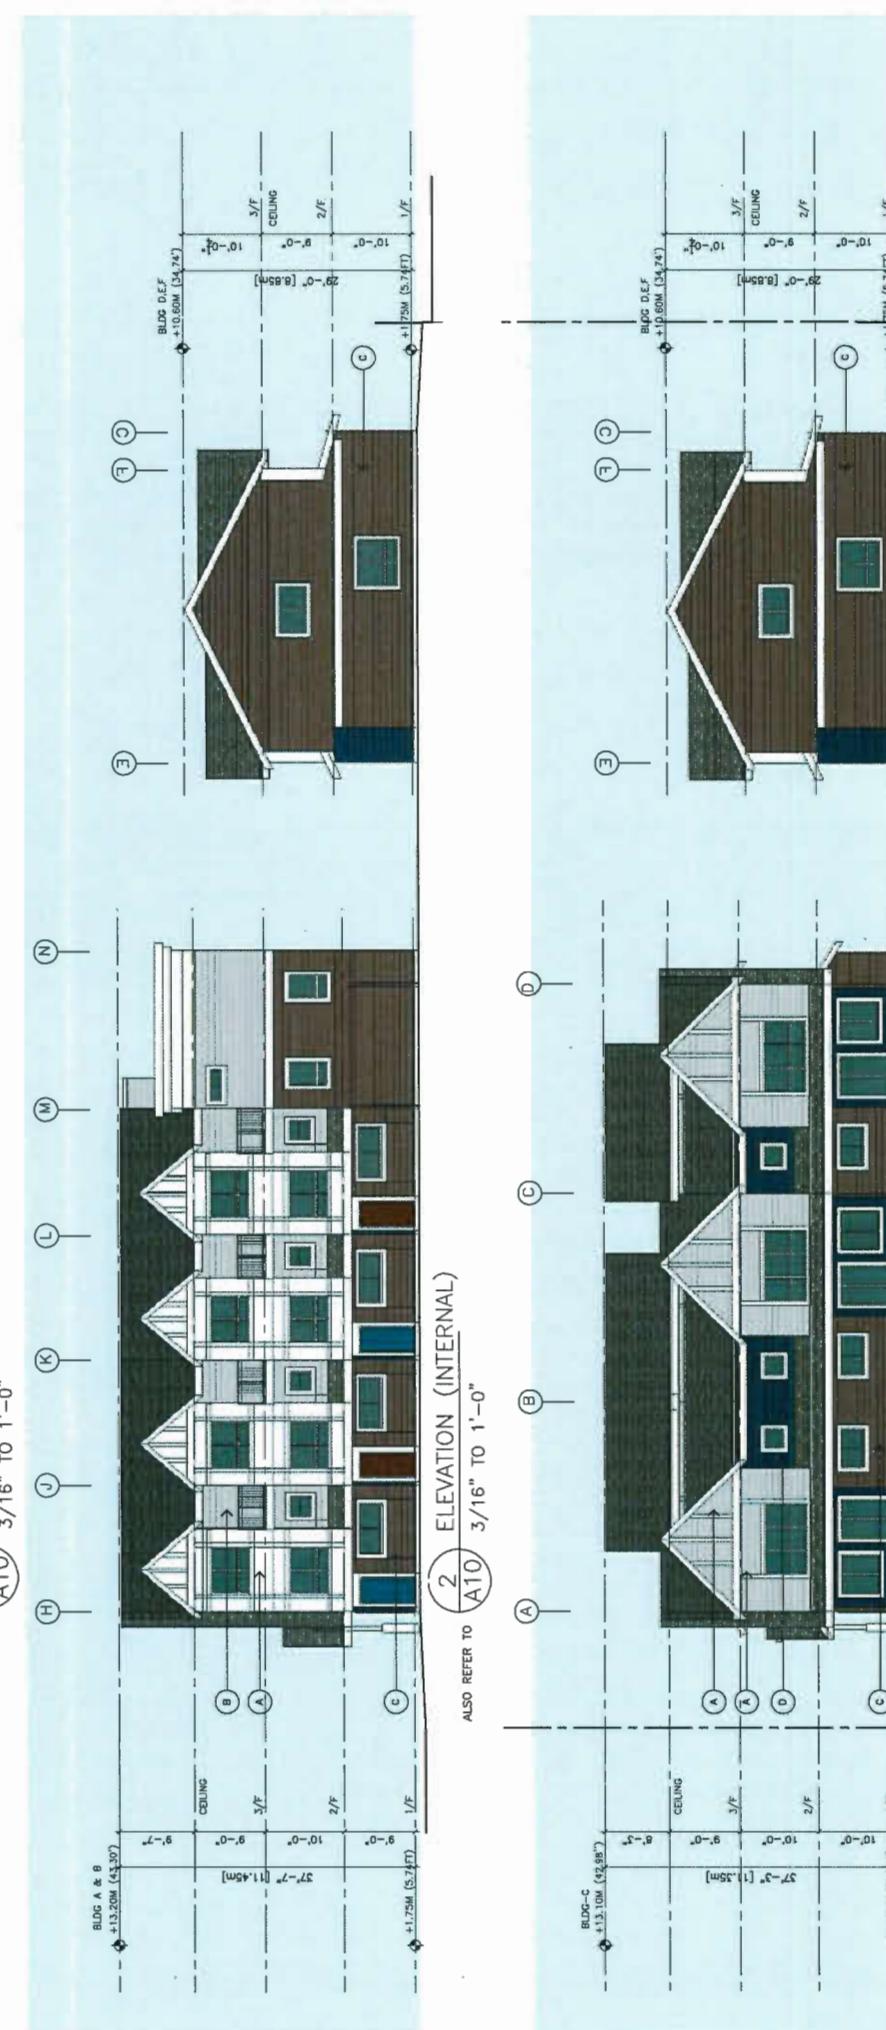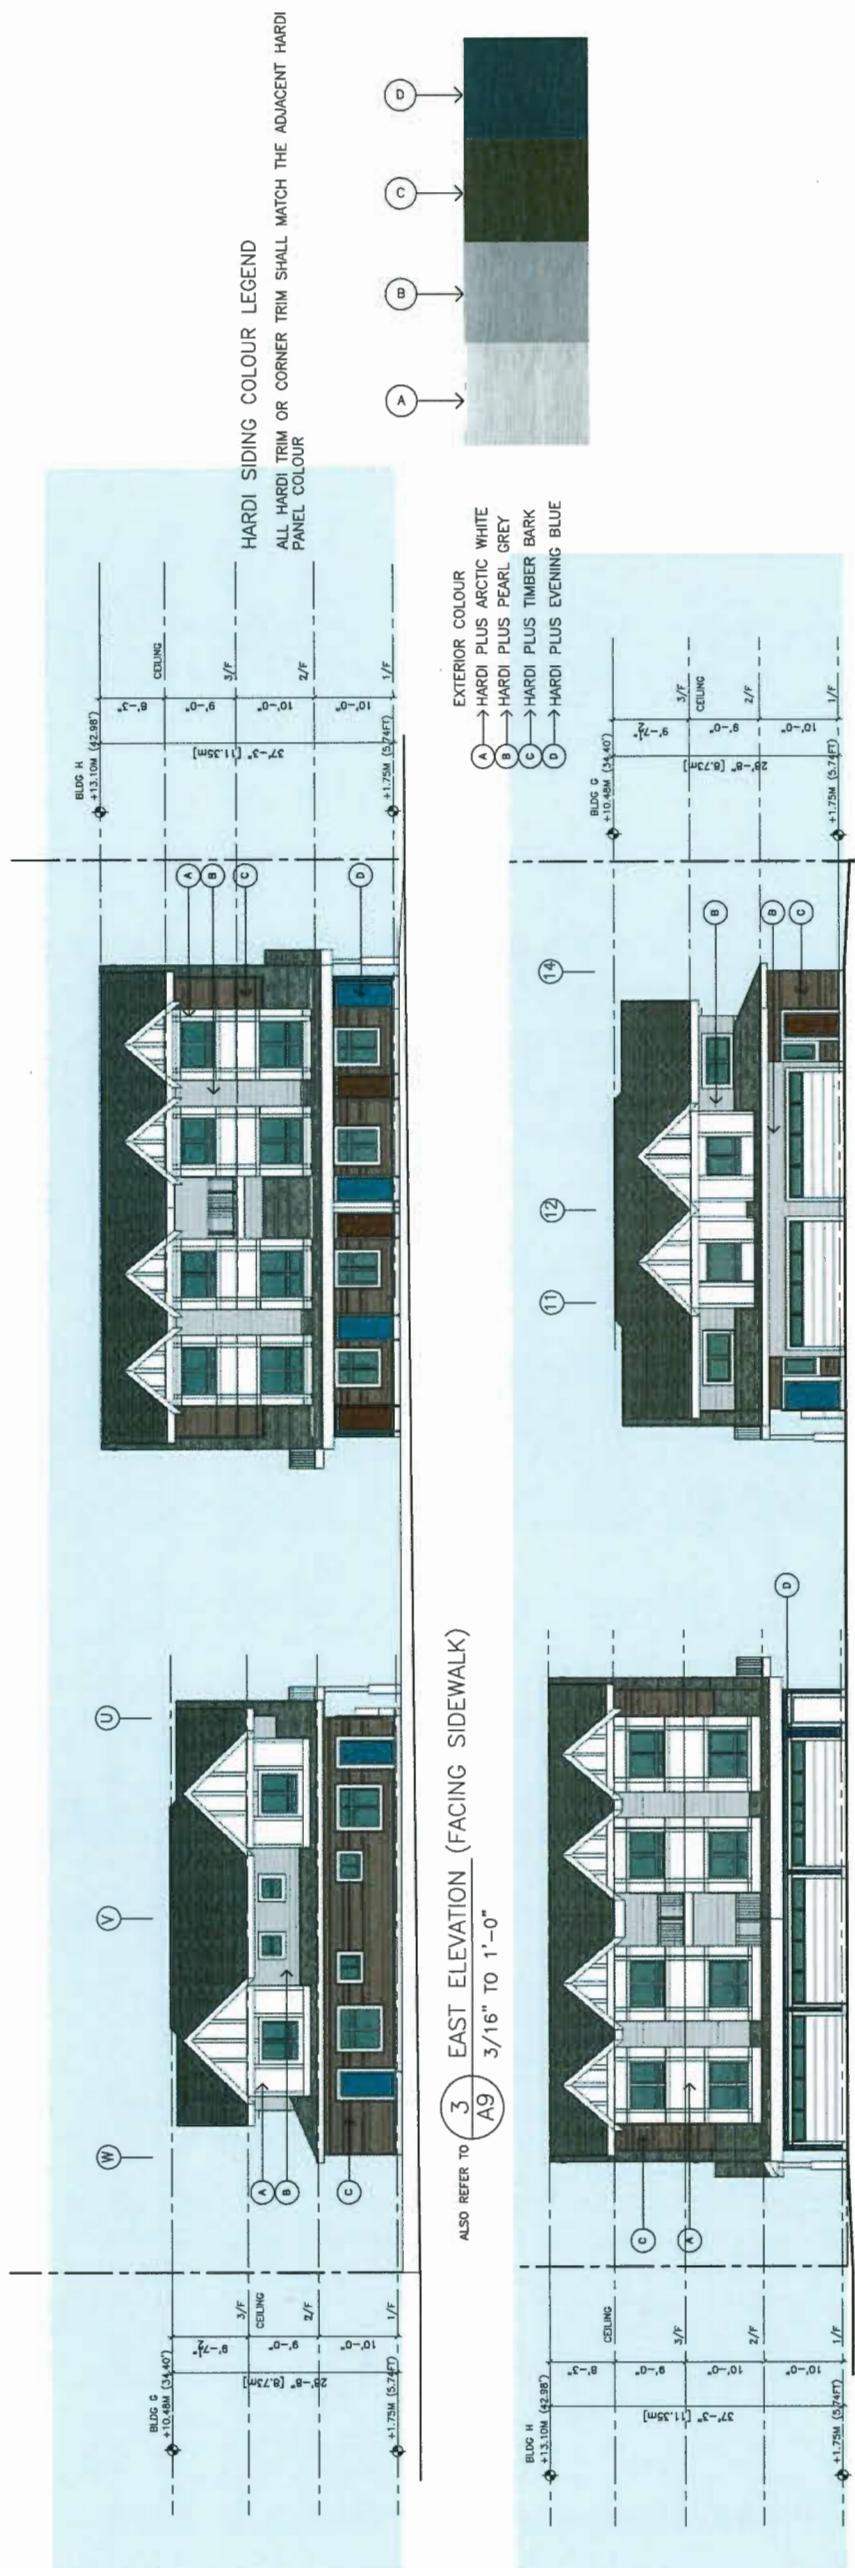
HARDI SIDING COLOUR LEGEND
ALL HARDI TRIM OR CORNER TRIM SHALL MATCH THE ADJACENT HARDI
PANEL COLOUR

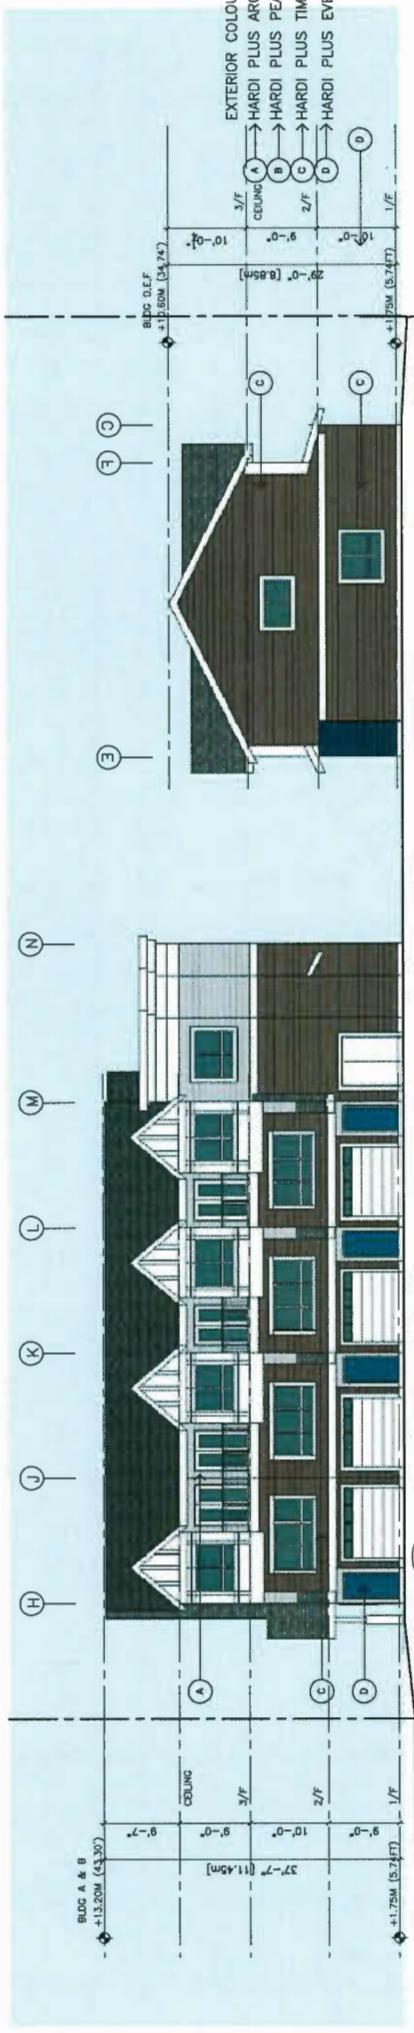


ALSO REFER TO A11 ELEVATION (INTERNAL DRIVE AISLE)
1 3/16" TO 1'-0"

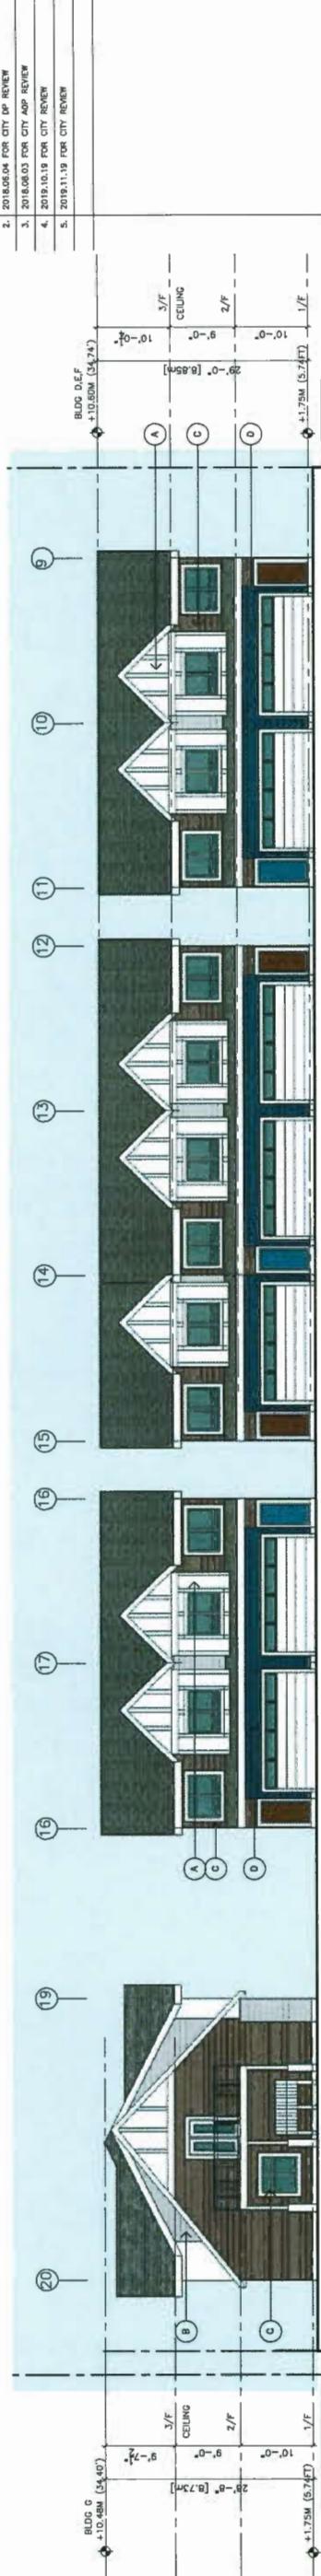

SO REFER TO 2 ELEVATION (INTERNAL DRIVE AISLE)
A 1 $\frac{3}{16}^{\prime \prime}$ TO $1^{\prime \prime}$ -0"

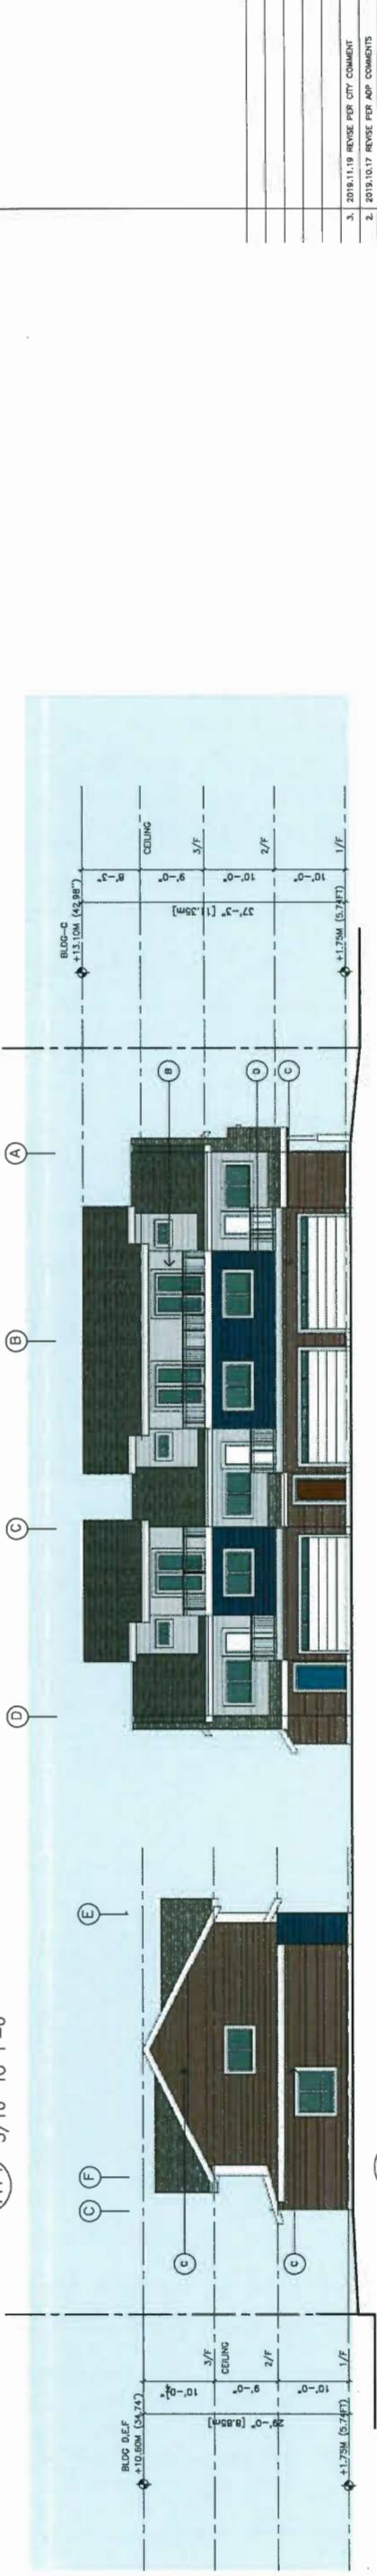

ALSO REFER TO  ELEVATION (INTERNAL DRIVE AISLE)
A12 3/16" TO 1'-0"

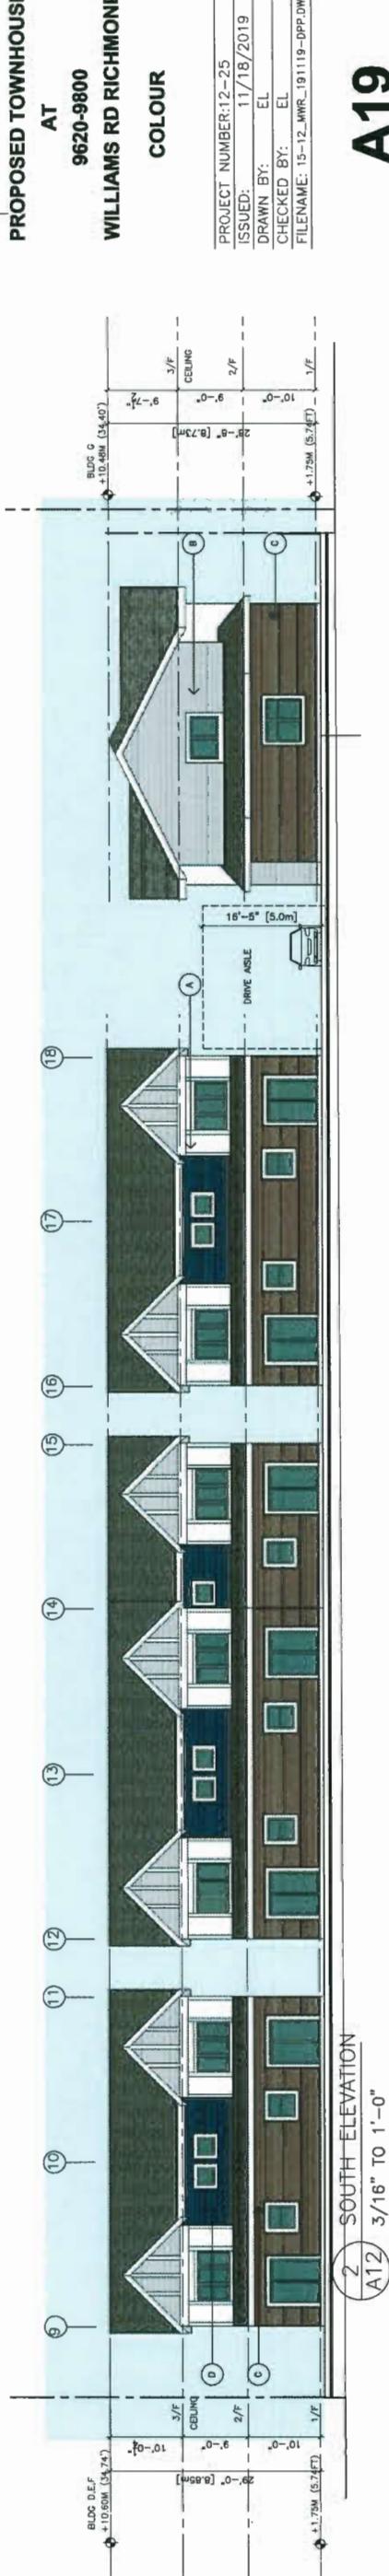

DP 18-797785 DEVELOPMENT PERMIT

PCLAN #2 1


**ERIC LAW
ARCHITECT**

ericlaw.architect@gmail.com
216 288 WEST AVENUE VANCOUVER BC
V6J 1H8
TEL: (604) 505-2099
FAX: (604) 505-2887


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ISSUED

1. 2018.01.11 FOR DEVELOPMENT PERMIT APPLICATION
2. 2018.06.04 FOR CITY DP REVIEW
3. 2018.08.03 FOR CITY AOP REVIEW
4. 2019.10.19 FOR CITY REVIEW
5. 2019.11.19 FOR CITY REVIEW

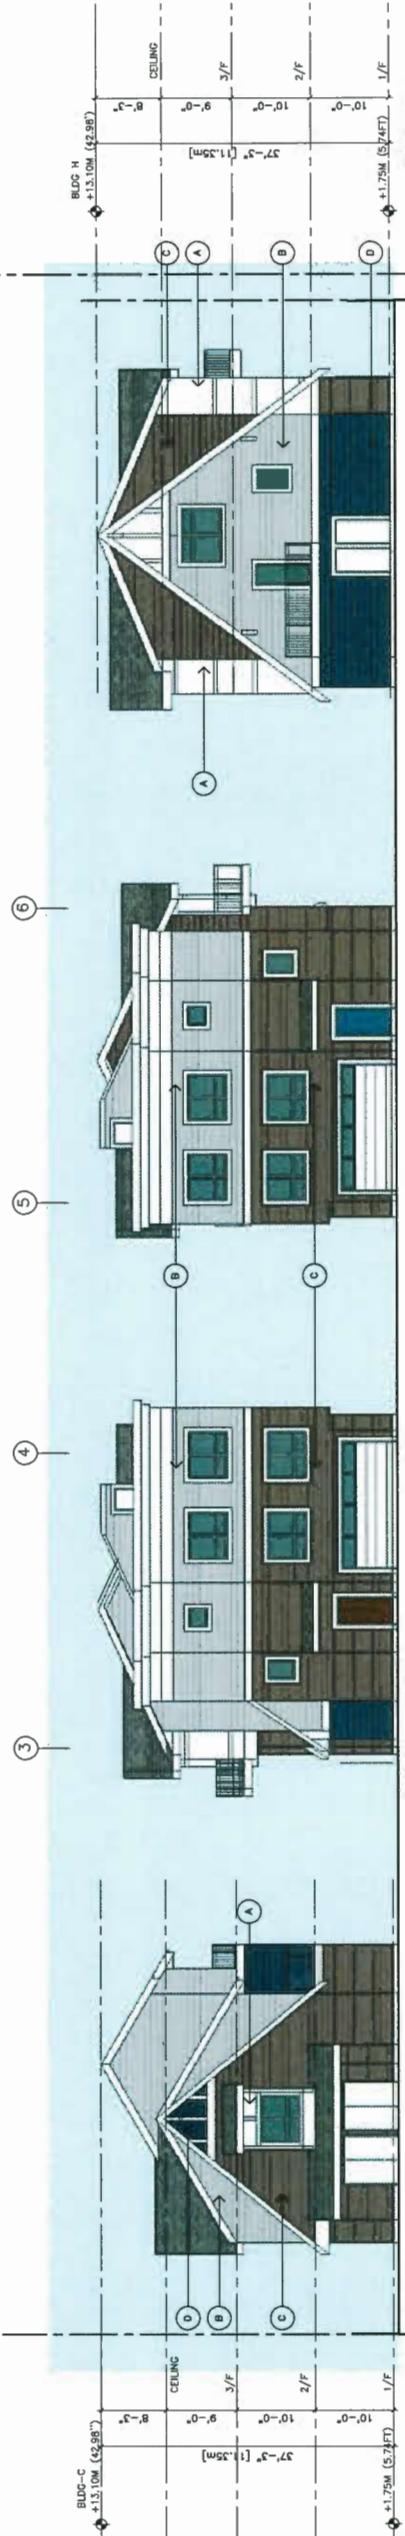

HARDI SLIDING COLOUR LEGEND
ALL HARDI TRIM OR CORNER TRIM SHALL MATCH THE ADJACENT HARDI
PANEL COLOUR

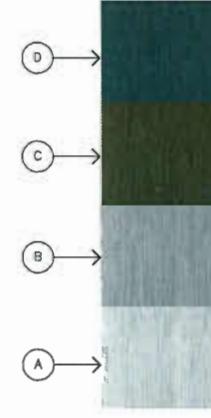

EXTERIOR COLOUR
 A → HARDI PLUS ARCTIC WHITE
 B → HARDI PLUS PEARL GREY
 C → HARDI PLUS TIMBER BARK
 D → HARDI PLUS EVENING BLUE

**PROPOSED TOWNHOUSE
AT
9620-9800
WILLIAMS RD RICHMOND**

COLOUR

PROJECT NUMBER: 12-25
ISSUED: 11/18/2019
DRAWN BY: EL
CHECKED BY: EL
FILENAME: 15-12_MWR_191119-DP.DWG

A20




LANDSCAPE
ARCHITECTS

Suite C100 - 4185 Still Creek Drive

Burnaby, British Columbia, V5C 6G9

P: 604 254-0011 | F: 604 254-0022

SEAL:

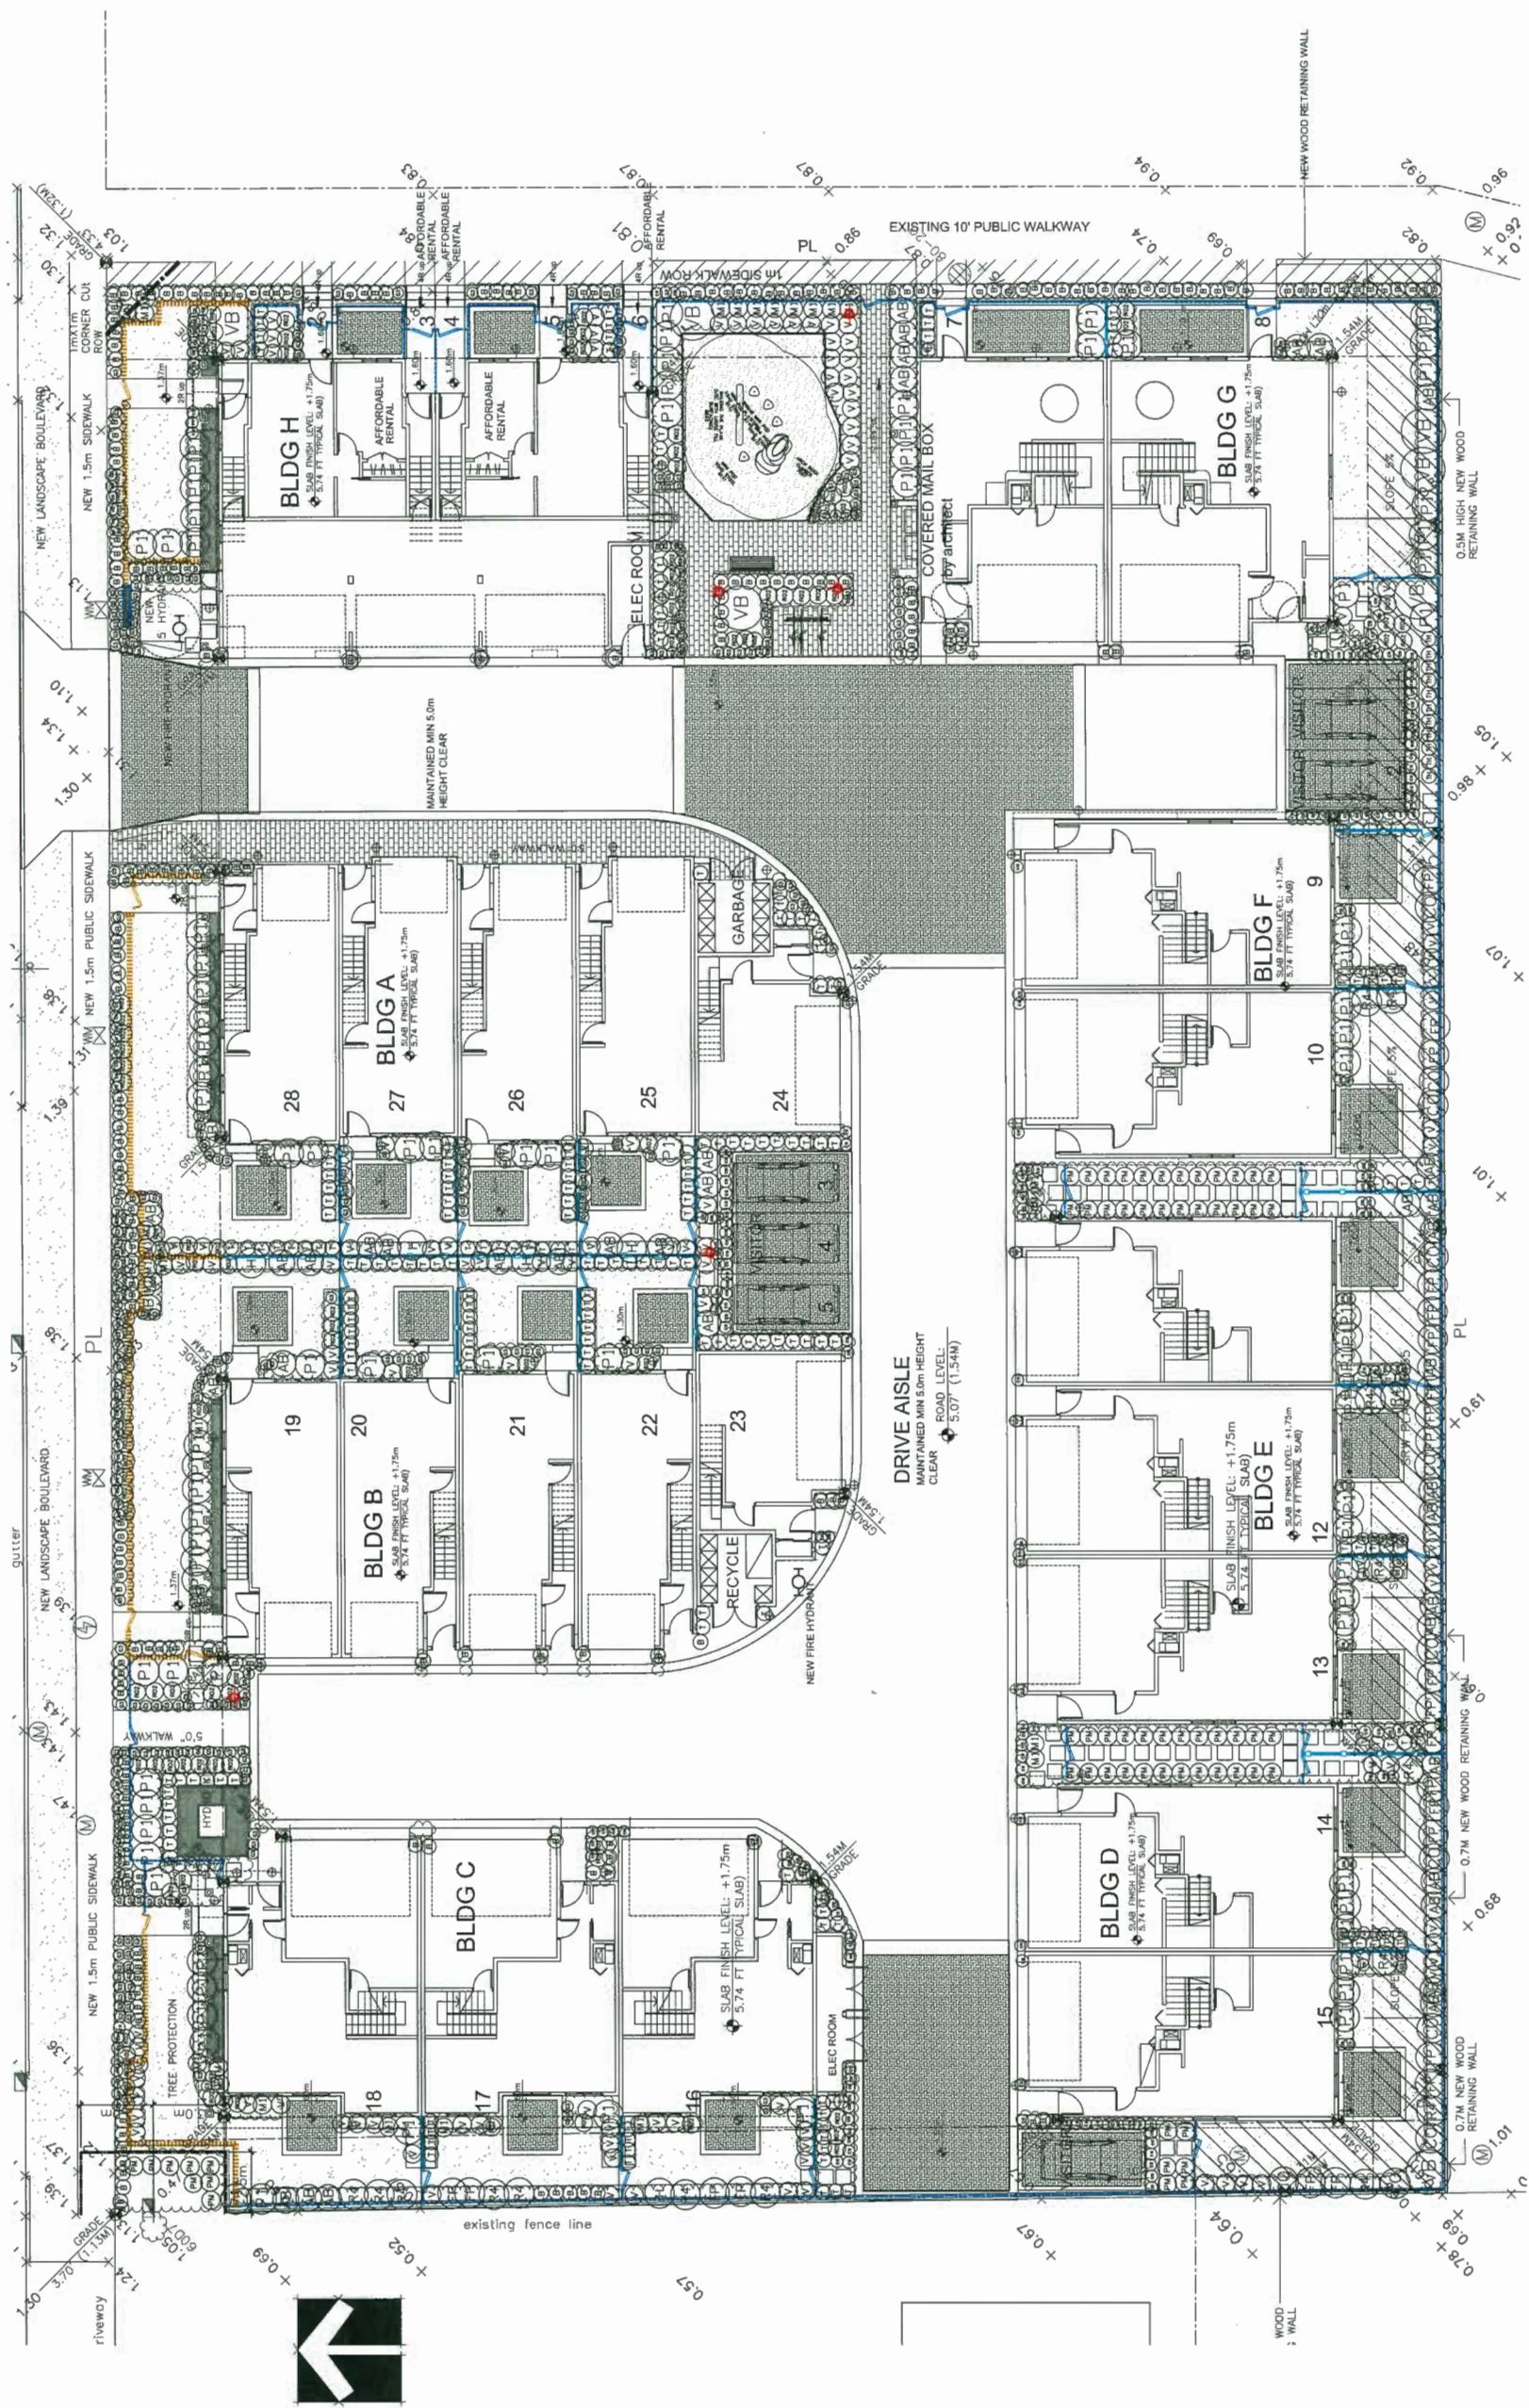

DP 18-797785
PLAN 3.B

1. ALL POSTS PRESSURE TREATED TO CSA STANDARD AND END CUTS TREATED WITH PRESERVATIVE.
2. ALL OTHER MEMBERS TO BE CEDAR, #2 (CONSTRUCTION) GRADE MINIMUM.
3. ALL HARDWARE HOT DIPPED GALVANIZED.
4. APPLY 2 COATS EXTERIOR STAIN TO MANUFACTURERS SPECIFICATION. ALL FENCE TO BE LEVEL, CHANGES IN GRADE TO BE IN 12'-18" STEPS MAX. GAPS TO GRADE TO FOLLOW FINISH GRADE, GATE TO BE 3'-8".

B'-O" MAX. O.C.

5'-0" / 3'-0" HEIGHT WOOD FENCE 1/2" = 1'-0"

PLANT SCHEDULE

TYPE AND LOCATION BY CITY	
STREET TREE	7CM CAL
STREET TREE	6CM CAL
NOTES: *PLANT SIZES IN THIS LIST ARE SPECIFIED ACCORDING TO THE BC LANDSCAPE STANDARD AND CANADIAN LANDSCAPE STANDARD LATEST EDITION. CONTAINER SIZES SPECIFIED AS PER CNL A STANDARD SIZE AND CONTAINER SIZE ARE THE MINIMUM ACCEPTABLE SIZES. REFER TO SPECIFICATIONS FOR DEFINED CONTAINER SIZES AND OTHER PLANT MATERIAL REQUIREMENTS. *SEARCH AND REVIEW MAKE PLANT MATERIAL AVAILABLE FOR OPTIONAL REVIEW BY LANDSCAPE ARCHITECT AT SOURCE OF SUPPLY, AREA OF SEARCH TO INCLUDE LOWER MAINLAND AND FRAZER VALLEY. *SUBSTITUTIONS OBTAIN WRITTEN APPROVAL FROM THE LANDSCAPE ARCHITECT PRIOR TO MAKING ANY SUBSTITUTIONS TO THE SPECIFIED MATERIAL. UNAPPROVED SUBSTITUTIONS WILL BE REJECTED. ALLOW A MINIMUM OF FIVE DAYS FOR DELIVERY OF PLANT MATERIAL. REQUEST TO SUBSTITUTE OR SUBSTITUTE CONDITIONS MUST BE MET IN ORDER TO AUTHORIZE DELIVERY. ALL LANDSCAPE MATERIAL AND WORKMANSHIP MUST BE EXCEDED BY LANDSCAPE STANDARD AND CANADIAN LANDSCAPE STANDARD TESTIGATION. ALL MATERIAL PROVIDED BY NURSERY, BIO-SOLIDS NOT PROVIDED BY NURSERY, BIO-SOLIDS NOT PROVIDED FROM CERTIFIED DISEASE FREE NURSERY.	
STREET TREE	5CM CAL
NOTES: *PLANT SIZES IN THIS LIST ARE SPECIFIED ACCORDING TO THE BC LANDSCAPE STANDARD AND CANADIAN LANDSCAPE STANDARD LATEST EDITION. CONTAINER SIZES SPECIFIED AS PER CNL A STANDARD SIZE AND CONTAINER SIZE ARE THE MINIMUM ACCEPTABLE SIZES. REFER TO SPECIFICATIONS FOR DEFINED CONTAINER SIZES AND OTHER PLANT MATERIAL REQUIREMENTS. *SEARCH AND REVIEW MAKE PLANT MATERIAL AVAILABLE FOR OPTIONAL REVIEW BY LANDSCAPE ARCHITECT AT SOURCE OF SUPPLY, AREA OF SEARCH TO INCLUDE LOWER MAINLAND AND FRAZER VALLEY. *SUBSTITUTIONS OBTAIN WRITTEN APPROVAL FROM THE LANDSCAPE ARCHITECT PRIOR TO MAKING ANY SUBSTITUTIONS TO THE SPECIFIED MATERIAL. UNAPPROVED SUBSTITUTIONS WILL BE REJECTED. ALLOW A MINIMUM OF FIVE DAYS FOR DELIVERY OF PLANT MATERIAL. REQUEST TO SUBSTITUTE OR SUBSTITUTE CONDITIONS MUST BE MET IN ORDER TO AUTHORIZE DELIVERY. ALL LANDSCAPE MATERIAL AND WORKMANSHIP MUST BE EXCEDED BY LANDSCAPE STANDARD AND CANADIAN LANDSCAPE STANDARD TESTIGATION. ALL MATERIAL PROVIDED BY NURSERY, BIO-SOLIDS NOT PROVIDED BY NURSERY, BIO-SOLIDS NOT PROVIDED FROM CERTIFIED DISEASE FREE NURSERY.	

PLANT SCHEDULE		CUTTING DATE
KEY	QTY	
FREE		

POLYSTICHUM MUNIMUM **WESTERN SWORD FERN**

#1 POT, 25CM

PLANT STANDARDS: "PLANT SIZES IN THIS LIST ARE SPECIFIED ACCORDING TO THE CANADIAN LANDSCAPE STANDARD, LATEST EDITION. CONTAINER SIZES SPECIFIED ARE FOR CNA STANDARDS. BOTH PLANT SIZE AND CONTAINER SIZE ARE THE MINIMUM ACCEPTABLE SIZES. REFER TO SPECIFICATIONS FOR DEFINED CONTAINER MEASUREMENTS AND OTHER PLANT MATERIAL REQUIREMENTS." SEARCH AND REVIEW, MAKE PLANT MATERIAL AVAILABLE FOR OPTIONAL PURCHASE BY LANDSCAPE ARCHITECT AT SOURCE OF SUPPLY. AREA OF SEARCH TO INCLUDE LOWER MAINLAND AND FRAZER VALLEY. SUBSTITUTIONS: PLANT MATERIAL NOT APPROVED BY LANDSCAPE ARCHITECT PRIOR TO MAKING ANY SUBSTITUTIONS TO THE SPECIFIED MATERIAL. UNAPPROVED SUBSTITUTIONS WILL BE REJECTED. DUE TO A MINIMUM OF FIVE DAYS PRIOR TO DELIVERY FOR REQUEST TO SUBSTITUTE, SUBSTITUTIONS ARE SUBJECT TO DELAY. PLANT MATERIAL NOT APPROVED BY LANDSCAPE ARCHITECT PRIOR TO DELIVERY, ALL LANDSCAPE MATERIAL AND WORKMANSHIP MUST MEET OR EXCEED CANADIAN LANDSCAPE STANDARDS. DEFINITION OF CONDITIONS OF AVAILABILITY: ALL PLANT MATERIAL MUST BE PROVIDED FROM CERTIFIED DISEASE FREE NURSERY."

NOTE

MAX 8'-0" O.C.

2" SQ METAL POST

1 1/2" SQ TOP RAIL

1" SQ VERTICAL RAIL

1" SQ BOTTOM RAIL

NOTES:
1. FENCE TO HAVE 2 COATS OF
PAINTED COAT IN BLACK.
2. 1/2" GAP AT TOP.

1/2" = 1'

4'2" HT ALUMINUM FENCE AND GATE

42" HT ALUMINUM FENCE AND GATE
1/2" = 1'-0"

SIZE / REMARKS

S. #	IMPROVEMENT	NEW SITE/BUILD/CITY COMMENTS	DD
5	IMPROV	NEW SITE/BUILD/CITY COMMENTS	DD
4	DOOR TO DOOR	NEW SITE/BUILD/CITY COMMENTS	DD
3	18 AUG 22	REMOVED STREET FURNITURE	DD
2	18 MAY 23	NEW SITE/BUILD/CITY COMMENTS	DD
1	17 NOV 24	NEW SITE PLAN	DD

PROJECT NUMBER:	17-493
SIZE / REMARKS	
L:	1.8M H:1.7' B:6B
L:	2M STD; BAB
L:	1.8M H:1.7' BAB
B:	BAB
L:	2M STD; BAB
L:	2M STD; BAB
H:	300CM
W:	40CM
D:	80CM
H:	550CM
W:	550CM
D:	100CM
H:	3
W:	BAB, TREE FORM

25CM
SIZES SPECIFIED
ARE DEFINED
AS OPTIONAL.
APPROVED
ARE SUBJECT TO
NOT EXCEED

NOTE:

42' HT. PICKET FENCE AND GATE AT 10' CLEARANCE FROM PMT

NOTE:

1. TREATED WITH PRESERVATIVE.
2. ALL OTHER MEMBERS TO BE CEDAR, #2 (CONSTRUCTION) GRADE MINIMUM.
3. ALL HARDWARE NOT COATED GALVANIZED.
4. APPLY 2 COATS EXTERIOR STAIN TO MANUFACTURERS SPECIFICATION.
5. ALL FENCES TO BE LEVEL CHANGES IN GRADE TO BE IN 2'-18" STEPS (MAX.). GAPS TO GRADE TO FOLLOW FINISH GRADE. GATE TO BE 3'-6" MAX. SPACING OF POSTS.

1/2" = 1'-0"

4 DEVELOPMENT SIGNAGE

L-1

(3) 42'-HT. PICKET FENCE AND GATE AT 10' CLEARANCE FROM PMT
L-1 1/2 = 1'-0"
L-2 1/2 = 1'-0"
L-3 1/2 = 1'-0"

1100

	NEW SITE/MAN/CITY COMMENTS	DD
\$ 19-M0115		00
4 450CL-12	NEW SITE/CHANGED CITY COMMENTS	00
3 18-AUG-12	REVISED STREET/NIGHTTIME	00
1 18-MAR-13	NEW SITE/FLAMMABLE COMMENTS	00
1 17-JUN-14	NEW SITE PLAN	00

NO. DAT
CLIENT:

TOWNHOUSE DEVELOPMENT
9620, 9640, 9660 & 9680 Williams Road

DRAWING TITLE: LANDSCAPE

DRAWING NUMBER:
13

DP 18-797785
DESIGN: DD
CHKD: PGM
OF 6
17 NOV



City of Richmond

Report to Development Permit Panel

To: Development Permit Panel

Date: November 20, 2019

From: Wayne Craig
Director, Development


File: DP 18-818671

Re: **Application by Christopher Bozyk Architects Ltd. for a Development Permit at
4693, 4720, 4740 Vanguard Road and Road Parcel Richmond Key 20909**

Staff Recommendation

That a Development Permit be issued which would:

1. Permit the construction of two industrial buildings on the consolidated parcel including 4693, 4720, 4740 Vanguard Road and Road Parcel Richmond Key 20909 on a site zoned “Industrial Retail (IR1)”; and
2. Vary the provisions of Richmond Zoning Bylaw 8500 to:
 - a) Increase the maximum height for buildings from 12.0 m to 16.15 m; and
 - b) Reduce the minimum vehicle manoeuvring aisle width from 7.5 m to 6.7 m.

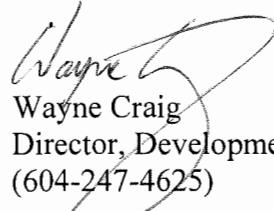
Wayne Craig
Director, Development
(604-247-4625)

WC:jr
Att. 5

Staff Report

Origin

Christopher Bozyk Architects Ltd. has applied to the City of Richmond for permission to develop two industrial buildings on a consolidated parcel including 4693, 4720, 4740 Vanguard Road and Road Parcel Richmond Key 20909. The development site is currently zoned “Industrial Retail (IR1)” and contains several large industrial buildings. A location map is provided in Attachment 1.

There is no associated rezoning, but two variances are requested.

Background

The subject site is located in the East Cambie planning area. Development surrounding the subject site is as follows:

- To the north, two large 5,818 m² and 3,562 m² (62,624 ft² / 38,341 ft²) lots containing industrial warehouses. Both lots are zoned “Industrial Retail (IR1)”.
- To the east, an 8,106 m² (87,252 ft²) vacant treed lot owned by the BC Transportation Financing Authority and zoned “School & Institutional Use (SI)”.
- To the south, Highway 91, beyond which is the Richmond Nature Park on a property zoned “School & Institutional Use (SI).” This property is also identified as part of the Agricultural Land Reserve (ALR).
- To the west, a rail right-of-way (ROW) corridor and Shell Road. The rail corridor is owned by CN Rail, and the portion of the corridor adjacent to the subject site is zoned “Industrial Retail (IR1).”

Related Policies and Studies

Aircraft Noise Sensitive Development Policy

The subject site is located within Aircraft Noise Area 1A, which restricts all new noise sensitive uses. The proposed industrial use is not restricted, and noise mitigation is not required. Prior to issuance of the Development Permit, the applicant is required to register an aircraft noise covenant on Title to address public awareness of the potential impact of aircraft noise on the site.

Floodplain Management Implementation Strategy

The proposed redevelopment must meet the requirements of Richmond Flood Plain Designation and Protection Bylaw 8204. Registration of a flood indemnity covenant on Title is required prior to issuance of the Development Permit.

Development Information

Please refer to the attached Development Application Data Sheet (Attachment 3) for a comparison of the proposed development data with the relevant Bylaw requirements.

The applicant proposes to construct two buildings on the consolidated site (referred to as Building A and Building B in the plans), which would have a combined net built area of 19,018 m² (204,714 ft²). The proposal is for stacked warehouse units, each with a main floor and a mezzanine, arranged on a central corridor forming a spine. The developer intends to stratify these units. Each building is described as having three storeys and one mezzanine, giving the appearance of a four-storey building.

Ground floor units are accessed directly from the drive aisle via insulated steel overhead rolling doors or via the internal central corridor. At upper levels, units are accessed from the central corridor within the building or perimeter corridors that run around the third floor. Stair cases are located at either end of the central corridor and at each of the four corners of each building. Each building has three elevators, including two freight elevators, located at the north end of the central corridor.

The exterior of the buildings consist of painted concrete, metal panels, spandrel panels, and extensive areas of clear glazing. Landscaping is proposed at the corners of each building and around the perimeter of the site, as well as on a portion of the third storey roofs. Unobstructed pedestrian pathways are provided around each building, and marked crosswalks are provided in key locations.

The applicant provided an ornithologist's report on the proposed development, which included recommendations for strategies to mitigate bird strikes. Recommendations incorporated into the proposal include reduced glazing on the upper storeys of the buildings, introduction of ceramic frit treatment on the south façade of Building A and the south and east facades of Building B, and use of full cut-off lighting on the building exteriors and parking area. These design measures are included in the DP plan set and secured accordingly.

Rezoning and Public Hearing Results

As the site does not require a rezoning, the proposed development was not required to go through a Public Hearing.

Staff Comments

The proposed scheme attached to this report has satisfactorily addressed the significant urban design issues and other staff comments identified as part of the review of the subject Development Permit application. In addition, it complies with the intent of the applicable sections of the Official Community Plan (OCP) and is generally in compliance with the "Industrial Retail (IR1)" except for the zoning variances noted below.

Zoning Compliance/Variances (staff comments in *bold italics***)**

The subject site's current "Industrial Retail (IR1)" zoning provides for a range of general industrial uses, stand-alone offices and a limited range of general retail uses. Retail uses currently permitted in the "Industrial Retail (IR1)" zone are generally limited to retail goods that require large floor areas like furniture, carpet, home appliances and building materials. Zoning compliance would be enforced through the Business Licensing and Building Permit application processes for each strata owner and/or building tenant. A legal agreement will be registered on Title notifying prospective buyers about the property zoning.

The applicant requests to vary the provisions of Richmond Zoning Bylaw 8500 to:

- a) Increase the maximum height for buildings in the “Industrial Retail (IR1)” zone from 12.0 m to 16.15 m.

Staff supports the proposed variance as the additional height allows the proposed units to be stacked, a new approach to warehouse buildings in Richmond that allows for more intensive use of the site while enhancing the open areas around each building.

The requested height variance includes 15.85 m to the top of the roof, plus an additional 0.30 m to accommodate solar panels, for a total building height of 16.15 m.

- b) Reduce the minimum vehicle manoeuvring aisle width from 7.5 m to 6.7 m.

The requested variance would apply to the drive aisles located on the west, south, and east portions of the site only. The reduced drive aisle width maintains two-way vehicle traffic throughout the site and adequate manoeuvring space at drive aisle intersections for vehicle turning movements. The centre and north drive aisles have a proposed minimum width of 7.87 m, which exceeds the Zoning Bylaw requirement.

Staff supports the proposed variance as the reduced drive aisles allow for separated pedestrian circulation around each building and will not impact the designated medium and large loading spaces. Transportation staff have reviewed the proposal and support the requested variance.

Advisory Design Panel Comments

At their meeting of December 6, 2018, the Advisory Design Panel (ADP) provided their support for the application subject to consideration of the Panel’s comments. The applicant has incorporated a number of design changes in response to the Panel’s comments, including:

- Design solutions to mitigate potential bird strikes;
- Enclosure and screening of rooftop mechanical systems;
- Improved landscaping throughout the site;
- Improved pedestrian circulation around buildings and from parking areas;
- Addition of permeable pavers to mark the entrance to the site;
- Addition of green roofs on each of the buildings; and
- Addition of solar panels on each of the buildings.

An excerpt from the Advisory Design Panel Minutes from December 6, 2018 is attached for reference (Attachment 4). The design response from the applicant has been included immediately following the specific Design Panel comments and is identified in ***bold italics***.

Analysis

Conditions of Adjacency

- The buildings have been designed to have a strong visible presence on Highway 91 and Shell Road, and include extensive clear glazing.

- The buildings are taller than the one and two storey buildings in the immediate area. However the height is comparable to recently approved industrial buildings north of Highway 99, continuing the revitalization of the area.
- The subject site is located across Highway 91 from the Richmond Nature Park. The applicant provided a report from an ornithologist which identified a moderate risk of bird strikes on the south elevation of Building A and the south and east elevations of Building B. Design solutions in the proposed development include ceramic frit on the sensitive building elevations, reduced area of glazed surfaces throughout, and use of full cut-off lighting in outdoor areas. Together, these measures reduce the potential for bird strikes.

Urban Design and Site Planning

- The proposal involves consolidation of the properties into a single lot, which will have a single vehicle access from Vanguard Road.
- The two buildings separated by a centre drive aisle and truck court, which contains loading and parking spaces. Additional parking spaces surround each building.
- Two garbage enclosures are proposed in the northwest and northeast corners of the site. The proposed enclosures are concrete with steel swing doors finished to match the metal cladding on each building. Landscaping is proposed to screen the concrete structure, with minimum 2.0 m tall “Emerald Cedar” hedges planted along the interface with Shell Road, consistent with the screening requirements contained in the Zoning Bylaw.

Parking and Access

- Access to the site is via a single driveway at the terminus of Vanguard Road. A small cul-de-sac will be constructed in the road allowance to accommodate turning movements of passenger vehicles without entering the site. Design and construction will be through the Servicing Agreement.
- Larger vehicles will be able to turn around on-site, and an SRW for public rights-of-passage will be secured for this purpose.
- On-site vehicle parking is in excess of the 75 spaces required in the Zoning Bylaw. A total of 208 spaces are provided, including 4 handicapped accessible spaces and 107 small car spaces. The handicapped spaces are located nearest the main entry points of each building.
- Three large loading spaces are located parallel to the drive aisle on the north side of the site, and twelve medium loading spaces are located in the central truck court, which exceeds the Zoning Bylaw loading requirements.
- Forty-eight (48) Class 1 bicycle spaces are provided within the building in individual units. There is no common secure bike facility proposed. An additional 48 Class 2 bicycle spaces are provided via several bicycle racks grouped in six locations near the building entrances.

Architectural Form and Character

- Two industrial buildings are proposed, each having the appearance of a four-storey building.
- The buildings are largely the same in design and appearance, except Building A is wider and each building is accented with a different primary colour.
- The buildings have a modern appearance, with extensive clear glazing on all four elevations and roofs that slope upwards gently.
- Full-height vertical elements break up the horizontal massing on the north and south elevations of each building.

- Corrugated metal screening will be provided for rooftop mechanical equipment, and will be located on either side of the spine of each building. The screens are set back from the edge of the roof and will not project above the 15.85 m height of the taller spine, minimizing their appearance from the ground.

Landscape Design and Open Space Design

- A total of 61 new trees are proposed to be planted on the development site, and include a mix of coniferous and deciduous species. Trees within the parking area are primarily deciduous to allow for clear sight lines, while conifers are primarily located in the larger landscaped areas where they can be clustered with other plantings.
- There are statutory rights-of-way for third party utilities along the north, west, and east property lines, which reduce opportunities for tree planting in these locations. As a result, the perimeter of the site is landscaped primarily with evergreen shrubs, flowering perennials, and ornamental grasses. The plantings are layered to provide seasonal variation and texture.
- Consistent with the OCP, a 3.0 m wide landscape buffer is provided along the south property line to screen and buffer the site from the Agricultural Land Reserve (ALR) across Highway 91. Continued maintenance of this buffer area will be secured through a legal agreement on Title.
- An enlarged landscaped area is provided at the terminus of the centre drive aisle.
- Parking spaces are broken up by landscaped bump-outs, which include shrubs and trees. Additional landscaping is provided at the corners of each building.
- Irrigation is provided for all soft landscape areas, including the landscaped bump-outs.
- Each building contains two green roof areas on the third storey, with a total planted area of 412 m² (4,436 ft²). The proposed green roof system will be planted with sedum mats.
- Defined pedestrian pathways lead from the Vanguard Road access to the main entry of each building. Additional pedestrian pathways are provided around the perimeter of the buildings.
- Permeable pavers are proposed at the entrance of the site, which will mark the transition from Vanguard Road into the site.
- No new fencing is proposed. There is an existing chain link fence separating the site from the railway to the west and Highway 91 to the south, which will be retained.
- The applicant is required to submit an acceptable security for landscaping in the amount of \$349,082, inclusive of a 10% contingency cost, prior to issuance of the Development Permit.

Tree Removal and Replacement

- One bylaw-sized tree on the subject site will be removed as it is located within the proposed building envelope. The OCP would require replacement at a 2:1 ratio.
- The landscape plans include 61 new on-site trees to be planted within the parking area, at the corners of each building, and along the southern perimeter of the site.
- Three bylaw-sized trees in the Highway 91 road right-of-way and one bylaw-sized tree in the rail right-of-way will not be impacted by the proposed development, and will be retained and protected.

Sustainability

- The buildings are designed to achieve ASHRAE 90.1-2010 energy standards, and the indoor and outdoor lighting will be 50% and 40% better than ASHRAE 90.1-2010, respectively.
- Solar panels will be installed on the flat roof forming the spine of each building, and will have an estimated power output of 40,000 kWh/year, which would meet the lighting and receptacle power demands of the buildings according to preliminary modelling by their consultant (Attachment 5). The system will be designed to qualify for the BC Hydro Net-Metering program, allowing excess electricity to be sold to BC Hydro for distribution on the larger electrical grid. Installation and maintenance of the agreed upon renewable energy system will be secured through a legal agreement on Title.
- Permeable pavers are proposed at the site entrance, along the west side of the site, and in various locations around the perimeter of both buildings in order to improve site drainage. Including the green roofs, permeable surfaces constitute approximately 21% of the site area.
- The applicant has agreed to provide Level 2 EV charging for 10% of the required vehicle parking spaces, i.e. 7 stalls. The provision and maintenance of the agreed upon vehicle charging infrastructure will be secured through a legal agreement on Title.

Crime Prevention Through Environmental Design

- The site has a single access point for vehicles and pedestrians. Marked pedestrian crossings are located away from the intersection to ensure clear sightlines.
- On-site lighting will be downward directed with full cut-off to avoid casting glare to the adjacent properties, Highway 91, and Shell Road. Lighting is predominantly building mounted, except for two pole mounted lights at the site entrance.
- There is an existing chain link fence located off-site, separating the site from the railway to the west and Highway 91 to the south. Landscaping around the perimeter of the site consists of taller shrubs in order to provide an additional barrier and screen headlight glare.
- Parking medians are landscaped with high-branching deciduous trees in order to preserve sightlines to and from parked vehicles.

Public Art


- The applicant has decided to provide a voluntary contribution to the City's Public Art Reserve in the amount of \$49,272 based on \$0.24 per buildable square foot. This contribution is consistent with the recommended Public Art contribution for applications received in 2018.

Site Servicing

- The applicant is required to enter into a Servicing Agreement for the design and construction of the required site servicing and off-site works described in Attachment 6, which include, but may not be limited to:
 - Watermain upgrades.
 - Cul-de-sac turning facility at the south end of Vanguard Road.

Conclusions

As the proposed development would meet applicable policies and Development Permit Guidelines, staff recommend that the Development Permit be endorsed, and issuance by Council be recommended.

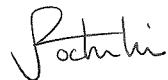

Jordan Rockerbie
Planning Technician – Design
(604-276-4092)


JR:blg

Attachments:

- Attachment 1: Location Map
- Attachment 2: Development Application Data Sheet
- Attachment 3: Excerpt from the Advisory Design Panel Minutes
- Attachment 4: Solar energy response letter
- Attachment 5: Development Permit Considerations



City of Richmond

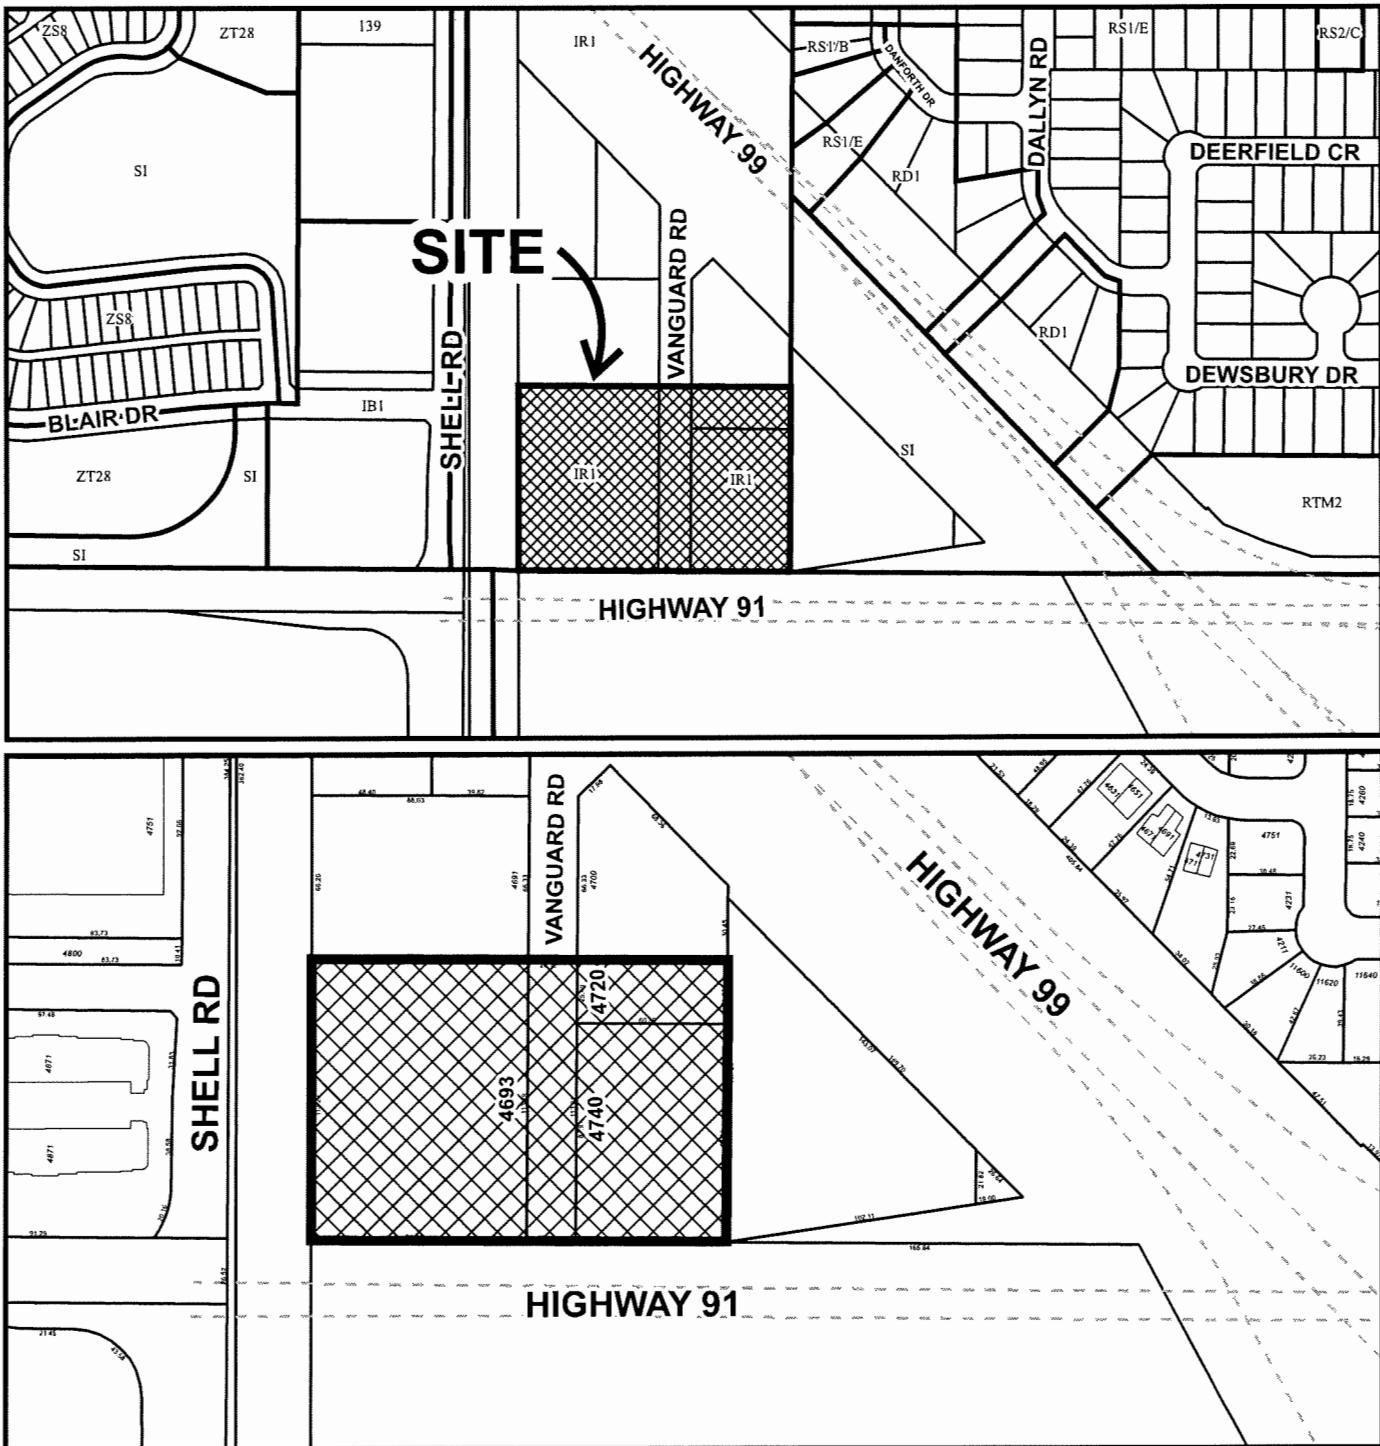

DP 18-818671

Original Date: 04/27/18

Revision Date: 08/20/19

Note: Dimensions are in METRES



City of Richmond

Development Application Data Sheet

Development Applications Department

DP 18-818671

Attachment 2

Address: 4693, 4720, 4740 Vanguard Road and Road Parcel Richmond Key 20909

Applicant: Christopher Bozyk Architects Ltd. Owner: 4693 Vanguard Road Holdings Ltd., Inc. No. BC 1045695

Planning Area(s): East Cambie

Floor Area Gross: 28,275.01 m² Floor Area Net: 19,018.00 m²

	Existing	Proposed
Site Area:	19,073 m ²	No change
Land Uses:	Three industrial buildings	Two industrial buildings
OCP Designation:	Mixed Employment (MEMP)	No change
Zoning:	Industrial Retail (IR1)	No change

	Bylaw Requirement	Proposed	Variance
Floor Area Ratio:	1.0	1.0	None permitted
Lot Coverage:	Max. 60%	37%	None
Setback – North Front Yard:	Min. 3.0 m	24.3 m	None
Setback – West Side Yard:	Min. 3.0 m	19.8 m	None
Setback – East Side Yard:	Min. 0 m	19.5 m	None
Setback – South Rear Yard:	Min. 0 m	19.2 m	None
Height (m):	Max. 12 m	16.15 m	Vary by 4.15 m
Lot Size:	No Minimum	19,073 m ²	None
Total Off-street Spaces:	73	208 (107 small car spaces)	None
Off-street Parking Spaces – Accessible:	2	4	None
Loading Spaces:	Medium: 4 Large: 3	Medium: 12 Large: 3	None
Bicycle Spaces:	Class 1: 47 Class 2: 48	Class 1: 48 Class 2: 48	None

**Excerpt from the Minutes from
The Design Panel Meeting**

**Wednesday, December 5, 2018 – 4:00 p.m.
Rm. M.1.003
Richmond City Hall**

1. DP 18-818671 – APPARENT FOUR-STORY INDUSTRIAL RETAIL DEVELOPMENT

ARCHITECT: Christopher Bozyk Architects

LANDSCAPE ARCHITECT: KD Planning and Design

PROPERTY LOCATION: 4693, 4720 and 4740 Vanguard Road

Applicant's Presentation

Chantal Bobyn, Christopher Bozyk Architects, Ltd., and Shan Tennyson, Krahn-KD Planning and Design, presented the project, and together with Gordon Yeh and Michael Chiang, Alliance Partners, answered queries from the project on behalf of the applicant.

Panel Discussion

Comments from Panel members were as follows:

- potential uses of the development could be flexible; however, the architectural design does not reflect this intent; some details in the design are missing for uses other than storage such as for commercial and office spaces, e.g. roof enclosures for mechanical units and continuous band of louvers for ventilation; incorporating these details will impact the shape and form of the development;

Primary and major use to be light industrial (light storage) with minor showroom/retail use on ground floor. No major commercial/office use.

An enclosure has been provided for the rooftop mechanical equipment.

- applicant is advised to confirm if vestibules are required for proposed storage use as per BC Building Code considering that provision of vestibules is required for office and retail uses;

Primary and major use to be light industrial (light storage) with minor showroom/retail use on ground floor. No major commercial/office use.

No requirement for vestibule.

- agree with the preceding comments from the Panel; proposed number of parking spaces would pose a challenge for other uses of the two buildings other than storage, e.g. office and commercial uses;

Primary and major use to be light industrial (light storage) with minor showroom/retail use on ground floor. No major commercial/office use.

- investigate opportunities for integrating louvers, opaque surfaces, or mesh screening on the building façade to reduce the potential for bird strikes into the proposed buildings;

We have reduced the amount of glazing by 38% by introducing concrete tilt wall panels. We believe this will help mitigate potential bird strikes.

- consider a strategy for screening of mechanical systems at this stage of the project if the proposed development will be utilized for uses other than a storage facility;

An enclosure has been provided for the rooftop mechanical equipment.

- consider designating planting areas on the corners of the buildings adjacent to the internal drive aisles that will not conflict with the drive aisles or alignment issues to provide a layering effect;

Addressing – Revised Site plan and Landscape plan to follow. See updated Site Plan & Landscape Plan Resubmitted.

- investigate opportunities for incorporating an outdoor amenity area within the site to take advantage of the forested area on the east side and the Shell Road Trail on the west side of the site; the outdoor amenity area could be located on the edge of the west side of the site and designed to work with the Shell Road Trail to the west;

Pedestrian connection to the park is not feasible due to an active rail line.

- consider eliminating the parking stalls immediately at the southern end of Vanguard Road and incorporate a planting area with mature planting to provide a buffer/screening to the south side of the site;

Addressing – Revised Site plan and Landscape plan to follow. See updated Site Plan & Landscape Plan Resubmitted.

- consider installing electric vehicle charging in the parking area;

Addressing – Revised Site plan and Landscape plan to follow. See updated Site Plan & Landscape Plan Resubmitted.

- consider installing a built louvers screening system for the large “unit sub” facility located immediately to the west of the driveway entrance;

After further considerations, Unit Sub is now eliminated (replace by PMTs)

- consider installing permeable pavers on the vehicle entrance to the north of the two buildings to identify the main entrances to the site;

Addressing – Revised Site plan and Landscape plan to follow. See updated Site Plan & Landscape Plan Resubmitted.

- consider a lighting strategy for outside of the buildings and for the parking area to address potential CPTED issues;

Yes, lighting will be provided to address

- appreciate the model and the applicant's presentation of the project;
- on-site landscaping appears thin; however, the site benefits from the existing greenery on all sides of the site;

See revised Landscape Plan.

- consider taking away a portion of the loading areas and parking stalls at the front of the two buildings to enhance the landscaping at the pedestrian entries to the site/building; landscaping should be given the same attention as the building architecture;

We believe the loading is best where located as it is close to entry and not requiring to circulate through the site. The unit sub is now eliminated so there will be some greenery gained.

- grasses on existing groundcovers are a step in the right direction as they require little maintenance; however, consider adding low groundcovers; ornamental grasses can grow taller and provide seasonal variation;

Addressing – Revised Site plan and Landscape plan to follow. See updated Site Plan & Landscape Plan Resubmitted.

- consider enhancing the landscaping around the “sub-unit” facility to provide more adequate screening;

After further considerations, Unit Sub is now eliminated (replace by PMTs)

- an outdoor amenity area within the site may not be necessary if there is strong connection to the existing greenery surrounding the site; a pedestrian connection could cut through the Shell Road Trail and across Blair Drive;

Pedestrian connection to the park is not feasible due to an active rail line.

- proposed form and character of the two buildings could function well as a storage facility; massing has been broken down and provides a nice variety; exterior corridors work well;
- exterior glazed massing could be broken up to reduce the potential for bird strikes into the buildings;

We believe bird strike won't be an issue with the proposed buildings. We have reduced the amount of glazing by 38% by introducing concrete tilt wall panels. We believe this will help mitigate potential bird strikes.

- there is a significant amount of hardscape in the project which could give rise to heat island effect and pose potential challenges to stormwater management; investigate opportunities for stormwater capture on the building roofs for irrigation and other uses; the applicant is also encouraged to provide more green spaces on-site which may require removing some parking stalls;

Addressing – Revised Site plan and Landscape plan to follow. See updated Site Plan & Landscape Plan Resubmitted.

- consider removing some of the parking stalls immediately adjacent to the building and incorporating an outdoor amenity area on the south side of the site;

Addressing – Revised Site plan and Landscape plan to follow. See updated Site Plan & Landscape Plan Resubmitted.

- pedestrian entry points off Vanguard Road would appear underwhelming if the proposed buildings will also be used for office spaces; note the limited amount of landscaping and weather protection and lack of identity of entry points; proposed building design and landscaping are appropriate for a storage facility and not for office spaces;

Primary and major use to be light industrial (light storage) with minor showroom/retail use on ground floor. No major commercial/office use.

After further considerations, Unit Sub is now eliminated (replace by PMTs)

- appreciate the daylit exterior stairs on the corners of the two buildings; applicant is encouraged to bring down the natural light all the way down to the ground floor;
- proposed materials for building exterior work well together; internal lay-out of the building is appropriate for industrial warehouse use and would pose some challenges for other uses;

Primary and major use to be light industrial (light storage) with minor showroom/retail use on ground floor. No major commercial/office use.

Retail accessible from exterior at ground floor only.

- staff is advised that an accurate aerial map would be helpful to the Panel to better understand the project site and its context;
- “sub-unit” facility could be relocated either to the northeast or northwest corner of the site; however, if relocation is not possible, consider screening with a hard structure which complements with the design of the building;

After further considerations, Unit Sub is now eliminated (replace by PMTs)

- pedestrian pathway goes right through the “sub-unit” facility;

After further considerations, Unit Sub is now eliminated (replace by PMTs)

- applicant needs to give careful thought regarding the screening of rooftop mechanical equipment if the two buildings will be used for a complex mix of uses in addition to storage given the prominent location and high visibility of the buildings;

Primary and major use to be light industrial (light storage) with minor showroom/retail use on ground floor. No major commercial/office use.

An enclosure has been provided for the rooftop mechanical equipment.

- support the Panel comment to incorporate an outdoor amenity area on-site in view of the potential for a mix of building uses; applicant could use some of the parking spaces; pedestrian connection to the park is not feasible due to an active rail line;

Addressing – Revised Site plan and Landscape plan to follow. See updated Site Plan & Landscape Plan Resubmitted.

- consider introducing an outdoor amenity area on the building rooftop; would have great views to the north and would receive adequate sun exposure;

See Solar Report provided and updated Roof Plan.

- lots of horizontal lines breaking up the two buildings may reduce the potential for bird strikes; consider getting advice from an ornithologist;

We believe bird strike won't be an issue with these buildings. We have reduced the amount of glazing by 38% by introducing concrete tilt wall panels. We believe this will help mitigate potential bird strikes.

- consider more lighting for the site in view of the potential mix of uses for the buildings;

See Lighting specs provided.

- support the Panel comment that the applicant could take advantage of, or provide interface with, the existing greenery around the site for landscaping of the site; and
- the applicant is advised that other potential uses for the proposed development, e.g. daycare, may not be feasible due to lack of accessibility features.

Primary and major use to be light industrial (light storage) with minor showroom/retail use on ground floor. No major commercial/office use.

Panel Decision

It was moved and seconded

That DP 18-818671 be supported to move forward to the Development Permit Panel subject to the applicant giving consideration to the comments of the Advisory Design Panel.

CARRIED

Opposed: Tom Parker and Jubin Jalili



ATTACHMENT 4

969G Laval Crescent
Kamloops, BC, V2C 5P4

Nov 7, 2019

Mr. Gordon Yeh
Alliance Partners
#100 – 88 W 8th Ave,
Vancouver, BC, V5Y 1M7

Dear Gordon,

At MAKE Projects request, we have reviewed the implications of a 40kWp grid connected solar PV system for each of Building A and B for your project at 4720 and 4740 Vanguard Road in Richmond, BC.

Key considerations for successfully integrating 40 kWp solar systems into your project include:

1. **Expected Energy Production:**

Properly designed and installed these solar PV systems will produce about 40,000 kWh per year for each building. This would offset 100% of the Building Basic House Loads (lighting and receptacles) consumption of 39,420 kWh per year estimated by your design team.

2. **Electrical Considerations:**

- Electrical House panels A6HDP and B6HDP (600/347V-3P) are suitably sized to be the points-of-connection to the grid for each PV system and require only dedicated circuit breakers and suitably sized transformers for this purpose.
- Alternately, 208/120V-3P panels A2H2 and B2H2 could be used if their bus and associated transformer capacities were increased.
- Lockable disconnection means is required for each system; preferably nearby the point-of-connection to the grid.
- Suitably sized, electrical conduits or cables between electrical room points-of-connection to the grid and rooftop array locations should be specified and installed during construction in advance of solar PV installation.
- Rooftop cable penetrations, array cabling raceway requirements, and routing should be planned well in advance of the solar PV installation.

3. **Structural Considerations:**

- We recommend ballasted solar PV racking systems to avoid racking attachment penetrations of the roof membrane.
- Solar PV installation proponents will provide a stamped engineered ballasting plan assuring racking designs meet site wind and seismic design loads. Subsequently, the project structural engineer of record must assure the building can manage the additional loading. Ballasted PV system array dead loads in the order of 6-11 PSF are not uncommon depending on site design conditions.



4. **Mechanical Considerations:**

- 40 kWp arrays will require approximately 3800-4000 ft² carefully designated in advance for this purpose on each building rooftop.
- Placing vents, exhaust stacks, fall arrest anchors, rooftop units, or other equipment which could impede the placement of solar racking and modules must be avoided in these designated array areas

We are available to advise your design team in detail to ensure the building designs are ready for seamless incorporation of 40 kWp PV systems under the BC Hydro Net-Metering program.

We hope you will find this guidance helpful and look forward to answering any questions you might have.

Sincerely;

A handwritten signature in black ink that reads "Ben Giudici". The signature is fluid and cursive, with a large, stylized "B" at the beginning.

Ben Giudici, P.Eng
Director – Riverside Energy Systems



**City of
Richmond**

Development Permit Considerations
Development Applications Department
6911 No. 3 Road, Richmond, BC V6Y 2C1

Address: 4693, 4720, and 4740 Vanguard Road

File No.: DP 18-818671

Prior to issuance of the Development Permit, the developer is required to complete the following:

1. Consolidation of the properties into a single lot (which will require the demolition of the existing buildings).
2. Installation of appropriate tree protection fencing around all trees to be retained as part of the development prior to any construction activities, including building demolition, occurring on-site.
3. Submission of a cash security or Letter-of-Credit for landscaping in the amount of \$349,082 inclusive of a 10% contingency cost (as per the landscape cost estimate provided by KD Planning & Design Ltd. on November 7, 2019).
4. City acceptance of the developer's offer to voluntarily contribute \$0.24 per buildable square foot (i.e. \$49,272) to the City's public art fund.
5. Registration of an Aircraft Noise covenant on Title (Area 1A).
6. Registration of a Flood Indemnity covenant on Title (2.9 m GSC - Area A).
7. Registration of an Agricultural Land Reserve (ALR) Buffer Area covenant on Title to identify the 3.0 m wide landscaped buffer area along the south property line and to ensure that landscaping planted within the buffer is maintained and will not be abandoned or removed. The legal agreement is also to indicate that the property is potentially subject to impacts of noise, dust, and odour resulting from agricultural operations.
8. Registration of an Electric Vehicle (EV) Charging Infrastructure covenant on Title, securing the owner's commitment to voluntarily provide, install, and maintain EV charging equipment for the use of the commercial tenants and others as determined to the satisfaction of the City through an approved Development Permit. More specifically, a minimum of 10% of the required parking spaces must be provided with Level 2 EV charging (ex. 7 spaces for the proposed development).
9. Registration of an agreement on Title ensuring that the proposed solar panels will be installed to the satisfaction of the Director of Building Approvals, maintained for the life of the building and will not be removed without City approval. The agreement will include provisions for alternative renewable technologies to replace the solar panel installations provided that equal or better performance is achievable to the satisfaction of the Director of Development and the Director of Building Approvals.
10. Registration of a legal agreement on Title identifying that the property is located in an industrial area and that use of the property must be consistent with the Zoning Bylaw, and requiring that the owner provide an acknowledgement of the same in all purchase and sale agreements.

11. Granting of a Statutory Right-of-Way for Public Rights-of-Passage across the driveway from Vanguard Road and a portion of the drive aisle, in order to accommodate vehicle maneuvering on site.
12. Enter into a Servicing Agreement* for the design and construction of site servicing and off-site works. A Letter of Credit or cash security for the value of the Service Agreement works, as determined by the City, will be required as part of entering into the Servicing Agreement. Works include, but may not be limited to:

Water Works:

- a) Using the OCP Model, there is 146 L/s of water available at a 20 psi residual at the Vanguard Road frontage. Based on your proposed development, your site requires a minimum fire flow of 250 L/s.
- b) Prior to the DP staff report being written, the Developer is required to coordinate with Richmond Fire Rescue to confirm whether fire hydrants are required along the proposed development's lane frontage. If required by RFR, the necessary water main and hydrant installations shall be reviewed by Engineering and added to the servicing agreement scope.
- c) At Developer's cost, the Developer is required to:
 - i) Submit Fire Underwriter Survey (FUS) or International Organization for Standardization (ISO) fire flow calculations to confirm development has adequate fire flow for onsite fire protection. Calculations must be signed and sealed by a Professional Engineer and be based on Building Permit Stage building designs.
 - ii) Review hydrant spacing on all road frontages and install new fire hydrants as required to meet City spacing requirements for the proposed land use.
 - iii) Provide right-of-ways for the water meters. Minimum right-of-way dimensions to be the size of the meter box (from the City of Richmond supplementary specifications) + any appurtenances Exact right-of-way dimensions to be finalized via the servicing agreement process.
 - iv) To address the issue of insufficient fire flow according to the OCP model, the developer has two options:
 - (1) Upgrade approximately 400m of the existing 200mm AC water main to 300mm PVC water main, within Vanguard road, from the north property line to Highway 99.
-OR-
 - (2) Loop the water system to Blair Drive, by installing approximately 150m of new 200mm PVC water main. Installing the new water main will require the registration of a 6m wide SRW within the development site extending approximately 90m west of Vanguard Road. In addition to the 6m wide SRW required onsite, the water main will have to pass through the railway right of way and the developer is required to acquire written permission from the Canadian National Railway to complete these works. In addition to the installation of the new water main, the developer must replace any sections of the water main within Vanguard Road which may be impacted by the lane works at the developer's costs.
 - v) Depending on which option the developer chooses to proceed with, at the developer's cost, the City will either:
 - (1) Cut and cap the existing water service connections at main;
Remove the existing blow-off then cut and cap the existing main at the property line;
Provide a 200mm line valve just north of the property line; and

Remove the cap then connect the on-site water system to the main at the property line
-OR-

(2) Cut and cap the existing water service connections at main;

Remove the existing blow-off then cut and cap the existing main at the property line; and
Provide new water service connections off of the new water mains within the 6m right of way.

Storm Sewer Works:

- d) At Developer's cost, the Developer is required to:
- i) Provide an erosion and sediment control plan for all on-site and off-site works, to be reviewed as part of the servicing agreement design.
 - ii) Extend the existing 450mm diameter storm sewer complete with a manhole and stub with cap at the property line.

Sanitary Sewer Works: Existing sanitary sewer connection to be retained.

Frontage Improvements:

- e) At Developer's cost, the Developer is required to:
- i) Coordinate with BC Hydro, Telus and other private communication service providers:
 - (1) To pre-duct for future hydro, telephone and cable utilities along all road frontages.
 - ii) Review street lighting levels along all road and lane frontages, and upgrade as required, should lighting be required along Vanguard Road, an LPT may be required.
 - iii) Locate/relocate all above ground utility cabinets and kiosks required to service the proposed development, and all above ground utility cabinets and kiosks located along the development's frontages, within the developments site (see list below for examples). A functional plan showing conceptual locations for such infrastructure shall be included in the development design review process. Please coordinate with the respective private utility companies and the project's lighting and traffic signal consultants to confirm the requirements (e.g., statutory right-of-way dimensions) and the locations for the aboveground structures. If a private utility company does not require an aboveground structure, that company shall confirm this via a letter to be submitted to the City. The following are examples of statutory right-of-ways that shall be shown on the architectural plans/functional plan, the servicing agreement drawings, and registered prior to SA design approval:
 - BC Hydro PMT – 4.0 x 5.0 m
 - BC Hydro LPT – 3.5 x 3.5 m
 - Street light kiosk – 1.5 x 1.5 m
 - Traffic signal kiosk – 2.0 x 1.5 m
 - Traffic signal UPS – 1.0 x 1.0 m
 - Shaw cable kiosk – 1.0 x 1.0 m
 - Telus FDH cabinet – 1.1 x 1.0 m
 - iv) Complete other frontage improvements as per Transportation requirements:
 - (1) Provide a vehicle turn-around facility at the south end of vanguard Road to allow the public to turn around without entering the subject site. The facility should:
 - (a) Be designed to accommodate the U-turning of a regular-size passenger vehicle in a continuous movement;
 - (b) Have a minimum design radius of 7.3 m;
 - (c) Include barrier curb along the edge; and
 - (d) Include any additional requirements identified by RFR or Environmental Services.

General Items:

- f) At Developer's cost, the Developer is required to:
 - i) As per GeoPacific's recommendations the developer is to conduct monitoring of settlements, using survey points spaced every 20 meters along their west property line, as this relates to impact to the railway.
 - ii) Submit a proposed strategy at the building permit stage for managing excavation de-watering. Note that the City's preference is to manage construction water onsite or by removing and disposing at an appropriate facility. If this is not feasible due to volume of de-watering, the Developer will be required to apply to Metro Vancouver for a permit to discharge into the sanitary sewer system. If the sanitary sewer does not have adequate capacity to receive the volume of construction water, the Developer will be required to enter into a de-watering agreement with the City to discharge treated construction water to the storm sewer system.
 - iii) Not encroach into City rights-of-ways with any proposed trees, retaining walls, or other non-removable structures. Retaining walls proposed to encroach into rights-of-ways must be reviewed by the City's Engineering Department.
 - iv) Enter into, if required, additional legal agreements, as determined via the subject development's Servicing Agreement(s) and/or Development Permit(s), and/or Building Permit(s) to the satisfaction of the Director of Engineering, including, but not limited to, site investigation, testing, monitoring, site preparation, de-watering, drilling, underpinning, anchoring, shoring, piling, pre-loading, ground densification or other activities that may result in settlement, displacement, subsidence, damage or nuisance to City and private utility infrastructure.

Prior to Building Permit* issuance, the developer is required to complete the following:

1. The applicant is required to obtain a Building Permit for any construction hoarding associated with the proposed development. If construction hoarding is required to temporarily occupy a street, or any part thereof, or occupy the air space above a street or any part thereof, additional City approvals and associated fees may be required as part of the Building Permit. *For further information on the Building Permit, please contact Building Approvals Department at 604-276-4285.*
2. Submission of a Construction Parking and Traffic Management Plan to the Transportation Department. Management Plan shall include location for parking for services, deliveries, workers, loading, application for any lane closures, and proper construction traffic controls as per Traffic Control Manual for works on Roadways (by Ministry of Transportation) and MMCD Traffic Regulation Section 01570.

Note:

- Where the Director of Development deems appropriate, the preceding agreements are to be drawn not only as personal covenants of the property owner but also as covenants pursuant to Section 219 of the Land Title Act. All agreements to be registered in the Land Title Office shall have priority over all such liens, charges and encumbrances as is considered advisable by the Director of Development. All agreements to be registered in the Land Title Office shall, unless the Director of Development determines otherwise, be fully registered in the Land Title Office prior to enactment of the appropriate bylaw.
The preceding agreements shall provide security to the City including indemnities, warranties, equitable/rent charges, letters of credit and withholding permits, as deemed necessary or advisable by the Director of Development. All agreements shall be in a form and content satisfactory to the Director of Development.
- Additional legal agreements, as determined via the subject development's Servicing Agreement(s) and/or Development Permit(s), and/or Building Permit(s) to the satisfaction of the Director of Engineering may be required including, but not limited to, site investigation, testing, monitoring, site preparation, de-watering,

drilling, underpinning, anchoring, shoring, piling, pre-loading, ground densification or other activities that may result in settlement, displacement, subsidence, damage or nuisance to City and private utility infrastructure.

- Applicants for all City Permits are required to comply at all times with the conditions of the Provincial *Wildlife Act* and Federal *Migratory Birds Convention Act*, which contains prohibitions on the removal or disturbance of both birds and their nests. Issuance of Municipal permits does not give an individual authority to contravene these legislations. The City of Richmond recommends that where significant trees or vegetation exists on site, the services of a Qualified Environmental Professional (QEP) be secured to perform a survey and ensure that development activities are in compliance with all relevant legislation.

Signed

Date



City of Richmond

Development Permit

No. DP 18-818671

To the Holder: CHRISTOPHER BOZYK ARCHITECTS LTD.

Property Address: 4693, 4720, 4740 VANGUARD ROAD AND
ROAD PARCEL RICHMOND KEY 20909

Address: C/O SUITE 414 – 611 ALEXANDER STREET
VANCOUVER, BC V6A 1E1

1. This Development Permit is issued subject to compliance with all of the Bylaws of the City applicable thereto, except as specifically varied or supplemented by this Permit.
2. This Development Permit applies to and only to those lands shown cross-hatched on the attached Schedule "A" and any and all buildings, structures and other development thereon.
3. The "Richmond Zoning Bylaw 8500" is hereby varied to:
 - a. Increase the maximum height for buildings from 12.0 m to 16.15 m; and
 - b. Reduce the minimum vehicle manoeuvering aisle width from 7.5 m to 6.7 m.
4. Subject to Section 692 of the Local Government Act, R.S.B.C.: buildings and structures; off-street parking and loading facilities; roads and parking areas; and landscaping and screening shall be constructed generally in accordance with Plans DP 18-818671-1 through DP 18-818671-17 attached hereto.
5. Sanitary sewers, water, drainage, highways, street lighting, underground wiring, and sidewalks, shall be provided as required.
6. As a condition of the issuance of this Permit, the City is holding the security in the amount of \$349,082 to ensure that development is carried out in accordance with the terms and conditions of this Permit. Should any interest be earned upon the security, it shall accrue to the Holder if the security is returned. The condition of the posting of the security is that should the Holder fail to carry out the development hereby authorized, according to the terms and conditions of this Permit within the time provided, the City may use the security to carry out the work by its servants, agents or contractors, and any surplus shall be paid over to the Holder. Should the Holder carry out the development permitted by this permit within the time set out herein, the security shall be returned to the Holder. The City may retain the security for up to one year after inspection of the completed landscaping in order to ensure that plant material has survived.
7. If the Holder does not commence the construction permitted by this Permit within 24 months of the date of this Permit, this Permit shall lapse and the security shall be returned in full.

Development Permit
No. DP 18-818671

To the Holder: CHRISTOPHER BOZYK ARCHITECTS LTD.

Property Address: 4693, 4720, 4740 VANGUARD ROAD AND
ROAD PARCEL RICHMOND KEY 20909

Address: C/O SUITE 414 – 611 ALEXANDER STREET
VANCOUVER, BC V6A 1E1

8. The land described herein shall be developed generally in accordance with the terms and conditions and provisions of this Permit and any plans and specifications attached to this Permit which shall form a part hereof.

This Permit is not a Building Permit.

AUTHORIZING RESOLUTION NO.
DAY OF , .


ISSUED BY THE COUNCIL THE

DELIVERED THIS DAY OF , .

MAYOR



City of Richmond

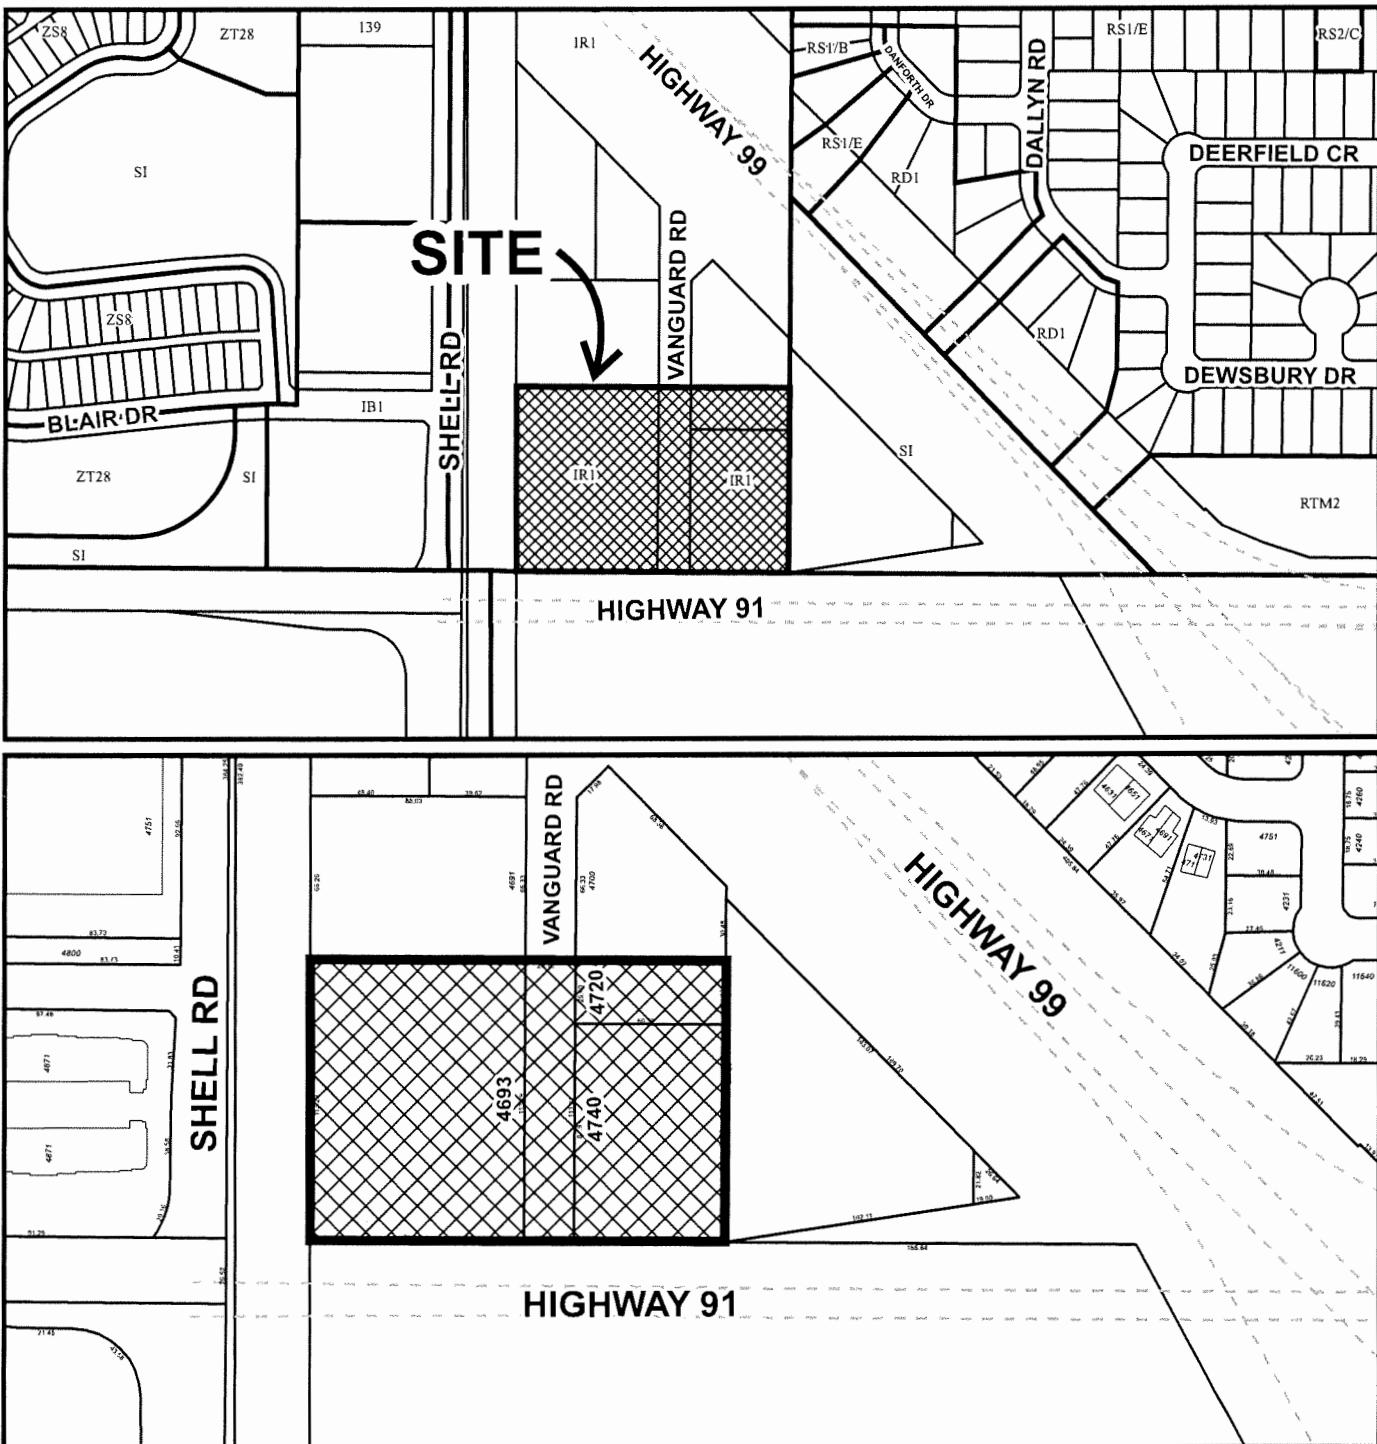

DP 18-818671
SCHEDULE "A"

Original Date: 04/27/18

Revision Date: 08/20/19

Note: Dimensions are in METRES



4720 + 4740 VANGUARD ROAD, RICHMOND BC

PROJECT STATISTICS

KEY INFORMATION

CIVIC ADDRESS: 403, 470, 470 VANGUARD ROAD
LEGAL DESCRIPTION: LOTS 24c, 245, 246 and 247; N.E. OF SECTION 26,
BLOCK 4, NORTH, PARCELS B & WEST, NYCO, PLAN 5628
ZONING: C-2, COMMERCIAL
BUILDING BY LAW: 2000 SF, MAX FLOOR AREA
ENERGY STANDARD CODE: ASHRAE 90.1 + 2016
CODE COMPLIANCE PATH: PRESCRIPTIVE

CODE DATA SUMMARY

REFER TO COMPLETE CODE ANALYSIS REPORT PREPARED BY JENSEN HUGHES.

WAREHOUSE

165' x 30' = 4,950 SF

3'

2'

YES

2,123

UNLIMITED

NONCOMBUSTIBLE

11

16

NOT LESS THAN THAT REQUIRED FOR THE SUPPORTED ASSEMBLY.
F.A.S.

FIRE SEPARATION REQUIREMENTS

EXIT FACILITIES

1

1h

<div data-bbox="4377 676 4389

PROJECT STATISTICS

TEAM HST

DRAWING LIST

08	01/05/2019	ISSUED FOR COORDINATION
07	03/19/2019	ISSUED FOR ADP RESPONSE TO COMMENTS


KEY INFORMATION		AREA SUMMARY		STATISTICS	
CIVIC ADDRESS:	4833, #270, 4700 YANGLIARD ROAD	SITE COVERAGE:		TOTAL GROSS FLOOR AREA:	
LEGAL DESCRIPTION:	LOTS 24A, 24B, 24C AND 24F; ALL OF SECTION 36, BLOCK 5, TOWNSHIP 8 WEST, NYC, PLAT 56262 ZONE: B-2 BUILDING BY LAW: RICHMOND ENERGY STANDARD CODE: ASHRAE 90.1 - 2016 CODE COMPLIANCE PATH: PRESCRIPTIVE	HEIGHT: "VARIANCE SETBACKS"		Front	
REFER TO COMPLETE CODE ANALYSIS REPORT PREPARED BY JENSEN HUGHES.		Exterior side yard		Exterior side yard	
USE	WAREHOUSE	Rear		Interior side yard	
OCCUPANCY	BULK HOLDING	Front		HC stalls	
BUILDING HEIGHT (STORIES)	3	Total Building A:		TOTAL:	
STREETS FACED	2	BUILDING B:		LOADING	
SPRINKLERED	YES	Site Area:		medium	
CONSTRUCTION ARTICLE	32x27.73	BUILDING B, FLOOR 1		large	
TYPE OF CONSTRUCTION	NONCOMBUSTIBLE	FAR PROVIDED			
FLORAL ASSEMBLY F.A.R.	1.1	FAR PROVIDED			
UNOCCUPIED ROOF F.A.R.	0.0				
LOADBEARING F.A.R.	NOT LESS THAN THAT REQUIRED FOR THE SUPPORTED ASSEMBLY				
CODE DATA SUMMARY		E.A.R.			
PER SEPARATION REQUIREMENTS		E.A.R.			
EVACUATION FACILITIES: DEFENDING THE 1 ST AND 2 ND STORIES		11			
ELECTRICAL EQUIPMENT ROOM (UNSPRKLED PER NFPA11)		11			
ELECTRICAL EQUIPMENT ROOM (PER 3.6.2.16)		21			
11		11			
FIRE ALARM & DETECTION SYSTEMS:					
FIRE ALARM ANNOUNCEMENT:					
MANUAL PULL STATIONS:					
HEAT DETECTION:					
SMOKE DETECTION:					
PROVIDED (SEE ELEC.)					
PROVIDED (SEE ELEC.)					
VISUAL SIGNAL DEVICES:					
STANDPIPE AND HOSE SYSTEMS:					
FREE DEPARTMENT CONNECTIONS:					
EMERGENCY POWER AND LIGHTING:					
NOTE: FOR CYCLE CLAS					
18-818671-1					

**COVER + PROJECT
STATISTICS**


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PHOTO FROM AIR FORCE 2147017

A000

VANGUARD
ROAD

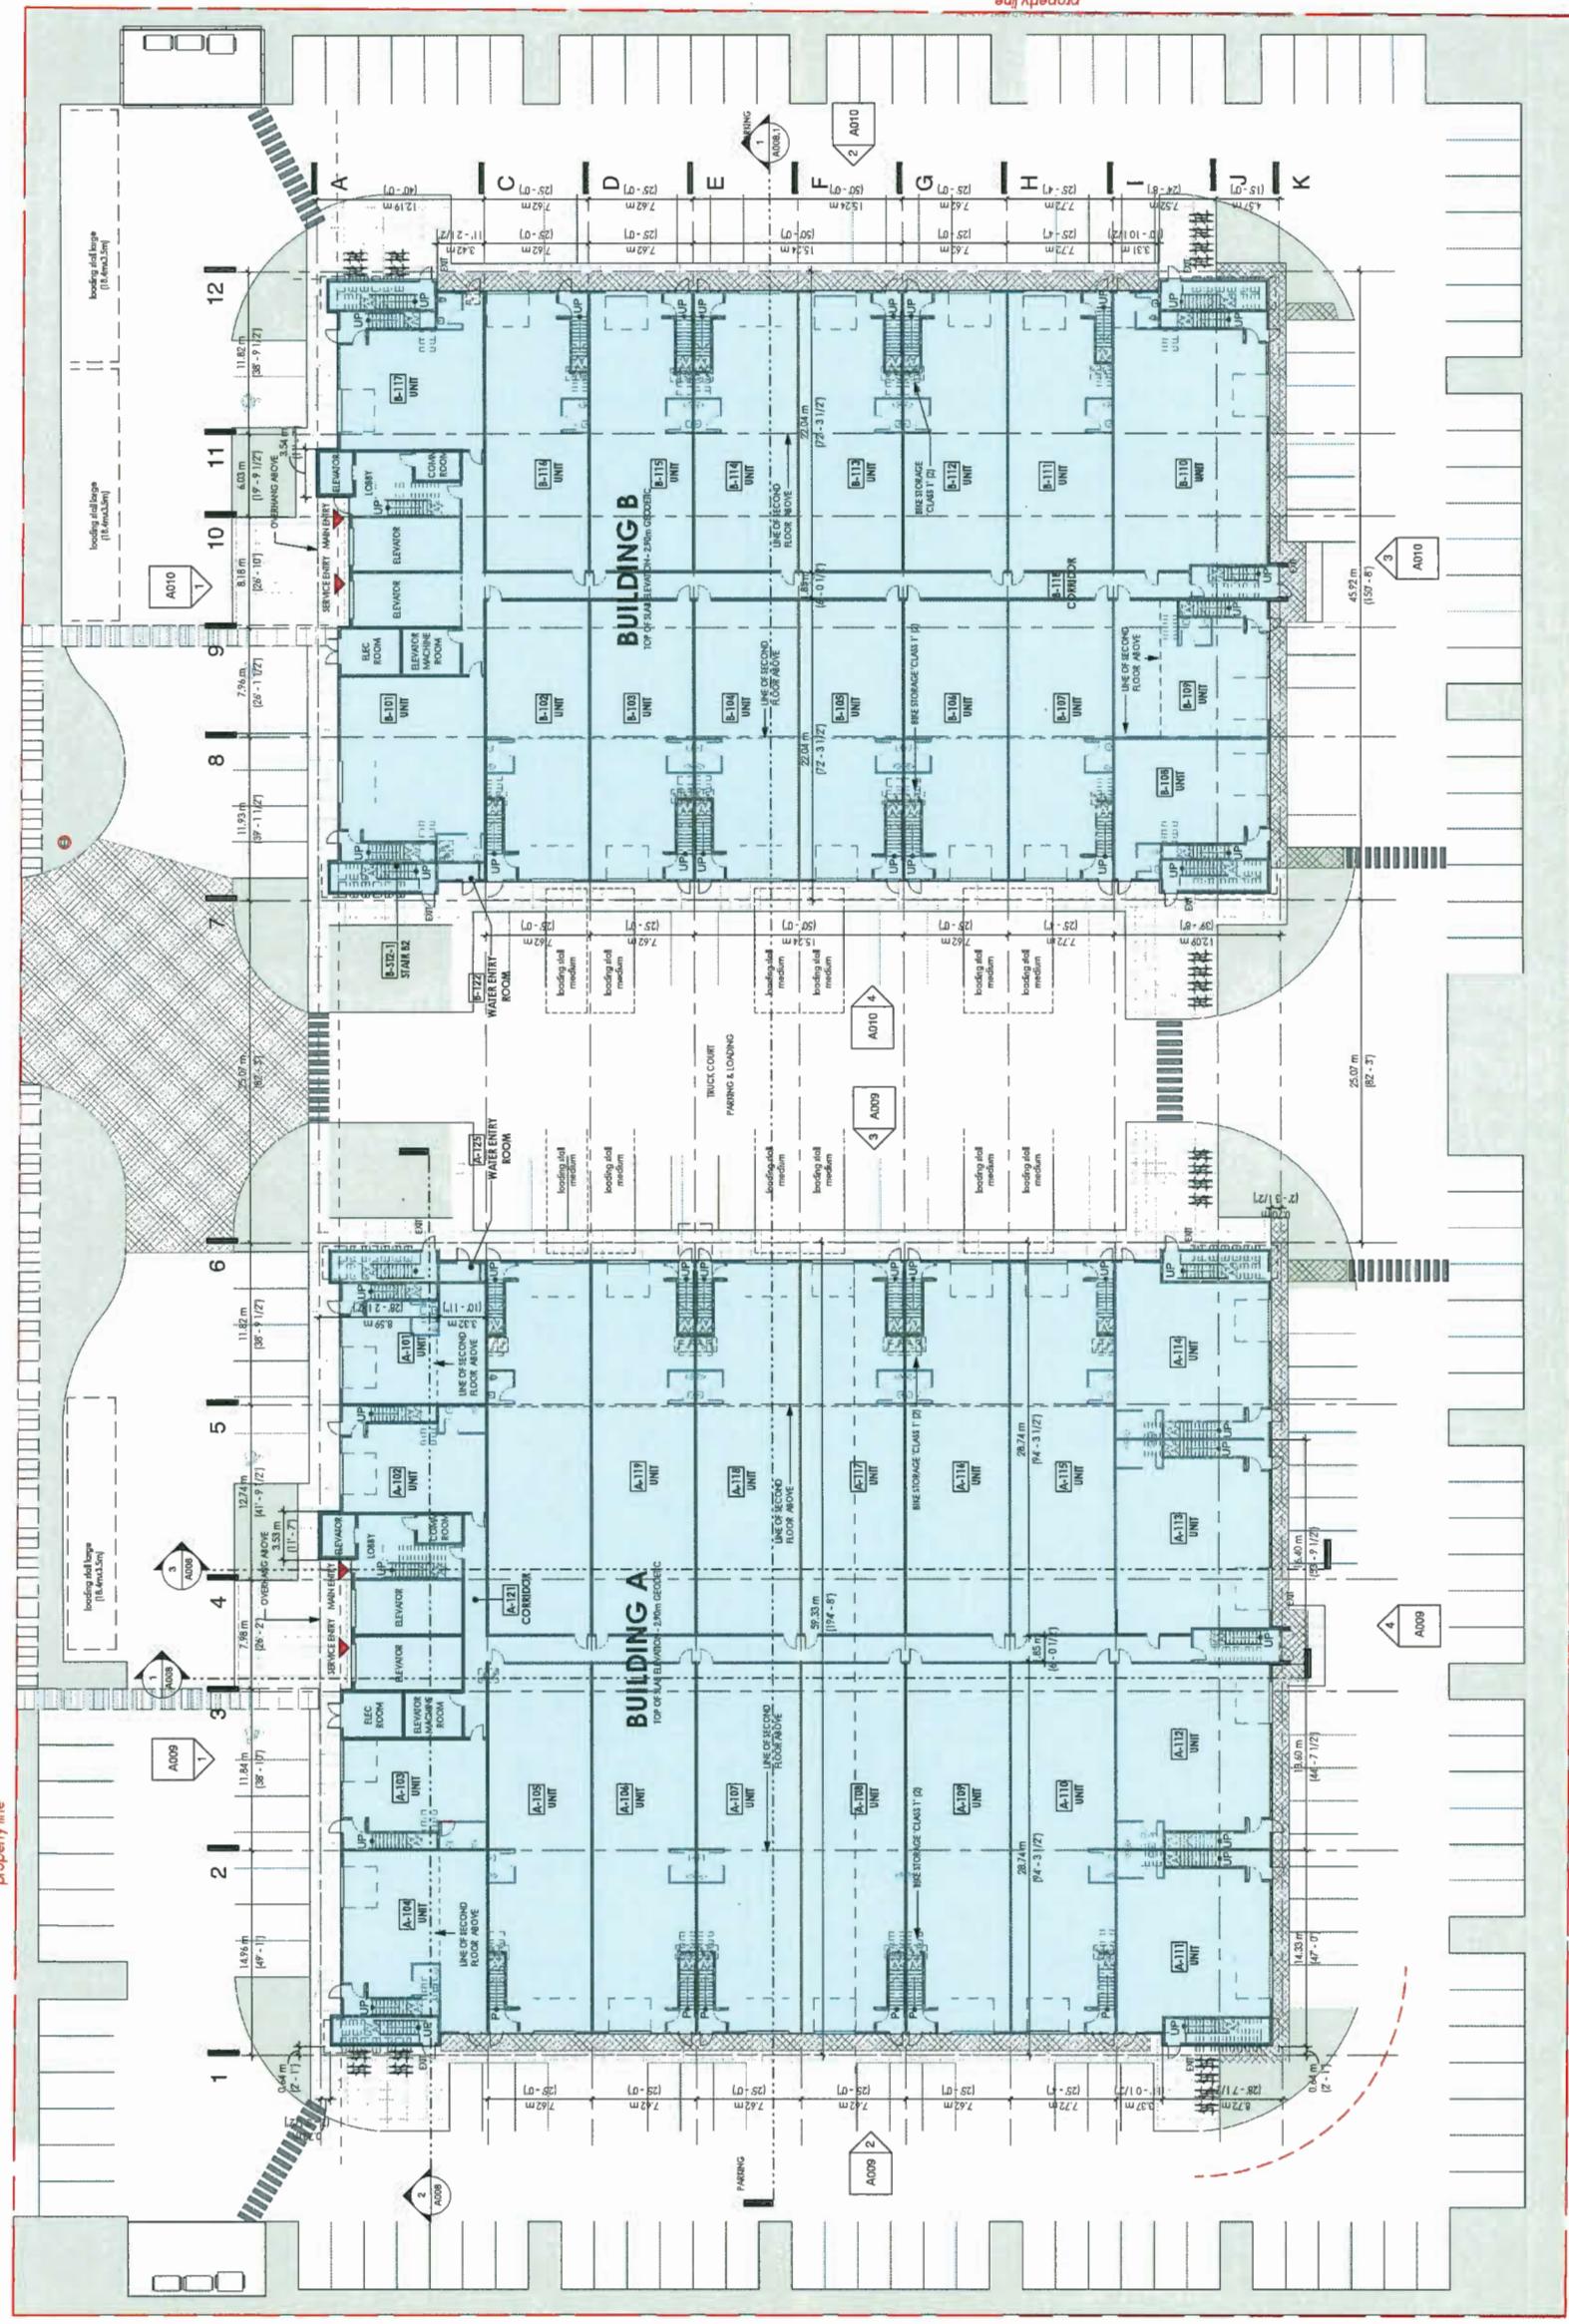

property line

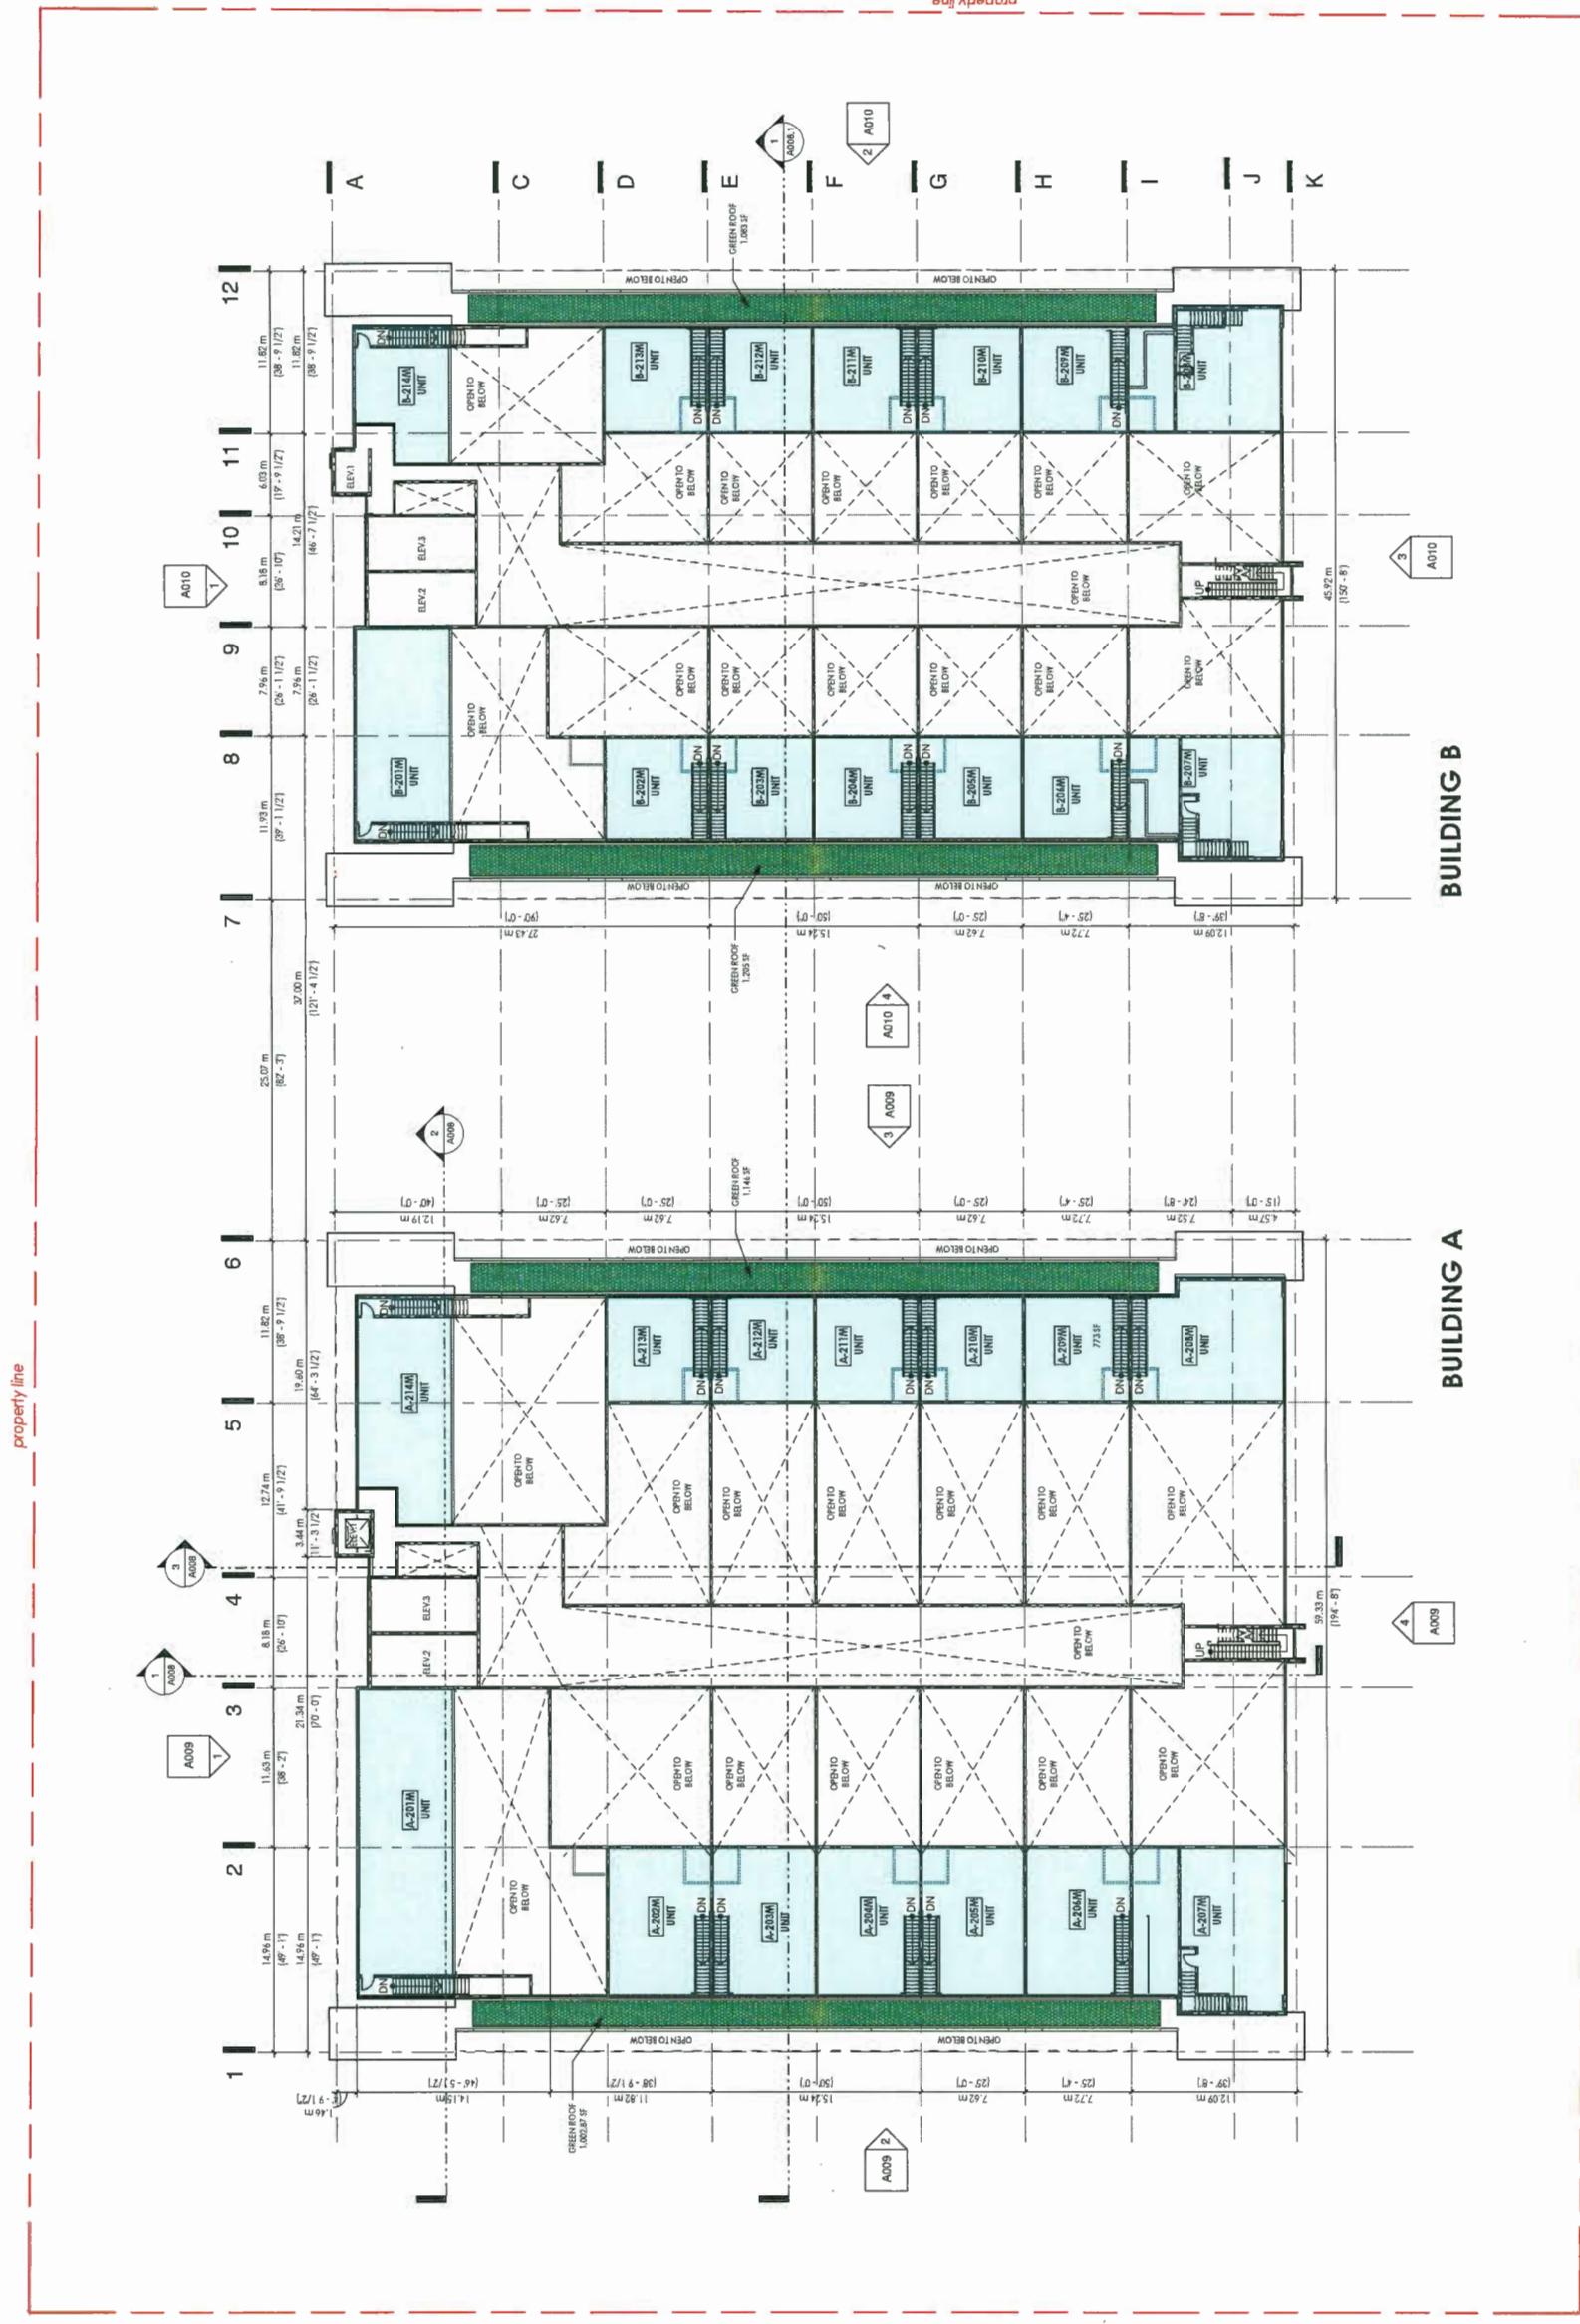

DP 18-818671-6

property line

① DP LEVEL THREE MEZZANINE

1" = 20'-0"

SCALE 1" = 20'-0"
DATE DEC 5 2018
PROJECT NUMBER
DRAWN/AUTHOR
211917

RELEASER: CHRISTOPHER BOZYK / DATE: DEC 5 2018 / DRAWN/AUTHOR: 211917

A006



LEVEL THREE MEZZANINE

4720 + 4740 VANGUARD RD
RICHMOND, BC

REVISION DATE	DESCRIPTION
08/11/2019	REISSUED FOR DP RESPONSE TO COMMENTS
08/09/2019	PERMEABLE AREA AND PAVING REQUIREMENTS
24/07/2019	REISSUED FOR DP RESPONSE TO COMMENTS
24/07/2019	ISSUED FOR COORDINATION
24/08/2019	REISSUED FOR DP RESPONSE TO COMMENTS
23/05/2019	REISSUED FOR DP RESPONSE TO COMMENTS
08/05/2019	ISSUED FOR COORDINATION
03/09/2019	ISSUED FOR DP RESPONSE TO COMMENTS
06/10/2018	ISSUED FOR DP
05/11/2018	RE-ISSUED FOR DP - ISSUED FOR DP
04/12/2018	RE-ISSUED FOR DP
03/09/2018	RE-ISSUED FOR DP
02/10/2018	RE-ISSUED FOR DP
01/11/2018	ISSUED FOR DP
04/12/2018	RE-ISSUED FOR DP

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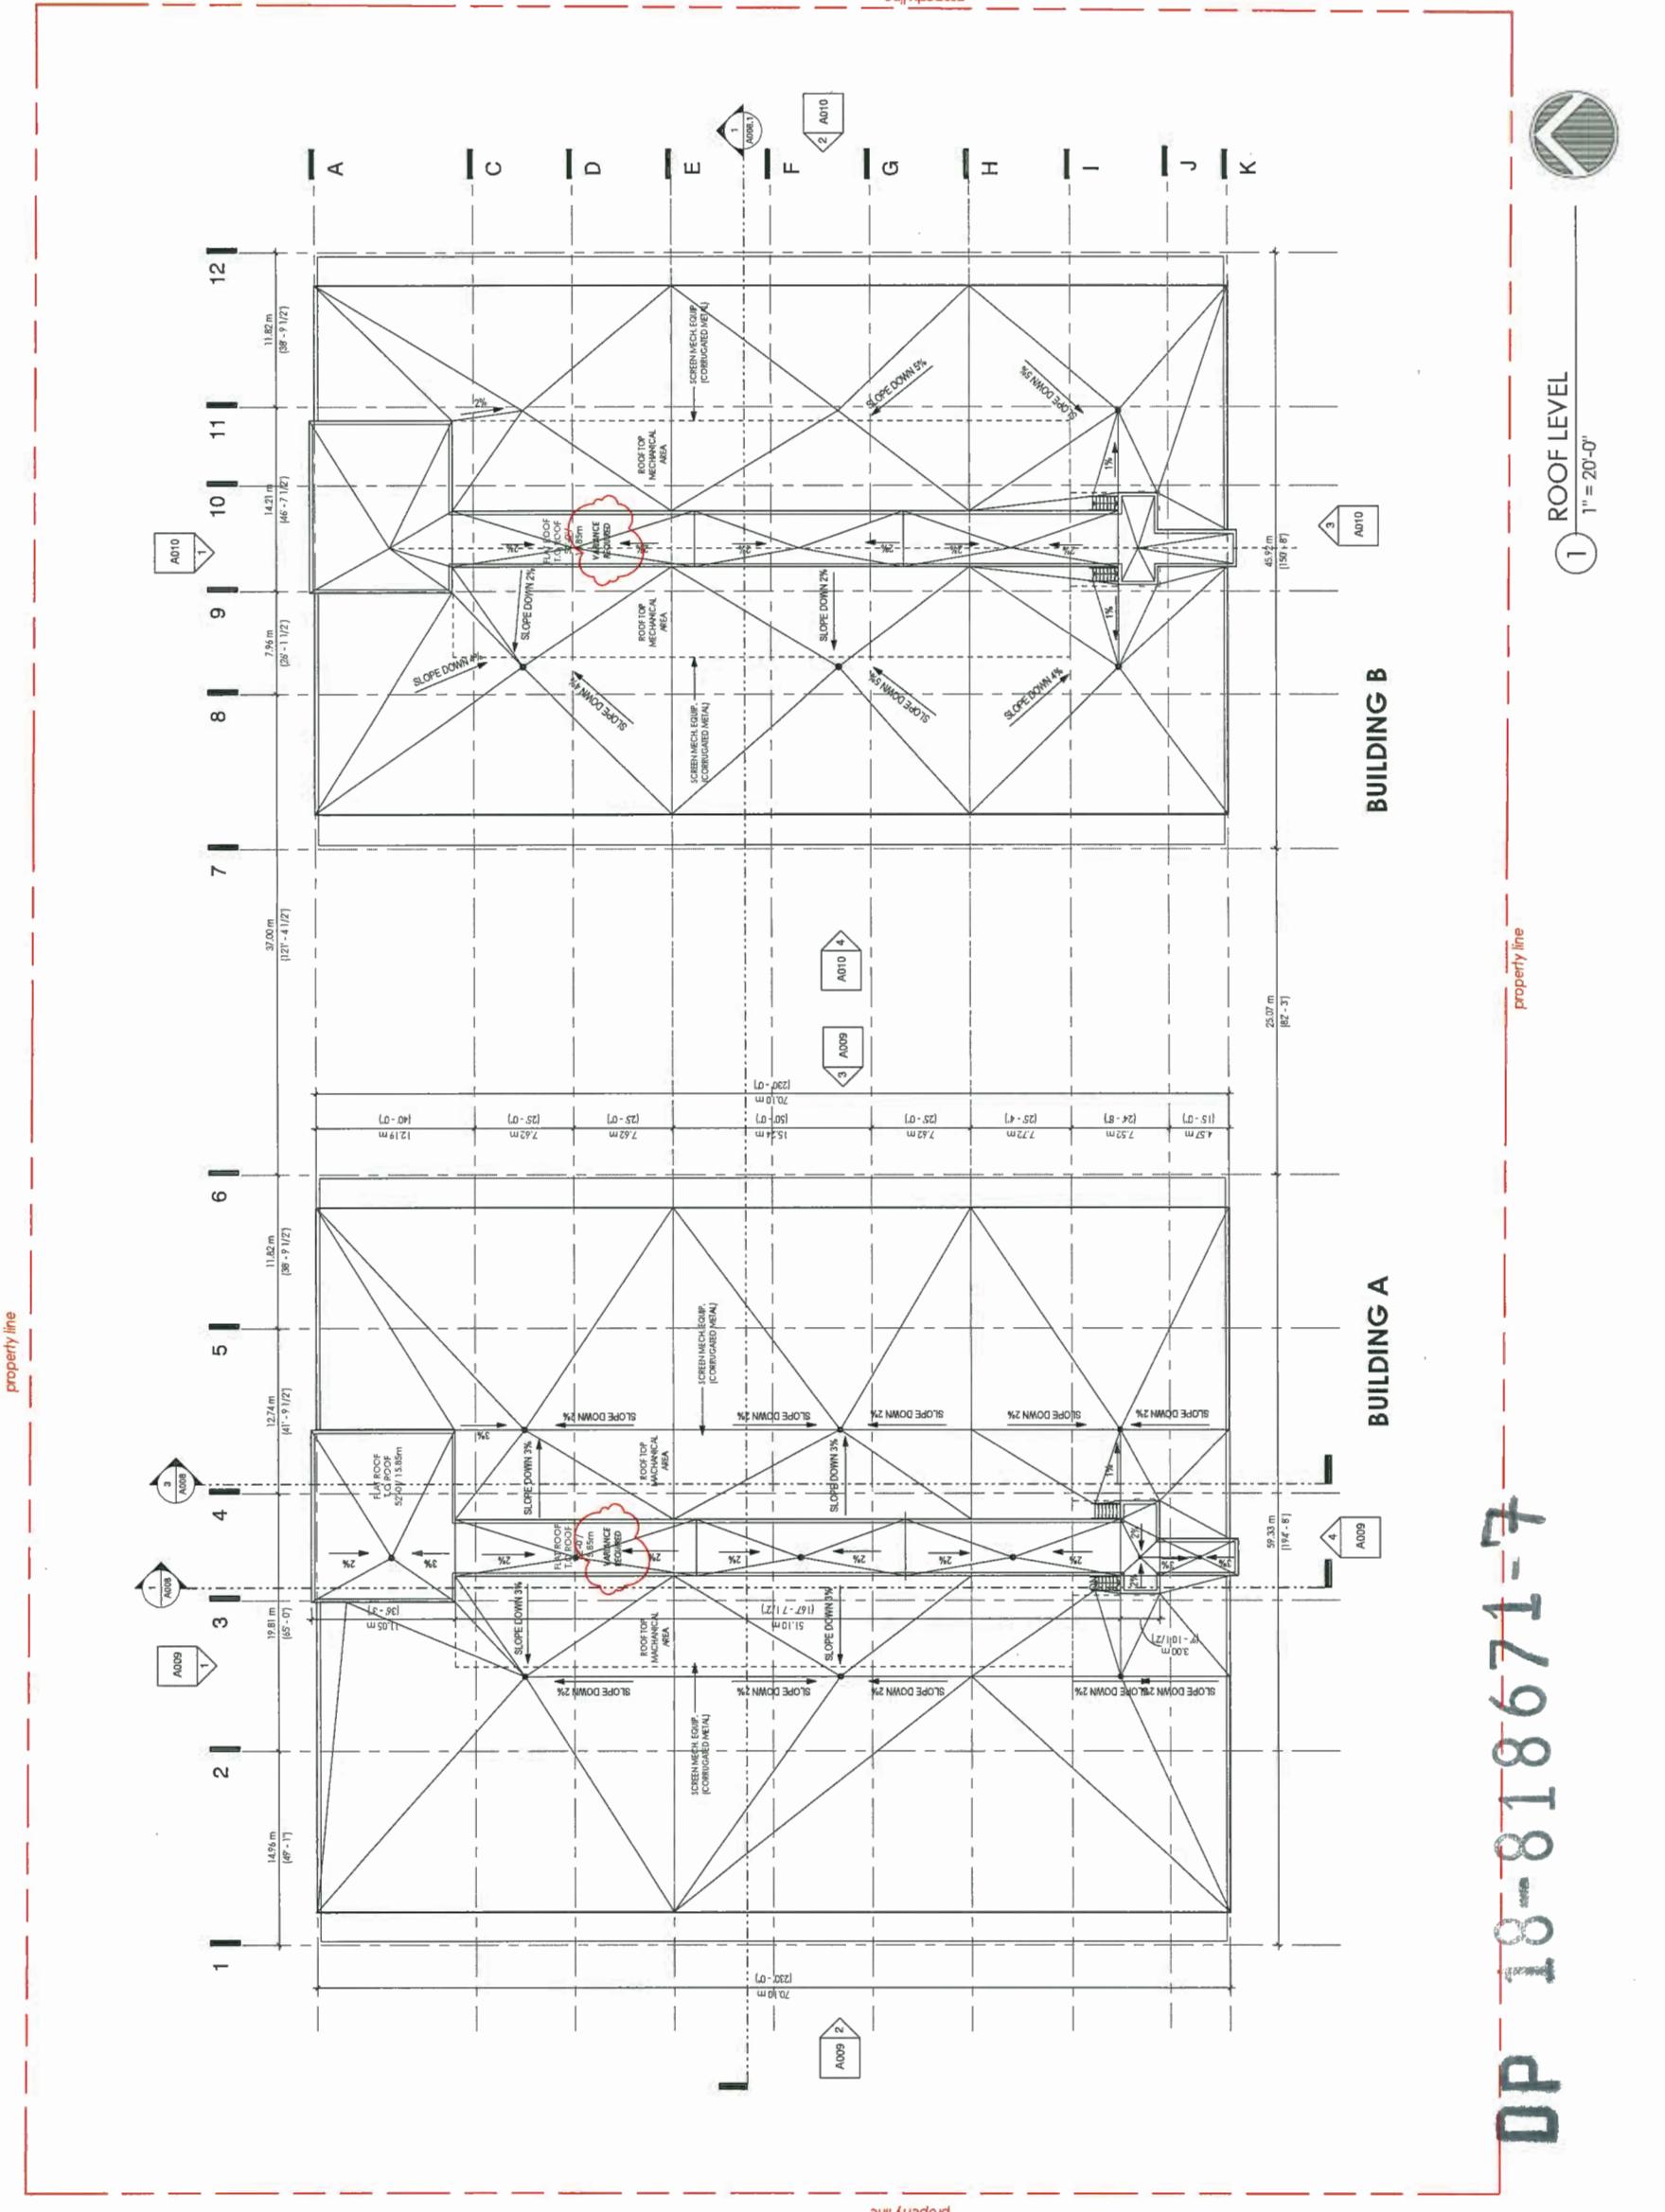
Within dimensions shall then proceede to sue for damages.


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arising from any

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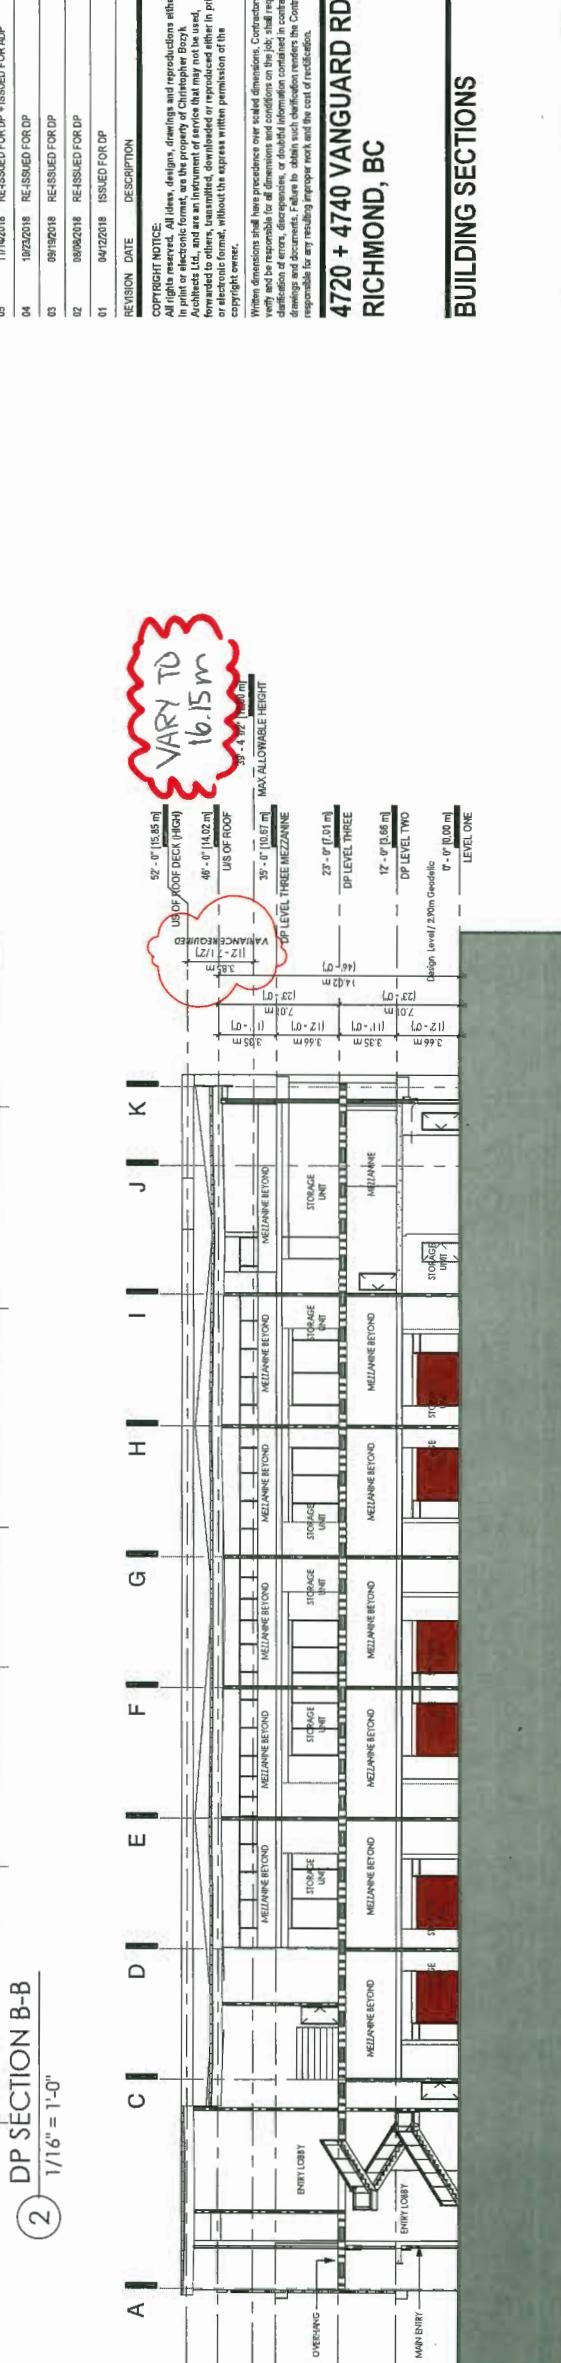
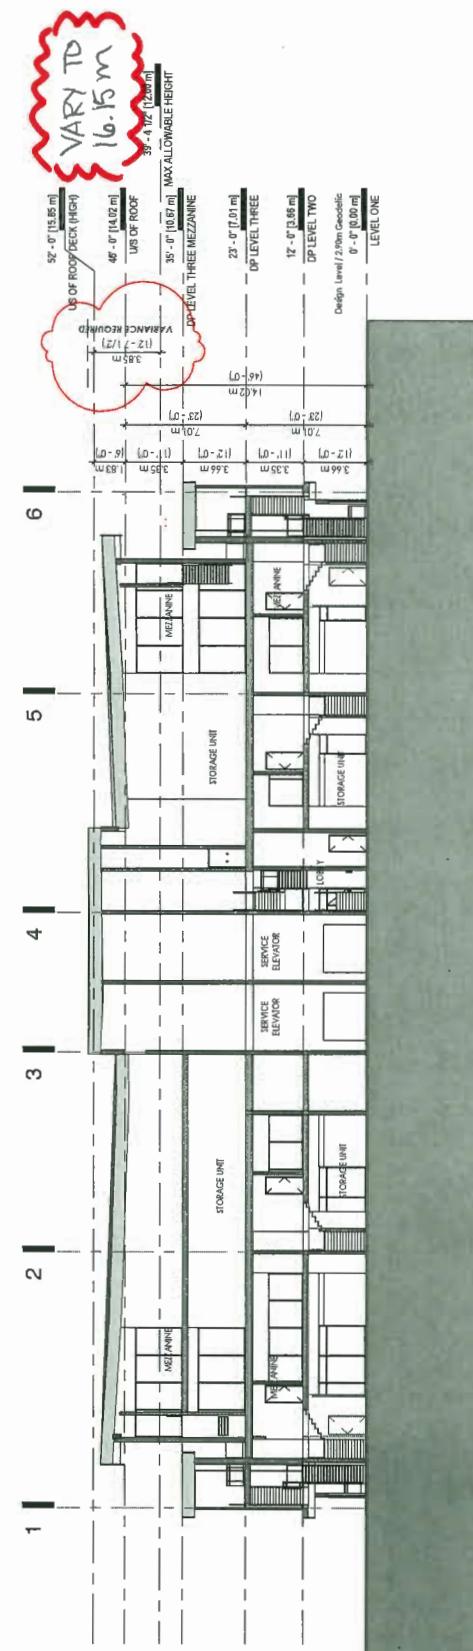
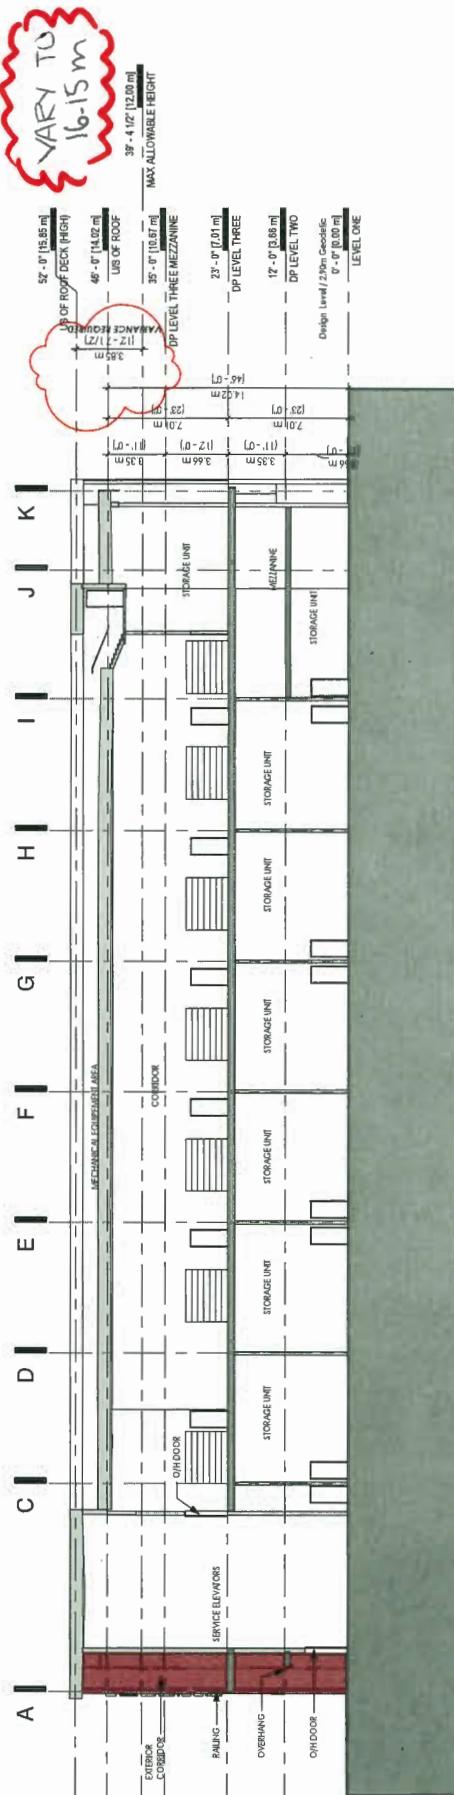


1 ROOF LEVEL - LOCATION FOR SOLAR PANELS

1 1" = 20'-0"

A007.1
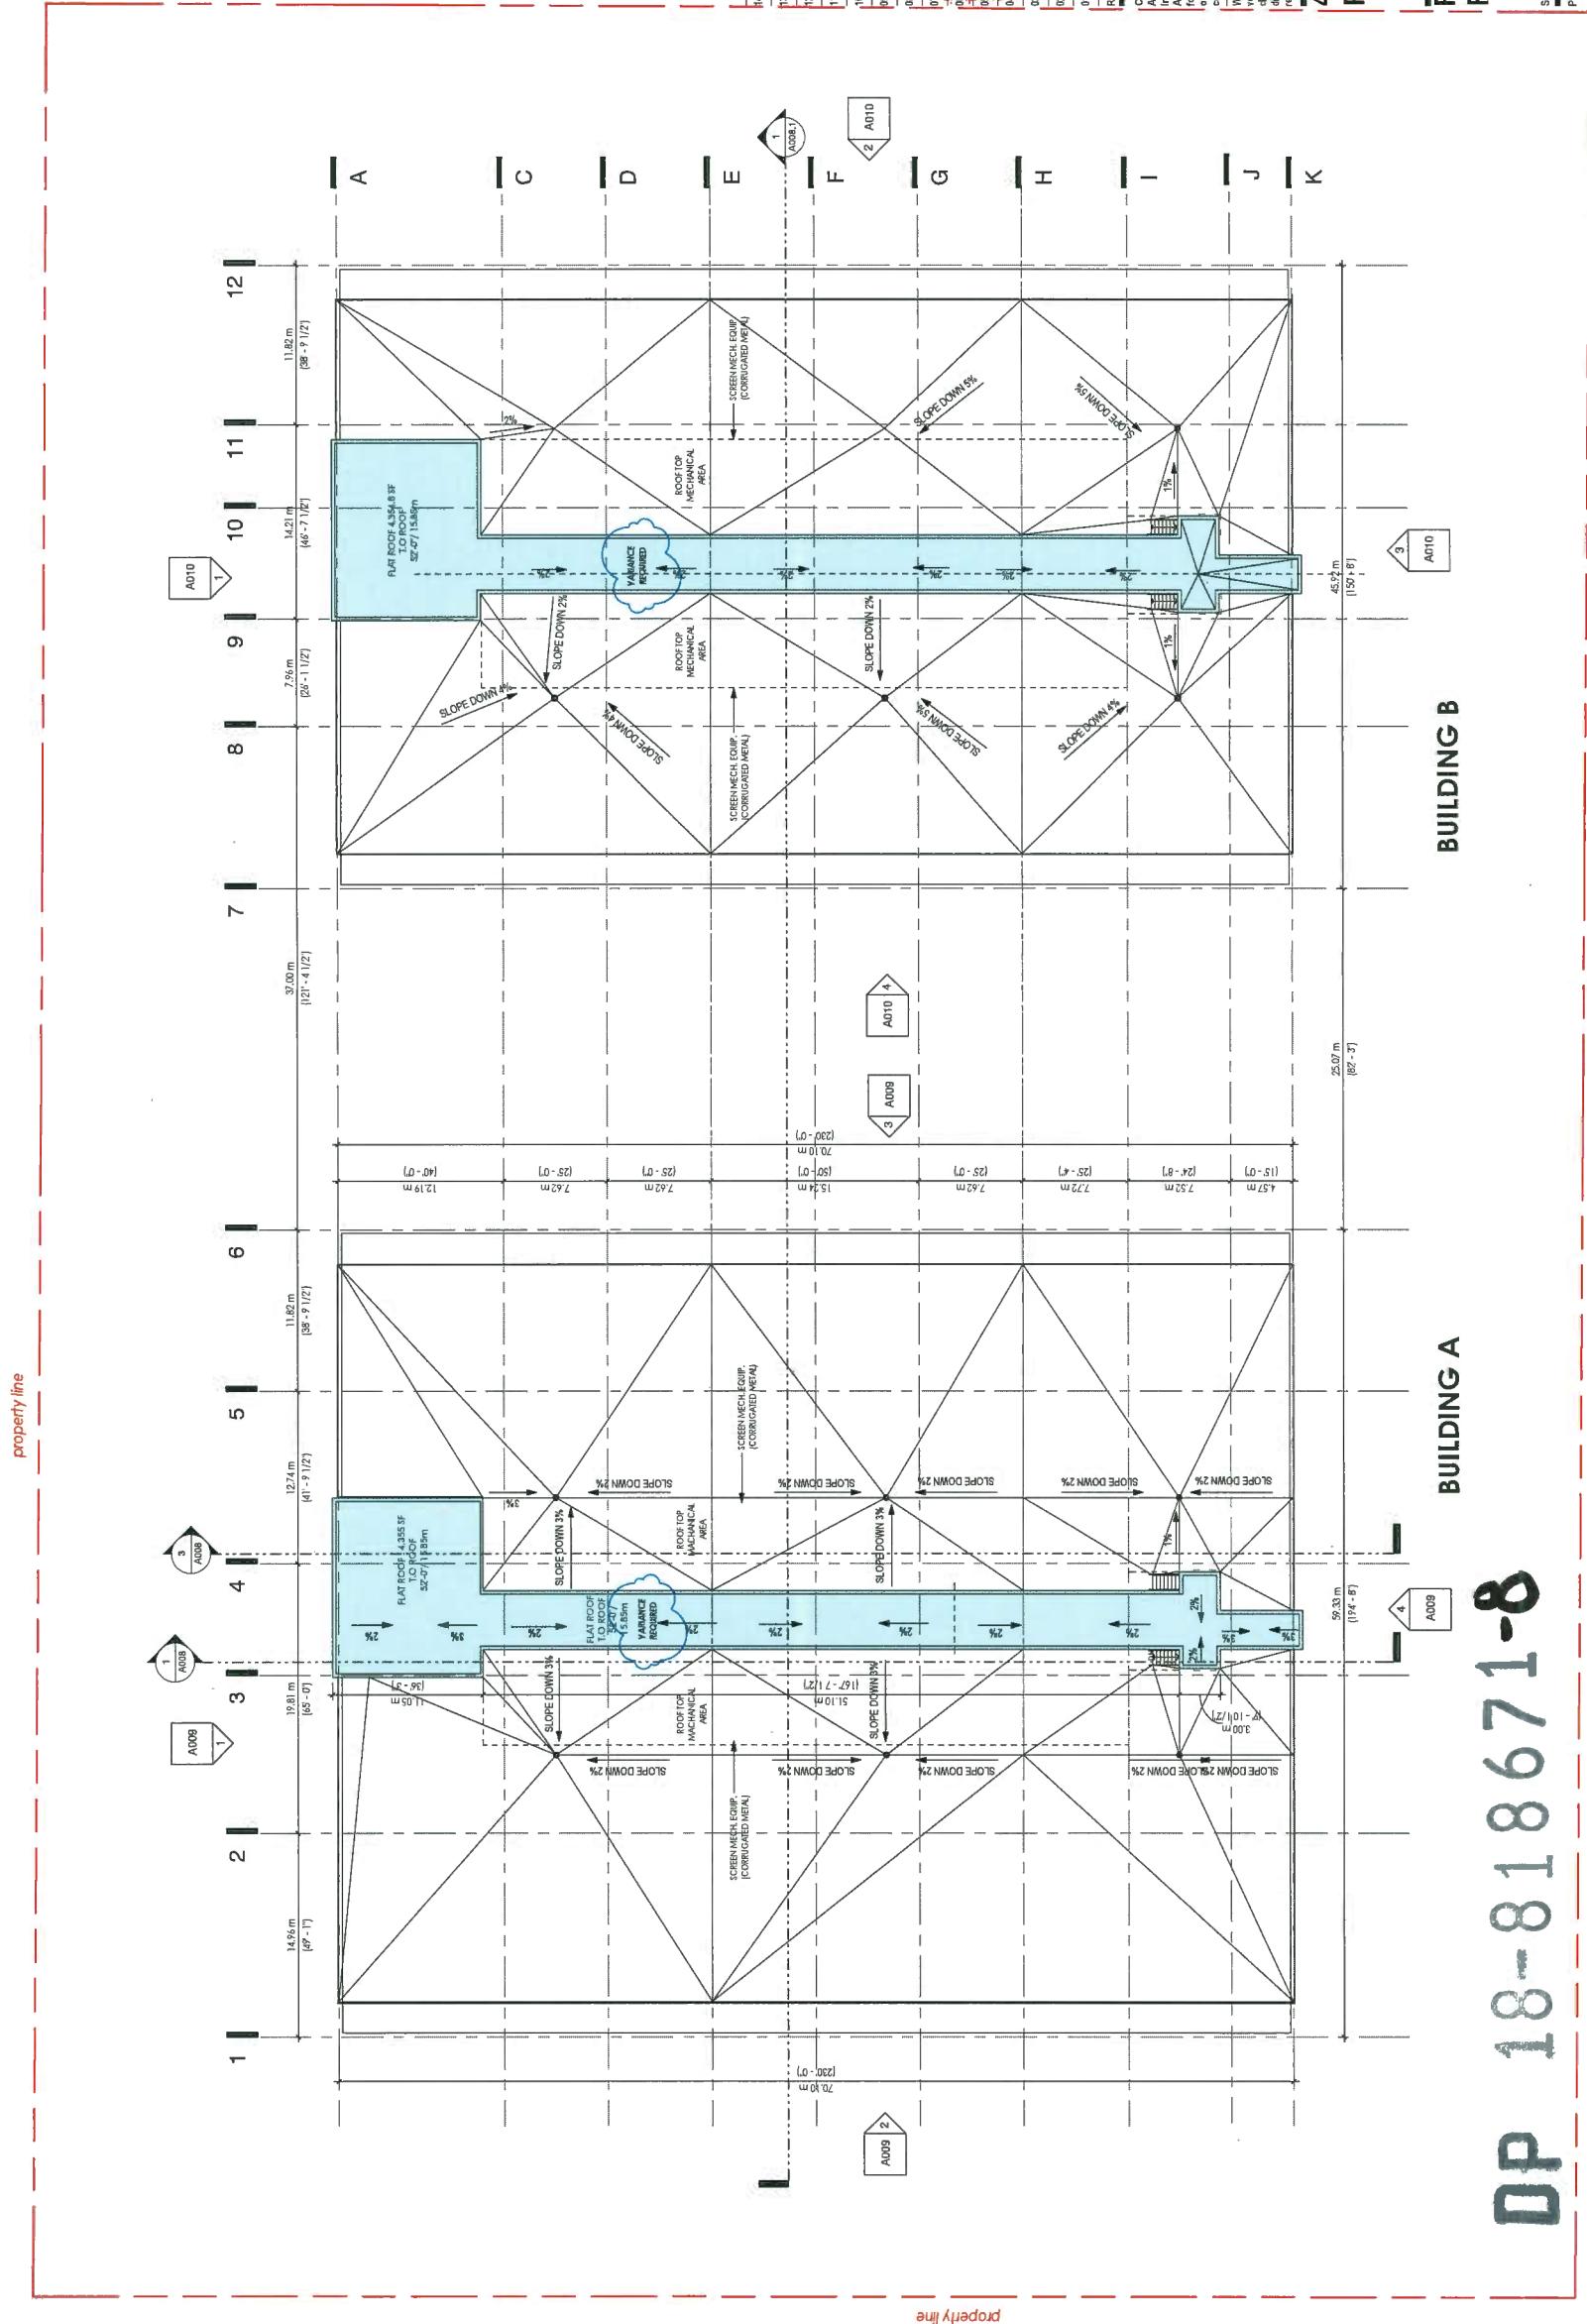
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SCALE 1/16" = 1'-0" DATE DEC 5, 2018 DRAWING AUTHOR
PROJECT NUMBER 21701

DP

18-818671-9

A008

TEL: 604-251-5446 FAX: 604-251-5988 E-MAIL: info@christopherbozyk.com WEBSITE: www.christopherbozyk.com

BUILDING SECTIONS

4720 + 4740 VANGUARD RD
RICHMOND, BC

- | REVISION | DATE | DESCRIPTION |
|----------|------------|---|
| 07 | 07/18/2019 | ISSUED FOR DP RESPONSE TO COMMENTS |
| 08 | 12/05/2018 | ISSUED FOR BP |
| 05 | 11/14/2018 | RE-ISSUED FOR DP & ISSUED FOR ADP |
| 04 | 10/25/2018 | RE-ISSUED FOR DP |
| 03 | 09/06/2018 | RE-ISSUED FOR DP |
| 02 | 08/08/2018 | RE-ISSUED FOR BP |
| 01 | 04/22/2018 | ISSUED FOR BP |
| 08 | 01/05/2019 | ISSUED FOR COORDINATION |
| 07 | 07/18/2019 | ISSUED FOR ADP RESPONSE TO COMMENTS |
| 06 | 12/05/2018 | ISSUED FOR BP |
| 12 | 2/07/2019 | RE-ISSUED FOR DP & RESPONSE TO COMMENTS |
| 11 | 2/07/2019 | ISSUED FOR COORDINATION |
| 10 | 2/05/2019 | RE-ISSUED FOR DP & RESPONSE TO COMMENTS |
| 09 | 2/05/2019 | RE-ISSUED FOR DP & RESPONSE TO COMMENTS |
| 08 | 01/05/2019 | ISSUED FOR COORDINATION |
| 14 | 01/11/2019 | RE-ISSUED FOR DP & RESPONSE TO COMMENTS |
| 13 | 01/05/2019 | PERMEABLE AREA AND PAVERS REQUIREMENTS |

MAX ALLOWABLE HEIGHT
39'-4 1/2" (12.01 m)

DP LEVEL THREE MEZZANINE
25'-0" (7.62 m)

DP LEVEL TWO
17'-0" (5.18 m)

Design Level /28m Geodetic
0'-0" (0.00 m)

LEVEL ONE

MAX ALLOWABLE HEIGHT
39'-4 1/2" (12.01 m)

DP LEVEL THREE MEZZANINE
25'-0" (7.62 m)

DP LEVEL TWO
17'-0" (5.18 m)

Design Level /28m Geodetic
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DP LEVEL TWO
17'-0" (5.18 m)

Design Level /28m Geodetic
0'-0" (0.00 m)

LEVEL ONE

1 DP SECTION A-A


2 DP SECTION B-B

3 DP SECTION C-C

414-611 ALEXANDER STREET VANCOUVER BC V6A 1E1
PHONE (604) 251-3440 FAX (604) 251-3848

MATERIALS LEGEND


METAL PANEL	
MC1	METAL CORRUGATED CLADDING PANEL. COLOUR TO MATCH CANTILEVER - 200.
MC2	METAL CORRUGATED CLADDING PANEL, BLUE. COLOUR TO MATCH BUCANT BUE [C-15].
MC3	METAL CORRUGATED CLADDING PANEL, GALVANIZED ALUMINIUM COLOR.
MC4	METAL CORRUGATED CLADDING PANEL, GRAY.
MC5	METAL CORRUGATED CLADDING PANEL, CHOCOLATE.
NM	FREIGHTED WHERE EACH PANEL BY AIR/ROAD
NPS	PREFINISHED CHOCOLATE, NFE, 14X100X1000. COLOUR TO MATCH MATERIAL CHOCOLATE.
CONCRETE	
PC1	EATONBLOCK PAINTED CONCRETE - COLOR TO MATCH BIN VENDYL CHOCOLATE, HC-16A.
PC2	NON-PERFECTED BLUE CONCRETE PANEL - PAINT - COLOR TO MATCH BIN VENDYL CHOCOLATE, HC-16.
GLAZING	
GL1	NOTE: CURVILINEAR GLAZING TO BE DONE DOUBLE GLAZED. LANNET SEALED AT 3MM, EXCEPT NOTED OTHERWISE.
GL2	GLAZED PRE-ASSEMBLED OR IN-BOX, SAW CUT E
GP	GLAZED PRE-ASSEMBLED OR IN-BOX, GLAZED
IP	POLYCARBONATE, IRIDESCENT WHITE PANEL

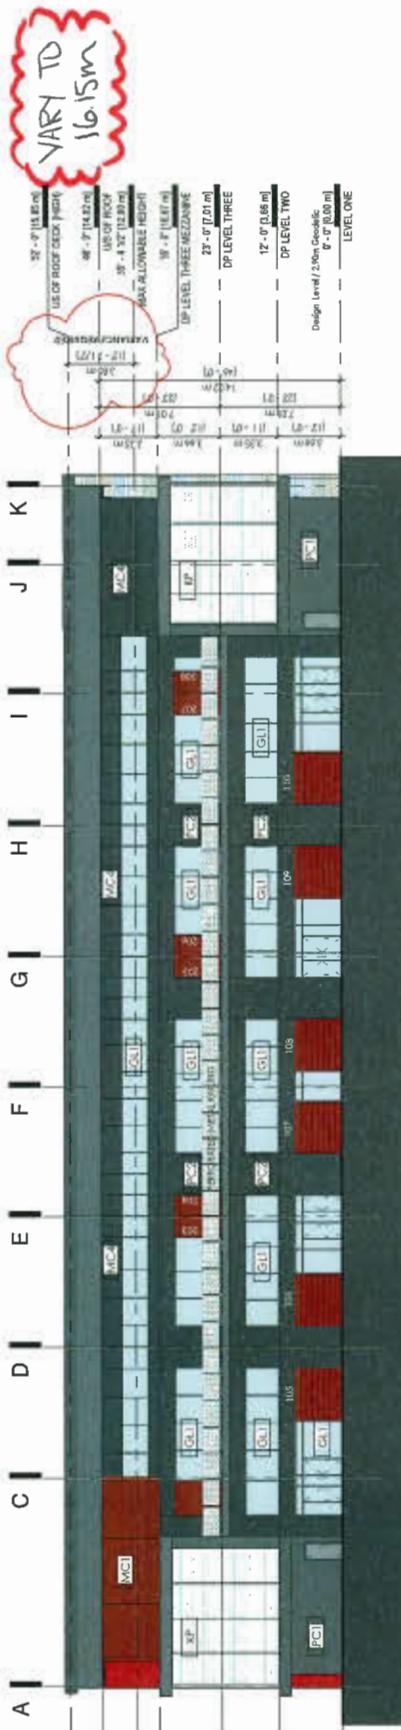


2) DP WEST ELEVATION_BLDG A



4 DP SOUTH ELEVATION_BLDG A

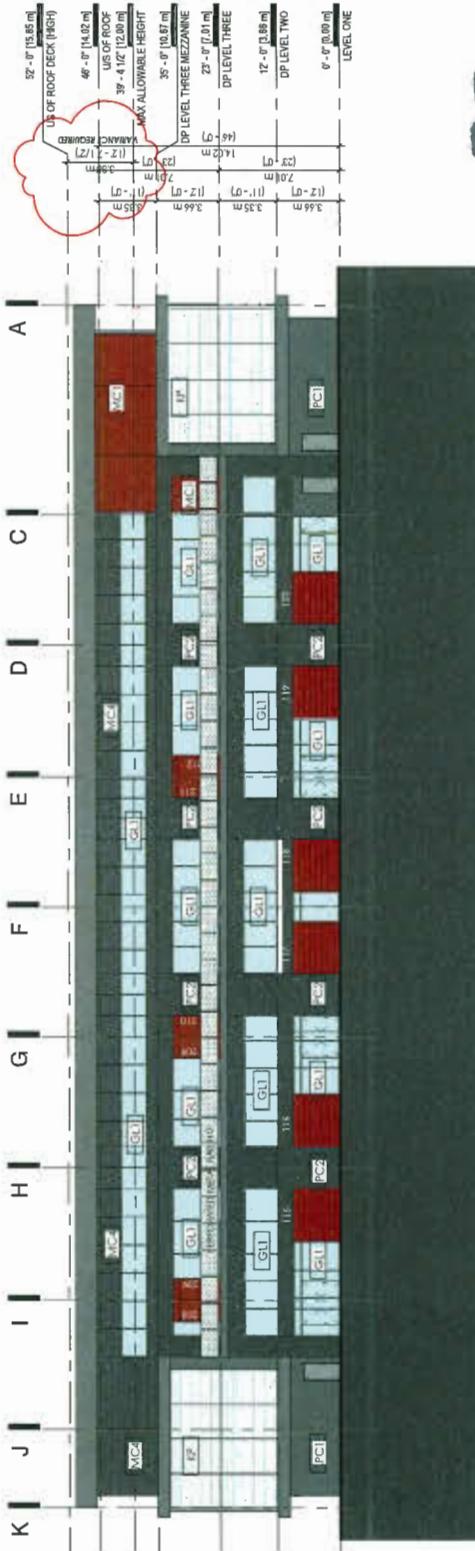

DP NORTH
1/16" = 1'-0"

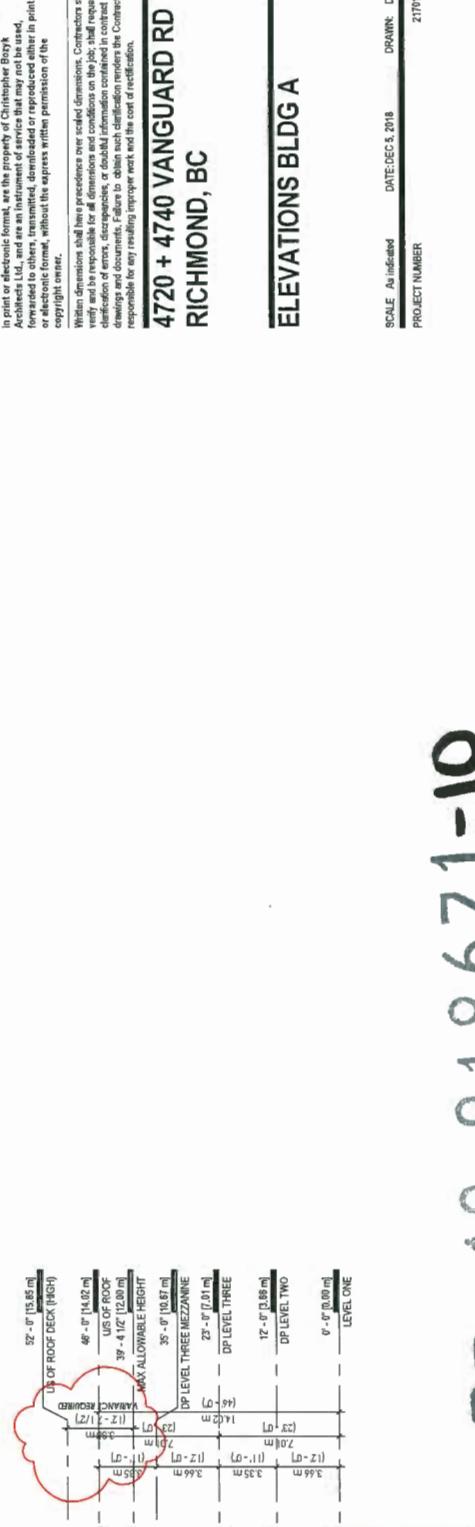

02	08/08/2018	RE-ISSUED FOR DP
01	04/22/2018	ISSUED FOR DP
REVISION DATE	DESCRIPTION	
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Within dimensions shall there be no recesses or overhanded conditions on the job, but request otherwise. In order to obtain such dimensions, measure the Contractor responsible for any resulting rework and the cost of re-fabrication.		

4720 + 4740 VANGUARD RD

RICHMOND, BC

SCALE As indicated DATE: DEC 5, 2018 DRAWN: DR
PROJECT NUMBER 217017



FILE PATH: C:\Users\louisw\Documents\VALUANCE_CURREN'S\BETWEEN\1579407.DAT DATE: 11/20/2013 9:15:29 AM

DRAFT 18-8186 / 1-10

DP EAST ELEVATION_BLDG A



MATERIALS LEGEND

MATERIAL PANEL	DESCRIPTION
MC1	METAL CORRUGATED CLADDING (PAINTED).
MC2	COLOR TO MATCH EXCAVATION PAINT BLUE.
MC3	COLOR TO MATCH EXCAVATION PAINT DUE TO MC1.
MC4	METAL CORRUGATED CLADDING (PAINT).
GP1	GAUDED ALUMINUM COLOR.
GP2	METAL CORRUGATED CLADDING (PAINT AND GRAY).
GP3	COLOR TO MATCH EXCAVATION PAINT HIC-164.
GP4	PREFINISHED ACM (PAINT BY FAUCONBIRD).
GP5	PREFINISHED ACM (PAINT BY FAUCONBIRD).
CONCRETE	CONCRETE.
PC1	EATONOMIC PAINTED CONCRETE - COLOR TO MATCH BIM MATERIAL COLOR CO. HIC-164.
PC2	INSULATED STEEL CONCRETE PANEL - PAINT COLOR TO MATCH BIM MATERIAL COLOR HIC-164.
GLASSING	NOTE: CUPROVIT GLAZING TO BE LOW-E DOUBLE GLAZED. LAMINATED GLAZING TO BE THICK, LIPCOPTIC PANE OTHERWISE.
GL1	GLAZED PANEL, CLEAR.
GL2	GLAZED PANEL, CEAMCUT, OR MILD, LOW E COATED, ACID ETCHED GLASS.
RF	POLYCARBONATE, TRANSPARENTE PANEL.
SP1	SPAGNETTE PANEL, WHITE.

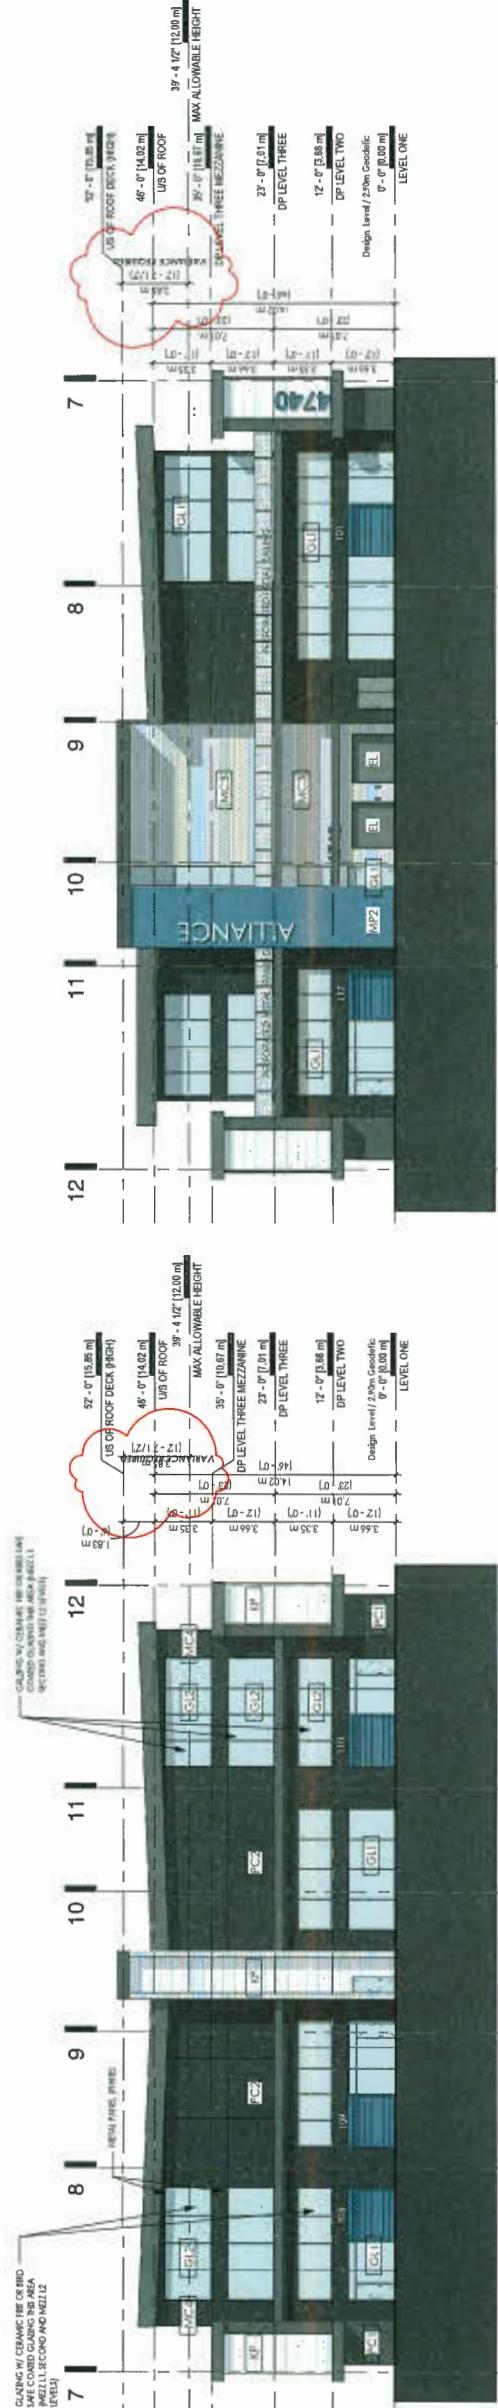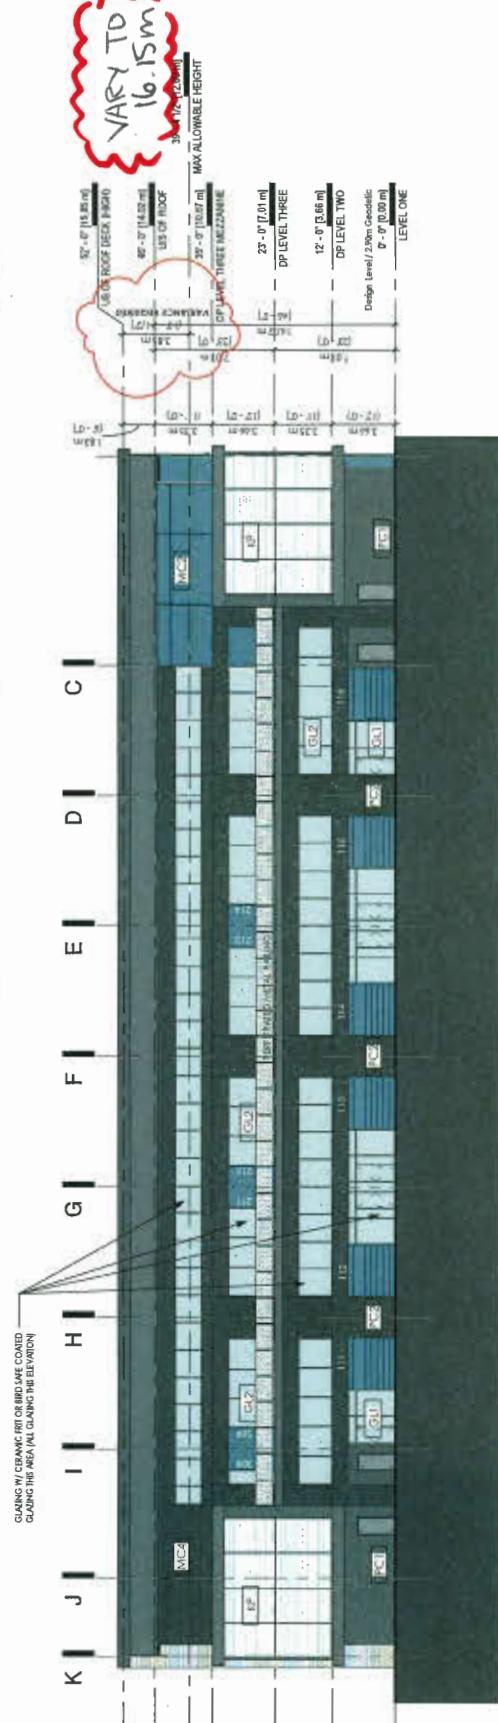


(3) $1/16'' = 1'-0''$

DP SOUTH ELEVATION_BLDG B

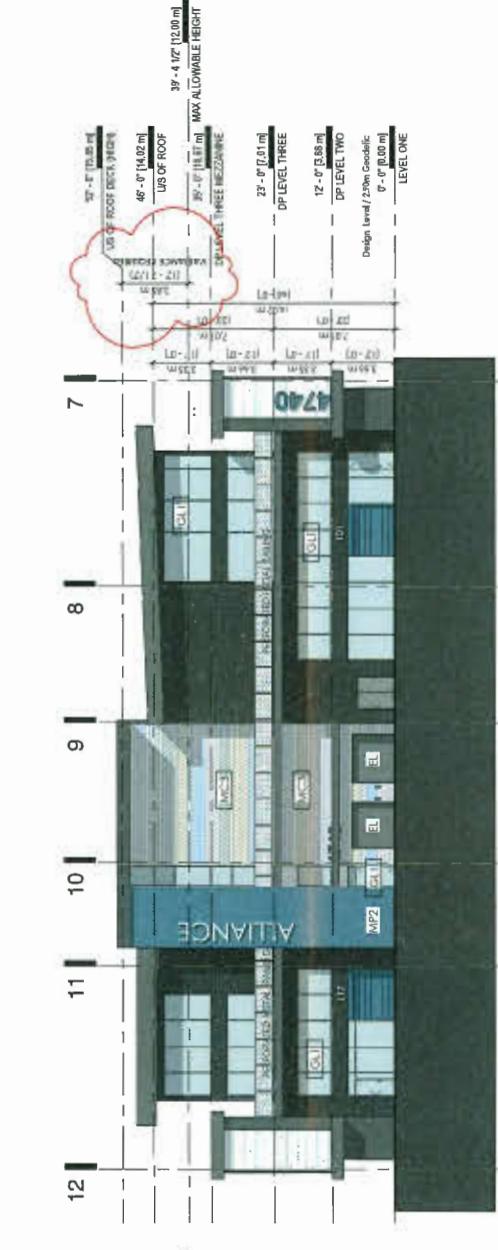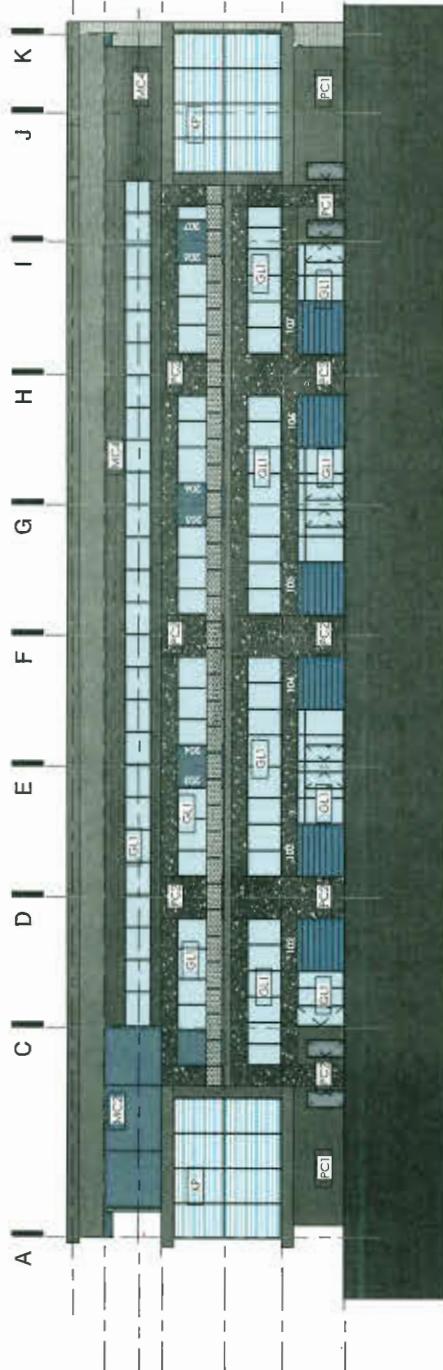

(1) $1/16'' = 1'-0''$

DP NORTH ELEVATION_BLDG B

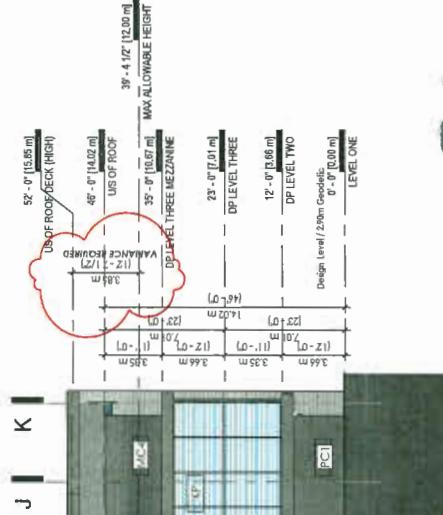

4720 + 4740 VANGUARD RD
RICHMOND, BC

ELEVATIONS BLDG B

SCALE: As indicated DATE: DEC 5, 2018 DRAWN/Editor
PROJECT NUMBER 21017

OP 18-818671-11



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K.D. PLANNING & DESIGN, INC.

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DP 18-818671-17

SECTION 6

SECTION 5

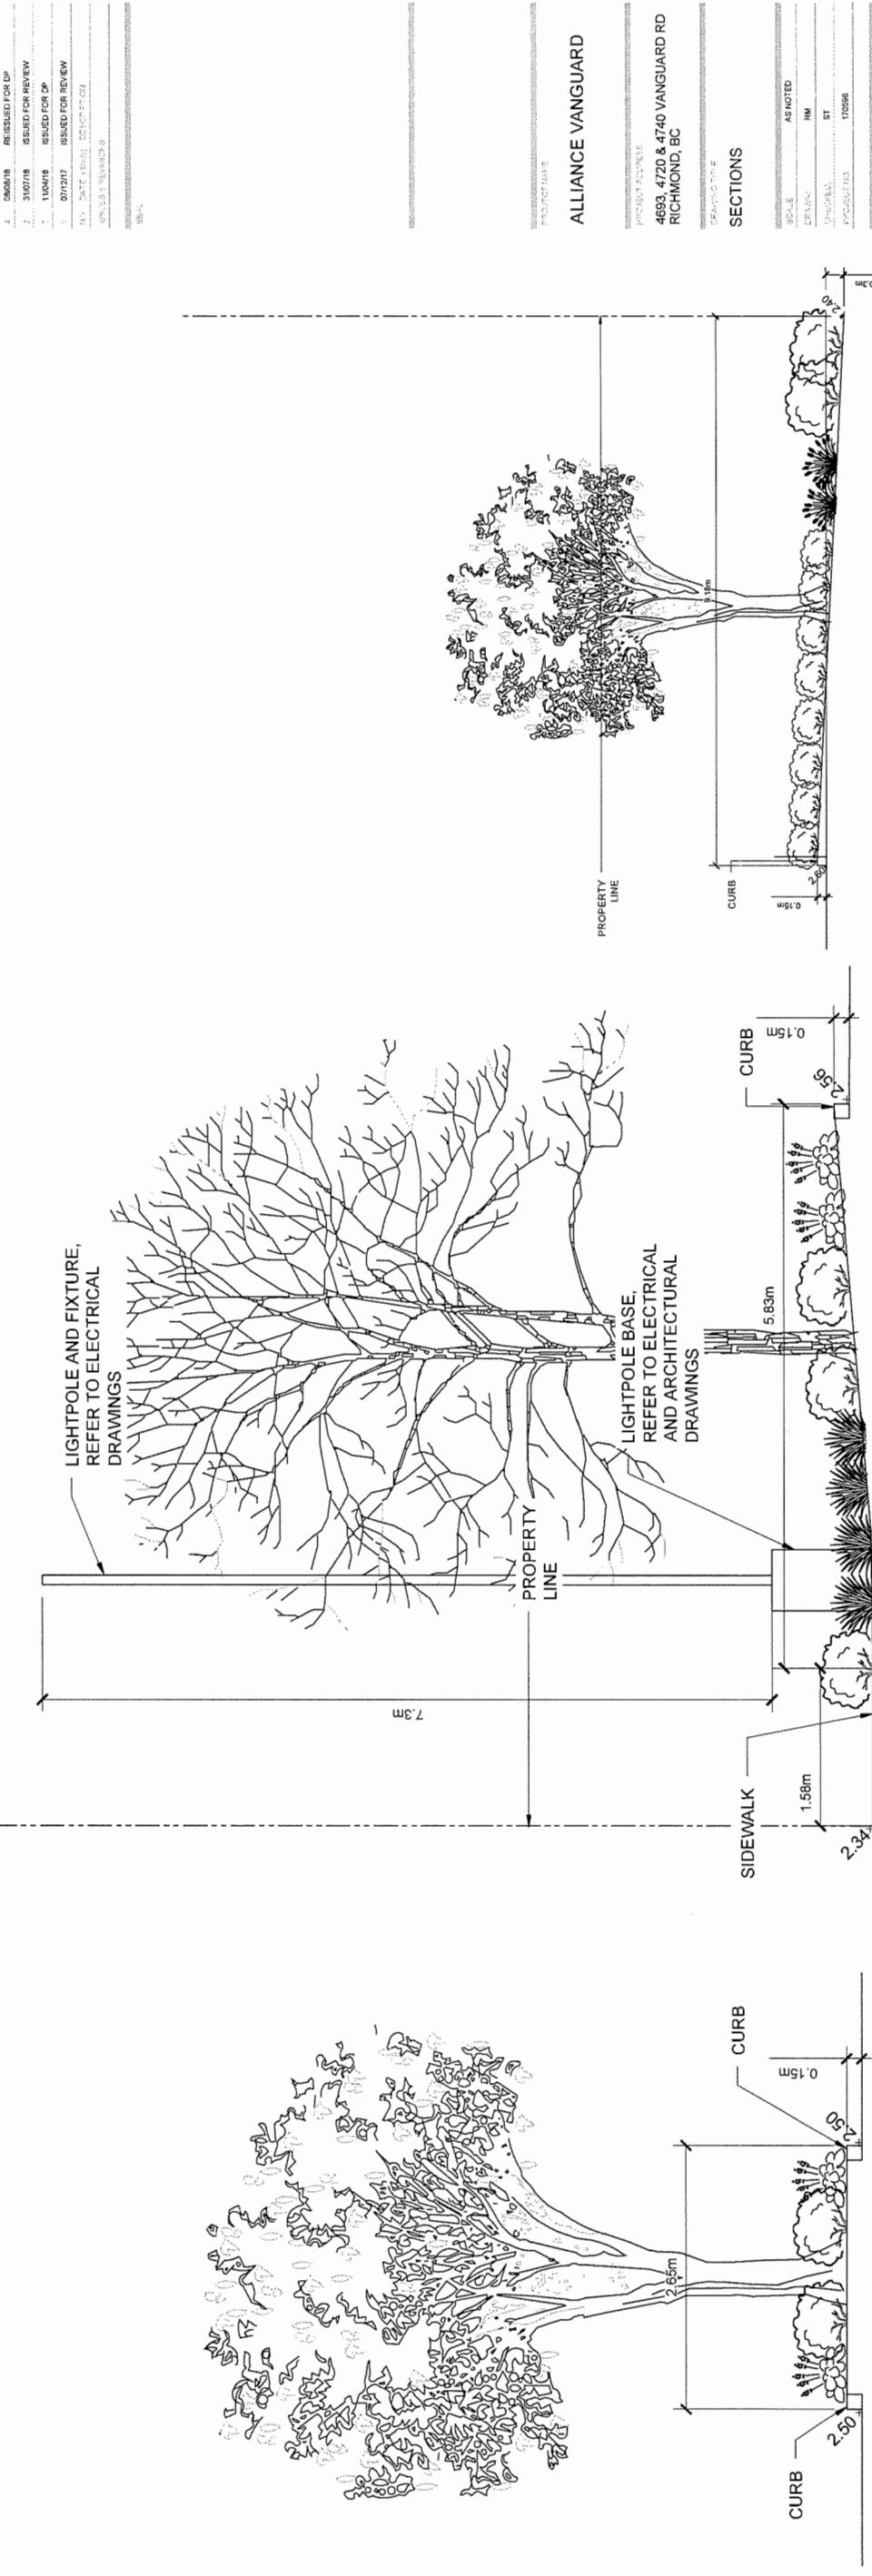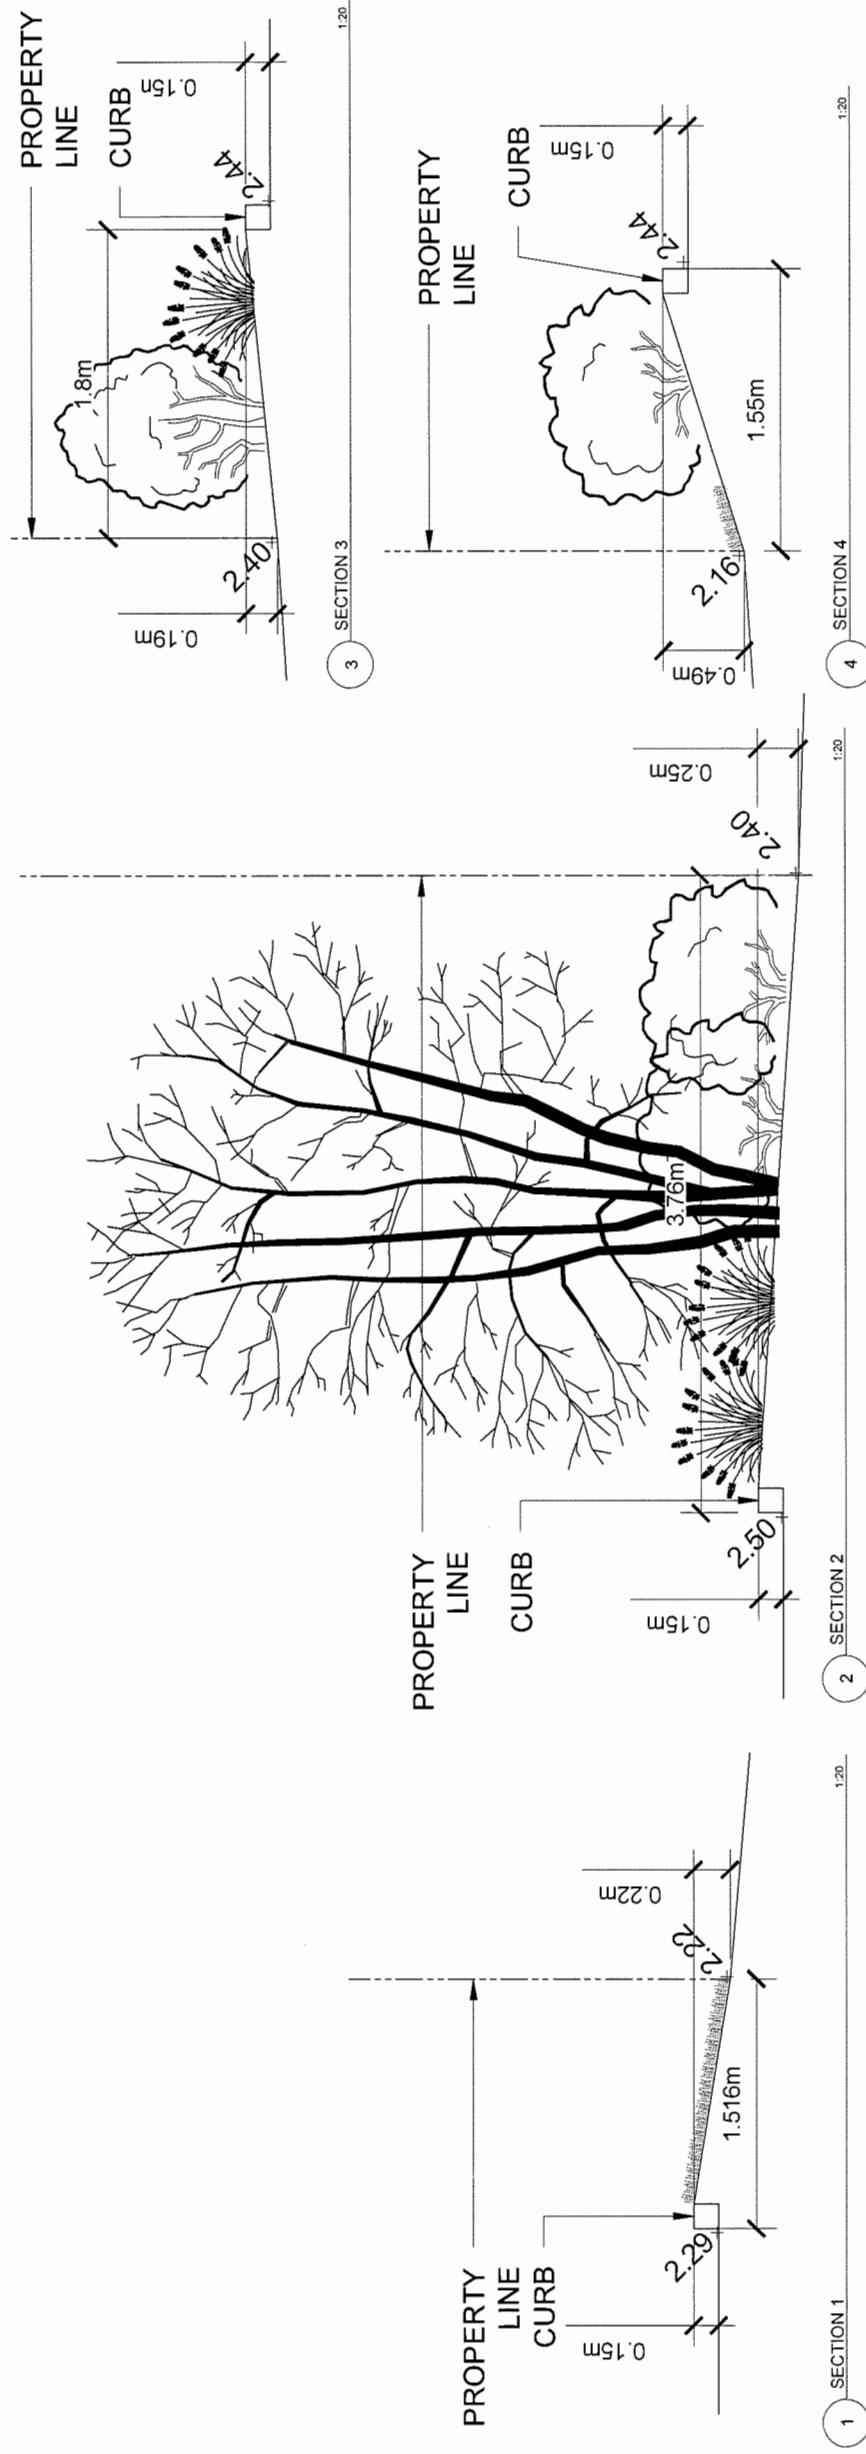

City of Richmond

Report to Development Permit Panel

To: Development Permit Panel

Date: November 19, 2019

From: Wayne Craig
Director, Development

File: DP 18-822743

Re: Application by GBL Architects for a General Compliance Ruling at
6340 No. 3 Road

Staff Recommendation

That the attached plans to apply a public art element to the glazing of the southwest corner of the project facing No. 3 Road and Cook Road, to change the glazing on the second floor west and south elevations of the office building facing No. 3 Road and Cook Road, and include painted design elements on the east elevation of the parkade podium wall facing the lane/pedestrian mews be considered to be in General Compliance with Development Permit (DP 18-822743).



Wayne Craig
Director, Development
(604-247-4625)

WC:mm
Att. 5

Staff Report

Origin

GBL Architects has requested a General Compliance ruling regarding changes to Development Permit (DP 18-822743) for a 15-storey, 53,794 m² (579,027 ft²), mixed-use development at 6340 No. 3 Road on a site zoned “High Density Mixed Use and ECD Hub (ZMU37) – Brighouse Village (City Centre)” (Attachment 1). The project includes three apartment towers and one office tower located above a large podium that includes interior parking and service areas, and retail space facing the public realm on the north, south and west sides of the project. This Development Permit was endorsed by Development Permit Panel on September 26, 2018, and was approved along with the rezoning for the project (RZ 17-773703) at the October 22, 2018 meeting of Council.

This Staff Report summarizes the proposed modifications to the Development Permit including changes to the glazing of the southwest corner of the project facing No. 3 Road and Cook Road, changes to the glazing on the second floor of the west and south elevations of the office building facing No. 3 Road and Cook Road, and changes to accommodate painted design elements on the east elevation of the building podium facing the lane/pedestrian mews. These proposed changes were also outlined in the Staff Report to the above-noted Development Permit Panel (DP Panel) meeting.

Background

Development surrounding the subject site is as follows:

- To the North: Adjacent, an undeveloped City lot subject to an application (DP 11-593871) to construct a Bus Mall adjacent to the Brighouse Canada Line Station in keeping with the City Centre Area Plan (CCAP) that was approved on July 22, 2019 and is zoned “Downtown Commercial (CDT1)” (DP 11-584010).
- To the East: Across the north-south City lane, at 6411 Buswell Street, an existing, low scale commercial and office use development and is zoned “Downtown Commercial (CDT1)”.
- To the South: Across Cook Road, existing, low-scale commercial buildings with surface parking and are zoned “Downtown Commercial (CDT1)”.
- To the West: Across No. 3 Road, the Richmond Centre Mall site, which is zoned “Downtown Commercial (CDT1)” and is subject to an Official Community Plan (OCP) amendment application (CP 16-752923), as well as a Development Permit application (DP 17-768248) for the first phase of mall redevelopment and new mixed-use building development, and are pending approval by City Council.

Staff Comments

The proposed changes to the scheme attached to this report are in general compliance with the original Development Permit considered by the Development Permit Panel (Attachment 2). In addition, the modified proposal (Attachment 3) complies with the intent of the applicable sections of the Official Community Plan (OCP), the City Centre Area Plan (CCAP), and is in compliance with the “High Density Mixed Use and ECD Hub (ZMU37) – Brighouse Village (City Centre)” zone.

Planned Public Art for the Southwest Corner of the Development

Under the approved Development Permit plans, a large triangular public art element is planned to be applied to the angled façade at the southwest corner of the office building facing the intersection of No. 3 Road and Cook Road. The approved plans specifically identified the angled corner area for a special façade treatment to be finished with uniquely coloured and patterned glass to differentiate it from the remainder of the facades. In this regard, the Staff Report to the September 26, 2018 Development Permit Panel stated:

“Once the art concept is determined and the technicalities of its implementation within the facade are fully understood, a General Compliance application will be required to modify the approved Development Permit and a general compliance report will be brought forward to the DP Panel for consideration.”

This corner of the development was included the Public Art Plan proposal at time of review of the original Development Permit plans. In follow-up to this consideration, the Richmond Public Art Advisory Committee (RPAAC) endorsed the Public Art Plan for this project at their meeting on October 16, 2018.

In follow-up to this endorsement by the RPAAC, the City prepared a “Call to Artists” in October, 2018 (Attachment 4). Through this process, City Public Art staff have commissioned Musqueam artist, Thomas Cannell, to prepare the Public Art design, “Sea to Sky”, which is proposed to be applied to the southwest corner of the building (shown in Attachment 3). The artist will work with the art glass fabricator, Franz Mayer of Munich, Germany to translate the artwork onto the glass curtain wall. This firm will use a combination of digital print technology, hand painting and airbrushing to transfer the artwork design into the Insulated Glazing Units (IGUs). The firm has confirmed that this method of production will ensure the artwork will last for a minimum of 40 years. Franz Mayer maintains quality standards to develop new artistic expressions in stained glass and mosaic in restoring historic buildings and creating contemporary projects for artists and architects worldwide. The firm has prepared custom samples of the proposed public art glass which have been reviewed by the applicant, the artist, City Child Care, Public Art and Planning staff (see glass sample photograph in Attachment 5). The artist will work with Franz Mayer and Keltic Development Ltd. to further refine the art glass fabrication technique prior to production of the glass.

The renderings of the selected public art and art glass sample were reviewed by and endorsed by the RPAAC on November 18, 2019.

Proposed Changes to Elevations

The Staff Report to the September 26, 2018 Development Permit Panel meeting also identified two other smaller areas of the building where additional design development detail would need to be provided and reviewed through a General Compliance application.

These areas include:

- *West and South Elevations - Early Childhood Development (ECD) Hub Glazing:* The ECD Hub was proposed to have coloured glass applied to its windows on the second floor of the office building facing Cook Road and No. 3 Road and its pedestrian entrance at street level. The coloured glass, which was proposed to include both vision and spandrel panels, was to be coordinated with the glass colours used in the façade over the office tower entry. The original DP Panel Report stated:

"Should the Public Art proposal move forward, the ECD Hub glass design may require modification to ensure an appropriate relationship with the Public Art work colours and design. If so, it would be included in the General Compliance application for the Public Art."

Upon further review by City Public Art, Project Development and Child Care staff, it has been determined that the same clear vision glass and spandrel panels proposed for rest of the office building should be specified in lieu of coloured glass on the second floor of the ECD Hub. This would also for most of the rooms in the ECD Hub to have a clear, unobstructed view towards the outside. The glazing at the street-level entrance to the ECD Hub has been specified to include coloured glass to be coordinated with the public art element at the southwest corner of the building.

- *East Elevation - North-South Pedestrian Mews:* The north-south pedestrian mews and lane on the east elevation of the office building is bordered on its lower levels by the development's parkade and service rooms. To enliven the pedestrian experience along the mews, the approved Development Permit plans included a notation that artistic decorative finish be applied to the lower levels of the building. The original Staff Report to DP Panel noted that these changes would be advanced for consideration in the General Compliance report along with the proposed Public Art and ECD Hub façade changes, if applicable.

In this regard, the applicant has worked with City staff to revise the lower section of the east elevation to include two painted modern, artistic design elements and complementary landscaping as shown in Attachment 3.

Analysis

Applicable Conditions of Adjacency and Landscape

- The location for the proposed public art element on the angled southwest corner of the building was included within the approved Development Permit plans. The proposed art element and selected coloured art glass will provide a focal point for the plaza at the southwest corner of the building and the adjacent streetcape on No. 3 Road and Cook Road. The variety of colours and textured painting technique will provide a rich and

nuanced form on the glazing of this corner of the building. From further away, the public art element will provide a landmark looking north along No. 3 Road and from the Richmond Centre development to west.

- The removal of the coloured glass proposed for the west and south facing windows of the ECD Hub on the second floor of the office building will remove visual distraction away from the public art on the southwest corner of the building and provide a better visual experience within ECD Hub by providing standard vision glass. There will be several coloured glass panels applied to the glazing to provide a visual cue for the pedestrian entrance to the ECD Hub at street level on No. 3 Road.
- The painted design element applied to the east side of the concrete parkade podium facing the lane/pedestrian mews on the rear side of the building will provide for an interesting visual experience to pedestrians. Furthermore, there have been adjustments to the location of the louvered building vents and the adjacent plantings along the base of the east elevation of the building to soften the appearance of the building and improve the pedestrian experience on the adjacent mews. The 12 Acer Circinatum (Vine Maple) trees with spreading branches have been replaced with 12 columnar Acer Rubrum (Red Rocket Maple) trees. This change from this broader to more slender tree species will provide a better view of the painted design element on the building behind the trees.

Conclusions

GBL Architects has requested a General Compliance ruling for proposed changes to the glazing of the southwest corner of the project facing No. 3 Road and Cook Road, changing the glazing on the ECD Hub on the second floor of the west and south elevations of the office building facing No. 3 Road and Cook Road, and accommodating painted design elements facing the lane/pedestrian mews on the east side of the site.

Staff have no objection to the proposed revisions. Staff recommends support of this General Compliance request for the proposed changes to the approved Development Permit.



Mark McMullen
Senior Coordinator - Major Projects
(604-276-4173)

MM:blg

Attachment 1: Context Map

Attachment 2: Relevant Approved Development Permit Plans

Attachment 3: Proposed New Development Permit Plans

Attachment 4: Call to Artists RFP for the Keltic Development, October 2018

Attachment 5: Photograph of Public Art Glass Sample

nuanced form on the glazing of this corner of the building. From further away, the public art element will provide a landmark looking north along No. 3 Road and from the Richmond Centre development to west.

- The removal of the coloured glass proposed for the west and south facing windows of the ECD Hub on the second floor of the office building will remove visual distraction away from the public art on the southwest corner of the building and provide a better visual experience within ECD Hub by providing standard vision glass. There will be several coloured glass panels applied to the glazing to provide a visual cue for the pedestrian entrance to the ECD Hub at street level on No. 3 Road.
- The painted design element applied to the east side of the concrete parkade podium facing the lane/pedestrian mews on the rear side of the building will provide for an interesting visual experience to pedestrians. Furthermore, there have been adjustments to the location of the louvered building vents and the adjacent plantings along the base of the east elevation of the building to soften the appearance of the building and improve the pedestrian experience on the adjacent mews. The 12 Acer Circinatum (Vine Maple) trees with spreading branches have been replaced with 12 columnar Acer Rubrum (Red Rocket Maple) trees. This change from this broader to more slender tree species will provide a better view of the painted design element on the building behind the trees. There has also been a change to planters adjacent to the east wall and a drop in the planter wall height to reduce screening of the proposed painted design element.

Conclusions

GBL Architects has requested a General Compliance ruling for proposed changes to the glazing of the southwest corner of the project facing No. 3 Road and Cook Road, changing the glazing on the ECD Hub on the second floor of the west and south elevations of the office building facing No. 3 Road and Cook Road, and accommodating painted design elements facing the lane/pedestrian mews on the east side of the site.

Staff have no objection to the proposed revisions. Staff recommends support of this General Compliance request for the proposed changes to the approved Development Permit.



Mark McMullen
Senior Coordinator - Major Projects
(604-276-4173)

MM:blg

Attachment 1: Context Map

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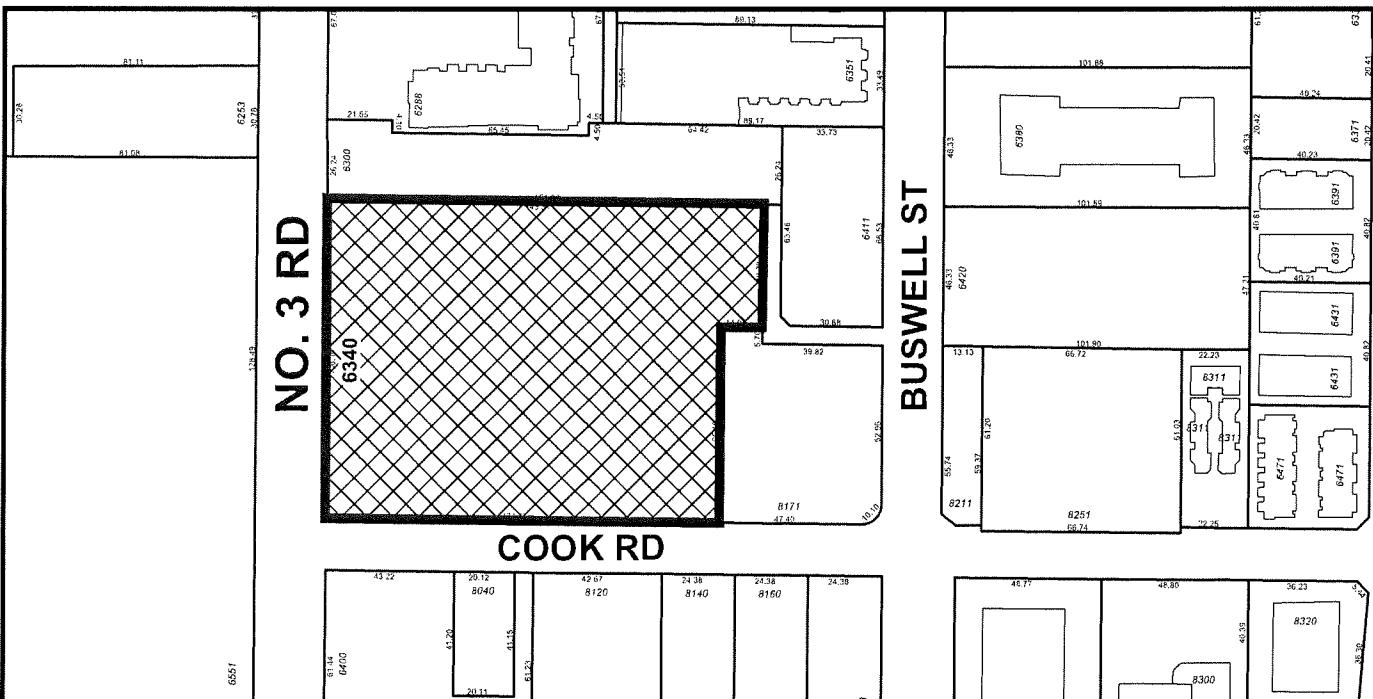
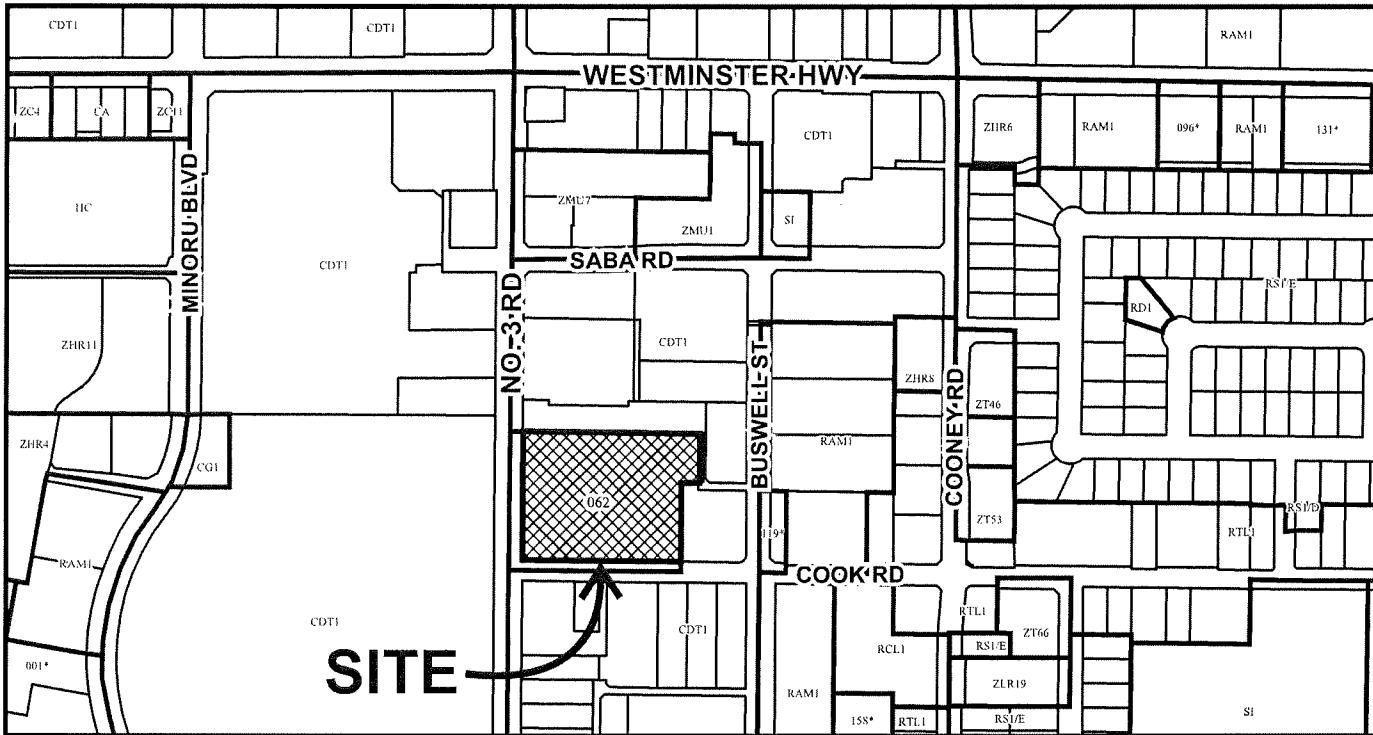
Attachment 3: Proposed New Development Permit Plans

Attachment 4: Call to Artists RFP for the Keltic Development, October 2018

Attachment 5: Photograph of Public Art Glass Sample



City of Richmond



1

DP 18-822743

Original Date: 06/25/18


Revision Date:

Note: Dimensions are in METRES

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OP 18-822743


TERIATERIALS		DESCRIPTION	COLOUR
#		CLEAR BLAZING	-
IA		BACK-PAINTED GLAZING SPANDEL.	WHITE
IC		COLOURED LAMINATED GLAZING	VARIES
IA		ALUMINIUM COMPOSITE PANEL - FRAME EDGE	BRONZE
IB		ALUMINIUM COMPOSITE PANEL - FRAME INTERIOR	WHITE
IP		CUSTOM PERFORATED METAL SCREENING	NATURAL
IA		ARCHITECTURAL CONCRETE	-
IG		Glass Guard	-
IS		Extruded Aluminium Sunshade	BRONZE
IL		Aluminum Louvers	-
IG		Glazed Canopy	-
I		STOREFRONT HULLINGS	CHARCOAL
RESIDENTIAL GLAZING TO BE PROVIDED BY:		RENTER	
OFFICE / FLOOR GLAZING TO BE PROVIDED BY:		RENTER	
WATERCAYER / MANUFACTURER		RENTER	

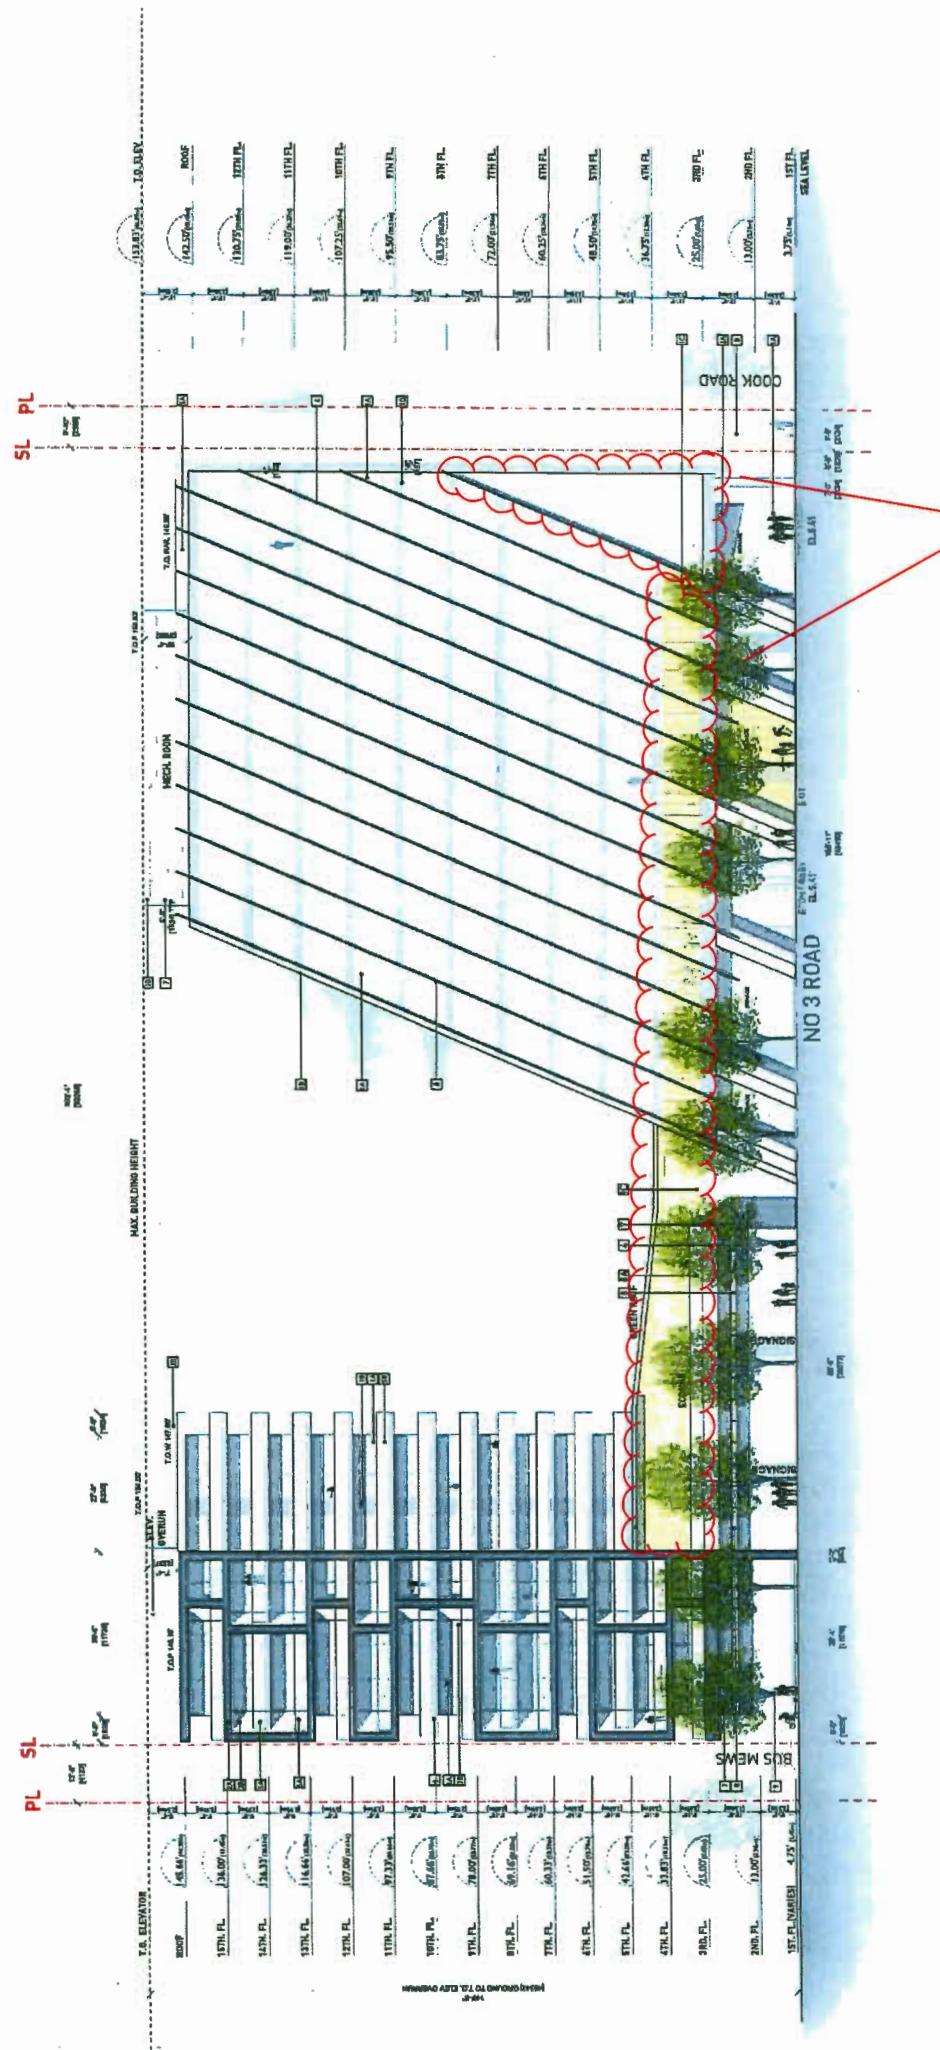

Areas Proposed to be Changed

A301

OP 18-822743

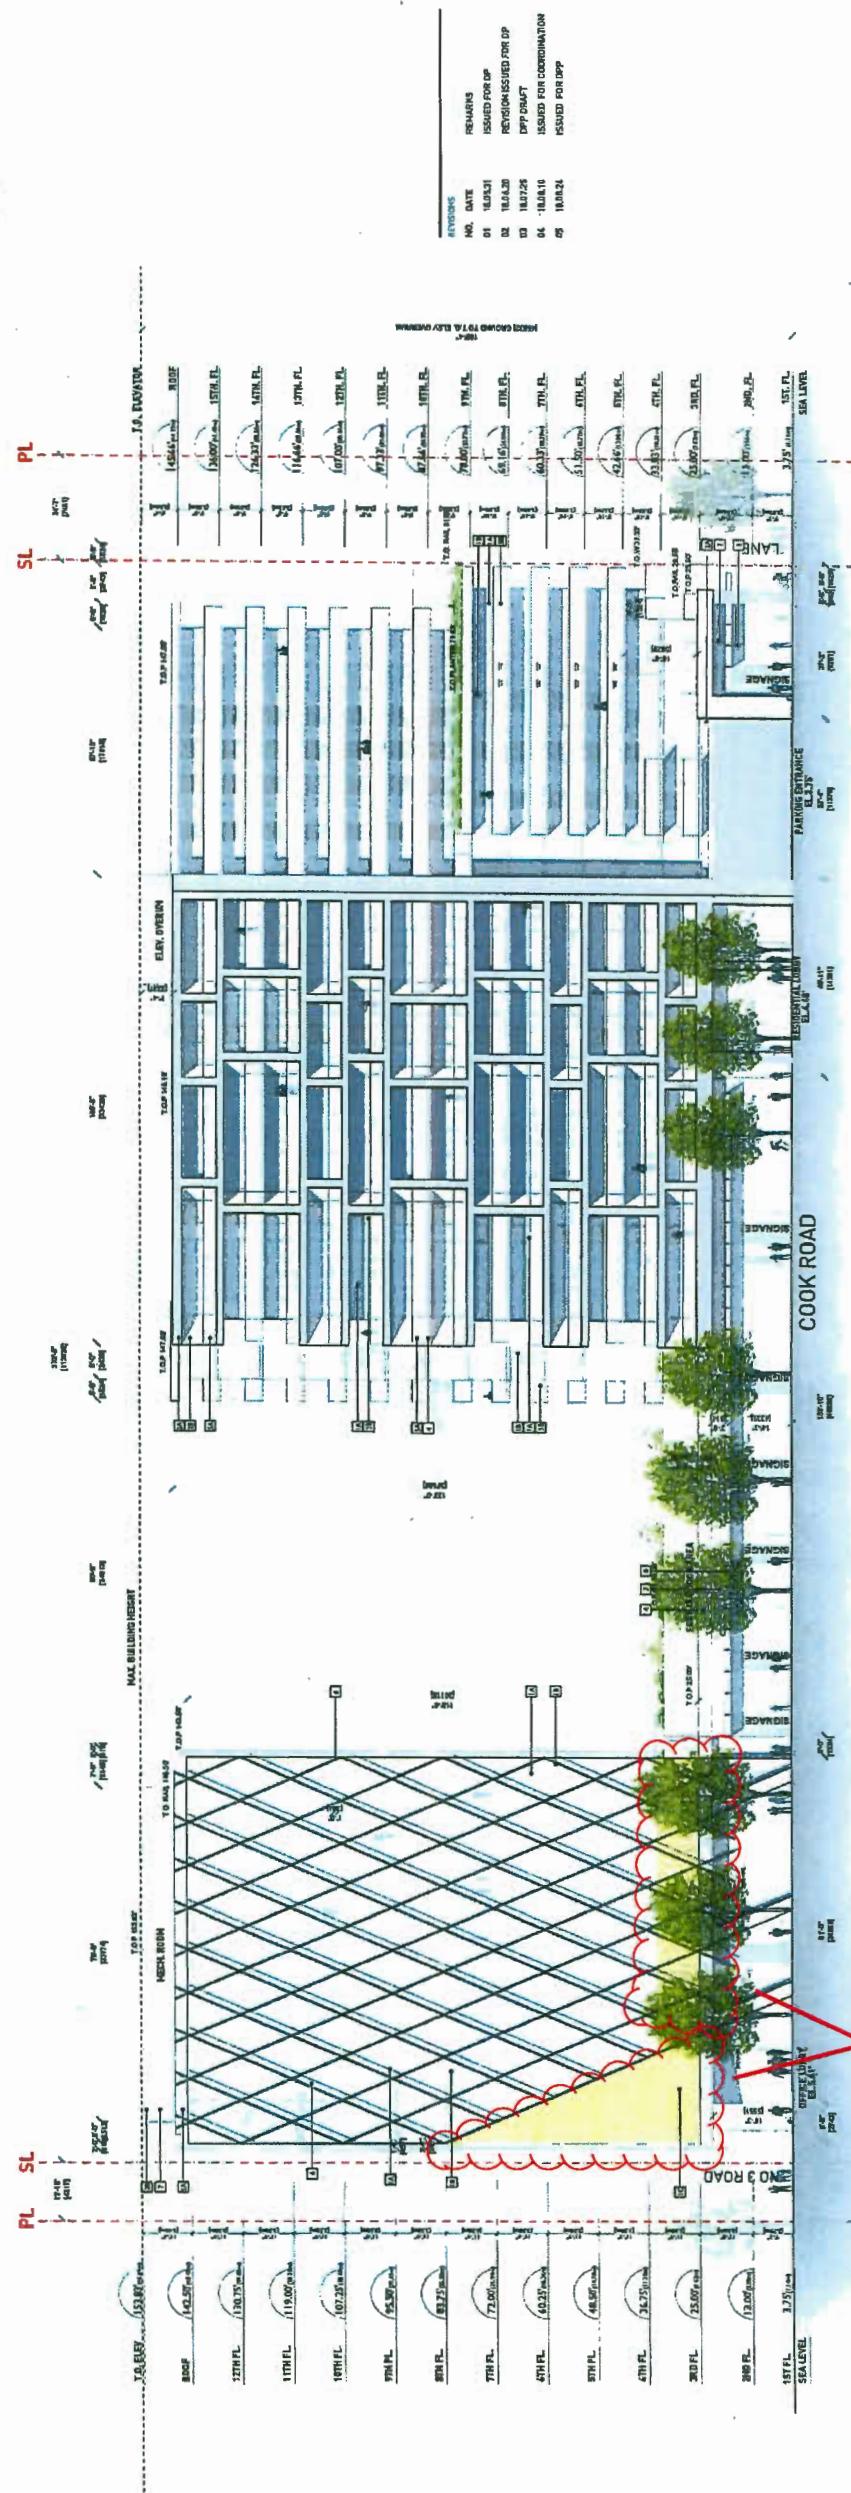

Areas Proposed to be Changed

6340 NO 3 RD
RICHMOND, BC

SOUTH ELEVATION


A3-02

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DP 18-822743

MATERIALS	DESCRIPTION	COLOUR
1A	CLEAR GLAZING	
1B	BACK-PAINTED GLAZING SPANDREL	WHITE
1C	COLOURED LAMINATED GLAZING	VARIES
2A	ALUMINUM COMPOSITE PANEL - FRAME EDGE	BRONZE
2B	ALUMINUM COMPOSITE PANEL - FRAME INTERIOR	WHITE
3	CUSTOM PERFORATED METAL SCREENING	-
4	ARCHITECTURAL CONCRETE	NATURAL
5A	GLASS GUARD	-
5B	GLASS GUARD	BRONZE
6	EXTRUDED ALUMINUM SUNSHADE	-
7	ALUMINUM LOUVERS	-
8	BLAZED CANOPY	-
9	STOREFRONT MULLIONS	CHARCOAL

GLAZING NOTES:
RECOMMENDED GLAZING TO BE MONOCHROMATIC.
OFFICE/WORK GLAZING TO BE CAPTIONED.
GROUND FLOOR RETAIL TO BE STOREFRONT OR INTEGRATED LOCATES.

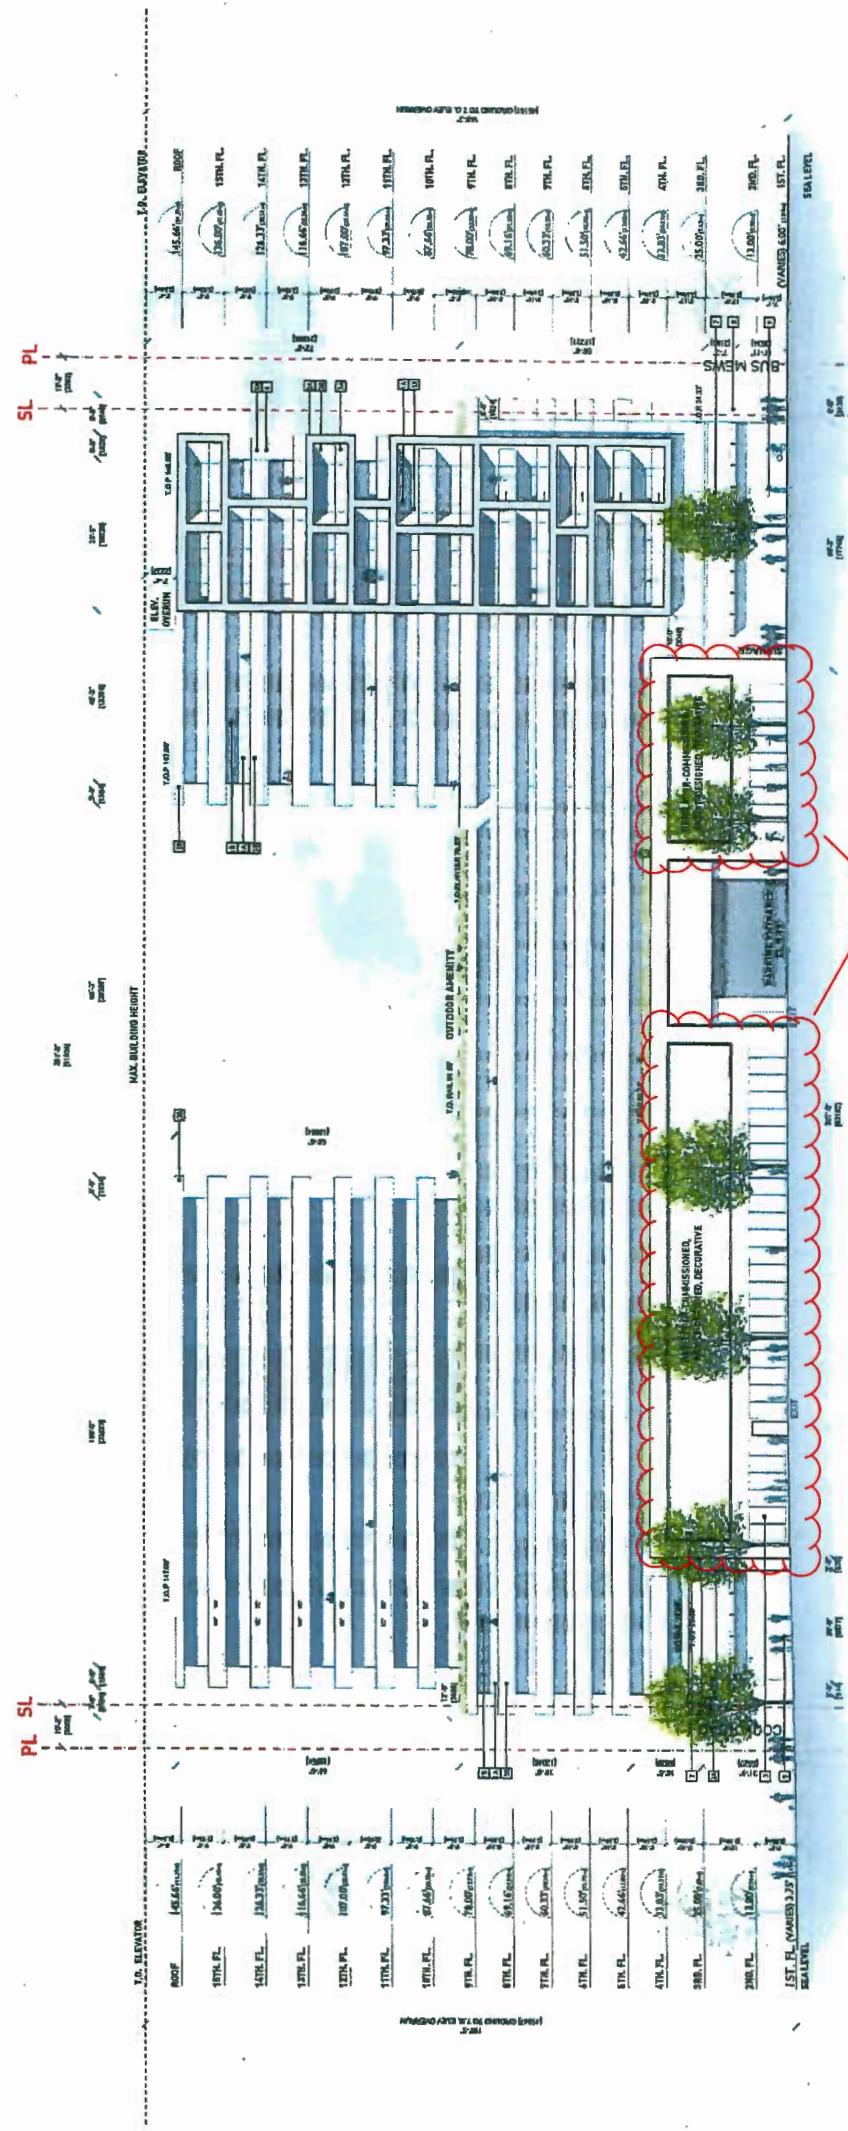

Areas Proposed to be Changed

EAST ELEVATION

**DATE ISSUED BY
CHECKED BY
SOLICITORS
JOB NUMBER**

A3.03

DPR 48-822743 #
PWL partnership
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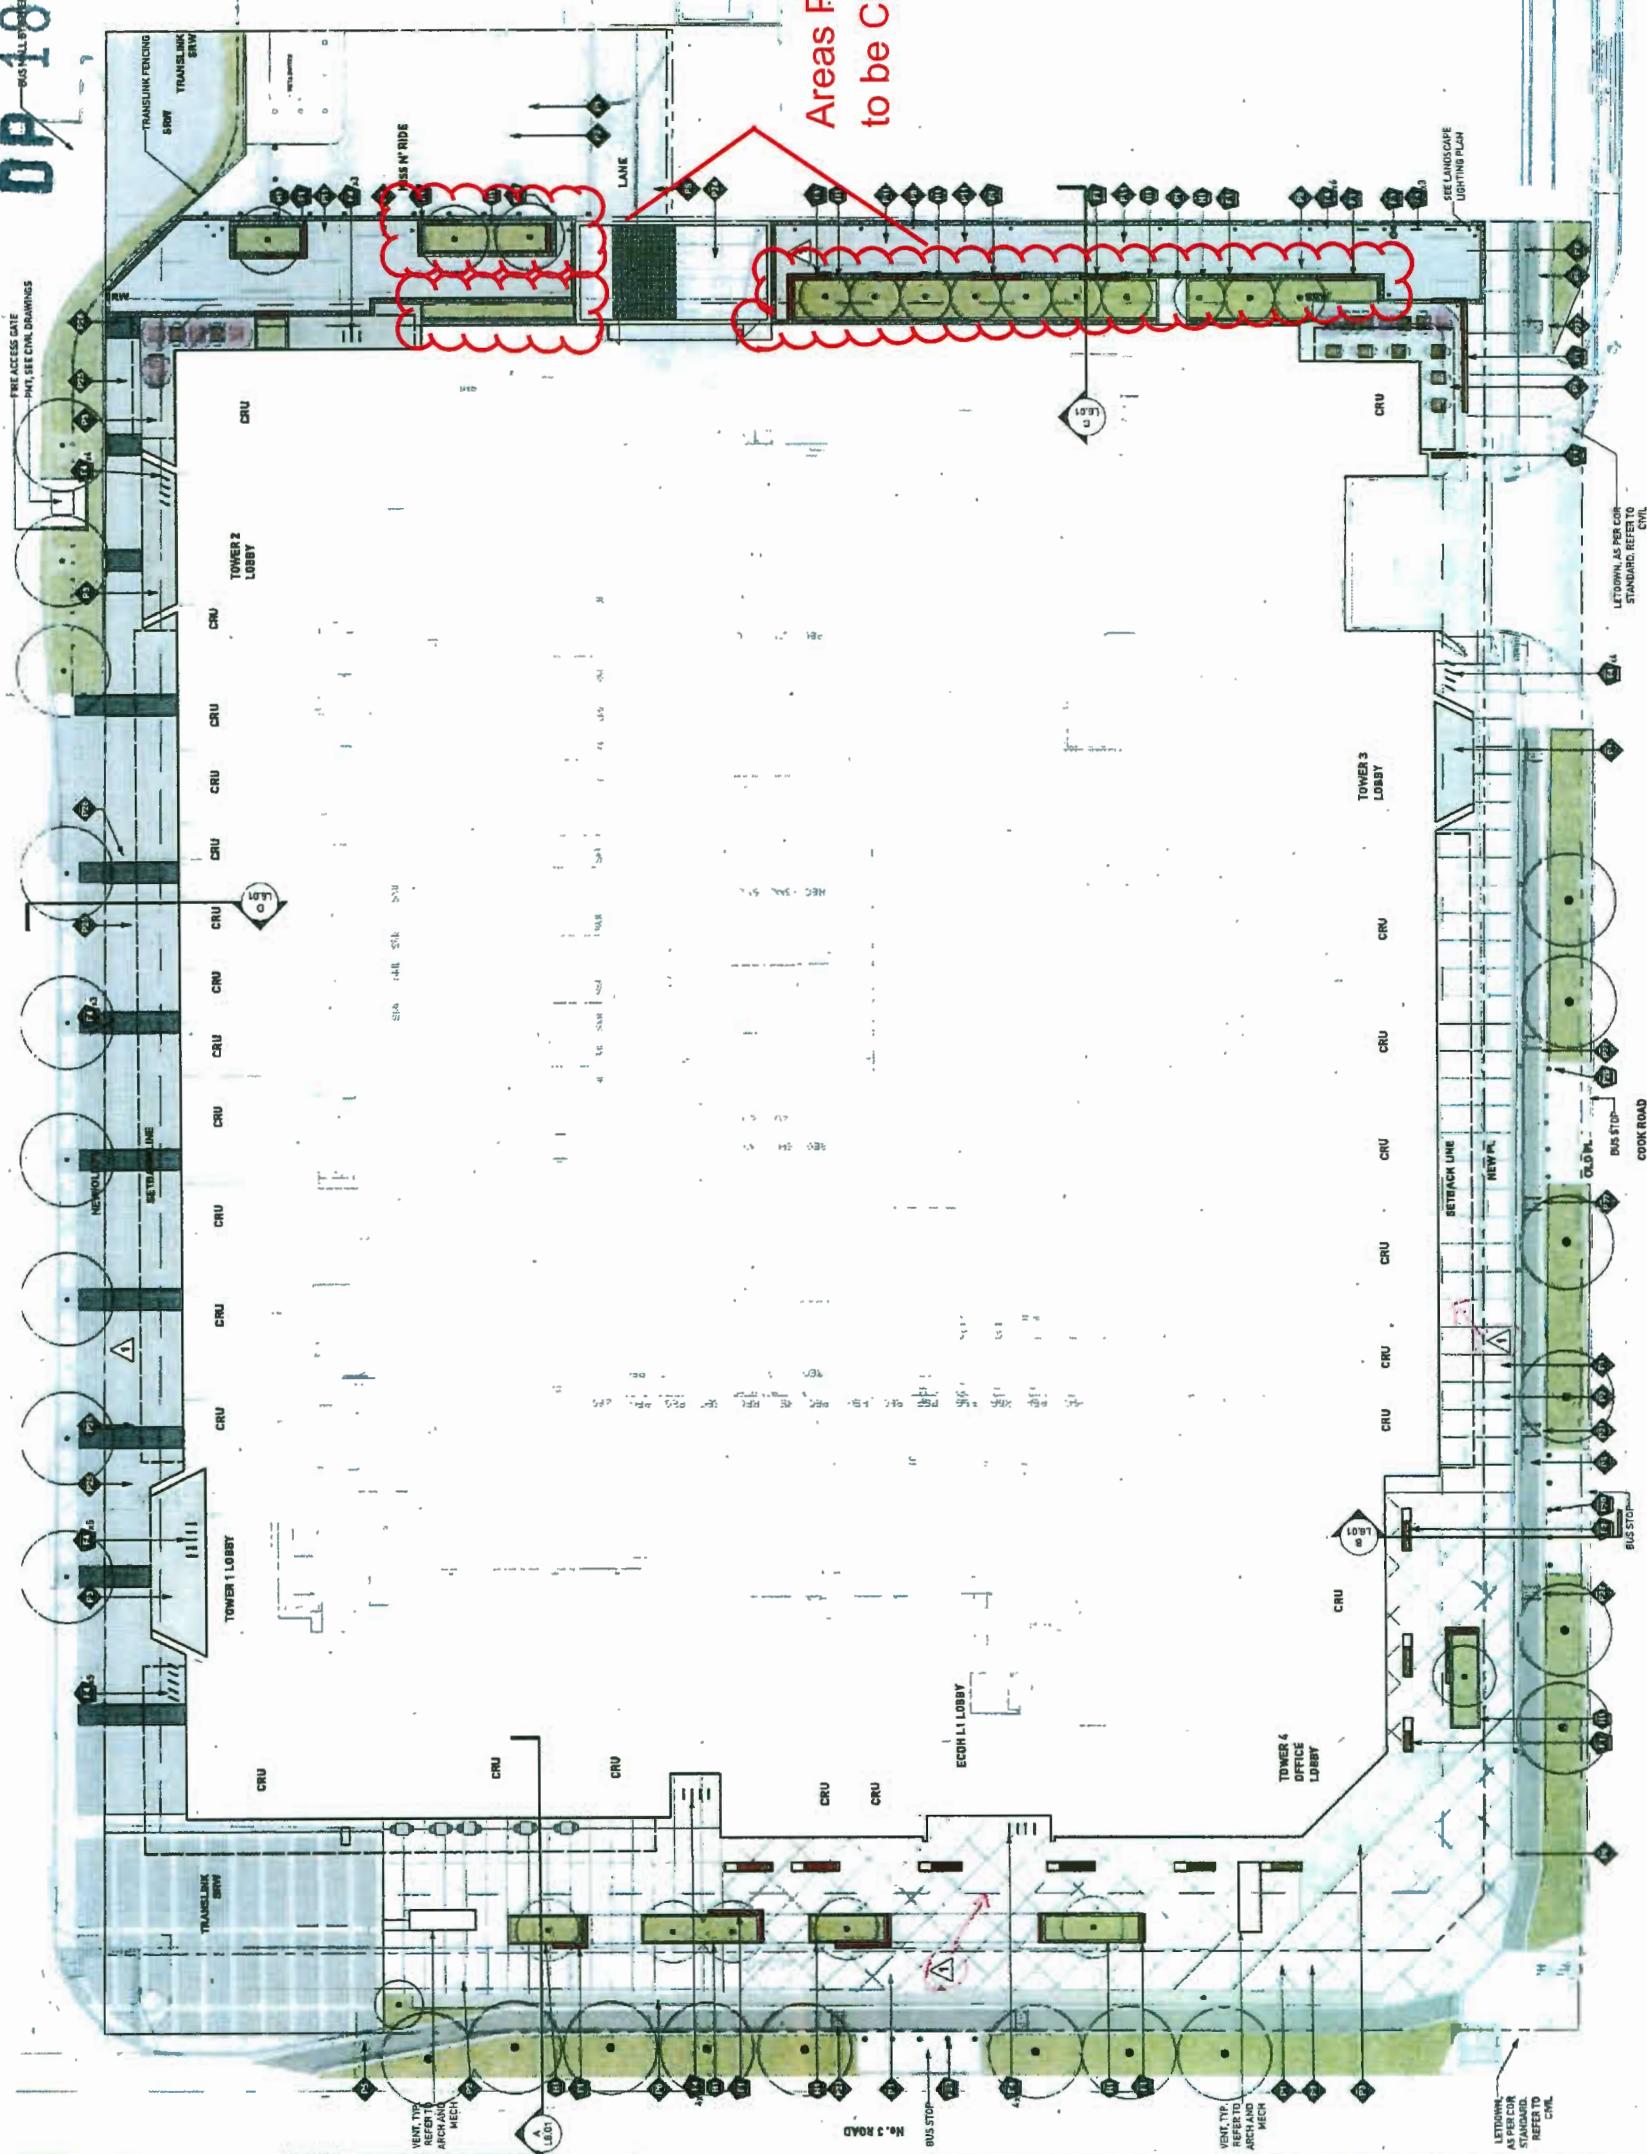


Areas Proposed to be Changed

NOTE: Some elements may be refined through coordination of the Service Agreement [S.A.] Frontage Work.

6340 No. 3 Road

L1 01



Plant List 6340 No. 3 Road Richmond BC							
ID	Qty	Botanical Name	Common Name	Scheduled Size	Spacing	Remarks	
Trees							
ACR	29	Acer circinatum	Vine Maple	3cm dia [10'-30' ht]			
AFN	33	Acer palmatum 'Goshiki'	Palmate Maple	5cm dia [17'-30' ht]			
AFN	13	Acer palmatum 'Red Dragon'	Maple	3cm dia [1.8m]			
AFN	27	Acer palmatum 'Yamashiro'	Shaina Maple	3cm dia [1.8m]			
AFN	13	Acer palmatum 'Red Dragon'	Maple	3cm dia [1.8m]			
ART	1	Acer rubrum 'Red Rocket'	Maple	8cm dia [3' cal]			
BNI	3	Balduina officinalis	River Birch	8cm dia [3' cal]			
FIC	1	Ficus carica 'Desert King'	Desert King Fig	5cm dia [2' cal]			
MGL	1	Magnolia 'Galaxy'	Galaxy Magnolia	7cm dia [2.1/2' cal]			
MKB	4	Magnolia kobus	Kobus Spruce	24m ht. [8'-9' dbh]			
POR	1	Picea omorika	Serbian Spruce	24m ht. [8'-9' dbh]			
PNG	8	Pinus nigra	Austrian Black Pine	24m ht. [8'-9' dbh]			
PVA	10	Prunus yedensis 'Akabana'	Dwarf Kiku Flowering Cherry	7cm dia [2.1/2' cal]			
DEL	9	Quercus palustris	Pin Oak	8cm dia [3' cal]			
Shrubs							
BAW	433	Buxus microphylla 'Winter Gem'	Winter Gem Boxwood	#1 pot	45cm [18']		
GSH	71	Gaultheria shallon	Sabice	#1 pot	45cm [18']		
LPL	818	Gaultheria shallon	Private Honeyuckle	#1 pot	45cm [18']		
PMP	236	Pinus mugo 'Pumilio'	Dwarf Mugo Pine	#1 pot	45cm [18']		
RWN	323	Rosa 'White Medicina'	White Knockout Rose	#1 pot	45cm [18']		
REH	238	Rosa 'Max Graf'	Max Graf Rose	#1 pot	45cm [18']		
SHH	1028	Sarcococca hookeriana humilis	Himalayan Jessamine	#1 pot	75cm [30']		
SJF	109	Spiraea 'Arguta'	Japanese Spirea	#1 pot	60cm [24']		
TAM	127	Tauzia rosea 'M. Edie'	M. Edie Yew	#1 pot	1.3m		
WDV	956	Vaccinium dentatum	Dwarf Blueberry	#1 pot	60cm [24']		
Ground Cover							
ALU	272	Aeonotrichys lutea	Kirkland	#1 pot	38cm [15']		
ESE	175	Euryops chrysanthemoides	Erinacea Gold	#1 pot	38cm [15']		
ETM	572	Geum urbanum 'Emerald Gaiety'	Asplenium Scraggy	#1 pot	38cm [15']		
Perennials							
LAA	1203	Lavandula angustifolia	True Lavender	#1 pot	45cm [18']		
LYV	65	Oregano vulgare	Oregano	#1 pot	38cm [15']		
ESD	153	Rubus idaeus 'Goldstraw'	Black Currant	#1 pot	45cm [18']		
SIA	129	Stachys lanata	Lamb's Ear	#1 pot	28cm [12']		
Ornamental Grasses							
CAG	77	Calamagrostis 'Karl Foerster'	Karl Foerster Feather Reedgrass	#1 pot	75cm [30']		
CDI	161	Carex morrowii 'Ice Dance'	Variegated Sedge	#1 pot	28cm [15']		
FPH	1231	Festuca 'Desert Gold'	Dwarf Fountain Grass	#1 pot	25cm [10']		
BCP	56	Bethlehemicus hamatus	Dwarf Fern	#1 pot	38cm [15']		
PAU	717	Polystichum munitum	Western Sword Fern	#1 pot	45cm [18']		
Extensive green conf on LA to be 6" LiveRoot trays with sun mix.							
Note: All Planting to be irrigated with high-efficiency, automated irrigation system.							

Note: All Planting to be irrigated with high-efficiency, automated irrigation system.

Changes to Plant List Proposed for Changed Landscape Areas



H. GRANT BRUMPTON
297
LANDSCAPE ARCHITECT

REGISTERED MEMBER

6340 No. 3 Road
N/A
12_00


Address	Plot No.	Section	Block	Range	Lot No.	Section	Block	Range
6340 No. 3 Road	17017	17	Block 201B					
			LOT 19	SECTION 18	BLK 4	18-23	LOT 14	4-547

6340 No. 3 Road
N/A
12_00

DP 18-822743

PWL partnership

gbl

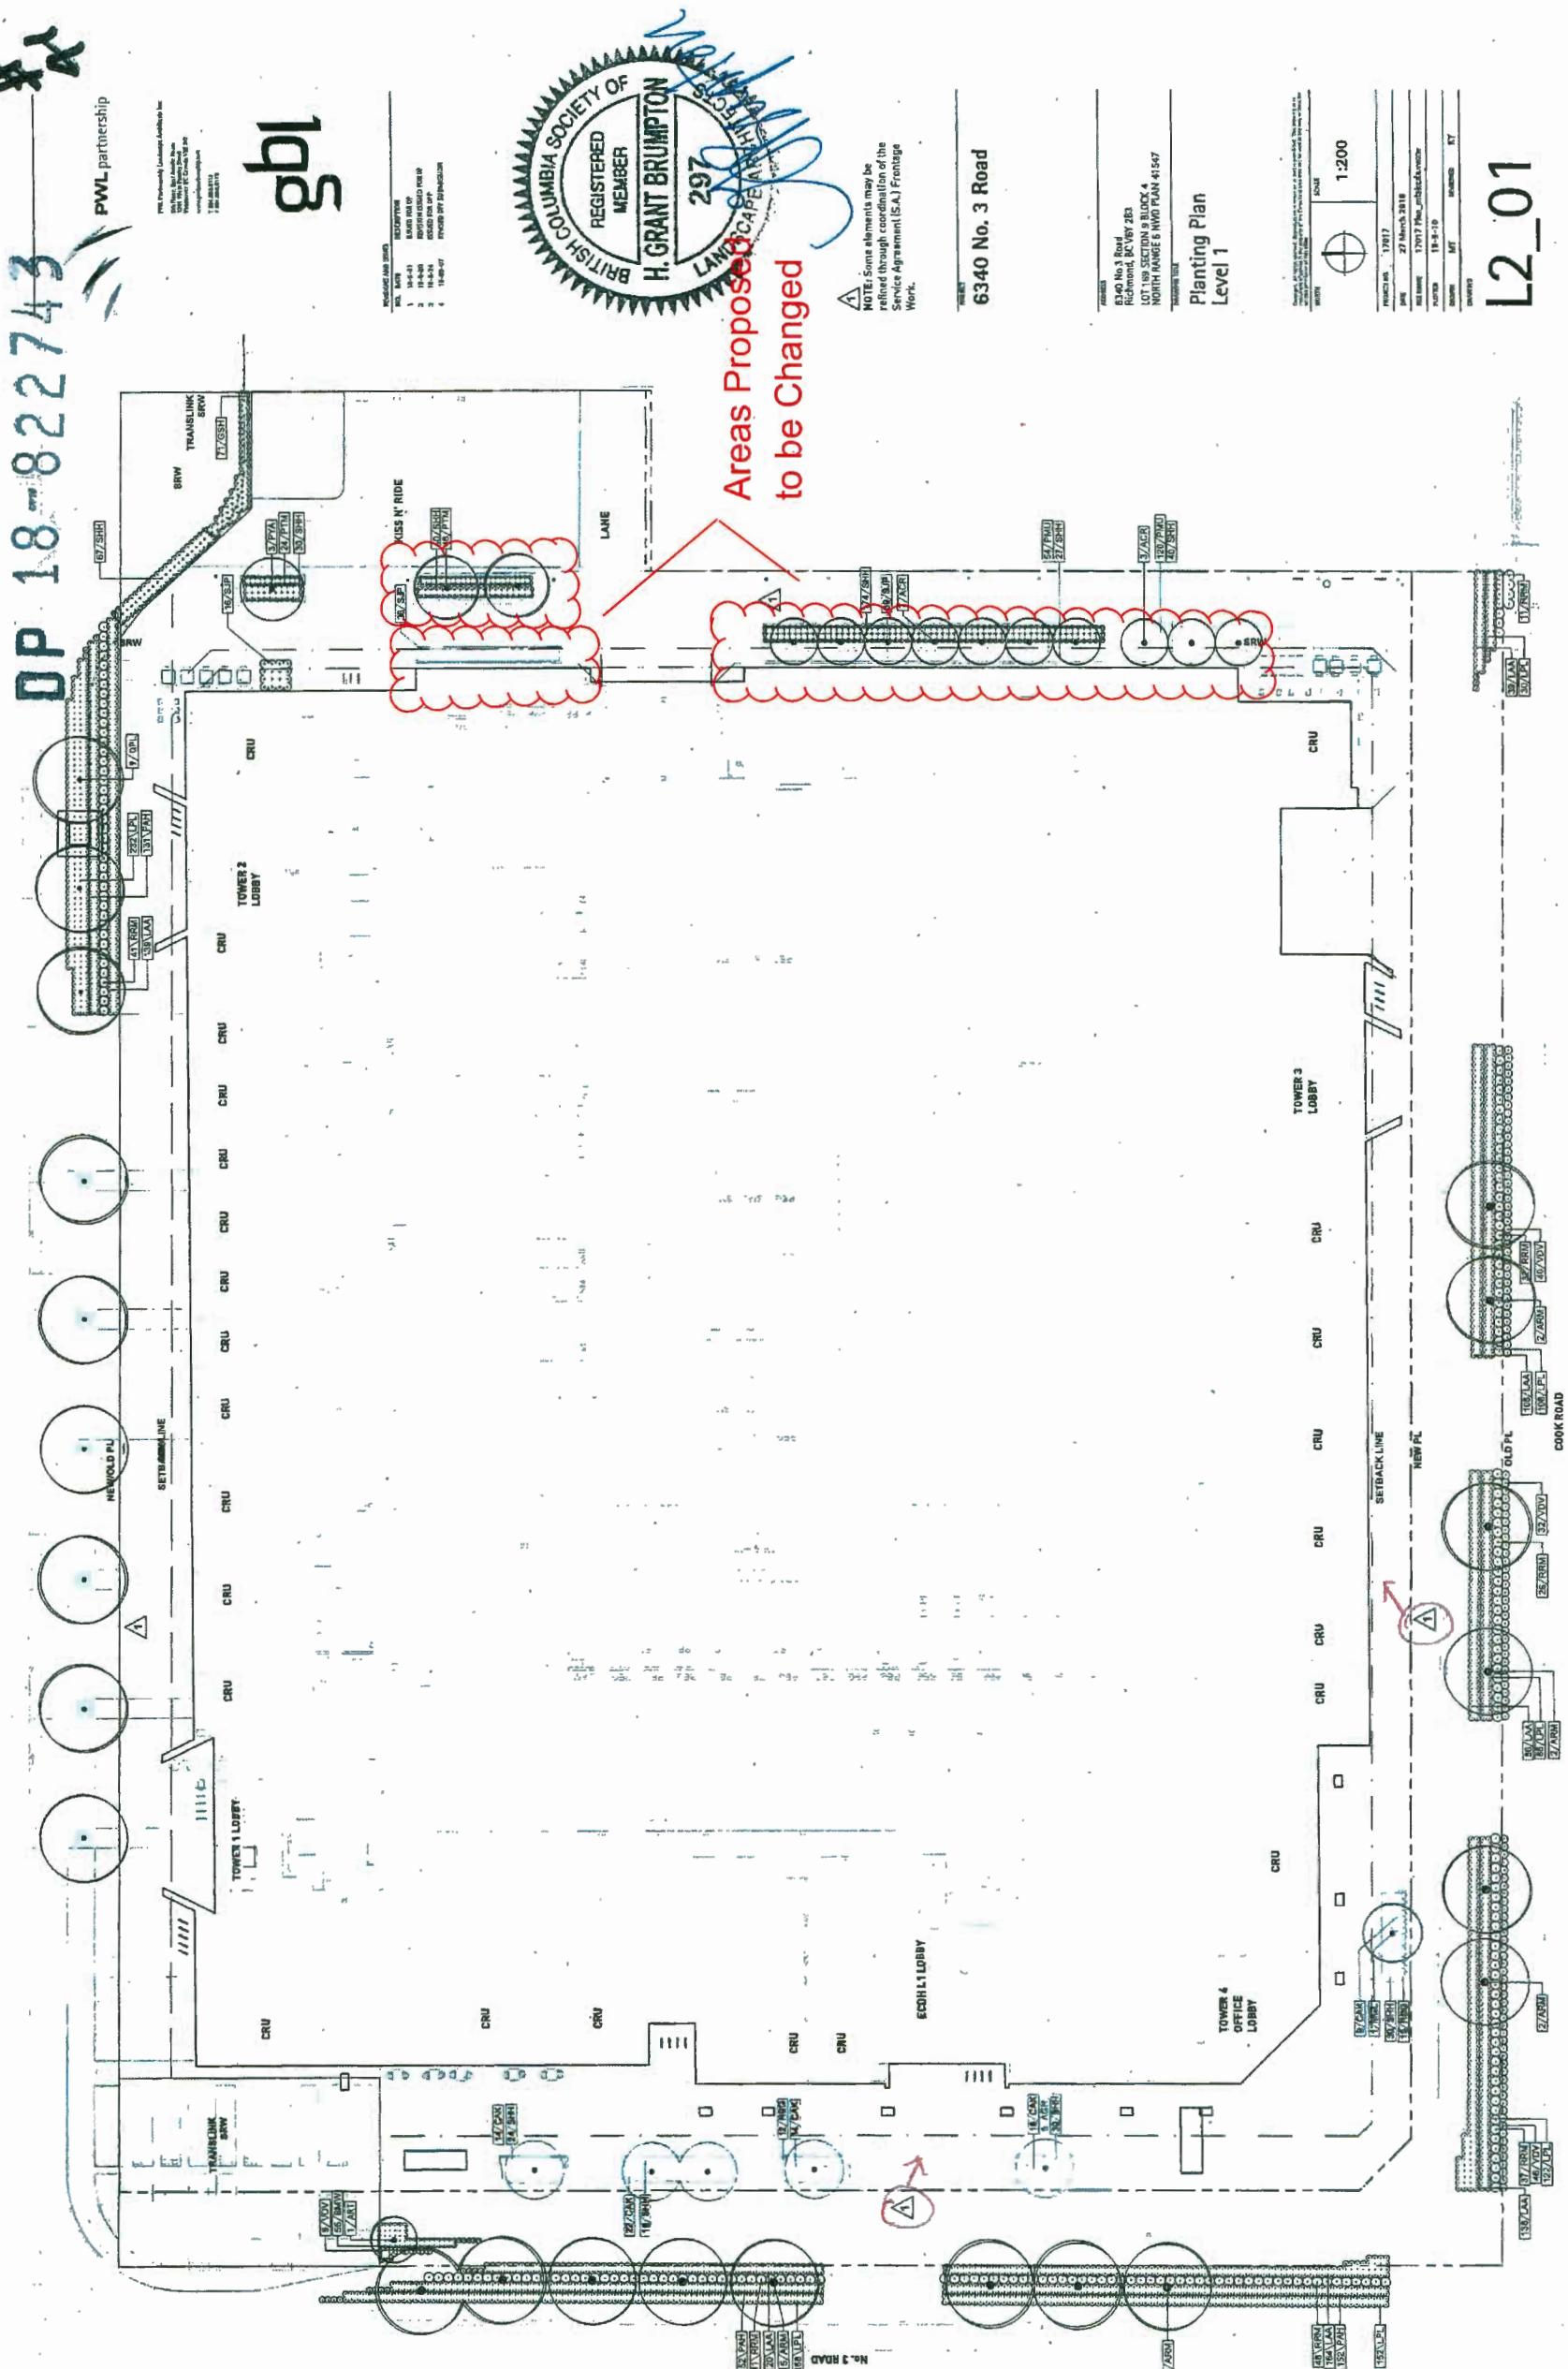

L2_01

		<p>gpl</p> <p>GEL ARCHITECTS INC. 139 EAST 8TH AVENUE VANCOUVER BC CANADA V5T 1R8 TEL 604.732.1156 FAX 604.731.5279 <small>Copyright Reserved. This plan contains neither recommendations nor conclusions of the City of Vancouver. It is the property of GEL Architects Inc. and is loaned to the City of Vancouver. It is the responsibility of the user to consult the official version of the plan which is on file at the City of Vancouver.</small></p> <p>NOTES</p> <p>REVISIONS</p> <table><thead><tr><th>NO.</th><th>DATE</th><th>DESCRIPTION</th></tr></thead><tbody><tr><td>25</td><td>10/26/19</td><td>DP AMENDMENT</td></tr></tbody></table>	NO.	DATE	DESCRIPTION	25	10/26/19	DP AMENDMENT	<p>6340 No 3 Rd & Cook Richmond, BC</p> <p>3D RENDERING</p> <p>DATE DRAWN BY CHECKED BY SCALE 10/27/2019 2:42:16 PM A. Baker O. Chioder</p> <p>JOB NUMBER 1646</p> <p>A3.00</p>
NO.	DATE	DESCRIPTION							
25	10/26/19	DP AMENDMENT							

gpl

GBL ARCHITECTS INC.
120 EAST 25TH AVENUE #400
VANCOUVER BC CANADA V5T 1H8
TEL: 604.726.1154 FAX: 604.721.8279
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NOTES

REVISIONS
NO. DATE DESCRIPTION
25 10/26/19 OF AMENDMENT

6340 No 3 Rd & Cook
Richmond, BC

3D RENDERING


DATE 10/27/2019 2:02:16 PM
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CHECKED BY Checker
SCALE
JOB NUMBER 1646

A3.00



MATERIAL LEGEND	
TAG	DESCRIPTION
9A	WINDOW/WALL MULLION - WHITE COLOUR
9B	CURTAIN WALL MULLION - ANODIZED ALUMINUM
10	METAL FILLER TO MATCH MULLION COLOUR
11	BALCONY DIVIDER - ALUMINUM WITH FRITTED GLASS
12	SINGLE GLASS DOOR
12B	DOUBLE GLASS DOOR
13	OPERABLE WINDOW
14	PAINTED CONCRETE - ART MURAL
15	METAL SINGLE DOOR
16	METAL SECURITY FENCE
18	METAL SCREEN - PERFORATED
20	METAL MESH GARAGE DOOR
21	FORMED METAL

REVISIONS
NO. DATE DESCRIPTION
25 10/26/11 DP AMENDMENT

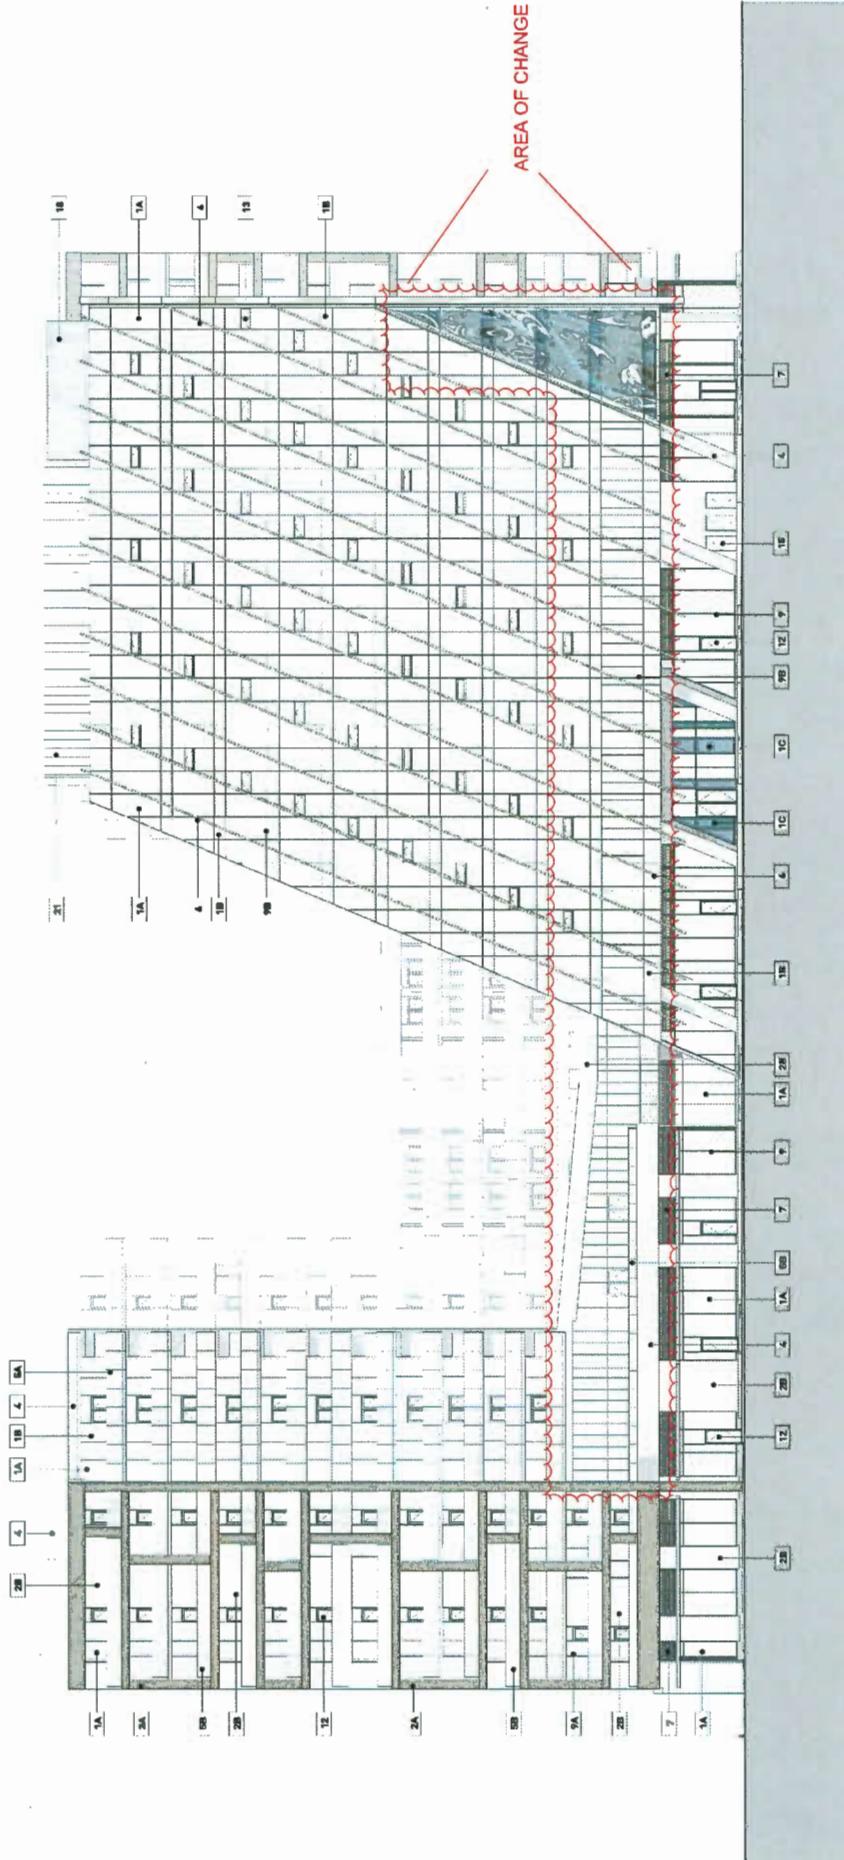

6340 No 3 Rd & Cook
Richmond, BC

WEST ELEVATION

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Author
Drafter
Scales
1:50
JOB NUMBER
1646

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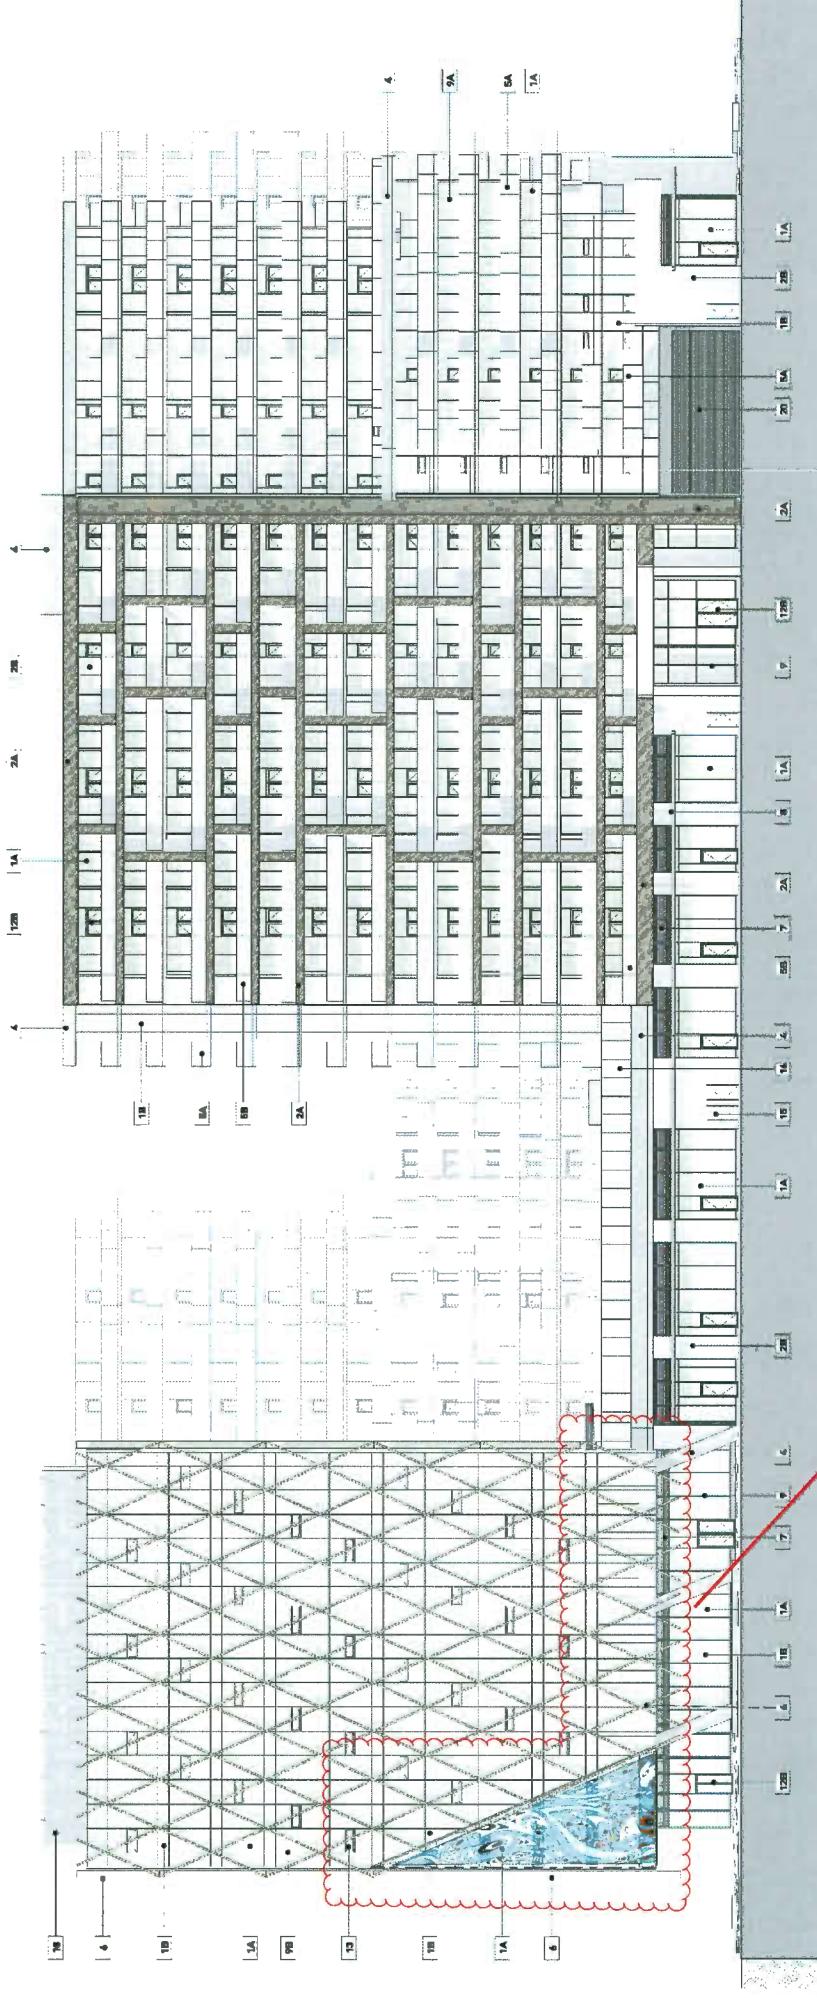
gpl

■ GEA ARCHITECTS INC.
139 EAST 8TH AVENUE V6A 1T8
VANCOUVER, BC CANADA
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FAX: 604/732.5297
OTHER OFFICES: TORONTO, MONTREAL AND CALGARY
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REVISIONS
NO. DATE DESCRIPTION

MATERIAL LEGEND	
TAG	DESCRIPTION
9A	WINDOW-WALL MULLION - WHITE COLOUR
9B	CURTAIN WALL MULLION - ANODIZED ALUMINUM
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16	METAL SECURITY FENCE
18	METAL SCREEN - PERFORATED
20	METAL MESH GARAGE DOOR
21	FORMED METAL

MATERIAL LEGEND	
TAG	DESCRIPTION
1A	CLEAR GLASS
1B	BACK-PAINTED GLAZING SPANDREL - WHITE
1C	COLOURED GLAZING - VARIES - CONFIRM WITH THE ARCHITECT
2A	ALUMINUM PANEL - FRAME EDGE - CHAMPAGNE
2B	ALUMINUM PANEL - FRAME INTERIOR - WHITE
3	CUSTOM PERFORATED METAL SCREENING
4	ARCHITECTURAL CONCRETE - PAINTED
5A	Glass Guard - Fritted
5B	Glass Guard - Clear
6	EXTRUDED ALUMINUM SUNSHADES - CHAMPAGNE
7	ALUMINUM LOUVERS
8	GLAZED CANOPY
9	STOREFRONT MULLIONS - CHARCOAL COLOUR



6340 No 3 Rd & Cook
Richmond, BC


SOUTH ELEVATION


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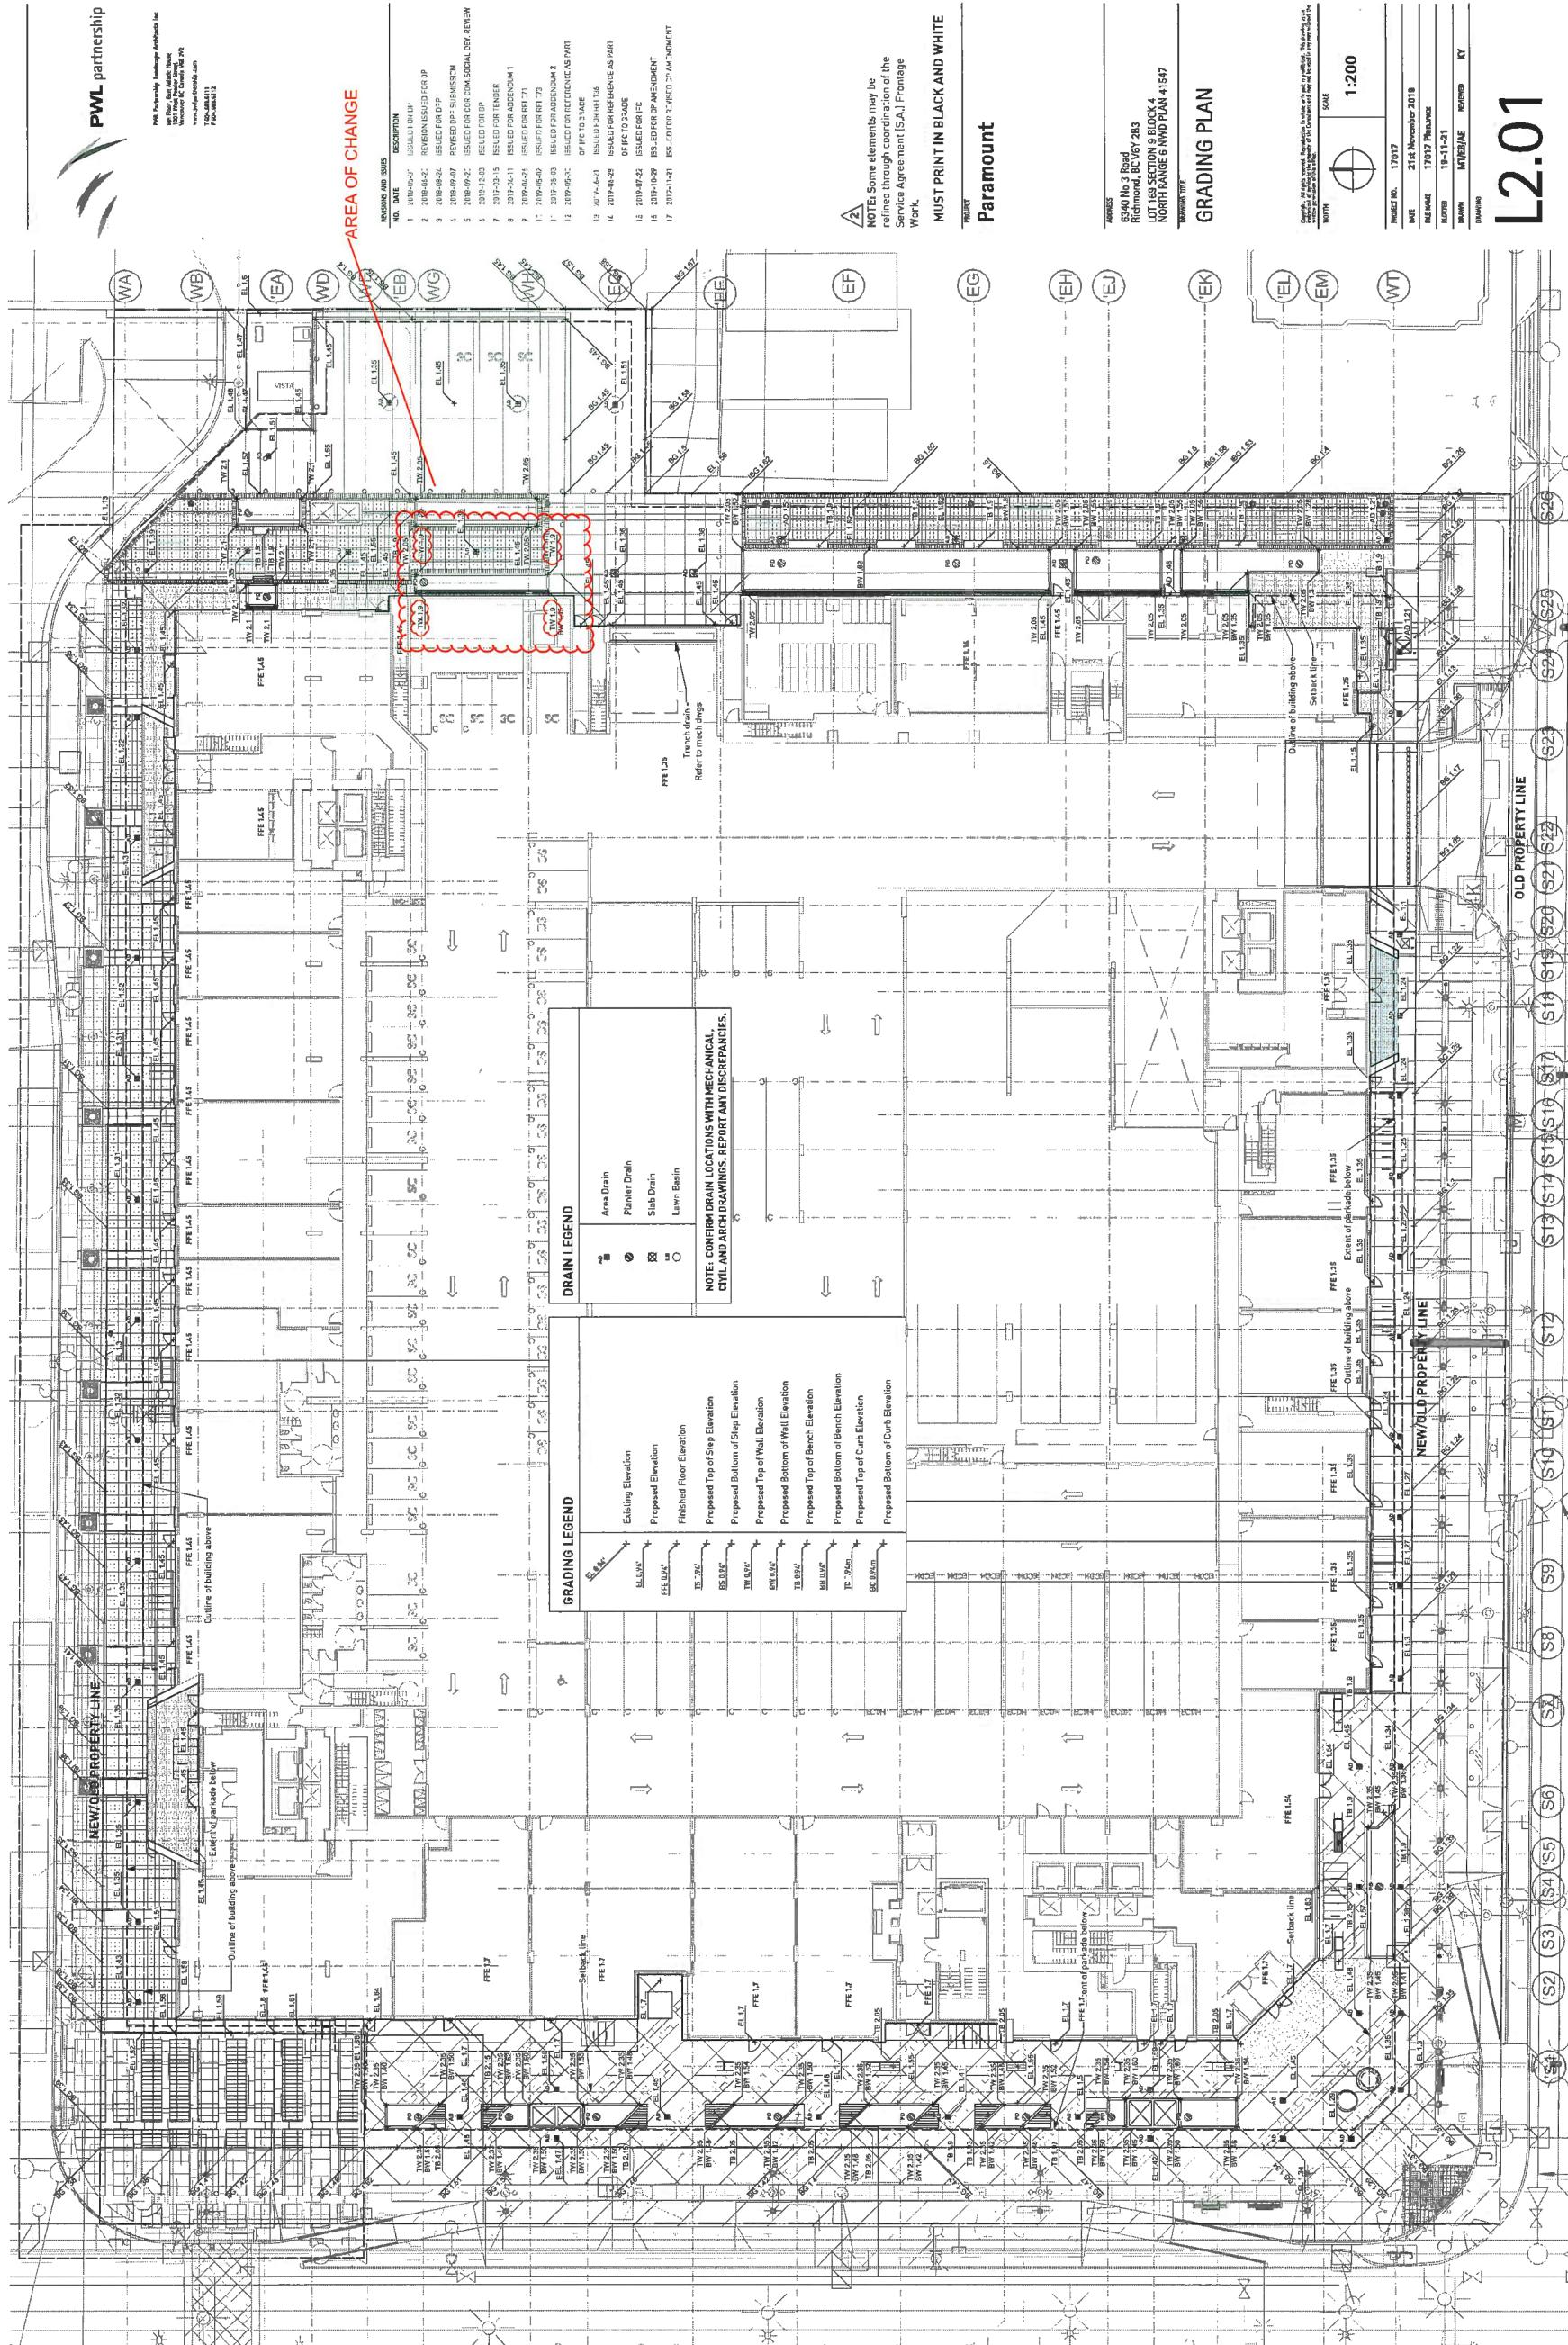
AREA OF CHANGE

MATERIAL LEGEND		MATERIAL LEGEND	
TAG	DESCRIPTION	TAG	DESCRIPTION
1A	CLEAR GLASS	9A	WINDOW-WALL MULLION - WHITE COLOUR
1B	BACK-PAINTED GLAZING SPANDREL - WHITE	9B	CURTAIN WALL MULLION - ANODIZED ALUMINUM
1C	COLOURED GLAZING - VARIES - CONFIRM WITH THE ARCHITECT	10	METAL FILLER TO MATCH MULLION COLOUR
2A	ALUMINUM PANEL - FRAME EDGE - CHAMPAGNE	11	BALCONY DIVIDER - ALUMINUM WITH FRITTED GLASS
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3	CUSTOM PERFORATED METAL SCREENING	12B	DOUBLE GLASS DOOR
4	ARCHITECTURAL CONCRETE - PAINTED	13	OPERABLE WINDOW
5A	GLASS GUARD - FRITTED	14	PAINTED CONCRETE - ART MURAL
5B	GLASS GUARD - CLEAR	15	METAL SINGLE DOOR
6	EXTRUDED ALUMINUM SUNSHADES - CHAMPAGNE	16	METAL SECURITY FENCE
7	ALUMINUM LOUVERS	18	METAL SCREEN - PERFORATED
8	GLAZED CANOPY	20	METAL MESH GARAGE DOOR
9	STOREFRONT MULLIONS - CHARCOAL COLOUR	21	FORMED METAL




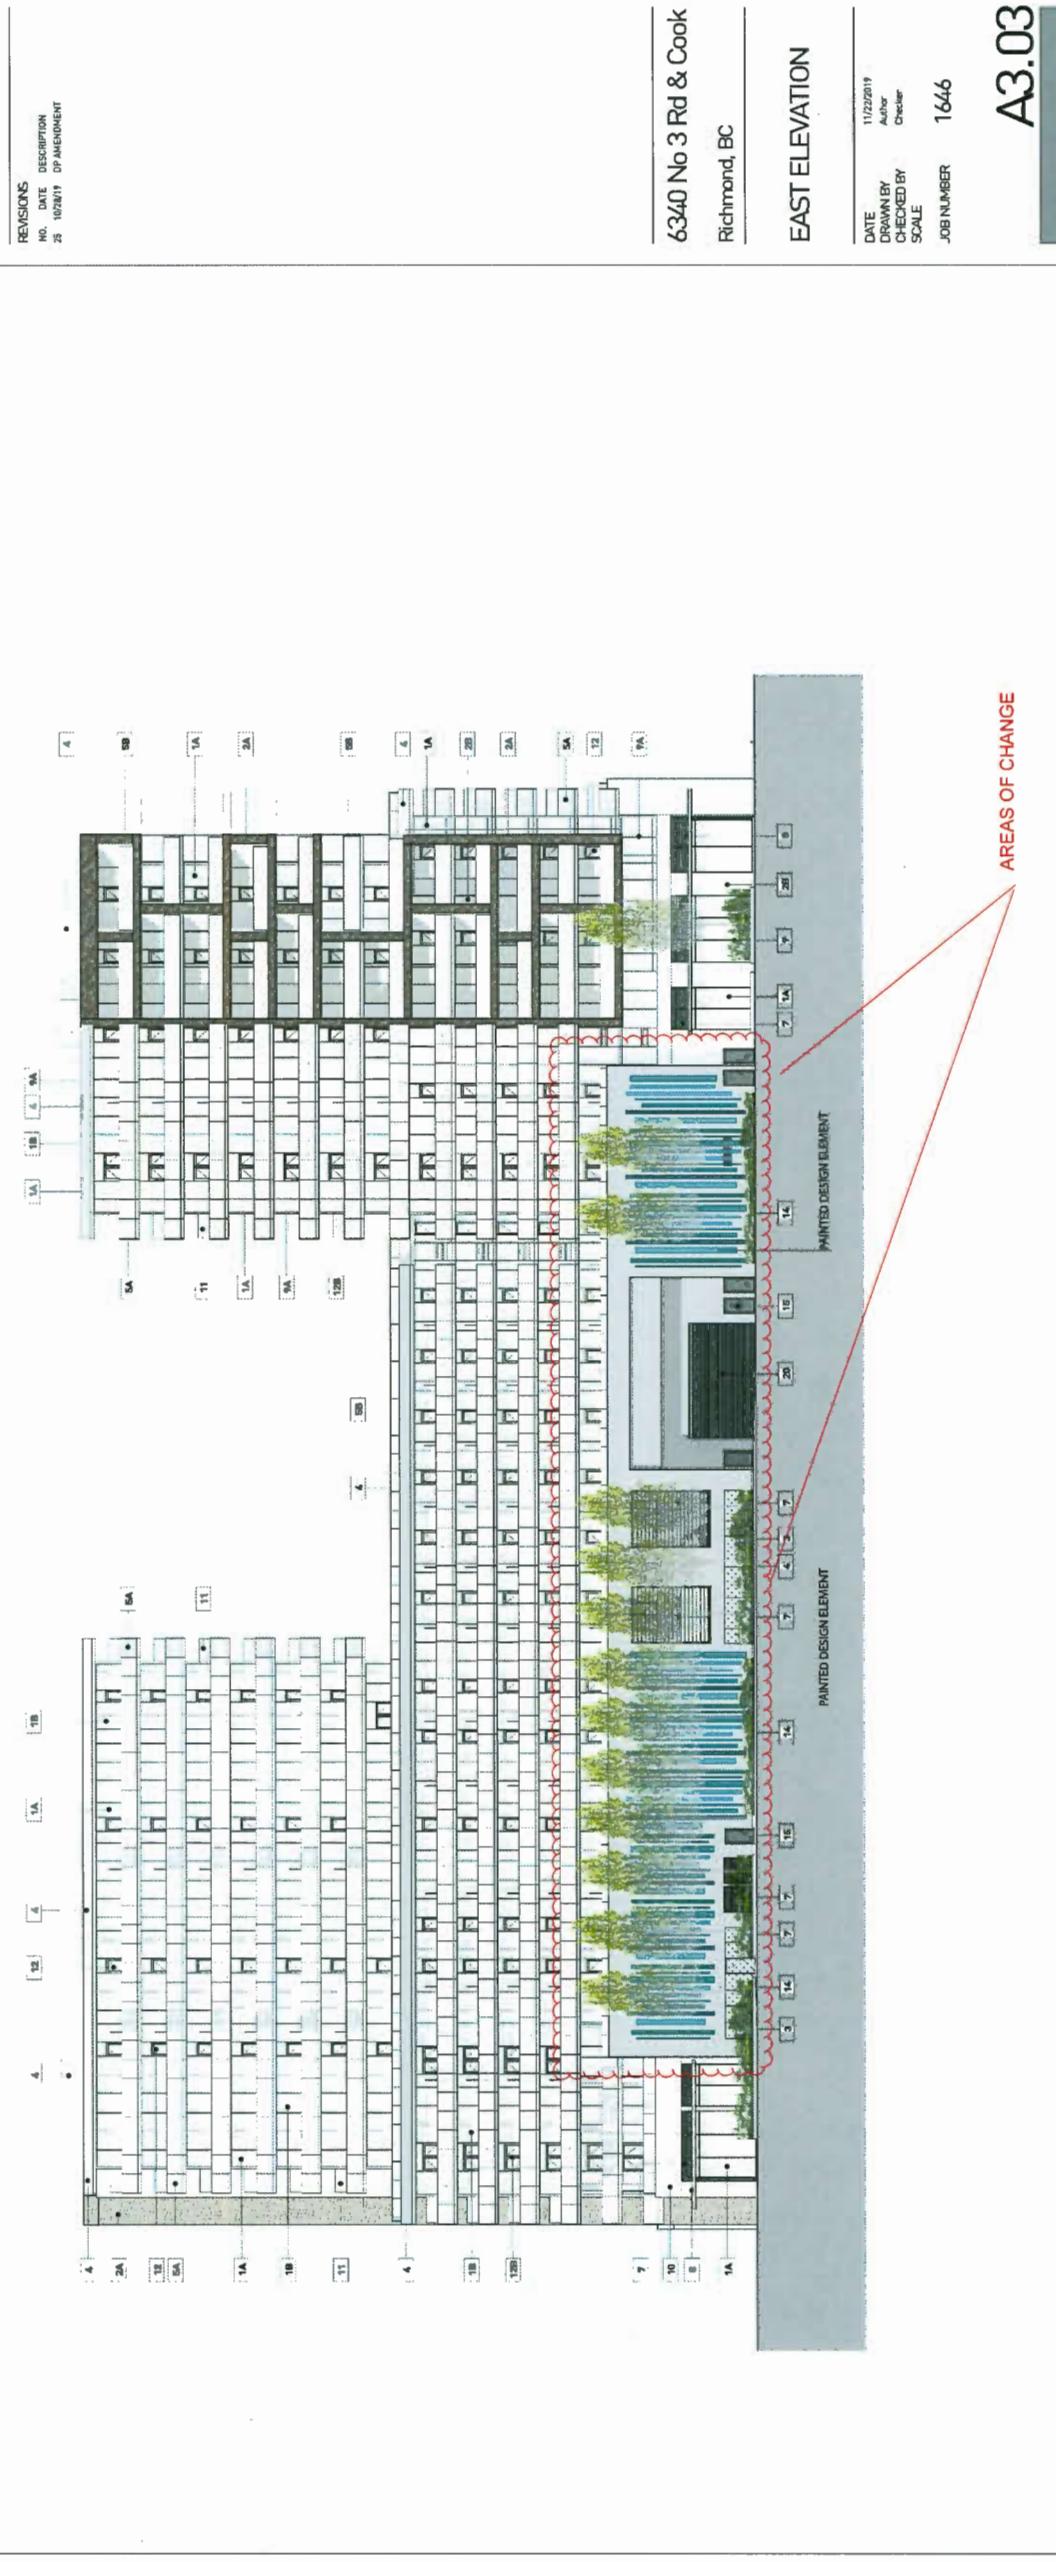

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DRAWING

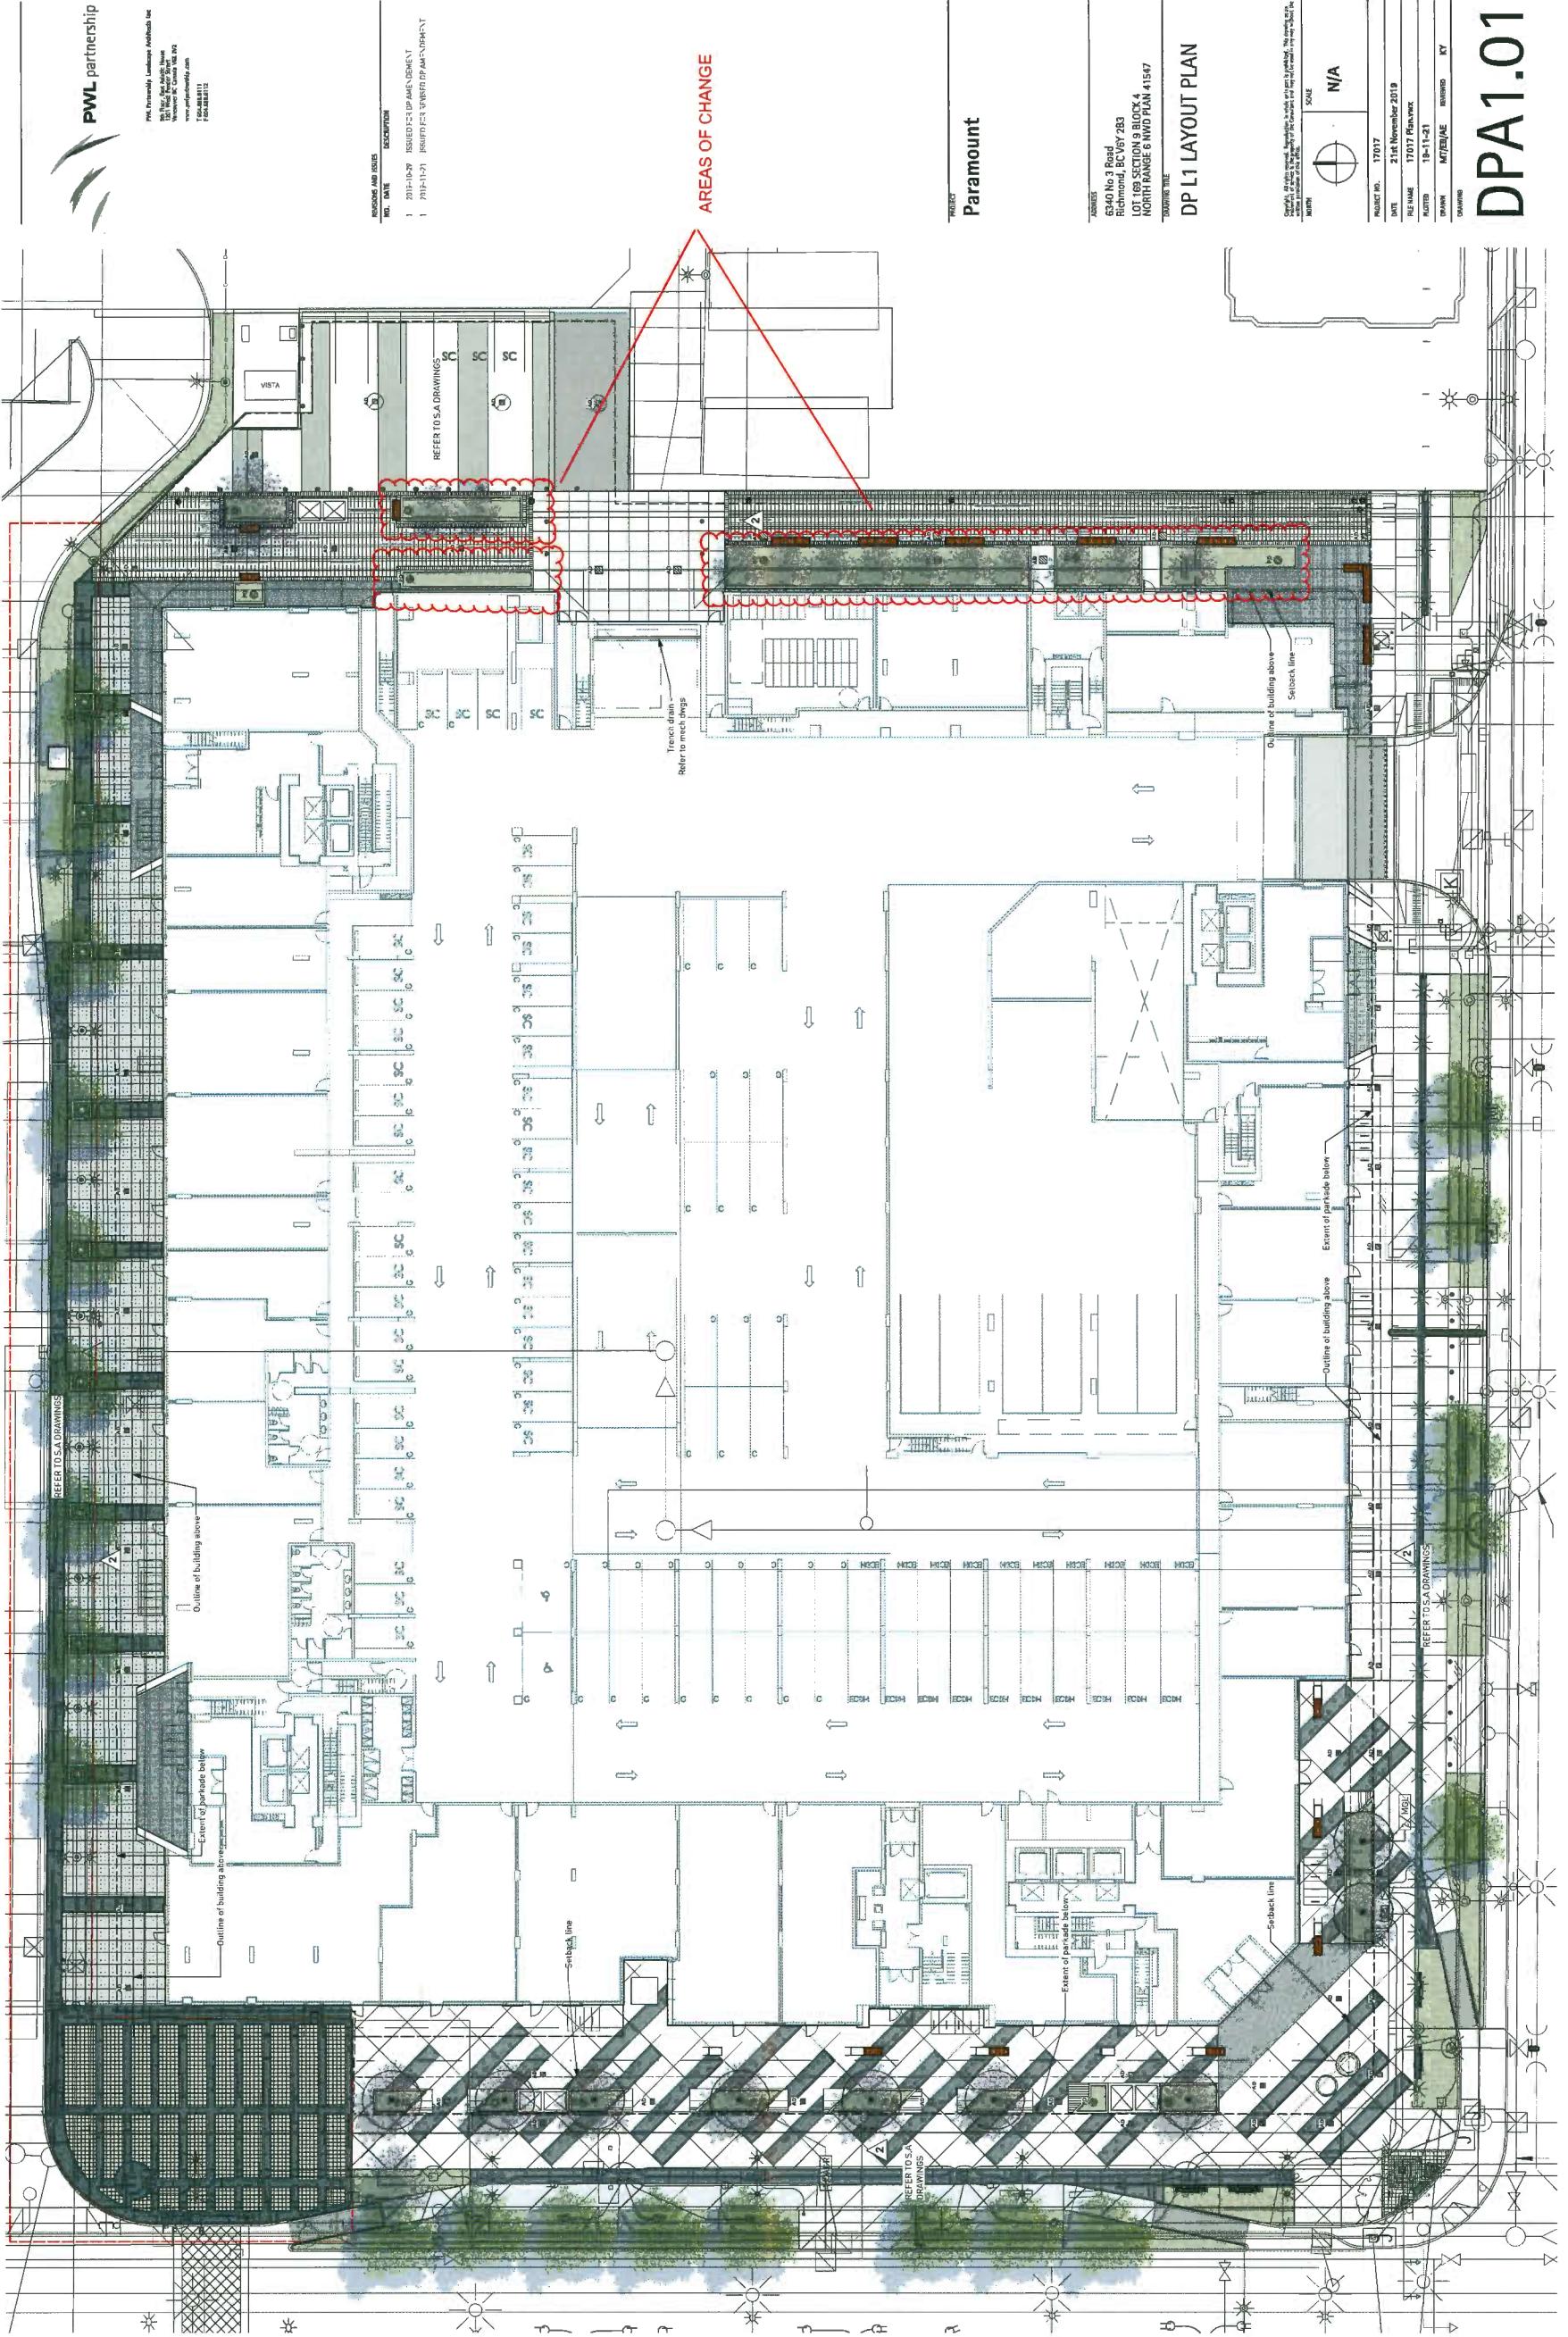

201

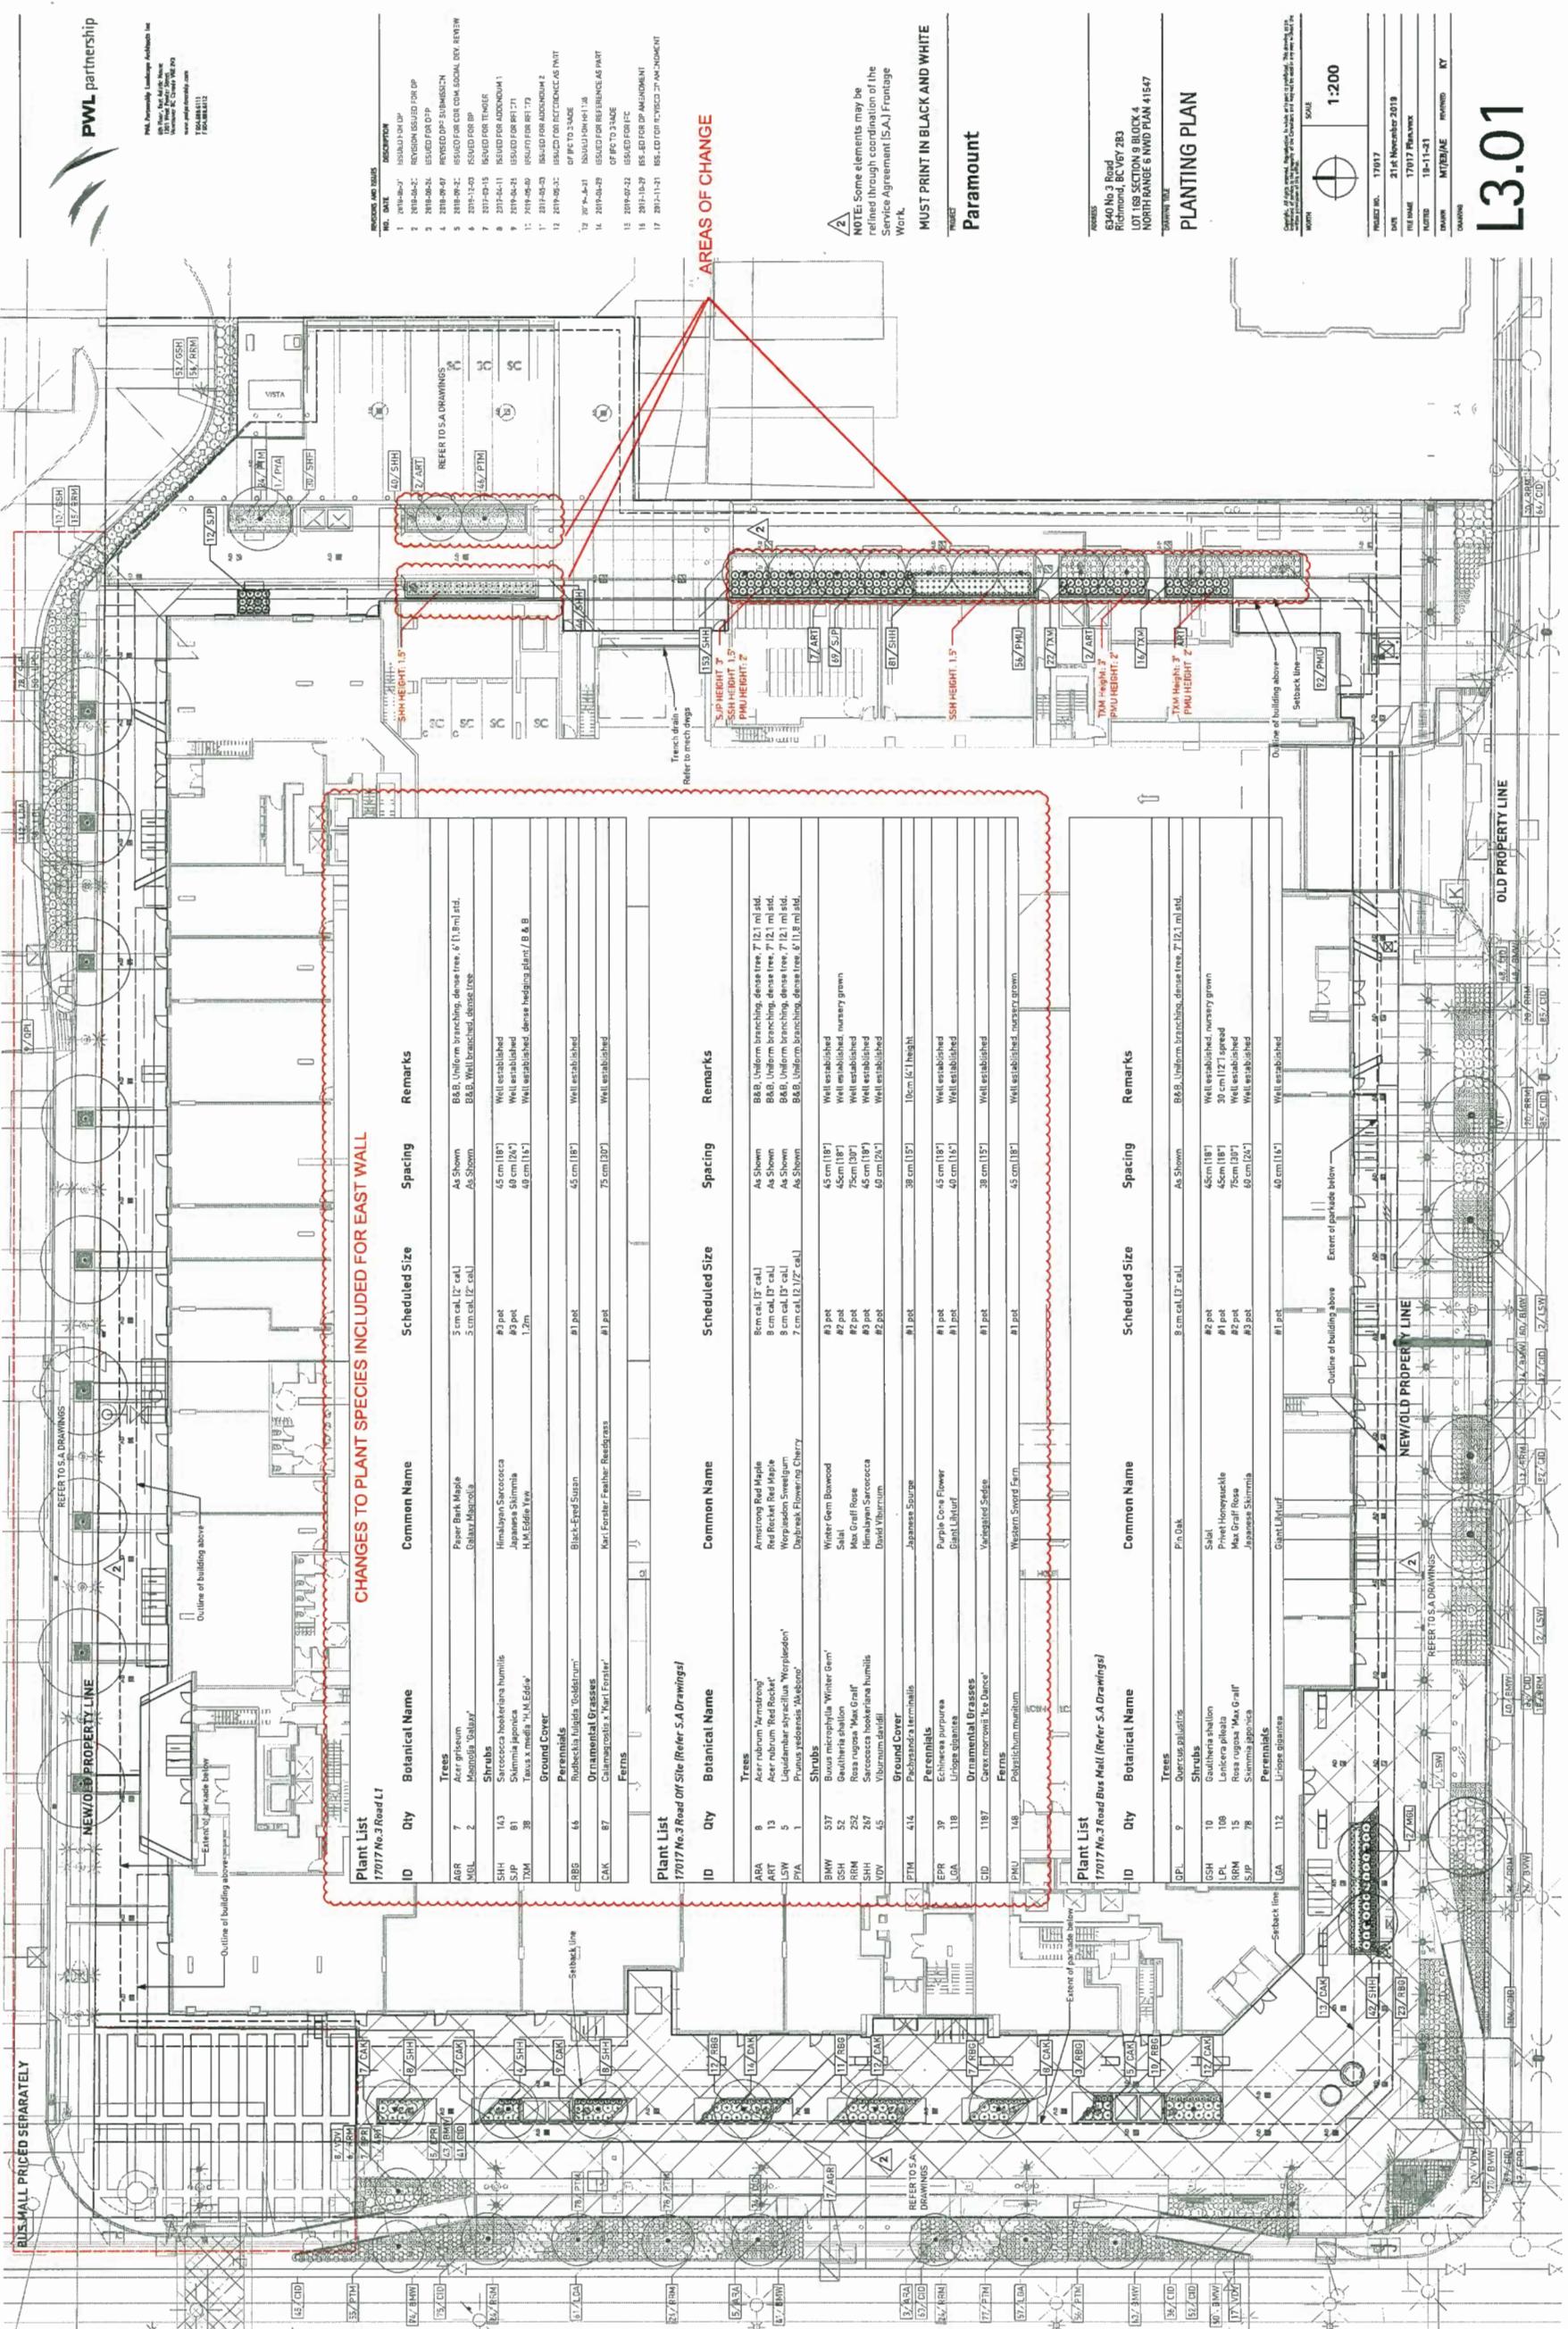

call to artists

PUBLIC ART
RICHMOND



Figure 1. Keltic Canada development, architectural rendering by GBL Architects.

OPPORTUNITY

The City of Richmond Public Art Program is seeking an artist to propose an integrated glass artwork for a new 15-storey, mixed-use commercial and residential development at 6340 No. 3 Road, Richmond, BC. The artist will work in collaboration with a specialist glass fabricator and GBL Architects during production and construction phases of the building.

A two-stage artist selection process will be implemented for this opportunity. For the first stage, artists will be selected based on demonstrated experience, past work and statement of intent. A \$1,500 CAN honorarium will be provided for shortlisted artists to develop a visual concept for the artwork. Artists will be reimbursed for travel and accommodation, up to \$1,000 CAN. Artists will not be responsible for fabrication and installation costs. The project will be funded from Keltic Canada's public art community amenity contribution.

Artist Fee: \$30,000 CAN

Eligibility: Open to all artists

Deadline: Thursday, December 6, 2018, 5:00 p.m. PST

Completion: Winter 2021

Keltic Development

Request for Proposals (RFP)

October 2018

call to artists

BACKGROUND

The Keltic mixed-used development is currently under construction in Brighouse Village, the traditional heart and civic focal point of Richmond's City Centre. This neighbourhood is a high priority for the inclusion of public art and creative placemaking initiatives, zoned for high-density, mixed commercial and residential use, with some of the largest buildings in the downtown core. The 15-storey commercial and residential development will include ground level commercial uses, four levels of parking, low-end market rental units and a 19,000-square-foot Early Childhood Development Hub.

The artwork will be in a prominent location on the building facade at the corner of No.3 Road and Cook Street in close proximity to the Brighouse Canada Line Station, directly across from Richmond Centre. As a large-scale signature artwork in the City Centre, the work will contribute to defining a vibrant and sustainable arts and culture experience in a rapidly growing Brighouse Village.

THEMATIC FRAMEWORK

Artists are invited to consider the notion of "welcome" within the context of creating safe, accessible and inclusive public realms. The artwork will be in close proximity to Brighouse Canada Line station, a main gateway and transportation hub in the city centre. This large-scale artwork will contribute to the "No.3 Road Art Walk" experience between Brighouse Station and Granville Avenue, framing formal streetscape views for passersby travelling north along No.3 Road.

Artists who are shortlisted for this opportunity will have demonstrated experience in creating work that engages the social, cultural and physical characteristics of the site and place. It is the expectation that the work will become a significant and iconic city centre public art experience.

Shortlisted artists will be invited to develop a visual concept for a welcome piece. Artists are not required to provide concept sketches for the first stage application process. Please refer to the submission requirements on page 4 for further information.

LOCATION

The artwork will be integrated into the glass façade of the building at the corner of No.3 Road and Cook Street and cover approximately 88 square metres of glazing. Refer to location plan and architect's renderings beginning on page 6.

ARTIST FEE

An artist fee of \$30,000 will be provided to the commissioned artist. This budget includes (but is not limited to) artist fees, travel, accommodation, design work, consultation work with the specialist glass fabricator and design

call to artists

consultants, administration, travel, photography, insurance and all taxes, excluding GST. The commissioned artist may be required to provide input in public engagement communication strategies. The artist will also be consulted during the selection process for the specialist art glass fabricator. Artists will not be responsible for fabrication and installation costs of the art glass panels. Non-resident artists may be subject to a Non-Resident Withholding Tax.

ARTIST ELIGIBILITY

This call is open to all artists including those who typically work in two-dimensional media. Artists who are currently contracted by the City for a public art commission are not eligible to apply. City of Richmond employees are not eligible to apply.

Experience and skills in digital post-production documentation techniques would be an asset. If working outside of digital media, any two-dimensional artwork will need to be translated into a digital file by the artist before working with the specialist glass fabricator. The artist may be required to engage a contractor to complete this scope of work.

SELECTION PROCESS

A five (5) member selection panel consisting of a combination of artists, art professionals and community representatives will engage in a two stage artist selection process to review all artist submissions.

Shortlisted artists will receive a \$1,500 (CAN) artist honorarium to develop a concept for the artwork and attend an interview to present the concept to the Selection Panel. Shortlisted artists will be reimbursed for travel and accommodation, up to \$1,000 (CAN), upon submission of receipts.

Shortlisted artists will be invited to attend an artist orientation meeting with project stakeholders to meet project stakeholders and ask questions. Attendance can be in-person or remotely via teleconference.

At the conclusion of the process, the panel will recommend one artist and art concept to be reviewed by the Richmond Public Art Advisory Committee and City of Richmond. If approved, the selected artist will enter into a contract with Keltic Canada and the City of Richmond for implementation stages.

ARTIST SELECTION CRITERIA – STAGE ONE

Submissions to the call will be reviewed and decisions made based on:

- Artist's practice and experience as demonstrated through past work.
- Ability of the artist to work with multiple project stakeholders, including community representatives, design and construction consultants as demonstrated through past work.

call to artists

- Artistic merit of statement of intent in response to the thematic framework.
- Appropriateness of the proposal to the Public Art Program goals: www.richmond.ca/culture/publicart/plans/policy.

ARTIST SELECTION CRITERIA – STAGE TWO

Shortlisted artists and their proposals will be reviewed and decisions made based on:


- Artistic merit of conceptual response to the theme.
- Ability of the artist to work with multiple project stakeholders, including design and construction consultants as demonstrated through past work.
- Use of bold colour palettes, while being sensitive to the needs of the Early Child Development facility located on the 2nd level.
- Artwork suitability and consideration of the professional nature of the businesses and organizations residing in the Keltic Canada development.
- Ability of the artwork to respond to the existing character of the site by taking into account scale, colour, material, texture, content and the physical characteristics of the location and building.
- Appropriateness of the proposal to the Public Art Program goals: www.richmond.ca/culture/publicart/plans/policy

SUBMISSION REQUIREMENTS


E-mail all documentation as one (1) PDF document, not to exceed a file size of 5 MB to: publicart@richmond.ca



- INFORMATION FORM – Please complete the information form attached to this document.
- STATEMENT OF INTENT – 500 words or less, explaining preliminary conceptual approach to the work, artist practice and methodology.
- ARTIST CV – (2 pages maximum). Teams should include one page for each member.
- WORK SAMPLES – Up to ten (10) supporting image examples of previous work. One image per page. Please include artist name(s), title, year, location and medium information on each image page.
- REFERENCES – Three (3) references who can speak to your past accomplishments, experience and expertise. Please provide name, title, contact e-mail and telephone number.

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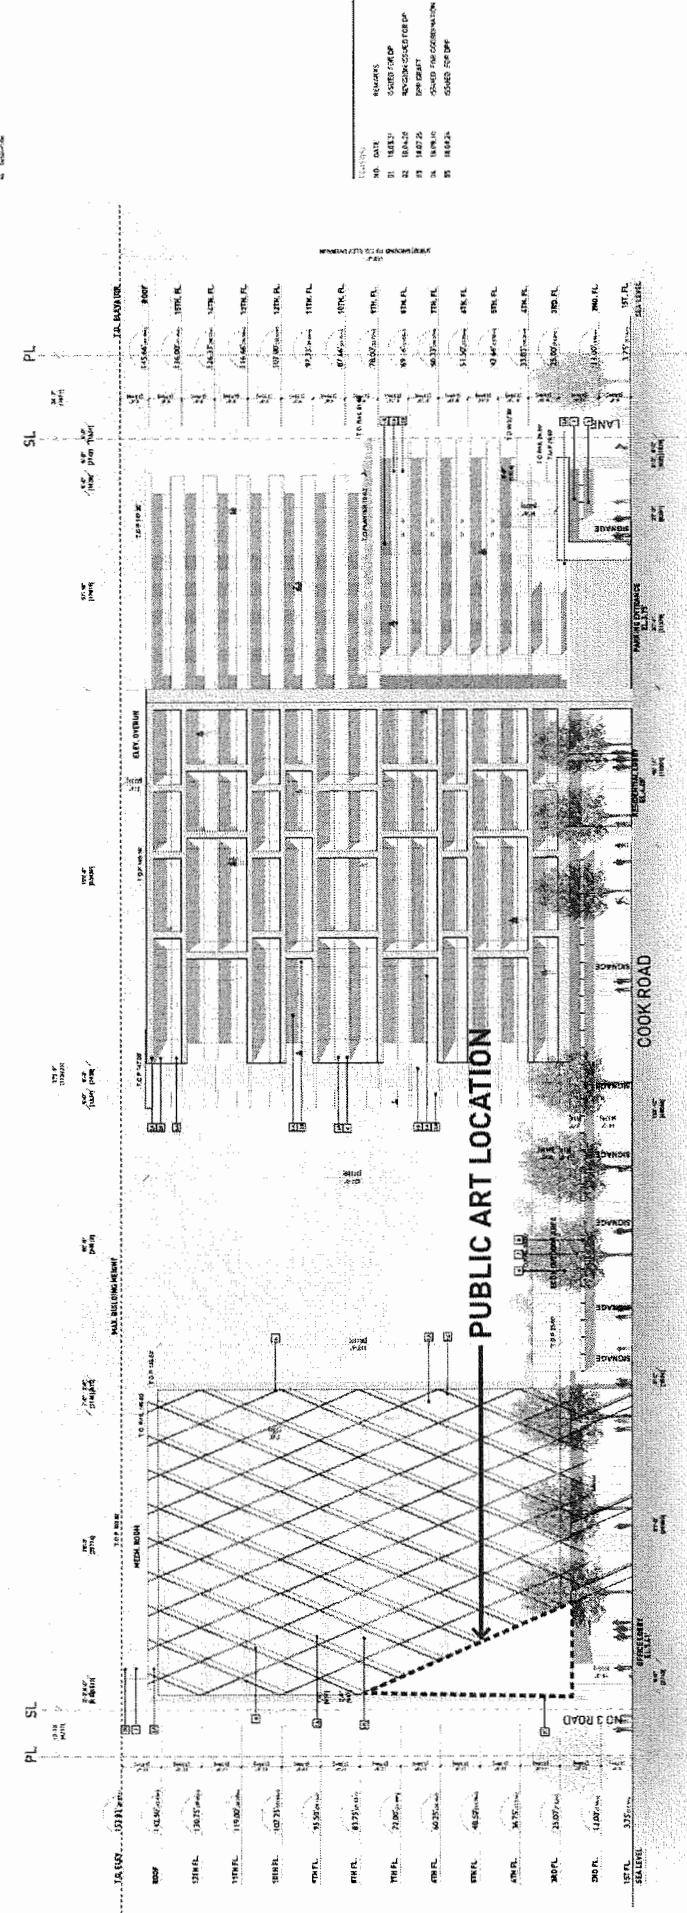


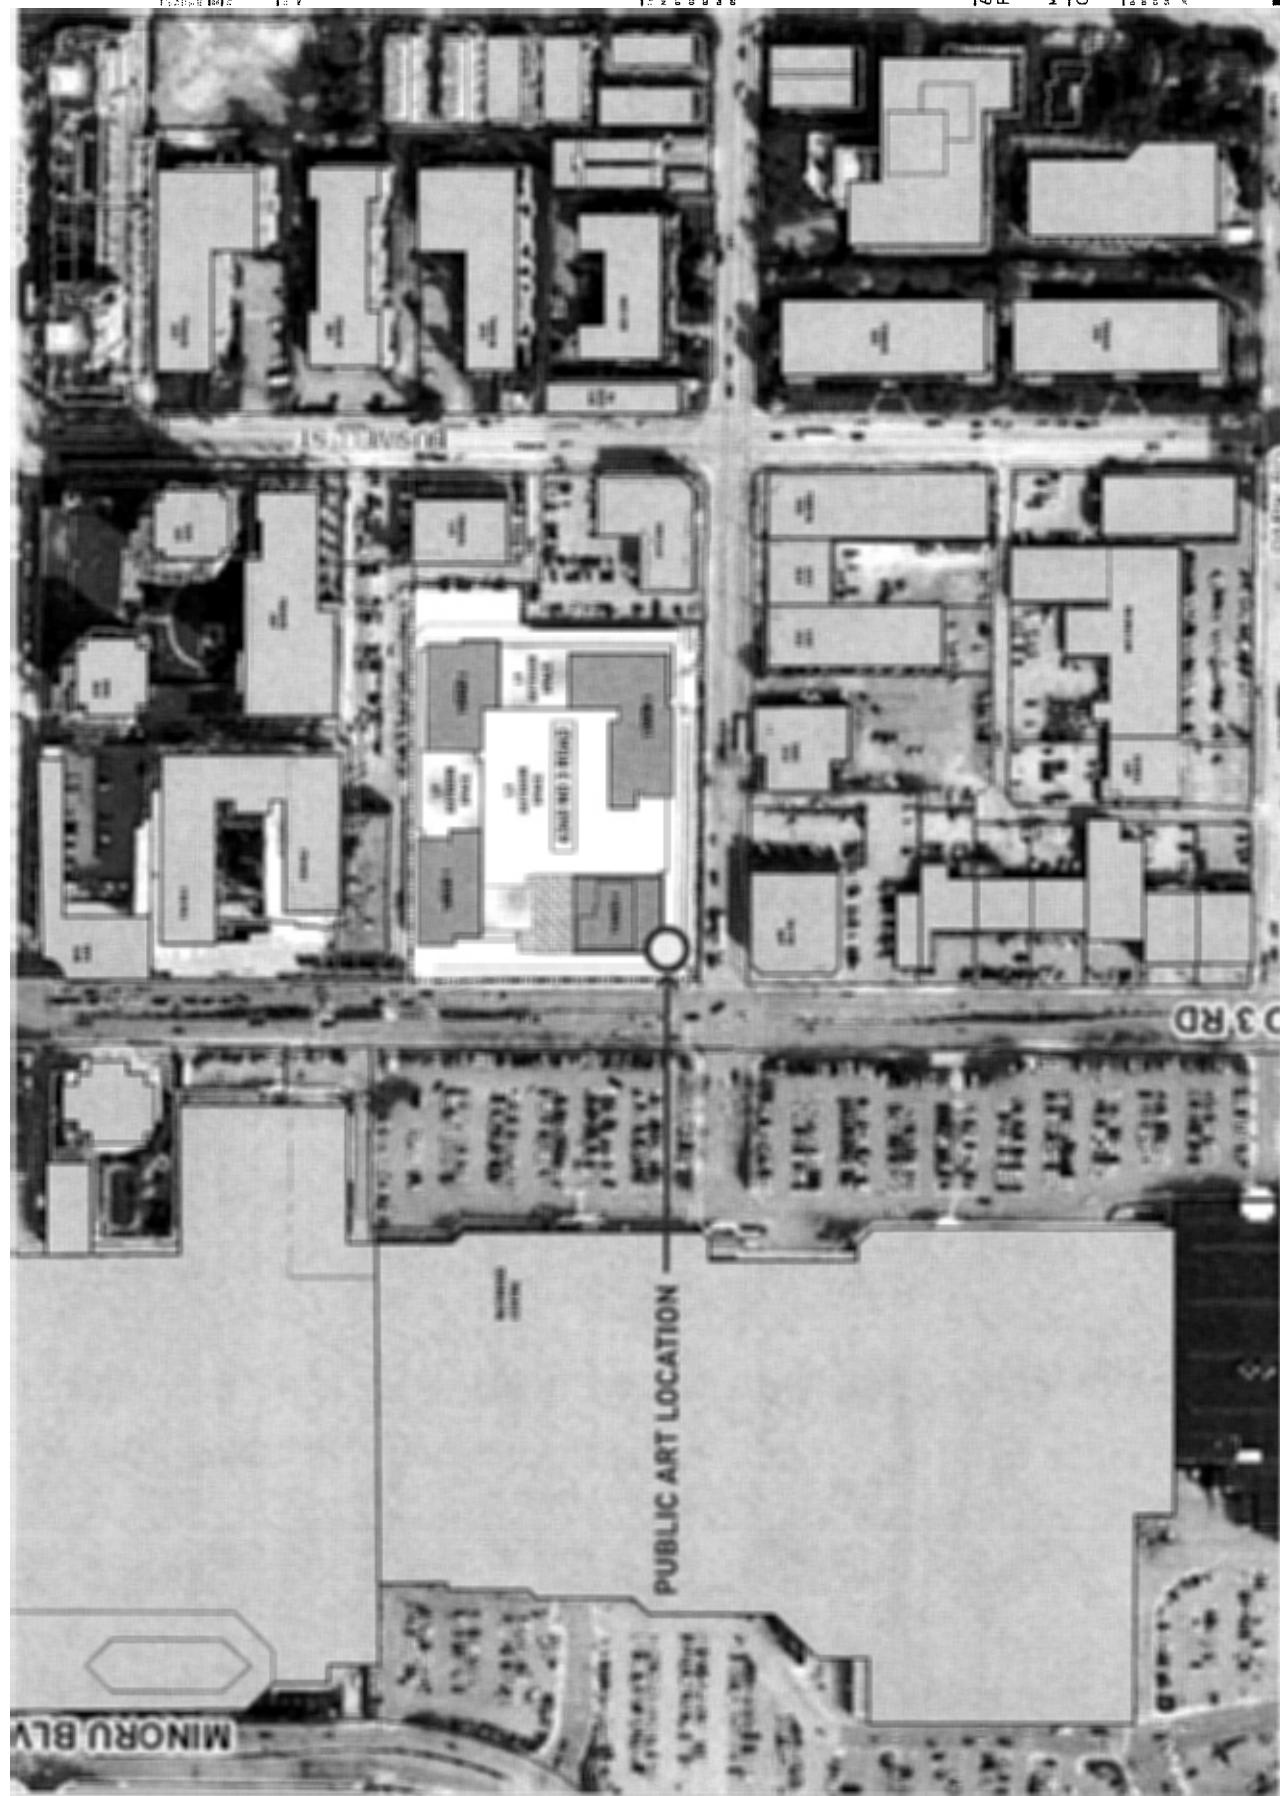- PUBLIC ART LOCATION

WEST ELEVATION

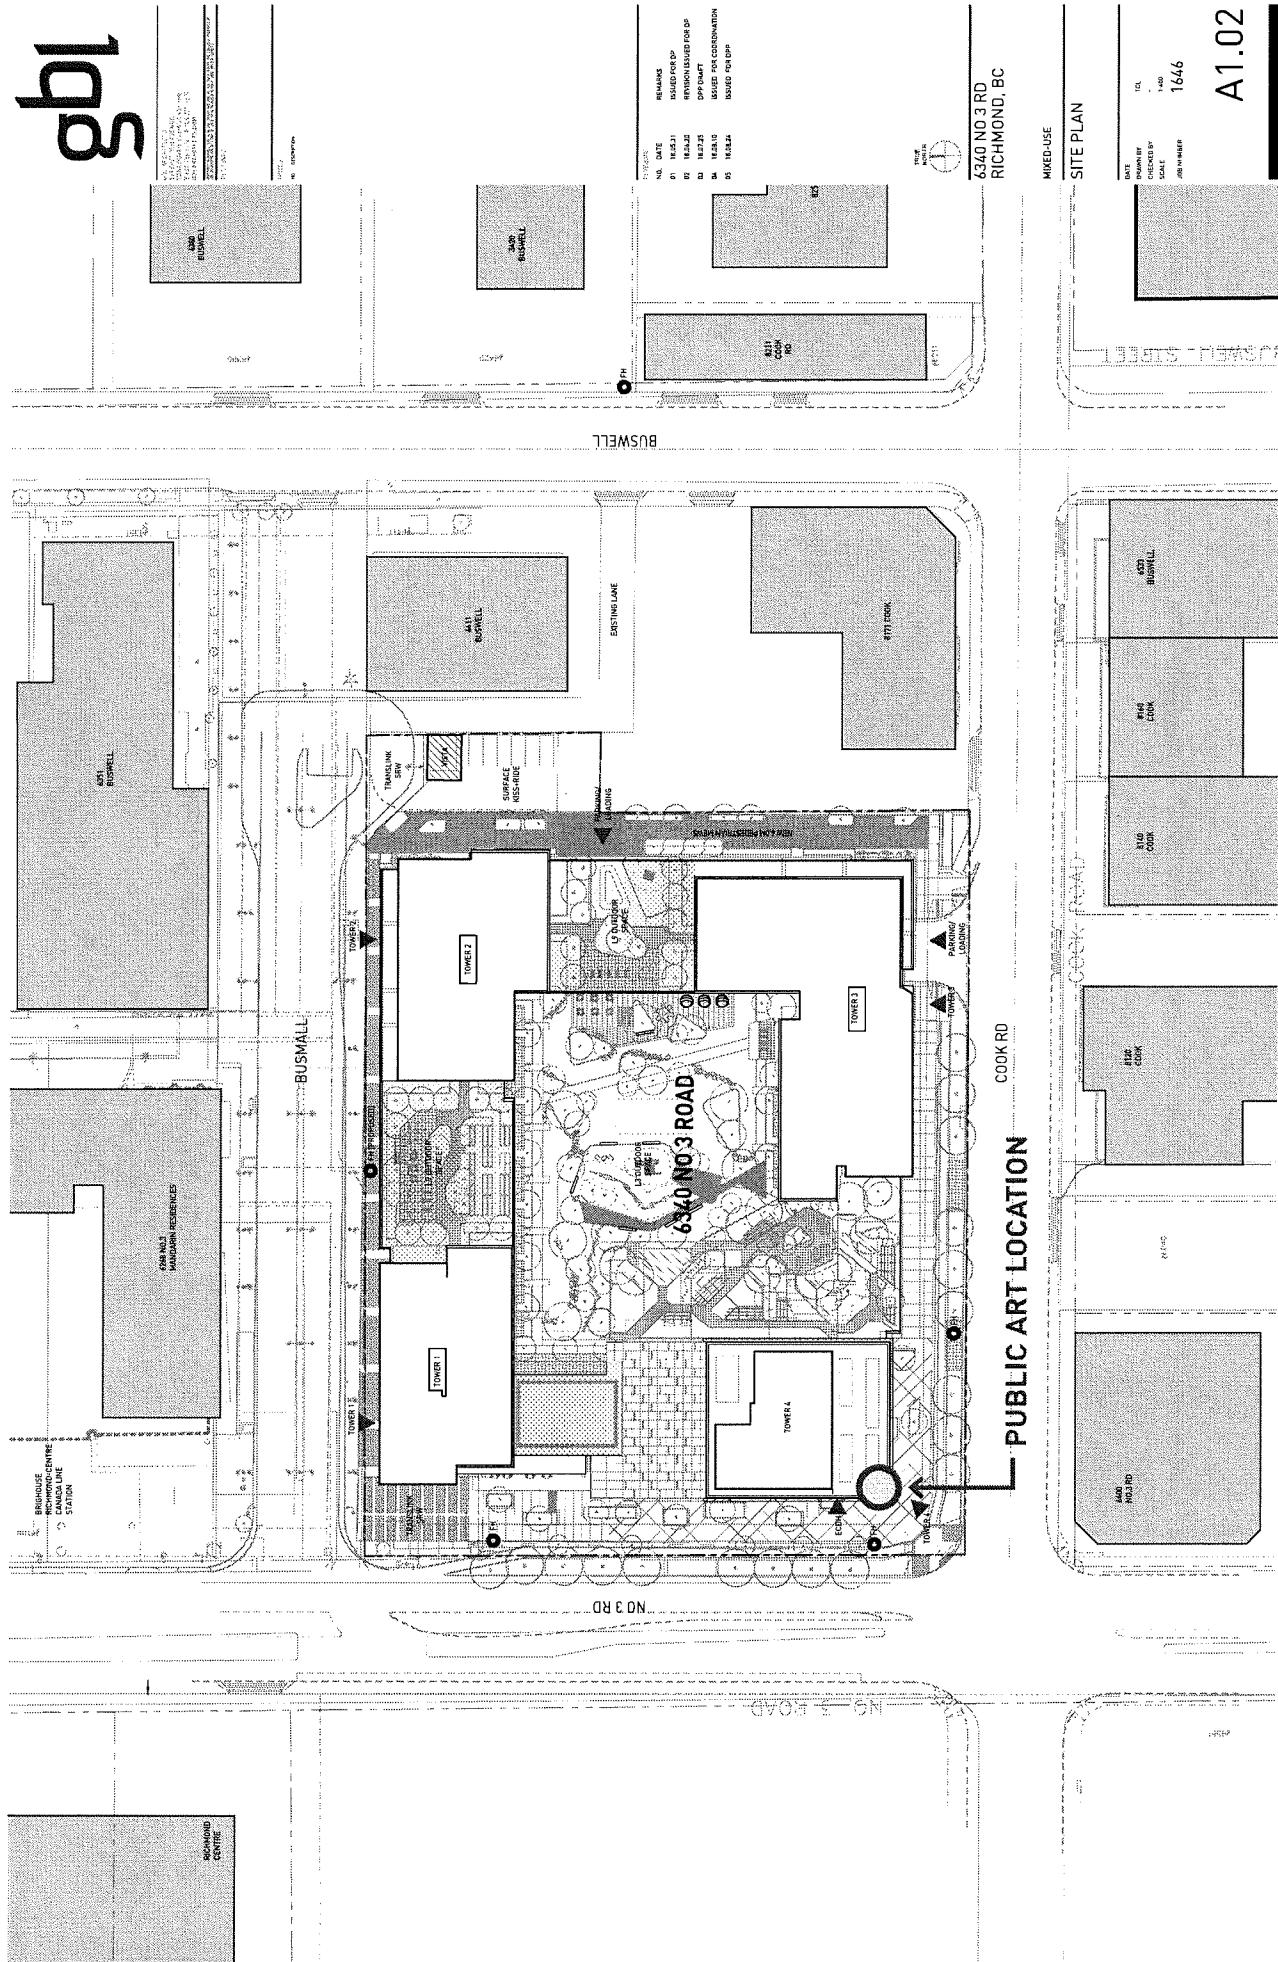A3.01

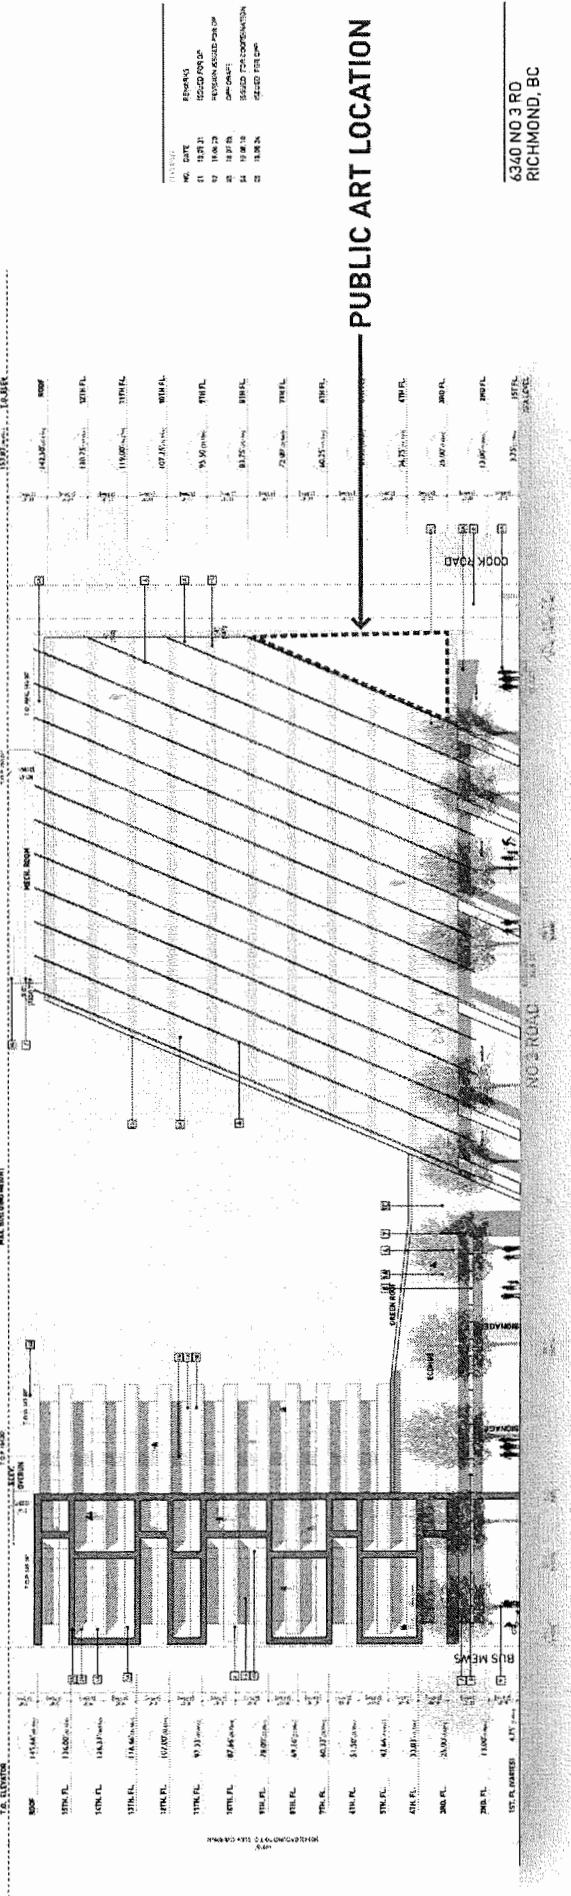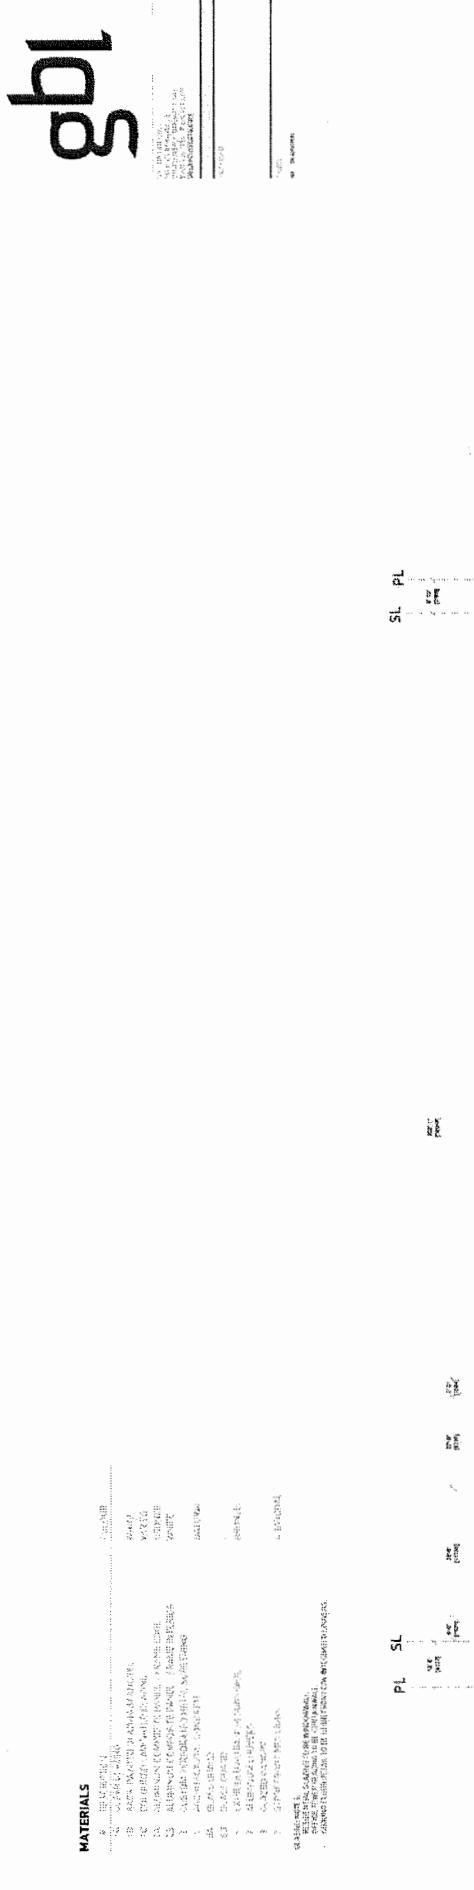MATERIALS



6340 NO 3 RD
RICHMOND, BC

SOUTH ELEVATION

1666



