



City of Richmond

Report to Development Permit Panel

To: Development Permit Panel

Date: December 16, 2013

From: Wayne Craig
Director of Development

File: DP 13-634111

Re: **Application by Integra Architecture Inc. for a Development Permit at 6511
Buswell Street**

Staff Recommendation

That a Development Permit be issued which would:

1. Permit the construction of a 15-storey mixed use (residential/commercial) tower at 6511 Buswell Street on a site zoned “Downtown Commercial (CDT1)”; and
2. Vary the provisions of Richmond Zoning Bylaw 8500 to:
 - a) Reduce the residential parking rate from the standard City-wide parking rate to the City Centre Zone 1 parking rate.


Wayne Craig
Director of Development

WC:bg

Staff Report

Origin

Integra Architecture Inc., has applied to the City of Richmond on behalf of Majorca International Investments Ltd., for permission to develop a 15-storey mixed use (residential/commercial) tower at 6511 Buswell Street on a site zoned “Downtown Commercial (CDT1)”. There is an existing 1-storey building with rooftop parking on the site, which includes Legend’s Pub as one of the tenants. No rezoning is required.

A separate Servicing Agreement (SA) is required for utility upgrades, service connections and frontage improvements, which has been agreed to by the owner/developer. See the attached Development Permit Considerations for a general description of the SA scope of work.

Development Information

Please refer to attached Development Application Data Sheet (**Attachment 1**) for a comparison of the proposed development data with the relevant Bylaw requirements.

Background

Development surrounding the subject site is as follows:

To the north, across Cook Road is a 3-storey commercial building located at 8171 Cook Road with “Downtown Commercial (CDT1)” zoning and designated Urban Core T6 (45m) in the City Centre Area Plan (CCAP) within the Brighouse Village;

To the east, across Buswell Street is an older 3-storey apartment building over parking located at 6560 Buswell Street with (RAM1) zoning and designated Urban Centre T5 (25m) according to the CCAP within the Brighouse Village;

To the south, across the existing 6 m wide lane is a surface parking lot and a older 2-storey commercial building located at 8091 Park Road with “Downtown Commercial (CDT1)” zoning and designated Urban Core T6 (45m) eligible for the Village Centre bonus according to the CCAP within the Brighouse Village; and

To the west, on the adjacent lot is an older 1-storey commercial building located at 8160 Cook Road with “Downtown Commercial (CDT1)” zoning and designated Urban Core T6 (45m) according to the CCAP within the Brighouse Village.

Staff Comments

The proposed development scheme attached to this report has satisfactorily addressed the significant urban design issues and other staff comments identified as part of the Development Permit application review process. In addition, it complies with the intent of the applicable sections of the Official Community Plan and is generally in compliance with the policies and design guidelines in the Official Community Plan (OCP) Schedule 2 – City Centre Area Plan (CCAP) – Brighouse Village. Zoning variances are required as noted below.

Zoning Compliance/Variances (staff comments in **bold**)

The applicant requests to vary the provisions of Richmond Zoning Bylaw 8500 to:

- a) Reduce the residential parking rate from the standard City-wide parking rate to the City Centre Zone 1 parking rate.

Staff supports the proposed parking variance since this site is located within the City Centre Zone 1 area due to proximity to the Canada Line therefore the variance would be consistent with Zone 1 parking rate and as the owner/developer has agreed to provide:

1. *Five (5) affordable housing units, to the approval of the City; and*
2. *Various measures that support Transit-Oriented Development (TOD) including:*
 - a) *Upgrade of the existing signal at the Cook Road and Buswell Street intersection to include the following:*
 - *APS (Accessible Pedestrian Signals) and illuminated street name signs; and*
 - *The provision of three (3) benches (one) 1 on Cook Road and two (2) on Buswell Street near existing bus stops).*
 - b) *Provision of a continuous canopy attached to building along Buswell Street in lieu of a \$25,000 contribution towards a bus shelter for the bus stop on Buswell Street.*

Advisory Design Panel Comments

The Advisory Design Panel was supportive of this development proposal. A copy of the relevant excerpt from the Advisory Design Panel Minutes from November 6, 2013 is attached for reference (**Attachment 2**). The design response from the applicant has been included immediately following the specific Design Panel comments and is identified in '***bold italics***'.

Analysis

Land Dedications & Statutory Right of Ways (SRW's)

- A. Land Dedications: The owner/developer has agreed to assume all costs associated with the dedication of two City owned lots that will formalize the Buswell Street road right-of-way.
- B. Statutory Right of Ways (SRW's)
 1. This development proposal includes the following SRW's along Cook Road:
 - a. A 4.20m wide Statutory Right of Way (SRW) along the entire Cook Road frontage for road, utility and sidewalk purposes; and
 - b. A 4m x 4m corner cut as a Statutory Right of Way (SRW) at the Cook/Buswell intersection for road, utility and frontage upgrade purposes.
 2. The development proposal also includes the following SRW's along Buswell Street:
 - a. A 1.1m wide Statutory Right of Way (SRW) along the entire Buswell Street frontage for road, utility and frontage upgrade purposes;
 - b. A 3m x 3m corner cut as a Statutory Right of Way (SRW) at the Buswell Street and lane intersection for road, utility frontage upgrade purposes.
 3. The development proposal also includes the following SRW's along the lane:
 - a) A 3.0m wide land dedication along the entire south property line adjacent to the lane for road, utility and frontage upgrades.

Conditions of Adjacency

- To the North: The reduced building setback from 6.0 m to 4.69 m is consistent with the Zoning Bylaw 8500, Section 9.3.6 since an acceptable streetscape interface has been proposed. There are no issues with existing development on the north side of Cook Road.
- To the East: The reduced building setback from 6.0 m to 3.0 m is consistent with the Zoning Bylaw 8500, Section 9.3.6 since an acceptable streetscape interface has been proposed. There are no issues with existing development on the east side of Buswell Street.
- To the South: The owner/developer has agreed to provide the requested SRW noted above to facilitate parallel load operations along the lane. Temporary lane lighting will be provided by private wall mounted lights until the property to the south is redeveloped. This will provide manoeuvring flexibility for loading vehicles servicing the subject site. There are no issues with existing development on the south side of the lane.
- To the West: The owner/developer has provided verification to substantiate the discharge of a legal agreement registered on title requiring the owner/developer of the subject site to provide 16 parking spaces for nearby site. The owner/developer has also submitted proof that the neighbouring 3 properties to the west are controlled by the same owner(s) and has demonstrated with a schematic redevelopment scenario that the proposed development of the subject site does not preclude the future redevelopment of the neighbouring 3 properties. In addition, the applicant proposes interim facade enhancements to the exposed west wall of the parkade, which will improve the visual appearance of the proposed parkade until redevelopment occurs on the neighbouring lots.

Urban Design and Site Planning

1. Urban Design: The proposed design responds to the existing and anticipated urban fabric surrounding the site with a continuous streetwall and a slender tower design, which results in a minimal amount of shading and minimal impacts on the views for neighbouring properties. The stepped building massing at the podium level allows flexibility for the adjacent site to redevelop with either a 2 or 3-storey parkade and the terraced rooftop design provides variety for the City skyline.
2. Site Planning: The design proposal for this narrow site provides all requested land dedications and SRW's and achieves a streetscape design that incorporates generous sidewalk widths with fronting uses that will help to active the street including appropriate pedestrian amenities. The commercial-retail units (CRU's) at-grade will help to active the street and the streetscape design includes pedestrian and transit amenities.
3. Public Art: The owner/developer prefers to make a financial contribution of approximately \$55,902 based on the applicable rates in the Public Art Policy to the City's public art reserve rather than a public art installation integrated with the proposed built form or as a stand-alone public art installation along the street. See the Development Permit considerations for the details.

Architectural Form and Character

1. Built Form Massing: The slender tower element represents a unusual built form massing for the City Centre and is a welcome departure from the typical square and squat towers in the City Centre. The tower element is set back from the Cook/Buswell intersection, which provides an opportunity to stagger the placement of future towers along Cook Road. This in turn allows the adjacent consolidated sites to achieve the maximum allowable density outlined in the CCAP and still comply with the minimum required tower separation. This design approach would also preserve maximum views from all towers (existing and future) as well as permit maximum sunlight penetration to the street below.
2. Architectural Character:
 - a) Podium Design: The proposed white metal banding that frames the podium accentuates the separation between the parking structure and the tower. The cantilevered spandrel elements at the intersection above the corner plaza add visual interest and drama to this relatively small pedestrian space. Facade improvements have been proposed for the west wall of the parking podium including concrete reveals and two different colours of paint.
 - b) Tower Design: The design of the tower is a combination of overlapping vertical and horizontal elements consisting of metal fins, louvers, screens and thin concrete slab extensions that create an interesting visual treatment of the tower facades. The elevator core is proposed along the exterior wall facing Buswell Street, which creates a strong vertical element that breaks the expansive glass wall system on this facade and contributes to the streetscape character. Facade enhancements to the previously blank wall of the elevator core along Buswell Street include textured concrete stucco or concrete panels and a coloured dark charcoal consistent with the proposed metal screens. The thin concrete floor slab balcony extensions create a rhythm of contrasting horizontal lines that balance the vertical lines of tower. The proposed clear glass guard railings and metal fins further help to accentuate the contemporary architectural character.
3. Indoor Amenities: The proposed design includes approximately 111m² (1,201 ft²) of indoor amenity space, which exceeds the minimum 100m² (1,076 ft²) requirement of the OCP. The indoor amenity space consisting of 2 separate but adjacent common use rooms including a gym room and a lounge/entertainment room. The lounge room incorporates a kitchen area and opens onto the podium roof deck with a complementary outdoor patio and seating area under a trellis structure with an adjacent children's play area.

Landscape Design and Open Space Design

1. Streetscape Design: Wide boulevards are proposed despite the narrow site, (i.e., 6.6 m wide along Cook Road and 5.6 m wide along Buswell Street) including the minimum 2.0 m wide sidewalks clear of any obstructions along both road frontages. The design features pedestrian amenities for the adjacent bus stop including weather protection via a continuous building canopy and 2 benches along Buswell Street. The proposal also includes decorative street lighting and boulevard paving that consists of standard City Centre concrete sidewalk panels in combination with exposed aggregate banding. The street tree planting is proposed at larger than the minimum sizes required at the time of planting (10 cm versus 7 cm caliper) and the laneway design incorporates a wider, reinforced concrete sidewalk and shared loading area on the north side of the lane with interim lighting attached to the building.

2. At-Grade Pedestrian Plazas: The proposed site plan features two relatively small, pedestrian plaza areas including:
 - a recessed corner plaza with a seating plinth that doubles as a small performance area; and
 - a small recessed space adjacent to the lobby area, which helps to separate the residential and commercial uses, to identify the residential entry and to create a more gracious sequence of arrival and entry to the residential lobby.
3. Parkade Rooftop Design: The proposed landscape design of the parking structure roof deck includes private outdoor patio use for the residential units on level 4 as well as two large outdoor patio areas for common use connected via a narrow walkway along the west edge of the roof deck. The outdoor patio area on the north side of the tower is proposed as a complementary space to the adjacent indoor amenity room while the other patio area on the south side of the parkade roof deck proposes raised planting beds for gardening, a fire pit and seating area, a small putting green, a bosque of trees in raised planters as well as a second children's play area.

Affordable and Accessible Housing

Accessible Housing:

1. All of the proposed units incorporate aging in place features to accommodate mobility constraints associated with aging. These features include:
 - stairwell hand rails;
 - lever-type handles for plumbing fixtures and door handles; and
 - solid blocking in washroom walls to facilitate future grab bar installation beside toilets, bathtubs and showers.
2. The proposed development includes the following provision for accessibility:

Accessible Units	Intent	Proposed Unit Accessibility	Notes
Basic Universal Housing Units (BUHU's)	designed to be easily renovated to accommodate a future resident in a wheelchair	70 of 70	Each BUHU is permitted a density exclusion of 1.86 m ² (20 ft ²) per unit. Each unit must comply with all Richmond Zoning Bylaw requirements to be eligible for the density exclusion.
Age-in-Place Units (AIPU's)	to accommodate mobility constraints associated with aging	70 of 70 units	Not required but strongly encouraged for all single level apartment units including lever-type handles for plumbing fixtures/door handles and solid blocking in washroom walls to facilitate future grab bar installation beside toilets, bathtubs and showers.

Affordable Housing:

1. The owner/developer has agreed to provide five (5) affordable housing units, to the approval of the City according to the following schedule:

Unit Number	Unit Type	No. of Units	Unit Area	Minimum Unit Area	Maximum Monthly Unit Rent**	Total Maximum Household Income**
AFHU 1 Level 2	1 Bedroom	1	707 ft ²	535 ft ²	\$950.00/month	\$38,000 or less
AFHU 2 Level 2	1 Bedroom	1	685 ft ²	535 ft ²	\$950.00/month	\$38,000 or less
AFHU 1 Level 3	1 Bedroom	1	707 ft ²	535 ft ²	\$950.00/month	\$38,000 or less
AFHU 2 Level 3	1 Bedroom	1	685 ft ²	535 ft ²	\$950.00/month	\$38,000 or less
AFHU B Level 5	2 Bedroom	1	853 ft ²	860 ft ²	\$1,162.00/month	\$46,500 or less
		5	3,637 ft ²			

2. The proposed affordable housing units on levels 2 and 3 have unusual linear layouts but provide larger than the minimum floor space. There is also parking on levels 2 and 3 but the affordable housing unit are sufficiently separated and buffered from the parking areas. These affordable housing units would be accessed directly from the main elevator core and are supported by staff.

Transportation and Traffic

1. The proposed development includes the requested land dedications, SRW's and frontage improvements. See the Development Permit Considerations for the details.
2. The proposed development incorporates the following Transit-Oriented Development (TOD) measures:
 - a) An upgrade of the existing traffic signals at the Cook Road and Buswell Street intersection including:
 - APS (Accessible Pedestrian Signals) and illuminated street name signs; and
 - A minimum of three (3) benches, one (1) along Cook Road and two (2) along Buswell Street near the bus stop in lieu of three (3) separate SRW's for the placement of benches along the two fronting streets.
 - b) A continuous canopy attached to the building along Buswell Street in lieu of a cash contribution in the amount of \$25,000.00 towards a bus shelter for the bus stop on Buswell Street.
3. Loading: The proposed development includes two shared, medium sized (SU9) loading bays, which meet the minimum requirements with one perpendicular to the lane in the building and one parallel to the lane that would straddle the property line but would permit two standard sized passenger vehicles to pass simultaneously during loading operations.

4. Parking: The proposed development includes the following provisions for parking:

Land Use	Required Parking	Parking Reduction	Proposed Parking Provided
Residential Housing Spaces (65 Units)	65 spaces (1 space/unit)	65 spaces (no reduction)	91 spaces
Residential Housing (5 Affordable Units)	5 spaces (0.9 spaces/unit)	5 spaces (no reduction)	
Residential Visitor Spaces	14 spaces (0.2 spaces/unit)	28 – 7 = 21 spaces (based on shared spaces and provision of a parking covenant)	
Commercial Spaces	14 spaces (3.75 spaces/100m ²)		
Total Spaces	98 spaces	91 spaces	
Small Car Stalls	max. 50%	(max. 45 spaces)	29
Accessible Parking Stalls	min. 2%	(min. 2 spaces)	2
Residential Class 1 Bike Parking	88 (1.25 stalls/resi.unit)	88 (provided in parkade)	88
Residential Class 2 Bike Parking	14 (0.2 stalls/resi. unit)	14 bike racks (provided on-street)	14
Commercial Class 1 Bike Parking	1 (0.27 spaces/100m ²)	1 (provided in parkade)	1
Commercial Class 2 Bike Parking	1 (0.4 space/100m ²)	1 (provided in parkade)	1
Loading Spaces	2 medium (SU9) spaces	-	2 shared medium spaces (SU9)

Note: A parking variance is required but supported based on the provision of affordable housing.

5. The proposed development also includes traffic signal modifications required at the sole cost of the owner/developer including but not limited to:
- Traffic pole/base relocations along the frontage of the development;
 - Junction box/conduit relocations;
 - Associated traffic signal cables/conductors and vehicle detector loops; and
 - Traffic signal modification design drawings if required and identified during the SA process.

Engineering and Servicing

1. All requested frontage improvements and utility upgrades are included in the SA requirements.
2. District Energy Utility (DEU): The owner/developer has agreed to the provision of a DEU-ready building including the registration of appropriate legal agreements in the Land Title Office to the approval of the City. See the Development Permit considerations for the details.
3. Supplemental Work: The owner/developer has also agreed to carry out the necessary survey and legal work to ensure the dedication of two (2) City-owned lots as road right-of-ways that formalize the road corridor for Buswell Street. These road dedications are required to facilitate both City and private utility servicing. All costs associated with these land dedications shall be borne by the owner/developer, including but not limited to survey work, preparation of legal plans and filing at the Land Title Office. See the Development Permit considerations for the details.

Sustainability and Crime Prevention Through Environmental Design (CPTED)

Sustainability

1. The proposed development includes the following sustainability features:
 - a) The site is close to transit, schools, shopping, and services;
 - b) The use of concrete construction for longer-life span;
 - c) The building would be designed to be DEU-ready;
 - d) Electric vehicle charging stations and preducting to expand the availability of plug-ins;
 - e) An efficient building envelope including entry overhangs improving building durability;
 - f) Both active and passive solar design features including balconies, louvers and roof overhangs to provide solar shading and exterior wall assemblies including low E glass to ensure an energy efficient design;
 - g) A balanced mechanical ventilation system;
 - h) All units provided with operable windows and corner units with windows on two sides to encourage passive cooling through cross ventilation;
 - i) A high albedo roof design with light grey patterned 2 ply SBS material on the upper roof;
 - j) A landscaped podium rooftop with planting beds and with garden plots;
 - k) Rainwater collection for watering on roof deck levels; and
 - l) Sustainable fit and finish of the building including energy star appliances, low flow fixtures, low VOC materials and finishes plus reduced allergen carpeting.

CPTED

1. The proposed development includes the following CPTED features:
 - a) Visible or no dead-end corridors in the parkade;
 - b) Parkade lighting and interior walls painted white;
 - c) Overlook to landscape roof deck areas from adjacent residential units;
 - d) Security features in the building lobby to limit access;
 - e) Retail at-grade with secure rear service entries;
 - f) Secured garbage, storage, and bike storage rooms;
 - g) Access control to the parkade via an overhead gate to the parkade for residents; and
 - h) Glazing to vestibule doors and enclosed corridors.

Conclusions

This development proposal provides an appropriate design response for this narrow site. The slender tower presents a welcome deviation from the usual broad based towers typical in Richmond with minimal view obstruction and over shading for surrounding development sites. The proposed built form responses to the surrounding urban fabric with enhanced facade treatments and an appropriate streetscape design. The tower location, which is set back from the corner, suggest a staggered pattern of tower placement on future development sites along Cook Road, which would allow for these consolidated sites to achieve the maximum allowable density. Staff supports this Development Permit application.



Brian Guzzi, MCIP, MCSLA
Senior Planner - Urban Design

BG:cas

Att:

Attachment 1: Development Application Data Sheet

Attachment 2: Advisory Design Panel Comments and Applicant Responses

Prior to forwarding this application to Council for Development Permit approval, the developer is required to complete the following requirements:

1. Provision of surveys, legal and other work required to dedicate two (2) City-owned lots (identified below) along the Buswell Street for road, utility and frontage upgrade purposes. The dedication of these City-owned lots is required to facilitate City and private utility servicing. All costs associated with these land dedication shall be borne by the owner/developer.
 - a) Northern lot:
PID: 011-212-705
Legal Address: Lot 38, Section 9, Block 4 North, Range 6 West, Plan 7312
 - b) Southern lot:
PID: 010-335-579
Legal Description: Lot 27, Section 9, Block 4 North, Range 6 West, Plan 7312
2. Provision the following Statutory Right of Ways (SRW's) along Cook Road:
 - a) A minimum 4.20m wide Statutory Right-of-Way (SRW) along the entire Cook Road for road, utility and frontage upgrade purposes to be designed and constructed by the owner/developer according Road Functional Plan(s) approved by the Director of Development and the Director of Transportation and maintained by the City;
 - b) A minimum 4m x 4m corner cut Statutory Right-of-Way (SRW) for road, utility and frontage upgrade purposes at the Cook Road and Buswell Street intersection to be designed and constructed by the owner/developer according Road Functional Plan(s) approved by the Director of Development and the Director of Transportation and maintained by the City; and
3. Provision the following Statutory Right of Ways (SRW's) along Buswell Street:

- a) A minimum 1.1m wide Rights of Passage – Right of Way (PROP-ROW) along the entire Buswell Street frontage for road, utility and frontage upgrade purposes to be designed and constructed by the owner/developer according Road Functional Plan(s) approved by the Director of Development and the Director of Transportation and maintained by the City;
 - b) A minimum 3m x 3m corner cut Statutory Right-of-Way (SRW) for road, utility and frontage upgrade purposes at the intersection of Buswell Street and the lane to be designed and constructed by the owner/developer according Road Functional Plan(s) approved by the Director of Development and the Director of Transportation and maintained by the City.
4. Provision the following Statutory Right of Ways (SRW's) along the south property line adjacent to the lane:
- a) A minimum 3.0m wide Statutory Right-of-Way (SRW) along the entire south property line adjacent to the lane for road, utility and frontage upgrade purposes to be designed and constructed by the owner/developer according Road Functional Plan(s) approved by the Director of Development and the Director of Transportation and maintained by the City.
5. City acceptance of the developer's offer to voluntarily contribute \$55,902.00 to the City's Public Art Reserve (e.g. total residential floor area or 70,551 ft² x \$0.77/ft² plus total commercial floor area or 3,849 ft² x \$0.41/ft²) in lieu of an on-site public art installation.
6. Receipt of a landscape Letter of Credit. The amount is based on an updated landscape cost estimate from a BC registered Landscape Architect including a 10% contingency.
7. Submission of an acoustical and mechanical report and recommendations prepared by an appropriate registered professional, which demonstrates that the interior noise levels and noise mitigation standards comply with the City's Official Community Plan and Noise Bylaw requirements. The standard required for air conditioning systems and their alternatives (e.g. ground source heat pumps, heat exchangers and acoustic ducting) is the ASHRAE 55-2004 "Thermal Environmental Conditions for Human Occupancy" standard and subsequent updates as they may occur. Maximum interior noise levels (decibels) within the dwelling units must achieve CMHC standards follows:

Portions of Dwelling Units	Noise Levels (decibels)
Bedrooms	35 decibels
Living, dining, recreation rooms	40 decibels
Kitchen, bathrooms, hallways, and utility rooms	45 decibels

8. Registration of an Aircraft Noise Sensitive Use Covenant on title in the Land Title Office.
- a. Registration of a legal agreement on title identifying that the proposed development must be designed and constructed in a manner that mitigates potential aircraft and road noise to the proposed dwelling units. Dwelling units must be designed and constructed to achieve:
 - i. CMHC guidelines for interior noise levels as indicated in the chart below:

Portions of Dwelling Units	Noise Levels (decibels)
Bedrooms	35 decibels
Living, dining, recreation rooms	40 decibels
Kitchen, bathrooms, hallways, and utility rooms	45 decibels

 - ii. The ASHRAE 55-2004 "Thermal Environmental Conditions for Human Occupancy" standard for interior living spaces.
9. Registration of a flood indemnity covenant on title.
10. Registration of the City's standard Housing Agreement to secure 5 affordable housing units, the combined habitable floor area of which shall comprise at least 5% of the subject development's total residential building area. Occupants of the affordable housing units subject to the Housing Agreement shall enjoy full and unlimited access to and use of all on-site indoor and outdoor amenity spaces. The terms of the Housing Agreements shall indicate that they apply in perpetuity and provide for the following:

Unit Number	Unit Type	No. of Units	Unit Area	Minimum Unit Area	Maximum Monthly Unit Rent**	Total Maximum Household Income**
AFHU 1 Level 2	1 Bedroom	1	707 ft ²	535 ft ²	\$950.00/month	\$38,000 or less
AFHU 2 Level 2	1 Bedroom	1	685 ft ²	535 ft ²	\$950.00/month	\$38,000 or less
AFHU 1 Level 3	1 Bedroom	1	707 ft ²	535 ft ²	\$950.00/month	\$38,000 or less
AFHU 2 Level 3	1 Bedroom	1	685 ft ²	535 ft ²	\$950.00/month	\$38,000 or less
AFHU B Level 5	2 Bedroom	1	853 ft ²	860 ft ²	\$1,162.00/month	\$46,500 or less
		5	3,637 ft ²			

** May be adjusted periodically as provided for under adopted City policy.

11. Registration of a restrictive covenant and/or alternative legal agreement(s), subject to the approval of the Director of Engineering to secure the owner's/developer's commitment to connect to a District Energy Utility (DEU), which covenant and/or legal agreement(s) will include, at minimum, the following terms and conditions:
 - a) No building permit will be issued for a building on the subject site unless the building is designed with the capability to connect to and be serviced by a DEU and the owner has provided an energy modelling report satisfactory to the Director of Engineering;
 - b) If a DEU is available for connection, no final building inspection permitting occupancy of a building will be granted until the building is connected to the DEU and the owner/developer enters into a Service Provider Agreement on terms and conditions satisfactory to the City and grants or acquires the Statutory Right-of-Way(s) and/or easements necessary for supplying the DEU services to the building;
 - c) If a DEU is not available for connection, no final building inspection permitting occupancy of a building will be granted until:
 - the City receives a professional engineer's certificate stating that the building has the capability to connect to and be serviced by a DEU;
 - the owner/developer enters into a covenant and/or other legal agreement to require that the building connect to a DEU when a DEU is in operation;
 - the owner/developer grants or acquires the Statutory Right-of-Way(s) and/or easements necessary for supplying DEU services to the building; and
 - the owner/developer provides to the City a letter of credit, in an amount satisfactory to the City, for costs associated with acquiring any further Statutory Right of Way(s) and/or easement(s) and preparing and registering legal agreements and other documents required to facilitate the building connecting to a DEU when it is in operation."
12. Registration of an appropriate legal agreement on title in the Land Title Office to ensure that the fourteen (14) shared commercial/residential visitor parking spaces are unassigned. This legal agreement is subject to the approval of the Director of Transportation.
13. Registration of an appropriate legal agreement on title in the Land Title Office to ensure that the two (2) medium sized (SU9) loading spaces are shared between the residential and commercial uses at all times. This legal agreement is subject to the approval of the Director of Transportation.
14. Registration of an appropriate legal agreement on title in the Land Title Office to ensure that the appropriate number of electrical vehicle charging stations are supplied and installed in the proposed parking structure to service the following number of electrical vehicle parking spaces:
 - a) A minimum of 20% of parking stalls to be provided with a 120V receptacle to accommodate electric vehicle charging equipment; and
 - b) An additional 25% of parking stalls to be constructed to accommodate the future installation of electric vehicle charging equipment (e.g. pre-ducted for future wiring).

15. Enter into a Servicing Agreement* for the design and construction of infrastructure upgrades and frontage improvements for the property located at 6511 Buswell Street. Works include, but may not be limited to the following:

A. Infrastructure Upgrades:

a) Drainage Works Servicing:

- i. Storm analysis is not required but the lane drainage from existing manhole STMH6237 (approx. 20m west of the west property line of development site) to existing manhole STMH6248 (Buswell Street) with a length of 56m must be upgraded to a min. 300mm by the developer.
- ii. The development site is to connect to the storm sewer on Cook Road.
- iii. The existing storm sewer along Cook Road and the rear lane is in close proximity to the development site. A geotechnical assessment is required to determine the impact due to site preparation, de-watering, drilling, underpinning, anchoring, shoring, piling, pre-loading, ground densification or other activities; the developer may be required to repair/relocate the existing storm sewer.

b) Water Works Servicing:

- i. Using the OCP Model, there is 182.9 L/s available at 20 psi residual on Cook Rd. Based on your zoning, your site requires a minimum fire flow of 220 L/s. The developer must submit fire flow calculations signed and sealed by a professional engineer based on F.U.S or ISO to confirm that there is adequate available flow to service the site; if the site cannot be serviced, upgrades will be required. The developer is responsible for the under-grounding of the existing private utility pole line and/or the installation of pre-ducting along Cook Road and Buswell Street frontage and the lane, subject to concurrence from the private utility companies. Private utility companies will require rights-of-ways for their equipment (i.e. vistas, kiosks, transformers, etc.) and/or to accommodate the future under-grounding of the overhead lines. The developer is required contact the private utility companies to learn of their requirements.
- ii. The distance from the existing fire hydrant to the southeast corner of the development site is approximately 115m, which exceeds the minimum 75m hydrant spacing required for commercial/industrial/multifamily areas. Since there is no watermain on Buswell Street, the developer's consultant's is responsible to ensure adequate fire hydrants are available. Approval may be required from Richmond Fire Department and the developer's consultant is required to provide written confirmation (signed/sealed).
- iii. The existing watermain along Cook Road is in close proximity to the development site. A geotechnical assessment is required to determine the impact due to site preparation, de-watering, drilling, underpinning, anchoring, shoring, piling, pre-loading, ground densification or other activities; the developer may be required to repair/relocate the existing watermain.

c) Sanitary Works Servicing:

- i. Under the OCP scenario the Richmond Centre Pump Station does not have adequate capacity to service the existing catchment area; the City has proposed to modify the catchment area and redirect flows from several properties to the Buswell Pump Station. This will require construction new a gravity sanitary system. Each development site will be responsible, at a minimum, for their frontage. The developer is required to provide contribution in the amount of \$122,378.00 (to be deposited into to account 2253-10-000-14913) for future sanitary sewer works within the pump station catchment.
- ii. The development site is to connect to the existing sanitary sewer along the rear lane at the east property line. A new manhole is required on the existing sanitary sewer.
- iii. The existing sanitary sewer along the lane is in close proximity to the development site. A geotechnical assessment is required to determine the impact due to site preparation, de-watering, drilling, underpinning, anchoring, shoring, piling, pre-loading, ground densification or other activities. The developer may be required to repair and/or relocate the existing sanitary sewer if deemed appropriate by the City.

B. Frontage Improvements:

- a) Provision of the following to support Transit-Oriented Development (TOD) in consideration of a parking variance (applying City Centre Zone 1 parking rates):
 - APS (Accessible Pedestrian Signals) and illuminated street name signs;
 - Three (3) benches (1 along the Cook Road frontage and 2 on Buswell Street near the bus stop) instead of SRW's for benches and a bus shelter pad; and
- b) Intersection Upgrades: The off-site improvements to include the design and construction of traffic signal modifications at the sole cost of the owner/developer including but not limited to:
 - Traffic pole/base relocations along the frontage of the development;
 - Junction box/conduit relocations;
 - Associated traffic signal cables/conductors and vehicle detector loops;
 - Traffic signal modification design drawings if required and identified during the SA process.
- c) Cook Road: Design and construct a new, minimum 2m wide City Centre standard sidewalk from the back of the new SRW with the remaining boulevard width to existing south curb of Cook Road to be hard surfaced to the satisfaction of Transportation staff. See the Servicing Agreement design drawing (SA 09-486006) for the recently constructed frontage improvements associated with the mixed-use, high-rise development located at 8160 Park Road. City infrastructure shall be located in the ultimate location(s).
- d) Buswell Street: Design and construct a new, minimum 2m wide City Centre standard sidewalk from the back of the new SRW with the remaining boulevard width to existing west curb of Buswell Street to be a landscaped boulevard. See also Buswell Street frontage details as part of SA 09-486006 for 8160 Park Road.
- e) Lane: Design and construct lane upgrades to City Centre standard with a new 1.5m wide concrete sidewalk and lighting along the north side of the lane.

Prior to Building Permit Issuance, the developer must complete the following requirements:

1. Submission of a Construction Parking and Traffic Management Plan to the Transportation Division. Management Plan shall include location for parking for services, deliveries, workers, loading, application for any lane closures, and proper construction traffic controls as per Traffic Control Manual for works on Roadways (by Ministry of Transportation) and MMCD Traffic Regulation Section 01570.
2. Incorporation of accessibility measures in Building Permit (BP) plans as determined via the Development Permit process.
3. Obtain a Building Permit (BP) for any construction hoarding. If construction hoarding is required to temporarily occupy a public street, the air space above a public street, or any part thereof, additional City approvals and associated fees may be required as part of the Building Permit. For additional information, contact the Building Approvals Division at 604-276-4285.

Note:

- * This requires a separate application.
- Where the Director of Development deems appropriate, the preceding agreements are to be drawn not only as personal covenants of the property owner/developer but also as covenants pursuant to Section 219 of the Land Title Act.
- All agreements to be registered in the Land Title Office shall have priority over all such liens, charges and encumbrances as is considered advisable by the Director of Development. All agreements to be registered in the Land Title Office shall, unless the Director of Development determines otherwise, be fully registered in the Land Title Office prior to enactment of the appropriate bylaw.
- The preceding agreements shall provide security to the City including indemnities, warranties, equitable/rent charges, letters of credit and withholding permits, as deemed necessary or advisable by the Director of Development. All agreements shall be in a form and content satisfactory to the Director of Development.

- Additional legal agreements, as determined via the subject development's Servicing Agreement(s) and/or Development Permit(s), and/or Building Permit(s) to the satisfaction of the Director of Engineering may be required including, but not limited to, site investigation, testing, monitoring, site preparation, de-watering, drilling, underpinning, anchoring, shoring, piling, pre-loading, ground densification or other activities that may result in settlement, displacement, subsidence, damage or nuisance to City and private utility infrastructure.
- Applicants for all City Permits are required to comply at all times with the conditions of the Provincial *Wildlife Act* and Federal *Migratory Birds Convention Act*, which contain prohibitions on the removal or disturbance of both birds and their nests. Issuance of Municipal permits does not give an individual authority to contravene these legislations. The City of Richmond recommends that where significant trees or vegetation exists on site, the services of a Qualified Environmental Professional (QEP) be secured to perform a survey and ensure that development activities are in compliance with all relevant legislation.

Signed

Date



**City of
Richmond**

Development Application Data Sheet

Development Applications Division

DP 13-634111

Attachment 1

Address:	6511 Buswell Street	
Applicant:	Integra Architecture Inc.	Owner: Majorca International Investments Ltd.
Planning Area(s):	City Centre Area Plan – Brighouse Village	
Floor Area	Gross: 6,912 m ² (74,400 ft ²)	Net: 6,801m ² (73,200 ft ²)

	Existing	Proposed
Site Area	2,117.61 m ² (22,794 ft ²)	same
Land Uses	Commercial	Mixed-Use (commercial/residential)
OCP Designation	Urban Core T6 (45m)	same
Zoning:	Downtown Commercial (CDT1)	same
Number of Units	3 commercial units	6 CRU's & 70 residential units

	Bylaw Requirement	Proposed	Variance
Floor Area Ratio:	max. 3.0 + 0.1 amenity + 0.15 affordable housing = 3.25 FAR	3.21 FAR	None permitted
Lot Coverage:	max. 90%	79 %	None required
Setback – Cook Road:	min. 6.0 m (may be reduced to 3.0 m)	4.69 m	Variance requested
Setback - Buswell	min. 6.0 m (may be reduced to 3.0 m)	3.0 m	Variance requested
Setback – Side Yard:	min. 0.0 m	0.0 m	None required
Setback – Rear (lane) Yard:	min. 0.0 m	1.5 m	None required
Maximum Height (m):	max. 47 m geodetic	46.9 m	None required
CDT1 Required Off-Street Parking Resident/Commercial/Visitor:	R 102+V 14+C 14 = 130	-	Not applicable based on the provision of 5 units of affordable housing
CCAP – Zone 1 Off-Street Parking Spaces Resident/Commercial/Visitor:	R 70 + V 14 + C 14 = 98	R 70 + V 14 + C 7 = 91	Variance requested based on shared visitor & commercial spaces
Small Car Parking Spaces	Max. 50%	29	None required
Off-street Parking Spaces Accessible:	HC stalls min. 2% of total	2	None required
Commercial Loading Spaces:	2 medium (SU9) spaces	2 shared SU9 spaces	No variance required with legal agreement
Common Indoor Amenity Space:	min 100 m ²	111 m ²	None required
Common Outdoor Amenity Space:	min. 10% of net site area	384 m ²	None required

Attachment 2

**Excerpt from the Minutes from
The Design Panel Meeting**

**Wednesday, November 6, 2013 – 4:00 p.m.
Rm. M.1.003
Richmond City Hall**

Item 2. DP 13-634111 – MIXED-USE - RESIDENTIAL & LIMITED COMMERCIAL (70 UNITS)

APPLICANT: INTEGRA ARCHITECTURE INC.

PROPERTY LOCATION: 6511 BUSWELL STREET

Applicant's Presentation

Duane Siegrist, Integra Architecture Inc., and William Harrison, Forma Design Inc., presented the project and answered queries from the Panel on behalf of the applicant.

Panel Discussion

In reply to the written queries from absent Panel members read by the Chair, Mr. Siegrist advised that (i) the project is not aiming for a Leadership in Energy and Environmental Design (LEED) equivalency, and (ii) all units in the project meet universal design guidelines.

Comments from the Panel were as follows:

- overall, the design is well resolved, especially the tower; ---*acknowledged*
- the podium is less well resolved; ---*acknowledged – refer to the revised applicant landscape drawings*
- context drawings show that the subject site borders on a residential area; look at opportunities for further planting and landscaping; ---*acknowledged -- refer to the revised applicant landscape drawings*
- the required Statutory Right of Ways (SRWs) for road purposes, which may reduce the boulevards on the subject site, will negatively impact on the public realm; could potentially reduce the amount of planting on site; ---*acknowledged*
- the corner plaza at Buswell Street and Cook Road needs a bigger and bolder gesture; it is a good location for public art which could be incorporated with the architecture of the building; ---*acknowledged — refer to the revised applicant landscape drawings for the revised design*
- transition at the podium corners is abrupt; ---*note that there is no further ability to provide further setbacks; we do not see this as a negative impact*

- parkade wall on the west side appears blank; consider further treatment to create some liveliness; ***--concrete reveals have been indicated (refer also to development application applicant response letter)***
- the narrow building is unique in Richmond; ***--acknowledged***
- appreciate the building form and character; ***--acknowledged***
- good solar shading; spandrel glass will provide insulation; ***--acknowledged***
- agree that the corner plaza at Buswell Street and Cook Road needs further design development; look at the proportion of the concrete circular plinth and the space around it; ***--acknowledged –per item addressed above and in the development permit response letter (above)***
- programming of activities at the podium is well organized; ***--acknowledged***
- soil volume in pots may not be adequate to enable trees to reach their full growth potential; consider a different solution to avoid future maintenance problems; ***— refer to the revised applicant landscape drawings for the revised design***
- consider further design development for the raised urban agricultural plots, i.e. better integration -and arrangement; applicant needs to provide a storage shed for urban agriculture; ***— refer to the revised applicant landscape drawings for the revised design***
- vertical screens are innovative and interesting; however, consider more appropriate vine species to be incorporated; ***— refer to the revised applicant landscape drawings for the revised design***
- appreciate the appearance of the slender building; fits well into the long and narrow site; ***--acknowledged***
- the project works well due to its corner location; appreciate the building setback from Cook Road; good resolution not only for this project but also for the other future developments on the block; ***--acknowledged***
- vertical fins enhance the slender appearance of the building; gives a unique shape for the building; a welcome addition to the City Centre Area; ***--acknowledged***
- appreciate the white metal ribbon wrapping around the podium; provides a welcoming feel to the podium entries; frames the podium well and enhances the separation of the tower from the podium; ***--acknowledged***
- lay-out of the affordable housing units is unusual; concern on solar gain, livability, and privacy of the affordable housing units; ***--acknowledged –refer to the revised applicant drawings as the façade has been further refined to indicate locations of spandrel glazing and opacity to address this comment***

- the back of the elevator shaft works in an unusual way as it becomes a central theme on the concrete wall façade; applicant needs to clarify the texture on the concrete wall; and ---***acknowledged -(refer also to development application applicant response letter)***
- the applicant is advised to reconsider contributing to the City's public art fund as there are good potential locations for the public art component of the project, i.e. at the corner plaza, the metal screens, and the concrete wall at the back of the elevator shaft. ---***acknowledged and the owner is to contribute to the Public Art Fund***

The Chair noted that the Panel members present expressed general support for the project.

Due to the absence of a quorum, a Panel recommendation could not be considered.



City of Richmond

Development Permit

No. DP 13-634111

To the Holder: Integra Architecture Inc.

Property Address: 6511 Buswell Street

Address: 416 West Pender Street,
Vancouver, BC V6B 1T5

1. This Development Permit is issued subject to compliance with all of the Bylaws of the City applicable thereto, except as specifically varied or supplemented by this Permit.
2. This Development Permit applies to and only to those lands shown cross-hatched on the attached Schedule "A" and any and all buildings, structures and other development thereon.
3. The "Richmond Zoning Bylaw 8500" is hereby varied to:
 - a) Reduce the residential parking rate from the standard City-wide parking rate to the City Centre Zone 1 parking rate.
4. Subject to Section 692 of the Local Government Act, R.S.B.C.: buildings and structures; off-street parking and loading facilities; roads and parking areas; and landscaping and screening shall be constructed generally in accordance with Plans #1 to #27 attached hereto.
5. Sanitary sewers, water, drainage, highways, street lighting, underground wiring, and sidewalks, shall be provided as required.
6. As a condition of the issuance of this Permit, the City is holding the security in the amount of \$269,156.00 to ensure that development is carried out in accordance with the terms and conditions of this Permit. Should any interest be earned upon the security, it shall accrue to the Holder if the security is returned. The condition of the posting of the security is that should the Holder fail to carry out the development hereby authorized, according to the terms and conditions of this Permit within the time provided, the City may use the security to carry out the work by its servants, agents or contractors, and any surplus shall be paid over to the Holder. Should the Holder carry out the development permitted by this permit within the time set out herein, the security shall be returned to the Holder. The City may retain the security for up to one year after inspection of the completed landscaping in order to ensure that plant material has survived.
7. If the Holder does not commence the construction permitted by this Permit within 24 months of the date of this Permit, this Permit shall lapse and the security shall be returned in full.

To the Holder: Integra Architecture Inc.

Property Address: 6511 Buswell Street

Address: 416 West Pender Street,
Vancouver, BC V6B 1T5

8. The land described herein shall be developed generally in accordance with the terms and conditions and provisions of this Permit and any plans and specifications attached to this Permit which shall form a part hereof.

This Permit is not a Building Permit.


AUTHORIZING RESOLUTION NO. ISSUED BY THE COUNCIL THE
DAY OF ,

DELIVERED THIS DAY OF ,

MAYOR



City of Richmond

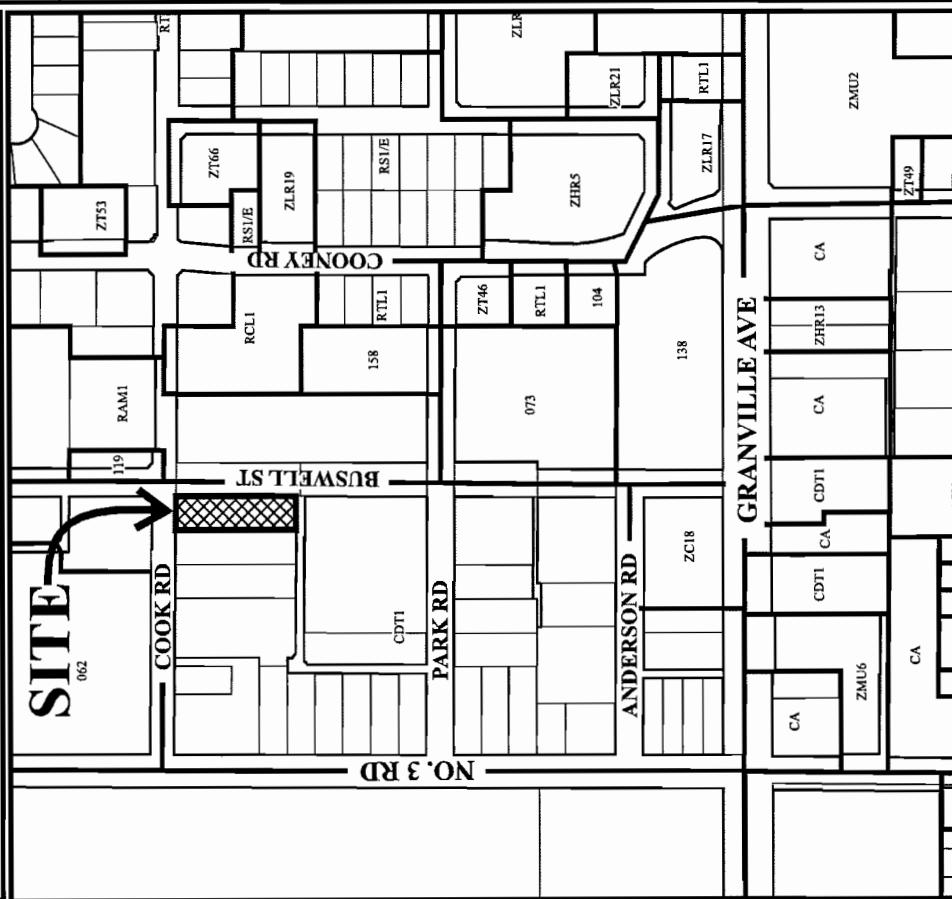


COOK RD

BUSHWELL ST


Original Date: 04/18/13
Revision Date:
Note: Dimensions are in METRES

DP 13-634111 SCHEDULE "A"

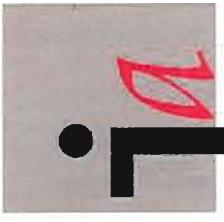


INTEGRA ARCHITECTURE INC.
416 WEST PENDER STREET
VANCOUVER, BC V6B 1T5
T 604.688.4220 F 604.688.4270
Info@integra-arch.com
www.integra-arch.com

Copyright Integra Architecture Inc. All rights reserved. This document contains neither recommendations nor conclusions of the City of Vancouver. It is the responsibility of the user to consult the official zoning bylaw and other applicable regulations of the City of Vancouver.

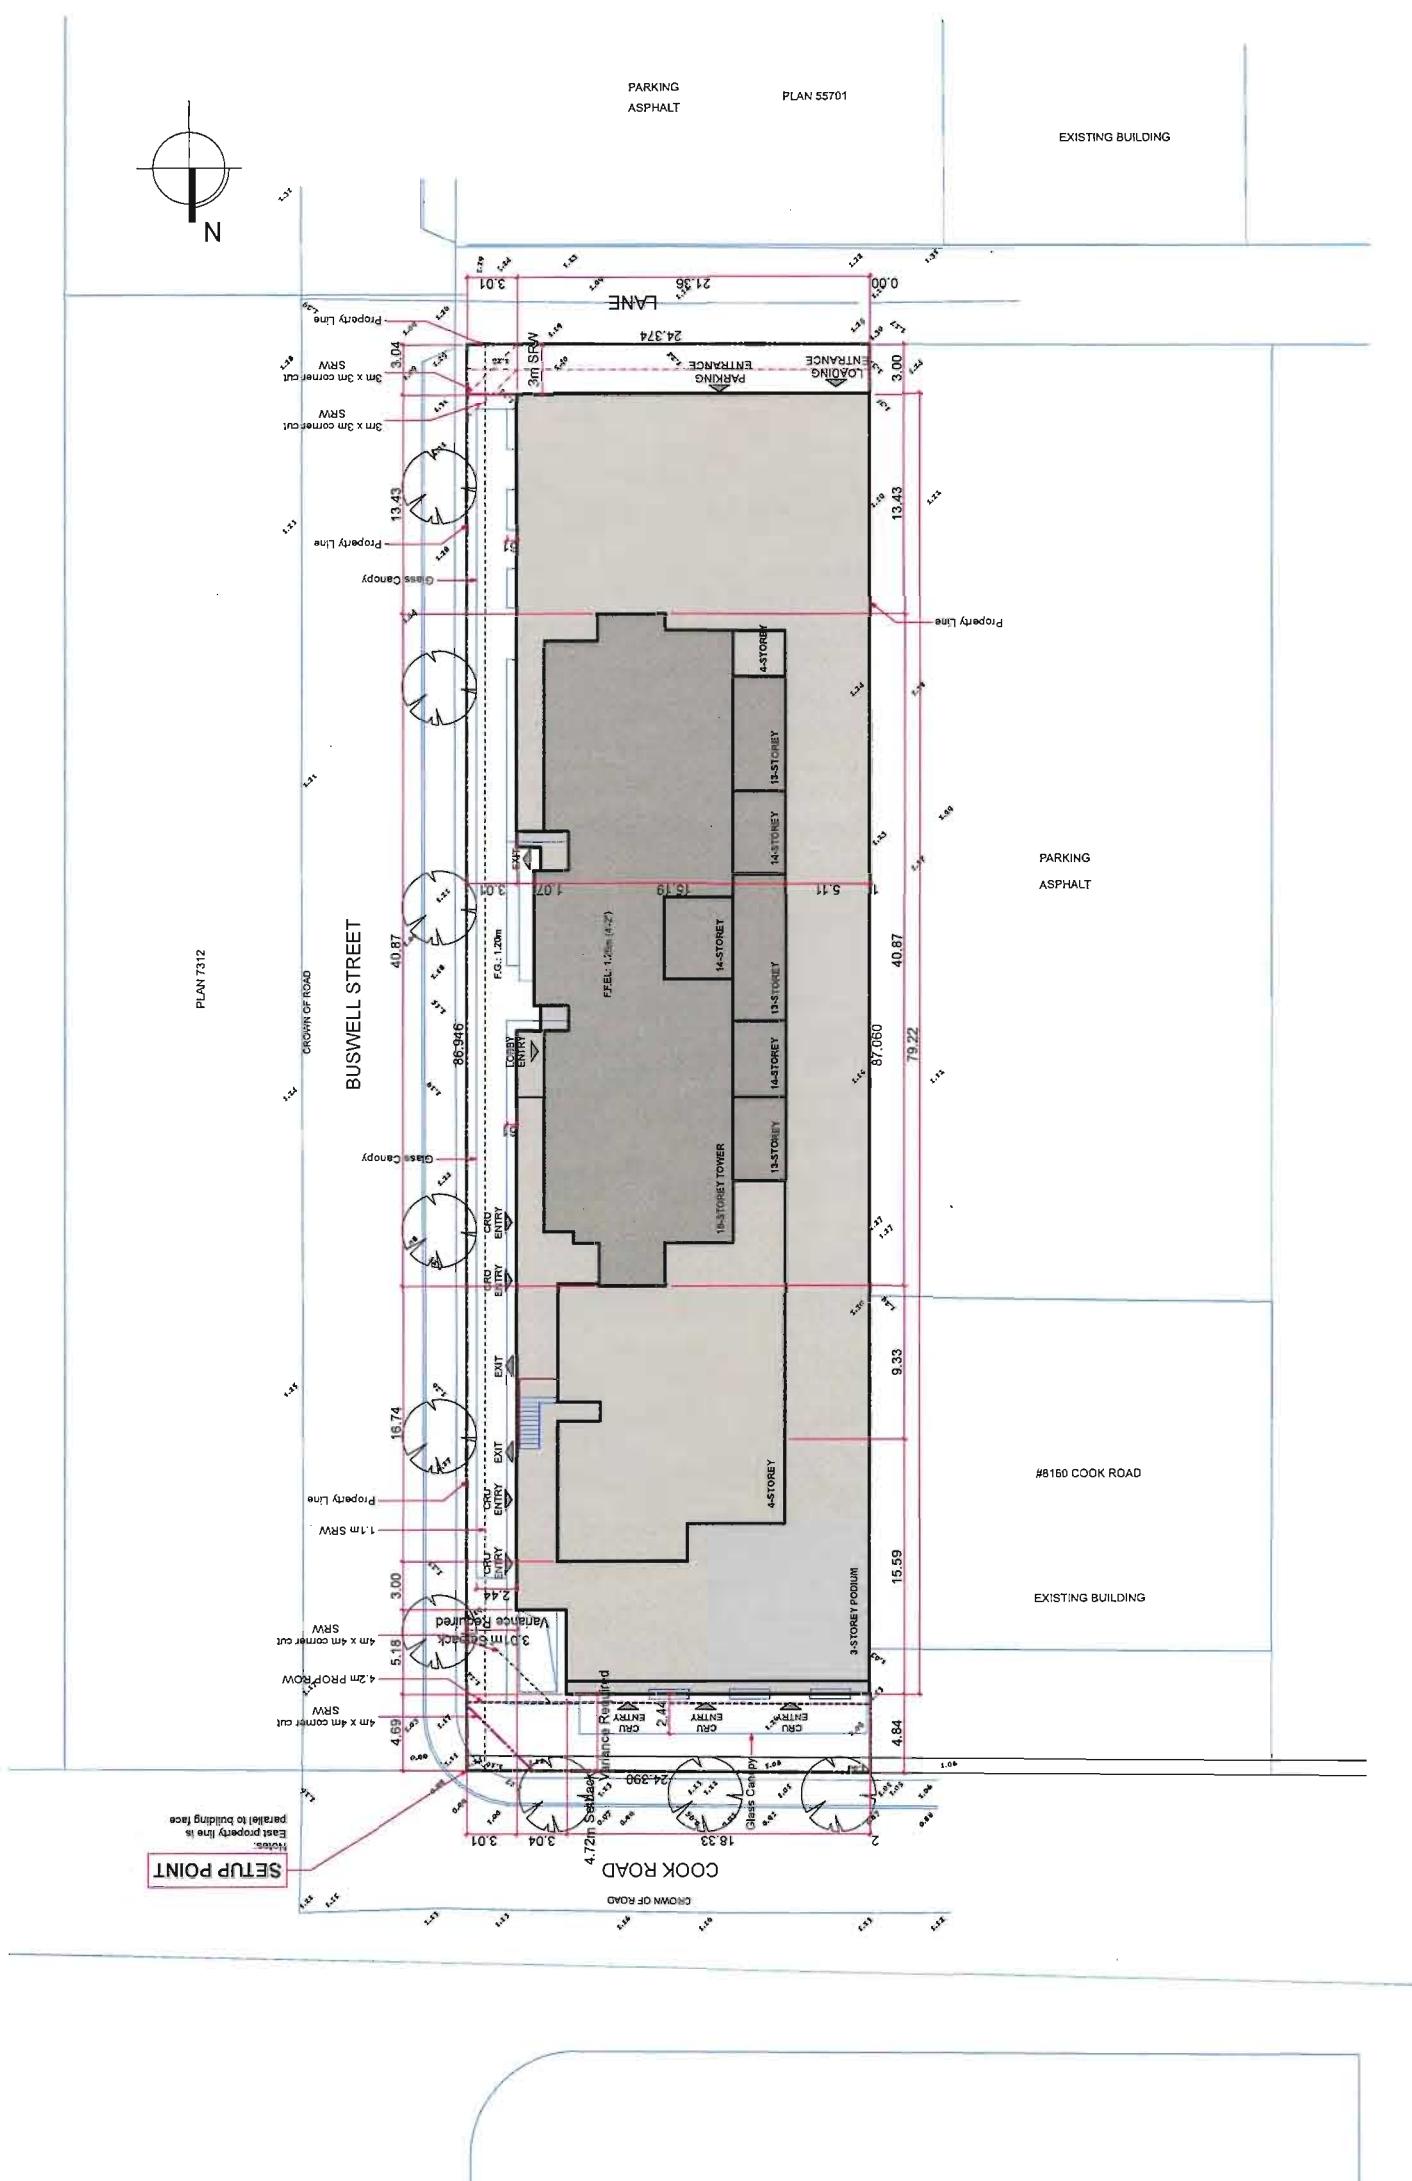


A-1.00

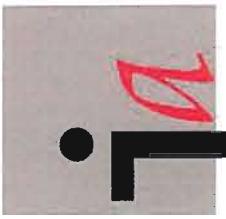


INTEGRA ARCHITECTURE INC.
416 WEST PENDER STREET
VANCOUVER, BC V6B 1T5
T 604.688.4220 F 604.688.4270
info@integra-arch.com
www.integra-arch.com

VEHICLE TURNING DIAGRAM

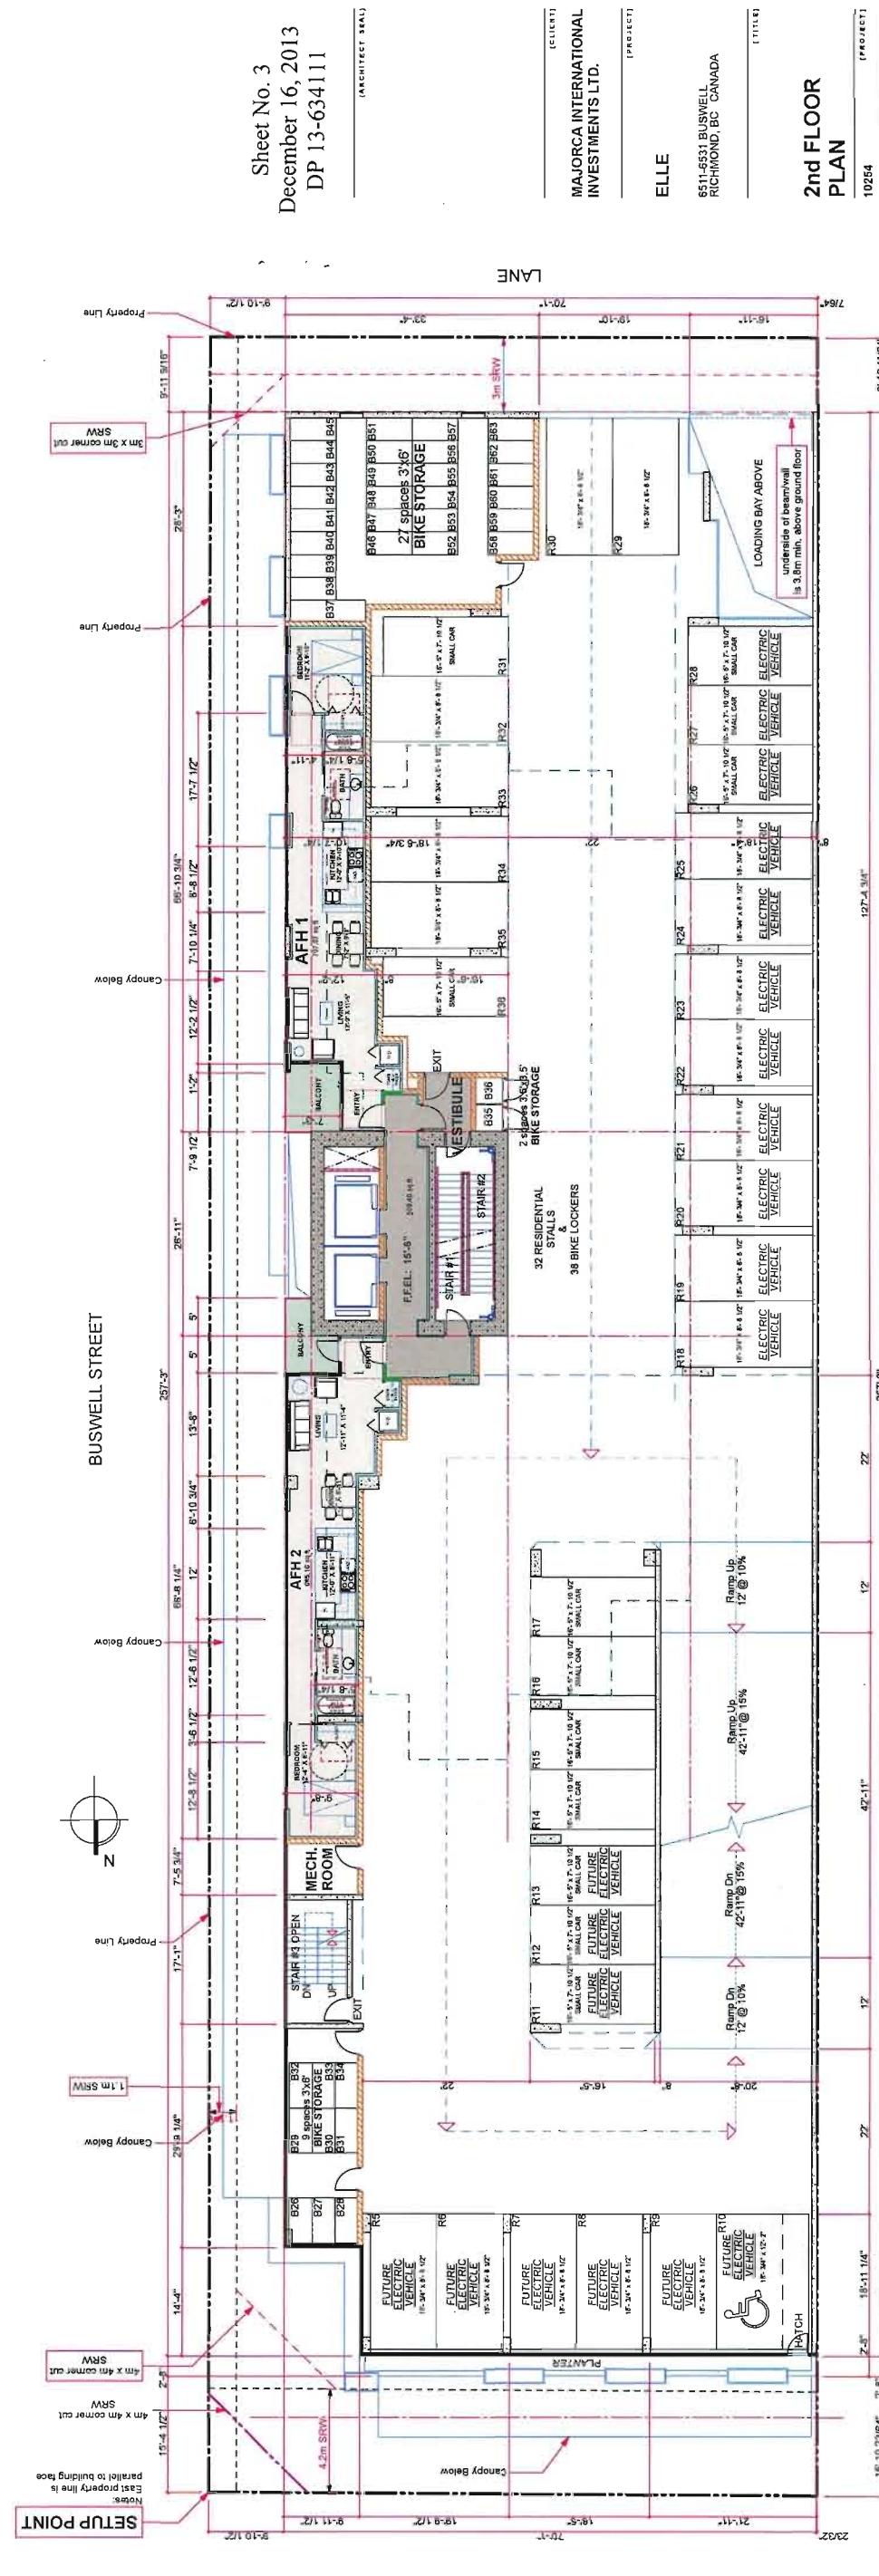

2nd EDITION

A-2.20

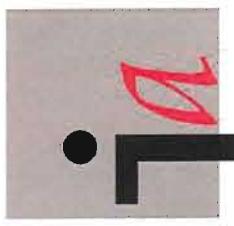

INTEGRA ARCHITECTURE INC.
416 WEST PENDER STREET
VANCOUVER, BC V6B 1T5
T 604.688.4220 F 604.688.4270
info@integra-arch.com
www.integra-arch.com


11

BUSWELL STREET

This architectural site plan illustrates the layout of Buswell Street, featuring two main buildings (AED 1 and AED 2) and surrounding infrastructure. Key features include:


- Buildings:** AED 1 (left) and AED 2 (right), each with multiple rooms and windows.
- Landscaping:** Small lawns, trees, and shrubs are scattered throughout the property.
- Infrastructure:**
 - PTAC Units:** Located on the roof of AED 1.
 - Driveway:** A paved driveway leads from the street to the rear of the buildings.
 - Storage:** A large storage area labeled "BIKE STORAGE" is located between the buildings, containing 9 spaces for 3x6' units.
 - Residential Units:** Six residential units (R1-R6) are shown along the right side of the property.
 - EV Charging Stations:** Two stations are indicated near the residential units.
 - Drainage:** A network of pipes and drains is shown at the bottom of the property.
 - Signage:** Various signs are present, including "No Trespassing", "No Smoking", and "No Dogs".
- Dimensions:** Property lines are marked with dimensions such as 28'-0" x 10'-0", 12'-0" x 10'-0", and 12'-0" x 10'-0". Building widths are also indicated.
- Vehicle Clearance:** A vehicle clearance diagram shows dimensions for Front Tire, Rear Tire, Vehicle Body, and 2ft Body Clearance.
- Steering Angles:** Steering angle diagrams for PTAC units are provided.
- Property Lines:** The property lines are clearly marked with red lines and labels like "Property Line" and "Sewer Line".

VEHICLE TURNING DIAGRAM

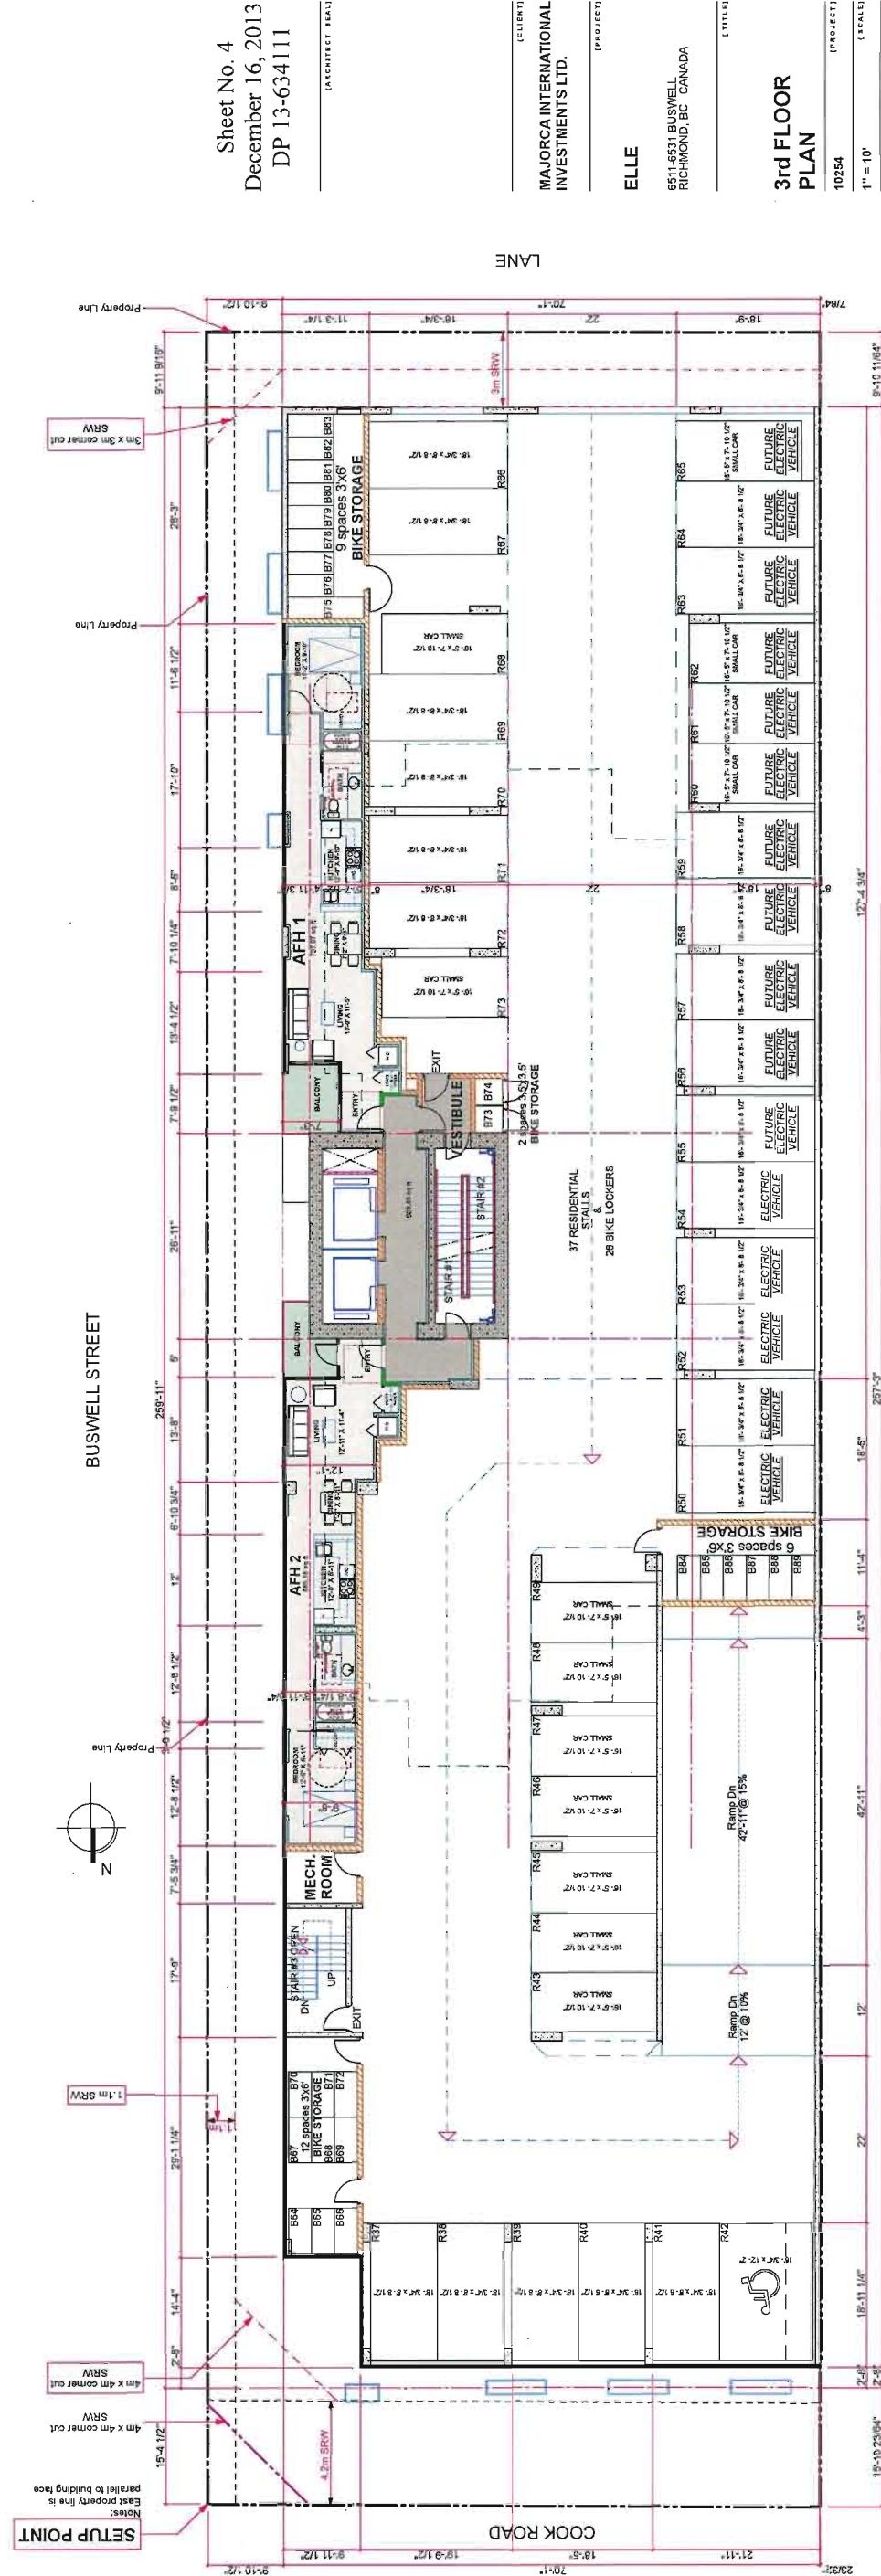


December 13, 2013 [DATE]
8 - DP Resubmission [ISSUE]

A-2.30

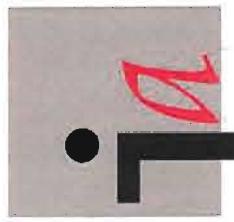

INTEGRA ARCHITECTURE INC.
4116 WEST PENDER STREET
VANCOUVER, BC V6B 1T5
T 604.688.4220 F 604.688.4270
info@integra-arch.com
www.integra-arch.com

Integra Architecture Inc. is a full-service architectural firm specializing in the design of residential, institutional, and commercial buildings. We have extensive experience in the design of multi-unit residential buildings, including townhouses, apartments, and condominiums. We also have experience in the design of institutional buildings, such as schools, hospitals, and government buildings. Our services include architectural design, engineering, and construction management. We are committed to providing our clients with high-quality designs that are both functional and aesthetically pleasing. We believe that good design is essential for creating successful buildings that meet the needs of their users. We are always looking for new opportunities to work on interesting projects and to work with new clients. If you are interested in learning more about our firm or our services, please don't hesitate to contact us. We would be happy to discuss your project with you and to provide you with a free estimate. We look forward to hearing from you.

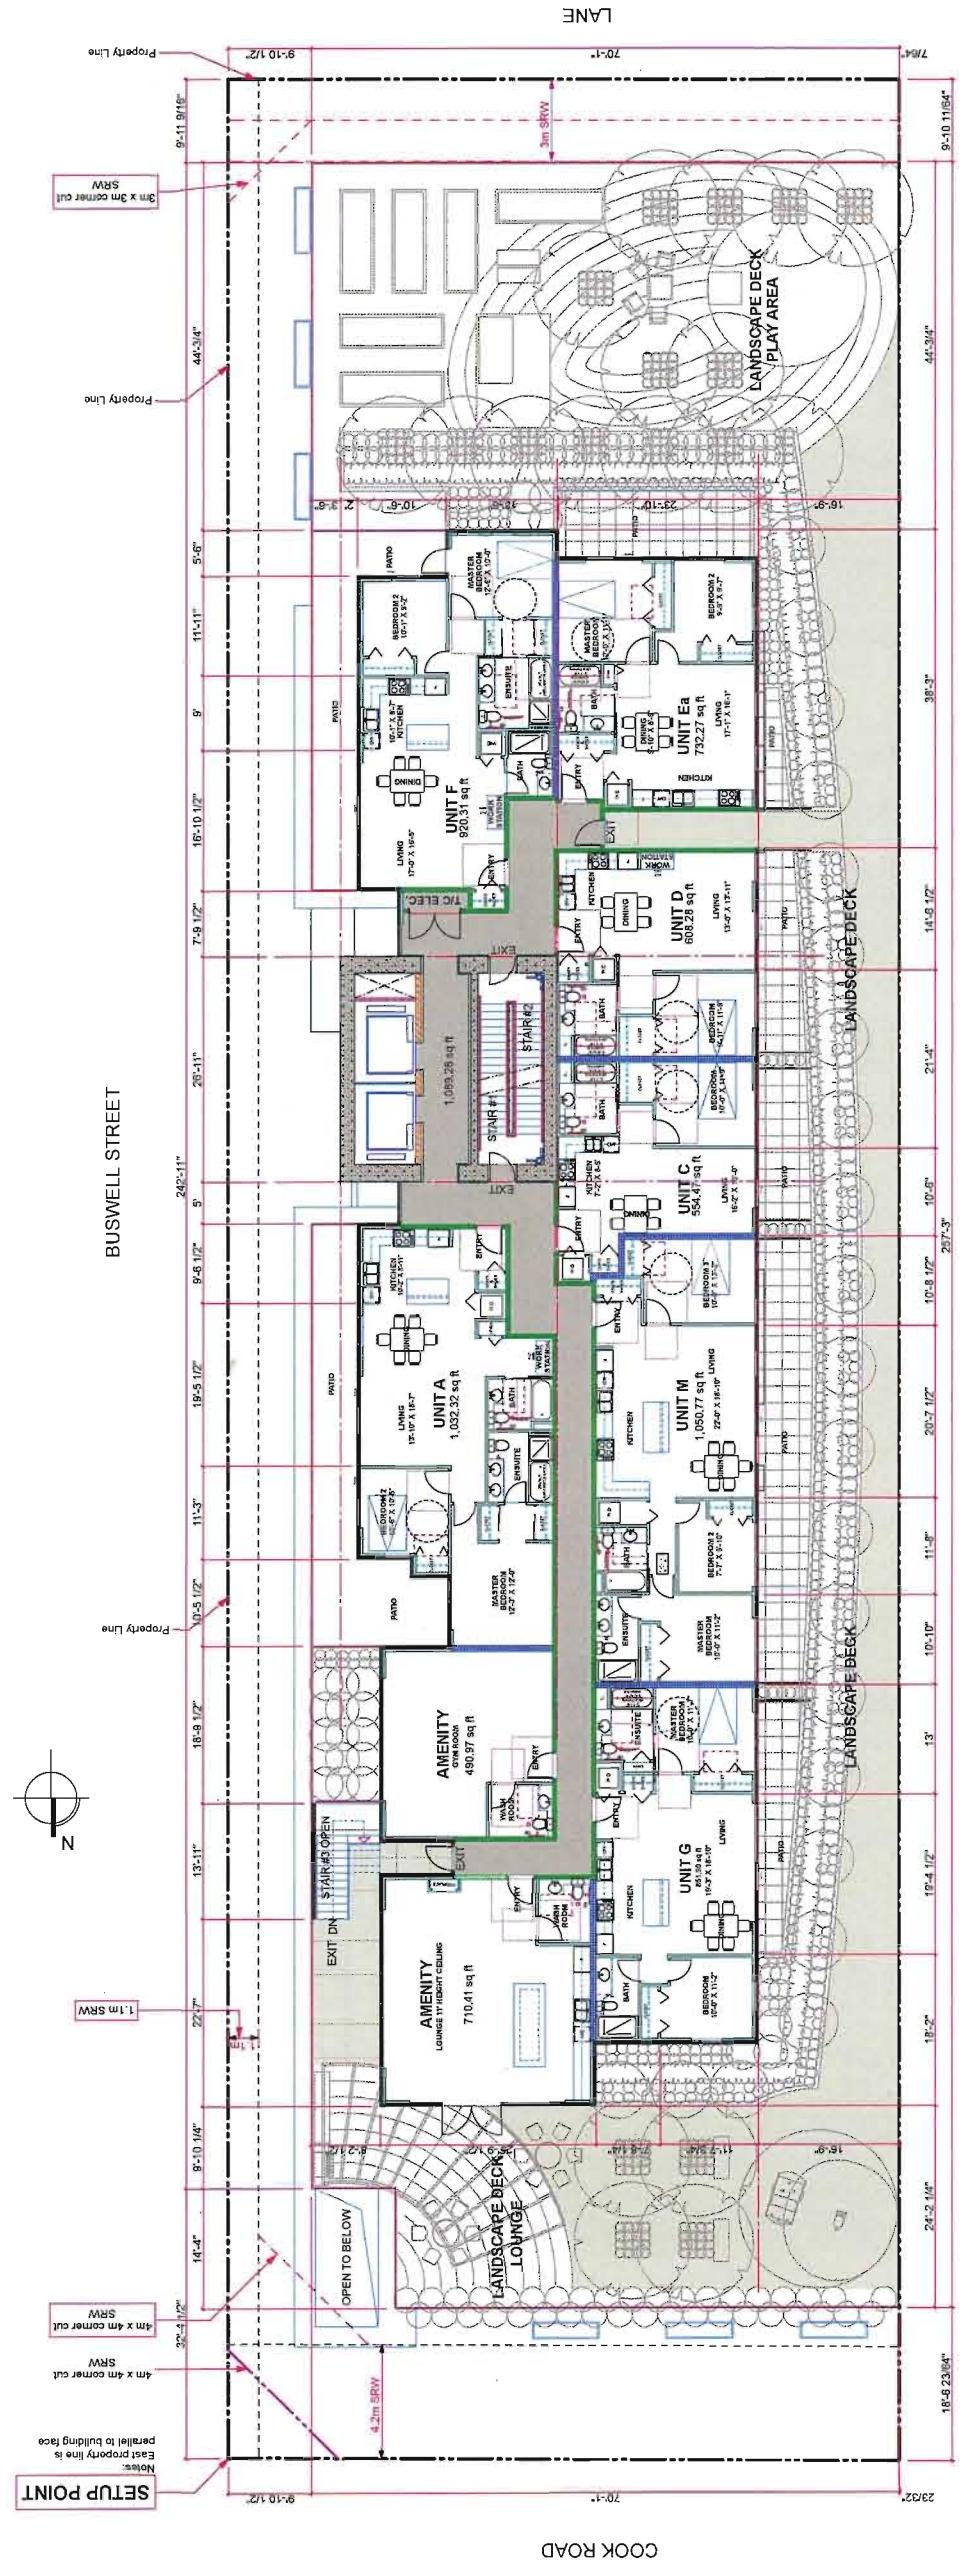

**MAJORCA INTERNATIONAL
INVESTMENTS LTD.**


ELLE

6511-6531 BUSWELL
RICHMOND, BC CANADA

[CLIENT] [PROJECT]

4th FLOOR	
PLAN	PROJECT 1
10254	1 SCALE
1"	= 10'
December 13, 2013	DATE
8 - DP Resubmission	ISSUE
	REVISION


A-2.40

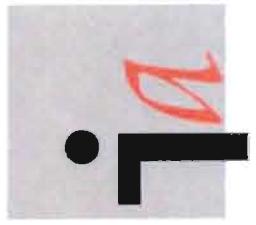

INTEGRA ARCHITECTURE INC.

416 WEST PENDER STREET
VANCOUVER, BC V6B 1T5
T 604.688.4220 F 604.688.4270
info@integra-arch.com
www.integra-arch.com

Copyright © Integra Architecture Inc. All rights reserved. This drawing contains neither recommendations nor conclusions of the City of Vancouver. It is the responsibility of the user to verify all information contained in this drawing against applicable by-laws, regulations, codes and other applicable documents.

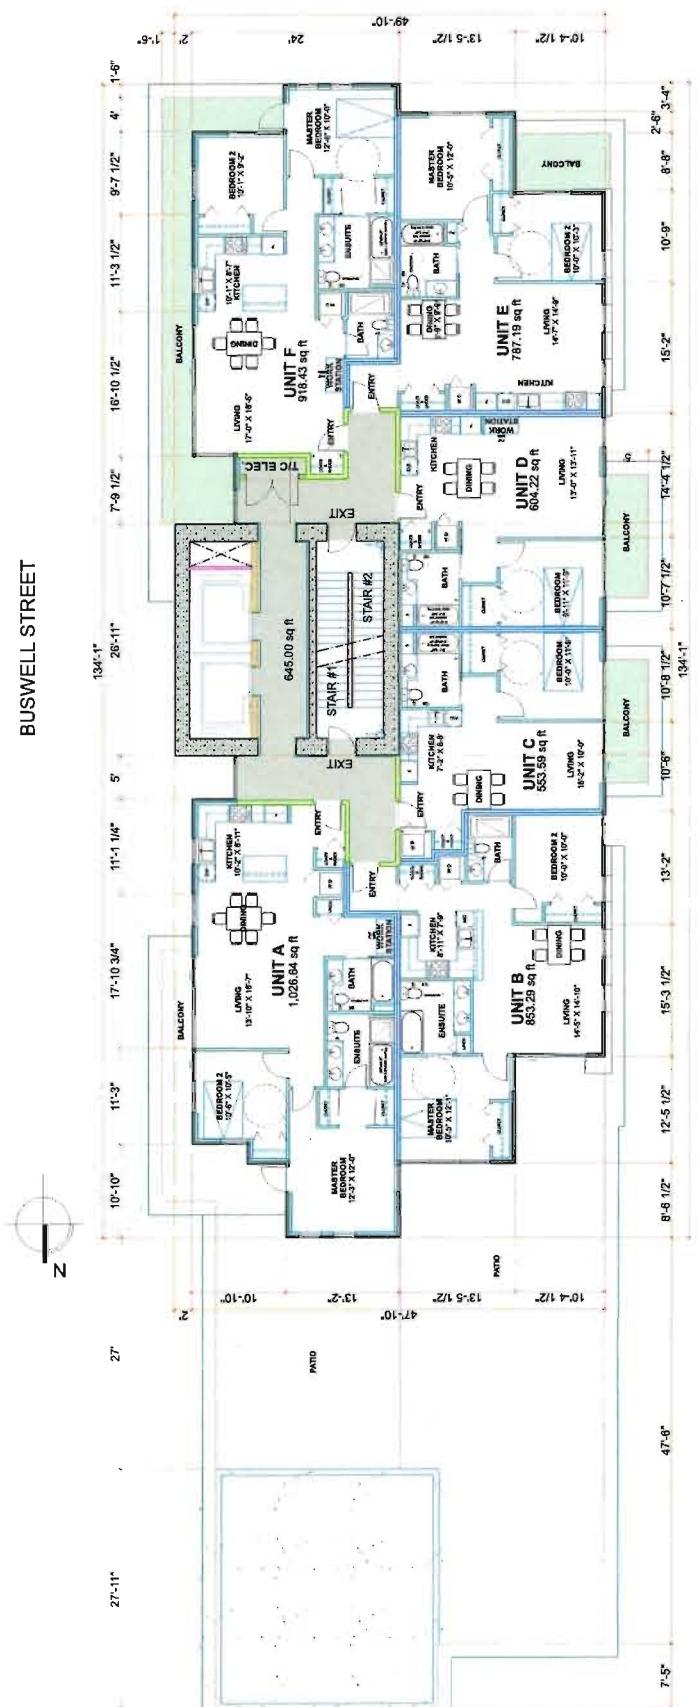


Sheet No. 6
December 16, 2013
DP 13-634111

(ELEMENT)
MAJORCA INTERNATIONAL
INVESTMENTS LTD.
(PROJECT)
ELLE

6511-6531 BUSWELL
RICHMOND, BC CANADA
(TITLE)


5th FLOOR PLAN

10254 (PROJECT)
1' = 10' (SCALE)
December 13, 2013 (DATE)
8 - DP Resubmission (STATUS)

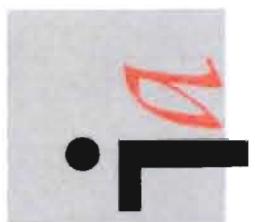

INTEGRA ARCHITECTURE INC.
416 WEST PENDER STREET
VANCOUVER, BC V6B 1T5
T 604.681.4220 F 604.688.4270
info@integra-arch.com
www.integra-arch.com

Copyright reserved. The drawings and designs contained herein are the exclusive property of Integra Architecture Inc. They are to be used only by the client named above and may not be reproduced without written consent.

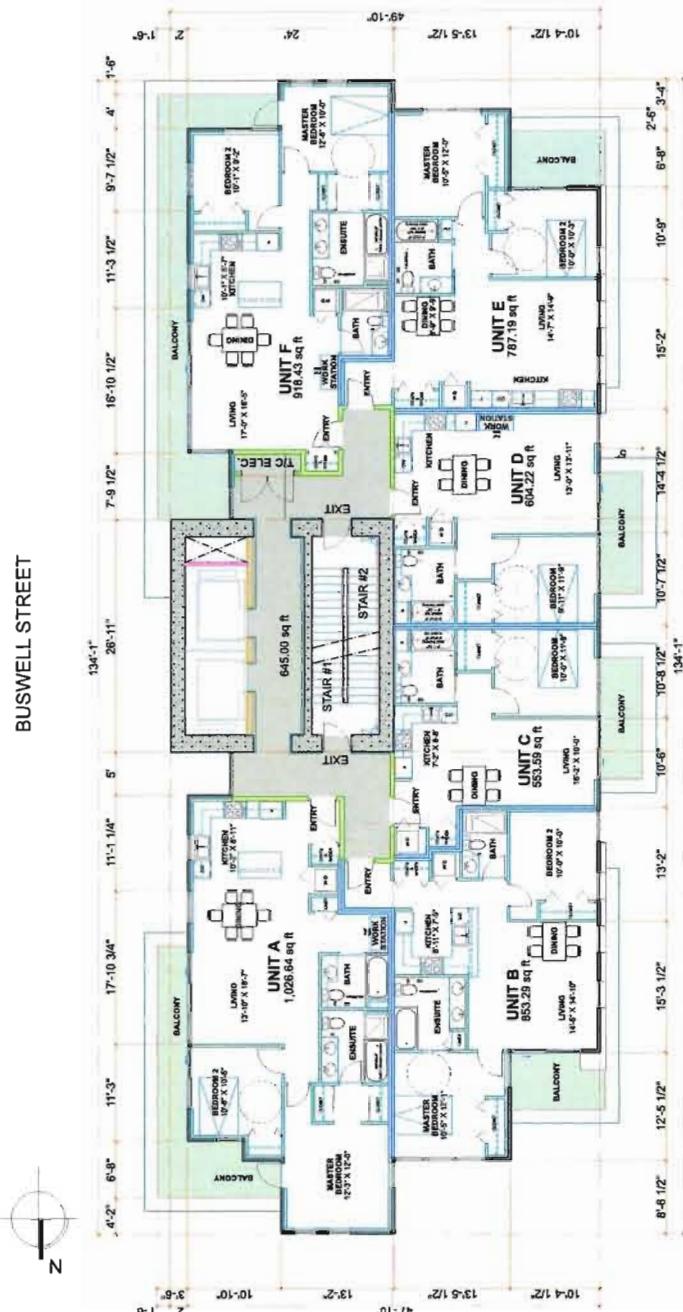

Sheet No. 7
December 16, 2013
DP 13-634111

ARCHITECTURE

MAJORCA INTERNATIONAL
INVESTMENTS LTD.

ELLE

6511-6531 BUSWELL
RICHMOND, BC CANADA

TYPICAL
6th~13rd FLOOR
PLAN


10254
1" = 10'
December 13, 2013
8 - DP Resubmission
DRAWN BY

ia

INTEGRA ARCHITECTURE INC.

416 WEST PENDER STREET
VANCOUVER, BC V6B 1T5
T 604.688.4220 F 604.688.4270
Info@integra-arch.com
www.integra-arch.com

Copyright © Integra Architecture Inc. This drawing and design is the sole property of Integra Architecture Inc. and cannot be used without the express written consent of the owner.

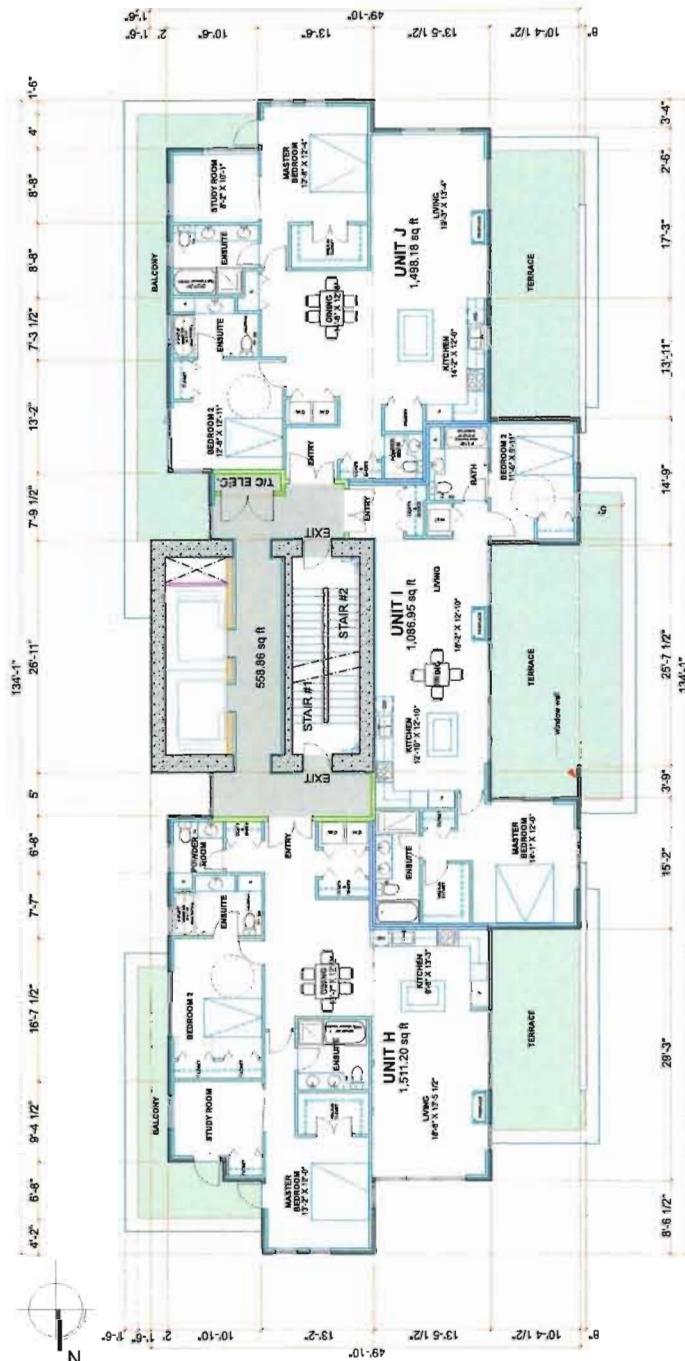

Sheet No. 8
December 16, 2013
DP 13-634111

[CLIENT]
MAJORCA INTERNATIONAL
INVESTMENTS LTD.

[PROJECT]
ELLE

[TITLE]
SUB-PENTHOUSE
14th FLOOR
PLAN

[SCALE]
1" = 10'
[DATE]
December 13, 2013
[DRAWN BY]
S - DP Resubmission
[DRAWN IN]
AutoCAD


A-2.60

1
A

INTEGRA ARCHITECTURE INC.

416 WEST PENDER STREET
VANCOUVER, BC V6B 1T5
T 604.688.4220 F 604.688.9270
info@integra-arch.com
www.integra-arch.com

Copyright reserved. This drawing and design is the sole property of Integra Architecture Inc. Any unauthorized copying or distribution is illegal.

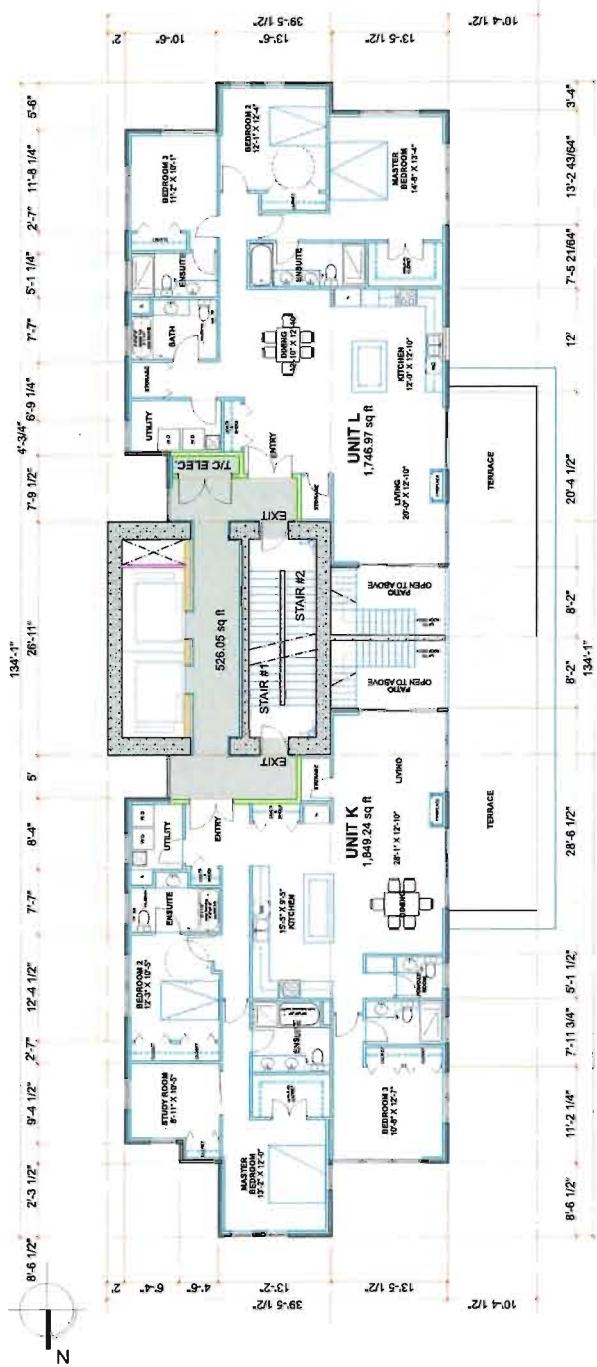


Sheet No. 9
December 16, 2013
DP 13-634111

MAJORDO INTERNATIONAL
INVESTMENTS LTD.
10254
1' = 10'
December 13, 2013
8 - DP Resubmission

ELLE

6511-6531 BUSWELL
RICHMOND, BC CANADA

PENTHOUSE
15th FLOOR
PLAN
10254
1' = 10'
December 13, 2013
8 - DP Resubmission

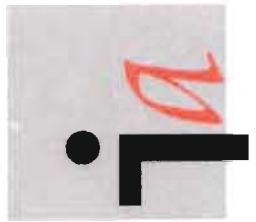

INTEGRA ARCHITECTURE INC.

416 WEST PENDER STREET
VANCOUVER, BC V6B 1T5
T 604.688.4220 F 604.688.4270
info@integra-arch.com
www.integra-arch.com

Copyright reserved. This design method is the property of INTEGRA ARCHITECTURE INC., and cannot be used without the written consent of INTEGRA ARCHITECTURE INC.

PRACTICAL

Architectural floor plan showing two levels of a building. The top level is labeled "ROOF" and contains "ELEVATOR MECH.", "MECH. SPACE", and "ROOF DECK". The bottom level is also labeled "ROOF" and contains "MECH. SPACE" and "ROOF DECK". Various dimensions are indicated around the perimeter, such as 134'-11" and 56'-1". A north arrow is present in the bottom left corner.

ROOF PLAN

Sheet No. 10
December 16, 2013
DP 13-641796


**MAJORCA INTERNATIONAL
INVESTMENTS LTD.**


[PROJECT] E11E

ROOF PLAN

1" = 10' [SCALE] December 13, 2013 [DATE]
8 - DP Resubmission [ISSUE]

A-2.80

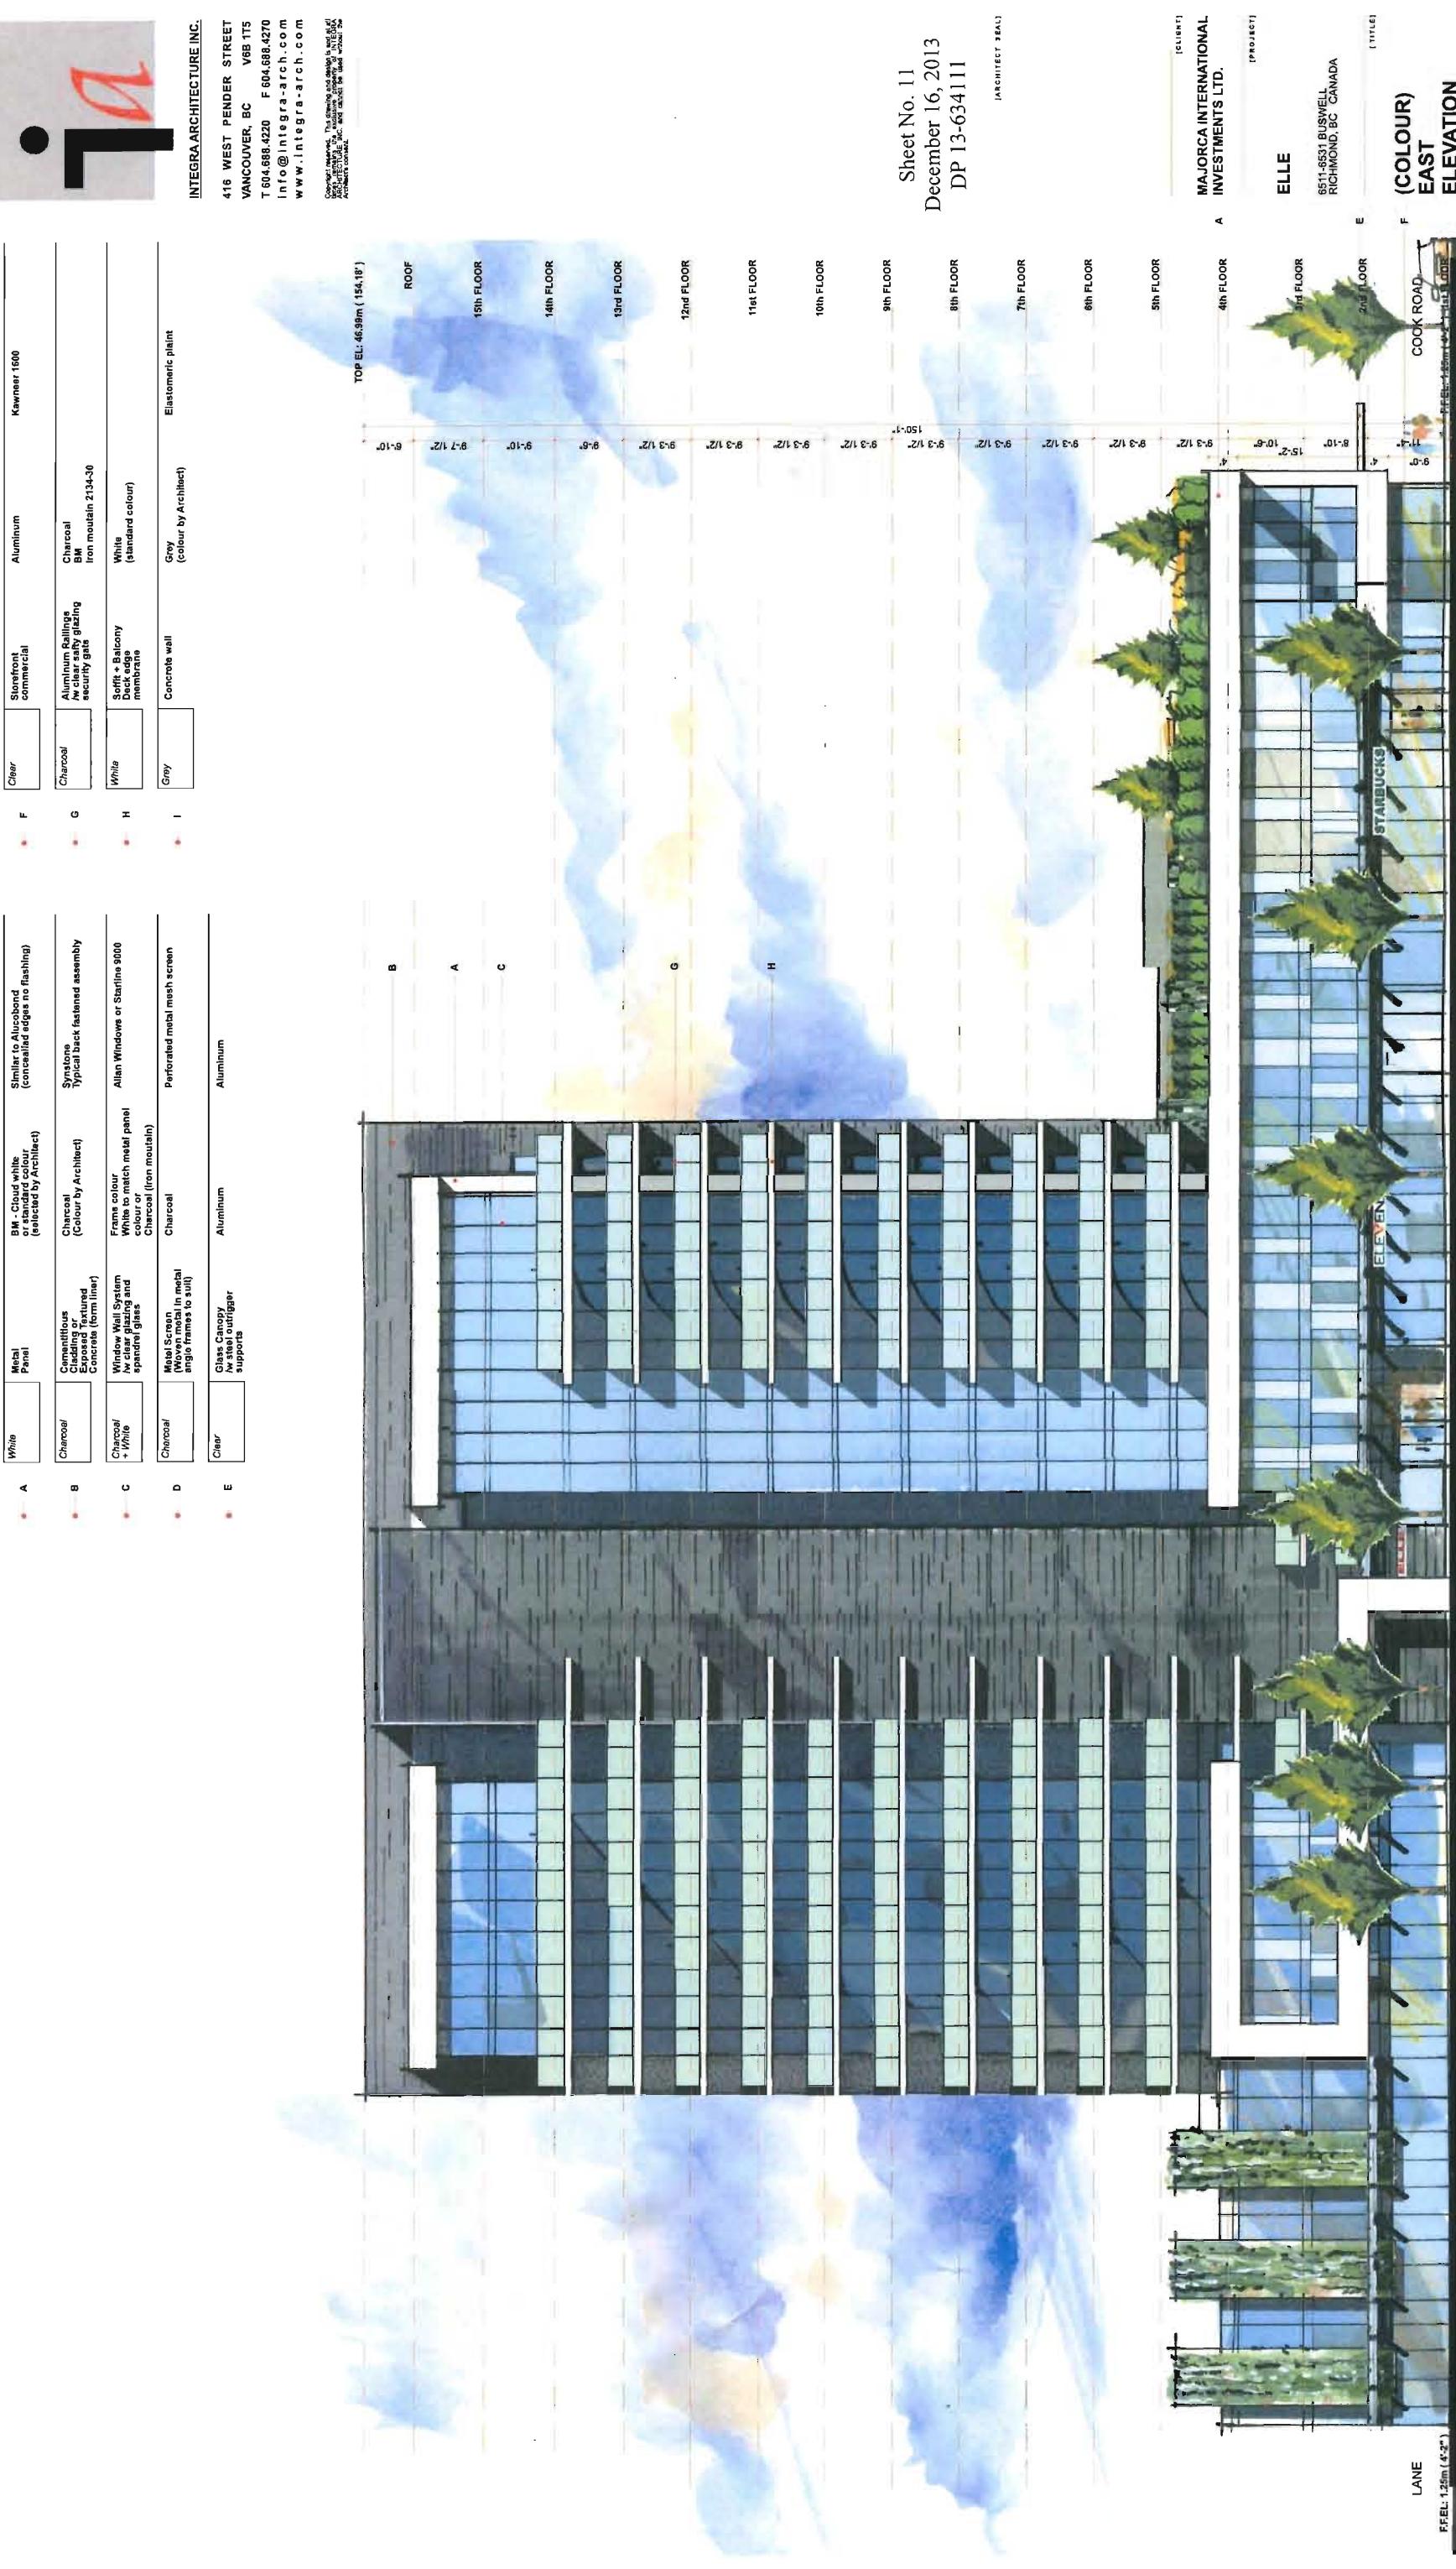EAST ELEVATION

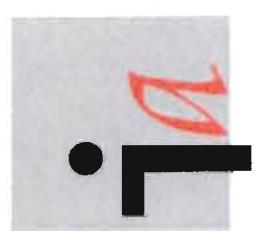


INTEGRA ARCHITECTURE INC.

4165 WEST PENDER STREET
VANCOUVER, BC V6B 1T5
T 604.688.4220 F 604.688.4270
info@integra-arch.com
www.integra-arch.com

Copyright reserved. This standard design is the exclusive property of INTEGRA ARCHITECTURE INC., 2000. All rights reserved. It may not be reproduced, in whole or in part, without written consent.

MATERIAL & COLOUR LEGEND

Material	Panel	Description	Dimensions	Surface finish	Alum/Inox	Karachi / 1600
White	Black - Coated white Panel	Standard to Alucobond (Specified digits no. handling) (selected by Architect)	F	Charcoal	Aluminium Railings or clear edge plating	Charcoal
Chamfered	Charcoal [Color by Architect]	Synthetic back faced assembly Typical back faced assembly	G	White	Iron modulus 2.14x10 [standard colour]	White (standard colour)
Chamfered	Charcoal [Color by Architect]	Frame colour White to match rail panel Orches [iron modulus]	H	White	Satin Balcony Deck edge membrane	White
Chamfered + White	White Wall Panel [No clear glazing and splices Green]	Alin Windows or Starline 2000	I	Concrete wall	Grey (color by Architect)	Elastomeric paint
Chamfered	Charcoal [Color by Architect]	Perforated metal mesh screen	J	Aluminium	Aluminium	
Clear	Dark in canopy [No clear glazing and splices Green]					

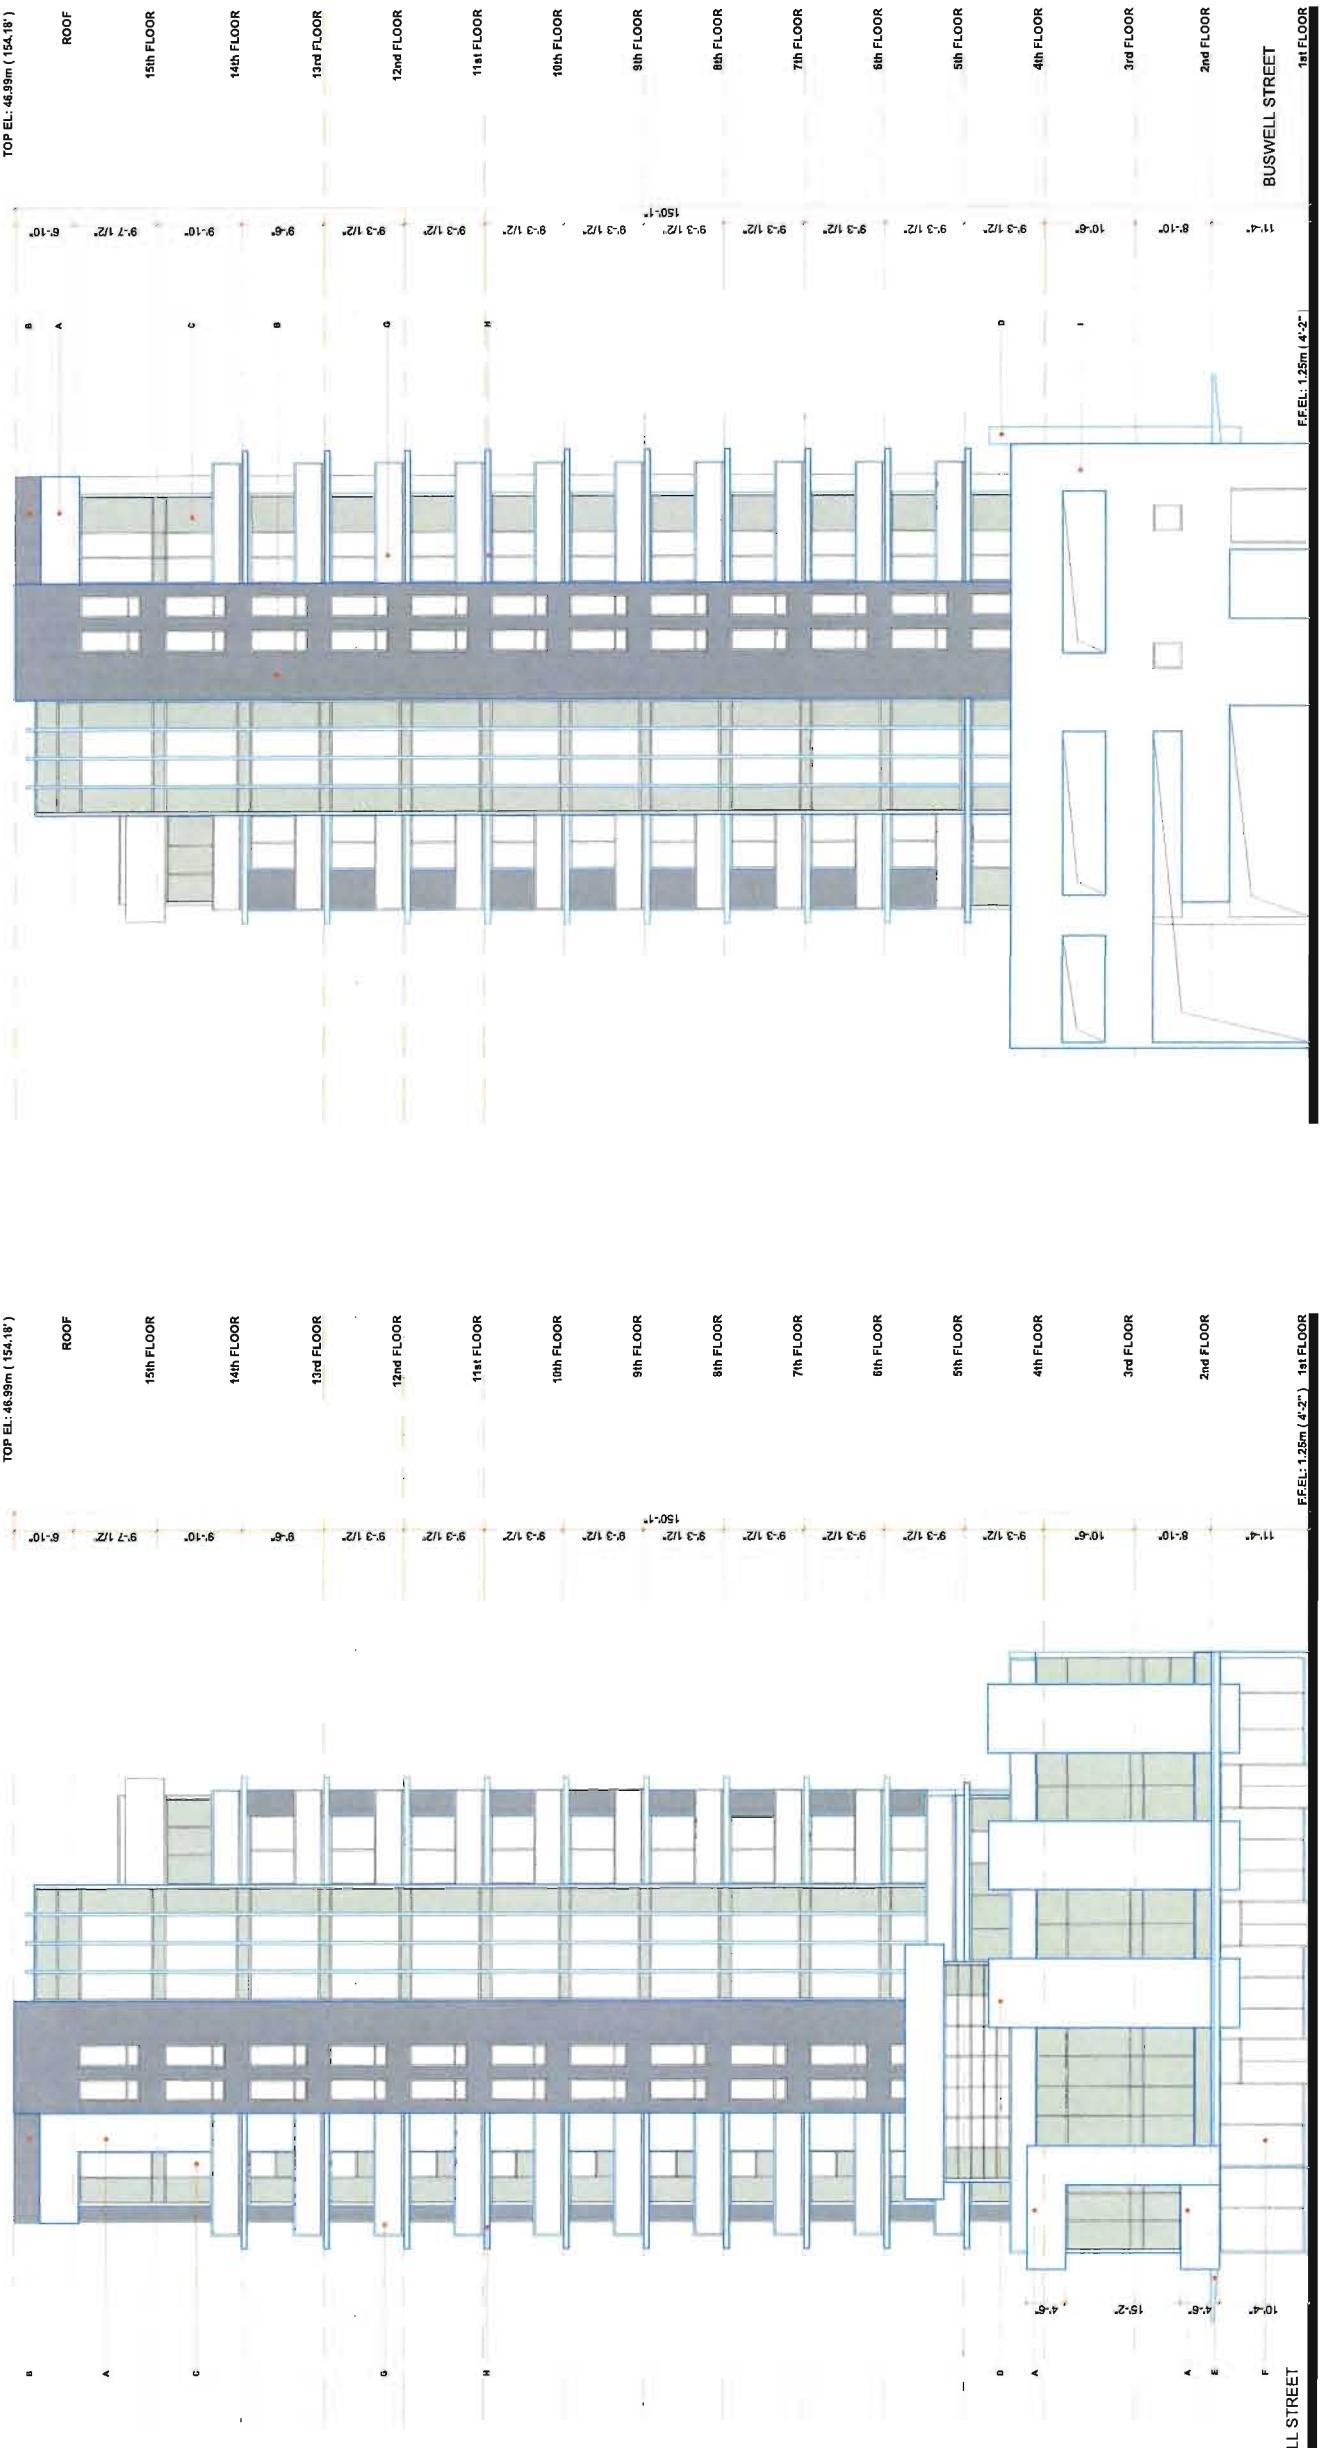

Sheet No. 14
December 16, 20
DP 13-63411

ARCHITECTURAL

**MAJORCA INTERNATIONAL
INVESTMENTS LTD.**

[PROJECT]
ELLE
6511-6531 BUSWELL
RICHMOND, BC CANADA

**NORTH & SOUTH
ELEVATION**

[SCALE] [DATE] [ISSUE]
1" = 10'
December 13, 2013
B - DP Resubmission

SOUTH EVALUATION

NORTH ELEVATION

1421

MAJORIA INTERNATIONAL
INVESTMENTS LTD.

[ARCHITECT SEAL]

[PROJECT]

[TITLE]

[DRAWING]

MAJORIA INTERNATIONAL
INVESTMENTS LTD.

[ARCHITECT SEAL]

[PROJECT]

[TITLE]

[DRAWING]

Sheet No. 15
December 16, 2013
DP 13-634111

[ARCHITECT SEAL]

[PROJECT]

[TITLE]

[DRAWING]

9th FLOOR

8th FLOOR

7th FLOOR

6th FLOOR

5th FLOOR

4th FLOOR

3rd FLOOR

2nd FLOOR

1st FLOOR

12th FLOOR

13th FLOOR

14th FLOOR

15th FLOOR

ROOF

11th FLOOR

10th FLOOR

9th FLOOR

8th FLOOR

7th FLOOR

6th FLOOR

5th FLOOR

4th FLOOR

3rd FLOOR

2nd FLOOR

1st FLOOR

12th FLOOR

13th FLOOR

14th FLOOR

15th FLOOR

ROOF

11th FLOOR

10th FLOOR

9th FLOOR

8th FLOOR

7th FLOOR

6th FLOOR

5th FLOOR

4th FLOOR

3rd FLOOR

2nd FLOOR

1st FLOOR

12th FLOOR

13th FLOOR

14th FLOOR

15th FLOOR

ROOF

11th FLOOR

10th FLOOR

9th FLOOR

8th FLOOR

7th FLOOR

6th FLOOR

5th FLOOR

4th FLOOR

3rd FLOOR

2nd FLOOR

1st FLOOR

12th FLOOR

13th FLOOR

14th FLOOR

15th FLOOR

ROOF

11th FLOOR

10th FLOOR

9th FLOOR

8th FLOOR

7th FLOOR

6th FLOOR

5th FLOOR

4th FLOOR

3rd FLOOR

2nd FLOOR

1st FLOOR

12th FLOOR

13th FLOOR

14th FLOOR

15th FLOOR

ROOF

11th FLOOR

10th FLOOR

9th FLOOR

8th FLOOR

7th FLOOR

6th FLOOR

5th FLOOR

4th FLOOR

3rd FLOOR

2nd FLOOR

1st FLOOR

12th FLOOR

13th FLOOR

14th FLOOR

15th FLOOR

ROOF

11th FLOOR

10th FLOOR

9th FLOOR

8th FLOOR

7th FLOOR

6th FLOOR

5th FLOOR

4th FLOOR

3rd FLOOR

2nd FLOOR

1st FLOOR

12th FLOOR

13th FLOOR

14th FLOOR

15th FLOOR

ROOF

11th FLOOR

10th FLOOR

9th FLOOR

8th FLOOR

7th FLOOR

6th FLOOR

5th FLOOR

4th FLOOR

3rd FLOOR

2nd FLOOR

1st FLOOR

12th FLOOR

13th FLOOR

14th FLOOR


15th FLOOR

ROOF

INTEGRA ARCHITECTURE INC.

416 WEST PENDER STREET
VANCOUVER, BC
V8B 1T5
T 604.688.0220 F 604.688.0270
Info@integra-arch.com
www.integra-arch.com

	A	B	C	D	E
	Metal Panel	Cementitious Cladding or Exposed Aggregate Concrete form liner)	Window Wall System (W Clear glass and spandrel glass)	Mail Screen (In metal angle frames to suit)	Glass Canopy (W steel outrigger supports)
White	BM - Cloud white or standard colour (selected by Architect)	Similar to Alucobond (concealed edges no flashing)	Alumina Windows or Starline 9000	Perforated metal mesh screen	Aluminum
Charcoal	Charcoal (Colour by Architect)	Charcoal (Colour by Architect)	Charcoal (W match metal panel colour or Charcoal (iron mouting))	Charcoal	Charcoal
A					
B					
C					
D					
E					

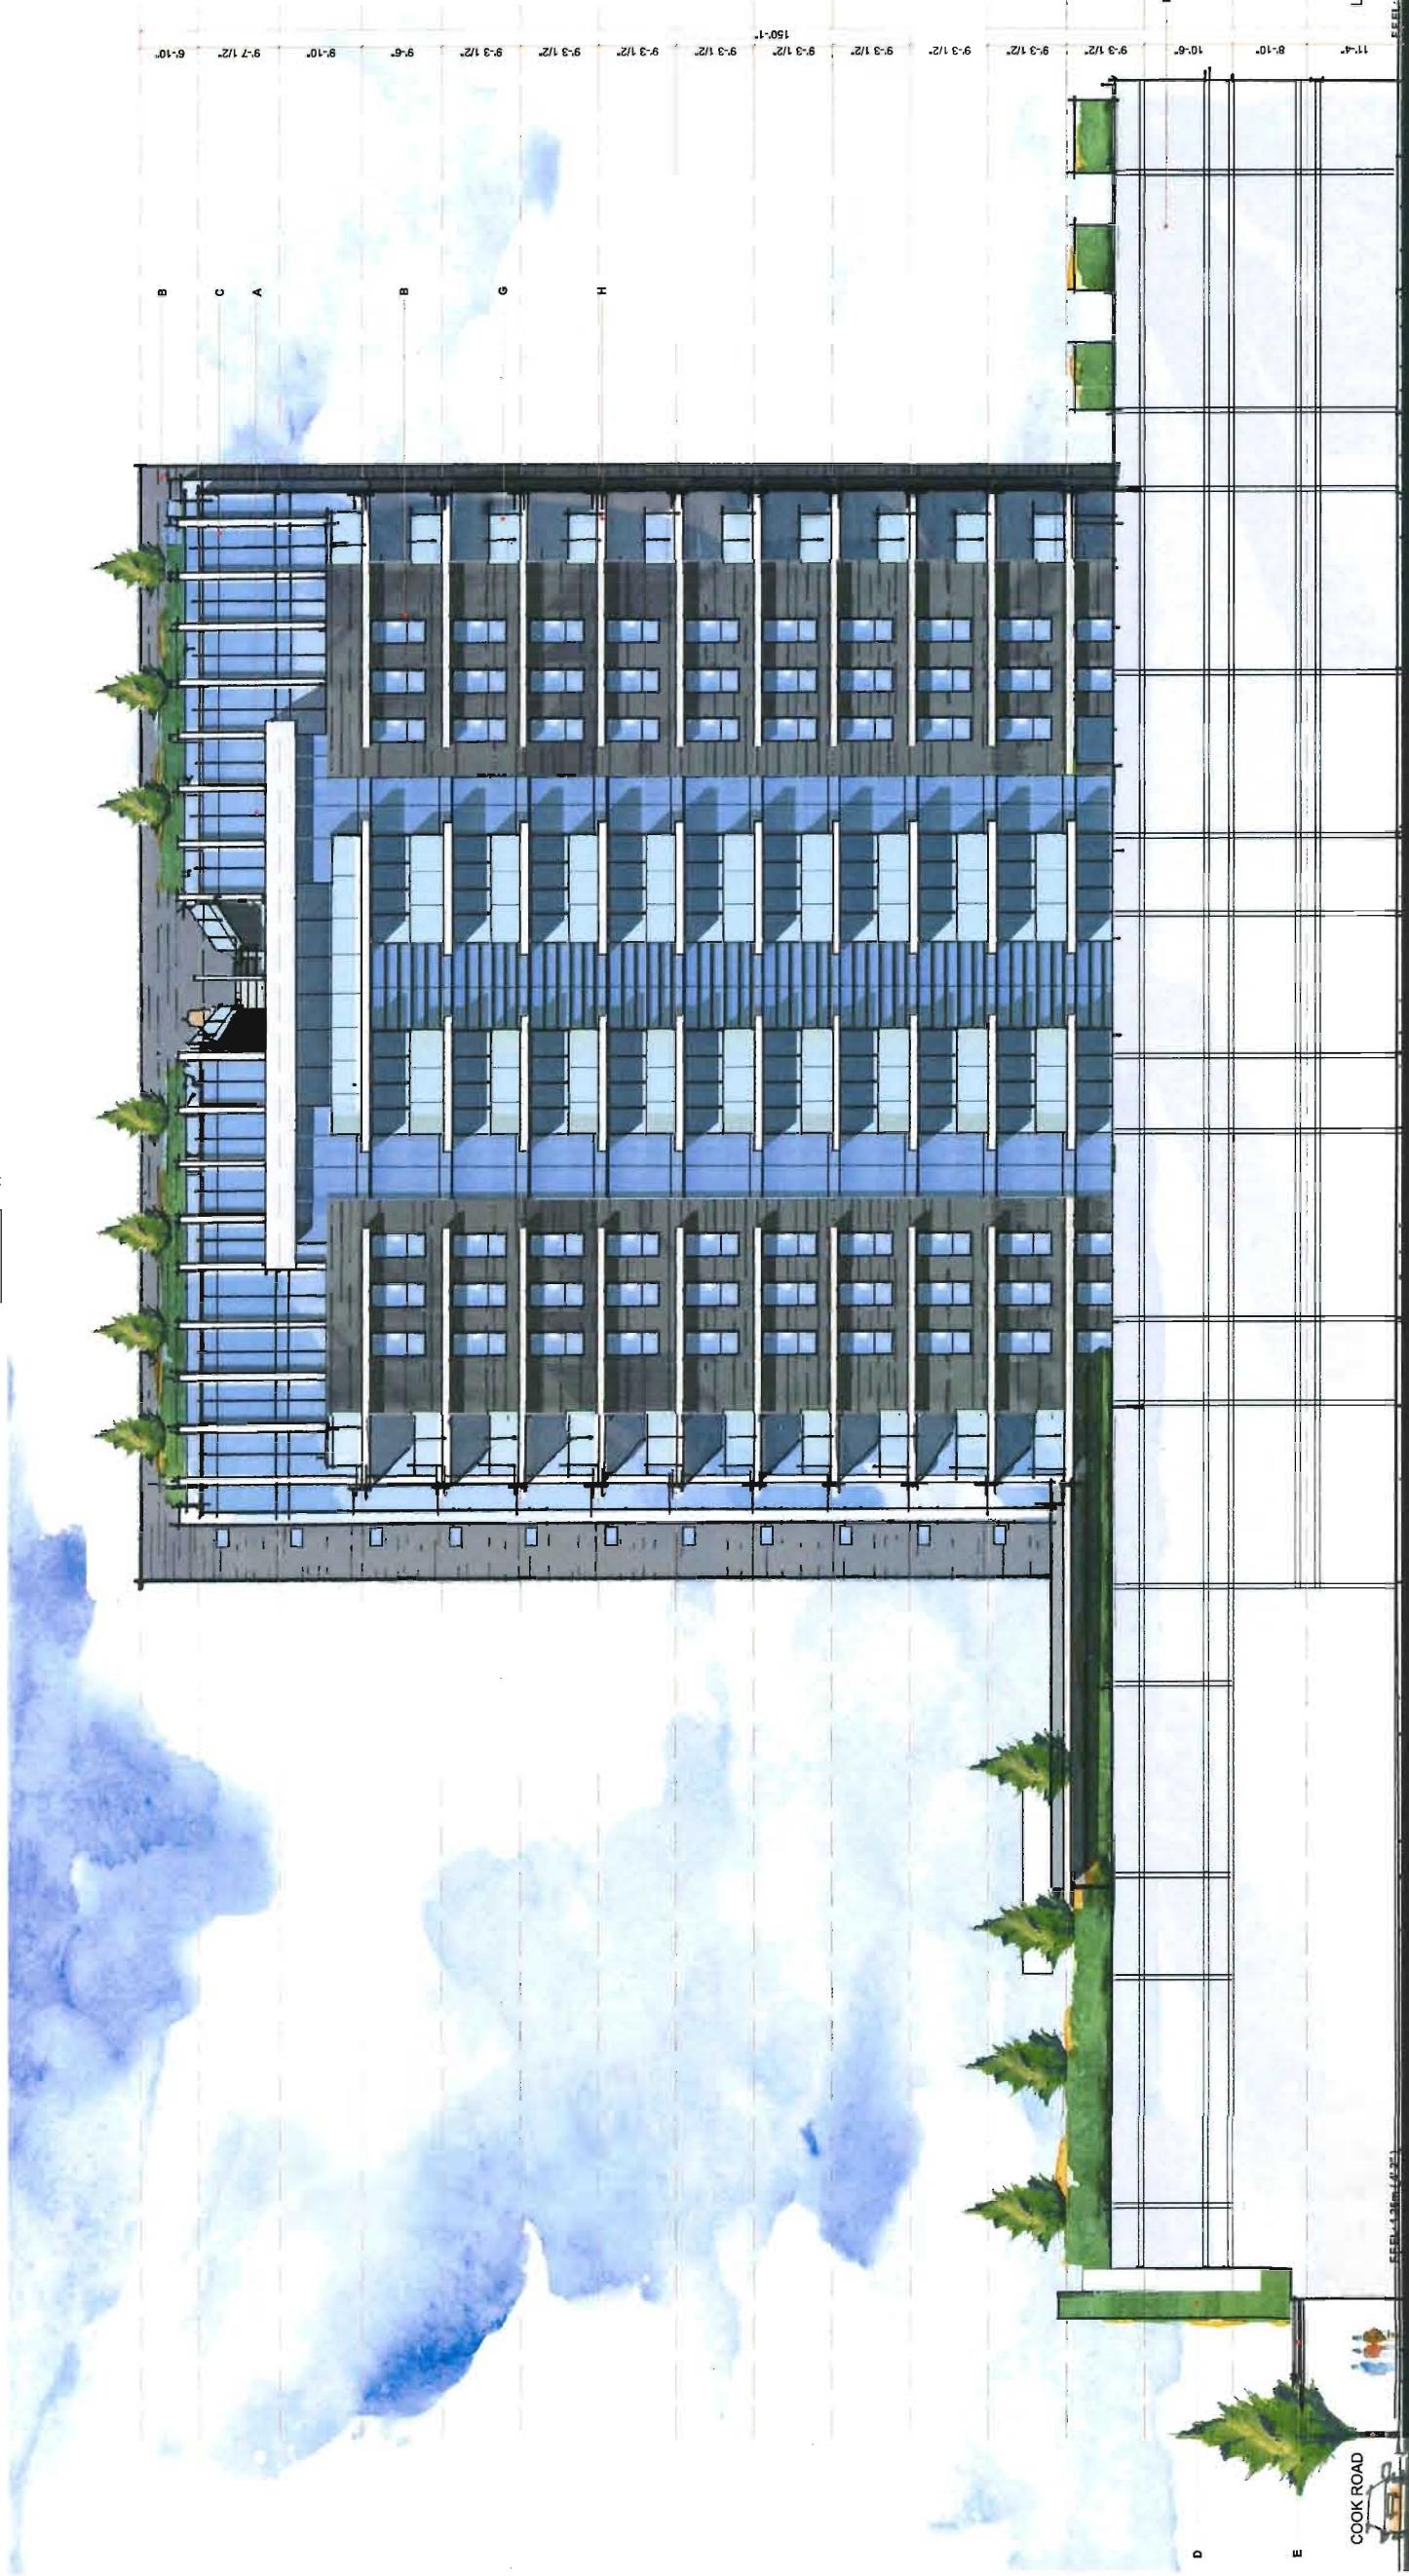


WEST ELEVATION



INTEGRA ARCHITECTURE INC.

418 WEST PENDER STREET
VANCOUVER, BC V6B 1T5
T 604.688.4220 F 604.688.4270
Info@integraph.com
www.integraph.com

Copyright Integra Architecture Inc. This drawing and copies thereof shall not be reproduced without the written consent of Integra Architecture Inc. and shall not be used without the written consent of Integra Architecture Inc.

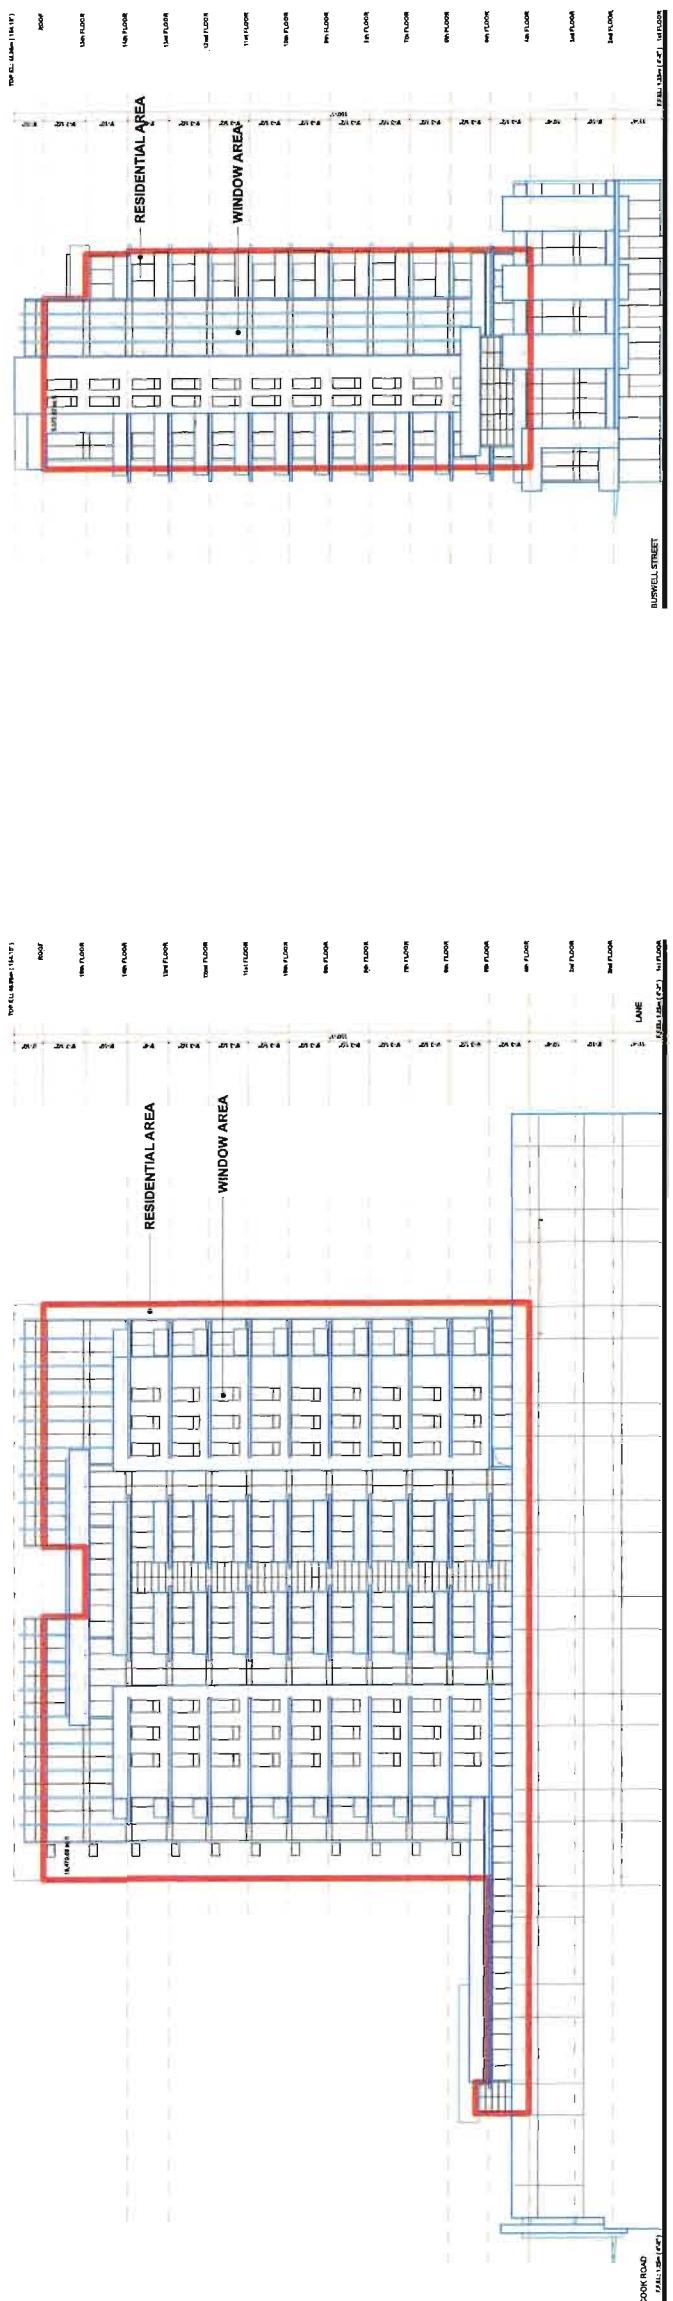**NORTH ELEVATION WINDOW/WALL RATION DIAGRAM**

$$\frac{\text{RESIDENTIAL WINDOW AREA: } 2,210.9 \text{ SFT}}{\text{RESIDENTIAL WALL & WINDOW AREA: } 5,572.6 \text{ SFT}} = 39.7\%$$

Sheet No. 17
December 16, 2013
DP 13-634111

[ARCHITECTURAL]

MAJORCA INTERNATIONAL
INVESTMENTS LTD.

[PROJECT]

ELLE

651-4531 BUSWELL,
RICHMOND, BC CANADA

WINDOW RATION
DIAGRAM


Project 1
1" = 20'
Date December 13, 2013
Issue 8 - DP Resubmission
Drawing [REDACTED]

EAST ELEVATION WINDOW/WALL RATION DIAGRAM

$$\frac{\text{RESIDENTIAL WINDOW AREA: } 7,206.2 \text{ SFT}}{\text{RESIDENTIAL WALL & WINDOW AREA: } 19,454.5 \text{ SFT}} = 37.1\%$$

SOUTH ELEVATION WINDOW/WALL RATION DIAGRAM

$$\frac{\text{RESIDENTIAL WINDOW AREA: } 2,212.8 \text{ SFT}}{\text{RESIDENTIAL WALL & WINDOW AREA: } 5,572.6 \text{ SFT}} = 39.7\%$$

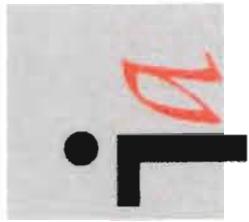

INTEGRA ARCHITECTURE INC.


416 WEST PENDER STREET
VANCOUVER, BC V6B 1T5
T 604.688.4220 F 604.688.4270
info@integra-arch.com
www.integra-arch.com

Copyright reserved. This drawing and any portion thereof may not be reproduced without the written consent of Integra Architecture Inc.

Copyright reserved. This drawing and any portion thereof may not be reproduced without the written consent of Integra Architecture Inc.




SECTION DIAGRAM B-B

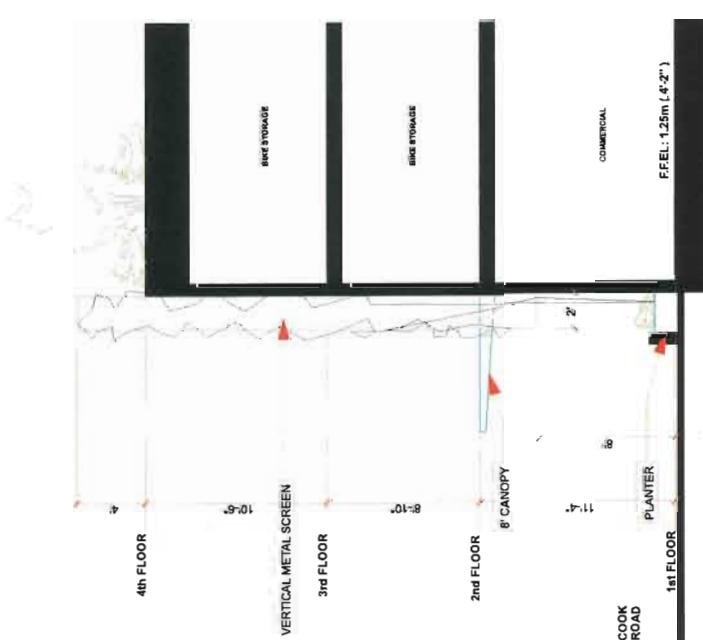

SECTION DIAGRAM A-A



SECTION DIAGRAM A-A

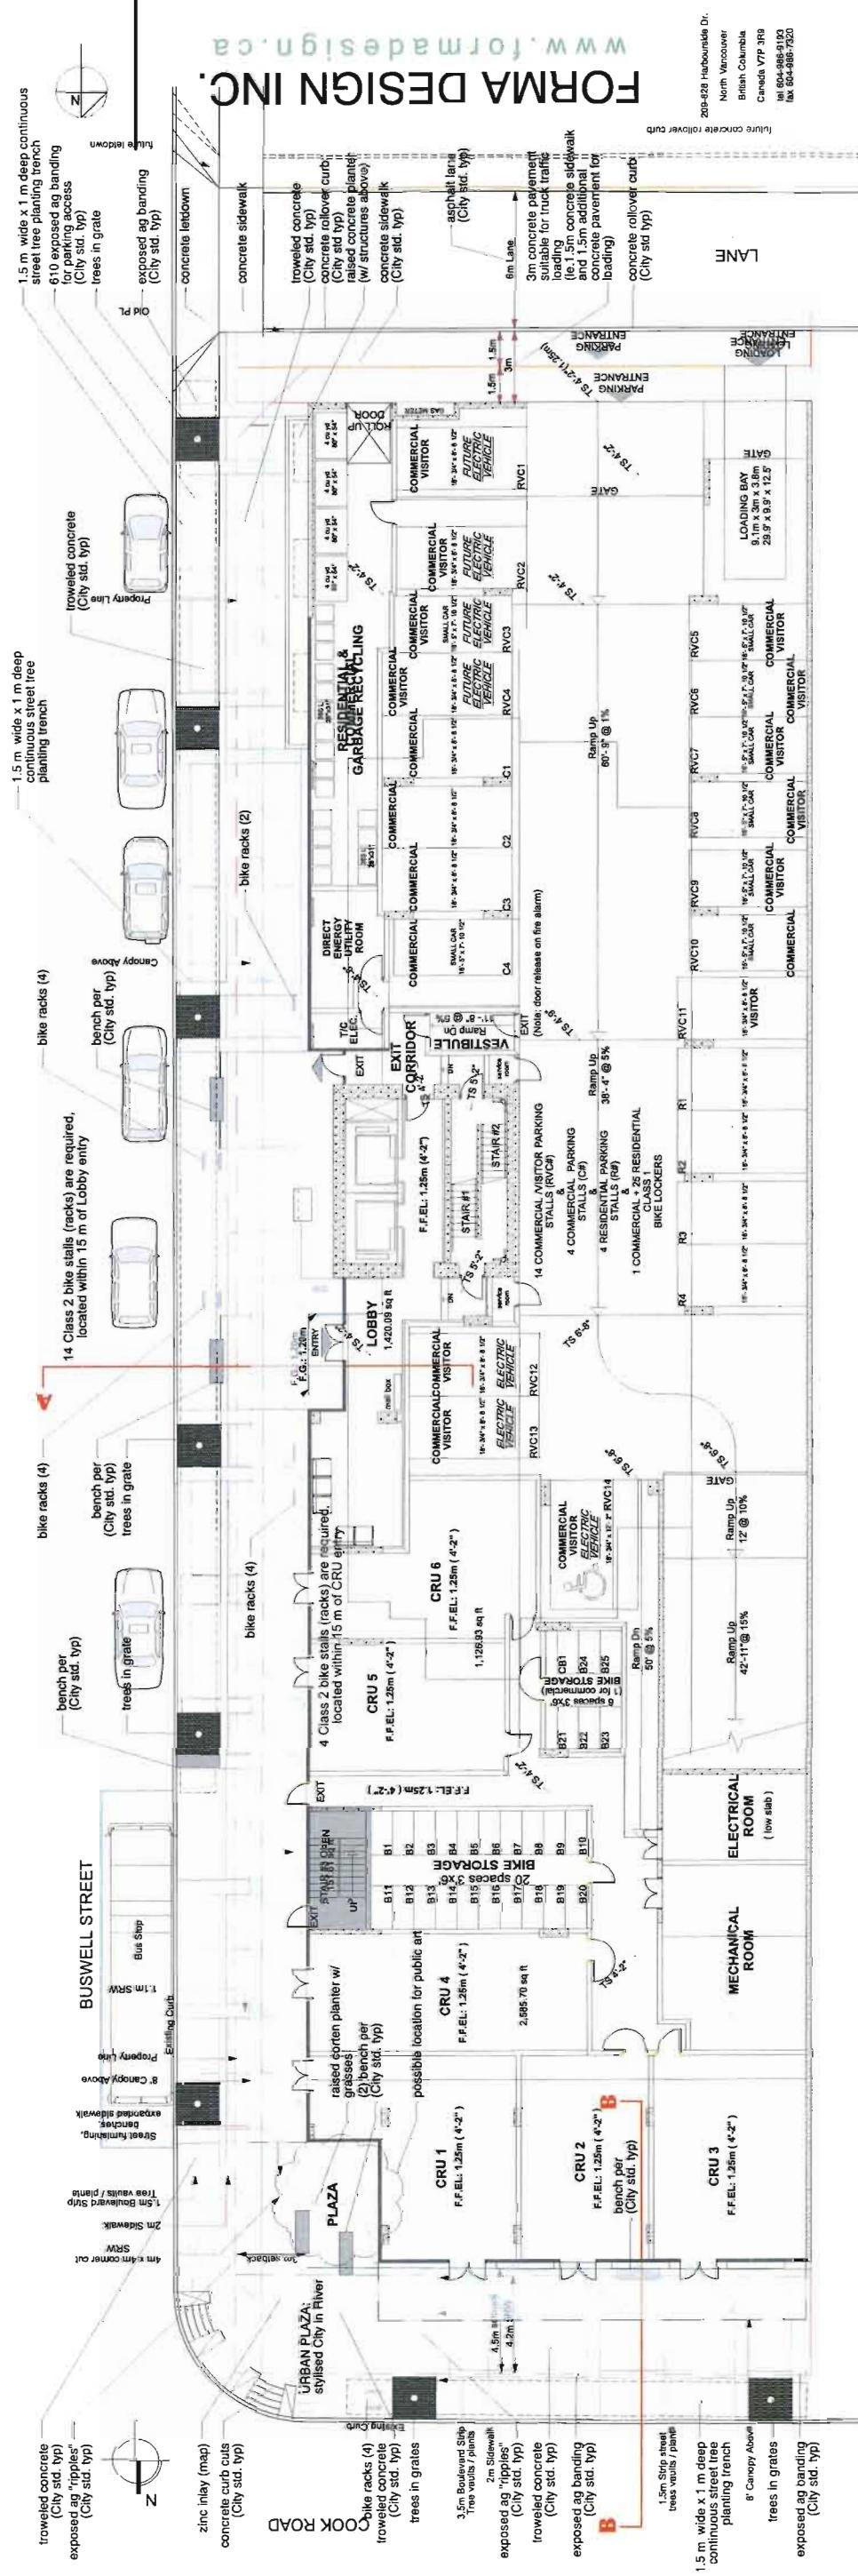

Sheet No. 21
December 16, 2013
DP 13-634111

- 3. Oct 23 2013 Resubmission ADP
- 4. Dec 13 2013 Resubmission ADP



sorten corner detail



SeeGrates;




trash container:
LWR250S-32 by Maglin
(www.maglin.com) or
equivalent, as req. by COR




ackless bench: MLB1400B
nch by Maglin
www.maglin.com) or
uivalent



Bike rack: SCBR1600 Series
Bike Rack by Maglin
(www.maglin.com) or
equivalent, as req. by COR

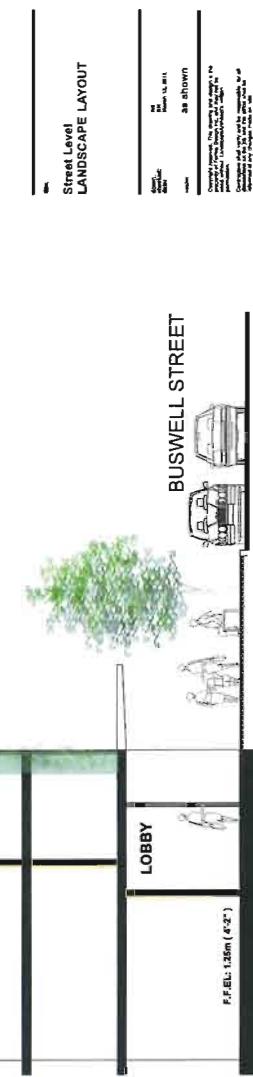

B-B - typical streetscape section @ Cook Road
scale 1/8" = 10"

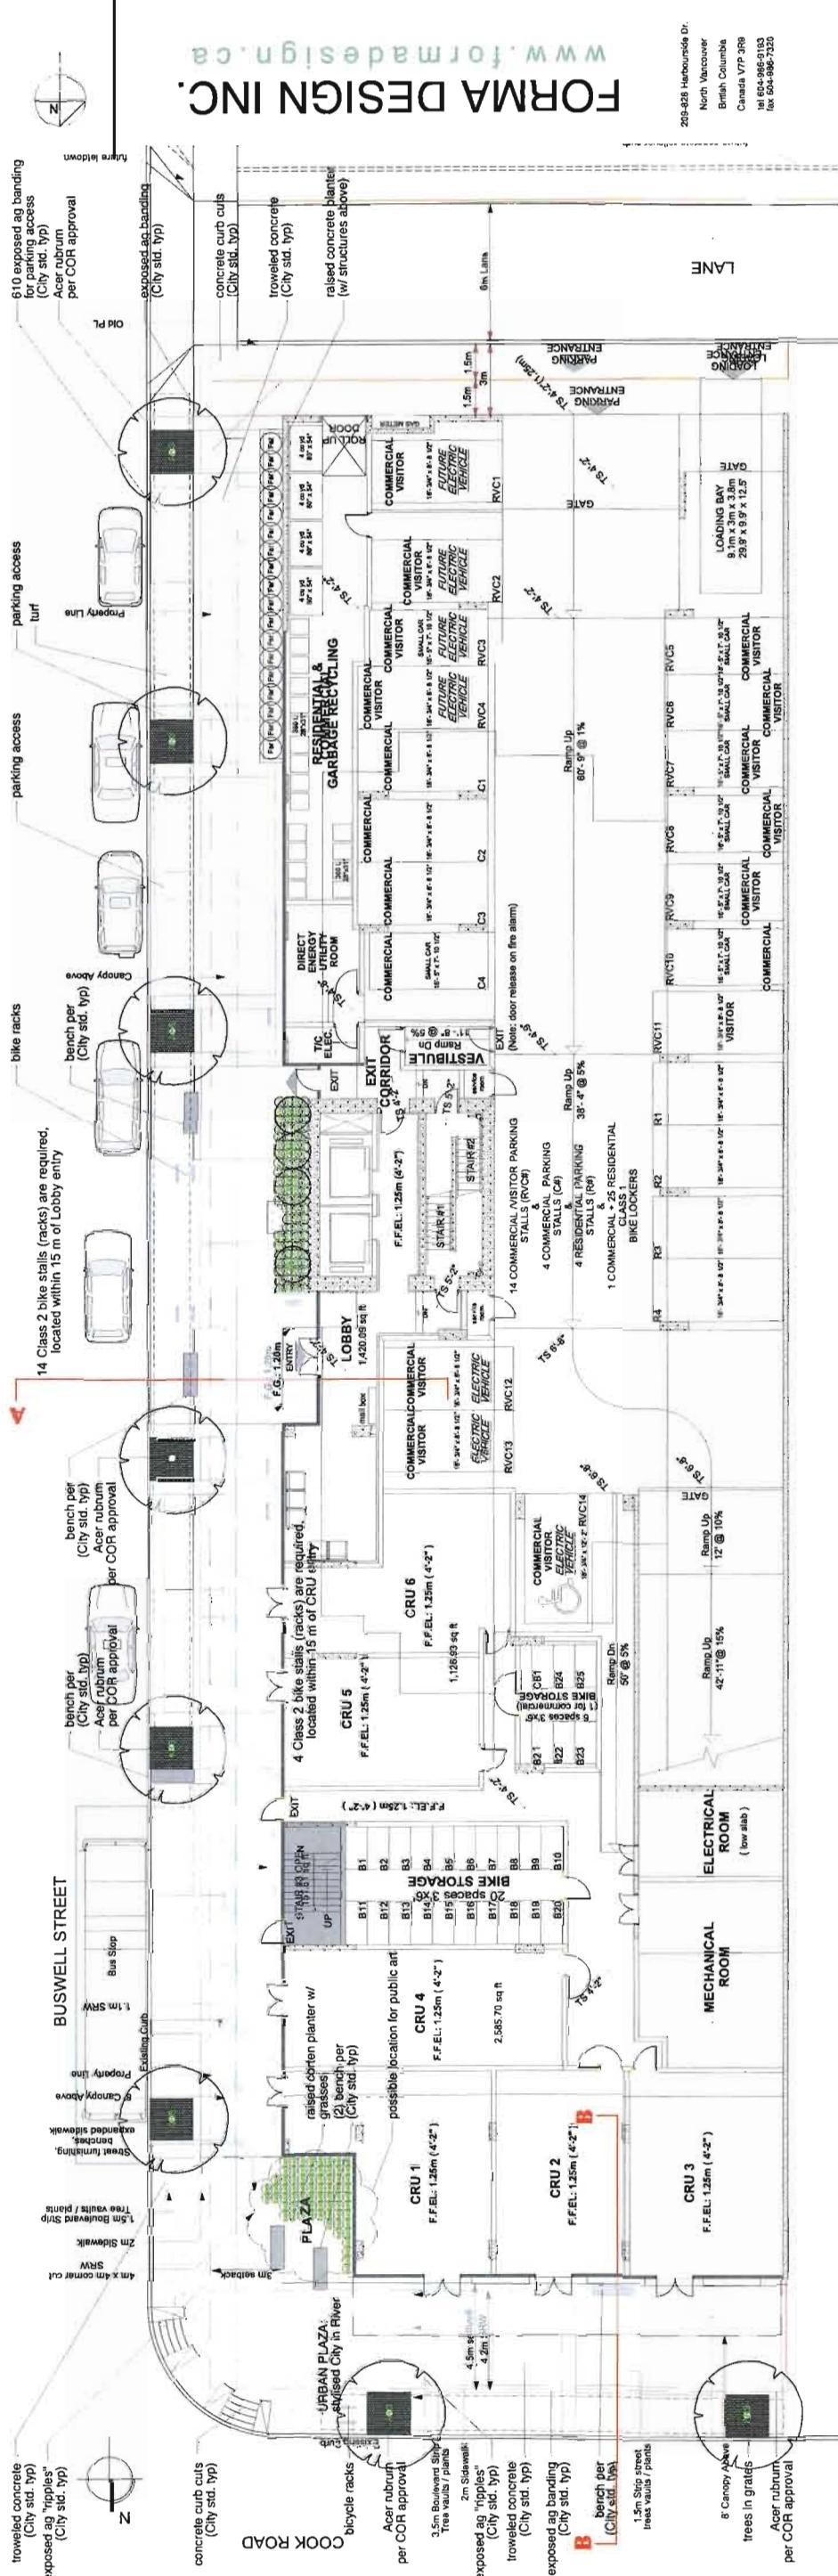

Sheet No. 22
December 16, 2013
DP 13-634111

REBATES:

- 1. Mar 28 2013 Development Application
- 2. Sep 28 2013 Resubmission DP
- 3. Oct 23 2013 Resubmission ADP
- 4. Dec 13 2013 Resubmission ADP

OFF-SITE PLANT LIST

				COMMON NAME	SIZE	CONDITION/COMMENTS
TREES	KEY	QTY	BOTANICAL			
MARS		7	<i>Acer rubrum</i> 'Red Sunset'	Red Sunset Maple	10cm cal.	B & B
POP		4	<i>Populus tremuloides</i>	Trembling Aspen	5 cm. cal.	B & B
SHRUBS						
VOT		85	<i>Vaccinium corymbosum</i> "Thunderbird"	Evergreen Huckleberry	-	#2 Pot
CAB		70	<i>Carex buchananii</i>	Curly Sedg	12"	SP #3
				GRASSES/OTHER		


Planting Notes

1. All materials and documentation of landscape works shall conform to the BCSLABCNTA Landscape Standard. Refer to written specifications for complete planting documentation.
2. The Landscape Committee shall ensure that the on-site planting medium/sil soil meets the specification and recommendations of the soil analysis taken at the time of Substantial Completion. All recommendations of the soil analysis shall be executed prior to Final Acceptance of the landscape works by the Consultants and the municipal authorities.




Street Level
LANDSCAPE PLANTING

L2 of 6

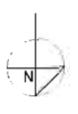

www.formadesign.ca

UHRMIA

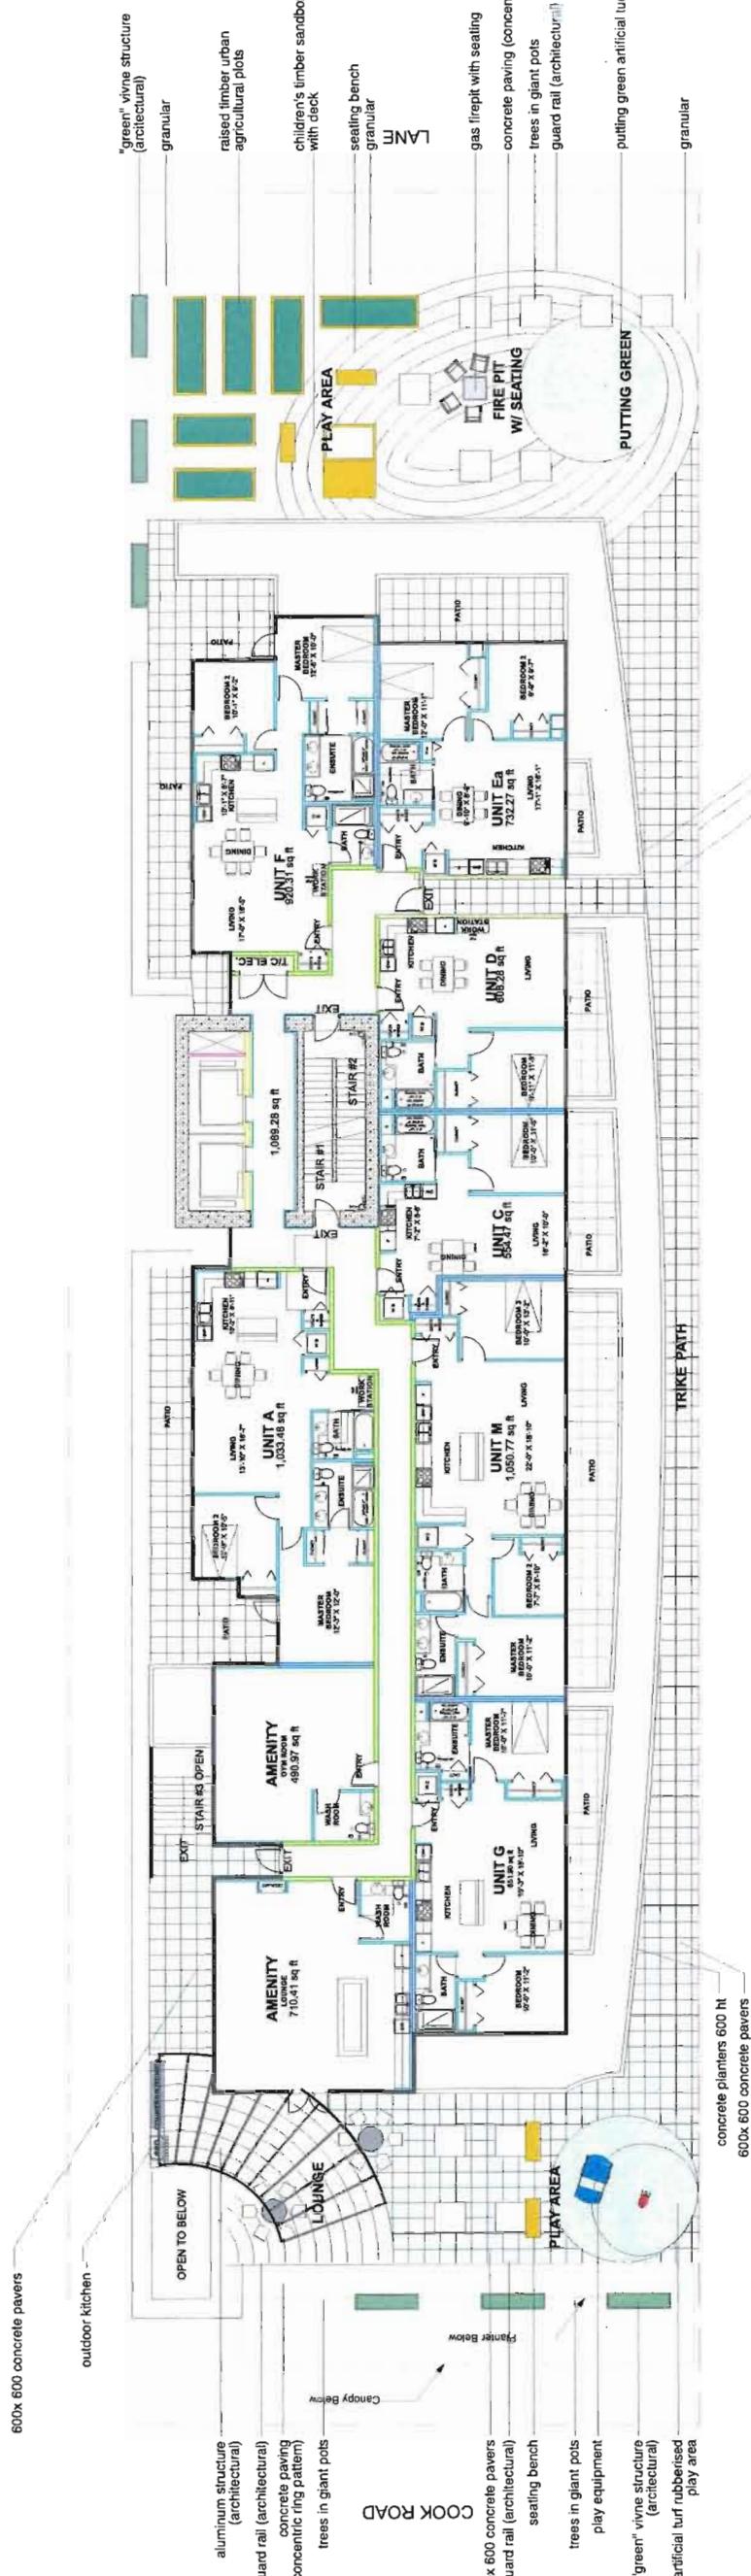

Sheet No. 23
December 16, 2011
DP 13-63411

1. MB 2B 2013 Development Application
 2. Sep 26 2013 Resubmission DP
 3. Oct 23 2013 Resubmission ADP
 4. Dec 13 2013 Resubmission ADP



Elevated 36" Halo Fire Pit by
Solus (www.solusdecor.com)
or equivalent



large scaled fibre reinforced concrete pots:



Backless bench: MLB872B-W
xBench by Maglinx
(www.maglinx.com) or equivalent



A photograph showing a long perspective view of a modern steel arbour structure. The arbour is made of vertical steel poles and horizontal beams, creating a series of rectangular frames that recede into the distance. The structure is partially covered with green plants and purple flowers hanging from above. The ground is paved with light-colored rectangular tiles. In the background, there are trees and a clear sky.




24X24 hyrapressed concrete pavers:



granular material between pavers:



**Buswell Street
Richmond, BC**

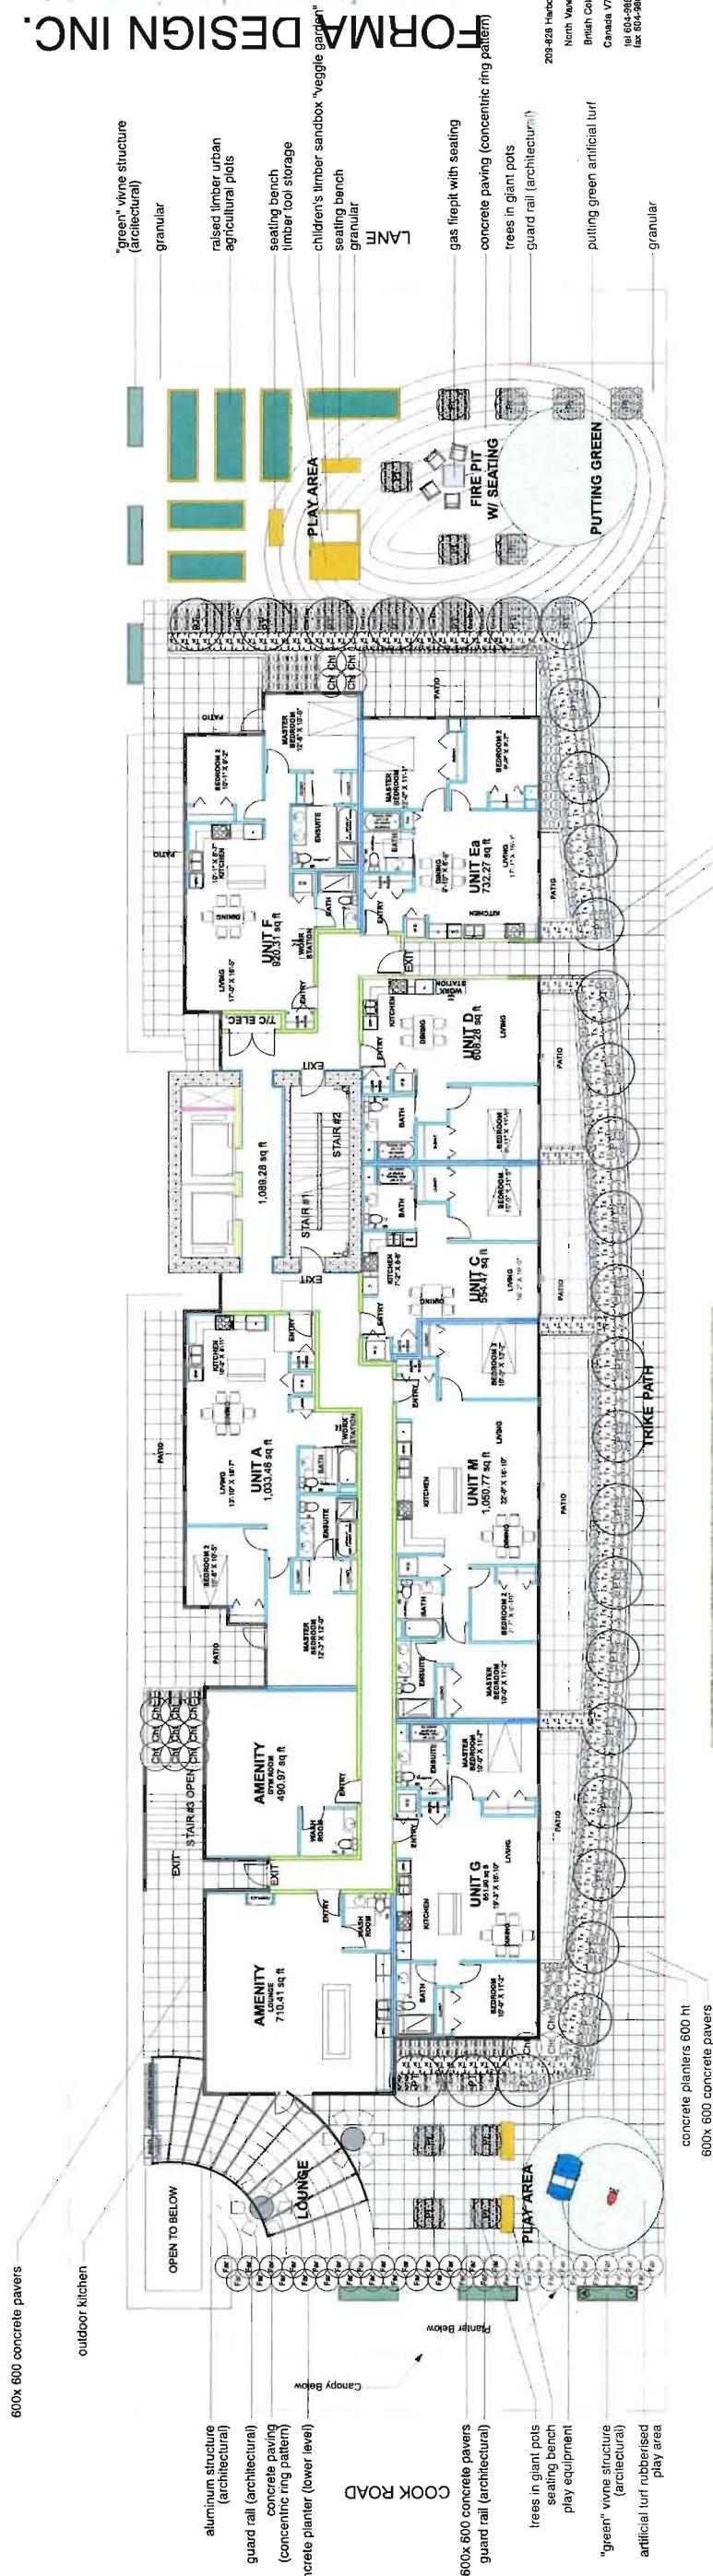

Sheet No. 24
December 16, 20
DP 13-63411


PLANT LIST						GROUND COVERS			PERENNIALS/ANNUALS/FERNS/GRASSES/AQUATIC			
KEY	QTY	BOTANICAL	COMMON NAME	SIZE	CONDITION	KEY	QTY	BOTANICAL	COMMON NAME	SIZE	CONDITION	COMMENTS
TREES												
APR2	4	Acer palmatum var.	Red Japanese Maple	3.0m ht.	B & B	SP43	12*	Agropyron repens	Blue wheat grass			
MMGG	6	Magnolia grandiflora "Little Gem"	Southern Magnolia	5 cm. cal.	B & B / 3.0m ht.	SP42	12*	Euphorbia "Wulfenii"	Euphorbia "Wulfenii"			
PT	29	Populus tremuloides "Erecta"	Columnar Trembling Aspen	5cm cal.	B & B / 2.5m ht.	SP41	.5m	Pandanus tectorius	Panda Bamboo			
SHRUBS												
Cht	16	Choisya ternata	Mexican Orange Blossom	-	#3 Pot	SP40	12*	Heuchera micrantha	Alumroot			
Piz	11	Prunus	Topiary	-	#3 Pot	SP39	.5m	Ophiopogon planiscapus	Black mondo Grass			
Tx	180	Taxus X Media "M. Eridge"	Yew Hedge	-	#3.5B / 1.2m ht.	SP38	12*	Eryngium planum	Sea Holly			
Tbc	15	Taxus baccata "con"	Toilairy Yew	-	#2.5B / 1.2m ht.	SP37	12*	Hedera helix	English Ivy			
Vot	6	Vaccinium ovalifolium "Thunderbird"	Evergreen Huckleberry	-	#2 Pot	SP36	12*	Hydrostachys laevigata	Hakonechloa			
GROUND COVERS						PERENNIALS/ANNUALS/FERNS/GRASSES/AQUATIC			PERENNIALS/ANNUALS/FERNS/GRASSES/AQUATIC			
ha	200	Hakonechloa macra aurea	Hakonechloa		#1 Pot	SP35	12*	Agrostis capillaris	Common bent grass			
VINES						SP34	12*	Euphorbia "Milii"	Euphorbia "Milii"			
IP1	12	Parthenocissus quinquefolia	Boston Ivy	-	#2 Pot	SP33	.5m	Fragaria ananassa	Rhubarb			
hh	24	Hedera helix	English Ivy	-	#2 Pot	SP32	12*	Humulus lupulus	Hops			
EDG	126	Aegopodium podagraria	Groundsel			SP31	12*	Ipomoea carnea	Ipomoea carnea			
GW	121	Euphorbia characias	Spurge			SP30	12*	Ipomoea tricolor	Ipomoea tricolor			
Far	57	Fagopyrum tataricum	Farfara			SP29	12*	Lathyrus odoratus	Sweet pea			
HH	141	Heuchera micrantha	Heuchera			SP28	12*	Malva sylvestris	Common mallow			
Opp	280	Ophiopogon planiscapus	Ophiopogon			SP27	12*	Malva neglecta	Malva neglecta			

Writting Notes
all materials and execution of landscape works shall conform to the BCSLACNTA Landscape standard. Refer to written specifications for complete landscape documentation. It applies.
The Landscape Contractor shall ensure that the on-site planting medium soil meets the specification and recommendations of the soil analysis taken at the site. All recommendations of the soil analysis shall be excused prior to final acceptance of the landscape works by the architect.

Minimum planting medium depths:

- l. 675mm

Notes:
1. All plant material shall meet minimum size requirements as indicated on plant list. Quality of plant material and grading of site conform to BCNTA

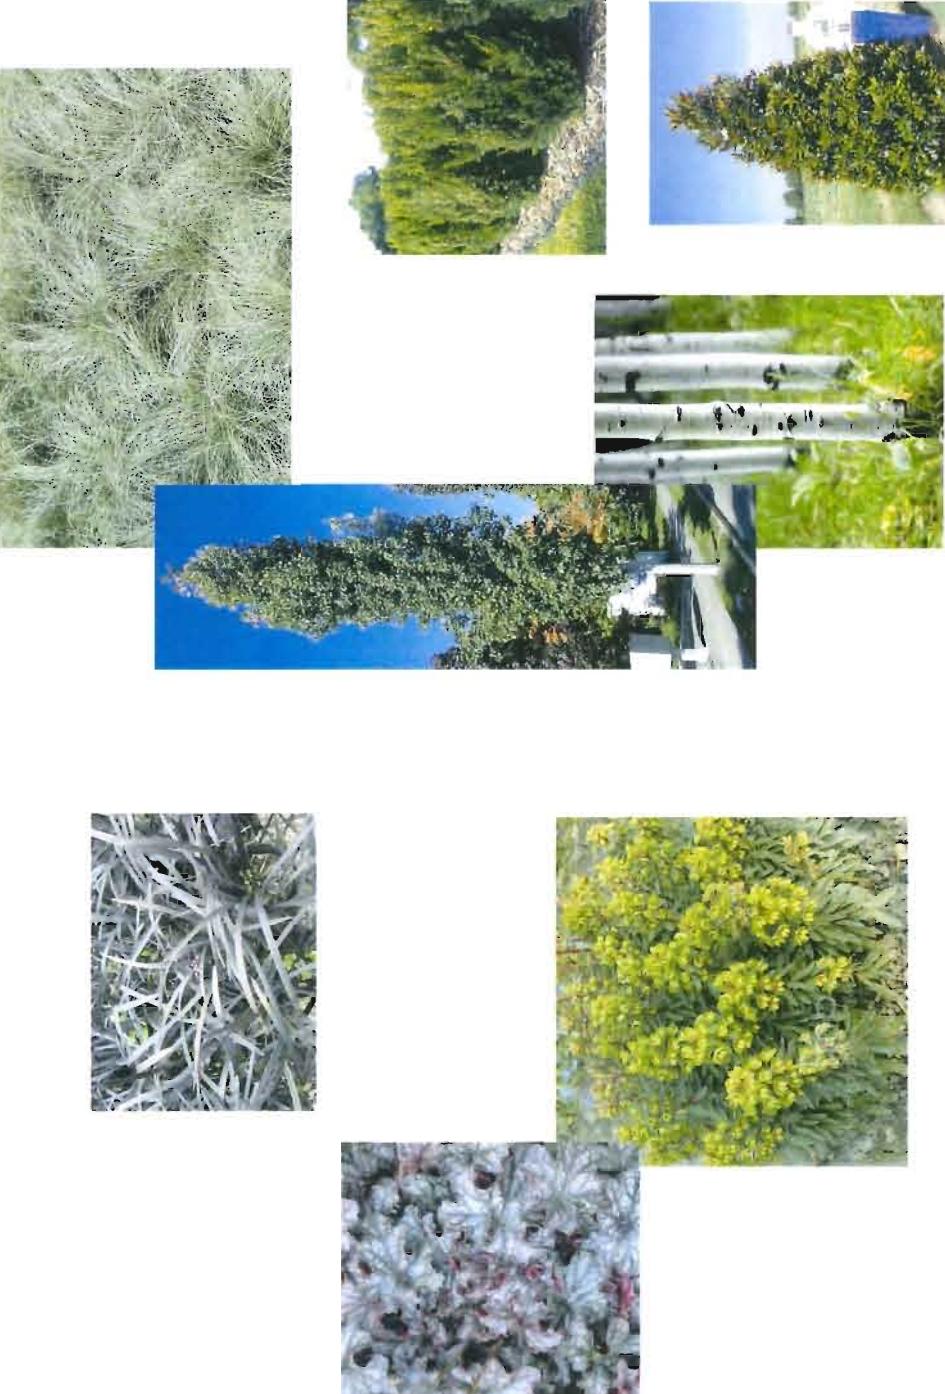



5th FLOOR




Fifth Floor Private Terraces
scale 3/32" = 1'0"

outdoor stainless steel kitchen
quest Metal or equal:




granular material between pavers.

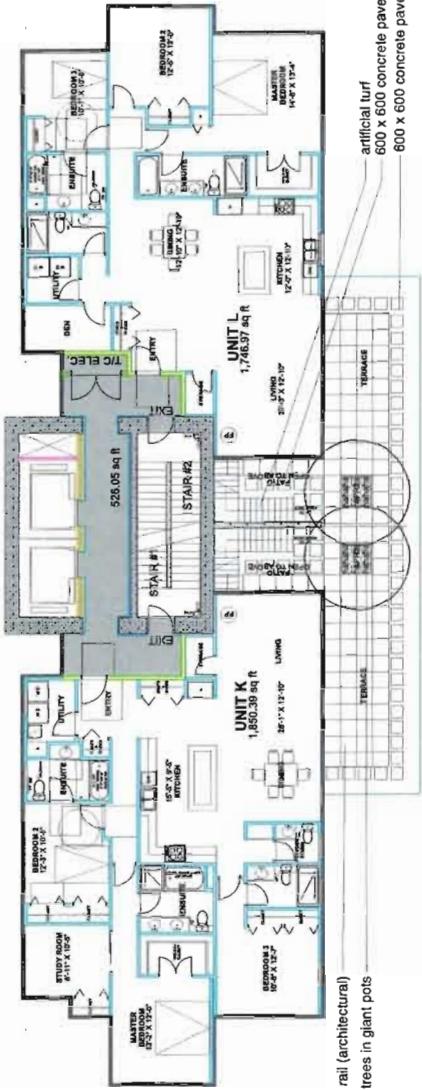


15th FLOOR (PENTHOUSE)




24X24 hinged-recessed concrete pavers.

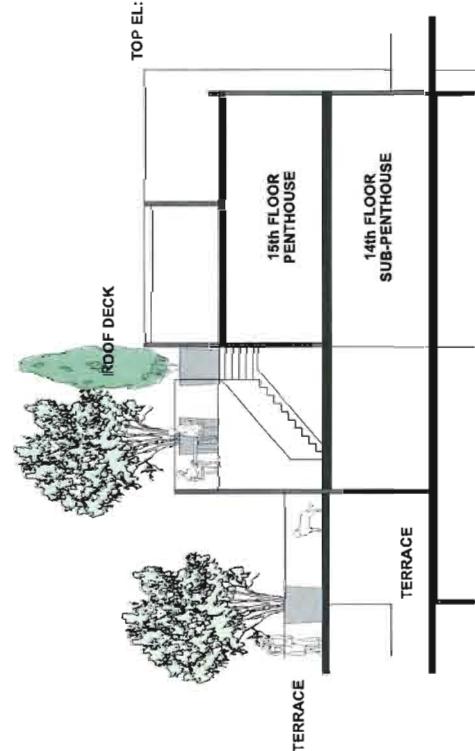

TOP EI · 46 99m (15)

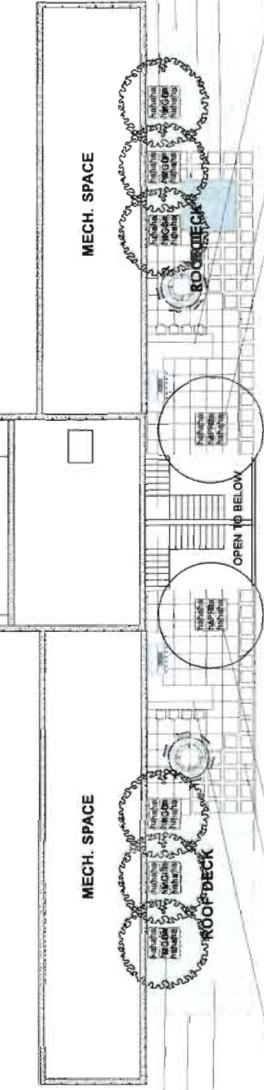

ROOF PLAN

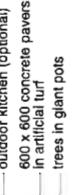

Penthouse Rooftop Private Terraces
scale 3/32" = 1'0"

Penthouse Rooftop Private Terraces

PART ONE GENERAL REQUIREMENTS

- 1.1 REFERREES**
1. This subcontractor shall furnish from its office or place of business a copy of the contract documents and is to read, interpreted and communicated with all other parties.
2. The intent of this written specification is to complement the drawn information as indicated on the landscape plan and used in conjunction with each other to conform to all applicable codes and regulations.
3. All landscape work to be performed under this contract to meet the applicable provisions and recommendations set forth in the Master Municipal Specifications & Standards Database and respect as Municipal Bylaws.

TESTING

1. The subcontractor shall furnish from its occupied local testing laboratory a certified analysis of the planting-soil and/or specification sheet.
2. Any alternate products that differ from those specified in the contract documents, must be pre-approved by the Landscape Architect.

WARRANTIES

1. The subcontractor shall warrant, in writing of commencing operations, that all rough graded areas are free of large boulders, concrete and other debris, and have been prepared for the required planting-soil and plants, sections allowing for the specified depth of planting-soil and much above the required plant height, and that no subcontractor shall remove at their cost any planting soil placed in areas other than as specified by the architect.
2. The subcontractor shall report all defects, irregularities, or unacceptable conditions in writing to the architect, owner, and/or architect's representative during construction.
3. All documents shall be held by the architect for a period of 10 years after completion of the project, prior to cancellation of a planting time for inspection by the architect, engineer or supervisor, or by the architect's representative.
4. During construction of this Subcontractor is the subcontractor's responsibility to contact and inspect the work for any deficiencies and to inform the architect, engineer or supervisor of the same.
5. Notify the architect when planting operations and plantings have been completed and the subcontractor performance inspection will be held. Should the work meet the consultant's approval, the 14 day maintenance period begins. Correct all deficiencies as required by the consultant.
6. Final inspection will be carried out at least 45 days after the substantial performance inspection. If all deficiencies have not been corrected at that time, the final inspection will take place when all deficiencies have been corrected.

WORKMANSHIP

1. The subcontractor shall be aware of the structural limitations of the site and is responsible for the protection of the water proofing membrane.
2. The subcontractor shall take all reasonable steps to ensure that the work is performed by a subcontractor at their own expense to the satisfaction of the consultant. Any damage shall be repaired by the subcontractor at their own expense to the satisfaction of the consultant.
3. To be submitted by the subcontractor to the consultant's satisfaction:
- a) Existing trees to be saved shall be protected from the following:
 - i) Stocking of earth or materials under spread of trees.
 - ii) Vehicle parking action driving under spread of tree.
 - iii) Dumping of refuse or chemicals in porous materials or liquids. - b) Container grading.
4. The subcontractor shall be aware of the structural limitations of the site and is responsible for the protection of the water proofing membrane.

WARRANTIES

1. General contractor for one year from date of substantial completion of the project. Hold comments established test to the consultant's satisfaction.
2. Contractor shall make available to the general contractor for one year from date of substantial performance inspection by the general contractor.
3. Contractor shall be entitled to a refund of the amount paid to the general contractor for one year from date of substantial performance inspection by the general contractor.
4. Contractor shall be entitled to a refund of the amount paid to the general contractor for one year from date of substantial performance inspection by the general contractor.

GENERAL REQUIREMENTS

1. Site plan, along with the drawings, forms part of the contract documents and is to read, interpreted and communicated with all other parties.
2. The intent of this written specification is to complement the drawn information as indicated on the landscape plan and used in conjunction with each other to conform to all applicable codes and regulations.
3. All landscape work to be performed under this contract to meet the applicable provisions and recommendations set forth in the Master Municipal Specifications & Standards Database and respect as Municipal Bylaws.

PRODUCTS

2.1 DESCRIPTION OF WORK AND SCOPE OF WORK

- This work includes all labour, materials, equipment, transportation and services necessary for:

4. PLANTING, PREPARATION AND MAINTENANCE

- Fresh grading of all planned areas to meet flush with all paved surfaces and building elevations as specified on the landscape architectural and engineering drawings.

5. IMPROVEMENT OF EXISTING PLANTING-SOIL AND SUPPLY AND PLACEMENT OF NEW PLANTING-SOIL

6. PLANTING, AND MAINTENANCE OF NEW TREES, SHRUBS, FOLIAGE, AND GROUND COVER

7. LEAF REMOVAL AND TRIMMING

8. CONTROLLER PLANTING AND MAINTENANCE

9. LANDSCAPE ARCHITECTURE

10. LANDSCAPE CONSTRUCTION

11. LANDSCAPE MAINTENANCE

12. LANDSCAPE INSPECTION

13. LANDSCAPE REPAIR

14. LANDSCAPE MAINTENANCE

15. LANDSCAPE CONSTRUCTION

16. LANDSCAPE MAINTENANCE

17. LANDSCAPE CONSTRUCTION

18. LANDSCAPE MAINTENANCE

19. LANDSCAPE CONSTRUCTION

20. LANDSCAPE MAINTENANCE

21. LANDSCAPE CONSTRUCTION

22. LANDSCAPE MAINTENANCE

23. LANDSCAPE CONSTRUCTION

24. LANDSCAPE MAINTENANCE

25. LANDSCAPE CONSTRUCTION

26. LANDSCAPE MAINTENANCE

27. LANDSCAPE CONSTRUCTION

28. LANDSCAPE MAINTENANCE

29. LANDSCAPE CONSTRUCTION

30. LANDSCAPE MAINTENANCE

31. LANDSCAPE CONSTRUCTION

32. LANDSCAPE MAINTENANCE

33. LANDSCAPE CONSTRUCTION

34. LANDSCAPE MAINTENANCE

35. LANDSCAPE CONSTRUCTION

36. LANDSCAPE MAINTENANCE

37. LANDSCAPE CONSTRUCTION

38. LANDSCAPE MAINTENANCE

39. LANDSCAPE CONSTRUCTION

40. LANDSCAPE MAINTENANCE

41. LANDSCAPE CONSTRUCTION

42. LANDSCAPE MAINTENANCE

43. LANDSCAPE CONSTRUCTION

44. LANDSCAPE MAINTENANCE

45. LANDSCAPE CONSTRUCTION

46. LANDSCAPE MAINTENANCE

47. LANDSCAPE CONSTRUCTION

48. LANDSCAPE MAINTENANCE

49. LANDSCAPE CONSTRUCTION

50. LANDSCAPE MAINTENANCE

51. LANDSCAPE CONSTRUCTION

52. LANDSCAPE MAINTENANCE

53. LANDSCAPE CONSTRUCTION

54. LANDSCAPE MAINTENANCE

55. LANDSCAPE CONSTRUCTION

56. LANDSCAPE MAINTENANCE

57. LANDSCAPE CONSTRUCTION

58. LANDSCAPE MAINTENANCE

59. LANDSCAPE CONSTRUCTION

60. LANDSCAPE MAINTENANCE

61. LANDSCAPE CONSTRUCTION

62. LANDSCAPE MAINTENANCE

63. LANDSCAPE CONSTRUCTION

64. LANDSCAPE MAINTENANCE

65. LANDSCAPE CONSTRUCTION

66. LANDSCAPE MAINTENANCE

67. LANDSCAPE CONSTRUCTION

68. LANDSCAPE MAINTENANCE

69. LANDSCAPE CONSTRUCTION

70. LANDSCAPE MAINTENANCE

71. LANDSCAPE CONSTRUCTION

72. LANDSCAPE MAINTENANCE

73. LANDSCAPE CONSTRUCTION

74. LANDSCAPE MAINTENANCE

75. LANDSCAPE CONSTRUCTION

76. LANDSCAPE MAINTENANCE

77. LANDSCAPE CONSTRUCTION

78. LANDSCAPE MAINTENANCE

79. LANDSCAPE CONSTRUCTION

80. LANDSCAPE MAINTENANCE

81. LANDSCAPE CONSTRUCTION

82. LANDSCAPE MAINTENANCE

83. LANDSCAPE CONSTRUCTION

84. LANDSCAPE MAINTENANCE

85. LANDSCAPE CONSTRUCTION

86. LANDSCAPE MAINTENANCE

87. LANDSCAPE CONSTRUCTION

88. LANDSCAPE MAINTENANCE

89. LANDSCAPE CONSTRUCTION

90. LANDSCAPE MAINTENANCE

91. LANDSCAPE CONSTRUCTION

92. LANDSCAPE MAINTENANCE

93. LANDSCAPE CONSTRUCTION

94. LANDSCAPE MAINTENANCE

95. LANDSCAPE CONSTRUCTION

96. LANDSCAPE MAINTENANCE

97. LANDSCAPE CONSTRUCTION

98. LANDSCAPE MAINTENANCE

99. LANDSCAPE CONSTRUCTION

100. LANDSCAPE MAINTENANCE

101. LANDSCAPE CONSTRUCTION

102. LANDSCAPE MAINTENANCE

103. LANDSCAPE CONSTRUCTION

104. LANDSCAPE MAINTENANCE

105. LANDSCAPE CONSTRUCTION

106. LANDSCAPE MAINTENANCE

107. LANDSCAPE CONSTRUCTION

108. LANDSCAPE MAINTENANCE

109. LANDSCAPE CONSTRUCTION

110. LANDSCAPE MAINTENANCE

111. LANDSCAPE CONSTRUCTION

112. LANDSCAPE MAINTENANCE

113. LANDSCAPE CONSTRUCTION

114. LANDSCAPE MAINTENANCE

115. LANDSCAPE CONSTRUCTION

116. LANDSCAPE MAINTENANCE

117. LANDSCAPE CONSTRUCTION

118. LANDSCAPE MAINTENANCE

119. LANDSCAPE CONSTRUCTION

120. LANDSCAPE MAINTENANCE

121. LANDSCAPE CONSTRUCTION

122. LANDSCAPE MAINTENANCE

123. LANDSCAPE CONSTRUCTION


124. LANDSCAPE MAINTENANCE

125. LANDSCAPE CONSTRUCTION

126. LANDSCAPE MAINTENANCE

127. LANDSCAPE CONSTRUCTION

128. LANDSCAPE

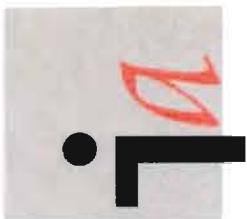

INTEGRA ARCHITECTURE INC.

416 WEST PENDER STREET
VANCOUVER, BC V6E 1T5
T 604.688.4220 F 604.688.4270
info@integra-arch.com
www.integra-arch.com

Copyright Integra. All rights reserved. The design and design of INTEGRA ARCHITECTURE INC. are trademarks of Integra Architecture Inc. and cannot be used without our consent.



MASSING STUDY VIEWS



RENDERING NIGHT VIEW



PERSPECTIVE FROM SOUTH-EAST

Sheet No. 27
December 16, 2013
DP 13-63411

(ARCHITECTURE)

MAJORCA INTERNATIONAL
INVESTMENTS LTD.

(PROJECT)

ELLE
6511-6531 BUSWELL
RICHMOND, BC CANADA

(Landscape)

CONCEPT
10254

(Project)

10254
December 13, 2013
8 - DP Resubmission

(Scale)

(Date)

(Issue)

SKETCH RENDERING