

Aberdeen, Lansdowne, Richmond-Brighouse Stations

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# 1.0 Summary/Design Rationale

Aberdeen, Lansdowne, and Richmond-Brighouse Stations are the three Canada Line stations located along No.3 Road in the City of Richmond. They are located in areas envisioned undergoing significant change with future development. The stations will serve as catalysts for this development, and will contribute positively to the changing character of No.3 Road and downtown Richmond. The stations, by being comfortable and safe, will encourage the use of transit and reduce dependence on automobiles.

The stations will incorporate repeated elements that clearly identify them as a family of stations. These include: a distinctive wood roof structure, a glazing system emphasizing openness and transparency, and high quality finish materials.

The wood roof elements will relate the stations to other high quality civic spaces in the City of Richmond, and to a larger regional identity associated with the use of wood. The material and form of the roof is intended to provide a 'soft' contrast to the 'hard', infrastructure character of some of the system elements. The 'waved' underside form of the roof also recalls the surface of the waters surrounding the City of Richmond, and the use of wood recalls the industrial heritage of the region in an updated and contemporary way.

The station designs, by using a distinctive, elegantly simple language, will contribute to an emerging image of the City of Richmond as a sophisticated, urban, centre.

Aberdeen Station (formerly named Cambie) is the first station along No.3 Road as you enter the City of Richmond from the north. Aberdeen and Lansdowne stations are seen as a pair of 'sister' stations. Aberdeen station is located in a neighbourhood with an international character, and in an area envisioned undergoing significant change with future development, including large scale, mixed-use, commercial development immediately adjacent to the station.

Aberdeen Station is located at the south-east corner of the intersection of No.3 Road and Cambie Road. The station is entered from the north. Inside the concourse, the station will be fully glazed to allow visibility into and out of the station. The elevators will be glazed to maintain visibility for passengers riding between the concourse and platform level. Stairs and escalators will be located on either side of the station concourse taking passengers between the concourse and platform levels. On the platform, the extensive use of glass will allow views out of the station, a visual connection to the surrounding area, and weather protection from the elements. Overhead, a distinctive wood roof will provide weather protection for the full extent of the platform and clearly identify the station as one of the family of No.3 Road, City of Richmond, Canada Line stations.

Lansdowne Station (formerly named Alderbridge) is located at the intersection of No.3 Road and Lansdowne Road. The station is envisioned serving a 'Downtown North' neighbourhood adjacent to a future civic plaza and park on the east side of No. 3 Road. The station area will undergo significant change with future development, including an envisioned large scale urban park and plaza on the east side of No.3 Road between Lansdowne Road and Alderbridge Way.

Lansdowne Station is located at the south east corner of the intersection of No.3 Road and Lansdowne Road. The station is entered from the south. Inside the concourse, the station will be fully glazed to encourage visibility into and out of the station. The elevators will be glazed to maintain visibility for passengers riding between the concourse and platform level. Stairs and escalators will be located on either side of the station concourse taking passengers between the concourse and platform levels. On the platform, the extensive use of glass will allow views out of the station, a visual connection to the surrounding area, and weather protection from the elements. Overhead, a distinctive wood roof will provide weather protection for the full extent of the platform and clearly identify the station as one of the family of Canada Line Station, City of Richmond, No.3 Road stations.

**Richmond – Brighouse Station** (formerly named Richmond City Centre) is the south terminus of the Canada Line. The station is envisioned as part of a south gateway to the City of Richmond's downtown and is in a neighbourhood that will undergo significant change with future development.

Richmond-Brighouse Station is located on the east side of No.3 Road, south of Saba Road. The station will be entered from the south and will be integrated with an adjacent transit bus loop serving both local and regional routes. Inside the concourse, the station will be fully glazed to encourage visibility into and out of the station. The elevators will be glazed to maintain visibility for passengers riding between the concourse and platform level. Stairs and escalators will take passengers between the concourse and platform levels. Richmond-Brighouse station is a single platform station because of its position at the terminus of the Richmond section of the Canada Line.

On the platform, the extensive use of glass will allow views out of the station, a visual connection to the surrounding area, and weather protection from the elements. Overhead, a distinctive wood roof will provide weather protection for the full extent of the platform and clearly identify the station and one of the family of No.3 Road, City of Richmond, Canada Line Stations.

#### Context Issues:

The Stations are seen as being clearly part of the Canada Line, with a similarity in the overall system aesthetic. The stations are also intended to be clearly identifiable as a family of City of Richmond, No.3 Road Stations. They will have similar, repeated, wood roof structures, glazing, and finish materials. The varying context in which the stations are located will be reflected in the station plaza design and landscape treatment. Strong colour, appropriate to the context will help to identify the stations. For example, Aberdeen Station may use the colour red to refer to the multicultural, vibrant neighbourhood in which it is located, and Lansdowne Station may use the colour green to relate to an envisioned, large scale, urban park and plaza adjacent to the station. The stations will be catalysts for future development, and the station plazas will contribute to 'place making' and other urban design strategies for No.3 Road.

Opportunities for future retail are provided under, and adjacent to the stations, and will contribute to the feeling of safety and security in the station environment, and encourage the use of transit. A retail kiosk will be provided in the station plaza, with the final location to be coordinated with the landscape plaza design.

#### Station Systems / Materials:

Glass: The station designs incorporate extensive glazing to allow visibility into and out of the stations, and to enhance the feeling of patron comfort and security. The ancillary spaces for the stations are potentially clad in opaque, strongly coloured glass and louver cladding to clearly identify the individual stations, and give a brighter, more finished appearance at the grade level around the stations. This element will be reviewed with the provisions for future retail below the station.

A glazing system that emphasizes transparency at the platform level assists passengers with way-finding. At platform level the glazing is full height on the east side of the station, and is to 2.5 m above the platform floor level on the west side. This corresponds with the prevelant direction of wind driven rain, and allows a more open, inviting expression for the west, No.3 Road elevation of the station.

Steel: Light steel framing supports the glazing and roof structure.

Concrete: The platform structure and guideway are heavy concrete elements, supporting the light steel, glass, and wood enclosure around them.

Wood: A wood platform roof structure provides weather protection for patrons, and a distinctive No.3 Road station identity. The use of wood also relates the stations to other City of Richmond public spaces, including: streetscape trees and furniture, and existing civic buildings.

Tile/Metal Panel: Public areas of the stations will incorporate durable tile floor finishes and metal panel wall finishes. Colour may be used to clearly identify the individual stations, similar to a strategy that may be employed for the ancillary block cladding.

Advertising: Advertising is proposed to be located along the centerline of the guideway, between the platforms, in order to prevent the exterior, transparent faces of the stations from being obstructed by advertising and signage. Station signage is incorporated into system-wide service chaseway elements at the platform and concourse level

#### Sustainability:

The stations, by being comfortable and safe, will encourage the use of transit and reduce dependence on automobiles.

Materials for the stations will be selected to reduce unnecessary waste in their construction and maintenance. They will be selected to ensure durability and longevity. Wood is proposed as a sustainable, regional material for the roof structure.

Daylight strategies will be employed at Richmond-Brighouse Station to ensure that even with future adjacent development daylight is brought into the station house.


Opportunities for rainwater collected on the roof to be incorporated into the adjacent landscape design features may be explored.

Other opportunities to incorporate sustainable design strategies into the stations will be pursued as the designs progress.




# ABERDEEN STATION

## KEY PLAN

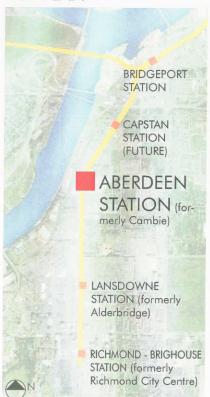

**EXISTING** 

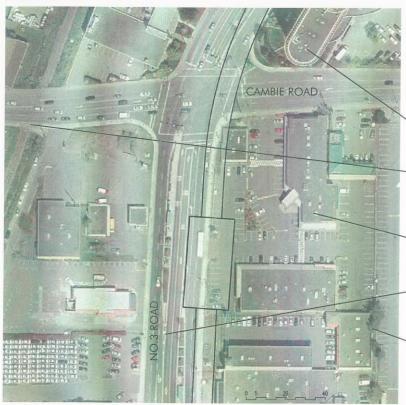

**Neighbourhood Character** 

The station is located at the south east corner of the intersection of Cambie and No. 3 Road. This section of No.3 Road is developing as a multi-cultural neighbourhood with an international character.

The **Radisson Hotel** is located on the north east corner of the intersection of No.3 Road and Cambie Road.

No. 3 Road at this location is approximately 80 m from the railway right of way parallel with No.3 Road. The shore of the **Fraser River** is a short distance beyond this.

One and two storey commercial buildings are currently on the station site, and on the west side of No.3 Road.

The current area **bus service** will be reorganized, and the station will be served by stops on No.3 Road.

The west face of the **Aberdeen Mall** parking structure is adjacent to the station site. Currently a residential building, integrated with the mall, is being construction along Cambie Road.

**Airplanes** landing and taking off at YVR fly directly over the station site.






Station Location

# Aberdeen Station (formerly named Cambie) is the first station along No.3 Road as you enter the City of Richmond from the north. The station is located in a neighbourhood with an international character, and an area envisioned undergoing significant change with future development.



View south on No.3 Road

## 2009/OPENING DAY

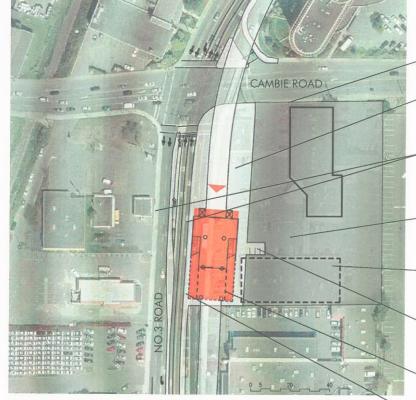

The **station entrance** is from the north near the intersection of No.3 Road and Cambie Street .

 Passenger pick up and drop-off is on Cambie Road.

#### Station Plaza

A station entry plaza will connect to the adjacent sidewalks and development.

#### **Bus Connections**

The station will be served by No.3 Road local bus service. Bus service along Cambie Road will also serve the station.

 Remaining portion of site to be sold for redevelopment.

An existing one storey commercial building is removed to allow the station construction.

Three parking spaces for station

servicing are provided off existing retail
parking adjacent to the station.

A traction power substation at this location is under review

No.3 Road is reconfigured to allow the elevated guideway along its east edge. Approximately 3m (10') is maintained between the curb of No.3 Road and the station to allow pedestrians and cyclists to pass.

In the future **Cambie** is envisioned becoming an important connection to a public greenway along the existing rail right of way parallel to No.3 Road, and to the development of a public Fraser River waterfront.

**Commercial development** is seen expanding to the area immediately adjacent to the station.

The **station entry plaza** will be integrated with adjacent development

**Mixed-use development** is seen significantly increasing in scale on the west side of No.3 Road

Future traction power substation within future adjacent development

**Pedestrian and cyclists** may circulate around station on both sides through an integrated plaza.









# LANSDOWNE STATION

## KEY PLAN

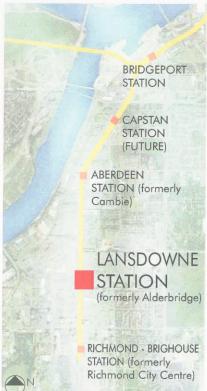

**EXISTING** 

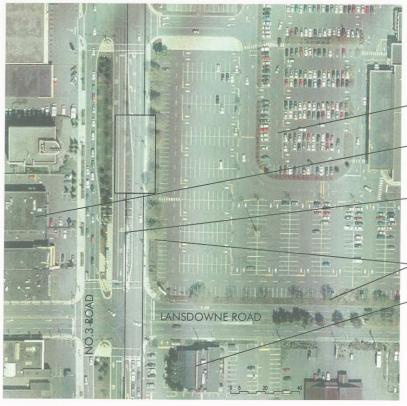

**Neighbourhood Character** 

The station is located at the north east corner of the intersection of No.3 Road and Lansdowne. This is envisioned as the 'Downtown North' neighbourhood of No.3 Road.

Adjacent Lansdowne Mall surface


A mix of small scale commercial buildings are located on the west side of No.3 Road.

The area **bus service** will be reorganized, and the station will be served by stops on No.3 Road.

Large scale street trees currently surround Lansdowne Mall parking area.

mix of small scale commercial buildings are located on the south side of Lansdowne Road.

# 2009/OPENING DAY

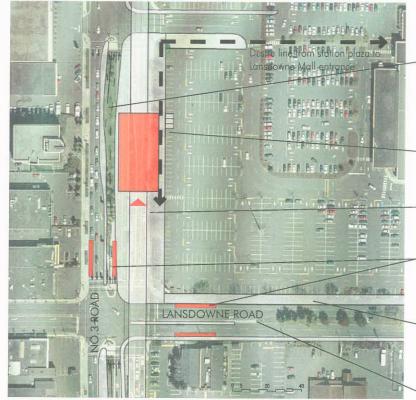

The station entrance will be from the south at the intersection of No.3 Road and Lansdowne Street

No.3 Road is reconfigured to allow the elevated guideway along its east edge. Approximately 3m (10') is maintained between the curb of No.3 Road and the station to allow pedestrians and cyclists to

Three parking spaces for station servicing are provided off existing retail parking adjacent to the station.

#### Station Plaza

A station entry plaza will connect to the adjacent sidewalks and development.

#### **Bus Connections**


The station will be served by No.3 Road local bus service. Bus service along Cambie Road will also serve the station.

#### Streetscape

There are potential improvements to the north side of Lansdowne Road adjacent to

Lansdowne Road is envisioned as a significant east-west street with the Olympic Speed Skating Oval facility to the east and the Garden City (DFO) land development to the west.

## **FUTURE**

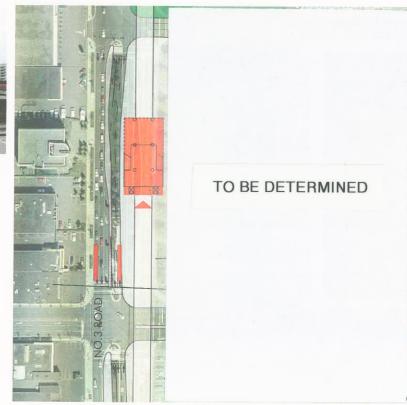

Lansdowne Station (formerly named Alderbridge) is located at the intersection of No.3 Road and Lansdowne Road. The station is envisioned serving a 'Downtown North' neighbourhood adjacent to a future civic plaza and park on the east side of No. 3 Road. The station area will undergoing significant change with future development.





Station Location



View south on No.3 Road

In the long term Lansdowne Mall is seen redeveloping as a mixed-use commercial and residential area with streets introduced across the block

The area immediately east of No.3 Road between Alderbridge Way and Lansdowne Road is envisioned becoming a large scale civic park and plaza

The station plaza is expanded and integrated with the adjacent civic park and future development.

The areas south of Lansdowne and west of No. 3 Road are envisioned developing with significantly increased density forming an urban street front along No.3 Road




# RICHMOND - BRIGHOUSE STATION

### KEY PLAN



Richmond - Brighouse Station (formerly named Richmond City Centre) is the south terminus of the Canada Line. It will be integrated with a bus exchange serving local and regional routes. The station is envisioned as part of a south gateway to the City of Richmond's downtown and is in a neighbourhood that will undergo significant change with future development.

## **EXISTING**

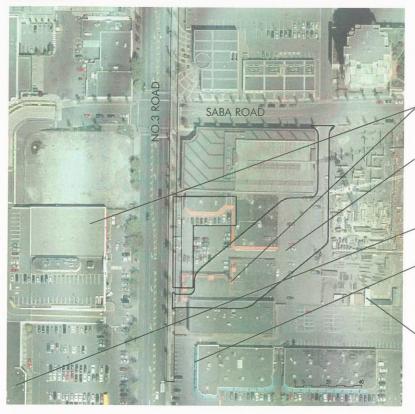

#### **Neighbourhood Character**

The station is located south of Saba Road along No. 3 Road. This area is seen as the 'Downtown South' segment of No.3 Road with an urban character of high density mixed-use development.

One and two storey commercial buildings are currently on the station site, and on the west side of No.3 Road.

The current area **bus service** will be reorganized, and the station will be served by a bus loop adjacent to the

Richmond Centre Mall is located across No.3 Road and to the south.

The buildings will be set-back from No.3 Road south of the station to encourage a connection with Richmond City Hall to

Adjacent mixed-use residential and commercial development.

The station together with Richmond City Hall, serves as a south gateway to Richmond's downtown

# 2009/OPENING DAY



The station will be served by an adjacent surface bus loop. This will be the terminus station for local and regional bus

The **bus loop** will be entered from No.3 road. Design is under review.

The station and bus loop will be planned to allow for future development of the

Three parking spaces for station servicing are provided adjacent to the station.

#### Station Plaza

A station entry plaza will connect to the adjacent sidewalks and development. The station is entered from the south and contributes to a south gateway for Richmond's

A tail track extends south of the station approximately 44m (145').

## SITE PHOTOS




Station Location



View north on No.3 Road

# **FUTURE**

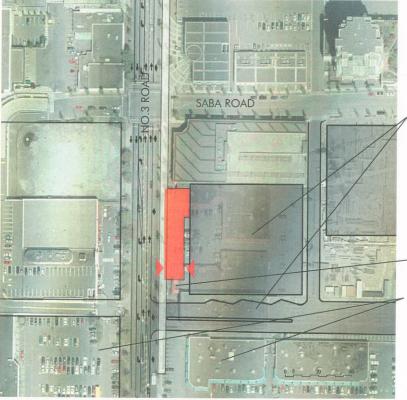

#### **Neighbourhood Character**

Long term the area around the station is seen developing as an urban mixed-use commercial and residential area.

In the future the bus loop may be relocated in favour of an open bus mall running between Buswell Street and No.3

The station plaza is expanded and integrated with the adjacent development.

The adjacent neighbourhood is seen developing with significantly increased density forming an urban street front along




# ABERDEEN STATION


Aberdeen Station (formerly named Cambie) is located at the south-east corner of the intersection of No.3 Road and Cambie Road. The station is entered from the north.

Aberdeen and Lansdowne stations are seen as a pair of 'sister' stations. Aberdeen station is envisioned next to a future large scale, mixed-use, commercial development.


Inside the concourse, the station will be fully glazed to allow visibility into and out of the station. The elevators will be glazed to maintain visibility for passengers riding to the upper platform level. Stairs and escalators will be located on either side of the station concourse taking passengers up to the platforms.


On the platform, extensive use of glass will allow views out of the station, a visual connection to the surrounding area, and weather protection from the elements. Overhead, a distinctive wood roof will provide weather protection for the full extent of the platform and clearly identify the station as one of the family of No.3 Road, City of Richmond, Canada Line Stations.

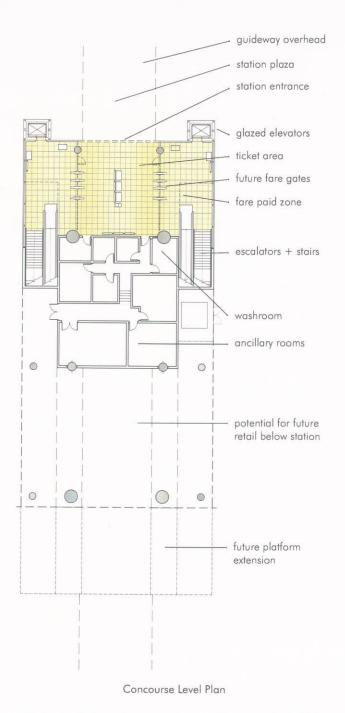

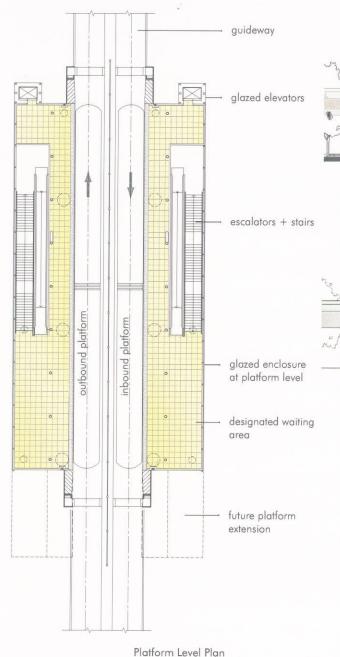



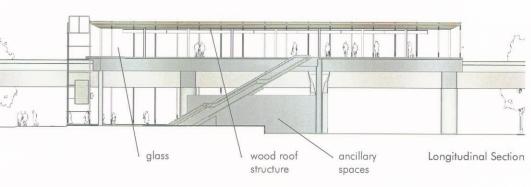

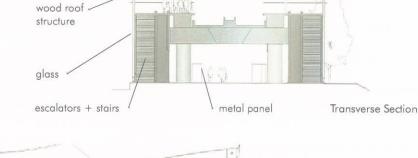







#### Context

The Stations are seen as being clearly part of the Canada Line, City of Richmond, No.3 Road family of Stations. They will have similar structures, glazing, and roof elements. The varying context in which the stations are located will be reflected in the station plaza design and landscape treatment.


Aberdeen Station will have future, adjacent, mixed-usecommercial development.

Lansdowne Station is at the south-west corner of an area envisioned as a future large scale civic park and plaza. Richmond-Brighouse Station is adjacent to future, large scale, urban development.

The stations will be catalysts for future development, and the station plazas will contribute to 'place making' and other urban design strategies for No.3 Road. Future retail provided under and adjacent to the stations will contribute to the feeling of safety and security in the station environment, and encourage the use of transit.

Distant views of Fraser River

and Mountians

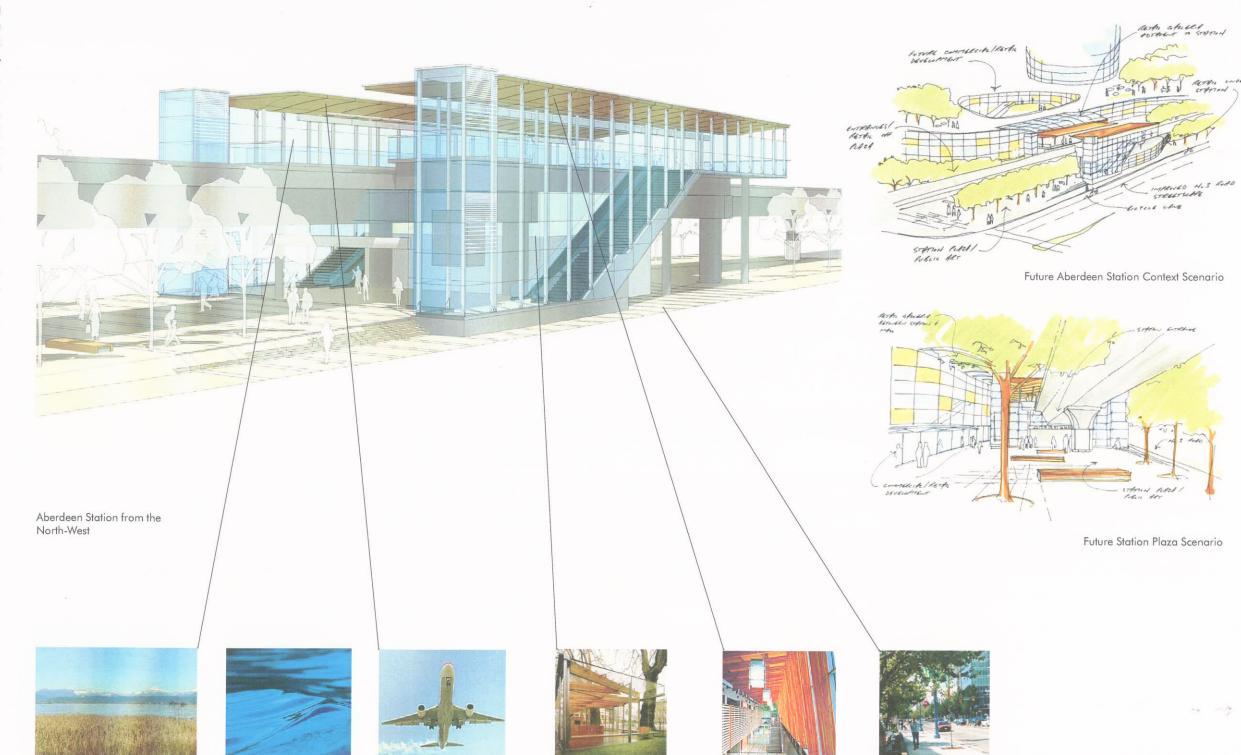





Roof form recalls the underside of a boat, or

Tel: 604.608.0200

Transparency ties stations to

context and increases sense

of comfort and security

Use of wood in the stations

Richmond civic buildings and

relates to other City of

public spaces

improved No.3 Road

Streetscape and civic

spaces




# LANSDOWNE STATION


Lansdowne (formerly named Alderbridge) is located at the south east corner of the intersection of No.3 Road and Lansdowne Road. The station is entered from the south.

Lansdowne and Aberdeen stations are seen as a pair of 'sister' stations. Lansdowne station will respond to the envisioned large scale urban plaza and park on the east side of No.3 Road.

Inside the concourse, the station will be fully glazed to encourage visibility into and out of the station. The elevators will be transparent to maintain visibility for passengers riding to the upper platform level. Stairs and escalators will be located on either side of the station concourse taking passengers up to the platform level.

On the platform, extensive use of glass will allow views out of the station, a visual connection to the surrounding area, and weather protection from the elements. Overhead, a distinctive wood roof will provide weather protection for the full extent of the platform and clearly identify the station as one of the family of Canada Line Station, City of Richmond, No.3 Road stations.

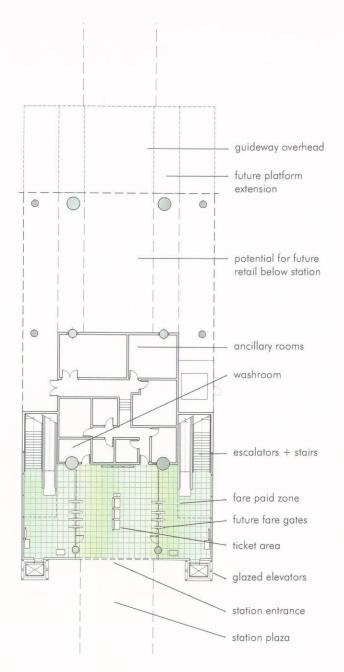

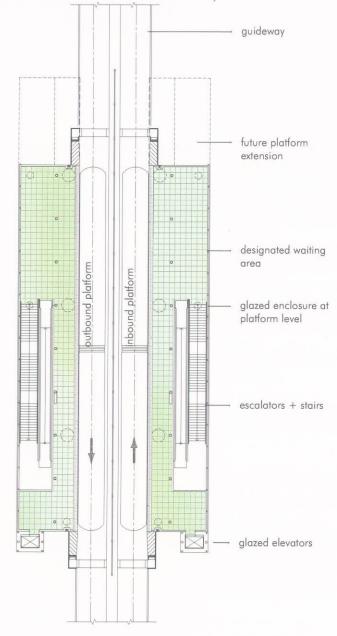



potential for future

retail below station



escalators + stairs



Transverse Section

West Elevation



Concourse Level Plan



Platform Level Plan

#### **Materials**

**Glass**: The station designs incorporate extensive glazing to allow visibility into and out of the stations, and to enhance the feeling of patron comfort and security.


**Steel**: Light steel framing supports the glazing and roof structure.

**Concrete**: The platform structure and guideway are heavy concrete elements, supporting the light steel, glass, and wood enclosure around them.

**Wood**: A wood platform roof structure provides weather protection for patrons, and a distinctive No.3 Road station identity. The use of wood also relates to other City of Richmond public spaces, including: streetscape trees and furniture, and existing civic buildings.

**Tile/Metal Panel**: Public areas of the stations will incorporate durable tile floor finishes and metal panel wall finishes. Colour may be used to clearly identify the individual stations.

Materials for the stations will be selected to convey a sense of timelessness and quality.

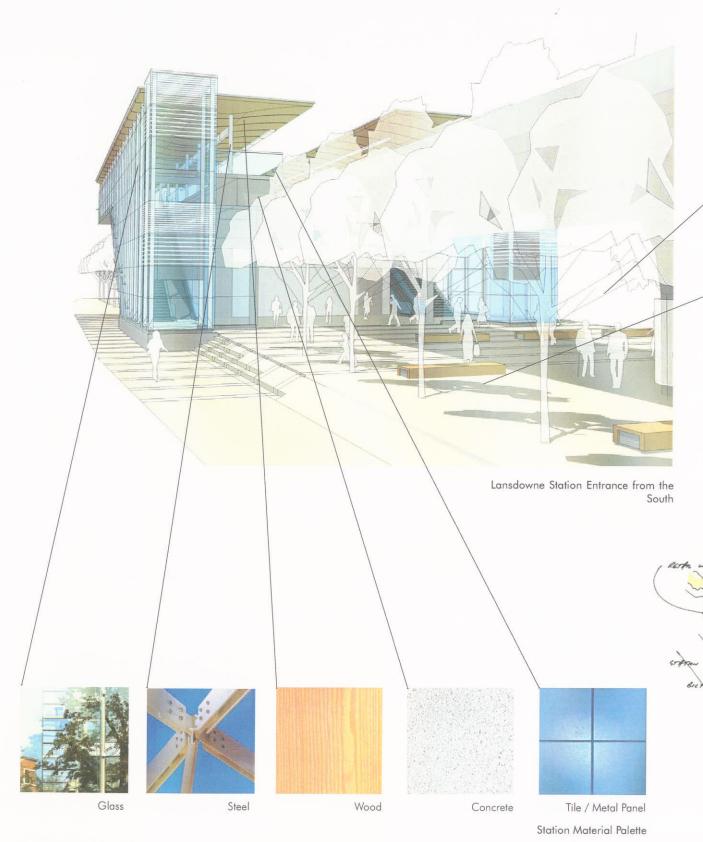



Provisions for retail kiosk in station plaza



Station plaza and furniture reflects context and quality of City of Richmond public spaces



Improved No.3 Road Streetscape




Hard and Soft Landscaping



Water / Public Art



Street Trees / Plaza

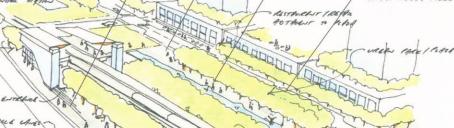

IMPROVED LANGDOWNE ROAD STREETSCAPE

Future Lansdowne Station context scenario



www.canadaline.ca

Tel: 604.608.0200





# RICHMOND-BRIGHOUSE STATION

Richmond-Brighouse Station (formerly named Richmond City Centre) is located on the east side of No.3 Road south of Saba Road. The station will be entered from the south and will be integrated with an adjacent transit bus loop serving both local and regional routes.

Inside the concourse, the station will be fully glazed to encourage visibility into and out of the station. The elevators will be transparent to maintain visibility for passengers riding to the upper platform level. Stairs and escalators will take passengers to the platform. Richmond-Brighouse station is a single platform station because of it's position at the terminus of the Richmond section of the Canada Line.

On the platform, extensive use of glass will allow views out of the station, a visual connection to the surrounding area, and weather protection from the elements. Overhead, a distinctive wood roof will provide weather protection for the full extent of the platform and clearly identify the station as one of the family of No.3 Road, City of Richmond, Canada Line Stations.

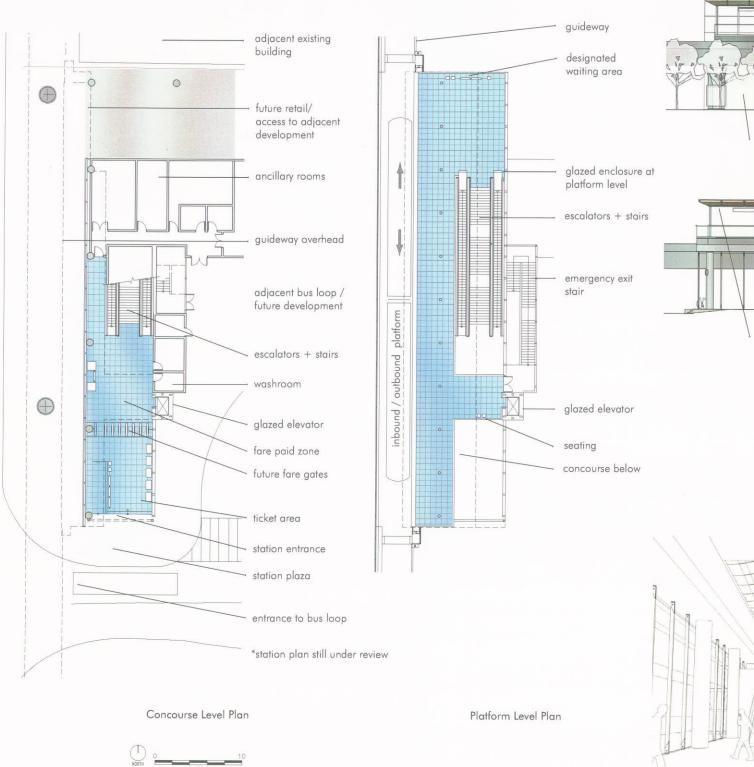

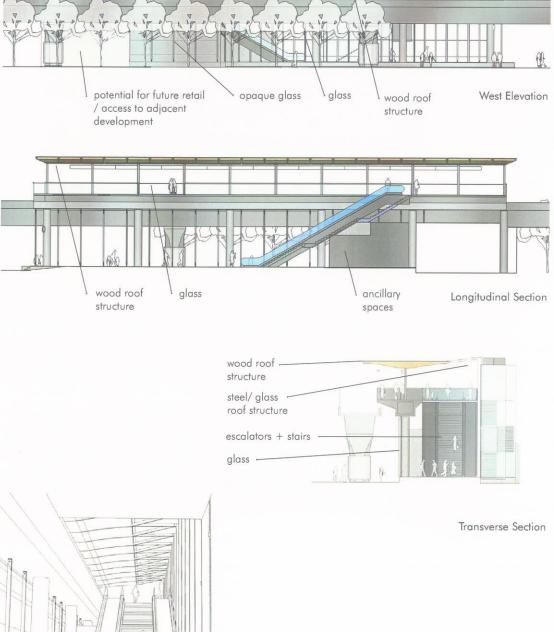





# CANADA LINE

# RICHMOND-BRIGHOUSE STATION

## Sustainability


The stations, by being comfortable and safe, will encourage the use af transit and reduce dependence on automobiles.

Materials for the stations will be selected to reduce unnecessary waste in their construction and maintenance. They will be selected to ensure durability and longevity.


**Daylight** strategies will be employed at Richmond-Brighouse Station to ensure that even with future adjacent development daylight is brought into the station house.

**Rainwater** collected on the roof may be incorporated into landscape design features.


Other opportunities to incorporate sustainable design strategies into the stations will be pursued as the designs progress.

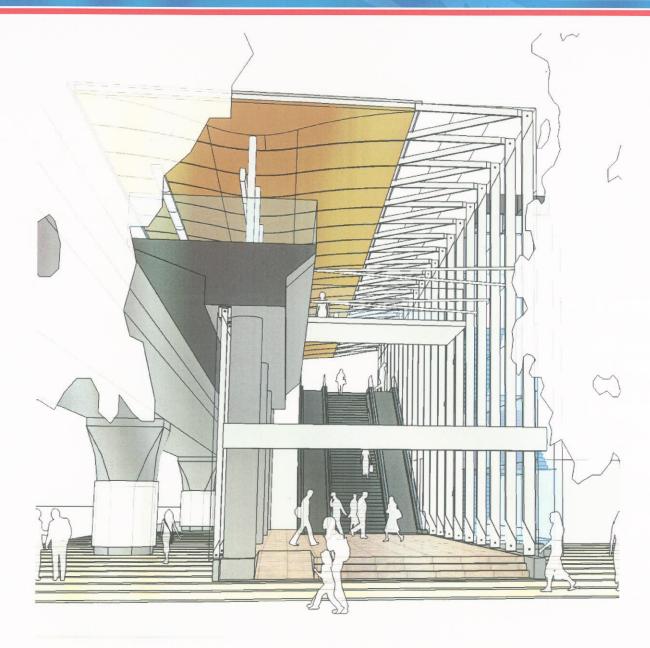

Richmond-Brighouse Station Entrance from the South

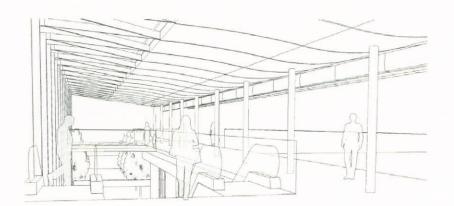

View at Platform Level

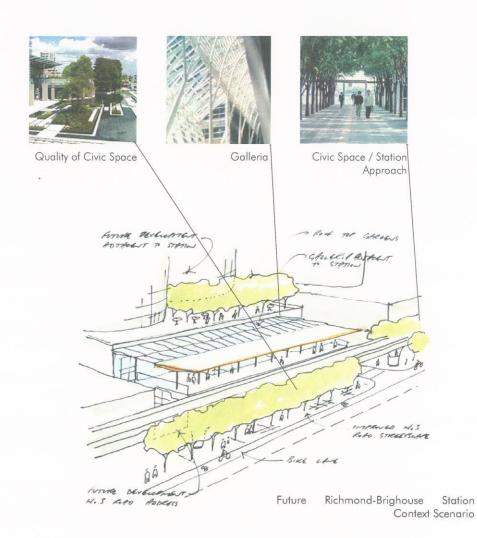



View from No.3 Road Showing Future Context









View from the North West


Aberdeen Station

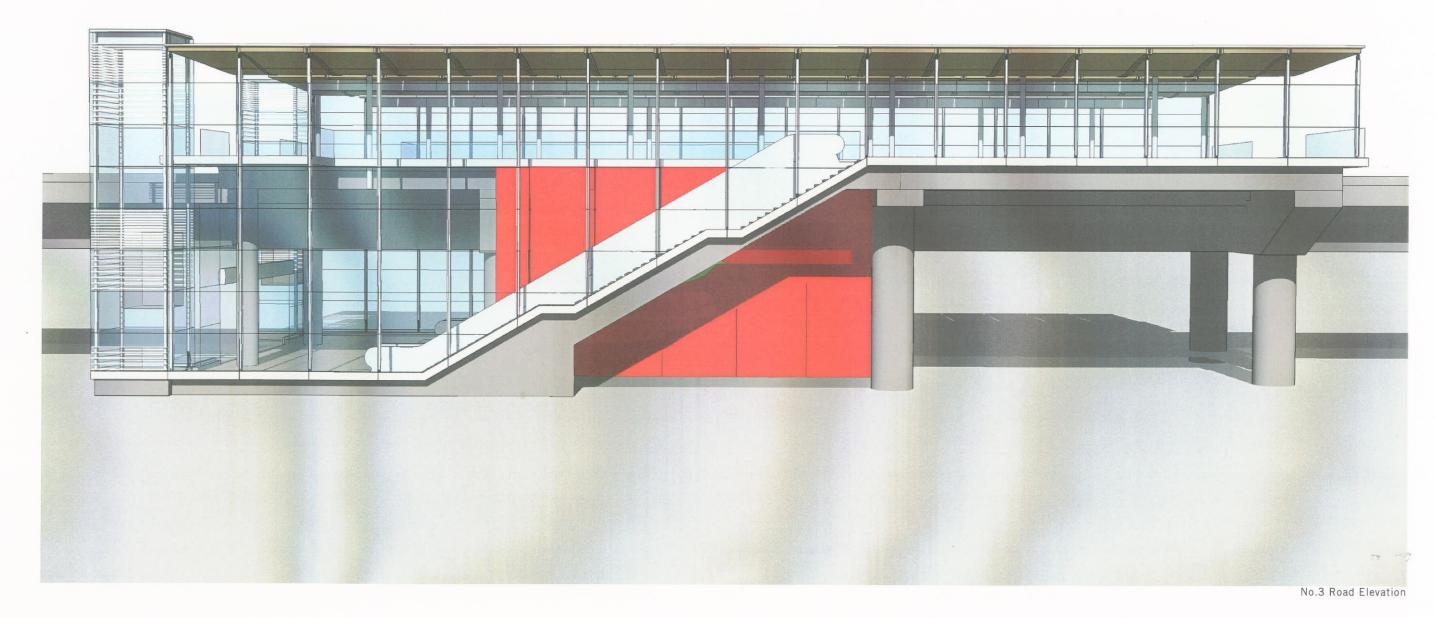

Aberdeen Station

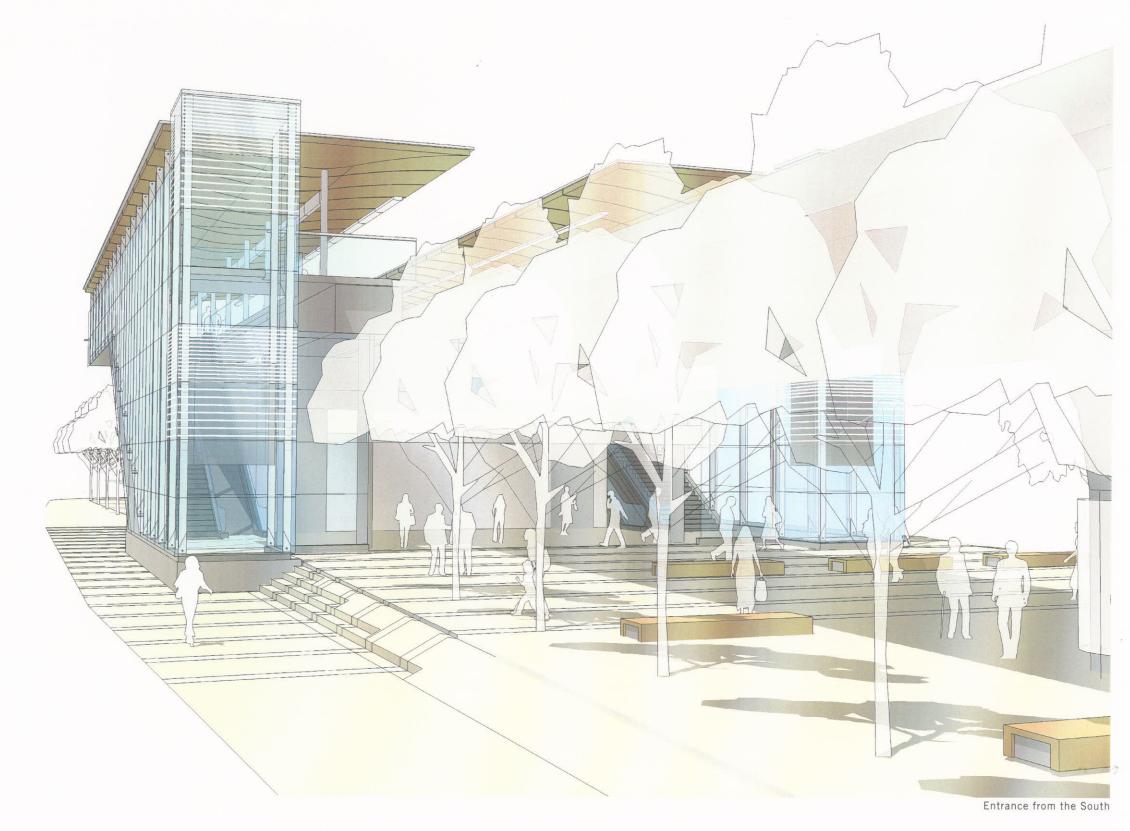

Lansdowne Station

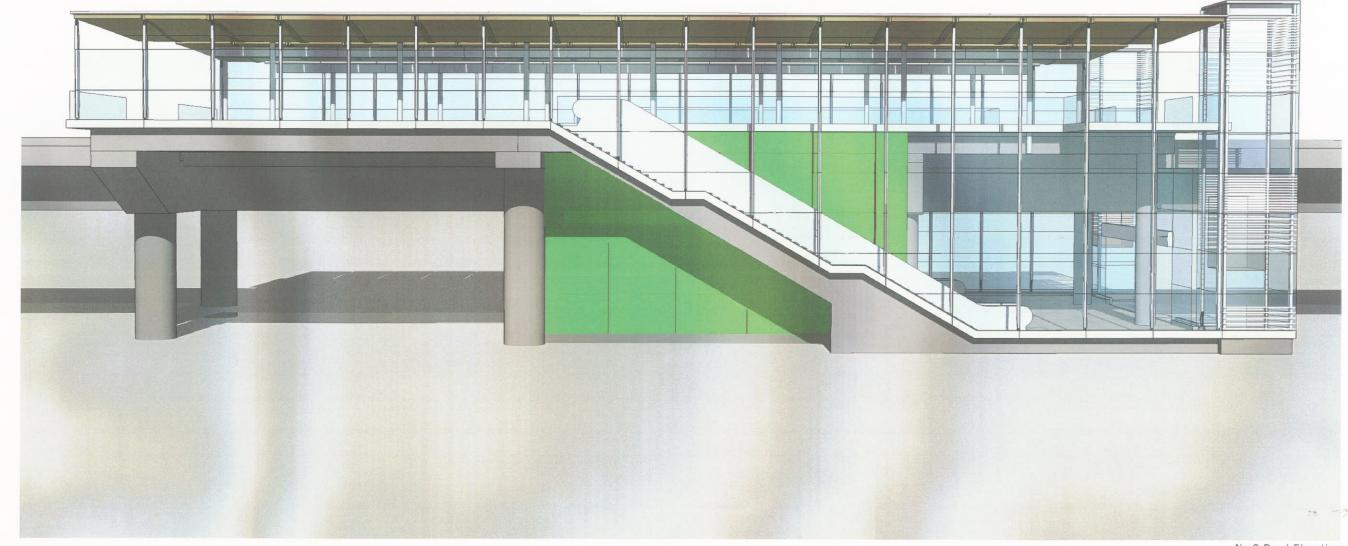


No.3 Road Elevation

# Lansdowne Station




View at Platform Level Showing Proposed Advertising Element

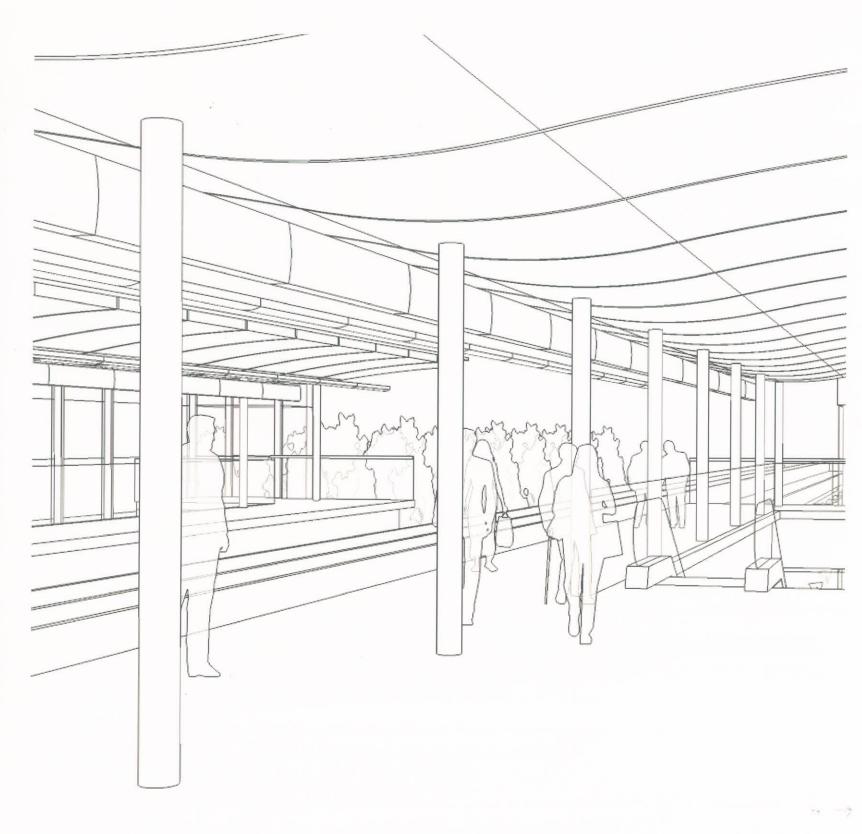

View at Platform Level

Aberdeen/Lansdowne Station

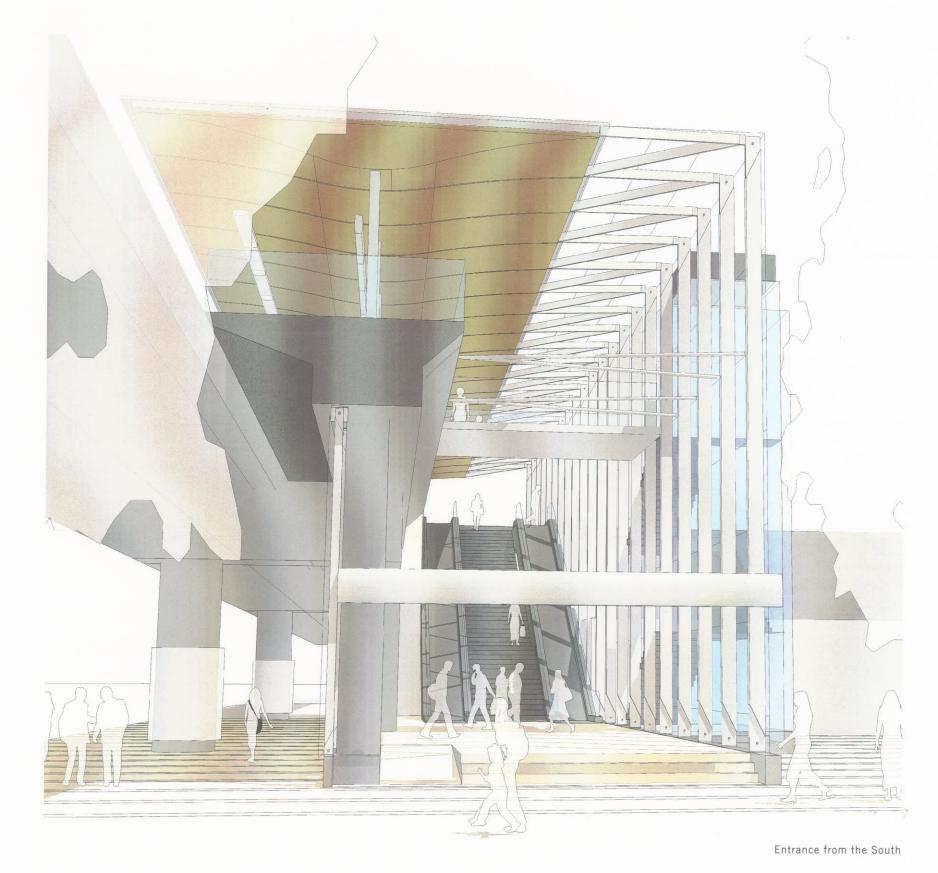


Richmond - Brighouse Station



Richmond-Brighouse Station



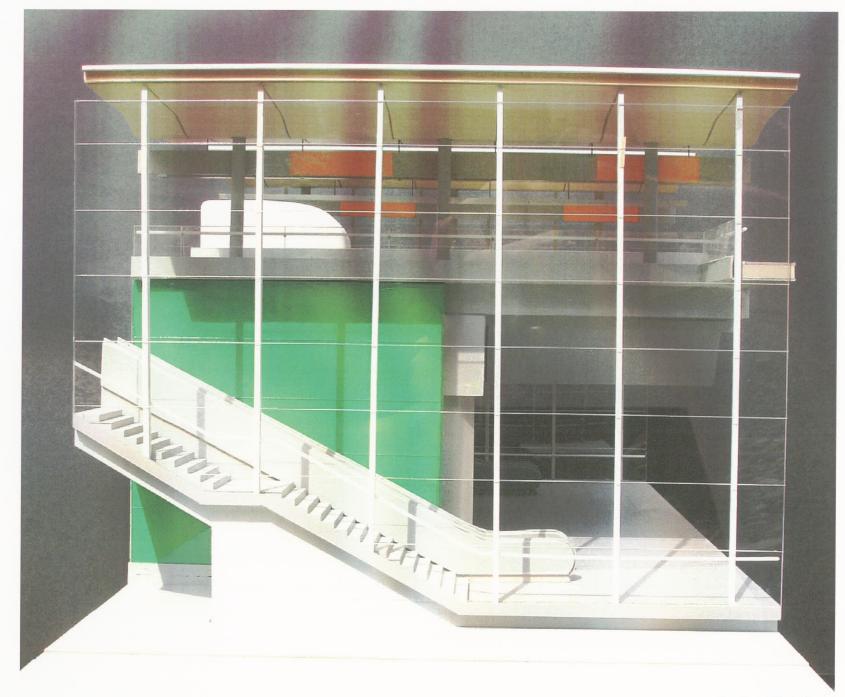


Sectional Study Model



Sectional Study Model

# Lansdowne Station

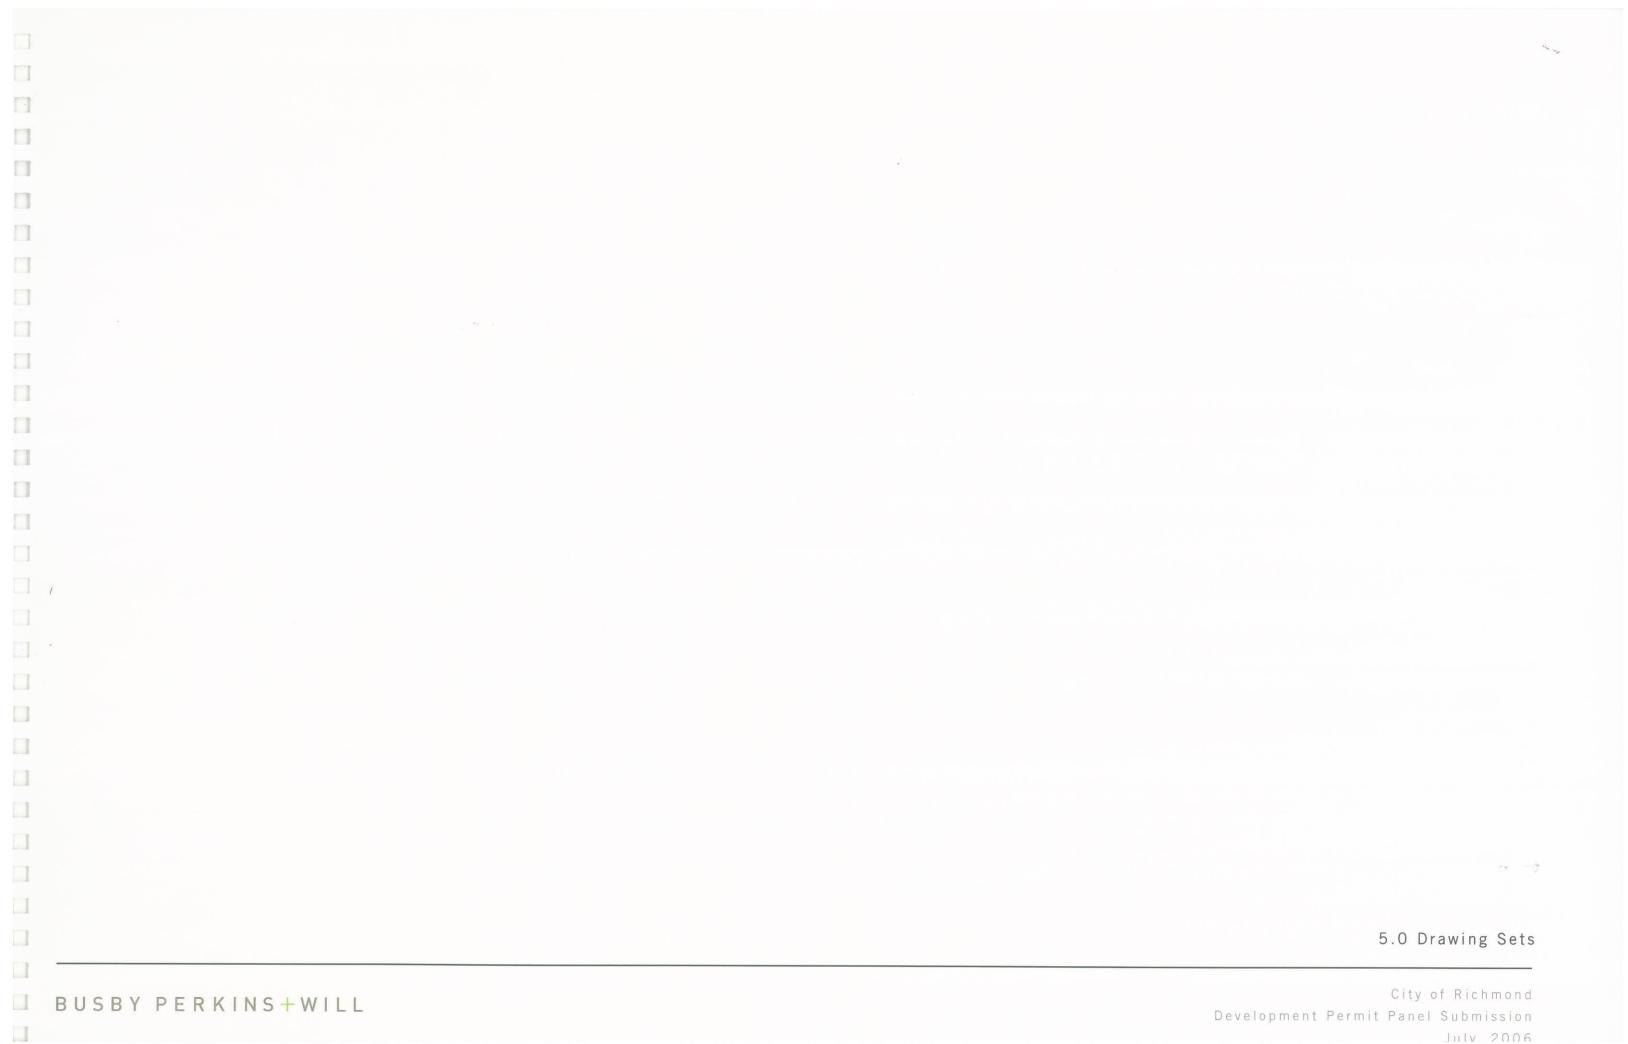

#### ABERDEEN STATION (PREVIOUSLY CAMBIE STATION)

ARCH	

drawing number	content	scale (full size or 11x17 version)
016876- 2110- 44DD- CA- 0003	Drawing Index	n/a
016876- 2110- 44DD- CA- 1000	Site + Context Plan	1:250 or 1:500
016876- 2110- 44DD- CA- 1001	Grade Level Plan	1:100 or 1:200
016876- 2110-44DD-CA- 1002	Platform Level Plan	1:100 or 1:200
016876- 2110-44DD-CA-1003	RCP- Grade Level	1:100 or 1:200
016876- 2110- 44DD- CA-1004	RCP- Platform Level	1:100 or 1:200
016876- 2110- 44DD- CA- 2000	Longitudinal Section	1:100 or 1:200
016876- 2110- 44DD- CA- 2002	Cross Sections - Option 2	1:100 or 1:200
016876- 2110- 44DD- CA- 3000	East + West Elevations	1:100 or 1:200
016876- 2110-44DD-CA-3001	North + South Elevations	1:100 or 1:200


STRUCT (Not Issued) see Lansdowne station drawings for structural drawings

Stns/

Richm





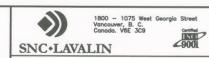


RICHMOND/AIRPORT/VANCOUVER

ABERDEEN STATION

DRAWING LIST

SCALE N/A	CONTRACT No.	SUB CONSULTANT PROJECT NO.				
DATE MAY 31, 06		PROJECT NO.				

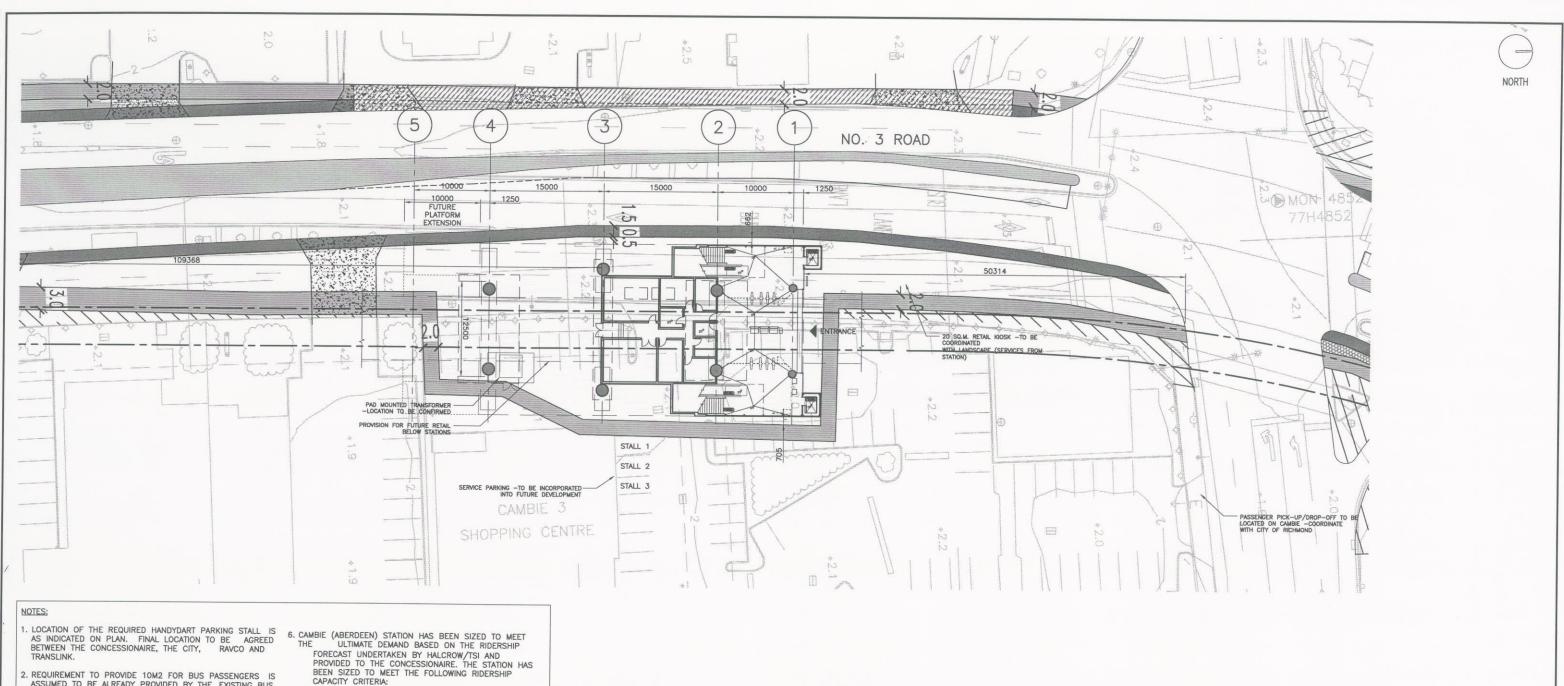

- 2. REQUIREMENT TO PROVIDE 10M2 FOR BUS PASSENGERS IS ASSUMED TO BE ALREADY PROVIDED BY THE EXISTING BUS STOPS ON CAMBIE AND NO. 3 ROAD.
- 3. PROVISION OF 1 PASSENGER PICK UP AND DROP OFF (PPUDO) AS INDICATED ON PLAN. FINAL LOCATION OF PPUDO STALL IS TO BE MUTUALLY AGREED BETWEEN THE CONCESSIONAIRE, THE CITY AND RAVCO.
- 4. NO BIKE LOCKER PROVISION AT THIS STATION.

DATE

RAW-SNC-DSIZE-SHEET.dwg
Rev. PC 558.8mm x 836.6mm METRIC

- 5. THE CONCESSIONAIRE IS RESPONSIBLE FOR THE MAINTENANCE AND UPKEEP OF ALL STATION SURFACE STRUCTURES, INCLUDING ENTRANCE, EXIT STAIRS, AND OTHER STATION STRUCTURES. THE EXTENT OF THE CONCESSIONAIRE'S RESPONSIBILITY TO MAINTAIN THE GROUND PLANE AND ASSOCIATED LANDSCAPING IS AS DEMARCATED ON THIS DRAWING.
- CAPACITY CRITERIA:
- a. MAXIMUM PLATFORM OCCUPANT LOAD UNDER EMERGENCY CONDITION
  - INCIDENT PLATFORM NON INCIDENT PLATFORM
- b. MAXIMUM VERTICAL CIRCULATION CAPACITY FOR DAILY PEAK SERVICE
  - ENTRAINING LOAD PER MINUTE DETRAINING LOAD PER MINUTE

10 FULL SIZE - 1:250 11X17 VERSION - 1:500

DESIGNED REFERENCE DRAWING REVISIONS DATE DWG No. DESCRIPTION DRAWN DESCRIPTION DATE 2006-05-31 ES ISSUED AT 15% COMPLETION 2006-07-18 ES ISSUED FOR COR DPP CHECKED DATE





CANADA LINE **TRANSITBC** 





RICHMOND/AIRPORT/VANCOUVER ABERDEEN STATION SITE + CONTEXT PLAN


SCALE 1:100 CONTRACT No.		CONTRACT No.	SUB CONSULTANT		
DATE	MAY 31, 06		PROJECT NO.		

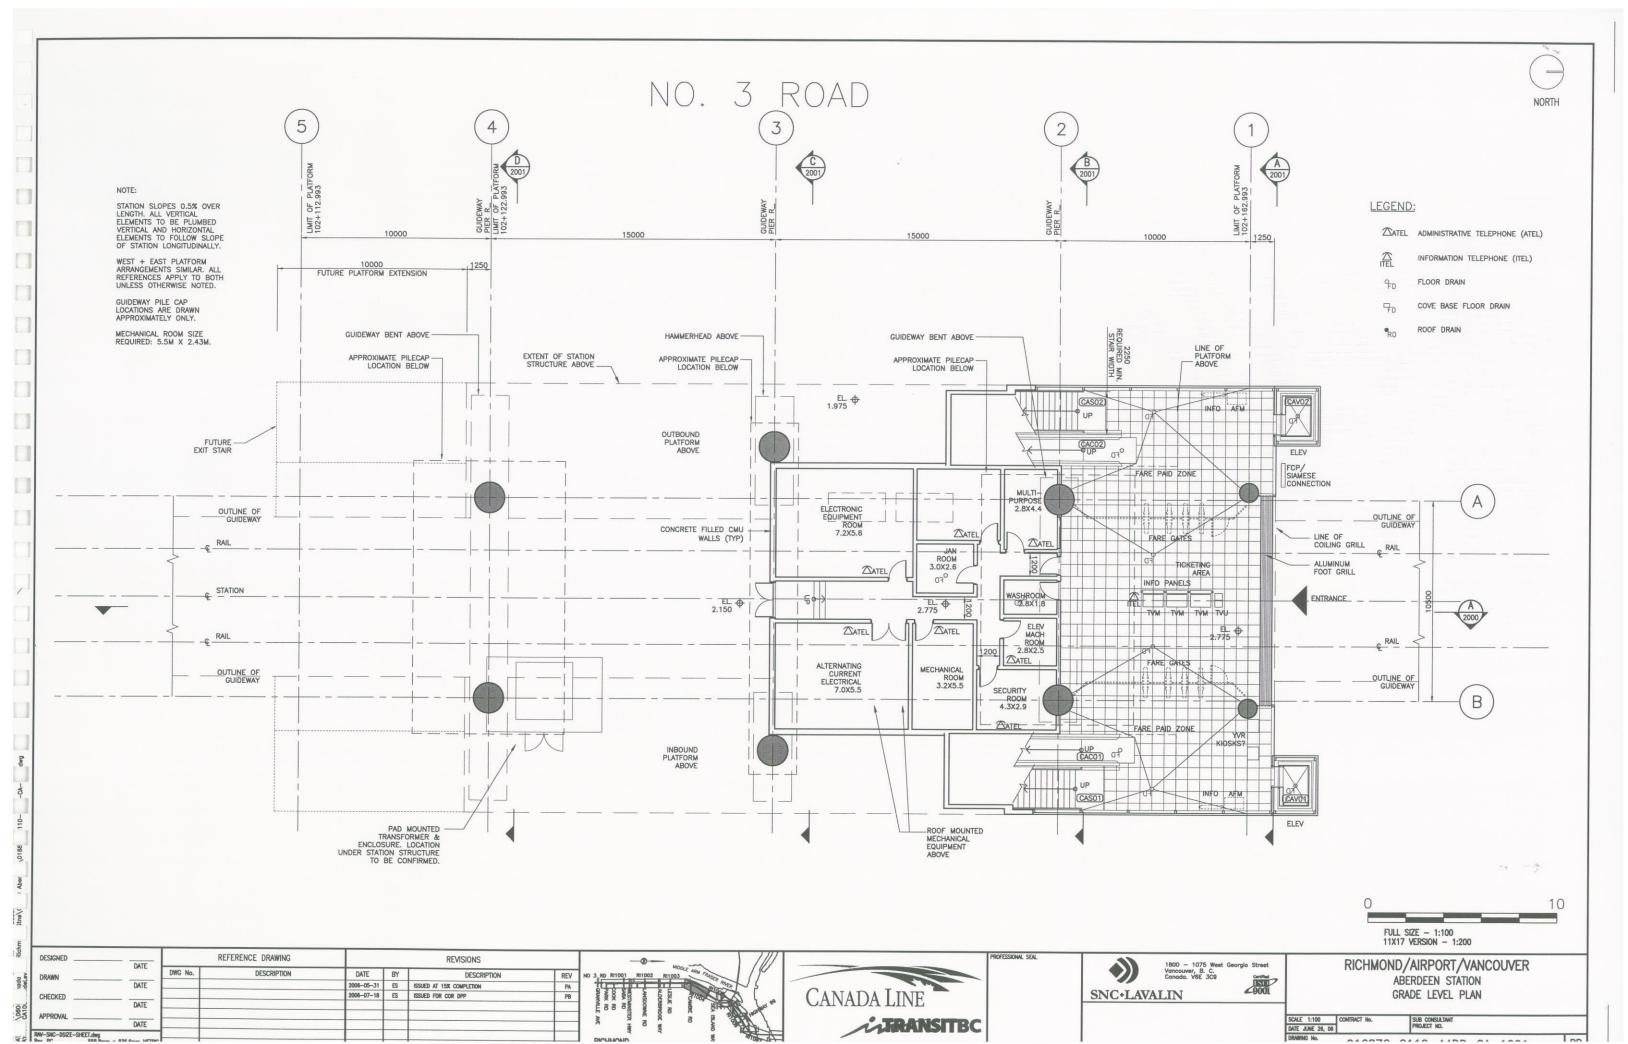


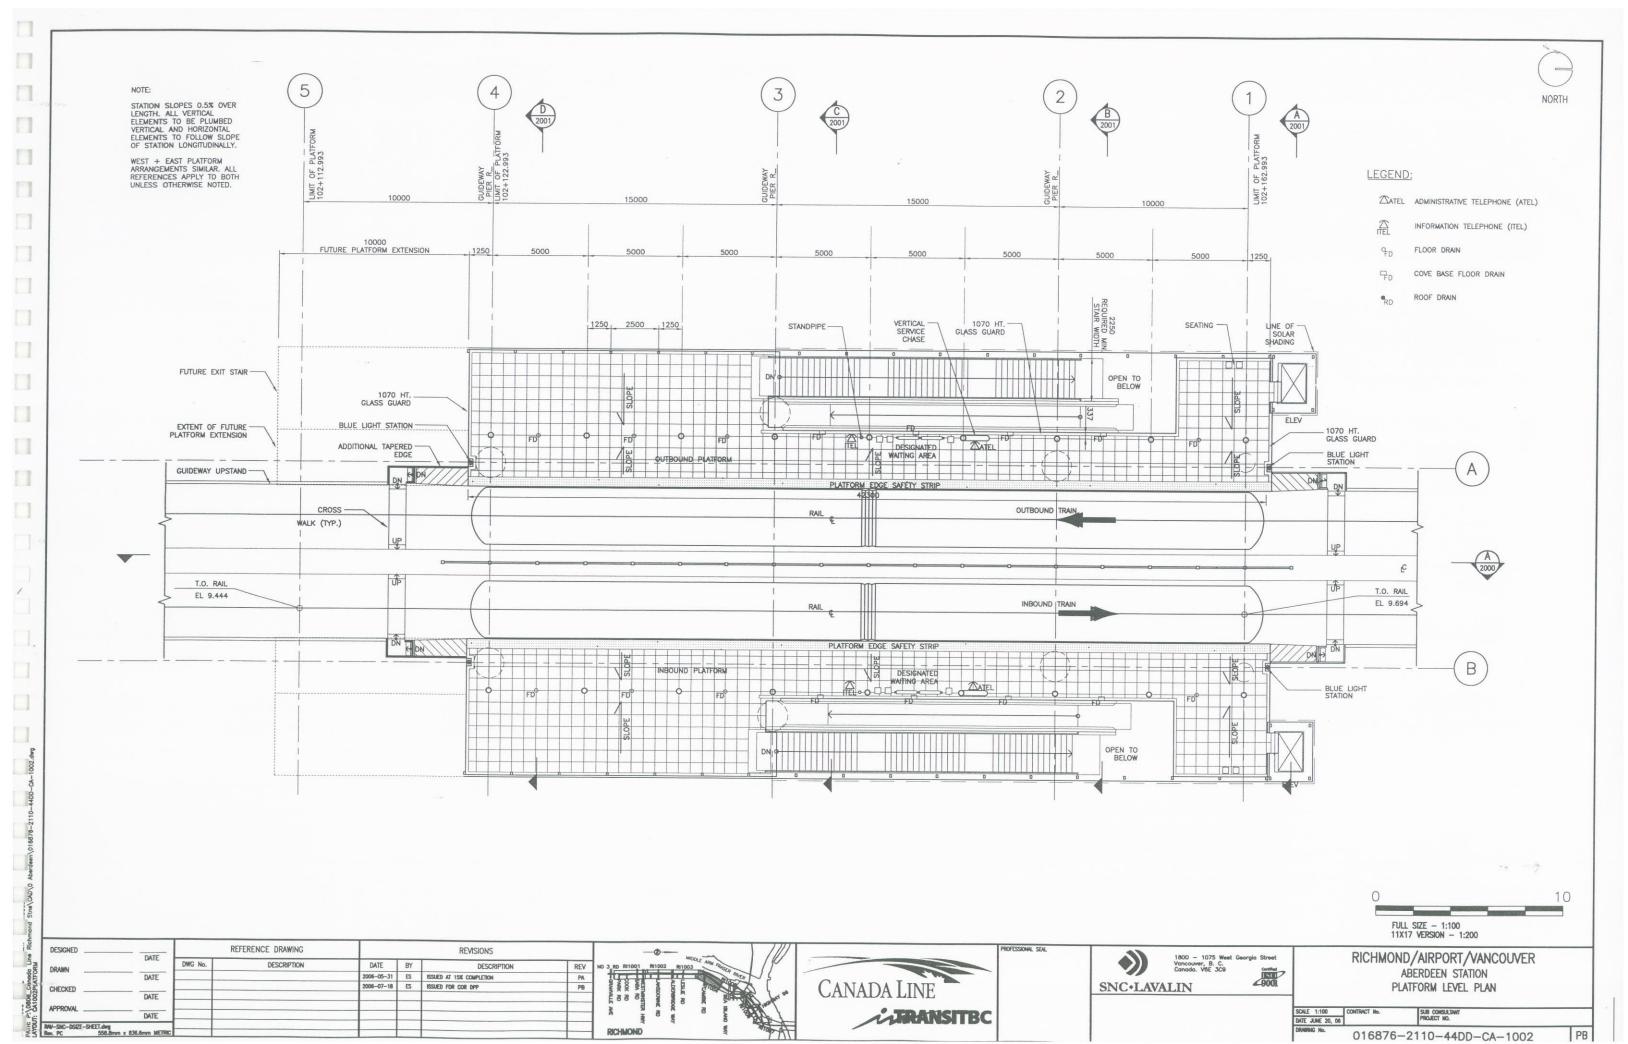


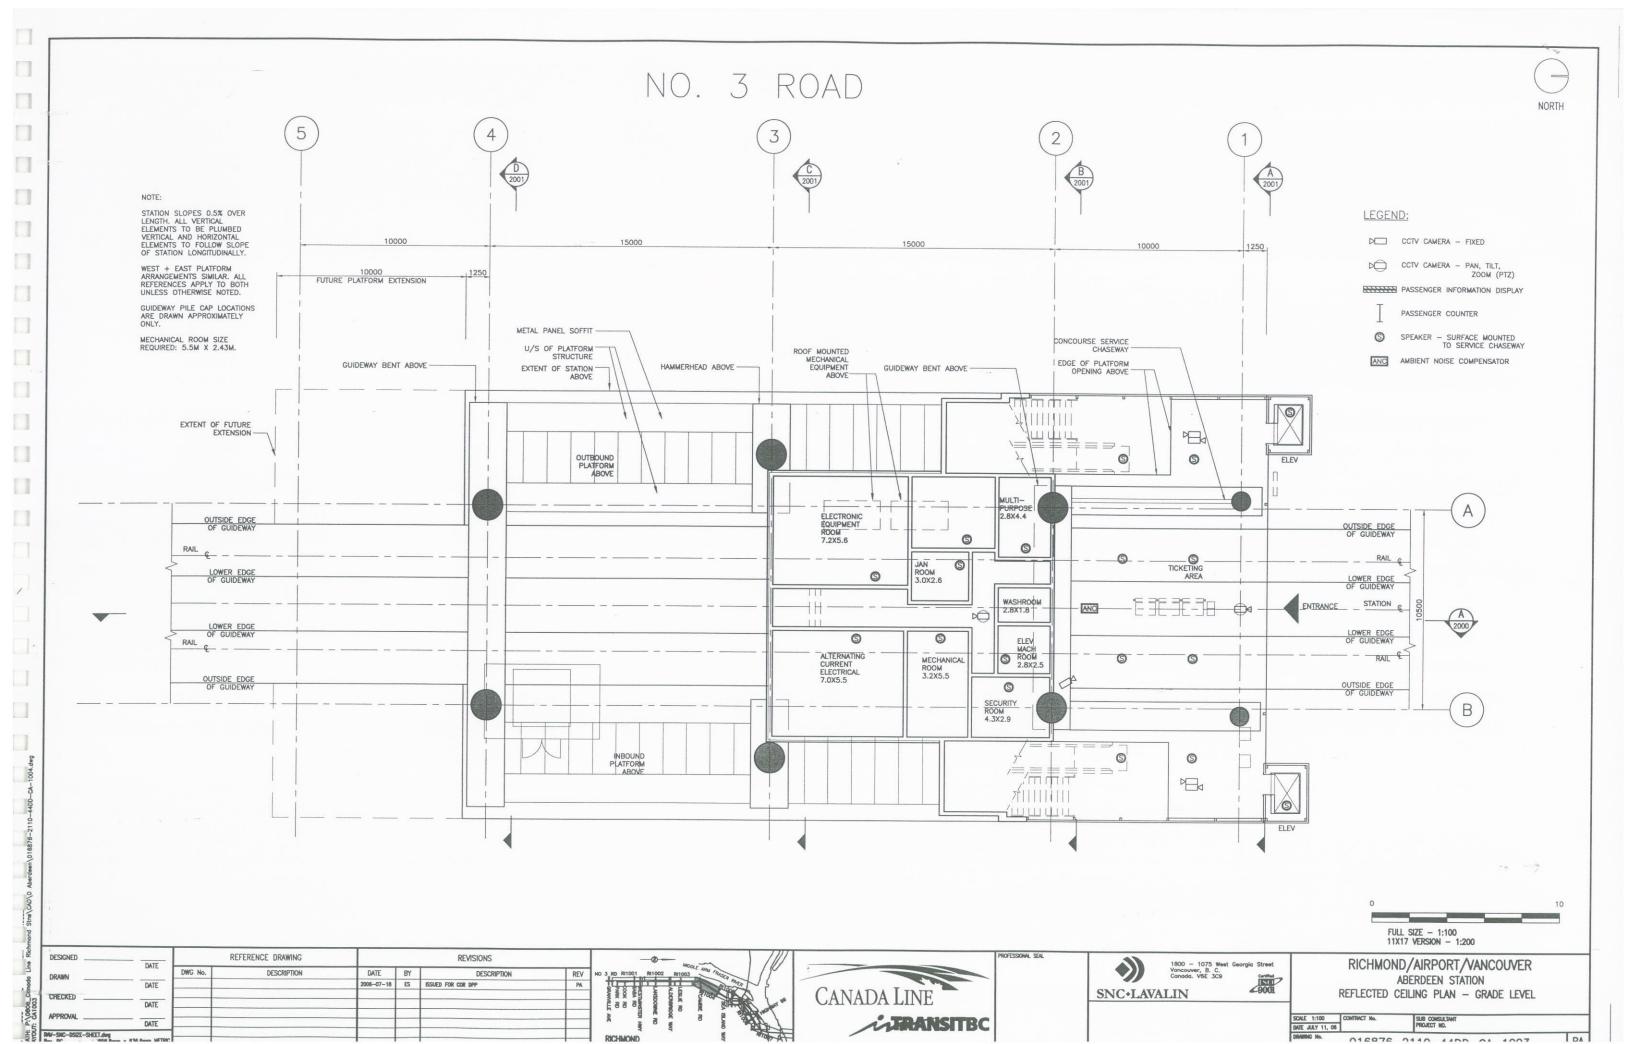

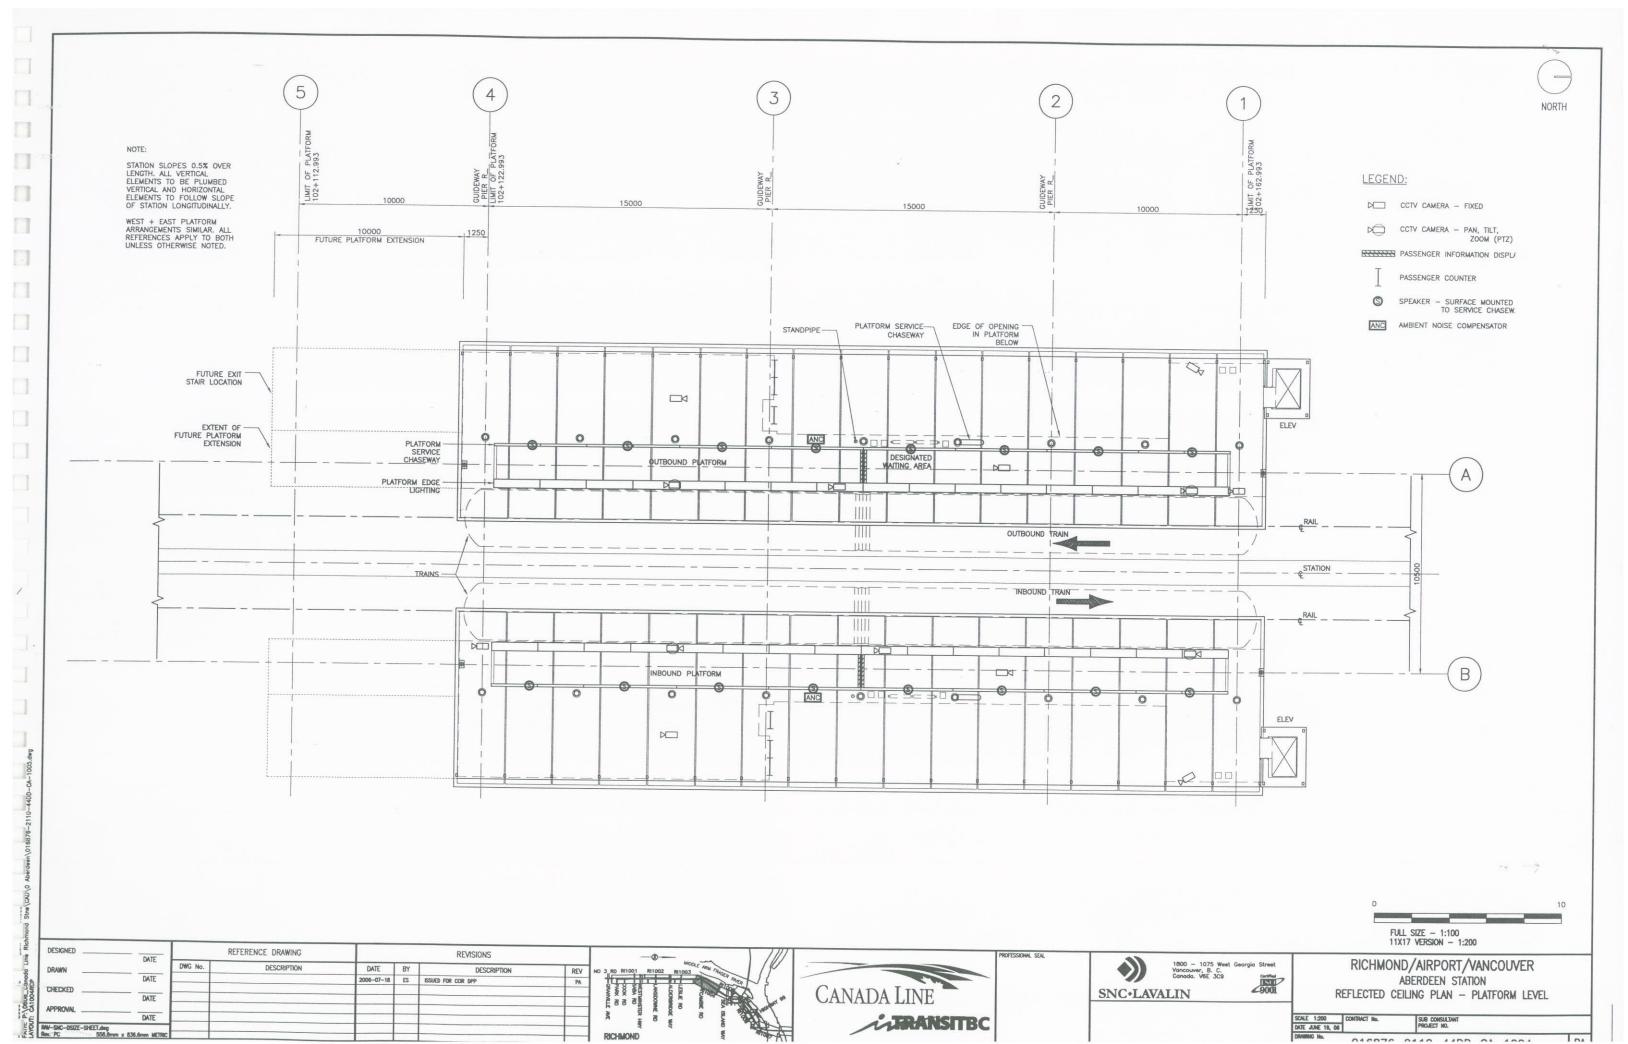

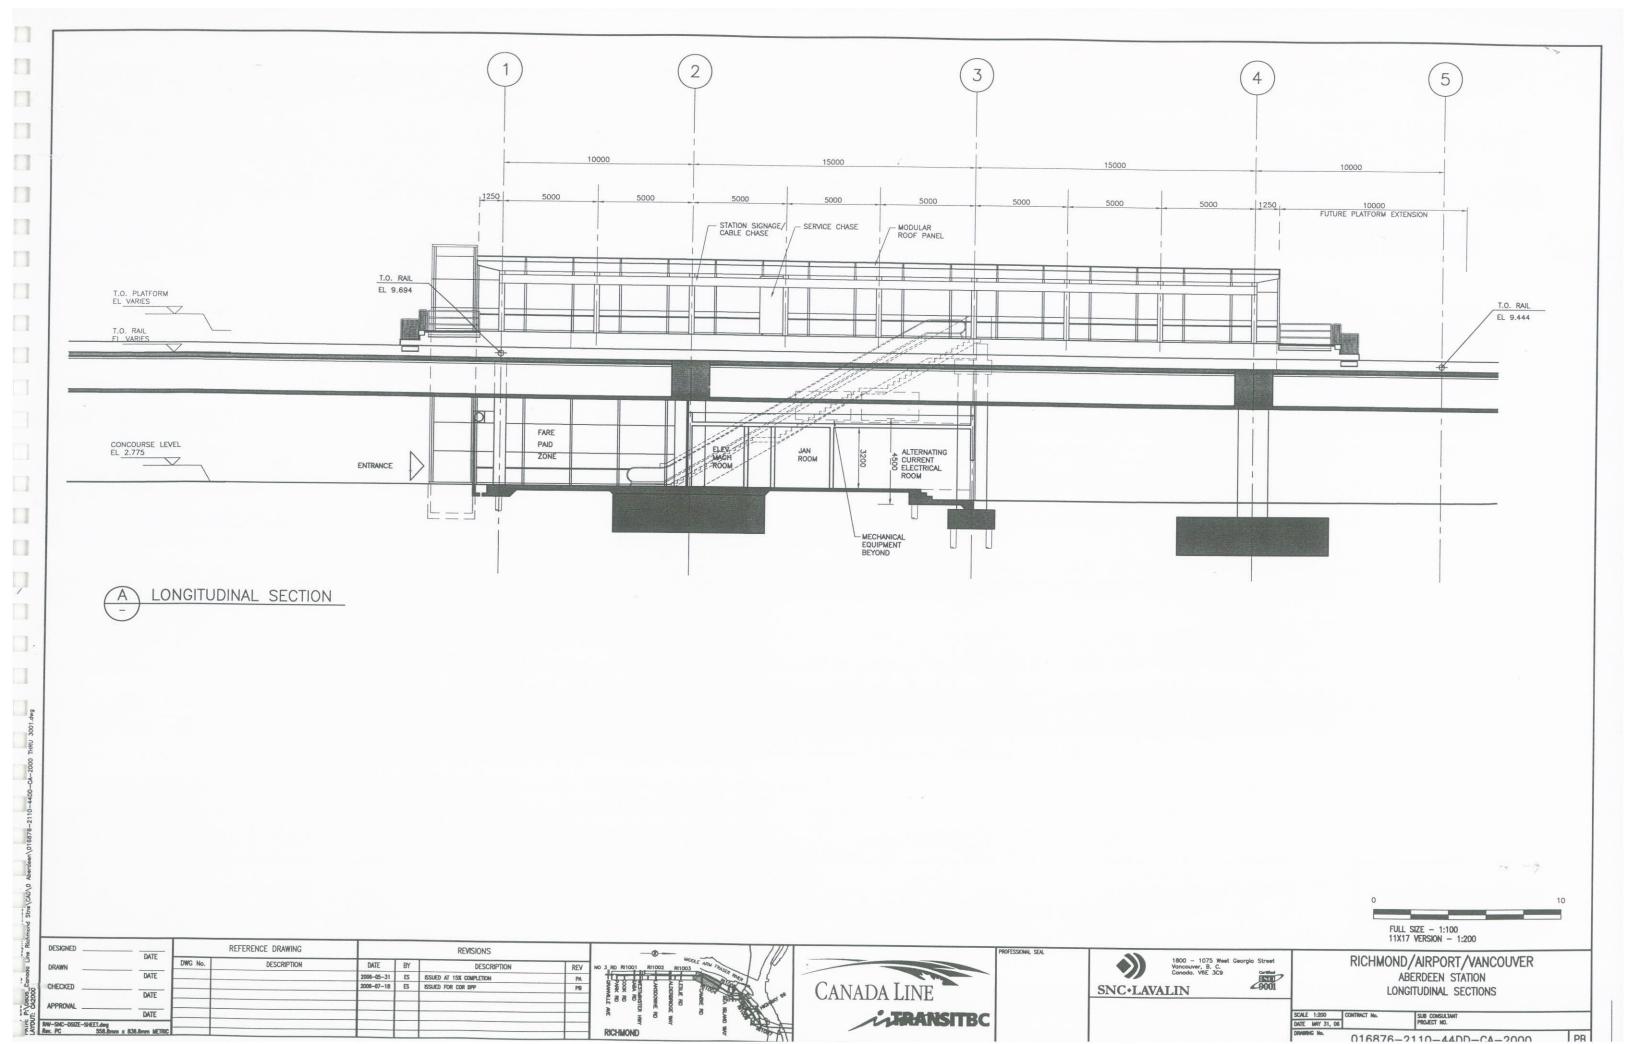

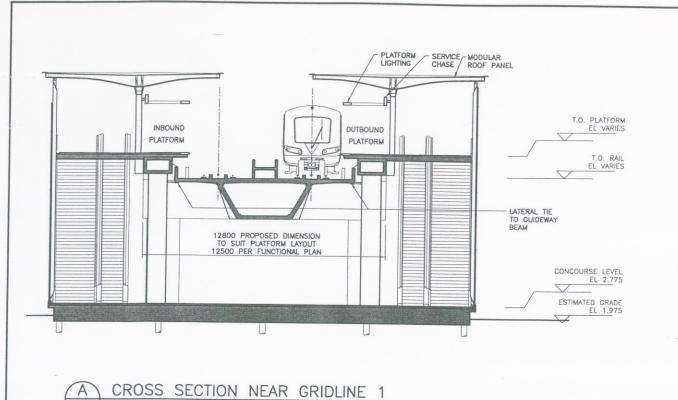

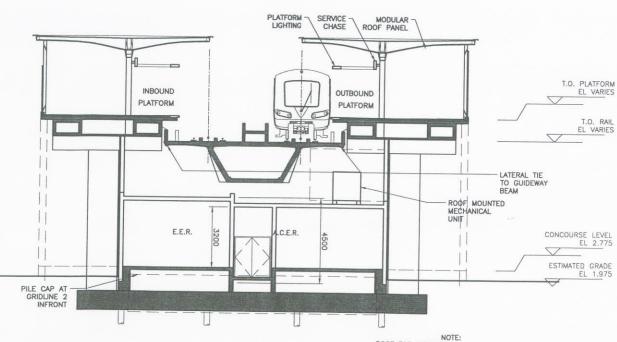

REVISIONS

2006-05-31 ES ISSUED AT 15% COMPLETION

2006-07-18 ES ISSUED FOR COR DPP

DESCRIPTION

RICHMOND

C CROSS SECTION NEAR GRIDLINE 3

REFERENCE DRAWING

DESCRIPTION


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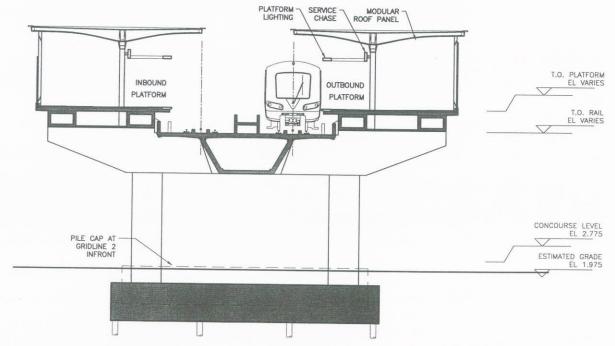
CHECKED

DATE

DATE

DWG No.



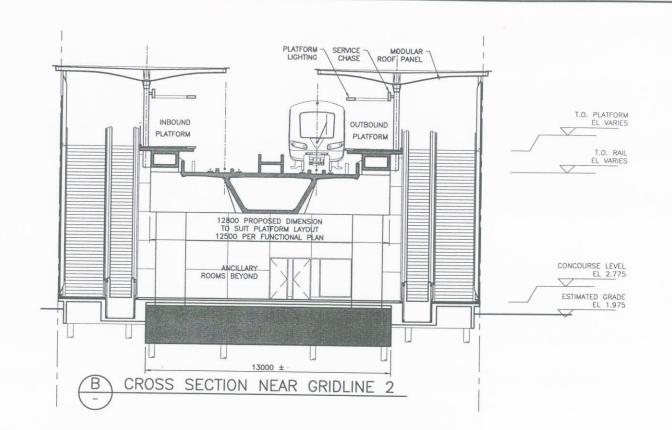

D CROSS SECTION NEAR GRIDLINE 4

PROFESSIONAL SEAL

PROFESSIONAL SEAL

1800 - 1075 Weet Georgia Street
Vancoulver, B. C.
Canedo, VGE 3C9
SNC+LAVALIN

PROFESSIONAL SEAL

RICHMOND/AIRPORT/VANCOUVER
ABERDEEN STATION
CROSS SECTIONS - OPTION 2


CANADA LINE


TRANSITEC


SCALE 1:200 CONTRACT No. SUB CONSULTINT
DATE May 31, 06

DENNING No. 016876-2110-44DD-CA-2002

PR

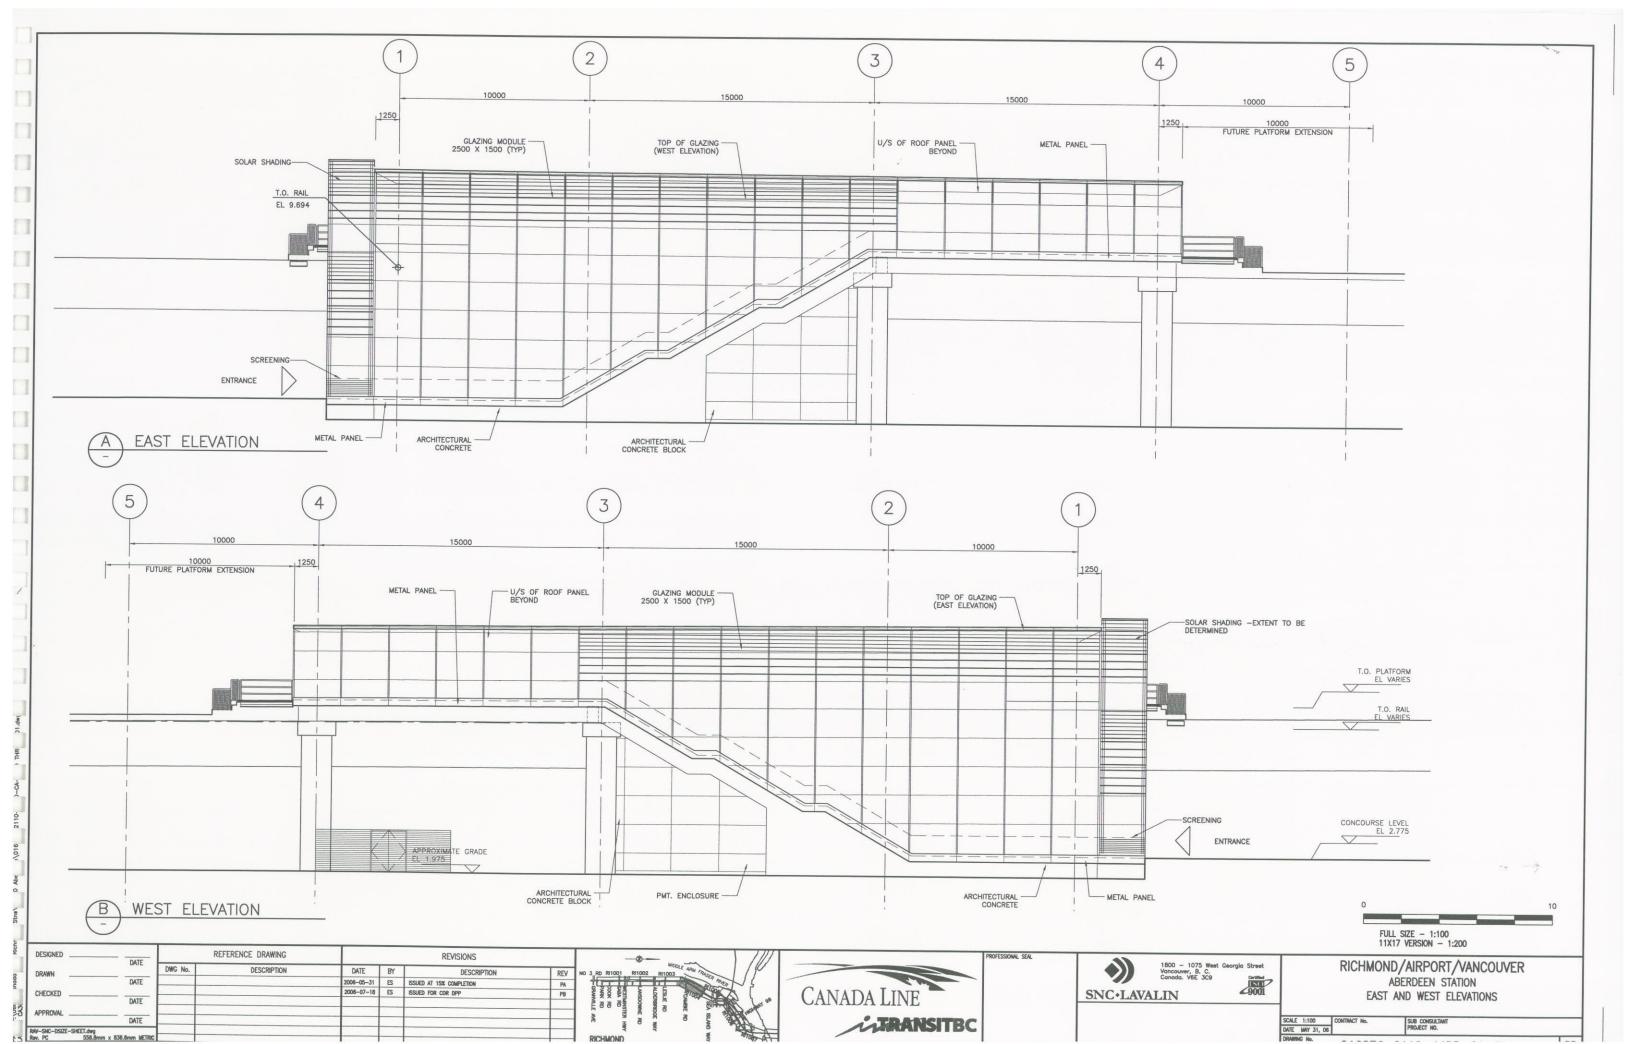

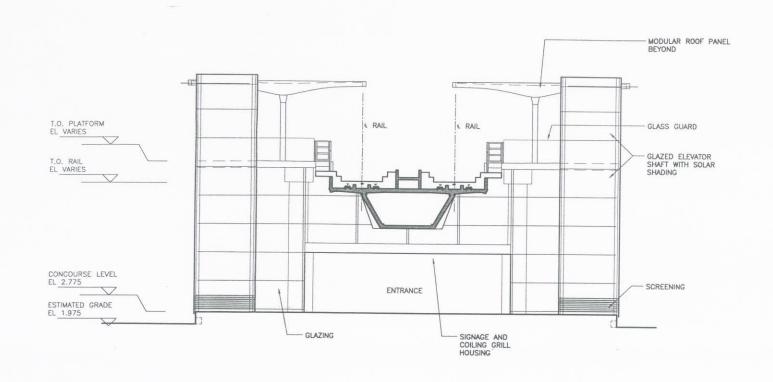

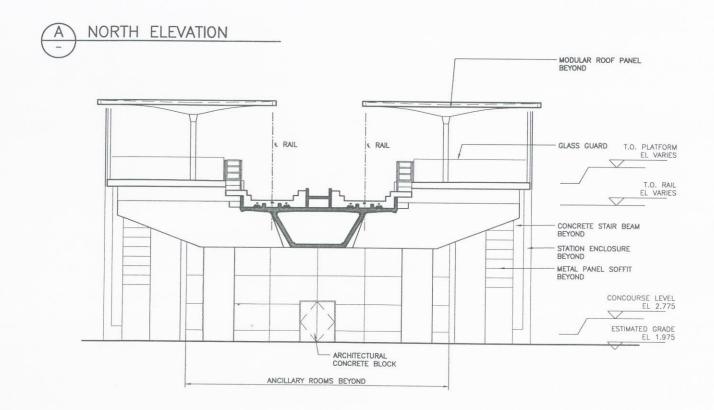

B SOUTH ELEVATION

DESIGNED	DATE	R	EFERENCE DRAWING			REVISIONS			
DRAWN	DATE	DWG No.	DESCRIPTION	DATE	BY	DESCRIPTION	REV	NO 3,	RD RI10
DIVINI	DATE			2008-05-31	ES	ISSUED AT 15% COMPLETION	PA	1 1	
CHECKED				2006-07-18	ES	ISSUED FOR COR DPP	PB	1 }	MAN
O'RLONED	DATE							1 8	88
APPROVAL								1 3	
re i nome	DATE							1 8	
BAY-SHC-DSDF-SHFFT.dwg								1	









RICHMOND/AIRPORT/VANCOUVER

ABERDEEN STATION

NORTH + SOUTH ELEVATIONS

SCALE 1:200 CONTRACT Mo. SUB CONSULTANT PROJECT NO.


FULL SIZE - 1:100 11X17 VERSION - 1:200

## LANSDOWNE STATION (PREVIOUSLY ALDERBRIDGE STATION)

### ARCHITECTURAL drawing number content 016876- 2120- 44DD- AB- 0003 Drawing Index 016876- 2120- 44DD- AB- 1000 Site + Context Plant Context	scale (full size or 11x17 version) n/a 1:250 or 1:500 1:100 or 1:200
016876- 2120- 44DD- AB- 0003 Drawing Index	n/a 1:250 or 1:500
	1:250 or 1:500
Site + Context Plai	1.230 01 1.300
016876- 2120- 44DD- AB- 1001 Grade Level Plan	1:100 or 1:200
0.10070 0.100 1.100 0.	
	1:100 or 1:200
	1:100 or 1:200
	1,100 011,200
	1,100 01 1,200
2019 Table 1	
Citation Control of Co	ption 2 1:100 or 1:200
	1:100 or 1:200
CARCOLLE CAR	1.300 01 1.200
016876- 2120- 44DD- AB- 3001 North + South Eleve	itions 1:100 or 1:200
016876- 2120- 44DD- AB- 6002 Glazing Details	1:100 or 1:200
016876- 2120- 44DD- AB- 6005 Platform Roof Detail	1,100 01 1,200
016876- 2120- 44DD- AB- 6007 Platform Edge Detail	
016876- 2120- 44DD- AB- 6008 Platform Edge Detail	1:100 or 1:200
STRUCTURAL (NOT ISSUED)	
drawing number content	scale
016876- 2120- 42DK- AB- 9000 Station loads on qui-	deway structure options varies
016876- 2120- 42DK- AB- 9001 **	valles
016876- 2120- 42DK · AB- 9002 "	
016876- 2120-42DK-AB- 9003 "	
016876- 42DK-AB-9004 "	
016876- 2120- 42DK- AB- 9010 Proposed Foundation	a Laurus
016876- 2120- 42DK- AB- 9011	a Layout
016876- 2120- 42DK- AB- 9012 *	
016876- 2120- 42DK- AB- 9013 "	
016876- 2120- 42DK- AB- 9014 "	
016876- 2120- 42DK- AB- 9015 "	
016876- 2120-42DK-AB-9016	
016876- 2120-42DK-AB-9017 "	
016876- 2120-42DK-AB-9018	
016876- 2120- 42DK- AB- 9019	
010070-2120-42DR-AB-9019	
016876- 2120-42DK-AB- 9020 Modular Roof Panels	
016876- 2120- 42DK- AB- 9021 "	
016876- 2120- 42DK- AB- 9022 "	
016876- 2120- 42DK- AB- 9023	

DESIGNED	DATE		REFERENCE DRAWING		REVISIONS			
RAWN	DATE.	DWG No.	DESCRIPTION	DATE	BY	DESCRIPTION	REV	NO 3
	DATE			2006-05-31	ES	ISSUED AT 15% COMPLETION	PA	
HECKED				2006-07-18	ES	ISSUED FOR COR DPP	PB	3
PPROVAL	DATE							
	DATE							No.
-SHC-DSIZE-SHEET.dwg PC 558.8mm x 83	36.8mm METHIC							

016876- 2120-42DK-AB- 9024 016876- 2120-42DK-AB- 9025 016876- 2120-42DK-AB- 9026

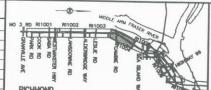








RICHMOND/AIRPORT/VANCOUVER
LANSDOWNE STATION
DRAWING LIST

SCALE N/A CONTRACT No. SUB-CONSULT.

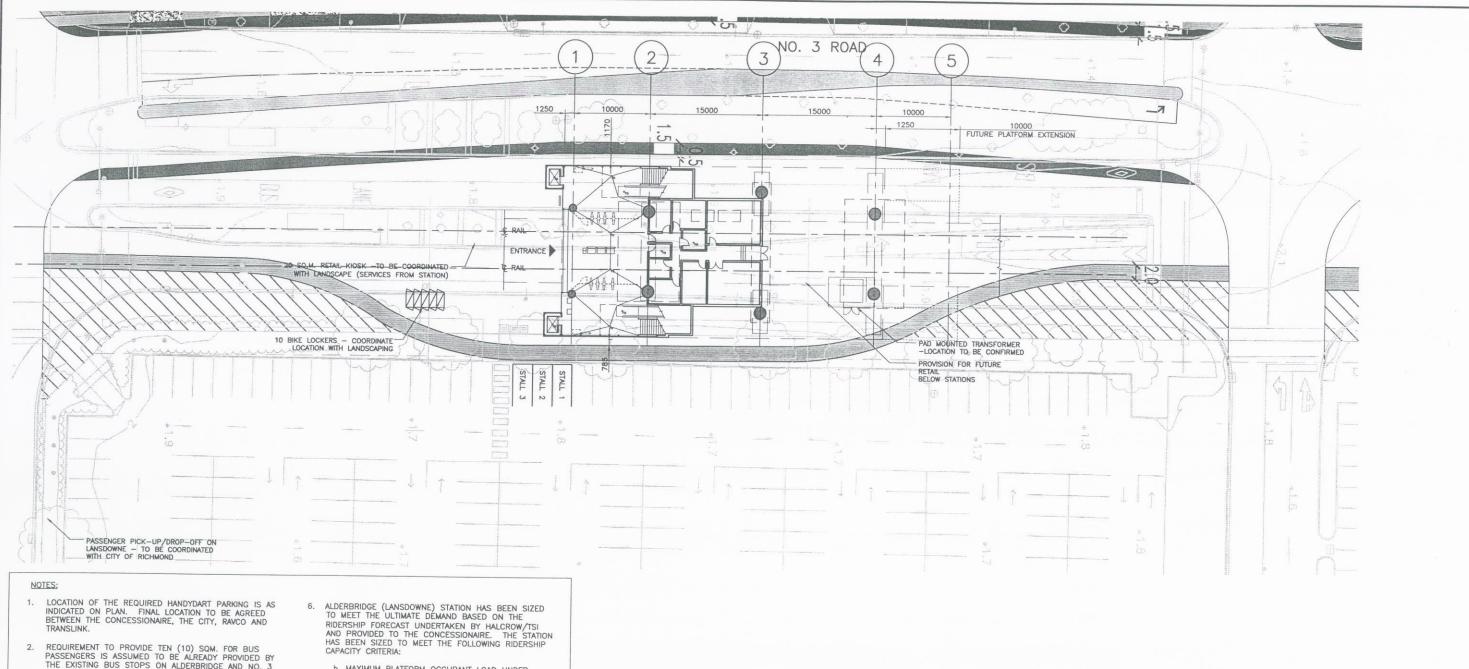

- REQUIREMENT TO PROVIDE TEN (10) SQM. FOR BUS PASSENGERS IS ASSUMED TO BE ALREADY PROVIDED BY THE EXISTING BUS STOPS ON ALDERBRIDGE AND NO. 3
- PROVISION OF SEVEN(7) PASSENGER PICK UP AND DROP OFF (PPUDO) STALLS IS ASSUMED AS INDICATED ON THIS DRAWING. LOCATED ON CITY STREETS.

  LOCATION OF PPUDO STALLS IS TO BE MUTUALLY AGREED BETWEEN THE CONCESSIONAIRE, THE CITY AND
- REQUIRED BIKE LOCKER PROVISION FOR THIS STATION IS TEN (10), AS INDICATED ON PLAN.
- THE CONCESSIONAIRE IS RESPONSIBLE FOR THE MAINTENANCE AND UPKEEP OF ALL STATION SURFACE STRUCTURES, INCLUDING ENTRANCE, EXIT STAIRS AND OTHER STATION STRUCTURES. THE EXTENT OF THE CONCESSIONAIRE'S RESPONSIBILITY TO MAINTAIN THE GROUND PLANE AND ASSOCIATED LANDSCAPING IS AS DEMARCATED ON DRAWINGS.

DATE

DATE

DATE

DATE

REFERENCE DRAWING

DESCRIPTION

DESIGNED

CHECKED

**APPROVAL** 

- b. MAXIMUM PLATFORM OCCUPANT LOAD UNDER EMERGENCY CONDITION
  - i. INCIDENT PLATFORM II. NON INCIDENT PLATFORM
- a. MAXIMUM VERTIVAL CIRCULATION CAPACITY FOR DAILY PEAK SERVICE

REVISIONS

ISSUED AT 15% COMPLETION

2006-05-31 ES ISSUED AT 15% COMPLI 2006-07-18 ES ISSUED FOR COR DPP

DESCRIPTION

i. ENTRAINING LOAD PER MINUTE II. DETRAINING LOAD PER MINUTE

FULL SIZE - 1:250 11X17 VERSION - 1:500


NORTH








Vancouver, B. C. Canada. V&E 3C9 1870) 9001 RICHMOND/AIRPORT/VANCOUVER LANSDOWNE STATION SITE + CONTEXT PLAN


SCALE 1:100 CONTRACT No.
DATE JUNE 27, 06

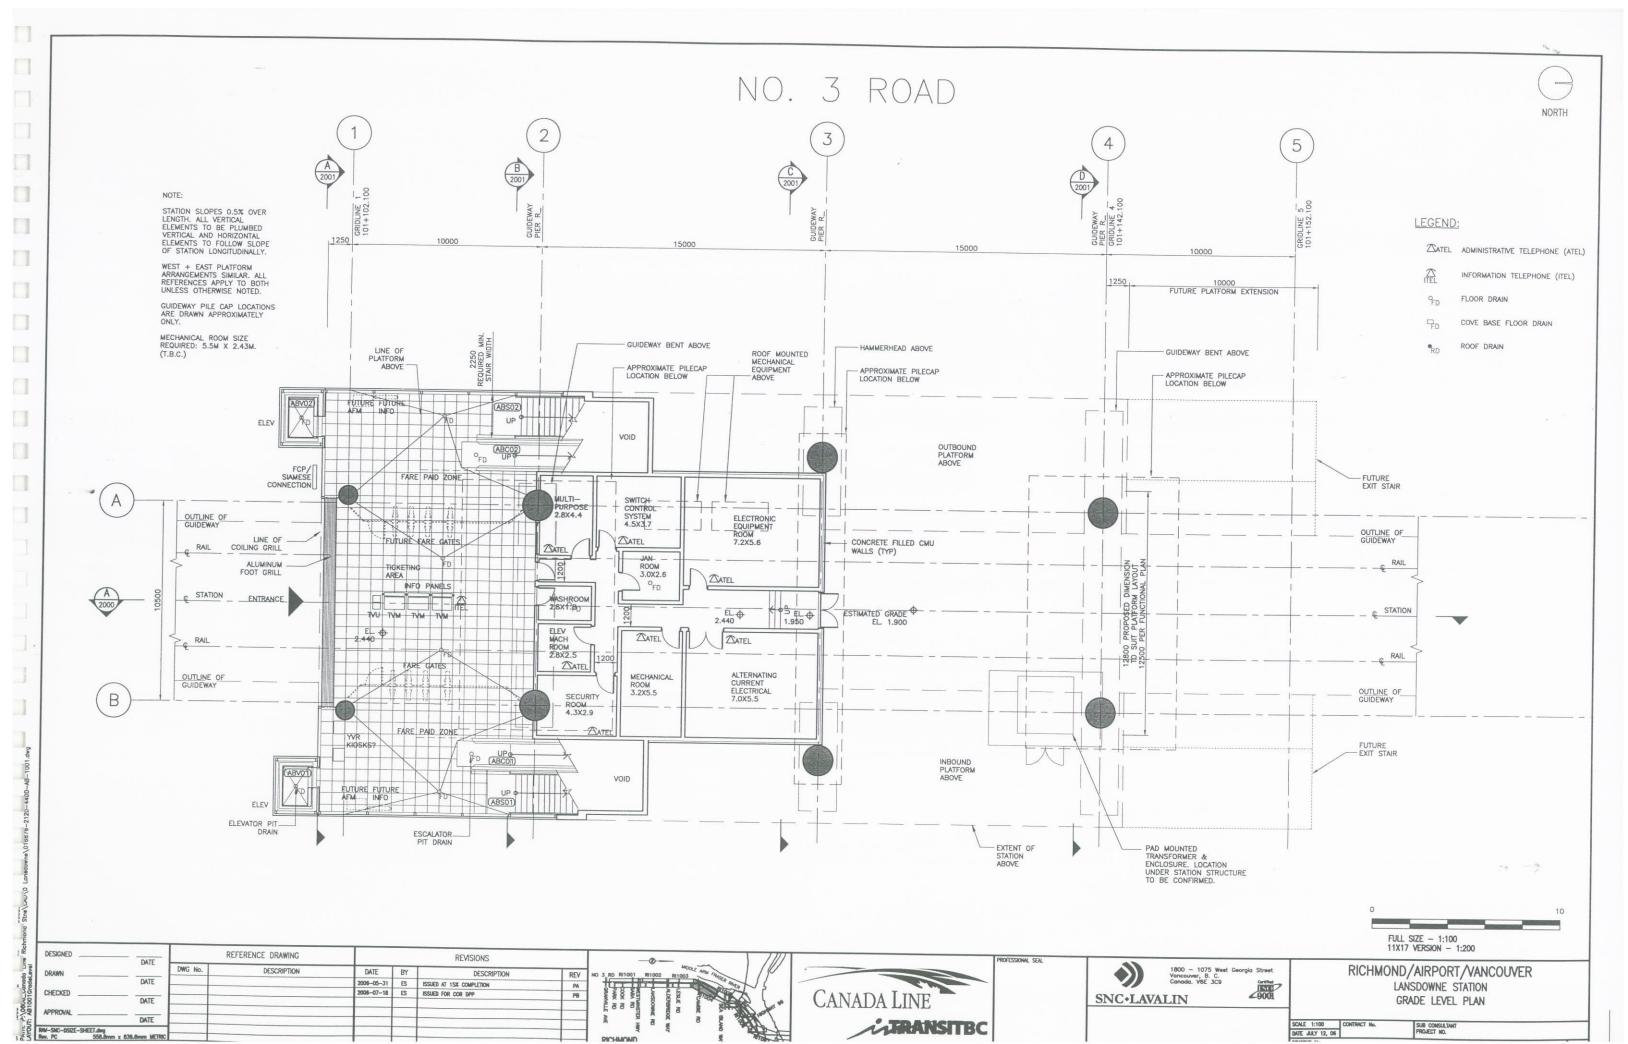


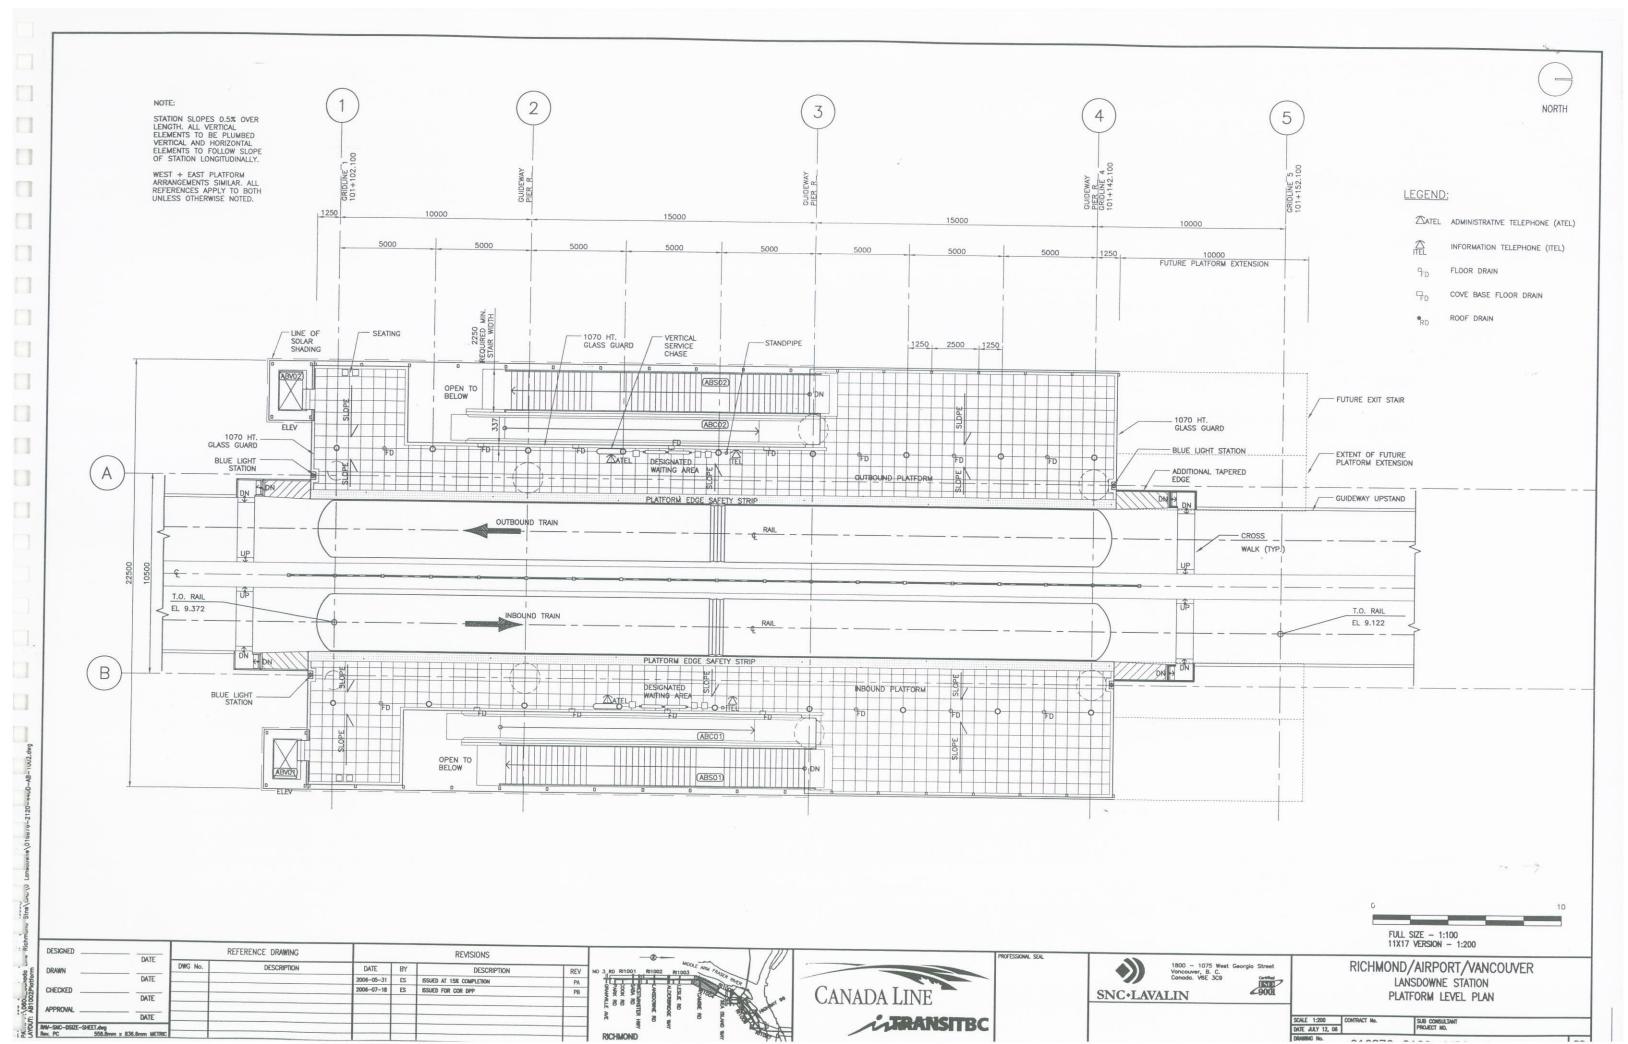


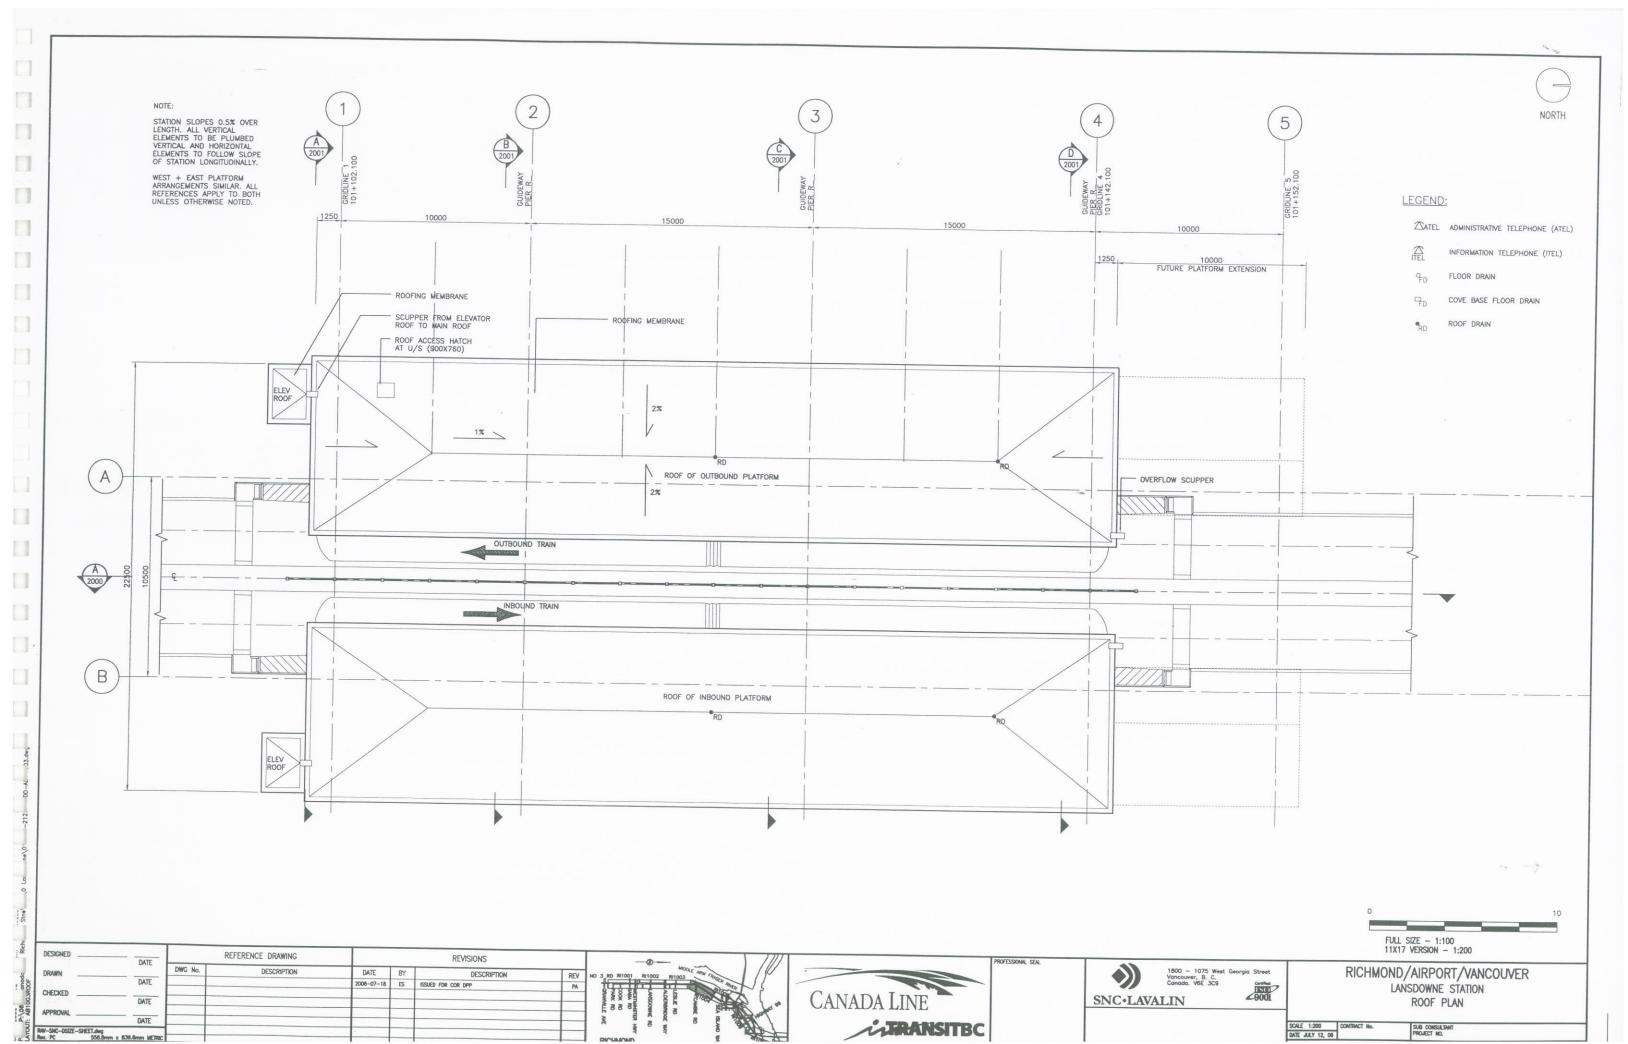


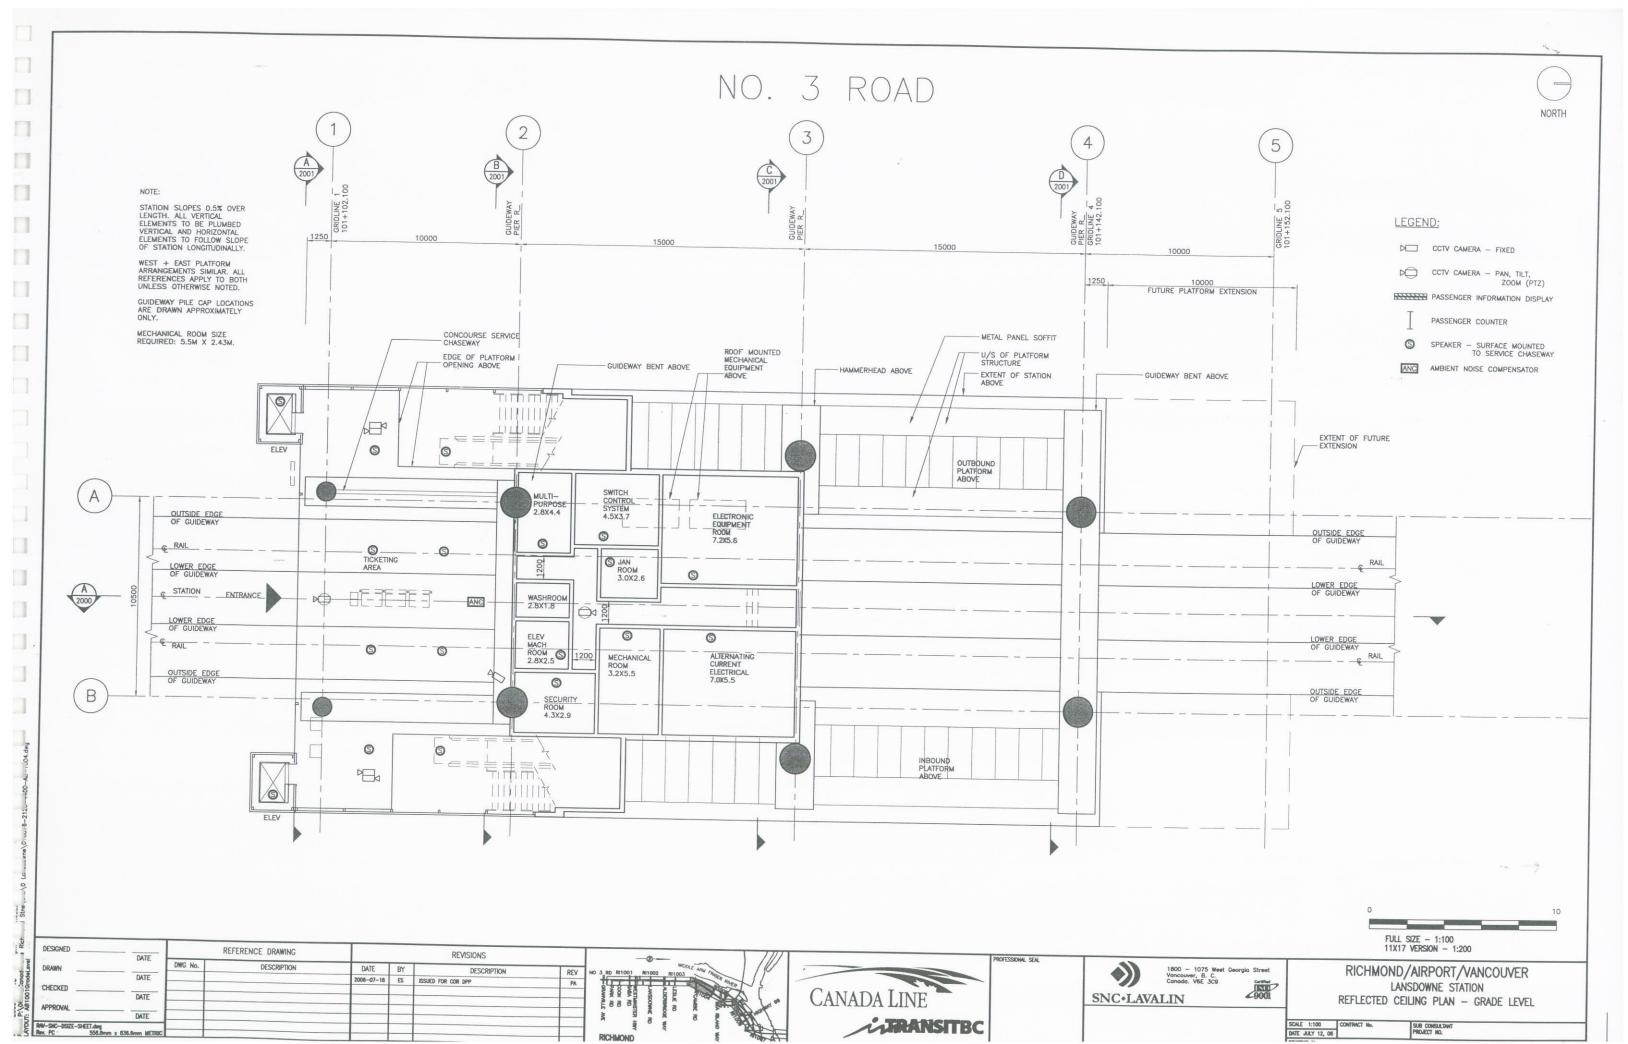


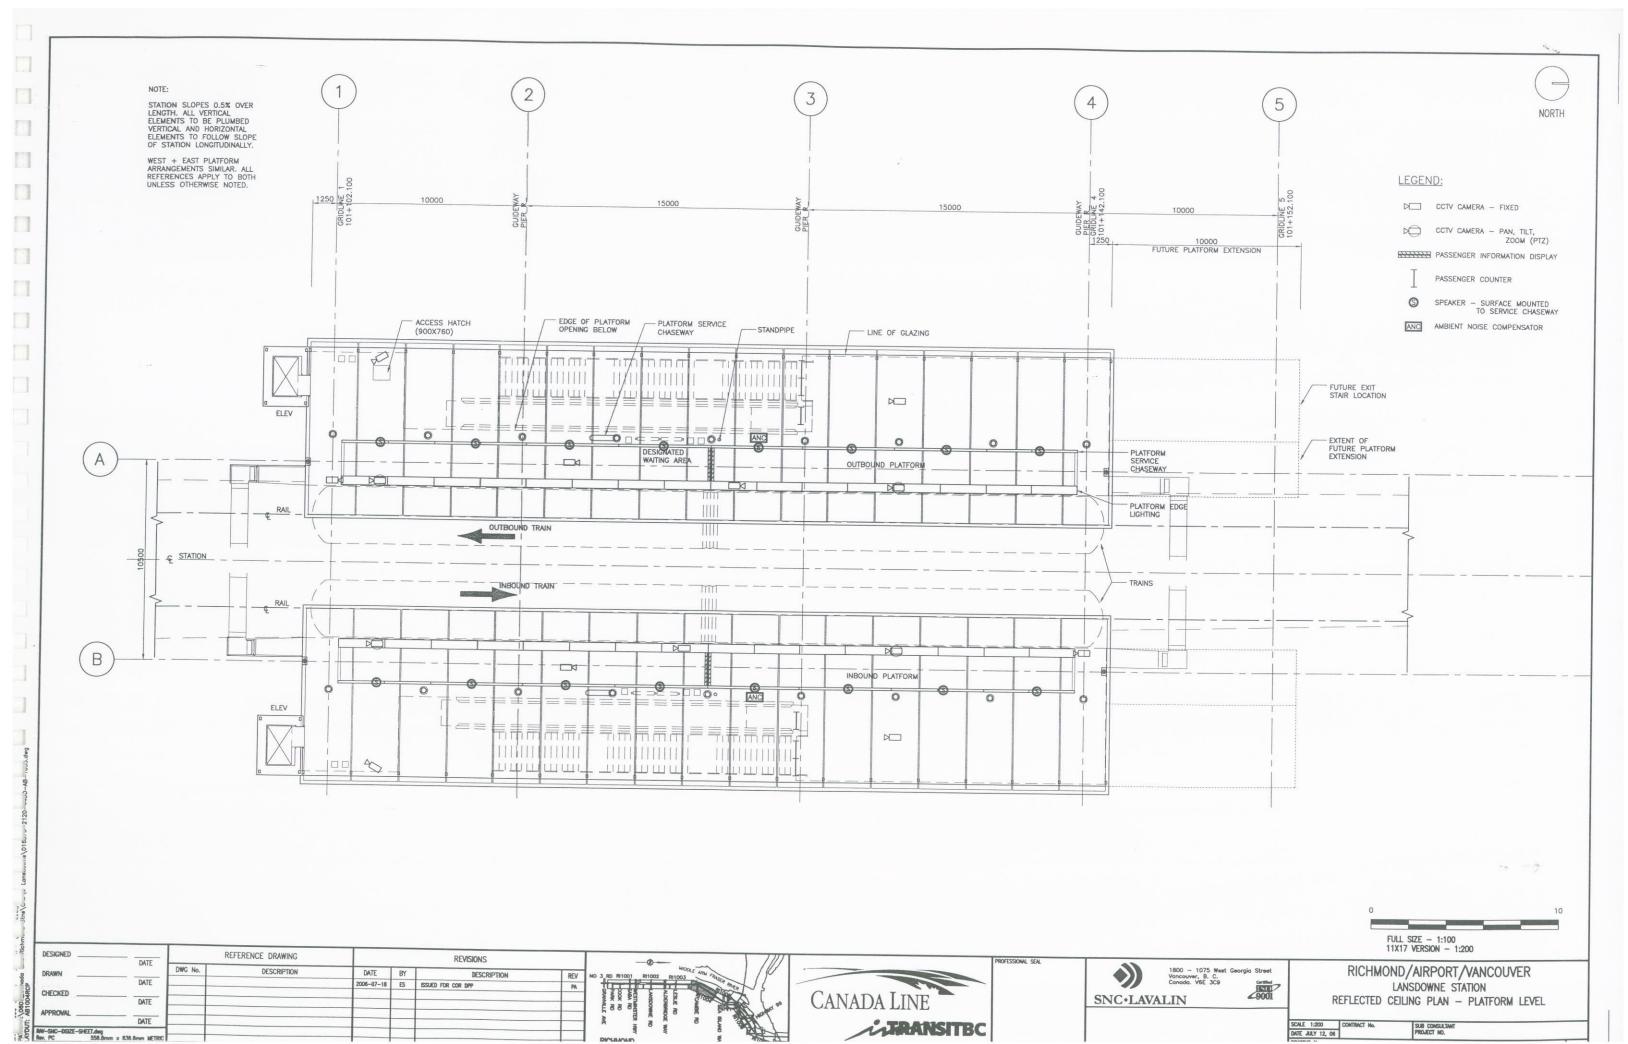


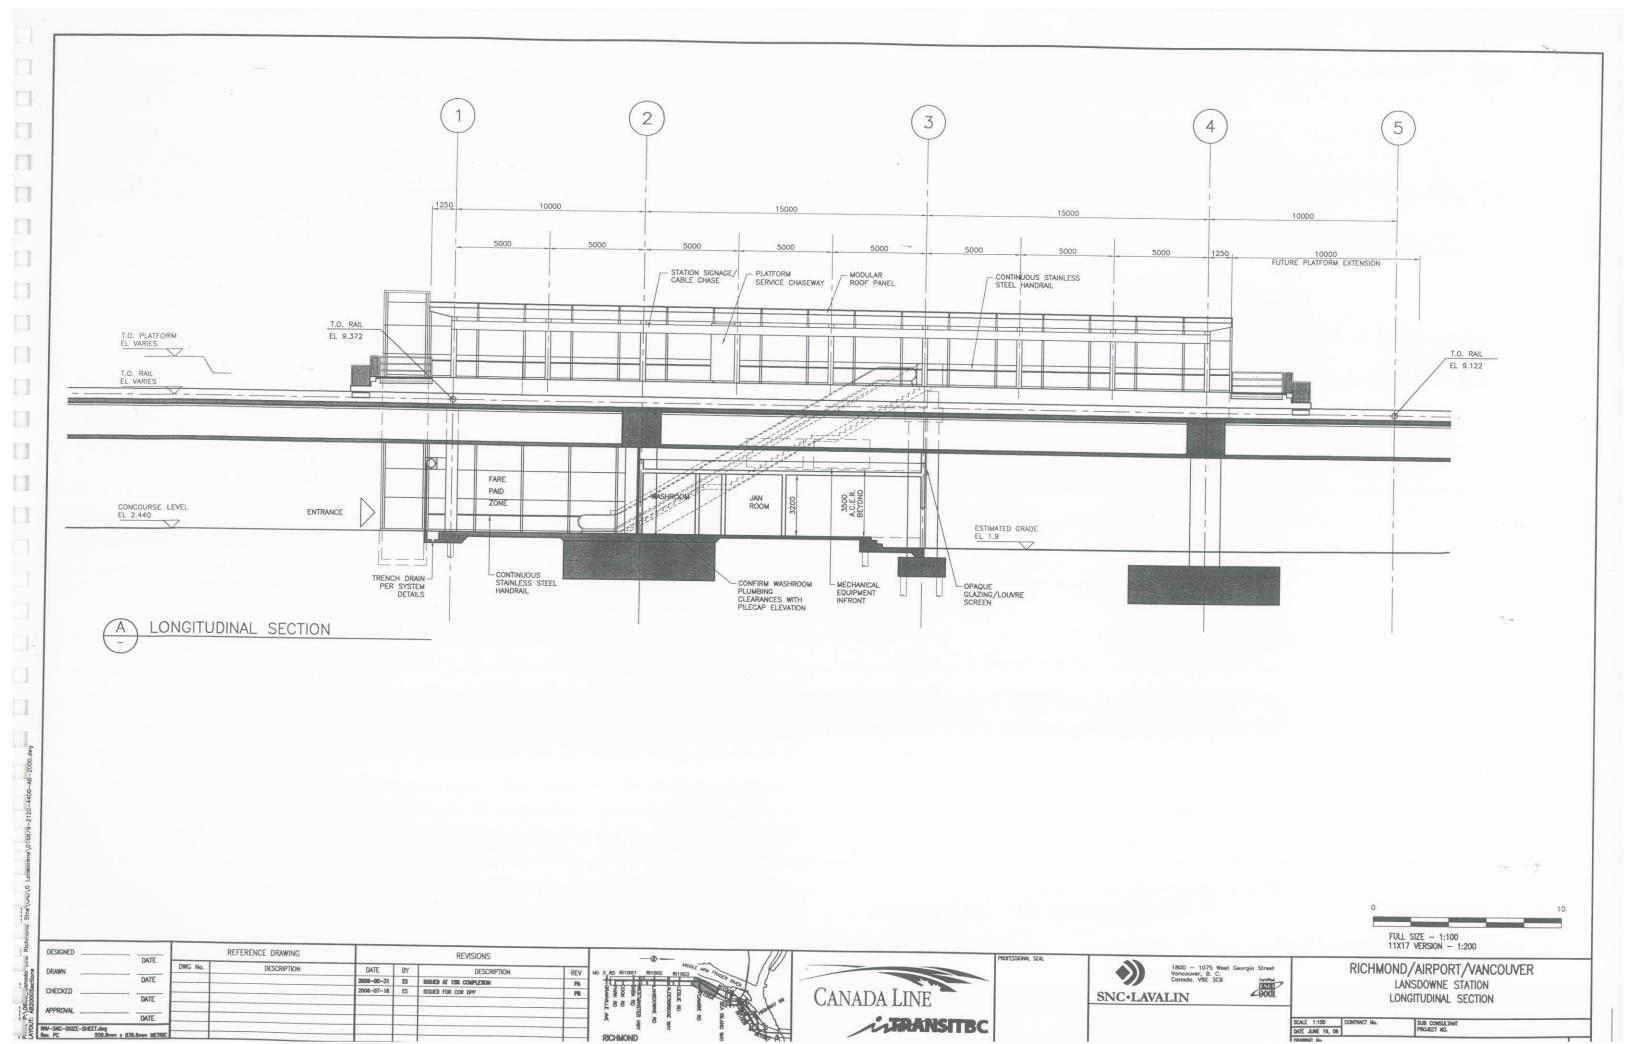

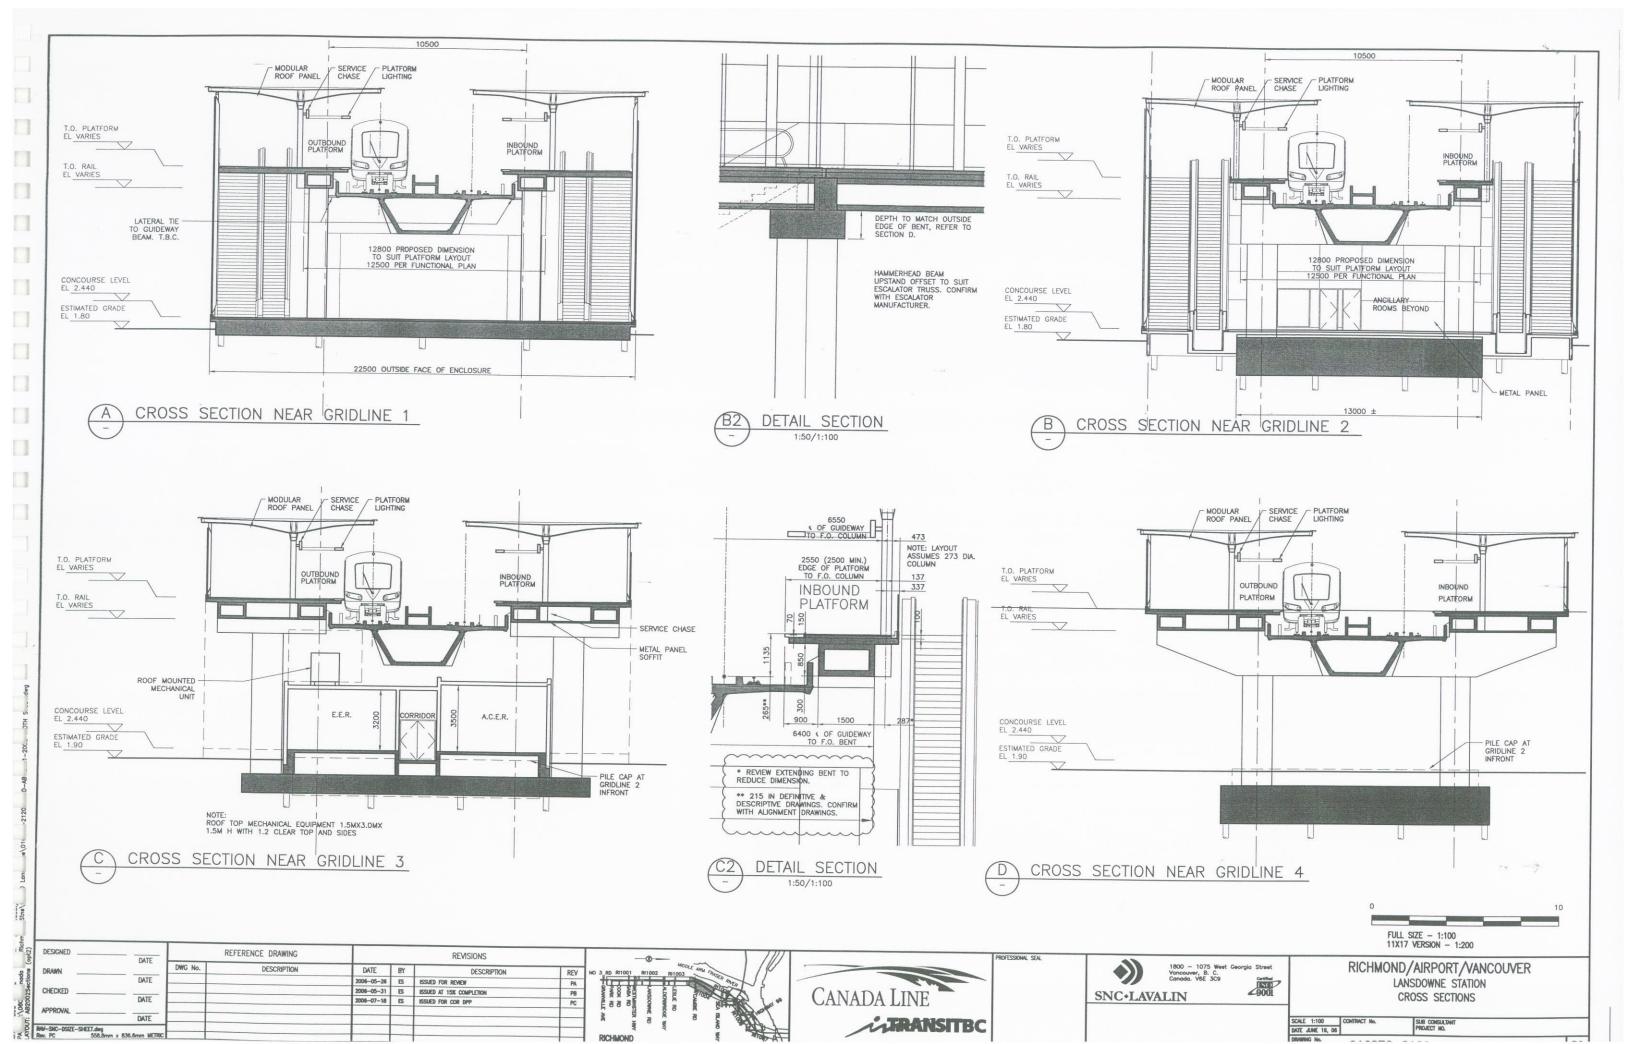


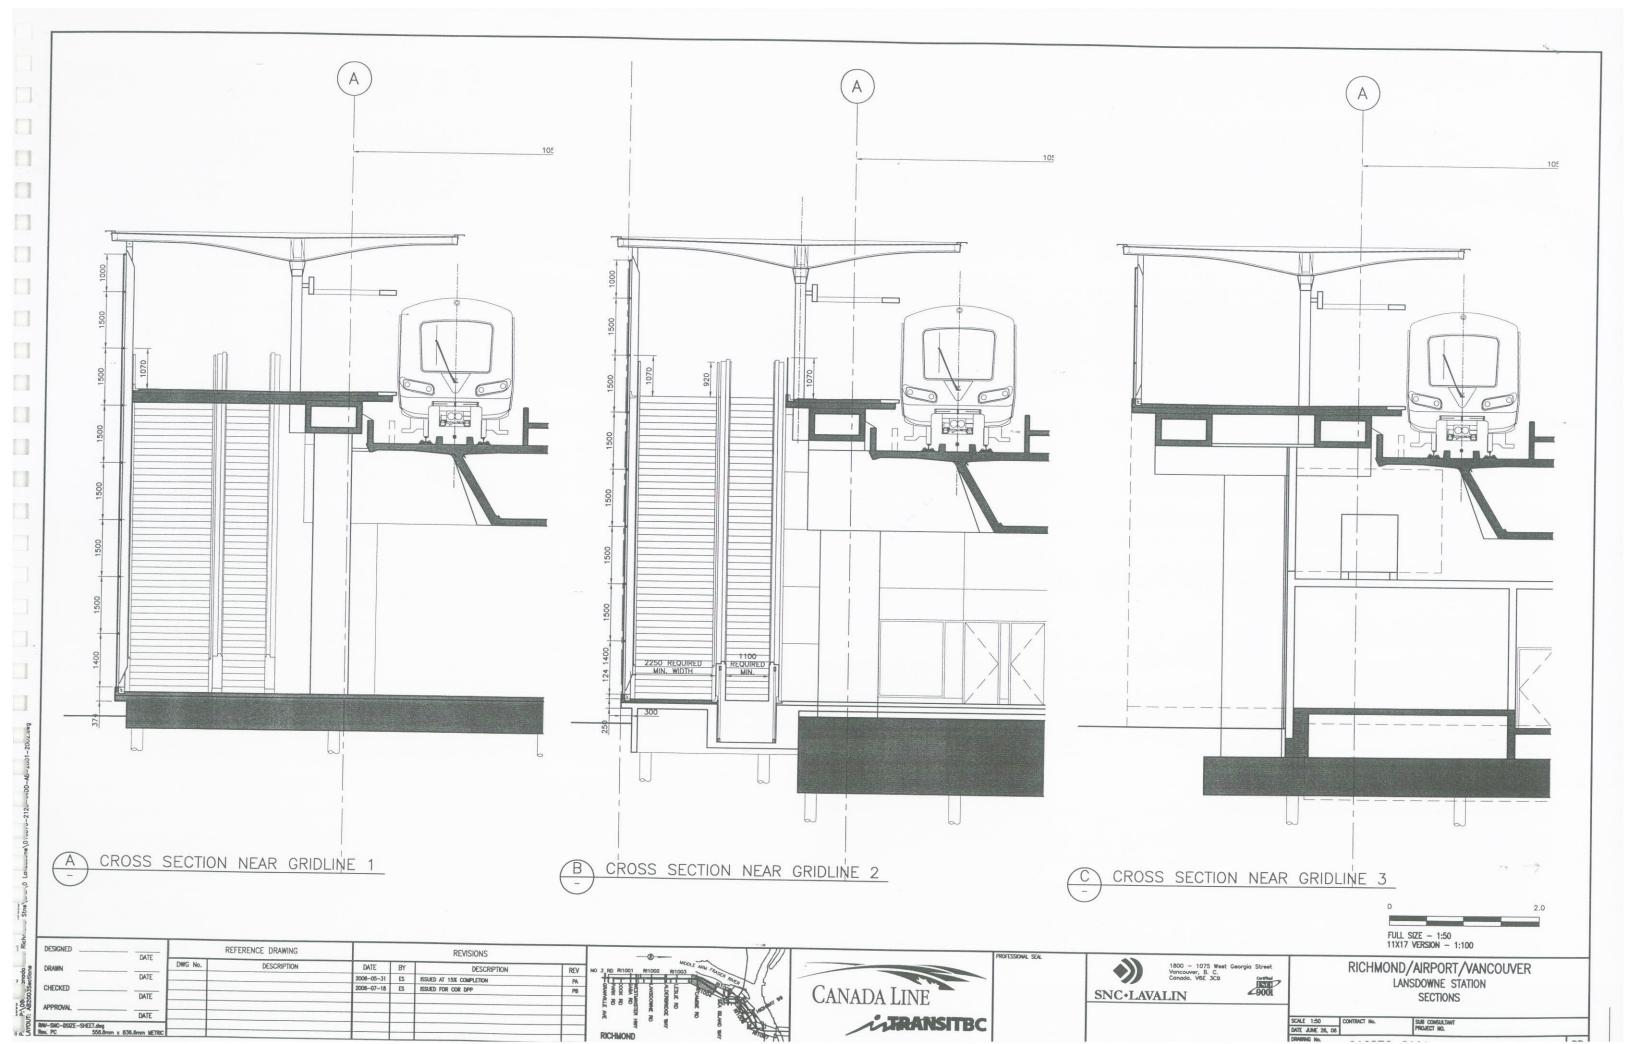

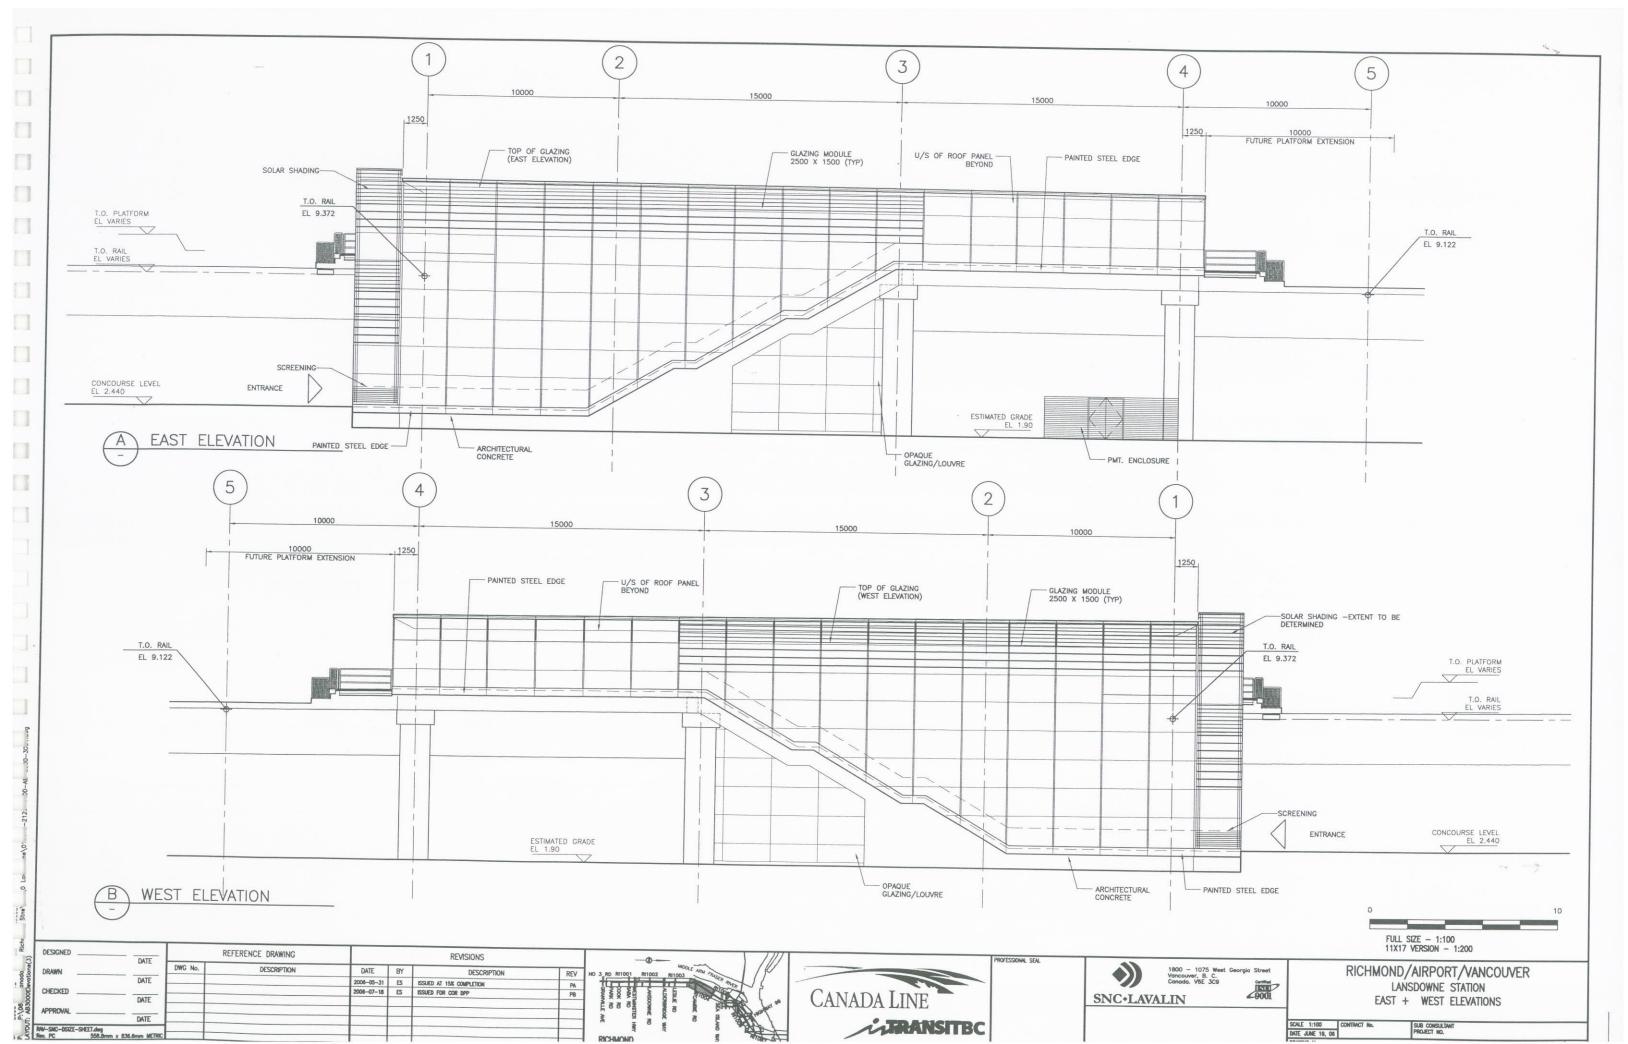

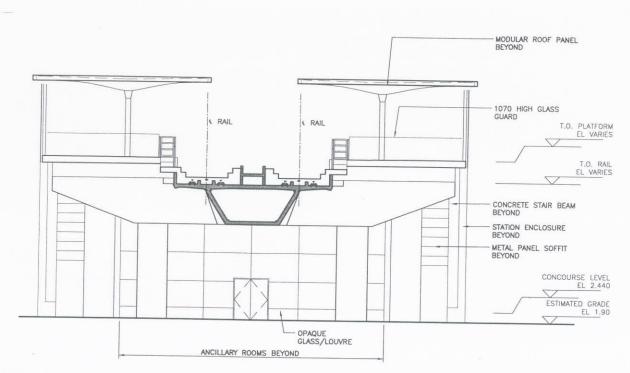


A NORTH ELEVATION

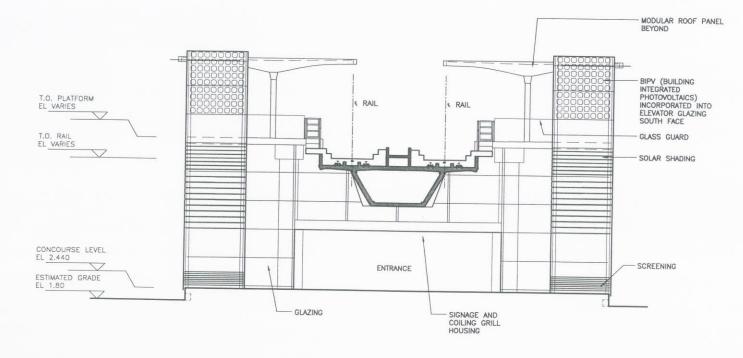

B SOUTH ELEVATION

DESIGNED	DATE	REFERENCE DRAWING		REVISIONS				_
DRAWN	UNIE	DWG No.	DESCRIPTION	DATE	BY	DESCRIPTION	REV	NO 3, RD RI1001
	DATE			2006-05-31	ES	ISSUED AT 15% COMPLETION	PA	10-11
CHECKED				2006-07-18	ES	ISSUED FOR COR DPP	PB	SARVA CON PARTY OF THE PARTY OF
	DATE						- 1.0	
APPROVAL								E 88 8 8
	DATE						_	- A - B
RMV-SMC-DSIZE-SHEET.dug		1					_	1 1

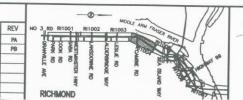






1800 - 1075 West Georgia Street Vancouver, B. C. Canada. V6E 3C9 FULL SIZE - 1:100 11X17 VERSION - 1:200 RICHMOND/AIRPORT/VANCOUVER

LANSDOWNE STATION NORTH + SOUTH ELEVATIONS

SCALE 1:100 CONTRACT No. SUB CONSULTANT
PROJECT NO.

DRIVE JUNE 19, 06

DRIVING No.

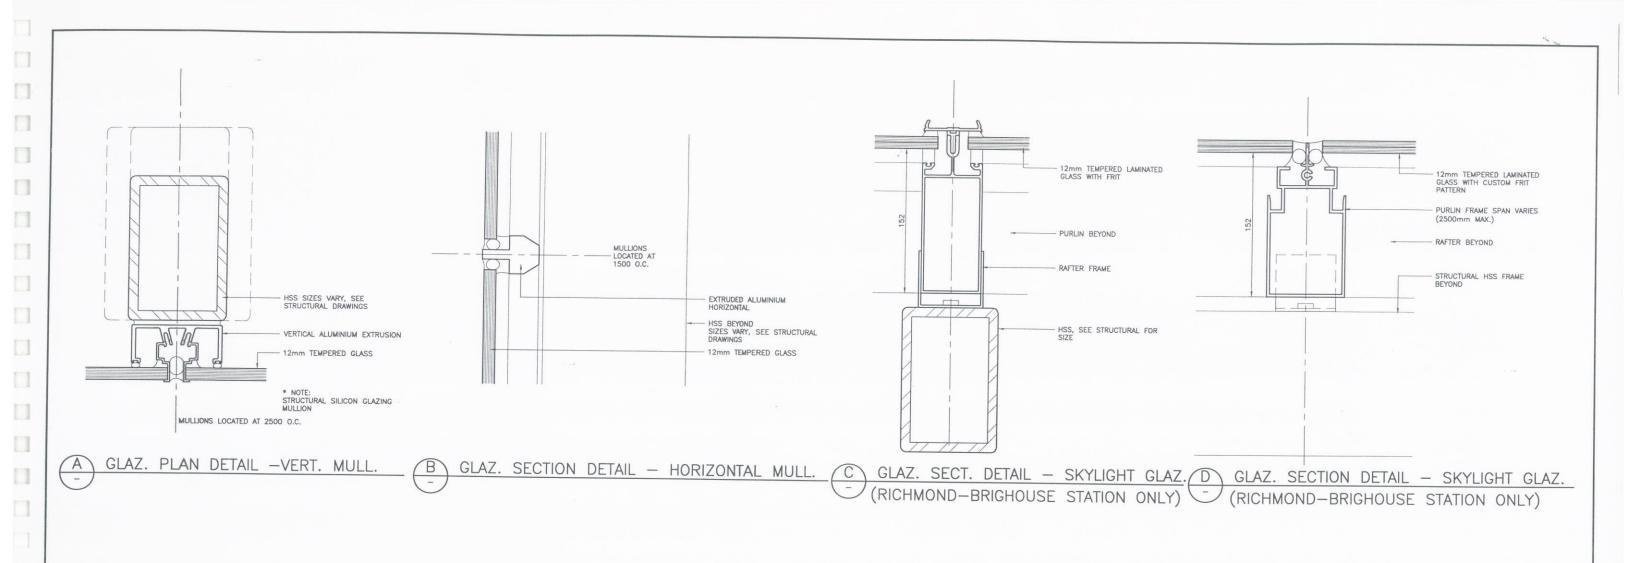

FULL SIZE - 1:2 11X17 VERSION - 1:4 RICHMOND/AIRPORT/VANCOUVER 9001

CANADA LINE TRANSITEC

DESIGNED

CHECKED

RW-SNC-DSIZE-SHEET.dwg
Rev. PC 558.8mm x 836.8mm METRIC

DATE

DATE

DATE DATE DWG No.

REFERENCE DRAWING

DESCRIPTION

REVISIONS

DESCRIPTION


REV

DATE BY


2006-07-18 ES ISSUED FOR COR DPP


SNC+LAVALIN

LANSDOWNE STATION GLAZING DETAILS SCALE 1:2 DATE JULY 14, 06

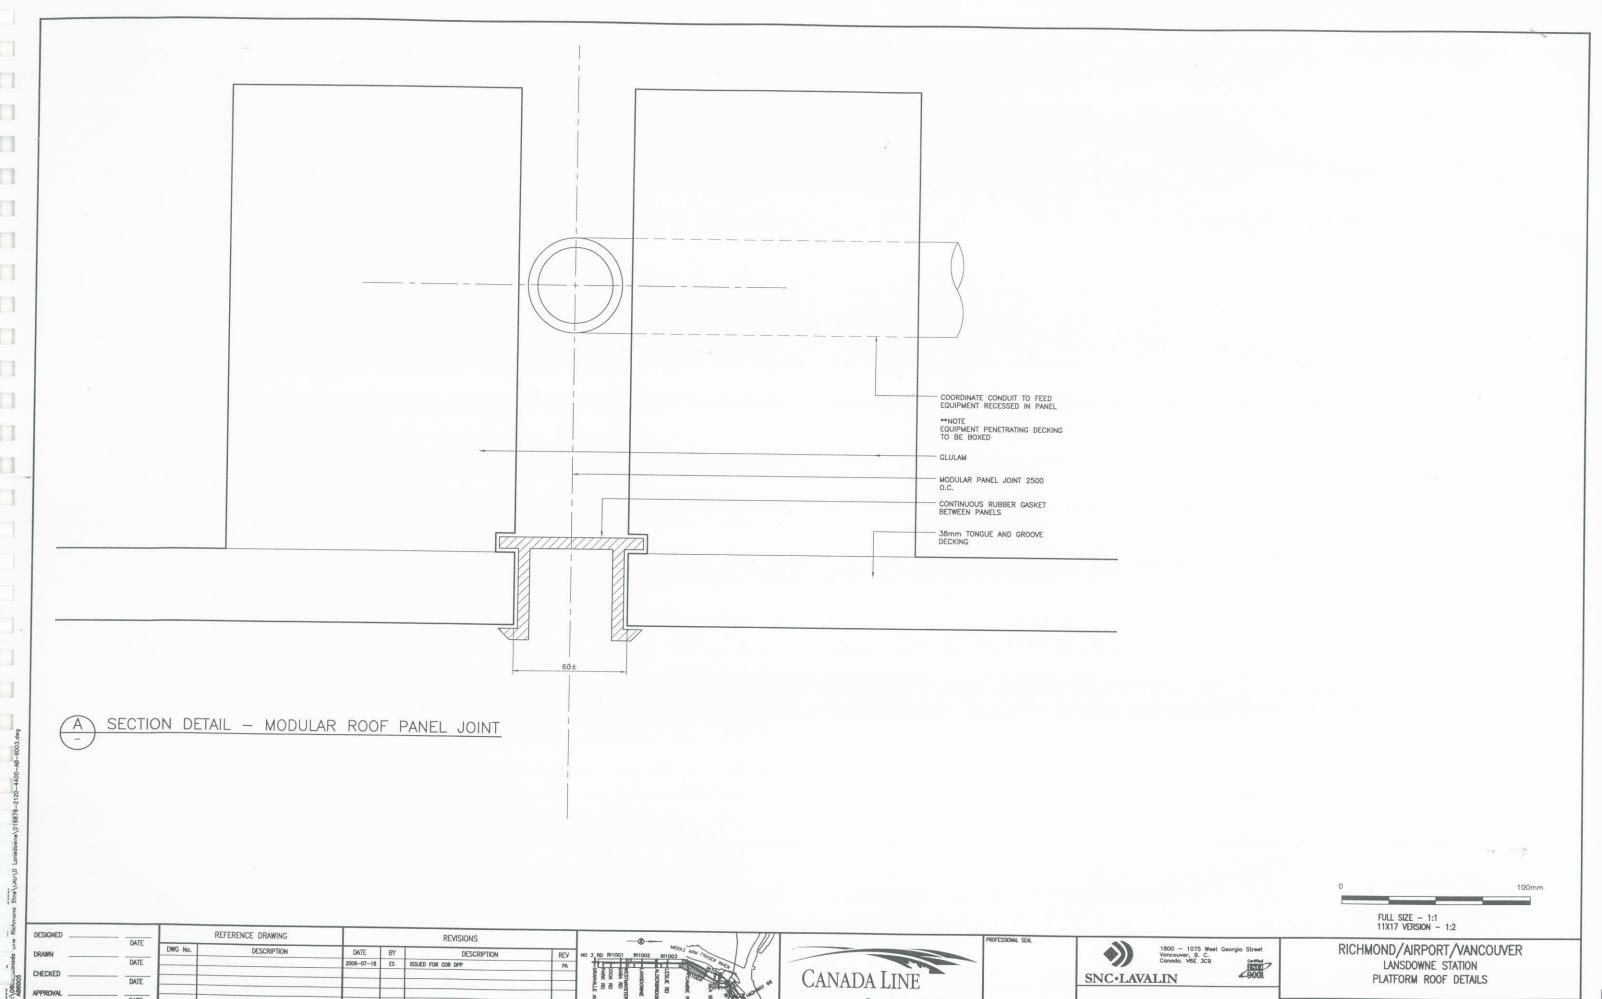

RICHMOND

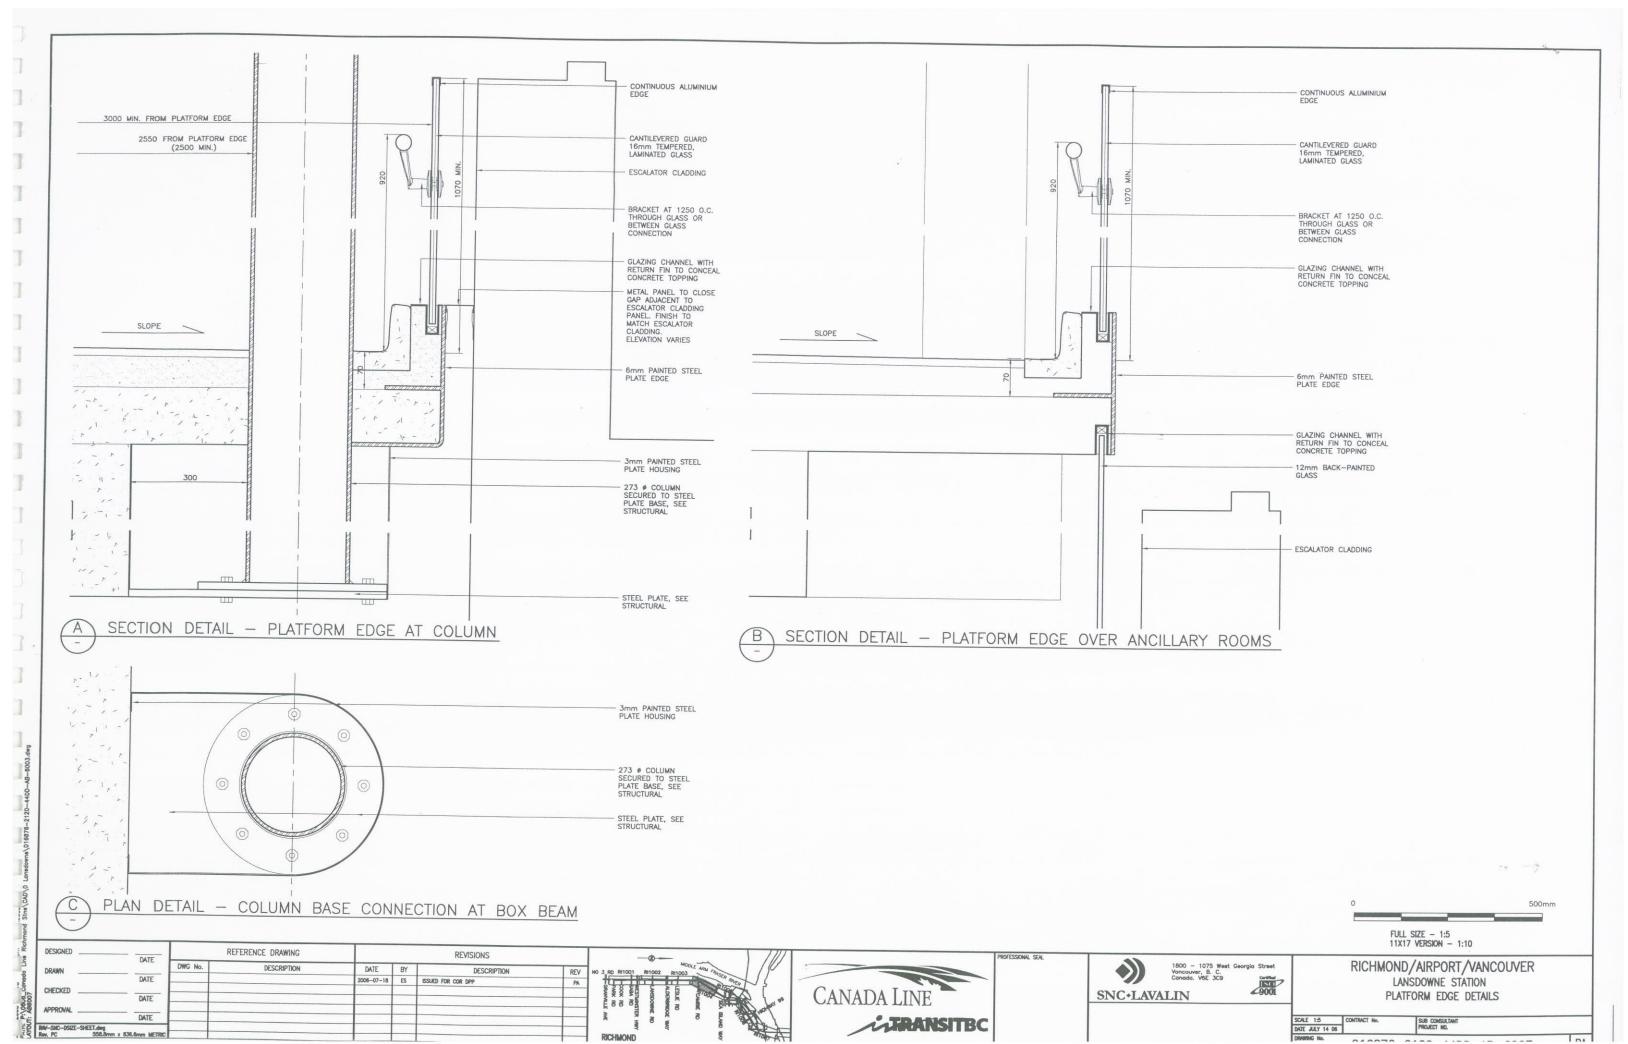

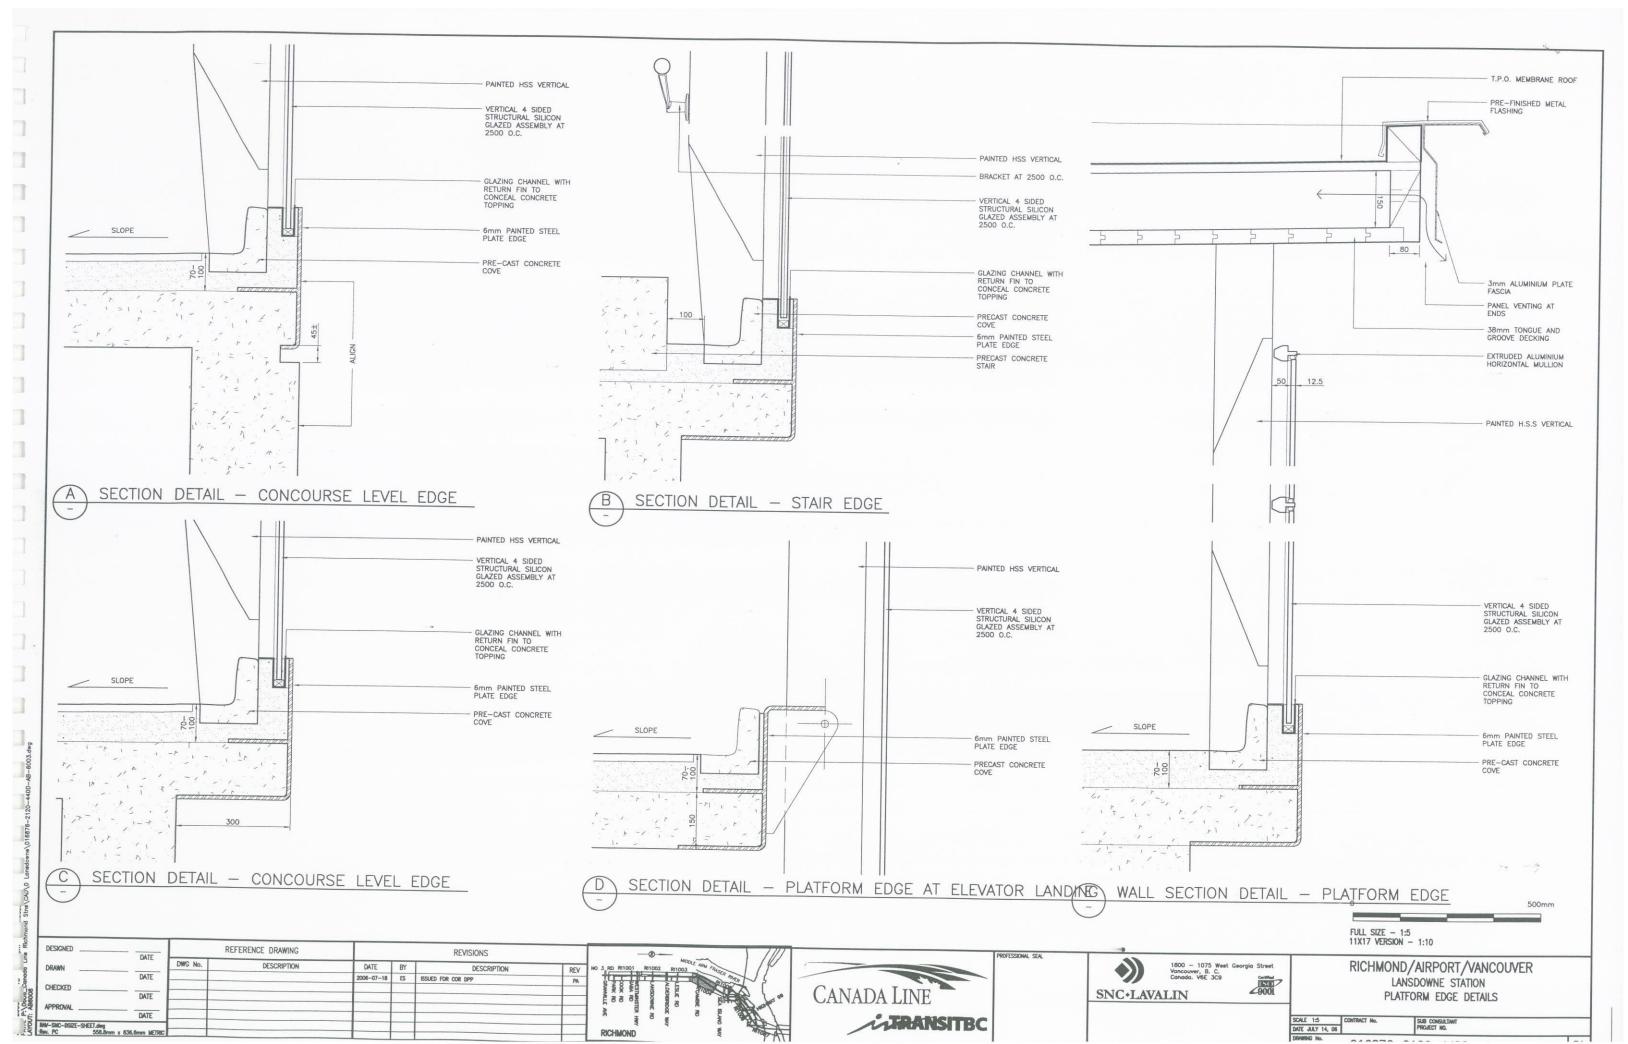

## RICHMOND - BRIGHOUSE STATION (PREVIOUSLY RICHMOND CITY CENTRE STATION)

drawing number	content	scale (full size or 11x17 version)
016876- 2130- 44DD- RC- 0003	Drawing Index	n/a
016876- 2130- 44DD- RC- 1000	Site Plan	1:250 or 1:500
016876- 2130- 44DD-RC- 1001	Ground Level Plan	1:100 or 1:200
016876- 2130-44DD-RC- 1002	Platform Level Plan	1:100 or 1:200
016876- 2130- 44DD-RC- 1003	Roof Plan	1:100 or 1:200
016876- 2130- 44DD-RC- 2000	Longitudinal Section	1:100 or 1:200
016876- 2130- 44DD- RC- 2001	Cross Sections	1:100 or 1:200
016876- 2130- 44DD- RC- 3000	East + West Elevations	1:100 or 1:200
016876- 2130- 44DD-RC- 3001	North + South Elevations	1:100 or 1:200


STRUCTURAL (NOT ISSUED)

drawing number content scale
016876- 2130- 42DK-RC- 9000 Station loads on guideway structure options varies
016876- 2130- 42DK-RC- 9001 "

see Lansdowne station drawings for roof module drawings

	DESIGNED	DATE	REFERENCE DRAWING		REVISIONS				
	DRAWN	DATE	DWG No.	DESCRIPTION	DATE	BY	DESCRIPTION	REV	NO 3
Did and	Divinit	DATE			2006-05-31	ES	ISSUED AT 15% COMPLETION	PA	1 '
1	CHECKED				2006-07-18	ES	ISSUED FOR COR DPP	PB	1
3		DATE							1
RCO	APPROVAL								1
#		DATE							1
Kin	RAV-SNC-DSIZE-SHEET.dwg Rev. PC 558.8mm x 8:	36.6mm METRIC							1,

Strie

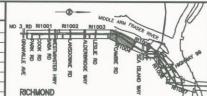





RICHMOND/AIRPORT/VANCOUVER
RICHMOND — BRIGHOUSE STATION
DRAWING LIST

SOLE N/A CONTRACT No. | SUB CONSULTANT | PROJECT NO. | DATE INVY 31, 06 | DRAWING No. | O16876-2130-44DD-RC-D003

