



# City of Richmond

## Report to Development Permit Panel

**To:** Development Permit Panel

**Date:** August 18, 2015


**From:** Wayne Craig  
Director of Development

**File:** DP 15-694729

**Re:** Application by Jacken Investments Inc. for a Development Permit at 10591,  
10611 and 10631 Gilbert Road

### Staff Recommendation

That a Development Permit be issued which would permit the construction of 14 townhouse units at 10591, 10611 and 10631 Gilbert Road on a site zoned "Low Density Townhouses (RTL4)".

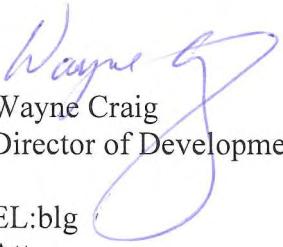  
Wayne Craig

Director of Development

EL:blg  
Att.

**Staff Report****Origin**

Jacken Investments Inc. has applied to the City of Richmond for permission to develop 14 townhouse units at 10591, 10611 and 10631 Gilbert Road. The site is being rezoned from “Single Detached (RS1/E)” to “Low Density Townhouses (RTL4)” for this project under Bylaw 9190 (RZ 13-649998), which received third reading following the Public Hearing on January 19, 2015. The site currently contains three (3) single-family homes (one on each lot) which will be demolished.

A Servicing Agreement for frontage beautification works and service connections is required prior to issuance of a Building Permit for the site. Granting of an approximately 1.2 m wide Public Rights of Passage (PROP) Statutory Right-of-Way (SRW) along the entire frontage (east property line) to accommodate a portion of the proposed new concrete sidewalk (exact width of the SRW to be determined at the Servicing Agreement stage) and granting of an a 1.5 m x 1.5 m utility Right-of-Way (ROW) for storm water service connection will also be required. These requirements were identified at Rezoning stage.

**Development Information**

Please refer to attached Development Application Data Sheet (Attachment 1) for a comparison of the proposed development data with the relevant bylaw requirements.

**Background**

Development surrounding the subject site is as follows:

- To the north, single-family homes on large lots zoned “Single Detached (RS1/E)”.
- To the east, across Gilbert Road, single-family homes on large lots zoned “Single Detached (RS1/E)”, backing on to Gilbert Road.
- To the south, single-family homes on legal non-conforming “Single Detached (RS1/E)” lots fronting Gilbert Road; and then a 40 unit two-storey townhouse development on a lot zoned “Low Density Townhouses (RTL1)”.
- To the west, single-family homes on large lots zoned “Single Detached (RS1/E)”, fronting on to Whistler Place.

**Rezoning and Public Hearing Results**

The Public Hearing for the rezoning of this site was held on January 19, 2015. The following concerns were expressed during the Public Hearing. The response to the concerns is provided in *italics*.

1. Tree retention from a safety perspective and margin of survivability.

*The City's Tree Preservation Coordinator met with the Project Arborist and two of the neighbours on June 18, 2015 to review the conditions of both on-site and off-site trees located at the southwest corner of the development site. The City's Tree Preservation Coordinator has agreed to the removal of two (2) additional trees on the subject site as these trees are co-dependent with the trees on the neighbouring property to the south at 10711 Gilbert Road, which have been removed recently due to poor condition (TP 15-706075). Planting of two (2) larger calliper (minimum 5 m high) conifer trees on the subject site will be required to compensate for the loss.*

2. Height of the development and interface; opportunity to reduce the building height.

*Main roofline along streetscape has been reduced to minimize building height and provide better transition to adjacent single-family homes. Hipped roofs are proposed on the east elevations of the rear units to minimize shadowing.*

3. Opportunity to increase the rear yard setback.

*Rear yard setback has been increased to a minimum of 6.0 m.*

4. Drainage; and how the location of perimeter drainage may be impacted by tree retention, or vice versa, if any.

*All perimeter drainage and proposed retaining walls are to be installed outside of tree protection area; the project arborist advised that mitigation measures are not necessary.*

5. Reduction of green space, sunlight, and privacy.

*The applicant has made an effort to maximize the green area on-site. A generous outdoor amenity area of 115 m<sup>2</sup> is provided (exceeds the Development Permit Guidelines of 84 m<sup>2</sup> for 14 units). Additional side and rear yard setbacks are provided (along the north and west property lines) to address adjacency issues, such as shadowing and privacy.*

6. Replacement of the hedgerow at the northeast corner of the development site.

*The Cedar hedge is to be removed as per Arborist's recommendation. A 6 ft. tall fence will be installed along the north property line and three (3) new trees will be planted at the northeast corner of the site.*

## **Staff Comments**

The proposed scheme attached to this report has satisfactorily addressed the significant urban design issues and other staff comments identified as part of the review of the subject Development Permit application. In addition, it complies with the intent of the applicable sections of the Official Community Plan (OCP) and is in compliance with the "Low Density Townhouses (RTL4)" zone.

## Advisory Design Panel Comments

The Advisory Design Panel supported the design of the project and the Design Panel's suggested design changes have been incorporated into the proposal. A copy of the relevant excerpt from the Advisory Design Panel Minutes from Wednesday, July 8, 2015 is attached for reference (Attachment 2). The design response from the applicant has been included immediately following the specific Design Panel comments and is identified in '***bold italics***'.

## Analysis

### *Conditions of Adjacency*

- The proposed height, siting and orientation of the buildings generally address the massing of the surrounding residential developments.
- Two (2) four-unit buildings are proposed along Gilbert Road. The end units adjacent to the north and south side yards, as well as the entry driveway are stepped down from three (3) storeys to two (2) storeys to compliment the adjacent single-family developments and balance the streetscape along Gilbert Road.
- Two-storey duplex and detached units are proposed along the rear property line to minimize privacy and overlook concerns. The proposed roof line is designed to diminish the impact of shadowing and scale to the neighbours.
- The proposed rear yard setback has been increase to a minimum of 6.0 m, which exceeds the minimum rear yard setback specified in the "Low Density Townhouses (RTL4)" zone and meets the Arterial Road Guidelines for Townhouses in the OCP.

### *Urban Design and Site Planning*

- The proposed site layout provides for an attractive pedestrian-oriented streetscape of townhouses fronting Gilbert Road, complete with a landscaped edge treatment, low metal fencing, and metal gates to individual townhouse unit front doors.
- The internal road layout is a T-shape, with future connections to the neighbouring properties to the north and south, secured by SRW at the Rezoning stage.
- All units have two (2) vehicle parking spaces in a side-by-side double car garage. A total of three (3) visitor parking spaces, including an accessible visitor parking space, are proposed, which meet the bylaw requirement. Both residential and visitor bicycle parking are provided and are also in compliance with the Zoning Bylaw requirements.
- Outdoor amenity space is proposed opposite the site entry for maximum casual surveillance opportunity and sun exposure. The size and location of the outdoor amenity space is appropriate in providing open landscape and amenity space convenient to all of the units.
- A covered mailbox kiosk and short-term bicycle parking spaces are provided at the entrance of the outdoor amenity space.
- The required garbage, recycling and organic waste storage enclosures are located at the back of the street fronting buildings and have been incorporated into the design of the townhouse clusters to minimize their visual impact.

***Architectural Form and Character***

- Tudor architectural style is proposed, with the use of decorative wood trim boards on hardi panel at the projected bays. Traditional brick is used to ground the overall massing.
- A combination of staggered units, alternating color schemes/materials and roof styles is provided to street fronting buildings to enhance visual diversity.
- The impact of blank garage doors has been mitigated with panel patterned doors, transom windows and planting islands along the drive aisle.
- The proposed building materials (asphalt roof shingles, hardi siding, brick cladding, wood trim/post/band/bracket/doors, and metal guard rail) are generally consistent with the Official Community Plan (OCP) Guidelines and are generally compatible with the existing single-family character of the neighbourhood.

***Tree Preservation***

- Subsequent to the Rezoning staff report, tree preservation has been reviewed again for the Development Permit application stage; a total of 37 bylaw-sized trees on-site are identified for removal. Based on the 2:1 tree replacement ratio goal stated in the OCP, 74 replacement trees are required. The applicant is proposing to plant 25 replacement trees on-site, including five (5) conifers and 20 deciduous trees.
- A voluntary contribution of \$22,000 to the City's Tree Compensation Fund in-lieu of planting 44 replacement trees has been secured at rezoning. The applicant has also agreed to provide a voluntary contribution of \$2,500 to the City's Tree Compensation Fund in lieu of planting the remaining five (5) replacement trees.
- Two (2) trees on-site and six (6) trees located on the neighbouring properties to the west are identified for retention. Tree protection fencing is required to be installed as per the Arborist Report recommendations prior to any construction activities (including demolition) occurring on-site. A Tree Survival Security will be required as part of the Landscape Letter of Credit as a condition to Development Permit issuance to ensure that these trees will be protected. No Landscape Letter of Credit will be returned until the post-construction assessment report, prepared by the Arborist, confirming the protected trees survived the construction, is reviewed by staff.

***Landscape Design and Open Space Design***

- Landscaping for this project has been designed to incorporate the protected trees on-site and off-site. The existing grade at the tree protection areas will remain the same; as such, stairs will be provided for front yards of Units Bb and C of Building #6 and rear yards to Buildings #2 to #5.
- A pedestrian-oriented streetscape along Gilbert Road is proposed; with a landscaped edge treatment, low metal fencing with concrete columns, and gates to individual townhouse unit front doors.
- Each unit will have a private yard with a shade tree and shrub/ groundcover planting, a patio, and small lawn area. All trees along the rear (west) property line are proposed outside of the SRW corridor.
- Hedges, shrubs and ground covers, as well as perennials and grasses have been selected to ensure the landscape treatment remains interesting throughout the year.

- The north and south end of the interior road will be treated with an arbour structure, with vines and fence behind, to screen views into the neighbouring properties.
- Armstrong Maple trees are proposed between the surface parking areas of the three-storey units and portions the parking pads are treated with structural soil to provide additional green space along the internal drive aisle.
- Portions of the entry driveway and internal drive aisle, as well as surface parking stalls, will be treated with permeable pavers for better permeability and to provide a variety in paving surfaces.
- Outdoor amenity space is proposed opposite the site entry and will be at the same grade as the internal roadway. A small children's play area with a play equipment and natural play elements for the younger children aged 2 to 5 will be included in the proposal.
- The chosen play equipment provides different play opportunities such as social, imagination, balance, sliding, climbing, and motor skills.
- Natural play opportunities will be created by using resources on-site such as logs from the tree to be removed on-site. Vertical logs will form the edge between the play area and the surrounding landscaping and flat boulders will be located in the middle of the active play area. The natural play elements will also provide opportunities for climbing, balancing, imaginative play and social interaction.
- In order to ensure that the proposed landscaping works are completed, the applicant is required to provide a landscape security of \$127,198.78 in association with the Development Permit.
- Indoor amenity space is not proposed on-site. A \$14,000 cash-in-lieu contribution has been secured as a condition of rezoning approval, consistent with the OCP.

### ***Crime Prevention Through Environmental Design***

- The architect advised that the following CPTED design/features are incorporated into the proposal:
  - Pedestrian walkway connecting Gilbert Road sidewalk to development for increased natural flow.
  - Street edge is metal fence with gates and low planting on either side of the fence for visual porosity into the site.
  - Windows provided at certain areas such as the amenity and "blind spots" near the electrical room to enhance surveillance opportunity.

### ***Sustainability***

- A Restrictive Covenant, specifying that all units are to be built and maintained to the EnerGuide rating of 82 or higher, and that all units are to be solar-hot-water-ready, has been secured at rezoning. A Certified Energy Advisor has confirmed that the proposed townhouse units will be designed to achieve an EnerGuide rating of 82. The report prepared by the Energy Advisor is on file and will be utilized through the Building Permit review process to ensure these measures are incorporated in the Permit drawings.

- The developer also advises that the following sustainability features will be incorporated into the development:
  - Retention of two (2) large existing trees on-site.
  - Native plants incorporated in landscaping design.
  - Permeable pavers at internal roadway and visitor parking stalls.
  - Larger gable overhangs to increase envelope performance.
  - Large operable windows to provide natural light and ventilation.
  - Energy efficient appliances.
  - Low energy lighting.
  - Water efficient toilets.
  - Drain water heat recovery from two (2) showers per unit.

### ***Accessible Housing***

- The proposed development includes one (1) convertible unit that is designed with the potential to be easily renovated to accommodate a future resident in a wheelchair. The potential conversion of this unit will require installation of a vertical lift in the stacked storage space (which has been dimensioned to allow for this in Unit B1) in the future, if desired.
- All of the proposed units incorporate aging in place features to accommodate mobility constraints associated with aging. These features include:
  - Stairwell hand rails.
  - Lever-type handles for plumbing fixtures and door handles.
  - Solid blocking in washroom walls to facilitate future grab bar installation beside toilets, bathtubs and showers.

### **Conclusions**

The applicant has satisfactorily addressed staff's comments regarding conditions of adjacency, site planning and urban design, architectural form and character, and landscape design. The applicant has presented a development that fits into the existing context. On this basis, staff recommend support of this Development Permit application.



Edwin Lee  
Planning Technician – Design  
(604-276-4121)

EL:blg

The following are to be met prior to forwarding this application to Council for approval:

- Adoption of Rezoning Bylaw 9190 (RZ 13-649998).
- Receipt of a Letter-of-Credit for landscaping and tree survival in the amount of \$127,198.78; Letter-of-Credit will not be released until the Letter of Assurance from the Landscape Architect confirming that landscaping are

installed as per Development Permit, as well as the Post Construction Impact Assessment Report from the Arborist confirming that the protected hedgerow survived the construction, are reviewed by staff.

Prior to future Building Permit issuance, the developer is required to complete the following:

- Enter into a Servicing Agreement for the design and construction of the design and construction of frontage improvements along entire frontage on Gilbert Road as well as the design and construction of Water, Storm, and Sanitary service connections
- The granting of an approximately 1.2 m wide Public Rights of Passage (PROP) Statutory Right-of-Way (SRW) along the entire frontage (east property line) to accommodate a portion of the proposed new concrete sidewalk (exact width of the SRW to be determined at the Servicing Agreement stage).
- Installation of appropriate tree protection fencing around all trees to be retained as part of the development prior to any construction activities, including building demolition, occurring on-site.
- Payment of DCC's (City & GVS&DD), School Site Acquisition Charges, Address Assignment Fee, and all required servicing costs.
- Incorporation of energy efficiency, CPTED, sustainability, and accessibility measures in Building Permit (BP) plans as determined via the Rezoning and/or Development Permit processes.
- The applicant is required to obtain a Building Permit for any construction hoarding associated with the proposed development. If construction hoarding is required to temporarily occupy a street, or any part thereof, or occupy the air space above a street or any part thereof, additional City approvals and associated fees may be required as part of the Building Permit. For further information on the Building Permit, please contact Building Approvals Department at 604-276-4285.
- Submission of a construction traffic and parking management plan to the satisfaction of the City's Transportation Department (<http://www.richmond.ca/services/ttp/special.htm>).
- If applicable, payment of latecomer agreement charges associated with eligible latecomer works.



**City of  
Richmond**

**Development Application Data Sheet**  
Development Applications Department

**DP 15-694729**

**Attachment 1**

Address: 10591, 10611 and 10631 Gilbert Road

Applicant: Jacken Investments Inc.

Owner: Gilbert CWL Investments Inc.

Planning Area(s): Blundell

Floor Area Gross: 2,158 m<sup>2</sup>

Floor Area Net: 2,035 m<sup>2</sup>

	<b>Existing</b>	<b>Proposed</b>
<b>Site Area:</b>	3,392 m <sup>2</sup>	3,392 m <sup>2</sup>
<b>Land Uses:</b>	Single-Family Residential	Multiple-Family Residential
<b>OCP Designation:</b>	Neighbourhood Residential	No Change
<b>Zoning:</b>	Single Detached (RS1/E)	Low Density Townhouses (RTL4)
<b>Number of Units:</b>	3	14

	<b>Bylaw Requirement</b>	<b>Proposed</b>	<b>Variance</b>
Floor Area Ratio:	Max. 0.60	0.60	none permitted
Lot Coverage – Building:	Max. 40%	39.3%	none
Lot Coverage – Non-porous Surfaces:	Max. 65%	62%	none
Lot Coverage – Landscaping:	Min. 25%	25.4%	none
Setback – Front Yard (m):	Min. 6.0 m	6.26 m Min.	none
Setback – North Side Yard (m):	Min. 3.0 m	3.56 m Min.	none
Setback – South Side Yard (m):	Min. 3.0 m	3.11 m Min.	none
Setback – Rear Yard (m):	Min. 3.0 m	6.0 m Min.	none
Height (m):	Max. 12.0 m (3 storeys)	10.79 m (3 storeys) Max.	none
Lot Width:	Min. 50.0 m	66.4 m	none
Off-street Parking Spaces – Regular (R) / Visitor (V):	2 (R) and 0.2 (V) per unit	2 (R) and 0.2 (V) per unit	none
Off-street Parking Spaces – Total:	31	31	none
Tandem Parking Spaces:	Max. 50% of proposed residential spaces in enclosed garages (28 x Max. 50% = 14)	0	none

Small Car Parking Spaces	Max. 50% when 31 or more spaces are provided on site (31 x Max. 50% = 15)	0	none
Handicap Parking Spaces:	Min. 2% when 3 or more visitor parking spaces are required (3 x Min. 2% = 1)	1	none
Amenity Space – Indoor:	Min. 70 m <sup>2</sup> or Cash-in-lieu	Cash-in-lieu	none
Amenity Space – Outdoor:	Min. 6 m <sup>2</sup> x 14 units = 84 m <sup>2</sup>	115 m <sup>2</sup>	none

**Excerpt from the Minutes from  
The Design Panel Meeting**

**Wednesday, July 8, 2015 – 4:00 p.m.  
Rm. M.1.003  
Richmond City Hall**

**Panel Discussion**

*Comments from the Panel were as follows:*

- appreciate the massing and materiality of the proposed development, in particular the use of bricks which is visually appealing and different from previous projects reviewed by the Panel; like the stepping down of end units to two-storeys;

*Noted.*

- concerned on the long row of garage doors along the internal drive aisle; consider breaking up the double garage doors to enhance visual appeal on the ground plane along the internal drive aisle;

***Buildings are staggered along the internal road to minimize row of doors. Duplex units have also been staggered to enhance the transition between their garage doors. Evergreen shrubs provided to between garage doors.***

- appreciate the siting of the bicycle rack and mail kiosk adjacent to the outdoor amenity area;

*Noted.*

- agree with comments regarding the long row of double garage doors along the internal drive aisle; consider introducing architectural treatment and enhancing the landscaping to visually break up the double garage doors;

***See response above regarding transition between garage doors.***

- appreciate the design and massing of the proposed development;

*Noted.*

- applicant needs to clarify whether there is a garage door in the west elevation (internal drive aisle) of the B unit in Buildings 1 and 6 as shown in the architectural drawings submitted by the applicant to the Panel;

***Garage door for B/Bb units of Bldg 1 & 6 provided at the north/south main drive aisle. Sliding doors with access to the garbage & recycling are proposed at the west elevations of these units.***

- appreciate the introduction of recesses which allow for more tree planting in the interior of the proposed development;

***Noted.***

- consider introducing architectural element to provide transition from the lower to upper level of brick cladding on the building façade; also consider introducing an element above the arches, e.g. by relocating the soldier course brick on the sides of the building, to provide transition and visually break up the brick cladding;

***Precast concrete cap provided to transition between brick cladding and hardi plank elements. Arches removed and shown with vertical soldier coarse brick.***

- appreciate the proportions, materiality and massing of the buildings; agree with comments to consider introducing soldier course brick above the arches; consider a straight line in lieu of a slight arch over the garage doors to provide a cleaner look;

***All brick clad garage doors proposed with a linear vertical coarse brick.***

- consider introducing a pedestrian walkway along one side of the east-west main drive aisle to provide pedestrian connection to the street sidewalk along Gilbert Road;

***Pedestrian walkway provided adjacent to the main drive aisle to connect proposed development and Gilbert Rd. sidewalk.***

- appreciate the retention of the big tree in the outdoor amenity area; also appreciate the integration of the bench, bicycle rack and mail kiosk in the outdoor amenity area which provide more benefits and use to the residents;

***Noted.***

- appreciate the stepping down to two-storeys of the end units and back units of the proposed development; also appreciate the provision of living spaces on the ground floor of the townhouse units which are beneficial to disabled residents;

***Noted.***

- consider an 800 mm door width for powder rooms in townhouse units;

***800mm width pocket doors provided.***

- appreciate the amount of planting along the main drive aisle; agree with comment to introduce a pedestrian walkway along the main drive aisle; also appreciate the use of special paving on the proposed development;

***See note pedestrian walkway note above.***

- look at the amount of planting under the tree to be retained; ensure the survivability of plants under the big tree; and

***Noted. Arborist and landscape architect to coordinate regarding the survivability of these plants.***

- appreciate the sustainability features of the project, e.g., heat recovery ventilators, insulated and double glazed building materials, condensing natural gas boilers and solar heat recoveries which are not normally found in other townhouse developments; the applicant is encouraged to maintain these sustainability features up to the construction stage.

***Noted. Client to maintain sustainable features until the construction stage.***

**Panel Decision**

It was moved and seconded

***That DP 15-694729 be supported to move forward to the Development Permit Panel subject to the applicant giving consideration to the comments of the Panel.***

**CARRIED**



# City of Richmond

## Development Permit

No. DP 15-694729

To the Holder: JACKEN INVESTMENTS INC.

Property Address: 10591, 10611 AND 10631 GILBERT ROAD

Address: C/O KEVIN PERATLA  
YAMAMOTO ARCHITECTURE INC.  
2386 OAK STREET  
VANCOUVER, BC V6H 4J1

1. This Development Permit is issued subject to compliance with all of the Bylaws of the City applicable thereto, except as specifically varied or supplemented by this Permit.
2. This Development Permit applies to and only to those lands shown cross-hatched on the attached Schedule "A" and any and all buildings, structures and other development thereon.
3. Subject to Section 692 of the Local Government Act, R.S.B.C.: buildings and structures; off-street parking and loading facilities; roads and parking areas; and landscaping and screening shall be constructed generally in accordance with Plans #1 to #4 attached hereto.
4. Sanitary sewers, water, drainage, highways, street lighting, underground wiring, and sidewalks, shall be provided as required.
5. As a condition of the issuance of this Permit, the City is holding the security in the amount of \$127,198.78 to ensure that development is carried out in accordance with the terms and conditions of this Permit. Should any interest be earned upon the security, it shall accrue to the Holder if the security is returned. The condition of the posting of the security is that should the Holder fail to carry out the development hereby authorized, according to the terms and conditions of this Permit within the time provided, the City may use the security to carry out the work by its servants, agents or contractors, and any surplus shall be paid over to the Holder. Should the Holder carry out the development permitted by this permit within the time set out herein, the security shall be returned to the Holder. The City may retain the security for up to one year after inspection of the completed landscaping in order to ensure that plant material has survived.
6. If the Holder does not commence the construction permitted by this Permit within 24 months of the date of this Permit, this Permit shall lapse and the security shall be returned in full.

**Development Permit**  
**No. DP 15-694729**

To the Holder: JACKEN INVESTMENTS INC.

Property Address: 10591, 10611 AND 10631 GILBERT ROAD

Address: C/O KEVIN PERATLA  
YAMAMOTO ARCHITECTURE INC.  
2386 OAK STREET  
VANCOUVER, BC V6H 4J1

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7. The land described herein shall be developed generally in accordance with the terms and conditions and provisions of this Permit and any plans and specifications attached to this Permit which shall form a part hereof.

This Permit is not a Building Permit.

AUTHORIZING RESOLUTION NO. ,  
DAY OF ,


ISSUED BY THE COUNCIL THE

DELIVERED THIS DAY OF ,

MAYOR



# City of Richmond

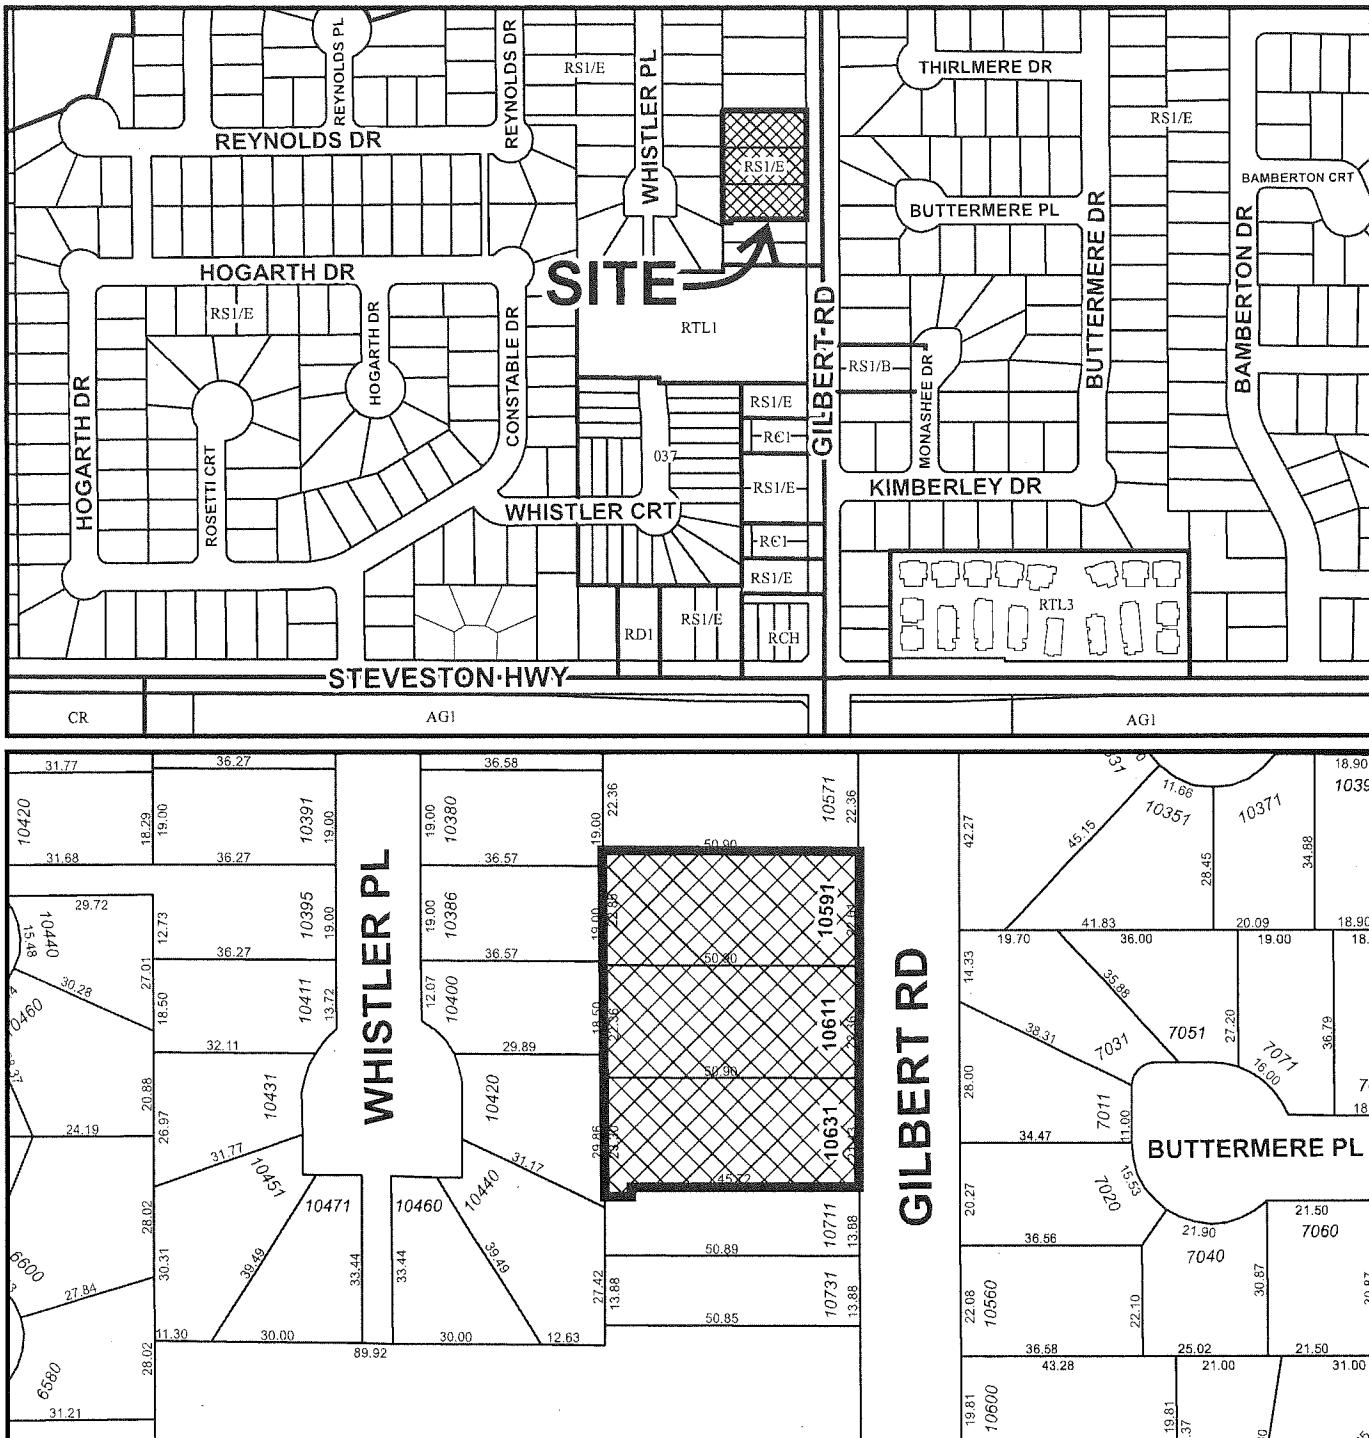

**DP 15-694729**  
**SCHEDULE "A"**

Original Date: 03/30/15

Revision Date:

Note: Dimensions are in METRES



**LEGEND:**

- ELECTRICAL CHARGE OUTLET
- FUTURE ELECTRICAL CHARGE OUTLET
- 3.5' HT. FENCE
- 6' HT. FENCE
- TPZ FENCE

## CONTEXT PLAN

SCALE : N.T.S.





### STATISTICS:

CIVIC ADDRESS:  
LEGAL DESCRIPTION:

10591, 10611, 10631 GILBERT RD.

SCALE : N.T.S.

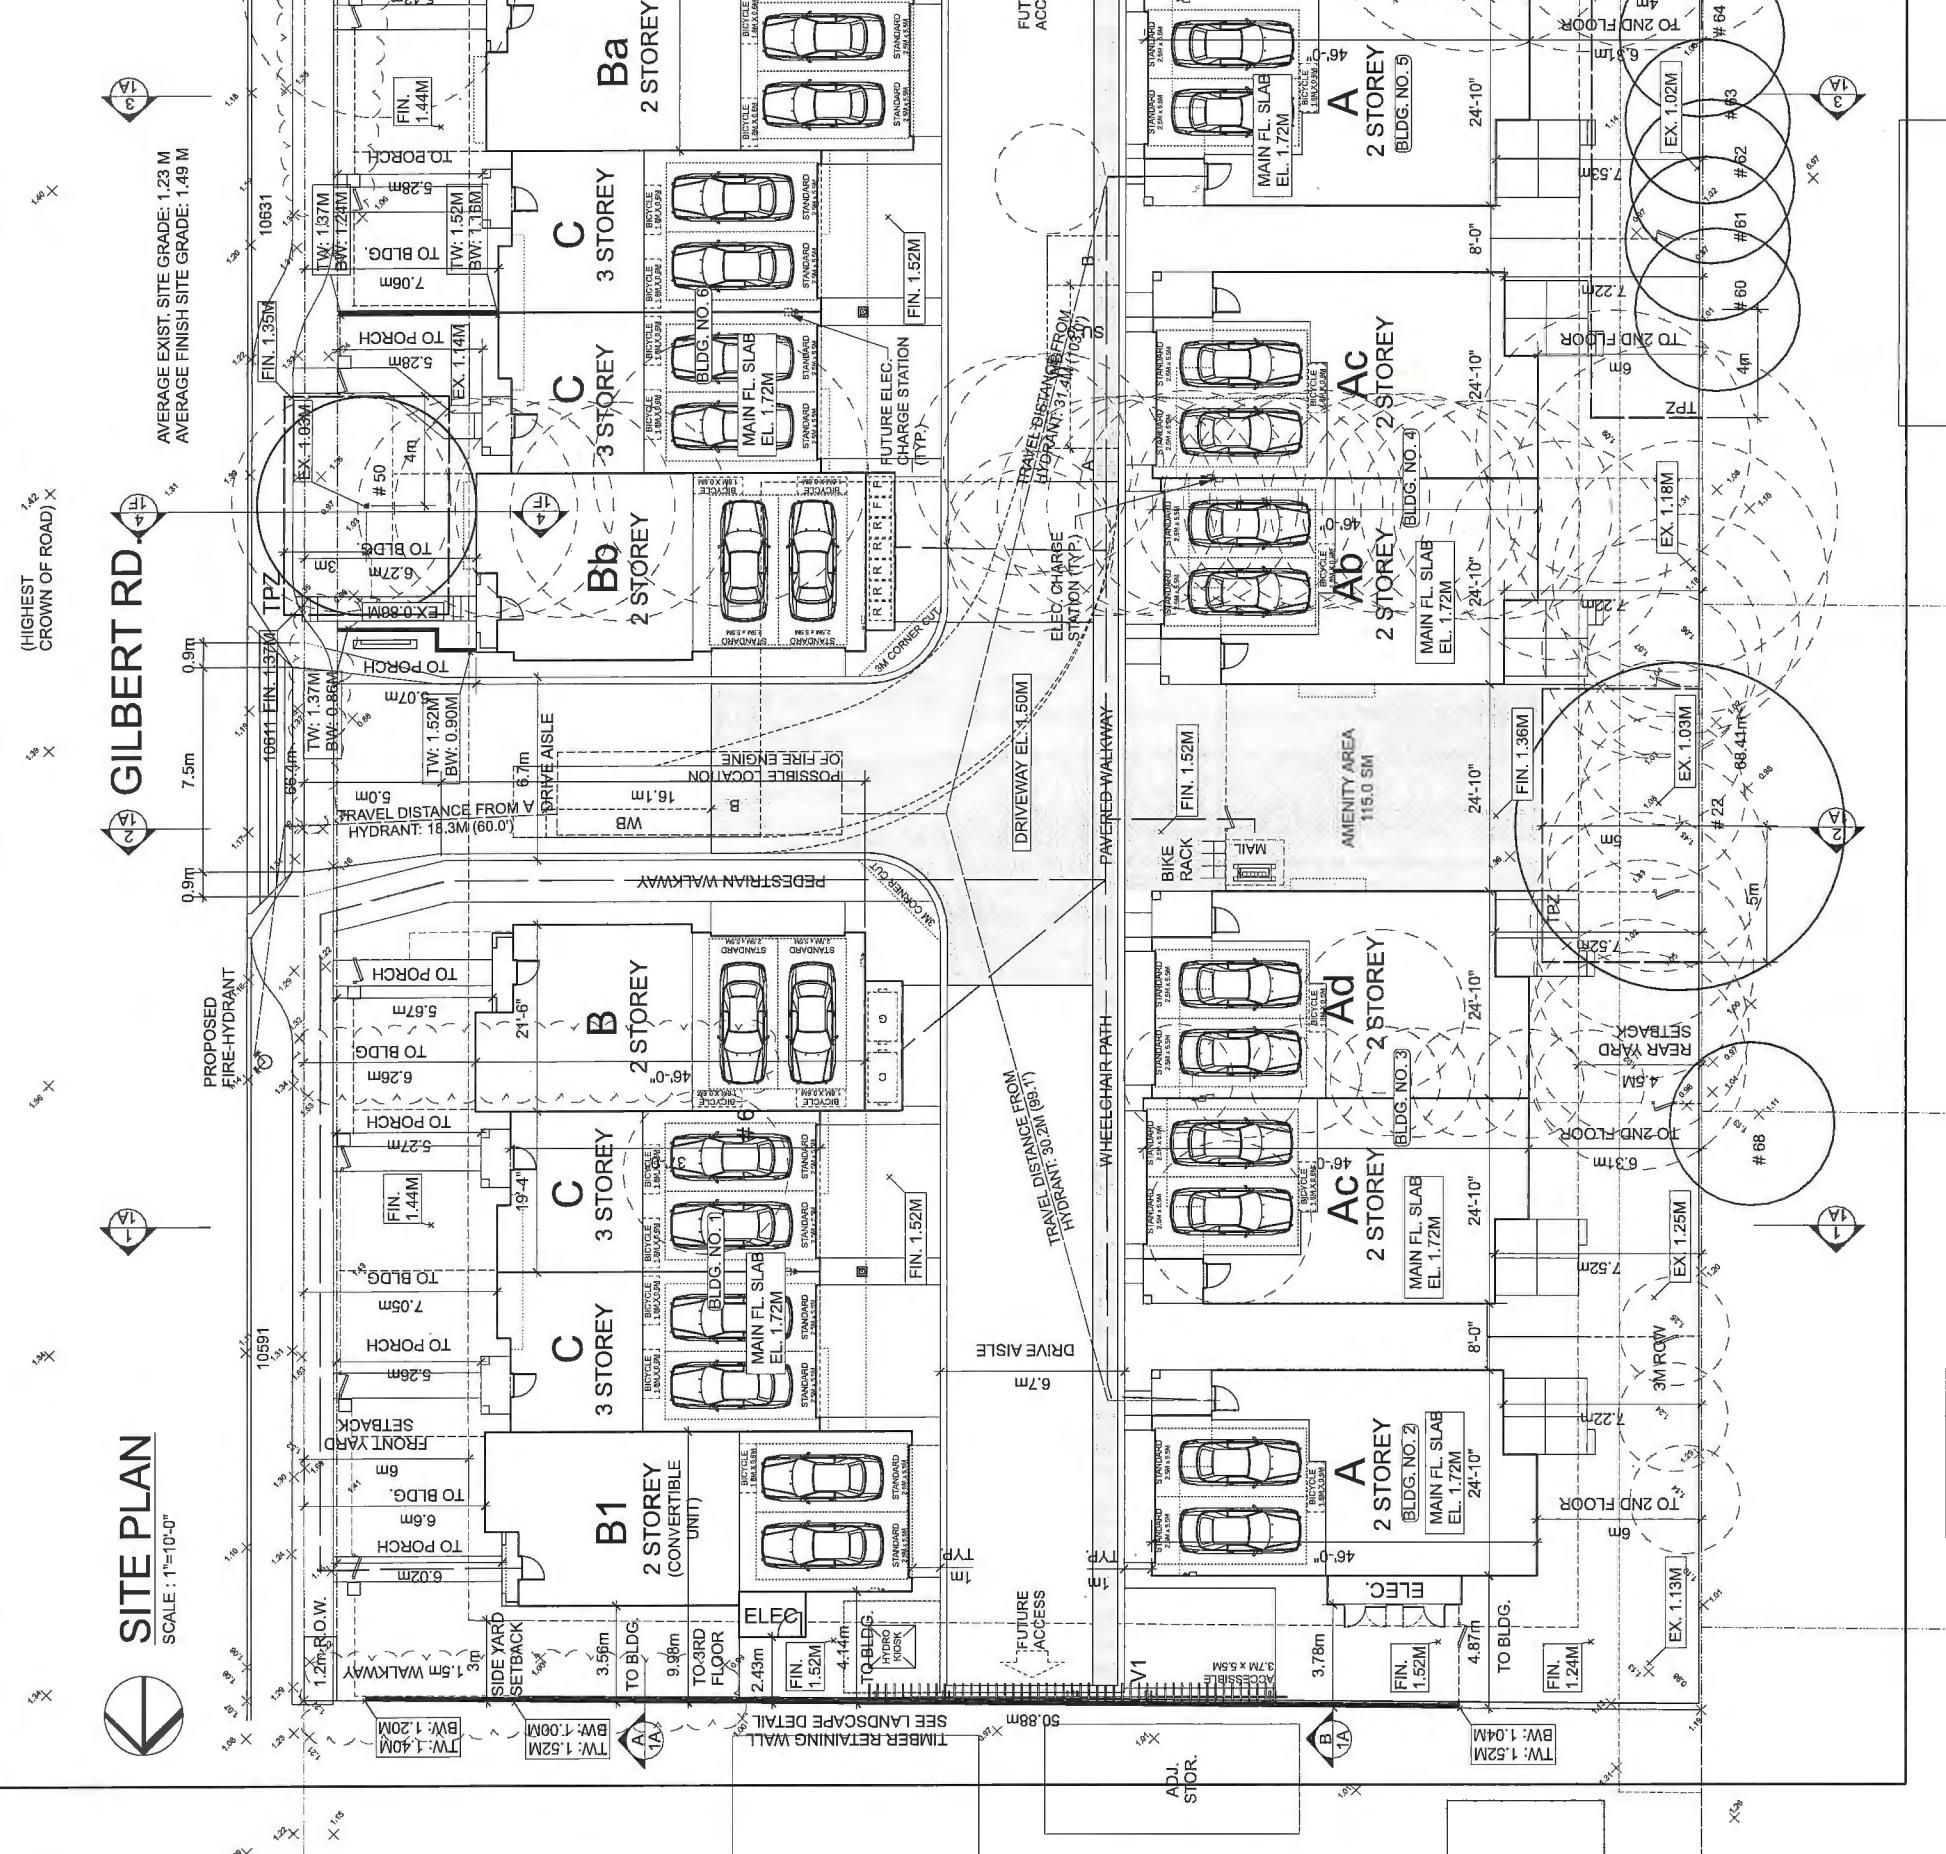

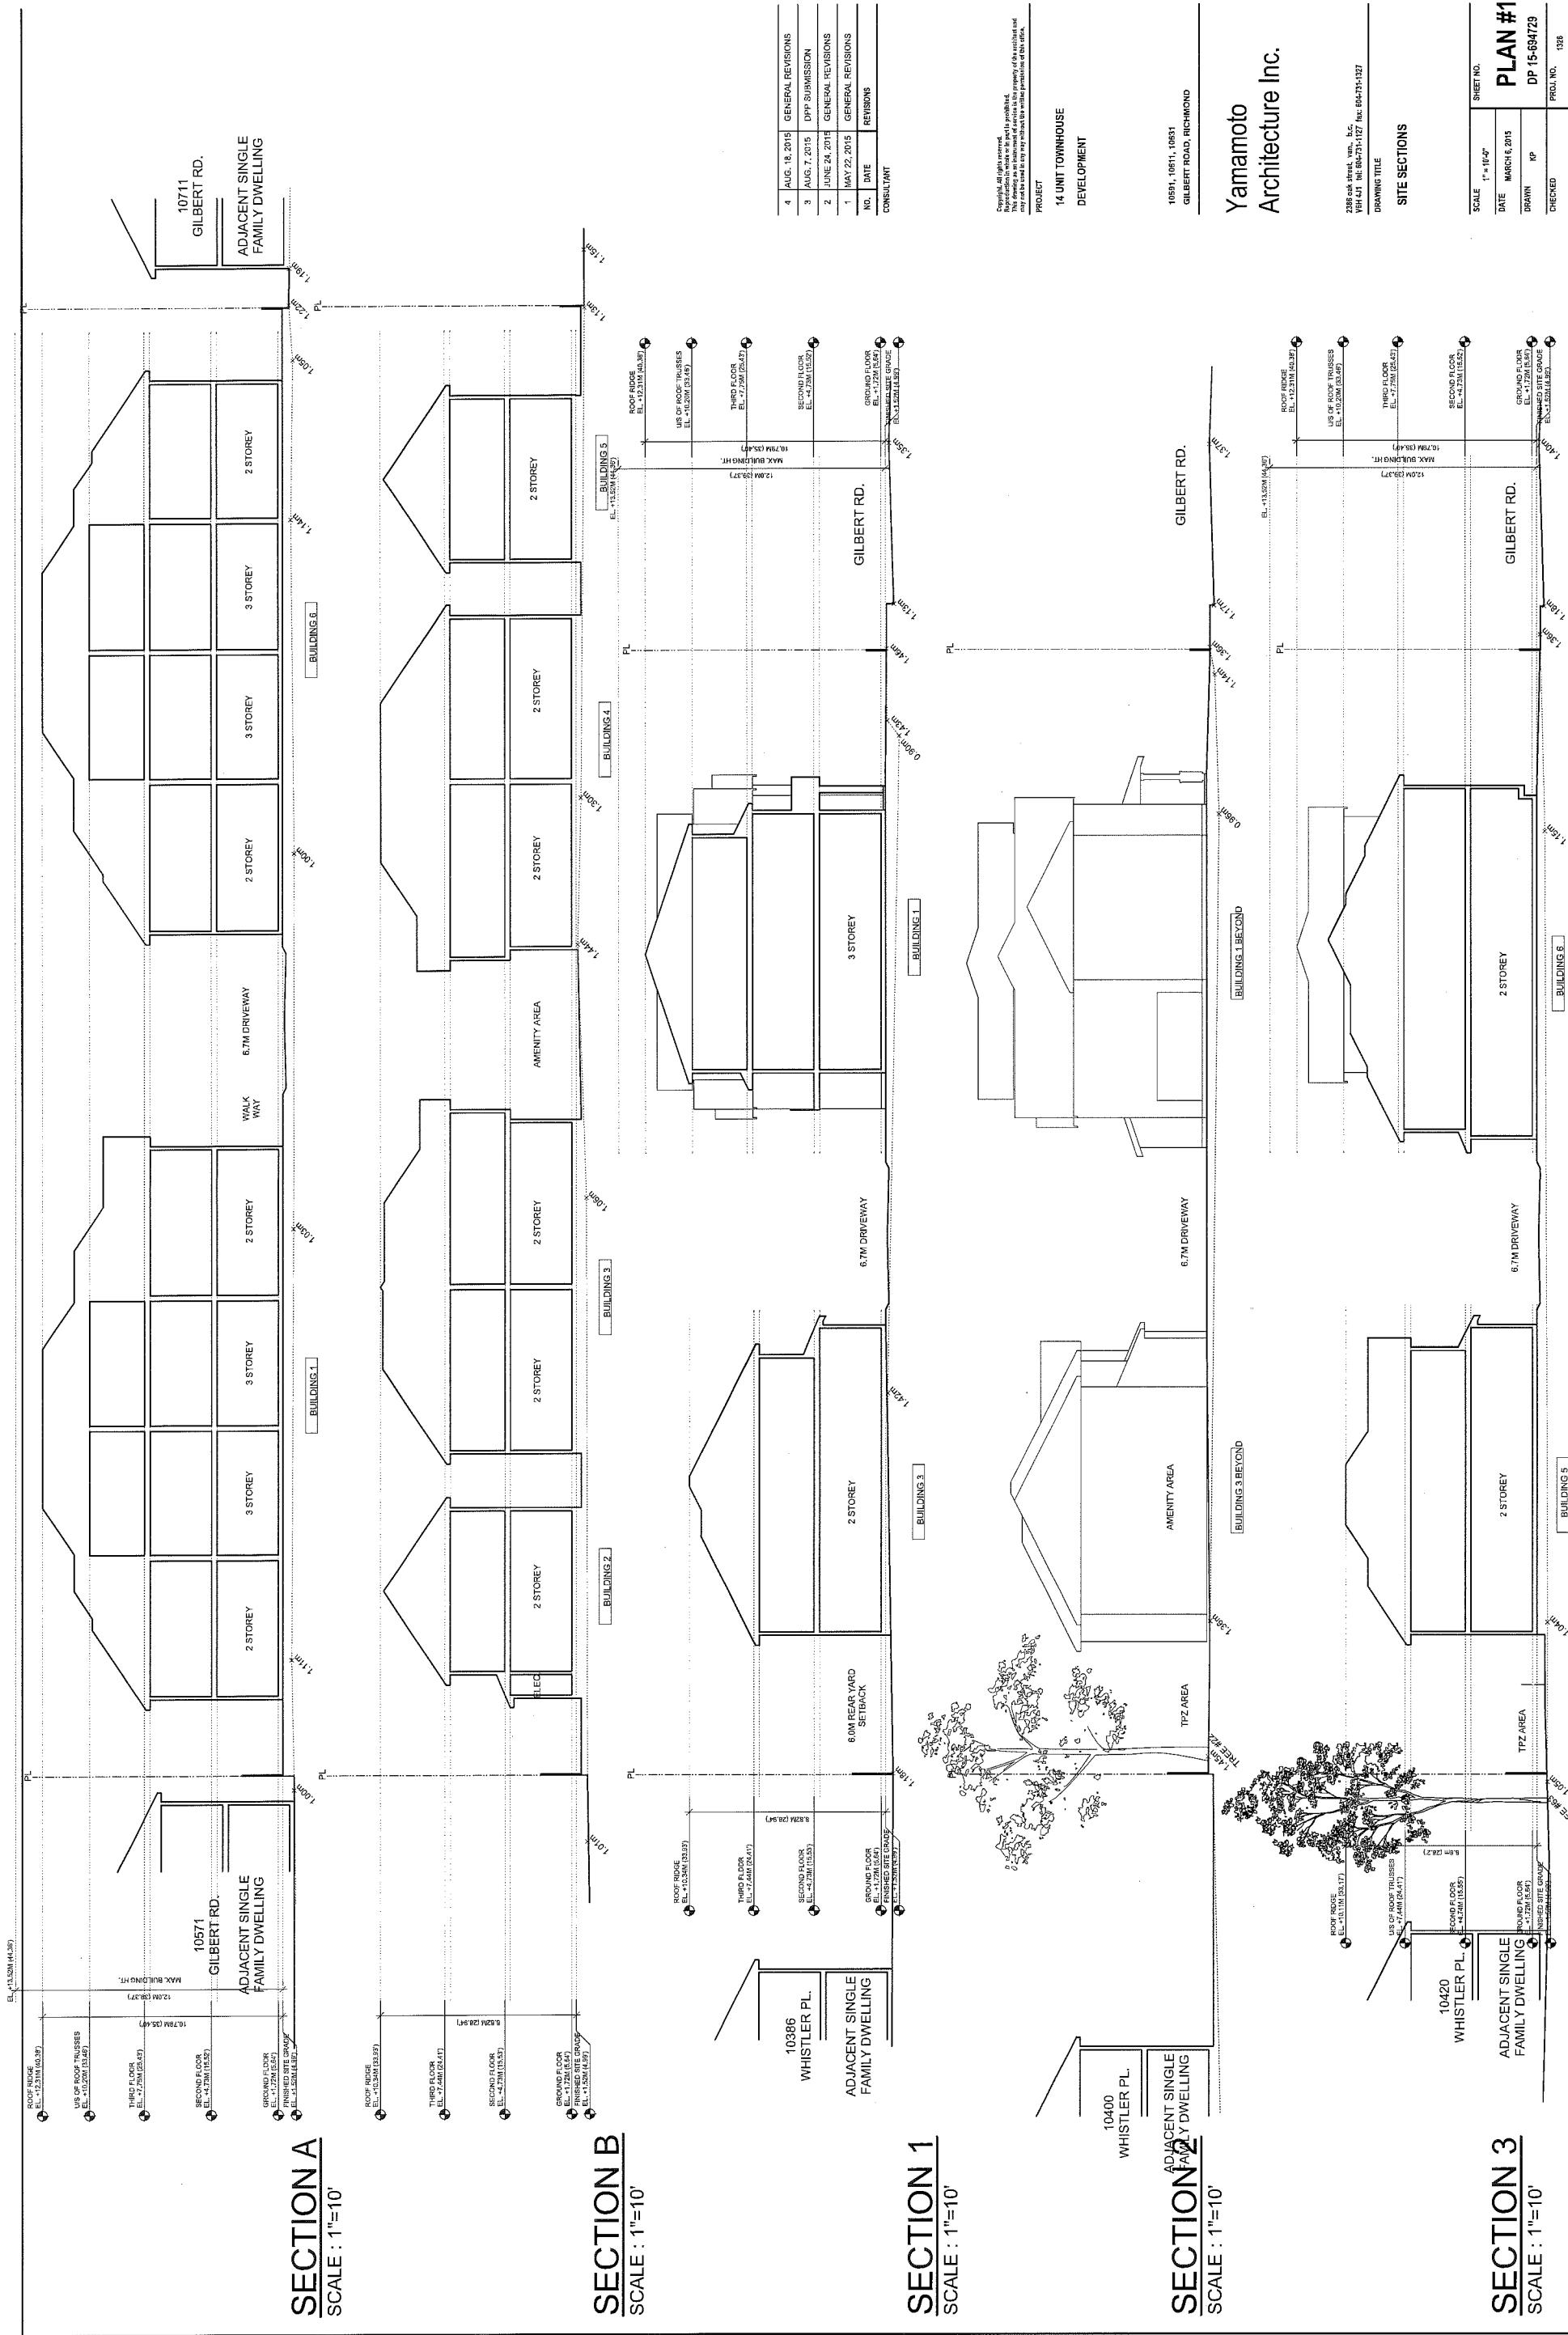



# PARKING / FIRE FIGHTING PLAN

SCALE : 1=10'-0"

PROPOSED

FIRE-HYDRANT

GILBERT RD.

HIGHEST  
CROWN OF ROAD



TRAVEL DISTANCE FROM HYDRANT: 18.3M (60.0')

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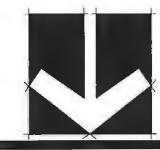
LANDSCAPE  
ARCHITECTS

Suite C100 - 4185 50th Street Drive

Burnaby, British Columbia, V5C 6G9

P: 604 284-0011; F: 604 284-0022

SEAL:




REF. #	CITY	BOTANICAL NAME	COMMON NAME	PLANTED SIZE / REWARDS
4		ACER PALMATEUM	JAPANESE MAPLE	60CM X 60CM STD. BBS
5		FRAUNIERIA PARVIFLORA	COLUMNAR MAHOGANY	60CM X 60CM STD. BBS
6		PRUNUS CERASIFERA 'COLUMNARIS'	AUTUMN PURPLE PLUM	60CM X 60CM STD. BBS
7		STYRAX JAPONICUS	COLONIAL SPINDLE TREE	60CM X 60CM STD. BBS
8		STRYCHNOS NIVULARIA 'VARIEGATA'	WHITE SNOWBELL	60CM X 60CM STD. BBS
9			WHITE SNOWBELL	
10			WHITE SNOWBELL	
11		BUXUS MICROPHYLLA 'WINTER GEM'	LITTLE-LEAF BOXWOOD	#3 POT 40CM
12		CERATOSTYLIS VICTORIA	CALIFORNIA JACARANDA	#2 POT 30CM
13		CHINQUAPIN ALBA 'ELAEANTHIA'	ROSE OF SHARON	#3 POT 30CM
14		HIBISCUS SYRIacus	MOUNTAIN ASH	#3 POT 30CM
15		KALMIA LATIFOLIA 'SNOWFLAKE'	MOUNTAIN LAUREL	#3 POT 30CM
16		PIERIS JAPONICA 'VALLEY VALENTINE'	PIERIS RED BLOOMS	#3 POT 30CM
17		RHOEADAURON 'LUDERS WHITE'	LODERS WHITE RHODODENDRON	10CM X 10CM
18		RUBUS IGLUCARIA	CARPET ROSE; RED	#2 POT 30CM
19		SHIMA JAPONICA (TOKI MALE)	JAPANESE S. KOMA	#2 POT 30CM
20		VACCINIUM 'SUMMER SNOWFLAKE'	HAWTHORN	#3 POT 30CM
21		VACCINIUM 'SUMMER SNOWFLAKE'	EVERGREEN HAWTHORN	#3 POT 30CM
22		VACCINIUM 'SUMMER SNOWFLAKE'	WHITE SNOWFLAKE VIBURNUM	#3 POT 30CM
23		WHITE SNOWFLAKE VIBURNUM	GOLDEN VARIGATED JAPANESE SEDGE	9CM X 9CM
24		CAREX MORROWII 'AUERI VARIAGATA'	LITTLE BUNNY FOUNTAIN GRASS	#1 POT
25		PENNISETUM AUREOVARIEGATUM	EVERGREEN GRAMMIS	#2 POT 30CM
26		CLEMATIS RUSTICANA	PURPLE COLEFLOWER	#1 POT
27		PERENNIAL	CORAL BELLS; PINK	#1 POT
28		ECHINACEA PURPUREA 'DOUBLE DECOR'	RODGEOLOGY EPP.	#1 POT
29		HEUCHERA EPP.	RUBEOGA FILIGRADA 'SULLIVANTI'	#1 POT
30		RUBEOGA FILIGRADA 'SULLIVANTI'	WHITE SNOWFLAKE	#1 POT
31		REGIA INCARVILLEAE	WESTERN STYRAX FERN	#1 POT
32		REGIA INCARVILLEAE		#1 POT
33		REGIA INCARVILLEAE		#1 POT
34		SHIMA JAPONICA (TOKI MALE)		#1 POT
35		VACCINIUM 'SUMMER SNOWFLAKE'		#1 POT
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167		VACCINIUM 'SUMMER SNOWFLAKE'		#1





Suitable Replacement Trees	
Species	Common Name
Botanical Name	
<i>ACER PALMATUM</i>	JAPANESE MAPLE
<i>ACER RUBRUM 'ARMSTRONG'</i>	COLUMNAR ARMSTRONG MAPLE
<i>FAGUS SYLVATICA 'PURPLE FOUNTAIN'</i>	PURPLE FOUNTAIN BEECH
<i>FRAXINUS AMERICANA 'AUTUMN PURPLE'</i>	AUTUMN PURPLE ASH
<i>PINUS CEMBRA 'COLUMNARIS'</i>	COLUMNARIS SWISS STONE PINE
<i>STYRAX JAPONICUS</i>	JAPANESE SNOWBELL
<i>SYRINGA RETICULATA 'IVORY SILK'</i>	IVORY SILK JAPANESE TREE LILAC

**NOTE: ALL TREES REGARDLESS OF SIZE ARE PROTECTED  
IN HIGH ENVIRONMENTALLY SENSITIVE AREAS**

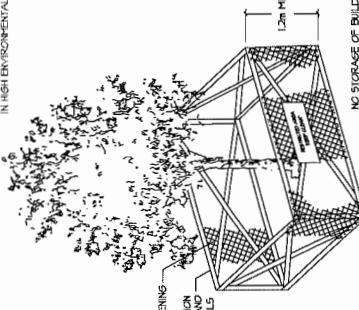

## 1A TREE PROTECTION BARRIER

SPECIES	BIRH		SPREAD		HABITAT	SPLASH
	THICK	SIMPL.	THICK	SIMPL.		
1 Cedar (Hedysarum)	—	3 x 15	—	—	Cypress Woods (Chamaesyce sp.)	2m
2 Spruce (Picea sp.)	38	3m	—	—	Pinetum sp.	11m
3 Spruce (Picea sp.)	30	3m	—	—	combined	8m
4 Spruce (Picea sp.)	32	3m	—	—	Pine (Pinus sp.)	11cm
5 Apple (Malus sp.)	23	4m	—	—	Cedar	11cm
6 White Pine (Pinus strobus sp.)	35cm	4m	—	—	Cedar	11cm
7 Cedar Hedge (Thuya sp.)	34	16	—	—	Cedar	11cm
8 Cedar (Thuya sp.)	19-68	3m	—	—	Cedar	11cm
9 Cherry (Prunus sp.)	28cm	5m	—	—	Cedar	11cm
10 Cedar (Thuya sp.)	25-76cm	5m	—	—	Cedar	11cm
11 Cedar (Thuya plicata)	—	—	—	—	Cedar	11cm
12 Sassafras (Sassafras albidum)	98cm	12m	—	—	Cedar	11cm
13 Sweetgum (Liquidambar styraciflua)	63cm	49m	—	—	Cedar	11cm
14 Cedar	25	3m	—	—	Cedar	11cm
15 Cedar	31	4m	—	—	Douglas fir (Pseudotsuga menziesii)	71cm
16 Cedar (Thuya sp.)	27	4m	—	—	Douglas fir (Pseudotsuga menziesii)	83cm
17 Cedar (Thuya sp.)	35cm	4m	—	—	combined	11m
18 Vine Maple (Acer circinatum)	41cm	5m	—	—	Vine (Acer sp.) & Hemlock (Tsuga sp.)	65cm and 63cm (15-23)
19 Cedar	45cm	8m	—	—	Huckleberry (Corylus sp.)	5m
20 Birch (Betula sp.)	—	—	—	—	combined	5m

## ①A TREE PROTECTION BARRIER

NO.	DATE	REVISION DESCRIPTION	DR.
25	15 AUGUST 17	NEW SITE PLAN	D2
26	15 AUGUST 17	NEW SITE PLAN	D2
33	15 JULY 16	CITY COMMANDS	D2
32	15 JUNE 17	NEW SITE PLAN	M2
71	15 SEPTEMBER 17	NEW SITE PLANNING & MANAGEMENT	D2
70	15 SEPTEMBER 17	NEW SITE PLAN	D2
9	15 NOVEMBER 17	REVISED BOUNDARY REPORT	D2
8	15 APRIL 18	NEW SITE PLAN	D2
17	15 MARCH 18	NEW SITE PLAN	D2
6	15 MARCH 18	NEW SITE PLAN	D2
3	15 MARCH 18	NEW SITE PLAN	D2
4	14 OCTOBER 18	REVISED SITE MANAGEMENT PLAN	D2
3	14 OCTOBER 18	NEW SITE PLAN	D2
2	14 SEPTEMBER 18	AS PLANNED ROTATION	D2
1	14 SEPTEMBER 18	NEW SITE PLAN	D2

OWNHOUSE  
MENT

10591-10631 Gilbert Road  
RICHMOND, BC

WITH:  
YAMAMOTO ARCHITECTURE INC.

**TREE MANAGEMENT  
PLAN**

DRAWING NUMBER:  
**3C**  
DATE:  
SCALE:  
DRAWN: DD

PMG PROJECT NUMBER: 14-044  
CHKD: PCM

卷之三

PLA#3C





**2 STOREY UNITS AT BLDG. ENDS (TYP.)**

## SECONDARY ROOF LINE (TYP.)

THIS IS A PRELIMINARY VERSION OF THE PAPER

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—

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卷之三

SUBJECT SITE

STREETSCAPE 1 - GILBERT RD.

2 STOREY DETACHED  
& DUPLEX PROPOSED ONLY

ROOFLINE REDUCED (TYP.)

MINIMIZE SHADOWING

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卷之三

This vertical strip shows a portion of a multi-story building's exterior. The facade features several rectangular windows with dark frames. A balcony is visible on the right side, enclosed by a railing. The building appears to be made of light-colored stone or concrete.

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**STREETSCAPE 2 - WEST PROPERTY LINE (REAR UNITS)**


Yamamoto  
Architecture Inc.

2386 oak street, van., b.c.  
v6h 4j1 tel: 604-731-1127 fax: 604-731-1327

SCALE	1/16" = 1'-0"	SHEET NO.	
DATE	MARCH 6, 2015	PLAN #4	
DRAIN	KP	DP 15-694129	
		PROJ. NO.	1326
		CHECKED	

PLAN #4 AUG 18 2015



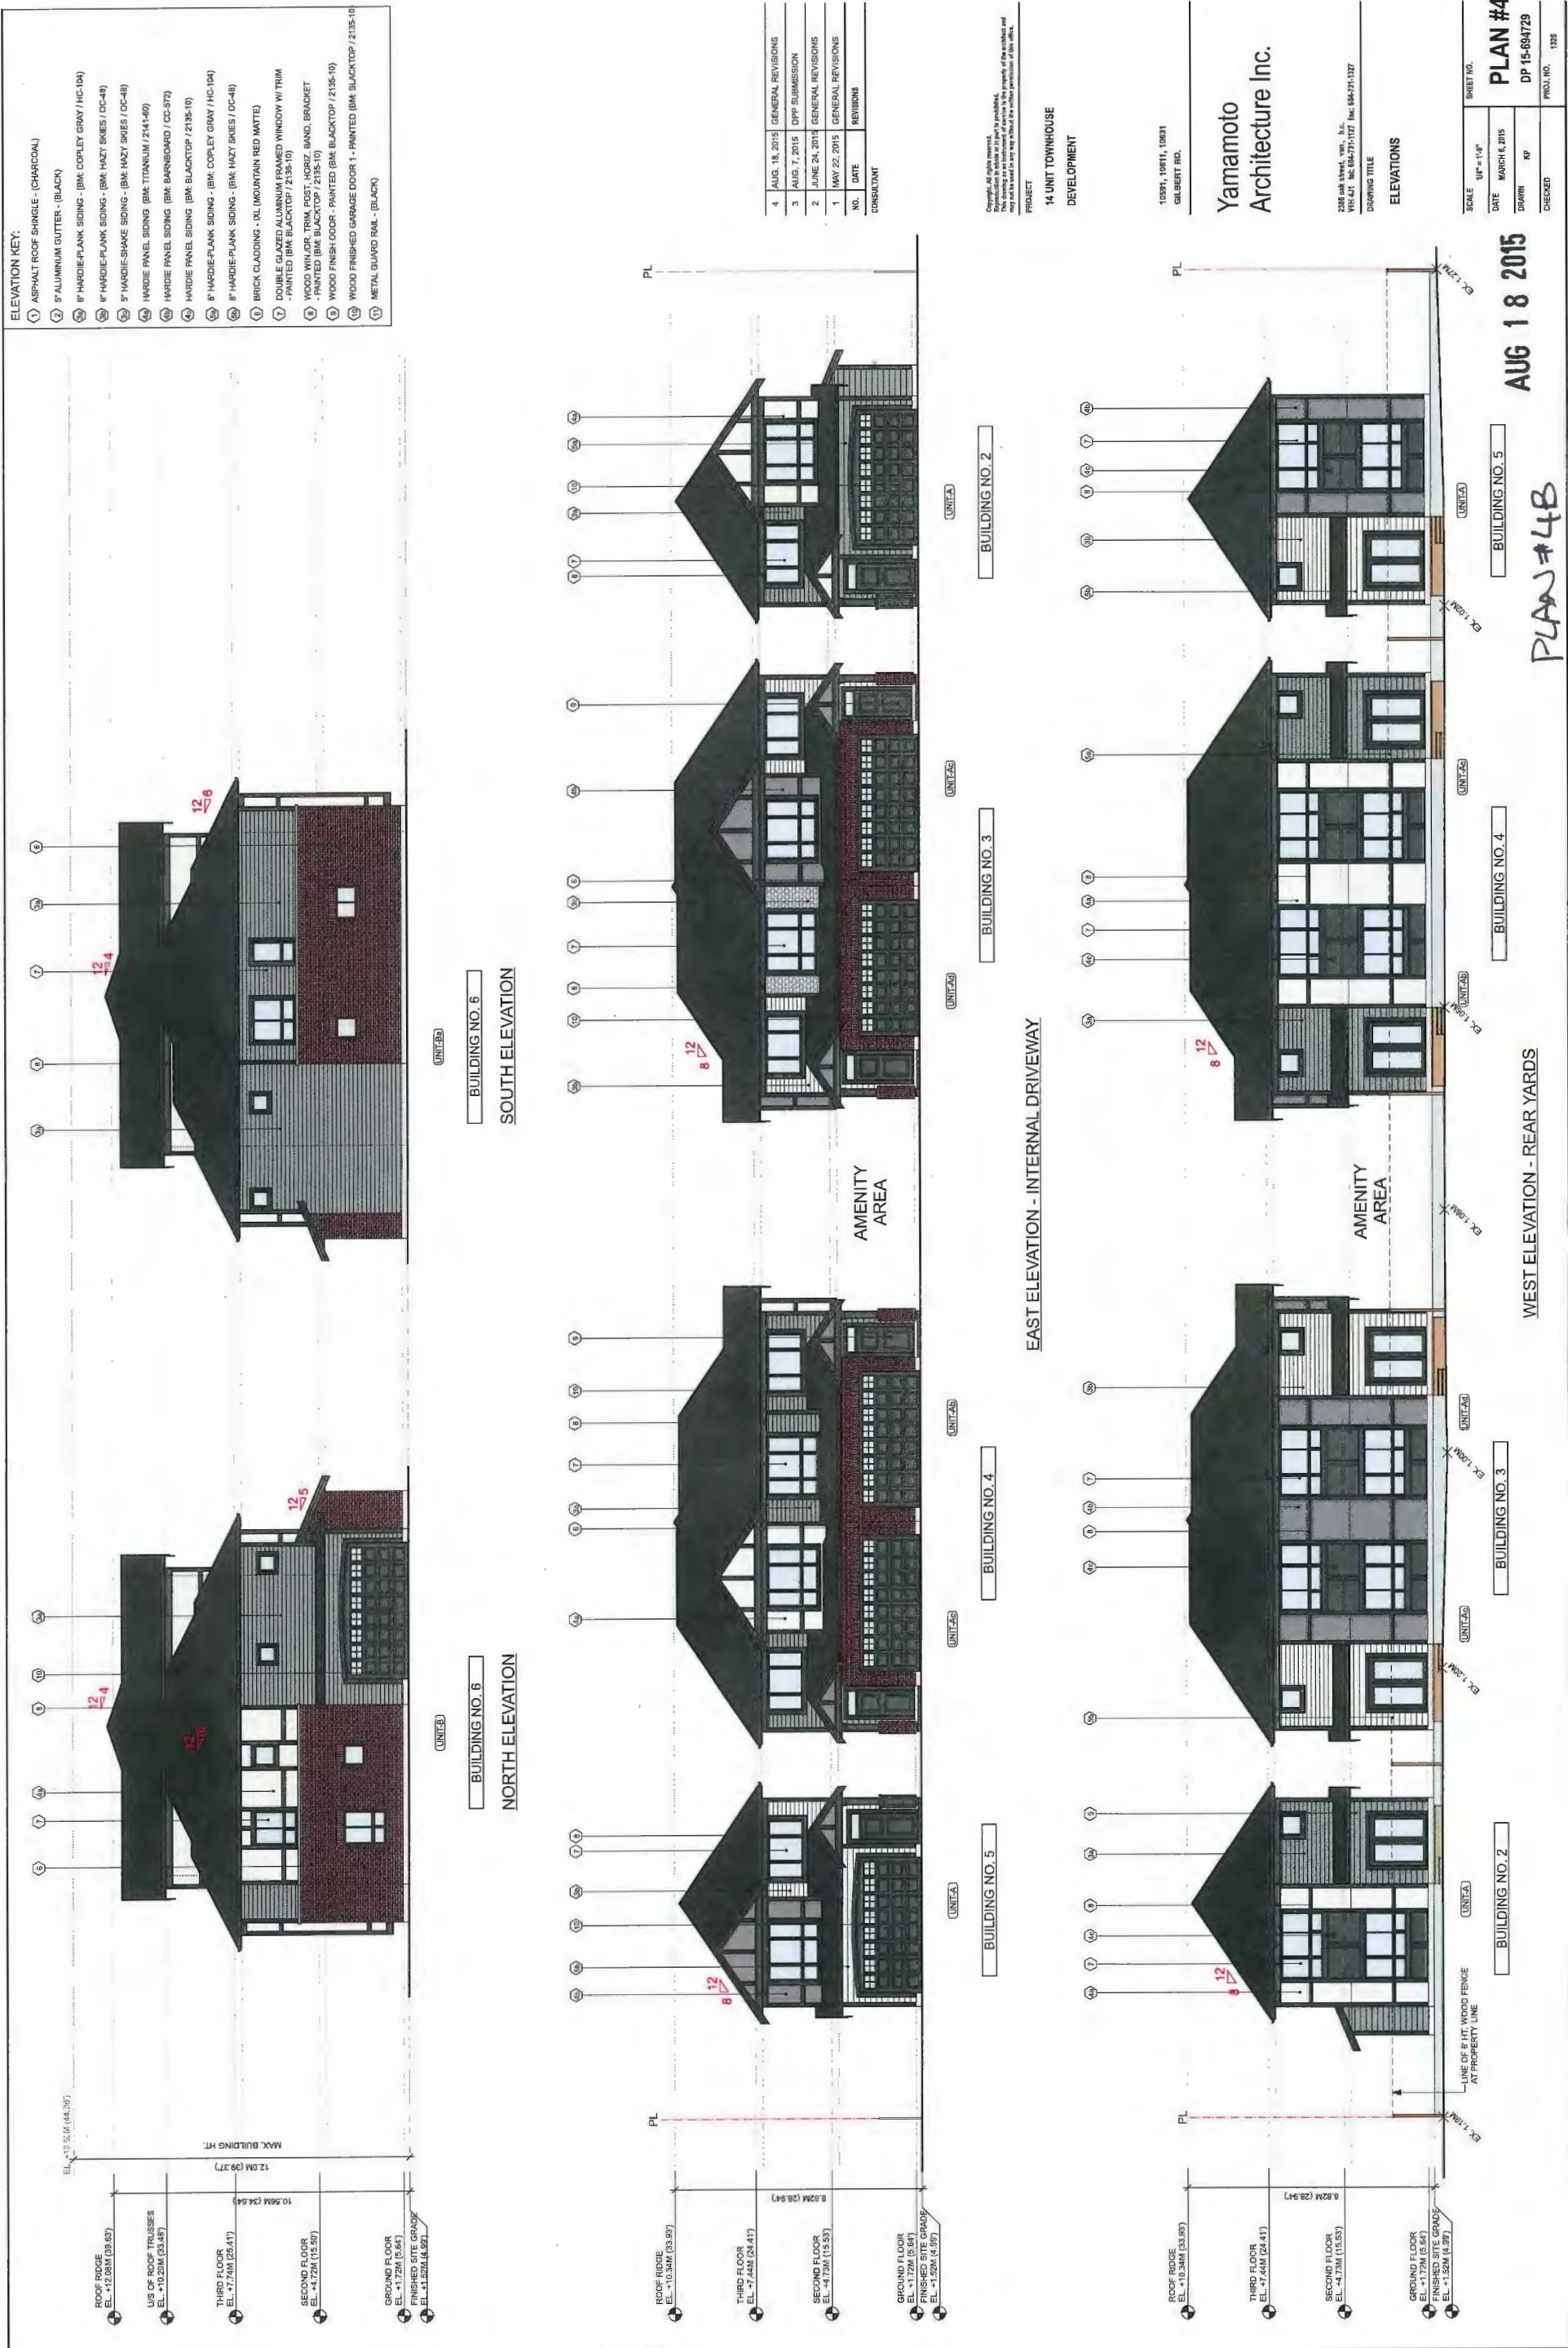

**SOUTH ELEVATION**  **BUILDING NO. 5**  **UNIT-A**

**NORTH / SOUTH ELEVATION**  **BUILDING NO. 2 & 5**  **UNIT-A**

**NORTH ELEVATION**  **BUILDING NO. 2**  **UNIT-A**

**ROOF RIDGE**  
EL. +10.34M (33.89')

**THIRD FLOOR**  
EL. +7.24M (24.41')

**SECOND FLOOR**  
EL. +4.73M (15.53')

**GROUND FLOOR**

**FINISHED SITE GRADE**  
EL. +1.12M (5.64')

**FINISHED SITE GRADE**  
EL. +1.12M (4.98')

NO.	DATE	REVISIONS
4	AUG. 18, 2015	GENERAL REVISIONS
3	AUG. 7, 2015	DPP SUBMISSION
2	JUNE 24, 2015	GENERAL REVISIONS
1	MAY 22, 2015	GENERAL REVISIONS

**CONSULTANT**

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may not be used in any other than the intended purpose of this project.

**PROJECT**

**14 UNIT TOWNHOUSE**

**BUILDING NO. 3**

**NORTH ELEVATION**

**BUILDING NO. 3**

**ELEVATION (ENTRANCE AREA)**

Yamamoto  
Architecture Inc.

10991, 10811, 10831  
GILBERT RD.

2185 old street, vancouver, b.c.  
V6H 4J1 tel: 604-734-1127 fax: 604-734-1227

DRAWING TITLE  
ELEVATIONS  
FRONT  
SIDE

ROOF RIDGE  
EL. +5.00M (16'6")  
EL. +2.50M (8'2")

FITS OF DOOR 22"

3.54M (11'6")

FINISHED SITE GRADE  
EL. +1.52M (4'9")

12'-8"

12'-5"

12'-6"


12'-5"

12'-6"


12'-8"

SHEET NO.		<b>PLAN #4</b>	
		DP 15-594729	
SCALE	1/4" = 1'-0"	DATE	MARCH 6, 2015
DRAWN	NP	CHECKED	PROJ. NO.
PRJL. NO. 11235			
<input type="checkbox"/> BUILDING NO. 4	NORTH ELEVATION (AMENITY AREA)		
<input type="checkbox"/> BUILDING NO. 4	SOUTH ELEVATION		
<b>DP 15 - 694729</b>			


- AGING IN PLACE FEATURES  
**(TO BE PROVIDED IN ALL UNITS):**
  - SOLID BLOCKING IN WASHROOM WALLS TO FACILITATE FUTURE CRAB BAR INSTALLATION
  - LEVER-TYPE HANDLES FOR PLUMBING AND DOOR HANDLES
- SUSTAINABILITY MEASURES  
**(TO BE PROVIDED IN ALL UNITS):**
  - ENERGUIDE 82 REQUIREMENTS
  - LOW E.G. GLAZING PROVIDED IN ALL WINDOWS
  - DRAIN WATER HEAT RECOVERY FROM 2 SHOWERheads
  - LOW ENERGY LIGHTING
  - ENERGY STAR APPLIANCES
  - WATER EFFICIENT TOILETS

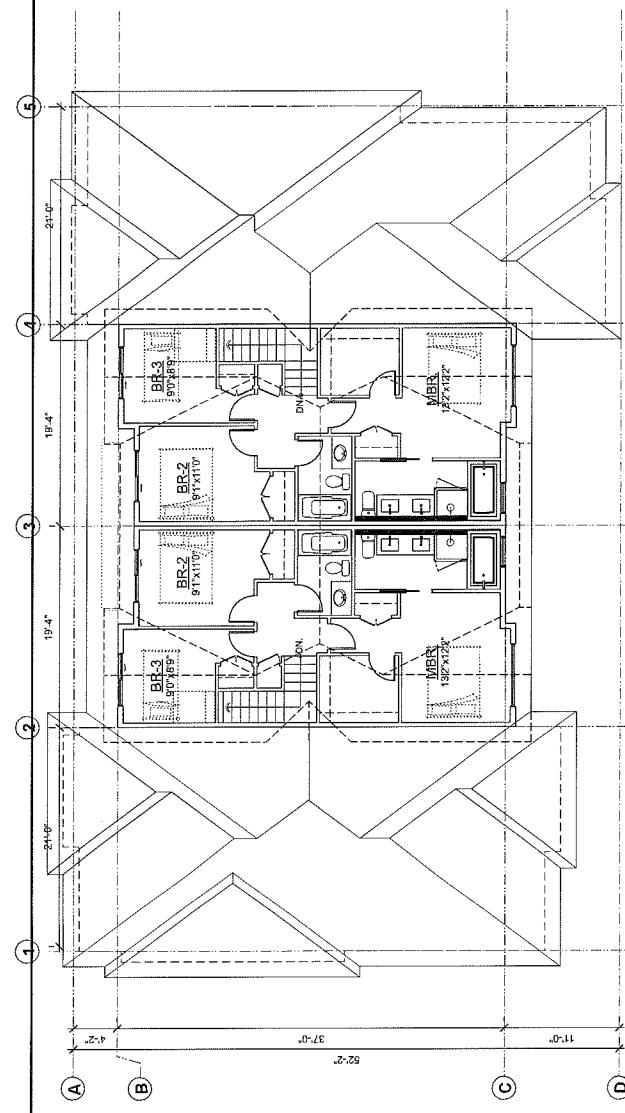


(D)  THIRD FLOOR PLAN

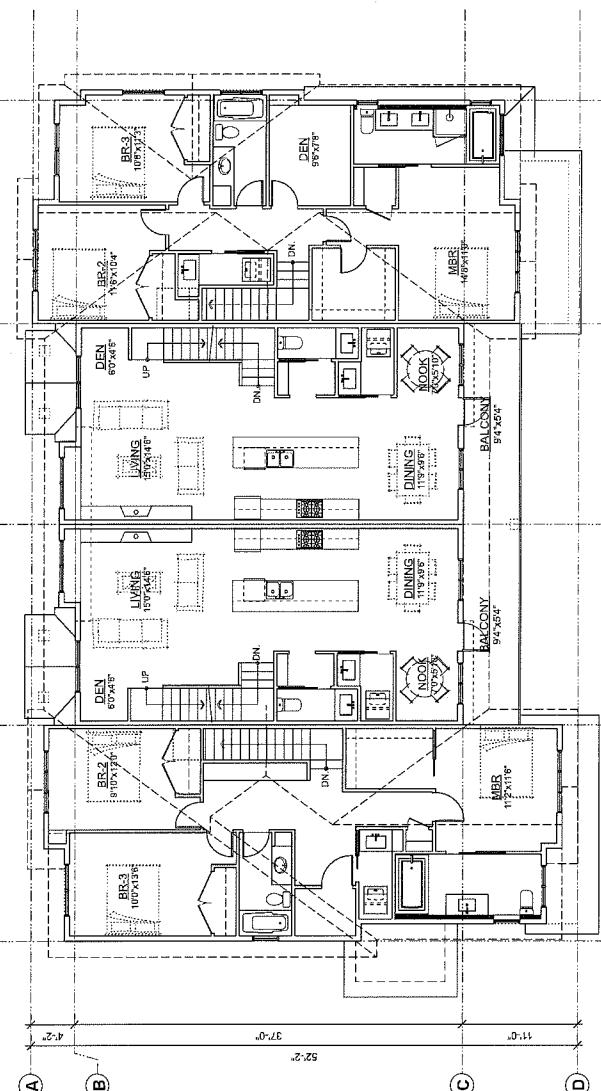

SECOND FLOOR PLAN

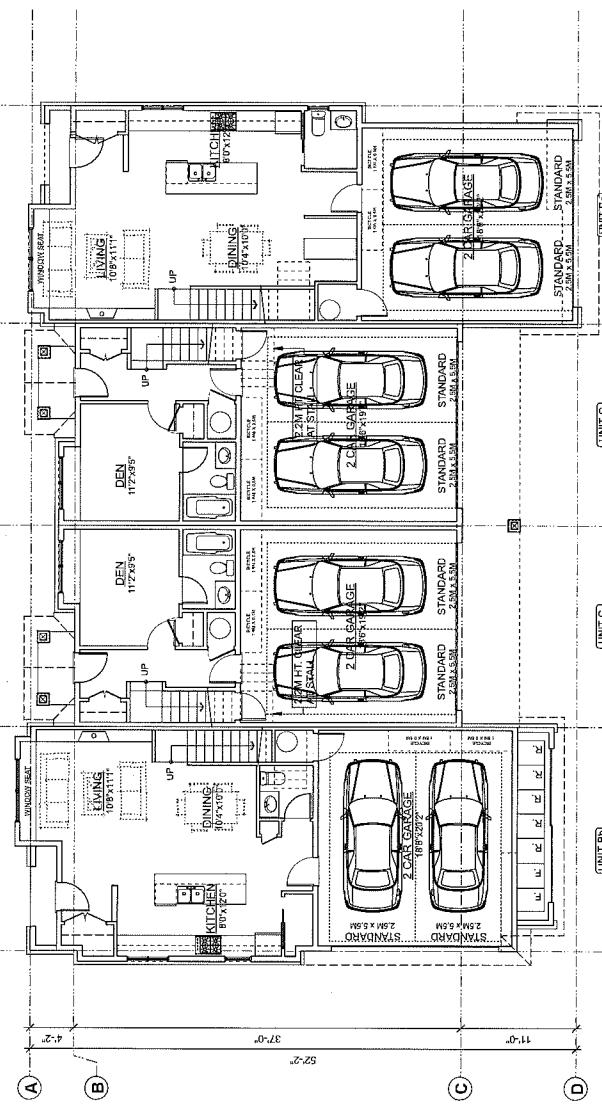

**GROUND FLOOR PLAN** (CONVERTIBLE)  
SCALE - 1<sup>INCH</sup> = 10' 0"

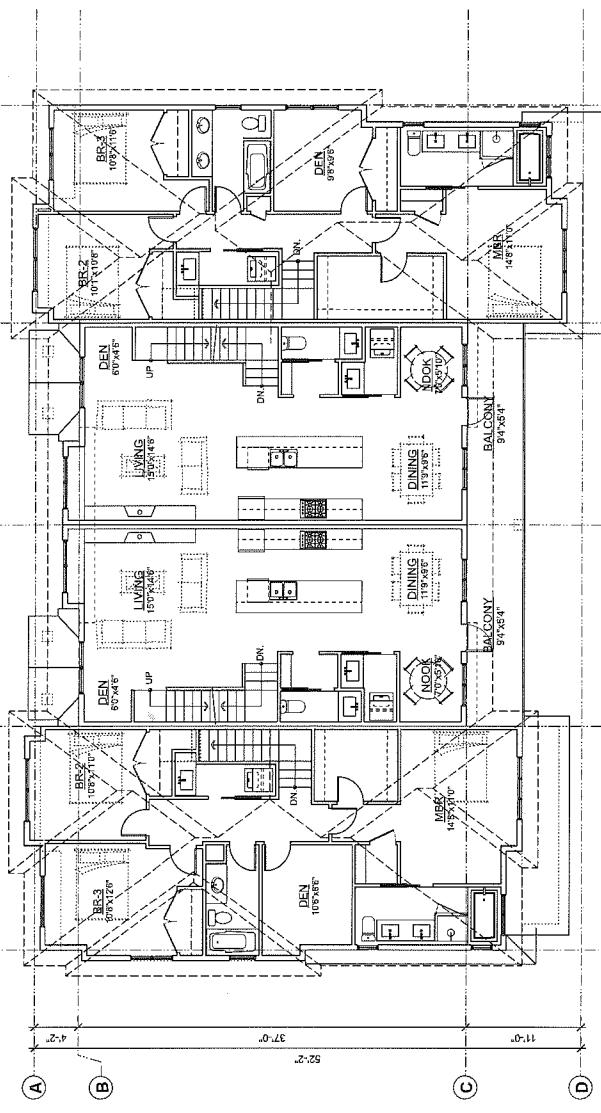

This architectural floor plan illustrates a three-story townhouse layout with various garage configurations. The plan includes:

- Ground Floor:** Living (10'9" x 11'11"), Dining (9'4" x 10'7"), Kitchen (8'10" x 12'0"), a central Staircase (UP), and a Garage area.
- Second Floor:** Two identical units, each with a Den (11'2" x 9'5"), a central Staircase (UP), and a Garage area.
- Third Floor:** A single unit featuring a Living room (10'9" x 11'11"), a Dining room (9'4" x 10'7"), a Kitchen (8'10" x 12'0"), a central Staircase (UP), and a Garage area.

The garage areas are detailed as follows:

- Standard Garage:** Located on the ground floor and in the second and third floor units. Dimensions: 20'0" x 5'5".
- 2-Car Garage:** Located on the ground floor and in the second and third floor units. Dimensions: 20'4" x 19'9".
- 2-Car Garage (Standard):** Located on the ground floor and in the second and third floor units. Dimensions: 20'4" x 19'9".
- 2-Car Garage (Standard):** Located on the ground floor and in the second and third floor units. Dimensions: 20'4" x 19'9".
- 2-Car Garage (Standard):** Located on the ground floor and in the second and third floor units. Dimensions: 20'4" x 19'9".
- 2-Car Garage (Standard):** Located on the ground floor and in the second and third floor units. Dimensions: 20'4" x 19'9".

Other features include a central staircase, multiple bedrooms, and a bathroom. The plan is labeled with letters A, B, C, and D at the bottom, and includes dimensions such as 37'-0", 52'-2", and 11'-0".

UNIT-BD UNIT-C UNIT-C UNIT-C BUILDING NO. 6

DPP SUBMISSION			
NO.	DATE	REVISIONS	CONSULTANT
3	AUG. 7, 2015	DPP SUBMISSION	
2	JUNE 24, 2015	GENERAL REVISIONS	
1	MAY 22, 2015	GENERAL REVISIONS	

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Yamamoto  
Architettura Inc.

SCALE 1/4" = 1'-0"	SHEET NO. <b>PLAN #5</b>	
DATE MARCH 6, 2015	DRAWN KP	DP 15-694729
		PIC# NO.
		CHECKED


AUG 18 2015  
PENNSYLVANIA

D 15-694729  
REFERENCE LIBRARY

<b>AGING IN PLACE FEATURES (TO BE PROVIDED IN ALL UNITS):</b>	
• LEVER-TYPE HANDLES FOR PLUMBING AND DOOR HANDLES	
• SOLID BLOCKING IN WASHROOM WALLS TO FACILITATE FUTURE GRAB BAR INSTALLATION	
• LOW E GLAZING PROVIDED IN ALL WINDOWS	
• DRAIN WATER HEAT RECOVERY FROM 2 SHOWERS	
• LOW ENERGY LIGHTING	
• ENERGY STAR APPLIANCES	
• WATER EFFICIENT TOILETS	

### SUSTAINABILITY MEASURES (TO BE PROVIDED IN ALL UNITS):

- ENERGUIDE 82 REQUIREMENTS
- LOW E GLAZING PROVIDED IN ALL WINDOWS
- DRAIN WATER HEAT RECOVERY FROM 2 SHOWERS
- LOW ENERGY LIGHTING
- ENERGY STAR APPLIANCES
- WATER EFFICIENT TOILETS

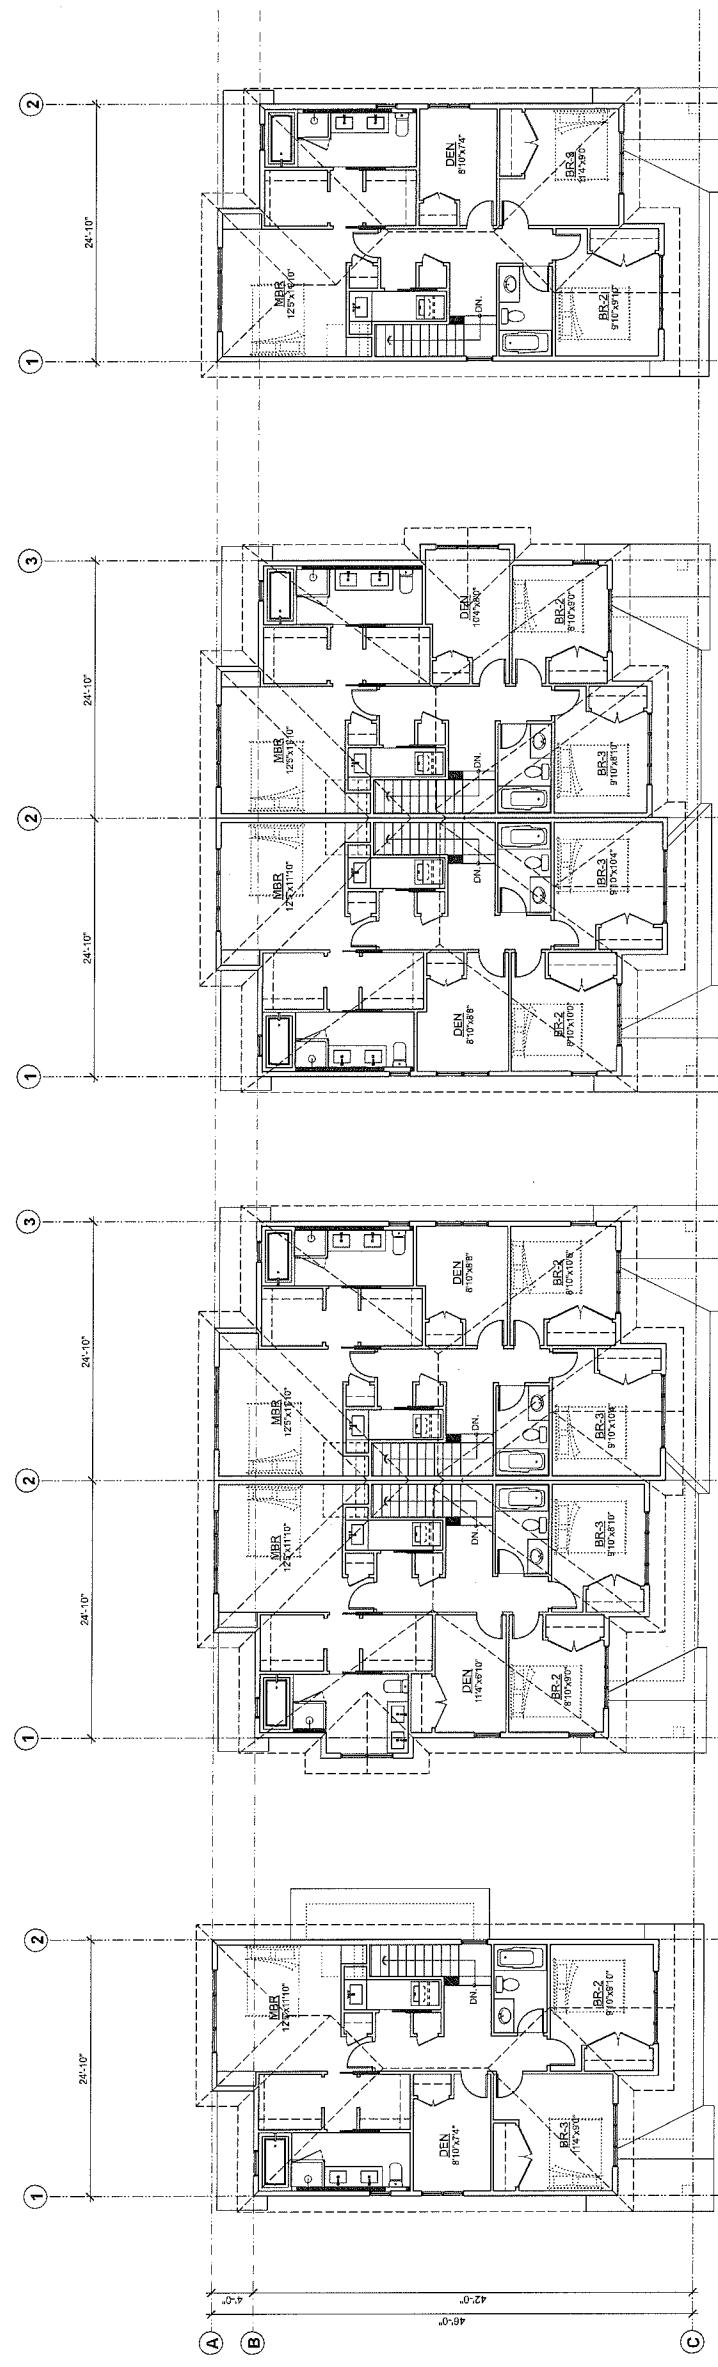

4	AUG. 16, 2015	GENERAL REVISIONS
3	AUG. 7, 2015	DPR SUBMISSION
2	JUNE 24, 2015	GENERAL REVISIONS
1	MAY 22, 2015	GENERAL REVISIONS
	NO. DATE	REVISIONS

CONSULTANT

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PROJECT	14 UNIT TOWNHOUSE DEVELOPMENT
10891, 10611, 10631	GILBERT RD.
2318 oak street, vancouver, b.c.	VER 4.1 file: 604-731-1227
DATE: MARCH 6, 2015	FAX: 604-731-1227
DRAWN: NP	SCALED: 1/8" = 1'-0"
CHECKED:	DP 15-99729
PROJ. NO.:	1228

**Yamamoto  
Architecture Inc.**

2318 oak street, vancouver, b.c.  
VER 4.1 file: 604-731-1227  
DATE: MARCH 6, 2015  
DRAWN: NP  
CHECKED:  
PROJ. NO.:

**AUG 18 2015**

BUILDING NO. 5

BUILDING NO. 4

BUILDING NO. 3

BUILDING NO. 2

BUILDING NO. 1

**PLAN #5A**  
SHEET NO.  
DP 15-99729

REFERENCE PLAN

SCALE: 1/8" = 1'-0"  
DATE: MARCH 6, 2015  
DRAWN: NP  
CHECKED:  
PROJ. NO.:

**DP 15 - 694729**

