



# City of Richmond

## Report to Development Permit Panel

**To:** Development Permit Panel

**Date:** February 5, 2015

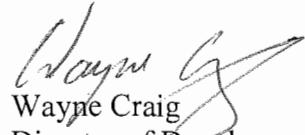
**From:** Wayne Craig  
Director of Development

**File:** DP 14-676361

**Re:** Application by the Greater Vancouver Sewerage & Drainage District for a  
Development Permit at 1000 Ferguson Road

### Staff Recommendation

That a Development Permit be issued which would permit the Greater Vancouver Sewerage & Drainage District to construct a 550 m<sup>2</sup> screening & degrit building, a 20 m diameter thickener, 25 m<sup>2</sup> thickener Pump station & four 36 m<sup>2</sup> digester mixing pump buildings (one for each of the existing digesters) at 1000 Ferguson Road on a site designated an Environmentally Sensitive Area (ESA).

  
Wayne Craig  
Director of Development

WC:dcb

**Staff Report****Origin**

Greater Vancouver Sewerage & Drainage District (aka Metro Vancouver) has applied to the City of Richmond for permission to construct a 550 m<sup>2</sup> screening & grit building, a 20 m diameter thickener, 25 m<sup>2</sup> thickener Pump station & four 36 m<sup>2</sup> digester mixing pump buildings (one for each of the existing digesters). The site is designated an Environmentally Sensitive Area (ESA). The Iona Island Wastewater Treatment Plant (IIWWTP) is located at 1000 Ferguson Road on a site zoned “School and Institutional Use (SI)”.

The 119 acre site currently contains the main portion of the Iona Island Wastewater Treatment facility that provides primary sewage treatment facilities for approximately 600,000 residents in Vancouver, the UBC Endowment Lands and parts of Burnaby and Richmond.

Under current Provincial legislation, the Greater Vancouver Sewerage & Drainage District (GVS&DD) is not required to submit a Development Permit application to the City for the proposed works however the GVS&DD has voluntarily agreed to bring its proposal forward for formal review through this Development Permit application.

A rezoning is not required for the proposed works.

**Development Information**

Please refer to the attached Development Application Data Sheet (Attachment 1) for a comparison of the proposed development data with the relevant Bylaw requirements.

**Surrounding Development:**

- To the north, the North Arm of the Fraser River;
- To the east, is Canfor Point within the Iona Island Regional Park – zoned “School and Institutional Use (SI)”;
- To the south, the Iona Island causeway and lands under Port Metro Vancouver jurisdiction – both are zoned “School and Institutional Use (SI)”; and,
- To the west, Iona Beach, Iona Jetty and the North Arm Jetty. Iona Beach is zoned “School and Institutional Use (SI)”. The North Arm Jetty is not zoned.

With the exception of the Iona and North Arm Jetties, Iona Island is entirely designated as “Conservation” in Richmond’s Official Community Plan and is zoned “School and Institutional Use (SI)” under Zoning Bylaw 8500.

The GVS&DD advises that the intent of the upgrade project is to “better enable the existing plant to meet the effluent quality requirements specified in its Operating Certificate” (Tera Environmental submission dated October, 2014). Specifically the upgrade will provide grit removal from the primary sludge, minimize screening debris entering the digesters, increase sludge thickening capacity and improve digester mixing efficiency.

The upgrade will result in seven (7) new structures erected on-site through this project:

- one – 550 m<sup>2</sup> Screening and Degrit Building;
- one – 20 m diameter Thickener;
- one – 25 m<sup>2</sup> Thickener Pump Station; and
- four – 25 m<sup>2</sup> Digester Mixing Pump Buildings.

All the structures except the digester mixing pump buildings will be located off the east edge of the existing treatment facility. The four digester mixing pump buildings will be located adjacent to each of the four existing digesters currently on the site and will not impact any environmental features on the site.

The screening and degrit building, the thickener facility and the thickener pump station need to be located on a raised and stabilized base in close proximity to the existing treatment plant. The location selected will result environmental impacts which are further detailed in this report along with a proposed mitigation/compensation strategy.

Site preparation activities anticipated with this project include:

- Clearing of trees and vegetation;
- Grubbing and stripping to remove organics and overburden;
- Ground improvements, including placement of fill and ground densification;
- Removing biosolids stockpiles from some of the project footprint area;
- Paving and fencing installations.

The GVS&DD is hoping to undertake the upgrade construction commencing in June, 2015 and completing the work by December, 2016. Project management is being undertaken by CH2M Hill Energy Canada. Environmental studies (environmental impact assessment and mitigation / compensation plan) were undertaken by Tera Environmental Consultants. EDI Environmental Dynamics Inc. were retained to delineate both the extent of the natural boundary/high water mark of McDonald Slough and an upland wetland feature present in vicinity of the project site.

## **Background**

The development site is located on Iona Island and is surrounded by portions of Metro Vancouver's Iona Beach Regional Park. The existing wastewater treatment plant opened in 1963 and has undergone 6 expansions since that time to accommodate growth and treatment upgrades. Metro Vancouver's web site notes that the facility is regulated through an Operational Certificate issued by the BC Ministry of Environment.

## **Related Policies and Bylaws**

The site is designated "Conservation" in Richmond's Official Community Plan. The OCP also designates the property as a Development Permit area as an Environmentally Sensitive Area. The specific designation at the subject site acknowledges the presence of Intertidal, Shoreline and Freshwater Wetlands. The focus of the ESA DP guidelines within the OCP are intended to protect and enhance the environmental resources and ecosystem services.

## **Zoning Compliance**

Under the “School and Institutional Use (SI)” zoning there are no maximums in terms of floor area ratio, site coverage or building/structure height (however Transport Canada maximum height regulations apply). The proposed development complies with the existing “School and Institutional Use (SI)” zone.

## **Advisory Design Panel Comments**

This application was not referred to the Advisory Design Panel as the upgrade project does not involve design components and is primarily focused on the mitigation and compensation efforts related to the foreseeable environmental impacts.

## **Analysis**

The proposed scheme attached to this report has satisfactorily addressed the significant urban design issues and other staff comments identified as part of the review of the subject Development Permit application. In addition, it complies with the intent of the applicable sections of the Official Community Plan and is generally in compliance with the “School and Institutional Use (SI)”. The environmental impacts and proposed Compensation Plan were reviewed by the City’s Environmental Review Panel (ERP) on December 10, 2014. The Compensation Plan elements outlined in this report reflect the changes recommended by the ERP.

An environmental assessment was undertaken by Tera Environmental (Compensation Plan final report dated January 2015). The assessment focuses on the anticipated impacts from the screening & dewatering facilities and the associated sludge thickener facilities that will be located to the east of the existing treatment plant since all the other building additions occur within the existing plant itself.

## Mitigation Measures

Tera’s report states that the initial planning and design of the project incorporated measures to mitigate environmental impacts. Specifically;

- The majority of the Project footprint is situated on previously disturbed land, an old parking area and the existing biosolids storage site.
- The Project footprint has been selected to minimize potential disturbance to the adjacent wetland and the forested buffer on the north edge of the wetland.
- The existing row of trees along the western edge of the Project site, south of Area C, will not be removed.
- The existing berm surround the wetland (outlined in blue on the attached reference plan) will not be removed.

### Environmental Surveys

Based on the addition requirements and site surveys, vegetation surveys were undertaken in four areas that would be impacted by the new addition. The survey areas are labelled A through D on Plan # 1.

Area A was found to be significantly vegetated with 68 trees (red alder, paper birch and cottonwood species) and a variety of understorey vegetation species (red elderberry, salmonberry, ivy, oceanspray, holly, etc.) The understorey was noted to include extensive areas noted to include invasive species (Himalayan blackberry) and non-native species.

Area B is located adjacent to a cattail marsh associated with a freshwater wetland to the southeast of the proposed addition. Treed overstorey in this area includes semi-mature red alders (14 trees) and 3 mature black cottonwoods. Understorey within the treed area was dominated by Himalayan blackberry, pockets of Oregon grape and Sitka willow. EDI Environmental Dynamics categorized the wetland to the east of Area B as having medium ecological value with high bird use (EDI 2014a). The wetland was noted as having no apparent direct connection to McDonald Slough.

Area C is located along the west side of the proposed addition. Vegetation in this area will be eliminated by the project. The report notes that a stand of 188 black cottonwood trees had been previously removed from this area. The remaining understorey vegetation includes Himalayan blackberry, red elderberry, grasses and Canada thistle.

Area D is located on biosolids stockpiles previously generated by the treatment plant operations. No trees are present in this area and ground vegetation includes herbaceous species such as grasses, nightshade and cattails. Approximately half of Area D will be impacted by the project.

### Bird Habitat

Field observations undertaken in August 2014 noted sixteen species of birds including spotted towhee, marsh wren, American robin, black-capped chickadee, cedar waxwing, American goldfinch, northwestern crow, song sparrow, common yellowthroat, Bewick's wren, Anna's hummingbird, willow flycatcher, barn swallow, glaucous-winged gull, Canada goose and a great horned owl. The breeding and non-breeding habitat of the observed bird species was used in determining which trees and shrub species would enhance the habitat in the area as part of the overall compensation strategy.

### Environmental Assessment and Impacts

Tera's Compensation Plan notes that a total of 0.66 ha of native vegetation would be removed as a result of the project. Their assessment notes that the understory vegetation in the impacted area is poor and weedy, highly invasive species dominate the area. The existing site disturbance and invasive species pose limitations to native plant growth and the development of native ecosystems needed by bird and animal species with more specific habitat requirements.

Additionally, the existing treed areas are noted as being patchy and dominated by red alder and cottonwood which limit secure cover or buffer vegetation. Based on the relatively poor

condition of the habitat present, Tera proposes that a compensation ratio of 50% (i.e. 0.33 ha) is appropriate for compensation and enhancement.

#### Compensation Measures and Overall Approach to Compensation

Compensation measures proposed for this project are generally described in Tera's report as follows:

- Removal of invasive species from areas identified for planting.
- Riparian restoration – planting of native trees and shrubs on the wetland berm on the east side of the existing parking lot and the project site.
- Planting with native, fruit-producing shrubs adjacent to the wetland berm and along the west side of the existing parking area.
- Native grass seeding adjacent to the new access road at the southeast end of the project.
- Tree replacement with native trees valued by bird species in selected areas (e.g. along the wetland berm, around the sewage lagoons and west of the existing parking area).
- Bird habitat enhancement through planting native trees and shrubs adjacent to the sewage lagoons west of the existing treatment plant.

The Compensation Plan proposes a maximum of 3,300 trees and shrubs to be planted inclusive of a minimum 564 trees (3:1 compensation for the trees removed in Area C). Compensation trees will be a mix of sizes with two thirds being greater than 1.2 m in height dbh and one third being small stock (30-45 cm) – sizes found to have a better survival rate than larger trees in natural areas and are also more likely to be available from local providers. The tree sizes are generally consistent with the Riparian Restoration Guidelines provided by the Ministry of Environment's planting guidelines.

Plan # 2 shows the primary areas proposed to be cleared and the general areas for compensation measures outlined above.

Plan # 3a provides a summary of the compensation plan showing the tree and shrub species and quantities to be planted in each of the proposed compensation locations identified in Plan #2. An overall balance sheet summarizing the anticipated impacts and the objectives of compensation measures proposed is provided in Plan #3b.

Plan # 4 provides plan details of the proposed building additions and site modifications needed to accommodate the treatment plant upgrades.

The Compensation Plan strategy assesses the different species of birds using this area and outlines their specific habitat needs in relation to what the existing habitat currently provides. From this information tree, shrub and ground cover selections are proposed which will fill in gaps and enhance the usefulness of the area for these birds. The enhancement planting is proposed to be installed in areas where invasive vegetation or lower quality vegetation will be removed. This approach should result in both a higher quality and more productive habitat for the bird species using this area.

Landscape Securities and Commitments

As Metro Vancouver is a superior level of government they have indicated that they are not able to bond for the landscaping installations as normally required through a Development Permit. Metro Vancouver has agreed, however, to provide a letter of commitment to undertake the vegetation installation and the other works outlined in the Compensation Plan. Metro Vancouver will also commit to preparing and reviewing the final detailed planting plan with the City of Richmond prior to the landscaping installations which will not occur until the majority of the site construction works have been completed (i.e. in approximately 2 years time). Consideration for notification signage of the compensation areas as protected natural areas can also be reviewed with the City at that time.

The Compensation Plan includes provision for monitoring the vegetation installations for a period of 3 years with a target of at least 80% survival. Replanting for any shortfall less than this target will be undertaken by the installer.

Other Issues Associated With the Project

## a.) Anticipated Traffic Impacts

CH2M Hill representatives have confirmed that the plant increase is expected to result in an increase of one truck every two days to the site. The City's Transportation staff have reviewed this from a traffic management perspective and advise that there are no transportation concerns with the expansion.

## b.) Environmental Management Act Release

The BC Ministry of Environment has provided a release pursuant to the Local Government Act (section 946.2(2)(b)) allowing the City of Richmond to approve the Development Permit for this project.

## c.) External approvals

CH2M Hill representatives have indicated that the project had been reviewed by Port Metro Vancouver in 2014 and the advice provided was that the project would not require notification to the BC Ministry of Forests, Lands and Natural Resource Operations as the shoreline will not be impacted by the expansion and the overall use is not changing.

### **Conclusions**

The Greater Vancouver Sewerage & Drainage District has voluntarily agreed to submit an application for Development Permit to address their expansion project and respond to the environmental impacts arising from the proposal. They have worked with City staff to address concerns related to these impacts and achieve a solution that will result in a net benefit to wildlife and habitat enhancement in the area.

Staff recommend support for the Development Permit to permit construction of a 550 m<sup>2</sup> screening & degrit building, a 20 m diameter thickener, 25 m<sup>2</sup> thickener Pump station & four 36 m<sup>2</sup> digester mixing pump buildings (one for each of the existing digesters) and the implementation of the Compensation Plan as outlined in this report.



David Brownlee  
Planner 2

DCB:cas

The following are to be met prior to forwarding this application to Council for approval:

- Receipt of a Letter of Commitment from Greater Vancouver Sewerage & Drainage District to:
  - Undertake and maintain the landscaping installations (outlined in the Compensation Plan from Tera Environmental Consultants (dated January 2015));
  - Implement the wetland mitigation measures outlined in the Memo from Tera Environmental Consultants (dated October 24, 2014); and,
  - Consult with the City of Richmond on the preparation of the detailed planting plan and consideration of the installation of Protected Natural Area signage prior to the landscaping installations as outlined in the Compensation Plan (Tera January 2015).

Prior to future Building Permit issuance, the developer is required to complete the following:

- The applicant is required to obtain a Building Permit for any construction hoarding associated with the proposed development. If construction hoarding is required to temporarily occupy a street, or any part thereof, or occupy the air space above a street or any part thereof, additional City approvals and associated fees may be required as part of the Building Permit. *For further information on the Building Permit, please contact Building Approvals Division at 604-276-4285.*
- Submission of a construction traffic and parking management plan to the satisfaction of the City's Transportation Division (<http://www.richmond.ca/services/ttp/special.htm>).
- If applicable, payment of latecomer agreement charges associated with eligible latecomer works.



**City of  
Richmond**

**Development Application Data Sheet**  
Development Applications Division

**DP 14-676361**

**Attachment 1**

Address: 1000 Ferguson Road      Greater Vancouver Sewerage &  
Applicant: Greater Vancouver Sewerage & Drainage District      Owner: Drainage District  
Planning Area(s): Sea Island

	<b>Existing</b>	<b>Proposed</b>
<b>Site Area:</b>	48.35 ha (Approx.119.5 acres)	Unchanged
<b>Land Uses:</b>	Park and Waste Water Treatment Facility	No Change
<b>OCP Designation:</b>	Conservation	No Change
<b>Zoning:</b>	School and Institutional Use (SI)	No Change

	<b>Bylaw Requirement</b>	<b>Proposed</b>	<b>Variance</b>
Floor Area Ratio:	No Maximum	Undetermined	none permitted
Lot Coverage:	No Maximum	Undetermined – aerial photo analysis conservatively estimates 6.5% of the site.	None
Setback – Front Yard:	Min. 6.0 m	Greater than 6.0 m	None
Setback – Interior Side and Rear Yards:	Min. 3.0 m	Greater than 3.0 m	None
Height (m):	Max. 12 m within 10 m of a residential zone. Elsewhere No Maximum	18.68 m including the support base.	None
Lot Size:	No Minimum	48.35 ha (Approx.119.5 acres)	None



# City of Richmond

## Development Permit

No. DP 14-676361

To the Holder: Greater Vancouver Sewerage & Drainage District

Property Address: 1000 Ferguson Road

Address: 4330 Kingsway,  
Burnaby BC V5H 4G8

1. This Development Permit is issued subject to compliance with all of the Bylaws of the City applicable thereto, except as specifically varied or supplemented by this Permit.
2. This Development Permit applies to and only to those lands shown cross-hatched on the attached Schedule "A" and any and all buildings, structures and other development thereon.
3. Subject to Section 692 of the Local Government Act, R.S.B.C.: buildings and structures; off-street parking and loading facilities; roads and parking areas; and landscaping and screening shall be constructed generally in accordance with Plans #1 to #4k attached hereto.
4. Sanitary sewers, water, drainage, highways, street lighting, underground wiring, and sidewalks, shall be provided as required.
5. If the Holder does not commence the construction permitted by this Permit within 24 months of the date of this Permit, this Permit shall lapse and the security shall be returned in full.
6. The land described herein shall be developed generally in accordance with the terms and conditions and provisions of this Permit and any plans and specifications attached to this Permit which shall form a part hereof.

This Permit is not a Building Permit.

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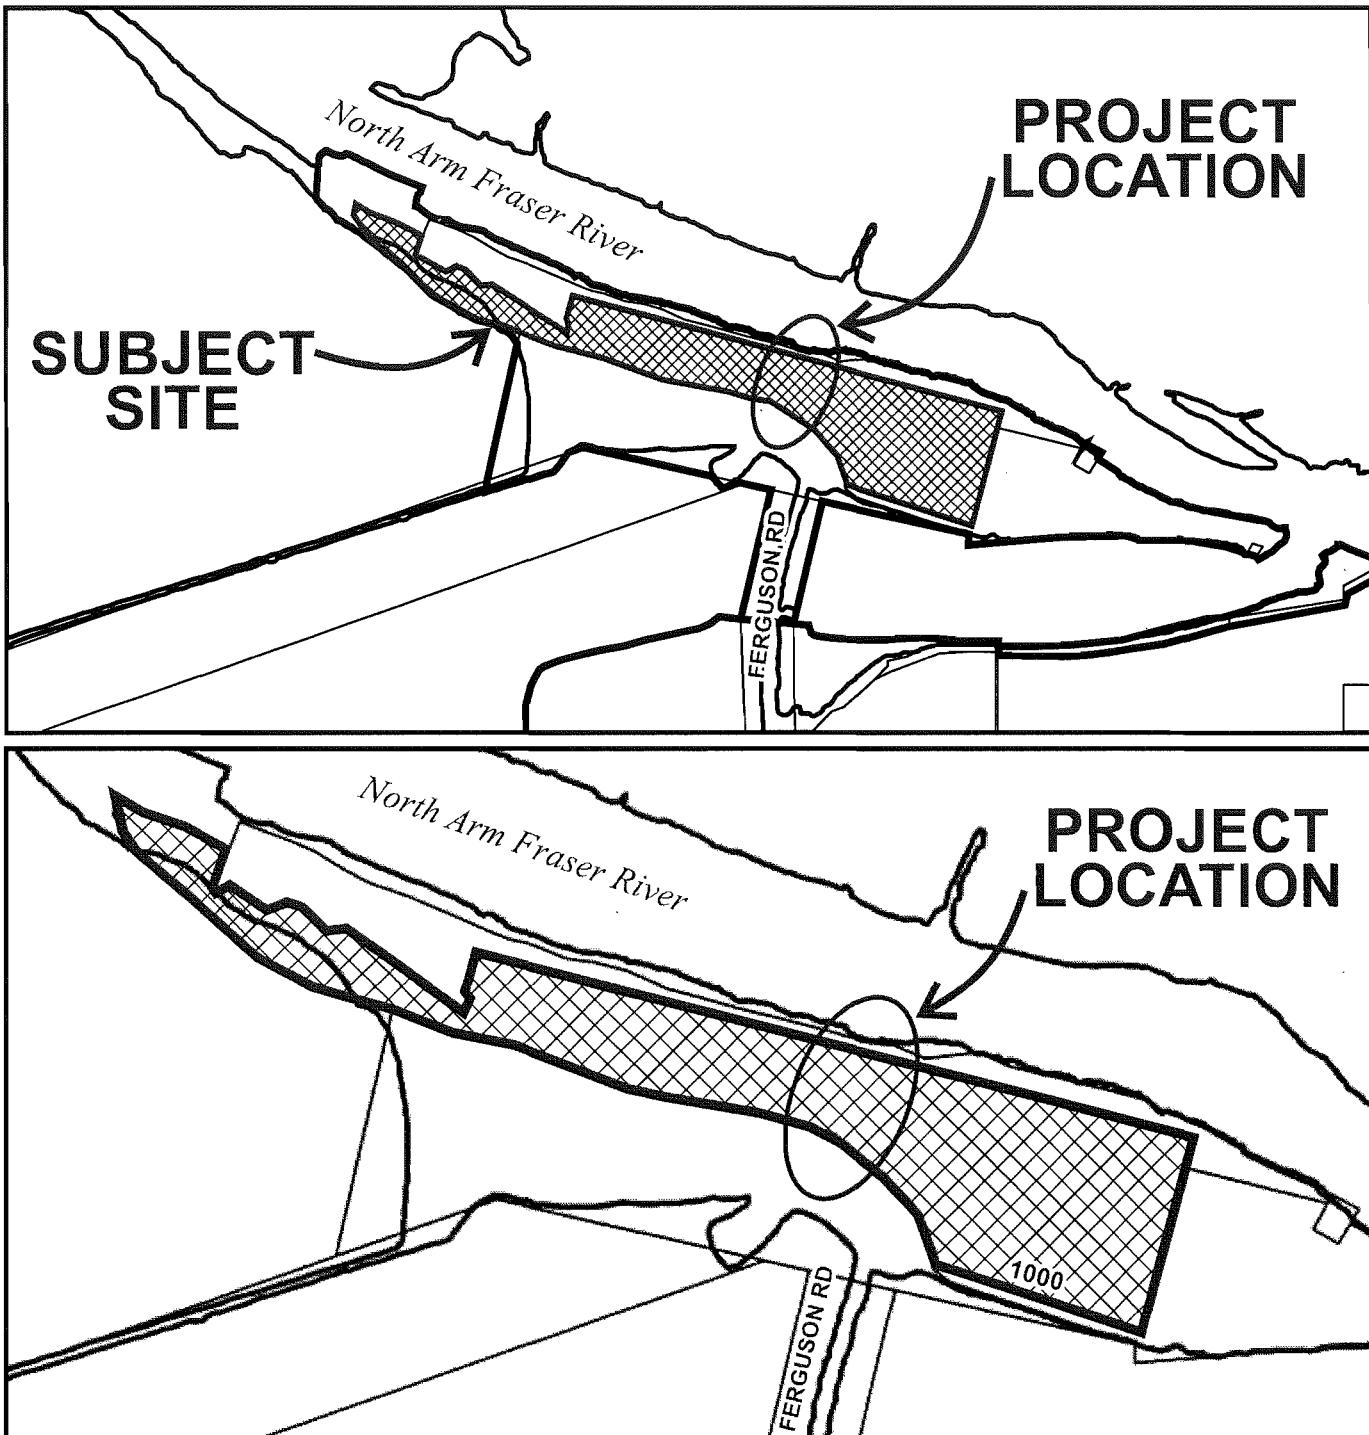
ISSUED BY THE COUNCIL THE

DELIVERED THIS DAY OF , .

MAYOR



**City of  
Richmond**



<b>N</b>	<b>DP 14-676361 SCHEDULE "A"</b>	Original Date: 11/18/14 Revision Date: 02/05/15 Note: Dimensions are in METRES
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# City of Richmond



DP 14-676361

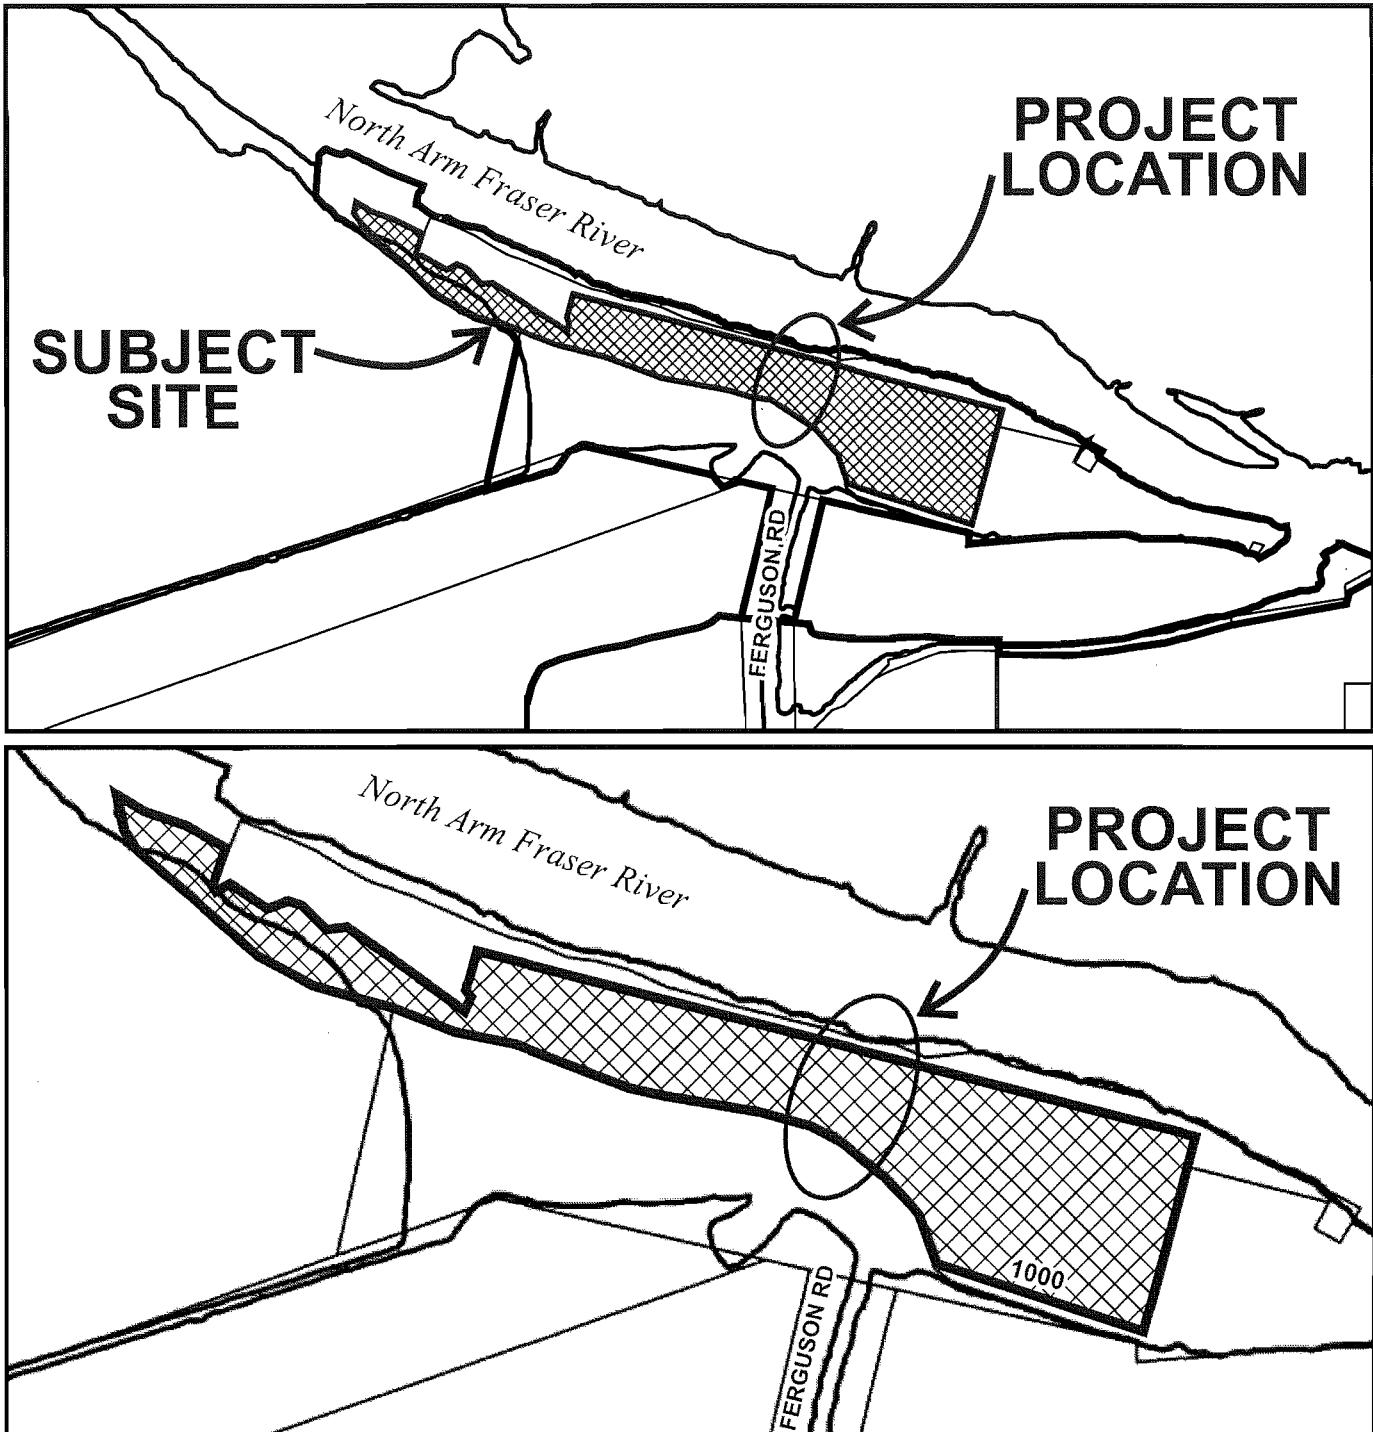
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**City of  
Richmond**



**DP 14-676361**

Original Date: 11/18/14

Revision Date: 02/05/15

Note: Dimensions are in METRES

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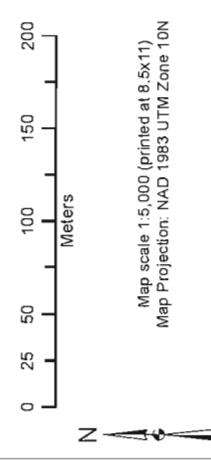
### Iona Island Wastewater Treatment Plant

Map 1 :  
Solids Handling System Upgrade  
Wetland and Project Jurisdiction

Drawn: P. Jost	Checked: J. Prive
Date: 20/08/2014	Data Sources: See References Section
EDI Project Number: 1410537	

### Legend

- Project Footprint- Approximate
- Port Metro Vancouver
- Metro Parks Boundary
- Wetland

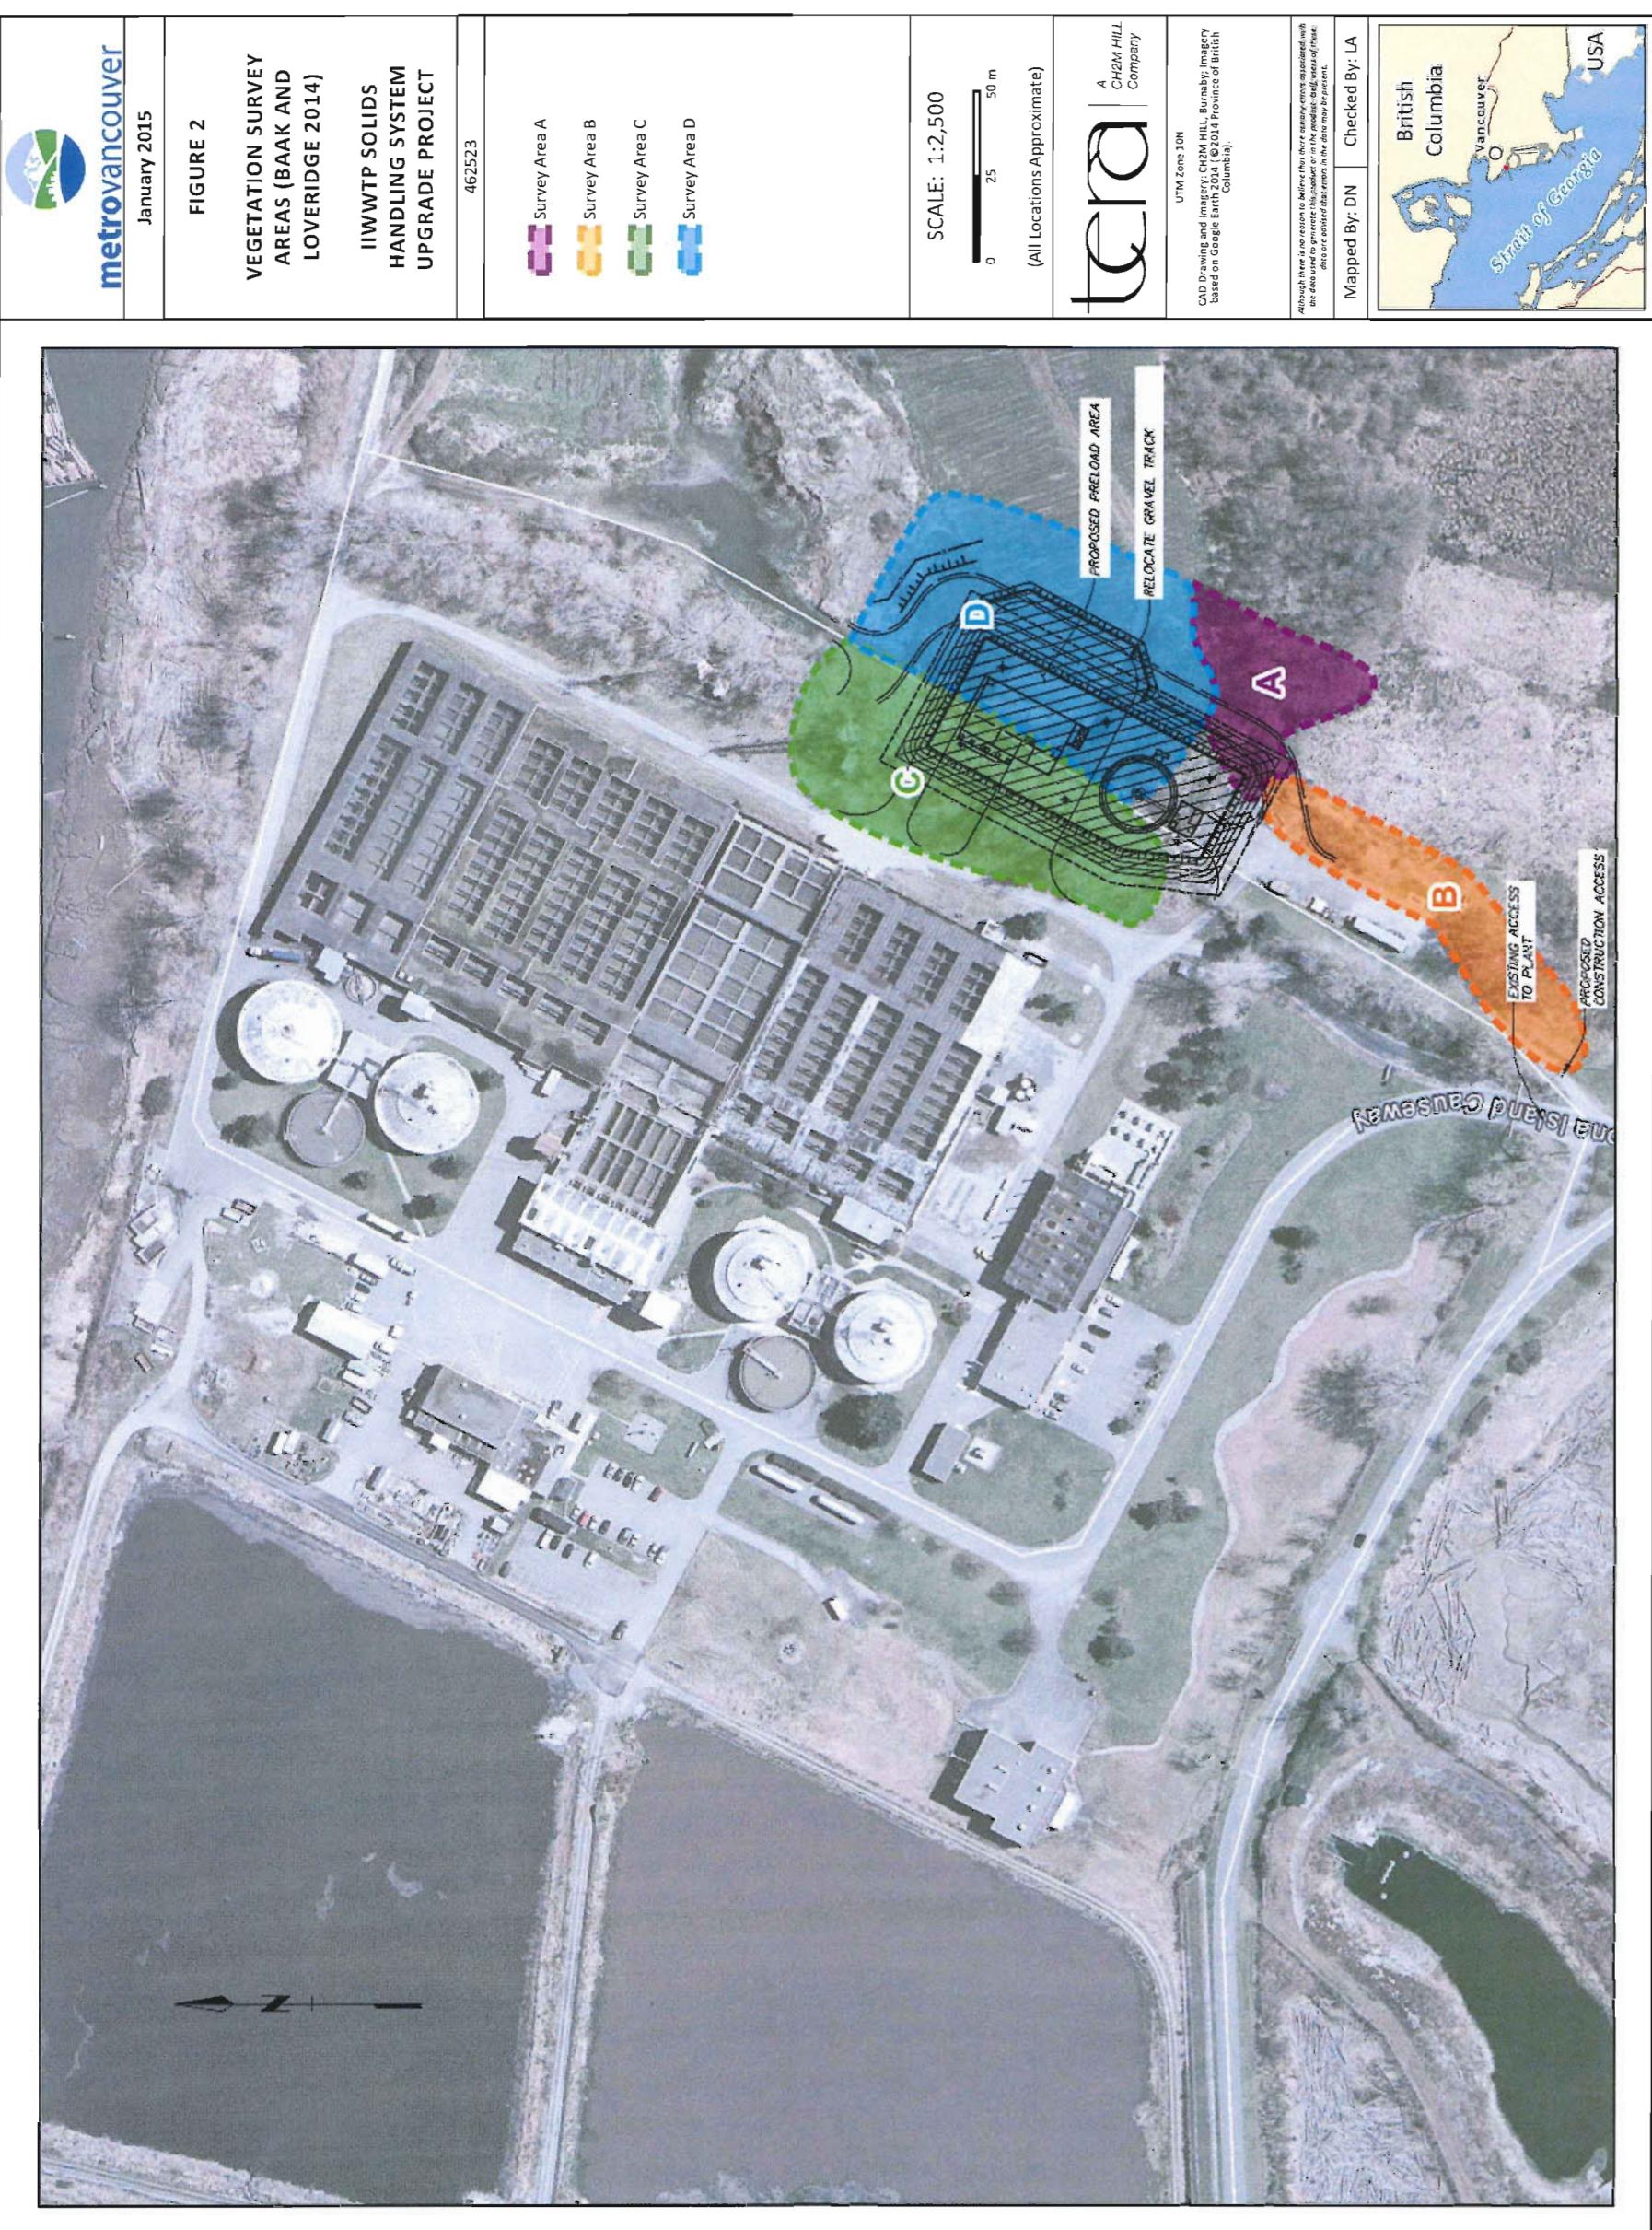


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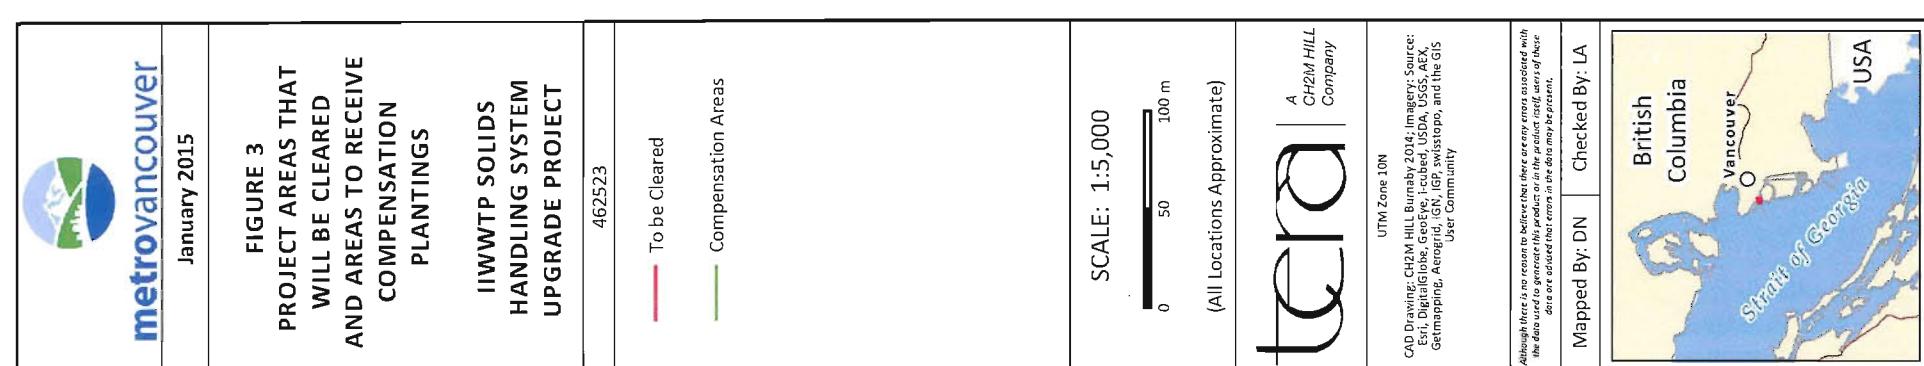
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DP 14-676361

Plan # 2



DP 14-676361

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Plan #3A

TABLE 2  
COMPENSATION PLAN SUMMARY

Compensation Location	Total Planting Area (ha)*	Total Number of Plants for the Location	Tree Species ^	No. of Tree Species ≥ 1.2 m	No. of Tree Species ≥ 30 cm	Shrub Species ^	No. of Shrub Species
<b>A</b> Wetland Berm	0.211	2110	• black cottonwood	30	10	• salmonberry	350
			• red alder	30	10	• thimbleberry	350
			• Pacific crabapple	20	5	• red elderberry	350
			• western redcedar	26	10	• willow	272
			• Sitka spruce	20	5	• hardhack	272
						• Nootka Rose	350
<b>Plant totals</b>				<b>126</b>	<b>40</b>	--	<b>1944</b>
<b>B</b> Western Fenceline	0.04	400	• Sitka spruce	25	20	• salmonberry	70
			• western redcedar	50	25	• thimbleberry	70
						• Red elderberry	70
<b>Plant totals</b>				<b>75</b>	<b>45</b>	--	<b>280</b>
<b>C</b> Sewage Lagoons	0.08	800	• Sitka spruce	25	13	• salmonberry	200
			• Douglas fir	25	15	• thimbleberry	122
			• black hawthorn	125	75	• Nootka rose	200
<b>Plant totals</b>				<b>175</b>	<b>103</b>	--	<b>522</b>
<b>Grand Total</b>				<b>376</b>	<b>188</b>	--	<b>2746</b>

Note: \* planting area may differ from the total Location area (Map A) because of planting patterns.

"A, B, C" correspond to the locations shown on Plan #2.

TABLE 3  
BALANCE SHEET

Impacts of Expansion Project	Compensation Measures	Plant Species (+ Identifies Berry Producing Species)	Plant Ratios (% of Planted Stock)
Permanent loss of highly disturbed and weedy native vegetation.	Improve the quality of wildlife habitat in three other areas of the site, the wetland berm, western fenceline and sewage lagoons. Methods include:	Areas will be replanted with native shrubs and trees following the removal of invasive plants. Plant species are listed below.	
	• Removal of invasive plants on the wetland berm and along the western fenceline.	• thimbleberry+ • salmonberry+ • red elderberry+ • Nootka rose+ • western redcedar	15% 21% 12% 21% 1%
	• Replanting native shrub and tree species with wildlife value including berry producing shrubs and trees and conifer and broadleaf trees that provide thermal cover and nesting and perching sites.	• red alder; • black cottonwood; • Pacific crabapple • Sitka spruce • Douglas-fir • red alder • black cottonwood • black hawthorn+	1% 1% 1% 3% 1% 1% 1% 6% 8%
	• Increase habitat structure.	• willow • hardhack	8% 8%
	Loss of large black cottonwoods and red alders in the construction site. These trees were cut down earlier and the downed trees remain on site.	Black cottonwood and red alder.	The number of stems used in the berm will depend on tree length and diameter. Trees that are ≥ 30 cm breast height diameter (dbh) will be placed in two rows on either side of the berm.
Establishment of invasive plants in disturbed soils	Seed disturbed soils with coastal sod-forming grasses and legumes. Mulch planted areas with wood chips.	NA	NA

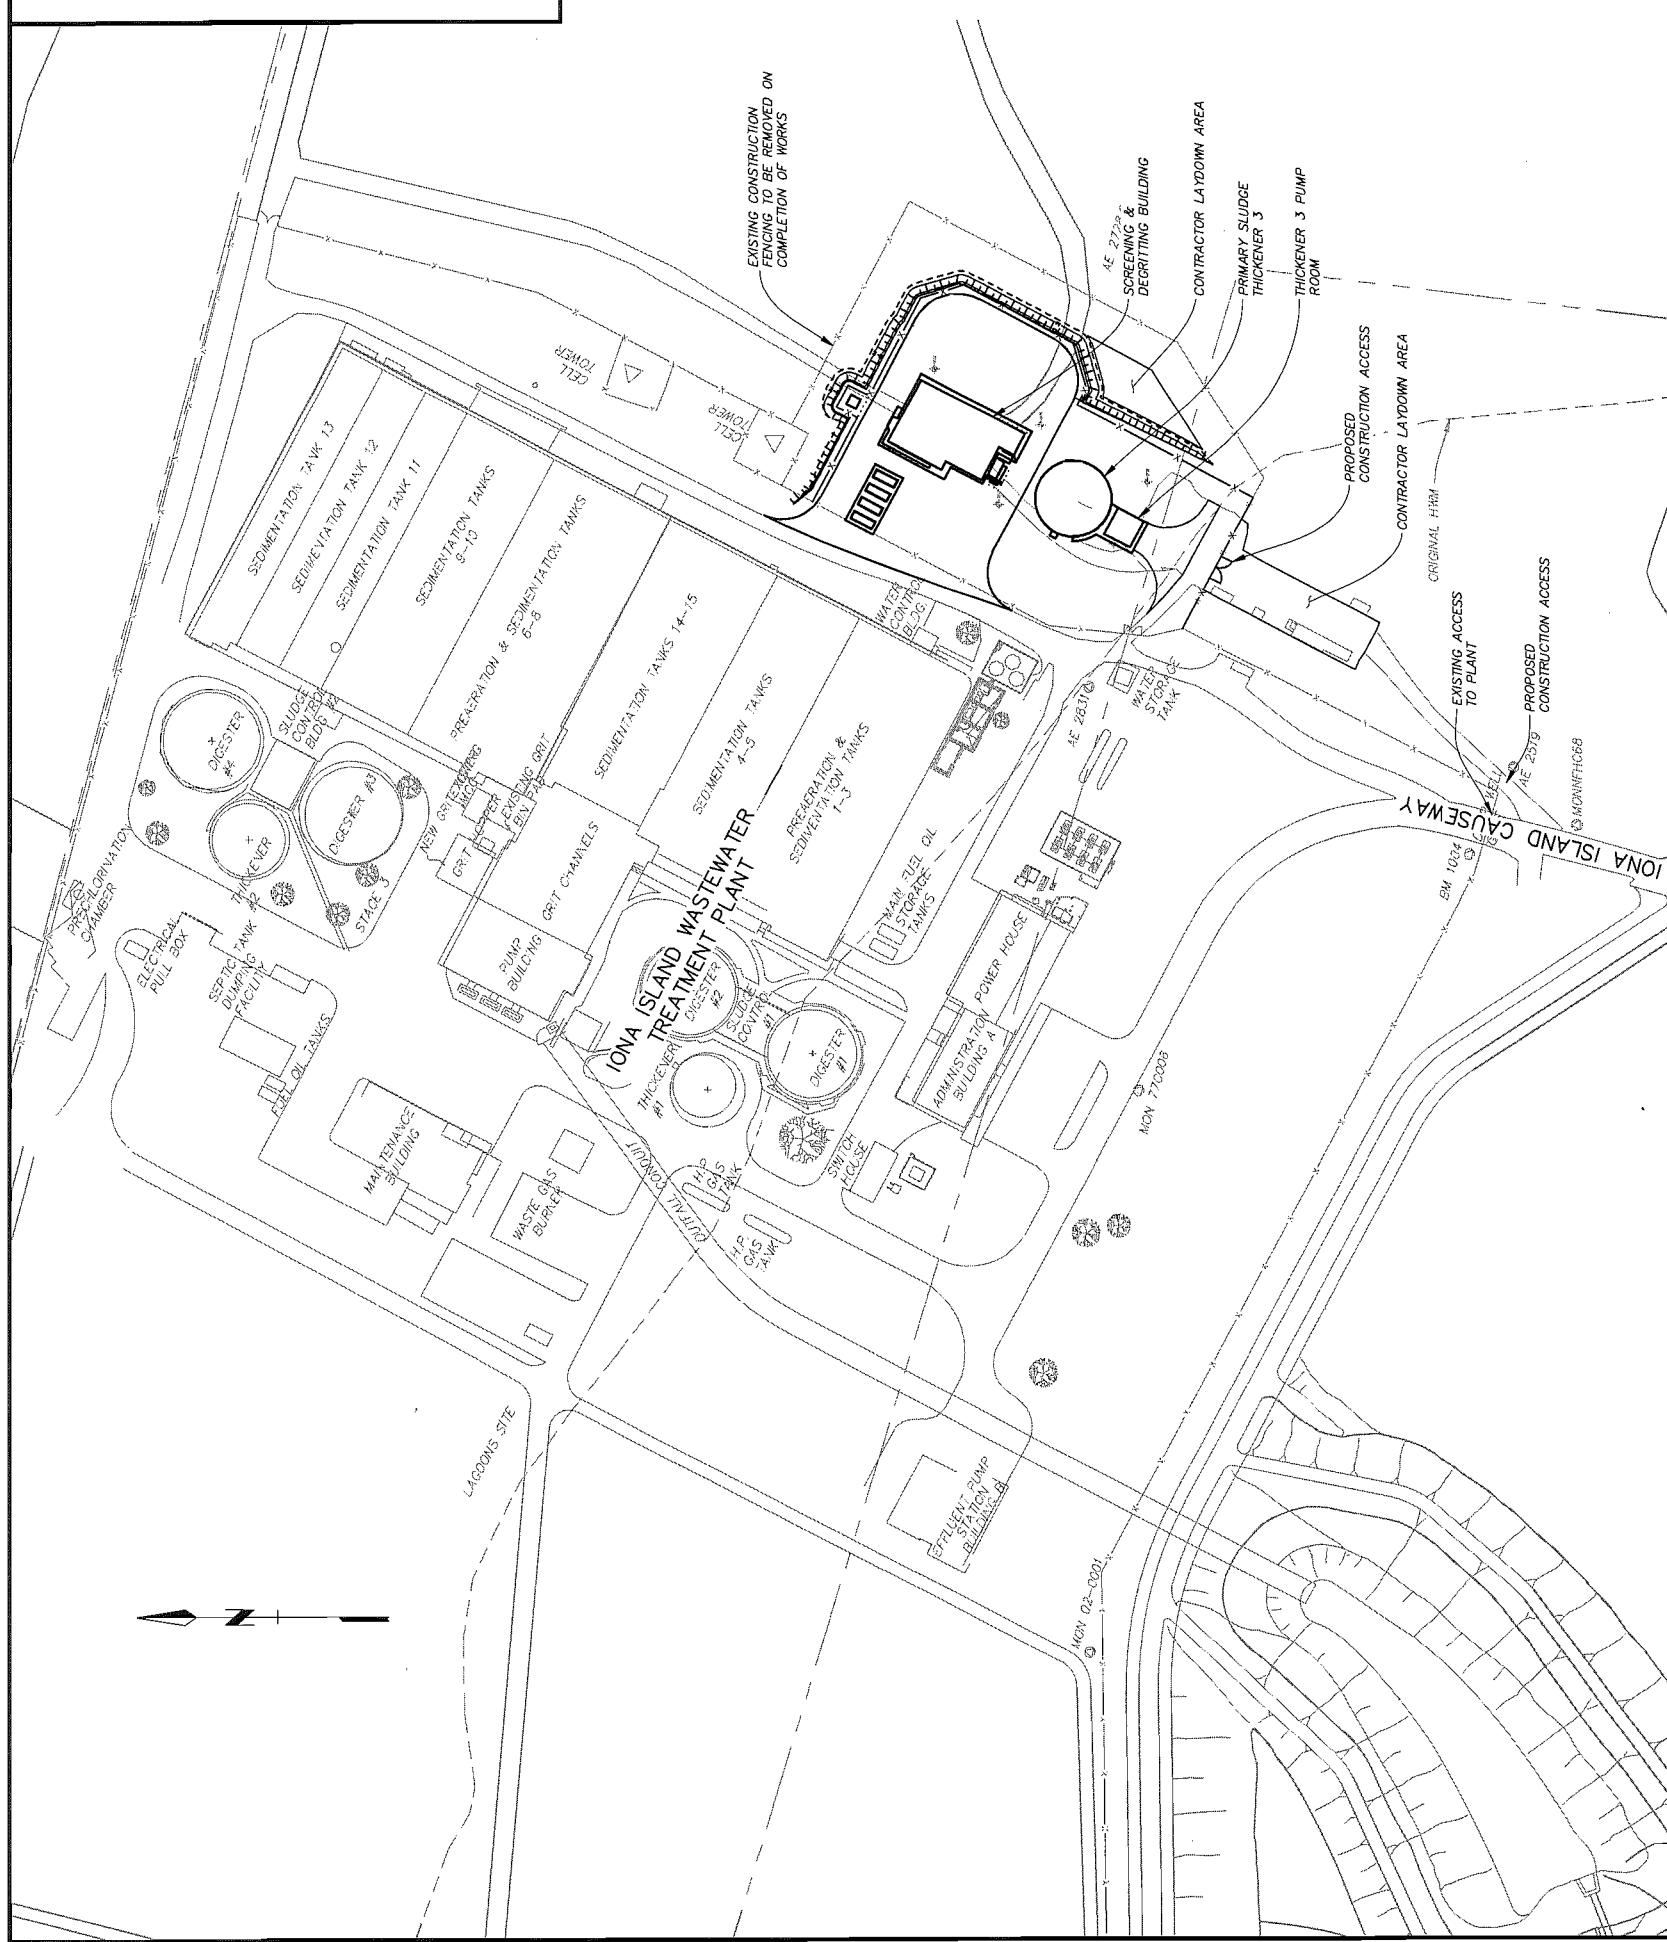
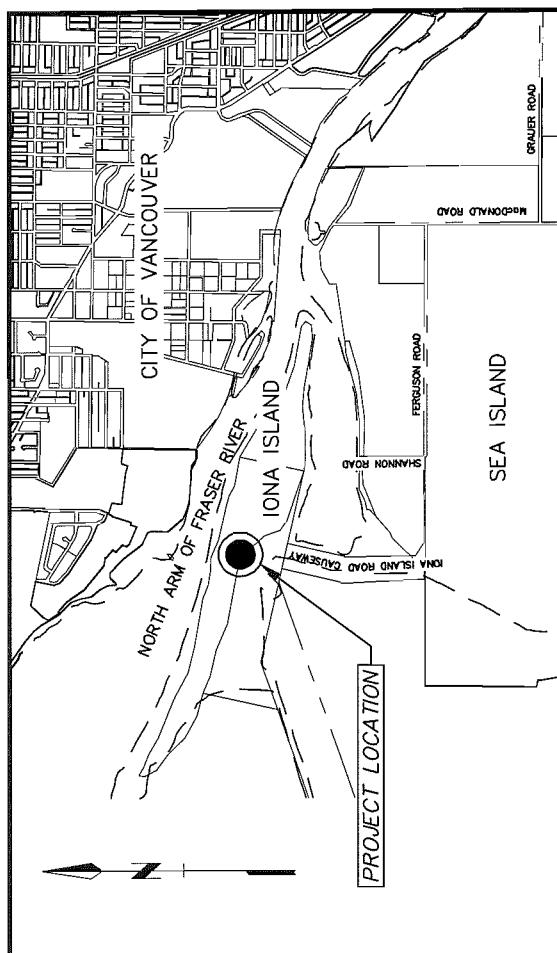
Note: Berry producing species account for 77% of the planting stock.

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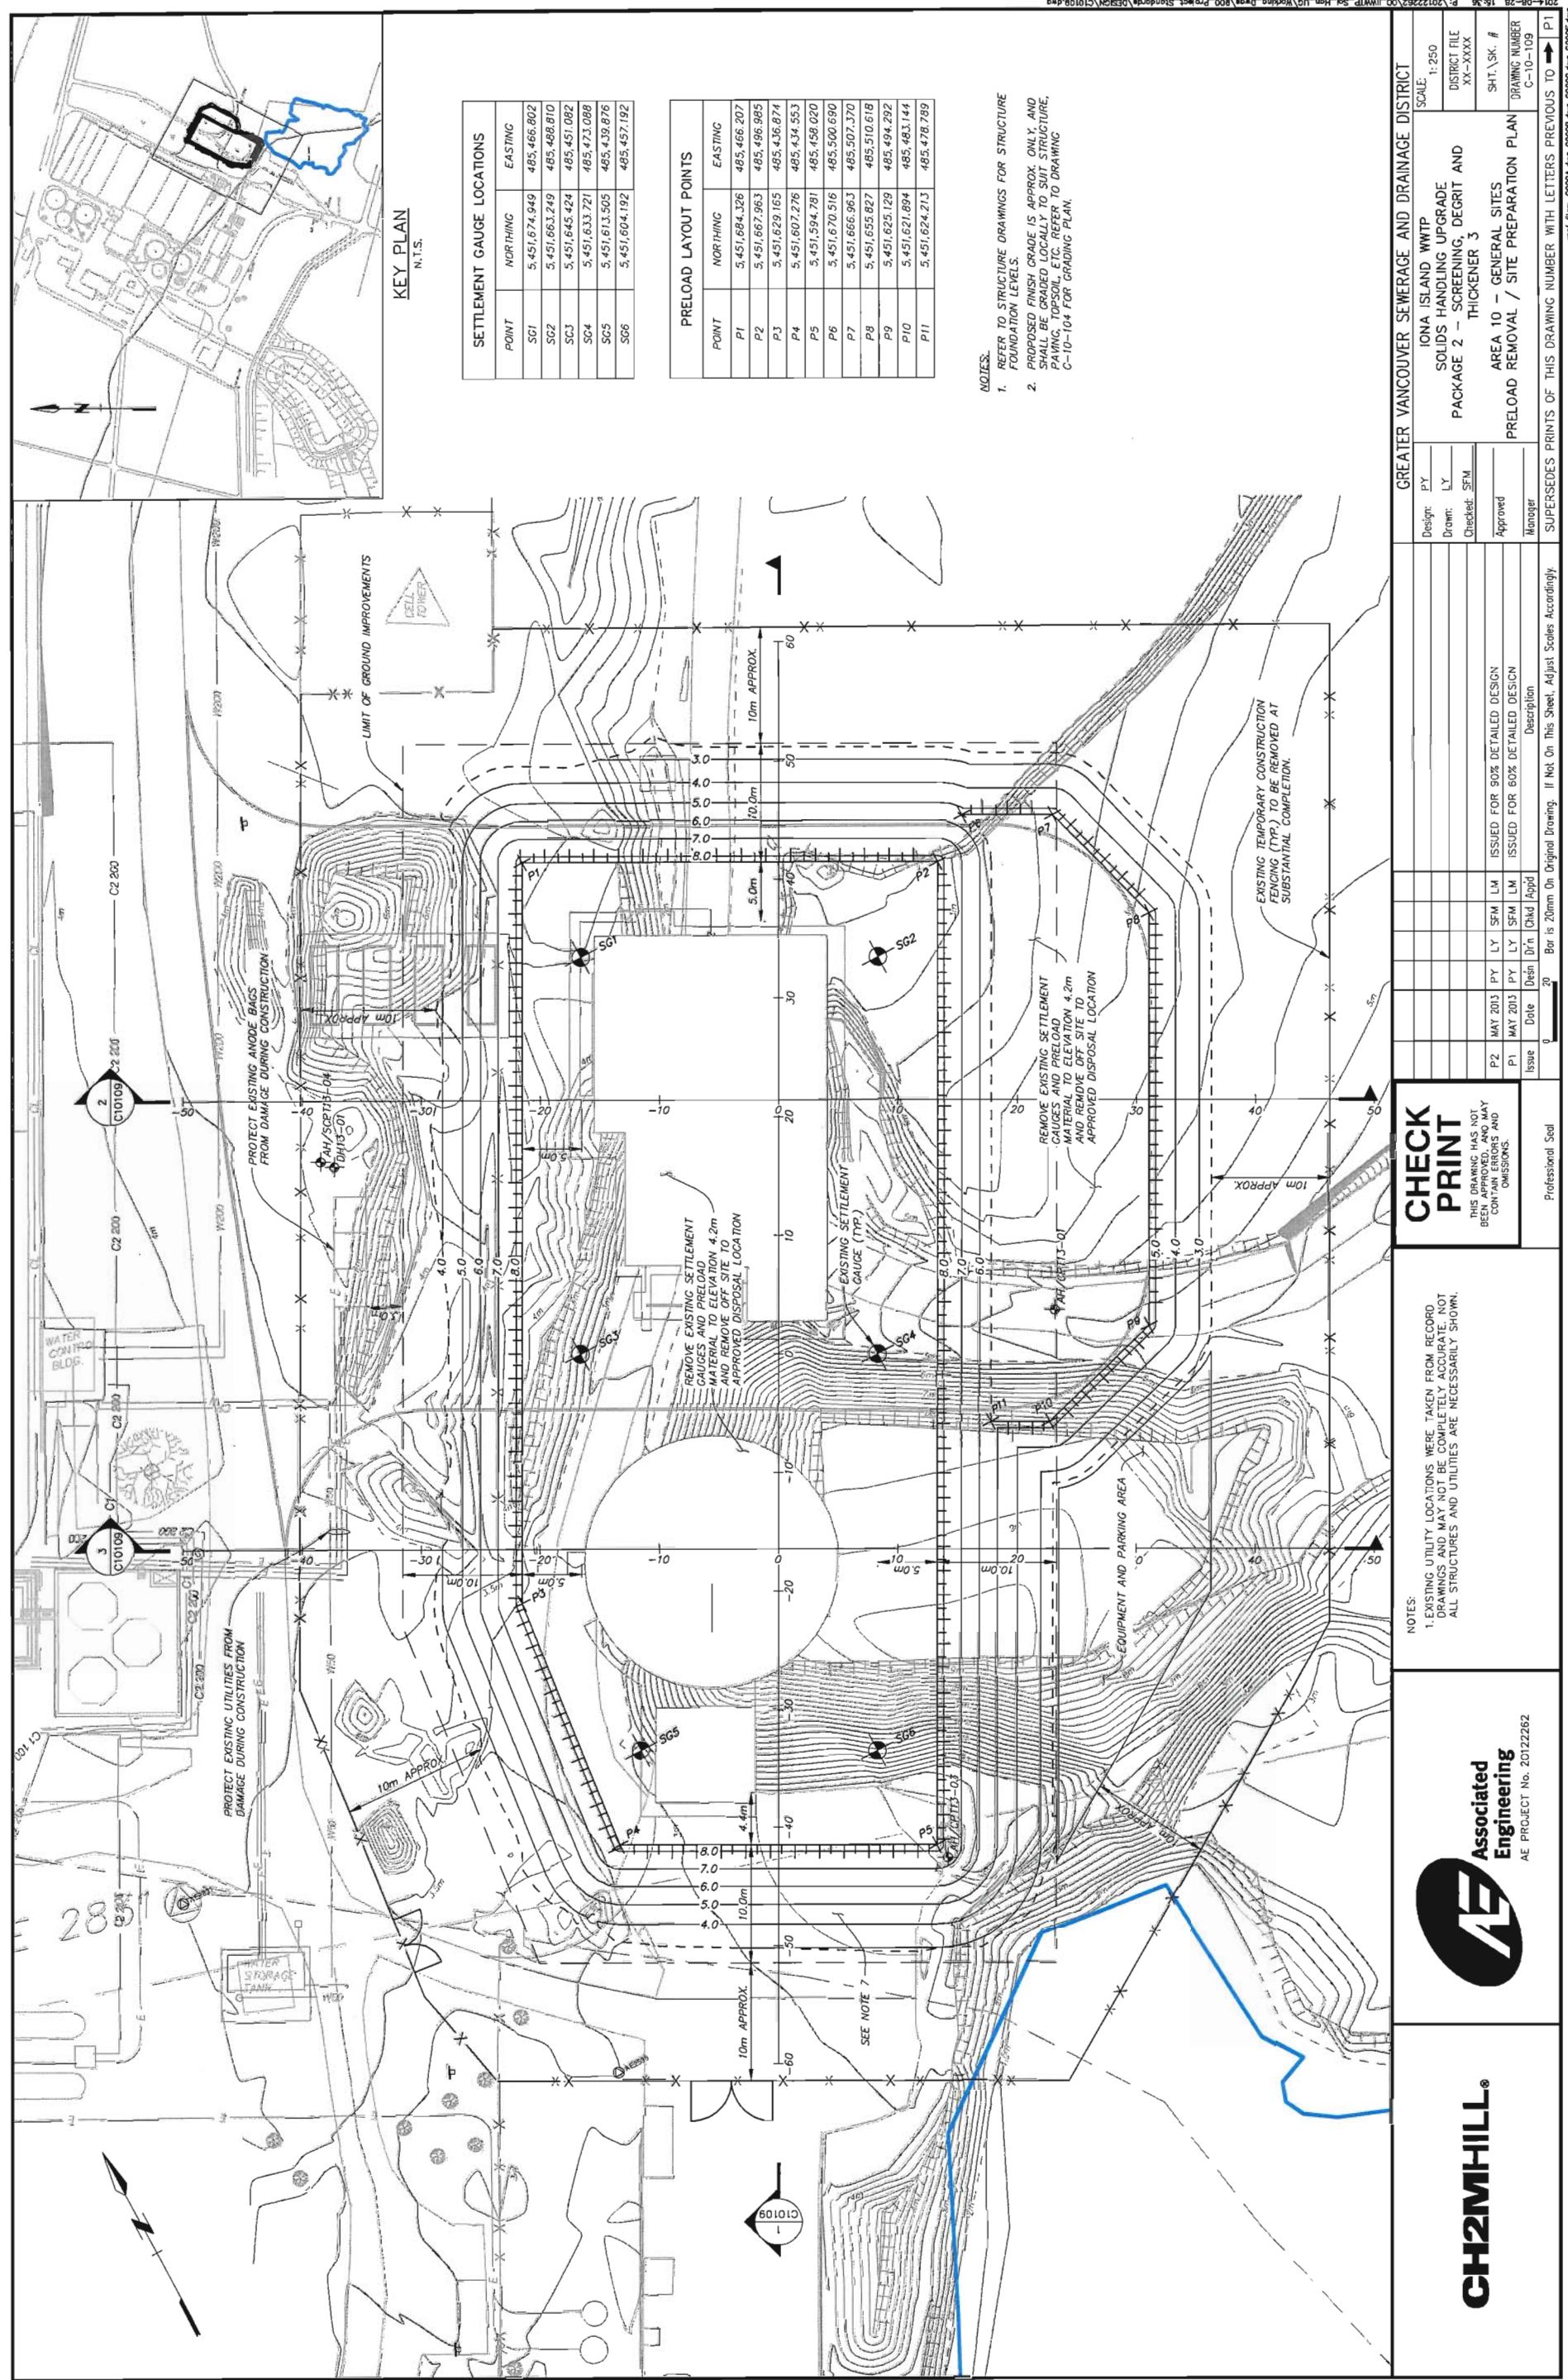
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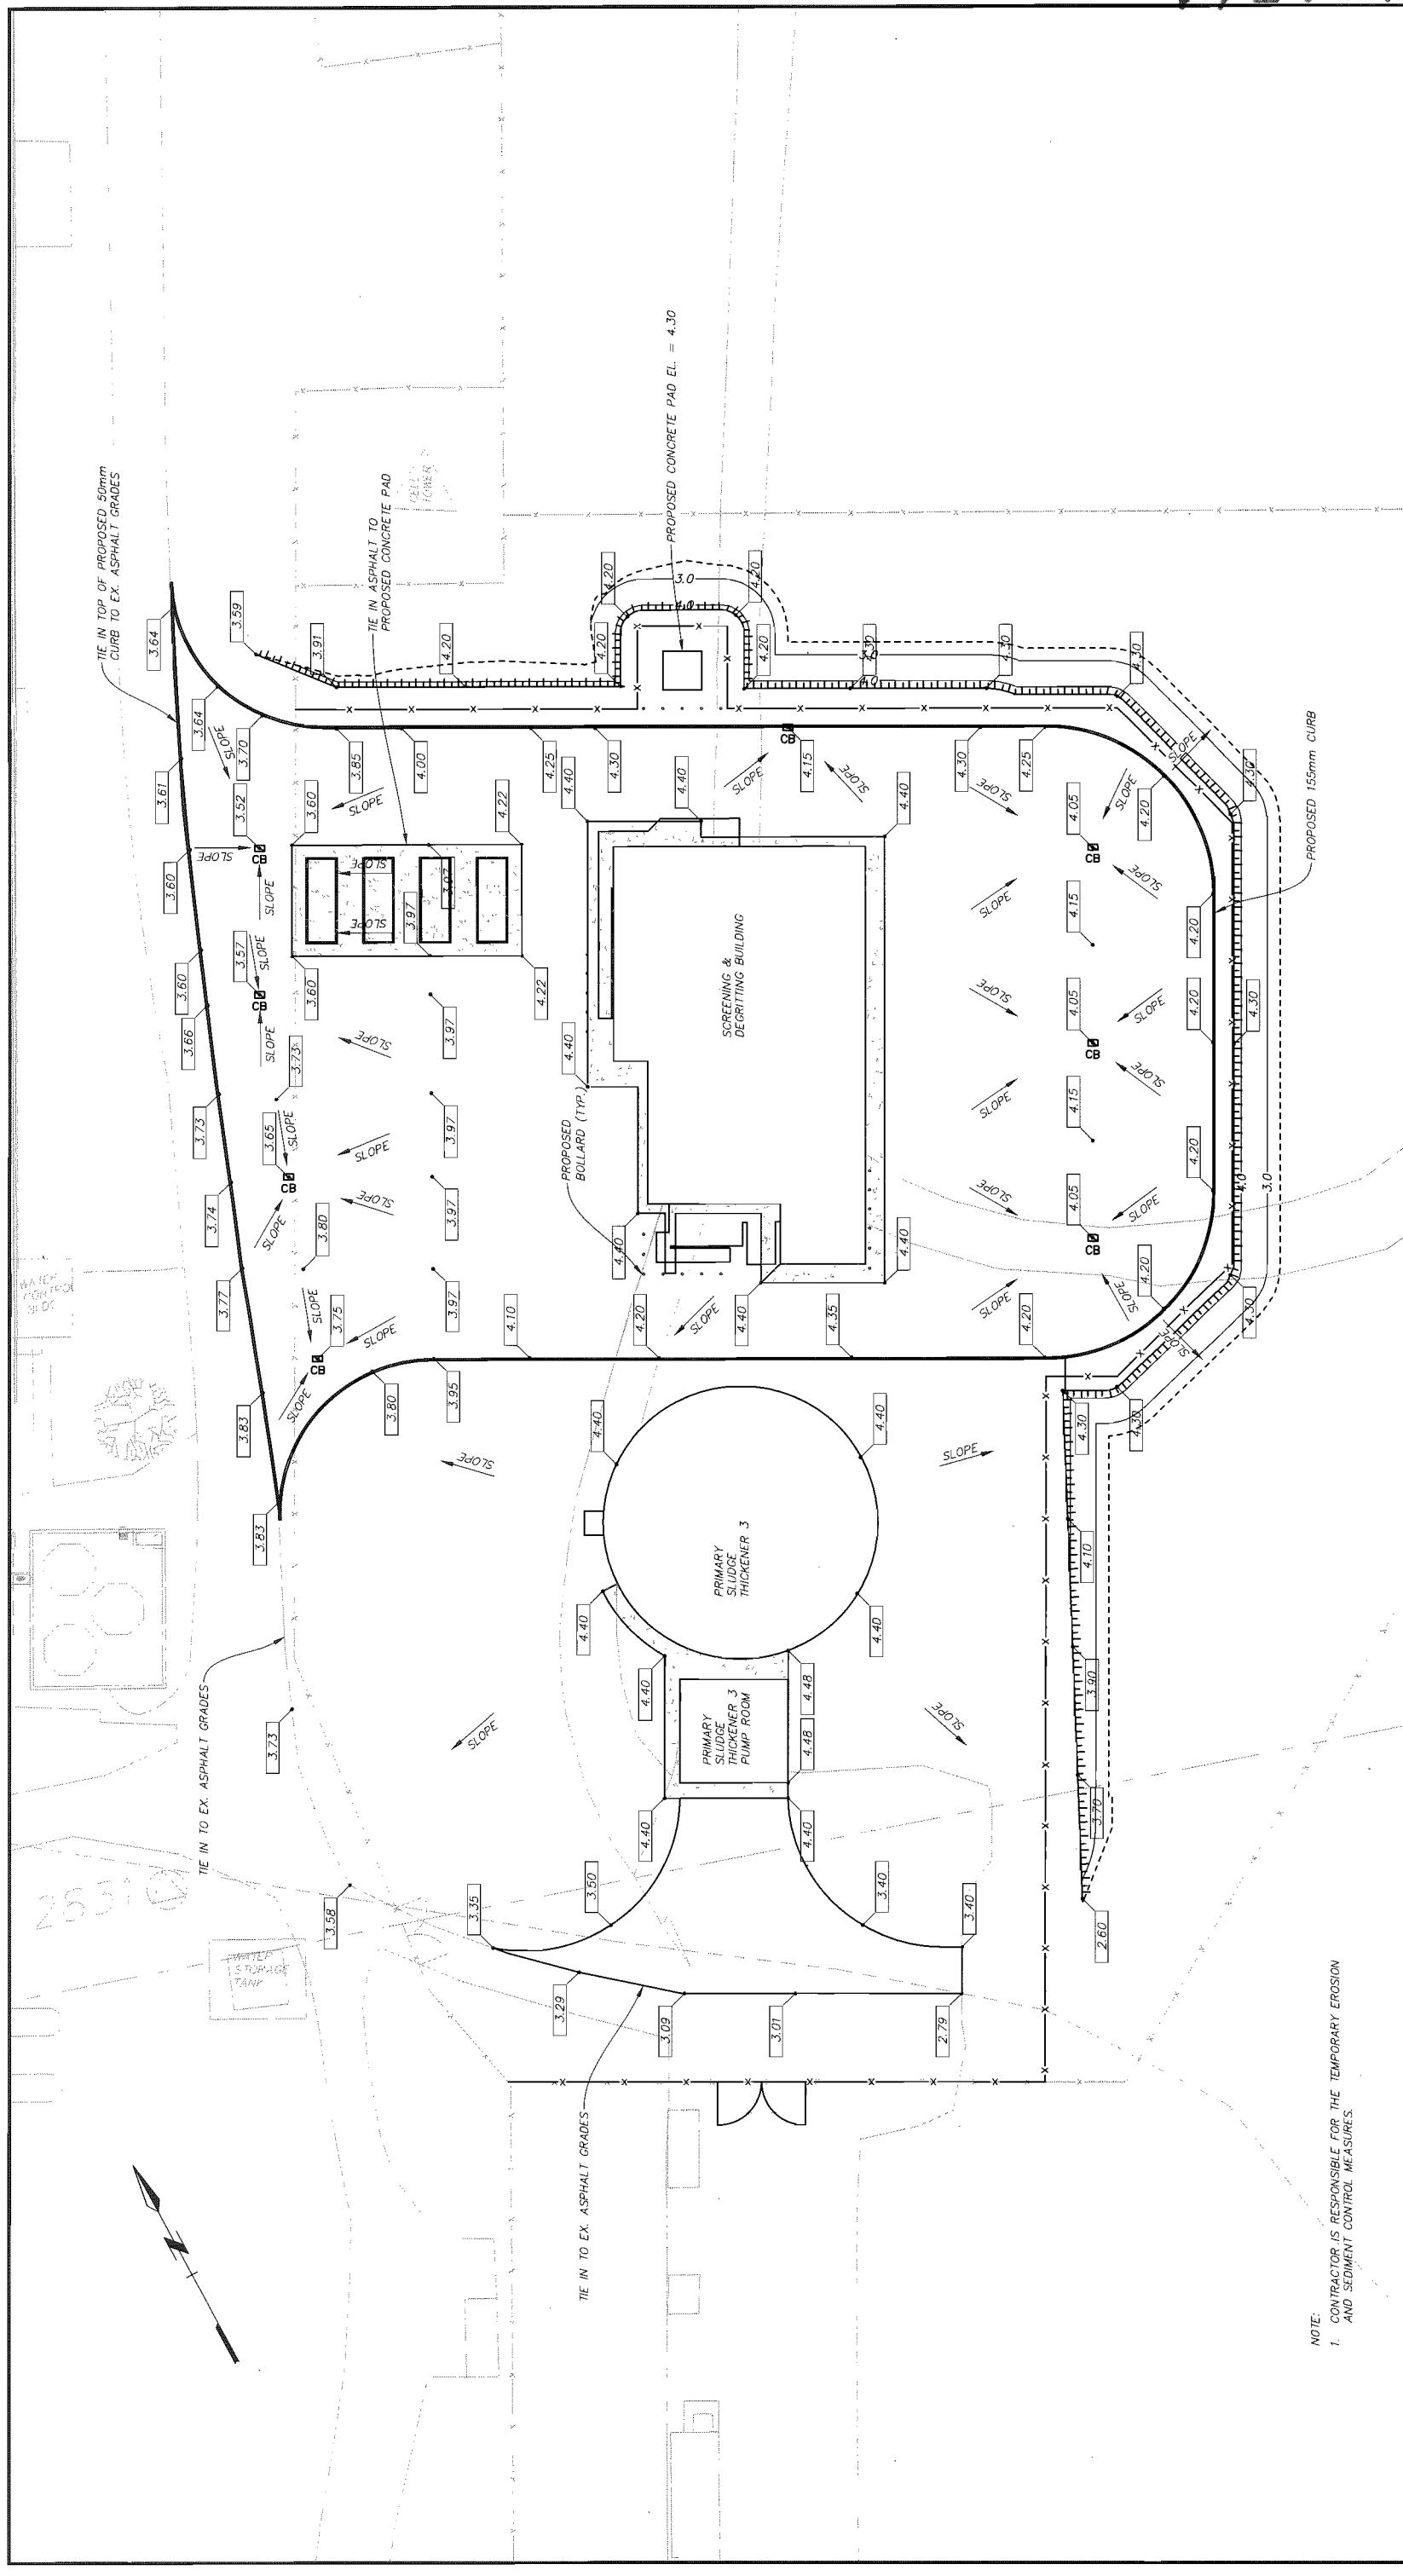
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<b>THIS DRAWING HAS NOT BEEN APPROVED AND MAY CONTAIN ERRORS AND OMISSIONS.</b>		<b>GREATER VANCOUVER SEWERAGE AND DRAINAGE DISTRICT</b>	
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		Manager: <u>      </u>	C-1D-104
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P2 AUG 2014	PY LY SFM LM	ISSUED FOR 90% DETAILED DESIGN	
P1 MAY 2013	PY LY SFM LM	ISSUED FOR 60% DETAILED DESIGN	
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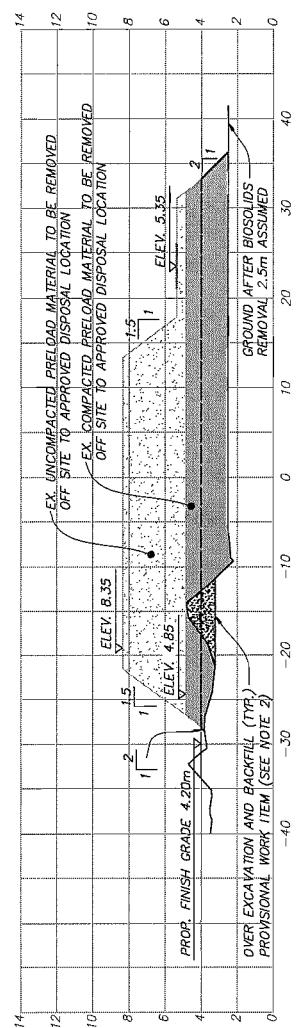
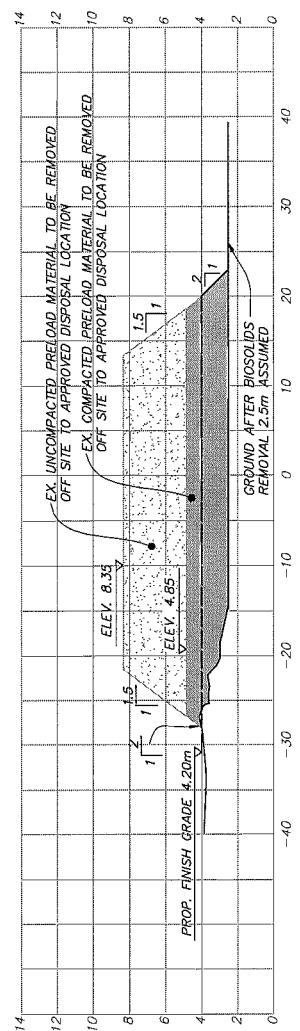
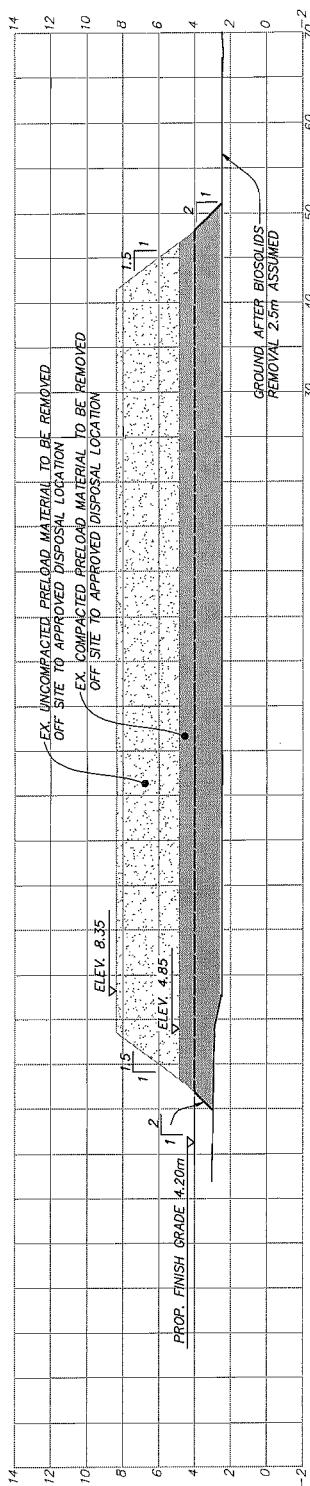
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14-676361

DP

Plan #4d

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**NOTE:**  
 1. PROPOSED FINISH GRADE IS APPROX. ONLY AND SHALL BE GRADED  
 LOCALLY TO SUIT STRUCTURES, PAVING, TOIL, SOIL, ETC. REFER TO  
 DRAWING C-10-104 FOR GRADING PLAN.  
 2. OVER EXCAVATION AND BACKFILL AS DIRECTED BY ENGINEER INCLUDES:  
 - IMPACTED FILL MATERIAL  
 - COMPACTION

GREATER VANCOUVER SEWERAGE AND DRAINAGE DISTRICT									
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				AREA 10 - GENERAL SITES		P1			
				PRELOAD REMOVAL / SITE PREPARATION		Manager			
Professional Seal									
Supersedes prints of this drawing number with letters previous to P1									

**CHECK PRINT**

THIS DRAWING HAS NOT BEEN APPROVED AND MAY CONTAIN ERRORS AND OMISSIONS.	
- IMPACTED FILL MATERIAL	
- COMPACTION	

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Associated Engineering  
AE PROJECT No. 20122262

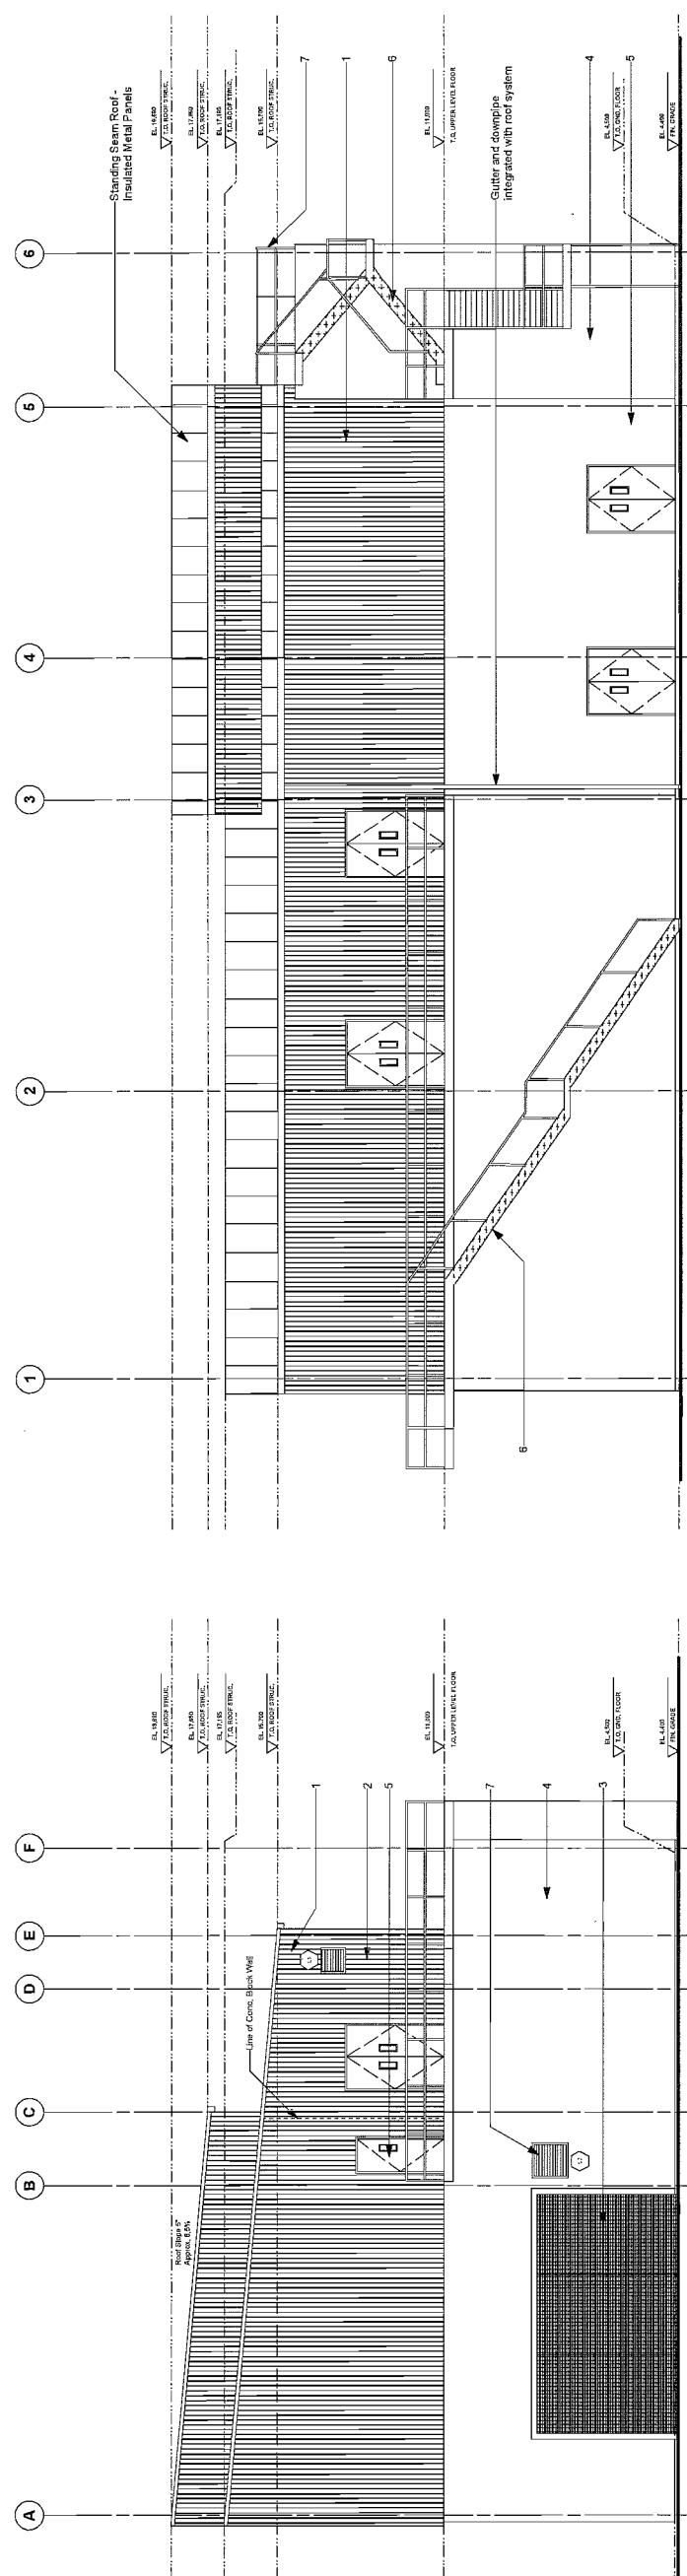


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D

Plan #4f


**DIALOG**  
**CH2MHILL®**
**CHECK  
PRINT**  
THIS DRAWING HAS NOT  
BEEN APPROVED, AND MAY  
CONTAIN ERRORS AND  
OMISSIONS.
**CH2MHILL®**

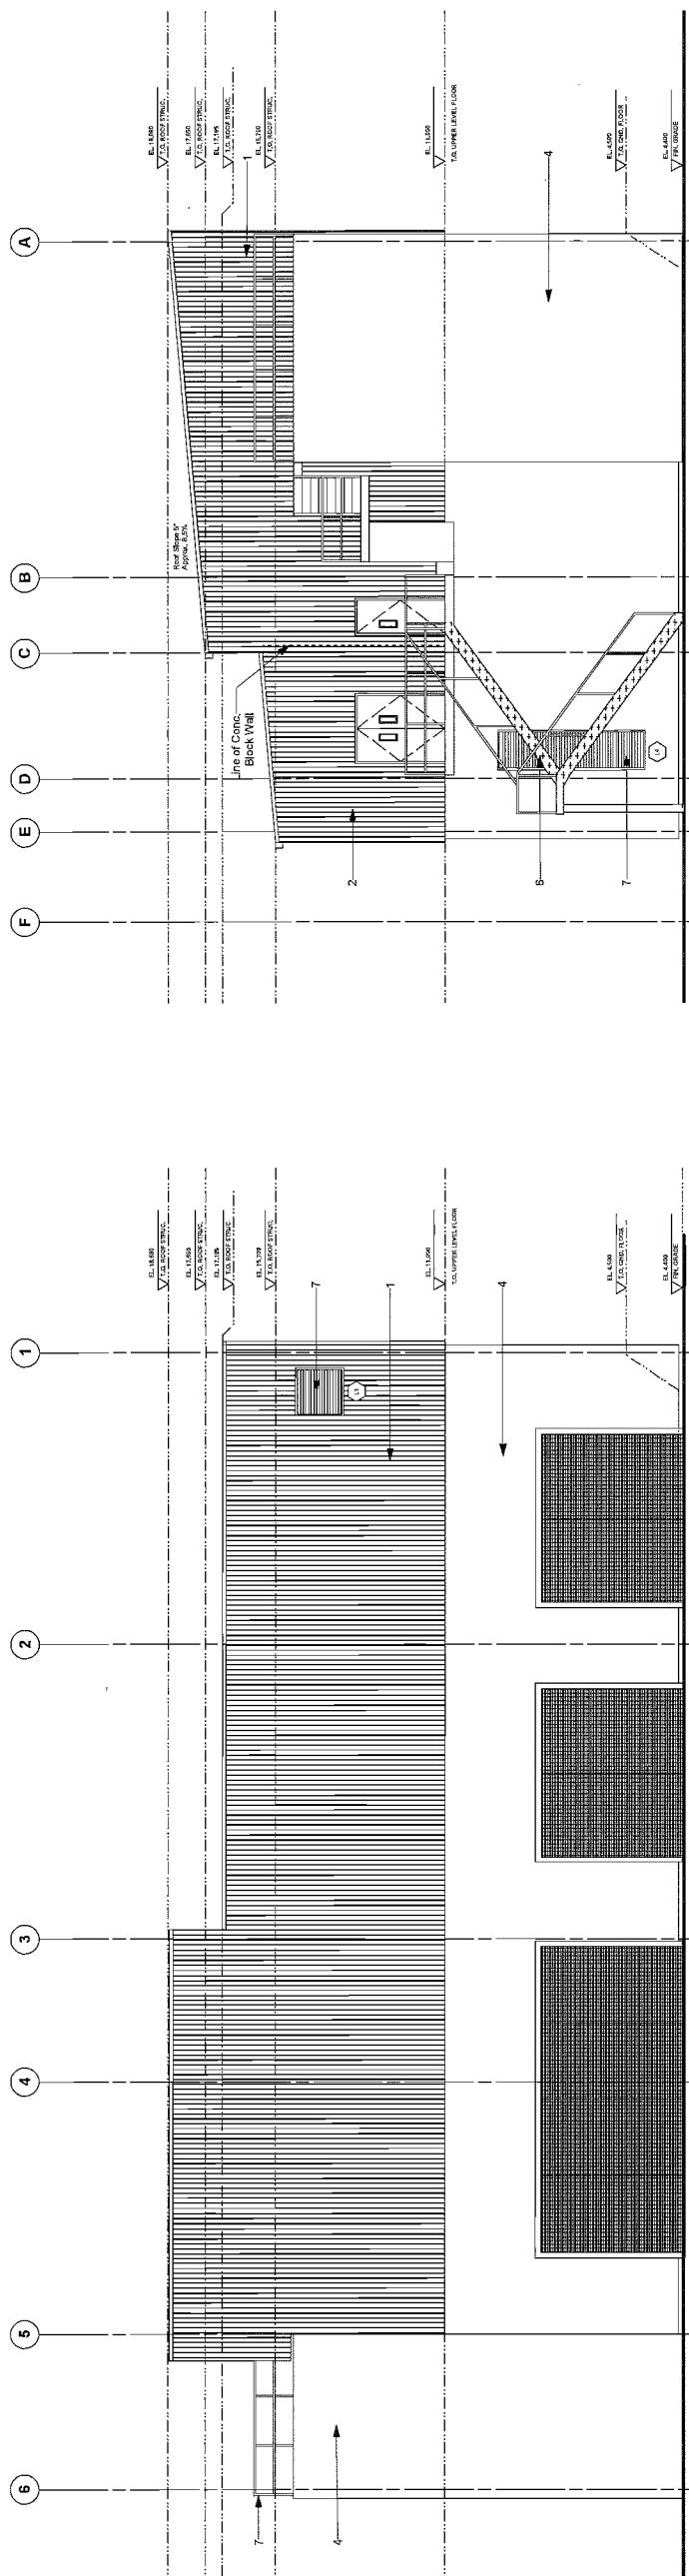
GREATER VANCOUVER SEWERAGE AND DRAINAGE DISTRICT									
IONA ISLAND WWTP							Design:	BH	AS NOTED
SOLIDS HANDLING UPGRADE							Drawn:	DS	DISTRICT FILE #_____
PACKAGE 2 - SCREENING, DEGRITTING AND							Checked:	BH	SHT/SK: #
THICKENER 3							Approved		AREA 21 - SCREENING AND DEGRITTING BUILDING
EXTERIOR ELEVATIONS							Manager		DRAWING NUMBER A-21-107
SUPERSEDES PRINTS OF THIS DRAWING NUMBER WITH LETTERS PREVIOUS TO P1									
Issue	Date	Desg	Drin	Chk	Appv	Description			
P2	AUG. 2014	BH	DS	BH	ISSUED FOR 90% DETAILED DESIGN				
P1	MAY 2014	BH	DS	BH	ISSUED FOR 60% DETAILED DESIGN				
0					20mm On Original Drawing. If Not On This Sheet, Adjust Scales Accordingly.				
Professional Seal									

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**LEGEND**

- Metal Clad Rainscreen Insulated
- Metal Panel Wall
- Galvanized Steel Galvalume®
- Decorative Metal Mesh (mesh shall be spaced to provide bird mitigation)
- Architectural concrete medium sand base w/ sealant/graffiti coating
- Painted Galvanized steel door
- Galvanized Steel Flat Bar Shutter Prefinished Louvers (see Mech)



<b>CHECK PRINT</b>		<b>GREAT VANCOUVER SEWERAGE AND DRAINAGE DISTRICT</b>									
		IONA ISLAND WWTP SOLIDS HANDLING UPGRADE PACKAGE 2 - SCREENING, DEGRIT AND THICKENER 3									
		AREA 21 - SCREENING AND DEGRITTING BUILDING EXTERIOR ELEVATIONS									
		SUPERSEDES PRINTS OF THIS DRAWING NUMBER WITH LETTERS PREVIOUS TO P1									
		Design: BH Drawn: DS Checked: BH Approved: Manager									
		Scale: AS NOTED District File # SH/TSK # Drawing Number A-21-106									
		THIS DRAWING HAS NOT BEEN APPROVED AND MAY CONTAIN ERRORS AND OMISSIONS.									
Issue	Date	Desg Drift	Chkd Appd	Description							
P2	AUG 2014	BH	DS BH	ISSUED FOR 90% DETAILED DESIGN							
P1	MAY 2014	BH	DS BH	ISSUED FOR 60% DETAILED DESIGN							
0 20 Bar is 20mm On Original Drawing. If Not On This Sheet, Adjust Scales Accordingly.											
Professional Seal											

**DIALOG**

**CH2MHILL**

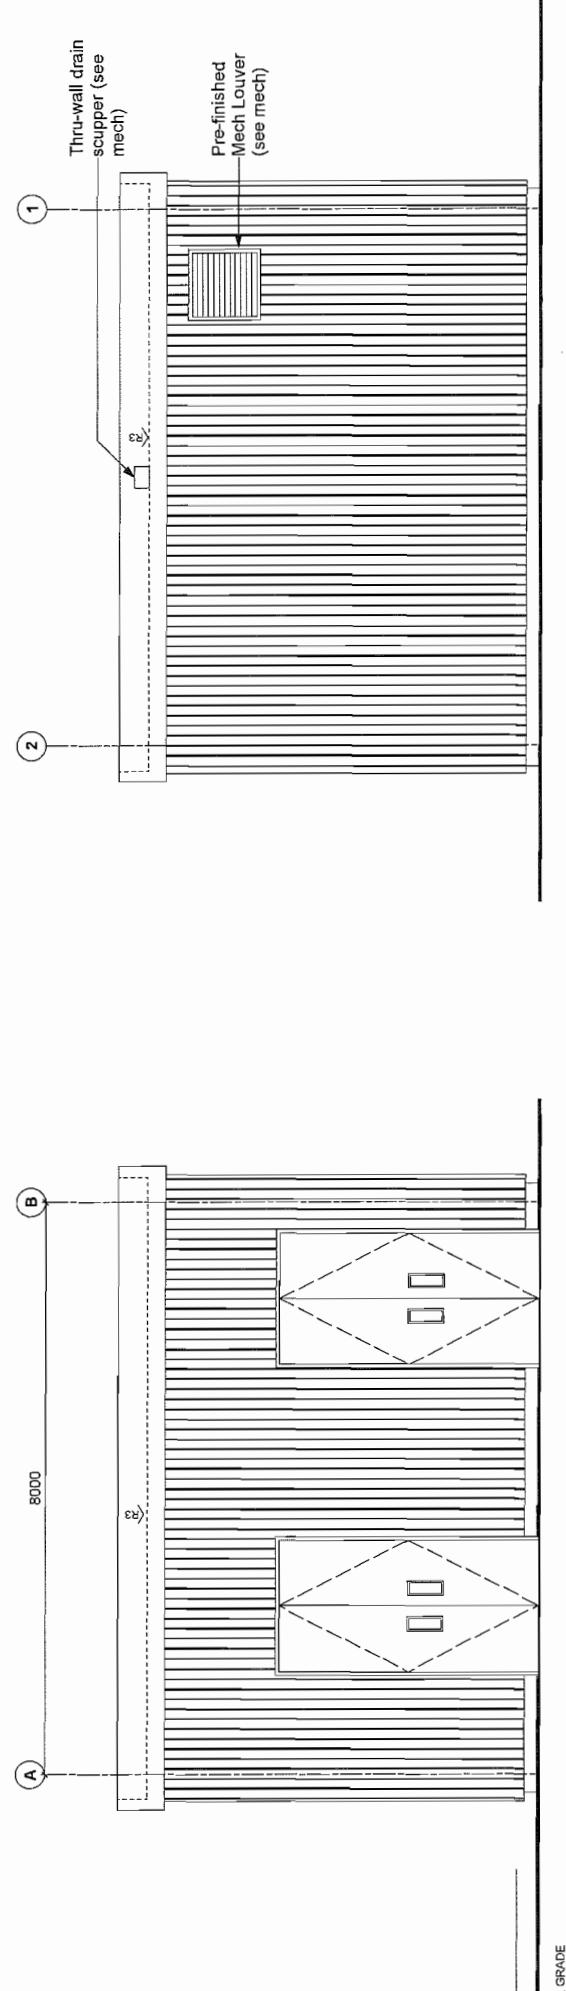


FEB 14 2015

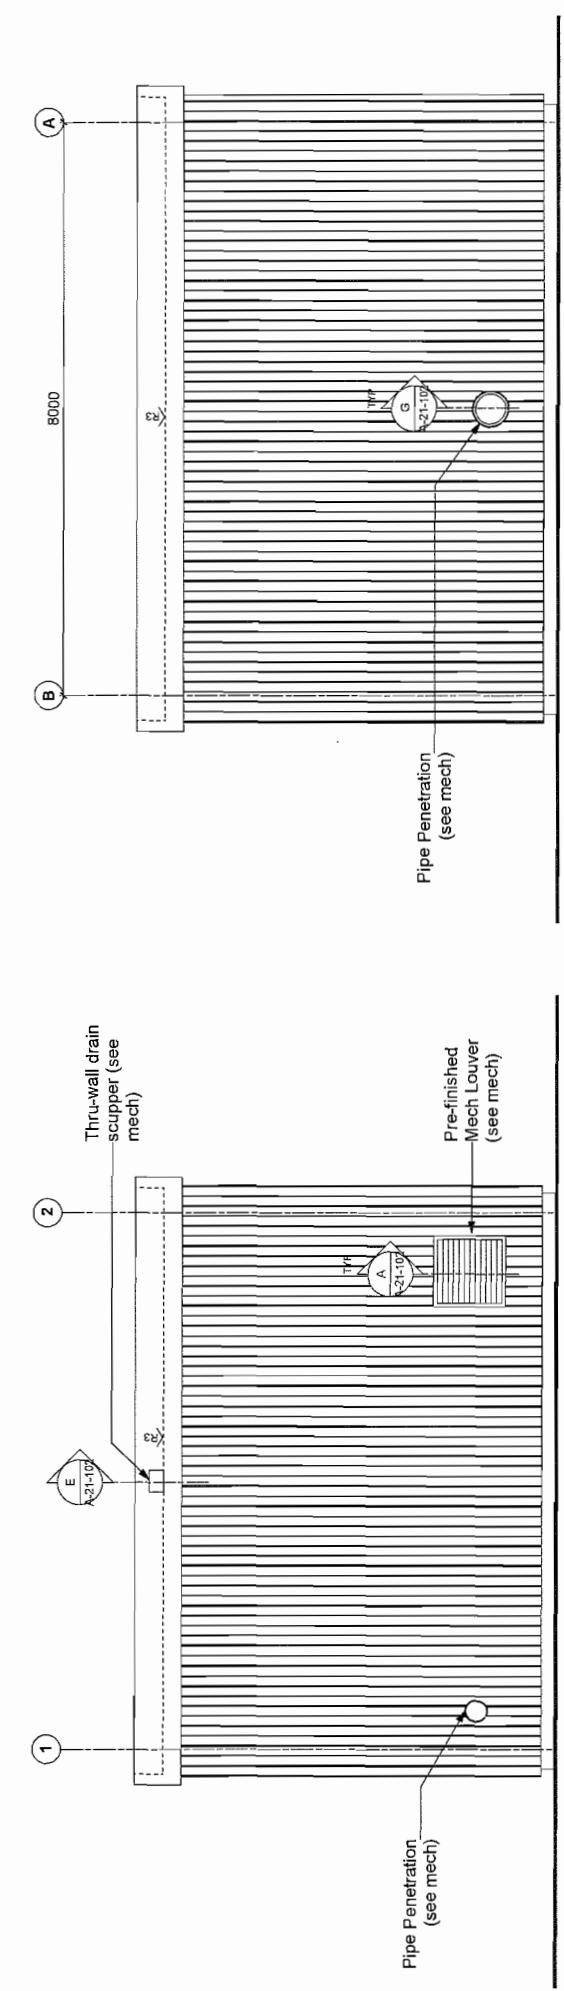
14-676361

DP

Plan 84:



SIDE ELEVATION  
SCALE: 1:50



BACK ELEVATION  
SCALE: 1:50

4

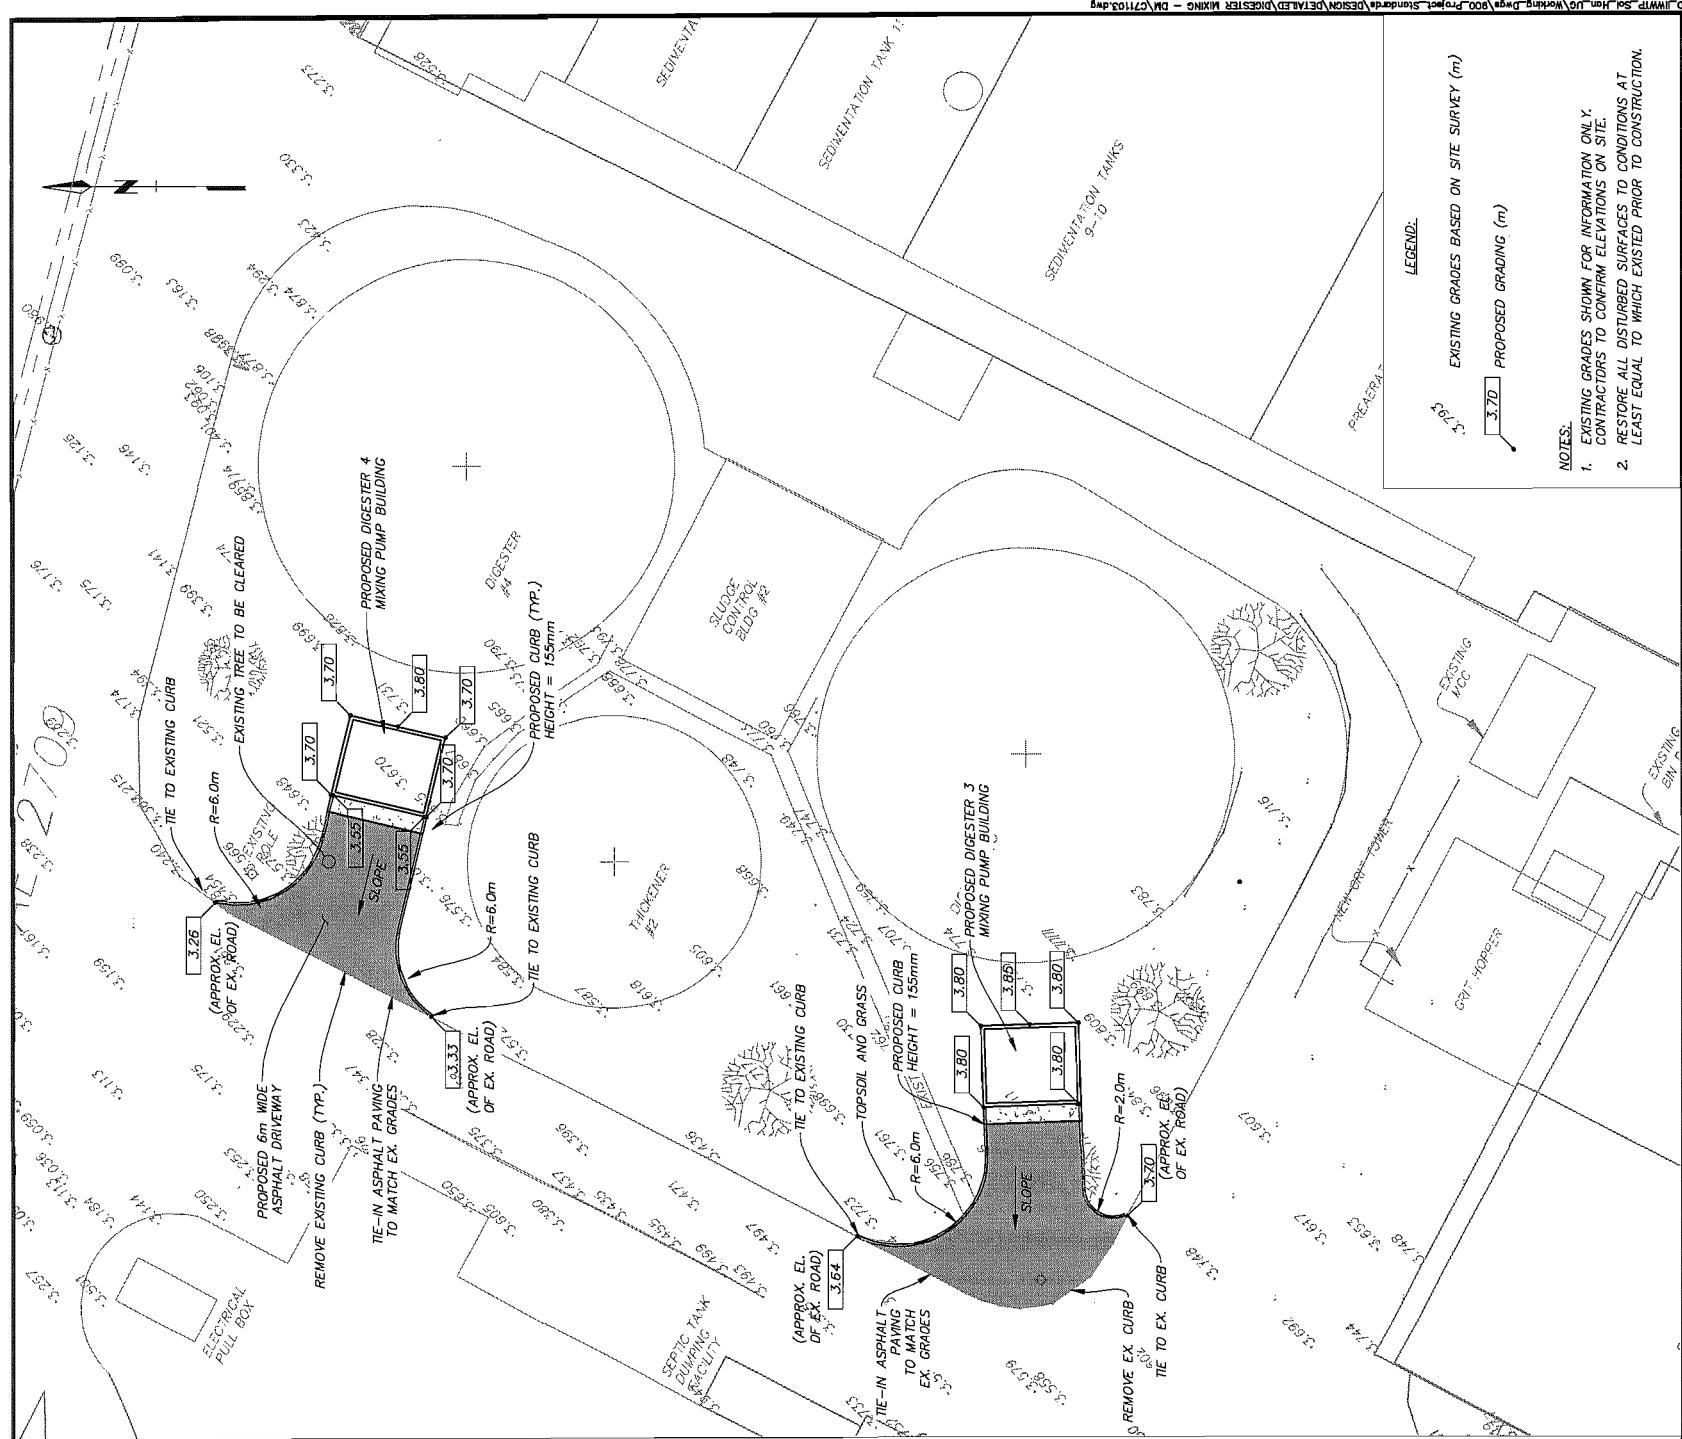


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**DIALOG**

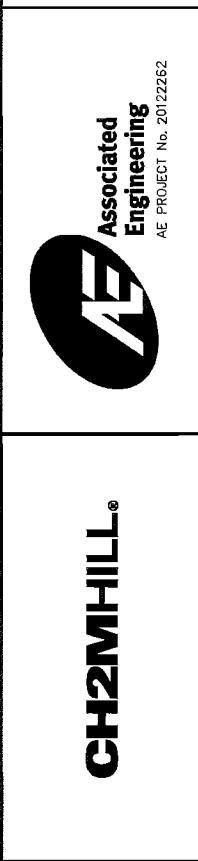
GREATER VANCOUVER SEWERAGE AND DRAINAGE DISTRICT	
Design:	SH
Drawn:	DS
Checked:	BH
Approved:	
Manager:	
IONA ISLAND WWTP SOLIDS HANDLING UPGRADE PACKAGE 2 - SCREENING, DEGRIT AND THICKENER 3	
AREA 21 - THICKENER PUMP ROOM BUILDING ELEVATIONS	
SUPERSEDES PRINTS OF THIS DRAWING NUMBER WITH LETTERS PREVIOUS TO → P1	
DRAWING NUMBER A-21-110	
SHEET NUMBER # #####	
SHEET / ISK #	
DRAWING NUMBER P1	

P2 AUG. 2014 BH DS BH ISSUED FOR 90% DETAILED DESIGN  
P1 MAY 2014 BH DS BH ISSUED FOR 60% DETAILED DESIGN  
Issue Date Desg Chkd App Description  
Professional Seal  
20 Bar is 20mm On Original Drawing. If Not On This Sheet, Adjust Scales Accordingly.



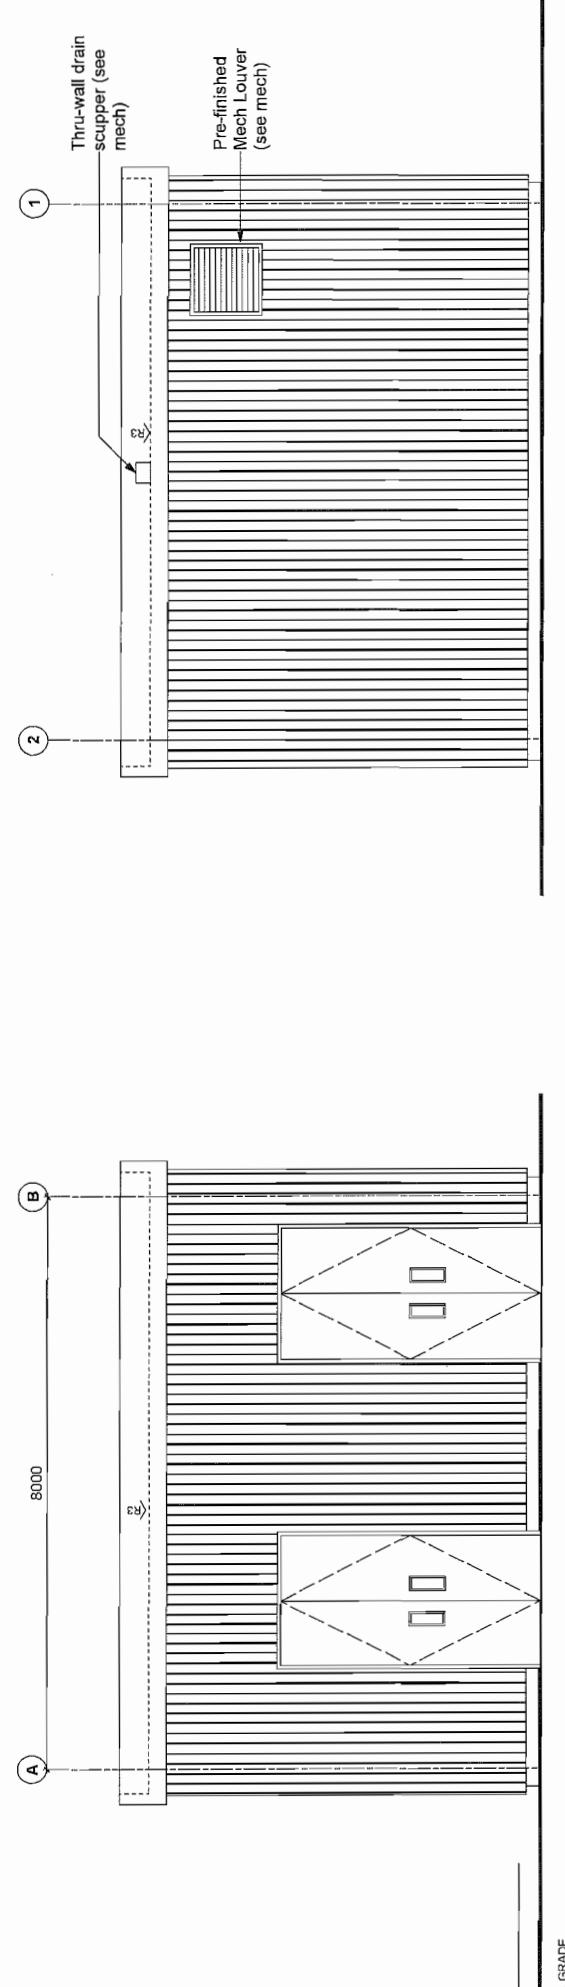
<b>CHECK PRINT</b>	
THIS DRAWING HAS NOT BEEN APPROVED AND MAY CONTAIN ERRORS AND OMISSIONS.	
Professional Seal	Date

GREATER VANCOUVER SEWERAGE AND DRAINAGE DISTRICT	
IONA ISLAND WWTP	
SOLIDS HANDLING UPGRADE	
PACKAGE 3 - DIGESTER MIXING	
AREA 10 - GENERAL SITES	
GRADING AND ROADWORKS	
Design: SFM	Drawn: PY
Checked: _____	Approved: _____
Manager: _____	
SUPERSEDES PRINTS OF THIS DRAWING NUMBER WITH LETTERS PREVIOUS TO P1	



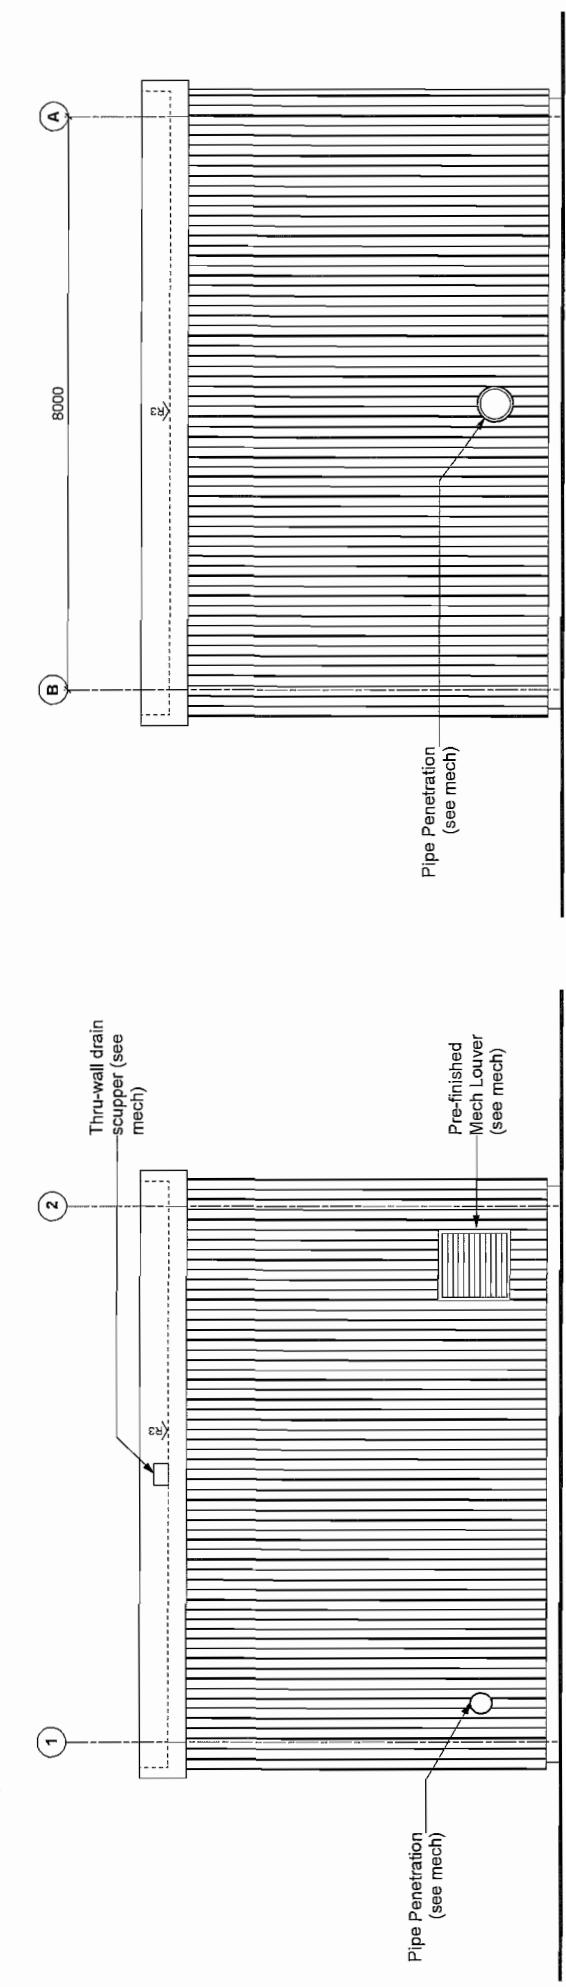
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SIDE ELEVATION

SCALE: 1:50



BACK ELEVATION

SCALE: 1:50

GREATER VANCOUVER SEWERAGE AND DRAINAGE DISTRICT		
Design:	BH	
Drawn:	DS	
Checked:	BH	
Approved:		
Manager:		
IONA ISLAND WWTP SOLIDS HANDLING UPGRADE PACKAGE 3 - DIGESTER MIXING		
AREA 71 - MIXING PUMP BUILDING EXTERIOR ELEVATIONS		
SUPERSEDES PRINTS OF THIS DRAWING NUMBER WITH LETTERS PREVIOUS TO → P1		
<b>CHECK PRINT</b>		
THIS DRAWING HAS NOT BEEN APPROVED, AND MAY CONTAIN ERRORS AND OMISSIONS.		
P2	AUG 2014 BH DS BH BH ISSUED FOR 90% DETAILED DESIGN	
P1	JUN 2014 BH DS BH BH ISSUED FOR 60% DETAILED DESIGN	
Issue	Date	Desg Dirn Chkd Appr
0		20Bar is 20mm On Original Drawing. If Not On This Sheet, Adjust Scales Accordingly.
Professional Seal		

**DIALOG®**

**CH2MHILL®**