

Report to Development Permit Panel

To:

Development Permit Panel

Date:

August 26, 2015

From:

Wayne Craig

File:

DP 12-624819

Di

Director of Development

Re:

Application by Matthew Cheng Architect Inc. for a Development Permit at 8200,

8220, 8280 and 8300 No. 1 Road

Staff Recommendation

That a Development Permit be issued which would permit the construction of 28 townhouse units at 8200, 8220, 8280 and 8300 No. 1 Road on a site zoned "Low Density Townhouses (RTL4)."

Wayne Craig

Director of Development

WC:ke

Staff Report

Origin

Matthew Cheng Architect has applied to the City of Richmond for permission to develop 28 townhouse units at 8200, 8220, 8280 and 8300 No. 1 Road on a site zoned "Low Density Townhouses (RTL4)". The dwellings on the site have been demolished and the site currently contains preload materials.

The four lots, which will be consolidated into one development site, are being rezoned from "Single Detached (RS1/E)" to "Low Density Townhouses (RTL4)" for this project under Bylaw 8929 (RZ 11-596490). The Public Hearing and 3rd Reading of the rezoning amendment bylaw was granted on September 5, 2012 A Servicing Agreement (SA 12-627162) for frontage upgrades along No. 1 Road is required to be completed as a rezoning consideration.

Development Information

Please refer to attached Development Application Data Sheet (Attachment 1) for a comparison of the proposed development data with the relevant Bylaw requirements.

Background

Development surrounding the subject site is as follows:

To the north, existing houses on lots zoned "Single Detached (RS1/E)";

To the east, existing houses on lots under Land Use Contract 102 in the Coldfall Court cul-desac:

To the south, existing houses on lots zoned "Single Detached (RS1/E)"; and

To the west, across No. 1 Road existing houses on lots zoned "Compact Single Detached (RC1)" and "Single Detached (RS1/E)".

Rezoning and Public Hearing Results

The Public Hearing for the rezoning of this site was held on September 5, 2012. At the Public Hearing, the following concerns about rezoning the property were expressed (responses are noted in Italics):

- 1. Location of visitor parking stalls adjacent to single-family homes to the east Through the rezoning, residents to the east noted concerns about the location of visitor parking contained within the 6 m (20 ft.) rear yard setback to the east next to the outdoor amenity for the project. As a result, the site plan was amended in advance of the Public Hearing to relocate all visitor parking outside of the rear yard setback, as shown in the Development Permit drawings.
- 2. Design interface and shadow impacts of the proposed development with single-family homes to the east.

The development maintains a 6 m (20 ft.) rear yard setback along the east edge of the site to the neighbouring single-family dwellings. Units that back onto the single-family

homes are oriented to provide a traditional rear yard interface (6 m or 20 ft. setback) at similar two-storey massing (8.2 m or 27 ft. building height) and a 3 m (10 ft.) north and south side yard setback. A shadow diagram has been submitted to show minimal impacts to surrounding properties. Privacy and overlook concerns are addressed through the design and orientation of the rear units of the development and proposed landscape buffer screen along the east edge of the site.

3. Tandem parking configuration for units along No. 1 Road.

A tandem parking configuration for only the buildings directly fronting No. 1 Road was outlined at rezoning. The proposed Development Permit application maintains this tandem parking configuration for 14 townhouse units fronting No. 1 Road proposed at rezoning. The remaining 14 townhouse units have two standard side by side parking stalls. The Zoning Bylaw allows 50% of required parking for the townhouse units only to be parked in tandem. The proposed tandem parking configuration complies with the Zoning Bylaw.

4. Potential impacts of the development on traffic through the existing residential neighbourhood to the east.

The proposed development provides the necessary off-street parking stalls required by the Zoning Bylaw of 2 parking stalls for each unit and a total of 6 visitor parking stalls. In response to concerns about increased traffic through the residential neighbourhood to the east, Transportation staff propose to monitor traffic in the neighbourhood before and after project completion/occupancy to identify any traffic pattern changes. Transportation staff plan to monitor traffic this upcoming fall to obtain initial traffic data. Follow-up traffic data collection will be sequenced with project build out and occupancy.

5. Retention of existing evergreen hedging along the east edge of the development site and shared with 8311 Coldfall Court

The existing evergreen hedge located along the east edge of the site (south side) and adjacent to 8311 and 8291 Coldfall Court is being retained as part of this development. Retention of this hedge has been reviewed by the consulting arborist and a tree protection zone has been established. The site and landscape plan has been designed to take into account the tree protection zone and ensure retention of the existing hedge.

Staff Comments

The proposed scheme attached to this report has satisfactorily addressed the urban design issues and other staff comments identified as part of the review of the subject Development Permit application. In addition, it complies with the intent of the applicable sections of the Official Community Plan and is in compliance with the "Low Density Townhouses (RTL4)" zoning district.

Advisory Design Panel Comments

The Advisory Design Panel was held on April 1, 2015. A copy of the relevant excerpt from the Advisory Design Panel Minutes from April 1, 2015 is attached for reference (Attachment 2). The design response from the applicant has been included immediately following the Advisory

Design Panel Comments. The Advisory Design Panel members supported the project and suggested design revisions have been incorporated into the project.

Analysis

Conditions of Adjacency

- The proposed development incorporates four (4) three-storey townhouse clusters that directly front onto No. 1 Road. These step down to two-storey massing along the north and south edges to provide transition to existing single-family homes. Six (6) two-storey duplex townhouse clusters are arranged along the rear portion of the site directly adjacent to existing single-family homes. Front and rear yard setbacks are maintained at 6 m (20 ft.) with 3 m (10 ft.) side yard setbacks, which will mitigate any potential overlook, privacy and shadowing impacts to existing single-family homes. The proposed conditions of adjacency of the townhouse project comply with the applicable Development Permit Guidelines for townhouse development along an arterial road.
- Currently, the elevation of the sidewalk and road along No. 1 Road are higher than the elevation of the lots to be developed and surrounding single-family homes. To address this grade difference, the project proposes to raise the finished grade of the site to generally match the elevation of the sidewalk and to meet the required minimum flood construction levels. Grade changes from the development site to the neighbouring single-family homes to the east will be dealt with through stepped retaining walls and landscaping within the project site to account for existing tree protection zone areas and avoid retaining walls directly adjacent to single-family homes.
- The vehicle entrance to the development located at the north edge of the site provides for additional setback and separation to the existing single-family home to the north. If redevelopment of the lots to the north occurs, vehicle access will be provided through this development and has been secured through a legal agreement as part of the rezoning. The location of the walkway mid-site to No. 1 Road provides for additional separation between the three-storey townhouse massing.
- The development site has a jog in the lot that results in a deeper lot depth for a portion of the
 consolidated development site. The existing geometry of the lot enables the outdoor amenity
 to be located in a central location and provides for a significant open/green space to abut the
 neighbouring single-family homes to the east to mitigate overlook concerns and potential
 shadowing impacts.

Urban Design and Site Planning

- Internal vehicle circulation is arranged around an internal T-shaped driveway through a main north-south running drive-aisle providing access to front and rear townhouse units with a small east-west running drive-aisle servicing a deeper portion of the site. This driveway layout enables all of the vehicle access to unit garages and visitor parking stalls to be internalized to the site and allows for on-site manoeuvring/turnaround for larger vehicles and trucks.
- A 6 m (20 ft.) front yard setback along No. 1 Road enables units fronting onto the arterial
 road to have a strong streetscape presence with direct pedestrian access at grade to the
 townhouses. This setback also allows space for appropriate landscaping and fencing in the
 open spaces for individual units and it transitions well to existing single-family homes in this
 area with similar landscaped front yard open spaces.

- The outdoor amenity area is located in a central location accessible to all units. A combination of play structure equipment, natural play features (rocks/logs), bench seating, bicycle racks and accompanying landscaping is featured in the amenity area with good southern exposure for natural sunlight. A dedicated pedestrian pathway located adjacent to the east-west drive-aisle provides a connection to the north-south running primary drive-aisle for the development. Additional pedestrian pavers are located in the drive-aisle to provide additional way-finding to the pathway to No. 1 Road. The total area of the outdoor amenity meets City requirements
- Garbage, recycling and organic waste service area is located in a dedicated enclosure that is
 incorporated into the three-storey building fronting No. 1 Road that is south of the drive-aisle
 entrance to the development. The enclosure is designed to blend in with the existing form
 and character of the building and reduces massing of this building adjacent to the drive-way
 entrance to one storey.

Architectural Form and Character

- The architect has reviewed surrounding building forms along No. 1 Road to the north and south of the subject site as well as single-family building forms in the residential area to the east. The proposed building form is contemporary with a combination of flat and asymmetrical roof lines featuring prominently throughout the development with matching finishing and cladding materials. This contemporary design approach does reference existing examples of other buildings in the area that demonstrate use of flat roof lines, strong vertical elements along the No. 1 Road frontage and asymmetrical roof forms in single-family homes.
- The project's rear units propose implementation of an asymmetrical roof form that provide a suitable transition from the contemporary flat roof form of development for buildings fronting onto No. 1 Road to the existing single-family homes located to the east of the site.
- The flat and asymmetrical roof forms in combination with the grading approach for the project helps to reduce the apparent scale and height of the development when compared to a townhouse project that implements traditional pitched roof forms.
- The overall contemporary form and modern architectural expression of the proposal was supported by the Advisory Design Panel and provides for enhanced architectural and built form variation of the No. 1 Road streetscape.
- Cladding and finishes (hardie lap siding/panelling; brick, cedar siding/soffits) are consistent
 with the contemporary design of the project. The cladding and colour are alternated in
 various ways within each building cluster and between building clusters along the No. 1
 Road streetscape. This avoids an overly repetitive expression and adds visual animation to
 the streetscape.
- Design detailing within the building elevations internal to the drive-aisle achieves a consistent implementation of cladding and finishes similar to the streetscape elevation along No. 1 Road including the application of cedar siding in building recesses and slatted cedar screens at unit entrances. This is intended to provide visual interest to the long drive-aisle.

Landscape Design and Open Space Design

• The landscape plan submission provides for an appropriate amount of deciduous and conifer trees to be planted on the subject site (60 total trees) to adequately compensate for tree removals required (29 on-site trees to be removed) and identified through the rezoning. The landscape plan also provides for the planting of two large evergreen trees at the pathway

- entrance to the development as recommended by City Tree Protection staff and retention of an existing evergreen hedge adjacent to neighbouring properties at 8311 and 8291 Coldfall Court as identified at Public Hearing through the rezoning.
- The open space for the townhouse units fronting No. 1 Road will have landscaping consisting of concrete walkways, lawn, a mix of deciduous/evergreen trees in combination with shrubs and groundcovers. The open space will be enclosed by a 1 m (3.5 ft.) tall metal fence.
- The open space for the rear townhouse units along the east edge of the site will have landscaping consisting of patio pavers and dividing screen/fence. Plantings consists of a mix of deciduous and evergreen trees in the open space along with a 1.8 m (6 ft.) tall wood perimeter fence and hedging implemented along the east edge to provide a suitable buffer screen to the neighbouring single-family homes. To address grading, the rear yard open spaces also contain a stepped wood retaining wall to transition back to the existing grade, thus avoiding the need for retaining walls located at the property line.
- A consistent design approach is implemented for the perimeter fencing and individual unit open space fencing/screening as well as the project signage and trellis entrance feature to the walkway along No. 1 Road that is coordinated with the contemporary design and finishing proposed for the buildings.
- A landscaping letter of credit/bond is required to be submitted through the Development Permit to secure the implementation of the proposed landscaping.

Crime Prevention Through Environmental Design

- Active and passive surveillance of the outdoor amenity area and mailbox enclosure area is achieved through the orientation of surrounding units to ensure visibility.
- Site lines are maximized within the internal drive-aisle through the large courtyard area created through at the intersection of the north-south and east-west drive-aisles.
- Landscaping and fencing is designed to enclose individual unit open spaces, providing privacy screens where needed but maintains visibility and site lines to unit doors/entrances.

Accessible Housing

- The proposed development includes one convertible unit that is designed with the potential to be easily renovated to accommodate a future resident in a wheelchair. The potential conversion of this unit will require installation of an appropriate vertical lift within a space in the unit that has been designed to accommodate a future lift.
- All of the proposed units incorporate aging in place features to accommodate mobility constraints associated with aging. These features include:
 - o stairwell hand rails;
 - o lever-type handles for plumbing fixtures and door handles; and
 - o solid blocking in washroom walls to facilitate future grab bar installation beside toilets, bathtubs and showers.

Sustainability Measures

• The rezoning application on this project was granted preliminary approval at the Public Hearing on September 5, 2012 prior to the City requiring energy efficiency guidelines for townhouses (i.e., solar hot water ready; Energuide 82 or Energy Star standards). Through the Development Permit application, the developer examined and determined that compliance

with current energy efficiency guidelines was not feasible as the primary components of building siting and design have already been established through the rezoning.

- Other sustainability measures incorporated into the project include:
 - O Use of energy efficient appliances (Energy Star rated product) and lighting fixtures throughout all units.
 - o Bathroom fixtures with water conservation measures (dual flush toilets).
 - o Permeable pavers and landscaping within setback areas to increase storm water retention.
 - o Retention of existing landscaping and hedging along the east edge of the site.

Conclusions

The proposed 28 unit townhouse complex has addressed surrounding adjacency conditions and complies with Development Permit guidelines for low-density multi-family developments located along arterial roads. The contemporary architecture proposed in this development makes reference to existing developments in the surrounding context and will add additional character and interest to the residential neighbourhood.

Kevin Eng Planner 2

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The following are to be met prior to forwarding this application to Council for approval:

Receipt of a Letter-of-Credit for landscaping in the amount of \$180,092

Prior to future Building Permit issuance, the developer is required to complete the following:

- The applicant is required to obtain a Building Permit for any construction hoarding associated with the proposed development. If construction hoarding is required to temporarily occupy a street, or any part thereof, or occupy the air space above a street or any part thereof, additional City approvals and associated fees may be required as part of the Building Permit. For further information on the Building Permit, please contact Building Approvals Department at 604-276-4285.
- Submission of a construction traffic and parking management plan to the satisfaction of the City's Transportation Department (http://www.richmond.ca/services/ttp/special.htm).



Development Application Data Sheet

Development Applications Department

DP 12-624819 Attachment 1

Address: 8200, 8220, 8280 and 8300 No. 1 Road

Applicant: Matthew Cheng Architect Inc. Owner: 0781829 BC Ltd.

Floor Area Gross: 3410.47 m² Floor Area Net: 3172.27 m²

| | Existing | Proposed |
|------------------|---------------------------|-------------------------------|
| Site Area: | 5330 m ² | 5289 m ² |
| Land Uses: | Vacant – Preload | Low-density townhouse |
| OCP Designation: | Neighbourhood Residential | No change |
| Zoning: | Single Detached (RS1/E) | Low Density Townhouses (RTL4) |
| Number of Units: | N/A | 28 units |

| | Bylaw Requirement | Proposed | Variance |
|---|-------------------------|--------------------------------|----------------|
| Floor Area Ratio: | 0.6 | 0.6 | none permitted |
| Lot Coverage: | Max. 40% | 40% | none |
| Setback – Front Yard: | Min. 6 m | 6 m | none |
| Setback – Side Yard (north): | Min. 3 m | 3 m | none |
| Setback – Side Yard (south): | Min. 3 m | 3 m | none |
| Setback – Rear Yard: | Min. 6 m | 6 m | none |
| Height (m): | Max. 12 m | 10.2 m | none |
| Off-street Parking Spaces – Residential | 56 parking spaces | 56 parking spaces | none |
| Off-street Parking Spaces – Visitor Parking | 6 parking spaces | 6 parking spaces | none |
| Total off-street Spaces: | 62 parking spaces | 62 parking spaces | none |
| Tandem Parking Spaces | Up to 50% permitted | 28 tandem parking spaces (50%) | none |
| Amenity Space – Outdoor: | Min. 168 m ² | 350 m ² | none |

Note:

Date: June 25, 2015 MCAI responses in *Red* PMG responses in *Green*

Advisory Design Panel Excerpt of April 1, 2015 Meeting Minutes

DP 12-624819 - 28-UNIT TOWNHOUSE DEVELOPMENT

APPLICANT:

Matthew Cheng Architect Inc.

PROPERTY LOCATION:

8200, 8220, 8280, 8300 No. 1 Road

Applicant's Presentation

Kush Panatch, President, Centro Properties Group, Architect Matthew Cheng, Matthew Cheng Architect Inc., and Landscape Designer Denitsa Dimitrova, PMG Landscape Architects, presented the project on behalf of the applicant and answered queries from the Panel.

Panel Discussion

Comments from the Panel were as follows:

- appreciate the provision of a space for art work at the entry to the proposed development; suggest that the applicant consult with the City's public art planner regarding the public art process; OneWest have decided not to proceed with any art work on site. They will be making payment in-lieu to the City's public art fund.
- the project is on the right track from a sustainability perspective; suggest that the applicant choose LED lights to save energy; also suggest that the applicant engage the services of a consultant at this stage of the project to do the analysis for Energuide 82 rating; applicant should also choose true energy star appliances consistent with ASHRAE 90.1 standards; *Will Proceed*
- appreciate the provision of a convertible unit; however, there are opportunities for improvement; identify a suitable space in the garage for future location of a vertical lift as opposed to the ground floor hallway; also consider reorienting the washrooms and bedrooms on level 2 to provide more workable entries; also consider introducing pocket doors in lieu of swinging doors; **PROVIDED Door of the Vertical Lift is provided to conveniently access coming out of the Garage.
- provision of one convertible unit for 28 townhouse units is inadequate; consider providing three convertible units for the proposed development; *Under Section 3.4 of OCP*, it states that "establish a certain percentage of townhouses with convertible housing" Therefore, there is no written bylaw of required number of convertible units.

- appreciate the public art proposal; *No comment*
- right scale along No. 1 Road; however, the flat roofs appear monolithic and in stark contrast to the neighbouring developments; consider design development to lessen the starkness and provide more variety in roof forms; **PROVIDED Stepping down of building 4C to two storey adds to the varied roof lines. Total of 6 varied rooflines provided along No. 1 Rd.
- reconsider use of reveals in some elevations; **PROVIDED
- appreciate the use of wood which provide warmth to the townhouse units; No comment
- proposed townhouse development is daring; refreshing to see a townhouse development trying to be different; *No comment*
- like the buildings at the back; roof forms look residential; *No comment*
- service rooms adjacent to the drive aisle entrance to the development pop out and do not integrate well with the building block; consider de-emphasizing the service rooms and integrating them more with the residential building block; **PROVIDED To enhance and activate the street edge, brick continues to wrap around the garbage/recycling room which integrates into the overall architecture of the building block. Also, roof of the garbage/recycling area is extended to the roof Unit 1 to de-emphasize and blend into the building block.
- appreciate the simplicity of the townhouse entries off No. 1 Road; No comment
- the contemporary style of the townhouse development looks good; *No comment*
- the 6-meter front and back setbacks are too big and results in a minimal internal drive-aisle space with reduced opportunities for landscaping; the proposed development looks flat and has a claustrophobic feel; opportunities for landscaping are lacking; consider design development to the roof forms to lessen the claustrophobic feel; *Roof Form Comment supersedes the comment above*.
- cedar should be used on the soffits, not on the walls due to durability issues; investigate the use of aluminum or other products that look like wood but are more durable to the elements; *Will Proceed*
- review the size of the two windows on the front elevation; **PROVIDED
- appreciate the smaller townhouse blocks in the proposed development; *No comment*
- appreciate the model presented by the applicant which provides a lot of detail; No comment
- like the high ceilings and good livability of the townhouse units; exterior architecture is bold and heavy-handed; appreciate the strong materials; however, consider a gentler colour palette; *No comment*

- separation between the building blocks are very tight; consider design development and review the location of the side windows to address adjacency and privacy issues; also consider design development for side windows at the stairway in the back units; **PROVIDED to address adjacency, privacy issue and mechanical units in between, side window is reduced. Window in the stairway is raised 7'-8" from the landing to reduce the privacy issue to the neighbourhood but still bringing natural light into the building.
- notice the lack of habitable space at grade along No. 1 Road; look at incorporating flex rooms at least in the corner units to provide animation and pedestrian interest at grade level; **PROVIDED Bedroom is provided in Unit 1 & 16 along No. 1 Rd.
- consider closing off the main walkway from the development to No. 1 Road as the walkway does not link with anything in the townhouse proposal; the walk access has been retained. Response to look at making the connection to the internal part of the site more pedestrian friendly by extending special paying to meet the walk
- consider design development to the utility closets, entry signage and art wall adjacent to the vehicular entry to make them more cohesive; *Entry Signage proposed*
- commend the applicant for integrating public art in the proposed development; artist should be allowed more freedom and creativity in the choice of medium for public art; reconsider the implementation of the trellis along the art wall as it may detract from the public art feature of the project; No Art wall proposed; trellis deleted along this edge. Plantings buffer this edge in updated version.
- relationship of the townhouse units with the bus stop is challenging; look at opportunities to strengthen the buffering; the screening of the bus stop has been increased with lattice screen as well as hedge. Lattice screen detail added.
- consider design development to the paving of the long driveway to visually break it down; the added special paving at the intersection of the internal roads breaks up the long driveway
- look at the long-term survivability and viability of plant materials on the tight spaces between the townhouse buildings; consider alternative landscaping materials for easier management by the strata; the areas of plantings have been replace by gravel in areas where long term viability may be in question.
- the applicant is encouraged to consult an arborist to review the survivability of plant materials under the existing trees; the arborist has reviewed the plantings under trees and advised that plantings appropriate.
- consider design development to the landscaping at the east end of the development and its relation to the outdoor amenity space, e.g. review the shape of the planters and type of trees; the amenity area layout and trees have been reviewed and slightly amended to have less shade in the play area.
- concerned with the mechanical units being visible in the yards; and the plan calls for
 plantings at the front part of the areas between units to screen where mechanical
 units area placed. (mechanical units will be placed on roof tops or balconies and
 hidden from view)

agree with comments regarding the need to better relate the landscaping structures with the overall architecture of the project. The fences, arbour and screens have been redesigned to be less in the traditional style and to co-ordinate with the more contemporary architectural expression.

Panel Decision

It was moved and seconded

That DP 12-624819 be supported to move forward to the Development Permit Panel subject to the applicant giving consideration to the comments of the Panel.

CARRIED

Opposed: Tom Parker



Development Permit

No. DP 12-624819

To the Holder:

Matthew Cheng

Property Address:

8200, 8220, 8280 and 8300 No. 1 Road

Address:

202 - Evans Avenue


Vancouver, BC V6A 2K9

- 1. This Development Permit is issued subject to compliance with all of the Bylaws of the City applicable thereto, except as specifically varied or supplemented by this Permit.
- 2. This Development Permit applies to and only to those lands shown cross-hatched on the attached Schedule "A" and any and all buildings, structures and other development thereon.
- 3. Subject to Section 692 of the Local Government Act, R.S.B.C.: buildings and structures; off-street parking and loading facilities; roads and parking areas; and landscaping and screening shall be constructed generally in accordance with Plan #1 to Plan #25 attached hereto.
- 4. Sanitary sewers, water, drainage, highways, street lighting, underground wiring, and sidewalks, shall be provided as required.
- 5. As a condition of the issuance of this Permit, the City is holding the security in the amount of \$180,092 to ensure that development is carried out in accordance with the terms and conditions of this Permit. Should any interest be earned upon the security, it shall accrue to the Holder if the security is returned. The condition of the posting of the security is that should the Holder fail to carry out the development hereby authorized, according to the terms and conditions of this Permit within the time provided, the City may use the security to carry out the work by its servants, agents or contractors, and any surplus shall be paid over to the Holder. Should the Holder carry out the development permitted by this permit within the time set out herein, the security shall be returned to the Holder. The City may retain the security for up to one year after inspection of the completed landscaping in order to ensure that plant material has survived.
- 6. If the Holder does not commence the construction permitted by this Permit within 24 months of the date of this Permit, this Permit shall lapse and the security shall be returned in full.

Development Permit No. DP 12-624819

| To the Holder: | Mattnew Cheng |
|---------------------------------|---|
| Property Address: | 8200, 8220, 8280 and 8300 No. 1 Road |
| Address: | #202 - Evans Avenue Vancouver, BC V6A 2K9 |
| | |
| | n shall be developed generally in accordance with the terms and s of this Permit and any plans and specifications attached to this a part hereof. |
| This Permit is not a Build | ding Permit. |
| AUTHORIZING RESOLUT DAY OF , | TION NO. ISSUED BY THE COUNCIL THE |
| DELIVERED THIS | DAY OF . |
| | |
| | |
| MAYOR | |
| | |



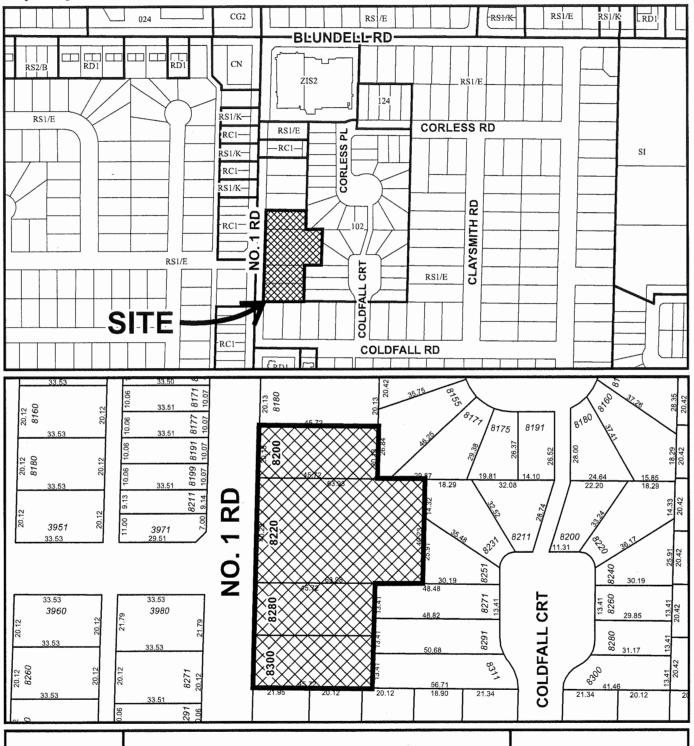



DP 12-624819 SCHEDULE "A"

Original Date: 11/28/12

Revision Date: 08/21/15

Note: Dimensions are in METRES

ISSUED FOR DEVELOPMENT PERMIT

DRAWING LIST

CIVIC ADDRESS:

8288 No. 1 Road, Richmond.

LEGAL ADDRESS:

1. 8200 NO. 1 ROAD, RICHMOND

LEGAL DESCRIPTION: P.I.D. 008-971-978 SOUTH HALF OF LOT 309 SECTION 23 BLOCK 4 NORTH RANGE 7 WEST NEW WESTMINSTER DISTRICT PLAN 52748

Unit 202 - 670 EVANS AVENUE VANCOUVER, BC V6A 2K9 Tel: (604) 731-3012 / Fax: (604) 731-3908 Cel: (604) 649-0669 / Email: matthew@mcai.ca

MATTHEW CHENG

ARCHITECT INC.

2. 8220 NO. 1 ROAD, RICHMOND

LEGAL DESCRIPTION: P.I.D. 009-939-008
LOT 17 EXCEPT: PART SUBDIVIDED BY PLAN 53609; SECTION 23
BLOCK 4 NORTH RANGE 7 WEST NEW WESTMINSTER DISTRICT PLAN 14449

3. 8280 NO. 2 ROAD, RICHMOND

LEGAL DESCRIPTION: 004-185-587 LOT 717 EXCEPT: THE NORTHERLY PORTION, SECTION 23 BLOCK 4 NORTH RANGE 7 WEST NEW WESTMINSTER DISTRICT PLAN 51164

4. 8300 NO. 1 ROAD, RICHMOND

LEGAL DESCRIPTION: P.I.D. 003-927-679 NORTH HALF LOT 717 SECTION 23 BLOCK 4 NORTH RANGE 7 WEST NEW WESTMINSTER DISTRICT PLAN 51164



OneWest - 8288 No. 1 Road, Richmond

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Checked: MC

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COVERPAGE

12-624819 AUG 2 6 2015

Address: 8200, 8220, 8280 and 8300 No. 1 Road, Richmond BC
Centro OneWest
Applicant: Matthew Cheng Architect Inc.
Owner: Development Ltd.

MATTHEW CHENG ARCHITECT INC. Using age. 400 PEAN SA MENUE VANCOUTRE, BC V Ne. 2020 Tet (600) 153-2026 Pean I matthew (2020) 153-2028 Cel. (609) 630-2659 Pean II matthew (2020)

3172.27 m2 (34,146 sf)

Floor Area Net:

Applicant: Matthew Cheng Architect Inc.
Planning
Area(s): Seafair
Floor Area
Gross: 3410.47 m² (36,7:0 sf)

THIS DRAWING MUST NOT BE SCALED. THE
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| | Existing | Proposed |
|------------------|----------------------------|----------------------------|
| Site Area: | 5330.09 m² | . 5288.81 m² |
| Land Uses: | SINGLE DETACHED | TOWNHOUSE |
| OCP Designation: | LOW-DENSITY RESIDENTIAL | LOW-DENSITY RESIDENTIAL |
| Zoning: | RS1/E | RTL4 |
| Number of Units: | 4 | 28 |

| | Bylaw Requirement | Proposed | Variance |
|--|------------------------|------------------------|----------|
| Floor Area Ratio: | 09.0 | 0.60 | none |
| Lot Coverage: | Max. 40% | 40% | Z |
| Setback - Front Yard: | Min. 6m | 6т | Z |
| Setback - Side Yard: | Min. 3m | 3 m | Z |
| Setback - Side Yard: | Min. 3m | 3 m | Z |
| Setback - Rear Yard: | Min. 3m | 6 m | z |
| Height (m): | Max. 12m | 10.2 m | z |
| Lot Size: | 5330.09 m² | 5288.81 m ² | Z |
| Off-street Parking Spaces – Regular/Commercial: | 56 and 6 | 55 and 6 | z |
| Off-street Parking Spaces – Accessible: | 4 | 1 | Z |
| Total off-street Spaces: | 62 | 62 | Z |
| Tandem Parking Spaces | not permitted | 28 | z |
| Amenity Space - Indoor: | Min. 70 m ² | CASH-IN-LIEU | Z |
| Amenity Space - Outdoor: | Min. 168 m² | 350 m² | Z |

OneWest - 8288 No. 1 Road, Richmond

Centro

DEVELOPMENT DATA & CONTEXT MAP

Building Height:

BLDG A – 9.6m (31'-6") BLDG B – 10.2m (33'-6") BLDG C – 9.6m (31'-6") BLDG D – 8.2m (26'-10") BLDG E – 7.9m (25'-9")

AUG 2 6 2015 PLAN #2

Scale: 1" = 40'-0"

Drawn: DC Checked: MC

> 624819 12-(

A01

Print Date: 08/27/15

| Baseline Service | |
|------------------|---------------------|
| Ou ogra o o ogna | az one asone as one |
| GAOR 1.ON | 9 8FDG18 OP SGT8 |

PACEMORE AVENUE

(1) CONTEXT PLAN



GILMORE PARK UNITED CHURCH

ALONG NO. 1 RD - FACING EAST



















MATTHEW CHENG

ARCHITECT INC.
Unit 2022 - 6070 EVANS A VENUE
VANCOLVER, BC V VA A XE9
Tel: (604) 731-301.7 few: (604) 731-398
Cel: (604) 649-0669/ Finali maniforvi@meai.



OneWest - 8288 No. 1 Road, Richmond

SITE CONTEXT / VISUAL CUES

| | | 0- | |
|-----------|-------------|---------------|-----------------|
| 20 | MC | 3/64" = 1'-0" | ımber; |
| Drawn: DC | Checked: MC | Scale: | Project Number: |

A02

12 - 624819AUG 2 6 2015 PLAN #3

ALONG NO. 1 RD - FACING EAST



I. Gilmore Park United Church



2. 8720, 8820, 8860, 8800, 8900 No. 1 Rd



3. 4211 Francis Rd.



4. 4420/4431 Coldchester Drive

Visual Cues

two main axis, Blundell Road and Francis Road which connects to the The OneWest Development is situated on an arterial road between series of commercial, religious, community centre, schools, singlemain city centre of Richmond. The development is surrounded by surrounding context, we have observed the architecture in the neighbourhood to look for visual cues that is referenced in the family residential to multi-family residential. Respecting the OneWest Development.

- Gilmore Park United Church Located along No. 1 Rd, just North of OneWest development on Blundell Road, we have continued the similar visual language such as; flat roof, variation of rooflines and tactile materials used as cladding along No. 1 Rd to enhance the street level experience.
- taken visual cues such as; flat roof, building height and colour of the 2. 8720, 8820, 8860, 8800, 8900 No. 1 Rd - Located along No. 1 Rd, just South of OneWest development on Youngmore Rd, we have exterior siding.
- 3. 4211 Francis Rd Adjacent to the 8720, 8820, 8860, 8800, 8900 No. 1 Rd on Francis Rd towards the single family development, we have continued and translated the same visual language such as; asymmetrical gable roof form, material palette as cladding.
- 4. 4420/4431 Coldchester Drive Behind the Rear units of OneWest translated the visual cues such as; asymmetrical gable roof form. development towards the single family development, we have

OneWest Townhouse Development at 8200, 8220, 8280 and 8300 No. 1 Road, Richmond, B.C.

DESIGN RATIONALE

Overview/Site

transition into the single family properties to the East. OneWest development is compatible in in RTL4 Zoning. Along the No. 1 Road as a face of the townhouse development, there will be a a stand-alone structure, the garbage and scale and from within the surrounding developments. The children's Play area and Outdoor street edge and add visual interests to the streetscape along the No. 1 Road. A garbage and recycling area will be located on north of the recycling area will be incorporated into architecture that will enhance the overall composition as buildings are 2-storey duplexes and they Matthew Cheng Architect and Centro OneWest Development Ltd. are submitting a package issued for the Development Permit Panel. "OneWest" is a 28-unit townhouse of FAR of 0.6 located site away from the outdoor amenity space, near the entrance of the driveway that will be easily Amenity Area are located in a centralized area where there is less vehicular traffic for safety row of 3-storey urban townhouses that will activate the it steps down from 3 storeys to 1 storey. The rear accessible by the garbage trucks. Instead of being reasons.

Accessibility

to the No.1 Road. A handicapped parking space is conveniently located close to the convertible A dedicated pedestrian walkway with the accessible path is located between Building 2B and 3B unit with the accessible path.

Building Scale/ Form/ Materials

MATTHEW CHENG

Unit 202 - 670 EVANS AVENUJE VANCOUVER, BC V6A 2K9 Tel: (604) 731-3012 / Fax: (604) 731-3908 Cel: (604) 649-0669 / Email: matthew@nca ARCHITECT INC.

Front Units

will add warmth to pedestrian experience looking from below. Series of "Floating Balconies" is a experience for pedestrians walking along the No. 1 Road. By wrapping the brick around the Floor. Also, the cedar siding is used as an accent material to highlight the entrance and the third level is to add lighter yet contemporary look and feel that is complimentary of the building's igorous architectural expression that will animate the Streetscape along the No. 1 Road. The variation of the height and rooflines provide visual diversity and work within the overall form of the balconies are choreographed in various sizes to create rhythmic expression that will activate the Street Edge and create visual interest. The balconies are positioned towards north to create The individual units of the front buildings along the No. 1 Road are staggered to articulate the verticality of each unit. By doing this, it also helps break up the flatness of the elevation. The development. The two end buildings also step down to 1 storey by the driveway and 2 storeys in South that are intended to respect the surrounding neighbouring buildings. The brick on the ground floor elevation is intended to activate the street edge and to enhance the street level building, it will enrich human scale especially in the entrance walkways. The use of Cedar Siding is to bring warmth and natural material and to contrast from the use of heavy brick on the Ground window wall in its vertical expression. The use of fibre-cement reveal panels on the second and use as wood and brick. A large roof overhang with a fibre cement soffit (to match cedar siding) privacy and to allow more natural light.

Rear Units

heavy brick. The large roof overhang with the fibre cement soffit (to match cedar siding) will add urban form. The use of Cedar Siding is to bring warm material palette and to contrast from the The 2-storey duplexes in the rear units reflect the single family character, working cohesively within the overall development. The rear buildings aim to introduce the same architectural language throughout the development, yet creating a new place-making within the development. The variation of the height and rooflines provide the visual diversity and articulation within the warmth to pedestrian experience looking from below.



OneWest - 8288 No. 1 Road, Richmond


DESIGN RATIONALE


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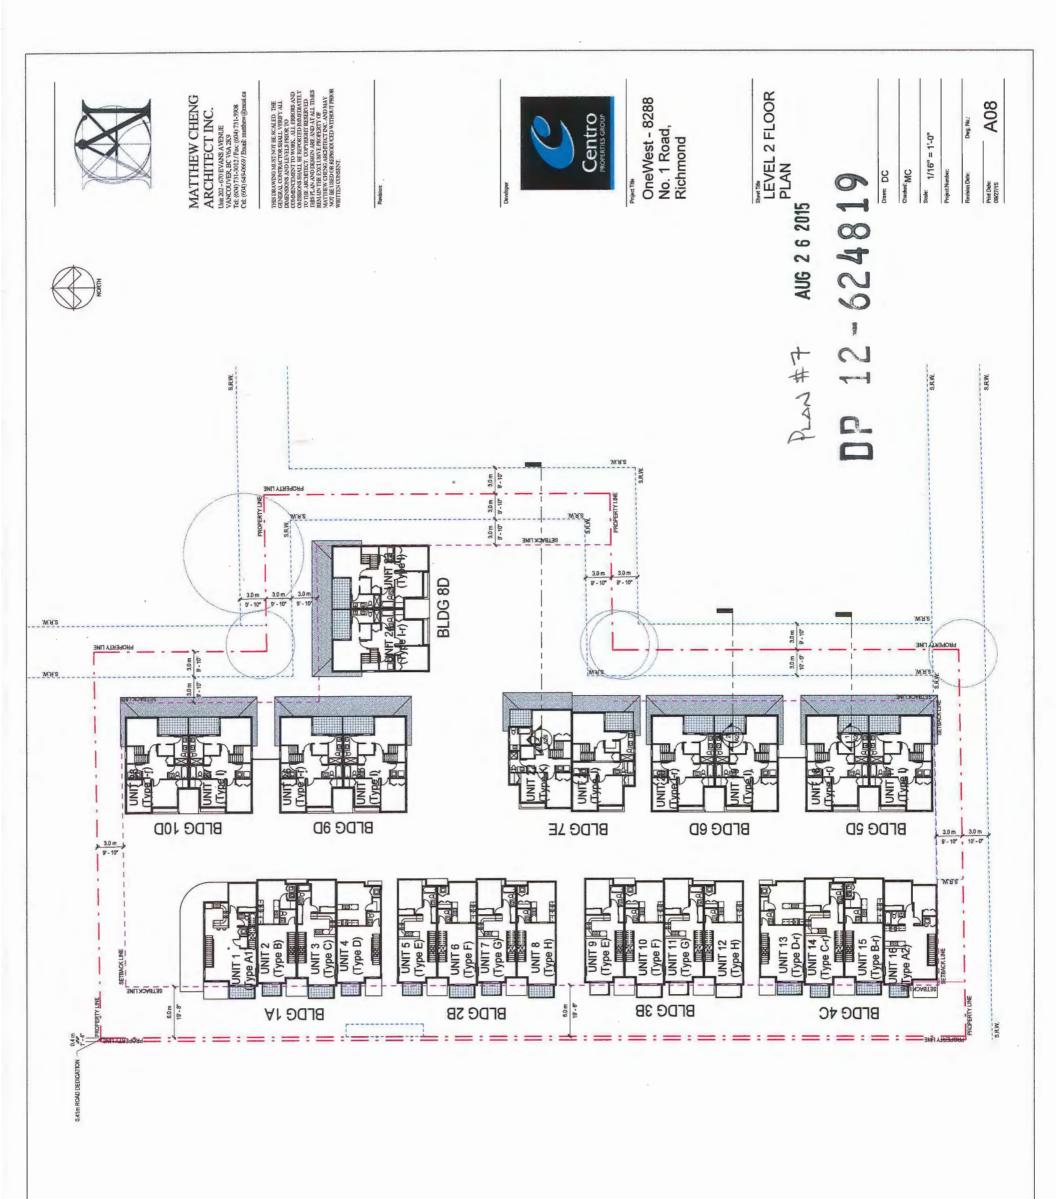
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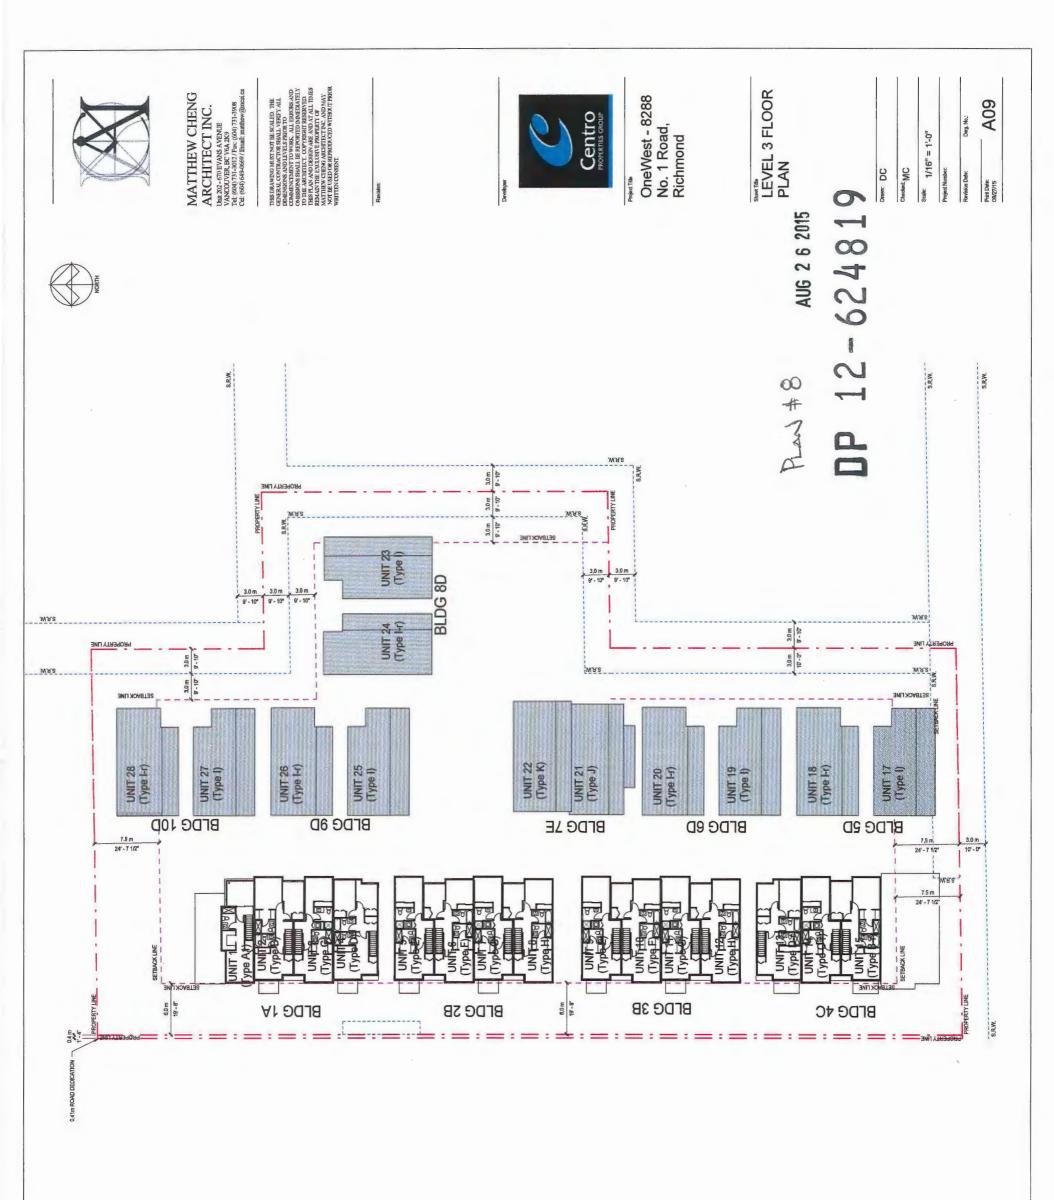
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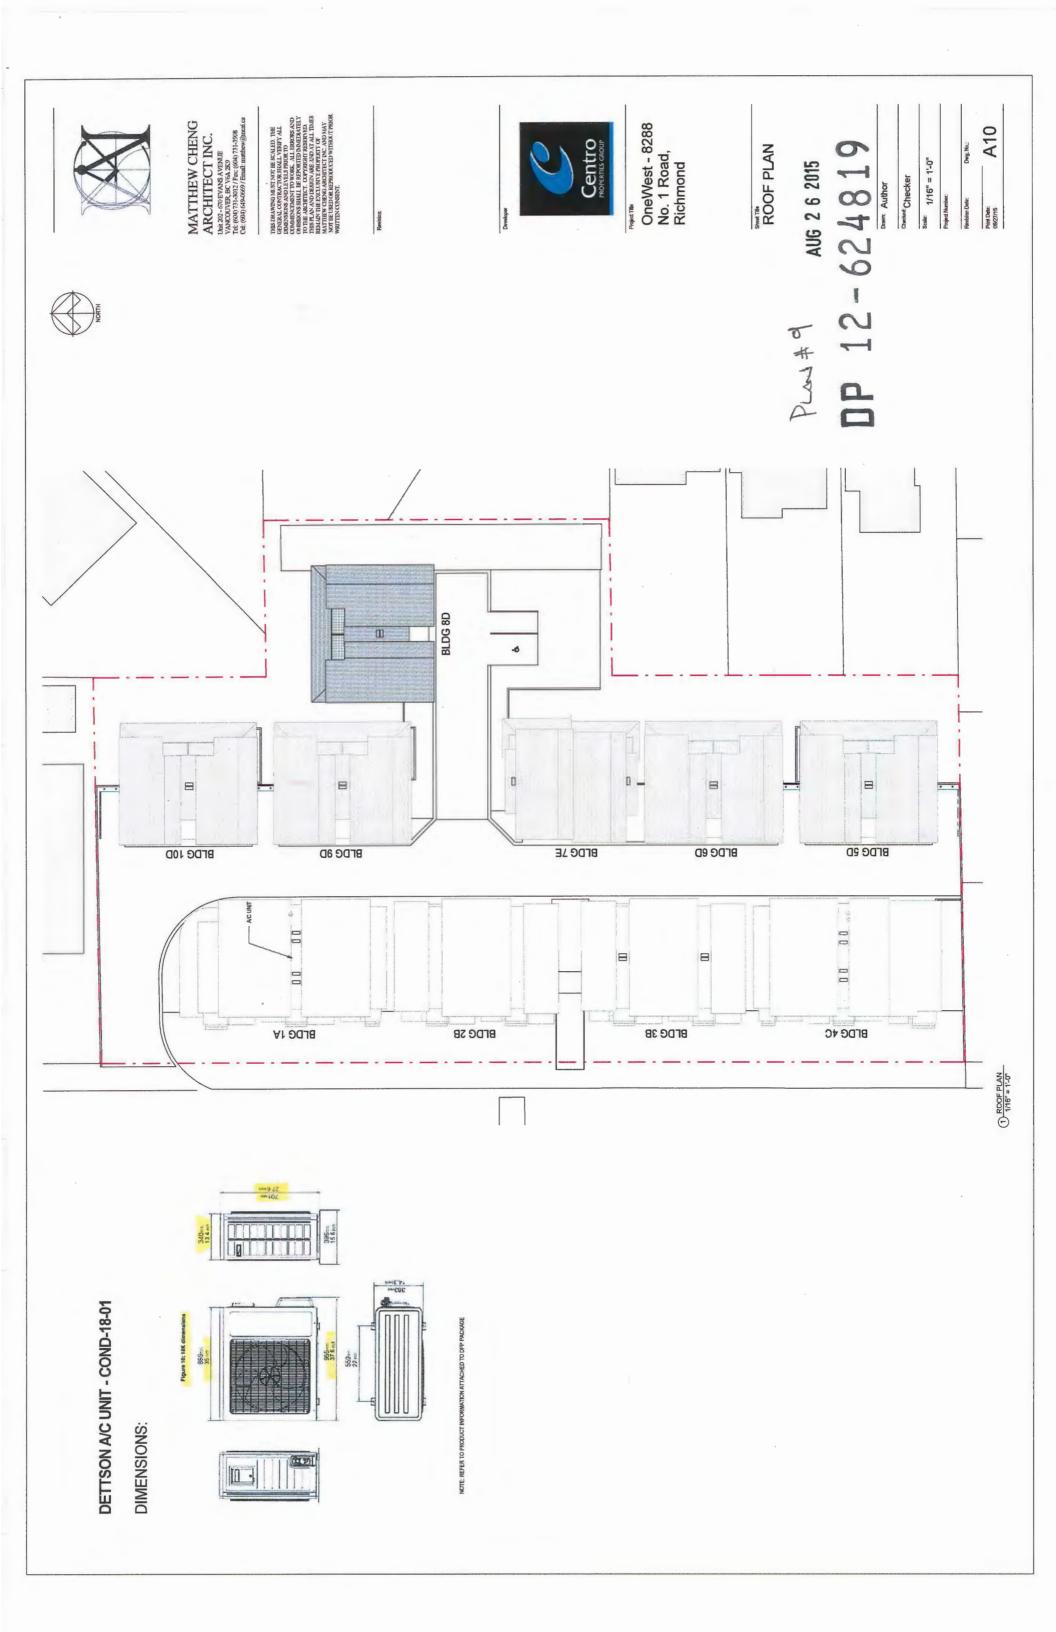
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MATTHEW CHENG ARCHITECT INC. Unit 202 - GOVERNAS APRENIE VANCOUVER, BC V/62, 2020 Tet (660)731-3308 CE (660) 520-5009 Tennit menthew @maxica

RS

Centro PROPERTIES GROUP

OneWest - 8288 No. 1 Road, Richmond

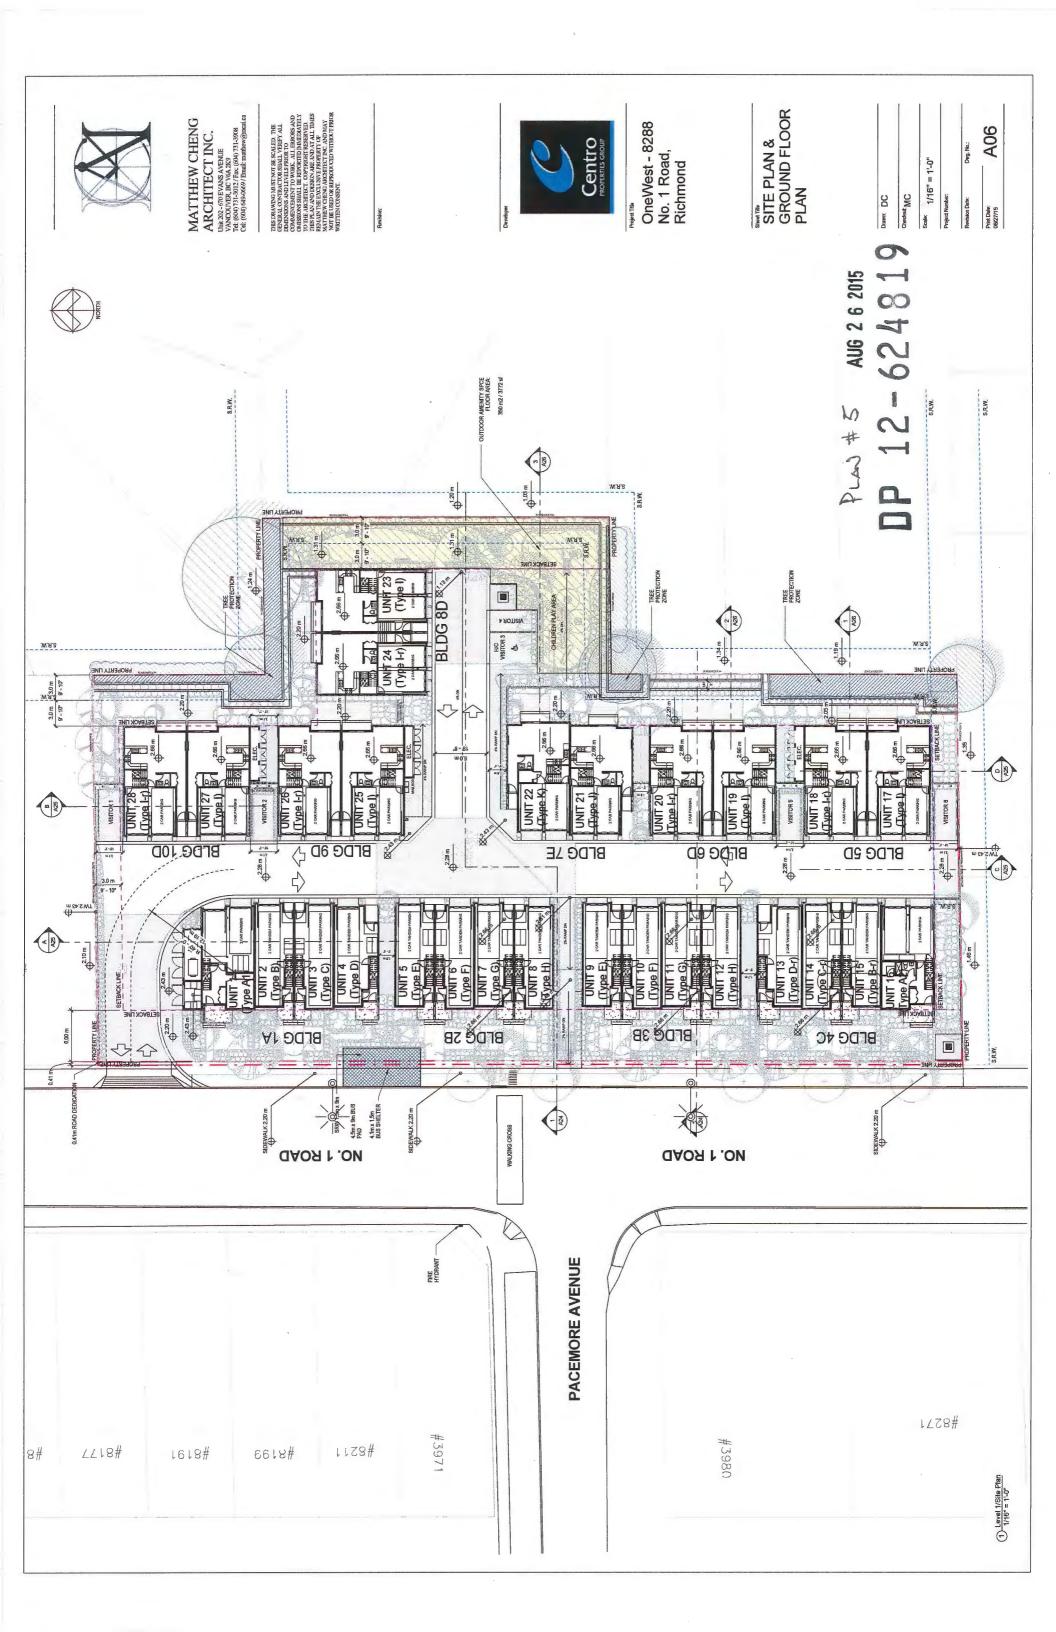STREETSCAPE ELEVATION -FRONT BLDGS (ALONG NO. 1 RD)

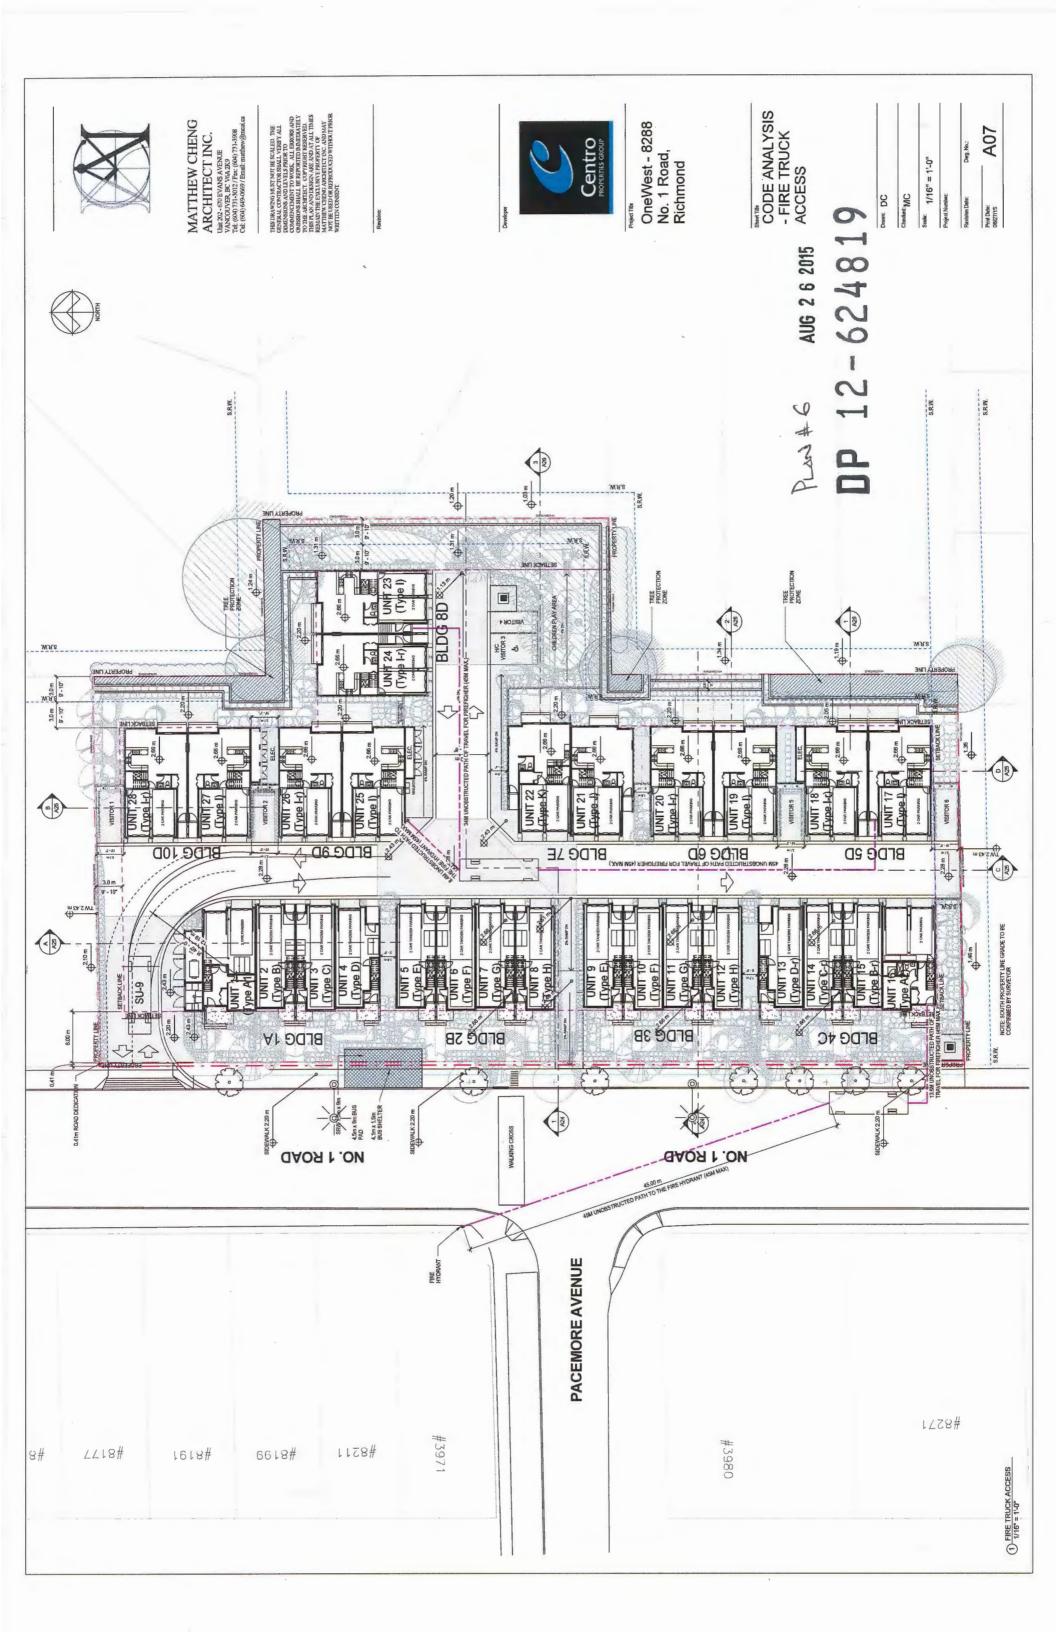Checked: MC Drawn: DC

A11 Dwg. No.: Revision Date:

624819

12-

PLAN #10

Scale: 1:150

(1) Front Bldgs - West (FACING NO.1 RD)



MATTHEW CHENG ARCHITECT INC. Union-one-wars arent vancouver be (was 2020) 14: (604) 711-308 (ct. (604) 711-308 (ct. (604) 519-2020) Tenni mathews@matica

Centro PROPERTIES GROUP

OneWest - 8288 No. 1 Road, Richmond

STREETSCAPE ELEVATION -REAR BLDGS

Checked: MC Diamic DC

Scule: 1:150

A12

Rear Bidgs- East

DP 12-624819 AUG 2 6 2015

1: 150


- Horizontal Cedar Siding (Semi Solid Oxford Brown Benjamin Moore)
- Light Sandstone Endicott
- Hardle Revzal Panel Benjamin Moore (2022-19) Hardle Revzal Panel Benjamin Moore (2111-50) 4, Fibreglass Door - Benjamin Moore (2111-50)
- 9. Hardie Soffit to match Cedar Siding

HardlePanel Vertical Siding - Benjamin Moore (2111-50)

- 10. Aluminium Garage Door w/ Solid Panels & Obscured Glass on top Charcoal
- Hardie-Panel Vertical Siding (Balconty)- Benjamin Moore (2111-50)
 Sofft (Balconty) Benjamin Moore (2111-50)
 Aluminium Stefront Door w/ Obscured Glass Charcoal





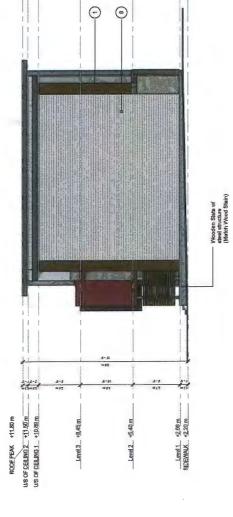

2 BLDG A - South 1/8" = 1'-0"

0

Θ 9

Level 3 +6.45 m


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(P)

3 BLDG A - East 1/8" = 1'-0"

SIDEWALK +2.20m SAL

Level 2 45.40 m

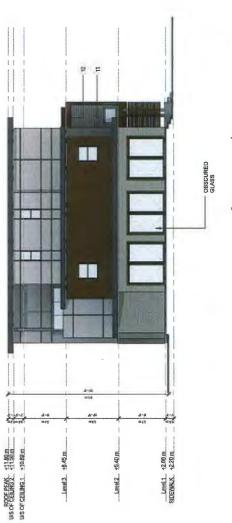

AUG 2 6 2015 Pia # 12

(4) BLDG A - North 1/8" = 1'-0"

DP 12-624819



MATTHEW CHENG ARCHITECT INC. List 202. - 600 EVANS AREALE VANCOUTER, BC VRA 2020 THE (6004) 73-1001 Time (4007713-3008) CR (6004) 630-2020 | Email pranthew (300-2020)

Centro

OneWest

BLDG A -BUILDING ELEVATIONS

Drawn: DC

Scale: As indicated Chacked: MC

Dwg. No.:

A14

BLDG 2B

Hardis Reveal Panel (Balcony) - Benjamin Moore (2125-70) Hardle Reveal Panel - Benjamin Moore (2111-50) Fibreglass Door – Benjamin Moore (2082-10)

Hardie Soffit to match Cedar Siding

9. Aluminium Garage Door wi Sodid Panels & Obscured dass on top - Charcoal
10. Handlebrad Vertical Siding (Balcony) - Benjamin Moore (2012-10)
11. Sorfit (Balcony) - Benjamin Moore (2012-10)

BLDG 3B

Horizontal Cedar Siding (Semi Boli stain – Benjamin Moore)

11. Soffit (Balcony) - Benjamin Moore (2111-50)

00


NOSEPEAK +1241m UNS GELLIGG +11,50m UNS GELLIGG 1, +10,00 m

Level 3 +8.45 m

Leyel 2, +5.40 m.

MATTHEW CHENG ARCHITECT INC. Unit 202 - 670 EVANS AVENUE VANCOUNTE, BC VIGAS TOE Tet (690) 731-3012, Free, (690) 731-3508 Cet (604) 649-6659 / Famili matthow@menica

 Sterns brosspot Smooth brick – Endicott
 Fibregiass Door – Benjamin Moore (2111-30)
 Hardie Reveal Panel (Balcory) - Benjamin Moore (282-10)
 Hardie Reveal Panel - Benjamin Moore (2111-30) S. Hardie Reveal Panel (Balcony) - Benjamin Moore (2012-10)
T. SPS Membrane
A. Hardie Sonft to match Cedar Siding
P. Alemibian Gazage Door vel Solid Panels & Obscured Glass on top - Charcol
Hardie Solid Panels (Balcony) - Benjamin Moore
10. Hardiebanel Vertical Siding (Balcony) - Benjamin Moore
(2111-49)

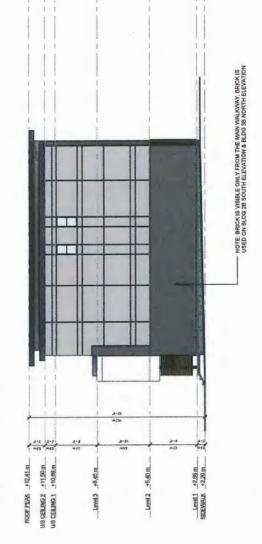

0

3 South 1/8" = 1'-0"

0

- Wooden Slats w

SIDEWALK +2.68 m.

4 West

Centro PROPERTIES GROUP

OneWest

BLDG B -BUILDING ELEVATIONS

US CEILING 2 +11,50 m...

DATE OF THE PARTY OF THE PARTY

ROOF PEAK +1241 m.

Level 3 +8.45 m

Leyel 3 +8.45 m

ROOF PEAK +1241 m.

Scale: As indicated Drawn: DC Checked: MC AUG 2 6 2015

A16

DP 12-624819

P.M #13

2 North 1/8" = 1'-0"

SIDEWALK +2.20 m.

a

SIDEWALK +2.20 m.

Level 2 +5.40 m

0

1/8" = 1:0"

- - HardkePanel Vertical Siding (Balcony) Benjami






3 BLDG C - South



1) BLDG C - East

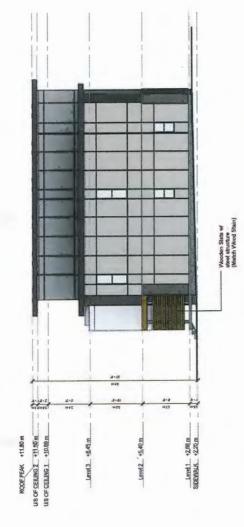

MATTHEW CHENG ARCHITECT INC. Listans. STORYMS APRIE VANCOUNTER BY VANCOUNTS AND THE (604) 731-3308 CR (604) 510-3025 [Paul' mathew@mata.

Centro PROPERTIES CROUP

OneWest

NSOF PEAK 11.80 m ... 11.80 m

Level 3 +6.45.m

Level 2 +5.40 m

BLDG C -BUILDING ELEVATIONS

Dawn: DC Checked: MC Scale: 1/8" = 1'-0"

PLAN # 14


SIDEWALK +2.70m


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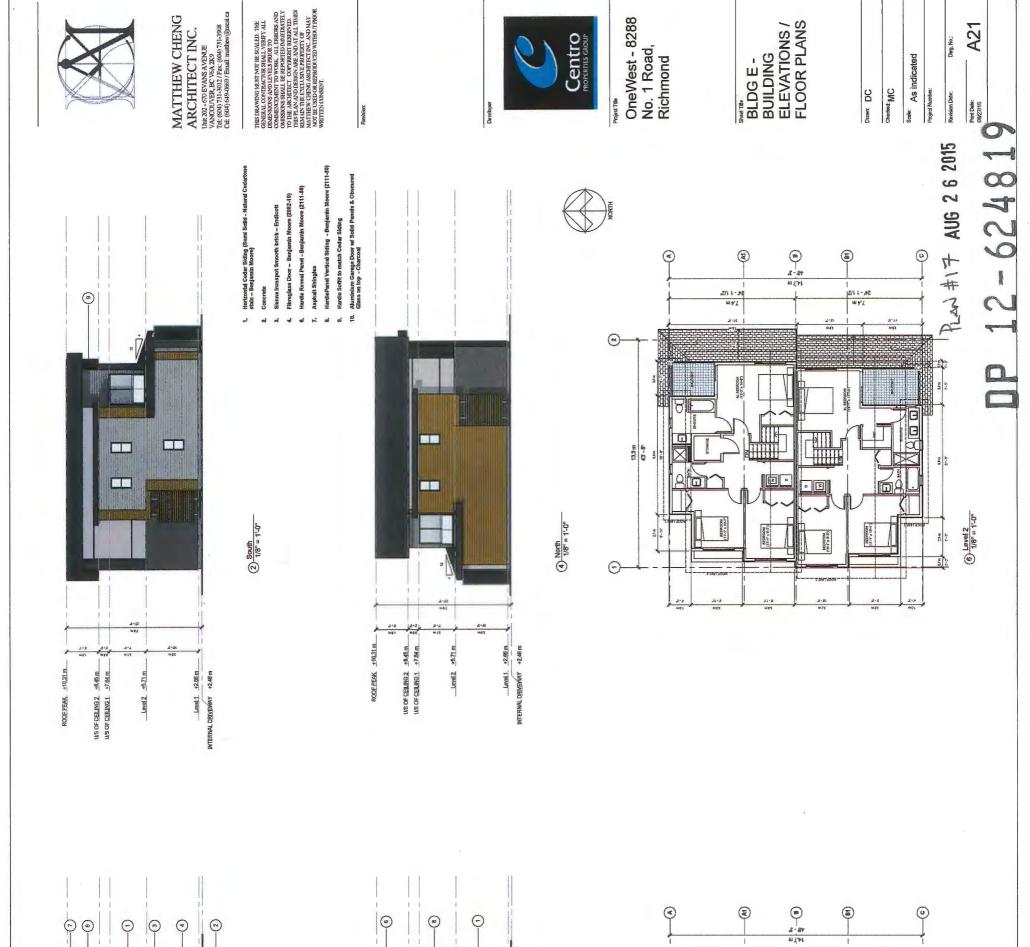
(4) BLDG C - North

12-624819

A18



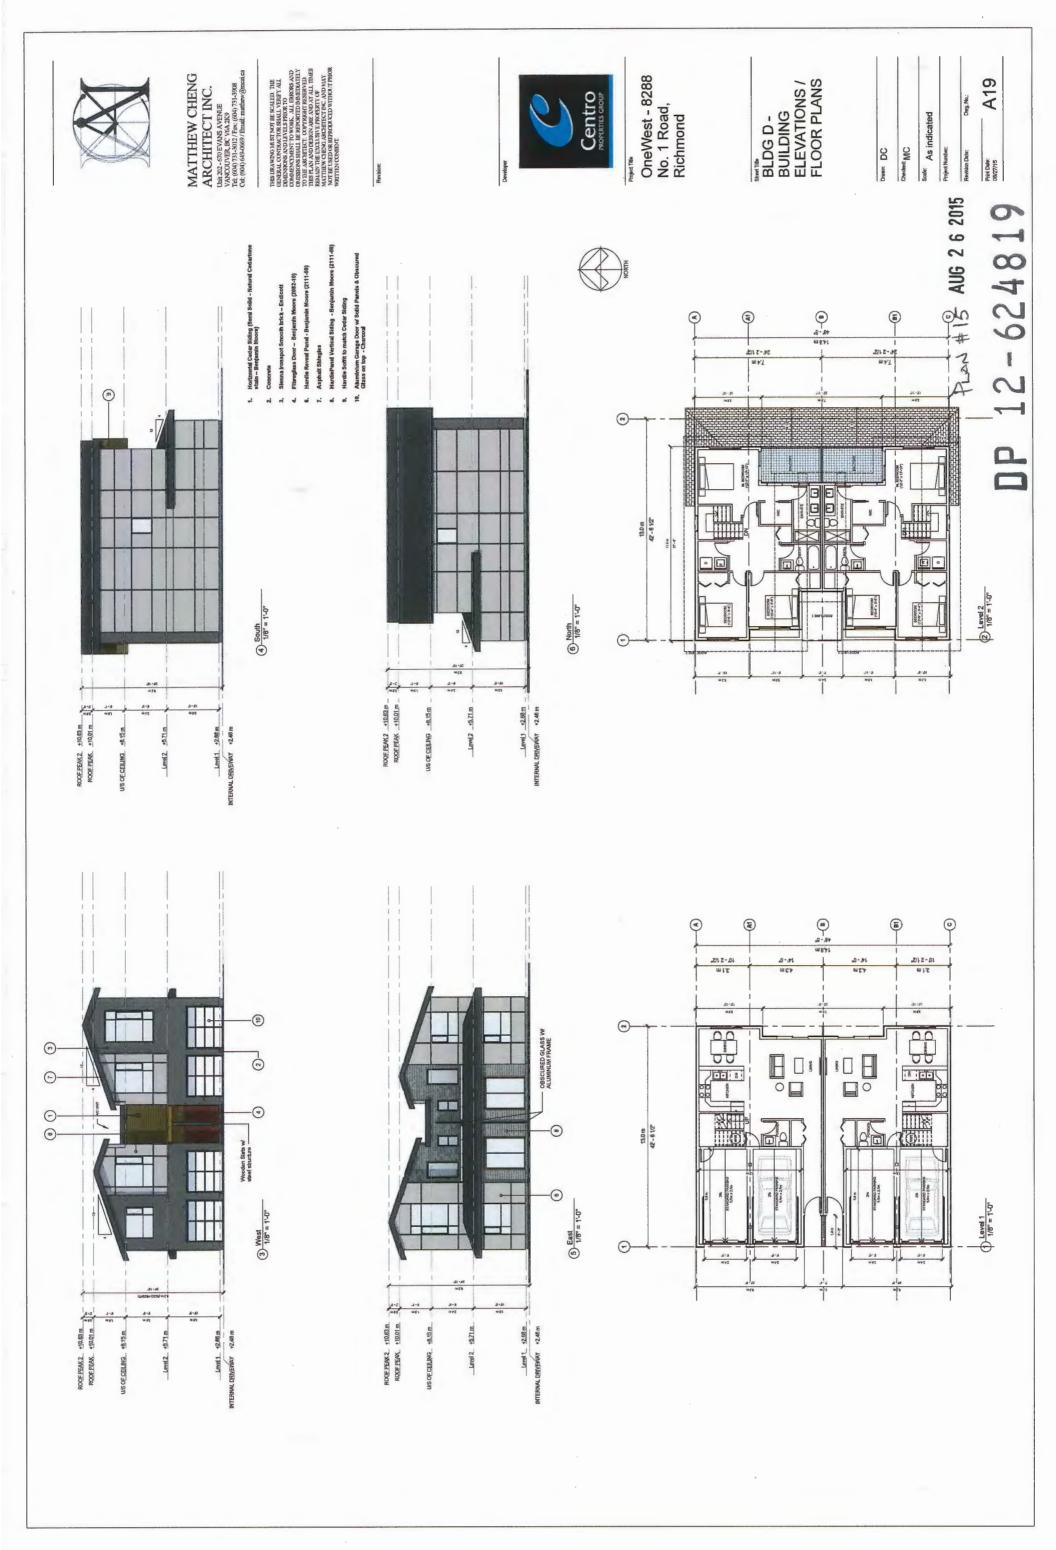

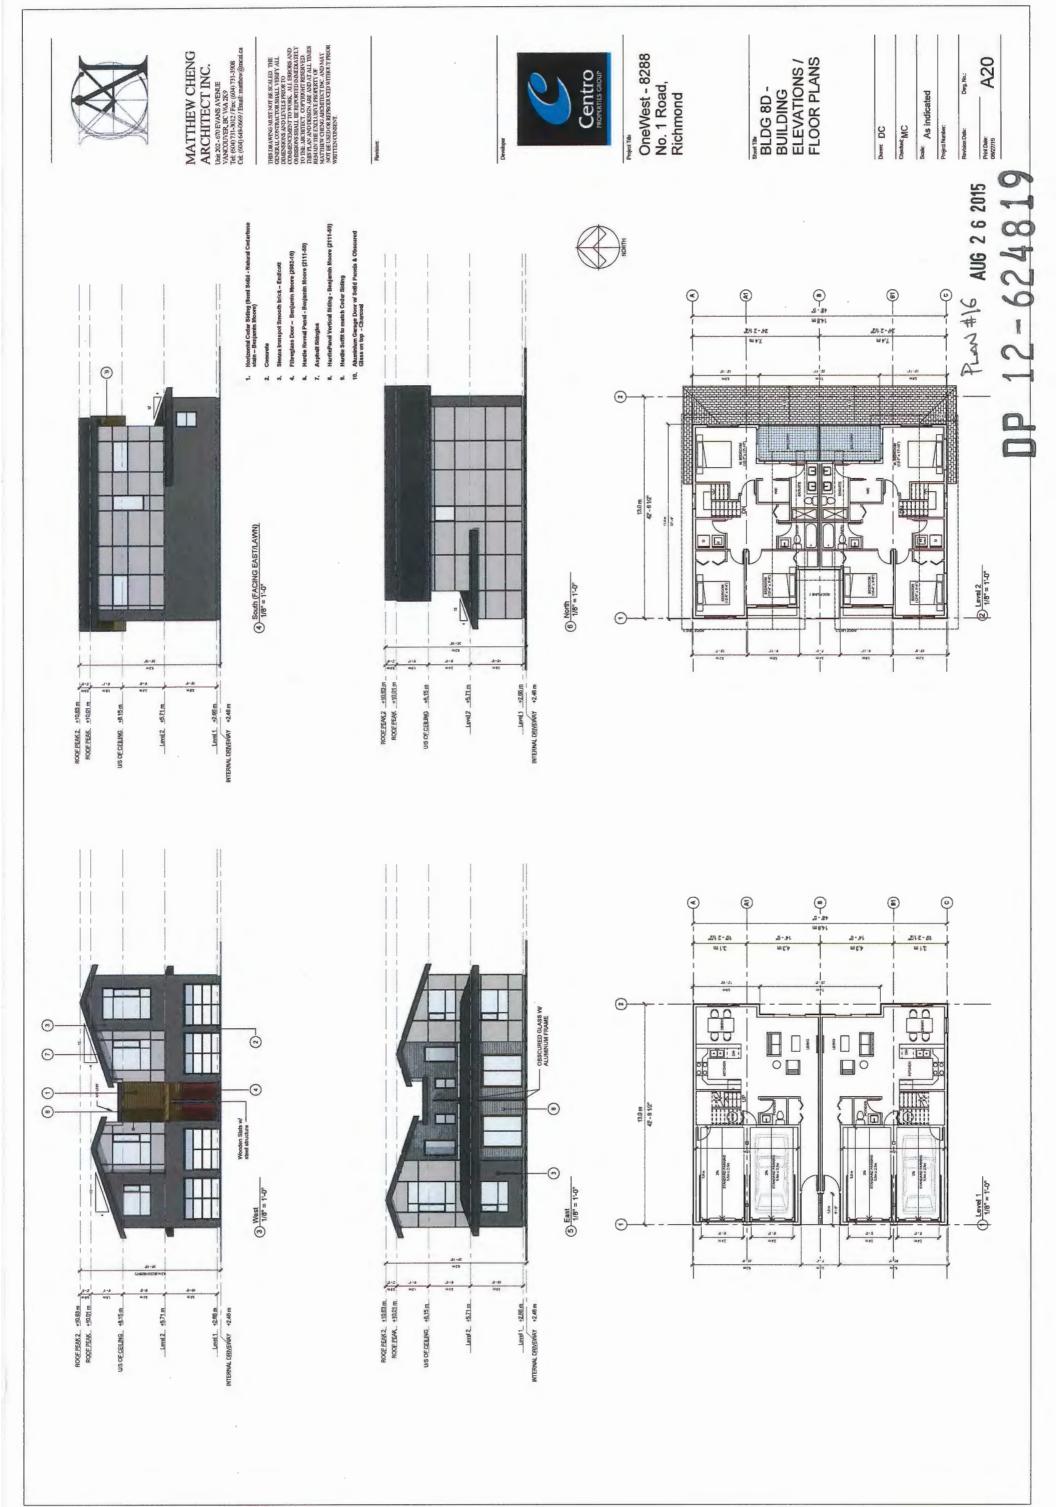

14.2 1/2 14.2 - 34

I Prince

18 B

0

Θ

13.5m 67.5

OBSCURED GLASS W/

3 East 1/8" = 1'-0"

Level 2_ +5.71 m

ROOF PEAK +10.31.

US OF CEILING 2 ... +8.45 m US OF CEILING 1 _. +7.84 m INTERNAL DRIVENAY +2.48 m

-(2)

1/8" = 1'-0"

U/S OF CELLING 2 +8.45 m. U/S OF CEILING 1 +7.84 m.


ROOF PEAK +10,31 m


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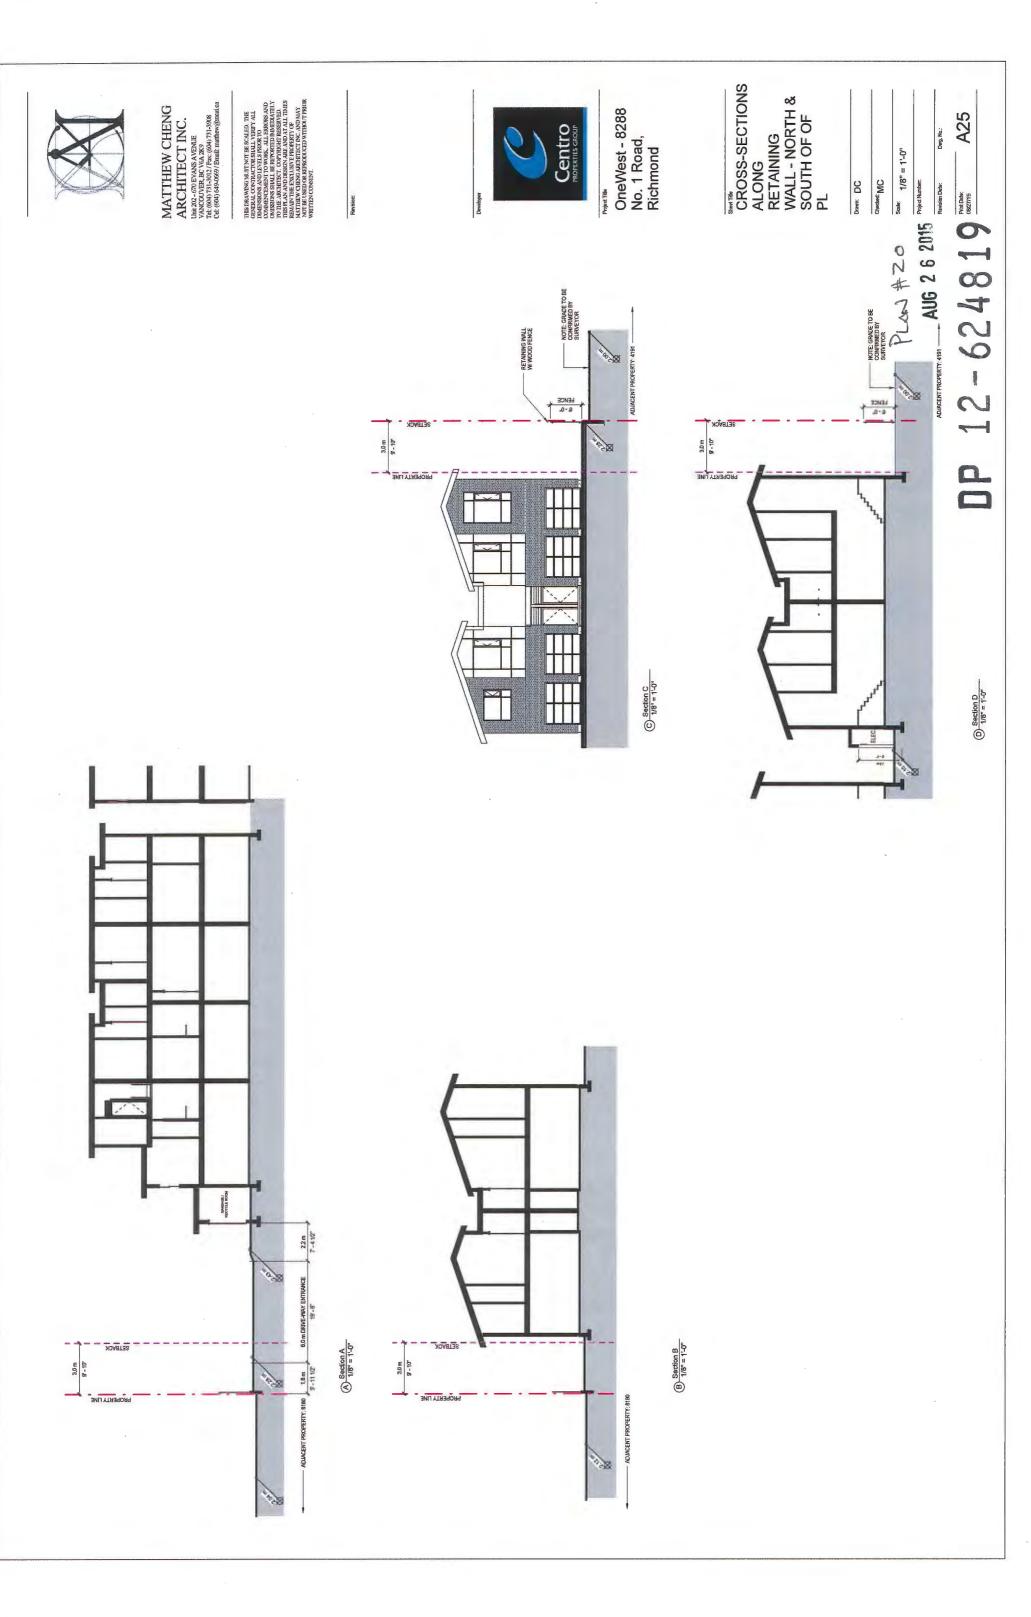
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8-31

5 Level 1 1/8" = 1:-0"





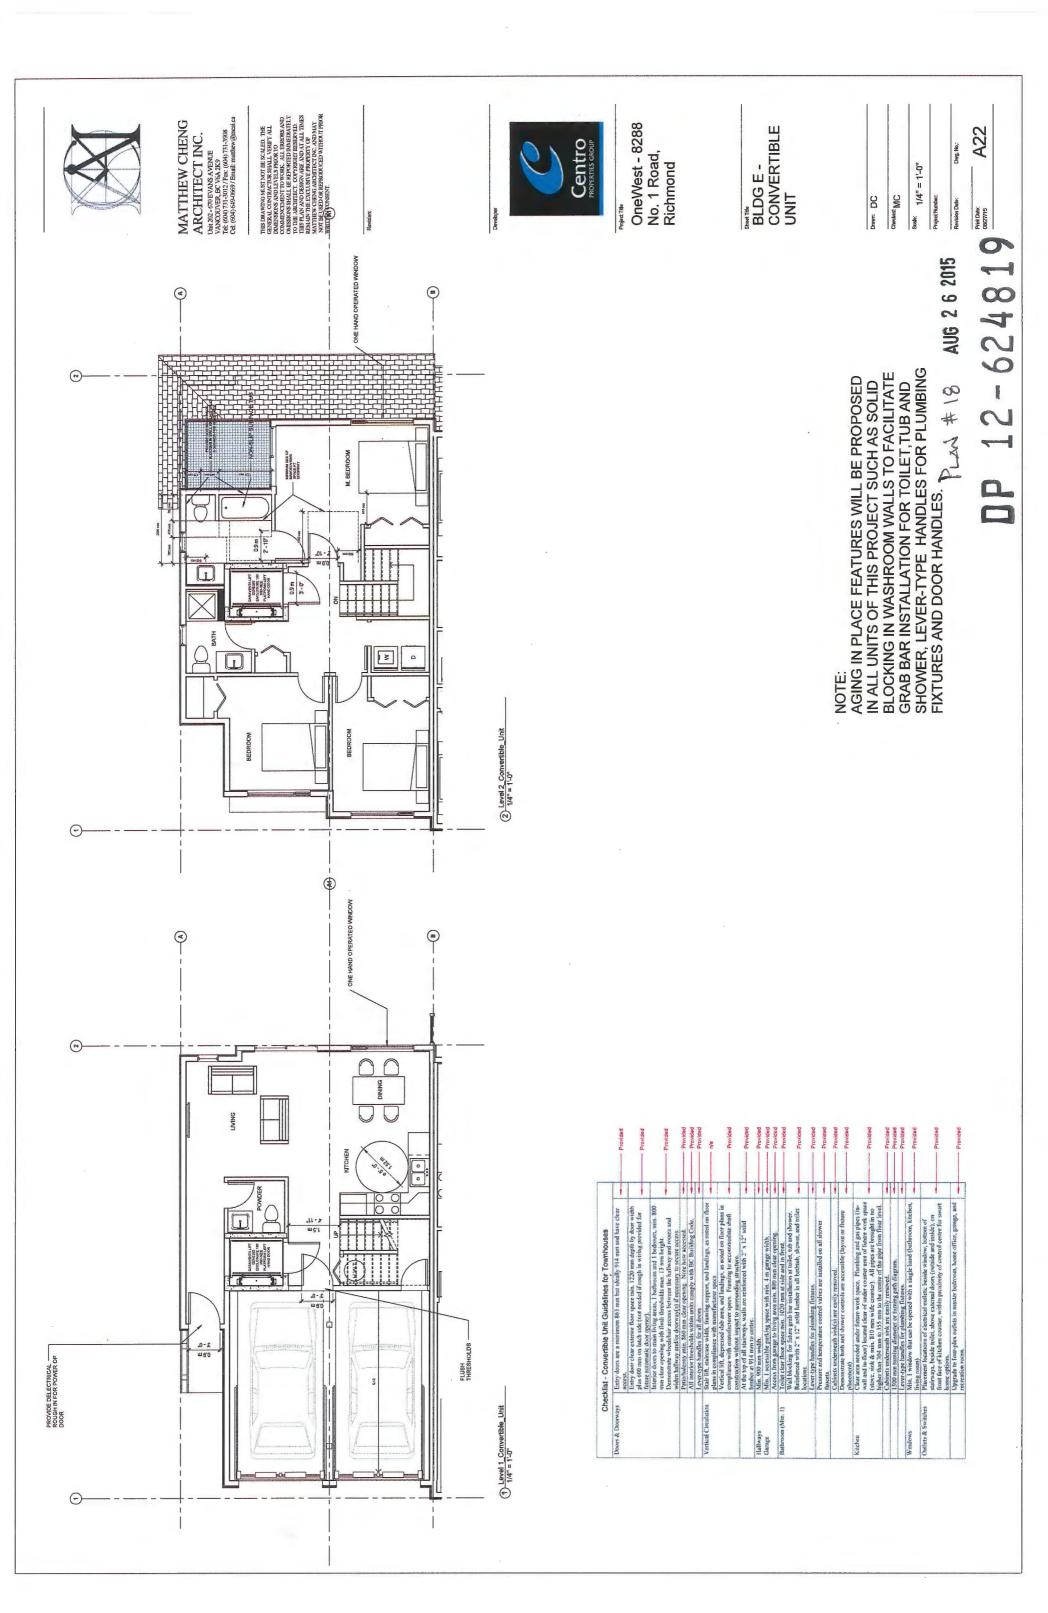

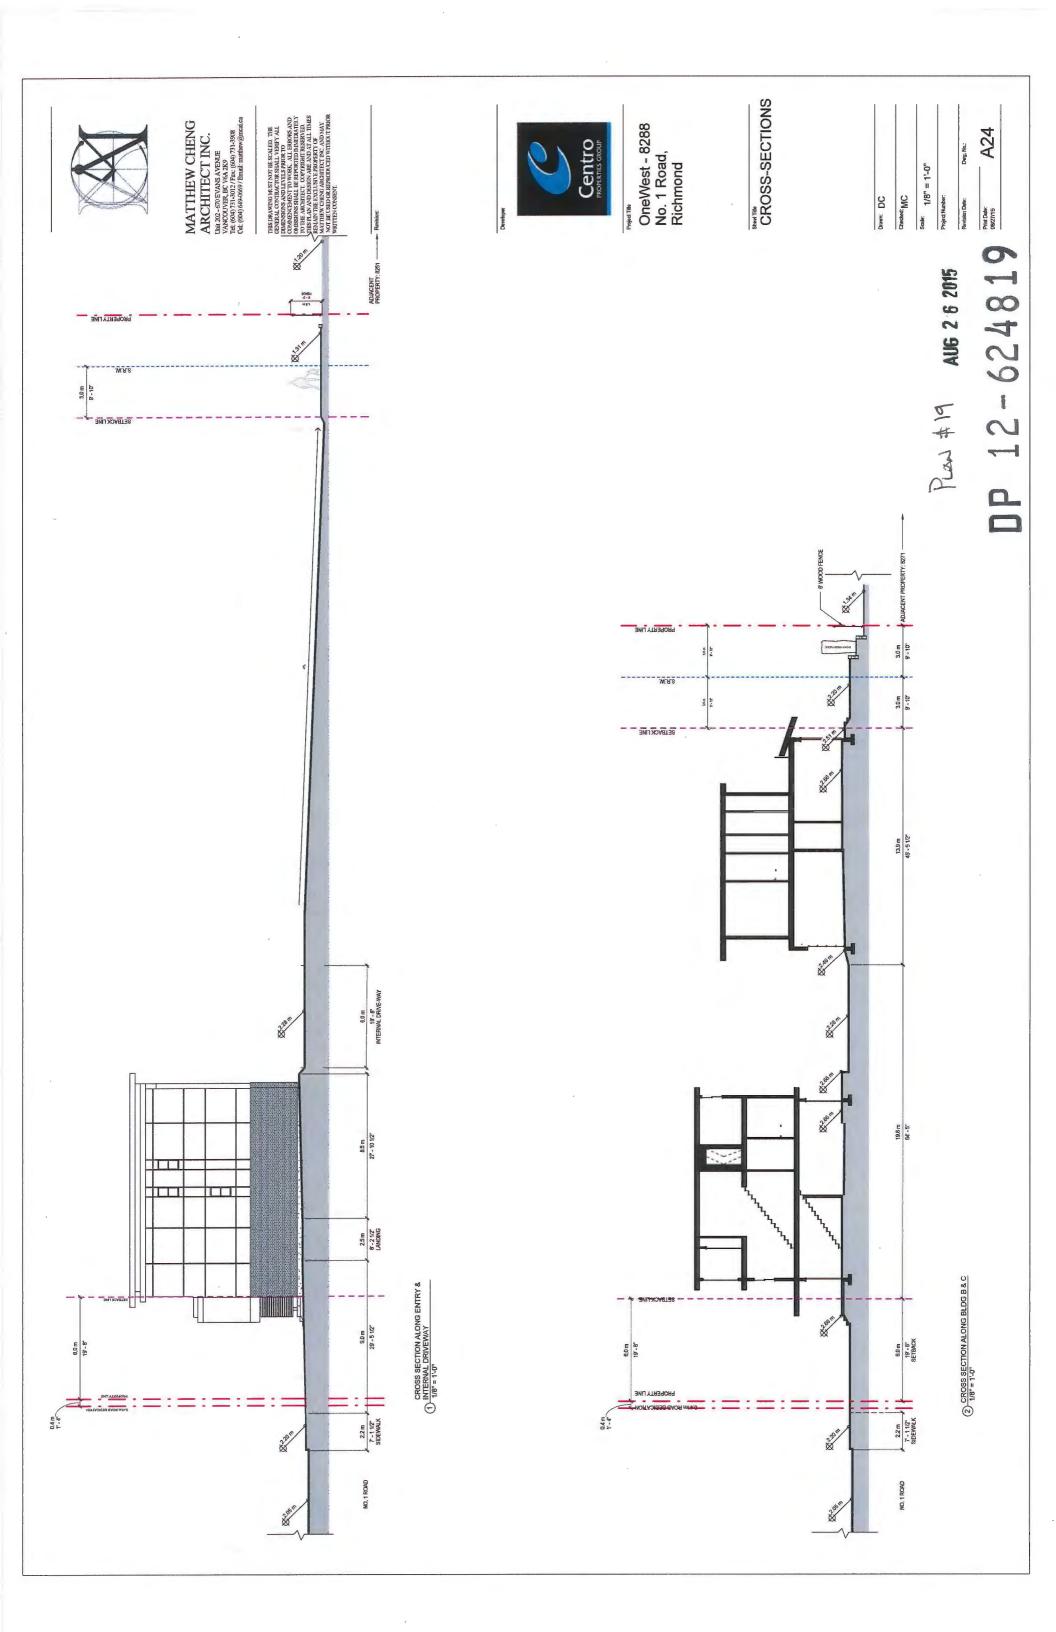MATTHEW CHENG
ARCHITECT INC.
Unit 202-670 EVANS AVENUE
VANCOUNEL, BE VIANA
Tet: (604) 731-3012, Tete: (604) 731-308.
Cet: (604) 689-6689/ Pamilt manthew@nexica ADJACENT (2) REAR GRADE SECTION B ADJACENT 3.0 m 9 - 10° TEAR GRADE SECTION A




OneWest - 8288 No. 1 Road, Richmond

624819 CROSS-SECTIONS ALONG RETAINING WALL - EAST OF PL

Scale: 1/4" = 1'-0" Checked Checker Drawn: Author

A26

NOTE: REFER TO LANDSCAPE PLAN FOR PLANTING SCHEME

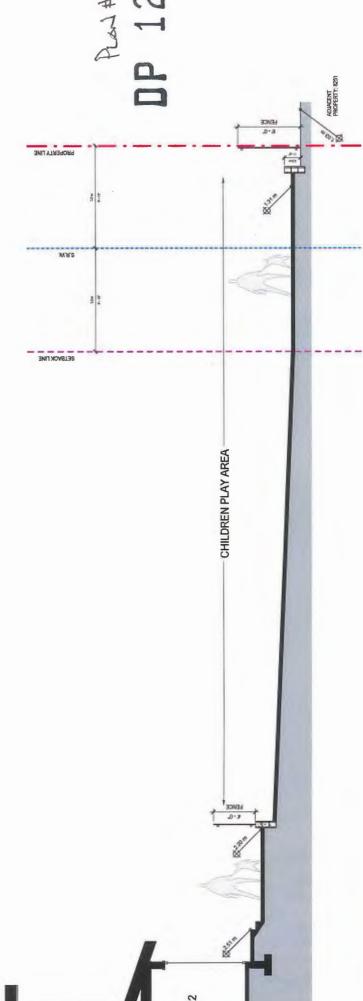

15-026

PLANT SCHEDULE
KEY QTY BOTANICAL NAME

HADCO; ALUMINIUM BOLLARD LIGHT (5)830, BLACK COLOUR

KOMPAN: Model-GSP 1020; CASTLE TOWER By RecTec Industries -Ph.:604-940-0067

Modens Park Bench; Model Number: M-5 BY WISHBONE SITE FURNISHINGS Long Lating Stainless Steel Hardware Coloins-Metallic silver

USE

WITH MATTHEW CHENG ARCHITECT DRAWING TITLE: LANDSCAPE PLAN

DESIGN: DD CHKD: PCM

PLAN #22


OF 5 15-026


DP 12-624819

8200, 8220, 8280, 8300 NO. 1 ROAD RICHMOND

| PROJECT: | 28 UNIT TOWNHO | DEVELOPMENT | "FOUNTAIN BLEU" | |
|----------|----------------|-------------|-----------------|--|
| | | | | |
| | | | | |

| BCM CAL; ZM STD; B&B BCM CAL; ZM STD; B&B | 9CM CAL; 1.8M STD; B&B | 6CM CAL; 1.8M STD, B&B | 3M HT; B&B-STD | 3M HT; B&B | BCM CAL; 1.5M STD; B&B | 6CM CAL; 1.5M STD; B&B | 6CM CAL; 2M STD; B&B | 4M HT; B&B | #3 PDT; 40CM | #2 POT; SOCM | #3 POT; SOCM | #2 POT; 30CM | #2 POT; 30CM | #2 POT; 30CM · | #2 PDT; 40CM | 1.5% B&B | 1.8M HT; B&B | #3 POT; 60CM | 11 CM POT | #1 PDT | #1 PDT | #2 PDT; 60CM STAKED | 11 CM POT | #1 POT; 20CM | #1 POT; 43CM | #1 POT; 20CM |
|--|------------------------|-------------------------|----------------|---------------------------|------------------------|------------------------|------------------------------------|-------------------|----------------|--------------------------|--------------|-------------------|-------------------|------------------|--------------------|------------|---------------------|-----------------------|---------------------------------|-------------------------|----------------|---------------------|-------------------------------|--------------|--------------------|---------------|
| COLUMNAR RED MAPLE RED SUNSET MAPLE | KATSURA TREE | PURPLE FASTIGIATE BEECH | STAR MAGNOLIA | VANDERWOLF'S PYRAMID PINE | AMANOGAWA CHERRY | CAPITAL PEAR | TO BE APPROVED BY PARKS DEPARTMENT | WESTERN RED CEDAR | COMMON BOXWOOD | VARIEGATED SHRUB DOGWOOD | PIERIS | RHODODENDRON; RED | FRAGRANT SWEETBOX | JAPANESE SKIMMIA | DWARF KOREAN LILAC | HICK'S YEW | EMERALD GREEN CEDAR | EVERGREEN HUCKLEBERRY | GDLDEN VARIGATED JAPANESE SEDGE | DWARF MAIDEN HAIR GRASS | FOUNTAIN GRASS | CLEMATIS; CRIMSON | HEARTLEAF BERGENIA; ROSE PINK | CARPET BUGLE | WESTERN SWORD FERN | DWARF WEIGELA |

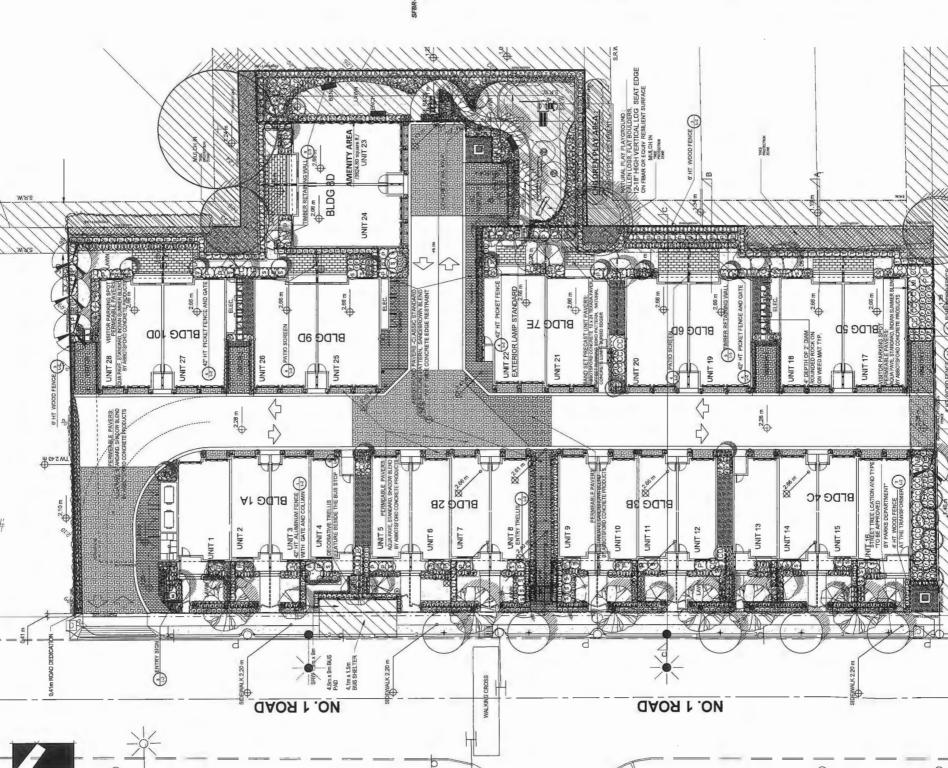

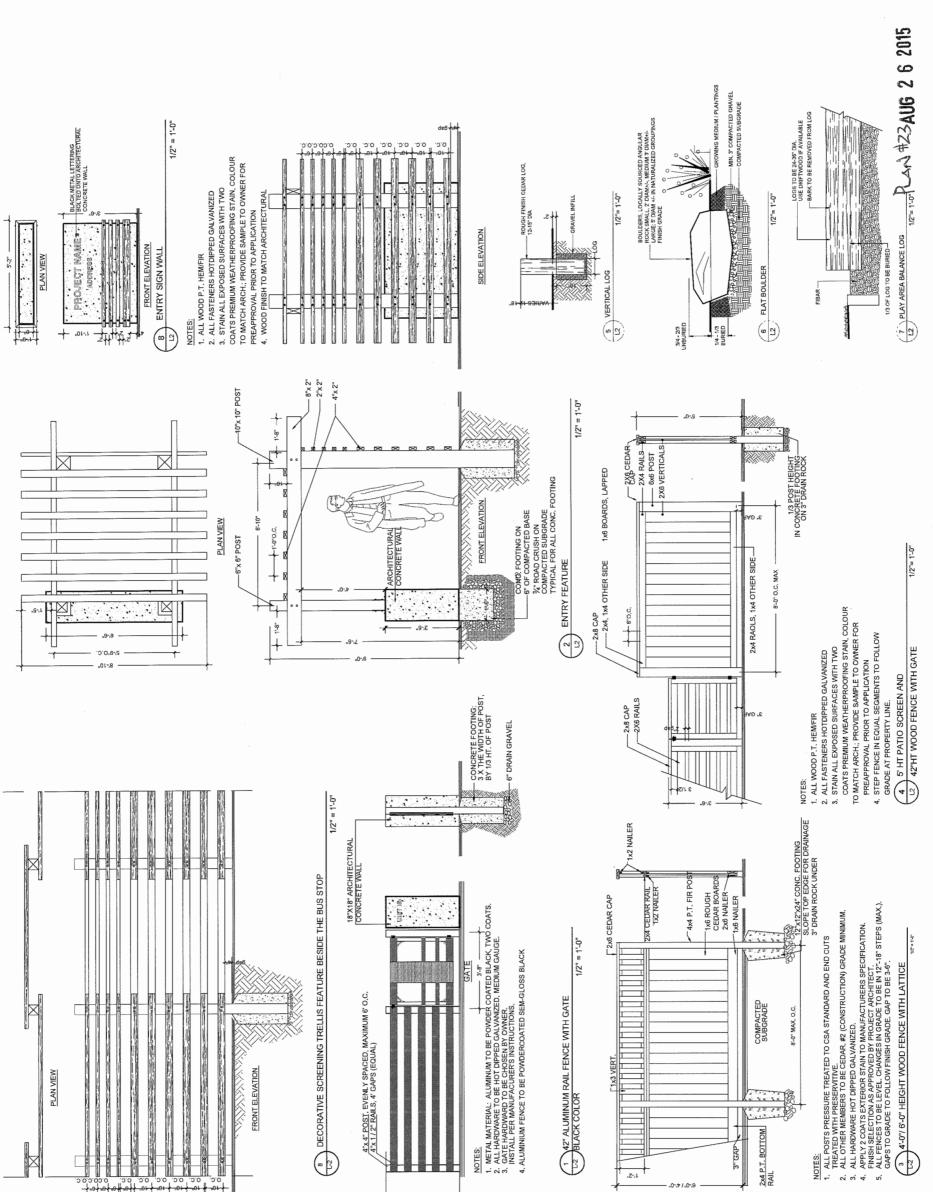

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DP 12-624819

15-026

PMG PROJECT NUMBER PCM

OF 5 2

8200, 8220, 8280, 8300 NO. 1 ROAD RICHMOND

WITH MATTHEW CHENG ARCHITECT INC. DRAWING TITLE:

LANDSCAPE DETAILS

DATE: February 25, 2015

DRAWN: DD DESIGN: DD

28 UNIT TOWNHOUSE DEVELOPMENT "FOUNTAIN BLEU"

NO. DATE

OF 5 © Copyright reserved. This drawing and design is the property of PMG Landscape Architects and may not be reproduced or used for other projects without their permission. 8200, 8220, 8280, 8300 NO. 1 ROAD RICHMOND ന TREE MANAGEMENT PLAN 28 UNIT TOWNHOUSE DEVELOPMENT "FOUNTAIN BLEU" WITH MATTHEW CHENG ARCHITECT INC. DRAWING TITLE: DATE: February 25, 2015 PMG PROJECT NUMBER: DRAWN: DD PCM EXTRAPOLATE PROTECTION RADIUS FOR TREES LARGER THAN 100CM digh. *(DIAMETRE AT BREAST HEIGHT OR 1,4M FF MINIMM REQUIRED PROTECTION RADIUS (DISTANCE FROM TRUNC IN METRES) TREE PROTECTION DISTANCE TABL any 12-624819 NOTE: ALL TREES REGARDLESS OF SIZE ARE PROTECTED IN HIGH ENVIRONMENTALLY SENSATIVE AREAS if there are any questions regarding arboriculture issues for this project, kindly contact Catherine MacDonald Ph.: 604-904-0302 or AUG 2 6 2015 4X6P.T. HEM/FIR TIMBERS PROVIDE WEEPHOLES @ BASE, MAX. 8' 0.C. catherine@catherinemacdonald.ca NO STORAGE OF BUILDING MATERIALS WITHIN OR AGAINST PROTECTION BARRIER BACKFLL IN 12' LAYERS, COMPAUT EACH LAYER TO 95% OF ORIGINAL DENSITY.
INDIRECTIVE REND THE WALLING RENAL HAND REPAIR FREE DEAUNING).
FROME GAPS IN BOTTOM ROW OF WALLEY, AS WEEP FOLES.
FROM DE OWNER TO PROSISTENT ELES AND FANCE FOR MALLING SECURITY TO BE SOME AT BACK OF WALL TO MOLUDE IT 7 TO 950L, WALL MADS BE WITHIN THE PROPERTY LINE. DRILL AND WAIL GACH TIMBER WITH GALVANIZED 10" SPIKES MAXIMUM 40" O.C., TWO EACH END. TIEBACK AT 8°0" O.C. MAXIMUM DEADMEN CONTINUOUS REBAR PINS AS SHOWN +43°0" INTO COMPACTED SUBGRADE. VINING BACKFILL 2m MIN TREE PROTECTION FENCE TIMBER RETAINING WALL X TO SERVICE STATE OF THE PROPERTY OF THE PROP X TREE TO REMOVE TREE TO RETAIN 1A TREE PROTECTION BARRIER
(-1) NOTE: D+24 4" DIAM, PERFORATED PIPE
CONNECTED TO STORM DRAIN SCALE: 1/2"=1'-0" PLASTIC MESH SCREENING SOLID 2X4 CONSTRUCTION WITH CROSS BRACING AND TOP AND BOTTOM RAILS 5.0 EX. ROW UNIT 23 TREE PROTECTION ZONE TREE PROTECTION ZONE BLDG 8D 雞 P HOTISIA UNIT 24 2.20 m \bigcirc TO ELEC. VISITOR 2 | HEC. 2.66 m j j m m m → 2.66 m Ф2.66 ш Ф2.66 ш 2.66 m Ф2.66 ш _2.66 m э≀ фаля Brbe ab вгрф ер BLDG 10D Brod 8D VISITOR 5 VISITOR 1 UNIT 21 UNIT 26 UNIT 19 UNIT 18 JNIT 20 □ 2.28 m 228 m 42.43 BLDG 2B BrDe ∜c BLDG 1A вгое зв MO. 1 ROAD MO. 1 ROAD

15-026

SECTION B

SECTION A

8200, 8220, 8280, 8300 NO. 1 ROAD RICHMOND

WITH MATTHEW CHENG ARCHITECT INC. DRAWING TITLE:

DATE: February 25, 2015 SCALE:

P. W. # 25


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0F 5 15-026

LANDSCAPE SECTIONS

28 UNIT TOWNHOUSE DEVELOPMENT "FOUNTAIN BLEU"



SECTION C

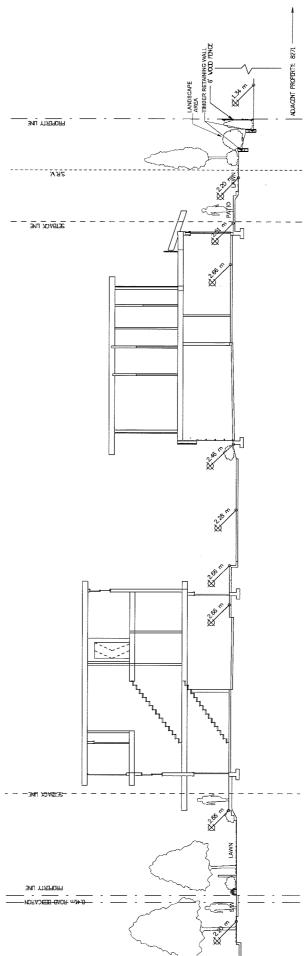

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(1) View from West (Along No. 1 Rd)



OneWest - 8288 No. 1 Road, Richmond

Siest Tite VIEWS - FRONT BLDGS

Drawn: DC

12-624819 AUG 2 6 2015 RETERENCE PLAN

A27

Dwg. No.:

Checked: MC

(2) View from North West

MATTHEW CHENG ARCHITECT INC. Union-streams and the VANCOUNTE BY VALABLE VANCOUNTE BY VALABLE THE (604) 731-308 EVEN THE (604) 731-308 EVEN THE (604) 731-308 EVEN THE (604) 731-308 EVEN THE PROPERTY OF THE PROPERTY OF T

Centro PROFESTES GROUP

OneWest - 8288 No. 1 Road, Richmond

VIEWS - REAR BLDGS

REFERENCE PLAN AUG 2 6 2015

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A28

(3) View from West (Along Internal Drive-Aisle)

1 Rear - View from West

MATTHEW CHENG ARCHITECT INC. Using ac.-empender Bey 184, 289 144 (604) 713-701/ Fee (604) 713-398 021 (604) 619-0009 Inmit member (602) 619-0009

Centro PROPERTIES CROUP

OneWest - 8288 No. 1 Road, Richmond

Sheet Tile VIEWS -WALKWAYS


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DP 12-624819

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4 ENTRANCE




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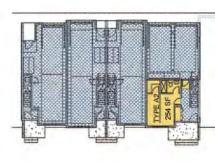
BFDC C


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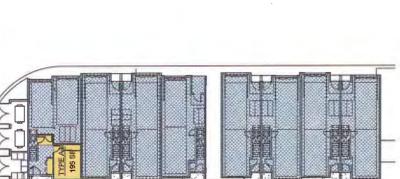
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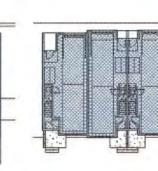


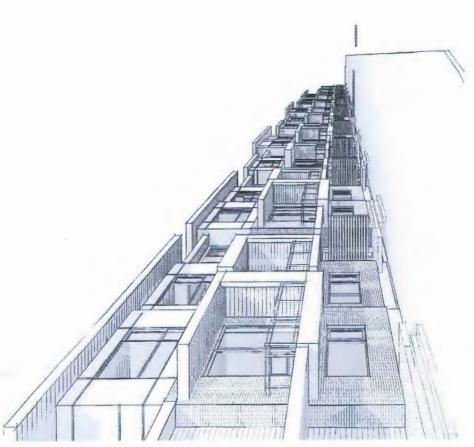
BLDG A




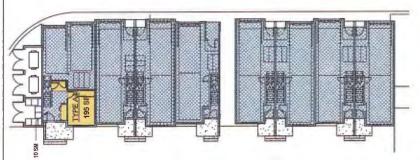





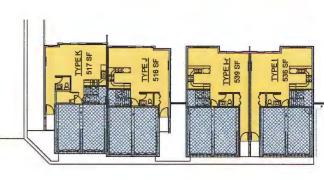


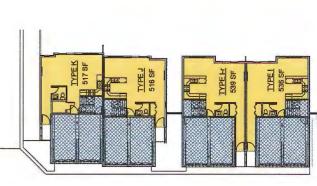

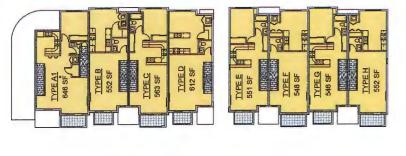

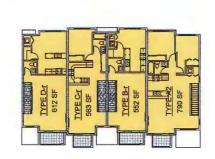


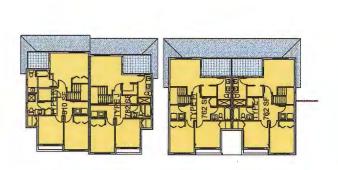

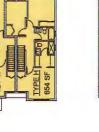

N/A 548 SF 648 SF 1196 SF

N/A 546 SF 528 SF 1074 SF

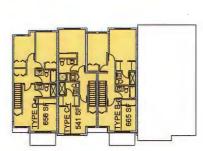

N/A 552 SF 654 SF 1206 SF

| DITTO | | | | |
|--------------------------------|---------------|---------------------|--------------------------|----------|
| Unit Type A2 | Net Hoor Area | Hoor Area Exemption | Reference (Zoning Bylaw) | Gross Ro |
| Level 1. | 254 SF | 108 5F | 4.4.1 b) c) | 36. |
| Level 2 | 3S 06Z | a/u | e/u | 79. |
| Total Unit Type A2 Roor Area | 1044 SF | | | 1152 |
| Unit Type B-r | | | | |
| Level 1 | N/A | 63.5F | 4,4,1 b) c) | 63 |
| Level 2 | \$52 SF | 42 SF | 4.4.1c) | 594 |
| Level 3 | 665 SF | n/a | nfa | 99 |
| Total Unit Type B-r Floor Area | 1217 SF | | | 137 |
| Unit Type C-r | | | | |
| Level 1 | N/A | 92.59 | 4.4.1b)c) | 63 |
| Level 2 | 563 SF | 42 SF | 4,4.1 c) | 505 |
| Level 3 | 543 SF | n/a | n/a | X |
| Total Unit Type C-r Floor Area | 1104 SF | | | 120 |
| Unit Type D-r | | | | |
| I level I | N/A | 82 SF | 4.4.1 b) c) | 82 |
| Level 2 | 612 SF | 44 SF | 4.4.10) | 65 |
| Lavel 3 | 656 SF | n/a | n/a | 656 |
| Total Unit Type D-r Roor Area | 1268 SF | | | 1394 |

| Unit Type i | Net Hoor Area | Hoor Area Exemption | Reference (Zoning Bylaw) | Gross Hoor Area |
|--------------------------------|---------------|---------------------|--------------------------|-----------------|
| 3 374 | 536 SF | 63.5F | 4.4.1 b)c) | 599 SF |
| Level 2 | 762 SF | n/a | n/a | 762 SF |
| Total Unit Type I Floor Area | 1298 SF | | | 1361 SF |
| Jult Type I-r | | | | |
| evel 1 | \$36 SF | 63.SF | 4.4.1 5/4) | 599 SF |
| evel 2 | 762 SF | a/u | 9/8 | 762 SF |
| Fotal Unit Type I-r Floor Area | 1298 SF | | | 1361.5F |

| Unit Type 1 Net Roor Area Floor Area Floor Area Floor Area Gross Roos Annal Dich Gross Roos Annal Dich 128 5F 782 5F 782 5F 782 5F 782 5F 782 5F 10th Type K 537 5F 61 5F 4.4.1.0 kg) 1359 5F 1359 5F 10th Type K 537 5F 61 5F 4.4.1.0 kg) 578 5F 578 5F 1coal Unit Type K 537 5F 61 5F 4.4.1.0 kg) 578 5F 578 5F 1coal Unit Type K 1327 5F 17.8 1359 5F 1359 5F 1359 5F | The state of the s | | | | |
|--|--|---------------|---------------------|--------------------------|--------------|
| S16 SF S13 SF S14 SF S14 SF S14 SF S15 SF S | Unit Type J | Net Hoor Area | Hoor Area Exemption | Reference (Zoning Bylaw) | Gross Hoor A |
| nit Type / Hoor Area 1298 55 n/s | Level 1 | 516 SF | 51 SF | 44.16)c) | 577 SF |
| mit Type i Hoor Area 1258 SF 61 SF 44.1.b) c) | Level 2 | 782 SF | nfa | n/a | 782 SF |
| ## 61.5° 44.1.6° 10.0° 1 | Total Unit Type J Hoor Area | 1298 SF | | | 1359 SF |
| MITTINGER HOOF AND STATE OF ST | Unit Type K | | | | |
| AUG 2 6 2015 | evel 1 | 517 SF | 61.SF | 4.4.1 b) c) | 578 SF |
| PRICE PLAN AUG 2 6 2015 | Level 2 | 810 SF | n/a | n/a | \$10 SF |
| PLAN AUG 26 | Fotal Unit Type K Floor Area | 1327 SF | | 4 | 1388 SF |
| | ZETER | 0 | | 9 7 | |

FLOOR AREA EXEMPTION

GROSS FLOOR AREA

sale: As indicated

Charlest: MC Drawn: DC

| 155 | 578 | 83(| 138 | O. |
|-----|-------------|-----|--------------|----|
| _ | | | _ | 7 |
| | 4.4.1 b) c) | e/u | 2015 | 0 |
| | | | 26 | |
| | | | AUG 2 6 2015 | 0 |
| | 61.5F | n/a | | 4 |
| | SF | SF | 35 | |



MATTHEW CHENG ARCHITECT INC. Using - streams and the VANCOUNER BY VALAGE THE (604)731-2082 FOR CHENGEL STREAMS CHE (604)731-2088

N/A 612 SF 656 SF 1268 SF

| eWest - 8288 1 Road, hmond | |
|----------------------------------|--|
| OneWe No. 1 R Richmo | |

FLOOR AREA OVERLAY & UNIT AREA CALCULATIONS

BLDG A - FLOOR PLANS MATTHEW CHENG ARCHITECT INC. Using ast. - 500 EVANS APENIE VANCOUVER BY VAN ARCO THE (660) 751 - 2012 Five (400) 751-3088 CR (630) 563-0569 (Final) matthew @menical OneWest 19.-14. 22.6m 74.-11* (0 9 (4) m de %- 41 #15.51 m&& T- Tt 12.5m 3 BLDG A - Level 3 (**4** (1) 0 "f - 'dt == 8.55 5.3 m m 8.2 m 4.E m 8.4 a B (B) SIB NO DELIVE 8 Security Sec 12.5m Do O Company of the state of the sta 2) BLDG A - Level 2 (3) (11) (0) -14-#4 10-1 TC-TI 27. F (1) BLDG A - Level 1 1/8" = 1'-0"



Checked: MC Drawn. DC

Scale: 1/8" = 1'-0"

A13

DP 12-624819

REFERENCE PLAN AUG 2 6 2015

MATTHEW CHENG ARCHITECT INC. Union-enderly acknown VANCOUNDER BEVAR 2028 Tele (69/171-2012 few (694).731-3088 Cet (693) (640-0669) Famail matthew@ancal ca

OneWest

BLDG B - FLOOR PLANS

3 Level 3 1/8" = 1'-0"

Scale: 1/8" = 1'-0" Checked: MC Drawn: DC


Dwg. No.:


A15

12-624819

AUG 2 6 2015 REFERENCE PLAN

m 48.4 "E - 'B! (m) 12.35 m 41'-2' 12:0 0

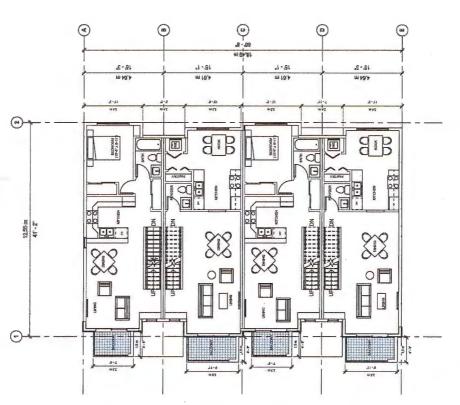

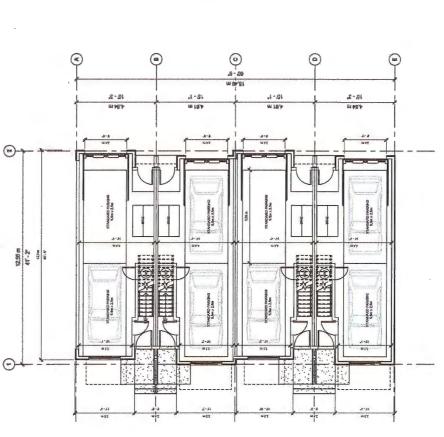

1/8" = 1'-0"

2 Level 2 1/8" = 1'-0"

A17 Scale: 1/8" = 1'-0" Chacked: MC Drawn: DC

BLDG C - FLOOR PLANS

OneWest

26.7 m

MATTHEW CHENG ARCHITECT INC. Using and - Group Inc. (1997) - SANCOLVER, BC V8A 2020 VANCOLVER, BC V8A 2020 Tet (1994) 17-1001 [Pew (1994) 13-1008 CR (1994) 503-0269 [Pamil: matthew@incal.ca.

(3)

3 BLDG C - Level 3

a B a B - 6 O 313 **F** O Bass Books | Θ-

(2) BLDG C - Level 2 1/8" = 1".0"

@ 125m STANDARD PARTIES SSex 2.25n

1) BLDG C - Level 1

624819 12-PETERENCE PLAN