



City of
Richmond

Report to Development Permit Panel

To: Development Permit Panel

Date: May 11, 2015

From: Wayne Craig
Director of Development

File: DP 07-363924

Re: Application by Matthew Cheng Architect Inc. for a General Compliance Ruling
at 7411 Moffatt Road (formerly 7411 and 7431 Moffatt Road)

Staff Recommendation

That the attached plans involving changes to the design be considered in General Compliance with Development Permit (DP 07-363924).


Wayne Craig
Director of Development

WC:el

Att.

Staff Report

Origin

Matthew Cheng Architect Inc. has requested a General Compliance Ruling regarding previously issued Development Permit DP 07-363924 for proposed development at 7411 Moffatt Road (formerly 7411 and 7431 Moffatt Road) (Attachment 1), which was endorsed by the Development Permit Panel at its meeting held on October 13, 2010 and approved by Council on May 14, 2012.

The main changes to the approved Development Permit include design modifications to the exterior materials and colours. The landscape design remains largely unchanged, with the exception of fence design. The applicant has provided a list from the architect (Attachment 2) and a list from the landscape architect (Attachment 3) to identify the affected areas. A brief design rationale is also provided for each of the proposed modifications.

Background

Development surrounding the subject site is as follows:

- To the North: A single-family home, zoned “Medium Density Low Rise Apartment (RAM1)”. The subject development is responsible for providing access to the future development on the existing single-family lot to the north;
- To the East: Across Moffatt Road, multiple-family developments (townhouse and apartments) zoned “Medium Density Low Rise Apartment (RAM1)”;
- To the South: Across from the driveway to apartment complexes to the west, a townhouse development, zoned “Medium Density Low Rise Apartment (RAM1)”;
- To the West: A four-storey condominiums (three (3) storeys over parking), zoned “Medium Density Low Rise Apartment (RAM1)”.

Finding of Facts

On May 16, 2013, Building Permit 11-559470 for the proposed townhouse development was issued in accordance with the approved Development Permit. A completed Schedule B – Assurance of Professional Design and Commitment for Field Review was included as a part of the Building Permit Application in which the architect confirmed that the Building Permit drawings comply with the Development Permit and conditions therein.

On October 8, 2014, Development Applications staff was approached by the architect regarding revisions to the cladding and landscaping. On December 10, 2014, a General Compliance application to address the changes in cladding and landscaping was received.

On January 21, 2015, Final Inspection by Building Approvals Department was rejected due to a number of Building Code issues and concerns related to the design modifications to the exterior materials and colours. While there has been Provisional Occupancy given to some units, the rest are being withheld until the General Compliance application is reviewed by the Development Permit Panel and Council.

On May 11, 2015, all requested supporting documents for the General Compliance application were received.

Analysis

The proposed changes to the townhouse development are within the scope of the General Compliance Guidelines as adopted by Council.

Cladding

The approved Development Permit calls for cladding materials such as Hardi Shingle Siding, Hardi Lap Siding, and cultured stone. The developer retained the Hardi Lap Siding and cultured stone as cladding materials in the new design but altered the scale of these materials and amended other finish materials to include metal panels and rock dashed stucco. While the character of the buildings is modified, the form and scale of the buildings are unchanged. The new cladding materials used are considered durable and relatively maintenance-free. Staff feel that the modifications in colours and materials not only created a more modern appearance but also maintained the integrity of the original approved design and complement existing recent developments in the neighbourhood.

Landscaping

The approved Development Permit calls for black aluminum rail fence and gates. The developer replaced this design with a combination of aluminum frame, vertical cedar wood panels, and translucent glass in the gate. This new fence design echoes the new cladding materials used on the buildings and creates a more modernize appearance of the project.

Conclusions

Matthew Cheng Architect Inc. has requested a General Compliance Ruling on the approved townhouse development project at 7411 Moffatt Road (formerly 7411 and 7431 Moffatt Road) to modify predominately the exterior materials and colours of the buildings as well as the fence design along the frontage. The proposed modification is within the scope of the General Compliance Guidelines as adopted by Council. Staff have no objection to the proposed revisions. Staff recommends support of this General Compliance request for the proposed changes to the approved Development Permit.




Edwin Lee
Planner 1

EL:cas

- Att. 1 Location Map
- Att. 2 Design Rationale (Architecture)
- Att. 3 Design Rationale (Landscaping)
- Att. 4 Copies of Relevant Approved Development Permit Plans
- Att. 5 Proposed New Development Permit Plans



City of Richmond

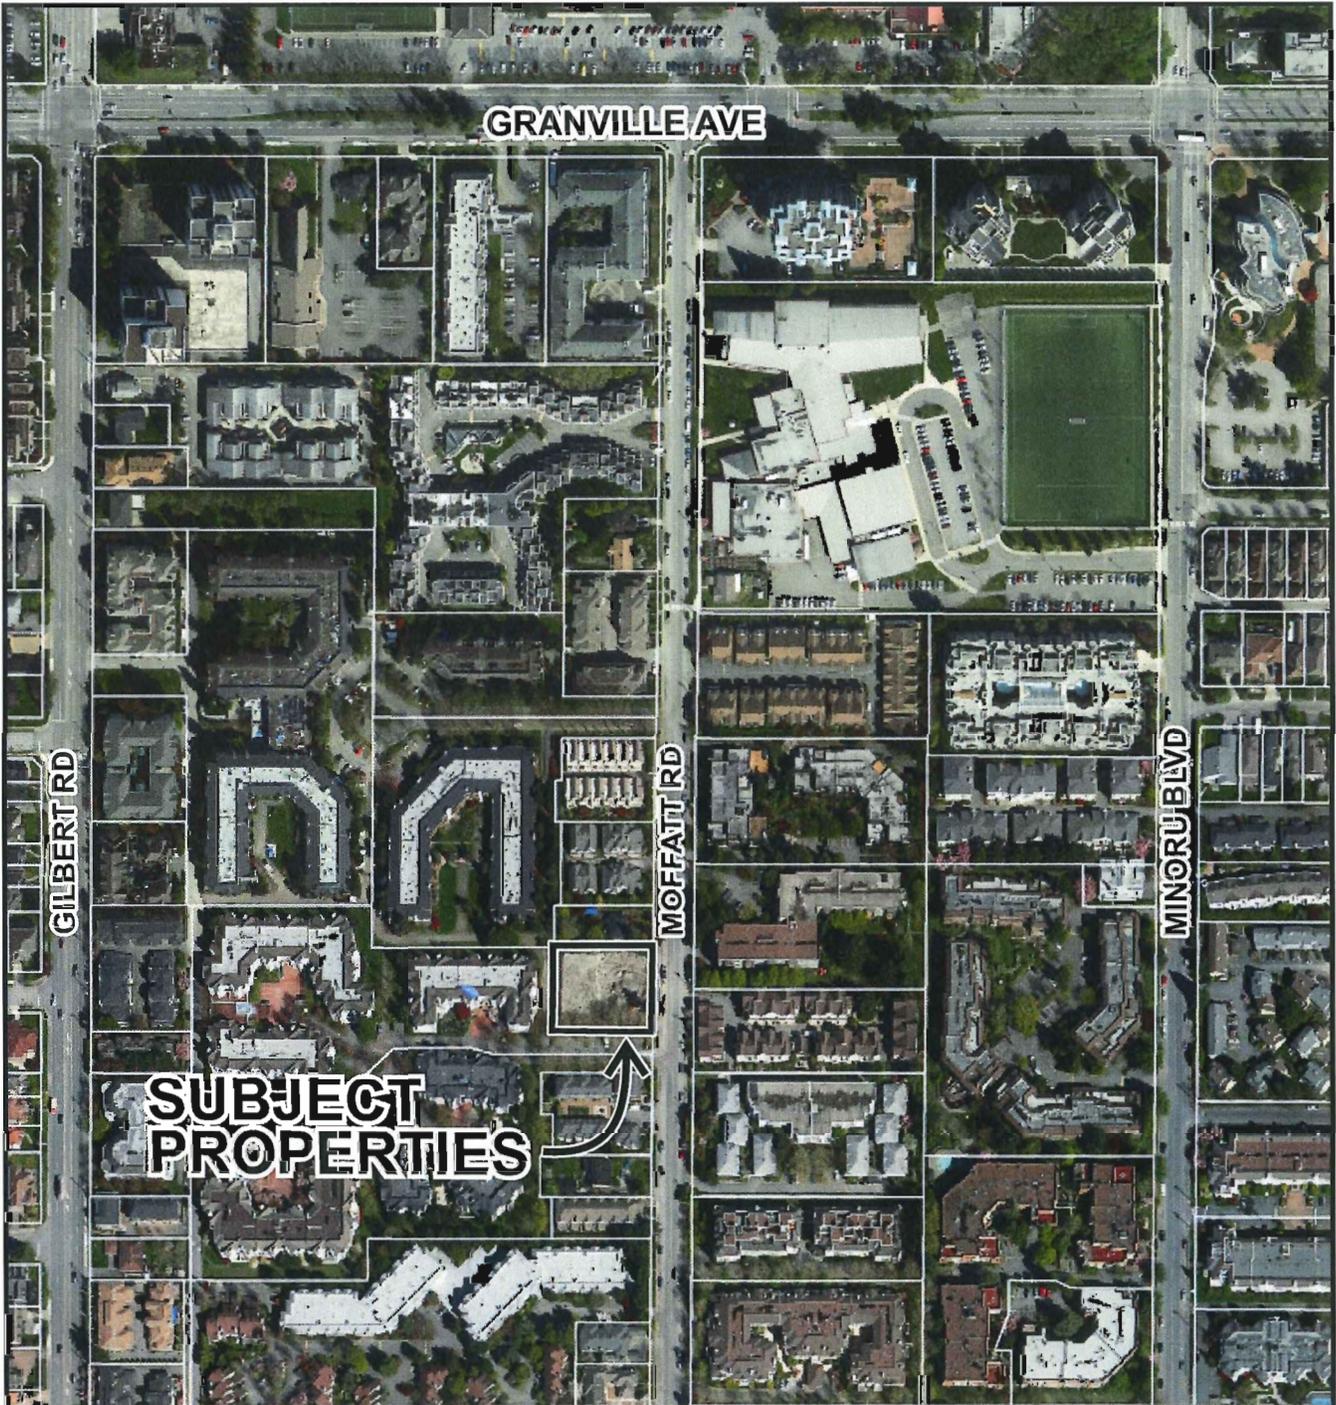

DP 07-363924

Original Date: 05/12/15

Revision Date:

Note: Dimensions are in METRES



MATTHEW CHENG ARCHITECT INC.

202-670 Evans Ave., Vancouver, B.C., Canada V6A 2K9

TEL: (604) 731-3012

FAX: (604) 731-3908

CELL: (604) 649-0669

Email: mcai@telus.net

March 30th, 2015

DP AMENDMENT RATIONALE

RE: 7411 MOFFATT ROAD
RICHMOND, B.C.

This Development Permit Amendment writing is to inform you that the client has decided to upgrade the building materials in order to target younger buyers as the City of Richmond and the site attract young families and professionals. The details are as follows:

- **Affected Area #1** - The use of Hardie Shingle siding on the gable of the elevations has been upgraded to Hardie lap siding to differentiate from the Hardie board & batten. (See Sheet R01, 4A & 4B – As Built/Proposed)
- **Affected Area #2** - The use of Hardie lap siding on East & West elevations of Building A and B has been upgraded to Hardie board & batten to break up the large volume of Hardie lap siding usage and highlight the verticality of the building. The colour of the Hardie board & batten has been matched to Cedar wood which is used on the guard rail. (See Sheet R01, 4A & 4B – As Built/Proposed)
- **Affected Area #3** - The façade of the units on West & East Elevations of building A and East elevation of building B, has been changed from Hardie shingle siding to Metal Panel to create modern design. (See Sheet R01, 4A & 4B – As Built/Proposed)
- **Affected Area #4** - The use of Hardie lap siding on the elevations has been upgraded to rock dash stucco to break up the large volume of Hardie lap siding usage and also bring more natural material palette to the building. (See Sheet R01, 4A & 4B – As Built/Proposed)
- **Affected Area #5** - The material on the ground level has been upgraded from Hardie lap siding to Cultured Stone to introduce street frontage which wraps around the buildings and highlight the entrances and garage access for the units. The natural material blends in harmony with the context and the landscape around the building. (See Sheet R01, 4A & 4B – As Built/Proposed)
- **Affected Area #6** - The entrance doors on Building A, East elevations (Facing Moffatt Road) and Building B, East elevations have been upgraded from three panel doors to solid cored oak veneer door with wood stain to create more modern and high-end entrance. (See Sheet R01, 4A & 4B – As Built/Proposed)
- **Affected Area #7** - The traditional picket guard rail has been upgraded to Cedar and glass guard rail to embrace local natural materials with sleek modern look of the glass. (See Sheet R01, 4A & 4B – As Built/Proposed)



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TEL: (604) 731-3012

FAX: (604) 731-3908

CELL: (604) 649-0669

Email: mcai@telus.net

-
- **Affected Area #8** - The three panel doors on Building A, West elevation have been upgraded to painted fiberglass door to create simple and modern look that fits within the overall design of the development. (See Sheet 4A– As Built/Proposed)
 - **Affected Area #9** - The garage door with a glass insert on Building A, West elevation and Building B, West elevation has been upgraded to garage door with windows and obscured glass to bring more natural light into the garage space and making it more transparent from the outside. (See Sheet 4A & 4B – As Built/Proposed)
 - **Affected Area #10** - On the Building A North elevation, the three panel doors have been upgraded to aluminum storefront door with translucent glass to make garbage and recycle area more accessible. Also by opening up the North Elevation with a translucent glass, it improves the pedestrian experience and makes the entry more inviting. (See Sheet 4A– As Built/Proposed)
 - **Affected Area #11** - The three panel doors on Building A, South elevation have been upgraded to solid painted fire rated metal door to create simple and modern look that fits within the design of the development. (See Sheet 4A– As Built/Proposed)
 - **Affected Area #12** - On the South elevation and the second level floor plan of building B, a window is removed due to practicality issue as the location of stovetop is aligned directly with the window and also to avoid condensation issue. (See Sheet 4B & 5B – As Built/Proposed)



Suite C100 - 4185 Still Creek Drive
Burnaby, British Columbia, V5C 6G9
p: 604 294-0011 ; f: 604 294-0022

May 06, 2015
DP AMENDMENT RATIONALE

RE: 7411 MOFFATT ROAD
RICHMOND, B.C.

The client for the project mentioned above has decided to upgrade the Building materials in order to target younger buyers the City of Richmond. The DP Amendment drawings for landscape is attached. The details are as follows:

Affected Area #13:

The as-built fence was upgraded from the proposed black aluminum rail fence to a fence with better transparency and improving the curb appeal in harmony with the existing exterior material used. The detail and use of vertical cedar panel is a continuation of the balcony detail. The fence now provides 4 inch spacing between the cedar panels.

The DP shows a staggered line location of the fence along the street frontage. The developer will move the street fronting fence on two middle units back 24" to replicate the staggered fence line per design intent of the DP. (See L1, L2 Landscape Plan and Details and L1 and L2 As Built/Proposed").

Affected Area #14:

During the development process it was recommended that a shared children's play area between this site and the site to the north would be encouraged. We showed how this shared play would work and for development permit we revised the landscape submission to show the half of that play area developed on our site and removed the half that would be built on the neighbouring site.

(See L1"As Built/Proposed" and L1"Approved").

Affected Area #15:

Plant Schedule has been revised to show changes in plant material. The design intent of the DP drawings is the same. The number and size of trees remains the same as DP drawings. There are consistently 23 trees on each version of the landscape plans- all as built are of size and quality species.

Affected Area #16:

The fence and gate design for Units 1-6 has been revised to increase transparency and create a blend in harmony with the context and landscape around the building. The amended open fence will provide the design intent of better transparency and light for the small back yards. The change in design of gate and fence highlights the verticality of the material used in the complex.

Affected Area #17:

The extent of porous pavers was co-ordinated with civil engineer. The permeable paver layout matches the design intent as proposed and meets Richmond's standard minimum. The as built area of pavers provides for a generous amount of pavers. It also reflects an approach that most other Townhouses of this scale have built.

Affected Area #18:

The landscape installation includes architectural concrete pillars in place of pillars covered in fake stone;



this change is to accentuate the front façade of the property highlighting the contrast in materials used – but provides that organizing streetscape element per the approved drawings.

Affected Area #19:

The Frances Andrew Bench; Centennial, Model C22-3a; Black Colour was substituted with a similar bench: the Frances Andrew Bench; Basic-Series 1- Model B1-3; Black Colour because of availability at the time of construction. The Landscape Plans have been amended to show the substituted bench. (See L1"As Built/Proposed" and L1"Approved").

Please contact me if there are questions regarding the project.

Sincerely

Patricia Campbell MBCSLA
Principal Landscape Architect
PMG Landscape Architects



MATTHEW CHENG ARCHITECT INC.


1208-206-698 EVANS AVENUE
VANCOUVER, B.C. V6A 3K7
Tel: (604) 686-6667 Email: matthew@matthewcheng.ca

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No.	Date	Revision
01	05/15/08	SCHEMATIC APPLICATION
02	07/23/09	PRELIMINARY DP REVIEW
03	07/23/09	ADP REVIEW
04	09/09/09	ADP REVIEW
05	09/09/09	ADP REVIEW
06	07/12/09	DP REVIEW
07	12/09/09	DP REVIEW
08	06/15/10	DP REVIEW
09	06/15/10	DP REVIEW
10	10/16/14	DP AMENDMENT

Consultants

- AFFECTED AREAS
- HARDIE SHINGLE SIDING
 - 4" HARDIE LAP SIDING
 - HARDIE SHINGLE SIDING
 - 4" HARDIE LAP SIDING
 - 4" HARDIE LAP SIDING
 - THREE PANEL DOOR (RESIDENTIAL ENTRANCE DOOR - BLDG A & B EAST ELEVATION)
 - PICKET GUARD RAIL
 - THREE PANEL DOOR (RESIDENTIAL ENTRANCE DOOR - BLDG A WEST ELEVATION)
 - CARAGE DOOR W/ GLASS INSERT
 - THREE PANEL DOOR (GARAGE/RECYCLING ROOM)
 - THREE PANEL DOOR (ELECTRICAL ROOM)
 - WINDOW NOT INSTALLED (REFER TO AS BUILT)

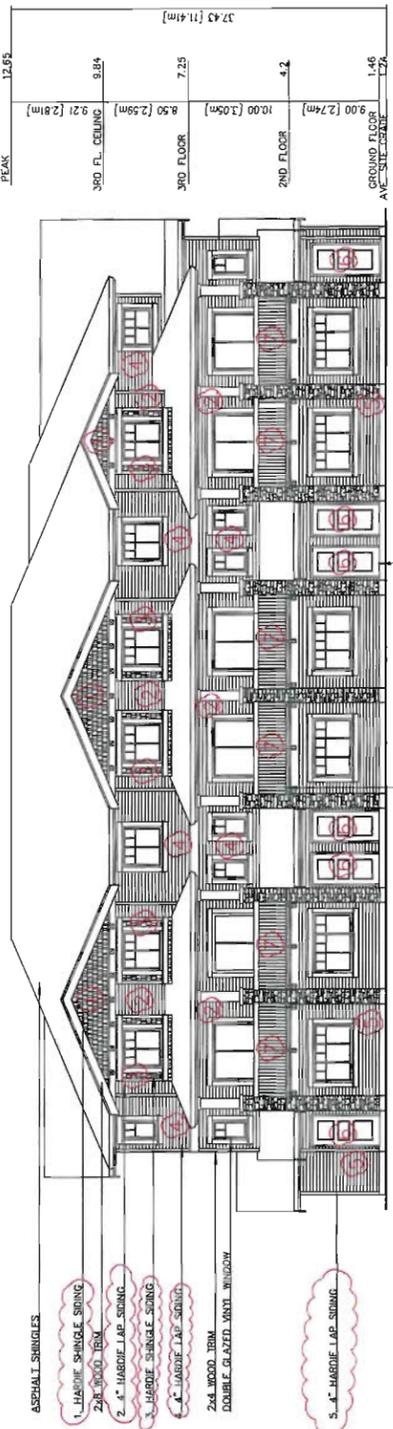


BUILDING A: EAST ELEVATION (MOFFATT)




BUILDING A: WEST ELEVATION

- HARDIE SHINGLES
- COUNTRY LEDGESTONE WHITEOAK
- 4" HARDIE SIDING
- TRIMS/FASCIAS
- ENTRY DOOR
- WINDOW FRAME
- ASPHALT SHINGLES
- GARAGE DOOR
- BM HC-65
- BM HC-870
- BM HC-12
- BM OC-90
- BM HC-154
- BEIGE
- MALARKEY'S HIGHLANDER
- STORM GRAY
- BM OC-90

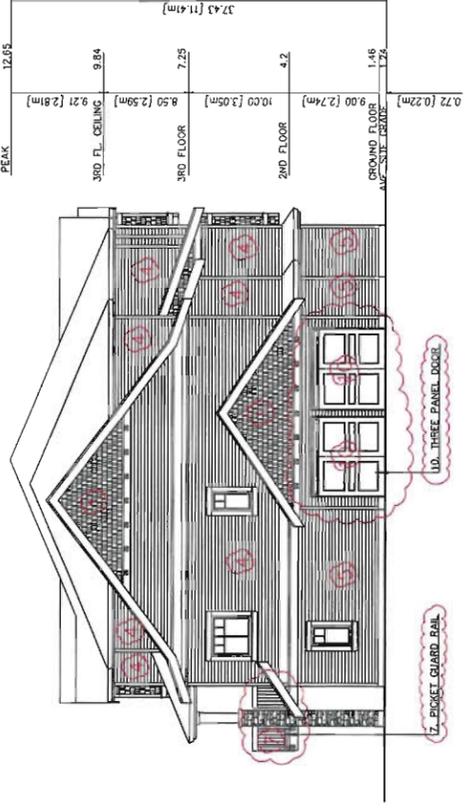

BUILDING A: NORTH ELEVATION

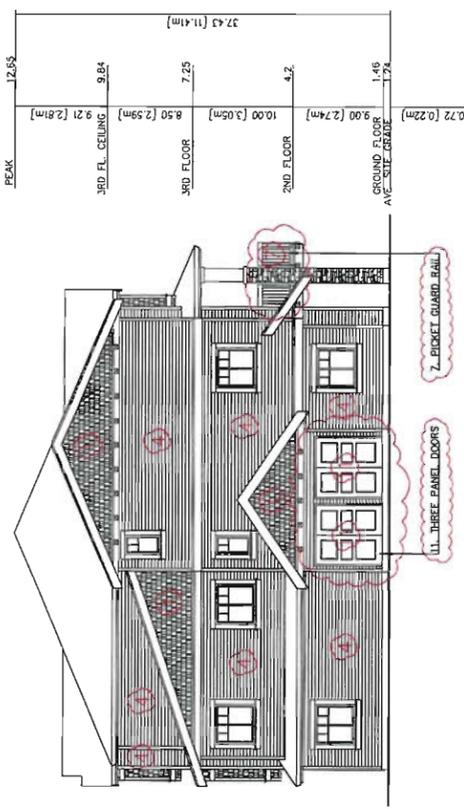

BUILDING A: SOUTH ELEVATION

Project Title
12-UNIT TOWNHOUSE DEVELOPMENT
7411 MOFFATT ROAD
RICHMOND, B.C.

Sheet Title
BUILDING A ELEVATIONS
(APPROVED)

Drawn:	HC
Checked:	MC
Scale:	1/8" = 1'-0"
Project Number:	
Revision Date:	2010/06/15
Print Date:	2015/03/30
Dwg. No.:	#4a



MATTHEW CHENG ARCHITECT INC.

Unit 202-698 EVANS AVENUE
VANCOUVER, B.C. V6A 2P3
Tel: (604) 681-3138
Cell: (604) 681-5669 Email: matthew@matck.ca

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No.	Date	Revision
01	11/21/08	REZONING APPLICATION
02	05/13/09	PRELIMINARY DP REVIEW
03	07/23/09	ADP REVIEW REVISE
04	08/06/09	ADP REVIEW REVISE
05	08/06/09	ADP REVIEW REVISE
06	07/12/09	DP REVIEW
07	07/09/10	DP REVIEW
08	12/09/10	DP REVIEW
09	06/15/10	DP REVIEW
10	10/15/14	DP AMENDMENT


Consultants

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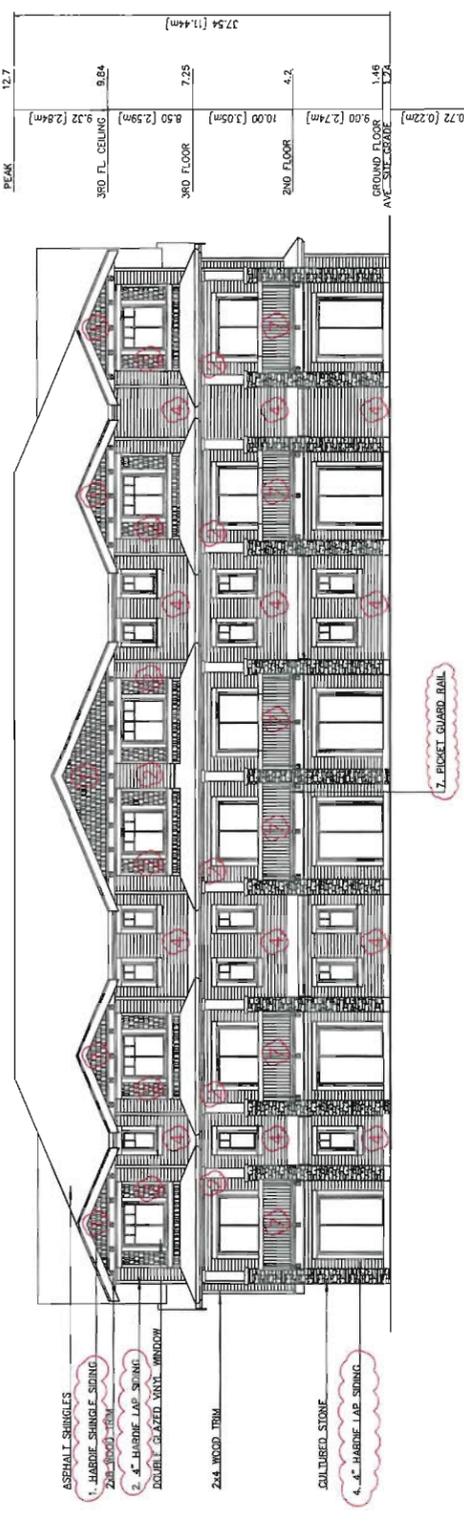
- BM HC-65 COUNTRY LEDGESTONE WHITEOAK
- BM HC-670 COUNTRY LEDGESTONE WHITEOAK
- BM HC-12 BEIGE
- BM OC-90 MALARKY'S HIGHLANDER STORM GRAY
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- CULTURE STONE
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- TRIMS/FASCIAS
- ENTRY DOOR
- WINDOW FRAME
- ASPHALT SHINGLES
- GARAGE DOOR




BUILDING B: EAST ELEVATION

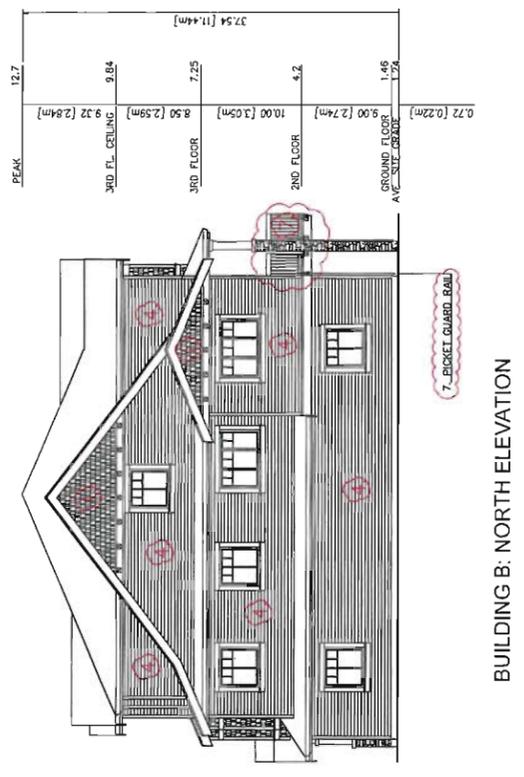

BUILDING B: NORTH ELEVATION



BUILDING B: WEST ELEVATION

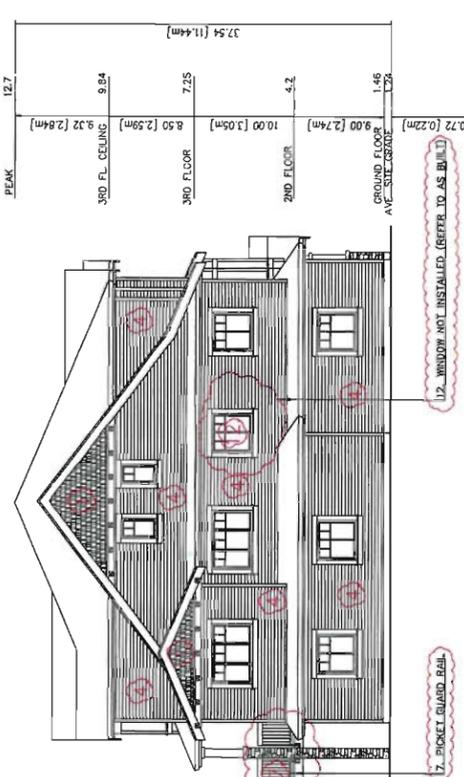

BUILDING B: SOUTH ELEVATION

Project Title
12-UNIT TOWNHOUSE DEVELOPMENT
7411 MOFFATT ROAD
RICHMOND, B.C.

Sheet Title
BUILDING A ELEVATIONS
(APPROVED)

Drawn: HC
Checked: MC
Scale: 1/8" = 1'-0"
Project Number:

Revision Date: 2010/06/15
Print Date: 2015/03/30
Orig. No. #4b



MATTHEW CHENG ARCHITECT INC.

1541 206th AVE EVANS AVENUE
VANCOUVER, BC V6A 2S7
Tel: (604) 271-9177 Fax: (604) 271-3818
Cell: (604) 664-6497 Email: matthew@mcga.ca

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No	Date	Revision	Application
01	05/11/08	PRELIMINARY	APPLICATION
02	05/15/08	PRELIMINARY	DP REVIEW
03	07/23/08	ADP REVIEW	ADP REVIEW
04	07/29/08	ADP REVIEW	ADP REVIEW
05	07/29/08	ADP REVIEW	ADP REVIEW
06	07/12/08	DP REVIEW	DP REVIEW
07	12/08/08	DP REVIEW	DP REVIEW
08	27/04/10	DP REVIEW	DP REVIEW
09	10/15/10	DP REVIEW	DP REVIEW
10	10/15/14	DP AMENDMENT	DP AMENDMENT

Consultants

Project Title
12-UNIT TOWNHOUSE
DEVELOPMENT
7411 MOFFATT ROAD
RICHMOND, B.C.

Sheet Title
SITEPLAN
SECOND FLOOR PLAN
(APPROVED)


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Project Number:


Revision Date:
2010/08/15
Print Date:
2015/03/20
Dwg. No.:
#5b



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- * BLOCKING TO BE PROVIDED IN ALL BATHROOMS FOR GRAB BARS.
- * LEVER HANDLE TO BE USED FOR ALL DOORS
- * LEVER FAUCET TO BE USED IN ALL BATHROOMS AND POWDER ROOMS

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NO.	DATE	REVISION DESCRIPTION	DR.
1	02/10/18	REVISED AS PER CITY COMMENT	DD
2	02/10/18	REVISED AS PER CITY COMMENT	DD
3	02/10/18	REVISED AS PER CITY COMMENT	DD
4	02/10/18	REVISED AS PER CITY COMMENT	DD
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6	02/10/18	REVISED AS PER CITY COMMENT	DD
7	02/10/18	REVISED AS PER CITY COMMENT	DD

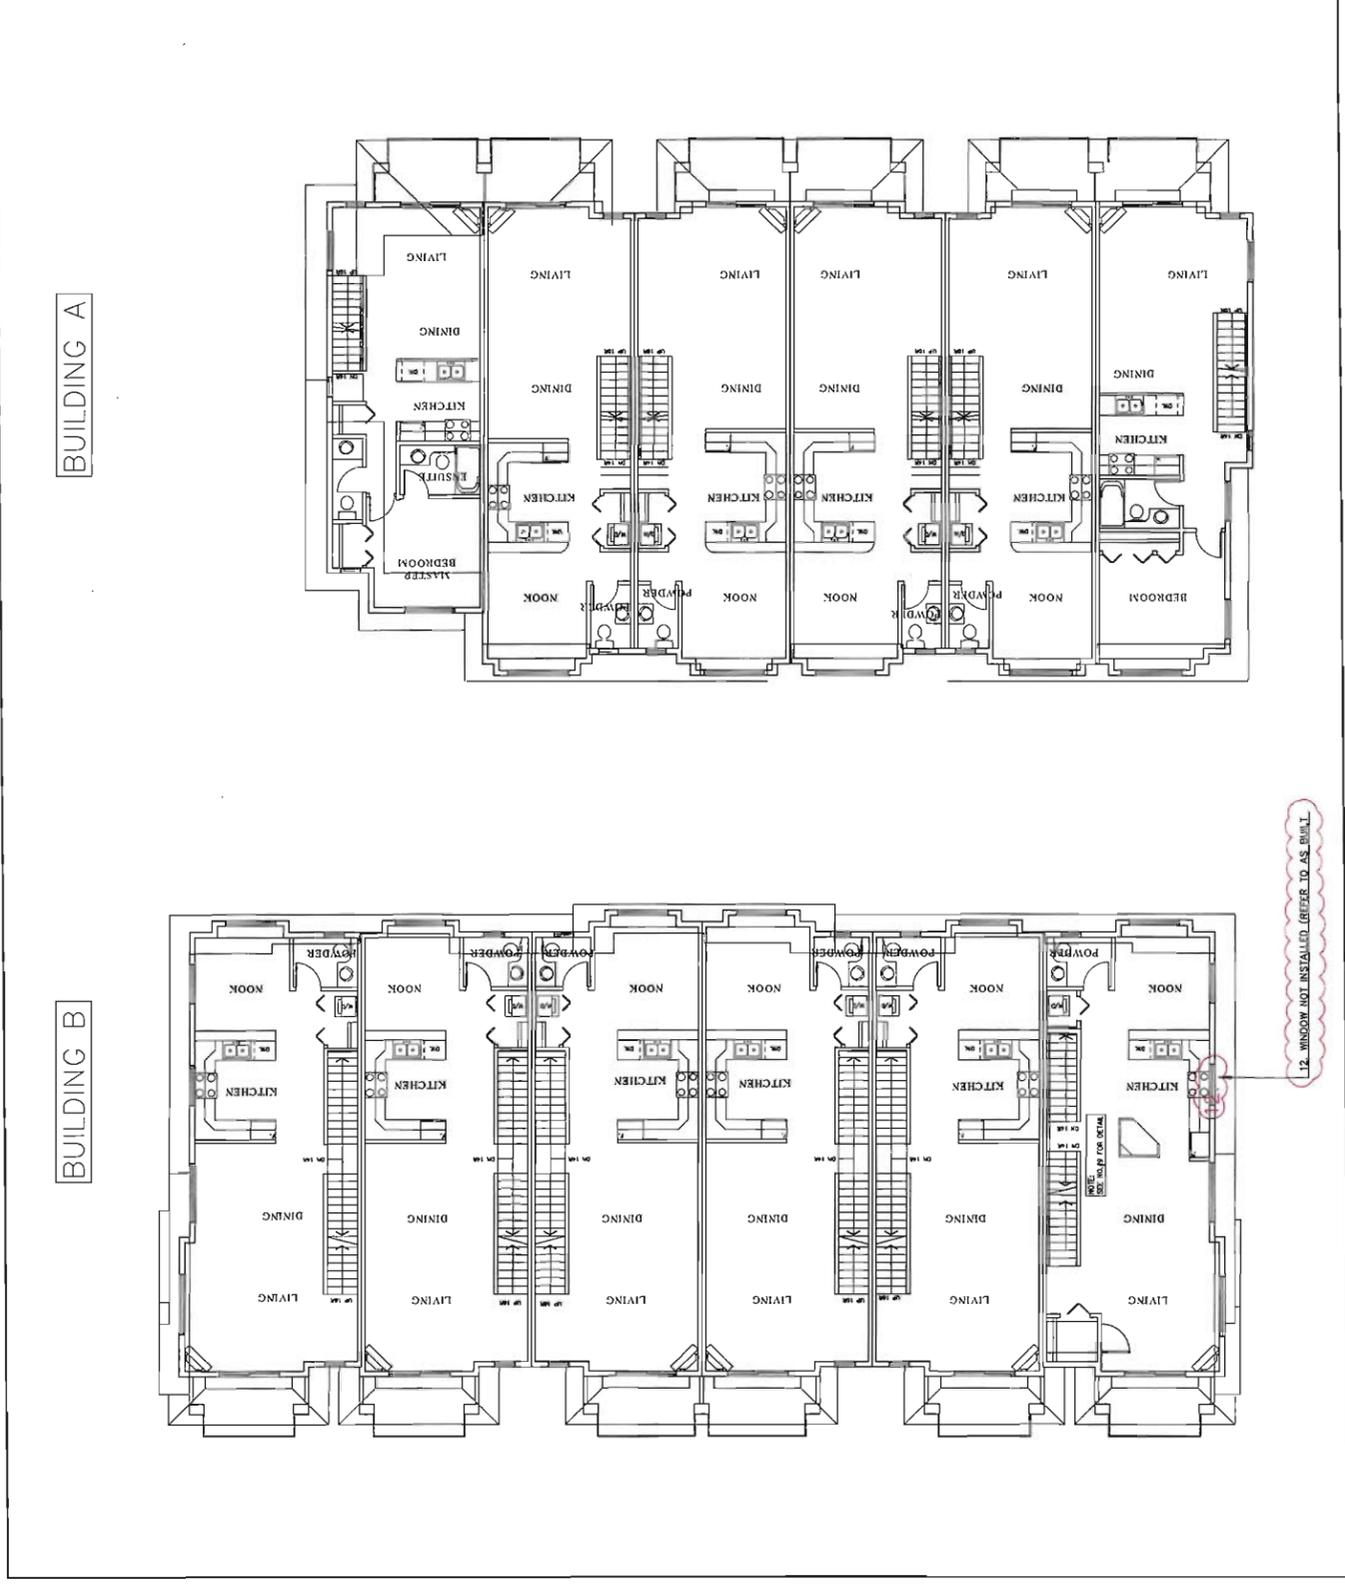

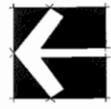
A Partnership of
 J.D. Mitchell & Associates Ltd.
 Patricia Campbell Mills Consultants Ltd.
 Mary Chan Trip Consultants Ltd.
 Suite C100 - 4185 Still Creek Drive
 Burnaby, British Columbia
 V5C 6S9
 PH (604) 437-3842; FX 437-8723

PROJECT:
12 UNIT TOWNHOUSE DEVELOPMENT
 7411 MOFFATT ROAD
 RICHMOND, BC

DRAWING TITLE:
LANDSCAPE PLAN

DATE: 09-JUN-18	DRAWING NUMBER
SCALE:	
DRAWN: DD	
DESIGN: DD	
CHKD: PC	
DMG PROJECT NUMBER:	09-082

L2
 Approved of 4

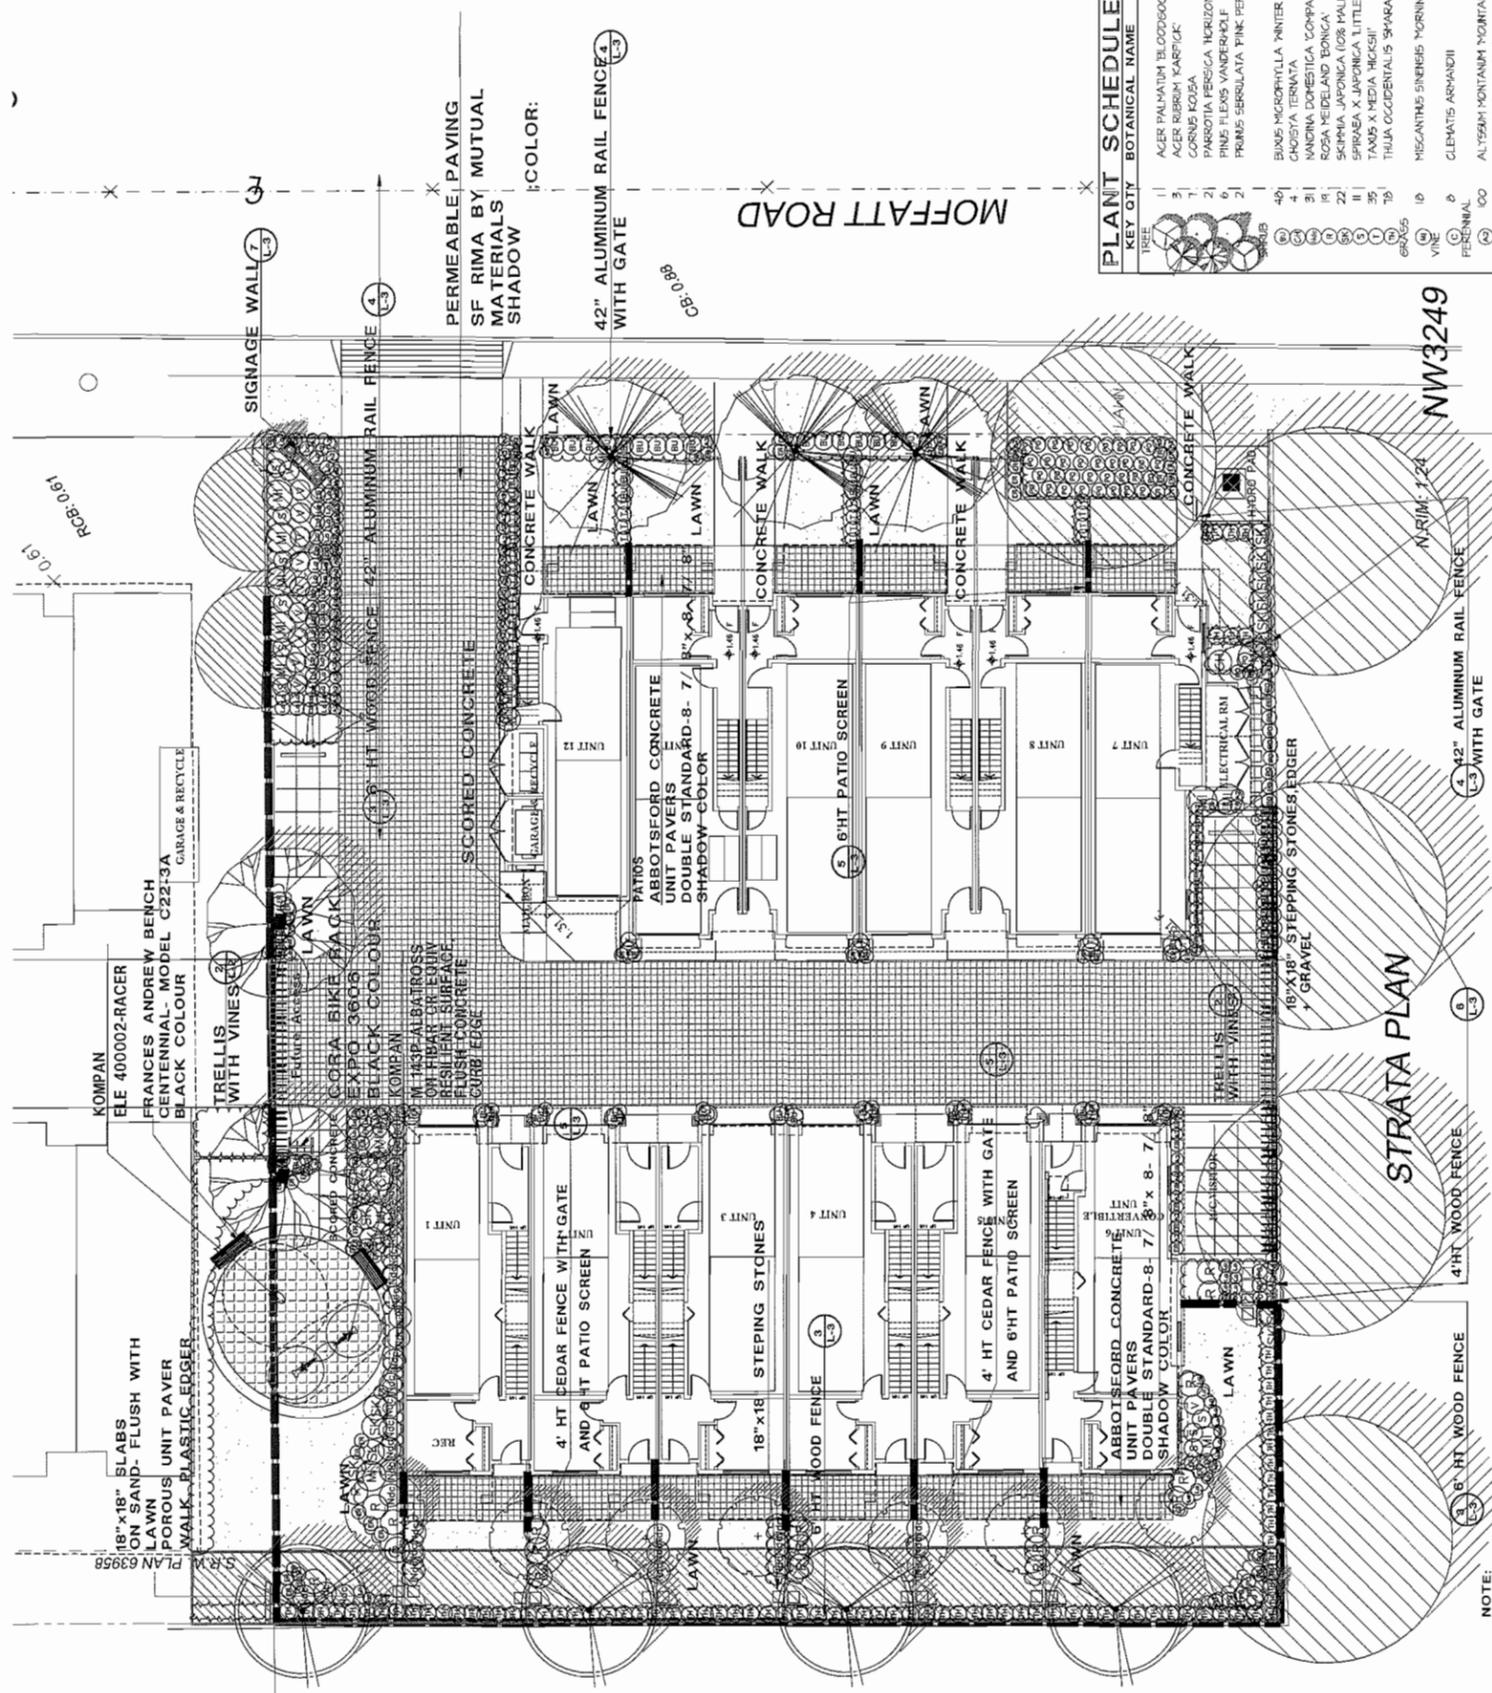

PLANT SCHEDULE

KEY CITY	BOTANICAL NAME	COMMON NAME	PLANTED SIZE / REMARKS
11	ACER PALMATHUM 'BLOODGOOD'	JAPANESE WAXLE	3M HT, B&B, UPRIGHT FORM
12	ACER RUBRA 'KARFOLC'	RED MAPLE	6CM CAL, 2M STD, B&B
13	CORNUS KOESA	KOEA DOGWOOD	1.8M HT, B&B
14	PARROTIA PERSICA 'HORIZONTAL VARIETY'	HORIZONTAL PERSIAN IRONWOOD	5CM CAL, 1.2M STD, B&B
15	PINKS FLEXUS VANDERHOF	PINE	2.3M HT
16	FRAXUS SEBRULATA 'PINK PERFECTION'	PINK PERFECTION FLOWERING CHERRY	6CM CAL, 2M STD, B&B
17	BUXUS MICROPHYLLA 'WINTER GEM'	LITTLE-LEAF BOX	#3 POT, 40CM
18	CHOISYA TERNATA	HEXAGON HOCK ORANGE	#2 POT, 40CM
19	MADRINA DORESTICA 'COMPACTA'	COMPACTA HEAVENLY BAMBOO	#2 POT, 20CM
20	ROSA HEDELAND 'BONICA'	HEDELAND ROSE, PINK	#2 POT, 40CM
21	SCIRPUS JAPONICA (10% PALE)	JAPANESE SKIRPIA	#2 POT, 30CM
22	SPIROEA X JAPONICA 'LITTLE PRINCESS'	LITTLE PRINCESS SPRAEA, PINK	#2 POT, 40CM
23	TAXUS X MEDIA 'HICKSII'	HICKS' TEN	#5 POT, 80CM
24	THUJA OCCIDENTALIS 'SHARADZ'	EMERALD GREEN CEDAR	1.8M HT, B&B
25	MEGACANTUS SINENSIS 'MORNING LIGHT'	MORNING LIGHT JAP SILVER GRASS	#2 POT
26	CLEMATIS ARSANDII	EVERGREEN CLEMATIS	#2 POT, 60CM, STAKED
27	ALYSSUM MONTANUM 'MOUNTAIN GOLD'	BASKET OF GOLD	9CM POT
28	HEPACALLIS BELVA	DAFFLE	#1 POT, 1/2 FAN
29	LAVENDULA ANGSTROEMIA 'MUNSTED'	ENGLISH LAVENDER	#1 POT
30	POLYSTICHUM MANTUM	WESTERN SWORD FERN	#1 POT, 20CM
31	VACCINIUM COAGSOLUM 'BLOODSTONE'	CREeping BLUEBERRY	#1 POT, 25CM

NOTE: * PLANT SPECIES IN THE LIST ARE SPECIFIED ACCORDING TO THE BC LANDSCAPE STANDARD LATEST EDITION. CONTAINER SPECIES SPECIFIED AS PER DATA STANDARDS. BOTH PLANT SIZE AND CONTAINER SIZE ARE THE MINIMUM ACCEPTABLE SIZES. * REFER TO SPECIFICATIONS FOR DEFINED CONTAINER REQUIREMENTS AND OTHER PLANT MATERIAL REQUIREMENTS. * SEARCH AND REVIEW MAKE PLANT MATERIAL AVAILABLE FOR OPTIONAL REVIEW BY LANDSCAPE ARCHITECT AT SOURCE OF SUPPLY. AREA OF SEARCH TO INCLUDE LOWER MAIN AND AND FRASER VALLEY. * SUBSTITUTIONS OBTAIN WRITTEN APPROVAL FROM THE LANDSCAPE ARCHITECT PRIOR TO MAKING ANY SUBSTITUTIONS TO THE SPECIFIED MATERIAL. UNAPPROVED SUBSTITUTIONS WILL BE REJECTED. ALLOW A MINIMUM OF FIVE DAYS PRIOR TO DELIVERY FOR REQUEST TO SUBSTITUTE. SUBSTITUTIONS ARE SUBJECT TO BC LANDSCAPE STANDARD - DEFINITION OF CONDITIONS OF AVAILABILITY.

ALL PLANT MATERIAL MUST BE PROVIDED FROM CERTIFIED DISEASE FREE NURSERY. PROVIDE CERTIFICATION UPON REQUEST.

NOTE:
 NO PERM. IRRIGATION SYSTEM
 ALL PLANT ARE DROUGHT TOLERANT.
 TREES PROVIDE SHADE PARTICULARLY ON SOUTH AND WEST SIDES
 OPTED LANDSCAPE AREAS CLEARLY ASSIGNED TO OWNERS AND MARKED WITH HEDGES AND FENCES.

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NO.	DATE	REVISION DESCRIPTION	DR.
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A Partnership of
 J.J. & M. Chan Architects Ltd.
 Paikisa Campbell & Associates Ltd.
 Healy Chan Yip Consultants Ltd.
 Suite C100 - 4885 Still Creek Drive
 Burnaby, British Columbia
 V5C 6S9
 PH (604) 437-3942, FX 437-8723


PROJECT:
12 UNIT TOWNHOUSE DEVELOPMENT
 7411 MOFFATT ROAD
 RICHMOND, BC

DRAWING TITLE:
LANDSCAPE DETAILS

DATE: 09 JUN 08	DRAWING NUMBER:
SCALE:	
DRAWN: DD	L3
DESIGN: DD	Approved
CHKD: PC	OF 4
DMG PROJECT NUMBER:	09-082




CORA BIKE RACK EXPO 3606 BLACK COLOUR

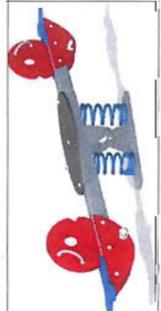


KOMPAN M 143P-ALBATROSS



FRANCES ANDREW BENCH CENTENNIAL-MODEL C22-3A BLACK COLOUR

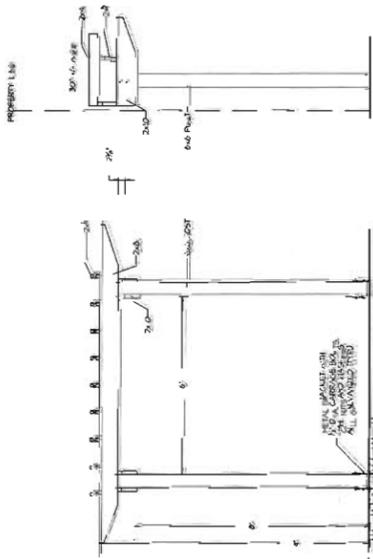


3 TRELLIS
 L3 1/2" = 1'-0"

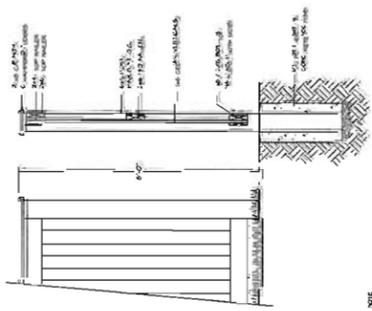


3 6'-0" HEIGHT WOOD FENCE
 L3 1/2" = 1'-0"

- NOTES:
1. ALL DIMENSIONS UNLESS OTHERWISE NOTED ARE IN MILLIMETERS.
 2. ALL DIMENSIONS ARE TO FACE UNLESS OTHERWISE NOTED.
 3. ALL DIMENSIONS ARE TO FACE UNLESS OTHERWISE NOTED.
 4. ALL DIMENSIONS ARE TO FACE UNLESS OTHERWISE NOTED.
 5. ALL DIMENSIONS ARE TO FACE UNLESS OTHERWISE NOTED.

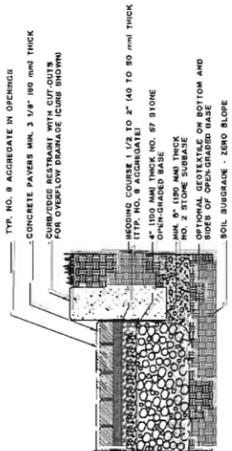


- NOTES:
1. ALL DIMENSIONS UNLESS OTHERWISE NOTED ARE IN MILLIMETERS.
 2. ALL DIMENSIONS ARE TO FACE UNLESS OTHERWISE NOTED.
 3. ALL DIMENSIONS ARE TO FACE UNLESS OTHERWISE NOTED.
 4. ALL DIMENSIONS ARE TO FACE UNLESS OTHERWISE NOTED.
 5. ALL DIMENSIONS ARE TO FACE UNLESS OTHERWISE NOTED.
 6. ALL DIMENSIONS ARE TO FACE UNLESS OTHERWISE NOTED.
 7. ALL DIMENSIONS ARE TO FACE UNLESS OTHERWISE NOTED.

7 SF PERMEABLE DRIVEWAY EXFILTRATION TO SOIL SUBGRADE
 L3 1/2" = 1'-0"

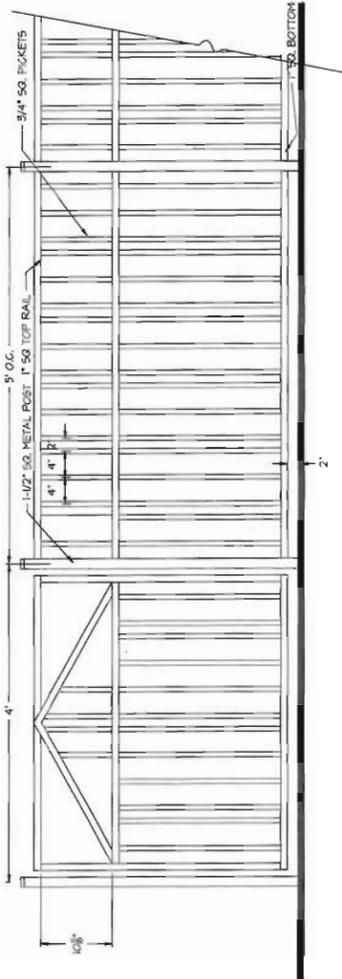


4 42" ALUMINUM RAIL FENCE WITH GATE BLACK COLOR
 L3 1" = 1'-0"

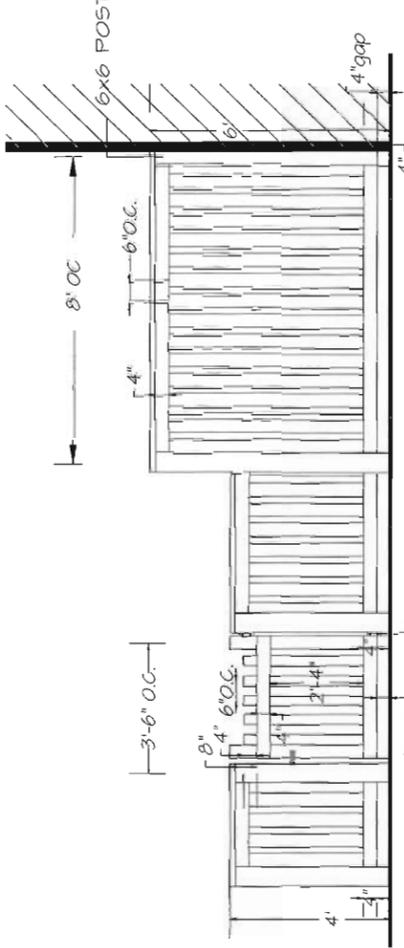


5 6' HT PATIO SCREEN AND 4' HT WOOD FENCE WITH GATE
 L3 1/2" = 1'-0"

- NOTES:
1. ALL DIMENSIONS UNLESS OTHERWISE NOTED ARE IN MILLIMETERS.
 2. ALL DIMENSIONS ARE TO FACE UNLESS OTHERWISE NOTED.
 3. ALL DIMENSIONS ARE TO FACE UNLESS OTHERWISE NOTED.
 4. ALL DIMENSIONS ARE TO FACE UNLESS OTHERWISE NOTED.
 5. ALL DIMENSIONS ARE TO FACE UNLESS OTHERWISE NOTED.

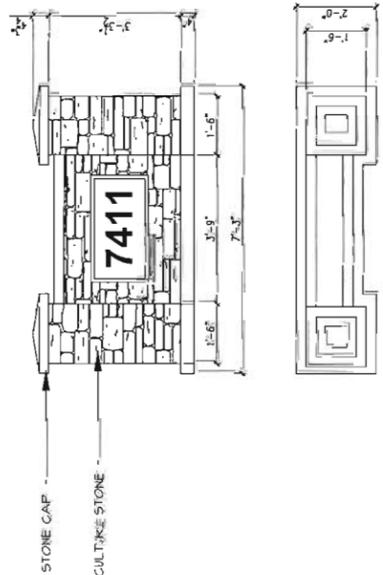

7 SIGNAGE WALL
 L3 1/2" = 1'-0"

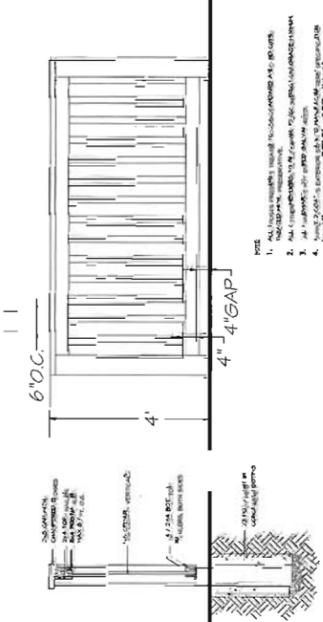

6 4' HT WOOD FENCE
 L3 1/2" = 1'-0"

- NOTES:
1. ALL DIMENSIONS UNLESS OTHERWISE NOTED ARE IN MILLIMETERS.
 2. ALL DIMENSIONS ARE TO FACE UNLESS OTHERWISE NOTED.
 3. ALL DIMENSIONS ARE TO FACE UNLESS OTHERWISE NOTED.
 4. ALL DIMENSIONS ARE TO FACE UNLESS OTHERWISE NOTED.
 5. ALL DIMENSIONS ARE TO FACE UNLESS OTHERWISE NOTED.



MATTHEW CHENG ARCHITECT INC.

108-261, 426 SWANSON AVENUE
VANCOUVER, BC, V6A 2K5
TEL: (604) 271-8662 / Fax: (604) 271-3988
Cell: (604) 999-8662 / Email: matt@mcgarch.com

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No.	Date	Revision
01	07/14/09	ISSUE FOR PERMIT
02	07/14/09	ISSUE FOR PERMIT
03	07/23/09	ADP REVIEW
04	07/23/09	ADP REVIEW
05	07/23/09	ADP REVIEW
06	07/23/09	ADP REVIEW
07	12/08/09	DP REVIEW
08	27/04/10	DP REVIEW
09	09/16/10	DP REVIEW
10	09/16/10	DP REVIEW
11	07/10/14	DP REV.

Consultants:





STREETSCAPE (FRONTING MOFFATT ROAD)

Project Title
12-UNIT TOWNHOUSE DEVELOPMENT
7411 MOFFATT ROAD
RICHMOND, B.C.


Sheet Title
COLOR ELEVATION

Checked:	HC
Checked:	MC
Scale:	1/8" = 1'-0"
Project Number:	

Revision Date:	May 11 2015	Draw. No.:	R01
Print Date:	2014/10/07		

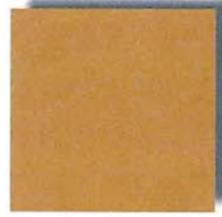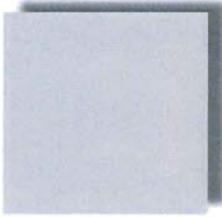- 
HARDIE BOARD AND BATTEN
Texas Honey Brown
- 
HARDIE HORIZONTAL SIDING
 - Kenroc Black Space Rock
 - Pro-fit Alpine LedgeStone- Black Rundle Stone Veneer
- 
CULTURED STONE
 - Kenroc Black Space Rock
 - Pro-fit Alpine LedgeStone- Black Rundle Stone Veneer
- 
FASCIA BOARD, COLUMN
 - Kenroc Black Space Rock
 - Pro-fit Alpine LedgeStone- Black Rundle Stone Veneer
- 
FASCIA BOARD, COLUMN
 - Kenroc Black Space Rock
 - Pro-fit Alpine LedgeStone- Black Rundle Stone Veneer
- 
CEDAR WOOD RAILING
ENTRY DOOR
- 
METAL PANEL CLADDING
040 Clear Anodized Aluminium

DP 07-363924

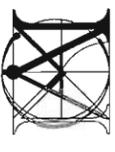

MATTHEW CHENG ARCHITECT INC.

106-302-4706 EVANS AVENUE
 SUITE 200 RICHMOND, B.C. V6X 1A2
 TEL: (604) 271-3912 FAX: (604) 271-5988
 C.E. #14949/669 / Email: matthew@mcara.ca

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No	Date	Revision
01	11/21/08	REZONING APPLICATION
02	05/13/09	PRELIMINARY OF REVIEW
03	07/29/09	ADP REVIEW REMISE
04	07/29/09	ADP REVIEW REMISE
05	08/05/09	ADP REVIEW
06	07/08/09	DP REVIEW
07	07/08/09	DP REVIEW
08	27/04/10	DP REVIEW
09	08/15/10	DP REVIEW
10	10/16/14	DP AMENDMENT

Consultants

AFFECTED AREAS

- HARDIE LAP SIDING
- HARDIE BOARD & BATTEN
- METAL PANEL
- ROCK DASH STUCCO
- CULTURED STONE
- SOLID CORED OAK VENEER DOOR W/ WOOD STAIN
- CEDAR & GLASS GUARD RAIL
- PAINTED FIBREGLASS DOOR
- GARAGE DOOR W/ WINDOWS AND OBSCURED GLASS
- ALUMINUM STOREFRONT DOORS W/ TRANSLUCENT GLASS
- PAINTED FIRE RATED METAL DOOR
- WINDOW NOT INSTALLED (REFER TO APPROVED)




BUILDING A: EAST ELEVATION (MOFFATT)




BUILDING A: WEST ELEVATION

- | | |
|-----------------------|---|
| HARDIE BOARD & BATTEN | TEXAS HONEY BROWN |
| HARDIE LAP SIDING | TEXAS HONEY BROWN |
| CULTURED STONE | PRO-FIT ALPINE LEDGESTONE-BLACK RUNDLE STONE VENEER |
| ROCK DASH STUCCO | HARDROCK BLACK STUCCO/KENROC BLACK ROCK |
| METAL PANEL | 040 CLEAR ANODIZED ALUMINIUM |
| TRIMS/FASCIAS | BENJAMIN MOORE HC-166 |
| ENTRY DOOR | OAK VENEER |
| WOOD RAILING | CEDAR WOOD |
| WINDOW FRAME | BEIGE |
| ASPHALT SHINGLES | MALARKEY'S HIGHLANDER |
| GARAGE DOOR | STORM GRAY |
| | BM CC-90 |

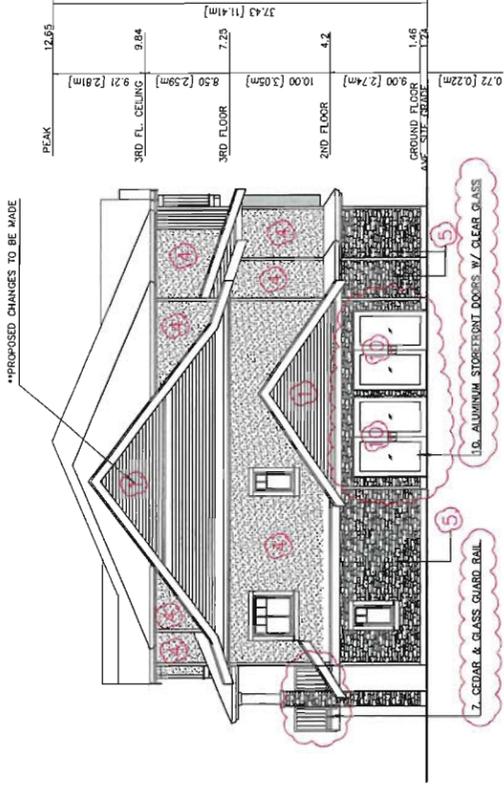

BUILDING A: NORTH ELEVATION

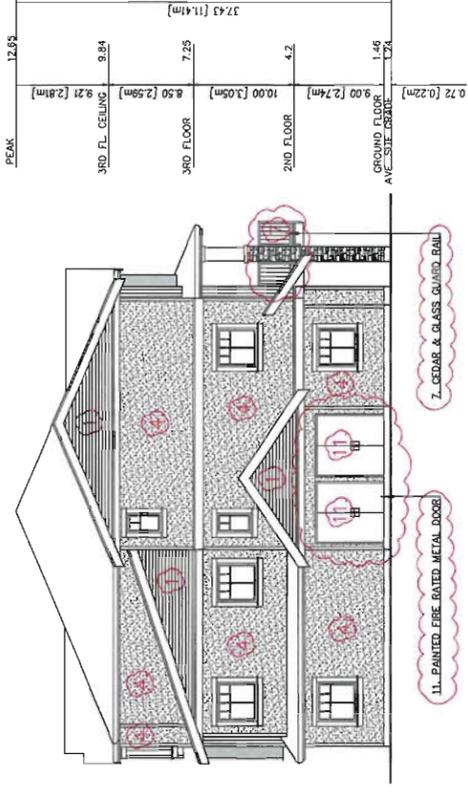

BUILDING A: SOUTH ELEVATION

Drawn: DC
 Checked: MC
 Scale: 1/8" = 1'-0"
 Project Number: _____

Revision Dates: 2015/03/30
 Print Date: 2015/03/30
 Dwg. No. #4a

MAY 11 2015

DP 07-363924



MATTHEW CHENG ARCHITECT INC.

100A 302 - 678 EVANS AVENUE
 VANCOUVER, BC V6A 2P6
 TEL: (604) 681-7150
 FAX: (604) 681-7151
 WWW: MCHENGARCHITECT.COM
 E-MAIL: MCHENG@MCHENG.COM

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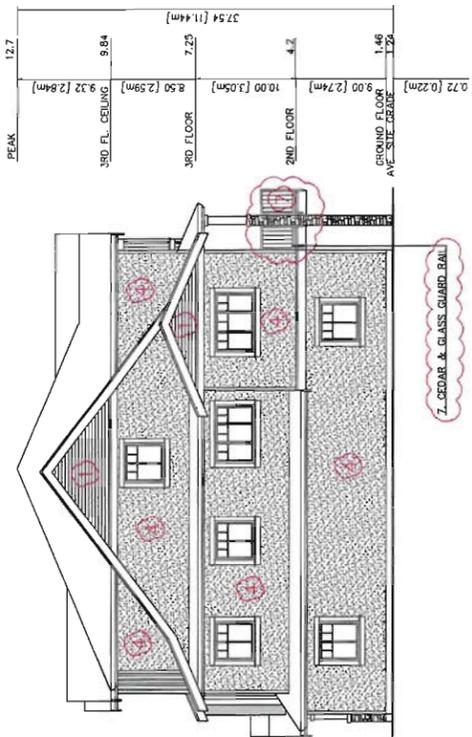
No	Date	Revision
01	11/21/08	REZONING APPLICATION
02	05/13/09	PRELIMINARY DP REVIEW
03	07/23/09	APP REVIEW REVISE
04	08/06/09	APP REVIEW REVISE
05	08/06/09	APP
06	07/12/09	DP REVIEW
07	07/12/09	DP REVIEW
08	07/04/10	DP REVIEW
09	08/15/10	DP REVIEW
10	10/16/14	DP AMENDMENT

Consultants


AFFECTED AREAS

- HARDIE LAP SIDING
- HARDIE BOARD & BATTEN
- METAL PANEL
- ROCK DASHED STUCCO
- CULTURED STONE
- SOLID CORED OAK VENEER DOOR W/ WOOD STAIN
- CEDAR & GLASS GUARD RAIL
- PAINTED FIBREGLASS DOOR
- GARAGE DOOR W/ WINDOWS AND OBSCURED GLASS
- ALUMINUM STOREFRONT DOORS W/ TRANSLUCENT GLASS
- PAINTED FIRE RATED METAL DOOR
- WINDOW NOT INSTALLED (REFER TO APPROVED)


- TEXAS HONEY BROWN
- TEXAS HONEY BROWN
- PRO-FIT ALPINE LEDGESTONE-BLACK RUNDLE STONE VENEER
- HARDROCK BLACK STUCCO/KENROC BLACK ROCK
- 040 CLEAR ANODIZED ALUMINIUM
- BENJAMIN MOORE HC-166
- OAK VENEER
- CEDAR WOOD
- BEIGE
- MALARKEY'S HIGHLANDER
- STORM GRAY
- BM OC-90
- HARDIE BOARD & BATTEN
- HARDIE LAP SIDING
- CULTURED STONE
- ROCK DASH STUCCO
- METAL PANEL
- TRIMS/FASCIAS
- ENTRY DOOR
- WOOD RAILING
- WINDOW FRAME
- ASPHALT SHINGLES
- GARAGE DOOR




BUILDING B: NORTH ELEVATION

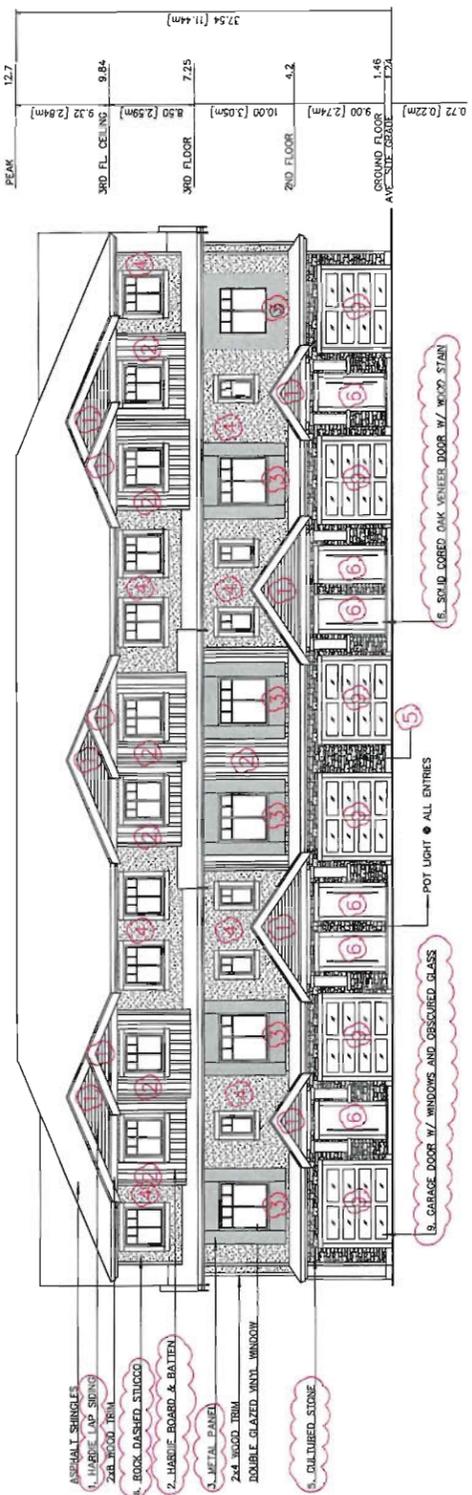

BUILDING B: EAST ELEVATION

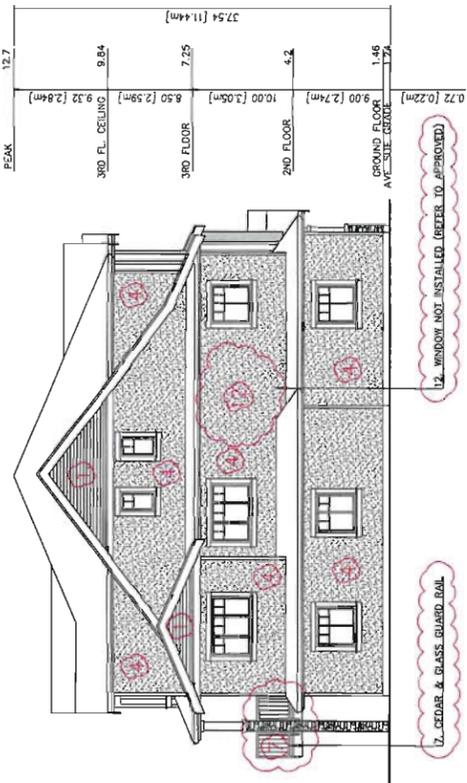

BUILDING B: SOUTH ELEVATION

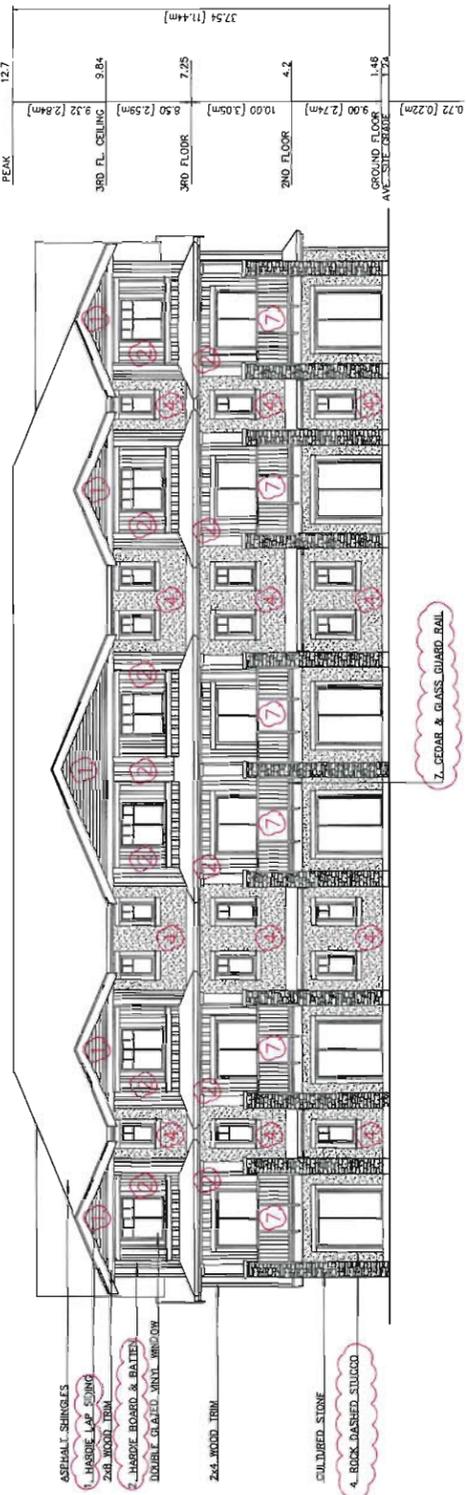

BUILDING B: WEST ELEVATION

Project Title
12-UNIT TOWNHOUSE DEVELOPMENT
 7411 MOFFATT ROAD
 RICHMOND, B.C.

Sheet Title
BUILDING B ELEVATIONS
 (AS BUILT/PROPOSED)

Drawn: DC
 Checked: MC
 Scale: 1/8" = 1'-0"
 Project Number:

Revision Date: 2015/03/30
 Print Date: 2015/03/30
 Draw. No. **#4b**

MAY 11 2015

DP 07-363924



MATTHEW CHENG ARCHITECT INC.

1200 - 47th AVENUE
 VANCOUVER, BC V6N 1C6
 TEL: (604) 271-2022 / Fax: (604) 271-2928
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No	Date	Revision
01	11/21/08	REZONING APPLICATION
02	05/13/09	PRELIMINARY DP REVIEW
03	07/29/09	APP REVIEW
04	07/29/09	APP REVIEW REVISE
05	08/06/09	APP REVIEW REVISE
06	07/12/09	DP REVIEW
07	07/12/09	DP REVIEW
08	27/04/10	DP REVIEW
09	09/15/10	DP REVIEW
10	10/16/14	DP AMENDMENT


Consultants

Project Title
 12-UNIT TOWNHOUSE DEVELOPMENT
 7411 MOFFATT ROAD
 RICHMOND, B.C.

Sheet Title
 SITEPLAN
 SECOND FLOOR PLAN
 (AS BUILT/PROPOSED)

Drawn:
 DC
Checked:
 MC
Scale:
 1/8" = 1'-0"
Project Number:

Revision Date
 2015/03/30
Print Date
 2015/03/30
Dwg. No.
 #5b

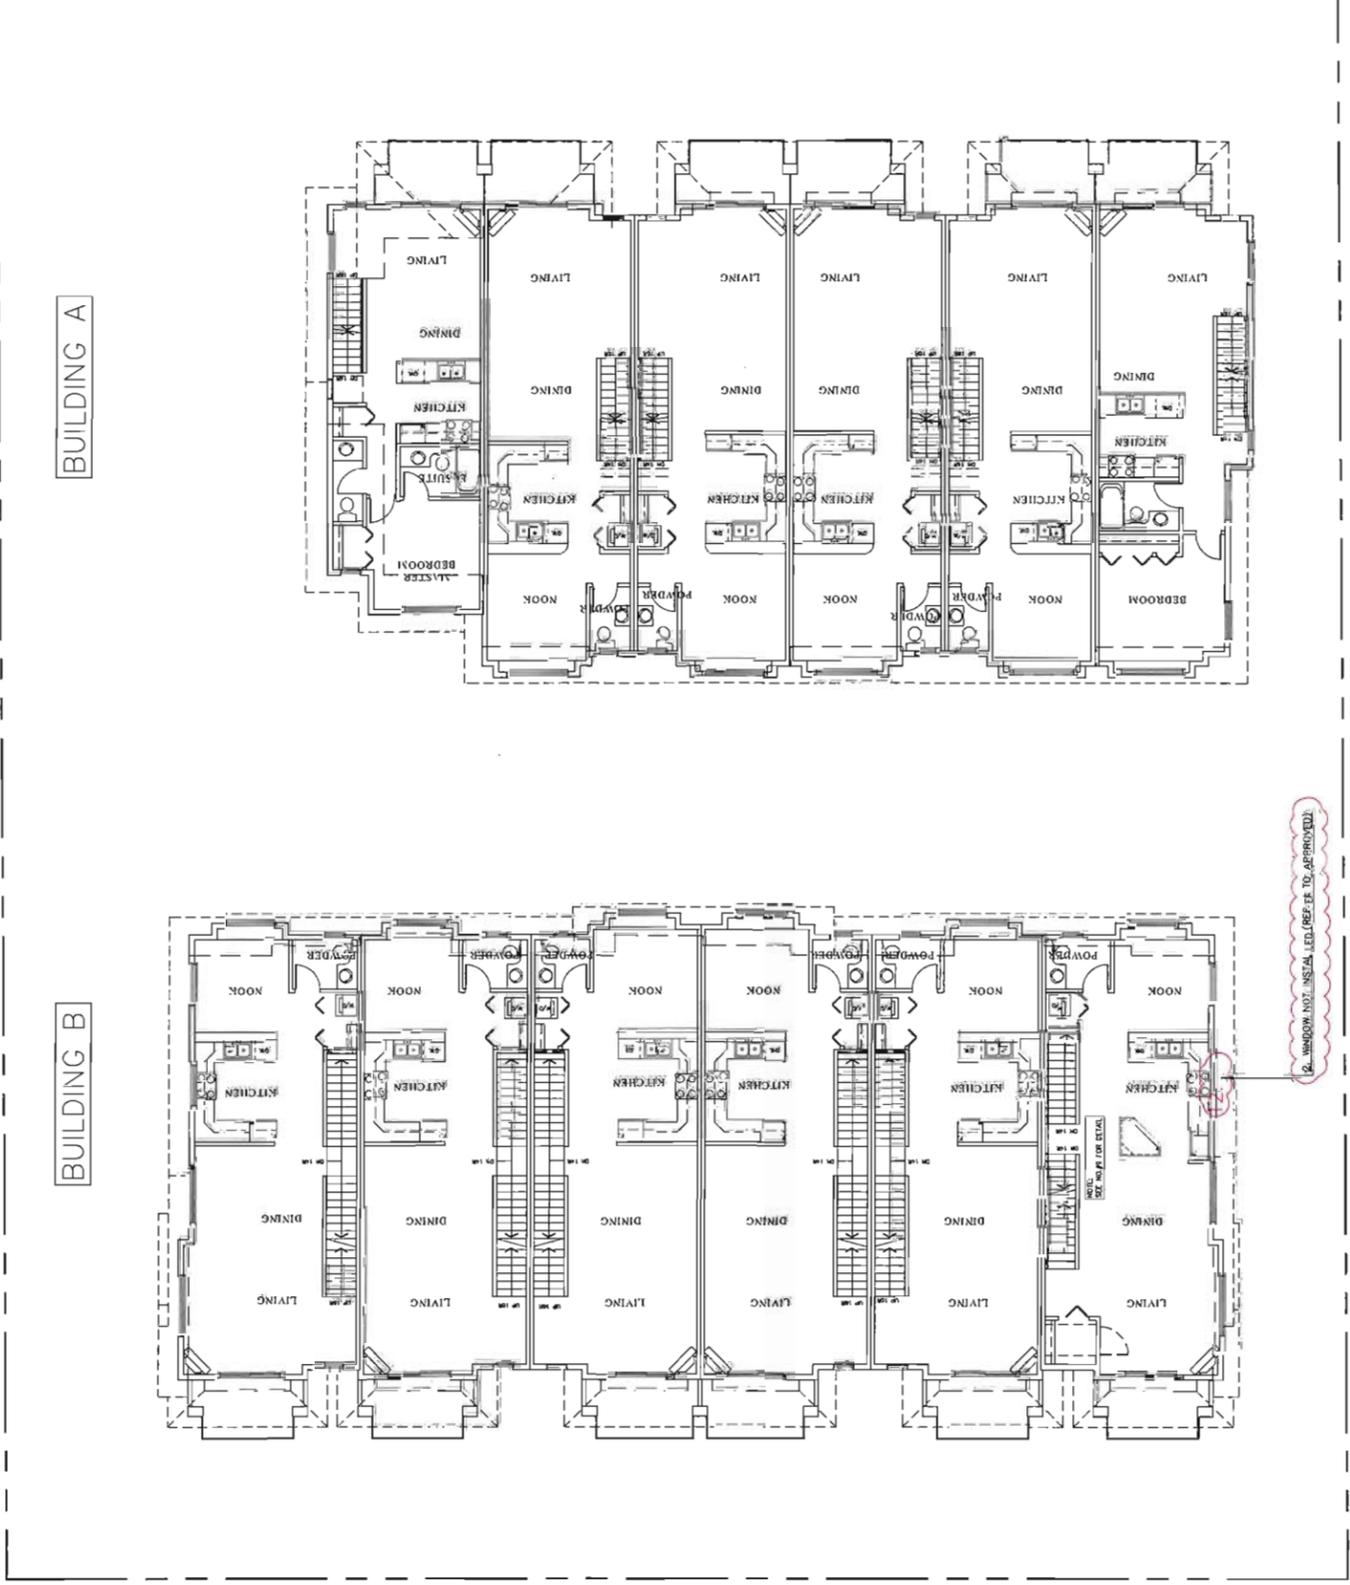

AFFECTED AREAS

1. HARDIE LAP SILING
2. HARDIE BOARD & BATTEN
3. METAL PANEL
4. ROCK DASHED STUCCO
5. CULTURED STONE
6. SOLID CORED OAK VENEER DOOR W/ WOOD STAIN
7. CEDAR & GLASS GUARD RAIL
8. PAINTED FIBREGLASS DOOR
9. GARAGE DOOR W/ WINDOWS AND OBSCURED GLASS
10. ALUMINUM STREPTOOR DOORS W/ TRANSLUCENT GLASS
11. PAINTED FIRE RATED METAL DOOR
12. WINDOW NOT INSTALLED (REFER TO APPROVED)

- * BLOCKING TO BE PROVIDED IN ALL BATHROOMS FOR GRAB BARS.
- * LEVER HANDLE TO BE USED FOR ALL DOORS
- * LEVER FAUCET TO BE USED IN ALL BATHROOMS AND POWDER ROOMS

2. WINDOW NOT INSTALLED (REFER TO APPROVED)

MAY 1 1 2015

DP 07-363924


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Burnaby, British Columbia, V5C 6G9
p: 604-294-0011 ; f: 604-294-0022


SEAL:

Affected area No13




4 STREET FRONTAGE - 42" HT FENCE WITH GATE
 Note: Mechanically fasten the cedar panel to the aluminum channel from the bottom to fixate the cedar panel in place.

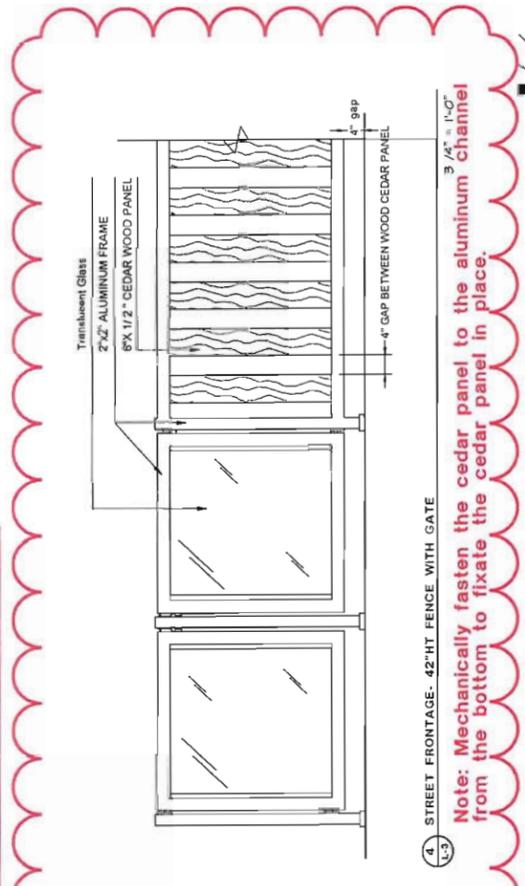Affected area No16

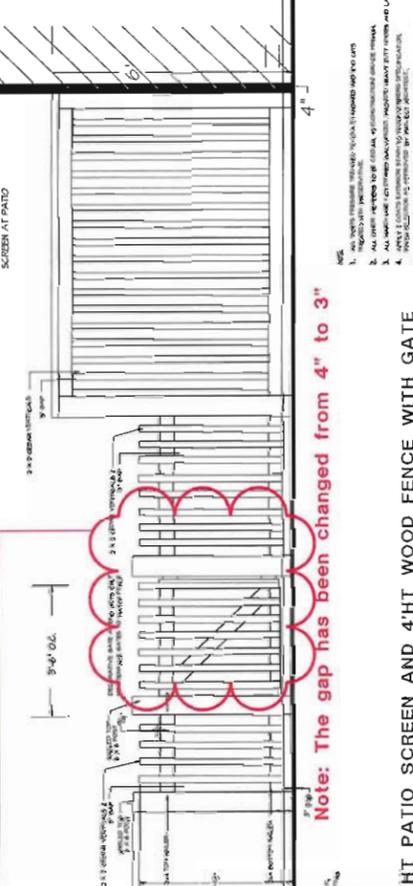


5 6' HT PATIO SCREEN AND 4" HT WOOD FENCE WITH GATE
 Note: The gap has been changed from 4" to 3"


Affected area No19

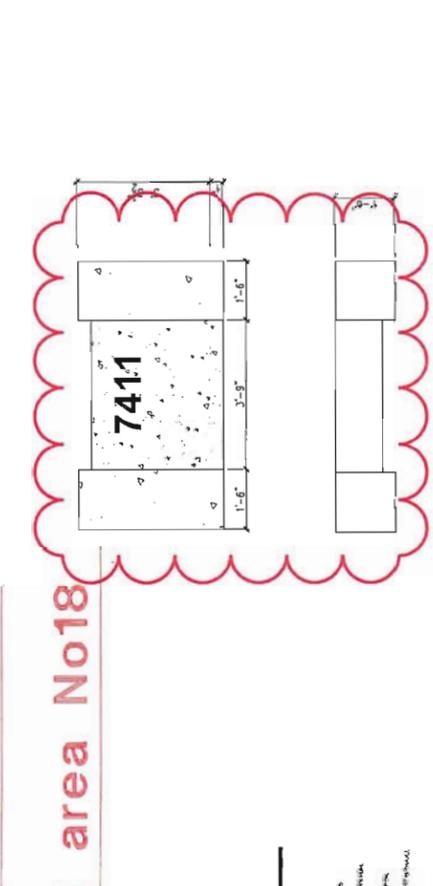


6 4" HT WOOD FENCE
 1/2" = 1'-0"

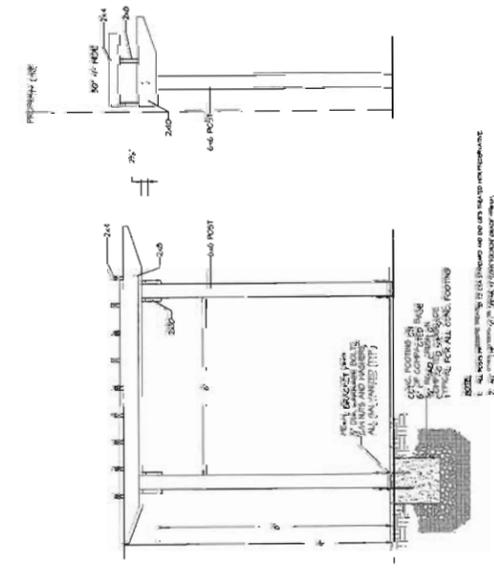


2 TRELLIS
 1/2" = 3'-0"

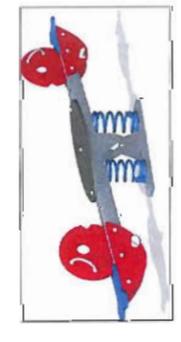


CORA BIKE RACK
 EXPO 3606
 BLACK COLOUR

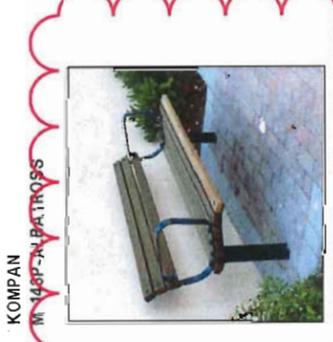

KOMPAN
 M 140P-JA PATROSS
 FRANCES ANDREW BENCH
 BASIC-SERIES 1- MODEL B
 BLACK COLOUR

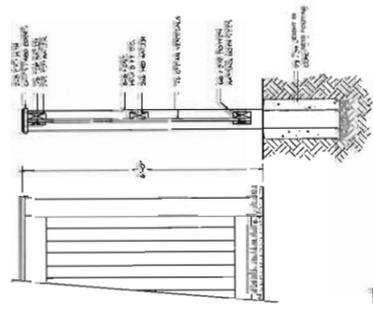

3 6'-0" HT WOOD FENCE
 1/2" = 1'-0"

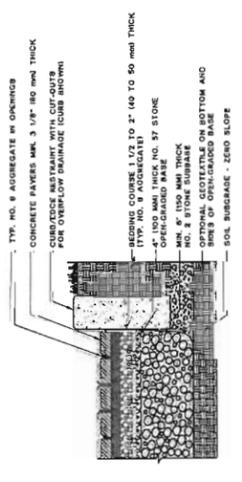

7 SF RIMA PERMEABLE DRIVEWAY
 EXFILTRATION TO SOIL SUBGRADE
 1/2" = 1'-0"

7 ARCHITECTURAL CONCRETE
 SIGNAGE WALL
 1/2" = 1'-0"

NO.	DATE	REVISION DESCRIPTION	DR.
1	06/20/09	REVISED AS PER CITY COMMENT	DR
2	07/01/09	REVISED AS PER CITY COMMENT	DR
3	07/01/09	REVISED AS PER CITY COMMENT	DR
4	07/01/09	REVISED AS PER CITY COMMENT	DR
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29	07/01/09	REVISED AS PER CITY COMMENT	DR
30	07/01/09	REVISED AS PER CITY COMMENT	DR

PROJECT:
 12 UNIT TOWNHOUSE
 DEVELOPMENT
 7411 MOFFATT ROAD
 RICHMOND, BC

DRAWING TITLE:
 LANDSCAPE
 DETAILS

DATE: 06 JUN 09
 SCALE: L3
 DRAWN: DD
 DESIGN: DD
 CHKD: PCM
 DRAWING NUMBER:
 As built/
 Proposed for 4

PMS PROJECT NUMBER: 09-082