

Report to Development Permit Panel

To:

Development Permit Panel

Date:

May 5, 2015

From:

Wayne Craig

File:

DP 15-692659

Director of Development

Re:

Application by Polygon Kingsley Estates Ltd for a Development Permit at

10440 and 10460 No. 2 Road

Staff Recommendation

That a Development Permit be issued which would:

- 1. Permit the construction of a townhouse development with 133 units at 10440 and 10460 No. 2 Road on a site zoned "Town Housing (ZT72) – London/Steveston (No. 2 Road)"; and
- 2. Vary the provisions of Richmond Zoning Bylaw 8500 to reduce the minimum rear yard setback from 3.0 m to 2.23 m for Building TH-16.

Wayne Craig

Director of Development

MM blg Att. (2)

Staff Report

Origin

Polygon Kingsley Estates Ltd. has applied to the City of Richmond for permission to develop a townhouse project with 133 units. The site is currently occupied by the former Steveston Secondary School.

The site is being rezoned from "School & Institutional Use (SI)" to "Town Housing (ZT72) – London/Steveston (No. 2 Road)" for this project under Bylaw 9155 (RZ 13-649524). The bylaw received third reading at a Public Hearing on January 19, 2015.

As a condition of rezoning, the applicant is also entering into a Servicing Agreement (SA15-695335) for frontage road works, a new traffic signal with left turn lanes and plaza on No. 2 Road, two (2) greenways to the north and south of the development, and an upgrade to the Oeser sanitary pump station.

Development Information

This Development Permit application for the townhouse project is being considered concurrently with the above-noted rezoning application for a larger 5.26 ha. (13.0 acre) site. Of this total area, the proposed townhouse project is located on a 2.86 ha. (7.06 acre) site as shown on the Site Plan included within the Development Permit. The rezoning application also includes the following two (2) additional sites:

- A 0.332 ha. (0.82 acre) parcel on which a community childcare facility and plaza will be constructed
- A 2.01 ha. (5.0 acre) parcel which includes two (2) greenways and a 1.72 ha. (4.26 acre) addition to the existing London/Steveston Park.

The design of the park, greenways and child care are the subject of separate City processes that are being coordinated with the Development Permit process. Specifically, a Concept Plan for the park and greenways has been developed through an intensive public consultation process. The Concept Plan is to be endorsed by Council prior to adoption of the rezoning. The greenways and plaza will be constructed by the applicant under the Servicing Agreement and the park addition will be built by the City at a later date. Lastly, the applicant is building and designing the child care facility in consultation with City staff. The facility will be taken to the Advisory Design Panel (ADP) for review prior to being advanced to Council for consideration this summer. The applicant is also required to post a construction security prior to rezoning adoption.

The applicant will also:

- Install a full traffic signal at the development's driveway entrance with new left turn lanes from No. 2 Road to the development. The signal will provide for vehicle traffic and for the crossing of pedestrians and bicycles onto the proposed greenways to the north and south of the development.
- Construct new sidewalks along the entire No. 2 Road frontage; with a separate adjacent multi-use greenway path leading from the intersection to the north greenway.

Please refer to the attached Development Application Data Sheet (Attachment 1) for a comparison of the proposed development data with the relevant bylaw requirements.

Background

Development surrounding the subject site is as follows:

To the North: Single-family dwellings fronting onto Goldsmith Drive, regulated by Land Use Contract 011.

To the East: Steveston/London Park zoned "School & Institutional Use (SI)" to which the subject development will provide additional park land as a condition of rezoning.

To the South: Single-family dwellings fronting onto Spender Drive and Dylan Place zoned "Single Detached (RS1/E)".

To the West: Single-family dwellings fronting onto No. 2 Road zoned "Single Detached (RS1/B)" and "Single Detached (RS1/E)".

Rezoning and Public Hearing Results

During the rezoning process, staff identified the following design issues to be resolved at the Development Permit stage:

- The need for smaller-scale articulation and architectural detailing of the townhouse buildings, particularly those facing the public realm.
- The landscape and grading interface of the townhouse development with the adjacent residential areas and proposed greenways to the north and south, No. 2 Road and the proposed park to the east.
- The overall form and character of the common indoor amenity building.
- The design of the common outdoor amenity space, including the children's play area.
- The detailed engineering design of the on-site roads to accommodate moving, recycling and fire trucks.
- Decorative paving treatments and alignment of sidewalks, curbs, and boulevards.

The Public Hearing for the rezoning of this site was held on January 19, 2015. At the Public Hearing, generally the following concerns about rezoning the property were expressed:

- The loss of a public school site and large outdoor school grounds.
- The unsuitability of the townhouse development within an existing single-family residential area.
- The proposed setbacks (including the 9.0 m (30 ft.) greenways and on-site 3.0 m (10.0 ft.) townhouse setback) between the proposed townhouse buildings and the existing single-family-residential lots.

- Drainage from the development onto adjacent residential lots.
- Concern regarding traffic generated by the development.

Staff worked with the applicant to address these issues in the following ways:

- The applicant included additional landscaping within the 3.0 m (10.0 ft.) townhouse setback adjacent to the greenways. The detailed design of the greenways included in the Servicing Agreement is being coordinated with the townhouse site landscape plans. Perimeter drainage will be installed on the townhouse site and within the greenways.
- The townhouse units facing both greenways step down to two (2) storeys to provide a better transition to the adjacent one-storey and two-storey single-family homes.
- There is finer articulation and architectural detailing of the townhouse building elevations facing the public greenways, the park to the east, No. 2 Road to the west and adjacent to the on-site pathways.
- The overall form and character of the common indoor amenity building has been further developed and is consistent with the character of the townhouses.
- The common outdoor amenity space includes a children's play area which will be custom-designed, subject to City staff review, instead of being a prefabricated structure.
- Detailed plans for on-site roads have been provided and truck turning movement for SU9 medium-size moving, recycling, garbage and fire trucks have been confirmed.
- Additional decorative on-site paving treatments and additional plantings adjacent to the on-site pathways and roadways will be provided.

Staff Comments

The proposed scheme attached to this report has satisfactorily addressed the significant urban design issues and other staff comments identified as part of the review of the subject Development Permit application. In addition, it complies with the intent of the applicable sections of the Official Community Plan (OCP) and complies with the "Town Housing (ZT72) – London/Steveston (No. 2 Road)" zone except for the zoning variance noted below.

Zoning Compliance/Variances (staff comments in bold)

The applicant requests to vary the provisions of Richmond Zoning Bylaw 8500 to reduce the minimum rear yard setback from 3.0 m to 2.23 m for Building TH-16.

(Staff supports the proposed variance as the proposed setback reduction accommodates additional building articulation to improve the appearance of the north side elevation of Building TH-16 which is visible from the proposed adjacent park. The reduction applies to a limited portion of this side elevation of the building comprising approximately one-third of the building's side elevation against which there is a large hedge adjacent to the park.)

Advisory Design Panel Comments

The Advisory Design Panel supported this application being brought forward to the Development Permit Panel. A copy of the relevant excerpt from the Advisory Design Panel Minutes from its April 1, 2015 meeting is attached for reference (Attachment 2). The design response from the applicant has been included immediately following the specific Advisory Design Panel comments and is identified in 'bold italics'.

Analysis

Conditions of Adjacency, Urban Design and Site Planning

The site planning and adjacency issues to the proposed greenways, park and existing single-family residential areas have been addressed as follows:

- The proposed setback for the townhouse buildings from the adjacent north and south greenways is 3.0 m (10 ft.). When combined with the 9.0 m (30.0 ft) wide greenways there will be a total 12.0 m (40 ft.) setback between the proposed townhouses to the rear property line of the existing single-family lots. The landscape proposed within this setback will be appropriately treated to address this interface with a hedge located on top of a maximum 1.0 m (3.3 ft.) high retaining wall adjacent to the greenway below.
- The townhouse buildings adjacent to the single-family homes to the north and south include two-storey units with a portion of each unit dropping to one-storey. When considering the entire development site (the townhouse project, park and child care), the townhouse buildings are oriented so that not more than 13% of the north property line and 26% of the south property line are flanked by townhouses.
- The plaza located to the north of the townhouse development driveway entrance onto No. 2 Road will integrate the child care facility and provide a connection to the north greenway. A major public art piece, reflecting the historic school use of the site, is planned for the plaza. The proposed public art has received preliminary support from the City's Public Art Advisory Committee.

Architectural Form and Character

The development includes 132 townhouse units (including 12 affordable units) within 28 townhouse buildings and an amenity building with one (1) caretaker suite. The proposed development includes the following elements:

- A range of neo-traditional Tudor buildings designs.
- Typical building heights of three (3) storeys; and lower two-storey units, with one-storey portions, adjacent to the north and south property lines.
- Garden mews of at least 12.0 m (39.4 ft.) separating the townhouse buildings with front yards and entry doors leading to common pathways located at the centre of each mew.
- The 120 market units will include side-by-side double garages. The 12 affordable housing units will have single garages as permitted by the zoning bylaw and approved by affordable housing staff and have 4.75 m (15.6 ft.) long driveways that can accommodate parking of a second small car.
- In addition to the one-story and two-storey stepped-down building forms adjacent to the north and south greenways, there are variations in the buildings related to the number of units and the design of the end units in the various buildings.
- Smaller-scale articulation and architectural detailing of the townhouse buildings facing the north and south greenways, the park, internal pathways and the prominent building ends facing the internal laneways provide more facade variation.

Landscape Design and Open Space Design

The landscape plan for development has well addressed the adjacent proposed greenways and child care facility. There are also good transitions between the on-site common laneways and pathways with each of the units' private yards. Specifically, the plans provide for:

- Additional shrub plantings and trees along the very long sections of the development backing onto the greenways and the units backing onto the proposed park.
- Pin Oak trees and ground cover between the driveways leading to the unit garages to soften the hard pavement treatment and provide for additional separation between the units' garages.
- Relatively large trees to separate the townhouse building front yards and entry doors facing each of mews that run between the rows of townhouse buildings.
- A 270 m² (2,910 ft²) outdoor amenity area adjacent to the two (2) storey, 185 m² (2,000 ft²) amenity building with caretaker suite and a common recreation room. The outdoor amenity space includes a large patio and barbeque along with a child play area.
- Retention and protection of a large double-trunked Deodar Cedar where special design considerations have been taken in creating a very large 9.0 m (30 ft.) wide landscaped median within the development's proposed driveway entrance at No. 2 Road to protect this tree.

Crime Prevention Through Environmental Design (CPTED)

The proposed development includes the following design elements that support CPTED principles:

- Relatively straight on-site roadways with good sight lines and individual driveways that provide for a greater sense of openness.
- The two-storey units facing the greenways have substantial windows facing the greenways, while having sufficient landscaping for privacy thus, providing for casual resident surveillance onto the greenways.
- The townhouse buildings facing No. 2 Road have front elevations with windows and front entry doors that provide for more "eyes on the street".
- The individual townhouse yards facing the internal pedestrian mews between the townhouse buildings are fenced and includes landscaping that provides a balance between privacy for the units and visibility onto the common pathways on the mews.
- The rear unit elevations facing the driveways include substantial glazing and decks over most of the garages providing further surveillance of the driveways.
- The development will include gated pathway entrances onto the greenways to the north and south and the park to the east.

Accessible Housing

The application includes the following accessible units as follows:

- 14 "Convertible Units" (being the split level end units adjacent to the north and south property lines) which will include the following features:
 - O Wider doors to facilitate wheelchair movement through the unit.
 - o Set heights for accessible electrical outlets.
 - O Greater clearances for easier access to items such as bathroom fixtures.
- 12 affordable housing units will include "Barrier Free Unit" features such as wheel-in shower stall in one (1) bathroom, grab bars in washrooms, lower countertops, kitchen work surfaces with knee space below, accessible appliances and cupboards, and wider circulation areas. The units will also provide for the ability to include a wheelchair lift within the staircase.
- All townhouse units will provide "aging in place" features which include:
 - Stairwell hand rails.
 - o Lever-type handles for plumbing fixtures and door handles.
 - O Solid blocking in washroom walls to facilitate future grab bar installation beside toilets, bathtubs and showers.

Energy and Sustainability

All 133 units will be constructed be Energuide 82 energy efficient and solar hot water ready. Submission of reports by a Certified Energy Advisor prior to Building Permit issuance and occupancy are required within a covenant being registered on title through the rezoning.

The development will also incorporate the following additional sustainability measures:

- Low-E glazing on all windows
- Energy Star appliances
- Low VOC paints in all units
- Dual flush toilets and low flow faucets
- Drywall with recycled gypsum and paper content
- Permeable surfaces for the internal pathways and pavers at driveway intersections Planting selections of native and non-native drought tolerant shrub species
- Provision of a minimum of 600mm (24") landscaping soil for stormwater retention and release rate management
- Preparation of a Landscape Maintenance and Integrated Pest Management Plan for Best Management Practices within the landscape

Conclusion

The proposed townhouse development has been designed to sensitively fit into and complement the existing surrounding single-family neighbourhoods. In particular, the development concept includes larger setbacks to the adjacent single-family residential areas with greenways located to the north and south of the development. The applicant has also worked with the City to ensure

good integration of the townhouse project with the 2.33 ha. (5.83 acres) being transferred to the City for the London/Steveston Park addition, the greenways, the public entry plaza and child care facility site on No. 2 Road.

Furthermore, the development provides for good integration of the 12 affordable housing units with the market units.

In summary, the proposed townhouse project is well designed to fit into the remaining 40 percent of the entire site being provided as park, plaza and community child care facility.

Given the above, staff recommends that the Development Permit for the proposed townhouse project be issued.

Mark McMullen

Senior Coordinator-Major Projects

(604-276-4173)

MM:blg

Attachment 1: Development Application Data Sheet

Attachment 2: Excerpt from the Minutes of the Advisory Design Panel Meeting

The following are to be met prior to forwarding this application to Council for approval:

• Receipt of a Letter-of-Credit for landscaping in the amount of \$2,297,540.00.

NOTE: Staff to ensure that landscape estimates include a 15% contingency cost.

Prior to future Building Permit issuance, the developer is required to complete the following:

- The applicant is required to obtain a Building Permit for any construction hoarding associated with the proposed development. If construction hoarding is required to temporarily occupy a street, or any part thereof, or occupy the air space above a street or any part thereof, additional City approvals and associated fees may be required as part of the Building Permit. For further information on the Building Permit, please contact Building Approvals Division at 604-276-4285.
- Submission of a construction traffic and parking management plan to the satisfaction of the City's Transportation Division (http://www.richmond.ca/services/ttp/special.htm).



Development Application Data Sheet

Development Applications Division

DP 15-692659 **Attachment 1**

Address: 10440 and 10460 No. 2 Road

Owner: Polygon Kingsley Estates Ltd Applicant: Polygon Kingsley Estates Ltd

Planning Area(s): Blundell

Floor Area Gross: 22, 381 m² Floor Area Net: 21,968 m²

	Existing Existing	Proposed
Site Area:	52,468 m ²	29, 044 m²
Land Uses:	Secondary School	Townhouse Development
OCP Designation:	"School"	Neighbourhood Residential"
Zoning:	"School & Institutional Use (SI)"	"Town Housing (ZT72) – London / Steveston (No. 2 Road)"
Number of Units:	None	133

	Bylaw Requirement	Proposed	Variance
Floor Area Ratio:	0.81	0.78	none permitted
Lot Coverage:	Max. 42 %	39%	none
Setback – Front Yard:	Min. 6.0 m	Min. 6.0 m	none
Setback – North Side Yard:	Min. 3.0 m	Min. 3.0 m	none
Setback – South Side Yard:	Min. 3.0 m	Min. 3.0 m	none
Setback – Rear Yard:	Min. 3.0 m	Min. 2.23 m	2.23 m On Building TH-16
Height - Townhouses(m): Height – Amenity (m):	11.0 m 13.0 m	10.36 m 12.2m	none
Lot Size:	27, 500 m ²	29, 044 m²	none
Off-street Parking Spaces-Regular	253 resident & 27 visitor	254 resident & 27 visitor	none
Off-street Parking Spaces – Accessible:	1	1	none
Total off-street Spaces:	280 Total	281 Total	none
Tandem Parking Spaces	50%	none proposed	none
Amenity Space – Indoor:	Min. 100 m ²	186 m²	none
Amenity Space – Outdoor:	Min. 804 m ²	270 m ²	none

Excerpt from the Minutes from The Design Panel Meeting

Wednesday, April 1 – 4:00 p.m. Rm. M.1.003 Richmond City Hall

APPLICANT:

Polygon Homes Ltd.

PROPERTY LOCATION:

10440/10460 No.2 Road

Applicant's Presentation

Chris Ho, Vice-President for Development, Polygon, Architect Keith Hemphill, Rositch Hemphill Architects, and Landscape Architect Doug Shearer, Hapa Collaborative, presented the project on behalf of the applicant and answered queries from the Panel.

Panel Discussion

Comments from the Panel were as follows:

- good site plan and unit lay-outs; efficient use of the townhouses; large site and square shape provide flexibility for the applicant in terms of project design; good public realm;
- appreciate the setbacks from neighbouring single-family homes; also appreciate the pedestrian walkway system throughout the proposed development;
- proposed building materials are high quality, e.g. brick and hardie; no vinyl proposed in the materials palette;
- appreciate the details on the garage doors and the roofline as they provide visual interest;
- appreciate the mews providing pedestrian access to the townhouse units; however, the resulting omission of pedestrian entries via the internal drive aisles means there is no break in the series of garage entries; assume that the applicant's signage package is well-thought out;
 - Understanding this condition, we have carefully maximized landscaping and included trees between driveways wherever possible. The sign package will be carefully planned and will include the differentiated mews highlighted by the differing trees within those individual mews.
- appreciate the raised greenway which gives primacy to the greenway over the drive aisles; provides not only a planting and decorative feature but also enhances the safety of pedestrians within the proposed development; also encourages responsible driving behaviour on the part of drivers;

- proposed revivalist type of architecture is well-handled; appreciate the wide aprons and provision of large trees in all driveway areas which are not normally seen in similar developments; also appreciate the projecting balconies facing the internal drive aisles which animate the space;
- site plan appears rigid; look at slightly angling (2-3 degrees) the buildings to enhance their revivalist architecture;
- the proposed Tudor-style townhouse development is well-done; the character sketch shows that the townhouse buildings have two-storey ends; however, most of the buildings in the project are larger and don't have smaller end units; consider visually breaking up the long buildings on the main loop as they are more visible to motorists going to the childcare facility;

We have visually broken up the long buildings on the main east west roads through careful site planning:

- 1. The main east west roads are not straight and the curve will focus the visual interest to the end of the north south buildings which have pedestrian entrances vs. garage entries only
- 2. There are no long rows of garages facing garages on the opposite side of the road as the east-west buildings are broken up on the other side of the road by buildings which are perpendicular
- 3. The main crossing of the pedestrian mews crosses the curves main east west road is raised allowing for the slowing of traffic and more visual interest combined with differing materials at these crossings
- 4. The garage elevations are punctuated by the maximization of trees between driveways
- internal road elevations of Building Nos. 17, 19 and 23 as shown on drawing A4.8 appear massive and have a different feel than other buildings with smaller end units; consider reducing the massing of these buildings; appreciate the landscaping of the project;

See above comment.

• the two colour schemes in the drawings submitted by the applicant to the Panel are different from the actual samples presented by the applicant; consider more differentiation between the two colour schemes; also consider two different brick colours;

We have revised the colour schemes to include more differentiation and have introduced two brick colours.

- appreciate the applicant's presentation which provided a rationale for the project design; unit lay-outs are simple and effective; a well-considered project;
- appreciate the provision of many convertible units;

consider improving the accessibility and usability of the convertible units; investigate the area at the corner of the garage on the first floor up to the closet on the second floor bedroom as future location of an access into the second floor; consider providing future alternate vertical access to the second floor without using stairs; useful to parents with small children;

We will provide vertical access if requested by a purchaser.

 consider using pocket doors in the washrooms on the first and second floors of the convertible units in lieu of swing doors to provide more usable space;

While pocket doors may provide more usable space, based on our long experience and our customer service department, they cause numerous maintenance issues that are difficult to repair and fix.

- appreciate the provision of affordable units; consider incorporating wider stairways in some of the affordable units to accommodate handrail-type stair lifts in the future;
- sustainability features such as high efficiency lighting and the provision of "Energy Star" rated appliances and provisions for solar photovoltaic system are good; the applicant should encourage the use of solar photovoltaic system by showcasing it in the amenity building;

We are currently investigating the functionality and feasibility of providing solar voltaic panels on the amenity building.

appreciate the applicant's commitment to incorporate public art in the project which will benefit the residents and the public;

Our landscape architect and arborist will review and inspect the areas noted to ensure adequate soil volume.

generally, the design of the project is good; however, the siting and design of A1 end units is repetitive and may make wayfinding challenging; consider design development and better ways to improve wayfinding;

The A-1 end units are at the entrances to the varying landscaped mews. This in combination with signage and the naming of these mews will provide strong wayfinding in the project.

- appreciate the project's edge treatments and the applicant's explanation on how they work;
- interior pedestrian traffic will be concentrated on the mews; character of the mews needs to be treated to ensure equal amount of privacy to the townhouse units;

The public passages are differentiated through hedging which define the front yards of the townhomes.

notice that the applicant has done additional work since the submission of the package for the Panel's review; applicant should have provided more information on the planting scheme;

We will continue to develop the planting scheme cooperatively with Planning and Parks and coordinate it with the proposed public greenway, parks and no. 2 road frontage.

the size of the children's play area is small relative to the size of the development; applicant needs to include the rationale for the proposed children's play area in their response to the Panel's comments; and

The children's play area has been minimized due to the close proximity of the large play area in the adjacent public park. Most residents will take the short walk to the adjacent park which includes a large neighbourhood sized play area.

appreciate the applicant's move to plant more trees along the driveways than what is normally provided; however, ensure adequate soil volume through the provision of structural soil.

Our landscape architect and arborist will review and inspect the areas noted to ensure adequate soil volume.

Panel Decision

It was moved and seconded

That DP 15-692659 be supported to move forward to the Development Permit Panel subject to the applicant giving consideration to the comments of the Panel.

CARRIED



Development Permit

No. DP 15-692659

To the Holder:

POLYGON KINGSLEY ESTATES LTD.

Property Address:

10440 AND 10460 NO. 2 ROAD

Address:


C/O CHRIS HO, VICE-PRESIDENT 900 - 1333 WEST BROADWAY VANCOUVER, BC V6H 4C2

- 1. This Development Permit is issued subject to compliance with all of the Bylaws of the City applicable thereto, except as specifically varied or supplemented by this Permit.
- 2. This Development Permit applies to and only to those lands shown cross-hatched on the attached Schedule "A" and any and all buildings, structures and other development thereon.
- 3. The "Richmond Zoning Bylaw 8500" is hereby varied to reduce the minimum rear yard setback from 3.0 m to 2.23 m for Building TH-16.
- 3. Subject to Section 692 of the Local Government Act, R.S.B.C.: buildings and structures; off-street parking and loading facilities; roads and parking areas; and landscaping and screening shall be constructed generally in accordance with Plans #DP15-692659-1 to #DP15-692659-48 attached hereto.
- 4. Sanitary sewers, water, drainage, highways, street lighting, underground wiring, and sidewalks, shall be provided as required.
- 5. As a condition of the issuance of this Permit, the City is holding the security in the amount of \$2,297,540.00 to ensure that development is carried out in accordance with the terms and conditions of this Permit. Should any interest be earned upon the security, it shall accrue to the Holder if the security is returned. The condition of the posting of the security is that should the Holder fail to carry out the development hereby authorized, according to the terms and conditions of this Permit within the time provided, the City may use the security to carry out the work by its servants, agents or contractors, and any surplus shall be paid over to the Holder. Should the Holder carry out the development permitted by this permit within the time set out herein, the security shall be returned to the Holder. The City may retain the security for up to one year after inspection of the completed landscaping in order to ensure that plant material has survived.
- 6. If the Holder does not commence the construction permitted by this Permit within 24 months of the date of this Permit, this Permit shall lapse and the security shall be returned in full.

Development Permit No. DP 15-692659

To the Holder:	POLYGON KINGSLEY ESTATES LTD.
Property Address:	10440 AND 10460 NO. 2 ROAD
Address:	C/O CHRIS HO, VICE-PRESIDENT 900 - 1333 WEST BROADWAY VANCOUVER, BC V6H 4C2
AUTHORIZING RESOLUT DAY OF ,	ION NO. ISSUED BY THE COUNCIL THE
DELIVERED THIS	DAY OF , .
MAYOR	



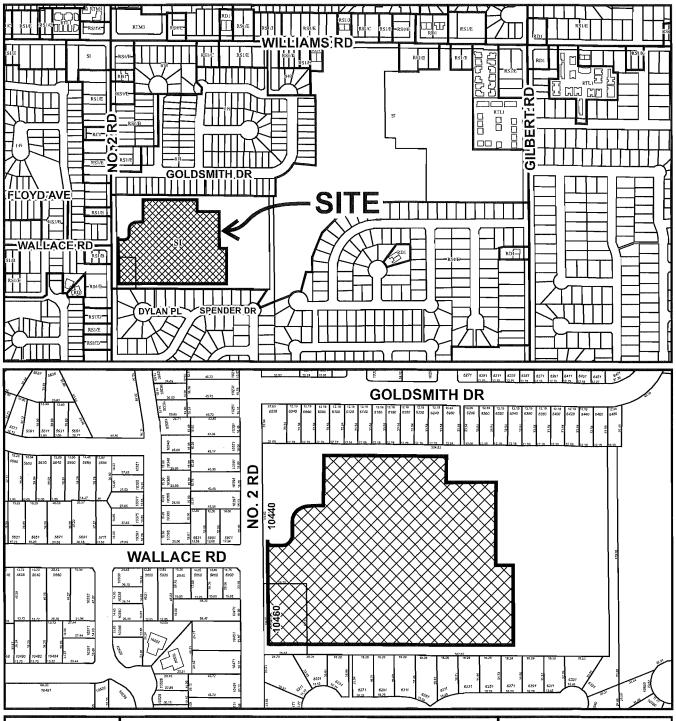



DP 15-692659 SCHEDULE "A"

Original Date: 02/24/15

Revision Date:05/04/15

Note: Dimensions are in METRES

<u>S</u> PROJECTS STATIST

LOT AREA: ZONE: 2 AND 3 STOREY WOOD FRAMED TOWNHOUSE BUILDINGS PROJECT DESCRIPTION: MUNICIPAL ADDRESS: 10388 No. 2 ROAD, RICHMOND, B.C.

FIRE PROTECTION:

2.90 HA (7.177 AC) (29,044 M²) (312,628 FT²) AS PROVIDED BY BENNETT LAND SURVEYORS

9

UNSPRINKLERED BUILDING, COMBUSTIBLE CONSTRUCTION

UNIT TYPE	Remarks	Garage	Lower	PiW	Upper	# of Units	Gross Floor Area garage excluded	Floor Area Ratio w/level 1 stair exclusions	Parking Required Parking # of Lot 1.75cars/unit required Provided Beds Coverage sq.ft.	uired Fr	Parking # of Provided Beds	# of 3eds C		# of Units	Unit %
TH - AF1	12'4, 2br, Affordable	260	230	503	516	12	1,249	1,203 1	1,203 1 cars/unit provided	12	12	24	6,828	12	%0.6
TH - A1	20', 3br + flex, interlock	368	377	191	819	34	1,987	1,954 ½	1,954 2 cars/unit provided	68	89	102	29,070	34	25.6%
TH - A1b	20', 3br + flex, interlock	400	380	822	851	4	2,053	2,020 ½	2,020 2 cars/unit provided	80	80	12	3,444	4	3.0%
TH - A1b TH10	TH - A1b TH16 20', 3br + flex, interlock	407	397	822	851	Η	2,070	2,037 ½	2,037 2 cars/unit provided	7	2	က	861	1	0.8%
TH - A1end	20', 3br + flex, interlock, end unit	407	406	824	826	13	2,056	7,866,1	1,993 2 cars/unit provided	26	26	39	11,466	13	9.8%
TH - A2	20', 3br + flex, interlock	396	377	161	822	52	1,990	1,957 ½	1,957 2 cars/unit provided	104	104	156	45,448	52	39.1%
TH - B	23', 3br + flex, end unit	200	356	865	856	7	2,077	2,021 2	2,021 2 cars/unit provided	4	4	9	1,926	2	1.5%
TH - C	25'3, 3br + flex, end unit	470	950	826	0	14	1,776	1,738 ½	1,738 2 cars/unit provided	28	28	42	19,880	14	10.5%
TH - E	Manager's Suite (Above Amenity Bldg)				1,225	1	1,225	1,225 1	1,225 1 cars/unit provided	1	2	7	1,000	Н	0.8%
								~)	Subtotal res. parking	253	254				
									Visitor . 20 cars / unit	27	27				
Totals						133	242,997	238,144		280	281	386 1	386 121,223	133	100%

Note: G.F.A Areas calculated to the exterior face of wall sheathing or to the center line of interior garage walls where applicable

Summary:

Overall Density and requirements for Kingsley Estates Site:	for Kings	ley Estate	es Site:				NO, REVISION: DATE:
Lot Area	Ha.	Acres	Sq. Ft.	Sq. m.	Building Height:		The spaning as an inetaurism of service is the property of Roelich Hompfell Architods, and croy not be imperiduced softhaut the form's inecutation All information states on the
Area - excluding park and daycare	2.90	7.177	312,628	29,044.1	Max Townhouse Height (Dimensional):	34'to mid height of roof	directing is for any in Alba specific propose only and stood not be used otherwise without without permission from this
Road Dedication Area	0.05	0.127	5,513	512	Max Amenity Height (Dimensional):	40'to ridge roof	office. Contractors shall restly and be responsible for all demonstrates in the job and this office while the independent and the contaction and sanishers observe on the desiration.
Area - excluding park, daycare and dedication	2.85	7.051	307,115	28,532	Max Height (Storeys):	3 storeys	ARCHITECTURAL SEAL:
Proposed FAR	0.78	of lot area					
					Setbacks:		
Lot Coverage	39%	of lot area	of lot area (bldgs, decks, & amenity)	, & amenity)	Front (No.2 Road):	19'8" (6.0m) from Road	
Paved Lot Coverage	18%	of lot area	of lot area (internal roads only)	ds only)	Side (North):	9-10" (3.0m) from Park	
Density					Side (South):	9-10" (3.0m) from Park	
Proposed No. of Units / Hectare	46.6	Units / Ha.			Rear (East):	9-10" (3.0m) from Park	
					Setback variance at TH-16 to 7'-4" from park		CLENT:
Parking							POLYGON TO THE POLYGON
Provided:					Bicycle Parking:		Sair 900 - 133 Vaci Breades, Varzoner, B., Conses Welviz 15(60)877-13315(50)871-4250
Residential (18x83)	254				Provided Secure	166	PROJECT:
Visitor (18x8'3)	26				Provided Short-term	27	Kingsley Estates
HC (18x12'2)	П						10388 No. 2 Kg. Kichmond, BC
Required:					Required Secure 1.25/unit	166	DRAWING TITLE.
Residential	253				Required Short-term 0.2/unit	27	SIAIISIICS
Visitor (0.2 per unit)	27						
					Loading (Larger WB17 & Medium SU9 Truck):	Layby off of No.2 Road	DATABASE: 1321-A0.0.dwg
Amenity Requirement for Steveston Site					Garbage & Recycling:	Individual Curbside Pickup	
Provided Indoor:	2,000.0	Sq.Ft.	Amenity building	ding	Percentage of unit to property line length:		CHECKED: NSH PROJECT NO.
Provided Outdoor:	2,910.0	Sq.Ft	At amenity building	uilding	North:	13%	1321
					South:	25.9%	۵
						The second secon	[2] AO.1
						コローに「たのいべにの話が	D.P. No:




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DATE: 11 FEB 2015 15 APR 2015 17 APR 2015 29 APR 2015 ISSUED:
1. DP APPLICATION
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4 MAY 2015







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E: /ACADJOB/2013/1321/1321-A3.0-A18 ELEC ROOM.DWG

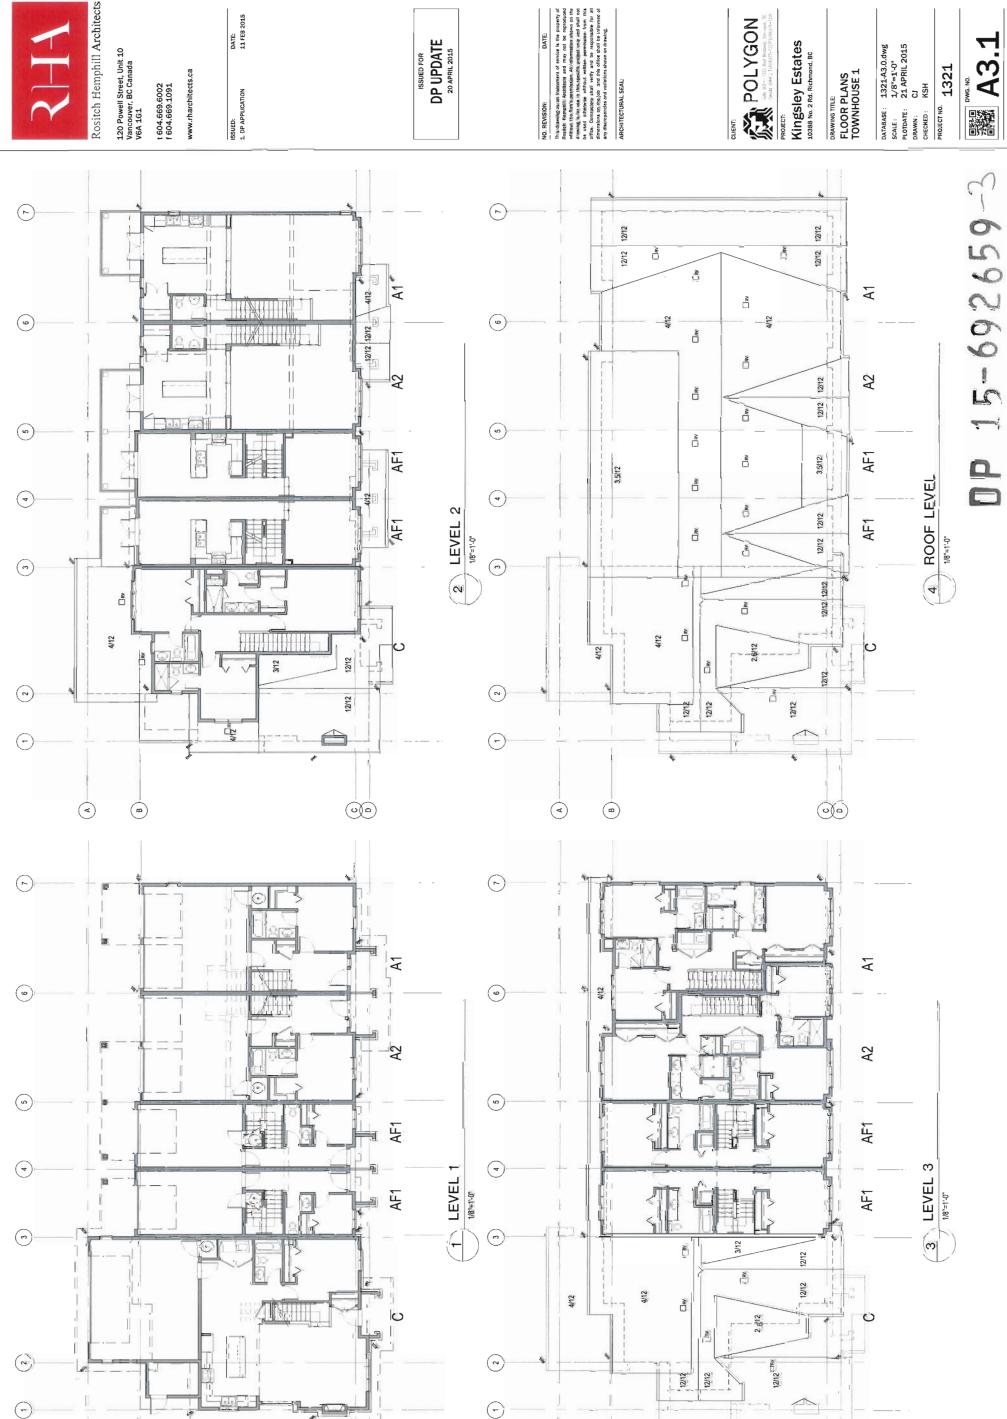

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1321

1321-A3.0.dwg 1/8"=1'-0" 21 APRIL 2015 CJ KSH

DRAWING TITLE: FLOOR PLANS TOWNHOUSE 4, 5, 8, 12 & 13

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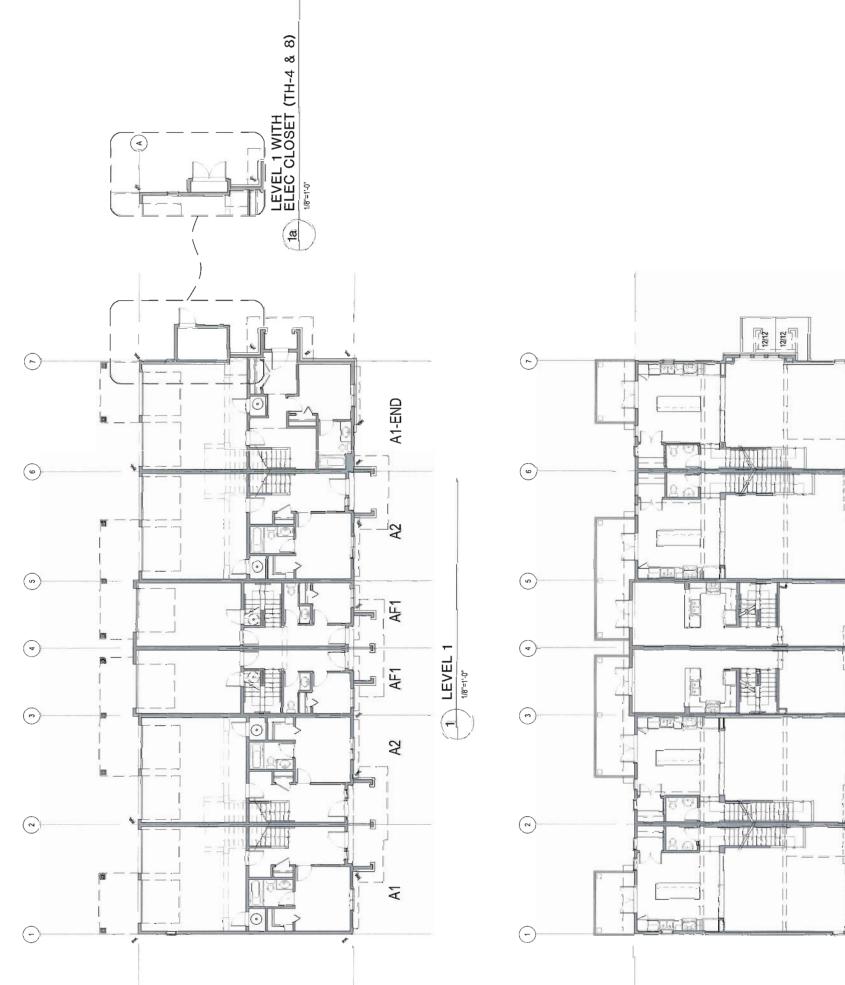
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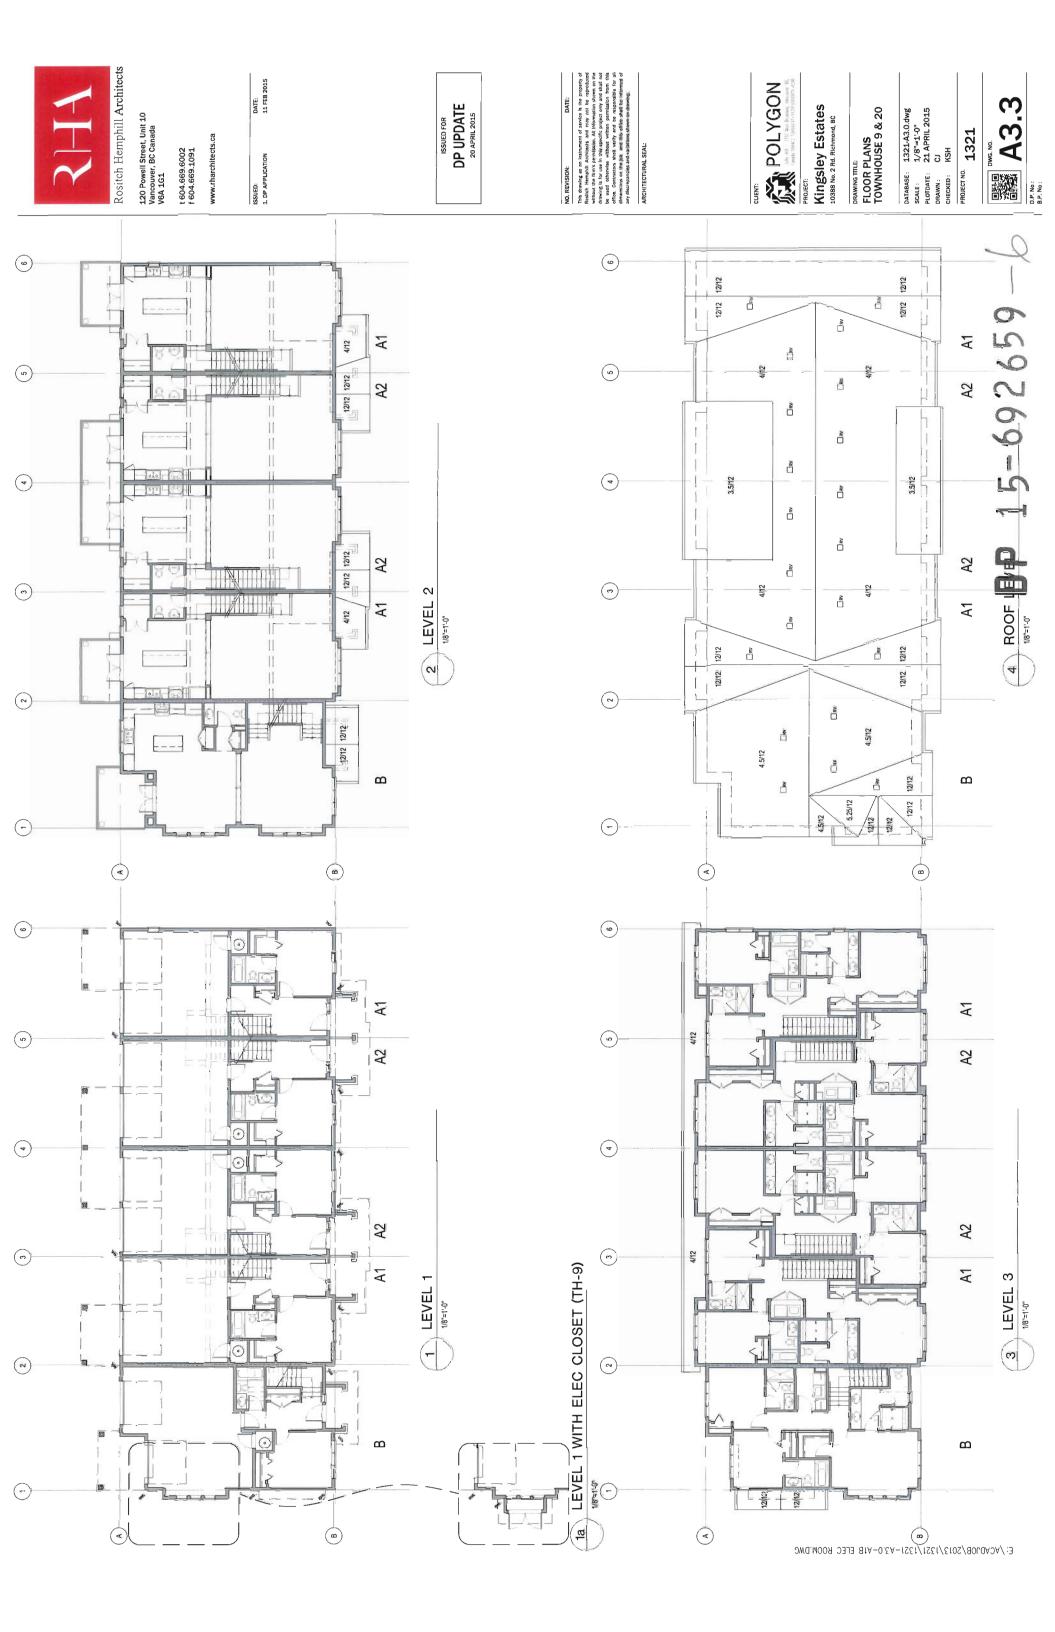
Kingsley Estates

PRAWING TILE.
FLOOR PLANS
TOWNHOUSE 4, 5, 8, 12 & 13

олтавая: 1321-A3.0.dwg sare: 1/8"=1.0" рютрате: 21 APRIL 2015 ряами: СJ снескер: КSH PROJECT NO. 1321 B.P. No.:

15-692659-5

12/12 (<u>-</u>) (-) 12/12 12/12 12/12 A1-END A1-END 12/12 [] § 05 <u></u> (9) (9) 1 () A2 A2 12/12 5 _\ (0) (0) W. AF1 AF1 ROOF LEVEL 3.5/12 5 3 LEVEL 3 4 3.5/12 AF1 AF1 VA. (0) (0) 12/12 A2 A2 ORY. 12/12 **□** 5 (~) (~) T S \$ 12/12 12/12 12/12 **A A1** 12/12 <u>-</u>



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Kingsley Estates 10388 No. 2 Rd. Richmond, BC

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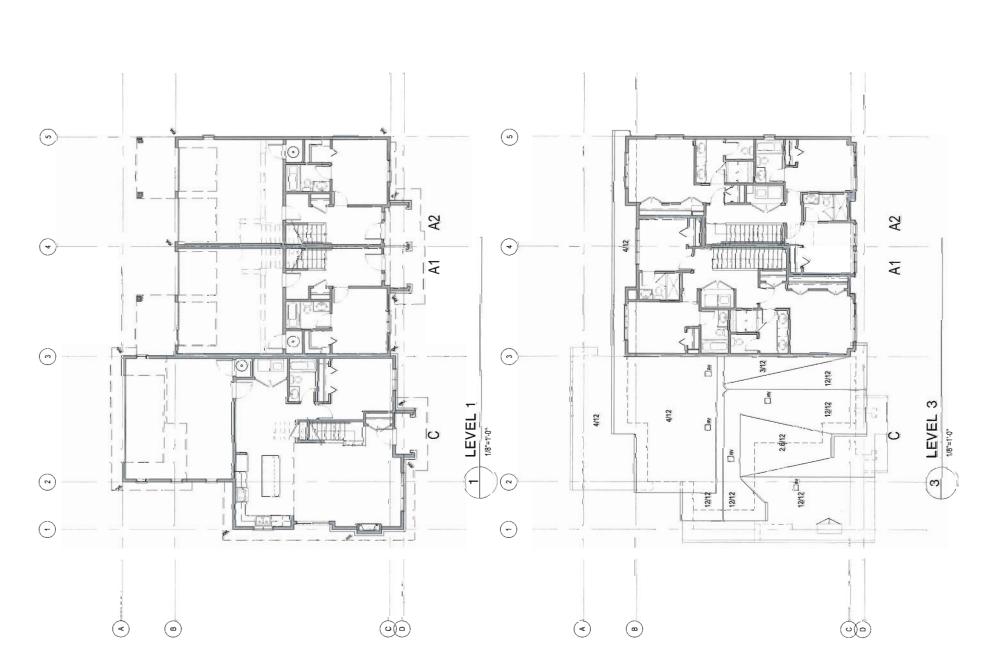
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PLOTDATE: 21 APRIL 2015
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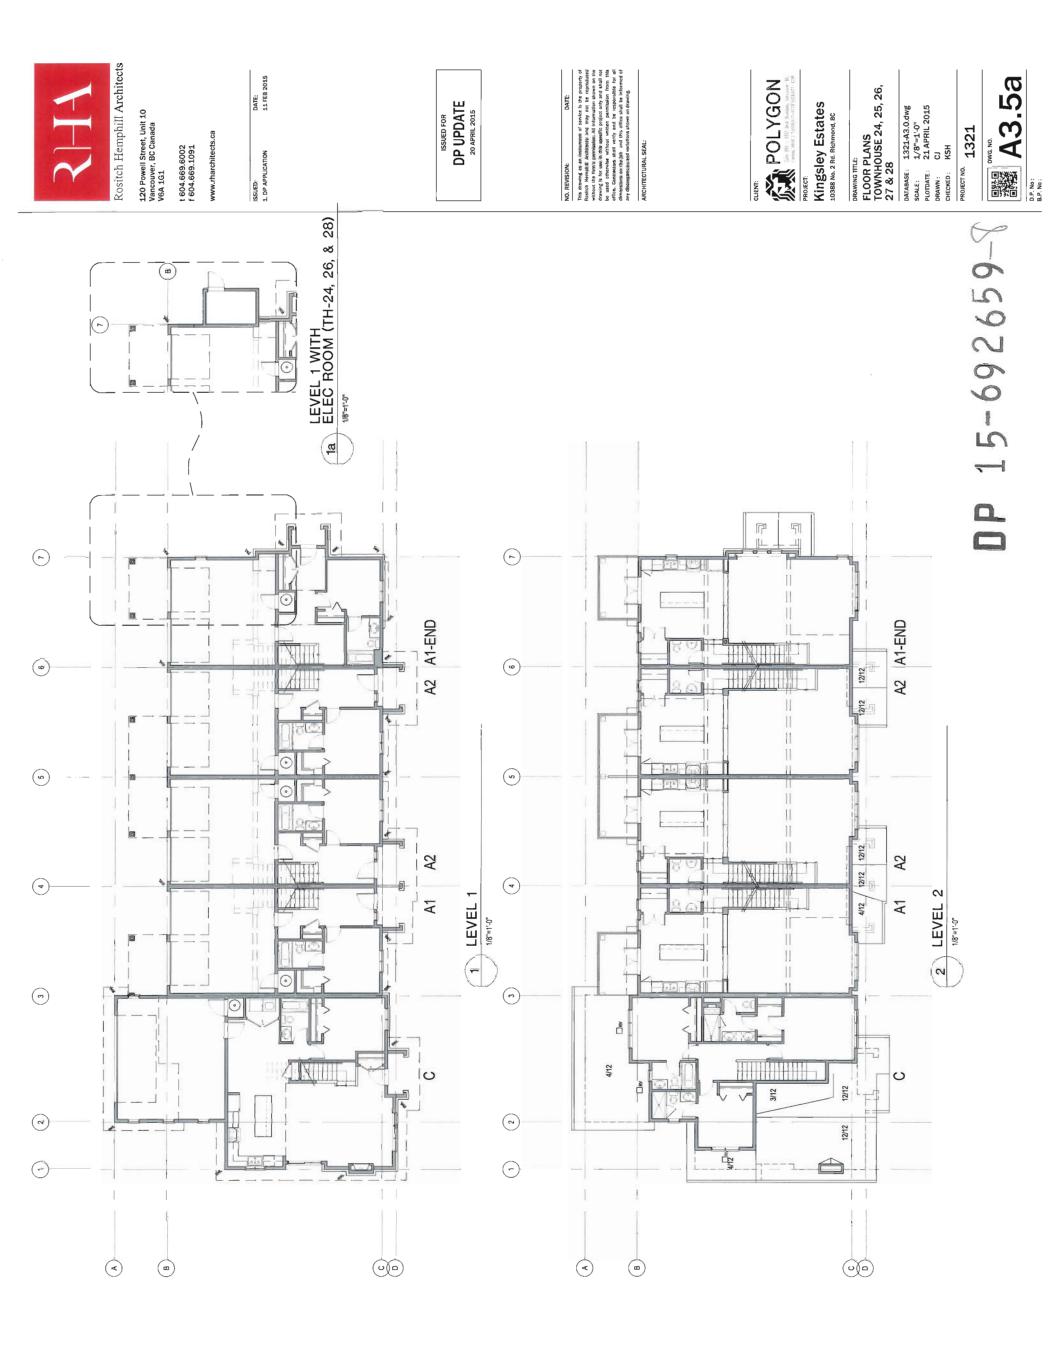
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15-69269-4

(0) (n) 12/12 12/12]]]]]]]] 12/12 12/12 2 å 5 12/12 12/12 **A**2 **Y**2 Ğ 4 4 - B ΑJ A Š 12/12 | 12/12 12/12 12/12 ₩ □ N. (2) (7) A ROOF LEVEL 12/12 12/12 2 LEVEL 2 □ S 2 2 4/12 4/12 4/12 12/12 3/12 (~) (7) 12/12 12/12 12/12 4/12 RV 0 \odot

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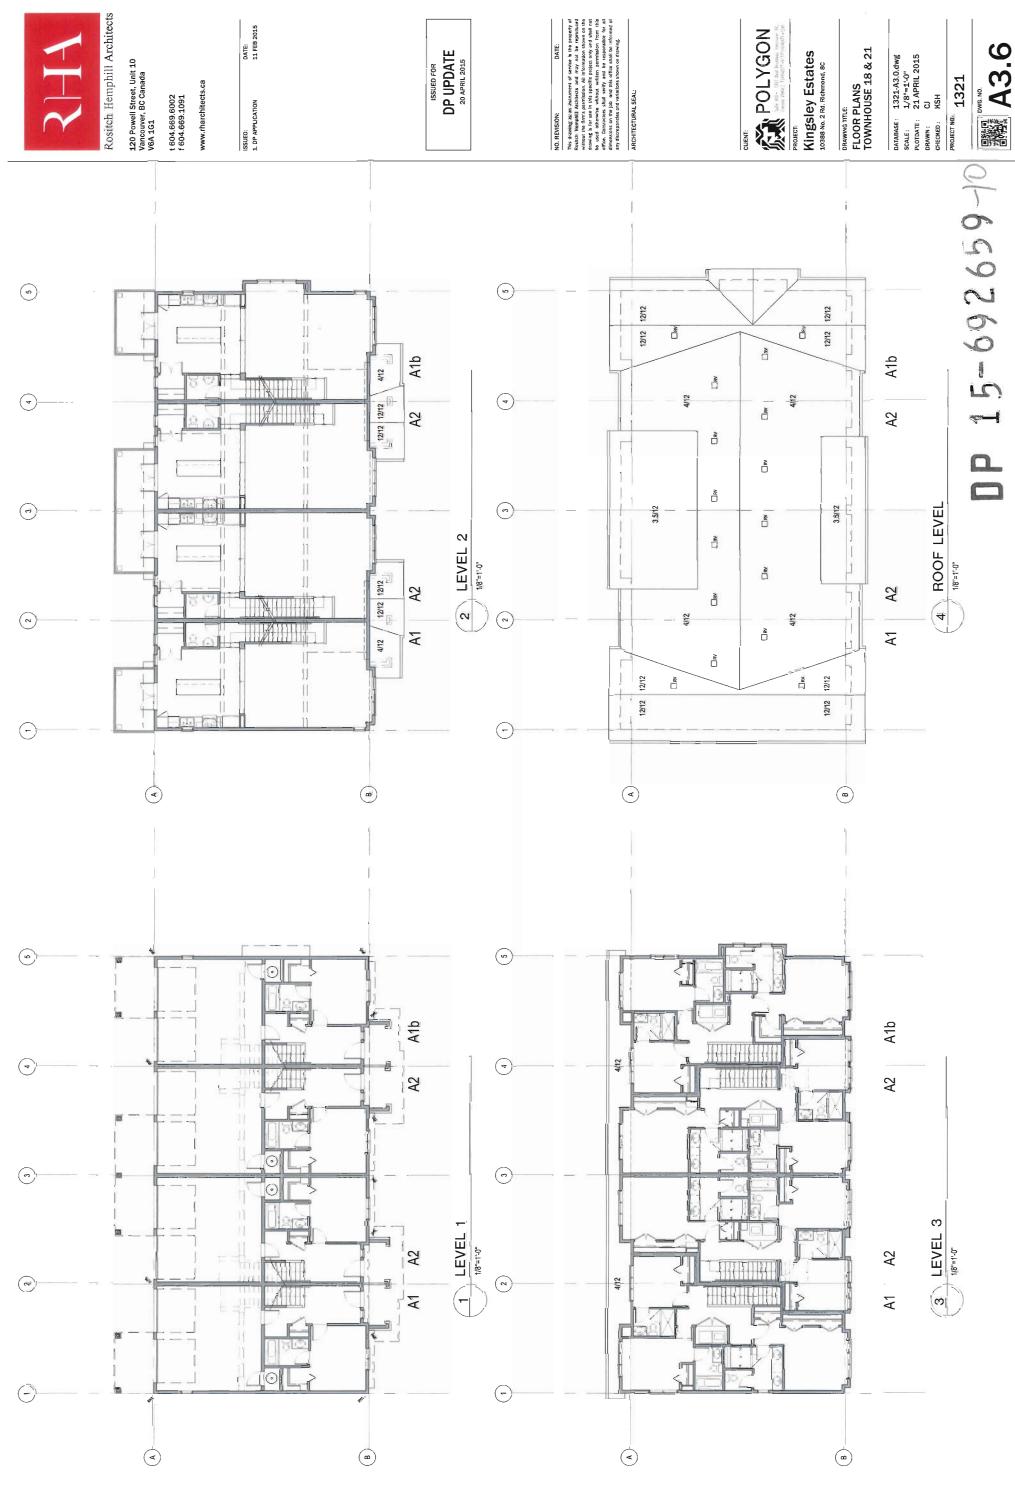
овамию тите: FLOOR PLANS TOWNHOUSE 24, 25, 26, 27, & 28

DATABASE: 1321-A3.0.dwg
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PLOTDATE: 21 APRIL 2015
DRAWN: CJ
CHECKED: KSH

PROJECT NO. **1321**

DP 15-692659-9 (-) $\overline{}$ 12/12 12/12 12/12 12/12 <u>\$</u> A1-END A2 A1-END 2 (**o**) (**o**) 2 A2 2 2 2 3.5/12 3.5/12 (c) (0) <u>\$</u> \$ Ē **A**2 A2 ROOF LEVEL 2 A1 4 4 4/12 2 3 LEVEL 3 ¥ ě 12/12 12/12 <u>₹</u> 12/12 12/12 **⊋** (m) (m) 2 12/12 12/12 12/12 2 8 12/12 4/12 4/12 2 2 12/12 □ \$ 2 12/12 City (7) (2) å 12/12 12/12 12/12 12/12 12/12 <u>-</u> 0

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DATE: 11 FEB 2015



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DRAWING TITLE
FLOOR PLANS
TOWNHOUSE 16 & 22

DATABASE: 1321-A3.0.dwg SCALE: 1,78"=1.0" PLOTDATE: 21 APRIL 2015 DRAWN: CJ CHECKEO: KSH

реолест NO. **1321**

DP 15-692659-12 12/12 \bigcirc (-) 12/12 12/12 12/12 □ BA A1b A1b □ 8 (0) 8 **Y**2 D & OR S D 85 (u) - -(r) 3.5/12 □ 88 11 □ § **¥**2 **Y**2 ROOF LEVEL 0 4 3 LEVEL 3 A T **A**1 N8⊓ O BS □ \$5 3.5/12 (0) (7) () () D ... O W А A □ 85 (N)--(4) **A**2 **A**2 □ WA 12/12 12/12 12/12 12/12 5 <u>-</u>

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20 APRIL 2015

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Kingsley Estates 10388 No. 2 Rd. Richmond, BC

A3.8a PRAWING TITLE FLOOR PLANS TOWNHOUSE 17, 19, & 23

 DATABASE:
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 21 APRIL 2015

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 PROJECT NO. 1321 D. P. No :

15-69269-13 O D (<u>-</u>) A1-end (**9**) 12/12 12/12 A2 (0) 12/12 12/12 A2 4 2 LEVEL 2 A1 4112 (m) A1 (2) 0-8



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PRAWING TITLE: FLOOR PLANS TOWNHOUSE 17, 19, & 23

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A3.8b РRОЈЕСТ NO. **1321**

DP 15-692659-14 (~) 12/12 12/12 12/12 12/12 2 D. A1-end A1-end 2 □ R (9) 4/12 D S **A**2 **A**2 □ 8 9 (0) 3.5/12 ***** <u>≩</u> ê | A2 **\$** € A ROOF LEVEL 4 4/12 3 LEVEL 3 2 A1 Ą 2 2 O R (0) 3.5/12 3.5/12 Ž. **₽** ΑJ A Š (2) 4/12 **A**2 OR O **A**2 <u>\$</u> 1212 1212 12/12 12/12 2

1321-A3.4.dwg 1,4"=1"-0" 25 FEBRUARY 2015 CJ KSH DRAWING TITE.
FLOOR PLANS
AMENITY BUILDING PROJECT NO. 1321 DP 15-692659-15

2 PLAN - AMENITY BUILDING - LEVEL 2

Kingsley Estates

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11-9" 10-4 1/2" 19-0 8-0 NO 30'-9" 4.-0" 10-4 1/2" 20'-2"

Z/101-Z ..9-.87 56-3" 16-4 112" 13'-11 3/4" 17'-11 3/4" -5 3/4" 50'-33'-3" PPP.

17.7 1/2"

181-611

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PLAN - AMENITY BUILDING - LEVEL 1

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одлаваse: 1321-A4.0dwg scale: 3/16"=1'-0" рготовте: 04 МАУ 2015 оваwи: СЈ снескер: KSH

леолест NO. 1321

BM 2134-30 'IRON MOUNTAIN' BM HC-77 'ALEXANDRIA BEIGE'
MATCH THE COLOUR OF FLASHING TO THE MATERIAL IT COVERS
SEE FLASHING SCHEDULE FOR SPECIFIC COLOURS BM HC-77 'ALEXANDRIA BEIGE MITTEN 'SANDALWOOD'
GENTEK - TAN'
KAYCAN - 'SANDALWOOD' BM CC-90 'NATURAL LINEN' BM CC-90 'NATURAL LINEN' SCHEME B A1-END A1-END STOCK BLACK STOCK BLACK ASPEN COUNTRY LEDGESTONE BM 2111-50 'STONE HARBOUR' (0) BM 2134-30 'IRON MOUNTAIN' GENTEK - 'SLATE'
KAYCAN - 'CHARCOAL'
- SOLDSTANED TBD MITTEN 'BROWNSTONE' SCHEME A (P) (10) (4) **A**2 -PAINTED -PAINTED -PAINTED A2 (5) 6)-20 LANDSCAPE FENCING at GRADE 14 PRIVACY FENCING at DECKS 13 EXTERIOR SERVICE DOORS MATERIALS े ि COLOUR SCHEME A (e) A2 COLOUR SCHEME B 11 O/H GARAGE DOORS 17 METAL PLANTER BOX 19 GUTTERS & RWLS 21' CULTURED STONE 15 METAL FLASHING 16 LIGHT FIXTURE 12 REAR DOORS 18 SOFFIT MM - AUTUMN BLEND - MISSION MM - RED VARITONE - MISSION 8M HC-77 'ALEXANDRIA BEIGE' BM CC-90 'NATURAL LINEN' BM CC-90 'NATURAL LINEN' 8M 2057-10 'RIVER BLUE' BM 2111-30 'MUSTANG' SCHEME B (1) STOCK WHITE SACKED FINISH STOCK BLACK 46 0 A1 ं के कि A1 - FRE-PRINES BM 2111-59 'STONE HARBOUR' PANTED

PRANTED

BM 2134-30 'IRON MOUNTAIN'

PREMITED

P BM 2134-30 'IRON MOUNTAIN' PRINCE BM HC-167 'AMHERST GRAY' PRINCE BM OC-5 WARITIME WHITE SCHEME A FIBER CEMENT HORIZ, SIDING 6" EXPOSURE-LIGHT 4 FIBER CEMENT HORIZ. SIDING 6" EXPOSURE-DARK HERM, BROKEN WINDOWS & 3000RS PROFILE ASPHALT SHINGLES FINISH SCHEDULE (d) -(b) ပ MATERIALS PANEL ING. ALUMINUM RAIL 5 FIBER CEMENT ENTRY DOORS ROOF: HEAVY 6 WOOD TRIM 2 BRICK



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See 200 - 133 For Boundary, Bacacan, E.
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Kingsley Estates

PRAWING TILE:
REAR ELEVATION & AMENITY
COLOUR SCHEMES

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PROJECT NO. 1321


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(D) 9 (=) ပ 6 0 A A2 (1) COLOUR SCHEME A (S) -(4) <u>-</u> **A**2 4 A1-END

	FINISH SCHEDULE MATERIALS		SCHEME A	SCHEME B	MATERIALS		SCHEME A	SCHEME B
	ROOF: HEAVY PROFILE ASPHALT SHINGLES		GAF TIMBERLINE-W	IMBERLINE-WEATHERED WOOD'	11 O/H GARAGE DOORS	-PANTED	BM 2111-50 'STONE HARBOUR'	BM CC-90 'NATURAL LINEN'
2	2 BRICK		MM - AUTUMN BLEND - MISSION	MM - RED VARITONE - MISSION	12 REAR DOORS	-PAINTED	BM 2134-30 'IRON MOUNTAIN'	BM HC-77 'ALEXANDRIA BEIC
ω	3 FIBER CEMENT HORIZ, SIDING 6" EXPOSURE-LIGHT - PRE-PRINTED. PRINTED.	- PRE-PRIMED - PAUNTED	BM 2111-50 'STONE HARBOUR'	BM CC-90 'NATURAL LINEN'	13 EXTERIOR SERVICE DOORS	-PAINTED	BM 2111-50 'STONE HARBOUR'	BM.CC-90 NATURAL LINEN
4	FIBER CEMENT HORIZ. SIDING 6" EXPOSURE- DARK	- PRE-PRIMED - PAINTED	BM HC-167 'AMHERST GRAY'	BM 2111-30 'MUSTANG'	14 PRIVACY FENCING at DECKS	PANIED	BM 2134-30 'IRON MOUNTAIN'	BM HC-77 'ALEXANDRIA BEIG
(C)	5 FIBER CEMENT PANEL	- PRE-PRIZED	BM OC-5 'MARITIME WHITE'	BM CC-90 'NATURAL LINEN'	15 METAL FLASHING		MATCH THE COLOUR OF FLASHING TO THE MATERIAL IT COVE SEE FLASHING SCHEDULE FOR SPECIFIC COLOURS	4 THE COLOUR OF FLASHING TO THE MATERIAL IT COVE SEE FLASHING SCHEDULE FOR SPECIFIC COLOURS
9	3 WOOD TRIM	- PRE-PRIZED - PAINTED	BM 2134-30 YRON MOUNTAIN"	BM HC-77 'ALEXANDRIA BEIGE'	16 LIGHT FIXTURE		STOCK BLACK	BLACK
7	ENTRY DOORS	- PRE-PRIVED - PAINTED	BM 2085-20 'POTTERY RED'	BM 2057-10 'RIVER BLUE'	17 METAL PLANTER BOX	- PAINTED	STOCK BLACK	BLACK
80	3 ALUMINUM RAILING		STOCK BLACK	BLACK	18 SOFFIT		MITTEN 'BROWNSTONE'	MITTEN 'SANDALWOOD'
6	DBLE, GLAZED THERM, BROKEN WINDOWS & SLIDING PATIO DOORS		STOCK WHITE	WHITE	19 GUTTERS & RWLS		GENTEK - 'SLATE' KAYCAN - 'CHARCOAL'	GENTEK - TAN' KAYCAN - SANDA LWOOD'
-	10 CONCRETE		SACKED FINISH	FINISH	20 LANDSCAPE FENCING at GRADE	SOLID STAINED		
					21 CULTURED STONE		ASPEN COUNTRY LEDGESTONE	. !

AMENITY BUILDING

21) (21) (3)

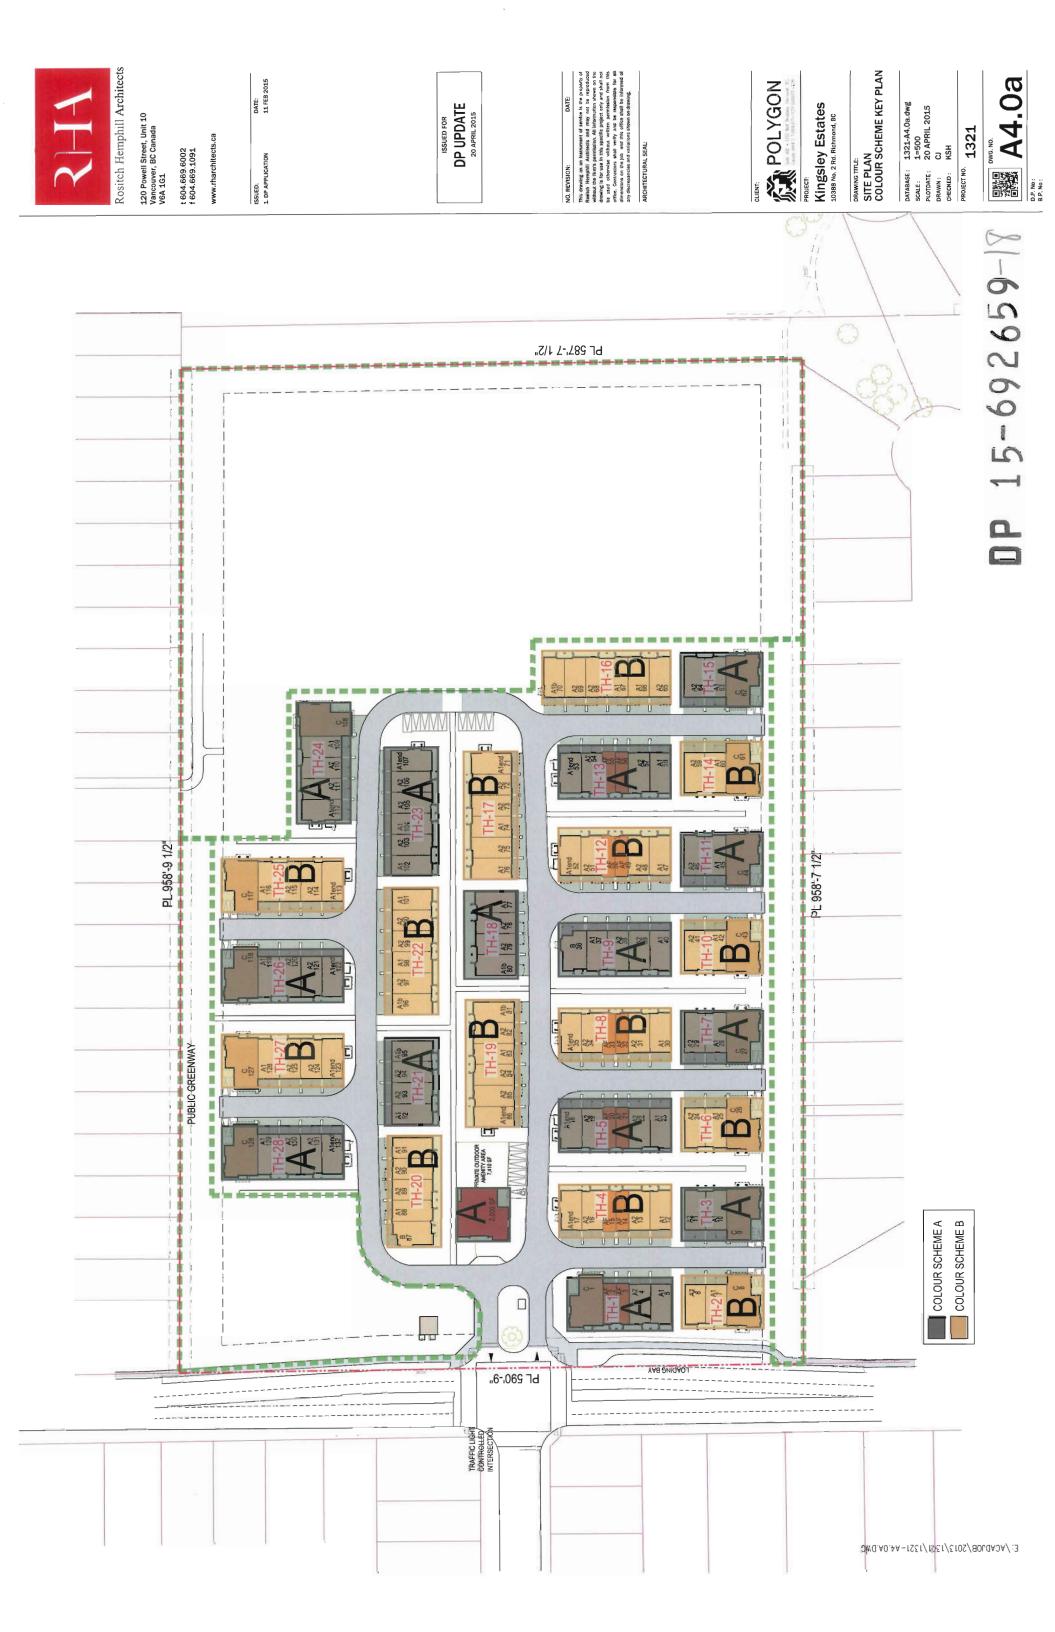

PROJECT NO. 1321


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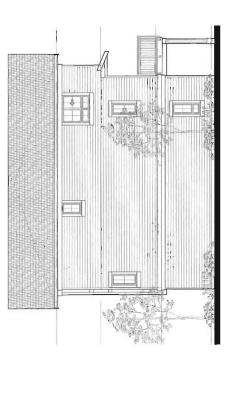
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A1 SIDE ELEVATION

DP UPDATE



MM 23 (2) 41-4 1/3, (1/33 W) 8:0.0 (5/44 W) M 25 (2) 41-4 1/3, (1/33 W) M 25 (2) 41-4 1/3, (1/ 520.W MAIN BESSIM 230 M **A**1 A2 AF1 AF1 NO. 2 ROAD ELEVATION \circ

4-4-1/2 [1.33 M] 8-0* [2.44 M] SEEM 230 M 8

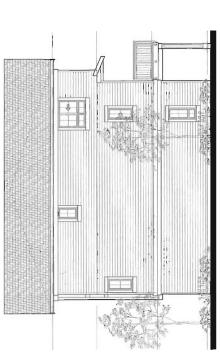ပ AF1 AF1 (INTERNAL ROAD ELEVATION A2 A

POLYGON

Kingsley Estates 10388 No. 2 Rd. Richmond, 8C

C SIDE ELEVATION

DRAWING TITLE
ELEVATIONS
TOWNHOUSE 1

15-692659-19



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ARCHITECTURAL SEAL:

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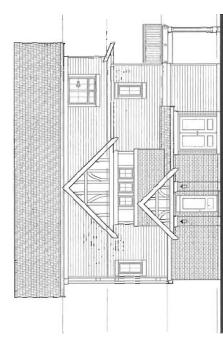
Kingsley Estates 10388 No. 2 Rd. Richmond, BC

DRAWING TITE: ELEVATIONS TOWNHOUSE 4, 5, 8, 12 & 13


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PLOTDATE: 21 APRIL 2015
DRAWN: CJ
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PROJECT NO. 1321

ELECTRICAL ROOM (TH-5, 8, 12 & 13) A1-end SIDE ELEVATION WITH



A1-end SIDE ELEVATION WITH **ELECTRICAL ROOM (TH-4)**

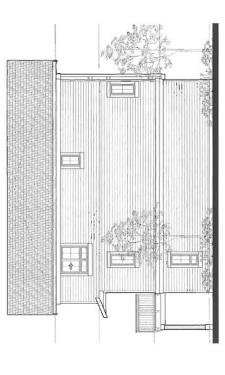

M 850 13 MM 850 12 14 MM 850 12 13 MM 850 12 14 MM 850 12

BSW UPPER

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INTERNAL ROAD ELEVATION

Y2

A1-end

A1 SIDE ELEVATION

DP 15-692659-20

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AF1 AF1 MEWS ELEVATION



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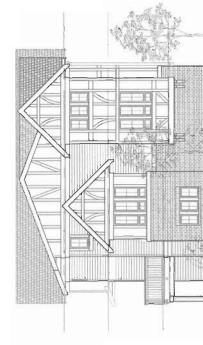
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A1 SIDE ELEVATION




DP UPDATE

B SIDE ELEVATION (TH-20)

POLYGON

Kingsley Estates

ELEVATIONS TOWNHOUSE 9 & 20

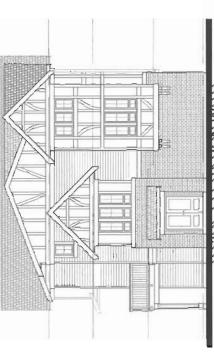

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44 107 [1.33 M] 8-07 [2.44 M] 1000 B UPPER SZBM

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Kingsley Estates 10388 No. 2 Rd. Richmond, BC

DRAWING TITLE ELEVATIONS TOWNHOUSE 2, 3, 6, 7, 10, 11, 14 & 15

DATABASE: 1321-A4.0.dwg
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PLOTDATE: 21 APRIL 2015
DRAWN: CJ
CHECKED: KSH

РРОЈЕСТ NO. 1321

S20 M 855 W UPPER 2304

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2-0-M 10'-6" [3,20M]

 \circ A2 A1 INTERNAL ROAD ELEVATION

C SIDE ELEVATION

DP 15-692659-21



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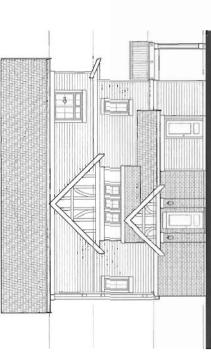
Kingsley Estates

DATABASE: 1321-A4.0.dwg
SCALE: 1/8"=1.0"
PLOTDATE: 21.APRIL 2015
DRAWN: CJ
CHECKED: KSH


A4.5 0. P. No :

UPPER 230W SZOM

A1-END SIDE ELEVATION (TH-25 & 27)



A1-END SIDE ELEVATION WITH ELECTRICAL ROOM (TH-24, 26 & 28)

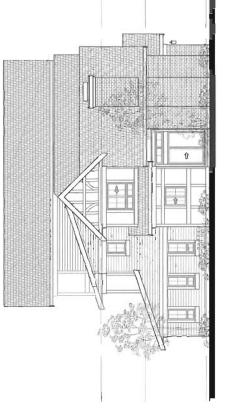

SES N MAUN

C SIDE ELEVATION

DP 15-692659-73

E:/ACADJOB/2013/1321/1321-A4.1.DWG

A1-END

 \circ

A2 A2 MEWS ELEVATION A

BSS W

A1-END

A2

INTERNAL ROAD ELEVATION

230 M \circ

POLYGON

ELEVATIONS TOWNHOUSE 24, 25, 26, 27 & 28

PROJECT NO. 1321



120 Powell Street, Unit 10 Vancouver, BC Canada V6A 1G1

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POLYGON

Kingsley Estates 10388 No. 2 Rd. Richmond, BC

DRAWING TITLE
ELEVATIONS
TOWNHOUSE 18 & 21


DATABASE: 1321-A4.0.dwg SCALE: 1/8"=11-0" PLOTDATE: 21 APRIL 2015 DRAWN: CJ CHECKED: KSH

A4.6 PROJECT NO. 1321 D. P. No :

15-692659-74 A1 SIDE ELEVATION

4-4 1/2" [1.33 M] 8:0" [2.44 M] 900 US 1 1/2" [1.33 M] 8:0" [2.44 M] 900 US 1 1/2" [1.33 M] 8:0" [2.44 M] 900 US 1 1/2" [1.33 M] 900 US 1 SZIM 8.55 M UPPER 230 N 11'-0" [3.35 M] A1b A2 MEWS ELEVATION **A**2 A

A1b SIDE ELEVATION

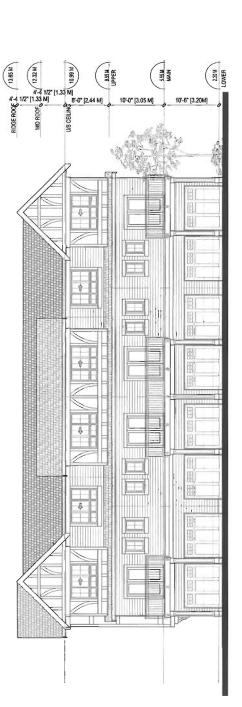



8.55.M UPPER

5.20 K

238 M

A1b

A2

A2 A1 MEWS ELEVATION

R2


A

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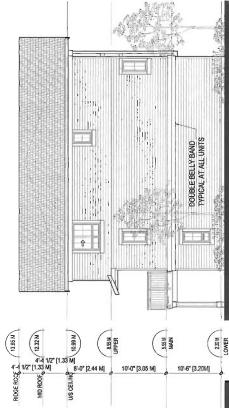
DATE: 11 FEB 2015

ISSUED: 1. DP APPLICATION



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A1b SIDE ELEVATION WITH ELECRICAL CLOSET (TH-16)

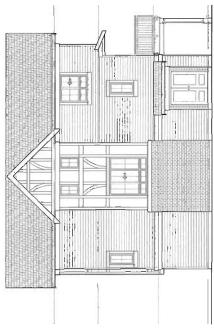

POLYGON

DRAWING TITLE:
ELEVATIONS
TOWNHOUSE 16 & 22

Kingsley Estates 10388 No. 2 Rd. Richmond, BC

1321-A4.0.dwg 1/8"=1'-0" 21 APRIL 2015 CJ KSH

DATABASE: SCALE: PLOTDATE: DRAWN: CHECKED:

ряојест NO. 1321

D. P. No : :

A2 SIDE ELEVATION

A

K2

A2 NTERNAL ROAD ELEVATION

A2

DP 15-692659-75

230M LOWER B.SS.M UPPER S.S.N. 8 \$

0 DOUBLE BELLY BAND TYPICAL AT ALL UNITS

A1b SIDE ELEVATION (TH-22)

E:/ACADJOB/2013/1321-A4.1.DWG



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t 604.669.6002 f 604.669.1091

135 MIN TO 127 (1.33 MIN TO 12.44 MIN TO 13.44 MIN TO 13.

855 W UPPER

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POLYGON

Polygon at the best sense & Kingsley Estates 10388 No. 2 Rd. Richmond, BC A1 SIDE ELEVATION

1 ASSIDE FOR VOTIONSTING 1912

A1-END

Y2

A1

230W LOWER

SSS W MAIN



X A1

A1 A2 MEWS ELEVATION

A1-END

230 M

SZON

A1-END SIDE ELEVATION

A2

M 255 LT 1 275 MM 25 LT 1 275 MM 25

838 W UPPER

A2 A1 INTERNAL ROAD ELEVATION



ELEVATIONS
TOWNHOUSE 17, 19 & 23

DATABASE: 1321-A4.0.dwg
SCALE: 1/8"=11-0"
PLOTDATE: 21 APRIL 2015
DRAWN: CJ
CHECKED: KSH

PROJECT NO. 1321

Rositch Hemphill Architects 120 Powell Street, Unit 10 Vancouver, BC Canada V6A 1G1 t 604.669.6002 f 604.669.1091

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POLYGON
See 90 - 133 Red Broken, Section 85.

Kingsley Estates

DRAWING THE ELEVATIONS AMENITY BUILDING

PROJECT NO. 1321

DATABASE: 1321-A3.4.dwg
SCALE: 1,4"=1.0"
PLOTDATE: 25 FEBRUARY 2015
DRAWN: CJ
CHECKED: KSH

DP 15-692659-27

ARCHITECTURAL SEAL: 1 SOUTH ELEVATION (INTERNAL ROAD) 1 EAST ELEVATION (OUTDOOR AMENITY) 1 Û 1 Ŷ

4 WEST ELEVATION (TOWARDS No. 2 ROAD) SCALE INSTITUTE

1

NORTH ELEVATION (PATHWAY)

E: /ACADJO8/2013/1321/1321-A4.9.DWG

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11.-3 1/2"

DP UPDATE

ARCHITECTURAL SEAL:


POLYGON
Sub-pig. - 533 Sept Bookey, Wesserse, B.,
Coons Spring: 1537 Sept Bookey, Wesserse, B.,


Kingsley Estates 10388 No. 2 Rd. Richmond, BC DRAWING TITLE
UNIT PLANS
UNIT TYPE A1

DATABASE: 1321-A7.0.dwg
SQALE: 1,4"=1"-0"
PLOTDATE: 25 FEBRUARY 2015
DRAWN: CJ
CHECKED: KSH

PROJECT NO. 1321

708 5928 BEDROOM 9'-6"X10'-6" ENSUITE 8-0"X10'-6" BATH 8-0"X5-0" SH 4'0x4'0 14'-8" SH 5'0x2'8 DN 10' 17R @7.06" EA 5.4" BEDROOM 9'4'X9'-0" 5,-6, "G-,G[12'-3 1/2"

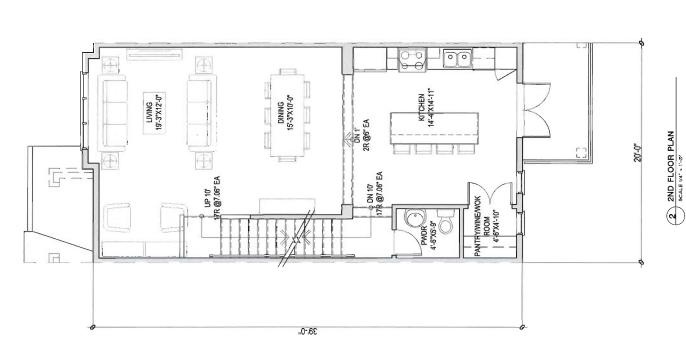


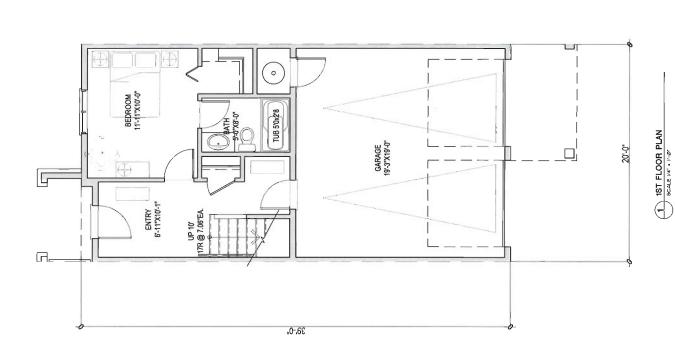

DP 15-692659-78

DP 15-692659-19

PROJECT NO. 1321

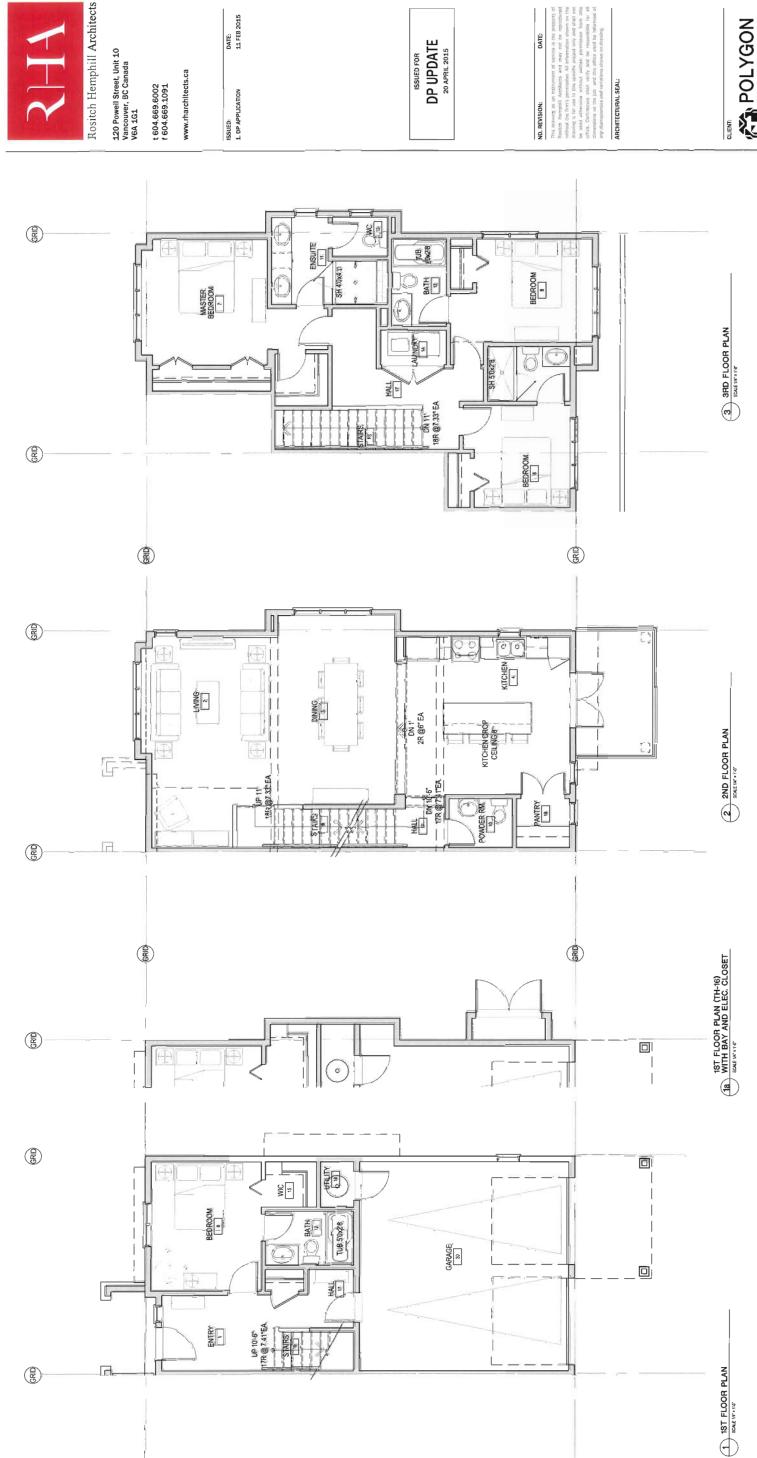

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DATE: 11 FEB 2015



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14.10.

5.4

5.4"

12:-3 1/2"

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ARCHITECTURAL SEAL:

12:3 1/2"

POLYGON

See 50 - 133 and Booder, Stronger, 33.

Company "Spirity: "3(8)0157: 438

Kingsley Estates 10388 No. 2 Rd. Richmond, BC

3 3RD FLOOR PLAN

DATABASE: 1321-A7.0.dwg SCALE: 1/4"=1"0" PLOTDATE: 25 FEBRUARY 2015 DRAWN: CJ CHECKED: KSH DRAWING TITE: UNIT PLANS UNIT TYPE A1-END РROJECT NO. 1321 DP 15-692659-30

BEDROOM 9-6"X10"-6" SH 4'0x4'0 DN 10" 17R.@7.06" EA BEDROOM 9'4'X9'0"

,g-,gl

F DINING 15:3'X10'0' LIVING 19-3"X12-0" DN (*) -0 DN 10" 17H @7.06" EA

5 GARAGE 19:3"X19'-0" BATH 8'-8"X6'-0"

.0-.07

2 2ND FLOOR PLAN SCALE V4. · I'.O'



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POLYGON

Self 700 - 135 441 Brades, Stroomer 35,
Gones 198427 1 (2019)27-1 (2014)584371-1 (2014)

РВОЈЕСТ NO. **1321**

DP 15-692659-3)


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DRAWING TITLE
UNIT PLANS
UNIT TYPE A2

DATABASE: 1321-A7.0.dwg
SCALE: 1,4"-1"-1"
PLOTDATE: 25 FEBRUARY 2015
DRAWN: CJ
CHECKED: KSH

3 3RD FLOOR PLAN SCALE 14" · 1"-0"

BEDROOM 9'-6"X9'-0" MASTER BEDROOM 111:6"X11"-111" 4-8 DN 10° 5.4" BEDROOM 9'4"X9'0" 5.4 12'-3 1/2" 12'-3 1/2" \$ 10-12-b .g-,g1

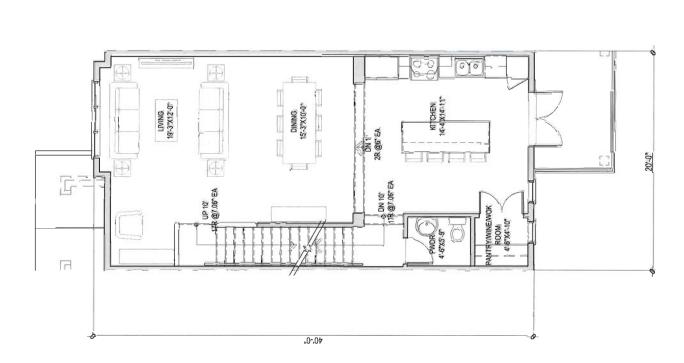

GARAGE 19'-3"X19'-0" 6'-11'X10'-1" "Q-'Q4

1ST FLOOR PLAN

2 2ND FLOOR PLAN SCALE 1/4" : 1"-0"

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POLYGON

Sale 20. - 1213 Act Casabou, Visconen-250.

Sale 20. - 1213 Act Casabou, Visconen-250.

Kingsley Estates

DRAWING TITLE: UNIT PLANS UNIT TYPE B

DATABASE: 1321-A7.0.dwg
SAALE: 1,4"=1".0"
PLOTDATE: 25 FEBRUARY 2015
DRAWN: CJ
CHECKED: KSH

PROJECT NO. **1321**

DP 15-692659-31

S-0'X9-0' TUB 50x2'8 BEDROOM 10'-4"X9"-0" MASTER BEDROOM 10'4'X15'8" 23'-2" SH 4'0x4'0 17R @7.06" EA ENSUITE 7'-6"X10"-4" BEDROOM 10'-0"X10'-1" 8-0"X5-6" SE 5'0x2'8 36.0.

DINING 11-5*X14-5* 15-10"X15-9" UP 1' 2R @6" EA 23.5" DN 9' 16R @6/75" EA PANTRY AITCHEN 12-4"X14"3" 30-0

"Ű-,6E

1 1ST FLOOR PLAN

2 2ND FLOOR PLAN SCALE 1/4" . 1"-0"

3 3RD FLOOR PLAN SCALE UT . 1.0"

E:/ACADJOB/2013/1321/1321-A7.0.DWG

DRAWING TITLE: UNIT PLANS UNIT TYPE C

DATABASE: 1321-A7.0.dwg SCALE: 1,4"=1.0" PLOTDATE: 25 FEBRUARY 2015 DRAWN: CJ CHECKED: KSH

РРОЈЕСТ NO. **1321**


IJ

DP 15-692659-33

2 2ND FLOOR PLAN

8-0"X9"4" SH5:0"x3:0 MASTER BEDROOM 11'-4"X12'-9" BEDROOM 111-5"X10-3" 12'-3 1/2" DN 10 17R @7.06" EA HALL 6'-8'X6'-11" [__ TUB 50°x2'8 S-gyke-d SH 5'0"x2'8 17'-0 1/2" BEDROOM 9'-6"X10'-0"

<u>.</u>g-181

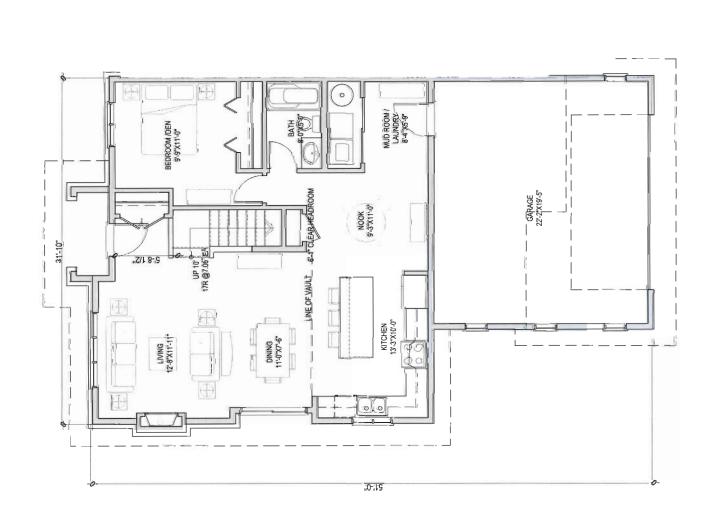

ar ill

15.0.

1ST FLOOR PLAN SCALE V4* x 1-Ø*

E:/ACADJOB/2013/1321/1321-A7.0.DWG

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MASTER BEDROOM 11'-7"X9'-10"

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POLYGON

Set 50 - 133 het Beson, steuent &

canda passez (BRSET-102) (BRSET-125)

BEDROOM 11'-7''X9'-1"

Kingsley Estates 10388 No. 2 Rd. Richmond, BC

ORAWING TITLE: UNIT PLANS UNIT TYPE AF

DATABASE: 1321-A7.0.dwg
SCALE: 1,4"=1-0"
RLOTDATE: 25 FEBRUARY 2015
DRAWN: CJ
CHECKED: KSH

A7.6 РРОЈЕСТ NO. **1321**

DP 15-692659-34

DN 91 68 @6.75".EA

BATH 8-2"X4"-10"

16R @6.75" EA DINING 111-7"X9"-7" LIVING 11'-7'X12'-2" KITCHEN 8-2-X9-4 12'-4" 37-9"

.6-.ZE

3.10x11'6 EA GARAGE 11'-7"X19'-0" .6⁻.4<u>E</u>

1ST FLOOR PLAN SCALE IN: "-O"

2 2ND FLOOR PLAN SCALE 1/8' - 1'-0"

3 3RD FLOOR PLAN

E: / ACADJOB/2013/1321/1321-A7.0.DWG

Landscape Architecture
Urban Design
403 - 275 West Effit Avenue
Vancouver BE. V57 JJB
604 909 4150
Papacoto; com




KINGSLEY ESTATES

LANDSCAPE CONCEPT PLAN

Drawing Number		55	[1.0]
April 21, 2015	1336	See Drawing	20/45
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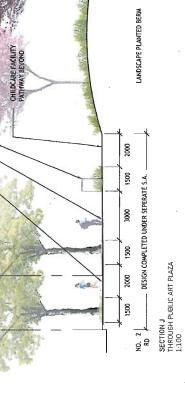
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April 21, 2015	1338	See Drawing	vn/05	49
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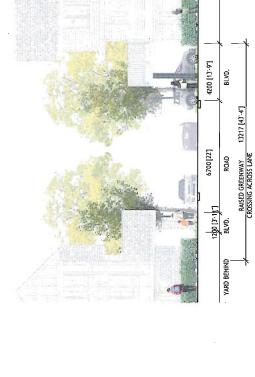


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SECTION A THROUGH MULTI USE TRAIL & TH-1 1:100

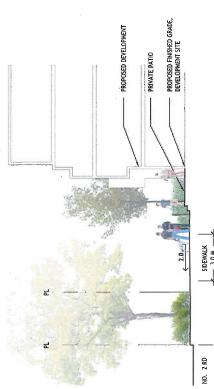


SIDEWALK BEYOND



7518 [24:81]

SECTION H LANE AT N-S GREENWAY LOOKING WEST 1:100

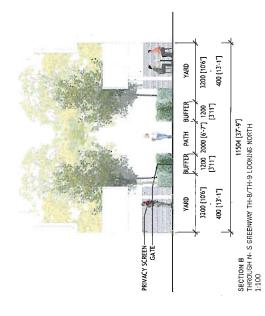

KINGSLEY ESTATES

LANDSCAPE SECTIONS
 Date
 April 2, 2015
 President Reservoir


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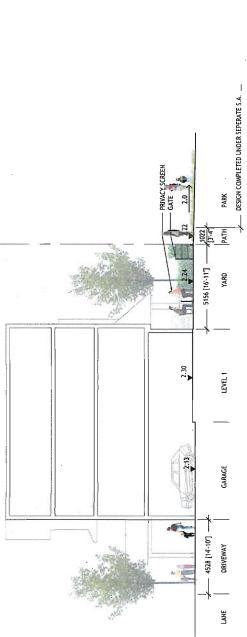
ADJACENT REAR YARD

2000

3000 [9-10"] PUBLIC GREENWAY

PATIO 3048 [10] TOWNHOUSE SETBACK

9000 [29:45] DESIGN COMPLETED UNDER SEPERATE S.A.

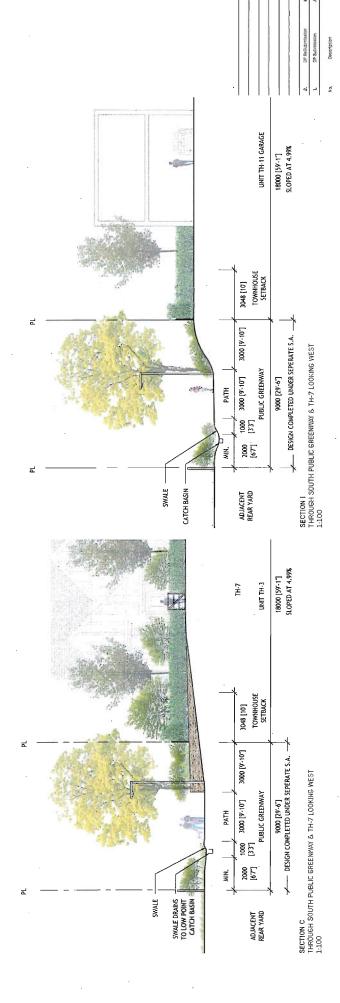


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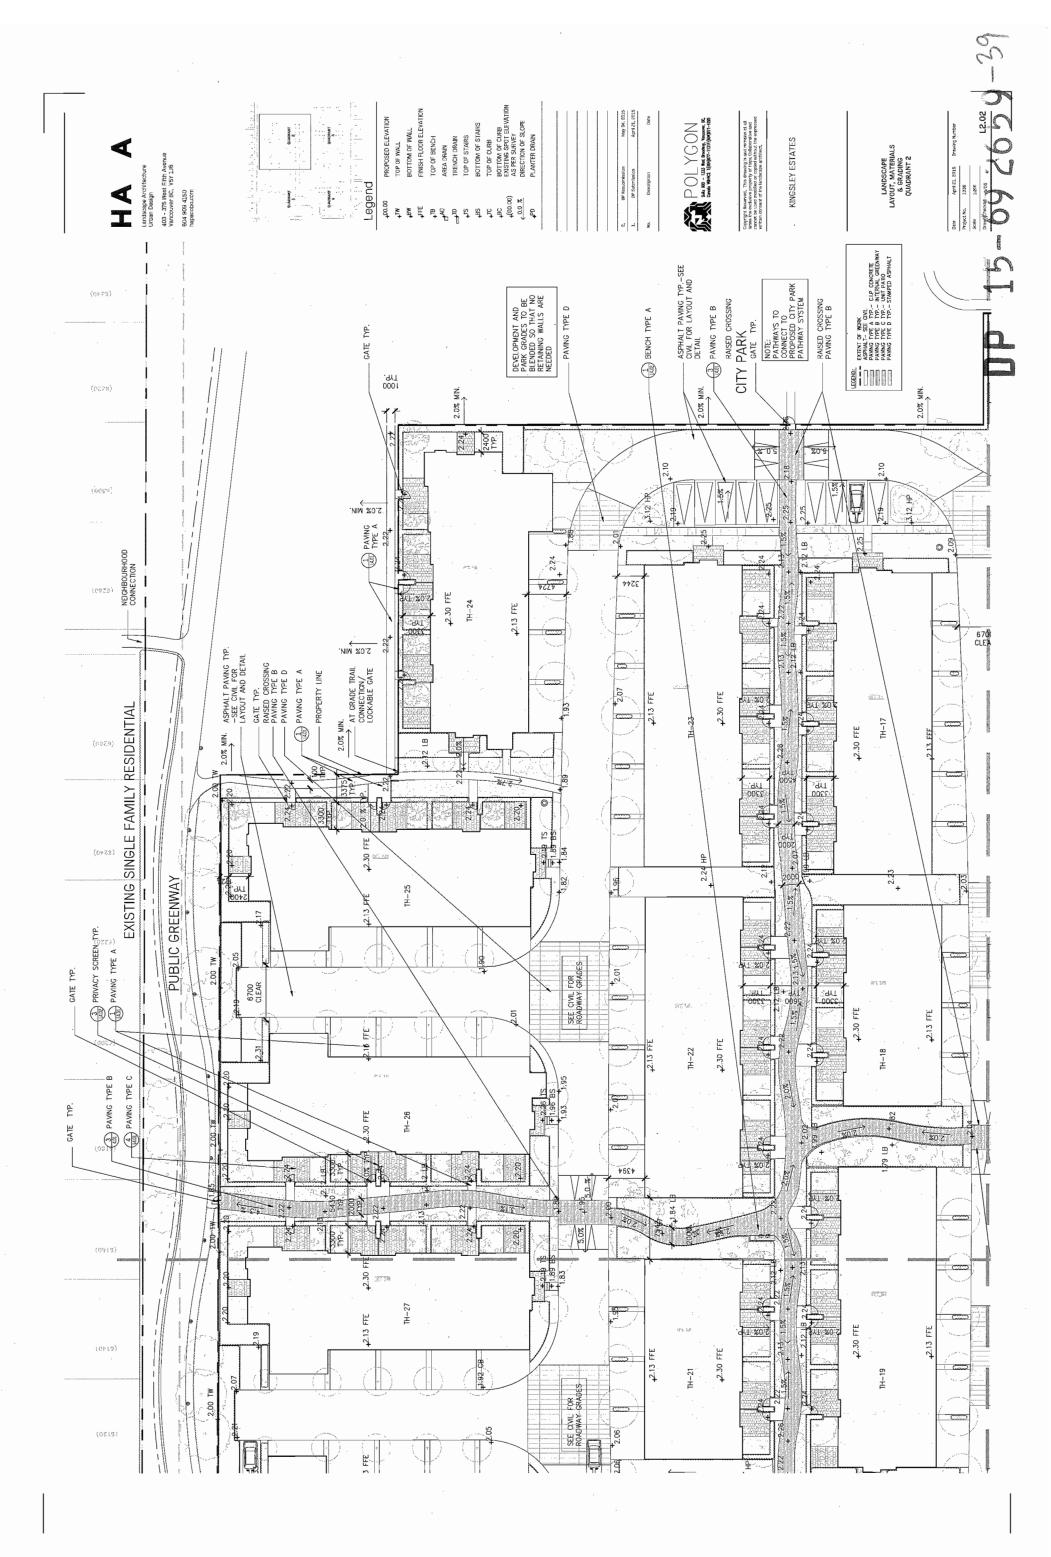
KINGSLEY ESTATES


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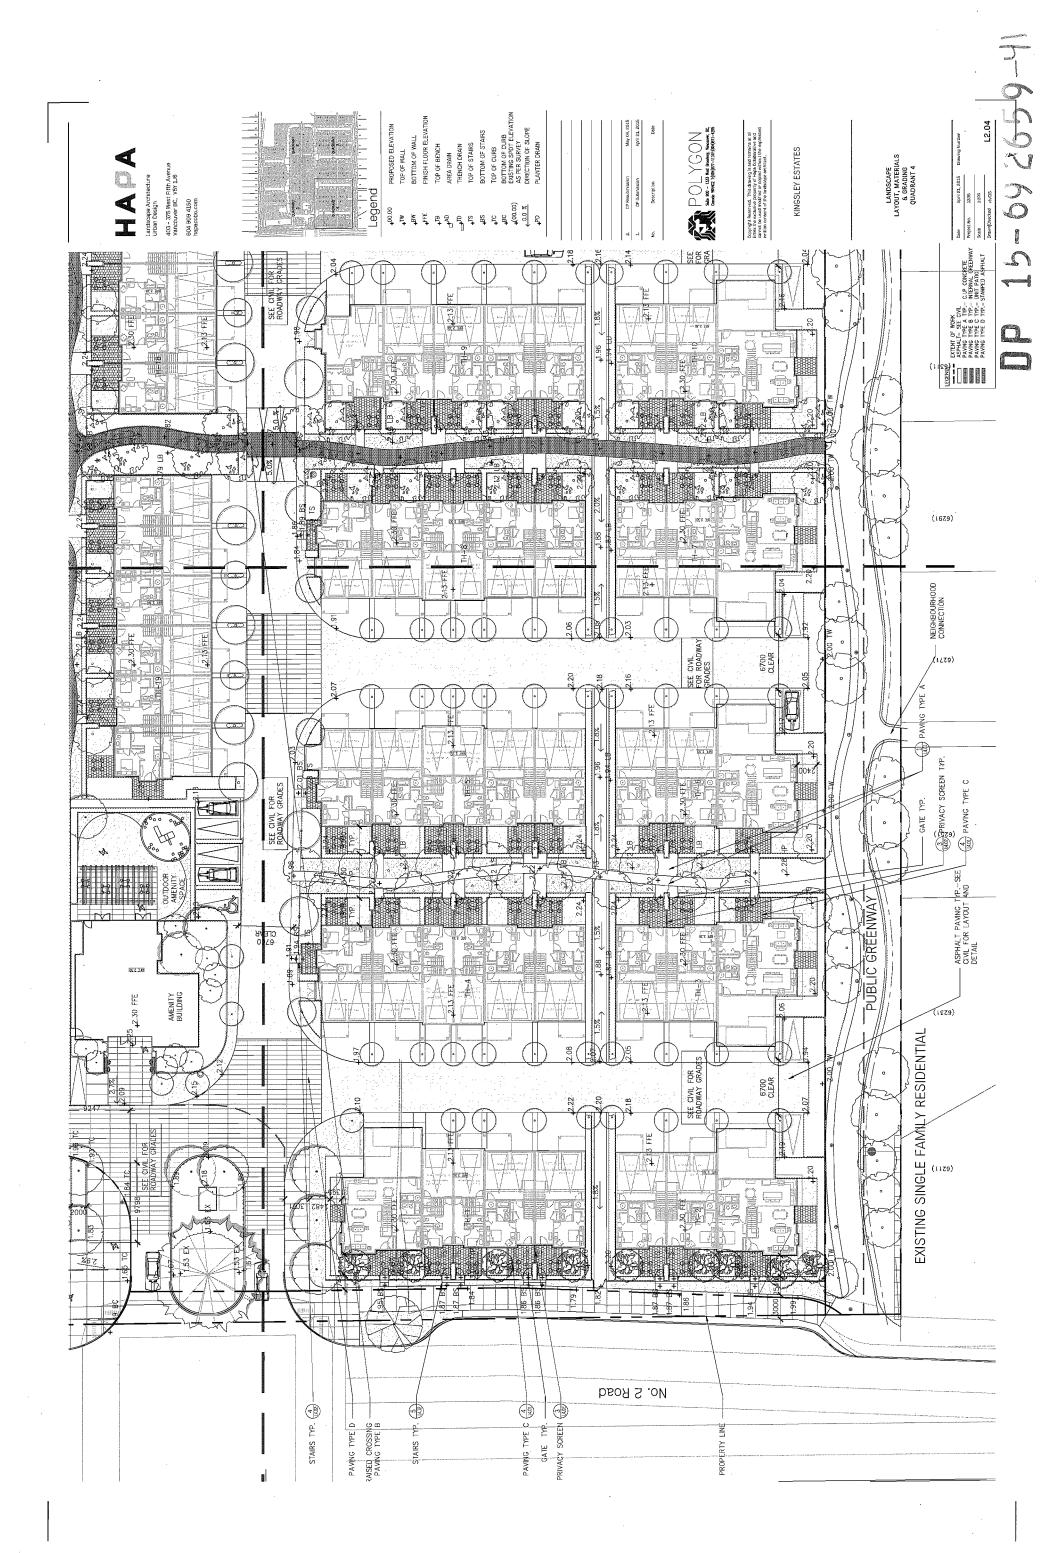
SECTION E THROUGH THIS AND PARK LODKING NORTH 1.100

LANDSCAPE SECTIONS OEVELOPMENT- PARK





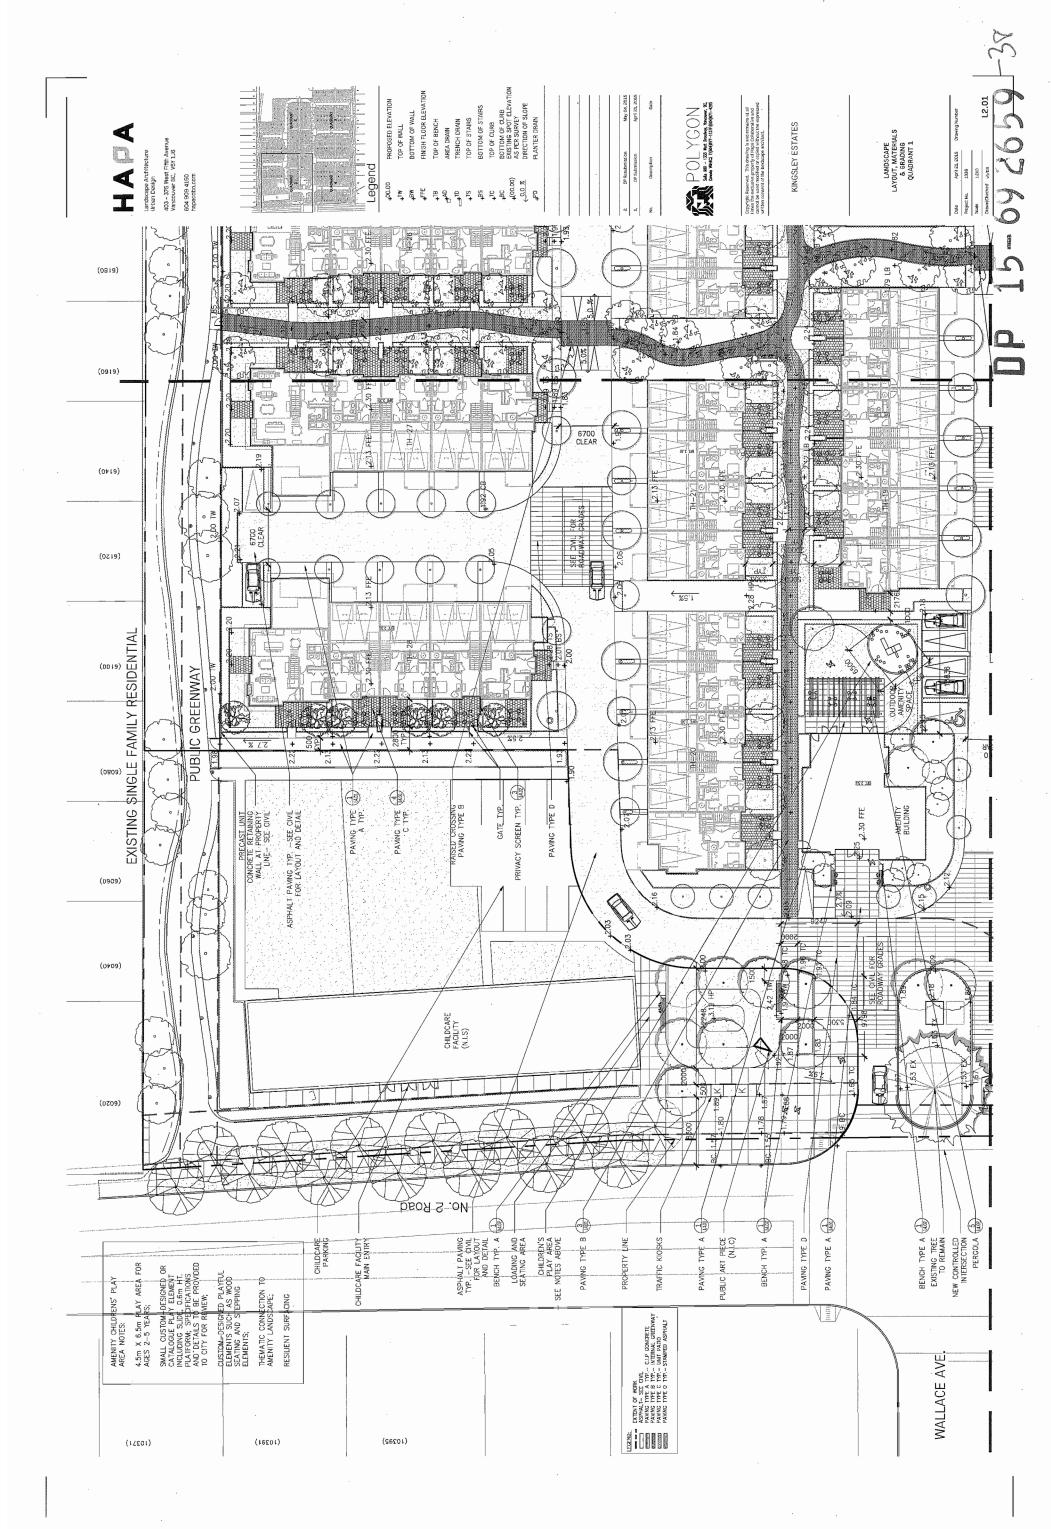

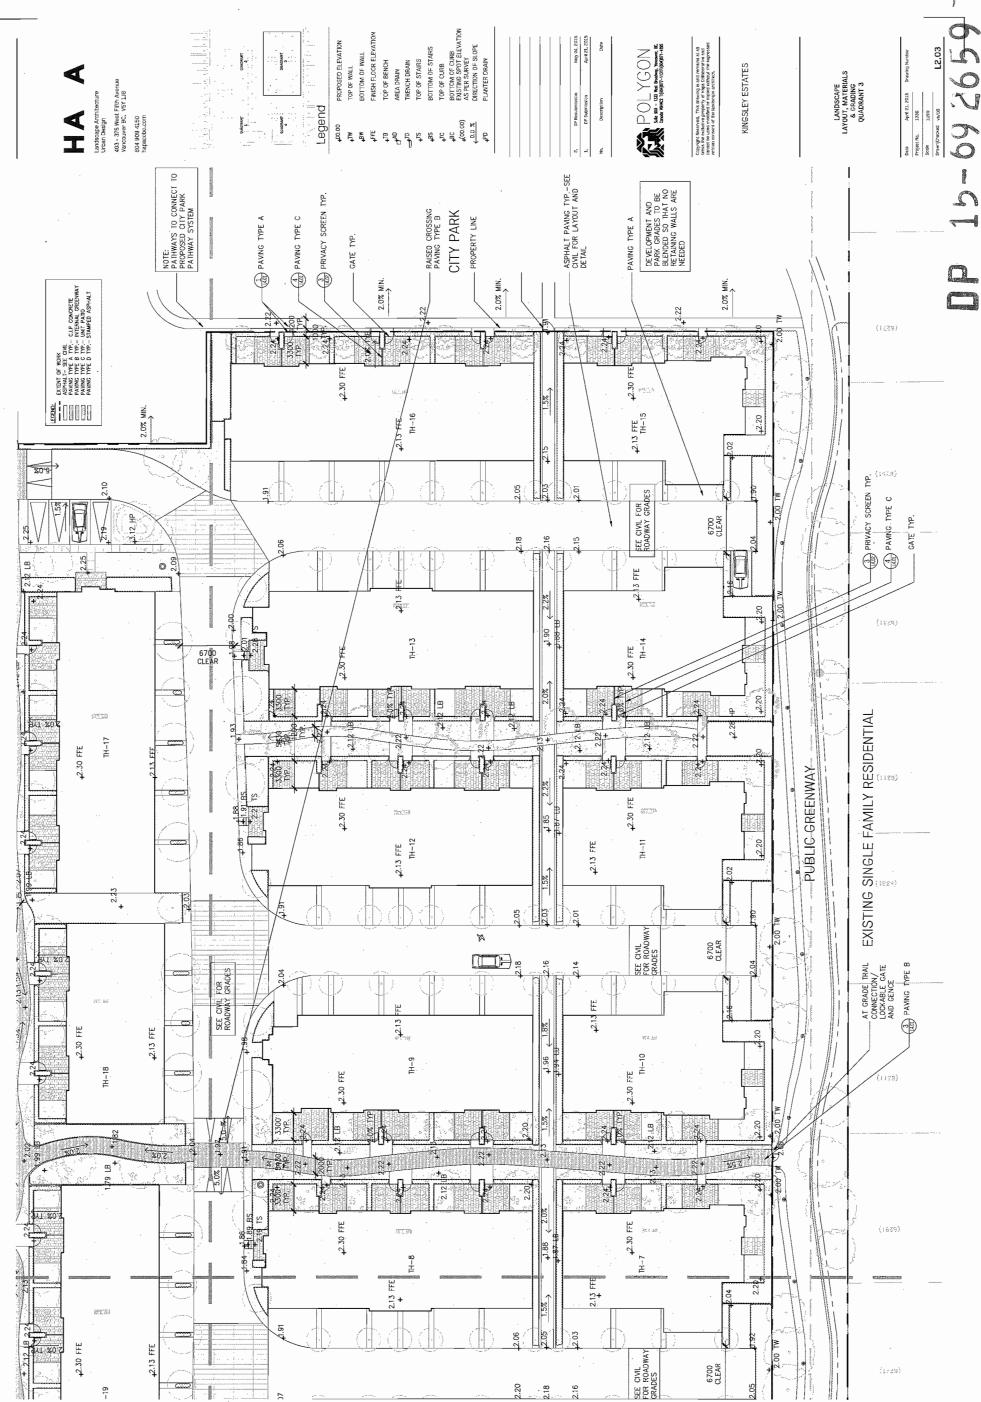

PLANTING PALETTE

Landscape Architecture
Urban Disign
403 - 375 West Fifth Avenue
Vancouver Et. V97 Lib
Roba 909 4155
Papeadboloom

Plant Schedule Sym Qty Bol	Jule Botanical Name	Common Name	Spacing & Size	
				である。
<	Acer rubrum 'Armstrong'	Armstrong maple	5° cal., 8&8	新兴
Ø.	Acer circinatum	vine maple	8ft. ht., 8&B	J.
Ξ.	raxinus oxycarpa 'Raywood'	raywood ash	5 cal., B&B	
~ ~	Magnolia kobus M. x soulangeana	kobus magnolia saucer magnolia	2. cal., 8&8 2.5. cal., 8&8	
-	Rustica Rubra'			とは人の
ш	Parrotia persica	Persian ironwood	2.5° cal., B&B	
_	Quercus balustris 'Green Pillar'	green pillar pln oak	5- cal., 8&B	
LL.	Prunus serrulata 'Shìrofugen'	white goddess cherry	2.5 ⁻ cal., 8&B	
0,	Stewartia monadelpha	tall stewartia	2.5° cal, 8&8	
-,	Styrax japonicus	Japanese snowbell	2.5° cal., 8&8	
_	Cedrus deodara	Deodar Cedar	15' ht., B&B	
ш.	Euonymous fortunei	wintercreeper	#2 pot, 30" 0.C.	
-	Civil good agety	1	18:00	1
	Foklanthus campanilatus	cad-veloed enklanthus	#0 cot 30 0 C	Magonli
	Cholsya ternata	Mexican orange	#2 pot, 30- 0.c.	
		blossom		
	Kalmia latifolia	dwarf mountain laurel	#2 pot, 18" 0.C.	
	Rosa nutkana	nutka rose	#2 pot, 30, 0.C.	1
	Fothergilla major	witch alder	#2 pot, accent	
	Hamamells x intermedia	witch hazel	#2 pot, accent	
	Lonicera pileata	privet honeysuckle	#2 pot, 30, 0.C.	
	Osmanthus delavayii	Delevayi's osmanthus	#2 pot, 30, 0.C.	
	Physocarpus opurolius	dart's gold ninebark	#2 pot, accent	
	'Oart's Gold'	,		
	Lavandula angustifolia 'Munstead'	lavender	#1 pot, 18* 0.C.	9
				1
	Elaeagnus ebbingei	gilt's edge	#2 pot, 30" 0.C.	
	Taxus x media 'Hicksii'	Hick's yew	#2 pot, 30" 0.C.	
	Prunus lauroceracus	common laurel	#2 pot, 30- 0.C.	No. of the last
	Laurus nobilis	sweer bay	#2 pot, 30 0.c.	No.
	Ground covers	:		
	Cornus canadensis	bunchberry	#1 pot, 12" 0.c.	Prunus
	lancour on control	Illia to confe	13.00	
	Liriope muscari	IIIy turi dwaef foriotain ocass	#1 pot, 12 U.C.	12
	'Hamelin'	Over 100011tall Blass	** pot: 15 o.c.	
	Epimedium x youngianum		#1 pot, 12" 0.C.	
	Convallaria majalis	lily of the valley	#1 pot, 12" 0,C.	
	Astilbe arendsil 'Amethyst'		#1 pot, 12 0.C.	は、下皮
	Echinacea pupurea	coneflower	#1 pot, 12, 0,C.	
	Helloborus orientalis		#1 pot, 12" 0.C.	The state of the s
	Heuchera sp	purple	#1 pot, 12 0.C.	To the second
	Rudbeckia goldstrum	plack eved susan	#1 pot. 12 D.C.	1000年代の日本

#1 pot, 12' 0:0.	
purple black eyed susan	
neuchera sp Rudbeckia goldstrum	٠
	tes
	5



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KINGSLEY ESTATES

Date April 21, 2015 citraving Number Project Ho. 1338
Sope Sections 13.00

 Date
 April 21, 2015

 Project No.
 1336

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 vb/0S
 フ **つ**

4 4 T 403 - 375 West Fifth Avenue Vancouver BC, V5Y 1.16 604 909 4150 hapacobo.com Landscape Architecture Urban Design Shrub Mix - Type C Shrub Mix - Type D Shrub Mix - Type E Hedges Lawn

255m² 1500m² 2646m² 116m² 222m² Mews Planting - Type A (40.60 small mix)
Mews Planting - Type B (40.60 small shrub/perennial mix)
Mews Planting - Type C (40.60 small mix)
Mews Planting - Type D (40.60 small mix)
Shrub/perennial mix) Shrub mix - Type A Shrub Mix - Type B

r rubrum "Armstrong" r circinatum kinus oxycarpa "Raywood" inolia kobus Plant Schedule Sym Qty Botanicai Name

5' cal., 888 6ft, ht., 868 5' cal., 868 2.5' cal., 868 5' cal., 868 5' cal., 868 2.5' cal., 868 Armstrong maple vine maple vine maple raywood ash kobus magnolia saucer magnolia

#2 pot, 18" 0.C. #2 pot, 30" 0.C. #2 pot, 30" 0.C. #2 pot, 30° 0.C. Persian ironwood green pillar pin oak white goddess cherry tall stewartia Japanese snowbell Deodar Cedar wintercreeper Parrotia persica Quercus palustris 'Sreen Pillar' Prunus serrulata 'Shirotugen' Stewartia monadelpha Styrax japonicus Cedrus deodara

Shrubs Eu

용보은

boxwood
red-veined enklanthus
Mexican orange
Blossom
dwarf mountain laurel
nutka rose
witch lader
witch hazel
perivet honeysuckle
Delevayi's osmanthus
dart's gold ninebark

Karmia latifolia Aosa untkara Fothergilla major Harnamalis x intermedia Lontoera pileati Osmanthus delavayii Pyysocarpus opufolius 'Darf's Solot' Lavandula angustifolia 'Munste. Б

#2 pot, 18" 0.C. #2 pot, 30" 0.C. #2 pot, accent #2 pot, accent #2 pot, 30" 0.C. #2 pot, 30" 0.C. #2 pot, accent

gilt's edge Hick's yew common laurel sweet bay Elaeagnus ebbingei Taxus x media "Hicksii" Prunus lauroceracus Laurus nobilis Hedges Ee -Tm -P! -

#2 pot, 30° 0.C. #2 pot, 30° 0.C. #2 pot, 30° 0.C. #2 pot, 30° 0.C.

#1 pot, 18" 0.C.

lily turf dwarf fountain grass bunchberry Ground covers cc - Cornus canadensis Perennials Im -pa -

lily of the valley coneflower Hamelin x younglanum Epimedium x younglanum Convallaria majalis Astilibe arendsii 'Amethyst' Echinacea pupurea Helioborus orientalis Heuchera sp Rudbeckia goldstrum

#1 pot, 12: 0.C. #1 pot, 12: 0.C.

#1 pot, 12' 0.C. #1 pot, 12' 0.C.

#1 pot, 12, 0.C.

purple black eyed susan

Notes

1. All plant material to BCNTA and BCSLA standards, Refer to the BCSLA Landscape Standard, a fasts edition.

2. Area of search for plant material: Pacific Northwest including British Columbia, Washington and Oregon.

3. Refer to specification for general conditions, materials and installation requirements.


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KINGSLEY ESTATES

LANDSCAPE PLANTING PLAN QUADRANT 1

Plant Legend 130m² 342m² . 230m² 277m² ey cm aa bo bo rg 10 BW صح (28)



Shrub Mix - Type D Shrub Mix - Type E Shrub Mix - Type C Hedges Lawn 1500m² 2646m² 222m² 255m² Mews Planting - Type A (40:60 small mix)

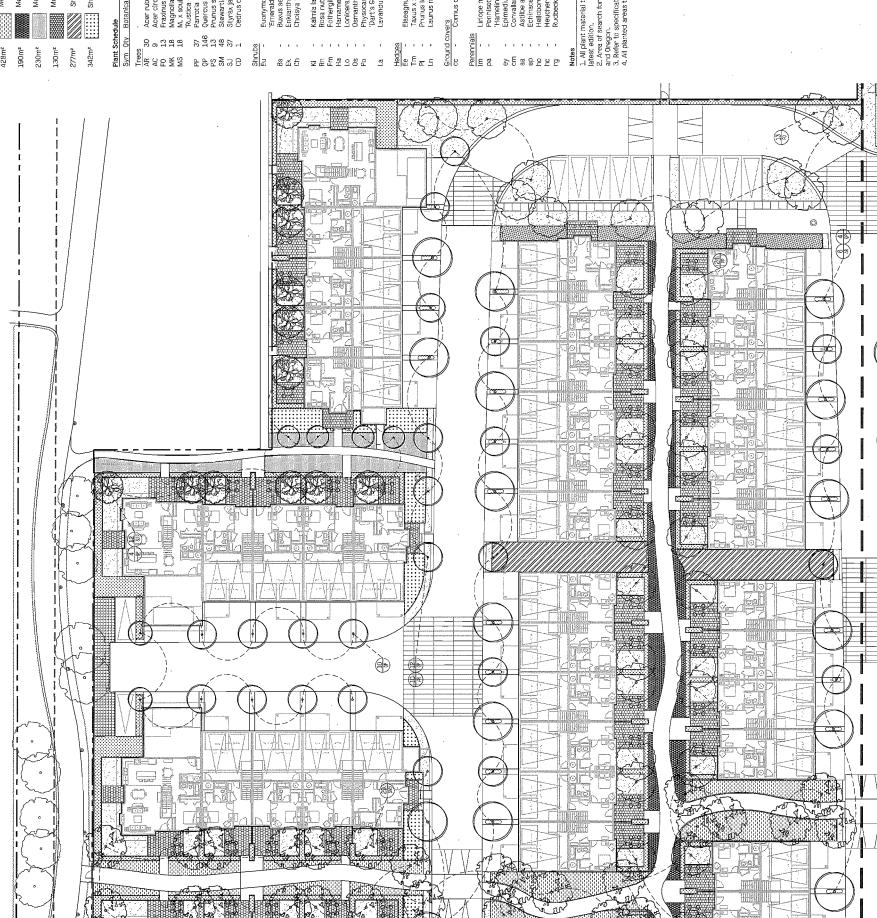Mews Planting - Type B (40:60 small sinub/perennial mix)

Mews Planting - Type C (40:60 small sinub/perennial mix)

Mews Planting - Type C (40:60 small sinub/perennial mix) Shrub mix - Type A Shrub Mix - Type B

403 - 375 West Fifth Avenur Vancouver BC, VSY 1.16 Landscape Architecture Urban Design

CLASSON

#2 pot, 18" 0.C.
#2 pot, 30" 0.C.
#2 pot, accent
#2 pot, accent
#2 pot, 30" 0.C.
#2 pot, 30" 0.C. #2 pot, 18' 0.C. #2 pot, 30' 0.C. #2 pot, 30' 0.C. #2 pot, 30" 0.C. #1 pot, 18" 0.C. 2.5° cal., B&B 5° cal., B&B 2.5° cal., B&B 2.5° cal., B&B 2.5° cal., B&B 15° ht., B&B 5' cal., B&B 6ft, ht., B&B 5' cal., B&B 2' cal., B&B 2.5' cal., B&B boxwood
red-veined enkianthus
Mexican orange
blossom
dwarf mountain laurel
nutka rose
witch hazel
witch hazel
witch hazel
elevay's osmanthus
dert's gold ninebark Perstan fronwood green pillar pin oak white goddess cherry tall stewartia Japanese snowbell Deodar Cedar Armstrong maple vine maple vine maple raywood ash kobus magnolia saucer magnolia wintercreeper lavender Kalmia latifolia
Rosa nutkana
Fothergilain major
Fothergilain major
Harnamelis x intermedia
Lonicera pileata
Osmaahtus delavayii
Physocarpus opurolius
'Dar's Gold'
Lavandula angustifolia' Munstead M. x soulangean Rustice Rubra Perrotia persica Quercus palustria 'Green Pillar' Prunus servulara 'Shirofugen' Styrax, japonicus Cedrus deodara Acer rubrum 'Armstrong' Acer circinatum Fraxinus oxycarpa 'Raywood' Magnoia kobus M. x soulangeana 'Rustica Rubra' Euonymous fortunei Emerald Galety' Buxus sempervirens Enkianthus campanulatus Choisya temata

#2 pot, 30" 0.0. #2 pot, 30" 0.0. #2 pot, 30" 0.0. #2 pot, 30" 0.0. #1 pot, 12" 0.C. gilt's edge Hick's yew common laurel sweet bay bunchberry Elaeagnus ebbingei Taxus x media 'Hicksii" Prunus lauroceracus Laurus nobilis Ground covers cc - Comus canadensis

#1 pot, 12° 0.C. #1 pot, 12° 0.C. #1 pot, 12' 0.C. fily turf dwarf fountain grass lily of the valley coneflower

Notes

1. All plant material to BCNTA and BCSLA standards. Refer to the BCSLA Landscape Standard, latest edition.
2. Area of search for plant material: Pacific Northwest including British Columbia, Washington and Oregon.
3. Refer to specification for general conditions, materials and installation requirements.

Substitution of the substitution of control (strong Hirtory (strong Hirtory (strong Hirtor) (s

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KINGSLEY ESTATES

LANDSCAPE PLANTING PLAN QUADRANT 2

Shrub Mix - Type C Shrub Mix - Type D Shrub Mix - Type E $116 m^2$ Mews Planting - Type A (40:60 small mix)

Mews Planting - Type B (40:60 small struct) perennial mix)

Mews Planting - Type C (40:60 small mix)

Mews Planting - Type D (40:60 small mix) Mews Planting - Type C shrub Mews Planting - Type D shrub Mix - Type A shrub Mix - Type A shrub Mix - Type B

230m²

130m² 277m² 342m²

Plant Legend

428m² 190m²

sym Uty Botanical	Lavandula			Elaeaguns	Taxus x m	Prunus lau	Laurus no		covers	Cornus ca		ङ।	Liríope m.	Pennisetu	"Hamelin"	Epimediur	Convallari	Astilbe an	Echinacea	Helloborus	Heuchera	Rudbeckia			 All plant material to 	ition.	2, Area of search for p	Jou.	Refer to specification	A All minden A annual to
Sym VC	.• [a		Hedges	9	Tm_		5		Ground covers	8		Perennials	<u> </u>	ьа		- Ke	- WO	- 22	- de	- 유	· 원	ē.		Notes	1. All pla	latest edition.	2, Area (and Oregon.	3. Refer	A All Plans
Spacing & Size		5 cal., B&B	6ft, ht., B&B	5 cal., B&B	2' cal., B&B	2.5° cal., B&B		2.5° cal., B&B	5° cal., B&B	2.5° cal., B&B	2,5' cal, B&B	2.5" cal., B&B	15' ht., B&B			#2 pot, 30° 0.C.		#2 pot, 18" 0.C.	#2 pot, 30" 0.C.	#2 pot, 30, 0.C.		#2 pot, 18' 0.C.	#2 pot, 30° 0.C.	#2 pot, accent	#2 pot, accent	#2 pot, 30" 0.C.	#2 pot, 30" 0.C.	#2 pot, accent		
Common Name		Armstrong maple	vine maple	raywood ash	kobus maqnolia	saucer magnolia		Persian ironwood	green pillar pin oak	white goddess cherry	tall stewartia	Japanese snowbell	Deodar Cedar			wintercreeper		роомход	red-veined enklanthus	Mexican orange	plossom	dwarf mountain laurel	nutka rose	witch alder	witch hazel	privet honeysuckle	Delevayi's osmanthus	dart's gold ninebark		
ym Uty Botanical Name		Acer rubrum 'Armstrong'	Acer circinatum	Fraxinus oxycarpa 'Raywood'	Magnolia kobus	M. x soulangeana	'Rustica Rubra'	Parrotia persica	Onercus palustris 'Green Pillar'	Prunus serrulata 'Shirofugen'	Stewartia monadelpha	Styrax japonicus	Cedrus deodara			Euonymous fortunei	'Emerald Gaiety'	Buxus sempervirens	Enkianthus campanulatus	Choisya ternata		Kalmia latifolia	Rosa nutkana	Fothergilla major	Hamamelis x intermedia	Lonicera pileata	Osmanthus delavayii	Physocarpus opufolius	'Dart's Gold'	
Š	SS	8	o	13	18	18		37	146	13	48	37	Н		hrubs	'		,	,	,		. ,	,	,	,	,	•	•		
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9	Spacing & Size	Sym Qty	Botanical Name	Common Name	Spacing & Size
		. .	Lavandula angustifolia 'Munstead'	lavender	#1 pot, 18° 0.C.
able	5 cal., B&B				
	6ft. ht., B&B	Hedges			
	5 cal., B&B	Ee	Elaeagnus ebbingei	gilt's edge	#2 pot, 30° 0.C.
<u>la</u>	2 cal. B&B	THE	Taxus x media 'Hicksii'	Hick's yew	#2 pot, 30, 0.C.
olia	2.5° cal., B&B	۰ <u>۵</u>	Prunus fauroceracus	common laurel	#2 pot, 30° 0.C.
		ح	Laurus nobilis	sweet bay	#2 pot, 30" 0,C,
poo	2.5° cal., B&B				
în oak	5° cal., B&B	Ground covers	Sie		
s cherry	2.5 cal., B&B	8	Cornus canadensis	bunchberry	#1 pot, 12. 0.C.
	2.5° cal, B&B				
Medw	2.5" cal., B&B	Perennials			
	15' ht. B&B	<u>=</u>	Liriope muscari	lily turf	#1 pot, 12" 0.C.
		ba -	Pennisetum alopecuroides	dwarf fountain grass	#1 pot, 12" 0.C.
			"Hamelin"		
	#2 not 30" 0.C.	- Ae	Epimedium x youngianum		#1 pot, 12" 0.C.
		- ED	Convallaria majalis	lily of the valley	#1 pot, 12, 0.C.
	#2 ppt. 18: 0.C.	- 23	Astilbe arendsii 'Amethyst'		#1 pot, 12, 0.C.
kianthus	#2 not 30" 0.C.	- de	Echinacea pupurea	coneflower	#1 pot, 12, 0.C.
	#2 not 30" 0.5	· 원	Helloborus orientalis		#1 pot, 12, 0.C.
		ر ا	Heuchera sp	ejdund	#1 pot, 12" 0.C.
ain laurel	#2 pot, 18, 0.C.	5	Rudbeckia goldstrum	black eyed susan	#1 pot, 12° 0.C.
	#2 pot, 30* 0.C.				
	#2 pot, accent	Notes			
	#2 pot, accent	1. All plant	 All plant material to BCNTA and BCSLA standards. Refer to the BCSLA Landscape Standard. 	ards, Refer to the BCSLA La	ndscape Standard,
suckle	#2 pot, 30" 0.C.	latest edition,			
nanthus	#2 pot, 30" 0.C.	2, Area of	Area of search for plant material: Pacific Northwest including British Columbia, Washington	thwest including British Col	umbia, Washington
nebark	#2 pot, accent	and Oregon.	٠.		
		3. Refer to	Refer to specification for general conditions, materials and installation requirements.All planted areas to have automatic indication.	materials and installation r	equirements.

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			# # # # # # # # # # # # # # # # # # #	annual plants
#_pov_L2_0.0. #_pov_L22_0.0. #_pov_L22_0.0. #_pov_L22_0.0. #_pov_L22_0.0.	Landscape Standard,	olumbia, Washington	ı requirements,	

			May 04, 2015	April 21, 2015	Pale
			OP Resubmission	DP Submission	Description
			2	1	Ą.



KINGSLEY ESTATES

LANDSCAPE PLANTING PLAN QUADRANT 3

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Drawing Number			L3.03	7.	
April 21, 2015	1338	1-200	vh/DS	5	
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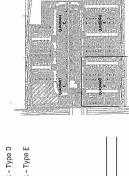
Drawing Number			L3.03	
April 21, 2015	1336	1-200	vh/DS	7
Dale	Project No.	Scale	Drawn Checked vh/05	
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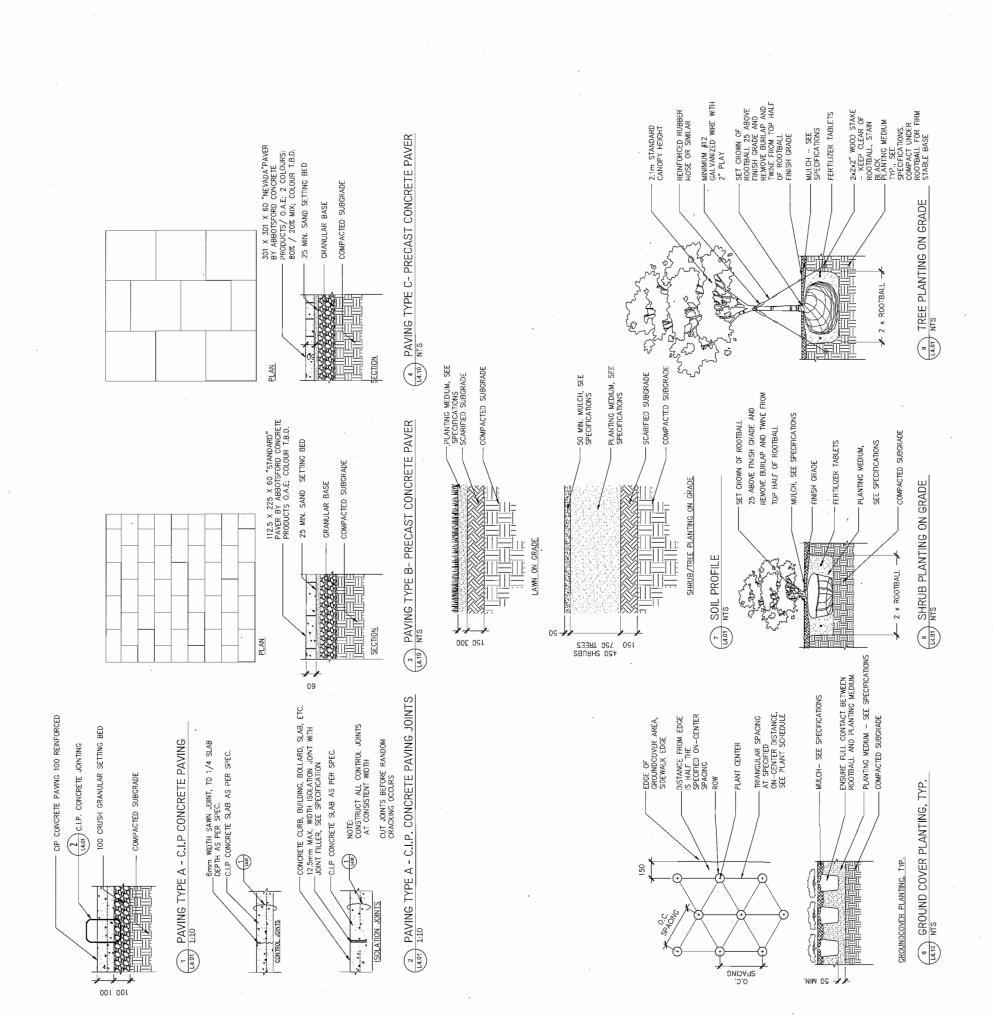
Plant Legend



The state of the s	1				2. (pr Resubmission May Cu. 2015. 1. (pr Resubmission April 21, 2015. No. Description Ealer	A Control PC C C C C C C C C C C C C C C C C C	Copyright Reserved. This drawing is and remote at all remote at all remote for each for each of property of linesy control for seed modified or copies without his expressed intitle coreset of its biocopies a delired;	KINGSLEY ESTATES
Shrub Mix - Type C Shrub Mix - Type D Shrub Mix - Type E Hedges Hedges	Spacing & Size	5' cal. 888 6ft, ht. 868 5' cal., 868 2' cal., 868 2-5' cal., 868 5' cal., 868 2.5' cal., 868 2.5' cal., 868 2.5' cal., 858 2.5' cal., 858 2.5' cal., 858	#2 pot, 30' 0.C. #2 pot, 18' 0.C. #2 pot, 30' 0.C. #2 pot, 30' 0.C.	#2 pot, 18" 0.C. #2 pot, 30" 0.C. #2 pot, accent #2 pot, accent #2 pot, 30" 0.C. #2 pot, 30" 0.C. #2 pot, 30" 0.C. #1 pot, 18" 0.C.	#2 pot, 30' 0.C. #2 pot, 30' 0.C. #2 pot, 30' 0.C. #2 pot, 30' 0.C.	#1 pot, 12° 0.C. #1 pot, 12° 0.C. #1 pot, 12° 0.C.	#1 pot, 12" 0.0.	ndscape Standard,
Yype A (40:60 small shub) (40:60 small shub) (222m² shub) (26 small shub) (255m² shub) (26 small shub) (255m² shub) (26 small	Common Name	Armistrong maple vine maple raywood ash kobus magnolia saucer magnolia saucer magnolia Persian ironwood green pillar pin oak wihte goddess cherry tal stewarta Japaness snowbell beodar Cedar	wintercreeper boxwood red-veined enkianthus Mexican orange	biossoon dwarf mountain laurel nutka rose witch bazde privet honeysuckle pelevayi's osmanthus darf's gold ninebark lavender	glit's edge. Hok's yew common laurel sweet bay	bunchberry Illy turf dwarf fountain grass	lily of the valley coneflower purple black eyed susan	dards. Refer to the BCSLA La
Mews Planting Mews Planting Mews Planting Shrub mix - Type	Botanical Name	Acer rubrum 'Armstrong' Acer circinatum Fraxinus oxycarpa 'Raywood' Magnolla kobus M.x. soulangeana "Rustica Rubra" "Rustica Rubra" "Rustica Bustris' Green Pillar' Purunts servultar 'Shirofugen' Strwartia monadelpha Styrax japonicus Cedrus deodara	Euonymous fortunei Emerald Gaiety' Buxus sempervirens Enklanthus campanulatus Cholsya ternata	Kalmia latifolia Rosa nutkana Fothergilia major Harnamelis x infermedia Loricera pileata Osmanthus delavayii Physocapus opufolius "Darf's Gold' Lavandula angustifolia 'Munstead'	Eleagrus ebbingei Taxus x media Hicksii? Prunus lauroceracus Laurus nobilis	Vers Cornus canadensis Liriope muscari Pennisetum alopecuroides	nations younglanum Convaliaria magalis Astiba arendai Amethyst Echinacea pupurea Helioborus orientalis Heuchera sp Rudbeckia goldstrum	Notes 1. All plant material to BCNTA and BCSIA standards. Refer to the BCSIA Landscape Standard.
230m² [190m² [19	Sym Oty	AR 30 AC 9 AC 13 AMK 118 MS 18 MS 18 PP 37 PP 148 SM 48 SM 48 SM 48 SM 50 CD 1	Shrubs Eu : Bs - Ch -	Par Far Far Far Far Far Far Far Far Far F	Hedges Ee Ela Tm - Ta Pl - Pru Ln - La	Perennials	ey a a a c c c c c c c c c c c c c c c c	Notes 1. All plant

1. All plant material to BCNTA and BCSIA standards. Refer to the BCSIA Landscape Standard, latest edition.
2. Area of search for plant material: Pacific Northwest including British Columbia, Washington and Oregon.
3. Refer to specification for general conditions, materials and installation requirements.
4. All planted areas to have automatic irrigation.

LANDSCAPE PLANTING PLAN QUADRANT 4



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Landscape Architecture
Urban Dasign
403 - 375 West Fifth Avenue
Vancouver BG. VSY JJB
604 909 4150
haptecbo.com

2. OP Revolumentson May D4: 1.
1. OP Submission April 21.
No. Description Date


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KINGSLEY ESTATES

LANDSCAPE DETAILS SURFACE TREATMENT & PLANTINGS School of the Confession of th



Kingsley Estates 10388 No. 2 Road, Richmond, B.C.

Rositch Hemphill Architects

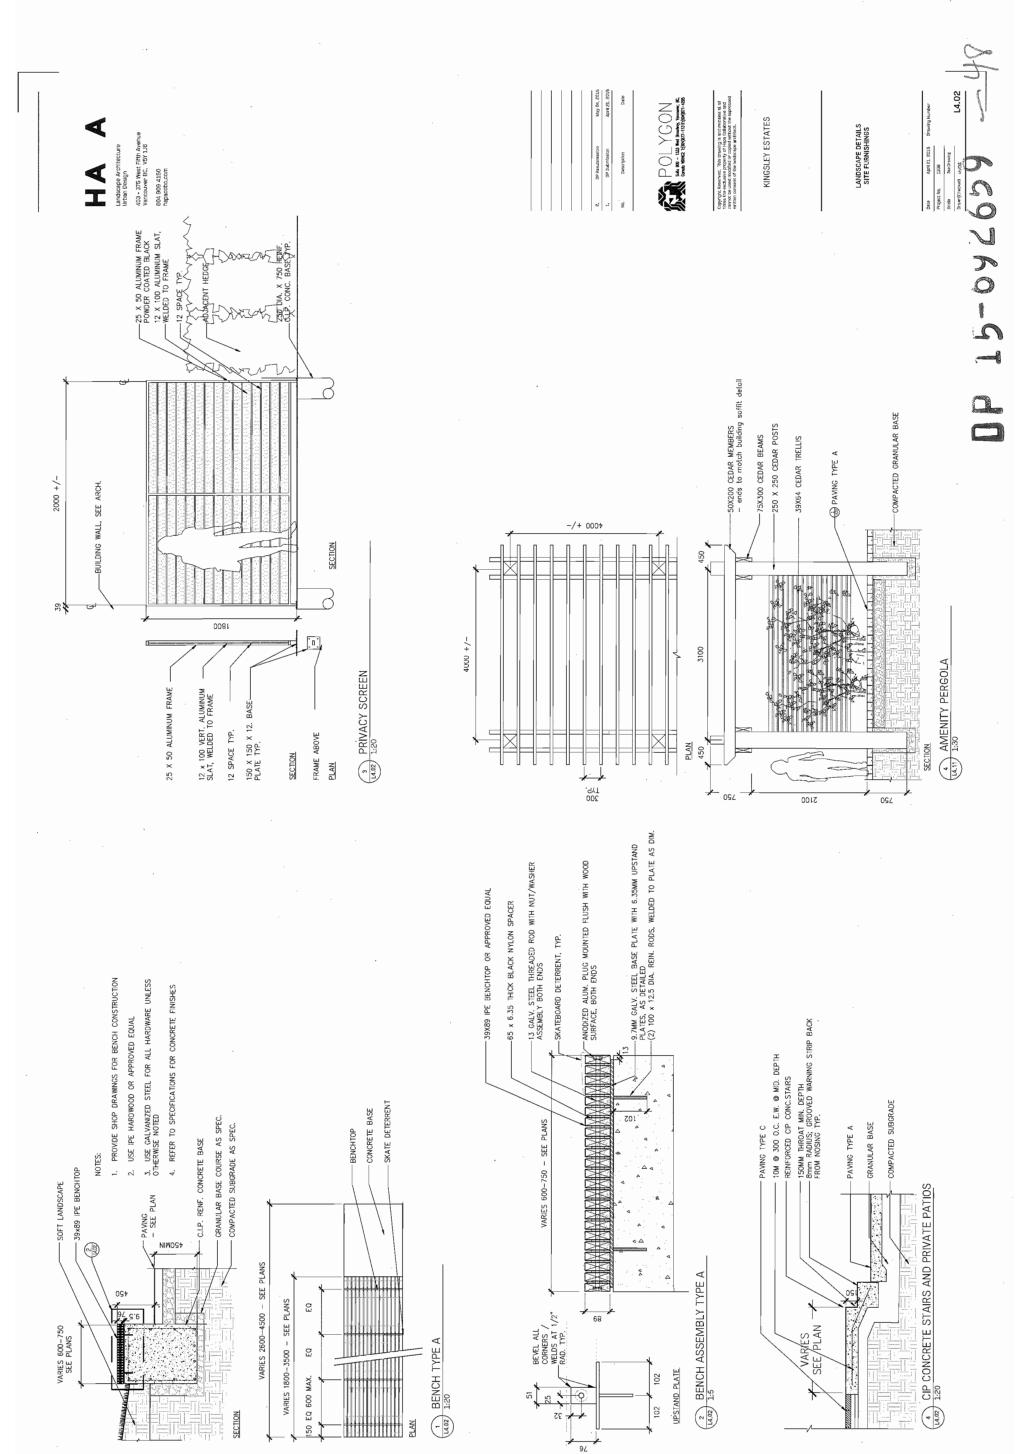120 Powell Street, Unit 10 Vancouver, BC Canada V6A 1G1

t 604.669.6002 f 604.669.1091

41H



ISSUED FOR

DP UPDATE
20 APRIL 2015

AMENITY BUILDING CHARACTER SKETCH

POLYGON
S. de 1911-1331 fed Boarder, Necesser, R.
G. conest (1984) 2. 1331 fed Boarder, Necesser, R.

Kingsley Estates

DRAWING TITLE COVER SHEET


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SCALE: NTS
PLOTIDATE: 25 FEBRUARY 2015
DRAWN: CJ
GHECKED: KSH

DP 15-692659

back or sthable

TYPICAL BUILDING FRONT ELEVATION CHARACTER SKETCH

E: / ACADJOB / 2013 / 1321 / 1321 - A0.0.0WG

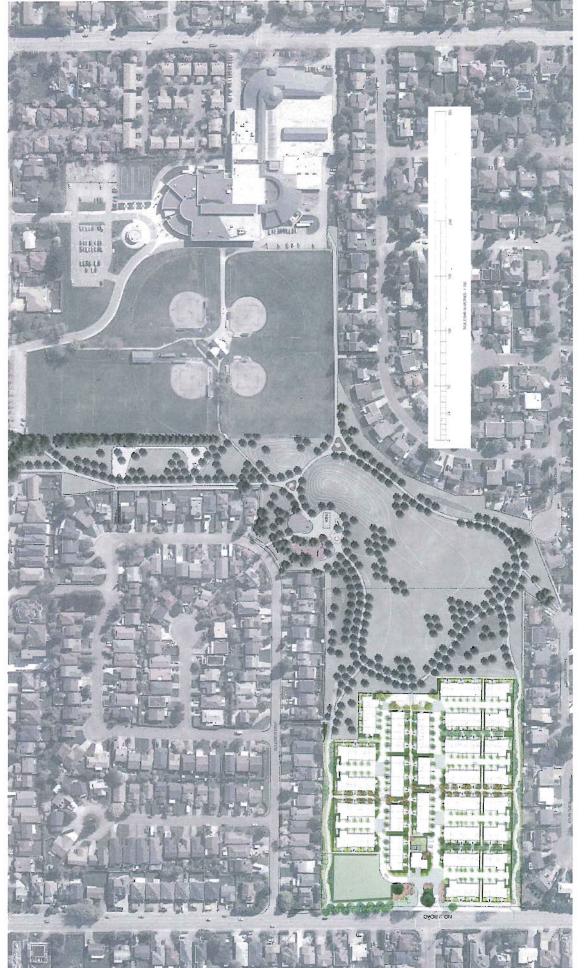

KINGSLEY ESTATES RICHMOND, BC

DRAWING LIST

LO.00 COVER SHEET
LO.01 DESIGN RATIONALE
LLO.1 CONCEPT PLAN
LLO.2 - O3 SECTIONS
LL.01 LAYOUT, MATERIALS AND GRADING QUADRANT 1
LL.02 LAYOUT, MATERIALS AND GRADING QUADRANT 2
LL.03 LAYOUT, MATERIALS AND GRADING QUADRANT 3
LL.04 LAYOUT, MATERIALS AND GRADING QUADRANT 4
L3.00 PLANTING PLAN QUADRANT 1
L3.02 PLANTING PLAN QUADRANT 2
L3.03 PLANTING PLAN QUADRANT 3
L3.04 FLANTING PLAN QUADRANT 3
L3.04 FLANTING PLAN QUADRANT 4
L4.01-02 LANDSCAPE GETAILS

KINGSLEY ESTATES

Projective, 1388 State Sections Dividing on 1303 Constitution of 1304 Constitution o		Date	April 21 2015	Branking Number
Present voiss		Project No.	1336	
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The Kingsley Estates landscape takes its inspiration from the English Tudor style of architecture of the townhomes. Materials, features and planting are designed to evoke an English residential landscape, while responding to the context of the surrounding Richmond neighbourhood and the specific environmental aspects of the site.

2. PEDESTRIAN CIRCULATION

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Open Space and Circulation:

A hierarchy of open space organizes the large townhome site. The development parcel is surrounded by public open space on all four sides; No. 2 Road to the west, a new public greenway on the north and south sides, and the scon-to-be-built Steveston-London Park on the east side. The entry plaza off No. 2 Road is also public, and features a public art piece. The proposed community facility on the northwest corner of the site will be semi-public. Within the development site, there is ample common strata open space, including four "mews" onto which many of the / building (including a children's play area), and the treed laneways. Each townhouse has its own private open space patio and soft landscape. townhouses front, the landscape around the amenity

The site features extensive pedestrian connections, including the public open spaces circling the site, interior pathways which connect through the site to the public open space, and treed laneways. Vehicular circulation is centred on a main, oval laneway, which is gently bowed on both its north and its south franks to visually minimize its long lengths. Six secondary lanes stem off of the main loop. Visitor parking is distributed throughout the site,

Planting and Materials Palette:

trees, including cherries, snowbells and two varieties of magnolias, enhance the identities of the townhome blocks and their mews. Large, moderately columnar oak and red maple trees soften and enhance the laneways. The land-scape palette is rounded out with concrete unit paving for the patios and the common strata pathways, finely detailed wood gates and screens, and a timber pergola in the amenity area. Planting has been designed to provide amenity, evoke the English Landscape, strengthen identity of the mews, and minimize the effect of the laneway lengths. Around and between the townhomes, there is a combination of evergreen hedging for screening structure, and flowering shrubs and perennials for visual interest. Small flowering

1. OPEN SPACE HIERARCHY



semi public

public




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KINGSLEY ESTATES



PROPERTY LINE VIEWS

Kingsley Estates
10388 No. 2 Rd., Richmond, BC

POLYGON
Sule 900 - 1333 West Broadmay, Vanzouwer, BC,
Canada VerHoz TrigolygyT-1131 F-jodyjeT-1130

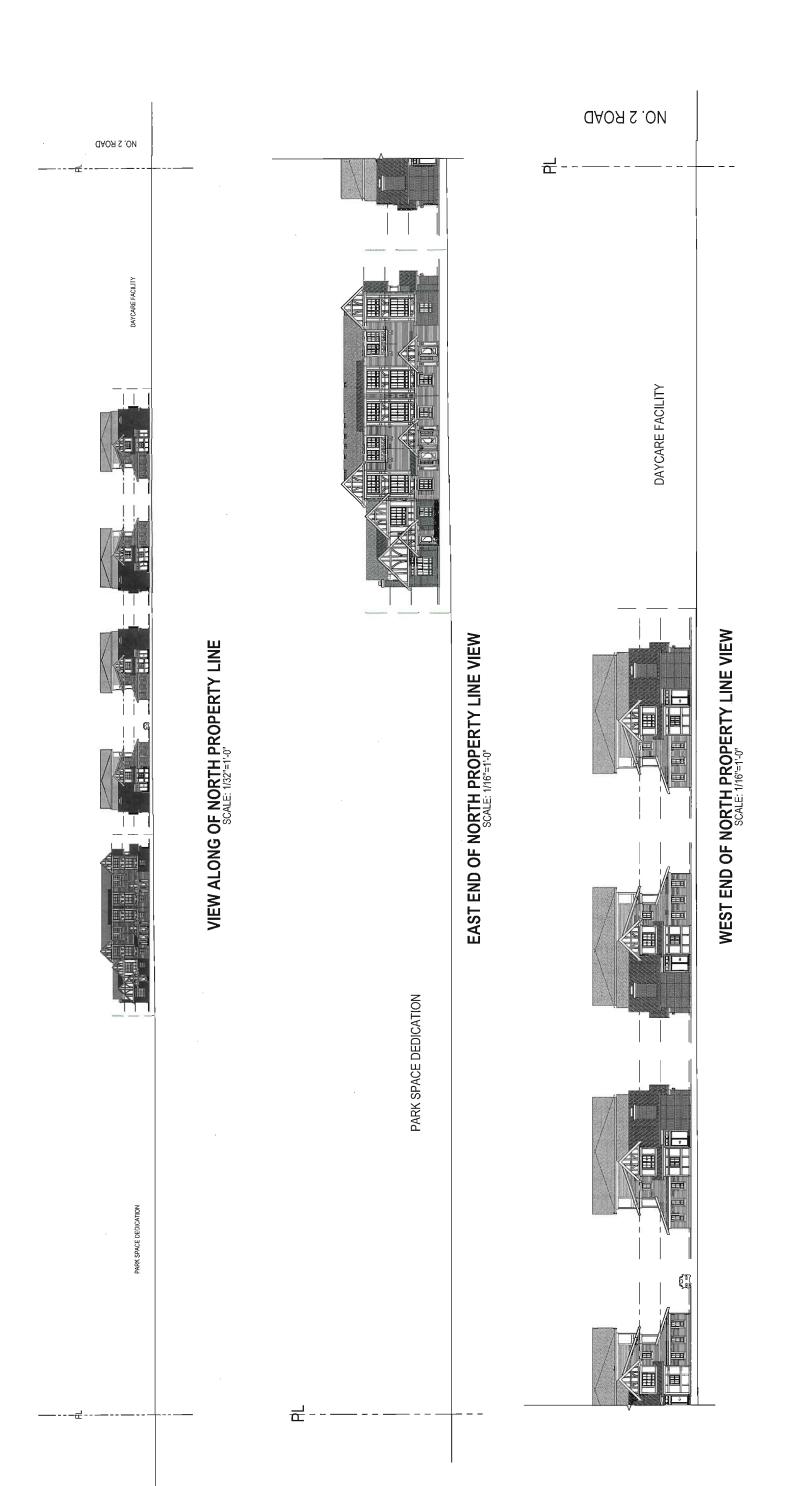1321-STREET

DATABASE:
PROJECT NO:
DATE:
SCALE:

1321 04 MAR 2015 1/16" = 1'-0"

15-04 6054-Reference

Rositch Hemphill Architects

120 Powell Street, Unit 10 Vancouver, BC Canada V6A 1G1 t 604.669.6002 f 604.669.1091 www.rharchitects.ca



Kingsley Estates
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1321-STREET

DATABASE: PROJECT NO: DATE:

POLYGON Suite 900 - 1333 West Broatkery, Vancourer, BC, Cannata WEHCZ T(BOO)877-1131 F(BO)877-1131

