



City of Richmond

Report to Committee

To: Planning Committee **Date:** May 3, 2021
From: Wayne Craig **File:** RZ 18-831725
Re: **Application by Kadium No. 4 Development Ltd. for Rezoning at 10340, 10360, 10380, 10400 and 10420 No. 4 Road from the "Single Detached (RS1/E)" Zone to the "Medium Density Townhouses (RTM2)" Zone**

Staff Recommendation

1. That Richmond Zoning Bylaw 8500, Amendment Bylaw 10261, for the rezoning of the site at 10340, 10360, 10380, 10400 and 10420 No. 4 Road from the "Single Detached (RS1/E)" Zone to the "Medium Density Townhouses (RTM2)" Zone, be introduced and given first reading.

Wayne Craig
Director, Development
(604) 247-4625

WC:rp/js/blg

Att. 6

REPORT CONCURRENCE		
ROUTED TO:	CONCURRENCE	CONCURRENCE OF GENERAL MANAGER
Affordable Housing	<input checked="" type="checkbox"/>	

Staff Report

Origin

Kadium No. 4 Development Ltd. has applied to the City of Richmond for permission to rezone 10340, 10360, 10380, 10400 and 10420 No. 4 Road (Attachment 1) from the "Single Detached (RS1/E)" zone to the "Medium Density Townhouses (RTM2)" zone in order to develop a 19-unit townhouse project, including four studio secondary suites, with access from No. 4 Road. A Location Map for the subject site is provided on Attachment 1.

Findings of Fact

A Development Application Data Sheet providing details about the development proposal is provided with this report on Attachment 2.

Subject Site Existing Housing Profile

The subject site currently contains five single-family dwellings, none of which contain secondary suites. The existing dwellings are each currently being rented for residential use. The existing dwellings would be demolished.

Surrounding Development

Existing development immediately surrounding the subject site includes the following:

To the North: Single detached residential properties, designated Neighbourhood Residential and designated for arterial road townhouse development in the Official Community Plan (OCP), and zoned "Single Detached (RS1/E)".

To the South: Existing single detached residential properties, designated Neighbourhood Residential and designated for arterial road townhouse development in the OCP and zoned "Single Detached (RS1/E)".

To the East: Existing single detached dwellings fronting Dennis Crescent, designated Neighbourhood Residential in the OCP and zoned "Single Detached (RS1/E)".

To the West: No. 4 Road, which is an Arterial Road with a public sidewalk on the west side, and across which is an existing single detached residential properties, designated for arterial road townhouse development in the OCP and zoned "Single Detached (RS1/E)".

Related Policies & Studies

Official Community Plan

The subject site is located in the Shellmont planning area, and is designated "Neighbourhood Residential" in the Official Community Plan (OCP) (Attachment 3). The "Neighbourhood Residential" designation accommodates single-family, two-family, and multiple family housing as principal uses, to which the proposed development is consistent.

Arterial Road Policy

The subject site is located in an area governed by the Arterial Road Land Use Policy, and is designated “Arterial Road Townhouses”. The subject site has a 104.6 m (343 ft.) frontage along No. 4 Road, which exceeds the 50 m (164 ft.) minimum development site frontage on major arterial roads, such as No. 4 Road.

The proposal is consistent with the Arterial Road Policy.

Floodplain Management Implementation Strategy

The proposed redevelopment must meet the requirements of the Richmond Flood Plain Designation and Protection Bylaw 8204. Registration of a flood indemnity covenant on Title is required prior to final adoption of the rezoning bylaw.

Affordable Housing Strategy

The City’s Affordable Housing Strategy requires a cash-in-lieu contribution of \$8.50 per buildable square foot towards the City’s Affordable Housing Reserve Fund for all rezoning applications involving townhouse developments. A \$215,051.65 contribution is required prior to final adoption of the rezoning bylaw.

Public Consultation

A rezoning sign has been installed on the subject property. Staff have not received any comments from the public about the rezoning application in response to the placement of the rezoning sign on the property.

Should the Planning Committee endorse this application and Council grant first reading to the rezoning bylaw, the bylaw will be forwarded to a Public Hearing, where any area resident or interested party will have an opportunity to comment. Public notification for the Public Hearing will be provided as per the *Local Government Act*.

Analysis

Urban Design and Site Planning

The applicant proposes 19 units in six buildings arranged on either side of a central north-south drive aisle. The site plan and massing are generally consistent with the Development Permit Guidelines for Arterial Road Townhouses. Conceptual development plans are provided in Attachment 4.

The 13 units along No. 4 Road have direct pedestrian access to the sidewalk through landscaped front yards. All of the street-fronting units are three storeys, with living space primarily located on the second and third storeys. There are four proposed secondary suites (units #1, #7, #14 and #19). The end street-fronting units (units #7 and #14) are set back 3.0 m and both step down to two storeys: the third storeys are additionally stepped back 4.45 m on northerly unit #7 and 4.75 m on southerly unit #14, considering that the north and south adjacencies are single-detached residential dwellings.

The six units at the rear of the property have pedestrian access from the drive aisle and are designed with living space on both the first and second storeys. The proposed rear buildings are each two storeys and are set back 6.0 m from the east (rear) property line (3.0 m from the west boundary of the sanitary SRW), considering the interface with the single-family neighbourhood to the east.

Two convertible units (units #7 and #14) are provided that are designed with the potential to be easily renovated to accommodate a future resident in a wheelchair. These units each feature an accessible parking spaces. In addition, one of the visitor parking spaces (at northeast corner of the site) is an accessible parking space.

All of the units have private outdoor space at grade in the form of a landscaped front or rear yards.

The 114.1 m² shared outdoor amenity area is proposed at the rear of the site, opposite the main access drive-aisle. The current concept includes a play structure for young children, a modest patio area with a mail box, Class 2 bicycle parking and bench seating. The area would be delineated and screened from adjacent private outdoor spaces by fencing. The size of the shared outdoor amenity area complies with associated design guidelines; a detailed design and programming of the private and shared outdoor amenity areas will be reviewed through the Development Permit process.

The applicant has also provided a general demonstration of how the property to the north could be developed for townhouses.

Existing Legal Encumbrances

There is an existing 3.0 m wide statutory right-of-way (SRW) along the rear property line for the sanitary sewer. The applicant is aware that no construction or tree planting is permitted within the SRW area.

Transportation and Site Access

Vehicle access to the subject site is proposed from a driveway crossing to No. 4 Road. The vehicle access will be shared and provide access to the future development to the north. A statutory right-of-way (SRW) for public rights-of-passage (PROP) will be registered on title prior to adoption of the rezoning bylaw. On-site vehicle maneuvering is accommodated by a T-shaped drive aisle.

This section of No. 4 Road currently only has a sidewalk along the west side of the road. A 2.0 m wide road dedication is required across the entire No. 4 Road frontage in order to accommodate the standard sidewalk and boulevard width, as well as a segregated cycling path. A segregated cycling path is proposed along the City boulevard, between the City sidewalk and the tree planting strip that is adjacent to the curb of No. 4 Road. This road dedication is required prior to final adoption of the rezoning bylaw.

Vehicle and bicycle parking for residents are provided consistent with Richmond Zoning Bylaw 8500. Each unit includes a two-car garage in a side-by-side arrangement, with an energized outlet capable of providing Level 2 EV charging outlet, consistent with Richmond Zoning Bylaw 8500, and space for Class 1 bicycle parking.

Visitor parking is provided consistent with Richmond Zoning Bylaw 8500. Two visitor parking spaces, including one accessible visitor parking space, are provided on the north end of the site and two visitor parking spaces are provided on the south end, for a total of four visitor parking spaces. Class 2 bicycle parking is provided at the shared outdoor amenity area, adjacent to the children's playground.

Tree Retention and Replacement

The applicant has submitted a Certified Arborist's Report; which identifies on-site and off-site tree species, assesses tree structure and condition, and provides recommendations on tree retention and removal relative to the proposed development. The Report assesses 18 bylaw-sized trees on the subject property and four trees on neighbouring properties. No street trees are located within the existing City boulevard.

The City's Tree Preservation Coordinator has reviewed the Arborist's Report and supports the Arborist's findings, with the following comments:

- There are 18 on-site trees:
 - Three trees are located within the proposed road dedication area and are in poor health. Tree #420 (a Cedar tree) has a significant lean to the south, this tree has also been Hydro pruned for overhead line clearance, resulting in an unbalance canopy (heavy in the direction of the lean). Tree #432 (a Cherry tree) is in very poor condition as the tree has poor vigor and health, sparse foliage, and has been previously topped and bark is crumbly. Tree #433 (a Norway Maple tree) has a twin stem with a crack in the trunk that extends to the base. Approximately a third of its canopy has been removed by BC Hydro for Hydro line clearance. The health of these trees and the requirements for frontage improvements and continual canopy removal by BC Hydro for line clearance do not make these trees candidates for retention and they should be replaced.
 - Four trees (#419, #430, #431 and #436) are located within the rear yard, all of which are in poor condition, in conflict with the required sanitary sewer upgrade and should be removed.
 - 11 other on-site trees:
 - Two trees are proposed to be relocated within the site:
 - Tree # 422 (a Japanese Maple tree) and #435 (a Japanese Snowbell tree) are in good condition and located within the driveway. However, the applicant has agreed to relocate these trees to or near the shared outdoor amenity area in order to retain them. These trees are identified on the marked-up Tree Management Plan that is provided on Attachment 5.
 - Eight on-site trees (#421, #423 - #426, #428, #429, and #434) would be removed and replaced, due to their poor condition.

- One tree (#427; a Japanese Maple tree) is in good condition but needs to be removed as the site geometry, site access requirements and the tree's size prevent its retention in its current location or its relocation within the site.
- There are several hedges on-site, none of which are subject to the tree bylaw.
 - Hedge H1-H7 is located along the south property line. This hedge is to be retained and, through the Development Permit process, would be determined to either remain in its existing location (as a visual terminus to the interior driveway) or be relocated to elsewhere along the south lot line (to serve as screening from the adjacent lot to the south). This hedge is identified on the marked-up Tree Management Plan that is provided on Attachment 5.
 - All other on-site hedges are located along existing property lines or within the sanitary SRW and are not in good condition, and should therefore be removed.
- There are four mature off-site trees (Tags# OS1, OS2, OS3 and OS4) located on an adjacent neighbouring property (10311 Dennis Crescent) and within an existing sanitary SRW are to be retained and protected, and tree protection must be provided as per City of Richmond Tree Protection Information Bulletin Tree-03.

Considering that the four off-site trees are located within an existing SRW, within which the sanitary infrastructure requires replacement, the project arborist should work with City Engineering staff to coordinate methods for minimize harm to the tree during infrastructure works within the Tree Protection Zone. In the event that City staff are unable to accept the arborist's methods for works within the Tree Protection Zone, the applicant should either:

- Provide additional SRW area for the sanitary sewer line in order to accommodate a diversion around the dripline of the subject trees.
- Coordinate an alternative solution that is acceptable to City Engineering staff.
- Obtain permission from the owner of the subject trees in order to remove them and provide replacement trees in accordance with Tree Protection Bylaw No. 8057.

Tree Replacement

The applicant proposes to remove 16 on-site trees (Trees # 420, 421, 432, 433, 434, 436, 423, 424, 425, 426, 427, 428, 429, 430, 431 and 419). The 2:1 replacement ratio would require a total of 32 replacement trees. The applicant has agreed to plant 36 trees on the development site; for a total of 38 trees, including the relocated trees. The required replacement trees are to be of the following minimum sizes, based on the size of the trees being removed as per Tree Protection Bylaw No. 8057.

No. of Replacement Trees	Minimum Caliper of Deciduous Replacement Tree	Minimum Height of Coniferous Replacement Tree
10	6 cm	3.5 m
12	8 cm	4 m
4	9 cm	5 m
2	10 cm	5.5 m
4	11 cm	6 m

Tree Protection

Four mature off-site trees (Tags# OS1, OS2, OS3 and OS4) located on an adjacent neighbouring property (10311 Dennis Crescent) and within a sanitary SRW should be retained and protected. As such, the applicant would be required to complete the following items to ensure that the subject trees are protected at development stage:

- Prior to final adoption of the rezoning bylaw, submission to the City of a contract with a certified arborist for the supervision of all works conducted within or in close proximity to tree protection zones. The contract must include the scope of work required, the number of proposed monitoring inspections at specified stages of construction, any special measures required to ensure tree protection, and a provision for the arborist to submit a post-construction impact assessment to the City for review.
- Prior to demolition of the existing dwelling on the subject site, installation of tree protection fencing around all trees to be retained. Tree protection fencing must be installed to City standard in accordance with the City's Tree Protection Information Bulletin Tree-03 prior to any works being conducted on-site, and remain in place until construction and landscaping on-site is completed.

Variance Requested

The proposed development is generally consistent with the “Medium Density Townhouses (RTM2)” zone, except for the variance noted below (Staff comments in ***bold italics***).

1. Decrease the minimum front setback from 6 m to 4.5 m.

Staff are supportive of the proposed variance for the following reasons:

- *The Arterial Road Guidelines for Townhouses in the OCP support a reduced front yard setback where a larger rear yard is provided, on the condition that there is an appropriate interface with neighbouring properties. The proposal includes a 9.4 m building setback from the future back-of-curb location and a 6 m landscaped rear yard setback.*
- *The variance is a function of the required road dedication along No. 4 Road and the installation of the new off-street bike path and sidewalk.*
- *Prior to Development Permit issuance, the applicant must provide an acoustic report demonstrating that the proposed units fronting No. 4 Road will meet the appropriate CMHC noise thresholds and standards for indoor spaces.*

Townhouse Energy Efficiency and Renewable Energy

The proposed development consists of townhouses that staff anticipate would be designed and built in accordance with Step 3 of the Energy Step Code for Part 9 construction (Climate Zone 4). As part of a future Development Permit application, the applicant will be required to provide a report prepared by a Certified Energy Advisor which demonstrates that the proposed design and construction will meet or exceed these required standards.

Amenity Space

The applicant is proposing a cash contribution in-lieu of providing the required indoor amenity space on-site. The total cash contribution required for the proposed 19-unit townhouse development is \$33,611, based on \$1,769 per unit, as per the OCP, and must be provided prior to rezoning adoption.

A 114.1 m² outdoor amenity space is provided on site. Based on the preliminary design, the size of the proposed outdoor amenity space is consistent with the OCP minimum requirement of 6 m² per unit (114.0 m²). Staff will work with the applicant at the Development Permit stage to ensure the design of the outdoor amenity space meets the Development Permit Guidelines contained in the OCP.

Development Permit Application

Prior to final adoption of the rezoning bylaw, a Development Permit application is required to be processed to a satisfactory level. Through the Development Permit, the following issues are to be further examined:

- Compliance with Development Permit Guidelines for the form and character of multiple-family projects provided in the OCP.
- Confirmation that interior noise levels and noise mitigation measures comply with the City's Official Community Plan and Noise Bylaw requirements, via provision of an acoustical and thermal report and recommendations prepared by an appropriate registered professional.
- Refinement of the landscape design and the interface with abutting low density residential lots.
- Refinement of the shared outdoor amenity area design, including the choice of play equipment, to create a safe and vibrant environment for children's play and social interaction.
- Review of the design for the four units that include secondary suites.
- Review of relevant accessibility features for the two proposed convertible units and aging-in-place design features in all units.
- Review of a sustainability strategy for the development proposal.
- Ensure that plantings within the sanitary SRW, if any, are to the satisfaction of City Engineering staff.
- Ensure the on-site relocation of trees #422 and #435 are proposed in viable locations.
- Accommodate the viable retention of hedge H1 – H7.

Site Servicing and Frontage Improvements

Prior to final adoption the rezoning bylaw, the applicant is required to enter in to a Servicing Agreement for the design and construction of the required site servicing and frontage works, as described in Attachment 6. Site servicing and frontage improvements include, but may not be limited to:

- Replace the existing sanitary sewer along the rear yard.
- Provide frontage improvements that include a new sidewalk and cycling path.

Financial Impact or Economic Impact

This rezoning application results in an insignificant Operational Budget Impact (OBI) for off-site City infrastructure (such as roadworks, waterworks, storm sewers, sanitary sewers, street lights, street trees, and traffic signals).

Conclusion

The purpose of this application is to rezone the site at 10340, 10360, 10380, 10400 and 10420 No. 4 Road from the “Single Detached (RS1/E)” zone to the “Medium Density Townhouses (RTM2)” zone, to permit the development of 19 townhouse units with vehicle access from No. 4 Road.

The proposed rezoning and ensuing development of the site is generally consistent with the land use designations and applicable policies contained in the Official Community Plan (OCP) for the subject site. Further review of the project design will be completed as part of the Development Permit application review process.

The list of rezoning considerations is included in Attachment 6, which has been agreed to by the applicant (signed concurrence on file).

It is recommended that Richmond Zoning Bylaw 8500, Amendment Bylaw 10261 be introduced and given first reading.



Robin Pallett, RPP, MCIP
Planner 2
(604) 276-4200

RP:js/blg


Attachments:

- Attachment 1: Location Map and Aerial Photo
- Attachment 2: Development Application Data Sheet
- Attachment 3: Shellmont Area Land Use Map
- Attachment 4: Conceptual Development Plans
- Attachment 5: Tree Management Plan with Staff Comments
- Attachment 6: Rezoning Considerations

Attachment 1


Location Map and Aerial Photo

**City of
Richmond**

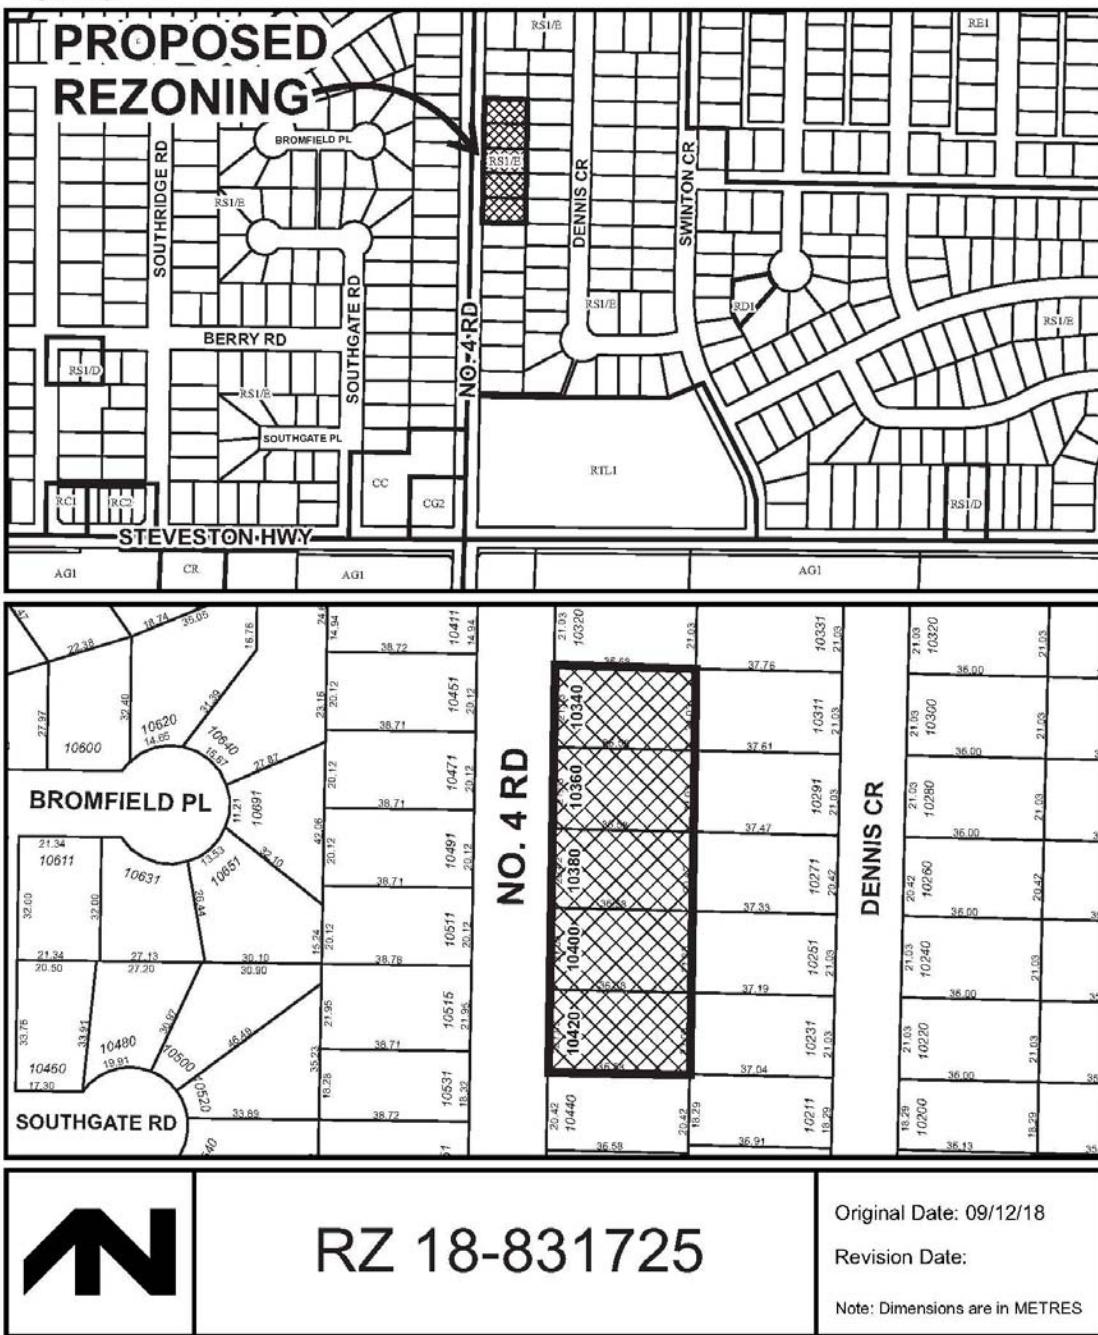



**City of
Richmond**

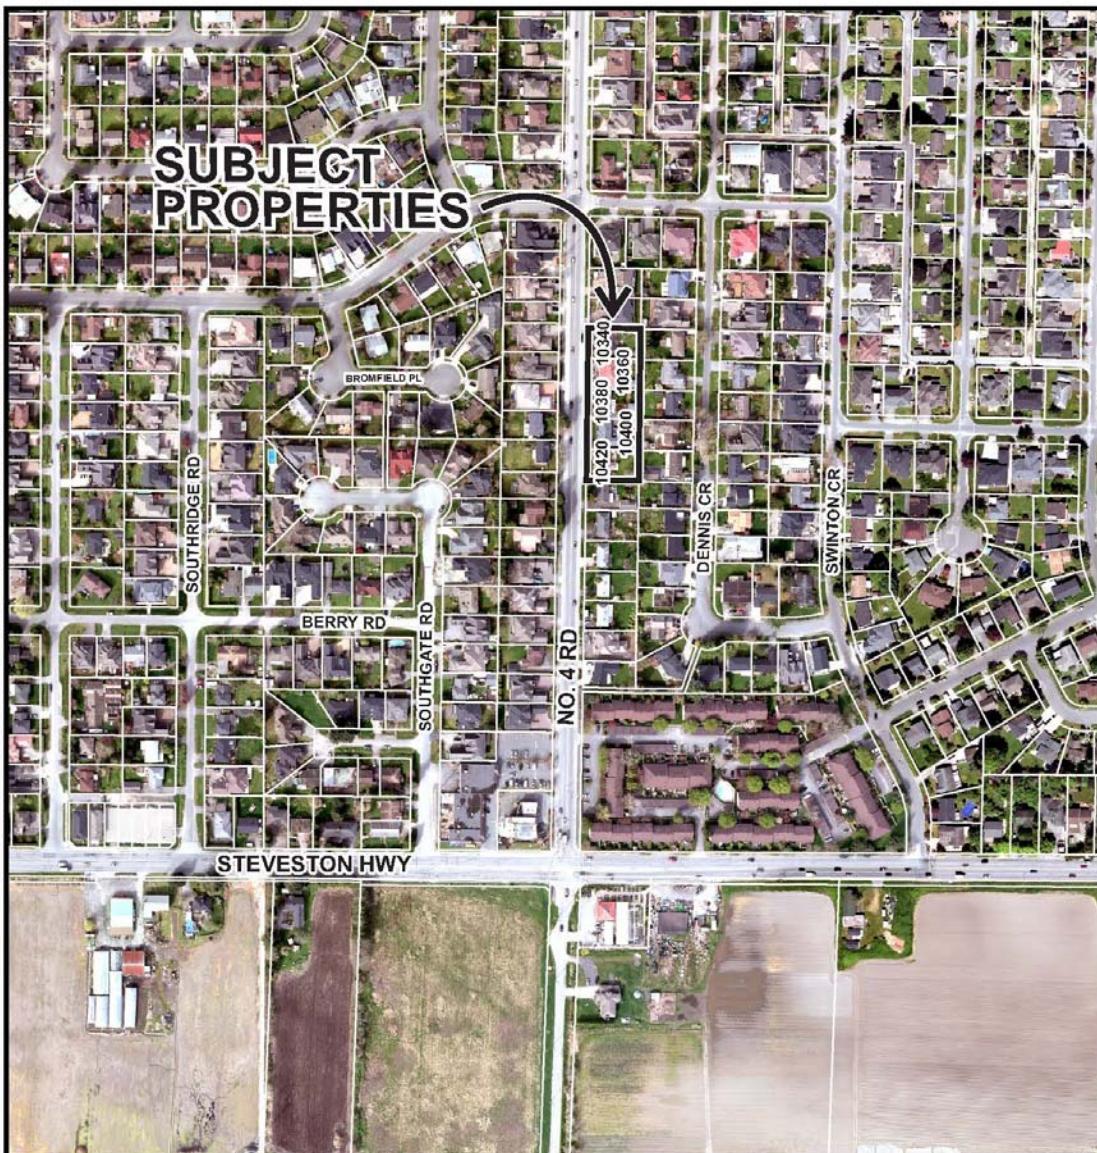

	RZ 18-831725	Original Date: 09/12/18 Revision Date: Note: Dimensions are in METRES
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**City of
Richmond**

Development Application Data Sheet
Development Applications Department

RZ 18-831725

Attachment 2

Address: 10340, 10360, 10380, 10400 and 10420 No. 4 Road

Applicant: Kadium No. 4 Development Ltd.

Planning Area: Shellmont

	Existing	Proposed
Site Area:	3,824.9 m ²	3,616.1 m ²
Land Uses:	Single-family residential	Multiple-family residential
OCP Designation:	Neighbourhood Residential (NRES)	No change
Zoning:	Single Detached (RS1/E)	Medium Density Townhouse (RTM2)
Arterial Road Land Use Policy Designation	Townhouse	No change
Number of Units:	5 single-family dwellings	19 townhouse dwellings


On Future Subdivided Lots	Bylaw Requirement	Proposed	Variance
Floor Area Ratio:	Max. 0.65	0.65	none permitted
Buildable (net) Floor Area:*	Max. 2,350.4 m ²	2,348.8 m ²	None
Lot Coverage (% of lot area):	Building: Max. 40% Non-porous Surfaces: Max. 65% Live Landscaping: Min. 25%	Building: 38.7% Non-porous Surfaces: 58.9% Live Landscaping: Min. 26.7%	None
Lot Size:	No minimum	3,616.1 m ²	None
Lot Dimensions:	Width: 30 m Depth: 35 m	Width: 104.6 m Depth: 36.6 m	None
Setbacks:	Front/West: Min. 6.0 m	Front/West: 4.5 m	Variance requested
	Rear/East: Min. 3.0 m	Rear/East: 6.0 m	None
	South Side: Min. 3.0 m	South Side: 3.0 m	None
	North Side: Min. 3.0 m	North Side: 3.1 m	None
Building Height	Max. 12 m	Street-Fronting Buildings (A, B &G): 9.35 m	None
		Rear Buildings (C, D, E & F): 6.61 m	

On Future Subdivided Lots	Bylaw Requirement	Proposed	Variance
Off-street Parking Spaces – Regular (R) / Visitor (V):	Min. 2 (R) and 0.2 (V) per unit	2 (R) and 0.2 (V) per unit	None
Off-street Parking Spaces – Visitor Accessible:	Min 2% when three or more visitor stalls required = Min. 1 space	1 (at the northeast corner of the site)	None
Total off-street Spaces:	Min. 38 (R) and 4 (V)	38 (R) and 4 (V)	None
Tandem Parking Spaces:	Permitted – Max 50% of required spaces	0% (0 spaces)	None
Small Car Parking Spaces:	Max. 50%	36.8%	None
Bicycle Parking Spaces – Class 1:	Min. 1.25 per unit	2.0 per unit	None
Bicycle Parking Spaces – Class 2:	Min. 0.2 per unit	0.2 per unit	None
Bicycle Parking Spaces – Total:	Min. 24 (Class 1) and 4 (Class 2)	38 (Class 1) and 4 (Class 2)	None
Amenity Space – Indoor:	Min. 50 m ² or cash-in-lieu	Cash-in-lieu	None
Amenity Space – Outdoor:	Min. 6 m ² per unit = 114 m ²	114.1 m ²	None


* Preliminary estimate; not inclusive of garage; exact building size to be determined through zoning bylaw compliance review at Building Permit stage.

Shellmont Area Land Use Map

8. Shellmont

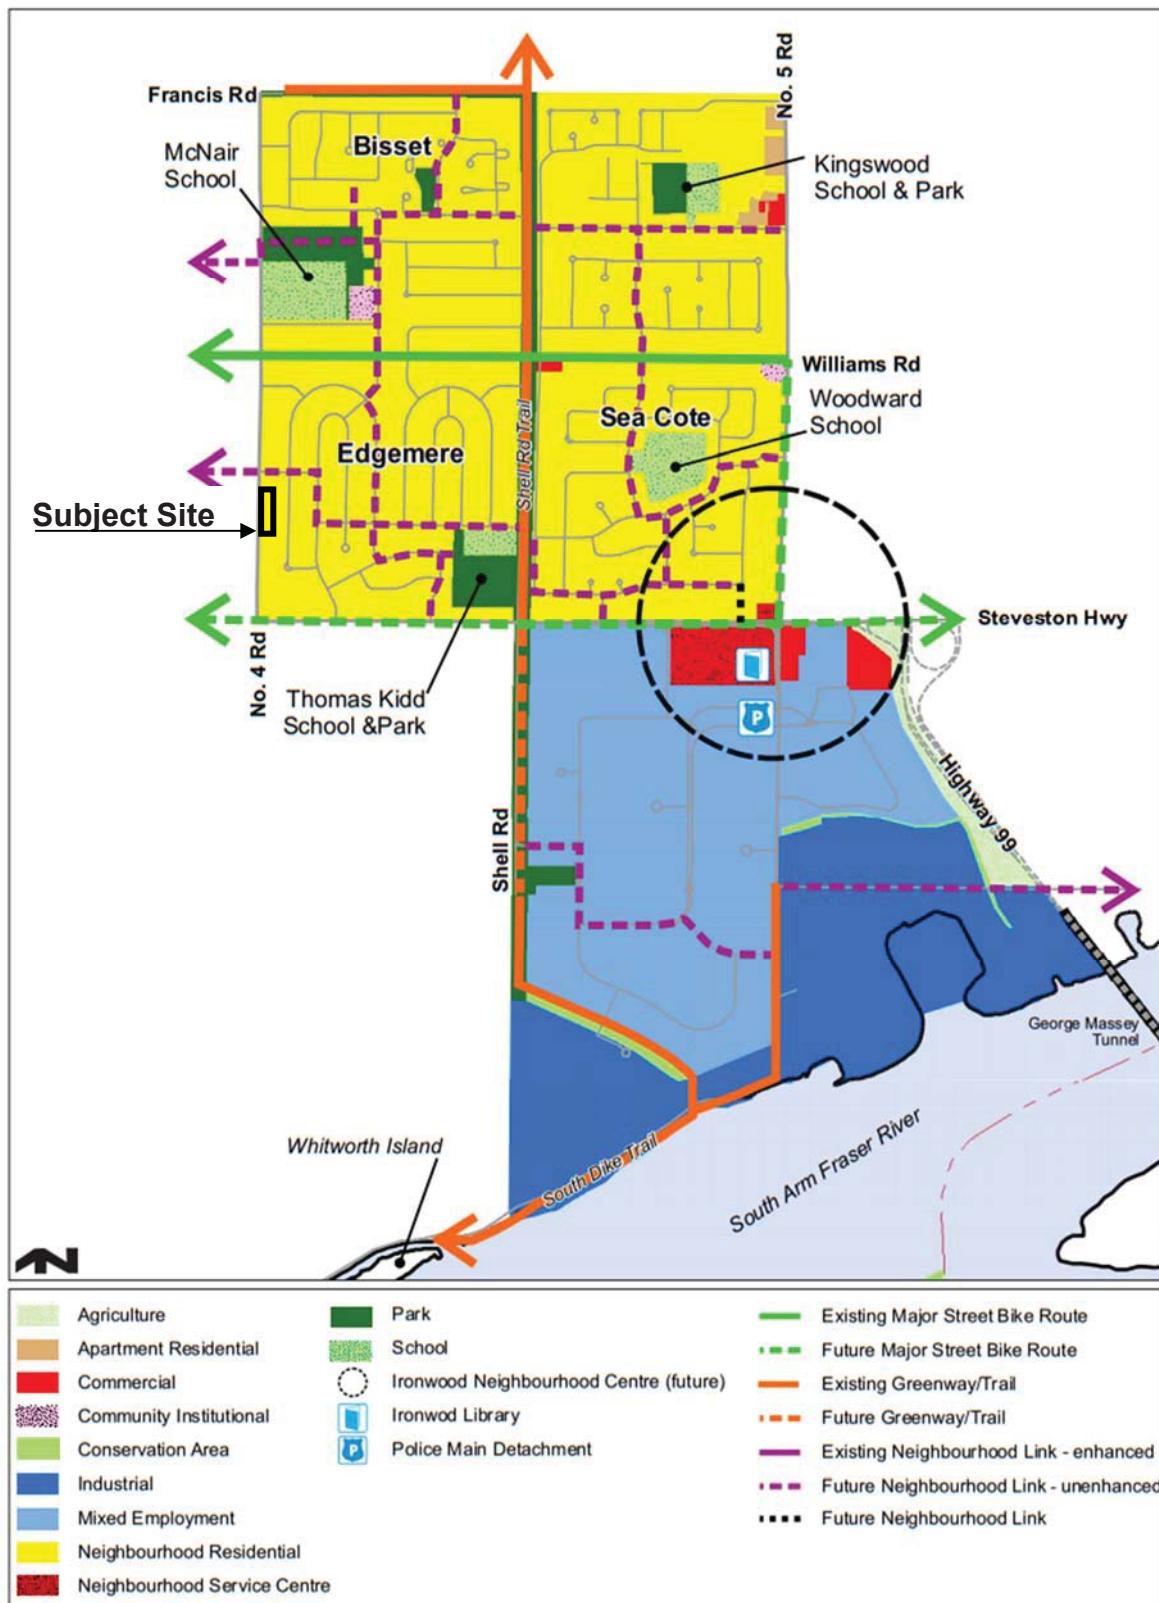


N L. 4 FLAT

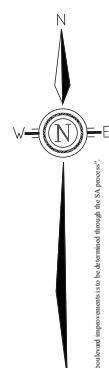

Nail in aluminum
Tag #306
Site Benchmark
Elevation: 0.92


"The ultimate design of the boulevard improvements is to be determined through the SA process."

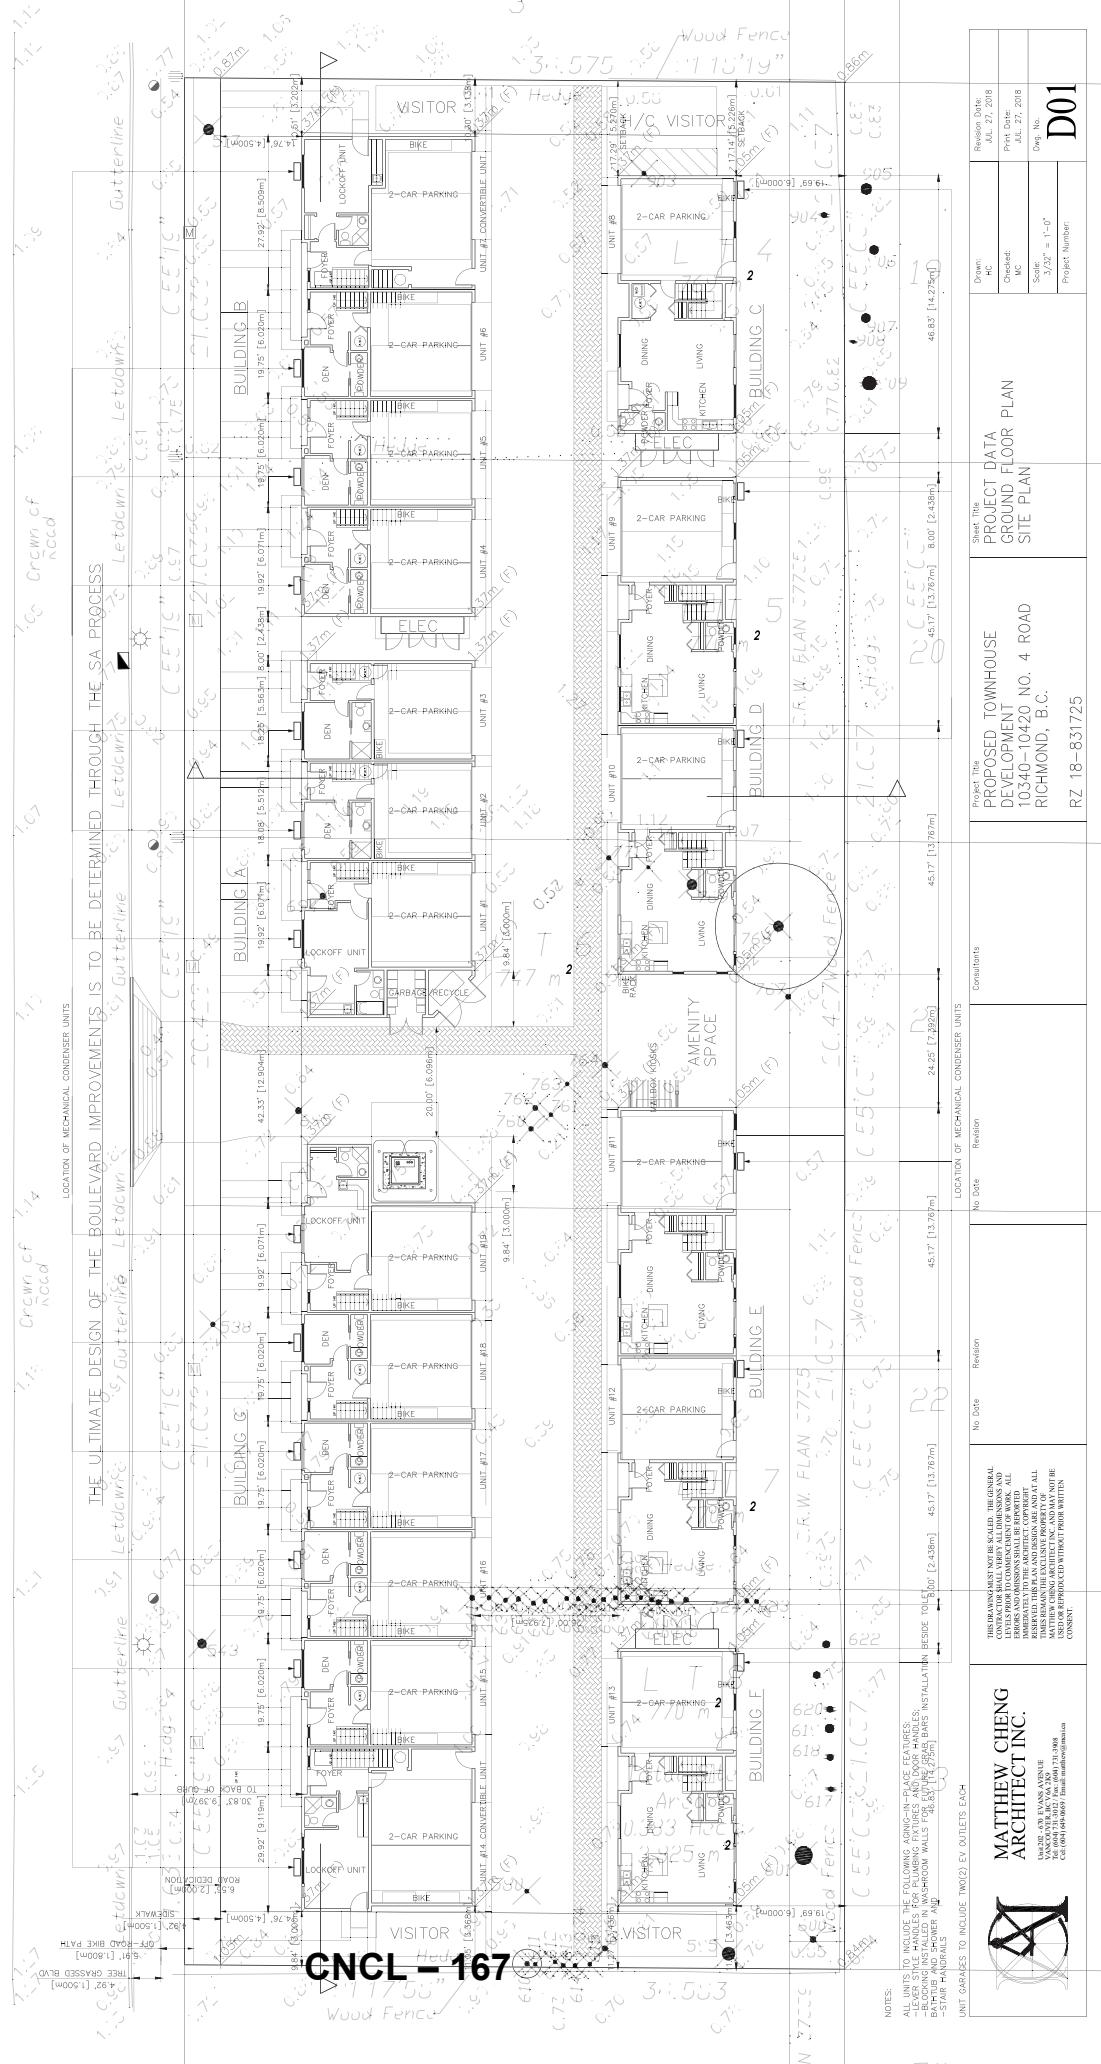

N L. 4 R L A T




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Tag #306
Site Benchmark
Elevation: 0.92

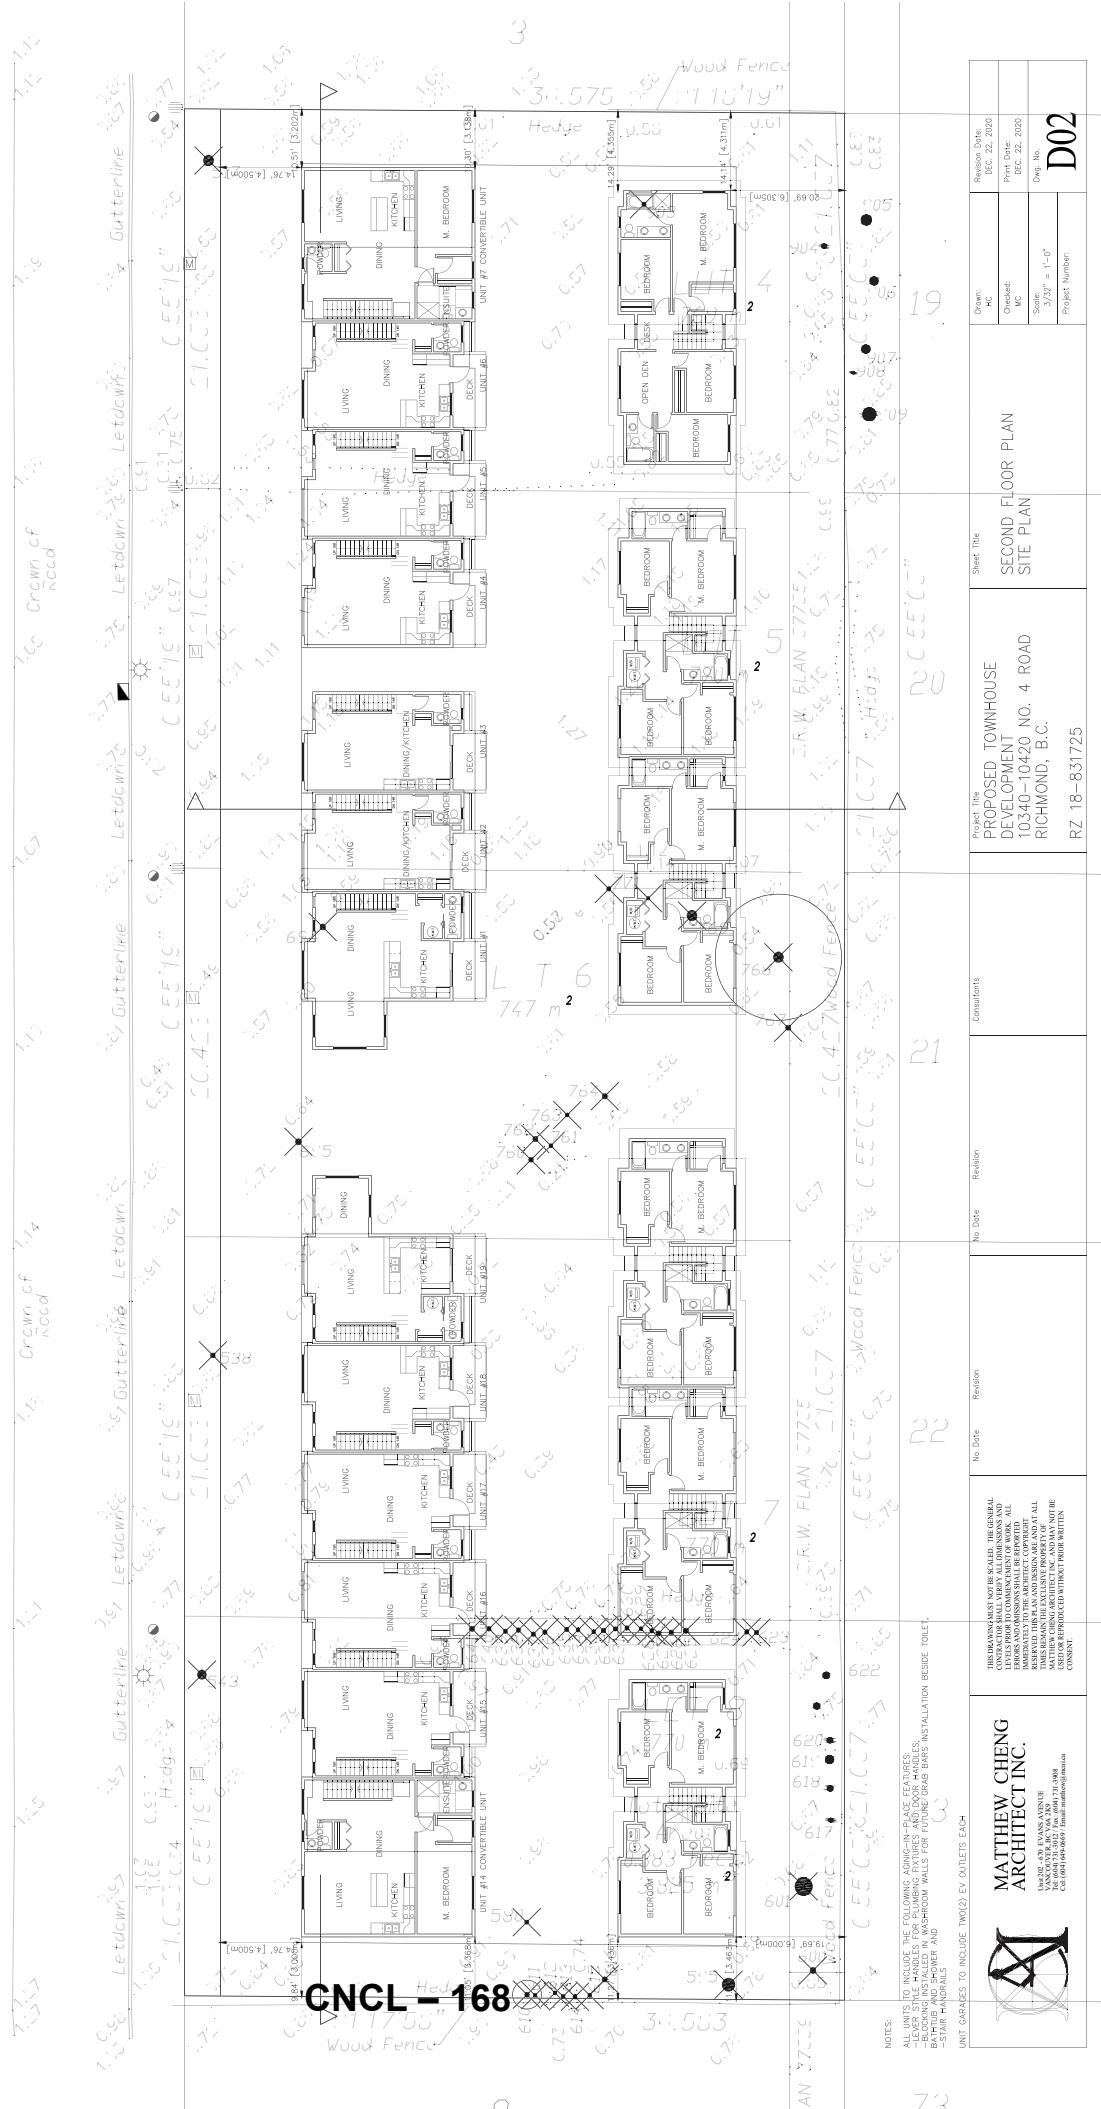


N L. 4 R L A T



Nail in aluminum
Tag #306
Site Benchmark
Elevation: 0.92

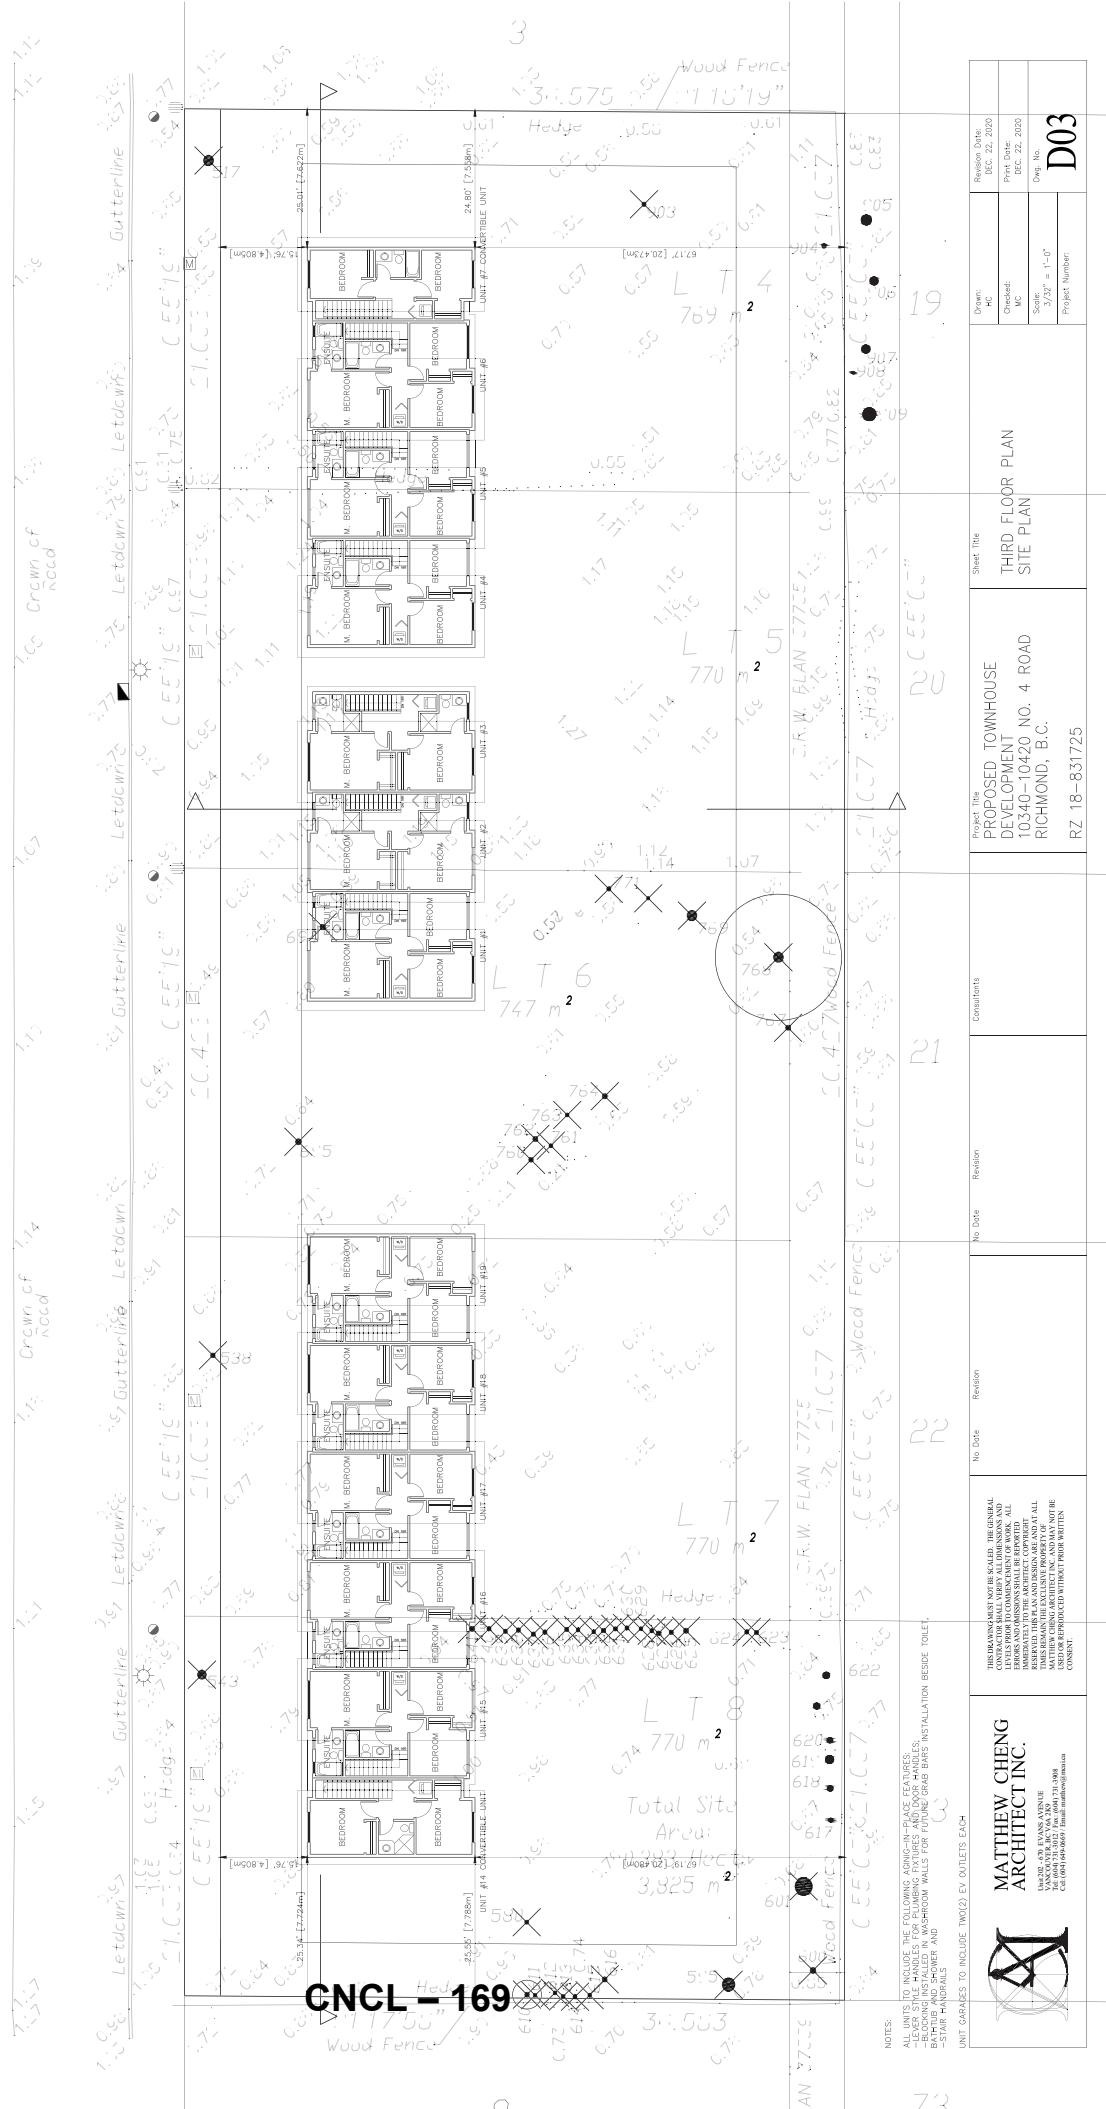



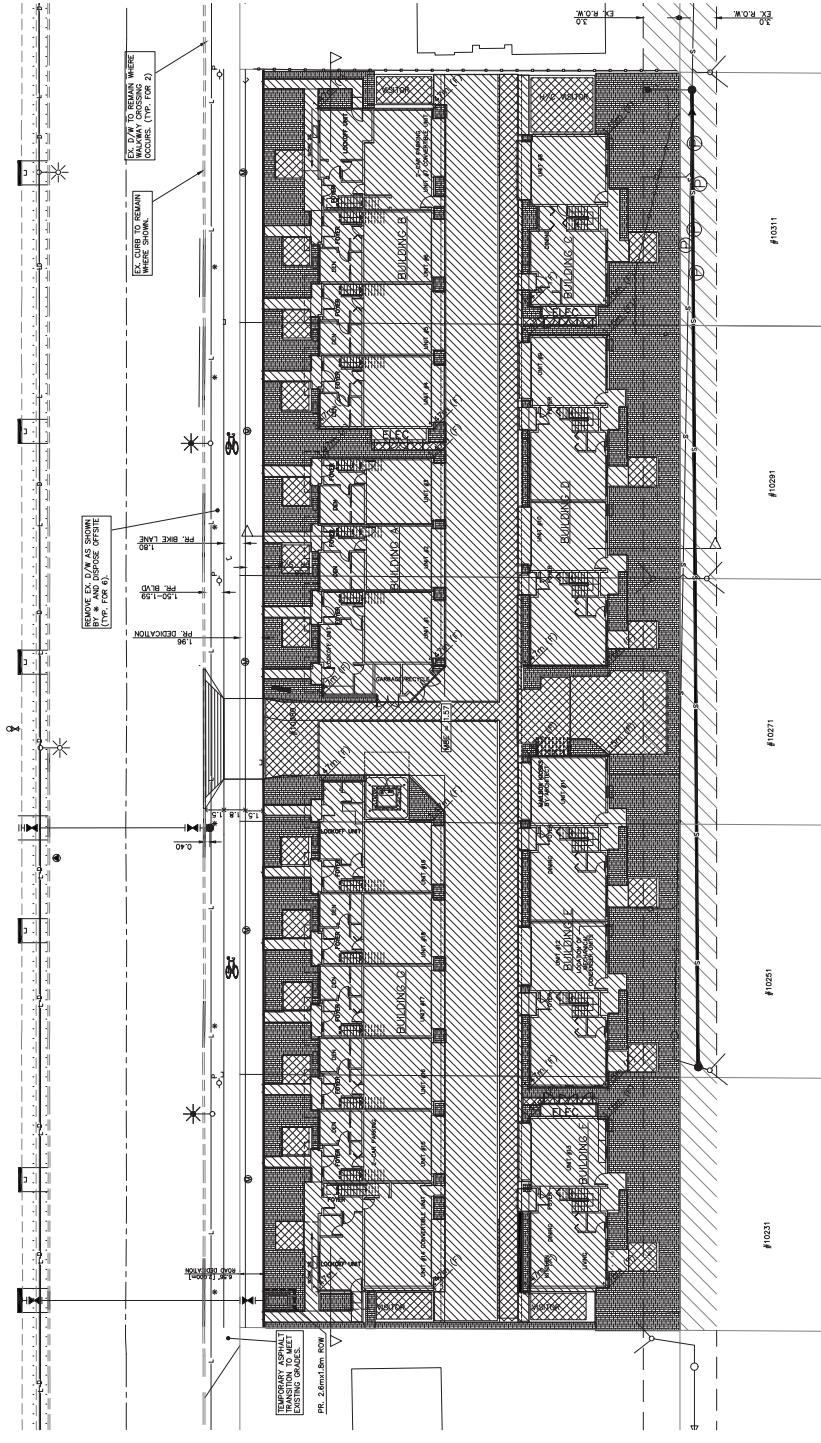


COVERAGE WITH LIVE PLANT MATERIAL	50.233x5.93x0.3m
COVERAGE WITH OF PERMEABLE SURFACE	14.750x5.34x0.138m
COVERAGE WITH OF NON-PERMEABLE SURFACE	59.000x23.33x0.167/0.20m

PROJECT:
19 UNIT TOWNHOUSE
DEVELOPMENT
10340 - 10420 NO. 4 ROAD
RICHMOND
VA 23231
R2:18-831725

LIVE PLANT MATERIAL
COVERAGE PLAN

DRAWING NUMBER:
DATE: May 22, 2019
SCALE: 1/116=1'-0"
DRAWN: DD
DESIGN: DD
CHECK: PM
OF 5

pmg PROJECT NUMBER:
SP045 6.22P

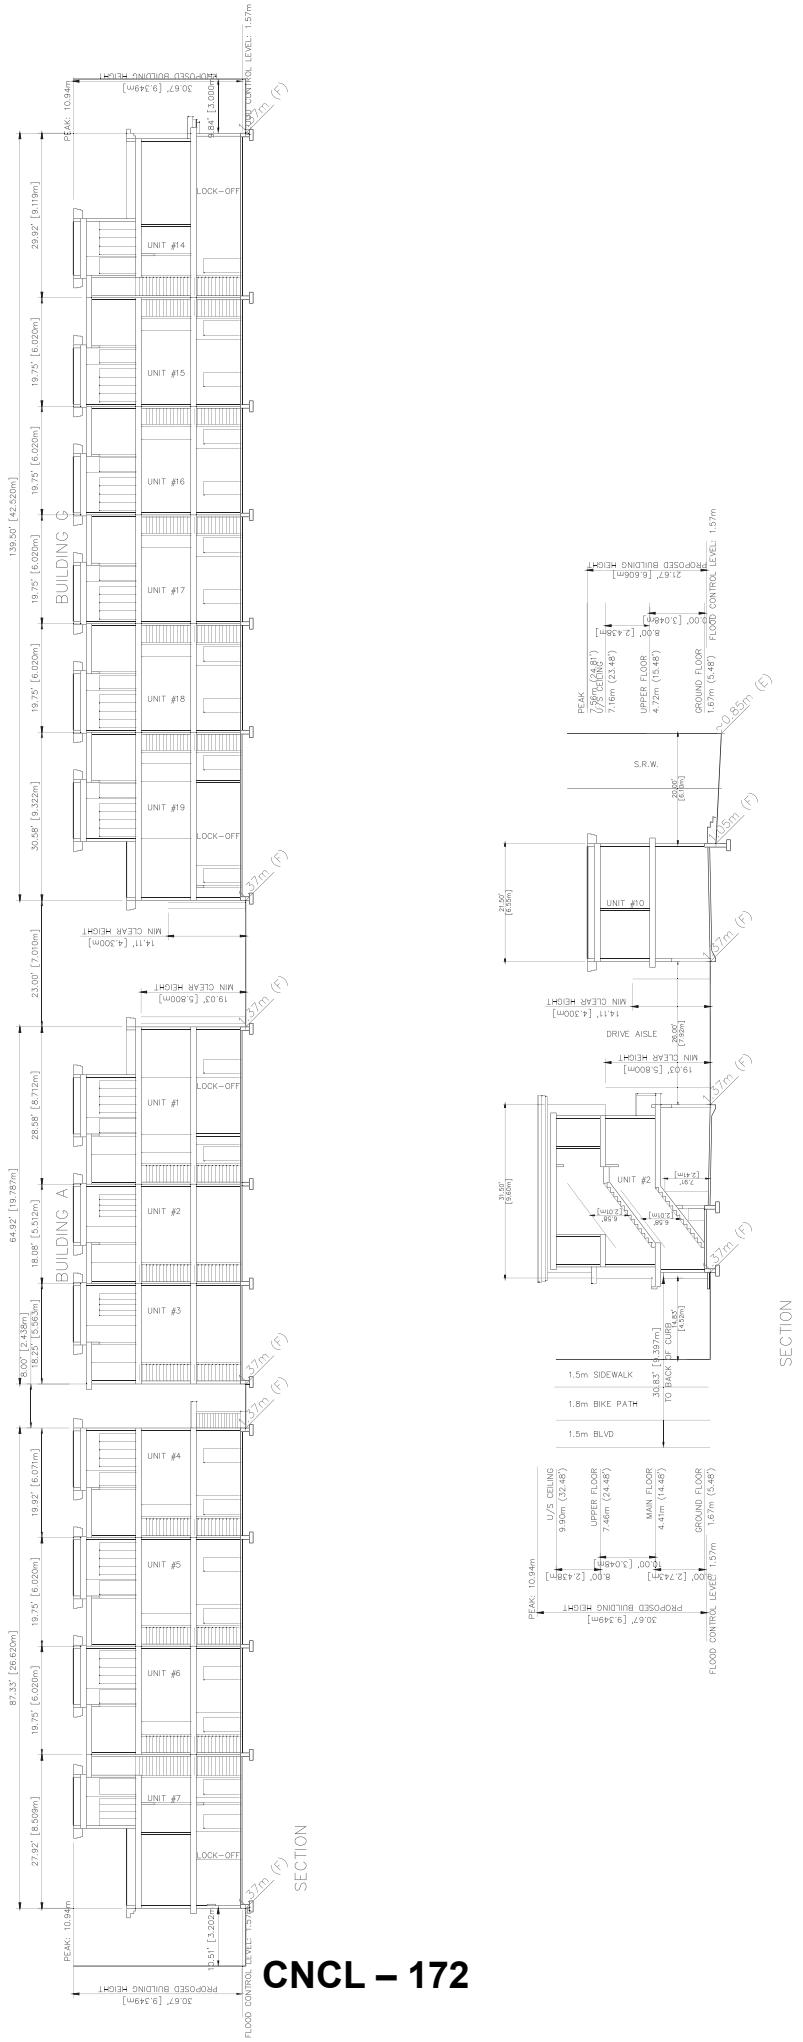

Project File PROPOSED TOWNHOUSE DEVELOPMENT 10340-10420 NO. 4 ROAD RICHMOND, B.C.	Sheet Title SITE SECTIONS	Drawn:	
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		MC	DEC. 22, 2020
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		Project Number: RZ 18-831725	D05




THE DRAWING MUST NOT BE SCALED. THE GENERAL
LEVELS PRIOR TO COMMENCEMENT OF WORK, ALL
IMPROVEMENTS AND CONSTRUCTION SHALL BE REFERRED
TO THE PLAN AND DESIGN AS ON THE
MANUFACTURED SHEET. THIS DRAWING MAY NOT BE
USED OR REPRODUCED WITHOUT PRIOR WRITTEN
CONSENT.



10340-10420 NO. 4 ROAD
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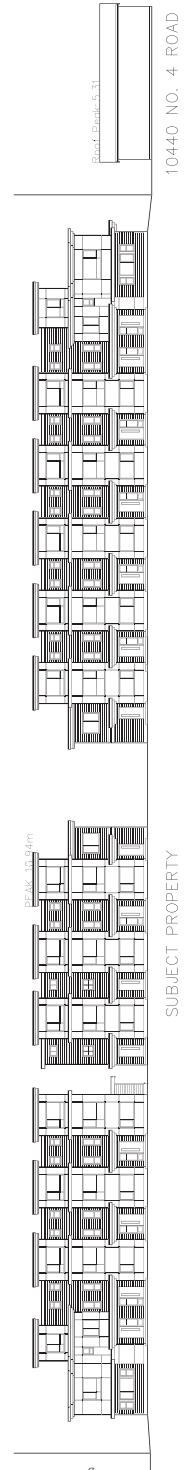
Project File No.	Sheet Title	Drawn:	Revised Date:
PROPOSED TOWNHOUSE DEVELOPMENT 10340-10420 NO. 4 ROAD RICHMOND, B.C.	ELEVATIONS	40	DEC. 22, 2020
RZ 18-831725			
Checklist:	Print Date:	Checked:	Printed:
3/327 = 1'-0"		3/327	
Drawn:	Revised Date:	Checked:	Printed:
Project Number:	Drawn:	Revised Date:	Printed:
D04a			

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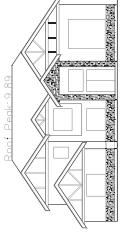





CONTEXT PLAN

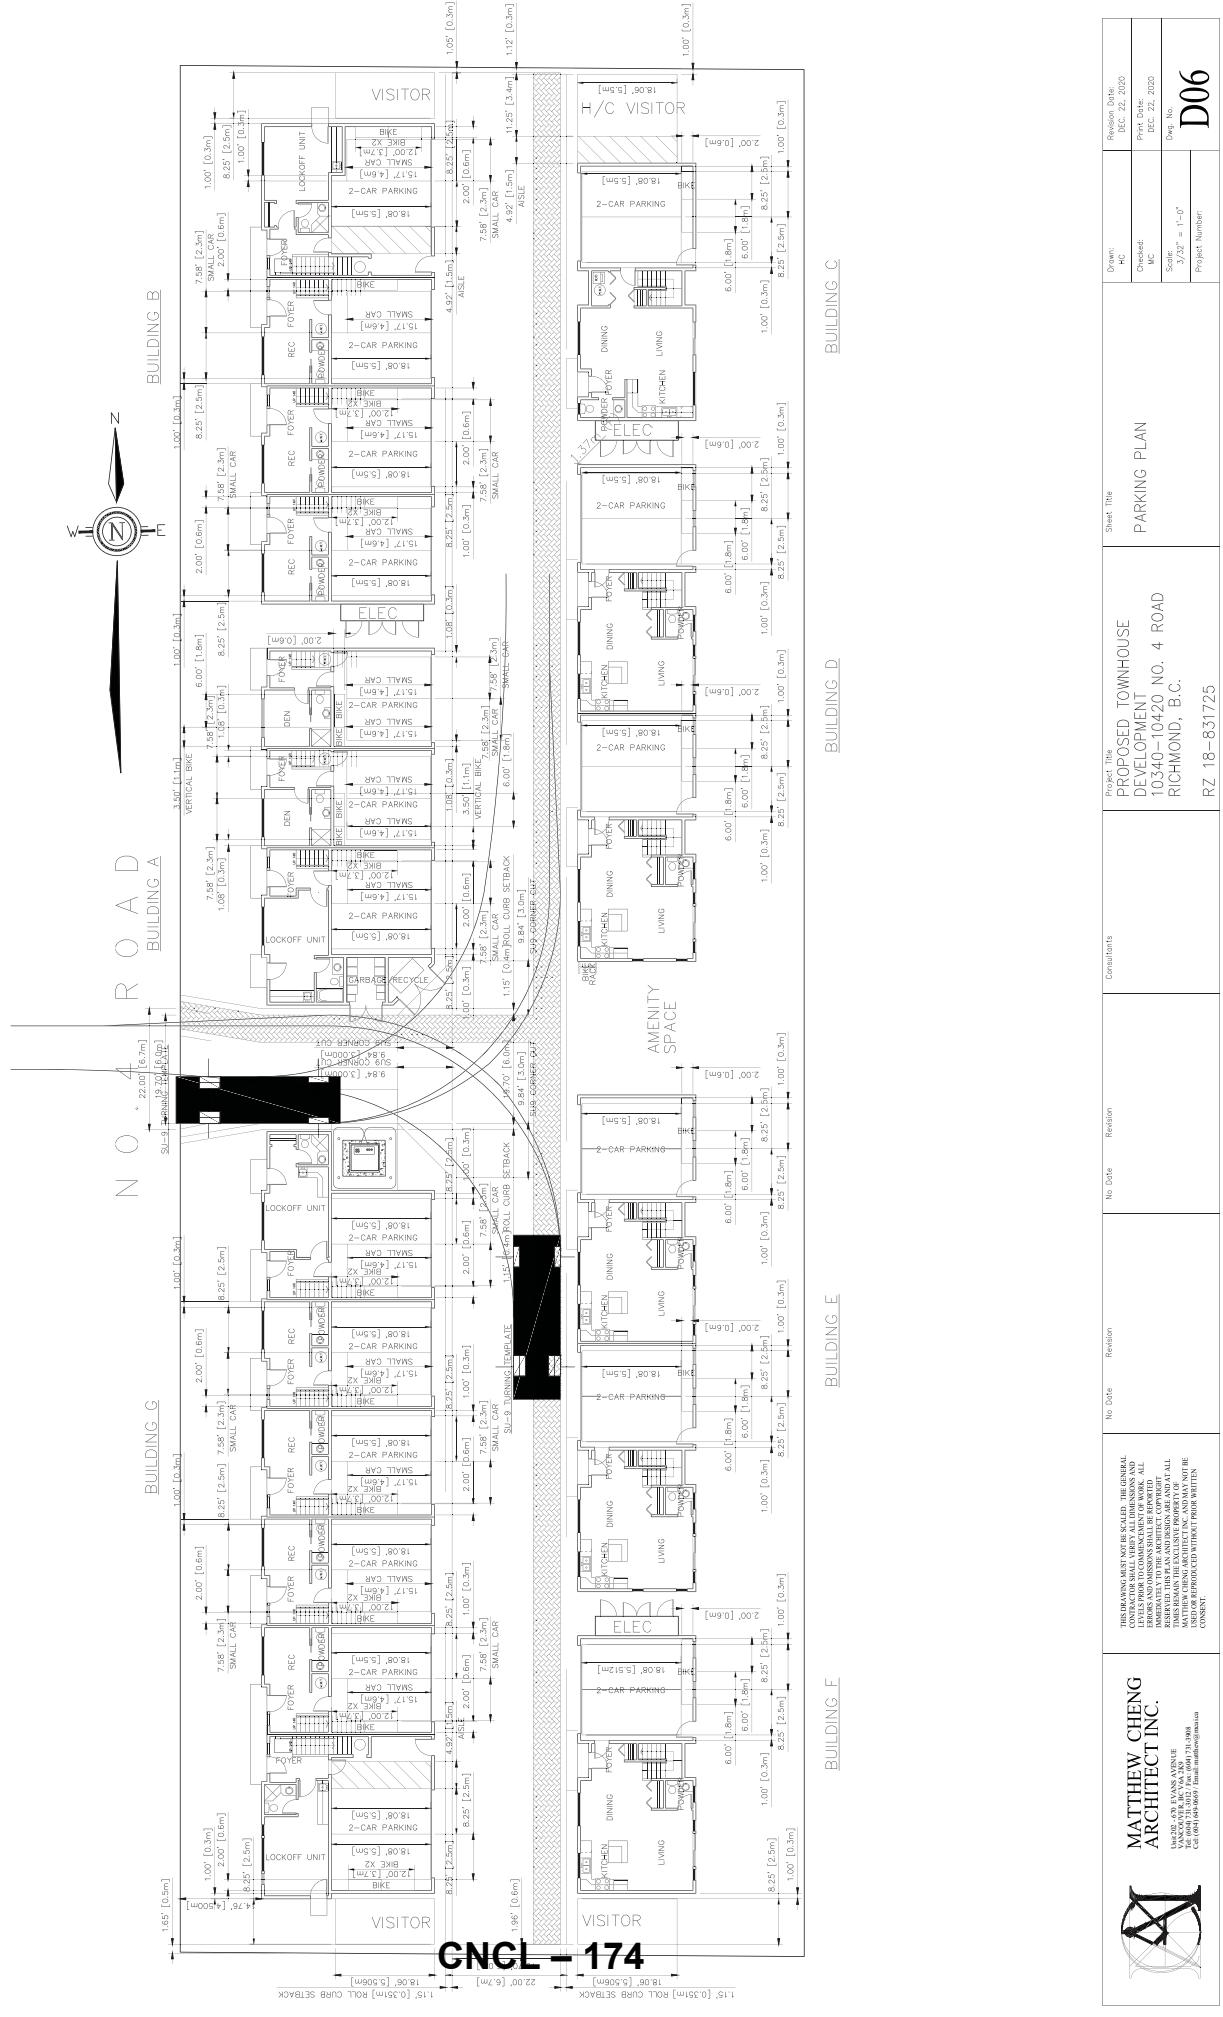

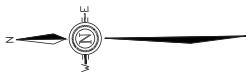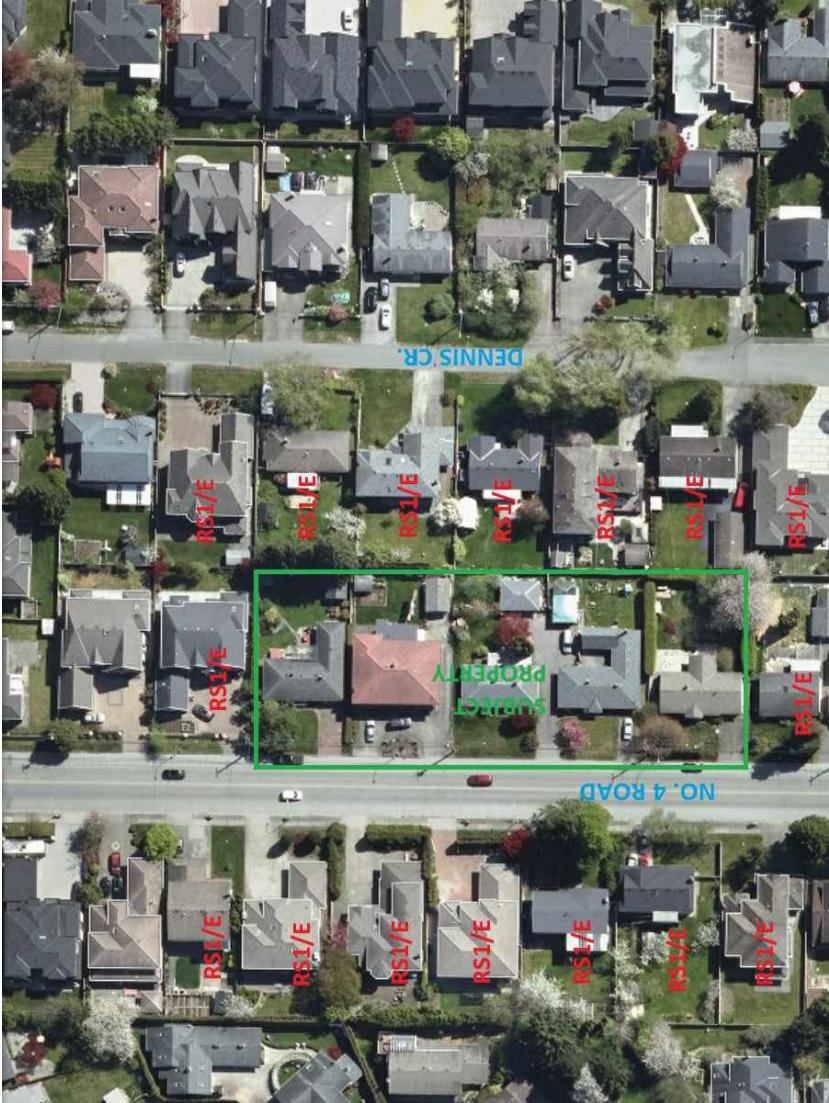STREETSCAPE ALONG NO. 4 ROAD



10320 NO. 4 ROAD

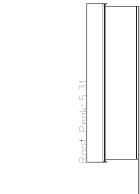


10440 NO. 4 ROAD

CNCL - 175

MATTHEW CHENG ARCHITECT INC. 10320 30 AVENUE VANCOUVER, BC V5A 2Z9 CANADA TEL: (604) 543-9669 Email: matthew@matthewcheng.ca	No Date Revision No Date Revision Consultants	PROPOSED TOWNHOUSE DEVELOPMENT 10340-10420 NO. 4 ROAD RICHMOND, B.C.	Sheet title CONTEXT PLAN	Drawn: HC	Revised: MC	Print Date: JUL. 27, 2018	Sheet No. 10340-10420	Revision Date: JUL. 23, 2018
			Break 10.34m	Break 9.82m	Break 5.31m	Scale: 1/8" = 1'-0"	D07	Project Number:



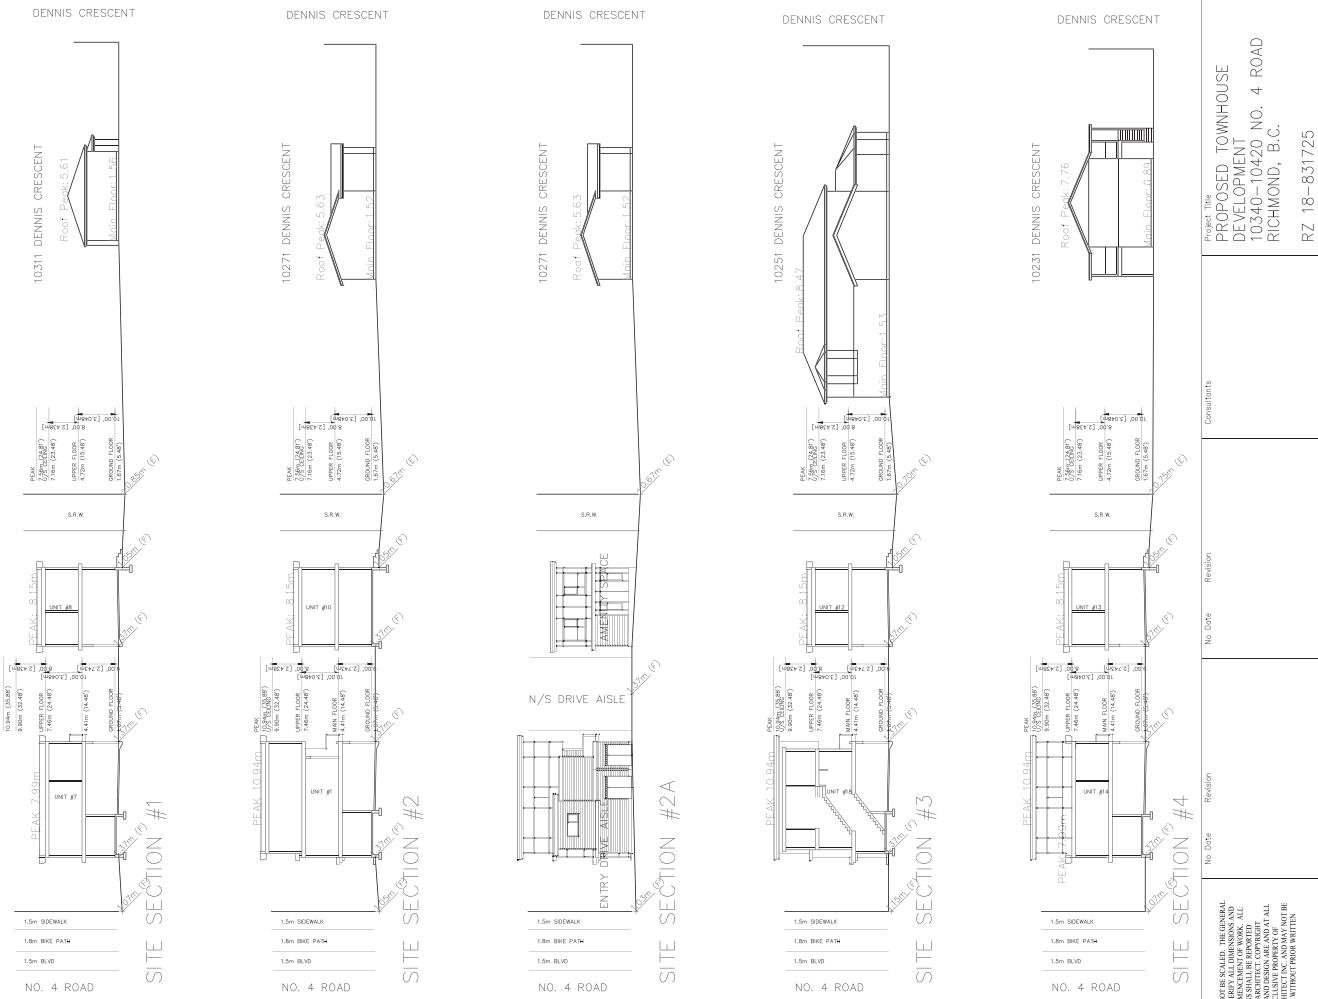

CNCL - 176

	MATTHEW CHENG ARCHITECT INC. 1420-20 STANLEY AVENUE, VANCOUVER, BC V6Z 1L2 CANADA TEL: (604) 683-9669 / FAX: (604) 683-9669 E-MAIL: matthew@matthewcheng.com	Sheet title CONTEXT PLAN			Drawn: HC	Revised Date: JUL. 21, 2018
		Checked: MC	Print Date: JUL. 27, 2018	Drawn No.: D07a	Scale: 1/8" = 1'-0"	Project Number: RZ 18-831725

N O . 4 R O A D




FIRE TRUCK LOCATION #1
20.12m TO FIRE HYDRANT

43.03m TO LAST ENTRY

FIRE TRUCK LOCATION #2
26.22m TO FIRE HYDRANT

43.95m TO LAST ENTRY

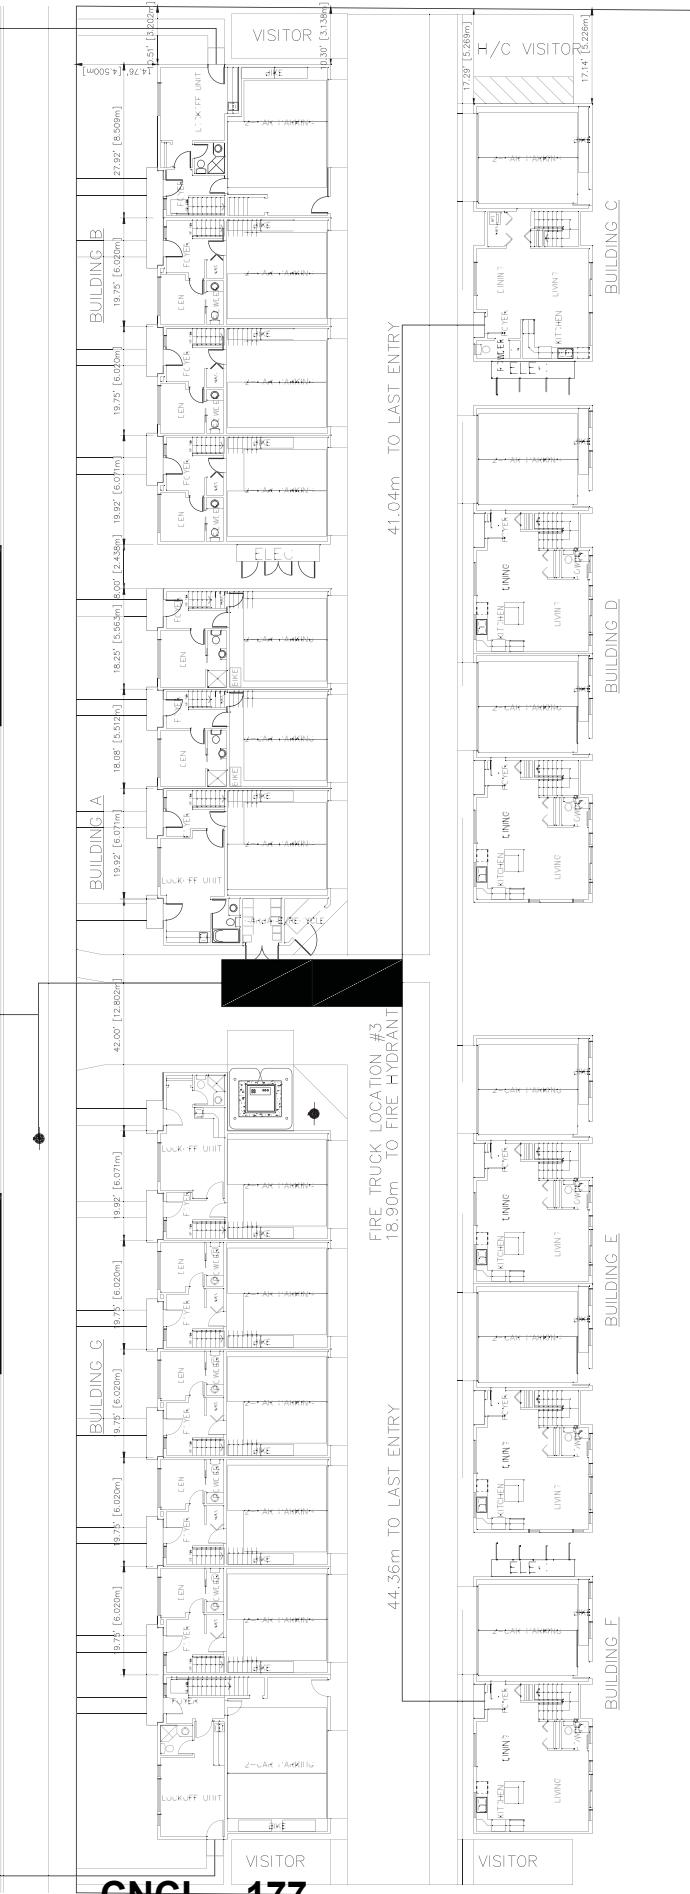

CNCL - 177

Project File		Sheet Title	
PROPOSED TOWNHOUSE DEVELOPMENT 10340-10420 NO. 4 ROAD RICHMOND, B.C.		FIRE ACCESS PLAN	
Drawn:	Revised:	Print Date:	Revision Date:
HC	MC	DEC. 22, 2020	DEC. 22, 2020
Approved:	Draw No.	Scale:	Sheet No.
Matthew Cheng Architect Inc.	D08	3'-0" = 1'-0"	
10340-10420 NO. 4 ROAD, RICHMOND, B.C., V6V 2Z9, CANADA	Project Number:		
TEL: (604) 543-9669 FAX: (604) 543-9669			
E-mail: matthew@matthewcheng.ca			

CONVERTIBLE UNIT GUIDELINES:

DOORS & DOORWAYS
-ENTRY DOORS ARE MINIMUM 963 MM, BUT IDEALLY 914 MM AND HAVE CLEAR ACCESS IF NOT NEEDED IF ROUGH IN WIRING PROVIDED FOR FUTURE AUTOMATIC DOOR OPENED.
LIVING AREAS, 1 BATHROOM, AND 1 BEDROOM, MIN. 800 MM DEPTH BY DOOR WIDTH PLUS 600 MM ON LATCH SIDE (NOT NEEDED IF ROUGH IN WIRING PROVIDED FOR FUTURE AUTOMATIC DOOR OPENED).
ACCESSES TO BATHROOM, MIN. 800 MM DEPTH BY DOOR WIDTH PLUS 600 MM ON LATCH SIDE (NOT NEEDED IF ROUGH IN WIRING PROVIDED FOR FUTURE AUTOMATIC DOOR OPENED).
-PATIO/PORCH MIN. 860 MM CLEAR OPENING. NOTE HOW ACCESSED. ALL INTERIOR HINGED UNITS COMPLY WITH BC BUILDING CODE.
-LEVER-TYPE HINGES FOR ALL DOORS.

FRAMING SUPPORT, AND LANGLONGS AS NOTED ON FLOOR PLANS IN COMPLIANCE WITH MANUFACTURER SPECIFICATIONS. FRAMING TO ACCOMMODATE 5x6FT OR 6x6FT STACONIC AND VERTICAL LUMBER DEPRESSED AREA OF STAIRS AND LANDINGS LOCATED ON FLOOR PLANS IN COMPLIANCE WITH MANUFACTURER SPECIFICATIONS.

AT THE TOP OF ALL STAIRWAYS, WALLS ARE REINFORCED WITH 2" X 12" SOLID LUMBER AT 914 MM TO CENTRE.

HALLWAYS -MIN. 900 MM WIDTH.

GARAGE -MIN. 1 ACCESSIBLE PARKING SPACE WITH MIN. 4 M GARAGE WIDTH.

BATHROOM (MIN. 1)
-TOILET QUIT FLOOR SPACE MIN. 1020 MM AT SIDE AND IN FRONT. WALL BLOCKING FOR FUTURE GRAB BAR INSTALLATION AT TILT, TUB AND SHOWER. REINFORCED WITH 2" X 12" SOLID LUMBER IN ALL BATH TUB, SHOWER, AND TOILET.

Lever-type handles for plumbing fixtures.

-PRESSURE AND TEMPERATURE CONTROLS ARE INSTALLED ON ALL SHOWER FAUCETS.

-CABINETS UNDERBATH SINK(S) ARE EASILY REMOVED. DEMONSTRATE BATH AND SHOWER CONTROLS ARE ACCESSIBLE (LAYOUT OR FIXTURE PLACEMENT).


KITCHEN -CLEAR AREA NEEDED UNDER FUTURE WORK SPACE PLUMBING, AND GAS PIPES (IN-WALL AND IN-FLOOR) LOCATED CLEAR OF UNDER COUNTER AREA OF FUTURE WORK SPACE (STOVE, SINK & MIN. 1 M WIDE COUNTER). ALL PIPES ARE EASILY REMOVED.

-CABINETS UNDERBATH SINK ARE EASILY REMOVED.


-LEVER-TYPE HINGES FOR PLUMBING FAUCETS.

WINDOWS -MIN. 1 WINDOW THAT CAN BE OPENED WITH A SINGLE HAND (BA TERRACE, KITCHEN, LINENS ROOM)





-WALLS, SWIFTS, OUTLETS, & SWITCHES PLACED IN LOCATIONS OF ELECTRICAL OUTLETS, BESIDE WINDOW, BOTTOM OF STAIRWAYS, BESIDE TOILET, ABOVE EXTERNAL DOORS (OUTSIDE AND INSIDE), AND IN RECREATION ROOM, WITHIN PROXIMITY OF CONTROL CENTRE FOR SMART HOME OPTONS. -UPGRADE TO FOUR-PLEX OUTLETS IN MASTER BEDROOM, HOME OFFICE, GARAGE, AND RECREATION ROOM.

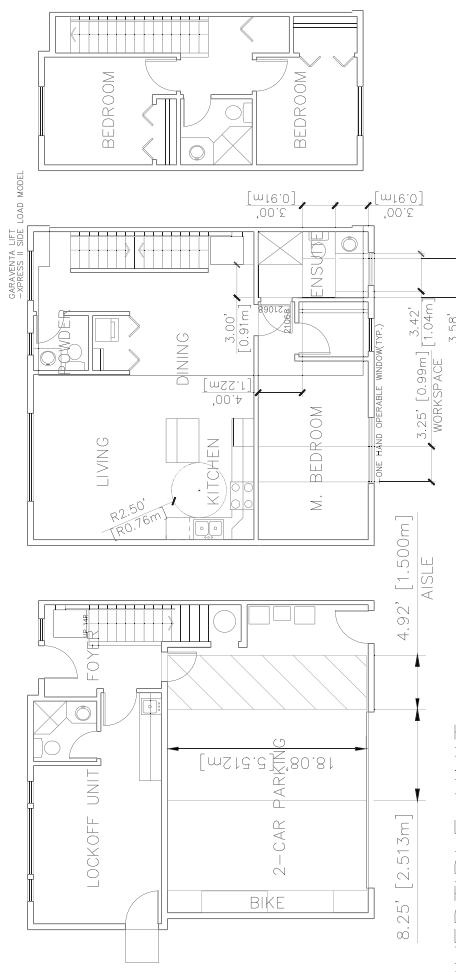

CNCL - 178

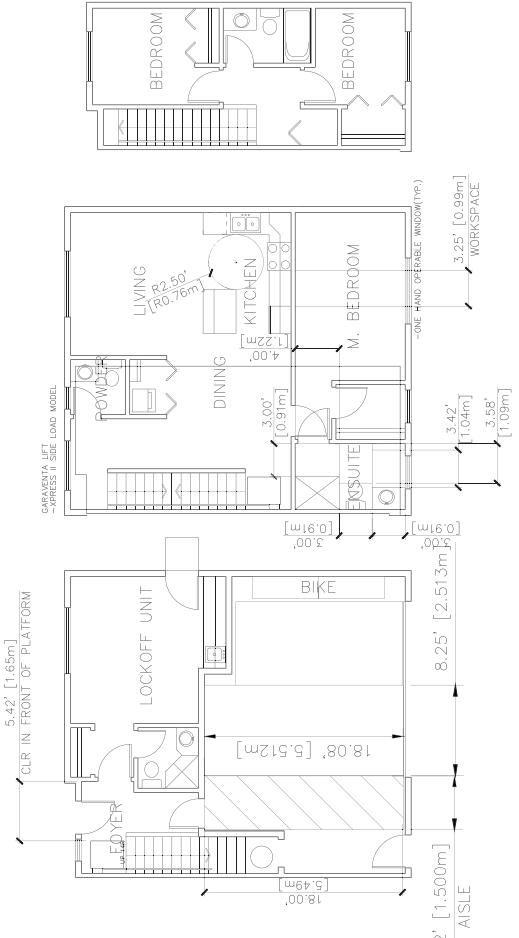


Project File	Proposed Townhouse Development 10340-10420 No. 4 Road Richmond, B.C.	Sheet Title	Drawn:	Revised:	Print Date:	Revision Date:
RZ 18-831725	CONVERTIBLE UNIT FLOOR PLANS	D09	MC	3/16" = 1'-0"	DEC. 22, 2020	Dec. 22, 2020

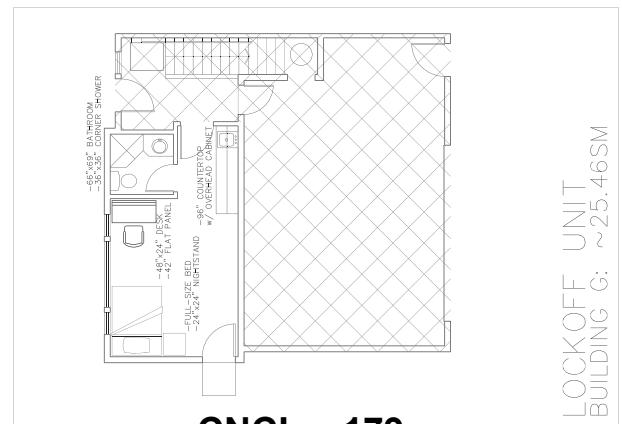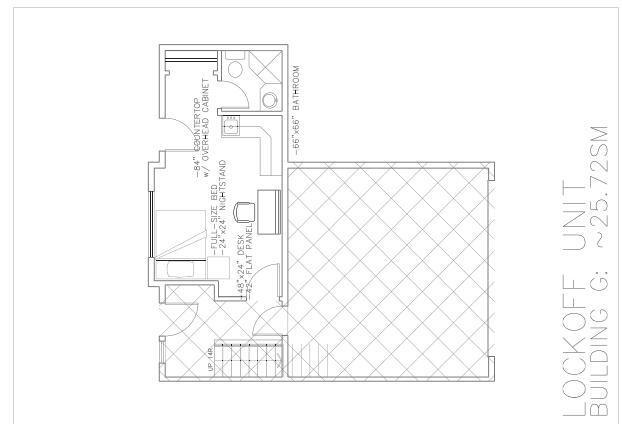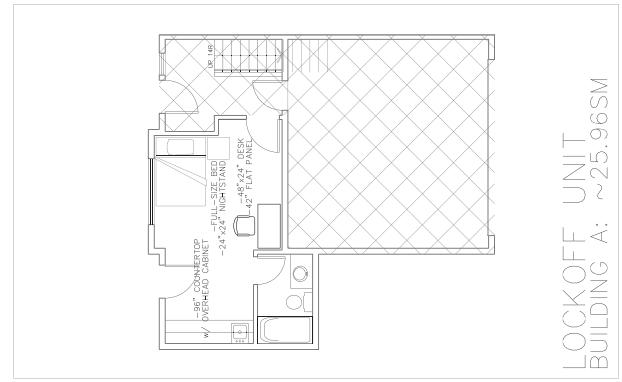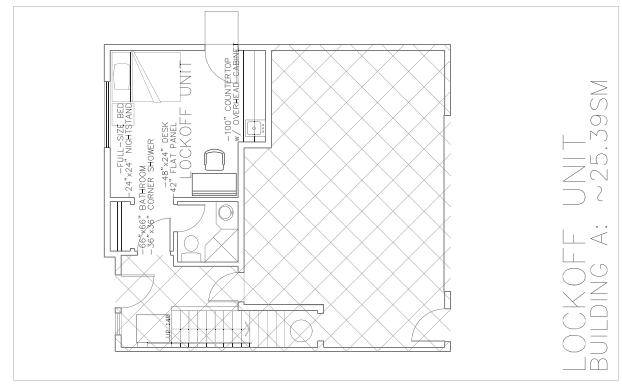

CNCL - 179

 <p>MATTHEW CHENG ARCHITECT INC. 1020 23 ST. VANS MONTAGE VANCOUVER, BC, V6B 2Z9 CANADA TEL: (604) 685-9669 Email: matthew@matthewcheng.ca</p>	No Date	Revision	No Date	Revision	Project Title PROPOSED TOWNHOUSE DEVELOPMENT 10340-10420 NO. 4 ROAD RICHMOND, B.C.	Sheet Title LOCK-OFF UNIT FLOOR PLANS	Drawn: HC	Revised: MC	Printed: DEC. 22, 2020
							Scale: 3/16" = 1'-0"	Drawn No. D09a	Print No.

N O . 4 R O A D

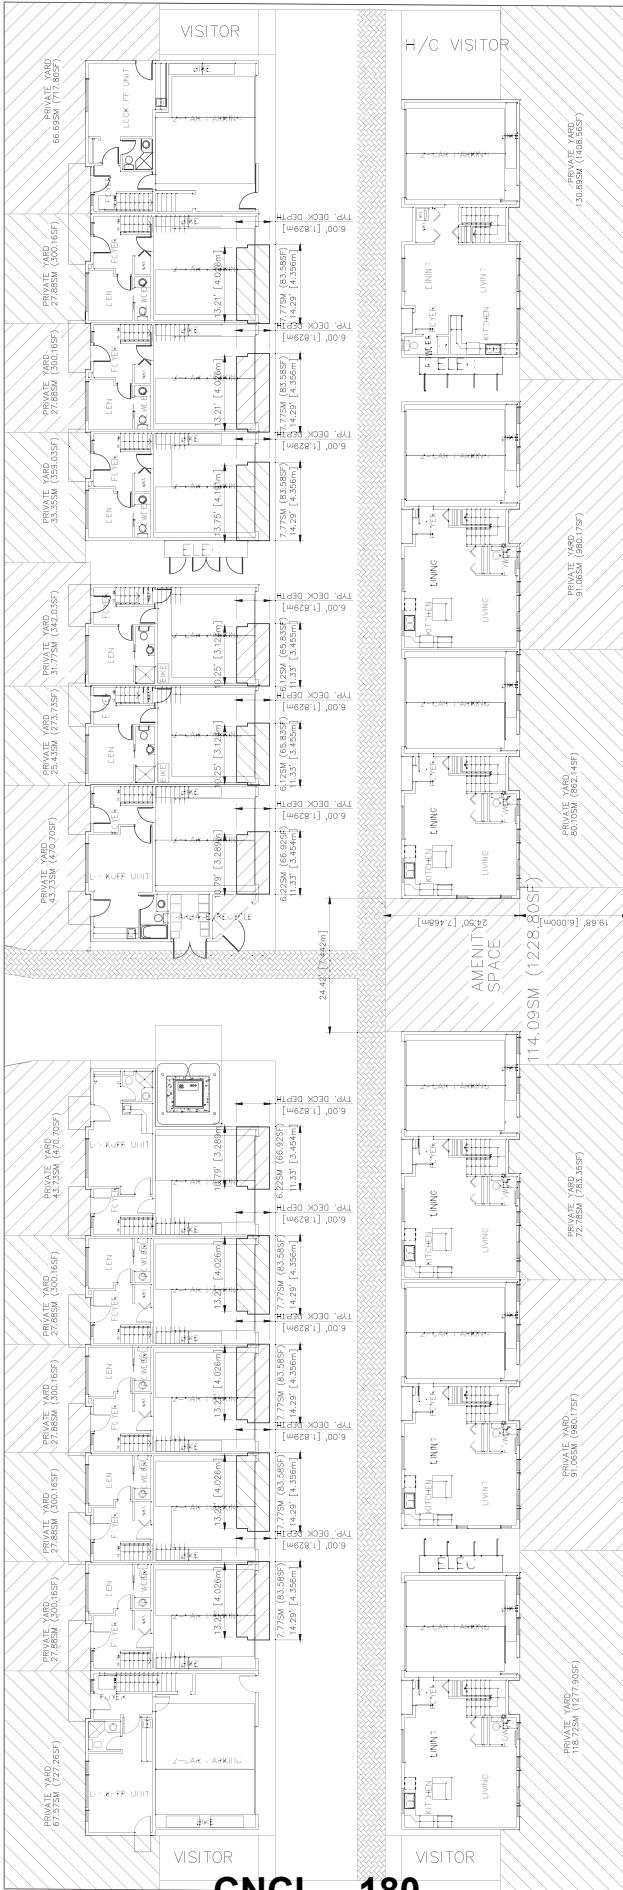

CNCL - 180




Project Name PROPOSED TOWNHOUSE DEVELOPMENT 10340-10420 NO. 4 ROAD RICHMOND, B.C.	Sheet Title OUTDOOR SPACE- CALCULATIONS	Drawn: HC	Revised: MC	Print Date: DEC. 22, 2020	Revision Date: DEC. 22, 2020
MATTHEW CHENG ARCHITECT INC. 10340-10420 NO. 4 ROAD VANCOUVER, BC V6P 5E6 TEL: (604) 685-0669 FAX: (604) 685-0669 E-mail: matthew@matthewcheng.com	Comments:	No Date	Revision	No Date	Project Number RZ 18-831725

THE DRAWING MUST NOT BE SCALLED. THE GENERAL
LEVELS PRIOR TO CONSTRUCTION AND IN USE
FOR EXTERIOR CONSTRUCTION SHALL BE REFERRED
TO REFERRED TO THE PLANS AND DESIGN ARE AS ALL
MADE NEW OR RECALCULATED AS NECESSARY.
NOT BE
CONSENT





MATTHEW CHENG ARCHITECT INC.	No Date	Revision	Sheet Title	Project File										
													SHADOW ANALYSIS	PROPOSED TOWNHOUSE DEVELOPMENT 10340-10420 NO. 4 ROAD RICHMOND, B.C. RZ 18-831725
														Drawn: HC Checked: MC Printed: DEC. 22, 2020 Dwg. No. 3/32' = 1'-0" Project Number D12

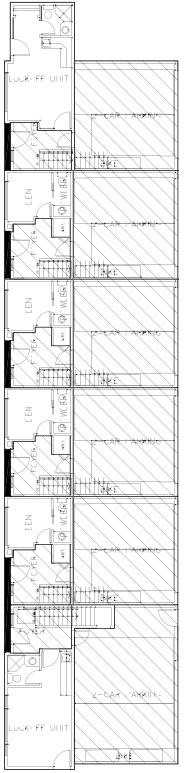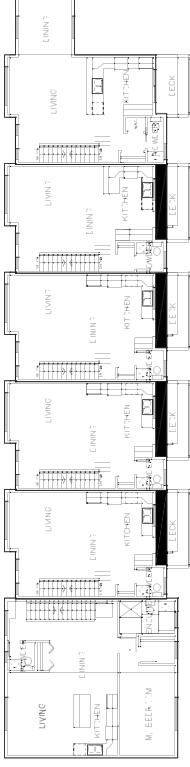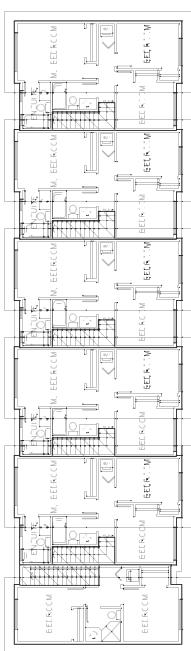

UNIT #5





UNIT #6

UNIT #4

UNIT #3

UNIT #2

UNIT #1

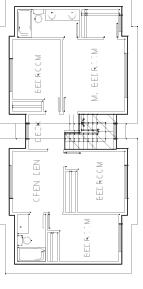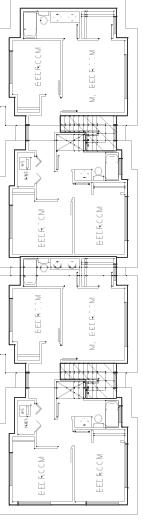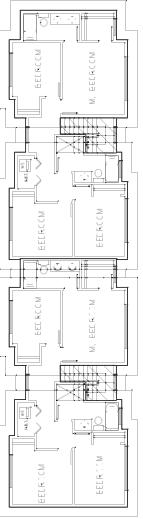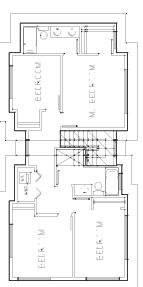

UNIT #13

UNIT #14

UNIT #9

UNIT #8

UNIT #7

UNIT #6

UNIT #5

UNIT #4

UNIT #3




UNIT #2

UNIT #1

LEGEND



FLOOR SURROUNDED BY 3 WAILS (INCLUDED)

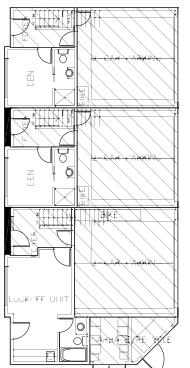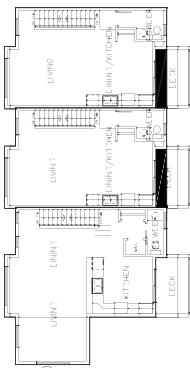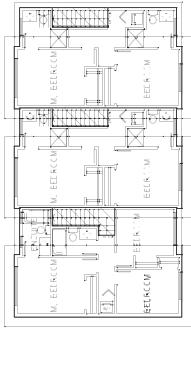

UNIT #7

UNIT #6




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UNIT #4

UNIT #3

UNIT #2

UNIT #1

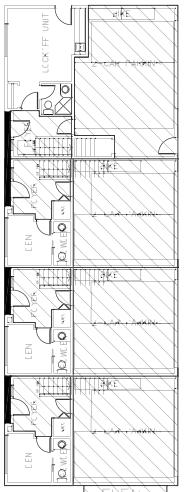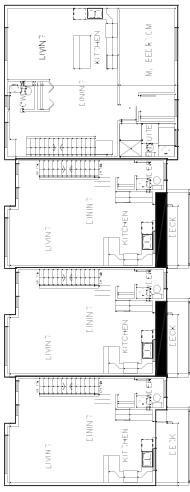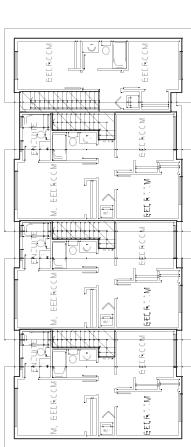

UNIT #7

UNIT #6

UNIT #5


UNIT #4

UNIT #3

UNIT #2

UNIT #1

Project Name	Drawing No.	Revision Date	Check Date	Print Date	Dwg. No.	Sheet Title	FLOOR AREA OVERLAY	
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MATTHEW CHENG ARCHITECT INC.	RZ 18-831725	No Date	Revision	No Date	Consultants	Drawn:	4C	Revised:
						Checked:	MC	Printed:
						Date:	DEC. 22, 2020	Dec.:
						Scale:	3'-0" = 1'-0"	Sheet No.:
						Comments:	MADE FOR INFORMATIONAL PURPOSES ONLY. DRAWINGS NOT TO BE USED OR REPRODUCED WITHOUT PRIOR WRITTEN CONSENT.	
							© 2018 MATTHEW CHENG ARCHITECT INC. ALL RIGHTS RESERVED.	
							10340-10420 NO. 4 ROAD RICHMOND, B.C. V6V 1Z9	
							T: 604-543-9669 F: 604-543-9666 Email: matthew@matthewcheng.com	

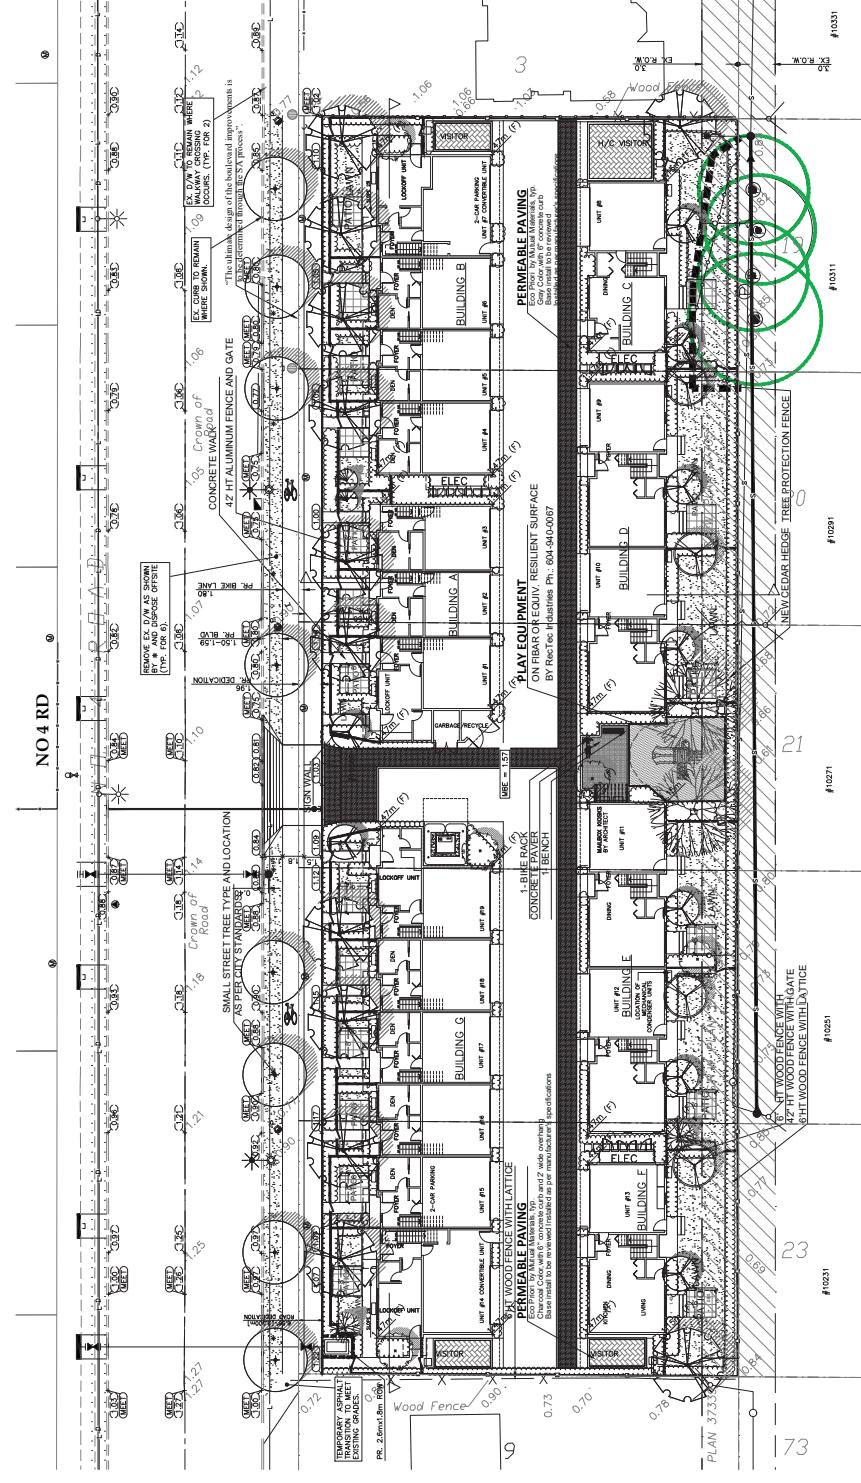

FURNITURE LEGEND



PVAER LEGEND





PLANT SCHEDULE, SHRUBS & GROUND COVERS

PAG PROJECT NUMBER: 9.983

PLANTED SIZE/REMARKS

KEY	QTY	BOTANICAL NAME	COMMON NAME		
				PLANT SIZE	REMARKS
SHRUBS	6	AUCUBA JAPONICA NR. GOLD DUST	MR. GOLD DUST AUCUBA	63 CM x 60 CM	
② ③	3	ZIZYPHUS JUWEL NR. CHOCOLATE	ZIZYEA (SINGEE LEAF CRISPINSON)	62 CM x 60 CM	
BIGBEANS THUNBERGII MONDORF'	5	BIGBEANS THUNBERGII MONDORF'	CHERRY TOMOR BARBERRY	62 CM x 60 CM	
BUXUS MICROPHYLLA 'WINTER GEM'	166	BUXUS MICROPHYLLA 'WINTER GEM'	LITTLE LEAF BOX	48 CM x 50 CM	
CHIOSYA TERNATA	7	CHIOSYA TERNATA	MEXICAN MOCK ORANGE	41 CM x 26 CM	
EVERGREEN HAWTHORN	39	EVERGREEN HAWTHORN	EVERGREEN HAWTHORN	62 CM x 60 CM	
HEMISPERMIA CONVEXA	6	HEMISPERMIA CONVEXA	JAPANESE HOLLY	63 CM x 60 CM	
KALMA LAFOLIA ELF	43	KALMA LAFOLIA ELF	DWARF MOUNTAIN LAUREL	63 CM x 60 CM	
PIERS TAWANICA 'VALLEY FIRE'	32	PIERS TAWANICA 'VALLEY FIRE'	VALLEY FIRE PERIS	62 CM x 60 CM	
ROSA KNOCOURT TRADOUW	27	ROSA KNOCOURT TRADOUW	TAWA PERIS DWARF	62 CM x 60 CM	
SIMONEA LACINIATA (L.)	40	SIMONEA LACINIATA (L.)	RADKOZ' KNOCKOUT ROSE	62 CM x 60 CM	
SMILAX LAEVIGATA (L.)	11	SMILAX LAEVIGATA (L.)	ABRAHAM'S SWING	62 CM x 60 CM	
TAMIS X AEDA 'HOSHII'	103	TAMIS X AEDA 'HOSHII'	HICKORY GREEN CEDAR	120 CM x 60 CM	
THUJA OCCIDENTALIS 'MARIPOSA'	92	THUJA OCCIDENTALIS 'MARIPOSA'	BURNWOOD/BURNLUM	1.8M H x 60 CM	
VIBURNUM X BURKWOODII	3	VIBURNUM X BURKWOODII	1.0M H x 60 CM		
GROSES	57	CALANDRIGERUS X. 'KARE FEURSTER'	KARE FEURSTER FEATHERBED GRASS	182 CM x 60 CM	
CAREX ICE DANCE	101	CAREX ICE DANCE	FROSTEDICE GRASS	181 CM x 60 CM	
MISCANTHUS SINENSIS 'MORNING LIGHT'	43	MISCANTHUS SINENSIS 'MORNING LIGHT'	MORNING LIGHT GAPS OVER GRASS	182 CM x 60 CM	
PENNISETA ALOPECHIORIDES HAMILTON	73	PENNISETA ALOPECHIORIDES HAMILTON	DWARF FOUNTAIN GRASS	182 CM x 60 CM	
PERENNIAL	35	ASTRANTIA WAR. NEPTUNIA WAR.	MASTERWORT	15CM POT	
NEPTUNIA WAR.	37	NEPTUNIA WAR.	DWARF CANTIMP	15 CM POT	
SUBSTRATE TELEPHUM MONICHENII	12	SUBSTRATE TELEPHUM MONICHENII	AUTUMN ZEST STONECROP	15 CM POT	
NANDINA DOMESTICA 'MARBLE GAYETY'	9	NANDINA DOMESTICA 'MARBLE GAYETY'	ELONNIA SILVER VARIATED	182 CM x 60 CM	
POLYSTICHUM MUNITUM	71	POLYSTICHUM MUNITUM	HARBOUR DWARF NANNA	182 CM x 60 CM	
			WESTERN SWORD FERN*	182 CM x 60 CM	

NOTES: PLANT SIZES IN THIS LIST ARE SPECIFIED ACCORDING TO THE B.C. BUILDING CODE AND CANADIAN LANDSCAPE STANDARD. LATEST EDITION. CONTAINER SIZES MEASUREMENTS AND OTHER PLANT MATERIAL REQUIREMENTS FOR OTHER PLANT MATERIAL ARE AVAILABLE FOR REVIEW BY LANDSCAPE ARCHITECT AT SOURCE OF SUPPLY. AREA OF SEARCH TO INCLUDE LOWER MANLAND AND FRAZER VALLEY. SUBSTITUTIONS, CREDIT/WAIVER APPROVAL FROM THE LANDSCAPE ARCHITECT FOR REQUEST TO SUBSTITUTE PLANT MATERIALS ARE SUBJECT TO B.C. LANDSCAPE STANDARDS AND CANADIAN LANDSCAPE STANDARD. DEFENCE OF CONDITIONS OF AVAILABILITY, ALL LANDSCAPE MATERIAL AND WORKMANSHIP MUST BE SUBMITTED TO B.C. LANDSCAPE STANDARDS AND CANADIAN LANDSCAPE STANDARD. LATEST EDITION. ALL PLANT MATERIAL MUST BE PROVIDED FROM CERTIFIED RESEED FREE NURSERY. BIO-SOLES NOT PERMITTED IN GROWING MEDIUM UNLESS AUTHORIZED BY LANDSCAPE ARCHITECT.

PROJECT:

19 UNIT TOWNHOUSE
DEVELOPMENT
10340 - 10420 NO. 4 ROAD
RICHMOND

REF: R2-18-331725

DRAWING NUMBER:

L2

DRAWING NUMBER:

5

DRAWING NUMBER:


OF 5

DRAWING NUMBER:

19-093



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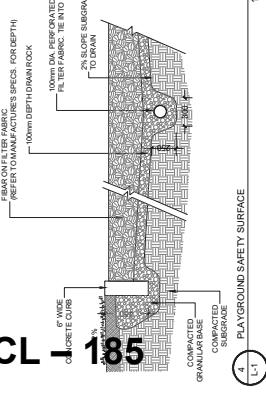
NOTES:
1. ALL FASTERS NOTCHED GALVANIZED
2. SMOOTH WELD ALL JOINTS
3. STAIN ALL EXPOSED SURFACES WITH TWO
COAT PREMIUM NEUTRALIZING TAN COLOUR
TO MATCH ARCH. PROPOSAL SAMPLE TO OWNER FOR
PREFAPPROVAL PRIOR TO APPLICATION
4. STEP FENCE IN EQUAL SEGMENTS IS TO FOLLOW
GRADE AT PROPERTY LINE.

1. METAL GALVANIZED ALUMINUM PICKETS
2. SMOOTH WELD ALL JOINTS
3. ALL HARDWARE NOT DIPPED OR GALVANIZED
5. LETTERS TO BE GALVANIZED METAL AND POWDER COATED
WITH BLACK FINISH.

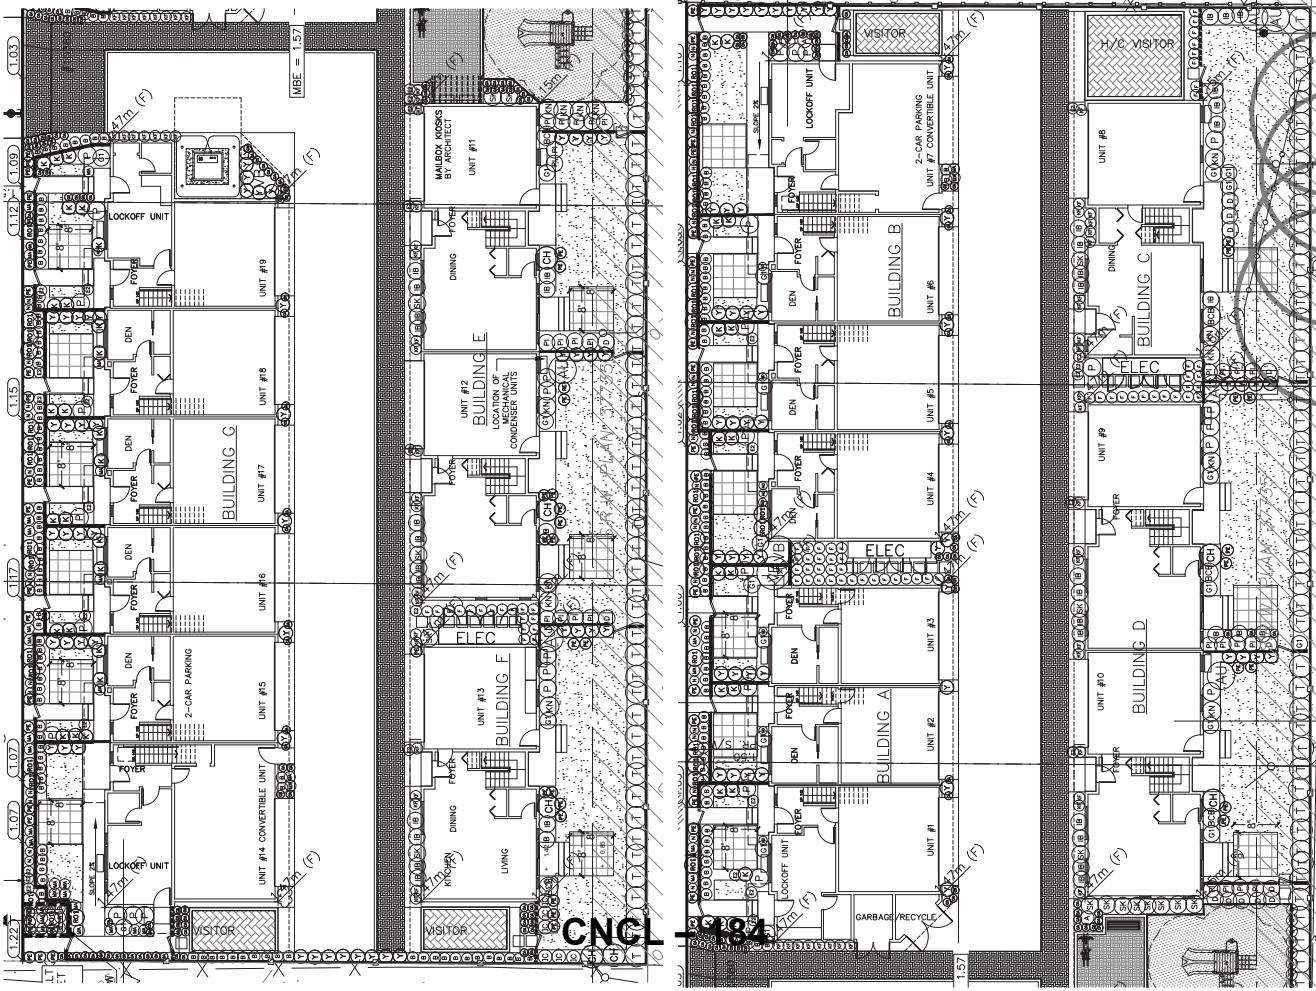


1 6' HT PATIO SCREEN AND 2 HT WOOD FENCE WITH LATTICE
1/2" = 1'-0"


3 42' HT ALUMINUM FENCE WITH GATE
1/2" = 1'-0"

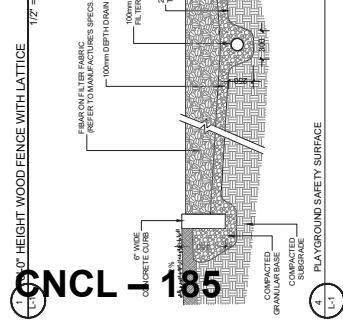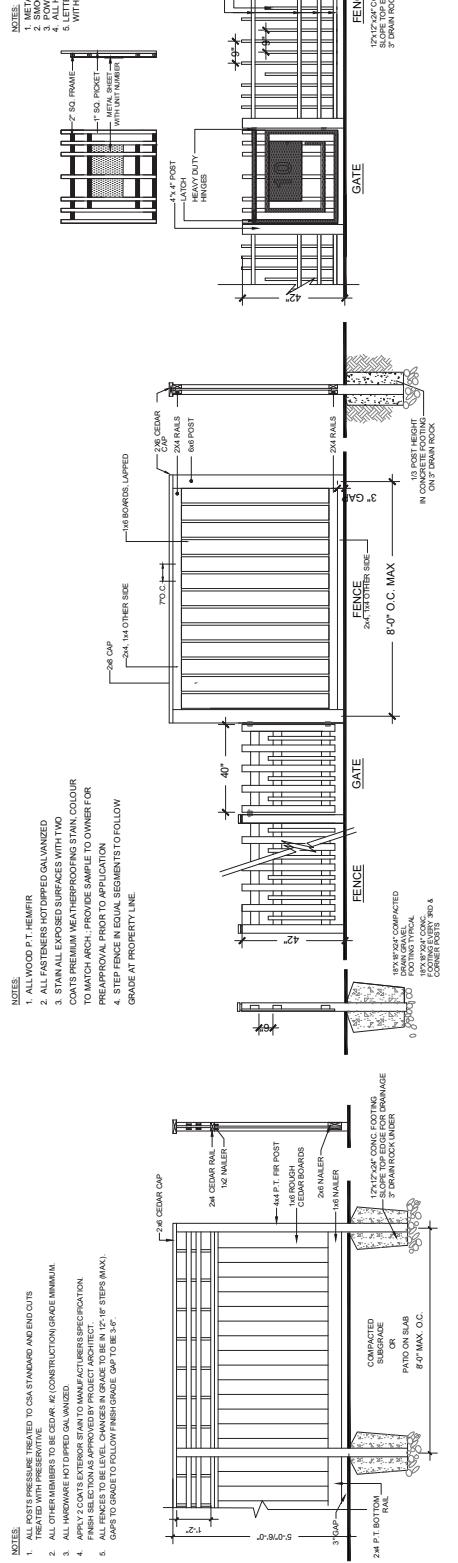

4 PERMEABLE PAVERS
1/2" = 1'-0"

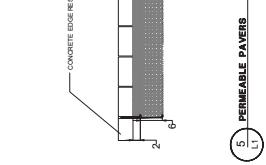

5 PAVERS THROUGH ROOT ZONE
1/2" = 1'-0"

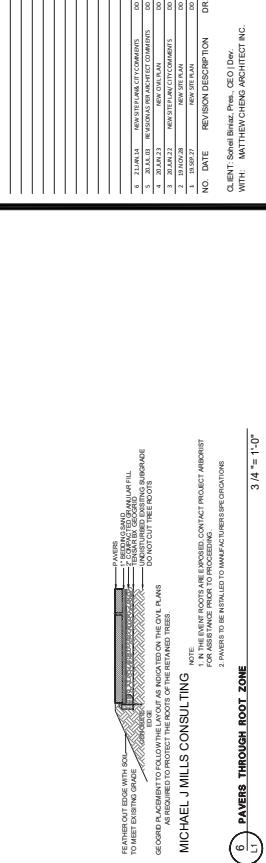

2 42' HT ALUMINUM FENCE WITH GATE
1/2" = 1'-0"


PROJECT:
19 UNIT TOWNHOUSE
DEVELOPMENT
10340 - 10420 NO. 4 ROAD
RICHMOND
R218-831725

DRAWING TITLE:
LANDSCAPE DETAILS


DATE: July 22, 2019
SCALE: DD
DRAWN: DD
DESIGN: DD
CHECK: PM
DR:

L3

OF 5
PMG PROJECT NUMBER: 30959-6229

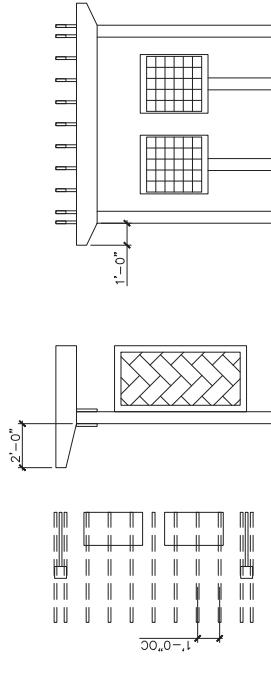




6 MAIL KIOSK
1/2" = 1'-0"

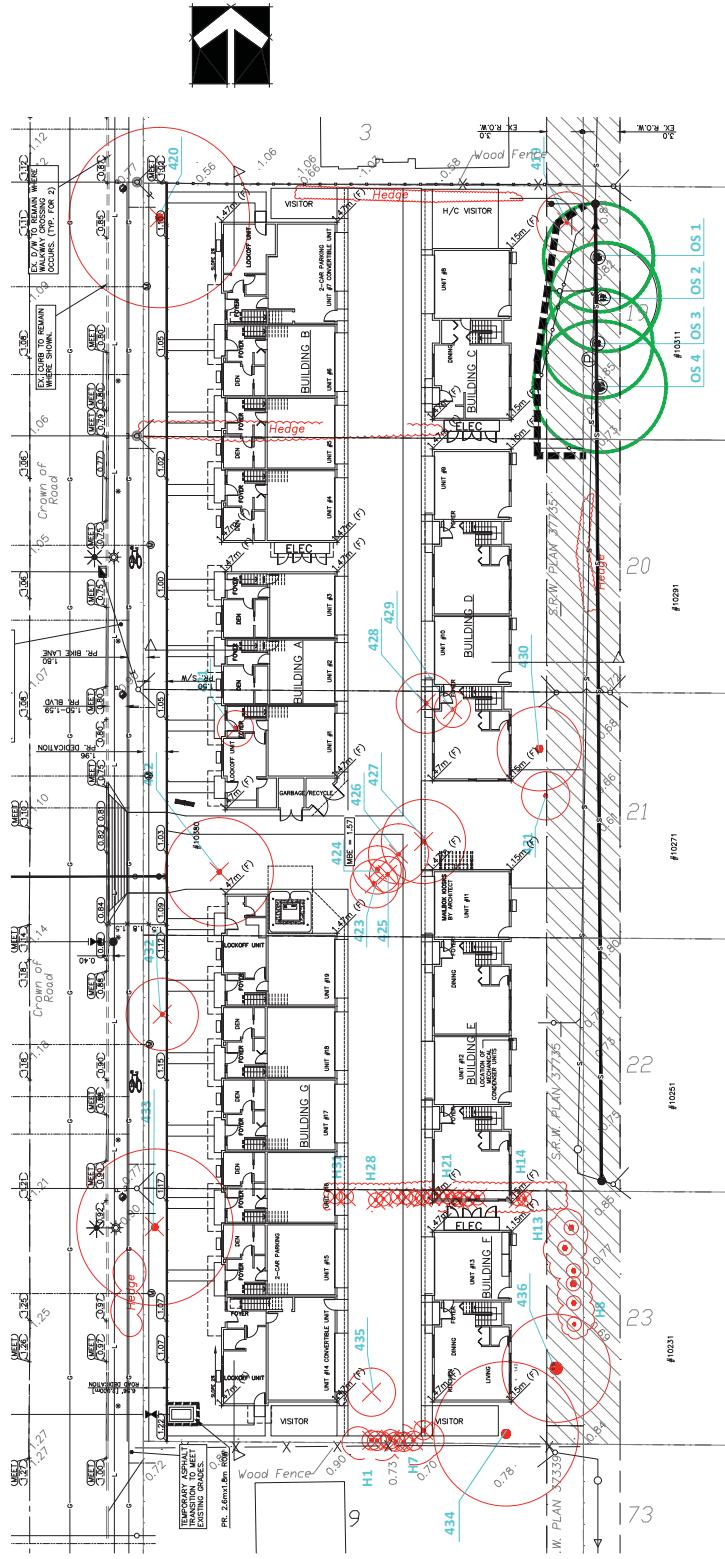

PROJECT: 2100 N WOODWARD AVENUE
3 384X23 NEW CONCRETE
4 384X23 NEW CONCRETE
5 384X23 NEW CONCRETE
7 384X23 NEW CONCRETE
1 384X23 NEW CONCRETE


NO. DATE REVISION NUMBER: DR

Q:ENT: Sonal Birn, Pre- :CE :C Dev.
WITH: MATTHEW CHENG ARCHITECT

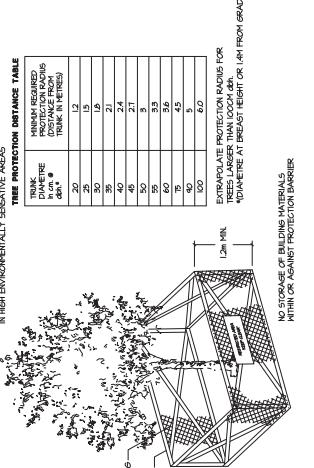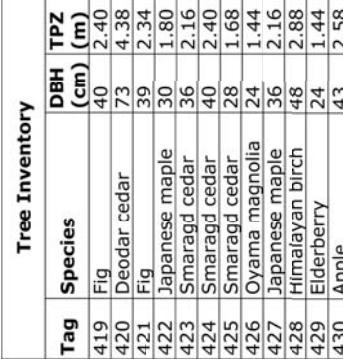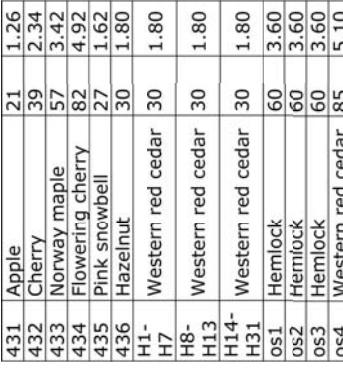

DRAWING NUMBER: L4
DRAWN: DD
DESIGN: DD
CHECK: PDM
DR:

DRAWING NUMBER:
DATE: May 22, 2019
SCALE: 1/16=5'-0"
DRAWN: DD
DESIGN: DD
CHECK: PDM
DR:
PONG PROJECT NUMBER: 201905-6-229

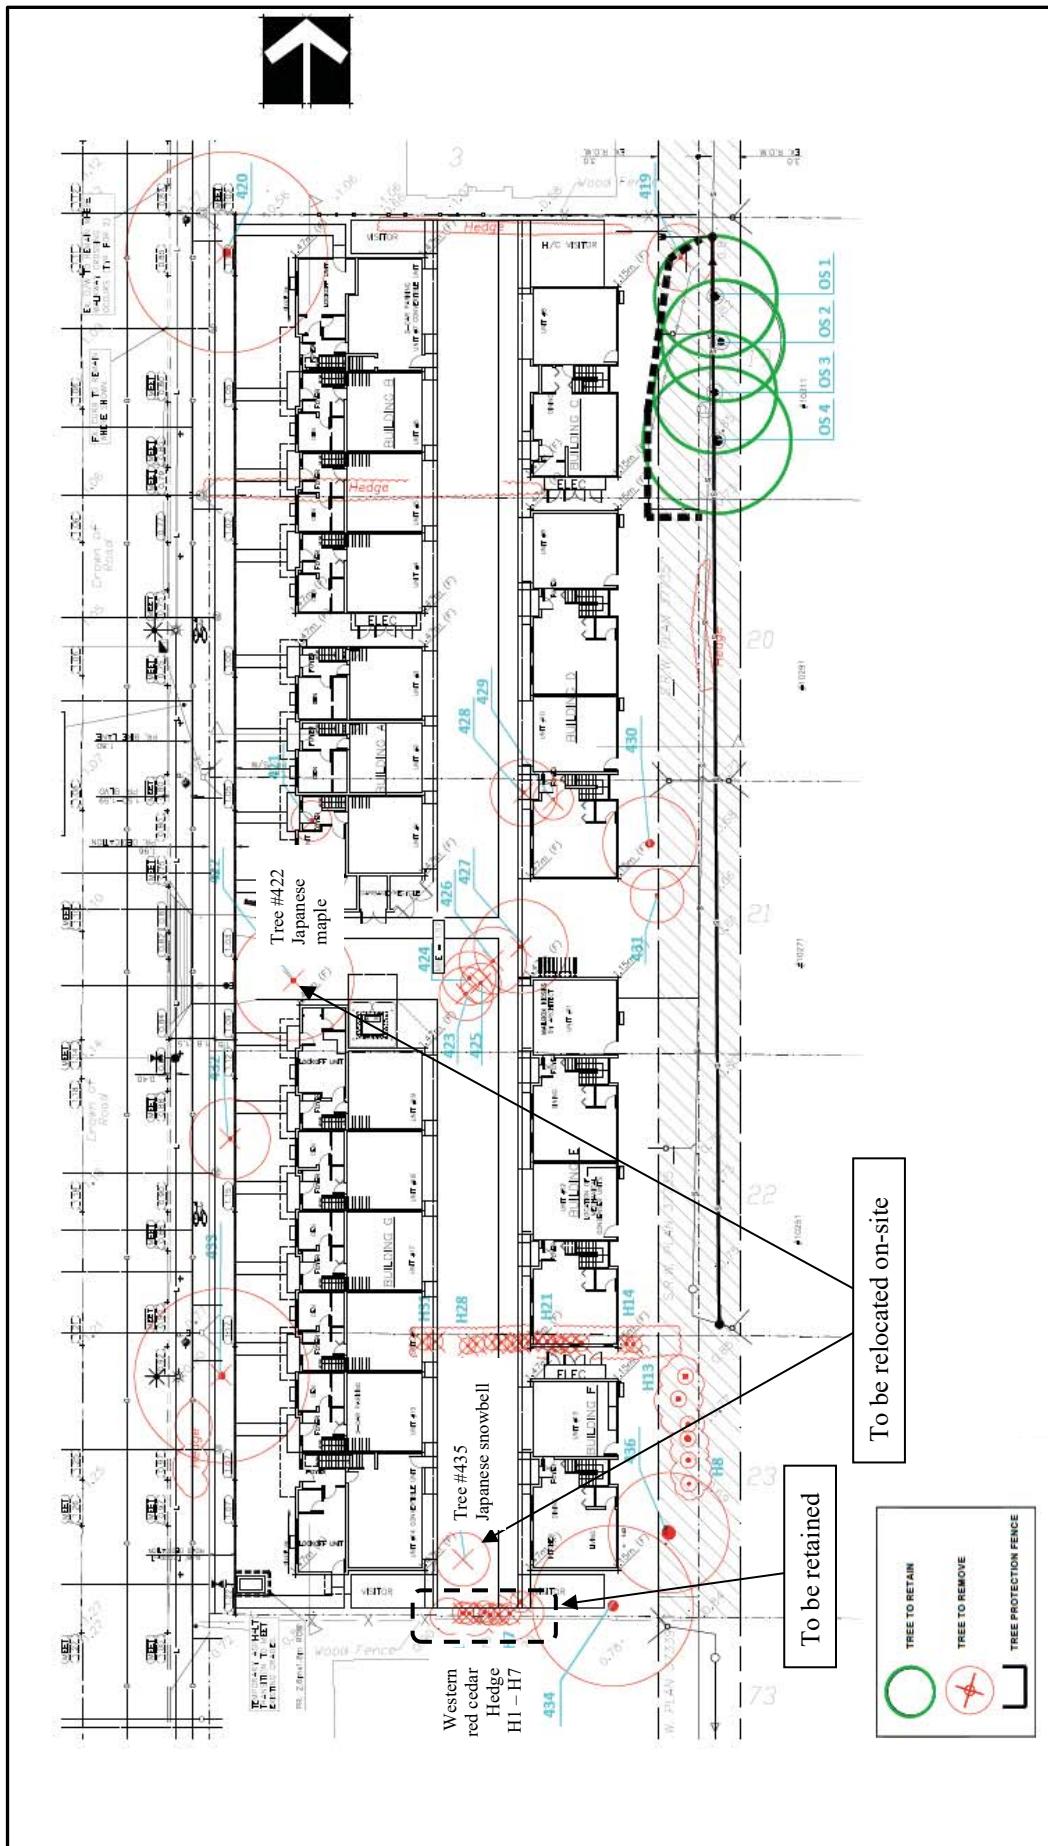



City of Richmond

Attachment 6

Rezoning Considerations

Development Applications Department
6911 No. 3 Road, Richmond, BC V6Y 2C1

Address: 10340, 10360, 10380, 10400 and 10420 No. 4 Road

File No.: RZ 18-831725

Prior to final adoption of Richmond Zoning Bylaw 8500, Amendment Bylaw 10261, the developer is required to complete the following:

1. 2.0 m road dedication along the entire site frontage.
2. Consolidation of all the lots into one development parcel (which will require the demolition of the existing dwellings).
3. Retention of on-site trees #422 and #435, and off-site trees #OS1, #OS2, #OS3 and #OS4, requires the following:
 - a) Submission of a Contract entered into between the applicant and a Certified Arborist for supervision of any on-site works conducted within the tree protection zone of the trees to be retained. The Contract should include the scope of work to be undertaken, including: the proposed number of site monitoring inspections, and a provision for the Arborist to submit a post-construction assessment report to the City for review.
 - b) Submission of a Tree Survival Security to the City in the amount of \$3,000 for the four off-site trees to be retained (\$750/tree).
 - c) installation of appropriate tree protection fencing around all trees to be retained as part of the development prior to any construction activities, including building demolition, occurring on-site.
4. Registration of a legal agreement on title identifying that the proposed development must be designed and constructed in a manner that mitigates potential traffic noise generated by No 4 Road to the proposed dwelling units. Dwelling units must be designed and constructed to achieve:
 - a) CMHC guidelines for interior noise levels as indicated in the chart below:

Portions of Dwelling Units	Noise Levels (decibels)
Bedrooms	35 decibels
Living, dining, recreation rooms	40 decibels
Kitchen, bathrooms, hallways, and utility rooms	45 decibels

- b) the ASHRAE 55-2004 "Thermal Environmental Conditions for Human Occupancy" standard for interior living spaces.
5. Registration of a flood indemnity covenant on title.
6. Registration of a cross-access easement, statutory right-of-way, and/or other legal agreements or measures, as determined to the satisfaction of the Director of Development, over the internal drive-aisle in favour of future developments to the north of the site, including the installation of way-finding and other appropriate signage on the subject property, and requiring a covenant that the owner provide written notification of this through the disclosure statement to all initial purchasers, provide an acknowledgement of the same in all purchase and sale agreements, and erect signage in the initial sales centre advising purchasers of the potential for these impacts.
7. The submission and processing of a Development Permit* completed to a level deemed acceptable by the Director of Development.
8. Contribution of \$1,769 per dwelling unit (e.g. \$33,611) in-lieu of on-site indoor amenity space to go towards development of City facilities.
9. City acceptance of the developer's offer to voluntarily contribute \$8.50 per buildable square foot (e.g. \$215,051.65) to the City's affordable housing fund.
10. Enter into a Servicing Agreement* for the design and construction of engineering infrastructure improvements. A Letter of Credit or cash security for the value of the Service Agreement works, as determined by the City, will be required as part of entering into the Servicing Agreement. Works include, but may not be limited to:

Water Works

- a) Using the OCP Model, there are 288 L/s of water available at 20 psi residual at the hydrant on the west side of No. 4 Road, fronting lot 10491 No 4 Road. Based on your proposed development, your site requires a minimum fire flow of 220 L/s.

- b) The Developer is required to:
- i. Confirm with Richmond Fire Rescue (RFR) that the fire hydrant on the west side of No. 4 Road, fronting lot 10491 No 4 Road, is sufficient to service the development. Knowing that in the event of an emergency the Fire Truck and hose would shut down No. 4 Road in both the North and South directions if the hydrant at 10491 No 4 Road will be utilized.
 - ii. Submit Fire Underwriter Survey (FUS) or International Organization for Standardization (ISO) fire flow calculations to confirm the development has adequate fire flow for onsite fire protection. Calculations must be signed and sealed by a Professional Engineer and be based on Building Permit Stage and Building designs.
 - iii. Provide right of way for water meter chamber, exact dimensions and location of the right of way shall be finalized at the servicing agreement stage.
- c) At the Developer's cost, the City is to:
- i. Cut and cap at main the existing water service connections at the No. 4 Road frontage.
 - ii. Install a new water service connection at the No. 4 Road frontage, complete with water meter and meter chamber in a right-of-way onsite which will be provided by the developer.

Storm Sewer Works

- d) At the Developer's cost, the City will:
- i. Cut and cap the existing connections along No. 4 Road frontage.
 - ii. Remove all old connections and install one new storm sewer connection to service the proposed site. Details of the new storm service shall be finalized via the servicing agreement design review.

Sanitary Sewer Works

- e) The Developer is required to:
- i. Replace the existing sanitary sewer along the rear yard to 200mm diameter PVC, approximately 80m in length, and install one new 1200mm manhole 1.5m south of the northern property line. An additional 1200mm manhole to be installed at high end of system, located at southern PL of lot 10400 No 4 Road. This is required as the current sanitary line will sit beneath the necessary retaining wall (and approx. 1m of fill) required to raise the site above flood construction level.
 - ii. The new sanitary sewer is to sit 1.5m east of the property line, in the middle of the City's right of way within the properties to the east.
 - iii. Notify neighbors to the east about the required sanitary works occurring in the City's right of way within their property line.
 - iv. Re-connect existing single family homes to east of development to the new sanitary sewer as they are part of the same system.
 - v. Restore all rear yard landscaping that would be impacted by the sanitary works at developer's cost.
 - vi. Provide one new sanitary service connection to accommodate the development at the northern property line.
 - vii. All site preparation works (e.g., preload, etc.) and building foundation works shall not commence until the required sanitary works are complete. Therefore, the developer may have to finalize the SA design and construct the sanitary works prior to site preparation works.
- f) At the Developer's cost, the City is to:
- i. Cap existing sanitary connections along the property line.

Frontage Improvements

- g) The Developer is required to:
- i. Coordinate with BC Hydro, Telus, and other private communication service providers to:
 - ii. Review existing street lighting levels along No. 4 Road and upgrade accordingly along development's frontage.

- iii. Provide other frontage improvements as per Transportation's requirements. Improvements shall be built to the ultimate condition wherever possible.

General Items

- h) The Developer is required to:
- i. Provide if pre-load is required, prior to pre-load installation, a geotechnical assessment of preload and soil preparation impacts on the existing utilities fronting or within the development site, proposed utility installations, and provide mitigation recommendations. The mitigation recommendations shall be incorporated into the first SA design submission or if necessary to be implemented prior to pre-load.
 - ii. Additional legal agreements, as determined via the subject development's Servicing Agreement(s) and/or Development Permit(s), and/or Building Permit(s) to the satisfaction of the Director of Engineering may be required, including, but not limited to, site investigation, testing, monitoring, site preparation, de-watering, drilling, underpinning, anchoring, shoring, piling, pre-loading, ground densification or other activities that may result in settlement, displacement, subsidence, damage or nuisance to City and private utility infrastructure.
11. Ensure that, via the Servicing Agreement process, the required replacement of sanitary infrastructure is accommodated through:
- a) the removal of trees that are located within the existing sanitary statutory right-of-way, including:
 - i. provision of additional replacement trees (two replacement trees for every off-site tree that permission is obtained for removal) reflected on an updated landscaping plan or tree planting plan and submission of a Landscape Security in the amount of \$750 per additional replacement tree; minimum 6 cm deciduous caliper or 3.5 m high conifers). NOTE: minimum replacement size to be as per **Tree Protection Bylaw No. 8057 Schedule A – 3.0 Replacement Trees**; or
 - ii. provision of the developer's offer to voluntarily contribute \$750 per additional replacement tree that is unable to be planted on-site to the City's Tree Compensation Fund for the planting of replacement trees within the City.
 - b) provision of additional statutory right-of-way area, for which the design must be prepared in accordance with City specifications & standards. Works to be secured via Servicing Agreement (SA). The maintenance & liability responsibility is to be clearly noted. The design must be prepared in accordance with City specifications & standards and the construction of the works will be inspected by the City concurrently with all other SA related works; or;
 - c) an alternative solution that is acceptable to City Engineering staff.
12. If deemed necessary by City Engineering staff via the Servicing Agreement process, registration of a new sanitary statutory right-of-way (or modification of the existing statutory right-of-way) on the subject site in order to accommodate sanitary infrastructure.

Prior to a Development Permit* being forwarded to the Development Permit Panel for consideration, the developer is required to:

13. Ensure that, via the Servicing Agreement process, the required replacement of sanitary infrastructure is accommodated through:
- a) the removal of trees that are located within the existing sanitary statutory right-of-way, including:
 - iii. provision of additional replacement trees (two replacement trees for every off-site tree that permission is obtained for removal) reflected on an updated landscaping plan or tree planting plan and submission of a Landscape Security in the amount of \$750 per additional replacement tree; minimum 6 cm deciduous caliper or 3.5 m high conifers). NOTE: minimum replacement size to be as per **Tree Protection Bylaw No. 8057 Schedule A – 3.0 Replacement Trees**; or
 - iv. provision of the developer's offer to voluntarily contribute \$750 per additional replacement tree that is unable to be planted on-site to the City's Tree Compensation Fund for the planting of replacement trees within the City.
 - b) provision of additional statutory right-of-way area, for which the design must be prepared in accordance with City specifications & standards. Works to be secured via Servicing Agreement (SA). The maintenance & liability

responsibility is to be clearly noted. The design must be prepared in accordance with City specifications & standards and the construction of the works will be inspected by the City concurrently with all other SA related works; or;

- c) an alternative solution that is acceptable to City Engineering staff.
14. Ensure that no part of a building, structure hard ground surface or tree is proposed to be located within or encroach into an existing or proposed statutory right-of-way.
15. Submission of a Landscape Plan and a landscaping cost estimate that (including installation costs), prepared by a Registered Landscape Architect, to the satisfaction of the Director of Development. The cost estimate should include a 10% contingency. The Landscape Plan should:
- ensure that a total of 32 replacement trees are planted and maintained (minimum 6 cm deciduous caliper or 3.5 m high conifers).
 - not include hedges or trees within a sanitary SRW
 - not include hedges along the front property line;
 - not include species that are prone to contemporary blights;
 - include a mix of coniferous and deciduous trees; and
 - include the dimensions of tree protection fencing as illustrated on the Tree Retention Plan attached to this report.

No. of Replacement Trees	Minimum Caliper of Deciduous Replacement Tree	Minimum Height of Coniferous Replacement Tree
10	6 cm	3.5 m
12	8 cm	4 m
4	9 cm	5 m
2	10 cm	5.5 m
4	11 cm	6 m

16. Complete an acoustical and thermal report and recommendations prepared by an appropriate registered professional, which demonstrates that the interior noise levels and noise mitigation standards comply with the City's Official Community Plan and Noise Bylaw requirements. The standard required for air conditioning systems and their alternatives (e.g. ground source heat pumps, heat exchangers and acoustic ducting) is the ASHRAE 55-2004 "Thermal Environmental Conditions for Human Occupancy" standard and subsequent updates as they may occur. Maximum interior noise levels (decibels) within the dwelling units must achieve CMHC standards follows:

Portions of Dwelling Units	Noise Levels (decibels)
Bedrooms	35 decibels
Living, dining, recreation rooms	40 decibels
Kitchen, bathrooms, hallways, and utility rooms	45 decibels

17. Complete a proposed townhouse energy efficiency report and recommendations prepared by a Certified Energy Advisor which demonstrates how the proposed construction will meet or exceed the required townhouse energy efficiency standards (BC Energy Step Code Step 3 or better), in compliance with the City's Official Community Plan.

Prior to a Development Permit* being forwarded to Council for consideration, the development must complete the following requirements:

18. Submission of a Landscape Security based on the cost estimate provided by the Landscape Architect plus a 10% contingency.

Prior to Building Permit Issuance, the developer must complete the following requirements:

19. Submission of a Construction Parking and Traffic Management Plan to the Transportation Department. Management Plan shall include location for parking for services, deliveries, workers, loading, application for any lane closures, and proper construction traffic controls as per Traffic Control Manual for works on Roadways (by Ministry of Transportation) and MMCD Traffic Regulation Section 01570.

20. Incorporation of accessibility measures in Building Permit (BP) plans as determined via the Rezoning and/or Development Permit processes.
21. Obtain a Building Permit (BP) for any construction hoarding. If construction hoarding is required to temporarily occupy a public street, the air space above a public street, or any part thereof, additional City approvals and associated fees may be required as part of the Building Permit. For additional information, contact the Building Approvals Department at 604-276-4285.

Note:

- * This requires a separate application.
- Where the Director of Development deems appropriate, the preceding agreements are to be drawn not only as personal covenants of the property owner but also as covenants pursuant to Section 219 of the Land Title Act.

All agreements to be registered in the Land Title Office shall have priority over all such liens, charges and encumbrances as is considered advisable by the Director of Development. All agreements to be registered in the Land Title Office shall, unless the Director of Development determines otherwise, be fully registered in the Land Title Office prior to enactment of the appropriate bylaw.

The preceding agreements shall provide security to the City including indemnities, warranties, equitable/rent charges, letters of credit and withholding permits, as deemed necessary or advisable by the Director of Development. All agreements shall be in a form and content satisfactory to the Director of Development.

- Additional legal agreements, as determined via the subject development's Servicing Agreement(s) and/or Development Permit(s), and/or Building Permit(s) to the satisfaction of the Director of Engineering may be required including, but not limited to, site investigation, testing, monitoring, site preparation, de-watering, drilling, underpinning, anchoring, shoring, piling, pre-loading, ground densification or other activities that may result in settlement, displacement, subsidence, damage or nuisance to City and private utility infrastructure.
- Applicants for all City Permits are required to comply at all times with the conditions of the Provincial *Wildlife Act* and Federal *Migratory Birds Convention Act*, which contain prohibitions on the removal or disturbance of both birds and their nests. Issuance of Municipal permits does not give an individual authority to contravene these legislations. The City of Richmond recommends that where significant trees or vegetation exists on site, the services of a Qualified Environmental Professional (QEP) be secured to perform a survey and ensure that development activities are in compliance with all relevant legislation.

Signed

Date



**Richmond Zoning Bylaw 8500
Amendment Bylaw 10261 (RZ 18-831725)
10340, 10360, 10380, 10400 and 10420 No. 4 Road**

The Council of the City of Richmond, in open meeting assembled, enacts as follows:

1. The Zoning Map of the City of Richmond, which accompanies and forms part of Richmond Zoning Bylaw 8500, is amended by repealing the existing zoning designation of the following area and by designating it "**MEDIUM DENSITY TOWNHOUSES (RTM2)**"

P.I.D. 003-561-674

Legal Lot 4, Block 4N, Sub Block 3, Plan NWP15456, Section 35, Range 6W,
New Westminster Land District

P.I.D. 003-586-626

Lot 5, Block 4N, Sub Block 3, Plan NWP15456, Section 35, Range 6W, New Westminster
Land District

P.I.D. 004-058-941

Lot 6, Block 4N, Sub Block 3, Plan NWP15456, Section 35, Range 6W, New Westminster
Land District

P.I.D. 010-121-790

Lot 7, Block 4N, Sub Block 3, Plan NWP15456, Section 35, Range 6W, New Westminster
Land District

P.I.D. 003-823-865

Lot 8, Block 4N, Sub Block 3, Plan NWP15456, Section 35, Range 6W, New Westminster
Land District

2. This Bylaw may be cited as "**Richmond Zoning Bylaw 8500, Amendment Bylaw 10261**".

FIRST READING

CITY OF
RICHMOND

APPROVED
by


APPROVED
by Director
or Solicitor


PUBLIC HEARING

SECOND READING

THIRD READING

OTHER CONDITIONS SATISFIED

ADOPTED

MAYOR

CORPORATE OFFICER