and and a second

4 UNIT DUPLEX DEVELOPMENT (RZ 19-878165 / DP 22-011557) AT 6531 FRANCIS ROAD, RICHMOND, BC

ISSUED FOR DP RESUBMISSION 2023-09-05

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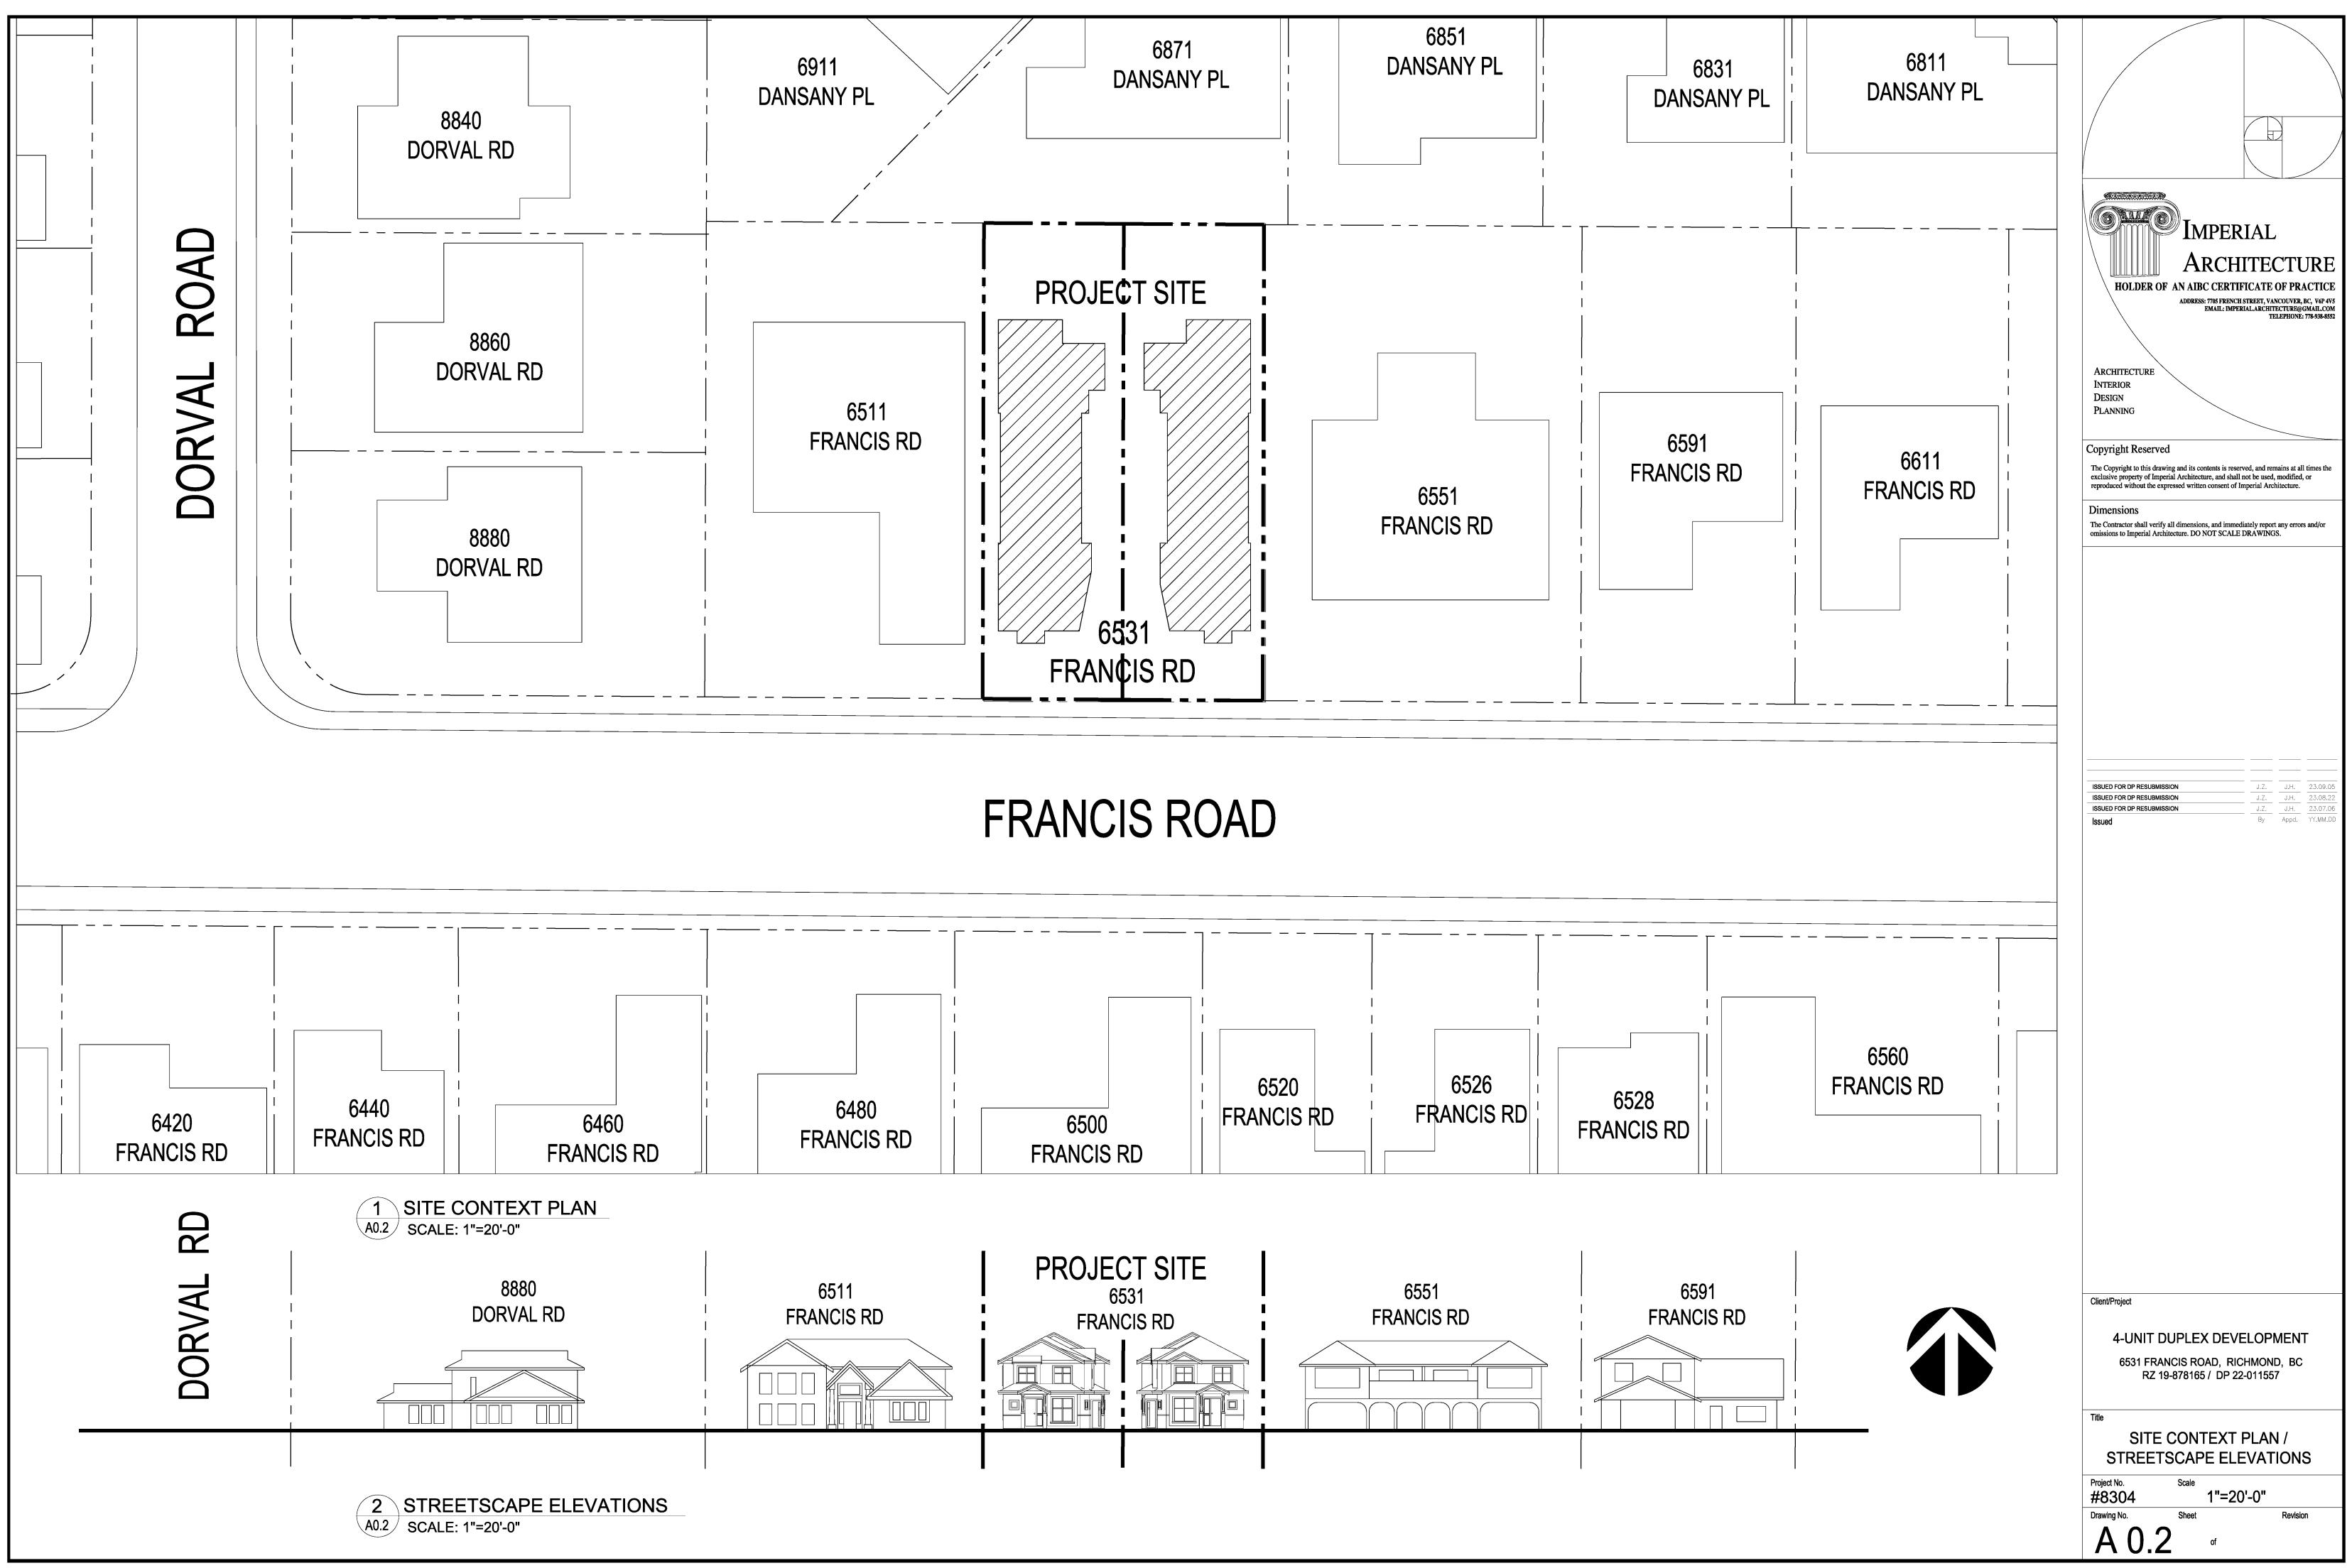
- A0.0 COVER SHEET
- A0.1 SITE AERIAL PHOTO
- A0.2 SITE CONTEXT PLAN / STREET ELEVATION
- A0.3 PROJECT DATA & STATISTICS
- A0.4 PROJECT DATA & STATISTICS
- A0.5 COLOR RENDERINGS
- A0.6 COLOR RENDERINGS
- A0.7 COLOR SAMPLE BOARD
- A0.8 COLOR RENDERINGS
- A0.9 COLOR SAMPLE BOARD
- A1.0 SITE SURVEY
- SITE PLAN A1.1
- A1.2 PARKING PLAN
- A1.3 SITE COVERAGE OVERLAY
- PRIVATE OUTDOOR SPACE OVERLAY A1.4
- A1.5 SUBDIVISION PLAN
- A1.6 FIRE FIGHTING PLAN

A2.2 A2.3 A2.3A A2.4 A2.4	BLDG A & B LEVEL 1 CONTEXT FLOOR PLANS BLDG A & B LEVEL 2 CONTEXT FLOOR PLANS BLDG A LEVEL 1 & 2 FLOOR PLANS BLDG A LEVEL 1 & 2 AREA OVERLAY BLDG B LEVEL 1 & 2 FLOOR PLANS BLDG B LEVEL 1 & 2 AREA OVERLAY BLDG A & B ROOF PLANS	
A3.1	BUILDING A ELEVATIONS BUILDING B ELEVATIONS	Client/Project 4-UNIT DUPLEX DEVELOPMENT
A4.1	BUILDING SECTIONS	6531 FRANCIS ROAD, RICHMOND, BC RZ 19-878165 / DP 22-011557
A5.1	CONVERTIBLE UNIT FLOOR PLANS	
		Project No. Scale #8304 N.T.S. Drawing No. Sheet Revision
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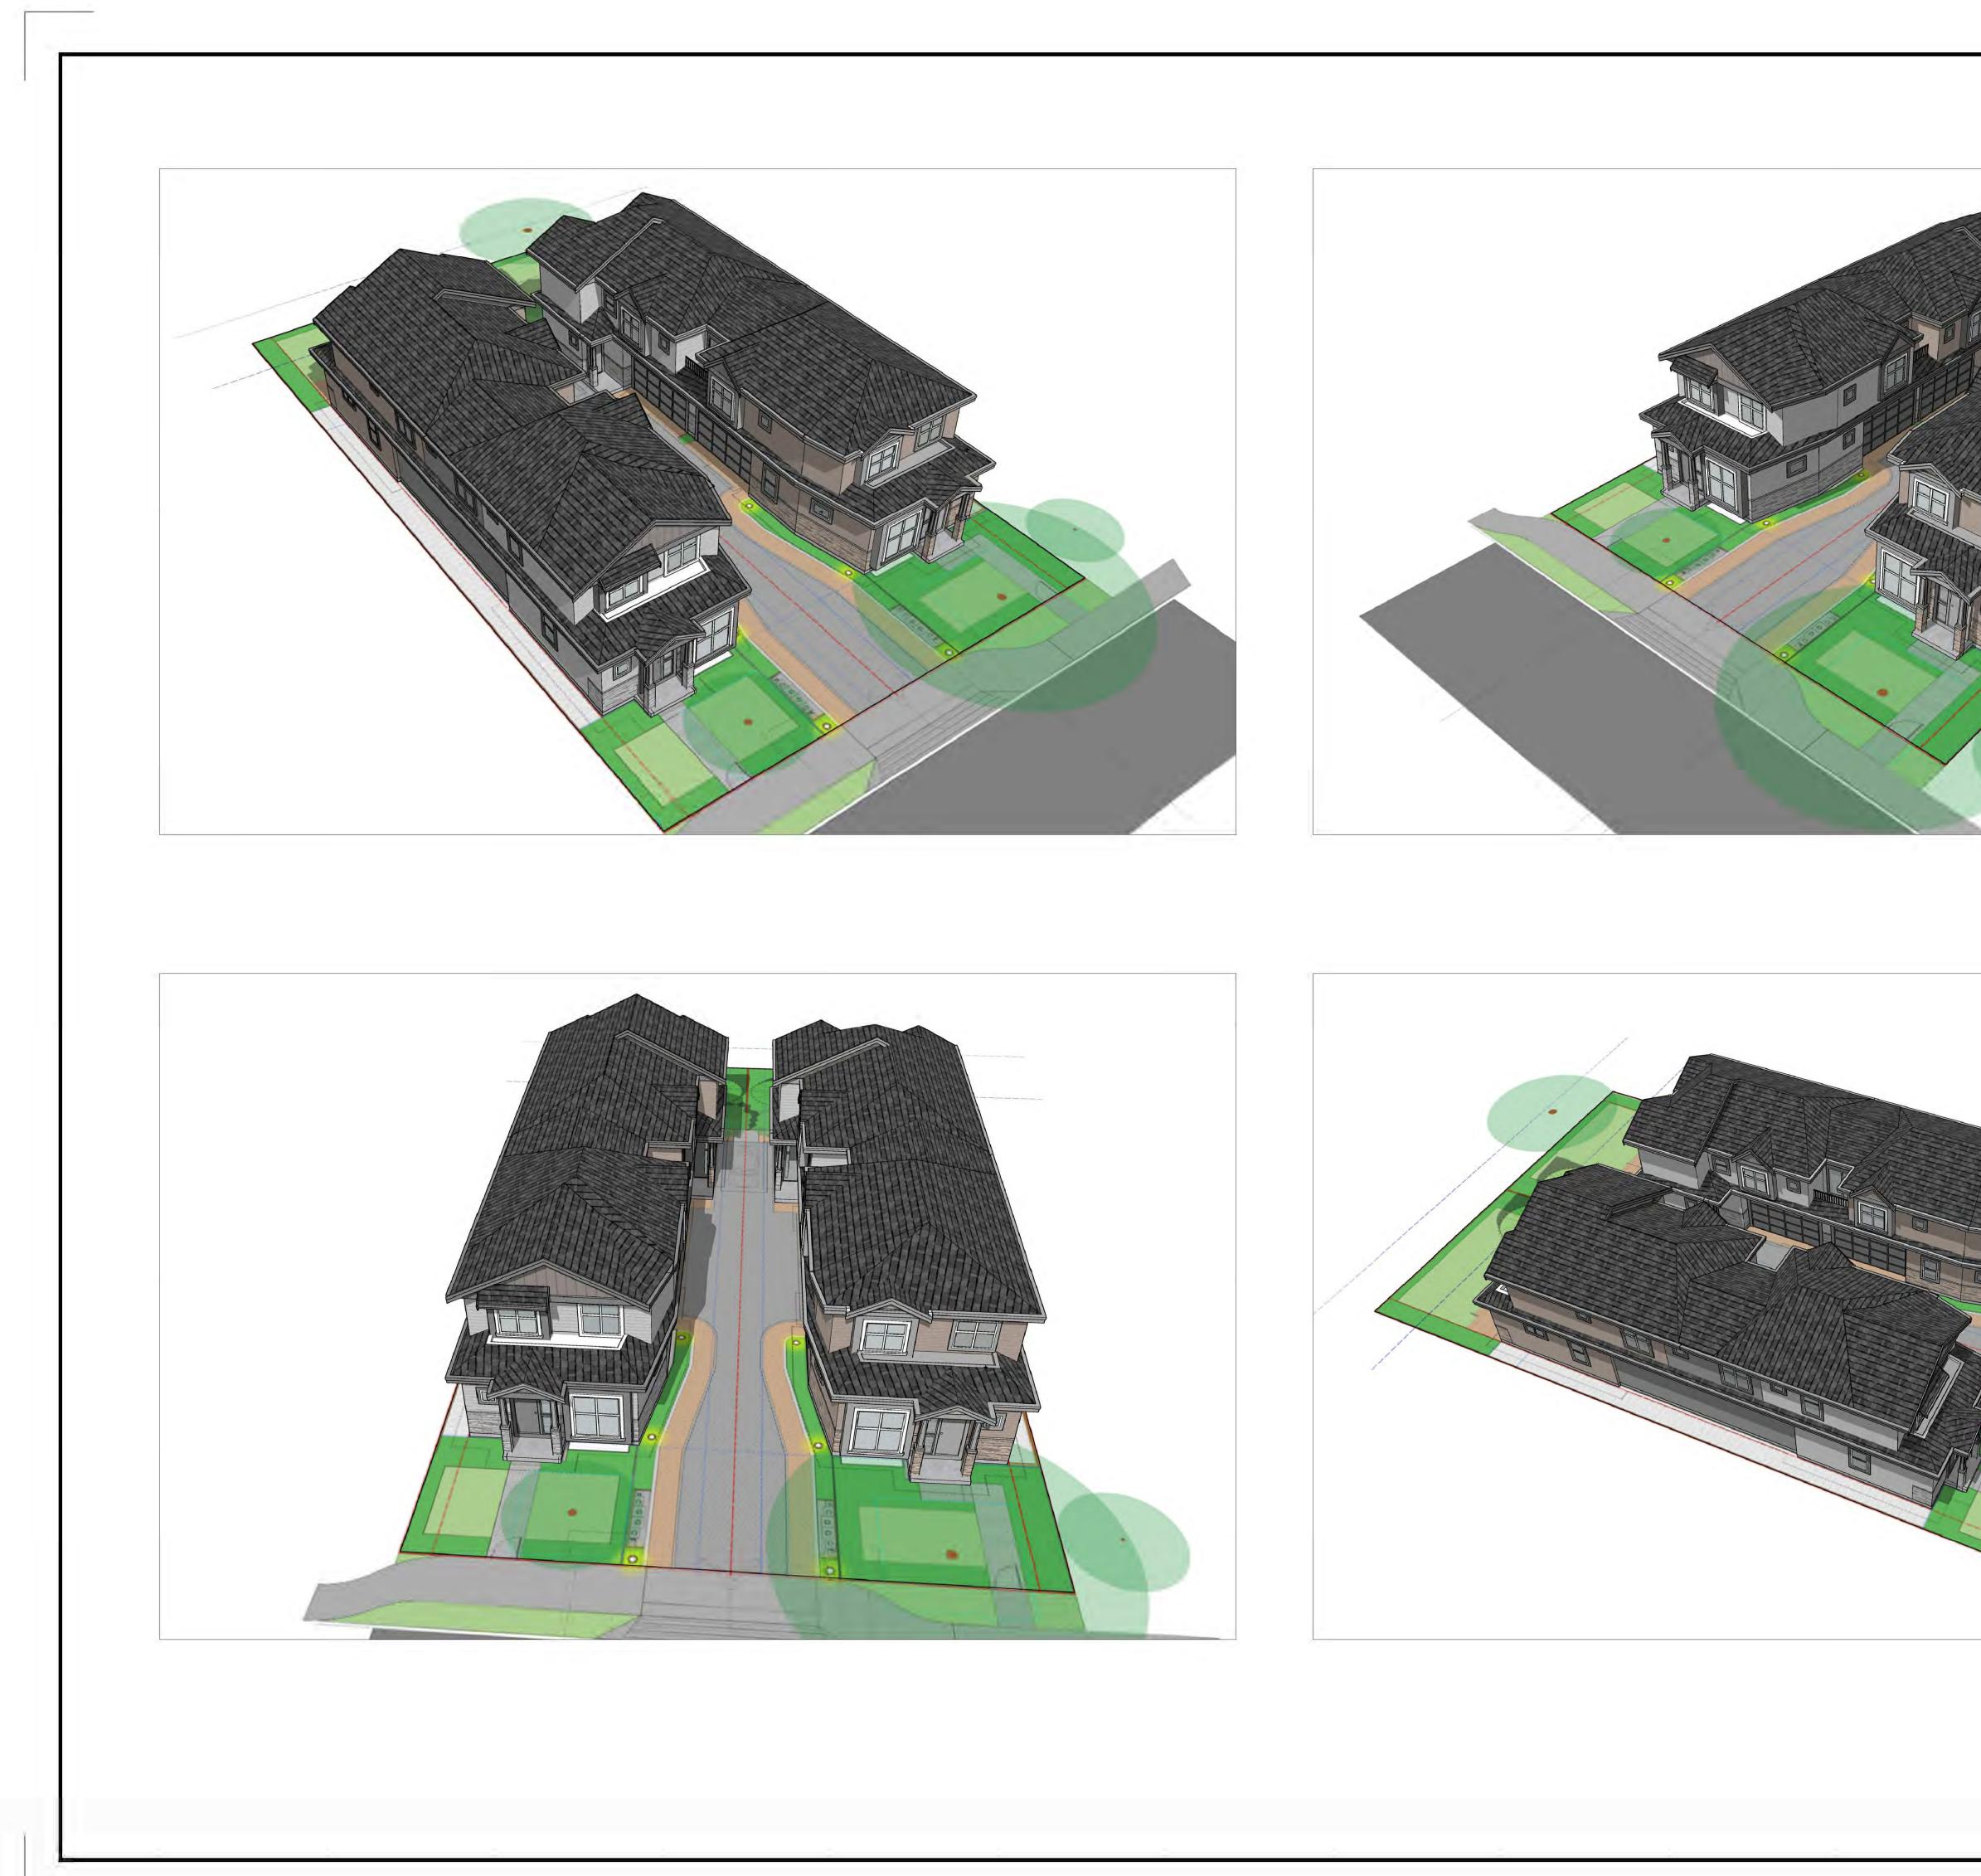





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Client/Project	
4-UNIT DUPLEX D	
	, RICHMOND, BC
4-UNIT DUPLEX E 6531 FRANCIS ROAD	, RICHMOND, BC
4-UNIT DUPLEX E 6531 FRANCIS ROAD RZ 19-878165 / 1	, RICHMOND, BC DP 22-011557
4-UNIT DUPLEX E 6531 FRANCIS ROAD RZ 19-878165 / I Title SITE AERIA Project No. Scale	, RICHMOND, BC DP 22-011557









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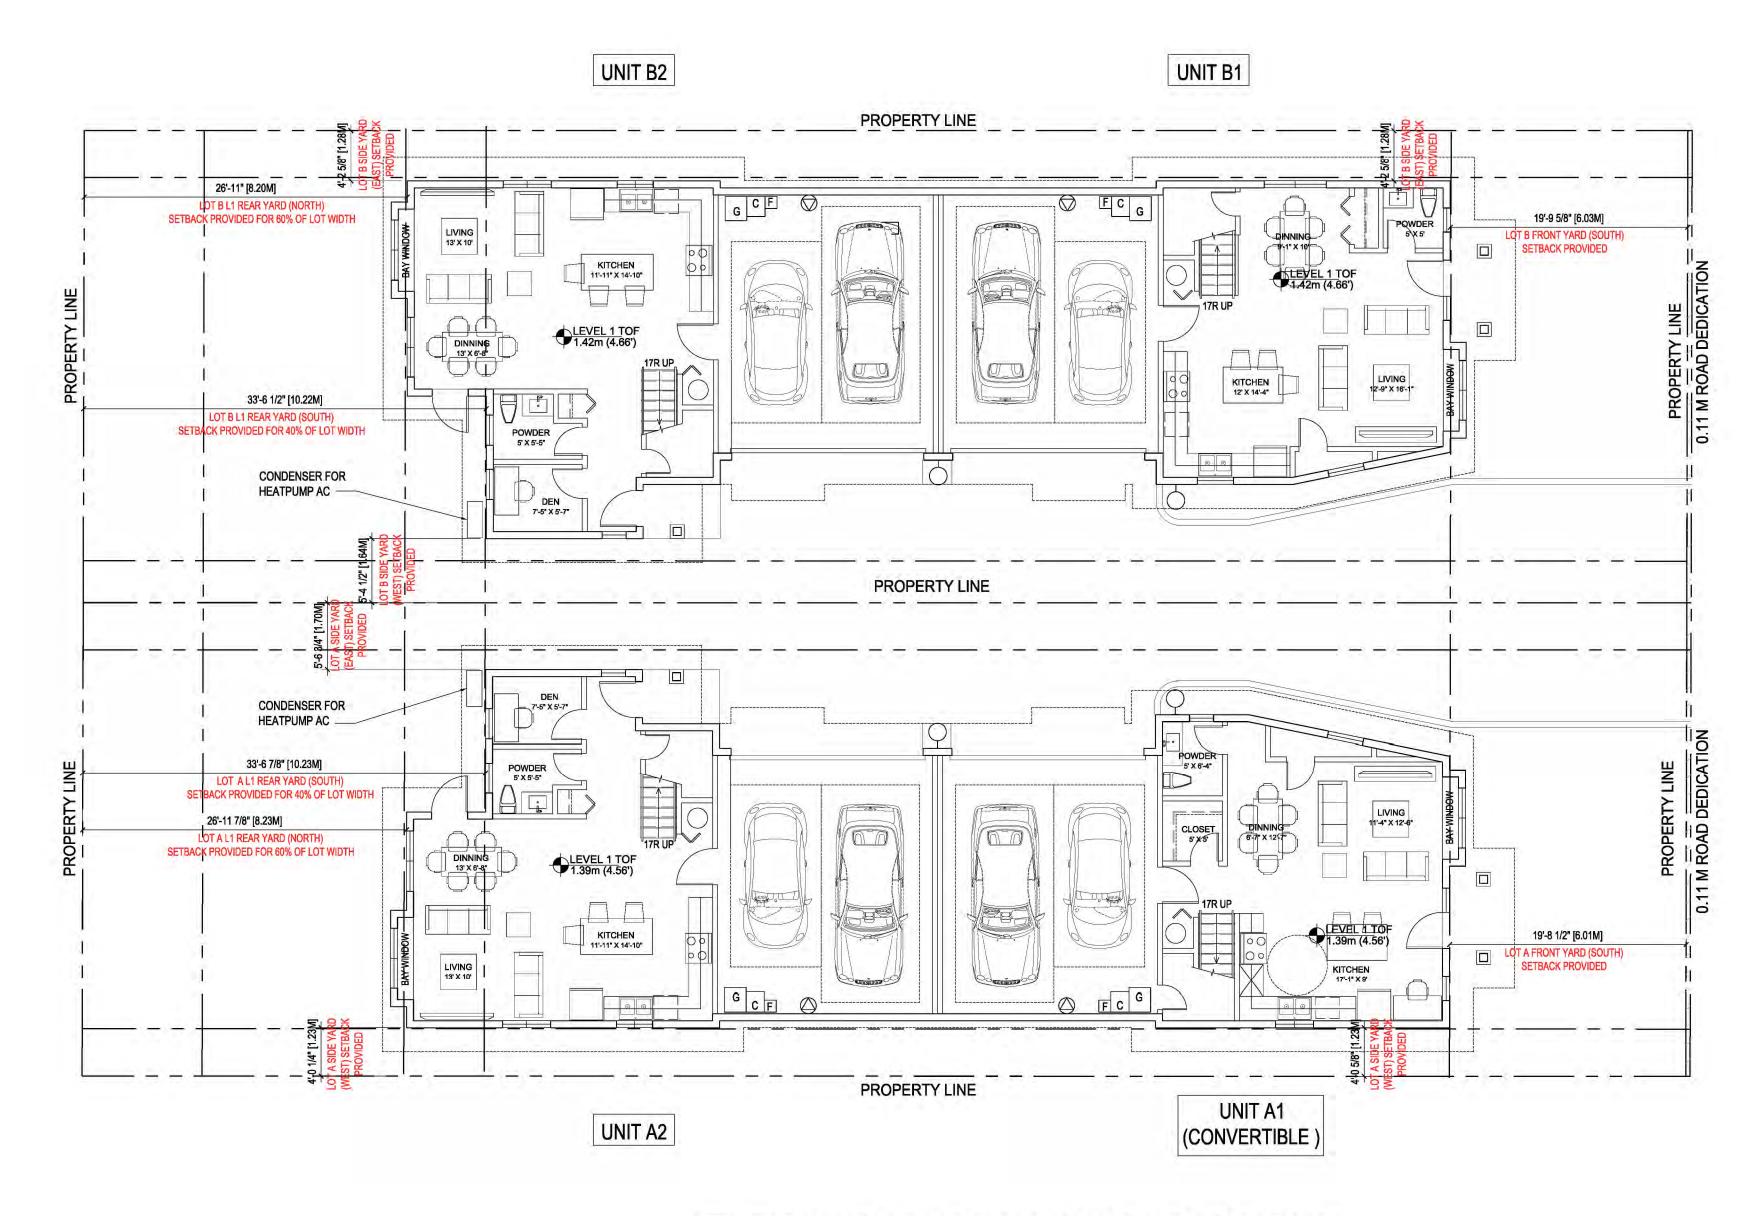


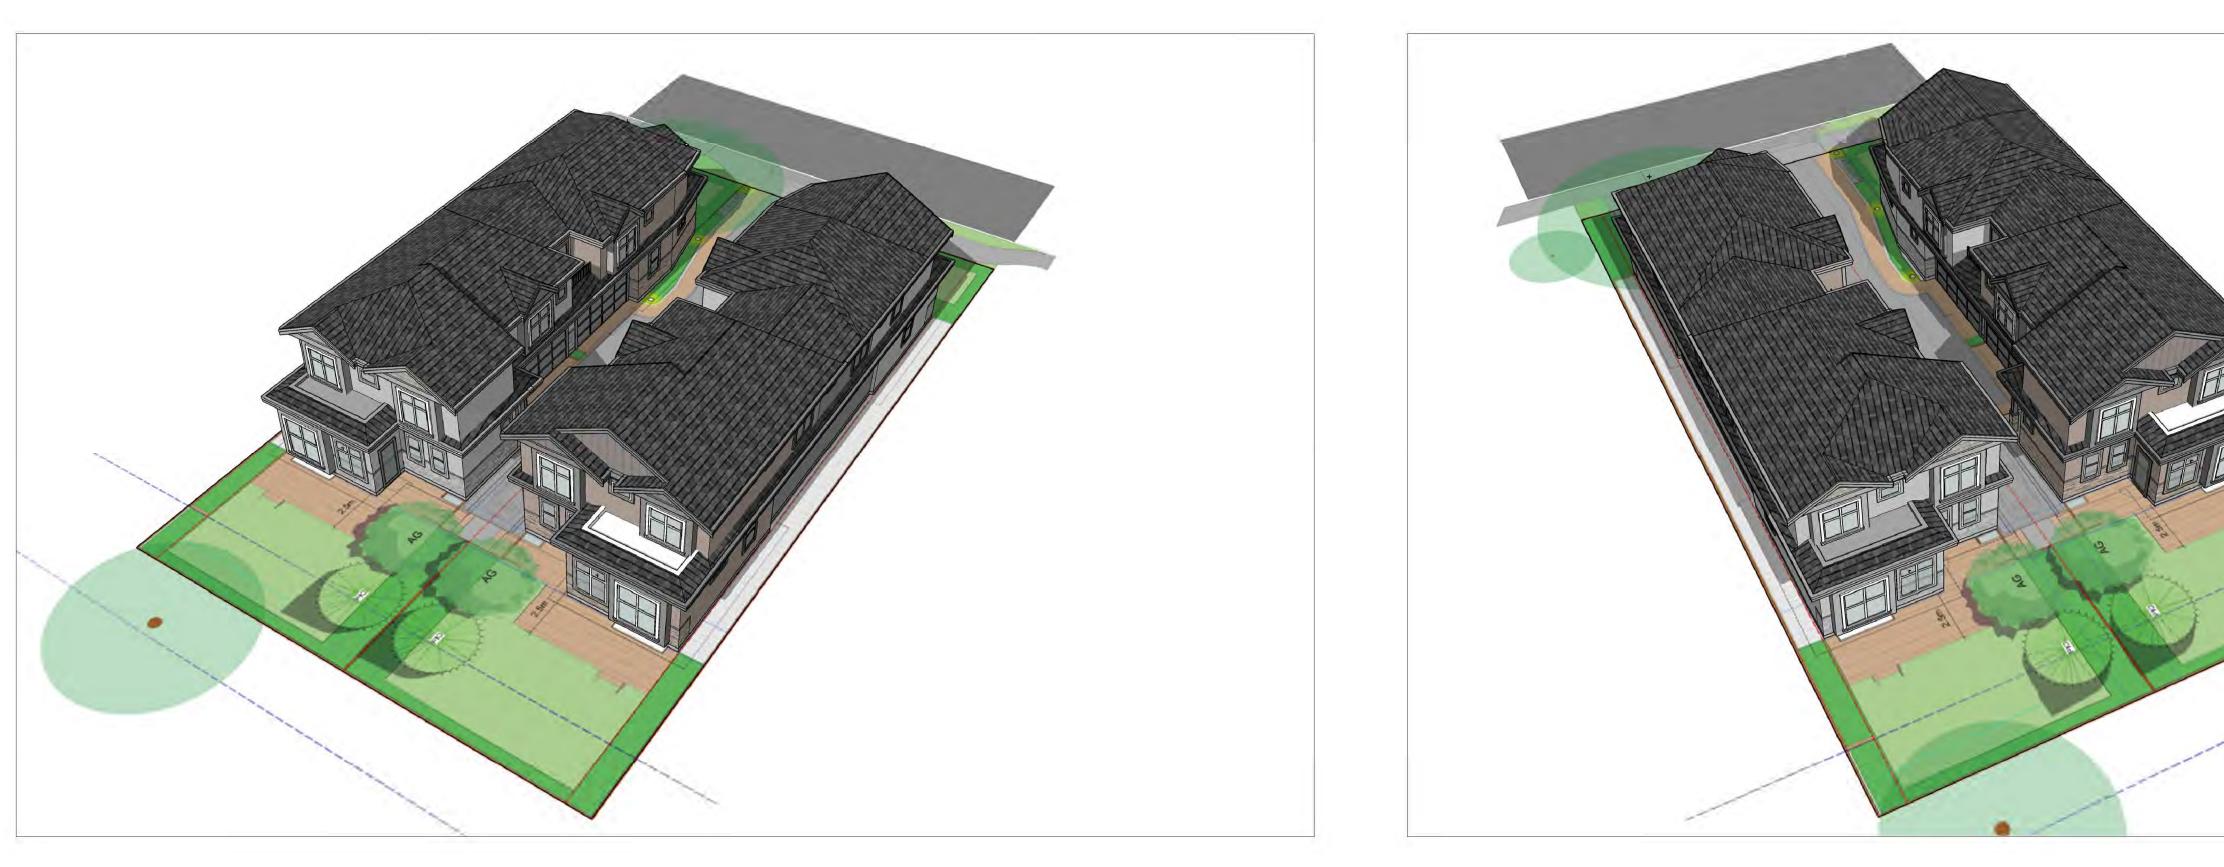

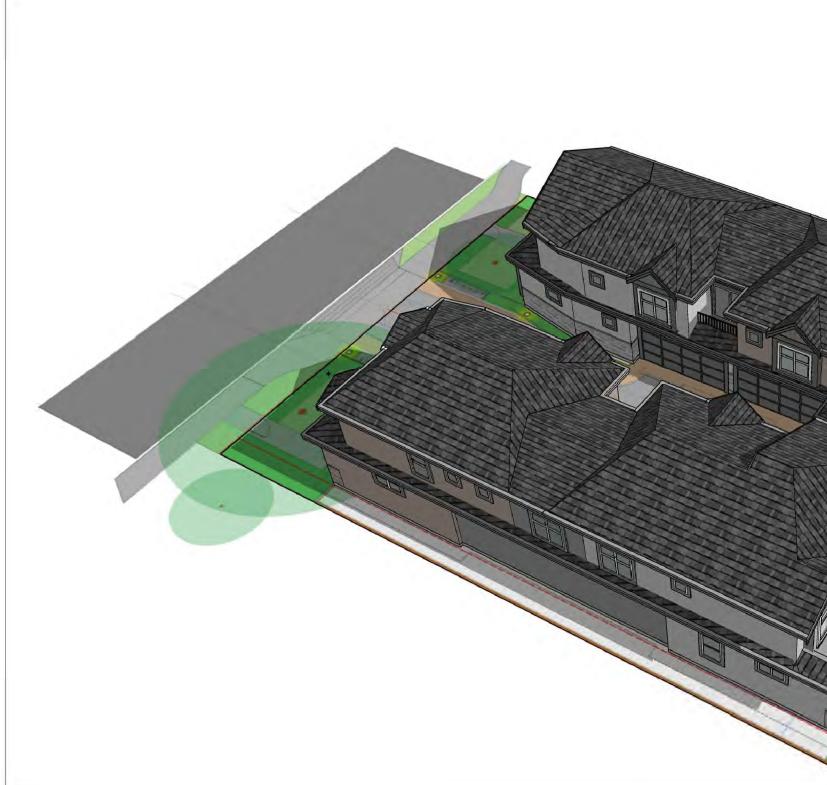

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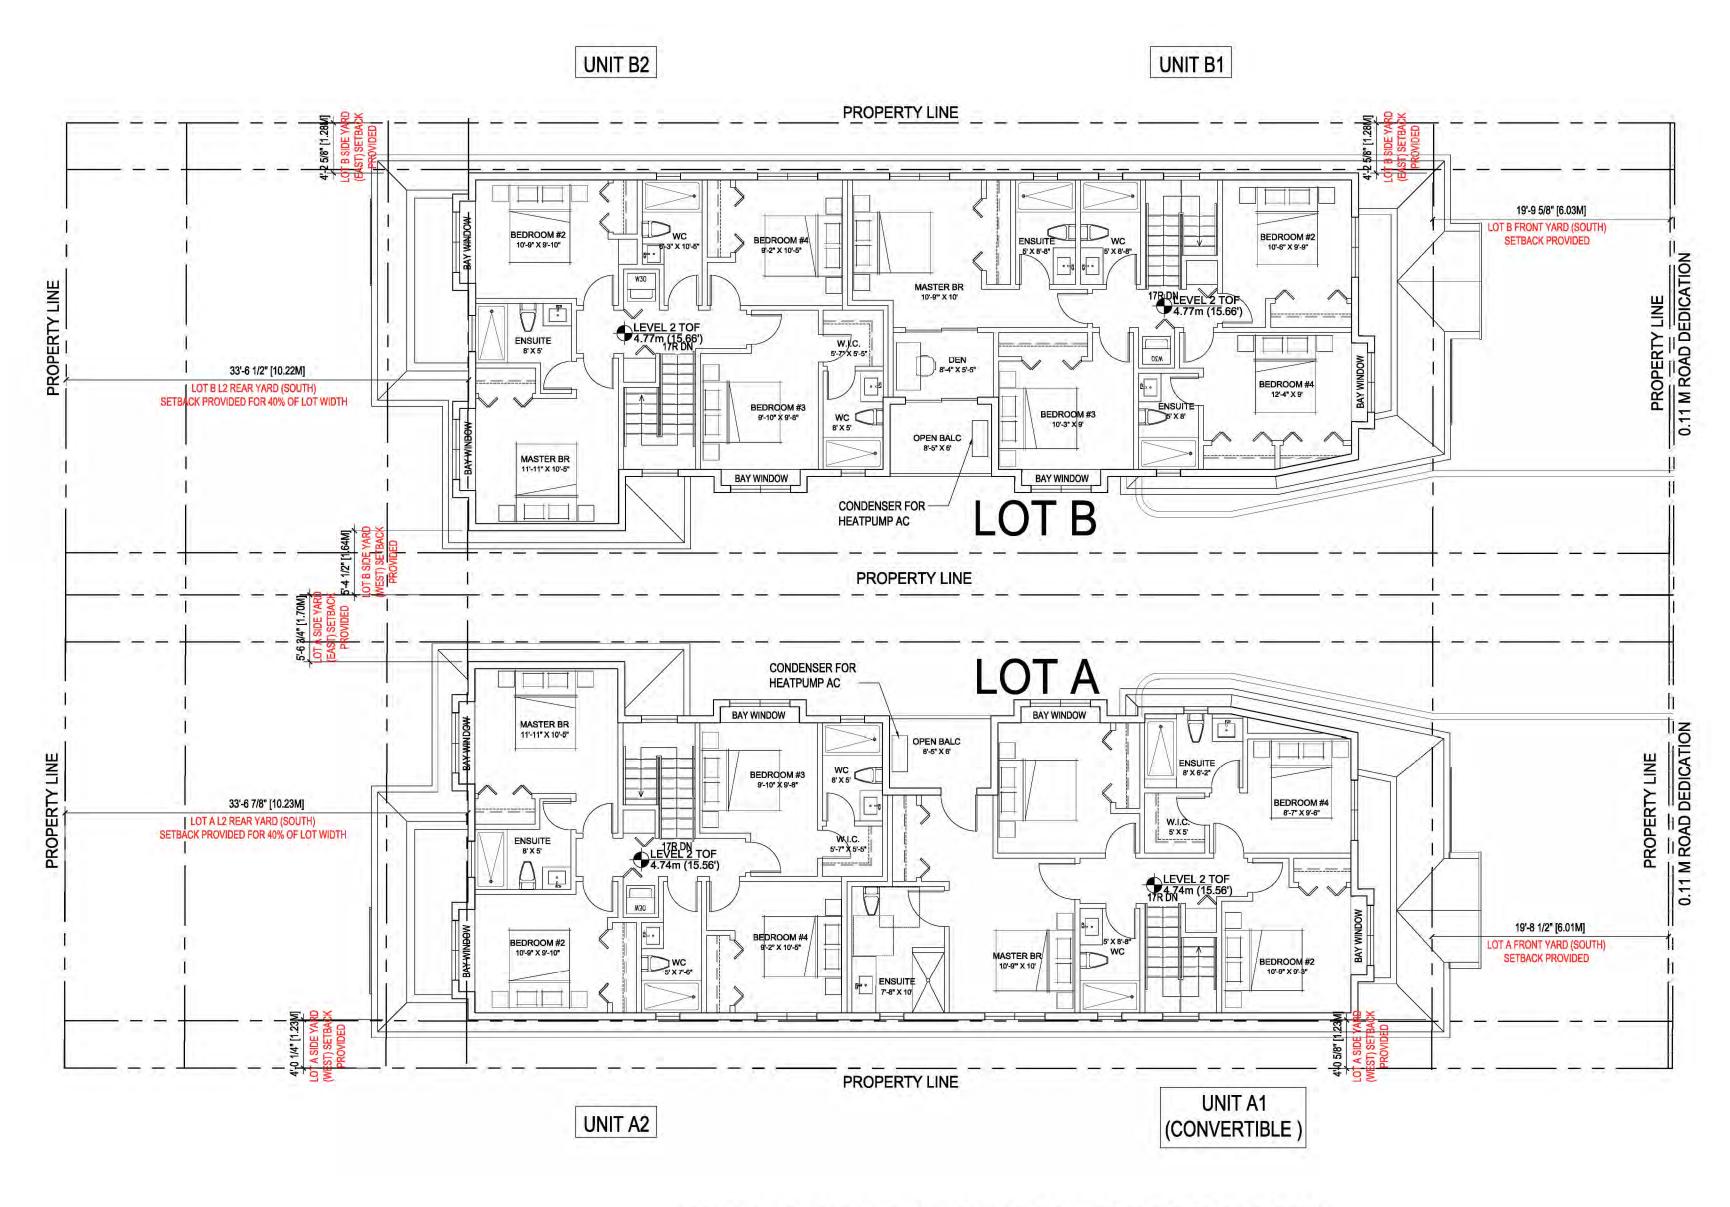


	1.1.1.1		Buildin	gA		
Address	Unit	Uni	t A2	Total		
Feature (BD / DEN)	4 Bedroom		4 Bec	Iroom	2	Units
Feature (Bath)	4 Bath		4 B	ath		
Convertible Unit	1	/				
	SF	SM	SF	SM	SF	SM
Level 1 Gross Area	1046.05	97.18	1096.39	101.86	2142.44	199.04
Level 2 Gross Area	976.06	90.68	903.74	83.96	1879.80	174.64
Total Gross Area	2022.11	187.86	2000.13	185.82	4022.24	373.68
Garage Area exemption	403.64	37.50	403.64	37.50	807.28	75.00
Covered Porch Area exemption	26.18	2.43	15.63	1.45	41.81	3.88
Top Stair Area exemption	10.00	0.93	10.00	0.93	20.00	1.86
Total Exempted Area	439.82	40.86	429.27	39.88	869.09	80.74
Net Floor Area per unit Provided	1582.29	SF	1570.86	SF	3153.15	SF
	147.00	SM	145.94	SM	292.94	SM
Min. Floor Area Per Unit Regruied	125.40	SM	125.40	SM		
Max. Floor Area Per Unit Allowed	183.90	SM	183.90	SM		
Complied with Min. and Max. Floor Area per Unit Allowed	Ye	5	Y	es		

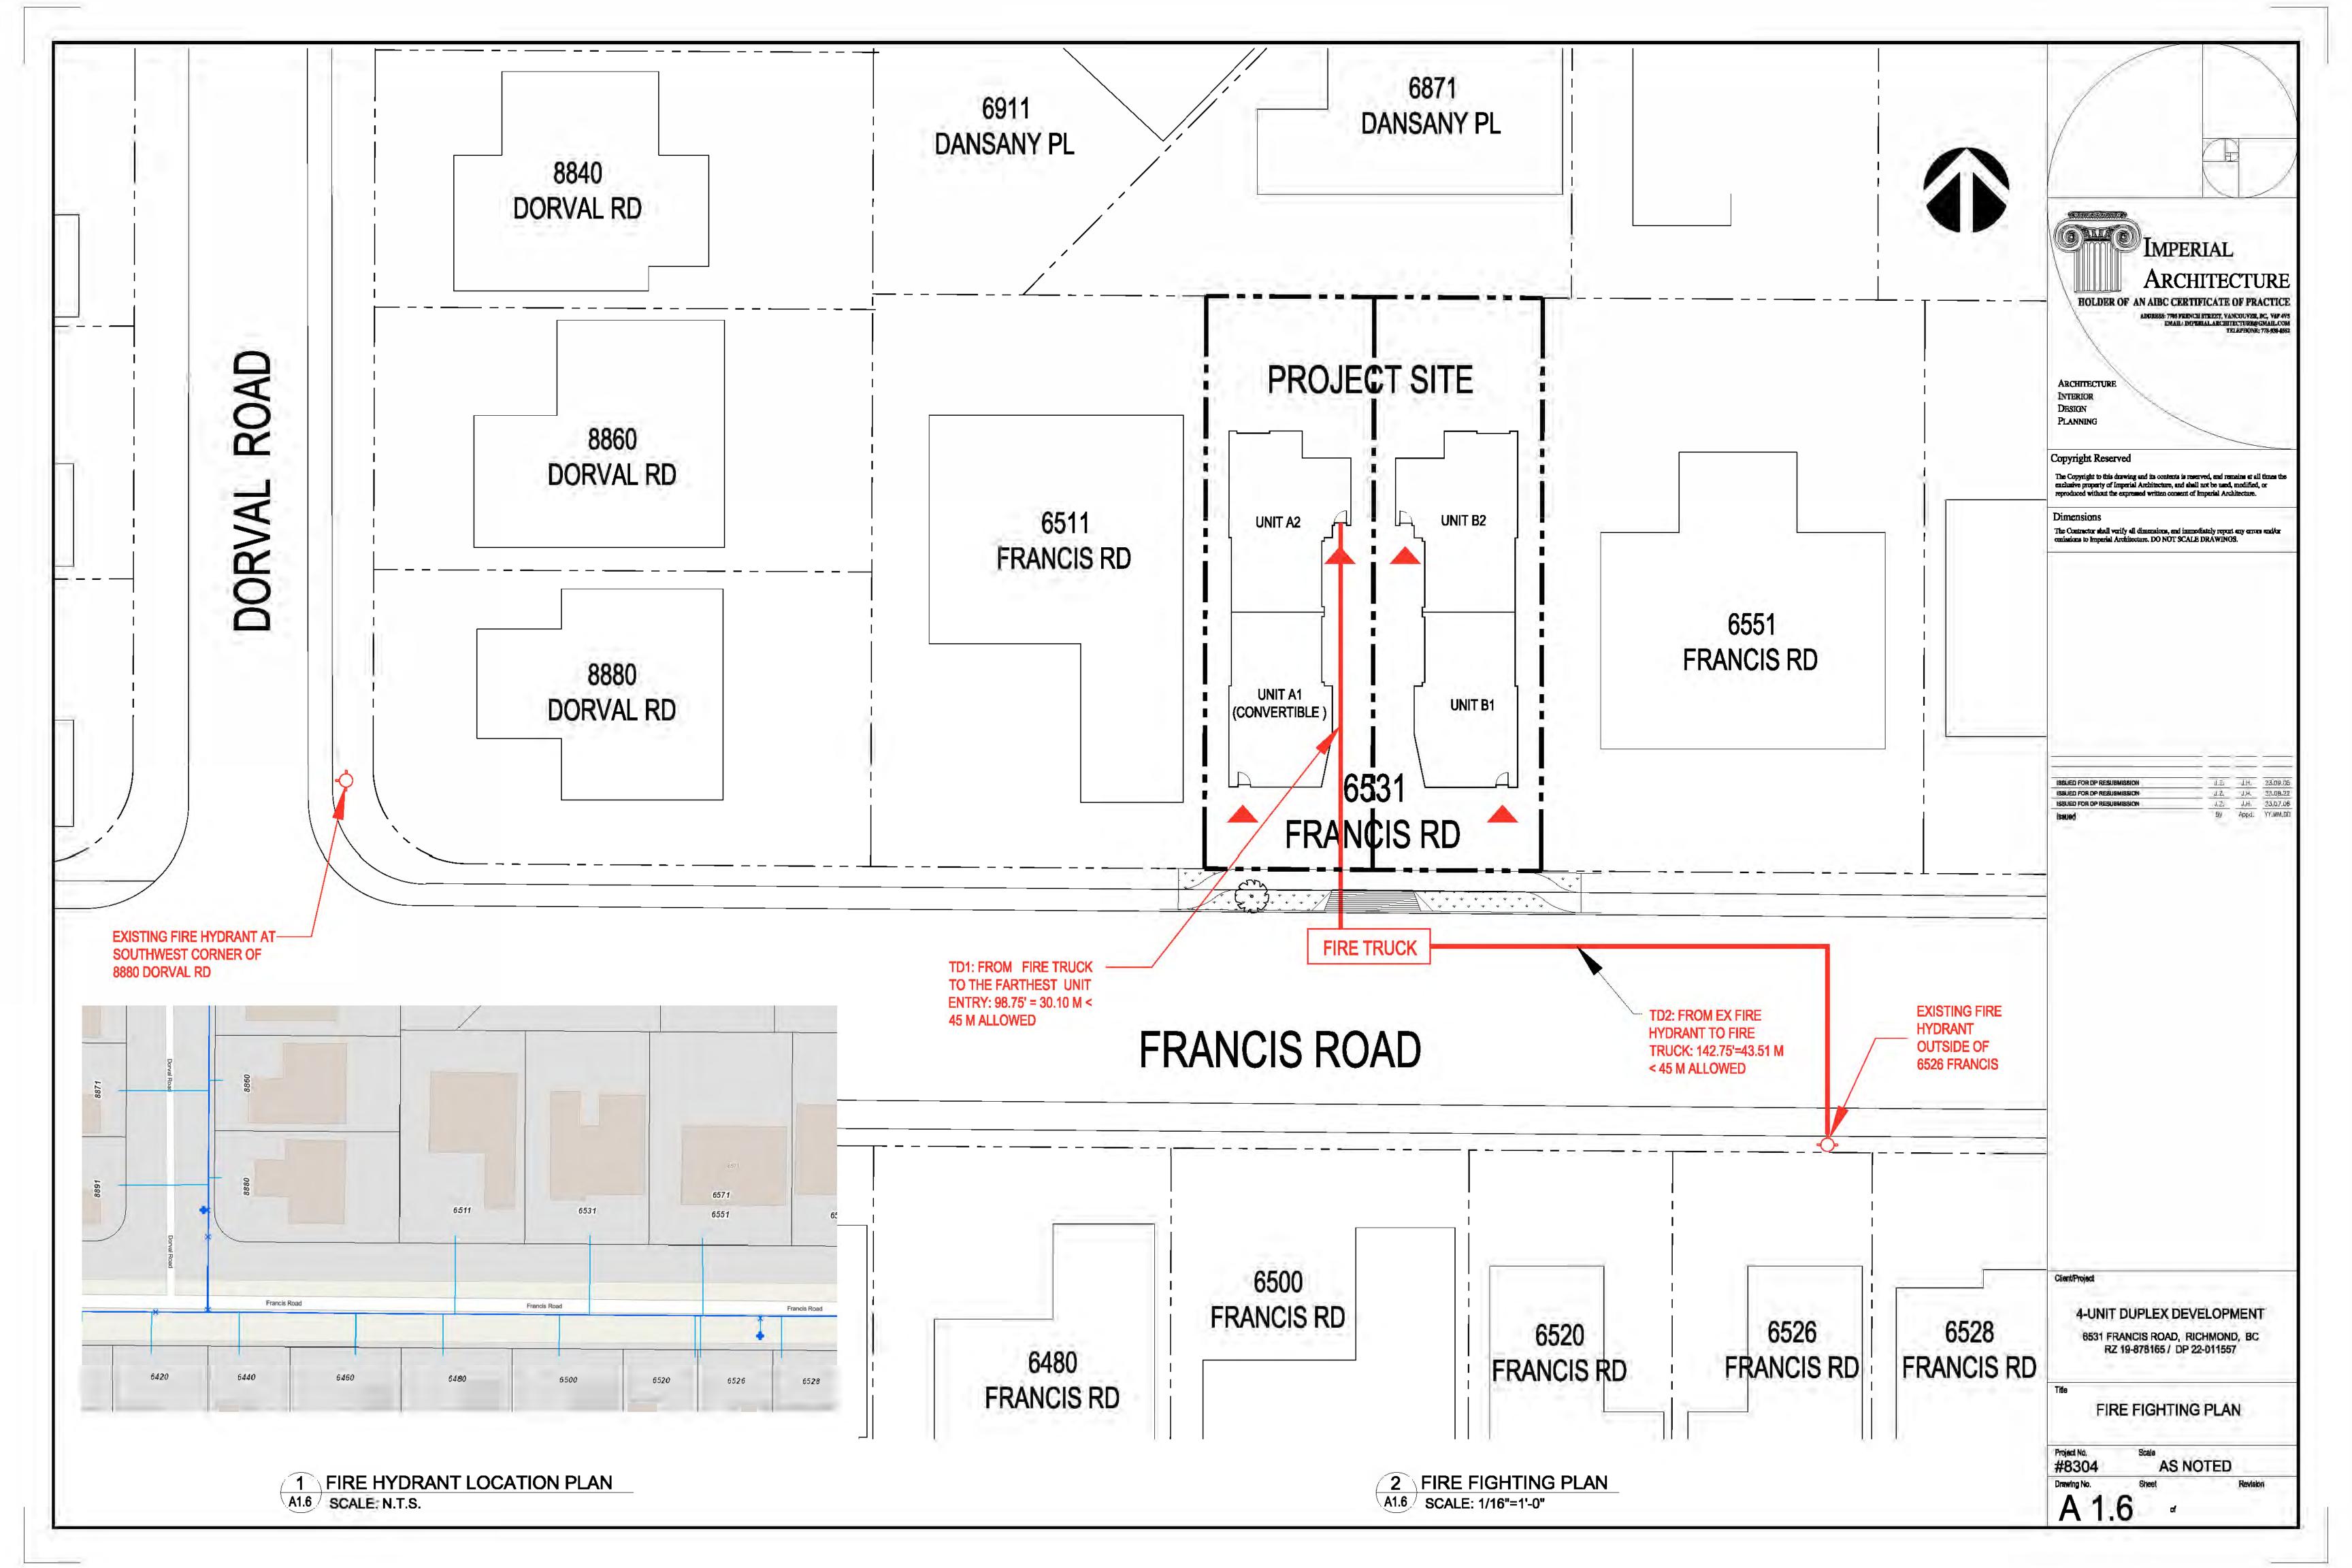1 BLDG A & B LEVEL 1 CONTEXT FLOOR PLANS A2.0 SCALE: 1/8"=1'-0"

Floor Area Calculation - Lot B							
		Building B					
Address	Un	Unit B1		Unit B2		otal	
Feature (BD / DEN)	4 Be	4 Bedroom		4 Bedroom		Units	
Feature (Bath)	41	Bath	4 Bath				
Convertible Unit		1	- 7				
	SF	SM	SF	SM	SF	3	
Level 1 Gross Area	1038.88	96.52	1096.39	101.86	2135.27		
Level 2 Gross Area	970.36	90.15	905.52	84.13	1875.88		
Total Gross Area	2009.24	186.66	2001.91	185.98	4011.15		
Garage Area exemption	403.64	37.50	403.64	37.50	807.28		
Covered Porch Area exemption	26.18	2.43	15.63	1.45	41.81		
Stair Area exemption	10.00	0.93	10.00	0.93	20.00		
Total Exempted Area	439.82	40.86	429.27	39.88	869.09		
Not Elear Area per unit Provided	1569.42	SF	1572.64	SF	3142.06	SF	
Net Floor Area per unit Provided	145.80	SM	146.10	SM	291.91	SM	
Min. Floor Area Per Unit Reqruied	125.40	SM	125.40	SM		1	
Max. Floor Area Per Unit Allowed	183.90	SM	183.90	SM			

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	ISSUED FOR DP RESUBMISSION J.Z. J.H. 23.09.05 ISSUED FOR DP RESUBMISSION J.Z. J.H. 23.09.05 ISSUED FOR DP RESUBMISSION J.Z. J.H. 23.09.05 ISSUED FOR DP RESUBMISSION J.Z. J.H. 23.07.06 ISSUED By Appd. YY.MM.DD
IEVEL 2 EV CHARGE METHOD IS DEFINED AS: VOLTAGE OF 208V TO 240V AC; AND CURRENT OF 16A TO 80A WALL MOUNTED EXTERIOR LIGHTING FIXTURE ROAD DEDICATION	
8.37 4.28 2.65 5.00 3.88 1.86 0.74	Client/Project 4-UNIT DUPLEX DEVELOPMENT 6531 FRANCIS ROAD, RICHMOND, BC RZ 19-878165 / DP 22-011557
	Title BUILDING A & B LEVEL 1 FLOOR PLANS Project No. Scale
	Project No. Scale #8304 1/8"=1'-0" Drawing No. Sheet Revision A 2.0 of




			Buildin	gA			
Address	Unit A1			t A2	Total		
Feature (BD / DEN)	4 Bedroom		4 Bec	Iroom	2	Units	
Feature (Bath)	4 Bath		4 B	ath			
Convertible Unit		 Image: A start of the start of					
	SF	SM	SF	SM	SF	SM	
Level 1 Gross Area	1046.05	97.18	1096.39	101.86	2142.44	199.0	
Level 2 Gross Area	976.06	90.68	903.74	83.96	1879.80	174.6	
Total Gross Area	2022.11	187.86	2000.13	185.82	4022.24	373.6	
Garage Area exemption	403.64	37.50	403.64	37.50	807.28	75.0	
Covered Porch Area exemption	26.18	2.43	15.63	1.45	41.81	3.8	
Top Stair Area exemption	10.00	0.93	10.00	0.93	20.00	1.8	
Total Exempted Area	439.82	40.86	429.27	39.88	869.09	80.7	
Net Floor Area per unit Provided	1582.29	SF	1570.86	SF	3153.15	SF	
	147.00	SM	145.94	SM	292.94	SM	
Min. Floor Area Per Unit Regruied	125.40	SM	125.40	SM			
Max. Floor Area Per Unit Allowed	183.90	SM	183.90	SM			
Complied with Min. and Max. Floor Area per Unit Allowed		/es	Y	es			

1 BLDG A & B LEVEL 2 CONTEXT FLOOR PLANS A2.1 SCALE: 1/8"=1'-0"

Floor Area Calculation - Lot B						
		Building B				
Address	Un	Unit B1 Unit B2		it B2	Total	
Feature (BD / DEN)	4 Be	4 Bedroom		droom	2	2 Units
Feature (Bath)	41	Bath	46	Bath		
Convertible Unit						1
	SF	SM	SF	SM	SF	
Level 1 Gross Area	1038.88	96.52	1096.39	101.86	2135.27	
Level 2 Gross Area	970.36	90.15	905.52	84.13	1875.88	
Total Gross Area	2009.24	186.66	2001.91	185.98	4011.15	
Garage Area exemption	403.64	37.50	403.64	37.50	807.28	
Covered Porch Area exemption	26.18	2.43	15.63	1.45	41.81	
Stair Area exemption	10.00	0.93	10.00	0.93	20.00	
Total Exempted Area	439.82	40.86	429.27	39.88	869.09	
Not Elear Area per unit Browided	1569.42	SF	1572.64	SF	3142.06	SF
Net Floor Area per unit Provided	145.80	SM	146.10	SM	291.91	SM
Min. Floor Area Per Unit Regruied	125.40	SM	125.40	SM		
Max. Floor Area Per Unit Allowed	183.90	SM	183.90	SM		

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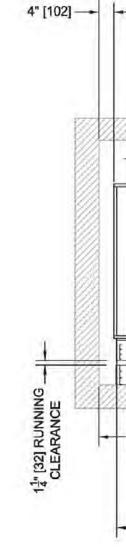


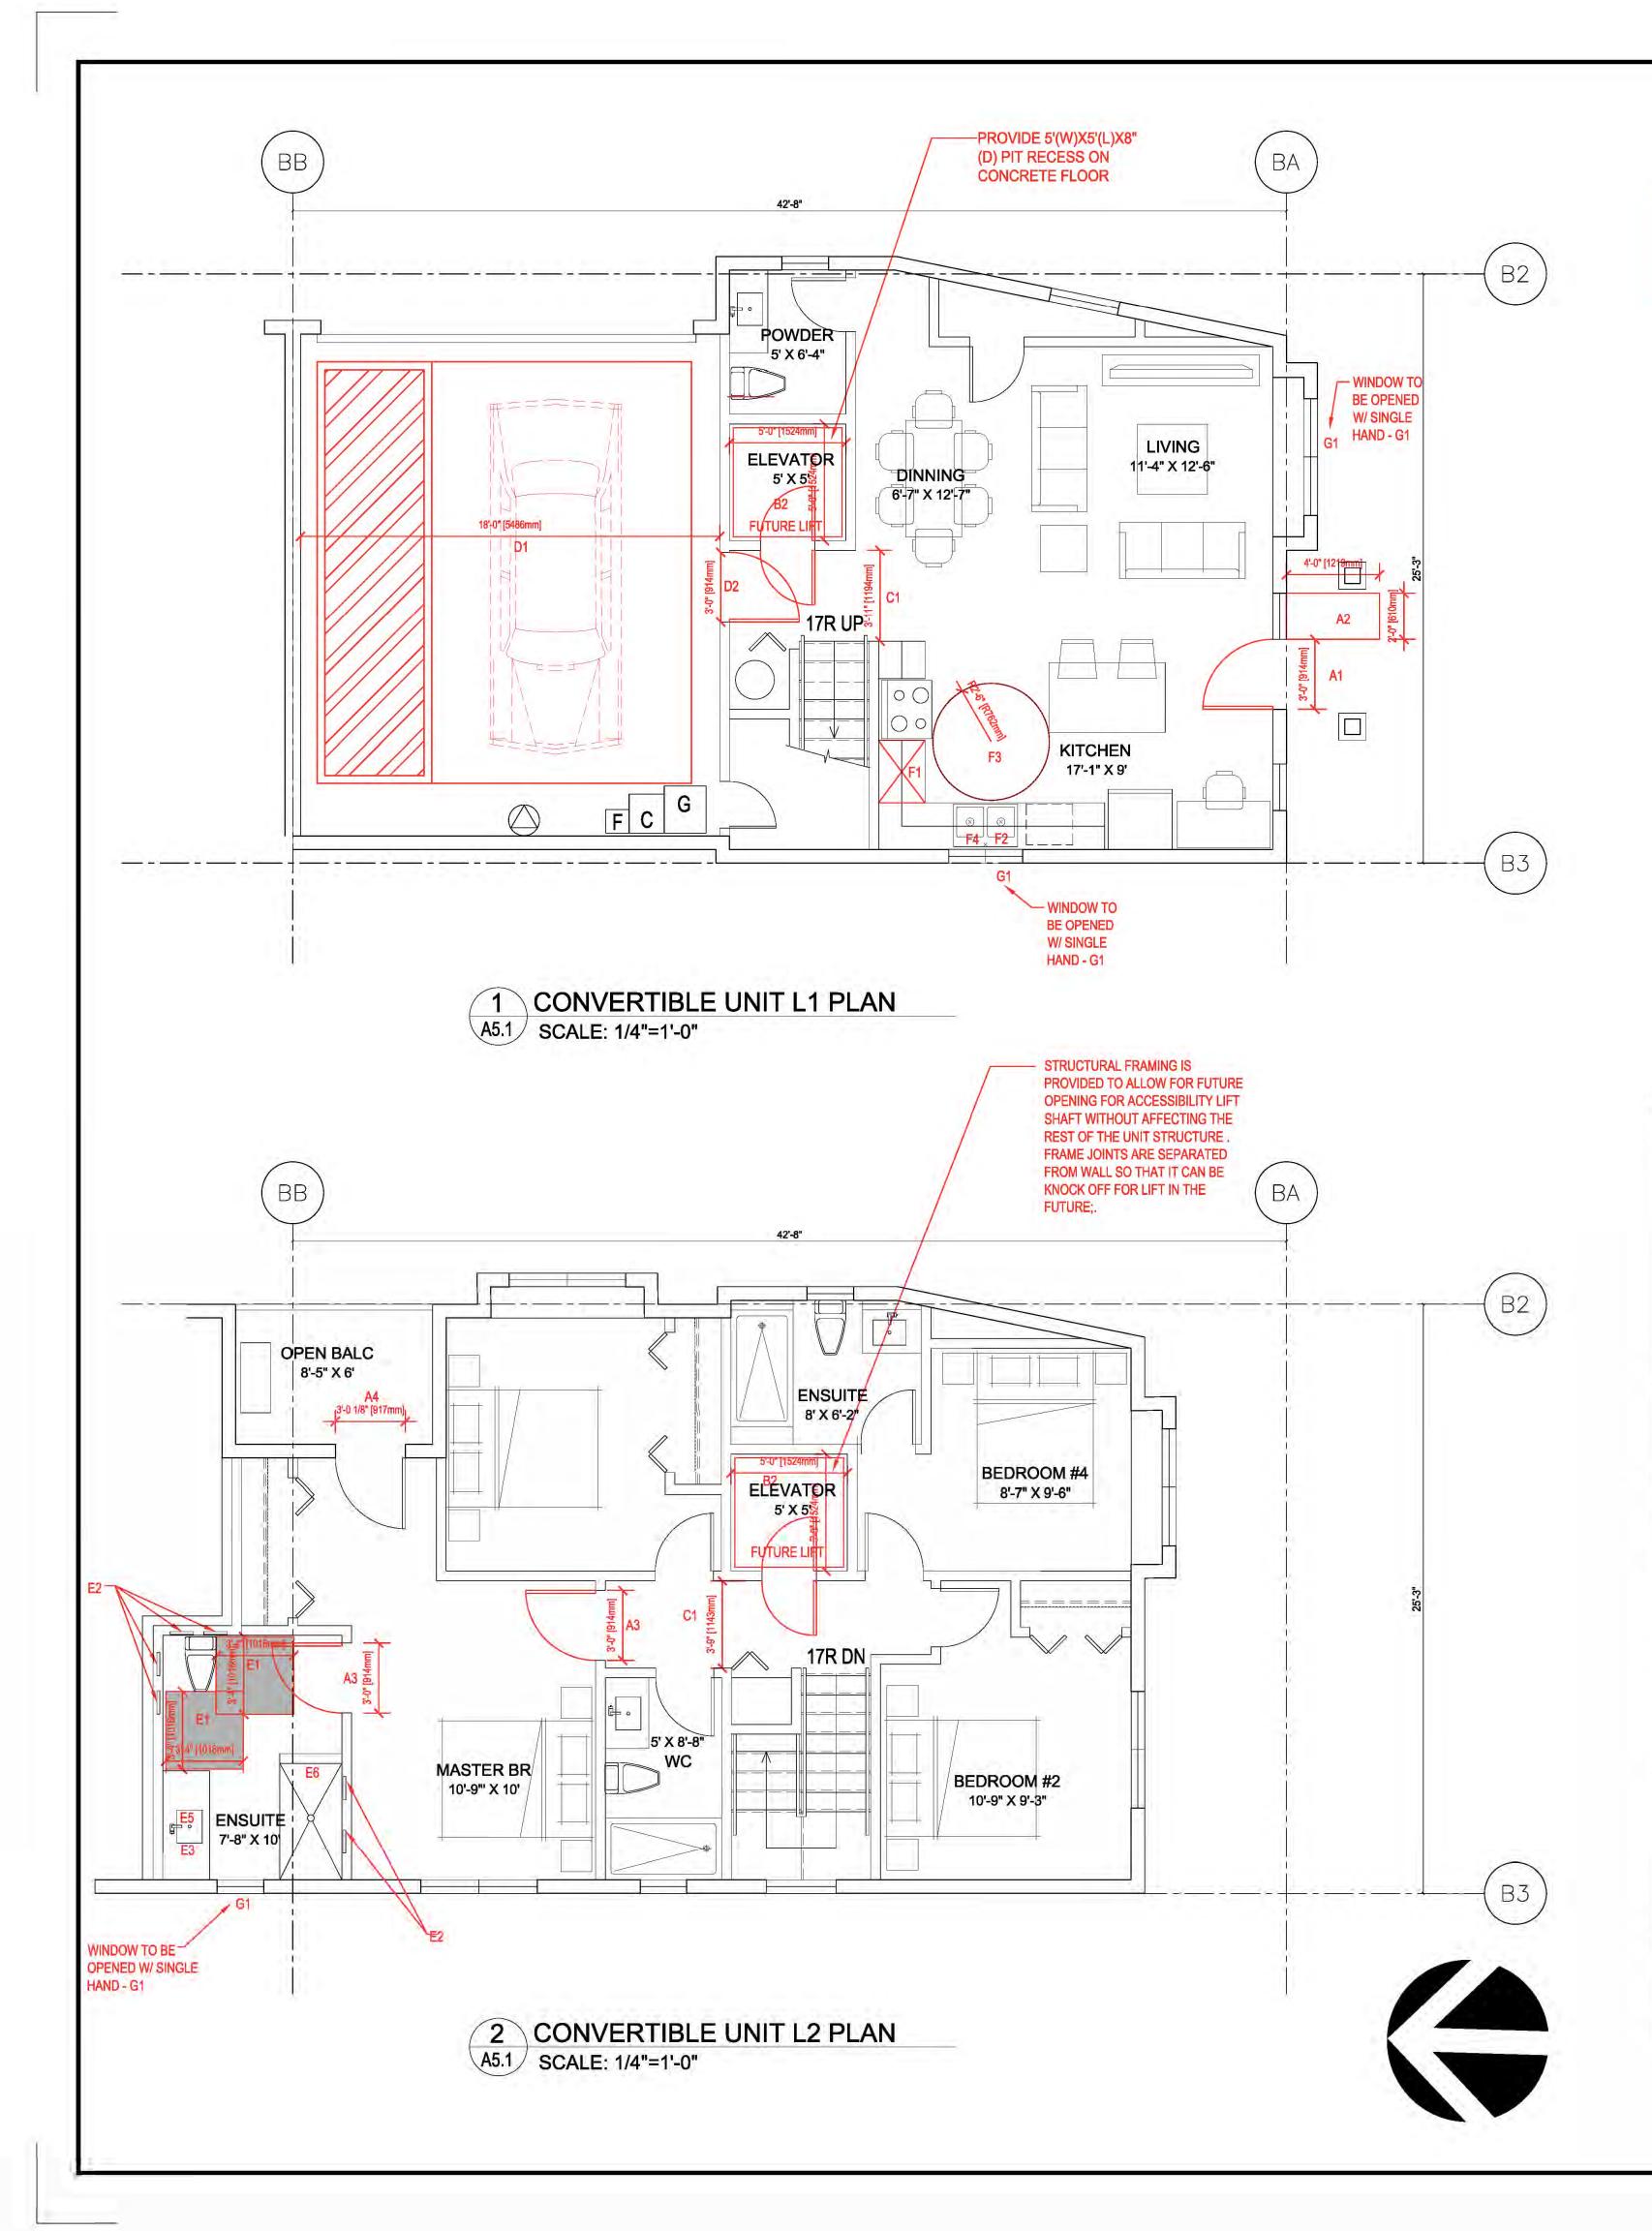clear cab size	hoistway width	hoistway length	jack c
40" x 50"	60-1/2"	59-1/2"	29
40" x 54"	60-1/2"	63-1/2"	31
42" x 60"	62-1/2"	69-1/2"	34
48" x 60"	68-1/2"	69-1/2"	34
minimum*	54-1/2"	59-1/2"	



Garaventa Lift

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C	ONVERTIBLE	JNIT GL	JIDELINES (NOTE: SAFERHOME CRITERIA PROPOSED
	1	A1	ENTRY DOORS ARE A MINIMUM 863 MM BUT IDEALLY 914 MM AND HAVE CLEA
		A2	ENTRY DOOR CLEAR EXTERIOR FLOOR SPACE MIN. 1220 MM DEPTH BY DOO IN WIRING PROVIDED FOR FUTURE AUTOMATIC DOOR OPENER).
			INTERIOR DOORS TO MAIN LIVING AREAS, 1 BATHROOM AND 1 BEDROOM, M


		~2	IN WIRING PROVIDED FOR FUTURE AUTOMATIC DOUR OPENER).
A	DOORS & DOORWAYS	A3	INTERIOR DOORS TO MAIN LIVING AREAS, 1 BATHROOM AND 1 BEDROOM, MII MM HEIGHT. DEMONSTRATE WHEELCHAIR ACCESS BETWEEN THE HALLWAY NECESSARY TO SECURE ACCESS.
		A4	PATIO / BALCONY MIN. 860 MM CLEAR OPENING. SMALL REMOVABLE WOOD F BETWEEN FINISHED SURFACES WHEN THE UNIT IS CONVERTED TO ACCESSI
		A5	ALL INTERIOR THRESHOLDS WITHIN UNITS COMPLY WITH BC BUILDING CODE
1.00		A6	LEVER-TYPE HANDLES FOR ALL DOORS
В	VERTICAL CIRCULATION	B2	VERTICAL LIFT, DEPRESSED SLAB AREA, AND LANDINGS, AS NOTED ON FLOO FRAMING TO ACCOMMODATE SHAFT CONSTRUCTION WITHOUT IMPACT TO S
		B3	AT THE TOP OF ALL STAIRWAYS, WALLS ARE REINFORCED WITH 2" X 12" SOL
С	HALLWAYS	C1	MIN. 900 MM WIDTH.
	010105	D1	MIN. 1 ACCESSIBLE PARKING SPACE WITH MIN. 4 M GARAGE WIDTH.
D	GARAGE	D2	ACCESS FROM GARAGE TO LIVING AREA MIN. 800 MM CLEAR OPENING.
		E1	TOILET CLEAR FLOOR SPACE MIN. 1020 MM AT SIDE AND IN FRONT.
		E2	WALL BLOCKING FOR FUTURE GRAB BAR INSTALLATION AT TOILET, TUB AND BATHTUB, SHOWER, AND TOILET LOCATIONS.
E	BATHROOM (MIN.1)	E3	LEVER-TYPE HANDLES FOR PLUMBING FIXTURES.
		E4	PRESSURE AND TEMPERATURE CONTROL VALVES ARE INSTALLED ON ALL SI
		E5	CABINETS UNDERNEATH SINK(S) ARE EASILY REMOVED.
		E6	DEMONSTRATE BATH AND SHOWER CONTROLS ARE ACCESSIBLE (LAYOUT C
		F1	CLEAR AREA NEEDED UNDER FUTURE WORK SPACE. PLUMBING AND GAS PIF COUNTER AREA OF FUTURE WORK SPACE (STOVE, SINK & MIN. 810 MM WIDE MM TO 355 MM TO THE CENTRE OF THE PIPE FROM FLOOR LEVEL.
F	KITCHEN	F2	CABINETS UNDERNEATH SINK ARE EASILY REMOVED.
		F3	1500 MM TURNING DIAMETER OR TURNING PATH DIAGRAM.
		F4	LEVER-TYPE HANDLES FOR PLUMBING FIXTURES.
G	WINDOWS	G1	MIN. 1 WINDOW THAT CAN BE OPENED WITH A SINGLE HAND (BATHROOM, KIT
H	OUTLETS &	H1	PLACEMENT LOCATIONS OF ELECTRICAL OUTLETS: BESIDE WINDOW, BOTTO DOORS (OUTSIDE AND INSIDE).ON FRONT FACE OF KITCHEN COUNTER, WITH
10.02	SWITCHES	H2	UPGRADE TO FOUR-PLEX OUTLETS ILL MASTER BEDROOM, HOME OFFICE, GA


ck centerline 29-3/4" 31-3/4" 34-3/4" 34-3/4"	entrance centerline 35-3/4" 39-3/4" 45-3/4" 45-3/4"	
ED FOR INCLUSION CLEAR ACCESS. DOOR WIDTH PLUS 600 MM O M, MIN. 800 MM CLEAR OPEN WAY AND ROOMS AND WIDE DOD RAMP WILL BE USED TO ESSIBLE UNIT (I.E. WHEN THE CODE. FLOOR PLANS IN COMPLIAN TO SURROUNDING STRUCT SOLID LUMBER AT 914 MM	ACK + 4" [102] b b c c c c c c c c c c c c c	HOLDER OF A ARCHITECTURE INTERIOR DESIGN PLANNING Copyright Reserved The Copyright Reserved The Copyright of timerial reproduced without the express Dimensions The Contractor shall verify all omissions to Imperial Architec ISSUED FOR DP RESUBMISSION ISSUED FOR DP RESUBMISSION
	LOOR) LOCATED CLEAR OF UNDER ARE BROUGHT IN NO HIGHER THAN 304	Client/Project 4-UNIT DU 6531 FRANC RZ 19-8
OTTOM OF STAIRWAYS, BES	IDE SWITCHES TOILET, ABOVE EXTERNAL TROL CENTRE FOR SMART HOME OPTIONS. ON ROOM.	
		Project No. #8304 Drawing No. A 5.1

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6531 FRANCIS ROAD. RICHMOND, BC






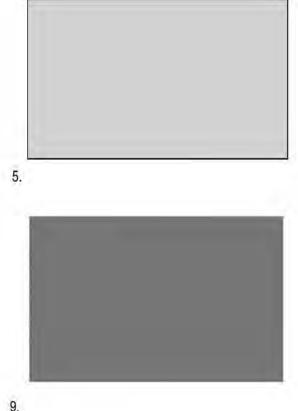

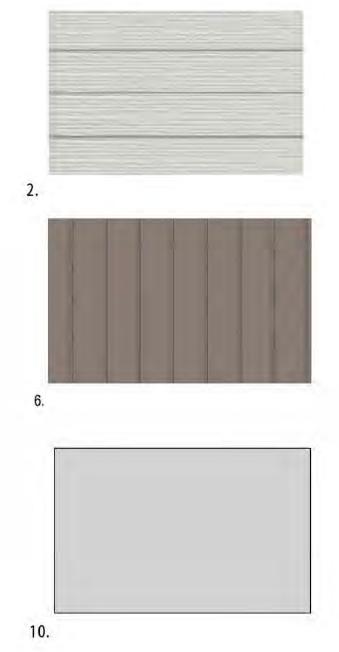





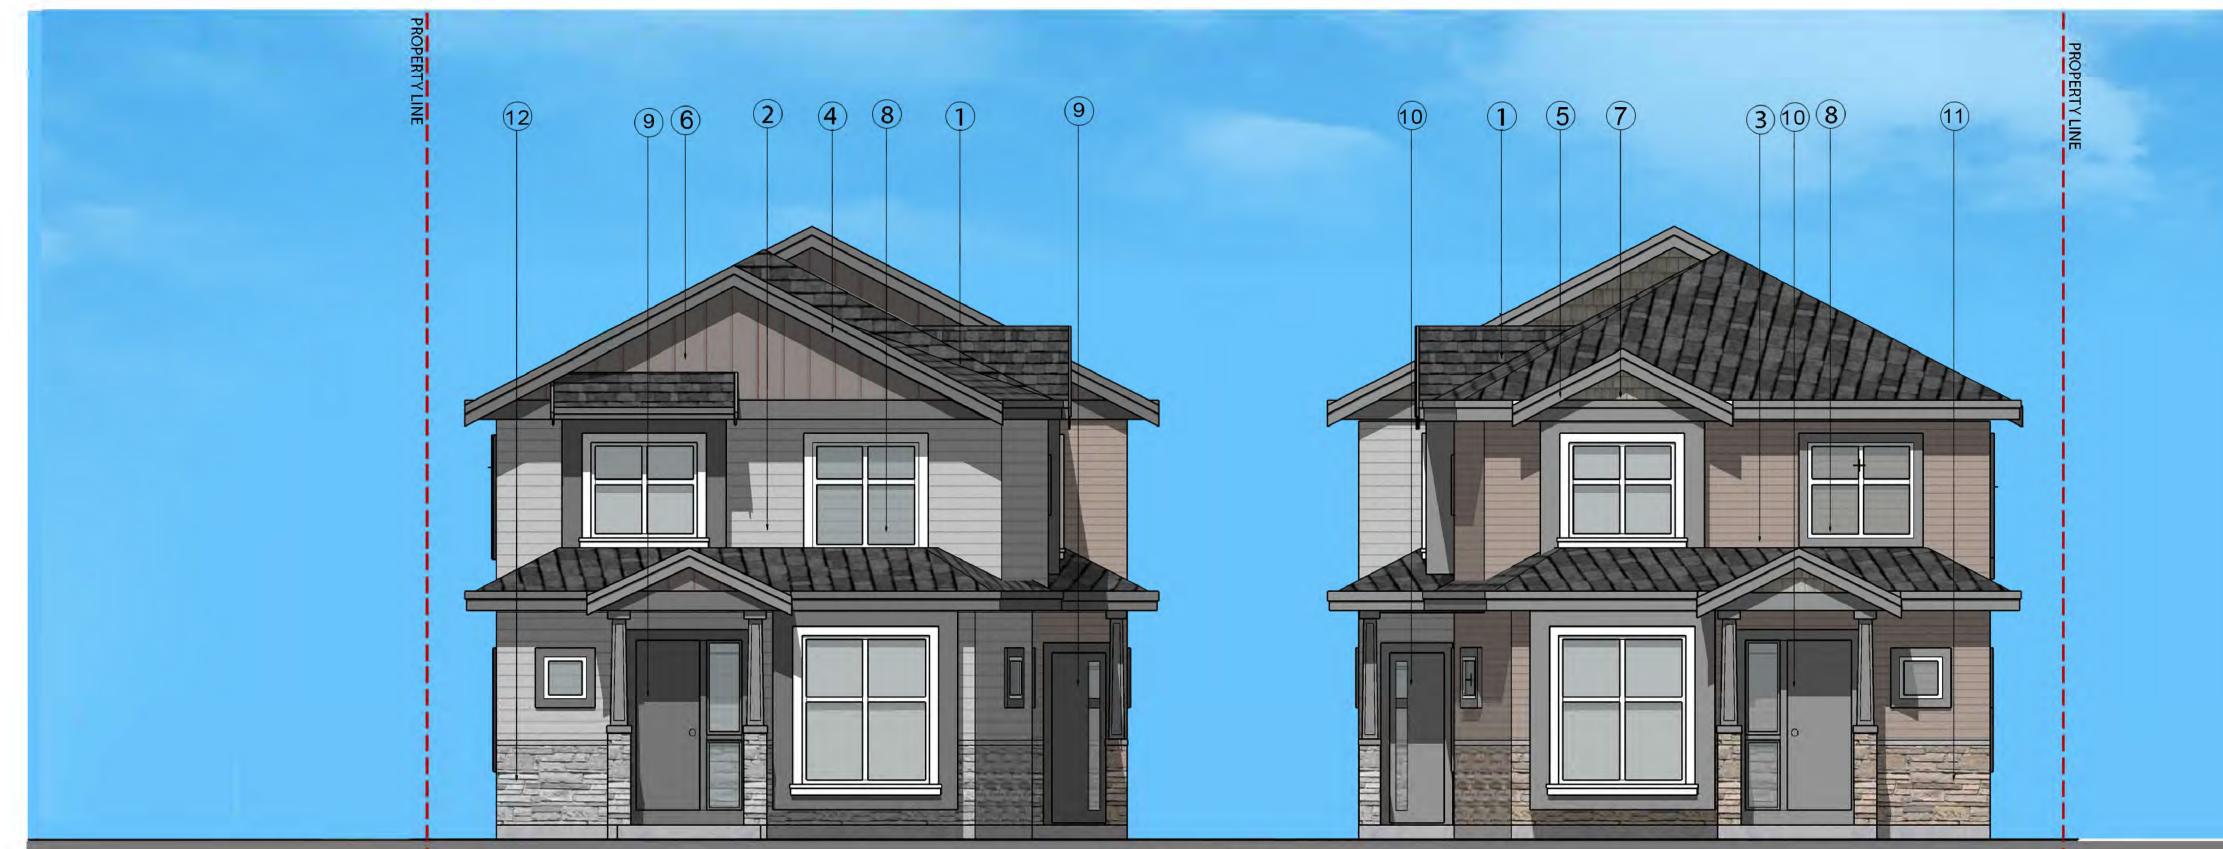


EXTERIOR FINIS

12.

1.HIGH PROFILE ASPHALT SHINGLES 2.COMPOSITE CEMENT-HARDIELAP 3.COMPOSITE CEMENT-HARDIELAP 4.WOOD FASCIA BOARD / TRIM AND (DARK GREY) 5.WOOD FASCIA BOARD / TRIM AND (LIGHT GREY) 6.COMPOSITE CEMENT-HARDIELAP 7.COMPOSITE CEMENT - HARDIE SH 8.VINYL WINDOW WI CLEAR DOUBLE 9.SOLID WOOD DOORS (DARK GREY 10.SOLID WOOD DOORS (LIGHT GRE 11.STONE CLADDING (LIGHT GREY) 12.STONE CLADDING (LIGHT BRWON

Francis Road Elevation

SI GREY) SI DING(LIGHT GREY) SI DING(LIGHT BROWN) COMPOSITE CEMENT FLAT PANEL COMPOSITE CEMENT FLAT PANEL SI DING (LIGHT BROWN) HAKE (LIGHT GREY) E GLAZING & WHITE FRAME Y) FY No		
State CentProject 1/2 1/2 3/2 <	S (GREY) 9 SIDING(LIGHT GREY) 9 SIDING(LIGHT BROWN) 0 COMPOSITE CEMENT FLAT PANEL 9 COMPOSITE CEMENT FLAT PANEL 9 SIDING (LIGHT BROWN) HAKE (LIGHT GREY) E GLAZING & WHITE FRAME Y) EY)	IMPERIAL ARCHITECTURE INTERIOR DESIGN PLANNING Copyright Reserved The Copyright to this drawing and its contents is reserved, and remains at all times the exclusive property of Imperial Architecture, and shall not be used, modified, or reproduced without the expressed written consent of Imperial Architecture.
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Drawing No. Sheet Revision		4-UNIT DUPLEX DEVELOPMENT 6531 FRANCIS ROAD, RICHMOND, BC RZ 19-878165 / DP 22-011557 Title COLOR SAMPLE BOARD
A () 9 of		#8304 N.T.S. Drawing No. Sheet Revision

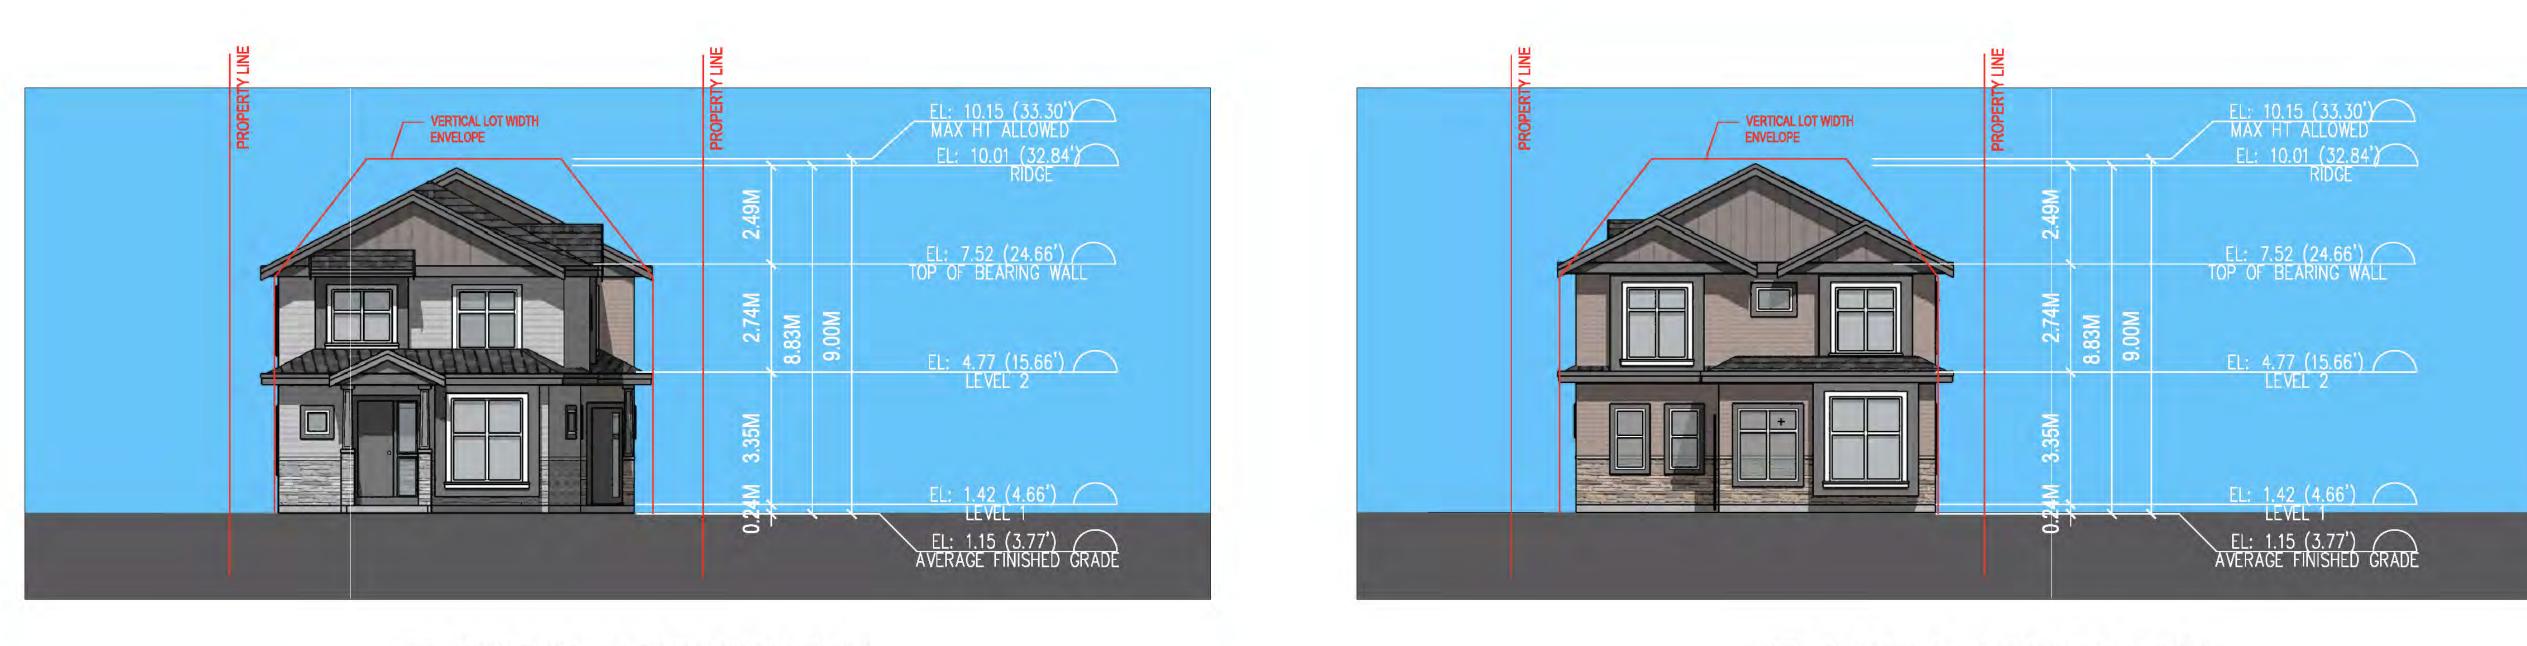

BUILDING A SOUTH ELEVATION 1 A3.1 SCALE: 1/8"=1'-0"






2 BUILDING A NORH ELEVATION A3.1 SCALE: 1/8"=1'-0"


3 BUILDING A EAST ELEVATION A3.1 SCALE: 1/8"=1'-0"




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1.	DEVELOPMENT
6531 FRANCIS ROA	D, RICHMOND, BC
	DP 22-011557
Title BUILDING A I	ELEVATIONS
	/8"=1'-0"
Drawing No. Sheet	Revision

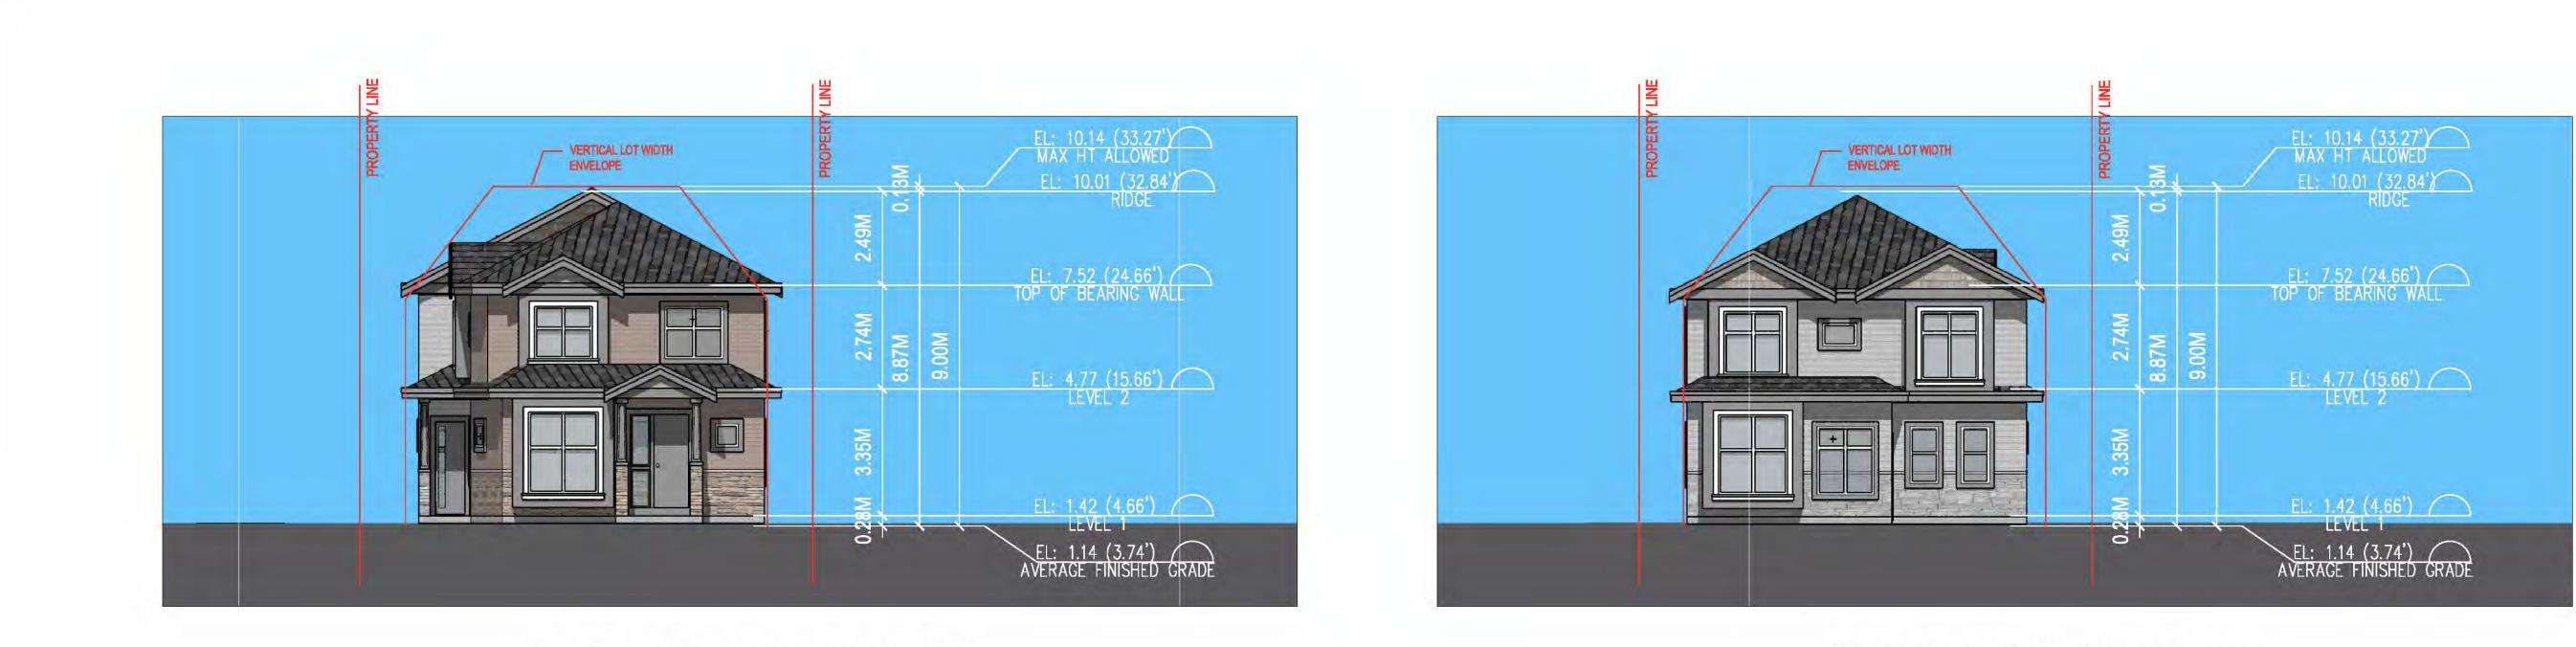



1 BUILDING B SOUTH ELEVATION A3.2 SCALE: 1/8"=1'-0"

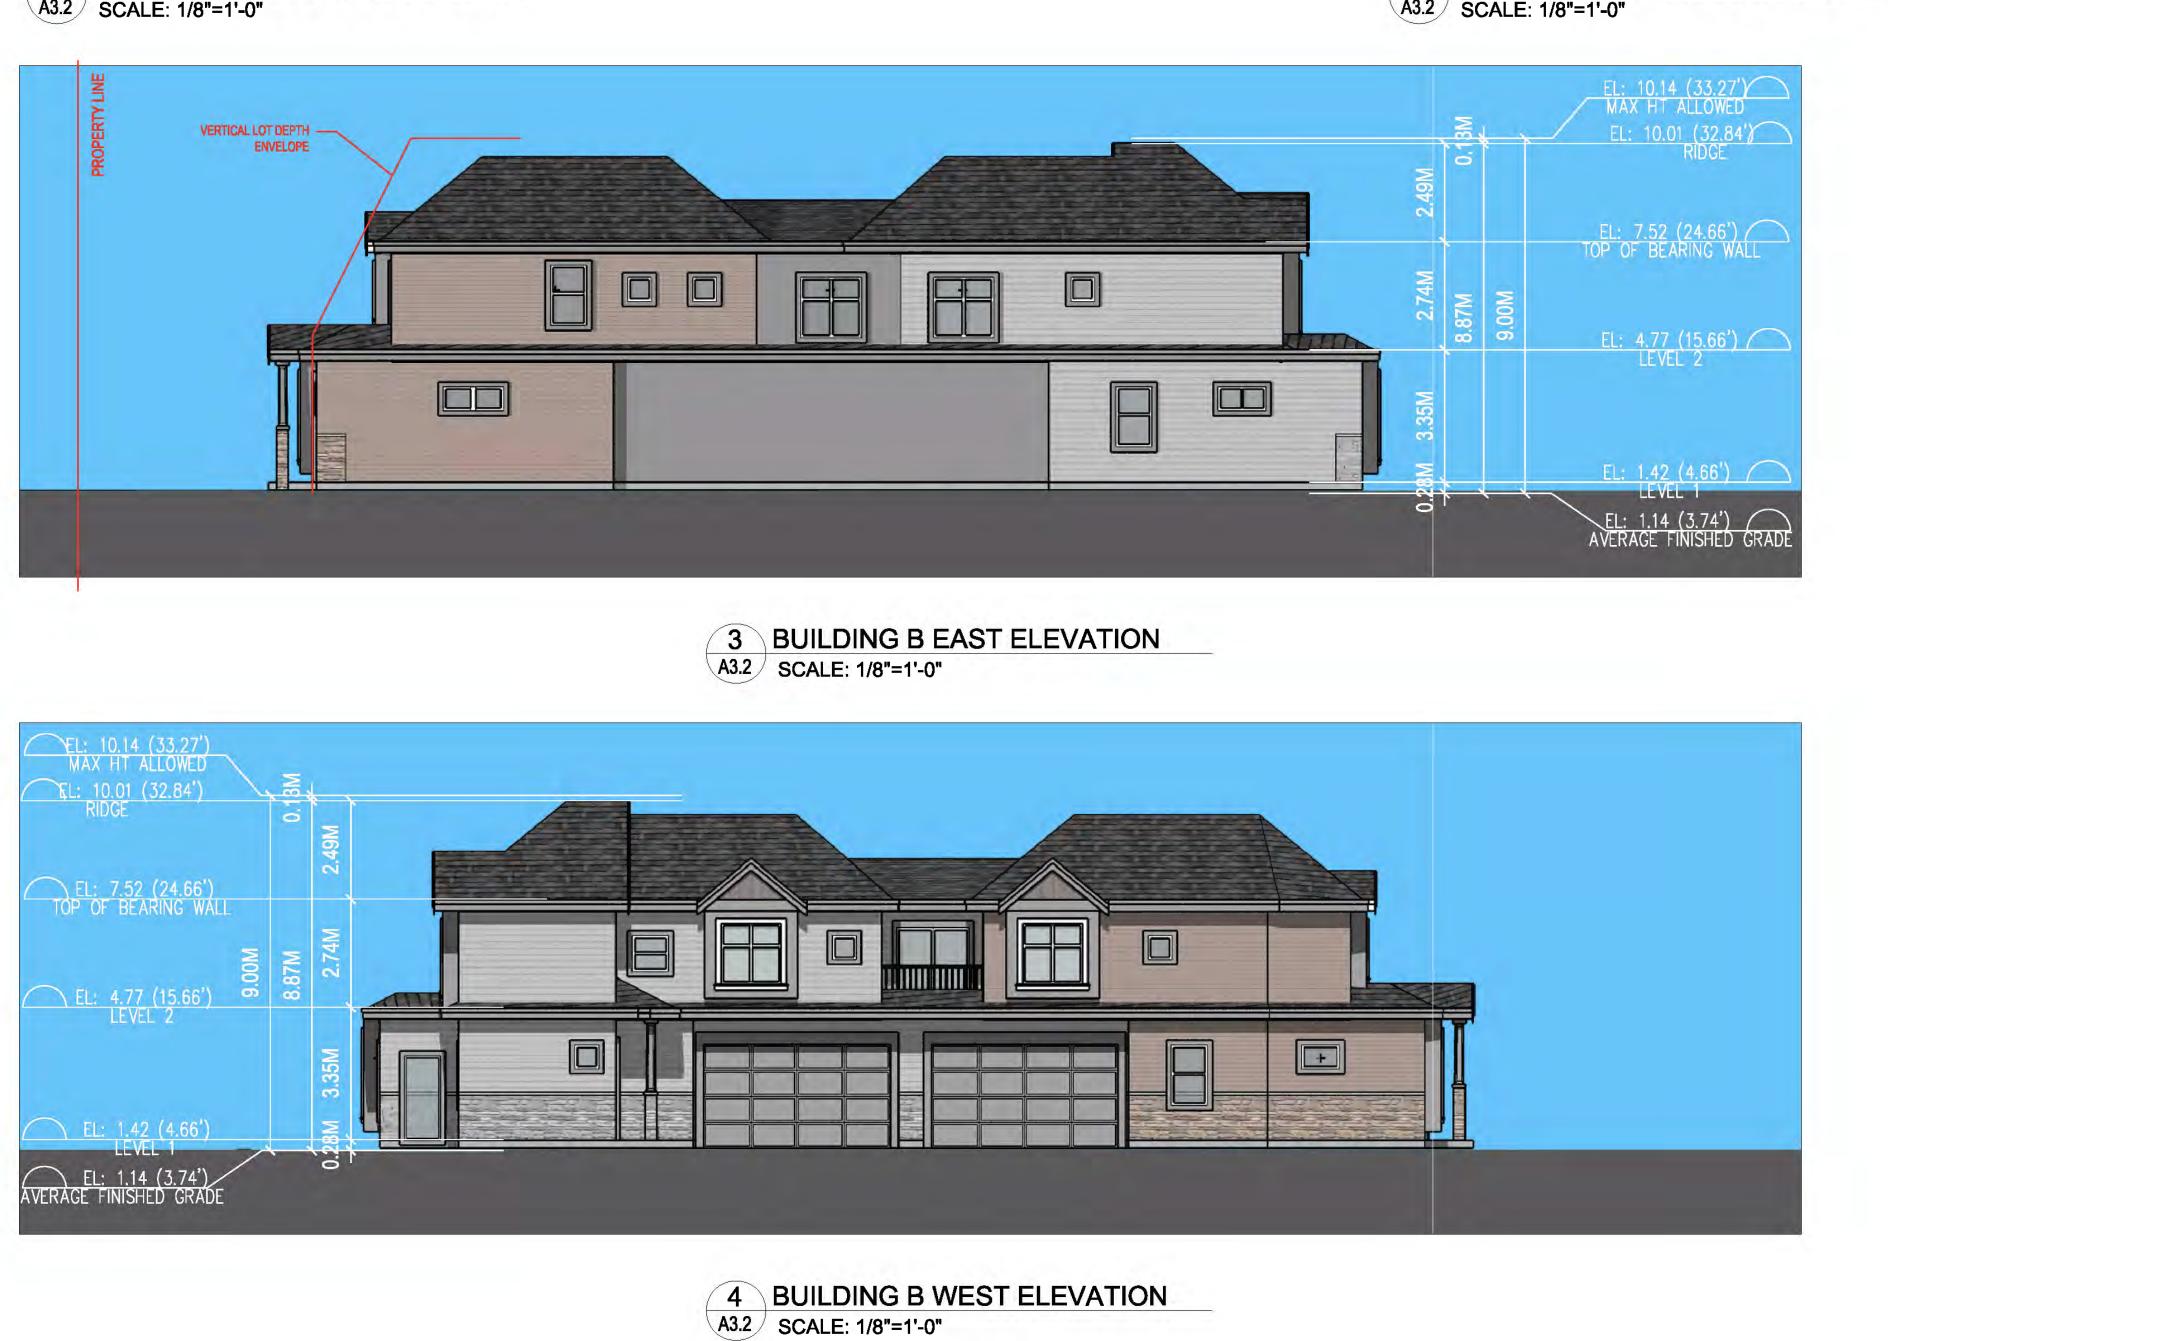

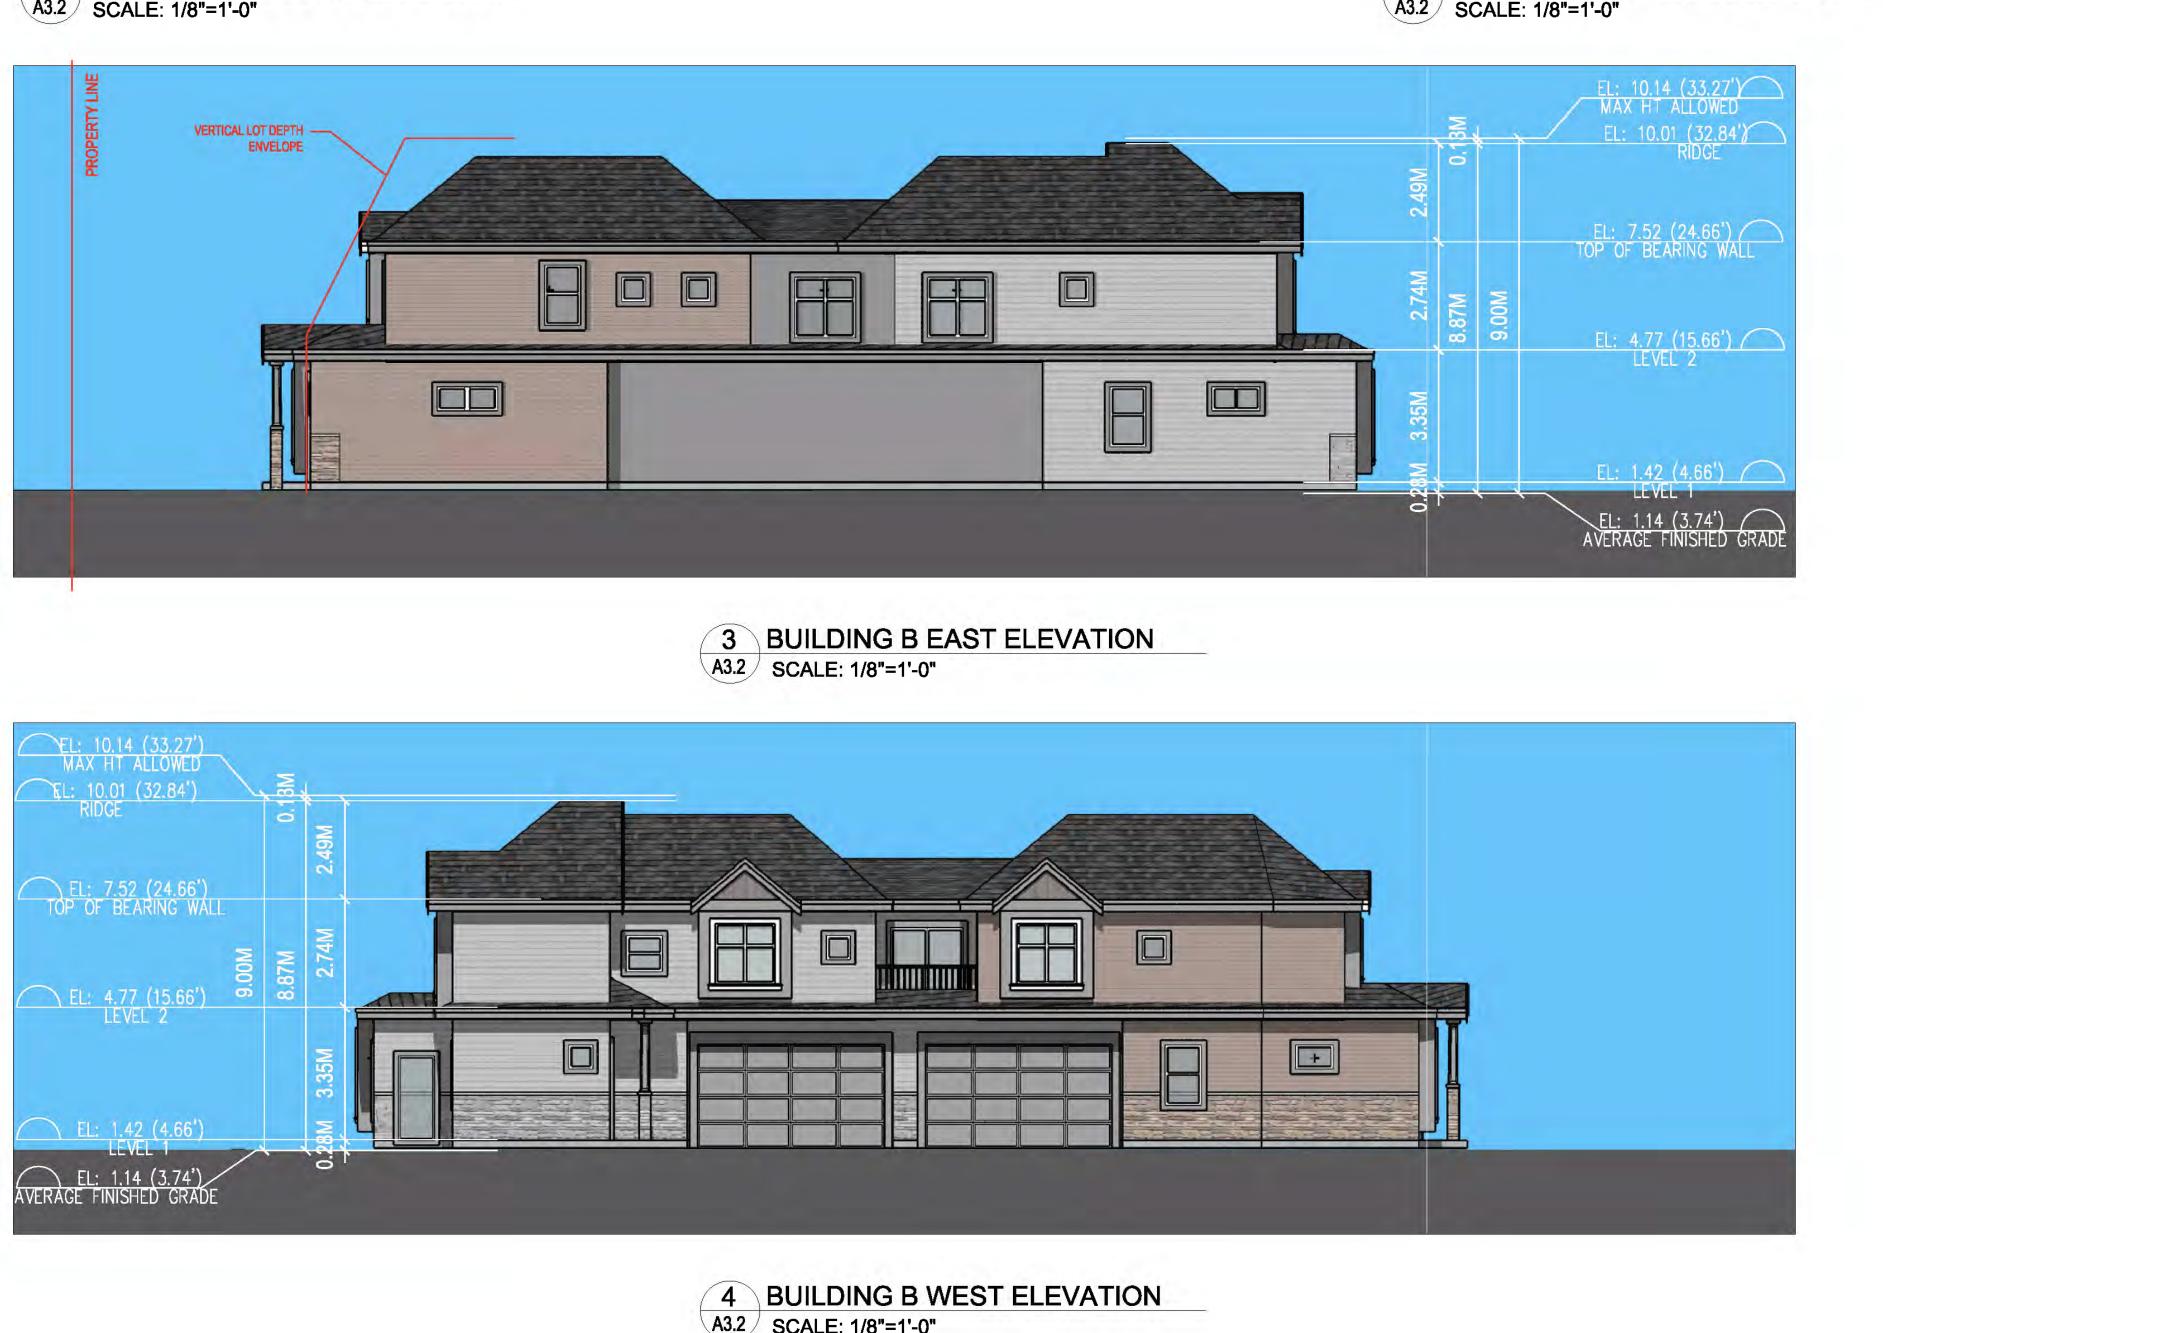

2 BUILDING B NORH ELEVATION A3.2 SCALE: 1/8"=1'-0"

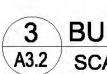

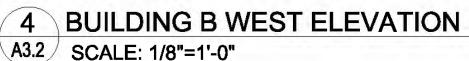




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HOLDER OF AN AIBC CERT ADDRESS: 7765 FRENC EMAIL: IMP	H STREET, VANCOUVER, BC, VEP 4V5 ERIAL ARCHITECTURE@GMAIL.COM
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ISSUED FOR DP RESUBMISSION	J.Z. J.H. 23.07.06 By Appd. YY.MM.DD
Client/Project	
4-UNIT DUPLEX DEV 6531 FRANCIS ROAD, RI	
RZ 19-878165 / DP 2	
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Project No. Scale #8304 1/8"=	
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ISSUED FOR DP RESUMISSION J.Z. J.H. 23.09.05 ISSUED FOR DP RESUMMISSION J.Z. J.H. 23.07.26 ISSUED FOR DP RESUMMISSION J.Z. J.H. 23.07.26 ISSUED FOR DP RESUMMISSION J.Z. J.H. 23.07.26 Issued By Appd. YY.MM.DD
Client/Project 4-UNIT DUPLEX DEVELOPMENT 6531 FRANCIS ROAD, RICHMOND, BC CBU P 22-011557 Title COLOR RENDERINGS Project No. Scale #8304 N.T.S. Drawing No. Sheet Revision A 0.55



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Client/Project
4-UNIT DUPLEX DEVELOPMENT 6531 FRANCIS ROAD, RICHMOND, BC RZ 19-878165 / DP 22-011557
Project No. Scale #8304 N.T.S. Drawing No. Sheet Revision
A 0.6 ď




EXISTING TREES INFORMATION PER ARBORIST REPORT

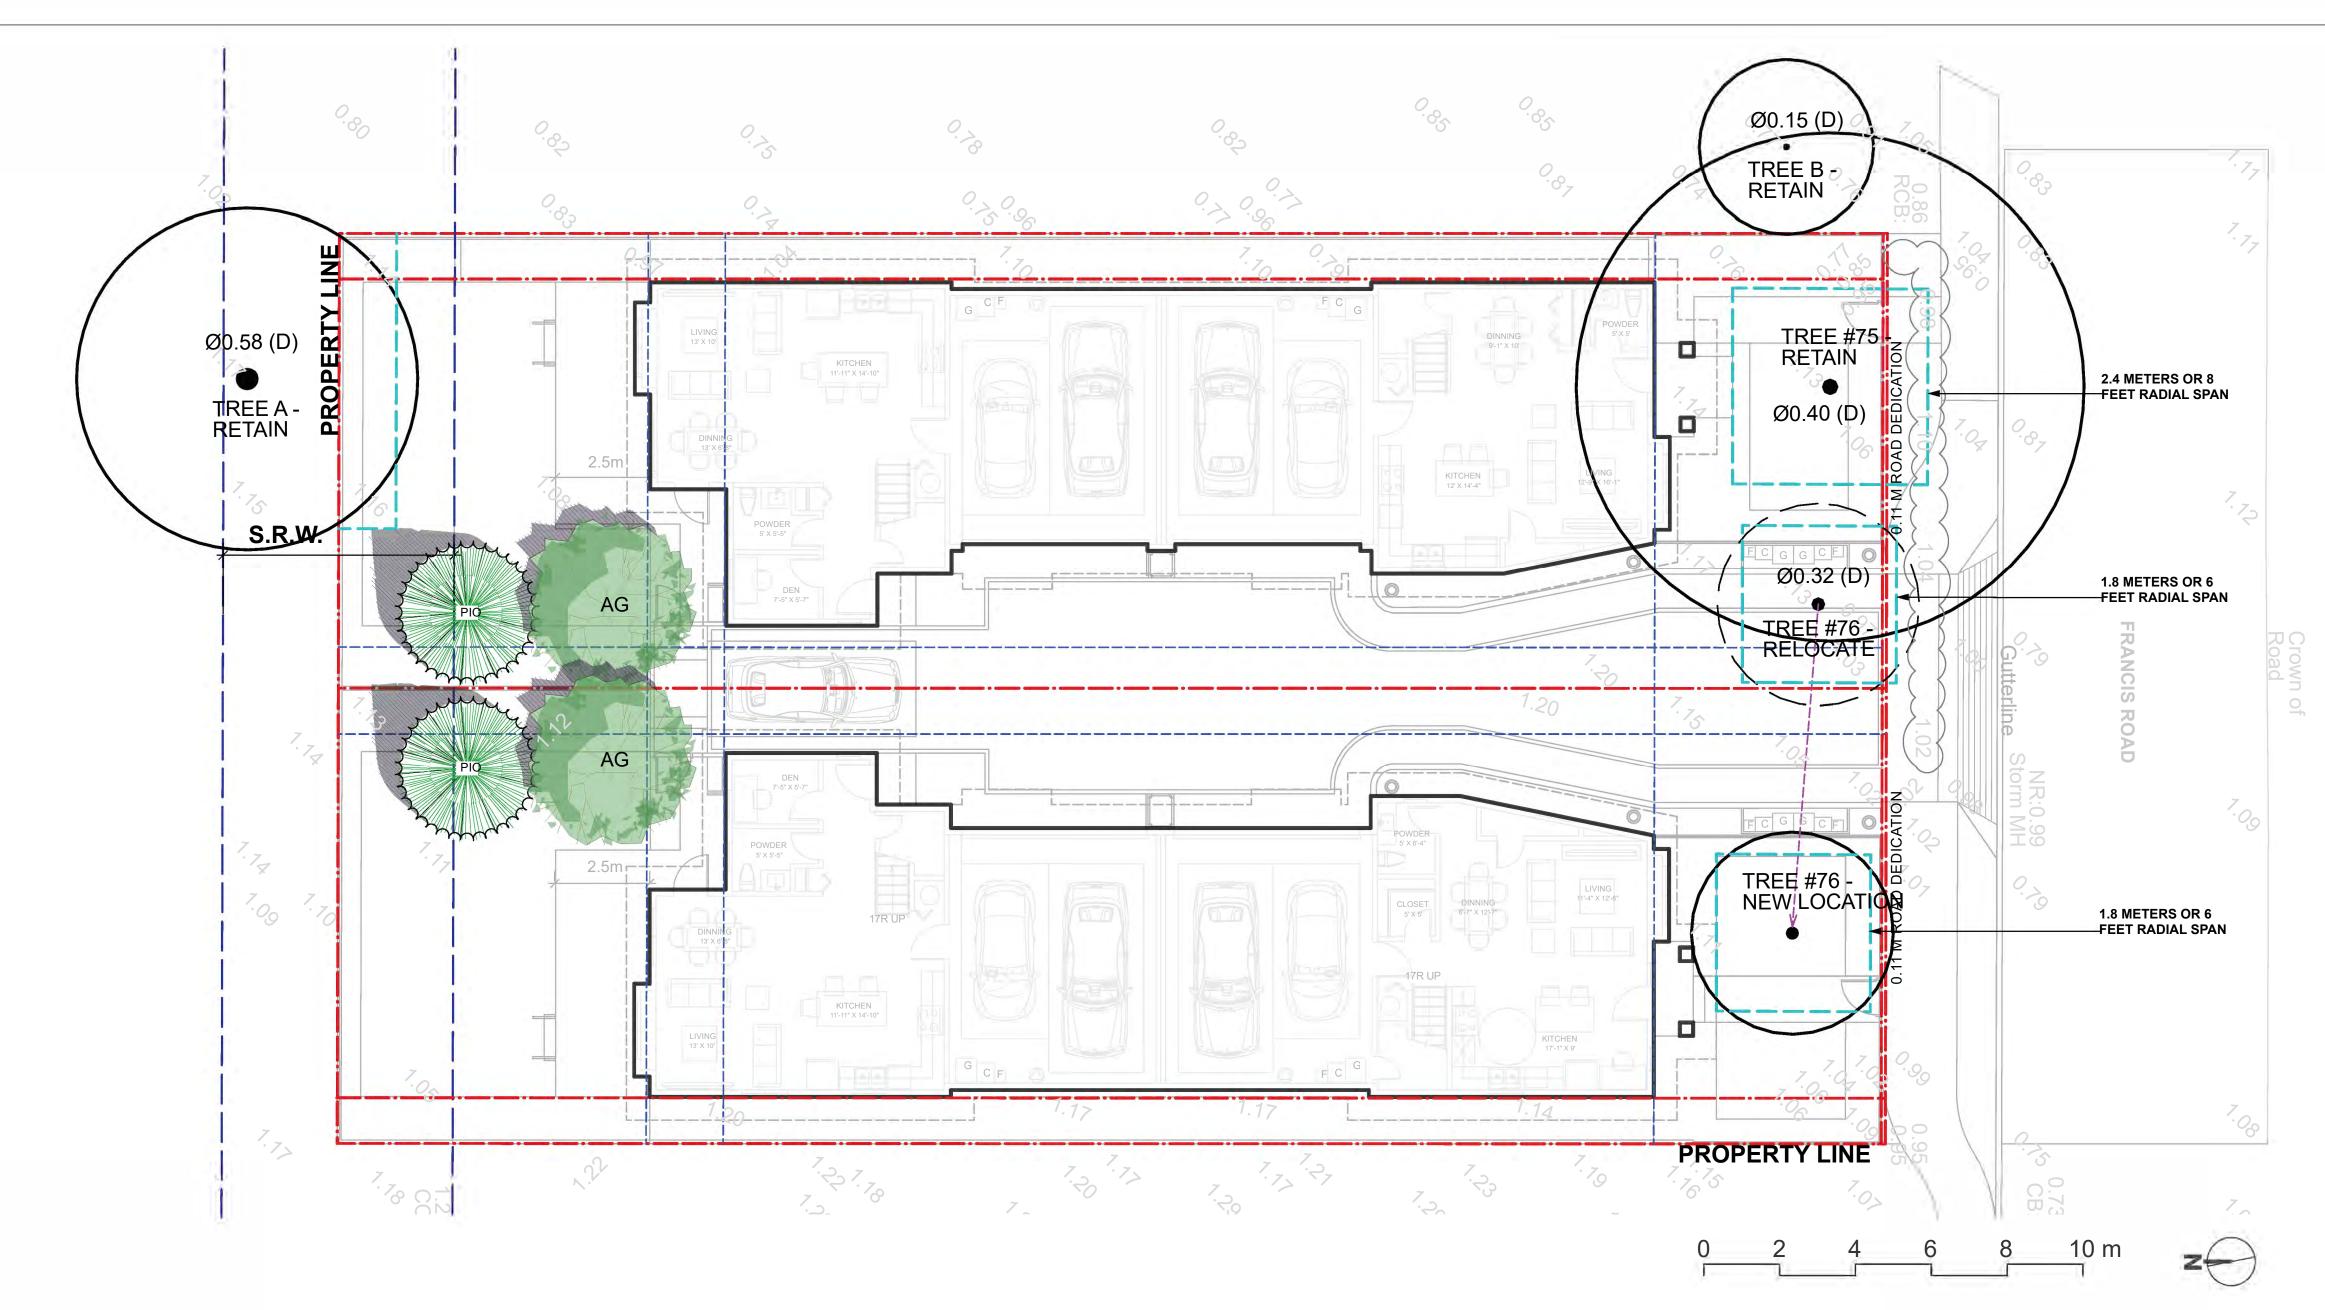
Tree Species	Tree ID #	DBH	Crown Spread	Tree Location	TPB	Tree Vigour - General Observations
Cherry	#75	40 cm DBH	N/A	SE corner of Lot B	RQD 2.4 m or 8 ft	LOW VIGOUR
Cherry	#76	33 cm DBH	N/A	SW corner of Lot B	RQD 1.8 m or 6 ft	LOW VIGOUR
Cherry	A	58 cm DBH	N/A	Lot B's north neighbour's SE corner	RQD 3.6 m or 12 ft	NEIGHBOUR'S TREE, IDENTIFIED FOR TPB CONSIDERATIONS ONLY
Japanese Maple	в	15 cm DBH	N/A	Lot B's east neighbour's SW quadrant	NOT RQD 1.2 m or 4 ft	NEIGHBOUR'S TREE, IDENTIFIED FOR TPB CONSIDERATIONS ONLY

PROPOSED REPLACEMENT TREES

ONSITE PLANT LIST				
ID	Latin Name	Common Name	Quantity	Scheduled S
TREES (DECIDUOUS & CONIFEROUS)				
AG	Acer griseum	Paperbark Maple	2	8cm cal.
PIO	Pinus contorta var. contorta	Shore Pine	2	4m high.

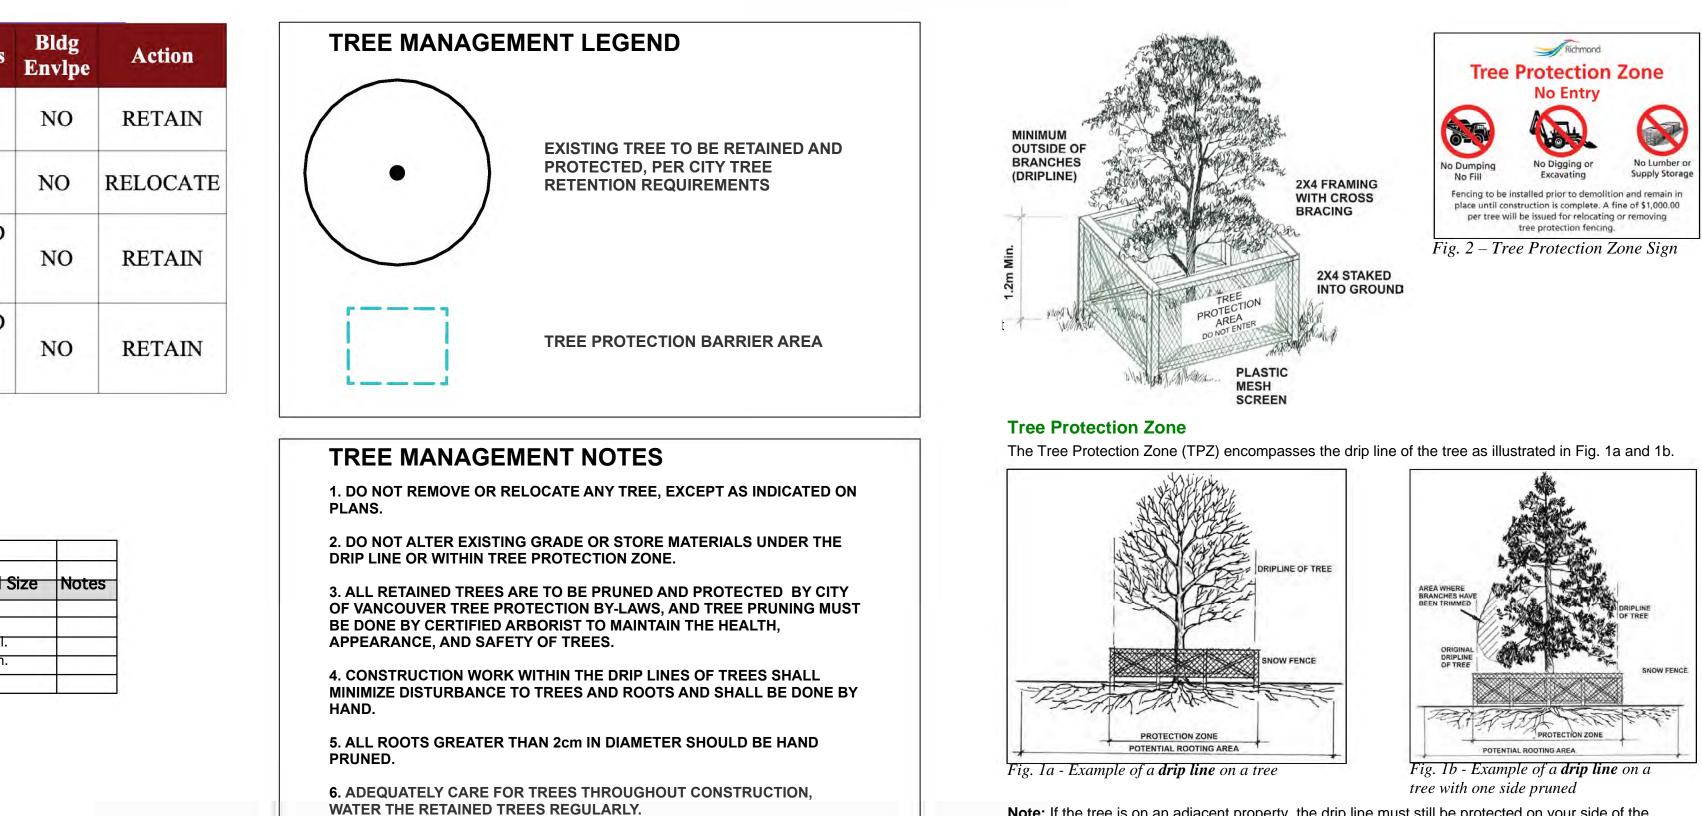

tree (Fig. 1b).

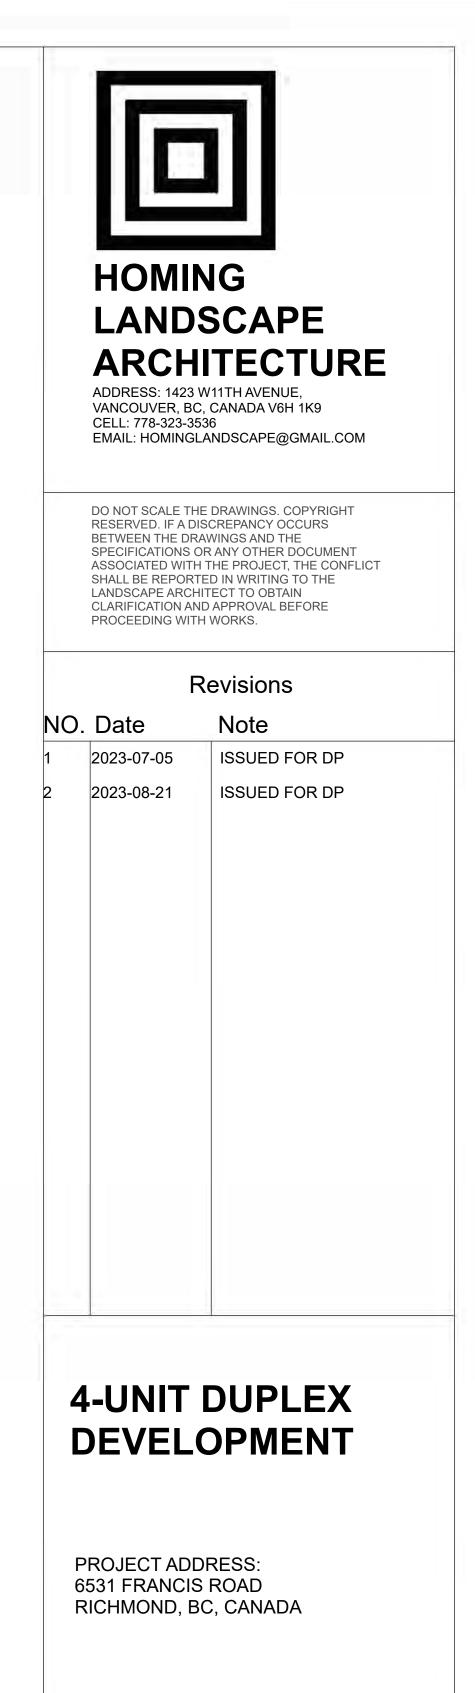

PROJECT NUMBER: 23-05

DRAWN BY: EL

SCALE: 1:100


REVIEWED BY: EL

PLAN #3.a



L0.1

Note: If the tree is on an adjacent property, the drip line must still be protected on your side of the property line. If the branches have been cut or pruned, the TPZ must protect the original drip line of the

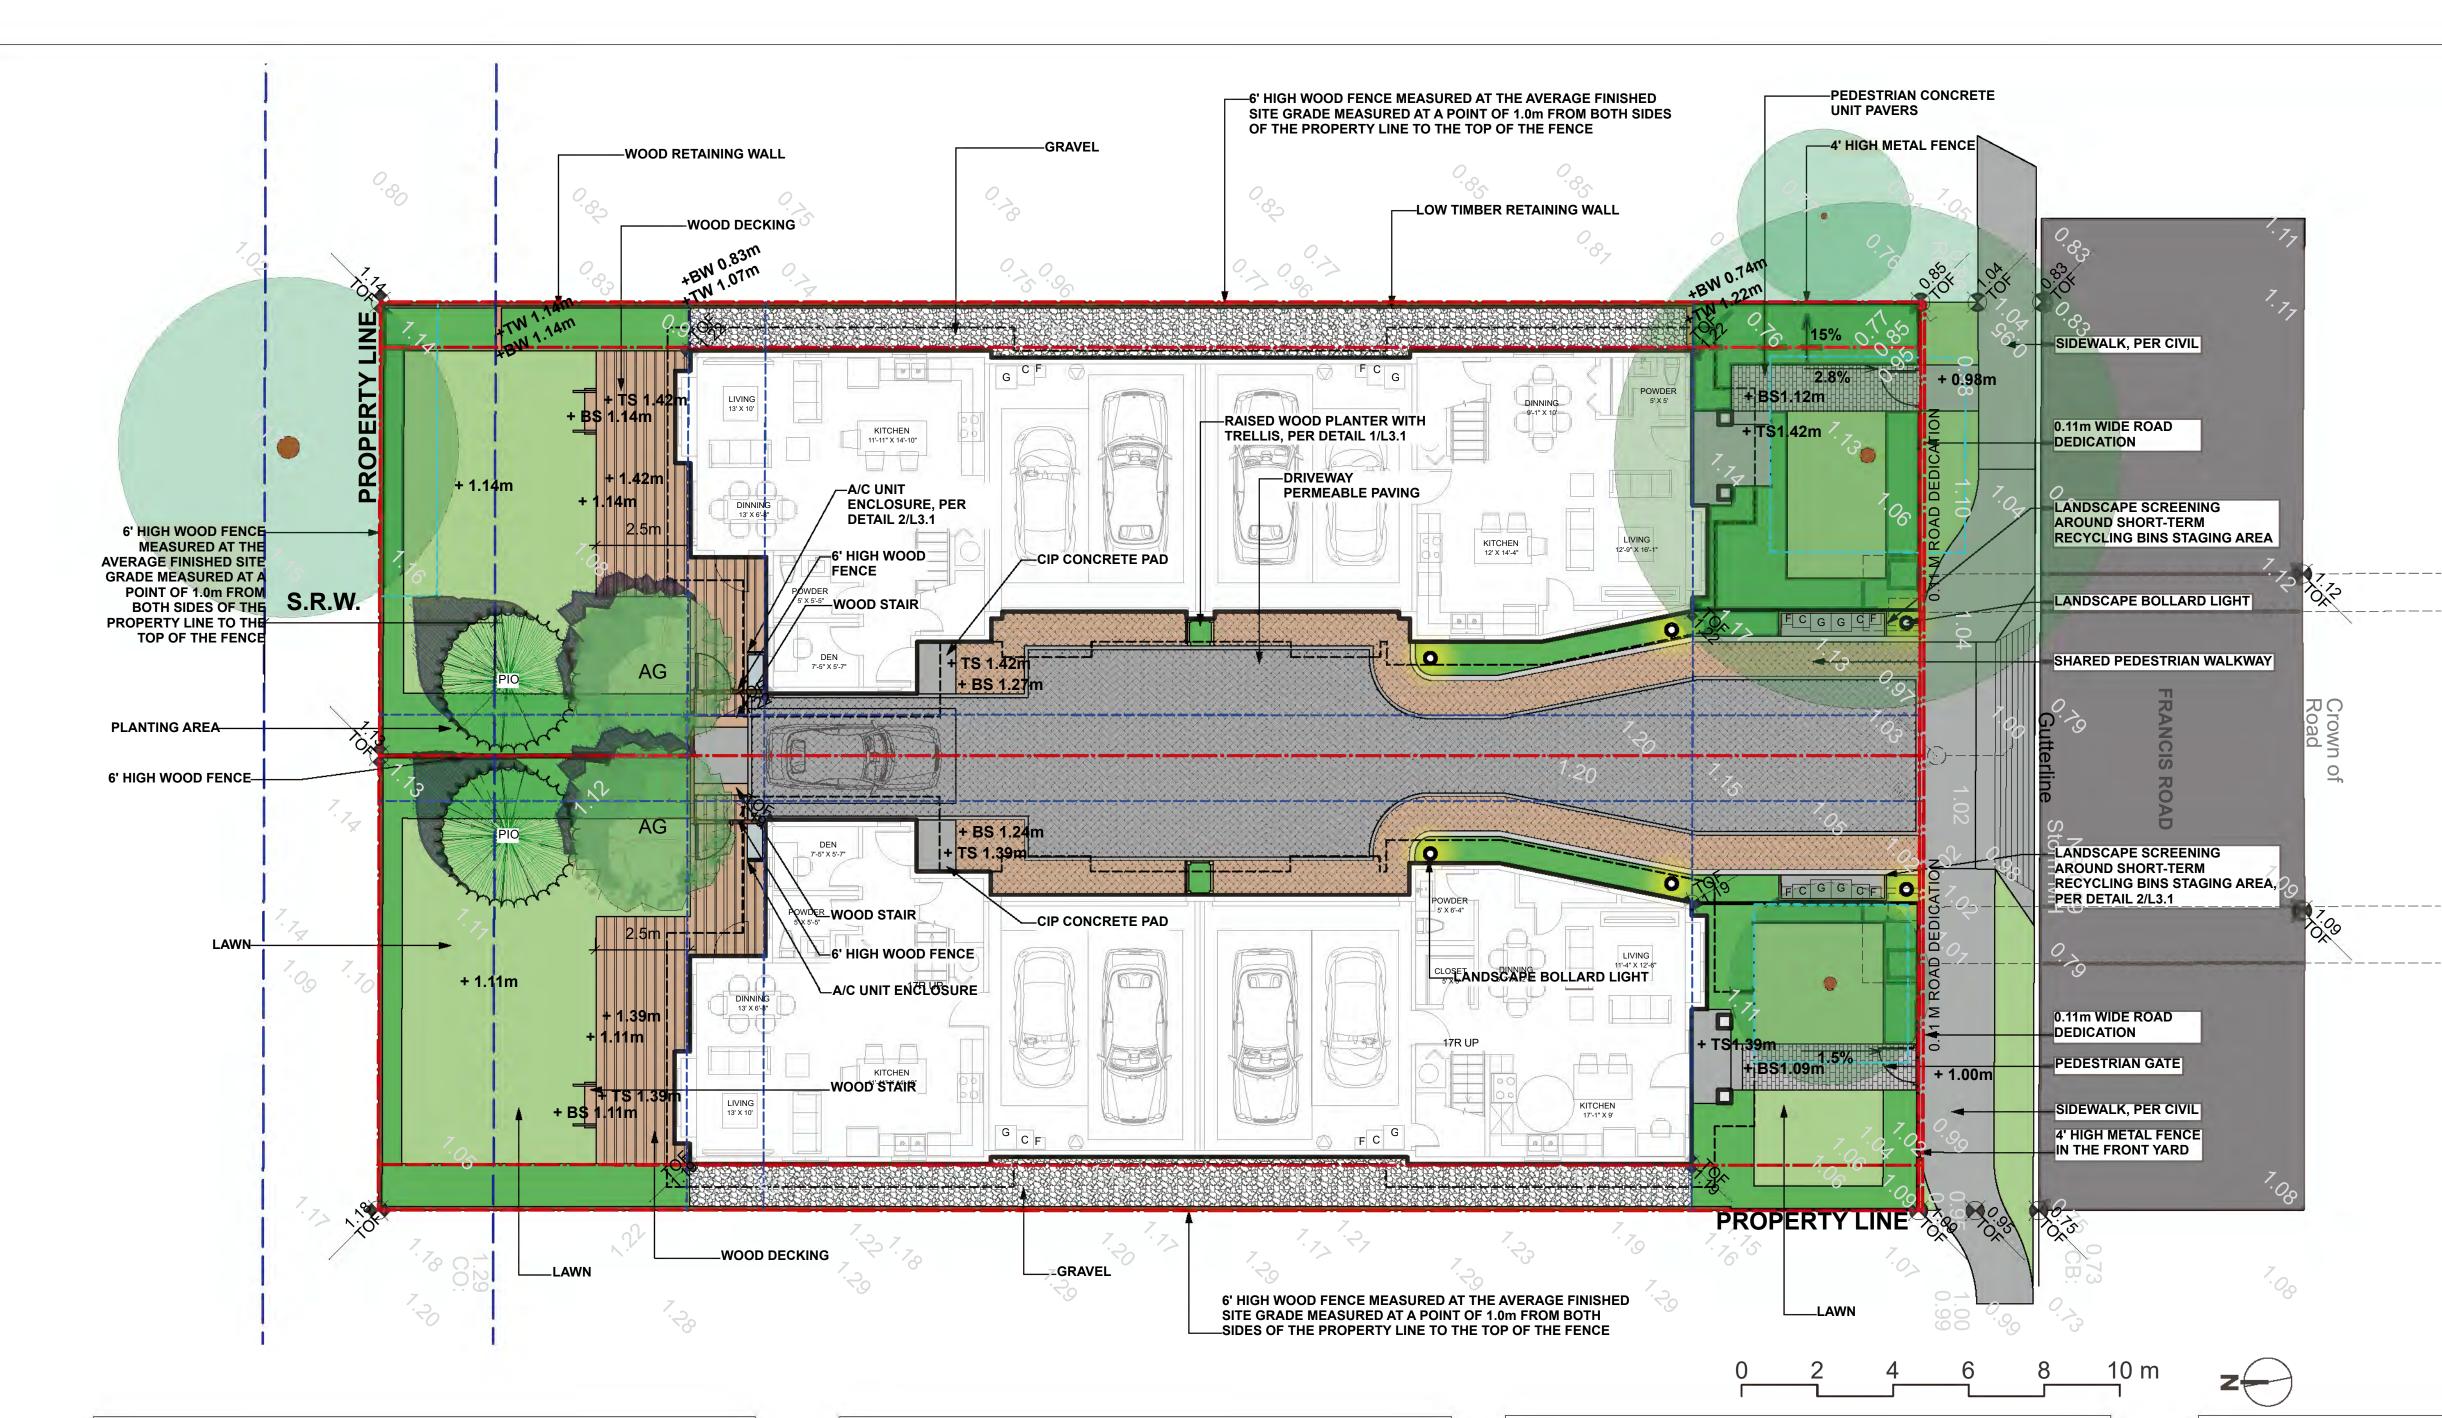

LANDSCAPE LEGENDS			
SYMBOL	MATERIALS	DETAILS	
	PEDESTRIAN CONCRETE UNIT PAVERS	2/L3.0	
	WOOD DECKING	5/L3.0	
	CIP CONCRETE PAVING	1/L3.0	
	80MM AQUA PAVER STANDARD PERMEABLE PAVERS FOR DRIVEWAY & PARKING	3/L3.0	
	80MM AQUA PAVER STANDARD PERMEABLE PAVERS FOR PEDESTRIAN PATH	3/L3.0	
	LAWN		
	PLANTING BED		
	6'-0" HIGH WOOD FENCE	4/L3.1	
. <u></u>	4' HIGH METAL FENCE	3/L3.1	
	WOOD RETAINING WALL		
	GRAVEL		
	EXISTING TREES		

LANDSCAPE NOTES

1. DO NOT SCALE DRAWINGS.

2. LAYOUT DRAWINGS ARE TO BE READ IN CONJUNCTION WITH ALL OTHER CONSULTANT DRAWINGS.

3.ALL EXISTING INFORMATION APPROXIMATE ONLY. VERIFY ALL EXISTING GRADES AND DIMENSIONS WITH SITE CONDITIONS. REPORT DISCREPANCIES TO CONSULTANT TEAM PRIOR TO PROCEEDING.

4. THE CONTRACTOR IS TO PROTECT ALL EXISTING UTILITIES, HARD SURFACES, STRUCTURES, WALLS, AND TREES FOR DURATION OF CONSTRUCTION.

5. THE LOCATION OF ALL PROPOSED HARDSCAPE AND SITE FURNISHINGS ARE TO BE FLAGGED OUT ONSITE BY THE CONTRACTOR AND APPROVED BY THE LANDSCAPE ARCHITECT PRIOR TO INSTALLATION.

6. ALL OFF-SITE WORKS TO CONFORM TO CITY OF **RICHMOND STANDARDS.**

7. LAYOUT OF ALL OFF-SITE WORKS, INCLUDING FURNISHINGS, PATHWAYS, WALLS, PLANTING, ETC., TO BE CONFIRMED WITH CITY OF RICHMOND PRIOR TO INSTALLATION.

GRADING LEGEND			
KEY	DESCRIPTION		
+1.30m	PROPOSED SPOT ELEVATIONS		
+ TW 1.60m	PROPOSED TOP OF WALL ELEVATION		
+ BW 1.30m	PROPOSED BOTTOM OF WALL ELEVATION		
+TS 1.60m	PROPOSED TOP OF STAIR ELEVATION		
+ BS 1.30m	PROPOSED BOTTOM OF STAIR ELEVATION		
0.85 TOT	PROPOSED ELEVATIONS PER ARCHITECTURE		
2% >	SLOPE PERCENTAGE		
0. . ₀₇	EXISTING ELEVATIONS, PER SURVEY		

1. ALL DIMENSIONS/ELEVATIONS ARE IMPERIAL (FEET, UNLESS OTHERWISE NOTED. DO NOT SCALE DRAWINGS.

3. REFER TO CIVIL DRAWINGS OFF-SITE ROAD GRADING INFORMATION.

4. REFER TO ARCHITECTURAL DRAWINGS FOR BUILDING ELEVATIONS.

5. ALL EXISTING SURVEY INFORMATION APPROXIMATE. VERIFY ALL EXISTING GRADES WITH SITE CONDITIONS. REPORT DISCREPANCIES TO CONSULTANT TEAM PRIOR TO PROCEEDING.

6. THE CONTRACTOR SHALL IDENTIFY AND PROTECT ALL EXISTING UTILITIES PRIOR TO CONSTRUCTION. ANY CONFLICTS FOUND WITH ULTITIES SHALL BE CLARIFIED WITH THE CONSULTANT TEAM PRIOR TO PROCEEDING.

7. UNLESS OTHERWISE NOTED, PROVIDE A MINIMUM 2% SLOPE ON ALL HARD AND SOFT LANDSCAPE AREAS TO ENSURE POSITIVE DRAINAGE AWAY FROM BUILDINGS AND TO DRAINAGE STRUCTURES. SOFT LANDSCAPE AREAS TO BE A MAXIMUM 3:1 SLOPE.

GRADING NOTES

2. ALL GRADING INFORMATION IS PRELIMINARY ONLY.

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4-UNIT DUPLEX DEVELOPMENT

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PROJECT NUMBER: 23-05


SCALE: 1:100 DRAWN BY: EL

REVIEWED BY: EL

PLAN #3


LANDSCAPE LAYOUT AND **GRADING PLAN**

L1.0

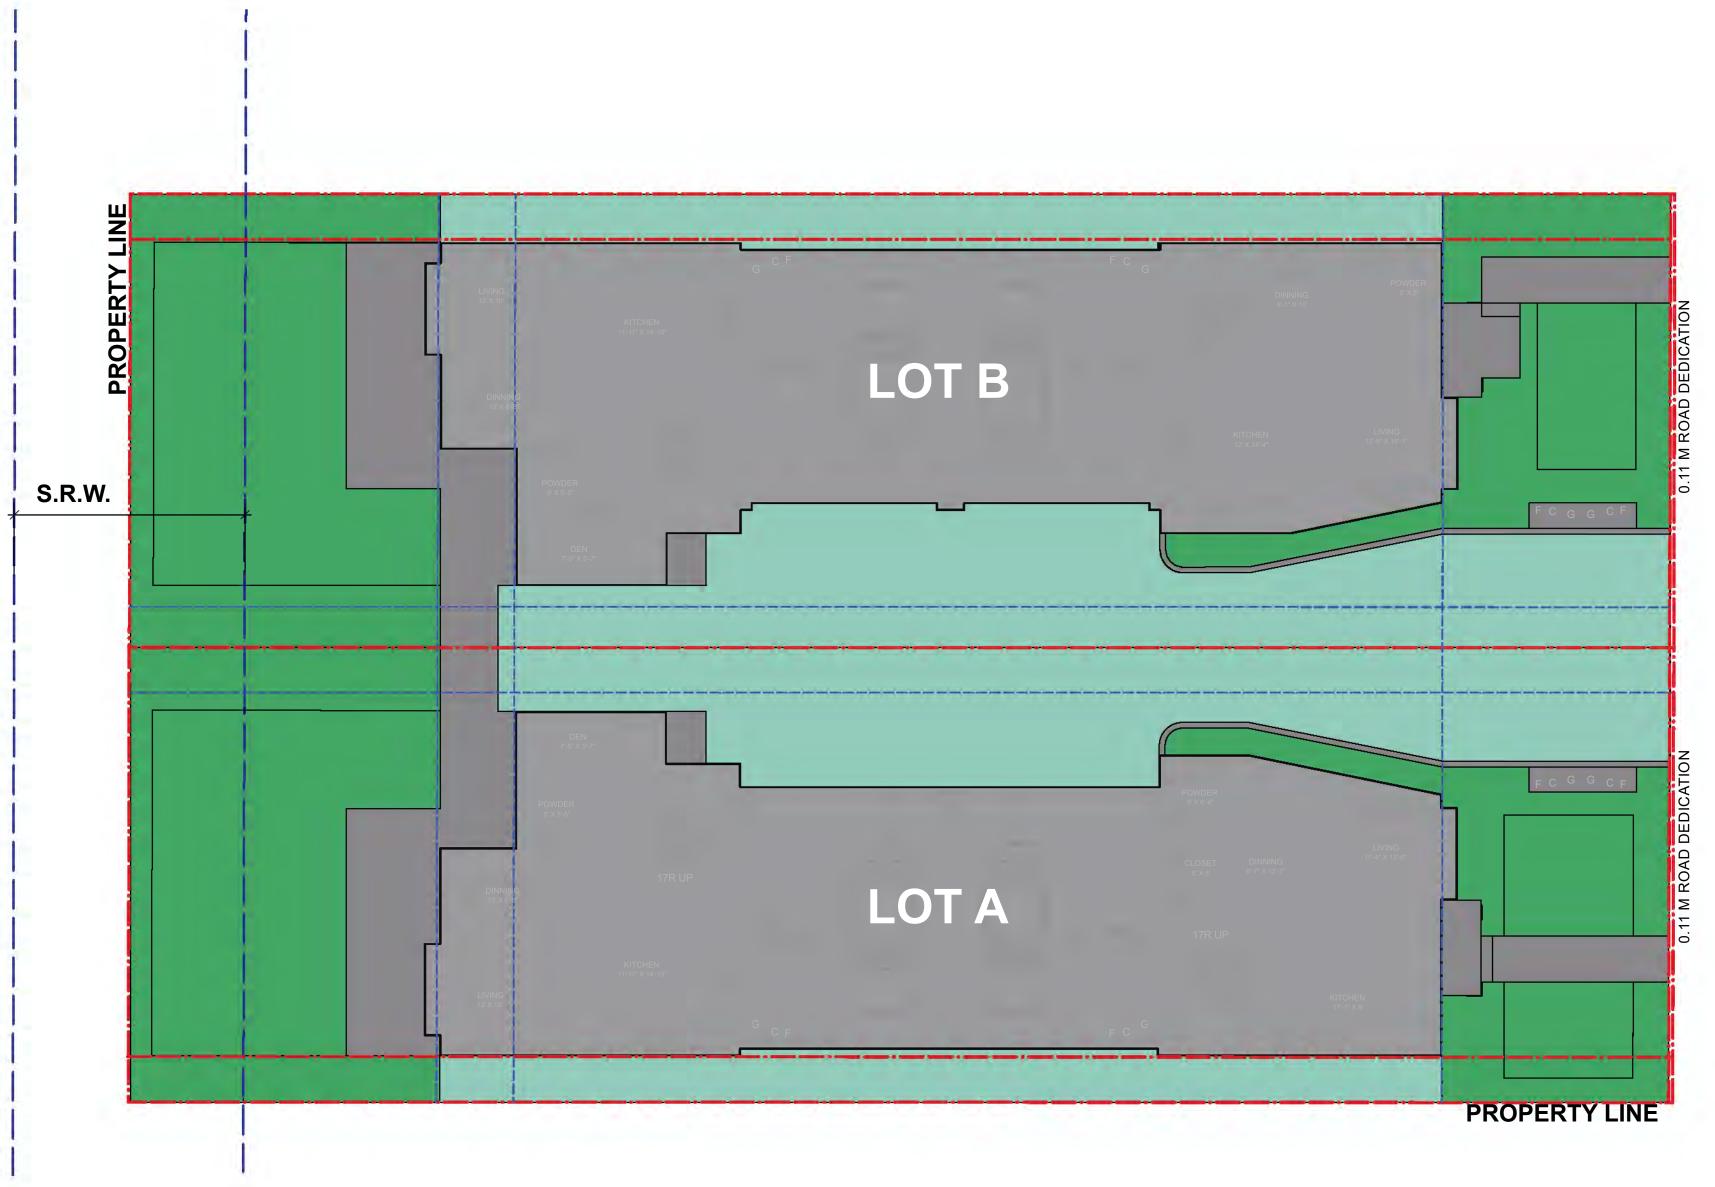

SYMBOL	MATERIALS	AREA	SYMBOL	MATERIALS	AREA	
	POROUS LANDSCAPING WITH LIVE PLANT MATERIAL: LAWN, GROUNDCOVER & SHRUB	128.8 m2		POROUS LANDSCAPING WITH LIVE PLANT MATERIAL: LAWN, GROUNDCOVER & SHRUB	127.1 m	
	POROUS HARDSCAPE MATERIAL: PERMEABLE PAVER & GRAVEL	123.2 ft2		POROUS HARDSCAPE MATERIAL: PERMEABLE PAVER & GRAVEL	125.3 ft	
TOTAL PORC	OUS SURFACE AREA: 252 m2		TOTAL PORO	US SURFACE AREA: 252.4 m2	2	
TOTAL LOT A	AREA: 488.68 m2		TOTAL LOT A	REA: 488.68 m2		
TOTAL PORC PERCENTAG	OUS SURFACE AREA COVERA E: 51.6%	GE	TOTAL PORO PERCENTAGE	US SURFACE AREA COVERA E: 51.6%	GE	
TOTAL NON- PERCENTAG	POROUS SURFACE AREA CO\ E: 48.4%	/ERAGE		TOTAL NON-POROUS SURFACE AREA COVERAGE PERCENTAGE: 48.4%		
TOTAL PORC	OUS LANDSCAPING AREA CO	VERAGE		TOTAL POROUS LANDSCAPING AREA COVERAGE PERCENTAGE: 26.0%		

0 2 4 6 8 10 m **Z**

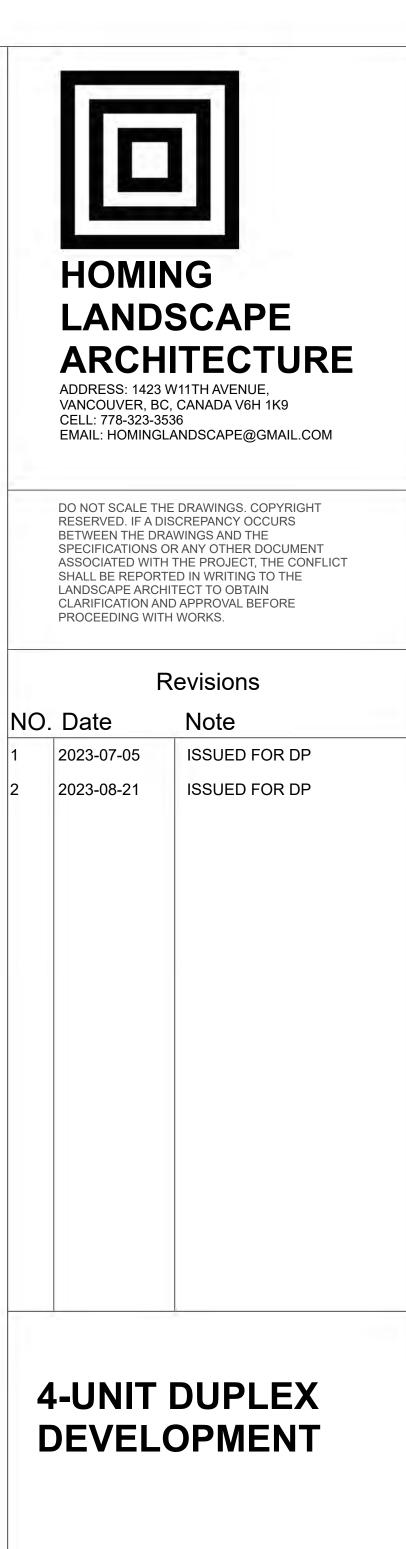

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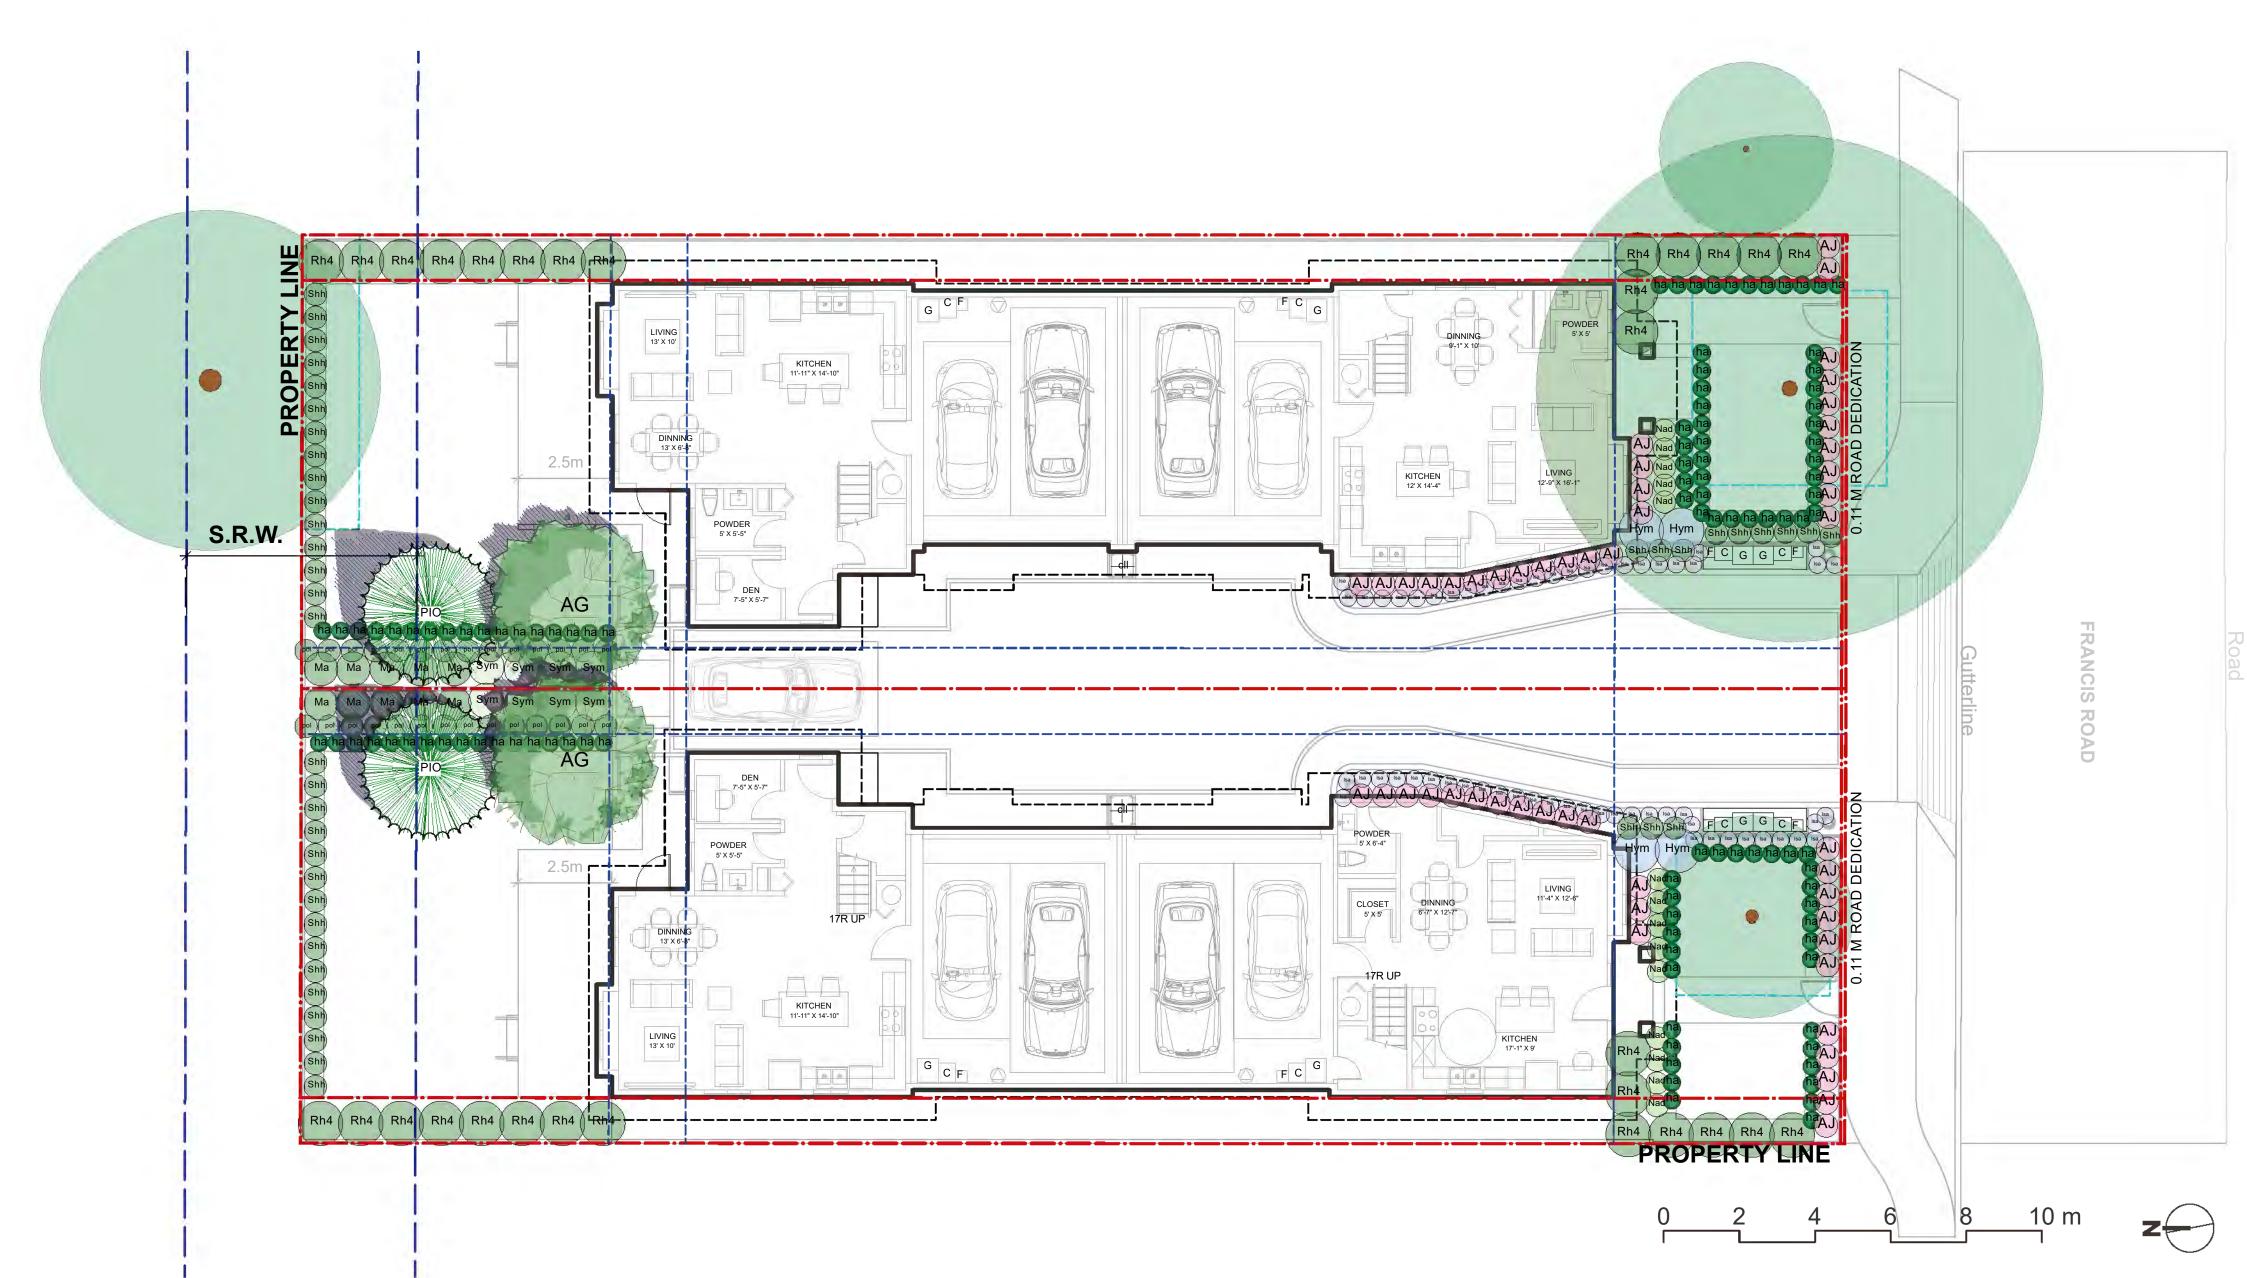
PROJECT NUMBER: 23-05

SCALE: 1:100 DRAWN BY: EL

REVIEWED BY: EL

POROUS AREA DIAGRAM

PLAN #3.b L1.1



UNSITE PLANT LIST					
ID	Latin Name	Common Name	Quantity	Scheduled Size	Notes
TREES (DECIDUOUS & CONIFEROUS)					+
AG	Acer griseum	Paperbark Maple	2	8cm cal.	
PIO	Pinus contorta var. contorta	Shore Pine	2	4m high.	
SHRUBS					+
AJ	Azalea japonica 'Kent's Pride'	Kent's Pride Azalea	51	#2 pot	
Hym	Hydrangea macrophylla	Bigleaf Hydrangea	4	#3 pot	
Ма	Mahonia aquifolium	Oregon Grape Holly	10	#2 pot	
Nad	Nandina domestica	Heavenly Bamboo	14	#2 pot	
Rh4	Rhododendron 'PJM'	PJM Rhododendron	30	#3 pot	
Shh	Sarcococca hookeriana var. humilis	Sweet Box	42	#2 pot	
Sym	Symphoricarpos alba	Snowberry	8	#2 pot	<u> </u>
PERENNIALS & GROUNDCOVERS					+
lsa	Lavandula angustifolia	English Spike Lavender	59	#2 pot	
pol	Polystichum munitum	Western sword fern	28	#1 pot	<u> </u>
ORNAMENTAL GRASSES & BAMBOOS					
ha	Hakonechloa macra `Aureola`	Golden Japanese Forest Grass	106	#1 pot	<u> </u>
					+
cll	Clematis ligusticifolia	Western White Clematis	2	#1 pot	<u> </u>
					+
					\pm

PLANTING NOTES:

1) In case of discrepancy between plant numbers on this list and on the plan, the latter shall prevail.

2) All planting shall be in accordance with CSLA Landscape Standard, latest edition.

3) The Landscape Contractor shall ensure that the on-site planting medium/soil meets the specification & recommendations of the soil analysis taken at the time of Substantial Completion. All recommendations of the soil analysis shall be executed prior to Final Acceptance of the landscape works by the Consultant and the municipal authorities.

4) Minimum planting medium depths: lawn - 6"/150mm groundcover - 12"/300 mm shrubs - 18"/450 mm trees - 24"/600 mm (around & beneath rootball)

5) All plant material to be supplied on the job site must be obtained from a nursery participating in the BCLNA Phytophthora ramorum Certificaiton Program.

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Revisions

NO. Date

2023-07-05 2023-08-21 Note ISSUED FOR DP ISSUED FOR DP

4-UNIT DUPLEX DEVELOPMENT

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PROJECT NUMBER: 23-05

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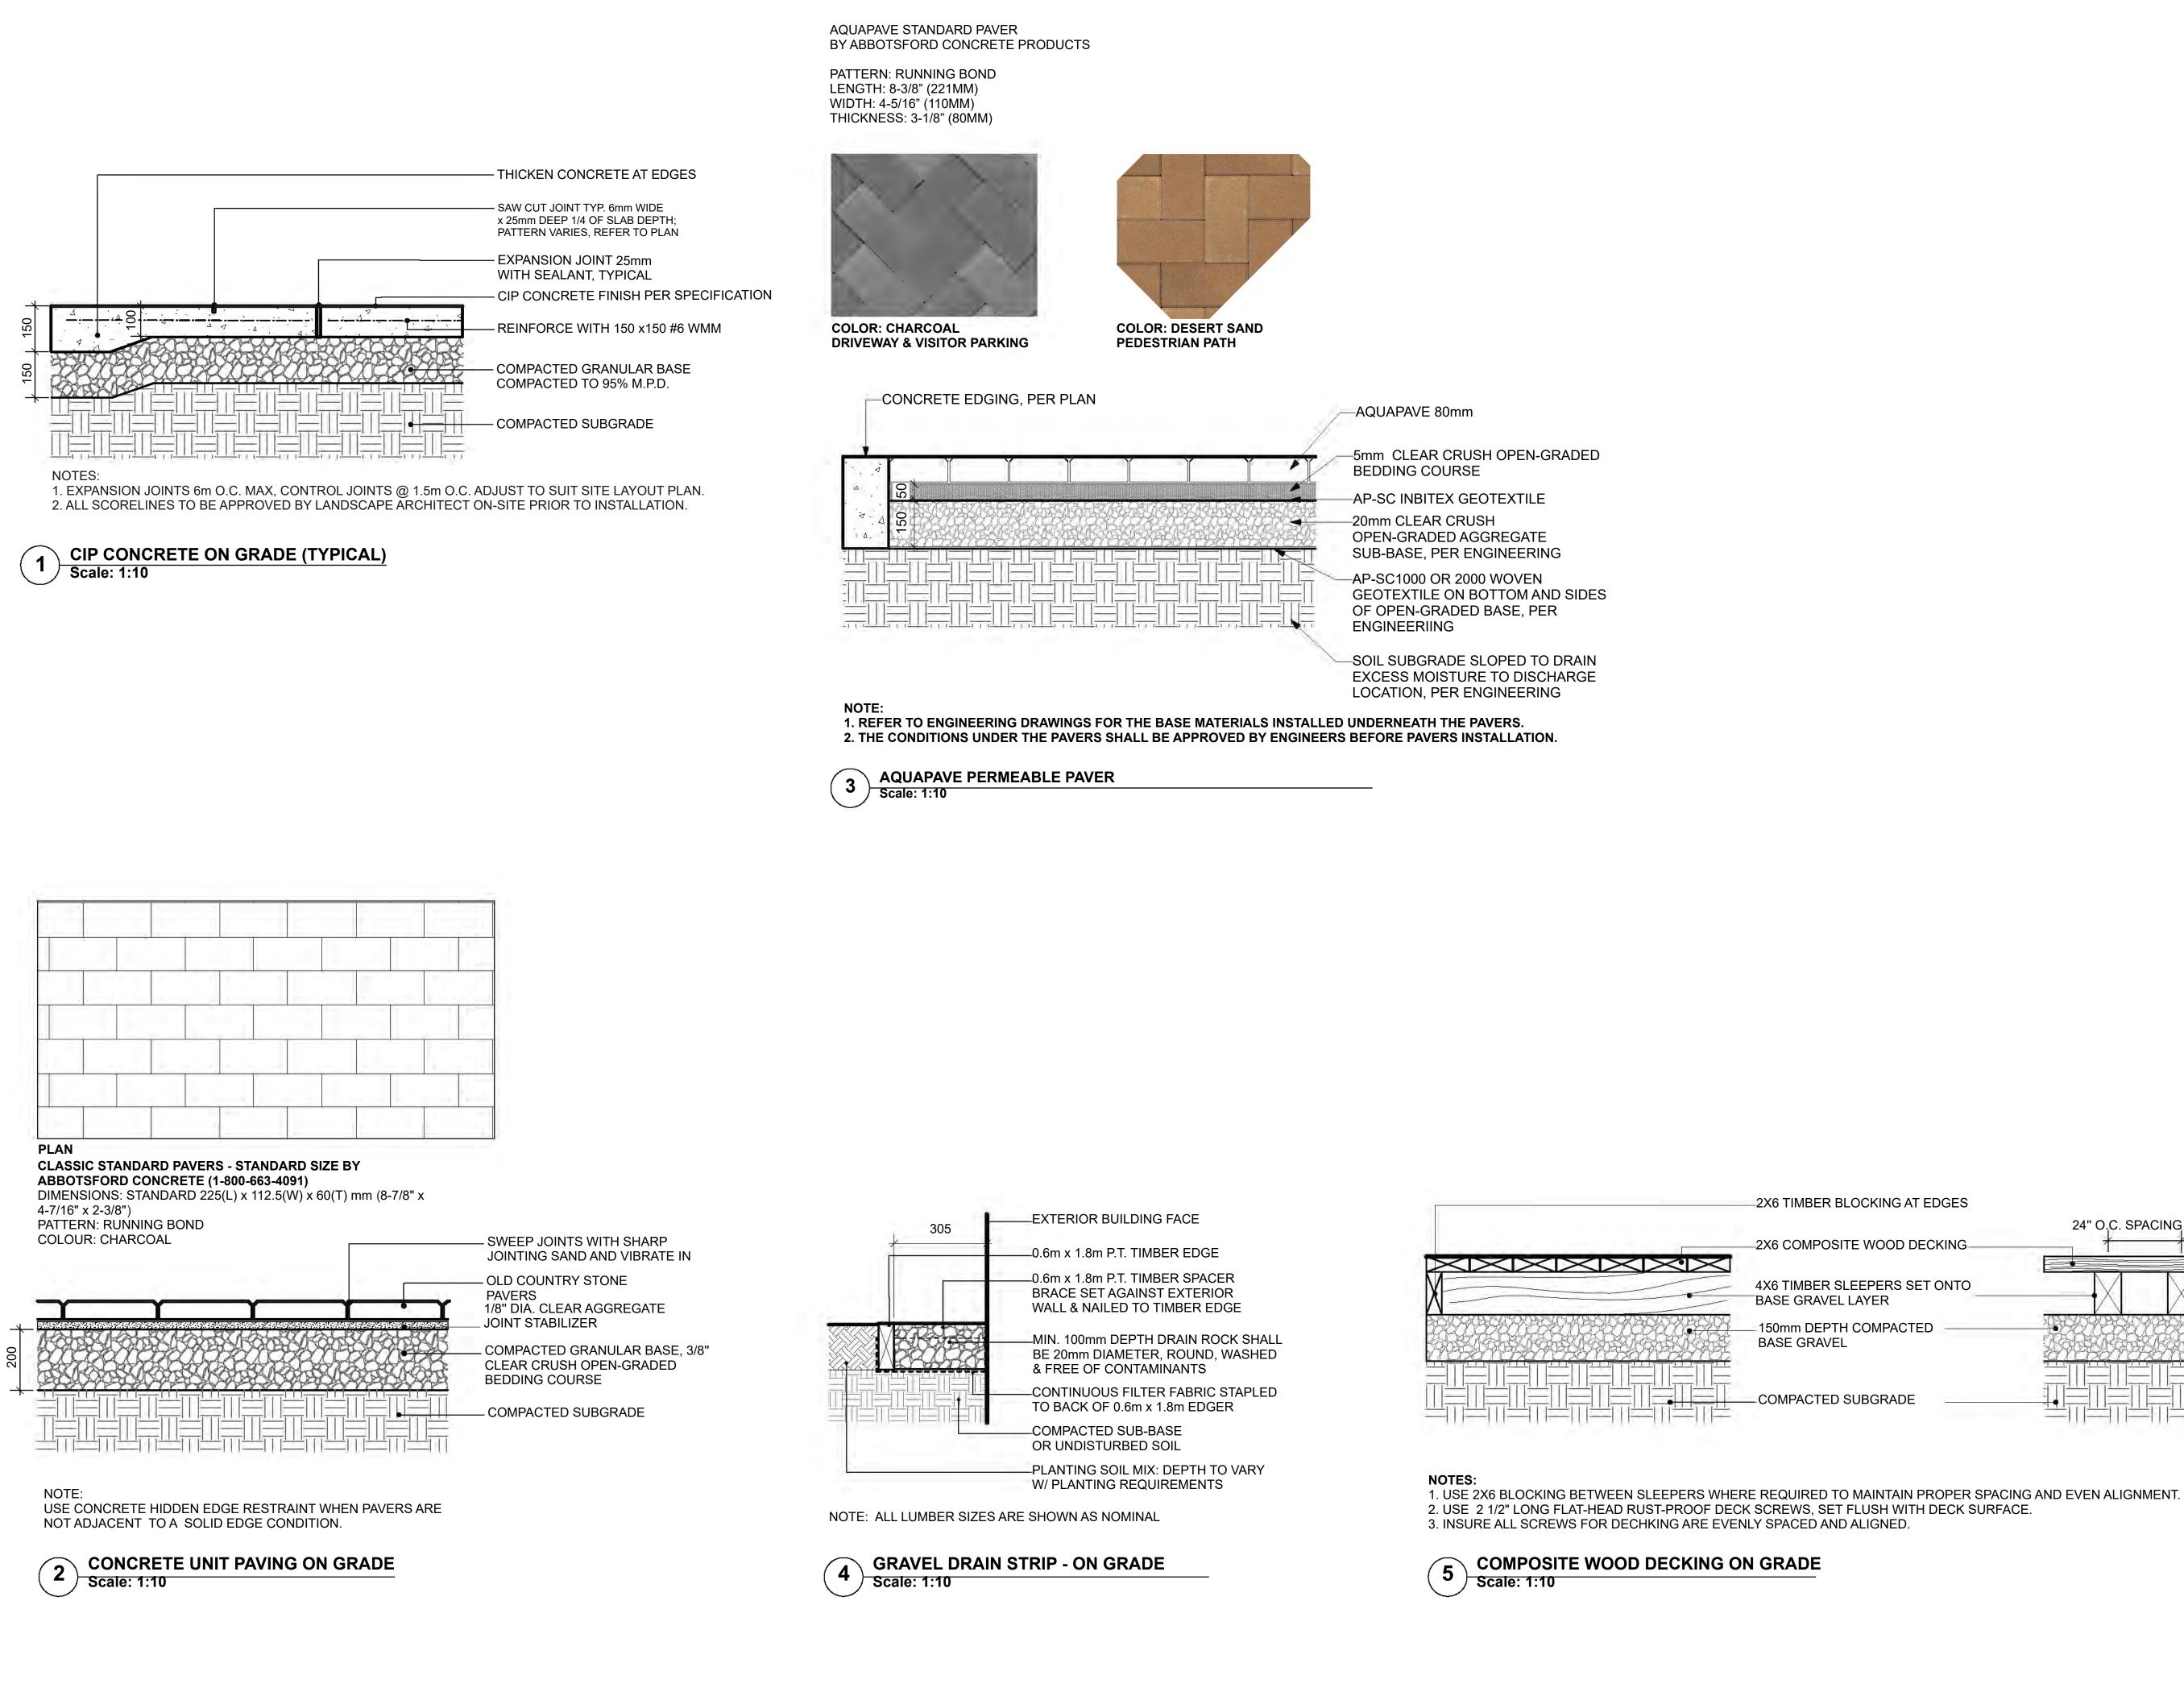
DRAWN BY: EL

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PLAN #3.c

LANDSCAPE PLANTING PLAN

L2.0







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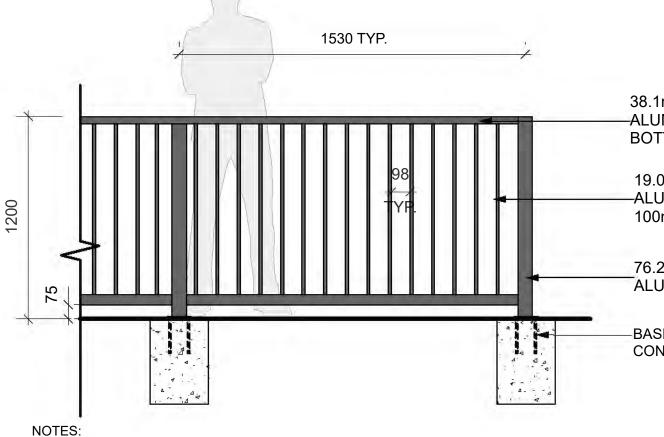
2X6 TIMBER BLOCKING AT EDGES 24" O.C. SPACING TYP. -2X6 COMPOSITE WOOD DECKING-4X6 TIMBER SLEEPERS SET ONTO BASE GRAVEL LAYER 150mm DEPTH COMPACTED BASE GRAVEL COMPACTED SUBGRADE

1 disc	DO NOT SCALE THE DRAWINGS. COPYRIGHT RESERVED. IF A DISCREPANCY OCCURS BETWEEN THE DRAWINGS AND THE SPECIFICATIONS OR ANY OTHER DOCUMENT ASSOCIATED WITH THE PROJECT, THE CONFLICT SHALL BE REPORTED IN WRITING TO THE LANDSCAPE ARCHITECT TO OBTAIN CLARIFICATION AND APPROVAL BEFORE PROCEEDING WITH WORKS.		
Revisions NO. Date Note			
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-6' HIGH, 2' WIDE PANEL TRELLIS



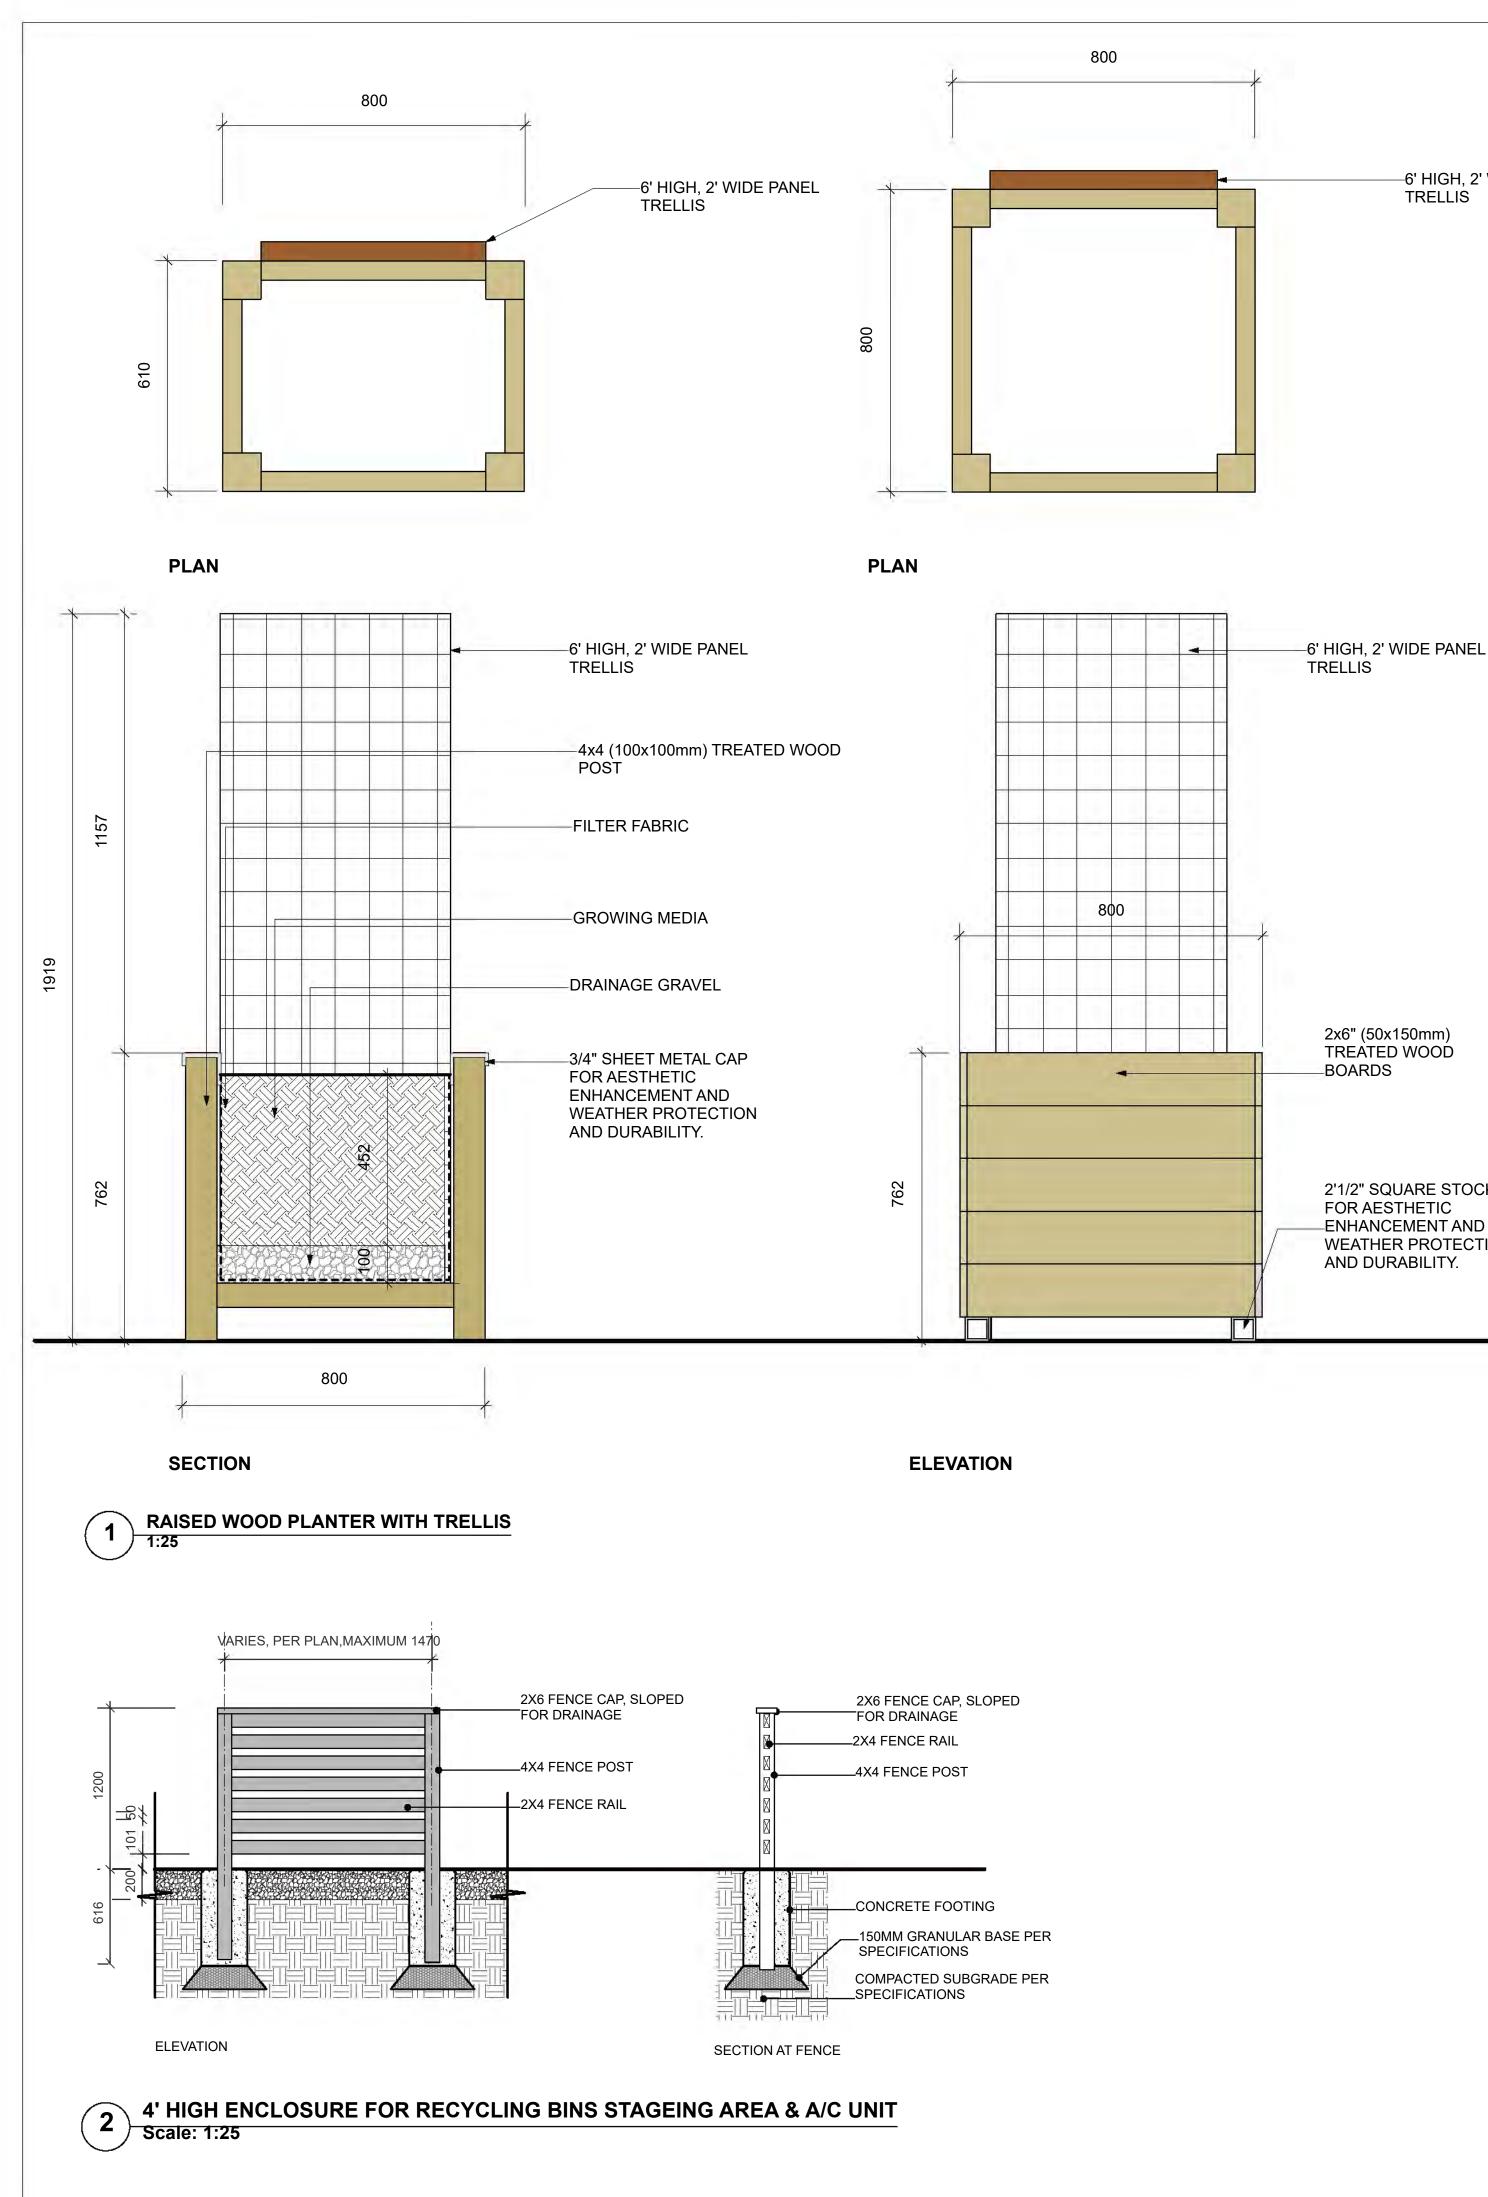

1. ALL METAL ALUMINUM WITH BLACK POWDERCOAT FINISH (TO BE FACTORY APPLIED) 2. ALL WELDED CONSTRUCTION.

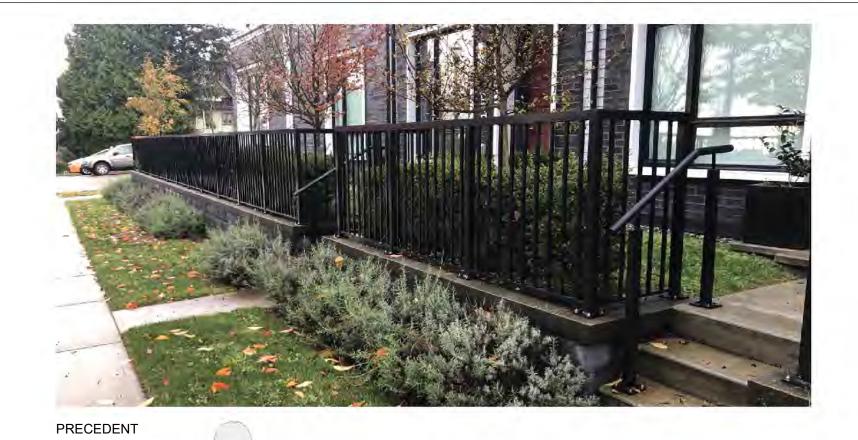
3. PROVIDE SHOP DRAWINGS FOR APPROVAL. 4. CONCRETE FOOTING TO BE CONFIRMED BY STRUCTURAL ENGINEER.

4' HIGH METAL FENCE IN THE FRONT YARDS ໌3 ີ

NOTE:

Scale: 1:20

6' HIGH FENCE IS MEASURED FROM THE AVERAGE FINISHED SITE GRADE (MEASURED AT A POINT 1.0m FROM BOTH SIDES OF THE PROPERTY LINE) TO THE TOP OF THE FENCE.

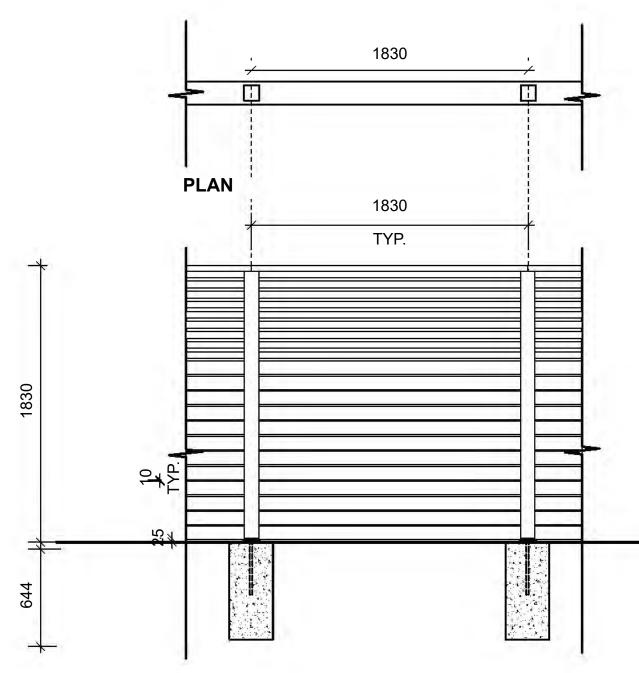

TYPICAL FENCE ELEVATION ON GRADE

NOTES:

1. ALL WOOD EXPOSED TO VIEW SHALL BE C AND BETTER CLEAR CEDAR.

2. ALL WOOD SHALL BE STRAIGHT, SOUND, AND FREE OF SPLITS, WARPS, CRACKS, LARGE KNOTS, AND OTHER DEFECTS.

3. WOOD PRESERVATIVE TO BE USED SHALL BE OLYMPIC MAXIMUM WATERPROOFING SEALANT, "CEDAR TINT".

4. ALL CUTS TO BE SQUARE AND CLEAN.

5. ALL METAL FIXTURES TO BE GALVANIZED (OR WHERE NOTED - STAINLESS STEEL).

6. ALL STRUCTURAL FASTENERS TO BE GALVINIZED CARRAIGE BOLTS (IE. TRELLIS, AND GATE)

4 6 nici Scale: 1:25 **6' HIGH WOOD PRIVACY SCREEN**



2x6" (50x150mm) TREATED WOOD BOARDS

2'1/2" SQUARE STOCK RAIL FOR AESTHETIC -ENHANCEMENT AND WEATHER PROTECTION AND DURABILITY.

38.1mm SQUARE (1-1/2") -ALUMINUM TOP AND **BOTTOM RAILS**

19.05mm SQUARE (3/4") -ALUMINUM PICKETS @ 100mm O.C.

76.2mm SQUARE (3") ALUMINUM POST

-BASE PLATE ANCHORED IN CONCRETE FOOTING



PRECEDENT WEST PROPERTY LINE _2X6 FENCE CAP, SLOPED FOR DRAINAGE 1X2 FENCE RAIL _4X4 FENCE POST 1X4 FENCE RAIL 330 CONCRETE RETAINING WALL 1000 1000

> FENCE SECTION ON THE TOP OF RETAINING WALL



LANDSCAPE ARCHITECTURE ADDRESS: 1423 W11TH AVENUE.

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Revisions NO. Date Note 2023-07-05 2023-08-21

ISSUED FOR DP ISSUED FOR DP

4-UNIT DUPLEX DEVELOPMENT

PROJECT ADDRESS: 6531 FRANCIS ROAD RICHMOND, BC, CANADA

PROJECT NUMBER: 23-05

SCALE: AS SHOWN DRAWN BY: EL

REVIEWED BY: EL

Furnituring Details

PLAN #3.e L3.1