
Schedule 1 to the Minutes of the Development Permit Panel meeting held on Wednesday, March 26, 2025



TOWNHOUSE DEVELOPMENT AT 9371 & 9391 FRANCIS ROAD, RICHMOND, BC (RZ 22-005593 / DP 23-029303)

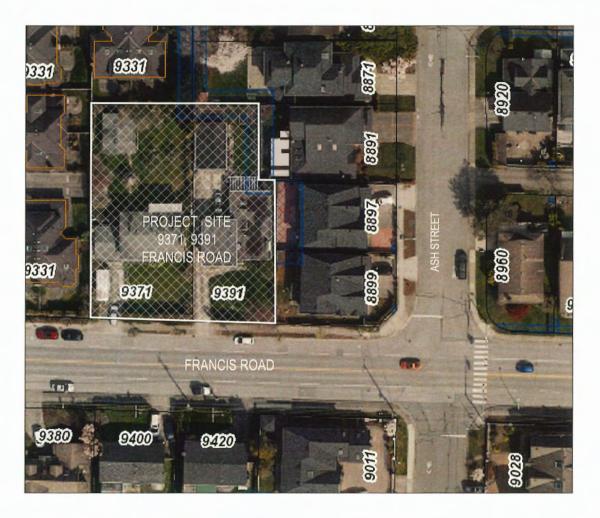























BESUED FOR GPP ARVEW	12_	JL_	23.07
RESULTS FOR DE RESULTAMBRION	JZ.	JL.	25.83
MINUS FOR AGP REVIEW	JZ	JL.	2410
M-SULED FOR DP REJUSEWEEKON	32.	JL	2410
MALLED FOR DF RESURNISHEN	12.	JL.	24.88
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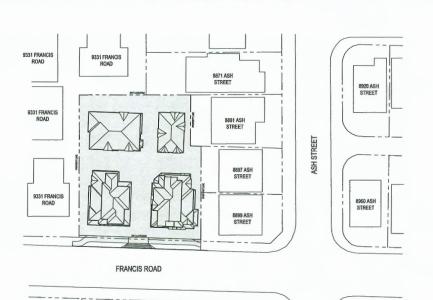
TOWNHOUSE DEVELOPMENT

9371 / 9391 FRANCIS ROAD RICHMOND, BC (RZ 22-005593, DP 23-029303)

CONTEXT STREET VIEWS

#8272 N.
Drawing No. Sheet

A 0.1 of N.T.S.



9011 ASH STREET

9380 FRANCIS ROAD

> 9400 FRANCIS ROAD

9420 FRANCIS ROAD



1 CONTEXT SITE PLAN A0.5 SCALE: 1"=30'-0"

2 STREETSCAPE SITE PHOTO SCALE: N.T.S.

3 STREETSCAPE ELEVATION

A0.5 SCALE: 1"=20'-0"



9028 ASH STREET



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TOWNHOUSE DEVELOPMENT 9371/9391 FRANCIS ROAD RICHMOND, BC (RZ 22-005593, DP 23-029303)

SITE CONTEXT PLAN & STREETSCAPE

#8272 Sorie AS NOTED

Deving No. Street Periods

A 0.5 of

Lot	Clyle	Address			L	egal Descri	ption		PID		
Lat 1	9371 Francis R	9371 Francis Road, Richmond, BC			LOT 58 EXCE 142, SECTION : NEWE		003-9				
Lot 2	9391 Francis Road, Richmond, BC		LOT 551	LOT 551 PLAN 58839, SECTION 22, BLOCK 4, NORTH RANGE 6 WEST, NEWESTMINSTER DISTRICT			ITH RANGE 6	003-907-422			
Planning Area		06 Broa	dmoor		10000			9000			
Gross Site Area		20580.58	SF		1912.00	SM					
Road Dedication		268.68	SF	=	24.96	SM					
Net Site Area		20311.90	SF		1887.04	SM					
Max. FSR Allowed (RTL4 Zone)		0.6						1000			
Floor Area Allowed		12187.14	SF	2	1132.22	SM					
Total Net floor Area Provided		12181.90	SF	*	1131.74	SM					
Total FSR Provided		0.60		<=	0.6						

Project Statistics					
	-	Existing		Proposed	Notes
Zoning		RS1/E		RTL4	
Land Use	Single F	amily Detached	1	lownhouse	
OCP Designation	Neighbor	rhood Residential	Neighbo	whood Residential	
Amount of Unit		2		9	-
	Regul	red / Allowed		Proposed	Notes
Floor Area Ratio		0.6		0.6	
Lot Coverage (Building & Porch)	4	10% Max.		39%	
Lot Coverage (Non Porous Materials)	6	55% Max.		62%	
Lot Coverage (Landscaping)	2	15% Max.		25%	
Setback - Front Yard (South)	6.00	Meters	4.57	Meters	Variance Required
Setback - Interior Side Yard (West)	3.00	Meters	3.04	Meters	
Setback - Interior Side Yard (East)	3.00 Meters		3.04	Meters	
Setback - Rear Yard (North)	3.00 Meters		6.01	Meters	
Building Height - 3 Storey (Meters)	12.00	Meters	11.16	Meters	
Building Height - 2 Storey (Meters)	9.00	Meters	8.72	Meters	

Points	Loca	stion	<b>Existing Grad</b>	de	Proposed Gr	rade		Notes			
1	South	hwest	1.18	Meter	1.18	Meter		cent to City's No		-	
2	Sout	heast	1.02	Meter	1.02	Meter		cent to City's No			
3	Nort	heast		Meter		Meter		RW and adjacent to neighboring propertie			
4	Nort	hwest	0.88	Meter	0.88	Meter	Adjac	ent to neighbori	ng properties		
5	Building A	Southeast				Meter					
6	Building A	Northeast				Meter					
7	Building A	Northwest				Meter					
8	Building A	Southwest				Meter				-	
9	Building B	Southeast				Meter					
10	Building B Northwest					Meter				-	
11						Meter				-	
12	Building B	Southwest				Meter				-	
13	Building C	Southeast				Meter			_	-	
14	Building C	Northeast				Meter			_	-	
15	Building C	Northwest				Meter				+	
16	Building C	Southwest				Meter			-	+	
17	Building D	Southeast				Meter				+	
18		Building D Northeast				Meter			-	-	
19	Building D	Northwest				Meter			-	+	
20	Building D	Southwest				Meter				-	
Total						Meter			10	_	
Average Grade					1,17	Meter		@ 26.60/	10		

<b>Ground Floor Interior Elevation Ca</b>	alculation	
Highest Point of Crown of adjacent Street	1.11 Meter	
Flood Protection Requirements for L1 Living Space	0.3 Meter	
Established L1 Interior elevation for Living Space	1.41 Meter	The state of the s
	-	

Covered Porch Area exemption	0.00	26.50	0.00	28.50	SF	2.46	
Top Stair Area examption	42.25	49.53	\$2,77	144.55	52	15.43	SM
ULINy Room Area examption	0.00	54,34	100.61	155.17	SF	14.42	SM
Green Building System Ares Examption	25.30	25.90	25.30	75.90	SF	7.03	
Total Area Exemption				1881.58	SF	174.80	SM
Total Het Floor Area		udding A		1843.91	\$2	857.11	IM
Building D Area Calculat		Level 1		Z411.34	Tex	224.02	lsu
Subtotal Gross Floor Area		Level 2		2126.16		197.31	
Subtotal Gross Floor Area		Level 3		1152.18	SF	107.04	
Total Gross Area	-	\$400.7	17	\$28.50			
LI Stair Area exemption	107.62	69.61	83.73	278.96	SF	23.92	3M
Garaga Area exemption	562.80	440.09	387.74	1210,63	SF	112.47	
Covered Porch Area exemption	0.00	26.50	0.00	26.50		2.46	
Top Stalr Area ecomption	42.00	49.53	51,12	142.65	SF	13.25	
Utility Room Area exemption	58.76	0.00	0.00	SB.76	SF.	5.46	
Green Building System Area Examption	25.30	25.30	25.30	75.90		7.05	
Total Area Exemption				1793.40		166.61	
Total Net Floor Area		uliding D		1896,30		361,96	

Building A Area Calculation
Subtrate Gross Floor Area
Subtrate Gross Floor Area
Subtrate Gross Floor Area

Subtotal Gross Floor Ares	Levi	of L	1048.61	SF	97.42	52
Subtotal Gres Floor Area	Lev	ni 2	1048.05	SF	\$7.37	334
Total Gross Area	Bylid	ing 8	2094.66	34	154.79	IM
1 Stair Area examption	107,62	SF	107.62	SF	10.00	344
Garage Area exemption	396.24	58	396.24	SF	36.81	31.
Covered Forth Area examption	23.47	S.F	23.47	53	2.18	34
Top Staly Area examption	57,88	SF	57.88	y v	5.34	W
Utility Room Area examption	0.00	3.5	0.00	SF	0.00	14
Green Building System Area Exemption	25.30	3.F	25.80	SF	2.33	SM
Total Area Examption			610.51	14	54.72	SI,
Total Not Floor Area	Byld	ne i	1489,13	10	138.07	TI.

Subtotal Gross Floor Area	Level 1		2136.18	SF	198.44	SM
Subtotal Gross Floor Area	Leve	1995.11	SF	183.33	SN	
Total Gross Area	Builds	AC.	4131.21	W	343.61	śМ
L1 Stair Area examption	107.61	107.61	215.22	SF	19.99	54
Garage Area exemption	382.51	340.89	772.40	SF	71.76	SN
Covered Porch Area examption	23.33	0.00	23.33	3.F	2.17	114
Top Stair Area exemption	57.11	57.11	114.22	SF	10.61	SM
Utility Room Area examption	0.00	0.00	0.00	SF	0.00	SN
Green Building System Area Exemption	15.30	25.30	\$0.60	547	4.70	SM
Total Area Exemption			1173.77	SF	109.23	1M
Total Het Floor Area	Bulldout		2985.52	¥	274.58	1M

Residential Parking Required	2	Stalls / Unit	X	9 Unit	=	18	Stalls		
Residential Parking (Standard) Provided						12	Stells		
Residential Parking (Small Car) Provided					$\overline{}$	6	Stells	Variance Re	quired
Total Residential Parking Provided						18	Stalls		
Level 2 @ 240V EV Charger Provided	2	Outlet / Unit	. х	9 Unit		18	Outlets		
Visitor Parking Required	0.2	Stalls / Unit	X	9 Unit		1.8	Stalls		
Visitor Parking Provided						2	Stalls		
Tandem Parking Allowed		50%	X	9 Stall		4.5			
Tandem Parking Provided						0	Stall		
Lock-off Unit Parking Required *						0	Stalls		
Lock-off Unit Parking Provided *						0	Stalls		
Lock off Unit Parking Requirement	No additional p	arking stall required v	when side by side doubl	e parking stalls pro-	rided in project	s located on art	erial roads		-
H/C Visitor Parking Required						0	Stall		
H/C Visitor Parking Provided						0	Stall		
Class 1 Bike Storage Required	1.25	Spaces / Unit	X	9 Unit	H	11.25	Spaces		
Class 1 Bike Storage Provided				STATE AND ADDRESS.		18	Spaces		
Class 2 Bike Parking Required	0.2	Spaces / Unit	X	9 Unit	*		Spaces		
Class 2 Bike Parking Provided	1000					2	Spaces		

		Huilding A		Building B	Building C		Bullding D			Total	
Unit #	Unit #1	Unit #2	Unit #3	Unit #4	Unit #5	Unit #6	Unit #7	Unit #8	Unit #9	9	Units
Convertible Unit				-		-					
Lock-off Unit					*						
Residential Parking (Standard) Provided	1	1		1 2	2	2	1	1	1	12	Stalls
Residential Parking (Small Car) Provided	1	1		1			1	1	1		Stalls
Residential Parking Provided	2	2		2 2	2	2	2	2	2	18	Stalls
Tandem Parking Provided	0	(		0	0	0	0	0	0	0	Stalls
Class 1 Bike (Horizontal)	2	2		2 2	2	2	2	2	2	18	Spaces
Class 1 Bike (Vertical)	0	(	)	0	0	0	0	0	0	0	Spaces
Total Class 1 Bike Provided	2	1		2 2	2	2	2	2	2	18	Spaces
Lock-off Unit Parking Requirement	No additional p	arking stall rec	guired for loc	k-off units who	er side by side	e double park	ing stalls pro	ridec			
Level 2 @ 240V EV Charger Provided	2	1		2 2	2	2	2	2	2	18	Outlet

Floor Area Calculation											
	Bulldin	A A	Buildi	ing B	Bulldi	rvg C	Bulldi	ng D	Tota	1	Note
	(SF)	(5M)	(5F)	(5M)	(SF)	(5M)	(SF)	(5M)	(SF)	(SM)	
Gross Floor Area	5725.51	531,92	2096.66	194.79	4131.29	383.81	5689.7	528.59	17643.16	1639,10	
Floor Area Exemption	1881.58	174.80	610,51	56.72	1175.77	109.23	1793.40	155.61	5461.26	507.37	
Net Floor Area	3843.93	357.11	1486.15	138.07	2955.52	274,58	3896.30	361.98	12181.90	1131,74	

Private Outdoor Area Cald	ulation										
	Building A			Building B	Bullding C		Building D			Total	
Unit #	Unit #1	Unit #2	Unit #3	Unit #4	Unit #5	Unit #6	Unit #7	Unit #8	Unit #9	9	Units
Convertible Unit				1							
Lock off Unit					-						
Private Yard	387.50	710.02	364.70	1016.87	558.68	954.63	362.58	717.81	387.49	5460.28	SF
Balcony	64,02								64.02	128.04	SF
Total Private Outdoor Space Provided (SF)	451,52	710.02	354.70	1016.87	558.68	954.63	362.58	717.81	451.51	5588.32	SF
Total Private Outdoor Space Provided (SM)	42.10	66.21	34.01	94.82	52.10	89.02	33.81	66.94	42.10	521.11	SM
Compiled with Min. 305M Requirement	Yes	Yes	Yes	Yes	Yes	Yes	Yes	Yes	Yes		

<b>Outdoor Amenity Area Cal</b>	culation				
Total Amount of Unit	9 Unit				
Required Outdoor Amenity Area Ratio	6 M/Unit	-	64.58	SF/Unit	
Total Outdoor Amenity Area Required	54.00 SM	H	581.25		
Provided Outdoor Amenity Provided	109,48 SM		1178.44	SF	

		Building A		Building D	Bulld	ling C		Bullding D		Total	
Unit #	Unit #1	Unit #2	Unit #3	Unit #4	Unit #5	Unit #6	Unit#7	Unit #8	Unit #9	9	Units
Convertible Unit				1							
tock-off Unit					1						
Covered Porch Area per Unit	0.00	26.50	0.00	23.47	23.33	0.00	0.00	26.50	0.00	99.80	SF
Total Covered Porch Area Allowed	2031,19	SF	6	10%							
Total Covered Porch Area Provided	99.80	SF									
Total Covered Porch Ratio	0.5%	<	10%	Allowed							

	Bulld	ing A	Build	ing B	Bulld	ing C	Bulldi	ng D	Tota	d	Note
	(5F)	(SM)	(SF)	(SM)	(SF)	(SM)	(5F)	(SM)	(SF)	(SM)	
Building Area Provided	2411.36	224.02	1048.61	97.42	2136.18	198.46	2411.36	224.02	8007.51	743,92	
Site Area	20311.90	SF									
Total Building Area Allowed	8124.76	SF	0	40%							
Total Building Area Provided	8007.51	SF	<	8124.76	SF						
Total Building Coverage Ratio Provided	39%		<	40%	Allowed						



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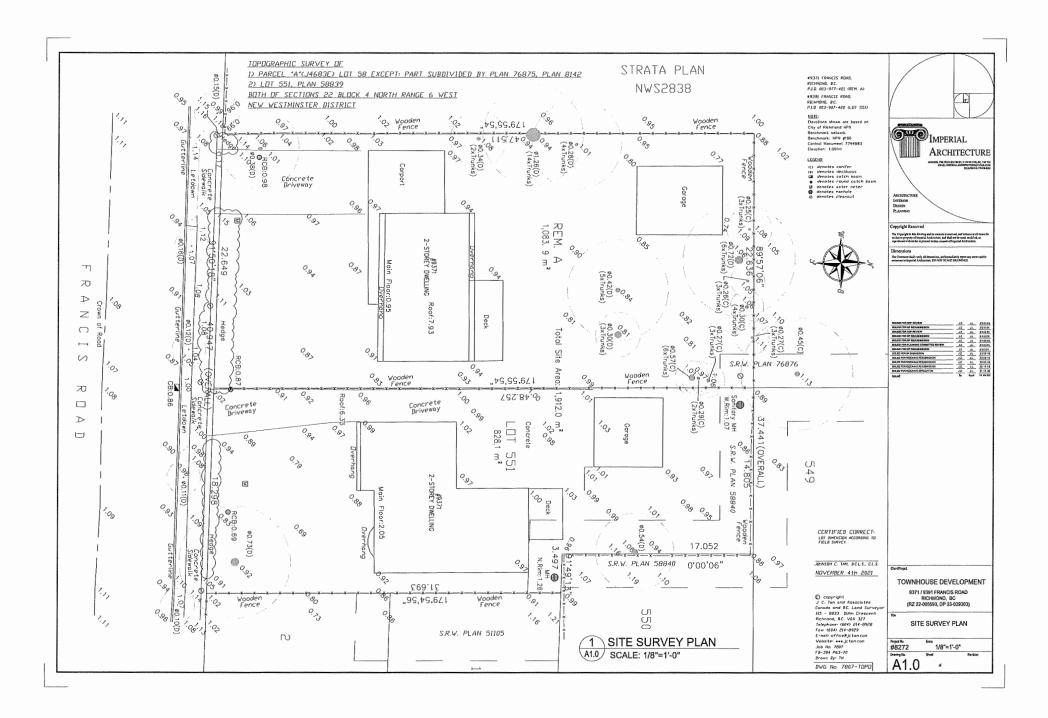
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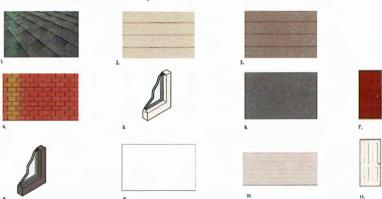
TOWNHOUSE DEVELOPMENT 9371 / 9391 FRANCIS ROAD RICHMOND, BC (RZ 22-005593, DP 23-029303)

PROJECT DATA & STATISTICS

Project No. #8272	Scale	N.T.S.	
Drawing No.	S'est		Ravision
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# 9371 FRANCIS ROAD. RICHMOND, BC



EXTERIOR FINISH MATERIAL SCHEDULE

1.HIGH PROFILE ASPHALT SHINGLES (LIGHT GREY) 2.PAINTED COMPOSITE CEMENT-HARDIELAP SIDING (GREY) 3.PAINTED COMPOSITE CEMENT-HARDIELAP SIDING (BROWN) 4.BRICK CLADDING (RED)
5.VINYL WINDOW W/ CLEAR DOUBLE GLAZING & LIGHT WHITE FRAME
6.PAINTED WOOD FASCIA BOARD / TRIM / STEEL DOOR /GUARDRAIL 7.PAINTED WOOD UNIT ENTRY DOOR (NATURAL WOOD COLOR) 8.VINYL WINDOW W/ CLEAR DOUBLE GLAZING & DARK BROWN FRAME 9.PAINTED COMPOSITE CEMENT SHEET PANEL (WHITE) 10.METAL GARAGE DOOR (LIGHT GREY) 11.PAINTED WOOD UNIT ENTRY DOOR (WHITE COLOR)








TOWNHOUSE DEVELOPMENT

9371 / 9391 FRANCIS ROAD RICHMOND, BC (RZ 22-005593, DP 23-029303)

COLORED EXTERIOR FINISH MATERIAL SAMPLE BOARD

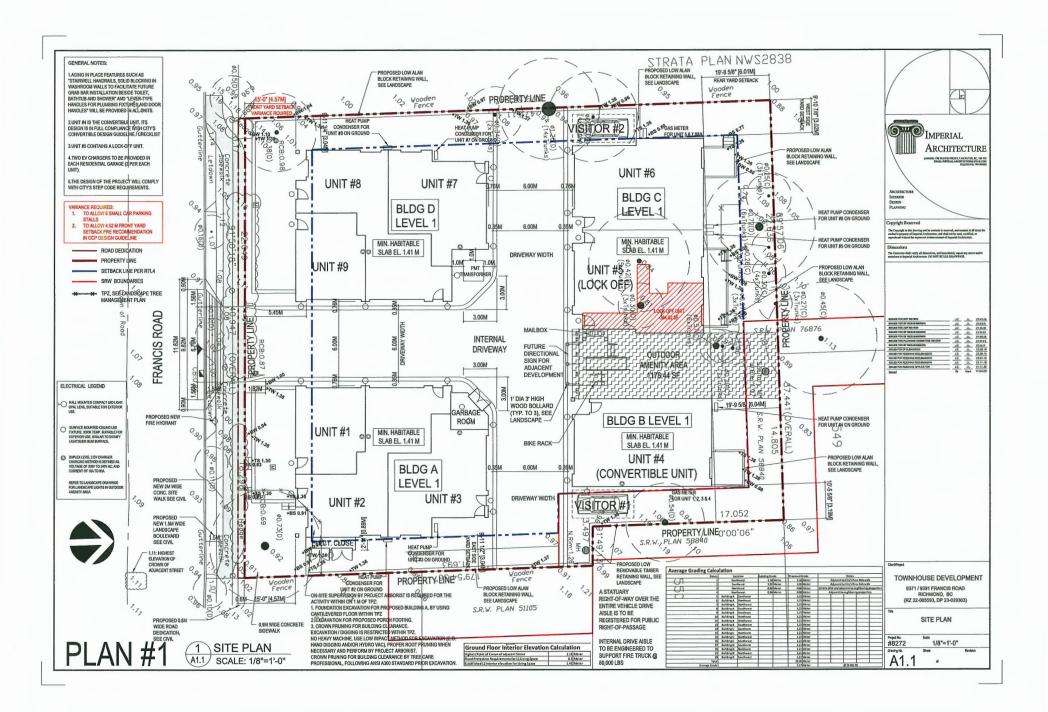







SHADOW ANALYSIS JUNE 21ST - 10:00AM



SHADOW ANALYSIS MARCH 20TH - 2:00PM



SHADOW ANALYSIS JUNE 21ST - 2:00PM





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TOWNHOUSE DEVELOPMENT

9371 / 9391 FRANCIS ROAD RICHMOND, BC (RZ 22-005593, DP 23-029303)

SHADOW ANALYSIS


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SHADOW ANALYSIS SEPT 23RD - 10:00AM SHADOW ANALYSIS SEPT 23RD - 2:00PM





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TOWNHOUSE DEVELOPMENT 9371 / 9391 FRANCIS ROAD RICHMOND, BC (RZ 22-005593, DP 23-029303)

SHADOW ANALYSIS
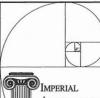
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TOWNHOUSE DEVELOPMENT


9371 / 9391 FRANCIS ROAD RICHMOND, BC (RZ 22-005593, DP 23-029303)

COLOR RENDERING

#8272 N.T.S.

Drawing No. 97est

A 0.11 #

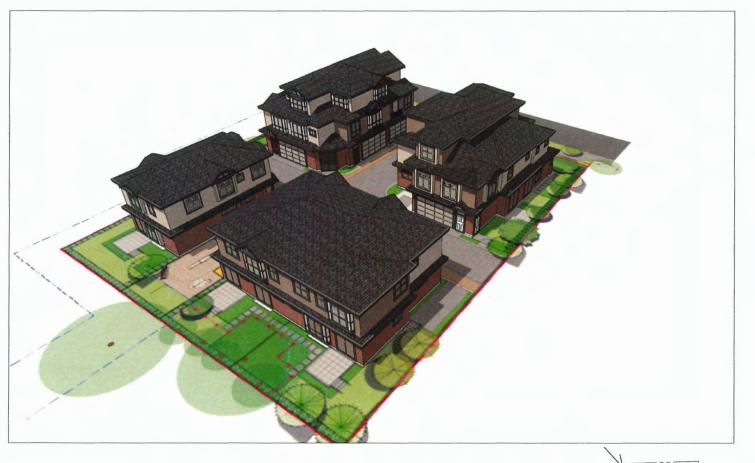



Dimensions

The Contractor shall verify all dissumines, and immediately report any arrays an aminima to imperial Architecture. DO NOT SCALE DRAWINGS.

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9371 /9391 FRANCIS RD

BLDG D BLDG A

Client/Pro

TOWNHOUSE DEVELOPMENT

9371 / 9391 FRANCIS ROAD RICHMOND, BC (RZ 22-005593, DP 23-029303)

COLOR RENDERING

Project No. 13 d Post Revision No. 13







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TORKED FOR RETOKING RETURNATION	J.Z.	AL.	23.04.10
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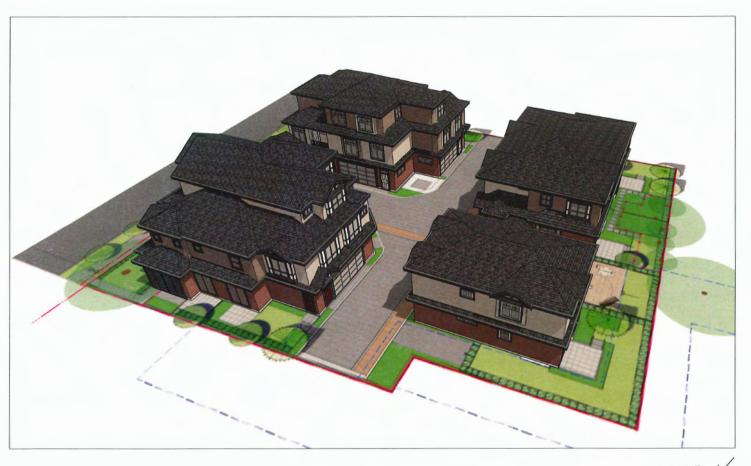
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TOWNHOUSE DEVELOPMENT

9371 / 9391 FRANCIS ROAD RICHMOND, BC (RZ 22-005593, DP 23-029303)

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TOWNHOUSE DEVELOPMENT 9371/9391 FRANCIS ROAD

9371 / 9391 FRANCIS ROAD RICHMOND, BC (RZ 22-005593, DP 23-029303)

COLOR RENDERING
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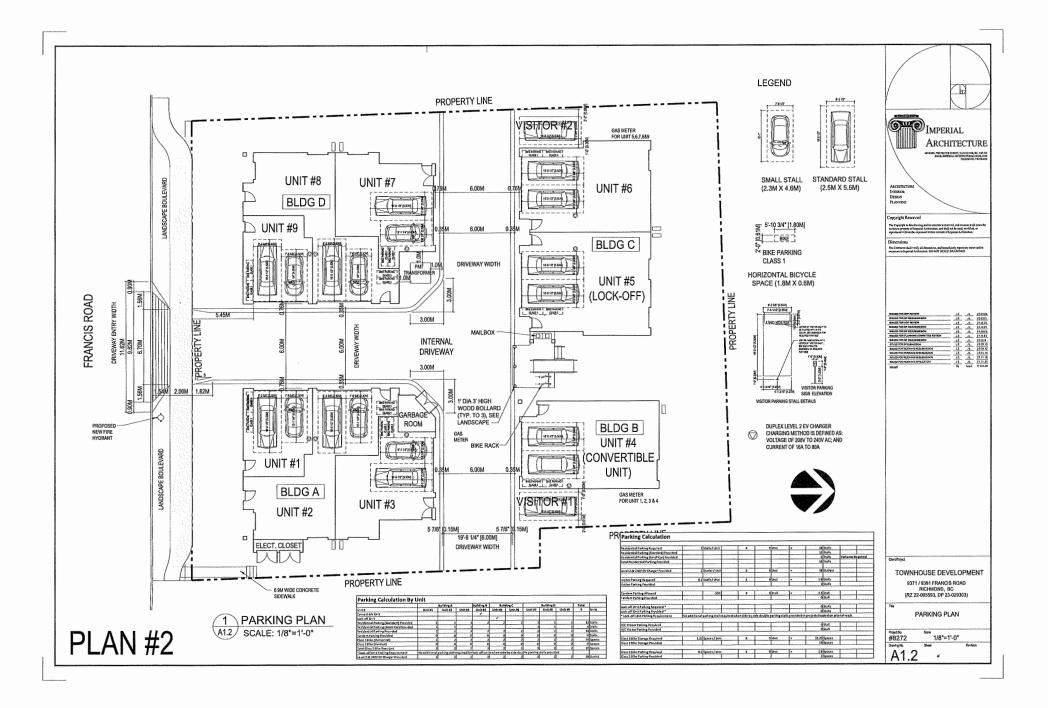
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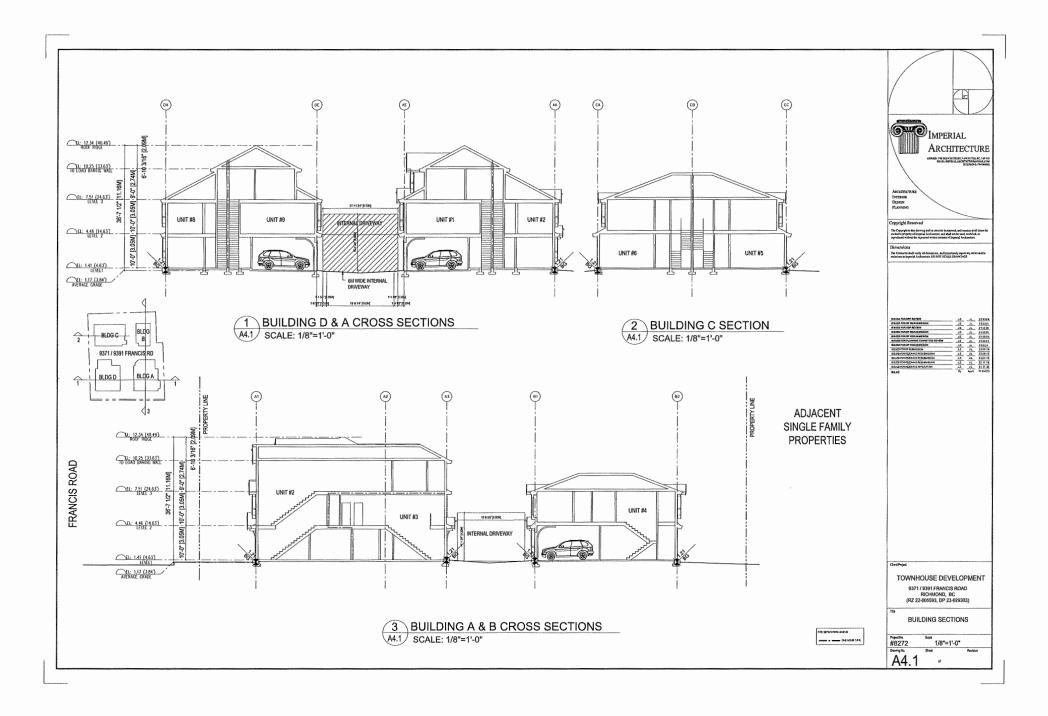
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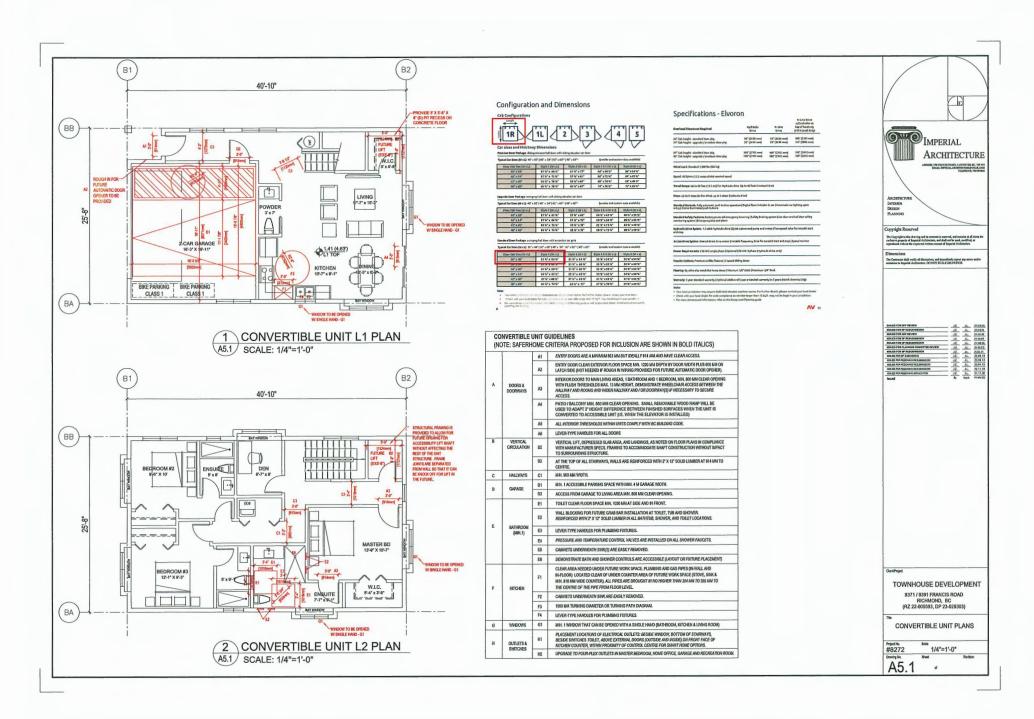
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Project No. 18272 N.T.S.
Drawing No. 18 New Revision

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info@irsengineering.com &04.320.1999 irsengineering.com

October 29, 2024

Project Number: VR23318

Development Permit Document Drawing Requirements Development Applications Department City of Richmond 6911 No. 3 Road, Richmond, BC V6Y 2C1

Re: 9371 Francis Road Townhouse Development - Development Permit Application

· Sustainability Strategy

As a part of the Development Permit Application for the 9371 Francis Road Townhouse Development Project, JRS Engineering (JRS) hereby commits to assisting the project team in implementing sustainability strategies. The proposed project is located at 9371 / 9391 Francis Road, Richmond, BC, and the project will be developed as a 10-unit townhouse development with 4 (four) 2-3 storey buildings (including one lock-off unit).

The following sustainability strategies have been analyzed and included in the building designs in order to reduce energy consumption and greenhouse gas emissions, and thus achieve the BC Energy Step Code compliance:


- Step 3 + EL-4. Effective October 31, 2023, Energy Step Code requirements for Part 9 Residential Buildings in Richmond include Step 5<sup>(a)</sup> + EL-2, Step 4<sup>(b)</sup> + EL-3, or Step 3<sup>(b)</sup> + EL-4. The project will target Step 3<sup>(b)</sup> + EL-4.
  - (a) Building envelope performance requirements can be achieved using all compliance pathways defined in BCBC.
  - (b) Building envelope performance requirements must be achieved using adjusted TEDI compliance pathways.
  - EL-2: Annual limit of  $\leq$  1050 kg CO<sub>2e</sub> per housing unit, or  $\leq$  6 kg CO<sub>2e</sub>/ $m^2$  of conditioned floor area and  $\leq$  2400 kg CO<sub>2e</sub> per housing unit
  - EL-3: Annual limit of  $\leq$  440 kg CO<sub>2</sub>e per housing unit, or  $\leq$  2.5 kg CO<sub>2</sub>e/m<sup>2</sup> of conditioned floor area and  $\leq$  800 kg CO<sub>2</sub>e per housing unit
  - EL-4: Annual limit of  $\leq 265$  kg CO<sub>2</sub>e per housing unit, or  $\leq 1.5$  kg CO<sub>2</sub>e/m<sup>2</sup> of conditioned floor area and  $\leq 500$  kg CO<sub>2</sub>e per housing unit

Note: Natural gas fueled systems are not allowed to be backup heating system after Oct 31, 2023.

· The proposed building skin is listed in Appendix A.

Building Excellence.

- Air source heat pump to reduce heating and cooling energy.
- ERV to reduce heating/cooling energy for conditioning ventilation air.
- Energy Star appliances to reduce energy consumption.
- · Electric hot water tank to further reduce the greenhouse gas emissions.

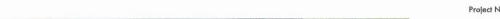



October 29, 2024

The project team will coordinate to incorporate the measures required to meet all requirements of the Richmond's BC Energy Step Code for Part 9 Townhomes.

Please contact the undersigned if you should require any additional information.

Sincerely,

JRS ENGINEERING EGBC Permit to Practice #1002484

Per

Jack Cui, M.Sc., P.Eng., LEED AP Principal, Energy and Sustainability

Encl: Appendix A - Proposed Building Skin

List of additional sustainability features that is not a part of the step code requirements proposed in this development:

EV charger, Low-E double glazing windows, Energy star certified appliances

Project Number: VR23318 Page 2 of 2



# **APPENDIX A**

PROPOSED BUILDING SKIN



APPENDIX A
PROPOSED BUILDING SKIN

#### PROPOSED BUILDING SKIN

The following building skin performance has been proposed to achieve Step 3 + EL-4:

- R-16.9 Wall
- R-35.3 Roof
- R-26.0 Floor
- Window Performance: U=0.25, SHGC=0.35
- Window to wall ratios:
  - Building A: 10%
  - Building B: 10%
  - Building C: 13%
  - Building D: 10%
- Airtight air barrier system

Project: VR23318 Page 1 of 1

# 9371/9391 FRANCIS ROAD TOWNHOUSE DEVELOPMENT

# LANDSCAPE SET: ISSUED FOR DP MARCH 3, 2025

#### LANDSCAPE DRAWING INDEX

	DRAWING INDEX	
SHEET No.	SHEET NAME	
L 0.0	LANDSCAPE COVER SHEET AND DESIGN RATIONALE	
£ 0.1	EXISTING TREE MANAGEMENT PLAN	
L 0.2	LANDSCAPE REPLACEMENT TREE PLAN	
L 1.0	LANDSCAPE LAYOUT AND MATERIALS PLAN	
L 1.1	LANDSCAPE GRADING PLAN	
L 1.2a	LANDSCAPE PLANTING PLAN - SOUTHWEST AREA	
L 1.2b	LANDSCAPE PLANTING PLAN - NORTHWEST AREA	
L 1.2c	LANDSCAPE PLANTING PLAN - SOUTHEAST AREA	
L 1.2d	LANDSCAPE PLANTING PLAN - NORTHEAST AREA	
L 1.3	LANDSCAPE PLANT LIST	
L 1.4	LANDSCAPE SOIL VOLUME DIAGRAM	
L 2.0	OUTDOOR AMENITY AREA ENLARGEMENT PLAN	
L 2.1	POROUS SURFACE DIAGRAM	
L 2.2	LANDSCAPE SECTIONS	
L23	DESIGN-BUILD IRRIGATION PLAN	
L 2.4	CONCEPTUAL LANDSCAPE LIGHTING PLAN	
L 2.5	RIGHT OF WAY AREA ENLARGEMENT PLAN	
L 2.6	TREE PROTECTION AREA PROFILE	
L 3.0	HARDSCAPE DETAILS	
L 3.1	FURNISHING DETAILS	
L 3.2	FURNISHING DETAILS	
L 3.3	SOFTSCAPE DETAILS	

#### **GENERAL NOTES**

ALL LANDSCAPE ARCHITECTURAL DRAWINGS IN THIS PACKAGE SHALL BE READ IN CONJUNCTION WITH ALL OTHER LANDSCAPE ARCHITECTURAL DRAWINGS, DETAILS, SPECIFICATIONS, AND OTHER CORRESPONDANCE THAT MAY BE ISSUED DURING THE COURSE OF THE CONTRACT.

IF A DISCREPANCY OCCURS BETWEEN THE DRAWINGS AND THE SPECIFICATIONS OR ANY OTHER DOCUMENT ASSOCIATED WITH THE PROJECT, THE CONFLICT SHALL BE REPORTED IN WRITING TO THE LANDSCAPE ARCHITECT TO OBTAIN CLARIFICATION AND APPROVAL BEFORE PROCEEDING WITH WORKS.

THE CONTRACTOR SHALL VISIT THE SITE TO VERIFY THE TRUE EXISTING CONDITIONS ANY UNCLEAR ISSUES SHALL BE CLARIFIED WITH THE LANDSCAPE ARCHITECT. NO CLAIM SHALL BE ALLOWED FOR EXTRAS WHICH MAY ARISE THROUGH NEGLECT OF THIS ADVICE.

ALL EXISTING INFORMATION IS BASED ON AVAILABLE RECORDS AND SHALL NOT BE CONSTRUED TO BE COMPLETE OR ACCURATE.

LAYOUT OF HARDSCAPE, SITE FURNITURE, SOIL, PLANTING, AND ALL OTHER MATERIALS IS TO BE STAKED OUT AND APPROVED BY THE LANDSCAPE ARCHITECT PRIOR TO INSTALLATION.

ALL PLANTING SHALL BE IN ACCORDANCE WITH CSLA LANDSCAPE STANDARD, LATEST EDITION

THE CONTRACTOR IS RESPONSIBLE FOR DETERMINING THE EXISTENCE, LOCATION, AND ELEVATION OF ALL UTILITIES AND CONCEALED STRUCTURES, AND IS RESPONSIBLE FOR NOTIFYING THE APPROPRIATE COMPANY, DEPARTMENT OR PERSON(S) OF ITS INTENTION TO CARRY QUIL ITS OPERATIONS.

HOMING LANDSCAPE ARCHITECTURE INC. DOES NOT GUARANTEE THE EXISTENCE, LOCATION, AND ELEVATION OF UTILITIES OR CONCEALED STRUCTURES AT THE PROJECT SITE.

FINAL SELECTION AND APPROVAL OF ALL STREET TREES TO BE DONE BY THE CITY OF

#### LANDSCAPE DESIGN RATIONALE

The site is facing Francia Road on the south side, so the landscape design intends to balance the public intenset with the privacy along the south side. The front yards facing Francis Road are one or two steps higher than the sidewalk, and the grade difference helps to separate the public sidewalk with the private yards. Four feet high lence is proposed in the front yards of most street-lacing units to ensure privacy and safety, and landscape buffer comprised of trees and shrubs there not you improves the privacy for the readerils. but also creates a green and beaufuld steet frontage features for the public

The site is surrounded by residential buildings on the north, west and east sides, so protecting the privacy for both the residents and the neighbours is the design goal. The existing trees in healthy conditions along the north properly line will be relained to create a dense landscape builder which addresses any potential privacy and overfoot concerns. New evergreen and decidious trees, yer hedge and solid 6' high privacy lences are also proposed along the properly lines to improve privacy and prevent overfoot.

The landscape design provides outdoor patios in individual yards for flexible outdoor activities. Each unit has a large outdoor patio surrounded by lawn, shivbs, and a mixed of decidious and evergreen frees, which brings nature dose to each resident. The heat pump condensers in private yards are also screened by 4 feet high wood screen with gate to minimize their visual impact on the natural yard landscape.

An outdoor amenity space is located at the T-intersection of the internal driveways, which is easily accessible for all residents and highly visible from the main driveway entry. Three removable boliards are designed at the entry of the outdoor amenity area to stop vehicles and ensure predestinan's safety. Three is also an outdoor gathering and local lapace that has malboxes, bike racks and picnic table and benches. A playground including chalkboard, sandtoor, small play structure, playhouse, game lawn and benches for parents to all, is proposed in the north part of outdoor amenity space that is a relatively sumy spot. The slide and game lawn will permote active play activities. Sandbox, playhouse, and chalkboard creates a dramatic play zone where children use their creativity and imagination to play and learn. Large man-made play structures are not considered in the nature-inspired playground for two reasons: that play area is not wide enough in the west-east direction to accommodate a play structure with large fall protection zone, second the playground in the Healther Dobphin Neighbourhood drawship and the stable adventure with stage fall protection zone, second the playground in the Healther Dobphin Neighbourhood crossing any streets. Therefore, the playground design on our site intends to create a flexible play area to encourage children reasons.



ADDRESS. 1423 W11TH AVENUE, VARCOUVER, BC, CANADA V6H 1K9 CELL: 778-323-3536 EMAIL: HOMINGLANDSCAPE@GMAIL.COM

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#### 9371/9391 FRANCIS ROAD TOWNHOUSE DEVELOPMENT

PROJECT ADDRESS: 9371/9391 FRANCIS ROAD RICHMOND, BC, CANADA

PROJECT NUMBER: 22-34


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REVIEWED BY: EL

Landscape Cover Page & Design Rationale

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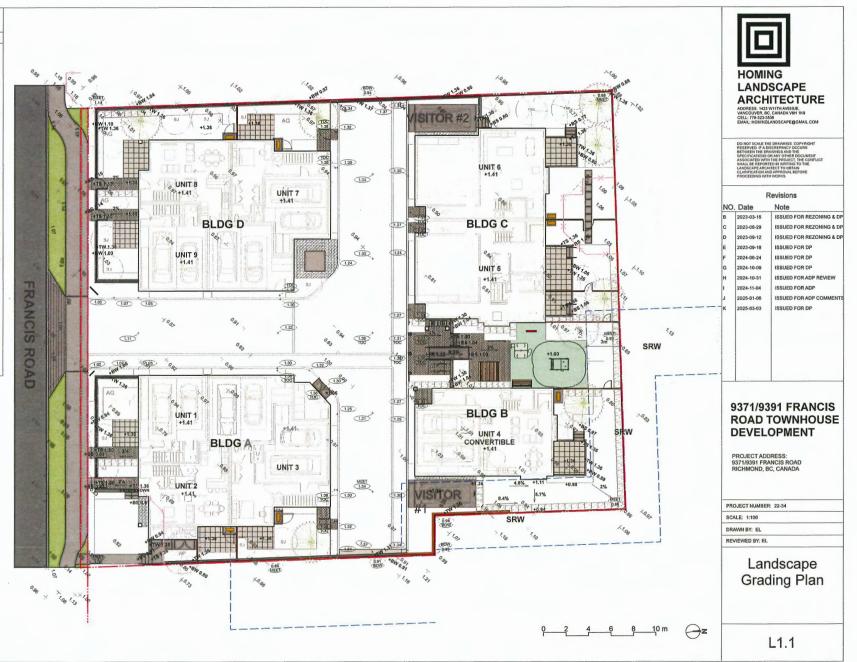
- 2. LAYOUT DRAWINGS ARE TO BE READ IN CONJUNCTION WITH ALL OTHER CONSULTANT DRAWINGS.
- 3.ALL EXISTING INFORMATION APPROXIMATE ONLY. VERIFY ALL EXISTING GRADES AND DIMENSIONS WITH SITE CONDITIONS, REPORT DISCREPANCIES TO CONSULTANT TEAM PRIOR TO PROCEEDING.
- 4. THE CONTRACTOR IS TO PROTECT ALL EXISTING UTILITIES, HARD SURFACES, STRUCTURES, WALLS, AND TREES FOR DURATION OF CONSTRUCTION.
- 5. THE LOCATION OF ALL PROPOSED HARDSCAPE AND SITE FURNISHINGS ARE TO BE FLAGGED OUT ONSITE BY THE CONTRACTOR AND APPROVED BY THE LANDSCAPE ARCHITECT PRIOR TO INSTALLATION.
- 6. ALL OFF-SITE WORKS TO CONFORM TO CITY OF RICHMOND STANDARDS.
- LAYOUT OF ALL OFF-SITE WORKS, INCLUDING FURNISHINGS, PATHWAYS, WALLS, PLANTING, ETC., TO BE CONFIRMED WITH CITY OF RICHMOND PRIOR TO INSTALLATION.



#### **GRADING LEGEND** KEY DESCRIPTION +1.41 PROPOSED SPOT ELEVATIONS +TW 1.36 PROPOSED TOP OF WALL ELEVATION +BW 1.04 PROPOSED BOTTOM OF WALL ELEVATION +TS 1.36 PROPOSED TOP OF STAIR ELEVATION PROPOSED BOTTOM OF STAIR ELEVATION +BS 0.91 2% SLOPE PERCENTAGE Year **EXISTING ELEVATIONS, PER SURVEY** 1.38 CIVIL ELEVATIONS, PER CIVIL
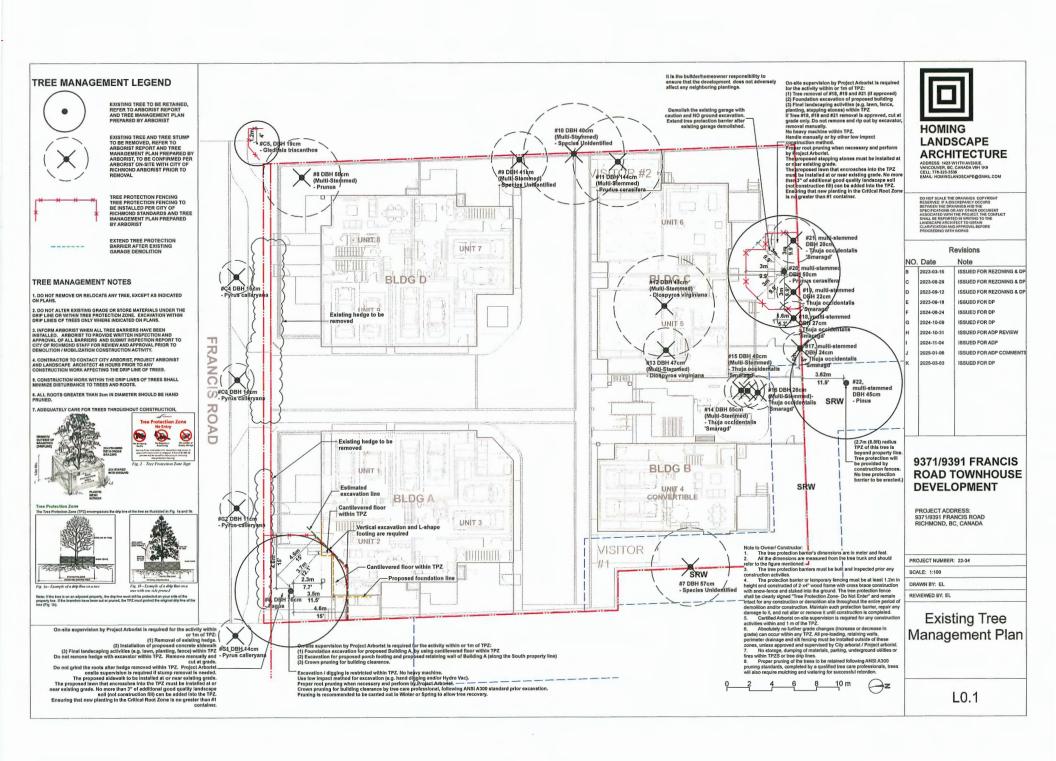
#### **GRADING NOTES**

- 1. ALL DIMENSIONS/ELEVATIONS ARE METRIC (METER, UNLESS OTHERWISE NOTED). DO NOT SCALE DRAWINGS.
- 2. ALL GRADING INFORMATION IS PRELIMINARY ONLY.
- 3. REFER TO CIVIL DRAWINGS FOR INTERNAL DRIVE AISLE AND OFF-SITE ROAD GRADING INFORMATION.
- 4. REFER TO ARCHITECTURAL DRAWINGS FOR BUILDING ELEVATIONS.
- 5. ALL EXISTING SURVEY INFORMATION APPROXIMATE. VERIFY ALL EXISTING GRADES WITH SITE CONDITIONS. REPORT DISCREPANCIES TO CONSULTANT TEAM PRIOR TO PROCEEDING.
- 6. THE CONTRACTOR SHALL IDENTIFY AND PROTECT ALL EXISTING UTILITIES PRIOR TO CONSTRUCTION. ANY CONFLICTS FOUND WITH ULTITIES SHALL BE CLARIFIED WITH THE CONSULTANT TEAM PRIOR TO PROCEEDING.
- 7. UNLESS OTHERWISE NOTED, PROVIDE A MINIMUM 2% SLOPE ON ALL HARD AND SOFT LANDSCAPE AREAS TO ENSURE POSITIVE DEALINGSE AWAY FROM BUILDINGS AND TO DRAINAGE STRUCTURES. SOFT LANDSCAPE AREAS TO BEA MAXIMUM 31 SLOPE.







# LANDSCAPE ARCHITECTURE

ADDRESS, 1423 W11TH AVENUE, VANCOUVER, BC, CANADA V6H 1K9 CELL: 778-323-3536 EMAIL: HOMINGLANDSCAPE@GMAIL.COM

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	K	2025-03-03	ISSUED FOR DP

# 9371/9391 FRANCIS ROAD TOWNHOUSE DEVELOPMENT

PROJECT ADDRESS: 9371/9391 FRANCIS ROAD RICHMOND, BC, CANADA

PROJECT NUMBER: 22-34


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REVIEWED BY: EL

Landscape Planting Plan -Southwest Area

L1.2a





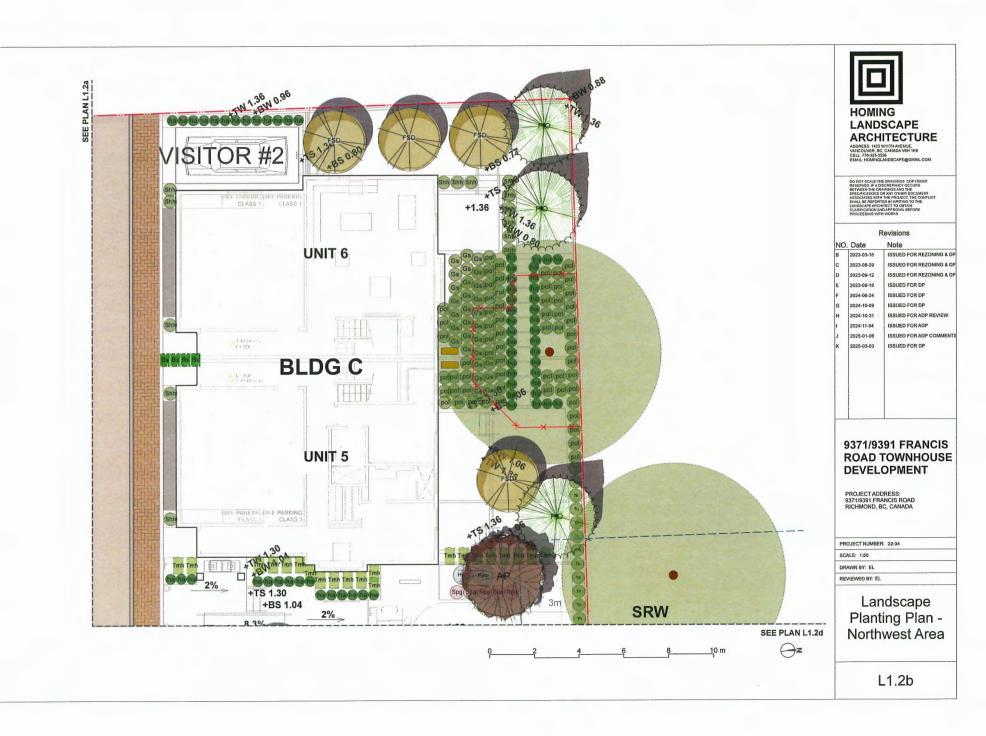

# LANDSCAPE **ARCHITECTURE**

ADDRESS: 1423 W11TH AVENUE, VANCOUVER, BC, CANADA V6H 1K9 CELL: 778-323-3536 EMAIL: HOMINGLANDSCAPE@GMAIL.COM

### Revisions

NO.	Date	Note
В	2023-03-15	ISSUED FOR REZONING & DP
С	2023-08-29	ISSUED FOR REZONING & DP
D	2023-09-12	ISSUED FOR REZONING & DP
Е	2023-09-18	ISSUED FOR DP
F	2024-06-24	ISSUED FOR DP
G	2024-10-09	ISSUED FOR DP
н	2024-10-31	ISSUED FOR ADP REVIEW
1	2024-11-04	ISSUED FOR ADP
J	2025-01-06	ISSUED FOR ADP COMMENTS
K	2025-03-03	ISSUED FOR DP

# 9371/9391 FRANCIS **ROAD TOWNHOUSE DEVELOPMENT**

PROJECT ADDRESS: 9371/9391 FRANCIS ROAD RICHMOND, BC, CANADA

PROJECT NUMBER: 22-34

SCALE: 1:50

DRAWN BY: EL

REVIEWED BY: EL

Landscape Planting Plan -Southeast Area

L1.2c



	1			1	
ID ID	Latin Name	Common Name	Quantity	Scheduled Size	Note
TREES (DECIDUOUS & CONIFEROUS)					
AG	Acer griseum	Paperbark Maple	4	8cm cal.	
AP	Acer palmatum	Japanese Maple	2	8cm cal.	
FSD	Fagus sylvatica 'Dawyck Gold'	Dawyck Gold Beech	5	8cm cal.	T
PIO	Pinus contorta var. contorta	Shore Pine	7	4m high.	
SJ	Styrax japonícus	Japanese Snowbell Tree	11	8cm cal.	1
SHRUBS					+
. Bx	Buxus microphylla	Littleleaf Boxwood	14	#2 pot	1
ec1	Erica carnea	Spring Heath	21	#1 pot	
Gs	Gaultheria shallon	Salal	39	#2 pot	
Hym	Hydrangea macrophylla	Bigleaf Hydrangea	11	#3 pot	
Nad	Nandina domestica	Heavenly Bamboo	26	#2 pot	
AJ	Perfecto Mundo® Double Pink	Reblooming Azalea	69	#2 pot	1
Rh4	Rhododendron 'PJM'	PJM Rhododendron	7	#3 pot	
Shh	Sarcococca hookeriana var. humilis	Sweet Box	97	#2 pot	
Spg	Spiraea x bumalda 'Goldflame'	Goldflame Spirea	9	#2 pot	
Tmh	Taxus x media 'Hicksii'	Hick's Yew	50	5¹ High	
Th	Thuja occidentalis 'Smaragd'	Emerald Cedar	72	5' High	1
PERENNIALS & GROUNDCOVERS					+
sa	Lavandula angustifolia	English Spike Lavender	45	#1 pot	_
pol	Polystichum munitum	Western sword fern	80	#1 pot	
					1
cmi	Carex morrowii 'Ice Dance'	Ice Dance Japanese Sedge	49	#1 pot	T
ha	Hakonechloa macra `Aureola`	Golden Japanese Forest Grass	135	#1 pot	1
VINES					+
cll	Clematis ligusticifolia	Western White Clematis	2	#1 pot	1
					+

OFFSITE PLANT LIST					
<b>ID</b>	Latin Name	Common Name	Quantity	Scheduled Size	Notes
TREES (DECIDUOUS & CONIFEROUS)					
SJ	Styrax japonicus	Japanese Snowbell Tree	6	8cm cal.	



### HOMING LANDSCAPE ARCHITECTURE

ADDRESS: 1423 WHITH AVENUE, VARICOUVER, BC, CAMADA V6H 1K9 CELL: 778-323-3538 EMAIL: HOMINGLANDSCAPE@GMAIL.COM

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NO.	Date	Note
В	2023-03-15	ISSUED FOR REZONING & DF
С	2023-06-29	ISSUED FOR REZONING & DR
D	2023-09-12	ISSUED FOR REZONING & DR
E	2023-09-18	ISSUED FOR DP
F	2024-06-24	ISSUED FOR DP
G	2024-10-09	ISSUED FOR DP
Н	2024-10-31	ISSUED FOR ADP REVIEW
ŀ	2024-11-04	ISSUED FOR ADP
J	2025-01-08	ISSUED FOR ADP COMMENTS
K	2025-03-03	ISSUED FOR DP

#### PLANTING NOTES:

1) In case of discrepancy between plant numbers on this list and on the plan, the latter shall prevail.

2) All planting shall be in accordance with CSLA Landscape Standard, latest edition.

3) The Landscape Contractor shall ensure that the on-site planting medium/soil meets the specification & recommendations of the soil analysis taken at the time of Substantial Completion. All recommendations of the soil analysis shall be executed prior to Final Acceptance of the landscape works by the Consuliant and the municipal authorities.

 Minimum planting medium depths: lawn - 6"/150mm groundcover - 18"/450 mm shrubs - 18"/450 mm trees - 24"/600 mm (around & beneath roolball)

 All plant material to be supplied on the job site must be obtained from a nursery participating in the BCLNA Phytophthora remorum Certification Program.

## 9371/9391 FRANCIS ROAD TOWNHOUSE DEVELOPMENT

PROJECT ADDRESS: 9371/9391 FRANCIS ROAD RICHMOND, BC, CANADA

PROJECT NUMBER: 22-34


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REVIEWED BY: EL

Landscape Plant List

L1.3



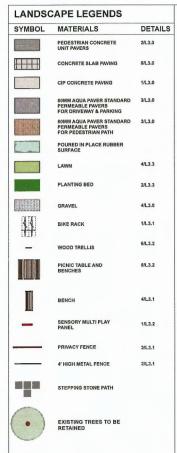

### LANDSCAPE NOTES

- 1. DO NOT SCALE DRAWINGS.
- 2. LAYOUT DRAWINGS ARE TO BE READ IN CONJUNCTION WITH ALL OTHER CONSULTANT DRAWINGS.
- 3.ALL EXISTING INFORMATION APPROXIMATE ONLY, VERIFY ALL EXISTING GRADES AND DIMENSIONS WITH SITE CONDITIONS. REPORT DISCREPANCIES TO CONSULTANT TEAM PRIOR TO PROCEEDING.
- 4. THE CONTRACTOR IS TO PROTECT ALL EXISTING UTILITIES, HARD SURFACES, STRUCTURES, WALLS, AND TREES FOR DURATION OF CONSTRUCTION.
- 5. THE LOCATION OF ALL PROPOSED HARDSCAPE AND SITE FURNISHINGS ARE TO BE FLAGGED OUT ONSITE BY THE CONTRACTOR AND APPROVED BY THE LANDSCAPE ARCHITECT PRIOR TO INSTALLATION.
- 6. ALL OFF-SITE WORKS TO CONFORM TO CITY OF RICHMOND STANDARDS.
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OUTDOOR AMENITY AREA ENLARGEMENT PLAN

#### VILLA PLAYHOUSE



#### FOREST GIRAFFE PLAY STRUCTURE



# CHALK BOARD



# HOMING

# LANDSCAPE **ARCHITECTURE**

ADDRESS: 1423 W11TH AVENUE, VANCOUVER, BC, CANADA V6H 1K9 CELL: 778-323-3536 EMAIL: HOMINGLANDSCAPE@GMAIL.COM

Revisions
Note

NC	). Date	Note
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### 9371/9391 FRANCIS **ROAD TOWNHOUSE** DEVELOPMENT

PROJECT ADDRESS: 9371/9391 FRANCIS ROAD RICHMOND, BC, CANADA

PROJECT NUMBER: 22-34

SCALE: 1:50

ORAWN BY: EL

REVIEWED BY: EL

**Outdoor Amenity** Area Enlargement Plan

#### POROUS SURFACE LEGENDS

SYMBOL

MATERIALS

AREA



POROUS LANDSCAPING WITH LIVE PLANT MATERIAL: LAWN, GROUNDCOVER & SHRUB

465 sq m / 5005 sq ft

POROUS HARDSCAPE MATERIAL: PERMEABLE 249 sq m PAVER & GRAVEL & / 2680 sq ft


TOTAL POROUS SURFACE AREA: 714 sq m / 7685 sq ft

TOTAL LOT AREA: 1887 sq m / 20311 sq ft

TOTAL POROUS SURFACE AREA COVERAGE PERCENTAGE: 37.8%

TOTAL NON-POROUS SURFACE AREA COVERAGE PERCENTAGE: 62.2%

TOTAL POROUS LANDSCAPING AREA COVERAGE PERCENTAGE: 25%

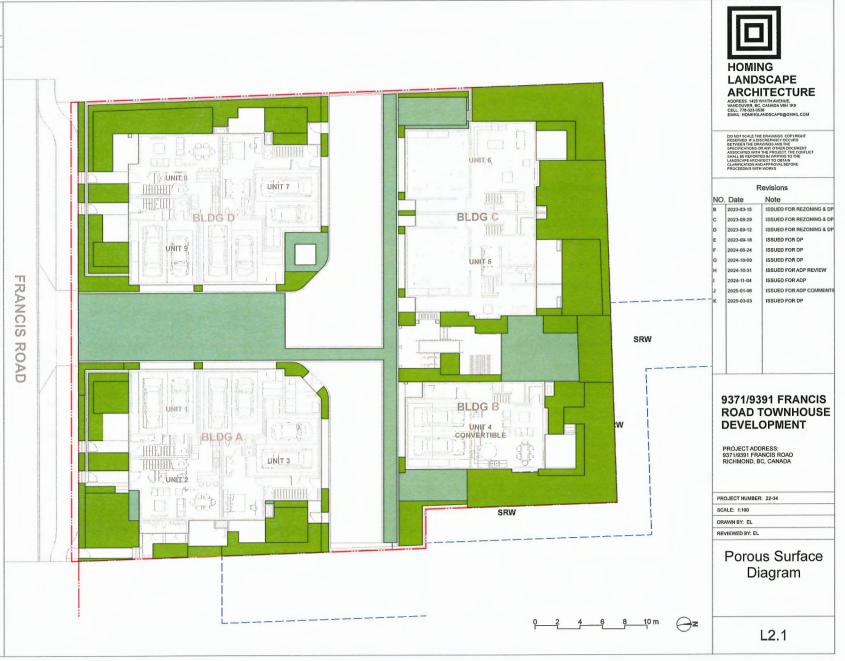



#### **IRRIGATION DIAGRAM LEGEND**

KEY DESCRIPTION

AREA TO BE IRRIGATED




IRRIGATION STUB OUT



# HOSE BIB

#### **DESIGN-BUILD IRRIGATION NOTES:**

- 1. LANDSCAPE CONTRACTOR TO PROVIDE COMPLETE DESIGN-BUILD SERVICES FOR ALL AUTOMATIC SITE IRRIGATION WORKS.
- 2. IRRIGATION CONTRACTOR PERFORMING THE WORK MUST HAVE MINIMUM (5) FIVE YEARS DOCUMENTED EXPERIENCE, AND A MEMBER IN GOOD STANDING OF THE KABC (IRRIGATION INDUSTRY ASSOCIATION OF BC).
- 3. IRRIGATION TO CONFORM TO ALL LOCAL PLUMBING AND ELECTRICAL CODE REQUIREMENTS CONTRACTOR IS RESPONSIBLE FOR COORDINATION WITH MECHANICAL AND ELECTRICAL CONSULTANTS
- IRRIGATION TO CONFORM TO ALL IIABC
  STANDARDS WITH THE FOLLOWING EXCEPTIONS:
   MATERIALS SECTION 8B: ALL PIPE TO BE
  MINIMUM CLASS 200
- MINIMUM CLASS 200
  b. MATERIALS SECTION 5G: NO WIRE SMALLER
  THAN 14 GAUGE DIRECT BURIAL
- 5. COORDINATE WITH CIVIL CONTRACTOR TO PROVIDE PVC SLEEVING WHERE REQUIRED.
- 6. IRRIGATION STUB-OUTS AND HOSE BIBS PER
- 7. PROVIDE SHOP DRAWINGS FOR IRRIGATION LAYOUT TO CONSULTANT FOR REVIEWAND APPROVAL RIFE TO FABRICATION AND BUT TO FABRICATION AND BUT TO FABRICATION AND BUT TO FABRICATION AND BUT TO FABRICATION COMPONENT SPECIFICATIONS. WALVE BOXES TO BE LOCATEO IN LOWNISIBLE, PLANTED ARRES ONLY AND LOCATIONS TO BE APPROVADE.
- 8. HIGH EFFICIENCY IRRIGATION TECHNOLOGY TO BE EMPLOYED INCLUDE, BUT ARE NOT LIMITED TO: CENTRAL SHUT-OFF VALVE, HIGH EFFICIENCY DRIP IRRIGARTION LINES AND MOTION SENOR/RAIN DELAY CONTROLLER
- 9. TEST SYSTEM PRIOR TO COMPLETION OF LANDSCAPE WORKS TO ENSURE NO LEAKAGE AND SPECIFIED PSI IS MET. PROVIDE WRITTEN NOTICE THAT PRESSURE TESTING HAS MET STANDARDS (LEAKS SHALL NOT BE REPAIRED BY PATCHING).
- 10. PROVIDE COVERAGE AND CONTROLLER TEST WHEN SYSTEM IS COMPLETE AND MAKE ADJUSTMENTS AS REQUIRED.
- 11. PROVIDE AS-BUILT RECORD DRAWINGS TO SCALE SHOWING LOCATIONS OF ALL CONCEALED COMPONENTS, PIPING SYSTEM AND CONDUIT.
- 12. MAINTAIN AND OPERATE IRRIGATION PER MANUFACTURER'S RECOMMENDATIONS THROUGHOUT WARRANTY PERIOD WINTERIZE AS REQUIRED.
- 13. PROVIDE (3) COPIES OF INSTRUCTIONS MANUALS FOR OPERATION AND MAINTENANCE OF SYSTEM AND CONTROLS, SEASONAL ACTIVITY AND SHUTDOWN AND MANUFACTURER'S PARTS CATALOGUE.
- 14. INSTRUCT OWNER'S PERSONNEL IN THE OPERATION AND MAINTENANCE OF SYSTEM, INCLUDING ADJUSTING OF SPRINKLER HEADS. USE OPERATION AND MAINTENANCE MATERIAL AS BASIS FOR DEMONSTRATION.

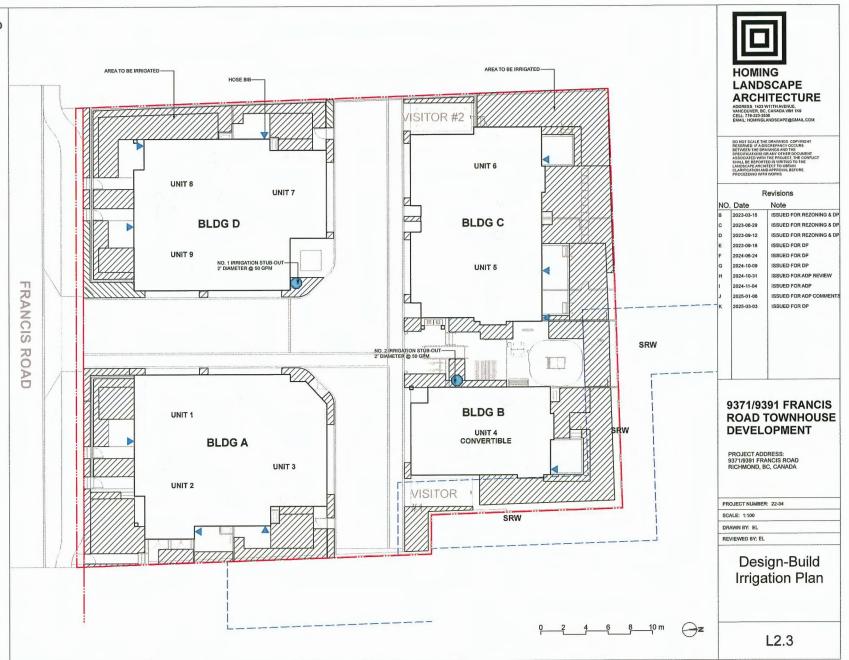

#### LANDSCAPE LIGHTING LEGENDS

SYMBOL MATERIALS

UPLIGHT WITH SHIELD





BOLLARD LIGHT WITH SHIELD



WALL MOUNTED LED DOWN LIGHT COMPACT LED LIGHT, OPAL LENS SUITABLE FOR EXTERIOR USE #

SURFACE MOUNTED CEILING LED FIXTURE



#### LIGHTING NOTES

1. LIGHTING PLANS PROVIDED FOR INFORMATION ONLY. ALL EXTERIOR LIGHT FIXTURES, QUANTITIES, AND LOCATIONS TO BE APPROVED BY THE CLIENTS PRIOR TO ORDERING AND INSTALLATION.

2. CONTRACTOR TO COORDINATE RECESSED FORMING, ELECTRICAL CONDUIT, AND LOCATION LOGISTICS WITH OTHER TRADES AS REQUIRED.

3. SUBSTITUTIONS OF SPECIFIED MATERIALS TO BE APPROVED BY THE CLIENTS PRIOR TO ORDERING AND INSTALLATION.

4. CONTRACTOR TO ENSURE ALL LIGHTING WIRE AND FIXTURES MUST BE INSTALLED TO MEET THE LOCAL ELECTRICAL REGULATIONS AND SAFETY REQUIREMENTS.





#### HOMING LANDSCAPE ARCHITECTURE

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## 9371/9391 FRANCIS ROAD TOWNHOUSE DEVELOPMENT

PROJECT ADDRESS: 9371/9391 FRANCIS ROAD RICHMOND, BC, CANADA


PROJECT NUMBER: 22-34

SCALE: 1:100

DRAWN BY: EL

REVIEWED BY: EL

Conceptual Landscape Lighting Plan

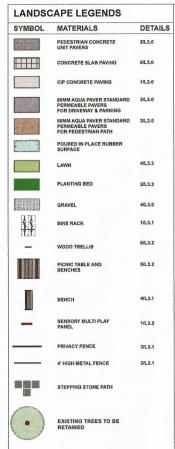

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SCALE: 1:60


DRAWN BY: EL

REVIEWEO BY: EL


# Right of Way Area Enlargement Plan




SECTIONS KEY PLAN

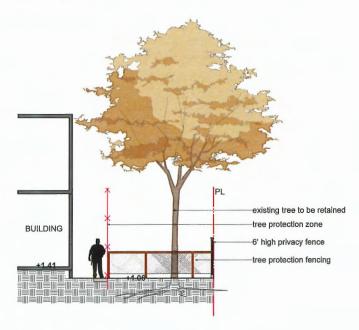



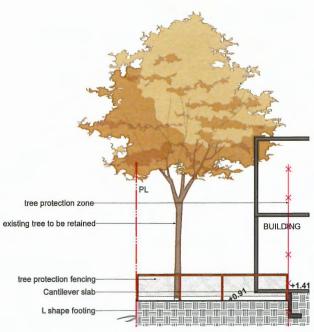

2 SECTION B

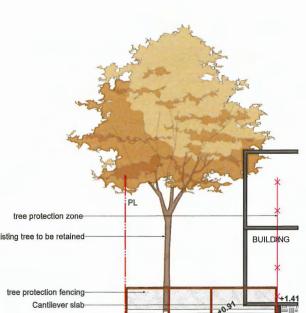



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#### Revisions

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SCALE: AS SHOWN

DRAWN BY: EL REVIEWED BY: EL

> Tree Protection Area Profile

THICKEN CONCRETE AT EDGES

-SHI WILL JOHN TIPE 6m NUGE
- 2 John DEP IN OF SHAD BEPTH
- NATTER! VANIES, REFER TO PLAN

- EXPANSION JOINT 25mm
- WITH SEALANT, TYPICAL
- CIP CONCRETE FINISH PER SPECIFICATION
- REINFORCE WITH 150 X150 #0 WMM

- COMPACTED GRANULAR BASE
- COMPACTED TO 95% M.P.D.

- COMPACTED TO 95% M.P.D.

- COMPACTED TO 95% M.P.D.

- COMPACTED SHADE
- COMPACTED TO 95% M.P.D.

- COMPACTED SHADE
- COMPACTED TO 95% M.P.D.


- COMPACTED SHADE
- COMPACTED TO 95% M.P.D.

NOTES:

1. EXPANSION JOINTS &m O.C. MAX, CONTROL JOINTS @ 1.5m O.C. ADJUST TO SUIT SITE LAYOUT PLAN.

2. ALL SCORELINES TO BE APPROVED BY LANDSCAPE ARCHITECT ON-SITE PRIOR TO INSTALLATION.

1 CIP CONCRETE ON GRADE (TYPICAL)
Scale: 1:10

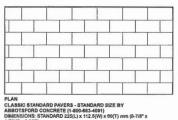

DIMENSIONS: STANDARD 225(L) x 112.5(N) x 80(T) mm (8-78" x 4-776" x 2-28")
PATTERN RUNNING BOND
COLOUR: CHARCOAL
JOINTING SAND AND VIBRATE IN
JOINTING SAND AND VIBRATE IN

PAVERS OF DIA. CLEAR AGGREGATE

JOINT STABILIZER

CHARLES AND STABILIZER

CHARLES AND STABILIZER

COMPACTED SUBGRADE

COMPACTED SUBGRADE

JOINT STABILIZER

CHARLES AND STABILIZER

CHARLES AND STABILIZER

COMPACTED SUBGRADE

COMPACTED SUBGRADE

JOINT STABILIZER

JO

OLD COUNTRY STONE

NOTE:
USE CONCRETE HIDDEN EDGE RESTRAINT WHIEN PAVERS ARE
NOT ADJACENT TO A SOLID EDGE CONDITION.

CONCRETE UNIT PAVING ON GRADE
Scale: 1:10


AQUAPAVE STANDARD PAVER BY ABBOTSFORD CONCRETE PRODUCTS

PATTERN: RUNNING BOND LENGTH: 8-3/8" (221MM) WIDTH: 4-5/16" (110MM) THICKNESS: 3-1/8" (80MM)





COLOR: DESERT SAND PEDESTRIAN PATH

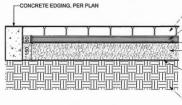

5mm CLEAR CRUSH OPEN-GRADED BEDDING COURSE

AP-SC INBITEX GEOTEXTILE

20mm CLEAR CRUSH
OPEN-GRADED AGGREGATE
SUB-BASE, PER ENGINEERING


-AQUAPAVE 80mm

AP-SC1000 OR 2000 WOVEN
GEOTEXTILE ON BOTTOM AND SIDES
OF OPEN-GRADED BASE, PER
ENGINEERIING

-SOIL SUBGRADE SLOPED TO DRAIN EXCESS MOISTURE TO DISCHARGE LOCATION, PER ENGINEERING

NOTE: 1. THE TO ENGINEERING DRAWINGS FOR THE BASE MATERIALS INSTALLED UNDERNEATH THE PAVERS. 2. THE CONDITIONS UNDER THE PAVERS SHALL BE APPROVED BY ENGINEERS BEFORE PAVERS INSTALLATION.

3 AQUAPAVE PERMEABLE PAVER

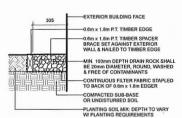


NOTE: ALL LUMBER SIZES ARE SHOWN AS NOMINAL

4 GRAVEL DRAIN STRIP - ON GRADE
Scale: 1:10



PLAN
TEXADA HYDRAPRESSED SLABS BY ABBOTSFORD CONCRETE PRODUCTS (1-800-853-4091)
DIMENSIONS: 457 mm x 457 mm x 40 mm
COLOUR: NATURAL.

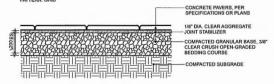

NOTE:

1. USE CONCRETE HIDDEN EDGE RESTRAINT WHEN PAVERS ARE NOT ADJACENT TO A SOLID EDGE CONIOTION.

2. BLACKJACK PEDESTAL SYSTEM AVAILABLE FROM ABBOTSFORD CONCRETE PRODUCTS, INSTALLATION PER MANUFACTURES INSTRUCTIONS.

5 CONCRETE SLAB PAVING Scale: 1:10



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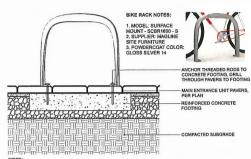
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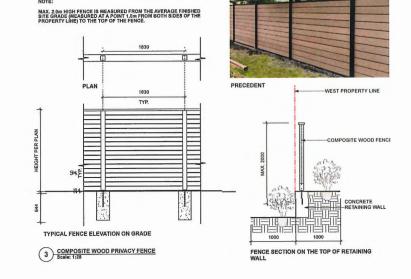
DRAWN BY: EL

REVIEWED BY: EL


# HARDSCAPE DETAILS









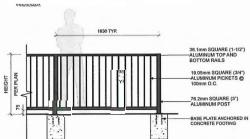



NOTES

1. ALL METAL ALUMINUM MITH BLACK POWDERCOAT FINISH (TO BE FACTORY APPLIED)

2. ALL MELDED CONSTRUCTION.
3. PROVIDE SIGN DRAWINGS FOR APPROVAL.
4. CONCRETE FOOTHING TO BE COMFIRMED BY STRUCTURAL ENGINEER.



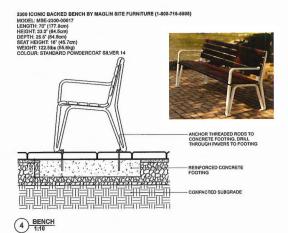

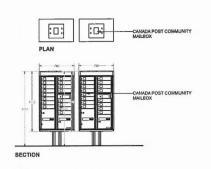

6 CANADA POST MAILBOX Scale: 1:25

# **HOMING**

# LANDSCAPE **ARCHITECTURE**

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Revis	sion
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DRAWN BY: EL

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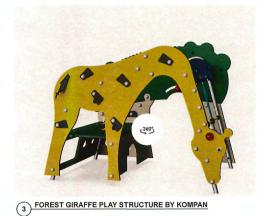
# **FURNITURING DETAILS**




1 SENSORY MULTI PLAY PANEL




2 VILLA PLAYHOUSE



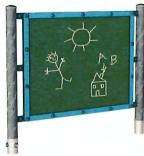


4 CHALK BOARD BY KOMPAN

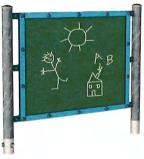







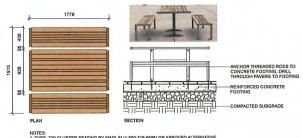


NOTES:

1. TYPE: 720 CLUSTER SEATING BY MAGLIN (1-800-716-6606) OR APPOVED ALTERNATIVE.

2. MODEL: MTB-0720-00002, SURFACE MOUNT, IPE WOOD.

3. COLOR: POWDERCOAT GLOSS COLLECTION SILVER 14

5 PICNIC TABLE AND BENCHES
Scale: 1:25

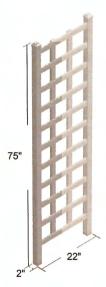



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к	2025-03-03	ISSUED FOR DP

# 9371/9391 FRANCIS **ROAD TOWNHOUSE** DEVELOPMENT

PROJECT ADDRESS: 9371/9391 FRANCIS ROAD RICHMOND, BC, CANADA


PROJECT NUMBER: 22-34

SCALE: AS SHOWN


DRAWN BY: EL

REVIEWED BY: EL


# **FURNITURING DETAILS**

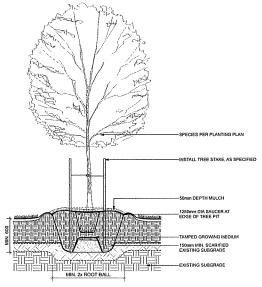


1 DECIDUOUS TREE PLANTING ON GRADE (TYPICAL) Scale: 1:20

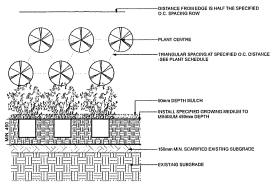

2 PLANTING ON GRADE (TYPICAL) Scale: 1:20

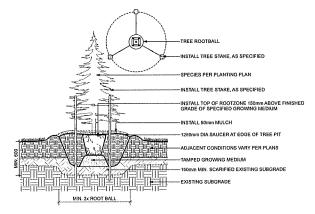

3 CONIFEROUS TREE PLANTING ON GRADE (TYPICAL)
Scale: 1:20

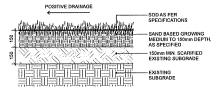

4 SOD LAWN (TYPICAL)
Scale: 1:10



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#### Revisions

NO.	Date	Note
8	2023-03-15	ISSUED FOR REZONING & DP
С	2023-08-29	ISSUED FOR REZONING & DP
O	2023-09-12	ISSUED FOR REZONING & DP
ε	2023-09-18	ISSUED FOR DP
F	2024-08-24	ISSUED FOR DP
G	2024-10-09	ISSUED FOR OP
н	2024-10-31	ISSUED FOR ADP REVIEW
1	2024-11-04	ISSUED FOR ADP
J	2025-01-06	ISSUED FOR ADP COMMENTS
ĸ	2025-03-03	ISSUED FOR OP

#### 9371/9391 FRANCIS **ROAD TOWNHOUSE DEVELOPMENT**

PROJECT ADDRESS: 9371/9391 FRANCIS ROAD RICHMOND, BC, CANADA

PROJECT NUMBER: 22-34

DRAWN BY: EL

REVIEWED BY: EL

SOFTSCAPE **DETAILS**