

Report to Development Permit Panel

To: Development Permit Panel

Date: February 20, 2024

From: Wayne Craig

Re:

File:

DP 23-014121

Director, Development

Director, Development

Application by 1166225 BC Ltd. for a Development Permit at 8880 Cook Road and

8751 Citation Drive

Staff Recommendation

That a Development Permit be issued which would:

- 1. Permit the construction of two six-storey buildings containing 339 rental units at 8880 Cook Road and 8751 Citation Drive on a site zoned "Low Rise Rental Apartment (ZLR44) Brighouse Village (City Centre)"; and
- 2. Vary the provisions of Richmond Zoning Bylaw 8500 to reduce the road setback to projecting balconies above the second floor from 3.0 m to 1.2 m.

Wayne Craig Director, Development

(604-247-4625)

WC:el Att. 3

Staff Report

Origin

1166225 BC Ltd. (Incorporation number: BC1165225; Directors: Yechuan Wu and Hongda Wu) has applied to the City of Richmond for permission to develop two six-storey buildings containing 339 rental units at 8880 Cook Road and 8751 Citation Drive on a site zoned "Low Rise Rental Apartment (ZLR44) – Brighouse Village (City Centre)".

The site is being rezoned from "Low Rise Apartment and Town Housing (ZLR32) – Brighouse Village (City Centre)" to "Low Rise Rental Apartment (ZLR44) – Brighouse Village (City Centre)" for this project under Bylaw 10396 (RZ 21-932698) which received third reading on October 17, 2022.

The site currently contains two apartment buildings with a total of 102 units, which will be demolished. The subject property was a strata owner-occupied apartment condo development that completed a "strata windup" process in July 2018 and then sold to the developer for redevelopment.

Key components of the proposal include:

- Approximately 20,107 m² (216,430 ft²) of purpose-built market rental housing consisting of 271 market rental housing units.
- Approximately 3,755 m² (40,427 ft²) of purpose-built moderate-income rental housing based on BC Housing's Housing Income Limits (HILs) consisting of 68 moderate-income rental units.
- A range of unit types from studio to three-bedroom apartment units, as well as two to three-bedroom townhouse units. All moderate-income rental housing units meet the minimum size requirements under the Low End Market Rental Program.
- Six accessible units (including two studios, two one-bedroom units and two two-bedroom units); all accessible units will be designed to meet the accessibility requirements under the BC Building Code.
- 296 Basic Universal Housing (BUH) units. 100 per cent of the apartment units proposed will be designed to meet BUH provisions or the accessibility requirements.
- Indoor amenity space of approximately 698 m² (7,508 ft²) in area, including a fitness centre, casual seating lounges, piano rooms, shared and private work spaces, meeting rooms, kitchens, washrooms and guest suites.
- Outdoor amenity space of approximately 3,355 m² (36,113 ft²) in area, including a central courtyard, a children's play area, outdoor seating areas, open turf area and garden pots throughout the development.
- Retention of a central grove of ten maple trees and oak trees.
- An on-site low carbon energy plant designed to connect to the future off-site City Centre district energy utility (DEU) system. The building design will also meet Energy Step Code - Step 3.

• Five publicly accessible open spaces (mini-pocket parks) at strategic locations along the periphery of the development with a total area of 379.7 m² (4,087 ft²).

An associated Servicing Agreement (SA 23-021998) was secured through the Rezoning (RZ 21-932698) for the design and construction of the publicly accessible open spaces (mini-pocket parks). An associated Servicing Agreement (SA 22-025603) was also secured at Rezoning for road and engineering improvement works required with respect to the subject development. Works include road widening, traffic signal improvements, frontage improvements along all road frontages and utility upgrades.

Development Information

Please refer to attached Development Application Data Sheet (Attachment 1) for a comparison of the proposed development data with the relevant Bylaw requirements.

Background

Development surrounding the subject site is as follows:

To the North: Across Cook Road, a number of two-storey townhouses on properties zoned "Low Density Townhouses (RTL1)".

To the South: Across Citation Drive, a four-storey apartment condo on a property on "Land Use Contract (LUC 025)", with the underlying "Low Rise Apartment and Town Housing (ZLR32) – Brighouse Village (City Centre)" zone.

To the East: Across Garden City Road, a 16-storey apartment condo on Cook Road zoned "Residential/Limited Commercial (ZMU3) – North McLennan (City Centre)" zone, and Garden City Park located to the south of Alberta Road.

To the West: Across Pimlico Way, a number of two-storey townhouses on a property on "Land Use Contract (LUC 025)", with the underlying "Low Rise Apartment and Town Housing (ZLR32) – Brighouse Village (City Centre)" zone.

Rezoning and Public Hearing Results

The Public Hearing for the rezoning of this site was held on October 17, 2022. At the Public Hearing, concerns regarding the potential impact to neighbouring developments, traffic, parking and tenant relocation support were expressed. Staff have also received similar inputs to the subject Development Permit application from an area resident. Responses to the concerns raised are provided below in *italics*.

1. Potential impact to the adjacent properties including shadowing

The proposed buildings are a maximum of six-storeys. With its ample building setbacks, the project will have minimal overshadowing impacts to adjacent properties, each of which is separated by a road or drive aisle in addition to the setbacks. The retention of trees and planting of new trees plus the provision of numerous pocket parks will create social gathering spaces and variety in the building massing while contributing to the pedestrian realm.

2. Traffic congestion and pedestrian safety

A Transportation Impact Assessment report prepared by Bunt & Associates was submitted and reviewed by the Transportation Department at the Rezoning stage. All potential future traffic generated from the project has been taken into account. The results of the future traffic operations analysis confirm that key intersections will remain well within capacity to accommodate the forecast increase in future peak period traffic projected to the Year 2036 without any road capacity improvements on either Garden City Road or Cook Road.

In addition, the proposed road and intersection design, including internal and external roads, and pedestrian circulation and movements, have all been designed and accommodated in compliance with the City's technical regulations and design criteria.

Furthermore, the developers have committed to upgrading the northbound Pimlico Way approach to the Cook Street intersection, incorporating separate left-turn and right-turn lanes.

3. Parking and delivery

This new proposed project will provide multiple dedicated parking stalls on site for temporary deliveries and drop off and will provide clear wayfinding and signage for deliveries. This way deliveries will avoid parking off-site when making deliveries to the lobby of the proposed building fronting Cook Road and not use the neighbour's parking stalls, thus making it safer for young families in the neighbouring townhouse complex.

4. Tenant relocation

The developer will comply with the forms of communication, commitment and assistance provided to their tenants in accordance with the City's required Tenant Relocation Plan secured at the Rezoning stage.

Staff Comments

The proposed scheme attached to this report has satisfactorily addressed the significant urban design issues and other staff comments identified as part of the review of the subject Development Permit application. In addition, it complies with the intent of the applicable sections of the Official Community Plan (OCP) and is generally in compliance with the "Low Rise Rental Apartment (ZLR44) – Brighouse Village (City Centre)" zone, except for the zoning variances noted below.

Zoning Compliance/Variances (staff comments in bold)

The applicant requests to vary the provisions of Richmond Zoning Bylaw 8500 to reduce the road setback to projecting balconies above the second floor from 3.0 m to 1.2 m.

Staff supports the proposed variance as the building envelope is limited by the significant road dedications along all fronting streets and retention of the tree grove in the centre of the site. Along the perimeter of the site, road dedications are required for road widening and frontage improvements, and dedications ranging from 5.07 m to 6.34 m. Surrounding the central courtyard, the building footprint must be located outside of the critical root zones of the protected tree grove and therefore pushed to the minimum setbacks from the new exterior property lines after road dedications.

The projecting balconies are proposed to meet the private outdoor space requirements under the Development Permit Guidelines and to provide additional visual interest of the buildings. The projecting balconies are proposed on level 3 or above and will not be encroaching into any SRW or common open spaces.)

Advisory Design Panel Comments

The Advisory Design Panel (ADP) was supportive of the application subject to consideration of the Panel's comments. A copy of the relevant excerpt from the Advisory Design Panel Minutes from December 6, 2023 is attached for reference (Attachment 2). The design response from the applicant has been included immediately following the specific Design Panel comments and is identified in 'hold italics'.

Analysis

Conditions of Adjacency

- Significant road dedications ranging from 5.07 m to 6.34 m are required for road widening
 and frontage improvements along all fronting roads of the site. The parking podium and
 residential buildings are pushed to the minimum road setbacks to allow for a larger central
 courtyard, to facilitate the preservation of a tree grove of ten trees in the middle of the site.
- Ground-oriented units are proposed along all fronting roads to screen the partially sunken, two-level parkade, and to provide a streetscape and residential character compatible with the adjacent townhouse developments across Cook Road and Pimlico Way.
- The proposed building height is six-storeys. Along the fronting streets, the proposal features four levels of apartment units on top of two levels of ground-oriented townhouse units. The proposal provides a transition between the apartment towers east of Garden City Road and the two-storey townhouse clusters west of Pimlico Way.
- Long frontages are broken into different building forms, and massing is broken into smaller
 vertical components to reinforce a stronger urban character that is more compatible in scale
 and form with the adjacent existing low-rise apartments and townhouse developments.
- The massing of the buildings is further broken down along Pimlico Way and Garden City Road to increase neighbourhood porosity through the site.
- The proposed design (including building height, setbacks, frontage treatments and built form, etc.) is consistent with the design guidelines under "Sub-Area B.2 Mixed Use Mid-Rise Residential & Limited Commercial" in the City Centre Area Plan, which is intended for medium-density, mid-rise (four-eight storeys) housing.

Urban Design and Site Planning

- Designing around the minimum road setbacks and critical root zones of the protected trees on site, a concrete podium containing one level of residential spaces oriented towards the fronting roads and two levels of parking surrounding the central courtyard is proposed.
- Two five-storey residential buildings are proposed on top of the podium. The buildings are
 placed towards the outermost extremes of the podium to allow for the inner courtyard to be
 maximized.

- The parkade will have direct openings around the courtyard to provide natural ventilation and natural light into the space.
- The use of a metal screen with planted vines will create a green wall and screen between the parkade and the open courtyard.
- Ground-oriented units along all sides of the site are set further away from the street, as
 compared to the upper levels, and set above the sidewalk elevation with individual unit
 access, stepped planters, large open patios spaces and gated entries to create more pedestrianfriendly streetscape.
- Two lobby entries, set at sidewalk elevation for a friendly, accessible approach to the building are provided at the northeast side of the site (Cook Road) and the southwest side of the site (Citation Drive) respectively.
- A vehicle access service area will be provided off Pimlico Way. This area is designed to
 provide parkade access, as well as a central pickup/drop off, garbage/recycling collection and
 loading area.
- While the introduction of new Provincial legislation under Bill 47 has come into effect, as this application received first reading prior to January 1, 2024, the City's current parking regulations under Richmond Zoning Bylaw No 8500 are still in effect.
- There is a total of 223 parking spaces provided in the parkade, including:
 - o 140 stalls for market rental units, including three accessible spaces.
 - o 28 stalls for moderate-income rental units, including one accessible space.
 - o 55 visitor parking stalls, including two accessible parking spaces and two car share spaces.
- The proposed number of parking spaces is consistent with the parking requirements under the ZLR44 zone subject to the provision of Transportation Demand Measures (TDM) to the satisfaction of the City. The TDM includes:
 - o Car Share Vehicles and Designated Parking Spaces provision of two car share vehicles and designated car share parking spaces.
 - o Car Share Membership provision of a car share membership for each dwelling unit.
 - O Subsidized Transit Passes provision of a Transit Pass Program offering a monthly two-zone pass for each dwelling unit, for one year.
 - o Additional Class 1 Bicycle Parking Provision of Class 1 bicycle parking at a rate of 1.9 spaces per unit (instead of 1.25 spaces per unit) for units that are one-bedroom or larger. The net increase of secured bike storage spaces for the project is 163 spaces. Bike storage rooms will have outlets for bicycle charging.
 - Bicycle Maintenance Facility provision of a bicycle maintenance room for resident use to include a bike stand, repair tools, bike washing area and opportunities for charging of e-devices.
 - o Shared Bike and Micro Mobility Station provision of a SRW and access to an area for a future shared e-bike and e-scooter parking corral on the site.
 - o Implementation of cycling facilities and enhancements along the site's frontage to be secured through the associated site Servicing Agreement for the application.

- Unassigned Parking registration of a restrictive covenant on Title to ensure that all residential parking spaces are unassigned and assignment is managed by the property manager.
- O Delivery vehicle parking provision of additional delivery vehicle parking for e-commerce vans (Amazon, etc.), food delivery vehicles and registration of a legal agreement on Title to outline the operation of the parkade gate to provide access to the delivery vehicle parking and to encourage the use of visitor parking on-site during daytime hours (i.e., from 8:00 a.m. to 7:00 p.m.).
- There is a total of 588 Class 1 (residential) bicycle parking spaces provided within bike storage rooms in the parkade. In which, 106 spaces are provided for moderate-income housing units and 482 spaces are provided for market rental housing units. The proposed number of Class 1 bicycle parking spaces is consistent with the requirements under the ZLR44 zone.
- There is a total of 68 Class 2 (visitor) bicycle parking spaces provided on-site. In which, 27 spaces are provided in the open area by each of the two residential lobbies, 25 spaces are provided within the parkade and 16 spaces are provided along the perimeter of the site, within the public pocket park areas. The proposed number of Class 2 bicycle parking spaces is consistent with the requirements under the zoning bylaw.
- The CCAP requires that multi-family developments comprising 200 units or more provide indoor amenity space at a standard of 2 m² (21.5 ft²) per dwelling unit. The subject development exceeds the CCAP minimum and provides for 698 m² (7,508 ft²) of indoor amenity spaces. Features include two guest suites on P2, a fitness centre on level two, as well as casual seating lounges, piano rooms, shared and private workspaces, meeting rooms, kitchens and washrooms on levels three and four.
- Outdoor amenity spaces proposed in this development also exceed the minimum OCP requirements. Outdoor amenity spaces proposed on-site include:
 - o a 1,888 m² (20,325 ft²) central courtyard on the ground level, featuring open lawn space beneath mature trees, various outdoor seating areas, planting areas and a children's play area:
 - o 1,149 m² (12,371 ft²) of open space on level two, featuring an open artificial turf, plating pods and outdoor walkways; and
 - o 317 m² (3,416 ft²) of outdoor space on level three, between two indoor amenity rooms, connected through exterior stairs to the second-level amenity deck and fourth-level indoor amenity room, featuring outdoor dining and lounging areas.

Architectural Form and Character

- The overall design intent is to introduce a low-rise building form in a manner that maintains a pedestrian-oriented building massing that, in turn, respects the scale of the immediate neighborhood to the north, west and south.
- The form and configuration of the building were dictated by the retention of trees in the central courtyard. A variety of building heights with breaks in architectural shapes, along with changes in massing, forms and character across the entire site has been implemented.

- A wide range of architectural design elements have been incorporated into the design of the project.
- A combination of suspended balconies and inset balconies have been provided to create rhythm and pattern for each elevation; balcony alignment has also been used to differentiate between fronting facades to create visual interest.
- The exterior cladding is a combination of fibre cement panel and brick with metal slats. The
 choice of materials and colour palettes reflect the residential nature of the project. A unique
 blend of materials and colours is selected for each mass and building to break up the long
 façade, provide individual character and help integrating the project into its surrounding
 context.

Tree Management

- Tree preservation was reviewed at the rezoning stage and reconfirmed during the Development Permit review process.
- 15 bylaw-sized trees located on site are to be retained and protected:
 - o Ten trees (tag# 1887, 1888, 1889, 1890, 1891, 1892, 1893, 1894, 1895 and 1896) located in the central courtyard;
 - o Four trees (tag# 1956, 1957, 1958 and 1959) located at the southwest corner of the site; and
 - One tree (tag# 1852) located at the northeast corner of the site.
- A Tree Survival Security in the amount of \$150,000.00 for the 15 trees has been secured at Rezoning stage.
- Significant discussion and effort by City staff and the applicant went into consideration of tree removal on site. The approach taken and supported by the City's Tree Preservation group was to retain the stands of trees in the centre and in key locations.
 - o In order to support this form of development and to accommodate the number of rental units proposed on the site; 19 trees that are in good to fair conditions but in conflicts with the building envelope, are identified for removal.
 - o Another 112 trees that are in poor condition will also be removed.
- 263 replacement trees are required for the removal of 131 trees on site.
- While the proposed development would occupy a significant amount of the site, the applicant is proposing to plant 135 replacement trees on site, including eight conifers and 127 deciduous trees.
- The applicant has agreed to provide a voluntary contribution of \$98,304.00 (\$768.00/tree) to the City's Tree Compensation Fund, in lieu of planting the remaining 128 replacement trees, prior to DP issuance.

Landscape Design and Open Space Design

• The overall landscape concept satisfactorily enhances the interface between the proposed development and the public realm.

- Building lobbies and private patios are proposed along the road frontages to animate the public realm.
- Private patios for the ground-oriented units along all of the site's four road frontages feature raised planters with layered shrubs, privacy hedging and individual gated accesses to enhance the residential character of the proposal and to provide a pedestrian-oriented streetscape.
- A series of publicly accessible open spaces (mini-pocket parks) are proposed in strategic locations along the periphery of the development:
 - O At the northwest corner: A drinking fountain, two feature benches in a striking blue hue and ten designated bike parking spaces are proposed to engage the intersection of Cook and Pimlico; distinctive paving will also be introduced to clearly define the space.
 - At the northeast corner: One mature tree will be preserved, providing shade and natural beauty amidst a spacious open lawn accessible to the public. Additionally, two distinctive benches in a vibrant yellow hue are planned to enhance public enjoyment and relaxation within the area.
 - At the southeast corner: Two feature benches in dark blue color and eight designated bike parking spaces are proposed to encourage individuals to rest in this area; distinctive paving will be implemented to delineate the space, enhancing its visual appeal and functionality.
 - O At the southwest corner: Four existing trees will be preserved, offering both shade and a natural view. An open lawn with two distinctively designed benches, adorned in a vibrant red hue, is envisioned to elevate public enjoyment and relaxation within the area.
 - O By the vehicle access to the site: A grove of specimen conifers that meet the minimum size of replacement trees as well as drought tolerant ground covers and shrubs are proposed to screen and soften the view of the service area/parkade entrances while enhancing the public realm. Along the sidewalk frontage, 14 visitor bike parking and three bench seating will be provided.
- The developer worked with the project arborist to retain the existing trees in the middle of the site while enhancing the central courtyard with amenity features for future residents. The space includes:
 - o Open lawn space beneath mature trees;
 - O An adventurous kid's place space for a range of ages with features such as a see-saw, a climbing net, two springers and a play-hut with a slide; and
 - o Wood platform seating, deck seating, and amphitheatre seating areas.
- The developers are providing as much children's play area as possible in one place, based on the ADP comments, given tree retention. On the second level, an artificial turf is proposed at the south end of the podium for active play.
- Elevated planters, trellis screening, shrubs and trees are proposed along the perimeter of the courtyard to screen the parkade walls and exposed concrete of the building base.
- A grand staircase with integrated planters and a hanging ramp system are also proposed in the courtyard to connect the outdoor amenity space on the ground-level and the second-level.

- Five garden pots are proposed at the northwest and southwest wings of the podium, on the second level, to provide urban agricultural opportunities on site.
- An amenity deck is proposed on the third floor between the two indoor amenity rooms. It
 features outdoor dining and lounging areas with fire pit and barbeque, perimeter planting
 pockets and raised planters with trees.
- A lighting plan is included in the DP plans, which indicates lighting provided throughout the site:
 - O Various types of lighting, including low planter wall lights, bollard lights, pedestrianscaled pole lights and wall sconce lights, have been proposed for different locations. Each light has been thoughtfully chosen to ensure that they are oriented downward, specifically designed to illuminate ground surfaces, building entrances and stairways effectively.
 - o Shielded and downward-facing lights were selected.
 - O Low planter wall lights and wall sconce lights were proposed at the parking courtyard to provide a safe walking experience, meanwhile, these lights were selected as non-glared.
 - O The lighting fixtures have been chosen to guarantee that the illumination level at the property line does not exceed three foot-candles.
- An irrigation system is proposed to ensure continued maintenance of live landscaping on site.
- In order to ensure that the proposed landscaping works are completed, the applicant is required to provide a landscape security of \$858,573.29 in association with the Development Permit.

Crime Prevention Through Environmental Design

- Crime Prevention Through Environmental Design (CPTED) principles have been considered throughout the proposed development.
- Public areas, pedestrian pathways and resident private/semi-private areas are designed to be
 well-defined by soft landscaping and hard fencing/gates to clearly delineate boundaries of
 uses.
- Entry lobbies are designed to be visually open from the sidewalk.
- The service area and parkade entry is designed with clear sight lines, clear signage and good lighting for both entry and exit.

Sustainability and Renewable Energy

- The subject site is within the City Centre District Energy Utility catchment area and connection to the utility will be required for this development. The developer is required to design, construct and transfer ownership to the City of a Low Carbon Energy Plant (LCEP) and related infrastructure on-site to facilitate a future connection to a City Centre District Energy Utility (DEU) system.
- The developer has committed to design the subject development to meet the City's Step Code requirements (i.e., Step 3). Details on how all units are to be built and maintained to this commitment will be reviewed at Building Permit stage.

- The architect advised that the following features will be specified in the development:
 - Air Source Feat Pumps (ASHPs).
 - o Heat Recovery Ventilators (HRVs).
 - o High efficiency LED.
 - o Electrified cooking in suites.

Accessible Housing

- The proposed development includes 296 basic universal housing units that are designed to be easily renovated to accommodate a future resident in a wheelchair. These single-storey units are required to incorporate all of the accessibility provisions listed in the Basic Universal Housing Features section of the City's Zoning Bylaw, and are permitted a density exclusion of 1.86 m² (20 ft²) per unit. The proposed development includes six accessible units that are designed to be fully accessible at the time of construction for a resident in a wheelchair. These units are required to incorporate all of the accessibility provisions listed in the Basic Universal Housing Features section of the City's Zoning Bylaw and in the BC Building Codes.
 - o Four of the accessible units will be designated as moderate-income housing units, and two of the accessible units will be designated as market rental units
 - o These accessible units will be secured in perpetuity with the Market Rental Agreement and the Moderate Income Housing Agreement registered on Title.
- All of the proposed units incorporate aging-in-place features to accommodate mobility constraints associated with aging. These features include:
 - o stairwell hand rails;
 - o lever-type handles for plumbing fixtures and door handles; and
 - o solid blocking in washroom walls to facilitate future grab bar installation beside toilets, bathtubs and showers.

Conclusions

As the proposed development would meet applicable policies and Development Permit Guidelines, staff recommend that the Development Permit be endorsed, and issuance by Council be recommended.

Edwin Lee Planner 2

(604-276-4121)

EL:js

Att. 1: Development Application Data Sheet

- 2: Excerpt from the Meeting Notes of Advisory Design Panel Meeting (December 6, 2023)
- 3: Development Permit Considerations



Development Application Data Sheet

Development Applications Department

DP 23-014121 Attachment 1

Address: 8880 Cook Road and 8751 Citation Drive

Applicant: 1166225 BC Ltd. Owner: 1166225 BC Ltd.

Planning Area(s): Brighouse Village (City Centre)

Floor Area Gross: 26,351 m² (283,640 ft²) Floor Area Net: 23,862 m² (256,857 ft²)

	Existing	Proposed	
Site Area:	13,879 m²	11,392 m²	
Land Uses:	Apartment Residential	No Change	
OCP Designation:	Apartment Residential	No Change	
Area Plan Designation:	City Centre Area Plan: General Urban T4 – High Density Townhouses	No Change	
Zoning:	Low Rise Apartment and Town Housing (ZLR32) – Brighouse Village (City Centre)	Low Rise Rental Apartment (ZLR44) – Brighouse Village (City Centre)	
Land Use Contracts:	Land Use Contract (LUC 025)	Discharge	
Number of Units:	102	339	

	Bylaw Requirement	Proposed	Variance
Floor Area Ratio:	Max. 1.8 FAR Market Rentals Min. 0.3 FAR Moderate Income Rentals	 Market Rentals: 1.765 FAR Moderate Income Rentals: 0.33 FAR 	none permitted
Buildable Floor Area (m²):*	 Market Rental: Max. 20,505.6 m² (220,720 ft²) Moderate Income Rental: Min. 3,417.6 m² (36,786 ft²) 	 Market Rental: 20,107.0 m² (216,430 ft²) Moderate Income Rental: 3,755.8 m² (40,427 ft²) 	none permitted
Lot Coverage (% of lot area):	 Building: Max. 60% Non-porous Surfaces: Max. 80% Landscaping with Live Plant Material: Min. 20% 	 Building: 45.5% Non-porous Surfaces: 78.3% Landscaping with Live Plant Material: 22.7% 	none
Lot Size:	Min. 11,000 m²	11,391 m²	none
Setbacks (m):	Road: Min.3.0 m	Cook Road: 3.0 m Garden City Road: 3.0 m Citation Drive: 3.0 m Pimlico Way: 3.0 m	none
Height (m):	Max. 25.0 m	24.04 m	none

Off-street Parking Spaces – Regular (R):	Total: 164 (R), including: - Market Rental Unit: 271 x 0.5 space/unit with TDM Reduction = 136 (R) - Moderate Income Rental: 68 units x 0.4 space/unit with TDM Reduction = 28 (R)	168	none
Off-street Parking Spaces – Visitor (V):	339 units x 0.16 space/unit with TDM Reduction = 55 (V)	55	none
Small Car Parking Spaces	Max. 50% when 31 or more spaces are provided on-site (225 x Max. 50% = 112)	96	none
Accessible Parking Spaces (Residential):	Min. 2% when 11 or more spaces are required: - Market Rental Unit: 136 x 2% = 3 - Moderate Income Rental: 28 x 2% = 1	5	none
Accessible Parking Spaces (Visitor):	Min. 2% when 11 or more spaces are required (55 x 2% = 2 spaces)	2	none
Bicycle Parking Spaces – Class 1	Total: 588, including: - Studio: 1.25 spaces per unit x 87 = 109 spaces - All other unit types: 1.9 spaces per unit x 252 = 479 spaces	588	none
Bicycle Parking Spaces – Class 2	339 units x 0.2 = 68 spaces	68	none
Amenity Space – Indoor:	Min. 2 m ² per unit = 339 x 2 m ² = 678 m ²	698 m²	none
Amenity Space – Outdoor:	Min. 6 m ² per unit + 10% of the net development site area = 339 units 6 m ² + 1,139.2 m ² = 3,173.2 m ²	3,355 m²	none

The Design Panel Meeting

Wednesday, Wednesday December 6, 2023 – 4:00 p.m. Remote (WebEx) Meeting

DP 23-014121 – TWO 6-STOREY RESIDENTIAL BUILDINGS CONTAINING 339 RENTAL UNITS

ARCHITECT: GBL Architects Inc.

LANDSCAPE Durante Kreuk Landscape Architects

ARCHITECT:

PROPERTY LOCATION: 8880 Cook Road and 8751 Citation Drive

Applicant's Presentation

Amela Brudar, GBL Architects Inc., introduced the project and Alejandro Martinez, GBL Architects, Inc., and Landscape Architect Alexa Gonzalez, Durante Kreuk Ltd., presented the project and answered queries from the Panel.

Panel Discussion

Comments from Panel members were as follows:

 appreciate the provision of six fully accessible units among the 296 Basic Universal Housing (BUH) units; also appreciate the variety of sizes of the accessible units which include studio and one-to three-bedroom units;

Applicant's response: acknowledged.

• concerned about access to parking for drivers with disabilities as after 10 pm the driver would have to get out of the vehicle to access the parkade and get back to the vehicle prior to proceeding to the parkade; consider other options to access the parkade after 10 pm, especially for drivers with disabilities;

Applicant's response: No change has been made. After a thorough examination and exhaustive technical analysis in collaboration with our traffic consultant, Bunt & Associates, we have explored various options, incorporating detailed turn radius assessments and Crime Prevention Through Environmental Design (CPTED) considerations. Our comprehensive investigation has led us to the determination that the most viable solution is to position the intercom system outside the entry gate of each building. Upon occupancy, these structures will leverage cutting-edge smart technology to facilitate seamless and secure access to the parkade and building, ensuring the convenience and safety of all residents and visitors, particularly when accessed from within their vehicles. For example, a smart intercom and security system would enable visitors to receive a time-limited barcode on their smartphone, which grants access to specific floors, units, and the parking area of the building.

- concerned about visitor access after hours; consider moving the parkade gates one car length down into the tunnel and putting the interphone on the left side on the pilaster to better facilitate the visitor parking process after hours;
 - Applicant's response: We are complying with CPTED guidelines, creating an alcove in the parkade entryway would regrettably be perceived as a potential area of shelter or refuge for individuals experiencing homelessness.
- the building design at the Garden City and Cook Road intersection needs more work to provide architectural and visual interest; consider incorporating cedar coloured metal planks at this building corner;
 - Applicant's response: Thank you for your insightful comment. We conducted a comprehensive review of the design, placing particular emphasis on the visual hierarchy of the corner. Our primary focus has been on showcasing the prominent tree that has been preserved at the site's corner, adhering to the City's directives for safeguarding its root zone. In our reassessment, we have strategically directed visual interest towards the main gateway entry, specifically the lobby entrance, and highlighted the distinctive suspended balconies featured on only these two building facades. We believe that the existing design effectively emphasizes these key elements, contributing to a compelling street view. Upon careful consideration, we've concluded that introducing additional architectural features may not enhance the overall design. In fact, it could potentially detract from the established visual hierarchy we've worked to achieve. We remain committed to preserving the balance and aesthetic appeal of the project, ensuring that each element contributes harmoniously to the overall composition.
- appreciate the unique design of the project which has turned its site constraint into the highlight of the project; the building design is straightforward and economical and achieves the intended purpose of the building; also appreciate the design of the central courtyard and the parkade;

Applicant's response: acknowledged.

review the proposed screening of the parkade wall from the central courtyard; in addition to the proposed trellis screen with climbing plants, consider introducing further treatment to the parkade wall, e.g. adding texture and colour to the parkade wall to break up and reduce the apparent height of the parkade wall surrounding the central courtyard;

Applicant's response: we have extensively investigated and tried to find a proper balance when it comes to the economic feasibility of wall treatments for a rental project. We have introduced additional planters at selected locations, with shrubs and trees to soften the parkade wall.

- For the north side of the West Parkade wall, the planter at the northwest corner has been expanded to partially cover the parkade wall. The planter is 3' high and hosts shade-tolerant shrubs and trees, enhancing the aesthetic appeal of the area. Additionally, the incorporation of hanging plants, specifically Cotoneaster, along the edge of the planter, serves to further soften the appearance of the wall.

In addition, another planter has been added between the social decking areas, positioned at curb height. This newly added planter also incorporates shrubs and trees, strategically placed to break up the parkade wall.

- For the south side of the West Parkade Wall, the planter along the wall has been widened, providing more space for denser planting and tree growth.
- For the North and East Parkade walls, we proposed hanging plants such as contoneater along the edge of parkade walls to allow green coverage from top to bottom. This complements the green trellises, which feature climbers growing from the bottom up, thereby enhancing the overall greenery and aesthetic appeal of the walls.
- support the Panel comment regarding further building treatment at the Garden City and Cook Road intersection to make the corner more visually interesting;

Applicant's response: see response above.

 consider introducing accent colours to the neutral colours of the buildings, especially around the lower level of the townhouses to make the building features stand out more;

Applicant's response: we have reviewed the design and have incorporated additional copper spandrel panels.

support the concept of pocket parks; however, there are few landscape elements
present in the proposed pocket parks in the project; consider adding more
landscape elements in the pocket parks to make them more usable and
enjoyable to users;

Applicant's response:

Drinking fountains have been added in both northwest and southeast plazas to improve the pedestrian experience by offering a convenient source of refreshment for both people and their companions.

The Seating benches have been transformed into distinctive, colorful variations. Each park now has its own unique palette, allowing for easy differentiation and enhancing the overall pedestrian experience.

• understand the constraints of the site and appreciate the applicant for coming up with an attractive building design;

Applicant's response: acknowledged.

concerned about how the public realm dedications have been allocated in the subject site; the design of the mid-block pocket park along Pimlico Way is problematic as it appears closed off and functions more as a landscaped buffer than a public space; consider reallocating this pocket park to consolidate with smaller pocket parks along the periphery of the site to allow for larger pocket parks that are more publicly accessible with additional public amenities;

Applicant's response: Pimlico Way pocket park has been revised to have a more welcoming use and improved programming/equipment.

 not convinced on the proposed variance to the balcony projection setback to fronting roads; investigate opportunities to introduce design changes to the building in order to meet the required balcony projection setback;

Applicant's response: We are unable to setback the building further due to setback constraints from the central courtyard tree root zone and the reduced site size resulting from road dedications on all four frontages.

concerned about the depth of the central courtyard and its relationship with the
parkade wall surrounding it; investigate opportunities to better address this
concern; as the central courtyard location will be fairly shaded, ensure that the
appropriate species of climbing plants on the parkade wall will be selected to
ensure their long-term survivability;

Applicant's response: We have extensively investigated and tried to find a proper balance when it comes to the economic feasibility of wall treatments for a rental project. New Planters and specimens have been added to soften down the wall expression.

• identified pedestrian routes from the building to the courtyard appear circuitous and challenging to persons with mobility issues and families with children; an accessible path from the elevator lobby at P1 to the courtyard would be a more realistic accessible route; consider making it more attractive and usable, e.g. ensuring it is well lighted and having adequate width to facilitate pedestrian circulation:

Applicant's response: All design considerations have been implemented and they provide a clear path of travel to anyone with mobility challenges. Path to the courtyard from the elevator lobby has been widened and clearly marked. We have also incorporated weather protection for pedestrians at the door access to the courtyard.

• consider consolidating the two children's play areas on the ground level and on Level 2 into one larger play area for easier supervision of children;

Applicant's response: we've successfully merged two play areas into a single space, expanding it slightly while carefully coordinating with existing tree protection measures.

• investigate opportunities to directly activate the central courtyard and make it more accessible to residents and directly link with the daily life of the residents;

Applicant's response: We have proposed a variety of programs to enhance daily use, including deck seating, playground, and great open reserved lawn areas covered with large mature trees. There is plenty of space for relaxing, kids playing, gathering, exercising, etc. On Level 2, we proposed urban agriculture to encourage residents to do gardening. As well as a big open artificial turf lawn to provide opportunity for gathering, games, and sports opportunities.

 proposed form and character of the building is reasonable, attractive, and appropriate for its site context;

Applicant's response: acknowledged.

agree with the Panel comment that the site constraint has been turned into an opportunity to design a building courtyard typology;

Applicant's response: acknowledged.

• the building design is modest, well executed, and appropriate for its intended use for affordable and market rental housing;

Applicant's response: acknowledged.

• the central courtyard has been successfully designed to create a park-like experience for users;

Applicant's response: acknowledged.

investigate opportunities for incorporating public art at the pocket parks; and

Applicant's response: The incorporation of public art is not mandated for 100% rental projects within the City, and as such, the proposed project is exempt from the obligation to integrate public art.

climbing plants for the proposed trellis on the parkade wall surrounding the
central courtyard may take a long time to be established due to the height of the
parkade wall; consider alternate treatments to screen the parkade wall; due to its
shady location, consider incorporating architectural in lieu of landscape
treatment to the parkade wall around the courtyard.

Applicant's response: we proposed two ways to mitigate the tall trellis. Firstly by raising the planters 3 feet high from the finished grade and adding hanging plants to soften the planter wall. Secondly we added hanging plants from level 2 edge planters.

Hanging plants are proposed in locations where planters are located along the parapet edge of level 2 as shown on planting plan sheet L-2.05. The guardrail location has been shifted from the parapet to the pathway side of these planters to allow for these cascading plants to grow uninterrupted. These cascading plants can be expected to cover up to 6' to 8' or more within 3 to 5 growing seasons, typically.

The following written comments submitted by Panel member Nicci Theroux were read into the record by the Chair:

- consider the inclusion of deciduous trees at the central pocket park on Pimlico Way for shade; the large landscape area provides a nice buffer to the road;
 - Applicant's response: Thank you for this comment. Trees were changed to 6 deciduous trees and 3 conifer trees instead of all conifer trees.
- consider including a pattern in the paving where pedestrians may cross the service area to indicate that this is a potentially a shared pathway;
 - Applicant's response: Thank you for this comment. A different pattern and color have been applied to the service area.
- the northern half of the play on Level 2 will be in shade at the solstice; consider what might be more appropriate in a shadier spot or combine the play to the south on Level 1 at the same time keeping some separation for age groups;
 - Applicant's response: We have consolidated the level 2 play area to Level 1 to make a larger playground.
- consider soil cells or structural soil under the sidewalk at Citation Drive as the tree trench does not appear to provide adequate soil volume for street trees; consider the same approach for Garden City Road and Pimlico Way;
 - Applicant's response: Structural soil has been proposed under the sidewalk along Citation Drive. For Garden City Road and Pimlico Road, the planted boulevard is 1.5m wide which allows approximately 15m³ soil volume per tree.
- soil volume for *acer griseum* in the courtyard appears inadequate; and
 - Applicant's response: we limited the acer griseum in the courtyard to where it can provide a minimum of 10m³ soil volume per tree.
- remainder of the trees are smaller in the courtyard; consider aiming for a minimum of 6 cubic metres of soil volume even for smaller trees.
 - Applicant's response: Thank you for this commnet. We have increased soil volume for trees in the courtyard by either increasing the planting area or raising up the planter heights.

Panel Decision

It was moved and seconded

That DP 23-014121 be supported to move forward to the Development Permit Panel subject to the applicant giving consideration to the comments of the Advisory Design Panel.

Opposed: Alan Tse

CARRIED

ATTACHMENT 3



Development Permit Considerations

Development Applications Department 6911 No. 3 Road, Richmond, BC V6Y 2C1

File No.: DP 23-014121

Address: 8880 Cook Road and 8751 Citation Drive

Prior to approval of the Development Permit, the developer is required to complete the following:

- 1. (OCP Amendment) Final adoption of OCP Amendment Bylaw 10395.
- 2. (Zoning Amendment) Final adoption of the Zoning Amendment Bylaw 10396.
- 3. (Tree Compensation) City acceptance of the developer's offer to voluntarily contribute \$98,304.00 (\$768.00/tree) to the City's Tree Compensation Fund for the planting of replacement trees within the City.
- 4. (Landscaping Security) Receipt of a Letter of Credit for landscaping in the amount of \$858,573.29 (based on the costs estimate provided by a CSLA registered landscape Architect including 10% contingency). A legal agreement is required to accompany the Landscape Security to set the terms for its use and release.
- 5. (Accessible Units) Registration of Market Rental Agreement and Moderate Income Housing Agreement on title securing the developer's offer to voluntarily provide four accessible, moderate income housing units, and two accessible market rental units. Languages should be included in the agreements that these units are required to incorporate all of the accessibility provisions listed in the Basic Universal Housing Features section of the City's Zoning Bylaw and in the BC Building Codes.

Prior to Demolition Permit Issuance, the developer must complete the following requirements:

- 1. Provide written confirmation and supporting documents to demonstrate that the proposed Tenant Relocation Plan has been implemented.
- 2. Installation of appropriate tree protection fencing around all trees to be retained as part of the development prior to any construction activities, including building demolition, occurring on-site.

Prior to Building Permit Issuance, the developer must complete the following requirements:

- 1. Confirm that "Land Use Contract (LUC 025)" has been discharged from the subject site.
- 2. Submission of a Construction Parking and Traffic Management Plan to the Transportation Department Management Plan shall include location for parking for services, deliveries, workers, loading, application for any lane closures, and proper construction traffic controls as per Traffic Control Manual for works on Roadways (by Ministry of Transportation) and MMCD Traffic Regulation Section 01570.
- 3. Incorporation of accessibility measures in Building Permit (BP) plans as determined via the Rezoning and/or Development Permit processes.
- 4. If applicable, payment of latecomer agreement charges, plus applicable interest associated with eligible latecomer works.
- 5. Obtain a Building Permit (BP) for any construction hoarding. If construction hoarding is required to temporarily occupy a public street, the air space above a public street, or any part thereof, additional City approvals and associated fees may be required as part of the Building Permit. For additional information, contact the Building Approvals Department at 604-276-4285.

Note:

- * This requires a separate application.
- Where the Director of Development deems appropriate, the preceding agreements are to be drawn not only as personal covenants of the property owner but also as covenants pursuant to Section 219 of the Land Title Act.
 - All agreements to be registered in the Land Title Office shall have priority over all such liens, charges and encumbrances as is considered advisable by the Director of Development. All agreements to be registered in the Land Title Office shall, unless the Director of Development determines otherwise, be fully registered in the Land Title Office prior to enactment of the appropriate bylaw.

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The preceding agreements shall provide security to the City including indemnities, warranties, equitable/rent charges, letters of credit and withholding permits, as deemed necessary or advisable by the Director of Development. All agreements shall be in a form and content satisfactory to the Director of Development.

- Additional legal agreements, as determined via the subject development's Servicing Agreement(s) and/or Development Permit(s), and/or Building Permit(s) to the satisfaction of the Director of Engineering may be required including, but not limited to, site investigation, testing, monitoring, site preparation, de-watering, drilling, underpinning, anchoring, shoring, piling, pre-loading, ground densification or other activities that may result in settlement, displacement, subsidence, damage or nuisance to City and private utility infrastructure.
- Applicants for all City Permits are required to comply at all times with the conditions of the Provincial Wildlife Act and Federal
 Migratory Birds Convention Act, which contains prohibitions on the removal or disturbance of both birds and their nests. Issuance
 of Municipal permits does not give an individual authority to contravene these legislations. The City of Richmond recommends
 that where significant trees or vegetation exists on site, the services of a Qualified Environmental Professional (QEP) be secured
 to perform a survey and ensure that development activities are in compliance with all relevant legislation.

Signed	Date



Development Permit

No. DP DP 23-014121

To the Holder:

1166225 BC Ltd.

Property Address:

8880 Cook Road and 8751 Citation Drive

Address:

c/o GBL Architects

224 W 8th Avenue Unit 300.


Vancouver, British Columbia, V5Y 1N5

- 1. This Development Permit is issued subject to compliance with all of the Bylaws of the City applicable thereto, except as specifically varied or supplemented by this Permit.
- 2. This Development Permit applies to and only to those lands shown cross-hatched on the attached Schedule "A" and any and all buildings, structures and other development thereon.
- 3. The "Richmond Zoning Bylaw 8500" is hereby varied to reduce the road setback to projecting balconies above the second floor from 3.0 m to 1.2 m.
- 4. Subject to Section 692 of the Local Government Act, R.S.B.C.: buildings and structures; off-street parking and loading facilities; roads and parking areas; and landscaping and screening shall be constructed generally in accordance with Plans #1 to #76 attached hereto.
- 5. Sanitary sewers, water, drainage, highways, street lighting, underground wiring, and sidewalks, shall be provided as required.
- 6. As a condition of the issuance of this Permit, the City is holding the security in the amount of \$858,573.29 to ensure that development is carried out in accordance with the terms and conditions of this Permit. Should any interest be earned upon the security, it shall accrue to the Holder if the security is returned. The condition of the posting of the security is that should the Holder fail to carry out the development hereby authorized, according to the terms and conditions of this Permit within the time provided, the City may use the security to carry out the work by its servants, agents or contractors, and any surplus shall be paid over to the Holder. Should the Holder carry out the development permitted by this permit within the time set out herein, the security shall be returned to the Holder. The City may retain the security for up to one year after inspection of the completed landscaping in order to ensure that plant material has survived.
- 7. If the Holder does not commence the construction permitted by this Permit within 24 months of the date of this Permit, this Permit shall lapse and the security shall be returned in full.

Development Permit No. DP DP 23-014121

To the Holder:	1166225 BC Ltd	d.						
Property Address:	8880 Cook Roa	8880 Cook Road and 8751 Citation Drive						
Address:	224 W 8th Aver	c/o GBL Architects 224 W 8th Avenue Unit 300, Vancouver, British Columbia, V5Y 1N5						
	ons of this Permit as m a part hereof.	ped generally in accordance with the terms and nd any plans and specifications attached to this						
AUTHORIZING RESOL DAY OF ,	UTION NO.	ISSUED BY THE COUNCIL THE						
DELIVERED THIS	DAY OF	,						
MAYOR								



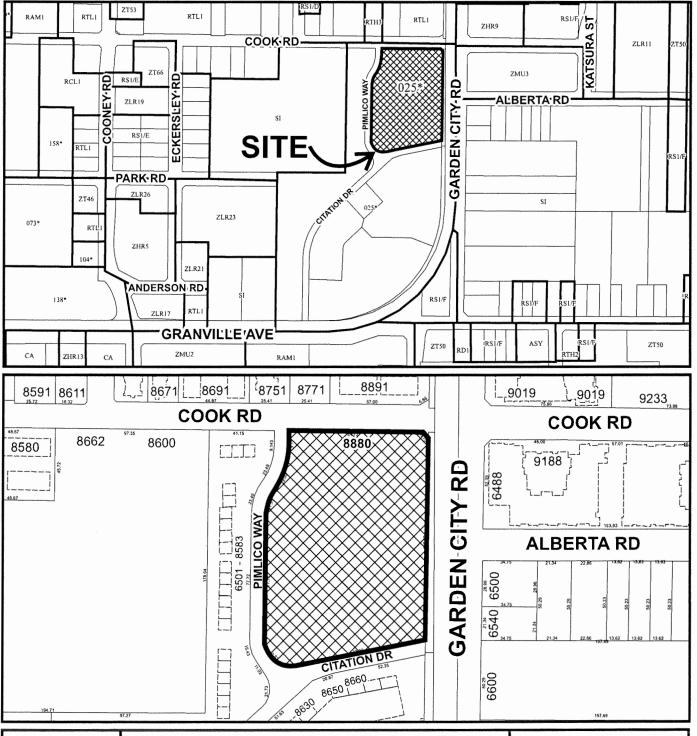




DP 23-014121 SCHEDULE "A"

Original Date: 03/27/23

Revision Date:

Note: Dimensions are in METRES



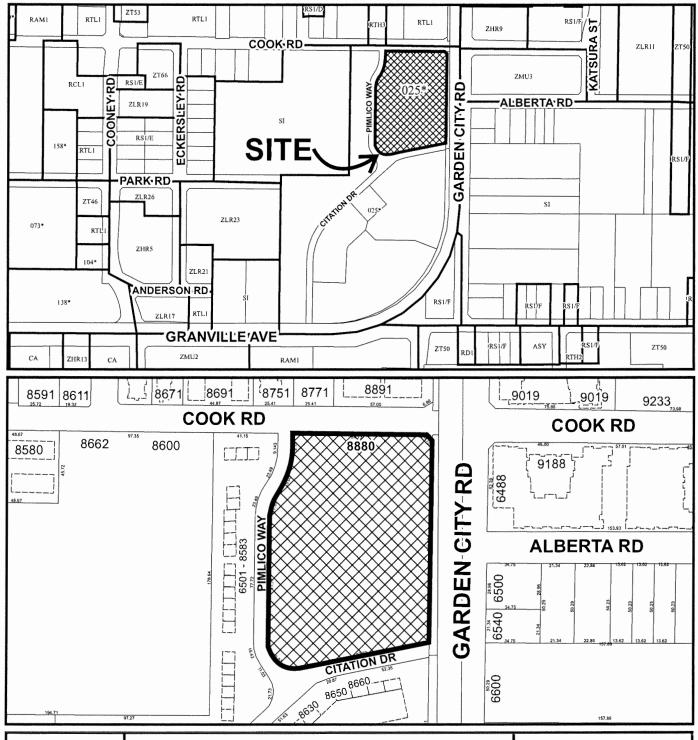



DP 23-014121

Original Date: 03/27/23

Revision Date:

Note: Dimensions are in METRES

8880 COOK RD. & 8751 CITATION DRIVE

RICHMOND, BC







PROJECT TEAM:

OWNER

EVERBRIGHT PROF

504.520 9199

ARCHITECT

AMELA BRUDAR 604.736.1156 ALEJANDRO MARTINEZ 604,736,1156 ext. 303 amartinez@oblarchilects.com

CODE

PROTECTION ENGINEERI

DENISE BOSÉ 604-482-0388, ext.

STRUCTURAL

DARRYL BOWER 604 294 3753

604 294 3753 bowers@wsb-en

MCW CONSULTANTS

KAREN SPOELSTRA 604 687.1821 EXT. 77

LANDSCAPE + ARBORIST

CONSULTANT COMPANY

ALEXA GONZALE 604 586 4611

.ca flore

NEMETY & ASOC.

GARY GEISSINGER

gar your entreez. com

TRAFFIC + TRANSPORTATION

PETER JOYCE

604 685 6427 ext. 22 pjoyce@bunleng.com

> CIVIL MPT ENGINEERING CO. LTG

> > EFF CRAWFORD

604.270.93

GEOTECHNICAL

HORIZON ENGINEER NG

JONAH SCHW PHONE

ENVELOPE

CONTACT NAME

SUSTAINABILITY

KANE CONSULTING

DANIEL ROBERTS 604.924.0094

INTERIOR DESIGN

PHONE PHONE

PHONE

DEVELOPMENT STRATEGIST

PASHAM MAHBQ PHONE parhamiörastrate

DP 23-014121 PLAN #1

8880 COOK RD. & 8751 CITATION DRIVE

RICHMOND, BC



	DRAWING LIST
Number	Name
A-0.01	STATS
A-0.01a	STATS II
A-0.02	SURVEY
A-0.04	CONTEXT PLAN
A-0.05	STREETSCAPE
A-0.06	STREETSCAPE
A-0.08	SHADOW STUDIES
A-0.09	DESIGN RATIONAL/ MASSING
A-0.10	NOTES & LEGENDS I
A-0.11	GENERAL NOTES, SYMBOLS & LEGENDS
A-0.12	MATERIALS I
A-0.13	MATERIALS II
A-0.14	SUSTAINABILITY RATIONALE
A-0.15	WALL ASSEMBLIES
A-0.16	FLOOR ASSEMBLIES
A-0,21	SITE PLAN
A-0.22	SITE AREA PLAN
A-0.23	LOT COVERAGE
A-0.24	SITE POROSITY
A-0.25	SITE S.R.W.
A-0.26	OUTDOOR AMENITY
A-0.27	LDT GRADING
A-0.28	LOT GRADING I
A-1,01	FLOOR PLANS - KEY LEGEND
A-1,02	FLOOR PLANS - PARKING LEGEND
A-1.03	FLOOR PLAN - P1
A-1.04	FLOOR PLAN - P2
A-1,05	FLOOR PLAN - L1
A-1.06	FLOOR PLAN - L2
A-1.07	FLOOR PLAN - L3
A-1.08	FLOOR PLAN - L4
A-1.09	FLOOR PLAN - L5
A-1.10	FLOOR PLAN - L6
A-1.11	FLOOR PLAN - ROOF
A-1.11 A-1.12	ENLARGED FLOOR PLANS
A-1.12 A-1.13	ENLARGED FLOOR PLANS
A-1.13 A-1.14	ENLARGED FLOOR PLANS
A-1.14 A-1.15	ENLARGED FLOOR PLANS
A-2.01	ELEVATIONS
A-2.02	ELEVATIONS
A-2.03	ELEVATIONS
A-2.04	ELEVATIONS
A-2.05	ELEVATIONS

	DRAWING LIST
Number	Name
A-2.06	ELEVATIONS
A-2.07	ELEVATIONS
A-2.08	ENLARGED ELEVATIONS
A-2.09	ENLARGED ELEVATIONS
A-2.10	ENLARGED ELEVATIONS
A-3.01	BUILDING SECTIONS I
A-3.02	BUILDING SECTIONS II
A-3.03	BUILDING SECTIONS III
A-4.00	UNIT NOTES
A-4.01	TYP. ACCESSIBLE UNITS
A-4.02	UNIT PLANS - STUDIO
A-4.03	UNIT PLANS - STUDIO
A-4.04	UNIT PLANS - 1BD
A-4.05	UNIT PLANS - 1BD
A-4.06	UNIT PLANS - 2BD
A-4.07	UNIT PLANS - 2BD
A-4.08	UNIT PLANS - 2BD
A-4.09	UNIT PLANS - 2BD
A-4.10	UNIT PLANS - 3BD
A-4.11	UNIT PLANS - 3BD
A-4.12	UNIT PLANS - TH - 2BD
A-4.13	UNIT PLANS - TH - 2BD
A-4.14	UNIT PLANS - TH - 2BD
A-4.15	UNIT PLANS - TH - 2BD
A-4,16	UNIT PLANS - TH - 28D
A-4.17	UNIT PLANS - TH - 2BD
A-4.18	UNIT PLANS - TH - 3BD
A-4.19	UNIT PLANS - TH - 3BD
A-4.20	UNIT PLANS - TH - 3BD
A-5.01	FAR - P1
A-5.02	FAR - P2
A-5.03	FAR - L1
A-5.04	FAR - L2
A-5.05	FAR - L3
A-5.06	FAR - L4
A-5.06 A-5.07	
	FAR - L5
A-5.08	FAR - L6
A-6.01	3D VIEWS
A-6.02	3D VIEWS
A-6.03	3D VIEWS
A-6.04	3D VIEWS
A-6.05	3D VIEWS
A-6.06	3D VIEWS

DRAWING LIST					
Number	Name				
A-6.07	3D VIEWS				
A-6.08	3D VIEWS				
A-7.01	TRAFFIC & TRANSPORTATION				
A-7.02	TRAFFIC & TRANSPORTATION				
A-8.00	PRIVACY SCREEN DETAILS				
A-8.01	METAL PLANKS DETAILS				
A-8.02	ROOF SCREENING DETAILS				
A-8.03	BALCONY DETAILS				
A-8.04	PARKADE AND STAIR SCREEN				
A-8.05	TH PRIVACY SCREEN DETAILS				
A-9.01	WASTE MANAGEMENT PLAN				
A-9.03	WASTE MANAGEMENT ROOMS				
A-9.04	WASTE MANAGEMENT ROOMS CALCULATION				
A-10.01	CIRCULATION PLAN - P1				
A-10.02	CIRCULATION PLAN - P2				
A-10.03	CIRCULATION PLAN - L1				
A-10.04	CIRCULATION PLAN - L2				
A-10.05	CIRCULATION PLAN - L3				
A-10.06	CIRCULATION PLAN - L4				
A-10.07	CIRCULATION PLAN - L5				
A-10.08	CIRCULATION PLAN - L6				
A-11.01	SIGNAGE AND WAYFINDING				
A-11.02	SIGNAGE AND WAYFINDING				
A-11.03	SIGNAGE AND WAYFINDING				
A-11.05	SIGNAGE AND WAYFINDING				
A-11.08	SIGNAGE AND WAYFINDING				
A-11.09	SIGNAGE AND WAYFINDING				
A-11.10	SIGNAGE AND WAYFINDING				
A-11.11	SIGNAGE AND WAYFINDING				
A-11.12	SIGNAGE AND WAYFINDING				

DP 23-014121 PLAN #2

PROJECT STATISTICS GENERAL INFORMATION

NET SITE AREA USED FOR FAR
CALCULATIONS

122,620

11392

BLDG. HEIGHT VARIES

AVERAGE BLDG. HEIGHT (meters)

18

SETBACKS

3.00m

FAR ALLOWED

	NEW SITE A	REA ALLOWED
DESCRIPTION	NET FAR	AREA [SF]
MARKET RENTAL	1.79	219,489
NON-MARKET RENTAL	0.31	38,171
TOTAL MAX	2.10	257,660

AREA BREAKDOWN - PROPOSED

		CIRCULATION	RENTABLE			EXCLUSIONS+		TOTAL		
DESCRIPTION	GFA (SF)	(SF)	(SF)	EFFICIENCY	SERVICE	BUH	AMENITY	EXCLUSIONS	FAR AREA	FAR
TOTAL	283,640	27,890	234,999	82.9%	3,499	15,776	7,508	26,783	256,857	2.09

PARKING REQUIREMENTS

DESCRIPTION	BYLAW	REQUIRED RATIO [PER UNIT]	TOTAL UNITS	VISITORS STALLS REQUIRED (0.16/UNIT)	RES. STALLS REQUIRED	TOTAL REQUIRED
MARKET RENTAL	Bylaw 10393 and Parking By Law 7.9.3 Table 7.9.3.1 Zone 2	0.5	271	44	136	180
MODERATE INCOME RENTAL	Bylaw 10396 and Parking By Law 7.9.3 Table 7.9.3.1 Zone 2	0.4	68	11	28	39
TOTAL REQUIRED			339	55	164	219
TOTAL PROVIDED				55	168	223

CESU JUL - API ING PEQUIPE 20 UF ST-	4
ACCESSIBLE PARKING PROVIDED	5
S ALL CARS LLOWED	1
SMALL CARS PROVIDED	96
CLASS A LOADING	2
MEDIUM SIZE LOADING	1

BICYCLE STALL REQUIREMENTS

REQUIREMENTS/UNIT		1.25	1.90	0.2		
	TOTAL UNITS	CLASS 1 (STUDIOS)	CLASS 1 (ALL OTHER UNITS)	CLA55 2	PROPORTION	BYLAW MAX
UNIT COUNT	339	87	252			
TOTAL REQUIRED	588	109	479	68		
CLASS-1 HOR (STANDARD, OVERSIZED, LOCKERS)	303			68	51.5%	N/A
CLASS-1 HOR STACKED	194				33.0%	33.0%
CLASS-1 VER	91				15.5%	33.0%
TOTAL PROVIDED	588		1	68		

AMENITY REQUIREMENTS

INDOOR AMENINTY	m2	SF
MINIMUM INCOOR AMENITY REG'D PER UNIT	2	21.52782
TOTAL UNITS	339	
TOTAL INDOOR AMENITY AREA REQ'O	678	7,298
PROVIDED INDOOR AMENITY AREA	698	7,508
OVER/UNDER AMENITY	20	210

OUTDOOR AMENITY	m2	SF
OUTDOOR SHARED AREA REQ'D PER UNIT	6	64.58346
TOTAL UNITS	339	
MIN. OUTDOOR AREA REQ'D	2034	21,894
10% SITE AREA REQ'D"	1139	12262
TOTAL OUTDOOR AREA REQUIRED	3173	34,156

OVER/UNDE DO 23-014121 PLAN #3

gbl

■ GBL ARCHITECTS INC.

IDD-224 WEST 8TH AVENUE VANCOUVER, BC CANADA VSY INS

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NOTES

ABBREVIATIONS

MR- MARKET RENTAL MIR - MODERATE INCOME RENTAL FAR - FLOOR AREA RATIO

UNIT MIX REQUIREMENTS

FAMILY UNIT BREAKDOWN				
RENT TYPE	BY-LAW MIN. FAMILY REQ'D (%)	UNITS PROVIDED	FAMILY UNITS PROVIDED	FAMILY UNITS PROVIDED (%)
MODERATE INCOME RENTAL (MIR)	15%	68	16	24%
MARKET RENTAL (MR)	40%	271	120	44%
TOTAL		339	136	40%

UNIT TYPE COUNTS RENT TYPE	STUDIO	1BD	28D	3BD	TH	TOTAL	BUH BY- LAW (%) REQUIRED	BUH REQUIRED	BUH PROVIDED
MODERATE INCOME RENTAL (MIR)	36	16	7	4	5	68	100%	63	63
MARKET RENTAL (MR)	51	100	75	13	32	271	100%	239	239
TOTAL UNIT PERCENTAGE [%]	87 26%	116 34%	82 24%	17 5%	37 11%	339 100%		302	302

			_	
D	FV	SI	ON	5

NO. DATE DESCRIPTION
4 MAR 10 2023 ISSUED FOR OP
5 OCT 06 2023 RE-ISSED FOR DP
6 JAN 19 2024 RE-ISSUED FOR DP
7 FEB 15 2024 RE-ISSUED FOR OP

MARKET RENTAL (MR)				
UNIT TYPE	NO. OF UNITS	MIN. SIZE (SF)	% FAMILY UNITS	% BUH UNITS
STUDIO	51		N/A	19%
1 BED	100		N/A	37%
2 BED	75		28%	28%
3 BED	13		5%	5%
TOWNHOUSE (2 BED)	26		10%	N/A
TOWNHOUSE (3 BED)	6		2%	N/A
TOTAL	271		44%	88%

Note: Townhouse design will not meet BUH provision. All apartment units will provide BUH requirements.

MODERATE INCOME RENTAL (MIR)						
UNIT TYPE	NO. OF UNITS	MIN. SIZE (SF)	% FAMILY UNITS	% BUH UNITS		
STUDIO	36	400	0%	57%		
1 BED	16	535	0%	24%		
2 BED	7	741	10%	10%		
3 BED	4	980	6%	6%		
TOWNHOUSE (2 BED)	5	741	7%	0%		
TOWNHOUSE (3 BED)	0	980	0%	N/A		
TOTAL	68		24%	97%		

Note: Townhouse design will not meet BUH provision. All apartment units to meeet BUH requirements.

8880 COOK RD. & 8751 CITATION DRIVE

RICHMOND, BC

STATS

DATE DRAWN BY CHECKED BY SCALE

Y 98L 1/2" = 1'-0"

2/14/2024 4:07:30 PM

JOB NUMBER

N_N N

GROSS AREA

TOTAL - GFA				
USE	AREA			
AMENITY	7508 S			
BUH EXCLUSION	6032 5			
CIRCULATION	27890 SI			
EXCLUSIONS	9744 SI			
RESIDENTIAL	228967 SI			
SERVICE	3499 SI			
TOTAL	283640 SI			

TOTAL - RENTABLE				
USE	AREA			
180	64907 SF			
280	65518 SF			
380	18855 SF			
BUH	6032 SF			
STUDIO	38693 SF			
TH	40995 SF			
TOTAL	234999 SF			

TDTAL - EXCLUSIONS				
USE	AREA			
AMENITY	7508 S			
BUH	6032 S			
ELECTRICAL ROOM	1259 5			
EXCLUSION	8570 S			
MECH, SHAFT	1174 5			
MECHANICAL	2240 S			
TOTAL	26783 5			

OUTDOOR AREA

PARKADE

PARKING - TOTAL CAR

RESIDENTIAL - H/C STALL 3
RESIDENTIAL - H/C VAN STALL 2

RESIDENTIAL - REGULAR STALL 91 RESIDENTIAL - SMALL STALL 72
 VISITOR - REGULAR
 30

 VISITOR - SMALL CAR STALL
 23

 VISITOR H/C STALL
 2

PARKING - RESIDENTIAL

RESIDENTIAL - SMALL STALL 72

PARKING - OTHER

MECHANICAL SHAFT AREA

TYPE AREA (SFI AREA (m2) L2 MECH. SHAFT 260 24.14 L3 MECH. SHAFT 256 23.76 L4 MECH. SHAFT 252 23.41

TYPE RESIDENTIAL - H/C STALL

ISITOR H/C STALL

MEDIUM SIZE LOADING

RESIDENTIAL - REGULAR STALL

CARS

OUTDOOR AMENITY AREA		
USE	LEVEL	AREA
OUTDOOR AMENITY	L1	20325 SF
OUTDOOR AMENITY	L2	1830 SF
OUTDOOR AREA	L2	10542 SF
OUTDOOR AMENITY	L3	3416 SF
TOTAL: 4		36113 SF

FAR AREA SUMMARY - BY LEVEL			
LEVEL	AREA	FAR	
P1	295 SF	0.00	
L1	24727 SF	0.20	
P2	281 SF	0.00	
L2	47003 SF	0.38	
L3	44792 SF	0.37	
L4	46559 SF	0.38	
L5	46737 SF	0.38	
L6	46463 SF	0.38	
TOTAL	256857 SF	2.09	

NET FAR - MARKET RENTAL			
LEVEL	AREA	FAR	
.1	18063 SF	0.147	
_2	33172 SF	0.271	
.3	22676 SF	0.185	
_4	31388 SF	0.256	
_5	41276 SF	0,337	
_6	42015 SF	0.343	
TOTAL	188541 SF	1,538	

NET FAR MODERATE INCOME BENTAL			
NET FAR - MODERATE INCOME RENTAL			
LEVEL	AREA	FAR	
L1	2508 SF	0.0	
L2	8383 SF	0,0	
L2 L3	1"733 SF	0.1	
L4	10755 SF	0.0	
L5	1048 SF	0.0	
TOTAL	40427 SF	0.3	

NET FAR - CIRCULATION			
LEVEL	AREA	FAR	
P1	275 ST	0.002	
LI	4156 SF	0.034	
P2	281 SF	0.002	
L2	5448 SF	0.044	
L3	4433 SF	0.036	
L4	4416 SF	0.036	
L5	4414 SF	0.036	
L6	4448 SF	0.036	
TOTAL	2"890 SF	0.727	

TYPE	AREA (SF)	FAR
BIKE LOCKERS	2924	0.02
DOG WASH	321	0.00
EXCLUSION	246	0.00
GARBAGE	2098	0.02
MECHANICAL	594	0.00
PARKADE	41143	0.29
RESIDENTIAL CIRCULATION	295	0.00
TOTAL AREA	47621	0.34

GROSS AREA - EXCLUSION = NET AREA

FAR BREAK DOWN P2		
TYPE	AREA [SF]	FAR
AMENITY	1033	0.01
BIKE LOCKERS	8218	0.06
ELECTRICAL ROOM	1259	0.01
EXCLUSION	873	0.01
MECHANICAL	1646	0.01
PARKADE	35300	0.25
RESIDENTIAL CIRCULATION	281	0.00
TOTAL AREA	48610	0.35

GROSS AREA - EXCLUSION = NET AREA 48610-[1033-8218-1259-873-1646-35300]= 281 SF

FAR BREAK DOWN L1		
TYPE	AREA (SF)	FAR
MANAGEMENT	387	0.00
OUTDOOR AMENITY	20325	0.15
PATIO	15037	0.11
RESIDENTIAL CIRCULATION	3769	0.03
TH	20571	0.15
TOTAL AREA	60090	0.43

GROSS AREA - EXCLUSION = NET AREA

TYPE	AREA (SF)	FAR
IBD	4670	0.03
2BD	5033	0,04
3BD	2081	0.01
AMENITY	1596	0.01
BALCONY	1872	0.01
BUH	720	0.01
EXCLUSION	1713	0.01
MECH, SHAFT	260	0,00
OUTDOOR AMENITY	1830	0.01
OUTDOOR AREA	10542	0.08
PATIO	6433	0.05
RESIDENTIAL	5448	0.04
STUDIO	9347	0.07
ГН	20424	0.15

GROSS AREA - EXCLUSION = NET AREA

{1596-1872-720-1713-260-1830-10542-6433}

FAR BREAK DOWN L3		
TYPE	AREA (SF)	FAR
180	15643	0.11
BD	12911	0.09
BD	3414	0.02
AMENITY	3269	0.02
BALCONY	5558	0.04
BUH	1320	0.01
EXCLUSION	1521	0.01
VECH. SHAFT	256	0.00
UTDOOR MENITY	3416	0.02
RESIDENTIAL CIRCULATION	4433	0,03
TUDIO	8392	0.06
OTAL AREA	60133	0.43

GROSS AREA - EXCLUSION = NET AREA 60133-(3269-5558-1320-1521-256-3416) =

FAR SUMMARY

VEL	AREA	FAR	
	295 SF	0.00	BIKE
	24727 SF	0.20	DOG
	281 SF	0.00	EXC
	47003 SF	0.38	GAR
	44792 SF	0.37	MEC
	46559 SF	0.38	PAR
	46737 SF	0.38	RES
	46463 SF	0.38	CIR
	256857 SF	2,09	TOT

NET FAR - MARKET RENTAL			
LEVEL	AREA	FAR	
LI	18063 SF	0.147	
L2	33172 SF	0.271	
L3	27676 SF	0.185	
L4	31388 SF	0.256	
L5	41276 SF	0,337	
L6	42015 SF	0.343	
TOTAL	188541 SF	1,538	

NET FAR - MOD	ERATE INCOME	RENTA
LEVEL	AREA	FAR
L1	2508 SF	0.0
L2	8383 SF	0.
L3	1"733 SF	0.
L4	10755 SF	0.0
L5	1048 SF	0.1
TOTAL	40427 SF	0.0

NET FA	R - CIRCULATIO	N
LEVEL	AREA	FAR
P1	295 SF	0.003
LI	4156 SF	0.034
P2	231 SF	0.002
L2	5448 SF	0.044
L3	4433 SF	0.036
L4	4416 SF	0.03
L5	4414 SF	0.036
L6	4448 SF	0.03
TOTAL	2"890 SF	0.72

-			
FAR	BREAK DOWN	I P1	
TYPE	AREA (SF)	FAR	_
BIKE LOCKERS	2924	0.02	
DOG WASH	321	0.00	
EXCLUSION	246	0.00	Ξ
GARBAGE	2098	0.02	
MECHANICAL	594	0.00	Π
PARKADE	41143	0.29	
RESIDENTIAL CIRCULATION	295	0.00	

FAR SUMMARY BY LEVEL

FAR BREAK DOWN L4 YPE AREA (SF) FAR

GROSS AREA - EXCLUSION = NET AREA 56888 - (1609-5602-1340-1526-252) =

FAR BREAK DOWN L5

GROSS AREA - EXCLUSION = NET AREA

FAR BREAK DOWN L6

GROSS AREA - EXCLUSION = NET AREA

55318 - (5494-1320-1528-259-255) =

46,462 SF

55432- (5587-1333 -1527-248) = 46,737 SF

CIRCULATION

IRCULATION

47621-(2924-321-246-2098-594-41143) = 295 SF

FARI	BREAK DOWN	1 P2
TYPE	AREA (SF)	FAR
AMENITY	1033	0.01
BIKE LOCKERS	8218	0.06
ELECTRICAL ROOM	1259	0.01
EXCLUSION	873	0.01
MECHANICAL	1646	0.01
PARKADE	35300	0.25
RESIDENTIAL CIRCULATION	281	0.00
TOTAL AREA	48610	0.35

FAR	BREAK DOWN	L1
TYPE	AREA (SF)	FAR
MANAGEMENT	387	0.00
OUTDOOR AMENITY	20325	0.15
PATIO	15037	0.11
RESIDENTIAL CIRCULATION	3769	0.03
TH	20571	0.15
TOTAL AREA	60090	0.43

60090 -(20325-15037) = 24,728 SF

FAR	BREAK DOWN	L2
TYPE	AREA (SF)	FAR
1BD	4670	0.03
2BD	5033	0,04
3BD	2081	0.01
AMENITY	1596	0.01
BALCONY	1872	0.01
BUH	720	0.01
EXCLUSION	1713	0.01
MECH, SHAFT	260	0,00
OUTDOOR AMENITY	1830	0.01
OUTDOOR AREA	10542	0.08
PATIO	6433	0.05
RESIDENTIAL CIRCULATION	5448	0.04
STUDIO	9347	0.07
TH	20424	0.15

TOTAL AREA 71968 0.52

= 47.0025F

FAR	BREAK DOWN	113
TYPE	AREA (SF)	FAR
180	15643	0.11
2BD	12911	0.09
3BD	3414	0.02
AMENITY	3269	0.02
BALCONY	5558	0.04
BUH	1320	0.01
EXCLUSION	1521	0.01
MECH. SHAFT	256	0.00
OUTDOOR AMENITY	3416	0,02
RESIDENTIAL CIRCULATION	4433	0,03
STUDIO	8392	0.06
TOTAL AREA	60133	0.43

UNIT SUMMARY

ALI	LUNITS	
NAME	COUNT	%
1BD	100	29%
1BD - MIR	16	5%
2BD	75	22%
2BD - MIR	7	2%
380	13	4%
3BD - MIR	4	1%
STUDIO	51	15%
STUDIO - MIR	36	11%
TH	32	9%
TH-MIR	5	1%
TOTAL	339	100%

UNITS BY LEVEL - MIR

NAME	COUNT	%
MIR		
L1		
TH-MIR	5	7%
	5	7%
L2		
1BD - MIR	2	3%
2BD - MIR	1	1%
3BD - MIR	1	1%
STUDIO ~ MIR	6	9%
	10	15%
L3		
1BD - MIR	10	15%
2BD - MIR	4	6%
3BD - MIR	1	1%
STUDIO - MIR	17	25%
	32	47%
L4		
1BD - MIR	4	6%
2BD - MIR	2	3%
3BD - MIR	1	1%

NAME	COUNT	%
MR		
LI		
TH	32	12%
	32	12%
L2		
1BD	6	2%
280	5	2%
380	1	0%
STUDIO	15	6%
	27	10%
L3 1BD	17	6%
2BD	13	5%
3BD	2	1%
STUDIO	2	1%
1BD	23	8%
280	17	6%
390	3	1%
STUDIO	4	-%
L5	47	17%
1BD	27	10%
2BD	20	7%
380	3	1%
STUDIO	15	6%
L6	65	24%
18D	27	10%
280	20	7%
380	4	196
STUDIO	15	6%
	66	24%
TOTAL: 271	271	100%

NAME	AREA	%	AV. UNIT
1BD	54726 SF	29%	563.98
18D - MIR	9457 SF	5%	593.88
280	60483 SF	22%	811.42
2BD - MIR	5759 SF	2%	916.84
3BD	14654 SF	4%	1051.82
3BD - MIR	4201 SF	1%	1017,00
STUDIO	22632 5F	15%	437.79
STUDIO - MIR	16061 SF	11%	437.79
TH	36046 SF	9%	1049.83

ALL UNITS BY LEVEL

AVERA

_			2001
2	3BD	3	0%
2	3BD - MIR	1	0%
_2	STUDIO	10	3%
		- 10	
_2	STUDIO -	3	1%
	MIR		
_2		26	8%
_3	180	10	3%
	18D - MIR	8	2%
L3	2BD	10	3%
_3	280 - MIR	3	1%
			0%
L3	3BD_	1	
L3	3BD - MIR	1	0%
L3	STUDIO	1	0%
			0.70
L3	STUDIO -	5	1%
	MIR		
L3		39	12%
L4	1BD	15	4%
		3	1%
L4	1BD - MIR		
L4	2BD	12	4%
L4	2BD - MIR	1	0%
L4	3BD	1	0%
L4	3BD - MIR	1	0%
	STUDIO	1	0%
L4		_	U70
L4	STUDIO -	5	1%
	MIR		170
L4		39	12%
	Town 1		
LS	180	18	5%
∟ 5	2BD	14	4%
L5	380	1	0%
L5	3BD - MIR	1	0%
L5	STUDIO	4	1%
L5		38	11%
		18	5%
L6	1BD		
L6			4%
L6 L6	280	14	4%
L6 L6 L6	28D 38D	14	1%
L6 L6	280	14	
L6 L6 L6	28D 38D	14	1%
L6 L6 L6 L6 L6	3BD STUDIO	14 2 4 38 197	1% 1% 11% 58%
L6 L6 L6 L6 L6	28D 38D STUDIO	14 2 4 38 197	1% 1% 11% 58%
L6 L6 L6 L6 L6	3BD STUDIO	14 2 4 38 197	1% 1% 11% 58%
L6 L6 L6 L6 L6 L6	28D 38D STUDIO	14 2 4 38 197	1% 1% 11% 58% 6% 0%
L6 L6 L6 L6 L6 L6 L1	28D 3BD STUDIO	14 2 4 38 197	1% 1% 11% 58% 6% 6%
L6 L6 L6 L6 L6 L6 L1 L1 L1	28D 38D STUDIO	14 2 4 38 197	1% 1% 11% 58% 6% 0% 6%
L6 L6 L6 L6 L6 L6 L1 L1 L1	28D 38D STUDIO	14 2 4 38 197	1% 1% 11% 58% 6% 6%
L6 L6 L6 L6 L6 L6 L1 L1 L1 L1	280 380 STUDIO TH TH-MIR	14 2 4 38 197	1% 11% 58% 6% 0% 6% 0% 1%
L6 L6 L6 L6 L6 SOUTH L1 L1 L1 L2 L2	280 380 STUDIO	14 2 4 38 197 19 1 20 1 2 5	1% 1% 11% 58% 6% 0% 6%
L6 L6 L6 L6 L6 L6 L1 L1 L1 L1	ZBD 3BD STUDIO TH TH-MIR 1BD 280 STUDIO 5TUDIO 5TUDIO	14 2 4 38 197	1% 1% 11% 58% 6% 0% 6% 0% 1%
L6 L6 L6 L6 L6 SOUTH L1 L1 L1 L2 L2	280 380 STUDIO	14 2 4 38 197 19 1 20 1 2 5	1% 1% 11% 58% 6% 0% 6% 0% 1% 1%
L6 L6 L6 L6 L6 L6 L1 L1 L1 L1 L2 L2 L2	ZBD 3BD STUDIO TH TH-MIR 1BD 280 STUDIO 5TUDIO 5TUDIO	14 2 4 38 197 19 1 20 1 2 5 3	1% 1% 11% 58% 6% 0% 6% 0% 1%
L6 L6 L6 L6 L6 L1 L1 L1 L2 L2 L2 L2	ZBD 3BD STUDIO TH TH-MIR 1BD 2BD STUDIO STUDIO STUDIO	14 2 4 38 197 19 1 20 1 2 5 3	1% 1% 11% 58% 6% 6% 6% 1% 1%
L6 L6 L6 L6 L6 L6 L1 L1 L1 L1 L2 L2 L2 L2 L2	280 380 STUDIO TH TH-MIR 180 280 STUDIO STUDIO - MIR	14 2 4 38 197 19 1 20 1 2 5 3	1% 1% 11% 58% 6% 0% 6% 0% 1% 1% 1%
L6 L6 L6 L6 L6 L1 L1 L1 L2 L2 L2 L2	280 380 STUDIO TH TH-MIR 180 280 STUDIO STUDIO - MIR	14 2 4 38 197 19 1 20 1 2 5 3	1% 1% 11% 58% 6% 6% 6% 1% 1%
L6 L6 L6 L6 L6 L1 L1 L1 L1 L2 L2 L2 L2 L2 L2 L2 L2 L3 L3	280 380 STUDIO TH TH-MIR 18D 280 STUDIO - MIR 18D - MIR	14 2 4 38 197 19 1 20 1 2 5 3	1% 1% 1% 11% 58% 6% 0% 6% 0% 1% 1% 1% 1%
L6 L6 L6 L6 L6 L6 L1 L1 L1 L1 L2 L2 L2 L2 L2 L2 L2	280 380 STUDIO TH TH-MIR 180 280 STUDIO STUDIO 5TUDIO MIR 180 180 - MIR 280	14 2 4 38 197 1 1 20 1 1 2 5 3	1% 1% 11% 58% 6% 0% 6% 0% 1% 1% 1% 1%
L6 L6 L6 L6 L6 L6 L1 L1 L1 L1 L2 L2 L2 L2 L2 L2 L2 L2	280 380 STUDIO TH TH-MIR 180 280 STUDIO STUDIO STUDIO - MIR 180 180 - MIR 280 280 - MIR	14 2 4 38 197 1 20 1 2 5 3 11 7 2	1% 1% 11% 58% 6% 0% 6% 0% 1% 1% 1% 2% 11%
L6 L6 L6 L6 L6 L6 L1 L1 L1 L1 L2 L2 L2 L2 L2 L2 L2	280 380 STUDIO TH TH-MIR 180 280 STUDIO STUDIO 5TUDIO MIR 180 180 - MIR 280	14 2 4 38 197 1 1 20 1 1 2 5 3	1% 1% 11% 58% 6% 0% 6% 0% 1% 1% 1% 1%
L6 L6 L6 L6 L6 L6 L6 L1 L1 L1 L1 L2 L2 L2 L2 L2 L2 L3 L3 L3 L3 L3	280 380 STUDIO TH TH-MIR 180 280 STUDIO STUDIO STUDIO MIR 180 180 - MIR 280 280 - MIR 380	14 2 4 38 197 1 20 1 2 5 3 11 7 2 3 1 1	1% 1% 11% 58% 6% 6% 6% 1% 1% 1% 1% 1% 00%
L6 L6 L6 L6 L6 L6 L1 L1 L1 L1 L2 L2 L2 L2 L2 L2 L3 L3 L3 L3 L3	280 380 STUDIO TH TH-MIR 180 280 STUDIO 5TUDIO MIR 180 180 - MIR 280 280 - MIR 38D STUDIO 5TUDIO	14 2 4 38 197 19 1 20 1 2 5 3 11 7 2 3 1 1 1	1% 1% 1% 11% 58% 6% 6% 6% 6% 1% 1% 1% 1% 0% 0% 0% 0% 0%
L6 L6 L6 L6 L6 L6 L6 L1 L1 L1 L1 L2 L2 L2 L2 L2 L2 L3 L3 L3 L3 L3	280 380 STUDIO TH TH-MIR 18D 280 STUDIO - MIR 18D - MIR 280 280 - MIR 38D STUDIO -	14 2 4 38 197 1 20 1 2 5 3 11 7 2 3 1 1	1% 1% 11% 58% 6% 6% 6% 1% 1% 1% 1% 1% 00%
L6 L6 L6 L6 L6 L6 L1 L1 L1 L1 L1 L2 L2 L2 L2 L2 L2 L2 L2 L2 L2 L2 L2 L2	280 380 STUDIO TH TH-MIR 180 280 STUDIO 5TUDIO MIR 180 180 - MIR 280 280 - MIR 38D STUDIO 5TUDIO	14 2 4 38 197 19 1 20 1 2 5 3 11 7 2 3 1 1 1 1	1% 1% 11% 58% 6% 0% 6% 0% 1% 1% 1% 1% 0% 0% 0% 1% 4%
L6 L6 L6 L6 L6 L6 L1 L1 L1 L1 L2 L2 L2 L2 L2 L2 L3 L3 L3 L3 L3	280 380 STUDIO TH TH-MIR 18D 280 STUDIO - MIR 18D - MIR 280 280 - MIR 38D STUDIO -	14 2 4 38 197 19 1 20 1 2 5 3 11 7 2 3 1 1 1	1% 1% 1% 11% 58% 6% 6% 6% 6% 1% 1% 1% 1% 0% 0% 0% 0% 0%
L6 L6 L6 L6 L6 L6 L1 L1 L1 L1 L2 L2 L2 L2 L2 L2 L2 L2 L3 L3 L3 L3 L3 L3 L3 L3 L3 L3 L3 L3 L3	280 380 STUDIO TH TH-MIR 180 280 STUDIO - MIR 180 - MIR 280 280 - MIR 380 STUDIO - MIR STUDIO - MIR	14 2 4 38 197 1 20 1 2 5 3 11 7 2 3 1 1 1 1 2 2 3 1 1 1 2 2 3 1 1 1 1 1	1% 1% 11% 11% 58% 6% 0% 6% 1% 1% 1% 1% 1% 4% 0% 6% 0% 6% 6% 6% 6% 6% 6% 6% 6% 6% 6% 6% 6% 6%
L6 L6 L6 L6 L6 L1 L1 L1 L1 L2 L2 L2 L2 L2 L2 L2 L3 L3 L3 L3 L3 L3 L3 L3 L3 L3 L3 L3 L3	280 380 STUDIO TH TH-MIR 18D 280 STUDIO - MIR 18D 280 STUDIO - MIR 18D 38D STUDIO - MIR 38D STUDIO - MIR 38D STUDIO - MIR	14 2 4 38 197 19 1 2 5 3 3 11 7 7 2 3 3 11 7 7 2 2 3 1 1 1 1 1 1 1 1 1 1 1 1 1 1 1 1 1	1% 1% 11% 11% 58% 6% 0% 6% 0% 1% 1% 1% 1% 1% 4% 6% 0% 6% 6% 6% 6% 6% 6% 6% 6% 6% 6% 6% 6% 6%
L6 L6 L6 L6 L6 L6 L6 L6 L1 L1 L1 L1 L2 L2 L2 L2 L2 L3 L3 L3 L3 L3 L3 L3 L3 L3 L3 L3 L3 L4 L4 L4 L5 L5 L5 L5 L6 L6 L6 L6 L6 L6 L6 L6 L7 L7 L7 L7 L7 L7 L7 L7 L7 L7 L7 L7 L7	280 380 STUDIO TH TH-MIR 180 280 STUDIO - MIR 180 180 - MIR 380 STUDIO - MIR 180 - MIR 380 STUDIO - MIR 180 - MIR	14 2 4 38 197 19 1 2 20 1 2 5 3 3 1 1 7 7 2 3 3 1 1 1 1 1 1 1 1 1 1 1 1 1 1 1 1 1	1% 1% 11% 58% 6% 0% 6% 0% 1% 1% 1% 1% 1% 1% 6% 0% 6% 6% 6% 6% 6% 6% 6% 6% 6% 6% 6% 6% 6%
L6 L6 L6 L6 L6 L1 L1 L1 L1 L2 L2 L2 L2 L2 L2 L2 L3 L3 L3 L3 L3 L3 L3 L3 L3 L3 L3 L3 L3	280 380 STUDIO TH TH-MIR 18D 280 STUDIO - MIR 18D 280 STUDIO - MIR 18D 38D STUDIO - MIR 38D STUDIO - MIR 38D STUDIO - MIR	14 2 4 38 197 19 1 2 5 3 3 11 7 7 2 3 3 11 7 7 2 2 3 1 1 1 1 1 1 1 1 1 1 1 1 1 1 1 1 1	1% 1% 11% 11% 58% 6% 0% 6% 0% 1% 1% 1% 1% 1% 4% 6% 0% 6% 6% 6% 6% 6% 6% 6% 6% 6% 6% 6% 6% 6%
L6 L6 L6 L6 L6 L6 L1 L1 L1 L1 L2 L2 L2 L2 L2 L3 L3 L3 L3 L3 L3 L3 L3 L3 L3 L3 L3 L3	280 380 STUDIO TH TH-MIR 18D 280 STUDIO - MIR 18D - MIR 28D 28D - MIR 38D STUDIO - MIR 18D - MIR 38D STUDIO - MIR 18D - MIR 28D - MIR 38D - MIR	14 2 4 38 197 19 1 20 1 20 1 2 5 5 3 1 1 7 7 2 2 3 1 1 1 1 1 1 1 1 1 1 1 1 1 1 1 1 1	1% 1% 11% 58% 6% 0% 6% 0% 1% 1% 1% 1% 4% 8% 2% 4% 8% 2% 1% 1% 1% 1%
L6 L6 L6 L6 L6 L6 L6 L6 L1 L1 L1 L1 L2 L2 L2 L2 L2 L2 L2 L2 L2 L2 L2 L2 L2	280 380 STUDIO TH TH-MIR 18D 280 STUDIO STUDIO STUDIO - MIR 18D 18D - MIR 38D STUDIO STUDIO - MIR 18D - MIR 38D STUDIO - MIR 28D 18D - MIR 28D 18D - MIR 28D	14 2 4 38 197 19 1 20 1 1 2 5 3 3 1 1 7 2 2 3 3 1 1 1 2 2 3 3 1 1 1 1 1 1 1 1 1	1% 1% 1% 11% 11% 58% 6% 0% 6% 6% 1% 1% 1% 1% 1% 1% 1% 1% 1% 1% 1% 1% 1%
L6 L6 L6 L6 L6 L6 L6 L6 L6 L1 L1 L1 L1 L2 L2 L2 L2 L2 L2 L2 L2 L2 L2 L2 L2 L2	280 380 STUDIO TH TH-MIR 180 280 STUDIO STUDIO 180 180 - MIR 380 STUDIO STUDIO 180 - MIR 380 STUDIO STUDIO STUDIO 180 - MIR 380 180 - MIR 380 280 - MIR 380 - MIR	14 2 4 38 197 19 1 20 1 20 1 2 5 3 3 11 7 7 2 2 3 1 1 1 1 1 2 2 3 1 1 1 1 1 1 1 1 1	1% 1% 1% 1% 1% 58% 6% 6% 6% 6% 6% 1% 1% 1% 1% 2% 1% 1% 0% 6% 6% 1% 1% 1% 1% 1% 1% 1% 1% 1% 1% 1% 1% 1%
L6 L6 L6 L6 L6 L6 L6 L6 L1 L1 L1 L1 L2 L2 L2 L2 L2 L2 L2 L2 L2 L2 L2 L2 L2	280 380 STUDIO TH TH-MIR 18D 280 STUDIO STUDIO STUDIO - MIR 18D 18D - MIR 38D STUDIO STUDIO - MIR 18D - MIR 38D STUDIO - MIR 28D 18D - MIR 28D 18D - MIR 28D	14 2 4 38 197 19 1 20 1 1 2 5 3 3 1 1 7 2 2 3 3 1 1 1 2 2 3 3 1 1 1 1 1 1 1 1 1	1% 1% 1% 11% 11% 58% 6% 0% 6% 6% 1% 1% 1% 1% 1% 1% 1% 1% 1% 1% 1% 1% 1%
L6 L	280 380 STUDIO TH TH-MIR 18D 280 STUDIO STUDIO STUDIO STUDIO - MIR 18D 28D - MIR 38D STUDIO STUDIO - MIR 18D - MIR 28D - MIR 38D STUDIO STUDIO - MIR 18D - MIR 38D 28D - MIR 38D 38D - MIR 38D - MIR 38D - MIR 38D - MIR	14 2 4 38 197 1 1 2 0 1 1 2 5 3 3 1 1 7 7 2 2 3 3 1 1 1 1 1 1 1 1 1 1 1 1 1 1 1 1	1% 1% 1% 1% 11% 18% 18% 6% 6% 6% 6% 6% 1% 1% 1% 1% 1% 1% 1% 1% 1% 1% 1% 1% 1%
L6 L6 L6 L6 L6 L6 L6 L6 L6 L1 L1 L1 L1 L2 L2 L2 L2 L2 L2 L2 L2 L2 L2 L2 L2 L2	280 380 STUDIO TH TH-MIR 180 280 STUDIO 5TUDIO 5T	14 2 4 38 197 19 1 20 1 20 1 2 5 3 3 11 7 7 2 2 3 1 1 1 1 1 2 2 3 1 1 1 1 1 1 1 1 1	1% 1% 1% 1% 1% 58% 6% 6% 6% 6% 6% 1% 1% 1% 1% 2% 1% 1% 0% 6% 6% 1% 1% 1% 1% 1% 1% 1% 1% 1% 1% 1% 1% 1%
L6 L	280 380 STUDIO TH TH-MIR 18D 280 STUDIO STUDIO STUDIO STUDIO - MIR 18D 28D - MIR 38D STUDIO STUDIO - MIR 18D - MIR 28D - MIR 38D STUDIO STUDIO - MIR 18D - MIR 38D 28D - MIR 38D 38D - MIR 38D - MIR 38D - MIR 38D - MIR	14 2 4 38 197 19 1 20 1 1 2 5 3 3 1 1 7 2 2 3 3 1 1 1 1 2 2 3 3 1 1 1 1 1 1 1 1	1% 1% 1% 1% 1% 58% 6% 6% 6% 6% 6% 1% 1% 1% 1% 1% 1% 1% 1% 1% 1% 1% 1% 1%
L6 L6 L6 L6 L6 L6 L6 L1 L1 L1 L1 L1 L2 L2 L2 L2 L2 L2 L2 L2 L2 L2 L2 L2 L2	280 380 STUDIO TH TH-MIR 180 280 STUDIO 5TUDIO 5T	14 2 4 38 197 1 1 2 0 1 1 2 5 3 3 1 1 7 7 2 2 3 3 1 1 1 1 1 1 1 1 1 1 1 1 1 1 1 1	1% 1% 1% 1% 11% 18% 18% 6% 6% 6% 6% 6% 1% 1% 1% 1% 1% 1% 1% 1% 1% 1% 1% 1% 1%
L6 L	280 380 STUDIO TH TH-MIR 18D 280 STUDIO STUDIO STUDIO - MIR 18D 18D - MIR 28D STUDIO STUDIO - MIR 28D 18D - MIR 28D STUDIO - MIR 380 STUDIO - MIR 28D 18D - MIR 38D STUDIO - MIR 38D STUDIO	14 2 4 38 197 19 1 1 2 2 3 3 1 1 1 2 2 7 8 1 1 2 2 3 3 8 2 8 2 8 2 8	1% 1% 1% 58% 6% 6% 6% 6% 6% 6% 6% 6% 6% 6% 6% 6% 6%
L6 L	280 380 STUDIO TH TH-MIR 180 280 STUDIO - MIR 180 280 - MIR 380 STUDIO - MIR 180 STUDIO - MIR 280 - MIR 380 STUDIO - MIR 180 - MIR 280 - MIR 380 - MIR	14 2 4 38 197 19 1 1 20 1 1 2 5 5 3 1 1 7 2 2 3 3 1 1 1 2 2 2 6 1 1 1 1 1 1 1 2 1 2 7 8 1 1 1 1 1 2 7 8 1 1 1 1 1 2 7 8 1 1 1 1 2 1 1 1 1 1 1 2 1 2 1 1 1 1 1	1% 1% 1% 1% 58% 6% 6% 6% 6% 1% 1% 1% 1% 1% 1% 1% 1% 1% 1% 1% 1% 1%
L6 L6 L6 L6 L6 L6 L6 L6 L6 L7 L1 L1 L1 L2 L2 L2 L2 L2 L3	280 380 STUDIO TH TH-MIR 18D 280 STUDIO STUDIO STUDIO STUDIO - MIR 18D 28D - MIR 38D STUDIO STUDIO - MIR 18D - MIR 28D - MIR 38D STUDIO STUDIO - MIR 18D - MIR 38D 28D - MIR 38D STUDIO STUDIO STUDIO - MIR 38D 38D STUDIO ST	14 2 4 38 197 19 11 2 20 11 1 7 2 3 3 1 1 1 1 12 2 7 8 1 1 2 2 7 8 8 1 1 2 2 8 9 9 6	1% 1% 1% 1% 1% 58% 6% 6% 6% 6% 6% 1% 1% 1% 1% 1% 1% 1% 1% 1% 1% 1% 1% 1%
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L6 L6 L6 L6 L6 L6 L6 L1 L1 L1 L1 L2	280 380 STUDIO TH TH-MIR 180 280 STUDIO 5TUDIO 5T	14 2 4 38 197 19 1 20 1 1 2 5 5 3 1 1 7 7 2 2 3 3 1 1 1 2 2 5 5 1 1 1 1 1 1 2 2 3 3 1 1 1 2 2 3 3 3 3 1 1 2 3 3 3 3	1% 1% 1% 58% 6% 6% 6% 6% 6% 1% 6% 6% 1% 1% 1% 1% 1% 1% 1% 1% 1% 1% 1% 1% 1%
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REN	TAL UNIT 1	TOTAL	MODERATE II	NCOME REA	NTAL
	COUNT	₩	NAME	COUNT	%
	100	37%	1BD - MIR	16	24%
	75	28%	2BD - MIR	7	10%
	13	50%	3BD - MIR	4	6%

		_			-	
E UNIT SIZE - MR			AVER	AVERAGE UNIT SIZE		
AREA	%	AV. UNIT SIZE (SF)	NAME	AREA	%	
4726 SF	37%	563.98	1BD - MIR	9457 SF	249	
0483 SF	28%	810.88	2BD - MIR	5759 SF	109	
4654 SF	5%	1056.47	3BD - MIR	4201 SF	6%	
2632 SF	19%	436.82	STUDIO -	16061 SF	539	
6046 SF	12%	1069.93	MIR			
8541 SF	100%		TH-MIR	4949 SF	7%	
			TOTAL	/0/22 CC	100	

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BEL ARCHITECTS INC

VANCOUVER, BC CANADA VSY INS

NOTES

ABBREVIATIONS

MR- MARKET RENTAL MIR - MODERATE INCOME RENTAL FAR - FLOOR AREA RATIO

REVISIONS

NO. DATE DESCRIPTION
6 JAN 19 2024 RE-ISSUED FOR DP 7 FEB 15 2024 RE- ISSUED FOR DP

8880 COOK RD. & 8751 CITATION DRIVE

RICHMOND, BC

STATS II

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1/2" = 1'-0" 20039

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DP 23-014121

BICYCLE

TOTAL CLASS 1 BIKES

BICYCLE - HOR. CLASS 1 285
BICYCLE - HOR. STACKED CLASS 1 194
BICYCLE - LOCKER 11
BICYCLE - OVERSIZE 6

TOTAL CLASS 2 BIKES

BICYCLE - VERT, CLASS 1

PLAN #4



SOUTH WEST VIEW





GREY FIBRECEMENT PANEL



PANEL

COPPER COLOUR FIBRECEMENT





CEDAR COLOUR FIBRECEMENT PANEL SOFFIT


MICROPERFORATED PANEL, **PAINTED**



WHITE BRICK



LIGHT GREY BRICK

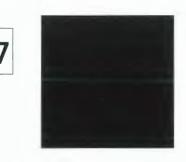

DOUBLE GLAZED PVC - VINYL FRAME WINDOWS WITH LO-E COATING

ALUMINUM WEATHER PROTECTION FOR UNPROTECTED DOORS TO BALCONIES

TEMPERED GLASS GUARD AND ALUMINUM TOP AND BOTTOM FRAME GUARD RAILS.

JOB NUMBER 20039

A-0.12

DP 23-014121 PLAN #5

February 20, 2024

REVISIONS

NO. DATE DESCRIPTION
4 MAR 10 2023 ISSUED FOR DP
5 OCT 06 2023 RE-ISSUED FOR DP
6 JAN 19 2024 RE-ISSUED FOR DP
7 FEB 15 2024 RE-ISSUED FOR DP

8880 COOK RD. & 8751 CITATION DRIVE

RICHMOND, BC

MATERIALS I

DATE DRAWN BY CHECKED BY SCALE 2/14/2024 4:13:19 PM AM & GT



NORTH WEST VIEW



WHITE BRICK



GREY FIBRECEMENT PANEL

LIGHT GREY BRICK



PANEL





CEDAR COLOUR FIBRECEMENT PANEL SOFFIT

MICROPERFORATED PANEL, PAINTED

ALUMINUM WEATHER PROTECTION FOR UNPROTECTED DOORS
TO BALCONIES

TEMPERED GLASS GUARD AND ALUMINUM TOP AND BOTTOM FRAME GUARD RAILS.

REVISIONS

NO. DATE DESCRIPTION
5 OCT 06 2023 RE-ISSED FOR DP
6 JAN 19 2024 RE-ISSUED FOR DP
7 FEB 15 2024 RE-ISSUED FOR DP

8880 COOK RD. & 8751 CITATION DRIVE

MATERIALS II

RICHMOND, BC

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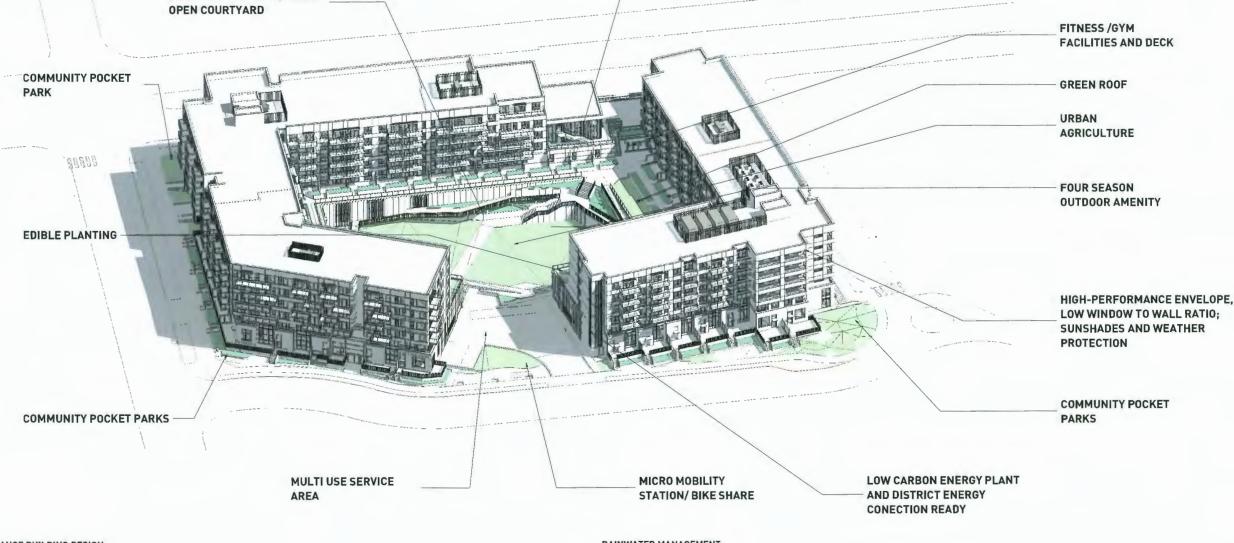
WINDOWS WITH LO-E COATING

DOUBLE GLAZED PVC - VINYL FRAME

February 20, 2024

DP 23-014121 **PLAN #6**





HIGH-PERFORMANCE BUILDING DESIGN

. Using a measured approach of building envelope, mechanical and electrical efficiency to deliver a low energy consuming and GHG emitting building

TREE PRESERVATION/ LARGE

EMISSIONS CONSCIOUS DESIGN

. Using modeling to establish the amount of embodied carbon and energy associated with its construction and identifying ways to reduce the building's impact through construction

RESILIENT CONSTRUCTION

- . Considering extreme heat events, power outages, extreme precipitation and resulting local flooding events, poor air quality, as well as earthquakes
- . In-suite four-pipe fancoil offering both heating and cooling to maintain comfortable indoor conditions and address the issues of higher future average temperatures, higher extreme temperatures and longer and more frequent heatwaves and droughts
- Description: Building heating and cooling will be provided by hot and chilled water from a central plant utilizing air source heat pumps (ASHPs). Suites, amenities rooms and management office will have four-pipe fan coil units and heat recovery ventilators (HRVs). Domestic hot water will be provided by ASHPs in the central plant.
- High performance envelope design and durable building construction
- Strategic window placement minimizing overheating and heat-loss and enhancing occupant comfort
- Air-source heat pump technology
- Low-carbon system
- Heat recovery technology for suite ventilation
- Dominantly electrified service water heating
- High efficiency LED
- Electrified cooking in suites
- Window to Wall ratio 33%

RAINWATER MANAGEMENT

- Transforming the site to a more biodiverse green environment and helping to reduce the flow of peak stormwater volumes to sensitive habitats through vegetated roof and planters
- Alignment with the City of Richmonds's rainwater management strategy

- · Providing residents with the best opportunity to live car-free with convenient location for bicycle parking
- Walking distance to many shops, restaurants, services, office etc.

INDOOR AMENITIES FOR FAMILIES, ENTERTAINMENT, CO- WORKING AND MUSIC

Access to frequent transit networks along Cook Rd and Garden City corridor.

LANDSCAPE

- Preference for native and adaptive plants
- High efficiency irrigation
- Bird-friendly fruit bearing trees
- Outdoor amenity spaces provide a balance of shaded, covered, and sunlit areas to promote year-round use during various weather conditions
- Providing universal access to diversity of social/gathering spaces for all ages and abilities

AMENITIES

- · Variety of generous indoor and outdoor amenities shared between all residents
- Family-friendly amenities including play gym, yoga, guest suites, music rooms, co working and private working rooms, entertainment and gathering, edible planting and plenty of common outdoor space.
- Pet-friendly amenities including dog-run and dog-wash
- On-site bike repair rooms
- EV charging for all residents.

REVISIONS NO. DATE DESCRIPTION

OCT 06 2023 RE-ISSED FOR DP JAN 19 2024 RE-ISSUED FOR DP

8880 COOK RD. & 8751 CITATION DRIVE


RICHMOND, BC


SUSTAINABILITY RATIONALE

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8880 COOK RD. & 8751 CITATION


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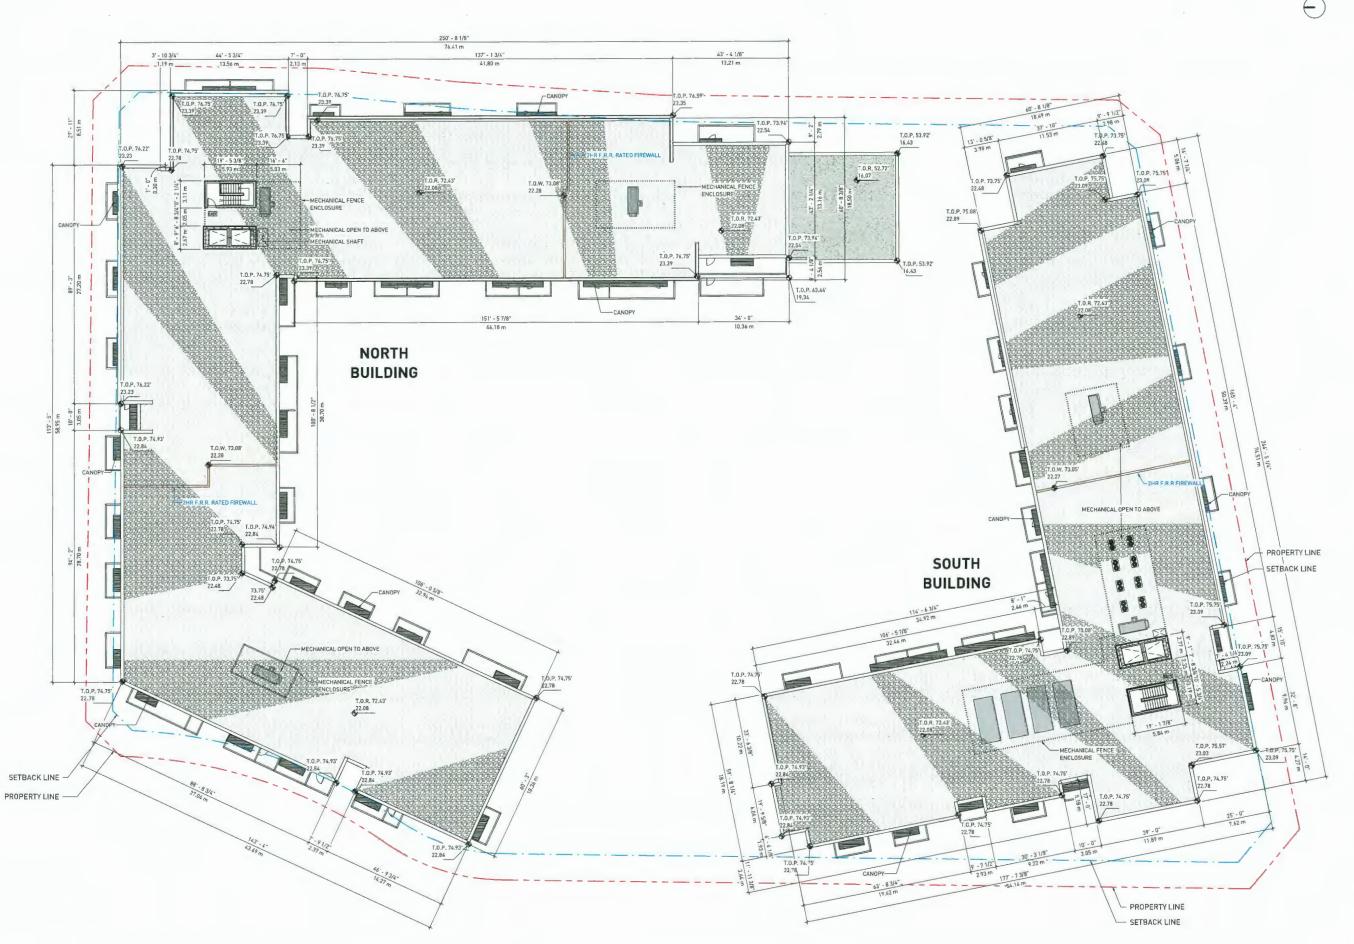
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PLAN #9 DP 23-014121

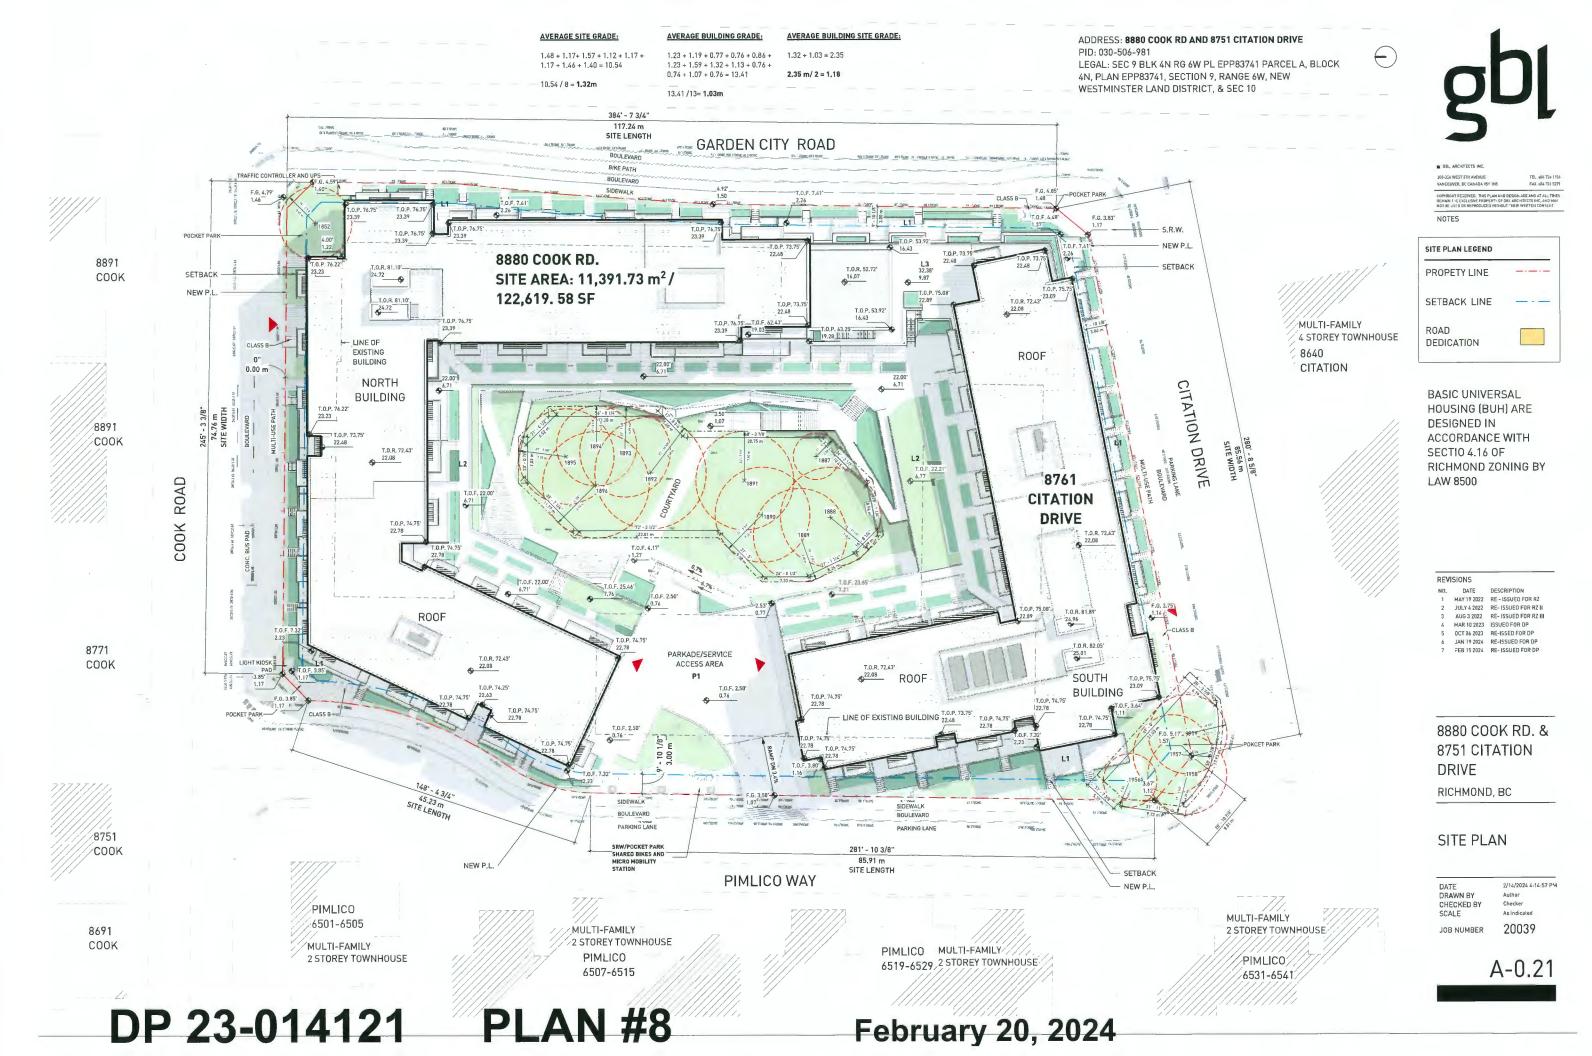

DP 23-014121 PLAN #10

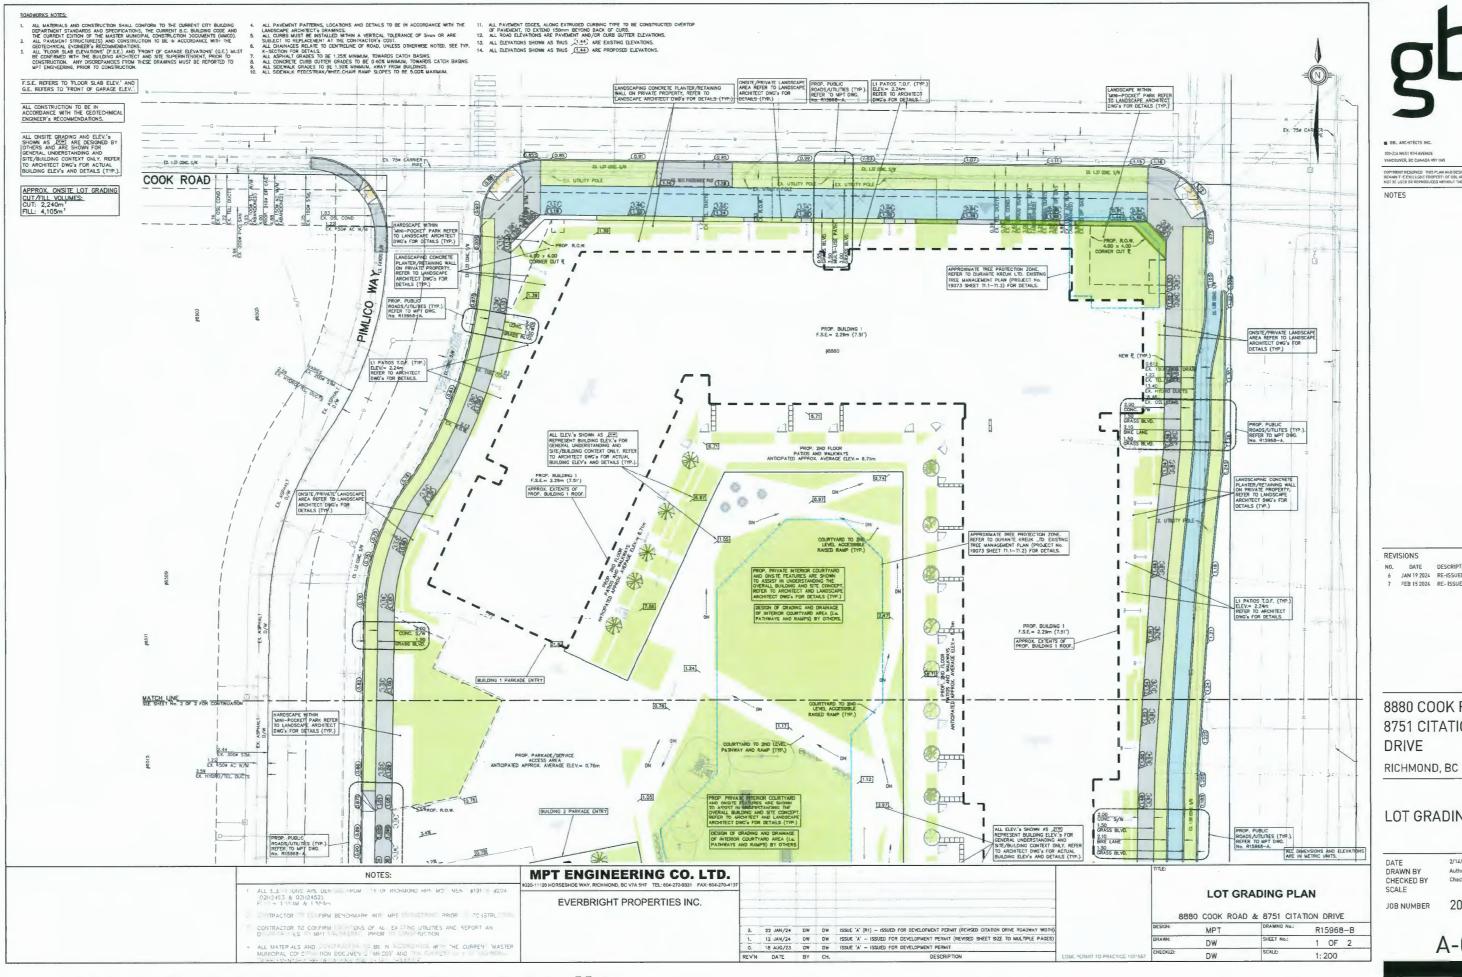

REVISIONS

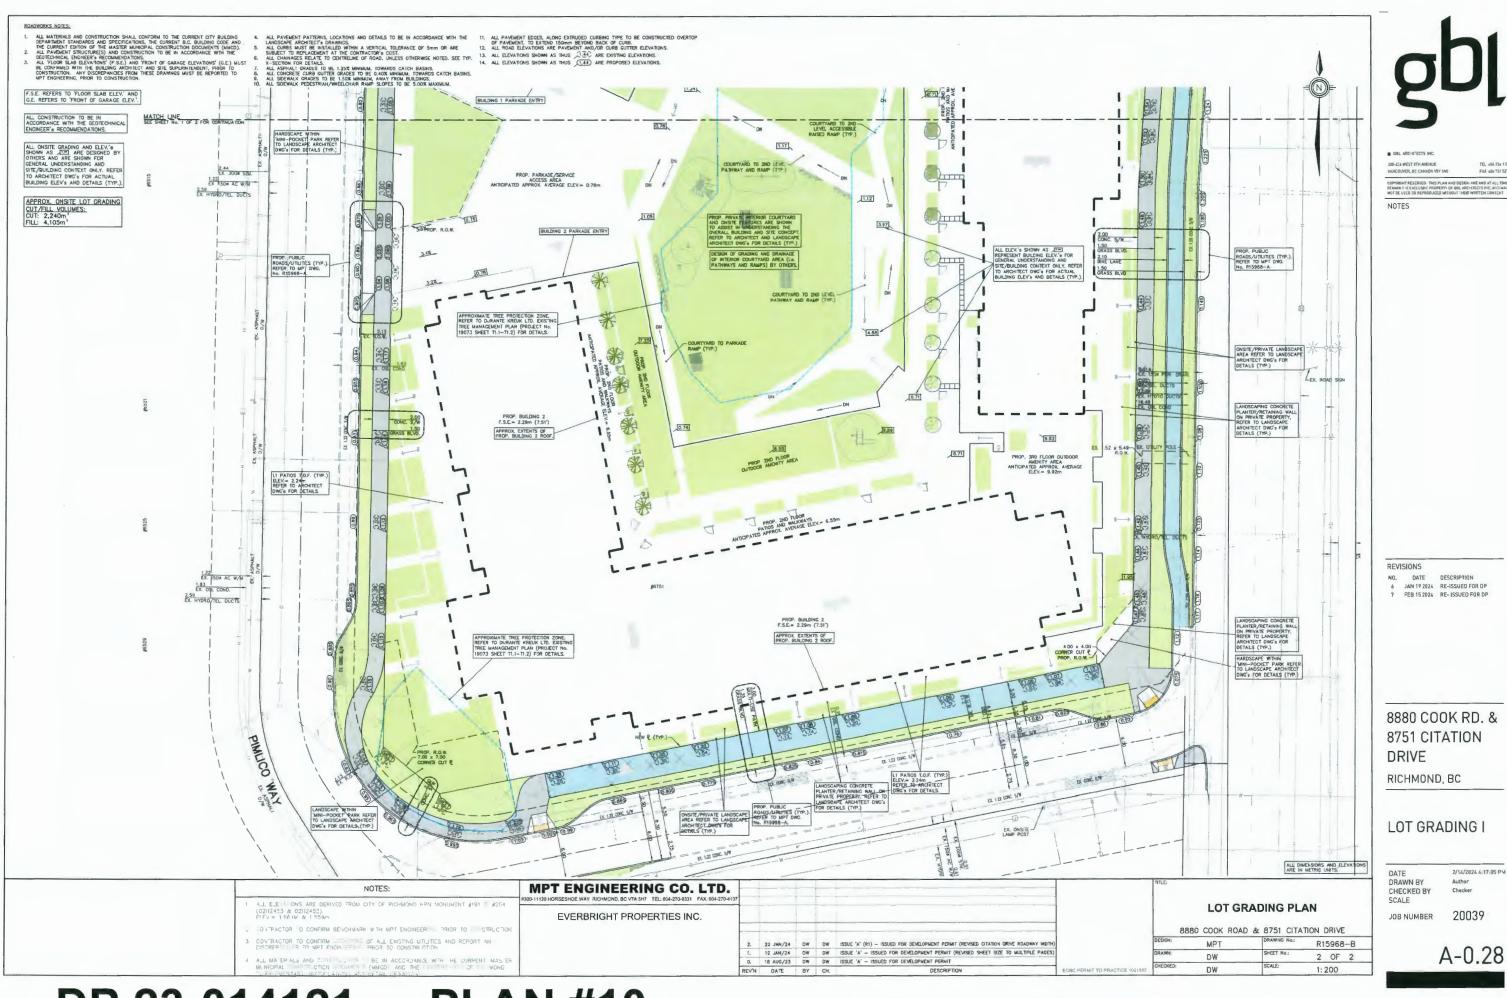DATE DESCRIPTION

MAY 19 2022 RE - ISSUED FOR RZ

JULY 4 2022 RE- ISSUED FOR RZ III

AUG 3 2022 RE- ISSUED FOR RZ III

MAR 10 2023 ISSUED FOR DP OCT 06 2023 RE-ISSUED FOR DP JAN 19 2024 RE-ISSUED FOR DP FEB 15 2024 RE-ISSUED FOR DP

8880 COOK RD. & 8751 CITATION DRIVE

RICHMOND, BC

FLOOR PLAN -ROOF

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A-1.11

DP 23-014121 **PLAN #11**



gbl

■ GBL ARCHITECTS INC.

EST BTH AVENUE CR. BC CANADA VSY INS

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NO. DATE DESCRIPTION

4 MAR 10 2023 ISSUED FOR OP

5 OCT 06 2023 RE-ISSED FOR DP

JAN 19 2024 RE-ISSUED FOR DP FEB 15 2024 RE-ISSUED FOR DP

7 FEB 15 2024 RE- ISSUED FOR DE

8880 COOK RD. & 8751 CITATION DRIVE

RICHMOND, BC

ENLARGED FLOOR PLANS


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JOB NUMBER

ER 20039

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DP 23-014121 PLAN #12



	MATERIAL LE	GEND
Ħ	DESCRIPTION	COLOR
01	FIBRECEMENT PANEL	WHITE
02	FIBRECEMENT PANEL	GREY
03	FIBRECEMENT PANEL	DARK GREY
04	FIBRECEMENT PANEL	COPPER
05	BRICK - Norman - Running Bond	WHITE
05a	BRICK - Norman - Running Bond	GREY
06	GLASS GUARDRAIL	TRANSPARENT
07	<varies></varies>	<varies></varies>
08	ALUMINUM FINS	CEDAR
09	GLASS	TRANSPARENT
10	SPANDREL GLASS	CHARCOAL
11	SPANDREL GLASS	COPPER
12	ALUMINUM SUNSHADE	BLACK
13	VINYL MULLION	BLACK
14	FRITZ GUARDRAIL	WHITE
15	ALUMINUM GUARDRAIL	BLACK
16	ALUMINUM FLASHING	WHITE
17	ALUMINUM FLASHING	CHARCOAL
18	ALUMINUM OVERHEAD DOOR	NATURAL ALUMN
19	ALUMINUM MULLION	BLACK
20	EXTERIOR TREATED WOOD	CEDAR
21	MICROPERFORATED STAINLESS STEEL MESH	WHITE
22	MICROPERFORATED STAINLESS STEEL MESH	BLACK

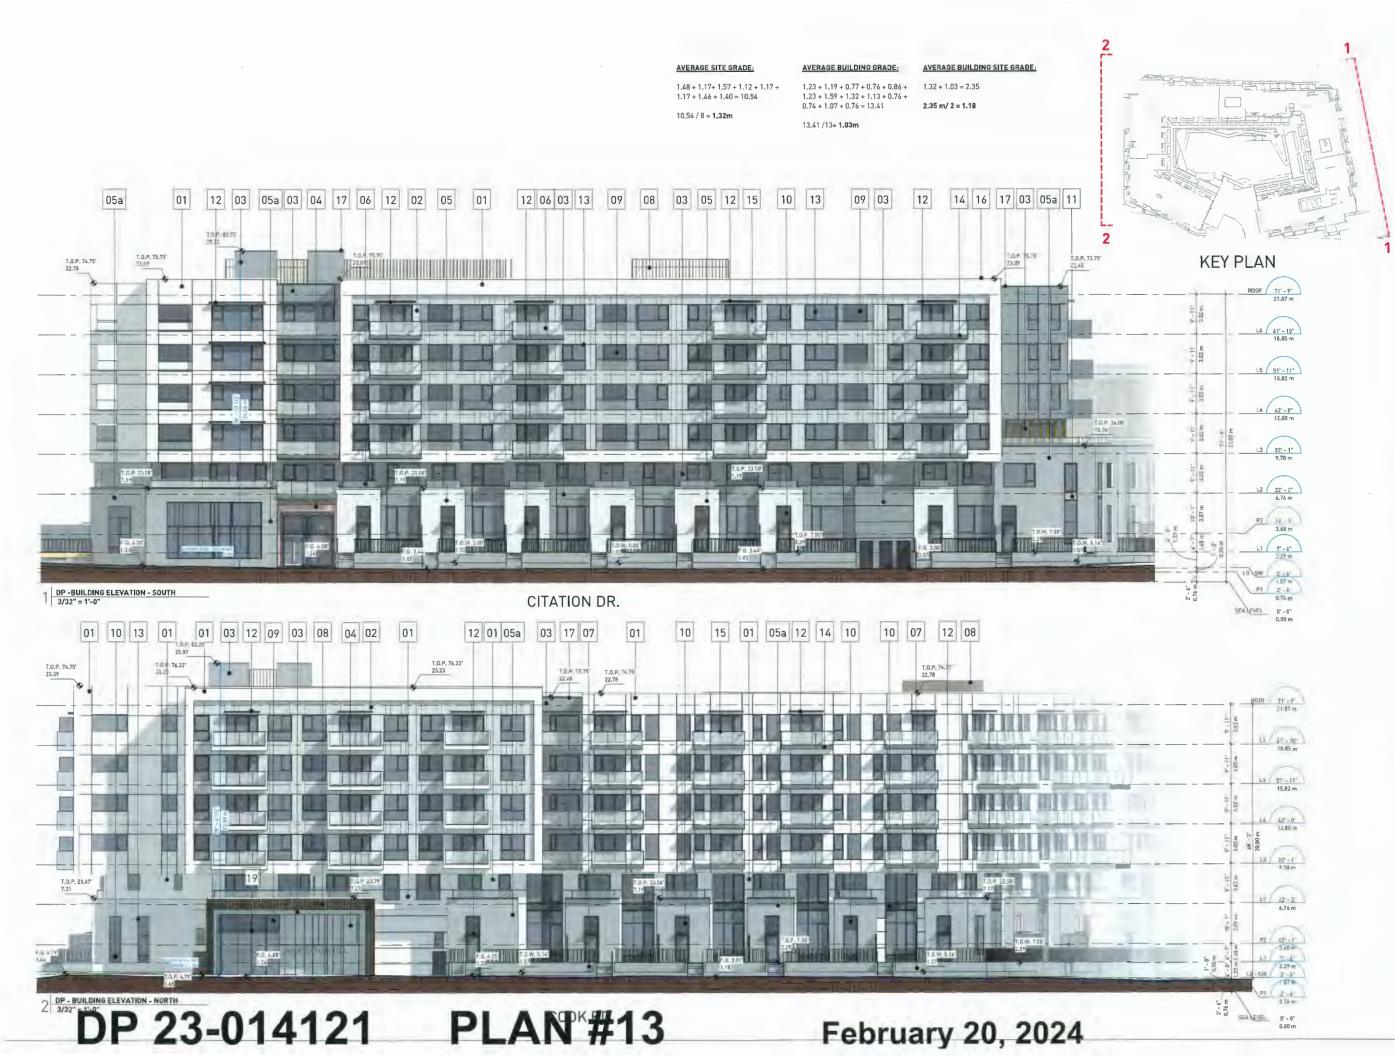REVISIONS

NO. DATE DESCRIPTION 1 MAY 19 2022 RE - ISSUED FOR RZ 2 JULY 4 2022 RE- ISSUED FOR RZ II AUG 3 2022 RE- ISSUED FOR RZ III MAR 10 2023 ISSUED FOR OP 5 OCT 06 2023 RE-ISSED FOR DP 6 JAN 19 2024 RE-ISSUED FOR DP 7 FEB 15 2024 RE-ISSUED FOR DP


8880 COOK RD. & 8751 CITATION DRIVE

RICHMOND, BC

ELEVATIONS

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A-2.01

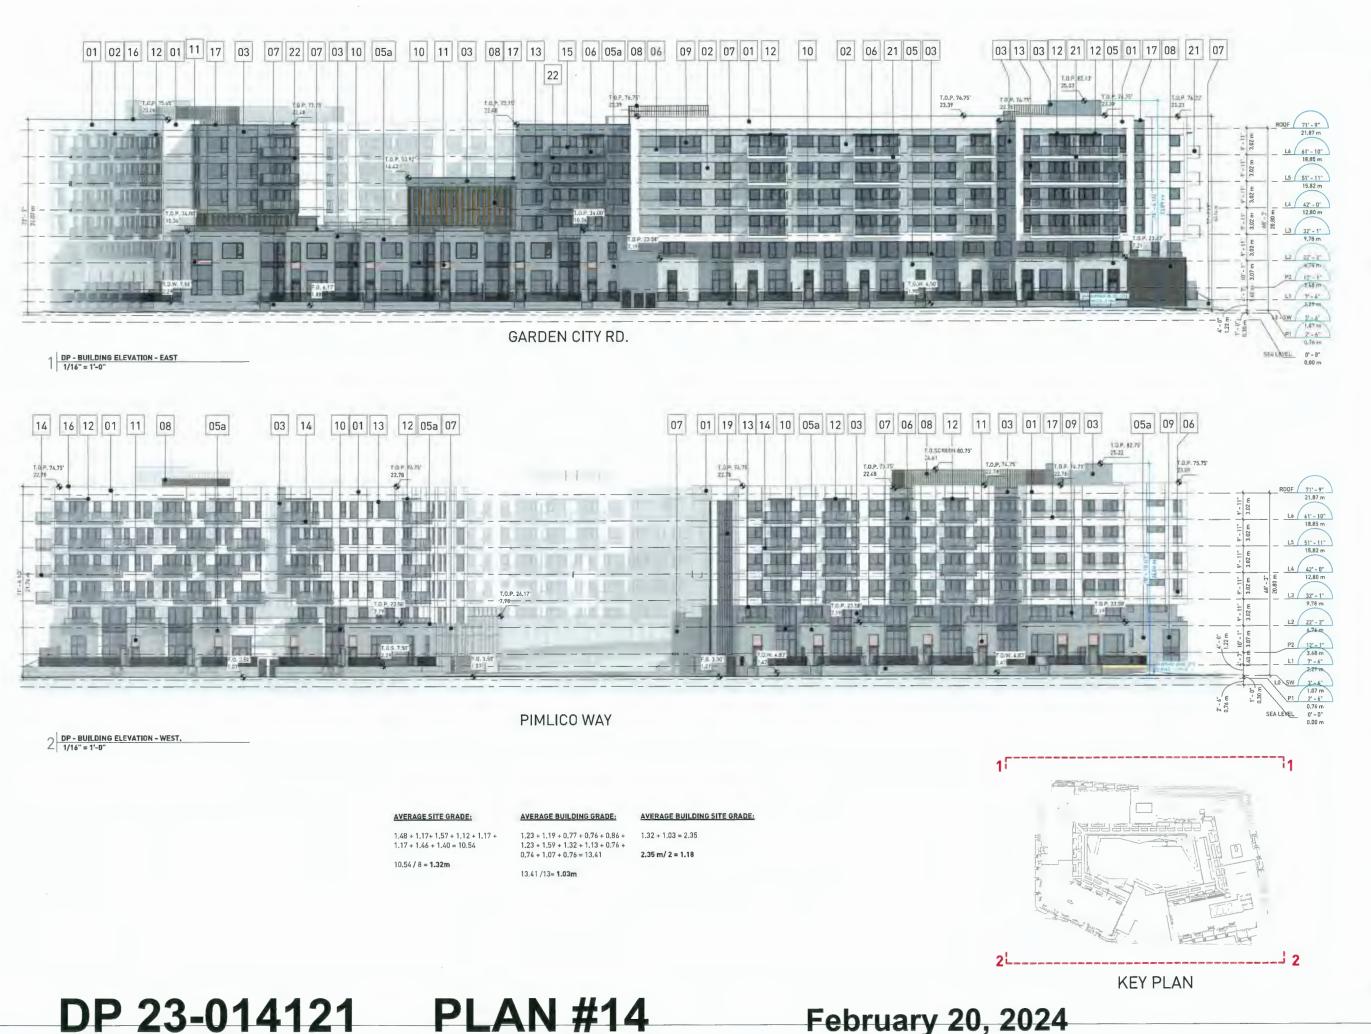

B GBL ARCHITECTS INC.

300-224 WEST 8TH AVENUE VANCOUVER, BC CANADA VSY INS

NOTES

	MATERIAL LE	GEND
#	DESCRIPTION	COLOR
01	FIBRECEMENT PANEL	WHITE
02	FIBRECEMENT PANEL	GREY
03	FIBRECEMENT PANEL	DARK GREY
84	FIBRECEMENT PANEL	COPPER
05	BRICK - Norman - Running Bond	WHITE
05a	BRICK - Norman - Running Bond	GREY
06	GLASS GUARDRAIL	TRANSPARENT
07	<varies></varies>	<varies></varies>
08	ALUMINUM FINS	CEDAR
09	GLASS	TRANSPARENT
10	SPANDREL GLASS	CHARCOAL
11	SPANDREL GLASS	COPPER
12	ALUMINUM SUNSHADE	BLACK
13	VINYL MULLION	BLACK
14	FRITZ GUARDRAIL	WHITE
15	ALUMINUM GUARDRAIL	BLACK
16	ALUMINUM FLASHING	WHITE
17	ALUMINUM FLASHING	CHARCOAL
18	ALUMINUM OVERHEAD DOOR	NATURAL ALUMN
19	ALUMINUM MULLION	BLACK
20	EXTERIOR TREATED WOOD	CEDAR
21	MICROPERFORATED STAINLESS STEEL MESH	WHITE
22	MICROPERFORATED STAINLESS STEEL MESH	BLACK

NO. DATE DESCRIPTION

1 MAY 19 2022 RE - ISSUED FOR RZ

2 JULY 4 2022 RE- ISSUED FOR RZ II

3 AUG 3 2022 RE- ISSUED FOR RZ III

4 MAR 10 2023 ISSUED FOR DP 5 OCT 06 2023 RE-ISSED FOR DP

JAN 19 2024 RE-ISSUED FOR DP FEB 15 2024 RE-ISSUED FOR DP

8880 COOK RD. & 8751 CITATION DRIVE

RICHMOND, BC

ELEVATIONS

DATE 2/14/2024 4:22:02 PM DRAWN BY CHECKED BY 20039 JOB NUMBER

A-2.02





VANCOUVER, BC CANADA VSY INS

NOTES

A	DESCRIPTION	COLOR
01	FIBRECEMENT PANEL	WHITE
02	FIBRECEMENT PANEL	GREY
03	FIBRECEMENT PANEL	DARK GREY
04	FIBRECEMENT PANEL	COPPER
05	BRICK - Norman - Running Bond	WHITE
05a	BRICK - Norman - Running Bond	GREY
06	GLASS GUARDRAIL	TRANSPARENT
07	<varies></varies>	<varies></varies>
08	ALUMINUM FINS	CEDAR
09	GLASS	TRANSPAREN"
10	SPANDREL GLASS	CHARCOAL
11	SPANDREL GLASS	COPPER
12	ALUMINUM SUNSHADE	BLACK
13	VINYL MULLION	BLACK
14	FRITZ GUARDRAIL	WHITE
15	ALUMINUM GUARDRAIL	BLACK
16	ALUMINUM FLASHING	WHITE
17	ALUMINUM FLASHING	CHARCOAL
18	ALUMINUM OVERHEAD DOOR	NATURAL ALUM
19	ALUMINUM MULLION	BLACK
20	EXTERIOR TREATED	CEDAR
21	MICROPERFORATED STAINLESS STEEL MESH	WHITE
22	MICROPERFORATED STAINLESS STEEL	BLACK

REVISIONS

MAY 19 2022 RE - ISSUED FOR RZ

JULY 4 2022 RE- ISSUED FOR RZ II
AUG 3 2022 RE- ISSUED FOR RZ III

7 FEB 15 2024 RE- ISSUED FOR DP

MAR 10 2023 ISSUED FOR DP OCT 36 2023 RE-ISSED FOR OP JAN 19 2024 RE-ISSUED FOR DP

8880 COOK RD. & 8751 CITATION DRIVE

RICHMOND, BC

ELEVATIONS

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A-2.03

AVERAGE SITE GRADE:

1.48 + 1.17+ 1.57 + 1.12 + 1.17 + 1.17 + 1.46 + 1.40 = 10.54

10.54 / 8 = 1.32m

AVERAGE BUILDING GRADE:


1.23 + 1.19 + 0.77 + 0.76 + 0.86 + 1.23 + 1.59 + 1.32 + 1.13 + 0.76 + 0.74 + 1.07 + 0.76 = 13.41

AVERAGE BUILDING SITE GRADE:

1.32 + 1.03 = 2.35

2.35 m/ 2 = 1.18

13.41 /13= **1.03m**

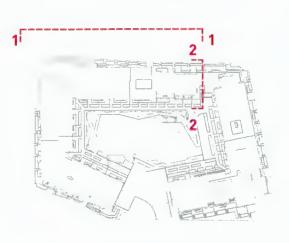

KEY PLAN

DP-BUILDING ELEVATION - AMENITY
DP 23-014121

17 12

T.O.P. 76.75

T.O.P. 33.50

T.O.F. 22.00°

23.39 m

T.D.P. 63.25

03 13 03 08

T.O.P. 73.75

03 17 22 03

T.O.P. 76.75

T.O.Planter 35.08' 10.69 m

> T.O.P. 34.00' 10.36 m

23.39 m

PLAN #15

CITY

GARDEN (

22' - 2" 6.76 m





■ GBL ARCHITECTS

0-224 WEST 8TH AVENUE NCOUVER, BC CANADA VSY INS

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NOTES

	MATERIAL LE	GEND
#	DESCRIPTION	COLOR
01	FIBRECEMENT PANEL	WHITE
02	FIBRECEMENT PANEL	GREY
03	FIBRECEMENT PANEL	DARK GREY
04	FIBRECEMENT PANEL	COPPER
05	BRICK - Norman - Running Bond	WHITE
05a	BRICK - Norman - Running Bond	GREY
06	GLASS GUARDRAIL	TRANSPARENT
07	<varies></varies>	<varies></varies>
08	ALUMINUM FINS	CEDAR
09	GLASS	TRANSPARENT
10	SPANDREL GLASS	CHARCOAL
11	SPANDREL GLASS	COPPER
12	ALUMINUM SUNSHADE	BLACK
13	VINYL MULLION	BLACK
14	FRITZ GUARDRAIL	WHITE
15	ALUMINUM GUARDRAIL	BLACK
16	ALUMINUM FLASHING	WHITE
17	ALUMINUM FLASHING	CHARCOAL
18	ALUMINUM OVERHEAD DOOR	NATURAL ALUI
19	ALUMINUM MULLION	BLACK
20	EXTERIOR TREATED WOOD	CEDAR
21	MICROPERFORATED STAINLESS STEEL MESH	WHITE
22	MICROPERFORATED STAINLESS STEEL MESH	BLACK

REVISIONS

8880 COOK RD. & 8751 CITATION DRIVE

RICHMOND, BC


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JOB NUMBER 20039

A-2.04

DP 23-014121 PLAN #16



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As indicated 20039

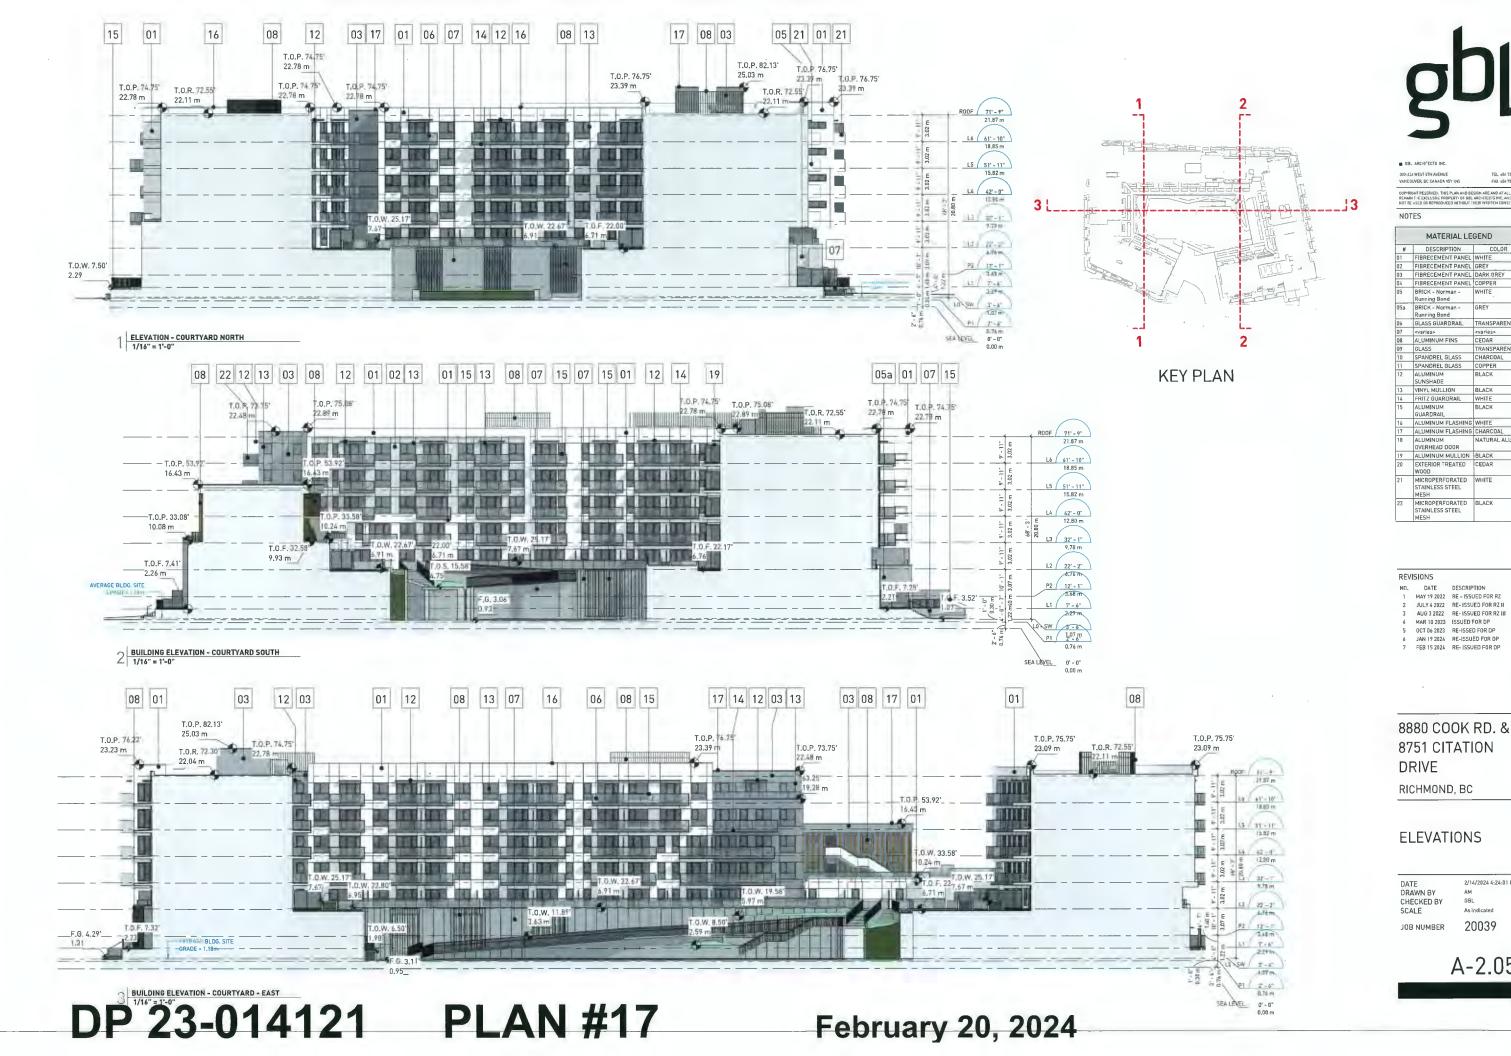A-2.05





KEY PLAN

ALUMINUM FLASHIN

18 ALUMINUM FLASHIN

19 ALUMINUM

OVERHEAD DOOR

19 ALUMINUM MULLION &

EXTERIOR TREATED

WOOD

MICROPERPORATED

STAINLESS STEEL

MESH

MISPO-MICROPERFORATED BLACK STAINLESS STEEL

MATERIAL LEGEND

REVISIONS NO. DATE DESCRIPTION 1 MAY 19 2022 RE ~ ISSUED FOR RZ 2 JULY 4 2022 RE- ISSUED FOR RZ II 3 AUG 3 2022 RE- ISSUED FOR RZ 111 4 MAR 10 2023 ISSUED FOR DP 5 DCT 06 2023 RE-ISSED FOR DP 6 JAN 19 2024 RE-ISSUED FOR OP 7 FEB 15 2024 RE-ISSUED FOR OP

8880 COOK RD. & 8751 CITATION DRIVE


RICHMOND, BC

ELEVATIONS

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A-2.06

03 15 09 12 15 01 01 13 12 09 06 07 13 14 01 T.O.P. 82.75' 25.22 m T.O.P. 75.75' T.O.P. 74.75' 22.78 m T.O.R. 72.55' 51' - 11" L5 42" - 0" L4 12.80 m 32' - 1" L3 9.78 m 22° - 2" L2 6,76 m MECH. VENTS LOUVRES T.O.F. 3.85* 3'-6' L0 1,07 m 2'-6' P1 0,76 m

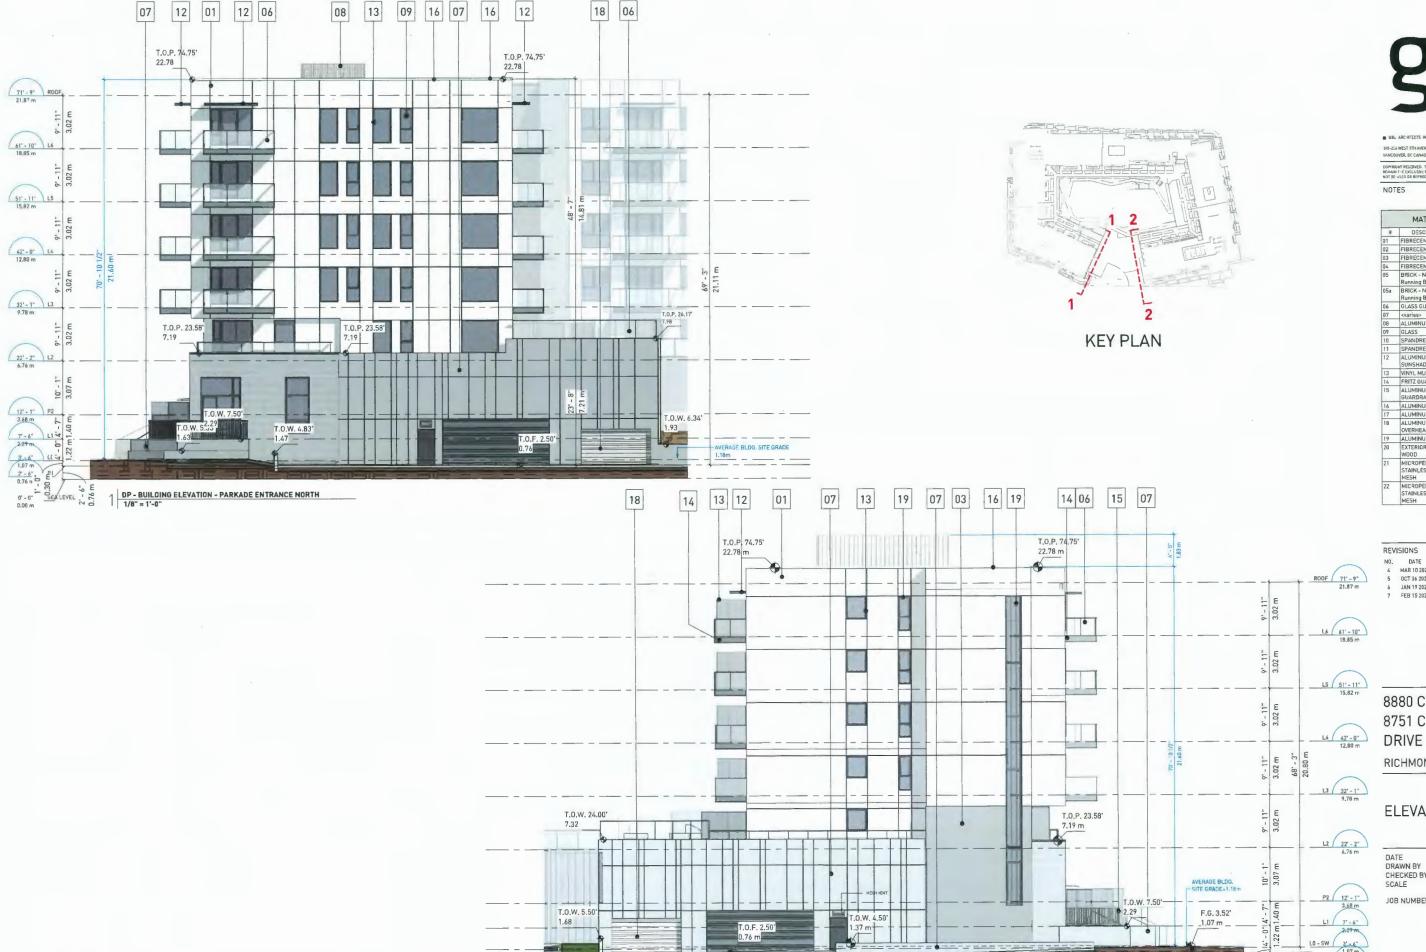

DP 23-014121

PLA® #19

February 20, 2024

108-224 WEST 3TH AVENUE VANCOUVER, BC CANADA VSY INS

	MATERIAL LE	GEND
Ħ	DESCRIPTION	COLOR
01	FIBRECEMENT PANEL	WHITE
02	FIBRECEMENT PANEL	GREY
03	FIBRECEMENT PANEL	DARK GREY
04	FIBRECEMENT PANEL	COPPER
05	BRICK - Norman - Running Bond	WHITE
05a	BRICK - Norman - Running Band	GREY
06	GLASS GUARDRAIL	TRANSPARENT
07	<varies></varies>	<varies></varies>
08	ALUMINUM FINS	CEDAR
09	GLASS	TRANSPARENT
10	SPANDREL GLASS	CHARCOAL
11	SPANDREL GLASS	COPPER
12	ALUMINUM SUNSHADE	BLACK
13	VINYL MULLION	BLACK
14	FRITZ GUARDRAIL	WHITE
15	ALUMINUM GUARDRAIL	BLACK
16	ALUMINUM FLASHING	WHITE
17	ALUMINUM FLASHING	
18	ALUMINUM OVERHEAD DOOR	NATURAL ALUMN
19	ALUMINUM MULLION	BLACK
20	EXTERIOR TREATED WOOD	CEDAR
21	MICROPERFORATED STAINLESS STEEL MESH	WHITE
22	MICROPERFORATED STAINLESS STEEL	BLACK

REVISIONS

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ELEVATIONS

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MATERIAL LEGEND

OVERHEAD DOOR
ALUMINUM MULLION BLACK
EXTERIOR TREATED
WOOD
MICROPERFORATED
STAINLESS STEEL
MICROPERFORATED
BLACK
STAINLESS STEEL
BLACK
STAINLESS STEEL
BLACK
STAINLESS STEEL STAINLESS STEEL

REVISIONS

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A-2.08 2 DP 23-014121 **PLAN #20**

VERTICAL TRELLIS FOR VINES (REF TO LANDSCAPE)


P2 12' - 1" 3,68 m

L1 7°-6" 2.29 m

REVEALS ON S COCRETE WALL

February 20, 2024

T.O.W. 5.50

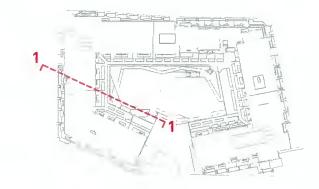





■ BBL ARCHITECTS

300-224 WEST 8TH AVENUE VANCOUVER, BC CANADA YSY 1NS

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NOTES

MATERIAL LEGEND

DESCRIPTION COLOR
01 FIBRECEMENT PANEL WHITE
02 FIBRECEMENT PANEL OARK GREY
03 FIBRECEMENT PANEL OARK GREY
04 FIBRECEMENT PANEL OARK GREY
05 BRICK - Norman - WHITE
05 BRICK - Norman - GREY
Running Bond
06 GLASS GUARDRAIL TRANSPAREN
07 Avaries
08 ALLUMINUM FINS CEDAR
10 SPANDREL GLASS CHARCOAL
11 SPANDREL GLASS CHARCOAL
11 SPANDREL GLASS CHARCOAL
11 SPANDREL GLASS CHARCOAL
12 ALUMINUM BLACK
SUNSHADE
13 VINYL MULLION BLACK
14 FRITZ GUARDRAIL
15 ALUMINUM BLACK
WHITE
15 ALUMINUM BLACK
16 ALUMINUM BLACK
WHITE
16 ALUMINUM FLASHING CHARCOAL
17 ALUMINUM FLASHING CHARCOAL
18 ALUMINUM FLASHING CHARCOAL
19 ALUMINUM FLASHING CHARCOAL
19 ALUMINUM BLACK
WOOD
19 ALUMINUM MULLION BLACK
WOOD
21 MICROPERFORATED
22 EXTERIOR TREATED
WOOD
21 MICROPERFORATED
STANLESS STEEL
MESH

REVISIONS

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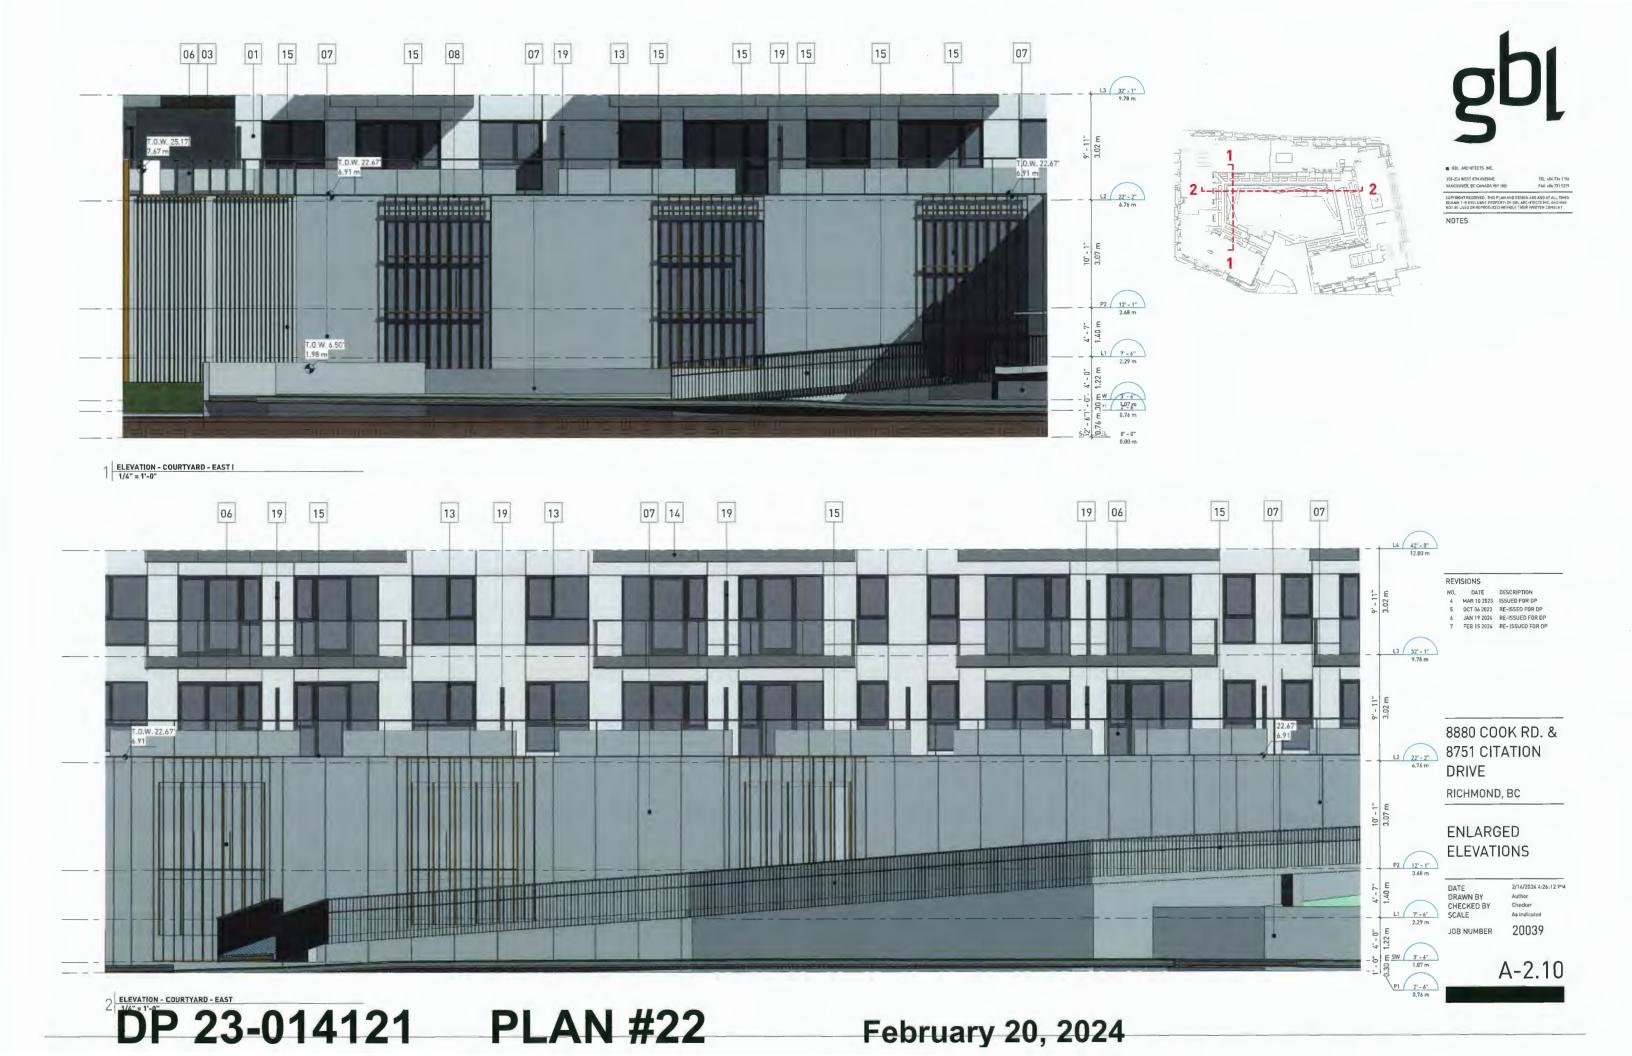
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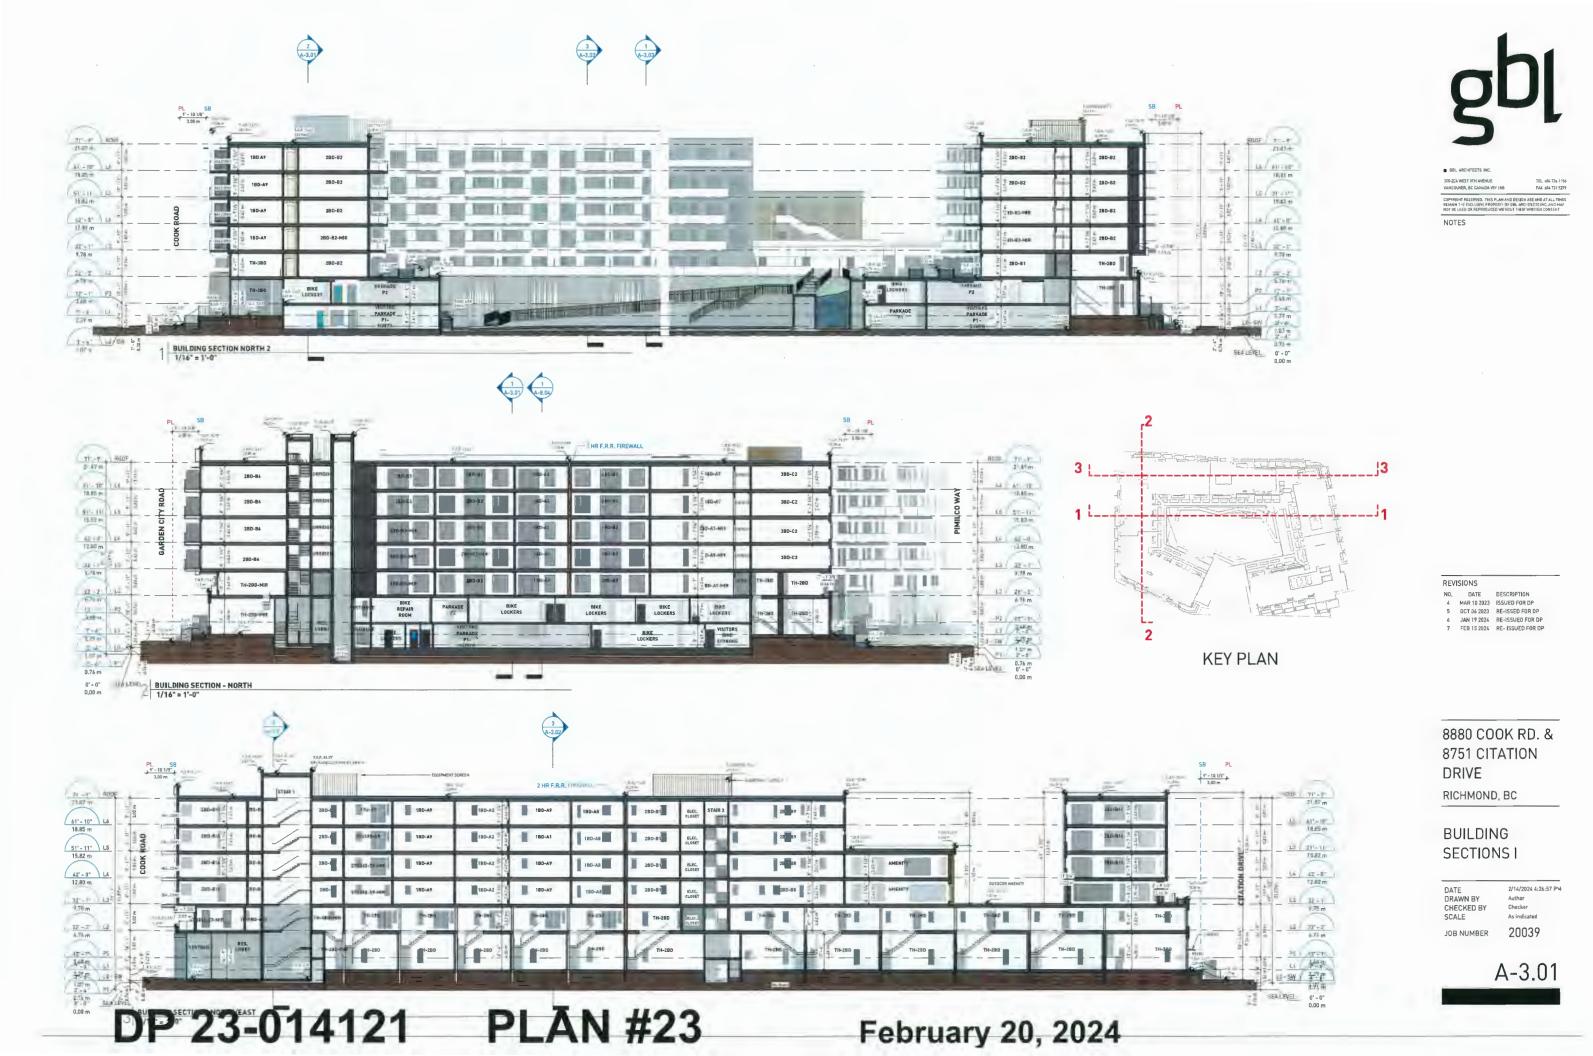
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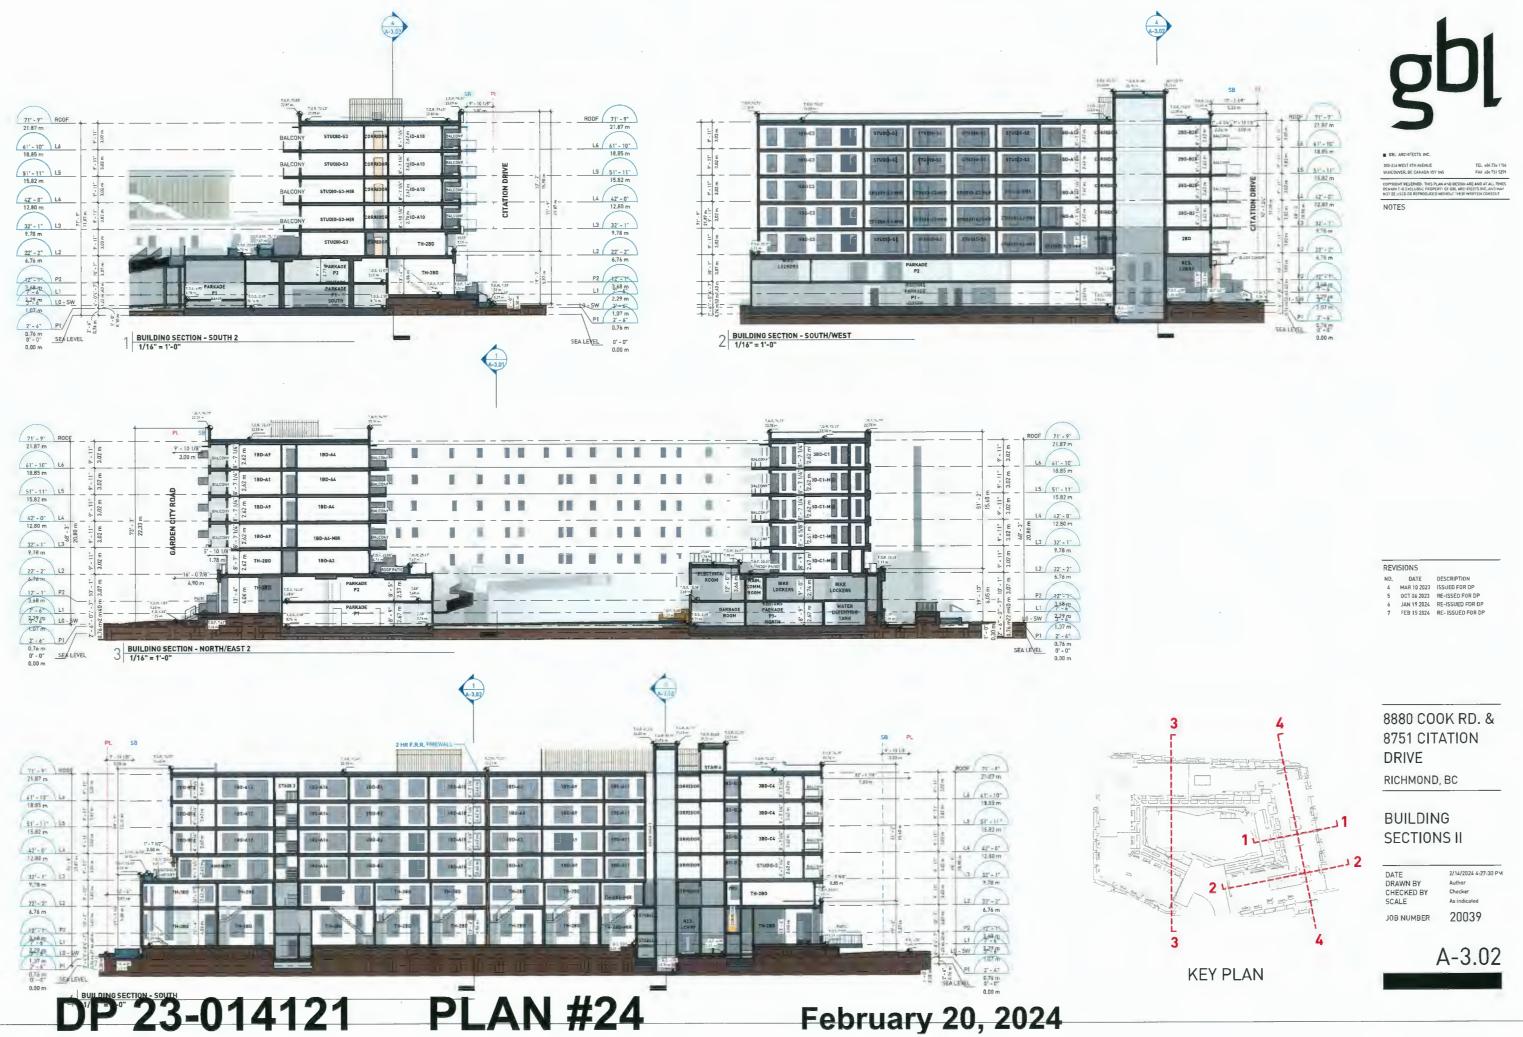
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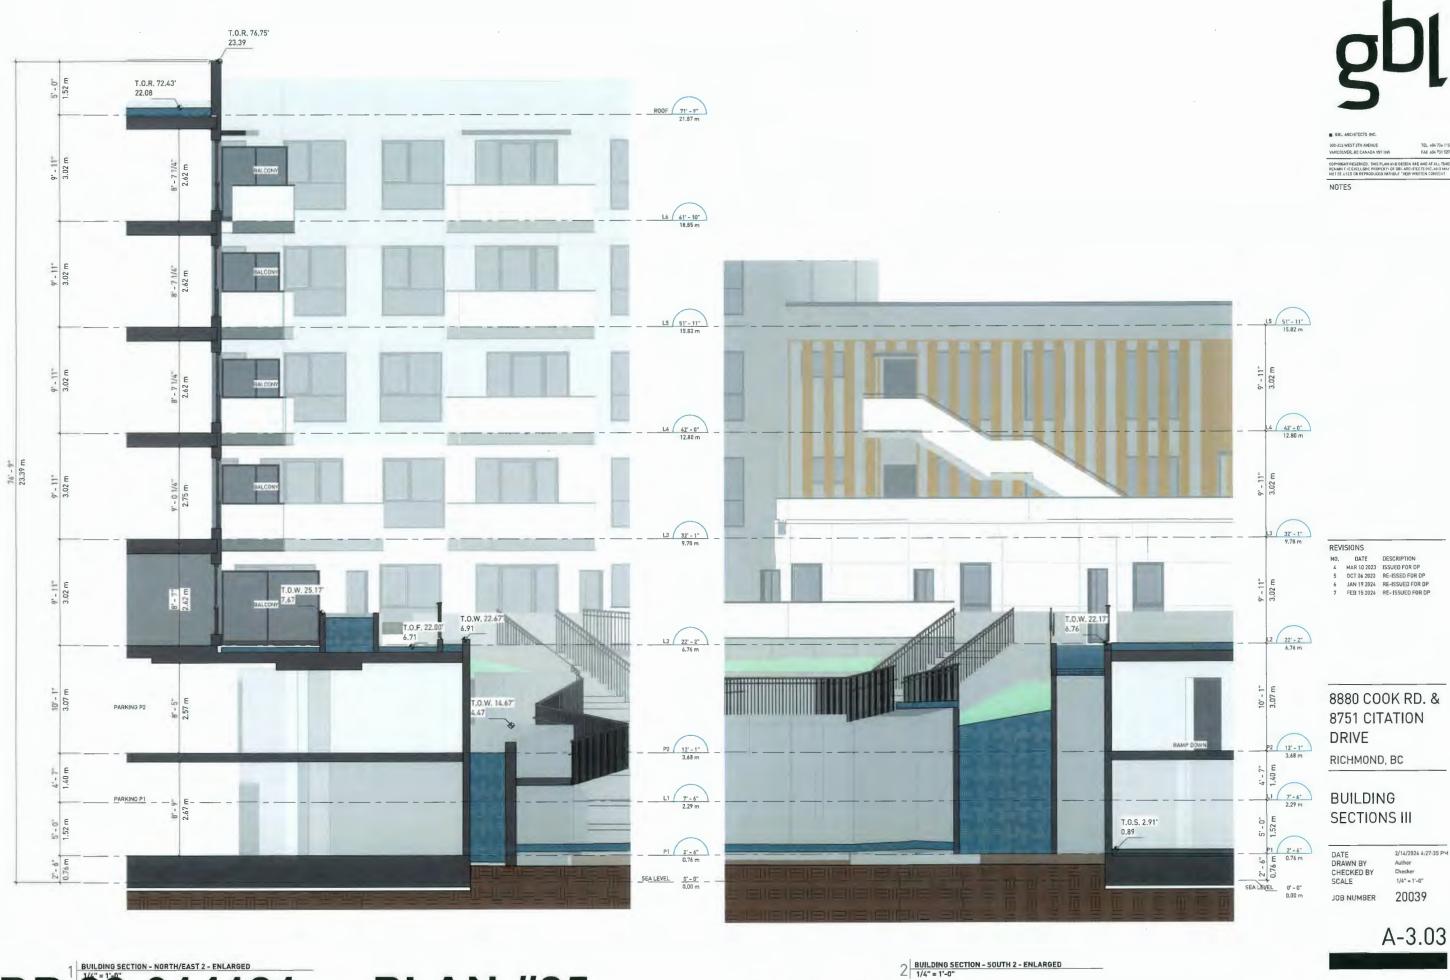
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DP 23-014121 **PLAN #25**



1 - NORTH EAST PERSPECTIVE

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3D VIEWS

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3D VIEWS

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3D VIEWS

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A-6.03

1 - SOUTH EAST - CORNER BETWEEN GARDEN CITY ROAD AND CITATION DRIVE DP 23-014121 PLAN #28



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JOB NUMBER

A-6.04

1 - AERIAL PARKADE ENTRY

DP 23-014121

PLAN #29





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3D VIEWS


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2 - TOWNHOUSE ENTRANCE
DP 23-014121

PLAN #30





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RICHMOND, BC

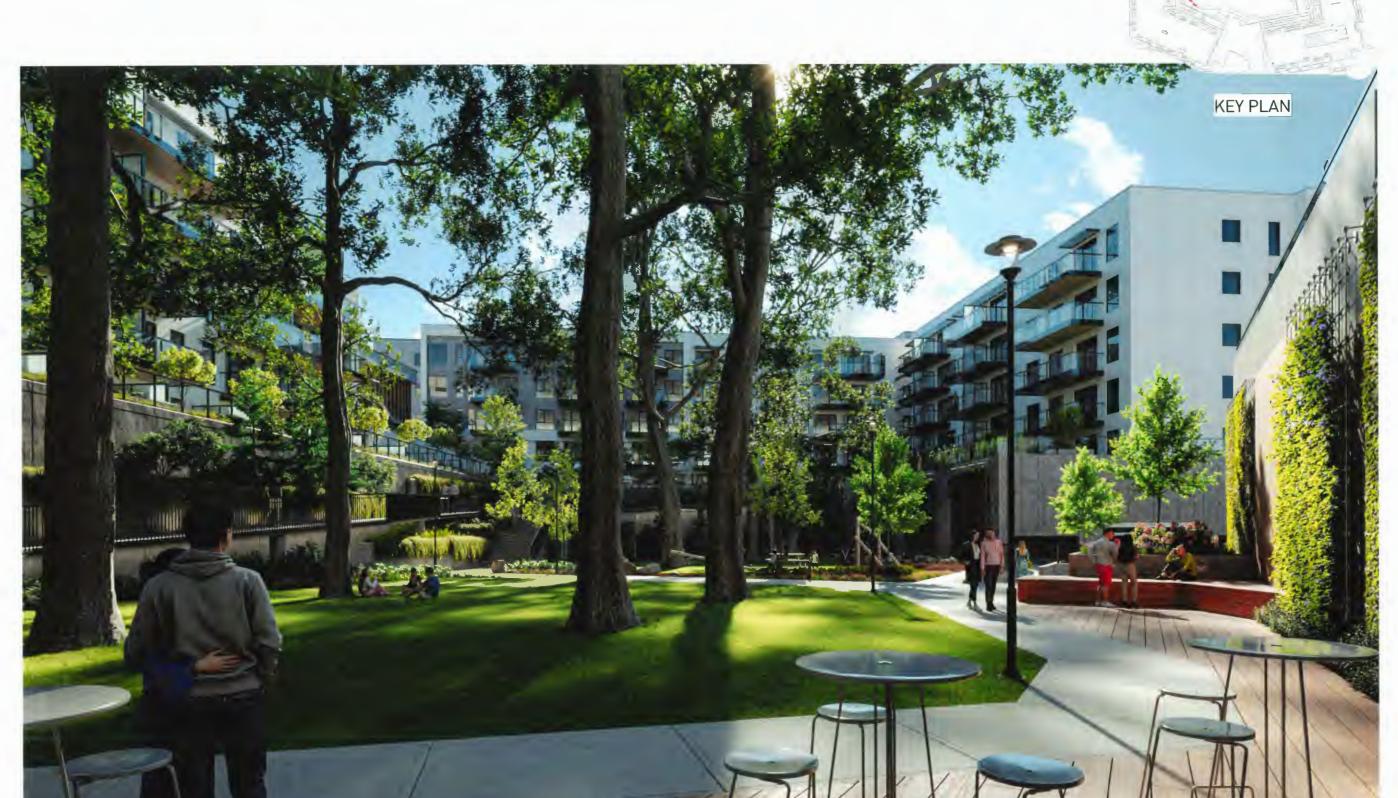3D VIEWS

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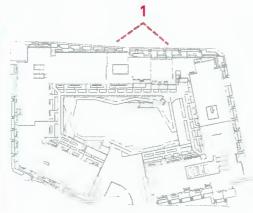
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1 - VIEW OF COURTYARD LOOKING SOUTH DP 23-014121

PLAN #31





KEY PLAN

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3D VIEWS

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1 - AERIAL VIEW **LOOKING WEST**

DP 23-014121 **PLAN #32**




1 - SOUTH EAST



2 - COOK RD. ENTRY



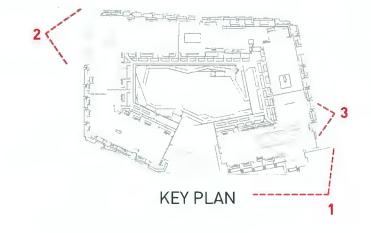



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3D VIEWS


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February 20, 2024

PLAN #33 DP 23-014121



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VANCOUVER, BC CANADA V5Y 1N5

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RICHMOND, BC

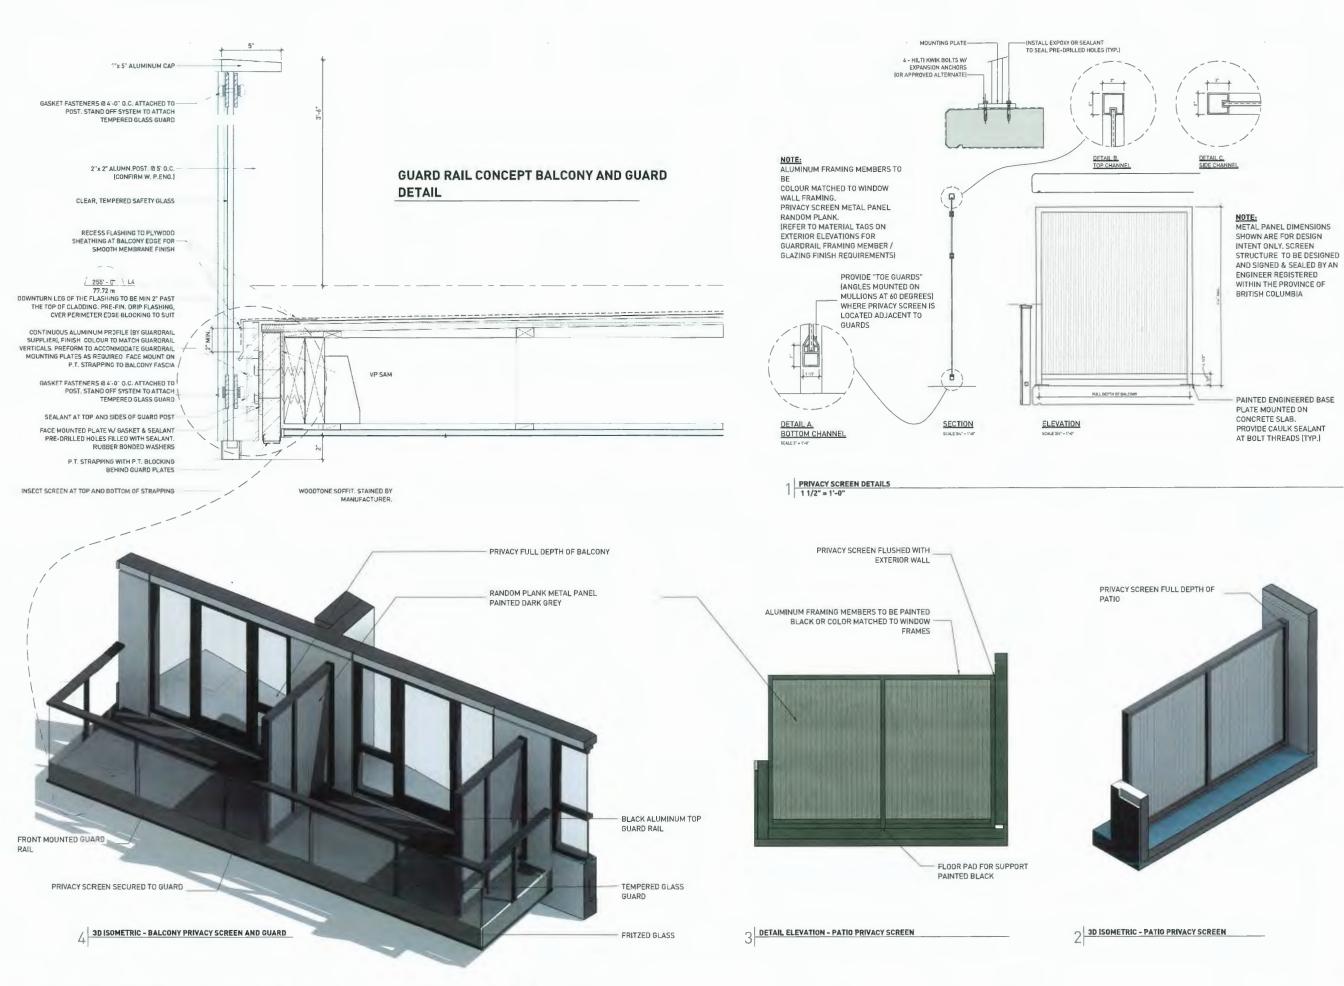DETAILS

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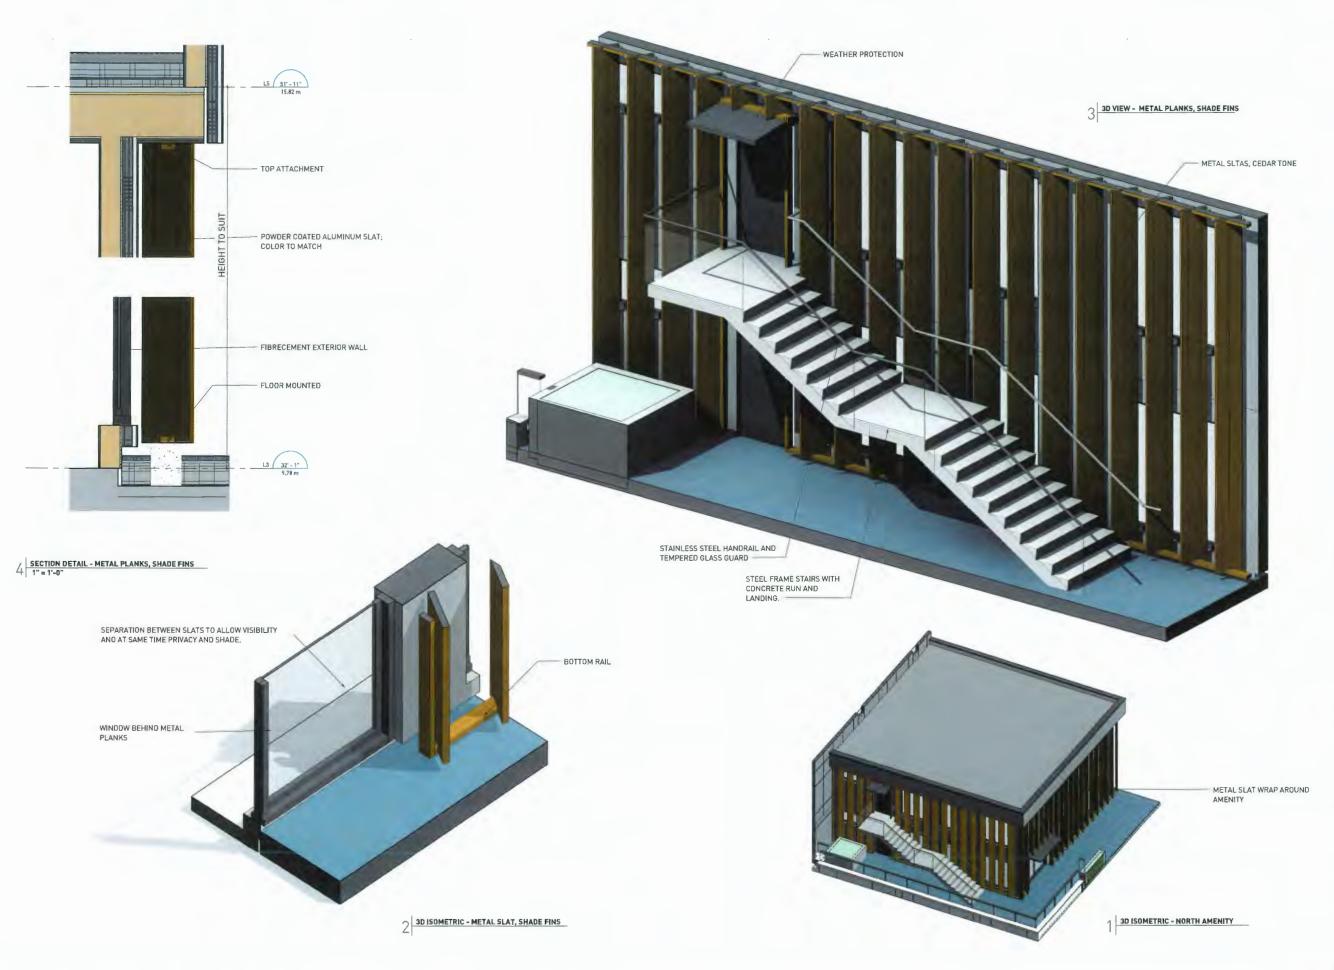
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8880 COOK RD. & 8751 CITATION

PRIVACY SCREEN

DP 23-014121 PLAN #34



gbl

B BBL ARCHITECTS IN

300-214 WEST 8TH AVENUE VANCOUVER, BC CANADA VSY 1NS

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8880 COOK RD. & 8751 CITATION DRIVE

RICHMOND, BC

METAL PLANKS DETAILS

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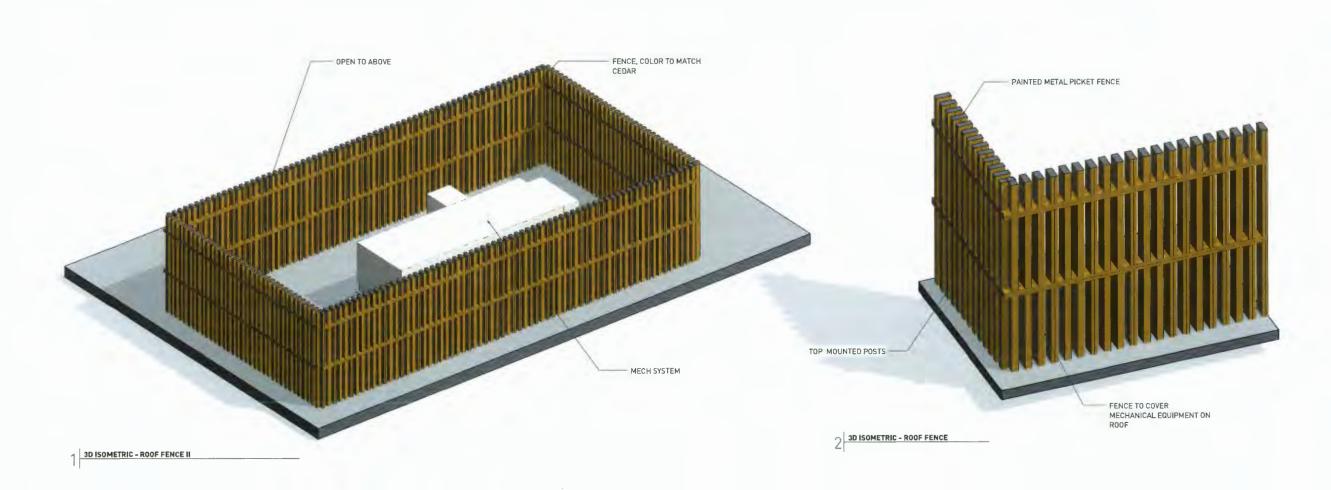
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RICHMOND, BC


ROOF SCREENING DETAILS

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20039 JOB NUMBER

A-8.02

DP 23-014121 PLAN #36

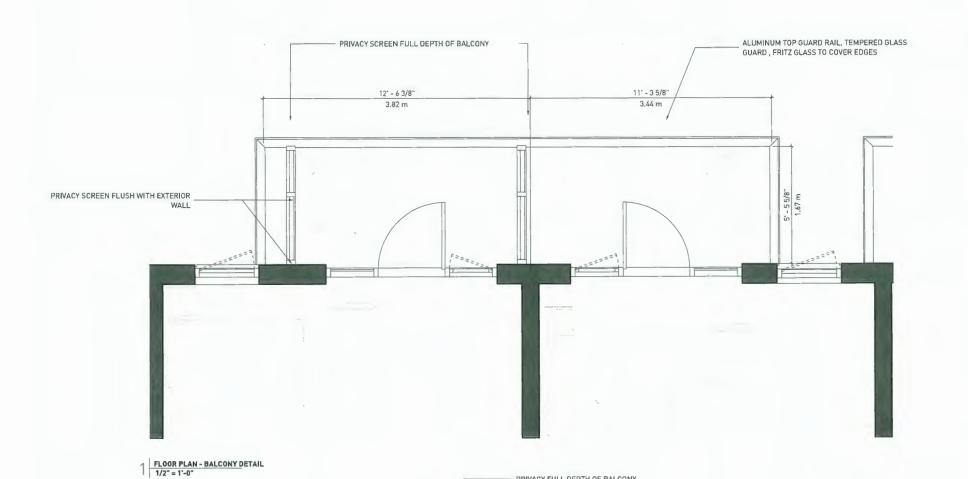

PRIVACY FULL DEPTH OF BALCONY

PRIVACY SCREEN SECURED TO GUARD

BLACK ALUMINUM TOP

GUARD RAIL

RANDOM PLANK METAL PANEL PAINTED DARK GREY



GBL ARCHITECTS INC.

300-224 WEST 8TH AVENUE

IUVER, BC CANADA V5Y INS

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NOTES

FULL DEPTH OF BALCONY ALUMINUM METAL FRAME RANDOM PLANK METAL PANEL SCREEN SCREEN ATTACHED TO **GUARD** BLACK ALUMINUM TOP GUARD RAIL LOW THRESHOLD FOR ACCESIBILITY FRONT MOUNTED TEMPERED GLASS GUARD FRITZED GLASS **BLACK ALUMINUM** BTM, FRAME FIBRECEMENT SOFFIT 5-61/2

REVISIONS

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BALCONY DETAILS

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DP 23-014121 PLAN #37


TEMPERED GLASS GUARD

FRITZED GLASS

FRONT MOUNTED GUARD

February 20, 2024

3 SECTION - BALCHY DETAIL

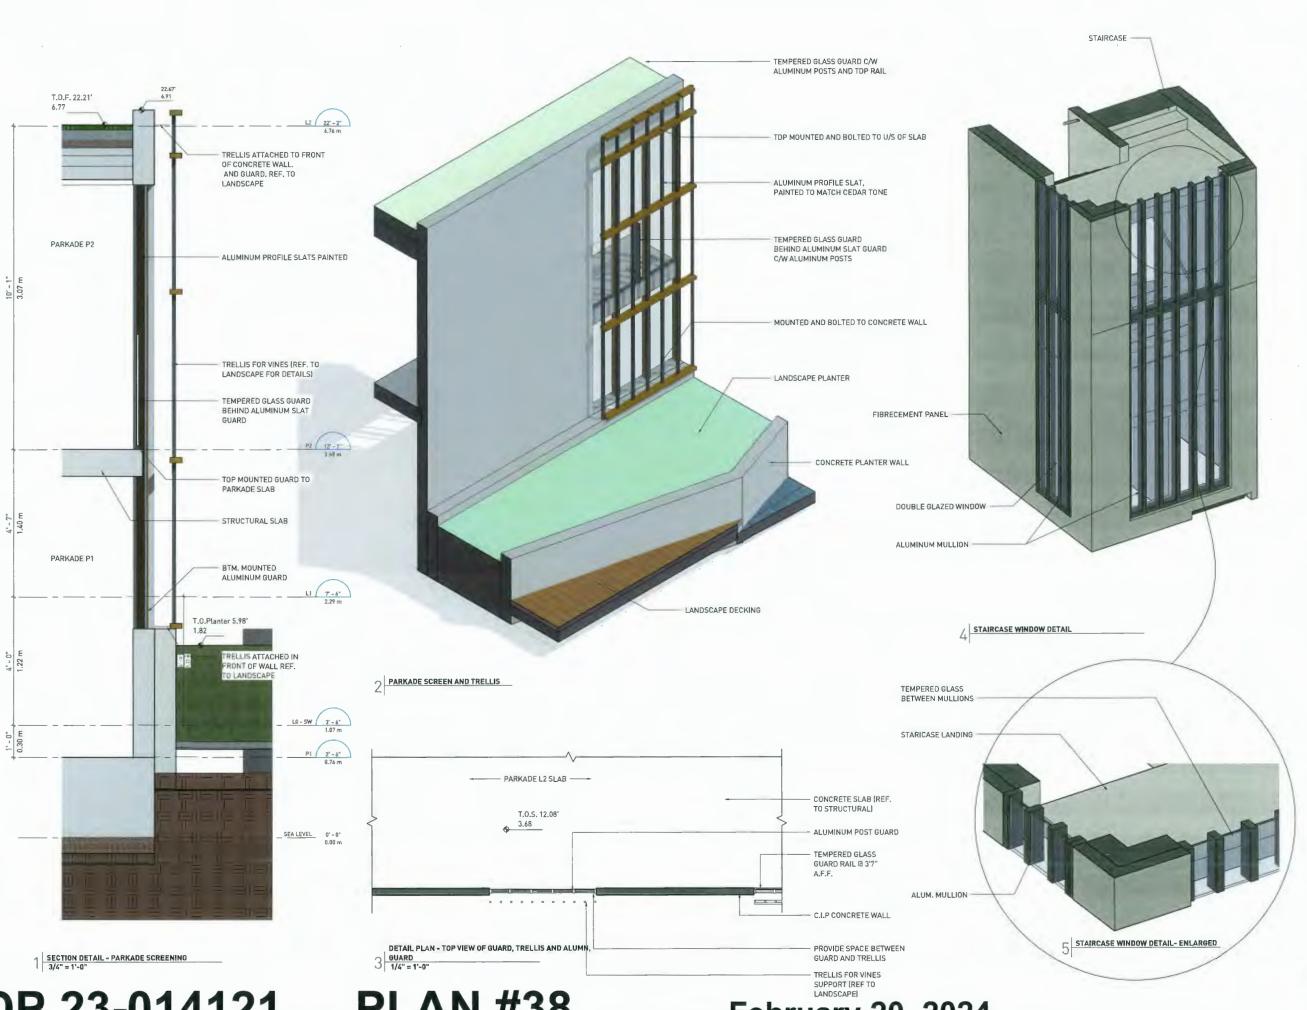

DP 23-014121

PLAN #38

February 20, 2024

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8880 COOK RD. & 8751 CITATION

DRIVE


RICHMOND, BC


PARKADE AND


STAIR SCREEN

20039

A-8.04

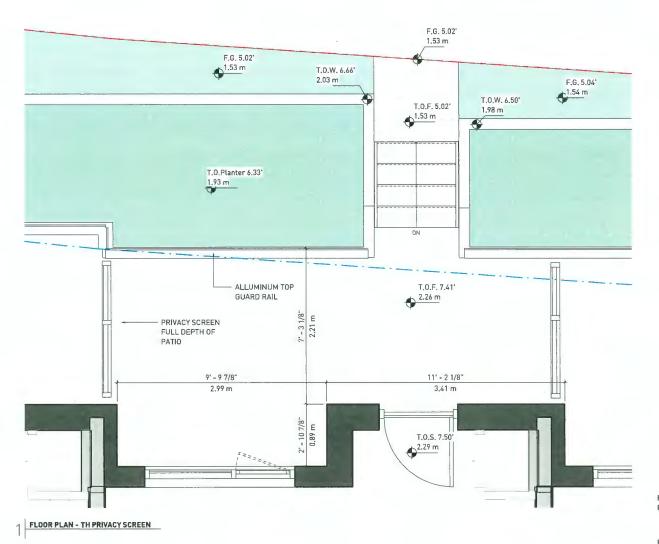

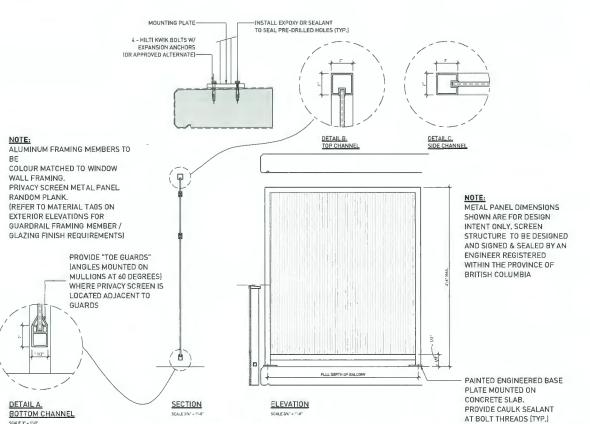

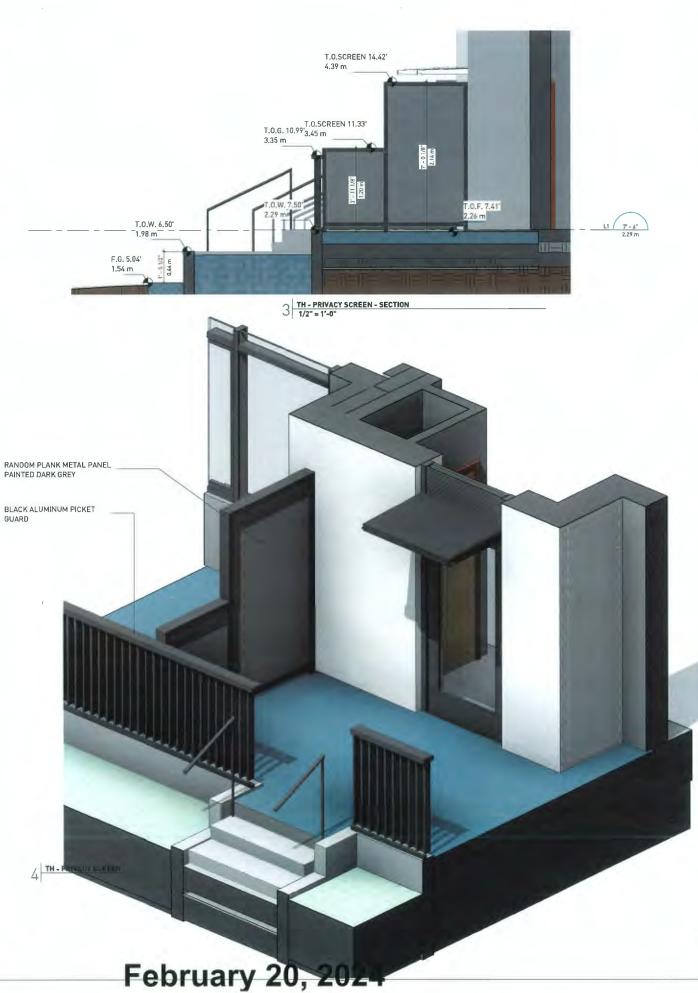



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TH PRIVACY
SCREEN DETAILS

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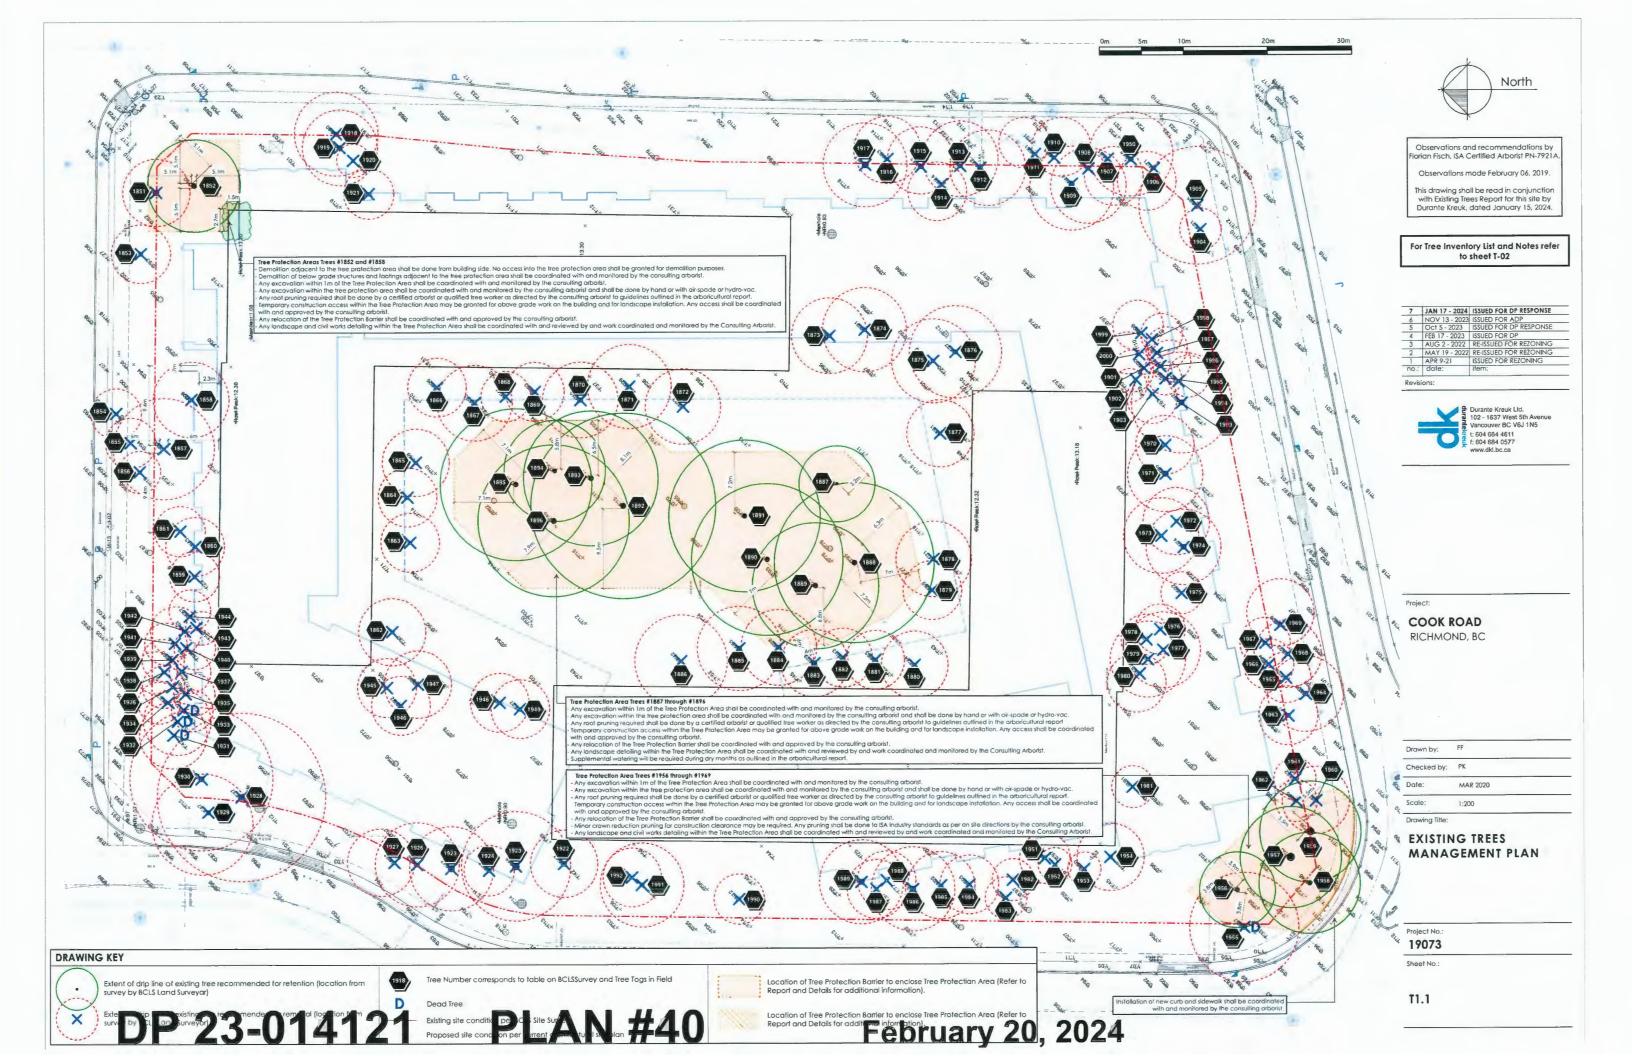
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PRIVACY S DP 23-014121 F


PLAN #39



William.	Species	Billy Stems	E Herm	M-pead-m	Bellaht-m		po and	產	Sibard Filtrane	Hillocole	Kellein
	Prunus var.	۰				ON SITE	-			Т	- 0
1851	(cherry)		65	٠	В	Co-daminant leaders.		•			c)
1852	Chamaecyparls (false cypress)		64	11	18	Reduced vigor. 60 % LCR.		٠			٠
	Prunus var.			Ī		Multiple Ganademia canks all lower					
1853	(cherry)		40	7	8	frunk. Watersprouts, Dieback from top.	•		ľ		c)
	unidentified deciduous	ē	34			Other stems 10, 10, 9, 1 stem dead, Poor			١.		-1
1854	(unidentified)	6	34	6	8	structure. Suppressed by adjacent trees. Next to power pole.			Ľ		c)
1855	llex vor.	2	27	6		Suppressed by adjacent trees. Asymmetrical crown, 2 Co-dominant			١,		a)
1020	(hally)	_	2	٥	0	leaders.		Ť		1	c)
1856	Thuja occidentalis (white cedar)	2	37	4	11	Joint crown Asymmetrical crown. Phototropic tean 100 % LCR.		•		•	c)
1857	Thuja plicata		94	59	26	2 Ca daminant leaders. Reduced			ic.		
1004	(western red cedar)		74	12	40	vigar, Joint crown, 95 % LCR. Joint crown 90 % LCR. Dieback		Ť		-	
1858	Pseudotsuga menziesii		31	9	26	(minimal) lower crown. 3m from			•	•	
	(Douglas fir) Acer palmatum					retaining wall. Suppressed by adjacent trees.			ŀ		
1859	(Japanese maple)	3	28	6	6	Asymmetrical crown, Surface root(s).			• •	•	
1860	Prunus var. (cherry ai plum)		26	7	7	Surface root(s). Along retaining wall. Heavily pruned. Poor structure.		٠	•	•	
1861	Prunus var.		22	6	6	Surface root(s) Heavily pruned. Poor structure. Asymmetrical crown.		•			
	(cherry or plum) Pinus contarta					Corrected lean. 2m from building.					
1862	(lodgeode pine)		40	8	3	Dieback (minimal). Asymmetrical crown, 85 % LCR.			• •	•	
	Cedrus attantico					Assembled moun Limbadus on					
1863	fatios cedari		63	7	3	bulding side. Woundwood development is moderate. Poor		•		•	
	,=====					structure. Reduced vigor. 80% LCR.					
1864	Cedrus allantico		33	7	3	bulding side. Woundwood development is moderate. Pagr		•		•	
	[aflas cedar]					structure. Reduced vigor. 65% LCR.					
1865	Cedrus atlantica		45	8	3	Asymmetrical arown, Limbed up on building side. Woundwood					
,000	(atlas cedar)		-23	3	9	development is moderate. Poor structure. Reduced vigor. 65% LCR.					
1866	Prunus var. (cherry)		21	7	10	Heavily poined Poorstayclum Close to			4	T	
1867	Prunus var.		30	9	10	Heavily pruned. Poor structure.					
	(cherry) Prunus var.										
1868	(cherry) Ager var.		21	6	10	Heavily pruned. Poor structure. Ram's hom from base to 2m above		•			
1869	(maple)	2	40		11	ground. Asymmetrical crown.		•	1	٠	
1870	Acervar. (maple)	3	52	9	10	Asymmetrical crown, 10cm a stem dead middle crown.		•	4	0	
	Acer var.					Anima abled oraca Mitmigally				1	
1871	(maxie)		38	10	10	dropped structural limbs. Potential decay column mid arown. Close to		•		٠	
	Cedrus atlantica					building. Limbed up to 65% LCR, Dieback lower					
1872	(attas cedar)		41	9	3	crown. Pruning wound(s). Woundwood development is good.		•	1	•	
1873	Pinus contartn		36	9	15	Joint crown. Surface root(s), Heaving pavement, 80% LCR. Deadwood in					
	[lodgepcle pine]		_			Joint crown. Surface root(s). Heaving					
1874	Pinus contarta		40	10	15	povement, 80 % LCR. Deadwood in		٠		٠	
	(lodgepole pine) Pinus cantata					lower crown. Joint crown. Surface root(s). Heaving					
1875	(lodgepole pine)		35	10	15	povernent, 80 % LCR. Deadwood in lower crown.		*	•	٠	
1876	Pinus contarta		40	12	15	Joint crown, Surface mot(s). Heaving pavement, 80 % LCR. Deadwood in					
10/0	(lodgepole pine)		40		13	lower crown.		•			
1677	Pinus contarta		30	8	15	Joint crown. Surface rool (s). Heaving pavement. 80 % LCR. Deadwood in				•	
	(fodgepole pine) Prunus var.					lower crown.					
1678	(cherry)		28	9	10	Watersprouts from roots.		•	•	٠	
1879	Prunus var.		25	7	10	Surface root (s). Poor structure. Watersprouts from roots.				•	
1880	(cherry) Prunus war.					Surface root (s). Poor structure. Watersprouts from roots.					
reati	(cherry)							*		-	
1581	Acervar. (maple)	2	39	7	10	Phototropic lean. Asymmetrical crown. Included bark.			•	•	
	Acervor.				۱	Included bark. Other stems 10cm e. 12cm e Pruning wound(st 1m above					
1882	(mode)	4	38	7	16	12cm a Pruning wound(s) 1m above ground. Woundward development is		*	,	•	
	Cectrus decidara					poor, Girdling rool (s). Carected lean. Close to building.					
1883			51	8	22	Asymmetrical crown, Limbed up on building side. Poor structure. Joint		•		٠	
	(deodar cedar)					crown, 60 % LCR.					_
1384	Cearus decdara		_		~	Corrected lean. Close to building. Asymmetrical crown. Limbed up on					
1004	(deodor cedor)		47	9	2	building side. Poor structure. Joint crown, 90 % LCR.		*		•	
	Cedrus decidaro					Carecled lean. Close to building					
1885	(deodar cedar)		52	10		Asymmetrical crown, Limbed up an building side. Poor structure. Joint crown, 85 % LCR.		*		•	
100	Acervaic		~			Girding roat(s), Asymmetrical trunk. Included bark, Asymmetrical crown.					
1886	(maple)		35	31		Included bank, Asymmetrical crown. Pruning wound(s), Woundwood development is poor, Surface root(s).		*	·	*	
1887	Acer platanoides		28	9		Carected lean, Sub-dominant, Deadwood lower crown.					♦ b)
and a	(Norway maple)		-			Deadwood lower crown. Surface root(s). Asymmetrical trunk. Flat					- 54
1888	Quercus rubra		61	19	24	on north side. Corected lean. Joint crown, Asymmetrical crown. Dieback			•		Ф b)
	Northern red udk					lower crown.					
1889	Quercus rubra		57	15	25	Surface root(s). Corrected tean, Joint crown, Asymmetrical crown, Dieback			•		♦ b]
	Northern red oak Quercus rubra					lower crown. Surface root(s). Carrected lean. Jaint					
1590	Northern red ook		58	18	2	crown. Asymmetrical crown. Dieback lower crown.			•		♦ b]
	Ouercus rubra					Surface root(s) Jag mid trunk. Reaction					

The No.	Species	& of Sherric	Will-cm	Spreed - rrs	Height - rrs	Reld Observations	Dissel	Pest	Pulls	Grand	Retourie	Relatin	Made
	Quercus rubra					ON SITE			ī		1		
1892	Northern red oak		66	22	37	Jaint crown. Dieback lower crown.				•	4	•	
1893	Quercus rubra Northern red oak		55	16	41	Jant crown, Asymmetrical crown. Dieback lower crown, Hanger.				٠			t
1894	Quercus rubra		48	12	43	Joint crown, Asymmetrical crown.				•			b
	Northern red odk Quercus rubra					Dieback lower crown Hanges Joint crown, Asymmetrical crown,				ŀ	1	-	ł
1895	Northern red oak		58	18	42	Dieback lower crown, Hanger.				•			t
1896	Quercus rubra Northern red oak		65	18	44	Joint crown, Asymmetrical crown. Dieback lower crown, Hanger,				٠			Ŀ
1901	Thuja plicata		21	4	12	Joint crown. Asymmetrical crown.						t	
1701	(western red cedar)		21	•	12	Deadwood inner crown, 100 % LCR.				•	*		
1902	Thuja pricata (western red cedar)		26	5	12	Joint crown, Asymmetrical crown. Deadwood inner crown, 100 % LCR.				•	٠		
1903	Thujaplicata		25	4	12	Joint crown, Asymmetrical crown, Deadwood inner crown, 100% LCR.				٠	+		
	(western red cedar)					Main leader previously removed.							
1904	Pinus contada		23	5	6	Woundwood development is poor. Suppressed by adjacent trees 80 % LCR			٠		٠		5
	(lodgepole pine)					of Im abovo ground.							
1905	Pinus contarta		72	14	15	Subdominant leader leaning on street ight. 70% LCR.				٠	٠		c
	(lodgepole pine) Pinus contarta					ioint cown kommencei cown						t	
1906	(lodgepole pine)		29	7	15	Deadwood lower crown. 80 % LCR.			•		٠		0
	Pinus contarta					Joint crown Asymmetrical crown.							
1907	{lodgepole pine}		26	7	15	Deadwood lower crown. 85 % LCR. Phototropic lean.			•		٠		c
	Pinus contada					Joint crown Asymmetrical crown.					+		
1908	(lodgepole pine)		34	9	15	Deadwood lower crown. 80 % LCR. Phototropic lean.			•		*		
	Pinus contarta					Joint crown Asymmetrical crown.					1		
1909	(lodgepole pine)	2	56	10	15	Deadwood lawer crown, 90 % LCR. Phototropic lean.			•	•	•		
	Pinus contorta					Joint crown Asymmetrical crown.			ĺ		+	1	
1910	(lodgepole pine)		30	7	15	Deadwood lower crown. 85 % LCR. Phototropic lean.			٠		•		•
1911	Pinus conforta		21	6	10	Distribution to a stirl and a							
4711	(lodgepole pine)		21	0	13	Deadwood lower crown. Joint crown.			*			-	
1912	Pinus conforta (lodgepole pine)		40	9	15	Phototropic lean. Asymmetrical crown. Deadwood lower crown. Joint crown.			•		+		
1913	Pinus cantarta			9	15	Phototropic Ican. Asymmetrical crown.							
IYIJ	(lodgepole pine)		41	y	12	Deadwood lower crown, Joint crown,			•		٦.		
1914	Pinus contarta (lodgepole pine)		30	7	15	Phatotropic lean. Asymmetrical arown. Deadwood lower crown, Joint arown.			٠		٠		
	Pinus contarta					Deadwood lower crown, Reduced							
1915	(fodgepale pine)		50	8	15	vigar Joint crown. Hanger, Heavily pruned.			•		٠		t
	Pinus contarta					Deadwood lower crown. Reduced							
1916	(fodgepole pine)		29	8	15	vigar. Joint crown, Hanger. Heavily pruned.			•		٠		0
	Pinus cantarta					Deadwood lower crown Reduced							
1917		2	67	10	15	viga: Joint crown, Hanger, Heavily pruned, Lhistorically large structrual			•		٠		t
	(lodgepole pine)					limb dropped.							
1918	Carylus var.	3	48	10	7	Deadwood substantial. Dead co- dominant leaders, Decay column.		•			٠		
	(hazel and filbert)					Reduced vigor. Other stems 10cm a. One co-dominant							
1919	Carylus var. (hazel and filbert)	5	52	9	7	leader is dead. Decay column.		•			٠		
	Piers japonica	-				Reduced vigor. Deadwood inner frown Reduced						+	
1920	(Japanese pieris)	2	24	9	5	vigor			•		•		
1921	Acervar. (maple)	3	36	6	7	Previously heavily pruned. Poor structure.			•		٠		
1922	Pinus contarta	- 2	57	8	16	Joint crown, Decdwood minimal lower							
1722	(lodgepale pine)	_ ^	37	•		crown. Asymmetrical crown.					-		
1923	Pinus contarta	2	82	13	18	Included bark. Joint crown. Deadwood inner crown. Ivy on lawer trunk.				•	٠		
	(lodgepole pine) Pinus contarta					Sween Anamorbical cares Joint					+	÷	
1924	(lodgepole pine)		35	6	14	crown. Deadwood innna crown.			*		•		
1925	Pinus contorto	2	75	10	16	Included bark. Joint crown, Deadwood in crown,					•		
jan	(lodgepole pine) Pinus contarta												
1926	(lodgepole pine)		48	10	13	Phototropic lean Joint crown.				*	*		
1927	(ladgepole pine)		35	8	9	Heavy phototropic lean. Joint crown.			•		•		•
	Cedhis deodoro					Corrected lean. Asymmetrical crown.							
1928	(deodar cedar)		70	20	21	Joint crown. 2 subdominant leaden Surface root(s).				*	*		
1929	Cedrus deodara		50	12	21	Asymmetrical crown, Joint crown, Deadwood in crown, Surface root(s).					•		
	(deodor cedor) Cedrus deodoro										-	-	
1930	(deodar cedar)		60	17	21	Joint crown. Surface root (s). Deadwood in crown.				•	*		
1931	Thuja plicata		34	8		Part of hedge.	+				٠		
	(western red cedar) Thuja plicata		_								-1		
1932	(western red cedar)		37	8	7	Part of hedge.	*			ŧ.	*		
1933	Thuja plicata (western red cedar)		21	4	7	Part of hedge. Asymmetrical crown.	4				٥		
1934	Thuja plicata		32	5	7	Part of hedge. Asymmetrical crown							
	(western red cedar)					80% dead. Part of hedge. Asymmetrical crown.		ĺ			1		
1935	Thuja plicata (western red cedar)		30	4	8	90% dead.		•			•		
1936	Thuja plicala	2	20	5	8	Part of hedge. Asymmetrical crown.							
	(western red cedar)	-				80% dedid keducad vigor.					4		
	(western redicedar)		25	5	8	Reduced vigar, 100% LCR.		•			•		
1937	Thuja plicata	2	34	5		Red of herine Assemblation crown					•		
1937	(western red cedor)			۱	ı	Red albertas to a serial and an a					1		
1938	Thuja plicata		14	5	9	100% LCR.			+		÷		
	Thuja plicara (western red cedar)												
1938	(western red cedar) Thuja plicara		22	5	9	Part of hedge. Asymmetrical arown.			*		٠		
1938 1939 1940	(western red cedar) Thuja plicara (western red cedar)					100% LCR.			*		٠	-	
1938	(western red cedar) Thuja plicara	2	22 36	5		Part of hedge. Asymmetrical arown. 100% LCR. Part of hedge. Asymmetrical crown 100% LCR.			•		•	ŀ	


Tree No.	Species	# of Sterns	Dall-orn	Riproved - Pri	Helight-rn	Raid Observations	Based	Pour	Petr	Steel	Estimate Estimate	Relatin	Mole
1943	Thuja plicata (western red cedar)	ī	20	4	9	ON SITE Part of hedge Asymmetrical crawn 100% LCR.	ï	N	٠	Ī	٠		Ī
1944	Thuja pficala	7	36	5	9	Part of hedge. Asymmetrical crown.			٠	ī	٠		
	(western red cedar) Pinus contarta					100% LCR. Girdling root(s). Asymmetrical crown.			ñ				
1945	(lodgepole pine)		30	7	15	Joint crown. Previously heavyly pruned. Deadwood lower crown. Surface			٠		٠		
	Pinus contarta		_			root(s), 80 % LCR. Asymmetrical crown, Joint crown,						-	
946	(lodgepole pine)		29	7	13	Corrected lean Deadwood lower crown, Surface root(s), 85 % LCR,			•		•		
1947	Pinus contenta (lodgepole pine)		30	8	14	Joint crown deadwood lower crown. Surface root(s), 80 % LCR.			*		٠		
1948	Pirus contarta (ladgepole pine)		34	7	14	Joint crown, Deadwood, Reduced vigar, Surface root(s), 75 % LCR.			•		٠		
1949	Pinus contanta		31	7	13	Joint crown, Deadwood, Reduced vigor, Surface root(s), 60 % LCR.			•		٠		
1990	(lodgepale pine) Pinus contarta		46	10	14	Included bark, Joint crown,							0
	(todgepole pine) Thuja picata					Reduced vigor. Corrected tean, Baze					1	L.	
1951	(western red cedar)		29	6	12	near building.			•		*		
1952	Thuja plicata (western red cedar)	2	23	4	5	Heavily pruned, Decay calumn. Suppressed by adjacent trees. Poor			٠		٠		
1953	Acer var.	3	29		5	structure. Heavily pruned. Suppressed by adjacent							
1323	(maple) Acervar.	3	27	•	2	trees. Poor structure. Reduced vigor. 2 Co-dominant leaders.			•		•		
1954	(maple)	2	43	8	12	Base near building. Included bark.			*		*		
1955	Pinus contarta		54	13	9	Dieback (minimal). Phototropic lean. Ivy an lower trunk 70% LCR Joint	•				٠		c
	(lodgepole pine)					crown. Dieback (minimal). Phototropic lean.							
956	(ladgepole pine)		45	9	20	Ivy an Jower trunk. 70% LCR. Joint crown.			•			+	
	Pinus cantoda				10	2 Co-dominant leaders at 2m above							
1957	(lodgepole pine)		86	12	¢D	ground. Ivy an Iower trunk. 85 % LCR. Joint crown.				*			
1958	Pinus contorta		49	12	23	3 Co-dominant leaders at 2m above ground. Ivy an lower trunk, 85 % LCR.			*			٠	
	(ladgepole pine) Pinus cantata	-1	Ţ		į	Joint crown, Asymmetrical crown. Deadwood minimal, Iw on lower trunk.						-	
1959	[lodgepole pine]	2	82	12	20	85 % LCR. Joint crown.			•			•	0
1960	Belulo var. (birch)		21	8	8	Dieback from top.		•			٠		0
1961	Cornus var. {dogwood}	3	30	5	8	Deadwood minimal.				*	٠		
1962	Pinus cantona	4	27	5	6	Deadwood minimal Phototropic lean. Other stems 7cm ø.				•	•		
1963	(todgepole pine) Pinus contana	-	40	7	14	Joint grown Deadwood lower grown.							
	(lodgepale pine) Pinus cantona		37	9							+		
964	(lodgepole pine)		3/	9	13	Joint crown. Dendwood Jower crown			•		•		
1965	(lodgepole pine)		28	6	14	Joint crown. Deadwood lower crown.			•		*		
1966	Pinus conforta (lodgepole pine)		25	6	14	Joint crown. Deadwood lower crown.			*		٠		
1967	Pinus contarta (lodgepole pine)		30	á	13	Joint crawn. Deadwood lower crown,			•		٠		
1968	Pinus cantarta		37	8	15	Joint crown, Deadwood lower crown.							
1969	(ladgepole pine) Pinus contada		36			Isiatana Bantandana							
	{lodgeoole pine} Befula var.			0	10	Heavy phototropic lean east Main leader dropped at 13m above			•		•		
1970	(birch)		21	7	18	ground.			•		*		
1971	Seluia var. (birch)	2	57	9	20					•	٠		
1972	Pinus contana (lodgepole pine)		31	8	11	Deadwood minimal.			•		٠		
1973	Belula var.		30	9	20								
1974	(birch) Befula var.	2			21	Included bark.							
19/4	Barning war	- 2	34	7	21	Previously heavily pruned. Poor			•		4		
1975	(cherry or pium)		21	4	5	structure. Sput bork.		*			*		
1976	Prunus var. (cherry or plum)		20	6	6	Previously heavily pruned. Poor structure. Woundwood development is			•		•		
1977	Champecyparis		27	9	10	Joint grown. Reduced vigor,							
	(false cypress) Prunus var.				70	Previously heavily pruned. Poor					+		
1978	(cherry or plum)		20	6	6	shucture. Woundwood development is			•		•		
1979	Chamaecypails (finished)	2	37	9	18	Joint crown. Included bark. 2 Co- dominant leaders. Reduced vigor.		•			٠		
	(false cypress) Chamaecypasis					Joint course Assembled about							
1980	((dise cypress)		20	7	18	Reduced vigor, Subdominant leader removed near base. Woundwood		•			٠		
	Prunus var.					development is poor. Previously havily pruned. Woundwood							
1981	(cherry or pium)		25	5	6	development is poor. Split bark. Poor structure.			•		•		
1982	Thuja plicato (western red cedar)	2	23	5	4	Shaped. Joint crown			•		٠		
1983	Thujaplicata	2	21	5	4	Shaped. Joint crown.					•		
1984	(western red codar) Pinus contarta		v	7	A	Stunted top, Joint grown.							
	(lodgepole pine) Pinus canloria					Studied Ion Joint court Supposered			,				
1985	(lodgepole pine)		25		10	by adjacent trees. Phototropic lean.			•		•		
1986	(lodgepale pine)	2	60	10	14	Joint crown.				•	•		
1987	Betula var. (birch)	2	29	7	18	Joint crown.				•	•		
1988	Befula var.		26	7	18	Joint crown. Suppressed by adjacent trees.					٠		
	(birch) Betula var.	2	58	10		Joint crown.							
1989			~										
1989	(birch) Comus var.					Asymmetrical crown, Lean west. Pruning wourd(s), Woundwood							

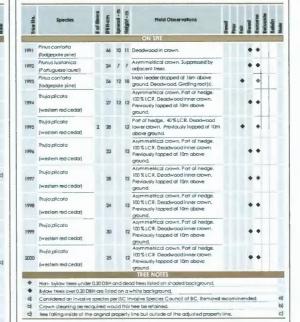

ARBORICULTURAL NOTES

Install tree protection barriers to City of Richmond requirements (see detail on this sheet) and maintain throughout construction.
 I rees, their environment, and their health and stability change with time.

2. Trees, their environment, and their health and stability change with time. Our recommendations to protect and retain trees are based on observations made on the date noted, and on a visual assessment of the trees using normal visual assessment procedures. Durante Kreuk Ltd. cannot guaranly that trees recommended for retention will remain whole or stable. Durante Kreuk Ltd. assumes no responsibility for tree protection unless we have been contracted to provide services in that regard, and provided appropriate notice when work on or near the trees is to be done.
3. Tree protection measures and all work on trees on City of Richmond Parks Land shall be pre-approved by City of Richmond arborist.

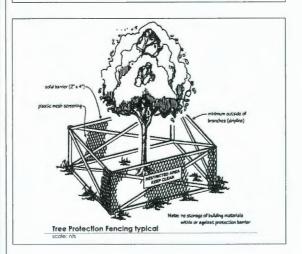

BOTANICAL HARR	COMMON WAME
Acer griseum	paperbark maple
Acer rubrum 'Autumn Spire'	autumn spire maple
Cornus 'Eddies White Wonder'	white wonder flowering dogwood
Fraxinus oxycarpa 'Raywood'	Raywood ash
Liquidambar styraciflua 'Silver King'	Silver King sweetgum
Parrotia persica 'Vanessa'	Persian ironwood
Picea omorika	Serbian spruce
Populus erecta	columnar Swedish aspen
Prunus serrulata 'Kwanzan'	Kwanzan flowering cherry
Pseudotsuga menziesii	Douglas fir
Ouercus robur 'Regal Prince'	Regal Prince English oak

7	JAN 17 - 2024	ISSUED FOR DP RESPONSE
6	NOV 13 - 2023	ISSUED FOR ADP
5	Oct 5 - 2023	ISSUED FOR DP RESPONSE
4	FEB 17 - 2023	ISSUED FOR DP
3	AUG 2 - 2022	RE-ISSUED FOR REZONING
2	MAY 19 - 2022	RE-ISSUED FOR REZONING
1	APR 9-21	ISSUED FOR REZONING
no.:	date:	item:

Revision



Project:

COOK ROAD RICHMOND, BC

Drawn by:	FF	
Checked by:	PK	
Date:	MAR 2020	
Scale:	NTS	

EXISTING TREES INVENTORY AND ARBORICULTURAL DETAILS

Project No.: 19073

Sheet No.

T1.2

DP 23-014121 PLAN #41


DRAWING LIST

L-0.00 LANDSCAPE COVER SHEET LANDSCAPE OVERALL SITEPLAN L-1.02 LANDSCAPE PORCKT PARKS PLAN L-1.03 NON POROUS AND LIVE PLANTING AREAS **MATERIALS & GRADING PLAN** L-1.2 MATERIALS & GRADING PLAN MATERIALS & GRADING PLAN L-1.3 MATERIALS & GRADING PLAN L-1.4 MATERIALS & GRADING PLAN L-1.5 LEVEL 3 AMENITY DECK L-1.6 LIGHTING PLAN L-2.1 LIGHTING PLAN L-2.2 LIGHTING PLAN L-2.3 L-2.4 LIGHTING PLAN LIGHTING PLAN L-2.5 **IRRIGATION COORDINATION PLAN** L-3.1 L-3.2 IRRIGATION COORDINATION PLAN **IRRIGATION COORDINATION PLAN** L-3.3 IRRIGATION COORDINATION PLAN L-3.4 L-3.5 **IRRIGATION COORDINATION PLAN** PLANTING PLAN L-4.1 PLANTING PLAN 1-42 L-4.3 PLANTING PLAN L-4.4 **PLANTING PLAN** PLANTING PLAN L-4.5 SOIL VOLUME PLAN L-4.6 LANDSCAPE SECTIONS L-5.1 L-5.2 LANDSCAPE SECTIONS L-5.3 LANDSCAPE SECTIONS LANDSCAPE DETAILS L-6.1 LANDSCAPE DETAILS L-6.2 L-6.3 LANDSCAPE DETAILS LANDSCAPE DETAILS L-6.4 LANDSCAPE DETAILS L-6.5 LANDSCAPE DETAILS L-6.6 L-6.7 LANDSCAPE DETAILS **EXISTING TREES MANAGEMENT PLAN EXISTING TREES INVENTORY**

MATERIALS KEY

MAIERIAL	TO VE I				
SURFACING			SITE FURNISHING		
€	CIP CONCRETE PAVING (PEDESTRIAN ONLY) 3ROOM FINISHED PATHWAYS 100MM THICK, SAWCUT AS PER PLAN	Ld 01 Ld 02 L-6.1 L-6.1	FD ###	METAL VISITOR BIKE PARKING Model: Bola Supplier: LandscapeFarms Installation: Surface Mount	Ld 01 L-6.4
(P2)	CIP STAMPED CONCRETE PAVING COLOR: CHARCOAL PATTERN: RUNNING BOND	Refer to Arch. Drowing for Detailing	F2 ===	PRE-FABRICATED BENCH Model: Neoliviana - 118" backed w/ center arms Supplier: LandscapeForms Installation: Surface Mount	Ld 02 L-6.4
P3	CIP STAMPED CONCRETE PAVING (POCKET PARKS) THICKNESS: 100MM THICK; COLOR: NATURAL PATTERN: DIAGONAL BASKET WEAVE	Ld 01 L-6.1	F3	CUSTUMIZED BENCH	Ld 05 L-6.4
P4	FEATURE CONCRETE PAVING HOLLAND PAVER SIZE: 4" X 8"; COLOUR: CHARCOAL GREY PATTERS: RUNNING BOND Locotions: Building Entries and Exits	Ld 06 L-6.1	F4) **	FEATURE BENCH Model: Air Collection Color: Five Different Colors for Each Park, Mixed Colors for Central Lawn Areo Supplier: LandscaoeForms	Ld 03 L-6.4
P5	HYDRAPRESSED CONCRETE PAVERS SIZE: 24"x24" COLOUR: NATURAL GREY	Ld 03/ Ld 04/ L-6/ L-6.1 L-6.1	F5	CLIMBING NET Model: NROB13	(40)
P6	HYDRAPRESSED CONCRETE PAVERS SIZE: 24'x24" COLOUR: CHARCOAL GREY	Ld 03/ Ld 04/ L4.01/ L4.01/ Ld 08/ L4.01/	幽	Supplier: Kompon	L-6.5
(P)	COMPOSITE WOOD DECKING	Ld 08 (Ld 09 (L-6.1)	F6 %	SEA-SAW, 2 PEOPLE Model: NRO015 Supplier: Kompan	Ld 02 L-6.5
PB	FIBAR PLAY SURFACING	Ld 10 L-6.1	F7 /	SPRINGER - BEE Model: NRO118 Supplier: Kompan	Ld 03 L-6.5
(P9)	ARTIFICIAL TURF	Ld 07 L-6.1	FB	SPRINGER - SNAIL Model: NRO115 Supplier: Kompan	Ld 04 L-6.5
	GRAVEL/RIVER ROCK DRAINAGE STRIP	Ld 11 Ld 12 L-6.1	PP	PLAY HUT W/ SLIDE *KOMPAN PLAY HUT AND SLIDE	(100
\$1)	SAND BASED SODDED LAWN	Ld 02 L-6.2			1-6.5
	URBAN AGRICULTURE		FIO	DECK SEATING	Ld 04 L-6.6
WALLS & FENCES	L HARDSCAPE			DRINKING FOUNTAIN - Pocket Park	(Ld 04)
			FII 🚜	DRINKING FOUNTAIN - FOCKET FOIR	L-6.4
	CIP CONCRETE RETAINING WALL		GRADING		
	CIP CONCRETE STAIRS		TW	TOP OF WALL	
			BW	BOTTOM OF WALL	
	METAL GATE	(Ld 01) (L-6.3)	+3.21	SPOT ELEVATION (METERS)	
	METAL GUARDRAIL VARYING HEIGHTS	Ld 02 L-6.3	FFE	FINISHED FLOOR ELEVATION	
	PRIVACY FENCING	Refer to Arch. Drowing for	L. Carren	SLOPE DIRECTION	
	VARYING HEIGHTS	Detoiling	LIGHTING		
	METAL EDGER (RETAINING) *SHEET PANELS, 12" HT RETAINING			RECESSED STEP LIGHTING	Ld 01 L-6.7
	LANDSCAPE BOULDERS		#	LANDSCAPE BOLLARD LIGHTING	Ld 02 L-6.7
	•SITE SALVAGED WHERE POSSIBLE		-	PEDESTIRAN SCALE POLE LIGHT	Ld 03 L-6.7
			8	WALL SCONCE LIGHT	Ld 04 L-6.7
			IRRIGATION & HO	OSE BIB	
			•	IRRIGATION STUB-OUT (CONNECTION PORFER TO MECHANICAL AND ELECTRICAL FOR F	OINT) FURTHER DETAIL
			ф	FROST FREE HOSE BIB REFER TO MECHANICAL AND ELECTRICAL FOR F	FURTHER DETAIL

PLANT LIST

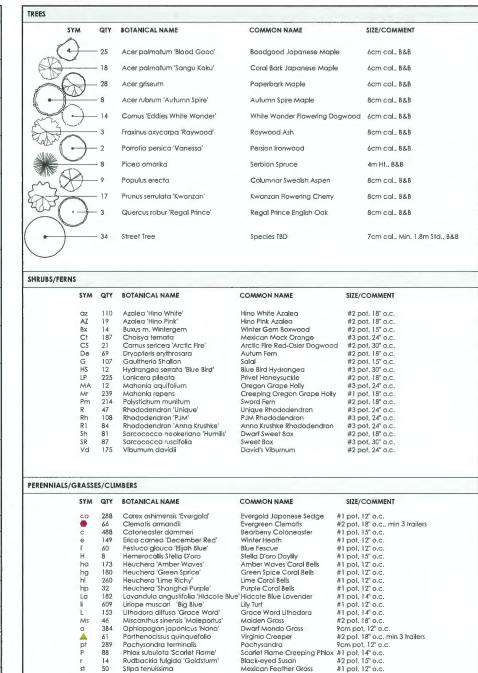

LANDSCAPE NOTES

- 1. All work shall meet or exceed the requirements as outlined in the current Edition of the Canadian Landscape Standard.
- 2. Plant sizes and related container classes are specified according to the Canadian Landscape Standard current Edition. For container classes #3 and smaller, plant sizes shall be as shown in the plant list and the Standard; for all other plants, bothplant size and container class shall be as shown in the plant list. Specifically, when the plant list call for #5 class containers, these shall be as defined in the BCNTA (ANSI) Standard.
 3. All trees to be staked in accordance with BCNTA Standards.
- ALL STREET TREES Install 8' x 24" Deep Root Barrier centred on each tree between tree pit and sidewalk (ON BOTH SIDES: CURB AND SIDEWALK).
- 5. For all existing on site services and survey symbols refer to survey drawings.
- 6. All landscaping and treatment of the open portions of the site shall be campleted in accordance with the approved drawings within six (6) months of the date of issuance of any required occupancy permit, or any use or occupancy of the proposed develop ment not requiring an occupancy permit, and thereafter permanently maintained in good conditions.
- 7. All Patios shall be equipped with hose bibs.
- 8. All irrigation valve boxes equipped with quick-couplers.
- Coniferous replacement trees shall be 4m height and deciduous replacement trees shall be 8cm caliper per City of Richmond.

7	Feb 19 - 2024	ISSUED FOR DP RESPONSE
-		
5	Oct 5 - 2023	RE-ISSUED FOR DP
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2	MAY 19 - 2022	RE-ISSUED FOR REZONING
1	APR 9-21	ISSUED FOR REZONING
no.:	date:	item:



Projec

COOK ROAD

RICHMOND, BC

Drown by: AG

Checked by: PK

Date: MAR 2020

Scale: NTS

Drowing Title:


LANDSCAPE COVER SHEET

Project No.: 19073

Sheet No.:

L-0.00

DP 23-014121 PLAN #42

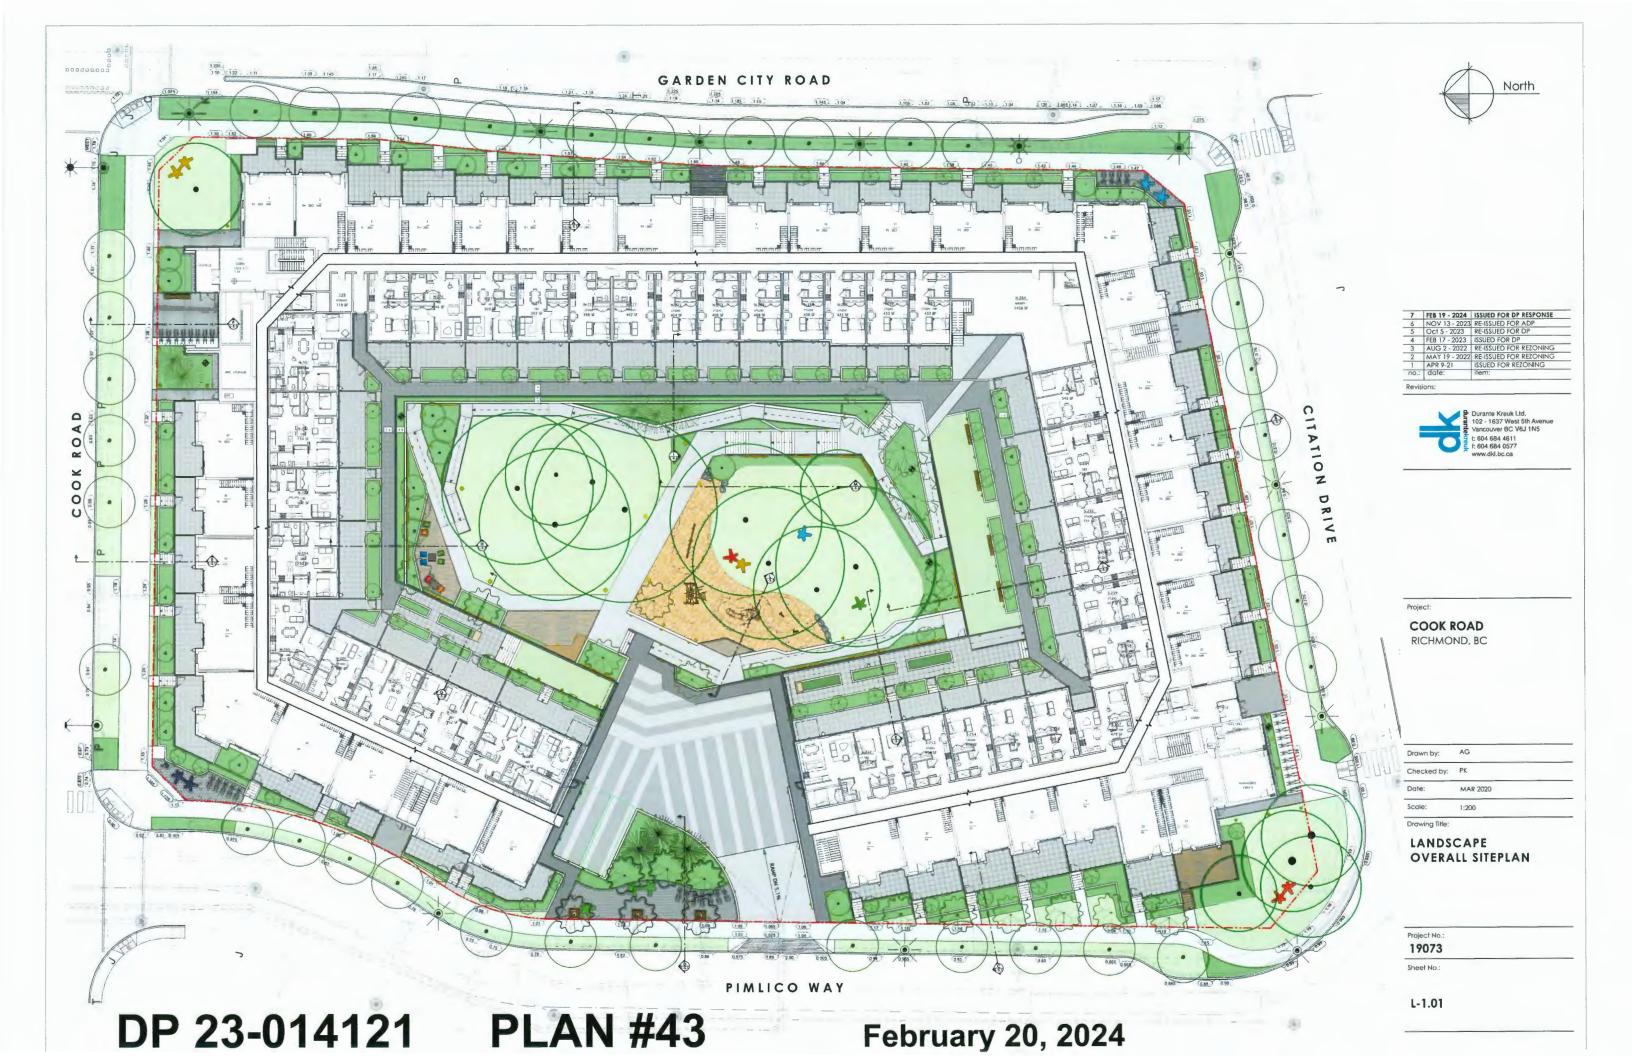

POCKET PARK PLANTING LIST:

SYM QTY BOTANICAL NAME

0 0

NE Pocket Park - 103 Sq m

- Existing Trees and Lawn to be Retained
- 2 Benches (colour: yellow)
- Irrigation to be provided and connected from the site

MATERIALS KEY		
(P3)	CIP STAMPED CONCRETE PAVING Thickness: 100mm Colour: natural Pattern: diagonal basket weave	Ld 01 L-6.1
	Existing Lawn. Details and Specifications Per City of Richmond Supplementary Specifications and Detail Drawings.	Ld 02 L-6.2

FURNISHING KEY		
国###	Metal Bike Rack Qty: 16 Bike Racks = 32 Bike Parking Model: Bola Bike Racks Supplier: LandscapeForms Installation:	Ld 01 1-6.4
F4 *	Feature Bench Qty: 11 Model: Air Collection Color: Five Different Colaurs for each Park Supplier: LandscapeForms	Ld 03 L-6.4
F12 🔊	Drinking Fountain Qty: 1	Ld 04 L-6.4

LIGHTING KEY		
#	Bollard Light Qty: 7	(Ld 03) (L-6.7)

I. Provide 1000mm deep continuous trench of growing medium for boulevards and median trees, where no utility conflicts exist - while:

- maintaining 300mm separation from back of curbs & front of sidewalks (i.e. curb & sidewalk gronular base material extent); and
- not encroaching into curb & sidewalk granular base suitable subgrade supporting material (i.e. 1h:1v slope fram tae of granular bose material extent).

 2. Consultant must field review oil construction. Contractor to supply notice of construction to Consultant, a minimum of 72 hours prior to construction.
- 3. Prior to issuance of the certificate of completion, the owner's engineer shall submit a certificate of inspection for the works in a form and content acceptable to the City and prepared and sealed by the owner's engineer certifying to the City that the warks have been constructed and completed in accordance with the approved plans and specifications.

 4. Contractor to supply complete as-constructed survey information to Consultant, upon substantial completion of construction.

NW Pocket Park - 30.5 Sq m

- 5 Bike racks (10 bike parking)
- 2 Benches (colour: blue)
- 1 Drinking fountain



Picea omorika Serbian Spruce 4m Ht., B&B Prunus semulata 'Kwanzan' Kwanzan Flowering Cherry 8cm cal., B&B Erica carnea 'December Red' Gaultherio shollon Hydrangea serrata 'Blue Bird' Liriope mascora 'Big Blue' Mahonia repens Blue Bird Hydrangea #3 pat. 30" o.c. Lily Turf Creeping Oregon Grape Holly #2 pot, 12" o.c. #2 pot, 18" o.c. Prunus Iguroceros 'Otto Lyuken' Laurel Hedge #3 pot. 30" o.c. David's Viburnum #2 pot, #24" a.c

COMMON NAME

SIZE/COMMENT

SE Pocket Park - 20 Sq m

- 4 Bike racks (8 bike parking) (F4) - 2 Benches (colour: blue)
 - Feature Paving

(FI) (P3)

NEW P.L.

TATION



COOK ROAD RICHMOND, BC

Drawn by:	AG	
Checked by:	PK	
Date:	MAR 2020	
Scale:	1:200	

LANDSCAPE POCKET PARKS PLAN

Project No.: 19073

Drawing Title:

Sheet No.:

L-1.02

SW Pocket Park - 111.6 Sq m


- Existing Trees and Lawn to be Retained - 2 Benches (colour: red) - Irrigation to be provided and connected from the site.


Central Pocket Park - 170 Sq m


- 7 Bike racks (14 bike parking) - 3 Bench (colour: green)
- Feature Paving
- Mixed Coniferous Trees and Deciduous Trees - Native Plants
- Irrigation to be provided and connected from the site


PIMLICO WAY


DP 23-014121 **PLAN #44**

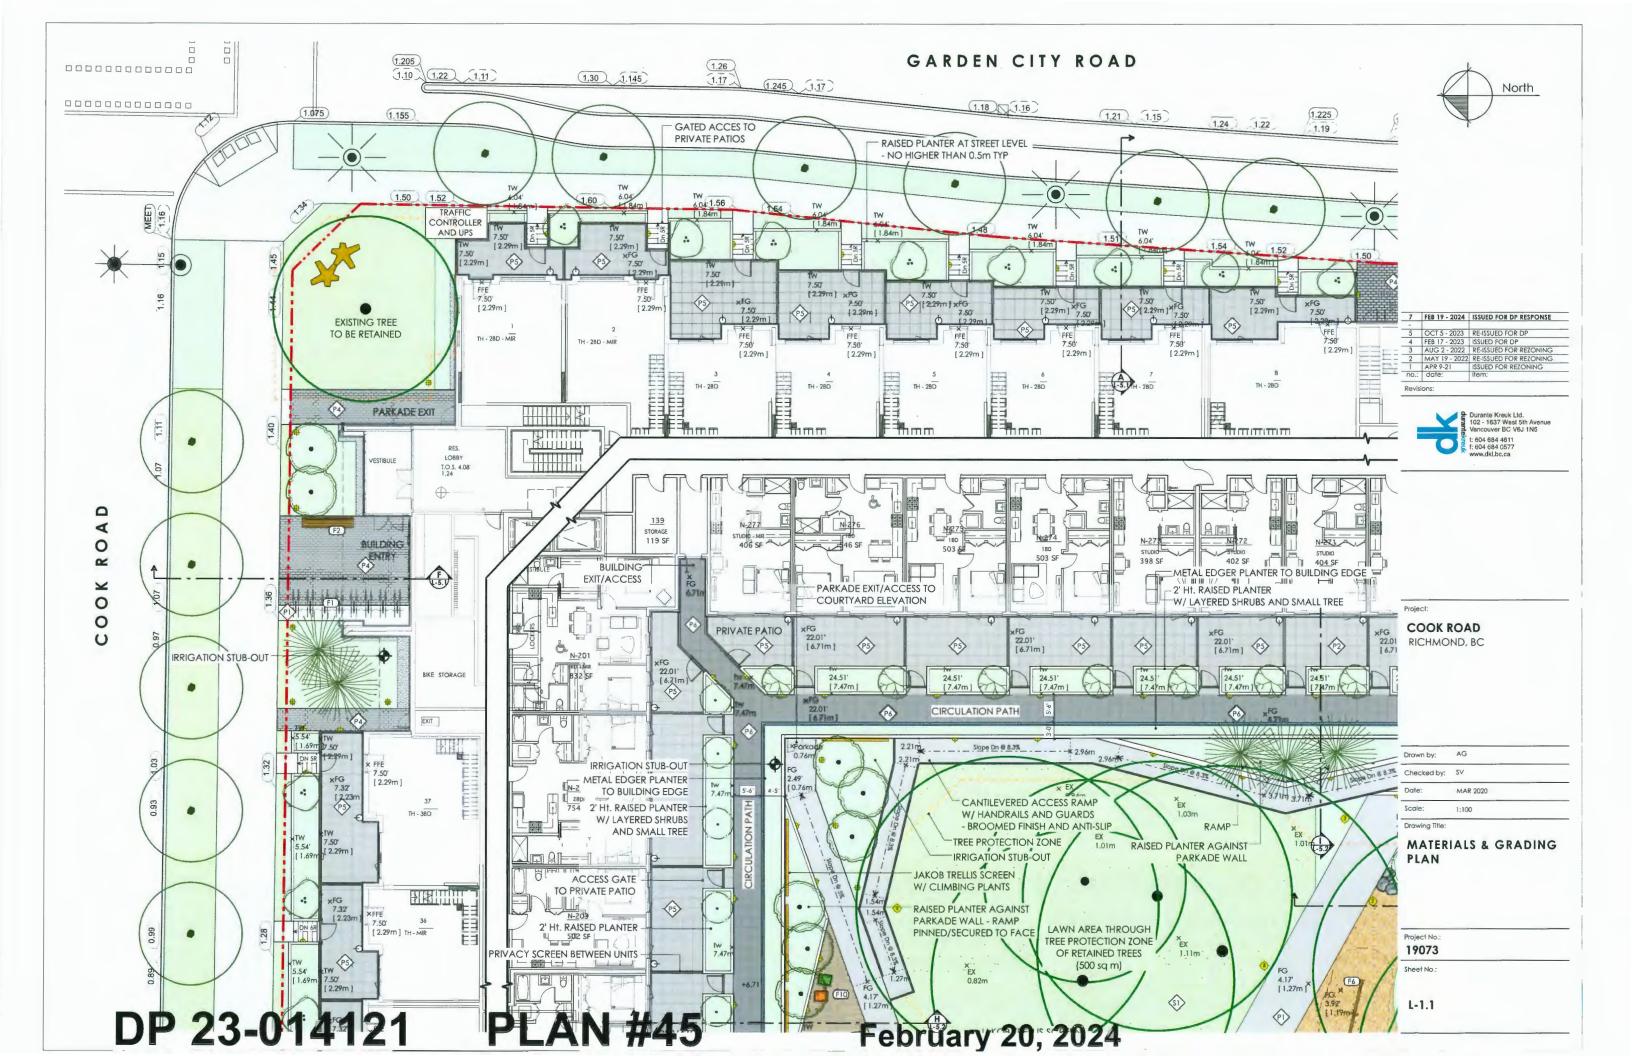

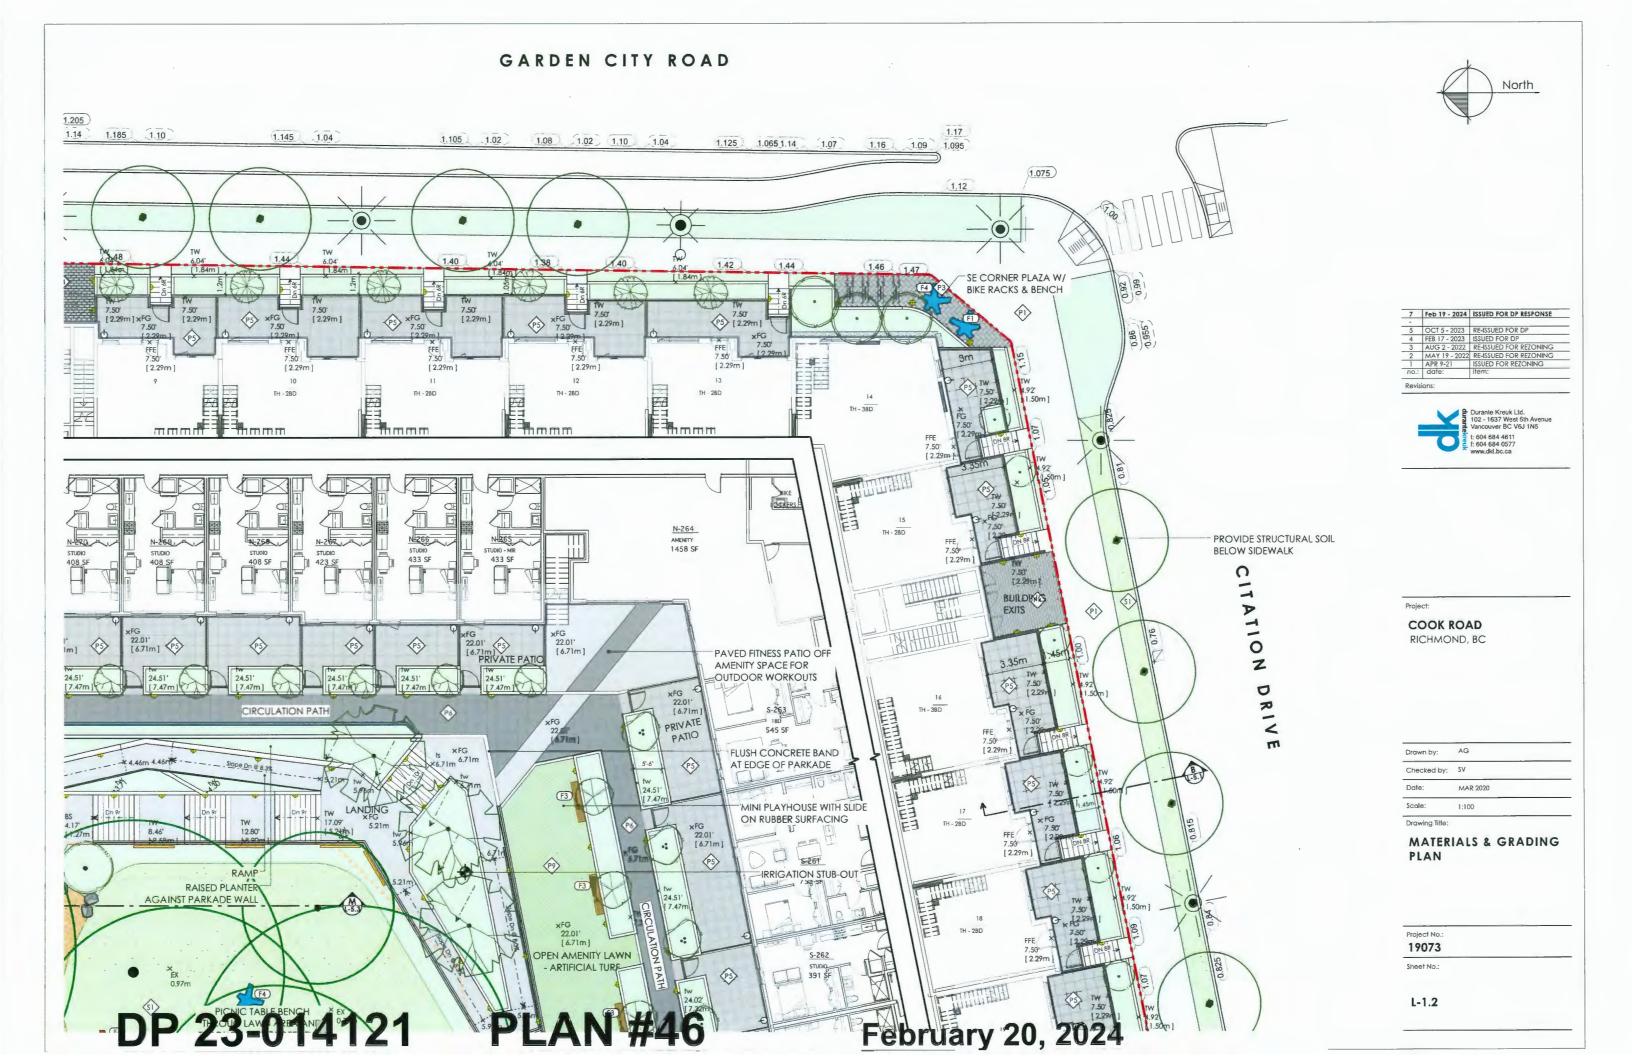


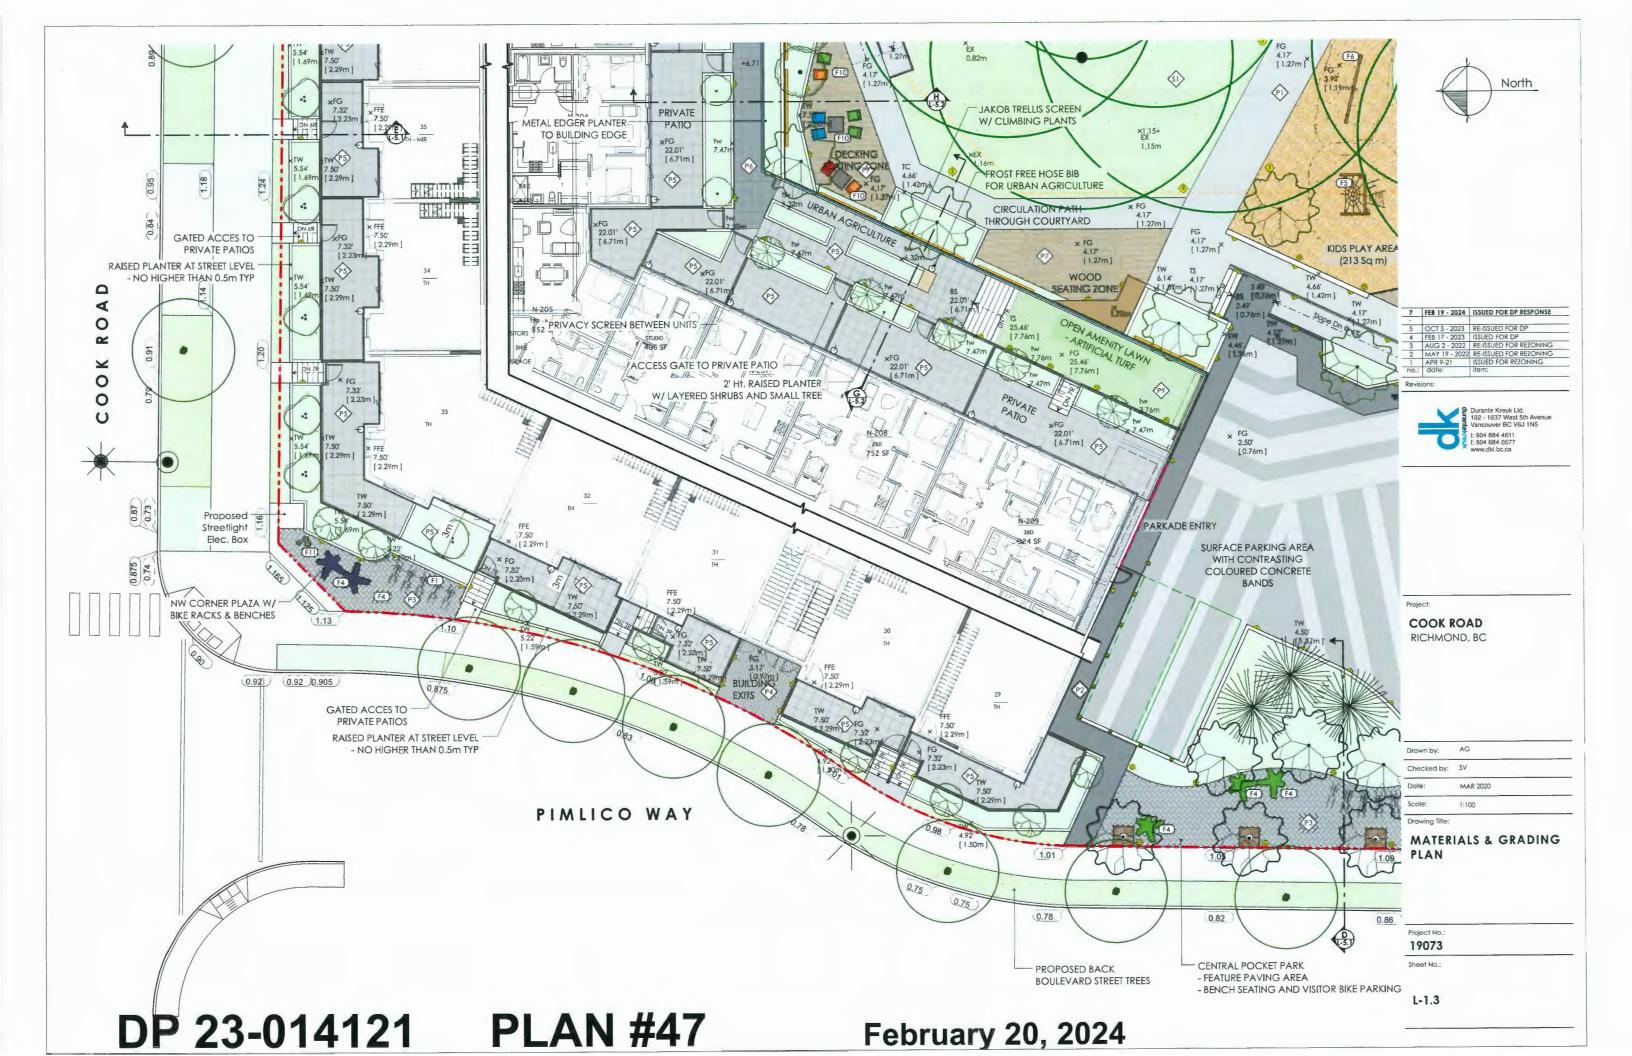

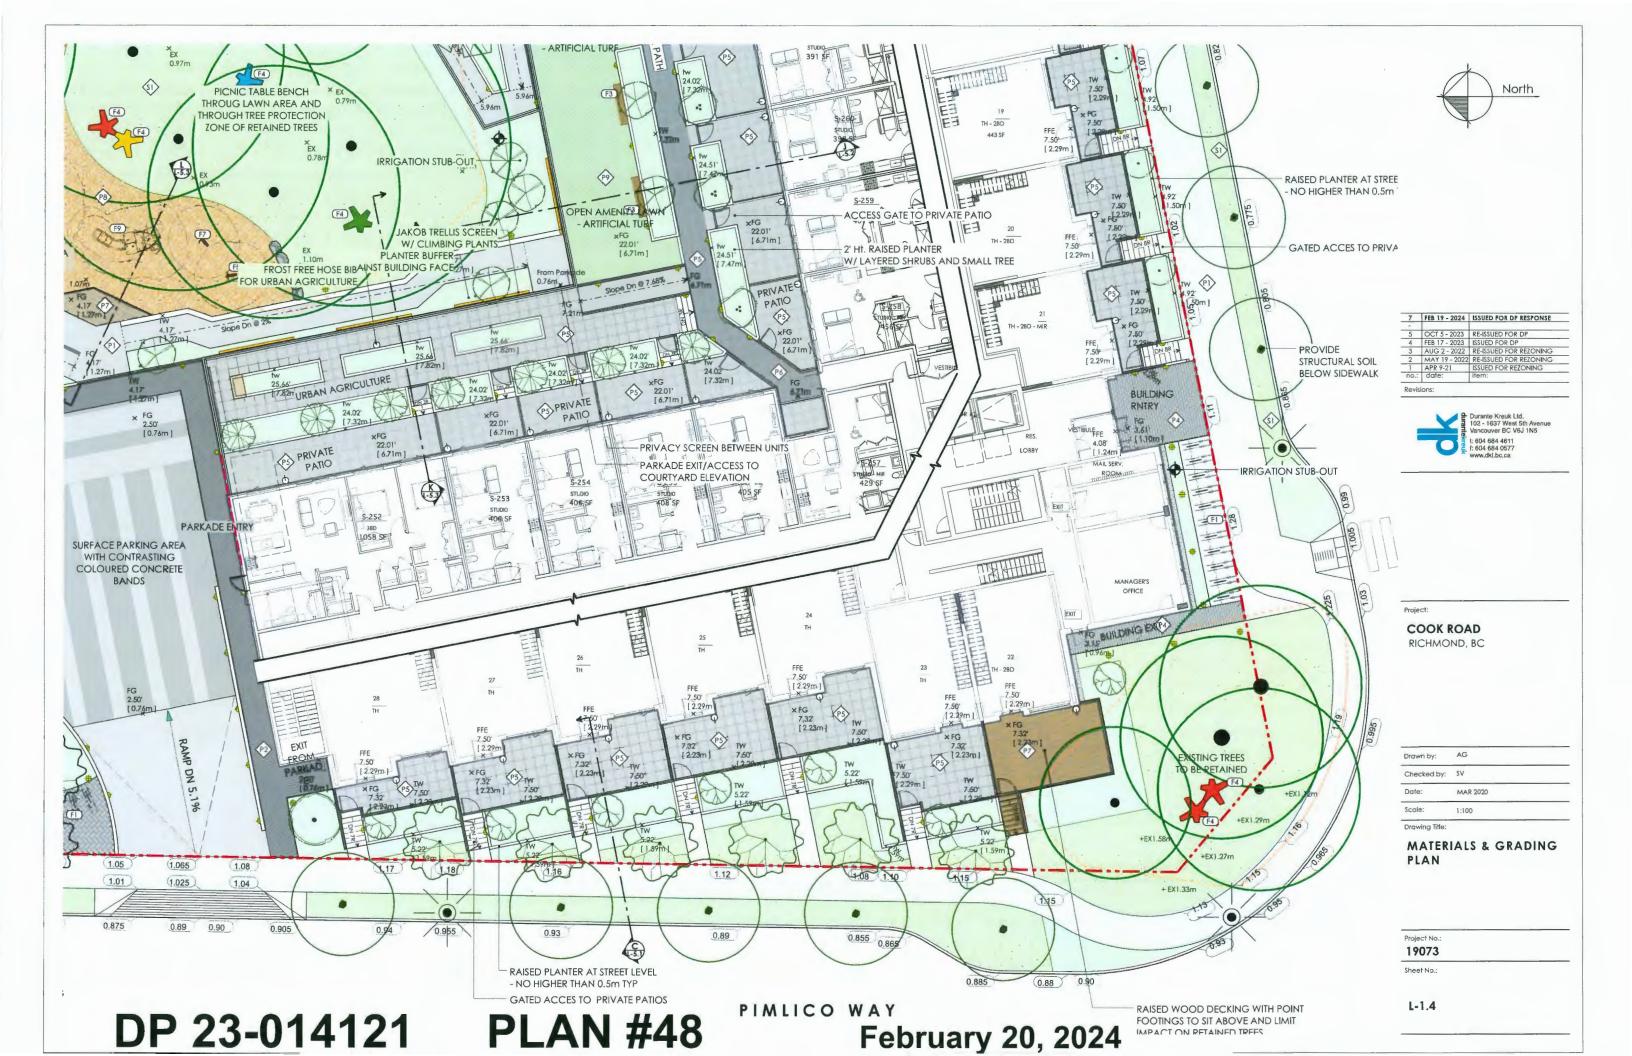

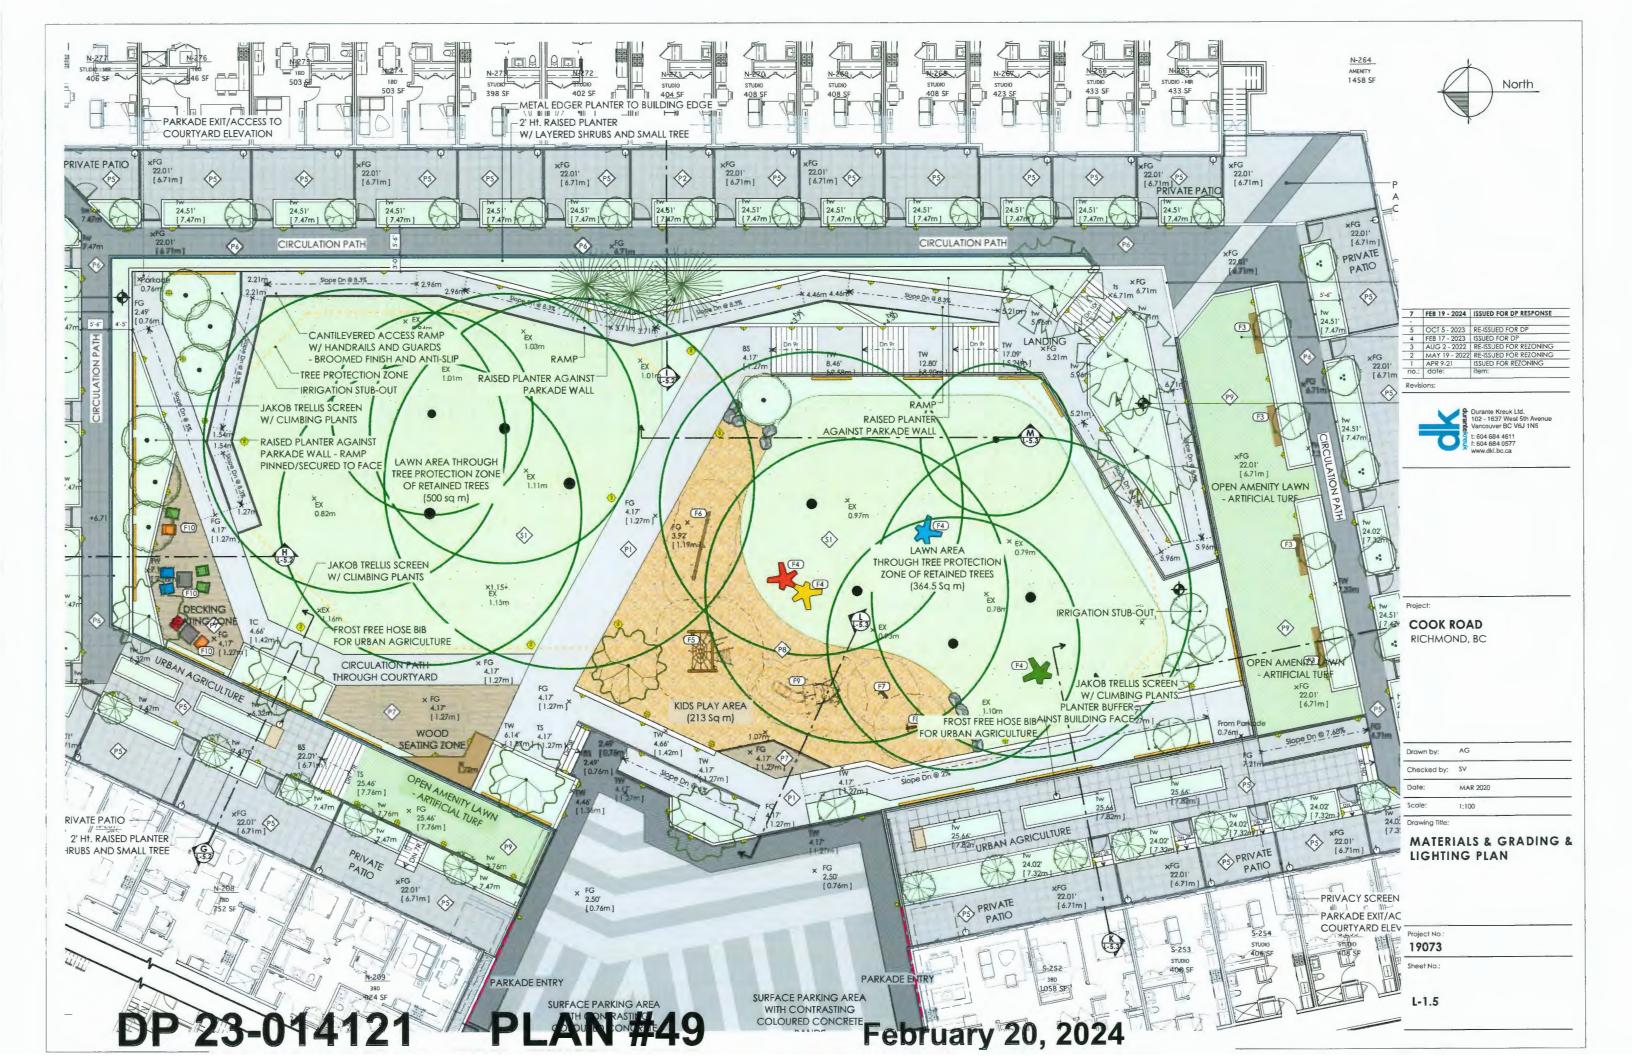



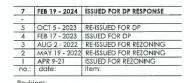



COOK ROAD RICHMOND, BC

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Checked by:	PK	
Date:	AUG 2023	
Scale:	1:100	


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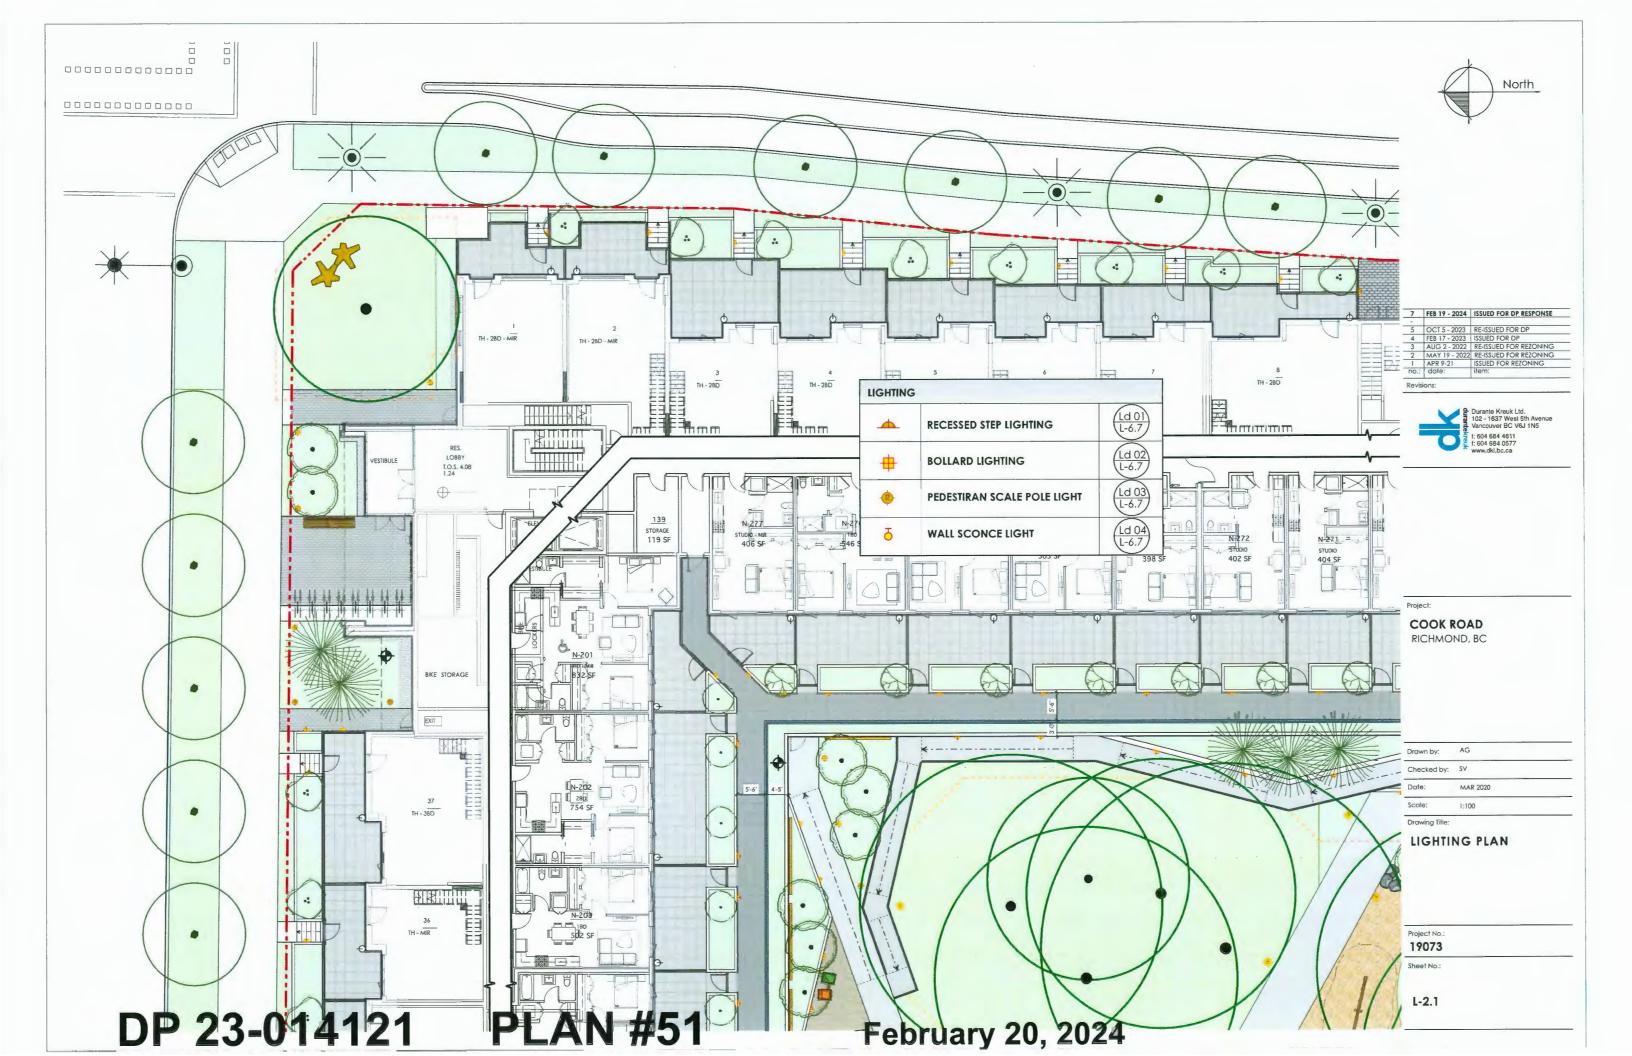
LANDSCAPE -LEVEL 3 AMENITY DECK

Project No.: 19073


L-1.6


Sheet No.:



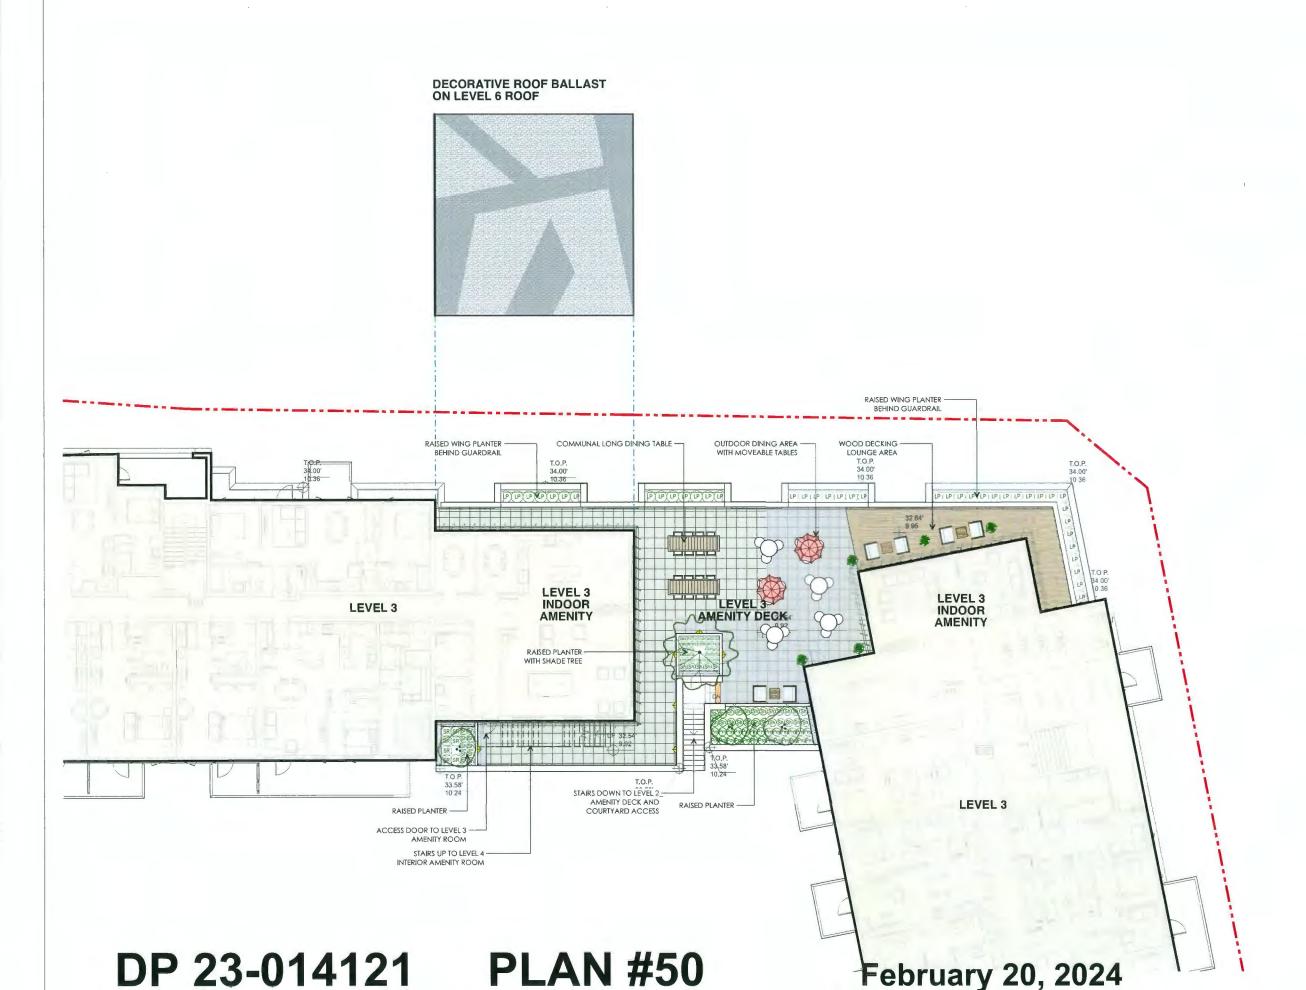





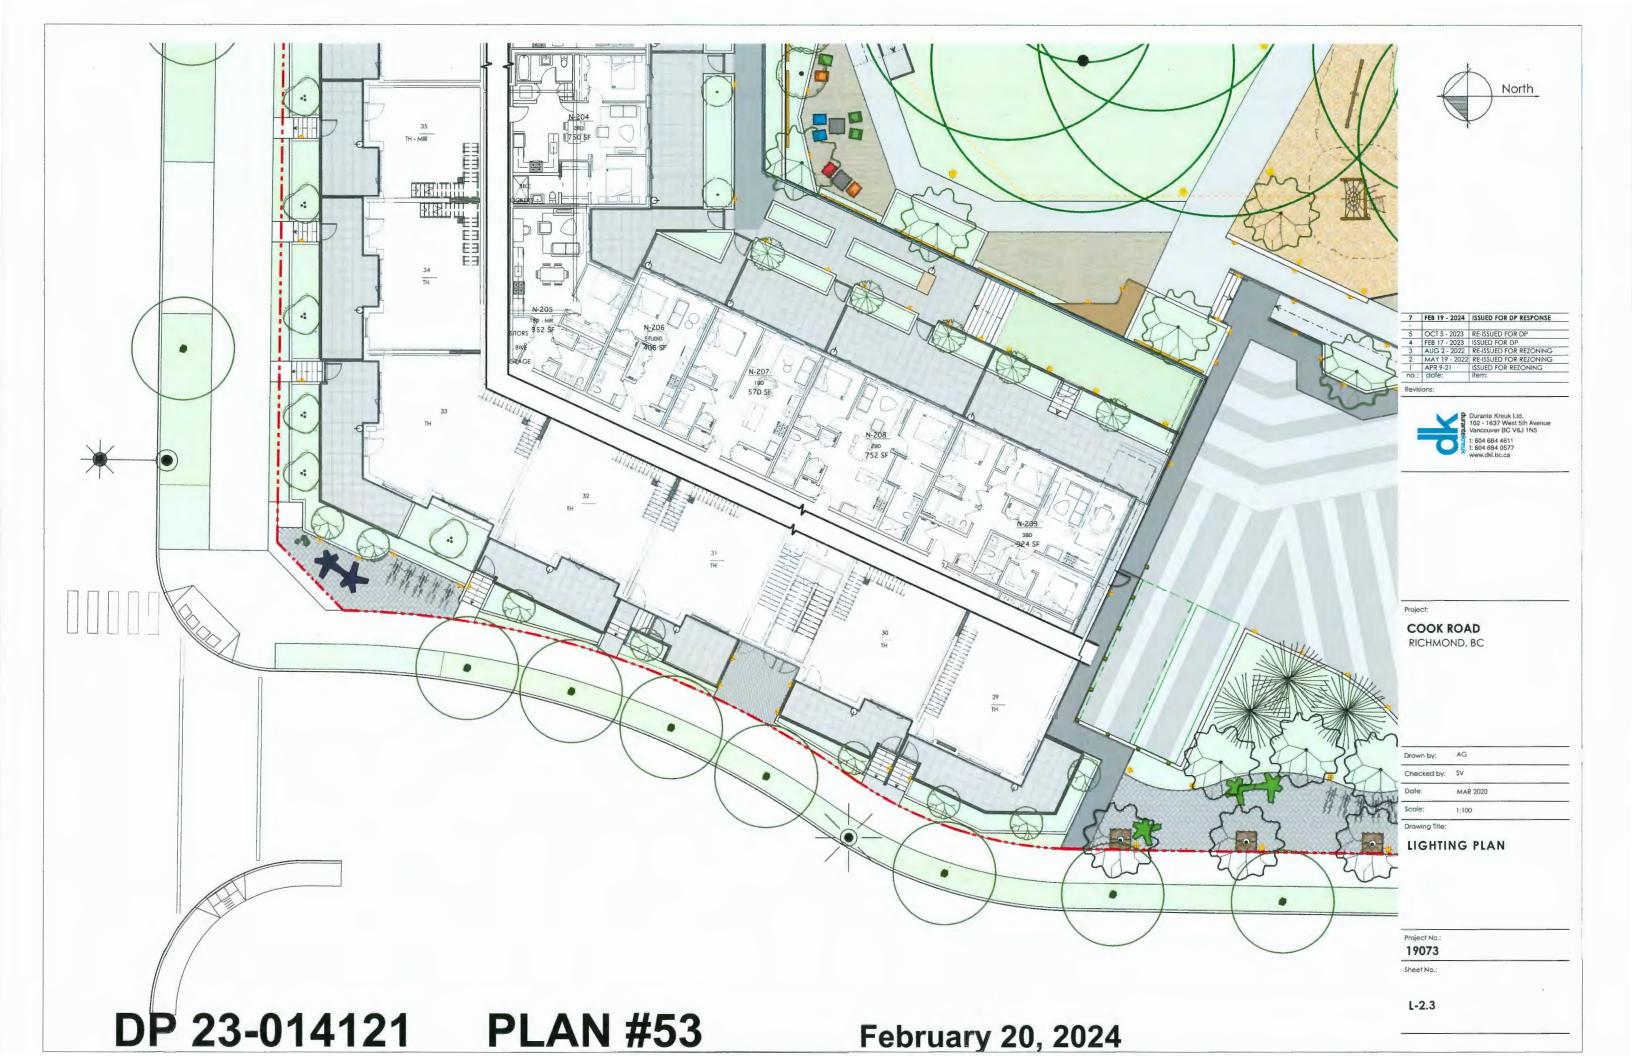

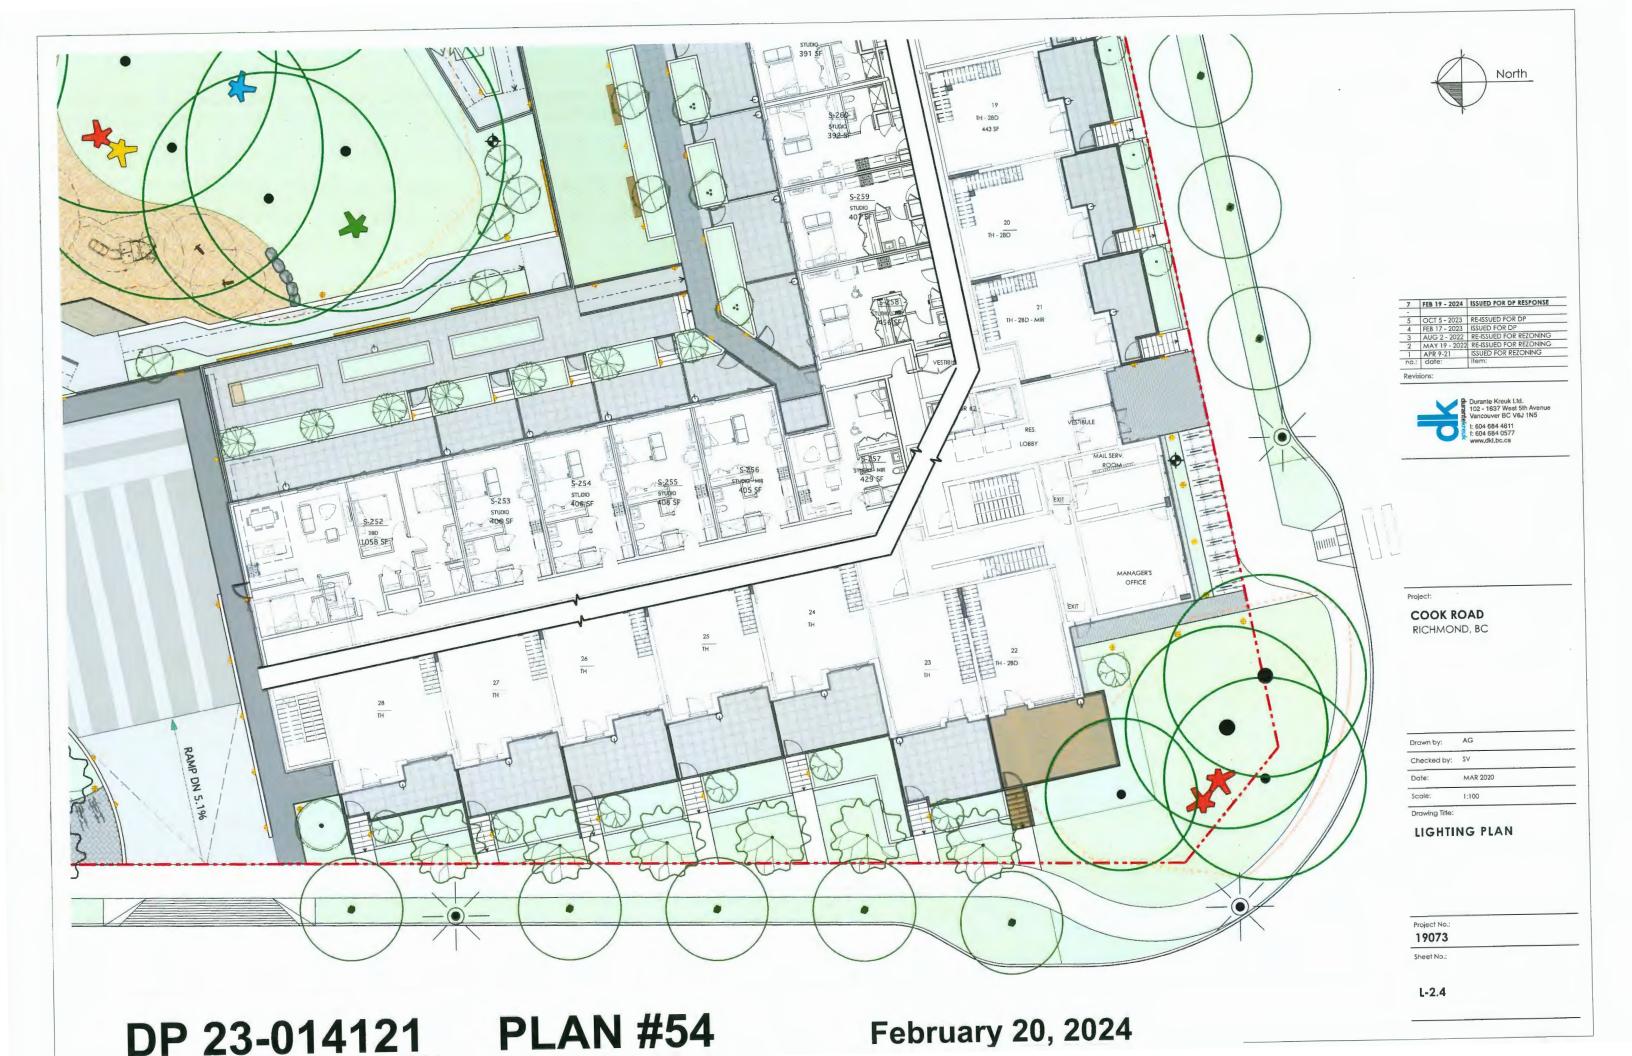



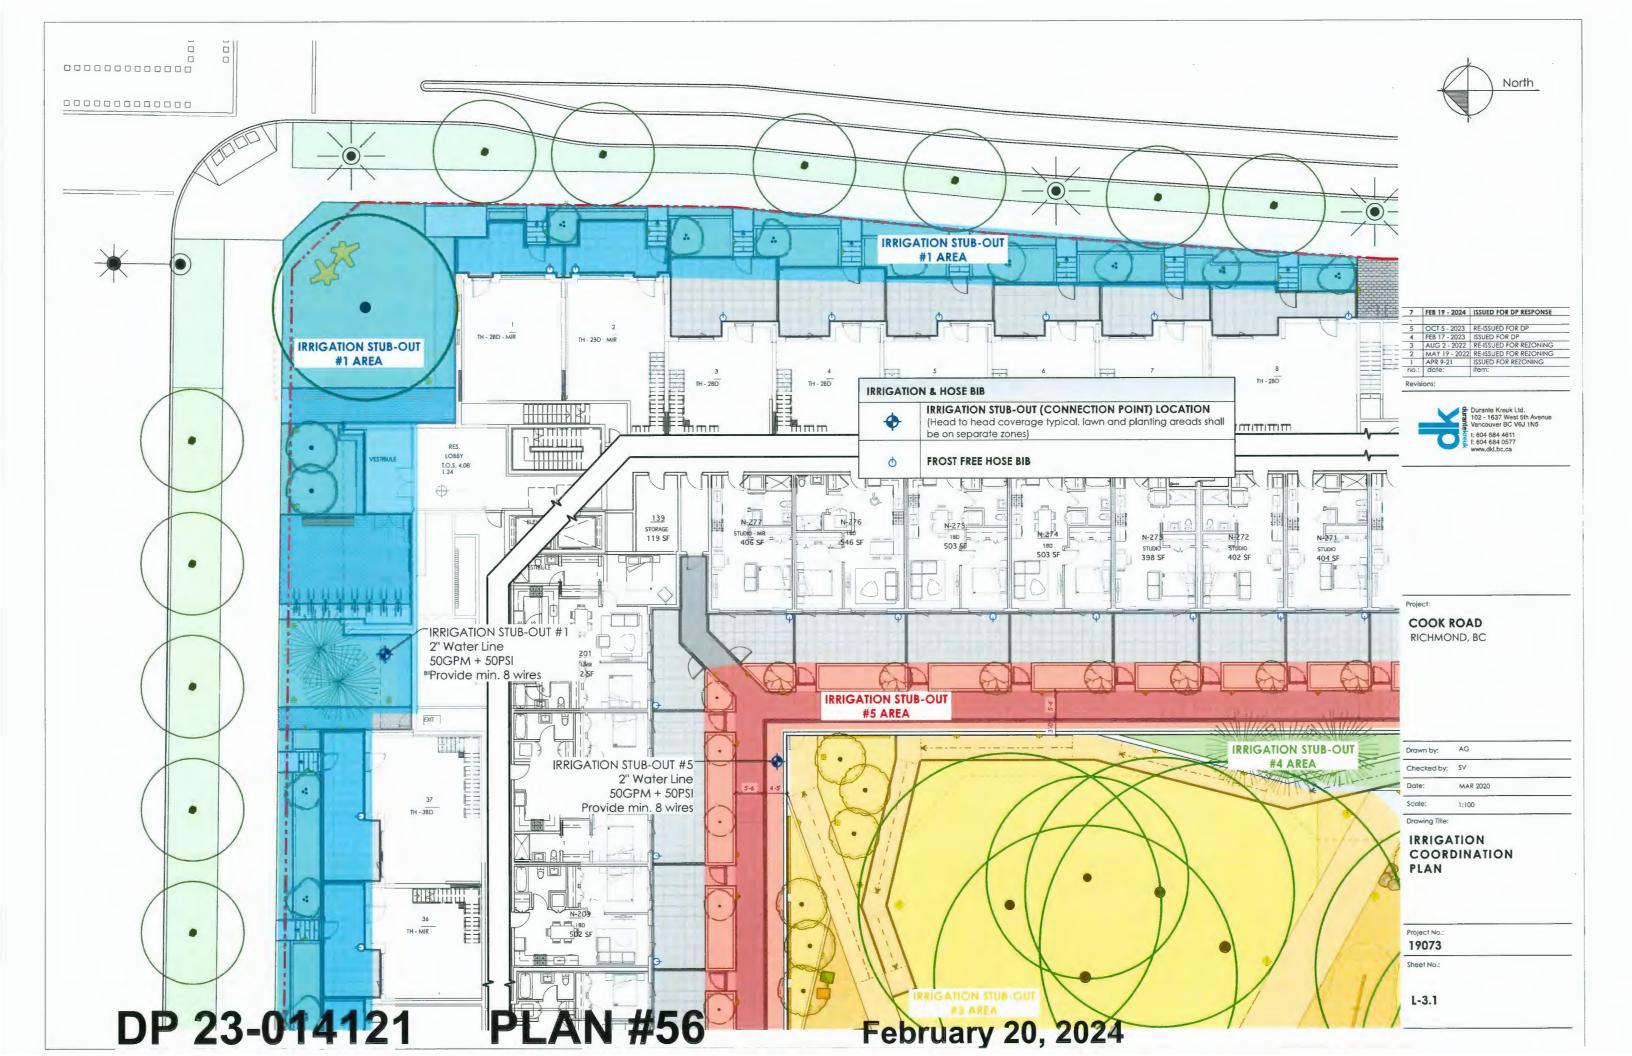

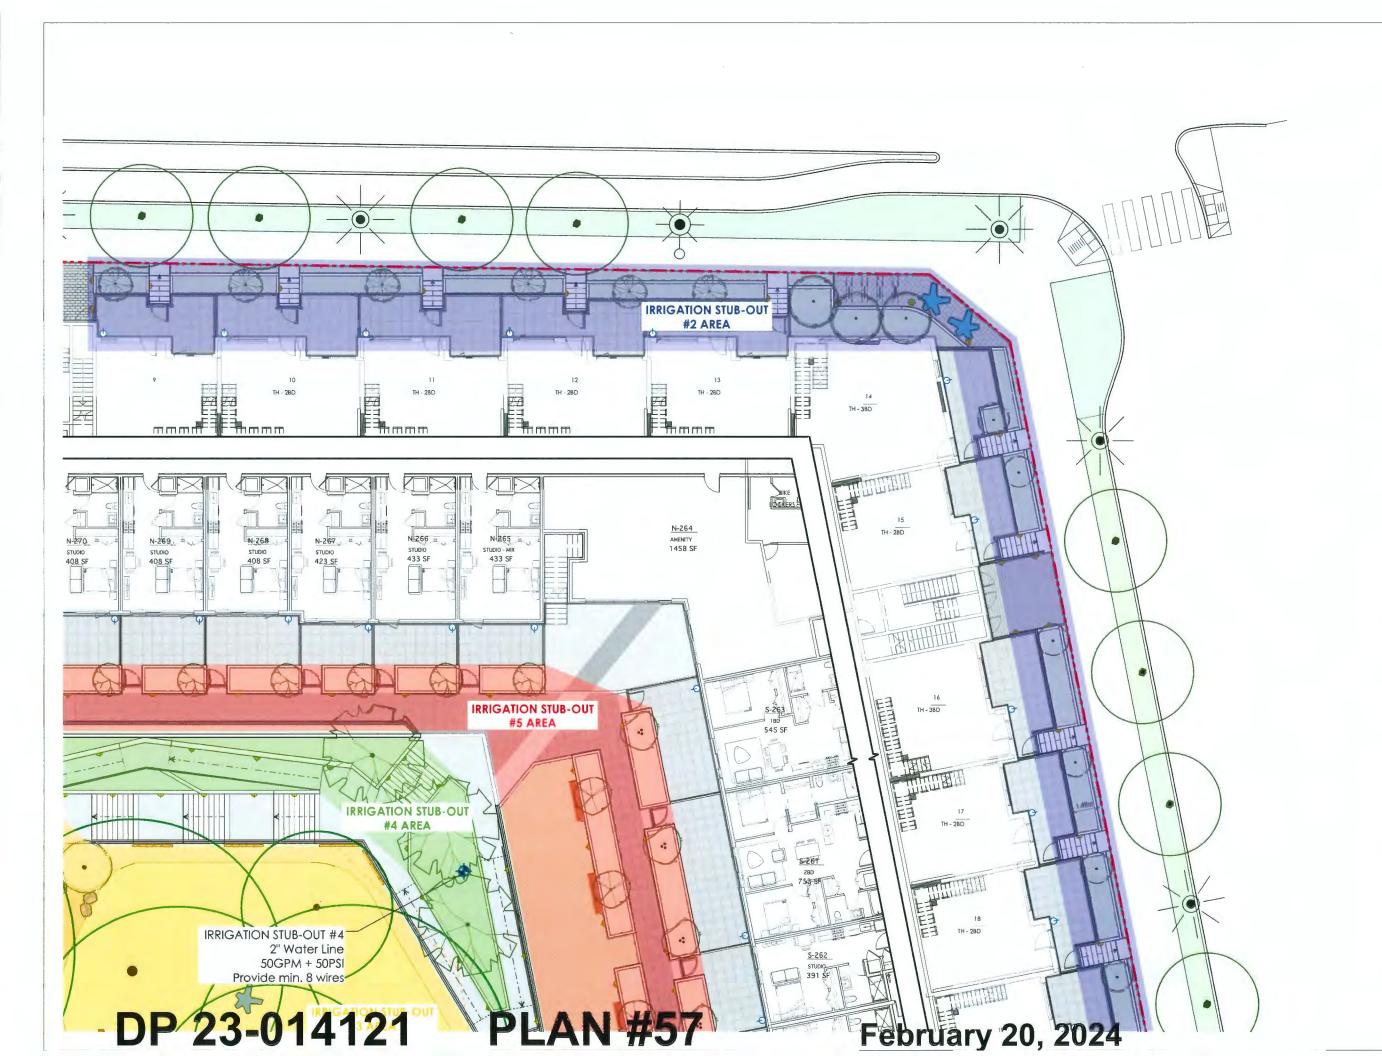



7	FEB 19 - 2024	ISSUED FOR DP RESPONSE
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2	MAY 19 - 2022	RE-ISSUED FOR REZONING
1	APR 9-21	ISSUED FOR REZONING
no.:	date:	item:

Durante Kreuk Ltd.

102 - 1637 West 5th Avenue
tvancouver BC V6J 1N5

1: 604 684 4811
1: 604 684 0877
www.kli.bc.ca

Project:

COOK ROAD RICHMOND, BC

Drawn by:	AG	
Checked by:	SV	
Date:	MAR 2020	
Scale:	1:100	


IRRIGATION COORDINATION PLAN


Project No.: 19073


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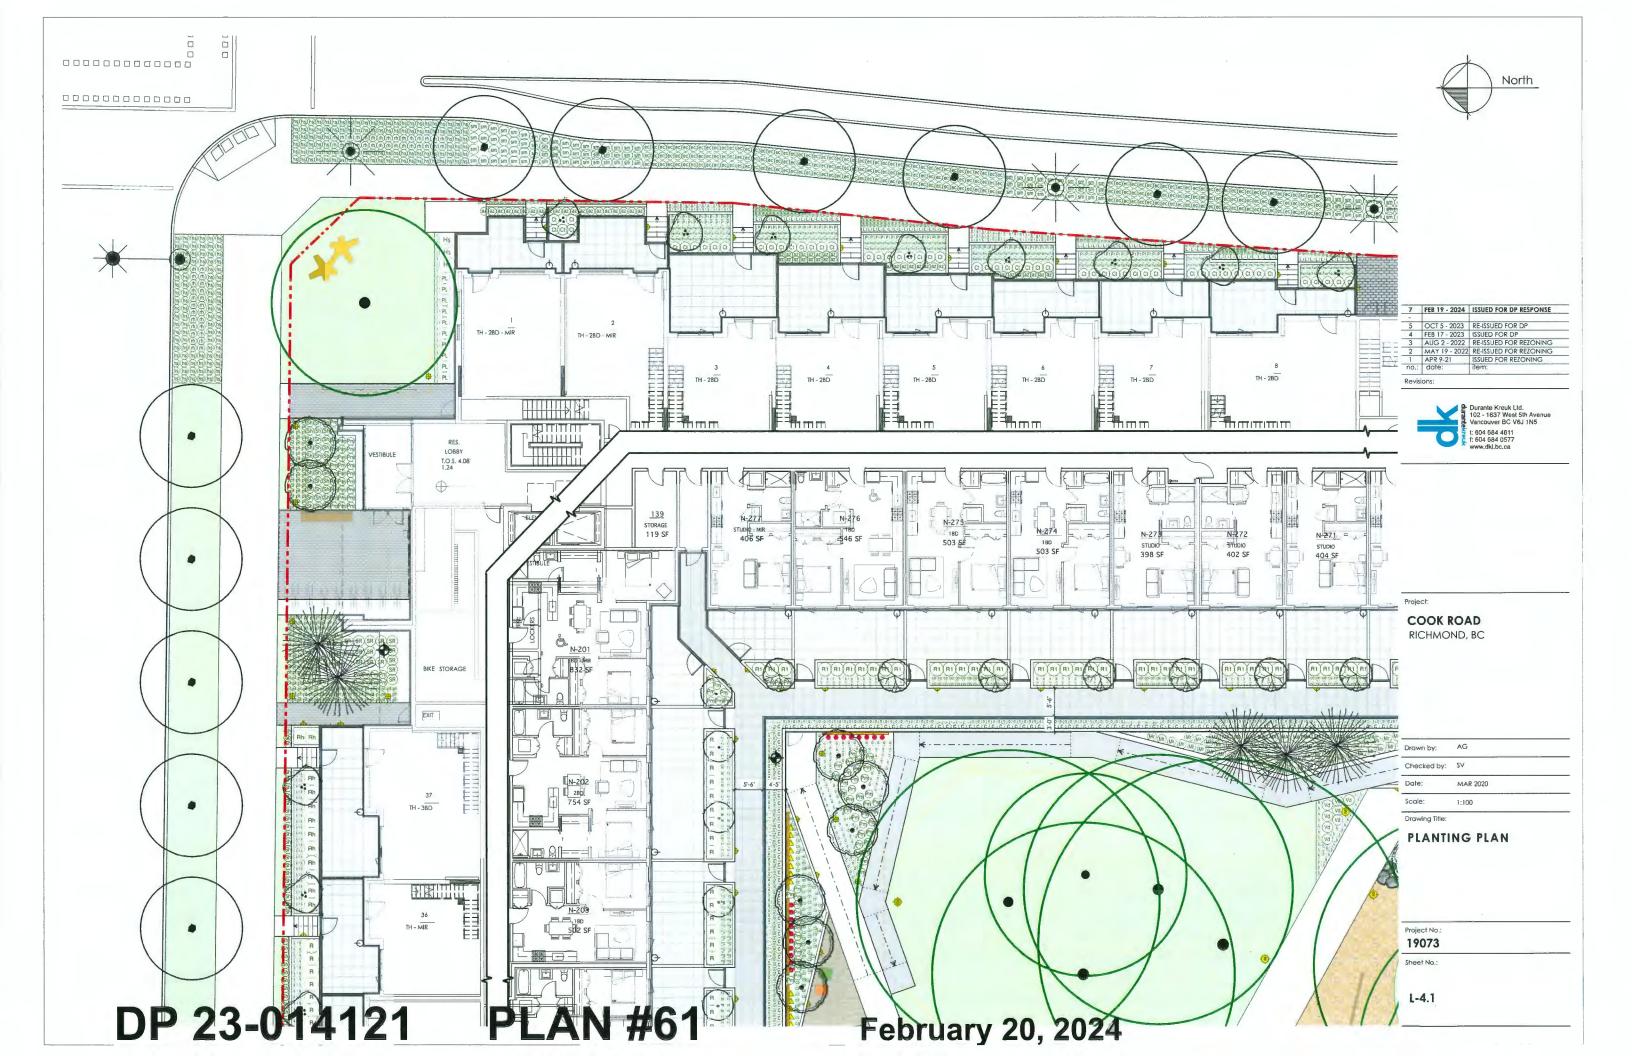
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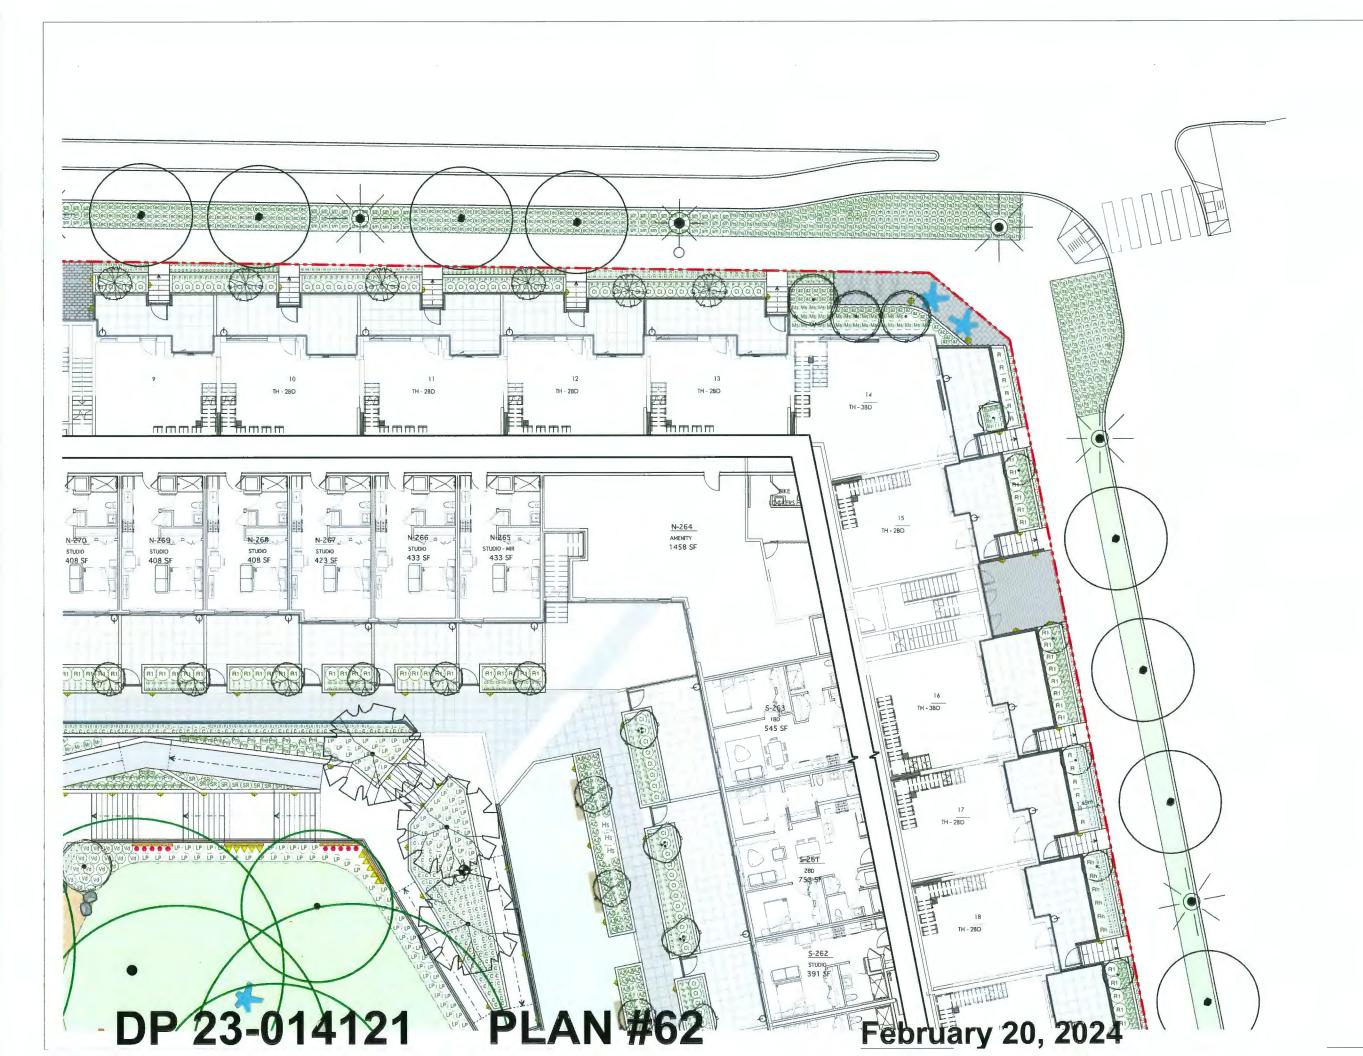
L-3.2





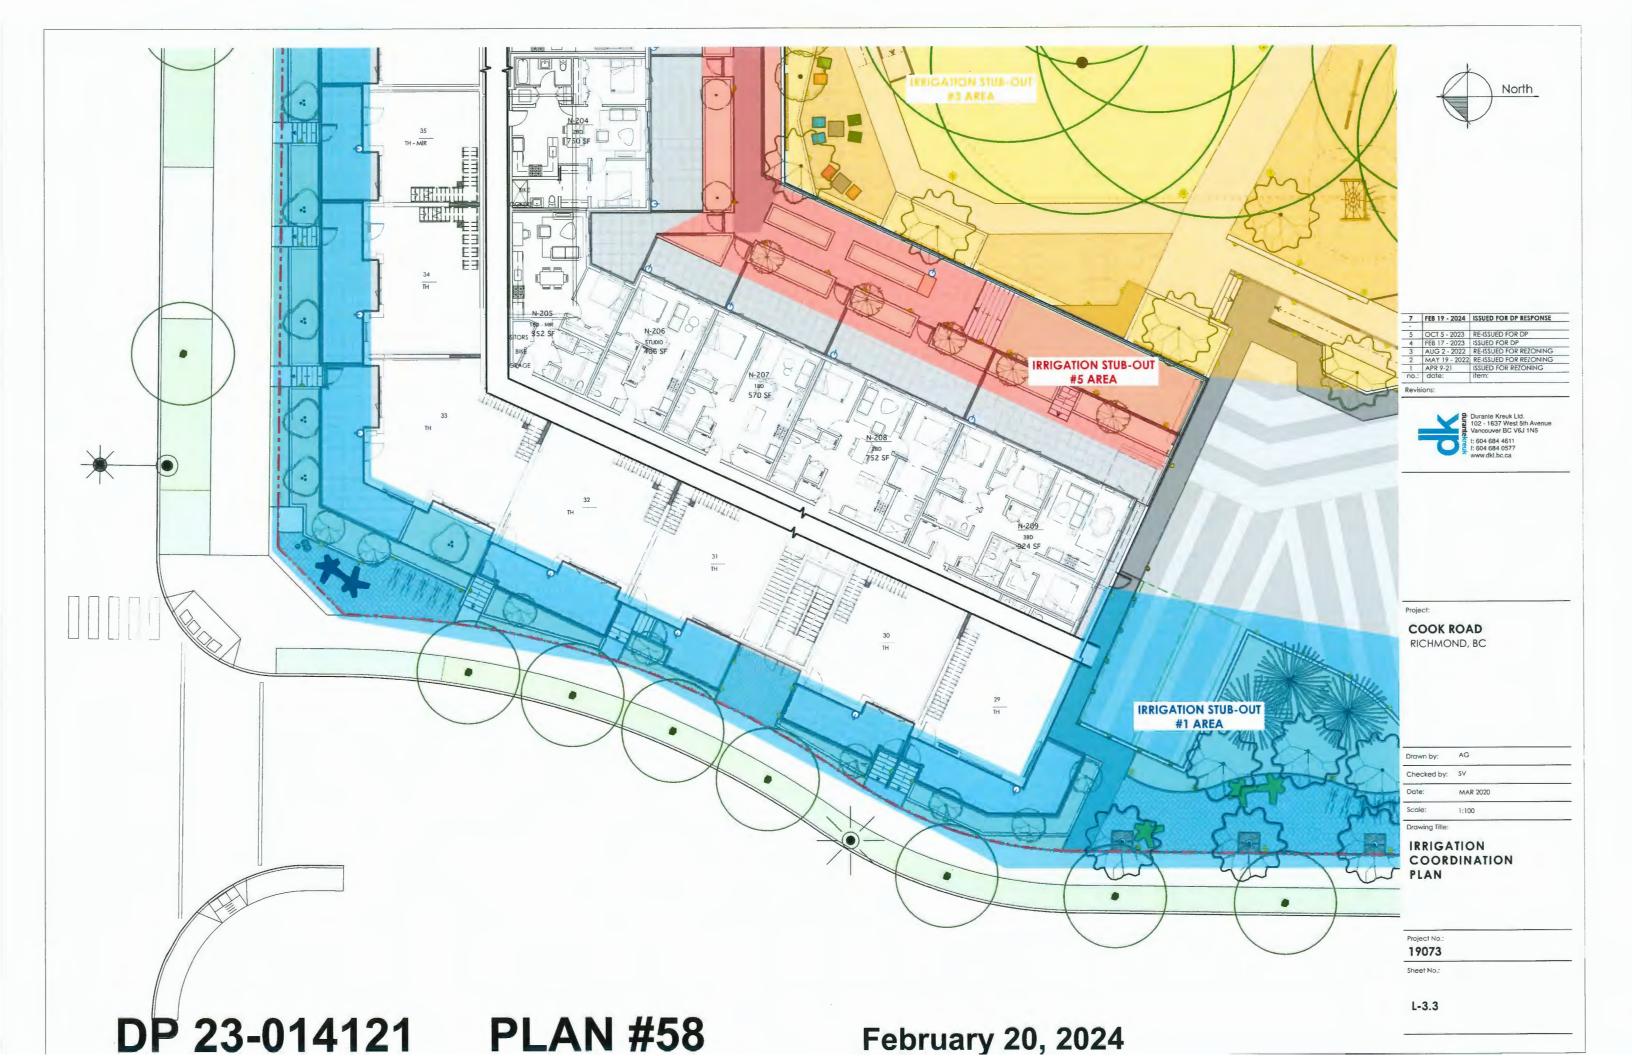

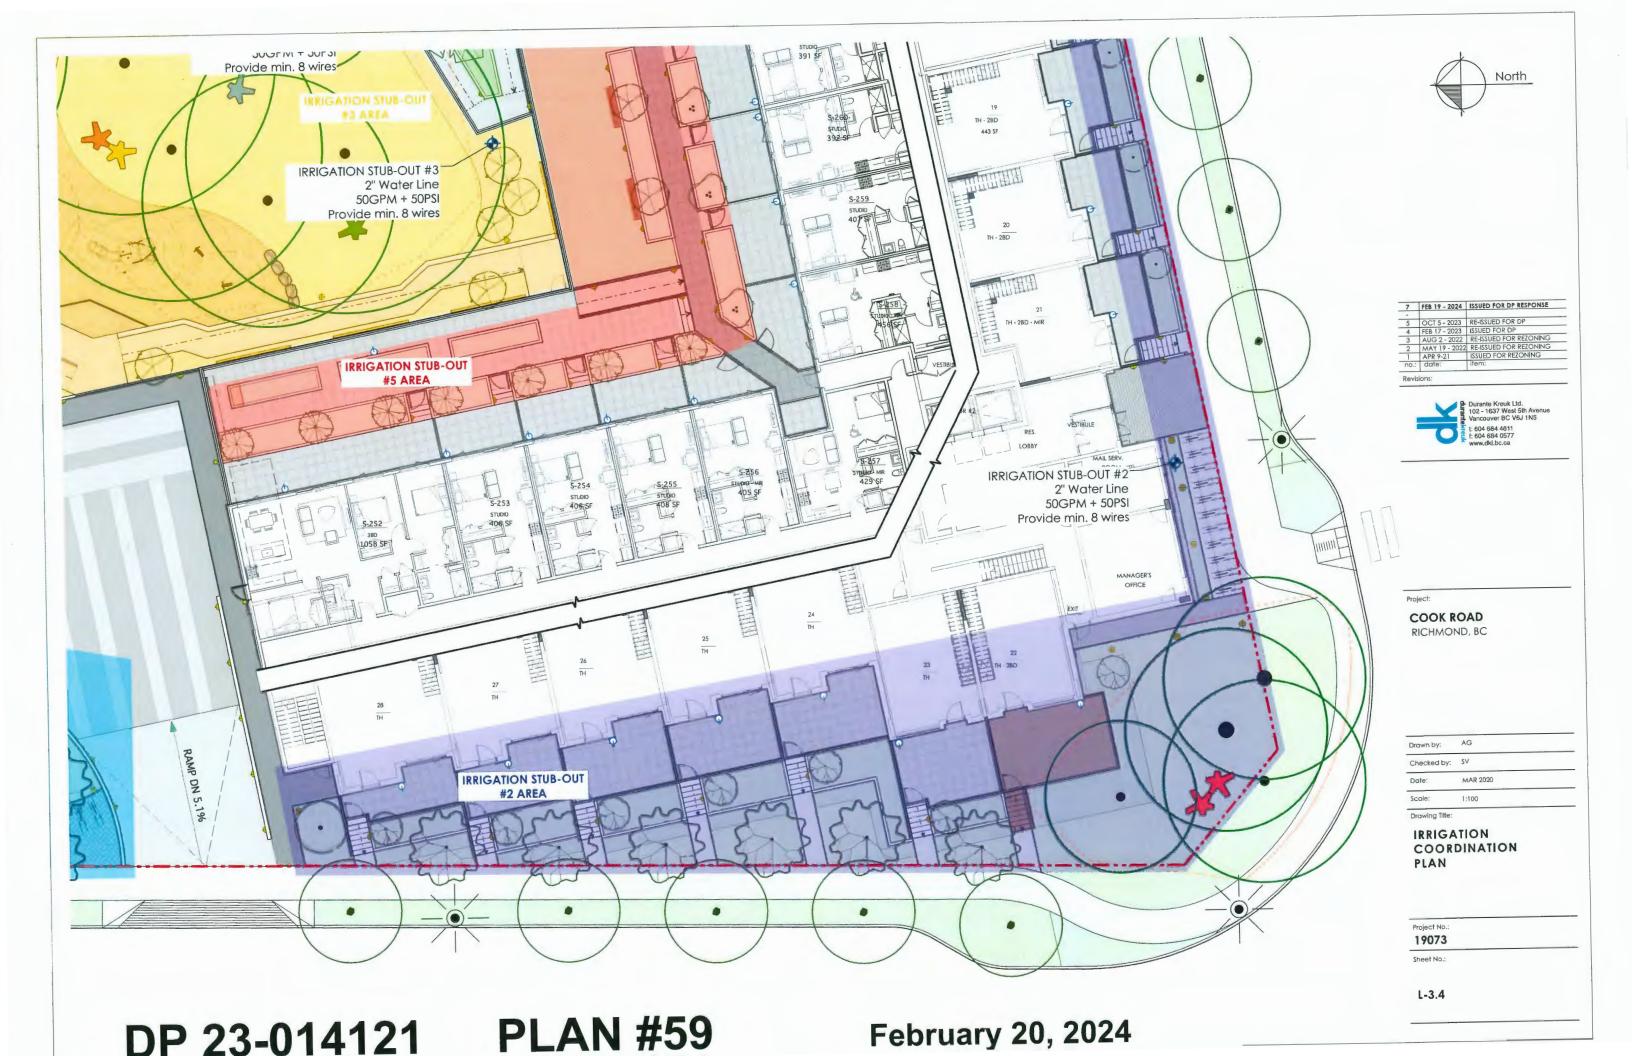

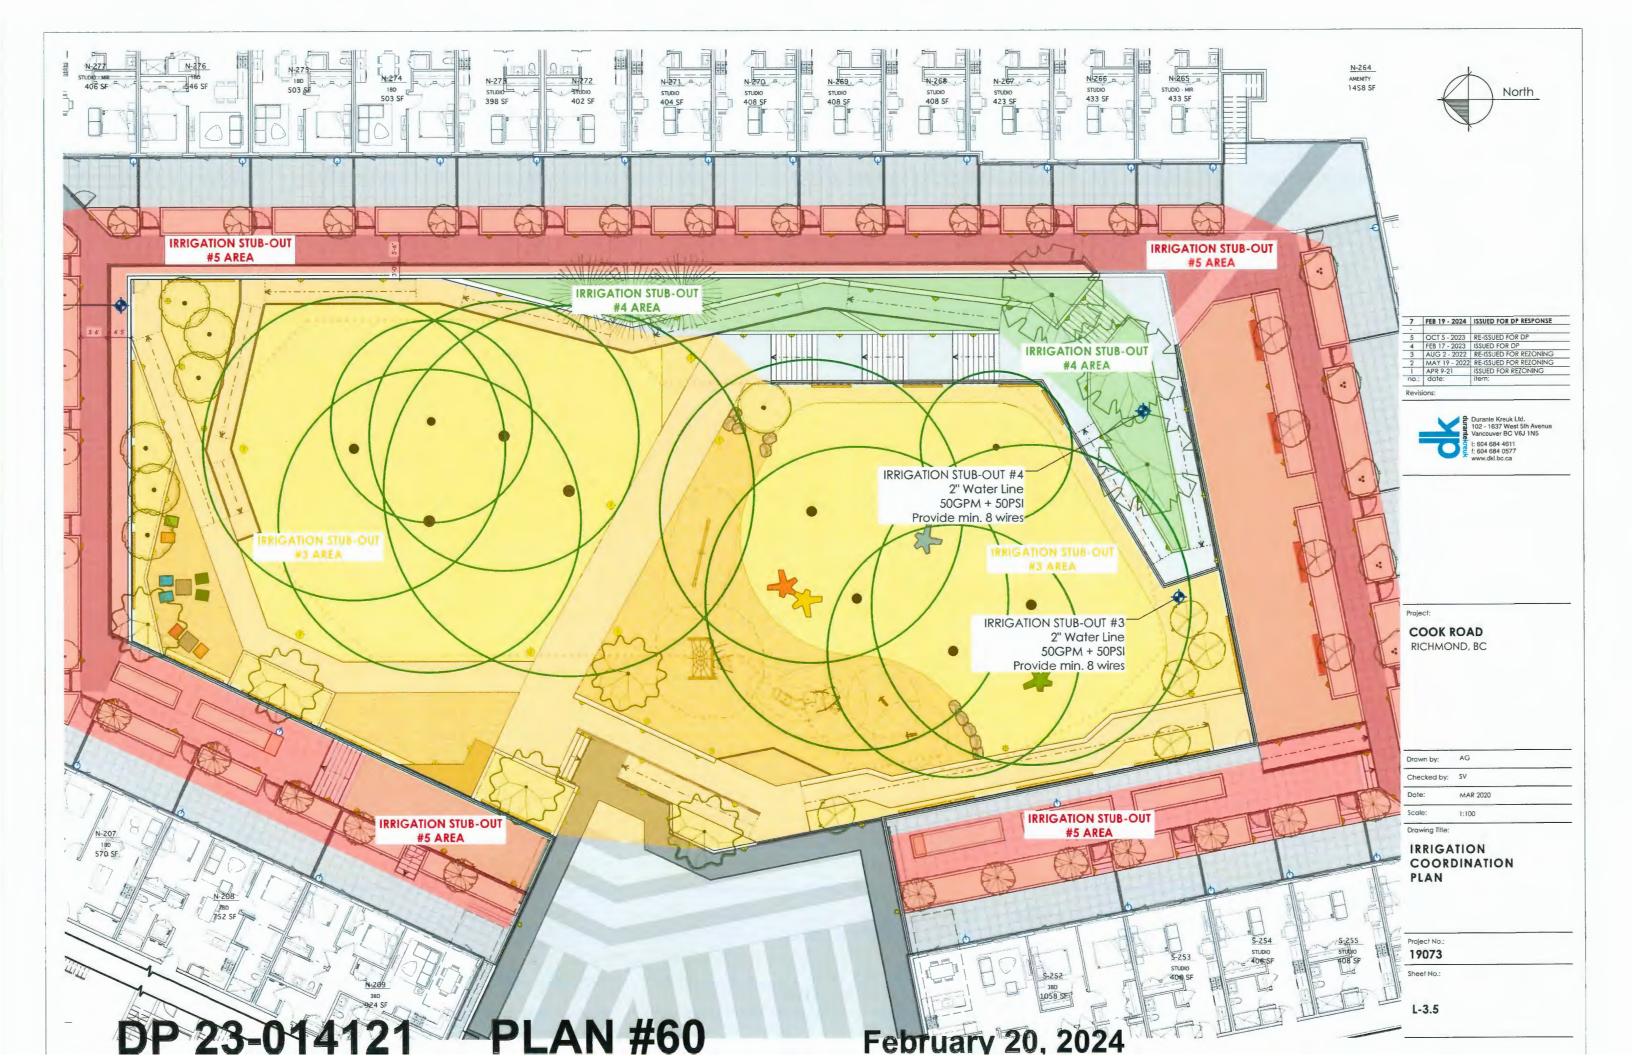



7	FEB 19 - 2024	ISSUED FOR DP RESPONSE
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no.:	date:	item:




COOK ROAD RICHMOND, BC


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Checked by:	SV	
Date:	MAR 2020	
Scale:	1:100	
Drawing Title:		


PLANTING PLAN


Project No.: 19073


L-4.2

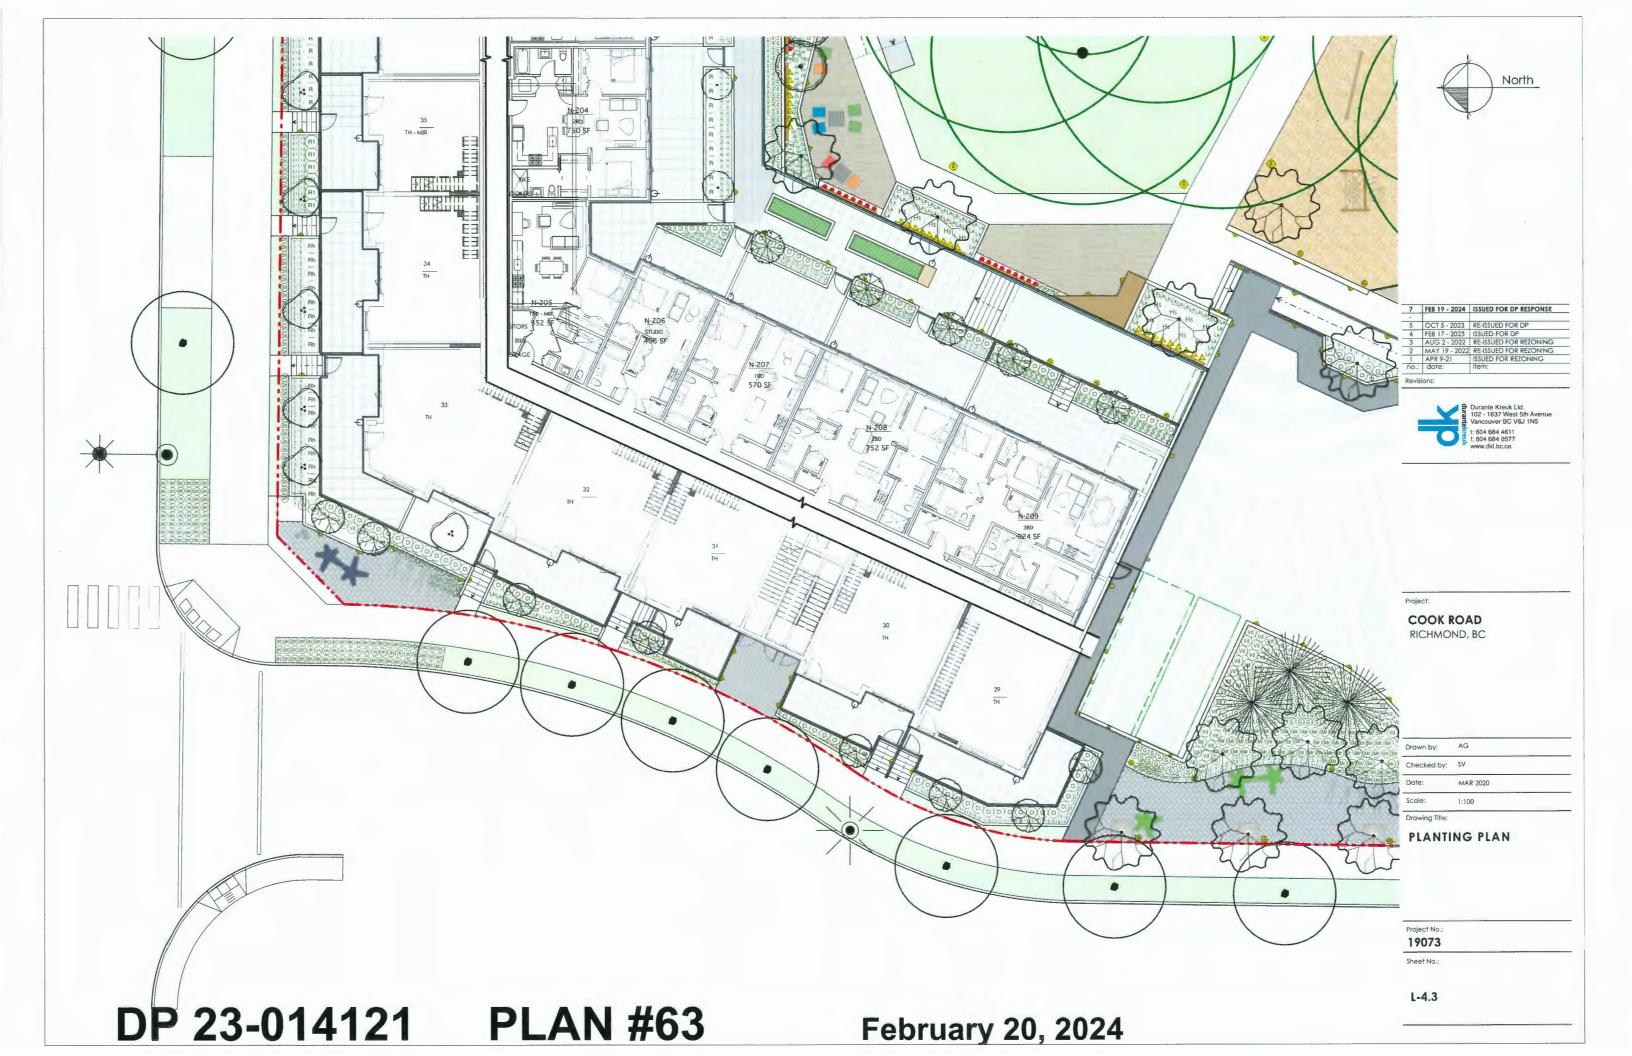


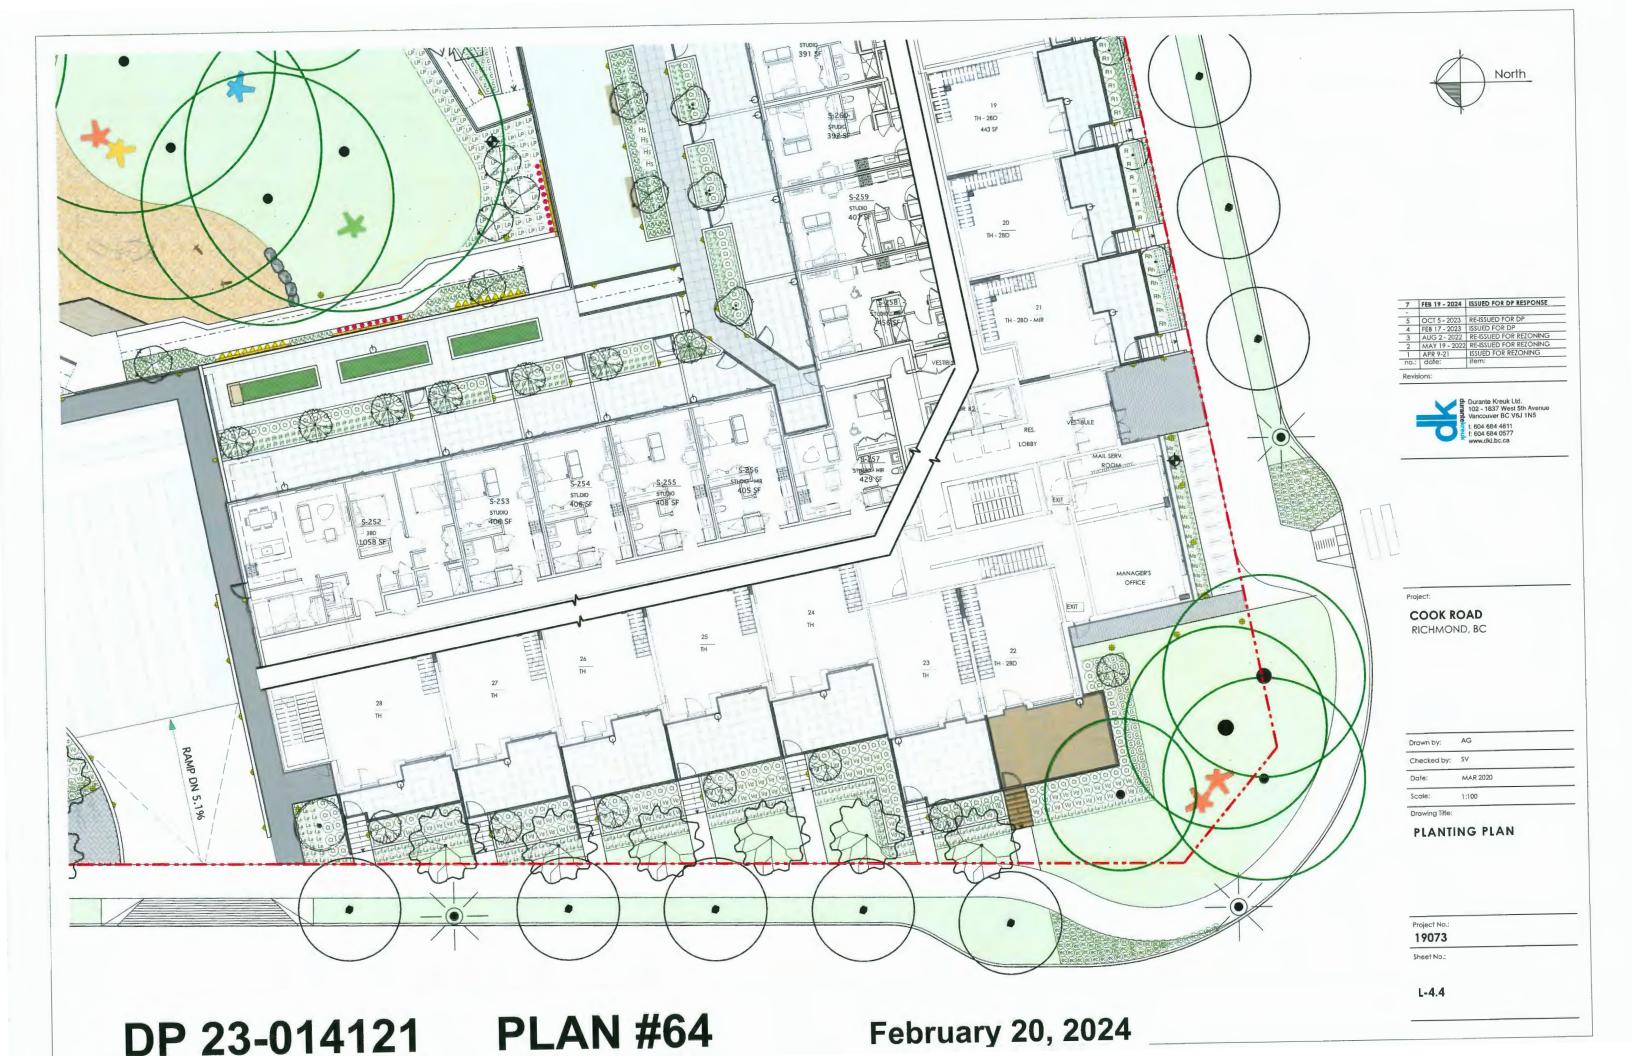


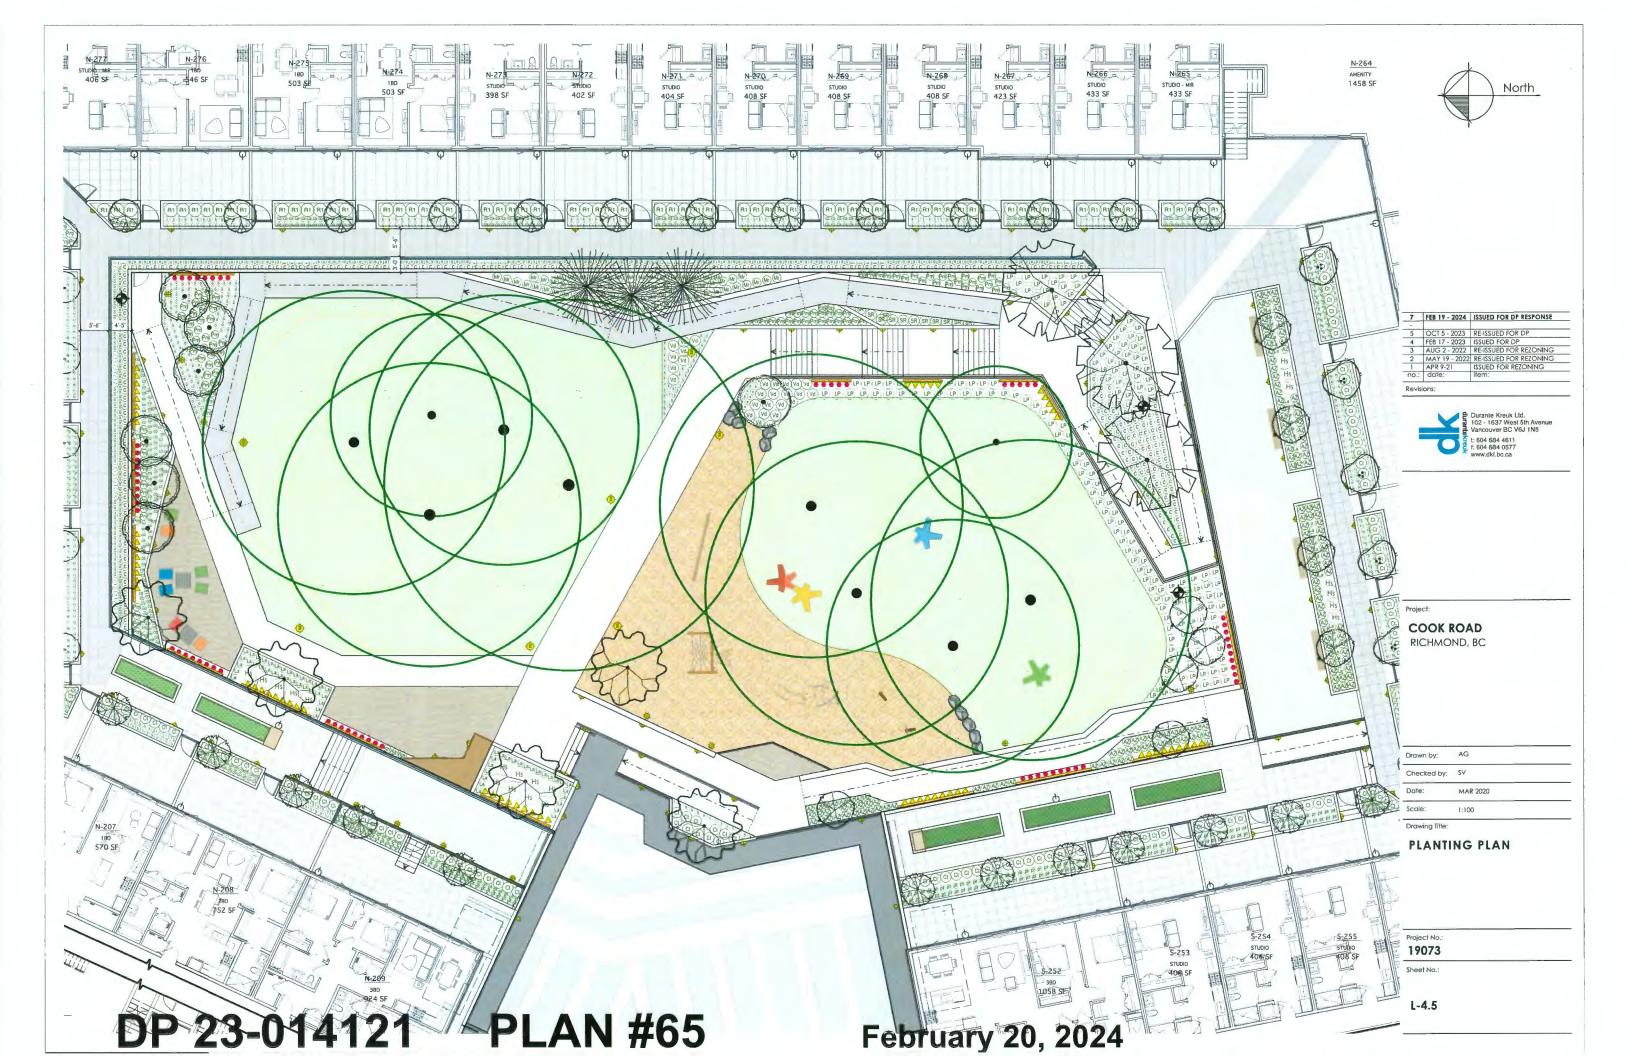


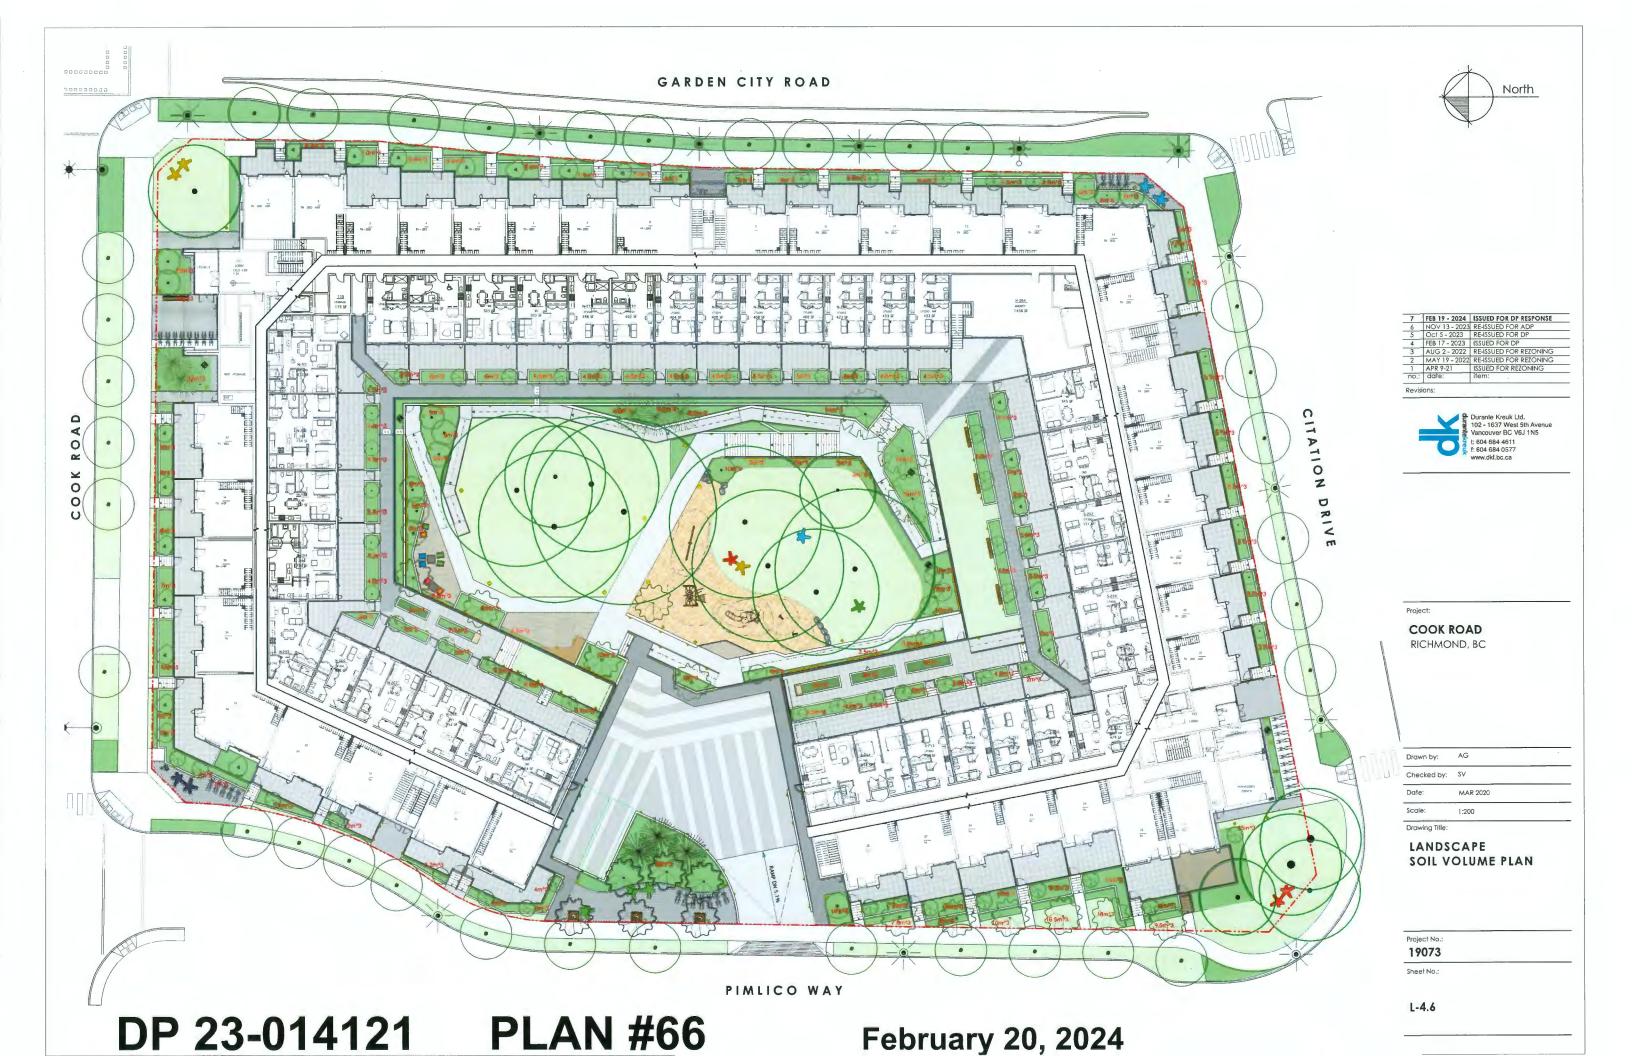

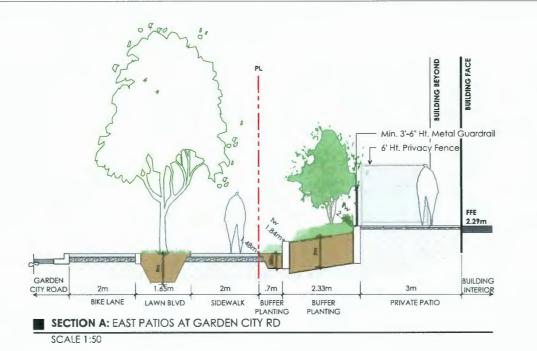

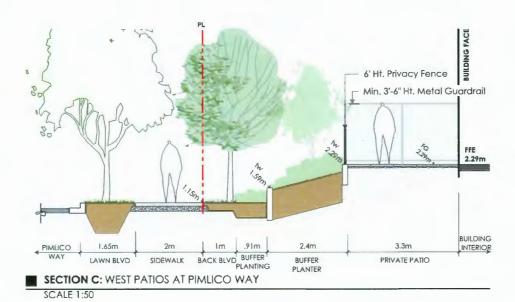


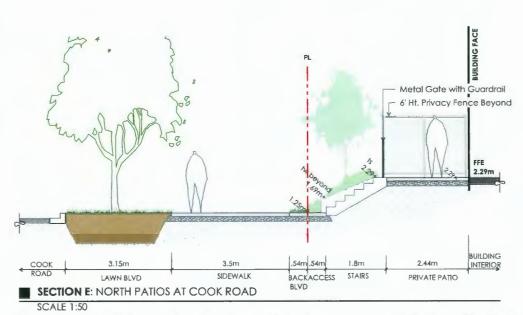


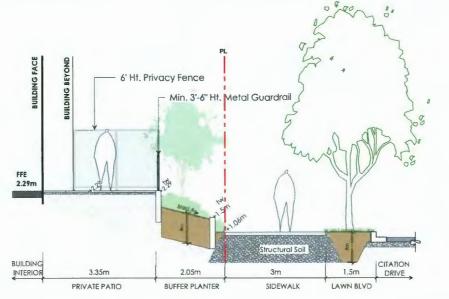

SECTION B: SOUTH PATIOS AT CITATION DRIVE

SCALE 1:50

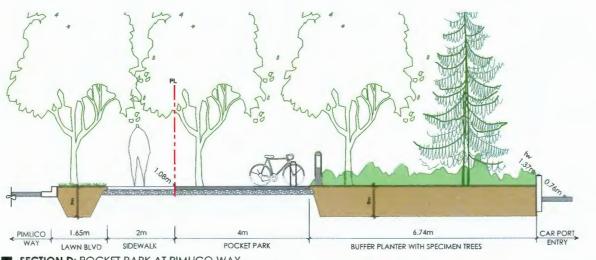

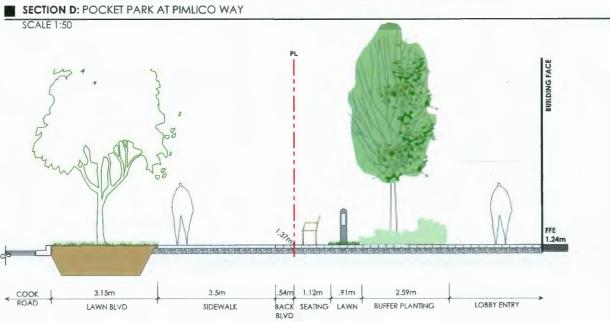

SECTION F: NORTH BLDG LOBBY ENTRY @ COOK ROAD SCALE 1:50

PLAN #67 DP 23-014121

February 20, 2024

0	reb 5 - 2024	1220ED LOK DL KEZLONZE
5	Oct 5 - 2023	RE-ISSUED FOR DP
4	FEB 17 - 2023	ISSUED FOR DP
3	AUG 2 - 2022	RE-ISSUED FOR REZONING
2	MAY 19 - 2022	RE-ISSUED FOR REZONING
1	APR 9-21	ISSUED FOR REZONING
no.:	date:	item:




COOK ROAD RICHMOND, BC

Drawn by:	AG/LF	
Checked by:	PK	
Date:	JAN 2024	
Scale:	Ad Shown	

LANDSCAPE SECTIONS

Project No.: 19073 Sheet No.:

L-5.1

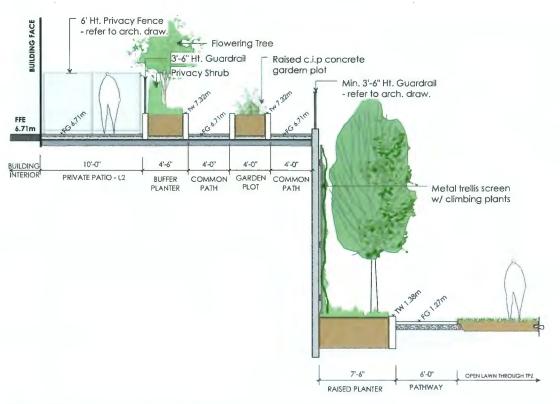

- 6' Ht. Privacy Fence Beyond Glass Guardrail 6.71m 1 68m RCULATION PRIVATE PATIO L2 BUFFER EXTENSI PLANTER PATH F_AnTIN Trellis Screen w/ Climbing Plants RAISED WOOD PLATFORM DECKING CIRCULATION PATH PLANTER SECTION H: PATIO-COURTYARD TRANSITION



COOK ROAD RICHMOND, BC

SECTION G: PATIO-COURTYARD TRANSITION



SECTION I: PATIO-COURTYARD TRANSITION SCALE 1:50

1.83m 1.83m AMENITY LAWN - ARTIFICIAL TURF CIRCULATION PATH BUFFER PLANTER PRIVATE PATIO - L2

SECTION J: PATIO-COURTYARD TRANSITION

Project No.: 19073

Sheet No.:

Drawn by: Checked by: PK


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Scale: Drawing Title: JAN 2024

LANDSCAPE SECTIONS


L-5.2

DP 23-014121 **PLAN #68**

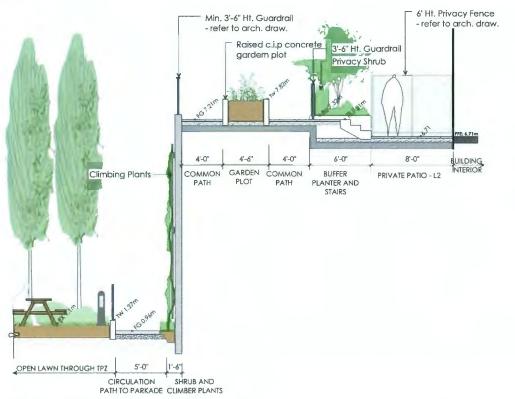


SECTION K: PATIO-COURTYARD TRANSITION

SCALE 1:50

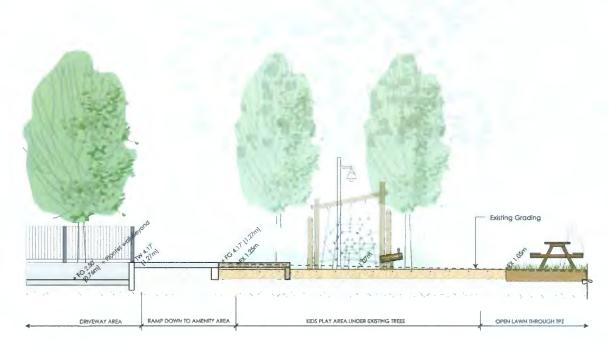

SECTION L: COURTYARD AMENITY AREA

SCALE 1:50

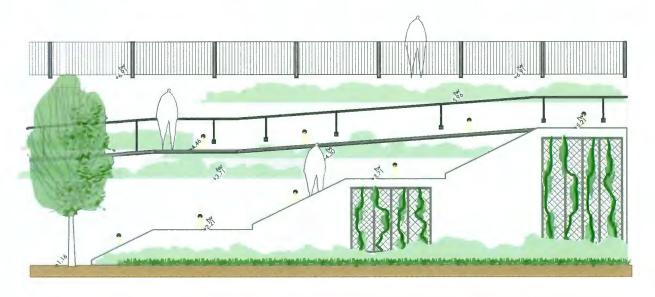

■ SECTION M: COURTYARD GRAND ACCESS STAIR

SCALE 1:50

Durante Kreuk Ltd.
102 - 1637 West 5th Avenue
Vancouver BC V6J 1N5
1: 604 684 4611
1: 604 684 0577

Projec

COOK ROAD RICHMOND, BC

 Drawn by:
 AG/LF

 Checked by:
 PK

 Date:
 JAN 2024

 Scale:
 As Shown

Drawing Title:


LANDSCAPE SECTIONS

Praject No.: 19073


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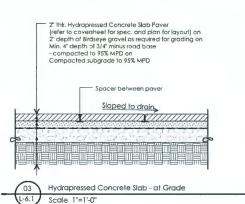
L-5.3

DP 23-014121 PLAN #69

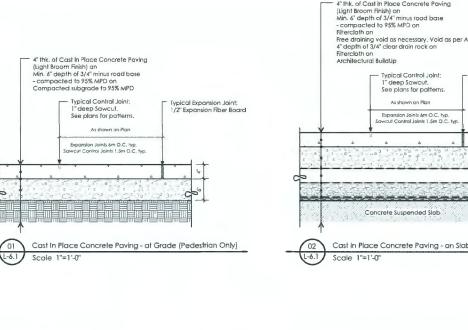

All work below & Include



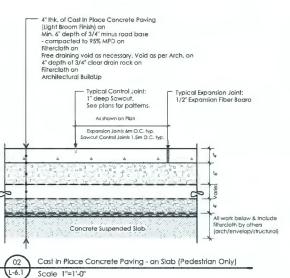

10. Provide Mock up of pover installation at Lobby Entry. Private patio (select one private patio as representative sample), for review and approval by Londscape Architect.

20. Cut all Povers as required to mainfain pattern/layout as shown on Layout Plans.

Oc. Cut all reven as required to maintain patient year as sown or cayout rears.
 All powers to be cut with Concrete Stone Saw, no guillotine cuts will be allowed.
 Min. paver cut to be no less than 1/3 of original size.
 Pavers loid directly on rigid insulation will be rejected.

HYDRAPRESSED CONCRETE SLAB PAVER NOTE:

HYDRAPRESSED CONCRETE SLAB PAVER NOTE:

101. Provide Mock up of paver installation of Lobby Entry, Private patio (select one private patio as representative sample), for review and approval by Landscape Architect.

20. Cut all Pavers as required to maintain pattern/fayout as shown on Layout Plans.

03. All payers to be cut with Concrete Stone Sow, no guillotine cuts will be allowed

O4. Min. paver cut to be no less than 1/3 of original size.
O5. Pavers laid directly on rigid insulation will be rejected.

 Thk. Hydrapressed Concrete Slob Paver (refer to coversheet far spec. and plan for layout) on 2" depth of Birdseye gravel as required for grading on Free draining void as necessary. Void as per Arch. on Filtercloth on Filtercioth on Architectural BuildUp Surface Drain - refer to Mech. Drow Sloped to drain

04 Hydrapressed Concrete Slab - on Slab Scale 1"=1'-0"



Project:

COOK ROAD RICHMOND, BC

Drawn by: Checked by: PK Date: MAR 2020 Scale: As Indicated


LANDSCAPE DETAILS


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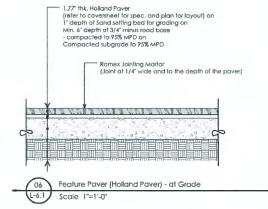
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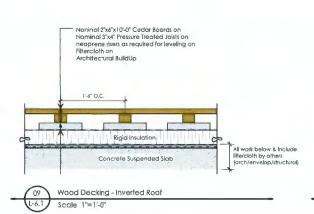
L-6.1

Emerold Pro by Precision Greens, Londley, 604-970-3673 or approved equal





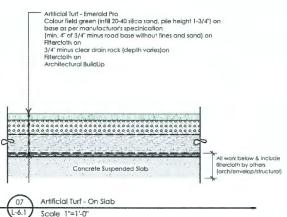

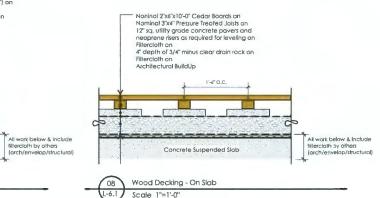

HYDRAPRESSED CONCRETE SLAB PAVER NOTE:

Scale 1"=1'-0"

05. Povers laid directly on rigid insulation will be rejected.

101. Provide Mack up of pover installation at Lobby Entry, Private patio (select ane private patio as representative sample), for review and approval by Landscape Architect.


20. Cut all Provers as required to maintain pattern/layout as shown on Layout Plans.


2" thk, Hydropressed Concrete Slab Paver (refer to coversheet for spec, and plan for layout) on Blackjack Padestal on


03. All pavers to be cut with Concrete Stone Saw, no guillotine cuts will be allowed.
04. Min. paver cut to be no less than 1/3 of original size.

Architectural BuildUp

Rigid Insulation

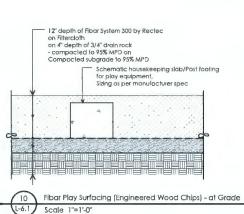

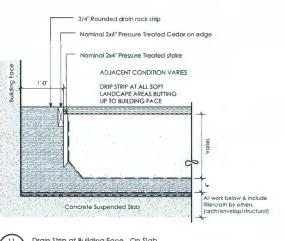

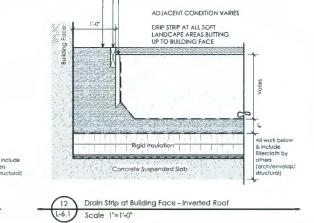

3/4" Rounded droin rock strip

Nominal 2x6" Pressure Treated Cedar on edge

General Notes:

1. Do not cut Tree Leader.


2. Protect thee from damage during planting. Ensure rootball protected from Sun, Frast or Desiccation.

3. Ensure tree location does not conflict with Underground Services. "Call before digging".

4. All street trees to be staked with 2 - 100mm/D x 2.5m lang. Minimum depth of stake embedment is 1m. Ensure stakes do not penetrate or damage rootball. Ensure all stakes are aligned parallel to sidewalk/road on tree pit centreline.

5. Provide min. 5 cubic meters of growing medium per tree.


6. Refer to Grawing Medium Chart below for surface area depth of Growing Medium.

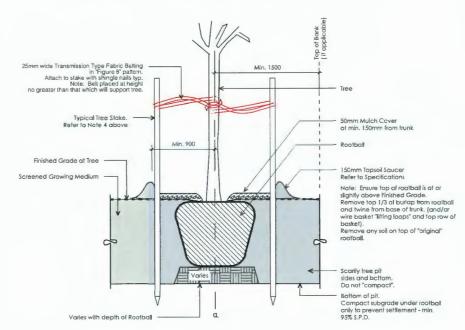

Depth of Growing Medium Total (mm)	Area (M2)	Variation 1 Size of Surface Square	Variation 2 Size of Surface Circle
450	11.11	3.3 M x 3.3 M	3.80 M Ø
600	8.33	2,9 M x 2,9 M	3.25 M Ø
750	6.67	2.6 M x 2.6 M	2.90 M Ø





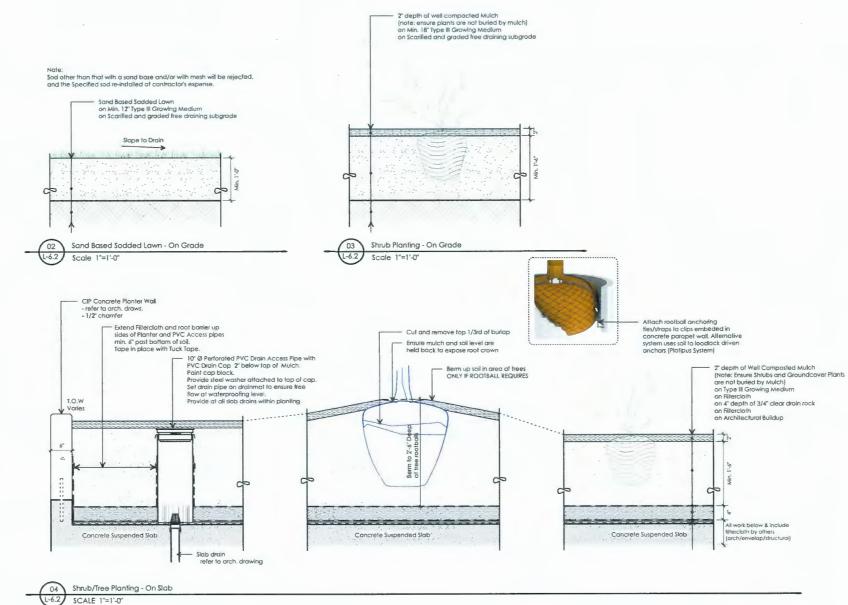

Revisions:

6 Jan 17 - 2024 ISSUED FOR DP RESPONSE
5 Oct 5 - 2023 RE-ISSUED FOR DP
4 FEB 17 - 2023 ISSUED FOR DP

Durante Kreuk Ltd. 102 - 1637 West 5th Avenue Vancouver BC V6J 1N5

COOK ROAD RICHMOND, BC

 Cut and remove top 1/3rd of burlap sides of Planter and PVC Access pipes min. 6" past bottom of soil. Tope in place with Tuck Tape. 2" depth of Well Composted Mulch (Note: Ensure Shrubs and Groundcover Plants are not buried by Mulch) on Type III Growing Medium on Filtercloth an 4" depth of 3/4" clear drain rock on Filtercloth on Architectural Buildup Ensure mulch and soil level are 10° Ø Perforoted PVC Drain Access Pipe with PVC Drain Cap 2° below top of Mulch. Paint ap black.
Paint ap black.
Provide steel wosher aftached to top of cap. Set droin pipe on drainrast to ensure tree flow at waterproofing level.
Provide at all slab drains within plantling. T.O.W Rigid Insulation Concrete Suspended Slab Concrete Suspended Slob


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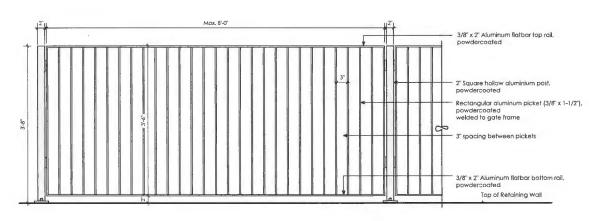
LANDSCAPE DETAILS

Project No.: 19073 Sheet No.:

L-6.2

DP 23-014121



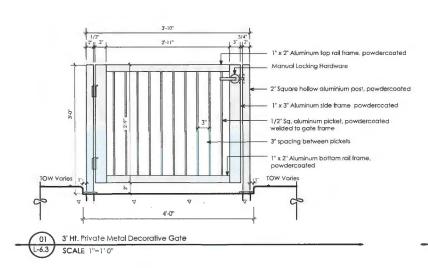

02 3'-6" Ht. Metal Guardrail L-6.3 SCALE 1"=1'-0"

- neral Metal Work Notes:

 Submit Sealed / Engineered shop drawings for review and approval for all metatwork prior to fobication and in accordance with specification section 05 50 00.

 Confirm all dimensions on site. Wodify shop drawings as required to maintain design intent. Consultant to approve all metatwork of tabrication prior to had tip galvanizing or powdercoating. All metal components to be cut or drilled, all weld faces ground smooth prior to powdercoating. Metal work Assemblies to be all-weld construction. All welding to be completed prior to powder coating. Fabrication to allow for mecnanical assembly of powder coated components on site.

 All metal work other than stainless steel to be powder coated unless noted otherwise.

 All fastening hordware to be stainless steel unless otherwise noted.

 Consultant to approve all panels at fabrication prior to pointed finish being applied.

 Smooth cut all edges. Any shap edges will not be accepted.

 RAL colour to be confirmed. Provide paint colous samples for review and approval prior to application.

- General Pawdercoating Notes:

 1. All metal to be RAL podwercoated to match Building Accents
 2. RAL powdercoal colour; Iran Mountain; Color picked by LEDINGHAM MCALLISTER.

6	Jan 17 - 2024	ISSUED FOR DP RESPONSE
5	Oct 5 - 2023	RE-ISSUED FOR DP
4	FEB 17 - 2023	ISSUED FOR DP
-		
-		
-		
no.:	date:	item:




COOK ROAD RICHMOND, BC

Drawn by:	AG	
Checked by:	PK	
Date:	MAR 2020	
Scale:	As Indicated	
Drawing Title:		

LANDSCAPE DETAILS

19073

L-6.3

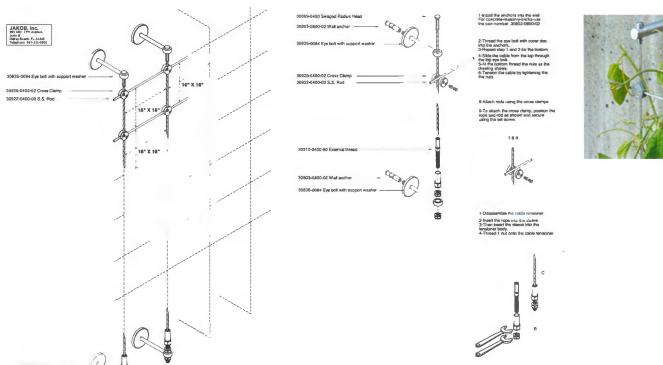



03 Jackob Trellis System L-6.3 SCALE 1"=1'-0"









Mends & 30 W 2/3

Metal Bike Rock and Prefabricated Bench - or Similar Desigh/Quality

Air Collection



Designer Emilio Turtón

Material - High-density polyetry line (HDPE) rotational motion; « a plastic transformation process that parmits the manufacturing of hollow or

Revised April 27 2022 | Landscape Ferms Inc. | 300.521.2546 | F 209.381.3457 | 7800 E. Michigan Ave., Kalamazro, MI 49348

Note: refer to Plan for color selection

for each pocket park.



02 Feature Bench at Packet Parks - or Similar Desigh/Quality



ELKAY

Elkay Outdoor Bi-Level Pedestal Fountain with Pet Station Non-Model LK4420DB

PRODUCT SPECIFICATIONS

Special Features:	316 Stainless, Heavy Duty Vandal Resistant. Pet Fountain
Finish:	Black (BK), Blue (BLU). Evergreen (EVG), Gray (GRY), Powder Coal (12 Color Options)
Power:	No Electrical Required
Bubbler Style:	Vandal Resistant
Activation by:	Mechanical Front Bubbler Button
Mounting Type;	Floor Mount/Freestanding
Chilling Capacity:	Non-refrigerated
Dimensions (L x W x H):	31" x 26" x 40-5/16"
Approx. Shipping Weight:	'70 lbs,
Installation Location:	Outdoor
No. of Stations Served:	2

- damage where climates dictate.


 Mechanically-Activated bubbler continues to supply water in event of service disruptions.



PRODUCT COMPLIANCE ADA & ICC A117.1 ASME A112.19.3/CSA 845 4 NSF/ANSI 61 & 372 (lead free

© 2023 Page 1

03 Drinking Fountain at Pocket Parks - or Similar Desigh

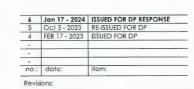



COOK ROAD RICHMOND, BC


Drawn by: Checked by: PK Date: MAR 2020 Scale: Drawina Title:


LANDSCAPE DETAILS

Project No.: 19073


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L-6.4



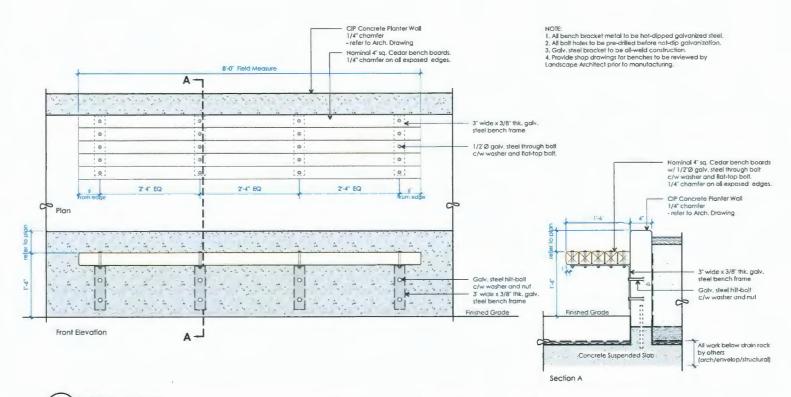

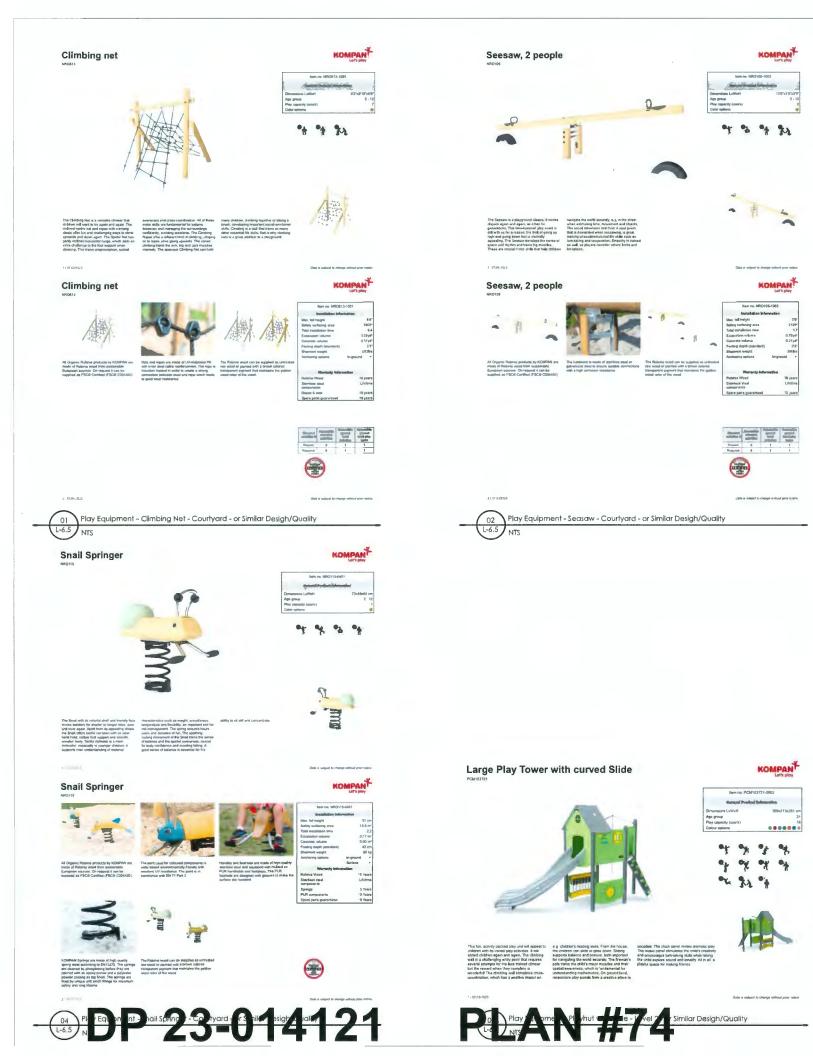



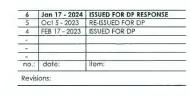

Projec

COOK ROAD RICHMOND, BC


Drawn by:	AG	
Checked by:	PΚ	
Date:	MAR 2020	
Scale:	As Indicated	

LANDSCAPE DETAILS


Project No.: 19073

Sheet No.:

L-6.5

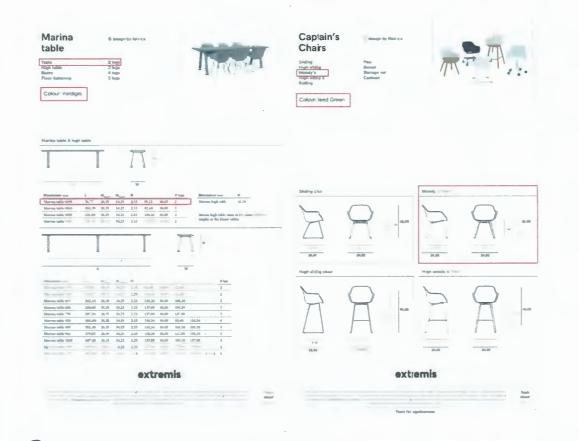



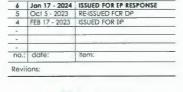



Movable Dining Takle and Chair or Similar - Level 3 Amenity Deck - or Similar Desigh/Quality





COOK ROAD

RICHMOND, BC

AG MAR 2020 As indicated Draving Title

LANDSCAPE DETAILS

Project No : 19073 Sheet No.:

L-6.6

DP 23-014121









Wall Recessed Path/Step Light - ar Similar Desigh/Quality











03 Pedestrian Scale Pale Light - or Similar Desigh/Quality
NTS





Wall Sconce Light - or Similar Desigh/Quality

LANDSCAPE DETAILS

As Indicated

COOK ROAD RICHMOND, BC


Project No.: 19073

Drawing Title:

L-6.7

DP 23-014121

PLAN #76

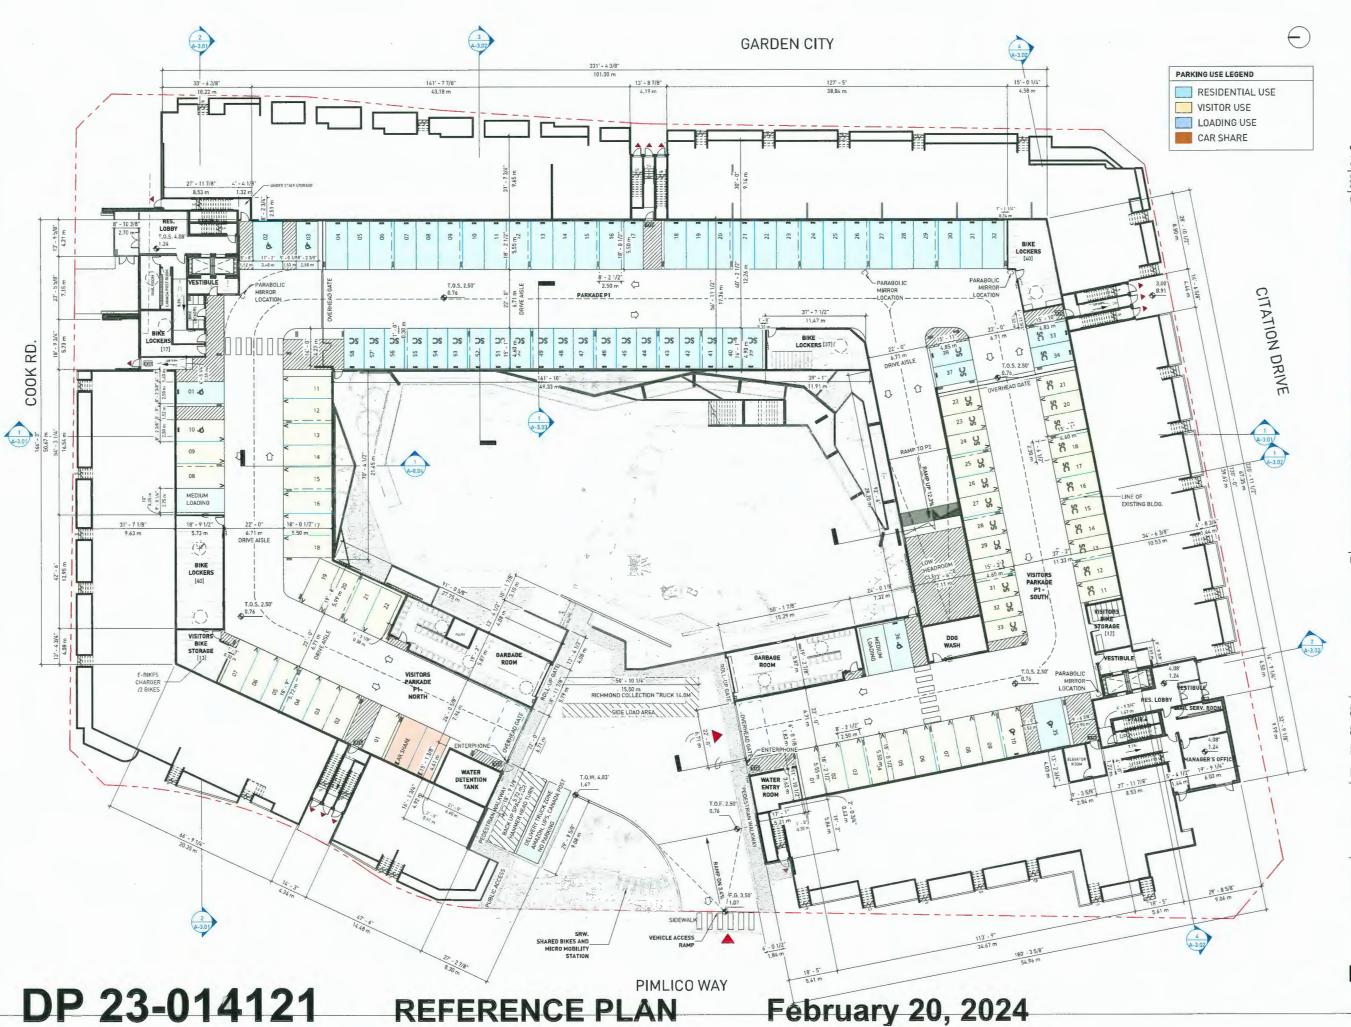

gbl

■ GBL ARCHITECTS IN

300-224 WEST 8TH AVENUE VANCOUVER, BC CANADA VSY INS

PRIGHT RESERVED: THIS PLAN AND DESIGN ARE AND AT AL AIN 1 -E EXCLUSIVE PROPERTY OF GBL ARCHITECTS INC. AN

NOTES

EV OUTLETS WILL NEED TO BE SUPPLIED WITH ENERGIZED OUTLETS IN ORDER TO SUPPORT EV CHARGING, WITH EACH PARKING SPACE CAPABLE OF RECEIVING "LEVEL 2" CHARGING AT A PERFORMANCE LEVEL OF AT LEAST 12

PARKING - P1		
TYPE	COUNT	
CAR SHARE	2	
CLASS A LOADING STALL	2	
GARBAGE TRUCK	1	
MEDIUM SIZE LOADING	1	
RESIDENTIAL - H/C STALL	3	
RESIDENTIAL - H/C VAN STALL	2	
RESIDENTIAL - REGULAR STALL	29	
RESIDENTIAL - SMALL STALL	24	
VISITOR - REGULAR	30	
VISITOR - SMALL CAR STALL	23	
VISITOR H/C STALL	2	
TOTAL	119	

PARKING - BIKES P1	
TYPE	COUN
BICYCLE - HOR, CLASS 1	57
BICYCLE - HOR. STACKED CLASS 1	56
BICYCLE - VERT. CLASS 1	27
TOTAL	140

FI - UNUSS AREA SU	OJJ AKEA JUMMAKI	
USE	AREA	
BIKE LOCKERS	2924 5	
DOG WASH	321 S	
EXCLUSION	246 S	
GARBAGE	2099 S	
MECHANICAL	594 S	
PARKADE	41143 S	
RESIDENTIAL CIRCULATION	295 5	
TOTAL	47621 S	

REVISIONS

NO. DATE DESCRIPTION

1 MAY 19 2022 RE - 155UED FOR RZ II

2 JULY 4 2022 RE-15SUED FOR RZ II

3 AUG 3 2022 RE-15SUED FOR RZ III

4 MAR 10 2023 ISSUED FOR DP

5 OCT 06 2023 RE-15SED FOR DP

6 JAN 19 2024 RE-ISSUED FOR DP 7 FEB 15 2024 RE-ISSUED FOR DP


8880 COOK RD. & 8751 CITATION DRIVE


RICHMOND, BC

FLOOR PLAN - P1

DATE 2/14/2024 4:17.56 PM DRAWN BY AM CHECKED BY 68L SCALE As indicated

JOB NUMBER 20039

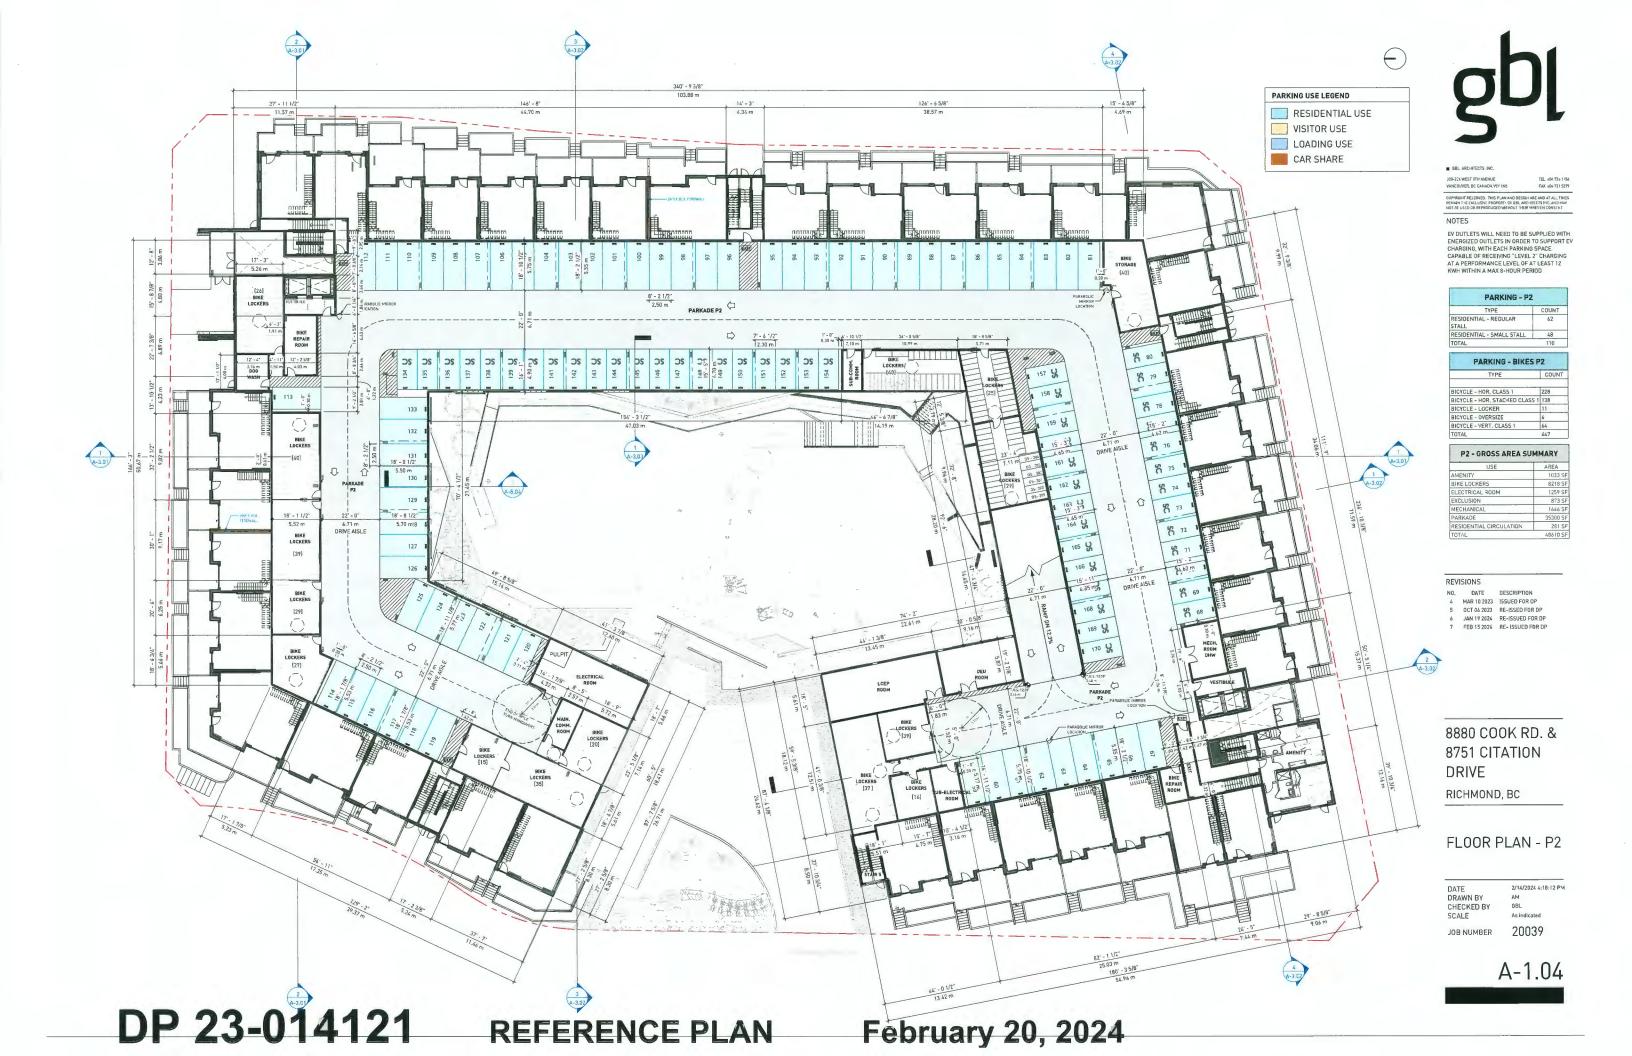

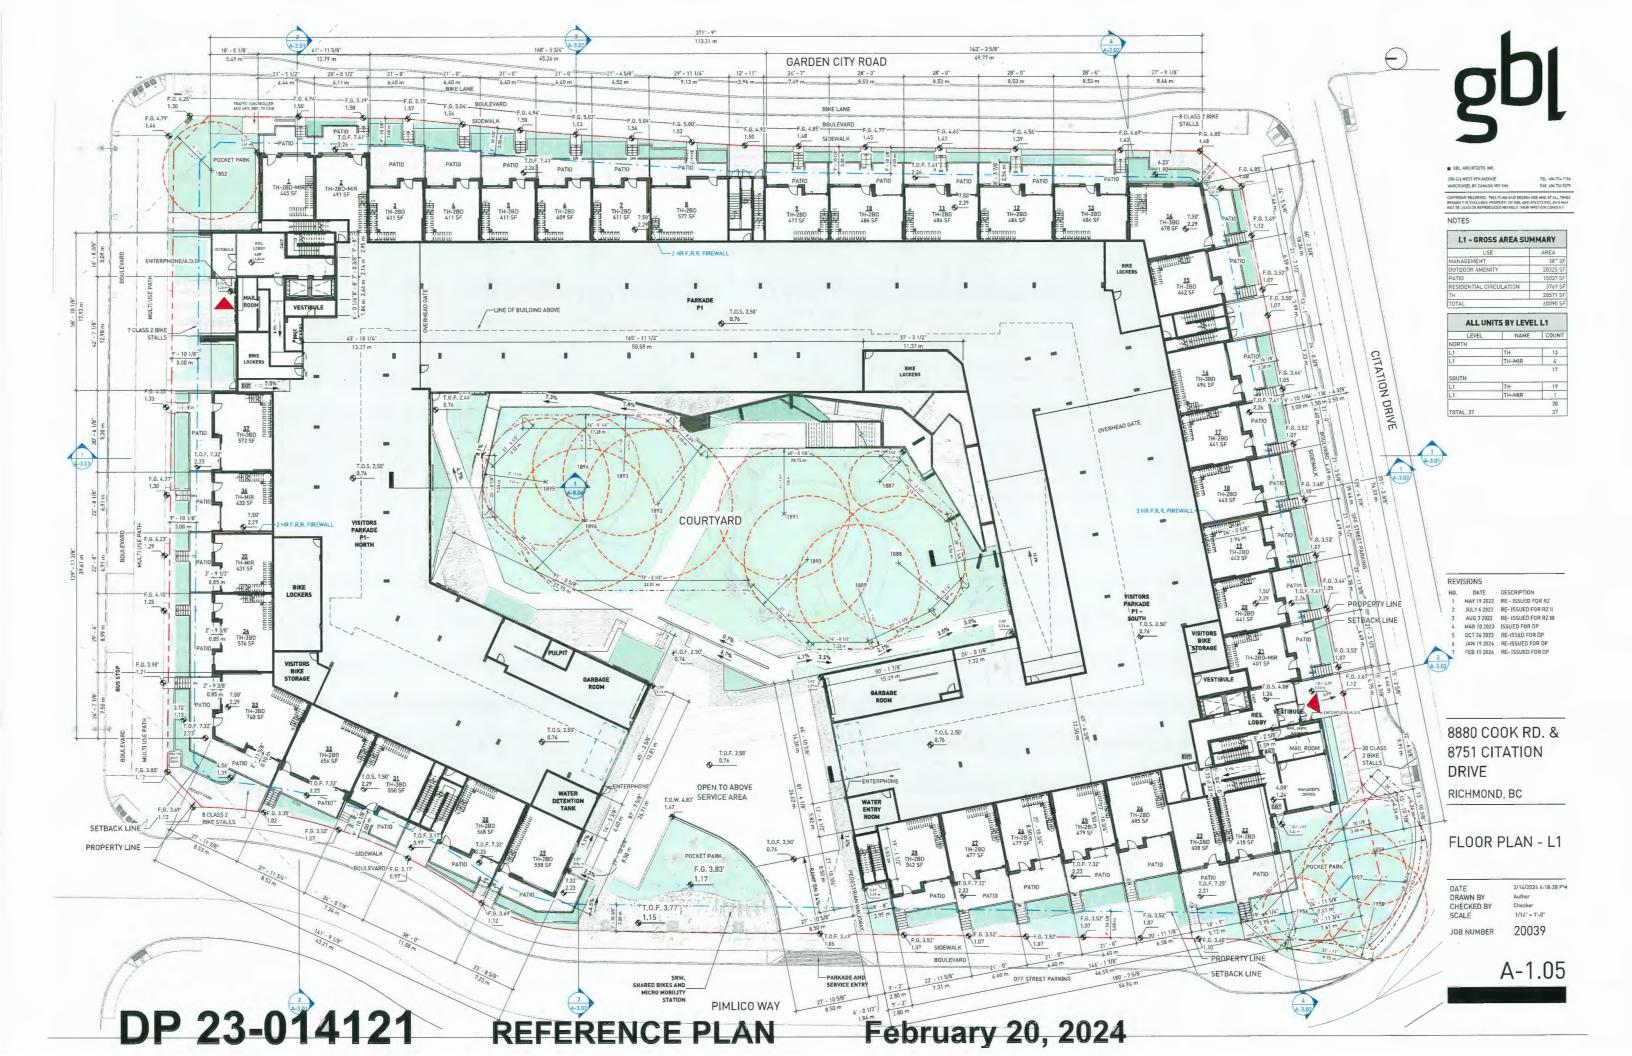



DP 23-014121

REFERENCE PLAN


February 20, 2024

USE	AREA
AMENITY	1596 SF
BUH	720 SF
RESIDENTIAL CIRCULATION	5449 SF
EXCLUSION	1713 SF
MECH, SHAFT	260 SF
BALCONY	1872 SF
OUTDOOR AMENITY	1830 SF
DUTDOOR AREA	'0542 SA
PATIO	6433 SF
16D	4670 SF
2ED	5033 SF
380	2081 SF
STUDIO	9347 58
TH	70474 SF
TOTAL	71968 SF

LEVEL	NAME	COUNT
NORTH		_
L2	180	5
L2	1BD - MiR	2
L2	2BD	3
L2	2BD - MIR	1
L2	3BD	1
L2	3BD - MIR	1
L2	STUDIO	10
L2	STUDIO - MIR	3
SOUTH		26
L2	1BD	1
L2	2BD	2
L2	STUDIO	5
L2	STUDIO - MIR	3
		11
TOTAL: 37		37

DATE DESCRIPTION
MAY 19 2022 RE - ISSUED FOR RZ
JULY 4 2022 RE-ISSUED FOR RZ II
AUG 3 2022 RE-ISSUED FOR RZ III
MAR 10 2023 ISSUED FOR OP
OCT 06 2023 RE-ISSED FOR DP JAN 19 2024 RE-ISSUED FOR DP FEB 15 2024 RE- ISSUED FOR DP

1/16" = 1'-0"

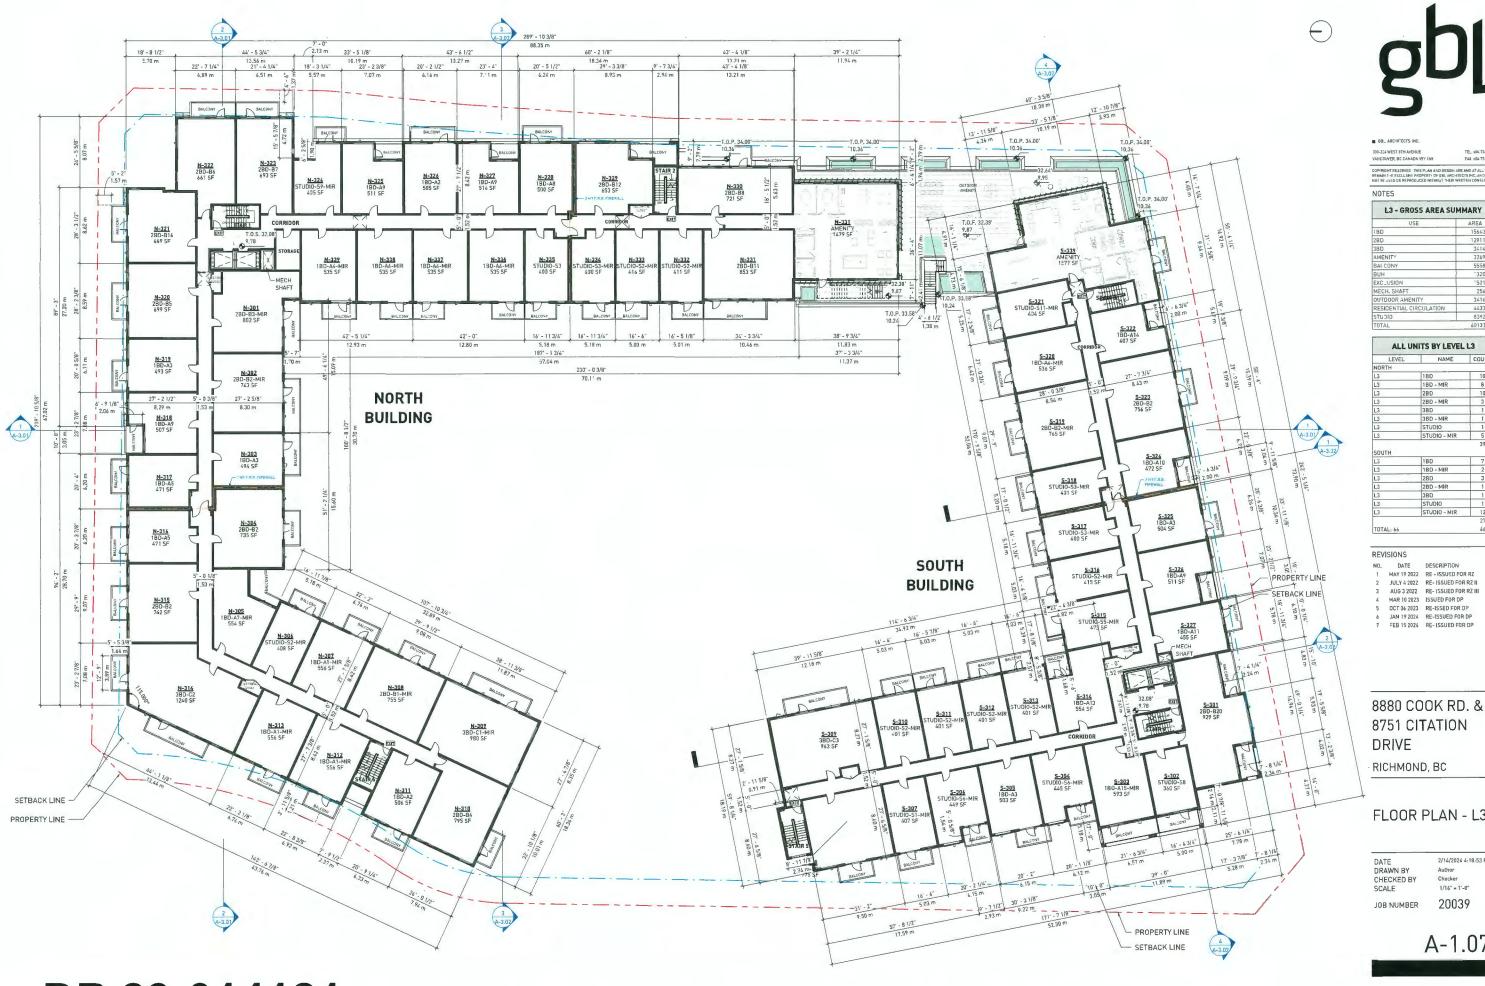

DP 23-014121 **REFERENCE PLAN**

February 20, 2024

L3 - GROSS AREA SUMMARY

ALL UNITS BY LEVEL L3

REVISIONS

DATE DESCRIPTION
MAY 19 2022 RE - ISSUED FOR RZ


JULY 4 202Z RE- ISSUED FOR RZ II AUG 3 2022 RE- ISSUED FOR RZ III

MAR 10 2023 ISSUED FOR DP OCT 06 2023 RE-ISSED FOR DP JAN 19 2024 RE-ISSUED FOR DP FEB 15 2024 RE- ISSUED FOR DP

FLOOR PLAN - L3

DRAWN BY CHECKED BY 2/14/2024 4:18:53 PM

1/16" = 1'-0" 20039

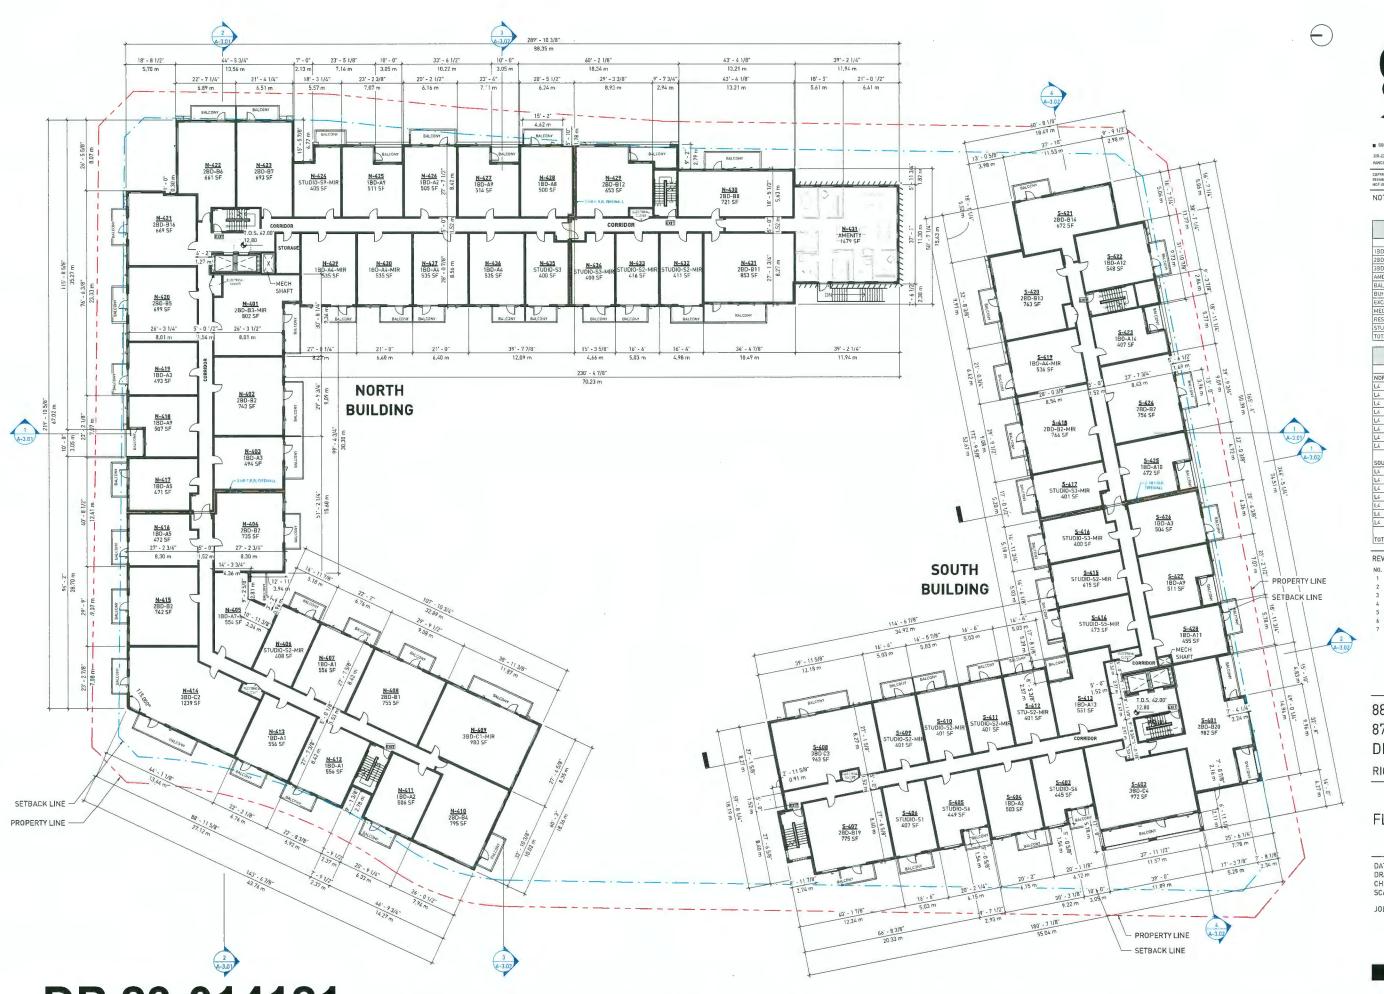



300-224 WEST 0TH AVENUE VANCOUVER, BC CANADA VEY INS

L4 - GROSS AREA SUMMARY

LEVEL	NAME	COUN.
NDRTH		
L4	180	15
L4	1BD - MIR	3
L4	2BD	12
L4	2BD - MIR	1
L4	3BD	1
L4	3BD - MIR	1
L4	STUDIO	1
L4	STUDIO - MIR	5
SOUTH L4	1BD	39
	1BD - MIR	1
L4		
L4	2BD	5
L4	2BD - MIR	1
L4	3BD	2
L4	STUDIO	3
L4	STUDIO - MIR	В
		28
TOTAL: 67		67

REVISIONS

DATE DESCRIPTION
MAY 19 2022 RE - ISSUED FOR RZ

JULY 4 2022 RE- ISSUED FOR RZ II AUG 3 2022 RE- ISSUED FOR RZ III

MAR 10 2023 ISSUED FOR DP 0CT 06 2023 RE-ISSED FOR DP JAN 19 2024 RE-ISSUED FOR DP

FEB 15 2024 RE- ISSUED FOR DP

8880 COOK RD. & 8751 CITATION DRIVE


RICHMOND, BC

FLOOR PLAN - L4

2/16/2024 4:19:02 PM DRAWN BY CHECKED BY 1/16" = 1'-0" 20039

A-1.08

DP 23-014121 **REFERENCE PLAN**

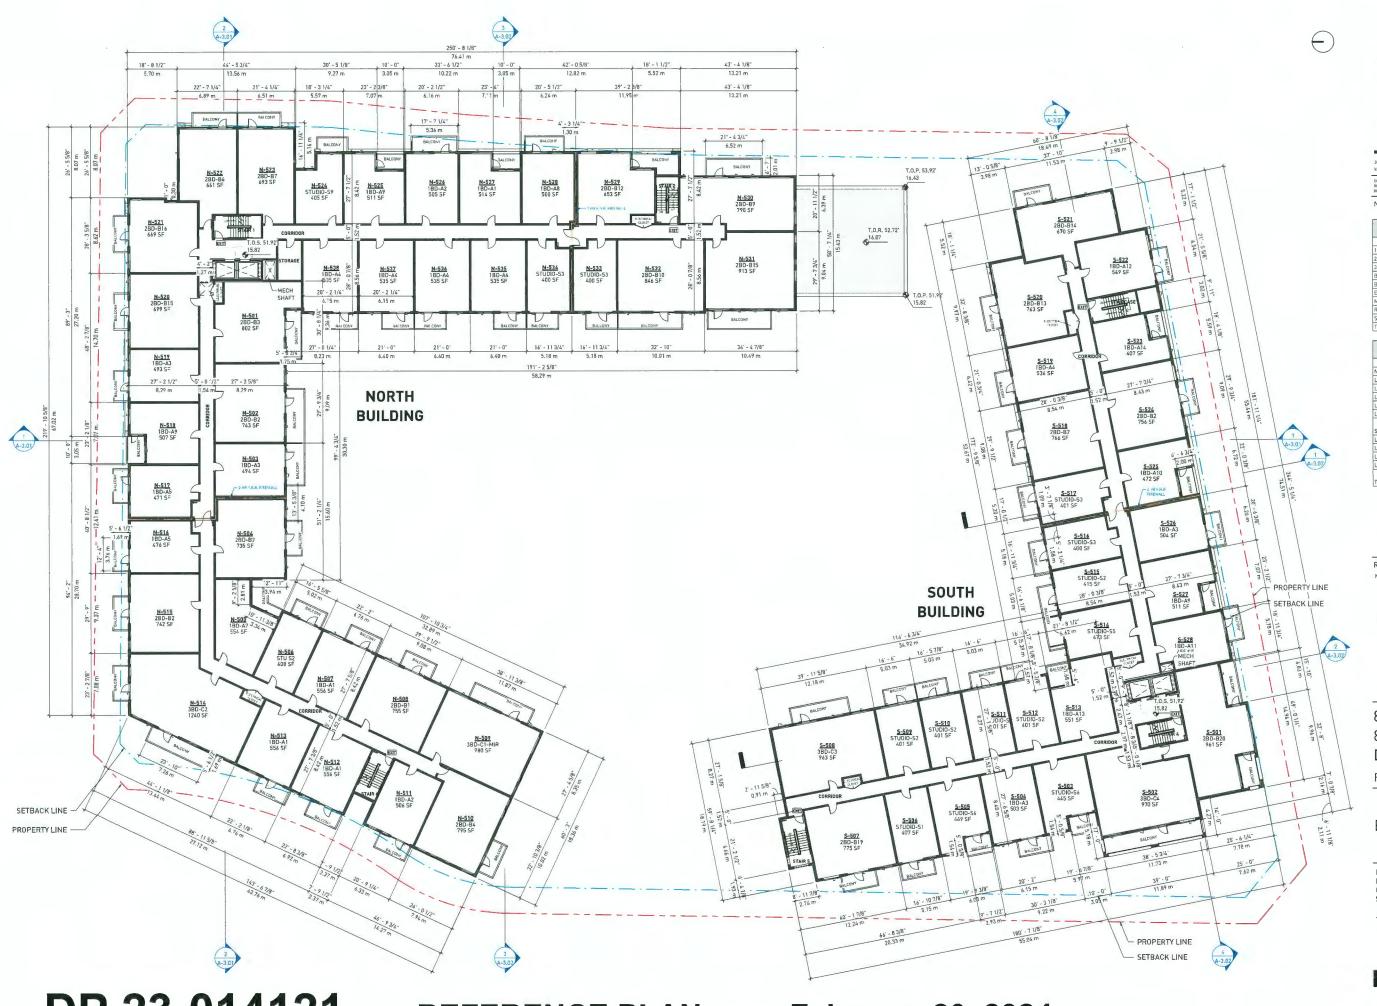

DP 23-014121

REFERENCE PLAN

February 20, 2024



300-224 WEST 8TH AVENUE VANCOUVER, BC CANADA VSY INS

L5 - GROSS AREA SUMMARY	
USE	AREA
1BD	148"5 SF
2BD	16304 SF
3BD	4454 SF
BALCONY	5587 SF
BUH	1333 SF
EXCLUSION	1527 SF
MECH. SHAFT	248 SF
RESIDENTIAL CIRCULATION	4414 SF
STUDIO	6691 SF

LEVEL	NAME	COUNT
NORTH		
L5	1BD	18
L5	2BD	14
L5	3BD	1
L5	3BD - MIR	1
L5	STUDIO	4
SOUTH		38
L5	1BD	9
L5	2BD	6
L5	3BD	2
L5	STUDIO	11
		28
TOTAL: 66		66

REVISIONS

DATE DESCRIPTION
MAY 19 2022 RE - ISSUED FOR RZ

JULY 4 2022 RE- ISSUED FOR RZ II AUG 3 2022 RE- ISSUED FOR RZ III

MAR 10 2023 ISSUED FOR DP OCT 06 2023 RE-ISSED FOR DP

JAN 19 2024 RE-ISSUED FOR DP

FEB 15 2024 RE- ISSUED FOR DP

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RICHMOND, BC

FLOOR PLAN - L5

2/14/2024 4:19:11 PM DRAWN BY CHECKED BY

1/16" = 1"-0"

20039



DP 23-014121 REFERENCE PLAN

February 20, 2024



L6 - GROSS AREA SUMMARY	
USE	AREA
180	14859 SF
2BD	16017 SF
3BD	4450 SF
BALCONY	5494 SF
BUH	1320 SF
EXCLUSION	1528 SF
MECH. SHAFT	259 SF
RESIDENTIAL CIRCULATION	4448 SF
ROOF DECK	255 SF
STUDIO	6670 SF

LEVEL	NAME	COUNT
NORTH		
L6	1BD	18
L6	2BD	14
L6	3BD	2
L6	STUDIO	4
SOUTH		38
	180	9
L6	IBD	7
	2BD	6
L6		
L6 L6	2BD	6
L6 L6 L6	2BD 3BD	6 2

REVISIONS

NO. DATE

MAY 19 2022 RE - ISSUED FOR RZ JULY 4 2022 RE- ISSUED FOR RZ II

AUG 3 2022 RE- ISSUED FOR RZ III MAR 10 2023 ISSUED FOR DP 5 OCT 06 2023 RE-ISSED FOR DP

6 JAN 19 2024 RE-ISSUED FOR DP 7 FEB 15 2024 RE-ISSUED FOR DP


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RICHMOND, BC

FLOOR PLAN - L6

2/14/2024 4:19:25 PM CHECKED BY SCALE

20039 JOB NUMBER



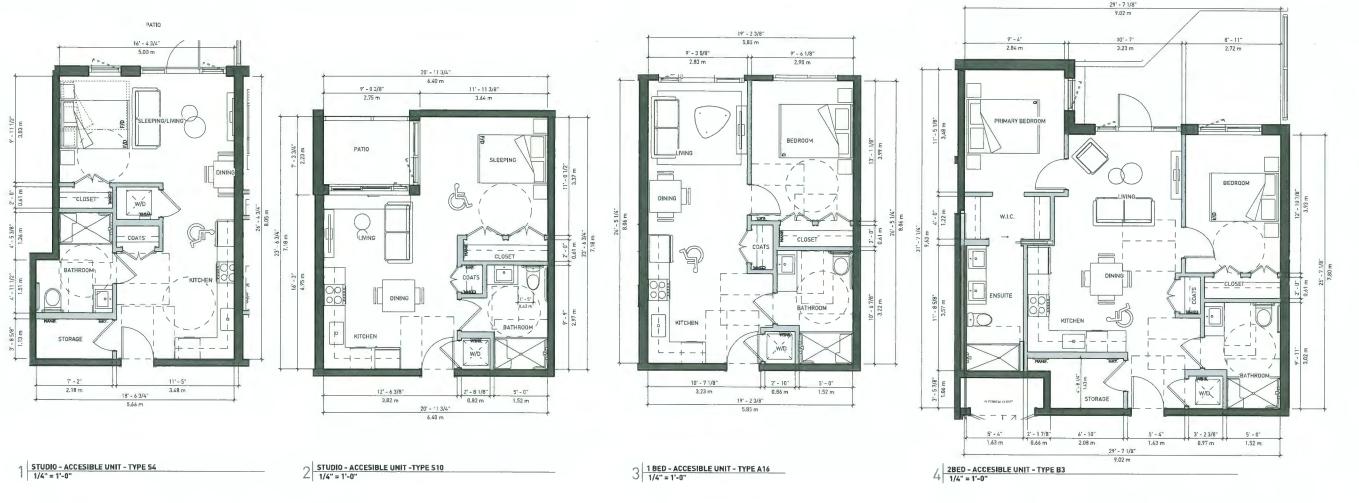

BASIC UNIVERSAL HOUSING (BUH) ARE DESIGNED IN ACCORDANCE WITH SECTION 4.16 OF RICHMOND ZONING BY LAW 8500



DATE DESCRIPTION
MAR 10 2023 ISSUED FOR OP

5 OCT 06 2023 RE-ISSED FOR DP 6 JAN 19 2024 RE-ISSUED FOR DP

7 FEB 15 2024 RE- ISSUED FOR DP

8880 COOK RD. & 8751 CITATION DRIVE

RICHMOND, BC

KEY PLAN

TYP. ACCESSIBLE UNITS

DATE DRAWN BY CHECKED BY 2/14/2024 4:41:21 PM SCALE As indicated JOB NUMBER 20039

A-4.01

15" - 8 1/8" 4.78 m 45' - 10 1/2" 13,98 m

6 2BED - ACCESIBLE UNIT - TYPE B18 1/4" = 1'-0"

February 20, 2024

33' - 4 7/8" 10,18 m 8' - 9 5/8" 2,68 m