

To:Development Permit PanelFrom:Joshua Reis<br/>Director, Development

Date: September 19, 2024

**File:** DP 23-029476

### Re: Application by Interface Architecture Inc. for a Development Permit at 5800, 5840, 5860 Granville Avenue

### Staff Recommendation

That a Development Permit be issued which would:

- 1. Permit the construction of 18 townhouse units at 5800, 5840, 5860 Granville Avenue on a site zoned "Low Density Townhouses (RTL4)"; and
- 2. Vary the provisions of Richmond Zoning Bylaw 8500 to:
  - a) Reduce the minimum exterior side yard (north yard) from 6.0 m to 4.5 m.
  - b) Permit an electrical closet projection of 0.6 m into the front yard (west yard).

Jun Per

Joshua Reis, MCIP, RPP, AICP Director, Development (604-247-4625)

JR:cl Att. 3

### **Staff Report**

### Origin

Interface Architecture Inc. has applied on behalf of 1275306 BC Ltd. (Directors: Satwant Singh Atwal and Surinder S. Grewal), to the City of Richmond for permission to develop 18 townhouse units at 5800, 5840, 5860 Granville Avenue, on a site zoned "Low Density Townhouses (RTL4)". A location map of the subject site is provided in Attachment 1.

The site is being rezoned from the "Small-Scale Multi-Unit Housing (RSM/L)" zone to the "Low Density Townhouses (RTL4)" zone for this project under Richmond Zoning Bylaw 8500, Amendment Bylaw 10470 (RZ 21-922202). The Bylaw was given third reading at the Public Hearing held on July 17, 2023, and the applicant is working to complete all of the rezoning requirements.

A Servicing Agreement is required prior to Building Permit issuance for servicing and frontage improvements, including without limitation drainage upgrades along Ledway Road and construction of boulevard improvements along Granville Avenue and Ledway Road.

### **Development Information**

Please refer to attached Development Application Data Sheet for a comparison of the proposed development data with the relevant Bylaw requirements (Attachment 2).

### Background

The subject site is located on the southeast corner of the intersection of Granville Avenue and Ledway Road. The site currently consists of three properties, each containing an existing single-detached dwelling and each having an individual driveway crossing. Existing development immediately surrounding the subject site is as follows:

To the North:	Across Granville Avenue, are lots zoned "Low Density Townhouses
	Zone (RTL1)", "Medium Density Low Rise Apartments (RAM1)", and
	"Assembly (ASY)" containing multi-family housing and the Canadian Martyrs
	Catholic Church, respectively.

- To the South: Are lots zoned "Small-Scale Multi-Unit Housing (RSM/L)", each containing single-detached dwellings fronting Linscott Road.
- To the East: Is a lot zoned "Small-Scale Multi-Unit Housing (RSM/L)" containing a singledetached dwelling fronting Granville Avenue, which is designated for "Arterial Road Townhouse" under the Arterial Road Land Use Policy in the Official Community Plan (OCP).
- To the West: Across Ledway Road are lots zoned "Small-Scale Multi-Unit Housing (RSM/L)", each containing single-detached dwellings fronting Ledway Road.

### **Rezoning and Public Hearing Results**

The Public Hearing for the rezoning of this site was held on July 17, 2023. At the Public Hearing, one member of the public inquired about the redevelopment potential of their property, and two members of the public expressed concerns about driveway access, increased traffic and demolition of a 12-year-old dwelling to facilitate the development proposal.

Staff note that this redevelopment proposal is consistent with the OCP and Arterial Road Land Use Policy and the Traffic and Parking Assessment was reviewed, and the findings supported by the City's Transportation Department as part of the Rezoning Application review process.

During the rezoning process, staff identified the following design issues to be resolved at the Development Permit (DP) stage:

- Examining site planning and landscaping opportunities with respect to the entry drive-aisle, extent of surface parking, outdoor amenity space, children's play structure and permeable surfaces.
- Refining the proposal to clarify the proposed lot grading and to demonstrate compliance with the maximum allowable building height.
- Confirming that all aging-in-place and convertible unit features have been incorporated into the dwelling design.
- Reviewing and finalizing the proposed exterior building material and colour palette.
- Reviewing the applicant's response to the principles of Crime Prevention Through Environmental Design (CPTED).
- Gaining a better understanding of the proposed environmental sustainability features associated with the project, including how the proposal will meet the Energy Step Code.

Through the review of this DP application, staff worked with the applicant to address these issues to the City's satisfaction and to ensure that the proposed architectural form and character is consistent with the intent of the applicable design guidelines contained within the OCP. The applicant has made revisions to the proposal to address the design issues identified, including:

- Refining the design of the drive-aisle at the entry to facilitate future shared access to neighbouring properties to the east upon their redevelopment.
- Enhancing the common outdoor amenity space with additional plant material and a more robust children's play structure.
- Increasing the amount of permeable surface on-site to maximize stormwater infiltration potential, to add visual interest and to serve as cues signifying the transition to areas used by both pedestrians and vehicles.
- Finalizing the proposed lot grading to ensure compliance with the flood construction level and maximum building height, while ensuring that existing grade is maintained within tree protection zones and an appropriate transition is provided to neighbouring properties.
- Demonstrating that all relevant accessibility features are incorporated into the design of the convertible units and that aging-in-place features are incorporated into all units.

- Refining the proposed architectural form and character, exterior building material scheme and colour palette to ensure consistency with the design guidelines in the OCP.
- Providing additional information to confirm how the proposal responds to Energy Step Code, and to the principles of environmental sustainability and Crime Prevention Through Environmental Design (CPTED).

### **Staff Comments**

The proposed scheme attached to this report (Plans # 1 to # 6) has satisfactorily addressed the significant urban design issues and other staff comments identified as part of the review of the subject DP application. In addition, it complies with the intent of the applicable sections of the OCP and is generally in compliance with the "RTL4" zone, with the exception of the zoning variances noted below.

### Zoning Compliance/Variances (staff comments in *bold italics*)

The applicant requests to vary the provisions of Richmond Zoning Bylaw 8500 to:

a) Reduce the minimum exterior side yard (north yard) from 6.0 m to 4.5 m.

### Staff supports the proposed variance for the following reasons:

- The proposed 4.5 m setback from the property line along Granville Avenue enables a deeper setback to be provided to the south property line, resulting in a more sensitive interface with existing adjacent single-detached housing to the south.
- Although the setback is reduced, the proposal maintains consistency with the minimum private outdoor space guidelines in the OCP in the form of yards at ground-level for all units and secondary spaces in the form of balconies off the main living areas on the second level for some units.
- Due to the site's location on an arterial road, the applicant has submitted an acoustic report and documentation by registered professionals confirming that the units as designed, will comply with the standards for interior noise levels and thermal comfort conditions identified in the OCP. Prior to final adoption of the rezoning bylaw, a traffic noise covenant is to be registered on Title of the subject site for public awareness and to ensure that construction complies with the City's standards.
- This variance was identified as part of the Rezoning Application and no concerns on this matter were raised by members of the public at that time.
- b) Permit an electrical closet projection of 0.6 m into the front yard (west yard).

Staff supports the proposed variance for the following reasons:

- The Zoning Bylaw permits an electrical closet to project up to 0.6 m into a side yard and rear yard, but not into the front yard. The corner lot geometry of the subject site after land assembly results in the front yard being technically off the shorter frontage along Ledway Road, into which an electrical closet projection is not permitted.
- Staff supports this projection into the front yard (west yard) along Ledway Road as it is consistent with the intent of the Zoning Bylaw were this not a corner lot.

### **Advisory Design Panel Comments**

The Advisory Design Panel reviewed this proposal on May 23, 2024 and supported the proposal to move forward to the DP Panel subject to the application giving consideration to the comments identified by the Panel members. A copy of the relevant excerpt from the Advisory Design Panel meeting minutes is attached for reference (Attachment 3). The design response from the applicant has been included immediately following the specific Advisory Design Panel comments and is identified in *'bold italics*.

### Analysis

### Conditions of Adjacency

- The proposed townhouses at the subject site have been designed with consideration of the existing surrounding housing context and are consistent with the design guidelines in the OCP for townhouses on arterial roads.
- Three-storey units are proposed along Granville Avenue and Ledway Road, which are either set back at least 7.5 m from, or step down to two storeys within 7.5 m of, common property lines with existing two-storey housing to the east and south, respectively.
- In the rear of the property, two-storey units in duplex form, with wider than minimum setbacks, are proposed along the interface with existing single-detached housing to the east and south (i.e., at least 6.0 m). New solid privacy fencing and hedging is also provided along common property lines with properties to the east and south.
- In addition, the proposed building and landscape design along the Granville Avenue and Ledway Road frontages provides for a pedestrian-oriented experience in the public realm.

### Site Planning, Access, and Parking

- The proposed development is for 18 townhouse units on a site that will be approximately 3,155 m<sup>2</sup> in area after the required corner cut road dedication at the intersection of Granville Avenue and Ledway Road.
- The site layout consists of five buildings arranged along a drive-aisle having access to Granville Avenue, as follows:
  - Two three-storey buildings are proposed along Granville Avenue, north of the east-west leg of the drive-aisle (Buildings 1 and 2). Building 1 contains five units and Building 2 contains six units.
  - Two two-storey duplex buildings are proposed south of the east-west leg of the driveaisle (Buildings 4 and 5).
  - One three-storey building that steps down to two storeys at the south end is proposed along Ledway Road to the west of the north-south leg of the drive-aisle, which contains three units (Building 3).
- Vehicle access to the subject site is proposed from Granville Avenue, consistent with the guidelines in the OCP for townhouses on arterial roads and was reviewed and supported by the City's Transportation Department as part of the Rezoning Application.

Prior to final adoption of the rezoning bylaw, the applicant is required to register on Title a Statutory Right-of-Way (SRW) over the drive-aisle for Public-Right-of-Passage to enable access to be shared in future by neighbouring properties to the east upon their redevelopment.

- Pedestrian access to the site is proposed via the driveway off Granville Avenue as well as via a pathway with entry trellis off Ledway Road. The dual use of the driveway by both vehicles and pedestrians is highlighted by decorative and permeable pavers at transition zones such as the main entry leading up to the Outdoor Amenity Space and the pedestrian entry off Ledway Road.
- On-site parking is provided consistent with Richmond Zoning Bylaw 8500. Resident vehicle parking spaces are proposed in individual garages and in surface parking spaces. Four surface parking spaces are proposed in the southwest portion of the site for visitors. Bike parking is also proposed within individual garages, while a bike rack for visitors is proposed at the entry to the Outdoor Amenity Space.
- Waste and recycling bins are to be located in individual garages consistent with the proposed door-to-door collection.

### Architectural Form and Character

- The proposed exterior design aims for a contemporary architectural vocabulary, which is considered appropriate given the existing surrounding context and the site's proximity to the City Centre.
- The proposed building massing and height are consistent with the design guidelines for Arterial Road Townhouses as the units are grouped into small building clusters and threestorey portions of buildings are located closest to the arterial road, stepping down to twostoreys along the interface with existing adjacent two-storey housing.
- To provide visual interest and further break down the building mass, portions of the upper floors are stepped back from the floors below and a combination of hipped and shed roof forms are used.
- The residential character of the development is reflected in the use of small-scale, pedestrianoriented features such as street-fronting pedestrian entrances with meaningful eave projections, articulation at different levels of the building façade and an appropriate variety of building cladding materials and colours.
- The proposed colour palette and cladding material consist of white Hardie panels with matching reveal edges, Hardie vertical-patterned panel siding in blue and light tan accent colours and Hardie lap siding in a dark tan accent colour.

### **Open Space & Landscape Design**

• Common outdoor amenity space is located in the southeast corner of the site (122 m<sup>2</sup>), which is larger than the 108 m<sup>2</sup> design guideline in the OCP. The space contains the mail kiosk, bench seating, a children's play structure that provides for climbing, jumping and sliding, as well as a variety of plants and a Pacific Dogwood tree.

- Private outdoor space for each of the units is provided consistent with the size guidelines in the OCP (min. 30m2 per unit) and is primarily in the form of yards at grade, with secondary balconies for the three-storey buildings along either the internal drive-aisle or Ledway Road.
- Tree retention and removal was assessed as part of the Rezoning Application, at which time it was identified that:
  - Five trees on the subject site are to be retained and protected (Trees # 455, 457, 458, 459, 467).
  - Four trees shared with City-owned property and neighbouring property to the east are to be retained and protected (Trees # 456, and 473, 474, 475, respectively).
  - Five trees on neighbouring properties to the south and east are to be retained and protected (Trees # N01, N04, N05, N06, and an unnumbered Walnut tree).
  - Two trees located in the boulevard on City-owned property are to be retained and protected (Trees # C05 and C06).
  - 11 on-site trees (one of which is shared with the City) are proposed to be removed (Trees # 460-465, 468-472), for which 22 replacement trees are required to be planted and maintained on-site consistent with the 2:1 replacement ratio in the City's OCP and Tree Protection Bylaw.
  - Two trees on neighbouring properties to the south (Trees # N02, N03) and two trees on City-owned property (Trees # C02, C03) are proposed to be removed
     Note: prior to removal of Trees # N02 and N03, the applicant must obtain tree removal permits and provide tree replacement on those properties (with authorization of/coordination with the neighbouring property owners). The applicant is also required to provide a \$4,500.00 contribution to the City's Tree Compensation Fund prior to final adoption of the rezoning bylaw for removal of the City trees.
  - Three non-bylaw hedgerows are proposed to be removed from the subject site, as are two non-bylaw hedgerows in the boulevards on City-owned property (#C01, C07).
- For eight of the trees retained on City-owned property and the subject site (Trees # C05, C06, 455-459), the design of the required frontage improvements is being adjusted to align the new sidewalk to the outside edge of the tree protection zone. The design will be further refined through the Service Agreement design review process.
- To ensure that retained trees are protected, the applicant is required to submit Tree Survival Securities totalling \$65,000.00 and enter into a legal agreement that sets the terms for the use and release of the securities prior to final adoption of the rezoning bylaw.
- The Landscape Plan shows that a mix of 24 deciduous and coniferous trees are proposed to be planted and maintained on-site, which exceeds the required number of replacement trees (i.e., Vine maple, Pacific Dogwood, Toba Hawthorn, Honey locust and Serbian spruce).
- A variety of shrubs, perennials and ground covers are also proposed on-site (e.g., Juniper, Hick's Yew, Azalea, Salal, Spirea, Ferns and Bugleweed).
- The Landscape Plan indicates that all soft landscaped areas are to be equipped with an automatic irrigation system approved by the registered Landscape Architect and installed by an accredited irrigation contractor.

- To define the street edge and clearly distinguish between public and private space, low aluminum picket fencing with pedestrian gates is proposed, while solid wood privacy fencing is proposed along common property lines with adjacent properties.
- To ensure that the Landscape Plan is adhered to, the applicant is required to submit a Landscaping Security in the amount of \$135,447.33, which is based on 100 per cent of the landscape cost estimate prepared by the Registered Landscape Architect (including all materials, installation and a 10 per cent contingency) prior to DP issuance. The applicant must also enter into a legal agreement that sets the terms for the use and release of the Landscaping Security.
- The proposed lot grading is designed to accommodate the required flood construction level while gently sloping to match the existing lot grade elevations at common property lines with adjacent properties.
- A concept for exterior lighting is provided, which illustrates that appropriate buildingmounted lighting is proposed at all unit entries and on the sides of buildings, as well as a bollard light at the pedestrian pathway to the site off Ledway Road.

### Indoor Amenity Space

• Consistent with the OCP, and as considered as part of the Rezoning Application, the applicant proposes to submit a contribution in the amount of \$37,188.00 to the City's Leisure Facilities Reserve Fund prior to final adoption of the rezoning bylaw in-lieu of providing common indoor amenity space on-site.

### Accessible Housing

- The proposed development includes two convertible units that are designed with the potential to be easily renovated to accommodate a future resident in a wheelchair or with mobility constraints. The potential conversion of these units will require the installation of a stair lift.
- All of the proposed units incorporate aging-in-place features to accommodate mobility constraints associated with aging. These features include:
  - stairwell hand rails;
  - lever-type handles for plumbing fixtures and door handles; and
  - solid blocking in washroom walls to facilitate future grab bar installation beside toilets, bathtubs and showers.

### Sustainability

- The applicant has submitted written confirmation from their certified Energy Advisory that the proposed design will meet BC Energy Step Code 3 with a low-carbon energy system. The key technical elements that enable this performance target to be achieved include additional insulation in floor, wall and roof assemblies, electric domestic hot water heating and air source heat pumps for both heating and cooling.
- The proposed energy performance target is consistent with the provisions for in-stream applications that were submitted to the City prior to October 31, 2023, subject to the DP application being considered and endorsed by the DP Panel and a complete Building Permit

application being submitted prior to October 31, 2024. The applicant is aware that if these deadlines are not met, the proposal must be updated to meet the current BC Energy Step Code performance targets (e.g., Step 3 + EL-4).

- To minimize visual impact, the heat pump condenser units for Buildings 1 and 2 are proposed to be located on the balconies along the internal drive-aisle; for Building 3 are located under the balconies behind the support columns; and for Buildings 4 and 5 are located abutting the rear building facades and screened with landscaping.
- The applicant has provided a report from an acoustical engineer confirming that the proposed heat pumps will comply with the City's Noise Regulation Bylaw.
- Additional environmental sustainability features of the proposal identified by the applicant include:
  - Energized outlets to support electric vehicle (EV) charging for all resident parking spaces, an energized outlet for one visitor parking space, and opportunity charging for one visitor parking space, as required by Richmond Zoning Bylaw 8500.
  - Permeable pavers within a portion of the drive-aisle and within the surface parking spaces to maximize stormwater infiltration potential.
  - Low-flow toilets and showers, energy-efficient LED lighting and Energy Star appliances.

### Crime Prevention Through Environmental Design (CPTED)

• The applicant has indicated that CPTED principles have been accounted for in the proposed design, such as the single vehicle access point off Granville Avenue and clearly-defined pedestrian access point off Ledway Road; the centralized outdoor amenity space within sight of the entrance and with a high level of passive surveillance; appropriately-sized windows on all building elevations to monitor adjacent private outdoor spaces and building entries; and lighting at unit entries and along the drive-aisle.

### Site Servicing and Off-site Improvements

- Servicing and off-site improvements to support the proposed development were identified during the Rezoning Application review process and will be undertaken as part of a Service Agreement to be entered into prior to Building Permit issuance. The scope of work includes, without limitation: drainage upgrades along approximately 50 m of Ledway Road to increase the size of the storm sewer to 600 mm diameter; water, storm and sanitary service connections and boulevard improvements to contain a new treed/grass boulevard and concrete sidewalk along both Granville Avenue and Ledway Road, as well as an off-street bike path along the Granville Avenue frontage.
- The design of the frontage improvements is to be adjusted to facilitate retention of eight of the existing City-street trees and trees on the subject site, and the design will be further refined through the SA design review process.

### Conclusions

This proposal is for an 18-unit townhouse development on a land assembly involving three lots at 5800, 5840, 5860 Granville Avenue.

The applicant has addressed the design issues identified through the Rezoning Application review process, as well as additional staff comments regarding site planning, urban design, architectural form and character, and landscape design as part of the DP Application review process. The proposal provides an appropriate response to the surrounding housing context and conforms to the applicable policies and design guidelines contained within the OCP.

The proposed development complies with the requirements of the "RTL4" zone, with the exception of the variances discussed.

On this basis, staff recommend that the DP be endorsed, and issuance by Council be recommended.

Cynthia Lussier Planner 2 (604-276-4108)

CL: js

### Att. 1. Location Map

- 2. Development Application Data Sheet
- 3. Excerpt from the May 23, 2024 Advisory Design Panel meeting minutes and the Applicant's design response

The following are to be met prior to forwarding this application to Council for approval:

- 1. Final adoption of Richmond Zoning Bylaw 8500, Amendment Bylaw 10470.
- 2. Receipt of a Letter of Credit or other form of security acceptable to the City for landscaping in the amount of \$135,447.33 (100 per cent of the cost estimate provided by the Registered Landscape Architect, including all materials, installation, and a 10 per cent contingency). To accompany the landscaping security, a legal agreement that sets the terms for use and release of the security must be entered into between the applicant and the City.
- 3. Payment of all fees in full for the cost associated with the Development Permit Panel Meeting Notices, consistent with the City's Consolidated Fees Bylaw No 8636, as amended.


Prior to future Building Permit issuance, the developer is required to complete the following:

- Incorporation of accessibility measures in Building Permit plans and construction, as determined via the Rezoning and Development Permit applications (e.g., aging-in-place features in all units and two convertible units).
- Incorporation of energy efficiency measures in Building Permit plans and construction to meet or exceed the applicable Energy Step Code performance target. Note: The applicant is aware that if the deadline for in-stream applications is not met, the proposal must be updated to meet the current BC Energy Step Code performance targets (e.g., Step 3 + EL-4).

- Obtain a Building Permit for any construction hoarding associated with the proposed development. If construction hoarding is required to temporarily occupy a street, or any part thereof, or occupy the air space above a street or any part thereof, additional City approvals and associated fees may be required as part of the Building Permit. For further information on the Building Permit, please contact Building Approvals Department at 604-276-4285.
- Submission of a construction traffic and parking management plan to the satisfaction of the City's Transportation Department (<u>https://www.richmond.ca/services/transportation/special.htm#TrafficPlan</u>).
- If applicable, payment of latecomer agreement charges, plus applicable interest associated with eligible latecomer works.



### **ATTACHMENT 1**

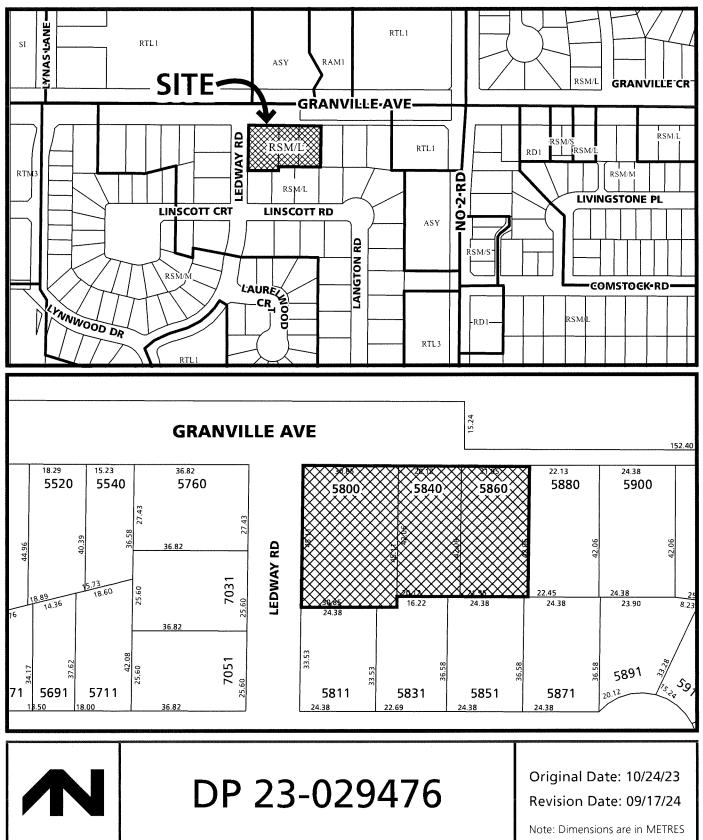



Owner: 1275306 BC Ltd.

**Development Applications Department** 

### DP 23-029476

Address: 5800, 5840, 5860 Granville Avenue

Applicant: Interface Architecture Inc.

Planning Area(s): Blundell

	Existing	Proposed
Site Area:	3,163 m <sup>2</sup>	3,155 m <sup>2</sup> (after the required 4 m x 4 m corner cut road dedication)
Land Uses:	Single detached housing	Townhousing
OCP Designation:	Neighbourhood Residential	No change
Zoning:	Small-Scale Multi-Unit Housing (RSM/L)	Low Density Townhouses (RTL4)
Number of Units:	3	18

	Bylaw Requirement	Proposed	Variance
Floor Area Ratio:	0.60	0.60	None permitted
Floor Area (Net):	Max. 1,893.00 m <sup>2</sup> Max. (20,376.08 ft <sup>2</sup> )	1,891.61 m <sup>2</sup> (20,361.00 ft <sup>2</sup> )	None permitted
Lot Coverage – Buildings:	Max. 40%	35.8%	None
Lot Coverage – Non-porous Surfaces:	Max. 65%	57.6%	None
Lot Coverage – Live Plant Material:	Min. 25%	27.2%	None
Setback – Front Yard (West):	Min. 6.0 m	6.0 m	To permit a 0.6 m electrical closet projection
Setback – Exterior Side Yard (North):	Min. 6.0 m	4.5 m	To reduce from 6.0m to 4.5 m
Setback – Side Yard (South):	Min. 3.0 m	6.0 m	None
Setback – Rear Yard (East):	Min. 3.0 m	6.8 m	None
Building Height (m):	Max. 12.0 m (3 storeys)	11.93 m (Bldgs. 1 & 2) 8.92 m (Bldgs. 3) 8.99 m (Bldgs. 4 & 5)	None
Minimum Lot Depth:	Min. 35.0 m	72.9 m	None
Minimum Lot Width:	Min. 30.0 m	43.6 m (average)	None



	Bylaw Requirement	Proposed	Variance
On-site Vehicle Parking Spaces:	Min. 2.0/unit - 36 spaces (R) Min. 0.2/unit - 4 spaces (V)	36 spaces (R) 4 spaces (V)	None
Standard Size: Small Size:	Min. 50% (18 spaces) Max. 50% (18 spaces)	86.1% (31 spaces) 13.9 % (5 spaces)	None
Tandem Vehicle Parking Spaces:	Max. 50% (18 spaces)	50 % (18 spaces)	None
Accessible Vehicle Parking Spaces:	Min. 2% (1 Van Accessible space)	1 Van Accessible space	None
Total Vehicle Parking Spaces:	40 spaces	40 spaces	None
Amenity Space – Indoor:	Min. 70 m <sup>2</sup>	Cash-in-lieu	None
Amenity Space – Outdoor:	Min. 6 m²/unit (i.e., 108 m²)	122 m <sup>2</sup>	None

### Excerpt from the Minutes from The Advisory Design Panel Meeting

### Thursday, May 23, 2024 – 4:00 p.m. Remote Meeting

## DP 23-029476 – PROPOSAL TO DEVELOP 18 TOWNHOUSE UNITS, WITH VEHICLE ACCESS TO/FROM GRANVILLE AVENUE

ARCHITECT:	Interface Architecture Inc.
LANDSCAPE ARCHITECT:	Donald V.S. Duncan Development Consultant Landscape Architect
PROPERTY LOCATION:	5800, 5840, 5860 Granville Avenue

### **Applicant's Presentation**

Architect Ken Chow, Interface Architecture Inc, and Landscape Architect Donald Duncan, Donald V.S. Duncan Development Consultant Landscape Architect, presented the project and answered queries from the Panel.

### Panel Discussion

Comments from Panel members were as follows:

- overall, appreciate the design of the project which is simple, utilitarian, and straightforward; also appreciate the form and character of the building which has a bit of a traditional look, is residential-looking and broken down in scale; the building massing also addresses well the project's site context;
- like the idea of differentiating the buildings with colours; however, the rationale behind the proposed placement of colours is not clear as it appears random, particularly at the ends of the buildings;

Cladding materials at Level 3 revised to Hardie panel (Arctic White); the side elevations are revised/simplified accordingly.

 understand the rationale behind the proposed fencing; however, consider a more transparent fencing to provide more visual connection to the subject site as some of the proposed fencing look solid;

## The frontage fence is composed of $25 \times 25$ pickets on 100 mm centres. The top rail has been removed to lighten the appearance.

 agree with the Panel comment that the applicant reduce the amount of fencing especially along the frontages and ensure that retained trees located adjacent to the fence will be protected during the installation of fencing;

The amount of fencing has been reduced, particularly near the retained trees.

- agree with the Panel comment that the approach to break down the building massing is appropriate for the neighbourhood; *Noted*.
- also agree with the Panel comment that there is no clear rationale for the use of colours in the buildings;

The colour scheme has been simplified: (i) the base of the building is dark brown horizontal Hardie siding, (ii) the two accent colours remain only in certain areas, (iii) and the white Hardie panel are found mainly at the upper levels.

 the design of the balconies looks like an afterthought; the balconies appear tacked on and do not integrate well with the overall architecture of the buildings;

This comment referred to the Ledway-facing balconies of Building 3. They are now redesigned with wider support columns and clad with Hardie panel to be visually integrated with the building.

- in general, the scale of the project is appropriate for the neighbourhood; *Noted.*
- appreciate the retained trees in the subject site; *Noted*
- agree with the staff comment to replace the proposed yew hedges along street frontages with evergreen flowering shrubs as yews tend to grow tall; *Noted*
- appreciate the alternating pattern of planting of two tree species in the yards of each unit along Granville Avenue; however, consider replacing the Slender Hinoki False Cypress with a more visually permeable tree species along the Granville Avenue frontage to make it more inviting but retain them in the middle between the two yards;

## The False Cypress has been replaced by the slender form of the Serbian Spruce (Picea omorika).

• concerned about the survivability of proposed planting under the overhangs and balconies, particularly on the Granville Avenue side and the south side; installing year-round irrigation would help but is expensive;

An irrigation system will be provided. Plantings under some overhangs have been reduced where appropriate, and retained where the overhang is nominal and where the plants are adjacent to open lawn.

• the two lawn areas located between buildings will be in full shade; consider replacing with full shade ground cover as lawns require a lot of sunlight exposure to survive;

Lawns between buildings have been replaced with mass plantings of Chocolate Bugleweed (Ajuga reptans) • consider installing ground cover directly in front of the fence along the Granville Avenue and Ledway Road sides of the subject site in order to mitigate the austere and utilitarian appearance of the boulevard;

The fence on Ledway Road has been offset by 650 mm behind shrubs to soften the appearance.

• consider installing buffer planting between the children's play area and the adjacent yard;

In addition to the solid privacy fencing along property lines, a hedge has been added between the children's play area and the adjacent properties and solid privacy fencing also is provided alongside the adjacent unit's private outdoor space.

• the location of the children's play area appears isolated and not part of the subject development;

The children's play area is adjacent to the mailboxes, bike parking, and seating area. It is also aligned with the main access to the site.

- overall, appreciate the clear presentation of the project; *Noted.*
- appreciate the applicant for not only providing a space for a stairlift for the convertible units but also for providing the technical information for the lift (i.e., the specifications);

### Noted. The specifications are included on sheet A2.4.

• the two convertible units are located adjacent to each other in the same building; consider relocating one of the convertible unit to another building to address their segregation from other residential units;

## The two convertible units have been relocated and are now in Units # 15 and 18.

• if a manual will be provided for future owners/occupants of the convertible units, consider recommending a portable rather than a fixed ramp for use on the south entrance of the convertible units so it can be easily be moved to facilitate access to the yards of neighbours the owners would like to visit;

This is the correct option for accessing the yards from the convertible units, and the removable ramp option is shown on sheet A2.4.

 balconies dominate the façade on Building 3 fronting Ledway Road and the front doors appear recessive; consider introducing design changes to make the doors more dominant;

## These three entry door alcoves are now more visually prominent by increasing the shed roofs from 3:12 to 6:12 slopes.

• overall, the architectural treatment is reasonable in terms of massing, scale and character of the proposed development; *Noted*.

agree with Panel comments regarding the lack of rationale for the proposed use of colours and materials; review the transitions in the use of colours and materials on the same plane and clarify the rationale and logic for the transitions, e.g. clarify the relationship between the base versus the upper levels, particularly at the side elevations where material changes appear random; similarly with the relationship of textures between the materials in trying to use textures to highlight the design concept;

The colour and material scheme has been simplified, and transitions have been improved: (i) the base of the building is dark brown horizontal Hardie siding, (ii) the two accent colours remain only in certain areas, (iii) and the white Hardie panel are found mainly at the upper levels.

 consider installing additional smaller windows on building elevations fronting Ledway Road;

### Additional small windows have been added to the third level of Building 3 fronting Ledway Road.

 rear entries fronting the mews for Buildings 1, 2, and 3, could be treated to read like main entry doors in terms of character; also look at ways to extend the porch and make the entries more inviting, especially for children using the mews for play space;

### The doors fronting the drive-aisle have been revised to entry doors with glass inserts, to match those on the front entries.

 agree with Panel recommendation to reduce the amount of fencing especially at the end of the mews facing Ledway Road; also consider shifting the fence line further inside the property line to allow planting in front of the fence to soften the appearance of the fence;

## The extent of the fence has been reduced and it has been set back from the property line on Ledway Road to allow for low shrub plantings in front.

• review the design of the entry gates to the residential units along Granville Avenue and Ledway Road and investigate opportunities to punctuate the streetscape to provide a better sense of address to the units;

The new fence design differentiates the gates from the fence to punctuate the entries.

• consider installing a planted buffer between the children's play area and the adjacent residential unit to mitigate noise coming from the children's play area;

## Solid wood fencing is provided to the west of the children's play area, and a hedge and solid wood fencing is provided on the east side.

consider installing a planted buffer between the visitor parking stalls and the adjacent yard at the southwest corner of the subject development; consider installing trees as there is a large open area at the southwest corner of the site; also consider relocating the electrical closet on the west elevation of Building 2 to this area;

Due to the existing 6 m wide statutory right-of-way for the sanitary sewer in the southwest corner of the site, building encroachments and tree planting are not permitted in this area.

• consider extending the on-site pedestrian accessible path up to the Ledway Road sidewalk and if necessary, install a gate that is accessible;

The accessible pedestrian path off the Ledway Road sidewalk has been widened to 1.5 m consistent with City guidelines, complete with entry trellis. At the dead-end of the drive-aisle, permeable pavers have been added to signify the transition zone to an area that is used by both vehicles and pedestrians.

- overall, the project is appropriate for the neighbourhood and the residential character of the project is apparent and generally well handled; *Noted.* and
- consider extending the strip of pedestrian walkway (that links the dead-end drive aisle to the Ledway Road sidewalk) up to the project's children's play area to provide a safe and continuous on-site pedestrian pathway.

To emphasize shared use of the drive-aisle by vehicles and pedestrians, the drive-aisle has been treated with permeable pavers in a herringbone pattern at key areas, such as the site's main entry up to the outdoor amenity space containing the children's play area, as well as where it meets the pedestrian path off Ledway Road.

The following written comment submitted by Panel member David Semczyszyn was read into the record by Virendra Kallianpur, Staff Liaison for the Panel:

• pleased to see the use of permeable pavers in the project. *Noted.* 

Clarification was sought by the applicant regarding the comments of the Panel. In reply, the Panel members stated the following:

• with regard to the Panel recommendation to relocate one of the two adjacent convertible units in Building 4, it was clarified that the applicant consider relocating the two convertible units farther from each other, i.e., one convertible unit to be located on the west end of Building 4 and the other convertible unit to be located on the east end of Building 5;

The two convertible units are now relocated to Units #15 and 18.

with regard to the Panel recommendation to extend the strip of pedestrian walkway from the Ledway Road sidewalk up to the children's play area and the proposed width and paving material to be used, it was clarified that the recommended pathway width be between 900 mm to 1200 mm and the same AquaPave unit pavers at the site entrance with a different colour be used for paving; and

The accessible pedestrian path off the Ledway Road sidewalk has been widened to 1.5 m consistent with City guidelines, complete with entry trellis. At the dead-end of the drive-aisle, matching permeable pavers to those used at the site entrance have been added to signify the transition to an area that is used by both vehicles and pedestrians.

• with regard to the Panel recommendation to reduce the amount of fencing and improve its transparency, it was clarified that the applicant consider (i) reviewing the relationship of posts (i.e., the concrete posts that frame the entrances to the yards) and the gates, (ii) reviewing the design of fencing as they stand out and appear not integrated with the building massing and consider a picketed fence with no solid top to enhance transparency, (iii) reviewing the height of fencing along the site's front yards, and (iv) investigating opportunities to reduce fencing at the end of the mews in order to highlight the accessible path into the development.

Fencing has been revised to include gates that are characterized by posts and a top rail, while the remainder of the fencing along the frontages includes pickets with no top rail. Side yard fences are retained at 1.8 m in height as solid privacy fencing. Fencing at the mews end has been removed, with a trellis providing an entry feature.

### **Panel Decision**

It was moved and seconded

That DP 23-029476 be supported to move forward to the Development Permit Panel subject to the applicant giving consideration to the comments of the Advisory Design Panel.

CARRIED



# No. DP 23-029476 To the Holder: Interface Architecture Inc. Property Address: 5800, 5840, 5860 Granville Avenue Address: Unit 230 - 11590 Cambie Road Richmond BC V6X 3Z5

- 1. This Development Permit is issued subject to compliance with all of the Bylaws of the City applicable thereto, except as specifically varied or supplemented by this Permit.
- 2. This Development Permit applies to and only to those lands shown cross-hatched on the attached Schedule "A" and any and all buildings, structures and other development thereon.
- 3. The "Richmond Zoning Bylaw 8500" is hereby varied to:
  - a) Reduce the minimum exterior side yard (north yard) from 6.0 m to 4.5 m.
  - b) Permit an electrical closet projection of 0.6 m into the front yard (west yard).
- 4. Subject to Section 692 of the Local Government Act, R.S.B.C.: buildings and structures; on-site parking and loading facilities; roads and parking areas; and landscaping and screening shall be constructed generally in accordance with Plans # 1 to # 6 attached hereto.
- 5. Sanitary sewers, water, drainage, highways, street lighting, underground wiring, and sidewalks, shall be provided as required.
- 6. As a condition of the issuance of this Permit, the City is holding the security in the amount of \$135,447.33 to ensure that development is carried out in accordance with the terms and conditions of this Permit. Should any interest be earned upon the security, it shall accrue to the Holder if the security is returned. The condition of the posting of the security is that should the Holder fail to carry out the development hereby authorized, according to the terms and conditions of this Permit within the time provided, the City may use the security to carry out the work by its servants, agents or contractors, and any surplus shall be paid over to the Holder. Should the Holder carry out the development permitted by this permit within the time set out herein, the security shall be returned to the Holder. The City may retain the security for up to one year after inspection of the completed landscaping in order to ensure that plant material has survived.
- 7. If the Holder does not commence the construction permitted by this Permit within 24 months of the date of this Permit, this Permit shall lapse and the security shall be returned in full.

To the Holder:	Interface Architecture Inc.
Property Address:	5800, 5840, 5860 Granville Avenue
Address:	Unit 230 - 11590 Cambie Road Richmond BC V6X 3Z5

8. The land described herein shall be developed generally in accordance with the terms and conditions and provisions of this Permit and any plans and specifications attached to this Permit which shall form a part hereof.

, .

This Permit is not a Building Permit.


AUTHORIZING RESOLUTION NO. DAY OF , .

ISSUED BY THE COUNCIL THE

DELIVERED THIS DAY OF

MAYOR



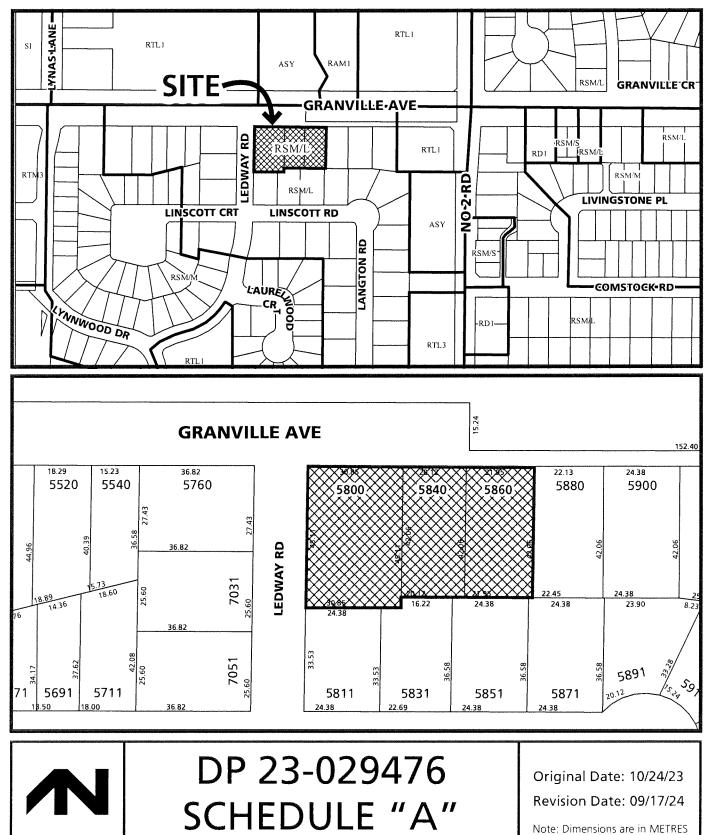

## **DEVELOPMENT PERMIT APPLICATION**

RESUBMISSION: SEPT 17, 2024

PROPOSED 18-UNIT TOWNHOUSE DEVELOPMENT 5800 / 5840 / 5860 GRANVILLE AVENUE

RZ 21-922202 / DP 23-029476











5771 GRANVILLE AVE.

5900 GRANVILLE AVENUE

5791 GRANVILLE AVE

7031 LEDWAY ROAD

5760 GRANVILLE AVENUE ALONG LEDWAY ROAD

PERSPECTIVE VIEW



5760 GRANVILLE AVENUE ALONG GRANVILLE AVE,



REVISIONS.	
SEP 17, 2024	DP4 RE-SUBMISSION
JULY 08, 2024	DP3 RE-SUBMISSION
MAY 10. 2024	ADP SUBMISSION
MAY 02, 2024	DP2 RE-SUBMISSION
SEP 22, 2023	DP APPLICATION
MAR 09, 2023	RZ3 RE-SUBMISSION
OCT 15, 2021	RZ2 RE-SUBMISSION
DEC 23, 2020	RZ1 APPLICATION
CONSULTANTS	

### SEPT 19 2024 DP 23-029476 PLAN #1

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Suite 230 11590 Camble Road Richmond BC Canada V6X 325 T 604 821 1162 F 604 821 1146

Proposed 18-Unit Townhouse Development		
3 LOT ASSEMBLY		
5800 / 5840 / 5860 GRANMLLE AVENUE RICHMOND, BC		
PROJECT NO. :		
2008GP.AN		
SCALE ·		
DATE :		
Dec 23, 2020		
DRAWN BY :		
KYC, SRS		
CHECK BY		
KYC		
SHEET TITLE :		
COVER SHEET		
DRAWING SHEET		

A0.0

#### CONTACTS

ARCHITECT INTERFACE ARCHITECTURE INC. #230 - 11590 CAMBIE ROAD RICHMOND, BC V6X 325 Tet 604-821-1162 Attn KEN CHOW Fax. NA Email: ken@interfacearchitecture.com

SURVEYOR J.C. TAM AND ASSOCIATES J,C, TAM AND ASSOCIATES #115 - 8833 ODLIN CRESCENT RICHMOND, BC V6X 327 Tel: 604-214-8928 Attn JOHNSON TAM Fax 604-214-8929 Email: office@jctam.com

ARBOURIST ACL GROUP ARBORTECH CONSULTING #145 – 12051 HORSESHOE WAY RICHMOND, BC VTA 4V4 Tet: 604-275-3484 Attn. NICK MCMAHON Fax - Email.nick@adgroup.ce

LANDSCAPE ARCHITECT DONALD DUNCAN LANDSCAPE ARCHITECT #603-220 11TH STREET, NEW WESTMINSTER BC V3M 6NS

Tel: 778-791-4323 Attn DONALD DUNCAN Fax: - Email: dvsduncan@gmail.com CIVIL

 
 MPT ENGINEERING CO, LTD

 #320 - 11120 HORSESHOE WAY

 RICHMOND, B.C. V/A 6H7

 Tet: 504-270-9331

 Attr: JEFF CRAWFORD

 Fax: 604-270-4137

 Email: jeff@mpl.bc.ca
 TRAFFIC ANALYSIS

 ISL ENGINEERING AND LAND SERVICES LTD.

 #201 - 8506 200 STREET

 LANGLEY TWP, BC, V2Y 0M1

 Tel: 604-37 L0091
 Atm. BORG CHAN

 Fax: 604-371-0098
 Email bchan@xelengineering.com

ACOUSTICAL BAP ACOUSTICS LTD. #122 - 2227 ST, JOHNS STREET PORT MOODY, B.C. V3H 2A5 Tel. 604-492-2992 Attn: ERIC DE SANTIS Fax: Email eric@bapacoustics.com

#### **ZONING SUMMARY** \* VARIANCE REQUESTED Richmond Zoning and Development Bylaw No. 8500 LOT ZONING: RTL4 PROPOSED (CURRENTLY, RS1/E) USES: LOW DENSITY TOWNHOUSES LOT SIZE GROSS AREA 34 046 SF = 0,78 ACRES = 3,163 M2 CORNER CUT 8 M2 (4M x 4M) NET AREA 3,155 M2 [33,960 SF] PERMITTED / REQUIRE PROJECT SPECIFIEC (PROPOSED) 71,9M (W) X 45,1M/42M (D) MIN, LOT SIZE 50M [W] X 35M [D] DENSITY (MAX) FAR 0,60 + 0,1 AMENITY FAR 0,60 (1891,61 M2 / 3,155 M2) [20,361 SF / 33,960 SF] LOT COVERAGE 40% MAX FOR BUILDINGS 35.8% (1,128.2 M2 / 3,155 M2) [12,144 SF / 33,960 SF] LOT IMPERMEABLE: 65% MAX NON-POROUS 57,6% (1,817,5 M2 / 3,155 M2)\* SEE L1-02 FOR OVERLAY 25% MIN. LIVE PLANTS 27.2% (857.8 M2 / 3.155 M2) \* SEE L1-02 FOR OVERLAY YARD SETBACKS FRONT (W) (LEDWAY 6 0 M (19.68') MIN 6.05M [19.85'] 4.56M [14,96'] 6,02M [19,75'] 6,88M [22,57'] AT BUILDING 5 10,70M [35,10'] AT BUILDING 1 SIDE (N) (GRANVILLE) SIDE (S) REAR (E) 6.0 M [19,68'] MIN 3.0 M [9,84'] MIN 3.0 M [9,84'] MIN YARD PROJECTIONS: PRINCIPAL BLDG, BAY WINDOWS BALCONIES PERGOLAS, ETC, ELECTRICAL CLOSE 1,5 M MAX FRONT YARD 1,0 M FRONT, 0,6 M REAR 1,5 M, BUT NOT AT SIDE N/A N/A 1.48M N/A BY CASE 0.6 M MAX, BUT NOT AT FRONT D.6 M BUILDING HEIGHT MAX MAX, 12 M/ 3-STOREY 11,93 M - 3-STOREY (BUILDING 1 & 2) 8,92 M - 2-STOREY (BUILDING 3) 8,99 M - 2-STOREY (BUILDING 4 & 5) FLOOD PLAIN C.L. TOP OF HABITABLE FLOOR AT 0.3 M MIN, ABOVE HIGHEST ROAD CROWN SET FCL AT 1.63 M [5.35 FT] (ROAD CROWN IS 1.33 M) PARKING (VEHICLE) RESID VISITOR SMALL CARS TANDEM SPACES ACC SPACES EV CHARGING OUTLET 36 SPACES (2.0 / UNIT) 4 SPACES (0.2 / UNIT) 50% MAX 50% MAX 50% OF VISTOR SPACES MIN, 36 (EVEL 2 EV ENGLED OUTLE FOR EACH RESIDENT SPACE) 1 VISTOR PARKING SPACE WITH LEVEL 2 ENERGIZED OUTLET AND 1 VISTOR PARKING SPACE WITH 1 VISTOR PARKI 35 SPACES (31 STD, 5 SML) 4 SPACES (35TD, 1 ACC) 13,9% (5 OUT OF 36 SPACES) 50% (18 OUT OF 36 SPACES) 1 VAN ACC VISITOR SPACE 36 LEVEL 2 EV ENERGIZED OF UTLETS 1 VISITOR PARKING SPACE WITH LEVEL 2 ENERGIZED OUTLET AND 1 VISITOR PARKING SPACE WITH OPPORTUNITY CHARGING

ARKING (BICYCLES) CLASS 1 (RESIDENT) 23 SPACES (1,25 / UNIT) MAX 33% PLACED VERT. 4 SPACES (0,2 / UNIT) CLASS 2 (VISITOR) AMENITY COMMON OUTDOOR PRIVATE OUTDOOR INDOOR 108 M2 (18 X 6 M2/UNIT

122,02 M2 SHOWN PROVIDED 30 M2/UNIT MIN. PAY-IN-LIEU 30 M2/UNIT (RECOMMENDED) 70 M2 OR PAY-IN-LIEU

### **PROJECT DESCRIPTION**

AN RTL4 REZONING OF THE 3163 M2 SITE [34,046 SF] (BLUNDELL AREA PLAN) IS PROPOSED TO DEVELOP AN 18-UNIT TOWNHOUSE PROJECT TO A MAXIMUM DENSITY OF 0.60 FAR IN 5 BULDINGS, DEVELOP MENT IS UBJECT TO TO THE ARTERIAL ROAD POLICY (OCP 3.6.1) AND MULTI-FAMILY DP DESIGN GUIDELINES (OCP 14.4.)

GRANVILLE AVENUE IS A MAJOR ARTERIAL ROAD. A BUS STOP IS LOCATED IN FRONT OF 5800. THERE IS AN EXISTING 6.0 M-WDDE SANITARY SRW ACROSS THE ENTIRE SOUTH PL. STRADDING ABOUT HALF OF THE EAST PORTION. SINGLE FAMILY PARCELS SURROUND THE SUBJECT SITE TO THE WEST SOUTH, & EAST. THERE IS NO LANE ACCESS. THE COP. IDENTIFIES POTENTIAL TOWHHOUSE EXPANSION AT THE EASTERN 3 LOTS. SITE PLANNING OBJECTIVES


- THE SITE ACCESS POINT, NOW REQUIRED TO BE AT THE EAST PL. REDUCES TRAFFIC CONGESTION AT THE LEDWAY FRONTAGE. PROVIDES CLEARANCE FROM THE EXISTING BUS STOP, AND ANTICIPATES FUTURE MULTI-FAMILY DEVELOPMENT TO THE EASTERN 3 LOTS. THE INTERNAL T-DRIVE AISLE ALLOWS SUG TRUCK MANOUEVERING AND 3. POINT TURNAROUND.
- POINT TURNAROUND. THE DEAD-END DRIVE AISLE WILL PRESERVE AN OFFSITE CITY TREE (C05, CHERRY PLUM) AT LEDWAY. THE A VISITOR SPACES (3 STANDARD. 1 ACCESSBLE) AND 4 ASSIGNED RESIDENTIAL SPACES (3 STANDARD. 1 SMALL) ARE GROUPED TOGETHER TO CREATE A DA'LIT CENTRAL OPEN SPACE. THE SINGLE PMT IS LOCATED AT THE DEAD END DRIVE AISLE BEHIND THE PROTECTED TREE COS AND WILL BE WELL-SCREENED WITH THICK LANDSCAPING AT THE LEDWAY FRONT YARD,

BUILDINGS 1 & 2 FRONTING GRANVILLE ARE 3-STOREYS, BUILDING 3 FRONTING LEDWAY IS 2-17, STOREYS AND BUILDINGS 4 & 5 ADJACENT TO SINGLE FAMILY HOUSES ARE 2-STOREY DUPLEXES, TWO CONVERTIBLE UNITS ARE PROPOSED AT BUILDINGS 4 & 5 (UNITS 15 & 19), NO LOCKOFF UNITS ARE PROPOSED.

TWO VARIANCES ARE PROPOSED. SETBACK VARIANCE AT THE FLANKING SIDE YARD (GRANVILLE) IS PERMITTED FROM 50M TO 4.5M. 2. ELECTRICAL CLOSET ENCROACHES 0.6M INTO FRONT YARD (LEDWAY ROAD).

	SITE	BLDG 1	BLDG 2	BLDG 3	BLDG 4	BLDG 5
SWCORNER	0.99	1.4	1.4	1,4	1.4	1.4
SE CORNER	1.22	1.4	1.4	1.4	1.4	1.4
NECORNER	0.94	1.4	1.4	1.4	1.4	1.4
NWCORNER	1.06	1.4	1.4	1.4	1.4	1.4
AVE GRADE	1.05 M	1.4 M	1.4 M	1.4 M	1.4 M	1.4 M

915
115
43
NG 71
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FAR AREA BY BUILDING					
BUILDING	NO. UNIT	UNIT TYPES	BLDG GROSS	BLDG EXEMPT	BLDG FAR AREA
1	5	2 x B-1, 2 x B-2, 1 x C	819,16 m2	(297,49 m2)	521.67 m2
2	6	2 x B-1, 3 x B-2, 1 x B-e	959,12 m2	(347.58 m2)	611.54 m2
3	3	1 x D-1, 1 x D-2, 1 x D-3	429,19 m2	(134.73 m2)	294.46 m2
4	2	1 x Ac, 1 x A	329.11 m2	(97.14 m2)	231.97 m2
5	2	1 x Ac, 1 x A	329,11 m2	(97.14 m2)	231.97 m2
TOTAL		18 UNITS			1891.61 m2
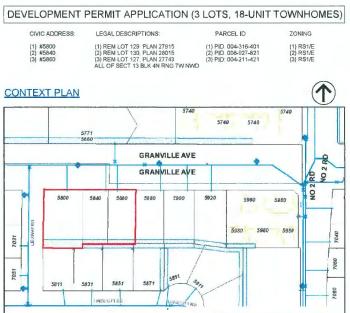
#### ARCHITECTURAL

- COVER SHEET PROJECT DATA PROPOSED STE PLAN PARKING PLAN, FIRE FIGHTING PLAN STE AREA OVERLAYS LOT COVERAGE, AND OUTDOOR SPACE FAR AREA OVERLAYS BUILLONG 3.4, & 5 FLOOR PLANS, BUILLONG 3.4, & 5 FLOOR PLANS, BUILLONG 3.4, & 5 A0,0 A1,1 A1,2 A1,3 A1,4 A1,5 A1,6 A2,1 A2,2 A2,4 A3,1 A3,2 A3,4 A3,4 A5,1 A6,1 A6,1 A9,1 A9,2 A9,3

- FAR AREA OVERLAYS. BUILDING 3, 4, 4 5 FLOOR PLANS. BUILDING 7 FLOOR PLANS. BUILDING 7 FLOOR PLANS. BUILDING 4, 6 FLOOR PLANS. BUILDING 4, 6 FLOOR PLANS. CONVERTIBLE UNIT BUILDING ELEVATIONS. BUILDING 1 BUILDING ELEVATIONS. BUILDING 4, 6 BUILDING ELEVATIONS. BUILDING 4, 8 BUILDING ELEVATIONS. BUILDING 4, 8

- BUILDING ELEVATIO SITE SECTIONS SHADOW STUDY MATERIAL BOARD PERSPECTIVES 1 PERSPECTIVES 2 PERSPECTIVES 3

LANDSCAPE

- L0-01 NOTES AND SYMBOLS L1-02 LANDSCAPE AREA L2-01 HARD LANDSCAPE PLAN L4-01 PLANTING PLAN L05-01 SOFT LANDSCAPE DETALLS L05-02 HARD LANDSCAPE DETALLS L05-03 HARD LANDSCAPE DETALLS L05-04 PLAY EQUIPMENT DETALLS

#### SURVEYOR

TOPOGRAPHICAL SURVEY DATED 23 NOVEMBER 2023

27 SPACES IN 18 UNITS 4% VERT.(1 OUT OF 27) 4 SPACES

ARBOURIST

TREE MANAGEMENT REPORT DATED 13 SEPTEMBER 2024


TRANSPORTATION (AUTOTURN ANALYSES)

AUTOTURN ANALYSIS DATED 3 MAY 2023

#### ACOUSTICAL

ACOUSTIC REPORT DATED 16 SEPTEMBER 2024

CIVIL (LOT GRADING PLAN) PRELIMINARY LOT GRADING PLAN DATED 16 MAY 2024

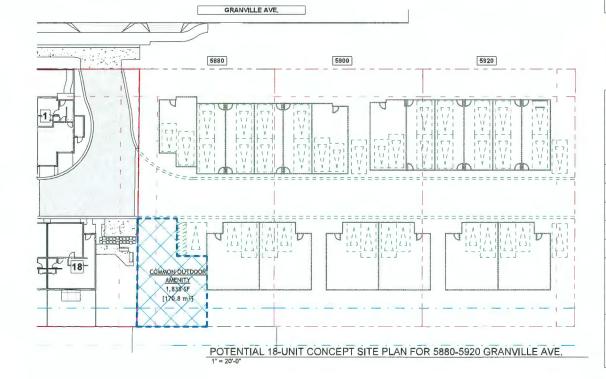

REVISIONS.	
SEP 17, 2024	DP4 RE-SUBMISSION
JULY 08, 2024	DP3 RE-SUBMISSION
MAY 10, 2024	ADP SUBMISSION
MAY 02, 2024	DP2 RE-SUBMISSION
SEP 22, 2023	DP APPLICATION
MAR 09, 2023	RZ3 RE-SUBMISSION
OCT 15, 2021	RZ2 RE-SUBMISSION
DEC 23, 2020	RZ1 APPLICATION
CONSULTANTS	


#### SEPT 19 2024 DP 23-029476 **PLAN # 1,A**

ALL DEGRETIS AND INTER INFORMATION OF WHI HERE ON ARE FOR THE USE OF THIS SPECIFIC PRIMERTICILLY NOTIFIELD THE USED OTHERWISE WITHOUT THE WRITTEN PERMISSION FORMATING SCRIPE. THIS DRAWING HUST NOT BE REPRICICED WITHOUT THE WRITTED PREAKSSION FROM THIS DREFTER, JACKALL PREACD LOTION MUST SHOW TH TAME OF THE OPERACE. THERE OF THE STATUS, UNITERSTORE AND SUBPORTERSTURES SHALL WEDRY & ID ARE REPORTING EFOR ALL DIREMSIONS AND CONSTITUTION OF THE ADD UPPER MICH BE PARAMEDIA AND TRUE MICH BE PARAMEDIA AND TRUE MICH BE PARAMEDIA THE MICH BE THE APLICITED 15 101 PESPON ABLE FOR THE METHOD AND QUALITY OF COLLECTION OF T CONTRACTOR AND THE SUBJOINTRACTORS.

### INTERFACE: Suite 230 1 1590 Cambie Road Richmond BC Canada V6X 325

T 604 821 1162


F 604 821 1146 www.interfacearchitecture.com
PROJECT
Proposed 18-Unit
Townhouse Development
3 LOT ASSEMBLY
5800 / 5840 / 5860 GRANVILLE AVENUE
RICHMOND, BC
PROJECT NO. :
2008GP.AN
SCALE :
1" = 20'-0"
DATE :
Dec 23, 2020
DRAWN BY :
KYC, SRS
CHECK BY
KYC
SHEET TITLE .
PROJECT DATA
DRAWING SHEET :
A 4 4
A1.1

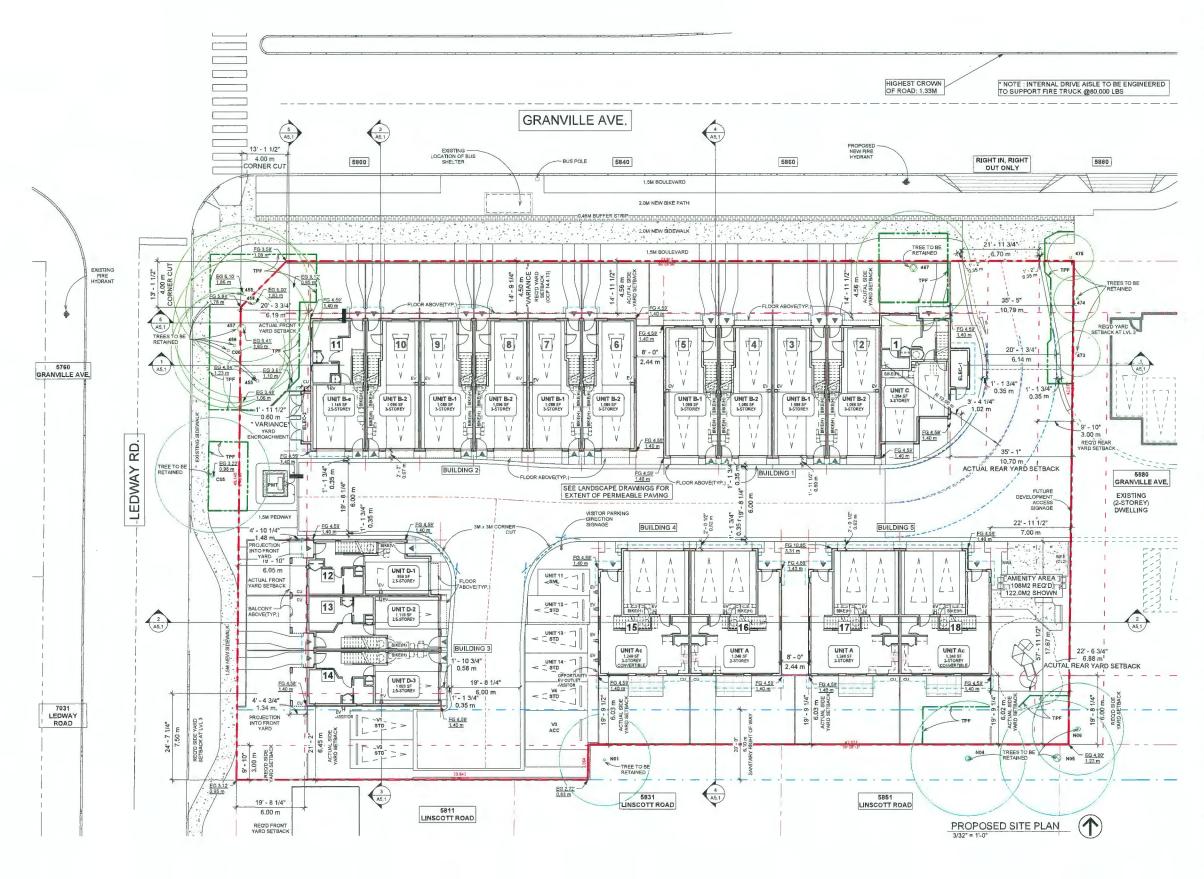


REVISIONS .
SEP 17, 2024 DP4 RE-SUBMISSION
JULY 08, 2024 DP3 RE-SUBMISSION
MAY 10. 2024 ADP SUBMISSION
MAY 02, 2024 DP2 RE-SUBMISSION
SEP 22, 2023 DP APPLICATION
MAR 09, 2023 RZ3 RE-SUBMISSION
OCT 15, 2021 RZ2 RE-SUBMISSION
DEC 23, 2020 RZ1 APPLICATION
SEPT 19 2024 DP 23-029476 PLAN # 1.B
INTERFACE: Suite 220 11550 Camble Road Richmond BC Canada V&X 325 T 664 821 1192 F 604 821 1146
www.interfacearchitecture.com
Proposed 18-Unit Townhouse Development
3 LOT ASSEMBLY
5800 / 5840 / 5860 GRANVILLE AVENUE RICHMOND, BC
PROJECT NO. :
2008GRAN
SCALE : 3/32" = 1'-0"
DATE : Dec 23, 2020
DRAWN BY : KYC, SRS
CHECK BY . KYC
SHEET TITLE .
SHEET TITLE . PROPOSED SITE PLAN
PROPOSED SITE PLAN

PARKING STALL TYPES				
CAR (ACCESSIBLE VAN)	CAR (STANDARD)	CAR (SMALL)	BIKE (HORIZONTAL)	BIKE (VERTIAL)
5.50	8' - 2 1/2" 2.50 m 2.50 m 	7'-61/2" 2.30 m E E E 9 5 5 5 5 5 5 5 5 5 5 5 5 5 5 5 5 5 5	1'-11 1/2" 0,60 m	1' - 11 1/2" 0.60 m E CO: 0.00 L

NOTE: • ALL RESIDENTIAL PARKING SPACES ARE CAPABLE OF LEVEL 2 EV CHRGING • 1 VISITOR PARKING SPACE WITH LEVEL 2 ENERGIZED CHARGING OUTLET • 1 VISITOR PARKING SPACE WITH OPPERTUNUTY CHARGING

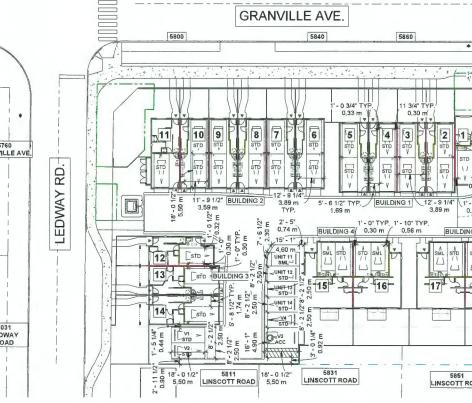

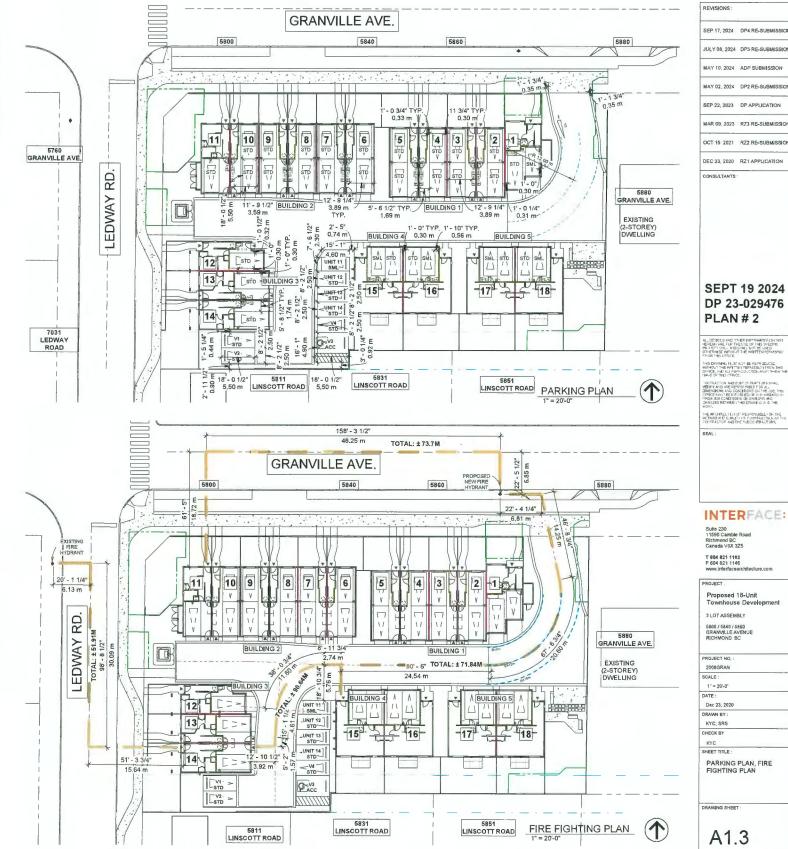

ALL DESIGNS AND STHER INFORMATION SHOWN MEREUN ARE FOR THE USE OF THIS SPECIFIC PR 3 SET OILS, WID SHALL WIT BE USED OTHERWISE WITHOUT THE WRITTEN REPAYSMENT FROM THIS USFICE. Final registration of the Reproducts https://www.sci.action.com/sci.action/ https://www.sci.action.com/sci.action/ https://www.sci.action.com/sci.action/ https://www.sci.action.com/ bits/sci.action/ bits THE AFCHTECT (2110" RESPONSIBLE) ON THE METHOD AID: SUALTY OF CONSTRUCTION OF 7: CONTRACTOR AND THE SUBJCUTRACTORS. INTERFACE:



### EXTERIOR FINISHES

1 FIBER CEMENT PANEL SIDING HARDIEPANEL (SMOOTH) Colour: Arctic White Reveal: White (match with siding colour)

2 FIBER CEMENT PANEL SIDING HARDIEPANEL (SIERRA 8) Colour: A - BM CC-782 (Georgian Bay) B - BM CC-410 (Boardwalk)

3 FIBER CEMENT LAP SIDING HARDIEPANEL (SELECT CEDARMILL) Colour: BM 2163-20 (Pony Brown)

4 FIBERGLASS ASPHALT ROOF SHINGLES Colour: Dark Gray (Multicolour, Textured)

5 VINYL-FRAMED DOUBLE-GLAZED WINDOWS Vinyltek or Equivalent, Colour: White

6 DOUBLE-GLAZED VINYL SLIDING DOOR Colour: White

7 ALUMINUM FASCIA GUTTER Colour: BM HC166 (Kendall Charcoal)

8 ENTRY SOLID WOOD DOOR WITH SIDELIGHT Door Colour: Natural Cedar Stain

9 OVERHEAD WOOD PANEL GARAGE DOOR Colour: BM CC-100 (Flurry)

10 METAL RAILING W/ TRANSLUCENT GLASS Railing Colour: Dark Gray

 BUILT UP POST - REFER TO DETAILS

 Door Colour: Natural Cedar Stain

12 6' HIGH TRANSLUCENT GLASS PARTITION TO MATCH RAILING SYSTEM

13 ELECTRICAL ROOM DOOR Colour: BM AF-685 (Thunder)

14 GARAGE MAN DOOR Colour: BM 2163-20 (Pony Brown)

REVISIONS:	
SEP 17, 2024	DP4 RE-SUBMISSION
JULY 08, 2024	DP3 RE-SUBMISSION
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OCT 15, 2021	RZ2 RE-SUBMISSION
DEC 23, 2020	RZ1 APPLICATION
CONSULTANTS	

### SEPT 19 2024 DP 23-029476 PLAN # 3

ALL DESCLIS AND THEE INFORMATION SHOWS HEREDIN AND FOR THE USE OF THIS SPECIAL MILLIST ONLY KARDSHALL NOT BE USED OTHERWISE WITHOUT THE WATTEN FERMISACI FROM THIS OFFICE.

THS DRAMME RUST NOT BE REPRODUCED WITHOUT THE WRITTEN PERMISSION FROM THS DETERS, AND ALL PERPODUCIDAL MUST SHOW THIS IMPLE OF THIS OFFICE COLIFICATION AND SUBCRITISM TO PERMIS

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THE APOINTED TO TRESPONDEDE FOR THE WORKDO ALC QUALITY OF CONVERTIGATION OF THE CONTRACTOR WO THE SUBJOATTRACTORS.

### INTERFACE:

Suite 230 11590 Cambie Road Richmond BC Canada V6X 325 T 604 821 1182 F 604 821 1146

PROJECT.
Proposed 18-Unit Townhouse Development
3 LOT ASSEMBLY
5800 / 5840 / 5860 GRAMVILLE AVENUE RICHMOND, BC
PROJECT NO. :
2008GRAN
SCALE :
1/8" = 1'-0"
DATE :
Dec 23, 2020
DRAWN BY :
SRS, AL
CHECK BY
KC
SHEET TITLE :
BUILDING ELEVATIONS - BUILDING 1
DRAWING SHEET
A3.1







NORTH ELEVATION (ALONG GRANVILLE AVE.) - BUILDING 2



### EXTERIOR FINISHES

1 FIBER CEMENT PANEL SIDING HARDIEPANEL (SMOOTH) Colour: Arctic White Reveal: White (match with siding colour)

2 FIBER CEMENT PANEL SIDING HARDIEPANEL (SIERRA 8) Colour: A - BM CC-782 (Georgian Bay) B - BM CC-410 (Boardwalk)

3 FIBER CEMENT LAP SIDING HARDIEPANEL (SELECT CEDARMILL) Colour: BM 2163-20 (Pony Brown)

4

9

13

14

FIBERGLASS ASPHALT ROOF SHINGLES Colour: Dark Gray (Multicolour, Textured)

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MAR 09, 2023	RZ3 RE-SUBMISSION
OCT 15, 2021	RZZ RE-SUBMISSION
DEC 23, 2020	RZ1 APPLICATION
CONSULTANTS	

### SEPT 19 2024 DP 23-029476 PLAN # 3.A

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#### Suite 230 11590 Cambie Road Richmond BC Canada V6X 325


14'- 11 1/2" ACTUAL SIDE YARD SETBACK ("VARIANCE") 4,50 m ARD SETBACK ( ARIANCE 33.35ft u/s Ceiling 10,16 m GRANVILLE AVE. Level 3 24.35ft 7.42 m Level 2 14.35ft 4.37 m FG 4.10' 1,25 m FG 4,59 1.40 m 5.35ft Level 1 1.63 m EAST ELEVATION - BUILDING 2

T 604 821 1162 F 604 821 1146 www.interfacearchitecture.com
PROJECT
Proposed 18-Unit Townhouse Development
3 LOT ASSEMBLY
5500 / 5840 / 5860 GRANVILLE AVENUE RICHMOND, BC
PROJECT NO. :
2008GRAN
SCALE .
1/8" = 1'-0"
DATE :
Dec 23, 2020
DRAWN BY :
SRS, AL
CHECK BY .
кс
SHEET TITLE :
BUILDING ELEVATIONS - BUILDING 2
DRAWING SHEET
A3.2





EAST ELEVATION - BUILDING 3

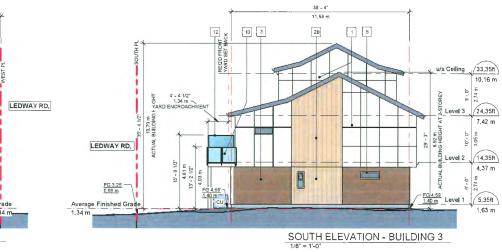



### EXTERIOR FINISHES

1

2

4

9

10

13

14

FIBER CEMENT PANEL SIDING HARDIEPANEL (SMOOTH) Colour: Arctic White Revea]: White (match with siding colour)

FIBER CEMENT PANEL SIDING HARDIEPANEL (SIERRA 8) Colour: A - BM CC-782 (Georgian Bay) B - BM CC-410 (Boardwalk)

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GARAGE MAN DOOR Colour: BM 2163-20 (Pony Brown)

REVISIONS .	
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JULY 08, 2024	DP3 RE-SUBMISSION
MAY 10 2024	ADP SUBMISSION
MAY 02. 2024	DP2 RE-SUBMISSION
SEP 22. 2023	DP APPLICATION
MAR 09 2023	RZ3 RE-SUBMISSION
OCT 15 2021	RZ2 RE-SUBMISSION
DEC 23, 2020	RZ1 APPLICATION
CONSULTANTS	

### SEPT 19 2024 DP 23-029476 PLAN # 3.B

### INTER

Suite 230 11590 Cambie Road Richmond BC Canada V6X 325 T 504 821 1162 F 604 821 1146

PROJECT
Proposed 18-Unit
Townhouse Development
3 LOT ASSEMBLY
5500/5840/5860
GRANVILLE AVENUE RICHMOND BC
PROJECT NO
2003GP AN
SCALE -
1/8" = 11-0"
DATE :
Dec 23 2020
DRAWN BY :
SRS, AL
CHECK B)
кс
SHEET TITLE .
BUILDING ELEVATIONS -
BUILDING 3
DRAWING SHEET
A3 3
/ (0.0



### EXTERIOR FINISHES

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9 OVERHEAD WOOD PANEL GARAGE DOOR Colour: BM CC-100 (Flurry)

10 METAL RAILING W/ TRANSLUCENT GLASS Railing Colour: Dark Gray

11 BUILT UP POST - REFER TO DETAILS Door Cotour: Natural Cedar Stain

6' HIGH TRANSLUCENT GLASS PARTITION TO MATCH RAILING SYSTEM

ELECTRICAL ROOM DOOR Colour: BM AF-685 (Thunder)

GARAGE MAN DOOR Colour: BM 2163-20 (Pony Brown)

REVISIONS .	
SEP 17, 2024	DP4 RE-SUBMISSION
JULY 08, 2024	DP3 RE-SUBMISSION
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SEP 22, 2023	DP APPLICATION
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OCT 15, 2021	RZ2 RE-SUBMISSION
DEC 23, 2020	RZ1 APPLICATION
CONSULTANTS	

### SEPT 19 2024 DP 23-029476 PLAN # 3,C

ALL DESIGNS AND STHER INFORMATION SATIVA HEREON ARE FOR THE USE OF THIS SPECIFIC INFORMET UNLY MID SHALL NOT BE USED OT HERWISE WITHOUT THE WRITTEN PERVISED FROM THIS COTICE.

THIS DRAWING MUST NOT BE REPRODUCED WITHOUT THE WRITTELI PERMISSION FROM THIS CERTER, AND ALL PERMIDDUCTION MUST SHOW TO HAVE OF THIS OFFICE. INTERACTOR AND SECONT RECTORS GALL VIDENT ALL ARE RECTOR RELET AS A DEFINITION OF ARE STORED TO THE FORM ALL DEFINITION OF AN CONTINUE OF ALL MASS CARLES NOT THE FORM RD OF ALL WARANGES PROVIDED CONTINUES DECEMBER AND CARLINGS SETWED: THIS DRAVALIS AND THE WORK

THE APOINTECT IS NOT PERPONSIBLE FOR THE METHOD PRO GUARTY OF COUNTRUCTION OF T CONTRACT OR AND THE SUBCONTRACTORY.

### INTERFACE:

Suite 230 11590 Camble Road Richmond BC Canada V6X 325

T 604 821 1162 F 604 821 1146 www.interfacearc

PROJECT . Proposed 18-Unit Townhouse Developmen 3 LOT ASSEMBLY

5500 / 5840 / 5860 GRANVILLE AVENUE RICHMOND, BC

PROJECT NO. 2008GRAN

CALE 1/8" = 1'-0"

DATE : Dec 23, 2020

DRAWN BY : SRS, AL

CHECK BY KC SHEET TITLE :

BUILDING ELEVATIONS -BUILDING 4 & 5

RAWING SHEET


A3.4


5851 LINSCOTT RD.


EG 3.87





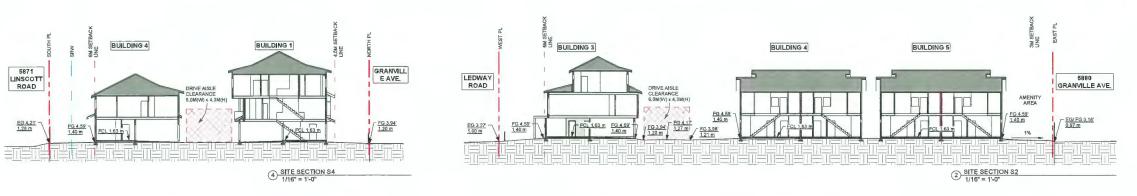

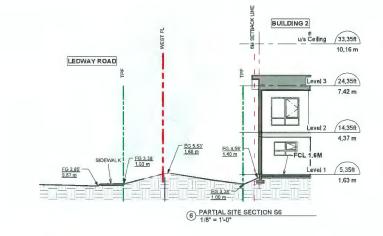

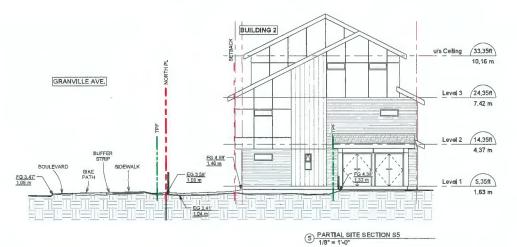

STREETSCAPE-Granville Ave.

REVISIONS :
SEP 17, 2024 DP4 RE-SUBMISSION
JULY 08, 2024 DP3 RE-SUBMISSION
MAY 10 2024 ADP SUBMISSION
SEP 22, 2023 DP APPLICATION
MAR 09 2023 RZ3 RE-SUBMISSION
OCT 15, 2021 RZ2 RE-SUBMISSION
DEC 23, 2020 RZ1 APPLICATION
SEPT 19 2024 DP 23-029476 PLAN # 3.D
Suite 230 11590 Cambia Road Rotmon Siz Ganata VK 325 Te64 821 1182 F 664 821 1182 F 664 821 1182
PROJECT .
Proposed 18-Unit Townhouse Development
3 LOT ASSEMBLY 5800 / 5840 / 5860
5800 / 5840 / 5860 GRANMLLE AVENUE RICHMOND, BC
PROJECT NO. : 2008GRAN
SCALE : As indicated
DATE:
Dec 23, 2020 DRAWN BY :
SRS, AL CHECK BY .
KC SHEET TITLE : SITE SECTIONS
A5.1



STREETSCAPE ALONG GRANVILLE AVENUE.



STREETSCAPE ALONG LEDWAY ROAD

REVISIONS	
SEP 05, 2024	DP4 RE-SUBMISSION
JULY 08, 2024	DP3 RE-SUBMISSION
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OCT 15, 2021	RZ2 RE-SUBMISSION
DEC 23, 2020	RZ1 APPLICATION
CONSULTANTS	•

### SEPT 19 2024 DP 23-029476 PLAN # 3.E

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### INTERFACE:

Suite 230 1159D Cambie Road Richmond BC Canada VSX 325

T 604 821 1152 F 604 821 1146 www.interfacearch/tecture.com

PROJECT . Proposed 18-Unit Townhouse Development 3 LOT ASSEMBLY

5800 / 5840 / 5860 GRANVILLE AVENUE RICHMOND, BC

NCHMOND, BC

PROJECT NO. . 2008GRAN SCALE : As indicated

DATE : Dec 23, 2020

DRAWN BY : SRS, AL

CHECK BY

KC SHEET TITLE .


MATERIAL BOARD


DRAWING SHEET :

A8.1



LEDWAY ROAD

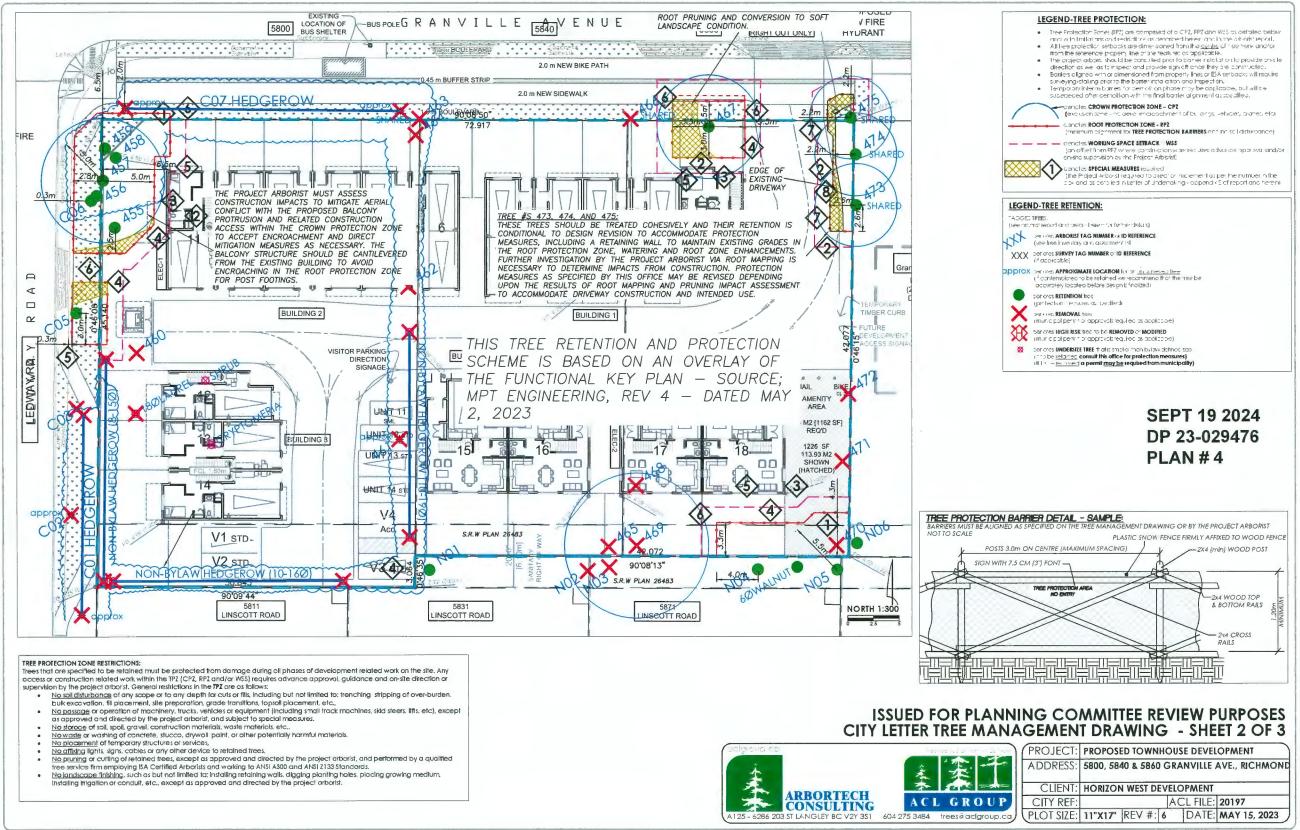

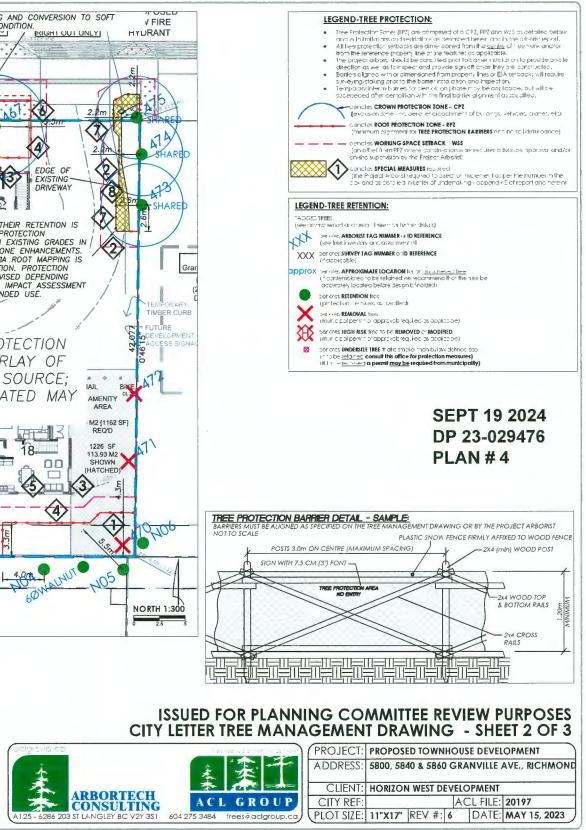

	12 A	find		PLANT LIST						
A	1 Hours	1 to set		AC 6 Acer circinatum	COMMON NAME Vine Maple	SIZE 4m clumu	COMMENTS	MATURE SIZE	AS SHOWN	RESIDENTIAL DEVEL
D	À a-	15 0 -09	)	- CN G Cornus natialla	Pacific Dogwood	8cm cal	150rm standard b48 min. 70cm root ball dia.	Sm spread 10m keight 9m spread	AS SHOWN	5800 GRANVILLE A
	\F	18 - t		CL 4 Crataegus v mordenensis 'Toh	a Toba Hawthorn	8cm cal	150cm standard 668 mm, 70cm root ball dia,	6m height 6m spread	AS SHOWN	
	K	To Alt		GT 1 Gleditsia triacanthos	Honey Locust	8cm cal	150cm standard D&B mm, 70cm root ball dra, Dense Tight Habit	21m height 21m spread 16m height	45 SHOWN	RICHMOND BC
X		A company of the second		PO 7 Picea omorika	Serbian Spruce	4.0 m ht.	bes min. sorm root hall dia.	6m spread	AS SHOWN	
		V A	NU	CONIFEROUS SHRUBS	COMMON NAME	SIZE	COMMENTS	MATURE SIZE		
DECIDUOUS TREES			*	JW		#2 pot	min, 30cm spread	15 cm height 120 cm spread 125 cm lieight	60cm 75cm	
		CT	-	tm 127 Taxus v media 'Hicksti'	Dwarf Mugo Pine Hick's Yew	#2 pot 1.2m	min. 30cm spread min. 20cm height min. 30cm spread use #1 pot in TPA – 28 th	125cm linight 250cm spread 150cm height 120cm spread	75cm	
	CL	<b>G</b>	Res S	ts 32 Thuja o, 'Smaragd'	Smaragd Hedging Cedai	1.5m	min, 30cm spread	100cm height 100cm spread	75cm	
		a strange		BROADLEAF EVERGREEN SHRUBS	COMMON NAME	6176	COMMENTS	MATHER CITE	PRACING	
			Vt.	Ah 41 Azalea japonica 'Hino Crimson		#2 pot	COMMENTS nun, 200mm bergint	MATURE SIZE 100cm limith 120cm width	75cm	
		Emos (	@-	au 13 Arbutus unedo 'Compacta'	Dwarf Strauberry Tree	#5 pot	mm, 45 cm height use #} pot in TPA – 6 ttl	300cm height 300cm spread	100cm	
Acer circinatum Corniis niittallii	Crataegus x mordenensis 'Toba'	Cinclutsua triacanthos	)	gs 119 Gaultheira shallon	Salal	#1 pot	mm, 20cm height mm, 15cm height	100cm height 120cm spread 100cm height	65cm	
		( in the second s	have	- sj 28 Skimmia japonica - ri - 12 Rhododendron 'Impeditum'	Japanese Skimmia Impeditum Rhododendron	#2 pot	use #1 pot in TPA = 4 til min, 30cm height use #1 pot in TPA = 3 til	130cm spread 60cm height	75cm	
CONIFEROUS TREES	FERNS	PERRENIALS	(-)-	vo 103 Vaccinium ovatum 'Thunderbis		#2 pot	nue #) pot in IPA = 3 m nue, 60cm height ust #1 pot in TPA = 5 m	75 rm spread 180 cm height 190 cm spread	75cm	
			and.	DECIDUOUS SHRUBS						
tm PO	pm	aj	<u> </u>	CODE QTY SCIENTIFIC NAME	COMMON NAME Redtwig Dogwood	SIZE #1 pol	COMMENTS mm, 50cm height	MATURE SIZE	SPACING 90cm	
	Cartan I	C.	5-	cc 2 Cotinus cogg. 'Royal Purple'	Smoke Tree	#5 pot	heavy heavy	200cm spread 200cm height 150cm width	90cm	
	Sec. 1		90°8_	rs 7 Ribes s, 'King Edward \II'	King Edward \   Currant	#1 pot	nun, 40cm height	240cm beight 120cm spread	75cm	DRAWING INDEX
	and the second	and the second			COMMON NAME	SIZE	COMMENTS	MATURE SIZE	SPACING	L0-01 NOTES & SYMBOLS
		0	>—	ay 45 Astille x japonica 'Rheinland'	Rhemland False Sprea	#1 pot	min. 25cm height	55 cm height 60 cm spread	45cm	L1~02 LANDSCAPE AREAS L2~01 HARD LANDSCAPE PLAN
Taxus x media "hickso" — Pitee orienta a	Polystichort munitum	Augureptions "Theodole Line"		FERNS			001/1171/20		0000000	L4-01 PLANTING PLAN L5-01 SOFT LANDSCAPE DETAILS
CONIFEROUS SHRUBS	GROUND COVER	DECIDUOUS SHRUBS	24	pm B Polystichum munitum	Swordfern	\$IZE #1 pot	COMMENTS min, 25cm height	MATURE SIZE 100cm beight 100cm spread	60cm	L5-02 HARD LANDSCAPE DETAILS L5-03 HARD LANDSCAPE DETAILS
			•	GROUND COVERS	1					L5-04 PLAY EQUIPMENT DETAILS
jh pp	pm	CS	<b>a</b>	ai 586 Ajuga replans 'Chocolate Chip	COMMON NAME Chocolate Bugleweed	10cm pot	COMMENTS min, 25cm spread s0cm O,C,	MATURE SIZE	30cm	
	MARKA PLANE			la Lawn	Shade Tolerant Blend		John Sei	both spread	30cm	
		A STATE OF BELLEVILLE		GENERAL NOTES						HARD LANDSCAPE KEY
				1. COMPLIANCE, GOVERMIENT ALL WORK		D. CRAINE	, ALLOWANCES AND TOPSO		CR MIL INCRYPT	
CONTRACTOR OF THE OWNER OF THE OWNER				THE SATISFACTION OF THE CITY OF RICHAR WITH ALL STANDARDS AND REGULATIONS C	OND AND SHALL COMPLY		A ALLOWARK ES AND TOPIC		LKALL DEPTH	ARBOUR
Jumperus horizontalis 'Wiltonn' Pinus mugo 'Pumillio'	Ajuga replans	Cornus stolonifera		CONTRACTORS SHALL ENSURE COMPLIANCE INSTALLATION,	E OF ALL WORK PRIOR TO	SHR	ASS AREAS RUB BEDS	150 MM 450 MM		
BROADLEAF EVERGREEN SHRUBS		cc		2, COMPLIANCE, BONTA BOSLA – ALL MATER PROCEDURES, AND INSTALLATION OF LAND	RIAL, SHIPPING	GRO	OUND COVER AREAS EES	300 NI/I 600 NI/I		BIKE RACK
		2000 C 200		CONFORM TO LATEST EDITION OF BENTA/B STANDARD AVAILABLE AT COMMENCEMENT	ILSLA LANDSCAPE	INST-ALLATE	IL SHALL BE TESTED NOT MO	BE SPECIFIC TO TH	IS WORK,	BENCH
aj au au	gs			3. COMPLIANCE, MINED - ALL WORKS SHALL			OR SHALL AMEND THE SOIL DATIONS OF THE SOILS TES		E	WOODEN BARRIER FENCE & GATE
				MINED OF AILS AND SPECIFICATIONS AVAIL OF WORK WHERE NO SPECIFIC DETAIL, NOTE PROVIDED IN THE DRAWING SET OR ATTACK	E OR SPECIFICATION IS	10, GRADIN ARCHITECT	IG, BUILDING FINISHED FLOO TURAL DRAWINGS	DR & CORNER ELEVA	TIONS - SEL	ALUMINUM FENCE & GATE
	State R			I. EXISTING SERVICES - REFER TO ENGINEER	ING DRAWINGS FOR	H, GRADIN	G, GENERAL RETENTION WO	RKS - ALL RETENT	ON WORKS,	450 X 450 PRECAST PAVING SLABS
		Cotinus coggygria 'Royal Pumle'		LOCATIONS OF ALL BURIED SERVICES, CONT FOR OBTAINING AND PAYING FOR ALL UTILI AND ALL COSTS WHICH ARISE FROM DAMAGE	TIES LOCATIONS AND ANY	CONDITION	WIN HERE OR REQUIRED DU	JCTION, SHALL BE S	PLIT FACED	CI.P. CONCRETE – BROOM FINISH
	and the state of the	rs		AND ALL COSTS WHICH ARISE FROM DAMAG ANY ACT OR FAILURE TO ACT OF THE CONT	RACTOR.	YARD DR-M	CK, WITH THE EXCEPTION O NAGE AREAS SPECIFICALLY I DULD UNANTICIPATED RETA	<b>NOTED AS PRESSURI</b>	TREATED	STANDARD CONCRETE UNIT PAVERS
Azalea japonica "Hino Crimion" Arbutus unedo	Guitlens shallon			5, COORDINATION - THESE DRAWINGS SHAL THE LARGER SET OF DRAWINGS AND SPECIF	ICATIONS, WHETHER	COLANDSC	APE ARCHITECT SHALL INFO HEIGHT AND EXTENT OF SU	RM THE CITY IN WR	ITING OF THE	AQUAPAVE CONCRETE UNIT PAVERS
sj ri	VO			DIRECTLY ATTACHED OR NOT, ISSUED FOR THE ASSOCIATED BOULEY ARD WORKS, THES READ IN CONCERT WITH SUCH DOCUMENTA	E DRAMINGS SHALL BE	12. PLANT M	MATERIAL, QUANTITIES – CO MATERIAL QUANTITIES, AN	DATRACTOR SHALL		DRAIN ROCK PAVING
	States for	Contraction of the second		CONFLICTS ARISE, THE CONTRACTOR SHALL SUCH CONFLICTS TO THE LANDSCAPE ARCH	I IMMEDIATELY REPORT	PLANT LIST CONSULT AF	AND THE DRAWING SHALL NT, IN CASE OF DISCREPAND	BE REPORTED TO THE	IE IALL INSTALL	PLAYGROUND PAVING
	Contraction of the second	and the second		DONE IN COORDINATION WITH THE CONTRA ENGAGED IN CONSTRUCTION OF SUCH ADJ	ACTOR OR CONTRACTORS	PLANT MAT IS A DISCRE	ERIAL AS PER DRAWING, IN PANCY BETWEEN GROUND (	CIRCUMSTANCES IV LOVER QUANTITY A	HERE THERE	
	A AMA A AMA	Ribes sanguineum King Edward \ II'		6. CONCRETE, FORMS - THE CONTRACTOR DIMENSIONS PROVIDED WITH SITE CONDITION	SHALL COMPARE		NG REQUIREMENT WILL PREV		το ριαλτ	
	A A No.			REPORT AN DISCREPANCIES TO THE LANDS ENGINEER, ONCE COMPLETED THE CONTRAC	CAPE ARCHITECT AND THE CTOR SHALL CALL FOR	LIST SHALL	BE MADE BY CONTRACTOR ATION FROM CONSULTANT,	NITHOUT PRIOR WE	ITTEN	
Skimmla japonica Rhodedendror impeditum	Vaccinium ovatum			INSPECTION OF THE FORAIS PRIOR TO PLACE CONTACT LANDSCAPE ARCHITECT A MINIM DESIDE IN OPERATION TO US			MATERIAL HEALTH = ALL PI		IST BE	
				DESIRED INSPECTION TIME. 7. CONCRETE, REINFORCEMENT – ALL CONC	RETE REINFORCEMENT	DISEASE FRE	EE FROM CERTIFIED NURSER	IES,		
				SHALL BE INSPECTED AND APPROVED BY TH PRIOR TO POURING OF CONCRETE, CONTAC	HE STRUCTURAL ENGINEER A	HEMI/FIR BA	- PLANTING AREAS SHALL I WRIT MULCH, THE USE OF CEI	DAR MULCH OR ANY	0 \1M OF ' MIX	
				AllNIMUM OF 48 HOURS PRIOR TO DESIRED I 8. GRADING, GENERAL – THE CONTRACTOR		CONTAININ	IG CEDAR IS NOT PERMITTE	),		
				SUCH THAT THERE IS, IN ALL AREAS, POSITI ADIACEAT DRAIN, MINIMUNI SLOPES SHALL	VE DRAINAGE TO AN	DESIGN BUI	ION – AN IRRIGATION SI ST ILD BY AN ACCREDITED IRRI	GATION CONTRACT	OR. THE	
				PEDESTRIAN PAVED AREAS VEHICULAR PAVED AREAS	1% 1%	SHALL PROY	ALL PROVIDE FULL COVERAG VIDE SLEEVES AND CORING SYSTEM SHALL BE PROVIDED	AS NECESSARY, A PL	AN OF THE	
				LAWN AREAS PLANTED BEDS	1% 2% 5%	ARCHITECT	FOR APPROVAL PRIOR TO I	NSTALLATION,	-	
						17, ANY CO HEDGE-UL	NTINUOUS PLANTINGS HAN E SHRUB MASS ALONG STRE	ING THE POTENTIAL	TO FORM A	
						ALAIN TAIN F	D AT A MAXIMUM HEIGHT O	E 1 314		

### DEVELOPMENT ILLE AVENUE

DATE	ISSUED FOR	REV
2020-12-23	REZONING	A.
2023-05-18	REZONING	В
2023-09-21	D.P.	C
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All dimensions shall be confirmed on site and discrepancies reported immediately, Required setbacks shall govern in all cases.


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Architectural: Arborist: Civil: Structural: Mechanical: Electrical;

SEPT 19 2024 DP 23-029476 **PLAN # 5** Div Donald V. S. Duncan DEVELOPMENT CONSULTANT LANDSCAPE ARCHITECT 603 - 220 Eleventh Street New Westminster BC Canada V3M 6N9 778-791-4323 dvsduncan@gmail.com RICHMOND FILE #


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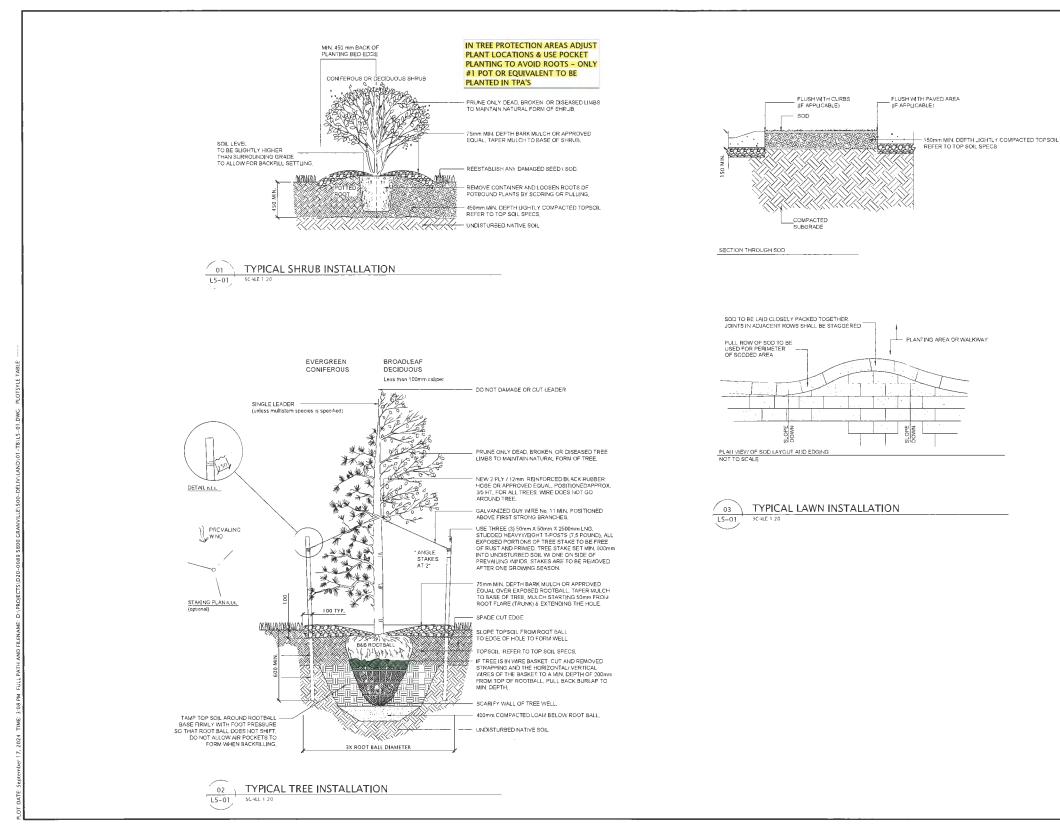
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SEPT 19 2024 DP 23-029476 **PLAN # 5.B** DONALD V.S. DUNCAN DEVELOPMENT CONSULTANT LANDSCAPE ARCHITECT CANUTSCAPE ANCHIEL 603 - 220 Eleventh Street New Westminster BC Canada V3M 6N9 778-791-4323 dvsduncan@gmail.com **RICHMOND FILE #** 

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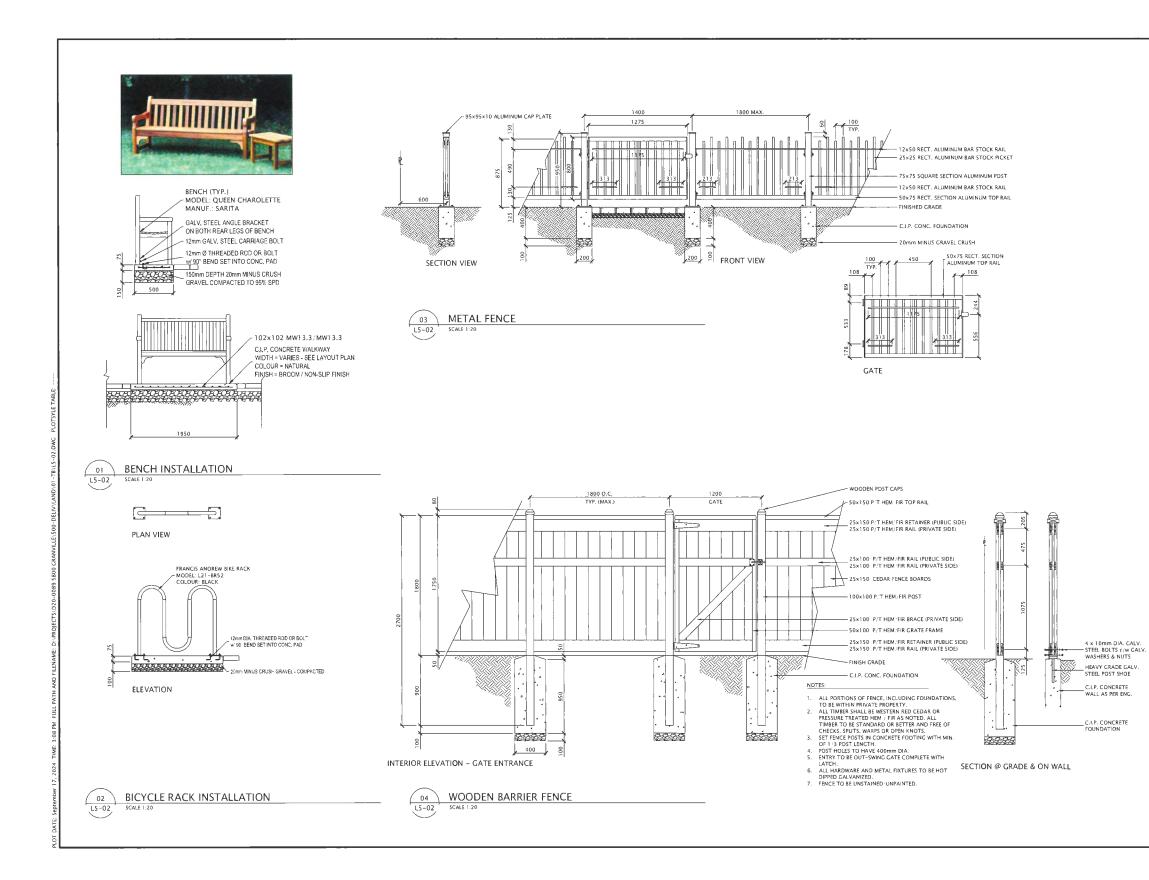
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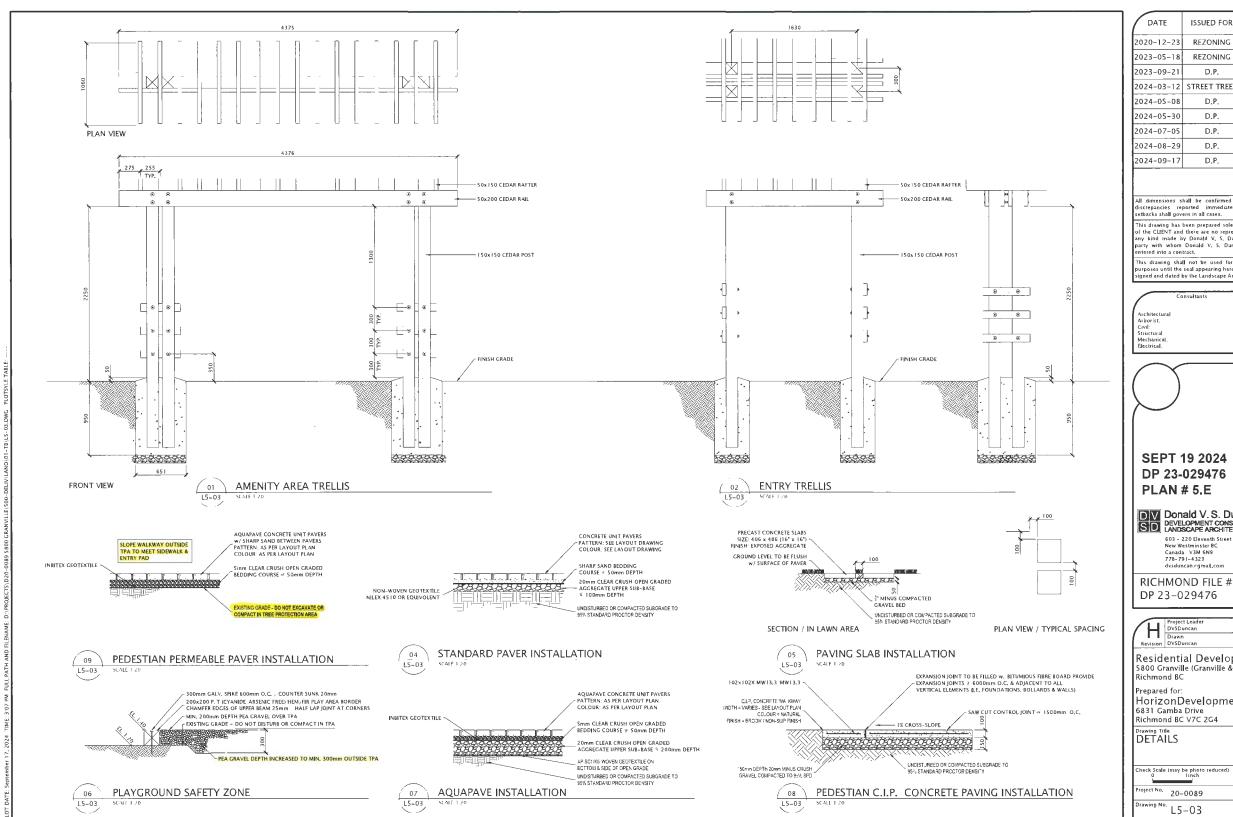
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Revision DVSDuncan Residential Development 5800 Granville (Granville & Ledwey) Richmond BC Prepared for: HorizonDevelopmentWest 6831 Gamba Drive Richmond BC V7C 2G4 DETAILS

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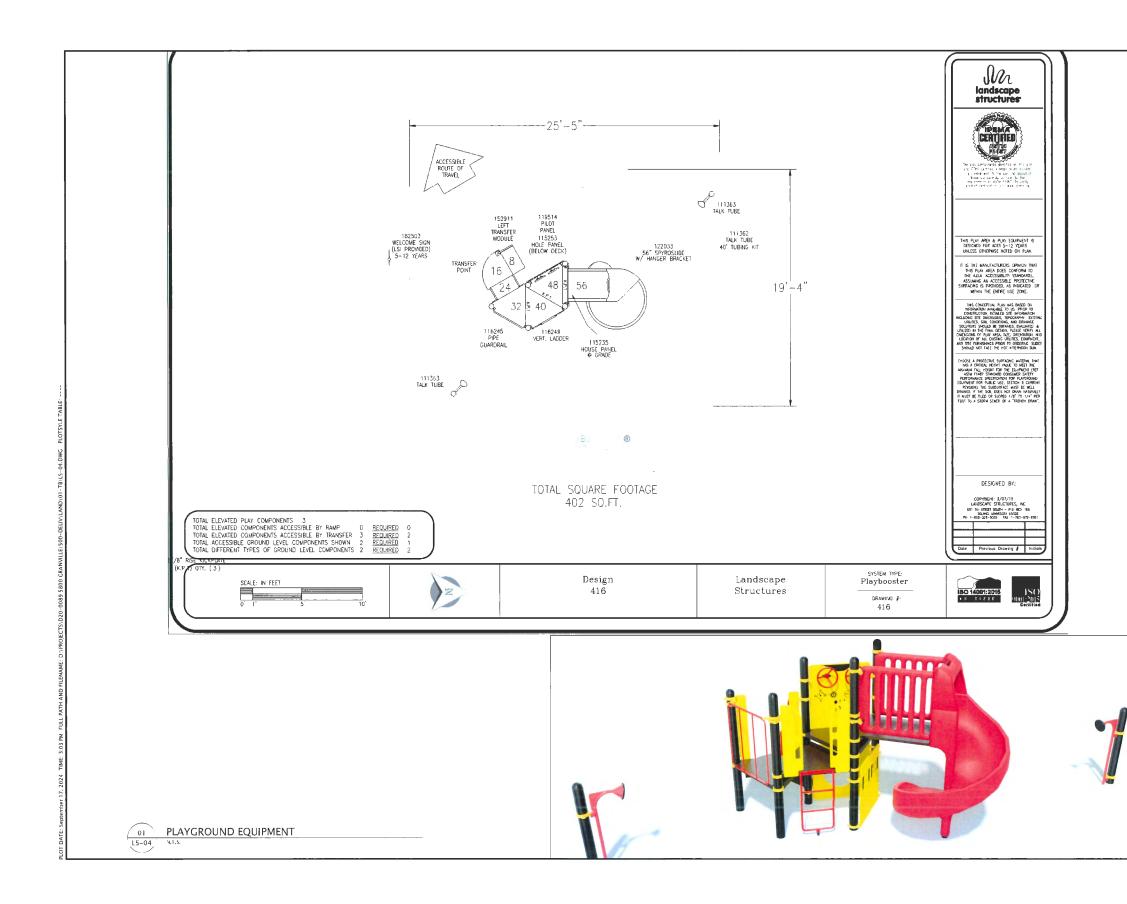

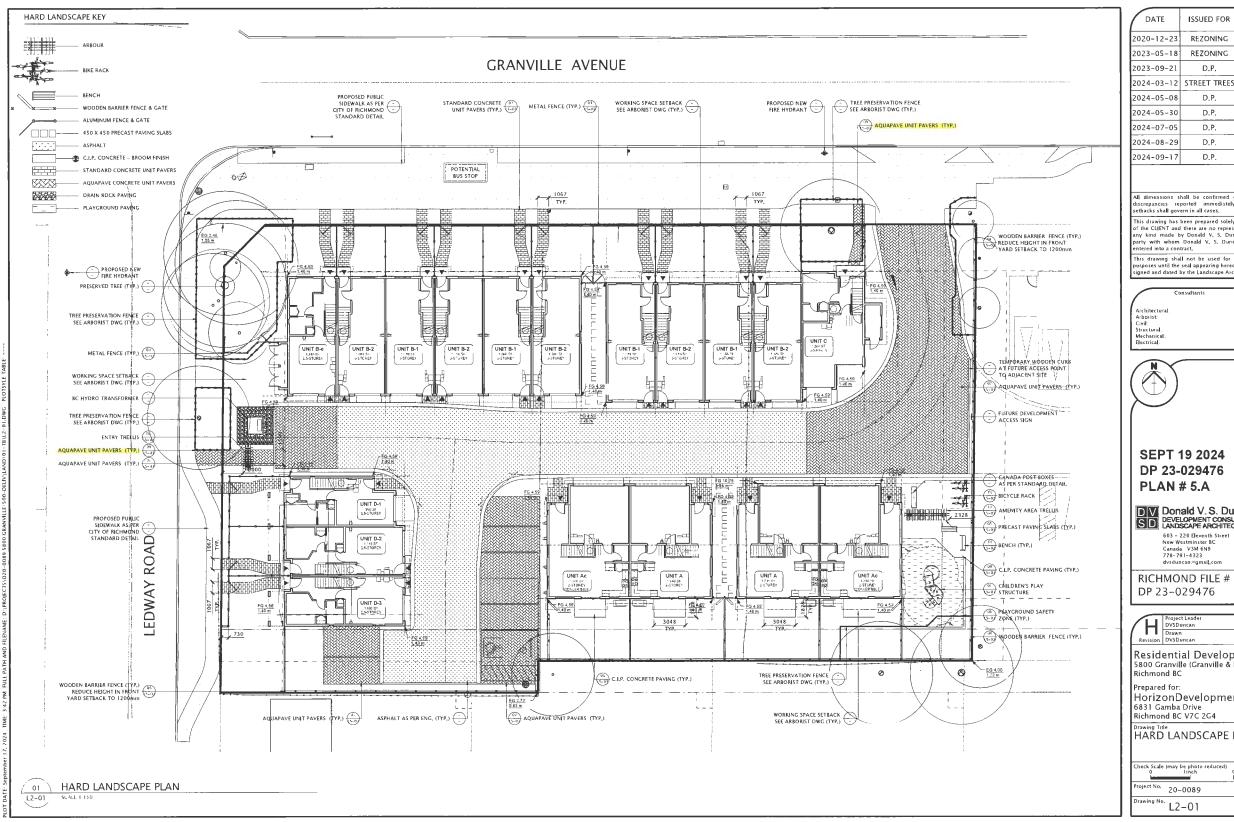
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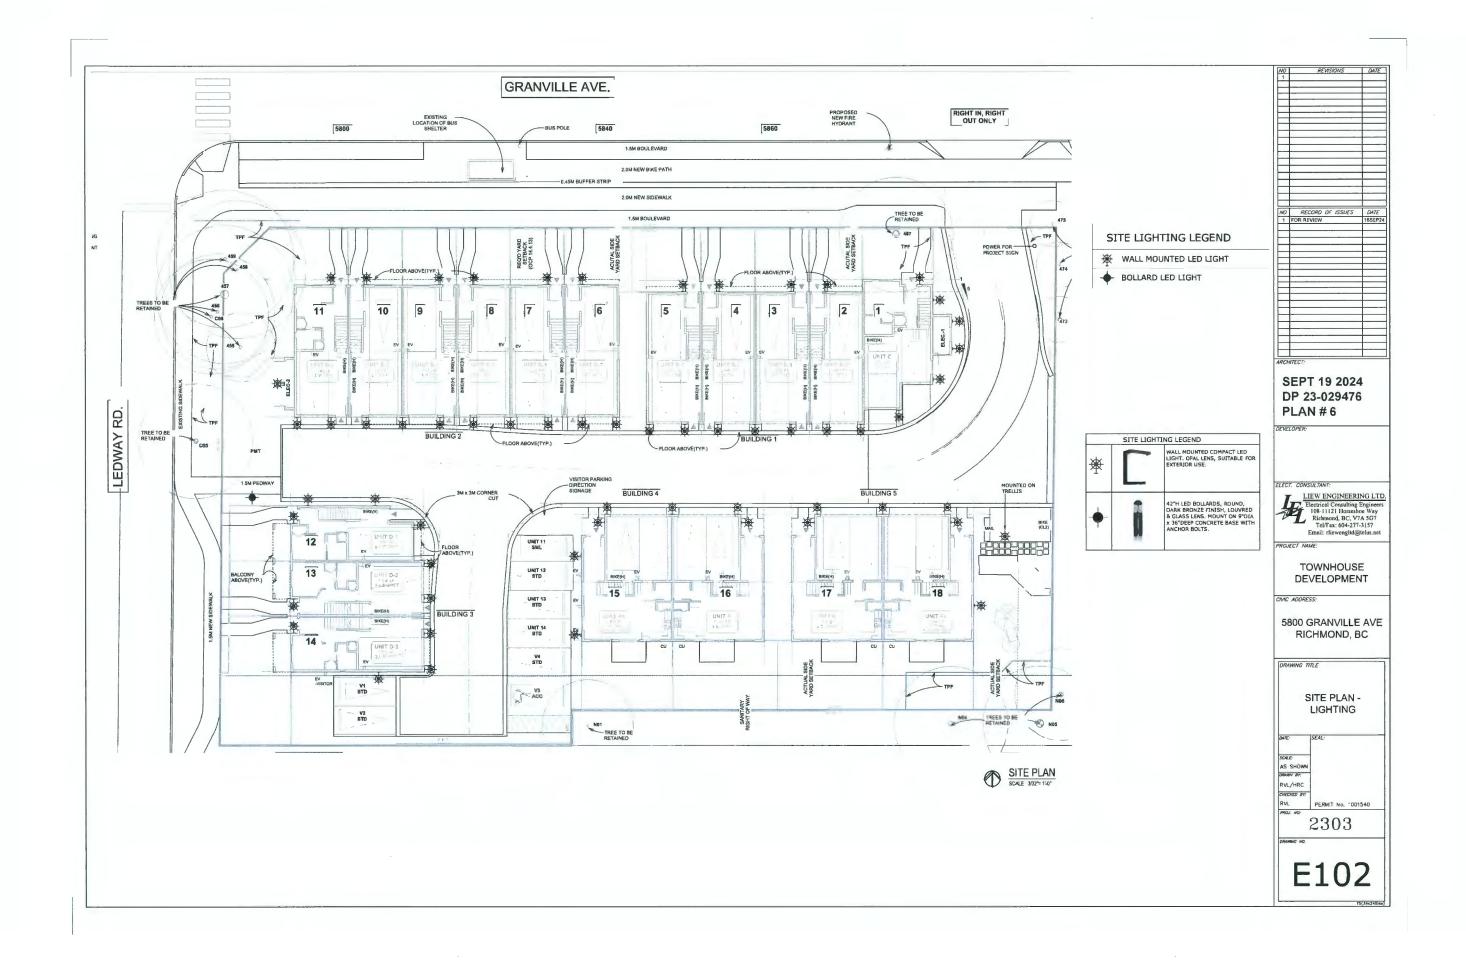


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	2023-05-18	REZONING	В
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	2024-03-12	STREET TREES	C
	2024-05-08	D.P.	D
	2024-05-30	D.P.	E
	2024-07-05	D.P.	F
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PERSPECTIVE IMAGE - BIRD EYE VIEW LOOKING SOUTH-EAST

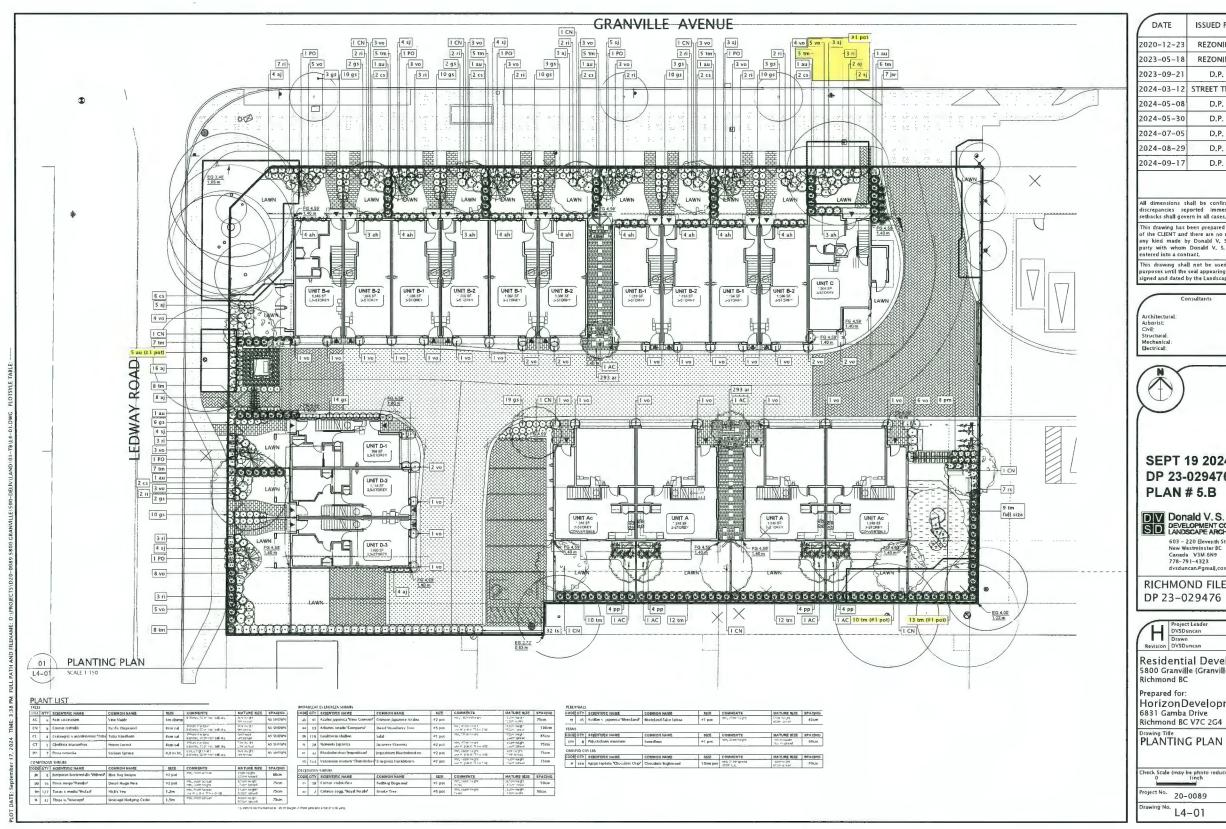

PERSPECTIVE IMAGE - BIRD EYE VIEW LOOKING NORTH-EAST

REVISIONS :	
SEP 17, 2024	DP4 RE-SUBMISSION
JULY 08, 2024	DP3 RE-SUBMISSION
MAY 10, 2024	ADP SUBMISSION
MAY 02, 2024	DP2 RE-SUBMISSION
SEP 22, 2023	DP APPLICATION
MAR 09, 2023	RZ3 RE-SUBMISSION
OCT 15, 2021	RZ2 RE-SUBMISSION
DEC 23, 2020	RZ1 APPLICATION
CONSULTANTS	

REFERENCE PLANS

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# INTERFACE:

Suite 230 11590 Camble Road Richmond BC Canada V5X 325 **T 604 821 1162** F 604 821 1146 www.iriteffacearchitecture.co

PROJECT .
Proposed 18-Unit Townhouse Development
3 LOT ASSEMBLY
5800 / 5840 / 5860 GRANVILLE AVENUE RICHMOND, BC
PROJECT NO. :
2008GRAN
SCALE ·
DATE :
Dec 23, 2020
DRAWN BY :
SR5, AL
CHECK BY
кс
SHEET TITLE :
PERSPECTIVES - 1
DRAWING SHEET
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PERSPECTIVE IMAGE - BIRD EYE VIEW LOOKING SOUTH-WEST



PERSPECTIVE IMAGE - PEDESTRIAN VIEW LOOKING SOUTH-WEST

DRAWING SHEET
PERSPECTIVES - 2
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CHECK BY
Dec 23, 2020 DRAWN BY : SRS, AL
DATE :
SCALE :
PROJECT NO 2008GRAN
5800 / 5840 / 5860 GRANVILLE AVENUE RICHMOND, BC
3 LOT ASSEMBLY 5800 / 5840 / 6860
Proposed 18-Unit Townhouse Development
PROJECT .
T 604 821 1162 F 604 821 1146 www.interfacearchitecture.com
11590 Camble Road Richmond BC Canada V6X 3Z5
Suite 230
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MAR 09, 2023 RZ3 RE-SUBMISSION
SEP 22, 2023 DP APPLICATION
MAY 02, 2024 DP2 RE-SUBMISSION
MAY 10, 2024 ADP SUBMISSION
JULY 08, 2024 DP3 RE-SUBMISSION
SEP 17, 2024 DP4 RE-SUBMISSION
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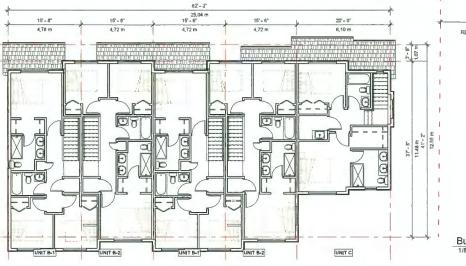
PERSPECTIVE IMAGE - PEDESTRIAN VIEW LOOKING NORTH-EAST





PERSPECTIVE IMAGE - PEDESTRIAN VIEW DRIVE AISLE LOOKING WEST


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INTERFACE: Suite 20 11590 Cambié Road Richmon BC Canada V8 325 T 604 821 1142 F 604 821 1142 F 604 821 1142
PROJECT.
Proposed 18-Unit Townhouse Development
3 LOT ASSEMBLY 5800 / 5840 / 5860 GRAMALLE AVENUE RJCHMOND, BC
PROJECT NO. : 2008GRAN
2008GRAN SCALE ·
DATE : Dec 23, 2020
DRAWN BY :
SRS, AL CHECK BY
KC SHEET TITLE :
PERSPECTIVES - 3
A9.3






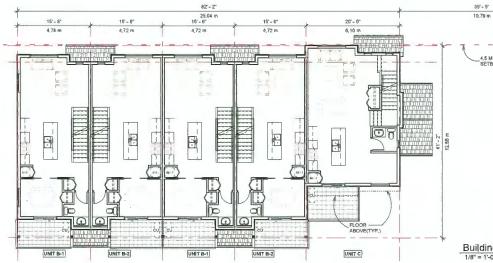

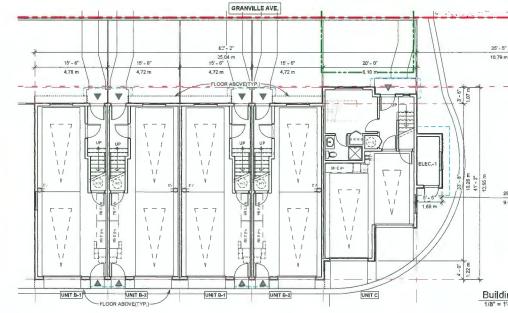


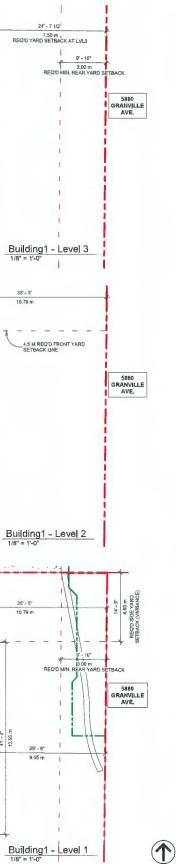


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SEAL :
INTERFACE:
Suite 230 11590 Cambie Road Richmond BC
Canada V6X 3Z5
T 604 821 1162 F 604 821 1146 www.interfacearchitecture.com
PROJECT.
Proposed 18-Unit Townhouse Development
3 LOT ASSEMBLY
5800 / 5840 / 5860 GRANVILLE AVENUE RICHMOND, BC
PROJECT NO. :
2008GRAN SCALE :
As mucated DATE :
Dec 23, 2020 DRAWN BY :
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Building 4 & 5 - Level 2

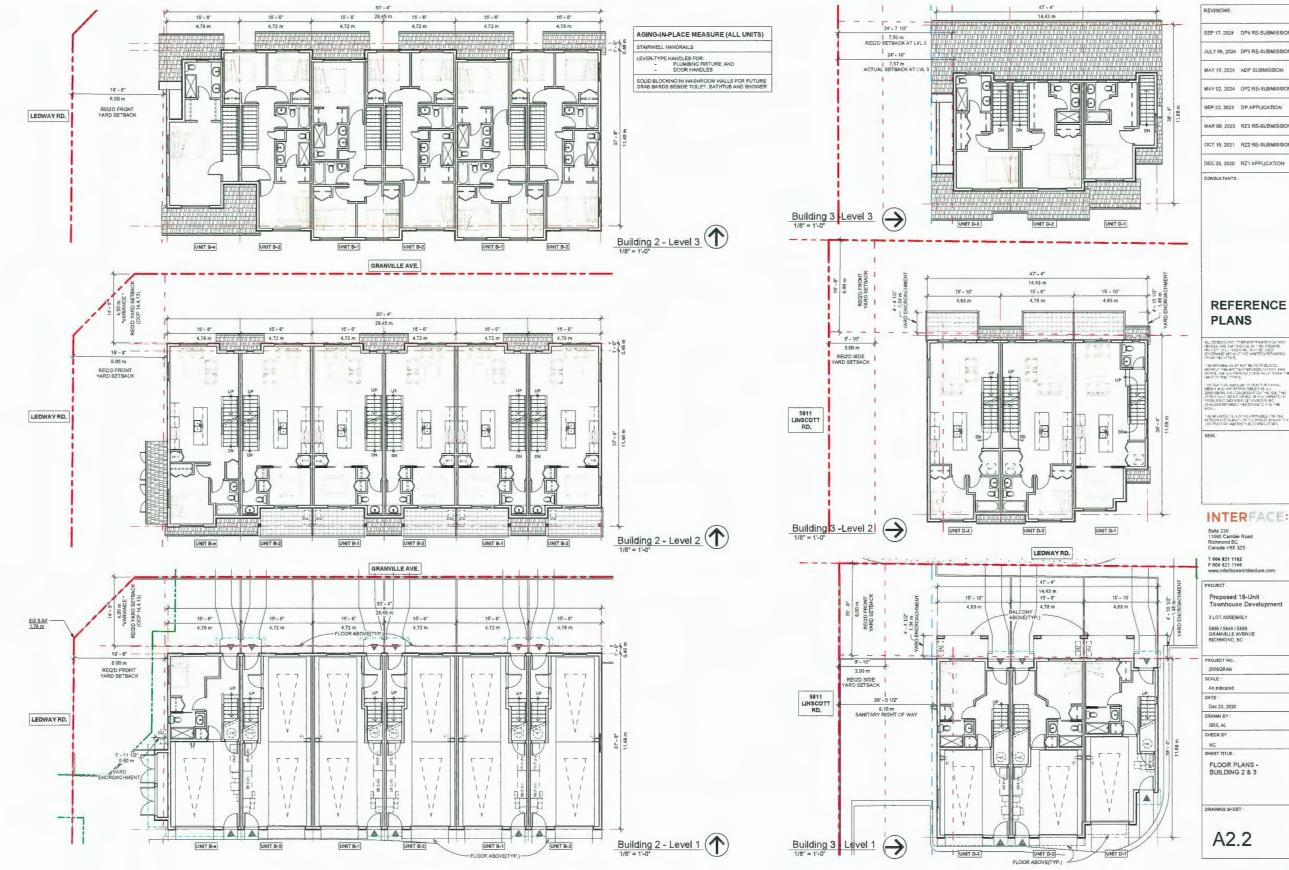

Building 4 & 5 -Level 1
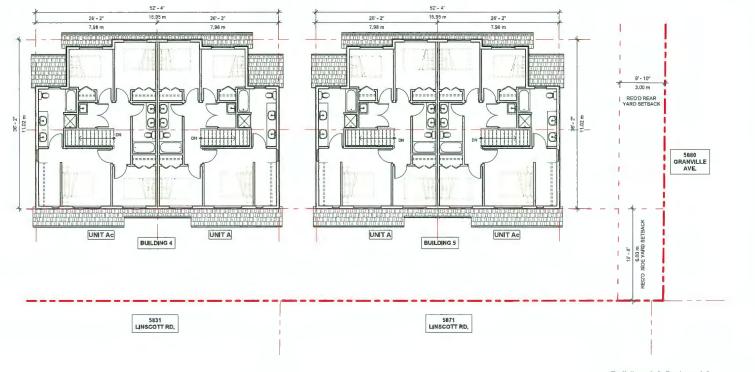
### AGING-IN-PLACE MEASURE (ALL UNITS)

LEVER-TYPE HANDLES FOR: - PLUMBING FIXTURE, AND - DOOR HANDLES

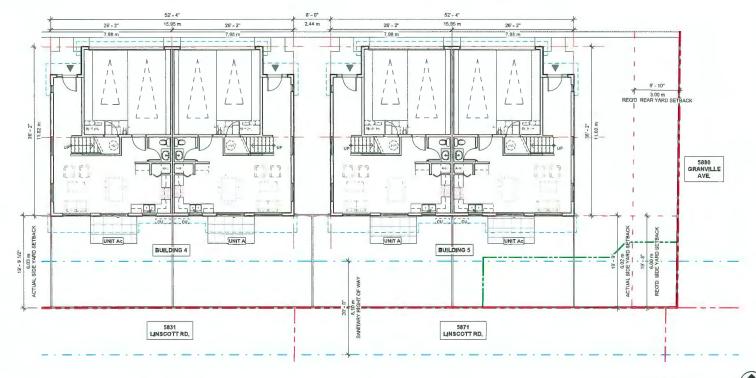STAIRWELL HANDRAILS

DOORS &

VERTICAL

GARAGE

BATHROOMS (MIN. 1/UNIT)

NTCHEN

WINDOWS

OUTLET & SWITCHES

SOLID BLOCKING IN WASHROOM WALLS FOR FUTURE GRAB BARDS BESIDE TOILET BATHTUB AND SHOWER

#### CONVERTIBLE UNIT FEATURES CHECKLIST

ENTRY DOORS MIN, 863 MM BUT IDEALLY 914MM AND HAVE CLEAR ACCESS

ENTRY DOOR CLEAR EXTERIOR FLOOR SPACE MIN 1220 MM DEPTH BY DOOR WIDTH PLUS 500 MM LATCH SIDE (NOT NEEDED IF ROUGH IN WIRING PROVIDED FOR FUTURE AUTOMATIC DOOR OPENER)

INTERIOR DOORS TO MAIN LIVING AREAS, 1 BATHROOM AND 1 BEDROOM, MIN, 800 MM CLEAR O'PENING MITH FLUSH THRESHOLDS MAX 13 MH BIGHT, DEMONSTRATE WHEELCHAR ACCESS BETWEEN HALLWAY AND ROOMS AND WIDEN HALLWAY AND/OR DOORWAYS JF NECESSARY TO SECURE ACCESS

PATIOBALCONY MIN, 860 MM CLEAR OPENING, ACCESSED FROM REAR DOOR AT GROUND FLOOR. ALL INTERIOR THRESHOLDS WITHIN UNITS COMPLY WITH BCBC,

LEVER-TYPE HANDLES FOR ALL DOORS

STAIR LIFT: STAIRCASE WDTH FRAMING SUPPORT, AND LANDINGS, AS NOTED ON FLOOR PLANS IN COMPLIANCE WITH MANUFACTURER SPECIFICATION. (E.G. ELAN STRAIGHT RAIL STAIRLIFT (SRE-3000)

AT THE TOP OF ALL STARWAYS WALLS ARE REINFORCED WITH 2"X12" SOLID LUMBER AT 914 MM TO CENTRE, HALLWAYS MIN. 900 MM WIDTH

MIN, 1 ACCESSIBLE PARKING SPACE WITH MIN, 4M GARAGE WIDTH

ACCESS FROM GARAGE TO LIVING AREA MIN. 800 MM CLEAR OPENING TOILET CLEAR FLOOR SPACE MIN. 1020 MM AT SIDE AND IN FRONT WALL BLOCKING FOR FUTURE GRAB BARS AT TOILET, TUB, AND

WALL BLOCKING FOR FUTURE GRAB BARS AT TOILET, TUB, AND SHOWER, REINFORCED WTH 27:12 SOLID LUMBER IN ALL BATHTUB, SHOWER, AND TOILET LOCATIONS. LEVER-TYPE HANDLES FOR PLUMBING RXTURES.

PRESSURE AND TEMPERATURE CONTROL VALVES ARE INSTALLED ON ALL SHOWER FAUCETS.

CABINETS UNDERNEATH SINK ARE EASILY REMOVED. DEMONSTRATE BATH AND SHOWER CONTROLS ARE ACCESSIBLE (LAYOUT OR FIXTURE PLACEMENT).

LAYOUT OR FIXTURE FLACEMENT). CLARA REA NEEDED UNGER FUTURE WORKSPACE FLUMBING AND GAS IPPES (IN-WALL AND IN FLOOR) LOCATED CLEAR OF UNDER COUNTER AREA OF FUTURE WORKSPACE (GTOVE), SINKA MIN, SID NM WIDE COUNTER), ALL IPPES ARE BROUGHT IN NO HGHER THAN 304 MM TO THE CONTRE OF THE IPPE FROM FLOOR LEVEL

TO THE CENTRE OF THE PIPE FROM FLOOR LEVEL CABINETS UNDERNEATH SINK ARE EASILY REMOVED.

1500 MM TURNING DIAMETER OR TURNING PATH DIAGRAM LEVER-TYPE HANDLES FOR PLUMBING PIXTURES,

MIN, 1 WINDOW THAT CAN BE OPENED WITH A SINGLE HAND (BATHROOM, KITCHEN, LIVING ROOM)

PLACEMENT LOCATIONS OF ELECTRICAL OUTLETS BESIDE WINDOW BOTTOM OF STARKWAYS, BESIDE TOLET ABOVE EXTERNAL DOORS (OUTSIDE AND INSIDE). ON FRONT FACE OF MITCHEN COUNTER, WITHIN PROXIMITY OF CONTROL CENTRE FOR SMART HOME OPTIONS.

UPGRADE TO FOUR-PLEX OUTLETS IN MASTER BEDROOM, HOME OFFICE, GARAGE, AND RECREATION ROOM,

# REVISIONS. SEP 17, 2024 DP4 RE-SUBMISSION JULY 08, 2024 DP3 RE-SUBMISSION MAY 10, 2024 ADP SUBMISSION MAY 10, 2024 ADP SUBMISSION MAY 10, 2024 ADP SUBMISSION MAY 02, 2024 DP2 RE-SUBMISSION MAY 02, 2024 DP2 RE-SUBMISSION MAR 09, 2023 R23 RE-SUBMISSION OCT 15, 2021 R22 RE-SUBMISSION DEC 23, 2020 RZ1 APPLICATION DEC 23, 2020 RZ1 APPLICATION

# REFERENCE PLANS

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## INTERFACE:

Sulte 230 11590 Cambie Road Richmond BC Canada V5X 3Z5

T 604 821 1162 F 604 821 1146 www.interfacearchitecture.com

PROJECT Proposed 18-Unit Townhouse Development 3 LOT ASSEMBLY

5800 / 5840 / 5860 GRAMAULE AVENUE RICHMOND, BC PROJECT NO. : 2008GRAN SCALE : As indicated DATE : Dec 23, 2020 DRAWN BY :


SRS, AL CHECK BY .

KC SHEET TITLE :

FLOOR PLANS -BUILDING 4 & 5

DRAWING SHEET :

A2.3

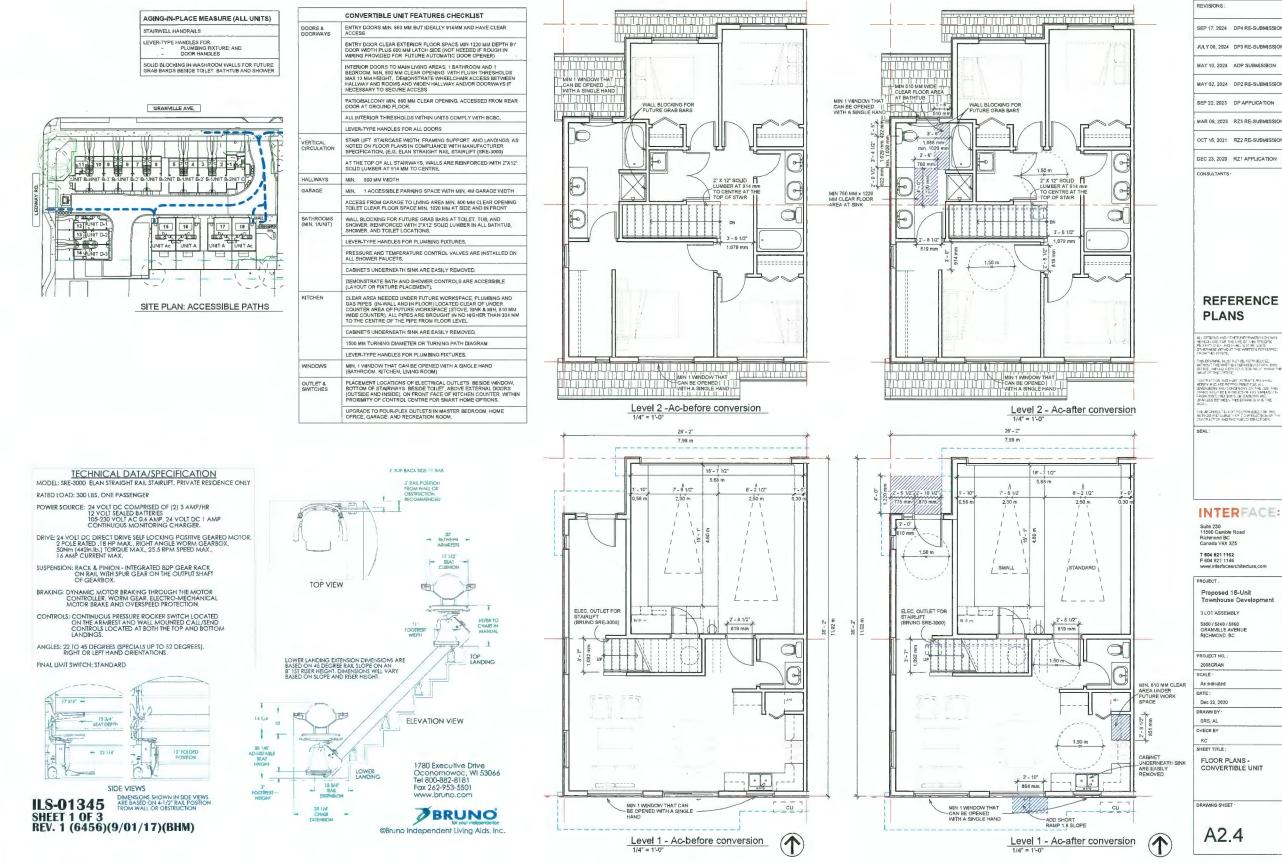


REFERENCE ALL DESIGNS AND STHER DEPREMATION SHOWS HEREON ARE FOR THE USE OF THIS SPECIFIC PROJECT ONLY MOSHINU NOT BE USED OTHERWISE WITHOUT THE WAITTEN PERMISSION FROM THIS OFFICE. These results are an end of the PEP adults and the THE APOINTELY IS TO TRESPONSIBLE FOR THE METHOD ALD SUALTY OF CONSTRUCTION OF TY CONTRACTOR AND THE SUBCONTRACTORS. INTERFACE:

# SPRING EQUINOX

# SUMMER SOLSTICE

# AUTUMN EQUINOX

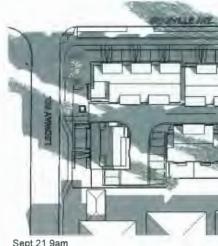












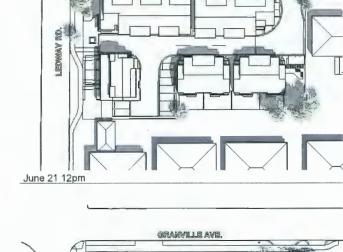




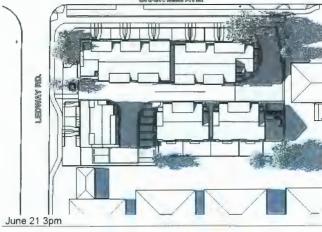

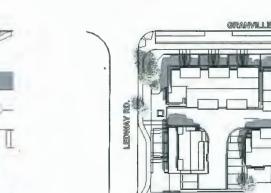

GRANVILLE AVE. M. D

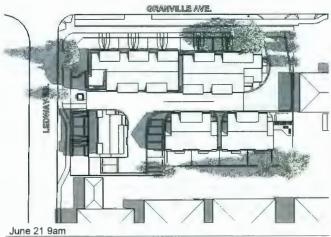

REVISIONS :
SEP 17, 2024 DP4 RE-SUBMISSION
JULY 08, 2024 DP3 RE-SUBMISSION
MAY 10, 2024 ADP SUBMISSION
MAY 02, 2024 DP2 RE-SUBMISSION
SEP 22, 2023 DP APPLICATION
MAR 09, 2023 RZ3 RE-SUBMISSION
OCT 15, 2021 RZ2 RE-SUBMISSION
DEC 23, 2020 RZ1 APPLICATION
REFERENCE PLANS
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PROJECT. Proposed 18-Unit
Townhouse Development
3 LOT ASSEMBLY 5800 / 5840 / 5860 GRAMMLLE AVENUE RICHMOND, BC
PROJECT NO. :
2008GRAN SCALE ·
DATE :
Dec 23, 2020
DRAWN BY : Author
CHECK BY . Checker
SHEET TITLE: SHADOW STUDY
DRAWING SHEET
A6.1