

Report to Development Permit Panel

To:

Development Permit Panel

Date:

July 31, 2024

From:

Joshua Reis

File:

DP 21-934620

Director, Development

Re:

Application by Zhao XD Architect Ltd. for a Development Permit at 8031, 8051,

8071 No. 2 Road and 5760, 5780, 5786 Blundell Road

Staff Recommendation

That a Development Permit be issued which would:

- 1. Permit the construction of 25 townhouse units at 8031, 8051, 8071 No. 2 Road and 5760, 5780, 5786 Blundell Road on a site zoned "Medium Density Townhouses (RTM3)"; and
- 2. Vary the provisions of Richmond Zoning Bylaw 8500 to:
 - a) Reduce the minimum front yard (north yard) and exterior side yard (east yard) from 6.0 m to 5.5 m.
 - b) Reduce the minimum lot width from 50.0 m to 43.0 m.

Joshua Reis, MCIP, RPP, AICP

Director, Development

Jan Her

(604-247-4625)

JR:cl Att. 3

Staff Report

Origin

Zhao XD Architect Ltd. has applied on behalf of 1085796 BC Ltd., 1209136 BC Ltd., and XWJ Enterprises Ltd. (Directors: Jia Xun Xu, Hua Han and Jie Xu, respectively) to the City of Richmond for permission to develop 25 townhouse units at 8031, 8051, 8071 No. 2 Road and 5760, 5780, 5786 Blundell Road, on a site zoned "Medium Density Townhouses (RTM3)". A location map of the subject site is provided in Attachment 1.

The site is being rezoned from the "Small-Scale Multi-Unit Housing (RSM/L)" zone to the "Medium Density Townhouses (RTM3)" zone for this project under Richmond Zoning Bylaw 8500, Amendment Bylaw 10378 (RZ 18-829337). The Bylaw was given third reading at the Public Hearing held May 16, 2022, and the applicant is working to complete all of the rezoning requirements.

A Servicing Agreement is required as a condition of rezoning bylaw adoption for servicing and frontage improvements, including construction of new sidewalks and treed/grass boulevards along No. 2 Road and Blundell Road, and widening of the existing driveway crossing to be shared with 8091 No. 2 Road to a width of 7.5 m, consistent with the City's Engineering Design Specifications.

Development Information

Please refer to attached Development Application Data Sheet for a comparison of the proposed development data with the relevant Bylaw requirements (Attachment 2).

Background

The subject site is located on the southwest corner of the intersection of No. 2 Road and Blundell Road. The site currently consists of six properties, each containing an existing single-detached dwelling and each having an individual driveway crossing to either No. 2 Road or Blundell Road. Existing development immediately surrounding the subject site is as follows:

To the north: Immediately across Blundell Road, are lots zoned "Small-Scale Multi-Unit

Housing (RSM/L)", each containing single-detached dwellings and which are designated for "Arterial Road Townhouse" development under the Arterial Road

Land Use Policy in the Official Community Plan (OCP).

To the east: Immediately across No. 2 Road, are lots zoned "Community Commercial (CC)",

"Community Commercial (ZC14) – Blundell Road", and "Neighbourhood Commercial (CN)", which are occupied by the Blundell Plaza shopping centre.

To the south: A lot zoned "Medium Density Townhouses (RTM1)", containing 10 townhouses

fronting No. 2 Road.

To the west: Are lots zoned "Small-Scale Multi-Unit Housing (RSM/L)", fronting Cantley

Road, one of which contains a duplex and the other contains a single-detached dwelling. To the west, fronting Blundell Road, is a lot zoned "Medium Density

Townhouses (RTM1)", containing 16 townhouses.

Rezoning and Public Hearing Results

The Public Hearing for the rezoning of this site was held on May 16, 2022. At the Public Hearing, concerns about the development proposal were expressed both in person and via written submissions. The nature of the concerns was primarily as follows:

- Comments respecting the proposed form of development with a preference to see apartment
 housing, which may be more affordable and have a lower lot coverage to enable tree and
 wildlife retention.
- The residents of the existing neighbouring townhouse site to the south at 8091 No. 2 Road were opposed to the proposed use of the shared driveway for vehicle access to the subject site due to cost-sharing and maintenance concerns, increased volume of traffic and parking, and traffic safety.

The proposed use is in compliance with the Official Community Plan land use designation and the Arterial Road Land Use Policy, and the applicant is proposing a townhouse development consistent with that designation. The retention of existing healthy trees was determined as part of the Rezoning Application and replacement of trees proposed for removal is proposed to be provided at a greater than 2:1 ratio.

In response to the concerns raised about the driveway use, staff have confirmed that there is an existing Statutory Right-of-Way (SRW) for Public-Right-of-Passage registered on Title of the townhouse site to the south at 8091 No. 2 Road for shared use of the driveway to access the subject site and that the driveway crossing will be widened and frontage improvements undertaken consistent with the City's current design standards. This approach serves to reduce the number of driveway crossings which can otherwise contribute to vehicle and pedestrian conflicts. Staff have continued to work with the applicant to encourage them to come to an agreement with the owners of the neighbouring townhouse site on the cost-sharing and maintenance of the driveway. To-date the applicant has advised that their efforts to engage their neighbours on this matter are ongoing and that the two parties are close to finalizing the terms of the agreement. The applicant has advised that the two parties will finalize the agreement as the proposal moves forward to construction stage.

During the rezoning process, staff also identified the following design issues to be resolved at the Development Permit (DP) stage:

- Detailed design review for compliance with the DP Guidelines for townhouses in the OCP.
- Review of the size and species of proposed new trees to ensure an appropriate mix of deciduous and coniferous tree species.
- Refinement of the common outdoor amenity space design and programming.
- Review of accessibility features, including the provision of Convertible Units and aging-inplace features in all units.
- Review of the sustainability features proposed as part of the development.

Review of any necessary noise attenuation features to be incorporated into the design to
mitigate impacts from traffic noise, as well as confirmation that the noise generated by any
proposed exterior mechanical systems complies with City bylaws.

Through the review of this DP Application, staff worked with the applicant to address these issues to staff's satisfaction and to ensure that the proposed architectural form and character is consistent with the intent of the applicable design guidelines contained within the OCP. The applicant has made revisions to the proposal to address the design issues identified, including:

- Revising the Landscape Plan to increase tree sizes and provide a greater variety of tree species throughout the site, as well as to refine the common outdoor amenity space design to provide for greater shrub and tree planting.
- Demonstrating on the plans that all applicable accessibility features are incorporated into the design of the four Convertible Housing units and that all units contain aging-in-place features.
- Describing the sustainability features proposed as part of the development, including confirmation that the proposed design will comply with the Energy Step Code.
- Incorporating noise attenuation features into the building design to mitigate traffic noise impacts consistent with the report recommendations by a registered Acoustic Engineer in order to meet the City's noise standards for interior living spaces, such as upgraded glazing and exterior wall assemblies (wall and glass type/thickness) for specific areas of the buildings, as shown on the drawings.
- Providing confirmation that noise associated with operation of the proposed exterior mechanical system (e.g., heat pump condenser units) will comply with the City's noise regulation bylaw and the City's guidelines for interior noise standards.

Staff Comments

The proposed scheme attached to this report (Plans # 1 to 4.I) has satisfactorily addressed the significant urban design issues and other staff comments identified as part of the review of the subject DP Application. In addition, it complies with the intent of the applicable sections of the OCP and is generally in compliance with the "RTM3" zone, with the exception of the zoning variances noted below.

Zoning Compliance/Variances (staff comments in bold)

The applicant requests to vary the provisions of Richmond Zoning Bylaw 8500 to:

a) Reduce the minimum front yard (north yard) and exterior side yard (east yard) from 6.0 m to 5.5 m.

Staff supports the proposed variance for the following reasons:

• It assists with off-setting the reduced lot dimensions resulting from road dedication to accommodate the required frontage improvements along both No. 2 Road and Blundell Road. Furthermore, the distance between the proposed buildings and the curb of the road remains at approximately 9.0 m despite the technical variance.

- Although the setback is reduced, the proposal maintains consistency with the minimum private outdoor space guidelines in the OCP (30 m² per unit) through the provision of a combination of yards at grade as well as secondary balconies along the drive-aisle on the second level of the three-storey units.
- Due to its location on an arterial roadway, the applicant has submitted an acoustic report and documentation by registered Acoustical and Mechanical Engineers, which confirm that the proposal will comply with the standards for interior noise levels and thermal comfort conditions in the OCP. Prior to DP issuance, a traffic noise covenant is to be registered on Title for public awareness and to ensure construction complies with the City's standards.

This variance was identified as part of the Rezoning Application and no concerns on this matter were raised by members of the public at that time.

b) Reduce the minimum lot width from 50.0 m to 43.0 m.

Staff supports this as it is a technical variance due to the resulting lot geometry after land assembly and the lot width measurement being derived using the shorter frontage on a corner lot. The proposal demonstrates that a functional site plan that meets the design guidelines in the OCP is achievable for this townhouse proposal despite the technical variance.

Advisory Design Panel Comments

The Advisory Design Panel review of the proposal was held on October 5, 2023, and received support to move forward to the DP Panel subject to the applicant giving consideration to the comments identified by the Panel members. A copy of the relevant excerpt from the Advisory Design Panel Minutes is attached for reference (Attachment 3). The design response from the applicant has been included immediately following the specific Design Panel comments and is identified in 'bold italics'.

Analysis

Conditions of Adjacency

- The proposed townhouses at the subject site have been designed with consideration of the
 existing surrounding housing context and are consistent with the design guidelines in the
 OCP for townhouses on arterial roads.
- Three-storey units are proposed along No. 2 Road consistent with that of townhouses to the south, and three-storey units proposed along Blundell Road step down to two-storeys next to existing two-storey townhouse end units to the west.
- Two-storey units in duplex form, with wider than minimum setbacks to the ground and second floors, are proposed along the rear yard interface with existing single-detached housing to the west, consistent with the design guidelines for Arterial Road Townhouses in the OCP (i.e., minimum 4.5 m and 6.0 m, respectively).

Site Planning, Access, and Parking

• The proposed development is for 25 townhouse units on a site that will be approximately 4,040 m² in area after the required road dedication along No. 2 Road and Blundell Road.

- The site layout consists of seven buildings located on either side of a drive-aisle that runs parallel to No. 2 Road and then west to run parallel to Blundell Road, as follows:
 - Two three-storey buildings are proposed fronting No. 2 Road, on the east side of the north-south leg of the drive-aisle, each of which contain six units (Buildings 1 and 2).
 - Two three-storey buildings are proposed fronting onto Blundell Road, on the north side of the east-west leg of the drive-aisle, one of which is a fourplex and the other a triplex (Buildings 3 and 4). The end unit at the west end of Building 4 steps down to two-storeys consistent with that of the existing adjacent townhouse end unit to the west.
 - Three two-storey duplex buildings are proposed on the west side of the north-south leg of the drive-aisle, along the rear yard interface with existing single-detached housing (Buildings 5 to 7).
- Vehicle access to the subject site was reviewed as part of the Rezoning Application and supported by the City's Transportation Department. Vehicle access to the site is proposed from No. 2 Road via the existing adjacent driveway crossing to the south at 8091 No. 2 Road, over which is secured a SRW for Public-Right-of-Passage for shared access to the subject site and which is to be widened to a total of 7.5 m as part of this development. As part of the Rezoning Application for the subject site, the applicant is required to register a reciprocal SRW for Public-Right-of-Passage on Title allowing residents and visitors of both sites to cross over the shared drive-aisles.
- Pedestrian access to the site is proposed from both No. 2 Road and Blundell Road via pathways between buildings, as well as via the shared driveway. The dual use of the shared driveway by both vehicles and pedestrians is highlighted by its decorative surface treatment at the entry.
- On-site parking is provided consistent with Richmond Zoning Bylaw 8500. Resident vehicle
 parking spaces are proposed in individual garages, while surface parking spaces are provided
 at various locations on-site for visitors. Bike parking is also proposed within individual
 garages, while a bike rack for visitors is proposed at the pedestrian access to the site between
 Buildings 2 and 3.
- A centralized storage room that is adequately sized to accommodate the required waste and
 recycling bins is incorporated into the south end of Building 1 near the entrance to the site for
 ease of servicing.

Architectural Form and Character

- The proposed building massing and height is intended to be sympathetic to and compatible
 with that of the existing surrounding context of varied development such as three-storey
 townhouses along the arterial roads, two-storey housing to the west and commercial
 development immediately across the street and on the northeast corner of No. 2 Road and
 Blundell Road.
- The proposed architectural character is inspired by the "French style" with an integration of the main mansard roof with the upper floor windows, creating a dormer-like expression that reflects a traditional residential character and assists with breaking down the apparent building height.

- The design employs repetition of typical residential façade components such as covered unit entries or entries accentuated with architectural detailing (e.g., pilasters and cornices) that are in alignment with upper floor windows, which assist to define each individual townhouse unit and to create a rhythm of expression along the street, while appropriate façade and colour variations are also provided to minimize monotony.
- Façade articulation and the proposed material and colour palette assist with providing visual interest and breaking down the buildings into smaller components. Masonry veneer cladding is proposed for portions of the ground floor walls while stucco and metal roofing in varying shades of the colour palette is proposed on upper stories.

Open Space & Landscape Design

- Common outdoor amenity space is centrally located on-site and is sized in accordance with the design guidelines in the OCP (150 m²). The space contains bench seating, a children's play structure that provides for climbing, jumping, sliding and imaginative play, a lawn area, as well as a variety of plant material and a Katsura Tree.
- Private outdoor space for each of the units is provided consistent with the size guidelines in the OCP (min. 30 m² per unit) and is primarily in the form of yards at grade, with secondary balconies along the internal drive-aisles for the street-fronting units.
- On-site tree retention and removal was assessed as part of the Rezoning Application, at which time it was identified that:
 - One tree on the subject site, as well as one shared tree, a hedge and five trees on the neighbouring property to the west at 8080 Cantley Road, are to be retained and protected (Trees # 385, 391, A to E). To ensure that retained trees are protected and maintained, the applicant is required to submit a Tree Survival Security in the amount of \$10,000.00 prior to final adoption of the rezoning bylaw.
 - 12 trees, including two significant trees, are to be removed and 26 replacement trees are required to be planted and maintained on-site.
- The Landscape Plan shows the trees that are to be retained and removed, and also shows that a mix of 31 deciduous and coniferous replacement trees are proposed to be planted and maintained on-site, which exceeds the required number of replacement trees (i.e., Columnar Bowhall Maple, Katsura Tree, Dawyck Gold Beech, Vanderwolf's Pyramidal Limber Pine, and Pink Flowered Japanese Snowbell).
- A variety of shrubs, grasses, perennial plants, and groundcovers are also proposed on-site, including (but not limited to): Azalea, Boxwood, Hydrangea, Skimmia, Viburnum, Evergold Japanese Sedge, Dwarf Fountain Grass, False Spirea, and Western Sword Fern.
- The Landscape Plan indicates that all soft landscaped areas are to be equipped with a highefficiency automatic irrigation system designed to industry standards.
- To define the street edge and clearly distinguish between public and private space along the street frontages, low fencing with pedestrian gates is proposed, while solid wood privacy fencing is proposed around the perimeter of the site.

- A concept for exterior lighting is provided and includes low bollard lighting at pedestrian
 access points, pathways and in the common outdoor amenity space, as well as downwardoriented building-mounted lighting at unit entries, along the drive-aisle and between
 buildings.
- To ensure that the Landscape Plan is adhered to, the applicant is required to submit a Landscaping Security in the amount of \$206,124.58, which is based on 100 per cent of the landscape cost estimate prepared by the Registered Landscape Architect (including installation and a 10 per cent contingency) prior to DP issuance. The applicant must also enter into a legal agreement to accompany the Landscaping Security, which sets the terms for use and release of the security.

Indoor Amenity Space

• Consistent with the OCP, and as considered as part of the Rezoning Application, the applicant proposes to submit a contribution in the amount of \$55,961.00 to the City's Leisure Facilities Reserve Fund prior to rezoning bylaw adoption in-lieu of the provision of common indoor amenity space on-site.

Accessible Housing

- The proposed development includes four Convertible Units that are designed with the potential to be easily renovated to accommodate a future resident in a wheelchair or with mobility constraints. The potential conversion of these units will require the installation of a stair lift.
- All of the proposed units incorporate aging-in-place features to accommodate mobility constraints associated with aging. These features include:
 - Stairwell handrails.
 - Lever-type handles for plumbing fixtures and door handles.
 - Solid blocking in washroom walls to facilitate future grab bar installation beside toilets, bathtubs and showers.

Sustainability

• The applicant has submitted written confirmation from their certified Energy Advisor that the proposed design will meet BC Energy Step Code 3 with a low carbon energy system. The key technical elements that enable this performance target to be achieved include additional insulation in building assemblies (walls, ceilings, roof, floors, slab), electric hot water tank, air source heat pumps for both heating and cooling and a heat recovery ventilation system. To minimize visual impact, the heat pump condenser units for the three-storey buildings are proposed to be located on the second-floor balconies along the internal drive-aisle while the condenser units for the two-storey buildings are proposed to be tucked into the articulated rear building façades. The applicant has provided a report from an acoustical engineer confirming that the heat pumps will comply with the City's Noise Regulation Bylaw.

- The proposed energy performance target is consistent with the provisions for in-stream applications that were submitted to the City prior to October 31, 2023, subject to the DP application being considered and endorsed by the DP Panel and a complete Building Permit application being submitted prior to October 31, 2024. Should the applicant be unable to meet these deadlines, the proposal must be updated to meet the current BC Energy Step Code performance targets (e.g., Step 3 + EL-4).
- Additional environmentally sustainable features of the proposal identified by the applicant include:
 - Energized outlets to support electric vehicle (EV) charging for all resident parking spaces, as required by Richmond Zoning Bylaw 8500.
 - Stucco made from all natural ingredients to be used as the primary cladding material.
 - Permeable pavers to maximize stormwater infiltration potential.

Crime Prevention Through Environmental Design

- The applicant has identified that the proposal responds to the following principles of CPTED, as encouraged in the design guidelines contained within the OCP:
 - Natural access control is demonstrated through a clearly-defined vehicle access point and individual unit entries, along with low fencing and landscaping to differentiate between public and private space without impeding natural surveillance.
 - Natural surveillance is also facilitated by the centralized location of the common outdoor amenity space, and windows and balconies overlooking the internal drive-aisle, pathways, spaces between buildings, and providing "eyes on the street" along No. 2 Road and Blundell Road. Lighting and clear sightlines provide unobstructed views throughout the site.
 - To ensure that the site is seen as a defensible space, the future strata council will need to ensure that landscaping, lighting and equipment is maintained and kept operable so that spaces are used for their intended purpose.

Site Servicing and Off-site Improvements

- Servicing and off-site improvements to support the proposed development were identified during the Rezoning Application review process and are required to be designed and constructed through a Servicing Agreement. The scope of the required works includes:
 - Design and construction of potential storm sewer upgrades, removal of a portion of an existing sanitary sewer line, as well as replacement of a portion of an existing water main that may be impacted by construction and the required upgrades.
 - Replacement of the existing boulevard condition with a new 2.0 m wide sidewalk at the new property line and minimum 1.5 m wide treed/grass boulevard along both No. 2 Road and Blundell Road, as well as widening of the existing driveway crossing at 8091 No. 2 Road to a width of 7.5 m consistent with the City's design specifications.
- To accommodate the required works and potential future road widening, road dedication ranging from approximately 0.9 m to 2.75 m is required along No. 2 Road and Blundell Road as secured through the Rezoning Application.

Conclusion

This proposal is for a 25-unit townhouse development on a land assembly involving six lots at 8031, 8051, 8071 No. 2 Road and 5760, 5780, 5786 Blundell Road.

The applicant has addressed the design issues identified through the Rezoning Application review process, as well as additional staff comments regarding site planning, urban design, architectural form and character and landscape design identified as part of the DP Application review process. The proposal provides an appropriate response to the surrounding townhouse and low-density housing context and conforms to the applicable policies and design guidelines contained within the OCP.

The proposed development complies with the requirements of the "RTM3" zone, with the exception of the variances discussed.

On this basis, staff recommend that the DP be endorsed, and issuance by Council be recommended.

Cynthia Lussier Planner 2

(604-276-4108)

CL:he

Att. 1

- 1. Location Map
- 2. Development Application Data Sheet
- 3. Excerpt from the October 5, 2023 Advisory Design Panel meeting minutes and the Applicant's design response

The following are to be met prior to forwarding this application to Council for issuance:

- 1. Final adoption of Richmond Zoning Bylaw 8500, Amendment Bylaw 10378.
- 2. Receipt of a Letter of Credit or other form of security acceptable to the City for landscaping in the amount of \$206,124.58 (100% of the cost estimate provided by the Registered Landscape Architect, including all materials, installation, and a 10% contingency). To accompany the landscaping security, a legal agreement that sets the terms for use and release of the security must be entered into between the applicant and the City.
- 3. Registration of a legal agreement on title identifying that the proposed development must be designed and constructed in a manner that mitigates the impacts of traffic noise to the proposed dwelling units while still enabling appropriate interior thermal conditions to be met. Dwelling units must be designed and constructed to achieve:
 - a) CMHC guidelines for interior noise levels as indicated in the chart below:


| Portions of Dwelling Units | Noise Levels (decibels) |
|---|-------------------------|
| Bedrooms | 35 decibels |
| Living, dining, recreation rooms | 40 decibels |
| Kitchen, bathrooms, hallways, and utility rooms | 45 decibels |

- b) the ASHRAE 55-2004 "Thermal Environmental Conditions for Human Occupancy" standard for interior living spaces, and subsequent updates as they may occur.
- 4. Payment of all fees in full for the cost associated with the Development Permit Panel Meeting Notices, consistent with the City's Consolidated Fees Bylaw No 8636, as amended.

Prior to future Building Permit issuance, the applicant is required to complete the following:

- Incorporation of accessibility measures in Building Permit plans and construction, as determined via the Rezoning and Development Permit applications (e.g., Aging-in-place features in all units and four Convertible Units).
- Incorporation of energy efficiency measures in Building Permit plans and construction to meet or exceed the applicable Energy Step Code performance target.
- Obtain a Building Permit for any construction hoarding associated with the proposed development. If
 construction hoarding is required to temporarily occupy a street, or any part thereof, or occupy the air space
 above a street or any part thereof, additional City approvals and associated fees may be required as part of the
 Building Permit. For further information on the Building Permit, please contact Building Approvals
 Department at 604-276-4285.
- Submission of a construction traffic and parking management plan to the satisfaction of the City's Transportation Department (https://www.richmond.ca/services/transportation/special.htm#TrafficPlan).
- If applicable, payment of latecomer agreement charges, plus applicable interest associated with eligible latecomer works.



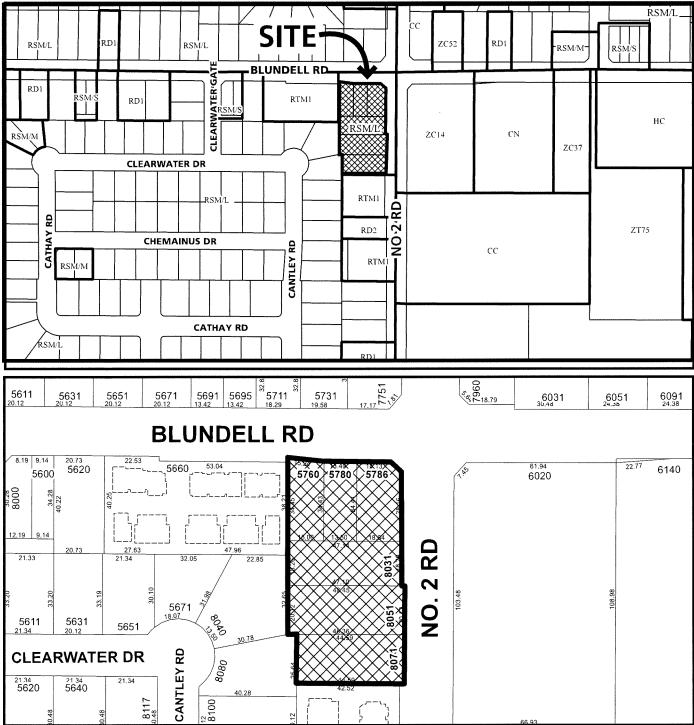



DP 21-934620

Original Date: 07/07/21

Revision Date: 07/29/24

Note: Dimensions are in METRES



Development Application Data Sheet

Development Applications Department

DP 21-934620

Address: 8031, 8051, 8071 No. 2 Road and 5760, 5780, 5786 Blundell Road

Applicant: Zhao XD Architect Ltd. Owner: 1085796 BC Ltd.

1209136 BC Ltd. XWJ Enterprises Ltd.

Planning Area(s): Blundell

| = | Existing | Proposed |
|------------------|---|--|
| Site Area: | 4,272.6 m ² (45,988.8 ft ²) | 4,040.1 m ² (43,486.5 ft ²) after road dedication |
| Land Uses: | Single Detached Residential | Townhouse |
| OCP Designation: | Neighbourhood Residential | No change |
| Zoning: | Small-Scale Multi-Unit Housing (RSM/L) | Medium Density Townhouses (RTM3) |
| Number of Units: | 6 | 25 |

| | Bylaw Requirement | Proposed | Variance |
|--|--|---|-------------------------------|
| Floor Area Ratio: | 0.70 | 0.70 | None permitted |
| Floor Area (Net): | Max. 2,828.07 m ² Max. (30,440.2 ft ²) | 2,828.07 m ² (30,440.2 ft ²) | None permitted |
| Lot Coverage – Buildings: | Max. 40% | 39.9% | None |
| Lot Coverage – Non-porous Surfaces: | Max. 65% | 64.8% | None |
| Lot Coverage – Live Plant Material: | Min. 25% | 25% | None |
| Setback – Front Yard (North): | Min. 6.0 m | 5.5 m | To reduce from 6.0 m to 5.5 m |
| Setback – Exterior Side Yard (East): | Min. 6.0 m | 5.5 m | To reduce from 6.0 m to 5.5 m |
| Setback – Interior Side Yard (West): | Min. 3.0 m | Bldg. 4 – 3.0 m Bldgs. 5 to 7 – min. 4.5 m (50% ground floor) and 6.0 m (50% ground floor & all second floor) | None |
| Setback – Rear Yard (South): | Min. 3.0 m | 3.0 m | None |
| Building Height: | Max. 12.0 m (3 storeys) | Bldgs. 1 to 4 – 12.0 m Bldgs. 5 to 7 – 9.0 m | None |
| Minimum Lot Depth: | Min. 35.0 m | 90.3 m | None |

| | Bylaw Requirement | Proposed | Variance |
|------------------------------------|--|-----------------------------------|---------------------------------|
| Minimum Lot Width: | Min. 50.0 m | 43.8 m (average) | To reduce from 50.0 m to 43.0 m |
| On-site Vehicle Parking Spaces: | Min. 50 (R) and 5 (V) | 50 (R) and 5 (V) | None |
| Standard Size: Small Size: | Min. 50% (28) Max. 50% (27) | 69% (38) 31% (17) | None |
| Tandem Vehicle Parking Spaces: | Max. 50% (25) | 44 % (22) | None |
| Accessible Vehicle Parking Spaces: | Min. 2% - 1 Van Accessible Parking Space | 1 Van Accessible Parking Space | None |
| Total Vehicle Parking Spaces: | 55 | 55 | None |
| Amenity Space – Indoor: | Min. 70 m ² | Cash-in-lieu | None |
| Amenity Space – Outdoor: | Min. 6 m²/unit (i.e., 150 m²) | 150 m² | None |

Excerpt from the Minutes from The Advisory Design Panel Meeting

Thursday, October 5, 2023 – 4:00 p.m. Remote (Webex) Meeting

1. DP 21-934620 - 25-UNIT TOWNHOUSE DEVELOPMENT WITH VEHICLE ACCESS VIA THE ADJACENT SITE TO THE SOUTH

ARCHITECT:

Zhao XD Architect Ltd.

LANDSCAPE ARCHITECT: PMG Landscape Architects

PROPERTY LOCATION:

8031, 8051, 8071 No. 2 Rd and 5760, 5780, 5786

Blundell Road

Applicant's Presentation

Architect Xuedong Zhao, Zhao XD Architect Ltd., and Landscape Designer Denitsa Dimitrova, PMG Landscape Architects, presented the project and answered queries from the Panel.

Panel Discussion

Comments from Panel members were as follows:

consider relocating the proposed accessible parking space from the west of the common outdoor amenity space to an area adjacent to the internal drive aisle at the corner and to make it more centrally located and accessible to residents of the convertible units:

The other visitor parking locations (V1, V2 and V3) are facing the drive aisle with busier traffic, which are less ideal for accessible parking in terms of maneuvering and wheelchair path safety. The suggested location at the corner has the same concern as it would be immediately adjacent to the other two driveways. Since the development site is not very large, the proposed V4 parking space is in an accessible location.

consider relocating the mail kiosk and visitor bike rack from the main vehicle entrance to the site to the area near Unit A2 in Building 5 and the would be relocated accessible parking space to make them less visible from the street but more accessible to residents:

The mail kiosk and visitor bike rack have been relocated (see revised plans).

appreciate the provision of aging-in-place features to all of the townhouse units; Noted.

• consider installing wider doorways to the secondary bedrooms of the four convertible units to accommodate mobility devices;

The doors to other two bedrooms are changed to wider door width per suggestions (see updated Sheet A13).

- not concerned about the proposed colour palette as they don't appear overly monotonous;
- the proposed design of Building 3 at the corner of No. 2 Road and Blundell Road does not incorporate landmarks; agree with staff comment that the applicant needs to incorporate a unique feature into the building design to improve the corner treatment in order to better highlight its presence at the street intersection;

A landscaping option (i.e., a unique on-site planting area) is proposed to provide visual interest at the corner to respond to this ADP comment (see updated site plan with notes and landscape architectural plans).

Furthermore as originally proposed, the east elevation of Building 3 (for the Unit 3 amongst the Unit B series) is specially designed for street frontage exposure with more glazing (windows) and more decorative items (brackets), while the other Unit B series come with simpler articulated façade treatments since they are not facing the No.2 Road and Blundell Road street corner.

The "corner turret" in rectangular shape is designed as a unique feature for the building to improve its corner treatment in order to better highlight a presence at the street intersection.

appreciate the provision of permeable pavers on certain portions of the subject site; however, consider a regular asphalt or porous asphalt treatment in lieu of permeable pavers at the main vehicle entrance to the site as permeable pavers may not be durable enough and not able to support in the long term the expected heavy use of large garbage and recycling trucks;

For the pavement articulations for the "street front" as well as for the south neighbour (in light of shared driveway use) the proposed permeable pavers are an aesthetically better selection for the driveway than asphalt paving. The proposed permeable pavers are selected to match those on the neighbouring site to the south for its strength and durability to suit the traffic load requirements (see Sheet L-1).

• consider installing gable roofs for the proposed townhouse buildings to make the proposed development fit better into the existing neighbourhood, break down the overall mass of the buildings, and provide more identity to individual units;

Very minor gable roof accents are used in the design. As the architectural form/design for the development is inspired by "French style", with mainly mansard roof (or gambrel-style hip roof), little gable roofs are proposed to fit this type of design intent. As the neighbourhood surrounding the site consists of a variety of different building types and styles, including both hip and gable

roofs, as well as commercial flat buildings across the street, the architectural form and scale/massing as proposed for the development should fit well to the existing neighborhood.

The townhouse design employs such typical façade components to be repeated such as "front door and porch" in alignment with 2nd floor and 3rd floor windows with roof dormer, to make their visibility for individual townhouse units, as well as for their unity within their building complex. They can thus clearly read as "individual units" well embedded in the buildings and building complex.

the main doors to the two-storey rear units facing the internal drive aisle need further architectural articulation to emphasize the main entries to units and make them more welcoming relative to the amount of garage doors at the back and in order to mitigate the monotony of the mews;

The variations in colour ("Aged Pewter" as chosen from colour palette) on portions of these 3 two-storey buildings are provided as suggested to emphasize the entries. See revised color elevations and perspectives for the entry areas on Buildings 5, 6 & 7 where the different colors are applied.

The colour of the entrance doors is also selected for its prominence, together with the articulated door canopies which are proposed above the doors to emphasize the main entry to townhouse units for the two-story buildings. Differentiation of the entrance door and garage door is further achieved with recessed walls (for both ground and upper stories) and recessed roof lines/eaves for the entrance doors, which also provide more transitional space at door front for functionality. Additional articulations are also employed for the entrance doors, such as the decorative brackets and lighting fixtures. To mitigate "the monotony of the mews", the building form for Building 7 is designed slightly differently from Buildings 5 and 6.

• consider a north-south orientation for the lane at the back of Buildings 3 and 4 with the open end of the lane facing Blundell Road to create a more arterial face to the Blundell Road frontage of the proposed development;

The development is on a corner lot facing two streets. The intent of City design guidelines is to avoid "side elevation" effects for the street frontage of the buildings as much as possible. Since the property has shorter frontage along Blundell Road than along No. 2 Road, we propose Building 3 with more front façade towards Blundell Road than to No. 2 Road, because we already have Buildings 1 and 2 with good amount of "building frontage" (facades) facing the No. 2 Road. To rotate Building 3 with "side elevation" facing Blundell Road would thus not be beneficial for the design of Blundell Road frontage. In addition, we have already addressed the "side elevation" issue, and the east elevation of Building 3 is designed with modifications for a more front-looking façade (refer to comments/responses for previous items).

• consider wrapping architectural features on the corner of Building 3 at No. 2 Road and Blundell Road to provide more articulation to the building faces highly visible from the street;

As rationalized above, the east elevation of Building 3 (for Unit B series) is specially made for street frontage exposure with more glazing (windows) and more decorative items (brackets), while the other Unit B series come with simpler articulated façade treatments since they are not facing the No. 2 Road and Blundell Road street corner.

The corner "turret" in rectangular shape is used to highlight the building's presence at the street intersection. The proposed projections and recesses, as well as the breakthrough of the eave line/roof line for the 'turret', make it an outstanding architectural feature to achieve the same intent also as suggested by ADP.

• ensure that the proposed stucco exterior wall cladding treatment will achieve its architectural intent for the buildings;

The mix of materials are proposed to break down the apparent use of the stucco. The proposed stucco wall areas are divided and segregated by other building composition elements (such as windows, trims, roof, sills) so that singular oversized stucco wall area is minimized in use. The intent is to mix the stucco wall areas well enough with other building materials, as well as to be applied on walls with recesses/projections in order to avoid a monotony of stucco material concentrated on one or more large exterior wall areas.

• the proposed mail kiosk at the main vehicle entrance to site is overly oriented towards the street; consider relocating to a more central location on the subject site;

The mail kiosk is relocated (see revised Site Plan).

• consider introducing more colour variation to the buildings to visually break down the overall mass of the buildings and prevent the monotonous repetition of architectural expression;

The ADP suggestions are considered and subtle variations have been introduced to the building design.

Since the architectural form/design is inspired by French style, the color variations are mainly the differentiations and interactions between the darker colored roof and the lighter colored building "body". The vertical projections of window dormers, "chimneys" and "turrets" prevent the architectural composition from being too monotonous as typically presented in the French style. Within the lighter portion of the spectrum of the color palette for the buildings, variations between stucco, trims and stone veneer are introduced for more visual interest. However, additional variations are still added to the street front facades with different stucco colors for the recessed wall portions in the middle of Buildings 1 and 2, and between Building 1 and the garbage/recycling room. A darker colour from within the chosen colour

palette has also been added to portions of Buildings 5 to 7 to better highlight the entries (see revised elevations and perspectives).

• the City could consider installing street trees along the boulevard on No. 2 Road and Blundell Road;

As shown on the landscape plans, Columnar Bowhall Maple trees are proposed on-site in the yards along both frontages, and City street trees are required to be planted in the boulevards along No. 2 Road and Blundell Road.

 consider relocating the BC Hydro kiosk away from the children's play area should the applicant agree to the proposal to shift the children's play area to the west;

The currently proposed BC Hydro kiosk location is relatively hidden and centrally located as intended, as well as in consideration of BC Hydro maintenance requirements for its adjacency to driveway. There appears no better location for the kiosk for site plan design. The children's play area is properly separated from the kiosk for both visual and safety considerations. The children's play area is also well protected by fences and landscaping.

• planting strips fronting Buildings 5, 6 and 7 are very small and in close proximity to the internal drive aisle which could impact their survivability;

Good selections of the plant species are made for survivability of the plants (see landscape plans).

Little-leaf boxwood is proposed at these locations. The species is selected to suit the site condition. Once established this plant is typically quite drought tolerant.

- appreciate the proposed design of the children's play area; the proposed location of the mail kiosk at the main vehicle entrance is preferred by Canada Post as it is close to the road;
- investigate whether the roof overhang on Buildings 1 and 2 along No. 2 Road are over some of the plantings below; consider appropriate measures to ensure survivability of plantings, e.g. installing irrigation;

Good selections of the plant species are made for survivability of the plants (see Landscape Plans). "Valley Fire Pieris" is a plant that also prefers open shade for the best flowering and growth. "Morning Light Japanese Silver Grass" is also a low-maintenance plant. The extent of roof overhang on Buildings 1 and 2 is negligible in comparison of its 2-story height where sunlight and rainwater are accessible.

support the Panel comment to install street trees along No. 2 Road and Blundell Road due to site's prominent corner location and in order to fit well with the surrounding landscape;

See written response to the item with the same topic above.

• consider revisiting the architectural articulation of Building 3 to better respond to its corner location; and

See two previous written responses to the Item(s) for the same topic.

• consider a terracing treatment for the one-meter high planter wall along No. 2 Road to break down the wall and in order to create a gradual approach to the grade transition along No. 2 Road.

The currently proposed planter also considers the "useable areas" of front yard patio and lawn, where additional layer of planter might make the front yards space less usable. Design revisions are however made for additional layer of the planters (see updated Landscape Plans).

Panel Decision

It was moved and seconded

That DP 21-934620 be supported to move forward to the Development Permit Panel subject to the applicant giving consideration to the comments of the Advisory Design Panel.

CARRIED



Development Permit

No. DP 21-934620

To the Holder:

ZHAO XD ARCHITECT LTD

Property Address:

8031, 8051, 8071 No. 2 Road and 5760, 5780, 5786 Blundell Road

Address:

11181 VOYAGEUR WAY SUITE 255

RICHMOND BC V6X 3N9


1. This Development Permit is issued subject to compliance with all of the Bylaws of the City applicable thereto, except as specifically varied or supplemented by this Permit.

- 2. This Development Permit applies to and only to those lands shown cross-hatched on the attached Schedule "A" and any and all buildings, structures and other development thereon.
- 3. The "Richmond Zoning Bylaw 8500" is hereby varied to:
 - a) Reduce the minimum front yard (north yard) and exterior side yard (east yard) from 6.0 m to 5.5 m.
 - b) Reduce the minimum lot width from 50.0 m to 43.0 m.
- 4. Subject to Section 692 of the Local Government Act, R.S.B.C.: buildings and structures; off-street parking and loading facilities; roads and parking areas; and landscaping and screening shall be constructed generally in accordance with Plans #1 to #4.I attached hereto.
- 5. Sanitary sewers, water, drainage, highways, street lighting, underground wiring, and sidewalks, shall be provided as required.
- 6. As a condition of the issuance of this Permit, the City is holding the security in the amount of \$206,124.58 to ensure that development is carried out in accordance with the terms and conditions of this Permit. Should any interest be earned upon the security, it shall accrue to the Holder if the security is returned. The condition of the posting of the security is that should the Holder fail to carry out the development hereby authorized, according to the terms and conditions of this Permit within the time provided, the City may use the security to carry out the work by its servants, agents or contractors, and any surplus shall be paid over to the Holder. Should the Holder carry out the development permitted by this permit within the time set out herein, the security shall be returned to the Holder. The City may retain the security for up to one year after inspection of the completed landscaping in order to ensure that plant material has survived.
- 7. If the Holder does not commence the construction permitted by this Permit within 24 months of the date of this Permit, this Permit shall lapse and the security shall be returned in full.

Development Permit No. DP 21-934620

| To the Holder: | ZHAO XD ARCHITECT LTD | | |
|---------------------------------|---|---|--|
| Property Address: | 8031, 8051, 8071 No. 2 Road and 5760, 5780, 5786 Blundell Road | | |
| Address: | 11181 VOYAGE RICHMOND BC | UR WAY SUITE 255 V6X 3N9 | |
| | s of this Permit an | ed generally in accordance with the terms and d any plans and specifications attached to this | |
| This Permit is not a Buil | ding Permit. | | |
| AUTHORIZING RESOLUT DAY OF , | ΓΙΟΝ NO. | ISSUED BY THE COUNCIL THE | |
| DELIVERED THIS I | DAY OF | , | |
| | | | |
| MAYOR | | | |



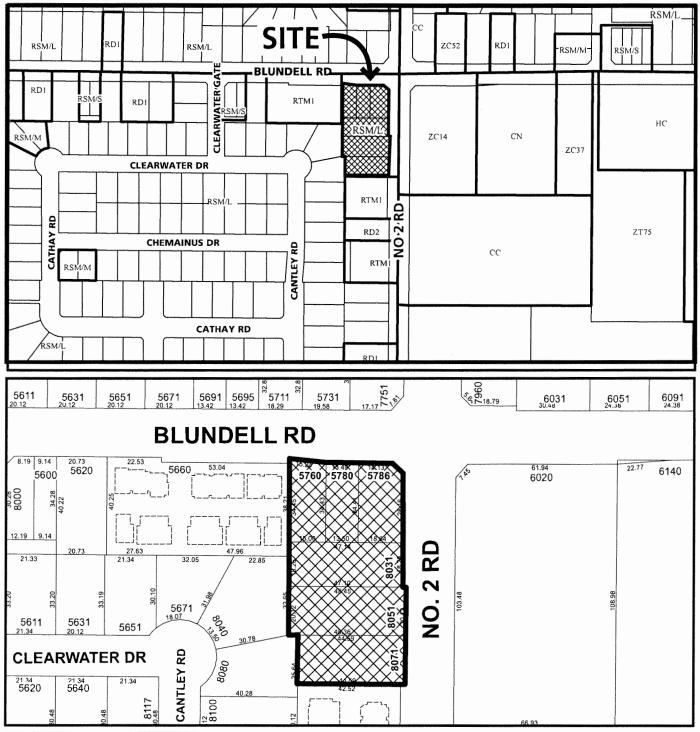



DP 21-934620 SCHEDULE "A"

Original Date: 07/07/21

Revision Date: 07/29/24

Note: Dimensions are in METRES



SCALE: NTS

AGING IN PLACE FEATURES FOR ALL UNITS.

-SOLID BLOCKING IN WASHROOM WALLS FOR FUTURE GRAB BARS BESIDE TOILET, BATHTUB, AND SHOOWER; -LEVER-TYPE HANDLES FOR PLUMBING AND DOOR HANDLES; -STAIRWELL HANDRAILS;

| FAR | CALCULATION: | LOT AREA: | 43486 O | SO FT |
|--------|--------------|-----------|---------|--------|
| F.A.K. | CALCULATION: | LUI AKEA: | 43400.U | SU.FI. |

CONTEXT PLAN

| F.A.R. (0.7): | FAR (MAX.) = 30440.2 | SQ.FT. |
|---------------|---|---|
| | /ERTIBLE UNIT) 2X 1239.30 /ERTIBLE UNIT) 2X 1239.30 | SQ.FT. |
| TOTAL PROPOSE | D = (0.7 FAR) 30440.20 | SQ.FT. |

F.A.R. CALCULATION: LOT AREA: 4040.10 S.M.

| THE OTHER | IN, LOT AREA: | 1010.10 | 5.M. |
|----------------|------------------|---------|------|
| (NUI | MBERS IN METRIC | C) | |
| A.R. (0.7): | FAR (MAX.) = | 2828.07 | S.M. |
| UNIT 'A' (COVE | ERTIBLE UNIT) 2X | 115.14 | S.M. |
| | ERTIBLE UNIT) 2X | | |
| UNIT 'B' | | 110.26 | S.M. |
| UNIT 'B2' | | 110.26 | S.M. |
| UNIT 'B3' | 3X | 110.26 | S.M. |
| UNIT 'B4' | 2X | 110.26 | S.M. |
| UNIT 'C' | 2X | 114.83 | S.M. |
| UNIT 'C2' | 2X | 114.83 | S.M. |
| UNIT 'D' | 2X | 107.85 | S.M. |
| UNIT 'D2' | 2X | 107.85 | |
| UNIT 'D3' | 2X | 116.98 | S.M. |
| UNIT 'D4' | | 116.98 | S.M. |
| UNIT 'E' | | 126.79 | S.M. |
| UNIT 'E2' | | 120.65 | S.M. |
| UNIT 'F' | | 106.58 | S.M. |
| TOTAL PROPOSED | = (0.7 FAR) | 2828.07 | S.M. |

REQUIREMENTS FOR ELECTRIC VEHICLE (EV) CHARGER SHALL FOLLOW BULLETIN NO. ENGINEERING -05 AND BYLAW 8500. ALL RESIDENTIAL PARKING SPACES (EXCLUDING VISITOR PARKING), LEVEL 2 EV CHARGING OUTLETS (208V TO 240V AC AND CURRENT OF 16A TO 80A).

NOTE: 4 CONVERTIBLE UNITS ARE PROVIDED FOR THE DEVELOPMENT.

NOTE: MECHANICAL SYSTEMS IN THIS PROJECT WILL MEET THE THERMAL COMFORT REQUIREMENTS AS PER THE ASHRAE 55-2004 STANDARD AND SUBSEQUENT UPDATES.

DEVELOPMENT DATA

ADDRESS: #8031- 8071 NO. 2 ROAD, #5760 - 5786 BLUNDELL ROAD

1) LOT 234 EXCEPT PARCEL E (REFERENCE PLAN LMP40316), PLAN 57659 LEGAL DESCRIPTION:

2) LOT 235 EXCEPT: PARCEL F (REFERENCE PLAN LMP40316), PLAN 57659 3) LOT 236 EXCEPT: PARCEL G (REFERENCE PLAN LMP40316), PLAN 57659

4) SOUTHERLY 60 FEET LOT A EXCEPT; PART ON PLAN LMP43723, PLAN 1691

5) LOT B PLAN 16911

6) LOT 2 EXCEPT FIRSTLY; THE SOUTH 72 FEET AND SECONDLY; PART ON PLAN 43278; PLAN 6188

ALL OF SECTION 24 BLOCK 4 NORTH RANGE 7 WEST NEW WESTMINSTER DISTRICT

P.I.D. NUMBERS: 003-829-529/003-829-731

003-829-880/004-206-193 003-644-375/001-931-164

PLANNING AREA(S) -ARTERIAL ROAD POLICY

| | EXISTING | PROPOSED |
|------------------------|---------------------------|---|
| SITE SIZE (SM): | 4272.6 (45988.8 SF) | 4040.1 (43486.5 SF) AFTER ROAD DEDICATION |
| LAND USES: | SINGLE-FAMILY RESIDENTIAL | TOWNHOUSE |
| OCP DESIGNATION: | NEIGHBOURHOOD RESIDENTIAL | NEIGHBOURHOOD RESIDENTIAL |
| AREA PLAN DESIGNATION: | OCP ARTERIAL ROAD POLICY | OCP ARTERIAL ROAD POLICY |
| ZONING [,] | SINGLE DETACHED (RS-1E) | MEDIUM-DENSITY TOWN HOUSING (RTM3) |
| NUMBER OF UNITS: | _ | 25 |

| | ************************************* | | |
|--|--|---|----------|
| *** | BYLAW REQUIREMENT | PROPOSED | VARIANCE |
| FLOOR AREA RATIO. | 0.7 2828.07 SM (30440.2 SF) | 0.7 2828.07 SM (30440.2 SF) | NONE |
| LOT COVERAGE - BUILDING: | MAX. 40% 1616.1 SM (17394.6 SF) | 40% 1613.3 SM (17387.4 SF) | NONE |
| LOT COVERAGE - LIVE LANDSCAPING: | MIN. 25% 1010.0 SM (10871.5 SF) | 25% 1010.0 SM (10871 5 SF) | NONE |
| LOT COVERAGE - NON-POROUS AREA: | MAX. 65% 2626.1 SM (28265.9 SF) | 65% 2620.8 SM (28208.9 SF) | NONE |
| COVERED AREA (SF): | MAX. 10% OF FSR | <10% | NONE |
| SETBACK - FRONT YARD (NORTH): | MIN 6.0M | 5.5M (BLDG, 3 & 4) | RQUIRED |
| SETBACK - EXTERIOR SIDE YARD (EAST): | MIN. 6.0M | 5.5M (BLDC. 1, 2 & 3) | ROUIRED |
| SETBACK — INTERIOR SIDE YARD (WEST): | MIN. 3.0M | 3.02M & 7.5M (3rd FL.) (BLDG. 4) 5.56M & 6.94M (50%) (BLDG 5 & 6) 4.5M & 6.0M (50%) (BLDG. 7) | NONE |
| SETBACK - REAR YARD (SOUTH) | MIN. 3.0M | 3.0M (BLDG. 7)* 3.0M (1-STOREY GARBAGE/BLDG. 1)* 7.32M (MAIN BLDG. 1) | NONE |
| HEIGHT- | 12M (3 STOREYS) 9M (2 STOREYS) | 12M (3 STOREYS) 9M (2 STOREYS) | NONE |
| LOT SIZE (MIN. DIMENSIONS): | (MIN. 50M WIDE) (MIN. 35M DEEP) | 45.8M WIDE 90.3M DEEP | RQUIRED |
| RESIDENTIAL PARKING SPACES: | 50 SPACES (2/UNIT) | 50 SPACES (2/UNIT) | NONE |
| VISITOR PARKING SPACES | 0.2 SPACES/ UNIT= 5 | 5 SPACES | NONE |
| OFF-STREET PARKING SPACES-TOTAL: | 55 SPACES | 55 SPACES | NONE |
| STANDARD SIZE PARKING SPACES: | 50% WIN. = 28 SPACES | 38 >28 SPACES | NONE |
| SMALL SIZE PARKING SPACES: | 50% MAX. = 28 SPACES | 17 <28 SPACES | NONE |
| TANDEM PARKING SPACES: | (MAX. 50% OF TOTAL PARKING) = 25 SPACES | 22 SPACES | NONE |
| VAN ACCESSIBLE PARKING SPACES: | 2% MIN.(FOR VISITOR) =1 SPACE | 1 SPACE | NONE |
| CONVERTIBLE UNITS: | 10% PROPOSED UNITS | 4 UNITS | NONE |
| ELECTRIC VEHICLE (EV) CHARGER REQUIREMENTS: | BULLETIN NO. ENGINEERING-D5 AND BYLAW 8500 | LEVEL 2 EV CHARGING OUTLETS (208V TO 240V AC AND CURRENT OF 16A TO 80A). | NONE |
| BICYCLE PARKING SPACE-CLASS-: | 1.25 SPACES PER UNIT | 2 SPACES PER UNIT | NONE |
| BICYCLE PARKING SPACE-CLASS-2: | 0.2 SPACES PER UNIT | 5 SPACES | NONE |
| AMENITY SPACE - INDOOR: | MIN. 70 SM OR CASH-IN-LIEU | CASH-IN-LIEU | NONE |
| AMENITY SPACE - OUTDOOR: | MIN. 6 SM PER UNIT | 150 SW (1614 6 SF) | NONE |
| PRIVATE OPEN SPACE | MIN. 30 SM PER UNIT | MIN. 30 SM PER UNIT | NONE |

^{*} WITH PERMITTED GROUND FLOOR ENCROACHMENT (LESS THAN 0.6M)

STEP CODE NOTES:

This project will comply with the City of Richmond's Step Code requirements by meeting Energy Step Code 3 + a Low Carbon Energy System.

Energy efficiency upgrades will include the following as needed:

Above grade walls: 2x6@16"oc R22 batt + 1.5" exterior rigid insulation

Ceilings: R50 insulation

- Electric baseboords for space heating ar air source heat pump for heating/cooling

- Electric hot water tank far DHW - HRV for principal ventilation



ZHAO XD ARCHITECT LTD.

\$255-11181 Voyageur Way, Richmond, BC V6X 3N9 Tel. (604) 275-8882 Fax (604) 909-1736

Email: info@zhaogrch.com



DP 21-934620 PLAN#1 JULY 31, 2024

| 19JUN/24 | DPP |
|-----------|-------------------|
| 17MAY/24 | OPP |
| 04APR/24 | CITY COMMENTS/DPF |
| 08NOV/23 | ADP COMMENTS/DPF |
| 15JUN/22 | ADP/DDP |
| 07JUL/21 | ROAD DEDICATION |
| 26APR/21 | DP APPLICATION |
| 02JULY/20 | FOR CITY COMMENTS |
| JUN/18 | RZ APPLICATION |
| Oate: | Issued For: |



B C C DETAIL SHEET

TOWNHOUSE DEVELOPMENT © NO. 2 ROAD & BLUDELL ROAD

8031-71 No. 2 Rd & 5760-88

Drawing Title

SITE PLAN, CONTEXT PLAN & DATA


2024-05-08 Date: Scale: AS SHOWN Orawn By XD ZHAO Checked By: XD ZHAO Project No: DP 21-934620


Drawing No.:

Α1

Q Q 2C VO 47 5K QD TQ 5G 5G 'CO 'CO 'CO 'SG 15G 15G 15G 15G 15G 15G 15G 15G 15G

This drawing is NOT to be scaled. Use figured dimensions only

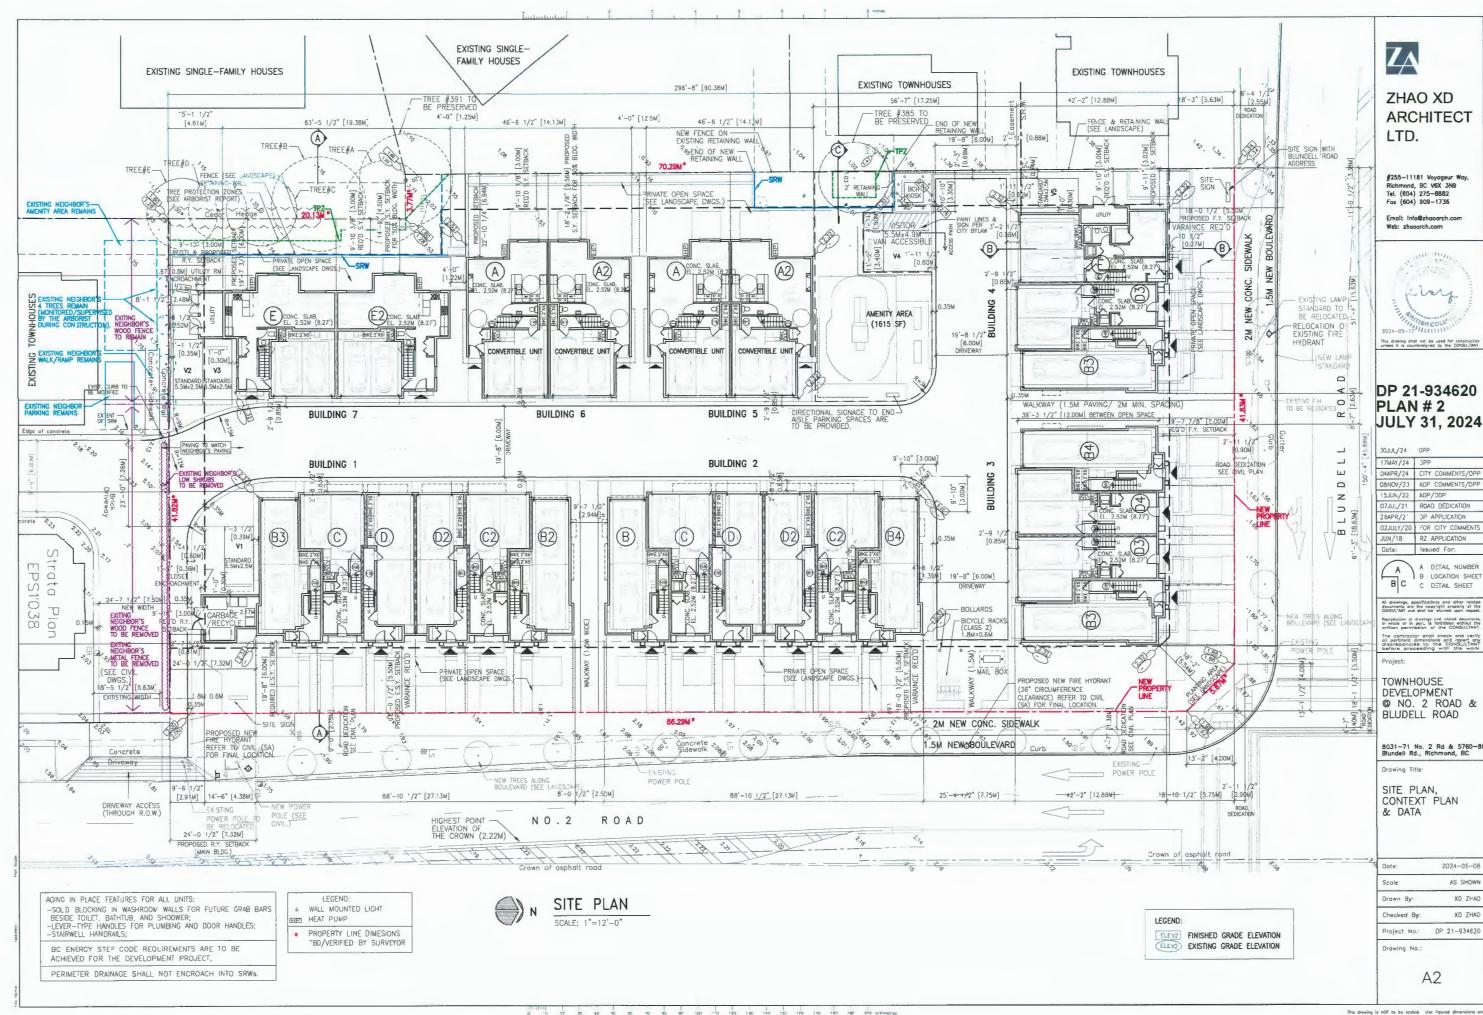

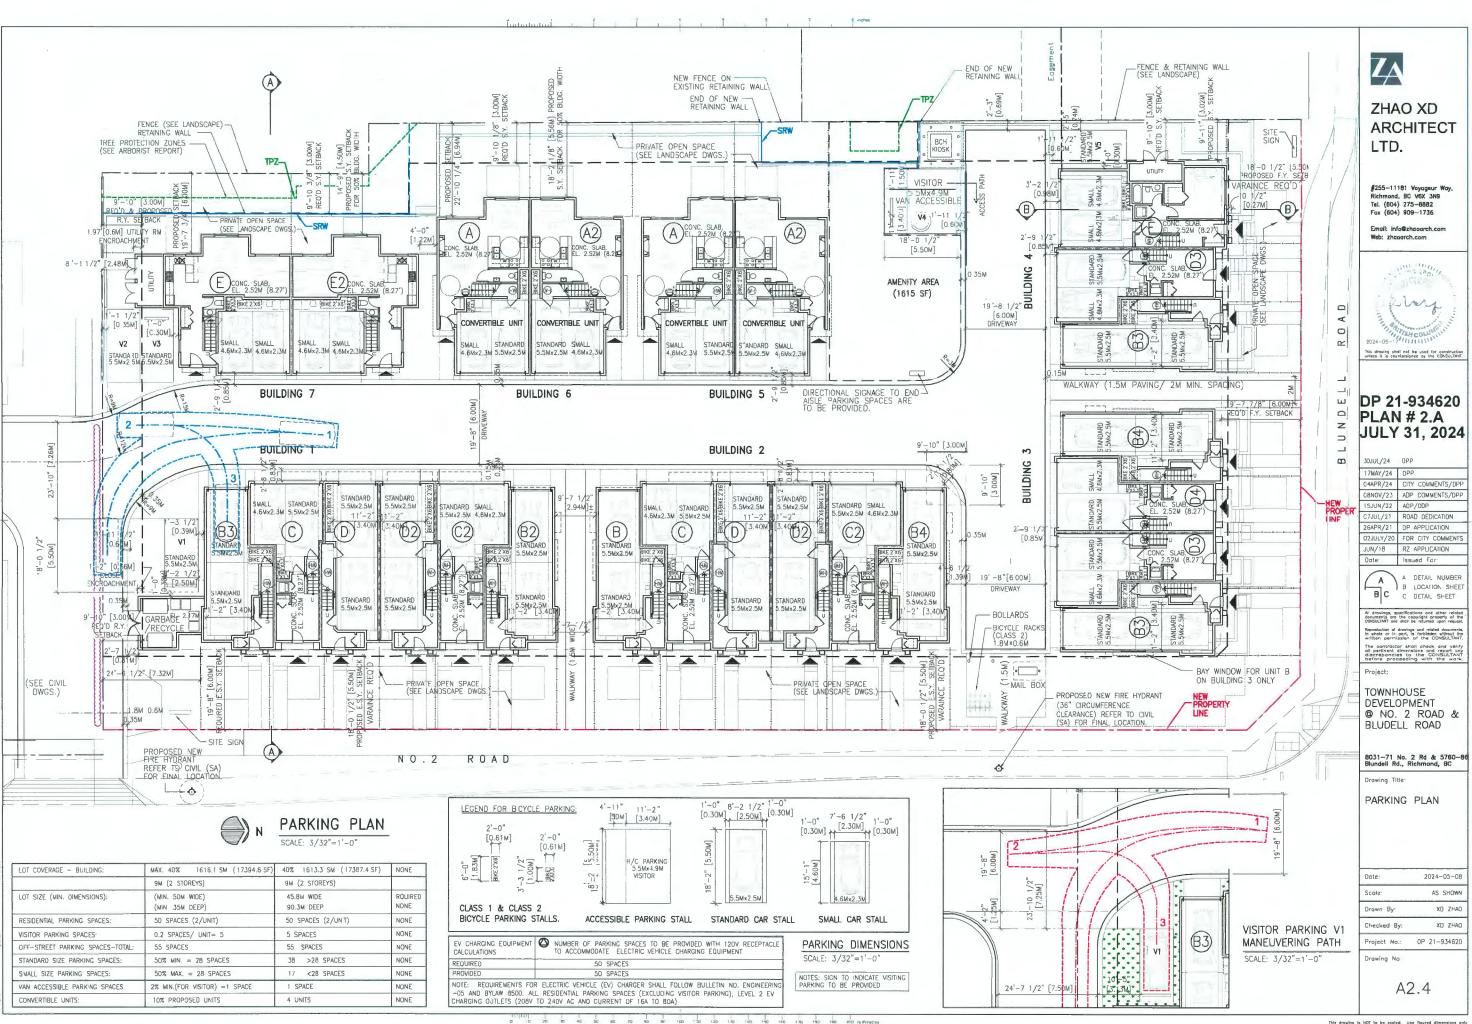







ZHAO XD ARCHITECT LTD.

25-UNIT TOWNHOUSE DEVELOPMENT 8031- 8071 No. 2 Road, 5760 - 5786 Blundell Road, Richmond, BC

EXTERIAL FINISH -

MATERIAL & COLOR

STAND SEAM METAL ROOF - VICWEST (PRESTIGE) SIGNATURE -SMP COATED METAL CHARCOAL 56072

5" ALUM. GUTTER ON 2X10 WOOD FASCIA BOARD - PAINTED COLOR MATCH TO "AGED PEWTER"

STUCCO WALL FINISH (OFF-WHITE)
BM OC36 NIVEOUS

HARDIE PANEL (EASYTRIM) AGED PEWTER

HORIZONTAL TRIM & TRIM BOARD MOULDING
-PAINTED
COLOR MATCH TO "AGED PEWTER"

WINDOW & DOOR TRIM
-PAINTED BM OC40 ALBESCENT

CULTURE STONE - SPAN HEWN STONE TIGHT-FITTED MORTAR JOINTS

SOLID CORE WOOD DOOR BJ 1231 WYNWOOD

GARAGE DOOR BM: AF-105 ELKHOM

#255-11181 Voyageur Way, Richmond, BC V6X 3N9 Email: info@zhaoarch.com













Tel: 604 275-8882 604 312-6278 Web: www.zhaoarch.com

IMAGES OF MATERIALS



56072 Charcoal

OC-36 Niveous

· Brand: Benjamin Moore






DP 21-934620 PLAN # 3.B JULY 31, 2024

IMAGES OF MATERIALS STANDING SEAM METAL ROOF (PRECEDENT SAMPLE)





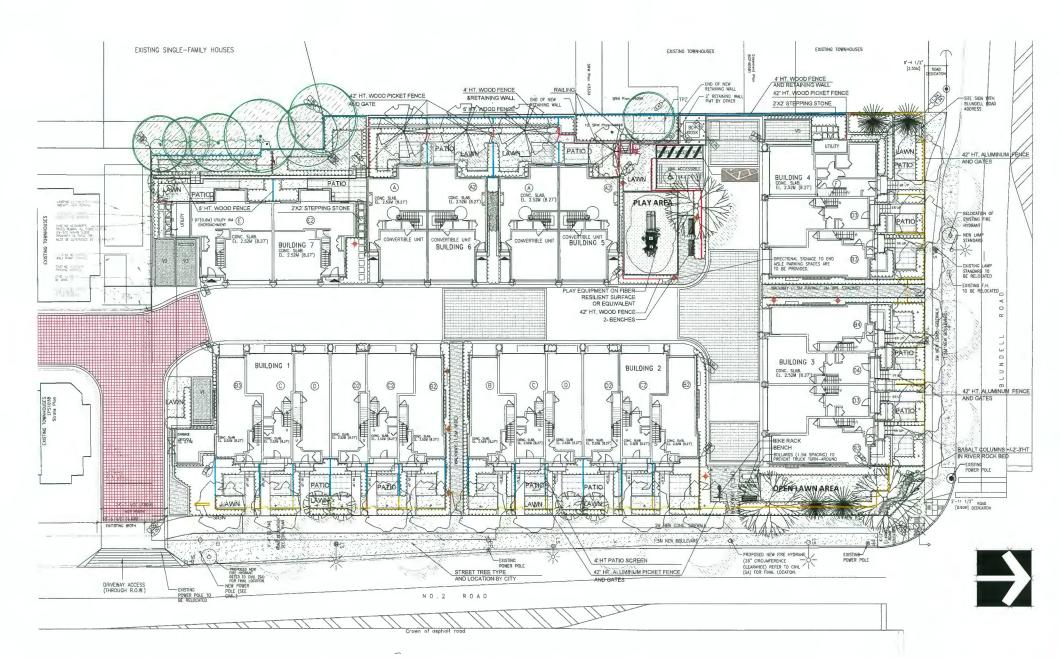


| _AN | T S | CHEDULE | | PMG PROJECT NUMBER: 21-04 |
|-------|-----|---------------------------------------|------------------------------------|---------------------------|
| KEY | QTY | BOTANICAL NAME | COMMON NAME | PLANTED SIZE / REMARKS |
| REE | | | · | |
| 7-0-1 | 15 | ACER RUBRUM 'BOWHALL' | COLUMNAR BOWHALL MAPLE | 8CM CAL; 2M STD; B&B |
| 42 | 3 | CERCIDIPHYLLUM JAPONICUM | KATSURA TREE | 8CM CAL; 1.8M STD; B&B |
| | 5 | FAGUS SYLVATICA 'DAWYCK GOLD' | DAWYCK GOLD BEECH | 8CM CAL; 1,8M STD; B&B |
| W/Z | 4 | PINUS FLEXILIS 'VANDERWOLF'S PYRAMID' | VANDERWOLF'S PYRAMIDAL LIMBER PINE | 4M HT;B&B |
| | 4 | STYRAX JAPONICUS 'PINK CHIMES' | PINK FLOWERED JAPANESE SNOWBELL | 8CM CAL; 1.8M STD; B&B |

NOTES: *PLANT SIZES IN THIS LIST ARE SPECIFIED ACCORDING TO THE BC LANDSCAPE STANDARD AND CANADIAN LANDSCAPE STANDARD, LATEST EDITION, CONTAINER SIZES SPECIFIED AS PER CILLA STANDARD, BOTH PLANT SIZE AND CONTAINER SIZE ARE THE MINIMUM ACCEPTABLE SIZES. *REFER TO SPECIFICATIONS FOR DEFINED CONTAINER MEASUREMENTS AND OTHER PLANT MATERIAL REQUIREMENTS. *SEARCH AND REVIEW MAKE PLANT MATERIAL AVAILABLE FOR OPTIONAL REVIEW BY LANDSCAPE ARCHITECT AT SOURCE OF SUPPLY, AREA OF SEARCH FOR INCLUDE LOWER MAINLAND AND FRASER VALLEY. *SUBSTITUTIONS OFTAIN WRITTEN APPROVAL FROM THE LANDSCAPE ARCHITECT PRIOR TO MAKING ANY SUBSTITUTIONS TO THE SPECIFIED MATERIAL UNAPPROVED SUBSTITUTIONS WILL BE REJECTED. ALLOW A MINIMUM OF FIVE CAY'S PRIOR TO DELIVERY FOR REQUEST TO SUBSTITUTIONS ARE SUBJECT TO BE CANDSCAPE STANDARD AND CANADIAN DEAFINITION OF CONDITIONS OF AVAILABILITY. *ALL LANDSCAPE MATERIAL AND WORKMANSHIP MUST MEET OR EXCEED BG LANDSCAPE STANDARD AND CANADIAN LANDSCAPE STANDARD LATEST EDITION. *ALL PLANT MATERIAL MUST BE PROVIDED FROM CERTIFIED DISEASE FREE NURSERY. *BIO-SOLIDS NOT PERMITTED IN GROWING MEDIUM UNLESS AUTHORIZED BY LANDSCAPE ARCHITECT.

NOTE:
-PROVIDE CESIGNED BUILD HIGH EFFICIENCY AUTOMATIC IRRIGATION SYSTEM TO LIAB.C. STANDARDS TO ALL SOFT LANDSCAPE AREAS.
SHOP DRAWINGS O BE REVIEWED AND APPROVED BY LANDSCAPE ARCHITECT PRIOR TO INSTALLATION.

| LANT S | SCHEDULE | | PMG PROJECT NUMBER: 21-041 |
|---------|----------------|---------------------------|----------------------------|
| KEY QTY | BOTANICAL NAME | COMMON NAME | PLANTED SIZE / REMARKS |
| REE 7 | STREET TREE | TYPE AND LOCATION BY CITY | 7CM CAL;1.8M STD; 8&B |

NOTES * PLANT SIZES IN THIS LIST ARE SPECIFED ACCORDING TO THE BC LANDSCAPE STANDARD AND CAMADIAN LANDSCAPE STANDARD, LATEST EDITION, CONTAINER SIZES SPECIFIED AS PER CHALS TANDARD, LATEST EDITION, CONTAINER SIZES SPECIFIED AS PER CHALS TANDARD, BOTH PLANT SIZE AND CONTAINER SIZES SPECIFIED AS PER CHALS THE MINIMUM ACCEPTABLE SIZES. "REFER TO SPECIFICATIONS FOR DEPINED CONTAINER MEASUREMENTS AND OTHER PLANT MATERIAL REQUIREMENTS. "SEARCH AND REVIEW MAKE PLANT MATERIAL AVAILABLE FOR OFTONIAL REVIEW BY LANDSCAPE ARCHITECT PRIOR TO MAKING ANY SUBSTITUTIONS TO THE SPECIFIED MATERIAL UNAPPROVED SUBSTITUTIONS WILL BE REJECTED. ALLOW A MINIMUM OF FIVE DAYS PRIOR TO DELIVERY FOR REQUEST TO SUBSTITUTE, SUBSTITUTIONS ARE SUBJECT TO BE LANDSCAPE STANDARD AND CAMADIAN LANDSCAPE STANDARD ADEPRITION OF CONDITIONS OF AVAILABILITY. "ALL LANDSCAPE MATERIAL AND WORKMANSHIP MUST MEET OR EXCEED BE LANDSCAPE STANDARD AND CANDARD AND UNDESS AND THE STEED FOR AVAILABILITY." ALL LANDSCAPE MATERIAL AND WORKMANSHIP MUST MEET OR EXCEED BE LANDSCAPE STANDARD AND CANDARD AND UNLESS AUTHORIZED BY LANDSCAPE.

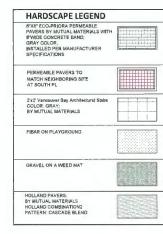











MAGLIN BIKE RACK -MBR-0400-00007



+/- 2'-3' HT BASALT COLUMNS BY NORTHWEST LANDSCAPE & STONE SUPPLY

ALL BENCHES AND BIKE RACKS TO BE INSTALLED T TO MANUFACTURER'S SPECIFICATION ON 3" THICK CONCRETE PAD.

LIGHTING LEGEND

| SYMBOL | STYLE | |
|--------|--|--|
| • | BOLLARD 35" HT LITHONIA RADEAN LEO BOLLARD | |
| | | |

© Copyright reserved. This drawing and design is the property of PMG Landscape Architects and may not be reproduced or used for other projects without their

Suite C100 - 4185 Still Creek Drive Burnaby, British Columbia, V5C 6G9 p: 604 294-0011 ; f: 604 294-0022

SEAL:

| _ | | | |
|-----|-----------|-------------------------------|----|
| _ | | | |
| _ | | | |
| | | | |
| | | | |
| 12 | 24.JUL 31 | REVISION AS PER CITY COMMENTS | DE |
| 11 | 24.JUL 25 | REVISION AS PER CITY COMMENTS | DO |
| 10 | 24.JUN.03 | NEW SITE PLAN & CITY COMMENTS | DO |
| 9 | 24.MAY.10 | NEW SITE PLAN | DO |
| 7 | 24 APR 25 | REVISION AS PER CITY COMMENTS | DD |
| 7 | 23.NOV.17 | NEW SITE PLAN &CITY COMMENTS | DD |
| 6 | 23.5EP.18 | NEW SITE PLANSITY COMMENTS | DD |
| 5 | 23.APR.28 | NEW SITE PLANS, CITYCOMMENTS | DD |
| 4 | 22.MAR.04 | REVISION AS PER CITY COMMENTS | DÊ |
| 3 | 22.JAN.21 | NEW SITE PLAN | DE |
| 2 | 21,NOV.04 | NEW FH | DE |
| 1 | 21.JUL 12 | NFW SIE PLAN | DE |
| NO. | DATE | REVISION DESCRIPTION | DR |

CLIENT: 1209136 BC LTD, WITH : ZHAO XD ARCHITECT LTD.

DP 21-934620 **PLAN # 4.A** JULY 31, 2024

PROJECT.

25 UNIT TOWNHOUSE DEVELOPMENT


8031-8071 NO. 2 ROAD AND 5760-5786 BLUNDELL ROAD RICHMOND

DRAWING TITLE

LANDSCAPE PLAN

DATE: March DRAWING NUMBER SCALE 1/ 15"=1'-0" DESIGN: DD OF 8 CHKD. PCM

21-041

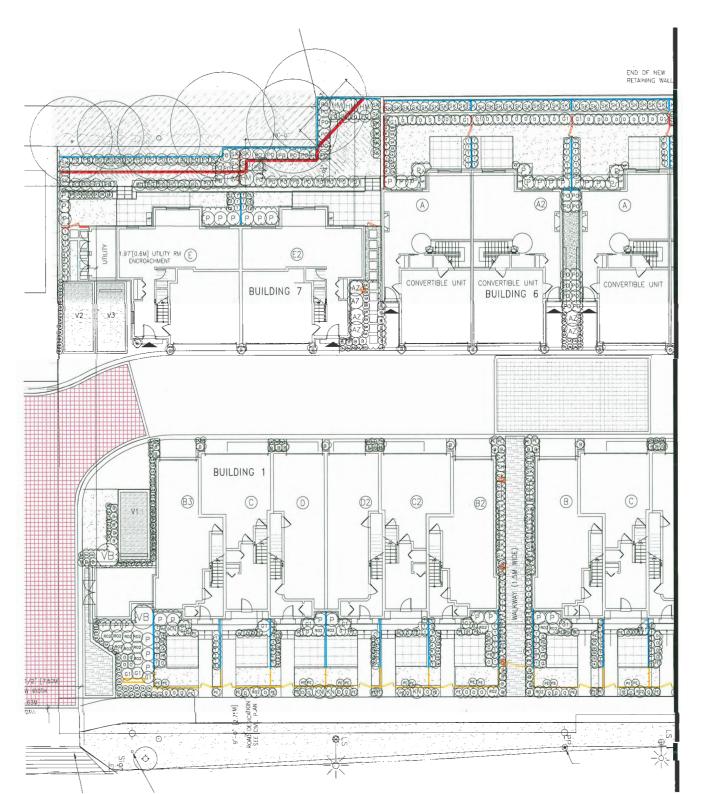



PLANT SCHEDULE PMG PROJECT NUMBER: 21-041 COMMON NAME PLANTED SIZE / REMARKS #3 POT: 40CM #3 POT: 50CM AZALEA MOLLIS HYBRIDS DÉCIDUOUS AZALEAS VARIETIES BUXUS MICROPHYLLA 'WINTER GEM' LITTLE-LEAF BOX HYDRANGEA MACROPHYLLA 'NIKKO BLUE' BIGLEAF HYDRANGEA (BLUE) #3 POT: 80CM KALMIA LATIFOLIA 'ELF' DWARF MOUNTAIN LAUREL #3 POT: 50CM #3 POT: 50CM PIERIS JAPONICA 'VALLEY FIRE' VALLEY FIRE PIERIS MOPS DWARF MUGO PINE RADRAZZ KNOCKOUT ROSE #2 POT: 25CM #2 POT PINUS MUGO 'MOPS' ROSA 'KNOCKOUT RADRAZZ' ROSA 'SCARLET MEIDILAND' SCARLET MEIDILAND ROSE #2 POT: 40CM SKIMMIA JAPONICA (10% MALE) JAPANESE SKIMMIA #3 POT; 50CM 100 #2 POT: 30CM DWARF SKIMMIA SKIMMIA REEVESIANA 1.00M B&B TAXUS X MEDIA 'HICKSII' HICK'S YEW 224 VIBURNUM X 'BURKWOODI!' BURKWOOD VIBURNUM #3 POT: 50CM GRASS (s) 32 (c) 273 (c) 38 (d) 67 (PE) 132 PERENNIAL KARL FOERSTER FEATHEREED GRASS CALAMAGROSTIS X A, 'KARL FOERSTER' #1 POT #2 POT CAREX OSHIMENSIS 'EVERGOLD' EVERGOLD JAPANESE SEDGE 273 MORNING LIGHT JAP SILVER GRASS MISCANTHUS SINENSIS 'MORNING LIGHT' OPHIOPOGON PLANISCAPUS 'NIGRESCENS' BLACK MONDO GRASS PENNISETUM ALOPECUROJDES 'HAMELIN' DWARF FOUNTAIN GRASS #1 POT 132 ASTILBE x ARENDSII 'RED SENTINEL' GC (33) RUDBECKIA FULGIDA VAR SULLIVANTII "GOLDILOCKSRUDBECKIA; YELLOW-ORANGE 15CM POT #1 POT: 25CM EUONYMUS JAPONICA 'EMERALD GAIETY' POLYSTICHUM MUNITUM WESTERN SWORD FERN #1 POT: 25CM

NOTES: * PLANT SIZES IN THIS LIST ARE SPECIFIED ACCORDING TO THE BC LANDSCAPE STANDARD AND CANADIAN LANDSCAPE STANDARD, LATEST EDITION, CONTAINER SIZES SPECIFIED AS PER CNLA STANDARD. BOTH PLANT SIZE AND CONTAINER SIZE ARE THE MINIMUM ACCEPTABLE SIZES, * REFER TO SPECIFICATIONS FOR DEFINED CONTAINER MEASUREMENTS AND OTHER PLANT MATERIAL REQUIREMENTS. * SEARCH AND REVIEW: MAKE PLANT MATERIAL AVAILABLE FOR OPTIONAL REVIEW BY LANDSCAPE ARCHITECT AT SOURCE OF SUPPLY, AREA OF SEARCH TO INCLUDE LOWER MAINLAND AND FRASER VALLEY, * SUBSTITUTIONS: OBTAIN WRITTEN APPROVAL FROM THE LANDSCAPE ARCHITECT PRIOR TO MAKING ANY SUBSTITUTIONS TO THE SPECIFIED MATERIAL, UNAPPROVED SUBSTITUTIONS WILL BE REJECTED. ALLOW A MINIMUM OF FIVE DAYS PRIOR TO DELIVERY FOR REQUEST TO SUBSTITUTION ARE SUBJECT TO BC LANDSCAPE STANDARD AND CANADIAN LANDSCAPE STANDARD. DEFINITIONS OF CONDITIONS OF AVAILABILITY, * ALL LANDSCAPE MATERIAL AND WORKMANSHIP MUST MEET OR EXCEED BC LANDSCAPE STANDARD AND CANADIAN LANDSCAPE STANDARD LATEST EDITION. * ALL PLANT MATERIAL MUST BE PROVIDED FROM CERTIFIED DISEASE FREE NURSERY. * BIO-SOLIDS NOT PERMITTED IN GROWING MEDIUM UNLESS AUTHORIZED BY LANDSCAPE ARCHITECT

© Copyright reserved. This drawing and design is the property of PMG Landscape Architects and may not be reproduced or used for other projects without their nemission.



Suite C100 - 4185 Still Creek Drive Burnaby, British Columbia, V5C 6G9 p. 604 294-0011 ; f: 604 294-0022

SEAL.

| _ | | | |
|-----|------------|--------------------------------|---|
| | | | |
| _ | | _ | |
| | | | |
| 12 | 24.JUL 11 | REVISION AS PER LITY LUMMENTS | D |
| 11 | 24.JUL 25 | REVISION AS PER CITY COMMENTS | D |
| 10 | 24.JUN.03 | NEW SITE PLAN & CITY COMMENTS | D |
| 9 | 24.MAY 10 | NEW SITE PLAN | U |
| 7 | 24 APR 25 | REVISION AS PER CITY COMPMENTS | 0 |
| 7 | 23.NOV 17 | NEW SITE PLAN &CITY COMMENTS | D |
| 6 | 23.5EP.18 | NEW SITE PLANSITY COMMENTS | U |
| 5 | 23 APR 28 | NEW SITE PLAN& CITYCOMMENTS | 0 |
| 4 | 72.MAR.04 | REVISION AS PER CITY COMMENTS | 0 |
| 3 | 22.JAH.21 | NEW SITE PLAN | D |
| 2 | 71.6(OV 04 | NEV FH | D |
| 1 | 71./UL 17 | NEW SIE PLAN | D |
| NO. | DATE | REVISION DESCRIPTION | D |

CLIENT 1209136 BC LTD. WITH: ZHAO XD ARCHITECT LTD.

DP 21-934620 PLAN # 4.B JULY 31, 2024

PROJE


25 UNIT TOWNHOUSE DEVELOPMENT

8031-8071 NO. 2 ROAD AND 5760-5786 BLUNDELL ROAD RICHMOND

DRAWING TITLE

SHRUB PLAN

| DATE: March | | DRAWING NUMBER: |
|-------------|--------------|-----------------|
| SCALE | 1/ 16"=1'-0" | |
| DRAWN DD | | 12 |
| DESIGN. DD | | |
| CHK'D PCM | | OF 8 |
| | | |

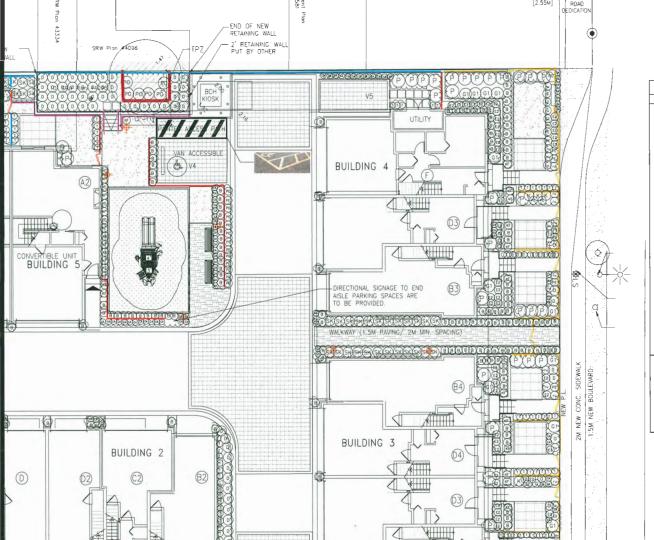

PROPOSED NEW FIRE HYDRANG

(36" CIRCUMFERENCE CLEARANCE) REFER TO CIVIL (SA) FOR FINAL LOCATION.

HONORIENDING GO CONTROL

1.5M NEW BOULEVARD



| PLAN | PLANT SCHEDULE PMG PROJECT NUMBER: 214 | | | PMG PROJECT NUMBER: 21-041 |
|---------------------|--|---|---------------------------------|----------------------------|
| KEY | QTY | BOTANICAL NAME | COMMON NAME | PLANTED SIZE / REMARKS |
| SHRUB | | | | |
| (27) | 6 | AZALEA MOLLIS HYBRIDS | DECIDUOUS AZALEAS VARIETIES | #3 POT; 40CM |
| 8 | 244 | BUXUS MICROPHYLLA "WINTER GEM" | LITTLE-LEAF BOX | #3 POT; 50CM |
| (a2) (B) | 5 | HYDRANGEA MACROPHYLLA 'NIKKO BLUE' | BIGLEAF HYDRANGEA (BLUE) | #3 POT; 80CM |
| ® | 4 | KALMIA LATIFOLIA 'ELF' | DWARF MOUNTAIN LAUREL | #3 POT; 50CM |
| P | 91 | PIERIS JAPONICA 'VALLEY FIRE' | VALLEY FIRE PIERIS | #3 POT; 50CM |
| | 4 | PINUS MUGO 'MOPS' | MOPS DWARF MUGO PINE | #2 POT; 25CM |
| (KN) | 14 | ROSA 'KNOCKOUT RADRAZZ' | RADRAZZ KNOCKOUT ROSE | #2 POT |
| 807 | 19 | ROSA 'SCARLET MEIDILAND' | SCARLET MEIDILAND ROSE | #2 POT; 40CM |
| 902 (SK) (SR) | 100 | SKIMMIA JAPONICA (10% MALE) | JAPANESE SKIMMIA | #3 POT: 50CM |
| | 18 | SKIMMIA REEVESIANA | DWARF SKIMMIA | #2 POT; 30CM |
| | 224 | TAXUS X MEDIA 'HICKSII' | HICK'S YEW | 1,00M B&B |
| (va) | 4 | VIBURNUM X 'BURKWOODII' | BURKWOOD VIBURNUM | #3 POT; 50CM |
| GRASS | | | | |
| (KF) | 32 | CALAMAGROSTIS X A, 'KARL FOERSTER' | KARL FOERSTER FEATHEREED GRASS | #2 POT, HEAVY |
| (64) | 273 | CAREX OSHIMENSIS 'EVERGOLD' | EVERGOLD JAPANESE SEDGE | #1 POT |
| \$350 | 38 | MISCANTHUS SINENSIS 'MORNING LIGHT' | MORNING LIGHT JAP, SILVER GRASS | #2 POT |
| (a) | 67 | OPHIOPOGON PLANISCAPUS 'NIGRESCENS' | BLACK MONDO GRASS | #1 POT |
| (PE) | 132 | PENNISETUM ALOPECUROIDES 'HAMELIN' | DWARF FOUNTAIN GRASS | #1 POT |
| PERENI | NIAL | | | |
| (95) | 6 | ASTILBE x ARENDSII 'RED SENTINEL' | FALSE SPIREA; RED | #1 POT |
| GC GS | 41 | RUDBECKIA FULGIDA VAR SULLIVANTII GOLDILO | OCKSRUDBECKIA: YELLOW-ORANGE | 15CM POT |
| | 66 | EUONYMUS JAPONICA 'EMERALD GAIETY' | EUONYMUS; SILVER VARIEGATED | #1 POT; 25CM |
| E2 (P0) | 73 | POLYSTICHUM MUNITUM | WESTERN SWORD FERN | #1 POT; 25CM |

NOTES: * PLANT SIZES IN THIS LIST ARE SPECIFIED ACCORDING TO THE BC LANDSCAPE STANDARD AND CANADIAN LANDSCAPE STANDARD. LATEST EDITION. CONTAINER SIZES SPECIFIED AS SPECIFIED

© Copyright reserved, This drawing and design is the property of PMG Landscape Architects and may not be reproduced or used for other projects without their negrissing.



Suite C100 - 4185 Still Creek Drive Burnaby, British Columbia, V5C 6G9 p: 604 294-0011 ; f: 604 294-0022

SEAL

| _ | | | |
|-----|------------|-------------------------------|---|
| _ | | | |
| _ | | | |
| _ | | | |
| _ | | | |
| 12 | 24.JUL 11 | READION V2 NEW CITA COMMENT? | D |
| 11 | 24 JUL 25 | REVISION AS PER CITY COMMENTS | D |
| 10 | 24.JUN.03 | NEW SITE PLAN & CITY COMMENTS | D |
| 9 | 24.MAY 10 | NEW SITE PLAN | D |
| 7 | 24 APR 25 | REVISION AS PER CITY COMMENTS | 0 |
| 7 | 23.NOV.17 | NEW SITE PLAN &CITY COMMENTS | D |
| 6 | 23.5EF.18 | NEW SITE PLANSITY COMMENTS | υ |
| 5 | 23 APR 25 | NEW SITE PLANS, CITYCOMMENTS | D |
| 4 | 77.MAR 04 | REVISION AS PER CITY COMMENTS | 0 |
| 3 | 22.JAN-21 | NEW SITE PLAN | 0 |
| 2 | 21.f10V.04 | NEW FH | 0 |
| 1 | 71.IUI 17 | NE'A SIE PLAN | 0 |
| NO. | DATE | REVISION DESCRIPTION | D |

CLIENT: 1209136 BC LTD, WITH ZHAO XD ARCHITECT LTD,

DP 21-934620 PLAN # 4.C JULY 31, 2024

PROJE

25 UNIT TOWNHOUSE DEVELOPMENT

8031-8071 NO. 2 ROAD AND 5760-5786 BLUNDELL ROAD RICHMOND

DRAWING TITLE


SHRUB PLAN

| DATE March | | DRAWING NUMBE |
|------------|--------------|---------------|
| SCALE | 1/ 15"=1'-0" | 1.3 |
| DRAWN DD | | L3 |
| DESIGN: DD | | |
| CHK'D. PCM | | OF |
| | | |



Suite C100 - 4185 Still Creek Drive Burnaby, British Columbia, V5C 6G9 p: 604 294-0011 ; f: 604 294-0022

SEAL

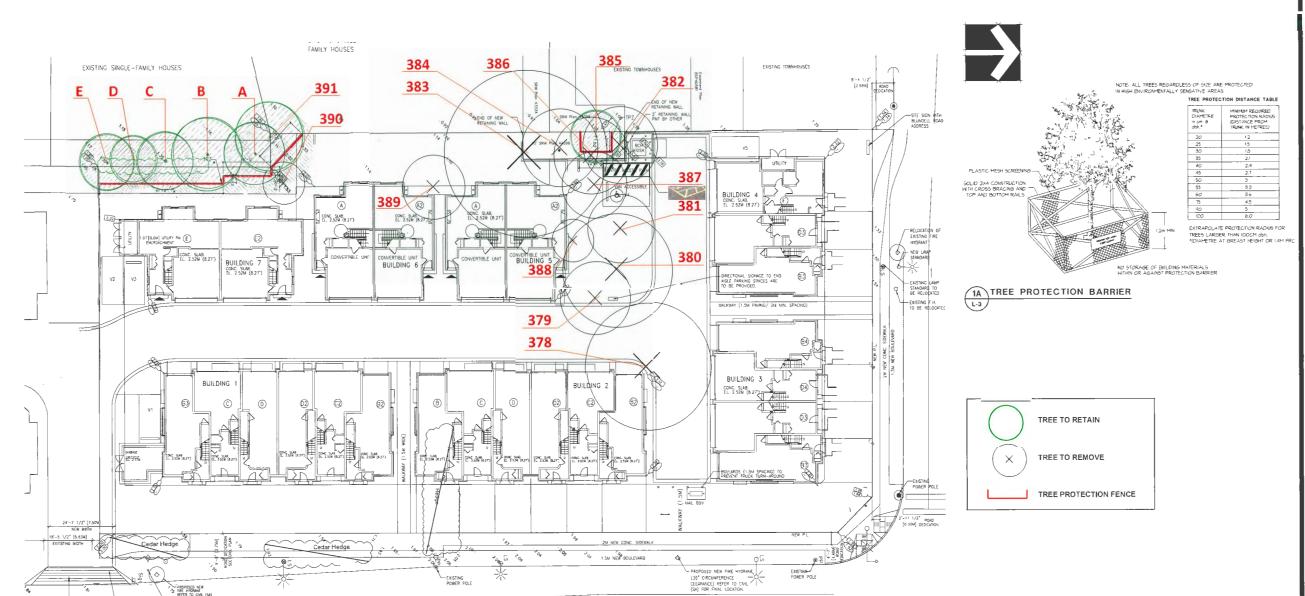

N O . 2 R O A D

| - | | | |
|-----|-----------|-------------------------------|----|
| _ | | | |
| 12 | 24.8UL ±1 | REVISION AS PER CITY COMMENTS | DI |
| 11 | 24.JUL 25 | REVISION AS PER CITY COMMENTS | DI |
| 10 | 24.JUN,03 | NEW SITE PLAN & CITY COMMENTS | DI |
| 9 | 24.MAY 10 | NEW SITE PLAN | U |
| 7 | 24 APR 25 | REVISION AS PER CITY COMMENTS | DI |
| 7 | 23.NOV:17 | NEW SITE PLAN & CITY COMMENTS | DI |
| 6 | 23.5EP.18 | NEW SITE PLANSITY COMMENTS | Đ |
| 5 | 23 APR 28 | NEW SITE PLANS CITYCOMMENTS | D |
| 4 | 22.MAR 04 | REVISION AS PER CITY COMMENTS | D |
| 3 | 22.JAN.21 | NEW SITE PLAN | D |
| 2 | 21.NOV.04 | NEW FH | D |
| 1 | 21 IUI 17 | NF'A SIF PLAN | D |
| NO. | DATE | REVISION DESCRIPTION | DF |

CLIENT: 1209136 BC LTD. WITH: ZHAO XD ARCHITECT LTD.

DP 21-934620 PLAN # 4.D JULY 31, 2024

PROJE

25 UNIT TOWNHOUSE DEVELOPMENT

8031-8071 NO. 2 ROAD AND 5760-5786 BLUNDELL ROAD RICHMOND

DRAWING TITLE

TREE MANAGEMENT PLAN

ATE: March 1/16"=1'-0" DRAWING NUMB


SCALE


DRAWN DD DESIGN. DD


CHK'D PCM

21041-12.ZIP PMG PROJECT NUMBER:

OF 8

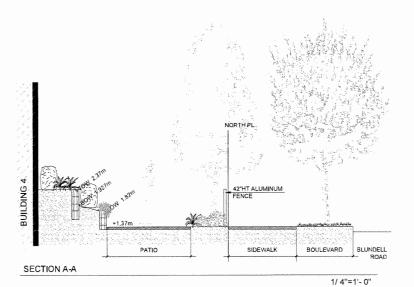

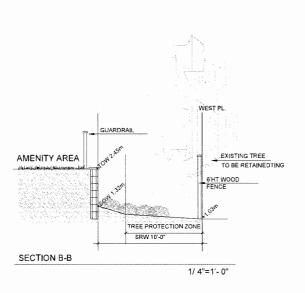

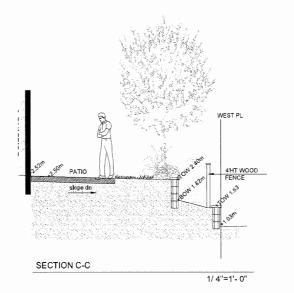

© Copyright reserved. This drawing and design is the property of PMG Landscape Architects and may not be reproduced or used for other projects without their nermission.



Suite C100 - 4185 Still Creek Drive Burnaby, British Columbia, V5C 6G9 p: 604 294-0011 ; f: 604 294-0022

SEAL

| 12 | 24.301.31 | REVISION AS PER LITY LOMMENTS | DE |
|-----|------------|---------------------------------|----|
| 11 | 24.IUL.25 | REVISION AS PER CITY COMMENTS | DE |
| 10 | Z4.JUN.03 | NEW SITE PLAN & CITY COMMENTS | 00 |
| 9 | 24.MAY-10 | NEW SITE PLAN | bt |
| 7 | 24 APR 25 | REVISION AS PER CITY CONMINENTS | DE |
| 7 | 23.NDV.17 | NEW SITE PLAN &CITY COMMENTS | DO |
| 6 | 23.5tP.18 | NEW SITE PLANSITY COMMENTS | DL |
| 5 | 23 APR 28 | NEW SITE PLANS CITYCOMMENTS | 06 |
| 4 | 77,MAR.04 | REVISION AS PER CITY COMMENTS | CC |
| 3 | 22.JASE.21 | NEW SITE PLAN | Di |
| 7 | 21.NOV.04 | NEW FH | DE |
| 1 | 21.RH 17 | NEW SIE PLAN | Df |
| NO. | DATE | REVISION DESCRIPTION | DF |
| | | | |

CLIENT: 1209136 BC LTD, WITH: ZHAO XD ARCHITECT LTD,

DP 21-934620 PLAN # 4.E JULY 31, 2024

PROJECT

25 UNIT TOWNHOUSE DEVELOPMENT

8031-8071 NO. 2 ROAD AND 5760-5786 BLUNDELL ROAD RICHMOND

DRAWING TITLE

LOT COVERAGE PLAN LANDSCAPE SECTIONS

ATE: March 1/16"=1'-0" DR

SCALE

DRAWN: DD
DESIGN: DD

CHK'D PCM


21041-12.ZIP PMG PROJECT NUMBER:


OF 8


L6


NOTES:


- ALL POSTS PRESSURE TREATED TO CSA STANDARD AND END CUTS TREATED WITH PRESERVITIVE.
- 2. ALL OTHER MEMBERS TO BE CEDAR, #2 (CONSTRUCTION) GRADE MINIMUM.
- 3. ALL HARDWARE HOT DIPPED GALVANIZED.
- APPLY 2 COATS EXTERIOR STAIN TO MANUFACTURERS SPECIFICATION, FINISH SELECTION AS APPROVED BY PROJECT ARCHITECT.
- ALL FENCES TO BE LEVEL, CHANGES IN GRADE TO BE IN 12"-18" STEPS (MAX.), GAPS TO GRADE TO FOLLOW FINISH GRADE, GAP TO BE 3-8".

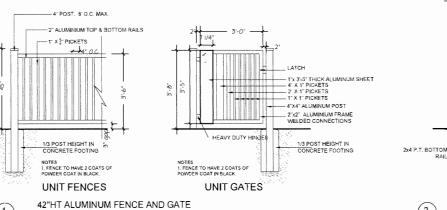

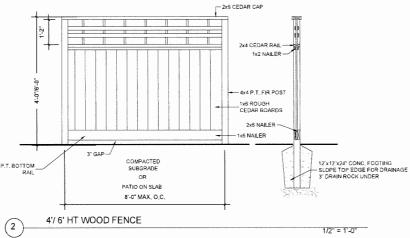


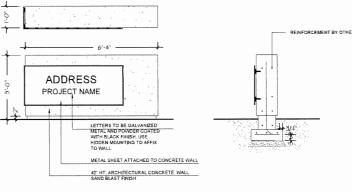

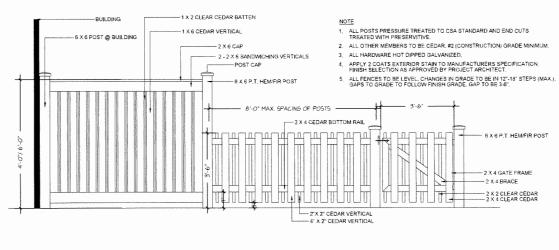

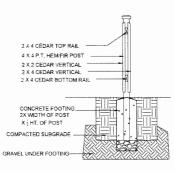

1/2" = 1'-0"

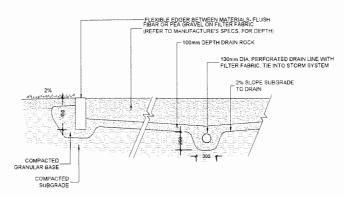


6'/4'HT PATIO SCREEN AND 42"HT WOOD FENCE AND GATE


1/2" = 1'-0"


1/2" = 1'-0"

PLAYGROUND SAFETY SURFACE

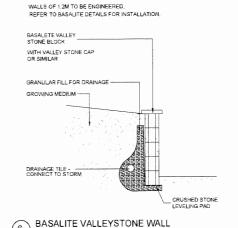


DRAIN TILE OUTPUT LOCATIONS TO BE COORDINATED WITH CIVIL ENG.

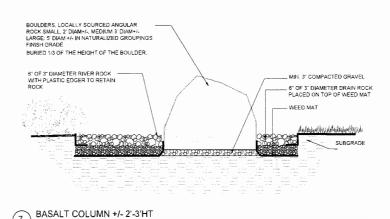

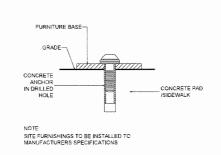

SITE FURNITURE MOUNTING

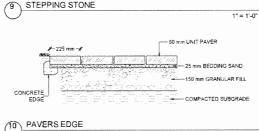


---- 1" SILICA SAND SETTING BED ----- 4" DENSE GRADE AGG, BASE -- NONJWOVEN FILTER FARRIC PREPARED SUBGRADE 9 STEPPING STONE

SCALE DRAWN: DD DESIGN: DD

PMG PROJECT NUMBER:

OF 8 21-041

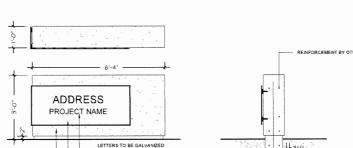

DEVELOPMENT SIGNAGE

1/2" = 1'-0"

1/2" = 1'-0"

1" = 1'-0"

21041-12 ZIP

DP 21-934620 **PLAN # 4.F** JULY 31, 2024

1 21.08.12

25 UNIT TOWNHOUSE DEVELOPMENT

ID 24.JUN.03 NEW SITE PLAN & CITY COMMENT 9 24.MAY.10 NEW SITE PLAN

7 23.NOV.17 NEW SITE PLAN &CITY COMMENT

4 27, MAR. D4 REVISION AS PER CITY COMMENT

NO. DATE REVISION DESCRIPTION CLIENT: 1209136 BC LTD. WITH: ZHAO XD ARCHITECT LTD.

© Copyright reserved. This drawing and design is the property of PMG Landscape Architects and may not be reproduced or used for other projects without their particular.

Suite C100 - 4185 Still Creek Drive Burnaby, British Columbia, V5C 6G9 p: 604 294-0011 ; f: 604 294-0022


SEAL

8031-8071 NO. 2 ROAD AND 5760-5786 BLUNDELL ROAD RICHMOND

DRAWING TITLE

LANDSCAPE DETAILS




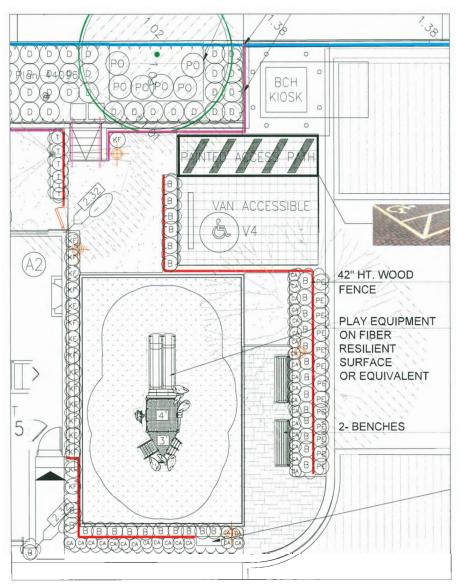

AMENITY AREA ENLARGEMENT

SCALE 3/ 16"=1'- 0"



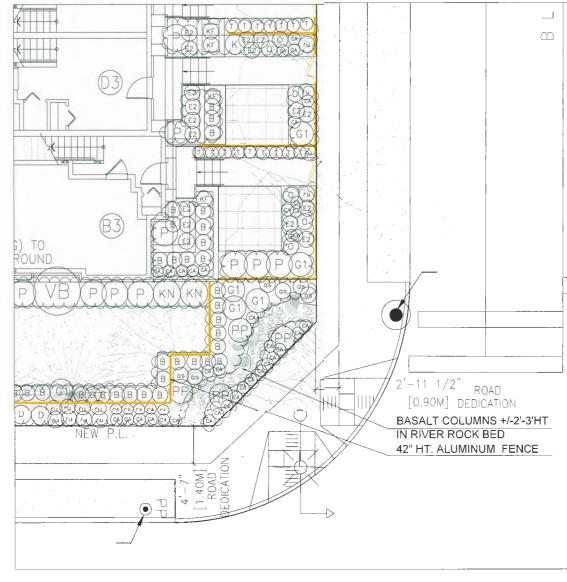

NORTH EAST CORNER ENLARGEMENT

SCALE 3/ 16"=1'- 0"

© Copyright reserved. This drawing and design is the property of PMG Landscape Architects and may not be reproduced or used for other projects without their



Suite C100 - 4185 Still Creek Drive Burnaby, British Columbia, V5C 6G9 p: 604 294-0011 : f: 604 294-0022

| 12 | 34.000.31 | REVISION AS PER LITY LOWINENTS | ĐO. |
|----|------------|--------------------------------|-----|
| 11 | 24./UL 25 | REVISION AS PER CITY COMMENTS | 00 |
| 10 | 24.10(4.03 | NEW SITE PLAN & CITY COMMENTS | 90 |
| 9 | 24.MAY 10 | NEW SITE PLAN | UU |
| 7 | 24 APR 25 | REVISION AS PER CITY COMMENTS | 90 |
| 7 | 23.NOV 17 | NEW SITE PLAN &CITY COMMENTS | 00 |
| 6 | 23.519.18 | NEW SITE PLANSITY COMMENTS | 00 |
| 5 | 23 APR.28 | NEW SITE PLATIS CITYCOMMETITS | DD |
| 4 | 72.MAR 04 | REVISION AS PER CITY COMMENTS | DD |
| 3 | 22.IAN.21 | NEW SITE PLAN | DD |
| 2 | 21.NOV 04 | NEW FH | DD |
| 1 | 71 JUL 17 | NEW SIE PLAN | UU |
| ın | DATE | DEVISION DESCRIPTION | DR |

CLIENT: 1209136 BC LTD, WITH: ZHAO XD ARCHITECT LTD.

DP 21-934620 PLAN # 4.G JULY 31, 2024

25 UNIT TOWNHOUSE DEVELOPMENT

8031-8071 NO. 2 ROAD AND 5760-\$786 BLUNDELL ROAD RICHMOND

DRAWING TITLE


LANDSCAPE **ENLARGEMENTS**


DATE: March A/S DRAWING NUMBER

SCALE DRAWN DD DESIGN. DD

L8

OF 8 21-041

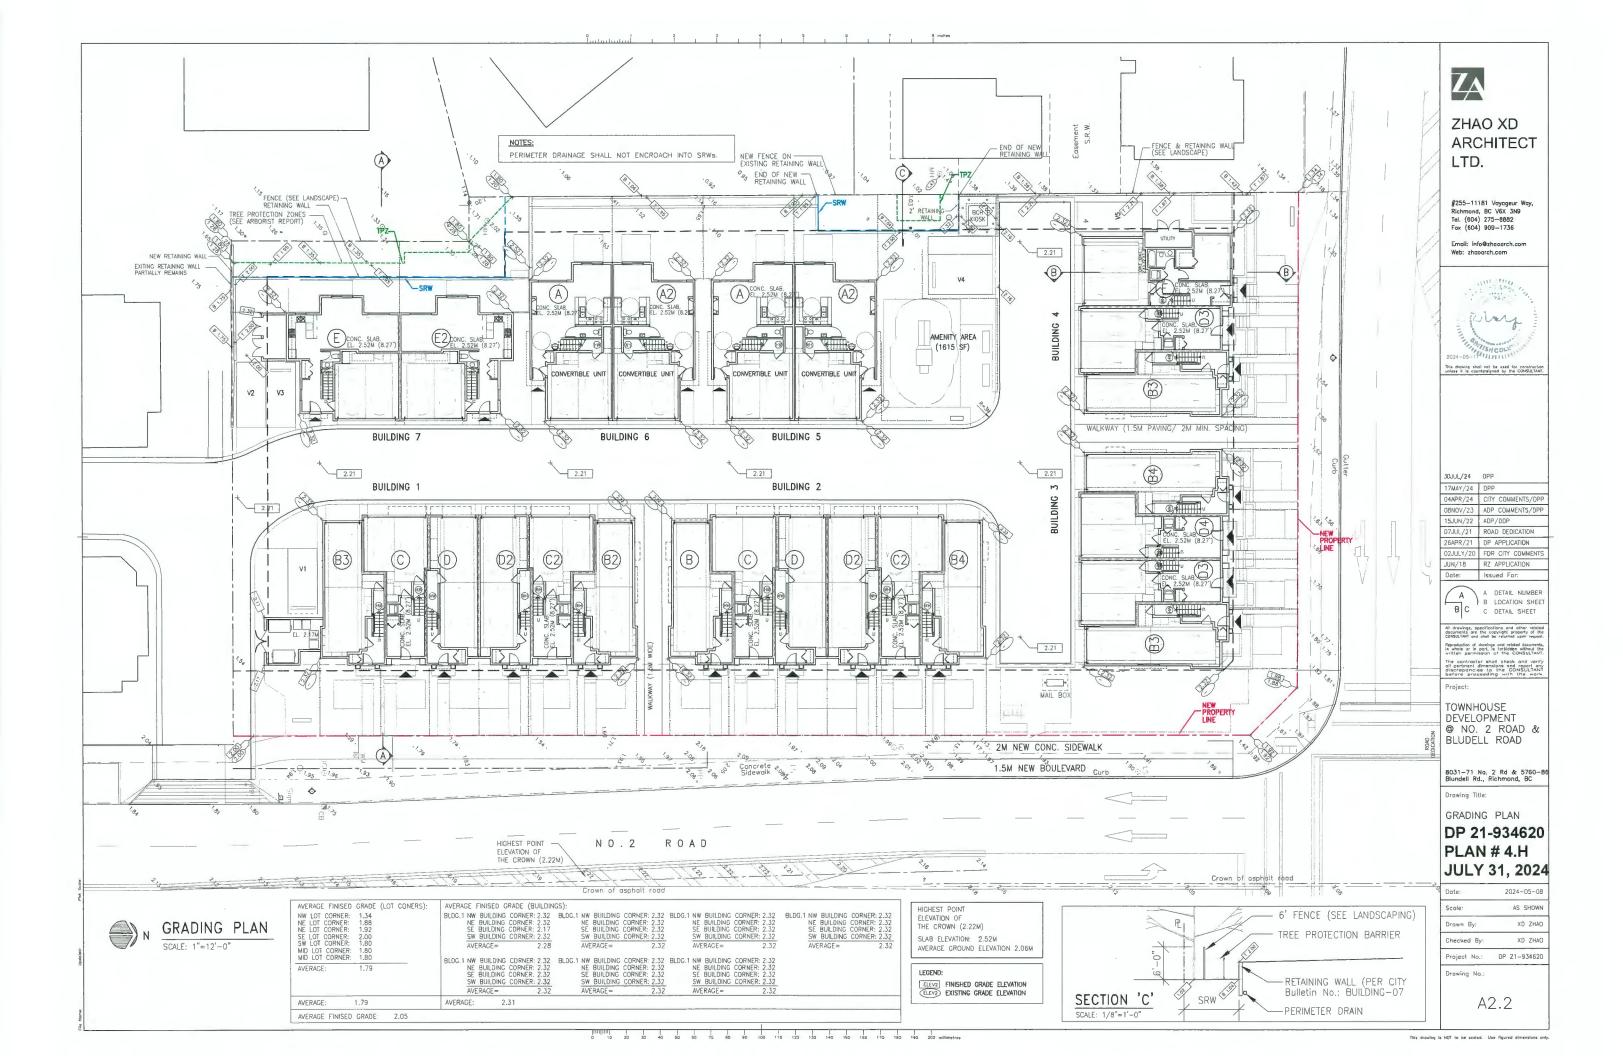

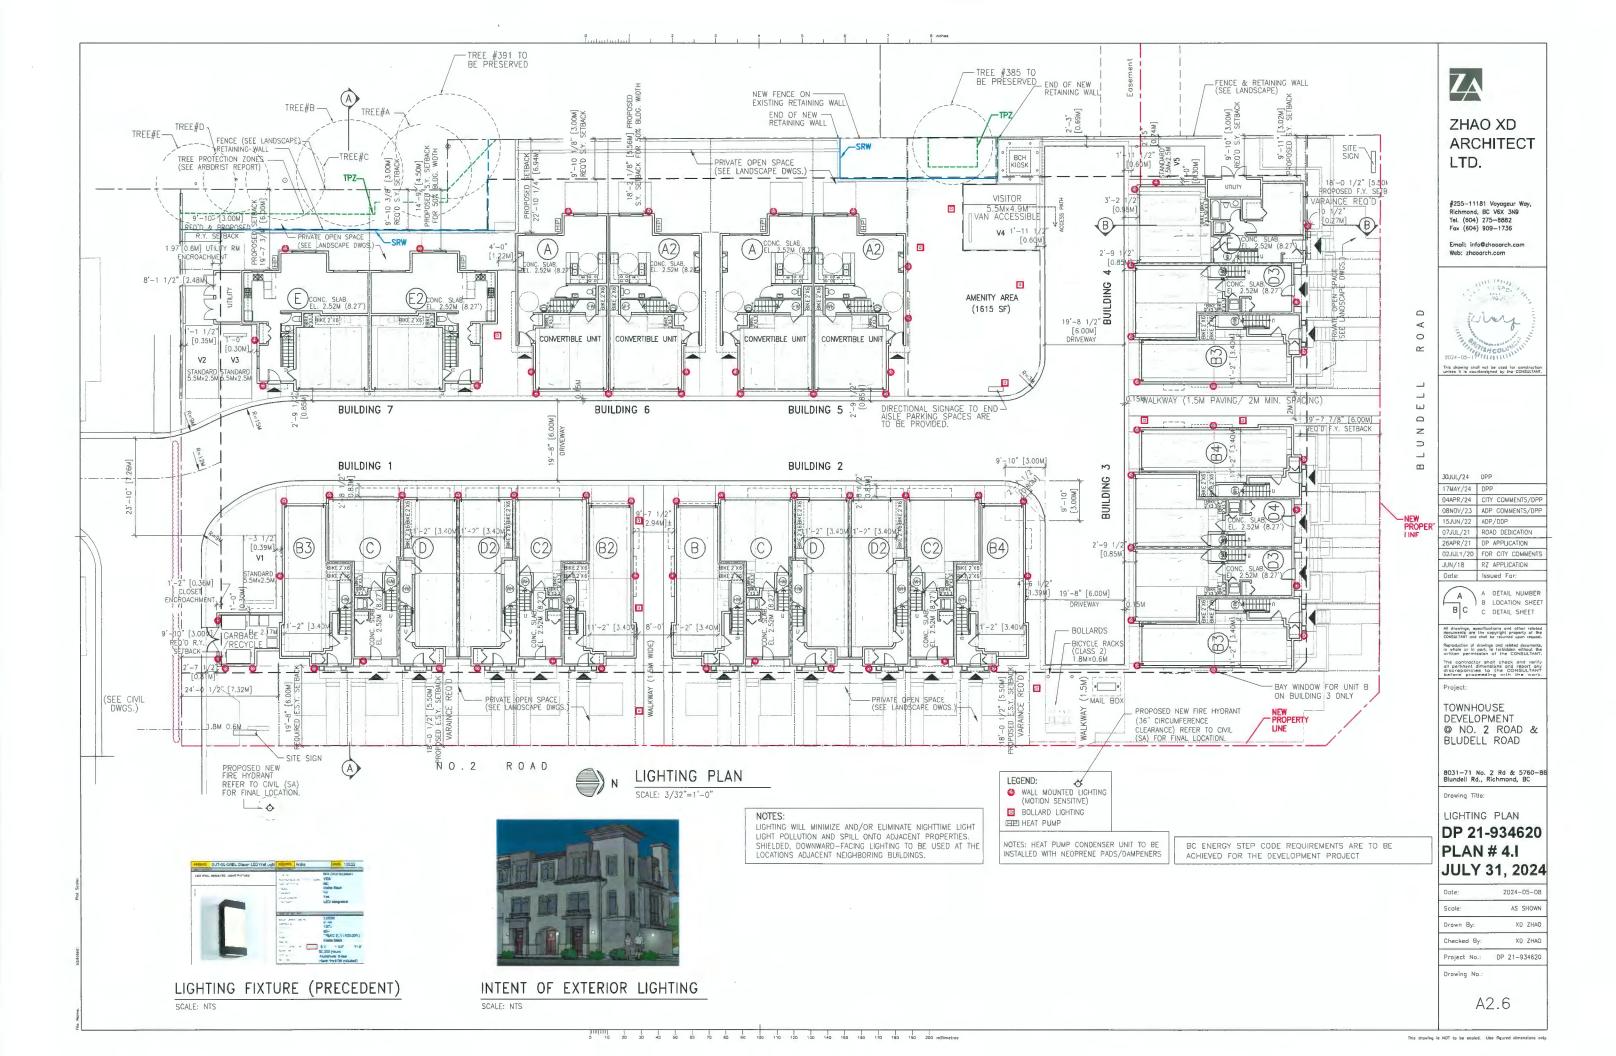



(PERSPECTIVE FOR BUILDING ONLY, SEE LANDCSCAPE FOR FENCES, GATES & PLANTS)

25-UNIT TOWNHOUSE DEVELOPMENT #8031- 8071 NO. 2 ROAD& #5760 - 5786 BLUNDELL ROAD RICHMOND, BC











25-UNIT TOWNHOUSE DEVELOPMENT

#8031- 8071 NO. 2 ROAD & #5760 - 5786 BLUNDELL ROAD RICHMOND, BC






25-UNIT TOWNHOUSE DEVELOPMENT #8031- 8071 NO. 2 ROAD & #5760 - 5786 BLUNDELL ROAD, RICHMOND, BC


(PERSPECTIVE FOR BUILDING ONLY, SEE LANDCSCAPE FOR FENCES, GATES & PLANTS)






REFERENCE PLANS

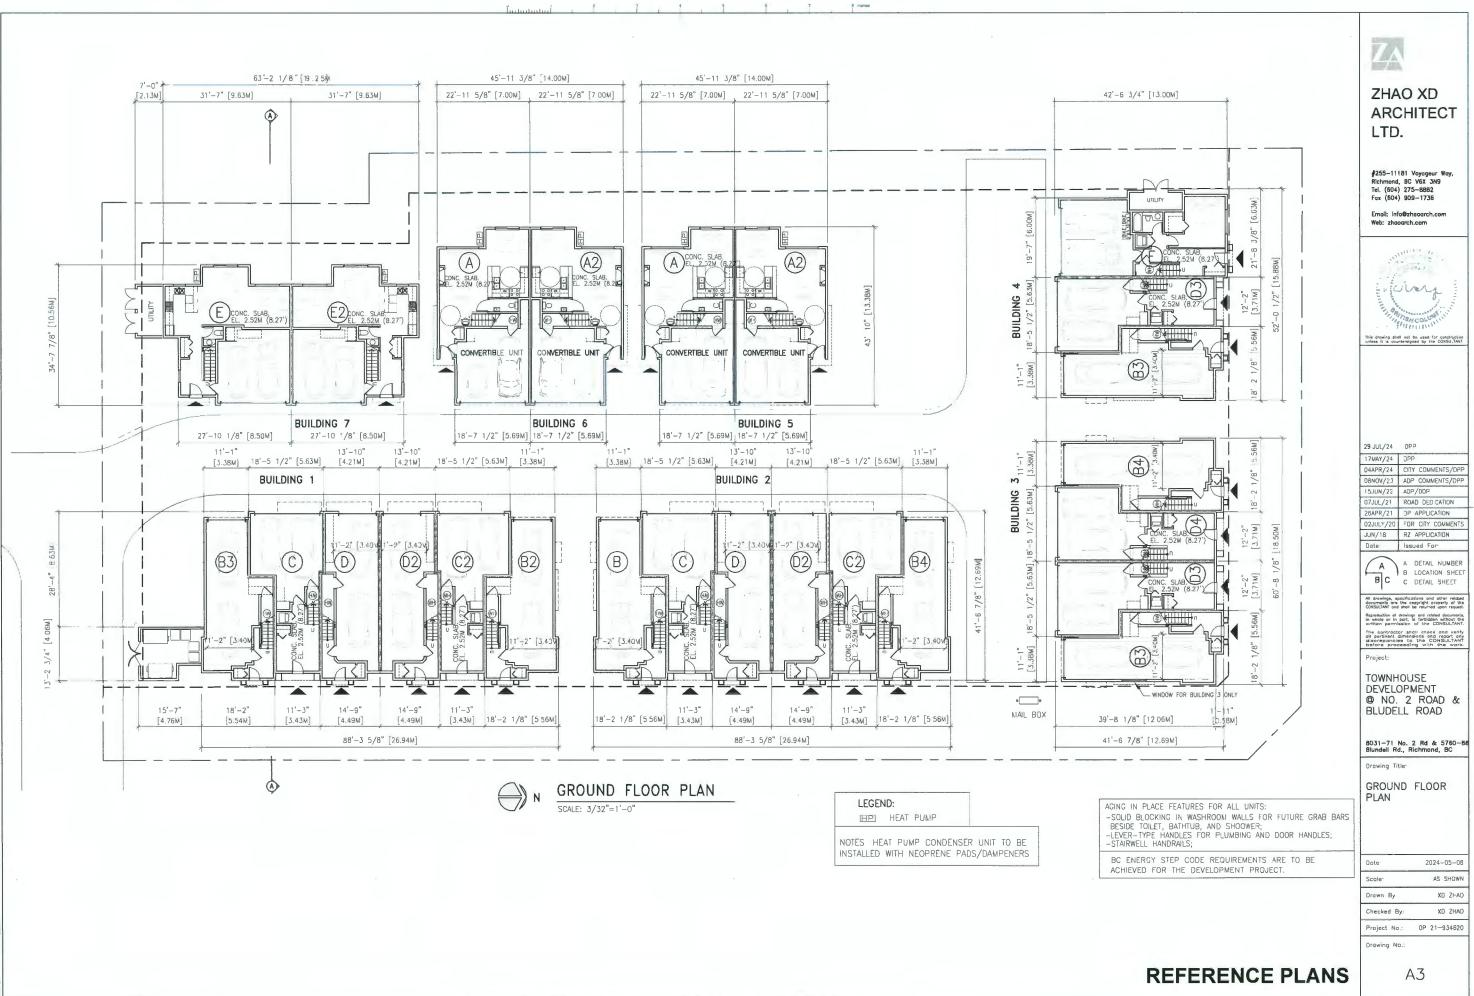

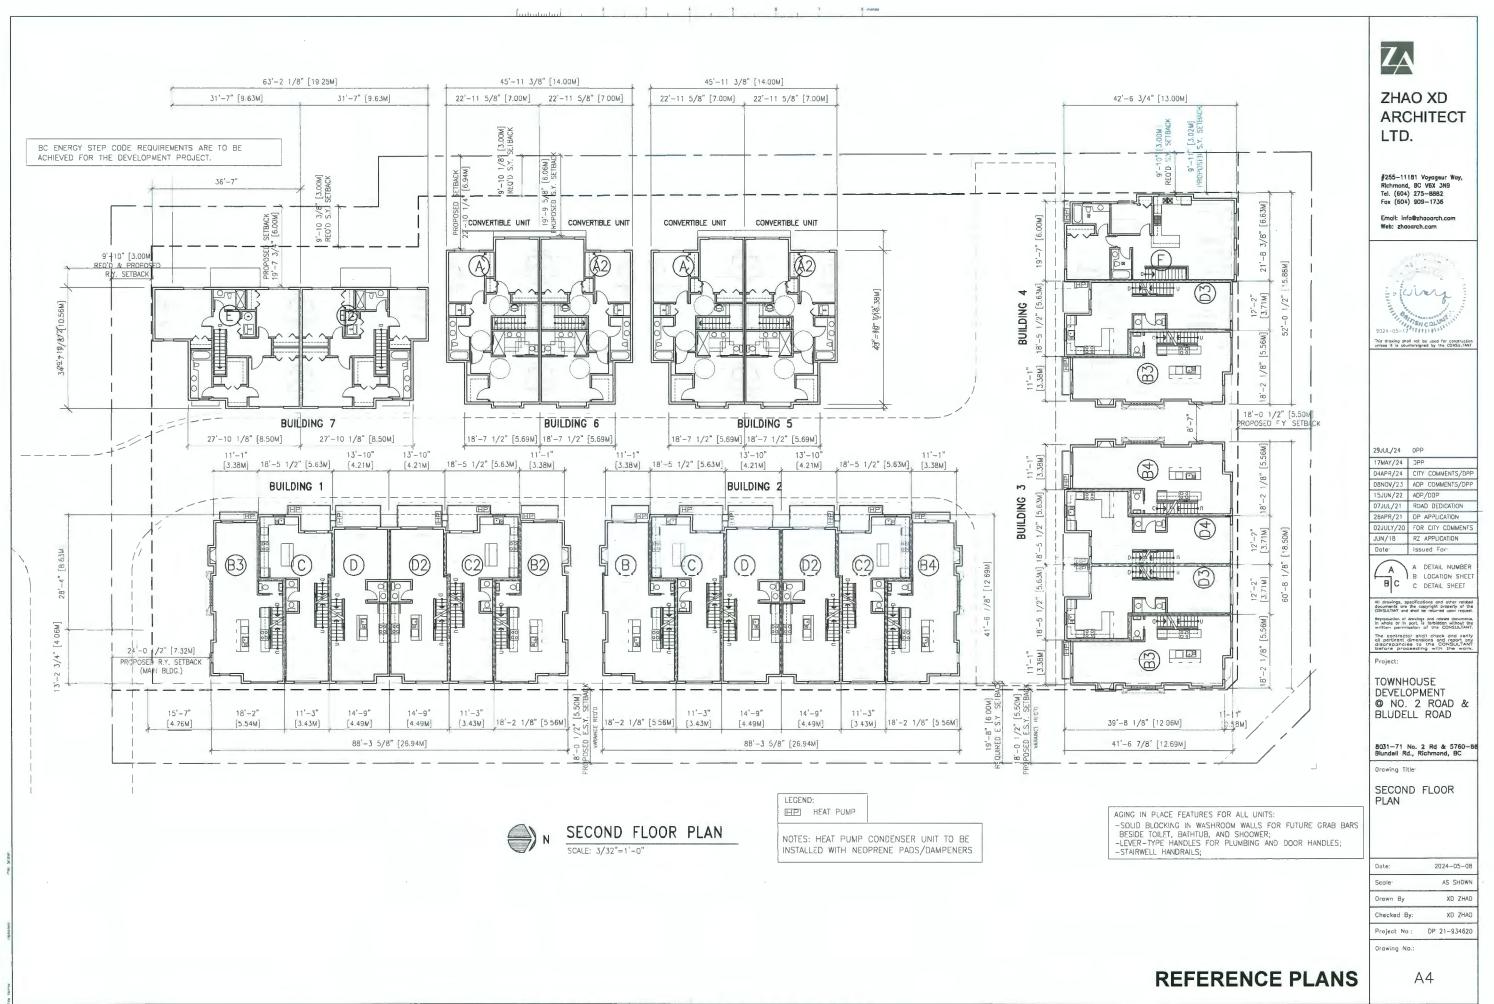

This drawing is NOT to be scaled. Jee figured dimensions only

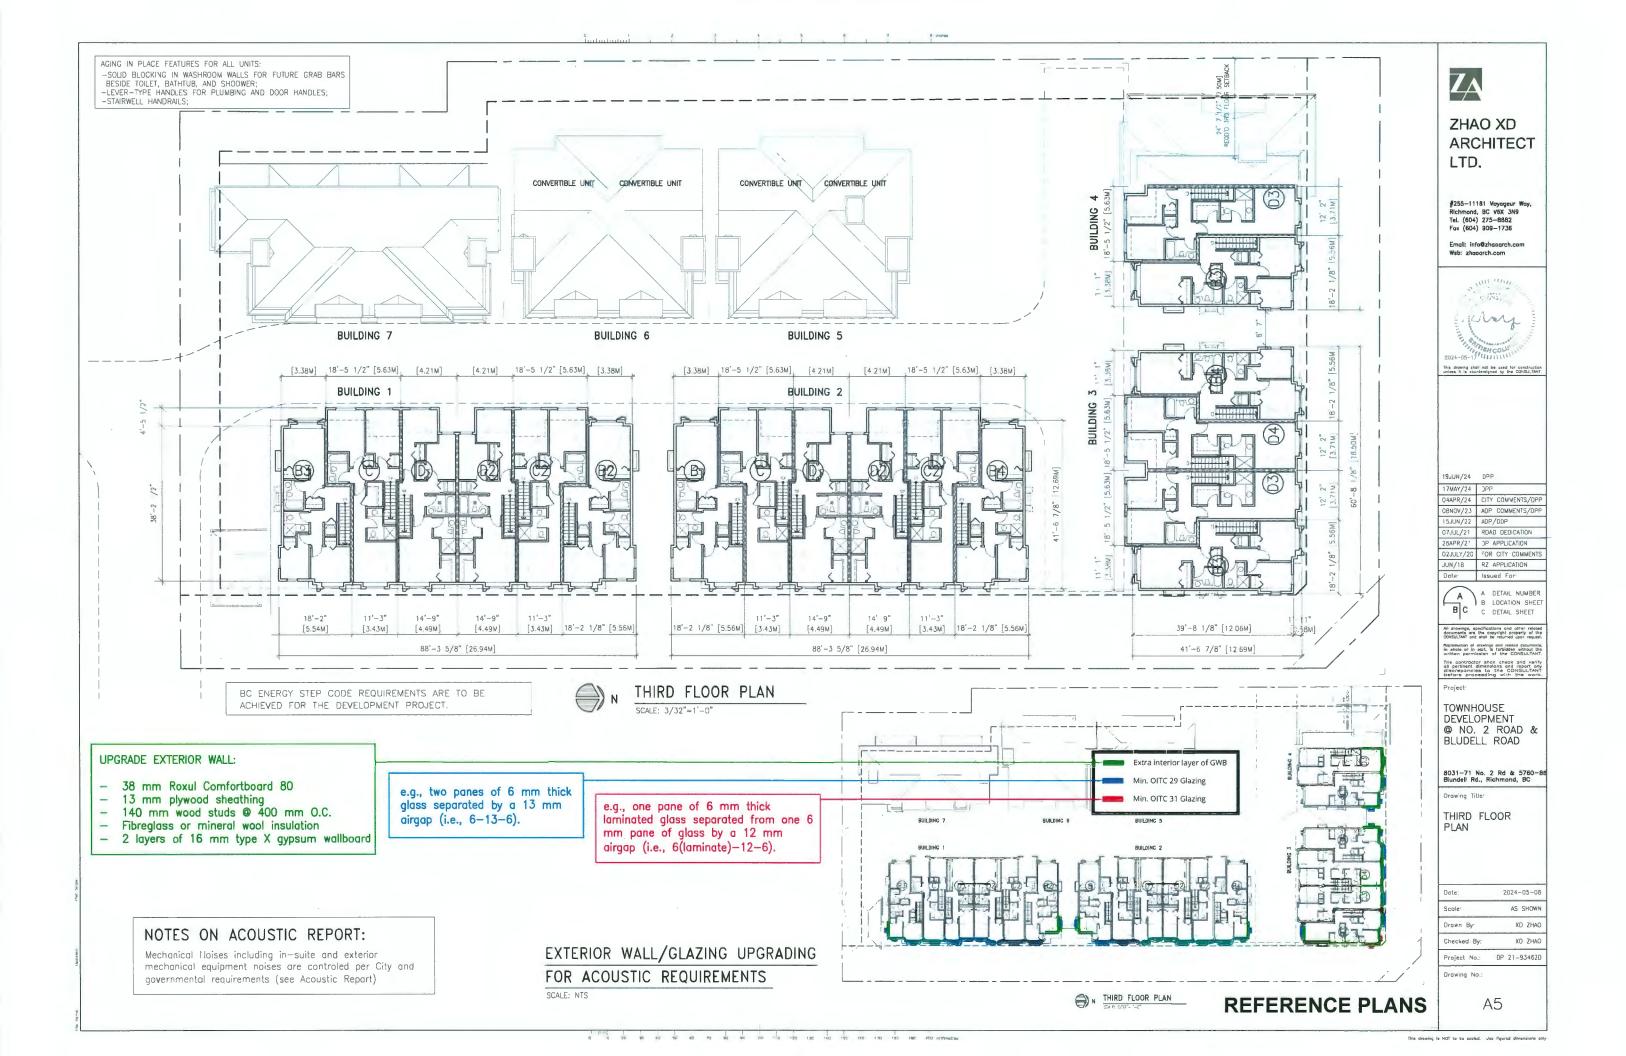

GROUND FLOOR


SCALE: 1/8"=1'-0" 427.20 SF 39.70 SM 366.8 SF 34.1 SM STAIR ENTRY: 107.6 SF 10.0 SM (EXCLUDED)

SECOND FLOOR

SCALE: 1/8"=1'-0" 812.1 SF 75.4 SM STAIRCASE. (EXCLUDED)

TOTAL FLOOR AREA: 1239.30 SF 115 1 SM LOT COVERAGE. 901.7 SF 7.8 SM GROSS FLOOR AREA: 159.2 SM EXEMPTED FLOOR AREA: 474.40 SF 44.1 SM

SH > WINDOW THAT CAN BE OPENED WITH A SINGLE HAND

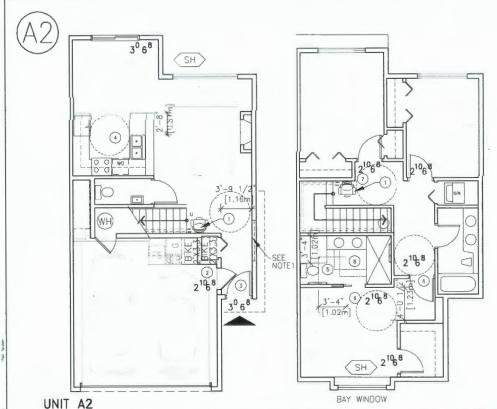

GROUND FLOOR

SCALE: 1/8"=1'-0" 427.20 SF 39.70 SM 366.8 SF 34.1 SM STAIR ENTRY: 107.6 SF 10.0 SM (EXCLUDED)

SECOND FLOOR

SCALE: 1/8"=1'-0" 812.1 SF 75.4 SM STAIRCASE: (EXCLUDED)

1239.30 SF 115.1 SM TOTAL FLOOR AREA 7.8 SM LOT COVERAGE 901.7 SF 1713.70 SF 159.2 SM GROSS FLOOR AREA:

EXEMPTED FLOOR AREA:

474.40 SF

44.1 SM

NOTE 1 : WINDOW ONLY FOR UNIT A2 OF BLDG. 5 ON N. ELEVATION.

BAY WINDOW NOTES:

AGING IN PLACE FEATURES FOR ALL UNITS: -SOLID BLOCKING IN WASHROOM WALLS FOR FUTURE GRAB BARS

BESIDE TOILET, BATHTUB, AND SHOOWER; -LEVER-TYPE HANDLES FOR PLUMBING AND DOOR HANDLES; -STAIRWELL HANDRAILS;

BAY WINDOW SEAT MIN. 2' ABOVE FINISHED FLOOR S STRUCTURALLY PROTRUDED FROM THE WALL NO FLOORING JOIST EXTENDS BEYOND THE WALL TO PREVENT A CONVERSION TO USABLE FLOOR SPACE.

(REEFER SECTION DETAIL ON A-10)



ZHAO XD **ARCHITECT** LTD.

#255-11181 Voyageur Way, Richmond, BC V6X 3N9 Tel. (604) 275-8882 Fax (604) 909-1736

Email: info@zhgogrch.com Web: zhaoarch.com

LEGEND FOR NOTES

- 1 LIFT CHAIR
- 2'-10" (D.863M) MIN. WIDTH CLEAR FLUSH THRESHOLDS (13MM MAX.)
- 3) PROVIDE WIRING IN WALL FOR FUTURE AUTOMATIC DOOR 2'-10" (0.863M) WIDTH CLEAR FLUSH THRESHOLDS (13MM MAX)
- PLUMBING & GAS PIPES LOCATED CLEAR OF UNDER COUNTER AREA OF FUTURE WORK SPACE
- 5) TOILET CLEAR FLOOR SPACE MIN. 1020 MM AT SIDE AND IN FRONT
- 6 2'-8" (0.8M) MIN. WIDTH CLEAR FOR DOORS TO MASTER BEDROOM & ENSUITE BATH ROOM (2'-8" SLIDING)
- 7 AT TOP OF ALL STAIRS, WALLS ARE REINFORCED WITH 2X12 SOLID LUMBER @ 3'-0" O.C.
- 8 SOLID WOOD BLOCK'G TO BE INSTALLED FOR UNITS) & LEVEL HANDLES TO BE USED



CHECKLIST - CONVERTIBLE UNIT FEATURES

ODORS & DOORWAYS

ENTRY DOOR WIN. 863 MM BUT IDEALLY 914MM AND HAVE CLEAR ACCESS. ENTRY DOOR CLEAR EXTERIOR FLOOR SPACE WIN. 1220 MM DEPTH BY DOOR WIDTH PLUS 600 MM ON LATCH SIDE (NOT NEEDED IF ROUGH IN WIRING PROVIDED FOR FUTURE AUTOMATIC DOOR OPENER)

INTERIOR DOORS TO MAIN LIVING AREAS, 1 BATHROOM AND 1 BEDROOM, MIN. 800 MM CLEAR OPENING WITH FLUSH THRESHOLDS MAX. 13MM HEIGHT. DEMONSTRATE WHEELCHAIR ACCESS BETWEEN THE HALLWAY AND ROOMS AND WIDEN HALLWAY ANO/OR DOORWAY(S) IF NECESSARY TO SECURE ACCESS.

PATIO/BA_CONY MIN 86DMM CLEAR OPENING.
(REMOVABLE THRESHOLD RAMP TO BE USEO FDR ACCESSIBILITY)
ALL INTERIOR THRESHOLDS WITHIN UNITS COMPLY BC BUILDING CODE. LEVER-TYPE HANDLES FOR ALL DOORS.

VERTICAL CIRCULATION

CHAIR LIFT (FOR VERTICAL CIRCULATION AS NOTED ON FLOOR PLANS) IN COMPLIANCE WITH MANUFACTURER SPECIFICATIONS. FRAMING TO ACGOMMONDATE CHAIR LIFT INSTALLATION WITHOUT IMPACT TO SOURROUNDING STRUCTURE. AT THE TOP OF ALL STAIRWAYS, WALLS ARE REINFORCED WITH 2X12 SOLID LUMBER AT 914MM TO CENTRE.

HALLWAYS

MIN. 900 MM WIDTH

GARAGE

MIN. 1 ACCESSIBLE PARKING SPACE WITH MIN. 4 M CARAGE WIDTH ACCESS FROM GARAGE TO LIVING AREA WITH MIN. 8DO MM CLEAR DOOR OPENING (2'-8" SLIDING OR 2'-10" SWINGING DOOR SPEC.) AND FLUSH THRESHOLDS MAX. 13 MM HEIGHT

BATHROOMS (MIN. 1)

TOILET CLEAR FLOOR SPACE MIN 1020 MM AT SIDE AND IN FRONT. WALL BLOCKING FOR FUTURE GRAB BAR INSTALLATIONAT TOILET, TUB AND SHOWER REINFORCED WITH 2X12 SOLID LUMBER IN ALL BATHTUB, SHOWER, AND TOILET LOCATIONS. LEVER-TYPE HANDLES FOR PLUMBING FIXTURES.

PRESSURE AND TEMPERATURE CONTROL VALVES ARE INSTALLED ON ALL SHOWER FAUCETS.

CABINETS UNDERNEATH SIN4(S) ARE EASILY REMOVED.

DEMONSTRATE BATH AND SHOWER CONTROLS ARE ACCESSIBLE (LAYOUT OR FIXTURE PLACEMENT).

MN. 800 MM CLEAR DOOR OPENING (2'-8" SLIDING OR 2'-10" SWINGING DOOR SPEC.)

WITH FLUSH THRESHOLOS MAX. 13 MM HEIGHT

KTICHEN

CLEAR AREA NEEDED UNDER FUTURE WORK SPACE. PLUMBING AND GAS PIPES

(IN-WALL AND IN-FLOOR) LOCATED C.EAR OF UNDER COUNTER AREA OF FUTURE WORK SPACE

(STOVE, SINK & MIN. 810 MM WIDE COUNTER). ALL PIPES ARE BROUGHT IN NO HIGHER THAN

304MM TO 355MM TO THE GENTRE OF THE PIPE FROM FLOOR LEVEL.

CABINETS UNDERNEATH SINK ARE EASLY REMOVED.

1500 MM TURNING DIAMETER OR TURNING PATH DIAGRAM.

M.N. 800 MM CLEAR DOOR OPENING (2"-8" SLIDING OR 2"-10" SWINGING DOOR SPEC.)

WITH FLUSH THRESHOLDS MAX. 13 MM HEIGHT

LEVER-TYPE HANDLES FOR PLUMBING FIXTURES

WINDOWS

MIN. 1 WINDOW THAT CAN BE OPENED WITH A SINGLE HAND (BATHROOM, KITCHEN, LIVING ROOM)

OUTLETS & SWITCHES

PLACEMENT LOCATIONS OF ELECTRICAL OUTLETS: BESIDE WINDOW, BOTTOM OF STAIRWAYS, BESIDE TOILET, ABOVE EXTERNAL DOORS (OUTSIDE AND INSIDE), ON FRONT FACE OF KITCHEN COUNTER, WITH PROXIMITY OF CONTROL CEVITRE FOR SMART HOME OPTIONS UPGRADE TO FOUR-PLEX OUTLETS IN MASTER BEDROOM, HOME OFFICE, CARAGE, AND RECREATION ROOM.

REFERENCE PLANS

| OPP |
|-------------------|
| JPP |
| CITY COMMENTS/DPF |
| ADP COMMENTS/DPF |
| ADP/ODP |
| ROAD DEDICATION |
| OP APPLICATION |
| FOR CITY COMMENTS |
| RZ APPLICATION |
| Issued For |
| |

A A DETAIL NUMBER B LOCATION SHEET ВС C DETAIL SHEET

All drawings, specifications and other related documents are the copyright property of the CONSULTANT and shall be returned upon request Reproduction of drawings and related document in whole or in part, is farbidden without the written permission of the CONSULTAN

TOWNHOUSE DEVELOPMENT NO. 2 ROAD & BLUDELL ROAD

8031-71 No. 2 Rd & 5760-8 Blundell Rd., Richmond, BC

Orawing Title

Project:

UNIT PLAN & **OVERLAYS**

2024-05-08 AS SHOWN Scale: XD ZHAO hecked By: XD ZHAO roject No OP 21-93462D

rawing No.:

A13

This drawing is NOT to be socied. Use figured dimensions only