

# **Report to Development Permit Panel**

To:

Development Permit Panel

Date:

January 8, 2020

From:

Wayne Craig

File:

DP 19-864104

Director, Development

Re: Application by Eric Stine Architect Inc. for a Development Permit at 8600, 8620,

stor, bevelopment

8640 and 8660 Francis Road

#### **Staff Recommendation**

That a Development Permit be issued which would:

- 1. Permit the construction of 18 townhouse units at 8600, 8620, 8640 and 8660 Francis Road on a site zoned "Low Density Townhouses (RTL4)"; and
- 2. Vary the provisions of Richmond Zoning Bylaw 8500 to reduce the front yard setback to Francis Road from 6.0 m to 5.8 m.

Wayne Craig

Director, Development

(604-247-4625)

WC:jr Att. 3

### **Staff Report**

## Origin

Eric Stine Architect Inc. has applied to the City of Richmond for permission to develop 18 townhouse units at 8600 8620, 8640, and 8660 Francis Road. The subject site is being rezoned from "Single Detached (RS1/E)" to "Low Density Townhouses (RTL4)" under Bylaw 9986 (RZ 18-814702), which received third reading following the Public Hearing on March 18, 2019. The site currently contains four single-family dwellings.

A Servicing Agreement is required as a condition of Building Permit issuance and includes, but is not limited to, the following improvements:

- New concrete sidewalk and landscaped boulevard along the Francis Road frontage; and
- Upgrades to water and storm sewer service mains in the Francis Road frontage.

#### **Development Information**

Please refer to attached Development Application Data Sheet (Attachment 1) for a comparison of the proposed development data with the relevant Bylaw requirements.

### **Background**

Development surrounding the subject site is as follows:

- To the North, across Francis Road: Four single-family dwellings with coach houses on lots zoned "Coach Houses (RCH)", and a lot undergoing redevelopment to create two single-family dwellings with coach houses as per the adopted rezoning (RZ 11-587257).
- To the South: Single-family dwellings on lots zoned "Single Detached (RS1/E)", with vehicle access from Wagner Drive.
- To the East and West: Are single-family dwellings on lots zoned "Single Detached (RS1/E)", with vehicle access from Francis Road. These lots are designated for townhouse development in the Arterial Road Policy.

### Rezoning and Public Hearing Results

The Public Hearing for the rezoning of this site was held on March 18, 2019. At the Public Hearing, the following concerns about rezoning the property were expressed:

- Overlook from upper storey windows to the property west of the subject site.
- Building height casting shadows on the property to the west of the subject site.

Staff worked with the applicant to address these issues in the following ways:

• Units 1 and 11 are both two-storeys. West-facing second-storey windows in both units are minimized, with the upper storey living spaces oriented primarily to the north and south.

- More intensive landscaping is provided in the side yard between Unit 1 and the neighbouring property. Specifically, three Pin Oak trees are proposed, which will provide additional screening above the fence line.
- Two Arnold Sentinel Austrian Black Pine trees are proposed in the side yard between Unit 11 and the adjacent property.
- To avoid shifting the overlook concern from one property to another, the second storey south-facing windows and balconies of the rear units, which face the rear yards of the adjacent single-family dwellings, are set back 6.94 m and 6.05 m, respectively.

Informational signage has been installed on the property and no additional correspondence has been received regarding the proposal.

#### **Staff Comments**

The proposed scheme attached to this report has satisfactorily addressed the significant urban design issues and other staff comments identified as part of the review of the subject Development Permit application. In addition, it complies with the intent of the applicable sections of the Official Community Plan (OCP) and is generally in compliance with the "Low Density Townhouses (RTL4)" zone except for the zoning variances noted below.

## Zoning Compliance/Variances (staff comments in bold italics)

The applicant requests to vary the provisions of Richmond Zoning Bylaw 8500 to:

1) Reduce the front yard setback to Francis from 6.0 m to 5.8 m.

Staff supports the proposed variance as it is a direct result of providing a 0.2 m road dedication to widen the sidewalk on Francis Road to 1.5 m. This road dedication was not identified in the rezoning, however the applicant has agreed to provide the dedication as a condition of this Development Permit.

The reduced setback is requested for Units 1 and 10 only. The remaining units have setbacks of 6.31 m and 6.61 m, adding articulation and visual interest to the streetscape. The existing curb would remain in place, and the distance from back-of-curb to the nearest building face would be approximately 8.95 m.

#### **Advisory Design Panel Comments**

The Advisory Design Panel (ADP) reviewed the proposal on September 18, 2019. A copy of the relevant excerpt from the ADP Minutes from September 18, 2019 is attached for reference (Attachment 2). The design response from the applicant has been included immediately following the specific Design Panel comments and is identified in 'bold italics'.

#### **Analysis**

## Conditions of Adjacency

• The subject site abuts single-family dwellings on three sides, which has informed the height and massing of the buildings. Units sharing a side yard with a single-family dwelling are two storeys in height to provide a sensitive transition and add visual interest to the long-term

- streetscape. These units are oriented to reduce the number and size of windows overlooking the neighbouring properties to the east and west.
- The buildings at the rear of the subject site are all two storeys, and contain either one or two townhouse units. Rear yard building setbacks of 4.84 m and 6.05 m are provided on the ground floor, and 6.05 m and 6.94 m on the second storey. A 1.8 m (6 ft.) privacy fence and new landscaping are proposed in the rear yard for added screening and privacy.
- Portions of the subject site will be raised with fill to achieve the required flood construction level. Finished site grade along the west and south property lines will be equivalent to the neighbouring properties. Finished site grade along the east property line will be 0.6 m (2 ft.) higher than the adjacent property, so a retaining wall with perimeter drainage will be required as part of the Building Permit to ensure storm water is managed appropriately.

## Urban Design and Site Planning

- Vehicular access to the proposed development is from a single driveway from Francis Road located in the centre of the site. Units are arranged on a T-shaped drive aisle.
- A statutory right-of-way (SRW) allowing access through the subject site to future developments to the east and west has been secured through the rezoning application.
- The design of the drive aisle includes visual cues to both indicate potential future extension and mark the transition to future development sites, including decorative pavers at each end, easily removable landscaping on the west end and no landscaping on the east end, and notification signage on each end.
- Units along Francis Road will have direct pedestrian access from the street, and rear units will have access from the drive aisle.
- Each unit has two parking spaces in a garage, which includes energized outlets for EV charging as per Richmond Zoning Bylaw 8500. Vehicle parking for the eight three-storey units is proposed in a tandem arrangement, for a total of 16 parking spaces (44% of the total required residential parking spaces), which is consistent with the maximum 50% contained in Richmond Zoning Bylaw 8500. A restrictive covenant to prohibit the conversion of the tandem parking garage area into habitable space has been secured through the rezoning application.
- Four visitor parking spaces are provided, including one accessible visitor parking space, which will be located on either end of the drive aisle. The number of visitor parking spaces proposed is in compliance with the minimum requirements found in Richmond Zoning Bylaw 8500.
- Class 1 bicycle parking is provided inside the garage of each unit. Class 2 bicycle parking for visitor is provided in bike racks located near the site entrance, across from the common outdoor amenity area.
- The shared outdoor amenity area is centrally located at the "T"-intersection, which maximizes sunlight penetration, provides an attractive view through the site, and allows for casual surveillance from adjacent units and the site entry. The amenity area is 136.2 m<sup>2</sup> (1,466 ft<sup>2</sup>), which is in excess of the minimum 6 m<sup>2</sup> per unit established in the OCP.
- Cash-in-lieu of indoor amenity space was secured through the rezoning application consistent with OCP policy.
- The required waste management enclosures and covered mailbox kiosk have been incorporated into the design of the buildings to minimize visual impact and add to the streetscape. Both are located on either side of the entry driveway.

#### Architectural Form and Character

- The proposed building form contains projecting window boxes, covered entry porches, gable roofs, and partially recessed balconies to provide articulation of the building façade and reinforce the residential scale.
- Street fronting units include steeply sloped roof elements to reduce the appearance of the third storey. A variety of projections and building articulation break up the massing and provide visual interest from the street.
- Buildings along the rear of the site have low sloped dormer roofs and contain either one or two townhouse units, suggesting a collection of smaller dwellings.
- The proposed cladding materials include red brick, white board and batten, black trim, and wood trellis structures. This combination of materials is used to give each building a distinct top, middle, and base.

## Landscape Design and Open Space Design

- Tree preservation was reviewed at rezoning stage, where 15 on-site trees were identified for removal. Based on a 2:1 replacement ratio contained in the OCP, 30 new trees are required. The applicant is proposing to plant 30 trees in the development, which include a variety of deciduous and coniferous species consistent with the Arterial Road Land Use Policy.
- Three trees located on 8751 Wagner Drive to the south are to be retained and protected.
- The proposal provides a pedestrian-oriented streetscape along Francis Road, including landscaped front yards for each unit, new trees, and trellis structures framing some of the walkways.
- Two pedestrian walkways from the sidewalk to the internal drive aisle are provided at the west and centre of the site. The west walkway includes landscaping and a trellis, while the central walkway is parallel to the vehicle drive way.
- Units accessed via the internal drive aisle have paired entries that include a small landscaped area with a fastigiated tree, softening the appearing of the drive aisle and providing some visual interest.
- Private outdoor space is provided for each unit in the form of a landscaped area with patio on the ground floor, and additional balcony space located off upper storey living spaces.
- A children's play area is proposed in the shared outdoor amenity area, and includes a play house and ping pong table to provide different play opportunities for different age groups. Seating is provided next to the play equipment for caregivers.
- The vehicle entrance, intersection in front of the shared outdoor amenity area, visitor parking stalls, and each end of the drive aisle will be treated with permeable pavers for better water infiltration and variety in paving surfaces.
- Irrigation is provided for all planted areas.
- To ensure that the proposed landscaping works are completed, the applicant is required to provide a landscape security in the amount of \$123,665 prior to issuance of the Development Permit.
- A \$28,800 contribution towards the development of City facilities in lieu of providing indoor amenity space was secured through the rezoning application.
- A \$20,137.35 contribution to the City's Public Art Fund was secured through the rezoning application.

### Crime Prevention Through Environmental Design

- Low permeable fencing and low landscaping are provided in the front yard to distinguish public and private space, while allowing for casual surveillance opportunities.
- New 1.8 m (6 ft.) fencing is proposed around the perimeter of the site to provide privacy and screening.
- The trees proposed between rear unit entries are a columnar species, so will not obstruct sightlines down the walkways.

### Sustainability

• The proposed development is required to achieve Step 3 of the BC Energy Step Code.

## Accessible Housing

- The proposed development includes two convertible units that are designed with the potential to be easily renovated to accommodate a future resident in a wheelchair. The potential conversion of these units will require installation of an elevator from the garage to the second floor and/or a chair lift in the staircase of Units 1 and 10.
- All of the proposed units incorporate aging in place features to accommodate mobility constraints associated with aging. These features include:
  - o Stairwell hand rails.
  - o Lever-type handles for plumbing fixtures and door handles.
  - o Solid blocking in washroom walls to facilitate future grab bar installation beside toilets, bathtubs and showers.

#### Conclusions

As the proposed development would meet applicable policies and Development Permit Guidelines, staff recommend that the Development Permit be endorsed, and issuance by Council be recommended.

The list of Development Permit Considerations is included in Attachment 3, which has been agreed to by the applicant (signed concurrence on file).

Jochhi

Jordan Rockerbie Planning Technician – Design (604-276-4092)

JR:blg

#### Attachments:

Attachment 1: Development Application Data Sheet

Attachment 2: Excerpt from the Meeting Minutes of the ADP (September 18, 2019)

Attachment 3: Development Permit Considerations



# **Development Application Data Sheet**

Owner: Mavic Properties Ltd.

**Development Applications Department** 

DP 19-864104 Attachment 1

Address: 8600, 8620, 8640 and 8660 Francis Road

Planning Area(s): Broadmoor

Applicant: Eric Stine Architect Inc.

Floor Area Gross: 3,359.9 m<sup>2</sup> (36,166 ft<sup>2</sup>) Floor Area Net: 2,196.3 m<sup>2</sup> (23,641 ft<sup>2</sup>)

	Existing	Proposed
Site Area:	3,668.28 m <sup>2</sup>	3,660.51 m <sup>2</sup>
Land Uses:	Single-family residential	Multiple-family residential
OCP Designation:	Neighbourhood Residential	No change
Zoning:	Single Detached (RS1/E)	Low Density Townhouses (RTL4)
Number of Units:	Four single detached dwellings	18 townhouse dwellings

	Bylaw Requirement	Proposed	Variance
Floor Area Ratio:	Max. 0.60	0.60	None permitted
Buildable Floor Area (m <sup>2</sup> ):*	Max. 2,196.3 m <sup>2</sup> (23,641 ft <sup>2</sup> )	2,196.3 m <sup>2</sup> (23,641 ft <sup>2</sup> )	None permitted
Lot Coverage (% of lot area):	Building: Max. 40% Non-porous Surfaces: Max. 65% Landscaping: Min. 25%	Non-porous Surfaces: Max. 65%  Non-porous Surfaces: 60.9%	
Lot Size:	N/A	3,660.51 m <sup>2</sup>	None
Lot Dimensions (m):	Width: 50.0 m Depth: 35.0 m	Width: 80.42 m Depth: 45.72 m	None
Setback – Front Yard (North):	Min. 6.0 m	5.8 m	Vary by 0.2 m
Setback – Side Yard (East)	Min. 3.0 m	4.04 m	None
Setback – Side Yard (West)	Min. 3.0 m	3.45 m	None
Setback – Rear Yard (South)	Min. 3.0 m	4.73 m	None
Height (m):	Max. 12.0 m (3 storeys)	11.14 m (3 storeys)	None
Off-street Parking Spaces – Regular (R) / Visitor (V):	2 (R) and 0.2 (V) per unit	2 (R) and 0.22 (V) per unit	None
Off-street Parking Spaces - Total:	al: 36 (R) and 4 (V) 36 (R) and 4 (V)	None	
Tandem Parking Spaces:	Permitted – Maximum of 50% of required residential spaces	16 (i.e. 44%)	None

	Bylaw Requirement	Proposed	Variance		
Small Car Parking Spaces:	Permitted – Maximum of 50% of total required spaces	12 (i.e. 33 %)	None		
Bicycle Parking Spaces – Class 1:	1.25 per unit (i.e. 23)	24	None		
Bicycle Parking Spaces - Class 2:	0.2 per unit (i.e. 4) 4		None		
Amenity Space – Indoor:	Min. 50 m <sup>2</sup> or \$1,600/unit cash-in-lieu (i.e. \$28,800)	\$28,800 cash-in-lieu	None		
Amenity Space – Outdoor:	6 m² per unit (i.e. 108 m²)	136.2 m <sup>2</sup>	None		

Other: Tree replacement compensation required for loss of significant trees.

# Excerpt from the Minutes from The Design Panel Meeting

Wednesday, September 18, 2019 – 4:00 p.m. Rm. M.1.003 Richmond City Hall

#### DP 19-864104 - 18-UNIT TOWNHOUSE DEVELOPMENT

ARCHITECT:

Eric Stine Architect Inc.

LANDSCAPE

PMG Landscape Architects Ltd.

ARCHITECT:

8600, 8620, 8640, 8660 Francis Road

PROPERTY LOCATION:

# Applicant's Presentation

Architects Eric Stine and Jason Skladan, and Denitsa Dimitrova, PMG Landscape Architects, presented the project and together with Stanford Siu, Admiral Operations, answered queries from the Panel on behalf of the applicant.

#### **Panel Discussion**

Comments from Panel members were as follows:

consider a softer treatment to the internal drive aisle so it would read as a space for shared vehicular and pedestrian use, e.g., internal drive aisle could also be used as play area, and a social and gathering place; consider extending the permeable surface paving treatment across the entire driveway and internal drive aisle to achieve this;

Response: Additional planting added at the intersection between driveway and internal drive aisle. Permeable paving revised to provide distinct zones along the internal driveway to facilitate play areas. Proposed trees between the rear units, and planting between the garage doors of front units soften the appearance of the drive aisle.

appreciate the separation of the rear townhouse units; however, applicant could have installed more windows and the floor layout designed to provide more daylighting to the bedrooms on the second floor; actual gain in terms of additional glazing for the rear units as a result of separation is offset by the lack of screening and landscaping of the visitor parking stalls adjacent to the east and west property lines;

Response: Additional windows added to sides of rear units, taking advantage of spatial separation.

- appreciate the applicant's presentation and organization of materials; form and character of the project is well handled;
- size of play area around the proposed children's play equipment is inadequate; consider moving the ping-pong table up north to create more play space; consider a different surface treatment around the ping-pong table as the proposed grass surface could quickly deteriorate due to constant activities around the equipment;

Response: Amenity area has been revised as per ADP comments.

• consider an additional bench on the outdoor amenity area to facilitate more social interaction among residents; also consider installing a small tree adjacent to the bench to provide shading but not pose a potential CPTED issue;

Response: A second bench and small tree adjacent to the bench have been proposed

proposed planting of viburnum shrub at the northeast and northwest corners of the outdoor amenity area could pose a potential CPTED concern as these could potentially grow more than one meter high;

Response: Viburnum has been deleted from north side of Amenity Area

appreciate the applicant contributing to the City's Public Art Reserve Fund; however, the applicant is encouraged to incorporate public art into the project to improve the public realm;

Response: Public art is not proposed on site, given the limited site area fronting Francis Road which is not dedicated as private outdoor space for the townhouse units. A grass boulevard will be added along Francis Road complete with street trees, adding to the public realm.

different paving colours and textures for pedestrian circulation areas around the project help enhance the pedestrian character of these areas; support the Panel comment to enhance the pedestrian character of the entire internal drive aisle;

Response: Planting is proposed where possible along the internal drive aisle: Small trees proposed between the rear units, and planting along the south face of the front buildings (between garage doors). Zones have created with the use of permeable paving to help break up the length of the internal drive aisle.

• consider adequate buffering at the east and west terminus of the internal drive aisle as these are adjacent to existing single-family dwellings;

Response: Planting is proposed at the west terminus of the internal drive aisle. There is limited space at the east terminus for planting. 6'-0" tall wood fencing, including a 1-2" trellis top is proposed to buffer the drive aisle on the east side. There is the potential for future townhouse projects to the east and west to use this drive aisle as well.

height of planting and other landscape features to be installed along the south property line adjacent to the children's play area should be appropriate to provide adequate screening to existing single-family dwellings to the south:

Response: Bigger shrubs have been proposed at the south end of the play area

- appreciate the provision of two convertible units in the project;
- design of convertible unit ground floor access from the garage is supported;
   however, exit to the garage could be widened to open the door for a person in a wheelchair;

Response: Layout revised to have clear space beside the door to garage.

 consider a pocket door or outward swinging door in lieu of an inward swinging door for the powder room on the ground floor of the convertible unit to enhance its accessibility;

Response: Powder room door revised to be a pocket door.

appreciate the second floor ensuite design for the convertible unit; consider an outward swinging door for the walk-in closet and a pocket door for the second bathroom to enhance their usability and accessibility;

Response: Layout revised to eliminate walk-in closet. A standard closet with sliding door is provided, to increase accessibility. Pocket doors are now being used of entry door to bedroom and ensuite.

[ch]airlift usability would require a wheelchair or a walker on each floor;

Response: Understood, blocking is provided for chairlift should this be the most appropriate mobility upgrade for a disabled resident. Future elevator location is also provided, from garage to send floor closet above.

• stacked storage spaces on the first and second floors could permit the future installation of a vertical lift which would be more useful to people with various types of disabilities; installation of a Garaventa lift is suggested with appropriate dimensions;

Response: Future elevator location proposed from garage to upper floor closet.

proposed river rock paving treatment for walkways between rear townhouse units is not appropriate for people in wheelchairs and strollers; also, stepping stones with big gaps will impede accessibility;

Response: Proposed river rock with stepping stones is for maintenance purposes only, not regular access to rear yard. There is a solid surface pathway to the front doors of each unit.

consider installing weather protection over the mail boxes;

Response: Revised to include a wood arbor with solid roof for weather protection over the mail boxes.

support Panel comments regarding the project's accessibility features;

proposed architectural design is appropriate for the scale of the project; however, design development is needed for the blank east façade of the end townhouse unit (i.e., Unit 5) on the west side of the driveway to enhance visual interest to the project's entry; consider an exterior cladding treatment using more brick at the base similar to the west façade treatment of the unit on the opposite side of the driveway where garbage and recycling facilities are located (i.e., Unit 6); and

Response: Additional windows have been added to the east facade of Unit 5, with arbor roof over mailboxes added. Brick cladding has been extended further on the end (west facade).

applicant needs to clarify the details of the curb elevations and treatments along the internal drive aisle, e.g. there are areas where two curbs converge at the radius; include labels for curb treatments in the drawings.

Response: Curb design has been simplified. Note, there is some flush concrete edging adjacent to permeable paving brick. This is flush with drive aisle, not a curb.

- The following comments of Jubin Jalili were read into the record by Sara Badyal:
- the project is required to meet or exceed BC Energy Step Code 3 requirements; could be achieved with higher insulation value, better windows and a high efficiency HRV: and

Response: BC Energy Step Code 3 will be achieved. We are working with Capital Home Energy to achieve this.

 applicant is considering to install airconditioning in the project; however, proposed location of outdoor units is not clear and needs consideration.

Response: Proposed outdoor location for air-conditioning units are now shown on site plan (see sheet A0.1)

#### **Panel Decision**

It was moved and seconded

That DP 19-864104 be supported to move forward to the Development Permit Panel subject to the applicant giving consideration to the comments of the Advisory Design Panel.

**CARRIED** 

File No.: DP 19-864104



# **Development Permit Considerations**

Development Applications Department 6911 No. 3 Road, Richmond, BC V6Y 2C1

Address: 8600, 8620, 8640, 8660 Francis Road

## Prior to approval of the Development Permit, the developer is required to complete the following:

- 1. Final adoption of the Zoning Amendment Bylaw 9986.
- 2. 0.2 m road dedication along the entire Francis Road frontage.
- 3. Receipt of a Letter of Credit for landscaping in the amount of \$123,665.00. The Letter-of-Credit will not be returned until a Letter of Assurance prepared by the Landscape Architect confirming the landscaping has been installed as per the Development Permit is reviewed by staff.

## Prior to Building Permit Issuance, the developer must complete the following requirements:

- 1. Installation of appropriate tree protection fencing around all trees to be retained as part of the development prior to any construction activities, including building demolition, occurring on-site. Should the developer wish to begin site preparation work after third reading of the rezoning bylaw, but prior to final adoption of the rezoning bylaw and issuance of the Development Permit, the applicant will be required to obtain a Tree Removal Permit (Rezoning in Process T3).
- 2. Submission of a Construction Parking and Traffic Management Plan to the Transportation Department. Management Plan shall include location for parking for services, deliveries, workers, loading, application for any lane closures, and proper construction traffic controls as per Traffic Control Manual for works on Roadways (by Ministry of Transportation) and MMCD Traffic Regulation Section 01570.
- 3. Incorporation of accessibility measures in Building Permit (BP) plans as determined via the Rezoning and/or Development Permit processes.
- 4. Obtain a Building Permit (BP) for any construction hoarding. If construction hoarding is required to temporarily occupy a public street, the air space above a public street, or any part thereof, additional City approvals and associated fees may be required as part of the Building Permit. For additional information, contact the Building Approvals Department at 604-276-4285.
- 5. Enter into a Servicing Agreement\* for the design and construction of engineering infrastructure improvements. A Letter of Credit or cash security for the value of the works, as determined by the City, will be required as part of entering into the Servicing Agreement. Works include, but may not be limited to, the following:

### Water Works:

- Using the OCP Model, there is 483.0 L/s of water available at a 20 psi residual at the Francis Road frontage. Based on your proposed development, your site requires a minimum fire flow of 220 L/s.
- At Developer's cost, the Developer is required to:
  - O Submit Fire Underwriter Survey (FUS) or International Organization for Standardization (ISO) fire flow calculations to confirm development has adequate fire flow for onsite fire protection. Calculations must be signed and sealed by a Professional Engineer and be based on Building Permit Stage Building designs.
  - Replace approximately 90 m of 300 mm AC water main with PVC in the roadway on Francis Road, complete with fire hydrants per City spacing requirements.
  - o Remove the existing AC water main and legally dispose offsite.
  - o Provide a right-of-way for the water meter and meter chamber (unless meter is to be located in a mechanical room), at no cost to the City. Exact right-of-way dimensions to be finalized during the servicing agreement process.

Initial:	

- At Developer's cost, the City is to:
  - o Reconnect all existing water service connections and hydrant leads to the new water main.
  - o Cut, cap, and remove all existing water service connections and meters to the development site.
  - o Install one new water service connection, meter to be located onsite in a right of way.
  - o Complete all tie-ins for the proposed works to existing City infrastructure.

#### Storm Sewer Works:

- At Developer's cost, the Developer is required to:
  - Perform a capacity analysis to size the proposed storm sewer in Francis Road. The analysis shall consider both the existing condition and the 2041 OCP condition. Storm sewers shall be interconnected where possible. Minimum pipe size shall be 600 mm.
  - o Install approximately 95 m of new storm sewer in Francis Road, sized via the required capacity analysis. The new storm sewer shall be located in the roadway.
  - o Remove the existing 300 mm storm sewer.
  - o Install one new storm service connection, complete with inspection chamber. Inspection chamber to be located in a right-of-way onsite.
  - o Provide an erosion and sediment control plan for all on-site and off-site works, to be reviewed as part of the servicing agreement.
- At Developer's cost, the City is to:
  - o Cut and cap all existing storm service connections to the development site and remove inspection chambers.
  - o Reconnect all existing storm connections, catch basins, and lawn basins to the proposed storm sewer.
  - o Complete all tie-ins for the proposed works to existing City infrastructure.

### Sanitary Sewer Works

- At Developer's cost, the Developer is required to:
  - o Not start onsite excavation or foundation construction prior to completion of rear-yard sanitary works by City crews.
- At Developer's cost, the City is to:
  - o Install one new sanitary service connection, complete with inspection chamber.
  - o Cut and cap all existing service connections to the development site, and remove inspection chambers.

#### Frontage Improvements:

- At Developer's cost, the Developer is required to:
  - o Return the existing Hydro lease lights and replace with City standard street lighting.
  - Coordinate with BC Hydro, Telus and other private communication service providers:
    - To relocate/underground the existing overhead lines and poles to prevent conflict with the proposed sidewalk.
    - To underground overhead service lines.
    - To pre-duct for future hydro, telephone and cable utilities along all road frontages.
    - To locate all proposed underground structures (e.g. junction boxes, pull boxes, service boxes, etc.) outside of bike paths and sidewalks.
    - Before relocating/modifying any of the existing power poles and/or guy wires within the property frontages.
    - To locate/relocate all above ground utility cabinets and kiosks required to service the proposed development, and all above ground utility cabinets and kiosks located along the development's frontages, within the developments site (see list below for examples). A functional plan showing conceptual locations for such infrastructure shall be included in the development process design review. Please coordinate with the respective private utility companies and the project's lighting and traffic signal consultants to confirm the requirements (e.g., statutory right-of-way dimensions) and the

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locations for the aboveground structures. If a private utility company does not require an aboveground structure, that company shall confirm this via a letter to be submitted to the City. The following are examples of statutory right-of-ways that shall be shown on the functional plan and registered prior to SA design approval:

- BC Hydro PMT  $-4.0 \times 5.0 \text{ m}$
- BC Hydro LPT 3.5 x 3.5 m
- Street light kiosk  $-1.5 \times 1.5 \text{ m}$
- Traffic signal kiosk 1.0 x 1.0 m
- Traffic signal UPS  $-2.0 \times 1.5 \text{ m}$
- Shaw cable kiosk 1.0 x 1.0 m
- Telus FDH cabinet 1.1 x 1.0 m
- o Provide other frontage improvements as per Transportation's requirements, including
  - Removal of the existing sidewalk and boulevard and replacement with new 1.5 m wide concrete sidewalk at the property line, min. 1.5 m wide landscaped boulevard with street trees and lighting, and 0.15 concrete curb;
  - Removal of the four existing driveways and replacement with frontage works as described above;
  - Construction of a new driveway to the development site; and
  - All works to tie-in t existing condition to the east and west of the development site.

#### General Items:

- At Developer's cost, the Developer is required to:
  - O Not encroach into the rear-yard sanitary right-of-way with proposed trees, retaining walls, non-removable fences, or other non-removable structures. No fill may be placed within the right-of-way without the City's review and approval.
  - O Provide, prior to start of site preparation works or within the first servicing agreement submission, whichever comes first, a geotechnical assessment of preload and soil preparation impacts on the existing utilities fronting the development site and provide mitigation recommendations.
  - Provide a video inspection report of the existing storm and sanitary sewers along the development's frontages prior to start of site preparation works or within the first servicing agreement submission, whichever comes first. A follow-up video inspection report after site preparation works are complete (i.e. pre-load removal, completion of dewatering, etc.) is required to assess the condition of the existing utilities and provide recommendations. Any utilities damaged by the pre-load, de-watering, or other development-related activity shall be replaced at the Developer's cost.
  - O Monitor the settlement at the adjacent utilities and structures during pre-loading, dewatering, and soil preparation works per a geotechnical engineer's recommendations, and report the settlement amounts to the City for approval.
  - O Enter into, if required, additional legal agreements, as determined via the subject development's Servicing Agreement(s) and/or Development Permit(s), and/or Building Permit(s) to the satisfaction of the Director of Engineering, including, but not limited to, site investigation, testing, monitoring, site preparation, dewatering, drilling, underpinning, anchoring, shoring, piling, pre-loading, ground densification or other activities that may result in settlement, displacement, subsidence, damage or nuisance to City and private utility infrastructure.

#### Note:

- \* This requires a separate application.
- Where the Director of Development deems appropriate, the preceding agreements are to be drawn not only as personal covenants of the property owner but also as covenants pursuant to Section 219 of the Land Title Act.
  - All agreements to be registered in the Land Title Office shall have priority over all such liens, charges and encumbrances as is considered advisable by the Director of Development. All agreements to be registered in the Land Title Office shall, unless the Director of Development determines otherwise, be fully registered in the Land Title Office prior to enactment of the appropriate bylaw.

Initial:	

The preceding agreements shall provide security to the City including indemnities, warranties, equitable/rent charges, letters of credit and withholding permits, as deemed necessary or advisable by the Director of Development. All agreements shall be in a form and content satisfactory to the Director of Development.

- Additional legal agreements, as determined via the subject development's Servicing Agreement(s) and/or Development Permit(s), and/or Building Permit(s) to the satisfaction of the Director of Engineering may be required including, but not limited to, site investigation, testing, monitoring, site preparation, de-watering, drilling, underpinning, anchoring, shoring, piling, pre-loading, ground densification or other activities that may result in settlement, displacement, subsidence, damage or nuisance to City and private utility infrastructure.
- Applicants for all City Permits are required to comply at all times with the conditions of the Provincial Wildlife Act and Federal Migratory Birds Convention Act, which contain prohibitions on the removal or disturbance of both birds and their nests. Issuance of Municipal permits does not give an individual authority to contravene these legislations. The City of Richmond recommends that where significant trees or vegetation exists on site, the services of a Qualified Environmental Professional (QEP) be secured to perform a survey and ensure that development activities are in compliance with all relevant legislation.

Signed	Date



# **Development Permit**

No. DP 19-864104

To the Holder:

ERIC STINE ARCHITECT INC.

Property Address:

8600, 8620, 8640 AND 8660 FRANCIS ROAD

Address:

C/O 1 - 1864 WEST 1ST AVENUE


VANCOUVER, BC V6J 1G5

- 1. This Development Permit is issued subject to compliance with all of the Bylaws of the City applicable thereto, except as specifically varied or supplemented by this Permit.
- 2. This Development Permit applies to and only to those lands shown cross-hatched on the attached Schedule "A" and any and all buildings, structures and other development thereon.
- 3. The "Richmond Zoning Bylaw 8500" is hereby varied to:
  - a) Reduce the front yard setback to Francis Road from 6.0 m to 5.8 m.
- 4. Subject to Section 692 of the Local Government Act, R.S.B.C.: buildings and structures; off-street parking and loading facilities; roads and parking areas; and landscaping and screening shall be constructed generally in accordance with Plans #1 to #27 attached hereto.
- 5. Sanitary sewers, water, drainage, highways, street lighting, underground wiring, and sidewalks, shall be provided as required.
- 6. As a condition of the issuance of this Permit, the City is holding the security in the amount of \$123,665.00 to ensure that development is carried out in accordance with the terms and conditions of this Permit. Should any interest be earned upon the security, it shall accrue to the Holder if the security is returned. The condition of the posting of the security is that should the Holder fail to carry out the development hereby authorized, according to the terms and conditions of this Permit within the time provided, the City may use the security to carry out the work by its servants, agents or contractors, and any surplus shall be paid over to the Holder. Should the Holder carry out the development permitted by this permit within the time set out herein, the security shall be returned to the Holder. The City may retain the security for up to one year after inspection of the completed landscaping in order to ensure that plant material has survived.
- 7. If the Holder does not commence the construction permitted by this Permit within 24 months of the date of this Permit, this Permit shall lapse and the security shall be returned in full.

# Development Permit No. DP 19-864101

To the Holde	r:	ERIC STINE ARCH	IITECT INC.	
Property Address:		8600, 8620, 8640 AND 8660 FRANCIS ROAD		
Address:		C/O 1 - 1864 WEST 1ST AVENUE VANCOUVER, BC V6J 1G5E		
condition Permit w	described hereir s and provisions hich shall form a nit is not a Build	s of this Permit and a part hereof.	generally in accordance w ny plans and specification	ith the terms and s attached to this
AUTHORIZ DAY OF	ING RESOLUT ,	ION NO.	ISSUED BY THE CO	UNCIL THE
DELIVEREI	THIS D	AY OF ,	·	
MAYOR				



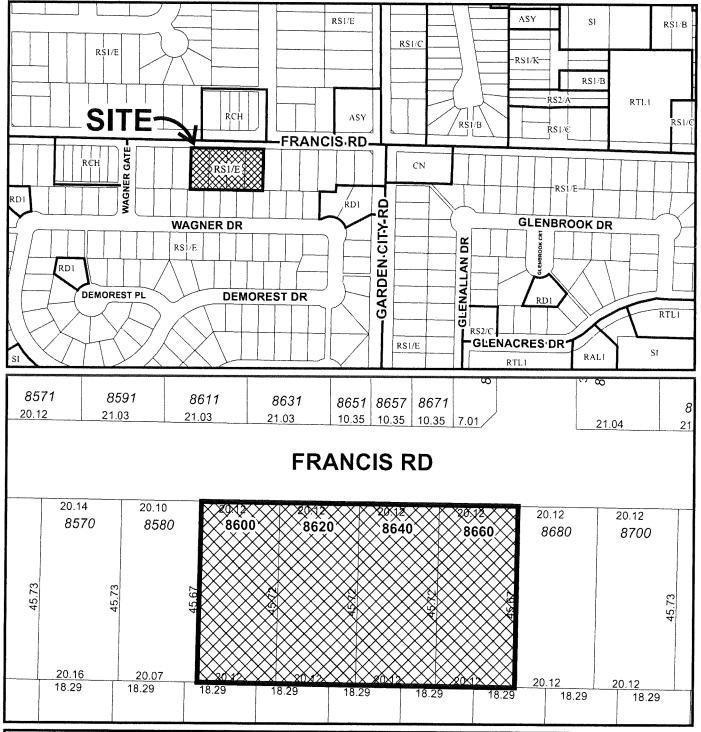



DP 19-864104 SCHEDULE "A"

Original Date: 06/12/19

Revision Date:

Note: Dimensions are in METRES

### LIST OF ARCHITECTURAL DRAWINGS:

3D VIEWS 3D VIEWS 0.01

SITE PLAN - GROUND FLOOR SITE PLAN #1 - SETBACK SITE PLAN SITE PLAN #2 - PARKING PLAN

A0.1-#2 SITE PLAN - SECOND FLOOR SITE PLAN - THIRD FLOOR FSR PLAN - SECOND FLOOR

FSR PLAN - THIRD FLOOR LOT GRADING PLAN

UNITS 1-5 GROUND FLOOR

UNITS 1-5 SECOND FLOOR UNITS 1-5 THIRD FLOOR

UNITS 1-5 ROOF PLAN UNITS 11-14 GROUND FLOOR

UNITS 11-14 ROOF PLAN

UNITS 1-5 ELEVATIONS

A3.1 OVERALL SECTIONS

UNIT 1-5 SECTIONS

REF 1

8600 / 8660 FRANCIS ROAD New Townhouse Development (DP-19-864104)



Aerial From Street

2 Aerial From Backyard

REVISED FOR DP REVISED FOR DP

DEC 0 4 2019

ERIC STINE

ARCHITECT INC

1 - 1864 W.1ST AVE. VANCOUVER, BC CANADA V6J 1G5 TEL: (604) 732-4545 FAX: (604) 736-9493

ERMIT NUMBER DP-2019-864101

SCALE Not To Scale

**NEW TOWNHOUSES** REZONING

8600 / 8660 Francis Road

**COVER PAGE** 

0.00

DRAWING NUMBER





A SH COLUMBIA

DEC 0 4 2019

Front Building - Streetfront





Front Building, Driveway Access

Front Building - Drive Aisle

4 ISSUED FOR DP
3 FOR REZONING
18-9-16

NO. ISSUE

ERICSTINE

ARCHITECTINE

ARCHITECTINE

L-1864 W.1ST AVE.
VANCOUVER, BC
CANADA V61 1GS
TEL: (604) 732-4545
FAX: (604) 732-455
FAX: (60

0.01

REF 2





DEC 0 4 2019

1 Rear Buildings - Ammenity Area Sideyard



ERIC STINE **NEW TOWNHOUSES** 8600 / 8660 Francis Road

REF3

Rear Building Entrances

4 Rear Buildings - Drive Aisle

0.02

3D VIEWS

#### LIST OF ARCHITECTURAL DRAWINGS:

0.00	COVER PAGE
0.01	3D VIEWS
0.02	3D VIEWS
A0.0	STATISTICS
A0.1	SITE PLAN - GROUND FLOOR
A0.1-#1	SITE PLAN #1 - SETBACK SITE PLAN
A0.1-#2	SITE PLAN #2 - PARKING PLAN
A0.2	SITE PLAN - SECOND FLOOR
A0.3	SITE PLAN - THIRD FLOOR
A0.4	FSR PLAN - GROUND FLOOR
A0.5	FSR PLAN - SECOND FLOOR
A0.6	FSR PLAN - THIRD FLOOR
A0.7	LOT GRADING PLAN
A1.1	UNITS 1-5 GROUND FLOOR
A1.2	UNITS 1-5 SECOND FLOOR
A1.3	UNITS 1-5 THIRD FLOOR
A1.4	UNITS 1-5 ROOF PLAN
A1.5	UNITS 11-14 GROUND FLOOR
A1.6	UNITS 11-14 SECOND FLOOR
A1.7	UNITS 11-14 ROOF PLAN
A1.8	UNIT TYPES
A1.9	CONVERTIBLE (ACCESSIBLE) UNITS
A2.1	UNITS 1-5 ELEVATIONS
A2.1	UNITS 1-5 ELEVATIONS UNITS 1-5 ELEVATIONS
A2.2	UNITS 6-10 ELEVATIONS
A2.4	UNITS 6-10 ELEVATIONS
A2.5	UNIT 11 ELEVATIONS
A2.6	UNITS 12-13 ELEVATIONS
A2.7	COLOURED ELEVATIONS
PAZ. I	OCCOUNTED ELEVATIONS
A3.1	OVERALL SECTIONS
A3.2	UNIT 1-5 SECTIONS
A3.3	UNIT 1-5 SECTIONS
A3.4	UNIT 11-14 SECTIONS
A3.5	UNIT 11-14 SECTIONS

WINDOW SCHEDULE

#### STATISTICS:

CIVIC ADDRESS: LEGAL DESCRIPTIONS

SITE AREA (After Road Dedication):

8600 // 8620 // 8640 // 8660 Francis Road Lot 24, Plan 25175, 42395 // Lot 81, Plan 25175 // Lot 79, Plan 24547. // Lot 25 Except: Firstly part subdivided by Plan24547, Secondly: Part subdivided by Plan 42395, Plan 12559 All of Section 28 Block 4, North Range 6 West, New Westminster District


Rezoning from Single Detached (RS1/E) to Low Density Townhouses (RTL4)

39,401.4 sq ft [3,660.51 sq m]


SITE COVERAGE :	PERMITTED	PROPOSED (Imperial Units)	PROPOSED (Metric Units)	NOTES
SITE COVERAGE	40.00 %	37.11 %	37.11 %	Based on RTL4
Main Floor and Garages	15.760.6 sq ft	14.621.3 sq ft	1,358.4 sa m	Dased Off KTE4
	13,700.0 50 11	14,021.3 5410	1,330.4 50 111	
IMPERMEABLE AREA	(65.00 %)	13,710.00 sq ft		Buildings
House, Garage and Exterior Stairs,		10,288.00 sq ft		Paving / Pathways
Pathways, Driveway		23,998.00 sq ft	2,229.5 sq m	TOTAL
	25.610.9 sa ft		(60.9%)	

<u>F.A.R. :</u>	PERMITTED	PROPOSED (Imperial Units)	PROPOSED (Metric Units)	NOTES
OVERALL AREA FAR	0.6 FAR	(0.60 FAR)	(0.60 FAR)	
OVERALL AREA FAR	23,640.9 sq ft	23,640.8 sq ft	2,196.3 sq m	
MAIN FLOOR		5,745.09 sq ft	533.74 sq m	
SECOND FLOOR		12,918.5 sq ft	1,200.2 sq m	
THIRD FLOOR		4,977.16 sq ft	462.39 sq m	
GARAGES		8,104.89 sq ft	752.97 sq m	
BALCONIES	13.7	1,366.29 sq ft	126.93 sq m	Excluded from FAR
GARBAGE / RECYCLE ROOM		245.20 sq ft	22.78 sq m	I




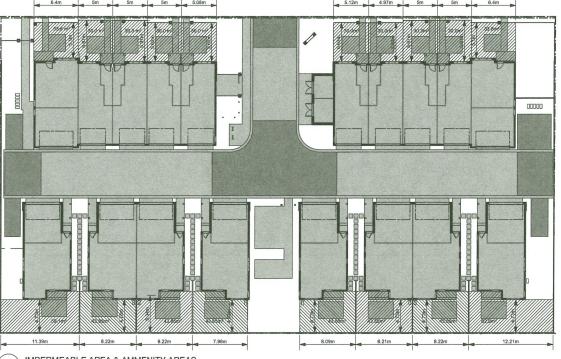

IMPERMEABLE AREA & AMMENITY AREAS

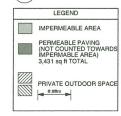

UNIT#	Balcony	Main	Main Floor		Third Floor	Total Interior	
UNII #	Баісопу	Garage	Living Space	Floor	Third Floor	Space	
1	63 sq ft	400 sq ft	484 sq ft	840 sq ft		1323 sq ft	
	(5.9 sq m)	(37.2 sq m)	(44.9 sq m)	(78.0 sq m)		(122.9 sq m)	
2	66 sq ft	548 sq ft	96 sq ft	638 sq ft	698 sq ft	1433 sq ft	
	(6.1 sq m)	(50.9 sq m)	(9.0 sq m)	(59.2 sq m)	(64.9 sq m)	(133.1 sq m)	
3	66 sq ft	548 sq ft	96 sq ft	641 sq ft	555 sq ft	1292 sq ft	
J	(6.1 sq m)	(50.9 sq m)	(9.0 sq m)	(59.5 sq m)	(51.6 sq m)	(120.1 sq m)	
4	67 sq ft	548 sq ft	96 sq ft	641 sq ft	691 sq ft	1428 sq ft	
4	(6.2 sq m)	(50.9 sq m)	(9.0 sq m)	(59.5 sq m)	(64.2 sq m)	(132.7 sq m)	
5	43 sq ft	563 sq ft	96 sq ft	653 sq ft	697 sq ft	1446 sq ft	
J	(4.0 sq m)	(52.3 sq m)	(9.0 sq m)	(60.6 sq m)	(64.7 sq m)	(134.3 sq m)	
6	67 sq ft	563 sq ft	96 sq ft	653 sq ft	697 sq ft	1446 sq ft	
O	(6.2 sq m)	(52.3 sq m)	(8.9 sq m)	(60.6 sq m)	(64.7 sq m)	(134.3 sq m)	
7	66 sq ft	548 sq ft	96 sq ft	641 sq ft	691 sq ft	1428 sq ft	
-	(6.1 sq m)	(50.9 sq m)	(9.0 sq m)	(59.5 sq m)	(64.2 sq m)	(132.7 sq m)	
8	66 sq ft	548 sq ft	97 sq ft	640 sq ft	555 sq ft	1292 sq ft	
0	(6.1 sq m)	(50.9 sq m)	(9.0 sq m)	(59.5 sq m)	(51.6 sq m)	(120.1 sq m)	
0	63 sq ft	548 sq ft	96 sq ft	638 sq ft	698 sq ft	1432 sq ft	
9	(5.9 sq m)	(50.9 sq m)	(9.0 sq m)	(59.2 sq m)	(64.9 sq m)	(133.1 sq m)	
40	43 sq ft	400 sq ft	484 sq ft	840 sq ft		1323 sq ft	
10	(4.0 sq m)	(37.2 sq m)	(44.9 sq m)	(78.0 sq m)		(122.9 sq m)	
44	95 sq ft	362 sq ft	597 sq ft	831 sq ft		1429 sa ft	
11	(8.8 sq m)	(33.6 sq m)	(55.5 sq m)	(77.2 sq m)		(132.7 sq m)	
40	95 sq ft	361 sq ft	597 sq ft	830 sq ft		1427 sq ft	
12	(8.8 sq m)	(33.5 sq m)	(55.5 sq m)	(77.1 sq m)		(132.6 sq m)	
42	95 sq ft	361 sq ft	597 sq ft	830 sq ft		1427 sq ft	
13	(8.8 sq m)	(33.5 sq m)	(55.5 sq m)	(77.1 sq m)		(132.6 sq m)	
4.4	93 sq ft	362 sq ft	597 sq ft	831 sq ft		1429 sq ft	
14	(8.7 sq m)	(33.6 sq m)	(55.5 sq m)	(77.2 sq m)		(132.7 sq m)	
AE	95 sq ft	362 sq ft	597 sq ft	831 sq ft		1429 sq ft	
15	(8.8 sq m)	(33.6 sq m)	(55.5 sq m)	(77.2 sq m)		(132.7 sq m)	
AC	95 sq ft	361 sq ft	597 sq ft	830 sq ft		1427 sq ft	
16	(8.8 sg m)	(33.5 sq m)	(55.5 sq m)	(77.1 sq m)		(132.6 sq m)	
47	95 sq ft	361 sq ft	597 sq ft	830 sq ft		1427 sq ft	
17	(8.8 sq m)	(33.5 sq m)	(55.5 sq m)	(77.1 sq m)		(132.6 sq m)	
40	95 sq ft	362 sq ft	597 sq ft	831 sq ft		1429 sq ft	
18	(8.8 sq m)	(33.6 sq m)	(55.5 sq m)	(77.2 sg m)		(132.7 sq m)	
TOTAL	1,366 sq ft	8,105 sq ft	6,516 sq ft	13,468 sq ft	5,283 sqft	25,268 sq fi	
	(127 sq m)	(753 sq m)	(605 sq m)	(1251 sq m)	(491 sq m)	(2347 sq m)	

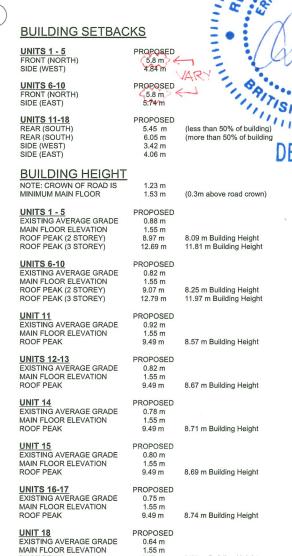


9.49 m


8.85 m Building Height

ROOF PEAK

REVISED FOR REZO ISSUED FOR DP FOR REZONING ERIC STINE ARCHITECT INC **NEW TOWNHOUSES** REZONING 8600 / 8660 Francis Road STATISTICS A0.0




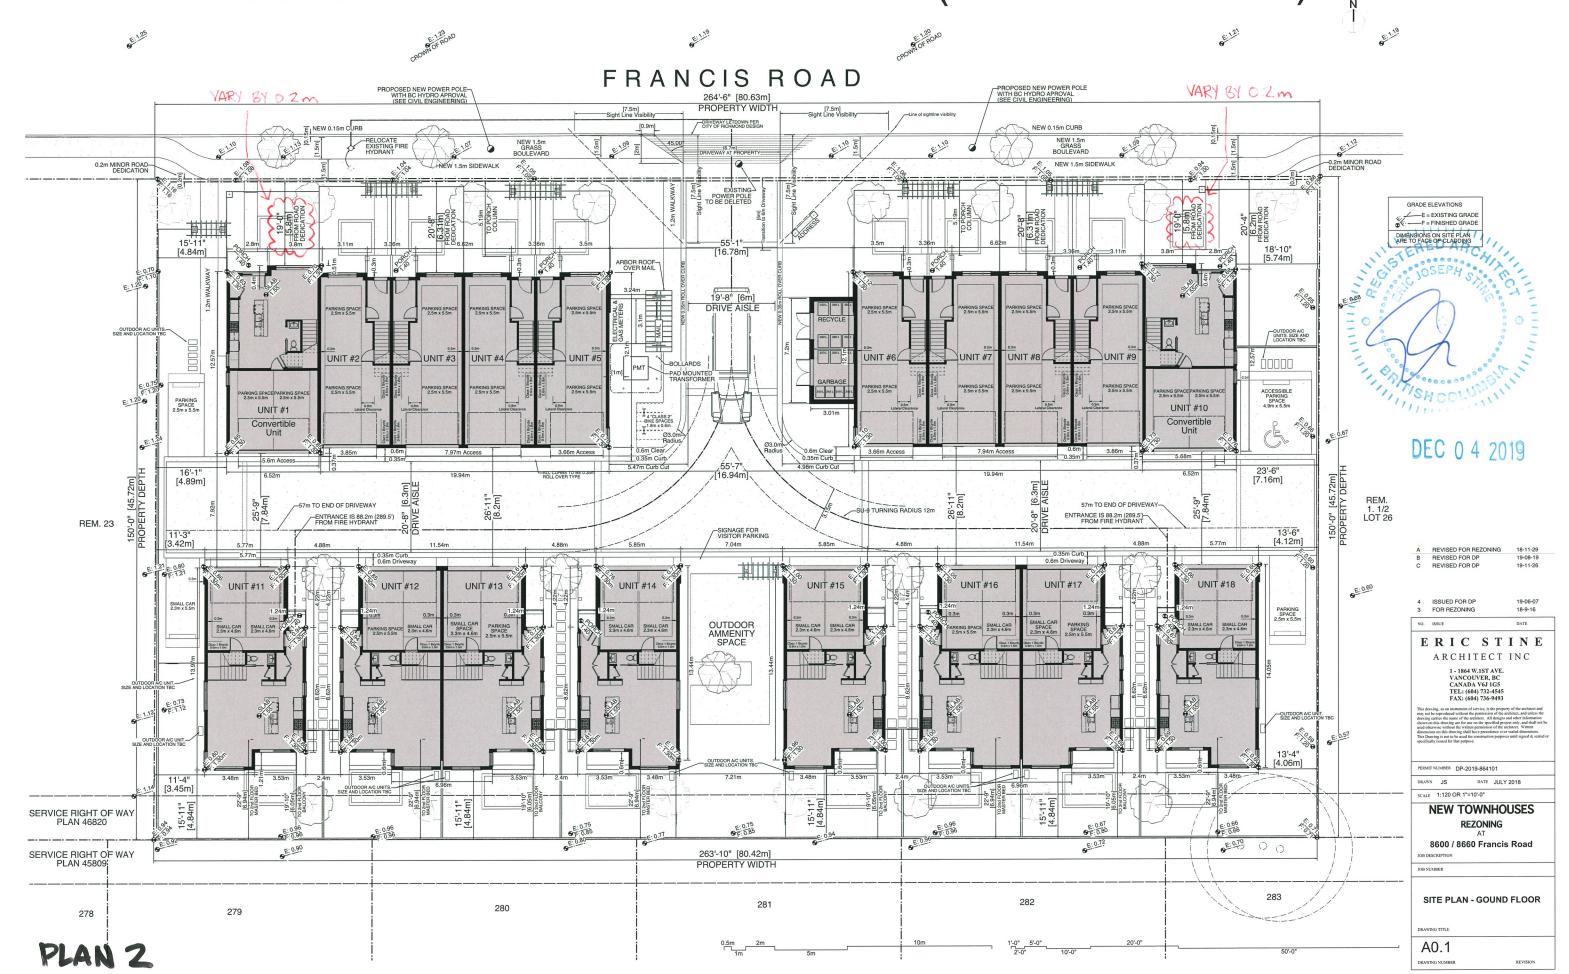

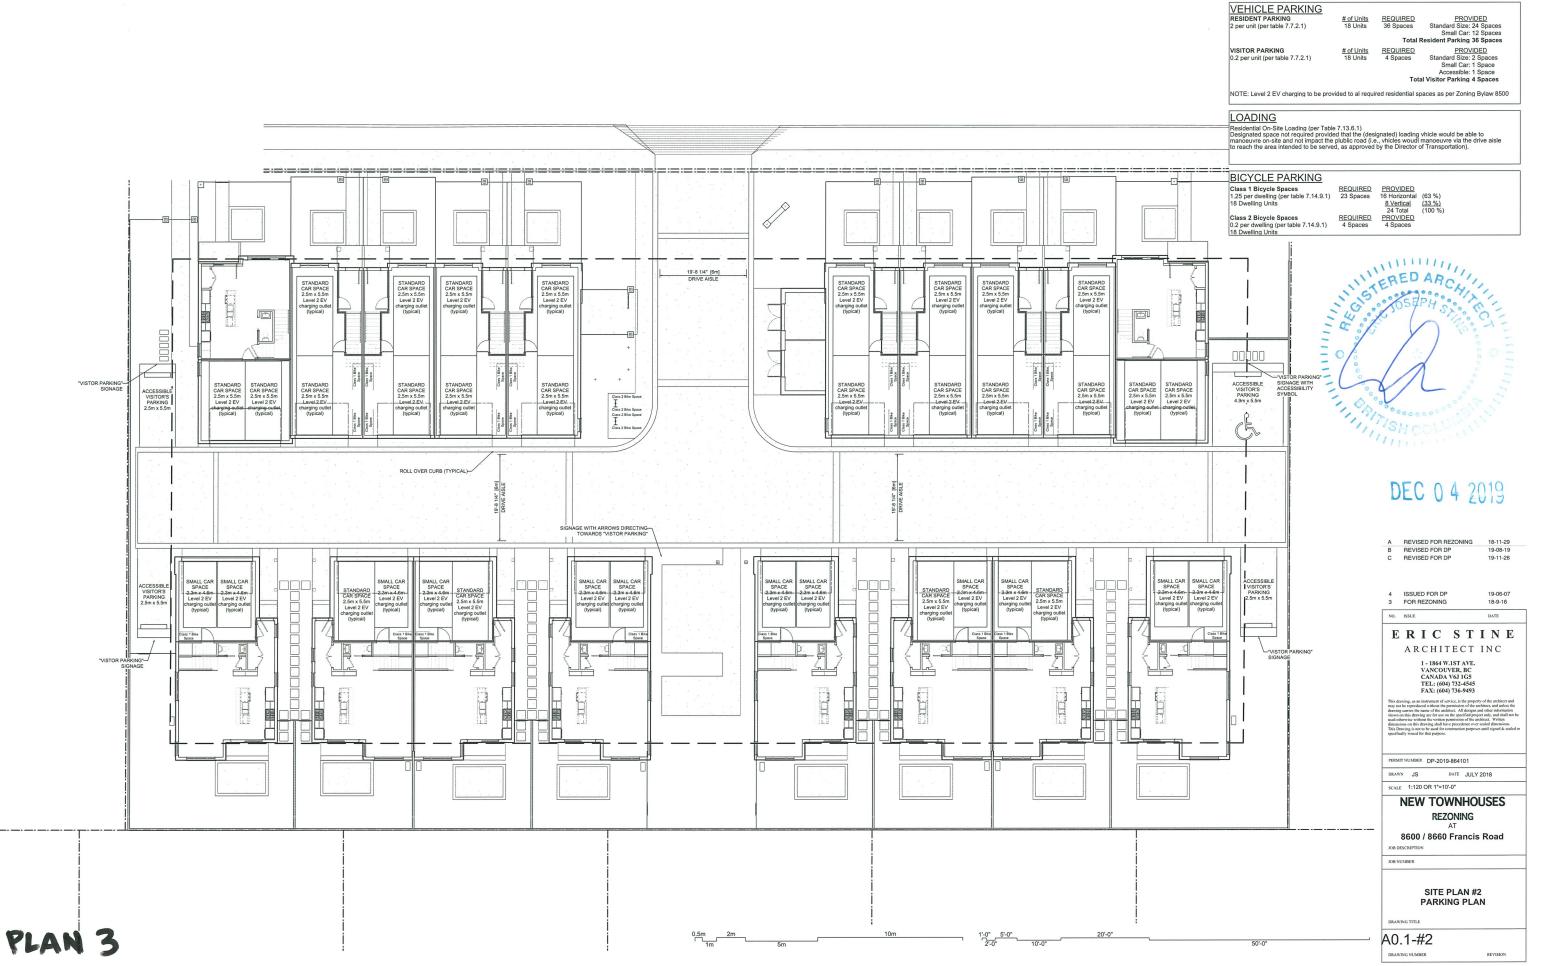


# 8600 / 8660 FRANCIS ROAD



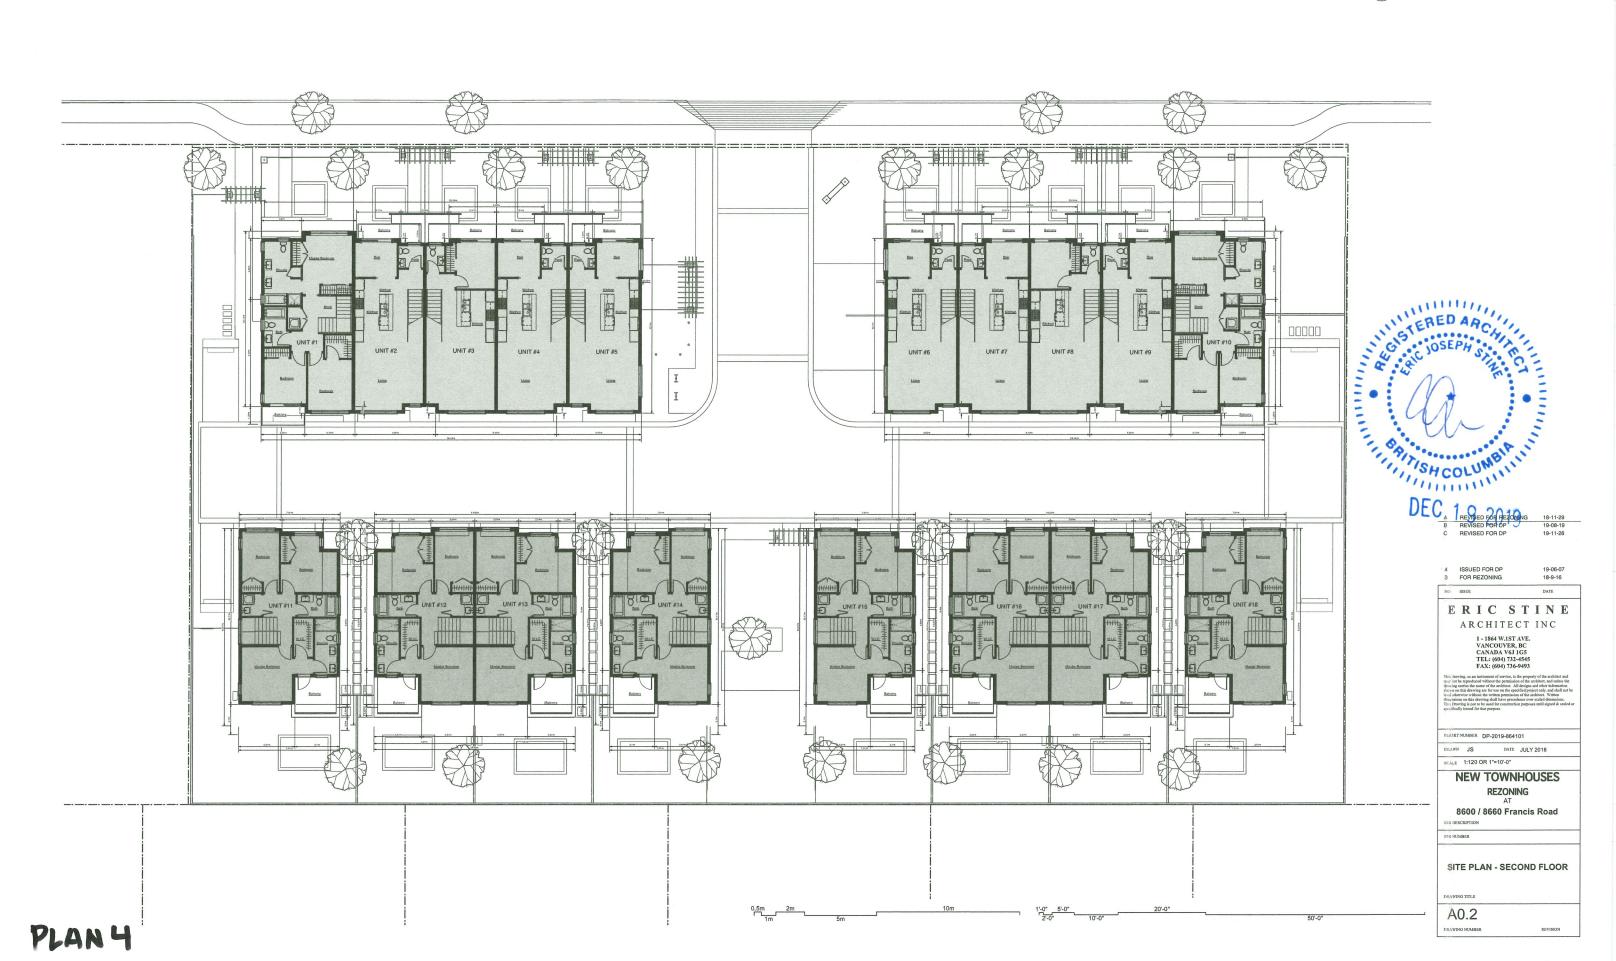


# 8600 / 8660 FRANCIS ROAD




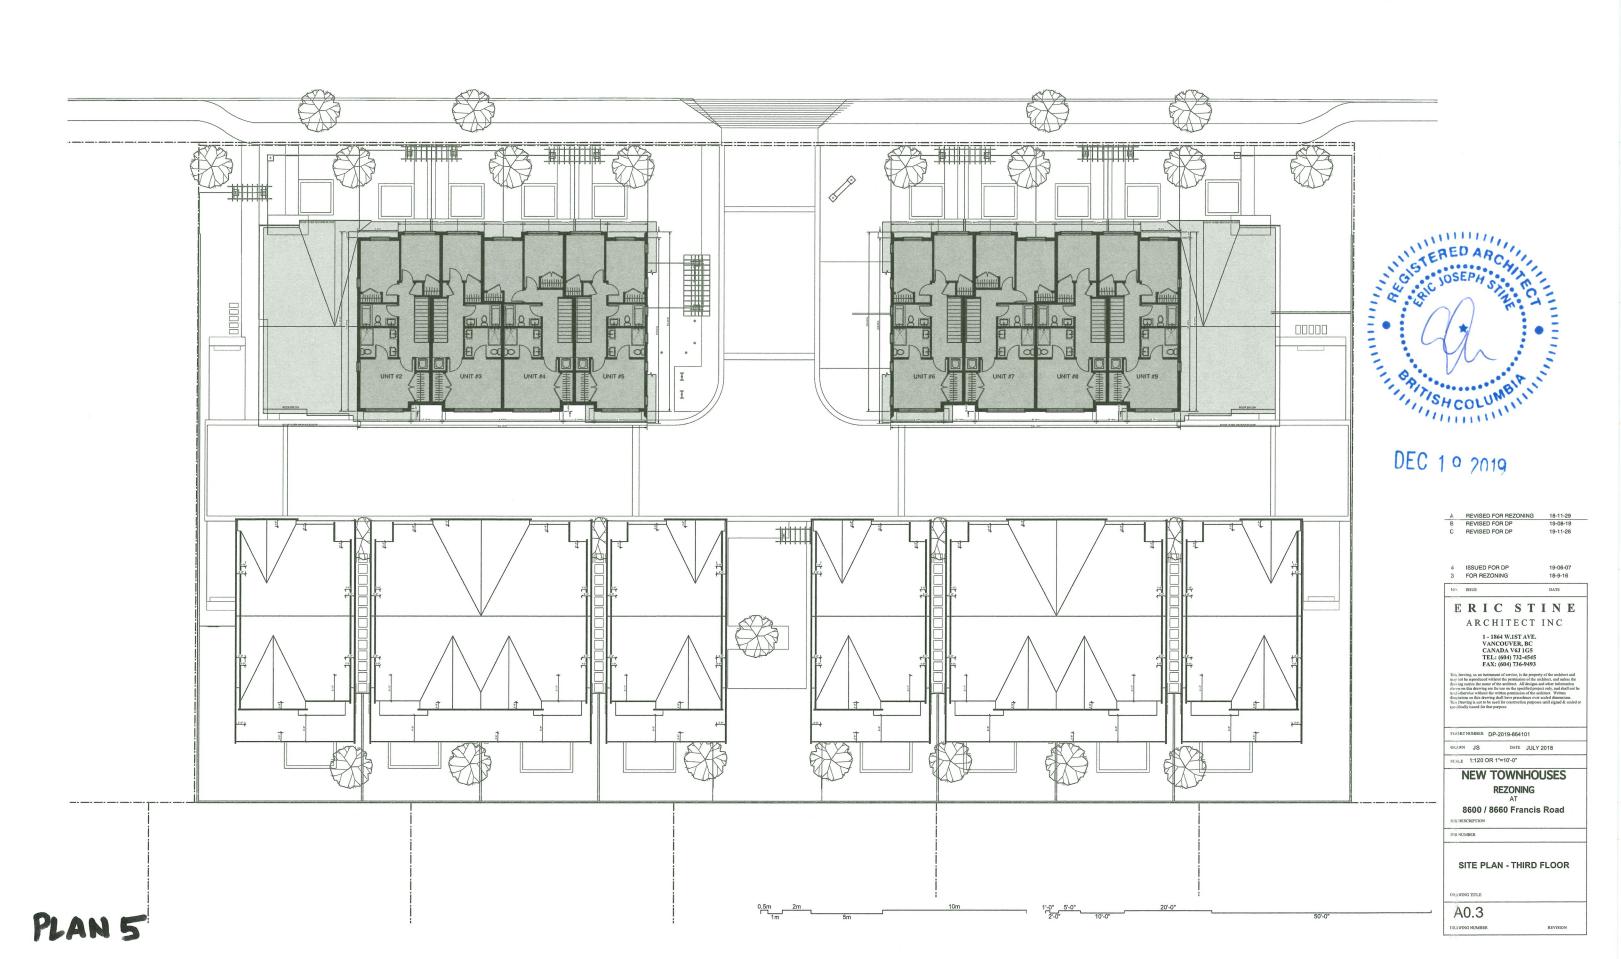



# FRANCIS ROAD


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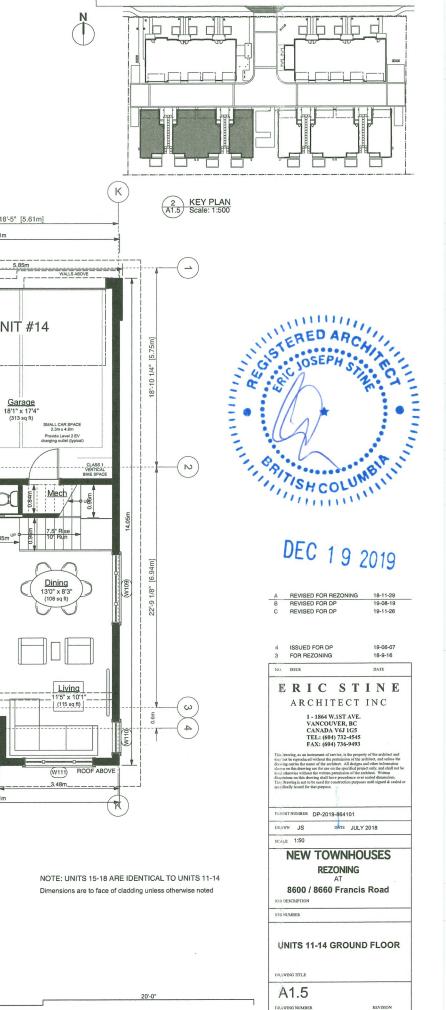


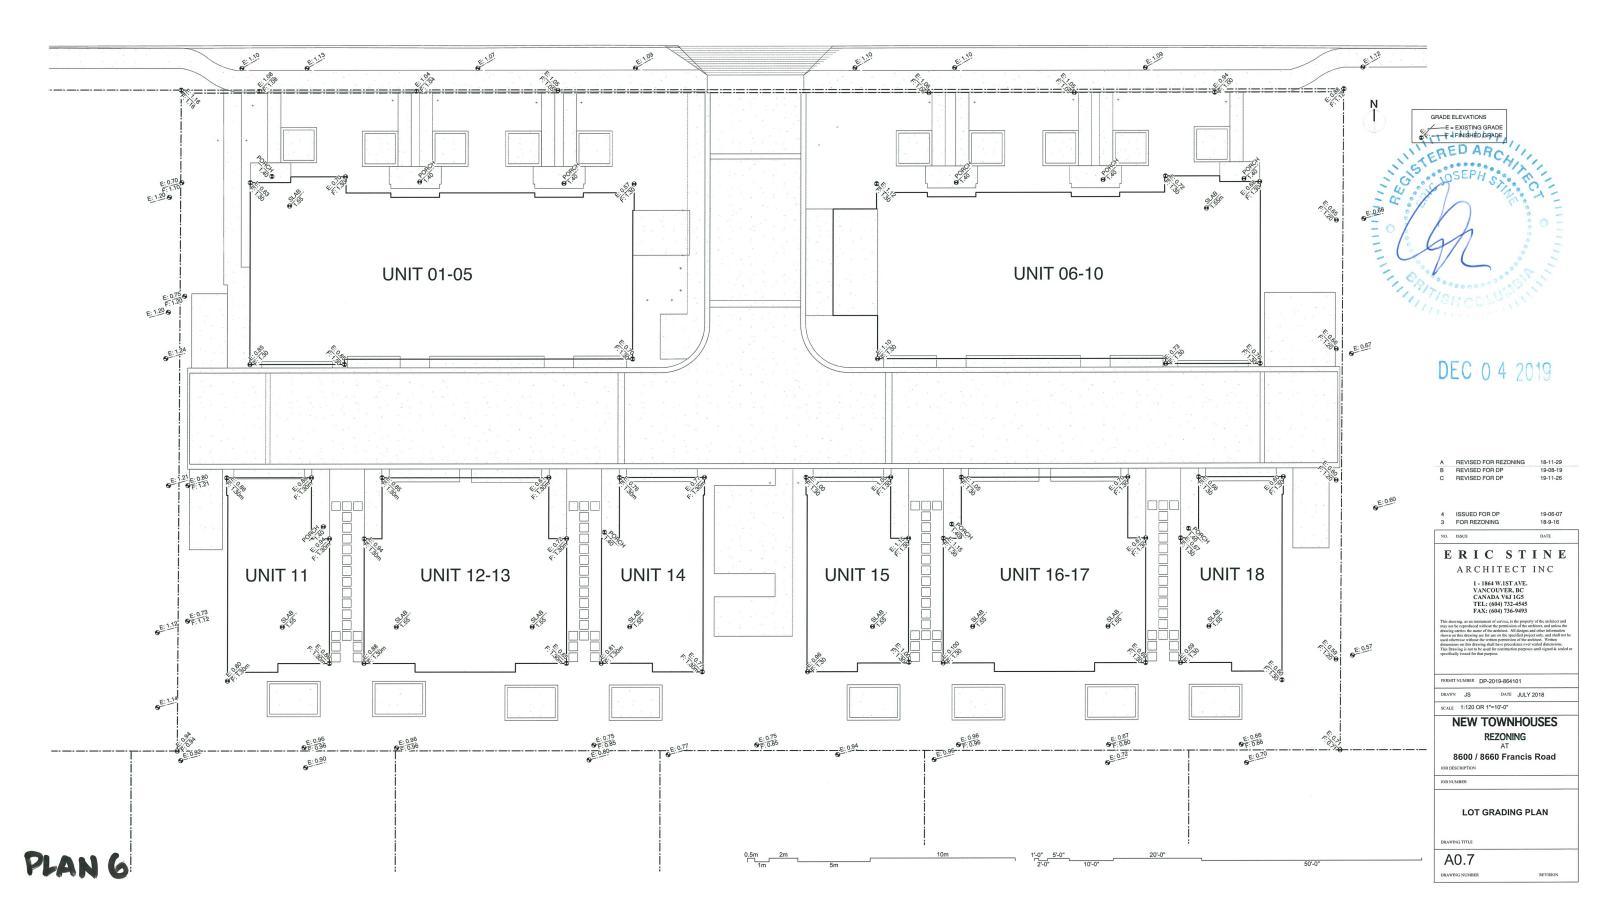


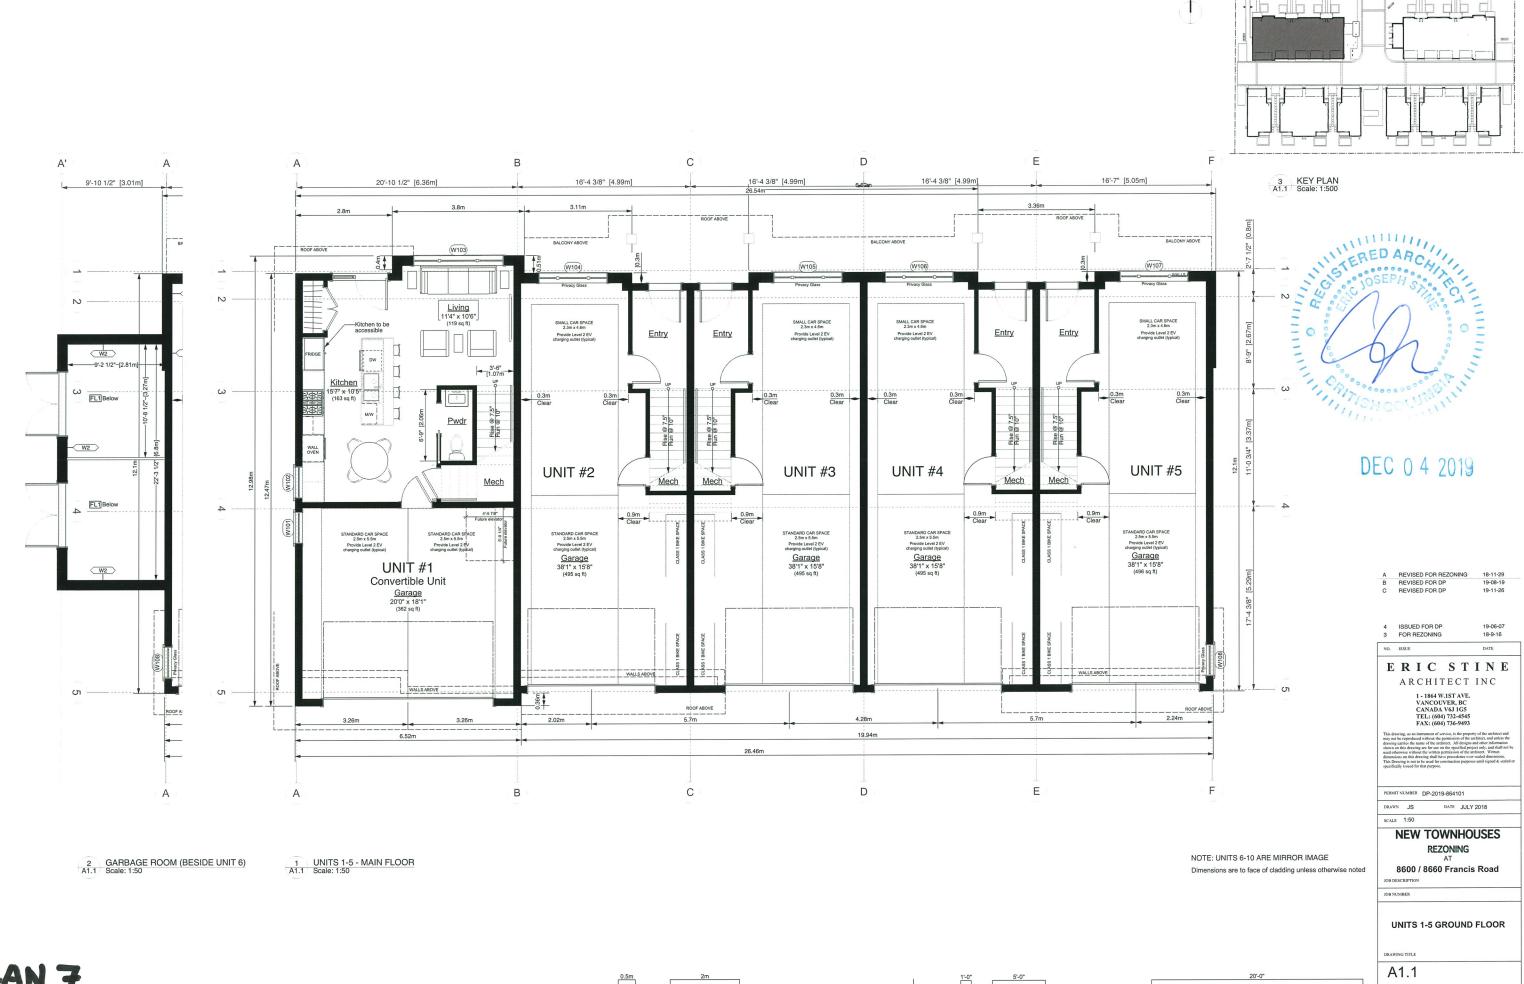

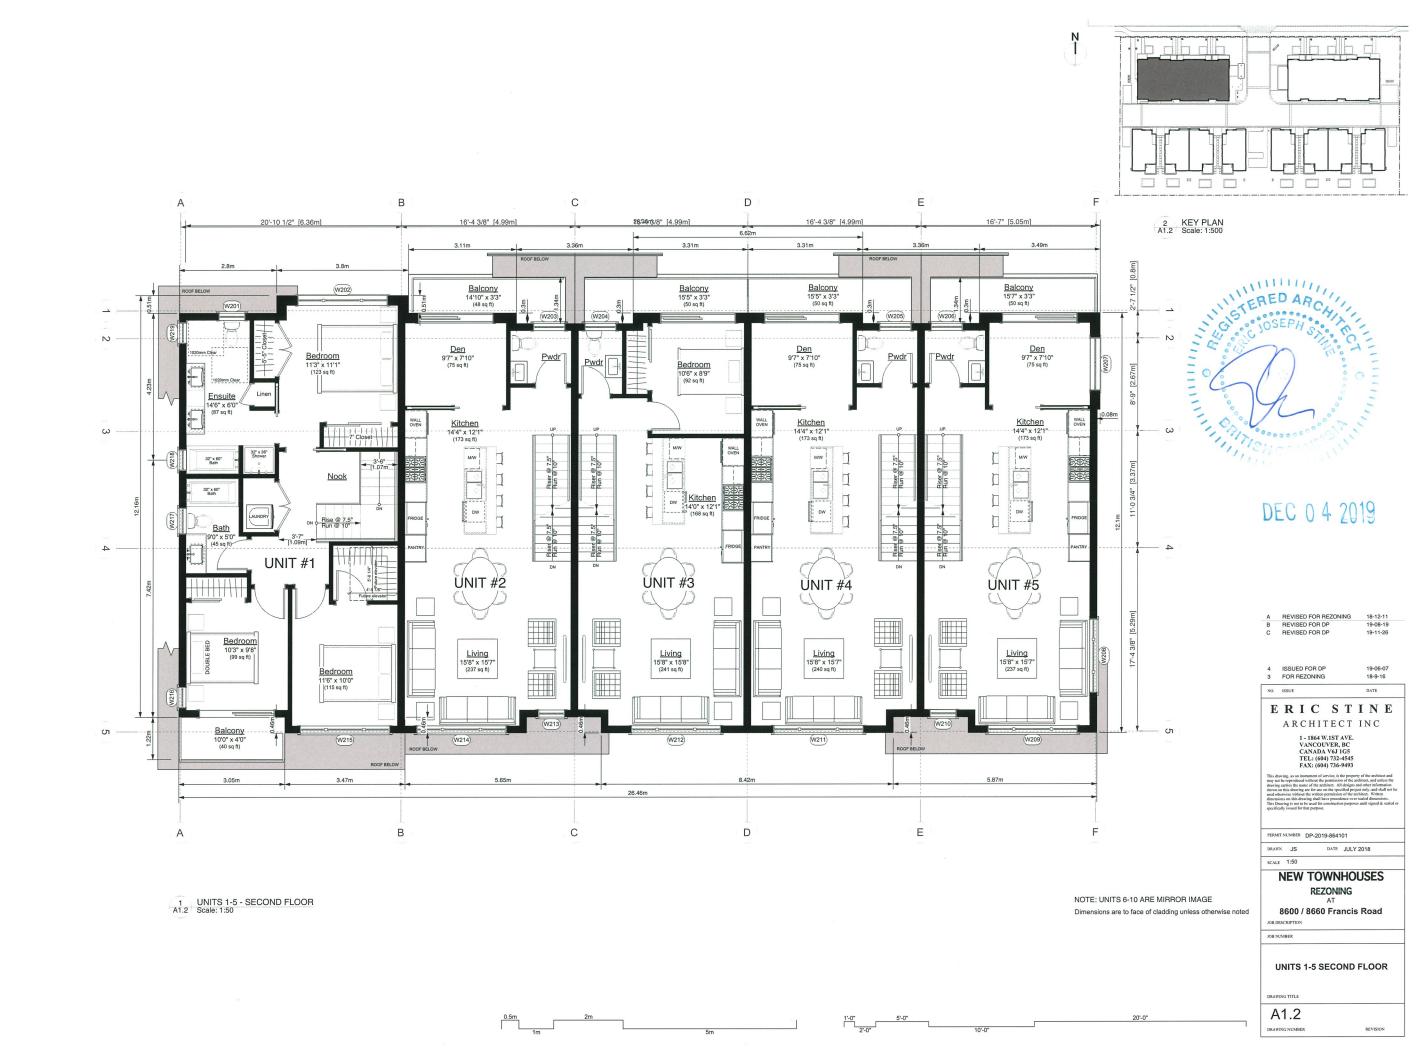


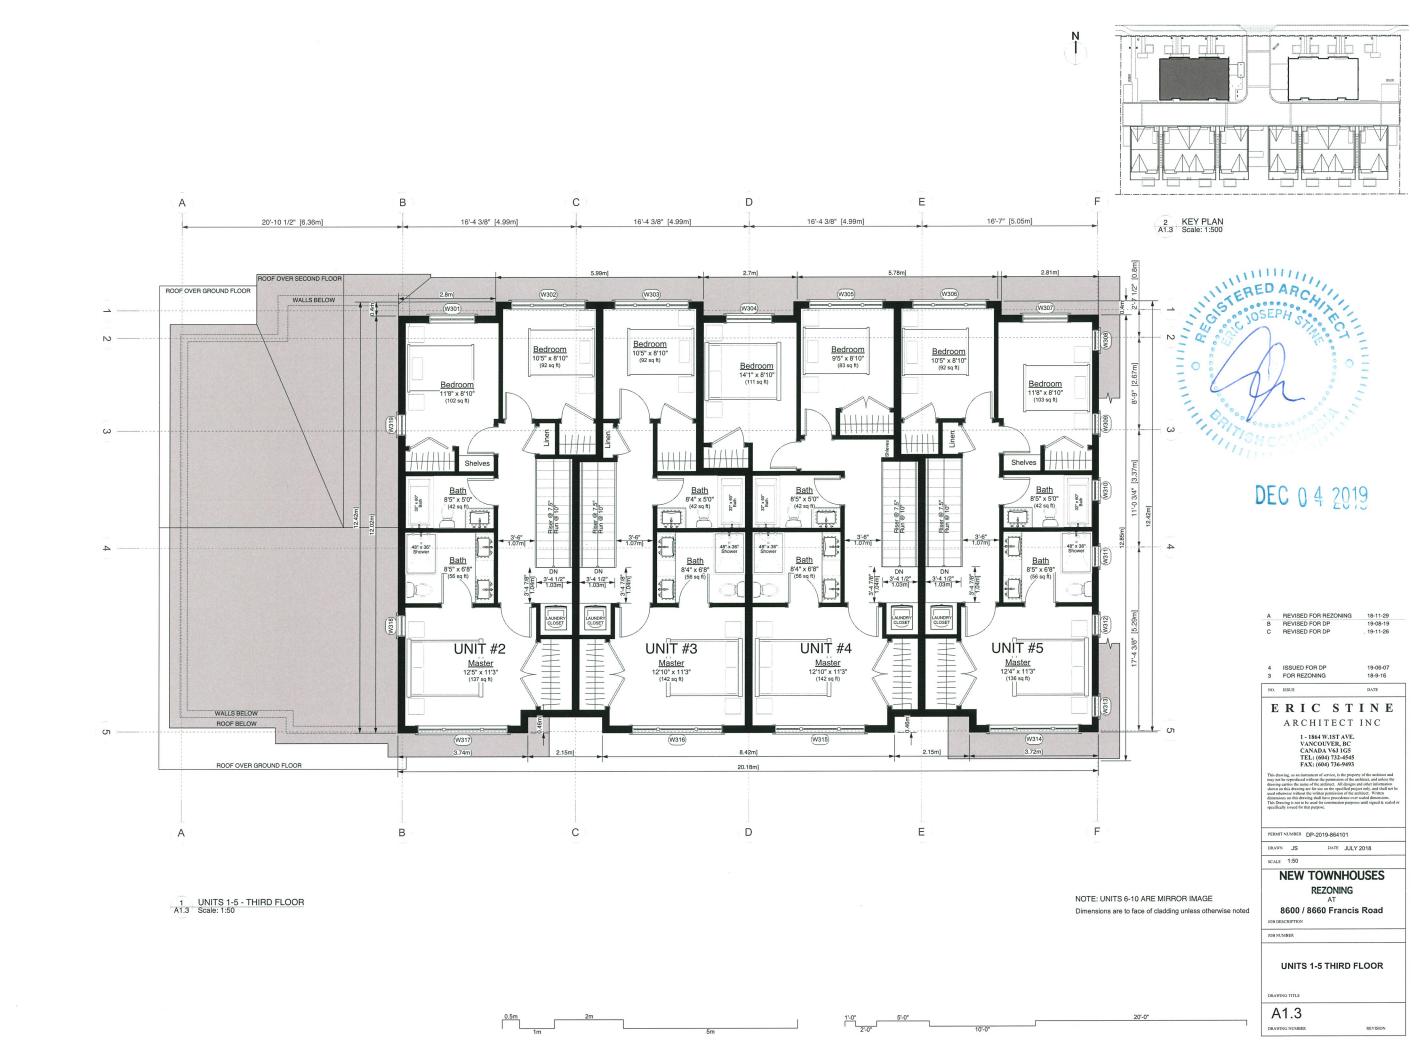


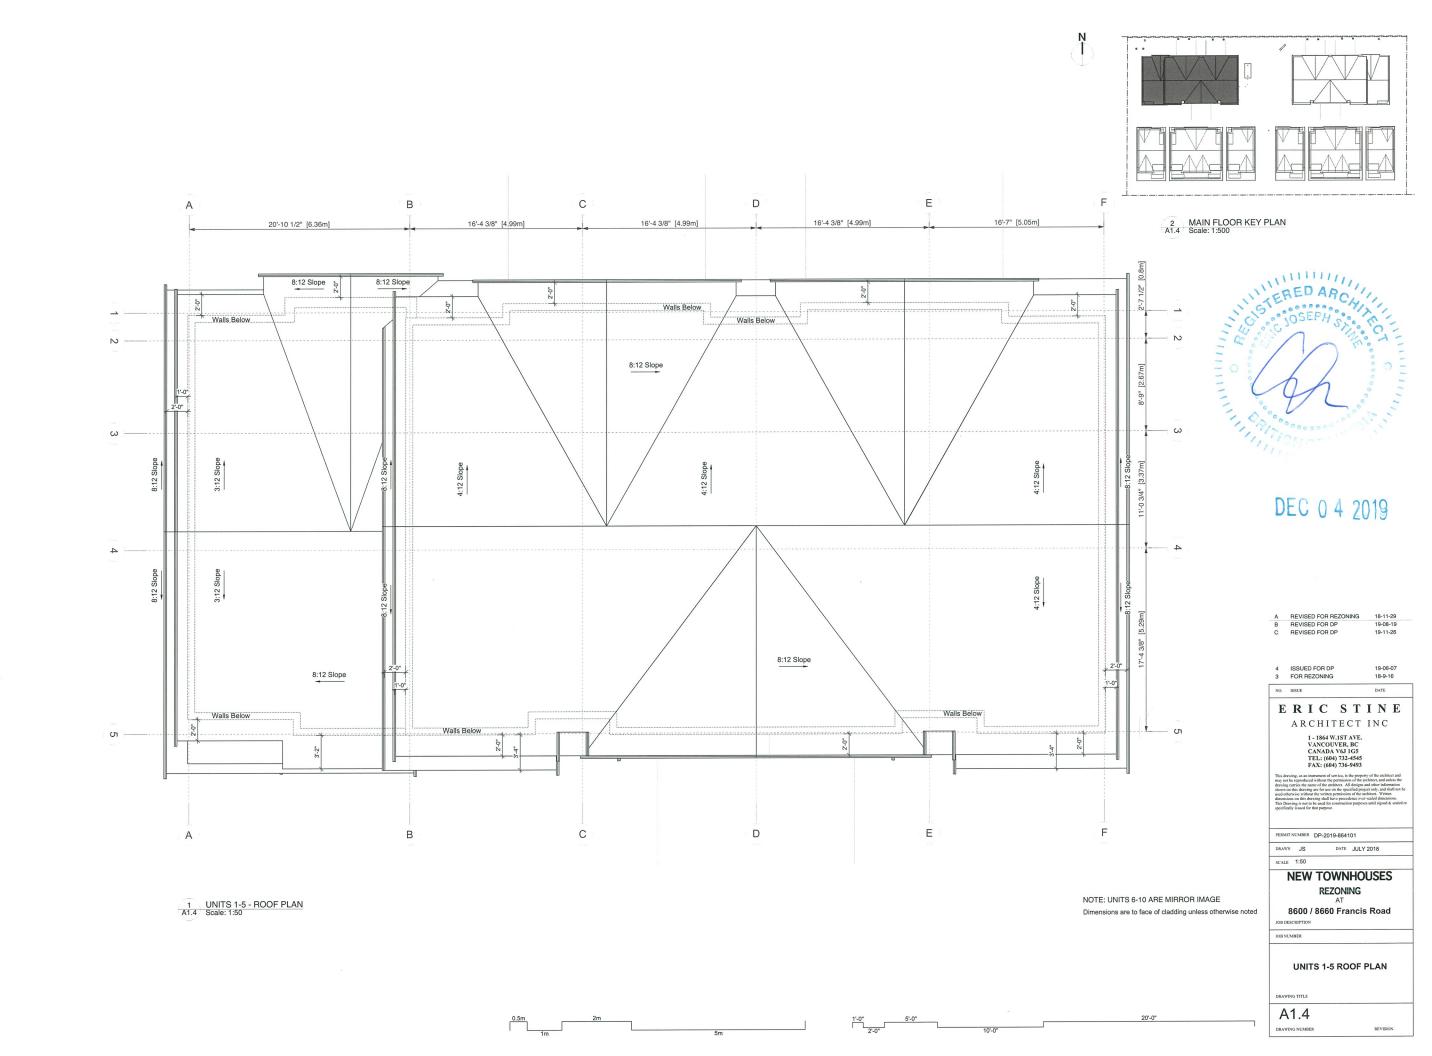

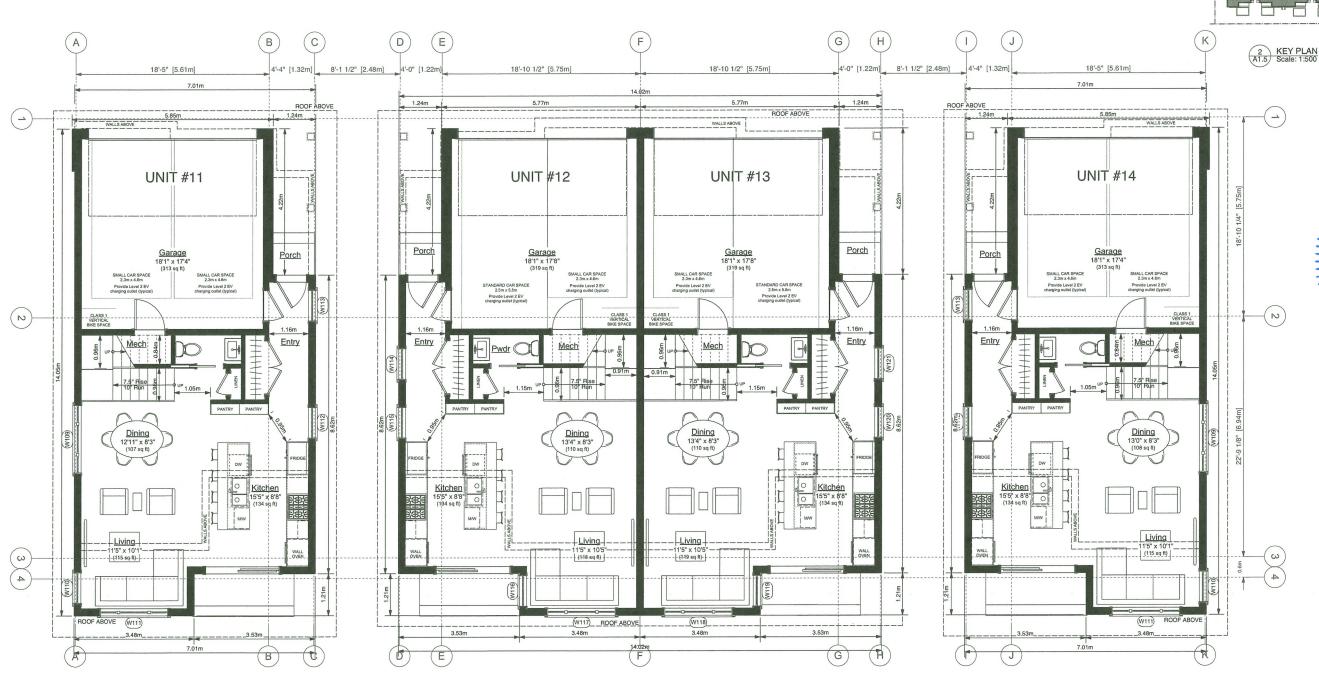


1 UNITS 11-14 / 15-18 - GROUND FLOOR A1.5) Scale: 1:50

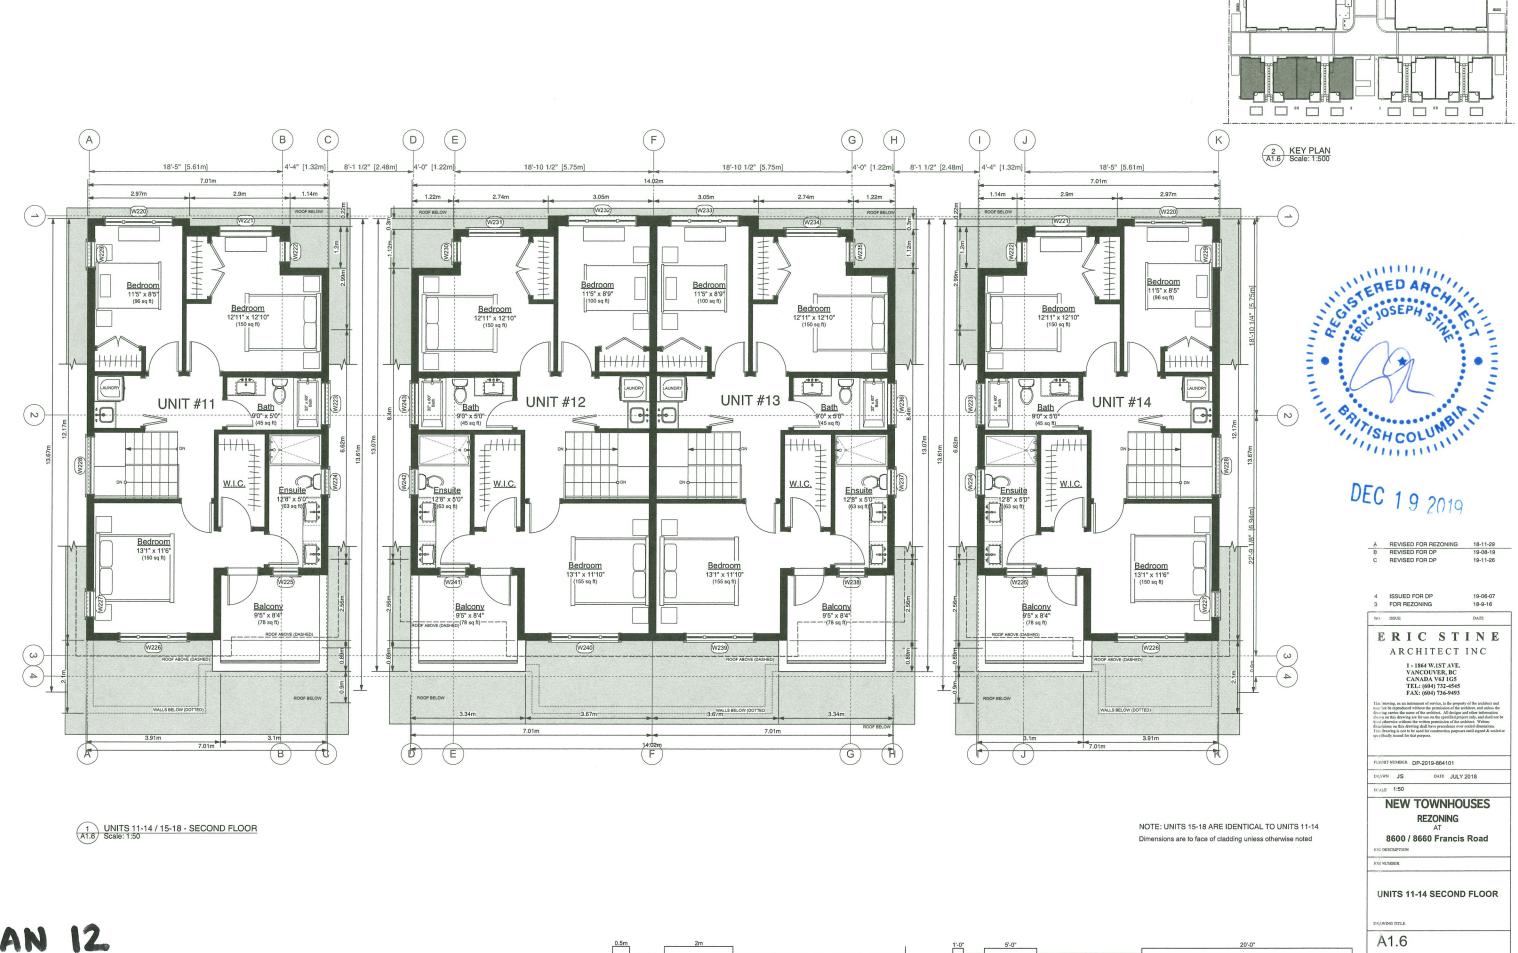

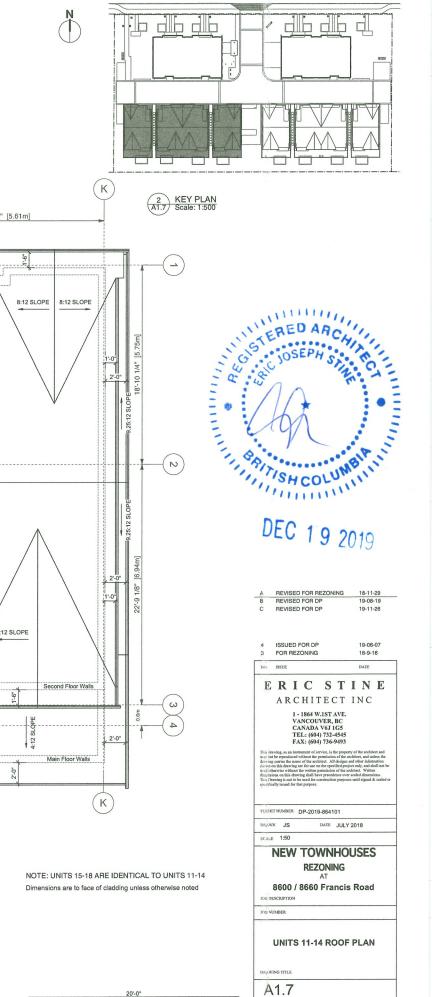

REVISION

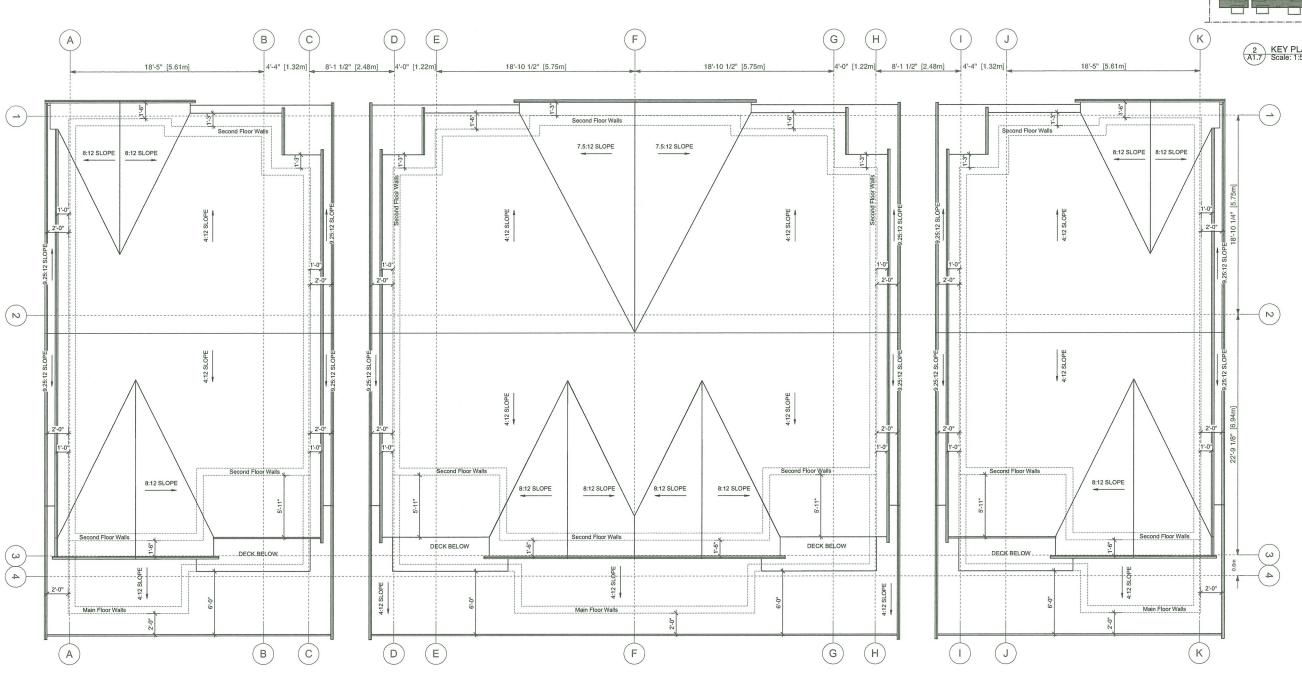

PLAN 13

1 UNITS 11-14 / 15-18 - ROOF PLAN Scale: 1:50


### **DWELLING UNIT AREAS**

UNIT#	Balcony	Main Floor		Second	Third Floor	Total Interior
		Garage	Living Space	Floor	Third Floor	Space
1	63 sq ft	400 sq ft	484 sq ft	840 sq ft		1323 sq ft
	(5.9 sq m)	(37.2 sq m)	(44.9 sq m)	(78.0 sq m)		(122.9 sq m)
2	66 sq ft	548 sq ft	96 sq ft	638 sq ft	698 sq ft	1433 sq ft
_	(6.1 sq m)	(50.9 sq m)	(9.0 sq m)	(59.2 sq m)	(64.9 sq m)	(133.1 sq m)
3	66 sq ft	548 sq ft	96 sq ft	641 sq ft	555 sq ft	1292 sq ft
	(6.1 sq m)	(50.9 sq m)	(9.0 sq m)	(59.5 sq m)	(51.6 sq m)	(120.1 sq m)
4	67 sq ft	548 sq ft	96 sq ft	641 sq ft	691 sq ft	1428 sq ft
	(6.2 sq m)	(50.9 sq m)	(9.0 sq m)	(59.5 sq m)	(64.2 sq m)	(132.7 sq m)
5	43 sq ft	563 sq ft	96 sq ft	653 sq ft	697 sq ft	1446 sq ft
	(4.0 sq m)	(52.3 sq m)	(9.0 sq m)	(60.6 sq m)	(64.7 sq m)	(134.3 sq m)
6	67 sq ft	563 sq ft	96 sq ft	653 sq ft	697 sq ft	1446 sq ft
	(6.2 sq m)	(52.3 sq m)	(8.9 sq m)	(60.6 sq m)	(64.7 sq m)	(134.3 sq m)
7	66 sq ft	548 sq ft	96 sq ft	641 sq ft	691 sq ft	1428 sq ft
	(6.1 sq m)	(50.9 sq m)	(9.0 sq m)	(59.5 sq m)	(64.2 sq m)	(132.7 sq m)
8	66 sq ft	548 sa ft	97 sq ft	640 sq ft	555 sq ft	1292 sq ft
	(6.1 sq m)	(50.9 sq m)	(9.0 sq m)	(59.5 sa m)	(51.6 sq m)	(120.1 sq m)
^	63 sq ft	548 sq ft	96 sa ft	638 sq ft	698 sq ft	1432 sq ft
9	(5.9 sq m)	(50.9 sq m)	(9.0 sq m)	(59.2 sq m)	(64.9 sq m)	(133.1 sq m)
10	43 sq ft	400 sq ft	484 sq ft	840 sq ft		1323 sq ft
	(4.0 sq m)	(37.2 sq m)	(44.9 sq m)	(78.0 sq m)		(122.9 sq m)
11	95 sq ft	362 sq ft	597 sq ft	832 sq ft		1429 sq ft
	(8.8 sq m)	(33.6 sq m)	(55.5 sq m)	(77.3 sq m)		(132.8 sq m)
12	95 sq ft	361 sq ft	597 sq ft	830 sq ft		1428 sq ft
	(8.8 sq m)	(33.5 sq m)	(55.5 sq m)	(77.1 sq m)		(132.6 sq m)
40	95 sq ft	361 sq ft	597 sq ft	830 sa ft		1428 sq ft
13	(8.8 sq m)	(33.5 sq m)	(55.5 sq m)	(77.1 sq m)		(132.6 sg m)
14	93 sq ft	362 sq ft	597 sq ft	832 sq ft		1429 sq ft
	(8.7 sq m)	(33.6 sq m)	(55.5 sq m)	(77.3 sq m)		(132.8 sq m)
4.5	95 sq ft	362 sq ft	597 sq ft	832 sq ft		1429 sq ft
15	(8.8 sq m)	(33.6 sq m)	(55.5 sq m)	(77.3 sq m)		(132.8 sq m)
40	95 sq ft	361 sq ft	597 sq ft	830 sa ft		1428 sq ft
16	(8.8 sq m)	(33.5 sq m)	(55.5 sq m)	(77.1 sq m)		(132.6 sq m
17	95 sq ft	361 sq ft	597 sq ft	830 sq ft		1428 sq ft
	(8.8 sq m)	(33.5 sq m)	(55.5 sq m)	(77.1 sq m)		(132.6 sq m)
18	95 sq ft	362 sq ft	597 sq ft	832 sq ft		1429 sq ft
	(8.8 sq m)	(33.6 sq m)	(55.5 sq m)	(77.3 sq m)		(132.8 sq m)
TOTAL	1,366 sq ft	8,105 sq ft	6,516 sq ft	13,471 sq ft	5,283 sq ft	25,271 sq ft
IOIAL	(127 sg m)	(753 sq m)	(605 sq m)	(1252 sa m)	(491 sa m)	(2.348 sa m)

# UNIT TYPE A (CONVERTABLE UNIT)





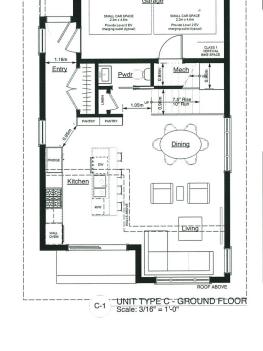

UNIT #14


UNIT TYPE C




# UNIT TYPE B

(4 DIFFERENT TYPES OF THE THIRD FLOOR OF UNIT B GROUND AND SECOND FLOORS REMAIN THE SAME IN ALL)

A-2 UNIT TYPE A - SECOND FLOOR Scale: 3/16" = 1'-0"

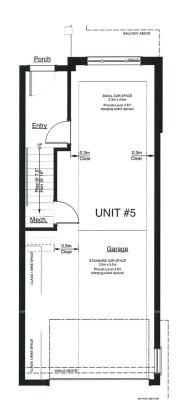

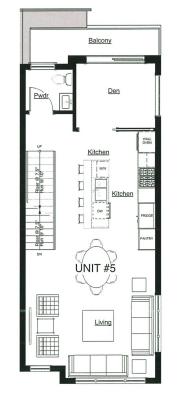










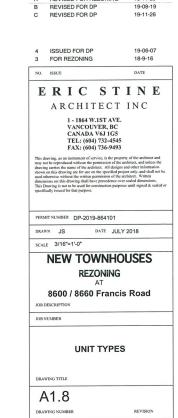

REVISED FOR REZONING

B-1 UNIT TYPE B1 - GROUND FLOOR Scale: 3/16" = 1'-0" B-2 UNIT TYPE B1 - SECOND FLOOR Scale: 3/16" = 1'-0" B-3(a) UNIT TYPE B(a) - THIRD FLOOR Scale: 3/16" = 1'-0"

B-3(b) UNIT TYPE B(b) - THIRD FLOOR
B-3(c) UNIT TYPE B(c) - THIRD FLOOR
B-3(d) UNIT TYPE B(d) - THIRD FLOOR

Scale: 3/16" = 1'-0"


B-3(d) UNIT TYPE B(d) - THIRD FLOOR

Scale: 3/16" = 1'-0"


10'-0"

20'-0"

## UNIT TYPE A (CONVERTABLE UNIT)

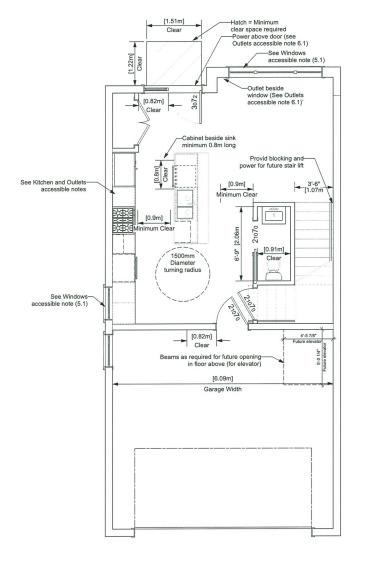

UNIT 1 - GROUND FLOOR Scale: 1/4" = 1'-0"

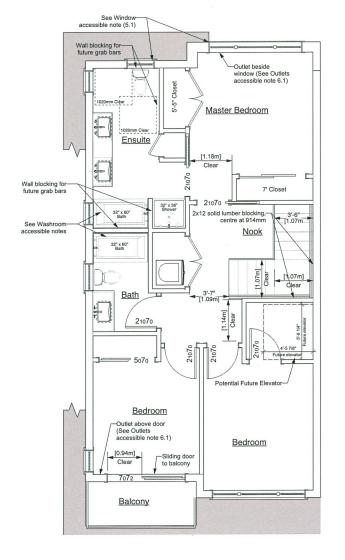

UNIT 1 - SECOND FLOOR Scale: 1/4" = 1'-0"

# ACCESSIBLE (CONVERTIBLE) UNITS 1 & 10

1.1 All interior thresholds within the unit to comply to BCBC 2018 where the threshold is not flush with the floor, the threshold shall be not more than 13mm, and where it is higher than 6mm shall be beveled to a slope no steeper than 1 in 2

1.2 All door handles to be lever type 1.3 All interior doors minimum 2'-10" leaf

2.2 Floor joists structured to allow for future elevator from garage to second floor

3.1 Master Ensuite

 Install 2x12 blocking for future grab bars at toilet and shower Cabinets below sink to be easily removable · Pressure and temperature control valves on shower faucet

lever type handles for all plumbing fixtures

4.2 Cabinets below sink to be easily removable4.3 Lever-type handles on all plumbing fixtures

(in master ensuite, kitchen and living room)

Outlets
6.1 electrical outlets to be provided beside windows, bottom of stairs, beside tollet, above external doors (outside and inside), on front face of kitchen counter, and within proximity of control centre for smart home options.

### ALL UNITS ACCESSIBLE NOTES

Doors & Doorways
7.1 All door handles to be lever type

#### Plumbing & Washrooms

8.1 All plumbing fixtures to be lever type
8.2 • Install 2x12 blocking for future grab bars at ensuite toilet and shower

DEC 0 4 2019

REVISED FOR REZONING REVISED FOR DP REVISED FOR DP

ISSUED FOR DP FOR REZONING

## ERIC STINE

ARCHITECT INC

PERMIT NUMBER DP-2019-864101

DRAWN JS DATE JULY 2018 SCALE 3/16"=1'-0"

**NEW TOWNHOUSES** 

## REZONING

8600 / 8660 Francis Road

OB DESCRIPTION

CONVERTIBLE UNITS


DRAWING TITLE A1.9


PLAN 15

NOTE: UNITS 10 IS A MIRROR IMAGE OF UNIT 1

Dimensions are to face of drywall inside



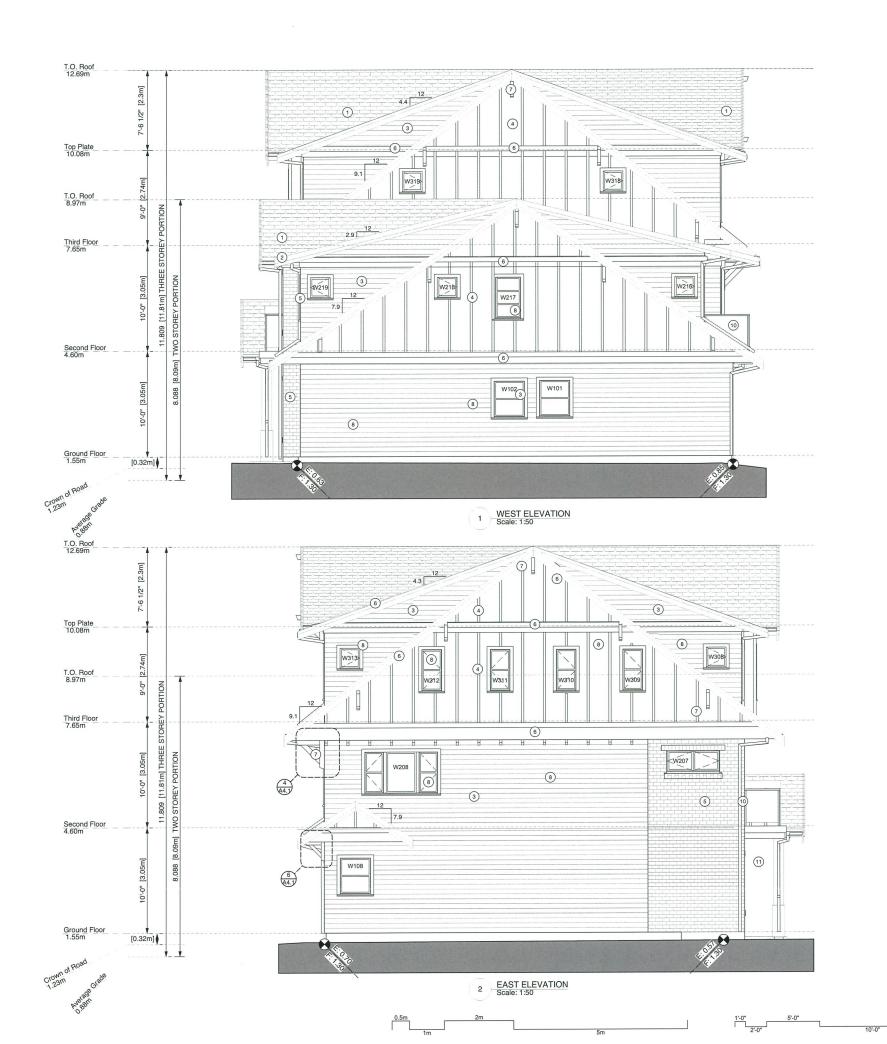

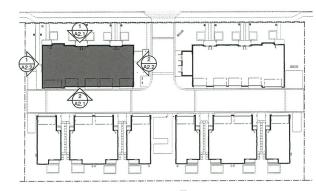

3 MAIN FLOOR KEY PLAN A2.2 Scale: 1:500

### **EXTERIOR FINISHES**

ASPHALT ROOFING SHINGLES ALUMINUM GUTTER PLANK CLADDING

BOARD & BATTEN CLADDING BRICK CLADDING

PAINTED TRIM & FASCIA BOARDS
PAINTED WOOD BRACKETS

7 PAINTED WOOD BRACKETS
8 VINNY UNIDOWS
TRUE DIVIDE LITES AND BALANCED SASHES
9 EXTERIOR DOORS
10 METAL AND GLASS RAILINGS
11 WOOD COLUMNS

10 METAL AND GLASS RAIL
WOOD COLUMNS
12 GARAGE DOORS
13 RAIN WATER LEADER

OSEPH
STORY
OSE

REVISED FOR REZONING REVISED FOR DP

NO. ISSUE

ERIC STINE ARCHITECT INC

18-11-29 19-08-19

DATE

1 - 1864 W.1ST AVE. VANCOUVER, BC CANADA V6J 1G5 TEL: (604) 732-4545 FAX: (604) 736-9493

PERMIT NUMBER DP-2019-864101

### **NEW TOWNHOUSES** REZONING

8600 / 8660 Francis Road

**UNITS 1-5 - ELEVATIONS** 


DRAWING TITLE

NOTE: UNITS 6-10 ARE MIRROR IMAGE

A2.2 DRAWING NUMBER





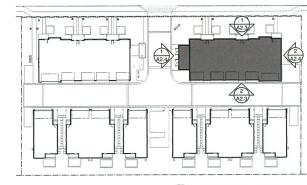

3 A2.4 MAIN FLOOR KEY PLAN Scale: 1:500

### **EXTERIOR FINISHES**

- ASPHALT ROOFING SHINGLES
  ALUMINUM GUTTER
  PLANK CLADDING
  BOARD & BATTEN CLADDING
- BRICK CLADDING
  PAINTED TRIM & FASCIA BOARDS
  PAINTED WOOD BRACKETS
- 8 VINYL WINDOWS
- TRUE DIVIDE LITES AND BALANCED SASHES
  9 EXTERIOR DOORS
  10 METAL AND GLASS RAILINGS



DEC 0 4 2019

REVISED FOR REZONING REVISED FOR DP REVISED FOR DP

4 ISSUED FOR DP 3 FOR REZONING

NO. ISSUE

19-06-07 18-9-16 DATE

ERIC STINE

#### ARCHITECT INC

1 - 1864 W.1ST AVE. VANCOUVER, BC CANADA V6J 1G5 TEL: (604) 732-4545 FAX: (604) 736-9493

PERMIT NUMBER DP-2019-864101

DRAWN JS

SCALE 1:50

## **NEW TOWNHOUSES**

REZONING AT


8600 / 8660 Francis Road

**UNITS 6-10 - ELEVATIONS** 

DRAWING TITLE


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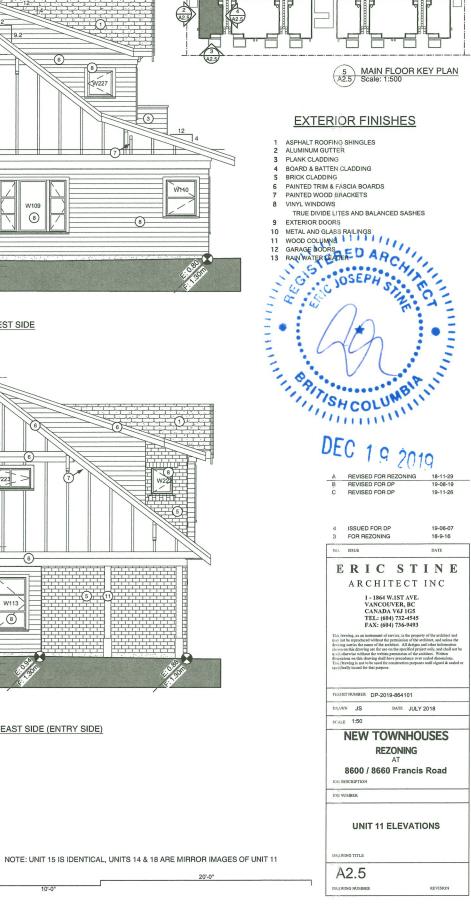
A2.4 DRAWING NUMBE

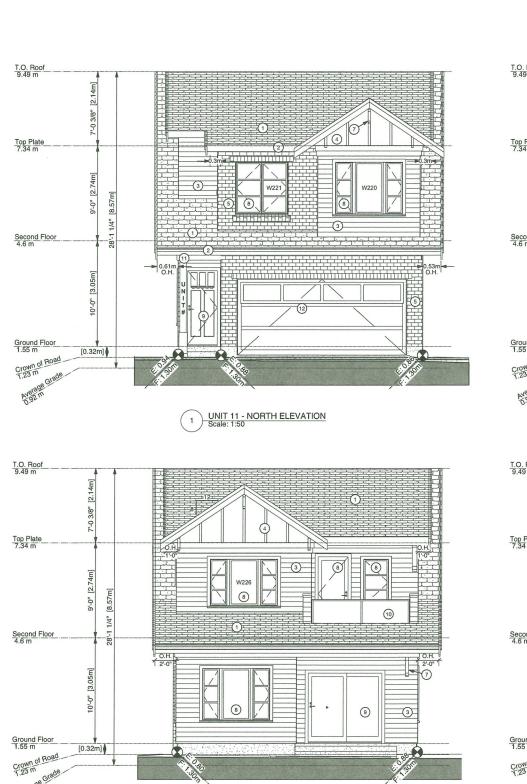

3 UNIT 11 - SOUTH ELEVATION Scale: 1:50





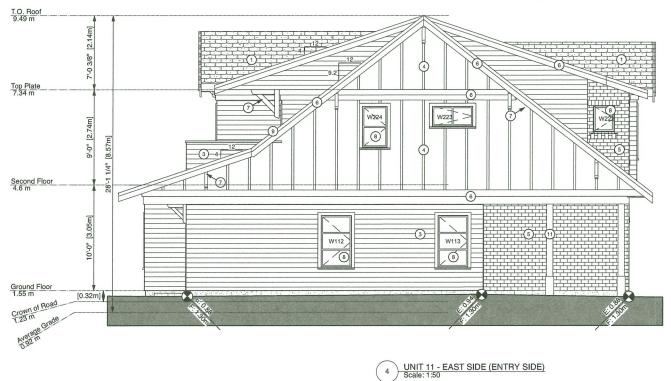





PRONT BUILDING - SOUTH ELEVATION
Scale: 1/8" = 1'-0"



REAR BUILDINGS - NORTH ELEVATION Scale: 1/8" = 1'-0"



REAR BUILDINGS - SOUTH ELEVATION Scale: 1/8" = 1'-0"

DEC 0 4 2019

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 REVISED FOR REZONING
 18-11-29

 REVISED FOR DP
 19-08-19

 REVISED FOR DP
 19-11-26

19-06-07 18-9-16 4 ISSUED FOR DP 3 FOR REZONING DATE NO. ISSUE

ERIC STINE ARCHITECT INC

1 - 1864 W.1ST AVE. VANCOUVER, BC CANADA V6J 1G5 TEL: (604) 732-4545 FAX: (604) 736-9493

PERMIT NUMBER DP-2019-864101

DRAWN JS DATE JULY 2018

**NEW TOWNHOUSES** REZONING AT

8600 / 8660 Francis Road


JOB DESCRIPTION

JOB NUMBER


COLOURED ELEVATIONS


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A2.7

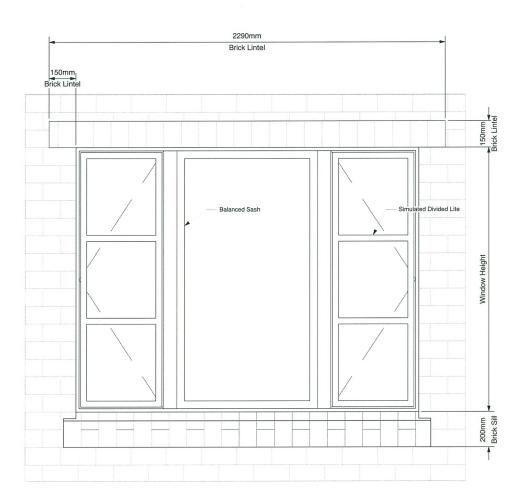


WINDOW/LINTEL DETAIL Scale: 1:10



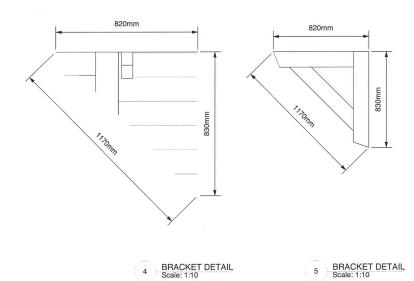

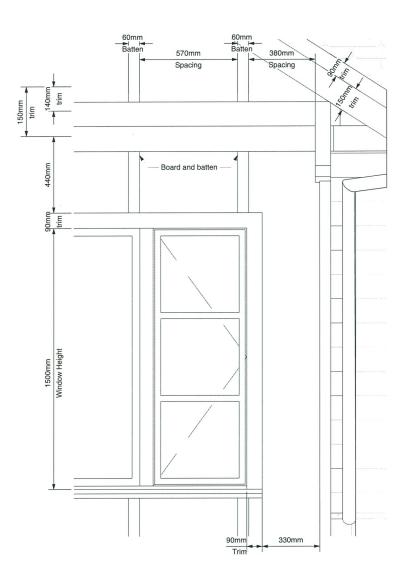2 WINDOW & TRIM ON BATTEN DETAIL Scale: 1:10

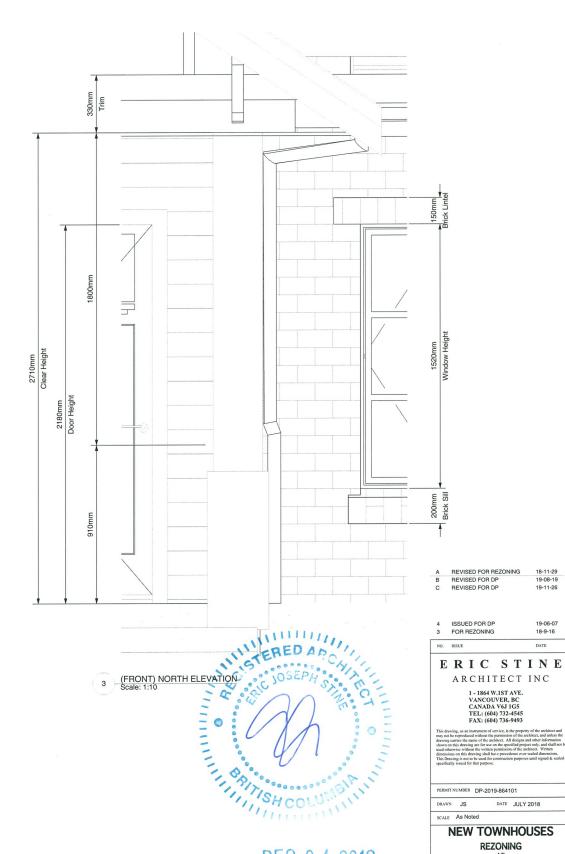

DEC 0 4 2019

SCALE As Noted

**DETAILS** 

**NEW TOWNHOUSES** REZONING AT


8600 / 8660 Francis Road

19-06-07 18-9-16 DATE

A4.1

REVISION

## DP 19-864104

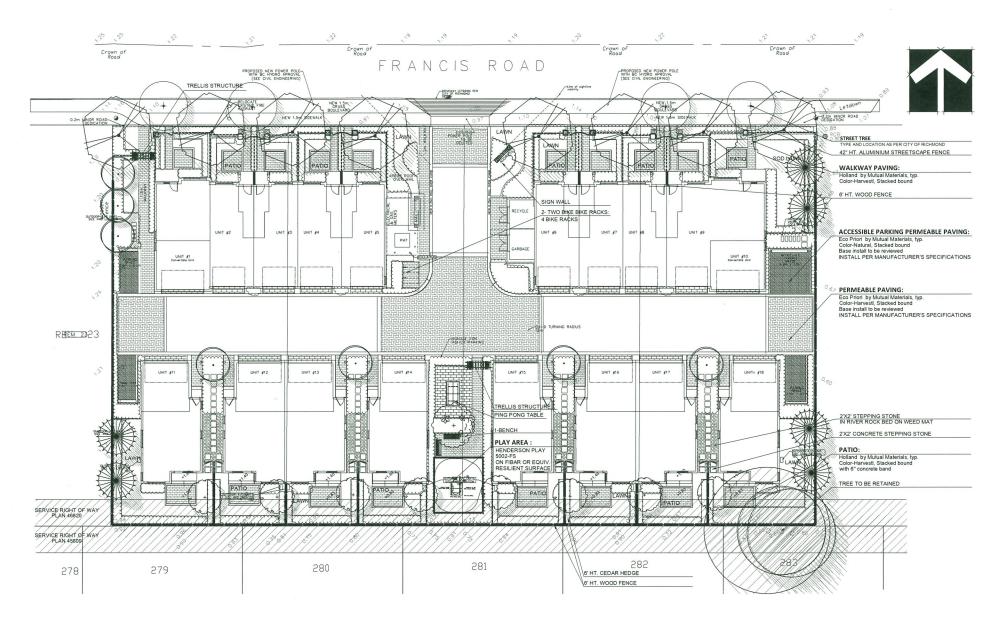

		SCHEDULE-STRE		PMG PROJECT NUMBER: 18-139
KEY	QTY	BOTANICAL NAME	COMMON NAME	PLANTED SIZE / REMARKS
TREE				
0	4	STREET TREE TYPE AND LOC	ATION BY CITY OF RICHMOND	6CM CAL, B&B
-				
OTES:	- PLAN	NT SIZES IN THIS LIST ARE SPECIFIE	ED ACCORDING TO THE BC LANDSCAPE STANDARD AND C	ANADIAN LANDSCAPE STANDARD, LATEST EDITION, CONTAINER SIZES
PECIFIE	ED AS	PER CNLA STANDARD. BOTH PLAN	IT SIZE AND CONTAINER SIZE ARE THE MINIMUM ACCEPTA	BLE SIZES. * REFER TO SPECIFICATIONS FOR DEFINED CONTAINER
MEASUR	EMEN	TS AND OTHER PLANT MATERIAL R	EQUIREMENTS. * SEARCH AND REVIEW: MAKE PLANT MAT	TERIAL AVAILABLE FOR OPTIONAL REVIEW BY LANDSCAPE ARCHITECT A
OURCE	OF SU	JPPLY. AREA OF SEARCH TO INCLI	JDE LOWER MAINLAND AND FRASER VALLEY. * SUBSTITUT	TIONS: OBTAIN WRITTEN APPROVAL FROM THE LANDSCAPE ARCHITECT
RIOR T	O MAK	ING ANY SUBSTITUTIONS TO THE:	SPECIFIED MATERIAL, UNAPPROVED SUBSTITUTIONS WILL	BE REJECTED. ALLOW A MINIMUM OF FIVE DAYS PRIOR TO DELIVERY
OR REC	QUEST	TO SUBSTITUTE. SUBSTITUTIONS	ARE SUBJECT TO BC LANDSCAPE STANDARD AND CANAD	IAN LANDSCAPE STANDARD - DEFINITION OF CONDITIONS OF
AVAILAB	ILITY.	* ALL LANDSCAPE MATERIAL AND V	VORKMANSHIP MUST MEET OR EXCEED BC LANDSCAPE S'	TANDARD AND CANADIAN LANDSCAPE STANDARD LATEST EDITION. * AI
PLANT N	MATERI	AL MUST BE PROVIDED FROM CER	TIFIED DISEASE FREE NURSERY * BIO-SOLIDS NOT PERMI	TTED IN GROWING MEDIUM UNLESS AUTHORIZED BY LANDSCAPE

PLANT SCHEDULE PMG PROJECT NUMBER: 18-139						
KEY	QTY	BOTANICAL NAME	COMMON NAME	PLANTED SIZE / REMARKS		
TREE						
1	8	ACER RUBRUM 'RED SUNSET'	RED SUNSET MAPLE	10CM CAL; 2M STD; B&B		
X . J	1	CORNUS KOUSA 'SATOMI'	PINK KOUSA DOGWOOD	2.5M HT; B&B		
. 100	8	FAGUS SYLVATICA 'DAWYCK'	FASTIGIATE OR DAWYCK BEECH	8CM CAL; 2M STD; B&B		
-	6	PINUS NIGRA 'ARNOLD SENTINEL'	ARNOLD SENTINEL AUSTRIAN BLACK PINE	4M HT; B&B		
	7	QUERCUS PALUSTRIS 'GREEN PILLAR'	GREEN PILLAR PIN AK	11CM CAL; 1.8M STD; B&B		
NOTES	PLANT	SIZES IN THIS LIST ARE SPECIFIED ACCORDING	TO THE BC LANDSCAPE STANDARD AND CANADIAN LANDS	CAPE STANDARD LATEST EDITION CONTAINER SIZES		
SPECIFIE	DASPE	R CNLA STANDARD. BOTH PLANT SIZE AND COI	NTAINER SIZE ARE THE MINIMUM ACCEPTABLE SIZES. * RE	FER TO SPECIFICATIONS FOR DEFINED CONTAINER		
MEASUREMENTS AND OTHER PLANT MATERIAL REQUIREMENTS. * SEARCH AND REVIEW: MAKE PLANT MATERIAL AVAILABLE FOR OPTIONAL REVIEW BY LANDSCAPE ARCHITECT AT						
SOURCE OF SUPPLY. AREA OF SEARCH TO INCLUDE LOWER MAINLAND AND FRASER VALLEY. * SUBSTITUTIONS: OBTAIN WRITTEN APPROVAL FROM THE LANDSCAPE ARCHITECT						
			ERIAL. UNAPPROVED SUBSTITUTIONS WILL BE REJECTED.			
FOR REQ	UEST TO	SUBSTITUTE. SUBSTITUTIONS ARE SUBJECT 1	O BC LANDSCAPE STANDARD AND CANADIAN LANDSCAPE	STANDARD - DEFINITION OF CONDITIONS OF		
			MUST MEET OR EXCEED BC LANDSCAPE STANDARD AND C			
PLANT M	ATFRIAL	MUST BE PROVIDED FROM CERTIFIED DISEASE	FREE NURSERY. * BIO-SOLIDS NOT PERMITTED IN GROWIN	IG MEDIUM UNLESS AUTHORIZED BY LANDSCAPE		

#### **FURNITURE**



MAGLIN Bike Rack, MBR500-S METAL-MATTE FINISH; BLACK COLOR, POWDER COATED



MAGLIN Bench, MLB510 METAL-MATTE FINISH; BLACK COLOR POWDER COATED





#### **PAVER**




Eco Priori by Mutual Materials, typ. Color-Natural, Stacked bound





Holland by Mutual Materials, typ.

Holland by Mutual Materials, typ. Color-Charcoal, Stacked bound

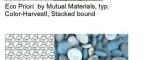

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NEW SITE PLAN NEW CIVIL PLAN REVISION AS PER CITY COM

CLIENT: MAVIC PROPERTIES LTD.

#### **18 UNIT TOWNHOUSE DEVELOPMENT**

8600 - 8680 FRANCIS ROAD RICHMOND

DRAWING TITLE:

### **LANDSCAPE PLAN**


DATE: July 31, 2018

DRAWING NUMBER

SCALE: 1/16"=1'-0" DRAWN: DD

CHK'D: PCM

OF 4

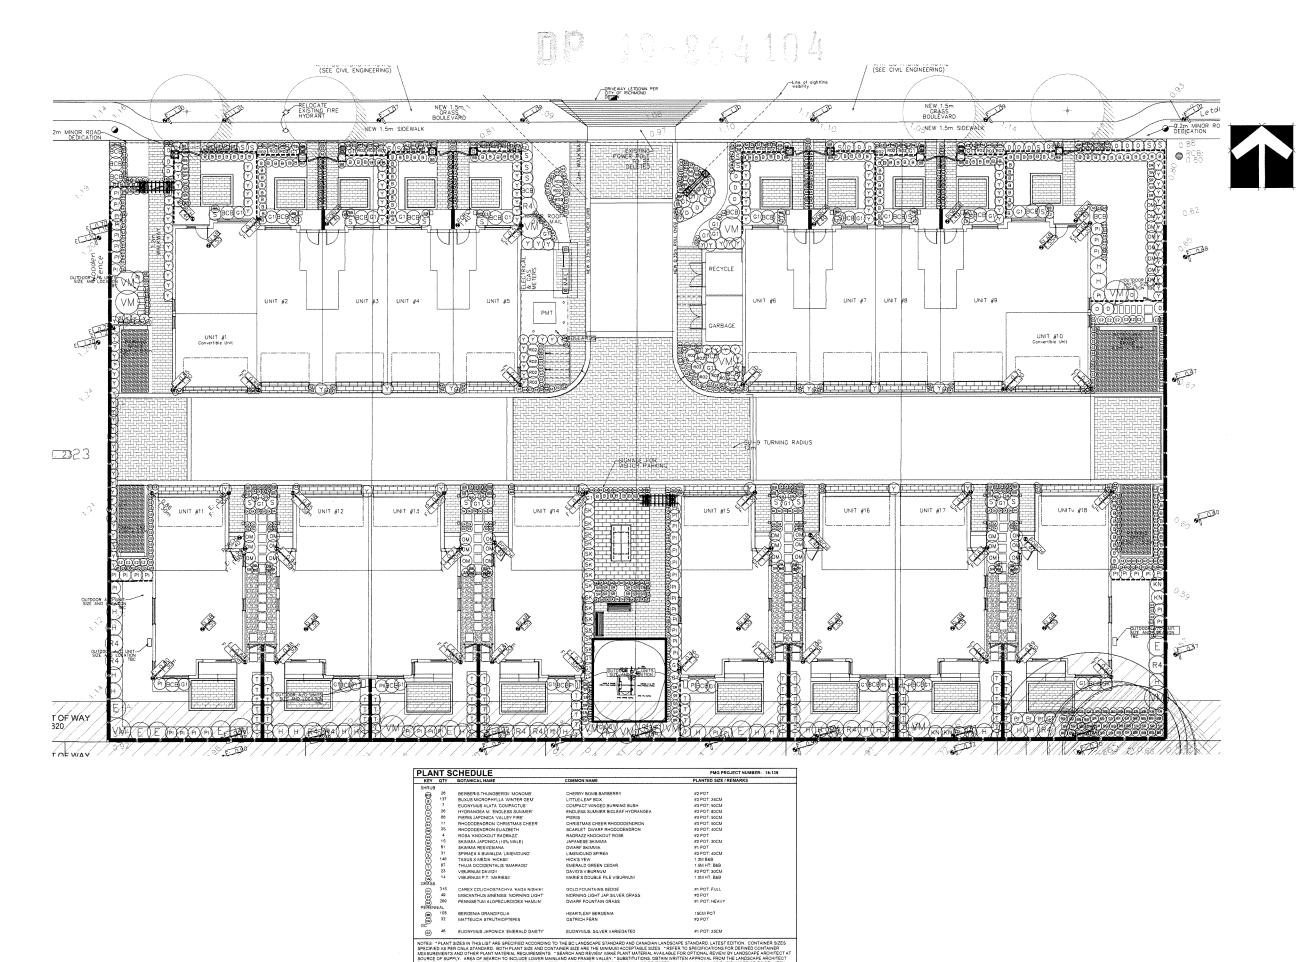

pe areas to be irrigated with automatically ostaliation to I.I.A.B.C. Standards, latest edition.

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SEAL:

9	20JAN.06	REVISION AS PER CITY COMMENTS	
8	19.NOV.26	NEW SITE PLAN	C
7	19.NOV.21	NEW CIVIL PLAN	E
6	19,0CT.29	REVISION AS PER CITY COMMENTS	E
4	19.AUG.15	NEW SITE PLAN/ CITY COMMENTS	
3	19.JUN.7	ISSUED FOR DP	F
2	18.DEC.14	NEW SITE PLAN	
1	18.OCT.01	NEW SITE PLAN	t
	D.4.T.F.	DELUCION DECODERION	

CLIENT: MAVIC PROPERTIES LTD.

PROJECT:

#### **18 UNIT TOWNHOUSE** DEVELOPMENT

8600 - 8680 FRANCIS ROAD RICHMOND

DRAWING TITLE:

#### **SHRUB AND GRADING** PLAN

DATE: July 31, 2018 SCALE: 3/32"=1'-0"


DRAWN: DD DESIGN: DD

DRAWING NUMBER

OF 4


18-139




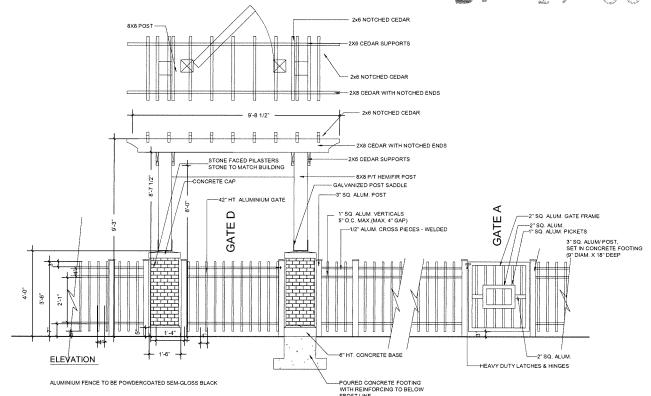


42" HT. ALUMINIUM STREETSCAPE FENCE WITH TRELLIS STRUCTURE

SCALE: 1/2"=1'-0"

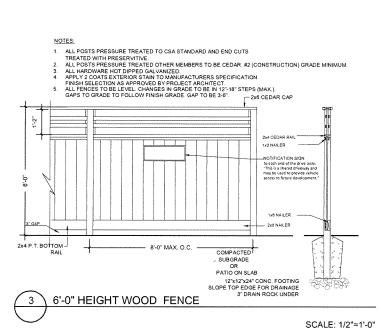

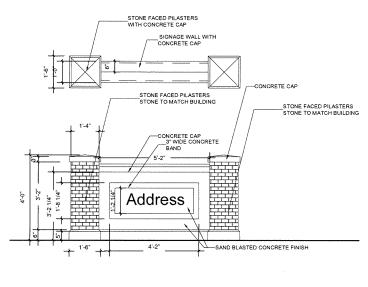




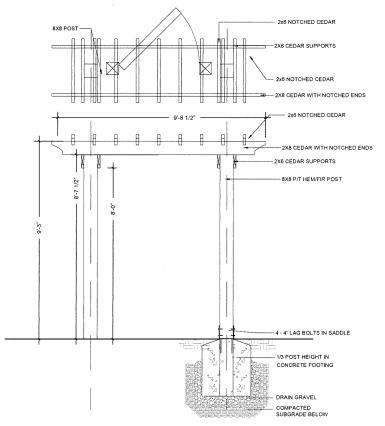

TRELLIS STRUCTURE AT AMENITY AREA

SCALE: 1/2"=1'-0"

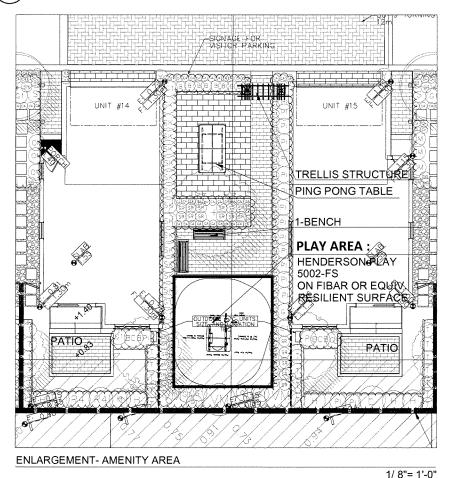

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9	20.JAN.05	REVISION AS PER CITY COMMENTS	- 1
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7	19.NOV.21	NEW CIVIL PLAN	
6	19.0CT.29	REVISION AS PER CITY COMMENTS	-
4	19.AUG.15	NEW SITE PLAN/ CITY COMMENTS	1
3	19.JUN.7	ISSUED FOR DP	
2	18.DEC.14	NEW SITE PLAN	
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NO.	DATE	REVISION DESCRIPTION	

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#### **18 UNIT TOWNHOUSE** DEVELOPMENT

8600 - 8680 FRANCIS ROAD RICHMOND

DRAWING TITLE:

#### LANDSCAPE **DETAILS**

DATE: July 31, 2018 DRAWING NUMBER: SCALE: DRAWN: DD


PLAN 26

18-139


OF 4

CHK'D: PCM

## DP 19-864104

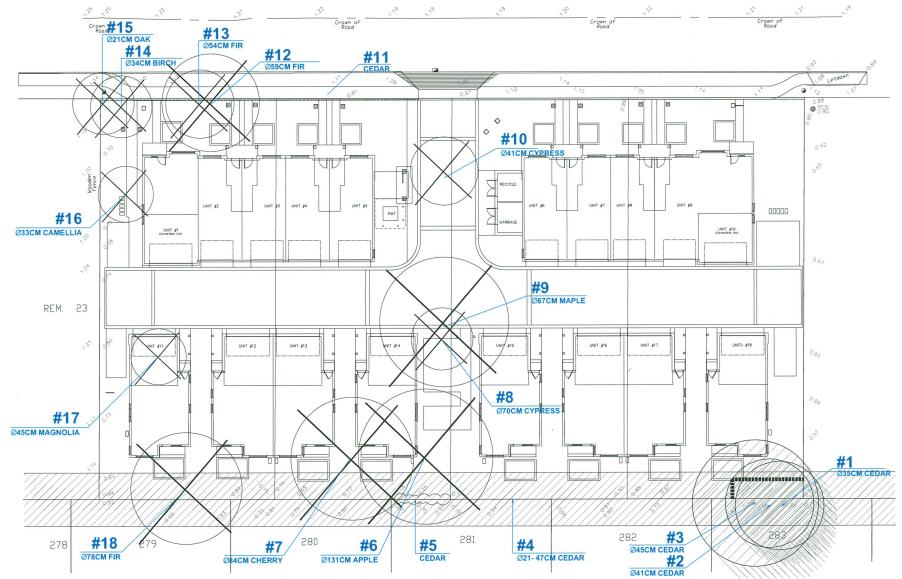

	SPECIES	DBH	SPREAD radius
#	(Botanical name)	(cm)	(m) est.
	Cedar	35 per	
1	(Thuja plicata)	survey	4.7m
	Cedar	41 per	
2	(Thuja plicata)	survey	4.8m
	Cedar	45 per	
3	(Thuja plicata)	survey	7.2m
	Cedar		
4	(Thuja plicata)	21 - 47 est.	5m
	Cedar		
5	(Thuja occidentalis)	-	1m
	Apple		
6	(Malus sp.)	131	7.4m
	Cherry		
7	(Prunus sp.)	84	6.8m
	Cypress		
8	(Chamaecyparis sp.)	70	3.6m
	Japanese Maple		
9	(Acer palmatum sp.)	67	7.2m
	Cypress		
10	(Chamaecyparis sp.)	41	4m
	Cedar		
11	(Thuja occidentalis)	-	1.8m
	Douglas fir		
12	(Pseudotsuga menziesii)	59	5.3m
	Douglas fir		
13	(Pseudotsuga menziesii)	54	3.5m
	Birch		
14	(Betula sp.)	34	3.3m
	Oak		
15	(Quercus sp.)	21	3.3m
	Camellia	33 per	
16	(Camellia sp.)	survey	2.5m
	Magnolia	45	
17	(Magnolia sp.)	combined	2.7m
	Douglas fir		
18	(Pseudotsuga menziesii)	78	6.3m

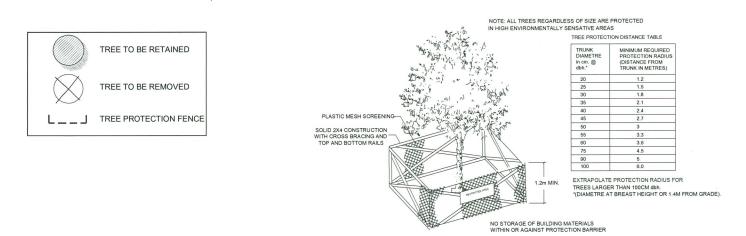



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	,		
9	20.JAN.06	REVISION AS PER CITY COMMENTS	
8	19.NOV.26	NEW SITE PLAN	
7	19.NOV.21	NEW CIVIL PLAN	
6	19.OCT.29	REVISION AS PER CITY COMMENTS	
4	19.AUG.15	NEW SITE PLAN/ CITY COMMENTS	
3	19.JUN.7	ISSUED FOR DP	- 1
2	18.DEC.14	NEW SITE PLAN	- 1
1	18.OCT.01	NEW SITE PLAN	
10.	DATE	REVISION DESCRIPTION	D

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#### **18 UNIT TOWNHOUSE** DEVELOPMENT

8600 - 8680 FRANCIS ROAD RICHMOND

DRAWING TITLE:

#### TREE MANAGEMENT **PLAN**

DATE: July 31, 2018 SCALE: 1/16"=1'-0"

DRAWN: DD DESIGN: DD

CHK'D: PCM

OF 4

18-139