

Report to Development Permit Panel

To:

Development Permit Panel

Date:

March 18, 2016

From:

Wayne Craig

File:

DP 14-671945

Re:

Director of Development

Application by Zhao XD Architect Ltd. for a Development Permit at 9800, 9820,

9840 and 9860 Granville Avenue

Staff Recommendation

That a Development Permit be issued which would:

- 1. Permit the construction of 18 three-storey townhouse units at 9800, 9820, 9840 and 9860 Granville Avenue on a site zoned "Medium Density Townhouses (RTM2)"; and
- 2. Vary the provisions of Richmond Zoning Bylaw 8500 to increase the rate of tandem parking spaces from 50% to 62%.

Wayne Craig

Director of Development

EL:blg Att.

Staff Report

Origin

Zhao XD Architect Ltd. has applied to the City of Richmond for permission to develop 18 three-storey townhouse units at 9800, 9820, 9840 and 9860 Granville Avenue. The site is being rezoned from "Single Detached (RS1/F)" zone to "Medium Density Townhouses (RTM2)" under Bylaw 9179 (RZ 14-658085), which received third reading following the Public Hearing on February 16, 2015. The site is currently vacant. A Servicing Agreement for road widening, frontage beautification, storm upgrades, and service connections is required prior to issuance of a Building Permit for the site.

Development Information

Please refer to the attached Development Application Data Sheet (Attachment 1) for a comparison of the proposed development data with the relevant Bylaw requirements.

Background

Development surrounding the subject site is as follows:

- To the north, across Granville Avenue, A.R. MacNeill Secondary School, on a site zoned "School & Institutional Use (SI)" and a seven (7) unit townhouse development on a site zoned "Town Housing (ZT60) North McLennan (City Centre)".
- To the east, two (2) single-family homes on large lots zoned "Single Detached (RS1/F)", fronting No. 4 Road; currently under a rezoning application (RZ 15-708960) to rezone these properties to "Medium Density Townhouses (RTM2)" to facilitate a seven (7) unit townhouse development.
- To the south, a 22-unit townhouse development, on a site zoned "Low Density Townhouses (RTL1)".
- To the west, a mix of newer and older single-family homes on large lots zoned "Single Detached (RS1/F)", fronting Granville Avenue.

Rezoning and Public Hearing Results

The Public Hearing for the rezoning of this site was held on February 16, 2015. At the Public Hearing, a property owner of the adjacent townhouse development to the south at 7060 Bridge Street expressed concerns in regards to settlements, noise, and potential damage to their units due to construction.

In response, the applicant has advised staff that, prior to any construction, the project team is willing to conduct inspections of the adjacent site to determine predevelopment conditions, and will document this for the owners. This documentation will be used to determine any damage that may occur during construction. This has been shared with the adjacent resident by way of a letter from the applicant. No property damage to the neighbouring properties is anticipated based on studies prepared by professional geotechnical and structural engineers for the applicant. Construction management will be in accordance with City's standards in terms of working hours and sound rating levels, as well as an approved Construction Traffic and Parking Management Plan.

Staff Comments

The proposed scheme attached to this report has satisfactorily addressed the significant urban design issues and other staff comments identified as part of the review of the subject Development Permit application. In addition, it complies with the intent of the applicable sections of the Official Community Plan (OCP) and is generally in compliance with the "Medium Density Townhouses (RTM2)" zone, except for the one (1) zoning variance noted below.

Zoning Compliance/Variances (staff comments in bold)

The applicant requests to vary the provisions of Richmond Zoning Bylaw 8500 to:

1) Increase the rate of tandem parking spaces from 50% to 62% to allow a total of 22 tandem parking spaces in 11 townhouse units;

(26 residential parking spaces are required for this 18-unit development; a maximum of nine (9) double car garages (18 residential parking spaces) can be in tandem arrangement. By permitting an extra two (2) tandem parking garages (4 residential parking spaces), the developer is able to provide 10 extra residential parking spaces on-site.

Tandem parking is generally supported, as it can reduce pavement area on-site and facilitate a more flexible site layout. With the extra residential parking spaces provided on-site and on-street parking available on Granville Avenue, staff do not envision any noticeable impact to parking in the immediate neighbourhood due to the proposed tandem parking variance.

This variance was identified in the Rezoning Report to Committee and no concerns were raised at the Public Hearing. A restrictive covenant to prohibit the conversion of the tandem garage area into habitable space has been secured at the rezoning stage.)

Advisory Design Panel Comments

The Advisory Design Panel supported the design of the project and the Design Panel's suggested design changes have been incorporated into the proposal. A copy of the relevant excerpt from the Advisory Design Panel Minutes from Wednesday, April 1, 2015 is attached for reference (Attachment 2). The design response from the applicant has been included immediately following the specific Design Panel comments and is identified in 'bold italics'.

Analysis

Conditions of Adjacency

- While the proposed rear yard setback meets the minimum zoning requirements (i.e., 3.0 m), there is no tree planting opportunity within the rear yards, as an existing sanitary statutory right-of-way (SRW) covers the entire 3.0 m wide rear setback area.
- Evergreen hedges and 1.8 m tall wood fence are proposed along the rear property line for screening between the subject and the neighbouring property to the south.
- Varied roof line, extra setback on the upper floors, reduced window sizes and window orientation are included in the architectural design to address potential adjacency issue.

- Second floor setback to the living room window is approximately 4.94 m to the rear (south) property line and there is no south facing bedroom windows on the third floor overlooking the neighbouring yards to the south.
- Perimeter drainage will be required as part of the Building Permit to ensure storm water is managed and addressed through the development and will not impact the neighbouring properties.
- Open fence at a maximum of 1.2 m (4 ft.) high is proposed along the east side property line to allow for a more open future outdoor amenity area on the adjacent development site to the east.

Urban Design and Site Planning

- The proposal consists of seven (7) clusters, including four (4) triplex and three (3) duplex buildings. Eleven (11) units have direct access from the Granville Avenue to the north and seven (7) units have access from the internal drive aisle.
- The internal road layout is a T-shaped, with future connections to the neighbouring properties to the east and west, secured by Statuary Right of Way (SRW).
- All units have two (2) vehicle parking spaces; seven (7) units have a side-by-side double car garage and 11 units have tandem garages. A Restrictive Covenant, prohibiting the conversion of tandem parking area into habitable area has been secured at rezoning.
- A total of four (4) visitor parking spaces, including an accessible visitor parking space, are proposed, which meets the minimum bylaw requirement. Both residential and visitor bicycle parking are provided in compliance with the Zoning Bylaw requirements.
- All units have private outdoor spaces consisting of front or rear yard and balconies on the second floors that can be accessed directly from the living space. The provision of private outdoor spaces exceeds the development guidelines (37 m² per unit).
- Outdoor amenity space is proposed opposite the site entry for maximum casual surveillance opportunity and sun exposure. The size and location of the outdoor amenity space is appropriate in providing open landscape and amenity space convenient to all of the units.
- A covered mailbox kiosk and short-term bicycle parking spaces are provided at the entrance of the outdoor amenity space.
- The required garbage, recycling and organic waste storage enclosures have been incorporated into the design of Building No. 2 (at the west side of the entry driveway) to minimize their visual impact.
- Additional outdoor amenity space (10% of the site area) as per the City Centre Amenity Space Provisions in the City Centre Area Plan is provided as landscaped area throughout the site.

Architectural Form and Character

• The architect advised that the architectural language adopted in the design is inspired from traditional Georgian style homes; with patterned fenestration, symmetrical or locally symmetrical façade composition. Individuality of dwelling units is expressed by their separate entry porches, differences in colours, and local massing variations. Building

- components refer to various styles and architectural languages, and are intended to be integrated with each other using an eclectic approach that also reflects contemporary functional and constructional practices.
- The overall appearance of the proposal generally conforms to the design guidelines of the North McLennan area and should fit in well with the character of the surrounding area.
- A pedestrian scale is generally achieved along the public streets and internal drive aisle through the inclusion of variation in building projections, recesses, entry porches, varying material/colour combinations, landscape features, and the use of individual unit entrances.
- The impact of blank garage doors has been mitigated with panel patterned doors, transom windows, unit entrances, planting islands along the drive aisle, and planters on the second floor balconies.
- The proposed building materials (asphalt roof shingles, hardie board/siding/panel, and wood fascia/trim/column) are generally consistent with the Official Community Plan (OCP) Guidelines and compatible with the existing single-family character of the neighbourhood.
- Earth tone colours have been used for all siding materials to fit with the context of the neighbourhood. Strong contrasting colours are used on the accent walls to provide visual interest.

Landscape Design and Open Space Design

- Tree preservation was reviewed at rezoning stage, two (2) City trees along the frontage of the site and 16 trees on site are identified for removal.
- Based on the 2:1 tree replacement ratio goal stated in the Official Community Plan (OCP), 32 replacement trees are required. The applicant is proposing to plant 20 replacement trees on-site, including five (5) conifers and 15 deciduous trees. A voluntary contribution of \$6,000 to the City's Tree Compensation Fund in lieu of planting the remaining 12 replacement trees has been secured at rezoning.
- Four (4) trees on site, two (2) street trees, and two (2) trees located on the neighbouring property to the east are identified for retention. Tree protection fencing is required to be installed as per the Arborist Report recommendations prior to any construction activities (including demolition) occurring on-site. A Tree Survival Security will be required as part of the Landscape Letter of Credit as a condition to Development Permit issuance to ensure that these trees will be protected. No Landscape Letter of Credit will be returned until the post-construction assessment report, prepared by the Arborist, confirming the protected trees survived the construction, is reviewed by staff.
- A pedestrian-oriented streetscape along Granville Avenue is proposed; with a landscaped edge treatment, low metal fencing with masonry columns, and gates and walkways to individual townhouse unit front doors.
- Each unit will have a private yard with landscaping, lawn area and a patio. Various hedges, shrubs and ground covers, as well as perennials and grasses have been selected to ensure the landscape treatment remains interesting throughout the year.
- The location of outdoor amenity space provides the easy access and visual transparency and surveillance for the townhouse residents.

- A children's play area, designed for children aged 2 to 5 years old, is proposed for the outdoor amenity area. The play equipment includes a double slide, a curly climber, a rock climb, and a boarding net; it was chosen to fit into the provided space and to allow multiple children to play at the same time. The equipment provides different play opportunities for the development of social, imagination, balance, and motor skills. A bench is also provided for caregivers.
- The existing grade at the mature trees is retained to create a less formal natural play area. The natural play area provides opportunities for imaginative play and social interaction. The difference in grading provides interest for children of all ages.
- The entry driveway, surface parking stalls, and a portion of the internal drive aisle will be treated with permeable pavers for better water infiltration and variety in paving surfaces. Feature paving will be used to identify and enhance the pedestrian route from the site entrance to the internal units.
- In order to ensure that the proposed landscaping works are completed, the applicant is required to provide a landscape security of \$106,086.40 in association with the Development Permit.
- Indoor amenity space is not proposed on-site. An \$18,000 cash-in-lieu contribution (\$1,000 per unit) has been secured as a condition of rezoning approval, consistent with the OCP.

Crime Prevention Through Environmental Design

- Site lighting and clear site lines provide unobstructed views of surrounding area.
- Plantings near residential entries are low to maximize views and casual surveillance opportunities.
- All entrances are visible and overlooked by pedestrians or by neighbour's windows.
- The landscape design avoids hiding places that would conceal criminals.
- Security lights including wall mounted lighting for drive aisles and lighting at entries to provide adequate outdoor security illumination.

Sustainability

- A Restrictive Covenant specifying that all units are to be built and maintained to the EnerGuide rating of 82 or higher, and that all units are to be solar-hot-water-ready, has been secured at rezoning. A Certified Energy Advisor has confirmed that the proposed townhouse units will be designed to achieve an EnerGuide rating of 82. The report, prepared by the Energy Advisor, is on file and will be utilized through the Building Permit review process to ensure these measures are incorporated in the permit drawings.
- The developer also advises that the following sustainability features will be incorporated into the development:
 - Use of drought tolerant or native dominant plantings.
 - Use of permeable surfaces on a portion of the drive aisle and surface parking stalls.
 - Use of exterior building materials require low maintenance and provide highly durable surfaces (i.e., hardie siding).

Accessible Housing

- The proposed development includes two (2) convertible units that are designed with the
 potential to be easily renovated to accommodate a future resident in a wheelchair. The
 potential conversion of these units will require installation of a vertical lift in the stacked
 storage space (which has been dimensioned to allow for this in Unit B2 & B3 of Building 5)
 in the future, if desired.
- All of the proposed units incorporate aging in place features to accommodate mobility constraints associated with aging. These features include:
 - Stairwell hand rails.
 - Lever-type handles for plumbing fixtures and door handles.
 - Solid blocking in washroom walls to facilitate future grab bar installation beside toilets, bathtubs and showers.

Conclusion

The applicant has satisfactorily addressed staff's comments regarding conditions of adjacency, site planning and urban design, architectural form and character, and landscape design. The applicant has presented a development that fits into the existing context. On this basis, staff recommend support of this Development Permit application.

Edwin Lee Planner 1 (604-276-4121)

EL:blg

The following are to be met prior to forwarding this application to Council for approval:

- Adoption of Rezoning Bylaw 9179 (RZ 14-658085).
- Receipt of a Letter-of-Credit for landscaping and tree survival in the amount of \$106,086.40; Letter-of-Credit will not be released until the Letter of Assurance from the Landscape Architect confirming that landscaping are installed as per Development Permit, as well as the Post Construction Impact Assessment Report from the Arborist; confirming that the protected trees survived the construction, are reviewed by staff. The City will release 80% of the security after construction and landscaping on the proposed townhouse complex are completed, inspections are approved, and an acceptable post-construction impact assessment report is received. The remaining 20% of the security will be released one year later subject to inspection.

Prior to future Building Permit issuance, the developer is required to complete the following:

- Installation of appropriate tree protection fencing around all trees to be retained as part of the development prior
 to any construction activities, including building demolition, occurring on-site.
- Enter into a Servicing Agreement for the design and construction of road widening, frontage beautification, storm upgrades, and service connections.
- Incorporation of energy efficiency, CPTED, sustainability, and accessibility measures in Building Permit (BP)
 plans as determined via the rezoning and/or Development Permit processes.
- Payment of DCC's (City & GVS&DD), School Site Acquisition Charges, Address Assignment Fee, and all required servicing costs.
- If applicable, payment of latecomer agreement charges associated with eligible latecomer works.

- Obtain a Building Permit (BP) for any construction hoarding. If construction hoarding is required to temporarily occupy a public street, the air space above a public street, or any part thereof, additional City approvals and associated fees may be required as part of the Building Permit. For additional information, contact the Building Approvals Division at 604-276-4285.
- Submission of a Construction Parking and Traffic Management Plan to the Transportation Division.
 Management Plan shall include location for parking for services, deliveries, workers, loading, application for any lane closures, and proper construction traffic controls as per Traffic Control Manual for works on Roadways (by Ministry of Transportation) and MMCD Traffic Regulation Section 01570.



Development Application Data Sheet

Development Applications Division

DP 14-671945 Attachment 1

Address: 9800, 9820, 9840 and 9860 Granville Avenue

Applicant: Zhao XD Architect Ltd. Owner: Zhang's Cubic Estates Holdings Ltd.

Planning Area(s): South McLennan Sub-Area (City Centre)

Floor Area Gross: 3,135.8 m² Floor Area Net: 1,997.6 m²

	Existing	Proposed
Site Area:	3,076 m ²	No Change
Land Uses:	Single-Family Residential	Multiple-Family Residential
OCP Designation:	Neighbourhood Residential	No Change
Zoning:	CCAP: General Urban T4 South McLennan Sub-Area Plan: Residential, 2½ storey typical (3-storeys maximum) with 0.55 base FAR	No Change
Number of Units:	4	18

	Bylaw Requirement	Proposed	Variance
Floor Area Ratio:	Max. 0.65	0.65 Max.	none permitted
Lot Coverage – Building:	Max. 40%	39.8%	none
Lot Coverage – Non-porous Surfaces:	Max. 65%	64.7%	none
Lot Coverage – Landscaping:	Min. 25%	25% Min.	none
Setback – Front Yard (m):	Min. 6.0 m	6.0 m Min.	none
Setback – East Side Yard (m):	Min. 3.0 m	3.0 m Min.	none
Setback – West Side Yard (m):	Min. 3.0 m	3.0 m Min.	none
Setback – Rear Yard (m):	Min. 3.0 m	3.63 Min.	none
Height (m):	Max. 12.0 m (3 storeys)	11.8 m (3 storeys)	none .
Lot Width:	Min. 50.0 m	74.69 m	none
Off-street Parking Spaces – Regular (R) / Visitor (V):	1.4 (R) and 0.2 (V) per unit	2 (R) and 0.2 (V) per unit	none
Off-street Parking Spaces - Total:	30	40	none

Tandem Parking Spaces:	Max. 50% of proposed residential spaces in enclosed garages (36 x Max. 50% = 18)	22 spaces (62%)	Variance Requested
Small Car Parking Spaces	Max. 50% when 31 or more spaces are provided on site (40 x Max. 50% = 20)	0	none
Handicap Parking Spaces:	1	1	none
Amenity Space – Indoor:	Min. 70 m² or Cash-in- lieu	Cash-in-lieu	none
Amenity Space – Outdoor:	Min. 6 m ² x 18 units = 108 m ²	108 m²	none

Excerpt from the Minutes from The Design Panel Meeting

Wednesday, April 1, 2015 – 4:00 p.m. Rm. M.1.003 Richmond City Hall

Panel Discussion

Comments from the Panel were as follows:

- stairs at the back units appear institutional;

 Larger head trims are added to windows on staircases, which reduces the punched window effect with the extra decoration adds more residential building character (see drawing A6, A8 & A8.1).
- driveways lack landscaping; consider reducing the setback from the street to provide more opportunities for landscaping;
 Pathways to rear entry doors for front units are re-designed to make additional landscaping area for more plantations.
- colonial design of the entries to the front units does not fit with the rest of the project; triplexes have heavy columns; consider design development to simplify the unit entries; The architectural language adopted in the design is inspired from traditional Georgia style homes with fenestration pattern and symmetrical or locally symmetrical design composition. Due to the nature of townhouse use, individuality of each units is expressed by separate entry porch among others factors. Porch as well as other parts of design elements is part of façade composition referring to various different styles and architectural language. The design philosophy is based on a more eclecticism architectural approach for a better functional, constructional and aesthetical adaptability. Front porches have been modified to reduce the apparent mass (see revised elevations drawing A7, A8). Two columns for front porches have been reduced from 24" to 18" for each which significantly reduces the porch massing.
- like the massing, setbacks and variation of townhouse units along Granville Avenue; however, proposed colours appear flat;
 Unit A & Unit A7 are revised to have 6" projection of wall thickness that make up a recess for adjacent units. The staggered footprint created by the recess makes the transitions of different wall materials and color less flat (see plans A-3 & A-4).
- look at opportunities for introducing greens along the internal drive aisles;

 Balcony planters are proposed (as shown on ADP package); extra plantation on the increased green areas adjacent to the combined path way to back doors should address the comments.

- look at softening the landscaping for the proposed amenity space and consider design development to allow more uses other than just a children's play area;
 As already shown on the landscape architectural design, pathway and bench have been proposed in addition to other items merely for children's play. The pathway and bench can be used by adults as a consideration to allow more uses other than just a children's play area.
- commend the applicant for retaining the trees; however, concerned that planting along the street frontage might encroach on the trunk of the tree; applicant needs to review the planting scheme;
 No planting will encroach on the tree trunks. The design proposal is made based on

arborist's recommendations.

- trees adjacent to the children's play area are boxed off and disconnected from the amenity area; look at opportunities to integrate them into the amenity area;
 The sunken area around tree is paved with mulch and about 1'-8" lower than the formal play area. It can be used for a less formal play area for children. The difference in grading provides interest for children of different ages.
- look at the survivability of planting materials between the buildings;

 As shown on the landscape plan, Western Sword Fern is mostly proposed in the areas between buildings. Sword ferns are very tough and can survive occasional dry periods, do well with light sunlight and prefer cool weather to overly warm.
- appreciate the decorative pavers at the entrance to the development; however, consider accentuating the utilities, e.g. garbage and recycling with distinct decorative pavers; Utility space such as garbage/recycling enclosure and mailbox kiosk are accentuated by geometry of paving and curbs. The presence of garbage/recycling enclosure would however preferably not be accentuated too much. As shown on the landscape and architectural site plan, the width of access driveway from street into the subject site changes, and additional curbed-off area is provided for garbage/recycling enclosure. The curb line variation and pavement differentiation between driveway area and curbed-off area accentuates the enclosure presence. Since the garbage/recycling enclosure is just a utility space, we would not like to emphasize it too much. Similar case applies to the amenity area, but the accentuation of its presence is much more preferred.
- agree with comments regarding the disconnect between the design of the townhouse entries along the street and the overall architecture of the buildings.
 As mentioned earlier, the design philosophy is based on a more eclecticism architectural approach for more flexibility. Porch design has been improved for the buildings facing Granville Ave. with additional details similar in scale to rest elements of each building (see drawings A7, A8), where the volume of the porch canopy has been broken into smaller segments to reduce massing of the porch as suggested. Eclecticism promotes a design approach that emphasizes more on pure architectural composition that compromise "different styles" into a "new" form rather than exclusion of one style from another. An approach called Neo-eclectic architecture as an example, is a name for an architectural style that has influenced residential building construction in North America in the later

part of the 20th century and early part of the 21st. The residential buildings built today are designed in the way incorporates many styles. Architects and designers call this new stylistic mix Neoeclectic, or Neo-eclectic which is the "style" we are commonly using today.



Development Permit

No. DP 14-671945

To the Holder:

ZHAO XD ARCHITECT LTD.

Property Address:

9800, 9820, 9840 AND 9860 GRANVILLE AVENUE

Address:

C/O XUEDONG ZHAO

255 - 11181 VOYAGEUR WAY

RICHMOND, BC V6X 3N9


- 1. This Development Permit is issued subject to compliance with all of the Bylaws of the City applicable thereto, except as specifically varied or supplemented by this Permit.
- 2. This Development Permit applies to and only to those lands shown cross-hatched on the attached Schedule "A" and any and all buildings, structures and other development thereon.
- 4. The "Richmond Zoning Bylaw 8500" is hereby varied to increase the rate of tandem parking spaces from 50% to 62% to allow a total of 22 tandem parking spaces in 11 townhouse units.
- 3. Subject to Section 692 of the Local Government Act, R.S.B.C.: buildings and structures; off-street parking and loading facilities; roads and parking areas; and landscaping and screening shall be constructed generally in accordance with Plans #1 to #4 attached hereto.
- 4. Sanitary sewers, water, drainage, highways, street lighting, underground wiring, and sidewalks, shall be provided as required.
- 5. As a condition of the issuance of this Permit, the City is holding the security in the amount of \$106,086.40 to ensure that development is carried out in accordance with the terms and conditions of this Permit. Should any interest be earned upon the security, it shall accrue to the Holder if the security is returned. The condition of the posting of the security is that should the Holder fail to carry out the development hereby authorized, according to the terms and conditions of this Permit within the time provided, the City may use the security to carry out the work by its servants, agents or contractors, and any surplus shall be paid over to the Holder. Should the Holder carry out the development permitted by this permit within the time set out herein, the security shall be returned to the Holder. The City may retain the security for up to one year after inspection of the completed landscaping in order to ensure that plant material has survived.
- 6. If the Holder does not commence the construction permitted by this Permit within 24 months of the date of this Permit, this Permit shall lapse and the security shall be returned in full.

Development Permit No. DP 14-671945

		No. DP 14-671				
To the Holder:	ZHAO XD ARC	HITECT LTD.				
Property Address:	9800, 9820, 98	9800, 9820, 9840 AND 9860 GRANVILLE AVENUE				
Address:	C/O XUEDONO # 255 - 11181 \ RICHMOND, B	OYAGEUR WAY				
	sions of this Permit a	ped generally in accordance with the terms and any plans and specifications attached to this				
This Permit is not all	Building Permit.					
AUTHORIZING RESO DAY OF ,	LUTION NO.	ISSUED BY THE COUNCIL THE				
DELIVERED THIS	DAY OF	,				

MAYOR



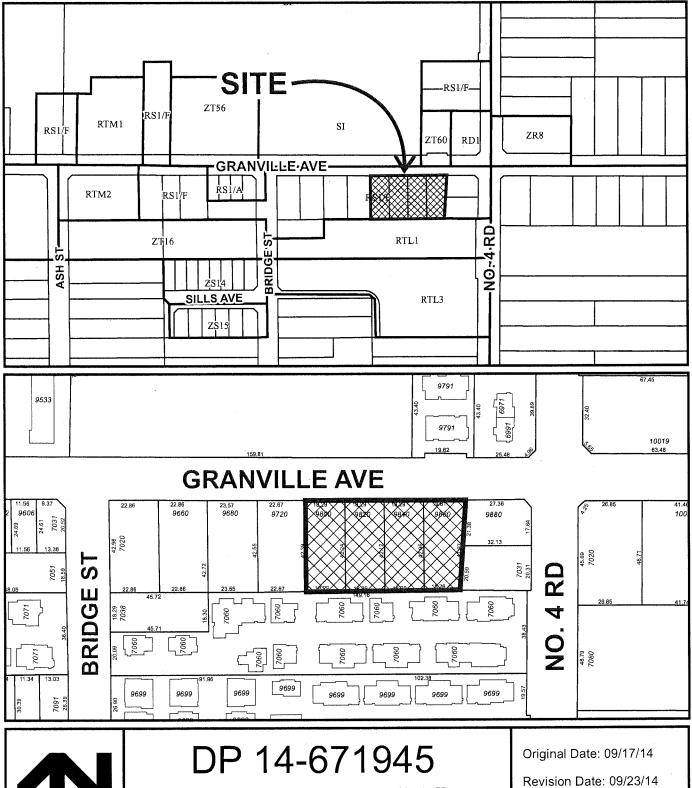



SCHEDULE "A"

Note: Dimensions are in METRES

ADDRESS: LEGAL DESCRIPTION:	LOTS 80 TO 84	40 & 9860 Granville avenue Section 15 Block 4 North NEW WESTMINSTER DISTRICT PLAN 475	45		BYLAW REQUIREMENT	PROPOSED	VARIANCE	LO
P.I.D. NUMBERS:		92 (LOT 80), PID 003-596-443 (LOT		FLOOR AREA RATIO:	MAX. 0.65 (21522.2 SF)	0.65 (21501.7 SF)		RE
P.I.U. NUMBERS:		15 (LOT 82), PID 003-558-886 (LOT		LOT COVERAGE - BUILDING:	MAX. 40% (13244.4SF)	39.8 % (13160.0 SF)	NONE	VIS
PLANNING AREA(S):	10 CITY CENTRE	(OCP SCH: 2.10D) MCLENNAN SOUT	'H SUB-AREA PLAN	LOT COVERAGE - LANDSCAPING (GREEN):	MIN. 25% (8277.0 SF)	MIN. 25% (8277.0 SF)	NONE	OF
		EXISTING	PROPOSED	LOT COVERAGE - NON-POROUS AREA:	MAX. 70% (23177.7 SF	64.7% (21424.4 SF)		SIE
SITE SIZE (SM):		3076 SM (33111 S.F.)	3076 SM (33111 S.F.)	COVERED AREA (SF):	MAX. 10% OF FSR	4.8% OF FSR (1575.8 SF)		TA
LAND USES:		SINGLE-FAMILY RESIDENTIAL	TOWNHOUSE	SETBACK - ROAD SETBACK (NORTH):	MIN. 6.0M	6.0M	NONE	BIC
OCP DESIGNATION:		NEIGHBOURHOOD RESIDENTIAL	NEIGHBOURHOOD RESIDENTIAL	SETBACK - EAST SIDE YARD::	MIN. 3.0M	3.0M	NONE	BIO
AREA PLAN DESIGNAT	ION:	10 CITY CENTRE (OCP SCH: 2.10D)	10 CITY CENTRE (OCP SCH: 2.10D)	SETBACK - WEST SIDE YARD:	MIN. 3.0M	3.0M	NONE	AM
ZONING:	-	SINGLE DETACHED (RS-1E)	MEDIUM-DENSITY TOWN HOUSING (RTM2)	SETBACK - REAR YARD (SOUTH):	MIN. 3.0M	3,63M	NONE	AM
NUMBER OF UNITS:		4	18	HEIGHT:	12M (3 STOREYS)	12M (3 STOREYS)	NONE	PR

DEVELOPMENT DATA

ZONING: NUMBER OF UNITS:

	BYLAW REQUIREMENT	PROPOSED	VARIANCE
LOT SIZE (MIN. DIMENSIONS):	(MIN. 30M WIDE) (MIN. 35M DEEP)	71.6M WIDE 41.8M DEEP	NONE
RESIDENTIAL PARKING SPACES:	26 SPACES (1.4/UNIT)	36 SPACES (2.0/UNIT)	NONE
VISITOR PARKING SPACES:	0.2 SPACES/ UNIT = 4	4 SPACES	NONE
OFF-STREET PARKING SPACES-TOTAL:	30 SPACES	44 SPACES	NONE
SIDE-BY-SIDE PARKING SPACES:	MIN. 13 SPACES	14 SPACES	NONE
TANDEM PARKING SPACES:	13 SPACES MAX.	12 AMONG REQUIRED 26 STALLS	VARIANCE REQ'E
BICYCLE PARKING SPACE-CLASS-1:	1.25 SPACES PER UNIT	2.44 PER UNIT	NONE
BICYCLE PARKING SPACE-CLASS-2:	0.2 SPACES PER UNIT	0.22 PER UNIT	NONE
AMENITY SPACE - INDOOR:	MIN. 50 SM OR CASH-IN-LIEU	CASH-IN-LIEU	NONE
AMENITY SPACE - OUTDOOR:	MIN. 6 SM PER UNIT	1163 SF (6 SM PER UNIT)	NONE
PRIVATE OPEN SPACE:	MIN. 37 SM PER UNIT	45.9 SM PER UNIT (AVG.)	NONE
	*	* INCL. LITHETY C	OSETS

INCL. UTILITY CLOSETS

AGING IN PLACE FEATURES FOR ALL UNITS: -SOLID BLOCKING IN WASHROOM WALLS FOR FUTURE GRAB BAR:
-LEVER-TYPE HANDLES FOR PLUMBING AND DOOR HANDLES

2 CONVERTIBLE UNITS ARE PROPOSED FOR THIS PROJECT.

NOTE FOR LIFT:

2 STOREY LIFT RISE LIFT BY THYSSENKRUPP DESTINY RESIDENTIAL ELEVATOR MIN. CLEAR HOISTWAY SIZE: 43"X60" (TYP.) DEPRESSED SLAB FOR LIFT

NOTE— NO ABOVEGROUND UTILITY INFRASTRUCTURE IMPROVEMENTS IS PERMITTED WITHIN THE FRONT YARD SETBACK, ALONG THE ENTRY DRIVEWAY, AND IN FRONT OR WITHIN THE DUTDOOR AMENITY SPACE.

F.A.R. CALCULATION: LOT AREA: 33111.0 SQ.FT.

1 July 1 Live	IITTED:	0.65	FAR =	21522.2	SQ.FT.
UNIT 'A'	1120.7	SQ.FT.	X 3 =	3362.1	SQ.FT.
UNIT 'A1'	1120.7	SQ.FT.	X 1 =	1120.7	SQ.FT.
UNIT 'A2'	1120.7	SQ.FT.	X 2 =	2241.4	SQ.FT.
UNIT 'A3'	1120.7	SQ.FT.	X 1 =	1120.7	SQ.FT.
UNIT 'A4'	1120.7	SQ.FT.	X 1 =	1120.7	SQ.FT.
UNIT 'A5'	1120.7	SQ.FT.	X 1 =	1120.7	SQ.FT.
UNIT 'A6'	1120.7	SQ.FT.	X 1 =	1120.7	SQ.FT.
UNIT 'A7'	1120.7	SQ.FT.	X 1 =	1120.7	SQ.FT.
UNIT 'B'	1280.2	SQ.FT.	X 2 =	2560.4	SQ.FT.
UNIT 'B2'	1280.2	SQ.FT.	X 2 =	2560.4	SQ.FT.
UNIT 'B3'	1395.2	SQ.FT.	X 1 =	1395.2	SQ.FT.
UNIT 'B4'	1377.8	SQ.FT.	X 1 =	1377.8	SQ.FT.
UNIT 'B'	1280.2	SQ.FT.	X 1 =	1280.2	SQ.FT.
	UNIT 'A1' UNIT 'A2' UNIT 'A3' UNIT 'A4' UNIT 'A6' UNIT 'A7' UNIT 'B' UNIT 'B2' UNIT 'B3' UNIT 'B3' UNIT 'B4'	UNIT 'A1' 1120.7 UNIT 'A2' 1120.7 UNIT 'A3' 1120.7 UNIT 'A4' 1120.7 UNIT 'A5' 1120.7 UNIT 'A6' 1120.7 UNIT 'A7' 1120.7 UNIT 'B1' 1280.2 UNIT 'B2' 1280.2 UNIT 'B3' 1395.2 UNIT 'B4' 1377.8	UNIT 'A1' 1120.7 SQ.FT. UNIT 'A2' 1120.7 SQ.FT. UNIT 'A3' 1120.7 SQ.FT. UNIT 'A4' 1120.7 SQ.FT. UNIT 'A5' 1120.7 SQ.FT. UNIT 'A6' 1120.7 SQ.FT. UNIT 'A7' 1120.7 SQ.FT. UNIT 'B1' 1280.2 SQ.FT. UNIT 'B2' 1280.2 SQ.FT. UNIT 'B3' 1395.2 SQ.FT. UNIT 'B3' 1395.2 SQ.FT. UNIT 'B4' 1377.8 SQ.FT.	UNIT 'A1' 1120.7 SQ.FT. X 1 = UNIT 'A2' 1120.7 SQ.FT. X 2 = UNIT 'A3' 1120.7 SQ.FT. X 1 = UNIT 'A4' 1120.7 SQ.FT. X 1 = UNIT 'A5' 1120.7 SQ.FT. X 1 = UNIT 'A6' 1120.7 SQ.FT. X 1 = UNIT 'A6' 1120.7 SQ.FT. X 1 = UNIT 'A7' 1120.7 SQ.FT. X 1 = UNIT 'B' 1280.2 SQ.FT. X 2 = UNIT 'B2' 1280.2 SQ.FT. X 2 = UNIT 'B3' 1395.2 SQ.FT. X 1 = UNIT 'B4' 1377.8 SQ.FT. X 1 = UNIT 'B4' 1377.8 SQ.FT. X 1 =	UNIT 'A1' 1120.7 SQ.FT. X 1 = 1120.7 UNIT 'A2' 1120.7 SQ.FT. X 2 = 2241.4 UNIT 'A3' 1120.7 SQ.FT. X 1 = 1120.7 UNIT 'A4' 1120.7 SQ.FT. X 1 = 1120.7 UNIT 'A5' 1120.7 SQ.FT. X 1 = 1120.7 UNIT 'A6' 1120.7 SQ.FT. X 1 = 1120.7 UNIT 'A6' 1120.7 SQ.FT. X 1 = 1120.7 UNIT 'A7' 1120.7 SQ.FT. X 1 = 1120.7 UNIT 'B1' 1280.2 SQ.FT. X 2 = 2560.4 UNIT 'B2' 1280.2 SQ.FT. X 2 = 2560.4 UNIT 'B3' 1395.2 SQ.FT. X 1 = 1395.2 UNIT 'B4' 1377.8 SQ.FT. X 1 = 1377.8

TOTAL PROPOSED = (0.65 FAR) 21501.7 SQ.FT.

GRANVILLE AVE

CONTEXT PLAN

- ENGERGUIDE RATING OF 82 OR ABOVE IS TO BE ACHIEVED FOR THE DEVELOPMENT PROJECT. PRE-DUCT FOR SOLAR HOT WATER IS REQUIRED FOR EACH UNIT.

DP 14-671945



ZHAO XD ARCHITECT LTD.

#255-11181 Voyageur Way, Richmond, BC V6X 3N9 Tel. (604) 275-8882 Fax (604) 909-1736

Email: info@zhaoarch.com Web: zhaoarch.com

This drawing shall not be used for construction unless it is countersigned by the CONSULTANT.

B C C DETAIL SHEET All drowings, specifications and other related documents are the copyright property of the CONSULTANT and shall be returned upon request. TOWNHOUSE

DP COMMENTS 11MAR/14 REZONING

A DETAIL NUMBER

DEVELOPMENT GRANVILLE AVE


9800-9860 GRANVILLE AVE. RICHMOND, BC


Drawing Title: SITE PLAN & DATA

Drawn By: Checked By:


Project No.: Drawing No.:

A1

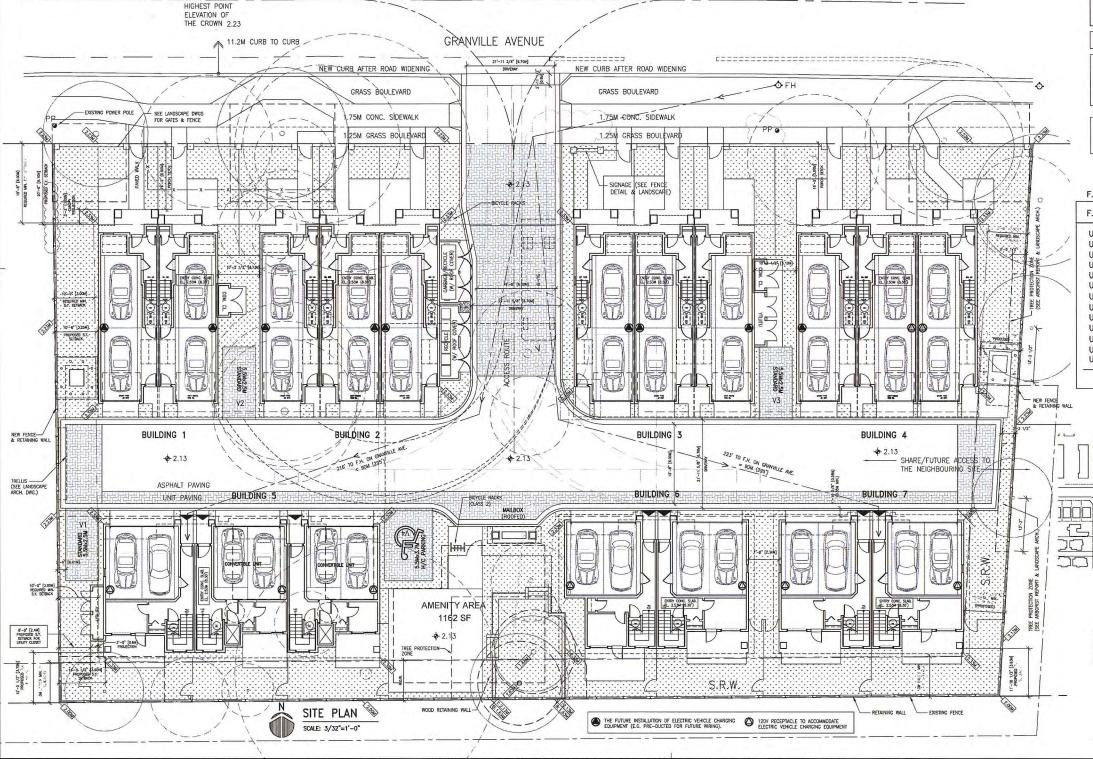

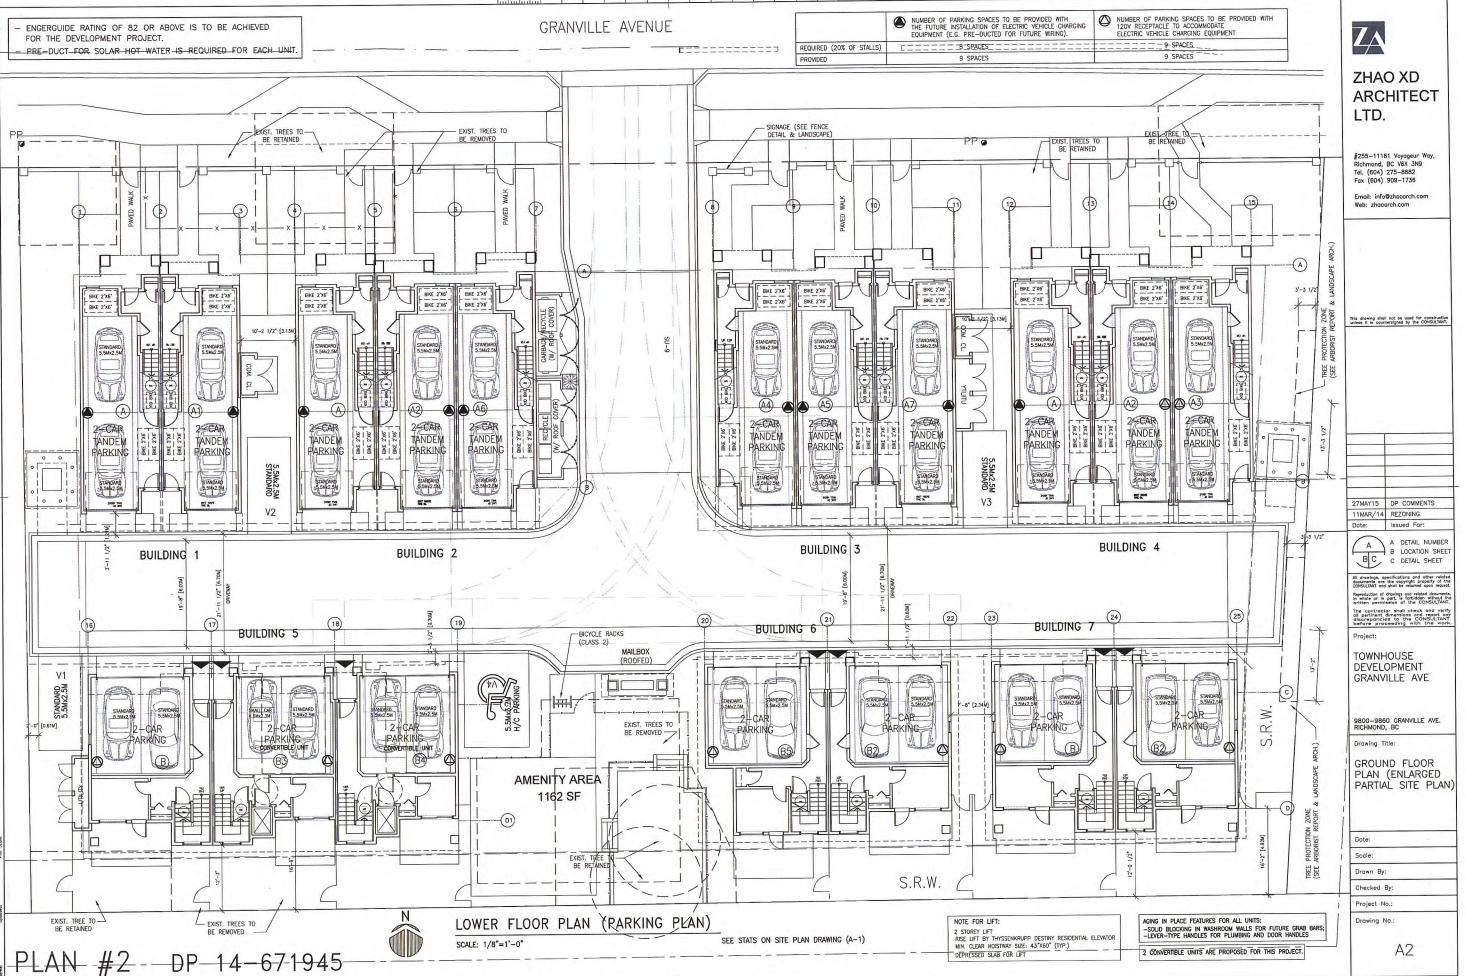

4-671945 PAN #11

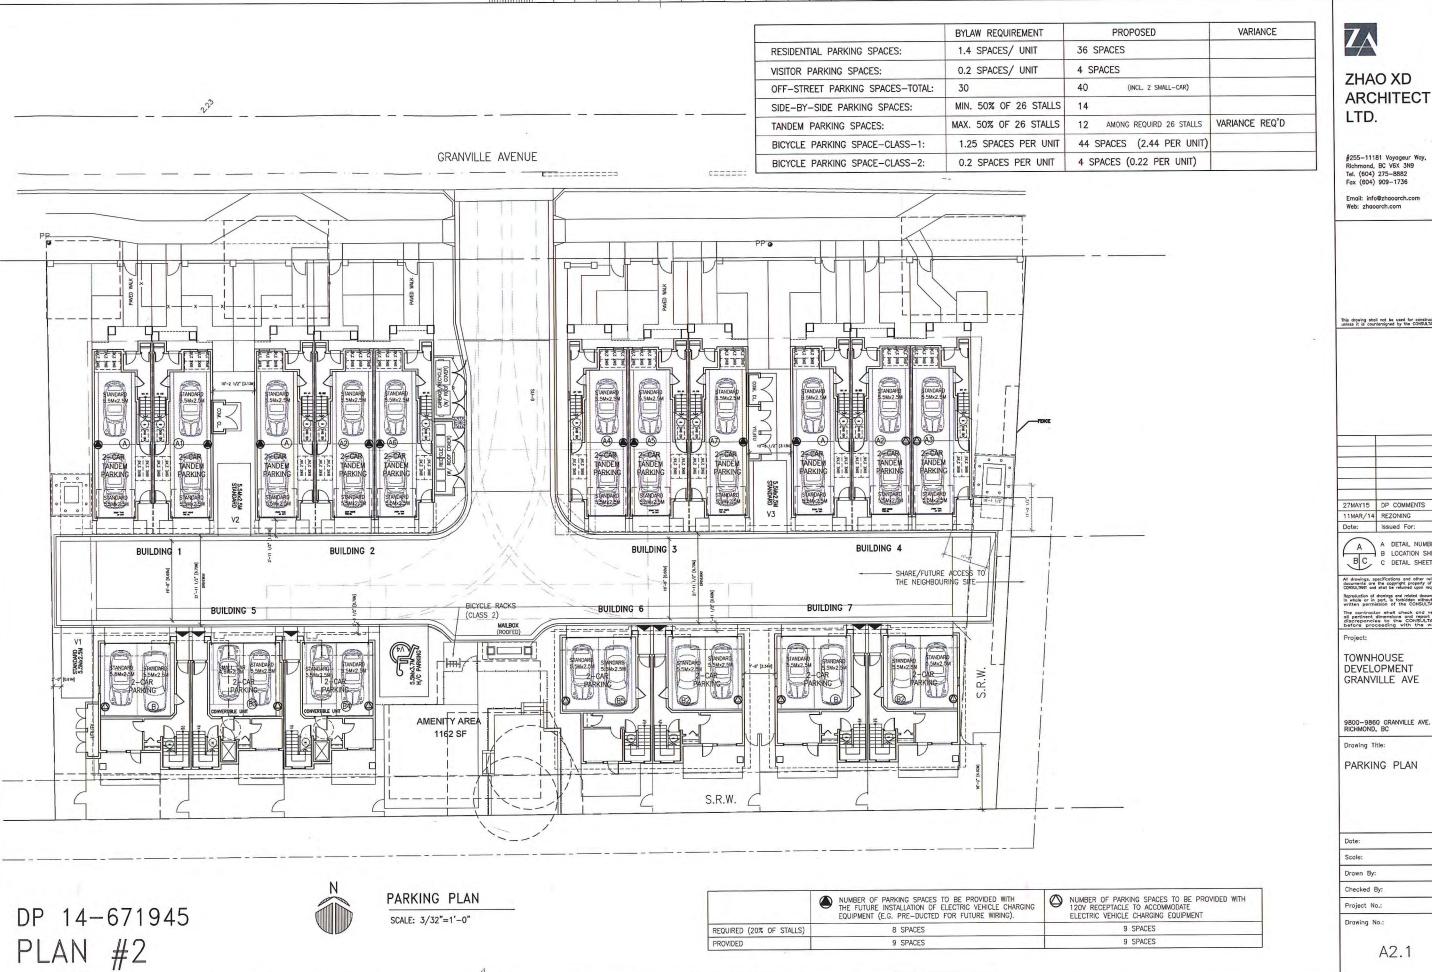

7/

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2016

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-MAR

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27MAY15 DP COMMENTS 11MAR/14 REZONING

Issued For: A DETAIL NUMBER B LOCATION SHEET B C C DETAIL SHEET


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Drawing Title:

PARKING PLAN

Drawn By: Checked By: Project No.:

A2.1

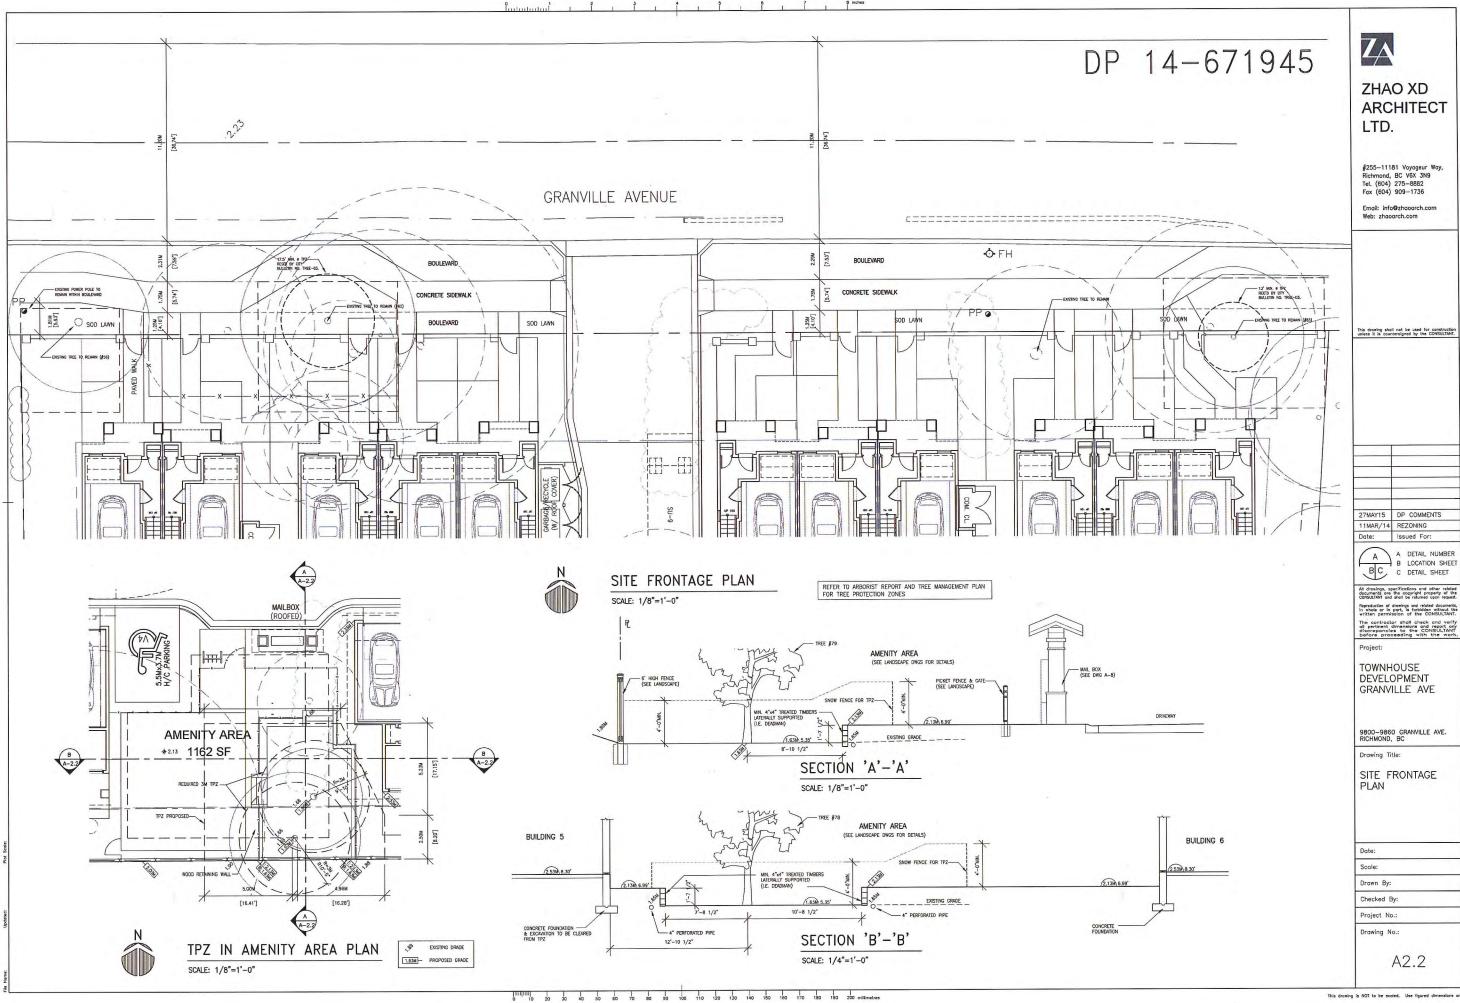

00

M

0

A2.2





CLIENT: ZHANG CUBIC ESTATES HOLDINGS LTD.

WITH ZHAO XD ARCHITECT LTD. PROJECT:

TOWNHOUSE DEV.

9800 GRANVILLE AVE RICHMOND, BC

DRAWING TITLE:

NOTE: NO ABOVEGROUND UTILITY
INFRASTRUCTURE IMPROVEMENTS (I.E.
KIOSKS, VAULTS, METERS, ETC.) IS
PERMITTED WITHIN THE FRONT YARD
SETBACK, ALONG THE ENTRY DRIVEWAY,
AND IN FRONT OR WITHIN THE OUTDOOR
AMENITY PROPE


AMENITY SPACE.

PLAN #3 LANDSCAPE

DATE: April 25,2014 3/32"=1'-0" SCALE:

DESIGN: DD CHK'D: PCM

14017-8.ZIP PMG PROJECT NUMBER:

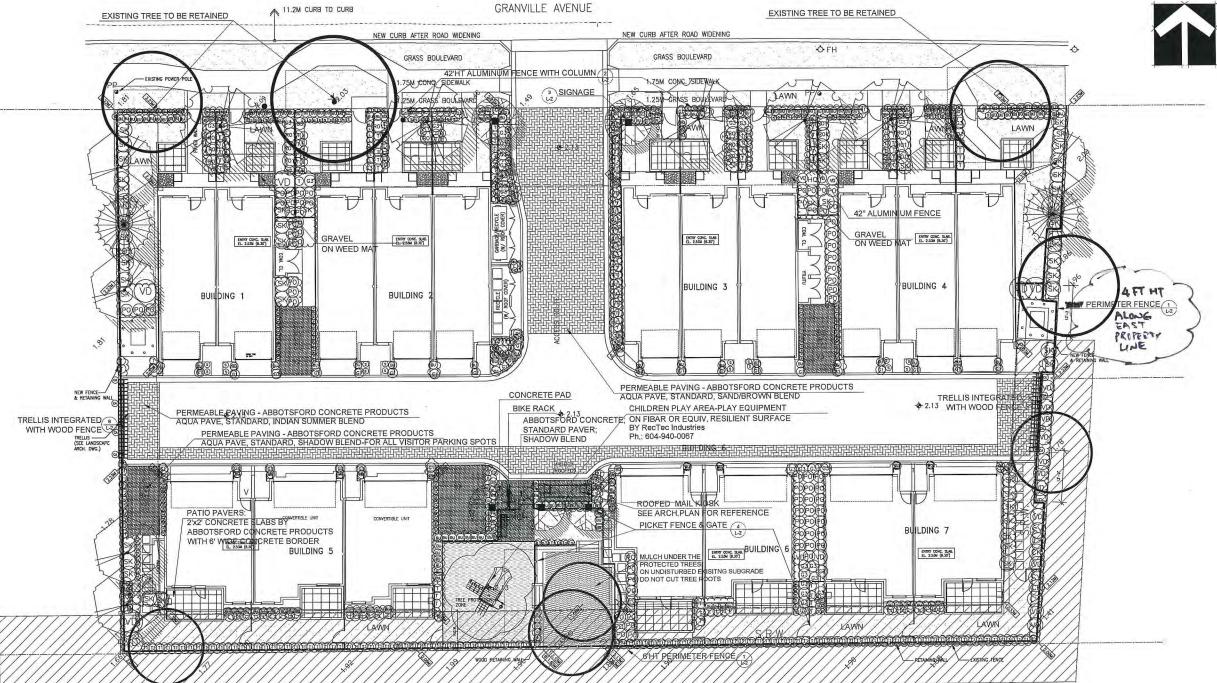

LAN	IT S	CHEDULE		PMG PROJECT NUMBER: 14-917
KEY	QTY	BOTANICAL NAME	COMMON NAME	PLANTED SIZE / REMARKS
REE	5	ACER RUBRUM 'ARMSTRONG'	COLUMNAR ARMSTRONG MAPLE	8CM CAL: 2M STD: B&B
173	5	ACER RUBRUM 'RED SUNSET'	RED SUNSET MAPLE	BCM CAL; 2M STD; B&B
213	3	CHAMAECYPARIS OBTUSA GRACILIS	SLENDER HINOKI FLASE CYPRESS	4M HT; B&B
	2	PINUS NIGRA 'ARNOLD SENTINEL'	ARNOLD SENTINEL AUSTRIAN BLACK PINE	4M HT; B&B
RUB	5	STYRAX JAPONICUS	JAPANESE SNOWBELL	8CM CAL; 2M STD; B&B
(BU)	204	BUXUS SEMPERVIRENS	COMMON BOXWOOD	#3 POT; 40CM
8	4	CORNUS ALBA 'ELEGANTISSIMA'	VARIEGATED SHRUB DOGWOOD	#2 POT; 50CM
(HD)	11	HYDRANGEA QUERCIFOLIA 'RUBY SLIPPERS'	RUBY SLIPPERS HYDRANGEA	#3POT
359386F	19	RHODODENDRON 'MRS, FURNIVAL'	RHODODENDRON; ROSE PINK; MAY	#2 POT; 30CM
SK	47	SKIMMIA JAPONICA (10% MALE)	JAPANESE SKIMMIA	#2 POT; 30CM
(50)	2	SYMPHORICARPOS DOORENBOSII 'ARISO'	PURPLE SNOWBERRY	#2 POT; 30CM
8	100	TAXUS X MEDIA 'HICKSII'	HICK'S YEW	1.2M B&B
\approx	120	THUJA OCCIDENTALIS 'SMARAGD'	EMERALD GREEN CEDAR	1.8M HT; B&B
(S)	28	VIBURNUM P.T. 'SUMMER SNOWFLAKE'	SUMMER SNOWFLAKE VIBURNUM	#3 POT; 60CM

(PO) 75	POLYSTICHUM MUNITUM	WESTERN SWORD FERN	#1 POT; 25CM	
(P) 109	PACHYSANDRA TERMINALIS	JAPANESE SPURGE	9CM POT;	
(L) 64 (S) 187	SEDUM M ATUMN JOY	SEDUM	15 CM POT	
(L) 64				
(40)	LAVENDULA ANGUSTIFOLIA ' HIDCOTE'	ENGLISH LAVENDER	#1 POT	
(i) 39 (ii) 3	HOSTA UNDULATA 'ALBO-MARGINATA'	WAVY LEAF HOSTA: WHITE VARIEGATED	#1 POT: 1 EYE	
	HEMEROCALLIS LITTLE WINE CUP	LITTLE WINE CUP DAYLILY; RED	#1 POT; 1-2 FAN	
(E) 29	ERYSIMUM 'BOWLES MAUVE'	SHRUBBY WALLFLOWER; PURPLE	15 CM POT	
ERENNIAL				
(A) 8	CLEMATIS ARMANDII	EVERGREEN CLEMATIS	#2 POT; 60CM STAKED	
(3) 77 (3) 35 INE	MISCANTHUS SINENSIS 'PURPURASCENS'	FLAME GRASS	WI FOI	
(a) 77			#1 POT	
GRASS	HELICTOTRICHON SEMPERVIRENS	BLUE OAT GRASS	#1 POT	

(6) 75 POLYSTICHOW MOUNTION
WESTERN STORDERS TANDARD, LATEST EDITION, CONTAINER SIZES SPECIFIED AS PER COTES. PLANT SIZES IN THIS LIST ARE SPECIFIED ACCORDING TO THE BE L'ANDSCAPE STANDARD, LATEST EDITION, CONTAINER SIZES SPECIFIED AS PER COTAS TANDARDS. BOTH PLANT SIZE AND CONTAINER SIZE ARE THE MINIMUM ACCEPTABLE SIZES, REFER TO SPECIFICATIONS FOR DEFINED CONTAINER MEASUREMENTS AND OTHER HANT MATERIAL, REQUISEMENTS. *SEARCH AND REVIEW. MAKE PLANT MATERIAL, AVAILABLE FOR OPTIONAL REVIEW BY LANDSCAPE ARCHITECT AT SOURCE OF SUPPLY, AREA OF SEARCH TO INCLUDE LOWER MAINLAND AND FRASER VALLEY. *SUBSTITUTIONS CONTAIN WRITTEN APPROVAL FROM THE LANDSCAPE ARCHITECT PRIOR TO MAKING ANY SUBSTITUTIONS OF THE SPECIFIED MATERIAL, UNAPPROVED SUBSTITUTIONS WILL BE REJECTED, ALLOWA MINIMUM OF FIVE DAYS PRIOR TO DELIVERY FOR REQUEST TO SUBSTITUTE, SUBSTITUTIONS ARE SUBJECT TO BC LANDSCAPE STANDARD. DEFINITION OF CONDITIONS OF AVAILABILITY, ALL LANDSCAPE MATERIAL AND WORKMANSHIP MEET OR EXCEED BC LANDSCAPE STANDARD. DEFINITION OF CONDITIONS OF AVAILABILITY, ALL LANDSCAPE MATERIAL AND WORKMANSHIP MEET OR EXCEED BC LANDSCAPE STANDARD. DEFINITION OF CONDITIONS OF AVAILABILITY, ALL LANDSCAPE MATERIAL AND WORKMANSHIP MEET OR EXCEED BC LANDSCAPE STANDARD SALTEST EDITION, ALL PLANT MATERIAL MUST BE PROVIDED FROM CERTIFIED DISEASE FREE NURSERY.


MAR


ALL POSTS PRESSURE TREATED TO CSA STANDARD AND END CUTS
 TREATED WITH PRESERVITIVE.


2. ALL OTHER MEMBERS TO BE CEDAR. #2 (CONSTRUCTION) GRADE MINIMUM

ALL HARDWARE HOT DIPPED GALVANIZED.
 APPLY 2 COATS EXTERIOR STAIN TO MANUFACTURERS SPECIFICATION, FINISH SELECTION AS APPROVED BY PROJECT ARCHITECT.

ALL FENCES TO BE LEVEL, CHANGES IN GRADE TO BE IN 12"-18" STEPS (MAX.). GAPS TO GRADE TO FOLLOW FINISH GRADE, GAP TO BE 3-6".

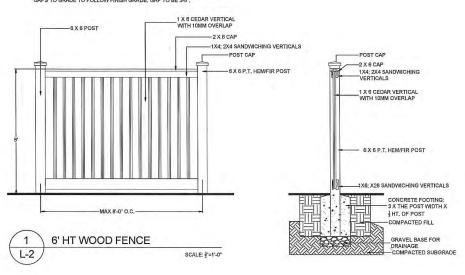


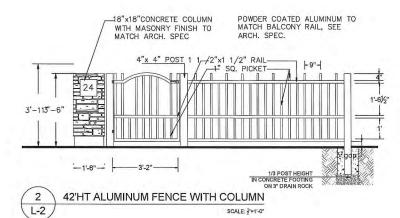


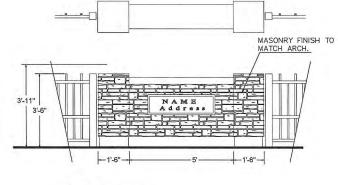


SIGNAGE

L-2

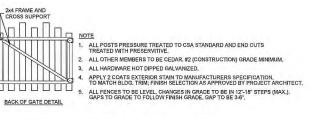

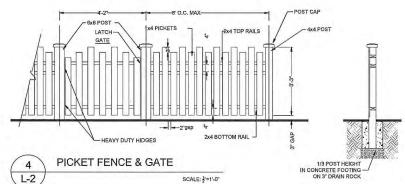

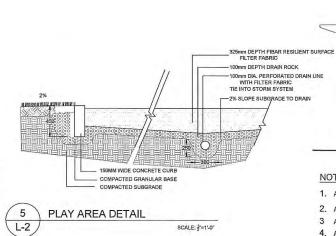



PLAN VIEW

2 - 2x4 BRACE

MATCH TRIM COLOUR PER ARCH SPEC, CONFIRM WITH ARCHITECT 5. COAT ALL CUT SURFACES WITH SIMILAR PRESERVATIVE AS ABOVE

TRELLIS STRUCTURE

L2



3/8" = 1'-0"

SCALE: 3"=1'-0"







MODENA PARK BENCH; MODEL SFBR-3, BLACK COLOUR

WISHBONE BIKE RACK MODEL SFBR-3, BLACK COLOUR

BIG TOYS CABANA, MEC-650, NATURAL COLOUR © Copyright reserved. This drawing and design is the property of PMG Landscape Architects and may not be eproduced or used for other projects without their



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NO. DATE REVISION DESCRIPTION

ZHANG CUBIC ESTATES HOLDINGS LTD.

WITH ZHAO XD ARCHITECT LTD.

TOWNHOUSE DEV.

9800 GRANVILLE AVE RICHMOND, BC

DRAWING TITLE:

LANDSCAPE DETAILS

DATE: April 25,2014 DRAWING NUMBER SCALE: DESIGN: DD CHK'D: PCM

14017-8.ZIP PMG PROJECT NUMBER: 14-017

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N

RAZ

7 15-59-14 AS PER CITY REPORTS
5 15-MAY.22 REVISION AS PER CITY COMMENTS
5 15-MAY.22 REVISION AS PER CITY COMMENTS
4 14-DEC.15 NEW SITE PLANFORM COMMENTS
1 14-NOV.21 REVISION REMARKING MENT PLANFORM COMMENTS
2 14-DCT.28 NEW SITE PLANFORM COMMENTS
1 15-SEP.04 REV. PER CITY COMMENTS
1 15-SEP.04 REV. PER CITY COMMENTS

NO. DATE REVISION DESCRIPTION CLIENT: ZHANG CUBIC ESTATES HOLDINGS LTD.

WITH ZHAO XD ARCHITECT LTD. PROJECT:

TOWNHOUSE DEV.

9800 GRANVILLE AVE RICHMOND, BC

DRAWING TITLE:

TREE MANAGEMENT PLAN

DATE: April 25,2014 SCALE: DRAWN: DD DESIGN: DD

PMG PROJECT NUMBER:


CHK'D: PCM

OF 5 14-017

14017-8.ZiP

TREE TO REMOVE

L_____ TREE PROTECTION FENCE

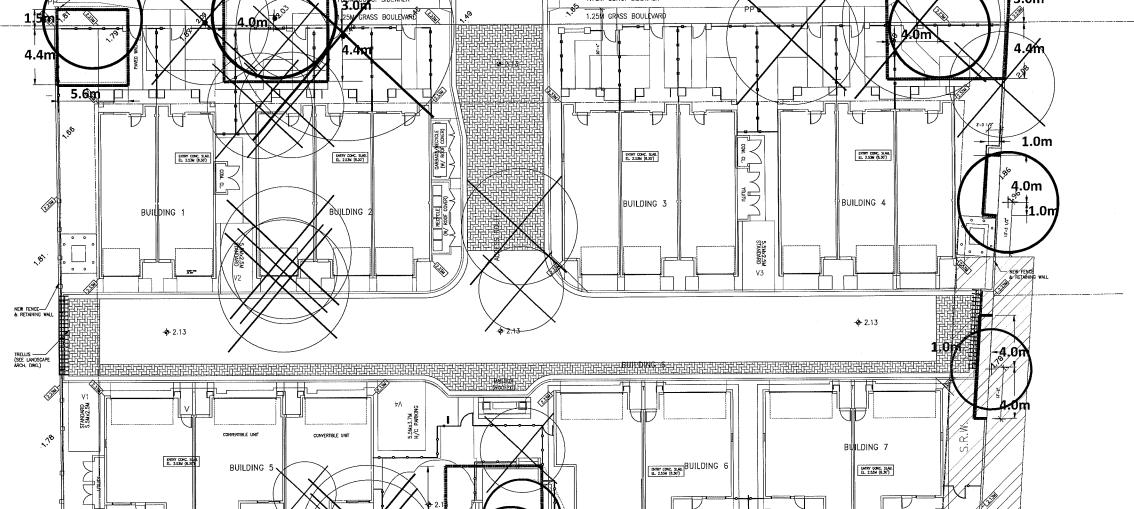

	Recommendation	ns by Arl	borist
Tree No.		Tree No.	A
No.56	Landscaping works can incorporate up to 15cm depth soil (including any sod or bark mulch) over the original grade, except within 1m of the retained tree trunks where the original grade must be maintained. The preferred, best practice is to maintain the original grade throughout the TPZ and apply only bark mulch overtop to a depth of 6 to 7cm. A summary of the above supervised works including any mitigating treatments conducted and any further recommendations will be prepared and submitted to the client and/or city staff.	No.78 & 79	Crown Pruning To prevent damage to the crowns of these trees during demolition/construction activities, the project arborist should make an assessment of the clearance required and conduct appropriate pruning as necessary prior to demolition. Demolition The removal of the existing fence and hedge should be conducted or supervised by the project arborist
No.62	Excavation Supervision: Arborist supervision during the excavation in the area adjacent to the TPZ. Concurrently, the arborist will conduct an assessment of damaged roots near the TPZ boundary and implement root pruning as required to facilitate wound closure, and promote new root development Patio Construction, Walkways, and Paving: Within the TPZ, the planned patio and walkway should be paving stone construction with the underlying roadbase and sand placed overtop the original grade (no excavation should be undertaken). Landscaping works can incorporate up to 15cm depth soil (including any sod or bark mulch) over the original grade, except within 1m of the retained tree trunks where the original grade must be maintained. The preferred, best practice is to maintain the original grade throughout the TPZ and apply only bark mulch overtop to a depth of 6 to 7cm.		where within the proscribed TPZ. Also, the compost pile should be removed (not by machinery) while maintaining the underlying natural grade as undisturbed. Excavation Supervision Arborist supervision during the excavation in the area adjacent to the TPZ. Concurrently, the arborist will conduct an assessment of damaged roots near the TPZ boundary and implement root pruning as required to facilitate wound closure, and promote new root development. Landscaping Landscaping works can incorporate up to 15cm depth soil (including any sod or bark mulch) over the original grade, except within 1m of the retained tree trunks where the original grade must be maintained. The preferred, best practice is to maintain the original grade throughout the TPZ and apply only bark mulch overtop to a depth of 6 to 7cm.
No.70	Crown Pruning – Pre Construction To prevent damage to the crown during demolition/construction activities, the project arborist should make an assessment of the clearance required and conduct appropriate pruning as necessary prior to demolition. Excavation Supervision Very little of the critical root zone north of the tree can now be retained given the newly expanded building footprint southward. Arborist supervision during the excavation in the area adjacent to the TPZ. Concurrently, the arborist will conduct an assessment of damaged roots near the TPZ boundary and implement root pruning as required to facilitate wound closure, and promote new root development. A reassessment of the viability of the tree's retention will be made at this time. Patio Construction & Landscaping Within the TPZ, the planned patio should be paving stone construction with the underlying roadbase	No.83	Excavation Supervision Arborist supervision during the excavation in the area adjacent to the TPZ. Concurrently, the arborist will conduct an assessment of damaged roots near the TPZ boundary and implement root pruning as required to facilitate wound closure, and promote new root development. Patio Construction, Walkways & Landscaping Within the TPZ, the planned patio and walkway should be paving stone construction with the underlying roadbase and sand placed overtop the original grade (no excavation should be undertaken). Landscaping works can incorporate up to 15cm depth soil (including any sod or bark mulch) over the original grade, except within 1m of the retained tree trunks where the original grade must be maintained. The preferred, best practice is to maintain the original grade throughout the TPZ and apply only bark mulch overtop to a depth of 6 to 7cm.
	and sand placed overtop the original grade (no excavation should be undertaken). Landscaping works can incorporate up to 15cm depth soil (including any sod or bark mulch) over the original grade, except within 1m of the retained tree trunks where the original grade must be maintained. The preferred, best practice is to maintain the original grade throughout the TPZ and apply only bark mulch overtop to a depth of 6 to 7cm.	A&B	Excavation Supervision Arborist supervision during the excavation in the area adjacent to the TPZ. Concurrently, the arborist will conduct an assessment of damaged roots near the TPZ boundary and implement root pruning as required to facilitate wound closure, and promote new root development.

	. Т	able of Trees		
	Spec	es		
Tree No.	Common Name	Botanical Name	DBH(cm)	CRZ radius (m)
No.56	Bigleaf maple	Acer macrophyllum	48	5.5
No.57	Douglas fir	Pseudotsuga mensiezii	56	4.0
No.62	Douglas fir	Pseudotsuga mensiezii	41	3.7
No.63	Western Redcedar	Thuja plicata	50	3.7
No.5	Alder	Alnus rubra	25	1.5
No.64	Dawyck Beech	Fagus sylvatica 'Dawyck''	32	4.2
No.65	Dawyck Beech	Fagus sylvatica 'Dawyck"	27	35
No.66	European Birch	Betula pendula	38	5.5
No.67	Dawyck Beech	Fagus sylvatica 'Dawyck"	25+20x2	5,5
No.68	Dawyck Beech	Fagus sylvatica 'Dawyck"	20+15x2	4
No.69	Dawyck Beech	Fagus sylvatica 'Dawyck"	60	6
No.70	Maple	Acer sp.	16+11	3.6
No.71	Douglas fir	Pseudotsuga mensiezii	24	4.2
No.73	European Birch	Betula pendula	13+9	3.5
No.75	Western Redcedar	Thuja plicata	38	4.1
No.76	Horse Chestnut	Aesculus Hippocastanum	41+23	7.0
No.77	Horse Chestnut	Aesculus Hippocastanum	43	4,9
No.78	Horse Chestnut	Aesculus Hippocastanum	19+15	5.1
No.79	Horse Chestnut	Aesculus Hippocastanum	13+9	3.7
No.80	Western Redcedar	Thuja plicata	25x2	4.2
No.81	Paper birch	Betula papyrifera	35+33+25	5.3
No.82	Paper birch	Betula papyrifera	30+23	5.0
No.83	Douglas fir	Pseudotsuga mensiezii	33	4.5
No.84	Paper birch	Betula papyrifera	20x2	4.0
Α	Cerry	Prunus	20+15	3.5
В	Douglas fir	Pseudotsuga mensiezii	25	3.8

Suitable Repla	Suitable Replacement Trees		
Species			
Botanical Name	Common Name		
ACER RUBRUM 'ARMSTRONG'	COLUMNAR ARMSTRONG MAPLE		
ACER RUBRUM 'RED SUNSET'	RED SUNSET MAPLE		
CHAMAECYPARIS OBTUSA GRACILIS	SLENDER HINOKI FLASE CYPRESS		
PINUS NIGRA 'ARNOLD SENTINEL'	ARNOLD SENTINEL AUSTRIAN BLACK PINE		
STYRAX JAPONICUS	JAPANESE SNOWBELL		

NOTE: ALL TREES REGARDLESS OF SIZE ARE PROTECTED IN HIGH ENVIRONMENTALLY SENSATIVE AREAS PLASTIC MESH SCREENING -SOLID 2X4 CONSTRUCTION WITH CROSS BRACING AND TOP AND BOTTOM RAILS

TREE PROTECTION DISTANCE TABLE

TRUNK DIAMETRE in cm. @ dbh.*	MINIMUM REQUIRED PROTECTION RADIUS (DISTANCE FROM TRUNK IN METRES)
20	1,2
25	1.5
30	1.8
35	2.l
40	2,4
45	2.7
50	3
55	3,3
60	3.6
75	4.5
90	5
100	6.0

EXTRAPOLATE PROTECTION RADIUS FOR TREES LARGER THAN IOOCM dbh, ¶(DIAMETRE AT BREAST HEIGHT OR I.4M FROM GRADE).

NO STORAGE OF BUILDING MATERIALS WITHIN OR AGAINST PROTECTION BARRIER

1A TREE PROTECTION BARRIER

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CLIENT: ZHANG CUBIC ESTATES HOLDINGS LTD.

TOWNHOUSE DEV.

9800 GRANVILLE AVE RICHMOND, BC

TREE MANAGEMENT PLAN

SCALE:

DRAWN: DD CHK'D: PCM

14017-8.ZIP PMG PROJECT NUMBER:

14-017

1 CCDC Doc 2 2008
Comply with all articles in the General Conditions of Contract in conjunction with this section unless superseded by other Contract Documents.

2 B.C. Landscape Standard, 2012 edition, prepared by the B.C. Society of Landscape Architects and the B.C. Landscape Livrsery Association, jointly, All work and materials shall meet standards as set out in the B.C. Landscape Standard unless superseded by this specification or as directed by Landscape Architect with written instruction.

- 3 MASTER MUNICIPAL SPECIFICATIONS & STANDARD DETAILS, 2000 edition, prepared by the Consulting Engineers of Brilish Columbia, Roadbuilders and Heavy Co

5 MUNICIPAL BYLAWS AND ENGINEERING SPECFICATIONS WHERE NOTEO.

.1 A current last more than one month test for all growing medium to be used on this site is required. Provide and pay for testing by an independent testing facility pre-approved by the Landscape Architect. Deliver growing medium test results to Landscape Architect for review and approval prior to placement. Refer to Section 3.4 Growin

2. Owner reserves the right to test or re-test materials. Contractor responsible to pay for testing if materials do not meet specification.

SUBMITTALS

1. Any alternate products differing from that contained in the contract documents must be pre-approved by the Landscape Architect

2 Submittals to consist of product sample or manufacturer's product description.

- STE REVEY.

 1. Under the Terms of the Landscape Architect's Contract with the Owner and where the Landscape Architect is the designated reviews, the Landscape Architect will observe construction as its necessary in their opinion to conferm conformance to the plans and specifications. Contract Owners Representative to arrange for cite observations such as many propositive literal. Native to open such confermance in the plans are designed to the following propositive literal. Native to open such confermations such that the following of the such part of the plans of the such part of the such part

- be held its review expected work and 40 to entry the acceptability of the subgrade and general all conditions to the Landscape Contractor. Proving growing modes that results for this needing.

 13 Progress 510 Visits. To observe malerials and warkmaning as notices and the condition is the Landscape Contractor. Proving growing modes and proving the course of the work. Review of different aspects of the work may be deadly as a page entit. So the descents may include SST Lands (Review) for each proving the course of the contractor of the contract of the contractor of

- .1 Unless otherwise instructed in the Contract Documents, the preparation of the subgrade shall be the responsibility of the General Contractor. Placement of growing medium constitutes acceptance of the subgrade required are the responsibility of the Landscape Contractor. Any subsequent corrections to the subgrade required are the responsibility of the Landscape Contractor.
- All work and superintendence shall be performed by personnel shilled in landscape contracting. In addition, all personnel applying herbitides and/or pesitides shall hold a current license issued by the appropriate authorities.
- 3 A site visit is required to become familiar with site conditions before bidding and before start of work.
- .4 Confirm location of all services before proceeding with any work.
- 5 Notify Landscape Architect of any discrepancies. Obtain approval from Landscape Architect prior to deviating from the plans.
- .6. Take appropriate measures to articl environmental damage. Do not dump any waste materials into water bodies. Conform with all federal, provincial and local statutes an
- .7. Collect and dispose of all debris and/or excess material from landscape operations. Keep pared surfaces clean and repair damage resulting from landscape work. Repairs are to be considered union to find considered.
- .8 Where new work connects with existing, and where existing work is aftered, make good to match existing undisturbed condition

.1 Guarantee all materials and workmanship for a minimum period of one full year from the date of Certificate of Completion

.2 Refer to individual sections for specific warranties.

PART TWO SCOPE OF WORK

- .1 Other conditions of Contract may apply. Confirm Scope of Work at time of tender. 2 Veterk includes supply of all related items and performing all operations necessary to consists of the following:

- Comman on the training.

 12. Rotations of this fireting and Landscape Parkage.

 12. Firstin Farning and Landscape Parkage.

 13. Sough and placement of growing medium.

 14. Testing of imported growing medium and/or site Impossit.

 15. Sough and imported growing medium and/or site Impossit.

 15. Sough and imported growing medium and/or site Impossit.

 16. Sough and imported growing medium and/or site Impossit.

 16. Sough and imported growing medium and/or site Impossit.

 16. Sough and placement of last medium and and/or site Impossit.

 17. Sough and placement of last medium.

 18. The Impossit is of claimed and accelerate offered overs und last coupled by Owers.

 18. Staffand The Park Establishment Mediumsons, Sociolo 31.

 18. Of these with when other hash this list, and specialled by Landscape Architect.

1 Growing Medium: Conform to BC Landscape Standard for definitions of imported and on-site topsoil. Refer to Yable One below.

Applications	Low Traffic Areas.	High Traffic	Planting Areas						
**	Trees and Large Shrubs	Lawn Areas	and Planters						
Growing Medium Types	žL.	ZH	29						
Texture		Percent Of Dry Yeight of Total Growin	g Hedium						
Coarse Gravel: larger than 25mm	0 - 1X	0 - 1X	0 - tx						
All Gravel: larger than Zmm	0 - 5%	0 - 5%	0 - 5X						
	Percent Of Dry Weight of Growing Mediun Excluding Gravel								
Send: larger than 0,05mm smaller than 2,0mm	50 - 80 x	. 70 - 90%	40 - 8000						
Silt: Larger than 0.002em smaller than 0.05em	10 - 25%	0 - 15%	10 - 25x						
(lay: smaller than 0.002mm	0 - 25X	0 - 15%	0 - 25X						
Clay and Silt Combined	пакінця 35%	maximum ISX	naxinun 35%						
Organic Content (coast):	3 - 10X	3 - 5X	10 - 70X						
Organic Content (interior):	3 - 5X	3 - 5%	5 - 20X						
Acidity lettle	6.0 - 7.0	6.0 - 7.0	45-65						

- 2 Fertilizer: An organic and/or inorganic compound containing Mitrogen (N), Phosphate (25), and Polash (soluble 2) in proportions required by soil lest.
- 3 Line: Ground pericultural linestone. Meet requirements of the B.C. Landscape Standard.
- 4. Organic Additive Commercial compast product to the requirements of the B.C. Landscape Standard, 6th edition and pre-approved by the Landscape Architect. Recommended suppliers: The Answer Garden Products, Fraser Richmond Soils & Fibre, Stream Organics Management.
- .5 Sand: Clean, washed pump sand to neet requirements of the B.C. Landscape Standard.
- 6. Composted Bark Midck: 10am (3/6*) winus Fir/Henlock bark chips and fines, free of chunks and slicks, dark brown in calour and free of all soil, stones, roots or other extraneous matter. Fresh orange in colour bark will be rejected. .7 Herbicides and Pesticides: If used, must conform to all federal, provincial and local stafutes. Appliers must hold current licenses issued by the the area.
- 8 Filter Fabric A non-biodegradable Market or other filtering embrane that will allow the passage of water but not fine soil particles. (Such as MRAP1 NO NL, GEDLON NLO OR AMOCO 6545 or alternate product pre-approved by the Leudscape Architect.)
- .9 Drainage Piping if required: Schedule 40 PVC nominal sizes.
- .10 Drain Rock: Clean, round, inert, durable, and have a maximum size of 19mm and containing no scaterial smaller than 10mm
- .11 Plant Material: To the requirements of the B.C. Landscape Standard. Refer to 3.9, Plants and Planting. All plant material must be provided from a certified disease free mursery. Provide proof of certification.

- .14 Piscellaneous: Any other material necessary to complete the project as shown on the drawings and described herein.

PART THREE SOFT LANDSCAPE DEVELOPMENT

- TRIES
 site—probect individual trees or plant groupings indicated as retained on landscape plans as regetation retention areas.
 The Landscape Architect will trag trees or areas to remain. Discuss tree retention areas at a start—up neeting with the Landscape Architect
- 2 A physical barrier must be installed to define the clearing boundaries. Refer to physical burrier detail. If detail not provided, comply with li
- 3 No machine travel through or within vegetation retention areas or under crowns of trees to be retained is allowed.
- & Do not stockpile soil, construction materials, or excavated materials within vegetation retention areas 5 Bo not park, fuel or service vehicles within regetation retention areas.
- .6 No debris fires, clearing fires or Irash burning shall be permitted within vegetation retention areas.
- No extravalions, drain or service trenches nor any other diaruption shall be permitted within vegetation retention areas without a review of the propose the Landscape Architect.
- .8 Do not cut branches or roots of retained trees without the approval of the Landscape Architec
- 9 Any damage to existing regulation intended for preservation will be subject to evaluation by an LS.A. Certified Arborist using the "Guide for Plant Appraisal", Eight
- 3.1 Replacement planting of equivalent value to the disturbance will be required. The cost of the evaluation and of the replacement planting will be the responsibility of the General Contractor and on the personnial responsible for the disturbance.
- .tl . In situations where required construction may disturb existing regetation intended for preservation, contact Landscape Architect for review prior to commencing

- oraces.

 1. Ensure subgrade is prepared to conform to depths specified in Section 3.5, Growing Medium Supply, below. Where planting is indicated close to existing trees, prepare subladie electrics posterized for existing trees, prepare subladie electrics posterized for existing trees, prepare subladie electrics posterized for existing trees, prepare subladie electrics produce and conform to the site grading and drainage plan.
- 2 On sloves in excess of 3.5 french subgrade across slope to 150nm (61) minimum at 1.5m (5 ft.) intervals minimum.
- 3 Starify the order subgrade immediately prior to placing growing medium. Re-cultivate where reticular traffic results in compaction during the construction procedures. Ensure that all planning areas are sensitive contoured after light compaction to finished grades.
- .4. Eliminate standing water from all finished grades. Provide a smooth, firm and even surface and conform to grades shown on the Landscape Gravings. Do not exceed maximum and minimum cradinate defined by the B.C.Landscape Standard.
- 5 Construct swales true to line and grade, smooth and free of sags or high points. Hinkous slope 2%, maximum side stopes NM. Assure positive drainage to collection point
- .6 Slope not to exceed the following maximums: Rough Grass 3:1, Lawn 4:1, Landscape plantinos 2:1. Finished soil/mutch elevation at building to comply with nunicipal requirements
- B Inform Landscape Architect of completion of finish grade prior to placement of seed, sod, plants or mulch

LANDSCAPE DRAINAGE .1 Related Mork: Growing medium and Finish Grading, Grass areas, Trees Shrubs and Groundcovers, Planters, Crib Walls.

- . Execution
 1.1 Do Frenching and Southilling in accordance with engineering celtais and specifications.
 1.2 Lay drains on pregueed leed, from to the and grade with inverta smooth and free of seps or high points. Ensure haved of each pipe is in contact with bed throughout full.
 1.2 Lay drains on pregueed leed, from to the and grade with inverta smooth and free of seps or high points. Ensure haved of each pipe is in contact with bed throughout full.
- nmence laying pipe at outlet and proceed in upstream direction.

 y perforated pipes with perforations at 8pm and 4pm positions.

- Lay perfected purs win pe to mome a grown on the perfect of the pe

- GROWING MEDIUM TESTING
- Somil representative same of graving majors proposed for use on this project is an independent laboratory. Provide test results to Landscape Architect prior to pictor. Test results in include:

 11. Priorizal propriate, K. Centelle of gravin, sand, still, city and experies.

 12. Addity for and quantities of the or support required to kindy within specified range.

 13. Addity for and quantities of the or support required to kindy within specified range.

 14. Centelly filtering when the second control of the required second

- Carbon/Nitrogen level.
 GROWING MEDIUM SUPPLY AND PLACEMENT
 Supply all growing medium required for the damaged. n. for the nerformance of the Contract. Do not load. Transport or spread proving motion when it is so wet that its structure is likely to be
- 2 Supply all growing medium admixtures as required by the soil test. Amended growing medium must meet the specification for growing medi
- 2.1 Theroughly nix required amendments into the full depth of the growing medium.
 2.2 Special nixes may be required for various situations. Refer to drawing nates for instructions
- 3 Place the amended growing medium in all grass and planting areas. Spread growing me shandon water.
- A Hisimum depths of growing medium placed and compacted to 80%:
- to depth of rootball width shall be at least twice the width of the root ball with savver shapes
- in-Galds

 Fig. 18 of the State of the State
- 5 Hanually spread growing medium/planting soil around existing trees, strubs and obstacles.
- .6 In normator seeded crass areas, feather growing median out to nothing at edges and blend into existing grades

.7 Finished grades shall conform to the elevations shown on landscape and site plans.

- ROUGH GRASS AREA SEERING

 1. Generals Rough grass area are nebted on the drawings as "Rough Grass". Treat all ureas defined as rough grass between all property lines of the project including all
- Preparation of Surfaces: To B.C. Landscape Standard Class 3 Areas (Rough grass) Section 7.1.13
 Clean existing soil by mechanical means of debris over 50am in any diamension.
 Roughly grade surfaces to allow for maintenance specified and for positive drainage.
- Time of Seeding: Seed from early spring Igenerally April 1st) to late fall (September 15th) of each year. Further ex Arribited
- Seed Supply & Testings All seed must be obtained from a recognized seed supplier and shall be No. 1 grass mixture definered in containers bearing the followings.
 Authorized of the seed sixture.
 Procretaging of each seed Page
- 5 Seet Pisture. All varieties shall be rated as strong performers in the Public Northwest and are subject to client agreeral.
 TACK Copying Red Persone
 SAX Stature Teaching Red
 SAX Stature Teaching Red
 SAX Stature Teaching Red
 SAX Formation of the Sax Stature Teaching Red Sax Red Sax Stature Teaching Red Sax Stature Teac
- 6. Fertilizerr Mechanical seeding: Apply a complete synthetic stow-release fertilizer with maximum 35% water soluble nitrogen and a formulation ratio of 18-19-18 -50% sudpict uses coated, 112 kg/ha/1000ba/xml using a mechanical spreader. 7 Seeding: Apply seed at a rate of 112k/H (10kbs /acre) with a mechanical spreader. Incorporate seed into the top 1/4" (Sem) of soil and lightly comp
- .8 Acceptance: Provide adequate protection of the seeded areas until conditions of acceptance have been met. Comply with Section 3.7 Hydroseeding.
- May not be used in areas of lawn unless pre-approved by the Landscape Architect prior to bidding.
- 3 Preparation and Groving Medium
 3.1 In areas of Rough Grass: Comply with Section 3.4 Bough Grass.
 3.2 Where approved for use in areas of lawn, comply with Section 3.8 Lawn Areas Sodding.
- A Protection Entire that fertilizer in solution does not come in contact book the foliage of any trans, shouth, or other susceptible regelation. Do not spray send or much or object not special to grow years. Periode circling site explorant, readways, laidbooking, reference points, nonmorels, nathers and situatives from damage. Where contamination come, recent seetings surface insidiation of much present policy for further of the contamination of
- 5. Moth shall consist of virgin wood fibre or recycled paper fibre designed for hydravilic seeding and dipel for ease of no for wood fibre substitute use 135% Dry weight). Conform to B.C. Landscape Standard for much requirements.
- J. Equipment: Use industry standard hydrack seeder/midder equipment with the task volume certified by an identification plate or slicker afficed requirent. The hydrackies seeder/midder shall be copied of sacisfication application to one the nativals idea a bomogeness storm and to maintain the durm until it is a spiced. The discharge purps and postmated shall be capable of application the maintains of maintains of the capable of application that maintains are referred to the capable of application.

ART THREE SOFT LANDSCAPE DEVELOPMENT - CONT

- Hotes: At the line of Tender provides, complete chart of all components of the mix proposed including mulch, tackifier, water etc. Stoped si
- .842 Perfixeer .8421 Royal forass: If a soil analysis is available, couply with results. .8422 Lawn: Where hydroseeding is approved, comply-with soil analysis recommendations.
- 3. Accorded possions the quantities of each of the materials in Declaraged into the hark other by mass or by a consumity accepted system of mass-collected volume necessreement. The materials shall be added to the fairs while it is being Time (all the clarge), and we never the consumer consequence read, feeliller. The reciption is not in the materials while the materials are all the materials and acceptance of the materials are all the materials. But expenditure the materials are all the materials are the last predictions.
- D Costribute sturry uniformly over the surface of the area to be hydroseeded. Blend application into previous applications and existing grass areas to form uniform surface
- I Clean up: Remove all materials and other debris resulting from seeding operations from the job site.
- 12. Hightomore, Depis maintemore innecitally after seeding and carinow for 60 days after Scholarskii (angivinis) and quest intervals where particularly not facility of the control of
- 33. Acceptance of the Bough Grass Areas: Propor genication of all specified years species is the responsibility of the Landscape Centrector. The grass shall be reasonably free of version be EL androape Standard, Section 13 Histohemace Level & Opphragues. Surfrograss after conductability completion, areas meeting the conditions shave will be blean over by the Owner. Areas seeded in fail will be accepted in Spring me month affordated growing season, promote that the above conditions for acceptance or efficient.

- 1 General: Treat all areas defined as lawn areas on the landscape plan between all property lines of the project including all boulevards to edge of roads and lanes.
- 2 Growing Medium: Comply with Section 2.2.1, Growing Medium. Prior to sadding, request an inspection of the linished grade, and depth and condition of graving medium by the
- 3 Time of Sodding. Sod from April 1st to October 1st. Further extensions may be obtained on concurrence of the Landscape Art .4 Sad Supply: Conform to all conditions of B.C. Landscape Standard, Section 8, B.C. Standard for Turfgress Sod.
- 5 Specified Turfgrass by area: Refer to Table 2 below.

Area	Description	Quality Grade	Hajor Species
CLASS 1	Laxo, all areas noted on drawings as lawn in urban development sites including boulevard grass	No. 1 Premium	Kentucky Blue for sun, Fescues for shad
LASS 2	Grass - public parks, industrial and institutional sites	No. 2 Standard	same
CASS 3	Rough Grass	see hydroseeding	1
COCCIAI	1 '		1

- 6 Line: The line shall be as defined in Section 2.2.3. Materials. Apply at rates recommended in required soil test. Refer to Section 3.4 for method.
- 7. Fertilizer: Refer to Section 222 Materials. Apply specified fertilizer at rates shown in the required soil test. Apply with a mechanical spreader. Cultivate into growing medica 48 focus prior to sodding. Apply separately front line.
- 8 Sodding. Propere a smooth, firm, even surface for laying sod. Lay sod staggered with sections closely butted, without overlapping or gaps, smooth and even with adjusting areas and roll (lightly, Water to obtain missiure penetration of 3° to 4° 17 10 cm.l. Comply with requirements of BC Landscape Standard Section 8, BC Standard for Turfgrass. 3. Hardenance: Begin minimance insectively after sedding and continue for 6th days after Solutarial's Conjection and wall accepted by the Downer. Prefect sedded areas from durage with temporary wire or having forces complete with figures well barn in Islam over by the Outer. When Is not all an address presentation of 7 to 4.°T. Profest all intervals sections; to 0 maintain sufficient ground for between 1-12°C and 22°C lost. Fromis designed appreciation of 27 to 4.°T. Profest all intervals sections; to 0 maintain sufficient ground of between 1-12°C lost and 22°C lost. Fromis designed appreciation of section exists and continue of the section of the 10 maintain supplement.
- 39 Acceptance of Lawn Areas: The hard shall be reasonably well established, with no apparent devel upons or have upons and shall be reasonably free of weeds to B.C. Landauge Stendard, Section II Shallmance Level Z Happarancel. Use hebridosis if eccessary for weed convolutions on their conditions of contract fortid their use. After the lawn has been on all east hards, are as remaining the conditions are will be before every the Owner.

PLANTS AND PLANTING

- .1 Conform to planting layout as shown on Landscape Plans
- 2 Obtain approval of Landscape Architect for layout and preparation of planting prior to commencement of planting opera
- 3 Make edge of beds with strooth clean defined lines.
- A. Time of Floating.
 A. The of Floating.
 A. The of Floating.
 A. The partners, shartes and groundcrears only during periods that are normal for such work as determined by local weather conditions when seasonal conditions are thely to ensure successful adopted into it plants to their new location. 5 Standards
 3. All plant enderial shall conform in the respirements of the 8.C. Landacape Standards The sellion 2004, unless exceeded by drawing Plant Schedule or this specification.
 3.1. All plant enderial shall conform the Schedule or Plants and Repailing and in Section 2.0.0.00. Standard for Container Grown Plants for anxions standards.
 3.2. Refer in Plant Schedule for general conformation of the Schedule or Plants and Schedule for plants and the Schedule or Plants and Schedule for plants and the last schedule for plants and the last schedule conditions shall be graven to villastand the site clients.

- Arailability.
 Arailability.
 Arac of search includes the Lower Mainland and Fraser Valley. Refer to Plant Schedule for any extension of area.
 Supply proof of the availability of the specified plant national within 30 days of the award of the Contract. A Socialisation

 1. Obtain writer apprecial of the Lankscape Architect prior to making any substitutions to the specified externial. Non-approved substitutions will be rejected.

 2. Allow a unionen of 5 days prior to delivery for recent all substitution.

 3. Socialisations are subject in fall, Substitutions or Gentlooms of Arakahity.
- Plant Species & Location
 Plant Species & Location
 Plant shall be true to name and of the height, caligur and size of root ball as shown on the (undexage/site plan plant schedule. Caliper of trees is to be taken 5" (15cm) anore grace.

 92 Plant all specified species in the location as shown on the landscape drawings. Notify Landscape Architect if conflicting rock or underground/overhead services are
- 93 Revisition of given planting location will only be allowed after review of the groposed deviation by the Landscape Architect.
- (9) Excavations
 (3) Total and large strudon Excavate a spacer shaped free pit to the depth of the rootball and to at least take the width of the rootball. Assure that finished grade is at the rejikal grade the tree was grown at.
- 3.1 Drainage of Planting Holes.
 3.1 Drainage of Planting Holes.
 3.1. Provide delayer of planting piles where required is, an aboved conditions, break out the side of the planting pile to discuss given before the planting that where the planting history is failed.
 3.1. Drainage when the above planting piles where required is made on the planting history is failed.
- Placing and Fertition procedure.

 Their all traces and should be like role placed in their natured growing position. If buy tapped, leaves around the log of like tall and cot away or field worker. Do not public the results of lab. If, Caroliday resource continuers without injuring like routballs. After satisfied in place, col failes. For viole bashelts, dip and remove top three rows of the satisfied place.
- vite
 1. The spating before years in the probability of the continuence Staking of Trees:
 Use (vo 2'x2'x5' stakes, unless superseded by municipal requirements. Set stakes minimum 2 ft. in soil. Do not drive stake through rootball.
- 32. Leave the Free carbilly a virial.

 33. Tevil the presponed connection, that was no payarupteen fairs belt, initious width Rom (3/L*1. Approved product). Arbor (is a vailable from Deeplood

 34. Conitarum Trees over 6 H. Inighth. Gov with three 2-shared wives (18 yaugu). Drive three status equidated around the tree constable below grade.

 35. Trees 8 H. on Nevad or Connect Deebs. Goy as above using three developes that in 2 Leave (18 on the nazional parallel digith instead of status.

 36. Hear 4 Lay with thinkin Belging status.
- 36 Prusing.
 36.3 Limit prusing to the minimum necessary to remove deed or injurned branches. Preserve the natural character of the plants, do not cut the loader. Use only clean, sharp node. Make all cuts clean and cut to link branch collar leaving no sixts. Shape affected areas so as not to retain scales. Remove damaged material.
- 5. Middings
 5.1. Midd all planting areas with an even layer of midth to 2-V2 3" it's 15em) depth. Confirm placement of midth in seess labeled "GrounGover Area" on drawings. Midth a 3-th. White all plantings continued to cities around trees in larm areas, leave a cities togge.
- In the district Middle-basence

 In Model facility Middle-basence

 In Model

- 39. Plat Marraily.
 31. Repta: all usualization plant malerial except floor designated "Specimen" for a period of one 10 year after this Certificial of Completion. Replace all usualization plant malerial designated "Specimen" for a period of next 10 years after this Certificial of Completion. Replace all usualization from a period of the 10 years after the Certificial of Completion. Replace all usualization from the specified complete in complete and substitution (appear of the temperature) and the specified nother the complete and complete on the specified. Such replaced is the specified complete in complete and complete on the specified. Such replaced and the specified is the specified plant plant

PART THREE SOFT LANDSCAPE DEVELOPMENT - CONT

- Als. For all pair salevial, the Landscape Architect reserves the right to extend the Contractor's responsibility for another graving reason if, in the opinion, test development and gravith and sufficient to exceed further salestation growth.

 15. Where the hours responsible for pile in ministenses and has not provided designate anxietnesses. The plant replacement section of the contract size to be extracted visit.

 15. Where the hours responsible for pile in ministenses were the positionary and the Est Landscape Standard, Section 13, Hardmannes ex the posit. The respited maintenance of source for a ministense of Level Times. Prefer to Section 13, Establishment Publishment and the position 13, Hardmannes ex the gravity of the position 13, Hardmannes and the contract of the propriets of the contract or responsible for regular any publishment of the Contract for the Contract or responsible to regular any publishment of the Contract for the Contract of the Contract or responsible to regular any publishment of the Contract for the Contract of the Contract or the Contract of the Contract or responsible to regular any publishment of the Contract for the Contract of the Contract or responsible to regular any publishment of the Contract for the Contract of the Contra

10 INSTALLING LANDSCAPE ON STRUCTURES

- ? Coordinate work with construction of planters and planter drainage. 2.1 Verify that planter drains are in place and pentitive drainage to roof drains is present prior to placing any drain rock or soil.
- 3 Provide clean out at all through-stab drain locations . Use 340on min. dia. PVC Pipe filled with drain rock unless specific drawing detail shown.
- 4. Install drain rock evenly to a minimum depth of 4" (100 mm) or alternate sheet drain; if specified. Install sheet drain as per manufacturer's recommendation
- 5 Corer drain rock lor alternate sheet drain it specified on drawing details) with filter fabric tapping 42 (550nm) at all edges. Obtain approval of drainage system prior to placing growing medium.
- Place an even layer of 25 59am clean washed pump sand over filter fabric.
- 7 Place growing median to depths specified in Section 35 above for various surface freatments. Refer to Drawing detals for any light weight filter-sequired to alter grade. Just Stronfoan Nock ever drain rock shaped to growde snooth surface transition at edges. But each piece highly logether and cover with falter fabric to prevent sail from

ESTABLISHMENT HAINTENANCE (Provide a separate price for this section)

- 1. Jaken 1. Na kiert d'Arstatelment mannennen is terroise erfficest zoet te very installeghet anviet for restillegh des pried et free he ener eincress his long jern accesse his papients. The objection in the adaptitude of destin is en aver die is verb en bis in the states in for alle in a destination of the state in the state in for the part exist part entaged in resting in the state of the state in the s
- 2 Haintenance Period: Provide maintenance of installed landscaping for 12 months following substantial com-
- 3 Related Standards and Legislation: B.C. Landscape Standard, latest edition; Fortilizer Code, B.C. Pesticide Control Act. 4. Site Rorien: In addition to the inspections at substantial completion, at final progress draw application, and all the end of the guarantee period, there should be three oil reviews during the X combins attended by the Contractor and a designated representative of the Owner. Notation is topinak and reporting procedures and submit to the designated representation.
- 5 Scheduling: Prepare a schedule of anticipated visits and submit to designated representative at start-up. Maintenance aperations shall be carried out predo the growing season between March 1st and Hovember 38th, however visits at other times of the year may be required. 6 Haintenance Level: Comply with B. C. Landscape Standard, Section 16, Yable 14-2, Maintenance Level 2 "Gronzed"
- Haterials: Compty with Part Two of this specification.
 Fertilizers: To the requirements of the B.C. Landscape Standard. Formulations and rates as required by soil testing.
- 8. That Micharia Catalitisment.

 3. Micharia Charlin for Cardina passan, valve may pints at least every two 100 days between August tot and July 2014, and every two 100 days between August tot and Saydeabet 10th. Micharu 25 gallenum per tree per application. During the second proving season, value may shade at least every two 150 days to the very two 150 days to the value of passand and exceletables. August at and september 2014, App of early a rate and orderina which lite has the control received (copylity the lite fight of the graving received.). Apply valve again when the value control received 25% of field capacity. Perside and register with valve in the event that any submixif circipation system addituration that and been conveiled or hinded. Subded or application of valve at which the seast of only two received days persident and which the submixing of th
- oncester, by the use of harbidose.

 Al. Peet and Discourt Control Inspect all planted areas for peets and diseases paried/city and at least every two moths during the growing section by an experienced person. Cerry coll treatment for peets of the section of the collection of the co
- Serias Areas Establishments

 5. Widering Use house and quivilence, implication professor or other methods to apply value of Class 1 and Class 2 grassed areas IRC. Landscape Shandard, Section 7, Lawres of Grazzad Jacob May press in maintening or incomplete authorities. The office of Grazzad Jacob May press in maintening or incomplete authorities of Grazzad Jacob May press of Landscape Shandard, Section 7, Lawres of Grazzad Jacob May press of Landscape Shandard Sandard May press of Landscape Shandard Sandard May press of Landscape Shandard Sandard Sandar
- apprecion of a sur man elementer in the ever popularities controlled to the every purpose of the every purpose of

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Suite C100 - 4185 Still Creek Drive 604 294-0011 ; f: 604 294-0022

SEAL

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NO. DATE REVISION DESCRIPTION

5 15.MAY.22 REVISION AS PER CITY COMMEN
4 14.DEC.16 NEW SITE PLAN/CITY COMMEN

NEW SITE PLAN/CITY COMMENTS

WITH ZHAO XD ARCHITECT LTD.

TOWNHOUSE DEV.

9800 GRANVILLE AVE

PROJECT:

DRAWING TITLE:

LANDSCAPE

RICHMOND, BC

SPECIFICATIONS

SCALE: DRAWN: DD DESIGN: DD

DATE: April 25,2014

CHK'D: PCM

14017-8.ZIP PMG PROJECT NUMBER:

ZHANG CUBIC ESTATES HOLDINGS LTD.

14-017

DRAWING NUMBER:









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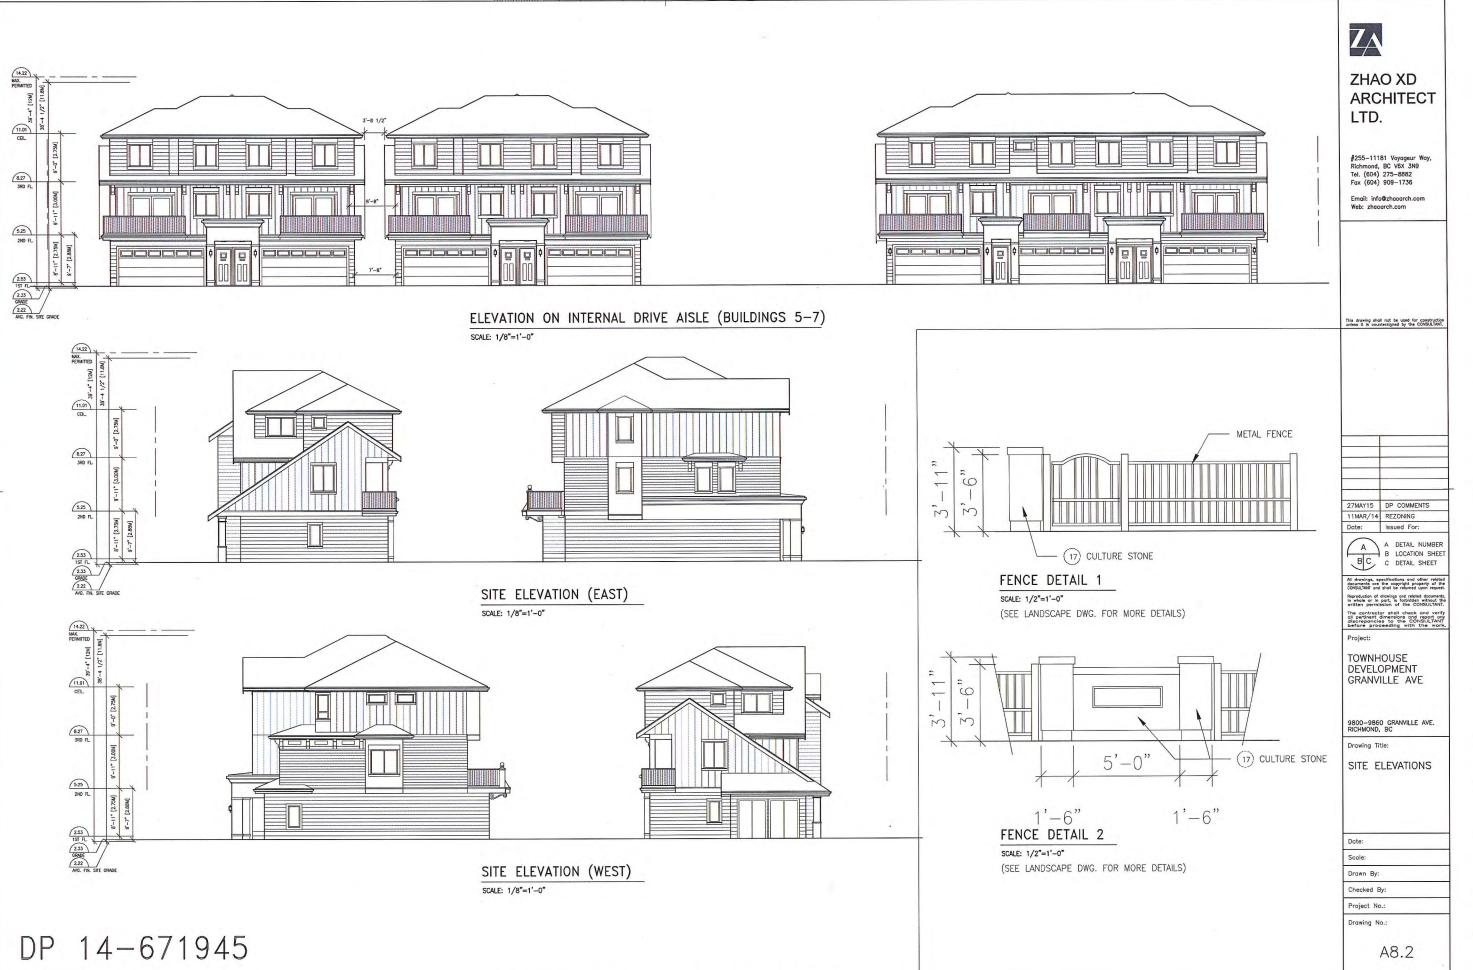
71945 PLAN #4C

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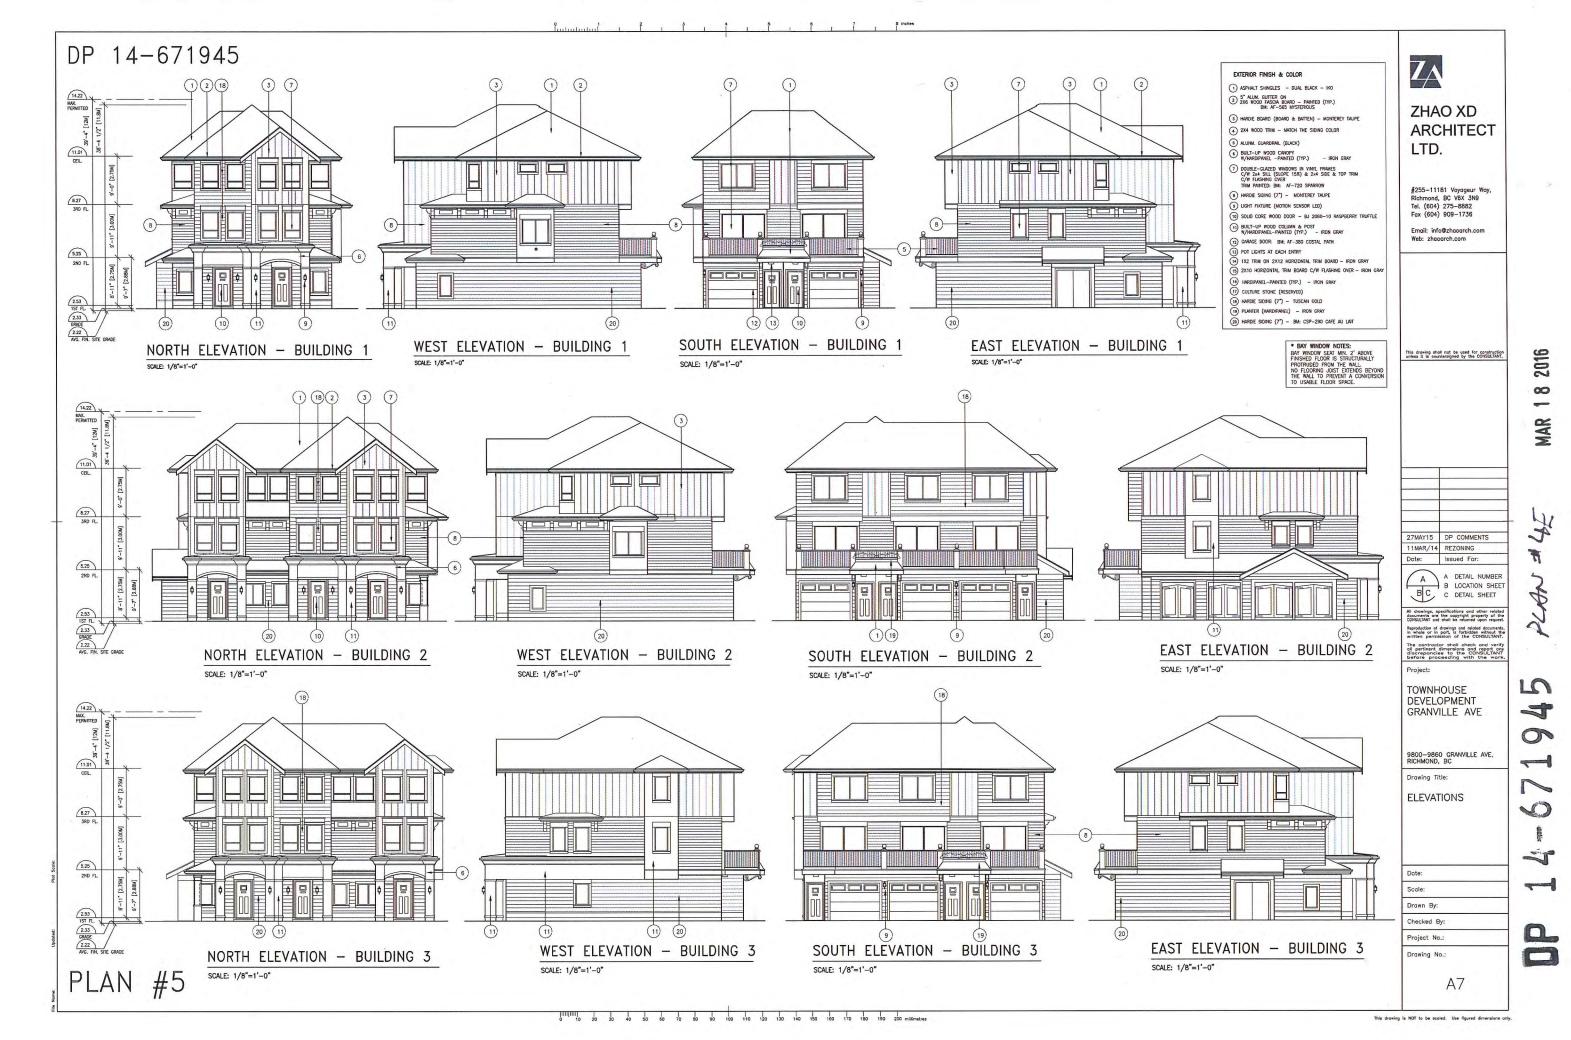


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DP 14-671945

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27MAY15 DP COOMENTS 11MAR/14 REZONING

Date: Issued For:

A DETAIL NUMBER
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Project:

TOWNHOUSE DEVELOPMENT GRANVILLE AVE

9800-9860 GRANVILLE AVE. RICHMOND, BC

UNIT PLANS & AREA OVERLAYS & ELEVATIONS

Drawn By:

Checked By: Project No.:

Drawing No.:

18 SOUTH ELEVATION - BUILDING 6

(18) 20 WEST ELEVATION - BUILDING 6

SCALE: 1/8"=1'-0"

SCALE: 1/8"=1'-0"

EXTERIOR FINISH & COLOR 1 ASPHALT SHINGLES - DUAL BLACK - IKO

- 5" ALUM, GUTTER ON 2X6 WOOD FASCIA BOARD PAINTED (TYP.) BM: AF-565 MYSTERIOUS
- 3 HARDIE BOARD (BOARD & BATTEN) MONTEREY TAUPE

20

SCALE: 1/8"=1'-0"

- (4) 2X4 WOOD TRIM MATCH THE SIDING COLOR
- 5 ALUNM. GUARDRAIL (BLACK)
- 6 BUILT-UP WOOD CANOPY W/HARDIPANEL -PAINTED (TYP.) IRON CRAY DOUBLE-CLAZED WINDOWS IN VINYL FRANCES
 C/W 2x4 SILL (SLOPE 15%) & 2x4 SDE & TOP TRIM
 C/W 7x4-SHNG OVER
 TRIM FRANCE: Bit: Ar-720 SPARROW
 MARDIE SIDING (7") — MONTEREY TAUPE
- (17) CULTURE STONE (RESERVED) 18 HARDIE SIDING (7") - TUSCAN GOLD (19) PLANTER

EAST ELEVATION - BUILDING 6

9 LIGHT FIXTURE (MOTION SENSOR LED)

20 HARDIE SIDING (7") - BM: CSP-290 CAFE AU LAIT

DP 14-671945 PLAN #4

10 (13(11)

NORTH ELEVATION - BUILDING 6

SCALE: 1/8"=1'-0"

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This drawing is NOT to be scaled. Use figured dimensions only.

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(1) BUILT-UP WOOD COLUMN & POST W/HARDIPANEL-PAINTED (TYP.) - IRON GRAY 12) GARAGE DOOR: BM: AF-380 COSTAL PATH

13 POT LIGHTS AT EACH ENTRY (14) 1X2 TRIM ON 2X12 HORIZONTAL TRIM BOARD - IRON GRAY

10) SOLID CORE WOOD DOOR - BJ 2080-10 RASPBERRY TRUFFLE

(15) 2X10 HORIZONTAL TRIM BOARD C/W FLASHING OVER - IRON GRAY (16) HARDIPANEL-PAINTED (TYP.) - IRON GRAY

A6

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LTD.

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TOWNHOUSE DEVELOPMENT GRANVILLE AVE

9800-9860 GRANVILLE AVE. RICHMOND, BC

Drawing Title: STREETSCAPE

Web: zhaoarch.com

Drawn By: Checked By:

Project No.:

Drawing No.:

A9



NORTH SITE ELEVATION - (GRANVILLE AVE.)

SCALE: 1/16"=1'-0"



LOCATION (WEATHER FILE)	METRO VANCOUVER, BC
CEILING	TRUSSES @ 24" O/C, R-40 INSULATION
FLAT CEILING	2X10 @ 24" O/C, R-28 INSULATION
EXTERIOR WALLS ABOVE GRADE	2X6 @ 16" O/C, R-20
WINDOWS	ENERGY STAR EQUIVALENT WINDOWS
DOORS	STEEL WITH FOAM CORE (FRONT: SOLID WOOD)
EXPOSED FLOORS	2X10 @ 16" O/C, R-28 INSULATION
FLOOR ON GRADE	R-12 UNDER SLAB
AIRTIGHTNESS CONSERVATIVE AIRTIGHTNESS	LEVEL (6.5 ACH @ 50 PA WITH DEFAULT ELA)
HEATING	AIR SOURCE HEAT PUMP (HSPF 6.7) WITH ELECTRIC BACKU
HOT WATER	ELECTRIC TANK
WALLS	2X6 FRAME, R-22 BATT INSULATION

PROPERTY LINE MIN. 6"X6" TREATED (2) TIMBERS LATERALLY SUPPORTED (I.E. DEADMAN) FOR RETAINING WALLS OVER 12" LATERAL SUPPORTS SHALL BE LOCATED AT EVERY THIRD TIE. SEE SITE PLAN FOR GRADE ADJACENT PROPERTY GRADE (SEE SITE PLAN) 20MM CONTINUOUS MEMBRANE OR TWO LAYERS OF 10MM CONTINUOUS MEMBRANE 4" (100MM) PERFORATED DRAIN PIPE -FILTER CLOTH WHERE RETAINING WALL WITH FENCE POSTS SAND FILL IS USED

EAST SITE ELEVATION

SCALE: 1/16"=1'-0"


AREA CALCULATIONS (PER UNIT)

		OUTDOOR	GROSS FLOOR AREA (SF):*			EXEMPTED FLOOR AREA (SF):				NET FLOOR	LOT COVERAGE	COVERED	GARAGE	
		SPACE (SF):	1ST FLOOR	2ND FLOOR	3RD FLOOR		1ST FLOOR	2ND FLOOR	3RD FLOOR	TOTAL	AREA (SF):	(SF):	AREA (SF):	AREA (SF):
	UNIT 'A'	417.30	698.5	583.6	547.78	1829.9	698.5	10.7	J	709.2	1120.7	698.5	73.5	528.2
BUILING 1	UNIT 'A1'	845.10	684.0	583.6	547.78	1815.4	684.0	10.7		694.7	1120.7	684.0	59.0	528.2
	UTILITY CL.					19.8						19.8		
BUILING 2	UNIT 'A'	562.10	698.5	583.6	547.78	1829.9	698.5	10.7	-	709.2	1120.7	698.5	73.5	528.2
	UNIT 'A2'	417.30	684.0	583.6	547.78	1815.4	684.0	10.7	1 1-1	694.7	1120.7	684.0	59.0	528.2
	UNIT 'A6'	402.70	695.3	583.6	547.78	1826.7	695.3	10.7	-	706.0	1120.7	695.3	70.3	528.2
	GARBAGE/RECY					167.9						167.9		
	UNIT 'A4'	402.70	695.3	583.6	547.78	1826.7	695.3	10.7	-	706.0	1120.7	695.3	70.3	528.2
BUILING 3	UNIT 'A5'	417.30	684.0	583.6	547.78	1815.4	684.0	10.7	-	694.7	1120.7	684.0	59.0	528.2
	UNIT 'A7'	562.10	698.5	583.6	547.78	1829.9	698.5	10.7	æ	709.2	1120.7	698.5	73.5	528.2
	UTILITY CL.					65.5						65.5		
	UNIT 'A'	562.10	698.5	583.6	547.78	1829.9	698.5	10.7	-	709.2	1120.7	698.5	73.5	528.2
BUILING 4	UNIT 'A2'	417.30	684.0	583.6	547.78	1815.4	684.0	10.7	e e	694.7	1120.7	684.0	73.5 59.0 73.5	528.2
	UNIT 'A3'	417.30	698.5	583.6	547.78	1829.9	698.5	10.7	-	709.2	1120.7	698.5	73.5	528.2
	UNIT 'B'	497.60	737.6	628.7	540.1	1906.4	571.0	55.2	-	626.2	1280.2	737.6	140.5	378.1
	UNIT 'B3'	407.90	744.1	641.6	603.1	1988.8	548.6	45	-	593.6	1395.2	744.1	103.2	382.9
BUILING 5	UNIT 'B4'	423.8	717.9	651.7	595.8	1965.4	542.6	45	-	587.6	1377.8	717.9	102.0	378.1
	UTILITY CL.					44.3						44.3		
	UNIT 'B5'	454.00	737.6	628.7	540.1	1906.4	571.0	55.2	-	626.2	1280.2	737.6	140.5	378.1
BUILING 6	UNIT 'B2'	524.70	737.6	628.7	540.1	1906.4	571.0	55.2		626.2	1280.2	737.6	140.5	378.1
0.00	UNIT 'B'	520.30	737.6	628.7	540.1	1906.4	571.0	55.2	. 4	626.2	1280.2	737.6	140.5	378.1
BUILING 7	UNIT 'B2'	623.30	737.6	628.7	540.1	1906.4	571.0	55.2	-	626.2	1280.2	737.6	140.5	378.1
	TOTAL:	8874.9	12769.1	10856.4	9925.0	33848.2	11565.3	483.7	740	12049.0	21501.7	13066.6	1651.8	8461.7

* INCLUDING GARAGE, COVERED AREA & STAIR ENTRY EXEMPTED AREA.



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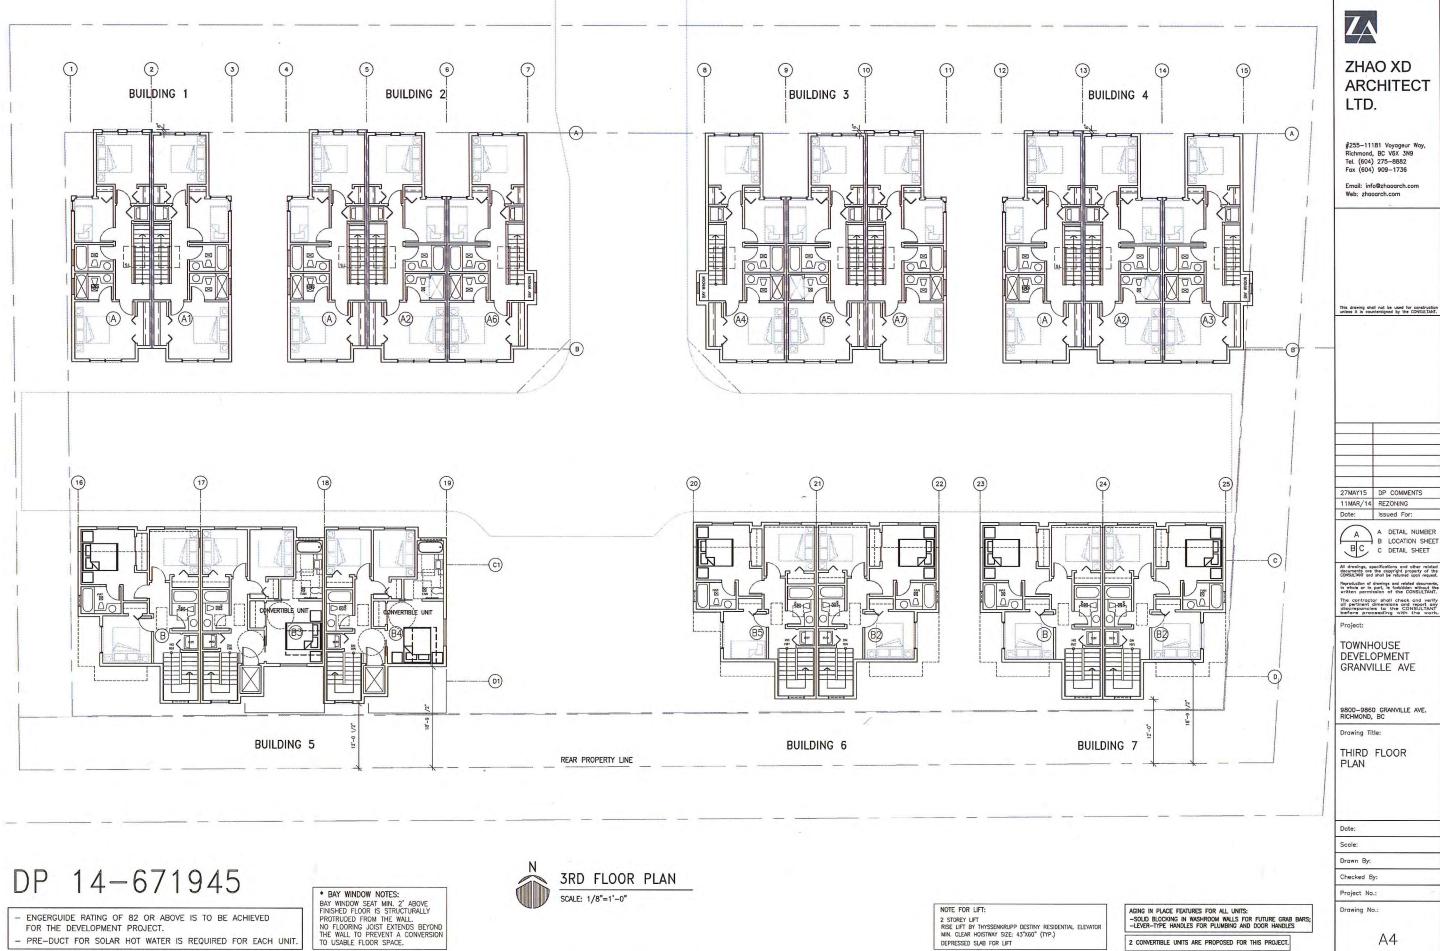


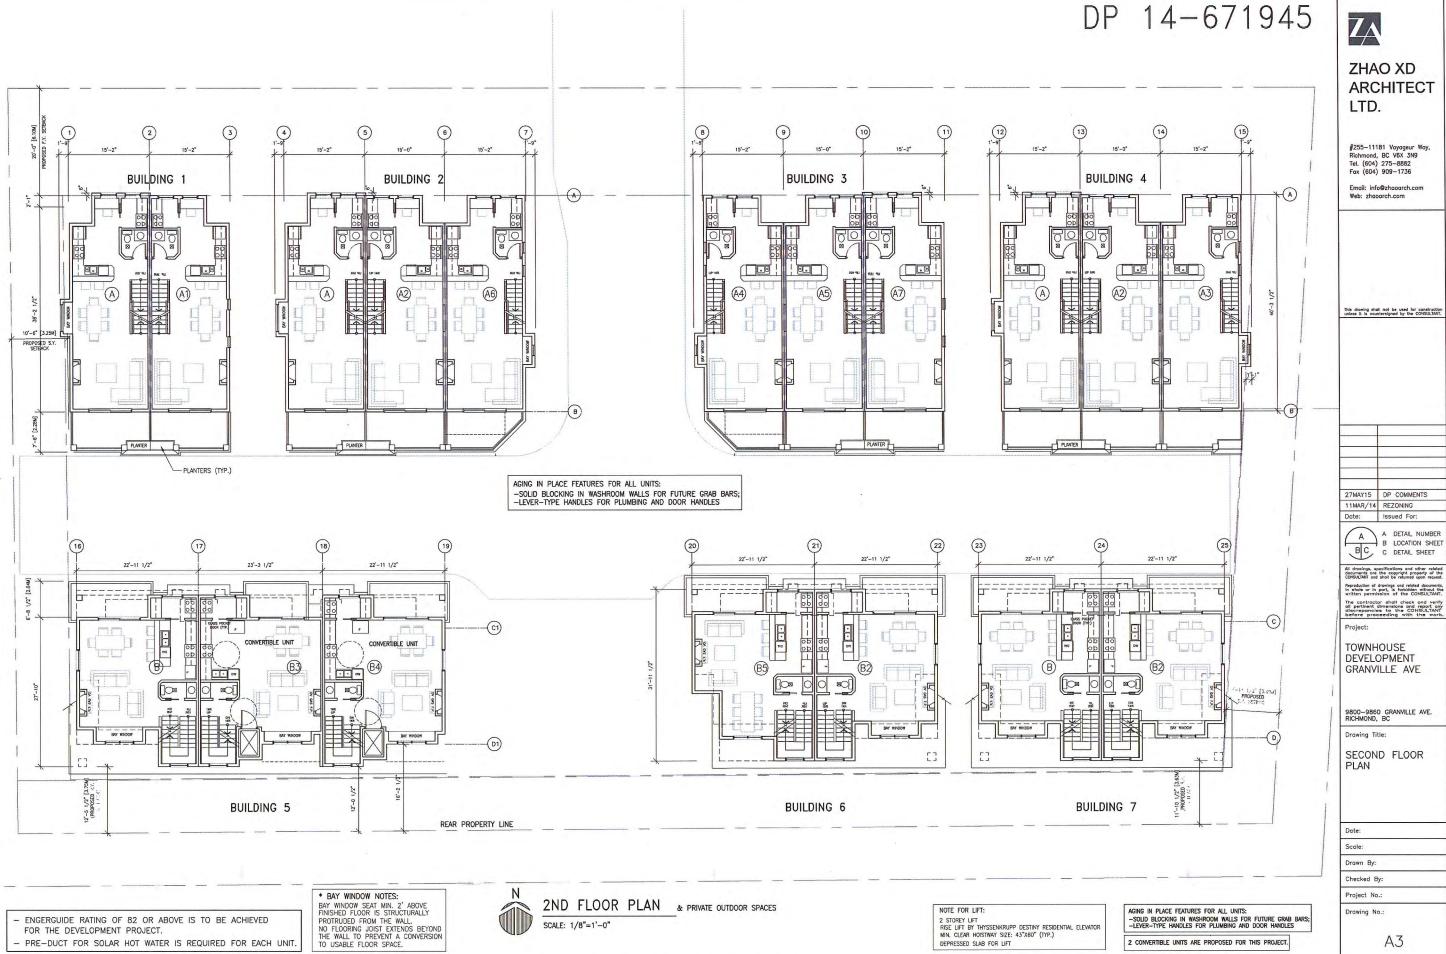

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DEPRESSED SLAB FOR LIFT

FOR THE DEVELOPMENT PROJECT.

- PRE-DUCT FOR SOLAR HOT WATER IS REQUIRED FOR EACH UNIT

2 CONVERTIBLE UNITS ARE PROPOSED FOR THIS PROJECT.

DP 14-671945

AGING IN PLACE FEATURES FOR ALL UNITS: -SOLID BLOCKING IN WASHROOM WALLS FOR FUTURE GRAB BARS; -LEVER-TYPE HANDLES FOR PLUMBING AND DOOR HANDLES

ENGERGUIDE RATING OF 82 OR ABOVE IS TO BE ACHIEVED FOR THE DEVELOPMENT PROJECT.

PRE-DUCT FOR SOLAR HOT WATER IS REQUIRED FOR EACH UNIT.

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Project:

TOWNHOUSE DEVELOPMENT GRANVILLE AVE

9800-9860 GRANVILLE AVE. RICHMOND, BC


Drawing Title:

UNIT PLANS & AREA OVERLAYS

Date: Scale: Drawn By Checked By:

Project No.: Drawing No.

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CHECKLIST - CONVERTIBLE UNIT FEATURES

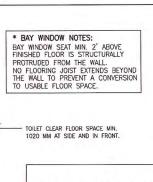DOORS & DOORWAYS

ENTRY DOOR MIN. 863 MM BUT IDEALLY 914MM AND HAVE CLEAR ACCESS. ENTRY DOOR CLEAR EXTERIOR FLOOR SPACE MIN. 1220 MM DEPTH BY DOOR WIDTH PLUS 600 MM ON LATCH SIDE (NOT NEEDED IF ROUGH IN WIRING PROVIDED FOR FUTURE AUTOMATIC DOOR OPENER)

INTERIOR DOORS TO MAIN LIVING AREAS, 1 BATHROOM AND 1 BEDROOM, MIN. 800 MM CLEAR OPENING WITH FLUSH THRESHOLDS MAX. 13MM HEIGHT. DEMONSTRATE WHEELCHAIR ACCESS BETWEEN THE HALLWAY AND ROOMS AND WIDEN HALLWAY AND/OR DOORWAY(S) IF NECESSARY TO SECURE ACCESS.

PATIO/BALCONY MIN. 860MM CLEAR OPENING. NOTE HOW ACCESSED. ALL INTERIOR THRESHOLDS WITHIN UNITS COMPLY BC BUILDING CODE. LEVER-TYPE HANDLES FOR ALL DOORS.

VERTICAL CIRCULATION

VERTICAL LIFT, DEPRESSED SLAB AREA, AND LANDINGS, AS NOTED ON FLOOR PLANS IN COMPLIANCE WITH MANUFACTURER SPECIFICATIONS. FRAMING TO ACCOMMONDATE SHAFT CONSTRUCTION WITHOUT IMPACT TO SOURROUNDING STRUCTURE AT THE TOP OF ALL STAIRWAYS, WALLS ARE REINFORCED WITH 2X12 SOLID LUMBER AT 914MM TO CENTRE.

HALLWAYS

MIN. 900 MM WIDTH

GARAGE

MIN. 1 ACCESSIBLE PARKING SPACE WITH MIN. 4 M GARAGE WIDTH ACCESS FROM GARAGE TO LIVING AREA WITH MIN. 800 MM CLEAR DOOR OPENING (2'-8" SLIDING OR 2'-10" SWINGING DOOR SPEC.) AND FLUSH THRESHOLDS MAX. 13 MM

BATHROOMS (MIN. 1)

TOILET CLEAR FLOOR SPACE MIN. 1020 MM AT SIDE AND IN FRONT. WALL BLOCKING FOR FUTURE GRAB BAR INSTALLATIONAT TOILET, TUB AND SHOWER. REINFORCED WITH 2X12 SOLID LUMBER IN ALL BATHTUB, SHOWER, AND TOILET LOCATIONS. LEVER-TYPE HANDLES FOR PLUMBING FIXTURES.

PRESSURE AND TEMPERATURE CONTROL VALVES ARE INSTALLED ON ALL SHOWER FAUCETS. CABINETS UNDERNEATH SINK(S) ARE EASILY REMOVED. DEMONSTRATE BATH AND SHOWER CONTROLS ARE ACCESSIBLE (LAYOUT OR FIXTURE PLACEMENT).

MIN. 800 MM CLEAR DOOR OPENING (2'-8" SLIDING OR 2'-10" SWINGING DOOR SPEC.) WITH FLUSH THRESHOLDS MAX. 13 MM HEIGHT


CLEAR AREA NEEDED UNDER FUTURE WORK SPACE. PLUMBING AND GAS PIPES (IN-WALL AND IN-FLOOR) LOCATED CLEAR OF UNDER COUNTER AREA OF FUTURE WORK SPACE (STOVE, SINK & MIN. 810 MM WIDE COUNTER) . ALL PIPES ARE BROUGHT IN NO HIGHER THAN 304MM TO 355MM TO THE CENTRE OF THE PIPE FROM FLOOR LEVEL. CABINETS UNDERNEATH SINK ARE EASILY REMOVED. 1500 MM TURNING DIAMETER OR TURNING PATH DIAGRAM MIN. 800 MM CLEAR DOOR OPENING (2'-8" SLIDING OR 2'-10" SWINGING DOOR SPEC.)

WITH FLUSH THRESHOLDS MAX. 13 MM HEIGHT LEVER-TYPE HANDLES FOR PLUMBING FIXTURES.

MIN. 1 WINDOW THAT CAN BE OPENED WITH A SINGLE HAND (BATHROOM, KITCHEN, LIVING ROOM)

OUTLETS & SWITCHES

PLACEMENT LOCATIONS OF ELECTRICAL OUTLETS: BESIDE WINDOW, BOTTOM OF STAIRWAYS, BESIDE TOILET, ABOVE EXTERNAL DOORS (OUTSIDE AND INSIDE), ON FRONT FACE OF KITCHEN COUNTER, WITH PROXIMITY OF CONTROL CENTRE FOR SMART HOME OPTIONS UPGRADE TO FOUR-PLEX OUTLETS IN MASTER BEDROOM, HOME OFFICE, GARAGE, AND RECREATION ROOM

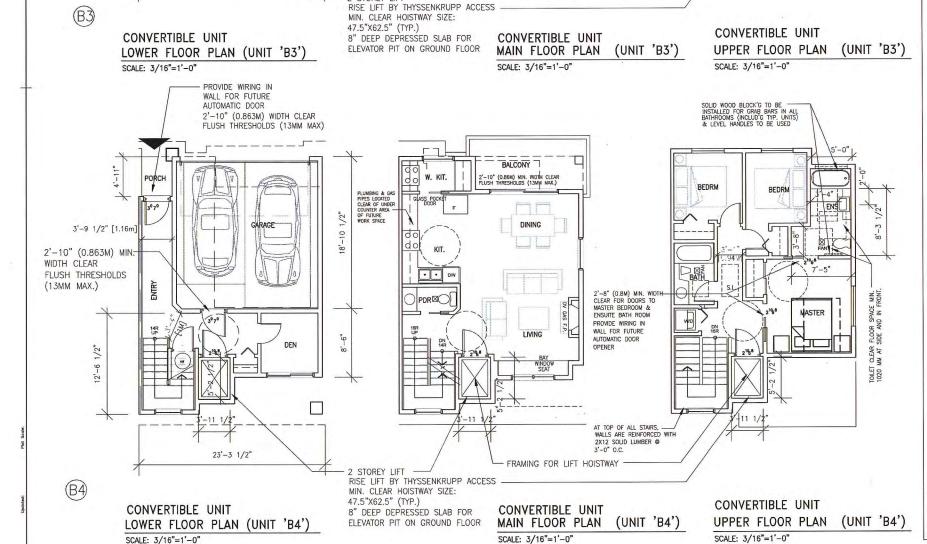

BALCONY

DINING

LIVING

FRAMING FOR LIFT HOISTWAY

W. KIT.

KIT.

. . DW

PDR 🖾

2 STORFY LIFT -

2108

PROVIDE WIRING IN WALL FOR FUTURE

2'-10" (0.863M) WIDTH CLEAR

FLUSH THRESHOLDS (13MM MAX)

GARAGE

DEN

AUTOMATIC DOOR

23'-3 1/2"

3'-9 1/2" [1.16n

2'-10" (0.863M) MIN:

FLUSH THRESHOLDS

WIDTH CLEAR

(13MM MAX.)

BEDRM

ASTER

2188

2'-8" (0.8M) MIN. WIDTH CLEAR FOR DOORS TO MASTER BEDROOM & ENSUITE BATH ROOM

AT TOP OF ALL STAIRS, —
WALLS ARE REINFORCED WITH
2X12 SOLD LUMBER @

PROVIDE WIRING IN

WALL FOR FUTURE

AUTOMATIC DOOR

OPENER