

Report to Development Permit Panel

To: Development Permit Panel

Date: October 24, 2024

From: Joshua Reis

File: DP 23-029433

Director, Development

Re: Application by Matthew Cheng for a Development Permit at 7300 St. Albans Road

Staff Recommendation

Jan Her

That a Development Permit be issued which would permit the construction of four townhouse units at 7300 St. Albans Road on a site zoned "High Density Townhouses (RTH1)".

Joshua Reis, MCIP, RPP, AICP

Director, Development

(604-247-4625)

JR:ak

Att. 2

Staff Report

Origin

Matthew Cheng, on behalf of the owner 1124053 BC Ltd. (Director: Pavendeep Kooner), has applied to the City of Richmond for permission to develop four townhouse units and one secondary suite at 7300 St. Albans Road on a site zoned "High Density Townhouses (RTH1)". The site currently contains an unoccupied single-family dwelling, which will be demolished. A location map is provided in Attachment 1.

The site is being rezoned from "Small-Scale Multi-Unit Housing (RSM/L)" to "High Density Townhouses (RTH1)" for this project under Bylaw 10494 (RZ 21-943417).

A Servicing Agreement is required as a condition of rezoning and includes, but is not limited to, the following improvements:

- Design and construction of frontage improvements including new landscaped/treed boulevard (minimum 1.5 m wide) and concrete sidewalk (minimum 2.0 m wide).
- Upgrade to the existing watermain from 150 mm to 200 mm.
- Provision of water, storm sewer and sanitary sewer service connections, water meters and inspection chambers as required.

Development Information

Please refer to attached Development Application Data Sheet (Attachment 2) for a comparison of the proposed development data with the relevant Bylaw requirements.

Background

Development surrounding the subject site is as follows:

To the North: The St. Albans' Anglican Church zoned "Assembly (ASY)".

To the South: A seven-unit townhouse complex zoned "Medium Density Low Rise Apartments (RAM1)".

To the East: A 36-unit townhouse complex zoned "Medium Density Low Rise Apartments (RAM1)".

To the West: Across St. Albans Road, a three-storey apartment (over a single-storey parking structure) zoned "Medium Density Low Rise Apartments (RAM1)".

Rezoning and Public Hearing Results

The Public Hearing for the rezoning of this site was held on November 20, 2023. No public correspondence was received at the Public Hearing.

Staff Comments

The proposed scheme attached to this report has satisfactorily addressed the urban design issues and other staff comments identified as part of the review of the subject Development Permit application. In addition, it complies with the intent of the applicable sections of the Official Community Plan and is generally in compliance with the "High Density Townhouse (RTH1)" zone.

Analysis

Conditions of Adjacency

- The proposed townhouses have been designed with consideration of the existing surrounding context. All units are three-storeys, providing a similar interface as adjacent townhouse developments.
- The existing grade along the rear (east) property line will be maintained to provide an appropriate transition to the adjacent townhouse development to the east and to accommodate on-site tree retention.
- Retaining walls, no taller than 0.5 m, are proposed along the north and south property lines to accommodate changes in grade. Perimeter drainage will be required as part of the Building Permit to ensure stormwater is managed and addressed through the development and will not impact the neighbouring properties.
- Seven existing trees on neighbouring properties, six on the south abutting property and one on the east abutting property will be retained. These trees will serve as a natural buffer between existing residential developments and the new townhouses.
- An existing 3.0 m wide City Statutory Right-of-Way (SRW) along the rear (east) property line of the subject site will remain. No encroachment is permitted within the SRW area.

Urban Design and Site Planning

- The proposed development consists of four townhouse dwellings in two, two-unit clusters arranged on either side of a central north-south drive aisle.
- Two units along St. Albans Road are proposed to have direct pedestrian access from the street through landscaped front yards. The two units at the rear of the property have pedestrian access from the drive aisle.
- One secondary suite is proposed to be located in the southeast unit (Unit 4). A separate access to the secondary suite is proposed along the south face of the building.
- All units will have enclosed vehicle parking spaces. The west two units will have single car garages while the east two units will have side-by-side double car garages.
- The visitor parking space is proposed to be located north of the northwest unit (Unit 1) at the end of the drive aisle.
- Both internal and external bicycle parking spaces have been incorporated into the proposal and are in compliance with the zoning bylaw requirements.

- The provision of private outdoor spaces generally complies with the Development Permit Guidelines of the OCP. All units will have private outdoor spaces at grade consisting of a front or rear yard. Units fronting St. Albans will also have balconies facing the drive aisle.
- Outdoor amenity space is proposed at the northeast corner of the site. The size and location of the outdoor amenity space facilitate tree preservation on-site. A mailbox kiosk with weather protection elements will be provided opposite the site entry, south of Unit 4.
- Cash in-lieu of indoor amenity space (\$8,264.00) was secured through rezoning, consistent with OCP policy.

Architectural Form and Character

- The proposed development presents a modern architectural approach with a simple colour scheme of white and grey. The apparent mass of the buildings is reduced through the use of projections, materials, colours and windows.
- Individuality of units is expressed through private landscape yards and roof overhangs for the street-fronting units, in addition to material and colour changes.
- The proposed main building materials include dark grey hardie panel, white hardie lap siding, black metal flashing and black shingles.

Landscape Design and Open Space Design

- On-site tree removal and retention were assessed as part of the rezoning application, at which point it was determined that two trees (tag# 545 and 546) are to be removed and two trees (tag# 547 and 548) are to be retained at the northeast (amenity space) and southeast corners of the site (Plan #13). Landscaping has been further refined to help ensure the retention of the two on-site trees.
- Consistent with the rezoning application (for the removal of two on-site trees and the historic unauthorized removal of one on-site tree), a total of eight replacement trees are required. The development proposes five replacement trees and a \$2,250.00 contribution to the City's Tree Compensation Fund in-lieu of the remaining three trees that cannot be accommodated on the subject property. Additional review as part of the Development Permit concluded it is not possible to accommodate the three trees on site due to site constraints in part due to conflicts with on-site infrastructure and the associated SRW located in the rear yard. The tree compensation contribution has been secured as part of the rezoning application.
- The lighting plan proposes warm, low glare lighting and fixtures such as wall mounted downlights, step lights, and bollard lights with shields.
- Removable pavers and slabs are proposed to create patio space for the two rear units (Units 3 and 4). All pavers and slabs in the SRW area are removable. No pour in place concrete is allowed within the SRW area.
- The shared outdoor amenity space is located at the northeast corner of site, adjacent to the Douglas fir (tag# 548) being retained on-site. The space contains children's play equipment and bench seating. Staff worked with the applicant to find suitable play equipment that could fit within the space meeting both the required fall zone and tree protection zone. The landscaping proposed provides a buffer between the drive aisle and outdoor amenity space.

- A high-efficiency irrigation system will be provided for all landscaped areas of the development.
- To ensure that landscaping works are completed, the applicant is required to provide a landscape security of \$124,322.00 in associated with the Development Permit.

Crime Prevention Through Environmental Design

- A 1.8 m (6 ft.) wood fence is proposed along the side and rear property lines for privacy and security. The wood fence along the front property line will be reduced to 1.2 m (4 ft.) tall to provide clear sightlines from the units to the sidewalk while maintaining the separation of the public and private realms.
- Adequate low glare lighting is provided to enhance security, particularly in spaces such as the visitor parking, mailbox and outdoor amenity areas.
- The mailbox kiosk is located next to the drive aisle by the southeast unit (Unit 4) and is covered, consistent with Development Permit Guidelines. Landscaping around the mailbox provides separation between the mail area and Unit 4.

Sustainability

- The applicant has submitted written confirmation from their Certified Energy Advisor indicating that the project will achieve Step Code 3 with EL-4, consistent with current City regulations.
- Air source heat pumps are proposed to be located along the drive aisle, by the visitor parking space and in the rear yards. Prior to Building Permit issuance, the applicant is required to provide a report from an Acoustical Engineer confirming that the heat pumps will comply with the City's Noise Regulation Bylaw.

Accessible Housing

- The proposed development includes one convertible unit (Unit 3) that is designed with the potential to be easily renovated to accommodate a future resident in a wheelchair. The potential conversion of this unit will require the installation of an elevator.
- All of the proposed units incorporate aging-in-place features to accommodate mobility constraints associated with aging. These features include:
 - o stairwell handrails;
 - o lever-type handles for plumbing fixtures and door handles; and
 - o solid blocking in washroom walls to facilitate future grab bar installation beside toilets, bathtubs and showers.

Conclusions

As the proposed development would meet applicable policies and Development Permit Guidelines, staff recommend that the Development Permit be endorsed, and issuance by Council be recommended.

Ashley Kwan Planner 1 (604-276-4713)

AK:he

Att.

- 1. Location Map
- 2. Development Application Data Sheet


The following are to be met prior to forwarding this application to Council for approval:

- Receipt of a Letter-of-Credit for landscaping in the amount of \$124,322.00.
 NOTE: staff to ensure that landscape estimates include a 10% contingency cost.
- Payment of all fees in full cost for cost associated with Public Notices.

Prior to future Building Permit issuance, the developer is required to complete the following:

- Incorporate of accessibility measures in Building Permit (BP) plans as determined in the Rezoning ad Development Permit processes.
- Provide a report from a Registered Professional confirming that the heat pumps will comply with the City's Noise Regulation Bylaw.
- The applicant is required to obtain a Building Permit for any construction hoarding associated with the proposed development. If construction hoarding is required to temporarily occupy a street, or any part thereof, or occupy the air space above a street or any part thereof, additional City approvals and associated fees may be required as part of the Building Permit. For further information on the Building Permit, please contact Building Approvals Department at 604-276-4285.
- Submission of a Construction Traffic and Parking Management Plan to the satisfaction of the City's Transportation Department (https://www.richmond.ca/services/transportation/special.htm#TrafficPlan).



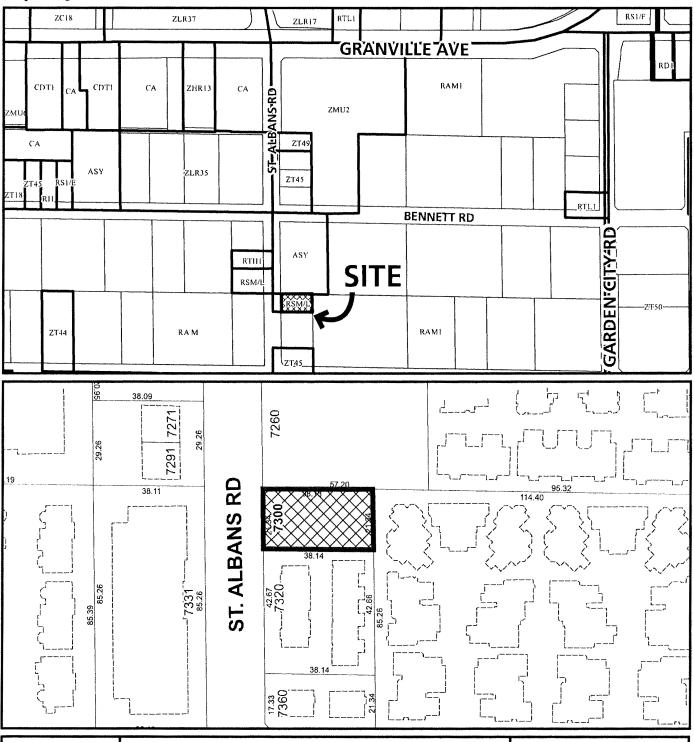



DP 23-029433

Original Date: 10/20/23

Revision Date: 10/16/24

Note: Dimensions are in METRES



Development Application Data Sheet

Development Applications Department

DP 23-029433 Attachment 2

Address: 7300 St. Albans Road

Applicant: Matthew Cheng Owner: 1124053 B.C. Ltd

Planning Area(s): St Albans Sub-Area Plan

Floor Area Gross: 827.30 m² Floor Area Net: 610.46 m²

	Existing	Proposed
Site Area:	813.9 m²	No Change
Land Uses:	Single Family Residential	Multi-Family Residential
OCP Designation:	Neighbourhood Residential	No Change
Zoning:	Multi-Family Low Rise	No Change
Number of Units:	Single Detached (RS1/E)	High Density Townhouses (RTH1)

	Bylaw Requirement	Proposed	Variance
Floor Area Ratio:	Max. 0.75	0.75	none permitted
Lot Coverage:	Building: Max. 45% Non-porous Surfaces: Max. 70% Landscaping: Min. 20%	Building: 33% Non-porous Surfaces: 70% Landscaping: 20%	none
Lot Size:	Min. 600 m²	813.9 m²	none
Setbacks (m):	Front: Min. 4.5 m Rear: Min. 2.0 m Side: Min. 2.0 m	Front: 4.5 m Rear: 4.5 m Side: 2.0 m	none
Height (m):	Max. 12.0 m (3 storeys)	11.3 m	none
Off-street Parking Spaces – Regular (R) / Visitor (V):	1.4 (R) and 0.2 (V) per unit	1.4 (R) and 0.2 (V) per unit	none
Off-street Parking Spaces - Total:	6 (R) and 1 (V)	6 (R) and 1 (V)	none
Bicycle Parking	Class 1: 5 Class 2: 1	Class 1: 5 Class 2: 1	none
Amenity Space – Indoor:	Min. 50 m ²	Cash in-lieu	none
Amenity Space – Outdoor:	Min. 24 m ²	29.0 m ²	none
Off-street Parking Spaces – Regular (R) / Visitor (V):	1.4 (R) and 0.2 (V) per unit	1.4 (R) and 0.2 (V) per unit	none
Off-street Parking Spaces - Total:	6 (R) and 1 (V)	6 (R) and 1 (V)	none



Development Permit

No. DP 23-029433

To the Holder:

Matthew Cheng

Property Address:

7300 St Albans Road

Address:

202-670 Evans Avenue, Vancouver, BC, V6A 2K9


- 1. This Development Permit is issued subject to compliance with all of the Bylaws of the City applicable thereto, except as specifically varied or supplemented by this Permit.
- 2. This Development Permit applies to and only to those lands shown cross-hatched on the attached Schedule "A" and any and all buildings, structures and other development thereon.
- 3. Subject to Section 692 of the Local Government Act, R.S.B.C.: buildings and structures; off-street parking and loading facilities; roads and parking areas; and landscaping and screening shall be constructed generally in accordance with Plans #1 to #21 attached hereto.
- 4. Sanitary sewers, water, drainage, highways, street lighting, underground wiring, and sidewalks, shall be provided as required.
- 5. As a condition of the issuance of this Permit, the City is holding the security in the amount of \$124,322.00. to ensure that development is carried out in accordance with the terms and conditions of this Permit. Should any interest be earned upon the security, it shall accrue to the Holder if the security is returned. The condition of the posting of the security is that should the Holder fail to carry out the development hereby authorized, according to the terms and conditions of this Permit within the time provided, the City may use the security to carry out the work by its servants, agents or contractors, and any surplus shall be paid over to the Holder. Should the Holder carry out the development permitted by this permit within the time set out herein, the security shall be returned to the Holder. The City may retain the security for up to one year after inspection of the completed landscaping in order to ensure that plant material has survived.
- 6. If the Holder does not commence the construction permitted by this Permit within 24 months of the date of this Permit, this Permit shall lapse and the security shall be returned in full.

Development Permit No. DP 23-029433

	140; DI 25-0254;			
To the Holder:	Matthew Cheng			
Property Address:	7300 St Albans Road 202-670 Evans Avenue, Vancouver, BC, V6A 2K9			
Address:				
	•			
AUTHORIZING RESOLUT DAY OF ,	TION NO. ISSUED BY THE COUNCIL THE			
DELIVERED THIS D	DAY OF , .			
MAYOR				



City of Richmond

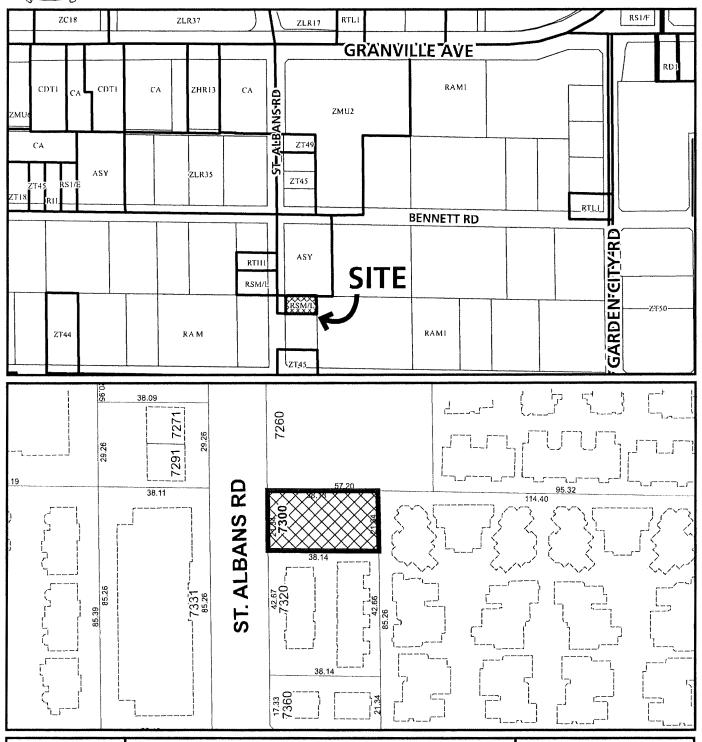



DP 23-029433 SCHEDULE "A"

Original Date: 10/20/23

Revision Date: 10/16/24

Note: Dimensions are in METRES



7300 ST ALBANS - 4 UNITS TOWNHOUSE- N.W VIEW **PROJECT DATA** PROPOSED EXISTING METRIC (M/SM) IMPERIAL (F/SF) METRIC (M/SM) IMPERIAL (F/SF) 7300 ST, ALBANS ROAD RICHMOND, BC. ADDRESS LOT 4 SEC 16 BLOCK 4 NORTH RANGE 6W NEW WESTMINSTER LEGAL DESCRITPTION DISTRICT PLAN 11330 SITE AREA 813.9 8.752 813.9 8,752 SINGLE FAMILY DWELLING LAND USE TOWNHOUSE RESIDENTIAL NO CHANGE OCP DESIGNATION RS1/E RTL1 ZONING NO. OF DWELLINGS REQUIRED / ALLOWED PROPOSED IMPERIAL (F/SF) METRIC (M/SM) METRIC (M/SM) IMPERIAL (F/SF) FLOOR AREA RATIO (FAR) 0.75 0.75 610.68 6,571 610.68 6,571 FLOOR AREA TOTAL LOT COVERAGE BUILDING (45% MAX.) 366.26 3.938 271.21 2,919 NON POROUS SURFACE (70% MAX.) 569.74 6,126 569.74 6,126 LIVE PLANT (20% MIN.) 162.78 1,750 165.00 1.775 SETBACK-FRONT YARD 4.5M 14'-09" 4.5M 14'-09" SETBACK-SIDE YARD (NORTH) 2M 6'-06" 2.3M 7'-06" SETBACK-SIDE YARD (SOUTH) 2M 6'-06" 2M 6'-06" SETBACK-REAR YARD 3M 9'-10" 4.5M 14'-09" HEIGHT (FLAT ROOF) 12M 3 STOREY 11.75M 3 STOREY LOT SIZE 813.9 8,752 813.9 8,752 OFF-STREET PARKING TOTAL OFF-STREETACCESSIBLE TANDEM PARKING SPACES SIDE BY SIDE PARKING SPACES 0 OFF-STREET PARKING VISITOR CLASS 1 BICYCLE SPACE 1.25X4=5 CLASS 2 BICYCLE SPACE .2X4=.8 MIN. 6 SM/UNIT=24SM 29.016 SM

MIN. 70 SM OR CASH IN LIU OF

\$1000.00/UNIT

ONE CONVERTIBLE UNIT IS PROPOSED

. PROJECT WILL ACHIVE ENERGUILD 82 RATING

AGING IN PLACE FEATURES ARE PROPOSED IN ALL UNITS OF THE PROJECT.

258

ALL UNITS IN THIS PROJECT MUST MEET THE REQUIEREMENTS OF THE SOLAR HOT WATER READY REGULATION

AMENITY SPACE - OUTDOOR

AMENITY SPACE - INDOOR

(10% OF NET SITE AREA) GENERAL NOTES:



CONTEXT PLAN

312.00

CASH IN-LIU





THE PROJECT COMPLIANCE WITH FLOOD PLAIN DESIGNATION AND PROTECTION BYLAW. NO AREA BELOW THE FCL WILL BE USED FOR THE INSTALLATION OF FURNACES OR OTHER FIXED EQUIPMENT SUSCEPTIBLE TO DAMAGE BY FLOOD WATER. THIS PROJECT WILL BE BUILT BASED ON ENERGY STEP CODE STEP 3 WITH LCES 1) ABOVE GRADE WALLS: 2X6@16-R-24 INSULATION

2) FLAT ROOF: R-40 INSULATION
3) FLOOR OVER UNHEATED SPACE: R-28 INSULATION
4) SLAB ON GRADE: R-12 BELOW THE SLAB

5) ACH: 2.5 OR LESS @ 50 PA 6) WINDOWS: U VALUE 1,20 OR LOWER AND SHGC 0,30 OR HIGHER

7) HEATING SYSTEM : AIR SOURCE HEATPUME

8) DOMESTIC HOT WATER - ELECTRIC

	Sheet List
Sheet Number	Sheet Name
A200	SITE PLAN
A201	LEVEL ONE
A202	LEVEL TWO
A203	LEVEL THREE
A301	East Building Elevations & North Elevation
A302	West Building Elevations & South Elevation
A400	FSR CALCULATION
A401	LOT COVERAGE OUTDOOR AREA CACULATION
A402	SHADOW STUDY
A403	CONVERTABLE UNIT
A404	STREETSCAPE SECTIONS
A405	EAST BUILDING COLOUR ELEVATIONS
A406	WEST BUILDING COLOUR ELEVATIONS



MATTHEW CHENG ARCHITECT INC.

Unit 202 - 670 EVANS AVENUE VANCOUVER, BC V6A 2K9 Tel: (604) 731-3012 Cel: (604) 649-0669 / Email: matthew@meai.ca

THIS DRAWING AIUST NOT BE SCALED. THE GENERAL CONTRACTOR SHALL VERIFY ALL DIMINIONS AND LEVELS PRIOR TO COMMENCEMENT TO WORK. ALL ERRORS AND OMISSIONS SHALL BE REPORTED IMMEDIATELY TO THE ARCHITECT. COPYRIGHT RESERVED. THIS PLAN AND DESION ARE AND AT ALL TIMES.

REMAIN THE EXCLUSIVE PROPERTY OF MATTHEW CHENG ARCHITECT INC. AND MAY NOT BE USED OR REPRODUCED WITHOUT PRIOR.

1) Oct 23rd, 2024 DP Final drawings

RE YY-MM-DD DESCRIPTION DRWN CHK

DP 23-029433 October 23, 2024 Plan #1


4 UNIT TOWNHOUSE DEVELOPMENT


7300 ST. ALBANS ROAD RICHMOND, BC

"3D VIEWS AND PROJECT DATA

Oraw n:	PW			
Checked:	МС			
Scal e:				
Project No	mber: 19 R Th	101		
Revision (Date:	0	wg. No.:	

Print Date: A100

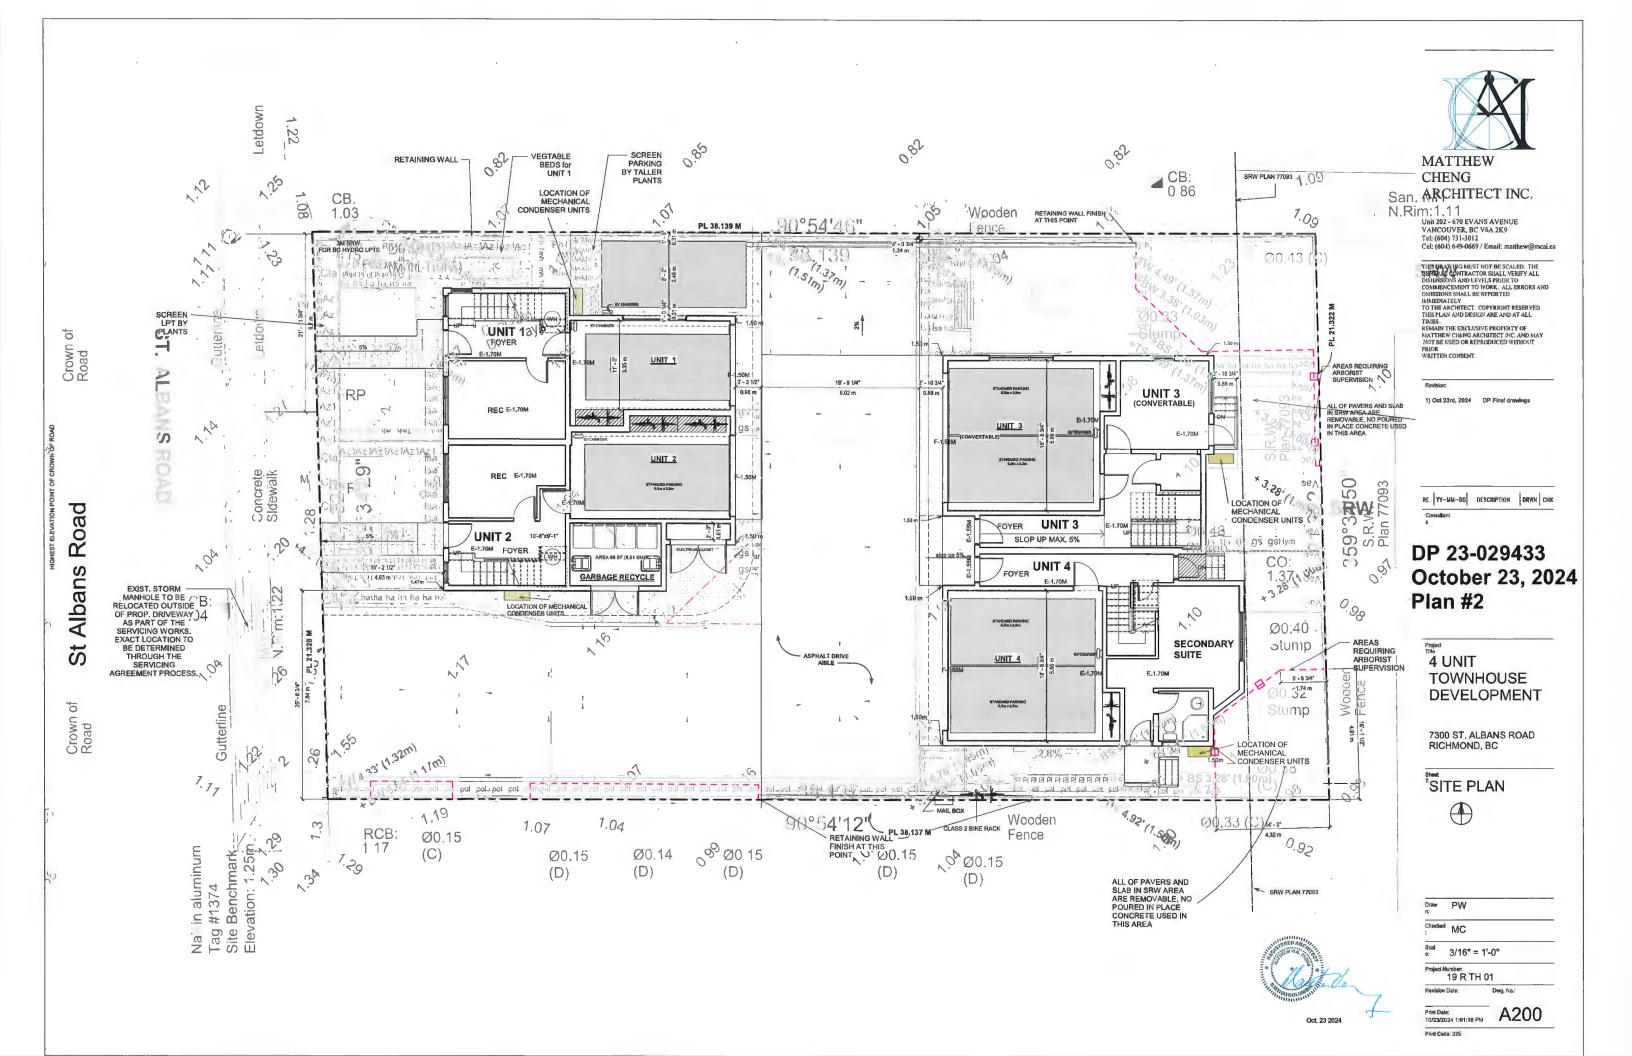

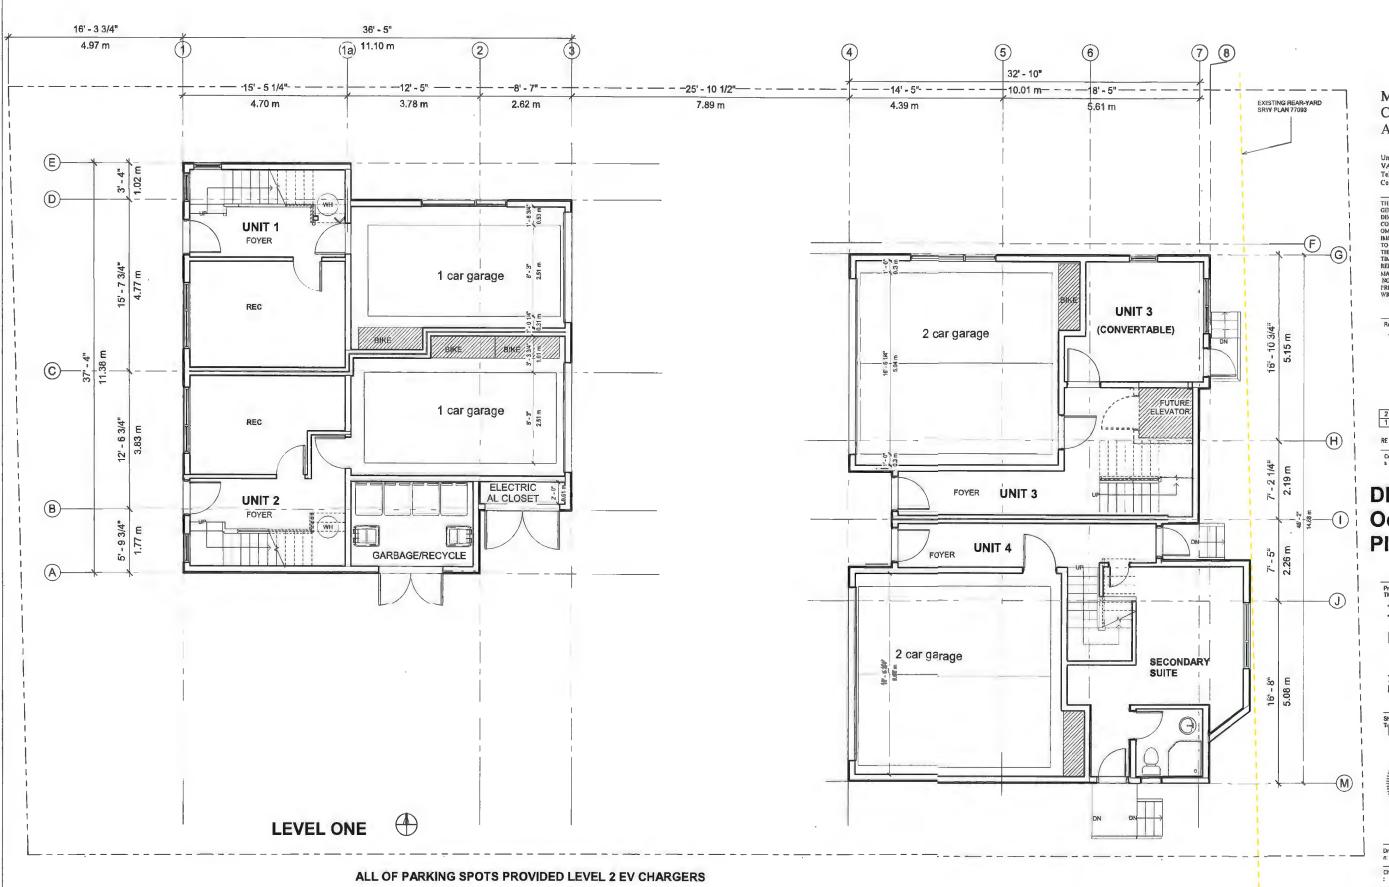



Unit 202 - 670 EVANS AVENUE VANCOUVER, BC V6A 2K9 Tel: (604) 731-3012 Col: (604) 649-0669 / Email: matthew@mcai.ca

THIS DRAWING AIUST NOT BE SCALED. THE GENERAL CONTRACTOR SILALL VERIFY ALL DIMENSIONS AND LEVELS PRIOR TO COMMENCEMENT TO WORK. ALL ERRORS AND OMISSIONS SHALL BE REPORTED IMMEDIATELY TO THE ARCHITECT. COPYRIGHT RESERVED THIS FLAN AND DESIGN ARE AND AT ALL TIMES REMAIN THE EXCLUSIVE PROPERTY OF MAITHEW CHENG ARCHITECT INC. AND MAY NOT BE USED OR REPRODUCED WITHOUT PRIOR WRITTEN CONSENT.

1) Oct 23rd, 2024 DP Final drawings

RE YY-MM-DD DESCRIPTION DRWN CHK

DP 23-029433 October 23, 2024 Plan #3

Project Title 4 UNIT TOWNHOUSE DEVELOPMENT

7300 ST. ALBANS ROAD

"LEVEL ONE



Oct. 23 2024


Checked MC

Scal a: 1/4" = 1'-0"

Project Number: 19 R TH 01

Date 2

Print Date: A201

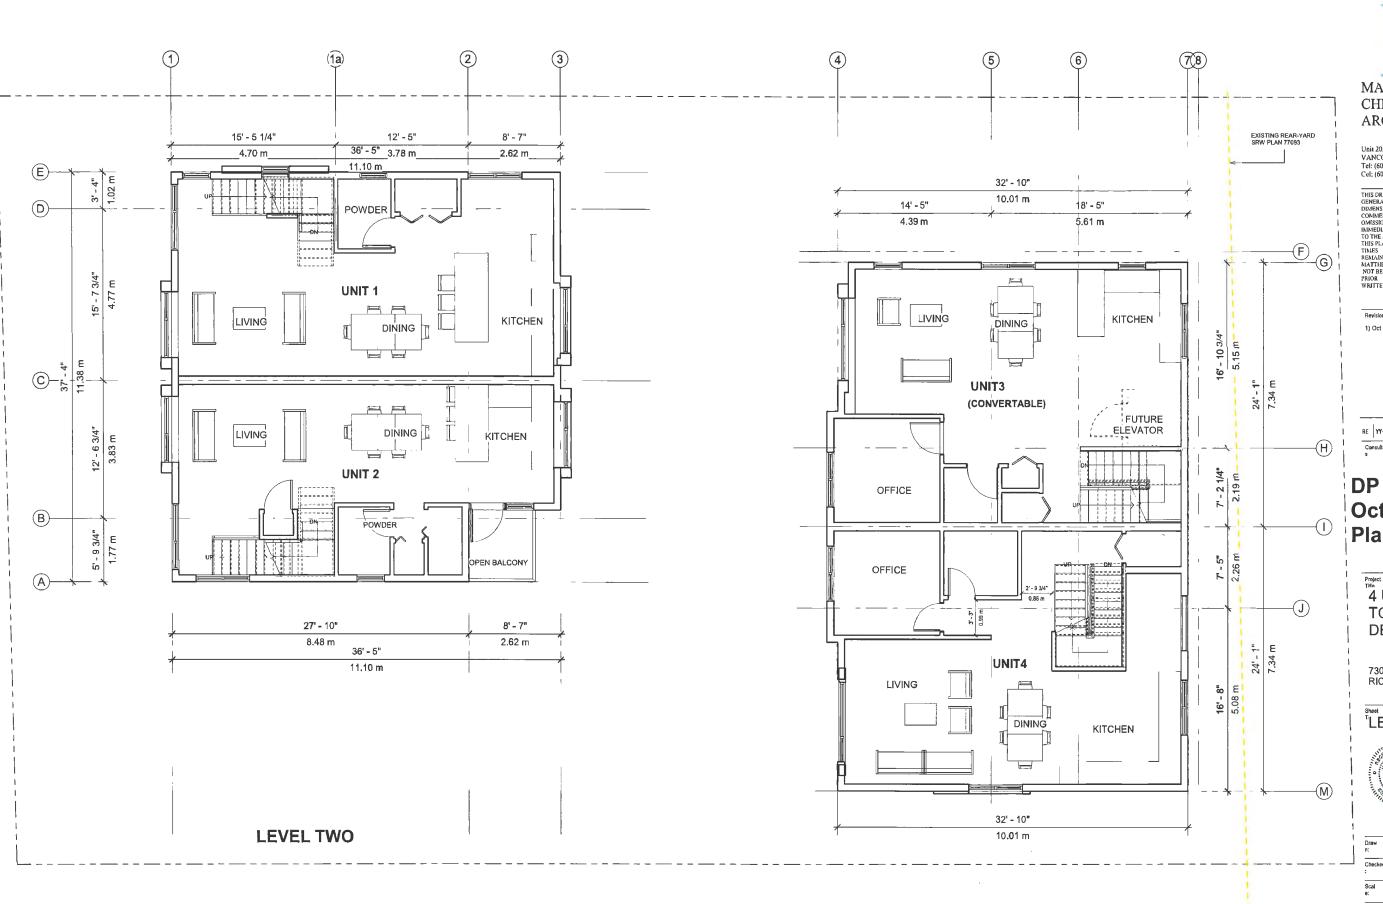



Unit 202 - 670 EVANS AVENUE VANCOUVER, BC V6A 2K9 Tel: (604) 731-3012 Cel: (604) 649-0669 / Email: nutthew@meai.ca

THIS DRAWING MUST NOT BE SCALED. THE GENERAL CONTRACTOR SHALL VERRY ALL DIMENSIONS AND LEVELS PRIOR TO COMMENCEMENT TO WORK. ALL ERRORS AND OMISSIONS SHALL BE REPORTED INMEDIATELY TO THE ARCHITECT. COPYRIGHT RESERVED THIS PLAN AND DESIGN ARE AND AT ALL TIMES REMAIN THE EXCLUSIVE PROPERTY OF MATTHEW CHENG ARCHITECT INC. AND MAY NOT BE USED OR REPRODUCED WITHOUT PRIOR WRITTEN CONSENT.

1) Oct 23rd, 2024 DP Final drawings

RE YY-MM-DD DESCRIPTION DRWN CHK

DP 23-029433 October 23, 2024 Plan #4

Project Title 4 UNIT TOWNHOUSE **DEVELOPMENT**

7300 ST. ALBANS ROAD RICHMOND, BC

LEVEL TWO



Oct. 23 2024


Checked MC

Scal e: 1/4" = 1'-0"

Project Number: 19 R TH 01

Print Date: 10/23/2024 1:02:12 PM A202

Print Code: 335

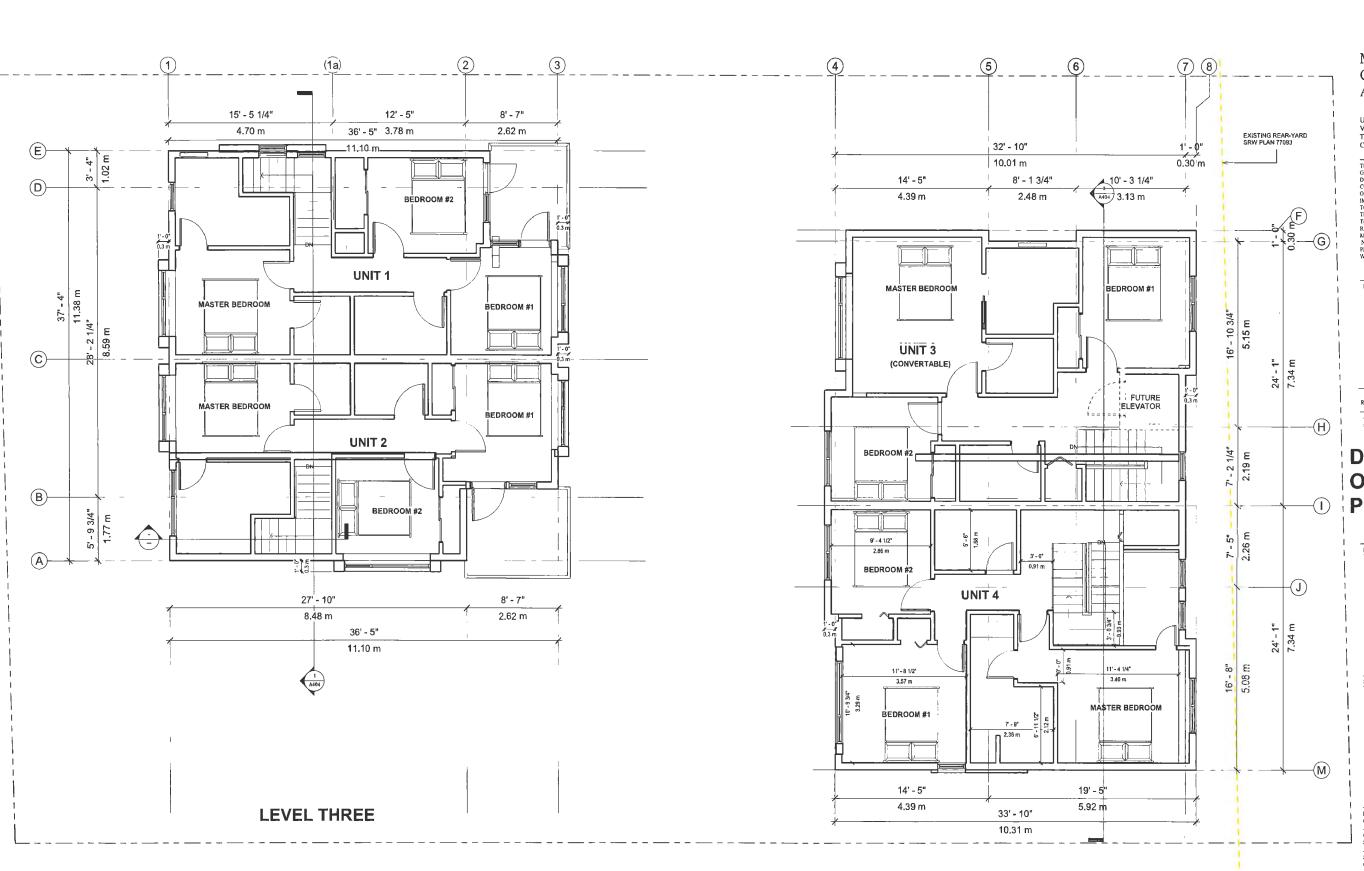



Unit 202 - 670 EVANS AVENUE VANCOUVER, BC V6A 2K9 Tel: (604) 731-3012 Cel: (604) 649-0669 / Email: matthew@mcai.ca

THIS DRAWING MUST NOT BE SCALED. THE GENERAL CONTRACTOR SHALL VERRY ALL DIMENSIONS AND LEVELS PRIOR TO COMMENCEMENT TO WORK. ALL ERRORS AND OMISSIONS SHALL BE REPORTED IMMEDIATELY TO THE ARCHITECT. COPYRIGHT RESERVED. THIS PLAN AND DESIGN ARE AND AT ALL TIMES REMAIN THE EXCLUSIVE PROPERTY OF MATTHEW CHENG ARCHITECT INC. AND MAY NOT BE USED OR REPRODUCED WITHOUT PRIOR WRITTEN CONSENT.

1) Oct 23rd, 2024 DP Final drawings

RE YY-MM-DD DESCRIPTION DRWN CHK

DP 23-029433 October 23, 2024 Plan #5

Project Tilla 4 UNIT TOWNHOUSE **DEVELOPMENT**

7300 ST. ALBANS ROAD RICHMOND, BC

LEVEL THREE



Oct. 23 2024

Checked MC


Scal e: 1/4" = 1'-0"

Project Number: 19 R TH 01

Print Date: 10/23/2024 1:03:39 PM A203





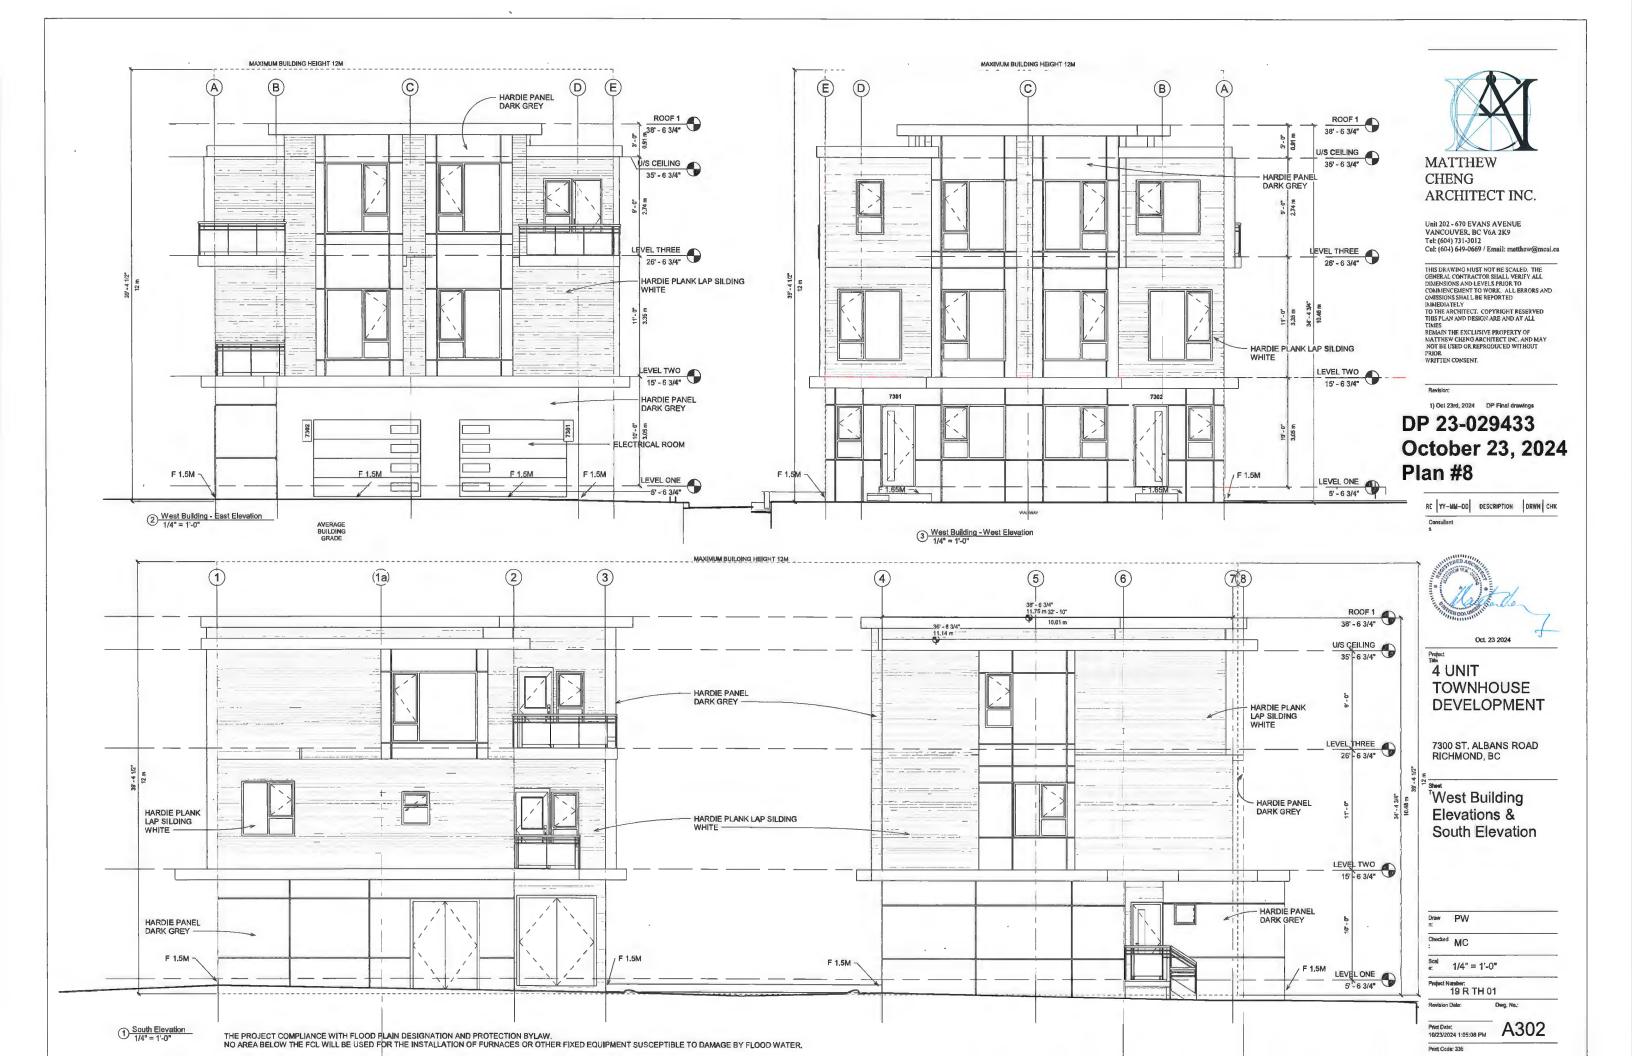



CONVERTIBLE UNIT GUIDELINES:

DOORS & DOORWAYS

-ENTRY DOORS ARE A MINIMUM $863~\mathrm{MM}$ BUT IDEALLY $914~\mathrm{MM}$ AND HAVE CLEAR ACCESS.

-ENTRY DOOR CLEAR EXTERIOR FLOOR SPACE MIN. 1220 MM DEPTH BY DOOR WIDTH PLUS 600 MM ON LATCH SIDE (NOT NEEDED IF ROUGH IN WIRING PROVIDED FOR FUTURE AUTOMATIC DOOR OPENER).

-INTERIOR DOORS TO MAIN LIVING AREAS, 1 BATHROOM AND 1 BEDROOM, MIN. 800 MM CLEAR OPENING WITH FLUSH THRESHOLDS MAX. 13 MM HEIGHT. DEMONSTRATE WHEELCHAIR ACCESS BETWEEN THE HALLWAY AND ROOMS AND WIDEN HALLWAY AND/OR DOORWAY(S) IF NECESSARY TO SECURE ACCESS.

-PATIO/BALCONY MÌN. 860 MM CLEAR OPENING. NOTE HOW ACCESSED. ALL INTERIOR THRESHOLDS WITHIN UNITS COMPLY WITH BC BUILDING CODE. -LEVER-TYPE HANDLES FOR ALL DOORS.

VERTICAL CIRCULATION

-STAIR LIFT, STAIRCASE WIDTH, FRAMING SUPPORT, AND LANDINGS, AS NOTED ON FLOOR PLANS IN COMPLIANCE WITH MANUFACTURER SPECIFICATIONS.

VERTICAL LIFT, DEPRESSED SLAB AREA, AND LANDINGS, AS NOTED ON FLOOR PLANS IN COMPLIANCE WITH MANUFACTURER SPECIFICATIONS. FRAMING TO ACCOMMODATE SHAFT CONSTRUCTION WITHOUT IMPACT TO SURROUNDING STRUCTURE.

-AT THE TOP OF ALL STAIRWAYS, WALLS ARE REINFORCED WITH 2" X 12" SOLID LUMBER AT 914 MM TO CENTRE.

HALLWAYS

-MIN. 900 MM WIDTH.

GARAGE

-MIN. 1 ACCESSIBLE PARKING SPACE WITH MIN. 4 M GARAGE WIDTH. -ACCESS FROM GARAGE TO LIVING AREA MIN. 800 MM CLEAR OPENING.

BATHROOM (MIN. 1)

- -TOILET CLEÀR FLÓOR SPACE MIN. 1020 MM AT SIDE AND IN FRONT.
 -WALL BLOCKING FOR FUTURE GRAB BAR INSTALLATION AT TOILET, TUB AND SHOWER. REINFORCED WITH 2" X 12" SOLID LUMBER IN ALL BATHTUB, SHOWER, AND TOILET LOCATIONS.
- -LEVER-TYPE HANDLES FOR PLUMBING FIXTURES.
- -PRESSURE AND TEMPERATURE CONTROL VALVES ARE INSTALLED ON ALL SHOWER FAUCETS.
- -CABINETS UNDERNEATH SINK(S) ARE EASILY REMOVED. DEMONSTRATE BATH AND SHOWER CONTROLS ARE ACCESSIBLE (LAYOUT OR FIXTURE PLACEMENT).

KITCHEN

- -CLEAR AREA NEEDED UNDER FUTURE WORK SPACE. PLUMBING AND GAS PIPES (IN-WALL AND IN-FLOOR) LOCATED CLEAR OF UNDER COUNTER AREA OF FUTURE WORK SPACE (STOVE, SINK & MIN. 810 MM WIDE COUNTER). ALL PIPES ARE BROUGHT IN NO HIGHER THAN 304 MM TO 355 MM TO THE CENTRE OF THE PIPE FROM FLOOR LEVEL.
- -CABINETS UNDERNEATH SINK ARE EASILY REMOVED.
- -1500 MM TURNING DIAMETER OR TURNING PATH DIAGRAM.
- LEVER-TYPE HANDLES FOR PLUMBING FIXTURES.

WINDOWS

-MIN. 1 WINDOW THAT CAN BE OPENED WITH A SINGLE HAND (BATHROOM, KITCHEN, LIVING ROOM)

OUTLETS & SWITCHES

-PLACEMENT LOCATIONS OF ELECTRICAL OUTLETS: BESIDE WINDOW, BOTTOM OF STAIRWAYS, BESIDE TOILET, ABOVE EXTERNAL DOORS (OUTSIDE AND INSIDE), ON FRONT FACE OF KITCHEN COUNTER, WITHIN PROXIMITY OF CONTROL CENTRE FOR SMART HOME OPTIONS. -UPGRADE TO FOUR-PLEX OUTLETS IN MASTER BEDROOM, HOME OFFICE, GARAGE, AND RECREATION ROOM.







Unit 202 - 670 EVANS AVENUE VANCOUVER, BC V6A 2K9 Tel: (604) 731-3012 Cel: (604) 649-0669 / Email: matthew@mcai.ca

THIS DRAWING MUST NOT BE SCALED. THE GENERAL CONTRACTOR SIGAL VERIFY ALL DIMFASIONS AND LEVELS PRIOR TO COMMENCEMENT TO WORK. ALL ERRORS AND OMISSIONS SIGAL IS REPORTED IMMEDIA FELY. TO THE ARCHITECT. COPVRIGHT RESERVED THIS PLAN AND DESIGN ARE AND AT ALL TRIFE PLAN AND DESIGN ARE AND AT ALL TRIFE EXCLUSIVE PROPERTY OF MATTHEW CHENG ARCHITECT INC. AND MAY NOT BE USED OR REPRODUCED WITHOUT PRIOR.

Revis

1) Oct 23rd, 2024 DP Final drawings

RE YY-MM-DD DESCRIPTION DRWN CHK
Consultant

DP 23-029433 October 23, 2024 Plan #11

Project Tiffe 4 UNIT TOWNHOUSE DEVELOPMENT

7300 ST. ALBANS ROAD RICHMOND, BC



Oct. 23 2024

Draw PW

Scal e: As indicated


Project Number: 19 R TH 01


19 R TH 01


Levision Date: Dwg. F


Print Date: A404


STREETSCAPE

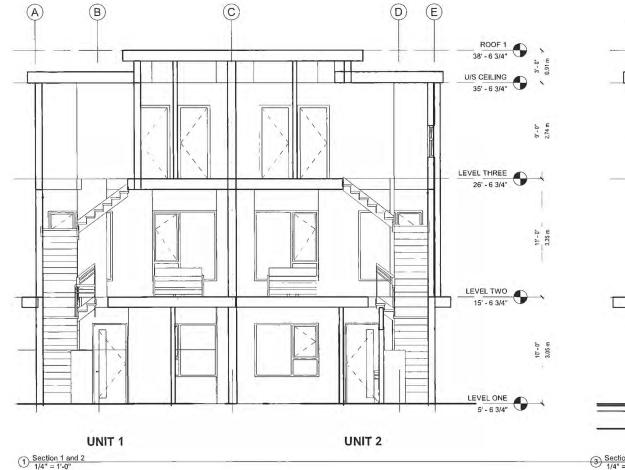


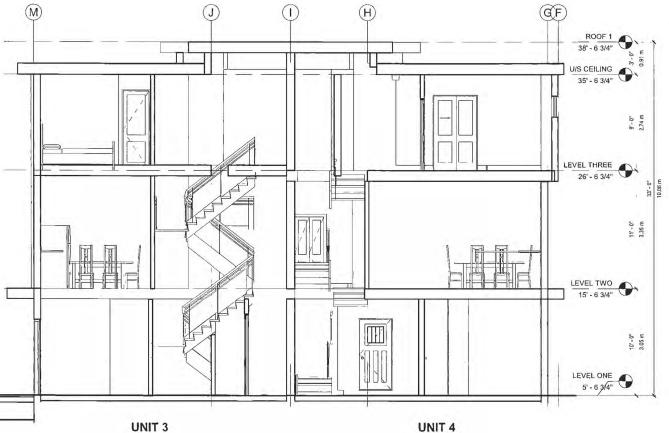


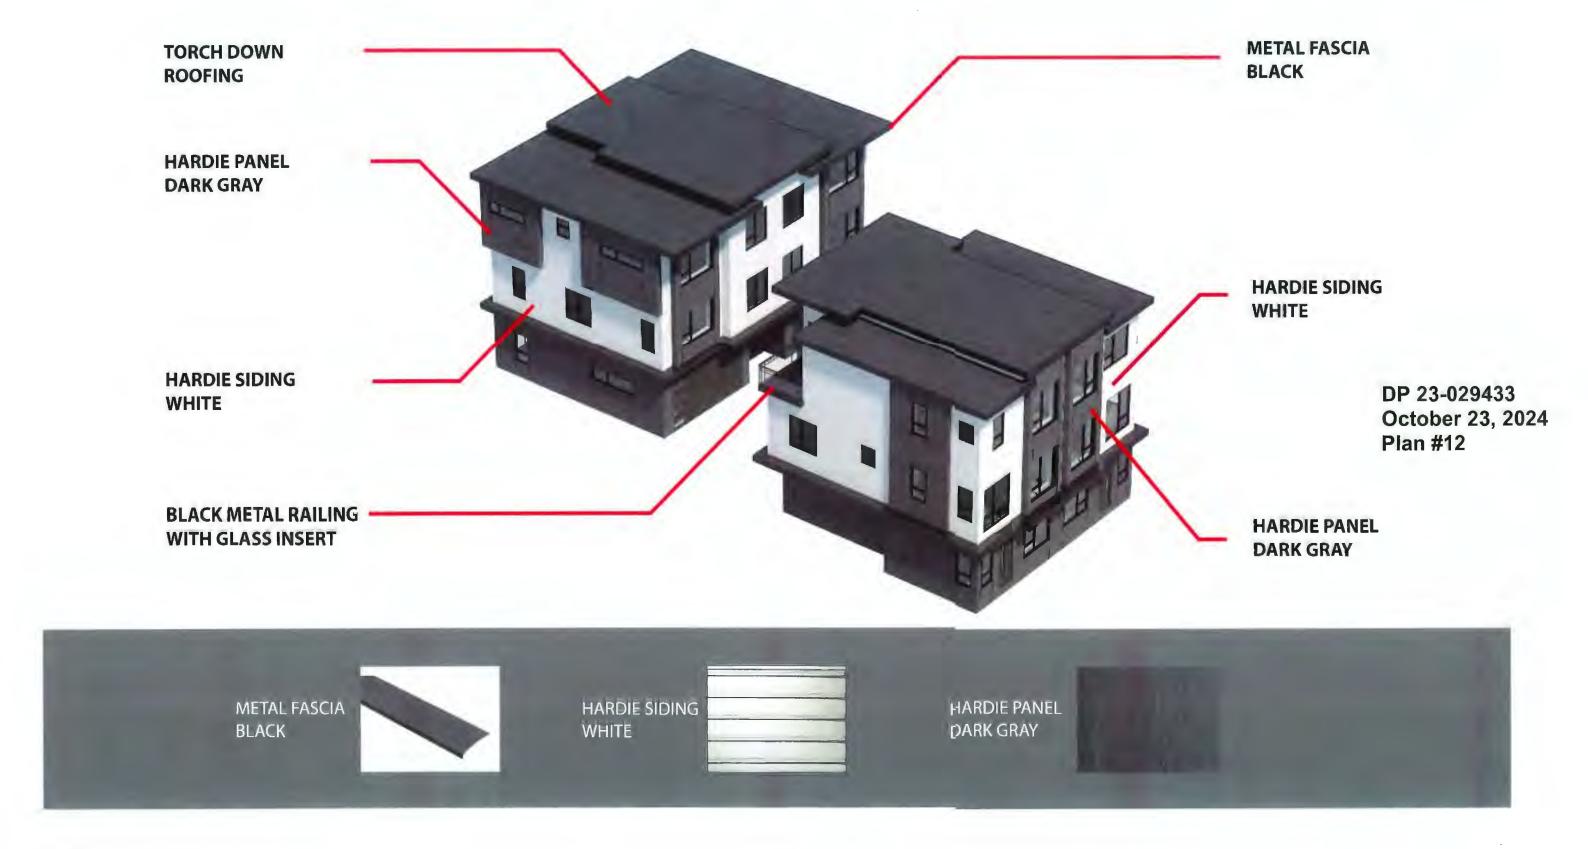

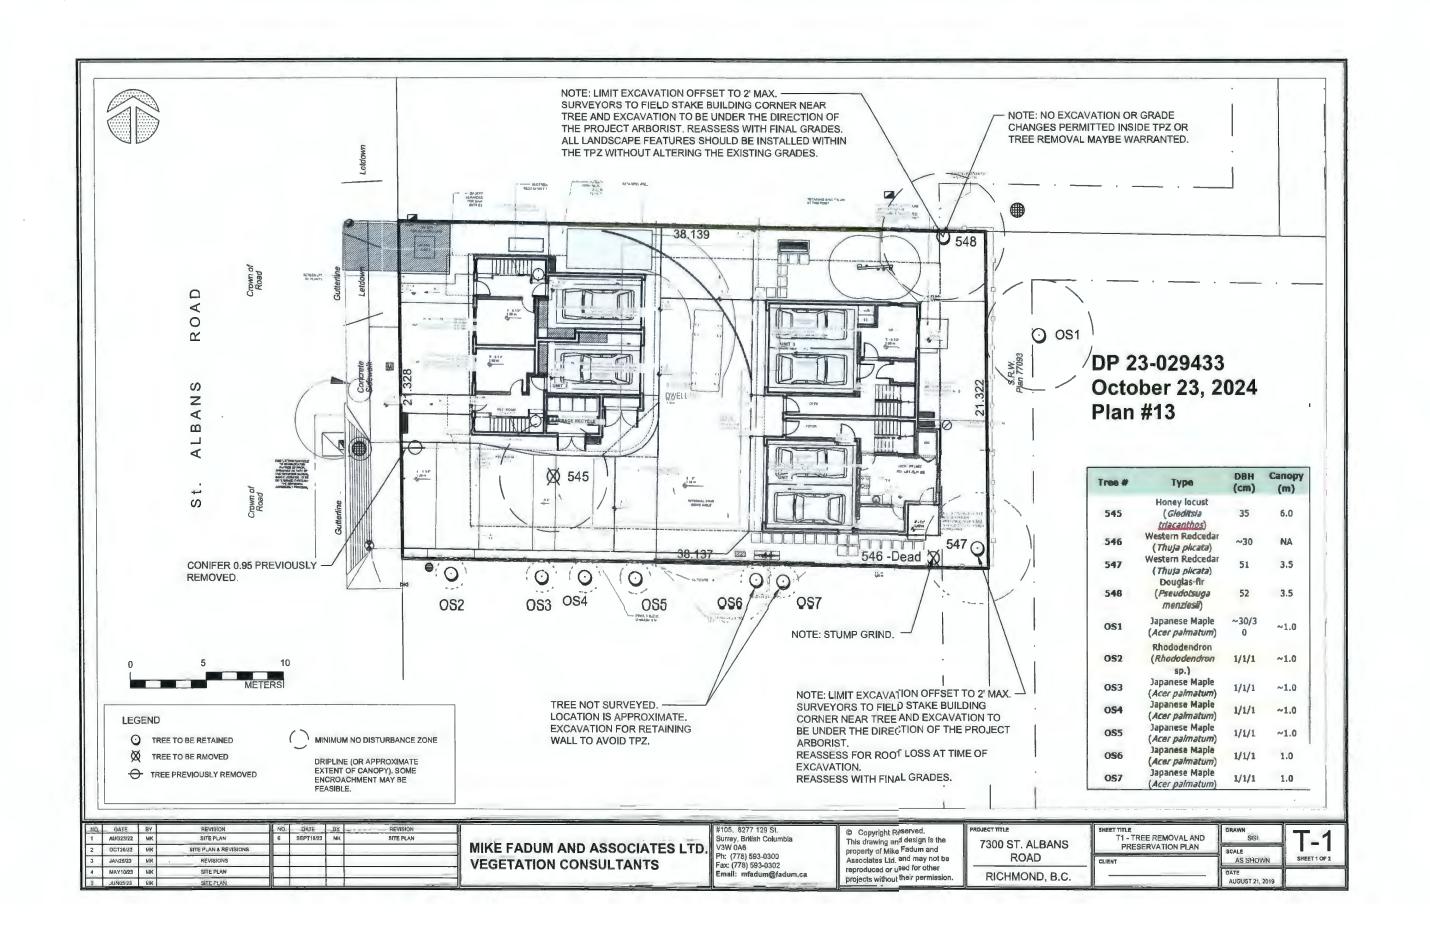

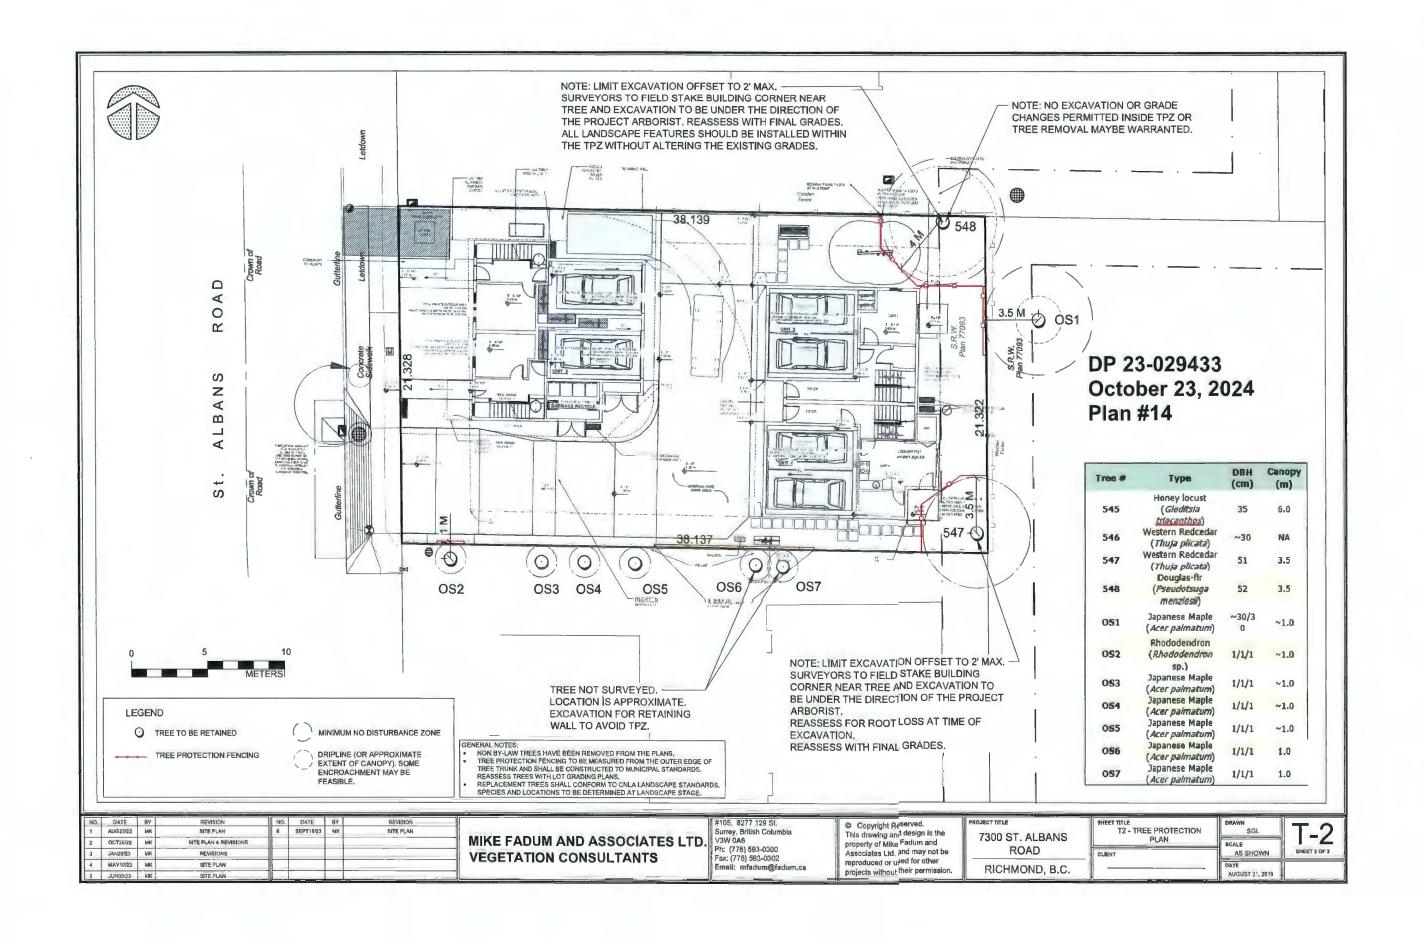

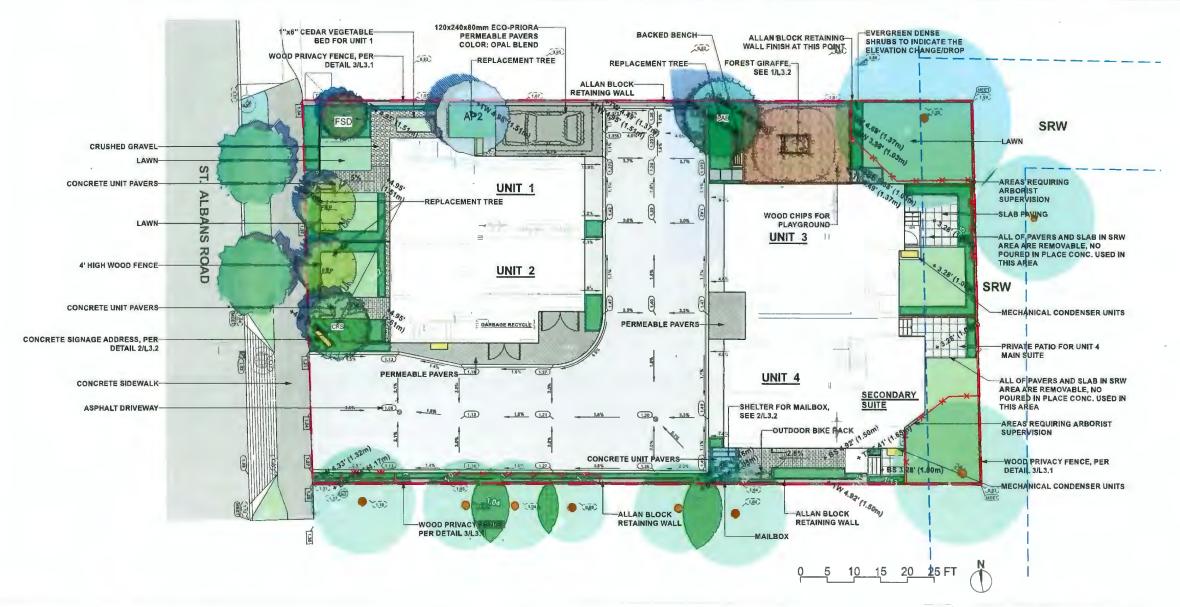

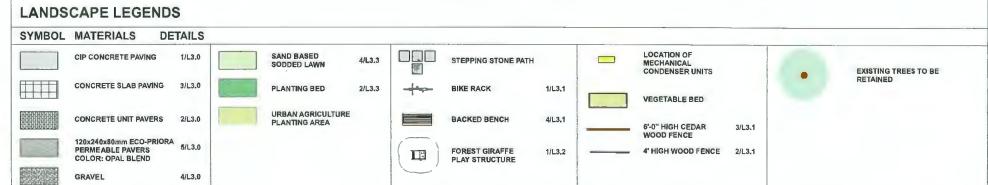

GRADING LEGENDS GRADING NOTES . ALL GRADING INFORMATION IS PRELIMINARY ONLY, KEY DESCRIPTION 2. REFER TO ARCHITECTURAL DRAWINGS FOR BUILDING ELEVATIONS. + 4.95' (1.51m) PROPOSED SPOT ELEVATIONS 3. ALL EXISTING SURVEY INFORMATION APPROXIMATE. VERIFY ALL EXISTING GRADES WITH SITE CONDITIONS. REPORT DISCREPANCIES TO CONSULTANT TEAM PRIOR TO PROCEEDING + TW 4.07' (1.24m) PROPOSED TOP OF WALL ELEVATION 4. THE CONTRACTOR SHALL IDENTIFY AND PROTECT ALL EXISTING UTILITIES PRIOR TO CONSTRUCTION, ANY CONFLICTS FOUND WITH ULTITIES SHALL BE CLARIFIED WITH THE CONSULTANT TEAM PRIOR TO PROCEEDING. PROPOSED BOTTOM OF WALL ELEVATION + BW 3.44' (1.05m) 5. UNLESS OTHERWISE NOTED, PROVIDE A MINIMUM 2% SLOPE ON ALL HARD AND SOFT LANDSCAPE AREAS TO ENSURE POSITIVE DRAINAGE AWAY FROM BUILDINGS AND TO DRAINAGE STRUCTURES. SOFT LANDSCAPE AREAS TO BE A MAXIMUM 3:1 SLOPE. 3% SLOPE PERCENTAGE EXISTING ELEVATIONS, PER SURVEY (1,26) CIVIL ELEVATIONS, PER CIVIL

IRRIGATION NOTES:

HIGH EFFICIENCY IRRIGATION WILL BE PROVIDED TO LANDSCAPE AREAS.



LANDSCAPE ARCHITECTURE

ADDRESS: 1423 W11TH AVENUE, VANCOUVER, BC, CANADA V6H 1K9 CELL: 778-323-3536 EMAIL: HOMINGLANDSCAPE@GMAIL,COM

DO NOT SCALE THE DRAWINGS, COPYRIGHT RESERVED. IF A DISCREPANCY OCCURS GETWEEN THE DRAWINGS AND THE SPECIFICATIONS OR ANY OTHER DOCUMENT ASSOCIATED WITH THE PROJECT, THE COMFLICT SHALL BE REPORTED IN WRITING TO THE LANDSCAPE ARCHITECT TO OBTAIN CLARIFICATION AND APPROVAL BEFORE PROCEEDING WITH WORKS.

Revisions

NC), Date	Note
1	2023-10-02	ISSUED FOR DP
2	2023-12-11	ISSUED FOR RZC LETTER RESPONSE
3	2024-03-18	ISSUED FOR DP
4	2024-05-12	ISSUED FOR DP
5	2024-05-30	ISSUED FOR DP
6	2024-07-10	ISSUED FOR DP
7	2024-08-03	ISSUED FOR DP
8	2024-09-18	ISSUED FOR DP
9	2024-10-10	ISSUED FOR DP
10	2024-10-22	ISSUED FOR DP

DP 23-029433 October 23, 2024 Plan #15

4 UNIT TOWNHOUSE DEVELOPMENT

PROJECT ADDRESS: 7300 ST ALBANS ROAD RICHMOND, BC, CANADA

PROJECT NUMBER: 23-25

SCALE: 1/8" = 1'-0'

LANDSCAPE NOTES

2, LAYOUT DRAWINGS ARE TO BE READ IN CONJUNCTION WITH ALL OTHER CONSULTANT

3.ALL EXISTING INFORMATION APPROXIMATE ONLY, VERIFY ALL EXISTING GRADES AND DIMENSIONS WITH SITE CONDITIONS, REPORT DISCREPANCIES TO CONSULTANT TEAM PRIOR TO PROCEEDING.

4. THE CONTRACTOR IS TO PROTECT ALL EXISTING UTILITIES, HARD SURFACES, STRUCTURES, WALLS, AND TREES FOR DURATION OF CONSTRUCTION.

5. THE LOCATION OF ALL PROPOSED HARDSCAPE AND SITE FURNISHINGS ARE TO BE FLAGGED OUT ONSITE BY THE CONTRACTOR AND APPROVED BY THE LANDSCAPE ARCHITECT PRIOR TO INSTALLATION.

7, LAYOUT OF ALL OFF-SITE WORKS TO BE CONFIRMED WITH CITY OF RICHMOND PRIOR TO INSTALLATION,


6. ALL OFF-SITE WORKS TO CONFORM TO CITY OF RICHMOND STANDARDS.

1, DO NOT SCALE DRAWINGS.

DRAWN BY: EL
REVIEWED BY: EL

Landscape Layout and Grading Plan

L1.0

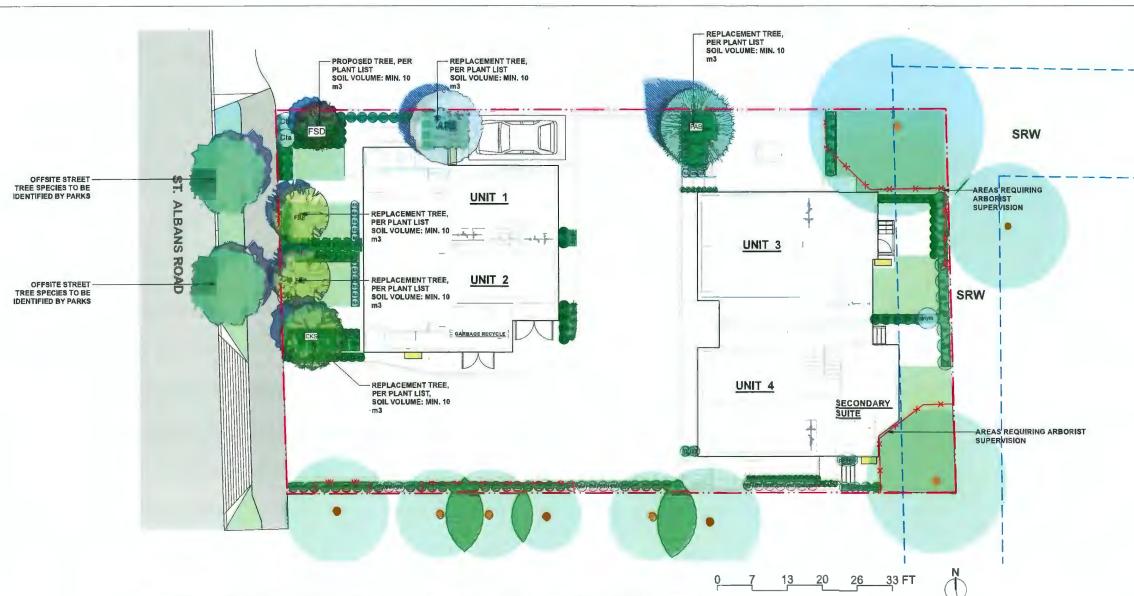

ONSITE PLANT LIST					
ID	Latin Name	Common Name	Quantity	Scheduled Size	Notes
TREES (DECIDUOUS & CONIFEROUS)					
AP2	Acer palmatum 'Osakazuki'	Green Japanese Maple	1	8cm cal.	REPLACEMENT TRE
CKS	Cornus kousa 'Satomi'	Pink Japanese Dogwood	1	8cm cal.	REPLACEMENT TRE
FSD	Fagus sylvatica 'Dawyckii'	Dawyckii Beech	1	— 6cm cal.	
FRP	Fraxinus pennsylvanica 'Prairie Spire'	Prairie Spire Green Ash	2	8cm cal,	REPLACEMENT TRE
PAB	Picea ables	Norway Spruce	1	4,0m ht.	REPLACEMENT TR
SHRUBS					
Az1	Azalea `Hino-Crimson`	Hino-Crimson Azalea	26	#2 pot	
Cta	Choisva ternata 'Aztec Pearl'	Mexican Orange Blossom	5	#3 pot	
gs	Gaultheria shallon	Sala -	11	#2 pot	
Hym	Hydrangea macrophylla	Bigleaf Hydrangea	1	#3 pot	
Mn	Mahonia nervosa -	Dwarf Oregon Grape	10	#1 pot —	
Rh4	Rhododendron 'PJM'	PJM Rhododendron	5	#3 pot	
Shh	Sarcococca hookeriana	Sweet Box	16	#2 pot	-
Tmh	Taxus x media 'Hicksii'	Hick's Yew	17	1.2m ht.	
Vac	Vaccinium parvijfojium	Red Huckleberry	. 11	1,2m ht.	
PERENNIALS & GROUNDCOVERS					
ar	Arctostaphylos uva-ursi 'Vancouver Jade'	Bearberry, Kinnikinick	- 7	#1 pot	
Isa	Lavandula angustifolia	English Spike Lavender	21	#1 pot	
Pj	Pachysandra terminalis	Japanese Spurge	87	#1 pot	
pol	Polystichum munitum	Western sword fern	59	#1 pot	
ORN. GRASSES					
ha	Hakonechloa macra `Aureola`	Golden Japanese Forest Grass	30	#1 pot	

PLANTING NOTES:

1) In case of discrepancy petween plant numbers on this list and on the plan, the latter shall prevail.

2) All planting shall be in accordance with CSLA Canadian Landscape Standard, latest edition.

3) The Landscape Contractor shall ensure that the on-site planting medium/soil meets the specification & recommentations of the soil analysis taken at the time of Substantial Completion. All recommentations of the soil analysis shall be executed prior to Final Acceptance of the landscape works by the Consultant and the municipal authorities.

4) Minimum planting medium depths: lawn - 6"/150mm

groundcover - 12"/300 mm shrubs - 18"/450 mm

trees - 24*/600 mm (around & beneath rootball)

5) All plant material to be supplied on the job site must be obtained from a nursery participating in the BCLNA Phytophthora ramorum Certification Program.

REPLACEMENT TREES NOTES:

TOTAL 5 REPLACEMENT TREES TO BE INSTALLED ON SITE.

IRRIGATION NOTES:

HIGH EFFICIENCY IRRIGATION WILL BE PROVIDED TO LANDSCAPE AREAS.

SOIL VOLUME NOTES:

MIN. 10 m3 SOIL SMALL BE PROVIDED FOR EACH ONSITE TREE.



HOMING LANDSCAPE ARCHITECTURE

ADDRESS: 1423 W11TH AVENUE, VANCOUVER, BC, CANADA V6H 1K9 CELL: 778-323-3536 EMAIL: HOMINGLANDSCAPE@GMAIL,COM

DO NOT SCALE THE DRAWINGS. COPYRIGHT RESERVED. IF A DISCREPANCY OCCURS BETWEN THE DRAWINGS AND THE SPECIFICATIONS OR ANY OTHER DOCUMENT ASSOCIATED WITH THE PROJECT, THE CONFLICT SHALL BE REPORTED IN WRITING TO THE LANDSCAPE ARCHITECT TO OBTAIN LARRIGATION AND APPROVAL BEFORE PROCEEDING WITH WORKS.

Revisions Note

NO. Date		Note	
1	2023-10-02	ISSUED FOR DP	
2	2023-12-11	ISSUED FOR RZC LETTE RESPONSE	
3	2024-03-18	ISSUED FOR DP	
4	2024-05-12	ISSUED FOR DP	
5	2024-05-30	ISSUED FOR DP	
6	2024-07-10	ISSUED FOR DP	
7	2024-08-03	ISSUED FOR DP	
8	2024-09-18	ISSUED FOR DP	
9	2024-10-10	ISSUED FOR DP	
10	2024-10-22	ISSUED FOR DP	

DP 23-029433 October 23, 2024 Plan #16

4 UNIT TOWNHOUSE DEVELOPMENT

PROJECT ADDRESS: 7300 STALBANS ROAD RICHMOND, BC, CANADA

PROJECT NUMBER: 23-25

SCALE: 1/8" = 1'-0"


DRAWN BY: EL

REVIEWED BY: EL

Landscape Planting Plan

L2.0



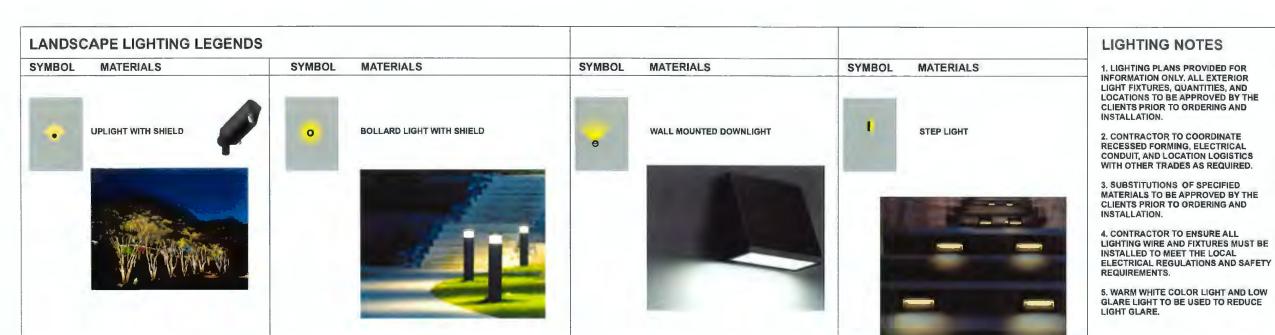



HOMING LANDSCAPE ARCHITECTURE

ADDRESS: 1423 W11TH AVENUE, VANCOUVER, 8C, CANADA V6H 1K9 CELL: 778-323-3536 EMAIL: HOMINGLANDSCAPE@GMAIL.COM

OO NOT SCALE THE DRAWINGS, COPYRIGHT RESERVED IF A DISCREPANCY OCCURS BETWEEN THE DRAWINGS AND THE SPECIFICATIONS OR ANY OTHER DOCUMENT ASSOCIATED WITH THE PROJECT, THE COMPLICT SHALL BE REPORTED IN WRITING ID THE LANDSCAPE ARCHITECT TO DETAIN CLARIFICATION AND APPROVAL BEFORE

	F	Revisions
NC	. Date	Note
1	2023-10-02	ISSUED FOR DP
2	2023-12-11	ISSUED FOR RZC LETTER RESPONSE
3	2024-03-18	ISSUED FOR DP
4	2024-05-12	ISSUED FOR DP
5	2024-05-30	ISSUED FOR DP
6	2024-07-10	ISSUED FOR DP
7	2024-08-03	ISSUED FOR DP
8	2024-09-18	ISSUED FOR DP
9	2024-10-10	ISSUED FOR DP
10	2024-10-22	ISSUED FOR DP

DP 23-029433 October 23, 2024 Plan #17

4 UNIT TOWNHOUSE DEVELOPMENT

PROJECT ADDRESS: 7300 ST ALBANS ROAD RICHMOND, BC, CANADA

PROJECT NUMBER: 23-25


SCALE: 1/8" = 1'-0"

DRAWN BY: EL
REVIEWED BY: EL

Conceptual Landscape

Lighting Plan

L2.1

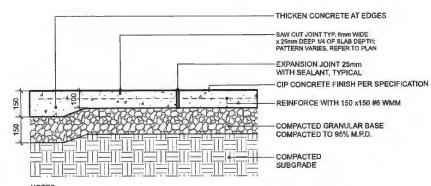

NOTES: 1. EXPANSION JOINTS 6m O.C. MAX, CONTROL JOINTS @ 1.5m O.C. ADJUST TO SUIT SITE LAYOUT PLAN. 2. ALL SCORELINES TO BE APPROVED BY LANDSCAPE ARCHITECT ON-SITE PRIOR TO INSTALLATION.

1 CIP CONCRETE ON GRADE (TYPICAL)
Scale: 1:10



PLAN
TEXADA HYDRAPRESSED SLABS BY ABBOTSFORD CONCRETE PRODUCTS (1-800-663-4091)
DIMENSIONS: 457 mm x 457 mm x 40 mm
COLOUR: NATURAL
PATTERN: GRID

CONCRETE PAVERS, PER
SPECIFICATIONS OR PLANS

1/8" DIA, CLEAR AGGREGATE
JOINT STABILIZER

COMPACTED GRANULAR BASE, 3/8"
CLEAR CRUSH OPEN-GRADED
BEDDING COURSE


COMPACTED SUBGRADE

NOTE:

1. USE CONCRETE HIDDEN EDGE RESTRAINT WHEN PAVERS ARE NOT ADJACENT TO A SOLID EDGE CONDITION.

2. BLACKJACK PEDESTAL SYSTEM AVAILABLE FROM ABBOTSFORD CONCRETE PRODUCTS, INSTALLATION PER MANUFACTURES INSTRUCTIONS.

3 CONCRETE SLAB PAVING Scale: 1:10

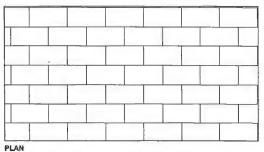

120x240x80mm ECO-PRIORA PERMEABLE PAVERS
DIMENSIONS: STANDARD 240(L) x 120(W) x 80(T) mm (10" x 5" x 3-1/8")
PATTERN: ECO-PRIORA A
COLOUR: OPAL BLEND


SWEEP JOINTS WITH SHARP
JOINTING SAND AND VIBRATE IN
OLD COUNTY STONE
PAVERS
1/8" DIA. CLEAR AGGREGATE
JOINT STABILIZER

COMPACTED GRANULAR BASE, 3/8"
CLEAR CRUSH OPEN-GRADED
BEDDING COURSE

COMPACTED SUBGRADE


NOTE: USE CONCRETE HIDDEN EDGE RESTRAINT WHEN PAVERS ARE NOT ADJACENT TO A SOLID EDGE CONDITION.

2 CONCRETE UNIT PAVING ON GRADE Scale: 1:10

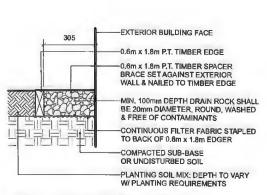

NOTE: ALL LUMBER SIZES ARE SHOWN AS NOMINAL

GRAVEL DRAIN STRIP - ON GRADE
Scale: 1:10

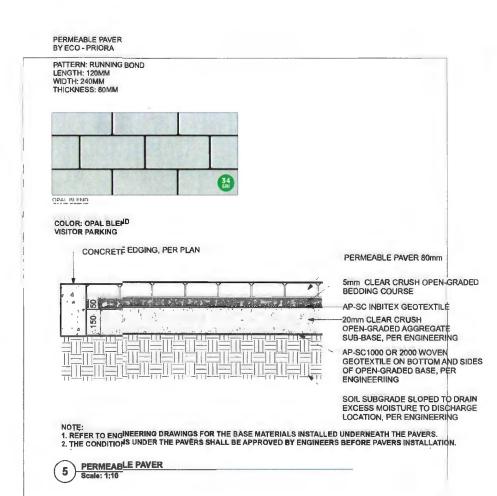



ADDRESS: 1423 W11TH AVENUE. VANCOUVER, BC, CANADA V6H 1K9 CELL: 778-323-3536 EMAIL: HOMINGLANDSCAPE@GMAIL.COM

DO NOT SCALE THE DRAWINGS. COPYRIGHT RESERVED. IF A DISCREPANCY OCCURS BETWEEN THE DRAWINGS AND THE SPECIFICATIONS OR ANY OTHER DOCUMENT ASSOCIATED WITH THE PROJECT, THE CONFLICT SHALL BE REPORTED IN WRITING TO THE LANGCOPE ARCHITECT O OBTAIN CLARIFICATION AND APPROVAL BEFORE PROCEEDING WITH WORKS.

		Revisions
NC). Date	Note
1	2023-10-02	ISSUED FOR DP
2	2023-12-11	ISSUED FOR RZC LETTER RESPONSE
3	2024-03-18	ISSUED FOR DP
4	2024-05-07	ISSUED FOR DP
5	2024-05-30	ISSUED FOR DP
6	2024-07-10	ISSUED FOR DP
7	2024-08-03	ISSUED FOR DP
8	2024-09-18	ISSUED FOR DP
9	2024-10-10	ISSUED FOR DP
10	2024-10-22	ISSUED FOR DP

DP 23-029433 October 23, 2024 Plan #18

4 UNIT TOWNHOUSE DEVELOPMENT

PROJECT ADDRESS: 7300 ST ALBANS ROAD RICHMOND, BC, CANADA

PROJECT NUMBER: 23-25


SCALE: AS SHOWN

DRAWN BY: EL


REVIEWED BY: EL

Hardscape

L3.0

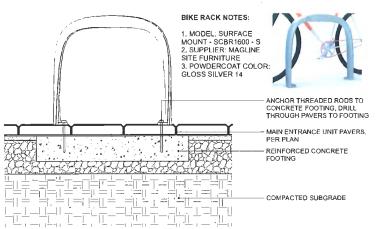

NOTE:
PER SUPPLIER FOR SPECIFICATIONS AND INSTALLATIONS.

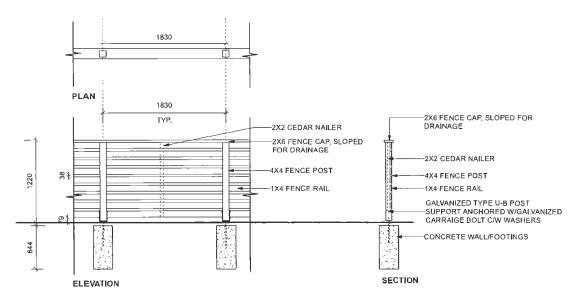


- 1, ALL WOOD EXPOSED TO VIEW SHALL BE CAND BETTER CLEAR CEDAR
- 2. ALL WOOD SHALL BE STRAIGHT, SOUND, AND FREE OF SPLITS, WARPS, CRACKS, LARGE KNOTS, AND OTHER DEFECTS.
- 3, WOOD PRESERVATIVE TO BE USED SHALL BE OLYMPIC MAXIMUM WATERPROOFING SEALANT, "CEDAR TINT".
- 4. ALL CUTS TO BE SQUARE AND CLEAN.
- 5, ALL METAL FIXTURES TO BE GALVANIZED (OR WHERE NOTED STAINLESS STEEL).
- 6. ALL STRUCTURAL FASTENERS TO BE GALVINIZED CARRAIGE BOLTS (IE. TRELLIS, AND GATE)



NOTE:

MAX. 2.0m HIGH FENCE IS MEASURED FROM THE AVERAGE FINISHED SITE GRADE (MEASURED AT A POINT 7.0m FROM BOTH SIDES OF THE PROPERTY LINE) TO THE TOP OF THE FENCE.

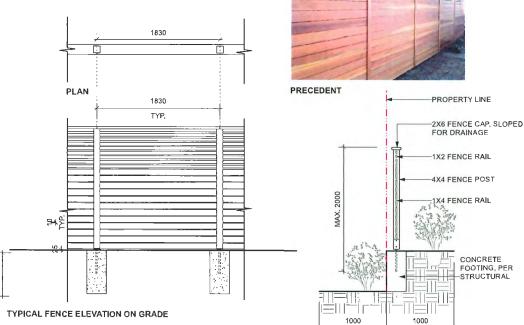

FENCE SECTION ON THE TOP OF RETAINING

1. ALL WOOD EXPOSED TO VIEW SHALL BE C AND BETTER CLEAR CEDAR.

2. ALL WOOD SHALL BE STRAIGHT, SOUND, AND FREE OF SPLITS, WARPS, CRACKS LARGE KNOTS, AND OTHER OFFECTS.

3. WOOD PRESERVATIVE TO BE USED SHALL BE OLYMPIC MAXIMUM WATERPRODFING SEALANT, 'CEDAR TINT'.

4. ALL CUTS TO BE SOUARE AND CLEAN.

5. ALL METAL FIXTURES TO BE GALVANIZED (OR WHERE NOTED - STAINLESS STEEL).

6. ALL STRUCTURAL FASTENERS TO BE GALVINIZED CARRAIGE BOLTS (IE, TRELLIS, AND GATE)

MAX. 2m HIGH WOOD PRIVACY SCREEN
Scale: 1:25

2300 ICONIC BACKED BENCH BY MAGLIN SITE FURNITURE (1-800-716-5506)

MODEL: MBE-2300-00017 LENGTH: 70* (177.8cm) HEIGHT: 33.3" (84.5cm) DEPTH: 25.5" (64.8cm)
SEAT HEIGHT: 18" (45.7cm)
WEIGHT: 122.5lbs (55.6kg)
COLOUR: STANDARD POWDERCOAT SILVER 14 - ANCHOR THREADED RODS TO CONCRETE FOOTING, DRILL THROUGH PAVERS TO FOOTING REINFORCED CONCRETE

COMPACTED SUBGRADE

4 BENCH 1:10



HOMING LANDSCAPE ARCHITECTURE

ADDRESS: 1423 W11TH AVENUE, VANCOUVER. BC, CANADA V6H 1K9 CELL: 778-323-3536 EMAIL: HOMINGLANDSCAPE@GMAIL.COM

DO NOT SCALE THE DRAWINGS, COPYRIGHT RESERVED, IF A DISCREPANCY OCCURS RESERVED. IF A DISCREPANCY OCCURS BETYLEEN THE DRAWINGS AND THE SPECIFICATIONS OR ANY OTHER DOCUMENT ASSOCIATED WITH THE PROJECT THE CONFLICT SHALL BE REPORTED IN WRITING TO THE LANDSCAPE ARCHITECT TO OSTAIN CLARIFICATION AND APPROVAL BEFORE PROCEEDING WITH WORKS.

l		
	R	evisions
NO. Date		Note
1	2023-10-02	ISSUED FOR DP
2	2023-12-11	ISSUED FOR RZC LETTER RESPONSE
3	2024-03-18	ISSUED FOR DP
4	2024-05-07	ISSUED FOR DP
5	2024-05-30	ISSUED FOR DP
6	2024-07-10	ISSUED FOR DP
7	2024-08-03	ISSUED FOR DP
8	2024-09-18	ISSUED FOR DP
9	2024-10-10	ISSUED FOR DP
10	2024-10-22	ISSUED FOR DP
l		

DP 23-029433 October 23, 2024 Plan #19

4 UNIT TOWNHOUSE DEVELOPMENT

PROJECT ADDRESS: 7300 ST ALBANS ROAD RICHMOND, BC, CANADA

PROJECT NUMBER: 23-25

SCALE: AS SHOWN

DRAWN BY: EL

REVIEWED BY: EL


Furnituring

L3.1


Forest Giraffe



1 FOREST GIRAFFE PLAY STRUCTURE

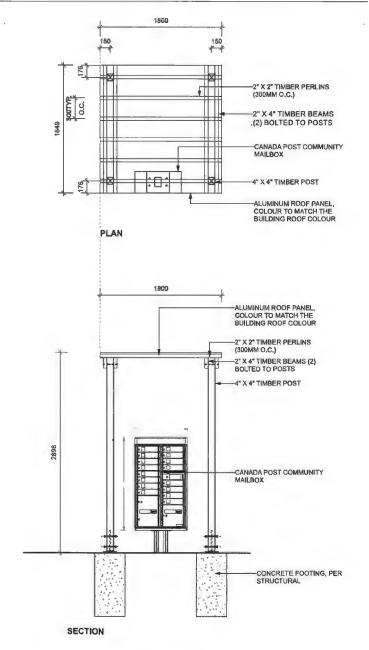

CANADA POST MAILBOX SHELTE

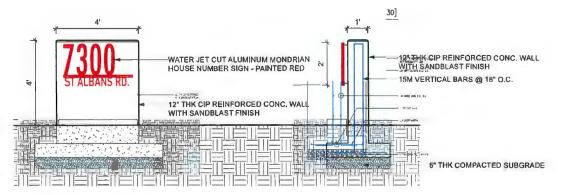

IIC V5.1 \$18 Contact : 404 358-5562 Emell : dimotrancis@gmo

1

HOMING LANDSCAPE ARCHITECTURE

ARCHITECTURE

ADDRESS: 1423 W11TH AVENUE,
VANCOUVER, BC, CANADA V6H 1K9
CELL: 778-323-3336
EMAIL: HOMINGLANDSCAPE@GMAIL.COM

DO NOT SCALE THE DRAWINGS, COPYRIGHT RESERVED, IF A DISCREPANCY OCCURS BETWEEN THE DRAWINGS AND THE SPECIFICATIONS OR ANY OTHER DOCUMENT ASSOCIATED WITH THE PROJECT THE CONFLICT SHAU, BE REPORTED IN WRITING TO THE LANDSCAPE ARCHITECT TO OBTAIN CLAREICATION AND APPROVAL BEFORE PROCEEDING WITH WORKS.

	f	Revisions
NC). Date	Note
1	2023-10-02	ISSUED FOR DP
2	2023-12-11	ISSUED FOR RZC LETTER RESPONSE
3	2024-03-18	ISSUED FOR DP
4	2024-05-07	ISSUED FOR DP
5	2024-05-30	ISSUED FOR DP
8	2024-07-10	ISSUED FOR DP
7	2024-08-03	ISSUED FOR DP
8	2024-09-18	ISSUED FOR DP
9	2024-10-10	ISSUED FOR DP
10	2024-10-22	ISSUED FOR DP

DP 23-029433 October 23, 2024 Plan #20

4 UNIT TOWNHOUSE DEVELOPMENT

PROJECT ADDRESS: 7300 ST ALBANS ROAD RICHMOND, BC, CANADA

PROJECT NUMBER: 23-25


SCALE: AS SHOWN

DRAWN BY: EL
REVIEWED BY: EL


Furnituring

L3.2


2 CORNOR SIGNAGE ENTRY
Scale: 1:25

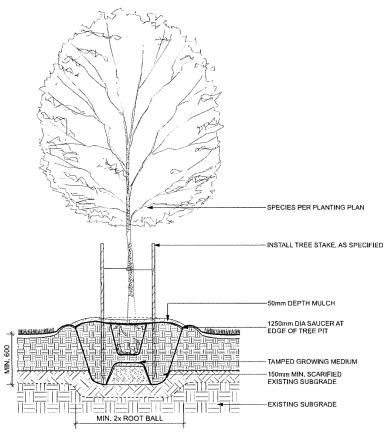


1 DECIDUOUS TREE PLANTING ON GRADE (TYPICAL)
Scale: 1:20

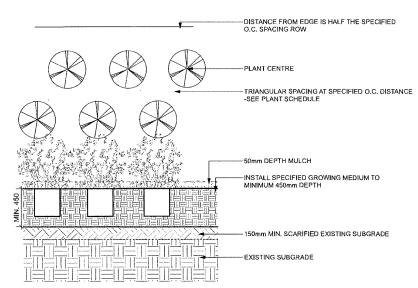

PLANTING ON GRADE (TYPICAL)
Scale: 1:20

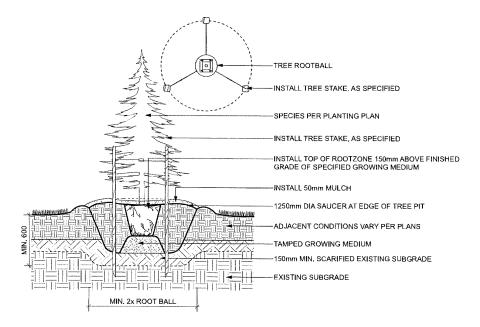

3 CONIFEROUS TREE PLANTING ON GRADE (TYPICAL)
Scale: 1:20

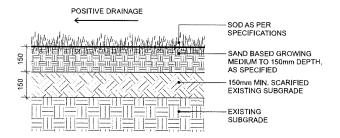

4 SOD LAWN (TYPICAL)
Scale: 1:10



ADDRESS: 1423 W11TH AVENUE, VANCOUVER, BC, CANADA V6H 1K9 CELL: 778-323-3536 EMAIL: HOMINGLANDSCAPE@GMAIL.COM

DO NOT SCALE THE DRAWINGS, COPYRIGHT RESERVED, IF A DISCREPANCY OCCURS BETWEEN THE DRAWINGS AND THE SPECIFICATIONS OR ANY OTHER DOCUMENT ASSOCIATED WITH THE PROJECT, THE CONFLICT SHALL BE REPORTED IN WRITING TO THE LANDSCAPE ANCHITECT TO ORTAIN CANSOCIATED ANCHITECT TO ORTAIN CANDED TO THE WORKS.

	Revisions		
NO.	Date	Note	
1	2023-10-02	ISSUED FOR DP	
2	2023-12-11	ISSUED FOR RZC LETTER RESPONSE	
3	2024-03-18	ISSUED FOR DP	
4	2024-05-07	ISSUED FOR DP	
5	2024-05-30	ISSUED FOR DP	
6	2024-07-10	ISSUED FOR DP	
7	2024-08-03	ISSUED FOR DP	
8	2024-09-18	ISSUED FOR DP	
9	2024-10-10	ISSUED FOR DP	
10	2024-10-22	ISSUED FOR DP	

DP 23-029433 October 23, 2024 Plan #21

4 UNIT TOWNHOUSE DEVELOPMENT

PROJECT ADDRESS: 7300 ST ALBANS ROAD RICHMOND, BC, CANADA

PROJECT NUMBER: 23-25

SCALE: AS SHOWN

DRAWN BY: EL

REVIEWED BY: EL

Softscape

L3.3




DP 23-029433 October 23, 2024 Reference Plans




DP 23-029433 October 23, 2024 Reference Plans




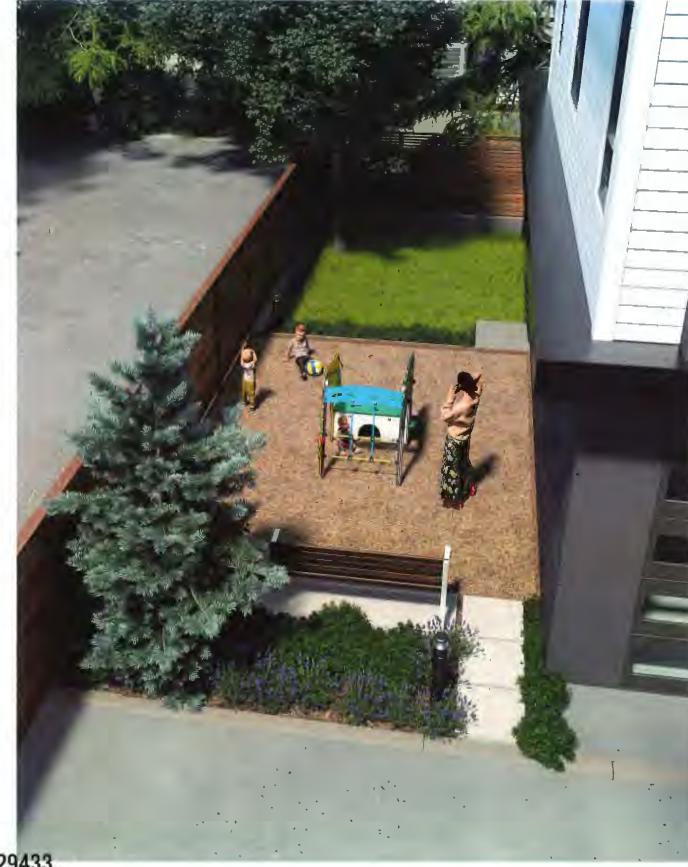



DP 23-029433

October 23, 2024

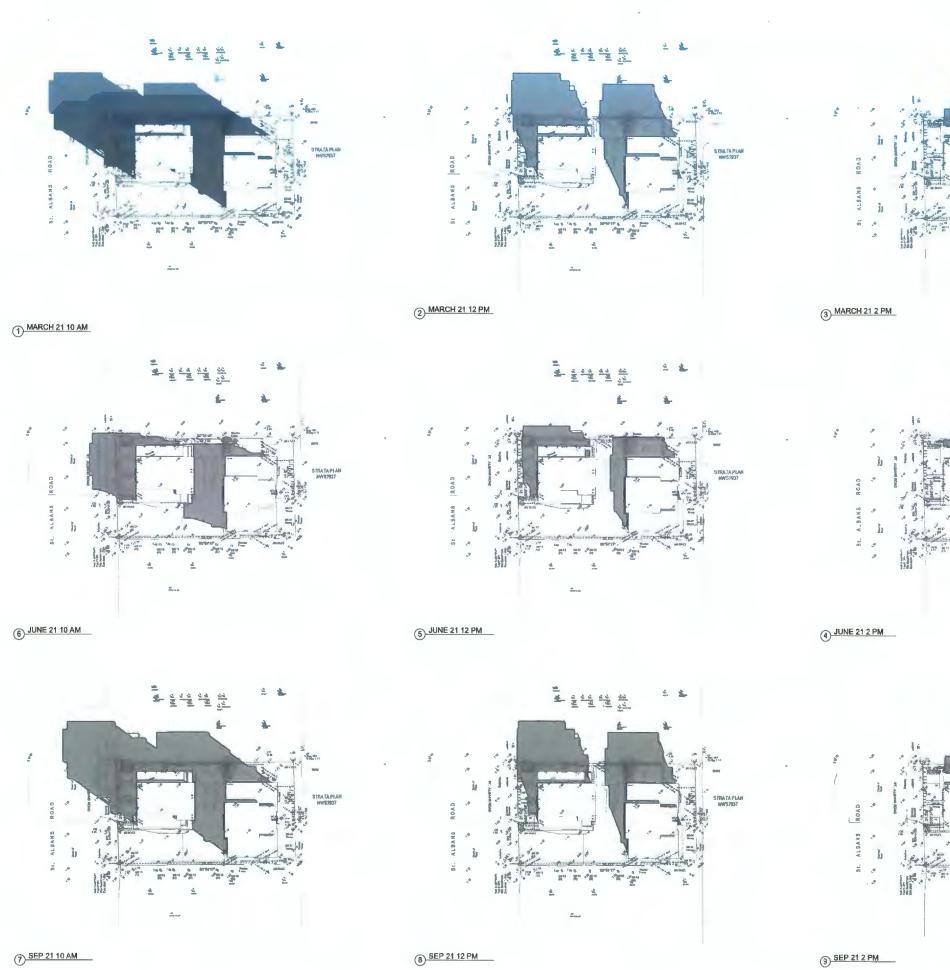

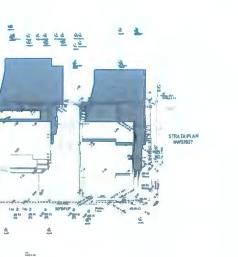

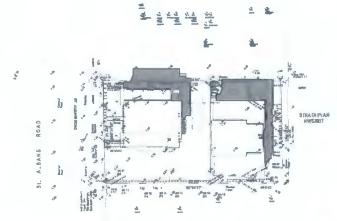

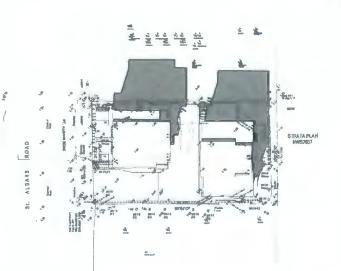

Unit 202 - 670 EVANS AVENUE VANCOUVER, BC V6A 2K9 Tel: (604) 731-3012 Cel: (604) 649-0669 / Email: matthew@mcai.ca

THIS DRAWING MUST NOT BE SCALED. THE GENERAL CONTRACTOR SHALL VERIFY ALL DIMENSIONS AND LEVELS PRIGR TO COMMENCEMENT TO WORK. ALL ERRORS AND OMISSIONS SHALL BE REPORTED MINISIONS SHALL BE REPORTED TO THE ARCHITECT. COPYRIGHT RESERVED THIS PLAN AND DESIGN ARE AND AT ALL TIMES.

REMAIN THE EXCLUSIVE PROPERTY OF MATTHEW CHENG ARCHITECT INC. AND MAY NOT BE USED OR REPRODUCED WITHOUT PRIOR WRITTEN CONSENT.

Revision

1) Oct 23rd, 2024 DP Final drawings

RE YY-MM-OD DESCRIPTION BRWN CHK

DP 23-029433 October 23, 2024 Reference Plans

4 UNIT TOWNHOUSE DEVELOPMENT

7300 ST. ALBANS ROAD RICHMOND, BC

Shaet TSHADOW STUDY

Checked MC
:
Scal
e:
Project Number:
19 R TH 01
Revision Date: Dwg. No.:

Print Date: 10/23/2024 1:11:15 PM A402