Minutes



Development Permit Panel Wednesday, January 17, 2024

Time:

3:30 p.m.

Place:

Remote (Zoom) Meeting

Present:

Cecilia Achiam, General Manager, Community Safety, Chair John Irving, General Manager, Engineering and Public Works Peter Russell, Director, Sustainability and District Energy

The meeting was called to order at 3:30 p.m.

MINUTES

It was moved and seconded

That the minutes of the meeting of the Development Permit Panel held on December 13, 2023 be adopted.

CARRIED

1. DEVELOPMENT PERMIT 20-919145

(REDMS No. 7317348)

APPLICANT:

Jonathan King

PROPERTY LOCATION:

4571, 4591 and 4611/4631 Steveston Highway

INTENT OF PERMIT:

- 1. Permit the construction of 16 townhouse units at 4571, 4591 and 4611/4631 Steveston Highway on a site zoned "Low Density Townhouses (RTL4)".
- 2. Vary the provisions of Richmond Zoning Bylaw 8500 to reduce the front yard setback along Steveston Highway from 6.0 m to 4.50 m.

Applicant's Comments

Jiang Zhu, Imperial Architecture Ltd., with the aid of a visual presentation (attached to and forming part of these minutes as <u>Schedule 1</u>), provided background information on the proposed development, highlighting the following:

- the proposed form, massing, and architectural design of the townhouse buildings are compatible with adjacent residential developments;
- a north-south entry driveway off Steveston Highway is proposed along the west property line and the proposed east-west internal drive aisle will provide shared access to future developments to the east and west;
- the development's proposed common outdoor amenity space will be available for shared use with the future development to the west;
- two electric vehicle (EV) charging will be provided for each garage;
- the unit entries and the proposed common outdoor amenity area are fully accessible; and
- the development includes two convertible units.

Zhipin Li, Homing Landscape Architecture, Corp., with the aid of the same visual presentation, briefed the Panel on the main landscape features of the project, noting that (i) existing landscape conditions such as existing trees and hedges will be retained as much as possible and additional trees are proposed to be planted to provide privacy, (ii) changes to existing site grade will be minimized for landscaping, (iii) a significant amount of native plant species is proposed for landscaping, (iv) the proposed common outdoor amenity space exceeds the required size and provides for a variety of uses, and (v) the proposed on-site turnaround area will be landscaped and used as an additional outdoor amenity space when the adjacent property to the west will redevelop in the future.

Staff Comments

Wayne Craig, Director, Development, noted that (i) the shared use of the proposed common outdoor amenity between the proposed development and the future development to the west is just a design intent and there is no formal sharing arrangement between the two developments, (ii) the project has been designed to achieve Level 3 of the BC Energy Step Code with on-site Low-Carbon Energy Systems, (iii) there is a Servicing Agreement associated with the project for frontage works and site services, (iv) the Servicing Agreement includes a provision for turning restriction within the driveway to ensure right-in/right-out turning movements, (v) the proposed front yard setback was identified at the time of rezoning, (vi) an acoustical report was provided by the applicant confirming that the units will meet Canada Mortgage and Home Corporation (CMHC) internal noise standards, and (vii) there will be future cross access over the east-west internal drive aisle with adjacent properties to the west and east of the subject site secured by a Statutory Right-of-Way.

Panel Discussion

In reply to a query from the Panel regarding the design of the two buildings fronting Steveston Highway, the applicant noted that (i) the two buildings are not identical as they have different roof forms to provide some variation in building design, and (ii) permeable pavers will be installed on the entry driveway, visitor parking stalls, internal pedestrian walkways and entries to common areas.

In reply to queries from the Panel, Mr. Craig noted that (i) there are other developments along Steveston Highway that have right-in/right-out turning restrictions for vehicle access, and (ii) all required replacement trees will be accommodated on the subject site.

Correspondence

None.

Gallery Comments

None.

Panel Discussion

The Panel expressed support for the project, noting that (i) the design of the proposed development has taken into consideration the existing adjacent developments as well as the future redevelopment of neighbouring properties, and (ii) the provision of low-carbon energy systems for the project is appreciated.

Panel Decision

It was moved and seconded

That a Development Permit be issued which would:

- 1. permit the construction of 16 townhouse units at 4571, 4591 and 4611/4631 Steveston Highway on a site zoned "Low Density Townhouses (RTL4)"; and
- 2. vary the provisions of Richmond Zoning Bylaw 8500 to reduce the front yard setback along Steveston Highway from 6.0 m to 4.50 m.

CARRIED

2. DEVELOPMENT PERMIT 21-943418

(REDMS No. 7451673)

APPLICANT:

Karla Castellanos Architect

PROPERTY LOCATION:

13888 Wireless Way

INTENT OF PERMIT:

- 1. Permit the construction of a three-storey light industrial and ancillary office building on a new lot created through subdivision of the west portion (proposed Lot 1) of the subject site at 13888 Wireless Way, on a site zoned "Industrial Business Park (ZI3) Crestwood Area (East Cambie)".
- 2. Vary the provisions of Richmond Zoning Bylaw 8500 to:
 - (a) reduce the required number of parking spaces from 2.8 spaces to 0.75 spaces for each 100 m² of gross leasable floor area of building on Lot 1;
 - (b) reduce the minimum required number of large-sized on-site designated loading spaces on Lot 1 from 1 space to 0 spaces; and
 - (c) reduce the minimum percentage of standard parking spaces on Lot 2 from 50 per cent to 30 per cent.

Applicant's Comments

Karla Castellanos, KCC Architecture, with the aid of a visual presentation (attached to and forming part of these minutes as <u>Schedule 2</u>), provided background information on the proposed development, highlighting the following:

- the proposal is a redevelopment of an existing site through subdivision of the lot to create a new lot;
- pedestrian access to the two buildings will be from the existing sidewalk along Wireless Way;
- a three-storey building for light industrial and ancillary office use is proposed on the new Lot 1 which has been designed to allow flexibility of use by future tenants;
- the proposed building mimics the form and character of the existing building;
- each unit will have a separate entry and a common lobby and corridor will also be provided for access to the individual units;
- high performance building materials are proposed to provide more efficient energy performance for the building;
- the Riparian Management Area (RMA) along the south edge of the site will be fully restored on new Lot 1 and partially restored on Lot 2;
- parking for Lot 1 is provided in front of the units;
- screening will be provided for the proposed rooftop mechanical equipment;
 - architectural treatment, i.e. different wall textures with interesting patterns and
- colours, is proposed for the flat west façade of the new building to provide visual interest; and
- there are three proposed variances related to parking and loading.

Clark Kavolinas, C. Kavolinas and Associates Inc., with the aid of the same visual presentation, briefed the Panel on the main landscape features of the project, noting that (i) landscaped and treed islands are proposed to break up the surface parking area in front of the proposed building on Lot 1, (ii) native plant species are proposed to be installed within the RMA setback along the south property line, (iii) a row of trees will be planted along the east side of Lot 2 and three additional trees will be incorporated into the existing surface parking area on Lot 2, and (iv) bicycle racks will be installed near the pedestrian access to the new building off Wireless Way.

Staff Comments

Mr. Craig noted that (i) there is a Servicing Agreement associated with the project for frontage works, (ii) there will be invasive plant removal within the RMA along the southern edge of the site and a three-year monitoring period over the planting within the RMA, (iii) an Agricultural Land Reserve (ALR) buffer covenant will be registered as a condition of the subject application, and (iv) the provision of rooftop solar panels is included in the project for on-site electricity generation approximately 40% of the roof area.

In reply to a query from the Panel, Mr. Craig noted that (i) the three proposed parking variances associated with the project were reviewed and accepted by the City's Transportation Department, (ii) the project's proposed Transportation Demand Management (TDM) package includes the provision of a three-year transit pass program for tenants or owners of the new building and a shuttle service to bring employees between the site and the Bridgeport Canada Line station, and (iii) the proposed TDM measures are secured by a legal agreement and will run for a minimum of three years.

In reply to a further query from the Panel, Mr. Craig noted that there will be improvements on the RMA along the southern edge of Lot 2 which include the removal of invasive species and additional planting within the planting area which require the removal of some parking stalls in Lot 2.

Panel Discussion

In reply to queries from the Panel, the applicant noted that (i) there will be 11 stratified units, (ii) each unit consists of three-storeys and have its own rooftop solar panels, and (iii) one roughed-in electric vehicle (EV) charging infrastructure will be allocated for each unit to accommodate future installation of an EV charging station.

The Panel then advised that the applicant clarify during the Building Permit stage the location and percentage of parking stalls that will be provided with roughed-in EV charging infrastructure.

Correspondence

None.

Gallery Comments

None.

Panel Discussion

The Panel expressed support for the project, noting that the applicant has put a lot of thought into the design of the project.

Panel Decision

It was moved and seconded

That a Development Permit be issued which would:

- 1. permit the construction of a three-storey light industrial and ancillary office building on a new lot created through subdivision of the west portion (proposed Lot 1) of the subject site at 13888 Wireless Way, on a site zoned "Industrial Business Park (ZI3) Crestwood Area (East Cambie)"; and
- 2. vary the provisions of Richmond Zoning Bylaw 8500 to:
 - (a) reduce the required number of parking spaces from 2.8 spaces to 0.75 spaces for each 100 m^2 of gross leasable floor area of building on Lot 1;
 - (b) reduce the minimum required number of large-sized on-site designated loading spaces on Lot 1 from 1 space to 0 spaces; and
 - (c) reduce the minimum percentage of standard parking spaces on Lot 2 from 50 per cent to 30 per cent.

CARRIED

3. DEVELOPMENT PERMIT 22-021165

(REDMS No. 7501936)

APPLICANT: 0853803 BC Ltd. and 1121648 BC Ltd.

PROPERTY LOCATION: 6571 and 6591 No. 1 Road

INTENT OF PERMIT:

- 1. Permit the construction of eight townhouse units at 6571 and 6591 No. 1 Road on a site zoned "Low Density Townhouses (RTL4)".
- 2. Vary the provisions of Richmond Zoning Bylaw 8500 to reduce the minimum required lot width on major arterial roads from 50.0 m to 40.2 m.

Applicant's Comments

Eric Law, Eric Law Architect, with the aid of a visual presentation (attached to and forming part of these minutes as <u>Schedule 3</u>), provided background information on the proposed development, highlighting the following:

- the project has been designed in consideration of its site context;
 - a new driveway is proposed along the north side adjacent to the existing single-
- family home to the north (6551 No. 1 Road) and secured by a Statutory-Right-of-Way (SRW) to provide more separation and shared access to the neighbouring property when it redevelops in the future;
- the site grade along the west property line will be raised to provide an appropriate
- interface with the adjacent townhouse development to the west and enhance the usability of the backyards of the rear units of the proposed development;
- the proposal includes one convertible unit;
- the project has been designed to achieve Level 3 of the BC Energy Step Code with Low Carbon Emission Systems; and
- the proposed landscaping for the three-storey front units along No. 1 Road includes installation of berms to reduce their apparent height to read like two-storey units.

Yiwen Ruan, PMG Landscape Architects, with the aid of the same visual presentation, briefed the Panel on the main landscape features of the project, noting that (i) permeable pavers are proposed to identify key points on the driveway and internal drive aisle, (ii) the common outdoor amenity area includes a children's play equipment and bench seating, (iii) nine trees are proposed to be planted on-site, and (iv) on-site irrigation will be provided for soft landscaping.

In addition, Mr. Law noted that one on-site and one off-site tree will be removed and four replacement trees will be installed.

Panel Discussion

In reply to a query from the Panel, Mr. Law noted that mechanical equipment for the townhouse units will be installed on the second floor of the units.

Staff Comments

Mr. Craig noted that (i) there is a Servicing Agreement associated with the project for frontage works and site services, and (ii) the proposed lot width variance is a technical variance and was identified at rezoning.

Correspondence

Shiraz and Almas Mohamed, 6551 No. 1 Road (Schedule 4)

Mr. Craig noted that the letter of Mr. Shiraz Mohamed and his wife, owners of the adjacent single-family home to the north (6551 No. 1 Road), pertains to land use which is outside of the purview of the Panel.

Gallery Comments

None.

Panel Discussion

The Panel expressed concern regarding the site grade, in particular the elevations of the driveway, internal drive aisle and ground floor/garage of the townhouse units which meet the bylaw requirements but are below the street level and potentially at risk of flooding.

Mr. Craig noted one option would be to refer the application back to staff to increase the site grade and provide time for the applicant to consider how that would be accomplished and address any architectural changes before returning. The other option for the Panel would be to endorse the Permit with direction that site grading be amended prior to the application being presented to City Council for consideration; however, the application would not then return to the Panel and would limit any changes the applicant could make to the application.

In reply to a query from the Panel, Mr. Law noted that the heating system includes an electrical hot water tank, located on second level. It was noted the equipment could be potentially located at grade once overall site grade is raised.

Discussion ensued regarding the need for the applicant to address this concern, and as a result of the discussion, the following **referral motion** was introduced:

It was moved and seconded

That DP 22-021165 be referred back to staff in order for the applicant to work with staff to increase the site grade and introduce necessary changes to the project design in order to mitigate the risk of flooding in the proposed development.

CARRIED

4. New Business

It was moved and seconded

That the Development Permit Panel meeting tentatively scheduled on Wednesday, January 31, 2024 be cancelled.

CARRIED

Date of Next Meeting: February 14, 2024

ADJOURNMENT

It was moved and seconded *That the meeting adjourn (4:59 p.m.).*

CARRIED


Certified a true and correct copy of the Minutes of the meeting of the Development Permit Panel of the Council of the City of Richmond held on Wednesday, January 17, 2024.


Cecilia Achiam Chair Rustico Agawin Committee Clerk

Schedule 1 to the Minutes of the Development Permit Panel meeting held on Wednesday, January 17, 2024



16 UNIT TOWNHOUSE DEVELOPMENT (DP 20-919145) AT 4571, 4591, 4611 STEVESTON HIGHWAY, RICHMOND, BC ISSUED DDP REVIEW 2024-01-17

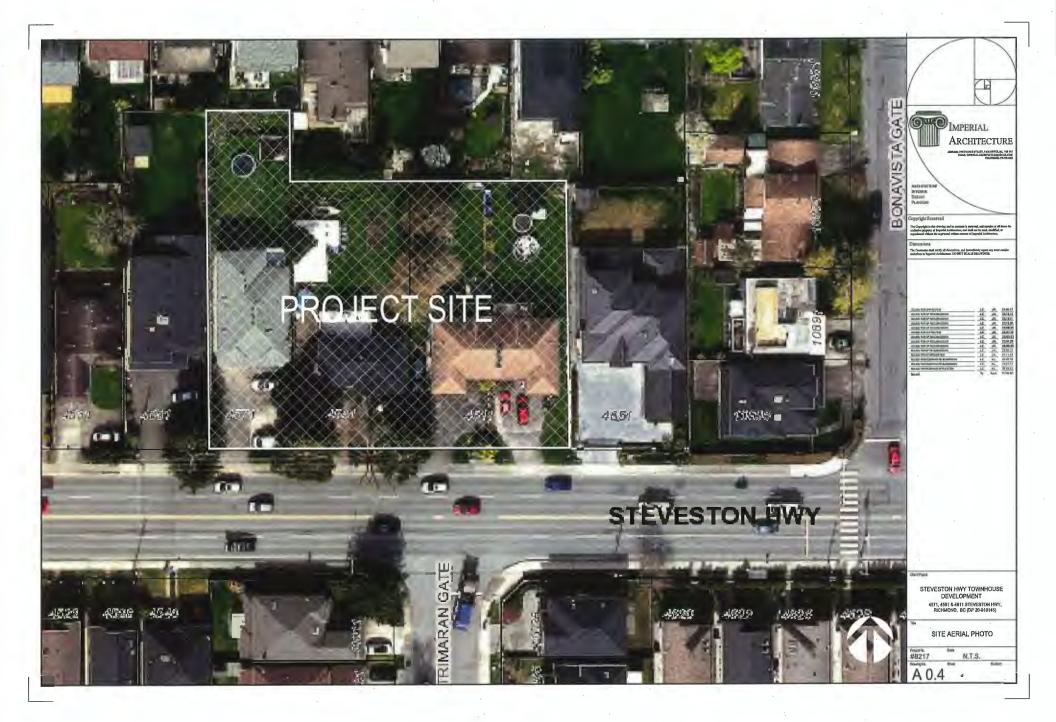

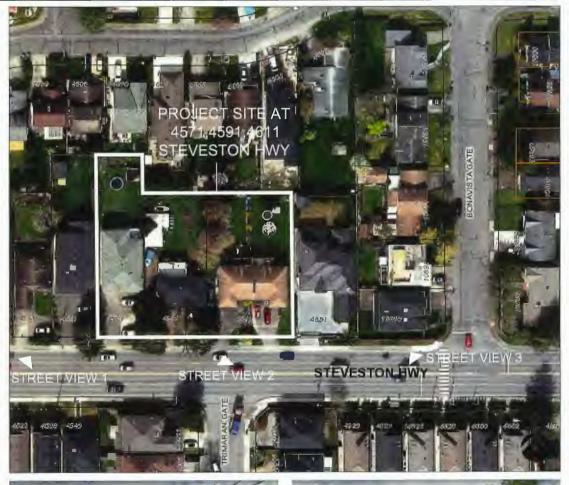













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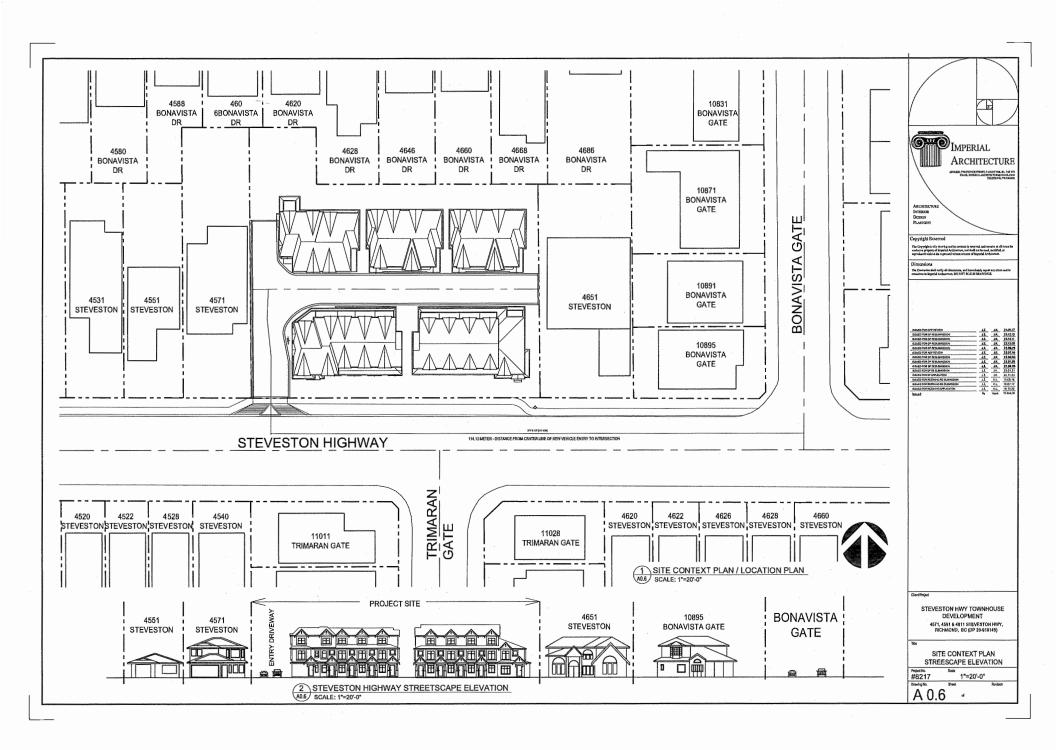
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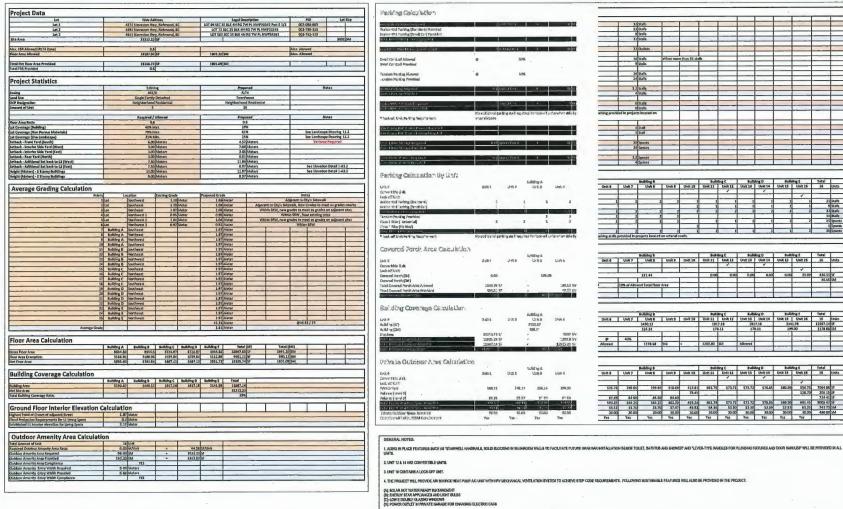
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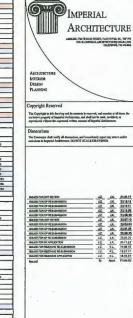


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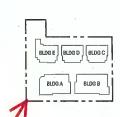
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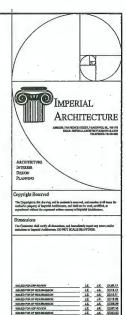
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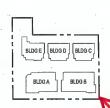












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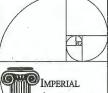
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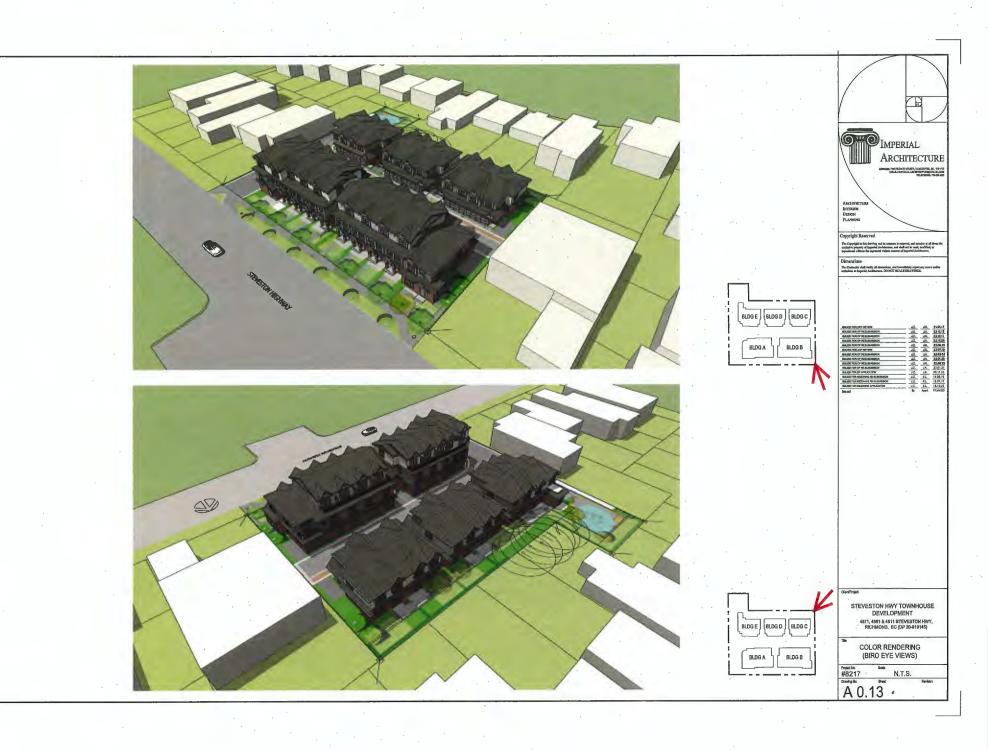
STEVESTON HWY TOWNHOUSE DEVELOPMENT 4571, 4591 & 4611 STEVESTON HWY, RICHMOND, BC (DP 20-616146)

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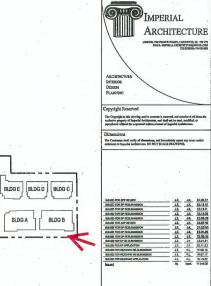
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> COLOR RENDERING (EYE LEVEL VIEWS)

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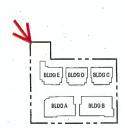
STEVESTON HWY TOWNHOUSE DEVELOPMENT 4571, 4591 & 4611 STEVESTON HWY, RICHMOND, BC (DP 20-919145)

COLOR RENDERING (EYE LEVEL VIEWS)













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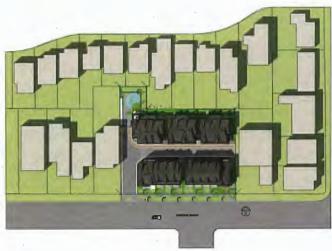
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SHADOW ANALYSIS MARCH 20TH - 2:00PM



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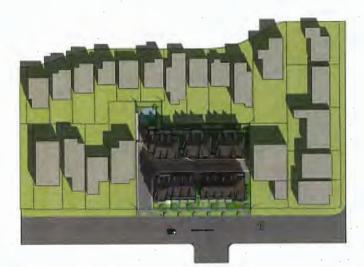
STEVESTON HWY TOWNHOUSE DEVELOPMENT 4571, 4591 & 4611 STEVESTON HWY, RICHMOND, BC (0P 20-919145)
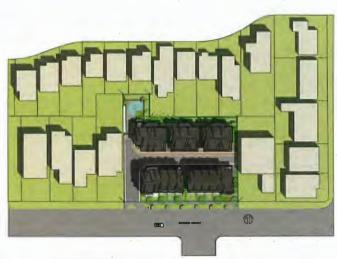
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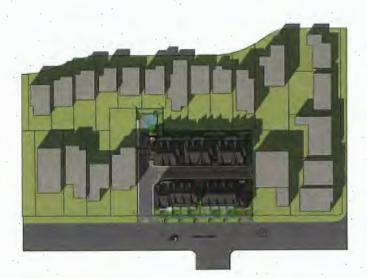


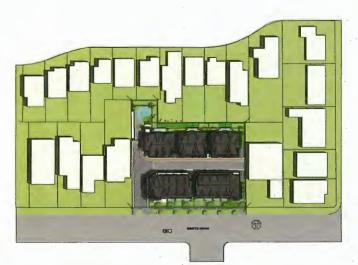

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Client/Project

STEVESTON HWY TOWNHOUSE DEVELOPMENT 4571, 4591 & 4611 STEVESTON HWY, RICHMOND, BC (DP 20-818145)


SHADOW ANALYSIS


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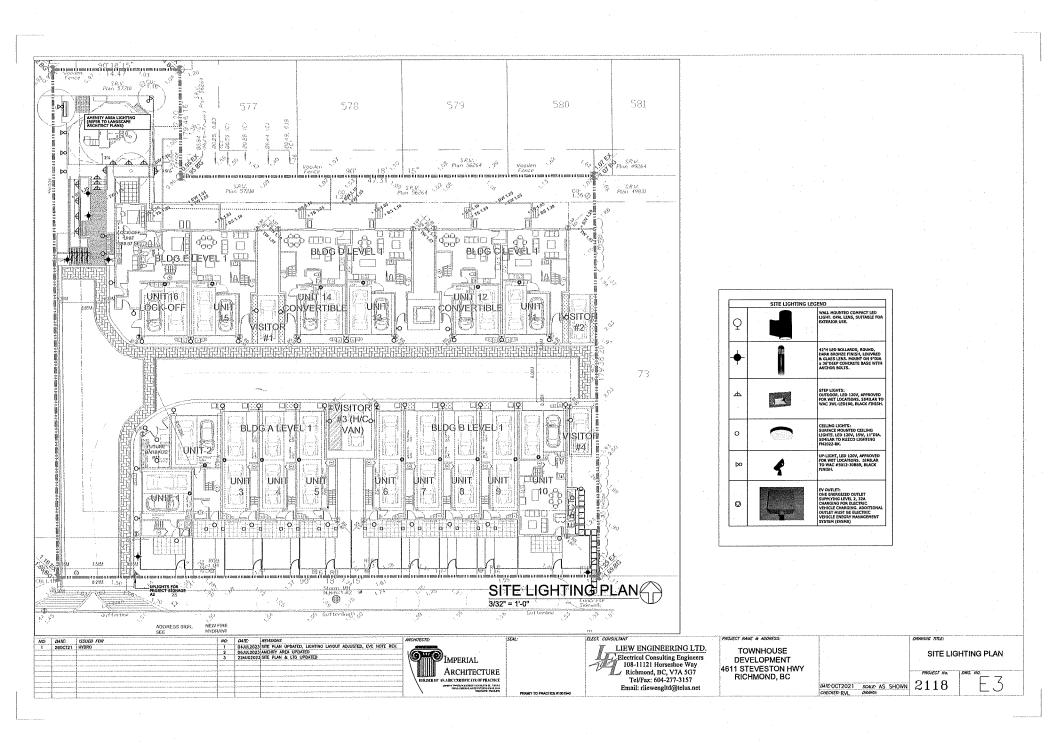
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4611 STEVESTON HWY. RICHMOND, BC





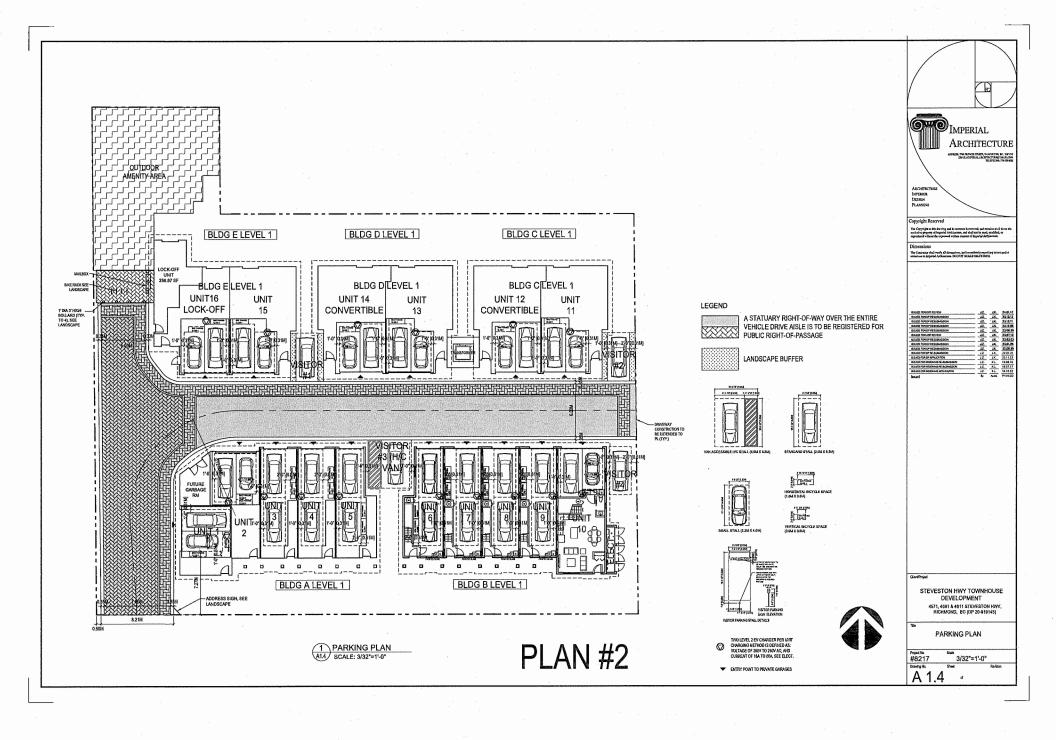

3, COMPOSIT CEMENT-HARDIELAP SIDING(BM PAINT GREENBROOK 517 LRV:15.00) 4.WOOD FASCIA BOARD & TRIM (BM PAINT BITTERSWEET CHOCOLATE 2114-10 (LRV:3.00) 5.METAL GUARDRAIL (BM PAINT BITTERSWEET CHOCOLATE 2114-10 (LRV;3.00) 6.WOOD AND MEAL DOORS (BM PAINT BITTERSWEET CHOCOLATE 2114-10 (LRV:3.00) 7.COMPOSITE CEMENT - HARDIE SHAKE (BM PAINT BEIGEWOOD 1007 LRV:24.00) 8. VINYL WINDOW WI CLEAR DOUBLE GLAZING & DARK BROWN FRAME (BM PAINT BITTERSWEET CHOCOLATE 2114-10 (LRV:3.00) 9.BRICK CLADDING (RED) 10.COMPOS IT CEMENT-HARDIELAP SIDING(BM PAINT SABRE GRAY 1482 (LRV:38,00) 11.COMPOSIT CEMENT-HARDIELAP SIDING(BM PAINT SPARROW AF-720 (LRV:20.00) BM PAINT DENOTES BENJAMIN MOORE PAINT, EXTERIOR MATERIALS TO BE PAINTED

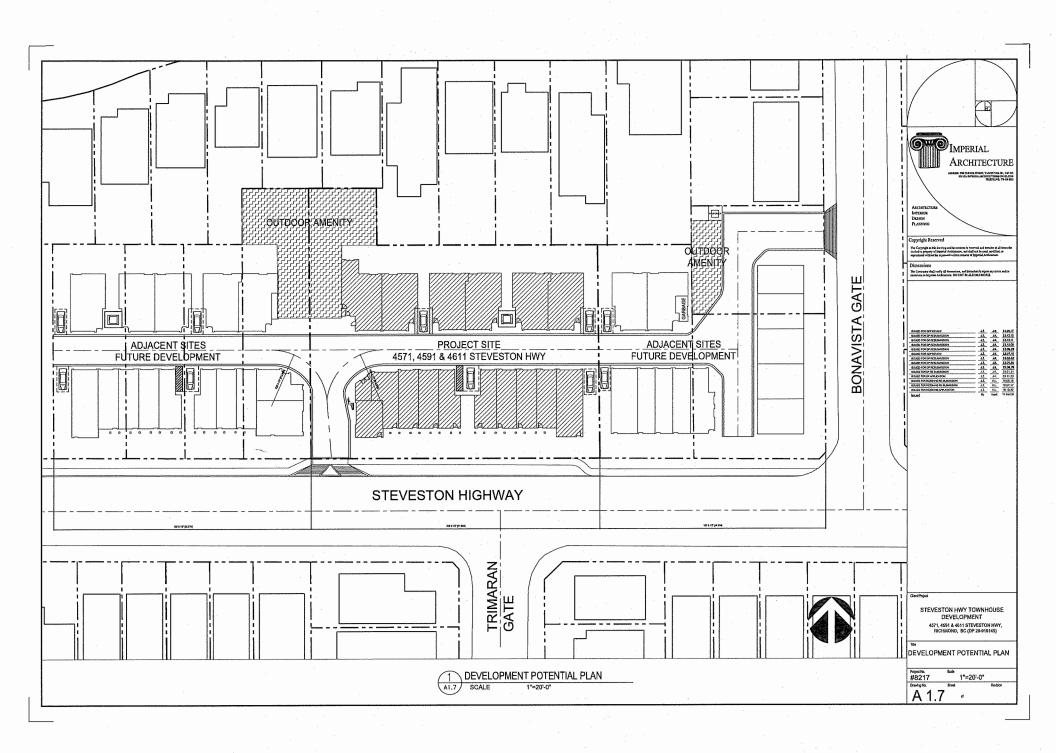2,COMPOSIT CEMENT-HARDIELAP SIDING (BM PAINT ARCTIC SHADOWS 1559 LRV:32.00)

1.HIGH PROFILE ASPHALT SHINGLES (LIGHT GREY)


TO MATCH SPECIFICATION PROVIDED





Convright Reserved



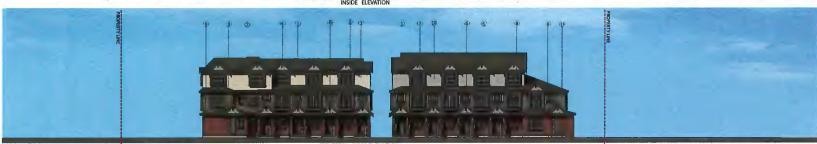

STEVESTON HWY TOWNHOUSE DEVELOPMENT 4571, 4591 & 4611 STEVESTON HWY, RICHMOND, BC (DP 20-919145)

COLOR SAMPLE MATERIAL BOARD

N.T.S.

A 0.9





BUILDING B SOUTH ELEVATION



BUILDING B NORTH ELEVATION BUILDING A NORTH ELEVATION



IMPERIAL ARCHITECTURE




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BUILDING C NORTH ELEVATION BUILDING D NORTH ELEVATION BUILDING E NORTH ELEVATION

DESIGN RATIONALE FOR COLOR SCHEME


- TWO COLOR SCHEMES WERE PROPOSED FOR CEMENT PANEL MATERIALS ON UPPER FLOORS OF ALL BUILDINGS AS WARM THEME (A) AND COLD THEME (B)
- BLDG A IN FRONT BUILDINGS AND BLDG C & E IN BACK BUILDINGS HAVE WARM COLOR THEME (A)
 WHILE BLDG B IN FRONT BUILDINGS AND BLDG D IN BACK BUILDINGS HAVE COLD COLOR THEME (B).
 EACH TWO ADJACENT BUILDINGS WILL HAVE DIFFERENT COLOR SCHEMES TO ACHIEVE THE
 STAGGERED EFFECT.
- WITHIN EACH COLOR THEME, A DARK AND A LIGHT COLORS WERE USED IN DIFFERENT BUILDING FACES BETWEEN FLOORS OF THREE STOREY BUILDINGS OR BETWEEN PLANES ON 2 STOREY BUILDINGS.
- 4. RED COLOR BRICK VENEER WILL BE USED ON GROUND FLOORS OF ALL BUILDINGS TO PROVIDE A UNIFIED COLOR DESPITE THE COLOR SCHEMES FOR UPPER LEVELS



STEVESTON HWY TOWNHOUSE DEVELOPMENT:
4871, 4991 A 4911 STEVESTON HWY, RICHMOND, BO (DP 20-419145)
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STEVESTON HIGHWAY

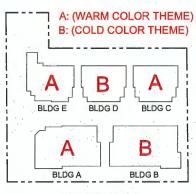

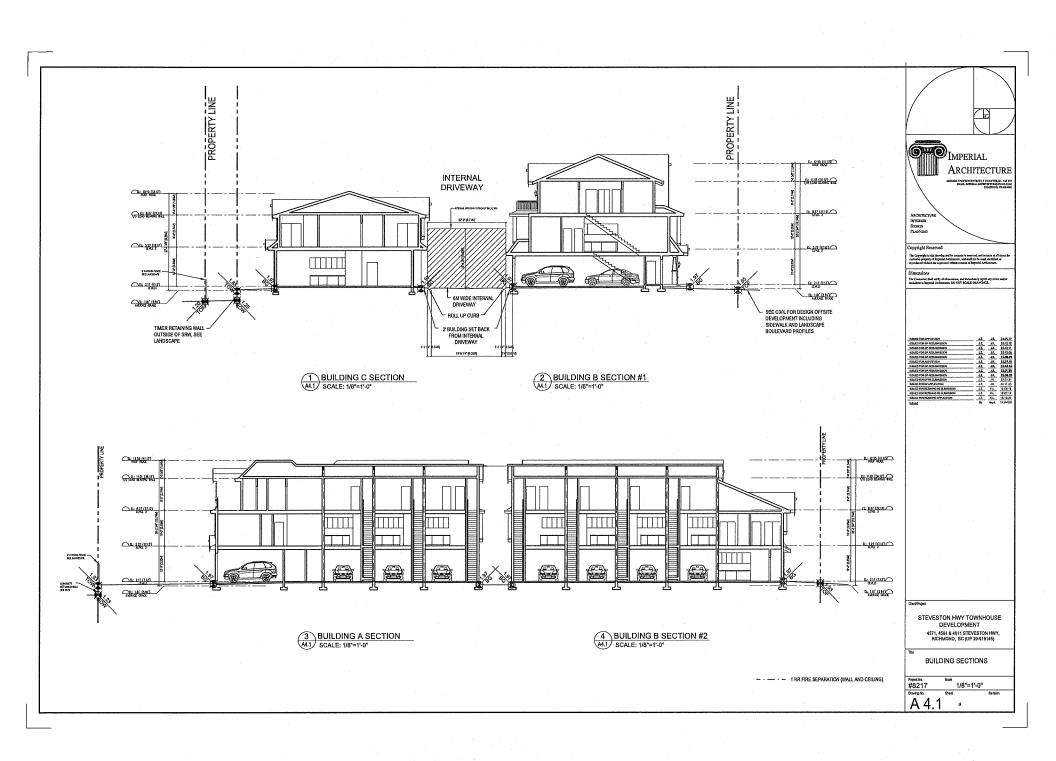


July 20, 2023

Accessibility Strategy

16 Unit Townhouse Development at 4571, 4591, 4611 Steveston Highway, Richmond, BC

The design of project is in compliance with relevant Aging-In-Place and accessibility requirements in various city documents such as OCP, Townhouse Design Guidelines etc.


- 1. Wheelchair access and circulation
 - 1.1 All units in front buildings (Buildings A, & B) expect unit 2 have their main unit entries facing Steveston Highway. Direct paved pathway between unit entry and public sidewalk for each front unit was proposed. The width and slope of each pathway were designed in consideration of the wheelchair usage and access.
 - 1.2 All units in back buildings (Building C, D & E) and Unit 2 in Building A have their main unit entries from internal driveway. The width and slope of the pathway were designed in consideration of the wheelchair usage and access.
- 2. Coverable Unit design and Aging-In-Place features for all units
 - 2.1 Unit 12 and 14 in Bulldings C and D were designed to meet requirements in City of Richmond's Coverable Unit design guideline. Detailed Convertible Unit plans demonstrated compliance with each requirement in the guideline. Refer to the attached convertible unit floor plans, manufacturer's specifications on future elevator for more information.
 - 2.2 Aging-In-Place features as listed in the OCP will be Incorporated into design of all units.
- 3. Accessibility to outdoor amenity area and H/C visitor parking stall
 - 3.1 Main access to outdoor amenity area is at the end of the internal driveway at northwest corner of the site which is connected to all unit entries. Residents from all units can get access to the outdoor amenity area through share pedestrian walkway on internal driveway as demonstrated on the attached wheelchair circulation route diagram.
 - 3.2 The Van access H/C visitor stall is located centrally between building A and B in the development beside the internal driveway. H/C visitor stall users can get access to all unit entries through the internal driveway as demonstrated on the attached wheelchair circulation route diagram.
- 4. Accessibility to private yards for convertible units
 - 4.1 Grading design for both convertible units' private yards complied with accessibility design standards. Maximum slope proposed is no greater than 5%.

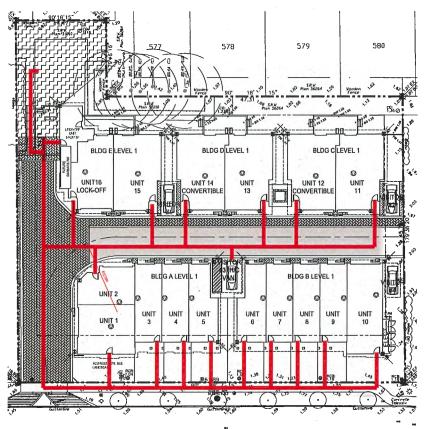

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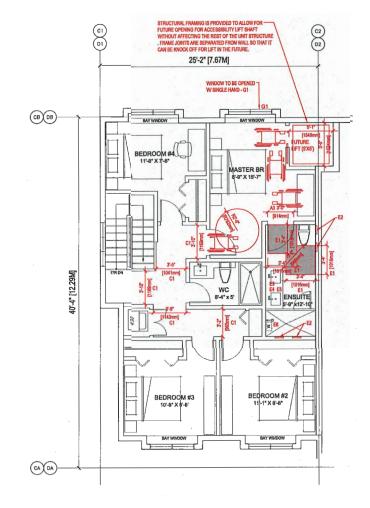
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STEVESTON HIGHWAY





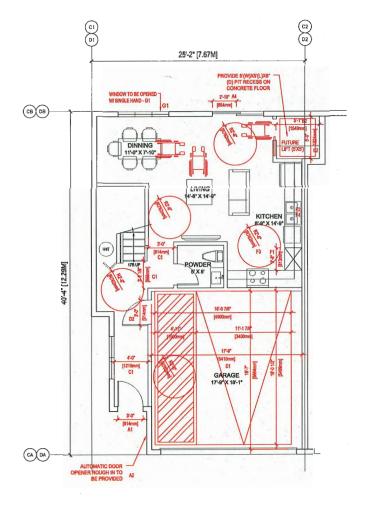







CONVERTIBLE UNIT GUIDELINES


(NOTE: SAFERHOME CRITERIA PROPOSED FOR INCLUSION ARE SHOWN IN BOLD ITALICS)

		A1	ENTRY DOORS ARE A MINIMUM 863 MM BUT IDEALLY 814 MM AND HAVE CLEAR ACCESS.
		A2	ENTRY DOOR CLEAR EXTERIOR FLOOR SPACE MIN, 1220 MM DEPTH BY DOOR WIDTH PLUS 600 MM ON LATCH SIDE (NOT NEEDED IF ROUGH IN WIRING PROVIDED FOR FUTURE AUTOMATIC DOOR OPENER).
۸	DOORS & DOORWAYS	A3	INTERIOR DOORS TO MAIN LIVING AREAS, 1 BATHROOM AND 1 BEDROOM, MIN. 800 MM CLEAR OPENING WITH FLUSH THRESHOLDS MAX. 13 MM HEIGHT, DEMONSTRATE WHEEL CHAIR ACCESS BETWEEN THE HALLWAY AND ROOMS AND WIDEN HALLWAY AND / OR DOORWAY(S) IF NECESSARY TO SECURE ACCESS.
		A4	PATIO / BALCONY MIN, 860 MM CLEAR OPENING. SMALL REMOVABLE WOOD RAMP WILL BE USEO TO ADAPT 2" HEIGHT OIFFERENCE BETWEEN FINISHED SURFACES WHEN THE UNIT IS CONVERTEO TO ACCESSIBLE UNIT (I.E. WHEN THE ELEVATOR IS INSTALLED)
		A5	ALL INTERIOR THRESHOLDS WITHIN UNITS COMPLY WITH BC BUILDING CODE.
		A6	LEVER-TYPE HANOLES FOR ALL DOORS
В	VERTICAL CIRCULATION	B2	VERTICAL LIFT, DEPRESSED SLAB AREA, AND LANDINGS, AS NOTED ON FLOOR PLANS IN COMPLIANCE WITH MANUFACTURER SPECS, FRAMING TO ACCOMMODATE SHAFT CONSTRUCTION WITHOUT IMPACT TO SURROUNDING STRUCTURE.
		В3	AT THE TOP OF ALL STAIRWAYS, WALLS ARE REINFORCED WITH 2" X 12" SOLID LUMBER AT 814 MM TO CENTRE.
С	HALLWAYS	C1	MIN, 900 MM WIDTH.
D	GARAGE	01	MIN. 1 ACCESSIBLE PARKING SPACE WITH MIN. 4 M GARAGE WIDTH,
	ONIVIOL	D2	ACCESS FROM GARAGE TO LIVING AREA MIN, 800 MM CLEAR OPENING.
		Εí	TOILET CLEAR FLOOR SPACE MIN, 1020 MM AT SIDE AND IN FRONT.
_		E2	WALL BLOCKING FOR FUTURE GRAB BAR INSTALLATION AT TOILET, TUB AND SHOWER. REINFORCED WITH 2" X 12" SOLID LUMBER IN ALL BATHTUB, SHOWER, AND TOILET LOCATIONS.
E	BATHROOM (MIN.1)	E3	LEVER-TYPE HANDLES FOR PLUMBING FIXTURES.
		E4	PRESSURE AND TEMPERATURE CONTROL VALVES ARE INSTALLED ON ALL SHOWER FAUCETS.
		E5	CABINETS UNDERNEATH SINK(S) ARE EASILY REMOVED.
		E 6	DEMONSTRATE BATH AND SHOWER CONTROLS ARE ACCESSIBLE (LAYOUT OR FIXTURE PLACEMENT)
F	KITCHEN	F1	CLEAR AREA NEEDED UNDER FUTURE WORK SPACE, PLUMBING AND GAS PIPES (IN-WALL AND IN-FLOOR), LOCATED CLEAR OF UNDER COUNTER AREA OF FUTURE WORK SPACE (STOVE, SINK & MIN. 810 MM WIDE COUNTER), ALL PIPES ARE BROUGHT IN NO HIGHER THAN 304 MM TO 355 MM TO THE CRETTER OF THE PIPE FROM FLOOR LEVEL.
		F2	CABINETS UNDERNEATH SINK ARE EASILY REMOVED.
		F3	1500 MM TURNING DIAMETER OR TURNING PATH DIAGRAM.
		F4	LEVER-TYPE HANDLES FOR PLUMBING FIXTURES,
G	WINDOWS	G1	MIN. 1 WINDOW THAT CAN BE OPENED WITH A SINGLE HAND (BATHROOM, KITCHEN & LIVING ROOM)
Н	OUTLETS & SWITCHES	Н1	PLACEMENT LOCATIONS OF ELECTRICAL OUTLETS: BESIDE WINDOW, BOTTOM OF STAIRWAYS, BESIDE SYNTCHES TOILET, ABOVE EXTERNAL DOORS (OUTSIDE AND INSIDE), ON FRONT FACE OF KITCHEN COUNTER, WITHIN PROXIMITY OF CONTROL CENTRE FOR SMART HOME OPTIONS.
	311110003	H2	UPGRADE TO FOUR-PLEX OUTLETS IN MASTER BEDROOM, HOME OFFICE, GARAGE AND RECREATION ROOM.
	•		

Style 5	E ** (4) ** - * * * * * * * * * * * * * * * * *		T - 4 11 17 17 1	CONTROL SECTION
clear cab size	hoistway width	hoistway length	jack centerline	entrance centerline
40" x 50"	60-1/2"	59-1/2"	29-3/4"	35-3/4"
40" x 54"	60-1/2"	63-1/2"	31-3/4"	39-3/4"
42" x 60"	62-1/2"	69-1/2"	34-3/4"	45-3/4"
48" x 60"	68-1/2"	69-1/2"	34-3/4"	45-3/4"
minimum*	54-1/2"	59-1/2"		



Garaventa Lift T 800 663 6556 (toll free North America) E Info@garaventallft.com | www.garaventalift.com

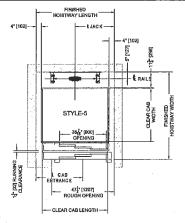

IMPERIAL ARCHITECTURE LTD. 5-8

Specifications

Overhead Clearances Required:	Hydraulic Drive	In-Line Drive	Drive w/Controller at top of hoistway
84" Cab height - standard door pkg,	96" (2438 mm)	96" (2438 mm)	108" (2743 mm)
84" Cab height - upgrade / premium door pkg.	96" (2438 mm)	96" (2438 mm)	114" (2896 mm)
96" Cab height - standard door pkg,	108" (2743 mm)	108" (2743 mm)	120" (3048 mm)
96" Cab height - upgrade / premium door pkg.	N/A	N/A	N/A

Speed: 40 ft/min (12.2 meters/min) nominal speed

Travel Range: Up to 50 feet (15.2 m)

Stops: Up to 6 stops

Standard Controls: Fully automatic push button operation | Digital floor indicator in car | Automatic car lighting upon entry |

Standard Safety Features: Battery-powered emergency lowering | Safety brake system | Cardoor and hall door safety monitoring system | Emergency stop and alarm

Hydraulic Drive System: 1:2 cable hydraulic drive | Quiet submersed pump and motor | Two-speed valve for smooth start and stop

In-Line Drive System: Geared direct drive motor | Variable frequency drive for smooth start and stop | Speed monitor


Power Requirements: 230 VAC single phase | Optional 208 VAC 3 phase (Hydraulic Drive only)

Popular Options: Premium fixtures | Integral emergency telephone | 3-speed sliding doors

Flooring: By others to match the home decor | Minimum 1/8" thick | Maximum 3/4" thick

Warranty: 2 year standard warranty | Optional additional 5 year extended warranty to 7 years (North America Only)

PRIVATE YARD GRADING DESIGN FOR CONVERTIBLE UNITS ON SHOWN ON LANDCAPE DRAWINGS

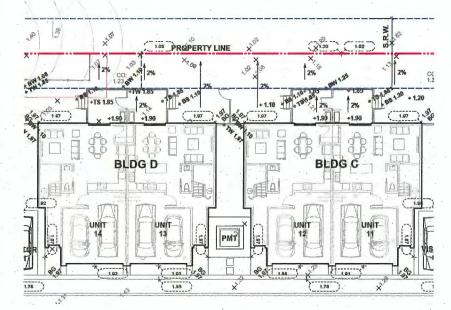



July 20, 2023

Building Approval Department City of Richmond 6911 No. 3 Road, Richmond, British Columbia

To whom it may concern.

Re: DP 20-919145 - 4571, 4591, 4611 Steveston Hwy, Richmond

I, Jiang Zhu Architect AIBC, am the architect for the Development Permit Application for DP 20-919145 – the 16-unit townhouse development at 4571, 4591, 4611 Steveston Hwy, Richmond.

On behalf the design consultant team, we hereby confirm that:

The applicable Energy Step Code performance targets have been considered in design, and that a Qualified Energy Modeler has been engaged to ensure that the proposed design can achieve the applicable performance targets.

For reference and record, below is the contact information of the Qualified Energy Modeler for this project:

Jack Cui, M.Sc. P.Eng., LEED AP Senior Energy Modelling Specialist | Division Manager JRS ENGINEERING 300 - 4595 Canada Way, Burnaby BC V5G 1J9 jcui@jrsengineering.com

Please refer to the attached letter from JRS dated July 7th, 2023 outlining details and pathways chosen by the consultant team for achieving the city's step code requirements.

Regards,



Jiang Zhu, Architect AIBC, CP, MRAIC, LEED AP BD+C Principal Imperial Architecture Ltd. Tel: 778-938-8552 Imperial.architecture@gmail.com

IMPERIAL ARCHITECTURE LTD.



SUSTAINABILITY STRATEGY

4611 STEVESTON

July 7, 2023

Development Permit Document **Drawing Requirements Development Applications Department** City of Richmond 6911 No. 3 Road, Richmond, BC V6Y 2C1

Re: 4611 Steveston - Development Permit Application DP 20-919145 - 4571, 4591, 4611 Steveston Hwy Sustainability Strategy

As a part of the Development Permit Application for 4611 Steveston JRS Engineering (JRS) hereby commits to assisting the project team in implementing sustainability strategies. The proposed project is located at 4611 Steveston Highway, Richmond, BC, and the project will be developed as a 16-unit townhouse complex with a total of five buildings.

The following sustainability strategies have been analysed and included in the building designs in order to reduce energy consumption and reduce greenhouse gas emissions, and thus achieve the BC Energy Step Code compliance:

- Step 3 with Low Carbon Energy System. Effective July 1, 2022, Energy Step Code requirements for Part 9 Residential Buildings in Richmond include Step 5(a), Step 4(b), or Step 3(b) + Low Carbon Energy System**. The project will target a low carbon energy system and thus Step 3 applies.
- (a) Building envelope performance requirements can be achieved using all campliance pathways defined in
- (b) Building performance requirements must be achieved using adjusted TEDI and MEUI compliance pathways. ** Annual limit of \leq 500 kg CQ2e per housing unit, or \leq 2.5 kg CQ2e/ m2 of conditioned floor area and \leq 1000 kg CO2e per housing unit.
- The proposed building skin is listed in the Appendix A
- Air source heat pump to reduce heating and cooling energy
- HRV/ERV to reduce heating/cooling energy for conditioning ventilation air
- Energy Star appliances to reduce energy consumption
- Electric hot water tank to further reduce the greenhouse gas emissions

The project team will coordinate to incorporate the measures required to meet all requirements of the Richmond's BC Energy Step Code for Part 9 Townhames.

Please contact the undersigned if you should require any additional information.

IRS ENGINEERING EGBC Permit to Practice #1002484

Per:

Jack Cui, MSc, PEng, LEED AP Sr Energy Modelling Specialist | Division Manager

www.JRSENGINEERING.com


VANCOUVER 300 - 4595 Canada Way Burnaby, British Columbia V5G 1J9 TEL: (604) 320 1999

CALGARY 115 - 1925 18th Avenue NE Calgary, Alberta T2E 718 TEL: (403) 452 3377



Appendix A

Proposed Building Skin

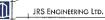

APPENDIX A - PROPOSED BUILDING SKIN

PAGE 1 OF 1

PROPOSED BUILDING SKIN

The following building skin performance has been proposed to achieve Step 3 + Low Carbon Energy System:

- R17.8 Wall
- R31.3 Roof
- Window Performance: U=0.25, SHGC=0.35
- Window to wall ratios:

 - o Building A: 14.2% o Building B: 13.4% o Building C: 13.5%

 - o Building D: 13.5% o Building E: 12.4%
- Airtight air barrier system

4611 STEVESTON TOWNHOUSE DEVELOPMENT JRS PROJECT: VR21302

STEVESTON HWY TOWNHOUSE DEVELOPMENT

LANDSCAPE SET: ISSUED FOR ADP COMMENTS DECEMBER 3, 2023

LANDSCAPE DRAWING INDEX

DRAWING INDEX			
SHEET No.	SHEET NAME		
L 0.0	LANDSCAPE COVER SHEET AND DESIGN RATIONALE		
L 0.1	LANDSCAPE TREE MANAGEMENT PLAN		
L 0.2	LANDSCAPE REPLACEMENT TREE PLAN		
L 1.0	LANDSCAPE LAYOUT AND MATERIALS PLAN		
L 1.1	LANDSCAPE GRADING PLAN		
£ 1.2	POROUS SURFACE DIAGRAM		
L 1.3	OUTDOOR AMENITY AREA ENLARGEMENT PLAN		
t. 1.4	LANDSCAPE SECTIONS		
L 1.5	FUTURE OUTDOOR AMENITY & TURNAROUND AREA PLAN		
L 2.0	LANDSCAPE PLANTING PLAN - NORTH AREA		
L 2.1	LANDSCAPE PLANTING PLAN - SOUTH AREA		
L 2.2	LANDSCAPE PLANT LIST		
L 2.3	DESIGN-BUILD IRRIGATION PLAN		
L 3.0	HARDSCAPE DETAILS		
L 3.1	FURNISHING DETAILS		
L 3.2	FURNISHING DETAILS		
L 3.3	FURNISHING DETAILS		
L 3.4	SOFTSCAPE DETAILS		

GENERAL NOTES

ALL LANDSCAPE ARCHITECTURAL DRAWINGS IN THIS PACKAGE SHALL BE READ IN CONJUNCTION WITH ALL OTHER LANDSCAPE ARCHITECTURAL DRAWINGS, DETAILS, SPECIFICATIONS, AND OTHER CORRESPONDANCE THAT MAY BE ISSUED DURING THE COURSE OF THE CONTRACT.

IF A DISCREPANCY OCCURS BETWEEN THE DRAWINGS AND THE SPECIFICATIONS OR ANY OTHER DOCUMENT ASSOCIATED WITH THE PROJECT, THE CONFLICT SHALL BE REPORTED IN WRITING TO THE LANDSCAPE ARCHITECT TO OBTAIN CLARIFICATION AND APPROVAL BEFORE PROCEPTING WITH WORKS.

THE CONTRACTOR SHALL VISIT THE SITE TO VERIFY THE TRUE EXISTING CONDITIONS. ANY UNCLEAR ISSUES SHALL BE CLARIFED WITH THE LANDSCAPE ARCHITECT. NO CLAIM SHALL BE ALLOWED FOR EXTRAS WHICH MAY ARISE THROUGH NEGLECT OF THIS ADVICE.

ALL EXISTING INFORMATION IS BASED ON AVAILABLE RECORDS AND SHALL NOT BE CONSTRUED TO BE COMPLETE OR ACCURATE.

LAYOUT OF HARDSCAPE, SITE FURNITURE, SOIL, PLANTING, AND ALL OTHER MATERIALS IS TO BE STAKED OUT AND APPROVED BY THE LANDSCAPE ARCHITECT PRIOR TO INSTALLATION,

ALL PLANTING SHALL BE IN ACCORDANCE WITH CSLA LANDSCAPE STANDARD, LATEST EDITION

THE CONTRACTOR IS RESPONSIBLE FOR DETERMINING THE EXISTENCE, LOCATION, AND ELEVATION OF ALL UTILITIES AND CONCEALED STRUCTURES, AND IS RESPONSIBLE FOR NOTIFYING THE APPROPRIATE COMPANY, DEPARTMENT OR PERSON(S) OF ITS INTENTION TO CARRY OUT ITS OPERATIONS.

HOMING LANDSCAPE ARCHITECTURE INC. DOES NOT GUARANTEE THE EXISTENCE, LOCATION, AND ELEVATION OF UTILITIES OR CONCEALED STRUCTURES AT THE PROJECT SITE.

FINAL SELECTION AND APPROVAL OF ALL STREET TREES TO BE DONE BY THE CITY OF

LANDSCAPE DESIGN RATIONALE

The sile is surrounded by single family houses on the north, west and east sides, and the landscape design intends to ensure the privacy of the adjacent neighbors. Existing hedges along the east property line will be retained and evergreen trees are proposed there to create a dense landscape buffer which addresses any potential privacy and overlook concerns. Evergreen hedges are proposed along the north property line, and a solid of high privacy fence with vines is proposed along the wast property line. All the landscape elements and design strategies mentioned above will help to protect the privacy of adjacent neighbors.

The landscape design inlends to bring nature close to the local residents. Lawn, flower bods, native shrubs, and a mixed of deciduous and evergreen trees are proposed in the front yards along the Steveston Highway, which creates a green buffer between the private houses and the public sidewalk. The rated planters with wood fellis and vines are provided to maximize the planting opportunities in the limited spaces along the internal drive ails. The rated planters also work as green dividers between the adjacent garages. There are large patios, lawn, planting beds and trees in the backyards of the Units 11 to 16, and the existing trees bablind the Units 14 to 15 are also to be retained as the important landscape features and the green background of the houses.

A large outdoor amenity space is located at the northwestern corner of the site which is highly visible from the driveway entry. Three removable bollards are designed at the entry of the outdoor amenity erea to stop vehicles and ensure pedestrian's safety. Bike racks end mailbox are elso located there for easy access for everyone including the disable. The key program of the outdoor amenity spece is a playground with various play elements for children at various ages. A large play structure is proposed in the center of playground to provide ective play opportunities such as climbing, jumping, running and sliding for older kids. Stepping stones in planting bed creates a nature play zone where children at various ages cen access nature to improve their creetivity. Sandbox and mud kitchen are provided to help the children to develop their social and communication skills while they are playing. An existing evergrean hedge is retained on the west and a couple of large trees will be planted on the wast and south sides of the playground to provide enough shade for the children and their parents. Two benches are provided for parents to sit and observe their children play. A 6' high privacy fence will be installed around the playground to ensure the children's safety. A multi-functional lawn is provided at the north end of the outdoor amenity space for flexible programs. The playground is designed at the existing grades, and a maximum 10% slope remp and stair are used to connect the playground with the amenity space entrance. A pedestrian path in different color of pavers is proposed along the north side of internal drive aiste to provide a safe pedestrian access to the outdoor amenity entrance.



AODRESS: 1423 W11TH AVENUE, VANCOUVER, BC, CANADA V6H 1K9 CELL: 778-323-3536 EMARL: HOMINGLANDSCAPE@GMAIL.COM

Revisions			
NO. Date		Note	
1	2022-01-21	ISSUED FOR DP	
2	2022-08-19	ISSUED FOR DP	
3	2023-01-24	ISSUED FOR DP	
4	2023-02-25	ISSUED FOR DP	
5	2023-08-23	ISSUED FOR ADP COMMEN	
6	2023-12-03	ISSUED FOR DP	
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STEVESTON HWY TOWNHOUSE DEVELOPMENT

PROJECT ADDRESS: 4571/4591/4611 STEVESTON HIGHWAY RICHMOND, BC, CANADA

PROJECT NUMBER: 21-14


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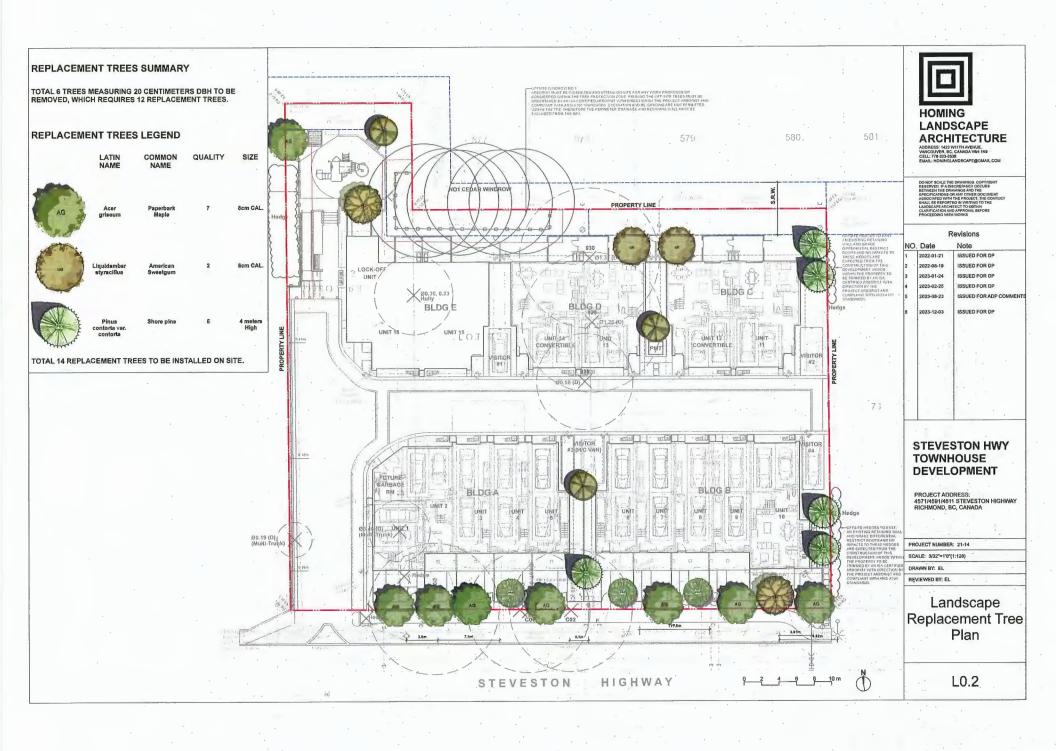
DRAWN BY: EL

REVIEWED BY: EL

Landscape Cover Sheet & Design Rationale

L0.0



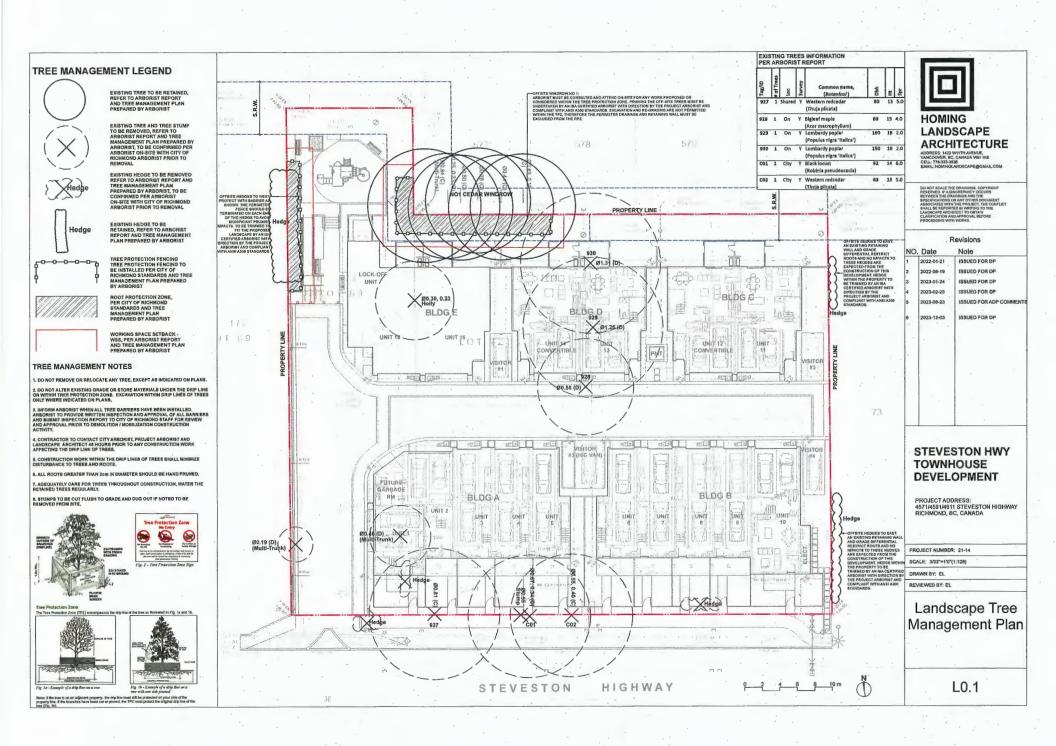





+ TS 1.85 PROPOSED TOP OF STAIR ELEVATION

+ BS 1.16 PROPOSED BOTTOM OF STAIR ELEVATION

PROPOSED ELEVATIONS
PER CIVIL


SLOPE PERCENTAGE


EXISTING ELEVATIONS, PER SURVEY

GRADING NOTES

2%

- 1. ALL DIMENSIONS/ELEVATIONS ARE METRIC (METER, UNLESS OTHERWISE NOTED). DO NOT SCALE DRAWINGS.
- 2. ALL GRADING INFORMATION IS PRELIMINARY ONLY.
- 3. REFER TO CIVIL DRAWINGS OFF-SITE ROAD GRADING INFORMATION.
- 4. REFER TO ARCHITECTURAL DRAWINGS FOR BUILDING ELEVATIONS.
- ALL EXISTING SURVEY INFORMATION APPROXIMATE. VERIFY ALL EXISTING GRADES WITH SITE CONDITIONS, REPORT DISCREPANCIES TO CONSULTANT TEAM PRIOR TO PROCEEDING
- 6. THE CONTRACTOR SHALL IDENTIFY AND PROTECTALL EXISTING UTILITIES PRIOR TO CONSTRUCTION. ANY CONFLICTS FOUND WITH ULTITIES SHALL BE CLARIFIED WITH THE CONSULTANT TEAM PRIOR TO PROCEEDING.
- 7. UNLESS OTHERWISE NOTED, PROVIDE A MINIMUM 2% SLOPE ON ALL HARD AND SOFT LANDSCAPE AREAS TO EMSURE POSITIVE ORNIANGE AWAY FROM BUILDINGS AND TO DRAINAGE STRUCTURES. SOFT LANDSCAPE AREAS TO BE A MAXIMUM 3:1 SLOPE.

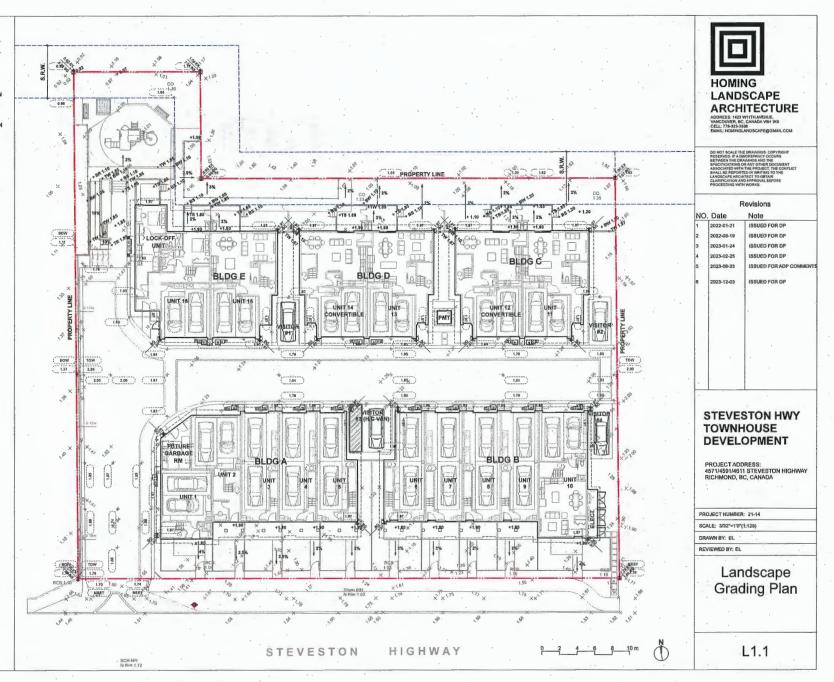

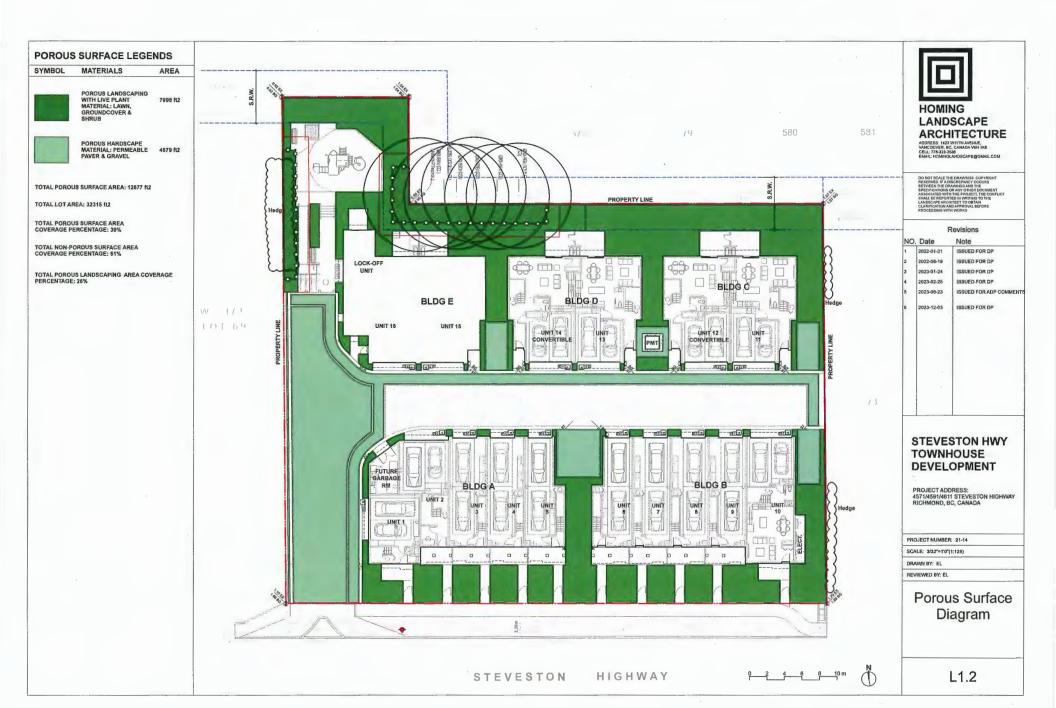











Play structure



Mud Kitchen



HOMING LANDSCAPE ARCHITECTURE

ADDRESS: 1423 W11TH AVENUE, VANCOUVER, BC, CANADA V8H 1K9 CELL: 778-323-3236 EMAIL: HOMINGLANDSCAPE@GMAIL.COM

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3	2023-01-24	ISSUED FOR DP				
6	2023-02-25	ISSUED FOR DP				
5	2023-08-23	ISSUED FOR ADP COMME				
8	2023-12-03	ISSUED FOR DP				

STEVESTON HWY TOWNHOUSE DEVELOPMENT

PROJECT ADDRESS: 4571/4591/4611 STEVESTON HIGHWAY RICHMOND, BC, CANADA

PROJECT NUMBER: 21-14

SCALE: 1:60


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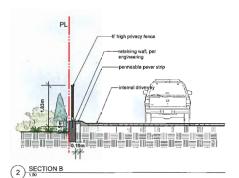
REVIEWED BY: EL


Outdoor Amenity Area Enlargement Plan

L1.3





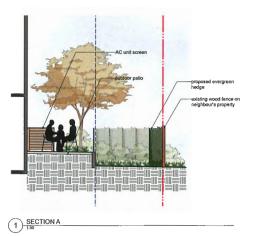

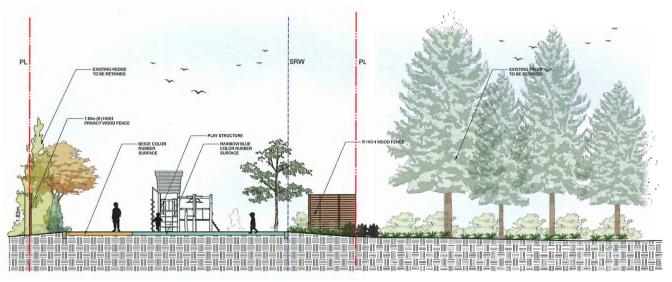

3) SECTION C



ADDRESS: 1423 WHITH AVENUE, VANCOUVER, BC, CANADA V6H 1K9 CELL: 778-323-3538 EMAIL: HOMINGLANDSCAPE@GMAIL.COM

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GHALL BE REPORTED BY WRITHOR TO THE
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PROCEEDING WITH WORKS

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PROJECT NUMBER: 21-14

SCALE: AS SHOWN

DRAWN BY: EL


REVIEWED BY: EL

Landscape Sections

L1.4



ISSUED FOR DP

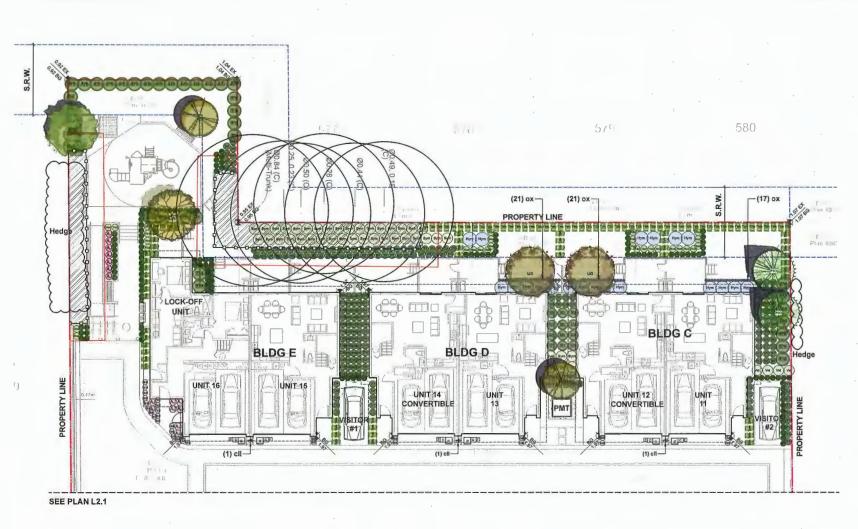





		CVIDIONID	
NO	D. Date	Note	
1	2022-01-21	ISSUED FOR DP	
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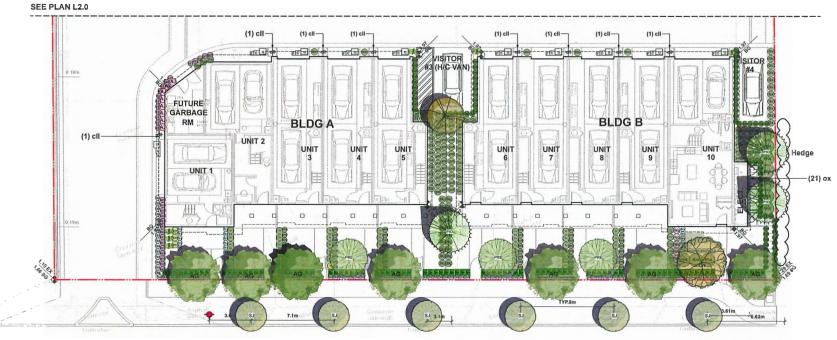
SCALE: 1/8"=1'0"(1:98)

DRAWN BY: EL

REVIEWED BY: EL

Landscape Planting Plan -North Area

L2.0





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Revisions

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PROJECT NUMBER: 21-14

SCALE: 1/8"=1'0"(1:96)

DRAWN BY: EL

REVIEWED BY: EL

Landscape Planting Plan -South Area

L2.1

ONSITE PLANT LIST					
ID	Latin Name	Common Name	Quantity	Scheduled Size	Notes
TREES (DECIDUOUS & CONIFEROUS)					
AG	Acer griseum	Paperbark Maple	9	8cm cal.	
BEP	Betula papyrifera	Paper Birch	3	6cm cal.	—
CN	Cornus nuttallii 'Eddie's White Wonder'	'Eddie's White Wonder' Dogwood	2	6cm cal.	
LIO	Liquidambar styraciflua	American Sweetgum	2	8cm cal.	
PIO	Pinus contorta var. contorta	Shore Pine	5	4m high.	T
PRE	Prunus emarginata	Bitter Cherry	3	6cm cal.	-
SHRUBS					
Arb	Arbutus unedo 'Compacta'	Compact Strawberry Bush	14	#3 pot	
AJ	Azalea japonica 'Kent's Pride'	Kent's Pride Azalea	23	#2 pot	
Bx	Buxus microphylla	Littleleaf Boxwood	91	#2 pot	
ec1	Erica carnea	Spring Heath	30	#1 pot	
Gs	Gaultheria shallon	Salal	109	#2 pot	
Hvm	Hydrangea macrophylla	Bigleaf Hydrangea	20	#3 pot	
Ma	Mahonia aquifolium	Oregon Grape Holly	12	#2 pot	
Nad	Nandina domestica	Heavenly Bamboo	32	#2 pot	
Rh4	Rhododendron 'PJM'	PJM Rhododendron	32	#3 pot	
Shh	Sarcococca hookeriana var. humilis	Sweet Box	8	#2 pot	
Skj	Skimmla japonica	Japanese Skimmia	25	#3 pot	
Spg	Spiraea x bumalda 'Goldflame'	Goldflame Spirea	6	#2 pot	
Sym	Symphoricarpos alba	Snowberry	42	#2 pot	
Tmh	Taxus x media 'Hicksii'	Hick's Yew	110	4' High	
Th	Thuja occidentalis 'Smaragd'	Emerald Cedar	40	#2 pot	
Vot	Vaccinium ovatum 'Thunderbird'	Thunderbird Evergreen Huckleberry	4	#3 pot .	
PERENNIALS & GROUNDCOVERS					
em	Euphorbia x martinii	Martin's Spurge	8	#1 pot	
lsa	Lavandula angustifolia	English Spike Lavender	136	#2 pot	
ox	Oxalis oregana	Oregon Oxalis	80	#1 pot	
pol	Polystichum munitum	Western sword fern	190	#1 pot	
cmi	Carex morrowii 'Ice Dance'	Ice Dance Japanese Sedge	48	#1 pot	
fes	Festuca glauca	Boulder Blue Fescue	26	#1 pot	
ha	Hakonechloa macra `Aureola`	Golden Japanese Forest Grass	206	#1 pot	
VINES					
cil	Clematis ligusticifolia	Western White Clematis	11	#1 pot	+
				L	

OFFSITE PLANT LIST					
ID	Latin Name	Common Name	Quantity	Scheduled Size	Notes
TREES (DECIDUOUS & CONIFEROUS)					
SJ	Styrax japonicus	Japanese Snowbell Tree	6	6cm cal.	



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Pavielone

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STEVESTON HWY TOWNHOUSE **DEVELOPMENT**

PROJECT ADDRESS: 4571/4591/4611 STEVESTON HIGHWAY RICHMOND, BC, CANADA

PROJECT NUMBER: 21-14

SCALE: 3/32"=1"0"(1:128)

DRAWN BY: EL

REVIEWED BY: EL

Landscape Plant List

L2.2

PLANTING NOTES:

1) In case of discrepancy between plant numbers on this list and on the plan, the latter shall prevail.

2) All planting shall be in accordance with CSLA Landscape Standard, latest edition.

3) The Landscape Contractor shall ensure that the on-site planting medium/soil meets the specification & recommendations of the soil analysis taken at the time of Substantial Completion. All recommendations of the soil analysis shall be executed prior to Final Acceptance of the landscape works by the Consultant and the municipal authorities.

4) Minimum planting medium depths: lawn - 6'/150mm groundcover - 12'/300 mm shrubs - 18'/450 mm tress - 24'/600 mm (around & beneath rootball)

All plant material to be supplied on the job site must be obtained from a nursery participating in the BCLNA Phytophthora ramorum Certification Program.

IRRIGATION DIAGRAM LEGEND

KEY

DESCRIPTION



AREA TO BE IRRIGATED



IRRIGATION STUB OUT









DESIGN-BUILD IRRIGATION NOTES:

- LANDSCAPE CONTRACTOR TO PROVIDE COMPLETE DESIGN-BUILD SERVICES FOR ALL AUTOMATIC SITE IRRIGATION WORKS.
- 2. IRRIGATION CONTRACTOR PERFORMING THE Z. IMMOSTION CONTRACTION PERFORMING THE WORK MUST HAVE MINIMUM (5) FIVE YEARS DOCUMENTED EXPERIENCE, AND A MEMBER IN GOOD STANDING OF THE IMBC (IRRIGATION INOUSTRY ASSOCIATION OF BC).
- 3. IRRIGATION TO CONFORM TO ALL LOCAL PLUMBING AND ELECTRICAL CODE REQUIREMENTS. CONTRACTOR IS RESPONSIBLE FOR COORDINATION WITH MECHANICAL AND ELECTRICAL CONSULTANTS
- 4. IRRIGATION TO CONFORM TO ALL IMAGE STANDARDS WITH THE FOLLOWING EXCEPTIONS: A MATERIALS SECTION 68: ALL PIPE TO BE MINIMUM CLASS 200 b MATERIALS SECTION 5G; NO WIRE SMALLER THAN 14 GAUGE DIRECT BURIAL
- 5. COORDINATE WITH CIVIL CONTRACTOR TO PROVIDE PVC SLEEVING WHERE REQUIRED.
- 6. IRRIGATION STUB-OUTS AND HOSE BIBS PER MECHANICAL PLANS.
- 7. PROVIDE SHOP DRAWINGS FOR IRRIGATION LAYOUT TO CONSULTANT FOR REVIEWAMD APPROVAL FROM TO FABRICATION AND PROVIDED TO FABRICATION AND PLANT OF THE SIZE, WAIVE BOXES, ETC., AND ALL IRRIGATION COMPONENT SPECIFICATIONS, WAIVE BOXES TO BE LOCATED IN LOW-VISIBLE, PLANTED AREAS ONLY AND LOCATIONS TO BE REPROVED.
- 8. HIGH EFFICIENCY IRRIGATION TECHNOLOGY TO BE EMPLOYED INCLUDE, BUT ARE NOT LIMITED TO: CENTRAL SHUT-OFF VALVE, HIGH EFFICIENCY DRIP IRRIGARTION LINES AND MOTION SENOR/RAIN DELAY CONTROLLER
- 9. TEST SYSTEM PRIOR TO COMPLETION OF LANDSCAPE WORKS TO ENSURE NO LEAKAGE AND SPECIFIED PSI IS MET. PROVIDE WRITTEN NOTICE THAT PRESSURE TESTING HAS MET STANDARDS (LEAKS SHALL NOT BE REPAIRED SY PATCHING).
- 10. PROVIDE COVERAGE AND CONTROLLER TEST WHEN SYSTEM IS COMPLETE AND MAKE ADJUSTMENTS AS REQUIRED.
- 11. PROVIDE AS-BUILT RECORD DRAWINGS TO SCALE SHOWING LOCATIONS OF ALL CONCEALED COMPONENTS, PIPING SYSTEMAND CONDUIT.
- 12. MAINTAIN AND OPERATE IRRIGATION PER MANUFACTURER'S RECOMMENDATIONS THROUGHOUT WARRANTY PERIOD WINTERIZE AS REQUIRED.
- 13. PROVIDE (3) COPIES OF INSTRUCTIONS MANUALS FOR OPERATION AND MAINTENANCE OF SYSTEM AND CONTROLS, SEASONAL ACTIVITY AND SHUTDOWN AND MANUFACTURER'S PARTS CATALOGUE.
- 14, INSTRUCT OWNER'S PERSONNEL IN THE OPERATION AND MAINTENANCE OF SYSTEM, INCLUDING ADJUSTING OF SPRINKLER HEADS. USE OPERATION AND MAINTENANCE MATERIAL AS BASIS FOR DEMONSTRATION.

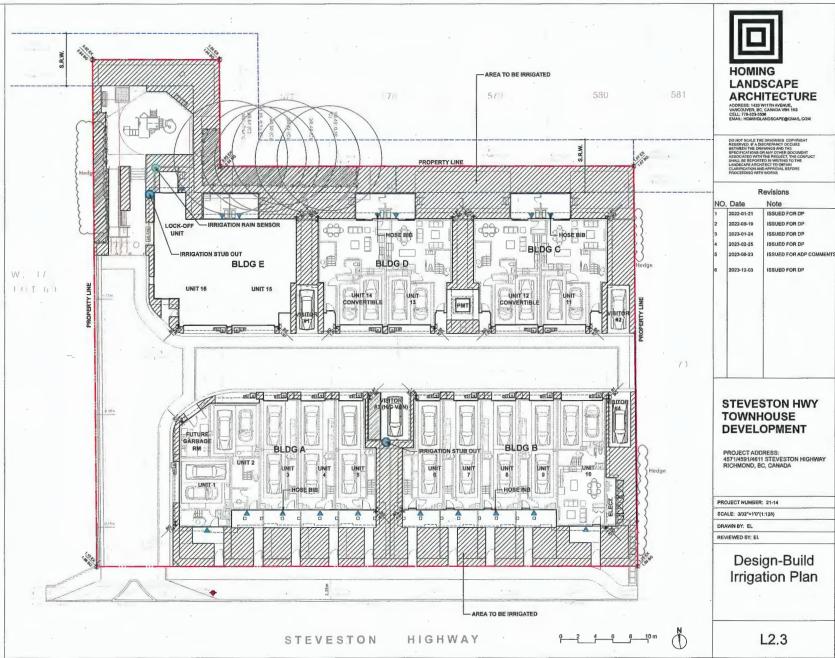

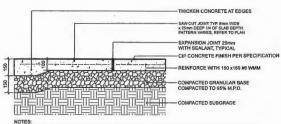


NOTES:

1. EXPANSION JOINTS 6m O.C. MAX, CONTROL JOINTS @ 1.5m O.C. ADJUST TO SUIT SITE LAYOUT PLAN.

2. ALL SCORELINES TO BE APPROVED BY LANDSCAPE ARCHITECT ON-SITE PRIOR TO INSTALLATION.

1 CIP CONCRETE ON GRADE (TYPICAL)
Scale: 1:10

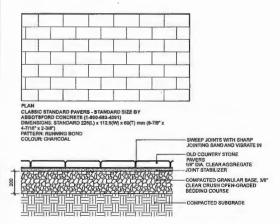

NOTE:
USE CONCRETE HIDDEN EDGE RESTRAINT WHEN PAVERS ARE
NOT ADJACENT TO A SOLID EDGE CONDITION.


2 CONCRETE UNIT PAVING ON GRADE

AQUAPAVE STANDARD PAVER BY ABBOTSFORD CONCRETE PRODUCTS

PATTERN: RUNNING BOND LENGTH: 8-3/8' (221MM) WIDTH: 4-5/16' (110MM) THICKNESS: 3-1/8' (80MM)






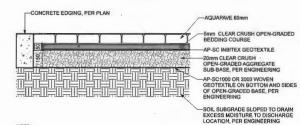


NOTE: 1. REFER TO ENGINEERING DRAVANGS FOR THE BASE MATERIALS INSTALLED UNDERNEATH THE PAVERS. 2. THE CONDITIONS UNDER THE PAVERS SMALL BIE APPROVED BY ENGINEERS BEFORE PAVERS INSTALLATION.

3 AQUAPAVE PERMEABLE PAVER

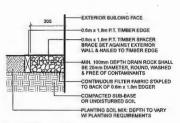


NOTE: ALL LUMBER SIZES ARE SHOWN AS NOMINAL

GRAVEL DRAIN STRIP - ON GRADE

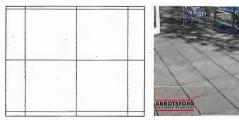

PCAN
TEXADA HYDRAPRESSED SLABS BY ABBOTSFORD CONCRETE PRODUCTS (1-800-663-4091)
DIMENSIONS: 457 mm x 457 mm x 40 mm
COLOUR: NATURAL
PATTERN: GRID

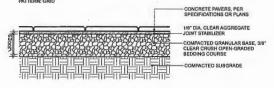

NOTE:

1. USE CONCRETE HIDDEN EOGE RESTRAINT WHEN PAVERS ARE NOT ADJACENT TO A SOLID EDGE CONDITION.

2. BLACKJACK PEDESTAL SYSTEM AVAILABLE FROM ABBOTSFORD CONCRETE PRODUCTS, INSTALLATION PER MANUFACTURES INSTRUCTIONS.

5 CONCRETE SLAB PAVING Scale: 1:10



HOMING LANDSCAPE **ARCHITECTURE**

ADDRESS: 1423 WITTH AVENUE, VANCOUVER, BC, CANADA VOH 1K9 CELL: 776-323-3530 EMAIL: HOMINGLANDSCAPE@GMAIL.COM

NO	D. Date	Note
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PROJECT ADDRESS: 4571/4591/4611 STEVESTON HIGHWAY RICHMOND, BC, CANADA

PROJECT NUMBER: 21-14

SCALE: AS SHOWN


DRAWN BY: EL

REVIEWED BY; EL

Hardscape Details



1 MUD KITCHEN BY HABITAT SYSTEMS

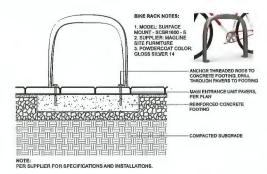




3 SANDBOX



4 PLAY STRUCTURE BY LANDSCAPE STRUCTURES

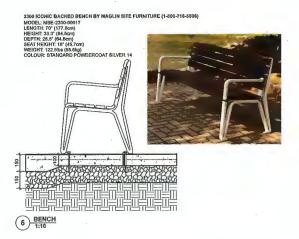



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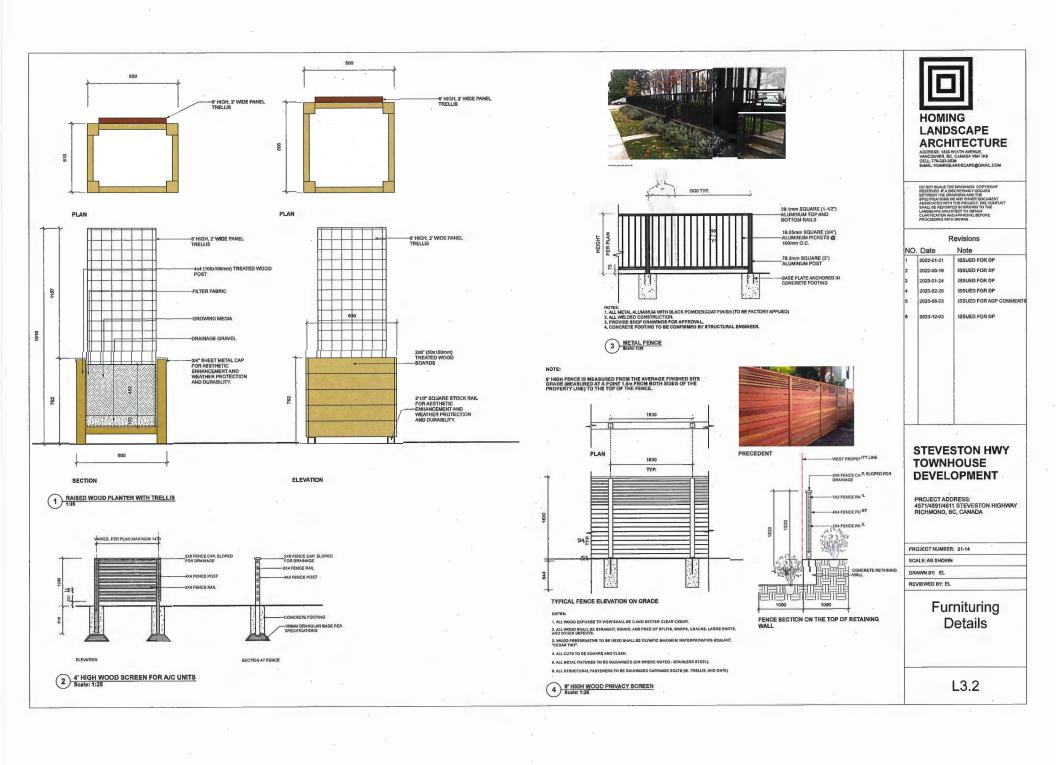
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SCALE: AS SHOWN


DRAWN BY: EL

REVIEWED BY: EL


Furnituring Details






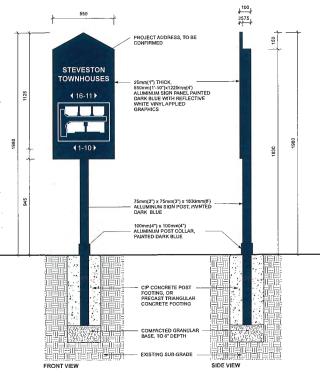

ADDRESS SIGN AND FIRE PROTECTION ORENTATION SIGN Scale; 1:10

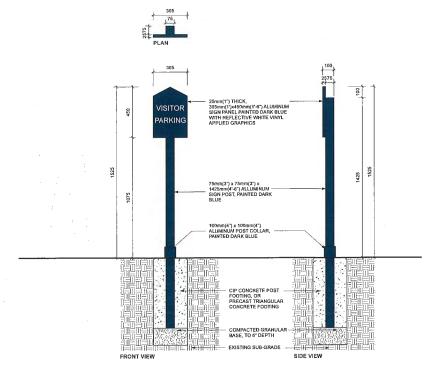

2 VISITOR PARKING SIGN Scale: 1:10

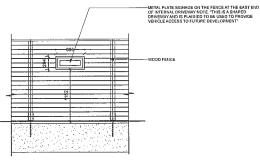

3 METAL PLATE NOTIFICATION SIGN Scale: 1:25



ARCHITECTURE

ADDRESS: 1423 WITTH AVENUE,
VALIGOUVER, BC, CALADA V6H 1K9
CELL: 778-323-3539

EMAIL: HOMIRICA ATIOS CAPE @ GMAIL COM

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4	2023-02-25	ISSUED FOR DP	
5	2023-08-23	ISSUED FOR ADP COMMENTS	
6	2023-12-03	ISSUED FOR DP	

STEVESTON HWY TOWNHOUSE DEVELOPMENT

PROJECT ADDRESS: 4571/4591/4611 STEVESTON HIGHWAY RICHMOND, BC, CANADA


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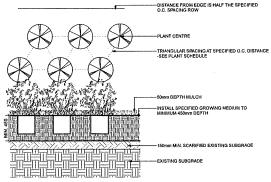
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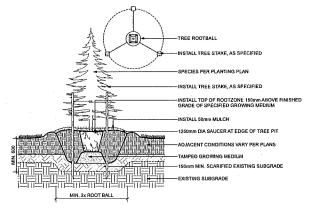
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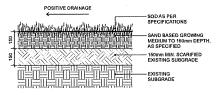
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ADDRESS: 1423 WITTH AVENUE, VANCOUVER, BC, CANADA V&H 1KB CELL: 778-323-3530 EMAIL: HOMINGLANDSCAPE@GMAIL.COM

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STEVESTON HWY TOWNHOUSE DEVELOPMENT

PROJECT ADDRESS: 4571/4591/4611 STEVESTON HIGHWAY RICHMOND, BC, CANADA

PROJECT NUMBER: 21-14

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Softscape Details

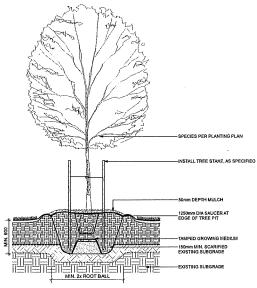Schedule 2 to the Minutes of the Development Permit Panel meeting held on Wednesday, January 17, 2024

SYMPHONY HILL TECH CENTRE 2

13888 WIRELESS WAY RICHMOND BC

DEVELOPMENT PERMIT PANEL PRESENTATION





TABLE OF CONTENTS

- 1.0 INTRODUCTION
- 2.0 PROJECT CONTEXT
- 3.0 DESIGN PROPOSAL
- 4.0 LANDSCAPE
- 5.0 RENDERINGS

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1.0 INTRODUCTION

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KCC ARCHITECTURE

1.1 PROJECT INTRODUCTION

The property is situated between Wireless Way and Westminster Highway, west of Sparwood Place, encompassing a total area of

20,088.73 square meters. Currently zoned as I3 Industrial Business Park in the Crestwood Area, the site hosts a three-story building at its centre. The proposed development aims to subdivide the western portion of the property, aligning with the city's initiative to enhance industrial land density.

Benefiting from its strategic location, the site boasts convenient access to major transportation routes such as Westminster Highway, Knight Street, and No. 6 Road, connecting to key highways in the lower mainland.

Surrounded by operational industrial developments to the north, east, and west, the property faces Westminster Highway to the south, featuring a statutory right of way along its southern boundary. Notably, this right of way is intended to extend Sparwood Place, providing secondary access to the adjacent western property.

In response to preliminary comments received on August 12, 2021, the City initially requested a separate site access for the new parcel. However, following a thorough review with the client, it was determined that sharing site access with the existing building would be preferred. This arrangement allows for the creation of a welcoming pedestrian plaza in front of the new building, enhancing the overall design and functionality of the development.





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2.0 PROJECT CONTEXT

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2.1 SITE CONTEXT



KCC ARCHITECTURE

2.2 APPLICABLE POLICIES & GUIDELINES



Climate Action Programs



Community Energy and Emissions Plan 2050



Development Permit Guidelines



Flood Protection Management Strategy 2019



Official Community Plan (OCP)



Waste Management Design Guidelines

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3.0 DESIGN PROPOSAL

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KCC ARCHITECTURE

3.1 DESIGN RATIONALE

3.1.1 Building Layout

The proposed new development comprises a **three-story building**, **with the first two levels designated for multitenant industrial units**. **The third level is allocated for additional office space**, either for the units below or for new tenants. All units will be offered as strata properties.

Assuming that the primary service connections are available along Wireless Way, service rooms have been strategically positioned to face North, specifically towards Wireless Way. To ensure a visually unobtrusive appearance, the illumination of the building will be confined within the property boundaries. Rooftop units will be carefully situated to remain out of sight from the street; where visibility is unavoidable, aesthetic screening will be implemented.

In response to the City's preliminary comments, parking has been meticulously provided. The parking spaces for the existing building adhere to the zoning requirements outlined in the original submission, ensuring compliance with city regulations.

3.1.2 Building Form and Character

The architectural design incorporates **prominent featured walls to seamlessly mirror and integrate with the existing building, maintaining a cohesive aesthetic.** The proposed building height is meticulously set at 14.3 meters.

The strategically positioned canopies introduce strong lines, highlighting and defining the entrances to each unit. Varied parapet heights, reveals, and painted stripes contribute to the nuanced articulation evident throughout the building elevations.

A judicious combination of materials and colours has been selected to accentuate both individuality and a harmonious overall design. In addition, the maximization of windows serves the dual purpose of allowing ample natural light to permeate interior spaces, enhancing the overall functionality and aesthetic appeal of the structure.



3.1 DESIGN RATIONALE

3.1.3 Accessibility Strategy

The accessible path leading to each building aligns with public accessibility standards, ensuring uniformity. Positioned in front of each building, the path runs parallel to the entire length of the structure. This layout allows individuals using wheelchairs to easily navigate, providing sufficient space to turn around and maneuver at the entrance door of each unit.

Internally, the design and finishing of the proposed building are intentionally structured for future stratification upon completion. As a result, we are currently adhering to the minimum code requirements per unit. This approach affords flexibility to prospective tenants, enabling them to tailor their spaces according to specific needs and preferences once they assume occupancy.

3.1.4 Sustainability Statement

The buildings incorporate high-performance building materials, including insulated tilt-up panels, double glass units with e-coating, and insulated overhead doors, reflecting a commitment to energy efficiency and sustainability. Specifically, windows in office/mezzanine areas feature canopies to mitigate direct sunlight, while strategically positioned skylights enhance natural light within the warehouse, contributing to reduced energy consumption.

To promote the use of electric vehicles, the new industrial facility will be equipped with one charging station for each unit. Thoughtful landscape design, encompassing both soft and hard elements, has been implemented to elevate common areas, minimize water consumption, and utilize native plants to reduce irrigation requirements.

In alignment with water conservation practices, all toilets within the facility will adhere to water-efficient standards. Complying with the latest British Columbia Building Code (BCBC) requirements during the Building Permit coordination process, we will develop a comprehensive building energy model. This model will ensure the **optimization of the building's energy performance**, **achieving a harmonious balance among mechanical**, **electrical**, **and building envelope components to enhance overall efficiency and effectiveness**.



3.3 LEGAL & SETBACKS





SITE DATA LOT 1

CIVIC ADDRESS

13888 WIRELESS WAY RICHMOND BC

LEGAL DESCRIPTION

LOT B SECTION 5 BLOCK 4 NORTH RANGE 5 WEST NEW WESTMINSTER DISTRICT PLAN BCP24407 PID 026-714-604

ZONING

INDUSTRIAL BUSINESS PARK (ZI3) - CRESTWOOD AREA (EAST

SITE AREA

SYMPHONY HILL CORPORATE LOT 1 (PROPOSED BUILDING)

TOTAL SITE AREA

41,568.45 SF (3,861.83 SM)

BUILDING FOOTPRINT

PROPOSED BUILDING

15,891.49 SF (1,476.37 SM)

PERMITTED

PROVIDED

SETBACKS

FRONT YARD (WIRELESS WAY)

6.0 M 7.3 M

REAR & INTERIOR SIDES YARDS NO MINIMUM REQUIRED

SITE DATA LOT 2

CIVIC ADDRESS

13888 WIRELESS WAY RICHMOND BC

LEGAL DESCRIPTION

LOT B SECTION 5 BLOCK 4 NORTH RANGE 5 WEST NEW WESTMINSTER DISTRICT PLAN BCP24407 PID 026-714-604

INDUSTRIAL BUSINESS PARK (ZI3) - CRESTWOOD AREA (EAST CAMBIE)

SITE AREA

SYMPHONY HILL CORPORATE LOT 2 (EXISTING BUILDING)

TOTAL SITE AREA 174,671.86 SF (16,227.54 SM)

BUILDING FOOTPRINT

EXISTING BUILDING FOOTPRINT 42,231.13 SF (3,923.40 SM)

SETBACKS

FRONT YARD (WIRELESS WAY)

PERMITTED 6.0 M PROVIDED 22.94 M

REAR & INTERIOR SIDES YARDS NO MINIMUM REQUIRED



3.4 PROJECT STATISTICS





SITE DATA LOT 1

BUILDING FOOTPRINT

PROPOSED BUILDING 15,891.49 SF (1,476.37 SM)

GROSS FLOOR AREA

15,891.49 SF (1,476.37 SM) 9,166.10 SF (851.56 SM) 15,295.71 SF (1,421.01 SM) LEVEL 1

40,353.30 SF (3,748.94 SM) TOTAL GFA

DENSITY (FAR)

PERMITTED PROPOSED 1.00 **0.97**

LOT COVERAGE

PERMITTED 60% 38% PROPOSED

BUILDING HEIGHT

ALLOWED

13.00 M (42.65') TO THE ROOF DECK 15.00 M (49.21') FOR MECHANICAL EQUIPMENT & ARCHITECTURAL FEATURES ONLY

PROPOSED

12,83 M (42,09') 13,90 M (45,60') ARCHITECTURAL FEATURES WALLS

AVERAGE FINISHED GRADE

PROPOSED 2,40 M

PARKING REQUIREMENT

INDUSTRIAL, WAREHOUSE 2.80 spaces per 100.0 m² of gross leasable floor area

REQUIRED The gross leasable floor area for the warehouse, including the ancillary office space: 3,436.87 SM 3,436.87 / $100 \times 2.80 = 96.23$ (96)

PROPOSED

Variance requested to use the Industrial General parking rate of 0.75 spaces per 100.0 m² of gross leasable floor area: 3,436.87 / 100 x 0.75 = 25.77 (26)

STANDARD PROVIDED 16 16 **32**

SMALL PROVIDED TOTAL PROVIDED

ACCESSIBLE PARKING

If required more than 11 spaces 2% are required accessible 2 x 26 / 100 = 0.52

1 (Van Accessible) REQUIRED

PROVIDED

LOADING SPACE

1 every 1,861 SM GFA, + 1 every 5,000 SM above 1,861 SM REQUIRED

2 (One medium loading space shared with the garbage truck space) PROVIDED

BIKE STORAGE

3,436.87 / 100 x 0.27 = 9.27 (9) 10 CLASS 1

3,436.87 / 100 x 0.40 = 13.74 (14) 16 CLAS\$ 2

SITE DATA LOT 2

BUILDING FOOTPRINT

EXISTING BUILDING FOOTPRINT 42,231.13 SF (3,923.40 SM)

GROSS FLOOR AREA

EXISTING TOTAL BUILDING AREA 126,693.39 SF (11,770.20 SM)

DENSITY (FAR)

PERMITTED PROPOSED 1.00 0.72

LOT COVERAGE

PERMITTED PROPOSED 60% 24%

BUILDING HEIGHT

13.00 M (42.65') TO THE ROOF DECK 5.00 M (49.21') FOR MECHANICAL EQUIPMENT & ARCHITECTURAL FEATURES ONLY ALLOWED

BUILDING HEIGHT REMAINS AS ORIGINALLY APPROVED BY THE CITY EXISTING

AVERAGE FINISHED GRADE

EXISTING 3.00 M

PARKING REQUIREMENT

2.80 spaces per 100.0 m² of gross leasable floor area 10,826.09 / 100 x 2.80 = 303.13 (304) REQUIRED


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ACCESSIBLE PARKING


If required more than 11 spaces 2% are required accessible $2 \times 303 / 100 = 6.06$ (6) 11 REQUIRED

PROVIDED

3.4 PROJECT STATISTICS



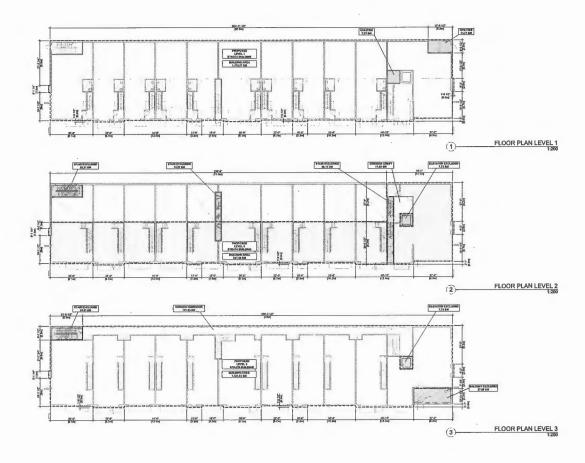


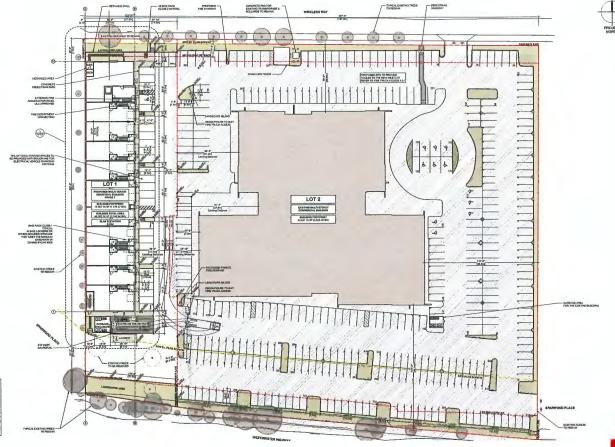


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3.6 FLOOR PLANS




3.6 FLOOR PLANS

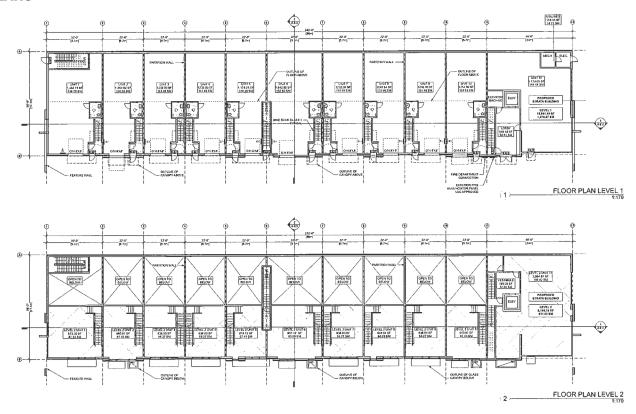



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3.7 ELEVATIONS

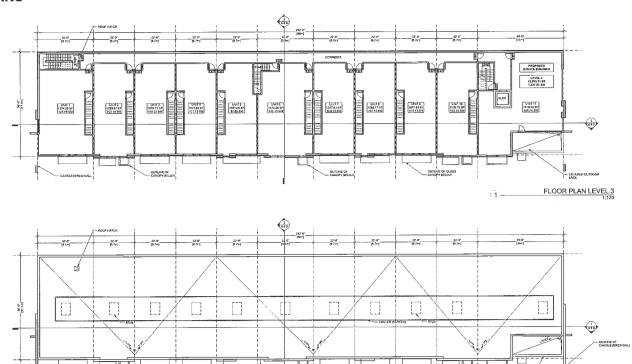

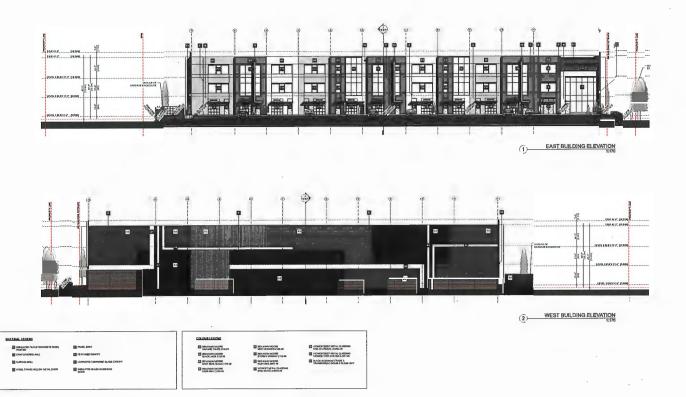3.7 ELEVATIONS



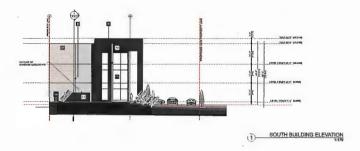
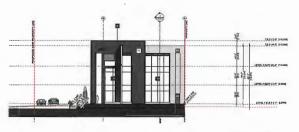
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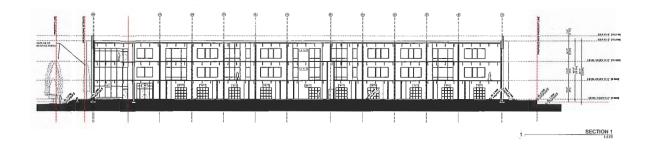
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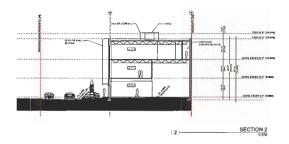
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3.8 SECTIONS





3.9 VARIANCES

3.9.1 Variance Rationale

We seek the City's consideration of the following variances, along with accompanying rationale for each:

(A) reduce the required number of parking spaces from 2.8 spaces to 0.75 spaces for each 100 square meter of gross leasable floor area of building on Lot 1


1. The primary purpose of the proposal is for warehouse and storage, requiring minimal utilization of parking spaces.

(B) reduce the minimum required number of large-sized on-site designated loading spaces on Lot 1 from 1 space to 0 spaces

- 1. The industrial units are intentionally designed to accommodate smaller operations, unsuitable for large-scale production, manufacturing, or extensive storage activities, The envisioned use primarily involves vans and pick-up trucks.
- 2. Each unit features an overhead door that opens directly to an adjacent parking space. This layout is purposefully designed to facilitate the loading and unloading of small to medium-sized packages, with the expectation that vans or pick-up trucks can park in close proximity to the overhead door.
- 3. Moreover, the proximity of the site to the existing office building on Lot 2 necessitates careful consideration in the size of trucks accommodated. The cohesive design of the new building is intended to seamlessly integrate with the existing structure, making larger trucks incongruent with the overall aesthetic. Therefore, accommodating larger trucks on this site would not be harmonious with the design intent and visual cohesion of the surrounding area.


(C) reduce the minimum percentage of standard parking spaces on Lot 2 from 50 percent to 30 percent

1. The existing building on Lot 2 included more parking spaces than required. Despite the reduction in standard parking spaces, the project still complies with Zoning requirements.

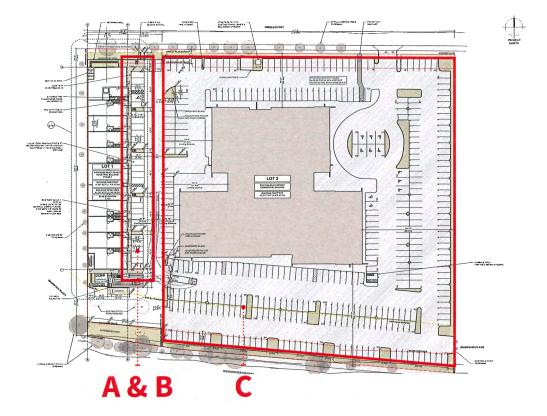



3.10 MATERIAL STRATEGIES

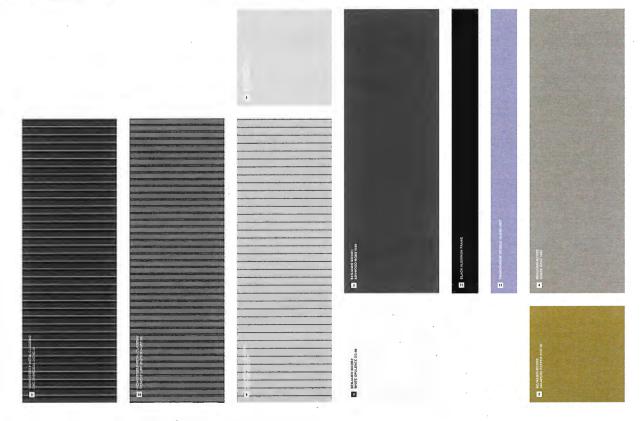



3.11 SHADOW ANALYSIS













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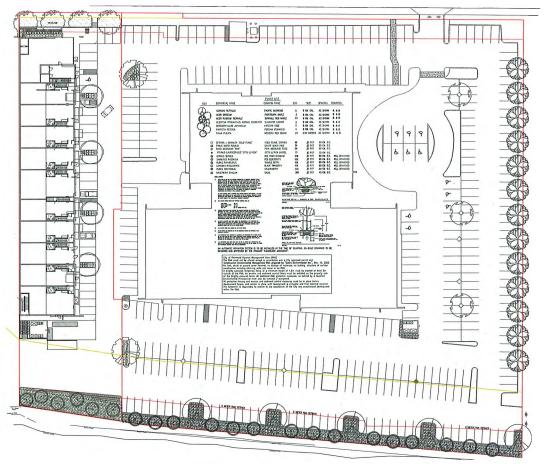
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4.0 LANDSCAPE

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4.1 LANSCAPE PLAN



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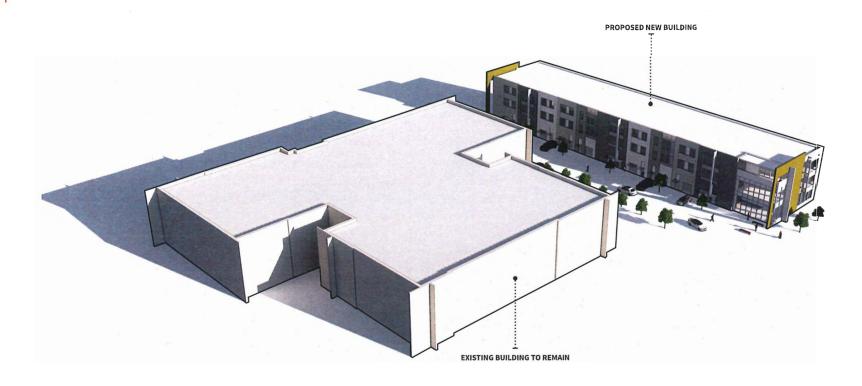
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5.0 RENDERINGS

KCC ARCHITECTURE

5.1 RENDERINGS



5.1 RENDERINGS



5.1 RENDERINGS



Schedule 3 to the Minutes of the Development Permit Panel meeting held on Wednesday, January 17, 2024







SITE VIEW TOWARD NEIGHBOUR TOWNHOUSE AT THE REAR



AERIAL CONTEXT VIEW



SITE VIEW ACROSS NO 1 ROAD



NEIGHBOUR SINGLE FAMILY HOUSE



NEIGHBOUR SINGLE FAMILY HOUSE OPPOSE NO. 1 ROAD

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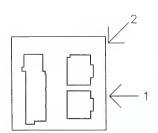
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PROPOSED TOWNHOUSE 6571-6591 NO, 1 ROAD RICHMOND BC

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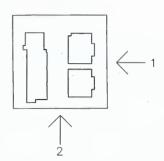
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1. AERIAL VIEW ALONG NO 1 ROAD



2. AERIAL SOUTH VIEW

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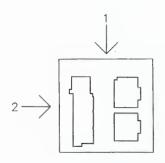
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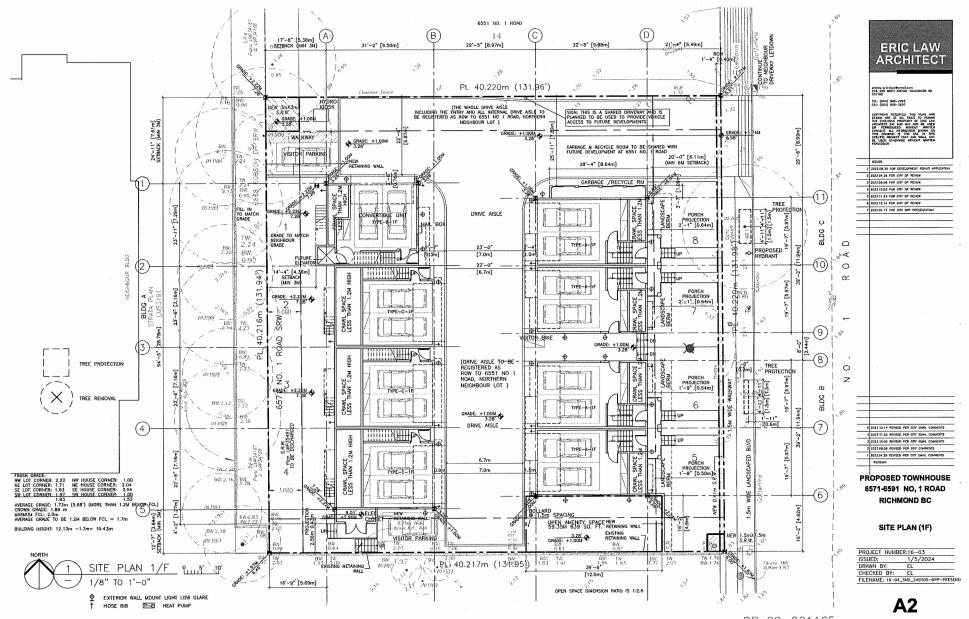
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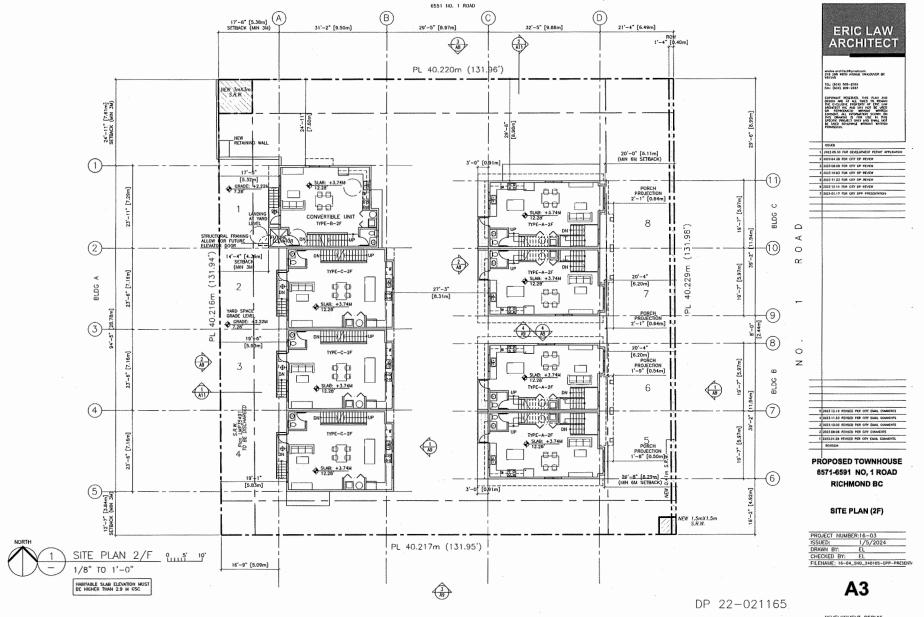
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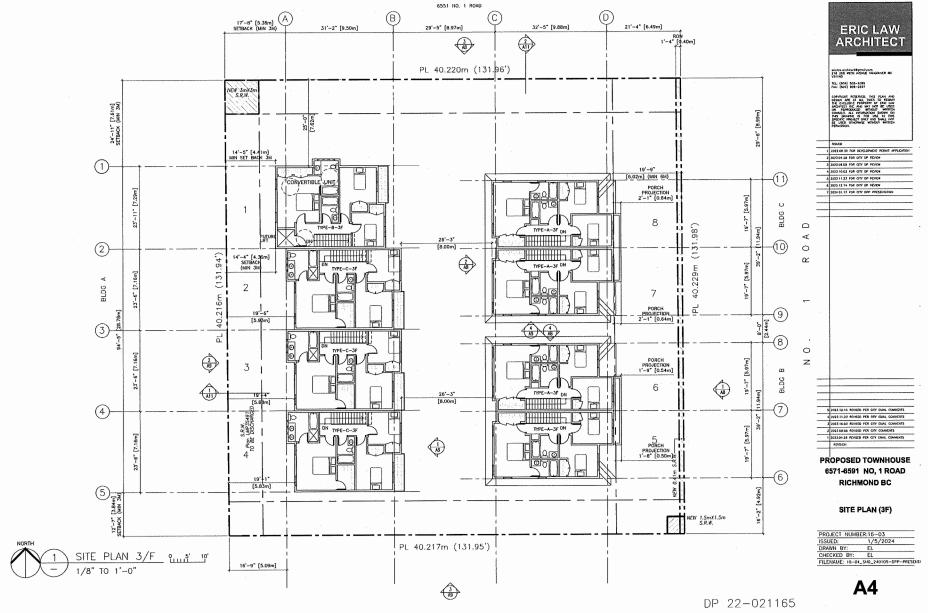
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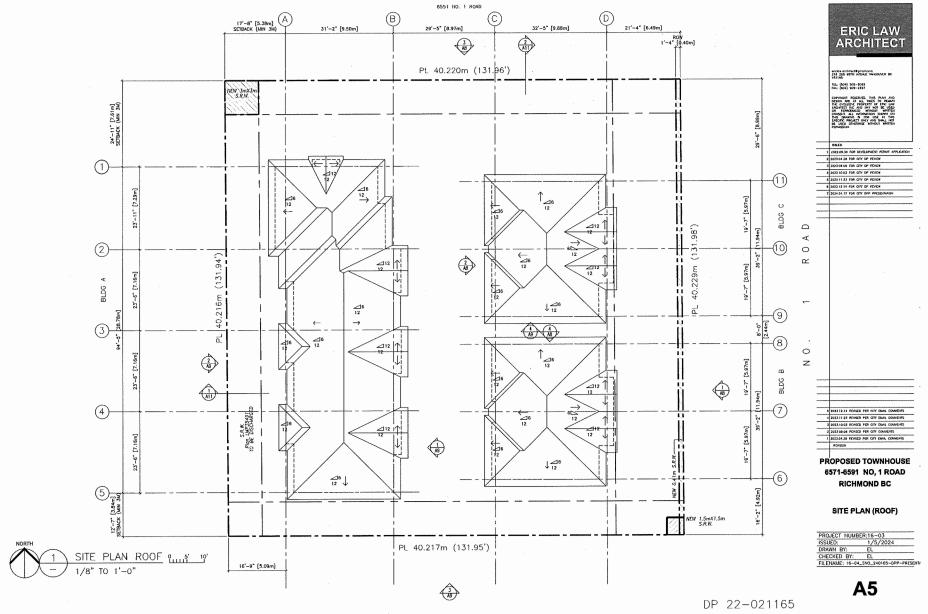
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ERIC LAW
ARCHITECT

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SOURCE

2023.04.30 FOR DEVELOPMENT PERMIT APPLICAT

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PROPOSED TOWNHOUSE 6571-6591 NO, 1 ROAD RICHMOND BC

COLOURS

PROJECT NUMBER:16-03
ISSUED: 1/5/2024
DRAWN BY: EL
CHECKED BY: EL
FILENAME: 16-04. SHO. 240105-DPP-PRESEN

A17



BRICK FINISH



BLACK ASPHALT ROOFING



AF-20

HARD BOARD PAINT COLOUR:

FASCIA & TRIM COLOUR: BENJAMIN MOORE 2126-20



DOOR COLOUR: **BENJAMIN MOORE HC185**





DOOR COLOUR: BENJAMIN MOORE 2062-20



TRIM, GARAGE DOOR COLOUR: BENJAMIN MOORE AF20

HARD PANEL PAINT COLOUR: BENJAMIN MOORE CC546

ERIC LAW

6571-6591 NO.1 ROAD RICHMOND BC

SAMPLE

SAMPLE



LANT SCHEDULE		CHEDULE		PMG PROMET HUMBER: 21-814	
	aty	BOTANICAL NAME	CONTROL HYME	PLANTED INCE / NEMARICO	
75	4	CERCIA CÁNADENSIA YORKST FAVEY	PORRET PANEY REDBUC	SCH CAL: 1 MI STD, SAB	
		PRINTED THE TANGET OF THE PARTY	VANDERVICE PR PYRANDAL LIMBER PINE	44 (47.949	
515					
20	3	STYRAS JAPONECIN THE CHARLE	PHICFLOHERID MFAHEIR BHOHBILL	(COL) CAL: LIM BYTO, BAIR	
0		* CURNAM BETWOEA	RED OBJER DODWOOD	KS POTT; IDICÍM	
8	-	* WALKING ENCONOMISSING	BION EALIERS	et seri, meta	
8	34	* SAAHOMA HERWORA	LCHILLEAF MAJIOHAA	#2 POT, 40CM	
X	80	BUDGUS MICHOPHYLLA WHYFER DEAF	LITTLE-LIKAP BOX	#7 POT, 19CM	
X	18	PIERUS JAPONICA FOREST PLAME	PREPAR, WHITE BLOCKIE	AS PCYT; BOCM	
8	20	ROBA SICARLET MEDILAND	SCARLET MEIDWAND ROSE	AG PICYT, ADCIM	
8	22	BIOLINIA REEVELINANA	CHARF BICABAN	#T POT	
8	84	TAXUE X MEDIA THICKEY	HICKS ABM	1.0ALHT, BAB	
83	~	VIII.INA.M X WEINKWOODS	SURIOVICIO VIBURIANI	1 CM HT, 888	
000000000	•	1001001110011			
0	40	CALAMAGROUTHI X A. YARR FORBRITEN	BARL FORRETER PRATHERSED ORAGA	IN POT, HEAVY	
×	117	CARLY NOR DANIES	PRIORITED BAZDOE	IN POT	
8	34	HILLICTOTRICHON BEMPERVERNIE	BLUE GAT GRABS	H2 POT	
9000	**				
0	15	CLEMATHS ARMANDS	EAST-WORKER CLEMATAI	FZ PCYT, BOCAL, BTAKED	
Q.	AAL.				
0	44	RUBBECKIA PULCIDA VAR BULLMANTE GOLDE.	OCKEUDBECKIA, YELLOW-ORANGE	SECIAL PROT	
0	٠.				
(P)		* POLYETICHUM MUNITUM	WESTERN SWORD FERN	WE PRITY, DOCKE	

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HARDSCAPE LEGEND	
ECO-PRIORA PERMEABLE PAVERS BY MUTUAL MATERIALS HERRINGSONE PATTERN, HARVEST BLEND INSTALLED PER MANUFACTURER SPECIFICATIONS	
2'x2'/2'x1' Vancouver Bay Architectural Slabs COLOR: GREY; BY MUTUAL MATERIALS	,
FIBER SAFETY SURFACE ON PLAYGROUND	





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Suite C100 - 4 165 8 still Creek Diving

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ZMN.20	DESCRIPTION AND PURE OFFE DESCRIPTION	
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DATE	REVISION DESCRIPTION	4

PROJECT

8 UNIT TOWNHOUSE DEVELOPMENT

6571 - 6591 ND. 1 ROAD RICHMOND


LANDSCAPE PLAN

DATE February 01,2021 BCALE 3/31"=1"-0"

DRAYN DD DEBIGN DD CIUCE PCM

14-6-2W PMG PROJECT

21-014

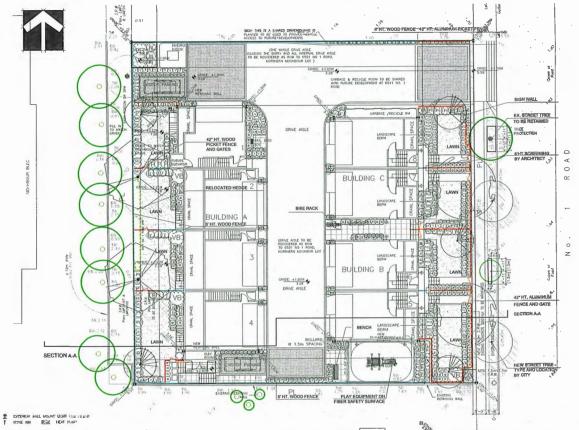

KEY	QTY	BOYANICAL HAME	COMMON NAME	PLANTED BOZE / REMARKS
110				
-	2	CERCIS CANADENSIS FOREST PANSY	FOREST PARSY REDBUD	BOM CAL; 1 AM STD, BAD
3	8	PHUS FLEXILIS VANDERWOLFS FYRALID	VANDERWOLF'S PYRANICAL LIMITER PINE	4M477,8AB
2	2	STYRAX MPONICUS PHA COMES	PROCEDURACIO LAPANESE SHOWSELL	eCM CAL, 1 AM STD, 685
0	7	* CORNUS SERICEA	RED OBIER DOGWOOD	#3 POT; BOCK!
8	40	* KALMA MICROPHITLIA	BOG LAUREL	AS POT; SOCM
8	24	* MANCINA NERVORA	LONGLEAF MAHONIA	#2 POT; 40CM
8	-	RURLIA MICROPHYLLA WHITER GEM	LITTLE-LEAF BOX	#2 POT; 29CM
8	64	PERM APONCA FOREST FLAME	PIERRIL WHATE BLOOMS	ata POT; BOCM
8	23	ROSA TICARLET MERITANO	BIGARLET MEIDILAND ROBE	#2 POT; 40CM
8	22	BEDDARA RESTYE BANA	DWARF BUILDINA	ata POT
8	-	TAXUE X SHEDIA POCKEE	HICKS AEM	1.294 HT, 8AB
000000000E	4	ABRIGHMY X ARMANDOOL	BURNWOOD VIBURIANIA	1 CEL HT, GAS
	49	CALAMAGROSTIS X A. KARL FORRETER	KARIL FOERSTER FEATHEREED GRASS	#3 POT, HEAVY
8	117	CAREX YOU DANCE	FROSTED SEDGE	#1 POT
1000g	31	HELICTOTICHON BEMPERWICHE	BILLYE CAT CAVABE	яз рот
PERCEN	15	CLEMATIS ARMANDII	EVERGREEN CLEMATIS	92 PCTL BOCH, BTAKED
000	41	RUDDECOGA FULCIÓN VAR BULLIVANTI! "GÓLÍM	OCKSTUDESCOOL TELLOW-OFWHOLE	18CM POT
(0)	7	· POLYBIICIPAN MURRIUM	WESTERN SWORD FERM	PS POT; 20CM

NOTE:
- PROVINCE DEMONED BUILD HIGH EPPICIENCY AUTOMATIC PRICATION SYSTEM TO LIABO STANDARDS TO ALL BOFT LANDSCAPE AREAS
- BIOLD DRAWNIGS O BE REVEWED AND APPROVED BY LANDSCAPE ACCUSTLET PRICAT TO RISTALLATION.

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PLANT S	CHEDULE-STRE	ET TREE	PHG PROJECT HUMBER: 21-014
KEY QTY	BOTANICAL HAME	соммом наме	PLANTED SIZE / REMARKS
TREE 2	STREET TREE .	TYPE AND LOCATION BY CHY	7CM CAL; 1 AM STO, BAD
SPECIFIED AS I MEASUREMENT SOURCE OF SU PRIOR TO MAKE POR REQUEST	FER CIMA STANDARD BOTH PL B AND OTHER PLANT MAYERIAL PPLY. AREA OF SEARCH TO THE HIG ANY SUBSTITUTIONS TO THE TO BURSTITUTE. SUBSTITUTION	FED ACCORDING TO THE BC LANDSCAPE STANDARD AND CAVADUAN ANT REZE AND CONTAINER SIZE ARE THE IMPAIRABL ACCEPTABLE SKEE INCOMPLIANTS. SEARCH AND REVIEW MAKE PLANT MATERIAL ALLIDE (OVER MANKAND AND PRASER VALLEY, "BIGGSTITIONS OF SEPICOPED MATERIAL, HAMPPOWD BIGGSTITIONS WILL BE RE- IG ARE SUBJECT TO SCLAMOSCAPE STANDARD AND CAVADE STANDARD OVEROMANISPED MATERIAL TO SKEED BC LANDED AND ACCADE BT STANDARD OVER STANDARD BATS HEET OR SKEED BC LANDED STANDARD AND CAVADE BT AND ACCEPT TO CONTINUE PROST HEET OR SKEED BC LANDED BY THE STANDARD AND CAVADE BT AND ACCEPT THE STANDARD BY THE STANDARD AND THE SKEED BC LANDED BY THE STANDARD AND CAVADE BT AND ACCEPT THE STANDARD BY THE STANDARD AND THE STANDARD AND CAVADE BY THE STANDARD AND CAVA	8. * REFER TO SPECIFICATIONS FOR DEPINED CONTAINER VALABLE FOR OPTIONAL REWIND BY LANDSCAPE ARCHITECT AT TITAN WRITTEN APPROVAL FROM THE LANDSCAPE ARCHITECT CITED ALLOW A MINIMAN OF FIVE BINAY PRIOR TO DELIVERY SIGNAPIL STANDARD - DEPINION OF CONDITIONS OF



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LANDSCAPE ARCHITECTS
Suite C100 - 4185 SW Creek Drive Burnaby, Brillah Columbie, V55 639 p: 604 294-0011; f: 604 264-0022

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CLIENT: SUITON GROUP - SEAFAIR REALTY, WITH; ERIC LAW ARCHITECT

PROJ

8 UNIT TOWNHOUSE DEVELOPMENT

6571 – 6591 NO. 1 ROAD RICHMOND

DRAWING TITLE:


LANDSCAPE PLAN

DATE: February 01,2021 SCALE: 3/32**3**0** DRAWN: DD DESIGN: OD

1/31'41'-0'

PARO PROJECT NUMBER:

21-014

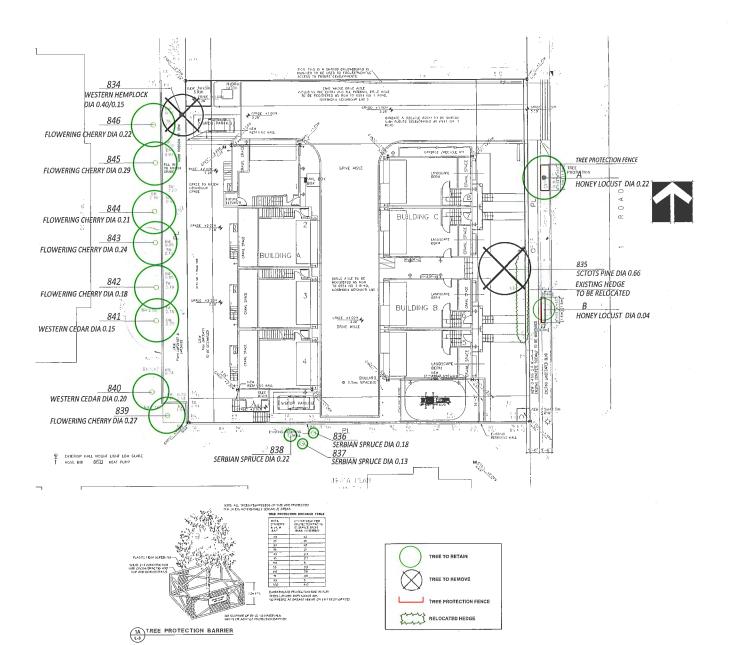

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PROJE

8 UNIT TOWNHOUSE DEVELOPMENT

6571 – 6591 NO. 1 ROAD RICHMOND

DRAWING TITE

TREE MANAGEMENT

DATE: February 01,2021 SCALE: 3/32*=1'-0*

1.0.

DRAYN: DD DESIGN: DD CHKD: PCM

1: 00 N: 00 PCM

21014-8.ZIP PMG PROJECT NUMBER:

21-014

Schedule 4 to the Minutes of the Development Permit Panel meeting held on Wednesday, January 17, 2024

To D	evel	pment	Perm	it Pane
Date	: JAA	MARY !	17,20	24
Item	#	3		
Re:_	DP	22-0	02116	5
			to the survey of the survey of	

From:

Shiraz Mohamed <shirazmohamed@hotmail.com>

Sent:

January 17, 2024 10:24 AM

To:

CityClerk

Subject:

Development Permit Panel Meeting for File 22-021165 Applicant 0853803 BC Ltd

Follow Up Flag:

Follow up Flagged

Flag Status:

City of Richmond Security Warning: This email was sent from an external source outside the City. Please do not click or open attachments unless you recognize the source of this email and the content is safe.

Hi Ashley Kwan,

My name is Shiraz Mohamed & my wife & I own the adjoining property # 6551 on No 1 Road.

Due to critical weather condition I am unable to attend the above meeting and am resorting to email to put forward my concerns that this permit should not be issued as I have addressed previously to the City the reasons for my concerns. We have lodged our objection to have the two lots developed since the start of this application and the City Planning and Development Division must have all my prior emails and communications.

If the Rezoning Application were to be approved, this would have very negative on both my wife and I:

- The Rezoning would immediately devalue our property causing unnecessary financial duress and hardship
- The Rezoning would make it very difficult to sell our property, once approved
- The Rezoning would greatly limit the redevelopment opportunities of our property and go against the City's development plan
- The Rezoning would interrupt the enjoyment of our property as we would now be sandwiched between two different townhouse developments.

Based on the points above, I strongly urge the City to reconsider and deny this application for Rezoning.

Thank you for your time. Shiraz & Almas With regards

Sent from my iPad