



City of Richmond

Report to Development Permit Panel

To: Development Permit Panel

Date: May 21, 2019

From: Wayne Craig
Director, Development

File: DP 18-818748

Re: **Application by Polygon Fiorella Homes Ltd. for a Development Permit at
3551, 3571, 3591, 3611 and 3631 Sexsmith Road**

Staff Recommendation

That a Development Permit be issued which would permit the construction of a high-rise building containing two affordable (work-only) studios for professional artists and approximately 168 dwellings, including 11 affordable (low-end-of-market) units at 3551, 3571, 3591, 3611 and 3631 Sexsmith Road on a site zoned “Residential/Limited Commercial (RCL4)”.


Wayne Craig
Director, Development
(604-247-4625)

WC:sb
Att. 5

Staff Report

Origin

Polygon Fiorella Homes Ltd. has applied to the City of Richmond for permission to develop a mixed use residential and artist studio high-rise development at 3551, 3571, 3591, 3611 and 3631 Sexsmith Road on a site zoned “Residential/Limited Commercial (RCL4)” (Attachment 1). The developer’s proposal includes:

- 16,321 m² (175,674 ft²) of multi-family residential uses, including 858 m² (9,238 ft²) for affordable low-end-of-market rental (LEMR) housing (designed and constructed, at the developer’s sole cost and secured in perpetuity with a Housing Agreement).
- 78 m² (839 ft²) of community amenity space in the form of two rentable-affordable-work only studio units for professional artists (designed and constructed, at the developer’s sole cost and secured in perpetuity with a legal agreement registered on Title).
- 168 dwelling units, including 11 LEMR units.
- Public open space secured with statutory right-of-ways, including a new Brown Road Plaza, and expansion of the existing north-south mid-block mews. The existing mid-block mews located on the adjacent existing development to the west of the site includes walkway and vehicle access areas, both of which are proposed to be widened.

The site is currently vacant except for preload material. The site is being rezoned from “Single Detached (RS1/F)” to “Residential/Limited Commercial (RCL4)” for this project under Bylaw 9836 (RZ 17-778835), which was given third reading on May 22, 2018.

The required off-site works will be designed and constructed, at the developer’s sole cost, through the City’s standard Servicing Agreement processes as a consideration of rezoning. The required works include the eastward extension of Brown Road to Sexsmith Road, Sexsmith Road improvements, Brown Road Plaza, north-south mid-block mews, and sanitary, storm and water works.

Development Information

Please refer to attached Development Application Data Sheet (Attachment 2) for a comparison of the proposed development data with the relevant bylaw requirements.

Background

The subject development is located in the City Centre’s rapidly developing Capstan Village area, at the crossroads of Sexsmith Road and Brown Road. Development surrounding the subject site is as follows:

To the north: Adjacent to the site is “Union Square”, a low-rise, strata commercial mall that, like the subject site, is designated under the City Centre Area Plan (CCAP) for medium density residential buildings and a limited amount of complementary commercial and other uses (General Urban T5 (35m)).

- To the south: Adjacent to the site is “Continental Shopping Centre”, a low-rise, strata commercial mall that is designated under the CCAP for medium density, mixed use development (General Urban T4 (25m) and Village Centre Bonus). In addition, along this frontage of the subject site, the developer is required to extend Brown Road to Sexsmith Road as part of the CCAP’s “major street” network.
- To the west: Three recently completed, residential towers (Polygon “Avanti”) (DP 12-612510), that, like the subject site, is designated under the City Centre Area Plan (CCAP) for medium density residential buildings and a limited amount of complementary commercial and other uses (General Urban T5 (35m)). This development provided for a portion of Brown Road and a shared north-south mid-block mews with walkway and vehicle access. In addition, along this frontage of the subject site, the developer is required to widen the mid-block mews.
- To the east: Sexsmith Road, beyond which the City is reviewing a rezoning application (RZ 18-836123) submitted by the same developer for a very large, predominantly vacant area (comprising several single-family homes, and open fields). Like the subject site, this area is designated under the City Centre Area Plan (CCAP) for medium density residential buildings and a limited amount of complementary commercial and other uses (General Urban T5 (35m)).

Rezoning and Public Hearing Results

During the rezoning process, staff generally identified that the proposal needed to achieve a more detailed level of design through the subject Development Permit process. This has been satisfactorily addressed as discussed in this report.

The Public Hearing for the rezoning of this site was held on May 22, 2018. Three residents from the adjacent Avanti development submitted emails to the Public Hearing, expressing the following development concerns about rezoning the property:

- Tree Retention: Existing trees were reviewed in the rezoning Staff Report, which included noting that the developer was unable to retain existing trees on the site. The proposed development includes the planting of 53 replacement trees on the site.
- Privacy and View Impacts: Potential privacy and view impacts between the proposed development and existing neighbouring Avanti development to the west of the site are mitigated through building siting and landscape screening. The proposal provides an 8.3 m (27 ft.) building separation along the mid-block mews between the proposed townhouses and the existing neighbouring Avanti townhouses and landscape screening is proposed with the planting of Maple trees which will reach an approximate height of 4.5 m (15 ft.) at maturity. The tower and low-rise building are pushed farther to the east, along the Sexsmith Road edge of the site, providing a 45 m (147 ft.) tower separation. The proposed development will provide attractive views for the neighbourhood. In addition, the tower and low-rise building are located along the east Sexsmith Road edge of the site, minimizing the impacts to existing views from the existing neighbouring Avanti development to the west.

- **Construction Impacts:** The applicant is required to design and construct the subject development in accordance with the BC Building Code safety requirements and not damage neighbouring development. Noise is regulated through the Noise Regulation Bylaw 8856, which limits construction activity noise for a development of this size to 7am through 8pm Monday through Friday, and 10am through 8pm on Saturdays. The applicant is aware of the noise regulation and is also aware of the City's Good Neighbour Program, which endeavour to manage construction activity impacts (e.g. dust and noise).
- **Construction Traffic Impacts:** The applicant is required to submit a Construction Traffic Management Plan for Transportation Department review and approval prior to Building Permit issuance.

Staff Comments

The proposed scheme attached to this report has satisfactorily addressed the significant urban design issues and other staff comments identified as part of the review of the subject Development Permit application. In addition, it complies with the intent of the applicable sections of the Official Community Plan (OCP) and is in compliance with the "Residential/Limited Commercial (RCL4)" zone.

Through the applicant's rezoning and related Development Permit processes, the developer has satisfied the following development requirements.

1. **Affordable Housing:** Housing Agreement (3551/3571/3591/3611/3631 Sexsmith Road) Bylaw No. 9927 associated with the development proposal was adopted by Council on November 13, 2018 to secure (in perpetuity) the developer's commitment to design and construct (on-site, to a turnkey level of finish, and at the developer's sole cost) 5% of the development's residential floor area in the form of 11 affordable low-end-of-market rental (LEMR) housing units. The developer is engaged in discussions regarding a potential non-profit operator to manage the LEMR units.

Affordable Housing		Affordable Unit Mix*				
Min. Floor Area	Proposed Floor Area	Studio	1-BR	2-BR	3-BR	Total
816 m ² (8,784 ft ²)	858 m ² (9,238 ft ²)	2	4	3	2	11

* 100% of the affordable housing units will satisfy Richmond's Basic Universal Housing (BUH) standards.

2. **Capstan Station Bonus (CSB):** Prior to rezoning adoption, the developer voluntarily agreed to satisfy the terms of the CSB, as set out in the Residential/Limited Commercial (RCL4) zone, as follows:
 - **Station Construction:** Registration of a legal agreement securing pre-payment of funds towards the future construction of Capstan Station, based on the Council-approved contribution rate in effect at the time of Building Permit issuance was secured at rezoning (i.e. current rate is \$8,780.96 per unit, which rate is in effect until September 30, 2019).

- Public Open Space: Registration of statutory right-of-ways (SRW's) and road dedication to the City to satisfy the CSB's required publicly-accessible open space contribution was secured at rezoning, which open space includes Brown Road Plaza, mid-block mews widening, and improvements along Brown Road and Sexsmith Road. As noted in the rezoning Staff Report, the total provided open space of 1,217 m² (13,101 ft²), exceeds the CSB requirement by 24%.
3. Parking Strategy: Prior to rezoning adoption, legal agreements were registered on Title to secure the developer's offer to voluntarily contribute towards various transportation-related features in compliance with Zoning Bylaw requirements for Parking Zone 1A (Capstan Village) and transportation demand management (TDM) parking reductions. The required features have been included in the required Servicing Agreement secured at rezoning and the proposed Development Permit design, as follows:
 - Cycling Network: Completion of the protected bike route along Brown Road and Sexsmith Road from Cambie Road to Capstan Way through construction of interim on-street bicycle lane improvements north of the subject site to Capstan Way through the required Servicing Agreement process.
 - Electric Bicycle Charging: Provision of energized outlets (120V) for electric bicycle charging; one outlet for every 10 class 1 bicycle storage spaces in each bicycle storage room.
 4. District Energy Utility (DEU): As noted in the rezoning Staff Report, the subject development must be designed and constructed to facilitate their connection to a future City DEU system. The subject development will become part of the City Centre DEU, constructing and transferring ownership of an on-site low carbon energy plant to the City or the City's DEU service provider, Lulu Island Energy Company.
 5. Pubic Art: A voluntary cash contribution of \$141,925 towards the City's Public Art Program was secured at rezoning.
 6. Transport Canada Height Regulations: The developer has submitted a letter prepared by a BCLS registered surveyor confirming that the maximum height permitted under Transport Canada regulations is 47 m (154 ft.) GSC, which allows for the proposed building height of 42.5 m (132.8 ft.) GSC.
 7. Aircraft Noise: The OCP permits residential and other aircraft noise sensitive uses in this location, subject to specific requirements. The City's standard aircraft noise legal agreement was secured at rezoning. An acoustic report, prepared by a certified professional, was submitted to the City and is required to be included in the Building Permit. The development is required to incorporate glazing upgrades to achieve required interior noise levels.
 8. View Blockage and Other Development Impacts: The City's standard legal agreement was secured at rezoning to notify purchasers of potential development impacts and ensure that the developer incorporates reasonable mitigation measures into the design.
 9. Flood Construction Level: The City's standard legal agreement was secured at rezoning, requiring a minimum habitable floor level of 2.9 m (9.5 ft.) GSC or 0.3 m (1.0 ft.) above the crown of the fronting street.

10. On-Site Tree Removal and Replacement: Through the rezoning process, Council approved the removal of 27 bylaw-size trees, secured with a \$40,000 Letter of Credit, and planting of 53 replacement trees. The subject Development Permit provides for the required 53 replacement trees.

Advisory Design Panel Comments

On January 23, 2019, the Advisory Design Panel (ADP) supported the subject Development Permit application moving forward to the Development Permit Panel, subject to the applicant giving consideration to the ADP's comments. A copy of the relevant excerpt from the Advisory Design Panel Minutes is attached for reference, together with the applicant's design response in '***bold italics***' (Attachment 3). All outstanding design issues have been resolved.

Analysis

The developer proposes to construct a high-rise, high density, limited mixed use development in Capstan Village. The proposed form of development, which combines articulated street wall building elements, a tower, and townhouses, complies with Zoning Bylaw requirements and the objectives of the CCAP's Development Permit Guidelines. More specifically, the development has successfully demonstrated:

- A strong urban concept contributing towards a high-density, high-amenity, environment, comprising of two rentable-affordable-work only studio units for professional artists, pedestrian-oriented publicly accessible park plaza along Brown Road, and a variety of dwelling types (including 84% family-friendly, two-bedroom and three-bedroom units).
- Variations in massing contributing towards streetscape interest, solar access to usable rooftops, and upper- and mid-level views across the site for residents and neighbours.
- An articulated building typology with distinctive forms and features that will contribute towards local identity, pedestrian interest, and a sense of human scale.
- Sensitivity to existing neighbours, by exceeding minimum recommended tower separation guidelines (e.g., 45 m/147 ft. provided, 35 m/115 ft. required) and enhancing public streets and walkways around the perimeter of the site.

Conditions of Adjacency

The subject site is located in Capstan Village, a planned high-rise, mixed use area in proximity to the Canada Line. The proposed development is designed to respect both existing and future surrounding development as follows.

1. To the east: The development responds to its existing residential neighbours by:
 - Providing three-storey townhouses along most of this frontage.
 - Ensuring that tower spacing across Sexsmith Road and between the subject site and future potential neighbours to the east will be at least 35 m (115 ft.), as per CCAP Development Guidelines.
 - Providing for complementary uses in the form of townhouses, residential lobby and indoor amenity space.

2. To the north: The development is set back along this frontage to:
 - Protect adjacent existing trees on the neighbouring site (e.g., Union Square shopping centre).
 - Accommodate development construction activities on-site. To accommodate future construction of the adjacent property to the north and closing off of the space along the north property line, the developer has agreed to provide statutory right-of-way (SRW) for the purposes of public rights-of-passage (PROP) along the entire north property line of approximately 0.6 m (2 ft.) wide as a consideration of the Development Permit.
3. To the west: The development responds to its existing residential neighbours (e.g., Polygon "Avanti") by:
 - Accommodating the development within a single tower at the site's southeast corner where it serves to maximize tower spacing, exceeds CCAP Development Guidelines tower spacing of at least 35 m by 10 m, and minimize shading and overlook.
 - Providing a coordinated approach to access and circulation through improvements.
 - Widening the existing landscaped, mid-block mews SRW from approximately 3 m (9.8 ft.) to 6 m (19.7 ft.) (which mews widening will be privately owned and maintained, as per the statutory right-of-way secured at rezoning).
 - Providing for complementary uses in the form of townhouses along the mid-block mews walkway.
 - Incorporating landscape features and uses that will enhance the mid-block mews walkway's visual appeal and amenity (e.g., a paved walkway, walkway lighting, trees, and planting).
4. To the south: The development seeks to enhance the neighbourhood's public space network and contribute towards a high amenity public realm through:
 - Providing a Brown Road Plaza public rights-of-passage (PROP) SRW, as secured at rezoning, together with trees, planting, street furnishings, and other landscape features, which will enhance the appearance, amenity, and casual surveillance of Brown Road; while tower spacing across Brown Road and between the subject site and future neighbours to the south will be at least 35 m (79 ft.), as per CCAP Development Guidelines.
 - Stepping down the podium towards the plaza to provide a more pedestrian-scale interface.
 - Locating the two rentable-affordable-work only studio units secured at rezoning in a manner that fronts the Brown Road Plaza and enhancing its relationship with the plaza by orienting its main entrances to the plaza, installing glazed, garage-style doors offering views and access to arts activities and providing opportunities for art activities in the plaza.

Urban Design and Site Planning

The proposed form of development takes advantage of the site's irregular shape and its proximity to the Canada Line, provision of affordable artist rental work studios and Brown Road Plaza and widening of a north-south mid-block mews to create a dynamic, high-density, urban environment that is consistent with CCAP objectives and characterized by:

1. Distinctive towers, in the form of slim slabs articulated with stepped rooflines and stacked projecting angled balconies that provide for a unique identity and street definition along the curving alignment of Brown Road and Sexsmith Road.
2. Massing variations, in combination with accessible and inaccessible rooftop landscape treatments, that help to further break down the scale of the buildings, provide for visual interest and varied recreation opportunities, and enhance upper-level views from on-site and neighbouring development.
3. Continuous, pedestrian-oriented residential, arts facility, and public plaza frontages that will contribute towards local liveability, enhance public enjoyment of open space amenities, and help support a lively public realm.
4. Service uses, parking, loading, and waste management are accommodated and screened from public view.

Architectural Form and Character

The CCAP encourages the development of a mosaic of distinctive, yet cohesive, urban villages. The subject development aims to satisfy this objective by building on the strong streetwall vocabulary established elsewhere in Capstan Village, while proposing a distinct tower and podium expression. In brief, features include:

1. A layering of dynamic, horizontal forms that contributes towards a modern, minimalist architectural expression including:
 - An active, transparent, residential/artist studio unit ground floor.
 - A distinct podium articulated with terracing and landscape treatment.
 - Distinct townhouse massing with pedestrian-oriented entries, raised patios and inset balconies.
 - A distinct street wall along the site's Sexsmith Road street frontage, stepped back from street-fronting townhouses and articulated with inset and projecting balconies, material and colour placement that provide rhythm, variety, and visual interest.
 - A slim, slab-like tower that angles gracefully away from the street wall, reflecting the site's curved Sexsmith Road street frontage, articulated with angled end balconies in addition to the inset and projecting balconies, material and colour placement that provide rhythm, variety, and visual interest.
2. An integrated landscape approach that provides for planting at all lower rooftop levels (not the tower roof).
3. Quality materials (e.g. architectural concrete, grey brick, black brick, metal panels, spandrel panels, aluminum frames, and glass guard rails) that contribute towards a distinct identity and high amenity urban environment.
4. A subdued, white-grey-black colour palette that, used in combination with variations in texture and additions of accent colour at residential and artist studio unit entries, on specific

inset balcony return walls, and the north parking structure wall, helps to break up the massing, reinforce the identity of key public spaces, and project a crisp, contemporary image.

Landscape Design and Open Space Design

For Capstan Village, the CCAP encourages the development of a network of neighbourhood parks, greenways, mid-block walkways, and other landscape features. In addition, Zoning Bylaw requirements in respect to the Capstan Station Bonus require that benefitting developments (including the subject development) provide public open space over and above basic CCAP park standards. The subject developer's public open space contribution is provided, in part, as road dedication, and in part 922.9 m² (17,262 ft²) of publicly-accessible open space, secured at rezoning with statutory right-of-ways, including the proposed Brown Road Plaza and mid-block mews expansion. These publicly-accessible open spaces are being designed and constructed via Servicing Agreement as secured at rezoning.

In addition to the public open space noted above, the development provides for on-site private open space features as follows:

1. 1,661 m² (17,879 ft²) of residential outdoor amenity space, based on the OCP standard of 6 m² (65 ft²) per dwelling unit, comprising a large, irrigated landscaped, multi-use, outdoor space at the podium roof level (co-located with required indoor residential amenity space) and smaller urban agriculture space at the lower level, designed to provide for children's play, strolling, socializing, relaxing, outdoor dining, and gardening (i.e. raised plots, tool storage, hose bibs, and related features).
2. Additional landscaping in the form of residential lobby entrance features, landscape buffers along townhouse frontages, and green roofs. All these landscaped areas will be irrigated.
3. Drought tolerant plants incorporated in green roof and vegetated outdoor areas to reduce reliance on irrigation.
4. Private outdoor patios and balconies for all dwelling units.
5. Prior to forwarding the subject application to Council, the developer is required to provide to the City a Letter-of-Credit for landscaping in the amount of \$557,691.00, as estimated by the project Landscape Architect, to ensure that on-site landscape features are provided in accordance with the Development Permit.

Shared Indoor Amenity Space

The OCP requires that multi-family developments comprising 40 units or more provide at least 100 m² (1,076 ft²) of indoor amenity space. The subject development exceeds the OCP minimum and provides for attractive indoor amenity features located adjacent to the main lobby and at the podium level co-located with the outdoor amenity space (e.g., meeting room and fitness area).

Dwellings	Minimum Requirement	Proposed
168	100 m ² (1,076 ft ²)	369 m ² (3,971 ft ²)

Crime Prevention Through Environmental Design

Measures are proposed to enhance safety and personal security including, but not limited to, the following measures.

1. Casual Surveillance: Minimization of blind corners, prominent residential lobby entrance, drop-off/pick-up visitor parking uses on the main floor of the parkade, clear sightlines to exits within the parkade, glazed vestibules, street-oriented residential and artist studio units, and pedestrian scale lighting.
2. Territoriality: Landscape buffers and grade changes between public and private spaces.
3. Target Hardening: Security features at all residential, artist studio, and parking entrances.

Accessible Housing

Richmond's OCP seeks to meet the needs of the city's aging population and people facing mobility challenges by encouraging the development of accessible housing that can be approached, entered, used, and occupied by persons with physical or sensory disabilities. To address the City's policy, the developer proposes to provide:

1. Barrier-free access to all common areas, indoor and outdoor amenity spaces.
2. Aging in place features in all dwellings (e.g., stairwell hand rails, lever-type handles for plumbing fixtures and door handles; and solid blocking in washroom walls to facilitate future grab bar installation (by others) beside toilets, bathtubs, and showers).
3. 32 Basic Universal Housing (BUH) units (i.e. 38% of total units) designed to satisfy all applicable Zoning Bylaw requirements, including 100% of affordable housing (11 units) and 13% of market housing (21 units).

Note: The developer proposes to use the Zoning Bylaw density exclusion of 1.86 m^2 (20 ft²) for each BUH unit provided.

Sustainability Measures

The project's sustainability goal is to provide a cost-effective, high-value development that meets or exceeds City standards (i.e. LEED "Silver" equivalent). The development proposal targets 54 LEED points and responds to City objectives for enhanced long-term environmental, fiscal, and social sustainability as per the attached LEED Checklist (Attachment 4). In brief, among other things the development will include:

1. A full building energy simulation to optimize energy efficiency measures and an enhanced commissioning process to ensure that the building's energy related systems are operating efficiently and as designed.
2. District Energy Utility (DEU) compatible building and mechanical system designs to facilitate a future connection to a City utility as secured at rezoning. The developer has agreed to construct and transfer ownership of an on-site low carbon energy plant to the City or the City's DEU service provider, Lulu Island Energy Company.

3. A solar array on the tower rooftop. The developer has agreed to register a legal agreement on Title as a Development Permit consideration, ensuring that the proposed solar panels will be installed and maintained for the life of the building. The agreement will include provisions for alternative renewable technologies to replace the solar panel installations provided that equal or better performance is achievable to the satisfaction of the Director of Development and the Director of Building Approvals.
4. Energized electric vehicle (EV) charging outlets for 100% for resident vehicle parking spaces (208V - 240V) and 10% of Class 1 (i.e. secure) bike storage (120V).
5. Low flow/flush plumbing fixtures (e.g., toilets, showers, and faucets) and a high efficiency irrigation system to reduce water usage.
6. Best practices to optimize air quality and provide a clean and healthy building for occupants.

Conclusions

The proposed development is consistent with Richmond's objectives for the subject property and Capstan Village as set out in the Official Community Plan (OCP), City Centre Area Plan (CCAP), and Zoning Bylaw. The project's distinctive form, pedestrian-oriented streetscapes, rentable-affordable-work only studio units for professional artists, affordable and basic universal housing, landscaping, and sustainable development measures, together with the developer's concurrent construction of off-site improvements secured through rezoning, will enhance the establishment of Capstan Village as a high-amenity, transit-oriented, urban community. On this basis, staff recommend that the Development Permit be endorsed and issuance by Council is recommended.

Sara Badyal

Sara Badyal
Planner 2
(604-276-4282)

SB:blg

Attachments:

Attachment 1: Location Map

Attachment 2: Development Application Data Sheet

Attachment 3: Advisory Design Panel Meeting Minutes Annotated Excerpt (January 23, 2019)


Attachment 4: LEED Checklist

Attachment 5: Development Permit Considerations



City of Richmond

ATTACHMENT 1

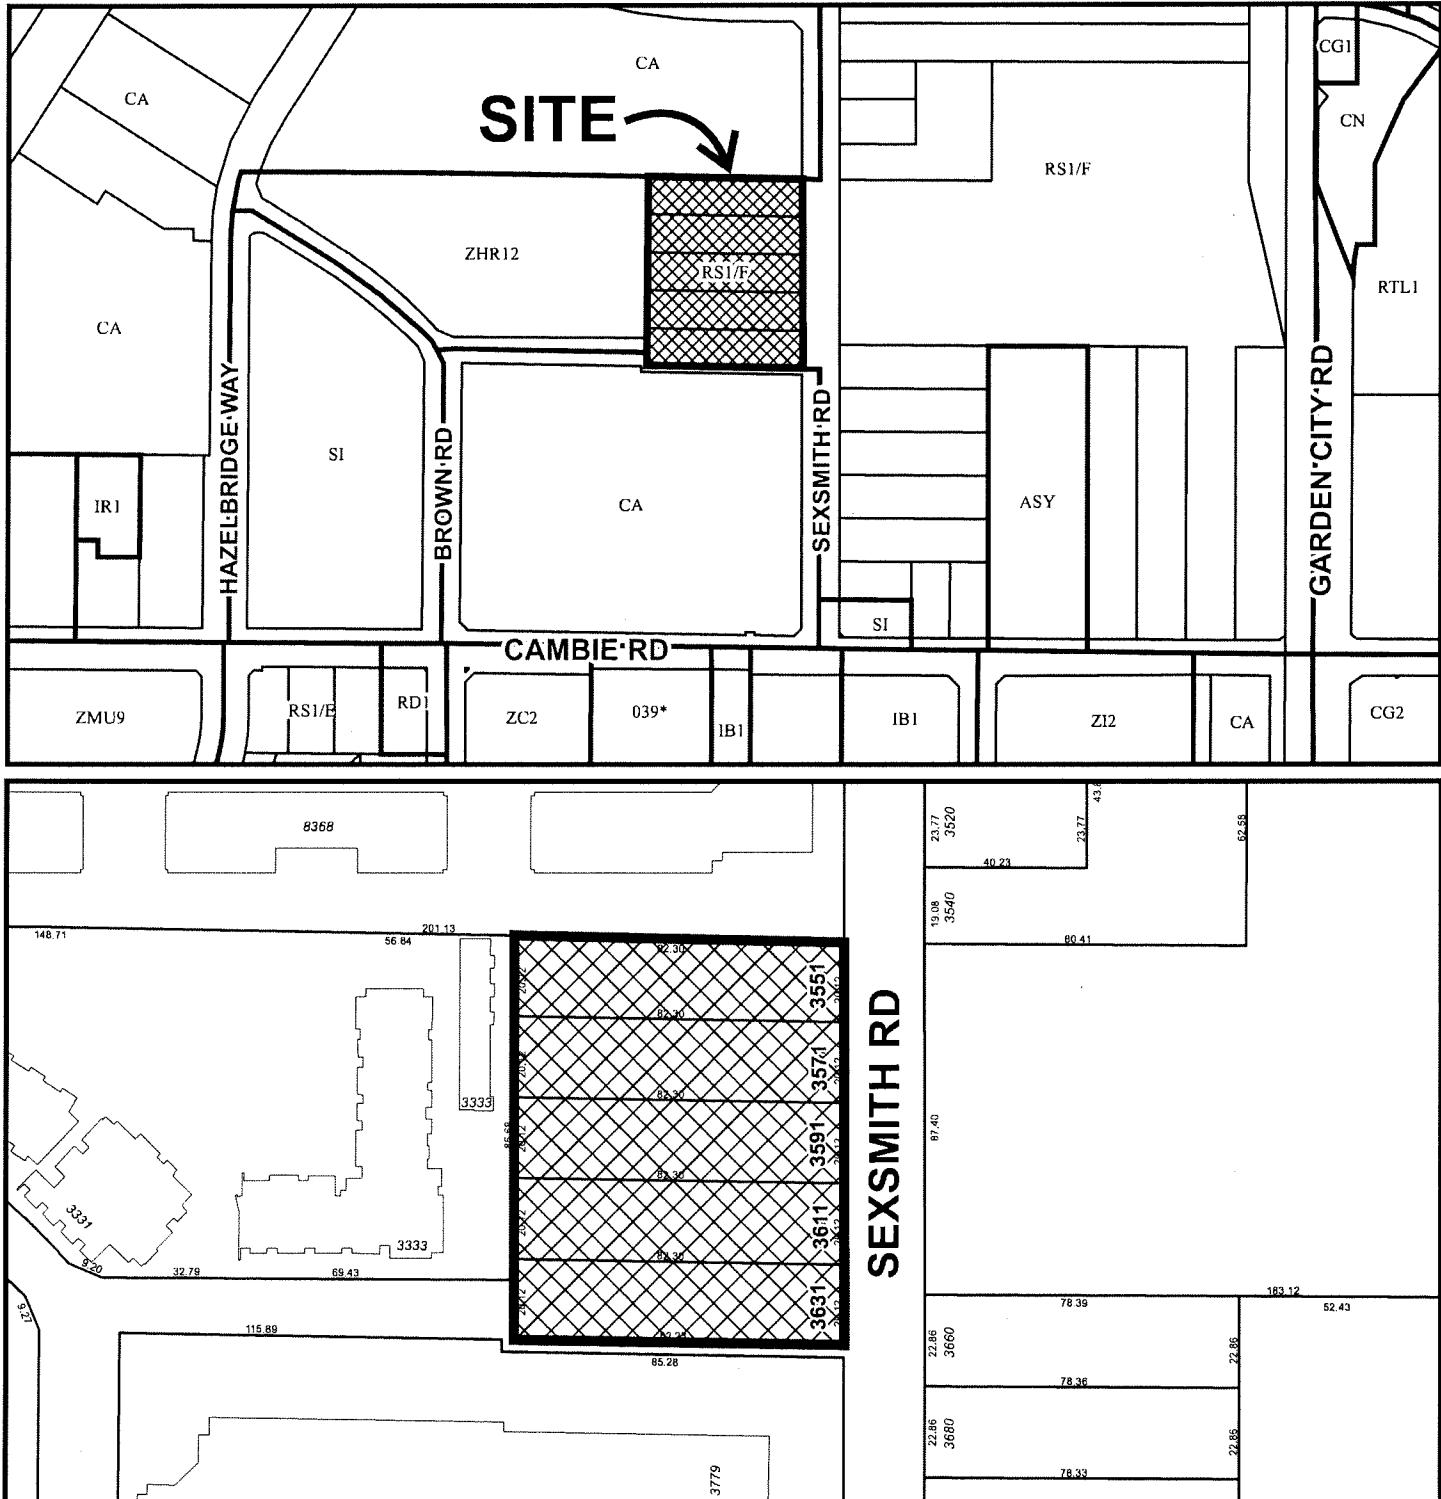

DP 18-818748

Original Date: 05/10/18

Revision Date:

Note: Dimensions are in METRES



City of Richmond

Development Application Data Sheet

Development Applications Department

DP 18-818748

Attachment 2

Address: 3551, 3571, 3591, 3611 and 3631 Sexsmith Road

Applicant: Polygon Fiorella Homes Ltd. Owner: Polygon Fiorella Homes Ltd., Inc. No. 0750635

Planning Area(s): City Centre (Capstan Village)

	Existing	Proposed
Site Area	Gross site 8,272.5 m ² (89,044.4 ft ²) Road dedications 2,035.1 m ² (21,905.6 ft ²) (includes 294.0 m ² eligible as Capstan Station Bonus public open space) Net site 6,237.4 m ² (67,138.8 ft ²)	6,237.4 m ² (67,138.8 ft ²)
Land Uses	▪ Large lot single family residential	High-rise, multi-family residential
OCP Designation	▪ Mixed Use	Complies
CCAP Designation	▪ Urban Centre T5 (35 m), allowing for additional building height ▪ Proposed Streets	Complies
Zoning	Residential/Limited Commercial (RCL4) subject to RZ 17-778835	Complies
Units	None	2 rental artist work units 168 residential units (including 11 affordable housing units)

	Bylaw Requirement	Proposed	Variance
Floor Area Ratio (max.)	2.618 FAR (with road dedication)	2.613 FAR	None permitted
Buildable Floor Area	Max. 16,328.5 m ² (175,758.5 ft ²)	16,321 m ² (175,674 ft ²), including: - Market: 15,463 m ² (95%) - Affordable: 858 m ² (5%)	None permitted
Lot Area	Min. 4,000.0 m ² (43,055.6 ft ²)	6,237.4 m ² (67,138.8 ft ²)	None
Lot Coverage	Max. 90%	90%	None
Setback – Road	3.0 m (9.8 ft.) min.	East: 3.0 m (9.8 ft.) min. South: 3.0 m (9.8 ft.) min.	None
Setback – Interior Property Line	Nil	West: 3.0 m (9.8 ft.) min. North: 0.6 m (1.9 ft.) min.	None
Setback – Projections	Balconies: 1.0 m (3.3 ft.) max. Architectural features: 0.6 m (2.0 ft.) max Weather protection: To the property line	Projections comply with required setbacks	None
Height	Max. 47 m GSC (154.2 ft.) with park area	42.5 m GSC (132.8 ft.)	None
Parking Spaces	183 total spaces with TDMs, including: 142 Market spaces 9 Affordable housing spaces 31 Visitor spaces 1 Brown Road Studios space	194 total spaces with TDMs, including: 152 Market spaces 10 Affordable Housing spaces 31 Visitor spaces 1 Brown Road Studios space	None
Parking – Accessible Spaces	Min. 2% (4 spaces)	2.6% (5 spaces)	None
Parking – Small Car Spaces	Max. 50% (96 spaces)	46% (88 spaces)	None
Off-Street Loading:	1 medium truck (SU-9) space	1 medium truck (SU-9) space	None

Bicycle Storage	214 class 1 secured bike spaces 34 class 2 bike rack spaces	214 class 1 secured bike spaces 34 class 2 bike rack spaces	None
EV (Energized) Charging for Cars	100% Market parking spaces 100% Affordable parking spaces	100% Market parking spaces 100% Affordable parking spaces	None
EV (Energized) Charging for Bikes	1 duplex (120 V) receptacle per 10 Class 1 bike spaces per bike room	1 duplex (120 V) receptacle per 10 Class 1 bike spaces per bike room	None
Amenity Space – Indoor	Min. 100 m ² (1,076 ft ²)	369 m ² (3,971 ft ²)	None
Amenity Space – Outdoor	Min. 1,008 m ² (10,850 ft ²)	1,661 m ² (17,879 ft ²)	None

**Excerpt from the Minutes from
The Design Panel Meeting**

**Wednesday, January 23, 2019 – 4:00 p.m.
Richmond City Hall**

2. DP 18-818748	One-Tower City Centre Mixed Use Development Including Two Rental Affordable Work Artist Studios
ARCHITECT:	Franci Architecture
LANDSCAPE ARCHITECT:	PWL Partnership
PROPERTY LOCATION:	3551, 3571, 3591, 3611 and 3631 Sexsmith Road

Applicant's Presentation

Walter Franci, Franci Architecture, and Bruce Hemstock, PWL Partnership, presented the project and together with Robin Glover, Polygon, answered queries from the Panel on behalf of the applicant.

Panel Discussion

Comments from Panel members were as follows:

- appreciate the applicant's presentation; like the look and feel of the development – *Noted*.
- ensure that benches to be provided have armrests to enhance accessibility for users – *Incorporated*.
- ensure that all outdoor amenity spaces are accessible, particularly the rooftop terrace on the podium indoor amenity space – *Providing elevator access to indoor amenity roof level is impractical; roof deck has been replaced with extensive green roof area*.
- appreciate the design of the project presented in a clear and legible way – *Noted*.
- provision of artist studios and the public space at the front are appropriate; appreciate the proposed programming and integrated solutions – *Noted*.
- support the proposed location of the urban agriculture garden on Level 2; consider introducing urban agriculture on the common residential outdoor amenity space on the podium adjacent to the children's play area to enable parents to do gardening while watching over their children – *Improved. A separate gardening area on the lower level with direct access to parking for loading is preferred, however an added convenience stair provides direct access between the two levels*.
- the façade design is interesting and successful; no issue with the colour choices; however, the applicant could be bolder in the amount of colours to be used on the façade, e.g. on the concrete panels, slats of wood, and materials on balconies, a splash of significant colours to the main building entrance to provide better identification – *Incorporated. The amount of colour on the residential elevations has been doubled and the range harmonized in a pink/red gradation to refer to the meaning of Fiorella ("flower" in Italian) on the residential building. The random pattern of the varying shades animates the building elevations as viewed on an angle. Colours in the teal/blue palette highlight the residential lobby and artist studios*.
- consider providing weather protection for the outdoor amenity areas of the proposed development – *Improved. A canopy projection was added at the southern end of the indoor amenity building*.
- consider removing or providing further articulation of the parkade exit door due to its visibility from the plaza – *Improved. The exit door, required by code for parkade emergency egress, has been shifted west and incorporated into the wall pattern design*.
- consider turning inward the open side of the concrete walls on three sides of the pad mounted transformer (PMT) so it will not be visible to pedestrians and cyclists – *Improved. BC Hydro stipulates the PMT must be directly accessible from the road so the south side will remain open. The other three sides are concealed by a solid retaining wall with landscape berms (3:1 slope) and access from the south is via grass paving system to visually disconnect it from the park*.
- appreciate the amount of work that the applicant has put into the development – *Noted*.

- the project is well-designed and well-programmed – **Noted**.
- appreciate the provision of artist studios in the proposed development as they animate the public space and make it more friendly; confirm the artist studios have adequate size and layout – **Considered. Artist studio area exceeds the requirement secured at rezoning.**
- proposed colours for the building do not fit well into the neighbourhood – **Noted**.
- in general, the project is good-looking and a nice addition to the area – **Noted**.
- appreciate the amount of planting on the podium; however, the applicant is advised to coordinate effectively with the mechanical and structural engineers to make the proposed landscaping work in detail – **Considered and will be addressed through ongoing consultant coordination.**
- consider installing more benches at the periphery of the shared open space, with some of them covered or shaded by trees – **Additional seating with arm rests were added.**
- appreciate the presentation and the model – **Noted**.
- support the proposed green roofs; nice to see – **Noted**.
- investigate opportunities for providing a common area and/or facilities on the third floor to encourage residents of three-storey townhouse units to use their large decks – **The podium patios of the three-storey townhomes are directly accessible from common areas within the townhomes to allow all occupants to easily enjoy both the townhome patio as well as the shared outdoor amenity.**
- investigate opportunities to provide more visual interest around the artist studio plaza; consider opportunities to make the artist studios more visually prominent and to provide separation privacy to residential units above – **Improved. The plaza paving has been differentiated from that of the park, highlighting the artist studios. Additional electrical receptacles and lighting rails have been added to building columns to facilitate lighting and amplification during special events. Bike racks have been relocated and overhead doors added to allow for better indoor-outdoor interaction.**
- appreciate the sun exposure and amount of planting adjacent to the public open space plaza; consider more connections and more open space around the lobby entry which are not all garden; look at potential maintenance issues for gardens that are deep – **Considered. The approach to the residential lobby is distinct from the artist studio plaza and includes landscaped mounds, seating, and bike storage.**
- consider bringing the colour of the building into the basalt-like brick wall, such as illuminating at night or integrating interesting elements to create a more dynamic civic space and encourage public engagement to it – **Improved. The design of the wall has evolved into three patterns of brick that emulate the arrangement of abalone and grey concrete panels in the residential elevations. Some brick panels sit proud of adjacent panels to create shadows and visual interest while providing a calm background to the park.**
- agree with Panel comment to make the artist studios more prominent; consider spilling out of the artist studios into the plaza; consider opening up the whole façade of the artist studios through installing a garage door or sliding door – **Overhead garage doors incorporated.**
- review artist studios to confirm meeting storefront and private working space needs – **Considered with other ADP comment related to artist studios and addressed as noted above.**
- consider the feature wall to the west of the artist studios opportunity to be programmed as an exhibition space – **Considered. The area to the west of the artist studio is a separate SRW with a character that is related to but distinct from the artist studio plaza. As such, the wall will have a direct relationship with the park and design finalized through the required Servicing Agreement secured at rezoning.**
- consider clearly delineating the space on the mews to separate vehicular access to the parkade from pedestrian space for going into the townhouses – **Considered. The mews is paved with pavers of the same colour to retain unity and pedestrian priority rather than emphasizing vehicle traffic and bollards provide pedestrian safety separation.**
- recessed space north of the main building entrance appears dark and hidden; investigate opportunities for treating the north face of the vestibules to open up the recessed space towards the north; consider relocating the bicycle racks from the artist studio frontage to the recessed space to make the space usable and free up the storefront of the artist studios – **Considered. The north wall of the vestibule is opaque to support**

enterphone and annunciator panel functions. Some bike racks have been relocated to the landscaped area immediately to the north of the vestibule entry.

- review whether the type 5 studio units on the upper floors located at the inner elbow spot of the larger high-rise building will receive sufficient daylight – **Reviewed. The Type 5 studios have 13' of horizontal window wall which is consistent with similar conditions at other developments.**
- in general, the project is beautiful – **Noted.**
- appreciate the project; a good solution to the site in terms of massing; appreciate the strength of the tower portion of the massing which has been torqued all the way around the corner – **Noted.**
- consider limiting the use of colours but consistent and deliberate – **Considered with other ADP comments related to colour and addressed as noted above.**
- the terracing of the outdoor amenity spaces and stepping down south is a strong expression of the project; consider continuing this expression down to the ground level; also consider connecting the decks – **Considered. During the early rezoning stage the design team explored connecting the terracing to the urban garden park. The separation of the two areas addresses issues of public versus private separation.**
- appreciate the presentation; also appreciate the shape and form of the project, the extensions, the setbacks, and use of solar shading panels; glass-to-wall ratio is appropriate – **Noted.**
- appreciate the project's sustainability features, e.g. use of solar PV panels, future connection to the City's District Energy System, and LEED silver equivalency; consider using heat recovery ventilators as they are more cost-effective and generate savings in terms of energy cost to building users – **Incorporated.**
- slab thickness on level 2 (shown in the building sections) gives rise to ceiling height questions, e.g., with respect to the washrooms above and plumbing; design team needs to look into this – **Considered. The thicker Level 2 slab occurs within storage areas on that floor and not within residential suites.**
- appreciate the applicant contributing to the City's Public Art Fund – **Noted.**
- appreciate the project and its presentation to the Panel – **Noted.**
- the brick wall facing the urban garden on the south side near Sexsmith Road is monolithic and not pedestrian-scaled; consider reducing the scale and make it more pedestrian-oriented through introducing another brick texture, colour, or banding patterns – **Considered with other ADP comments related to brick wall and addressed as noted above.**
- proposed massing and articulation of townhouses in terms of separating them from the larger building is successful; however, consider further breaking down the massing through further articulation of the individual units to better differentiate/distinguish each unit – **Improved. In order to articulate individual townhomes, each front entry door will receive a different shade of pink from the project colour palette, a recessed vertical band of black brick will define the extent of each home, and address plaques provided.**
- consider accentuating the use of colour accents or spandrel glass accent on the artist studio units to better differentiate/distinguish the artist studio units from the rest of the development – **Incorporated.**
- proposed colours could be muted/toned down and colour contrasts could be lessened to match the overall colour choices for the rest of the building – **Considered with other ADP comments related to colour and addressed as noted above.**

Panel Decision

It was moved and seconded

That DP 18-818748 be supported to move forward to the Development Permit Panel subject to the applicant giving consideration to the comments of the Advisory Design Panel.

CARRIED

Scorecard

Note: The information on this tab is READ-ONLY. To edit this information, see the Credit Category tabs.



Integrative Process

Preliminary Y 2 of 2 VI 1 Verified 0

IPc Integrative Process 2 of 2 VI 1



Location and Transportation

Preliminary Y 15 of 15 VI 1 Verified 0

LTp Floodplain Avoidance Required Not Verified

Performance Path

LTC LEED for Neighborhood Development 0 of 15 0

Prescriptive Path

LTC Site Selection 8 of 8 1

LTC Compact Development 3 of 3 0

LTC Community Resources 2 of 2 0

LTC Access to Transit 2 of 2 0



Sustainable Sites

Preliminary Y 3 of 7 VI 2 Verified 0

SSp Construction Activity Pollution Prevention Required Not Verified

SSp No Invasive Plants Required Not Verified

SSc Heat Island Reduction 0 of 2 1

SSc Rainwater Management 1 of 3 1

SSc Nontoxic Pest Control 2 of 2 0



Water Efficiency

Preliminary Y 5 of 12 VI 1 Verified 0

WEp Water Metering Required Not Verified

Performance Path

WEc Total Water Use 0 of 12 0

Prescriptive Path

WEc Indoor Water Use 3 of 6 0

WEc Outdoor Water Use 2 of 4 1



Energy and Atmosphere

Preliminary Y 12.5 of 37 VI 0 Verified 0

EAp Minimum Energy Performance Required Not Verified

EAp Energy Metering Required Not Verified

EAp Education of the Homeowner, Tenant or Building Manager Required Not Verified

EAc Annual Energy Use 12.5 of 30 0

EAc Efficient Hot Water Distribution System 0 of 5 0

EAc Advanced Utility Tracking 0 of 2 0



Materials and Resources

Preliminary Y 4 of 9 VI 1.5 Verified 0

MRp	Certified Tropical Wood	Required	Not Verified
MRp	Durability Management	Required	Not Verified
MRC	Durability Management Verification	1 of 1	0
MRC	Environmentally Preferable Products	1 of 5	1.5
MRC	Construction Waste Management	2 of 3	0



Indoor Environmental Quality

Preliminary Y 8 of 18 VI 2.5 Verified 0

EQp	Ventilation	Required	Not Verified
EQp	Combustion Venting	Required	Not Verified
EQp	Garage Pollutant Protection	Required	Not Verified
EQp	Radon-Resistant Construction	Required	Not Verified
EQp	Air Filtering	Required	Not Verified
EQp	Environmental Tobacco Smoke	Required	Not Verified
EQp	Compartmentalization	Required	Not Verified
EQc	Enhanced Ventilation	1 of 3	2
EQc	Contaminant Control	1 of 2	0
EQc	Balancing of Heating and Cooling Distribution Systems	1 of 3	0
EQc	Enhanced Compartmentalization	0 of 3	0
EQc	Combustion Venting	2 of 2	0
EQc	Enhanced Garage Pollutant Protection	1 of 1	0
EQc	Low-Emitting Products	2 of 3	0.5
EQc	No Environmental Tobacco Smoke	0 of 1	0



Innovation

Preliminary Y 1 of 6 VI 0 Verified 0

INp	Preliminary Rating	Required	Not Verified
INc	Innovation	0 of 5	0
INc	LEED Accredited Professional	1 of 1	0



Regional Priority

Preliminary Y 4 of 4 VI 0 Verified 0

RPc	Regional Priority	4 of 4	0
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Point Floors

The project earned at least 8 points total in Location and Transportation and Energy and Atmosphere

No

The project earned at least 3 points in Water Efficiency

No

The project earned at least 3 points in Indoor Environmental Quality

No

Total

Preliminary Y 54.5 of 110 VI 9 Verified 0

Certification Thresholds Certified: 40-49, Silver: 50-59, Gold: 60-79, Platinum: 80-110



**City of
Richmond**

Development Permit Considerations

Development Applications Department
6911 No. 3 Road, Richmond, BC V6Y 2C1

Address: 3551, 3571, 3591, 3611, and 3631 Sexsmith Road

File No.: DP 18-818748

Prior to Development Permit issuance, the developer is required to complete the following:

1. Granting of an approximately 0.63 m wide·49.3 m² (531 ft²) statutory right-of-way for the purposes of public rights-of-passage along the entire north property line. The intent of the right-of-way is to accommodate future redevelopment of the adjacent property construction access and coordination of closing off the area on the subject site between the proposed building and future neighbouring development. The works are to be built by the developer and are to be maintained by the owner. The design must be prepared in accordance with good engineering practice with the objective to optimize public safety and after completion of the works, the Owner is required to provide a certificate of inspection for the works, prepared and sealed by the Owner's Engineer in a form and content acceptable to the City, certifying that the works have been constructed and completed in accordance with the accepted design. Works to be secured via Development Permit.
2. Solar Array: Registration of an agreement on Title, prior to bylaw adoption, ensuring that the proposed solar panels will be installed to the satisfaction of the Director of Building Approvals, maintained for the life of the building and will not be removed without City approval. The agreement will include provisions for alternative renewable technologies to replace the solar panel installations provided that equal or better performance is achievable to the satisfaction of the Director of Development and the Director of Building Approvals.
3. Rezoning Legal Agreements: Satisfy the terms of legal agreements registered on Title prior to rezoning adoption (RZ 17-77835) with respect to the development's Development Permit (e.g. Brown Road Plaza, mid-block mews walkway and driveway, Brown Road Studios rental artist work units, affordable housing low end market rental units, electric vehicle charging infrastructure, and Servicing Agreements).
4. Receipt of a Letter-of-Credit for landscaping in the amount of \$557,691.00.

Prior to Building Permit* issuance, the developer is required to complete the following:

1. Legal Agreements: Satisfy the terms of legal agreements registered on Title prior to rezoning adoption (RZ 17-77835) and Development Permit approval (DP 18-818748) with respect to the development's Building Permit*.
2. Accessibility: Incorporation of accessibility measures in Building Permit plans as determined via the Rezoning and/or Development Permit processes.
3. Construction Traffic Management Plan*: Submission of a construction traffic and parking management plan to the satisfaction of the City's Transportation Department (<http://www.richmond.ca/services/ttp/special.htm>).
4. If applicable, payment of latecomer agreement charges, plus applicable interest associated with eligible latecomer works.
5. Construction Hoarding: Obtain a Building Permit* for any construction hoarding. If construction hoarding is required to temporarily occupy a public street, the air space above a public street, or any part thereof, additional City approvals and associated fees may be required as part of the Building Permit. For additional information, contact the Building Approvals Department at 604-276-4285.

Note:

- * This requires a separate application.
- Where the Director of Development deems appropriate, the preceding agreements are to be drawn not only as personal covenants of the property owner but also as covenants pursuant to Section 219 of the Land Title Act.
All agreements to be registered in the Land Title Office shall have priority over all such liens, charges and encumbrances as is considered advisable by the Director of Development. All agreements to be registered in the Land Title Office shall, unless the Director of Development determines otherwise, be fully registered in the Land Title Office prior to enactment of the appropriate bylaw.

The preceding agreements shall provide security to the City including indemnities, warranties, equitable/rent charges, letters of credit and withholding permits, as deemed necessary or advisable by the Director of Development. All agreements shall be in a form and content satisfactory to the Director of Development.

- Additional legal agreements, as determined via the subject development's Servicing Agreement(s) and/or Development Permit(s), and/or Building Permit(s) to the satisfaction of the Director of Engineering may be required including, but not limited to, site investigation, testing, monitoring, site preparation, de-watering, drilling, underpinning, anchoring, shoring, piling, pre-loading, ground densification or other activities that may result in settlement, displacement, subsidence, damage or nuisance to City and private utility infrastructure.
- Applicants for all City Permits are required to comply at all times with the conditions of the Provincial Wildlife Act and Federal Migratory Birds Convention Act, which contain prohibitions on the removal or disturbance of both birds and their nests. Issuance of Municipal permits does not give an individual authority to contravene these legislations. The City of Richmond recommends that where significant trees or vegetation exists on site, the services of a Qualified Environmental Professional (QEP) be secured to perform a survey and ensure that development activities are in compliance with all relevant legislation.

Signed copy on file

Signed

Date



City of Richmond

Development Permit

No. DP 18-818748

To the Holder: POLYGON FIORELLA HOMES LTD.

Property Address: 3551, 3571, 3591, 3611 AND 3631 SEXSMITH ROAD

Address: C/O ROBIN GLOVER
900 - 1333 WEST BROADWAY
VANCOUVER, BC V4H 4C2

1. This Development Permit is issued subject to compliance with all of the Bylaws of the City applicable thereto, except as specifically varied or supplemented by this Permit.
2. This Development Permit applies to and only to those lands shown cross-hatched on the attached Schedule "A" and any and all buildings, structures and other development thereon.
3. Subject to Section 692 of the Local Government Act, R.S.B.C.: buildings and structures; off-street parking and loading facilities; roads and parking areas; and landscaping and screening shall be constructed generally in accordance with Plans #1 to #45 attached hereto.
4. Sanitary sewers, water, drainage, highways, street lighting, underground wiring, and sidewalks, shall be provided as required.
5. As a condition of the issuance of this Permit, the City is holding the security in the amount of \$557,691.00 to ensure that development is carried out in accordance with the terms and conditions of this Permit. Should any interest be earned upon the security, it shall accrue to the Holder if the security is returned. The condition of the posting of the security is that should the Holder fail to carry out the development hereby authorized, according to the terms and conditions of this Permit within the time provided, the City may use the security to carry out the work by its servants, agents or contractors, and any surplus shall be paid over to the Holder. Should the Holder carry out the development permitted by this permit within the time set out herein, the security shall be returned to the Holder. The City may retain the security for up to one year after inspection of the completed landscaping in order to ensure that plant material has survived.
6. If the Holder does not commence the construction permitted by this Permit within 24 months of the date of this Permit, this Permit shall lapse and the security shall be returned in full.

Development Permit
No. DP 18-818748

To the Holder: POLYGON FIORELLA HOMES LTD.

Property Address: 3551, 3571, 3591, 3611 AND 3631 SEXSMITH ROAD

Address: C/O ROBIN GLOVER
900 - 1333 WEST BROADWAY
VANCOUVER, BC V4H 4C2

7. The land described herein shall be developed generally in accordance with the terms and conditions and provisions of this Permit and any plans and specifications attached to this Permit which shall form a part hereof.

This Permit is not a Building Permit.

AUTHORIZING RESOLUTION NO.
DAY OF ,


ISSUED BY THE COUNCIL THE

DELIVERED THIS DAY OF ,

MAYOR



City of Richmond

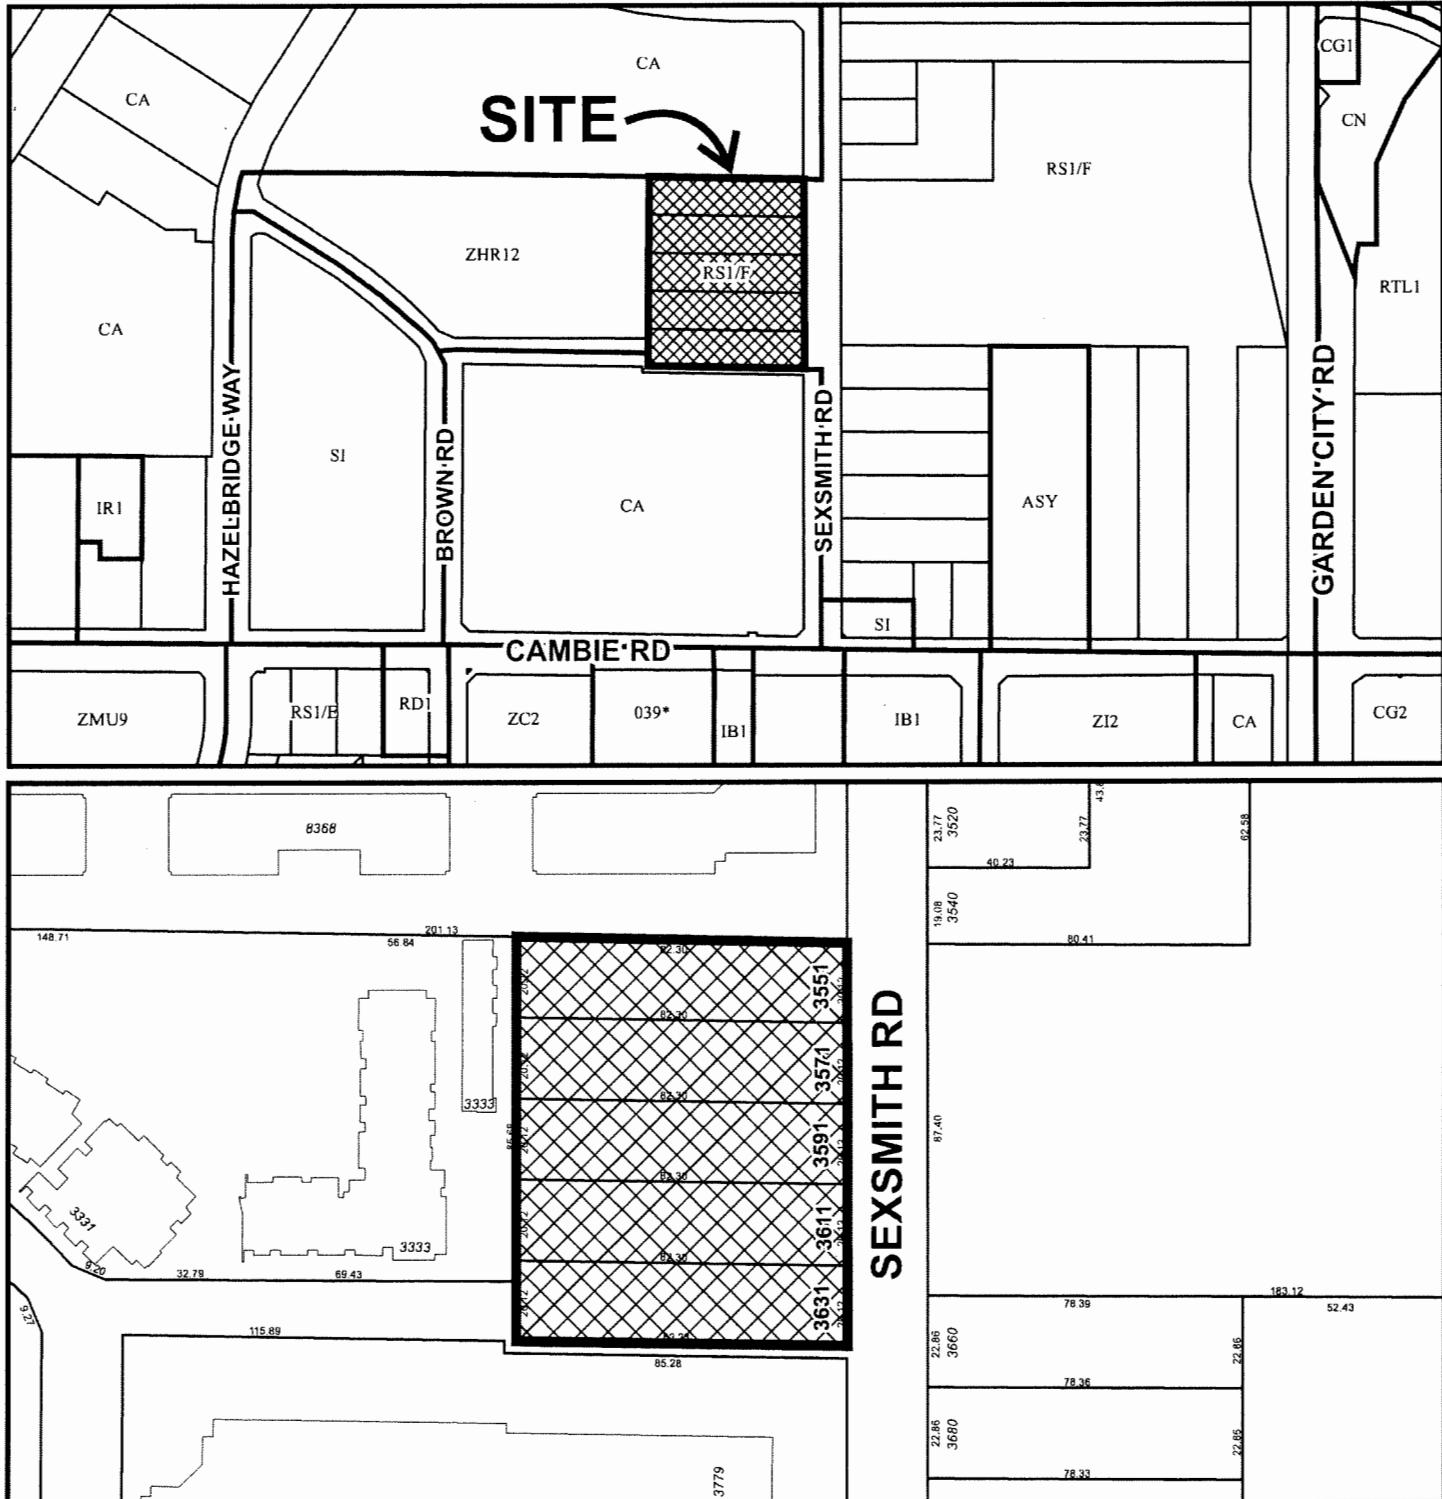

DP 18-818748
SCHEDULE "A"

Original Date: 05/10/18

Revision Date:


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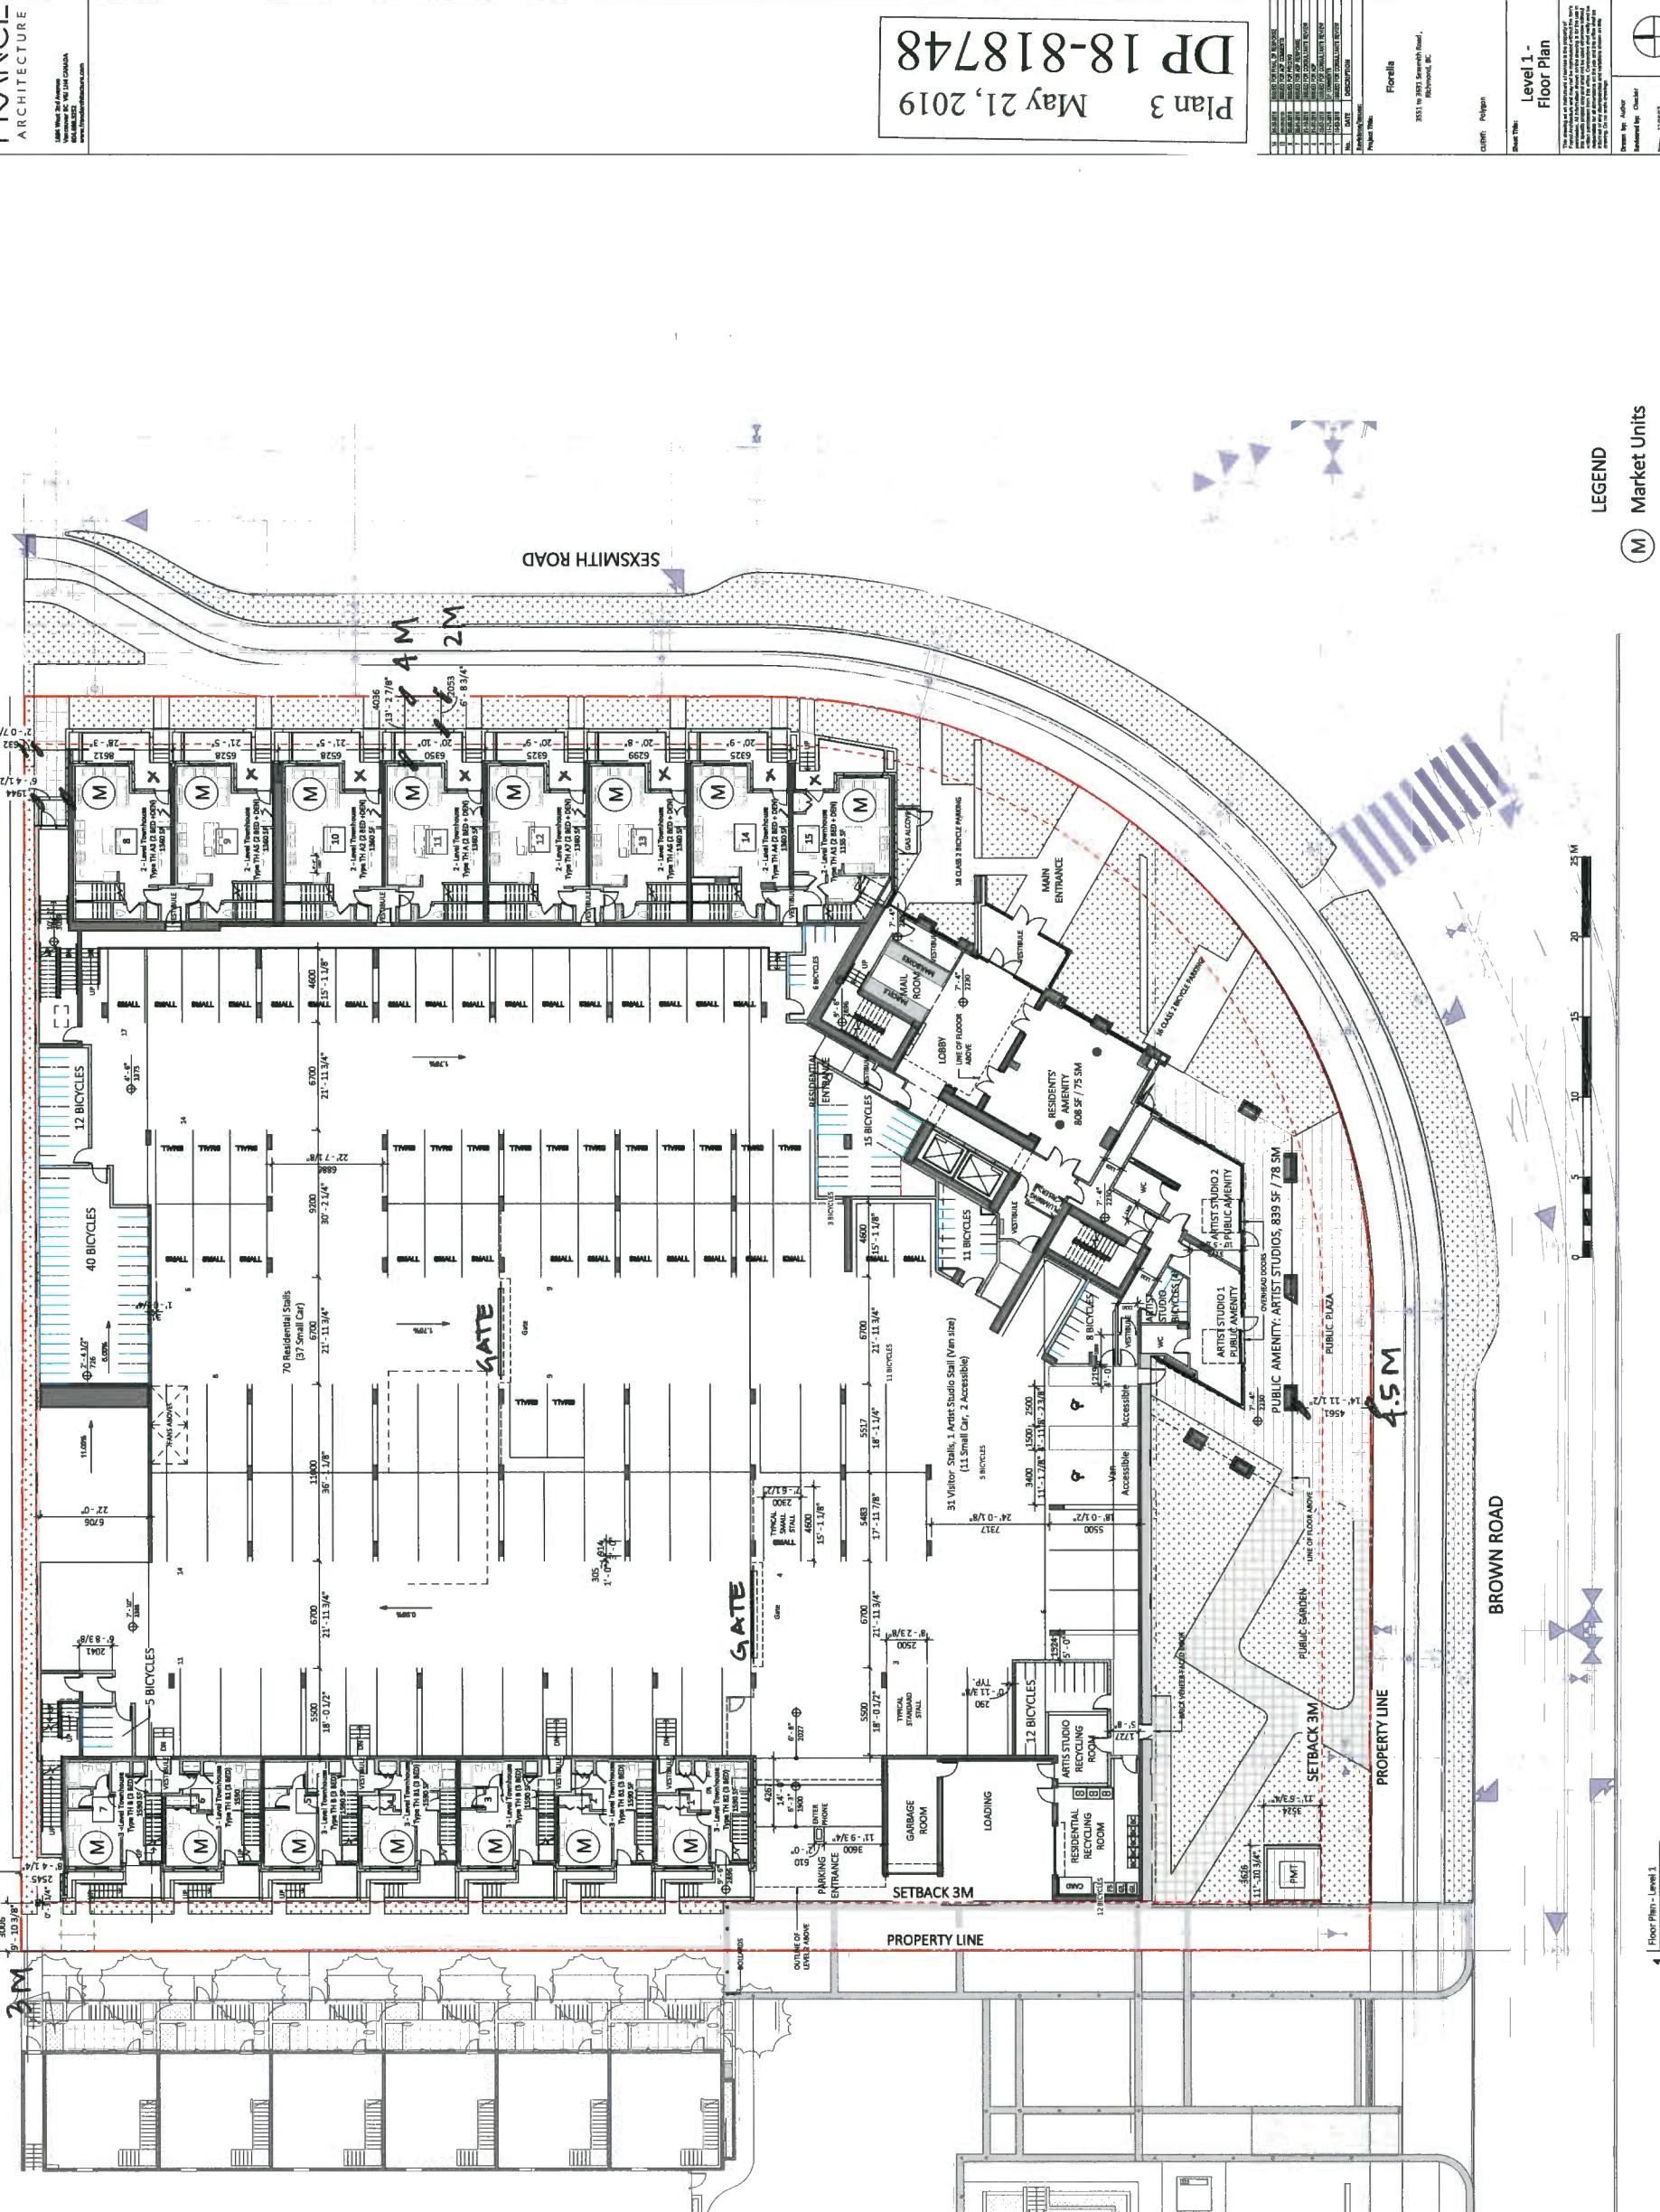
Statistics**Florella**

Architect:

None

None</

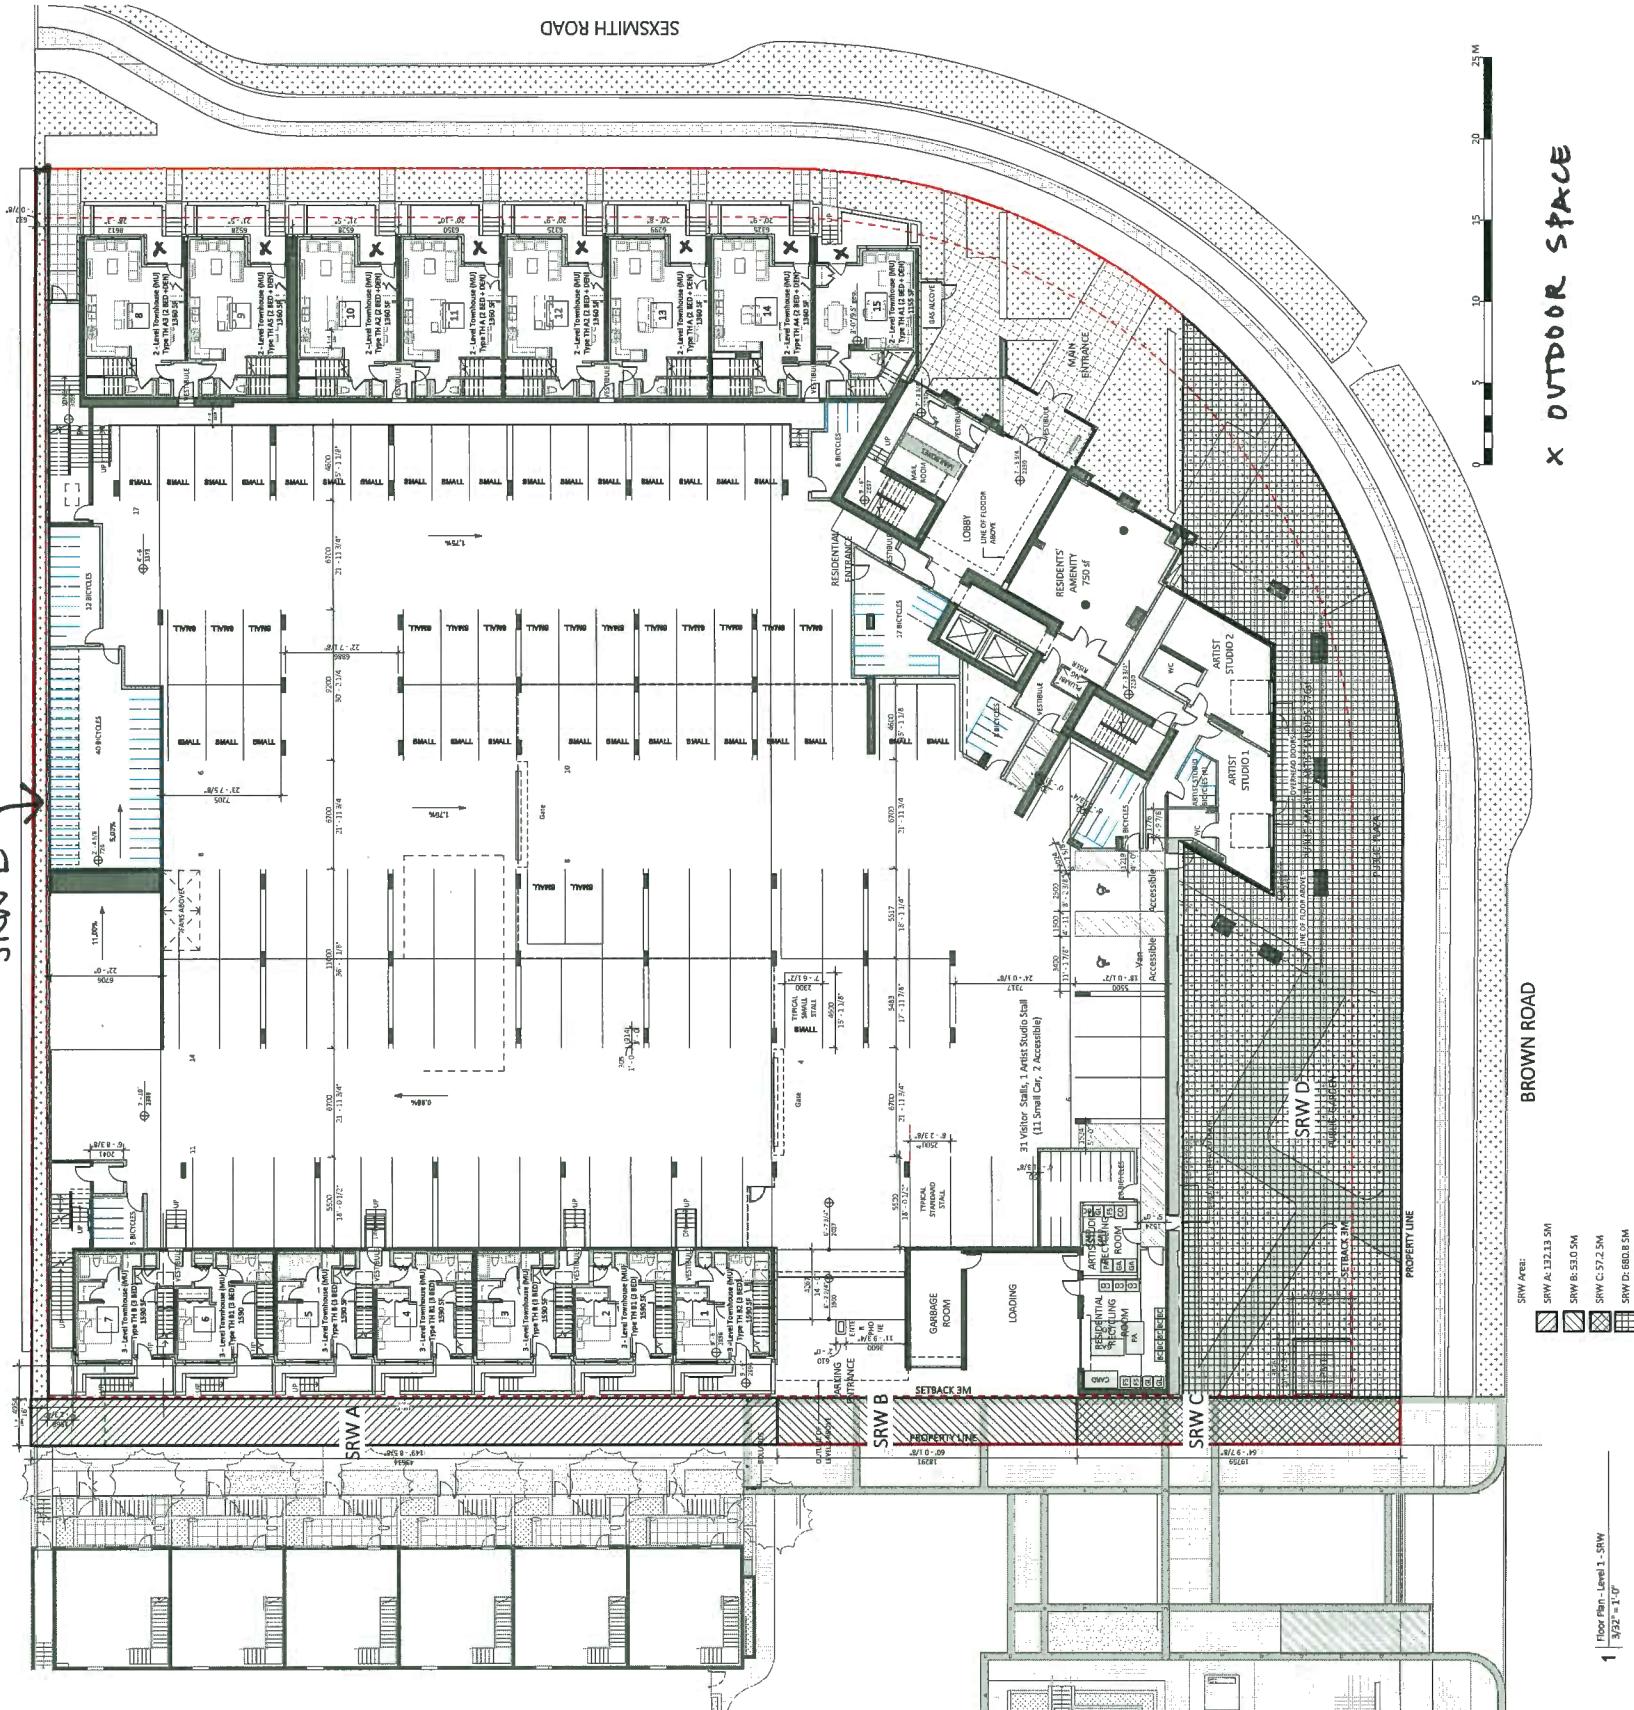


Floor Plan - Level 1
3/32" = 1'-0"

- LEGEND**
- (M) Market Units
 - (A) Basic Universal Housing Units Affordable
 - (U) Basic Universal Housing Units
 - (X) OUTDOOR SPACE


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Project Name:	Fionna
Architect:	3003 1361 Searchwood, IC
Draft by Author:	Reinhardt, KC
Date:	04/20/19
Graphic Scale:	1:1000
Sheet No.:	A-012
Project No.:	21723





1 Floor Plan - Level 3
3/32" = 1'-0"

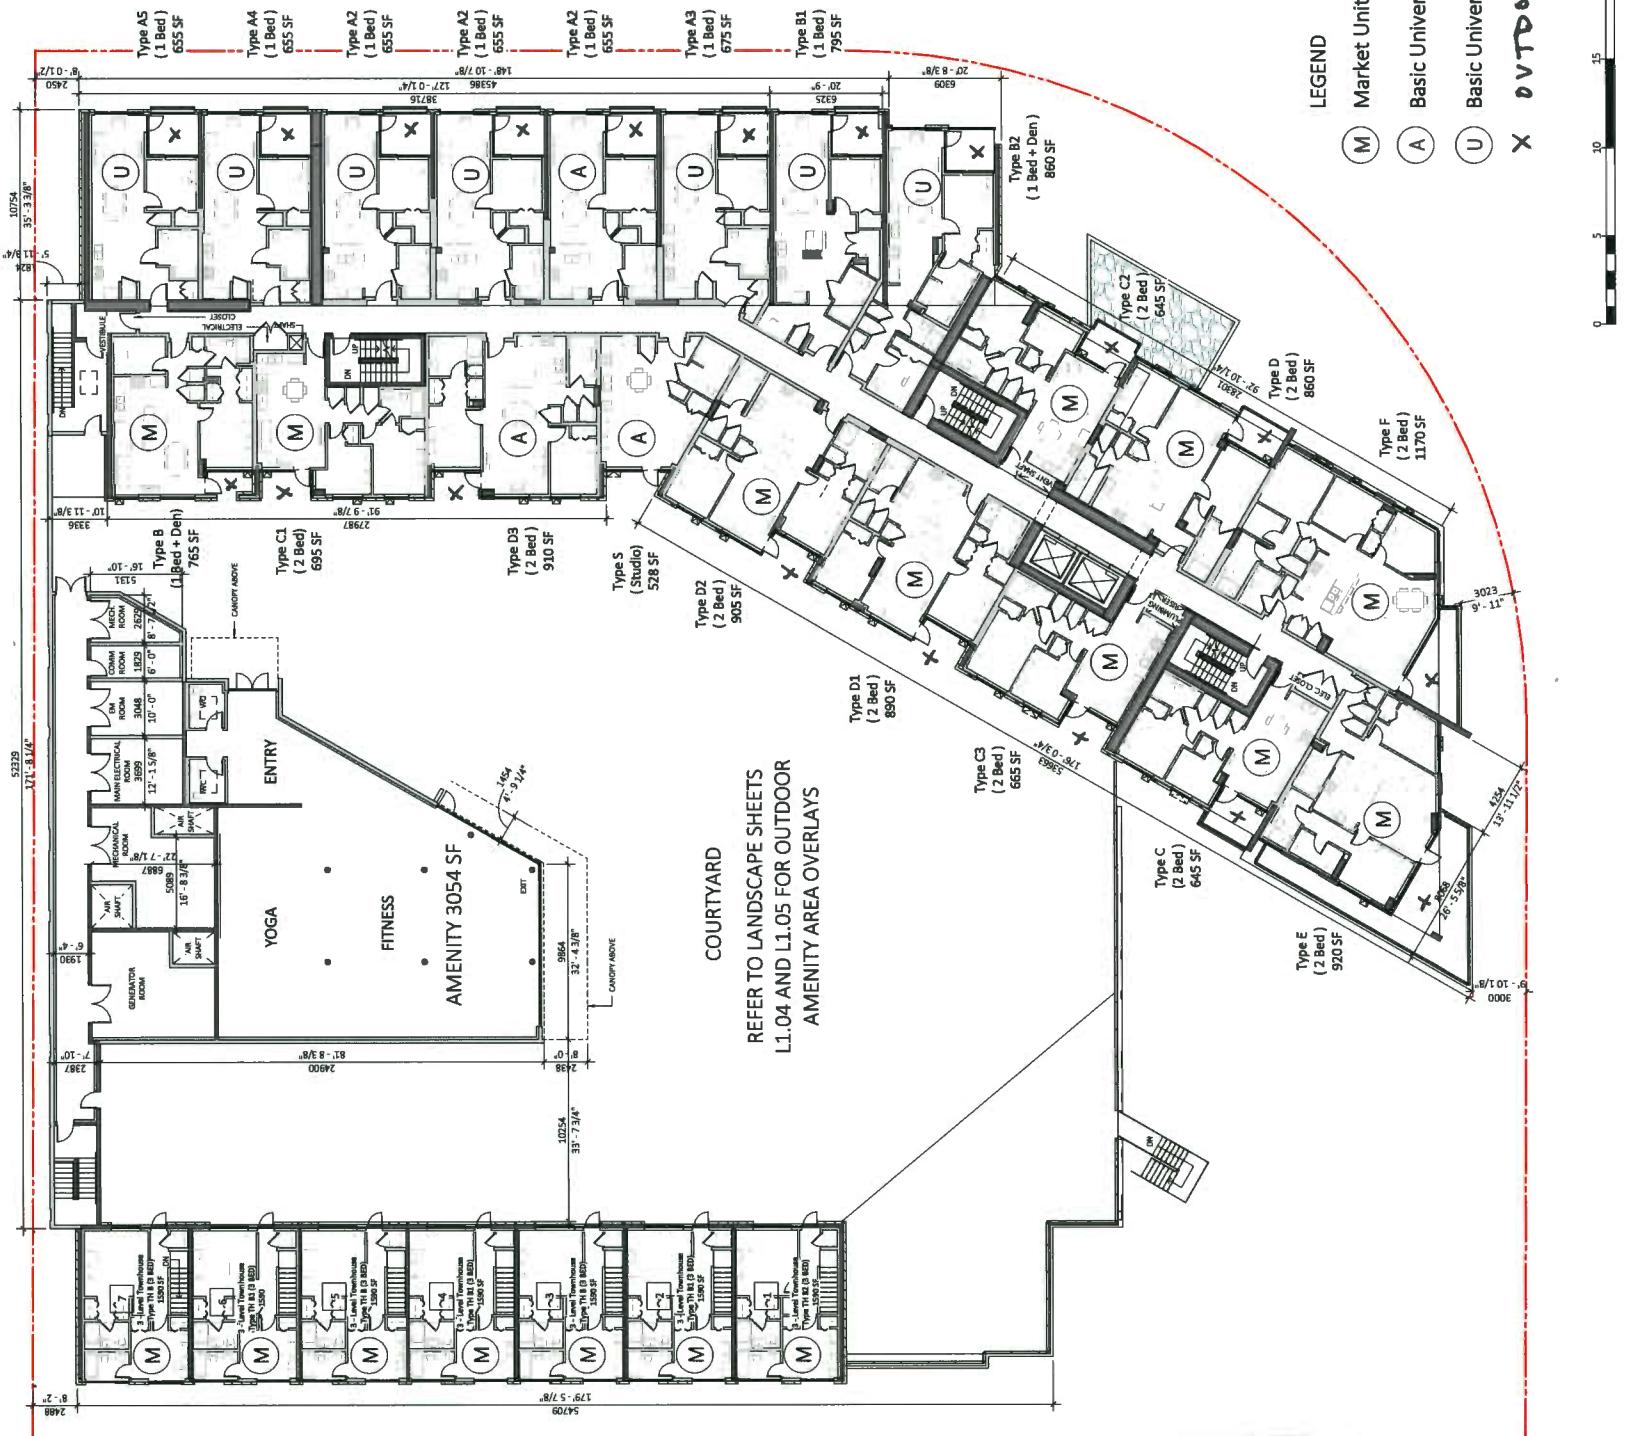



1 | Floor Plan - Levels 4-8
3/32" = 1'-0"

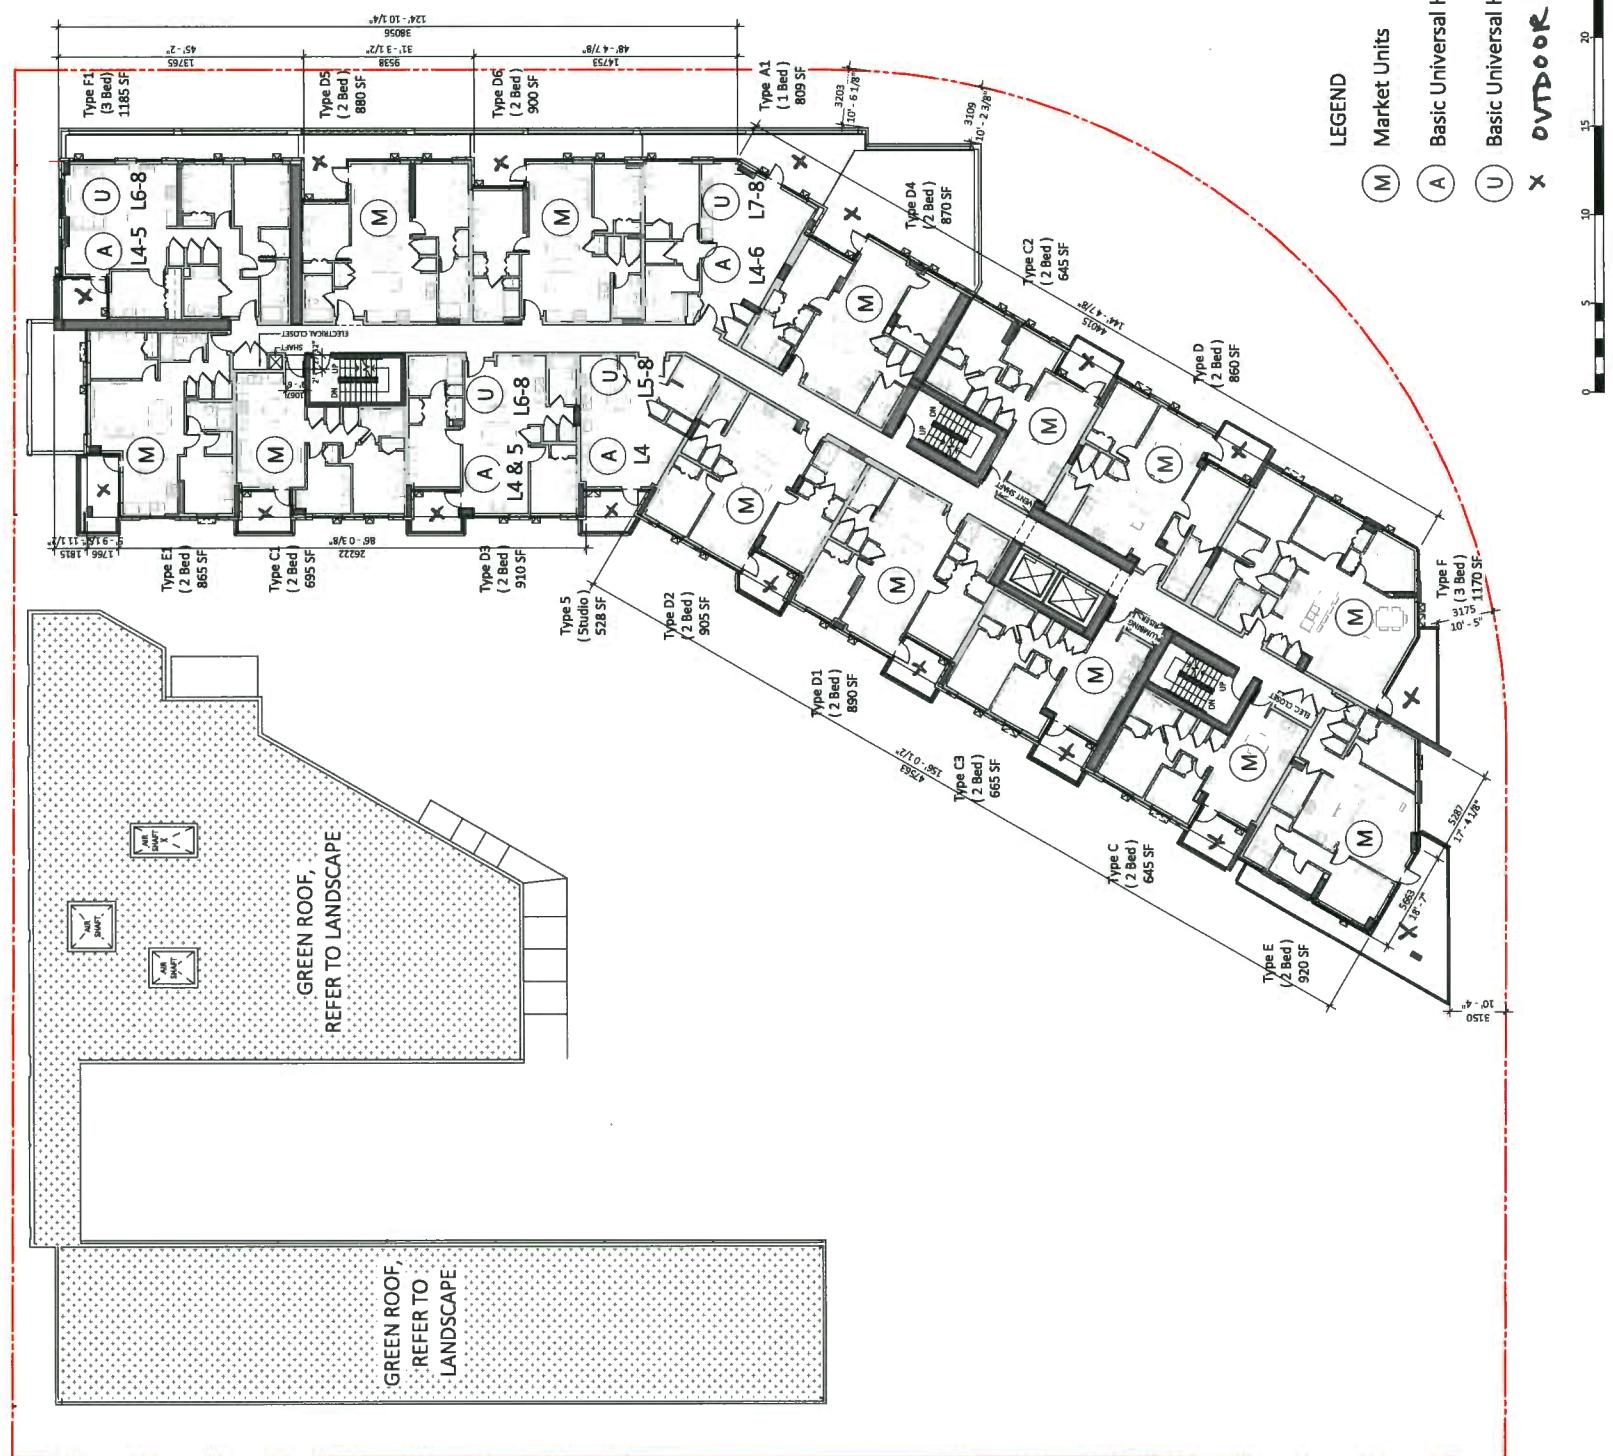Level 4-8 - Floor Plan	
Sheet Title:	Floor Plan
Sheet No.:	8651-1011, Growth Road, Richmond, BC
Drawn By:	Project Leader
Revised By:	Check
Date:	04/03/19
English Scale:	1:100
Project Name:	Ricella
Comments:	Project Name: Ricella Address: 8651-1011, Growth Road, Richmond, BC Drawing No.: 8651-1011 Revised By: Check Date: 04/03/19 English Scale: 1:100
Approved/Initials:	
Reviewed/Initials:	
Supervised/Initials:	
Drawn By:	
Revised By:	
Date:	
English Scale:	
Project No.:	A-013
Comments:	

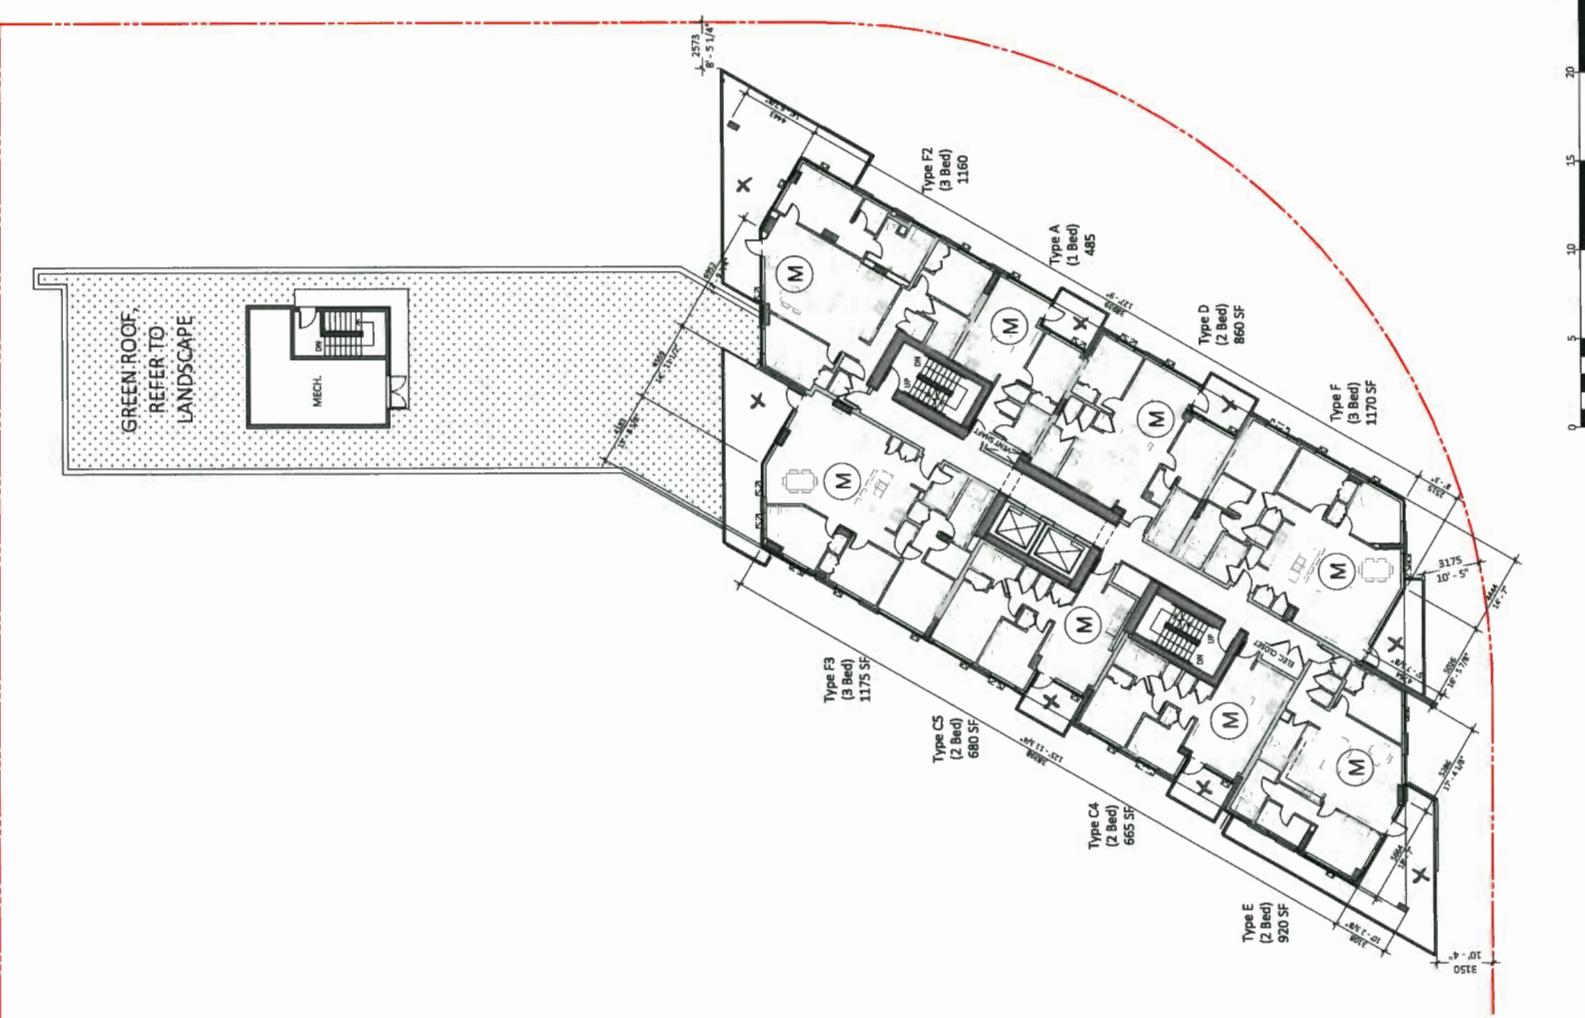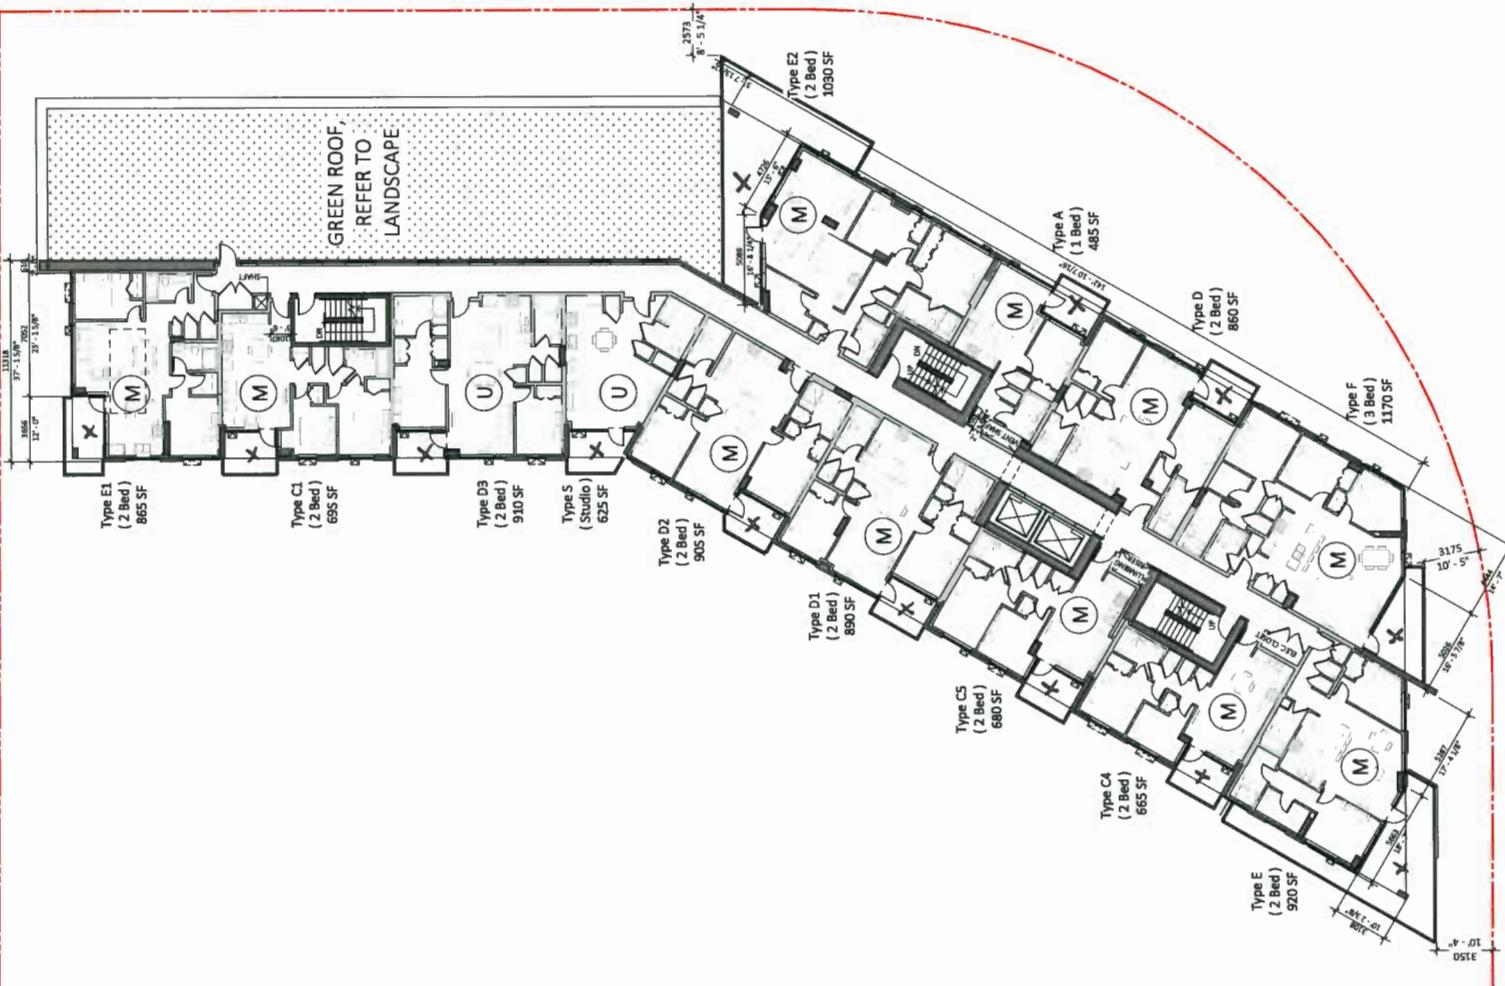
DP 18-818748
Plan 7 May 21, 20192 | Floor Plan - Levels 10-13
3/32" = 1'-0"1 | Floor Plan - Level 9
3/32" = 1'-0"

Project Name	Florella
Address/Location	3051 N. Bell Street, Room 100, Richardson, TX
Drawn By / Author	Rehman Syed
Reviewed By / Checker	
Date Drawn	05/21/2019
Comments	
Printed By	
Printed Date	
Project No.	A-014
Page No.	2/2

Project Name	Florella
Address/Location	3051 N. Bell Street, Room 100, Richardson, TX
Drawn By / Author	Rehman Syed
Reviewed By / Checker	
Date Drawn	05/21/2019
Comments	
Printed By	
Printed Date	
Project No.	A-014
Page No.	2/2

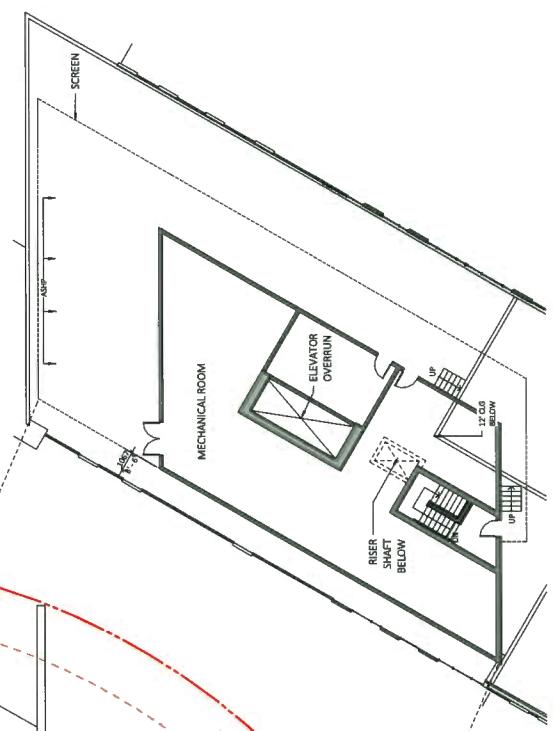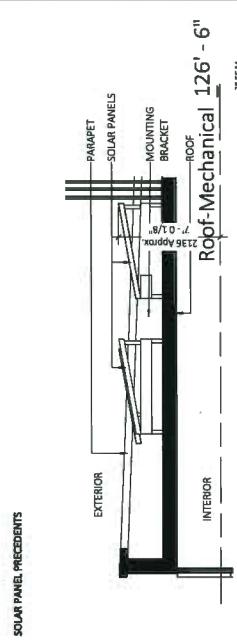DP 18-818748
Plan 8 May 21, 2019

0 5 10 15 20 25 M

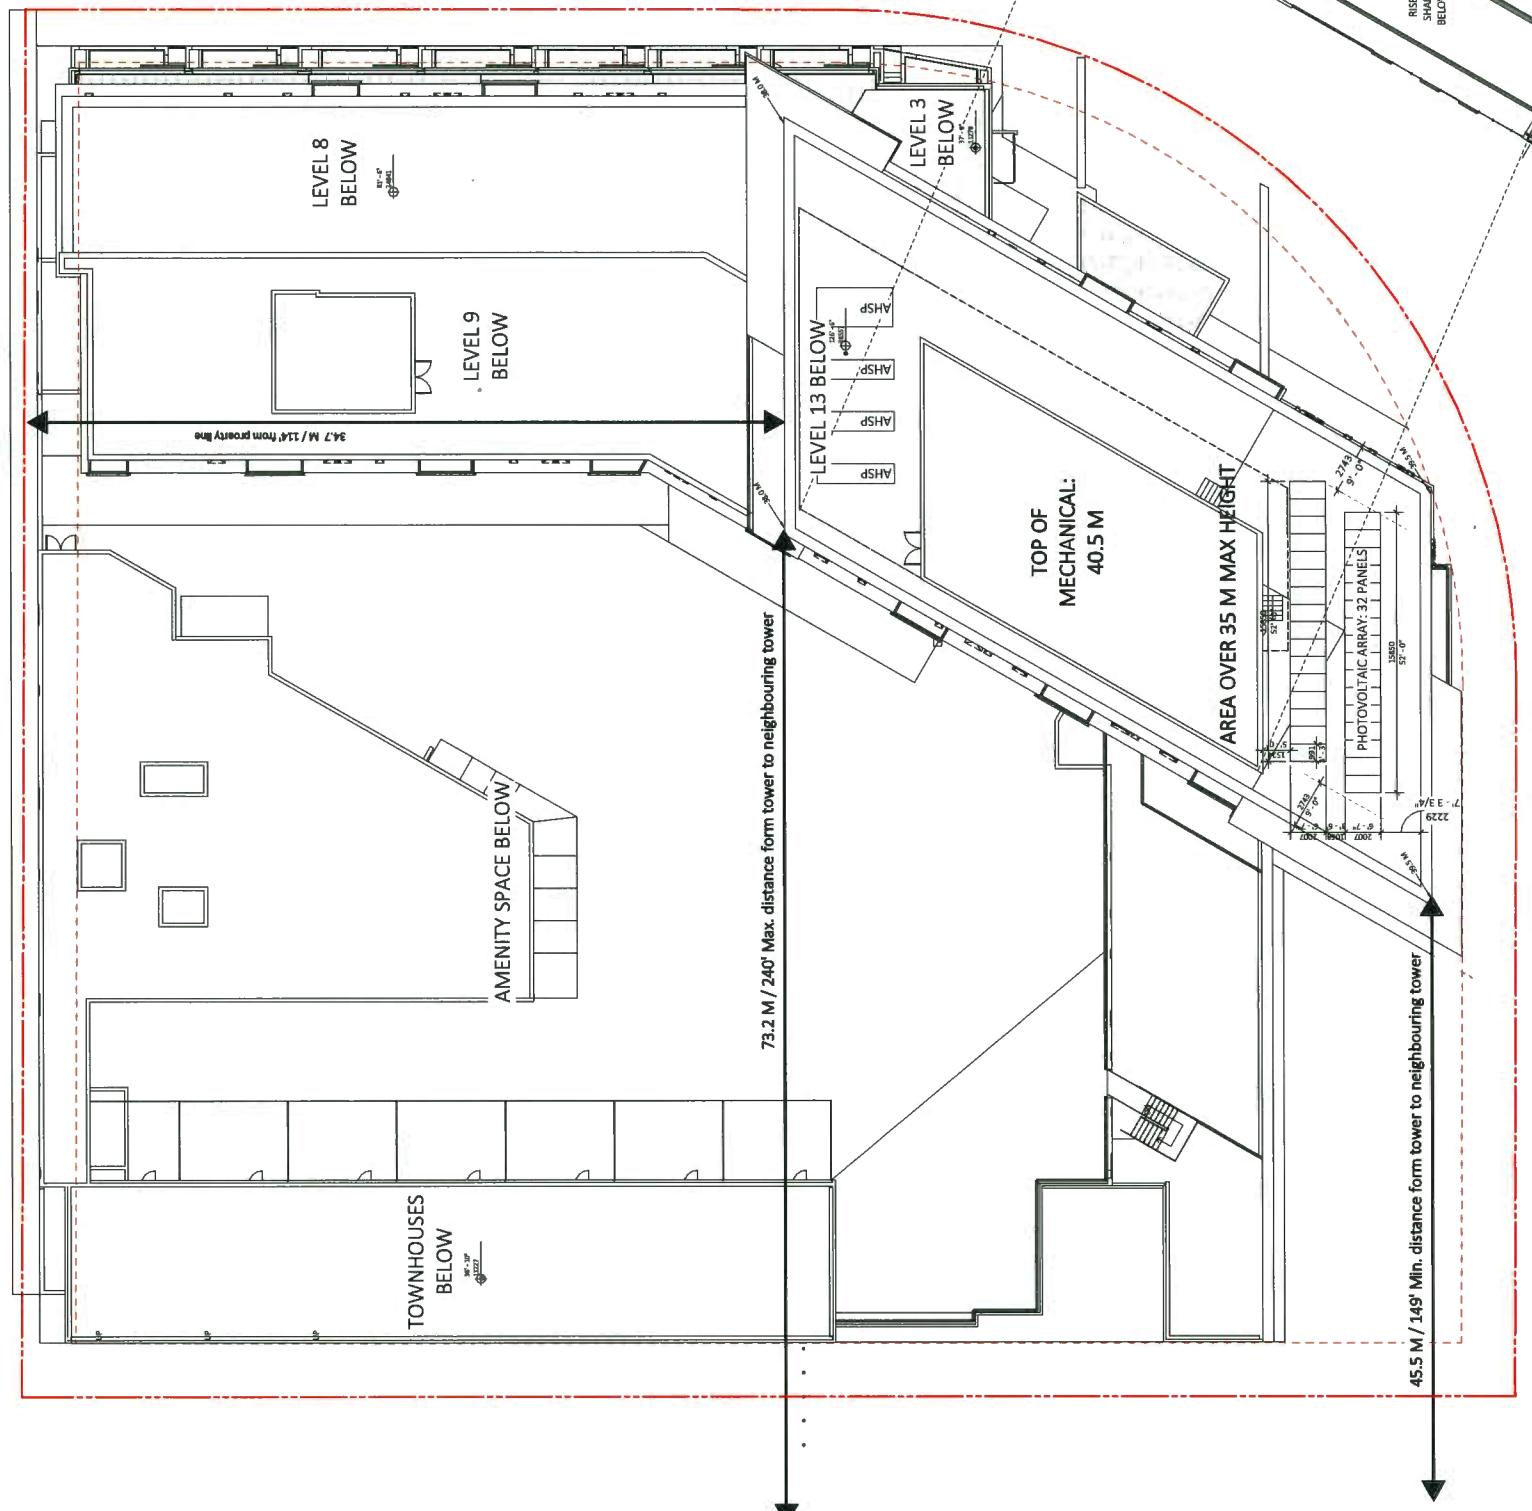2 | Floor Plan - Mechanical
3 3/32" = 1'-0"1 | Floor Plan - Roof Plan
3 3/32" = 1'-0"

Sheet Title:

Floor Plan

Drawing No.:

Project Name:

Drawing By:

Author:

Revised By:

Checker:

Date:

02/27/20

Comments:

Project Name:

Sheet Title:

Roof Plan

Drawing No.:

Project Name:

Drawing By:

Author:

Revised By:

Checker:

Date:

02/27/20

Comments:

Project Name:

Sheet Title:

Roof Plan

Drawing No.:

Project Name:

Drawing By:

Author:

Revised By:

Checker:

Date:

02/27/20

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Drawing By:

Author:

Revised By:

Checker:

Date:

02/27/20

Comments:

Project Name:

Sheet Title:

Roof Plan

Drawing No.:

Project Name:

Drawing By:

Author:

Revised By:

Checker:

Date:

02/27/20

Comments:

Project Name:

ALLOWABLE MAXIMUM HEIGHT 45 M / 147'-7"₂
MÉASURÉD FROM AVÉRAGE GRADE (2 M) (47 M GSC)

PROPOSED MAXIMUM HEIGHT 40.5 M / 132'-10 1/2"
MEASURED FROM AVERAGE GRADE (2 M / 6' 7" M.C.S.C.)

MAX. ALLOWABLE BUILDING HEIGHT FROM BASE GRADE
145 - 10 5/8"

MAX. PROPOSED BUILDING HEIGHT FROM BASE GRADE
12'-0" - 4"

Hannover, 8c

Sections

POLY(1,4-PHENYLENE TEREPHTHALAMIDE)

A-016
Drawing No. 1

North-South Section
1/8" = 1'-0"

ALLOWABLE MAXIMUM HEIGHT 45.0 M / 147'-1 1/2"
MEASURED FROM AVERAGE GRADE (2 M) (47 M GSC)

PROPOSED MAXIMUM HEIGHT 40.5 M / 132'-10 1/2"
MEASURED FROM AVERAGE GRADE (2 M) (A25 GSC)

Raaf Mechanicaal 126' - 6"

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110

二二

Level 10 5

Level 9 81 - 6

Level 8 72' - 6"

Level 7 63' - 6"

Level 6 54' - 6"

Level 45' - 6"


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SMITH ROAD





Level 1 7' - 4"

21

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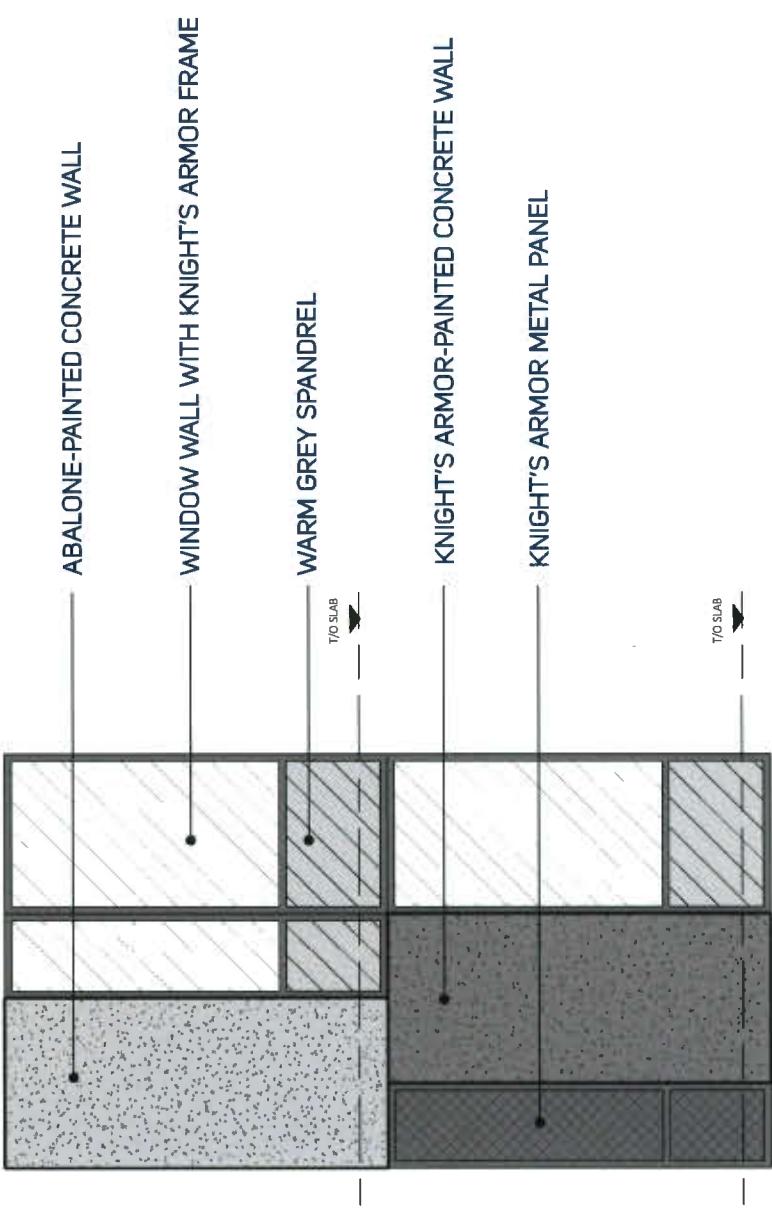


1 | East-West Section
1/8" = 1'-0"

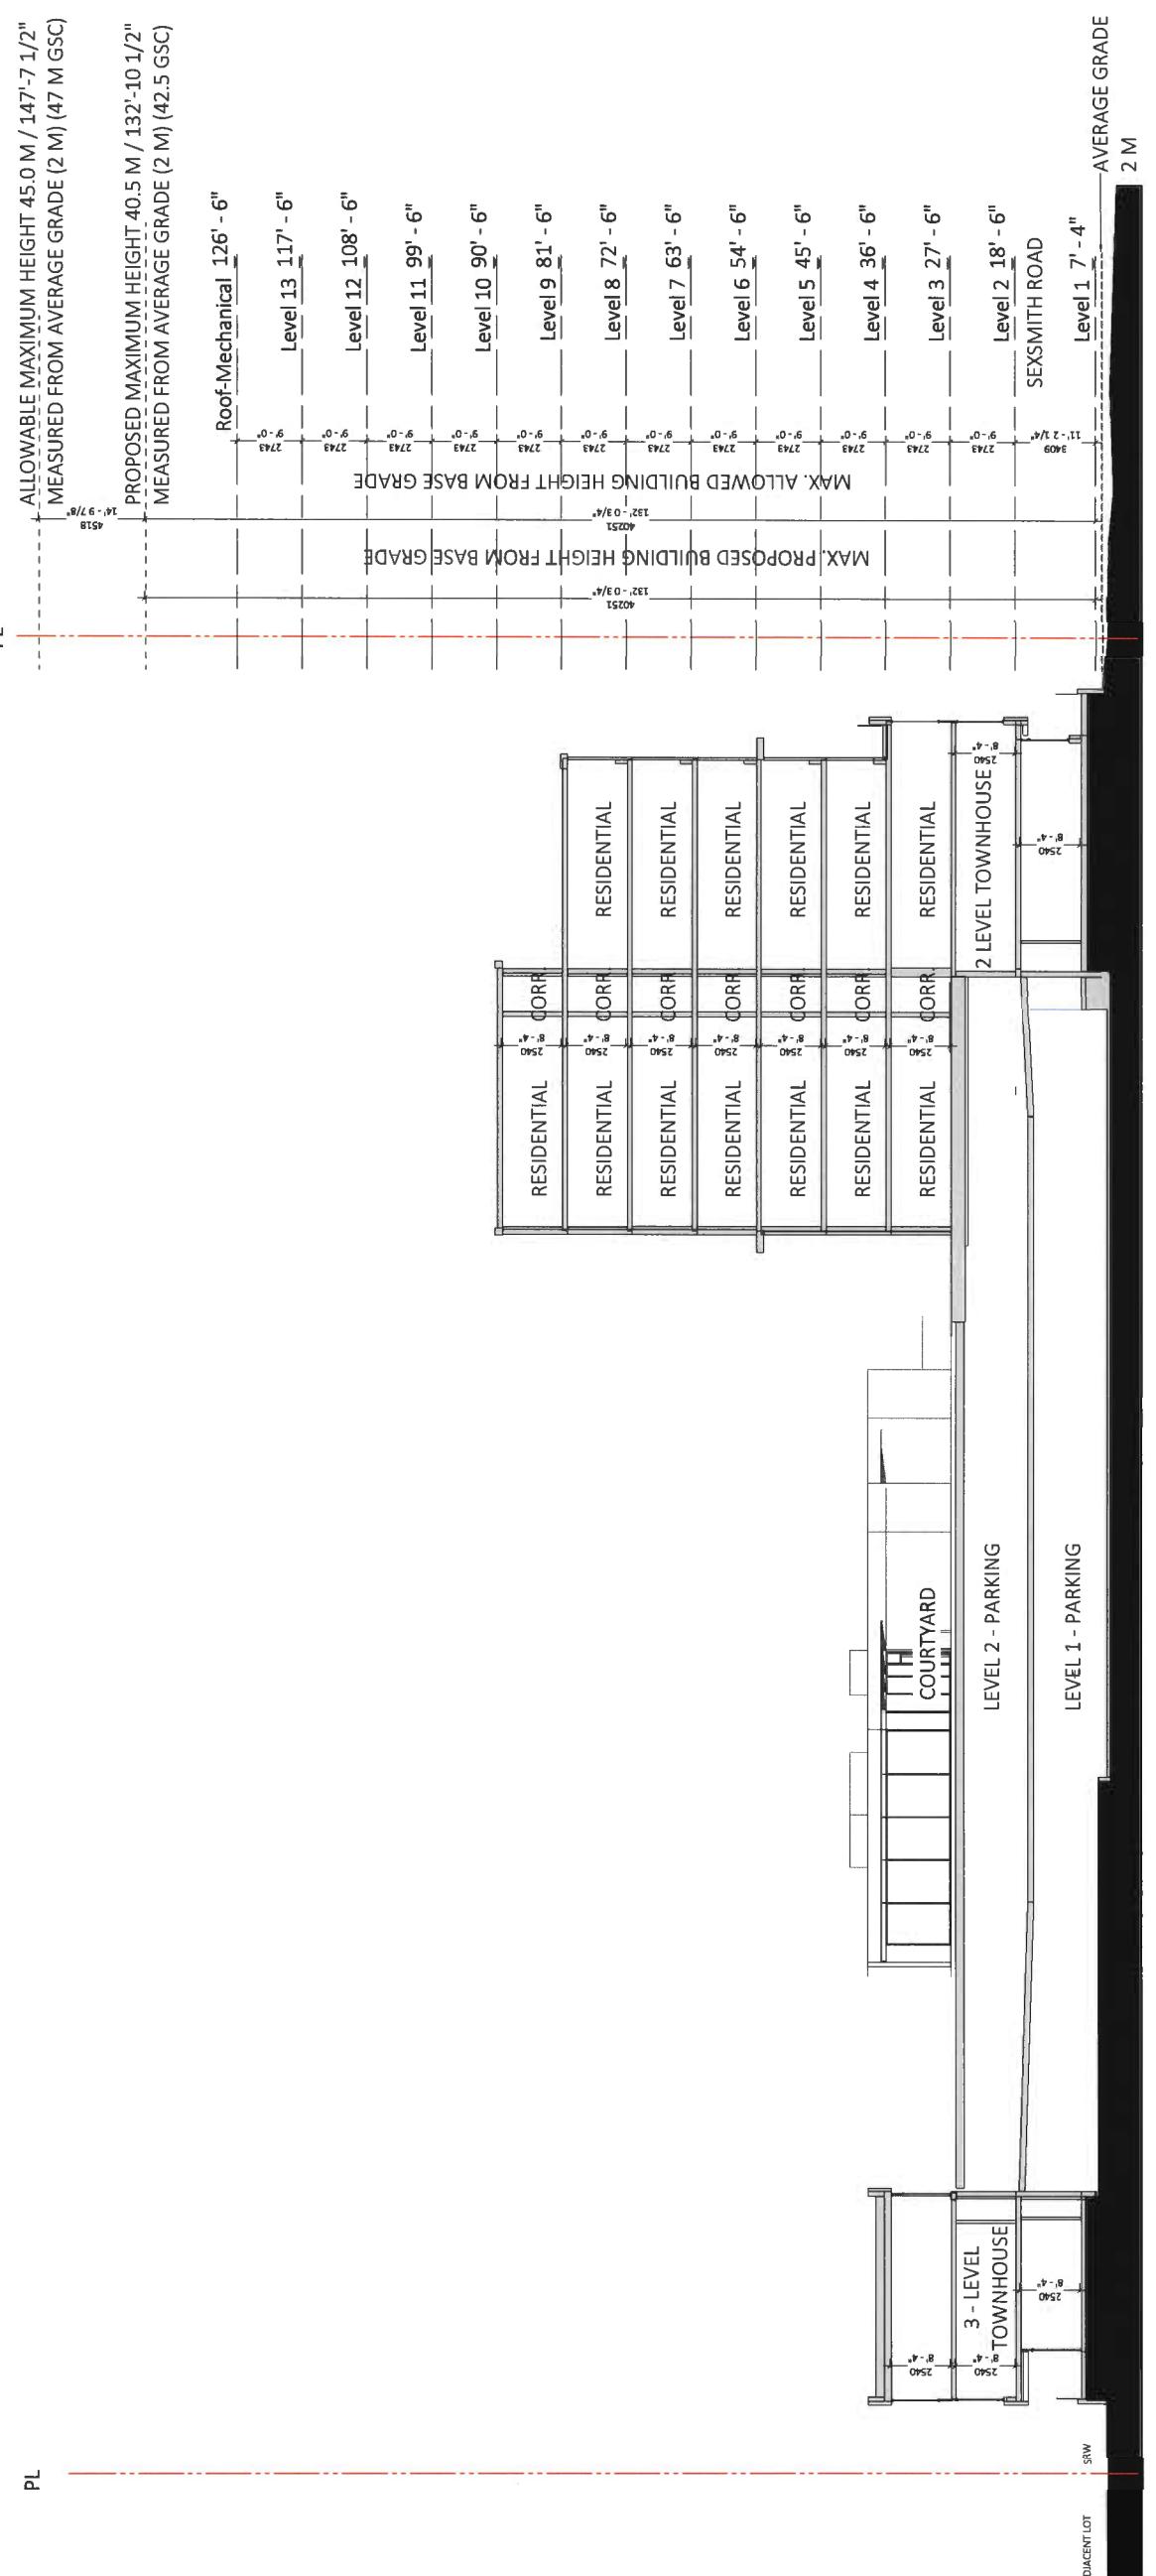

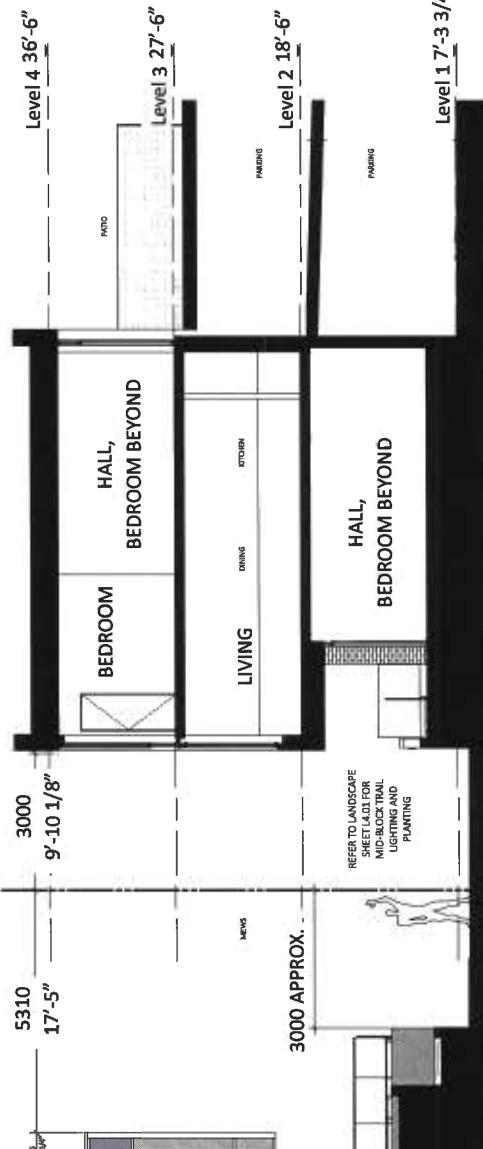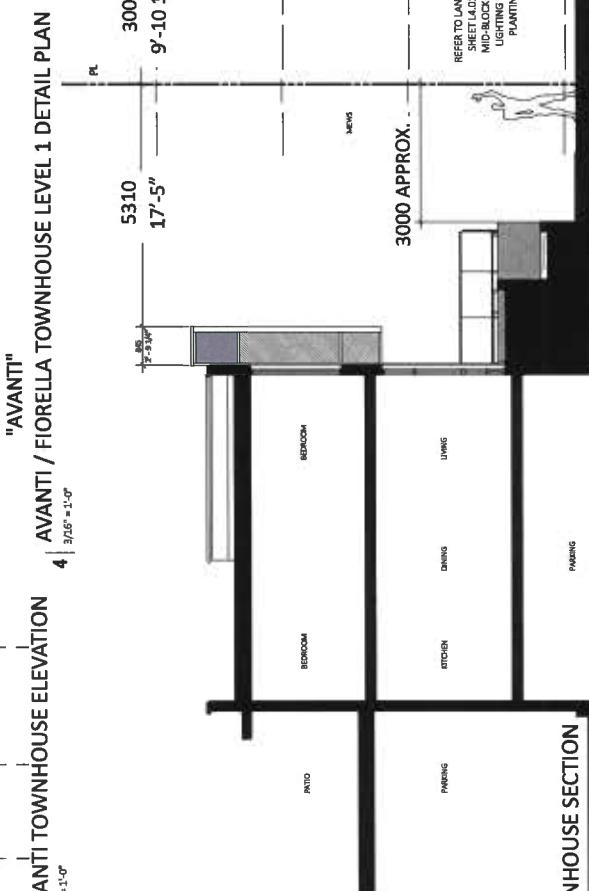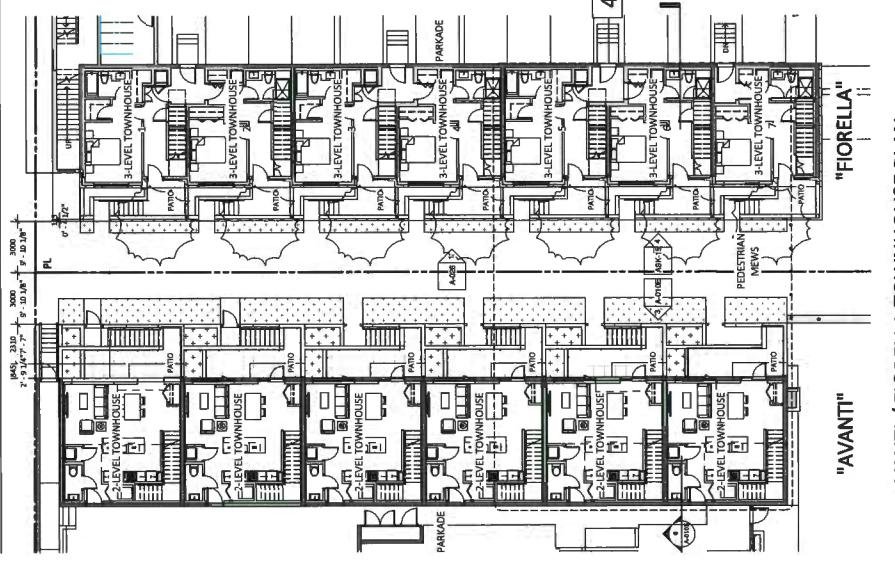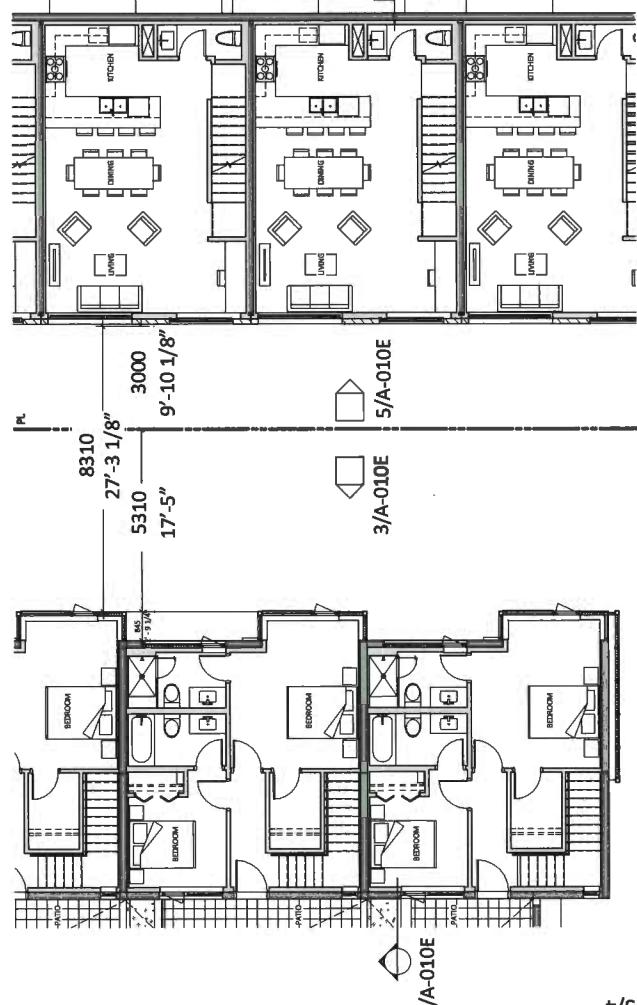6 | 1/4" = 1'-0"


Project Name:	Florella
Address:	3001 1/2 30th Street NW, Washington, DC
Date:	07/03/2019
Architect:	Polyn
Materials:	



PAINTED CONCRETE
BENJAMIN MOORE - 208-60
ABALONE



PAINTED CONCRETE, METAL PANEL
CLADDING AND WINDOW FRAME
PPG 1001-6 KNIGHT'S ARMOR

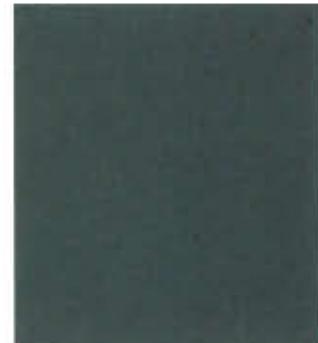


SPANDREL
WARM GREY

TIMBER ACCENT
CLEAR LACQUER BAMBOO



BRICK
BLACK WIRE CUT

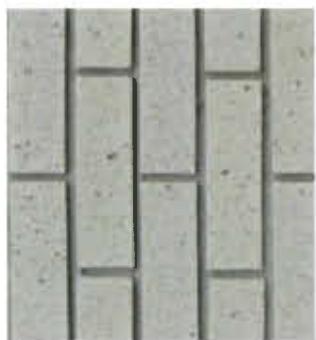

BRICK
PEWTER



ACCENT COLOUR 1
BENJAMIN MOORE -
PINK INNOCENCE 2082-60



ACCENT COLOUR 2
BENJAMIN MOORE -
BOUQUET ROSE 2172-50



ACCENT COLOUR 3
BENJAMIN MOORE -
CHEROKEE BRICK 2082-30



ACCENT COLOUR 4
BENJAMIN MOORE -
753 SANTA CLARA



ACCENT COLOUR 5
BENJAMIN MOORE -
756 VARSITY BLUES



ACCENT COLOUR 6
BENJAMIN MOORE -
756 VARSITY BLUES

DP 18-818748

Plan 13 May 21, 2019

FRANCI
ARCHITECTURESee reverse side for
Architectural Drawing
Information

ABALONE PAINTED CAST-IN-LACE
CONCRETE PANEL
CONCRETE WALL PAINTED WITH
ACCENT COLOUR
INSET BALCONY
BLACK CHARCOAL
(WINDOW WALL,
METAL PANEL AND
CONCRETE PANEL)



TYPICAL DETAIL

ACCENT COLOURS

The colour is applied to recessed balcony walls adjacent to abalone concrete panels. The colours alternate through the three accent colours. The accent colours emphasize the playful pattern established on the facade with the abalone and grey painted architectural concrete panels.




ACCENT COLOUR 3
BENJAMIN MOORE -
CHEROKEE BRICK 2082-30



ACCENT COLOUR 2
BENJAMIN MOORE -
BOUQUET ROSE 2172-50




ACCENT COLOUR 1
BENJAMIN MOORE -
PINK INNOCENCE 2082-60

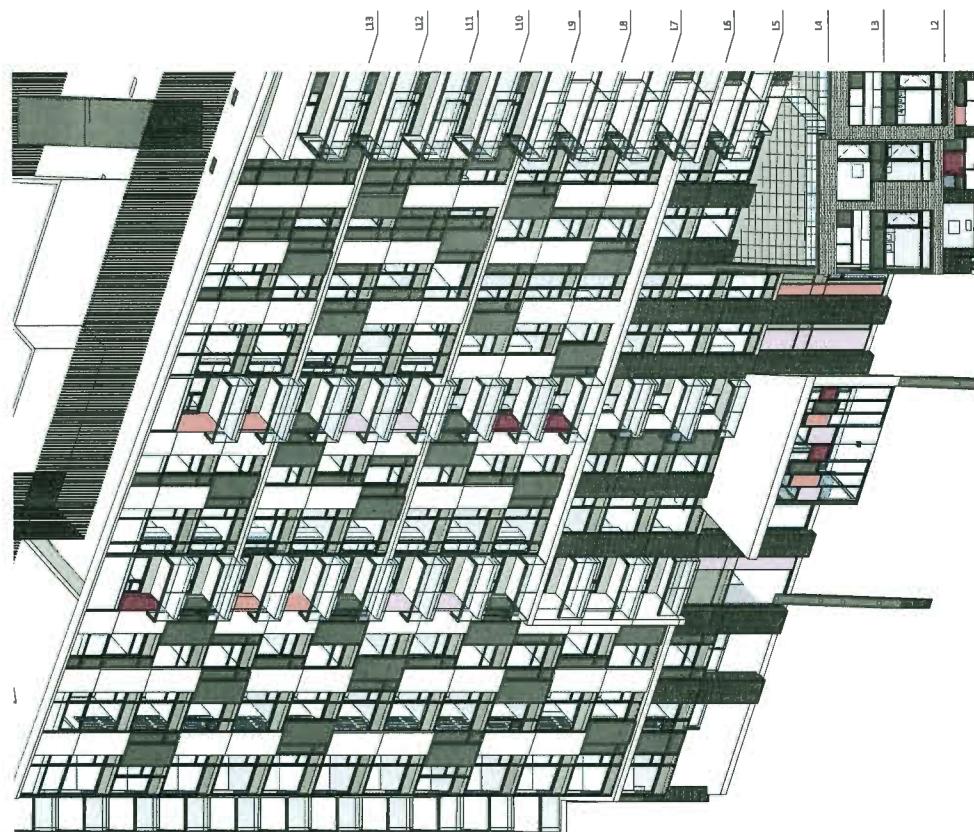

EAST ELEVATION 1



EAST ELEVATION 2

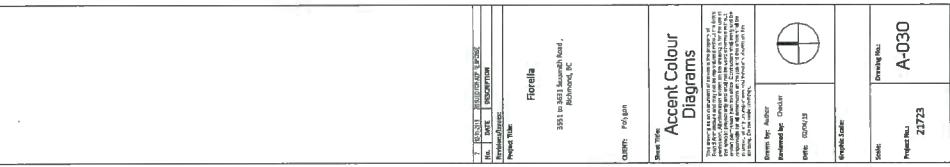Scale: 1/200
Project No.: A-030






Graphic Edit:

Scale: 1/200
Project No.: 21723

Graphic Edit:

Floor No.: 10
Project No.: G1013


Graphic Edit:

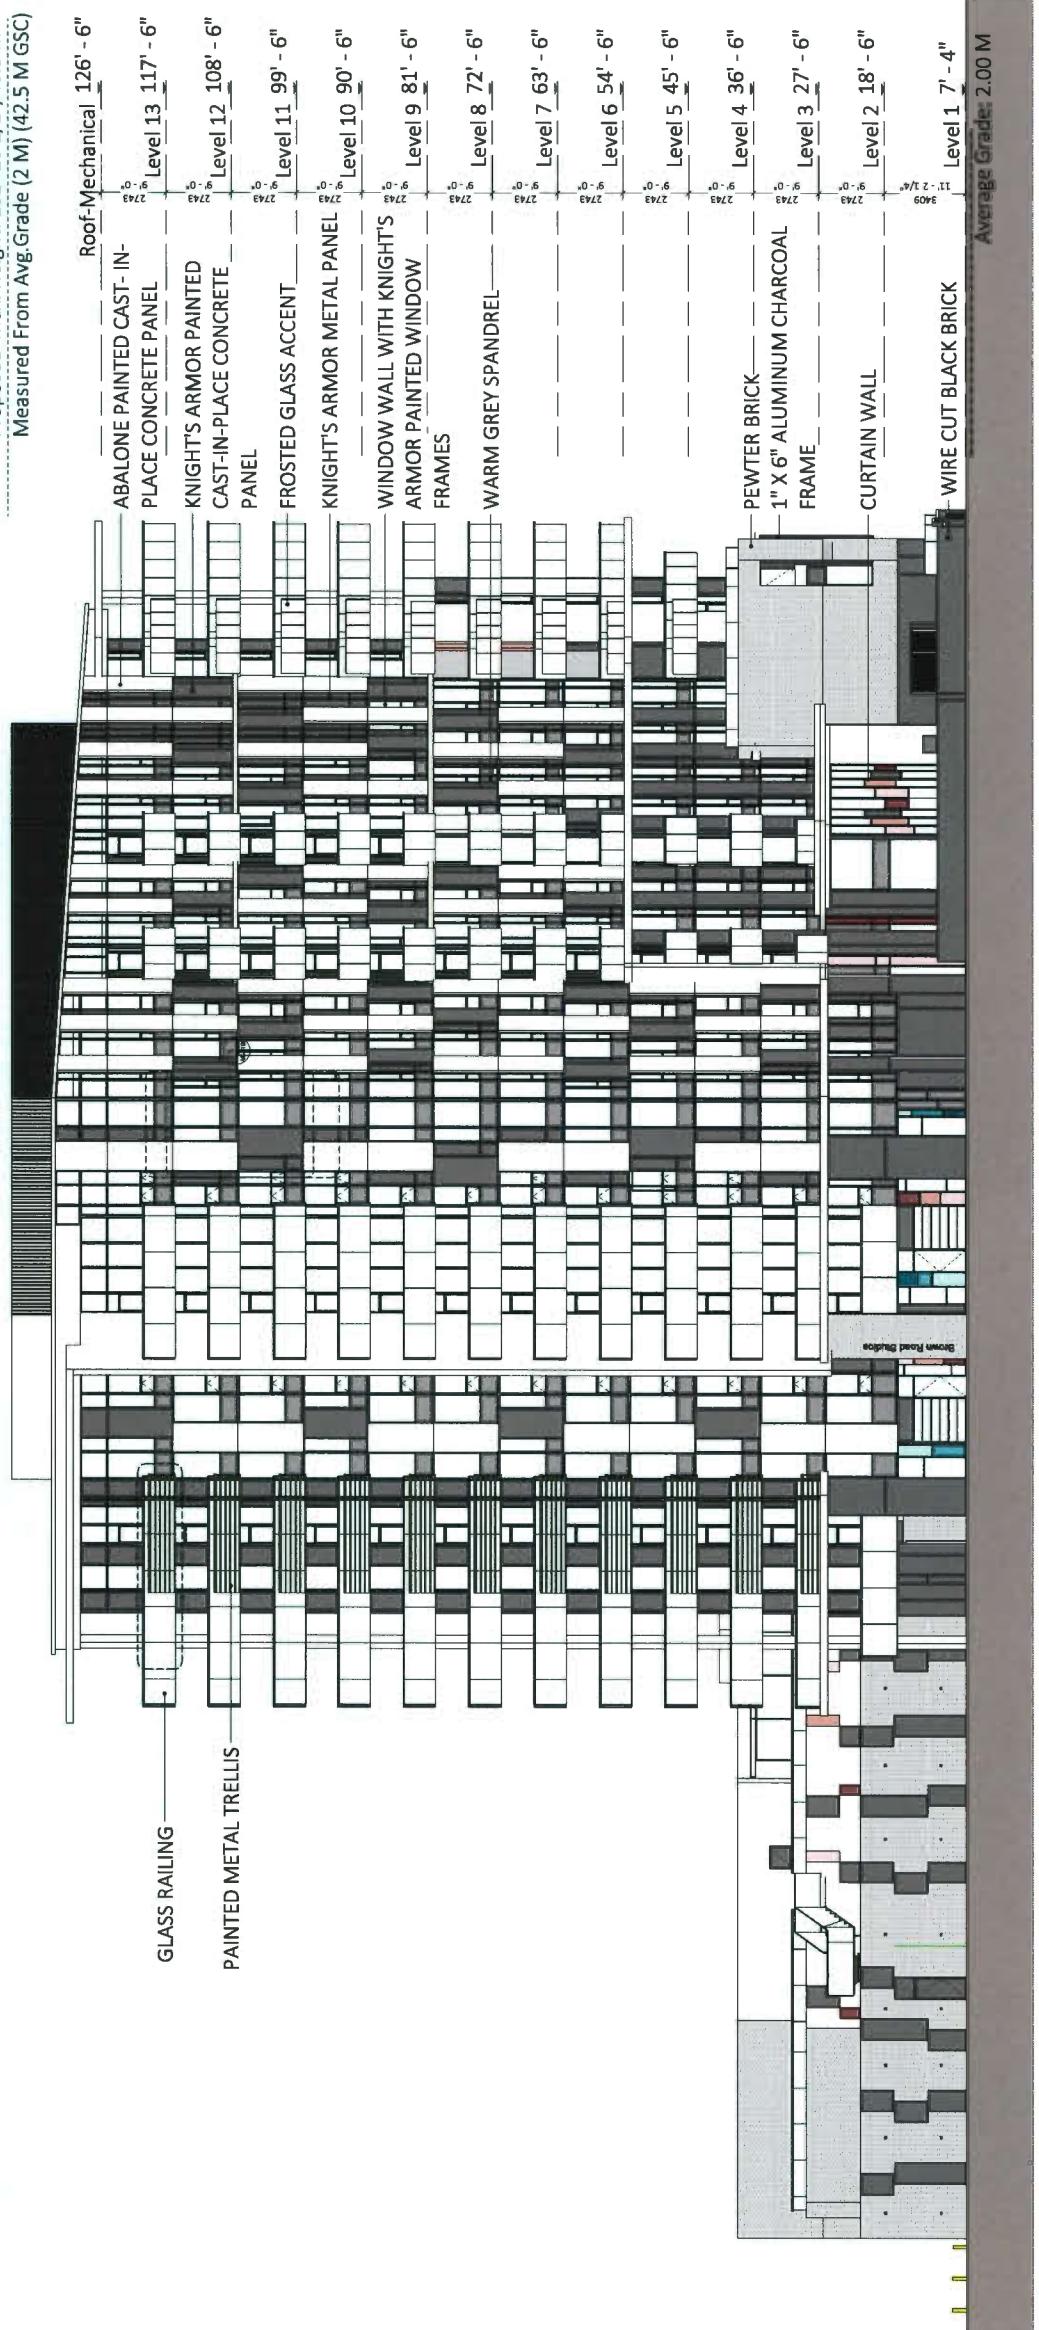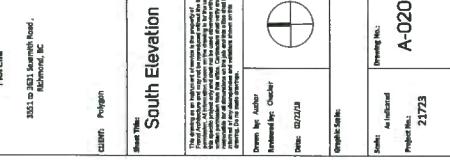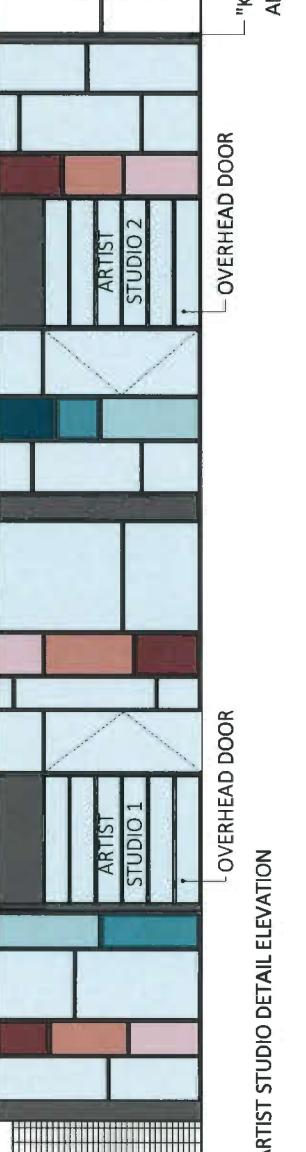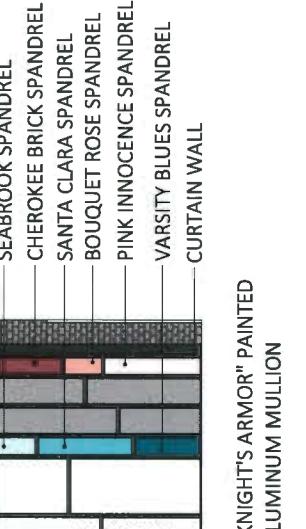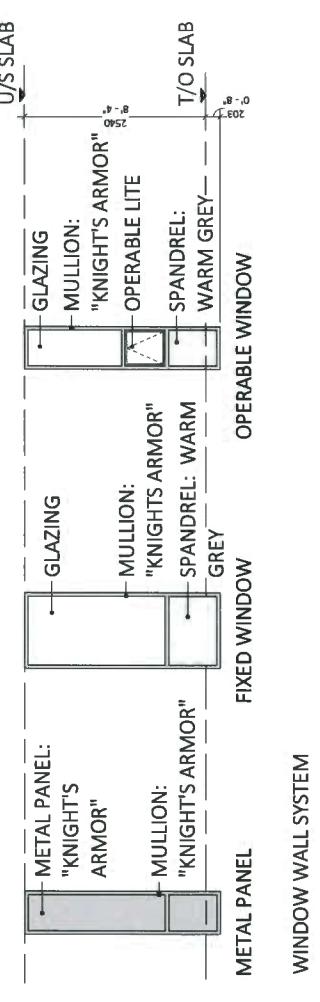Allowable Max. Height: 147'-7 1/2"/45 M
Measured From Avg. Grade (2 M) (47 M GSC)Proposed Max. Height: 132'-0 1/2"/40.5 M
Measured From Avg. Grade (2 M) (42.5 M GSC)DP 18-818748
Plan 15 May 21, 2019

Project Title: Florella
Address: 3551 Brown Road, Newark, NJ
Drawing No.: 18-818748
Architectural Rev.: Check
Date: 02/23/2019
Graphic Set No.: 21723
Status: As Required
Drawing No.: A-020
Graphic Set No.: 21723

DRAWING CONTINUED TO
1/A-020A EAST ELEVATION 1Allowable Max. Height: 14'7"-7 1/2"/45 M
Measured From Avg. Grade (2 M) (47 M GSC)Proposed Max. Height: 13'2"-10 1/2"/40.5 M
Measured From Avg. Grade (2 M) (42.5 M GSC)


20'

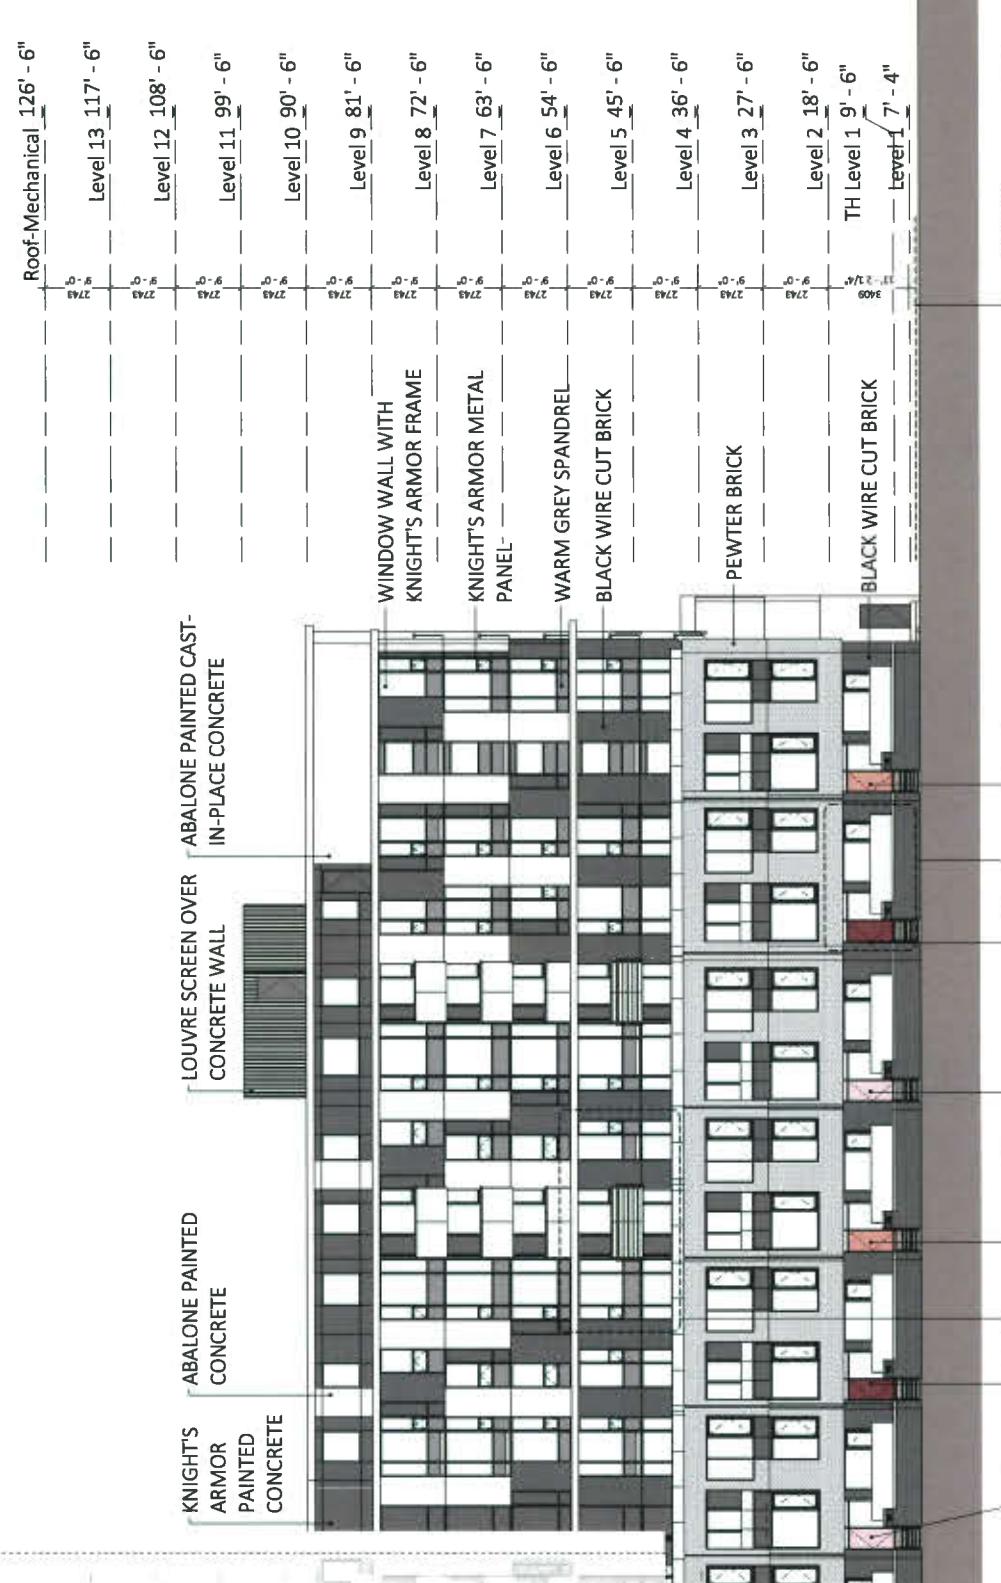1 | East Elevation 2 (Sexsmith Road)
1 1/8" = 1'-0"DP 18-818748
Plan 17 May 21, 2019


Average Grade: 2.00 M



TOWNHOUSE ENTRY DETAIL

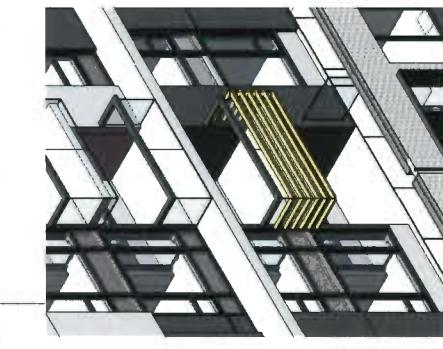

BRICK BALCONY RECESS DETAIL

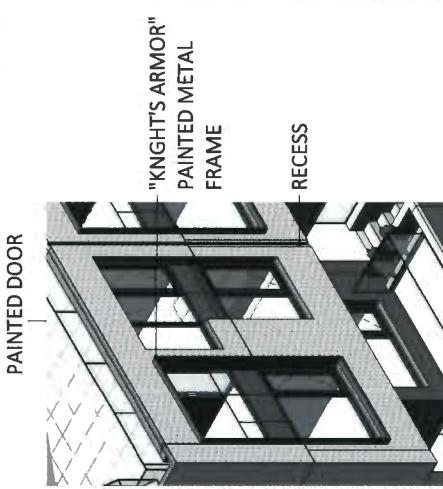

TOWNHOUSE SHADOW BOX DETAIL


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Allowable Max. Height: 14'7"-7 1/2"/45 M
Measured From Avg. Grade (2 M) (47 M GSC)Proposed Max. Height: 13'2"-10 1/2"/40.5 M
Measured From Avg. Grade (2 M) (42.5 M GSC)Drawing Title:
North ElevationDrawing No.:
5551-B-1801, Section Level,Revised by: *[Signature]*

Date: 02/20/18

Client: *[Signature]*Project Name: *[Signature]*Project No.: *[Signature]*Drawing No.: *[Signature]*

Date: 2/20/18

1 North Elevation
1/8" = 1'-0"Drawing No.: A-021
Drawing Date: 2/20/18

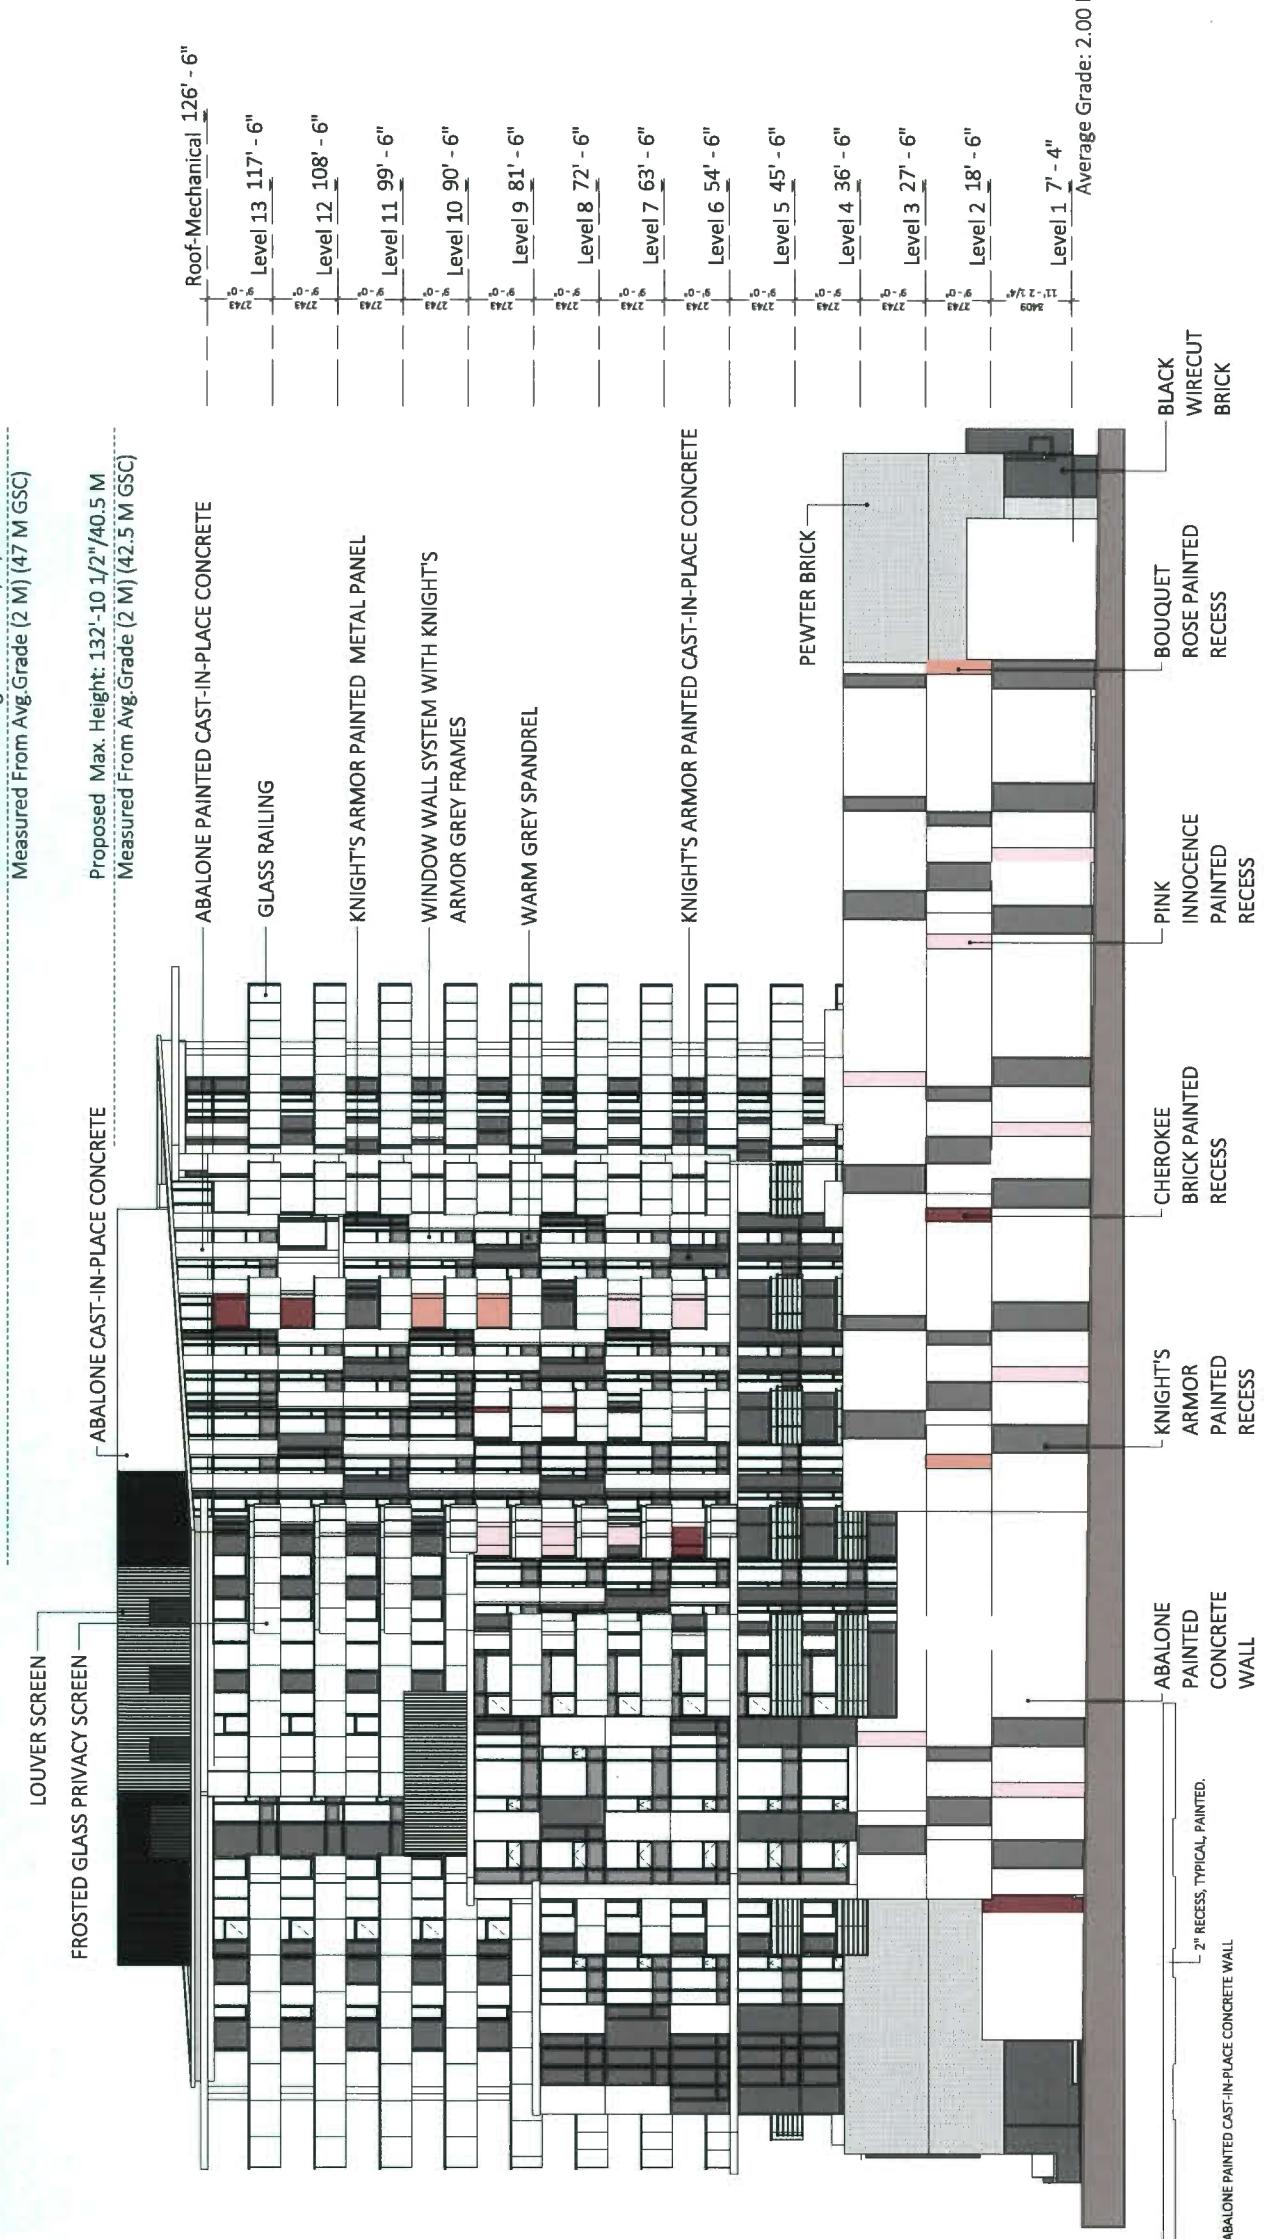Plan 19 May 21, 2019 DP 18-818748

Allowable Max. Height: 147'-7 1/2"/45 M
Measured From Avg. Grade (2 M) (47 M GSC)Proposed Max. Height: 132'-10 1/2"/40.5 M
Measured From Avg. Grade (2 M) (42.5 M GSC)

Roof Mechanical 126' - 6"

Level 13 117' - 6"

Level 12 108' - 6"

Level 11 99' - 6"

Level 10 90' - 6"

Level 9 81' - 6"

Level 8 72' - 6"

Level 7 63' - 6"

Level 6 54' - 6"

Level 5 45' - 6"


Level 4 36' - 6"

Level 3 27' - 6"

Level 2 18' - 6"

Level 1 7' - 4"

Average Grade: 2.00 M

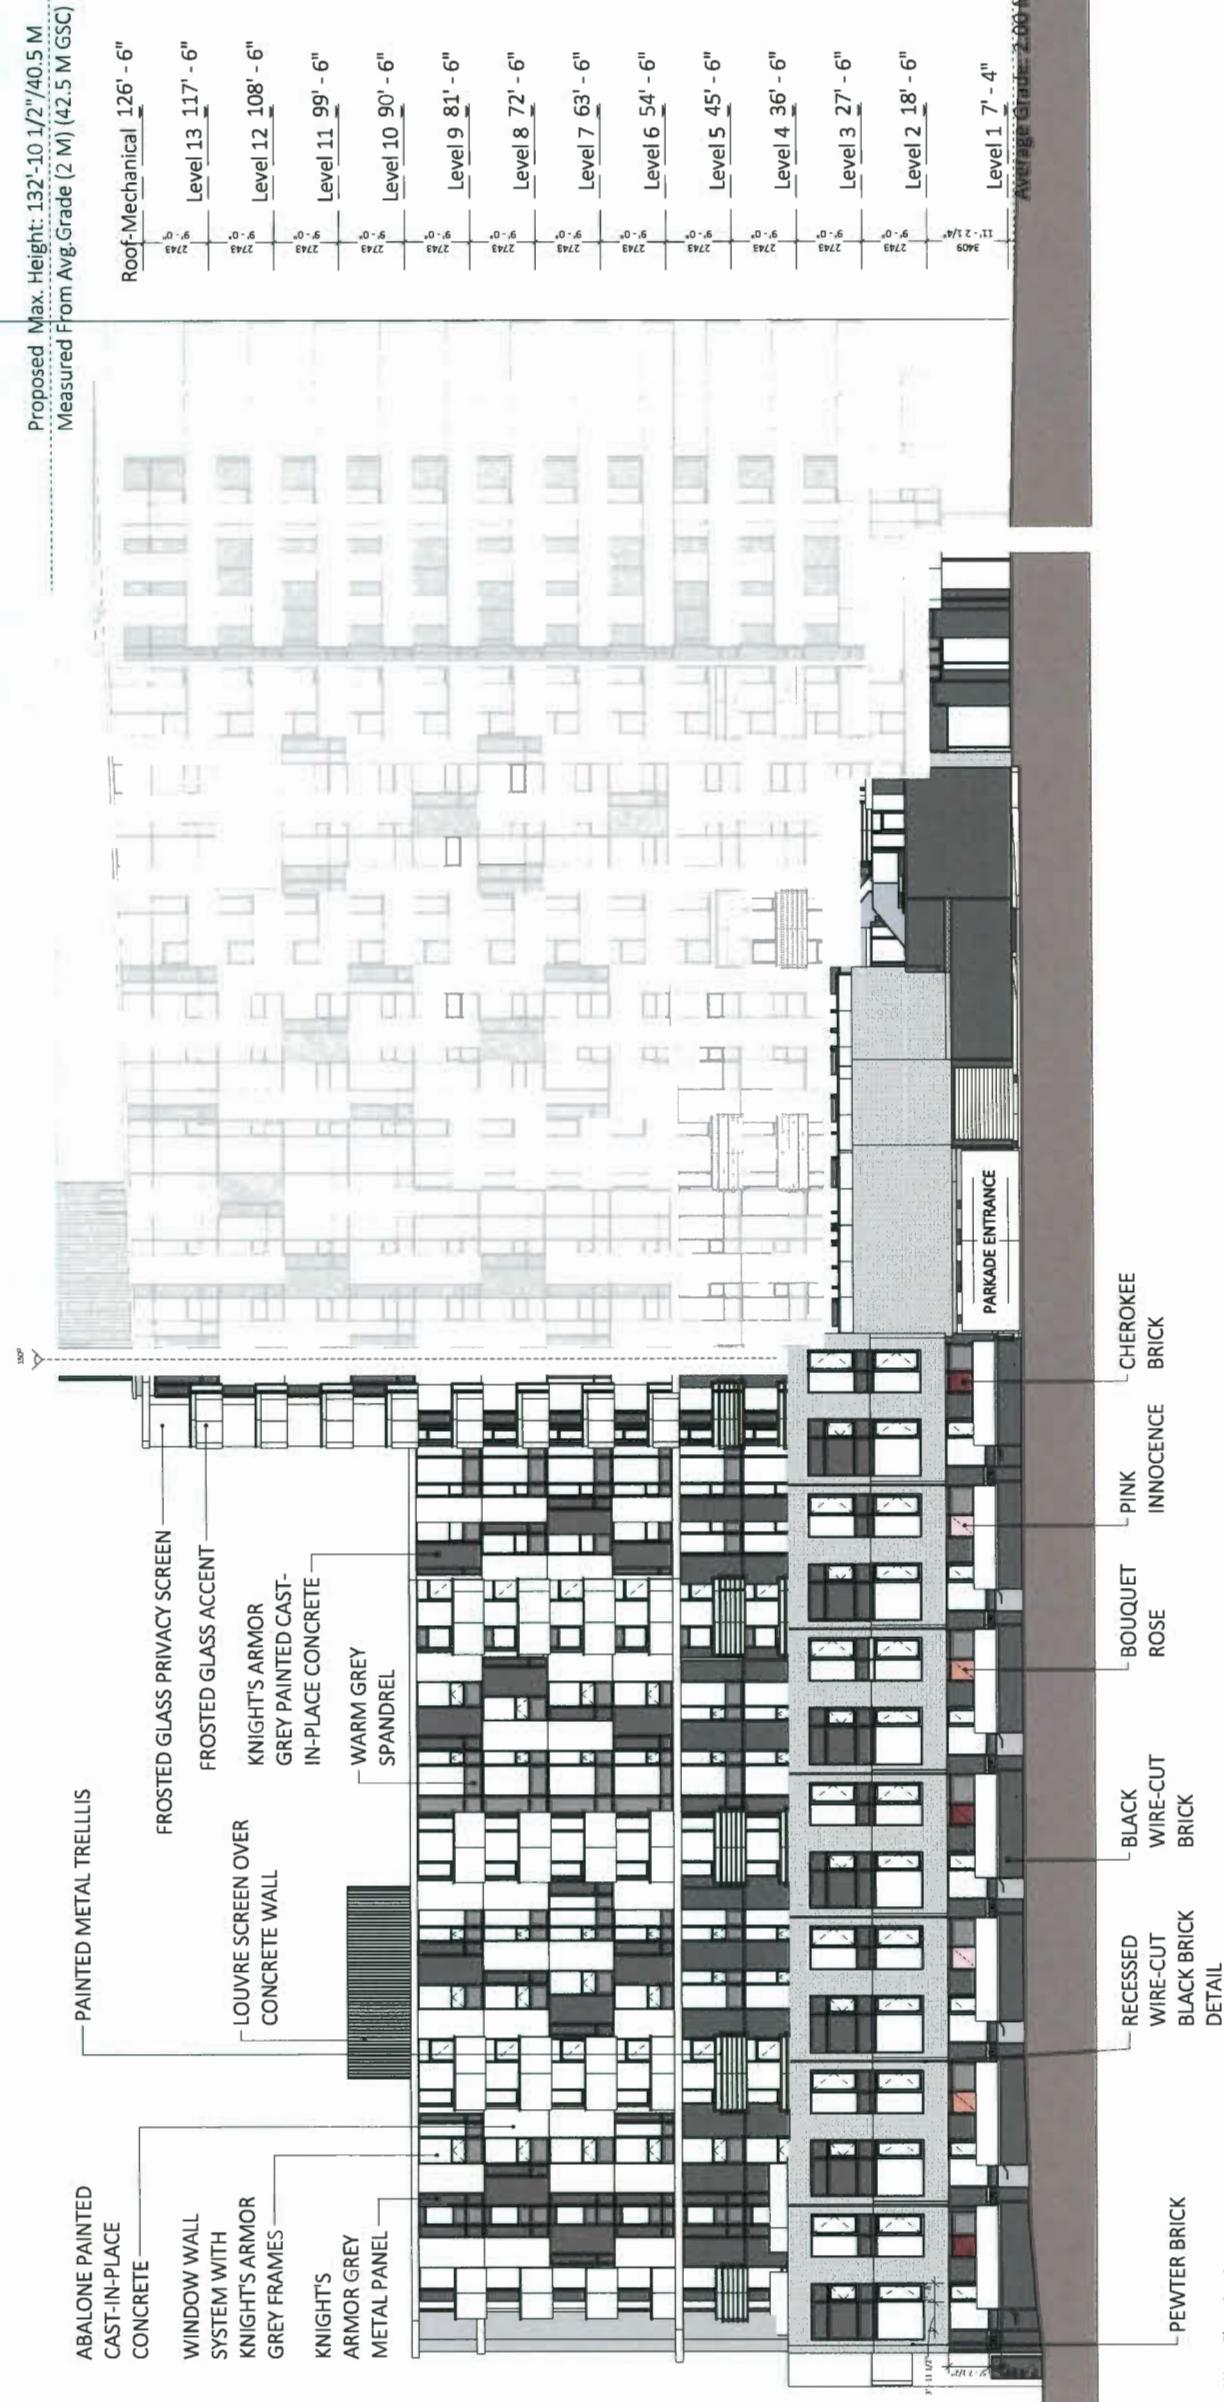1 | West Elevation 1
1/8" = 1'-0"

Elevations

2025-10-05, Search Result

Montréal, QC

www.b3d.ca

Project Name

Project No.

Drawing No.

Drawing Date

Drawing Time

Drawing Ver.

Drawing Rev.

Drawing Loc.

Drawing Desc.

Drawing Obj.

Drawing Ref.

Drawing Ver.

Drawing Rev.

Drawing Loc.

Drawing Desc.

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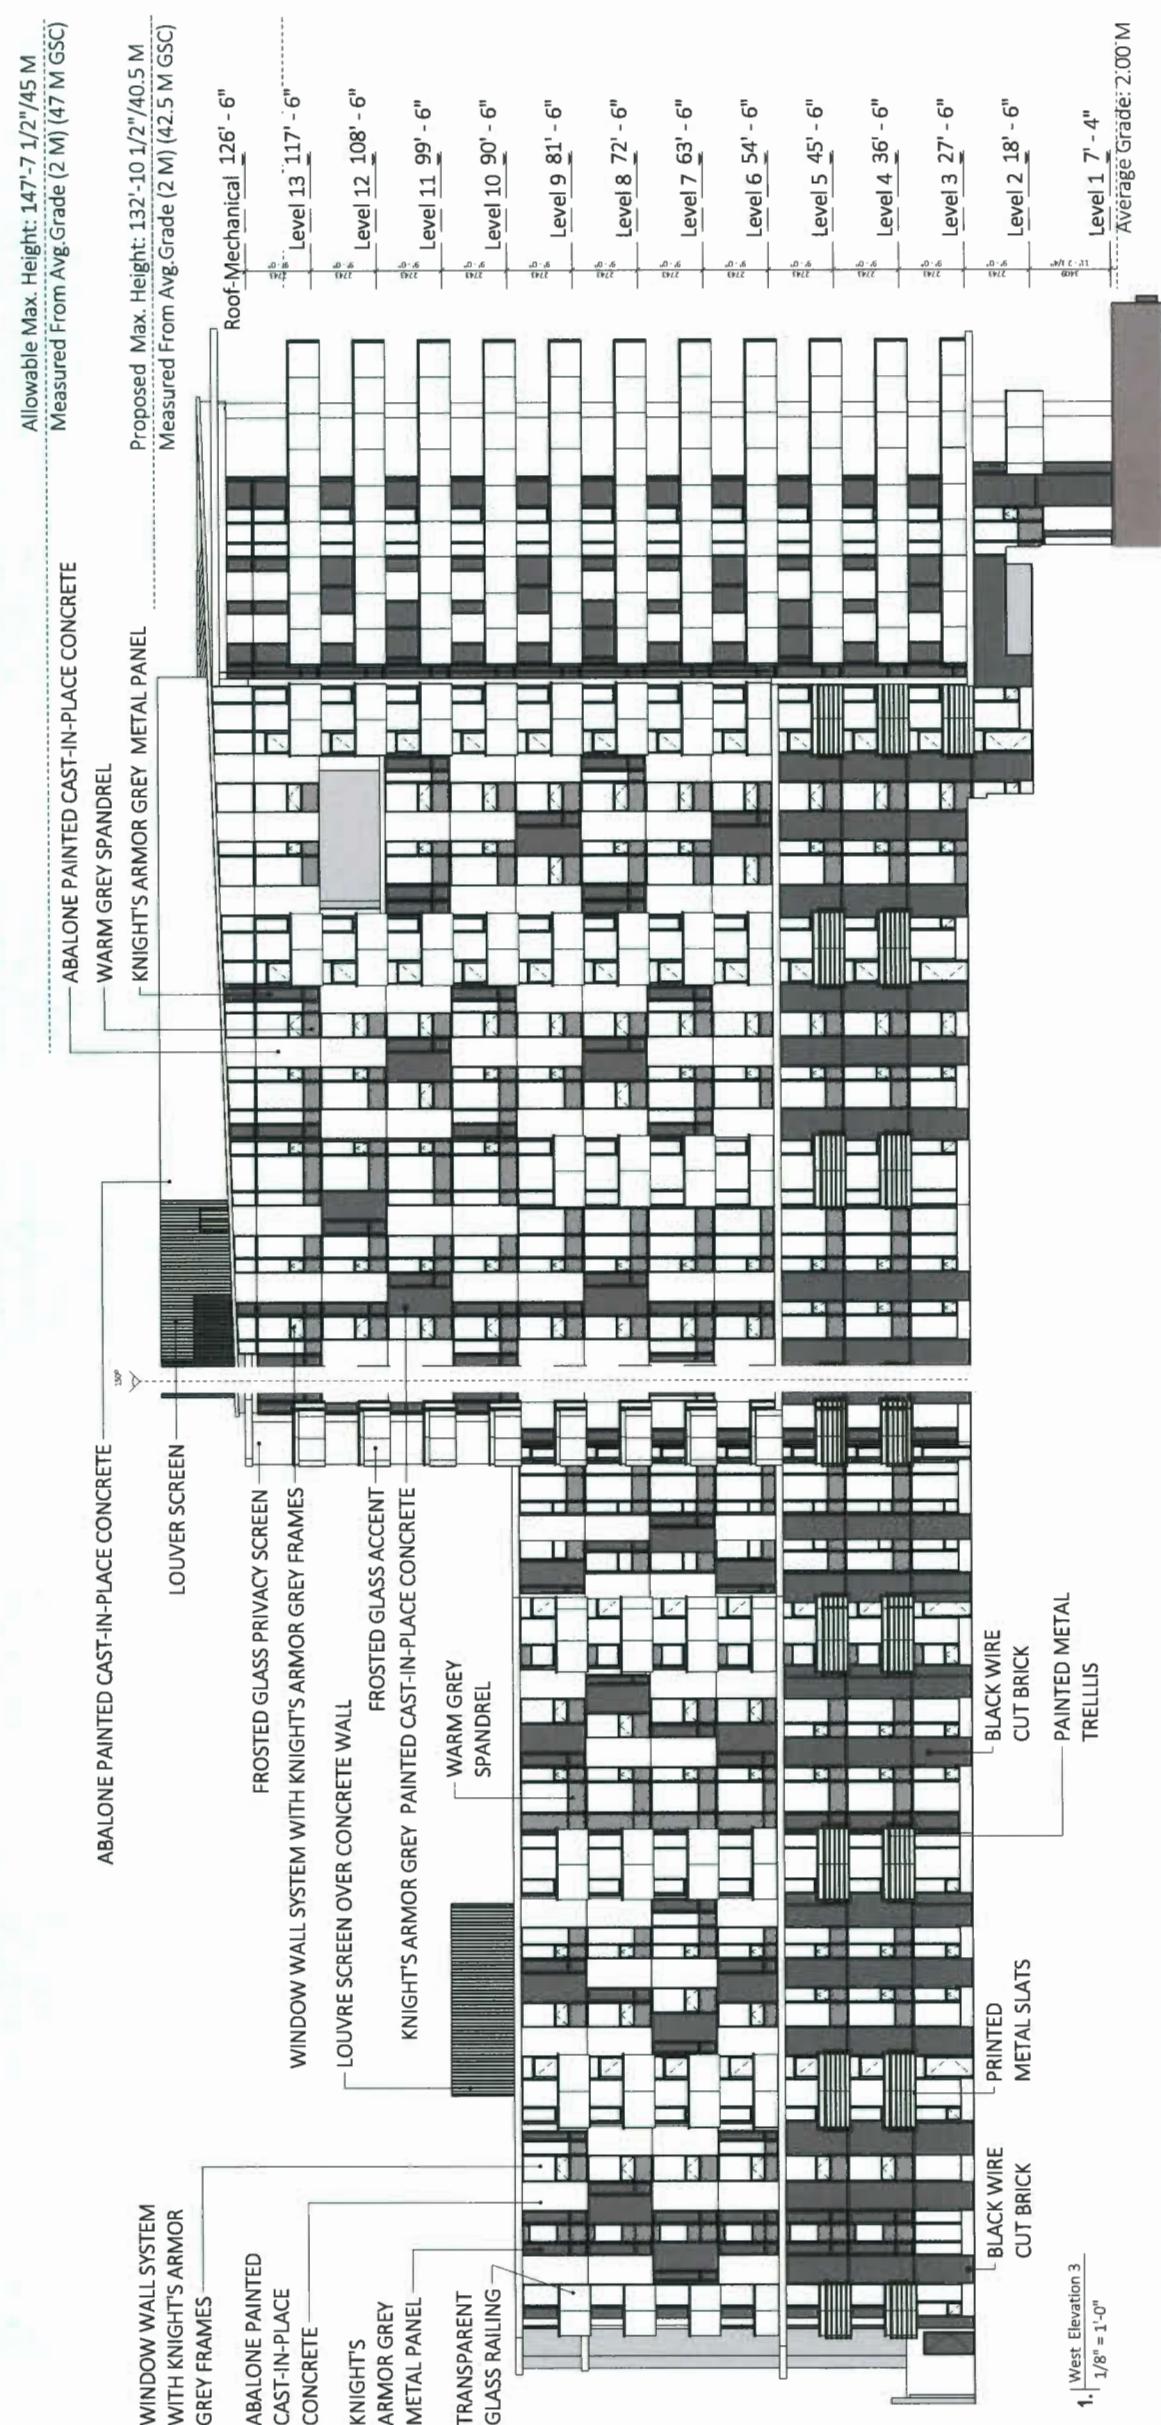
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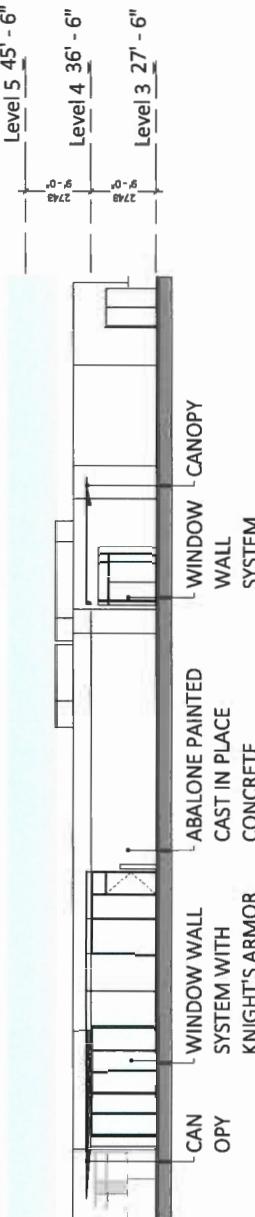
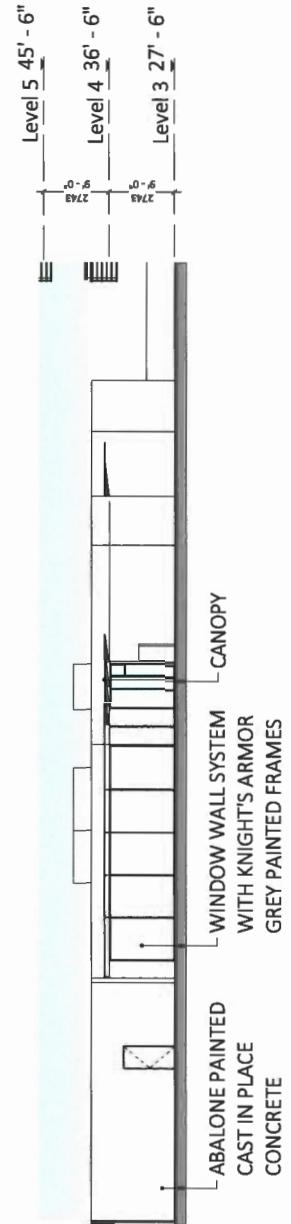
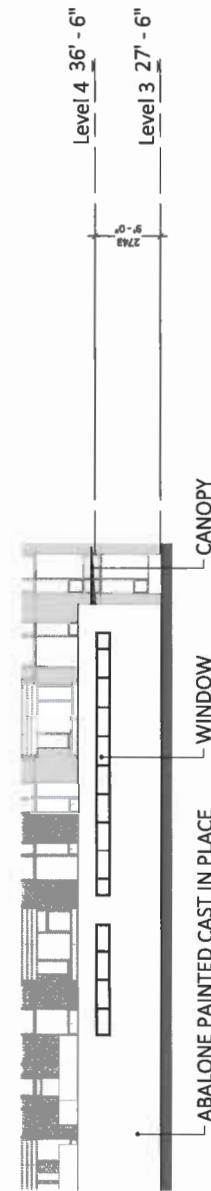
DP 18-818748
Plan 20 May 21, 2019Floorline
1055 10th Ave, Vancouver, BC
604.541.0000
www.francliarch.comProject Name
Project No.
Date: 04/27/19Client
Architect
Revised by
Date:

West Elevation 3

1/8" = 1'-0"
Project No.: A-021C
Date: 04/27/19Drawing No.: A-021C
Drawing Date: 04/27/19Drawing No.: A-021C
Drawing Date: 04/27/19




DP 18-818748
Plan 21 May 21, 2019

Architect/Engineer:	Project Title:
FRANCI ARCHITECTURE LTD.	3053 10th Street Road, Richmond, BC
Architect/Engineer:	Drawn By: Author Submitted By: Owner Date: 05/04/23
Architect/Engineer:	Elevations
Architect/Engineer:	Right Edge:
Architect/Engineer:	Scale: 1/8" = 1'-0" Project No.: A-021D Drawing No.: 21723



DP 18-818748

Plan 22 May 21, 2019

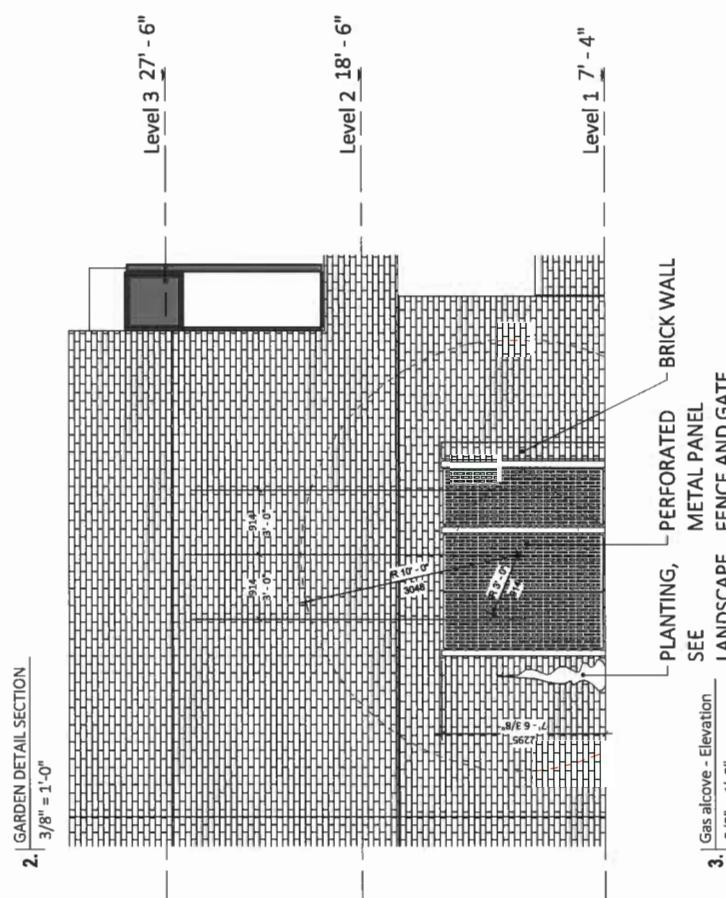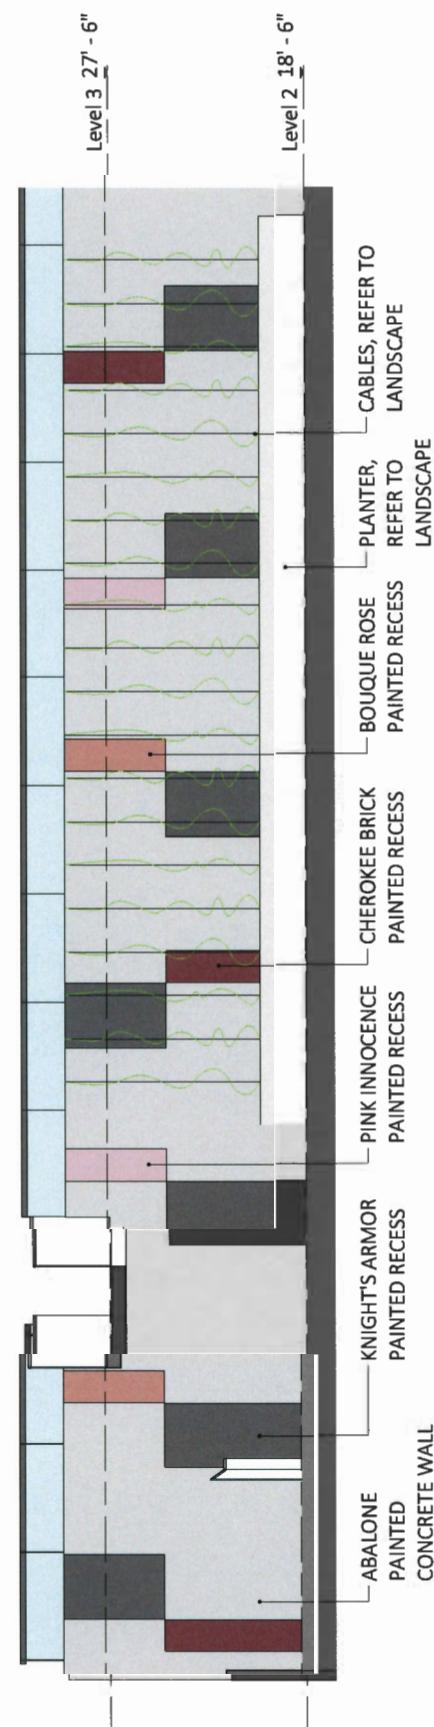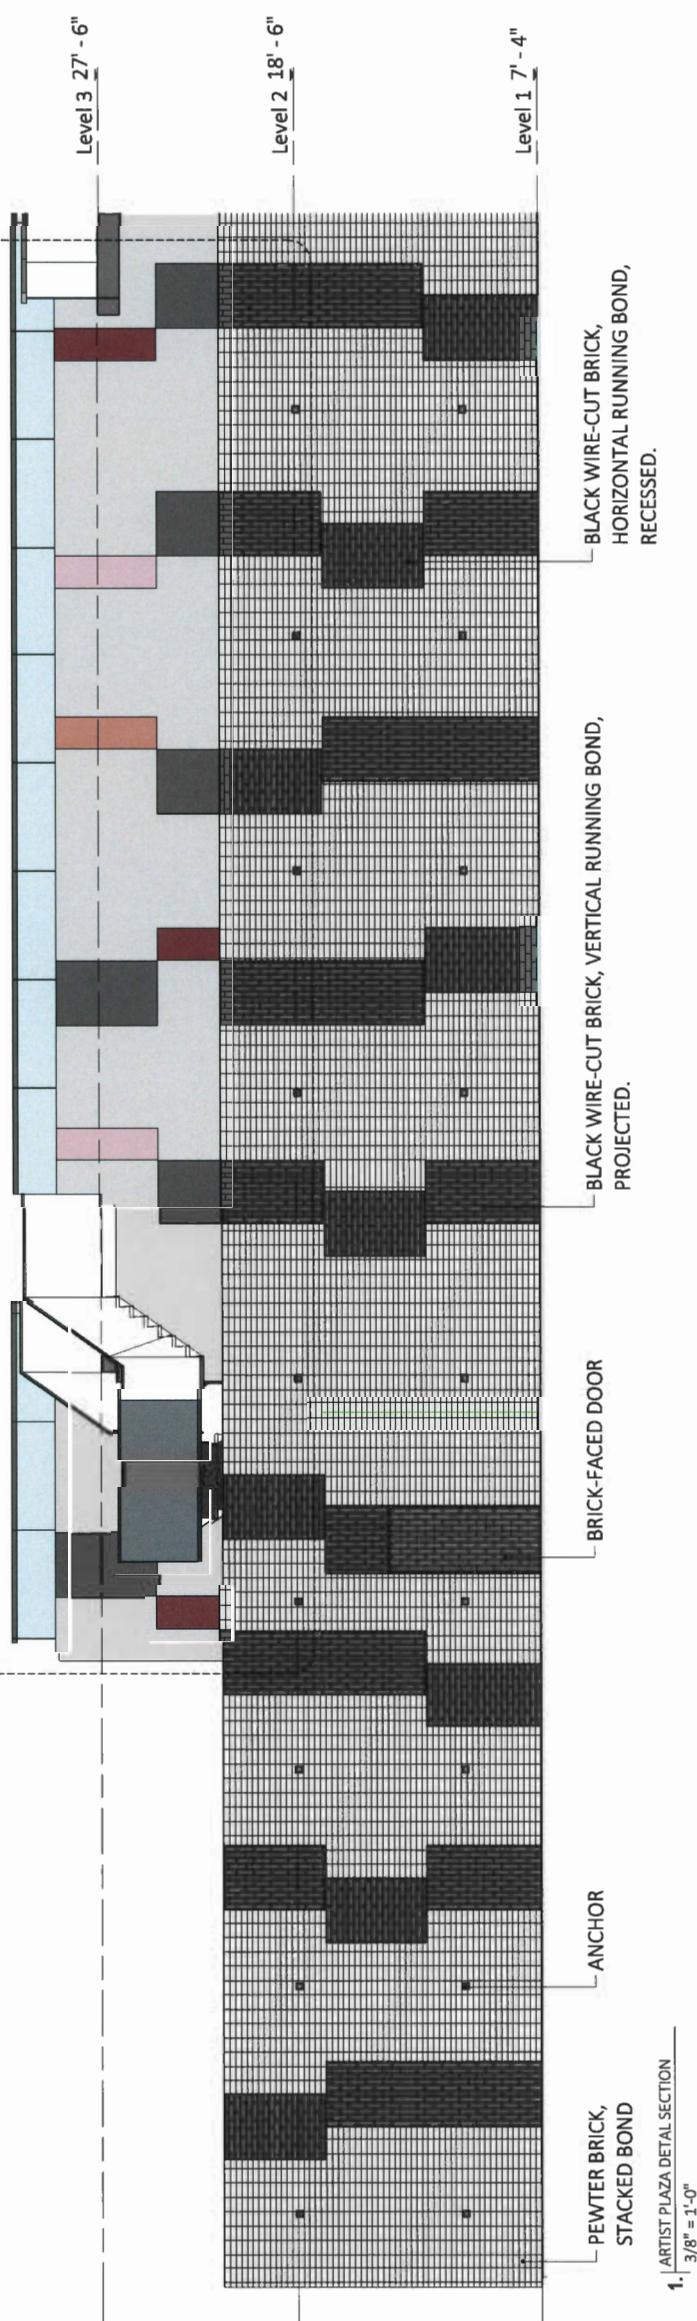

Sheet No:	18-818748	Drawing No.:	A-022
Date:	May 21, 2019	Project No.:	21723
Scale:	1/8" = 1'-0"	Architect:	Chandler
Comments:	Perforated metal fence and gate	Drawn by:	Florinda
Reviewed by:		Checked by:	
Approved by:		Date:	


Sheet No:	18-818748	Drawing No.:	A-022
Date:	May 21, 2019	Project No.:	21723
Scale:	1/8" = 1'-0"	Architect:	Chandler
Comments:	Perforated metal fence and gate	Drawn by:	Florinda
Reviewed by:		Checked by:	
Approved by:		Date:	

DP 18-818748
Plan 23 May 21, 2019




RENDER FROM DP SET SUBMISSION - APRIL 2018

THE BUILDING FORM HAS BEEN BROKEN INTO VARIOUS ELEMENTS THAT ARE STACKED, SLOWLY TERRACING UP AND STEPPING BACK. THE MAIN DESIGN ELEMENTS FOR THE DEVELOPMENT ARE THE VERTICAL CONCRETE PANELS RANDOMLY PLACED OVER THE SURFACE OF THE BUILDING. THE PURPOSE IS TO MAINTAIN THE VERTICAL ELEMENTS FROM THE FACADES AND CARRIED THEM OVER ALL THE WAY INTO THE

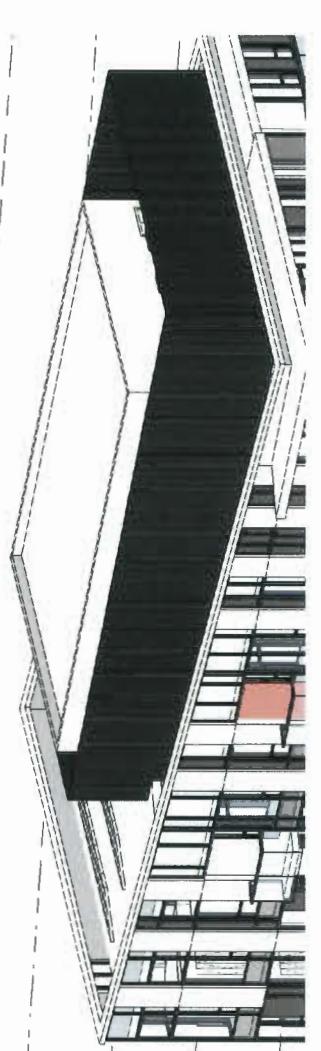

NORTHWEST VIEW

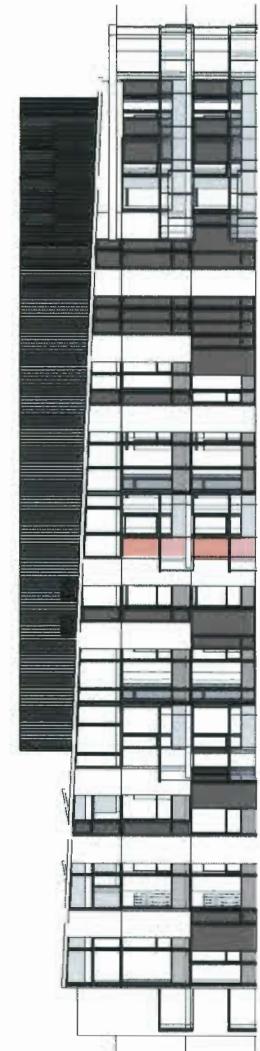


EAST VIEW


TRANSFER THE VERTICAL DESIGN ELEMENTS FROM ALL FAÇADES INTO THE MECHANICAL ENCLOSURE.



SOUTHWEST VIEW

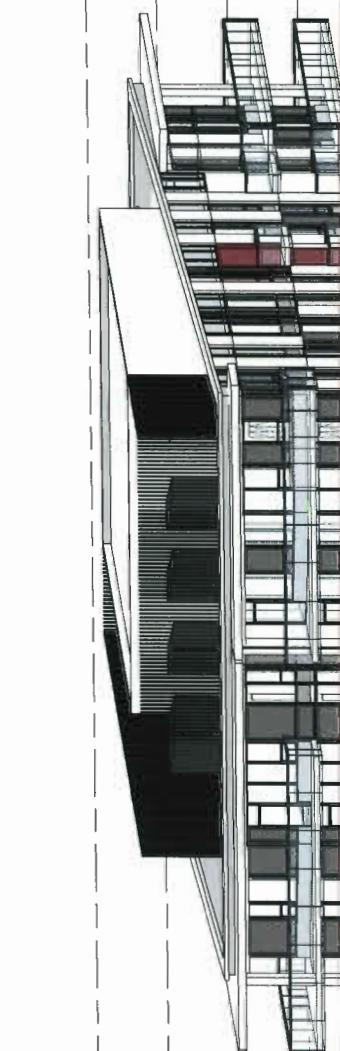

NORTH VIEW

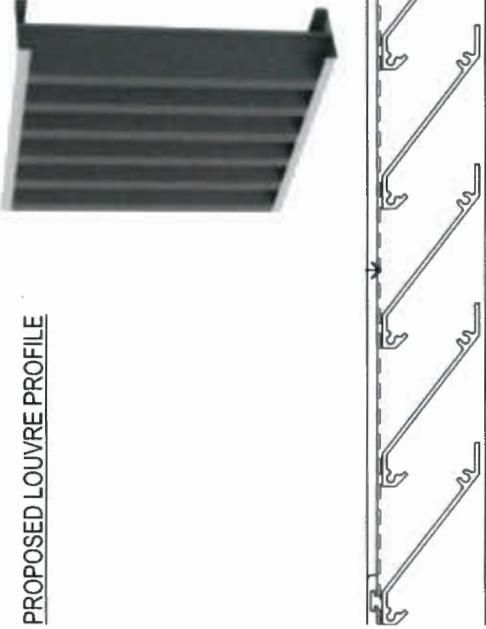

PROPOSED LOUVRE PROFILE

CONCEPT IMAGES OF PROPOSED ALUMINUM LOUVRE SCREENS

Project Name:	Project No.:	Architect:
3551 to 3631, Second Ave.,	04/2024	Patricia M. O'Farrell
Abbotsford, BC	Date:	Architect In Charge:
	04/2024	Patricia M. O'Farrell
	Completion Date:	Patricia M. O'Farrell
	Architect In Charge:	Patricia M. O'Farrell
	Project Manager:	Patricia M. O'Farrell
	Architectural Designer:	Patricia M. O'Farrell
	Structural Engineer:	Patricia M. O'Farrell
	Mechanical Engineer:	Patricia M. O'Farrell
	Electrical Engineer:	Patricia M. O'Farrell
	Plumbing Engineer:	Patricia M. O'Farrell
	Landscaping:	Patricia M. O'Farrell
	Interior Design:	Patricia M. O'Farrell
	Other:	Patricia M. O'Farrell

Project Name:	Project No.:	Architect:
2173	A-015A	Patricia M. O'Farrell
	Date:	Architect In Charge:
	04/2024	Patricia M. O'Farrell
	Completion Date:	Patricia M. O'Farrell
	Architect In Charge:	Patricia M. O'Farrell
	Project Manager:	Patricia M. O'Farrell
	Architectural Designer:	Patricia M. O'Farrell
	Structural Engineer:	Patricia M. O'Farrell
	Mechanical Engineer:	Patricia M. O'Farrell
	Electrical Engineer:	Patricia M. O'Farrell
	Plumbing Engineer:	Patricia M. O'Farrell
	Landscaping:	Patricia M. O'Farrell
	Interior Design:	Patricia M. O'Farrell
	Other:	Patricia M. O'Farrell



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REVISED AND ISSUED

NO. DATE

REVISIONS IN RESPONSE TO AIP

ISSUED FOR FINAL BP RESPONSE

6 19-208

6 19-423

DP 18-818748
Plan 25 May 21, 2019

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NORTH

SCALE



N/A

PROJECT NO. 17091

DATE 19-5-10

FILE NAME 17091_Fiorella_Plan.wrx

RELEASER

DRAWN JO REVISED BH

DRAWING

- PAVING LEGEND**

KEY	DESCRIPTION
P1	CIP Concrete Paving
P2	CIP Concrete Paving Vehicle Loading
P3	Hydrapressed Pavers
P4	Feature Paving Type 1 Colour: Natural
P5	Feature Paving Type 2 Colour: Charcoal
P6	Feature Paving Type 3 Colour: Moroccan Sunset
P7	Concrete Unit Pavers Colour : Charcoal -Vehicle (Herringbone pattern with soldier course outline)
P8	Concrete Unit Pavers Colour: Natural (Herringbone pattern with soldier course outline)
P9	CIP Concrete Band
P10	Resilient Rubber Surface
P11	River Rock
P12	GrassGrid

- SITE FURNISHING LEGEND**



KEY	DESCRIPTION
F1	Bike Rack
F2	Harvest Table
F3	Metal Trellis
F4	BBQ
F5	Bench w/ armrests
F6	Custom Feature Bench w/ armrests & skateboard deterrents
F7	Play Equipment
F8	Potting Table/Compost/Tool Storage
F9	Garden Planters
F10	Sand Box
F11	Metal Bollard
F12	Light Bollard
F13	Privacy Screen
F14	Vertical Cable Wire System

NOTE: CONFIRM DRAIN LOCATIONS WITH MECHANICAL CIVIL AND ARCH DRAWINGS, REPORT ANY DISCREPANCIES.

Hardscape Legend			
KEY	DESCRIPTION	KEY	DESCRIPTION
P1	CIP Concrete Paving	H1	CIP Concrete Stairs with Handrail
P2	CIP Concrete Paving Vehicle Loading	H2	Feature Wall See Architectural Drawings
P3	Hydrapressed Pavers	H3	CIP Concrete Wall
P4	Feature Paving Type 1 Colour: Natural	H4	Gate with Brick Plinth
P5	Feature Paving Type 2 Colour: Charcoal	H5	CIP Concrete Planter
P6	Feature Paving Type 3 Colour: Moroccan Sunset	H6	Modular Block Wall System

Site Furnishing Legend			
KEY	DESCRIPTION	KEY	DESCRIPTION
F1	Bike Rack	F2	Harvest Table
F3	Metal Trellis	F4	BBQ
F5	Bench w/ armrests	F6	Custom Feature Bench w/ armrests & skateboard deterrents
F7	Play Equipment	F8	Potting Table/Compost/Tool Storage
F9	Garden Planters	F10	Sand Box
F11	Metal Bollard	F12	Light Bollard
F13	Privacy Screen	F14	Vertical Cable Wire System

Grading Legend			
Existing Elevation	EL. 0.0m	Proposed Elevation	EL. 0.0m
Finished Floor Elevation	EL. 0.0m	Proposed Top of Wall Elevation	EL. 0.0m
Proposed Top of Wall Elevation	EL. 0.0m	Proposed Bottom of Wall Elevation	EL. 0.0m
Proposed Top of Stair Elevation	EL. 0.0m	Proposed Bottom of Stair Elevation	EL. 0.0m
Proposed Top of Curb Elevation	EL. 0.0m	Proposed Bottom of Curb Elevation	EL. 0.0m
Proposed Top of Ramp Elevation	EL. 0.0m	Proposed Bottom of Ramp Elevation	EL. 0.0m
Swale Elevation	EL. 0.0m	Existing Contour	70.5m
Proposed Contour	70.5m	Trench Drain	---
Area Drain	---	Perforated Pipe	---
Lawn Basin	---	Planted Drain	---
Planter Drain	---	Catch Basin	---
Catch Basin	---	Root Drain, shown for reference only, see mechanical and architectural drawings	---
Hose Bib	---	ER	Duplex Electrical Receptacle
Floodlight for Wall Illumination (staked in granular strip)	---	LX	---

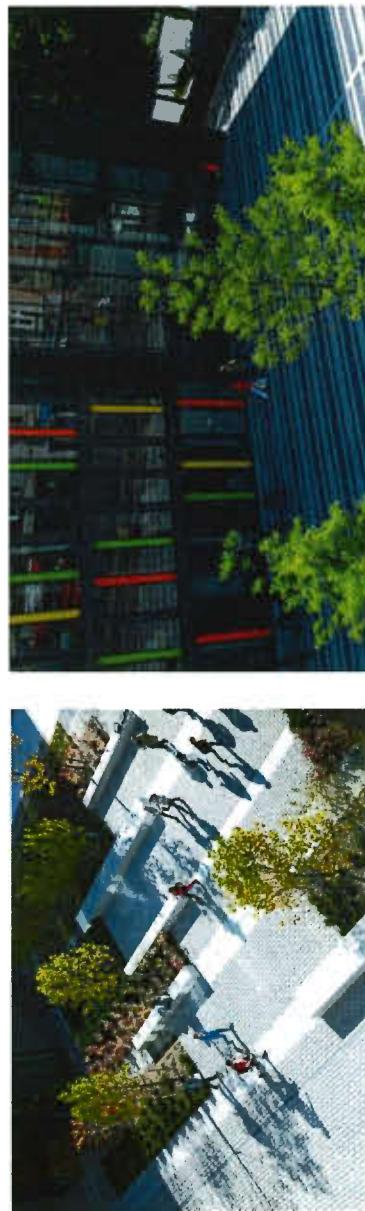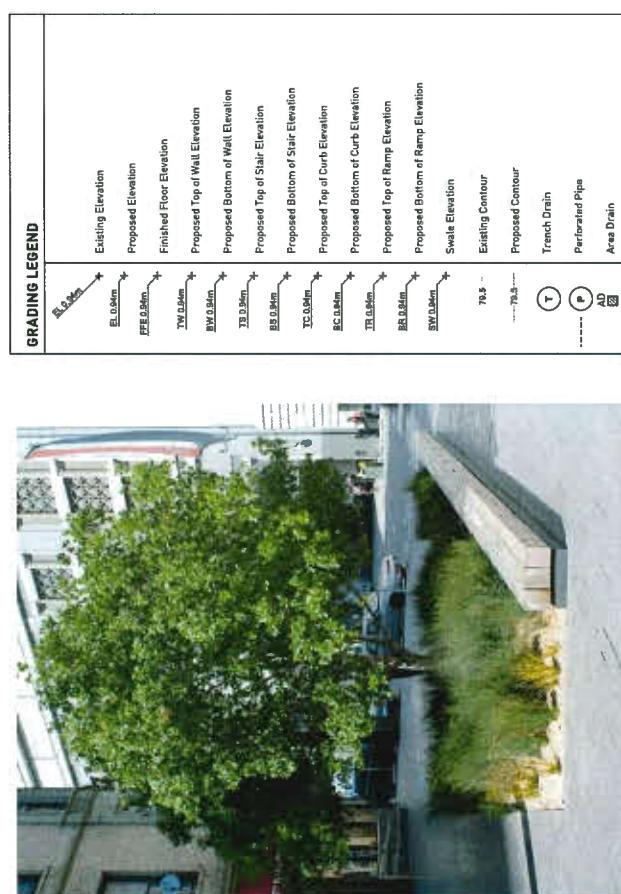

WATCH LINE

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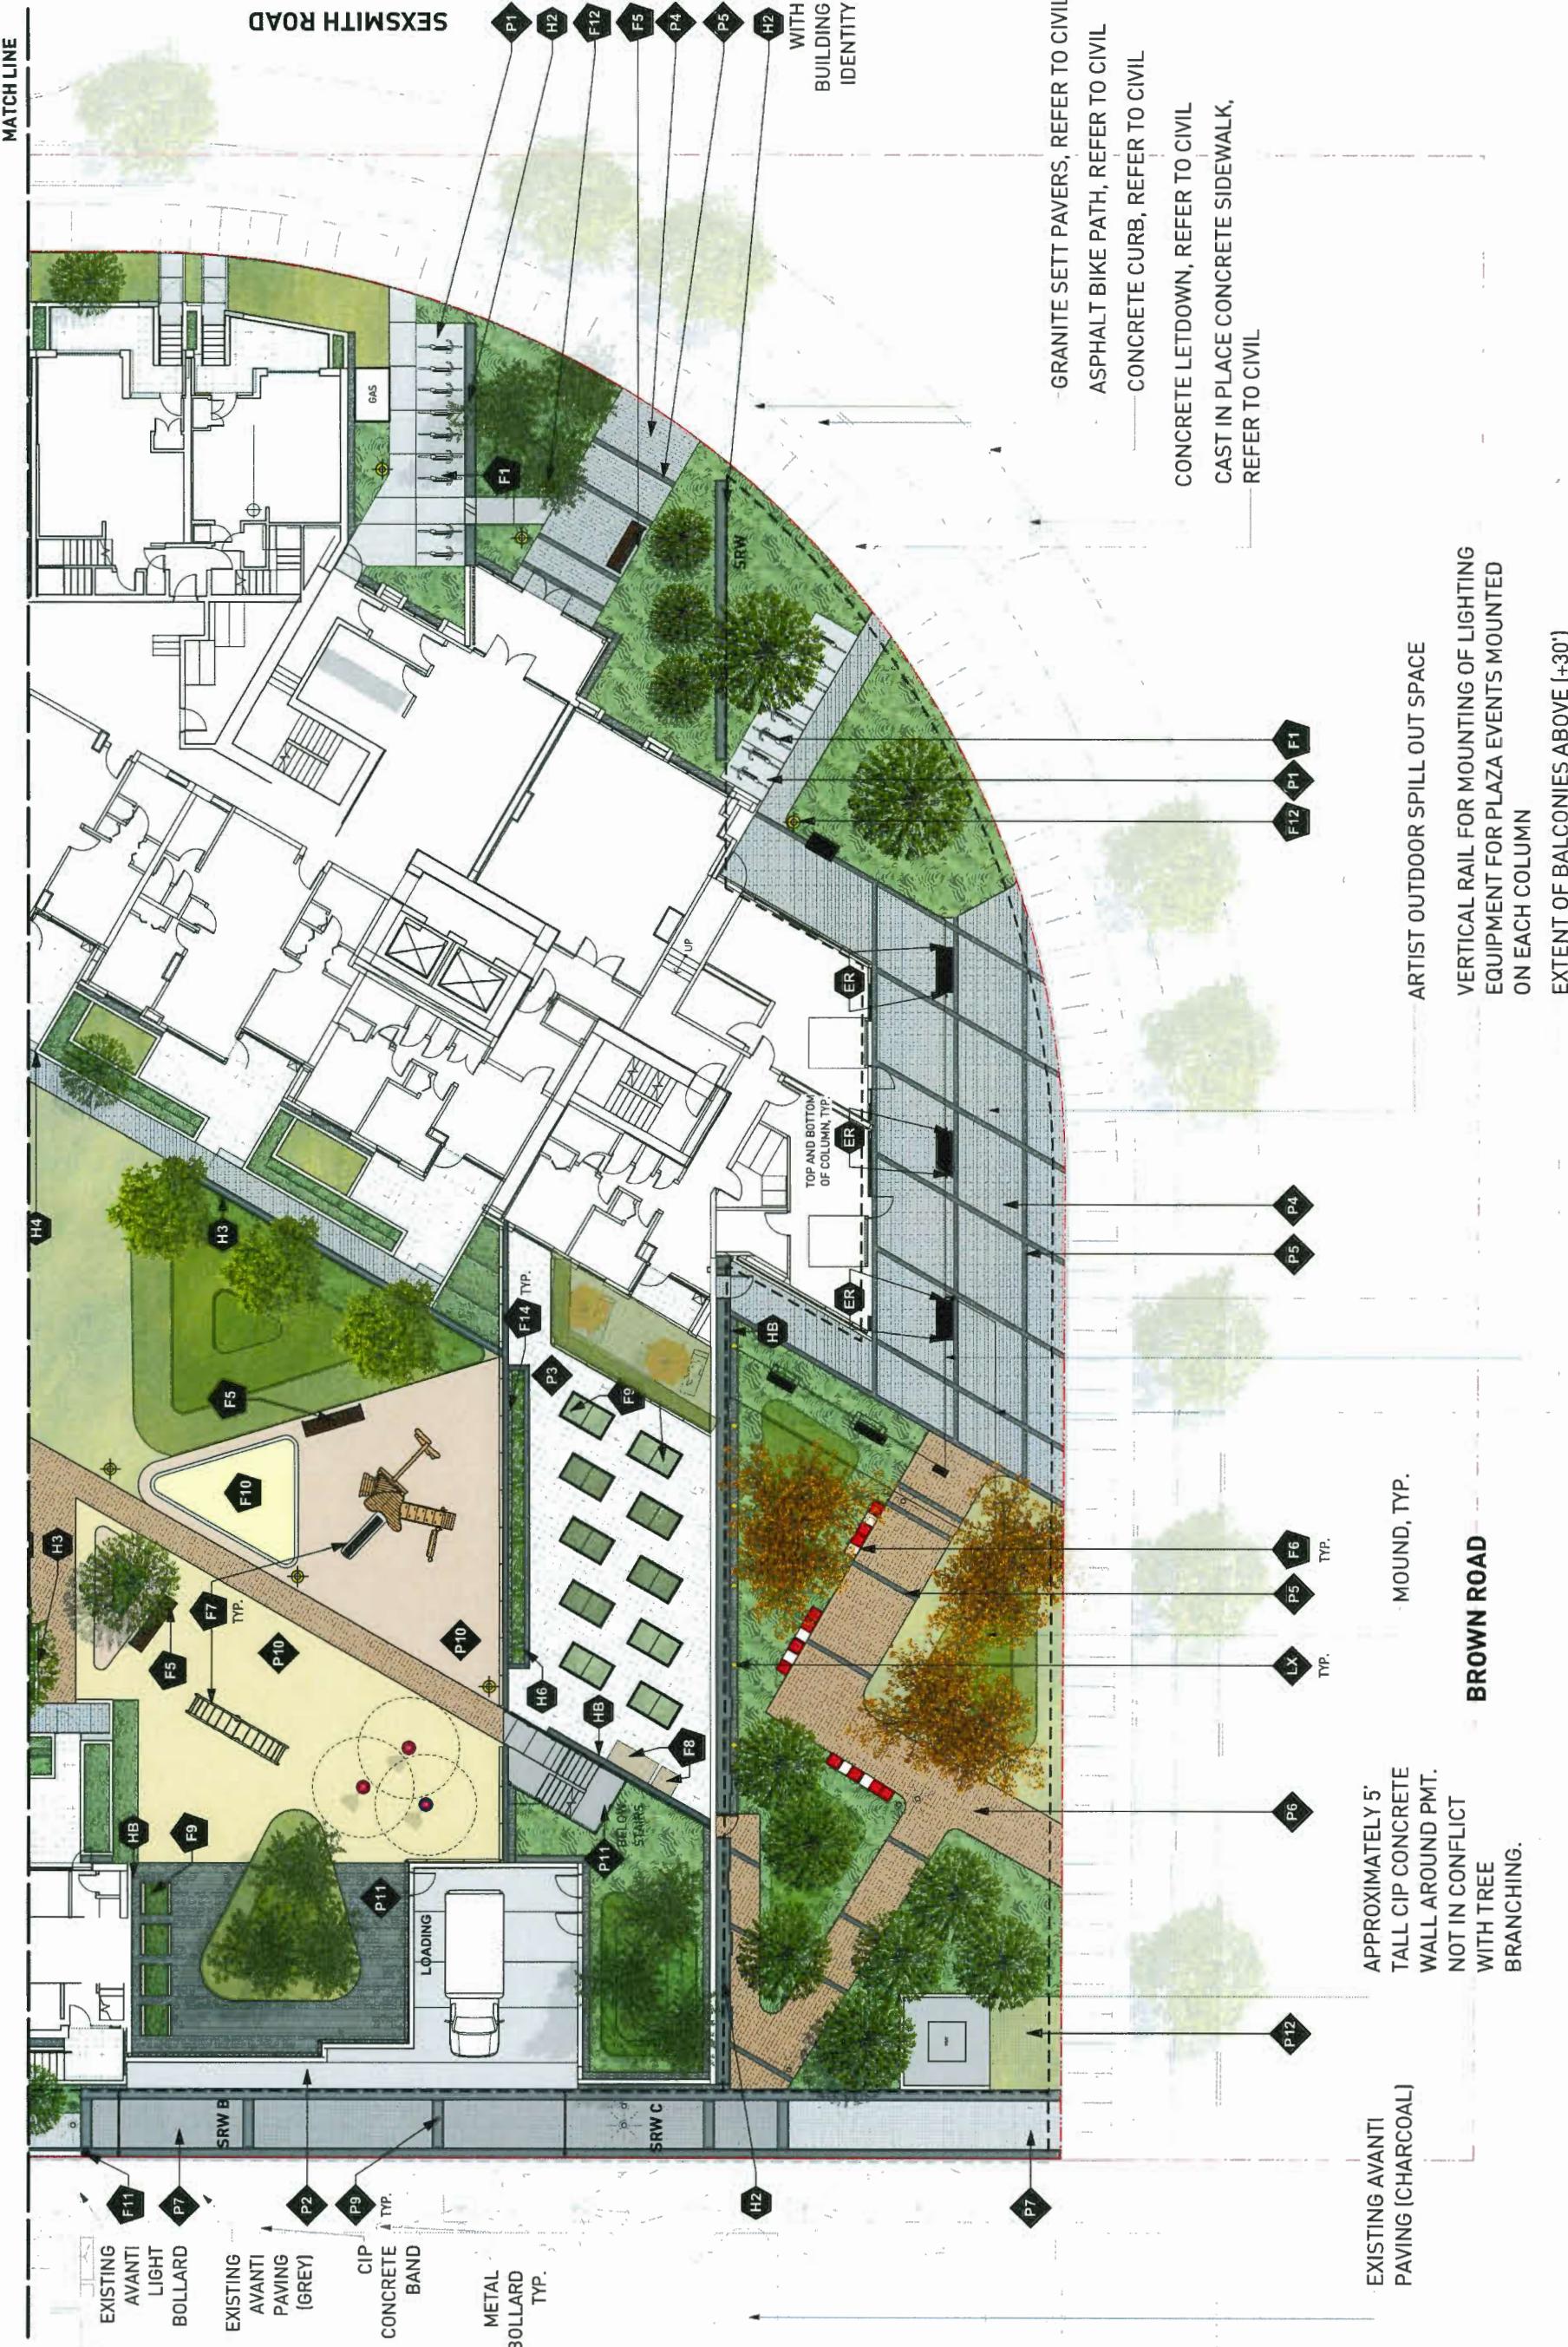
REASONS AND ISSUES		
Q.	DATE	DESCRIPTION
	19-3-08	Issued in Response to ADP
	19-4-23	Issued for Final DP Response

DP 18-818748
Plan 26 May 21, 2019

MATERIALS PLAN

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PROJECT NO.	17091		
DATE:	19-5-7		
FILE NAME: 17091 Florell Plan.wrx			
PLOTTED			
DRAWN	JO	REVIEWED	BH



DP 18-818748
Plan 27 May 21, 2019

TEMPORARY
SIDEWALK
ALIGNMENT
(DUE TO ROAD
ALIGNMENT,
REFER TO CIVIL)

ULTIMATE
SIDEWALK
ALIGNMENT

RESPONSE AND ISSUES
NO. DATE DESCRIPTION
5 19-3-08 Issued in response to ADP
6 19-4-23 Issued for Final DP Response

SEXSMITH ROAD

FIORELLA

MATERIALS PLAN


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NORTH

SCALE

3/32"=1'-0"

PROJECT NO. 17091
DATE 19-5-13
FILE NAME 17091 Fiorella Plan.wkx
PLOTTED
DRAWN JO
REVIEWED BH
DRAWING

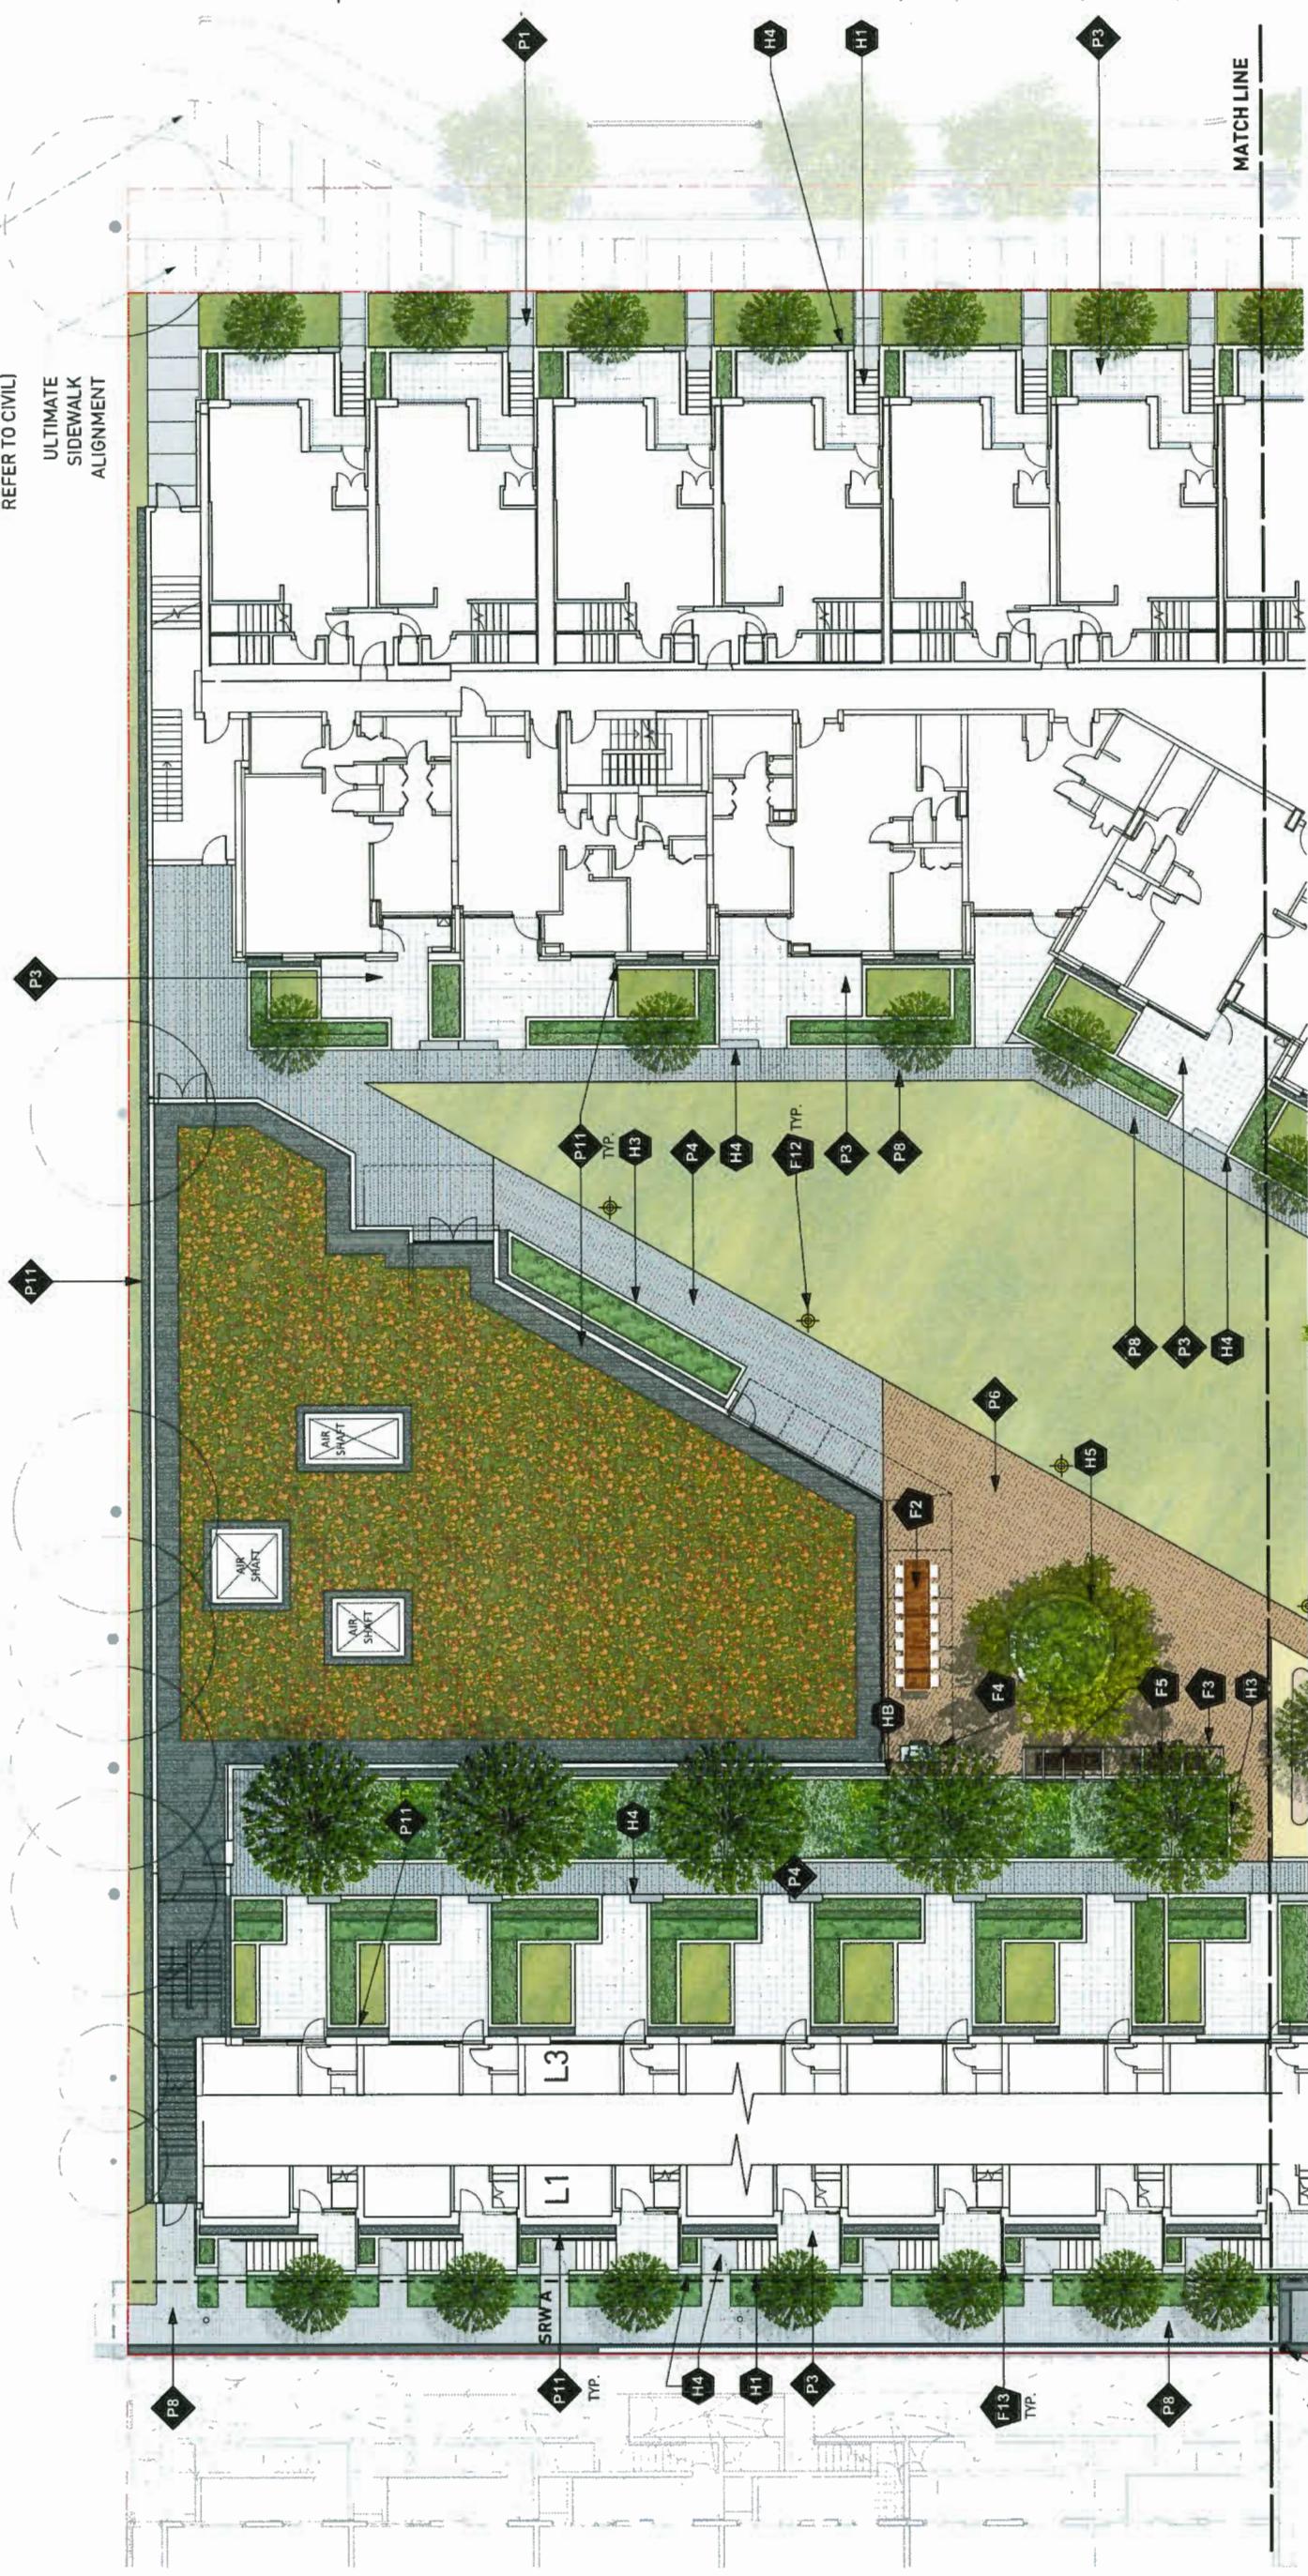

L1.02

DP 18-818748
Plan 28 May 21, 2019


PROJECT
FIORELLA

DRAWING TITLE
PUBLIC PLAZA
ENLARGEMENT

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NORTH
SCALE
1"=10'-0"

PROJECT NO. 17081
DATE 19-5-7
FILE NAME 17081 Fiorella Plaza.wkx
PLOTTED
DRAWN JG
REFERENCED BH
DRAWING



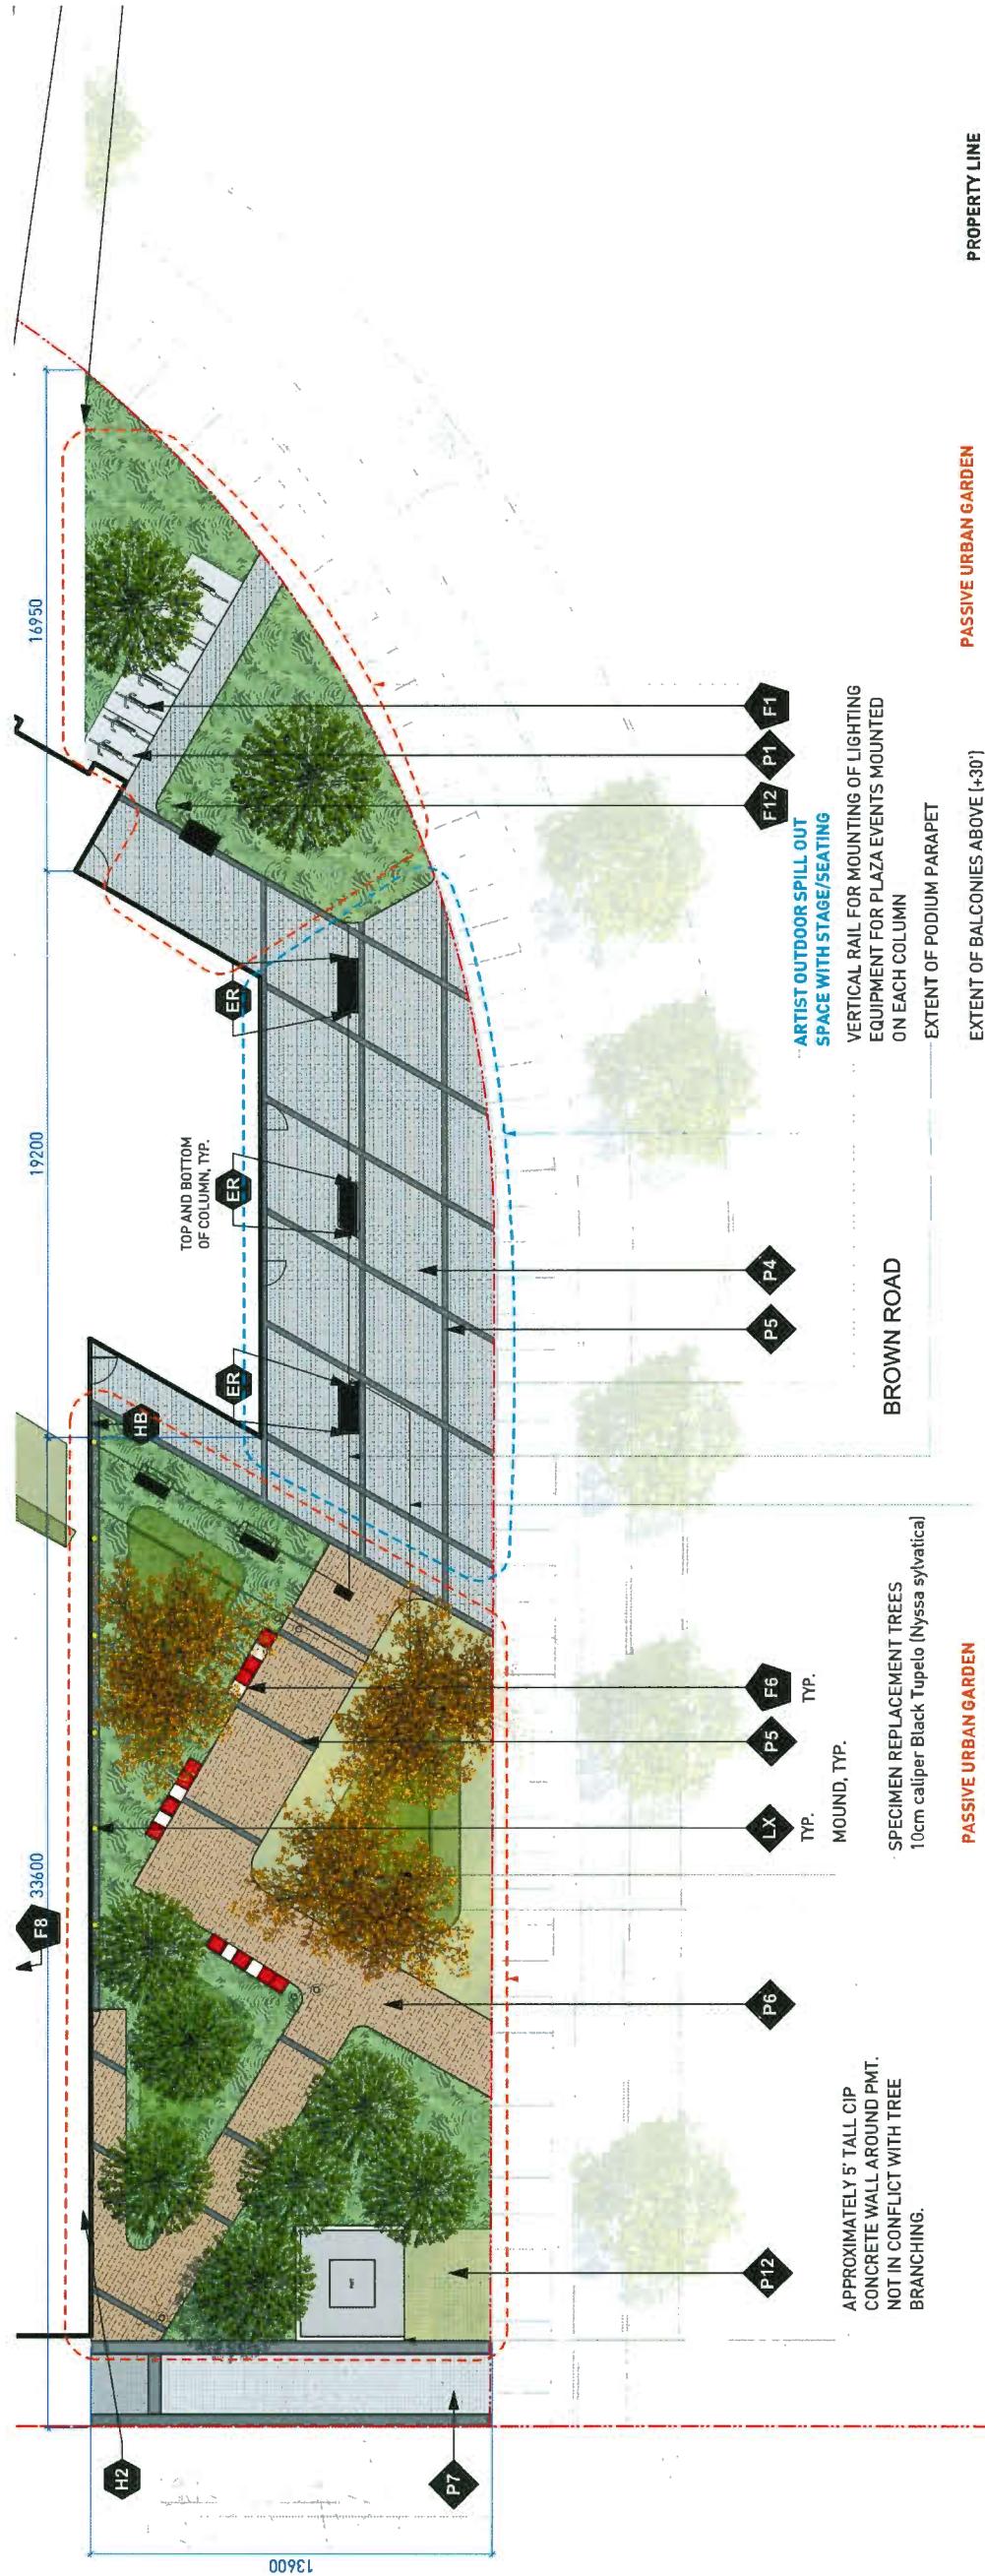

PAVING LEGEND	
KEY	DESCRIPTION
P1	CIP Concrete Paving
P3	Hydrapressed Pavers
P4	Feature Paving Type 1 Colour: Natural
P5	Feature Paving Type 2 Colour: Charcoal

REF ID: AND ISSUES
NO. DATE
5 18-3-08
6 18-4-23
REASON FOR ISSUES
Issued in response to ADP
Issued for Final DP Response

HARDSCAPE LEGEND	
KEY	DESCRIPTION
H1	CIP Concrete Stairs with Handrail
H2	Feature Wall See Architectural Drawings
H4	Gate with Stone Plinth

REF ID: AND ISSUES
NO. DATE
5 18-3-08
6 18-4-23
REASON FOR ISSUES
Issued in response to ADP
Issued for Final DP Response

SITE FURNISHING LEGEND	
KEY	DESCRIPTION
F1	Bike Rack
F12	Light Bollard



REF ID: AND ISSUES
NO. DATE
5 18-3-08
6 18-4-23
REASON FOR ISSUES
Issued in response to ADP
Issued for Final DP Response

DP 18-818748
Plan 29 May 21, 2019

Project: Fiorella
Drawing Title: Sexsmith Streetscape Plan Enlargement
North arrow
Scale: 1"=10'-0"
Drawing No.: 17091
Date: 19-5-7
File Name: 17091_Fiorella_Plan.wzc
Plotted
Drawn: JO
Reviewed: BH
Drawing:

Project No.: 17091
Date: 19-5-7
File Name: 17091_Fiorella_Plan.wzc
Plotted
Drawn: JO
Reviewed: BH
Drawing:

L1.04

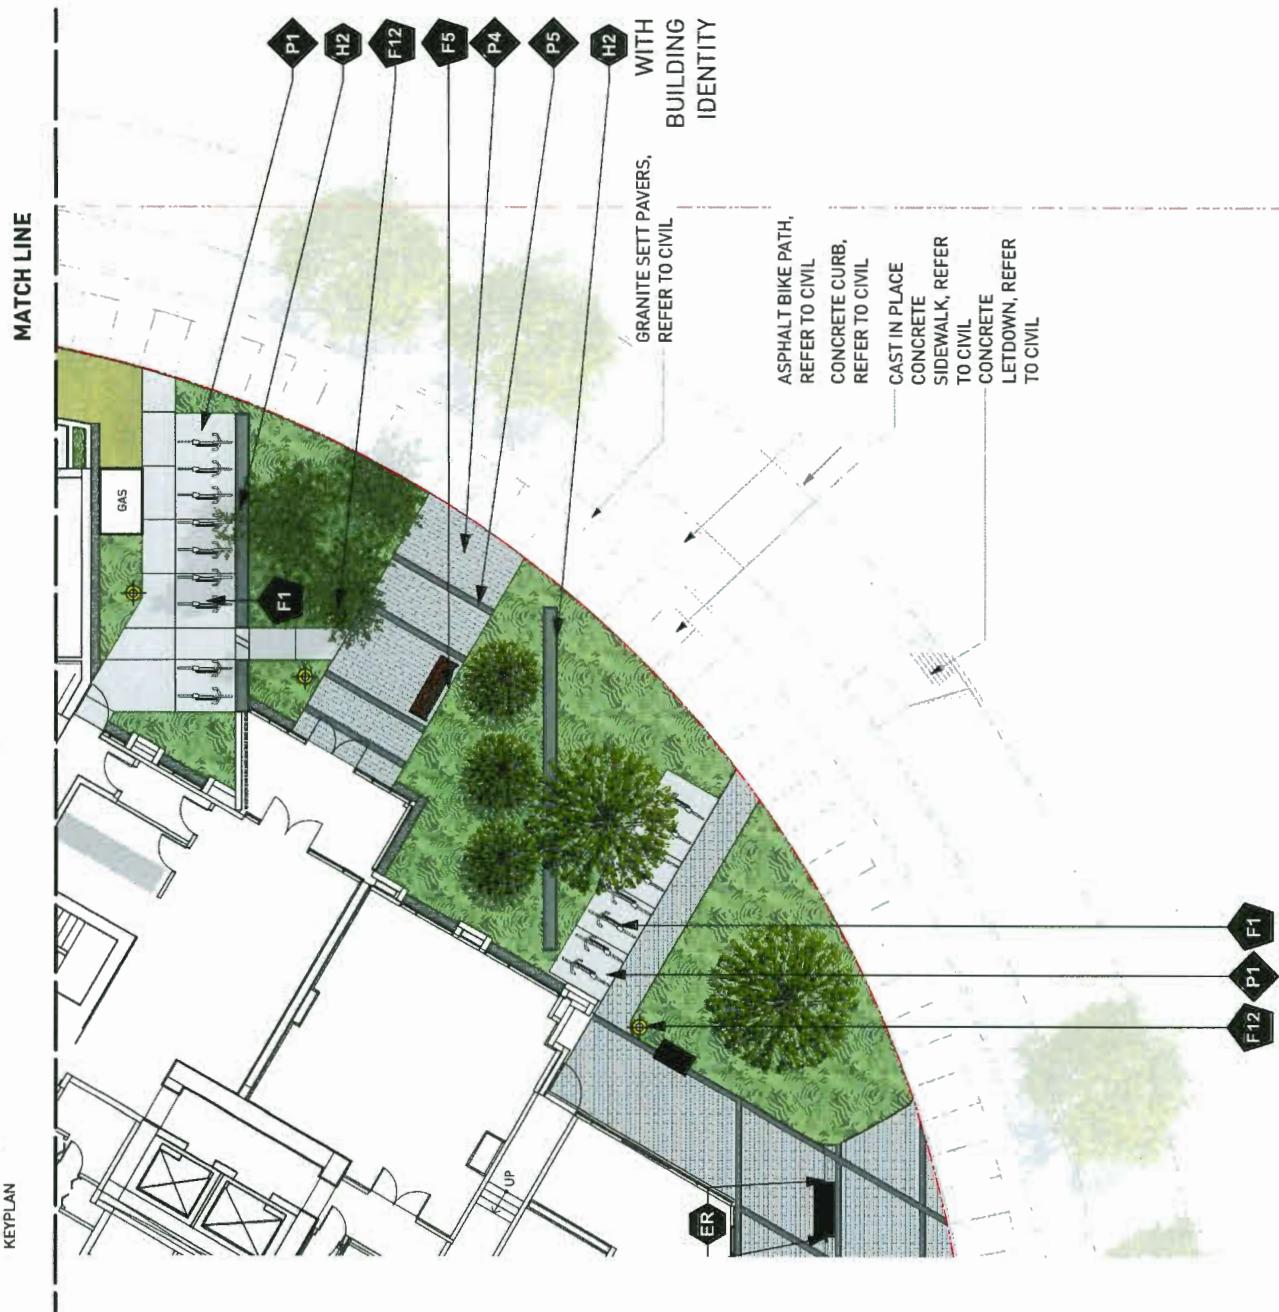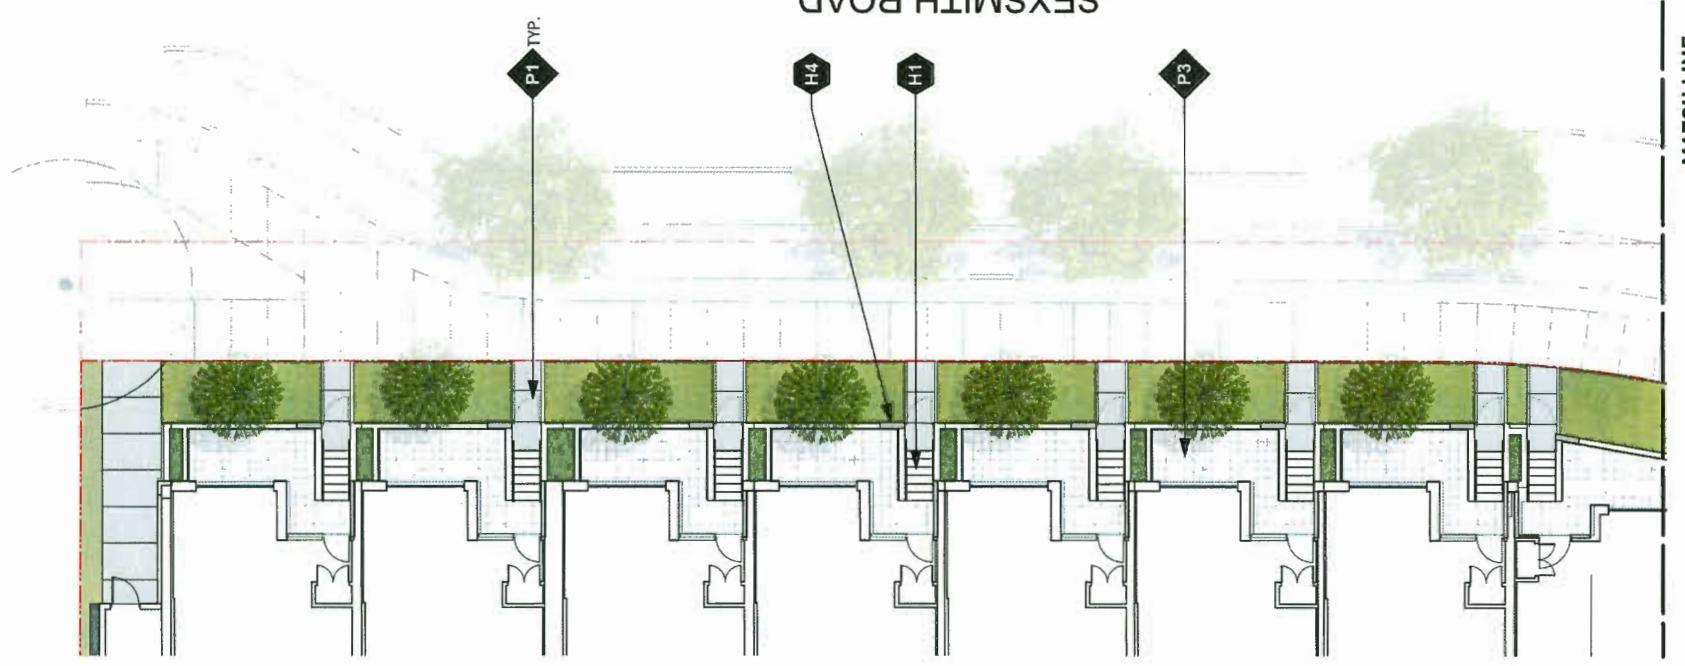



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DP 18-818748
Plan 30 May 21, 2019


HARDSCAPE LEGEND			
KEY	DESCRIPTION	KEY	
P1	CIP Concrete Paving	H1	CIP Concrete Stairs with Handrail
P2	CIP Concrete Paving Vehicle Loading	H2	Feature Wall See Architectural Drawings
P3	Hydrexpress Pavers	H3	CIP Concrete Wall
P4	Feature Paving Type 1 Colour: Natural	H4	Gate with Brick Plinth
P5	Feature Paving Type 2 Colour: Charcoal	H5	CIP Concrete Planter
P6	Feature Paving Type 3 Colour: Moroccan Sunset	H6	Modular Block Wall System
P7	Concrete Unit Pavers Colour: Charcoal-Vehicle		
P8	Concrete Unit Pavers Colour: Natural		
P9	CIP Concrete Band	F1	Bike Rack
P10	Resilient Rubber Surface	F2	Harvest Table
P11	Granular Paving	F3	Metal Trellis
P12	GrassGrid	F4	BBQ
		F5	Bench w/ armrests
		F6	Custom Feature Bench w/ armrests & skateboard deterrents
		F7	Play Equipment
		F8	Potting Table/Compost/Tool Storage
		F9	Garden Planters
		F10	Sand Box
		F11	Metal Bollard
		F12	Light Bollard
		F13	Privacy Screen
		F14	Vertical Cable Wire System

SITE FURNISHING LEGEND			
KEY	DESCRIPTION	KEY	
F1	Bike Rack		
F2	Harvest Table		
F3	Metal Trellis		
F4	BBQ		
F5	Bench w/ armrests		
F6	Custom Feature Bench w/ armrests & skateboard deterrents		
F7	Play Equipment		
F8	Potting Table/Compost/Tool Storage		
F9	Garden Planters		
F10	Sand Box		
F11	Metal Bollard		
F12	Light Bollard		
F13	Privacy Screen		
F14	Vertical Cable Wire System		

PODIUM
(SHARED SPACE
FOR RESIDENTS)

Podium (Shared space for residents)
The upper courtyard provides residents with diverse, shared open space that encourages the Fiorella community to gather, play, garden or just relax. The main gathering area with seating, trellis and BBQs is located in the centre of the podium space. It is directly adjacent to the indoor amenity area ensuring a seamless extension and mutual support of common amenity activities. The children's play area is located in the sunniest part of the site, providing residents and their children with a comfortable place to enjoy throughout all parts of the day. A large open lawn frames the gathering space, while providing a buffer for the residential units located on the patio level. Additional planting adjacent to private patios adds colourful interest while creating a soft buffer between the residential units and the more active central space. The design while fully functional and engaging also creates a positive visual experience for residents to look down onto.

PODIUM (SHARED SPACE) AREA: 144.1m²

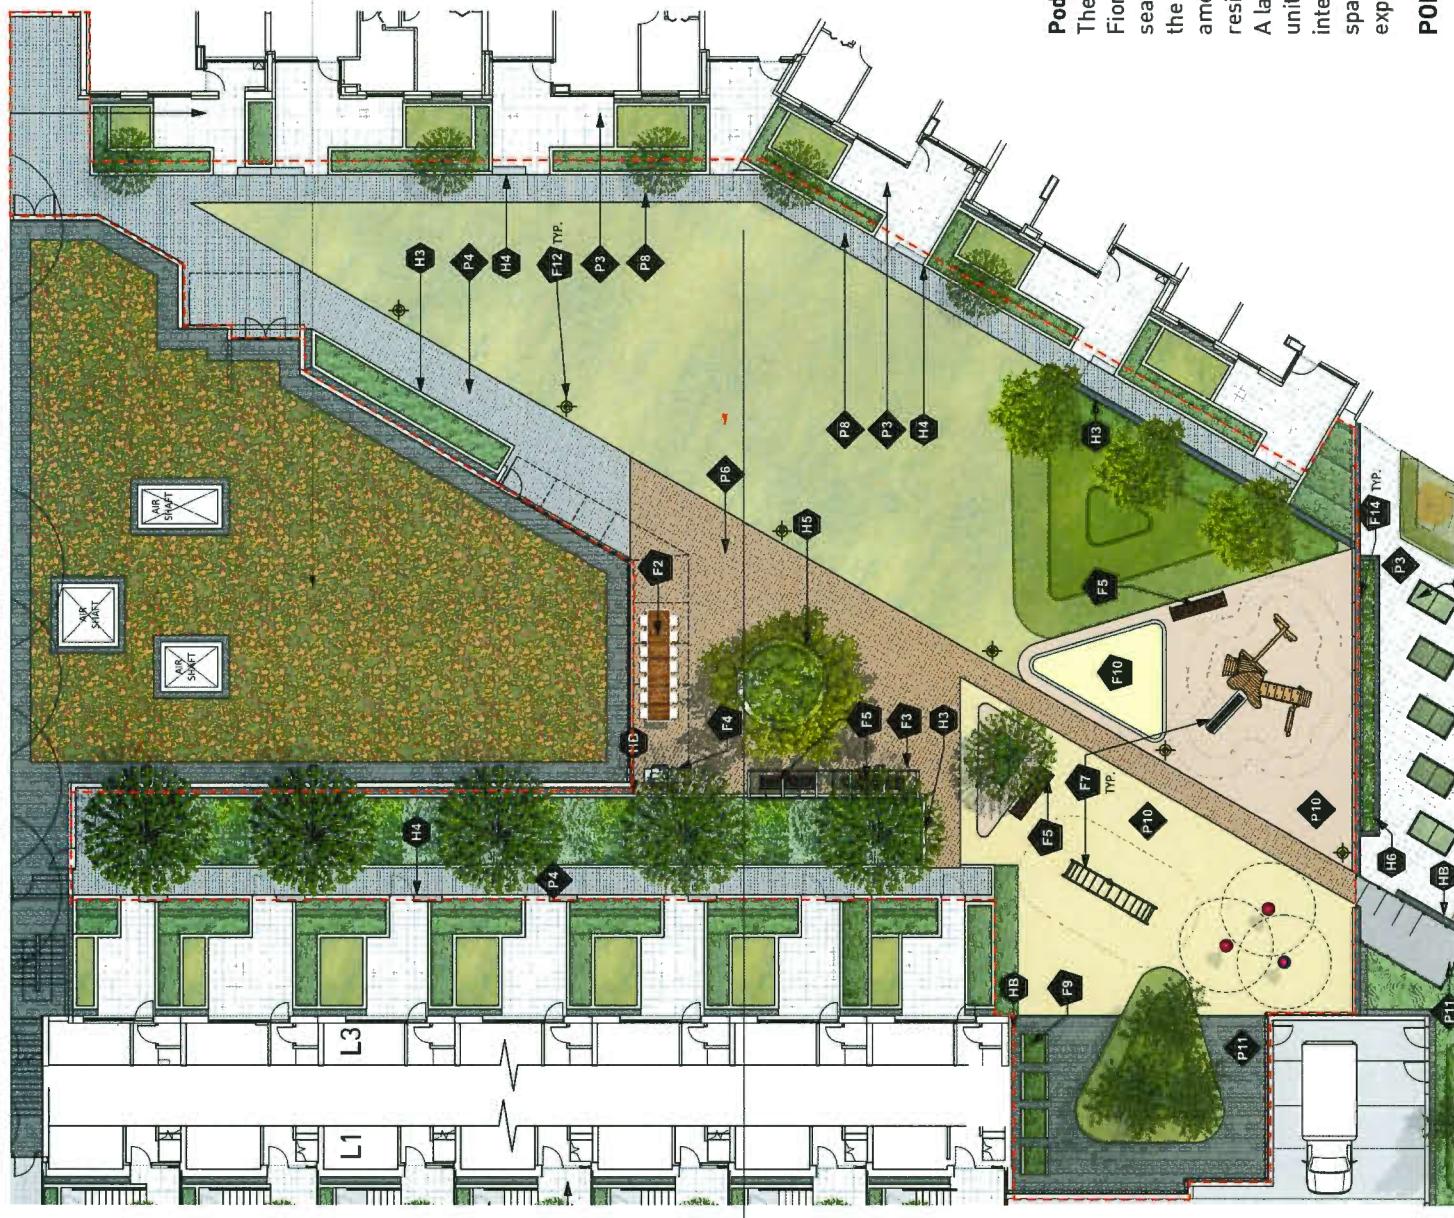

COURTYARD AND AMENITY ENLARGEMENT

COURTYARD AND AMENITY ENLARGEMENT	
PROJECT NO.	17081
DATE	19-5-17
FILE NAME	17081_Fiorella_Plans.wkx
SCALE	1:150
NORTH	
PLANTED	
DRAWN	
REFINED	
DRAWING	

COURTYARD AND AMENITY ENLARGEMENT	
REVISION AND ISSUES	as shown
NO. DATE	
5 19-3-06 Issued in Response to ADR	
6 19-4-23 Issued for Final DP Response	

COURTYARD AND AMENITY ENLARGEMENT	
KEY	
HB	Hose Bib
ER	Duplex Electrical Receptacle
LX	Floodlight for Wall Illumination [staked in granular strip]

L1.05

SECTION 1. PATIO PATH	
OUTDOOR AMENITY SPACE	40'0"
CENTRE LAWN	12'0"
PATIO PATH	12'0"
PLANTING PATH	11'0"
TOWNHOUSE PATH	4'0"
PATIO PATH	12'0"
SEMI-DETACHED ROOF ON TOWNHOUSE	4'6"



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info@pwlpartnership.com
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Instagram #11

DP 18-818748
Plan 31 May 21, 2019


HARDSCAPE LEGEND

KEY	DESCRIPTION	KEY	DESCRIPTION
P1	CIP Concrete Paving	H1	CIP Concrete Stairs with Handrail
P2	CIP Concrete Paving Vehicle Loading	H2	Feature Wall See Architectural Drawings
P3	Hydrapressed Pavers	H3	CIP Concrete Wall
P4	Feature Paving Type 1 Colour: Natural	H4	Gate with Brick Plinth
P5	Feature Paving Type 2 Colour: Charcoal	H5	CIP Concrete Planter
P6	Feature Paving Type 3 Colour: Moroccan Sunset	H6	Modular Block Wall System
P7	Concrete Unit Pavers Colour: Charcoal -Vehicle		
P8	Concrete Unit Pavers Colour: Natural		
P9	CIP Concrete Band		
P10	Resilient Rubber Surface		
P11	Granular Paving		
P12	GrassGrid		
			Bench w/ armrests

SITE FURNISHING LEGEND

KEY	DESCRIPTION
F1	Bike Rack
F2	Harvest Table
F3	Metal Trellis
F4	BBQ
F5	Bench w/ armrests
F6	Custom Feature Bench w/ armrests & skateboard deterrents
F7	Play Equipment
F8	Potting Table/Compost/Tool Storage
F9	Garden Planters
F10	Sand Box
F11	Metal Bollard
F12	Light Bollard
F13	Privacy Screen
F14	Vertical Cable Wire System

KEY	DESCRIPTION
P1	CIP Concrete Paving
P2	CIP Concrete Paving Vehicle Loading
P3	Hydrapressed Pavers
P4	Feature Paving Type 1 Colour: Natural
P5	Feature Paving Type 2 Colour: Charcoal
P6	Feature Paving Type 3 Colour: Moroccan Sunset
P7	Concrete Unit Pavers Colour: Charcoal -Vehicle
P8	Concrete Unit Pavers Colour: Natural
P9	CIP Concrete Band
P10	Resilient Rubber Surface
P11	Granular Paving
P12	GrassGrid
	Bench w/ armrests

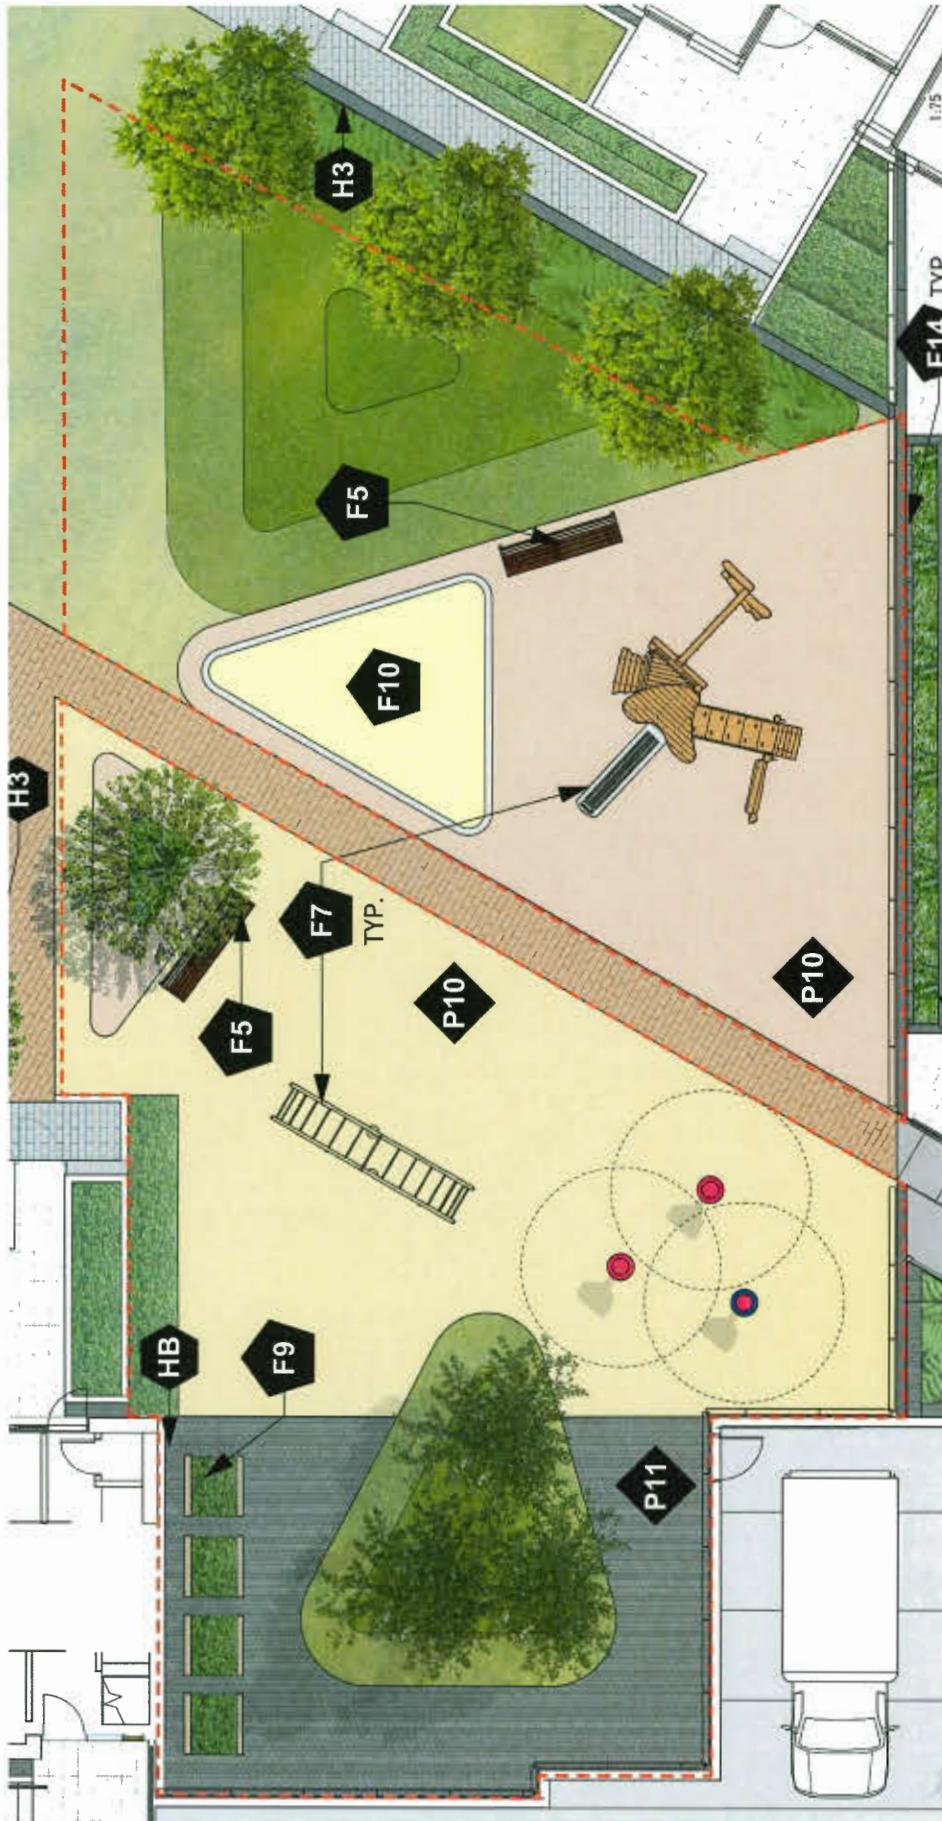



Children's Play Space

CHILDREN'S PLAY SPACE AREA: 465m²
LEVEL 2 AMENITY - URBAN AGRICULTURE AREA: 220m²

The children's play area is located in the sunniest part of the site, providing residents and their children with a comfortable place throughout all parts of the day. The play area provide a combination of sand play and traditional equipment together with mounded grass areas and urban agriculture for children.

Urban Agriculture Area

Similarly to the play area, the urban agriculture is located in a sunny area, providing residents with planters, potting table with storage and a compost bin. Due to it's exposure this location is a very successful place for urban gardening. A planter at the base of the south facing wall and wire cable vine structure on the wall soften the hard built edge while providing an interesting plant based vertical element.

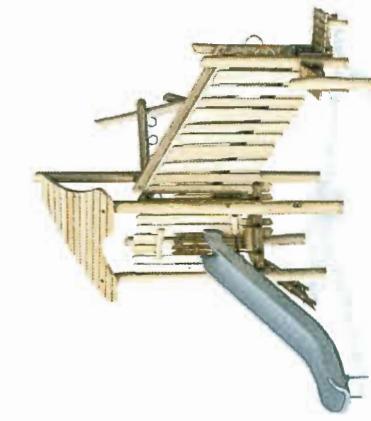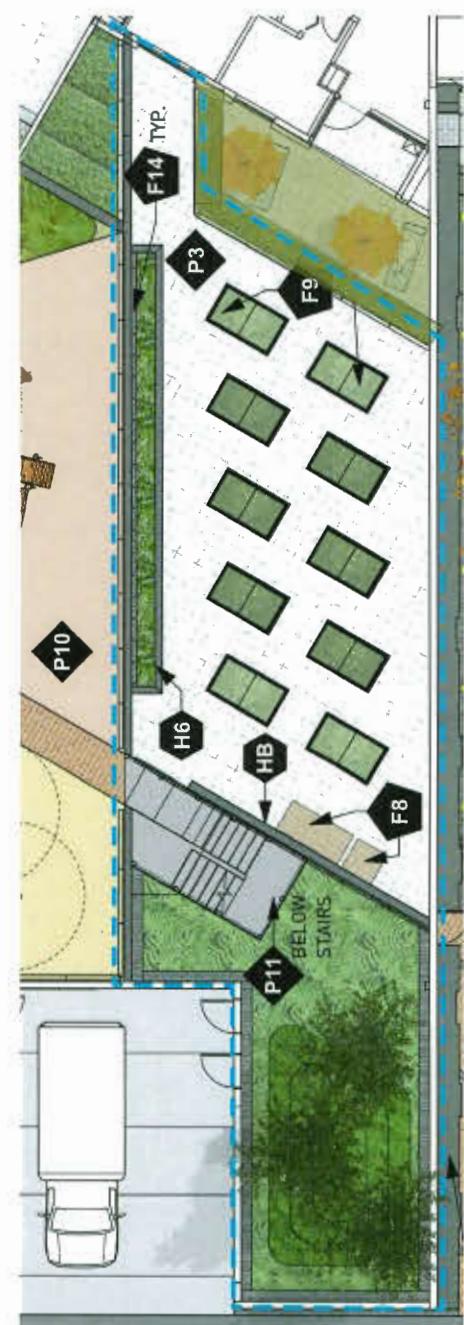

Climbing Ladder

Play Tower

PROJECT NO.	DATE	SCALE
17091	19-5-7	1:100
Fiorella Park.wks		
EDITED		
DRAWN	JG	REVISED BH
DRAWING		

HB Hose Bib
ER Duplex Electrical Receptacle
LX Floodlight for Wall Illumination (staked in granular strip)

1:100

L1.06

PWL partnership

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FAX 604-681-1112



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REVISIONS AND ISSUES
NO. DATE DESCRIPTION
5 18-2-08 Issued in Response to AIP
6 18-4-23 Issued for Final DP Response

DP 18-818748
Plan 32 May 21, 2019

PROJECT
FIORELLA

ADDRESS

DRAWING TITLE
ROOF PLAN

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PROJECT NO. 17091
DATE 19-5-27
FILE NAME 17091_Fiorella_Plan.vwx
PLATED DRAWN JD REVISED BH
DRAWING

SCALE 1/16"=1'-0"

- Sedum - Green Roof Mix:**
- 18% - Sedum spathulifolium [Broad-leaved Stonecrop]
 - 21% - Sedum album 'Mureale' [Murale Stonecrop]
 - 18% - Sedum floriferum 'Weihenstephaner Gold' [Weihenstephaner Gold Stonecrop]
 - 20% - Sedum hybridum 'Immergrunchen' [Immergrunchen Stonecrop]
 - 13% - Sedum rupestre [Rupstre Stonecrop]
 - 10% - Sedum spurium 'Dragons Blood' [Two-Row Stonecrop]



L1.07



LIGHTING LEGEND

DRAWINGS HAS BEEN DEVELOPED FOR REFERENCE TO FACILITATE COORDINATION
BETWEEN CONTRACTORS.

REFER TO ELECTRICAL ENGINEERING DRAWINGS FOR FIXTURE TYPES AND LAYOUT.
CONTRACTOR TO REPORT ANY DISCREPANCIES TO CONSULTANT FOR COMMENTS.

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1201 West Pender Street
Vancouver BC Canada V6E 2W7
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REVISIONS AND ISSUES	SEQ. NO.	DATE	DESCRIPTION
	5	19-3-08	Issued in Response to ADP
	6	19-4-08	Issued for Final DP Release

DP 18-818748
Plan 33 May 21, 2019

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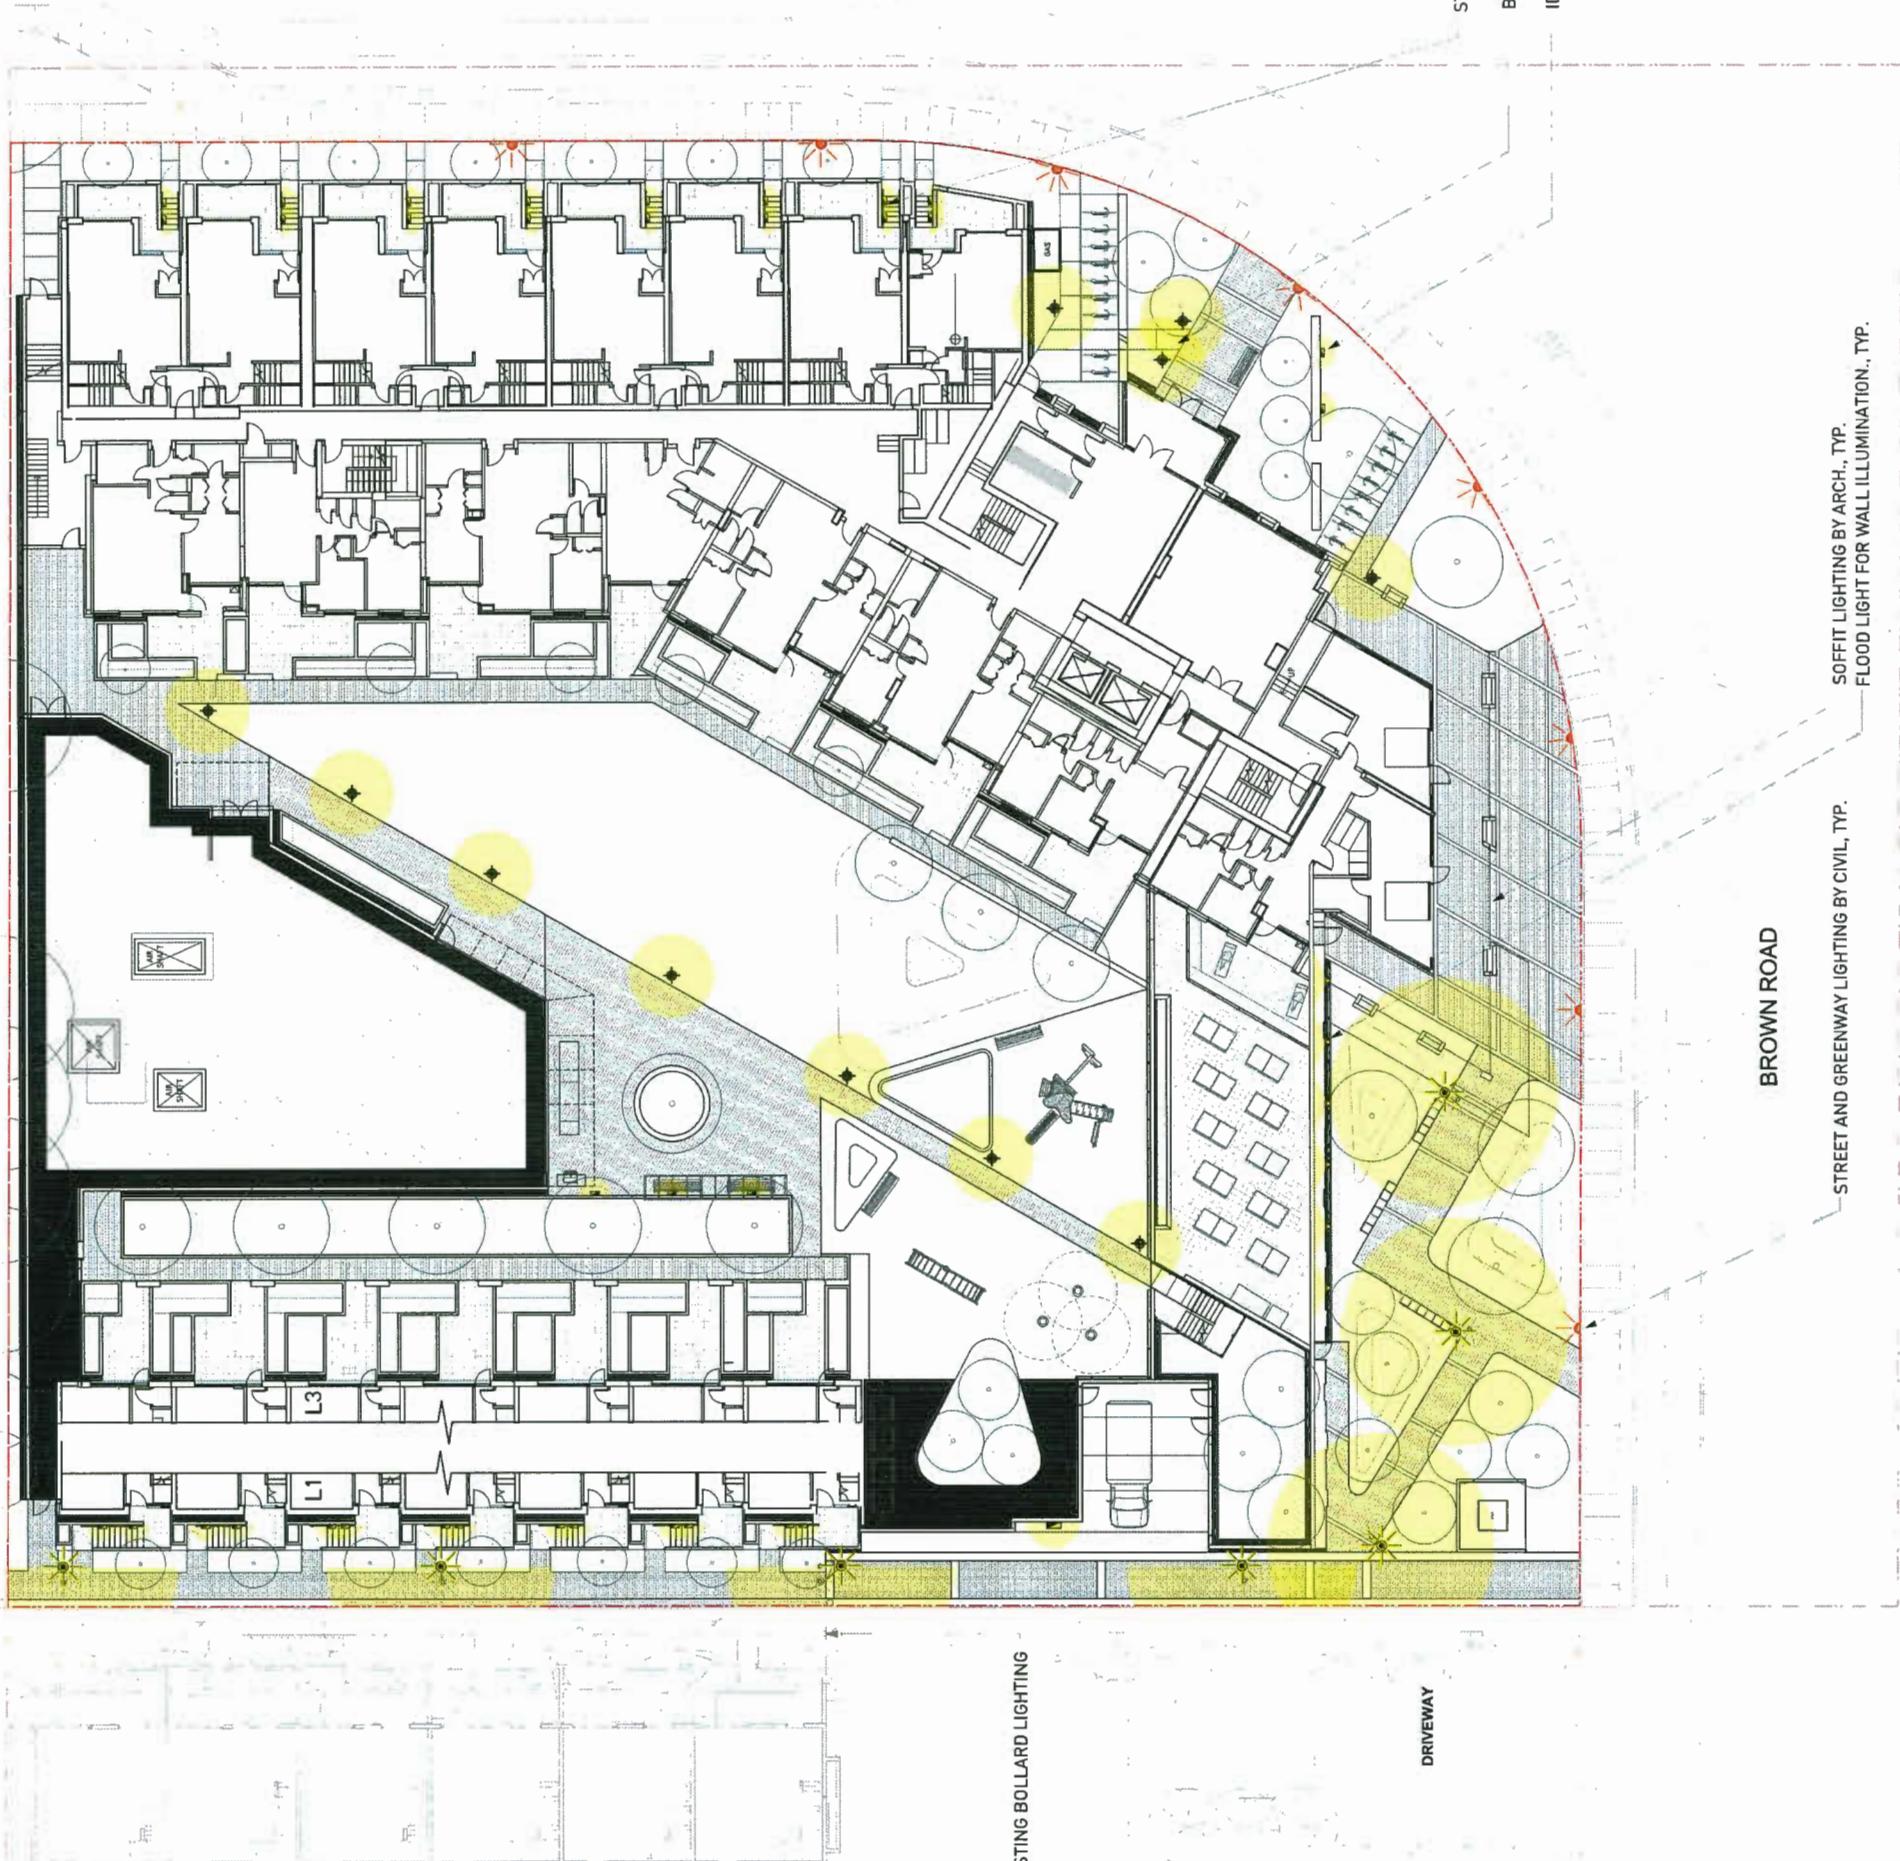
PROJECT NO.	17091	
DATE	19-5-7	
FILE NAME	17091 Fiorella Plans.wrx	
PLOTTED	DAWN	JO
	REVIEWED	BH

1.08



EXISTING BOLLARDS IN THE NEWS

SEXSMTIHD ROAD





PWL partnership

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Français
POLYGON

REVISIONS AND ISSUES		NO.	DATE	DESCRIPTION
		5	19-3-04	Issued in Response to ADP
		6	19-4-23	Issued for Final DP Response

DP 18-818748
Plan 34 May 21, 2019

FIORELLA

LAYOUT PLAN

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SCALE

1/16" = 1'-0"



PROJECT NO.	17091
DATE	19-5-7
FILE NAME	17091 Fiorella Plan.vwx
PLOTTED	

1.09





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REVISIONS AND ISSUES
NO. DATE
5 18-3-08
6 18-4-23
DESCRIPTION
Insert in Response to ADP
Insert for Final DP Response

DP 18-818748
Plan 35 May 21, 2019



PROJECT
FIORELLA


NOTES

GRADING PLAN

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PROJECT NO. 17081
DATE 18-5-7
FILE NAME 17081_Fiorella_Plan.WKX
BUTTED
DRAWN JO
REVISED BH
CARTWING

SCALE 31'32" = 1'-0"



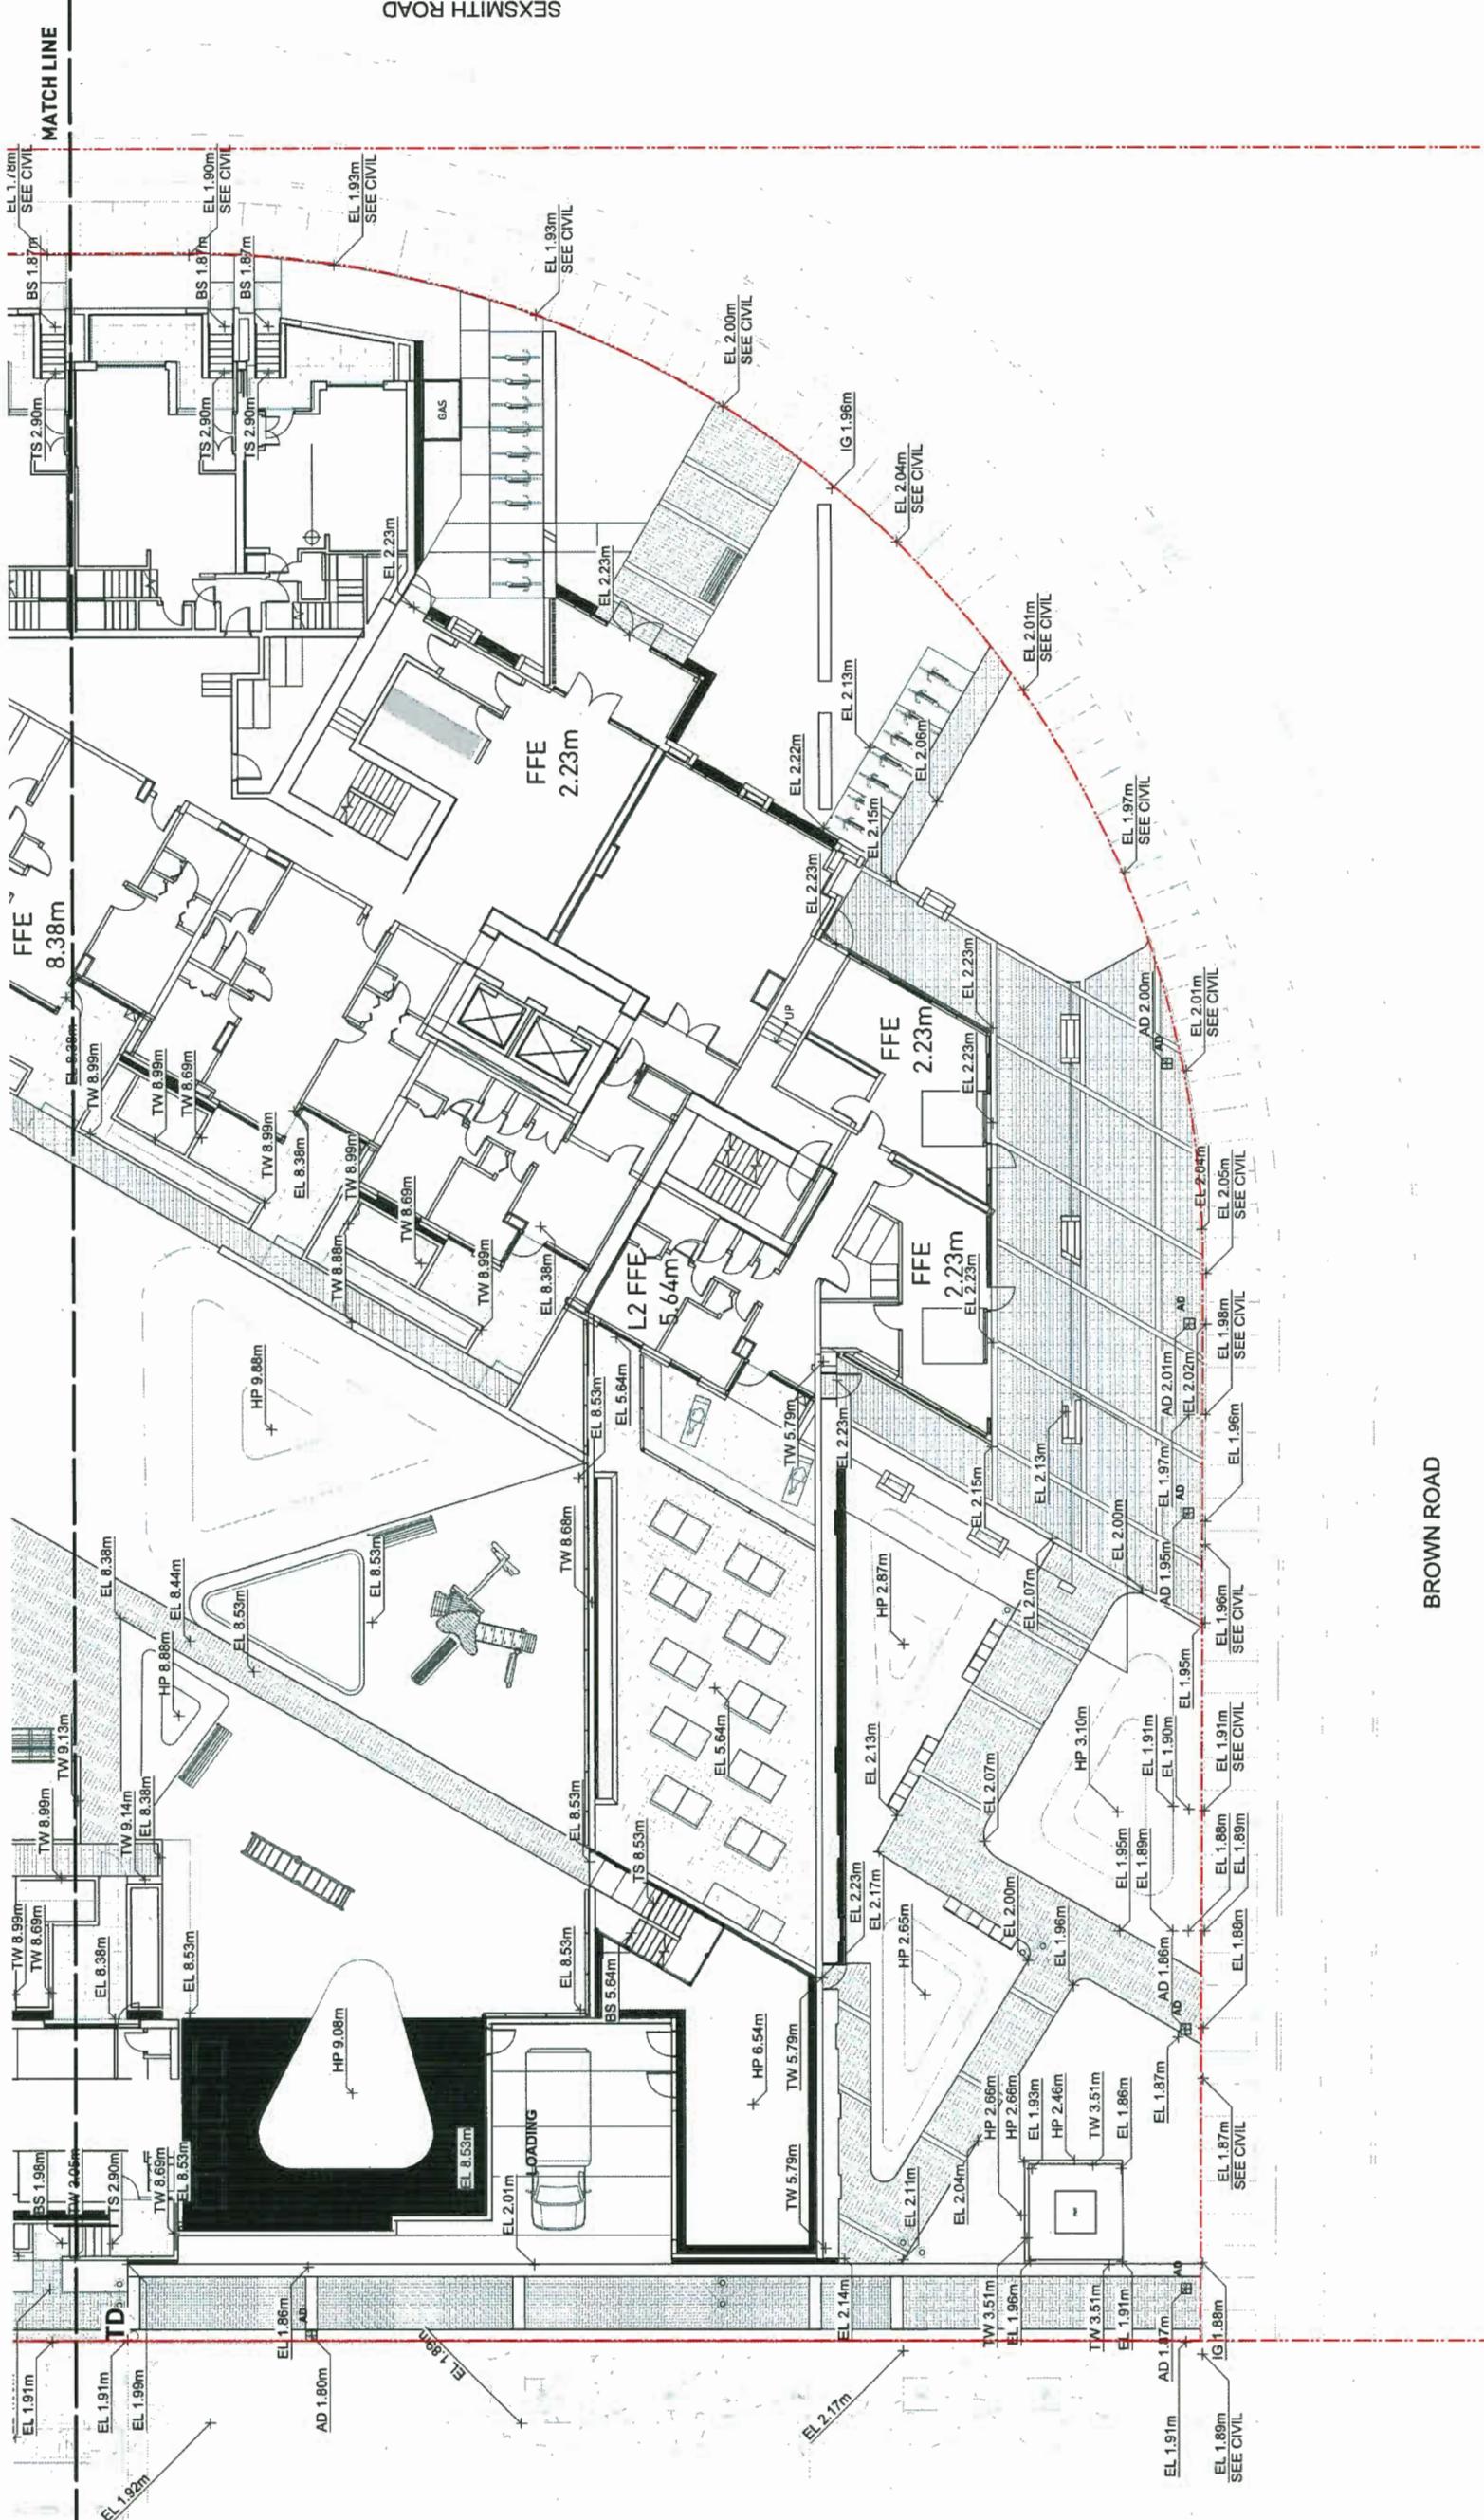

PWL partnership

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 5th Floor, East Austin House
 1201 West Pender Street
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10

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REVISIONS AND ISSUES		DESCRIPTION
NO.	DATE	
5	19-3-08	Issued in Response to Request for Final DR
6	18-4-23	

DP 18-818748
Plan 36 May 21, 2019

Plan 36 May 21, 2019

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NORTH	SCALE
	

3/32" = 1'-0"

PROJECT NO.	17091
DATE	19-5-7
FILE NAME	17091 Fiordla Plan.wkx
PLOTTED	

12.02



PW&L Partnership Leadership Architects Inc.
5th Floor, East Asiatic House
1201 West Hastings Street
Vancouver BC Canada V6E 2N7
www.pwlparchitects.com



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REVISIONS AND ISSUES		NO.	DATE	DESCRIPTION
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		6	19-4-23	Issued for Final Response


DP 18-818748
Plan 38 May 21, 2019

DRAWING TITLE

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PROJECT NO. 17091
DATE 19-5-10
FILE NAME 17091 Fierella Plan.wmv

DRAWINGS



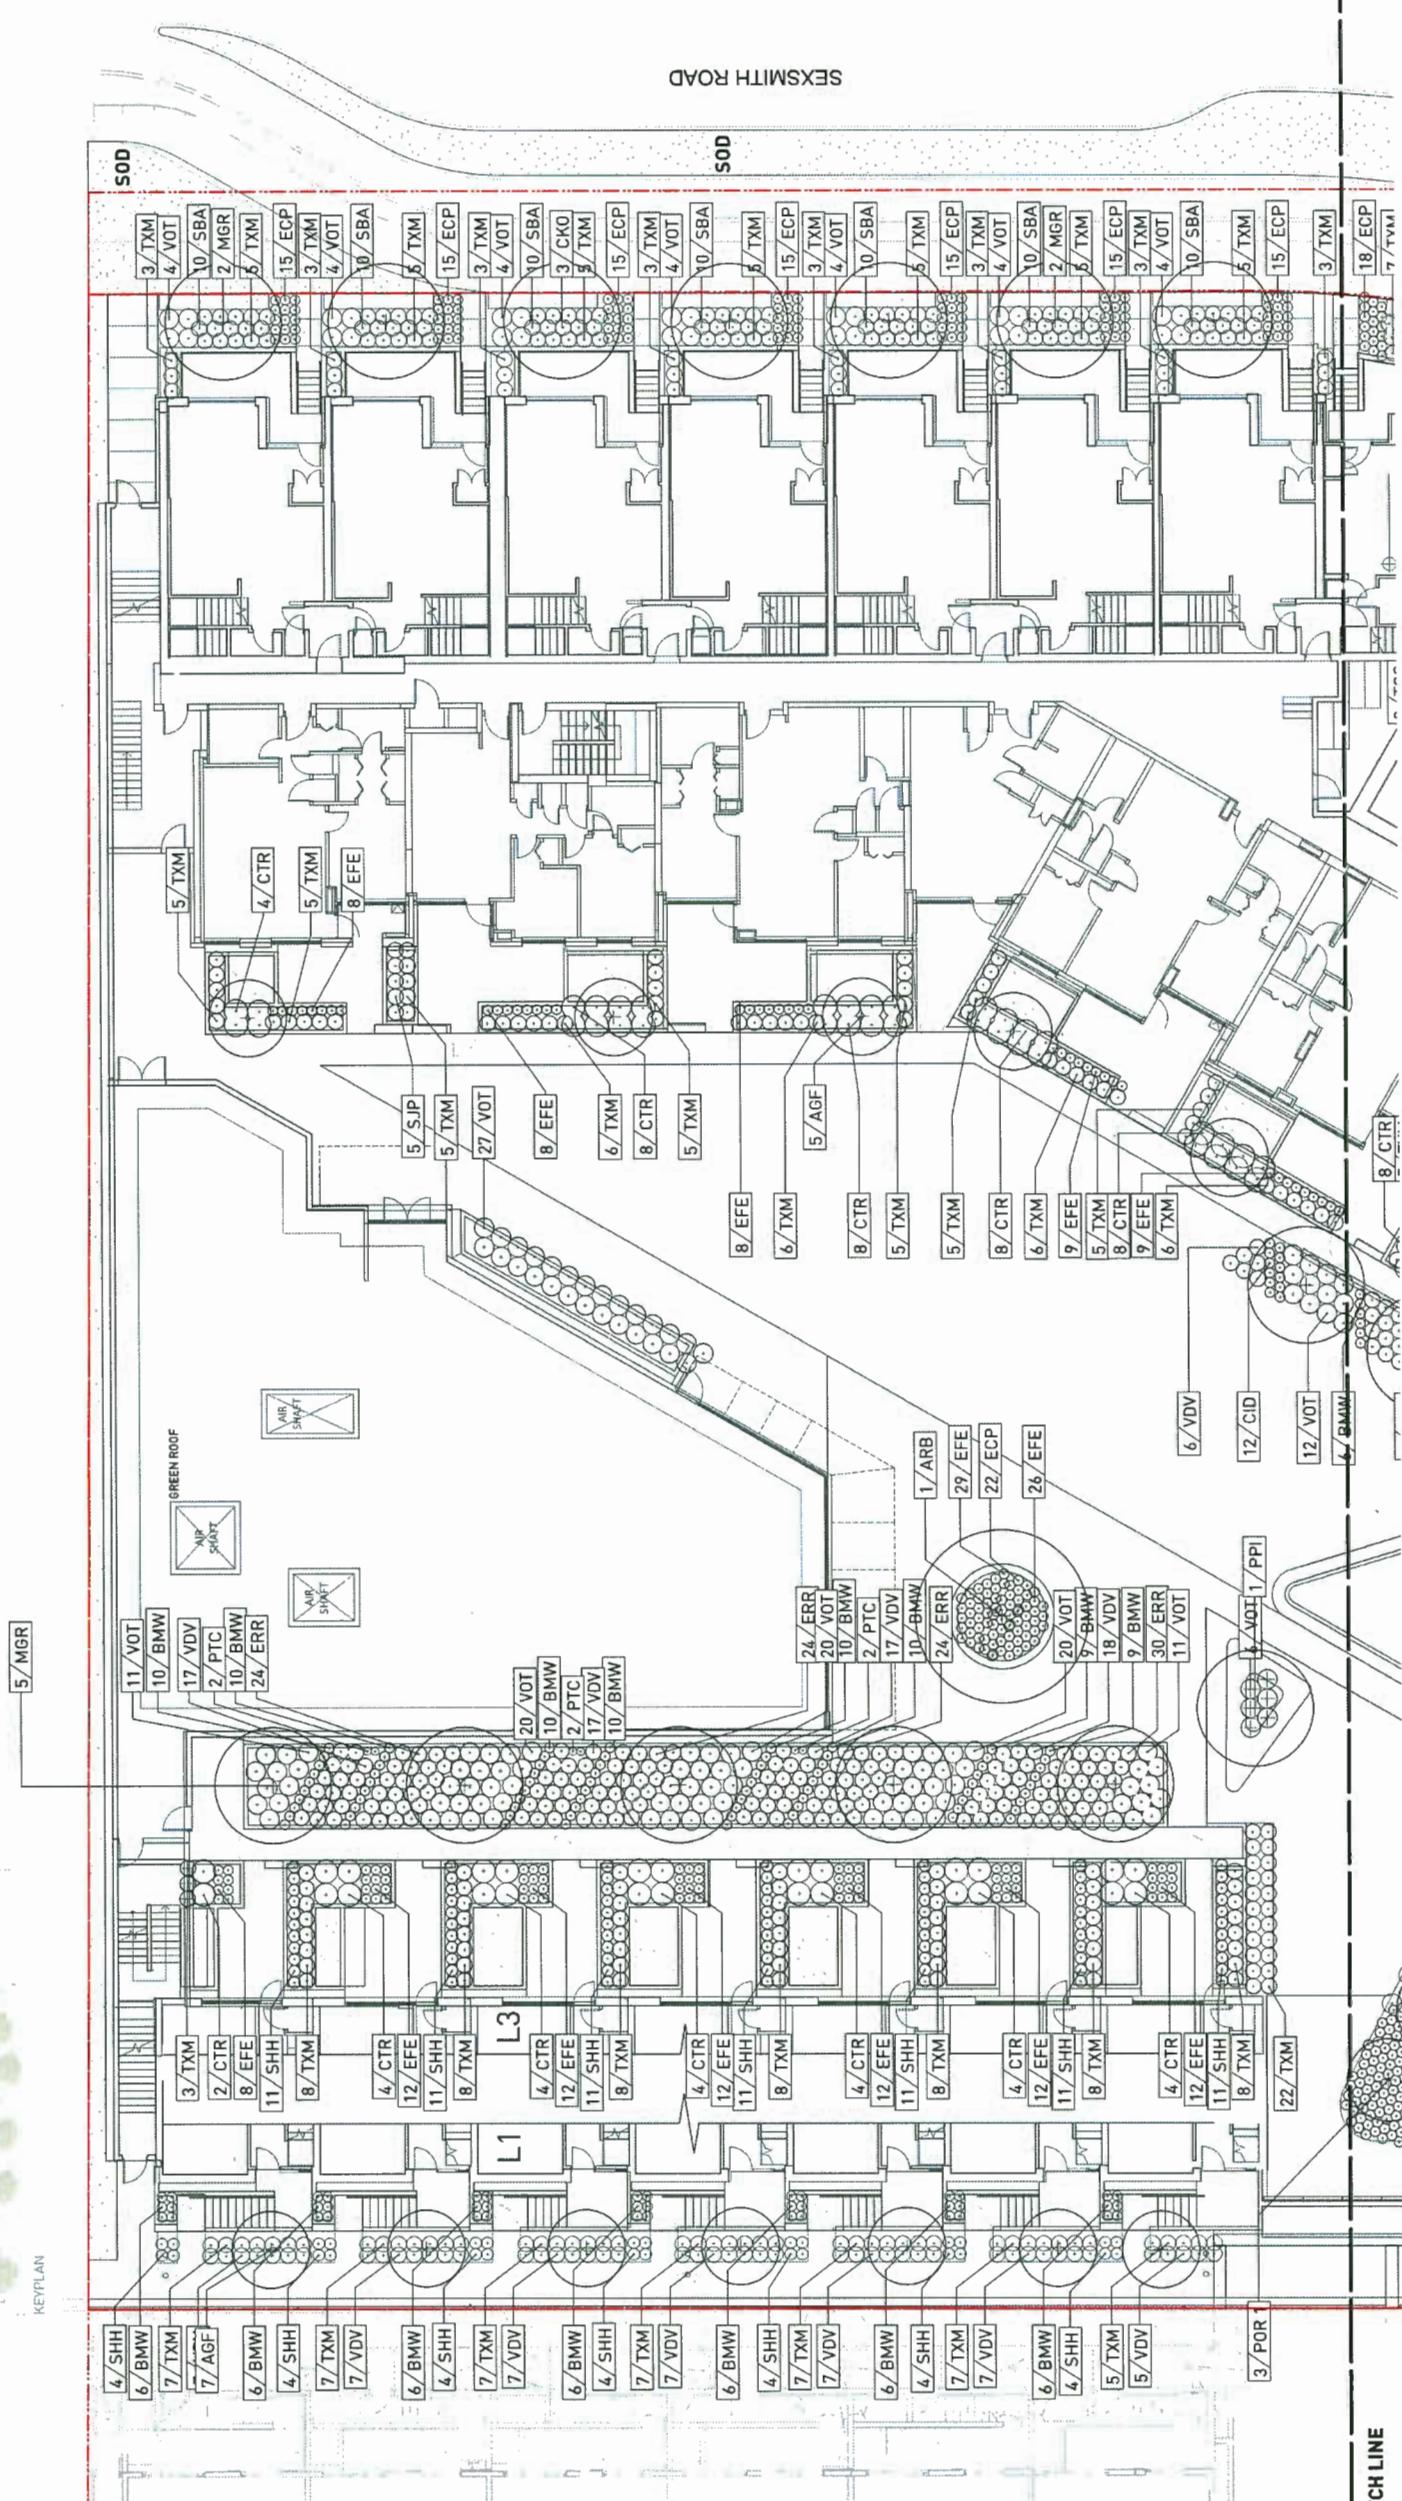

PWL partnership

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www.pmlandscapearch.com
1-604-681-1111

DOI:10.4236/jcsm.201909011


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卷之三

Response to ADP
at Final DP Committee

DP 18-818748
Plan 39 May 21, 2019

DRAWING TITLE PLANTING LIST

C:\PROJECT\17081\17081.FIN		17081	
N/A		18-6-7	17081 Finwell Park
SCALE		DATE	FILE NAME
NORTH		17081	PLUTED
		PROJECT NO.	
		DATE	
		FILE NAME	
		PLUTED	

A close-up photograph of a dense cluster of small, dark red flowers, likely Salvia microphylla 'Neon' (Lambs ear), growing on a green vine. The flowers are arranged in whorls along the stem.

A close-up photograph showing a dense cluster of green leaves, likely from a shrub or small tree. The leaves are ovate with serrated edges, creating a textured, dark green surface.

A close-up photograph of several green oak leaves, showing their characteristic serrated edges and lobed shape.

A vertical photograph showing a dense forest of green trees. A rocky path or stream bed runs along the right side of the frame.

A dense, green, leafy bush, likely a holly or similar evergreen, growing in a garden setting. The leaves are small and pointed, arranged in a tight, rounded cluster.

A close-up photograph of a white hibiscus flower with a yellow center, surrounded by green leaves.

Landscape and Lawn Areas to be Irrigated

Plant List

Plant List						
D O		Qty	Botanical Name	Common Name	Scheduled Size	Mature Size
Trees						
<i>Acer ginnala 'Flame'</i>	GF	12		Flame Amur Maple	6 cm cal. Standard 2.4 m ht. 18'-0" ht As Shown	15'-20' 20'-25'
<i>Acer griseum</i>	GR	3		Paper Bark Maple	6 cm cal [2.5" cal]	B&B, Use in cold climates only, single leader B&B, Uniform branching, dense tree 6'[1.8m] std.
<i>Acer rubrum 'Bowhall'</i>	RB	1		Bowhall Red Maple	7 cm cal [2.1/2" cal]	B&B, Uniform branching, dense tree, 7'[2.1 m] std.
<i>Cornus kousa</i>	KO	3		Kousa Dogwood	6 cm cal [2.5" cal]	B&B, Well branched, dense tree
<i>Magnolia grandiflora</i>	GR	9		Southern Magnolia	7 cm cal [2 1/2" cal]	B&B, Well branched, dense tree
<i>Nyssa sylvatica</i>	SY	3		Black Tupelo	10 cm cal [4" cal]	B&B, Uniform branching, dense tree, 7'[2.5 m] std.
<i>Parrotia persica 'Inge's Ruby Vase'</i>	PI	3		IRV Persian Ironwood	6 cm cal [2.5" cal]	B&B, Straight trunk, uniform branching, 5'[1.5 m] std.
<i>Picea omorika</i>	OR 1	6		Serbian Spruce	3.5 m ht. [11'-6" ht.]	B&B, Well branched, dense tree
<i>Picea omorika</i>	OR 2	3		Serbian Spruce	4.5 m ht. [15'-0" ht.]	B&B, Well branched, dense tree
<i>Quercus robur x Alba</i>	RA	3		Skinny Gens Oak	7 cm cal. [3" cal]	B&B, Well branched, dense tree
<i>Stewartia pseudocamellia</i>	PS	7		Japanese Stewartia	6 cm cal. [2.5" cal]	B&B, Well branched, dense tree
Shrubs						
<i>Berberis thunbergii 'atropurpurea'</i>	TA	183		Japanese Barberry	#3 pot	Well established
<i>Buxus microphylla 'Winter Gem'</i>	MMW	450		Winter Gem Boxwood	#3 pot	Well established
<i>Choisya ternata</i>	TR	91		Mexican Orange Blossom	#3 pot	Well established
<i>Daphne cneorum</i>	L	52		Rose Daphne	#3 pot	Well established
<i>Prunus laurocerasus 'Otto Luyken'</i>	LO	173		Otto Luyken laurel	#3 pot	Well established
<i>Rhododendron English Roseum'</i>	RR	141		English Roseum Rhododendron	#3 pot	Well established
<i>Sarcococca hookeriana humilis</i>	HH	105		Himalayan Sarcococca	#3 pot	Well established
<i>Skimmia japonica</i>	JP	37		Japanese Skimmia	#3 pot	Well established
<i>Spiraea bumalda 'Anthony Waterer'</i>	BA	212		Anthony Waterer Spiraea	#3 pot	Well established
<i>Taxus x media 'H.M.Eddle'</i>	KM	283		H.M.Eddie Yew	1.2m B&B	Well established, dense hedging plant / B & B
<i>Thuja occidentalis 'Smaragd'</i>	DS	3		Emerald Cedar	1.5m	Well established, dense hedging plant / B & B
<i>Vaccinium ovatum "Thunderbird"</i>	DT	398		Thunderbird Evergreen Huckleberry	#3 pot	Well established, nursery grown
<i>Viburnum davidii</i>	DV	302		David Viburnum	#3 pot	Well established
<i>Viburnum tinus 'Spring Bouquet'</i>	F	27		Spring Bouquet	#3 pot	Well established
Ground Cover						
<i>Erica carnea 'Springwood Pink'</i>	CP	305		Spring Pink Winter Heath	#1 pot	15cm [6"] height
<i>Erica carnea 'Springwood White'</i>	CS	28		Dwarf White Heath	#1 pot	15cm [6"] height
<i>Euonymus fortunei 'Emerald Gaiety'</i>	FE	397		Emerl Gaiety Wintercreeper	#1 pot	25cm [10"] spread. Minimum 3 leads
Perennials						
Ornamental Grasses						
<i>Carex morrowii 'Ice Dance'</i>				Variegated Sedge	#1 pot	38 cm [15"]
Vines						
<i>Akebia quinata</i>	Q	5		Five Leaf Akebia	As Shown	Staked, 1m [3'] leads
<i>Parthenocissus tricuspidata</i>	TC	6		Boston Ivy	As Shown	Staked, full development
Aquatic Plants						
Ferns						
Bulbs						
Sedum - Green Roof (TOTAL AREA - 1246m2)						
18% - Sedum spathulifolium (Broad-leaved Stonecrop)						
21% - Sedum album 'Murale'(Murale Stonecrop)						
18% - Sedum floriferum 'Weinenstephaner Gold'(Weinenstephaner Gold Stonecrop)						
20% - Sedum hybridum 'Immergruenchen' (Immergruenchen Stonecrop)						
13% - Sedum rupestre 'Ruprecht Stonecrop'						
10% - Sedum spurium 'Dragons Blood'(Two-Row Stonecrop)						



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REVISIONS AND GOLES
NO. DATE DESCRIPTION
6 15-3-08 Insert in Response to ADP
6 13-4-23 Insert for Field DR Response.

DP 18-818748
Plan 40 May 21, 2019

PROJECT
FIORELLA

ADDRESS


DRAWING TITLE
SOIL LOADING DIAGRAM

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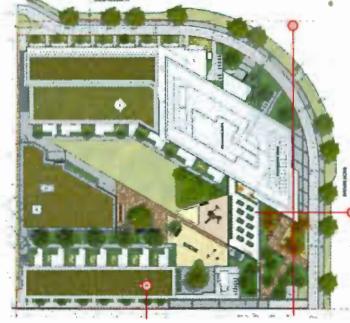
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PROJECT NO.	17091
DATE	18-5-7
FILE NAME	17091_Fiorellis_Plans.wks
AUDITED	
DRAWN BY	JD
REVIEWED	BH
TECHNICAL DRAWING	

SOIL DEPTH LEGEND	
TREE AREA	36" Depth Growing Medium
SHRUB AREA	18" Depth Growing Medium
LAWN AREA	12" Depth Growing Medium
GREEN ROOF	6" Depth Growing Medium

SEXTSMITH ROAD

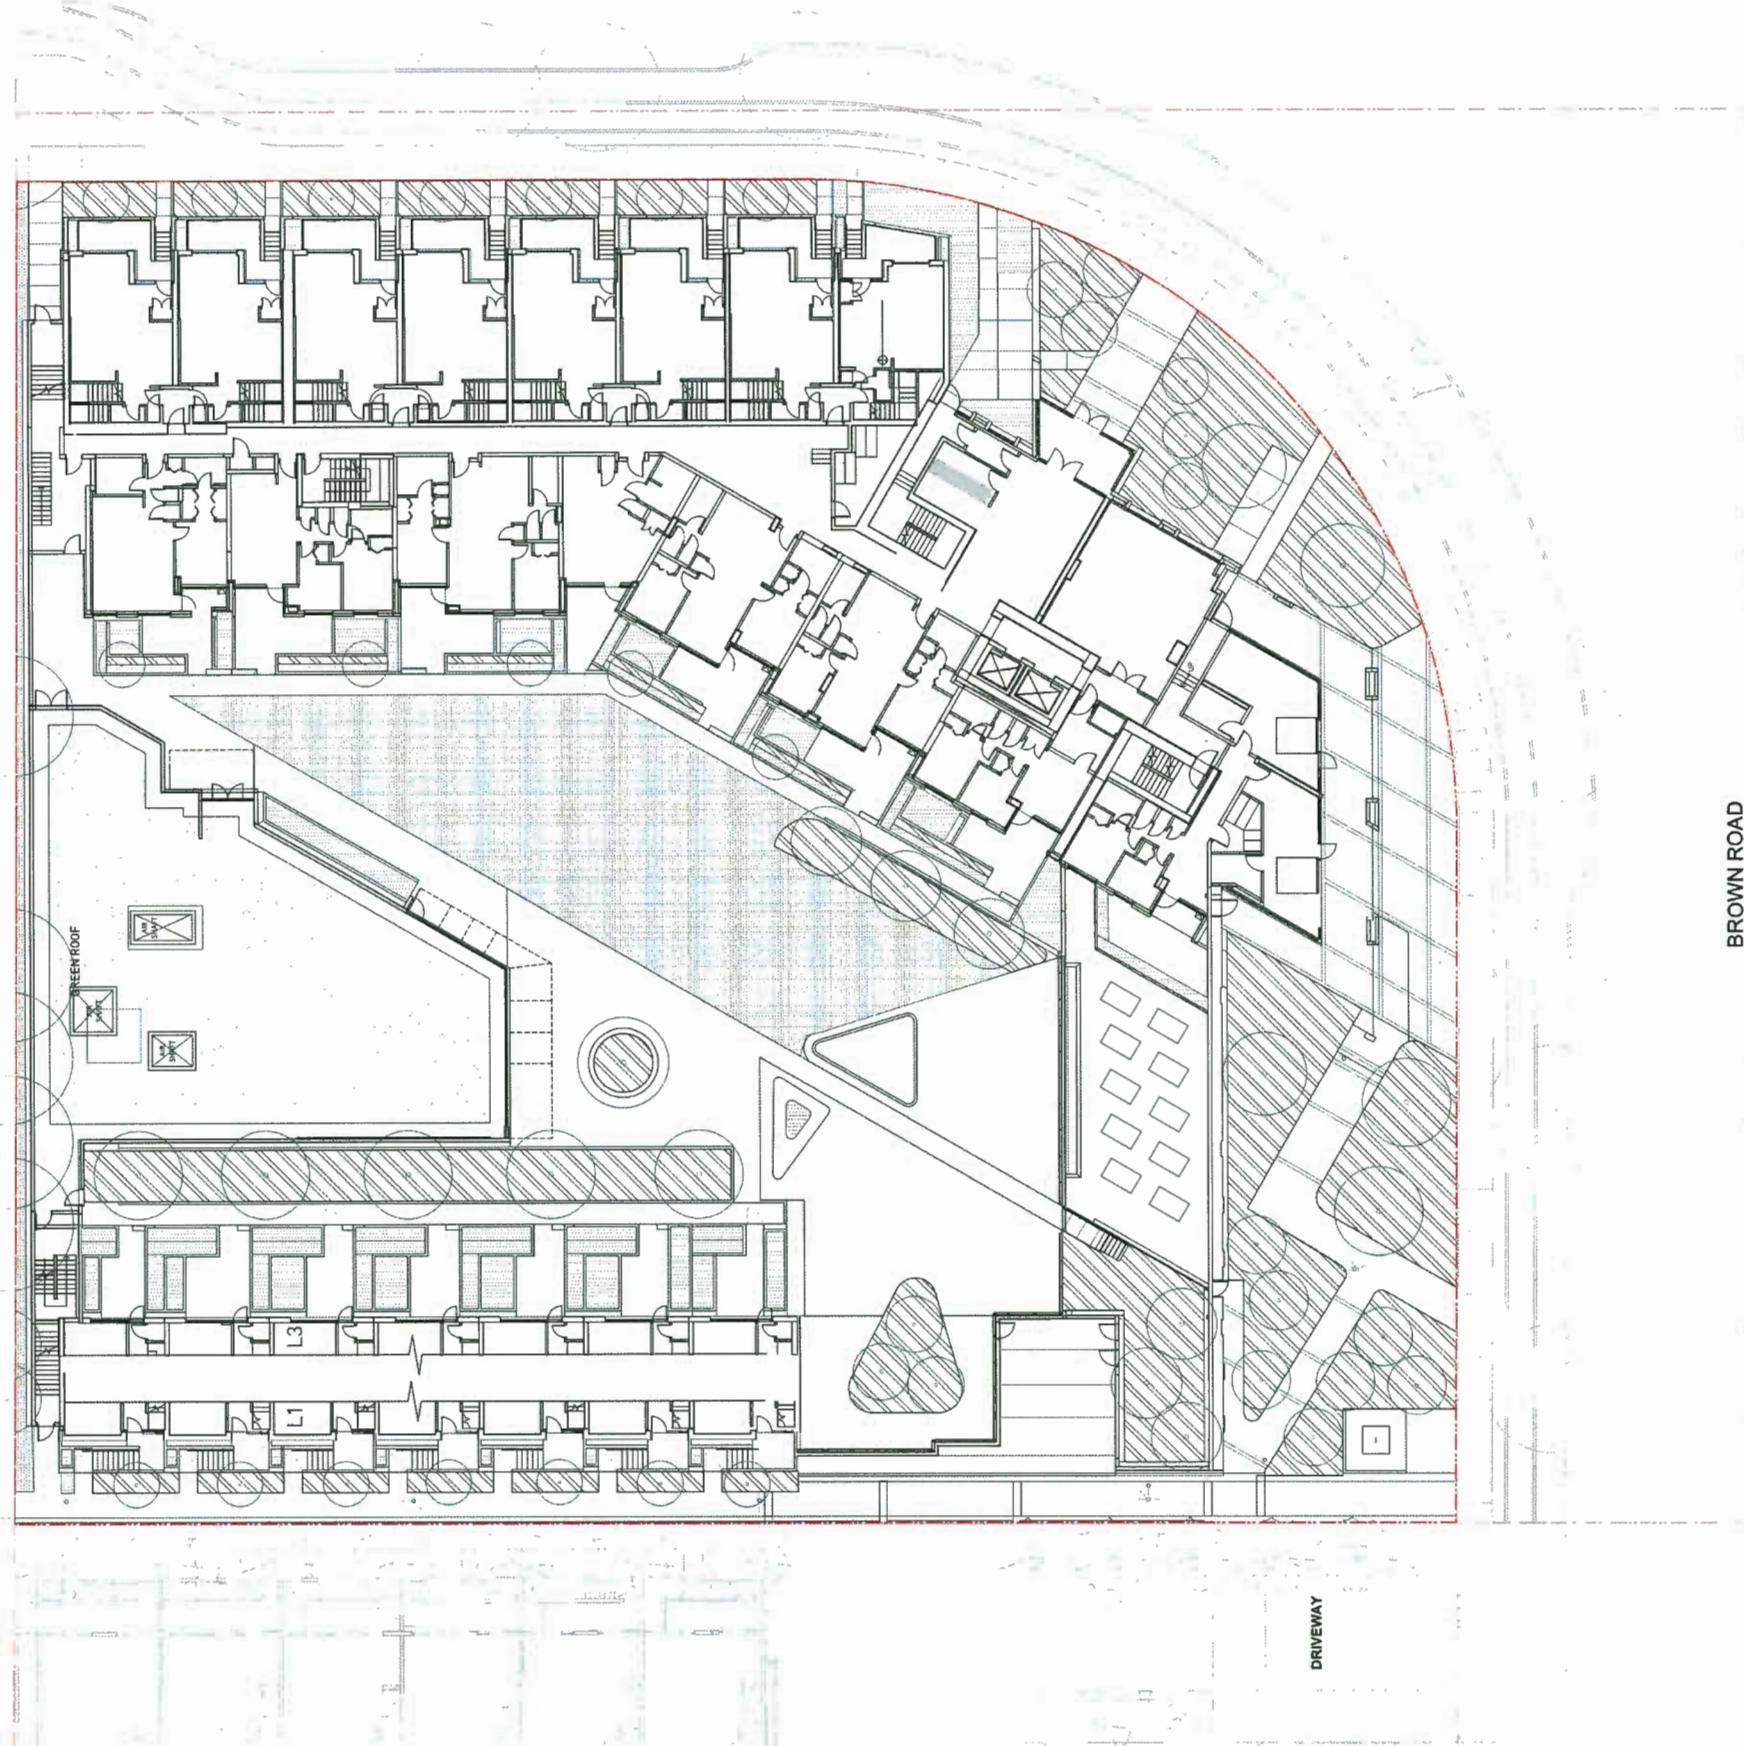

L3.03



 DP 18-818748
Plan 41 May 21, 2019

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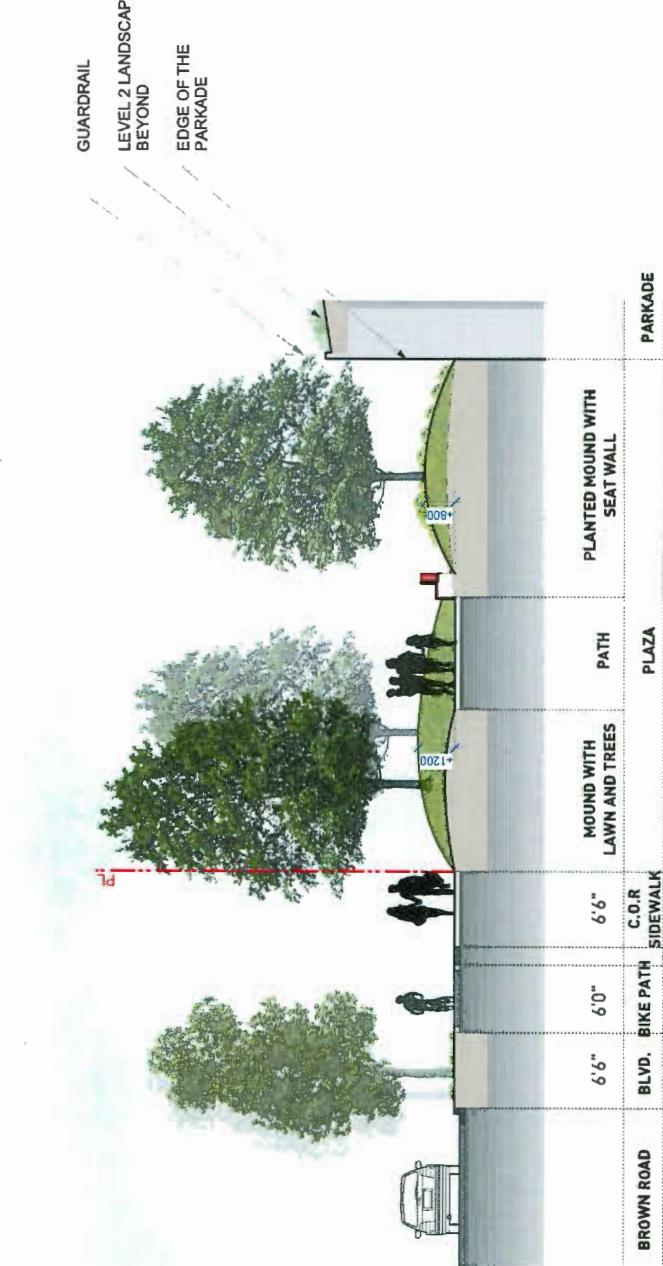
 ADDRESS
DRAWING TITLE
SECTIONS

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NORTH
SCALE

 1/8" = 1'-0"
PROJECT NO. 17091
DATE 17091 Forella Sections.vwx
FILE NAME 17091 Forella Sections.vwx
DRAFTED 19-5-7
DRAWN JO REVISED BH
DRAWING

L4.01

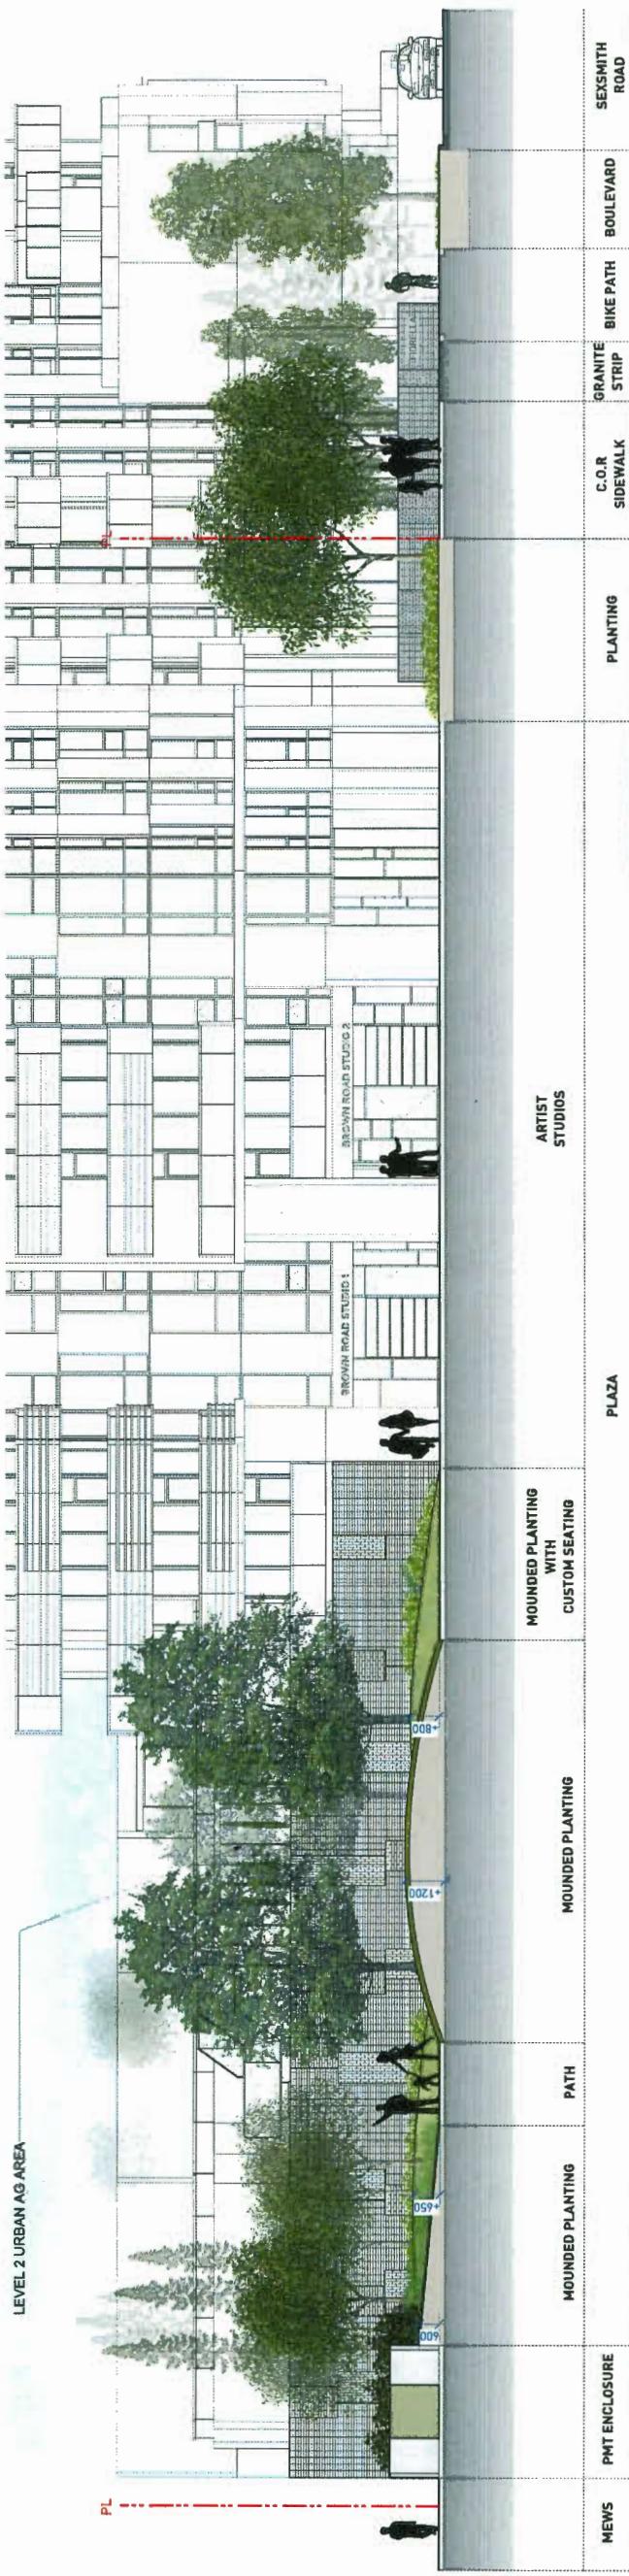 SECTION 1
1/8" = 1'-0"

 5500 [18'-0 1/2"]
2900[9'-10 1/8"]
PL

 AVANTI
SECTION 2
1/8" = 1'-0"

 SECTION 3
1/8" = 1'-0"

PLANTING STRIP

 SECTION 2
1/8" = 1'-0"




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5 18-3-08
6 18-4-23
DESCRIPTION
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Issued for Final DP Response



DP 18-818748
Plan 42 May 21, 2019

KEYPLAN
PROJECT
FIORELLA
ADDRESS
DRAWING TITLE
SECTIONS
NORTH
SCALE
1/8" = 1'-0"
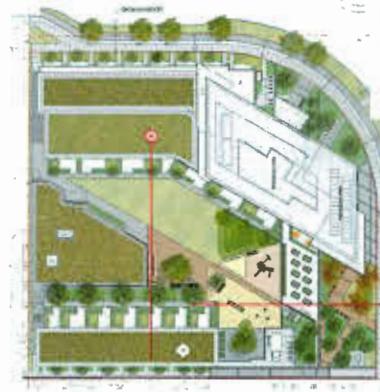
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PROJECT NO. 17091
DATE
FILE NAME 17091_Fiorella Sections.WXZ
PAGED 19-5-7
DRAWN JO REVIEWED BH
DRAWING


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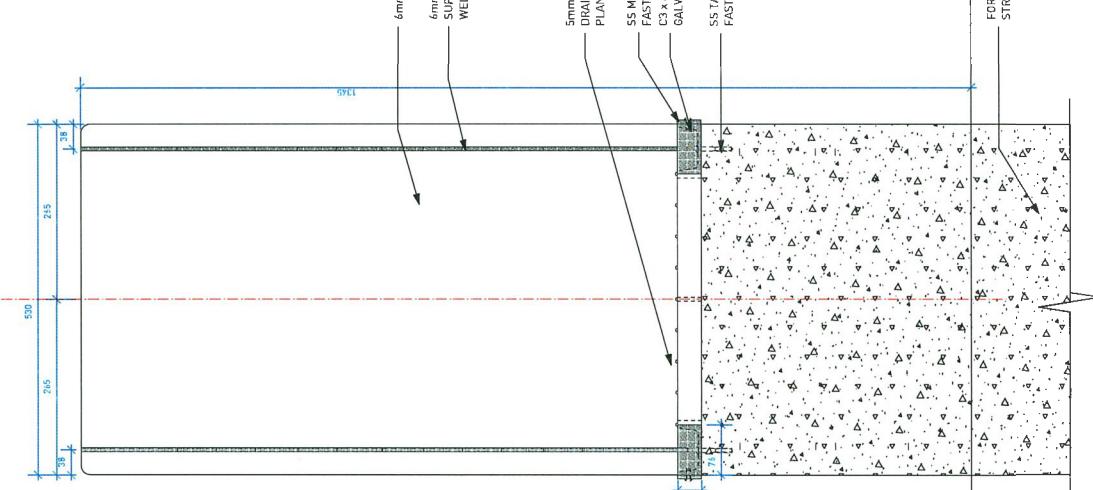
SECTION 5
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5

REVISIONS AND ISSUES		DESCRIPTION
NO.	DATE	
2	19-1-7	Issued for
3	19-2-01	Issued in
4	19-4-23	Issued to


E. CONTRACTOR TO SUBMIT SHOP DRAWINGS TO
DISCOSCAPE CONSULTANT FOR REVIEW
AND APPROVAL PRIOR TO FABRICATION.
ALL METAL TO BE STAINLESS STEEL
(IMMUNISSES NED # 302G).
ALL HARDWARE TO BE STAINLESS STEEL
WELDED TO BE CONTINUOUS AND GROUND
DOWN; NO SAW OR FIELD WELDING




23

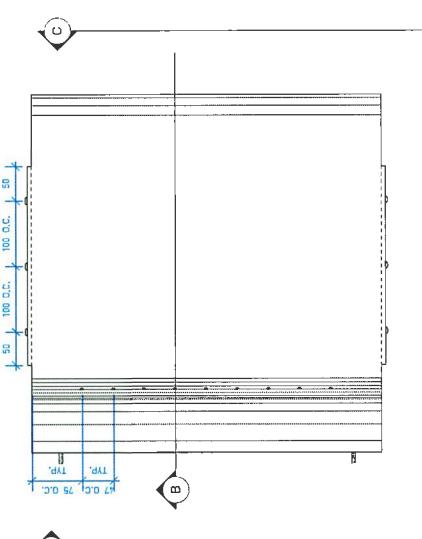

BACK ELEVATION A

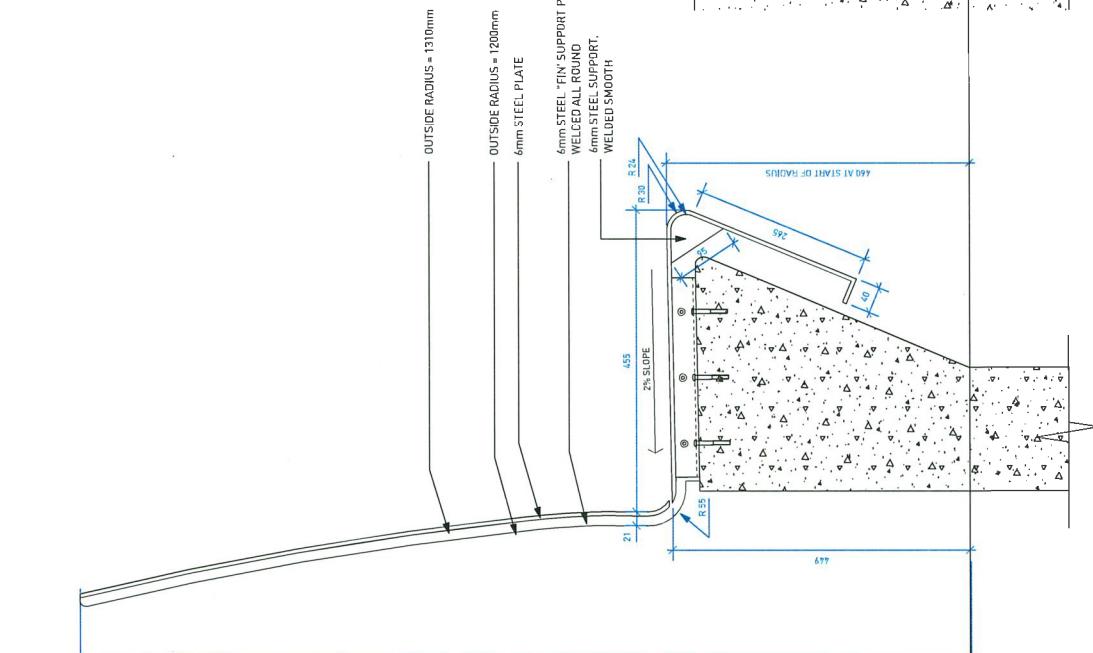

SECTION B

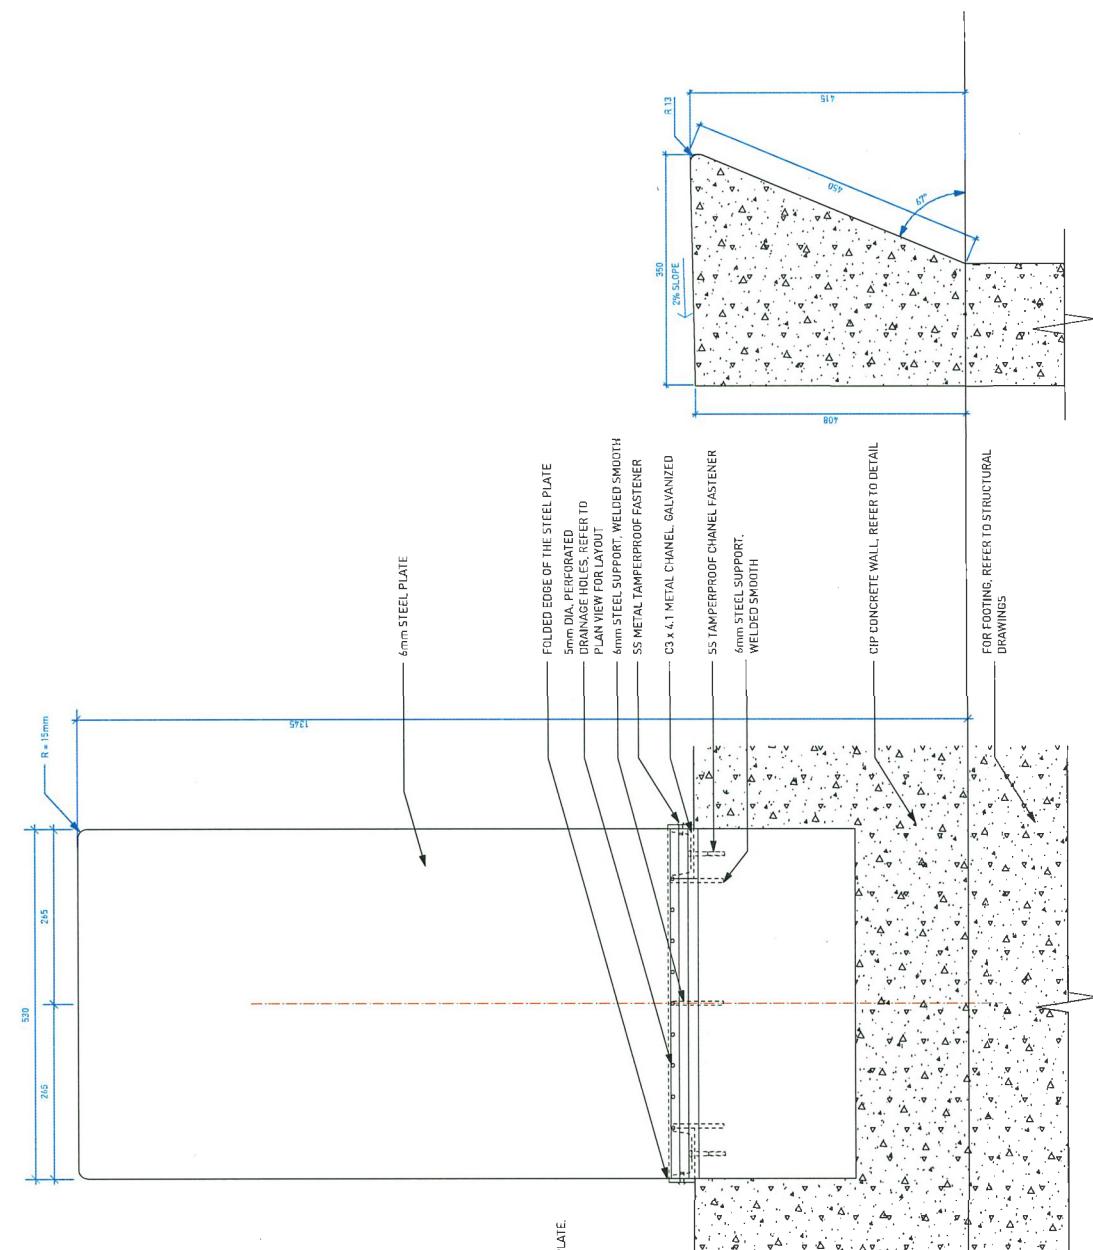

FRONT ELEVATION C

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Plan 44 May 21, 2019


REVISION AND DATES		DESCRIPTION
NO.	DATE	
2	19-1-7	Issued for ADP
3	19-2-01	Issued in response to ADP
4	19-2-23	Issued for final DR Response

FIORELLA

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DETAILS

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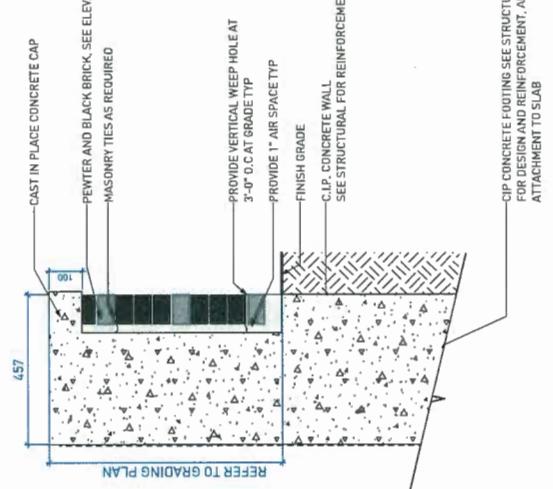
PROJECT NO.	17091
DATE	2019/11/20
FILE NAME	17091_Fiorella Details.vwx
PLATED	19-4-1-B
DRAWHN	J0
REVISED	EH
DRAWING	



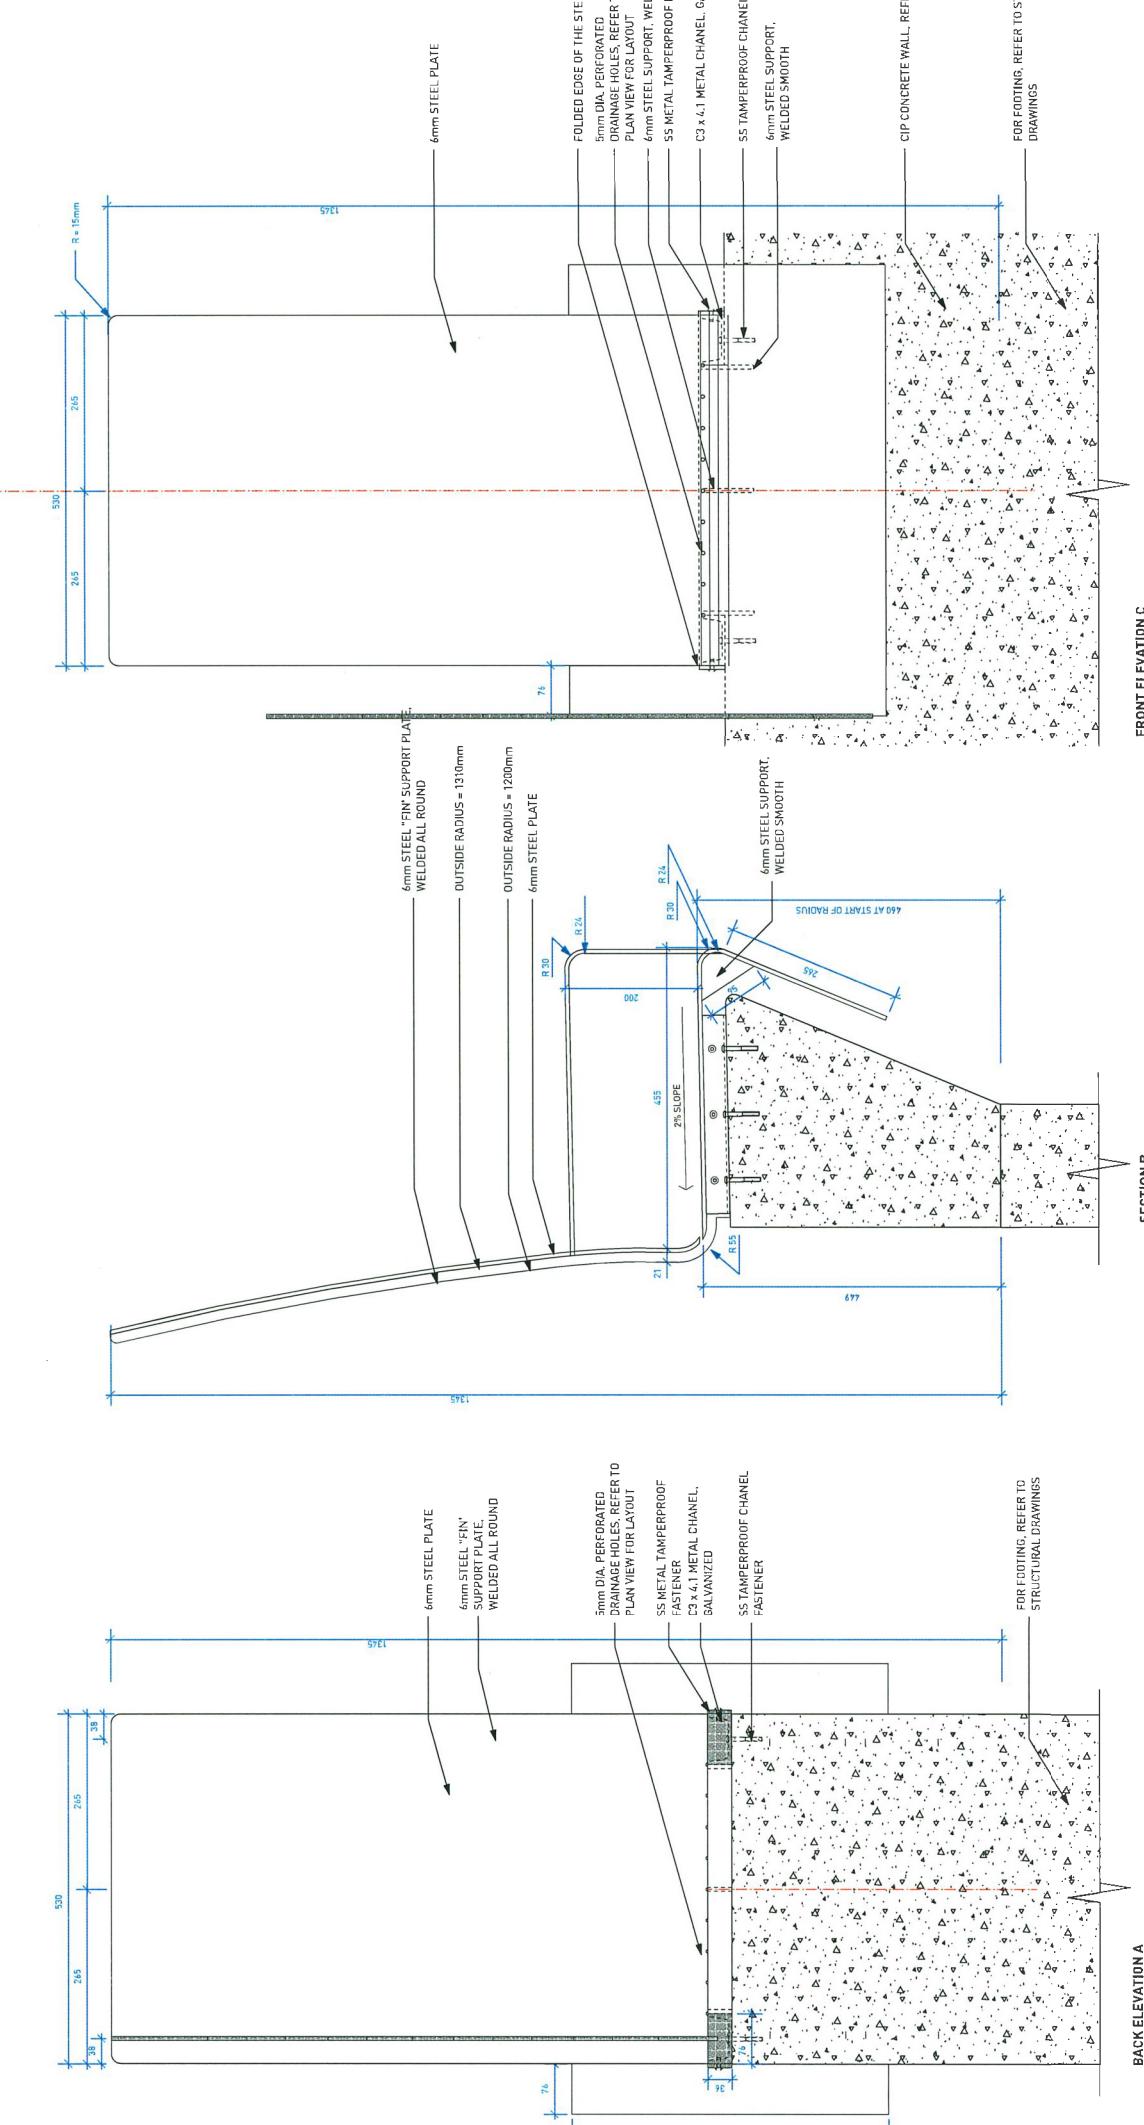


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DP 18-818748
Plan 45 May 21, 2019



② BRICK FEATURE WALL (SINGLE SIDE)

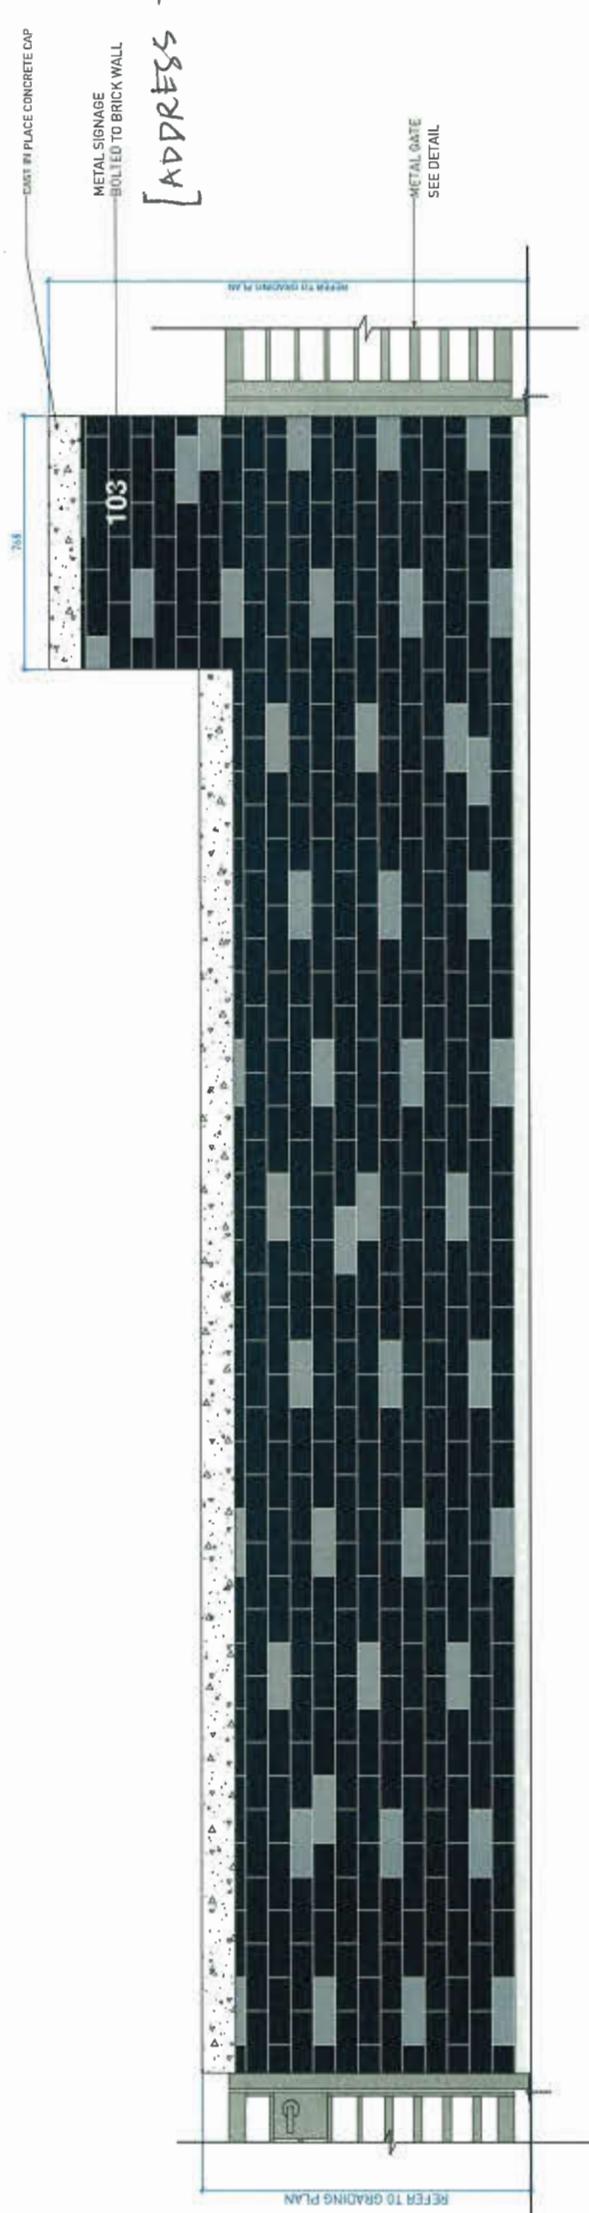

① BRICK WALL WITH SIGNAGE (LOWRISE PRIVATE ENTRY)
Scale: 1:10


REFERENCE AND DATES	NO. DATE	DESCRIPTION
	2 18-4-27	Issued for ADP
	3 18-4-31	Issued in Response to ADP
	4 18-4-23	Issued in Response to ADP

PROJECT: FIORELLA
ADDRESS:

DETAILS
DRAWING TITLE: AS SHOWN

PROJECT NO.	17091
DATE	2018/01/20
FILE NAME	17091_Fiorella_Details.rwx
REF ID	18-4-18
NORTH	
SCALE	

1
Scale: 1:10

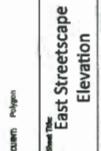DP 18-818748
Reference Plan May 21, 2019

FIORELLA

SEXSMITH ROAD STREETSCAPE

SUBJECT SITE

UNION SQUARE CENTRE



FIORELLA

SEXSMITH ROAD STREETSCAPE

SUBJECT SITE



AVANTI PHASE 3

BROWN ROAD STREETSCAPE

SUBJECT SITE

FIORELLA

3551 to 3531 Seawich Road,
Richmond, B.C.

Polygon

4

REVIEWES

THE INFLUENCE OF CULTURE

the first time in 1990. In addition, contributions of the party and its members to the campaign of the former president, George Bush, were also reported.

Digitized by Author

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DP 18-818748
Reference Plan May 21, 2019

Project Name:	Project Address:
Project Type:	Architectural Drawing
Client:	Project Manager:
Drawn By:	Reviewed By:
Date:	Date:
Approved By:	Approved Date:

Project Title:	Project No.:
Project Address:	Drawing No.:
Architect:	Architect's Initials:
Date:	Date:

Sheet Title:	Sheet No.:
Architect:	Architect's Initials:
Date:	Date:
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Sheet Title:	Sheet No.:
Architect:	Architect's Initials:
Date:	Date:
Approved By:	Approved Date:

Sheet Title:	Sheet No.:
Architect:	Architect's Initials:
Date:	Date:
Approved By:	Approved Date:


Sheet Title:	Sheet No.:
Architect:	Architect's Initials:
Date:	Date:
Approved By:	Approved Date:



PERSPECTIVE LOOKING NORTHEAST



PERSPECTIVE LOOKING NORTHWEST

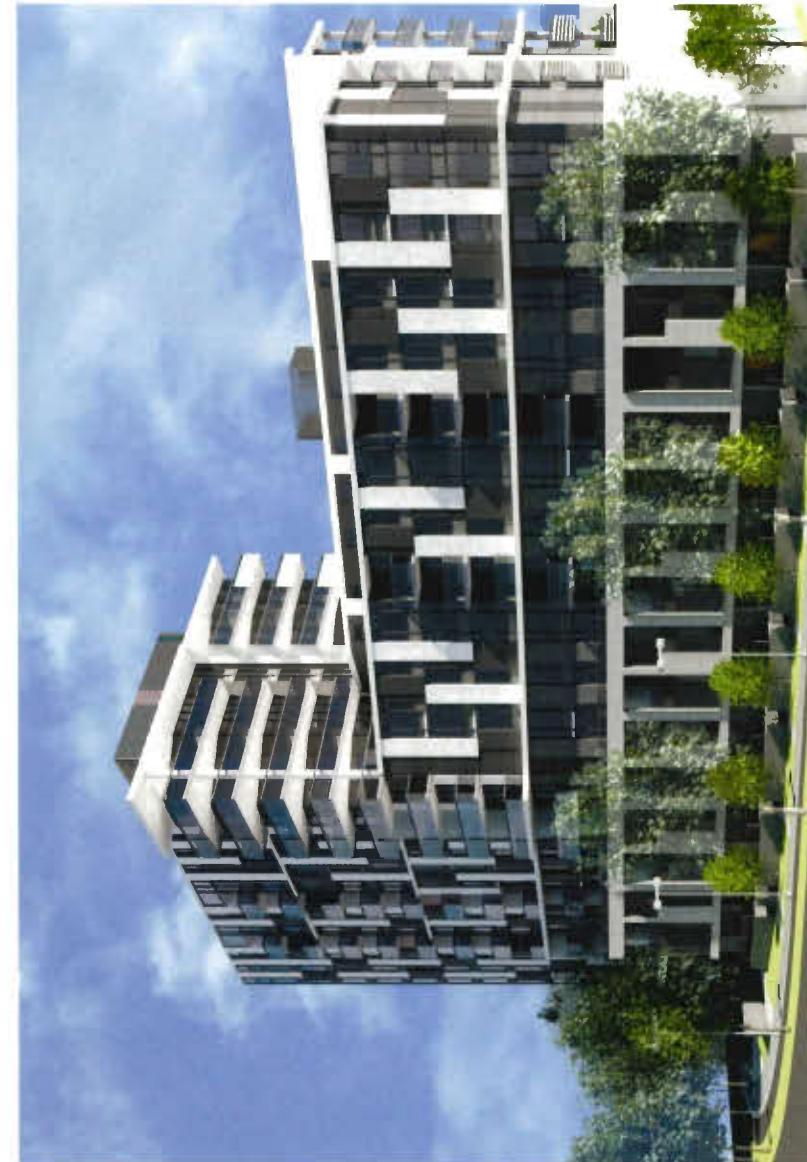


PERSPECTIVE LOOKING SOUTHWEST

DP 18-818748
Reference Plan May 21, 2019

ENTRANCE PERSPECTIVE



ARTIST STUDIO PERSPECTIVE LOOKING NORTHEAST

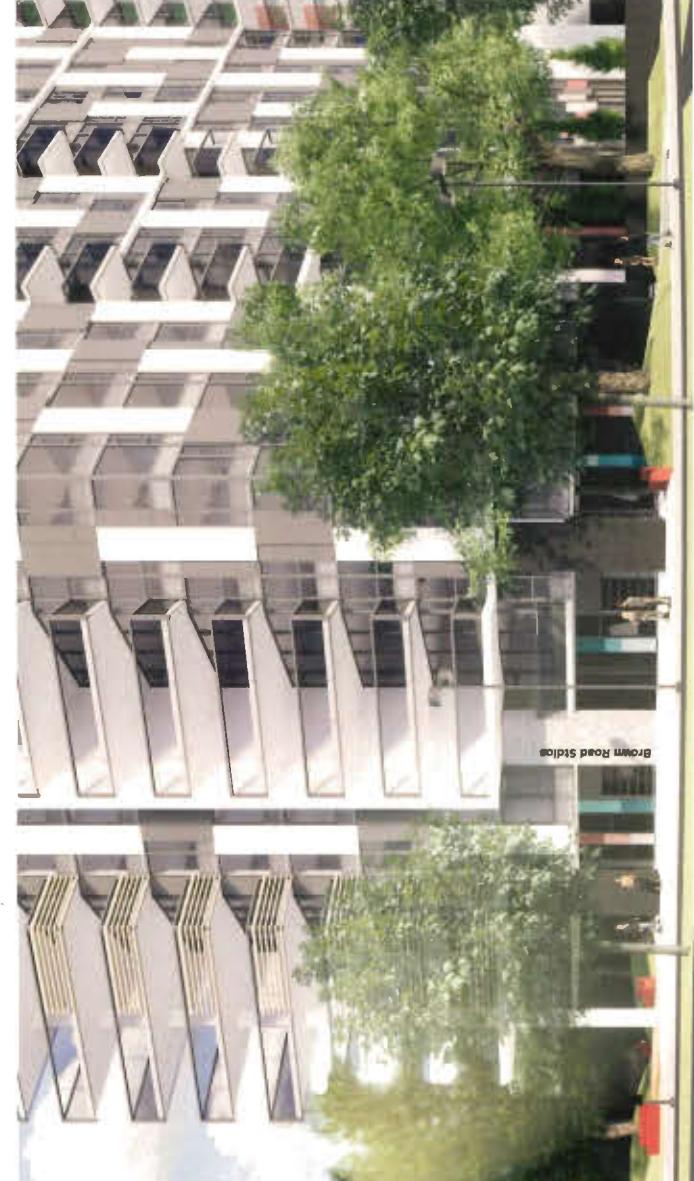

ARTIST STUDIO PERSPECTIVE LOOKING NORTHWEST

Drawing No.: A-007

Drawing Date: 05/21/19

Graphic Scale:

Sheet No. 21773

Drawing No.: A-007

Drawing Date: 05/21/19

Graphic Scale:


Sheet No. 21773

Drawing No.: A-007

Drawing Date: 05/21/19

Graphic Scale:

Sheet No. 21773

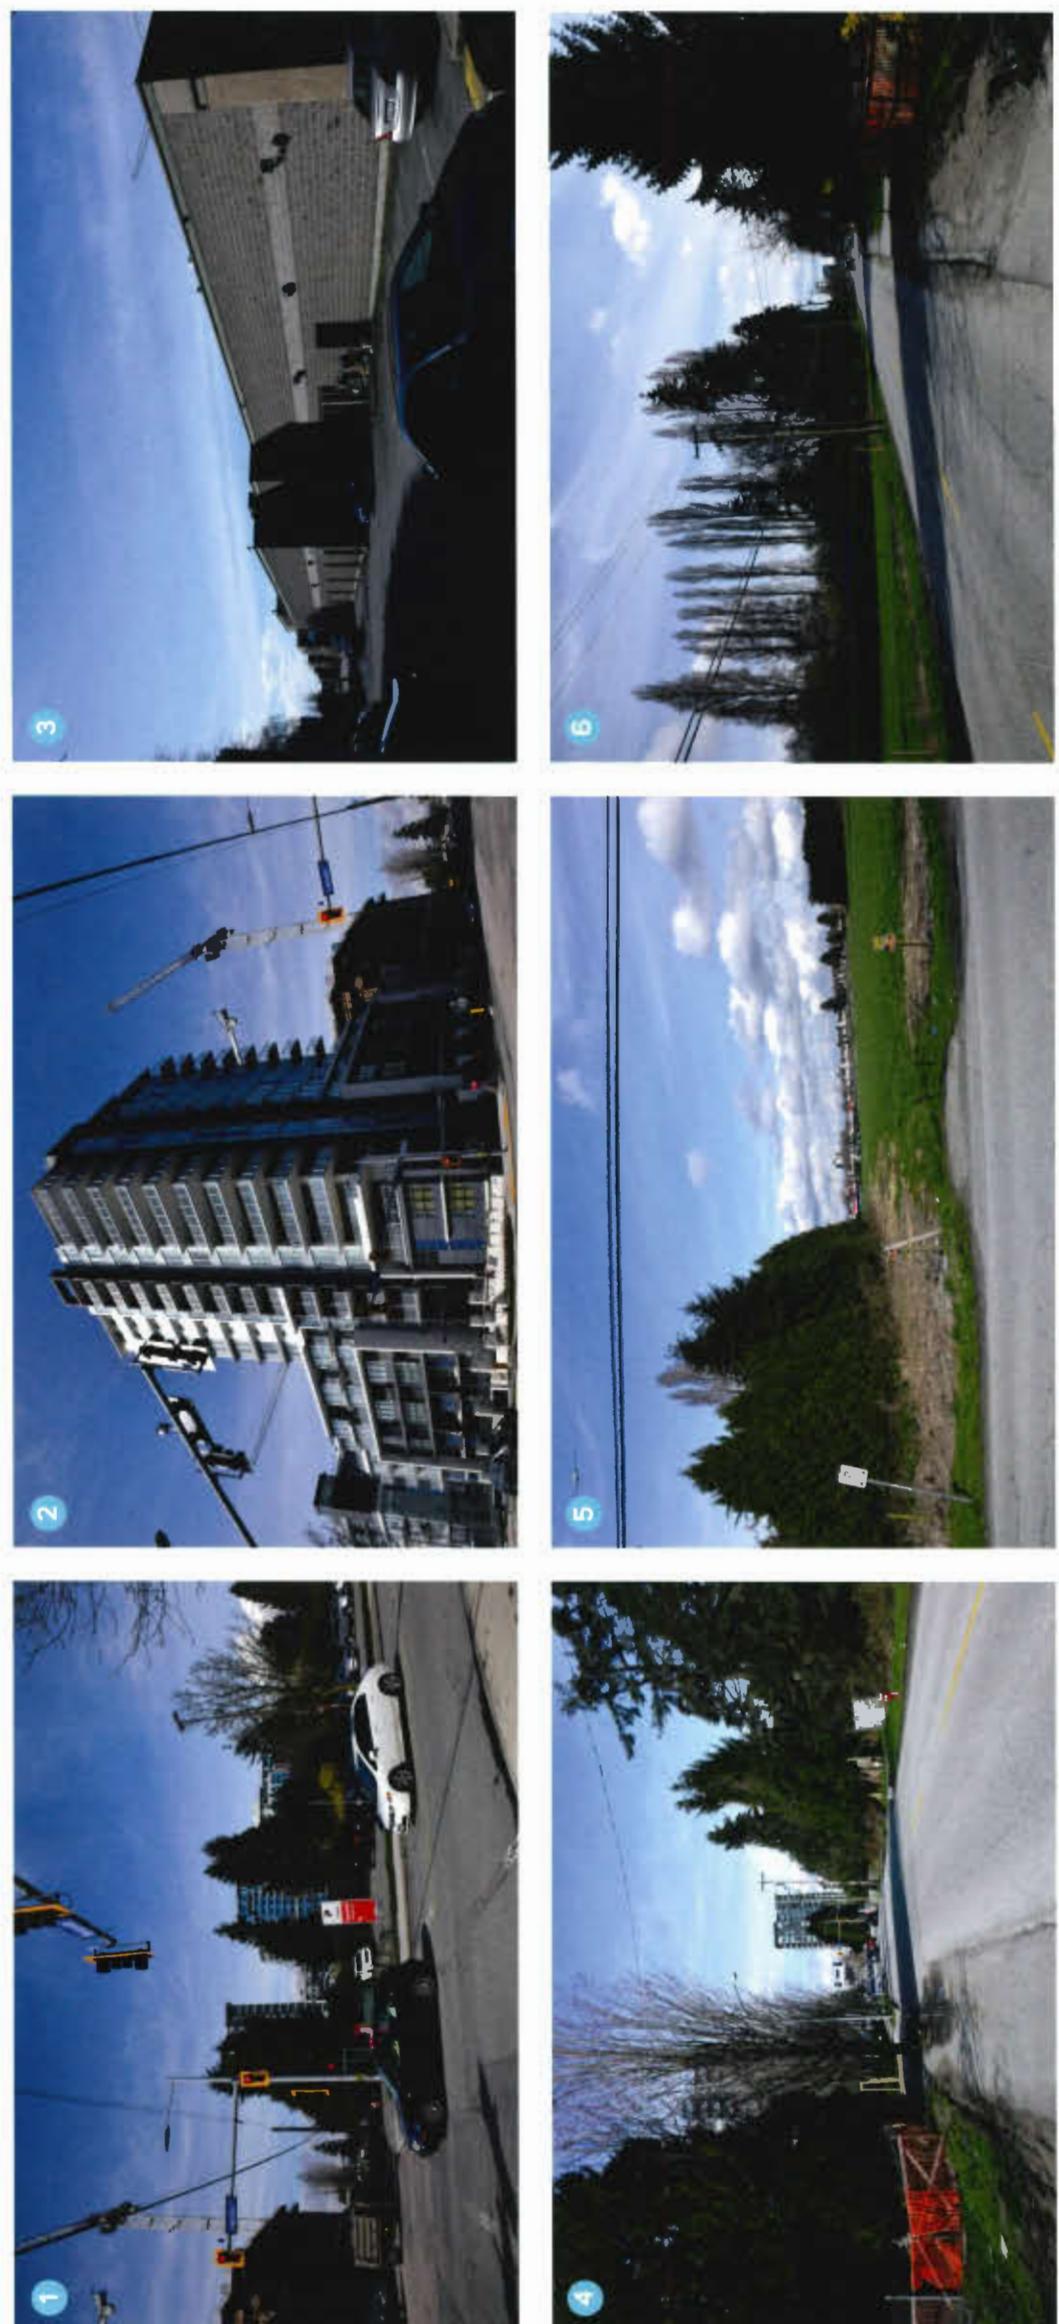

Fotolia

3051 m 821 821 821 821

Richmond, BC

Client:

Polycon

Location Plan and
Streetscape Images

Project Name	Project Type	Client Name	Architectural Firm	Date	Project No.
Fotolia	3051 m 821 821 821 821	Richmond, BC	Polycon	05/2019	A-003

Project Name:


Project Type:

Client Name:

Architectural Firm:

Date:

Project No.:

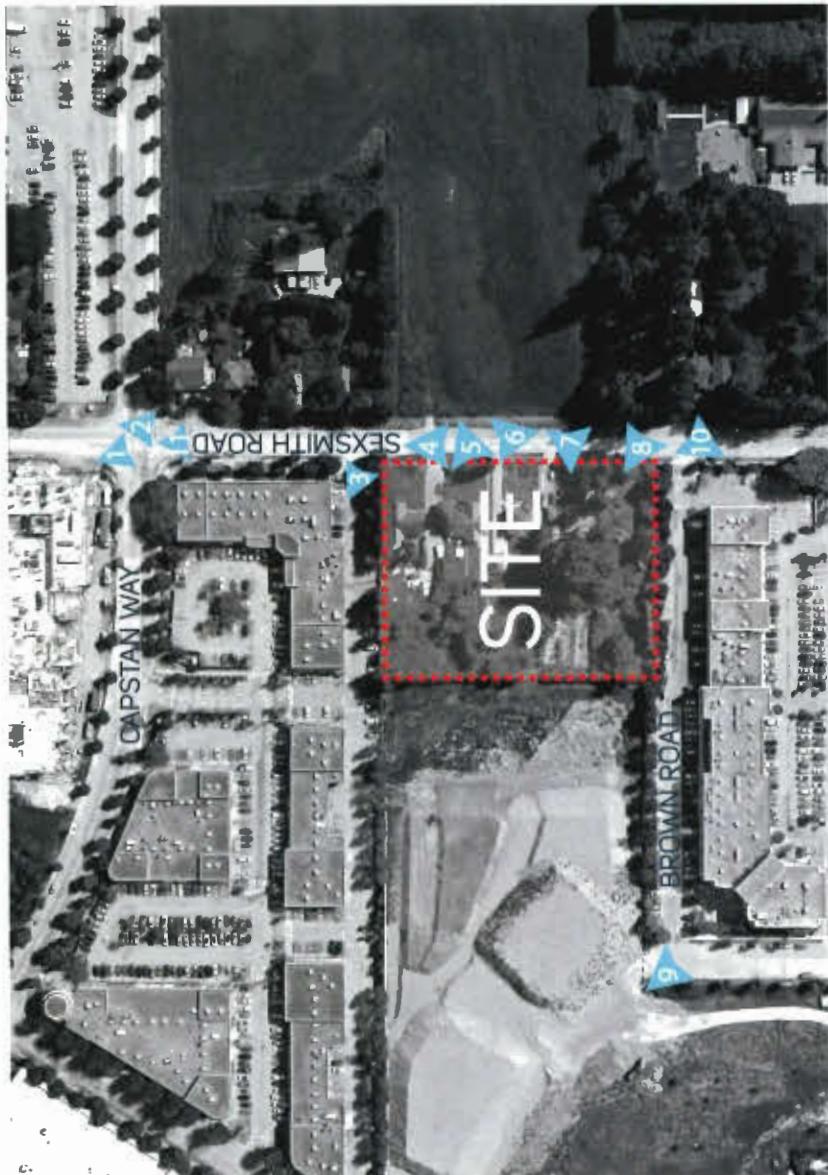

Project Name:

Prestella

3051 to 3051 Sherbrooke Street

Montreal, QC

Client:

Project:

GARDINER

Drawn by:

Author

Reviewed by:

Checklist

Date:

04/20/19

Architectural Drawings

Project Name:

A-003A

Date:

21/7/19

Architectural Drawings