



City of Richmond

Report to Development Permit Panel

To: Development Permit Panel

Date: March 20, 2018

From: Wayne Craig
Director, Development

File: DP 17-792088

Re: **Application by Interface Architecture Inc. for a Development Permit at 9211 and 9231 Williams Road**

Staff Recommendation

That a Development Permit be issued which would:

1. Permit the construction of eight townhouse units at 9211 and 9231 Williams Road on a site zoned "Low Density Townhouses (RTL4)"; and
2. Vary the provisions of Richmond Zoning Bylaw 8500 to:
 - a) Reduce the front yard setback from 6.0 m to 5.4 m and allow an additional 0.9 m ground floor projection of the "C" units into the front yard setback;
 - b) Allow one small car parking stall in each of the side-by-side garages (eight small car stalls in total) and allow small car parking stalls for the secondary suite units.


Wayne Craig
Director, Development
(604-247-4625)

WC:el
Att. 2

Staff Report

Origin

Interface Architecture Inc. has applied to the City of Richmond for permission to develop eight townhouse units at 9211 and 9231 Williams Road. Two out of the eight townhouse units are proposed to each contain a ground-level secondary suite. The site is being rezoned from “Single Detached (RS1/E)” zone to “Low Density Townhouses (RTL4)” zone for this project under Bylaw 9750 (RZ 16-729962); which received third reading following the Public Hearing on October 16, 2017. The properties currently contain two single-family dwellings; which will be demolished.

Frontage improvements were secured through the rezoning process and will be constructed through a separate Servicing Agreement (SA 17-788783). The Servicing Agreement must be entered into prior to final adoption of the rezoning bylaw. Works include, but are not limited to: frontage beautification, storm upgrades, and new service connections.

Development Information

Please refer to the attached Development Application Data Sheet (Attachment 1) for a comparison of the proposed development data with the relevant bylaw requirements.

Background

Development surrounding the subject site is as follows:

- To the north: Existing single family dwellings on lots zoned “Single-Detached (RS1/E)”.
- To the east: Existing single family homes with coach houses on compact lots zoned “Coach Houses (RCH)”, which are identified for future townhouse development under the Arterial Road Land Use Policy; and a 20-unit townhouse complex zoned “Medium Density Townhouses (RTM2)”.
- To the south: Across Williams Road, South Arm Park on lands zoned “School & Institutional Use (SI)”.
- To the west, existing single family dwellings on lots zoned “Single-Detached (RS1/E)”, which are identified for townhouse development under the Arterial Road Land Use Policy.

Rezoning and Public Hearing Results

The Public Hearing for the rezoning of this site was held on October 16, 2017. No concern regarding the rezoning application was expressed at the Public Hearing.

Staff Comments

The proposed scheme attached to this report has satisfactorily addressed the significant urban design issues and other staff comments identified as part of the review of the subject Development Permit application. In addition, it complies with the intent of the applicable sections of the Official Community Plan (OCP) and is generally in compliance with the “Low Density Townhouses (RTL4)” zone except for the zoning variances noted below.

Zoning Compliance/Variances (staff comments in **bold**)

The applicant requests to vary the provisions of Richmond Zoning Bylaw 8500 to:

- 1) Reduce the front yard setback from 6.0 m to 5.4 m and allow an additional 0.9 m ground floor projection of the "C" units into the front yard setback.
(Staff supports the proposed variance, as it is mainly a result of the road dedication required along the entire Williams Road frontage. This variance also permits a ground floor projection into the front yard setback to allow larger habitable spaces on the ground floor for the units with a secondary suite. Varied front yard setbacks contribute to the pedestrian scale along Williams Road. Appropriate interfaces with the adjacent properties to the east and west have also been provided through landscaping design).
- 2) Allow one small car parking stall in each of the side-by-side garages (eight small car stalls in total) and small car parking stalls for the secondary suite units.
(The Zoning Bylaw permits small car parking stalls only when more than 31 parking stalls are proposed on site. The proposed eight-unit townhouse development will provide 18 residential, plus two visitor parking spaces on-site. The small car stalls in the side-by-side garages allow for a more flexible site layout to provide a wider outdoor amenity space and a predominant two-storey massing. Transportation staff support the proposed variances to allow one small car stall in each of the side-by-side double car garages and small car parking stalls for the secondary suites).

All of these variances request were identified at rezoning stage, and no concerns were identified at that time.

Advisory Design Panel Comments

The subject application was not presented to the Advisory Design Panel on the basis that this small project generally meets all the applicable Development Permit Guidelines, and the overall design and site plan have adequately addressed staff comments.

Analysis***Conditions of Adjacency***

- The proposed height, siting and orientation of the buildings are similar to the townhouse developments on this block.
- While three storey units are proposed along Williams Road, the building height is stepped down to two storeys along the side property lines to provide appropriate transition to the adjacent single family homes.
- Two pairs of two-storey duplexes and the outdoor amenity area are proposed along the rear (north) property line to minimize privacy and overlook concerns.
- A six foot tall fence and hedging materials will be installed along the north property line to provide a buffer between the subject townhouse development and the adjacent single family homes.

- Properties to both east and west of the subject site are designated for townhouse development. A statutory right-of-way (SRW) allowing access to/from the adjacent future development sites through the subject site (over the entry driveway) has been secured at rezoning.
- A six foot tall fence will be installed along the east and west property lines and a Fastigiate Golden Leaf Beech tree will be planted in each of the side yards to provide screening between the proposed townhouse units and the adjacent single family homes to the east and west.
- Perimeter drainage will be required as part of the Building Permit to ensure storm water is managed and addressed through the development and will not impact the neighbouring properties.

Urban Design and Site Planning

- The layout of the townhouse units is oriented around a single driveway providing access to the site from Williams Road and an east-west internal manoeuvring aisle providing access to the unit garages.
- Four pairs of duplex are proposed; creating a total of eight units. Half of the units will have direct pedestrian access from the street and half of the units will have access from the internal drive aisle.
- Two of the units will each contain a one-bedroom ground-level secondary suite of approximately 23 m^2 (244 ft^2) in size.
- All units will have two vehicle parking spaces in a side-by-side double car garage. An additional surface parking stall will be assigned to each of the secondary dwelling units.
- A total of two visitor parking spaces will be provided throughout the site. The number of visitor parking spaces proposed is in compliance with the minimum bylaw requirement.
- Both residential and visitor bicycle parking are provided in compliance with the Zoning Bylaw requirements.
- The provision of private outdoor spaces complies with the Development Permit Guidelines (30 m^2 per unit) of the OCP. All units will have private outdoor spaces consisting of front or rear yard; the three-storey units will also have a covered deck on the second floor facing the internal drive aisle.
- Outdoor amenity space is proposed opposite to the site entry for maximum casual surveillance opportunity and sun exposure. The size and location of the outdoor amenity space is appropriate in providing open landscape and amenity space convenient to all units.
- A covered mailbox kiosk and short-term bicycle parking spaces will be provided within the outdoor amenity space.
- The required garbage, recycling and organic waste storage enclosures have been incorporated into the design of the street fronting buildings to minimize the visual impact of these enclosures.

Architectural Form and Character

- The architect advised that the design of this project follows a neo-Craftsman character, which is consistent with the typical housing vocabulary (i.e., gable/hipped roof forms, canopied entry doors, boxed windows, wood textured siding, etc.) used in the neighbouring townhouse developments. However, this development will be differentiated from the other developments by the use of shingled siding and decorative diamond windows.
- The front units will have individual canopies and stoops identifying the entry doors. Vertical architectural articulation (i.e., stacked box windows) will visually cue the buildings as duplexes. The rear duplexes will have large fronting gables that visually identify each dwelling unit.
- A pedestrian scale is generally achieved along the public streets and internal drive aisle through the inclusion of variation in building projections, recesses, entry porches, varying material/colour combinations, landscape features, and the use of individual unit entrances.
- The impact of blank garage doors has been mitigated with panel patterned doors, transom windows, unit entrances, and planting islands along the drive aisle.
- The proposed building materials (horizontal hardie plank cedar mill siding, hardies shingle siding, fiberglass asphalt roof shingles, wood trim/post & cross beams, cultured stone veneer etc.) are generally consistent with the Official Community Plan (OCP) Guidelines and compatible with the existing single family character of the neighbourhood.
- A palette of earth tone grays and cream colours is proposed, with charcoal for the metal gutters/downspouts, white for the wood trims and vinyl window frames. A darker shade of horizontal siding on the ground floor will tie all four buildings (eight units) together visually.

Landscape Design and Open Space Design

- Tree preservation was reviewed at rezoning stage; one tree on site is identified for removal. Based on the 2:1 tree replacement ratio goal stated in the Official Community Plan (OCP), two replacement trees are required. The applicant is proposing to plant 18 replacement trees on-site, including four conifers and ten deciduous trees.
- The proposal provides for a pedestrian-oriented streetscape fronting Williams Road; with a landscaped edge treatment including a new tree in each front yard, lawn and patio areas, low metal fencing, and metal gate to each street fronting unit.
- Typically, above-ground utility infrastructure improvements, such as a hydro kiosk, should be located outside of the front yard of a townhouse development. The hydro kiosk was originally proposed along the internal drive aisle within the side yard setback; and the site layout was generally accepted by staff. However, as encouraged by Council during the rezoning review process, the developer decided to provide two secondary suites in this development. In order to provide two surface parking stalls for the secondary suites, as per Zoning Bylaw requirement, the applicant proposed to relocate the hydro kiosk to the front yard in order to avoid significant revision to the accepted site layout. The kiosk will be screened by Cedar hedge on three sides, as the front side of the kiosk is not permitted to be screened. Staff will continue to guide the applicants of other development projects to locate all aboveground utility infrastructures outside of the front yard.

- Along the internal drive aisle, the central outdoor amenity area will be extended into the T-intersection in order to provide a landscape feature (i.e., a Maple tree) to visually interrupt the straight drive aisle; which may also dub as a traffic calming feature.
- Each unit will have a private yard with landscaping and lawn area. Various hedges, shrubs and ground covers, as well as perennials and grasses have been selected to ensure the landscape treatment remains interesting throughout the year.
- The location of outdoor amenity space provides the easy access and visual transparency and surveillance for the townhouse residents. An organic landscape plan is proposed to mask the ‘squareness’ of the space provided. The landscape design creates angled views, pockets of activity, and potential for textured landscape elements.
- A variety of stimuli are proposed within the outdoor amenity area. A number of sanded logs will define small areas within the play area and can be used for balance; vertical logs will also provide balancing and play opportunities. A bench is also provided for caregivers.
- In order to ensure that the proposed landscaping works are completed, the applicant is required to provide a landscape security of \$150,449.70 in association with the Development Permit.
- Indoor amenity space is not proposed on-site. An \$8,000 cash-in-lieu contribution (\$1,000 per unit) has been secured as a condition of rezoning approval, consistent with the OCP.

Crime Prevention Through Environmental Design

- The architect advised that the following CPTED design/features are incorporated into the proposal:
 - All building exterior side walls will have windows at upper floors; which would provide for passive surveillance over the common outdoor amenity area, visitor parking spaces, the garbage and recycle enclosures, and all main entries and garage doors along the internal drive aisle;
 - All unit entry doors will be clearly visible from the street and the internal drive aisle, will be well-lit, and will not be set back into the building;
 - The outdoor amenity area/children’s play area is centrally located at the rear portion of the site; where it has minimum conflict with vehicles, and is highly visible for passive surveillance.
 - Bollard lighting will be added to the outdoor amenity area and at the ends of the four visitor parking spaces.

Sustainability

- A Certified Energy Advisor has confirmed that the proposed townhouse units will be designed to achieve an EnerGuide rating of 82. The report prepared by the Energy Advisor is on file and will be utilized through the Building Permit review process to ensure these measures are incorporated in the Permit drawings.

- The architect advised that the following design/features are incorporated into the proposal:
 - Vented windows to allow natural ventilation.
 - South-oriented units with minimal window placement on the east and west elevation to decrease unwanted solar gain/loss.
 - Large usable private outdoor yards to encourage more outdoor activities and usage.
 - Use of fibre cement siding as the main cladding material to achieve sustainable building practices.
- Each garage will be equipped with a 240V receptacle to accommodate future electric vehicle charging equipment.

Accessible Housing

- The proposed development includes one convertible unit that is designed with the potential to be easily renovated to accommodate a future resident in a wheelchair. The potential conversion of this "Ac" unit will require installation of a chair lift (where the staircase has been dimensioned to accommodate this) in the future, if desired. <to be used for townhouse developments providing townhouse units that incorporate all of the convertible housing features listed in OCP section 3.4 Accessible Housing. Provide a description of renovation requirements (i.e. the installation of a stair lift or elevator)>
- All of the proposed units incorporate aging in place features to accommodate mobility constraints associated with aging. These features include:
 - Stairwell hand rails.
 - Lever-type handles for plumbing fixtures and door handles.
 - Solid blocking in washroom walls to facilitate future grab bar installation beside toilets, bathtubs and showers.

Conclusions

As the proposed development would meet applicable policies and Development Permit Guidelines, and the applicant has agreed to the list of Development Permit Considerations (signed concurrence on file) outlined in Attachment 2, staff recommend that the Development Permit be endorsed, and issuance by Council be recommended.



Edwin Lee
Planner 1
(604-276-4121)

EL:blg

Attachment 1: Development Application Data Sheet
Attachment 2: Development Permit Considerations



City of Richmond

Development Application Data Sheet

Development Applications Department

DP 17-792088

Attachment 1

Address: 9211 and 9231 Williams Road

Applicant: Interface Architecture Inc.

Owner: Chen Chia Shu & 7878 Holding Ltd.

Planning Area(s): Broadmoor

Floor Area Gross: 1,392.0 m²

Floor Area Net: 986.32 m²

	Existing	Proposed
Site Area:	1,692.5 m ²	1,668.9 m ²
Land Uses:	Single-Family Residential	Multiple-Family Residential
OCP Designation:	Low-Density Residential	No Change
Zoning:	Single Detached (RS1/E)	Low Density Townhouses (RTL4)
Number of Units:	2	8

	Bylaw Requirement	Proposed	Variance
Floor Area Ratio:	Max. 0.60	0.591	none permitted
Lot Coverage – Building:	Max. 40%	38.9%	none
Lot Coverage – Non-porous Surfaces:	Max. 65%	63.0%	none
Lot Coverage – Landscaping:	Min. 25%	28.2%	none
Setback – Front Yard (m):	Min. 6.0 m	5.4 m , except 4.5 m to the ground floor of the "C" units	variance required
Setback – East Side Yard (m):	Min. 3.0 m	3.01 m	none
Setback – West Side Yard (m):	Min. 3.0 m	3.03 m	none
Setback – Rear Yard (m):	Min. 3.0 m	6.0 m with 50% ground floor projection (at 4.5 m)	none
Height (m):	Max. 12.0 m (3 storeys)	<ul style="list-style-type: none">• 11.08 m (3 storeys) along Williams Road• 8.73 m (2 storeys) along north property line	none
Lot Width:	Min. 40.0 m	40.3 m	none
Lot Depth:	Min. 35.0 m	41.45 m	none
Off-street Parking Spaces – Regular (R) / Visitor (V):	2 (R) and 0.2 (V) per unit + 1 (R) per secondary suite	2 (R) and 0.25 (V) per unit + 1 (R) per secondary suite	none
Off-street Parking Spaces – Total:	18 (R) and 2 (V)	18 (R) and 2 (V)	none

Tandem Parking Spaces:	Max. 50% of proposed residential spaces in enclosed garages (16 x Max. 50% = 8)	0	none
Small Car Parking Spaces	None when fewer than 31 spaces are provided on site	10	variance required
Handicap Parking Spaces:	None when fewer than 3 visitor stalls are required	0	none
Bicycle Parking Spaces – Class 1 / Class 2:	1.25 (Class 1) and 0.2 (Class 2) per unit	1.25 (Class 1) and 0.25 (Class 2) per unit	none
Off-street Parking Spaces – Total:	10 (Class 1) and 2 (Class 2)	10 (Class 1) and 2 (Class 2)	none
Amenity Space – Indoor:	Min. 70 m ² or Cash-in-lieu	Cash-in-lieu	none
Amenity Space – Outdoor:	Min. 6 m ² x 8 units = 48 m ²	61 m ²	none



**City of
Richmond**

Development Permit Considerations

Development Applications Department
6911 No. 3 Road, Richmond, BC V6Y 2C1

Address: 9211 and 9231 Williams Road

File No.: DP 17-792088

Prior to approval of the Development Permit, the developer is required to complete the following:

1. Final adoption of the Zoning Amendment Bylaw 9750 (RZ 16-729962).
2. Submission of a Landscaping Security in the amount of \$150,449.70 (based on 100% of the cost estimate, including 10% contingency, provided by the landscape architect).

Prior to Building Permit Issuance, the developer must complete the following requirements:

1. Installation of appropriate tree protection fencing around all trees to be retained as part of the development prior to any construction activities, including building demolition, occurring on-site.

Note: Should the applicant wish to begin site preparation work after third reading of the rezoning bylaw, but prior to final adoption of the rezoning bylaw, the applicant will be required to obtain a Tree Permit and submit a landscape security (i.e. \$3,000) to ensure the replacement planting will be provided.

2. Incorporation of accessibility, CPTED and sustainability measures in Building Permit (BP) plans as determined via the Rezoning and/or Development Permit processes.
3. If applicable, payment of latecomer agreement charges associated with eligible latecomer works.
4. Submission of a Construction Parking and Traffic Management Plan to the Transportation Department. Management Plan shall include location for parking for services, deliveries, workers, loading, application for any lane closures, and proper construction traffic controls as per Traffic Control Manual for works on Roadways (by Ministry of Transportation) and MMCD Traffic Regulation Section 01570.
5. Obtain a Building Permit (BP) for any construction hoarding. If construction hoarding is required to temporarily occupy a public street, the air space above a public street, or any part thereof, additional City approvals and associated fees may be required as part of the Building Permit. For additional information, contact the Building Approvals Department at 604-276-4285.

Note:

- * This requires a separate application.
- Where the Director of Development deems appropriate, the preceding agreements are to be drawn not only as personal covenants of the property owner but also as covenants pursuant to Section 219 of the Land Title Act.

All agreements to be registered in the Land Title Office shall have priority over all such liens, charges and encumbrances as is considered advisable by the Director of Development. All agreements to be registered in the Land Title Office shall, unless the Director of Development determines otherwise, be fully registered in the Land Title Office prior to enactment of the appropriate bylaw.

The preceding agreements shall provide security to the City including indemnities, warranties, equitable/rent charges, letters of credit and withholding permits, as deemed necessary or advisable by the Director of Development. All agreements shall be in a form and content satisfactory to the Director of Development.

- Additional legal agreements, as determined via the subject development's Servicing Agreement(s) and/or Development Permit(s), and/or Building Permit(s) to the satisfaction of the Director of Engineering may be required including, but not limited to, site investigation, testing, monitoring, site preparation, de-watering, drilling, underpinning, anchoring, shoring, piling, pre-loading, ground densification or other activities that may result in settlement, displacement, subsidence, damage or nuisance to City and private utility infrastructure.
- Applicants for all City Permits are required to comply at all times with the conditions of the Provincial *Wildlife Act* and Federal *Migratory Birds Convention Act*, which contains prohibitions on the removal or disturbance of both birds and their nests. Issuance of Municipal permits does not give an individual authority to contravene these legislations. The City of Richmond recommends that where significant trees or vegetation exists on site, the services of a Qualified Environmental Professional (QEP) be secured to perform a survey and ensure that development activities are in compliance with all relevant legislation.

Signed

Date



City of Richmond

Development Permit

No. DP 17-792088

To the Holder: INTERFACE ARCHITECTURE INC.

Property Address: 9211 AND 9231 WILLIAMS ROAD

Address: C/O KEN CHOW
11590 CAMBIE ROAD, SUITE 230
RICHMOND BC V6X 3Z5

1. This Development Permit is issued subject to compliance with all of the Bylaws of the City applicable thereto, except as specifically varied or supplemented by this Permit.
2. This Development Permit applies to and only to those lands shown cross-hatched on the attached Schedule "A" and any and all buildings, structures and other development thereon.
3. The "Richmond Zoning Bylaw 8500" is hereby varied to:
 - a) reduce the front yard setback from 6.0 m to 5.4 m and allow an additional 0.9 m ground floor projection of the "C" units into the front yard setback; and
 - b) allow one small car parking stall in each of the side-by-side garages (eight small car stalls in total) and allow small car parking stalls for the secondary suite units.
4. Subject to Section 692 of the Local Government Act, R.S.B.C.: buildings and structures; off-street parking and loading facilities; roads and parking areas; and landscaping and screening shall be constructed generally in accordance with Plans #1 to #4 attached hereto.
5. Sanitary sewers, water, drainage, highways, street lighting, underground wiring, and sidewalks, shall be provided as required.
6. As a condition of the issuance of this Permit, the City is holding the security in the amount of \$150,449.70 to ensure that development is carried out in accordance with the terms and conditions of this Permit. Should any interest be earned upon the security, it shall accrue to the Holder if the security is returned. The condition of the posting of the security is that should the Holder fail to carry out the development hereby authorized, according to the terms and conditions of this Permit within the time provided, the City may use the security to carry out the work by its servants, agents or contractors, and any surplus shall be paid over to the Holder. Should the Holder carry out the development permitted by this permit within the time set out herein, the security shall be returned to the Holder. The City may retain the security for up to one year after inspection of the completed landscaping in order to ensure that plant material has survived.
7. If the Holder does not commence the construction permitted by this Permit within 24 months of the date of this Permit, this Permit shall lapse and the security shall be returned in full.

Development Permit
No. DP 17-792088

To the Holder: INTERFACE ARCHITECTURE INC.

Property Address: 9211 AND 9231 WILLIAMS ROAD

Address: C/O KEN CHOW
11590 CAMBIE ROAD, SUITE 230
RICHMOND, BC V6X 3Z5

8. The land described herein shall be developed generally in accordance with the terms and conditions and provisions of this Permit and any plans and specifications attached to this Permit which shall form a part hereof.

This Permit is not a Building Permit.

AUTHORIZING RESOLUTION NO.
DAY OF ,



ISSUED BY THE COUNCIL THE

DELIVERED THIS DAY OF ,

MAYOR



City of Richmond

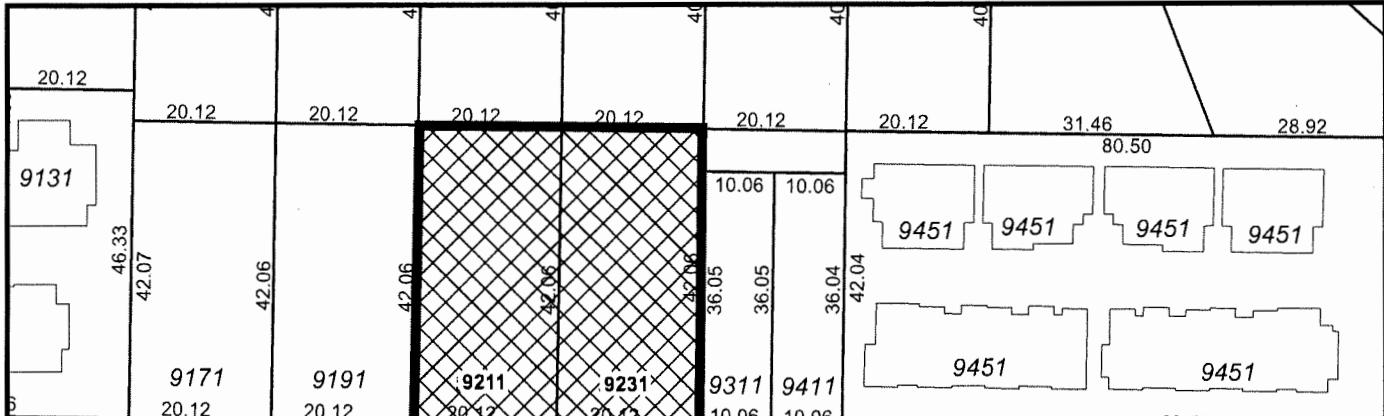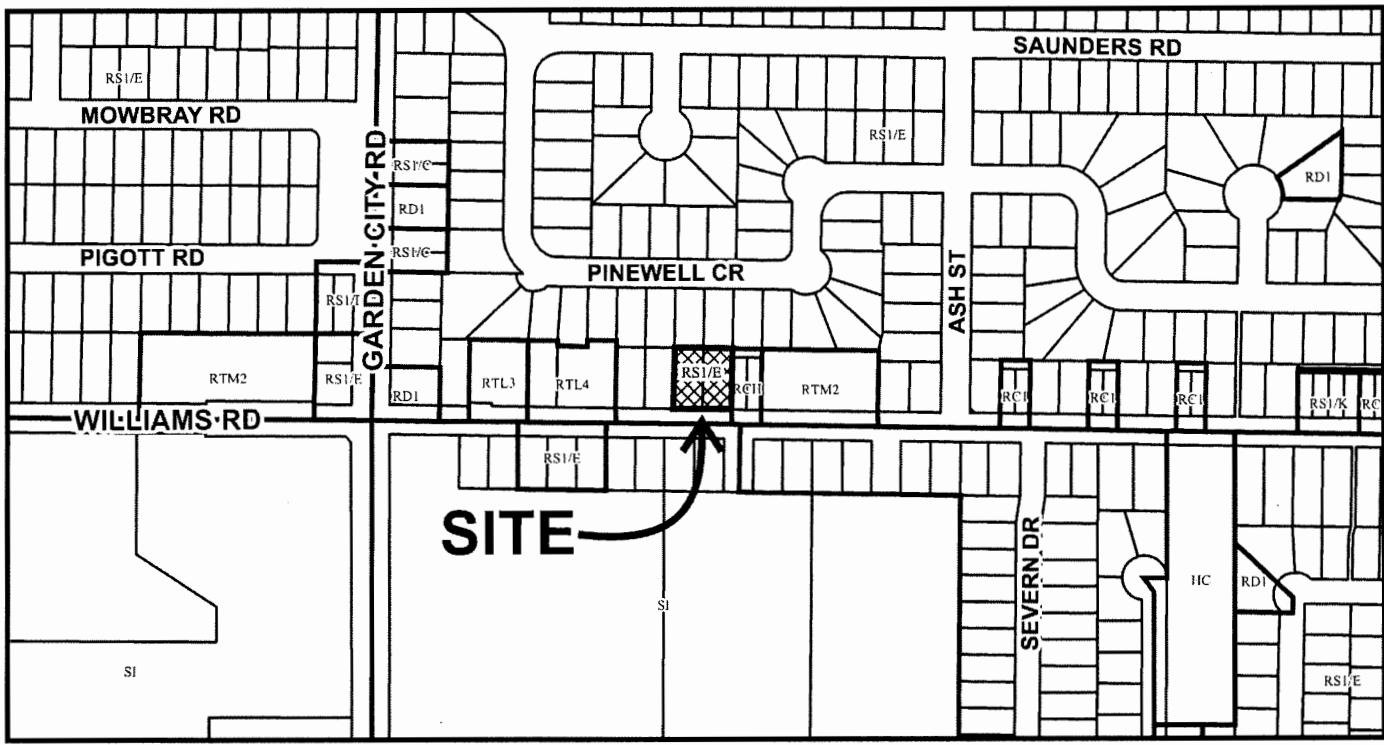

WILLIAMS RD

20	20.12 9140	20.12 9160	20.97 9180	20.42 9200	20.42 9220	20.42 9240	20.42 9260	20.42 9280
28	28	28	28	28	28	28	28	28

	DP 17-792088 SCHEDULE "A"	Original Date: 11/27/17 Revision Date: Note: Dimensions are in METRES
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DEVELOPMENT PERMIT APPLICATION

PROPOSED 8-UNIT TOWNHOUSE DEVELOPMENT

9211, 9231 WILLIAMS ROAD, RICHMOND BC

#102 - 11560 CANNIBAL RD	Alt: KEN CHOW	Email: ken@interfacearchitecture.com
Tel: 604-421-1182		
Fax: 604-821-1148		
Landscape Architect		
JONATHAN LOBEE LTD LANDSCAPE ARCHITECTURE	Alt: JONATHAN LOBEE	Email: jon@jonathanlobee.com
VANCOUVER, BC V1J 1H3		
Tel: 604-288-0103		
Fax: 604-586-0032		
Arborist		
ARBORTECH CONSULTING LTD.	Alt: NORM HOL	Email: norm@adgroup.ca
VANCOUVER, BC V7C 2Z3		
Tel: 604-275-3484		
Fax: 604-275-9854		
Civil (Offsite/Onsite)		
CORE CONCEPT CONSULTING LTD.		
4220 - 2639 MORNINGSIDE WAY		
RICHMOND, B.C. V6Y 3R7		
Tel: 604-249-5040		
Fax: 604-248-5041		
Alt: BRUCE DUFFY		
Email: bruce@coreconceptconsulting.com		
Mechanical		
SRC ENGINEERING CONSULTANTS	Alt: BILL KHANGURA	Email: bill.khangura@src-eng.com
#205 - 4180 LOUGHED HWY		
BURNABY, BC V5C 8A7		
Tel: 604-239-9091		
Fax: 604-285-5092		
Alt: GEORGE GHATTAS		
Email: george@src-eng.com		
Electrical		
SRC ENGINEERING CONSULTANTS	Alt: MATT KOKAN	Email: mokan@src-eng.com
#205 - 4180 LOUGHED HWY		
BURNABY, BC V5C 8A7		
Tel: 604-239-9092		
Fax: 604-285-5092		
Alt: KENNETH NG		
Email: kenneth@explorersurvey.com		
Geotechnical		
GEO PACIFIC CONSULTANT LTD.		
#410 - 1200 W. 73RD AVENUE		
RICHMOND, B.C. V6V 1H1		
Tel: 604-358-9922		
Fax: 604-358-9188		
Surveyor		
EXPLORER SURVEY		
#410 - 1200 W. 73RD AVENUE		
RICHMOND, BC V6V 1H1		
Tel: 604-358-9979		
Fax: 604-358-9979		
Alt: KENNETH NG		
Email: kenneth@explorersurvey.com		
Project Description		
A REZONING TO RT1.4 (LOW DENSITY TOWNHOUSES) IS PROPOSED TO PERMIT THE DEVELOPMENT OF A 8-UNIT TOWNHOUSE PROJECT FOR THIS 1692.5 m ² (18,476 SF) ZONE-ACTIVE SITE. THE SITE FRONTS A MINOR ARTERIAL ROAD (WILLIAMS ROAD) AND HAS NO REAR LANE, AND IS SURROUNDED ON 3 SIDES WITH SINGLE FAMILY HOMES, AND HAS A BM STATORARY RIGHT-OF-WAY (SANITARY) STRADDLING THE REAR PROPERTY LINE.		
THE COMBINED 2 PARCELS (14'32.0" WIDE X 138.0" DEPTH) ARE IN THE BROADMOOR OCP PLANNING AREA 2.6, BUT NOT YET SUBJECT TO A SPECIFIC SUBAREA PLAN. MULTI-FAMILY DENSIFICATION IS PERMITTED PER 3.6.1 ARTERIAL ROAD POLICY (MIN FRONTAGE 130 FT).		
THE PROJECT COMPRISES OF 8 UNITS IN 4 DUPLEXES. THERE ARE NO TANDEM UNITS. TWO LOCKOFF UNITS HAVE BEEN ADDED (1 IN EACH UNIT TYPE C). THREE ZONING VARIANCE ARE REQUESTED: (1) FRONT YARD SETBACK REDUCED FROM 8.0M TO 4.5M AT THE GROUND LEVEL TO TIE LOCKOFF UNITS, OVERALL FROM 8.0M TO 5.0M TO ALL OTHER UNITS; (2) PERMIT 10 SMALL CAR PARKING SPACES (1 IN EACH OF 8 UNITS, 2 OUTDOOR SPACES FOR LOCKOFF UNITS);		
* SEE CEA ENERGY INSPECTION REPORT FOR DETAILS		
* CEA WILL CONDUCT INSPECTION OF UNIT C TO VERIFY COMPLIANCE		
ONE CONVERTIBLE UNIT IS PROVIDED IN BUILDING 2.		

ENERGY Upgrades to meet Energuide 82

- 1. SOLAR HOT WATER READY
- * PER THE REQUIREMENTS OF THE BC HOT WATER READY REGULATION
- * 2 CONDUIT RUNS (1.3M2 AREA)
- 2. R22 NOMINAL ABOVE GRADE WALLS
- 3. R60 NOMINAL CEILINGS BELOW ATTIC
- 4. CONDENSING HOT WATER TANK WITH A MINIMUM EF 0.82 PROVIDING RADIANT FLOOR HEATING AND DOMESTIC HOT WATER (GAS-FIRED)
- 5. ENERGY STAR LED LIGHTING
- 6. ENERGY STAR APPLIANCES (CLOTHES WASHER/DRYER, FRIDGE, DISHWASHER)

* SEE CEA ENERGY INSPECTION REPORT FOR DETAILS

* CEA WILL CONDUCT INSPECTION OF UNIT C TO VERIFY COMPLIANCE

ONE CONVERTIBLE UNIT IS PROVIDED IN BUILDING 2.

PROJECT DESCRIPTION

A REZONING TO RT1.4 (LOW DENSITY TOWNHOUSES) IS PROPOSED TO PERMIT THE DEVELOPMENT OF A 8-UNIT TOWNHOUSE PROJECT FOR THIS 1692.5 m² (18,476 SF) ZONE-ACTIVE SITE. THE SITE FRONTS A MINOR ARTERIAL ROAD (WILLIAMS ROAD) AND HAS NO REAR LANE, AND IS SURROUNDED ON 3 SIDES WITH SINGLE FAMILY HOMES, AND HAS A BM STATORARY RIGHT-OF-WAY (SANITARY) STRADDLING THE REAR PROPERTY LINE.

THE COMBINED 2 PARCELS (14'32.0" WIDE X 138.0" DEPTH) ARE IN THE BROADMOOR OCP PLANNING AREA 2.6, BUT NOT YET SUBJECT TO A SPECIFIC SUBAREA PLAN. MULTI-FAMILY DENSIFICATION IS PERMITTED PER 3.6.1 ARTERIAL ROAD POLICY (MIN FRONTAGE 130 FT).

THE PROJECT COMPRISES OF 8 UNITS IN 4 DUPLEXES. THERE ARE NO TANDEM UNITS. TWO LOCKOFF UNITS HAVE BEEN ADDED (1 IN EACH UNIT TYPE C).

THREE ZONING VARIANCE ARE REQUESTED: (1) FRONT YARD SETBACK REDUCED FROM 8.0M TO 4.5M AT THE GROUND LEVEL TO TIE LOCKOFF UNITS, OVERALL FROM 8.0M TO 5.0M TO ALL OTHER UNITS; (2) PERMIT 10 SMALL CAR PARKING SPACES (1 IN EACH OF 8 UNITS, 2 OUTDOOR SPACES FOR LOCKOFF UNITS);

EACH TOWNHOUSE UNIT TO MEET ENERGUIDE 82 REQUIREMENTS.



ZONING SUMMARY

Richmond Zoning and Development Bylaw No. 8500

PROPOSED ZONING VARIANCE		F.A.R. AREA BREAKDOWN SF BY UNIT TYPE						
		UNIT TYPE	GROSS AREA	Covered Garage (Exempt)	STAIR LEVEL (EXEMPT)	FAR AREA	No. UNITS	TOTAL
LOT SIZE:		UNIT A	7,736	20	358	108	30	1,222
NET AREA:		UNIT B	7,736	20	355	108	34	1,224
LOW DENSITY TOWNHOUSES:		UNIT C	2,206	83	380	108	45	1,560
PERMITTED								10,877m ²
PROJECT SPECIFICS (PROPOSED)								
GROSS AREA: 18,223 SF = 2,418 ACRES (1,082.5 M ²)								
NET AREA: 2,206 SF = 0.041 ACRES (24.1 M ²)								
RT1.4 PROPOSED (CURRENTLY: RT1.4)								

INTERFACE

DATE	DRAWN BY	CHECKED BY	SHEET TITLE
MAR 12, 2016	KYC	KYC	
FEB 27, 2016	KYC	KYC	

ZONING SUMMARY

Richmond Zoning and Development Bylaw No. 8500

PROPOSED ZONING VARIANCE		F.A.R. AREA BREAKDOWN SF BY UNIT TYPE						
		UNIT TYPE	GROSS AREA	Covered Garage (Exempt)	STAIR LEVEL (EXEMPT)	FAR AREA	No. UNITS	TOTAL
LOT SIZE:		UNIT A	7,736	20	358	108	30	1,222
NET AREA:		UNIT B	7,736	20	355	108	34	1,224
LOW DENSITY TOWNHOUSES:		UNIT C	2,206	83	380	108	45	1,560
PERMITTED								10,877m ²
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GROSS AREA: 18,223 SF = 2,418 ACRES (1,082.5 M ²)								
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RT1.4 PROPOSED (CURRENTLY: RT1.4)								

ZONING SUMMARY

Richmond Zoning and Development Bylaw No. 8500


PROPOSED ZONING VARIANCE		F.A.R. AREA BREAKDOWN SF BY UNIT TYPE						
		UNIT TYPE	GROSS AREA	Covered Garage (Exempt)	STAIR LEVEL (EXEMPT)	FAR AREA	No. UNITS	TOTAL
LOT SIZE:		UNIT A	7,736	20	358	108	30	1,222
NET AREA:		UNIT B	7,736	20	355	108	34	1,224
LOW DENSITY TOWNHOUSES:		UNIT C	2,206	83	380	108	45	1,560
PERMITTED								10,877m ²
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GROSS AREA: 18,223 SF = 2,418 ACRES (1,082.5 M ²)								
NET AREA: 2,206 SF = 0.041 ACRES (24.1 M ²)								
RT1.4 PROPOSED (CURRENTLY: RT1.4)								

ZONING SUMMARY

Richmond Zoning and Development Bylaw No. 8500

PROPOSED ZONING VARIANCE		F.A.R. AREA BREAKDOWN SF BY UNIT TYPE						
		UNIT TYPE	GROSS AREA	Covered Garage (Exempt)	STAIR LEVEL (EXEMPT)	FAR AREA	No. UNITS	TOTAL

<tbl_r cells="9" ix="5

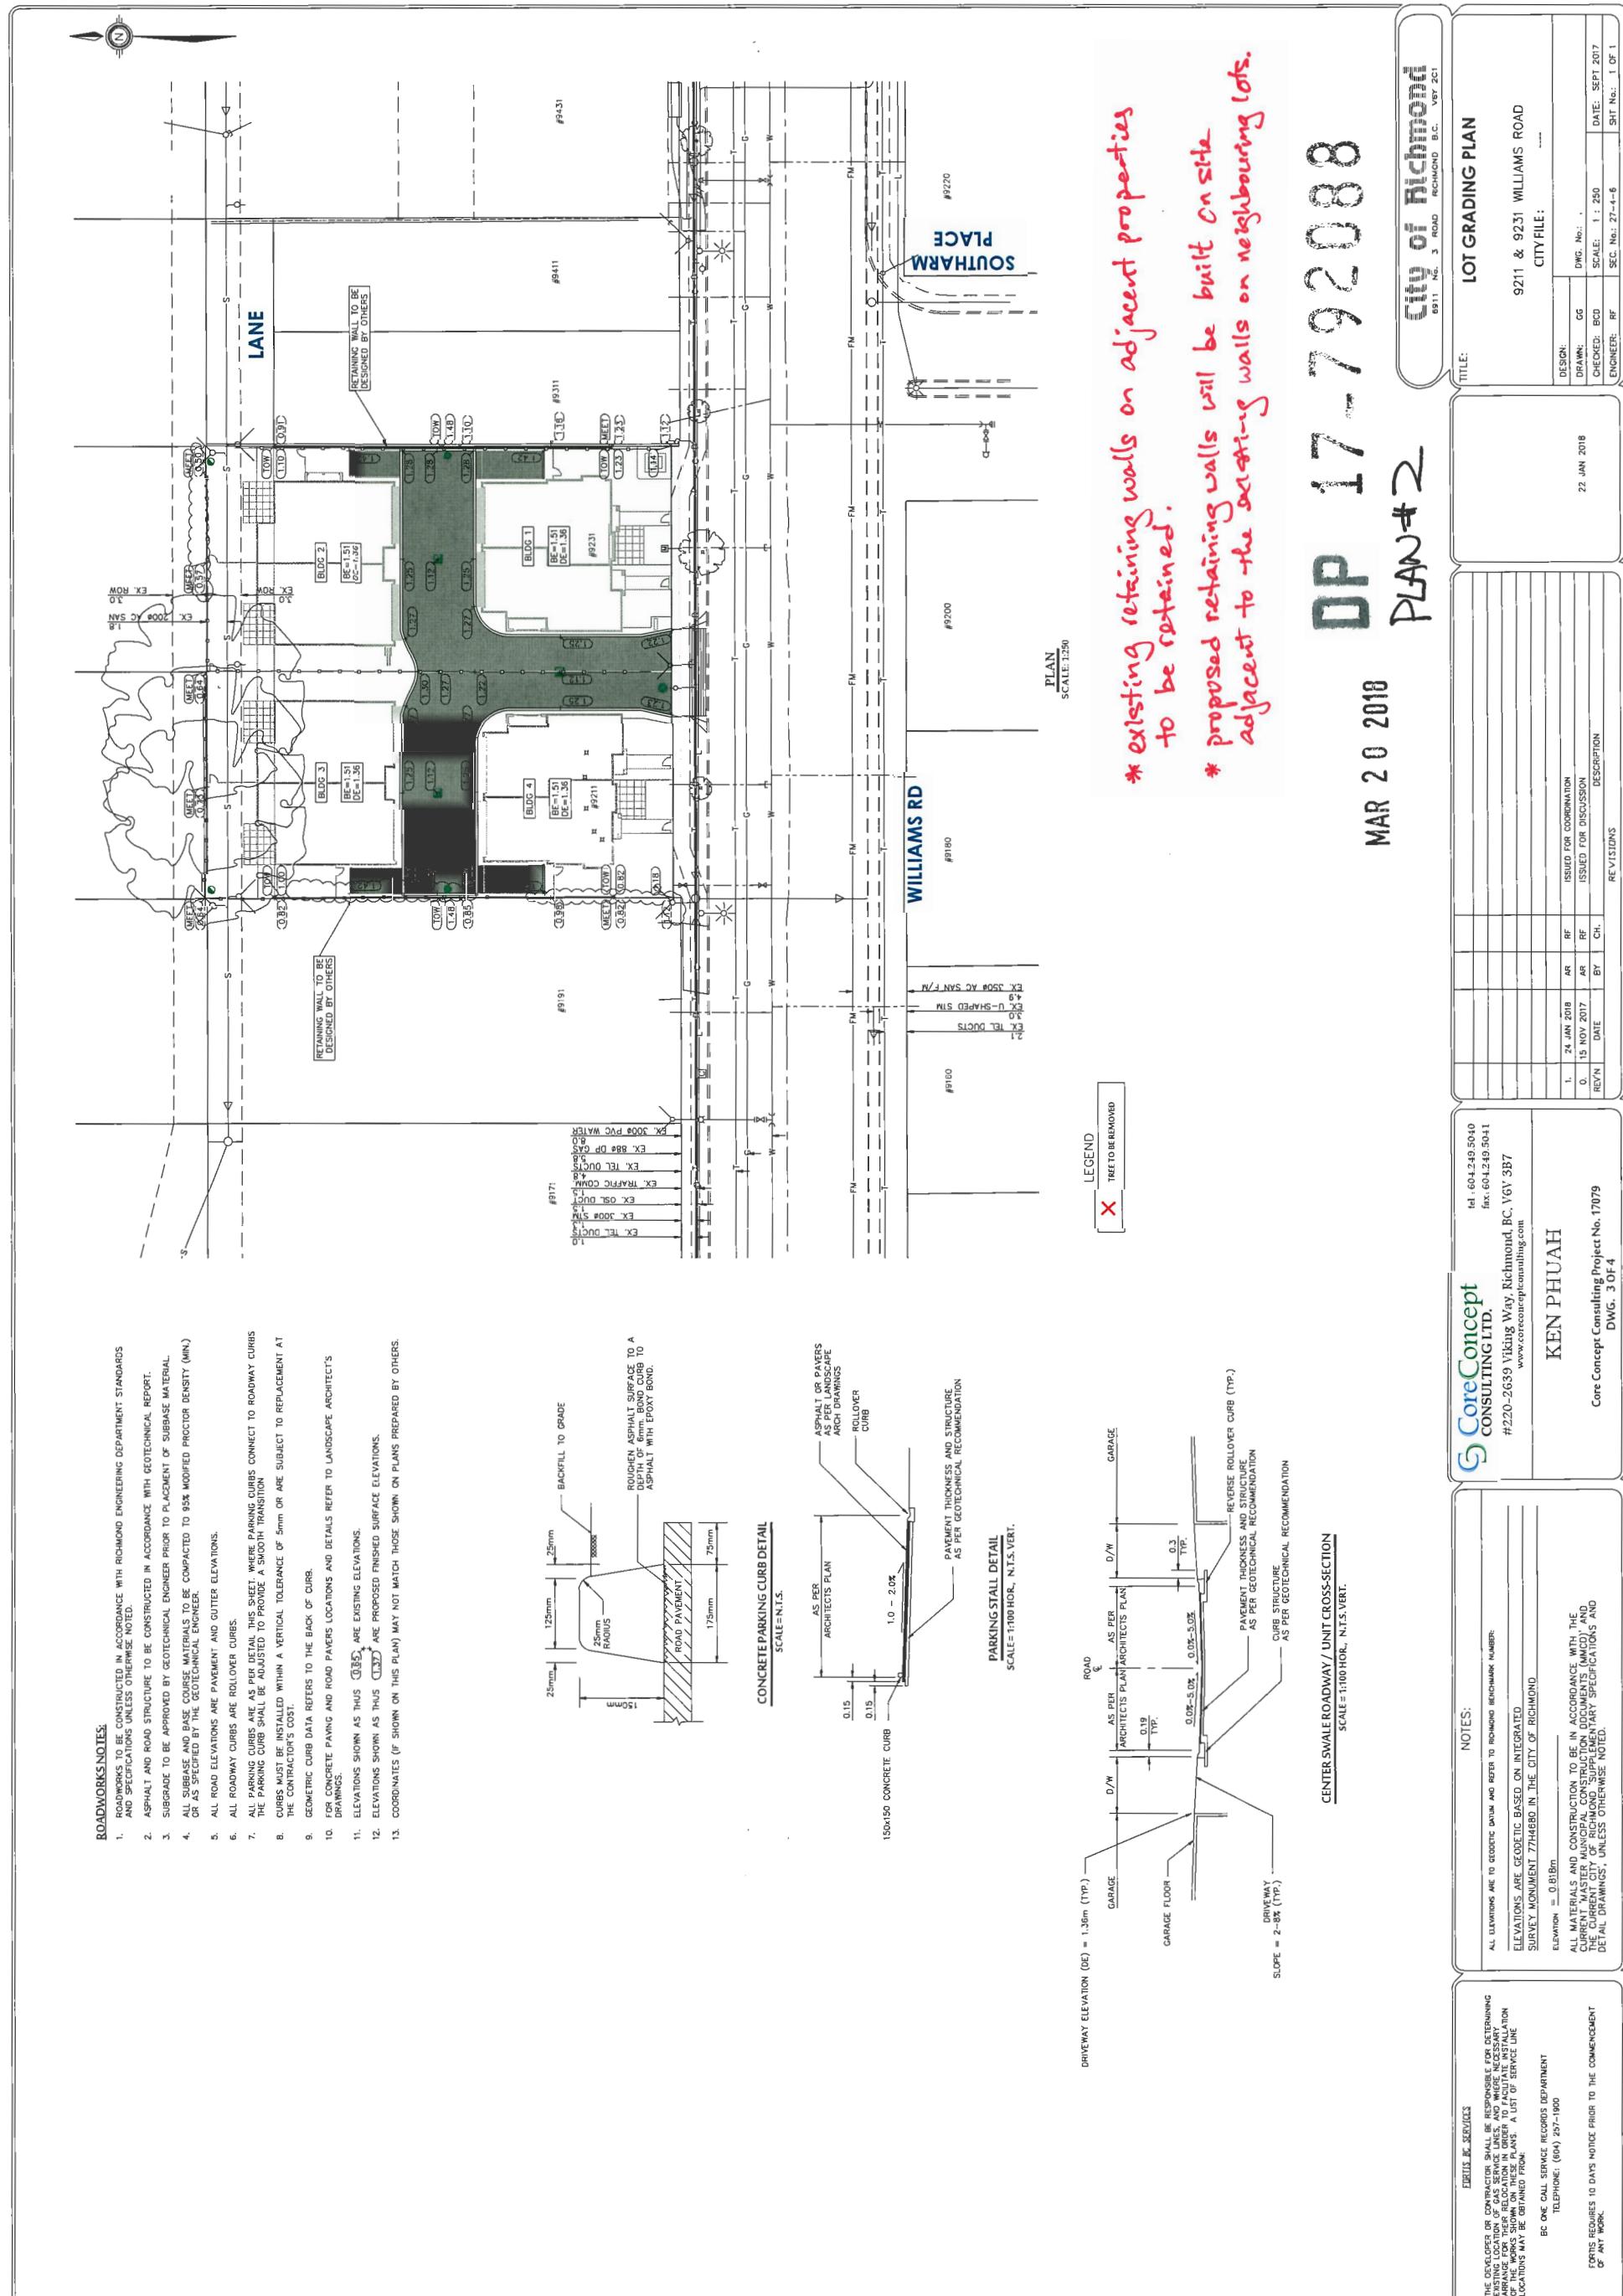

Notes:

ADJACENT PROPERTY
SINCE THE SURVEY WAS
NO PROTECTION

NOTE:
THREE
HAVE BEEN
COMPLETED
MEASUREMENTS

This hand-drawn site plan illustrates the layout of two buildings, Building 4 and Building 1, along with various landscape features and construction details.

Building 4: Located on the left, it has a footprint of approximately 12.09 x 6.55 meters. The drawing shows an "Existing Building" with dimensions of 12.09 x 6.55 meters. A "Disposal" area is indicated as 0.80m x 0.45m. A "FCL" area of 16.1m is shown to the right. A "Hedge" is drawn along the southern boundary. A "Driveway" is shown leading towards the building.

Building 1: Located on the right, it has a footprint of approximately 15.91 x 7.55 meters. The drawing shows an "Existing Building" with dimensions of 15.91 x 7.55 meters. A "Disposal" area is indicated as 0.80m x 0.45m. A "FCL" area of 16.1m is shown to the right. A "Hedge" is drawn along the southern boundary. A "Driveway" is shown leading towards the building.

Landscaping and Construction:

- STREET TREES:** Three street trees are labeled: Tree A (1.80m tall) at the top, Tree B (1.80m tall) in the center, and Tree C (1.80m tall) on the left.
- DRIVEWAYS:** Two asphalt driveways are shown, one leading to Building 4 and another leading to Building 1.
- WALKWAYS:** A paved walkway connects the two buildings.
- HEDGES:** Hedges are drawn along the southern boundaries of both buildings.
- PLANTERS:** Sidewalk planters are indicated along the walkways.
- CURB LINES:** Curb lines are shown along the edges of the walkways and driveways.
- WALLS:** A wall is shown separating the "Existing Building" from the "Disposal" area.
- WATER FEATURES:** A small water feature is shown near the bottom center of the site.

Annotations and Notes:

- NOTE:** STREET TREES B IS TO BE TRANSPLANTED TO A LOCATION IN SOUTH ARM PARK TO BE SPECIFIED BY PARKS DEPARTMENT. ALL TREE RELOCATION WORK TO BE COMPLETED BY AND/OR SUPERVISED BY ARBOTECH.
- NOTE:** STREET TREES A AND C GROWING IN SIDEWALK PLANTERS TO BE PROTECTED TO CITY STANDARDS (BARRIERS REQUIRED AT EDGE OF PLANTER).
- WILLIAMS**: A large label is present on the right side of the plan.
- ALL DISTANCES ARE IN METRES**: A note at the bottom right specifies unit of measurement.

1

NOTE: STREET TREES B IS TO BE TRANSPLANTED TO A LOCATION IN SOUTH BIRM PARK TO BE SPECIFIED BY PARKS DEPARTMENT. ALL TREE RELOCATION WORK TO BE COMPLETED BY AND/OR SUPERVISED BY ARBORTECH.

PLAN #3 MAR 20 2018

Tag #	Class	Dbh(cm)	Tree Type	Cond	Loc	Action	Additional Observations (based on VTA only)
754		39	Flowering cherry	U		Remove	<ul style="list-style-type: none"> This tree has weak structural form related to the scaffold unions being headed in their past and large weakly attached replacement leaders girdling from near the old heading cuts that exhibit presence of decay. History of improper pruning with pruning wounds up to 20cm in diameter and it is infected with cankers from disease infection. This tree species does not compartmentalise wood decay fungus and its life expectancy is significantly reduced due to historical improper pruning practices.
A	15	Flowering cherry	G	CITY		PROTECT	Parks Department to be contacted 4 days in advance. Tree moving to be performed and/or supervised by Arbotech.
B	14	Flowering cherry	G	CITY		TRANSPLANT	No defects.
C	8	Red maple	G	CITY		PROTECT	No defects.

LEGEND:

L denotes IAG NUMBER or ID REFERENCE

- AC** denotes ALDER or COTTONWOOD TREE (untagged by/law sized).

denotes DRIPLINE (spread of the branches and foliage) of the tree.

denotes RETENTION tree (proposed).

denotes REMOVAL tree (proposed).

denotes HIGH RISK REMOVAL tree (proposed).

denotes OFF-SITE tree (to be protected and/or owner contacted as noted).

denotes NON-BYLAWS undersize tree (as measured by project arborist).

denotes SITE or STUDY AREA BOUNDARY.





denotes TREE PROTECTION ZONE (TPZ) (other than marked or specified by project arborist).


1	JUL 5, 2017	TREE B TO BE TRANSPLANTED
0	APR 5, 2016	INITIAL SUBMISSION
	DATE	COMMENTS
TREE MANAGEMENT DRAWING		
PROJECT: TOWNHOUSE DEVELOPMENT PROJECT		
ADDRESS: 9211, 9231 WILLIAMS RD RICHMOND		
CLIENT: TOMS INVESTMENT GROUP		
ACL FILE: 16140		
SHEET: 1 OF 1		

The logo for ACL Group ArborTech Consulting. It features three stylized green pine trees arranged horizontally within three rounded rectangular ovals. Below this graphic, the word "ACL" is written vertically in white capital letters on a blue background, followed by "GROUP" in white capital letters on a light blue background, and "ARBORTECH CONSULTING" in blue capital letters on a white background.

PLAN NOTES
This plan is based
Professionals and
management of
dimensions them

A C L G R O U P C O N S U L T I N G
SUITE 145 - 12051 HORSESHOE WAY, RICHMOND, BC V7A 4V4
P 604 275 3484

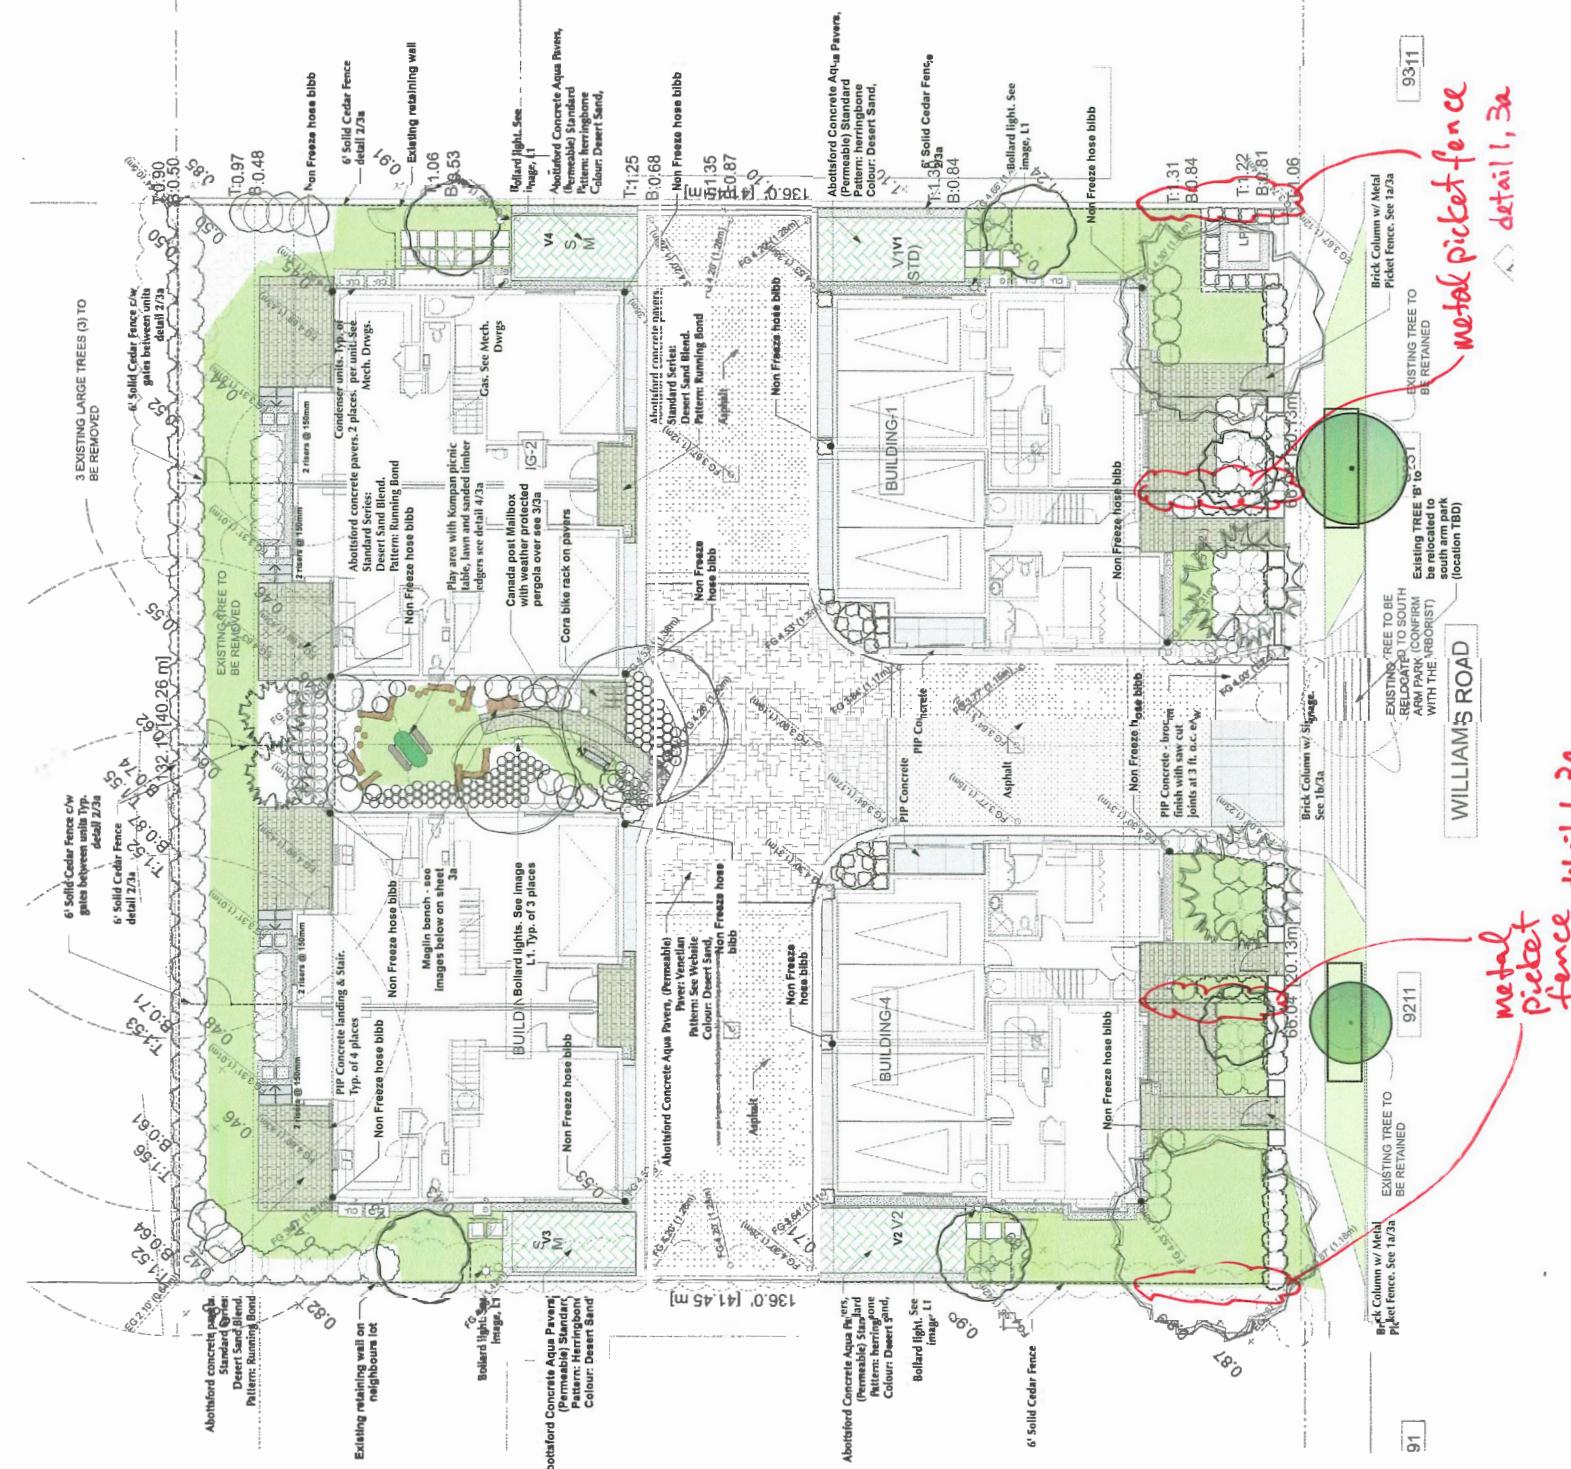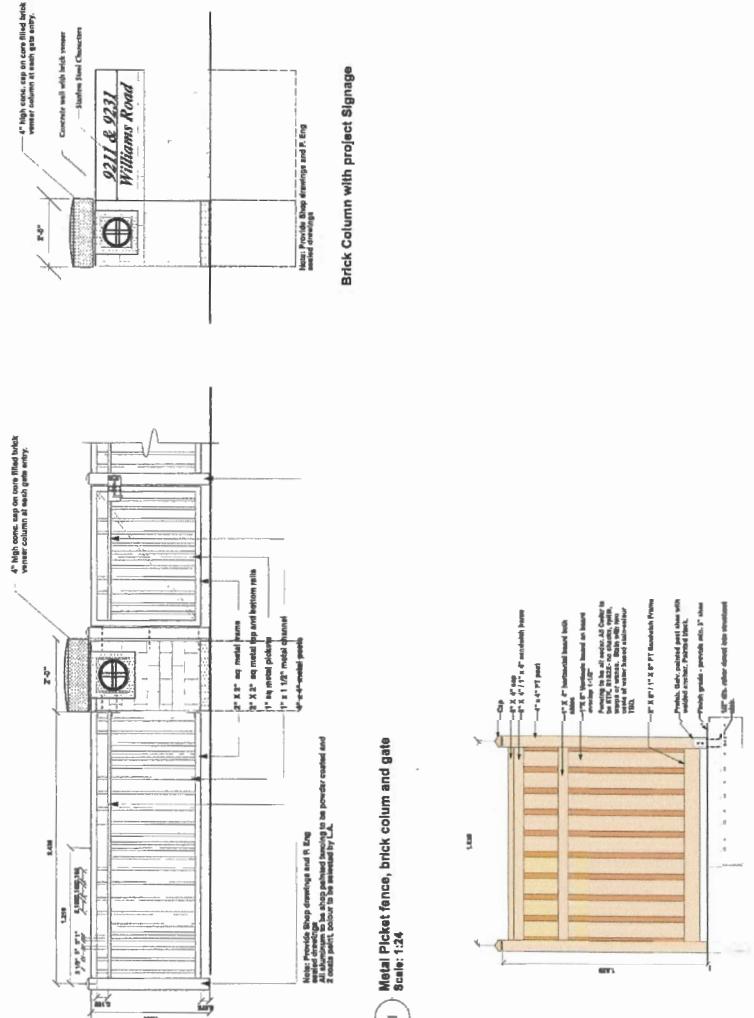


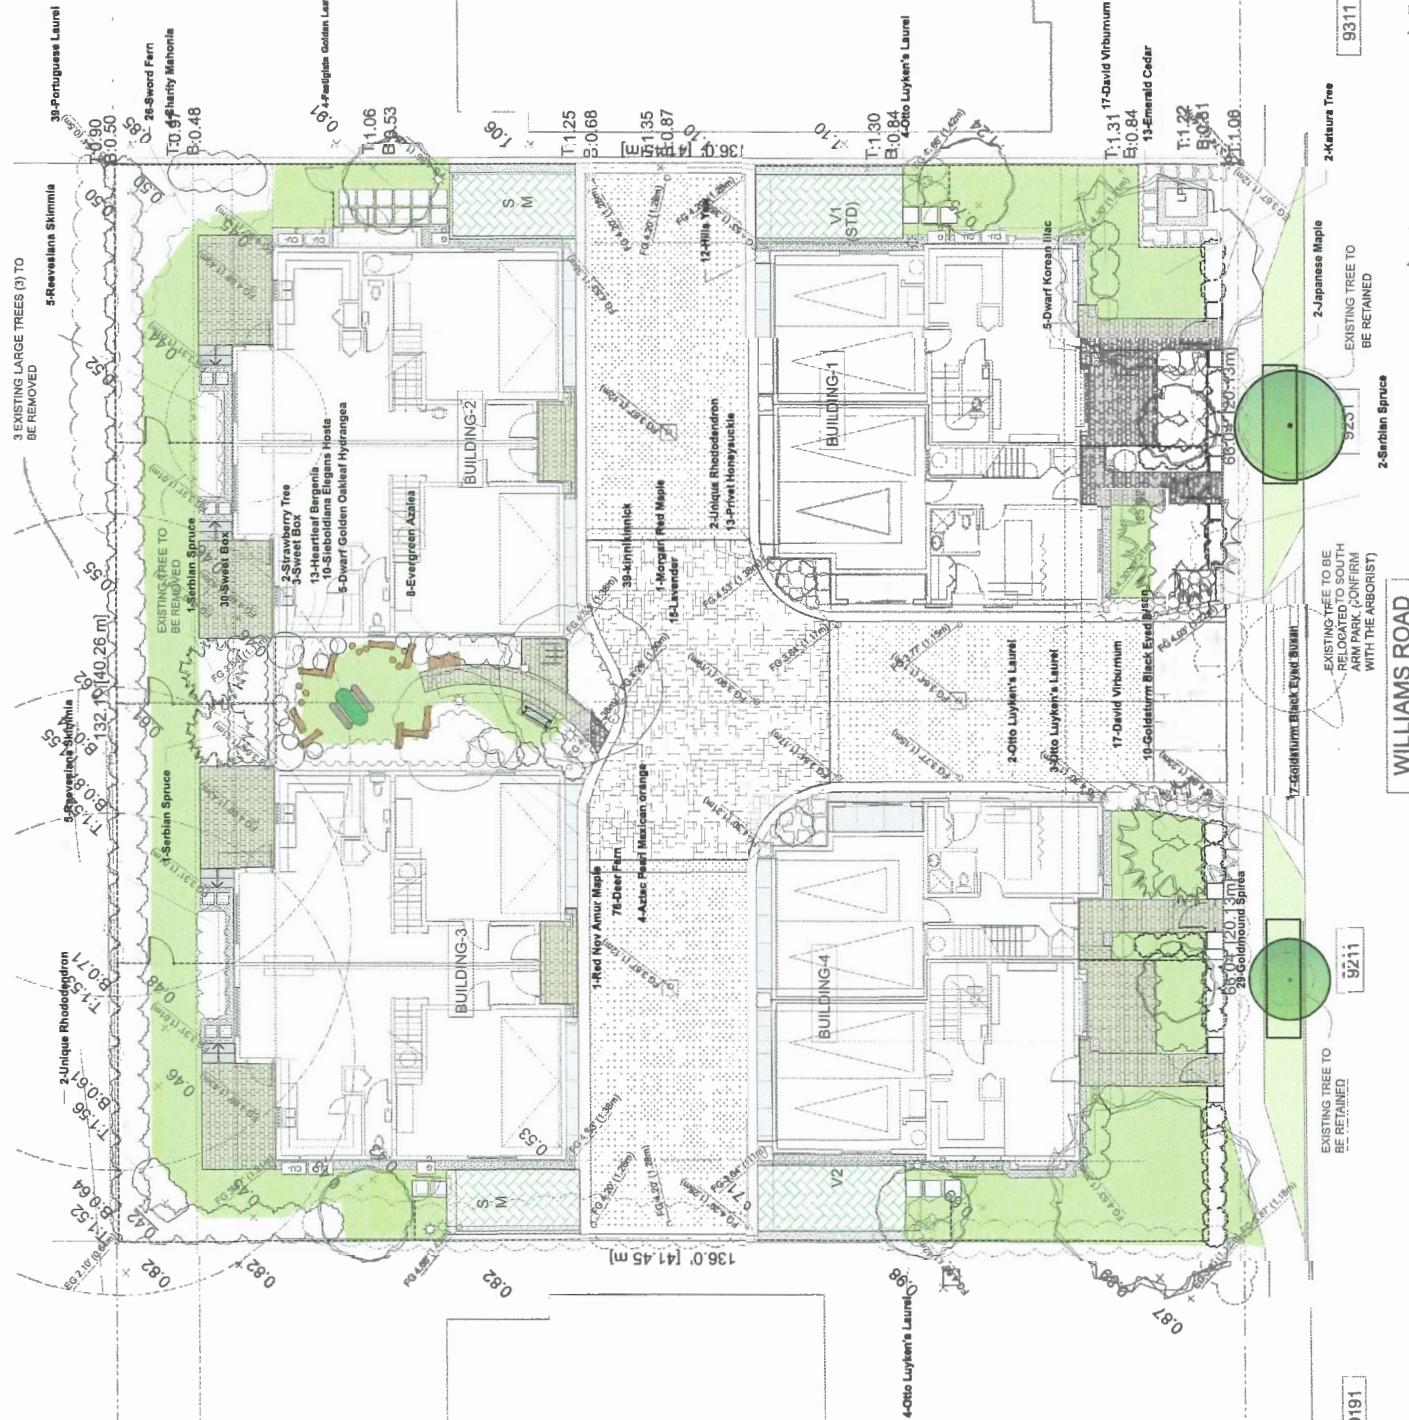

DP 17-792088

PCLN # 3B


LANDSCAPE NOTES

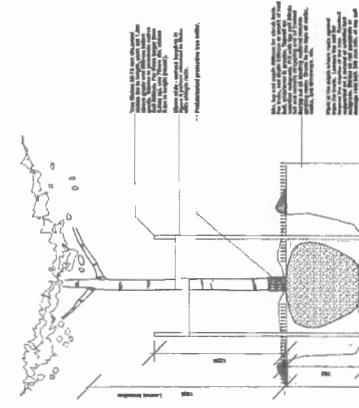

Siegler, die neue preiswerte



卷之三

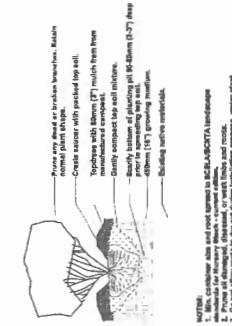

卷之三

Revisions:

Jonathan Losse Ltd.
Landscape Architecture

#102 - 1861 19th Ave.
Vancouver, B.C. V6J 4R6



Townhome Development
92119231 Williams Road
Brentwood, CA 94513

卷之三

REVISIONS				
MAR 12, 2016	DP REAPPLICATION			
FEB 21, 2016	DP REAPPLICATION			
NOV 21, 2017	DP APPLICATION			
JUL 26, 2017	RZ RESUBMISSION			
OCT 11, 2016	RZ RESUBMISSION			
APR 22, 2016	RZ APPLICATION			
CONSULTANTS				

PROJECT Proposed 8-Unit Townhouse Development 9211, 9231 Williams Road, Richmond, B.C.	
PROJECT NO. 1802WHLG	SCALE As Noted
DATE APR. 1, 2018	DRAWN BY KYC, SES, AL
CHECKED BY KYC	SHEET TITLE STREETSCAPE - WILLIAMS ROAD(NORTH) & DRIVE AISLE (NORTH) MATERIALS BOARD
	DRAWING

EXTERIOR FINISHES

- [1] HORIZONTAL HARDIE PLANK CEDAR MILL SIDING**
A: Main Floor (10") Colour: BM HC-105 Rockport Gray
B: Second Floor (4") Colour: BM HC-112 Revere Pewter

[2] CEDAR OR HARDIE SHINGLE SLIDING
Straight Edge Panels Colour: BM HC-172 (Revere Pewter)

[3] FIBERGLASS ASPHALT ROOF SHINGLES
Colour: Dark Gray (Multicolour; Textured)

[4] 2x6 WOOD TRIM BOARD - PAINTED
Colour: BM CC70 (Dove White)

[5] 1x4 TRIM BOARD ON 2x6 BARGE BOARD
Colour: BM CC70 (Dove White)

[6] 8x8 WOOD POST AND CROSS BEAMS
Colour: BM HC172 (Revere Pewter)

[7] VINYL-FRAMED DOUBLE-GLAZED WINDOWS
Vinyltek or Euhallent. Colour: Strand Ivory
2x6 WOOD TRIM BOARD - PAINTED
Colour: BM CC70 (Dove White)

[8] ALUMINUM FASCIA GLITTER
Colour: BM HC186 (Kendall Charcoal)



[9] SOLID WOOD DOOR WITH SIDE LIGHT
Door Colour: BM CC124 (Louisiana Hot Sauce Orange)

[10] OVERHEAD WOOD PANEL GARAGE DOOR
Colour: BM HC186 (Kendall Charcoal)

[11] METAL RAILING
Colour: BM HC186 (Kendall Charcoal)

[12] ELECTRICAL ROOM DOOR
Colour: BM Z122-60 (Palest PistaChio)

[13] CULTURED STONE VENEER
Apoen Corning Cultured Stone or Eulivalent
Oceans Dressed Reliefs (CSV-2040)

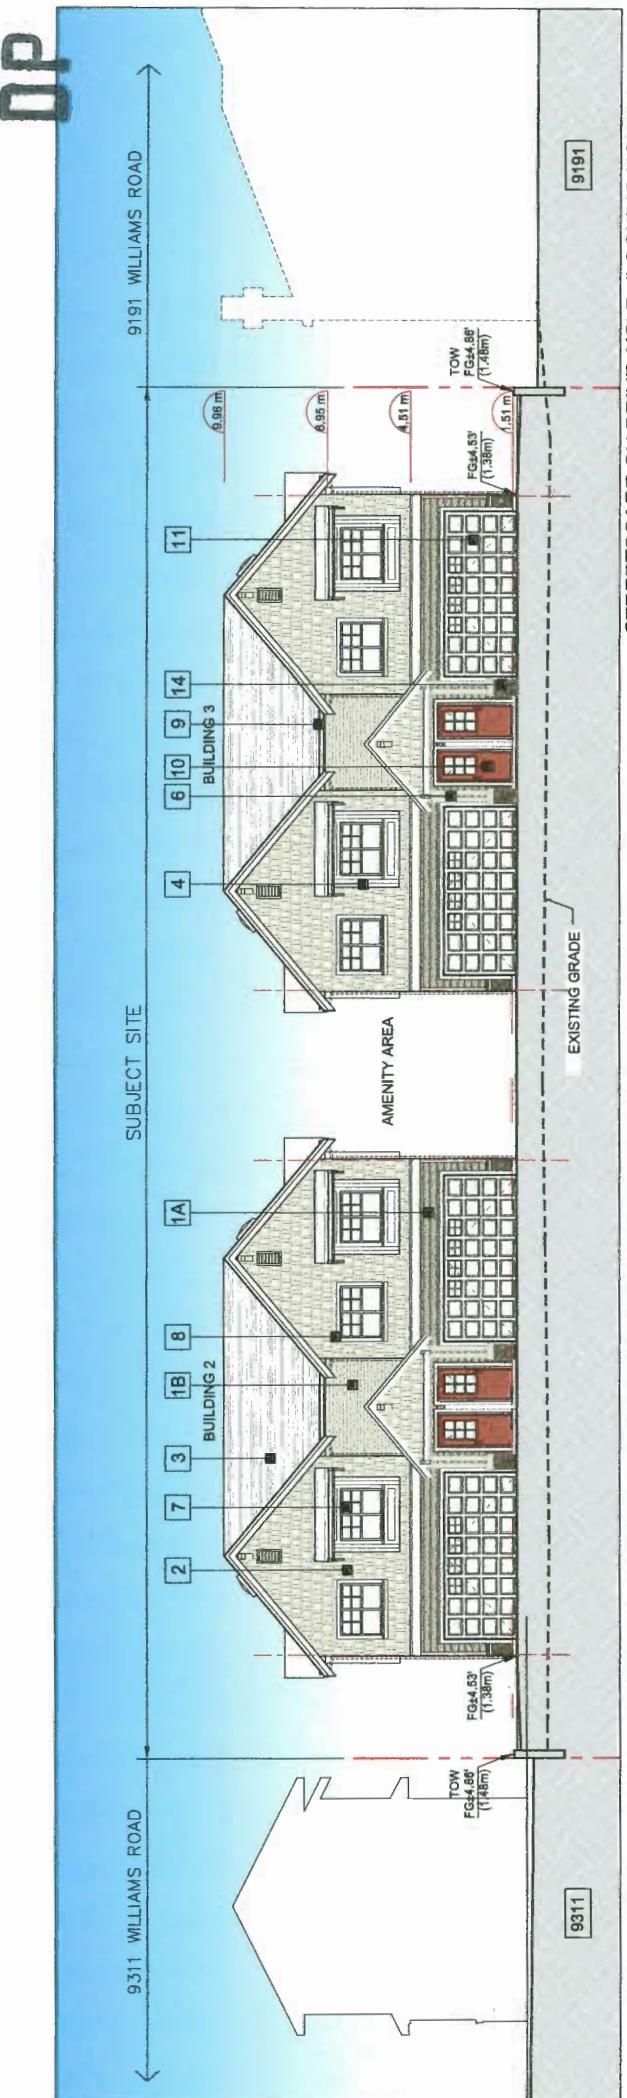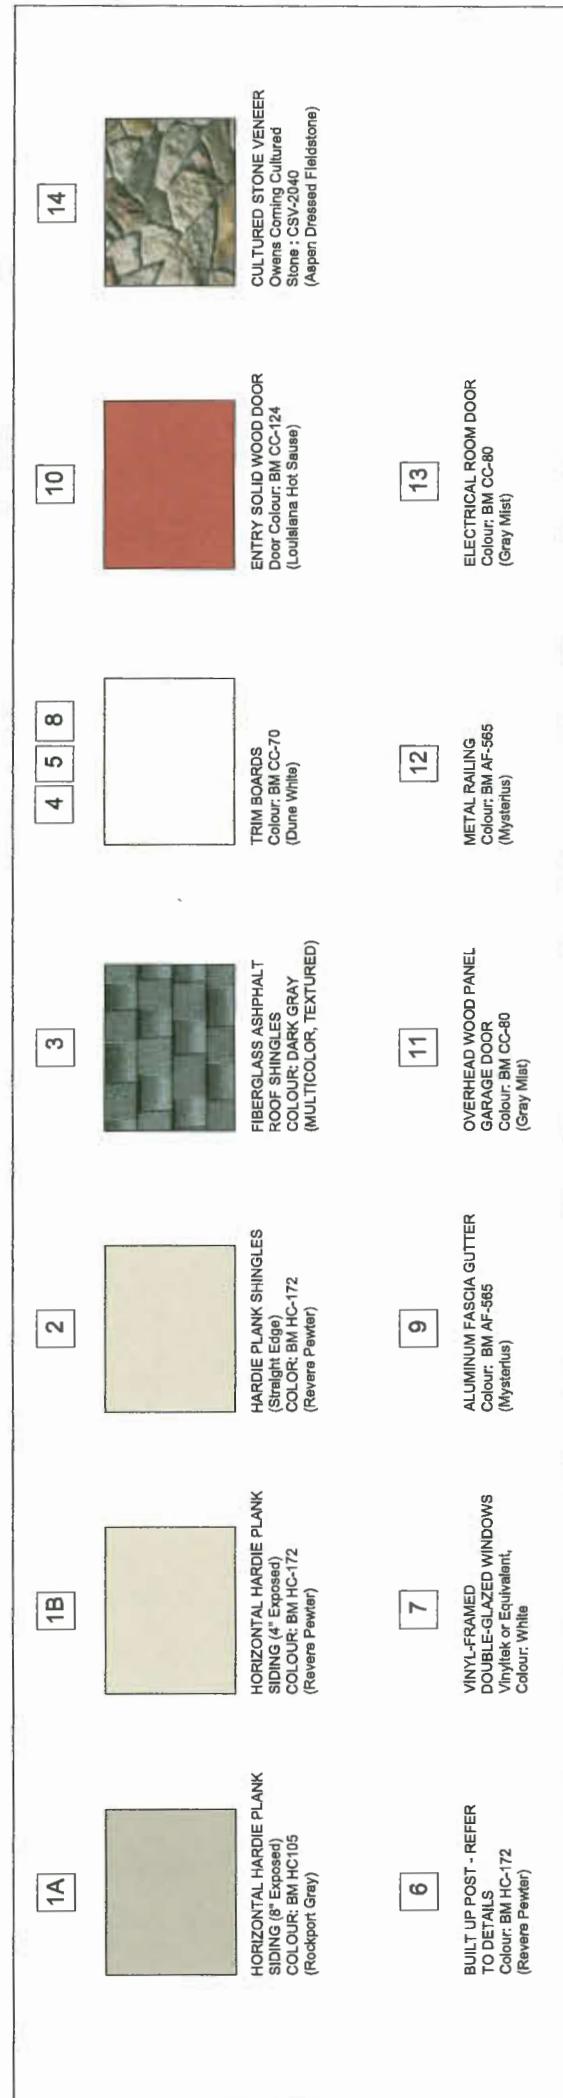

STREETSCAPE ON DRIVE AISLE (LOOKING NORTH)

REVISIONS	
MAR 12, 2016	DP REAPPLICATION
FEB 27, 2016	DP REAPPLICATION
NOV 21, 2017	DP APPLICATION
JUL 26, 2017	RZ RESUBMISSION
OCT 11, 2018	RZ RESUBMISSION
APR 22, 2016	RZ APPLICATION
CONSULTANTS	

INTERFACE:

Suite 230
11650 Cambie Road
Richmond BC
Canada V6X 3Z5
T 604 621 1182
F 604 621 1146
www.interfacearchitects.com
PROJECT

Proposed B-Unit
Townhouse Development
9211 Williams Road,
Richmond, B.C.

PROJECT NO.	1620WLG
SCALE	As Nailed
DATE	APR 1, 2016
DRAWN BY	KYC, SRS, AL
CHECKED BY	KYC
SHHEET TITLE	STREETSCAPES
DRAWING	

A5.2

MAR 20 2018 DP 17-792088 PLAN #4A



REVISIONS

MAR 12, 2016	DP REAPPLICATION
FEB 27, 2018	DP REAPPLICATION
NOV 21, 2017	IP APPLICATION
JUL 26, 2017	RZ RESUBMISSION
OCT 11, 2018	RZ RESUBMISSION
APR 22, 2018	RZ APPLICATION
CONSULTANTS	

INTERFACE: Suite 230
11590 Cambie Road
Richmond BC
Canada V6X 3Z6
www.interfacearchecture.com

PROJECT
Proposed 8-Unit
Townhouse Development
9211 Williams Road,
Richmond, B.C.

PROJECT NO.
1802WLG

SCALE
As Noted

DATE
APR. 1, 2018

DRAWN BY
KYC, SRS, AL

CHECKED BY
KYC

SHEET TITLE
SITE SECTIONS AND
STREET SCAPE

DRAWING

BUILDING 1

SITE SECTION A - A
Scale: 1/8"=1'-0"

BUILDING 2

SITE SECTION B - B
Scale: 1/8"=1'-0"

BUILDING 3

SITE SECTION C - C
Scale: 1/8"=1'-0"

DRAWING A4.1

DRAWING A4.2

DRAWING A4.3

PLAN #43 SITE: 18'-11" x 10' DP MAR 20 2018 17-792088

REVISIONS

MAR 12, 2018 DP REAPPLICATION
FEB 21, 2018 DP REAPPLICATION
NOV 21, 2017 DP APPLICATION
JUL 28, 2017 RZ RESUBMISSION
OCT 11, 2016 RZ RESUBMISSION
APR 22, 2016 RZ APPLICATION

CONSULTANTS

EXTERIOR FINISHES

- 1 HORIZONTAL HARDIE PLANK CEDARMILL SIDING
A: Main Floor (8') Colour: BM HC105 (Rockport Grey)
B: 2nd Floor (4') Colour: BM HC172 (Revere Pewter)
- 2 CEDAR OR HARDIE SHINGLE SIDING
Straight Edge Panels
Colour: BM HC172 (Revere Pewter)
- 3 FIBERGLASS ASPHALT ROOF SHINGLES
Colour: Dark Gray (Multicolour, Textured)
- 4 2x6 WOOD TRIM BOARD - PAINTED
Colour: BM CC70 (Dune White)
- 5 1x4 TRIM BOARD ON 2X8 BARGE BOARD
Colour: BM CC70 (Dune White)
- 6 8x8 WOOD POST AND CROSS BEAMS
Colour: BM HC172 (Revere Pewter)
- 7 VINYL-FRAMED DOUBLE GLAZED WINDOWS
Vinyl or equivalent, Colour: Strand Ivory
- 8 2x8 WINDOW TRIM BOARD - PAINTED
Colour: BM CC70 (Dune White)
- 9 ALUMINUM FASCIA GLITTER
Colour: BM HC166 (Kendall Charcoal)
- 10 ENTRY SOLID WOOD DOOR WITH SIDE LIGHT
Door Colour: BM CC124 (Louisiana Hot Sauce Orange)
- 11 OVERHEAD WOOD PANEL GARAGE DOOR
Colour: BM HC166 (Kendall Charcoal)
- 12 METAL RAILING
Colour: BM HC188 (Kendall Charcoal)
- 13 ELECTRICAL ROOM DOOR
Colour: BM 12280 (Paisley Piazzchio)
- 14 CULTURED STONE VENEER
Owens Corning Cultured Stone or Equivalent
Aspen Dressed Fieldstone (CSV-2046)

INTERFACE:

Suite 230
11580 Cambie Road
Richmond BC
Canada V6X 3Z5
T 604 821 1182
F 604 821 1146
www.interfacearchitects.com

PROJECT

Proposed B-Unit
Townhouse Development
9211 1231 Williams Road,
Richmond B.C.

PRODUCT NO.

1602W/LG

SCALE

As Nodred

DATE

APR. 1, 2016

DRAWN BY

KYC, SRS, AL

CHECKED BY

KYC

SHET TITLE

ELEVATIONS:
BUILDING 1
(BUILDING 4 SIM)

DRAWING


MAR 20 2018

ELEVATION: BUILDING 1 - WEST


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A3.1



DP 17-792088

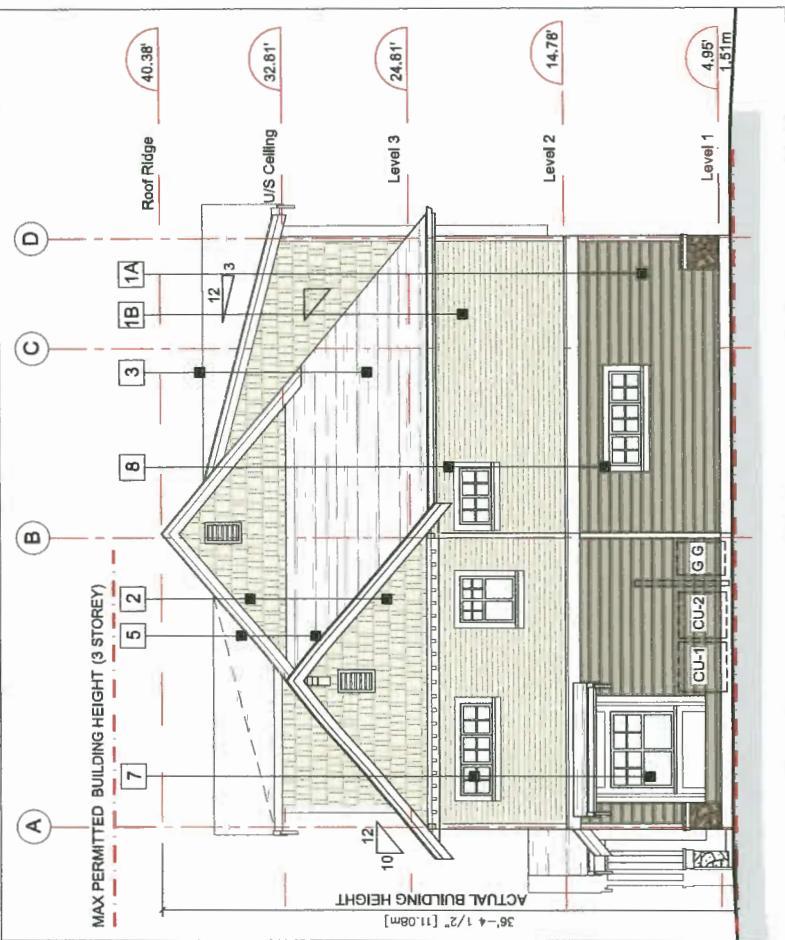

ELEVATION: BUILDING 1 - EAST
Scale: 3/16"=1'-0"

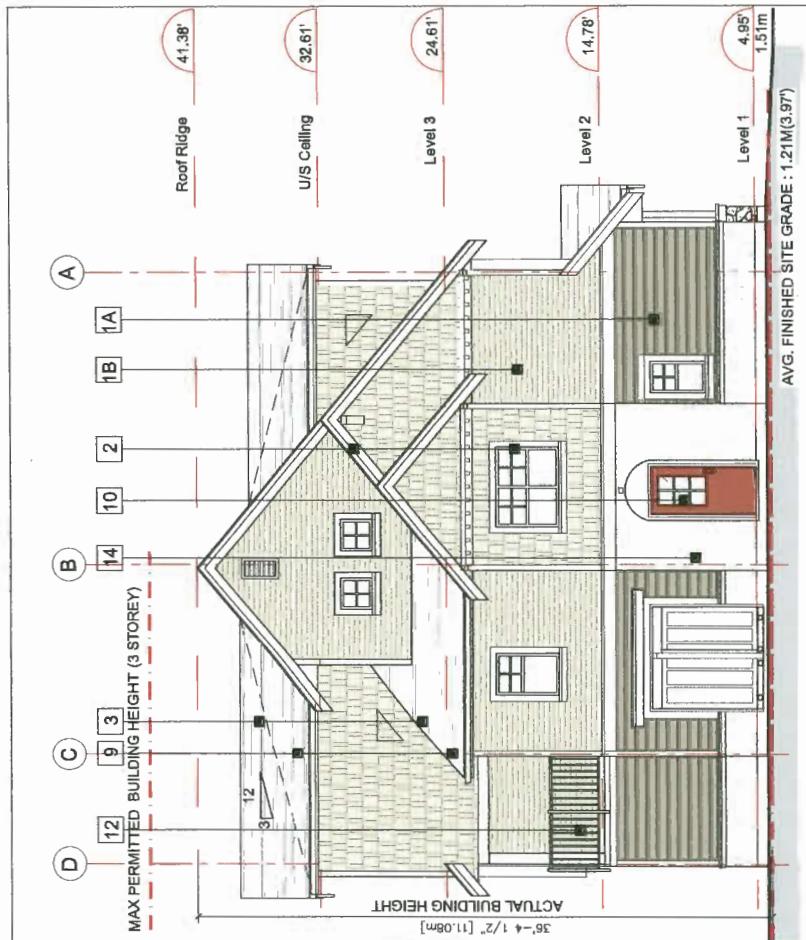

ELEVATION: BUILDING 1 - WILLIAMS ROAD (SOUTH)
Scale: 3/16"=1'-0"

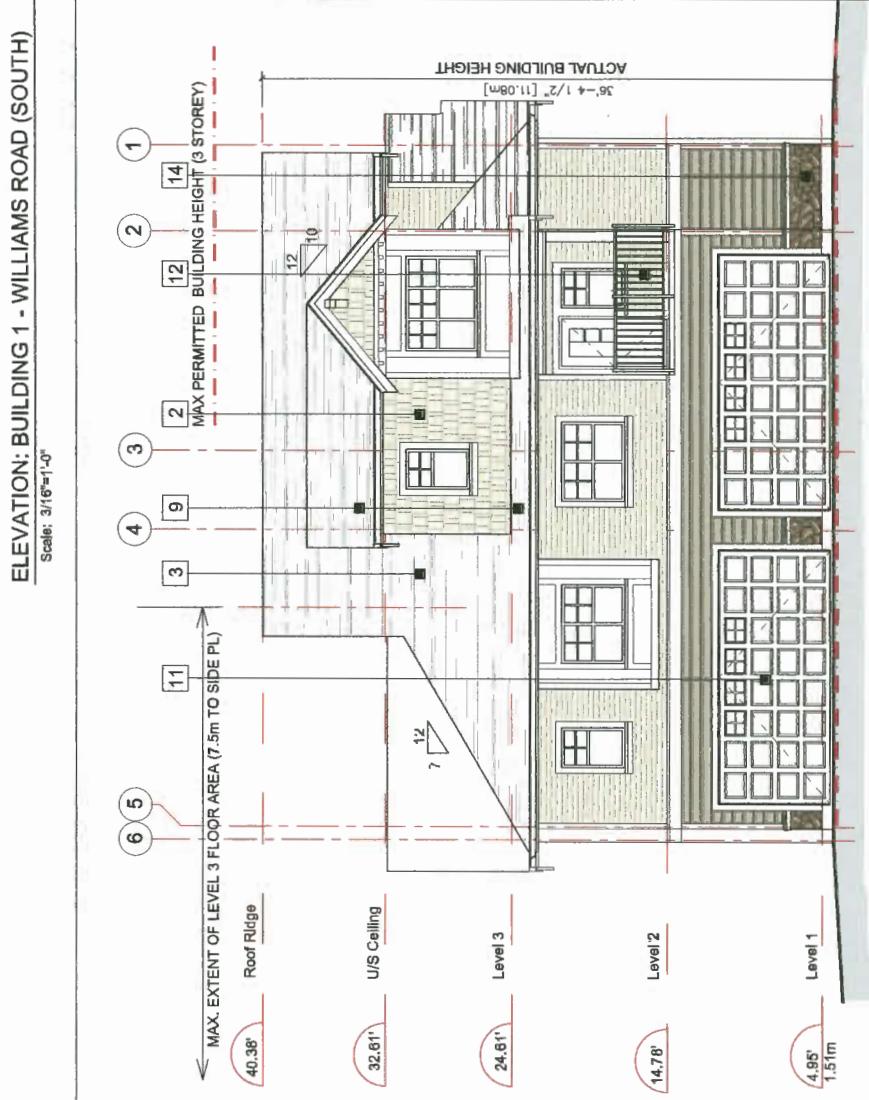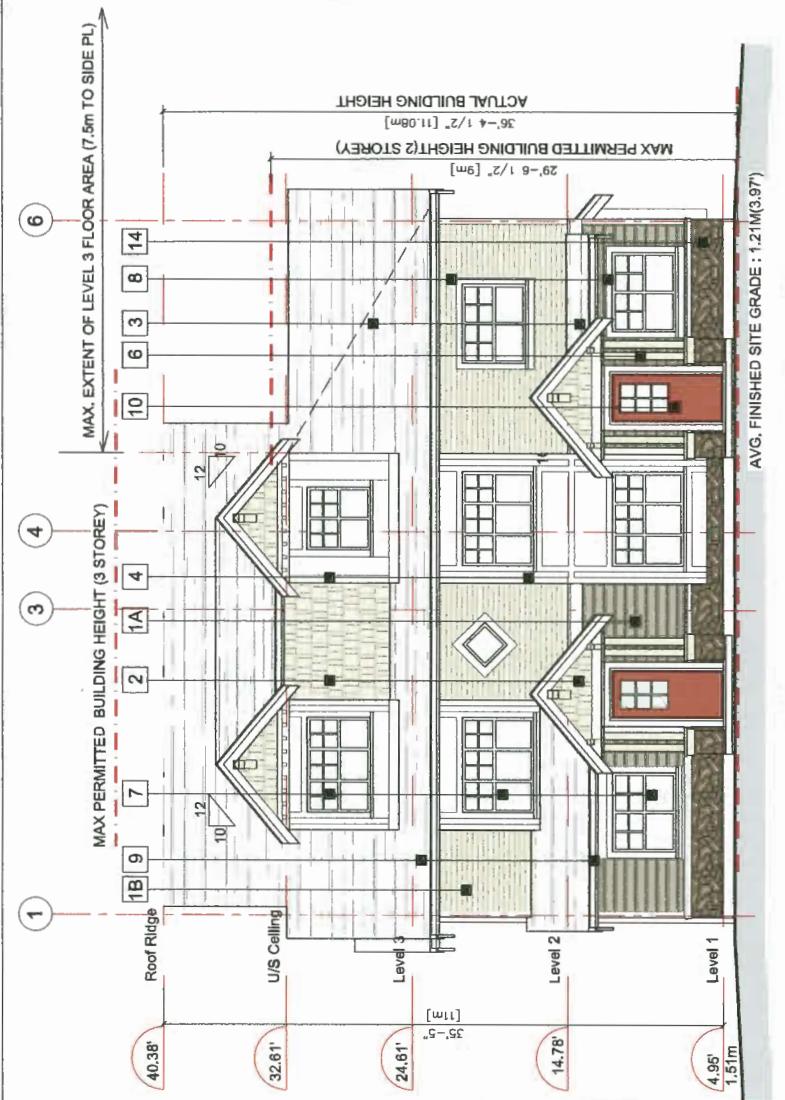

ELEVATION: BUILDING 1 - DRIVE AISLE (NORTH)
Scale: 3/16"=1'-0"

MAR 12, 2018	DP REAPPLICATION
FEB 27, 2018	DP REAPPLICATION
NOV 21, 2017	DP APPLICATION
JUL 26, 2017	RZ RESUBMISSION
OCT 11, 2016	RZ RESUBMISSION
APR 22, 2016	RZ APPLICATION
	CONSULTANTS

EXTERIOR FINISHES

- [1] HORIZONTAL HARDIE PLANK CEDARMILL SIDING
A: Main Floor (8') Colour: BM HC105 (Rockport Grey)
B: 2nd Floor (4') Colour: BM HC172 (Raven Pewter)
- [2] CEDAR OR HARDIE SHINGLE SIDING
Straight Edge Panels
Color: BM HC172 (Raven Pewter)
- [3] FIBERGLASS ASPHALT ROOF SHINGLES
Color: Dark Gray (Multicolour, Textured)
- [4] 2x6 WOOD TRIM BOARD - PAINTED
Color: BM C770 (Dune White)
- [5] 1x4 TRIM BOARD ON 2x8 BARGE BOARD
Color: BM C770 (Dune White)
- [6] 8x8 WOOD POST AND CROSS BEAMS
Color: BM HC172 (Raven Pewter)
- [7] VINYL-L-FRAMED DOUBLE-GLAZED WINDOWS
Vinyl/L or Equivalent, Colour: Strand Ivory
- [8] 2x6 WINDON TRIM BOARD - PAINTED
Color: BM C770 (Dune White)
- [9] ALUMINUM FASIA GLITTER
Color: BM HC188 (Kendall Charcoal)
- [10] ENTRY SOLID WOOD DOOR WITH SIDELIGHT
Door Colour: BM CC124 (Louisiana Hot Sauce Orange)
- [11] OVERHEAD WOOD PANEL GARAGE DOOR
Color: BM HC188 (Kendall Charcoal)
- [12] METAL RAILING
Color: BM HC188 (Kendall Charcoal)
- [13] ELECTRICAL ROOM DOOR
Color: BM 212280 (Pebble; Platacho)
- [14] CULTURED STONE VENEER
China Combing Cultured Stone or Equivalent
Aspen Dressed Fieldstone (CS4-V240)

INTERFACE:

Suite 230
11580 Cambie Road
Richmond BC
Canada V6X 3Z5
T 604 821 1182
F 604 821 1148
www.interfacearchitecture.com


PROJECT

Proposed B-Unit
Townhouse Development
8211 - 8231 Williams Road,
Richmond, B.C.
Canada V6X 3Z5
T 604 821 1182
F 604 821 1148
www.interfacearchitecture.com


Lot	1.16	1.14	0.50	0.64	3.46 m
BLDG 1	1.31	1.31	1.38	1.38	5.38 m
BLDG 2	1.38	1.36	1.11	1.11	4.98 m
BLDG 3	1.38	1.38	1.11	1.11	4.98 m
BLDG 4	1.31	1.31	1.38	1.38	5.38 m
AVERAGE FINISHED SITE GRADE					1.21 m
CALCULATION					(3.97)

ELEVATIONS:
BUILDING 2.3


DP 17-792088
Plan #4D MAR 20 2016

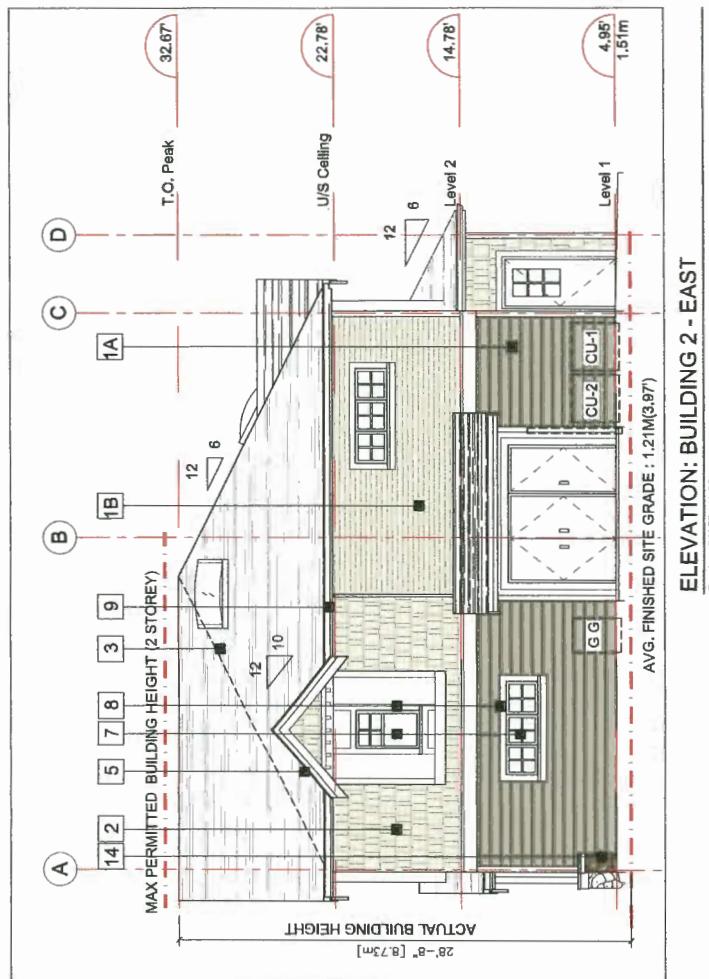


ELEVATION: BUILDING 2 - EAST
Scale: 3/16"=1'-0"

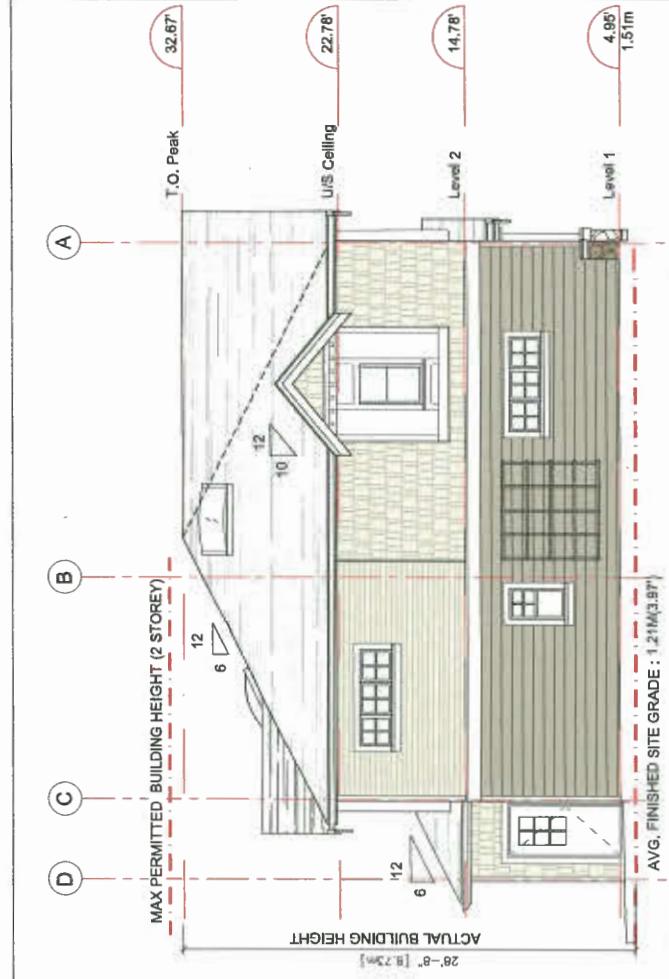

ELEVATION: BUILDING 2 - EAST
Scale: 3/16"=1'-0"

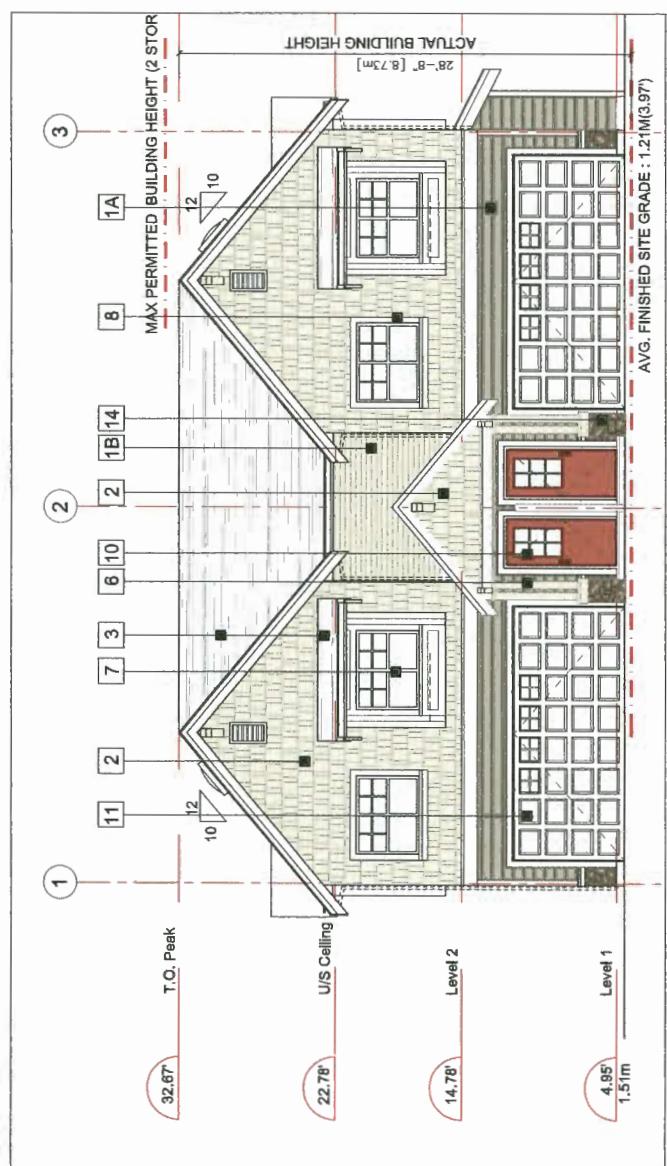

ELEVATION: BUILDING 2 - DRIVE AISLE (SOUTH)
Scale: 3/16"=1'-0"

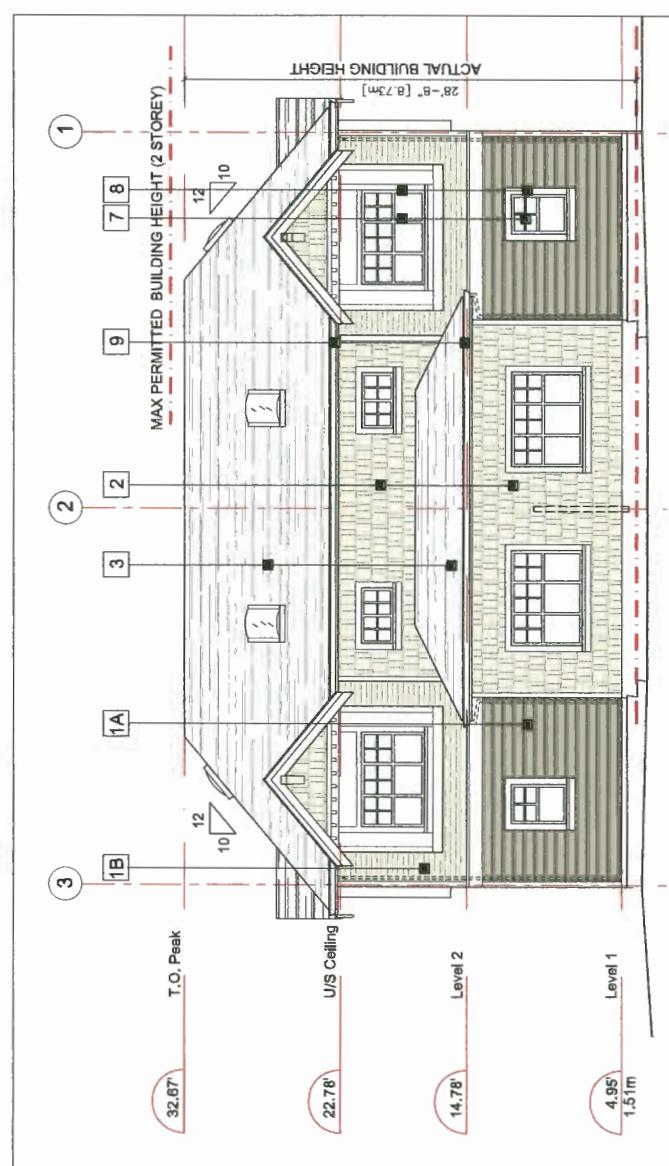

ELEVATION: BUILDING 2 - NORTH
Scale: 3/16"=1'-0"

DRAWING
A3.2

REVISIONS			
	MAR 12, 2018	DP REAPPLICATION	
	FEB 27, 2018	DP REAPPLICATION	
	NOV 21, 2017	DP APPLICATION	
	JUL 26, 2017	RZ RESUBMISSION	
	OCT 11, 2016	RZ RESUBMISSION	
	APR 22, 2016	RZ APPLICATION	
		CONSULTANTS	


INTERFACE

June 200
11590 Camille Road
Richmond BC
Canada V6X 3Z5


T 604 821 1162
F 604 821 1146
www.interfacearchitectecture.com

Proposed B-Unit Townhouse Development			
9211, 9231 Williams Road, Richmond, B.C.			
PROJECT NO.	1802WNLG		
SCALE	As Noted		
DATE	APRIL 1, 2016		
DRAWN BY	KTC, SRS, AL		
CHECKED BY	RTYC		
SHEET TITLE		FLOOR PLANS: BUILDING 1 - LEVEL 1,2,3 (BUILDING 4 SIM)	

A2

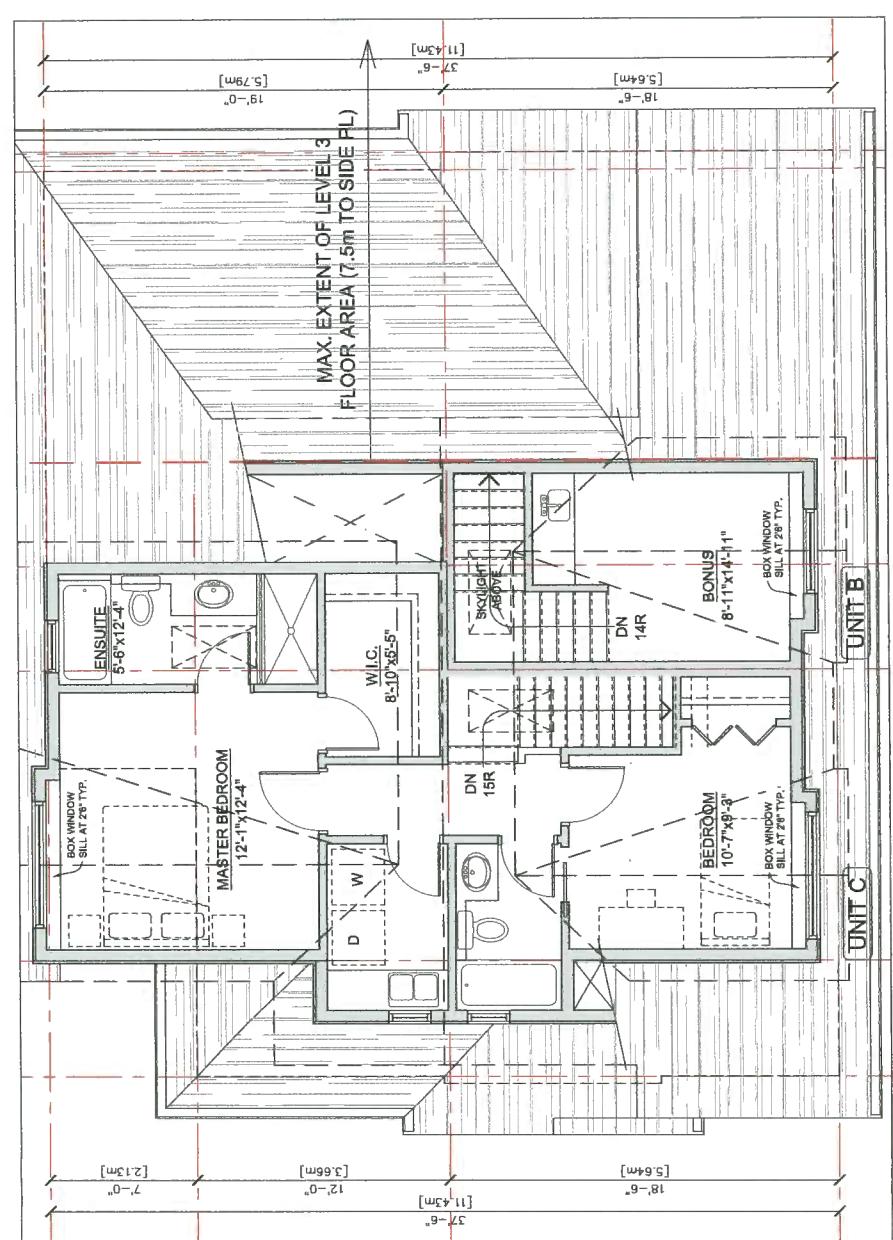


FLOOR PLAN: BUILDING 1,4 - LEVEL 3
SCALE: 1/4"=1'-0"

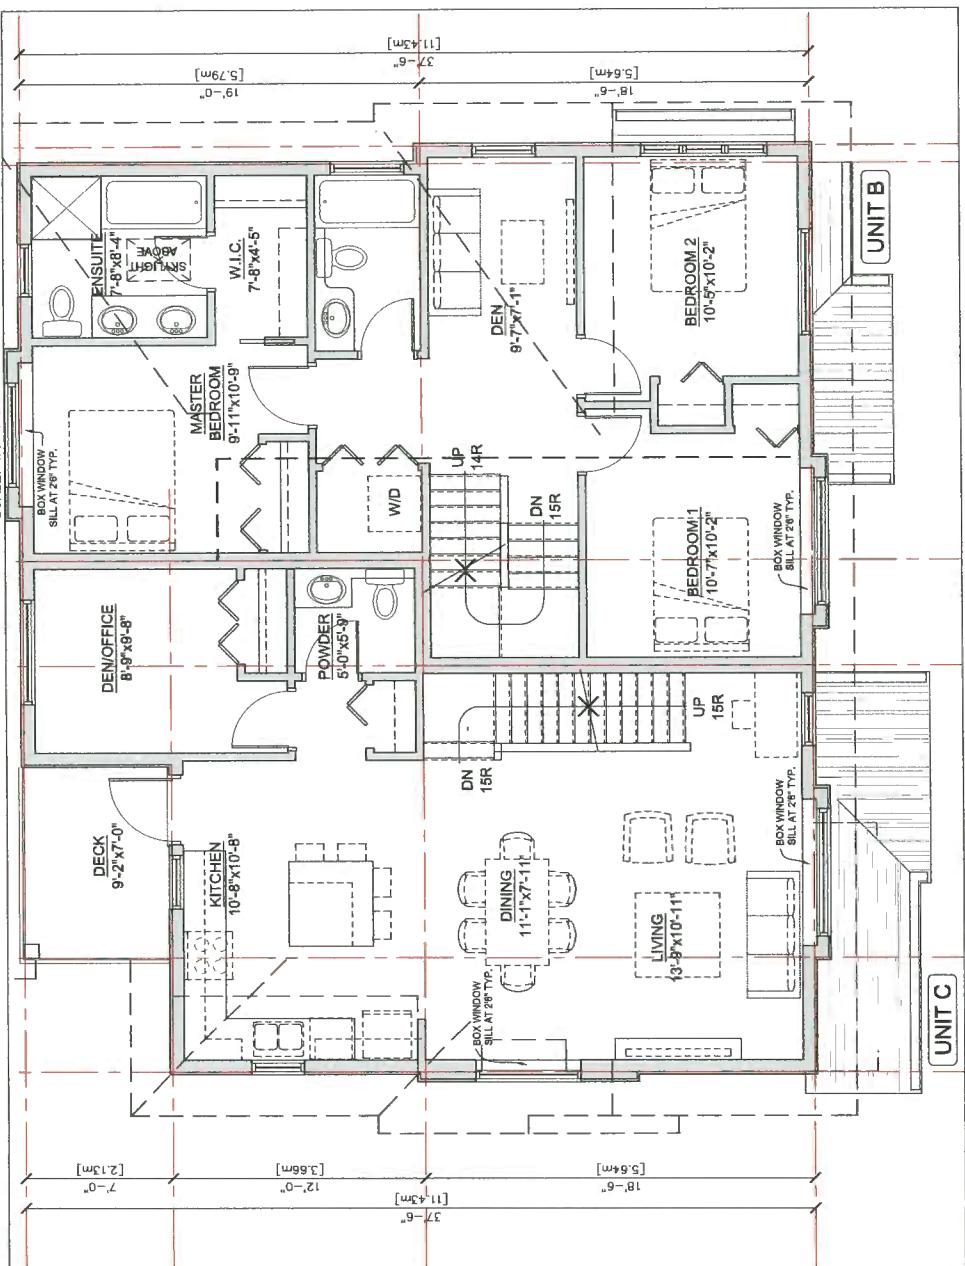

FLOOR PLAN: BUILDING 1,4 - LEVEL 2

DP 17-792088

MAR 20 2018

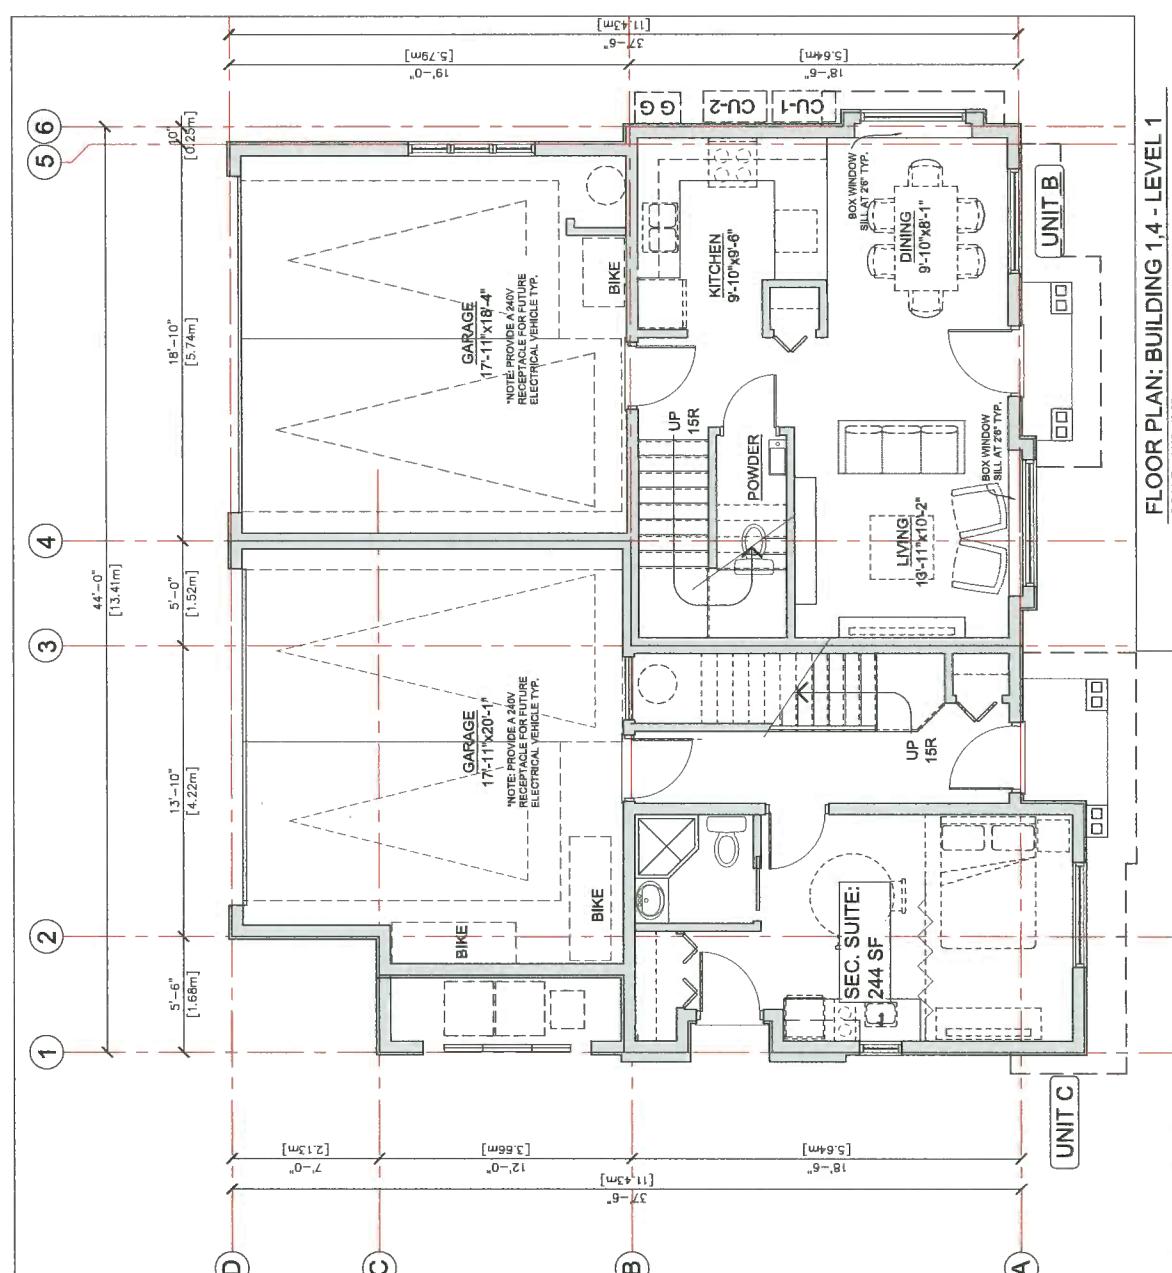

REVISIONS

MAR 12 2016	DP REAPPLICATION
FEB 27 2018	DP REAPPLICATION
NOV 21 2017	DP APPLICATION
JUL 26 2017	RZ RESUBMISSION
CCT 11 2016	RZ RESUBMISSION
APR 22 2016	RZ APPLICATION

CONSULTANTS

INTERFACE

Suite 230
11580 Cambie Road
Richmond BC V6X 3Z5
T 604 232 1146
F 604 232 1145
www.interfacearchitects.com

PROJECT

Proposed 8-Unit
Townhouse Development
9211 9231 Williams Road,
Richmond, B.C.

PROJECT NO.

SCALE

DATE

DRAWN BY

CHECKED BY

SHEET TITLE

APR 1, 2016
KYC, SRS, AL
KYC
FLOOR PLANS;
BUILDING 2.3 - LEVEL 1,2


DRAWING

A2.2


MAR 20 2018

REFERENCE PLAN

DP 17-792088

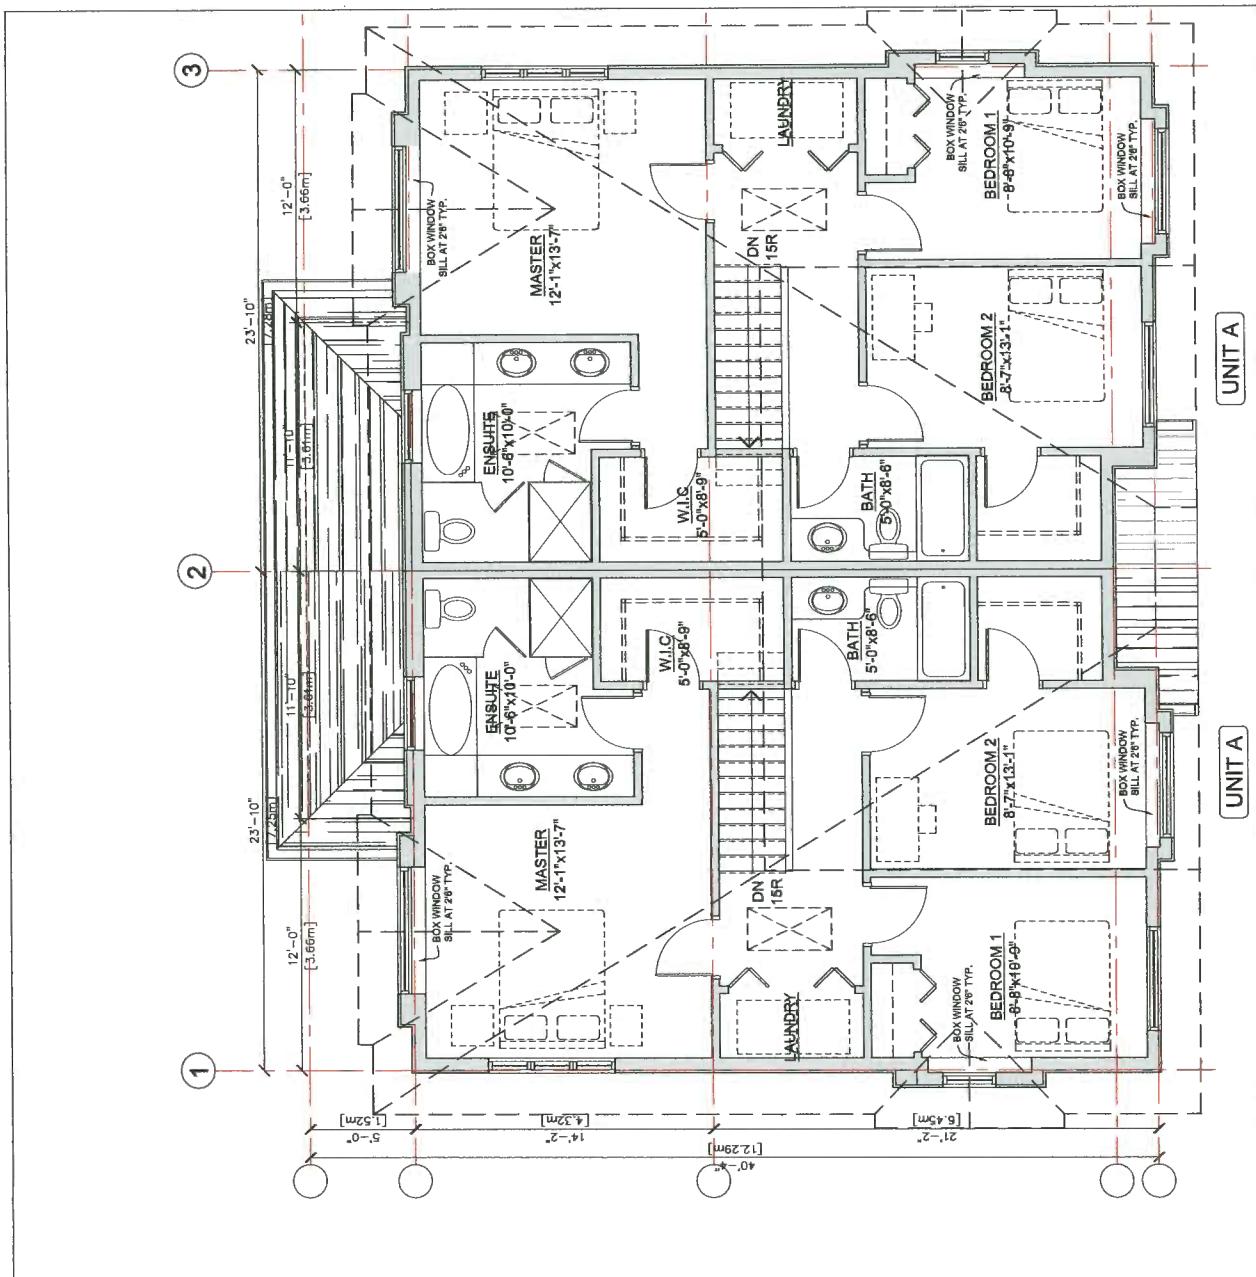

FLOOR PLAN: BUILDING 2.3 - LEVEL 2
SCALE: 1/4"=1'-0"

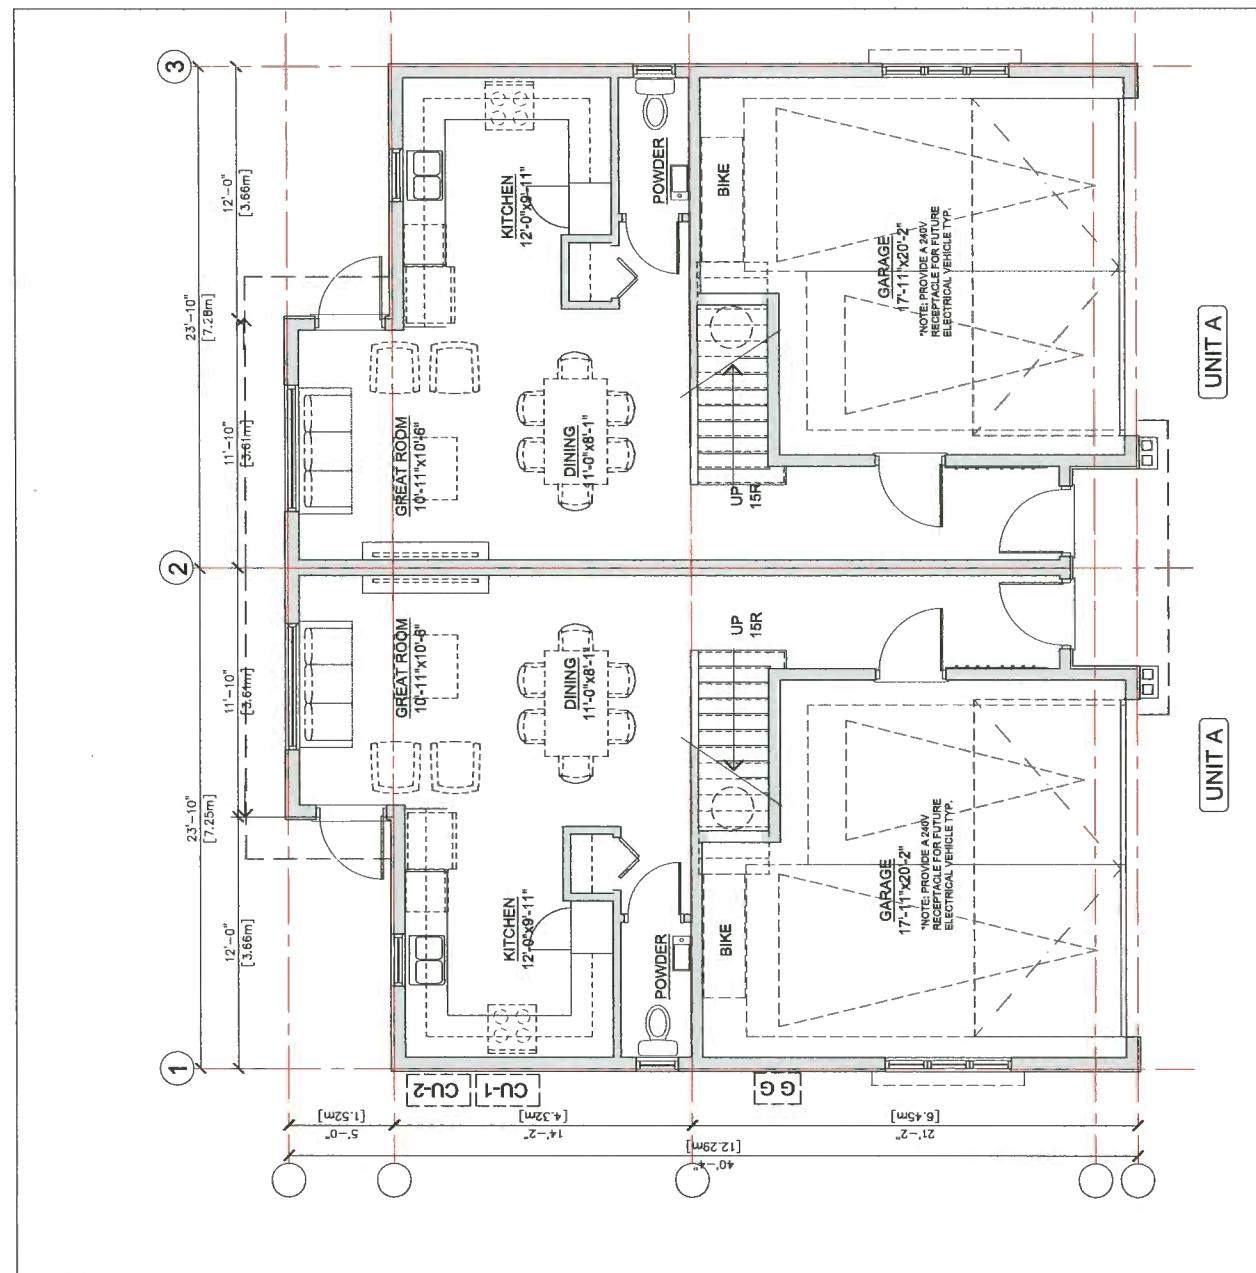

FLOOR PLAN: BUILDING 2.3 - LEVEL 1
SCALE: 1/4"=1'-0"

MAR 12 2016	DP REAPPLICATION
FEB 27 2016	DP REAPPLICATION
NOV 21 2017	DP APPLICATION
JUL 25 2017	RZ RESUBMISSION
OCT 11 2016	RZ RESUBMISSION
APR 28 2016	RZ APPLICATION
	CONSULTANTS


INTERFACE:

Suite 230
1190 Cambie Road
Richmond BC
Canada V6X 3E5
T 604 211 1182
F 604 211 1144
www.interfacearchitecture.com


PROJECT

Townhouse Development
9231 Williams Road,
Richmond, B.C.
PROJECT NO.
1602WWLG
SCALE
All Nodal
DATE APR 1, 2016
DRAWN BY KYC, SRS
CHECKED BY KYC
SHEET TITLE FLOOR PLANS:
CONVERTIBLE UNIT
DRAWING

A2.3
MAR 20 2018
REFERENCE PLAN
DP 17-792088

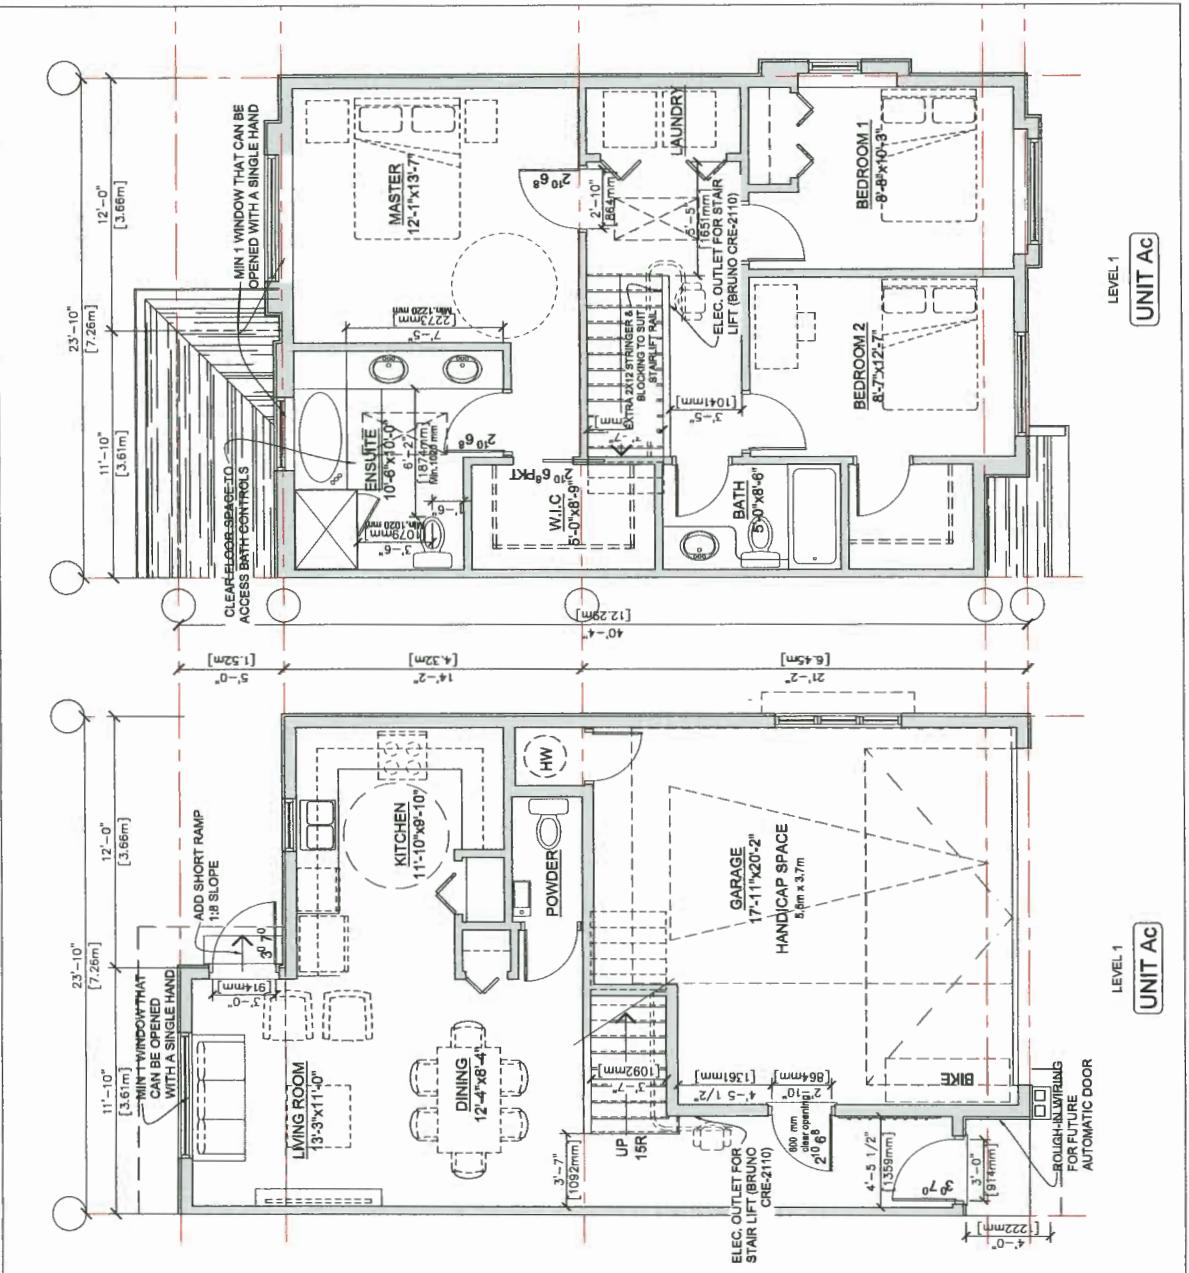

FLOOR PLAN: CONVERTIBLE UNIT AC (AFTER CONVERSION)
SCALE: 1/4"=1'-0"

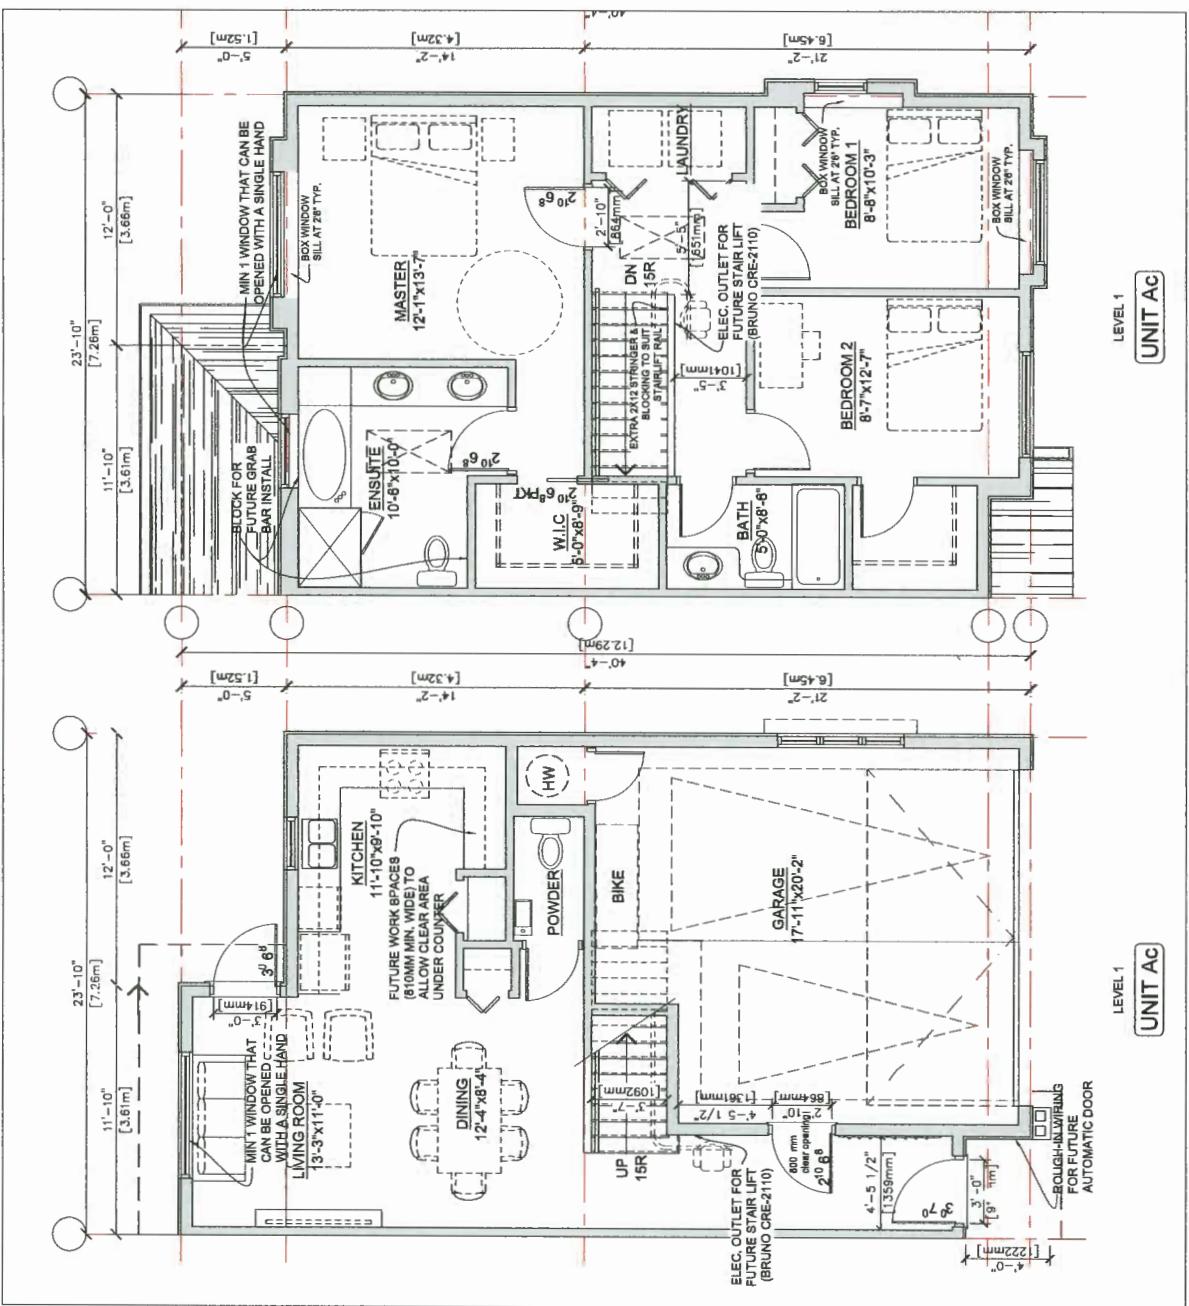

FLOOR PLAN: CONVERTIBLE UNIT AC (BEFORE CONVERSION)
SCALE: 1/4"=1'-0"

CONVERTIBLE UNIT FEATURES CHECKLIST

ENTRY DOORS MIN. 863 MM BUT IDEALLY 914MM AND HAVE CLEAR ACCESS	✓
DOORS & DOORWAYS	✓
ENTRY DOOR CLEAR EXTERIOR FLOOR SPACE MIN 1200 MM DEPTH IN WIRING PROVIDED FOR FUTURE AUTOMATIC DOOR OPENER	✓
INTERIOR DOORS MAX 13 MM HEIGHT. MIN 800 MM CLEAR OPENING WITH FLUSH THRESHOLD MAX 13 MM HEIGHT.	✓
Demonstrate wheelchair access between hallway and rooms. widen hallway and/or doorway if necessary to provide access.	✓
PATIO/BALCONY MIN. 880 MM CLEAR OPENING. NOTE HOW ACCESS IS PROVIDED. ALL INTERIOR THRESHOLDS WITHIN UNITS COMPLY WITH BCBC.	✓
LEVER-TYPE HANDLES FOR ALL DOORS	✓
HALLWAYS	✓
GARAGE	✓
VERTICAL CIRCULATION	✓
KITCHEN	✓
HALLWAYS	✓

AGING-IN-PLACE MEASURES (ALL UNITS)

ALL ROOMS	LARGE TOGGLE-TYPE ELECTRICAL SWITCHES LEVER TYPE DOOR HANDLES MINIMIZE THRESHOLD HEIGHTS (LESS THAN 1/2")
STAIRS & LANDINGS	MINIMIZE CONTRAST IN COLOURS OF FLOOR FINISHES WHERE POSSIBLE WALL BLOCKING FOR FUTURE ADDITIONAL HANDRAIL INSTALLATION INTERMEDIATE STAIR LANDINGS WHENEVER POSSIBLE LESS STEEP RISER/RUN DIMENSIONS WHERE POSSIBLE
BATHROOMS	SOLID WALL BLOCKING FOR FUTURE GRAB BAR INSTALLATION (AT BATHTUB, TOILET) LEVER-TYPE HANDLES FOR PLUMBING FIXTURES AND DOOR HANDLES 2-8° SLIDING DOORS WHERE POSSIBLE LEVER-HANDLE/TAPS AND FAUCETS MIN. 500 MM WIDTH
HALLWAYS	MIN. 800 MM WIDTH
GARAGE	ACCESS FROM GARAGE TO LIVING AREA MIN. 800 MM CLEAR OPENING
VERTICAL CIRCULATION	STAIR LIFT, STAIRCASE WIDTH, FRAMING SUPPORT, AND LANDINGS AS NOTED ON FLOOR PLANS IN COMPLIANCE WITH MANUFACTURER SPEC. SPEC NOTE: BRUNO CURVED RAIL STAIR LIFT (ELITE CURVE CRE-2110) MAX. LOAD: 400LBS, POWER: 24VDC COMPRISED OF (2) AH12V BATTERIES
HALLWAYS	VERTICAL LIFT, DEPRESSED SUB AREA, AND LANDINGS AS NOTED ON FLOOR PLANS IN COMPLIANCE WITH MANUFACTURER SPEC. ACCOMMODATE SHAF CONSTRUCTION WHO IMPACT TO SURF. STRUCTURE AT THE TOP OF ALL STAIRWAYS. WALLS ARE REINFORCED WITH 2X12 SOLID LUMBER AT 914 MM TO CENTRE.
WINDOWS	MIN. 1 WINDOW THAT CAN BE OPENED WITH A SINGLE HAND

FLOOR PLAN: CONVERTIBLE UNIT AC (AFTER CONVERSION)
SCALE: 1/4"=1'-0"

PROJECT

Townhouse Development
9231 Williams Road,
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PROJECT NO.
1602WWLG
SCALE
All Nodal
DATE APR 1, 2016
DRAWN BY KYC, SRS
CHECKED BY KYC
SHEET TITLE FLOOR PLANS:
CONVERTIBLE UNIT
DRAWING

ADDITIONAL NOTES FOR CONVERTIBLE UNITS:	
1. 210° LEAF DOORS PROVIDE MINIMUM 800mm CLEAR OPENING	✓
2. 30° LEAF DOORS PROVIDE MINIMUM 860mm CLEAR OPENING	✓
3. EXTERIOR DOOR THRESHOLDS ARE 2" HIGHER THAN EXTERIOR FLOOR SURFACE (FOR WATER INGRESS CONCERN)	✓
TOILET CLEAR FLOOR SPACE MIN. 1020 MM AT SIDE AND IN FRONT	✓
WALL BLOCKING FOR FUTURE GRAB BARS AT TOILETS, TUBS, AND SHOWERS	✓
LEVER-TYPE HANDLES FOR PLUMBING FIXTURES.	✓
PRESSURE AND TEMPERATURE CONTROL VALVE ARE INSTALLED ON ALL SHOWER FAUCETS.	✓
CABINETS UNDERNEATH SINK ARE EASILY REMOVED.	✓
DEMONSTRATE BATH AND SHOWER CONTROLS ARE ACCESSIBLE (LAY-OUT OR FIXTURE PLACEMENT).	✓
BATHROOMS (MIN 1/UNIT)	
PLACEMENT LOCATIONS OF ELECTRICAL OUTLETS, BESIDE TOILET, ABOVE EXTERNAL DOORS, BOTTOM OF STAIRWAYS, BESIDE TUB, ABOVE EXTERNAL DOORS, AND INSIDE ON FRONT FACE OF KITCHEN COUNTER, WITHIN PROXIMITY OF CONTROL CENTRE FOR SMART HOME OPTIONS.	✓
UPGRADE TO FOUR-PLEX OUTLETS IN MASTER BEDROOM, HOME OFFICE, GARAGE, AND RECREATION ROOM.	✓
OUTLETS & SWITCHES	
MIN. 800 MM WIDTH	✓
MIN. 1 ACCESSIBLE PARKING SPACE WITH MIN. 4M GARAGE WIDTH	✓
ACCESS FROM GARAGE TO LIVING AREA MIN. 800 MM CLEAR OPENING AS NOTED ON FLOOR PLANS IN COMPLIANCE WITH MANUFACTURER SPEC.	✓
KITCHEN	MIN. 800 MM WIDTH
GARAGE	STAIR LIFT, STAIRCASE WIDTH, FRAMING SUPPORT, AND LANDINGS AS NOTED ON FLOOR PLANS IN COMPLIANCE WITH MANUFACTURER SPEC. SPEC NOTE: BRUNO CURVED RAIL STAIR LIFT (ELITE CURVE CRE-2110) MAX. LOAD: 400LBS, POWER: 24VDC COMPRISED OF (2) AH12V BATTERIES
VERTICAL CIRCULATION	MIN. 1 WINDOW THAT CAN BE OPENED WITH A SINGLE HAND
HALLWAYS	MIN. 800 MM WIDTH
WINDOWS	MIN. 1 WINDOW THAT CAN BE OPENED WITH A SINGLE HAND (BATHROOM, KITCHEN, LIVING ROOM)