



City of
Richmond

Report to Development Permit Panel

To: Development Permit Panel

Date: October 2, 2018

From: Wayne Craig
Director, Development

File: DP 16-740262

Re: Application by 0989705 B.C. Ltd. for a Development Permit at
7960 Alderbridge Way and 5333 & 5411 No. 3 Road

Staff Recommendation

That a Development Permit be issued which would permit the construction of a high-density, mixed-use development consisting of approximately 18,720 m² (201,500 ft²) of office and commercial floor area and approximately 822 residential units at 7960 Alderbridge Way and 5333 & 5411 No. 3 Road on a site zoned "City Centre High Density Mixed Use (ZMU34) – Lansdowne Village".

A handwritten signature in black ink that reads "Wayne Craig".

Wayne Craig
Director, Development
(604-247-4625)

WC:jhd
Att. 6

Staff Report

Origin

0989705 B.C. Ltd. has applied to the City of Richmond for permission to construct a high-density, mixed-use development consisting of approximately 18,720 m² (201,500 ft²) of office and commercial floor area and approximately 822 residential units at 7960 Alderbridge Way and 5333 & 5411 No. 3 Road on a site zoned “City Centre High Density Mixed Use (ZMU34) – Lansdowne Village”. The proposal includes:

- One level of commercial uses.
- One 11-storey office tower.
- Six 14-storey residential towers.
- Three levels of below-grade parking.
- A total floor area of approximately 81,026 m² (872,157 ft²).
- Residential units including:
 - 38 secured affordable market rental units.
 - 115 secured market rental units.
 - 669 market strata units.

The site is being rezoned from “Auto-Oriented Commercial (CA)” to a new site-specific zone, “City Centre High Density Mixed Use (ZMU34) – Lansdowne Village”, under Richmond Zoning Bylaw 8500, Amendment Bylaw 9825 (RZ 15-692485). As considerations of rezoning, the developer will:

- Acquire a small, triangular portion of the City’s No. 3 Road road allowance adjacent to the site’s eastern boundary.
- Dedicate a small, triangular piece of land along the site’s southern boundary.
- Design and construct infrastructure improvements through a Servicing Agreement (SA) including:
 - New and upgraded City utilities.
 - Preducting for and/or undergrounding of private utility lines.
 - Relocation of all private utility equipment on-site.
 - Road dedications to provide for an enhanced back-of-curb public realm on No. 3 Road.
 - Road dedications to provide for new travel lanes and an enhanced back-of-curb public realm on Alderbridge Way.
 - Road dedications to provide for the development of a new north-south road on the western boundary of the site and a new east-west road near the southern boundary of the site.
 - Provision of a public right-of-passage (PROP) statutory right-of-way (SRW) for a mid-block pedestrian connection from No. 3 Road to the new north-south road.
 - Construction of frontage improvements on all sides of the development.
- Design, construct and transfer ownership of the on-site low carbon energy plant to the City.
- Provide cash-in-lieu contributions for child care and community amenity space.

Development Information

Please refer to the attached Development Application Data Sheet (Attachment 1) for a comparison of the proposed development data with the relevant Bylaw requirements. Please refer to the Development Permit Conditions of Approval (Attachment 2) for additional Development Permit requirements.

Site and Context

Existing Site and Development: The subject site is located within the City Centre Area Plan's Lansdowne Village. It sits on the west side of No. 3 Road to the south of Alderbridge Way and is comprised of three lots that have been cleared in preparation for development.

Surrounding Development: Development surrounding the subject site is as follows:

To the North: Across Alderbridge Way, existing, low-scale, commercial development.

To the East: Across No. 3 Road, the Lansdowne Mall site, which is subject to an Official Community Plan (OCP) amendment application to adjust the land use designation (CP 15-717017). This application is in process and will be the subject of separate reporting.

To the South: Across the future, new east-west road, existing low- and medium-scale commercial development. The lots at 5591, 5631, 5651 and 5671 No. 3 Road are subject to a rezoning application (RZ 17-779262) and Development Permit application (DP 18-829141) for a mixed-use development. These applications are in process and will be the subject of separate reporting. The lot at 5551 No. 3 Road is not part of the development site to the south.

To the West: Across the existing City lane, existing low-scale commercial and light industrial development with surface parking. The property at 5520 Minoru Boulevard (located to the south-west of the subject site) is subject to a rezoning application for a mixed-use development (RZ 16-744658). The application is in process and will be the subject of separate reporting.

Rezoning and Public Hearing Results

The Public Hearing for the rezoning of this site was held on July 16, 2018. There were no form and character concerns expressed about the proposed rezoning.

Staff Comments

The proposed scheme attached to this report satisfactorily addresses urban design, form and character and other City objectives identified as part of the review of the subject Development Permit application. In addition, the proposed scheme complies with the intent of the applicable sections of the Official Community Plan (OCP) and is generally in compliance with the site-specific zone "City Centre High Density Mixed Use (ZMU34) – Lansdowne Village".

Advisory Design Panel Comments

The Advisory Design Panel (ADP) reviewed the proposal and was supportive of the scheme subject to Panel comments. The applicant has addressed significant comments including:

- Differentiating the residential towers on the new north-south road with colour, massing breaks and varied balcony depths.
- Modification of the landscape plans to provide sun and shadow where appropriate, enhance views and support animation of the courtyard plaza.

A copy of the relevant excerpt from the Advisory Design Panel Minutes from July 5, 2018 is attached for reference (Attachment 3). The applicant's detailed design responses are provided in '*bold italics*' immediately following each Design Panel comment.

Analysis

Urban Design

Public Realm: The proposed development contributes to urban connectivity and public open space through a combination of: road improvements; new road development; deep ground level building setbacks; a mid-block pedestrian mews; and, a publicly-accessible internal courtyard plaza. Included are:

- On No. 3 Road, the back-of-curb cross-section with an enhanced bike lane, treed and planted boulevard and sidewalk (5.75 m wide).
- On Alderbridge Way and the new north-south and new east-west roads, the back-of-curb cross-section with a treed and planted boulevard and sidewalk (3.5 m wide).
- On all frontages, at the ground level, enhanced building setback areas ranging from 3.0 m to 9.0 m that will be used for access, circulation, outdoor display and/or patio seating.
- At both No. 3 Road intersections, further building setback areas that create small plazas at major building entries.
- From No. 3 Road, two wide, open air, pedestrian mews that lead to an internally-located ground level courtyard plaza.
- From the new north-south road, a wide pedestrian mews that also leads to the internally-located ground level courtyard plaza.
- The ground level, open air courtyard plaza.
- A pedestrian crossing on No. 3 Road, which will connect the proposed mid-block pedestrian mews and courtyard system with the lane system to the west and the Lansdowne Mall site to the east.

Design development of the frontage improvements and the PROP SRW for the mid-block pedestrian connection will occur through the Servicing Agreement process. To support comfortable transitions between the off-site, SRW and on-site landscape, minor adjustments of the approved Development Permit landscape plan may be recommended. Changes will be subject to a General Compliance application, if warranted.

Public Art: As a consideration of rezoning, the applicant has offered to make a contribution to the City's Public Art Program with an on-site work. A Public Art consultant has been retained and the Public Art Plan has been reviewed and endorsed by the Richmond Public Art Advisory Committee. The plan proposes to focus Public Art spending in the courtyard plaza. This will draw the public into the site and enliven it once they are there. A variety of opportunities have been identified including installation of a large, hanging sculpture that would be visible from the north-south streets, the Canada Line, and the office and residential spaces above. The artist and art concept selection process is underway and is expected to be completed by fall, 2018. This work is being managed through the public art process.

Public Adjacencies: The development concept proposes street-animating commercial uses at the ground level on all frontages, as well as throughout the extended public realm within the site. The remainder of the building massing is modulated to achieve specific urban design values on each frontage. On No. 3 Road and the new east-west road, lower podium heights and distinct massing breaks are used to reduce the scale impact of the development; optimize light penetration to the streets; and, establish a more spatially-interesting street experience. This section of No. 3 Road is expected to be heavily used by the public once the Lansdowne Mall site is redeveloped. On the other two frontages, higher midrise components, along with rhythmical tower placement, establish a more typical City Centre Area Plan (CCAP) street wall condition. All external and internal frontages are overlooked by residential uses providing for 'eyes on the street'.

Private Adjacencies: Because the proposed development has streets on all four sides, it is well separated from existing and future development on nearby private properties.

Grade Relationships and Flood Construction Level: To address the City's flood construction level requirements in the context of deeper building setbacks, disabled access requirements and comfortable patio seating slopes, a relaxation of the Flood Plain Designation and Protection Bylaw provisions is required. The applicant has reviewed the circumstances with Building Approvals staff, which have provided preliminary support for the proposed ground floor elevations subject to adequate protection from water intrusion. All habitable space will be at sidewalk elevation or higher.

Site and Functional Planning

Site Access: Proposed pedestrian access to the site includes: storefront entries located on the four frontages and the pedestrian mews and internal courtyard system; an office lobby at the No. 3 Road and new east-west road intersection; a major retail entry at the No. 3 Road and Alderbridge Way intersection; and, residential lobbies on No.3 Road, Alderbridge Way and the new north-south road.

Vehicle and truck access is proposed in two locations along the new north-south road. The south access leads to ground level car share parking and a small loading area. The north access leads to a large loading area and a waste management area. Both access points also lead to ramps to the below-grade parking.

Fire access has been vetted by Fire and Building Approvals staff based on the preliminary code analysis provided by the applicant. Access will be provided to the office and residential lobbies directly from the fronting streets. Planters and outdoor furnishings have been located to ensure functional and safe access/egress for the buildings and open spaces.

Parking and Loading: The proposed provision of bicycle, vehicle and truck spaces is consistent with or exceeds the site-specific bylaw (ZMU34) provisions.

Commercial and office Class 1 bicycle parking, as well as end-of-trip facilities, are provided in the first below-grade level of the parkade. Residential bicycle parking and bike maintenance facilities are provided in the first and second below-grade levels of the parkade. Class 2 bicycle spaces are distributed around the site on grade.

Proposed vehicle parking for the residential uses slightly exceeds the bylaw requirements. Proposed vehicle parking for the commercial and office uses also exceeds the bylaw requirements.

The north and south loading and waste management areas accommodate seven medium-size trucks and two large-size trucks that will be shared between non-residential and residential uses.

TDM Measures: As a consideration of rezoning the parking rates were reduced based on a Transportation consultant's assessment of needs and the provision of Transportation Demand Management measures. The measures include four car share spaces and cars, bicycle end of trip for non-residential uses, bicycle repair facilities for residential uses and a Transit Pass program. A Letter of Credit for \$446,054.04 is required prior to Development Permit approval to secure the Transit Pass program.

Waste Management: The waste management system includes a variety waste and recycling collection rooms. Those required for the commercial and office uses are located on the ground level of the development and are allocated between the north and south ends of the site to address the functional needs of the planned tenancies. Those required for the residential tenancies are located on the first below-grade parking level of the development. Materials from the below-grade facilities will be hauled to a ground-level temporary collection room on the north side of the development for pick-up. The Waste Management Plan is provided in the Development Permit drawings.

District Energy Utility: The low-carbon, central energy plant provided for the development will be transferred to the City to be integrated with the overall DEU system. The equipment is located on the top of the office tower, as well as in various connection, equipment and transfer rooms throughout the development. Sustainability staff have reviewed the proposed facilities and do not expect that changes affecting the form and character of the development will be required. Should changes be required, a General Compliance application will be advanced to the Panel, if warranted.

Third-party Utilities: All permanent third party utility equipment will be located on site. A BC Hydro VISTA box will be located adjacent to the new north-south road. The applicant has undertaken a detailed design review with BC Hydro to ensure that the location, layout and access are acceptable. A copy of BC Hydro's confirmation is on file.

Common Indoor Space: A total of 1,974 m² (21,249 ft²) of residential common indoor amenity space is proposed. This exceeds the CCAP objective of 2 m²/unit (22 ft²/unit) by approximately 300 m². Approximately 1,712 m² (18,428 ft²) of the overall proposed indoor amenity space is allocated for the shared use of the owners and/or tenants of the market strata units and the low end market rental (LEMR) units. Approximately 262 m² (2,820 ft²) of the overall proposed indoor amenity space is allocated exclusively for the use of the tenants of the market rental units.

- *Common Amenity Space:* The 1,712 m² (18,428 ft²) of shared indoor amenity space is allocated between various building levels and uses. Two large spaces are provided on Level 3. Facilities include rooms and/or areas for fitness, yoga, large parties, dining, games, children's play and studying. These spaces have direct access to the outdoor podium-top common residential amenity area. Three additional indoor amenity areas are provided on Level 10, each with associated outdoor common amenity area, while a series of guest suites are provided on Levels 4 through 9.
- *Market Rental Amenity Space:* The 262 m² (2,820 ft²) of market rental indoor amenity space located on Level 3 will also have direct access to the outdoor podium-top common amenity area and will include programming such as ping pong, indoor play, wet bar, general lounge area, washrooms, storage and the potential to divide the space into smaller components.
- *Shared Use Covenant:* Execution of a covenant establishing the shared use of the larger component of the indoor amenity space by the market strata and LEMR unit residents is a condition of Development Permit issuance.

Common Outdoor Space: A total of approximately 10,050 m² (108,189 ft²) of outdoor space is proposed. This includes spaces associated with the ground level pedestrian mews and courtyard, the office uses and the residential uses. The various areas meet or exceed the CCAP Development Permit Guideline (DP Guideline) expectations as described below.

- *Ground Plane:* Open space is provided on the ground level of the development in the form of deeper than required building setbacks and in the pedestrian mews and internal courtyard plaza. The area is approximately 5,015 m² (53,981 ft²) which significantly exceeds the CCAP DP Guidelines expectation for supplementary common outdoor area (e.g. 10% of the net development site area) of 2,082 m² (22,407 ft²). Staff note that the extensive ground-level on-site public and semi-public outdoor space system is made possible by the applicant's decision to locate all of the required parking below grade.
- *Office:* There is no requirement for office outdoor open space. However, a total of approximately 604 m² (6,501 ft²) of area is provided on Levels 3 and 6 adjacent to the office building. The Level 3 space provides for lounging and shared access via a stair and elevator to the courtyard plaza on the ground level below. The use of the office outdoor spaces will be allocated to all or part of the office tower floor area depending on the final tenancy or tenancies of the building.
- *Residential:* A total of 4,932 m² (53,088 ft²) of residential common outdoor space is provided on Levels 3, 6, 7 and 10. This area meets the minimum requirement of 6 m² (65 ft²) per unit. The Level 3 (podium-top) outdoor space is the largest and incorporates multiple social and recreational functions. On Level 6, an extensive urban agriculture area and a large children's play area are provided at the south end of the development where both will have good sun access. Smaller common outdoor amenity spaces areas accommodating casual gathering and children's play are provided over the midrise portions of the residential buildings (Towers A, B, C, E and F) where there is increased sunlight access and outlook. The combined area of the play spaces is 608 m² (6,545 ft²) which meets the OCP/CCAP area expectations calculated as 3 m²/unit to a maximum of 600 m². Please see the Landscape and Open Space section of this report for a description of the proposed play equipment and other design strategies for the play areas.

Private Outdoor Space: The applicant has provided either a patio or balcony for each residential unit, generally consistent with the expectations noted in the CCAP. The balconies range in depth from 1.4 m to 2.7 m (5.0 ft. to 8.7 ft.) and include a variety of configurations. Some are inset, some are projecting and some span the whole width of the unit in order to address sound attenuation, privacy and building articulation objectives.

Community Amenities

Affordable Housing: A total of 38 Low End Market Rental Housing (LEMR) units are proposed. These are clustered on Levels 3 through 6 of Building F on the north-east corner of the development. They have a combined floor area of 2,759 m² (29,701 ft²) and include a range of unit types (one bedroom through three bedroom). Those units with frontage on No. 3 Road or Alderbridge Way will be provided with an exterior, acoustic baffle system for noise mitigation.

AFFORDABLE HOUSING SUMMARY

Unit Type	Affordable Housing Strategy Requirements			Unit Mix	
	Min. Permitted Unit Area	Max. Monthly Unit Rent*	Total Max. Household Income*	% of Units	# of Units
1-Bedroom	50 m ² (535 ft ²)	\$975	\$38,250 or less	42%	16
2-Bedroom	69 m ² (741 ft ²)	\$1,218	\$46,800 or less	29%	11
3-Bedroom	91 m ² (980 ft ²)	\$1,480	\$58,050 or less	29%	11
TOTAL	2,759 m² (29,701 ft²)	Varies	Varies	100%	38

Market Rental Housing: The proposed rezoning includes approximately 115 market rental housing units within the development. The market rental floor area is 8,670 m² (93,323 ft²) and includes a range of units types (one bedroom to three bedroom). The market rental units are provided in a ‘standalone’ tower (Building D) facing No. 3 Road and will be secured with a market rental housing agreement.

MARKET RENTAL HOUSING SUMMARY

	STUDIO	1 BED / 1 BED+DEN	2 BED / 2 BED+DEN	3 BED / 3 BED+DEN	TOTAL
Units	0	48	44	23	115
Percentage	0%	42%	38%	20%	100%

Architectural Form and Character

The proposed development is very high density and sits on a large site. In this context, “human scaled streetscapes” and “varied and distinctive building forms” are important CCAP DP Guideline objectives. The proposed development includes design features at the massing, articulation and character levels that address these goals.

Massing: A podium and tower form of development is proposed. As a result of the site size, site configuration and frontage opportunities, a seven-tower concept is possible. The seven towers are distributed around the perimeter of the site and are interspersed with a combination of low and high streetwall forms. Two significant massing breaks are provided along No. 3 Road to highlight access to the expanded public realm within the site. The floor area that might typically be located in these breaks has been redistributed to the tower on the north-east corner of the site.

The proposed massing and distribution of uses address the design objectives of the CCAP DP Guidelines as follows.

- A high commercial base (6.0 m /19.75 ft.) underlies the whole development and contributes positively to the spatial scale and day/night animation of the public realm. This includes the commercial frontages on the four streets frontages and those lining the internal pedestrian mews and courtyard system.
- The proposed office uses are located in a distinct building form that sits at the intersection of No. 3 Road and the new east-west road. It is comprised of two massing components - a larger floorplate for the lower two levels and a series of smaller, stepped floorplates for the floors above. The lower component reinforces the streetwall and brings animation to the street. The upper component marks the intersection and establishes a higher level visual identity for the office uses. Because it is set back, the upper component reduces the scale impact of the tower at the street level.
- The residential uses are located in the remaining midrise and tower forms and are arrayed around the podium level courtyard. Various combinations of horizontal and vertical massing are used to differentiate the tower blocks on the four street frontages. In addition to the office tower described above, the No. 3 Road frontage includes a vertically-oriented “standalone” tower located approximately mid-block and a wrap-around, “streetwall” building located toward the Alderbridge Way intersection. The wrap-around building is comprised of two distinct horizontal massing components separated by a one-storey high “reveal”. On the new north-south road, a rhythmical arrangement of interlocking midrise and tower forms is arrayed down the street. The mid-rise forms are distinguished from the tower forms with curved floor plans and balconies that advance and recede from the street plane. Each mid-rise and tower set is also separated by a deep vertical recess.

Articulation: The proposed development addresses the building articulation objectives of the DP Guidelines in a variety of ways.

- The street side commercial frontages have been setback more than the minimum 3.0 m envisioned by the CCAP. These setback areas are double height and overhung by the building massing above. This provides visual depth to the façades and creates a sense of sheltered space at the street level, particularly in key high-use locations such as the No. 3 Road intersections.
- Within the pedestrian mews and courtyard plaza areas, spatial articulation is provided by the dynamic, angled, overhanging walkway system associated with the residential amenity space on Level 3. Columns, vertical circulation and Public Art will further articulate this space.
- The office tower combines two simple forms. Both components are clad with continuous, floor-to-ceiling, large-paned, glass windows. The resulting transparency, as shown on the renderings, replaces explicit articulation with a strong inside-outside relationship that engages and animates the public realm via the interior activity.

- Articulation of the residential buildings, which are all fairly rectilinear, relies on different combinations of balcony styles (inset/projecting), balcony railings (transparent/solid), cladding choices (solid/spandrel glass/vision glass), parapet styles and framing elements to create variety and distinctiveness between the residential towers. Building F, on the north-east corner of the site, is provided with vertical sound baffles that add to the façade articulation.
- On the new north-south road frontage, special colour treatments have been used in the articulated spaces at the lobby and amenity space levels, as well as in the recesses between each block. The colour treatments are intended to distinguish the individual “buildings” and highlight the ground-level lobby and upper level amenity spaces.

Rooflines: The proposed towers are all of a similar height and sit just below the maximum height of 41.5 m geodetic. This height was established through the Vancouver Airport Authority future runway planning process.

The DEU low carbon energy plant equipment is located on the top level the office tower. The façade of the building is extended through this level so that it has the appearance of another level of the tower rather than a screened rooftop mechanical room. A preliminary layout of the rooftop equipment is included in the Development Permit drawings.

To add visual interest to the rooflines, the applicant has proposed a variety of designs including: a thin, glass, spandrel panel parapet on the office tower; white concrete frame elements on some of the residential tower facades; a vertically-expressed dark parapet extension on other tower facades; and, thin, white, deeply-cantilevered balcony roofs on west-facing facades.

Character: The proposed development has incorporated a wide variety of the character features described in the CCAP DP Guidelines. “Strong horizontal expression” predominates in the office building and in the residential balcony treatments along the west façade. “West Coast Lifestyle Expression”, including active outdoor living, is supported with the multi-level landscaped open spaces and the ground-level public mews and courtyard plaza. Significant planting on the upper level terraces, much of which is visible from the streets and public areas of the site, supports “Garden City Expression”. “Green Building Expression” gives rise to the deep balconies provided for sun shading on the west façade.

Materials and Colour: The proposed cladding combines curtain wall and window wall glazing with terra cotta panelling, spandrel panels, various metal elements and painted concrete. The curtain and window wall glazing is clear. The curtain wall will be used on the office building and commercial spaces and is provided with structural silicone joints to reduce the appearance of frames. The glass units are 10 ft. wide in the case of the office building and 7 ft. wide on the commercial level. This combination will enhance the transparent inside/outside relationship along the streetscapes and will highlight the office and commercial role of the development. The glazing for the residential units is also clear but includes a 4 ft. framing grid to provide for a more intimate residential scale.

Much of the solid area of the cladding system is comprised of corrugated terracotta panels which will run vertically on the buildings. The terra cotta will be white and glazed: the colour and reflectivity will lighten the massing and brighten the streetscapes. In other solid areas, there will be charcoal grey spandrel panels and louvers. This simple colour palette will be contrasted in key areas of the development including the previously-mentioned buildings along the north-south road and within the pedestrian mews and courtyard plaza system described below.

Special Design Feature: The provision of the proposed mid-block pedestrian mews and courtyard plaza system is made possible because the applicant has elected to locate all of the vehicle parking below grade. This gesture supports pedestrian connectivity on a 100 m grid, as envisioned by the CCAP. An outdoor mews and courtyard lined with commercial uses will add an exciting new dimension to the public experience of the City Centre. To support the success of the mid-block system, the applicant has proposed a number of design features including:

- Spatially dynamic open air passageways leading from the street to the courtyard plaza.
- An expressly directional paving pattern to draw the public into the site.
- Planters with integrated seating and large trees at both the mews entrances and in the courtyard.
- Special lighting of the balcony railings lining the upper courtyard overhangs.
- Special soffit design on the underside of the upper courtyard overhangs.
- The proposed Public Art piece or pieces.

In addition, the applicant is exploring adding features to support space programming such as a large projection screen on one of the solid walls within the courtyard.

Signage: A comprehensive signage and wayfinding package was presented to the Advisory Design Panel. The package was created to establish a contemporary urban identity for the development in addition to addressing the multiple functional objectives necessitated by a development of this scale. A separate Sign Permit Application is required for the proposed commercial signage.

Landscape and Open Space Design

Ground Plane Open Space: A significant feature of the proposed ground level open space design is the use of a distinctive paving pattern to identify and unify the ground plane. This includes the building setback areas along the street frontages as well as the pedestrian mews and courtyard plaza. The paving pattern is designed with banding in contrasting paver colours. The width and colour emphasis of the banding is modulated through the site in order to define different functional and programmatic areas (e.g. building and parkade entries) and to add visual interest along the frontages. The paving is also used in areas of the ground plane, such as the car share, to improve the view from the street and enhance the user experience of the functional areas.

The ground level plan includes strategically located raised planters with various combinations of trees, underplanting and benches. In some cases, the planters are used to mark the edges of the property where they will be able to provide buffering for any outdoor seating areas associated with the commercial uses. In other areas, they mark the entries to the pedestrian mews system. The mews planters are also designed to mask the exhaust vents from the underground parking.

In addition to the integrated planter benches, “C” shaped benches are proposed in key public-use locations. The remaining areas of the ground plane are intended to be furnished (e.g. seating and free-standing planting) by the adjacent commercial businesses. Class 2 bicycle parking is also distributed throughout the ground level.

Office Open Space: The office building is provided with open space on Levels 3 and 6 of the development. The spaces, which are primarily finished with decking, are located on the east and north sides of the tower. A treed landscape buffer is provided on Level 6 on the north side of the tower to reduce privacy issues with residential units opposite.

Residential Open Space: The residential open space is distributed between the podium level and six mid-rise roof top areas. The podium level space is divided into private and common areas separated by treed planters. The common areas include outdoor patios associated with the indoor amenity spaces on the east and west sides of the podium. The podium also has roofed and open exercise areas and a walkway system connecting the various towers, open spaces and circulation to the courtyard plaza below. The podium is intensively landscaped and will benefit from south sunlight.

Urban agriculture and child’s play facilities are provided on Level 6 in a south-facing gap between the office tower and the residential tower to its west. The urban agriculture area includes raised planters, fruit trees and a farm table entertaining area. The children’s play area combines conventional play equipment with adventure and nature play and emphasizes adventure and nature play in order to reduce the use of plastics. The play structure area is 44.8 m² (481.9 ft²) and is set on a rubber surface. It is suitable to children aged 2-5 years, and includes ground level and elevated activities involving different kinds of crawling, climbing and sliding. The playhouse includes covered play benches and is set under the trees. A play deck is also provided and is set in one of the open grassed areas of the play space. The adventure and nature play features include a grassed and treed “hill”, climbing and jumping logs and stumps and deck areas to run and play. There is also deck for parent seating and quiet conversation.

Smaller common outdoor amenity spaces generally associated with smaller indoor amenity areas are provided for each residential tower on Level 7 or Level 10. These areas are programmed with lounging, gathering and child’s play areas. They include treed and grassed areas and their locations offer sun access at different times of the day as well as outward views from the development. Conventional play equipment is not provided due to lack of space and a desire to avoid the use of plastics.

Green Roof: Extensive green roofs with areas of river rock are proposed on all the towers. In addition to contributing to sustainability, the green roofs may be visible from future surrounding development.

Tree Retention and Replacement: There were no on-site bylaw-sized trees except on the piece of City land that is proposed to be added to the site. These will be relocated. Off-site trees will be retained or replaced with compensation, consistent with the considerations of rezoning.

Landscape Letter of Credit: Completion of the on-site landscaping will be secured with a Letter of Credit for \$3,103,570.40.

Sustainability

LEED: As considerations of rezoning, the development will target LEED Silver (Attachment 4).

Livability

Accessibility: All units will be provided with Aging-in-Place features (stairwell hand rails; lever-type handles for plumbing fixtures and door handles; and solid blocking in washroom walls to facilitate future grab bar installation beside toilets, bathtubs and showers). The proposal also includes 192 units that are further enhanced with Basic Universal/Adaptable housing features (including all of the accessibility provisions listed in the Basic Universal/Adaptable housing features).

Basic Universal Housing

Unit Tenure	Unit type	Total Units
Low End Market Rental	1B through 3B+D	38
Market Rental	1B through 3B+D	131
Market Strata	1B + D	23

Noise Mitigation: The applicant has provided a preliminary opinion from an acoustical consultant indicating that the residential component of the development will not require redesign, although upgrades to the façade details may be required to meet acoustic requirements (Attachment 5). Additional analysis regarding sound attenuation for the DEU central plant and the Canada Line noise has been requested. Submission of the final consultant report is a condition of Development Permit issuance.

Crime Prevention through Environmental Design: The applicant has provided a list of CPTED features to be incorporated into the development that address Section 14.2.11 of the OCP (Attachment 6).

Conclusions

As the proposed development would meet applicable policies and Development Permit Guidelines, staff recommend that the Development Permit be endorsed, and issuance by Council be recommended.



Janet Digby
 Planner 3
 (604-247-4620)

JD:blg

Attachments:

- Attachment 1 Development Application Data Sheet
- Attachment 2 Development Permit Conditions of Approval
- Attachment 3 Advisory Design Panel Minutes (annotated)
- Attachment 4 LEED Checklist
- Attachment 5 Preliminary Acoustic Report
- Attachment 6 CPTED Features



City of
Richmond

Development Application Data Sheet
Development Applications Department

DP 16-740262	
Address:	7960 Alderbridge Way and 5333 & 5411 No. 3 Road
Applicant:	0989705 B.C. Ltd.
Owner:	0989705 B.C. Ltd. (South Street Development Group)
Planning Area(s):	City Centre – Lansdowne Village

DP 16-740262	Required	Proposed
Site Area:	Min. 16,800 m ²	16,930.6 m ²
Net Development Site Area:	20,817 m ²	20,817 m ²
Land Uses:	Mixed Use	Mixed Use
OCP Designation:	Downtown Mixed Use	Downtown Mixed Use
Area Plan Designation:	Urban Core T6 (45 m)	Urban Core T6 (45 m)
Zoning:	ZMU34	ZMU34
Number of Residential Units:	n/a	822

DP 16-740262	Bylaw Req't	Proposed	Variance
Floor Area Ratio (FAR):	Max. 3.95	3.89	n/a
Floor Area per FAR:	Max. 82,227 m ²	81,026 m ²	n/a
Non-residential Floor Area:	N/A	18,720 m ²	-
Residential Floor Area:	Max. 62,451 m ²	62,306 m ²	-
Lot Coverage:	Max. 90%	78%	-
Lot Size:	Min. 16,800 m ²	16,930.6 m ²	-
Lot Dimensions:	n/a	n/a	-
Setback – Alderbridge Way:	Min. 0.0/3.0 m *	0.0/3.0+ m	-
Setback – No. 3:	Min. 0.0/3.0 m *	0.0/3.0+ m	-
Setback – North South Road:	Min. 0.0/3.0 m *	0.0/3.0+ m	-
Setback – East West Road:	Min. 0.0/3.0 m *	0.0/3.0+ m	-
Height Dimensional (geodetic):	Max. 41.5 m	41.5 m	-
Off-Street Parking Spaces – Residential Unit:	542	548	-
Off-Street Parking Spaces – Market Rental Unit:	83	83	-
Off-Street Parking Spaces – Affordable Housing Unit:	27	27	-
Off-Street Parking Spaces – Visitor (Shared):	90	90	-
Off-Street Parking Spaces – Commercial:	224**	225	-
Off-Street Parking Spaces – Office:	133**	255	-
Off-Street Parking Spaces – Car Share Spaces:	4	4	-
Off-Street Parking Spaces – Total:	1,013	1,142	-
Loading Space – Large Size:	2	2	-
Loading Spaces – Medium Size:	7	7	-
Bicycle Parking Spaces – Class 1:	1078	1078	-
Bicycle Parking Spaces – Class 2 (shared):	119	119	-

* Below-grade and above-grade

** CDT1 Rates may be applied / includes TDM



City of
Richmond

Development Permit Conditions of Approval
Development Applications Department

The following conditions are to be met prior to forwarding this application to Council for approval:

1. Receipt of a Letter-of-Credit for landscaping in the amount of \$3,103,570.40 which includes the cost of construction and a 10% contingency amount for landscape shown in the Development Permit plans.
2. Provision of a final acoustic report and recommendations by a professional acoustic consultant with respect to sound mitigation measures required as a consideration of rezoning and including noise from DEU mechanical equipment.
3. Provision of a copy of the draft contract between the owner and the car share operator describing the terms of the provision of car sharing services.
4. Receipt of a Letter of Credit in the amount of \$446,054.04 to secure the owner's commitment to provide transit passes based on 110% of transit pass costs (including 100% for transit pass purchases and 10% for future transit pass cost increases and administration).
5. Revision of the Transportation Impact Analysis to reflect the final Development Permit statistics and other revisions resulting from design development of the transportation aspects of the proposal.
6. Registration of a restrictive covenant on Title noting that the all common indoor and outdoor residential amenity space, including the guest suites on Levels 4 through 9 but excluding the indoor and outdoor amenity space for Building D, shall be made available for the use of all owners/tenants of the development except the owners/tenants of Building D.

Annotated Excerpt of the Minutes
Advisory Design Panel Meeting
Wednesday, August 8, 2018 – 4:00 p.m.
Rm. M.1.003
Richmond City Hall

1. DP 16-740262 - 7-TOWER CITY CENTRE MIXED USE COMMERCIAL, OFFICE AND RESIDENTIAL DEVELOPMENT

ARCHITECT: GBL Architects

PROPERTY LOCATION: 7960 Alderbridge Way and 5333 and 5411 No. 3 Road

Applicant's Presentation

Achim Charisius, GBL Architects, and Chris Phillips, PFS Studio, presented the project and answered queries from the Panel on behalf of the applicant.

Panel Discussion

Comments from Panel members were as follows:

- consider differentiating the lobbies of buildings B and C to improve site wayfinding as the two buildings look alike;

GBL Response:

The project team developed differentiating colour/material themes for the towers (See figure 1)

These themes are being expressed in the following building materials within the entrance lobbies on level 1 and the amenity areas on level 10

- ***Feature Ceiling***
- ***Flooring***
- ***Feature Wall***
- ***Coloured Glazing in curtain wall***
- ***Address Signage***

Tower A: Beach (See figure 2 and figure 12)

Tower B: Mountain Sky Grasslands (See figure 3 and figure 12)

Tower C: Grasslands (See figure 4 and figure 12)

- consider carving the portion of the gap between the office building and rental building along No. 3 Road to create more landscaped/green ledges (e.g. by incorporating amenity decks on office podium), leading down to the level of the street to provide visual connection between street level and upper level landscaping; would enhance the pedestrian experience of the courtyard and enhance the views of the south-facing units;

GBL Response:

We are proposing to create a green ledge by applying a staggered, foliage-themed, white frit pattern to the office glazing, connecting the landscape visually between podium and courtyard levels and improving views and privacy for south facing units.

(See figure 5)

- consider further exposing outdoor views through the buildings through the podium levels; investigate opportunities for this approach for the podium between buildings B and C;

GBL response:

An additional break through the building is has been incorporated providing daylighting and views (See figure 6):

- consider varying the topography of the landscape at the upper levels to create a subtle sense of difference in character in the upper levels;

PFS Response: Due to the geometry and limited space at the upper levels we have tried to maintain as much flexibility as possible. 3 dimensional planters and furnishing elements have been introduced at the upper levels. Additionally, planted mound has been proposed on Level 5. (see figure 7)

- the applicant is advised to maintain flexibility of the programmable areas on the street plaza level; look at the density of trees on street plaza level; consider incorporating water elements in the central plaza to animate the plaza;

PFS response: A series of programing diagrams have been developed to confirm the flexibility of the plaza space. For that reason, North portion of the plaza has been maintained as an open space to accommodate various events. The South part of the plaza is shady and therefore not suitable for a water feature. (see figure 7)

- consider modifying certain portions of the glazing on certain building types to allow differentiation of expression, e.g. by introducing different tints, colours or tones;

GBL Response:

The project team developed differentiating colour/material themes for the towers (See figure 1)

These themes are being expressed in the following building materials within the entrance lobbies on level 1 and the amenity areas on level 10

- ***Feature Ceiling***
- ***Balcony Soffits***
- ***Flooring***
- ***Feature Wall***
- ***Coloured Glazing in curtain wall***
- ***Coloured glazing in entrance canopy***
- ***Address Signage***

Tower A: Beach (See figure 2 and figure 12)

Tower B: Mountain Sky Grasslands (See figure 3 and figure 12)

Tower C: Grasslands (See figure 4 and figure 12)

- appreciate the project and the package provided by the applicant;
- agree with the Panel comment that landscaping on the upper levels of the building needs to come down to the central plaza;
PFS response: Added a larger planting area on the central retail plaza to soften the plaza and provide more seating opportunities, but still provide enough space for programming (see figure 7).
- appreciate the idea of retail and neighbourhood events taking place in the central plaza; however, concerned on the frequency of these events as lack of animation would make the large plaza look exposed;
PFS response: Permanent features have been added to provide an inviting space for everyday use for the visitors of retail units. Additionally, tree canopies and planters create intimate spaces within the larger plaza (see figure 7).
- appreciate the green roofs;
- consider providing visual interest to the parking vents at the entrance to the plaza to draw people into the plaza;
PFS response: Noted. We will look for the opportunities for enhancing the appearance of the parking vents.
- consider relocating the urban agriculture area on level 5 farther to the north and installing trees along the edge as the proposed location will be subject to too much sun exposure;
PFS response: Changed the south urban agriculture plots to concrete planters with row of trees to provide shade for the rest of the garden plots. Additional shade is also provided by the trees already planted in the garden plots (see figure 7).

- consider orienting the passive/quieter areas on level 10 outdoor amenity spaces westward rather than inside to enable residents to view the sunset;
PFS response: Level 10 design have been developed further and the wood deck / trellis have been relocated to the west side to allow residents to view the sunset. (see figure 7)
- consider using the oversized west-facing balconies to create more variation in the design of the west façade through varying the design of the soffits or guard rails of balconies (e.g. through variation in graphics or colours) to further visually break down the massing of the west façade;

GBL Response:

The project team developed differentiating colour/material themes for the towers (See figure 1)

These themes are being expressed in the following building materials within the entrance lobbies on level 1 and the amenity areas on level 10

- **Feature Ceiling**
- **Balcony Soffits**
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Tower A: Beach (See figure 2 and figure 12)

Tower B: Mountain Sky Grasslands (See figure 3 and figure 12)

Tower C: Grasslands (See figure 4 and figure 12)

Further, we varied the depth of the podium 'ribbon' balconies to be deeper than the glazed tower balconies.

- future acoustic report for the project should also include a study of reverberation of inside spaces in the building in view of the length and proportion of the plaza and the amount of glass along the Alderbridge Way and No. 3 Road elevations;
GBL response: noted and advised acoustic consultant.
- the applicant is encouraged to locate small-sized CRUs, e.g. little cafes with tables and chairs, around the central plaza to animate the plaza, especially during periods when there are no retail and neighbourhood events occurring in the plaza;
GBL response: smaller CRU's have been incorporated (see figure 8)
- the applicant is advised that pre-planning for mechanical ventilation be conducted should a large-sized restaurant be located in the plaza so that residents will not be inconvenienced as provision for mechanical ventilation is not currently shown in the floor plans;
GBL response: Mechanical consultant maintains all required distances to residential units.

- appreciate the opportunity to incorporate an iconic art piece in the project with the significant budget for public art allocated by the applicant; the applicant is advised to do pre-planning to anchor this public art piece;
GBL: noted, will be suggested to artist.
- landscaped areas on level 3 and upper level podiums are well done and provide an urban park for residents;
- ensure edge protection for zigzag walkways to provide safety for people using wheelchairs and strollers;
PFS: Noted
- spacing of paving stones on rooftop gardens on levels 7 and 10 can be problematic for people using wheelchairs and strollers; consider a sidewalk width for the overlapping space to allow two people to walk side-by-side;
PFS: Noted. Level 10 design have been developed further - stepping stones have been deleted. (see figure 7)
- appreciate the linear aspect of the coloured paving; provides good orientation for people with impaired/limited vision;
- consider making the powder room of the one-bedroom typical unit an ensuite bathroom to the single bedroom as well as a bathroom for visitors through the walk-in closet; look at the possibility of making the walk-in closet accessible from two directions;
GBL response: the suggestion was addressed (see unit ABC2) (see figure 9)
- consider eliminating the inward opening door for the den in the typical two-bedroom unit as it occupies a significant amount of space in the den;
GBL response: the fancoil was relocated, and the inward door was replaced with a pocket door. (see unit A4) (see figure 10)
- consider an outward swinging door that swings into the entry space in lieu of an inward swinging door for the bathroom adjacent to the unit entry for the typical two-bedroom unit; would enhance the usability of the bathroom;
GBL response: the suggestion was addressed (see unit A4) (see figure 10)
- consider an outward swinging door in lieu of an inward swinging door for the bathroom in the typical three-bedroom unit;
GBL response: the suggestion was addressed (see unit A3) (see figure 11)
- appreciate the applicant's efforts to incorporate public art in the early stage of the project and integrate public art in the overall design of the project;
- ensure the visibility of the public art piece in the central plaza from the street to highlight the public character of the plaza;
PFS: Noted
- consider further articulation of the parkade space on the west face of the plaza to provide visual interest to pedestrians;
GBL: noted

- pedestrian crossing from No. 3 Road to the new north-south road through the central plaza will enhance the Lansdowne Village neighbourhood and distinguish the area as a distinct place;
- appreciate the signage plan and wayfinding strategy for the project; and
- consider differentiating more the residential entrances from the retail and public spaces through further articulation.

GBL Response:

The project team developed differentiating colour/material themes for the towers (See figure 1)

These themes are being expressed in the following building materials within the entrance lobbies on level 1 and the amenity areas on level 10

- ***Feature Ceiling***
- ***Balcony Soffits***
- ***Flooring***
- ***Feature Wall***
- ***Coloured Glazing in curtain wall***
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Tower A: Beach (See figure 2 and figure 12)

Tower B: Mountain Sky Grasslands (See figure 3 and figure 12)

Tower C: Grasslands (See figure 4 and figure 12)

Further to this, the canopy height and fenestration details have been altered to contrast with the commercial storefront expression.



July 25, 2018

Planning and Development Services
City of Richmond

Re: 7960 Alderbridge Way– Summary of Proposed Sustainability Measures

The applicant and design team are committed to incorporating green building principles into the design and long term operations of the proposed residential, commercial, and retail development at 7960 Alderbridge Way. The project will utilize the Canada Green Building Council's LEED v4 for New Construction rating system to demonstrate its environmental performance and will target a sufficient number of credits to be equal to Silver level LEED certification strategy. The following list, along with a preliminary LEED Checklist, highlights the prominent sustainable features which will meet the intent of 54 points, which is above the minimum threshold for LEED Silver certification by 4 points. Beyond these targets, several other strategies are potentially available and will be confirmed as the design is refined.

This development will demonstrate environmentally responsible building construction through the following:

Location and Transportation

The project is located on a previously developed infill site, avoiding sensitive habitats and taking advantage of existing infrastructure and surrounding amenities which promote a walkable community. The development's design densifies the existing site to maximize land usage. The site is located within a short walking distance of No. 3 Road. This location provides optimum connectivity to pedestrian, bicycle and public transit options. The connection to No. 3 Road offers immediate connection to over 6 different bus lines and the Lansdowne Skytrain station within 800m of the site. This encourages building occupants to utilize alternative transportation opportunities, reducing dependence on single occupancy vehicles. The location along these transit corridors combined with secured storage for bicycles and bicycle networks accessible along No. 3 Road and Alderbridge streets afford a distinct advantage for carless commuters.



Figure 1: Walking distance to local services

Sustainable Sites

Landscaping on the roof and ground surfaces will utilize a selection of vegetation to be native and adaptive vegetation best suited to the long term durability and aesthetic of the project. A combination of extensive vegetation and accessible space will offer occupants a positive outdoor space to encourage time outside of the built environment. The development's hardscapes and green spaces will be considerate of urban heat island effect and support the project's larger irrigation and water use reduction targets.



Figure 2: Extensive proposed on-site vegetation throughout

An erosion and sedimentation control plan will be implemented to minimize erosion and sedimentation during demolition, site preparation and throughout construction. Best practices will be implemented during construction to optimize air quality for site workers and the surrounding area, and provide a clean and healthy building for future residents.

Water Use Efficiency

The project's management of rainwater runoff will be done in such a fashion as to minimize where feasible the volume of stormwater released to the City of Richmond's stormwater system. The project will address water management through two design approaches. Firstly, water conservation through low flow plumbing fixtures, the project will be targeting a 45% reduction in the use of potable water through selection of plumbing fixtures. Secondly, given the scale of the plantings proposed the project irrigation demand will be a major focus. The project has established a target of reducing irrigation demand for potable water by 50% for the irrigation of the project's landscaping. This will be done using combination of water efficient planting selections, water efficient irrigation systems, and demand based irrigation control systems combined with rain sensing controllers.

Energy Performance

The project will be designed to satisfy the LEED minimum energy efficiency of a 22% reduction in energy cost relative to an ASHRAE 90.1- 2010 baseline. High performance systems will be considered throughout design to ensure the project's energy performance is met.

To maximize the envelope efficiency of the building, moderate window to wall ratios on the majority of the project will be utilized to manage solar heat gains through the exterior glazing while retaining energy to maintain thermal comfort. Windows will likely be double-glazed to optimize energy retention and will consider a variety of solar heat gain coefficients to best maximize solar gains. The opaque wall systems for the building will be specified to support the window assemblies in their performance and be well insulated to eliminate energy transfer between the interior and exterior spaces. At present this will include a preliminary effective wall R-value target of R5 and a glazing U value of .38.



Figure 2: Moderate ratio of window to wall area represented.

In addition to a high efficiency envelope, the development will further reduce energy and carbon emissions through high efficiency HVAC design. The central heating and cooling plant will be comprised of a highly efficient air source heat pump with condenser boiler backup, having an effective seasonal Coefficient of Performance (CoP). This system will be electric powered, resulting in continually reduction of its carbon footprint during operation in comparison to gas powered. Furthermore, heat recovery will be implemented throughout the entire development to further improve the efficiency of the system. In situations where one building may require heating and another may require cooling, heat will be extracted from the building in demand of cooling, and provided to the building in demand of heating. This reduces the use of the air source heat pumps to provide newly conditioned air, therefore resulting in energy-use reductions.

Individual distribution of conditioned air throughout the building is likely to utilize a four-pipe hydronic system with fan coils to provide specific thermal controllability to each zone. LED lighting in the parkade and potentially in the suites themselves will also be considered.

The building space heating and domestic hot water systems will be designed to satisfy the applicable City of Richmond DES connectivity guidelines. A central heating plant consisting of high efficiency condensing boilers will provide heating hot water for the entire development. Cooling will also be provided by high efficiency water cooled chillers in combination with cooling towers.

Building Materials

Through the use of a building lifecycle impact analysis and innovative material product disclosures the project will aim to demonstrate building lifecycle impact reductions in overall Co2 emissions, depletion of non-renewable energy resources, eutrophication and other global impact categories. Materials will be selected to provide industry regulated ingredient declarations, and identify the environmental impacts associated with each material. Reductions in the lifecycle impact categories will likely come from increased the recycle content in the concrete used, reductions in excess material consumption through design, and locally sourced material selection.

Construction waste management will be an integral part of the building process, firstly through source minimization, smart product selection, packaging and transport. Furthermore, waste generated on site during construction will be addressed through a comprehensive waste management plan, detailing recycling facilities and documenting the diversion of standard debris from landfill.

Indoor Environment

Ventilation air will be delivered to each space by means of rooftop air handling units and in suite fancoils. Outdoor air ventilation will be implemented and adhere to ASHRAE 62.1-2010 to reduce occupant exposure to indoor pollutants by ventilating with outdoor air.

Given the unique shape of the floorplate, the opportunities for daylight autonomy and views access will be maximized. To improve the indoor environment for occupants, the design team will be considerate of daylighting design strategies and encourage to implement them where feasible.

Conclusion

The above noted strategies support a holistic approach to addressing the requirements of the City of Richmond and the goal of LEED Silver level equivalency. Implementing these strategies through design and construction will produce an intelligently designed project capable of delivering enhanced building performance while also improving indoor environmental quality for tenants. A Development Permit LEED checklist is included with the application for review.



Alderbridge: Silver-level Checklist
LEED v4 BD+C: NEW CONSTRUCTION
 Date Issued: 12/07/2018
 USGBC Project No.: 1000105590

54	4	6	4
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Project Total Silver 50 to 59 points Gold 60 to 79 points Platinum 80 to 110 points

Materials + Resources Possible Points: 13

MR1	MR2	MR3	MR4	MR5
1	1	1	2	2

Integrative Process Possible Points: 1

IP1	1
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Storage & Collection of Recyclables

Construction and Demolition Waste Management Planning
 Building Life-Cycle Impact Reduction
 Building Product Disclosure & Optimization: Environmental Product Declarations
 Building Product Disclosure & Optimization: Sourcing of Raw Materials
 Building Product Disclosure & Optimization: Material Ingredients
 Construction & Demolition Waste Management

Location + Transportation Possible Points: 16

L11	L12	L13	L14	L15	L16	L17	L18
1	1	2	2	2	1	1	1

Indoor Environmental Quality Possible Points: 16

EQ1	EQ2	EQ3	EQ4	EQ5	EQ6	EQ7	EQ8	EQ9	EQ10
1	1	1	1	1	1	1	1	1	1

Sustainable Sites Possible Points: 10

SS1	SS2	SS3	SS4	SS5	SS6
1	1	1	1	1	1

Innovation + Design Process Possible Points: 6

ID1	ID2	ID3	ID4	ID5	ID6
1	1	1	1	1	1

Water Efficiency Possible Points: 11

WE1	WE2	WE3	WE4
1	1	1	1

Regional Priority Credits Possible Points: 4


RPC1	RPC2	RPC3	RPC4
1	1	1	1

Energy + Atmosphere Possible Points: 33

EAP1	EAP2	EAP3	EAP4	EAP5	EAP6	EAP7	EAP8	EAP9	EAP10	EAP11	EAP12	EAP13	EAP14	EAP15	EAP16
1	1	1	1	1	1	1	1	1	1	1	1	1	1	1	1

1	1	1	1	1	1	1	1	1	1	1	1	1	1	1	1
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Brown Strachan Associates
Consulting Engineers in Acoustics

Project: 368.17A

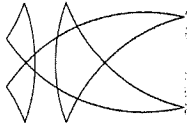August 27, 2018

GBL Architects
139 East 8th Avenue
Vancouver, BC V5T 1R8

Attention: Mr. Achim Charisius, Senior Associate

Dear Mr. Charisius:

Re: 7960 Alderbridge Way, Richmond

Appended is our report entitled "7960 Alderbridge Way - Acoustical Evaluation".

Please call if you have any questions.

Yours very truly,

BROWN STRACHAN ASSOCIATES



Andrew R. Fawcett, Eng.L., ASCT.

ARF/sb/18Aug/GBL.ttl

7960 ALDERBRIDGE WAY
ACOUSTICAL EVALUATION

Prepared for:
GBL ARCHITECTS

Andrew R. Fawcett, Eng.L., ASCT.
David W. Brown, P.Eng.
August 27, 2018

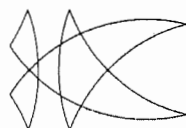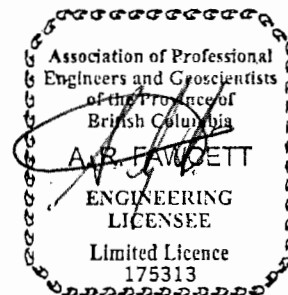

Brown Strachan Associates
Consulting Engineers in Acoustics

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- 1.0 INTRODUCTION
- 2.0 DESIGN CRITERIA
- 3.0 RECOMMENDATIONS
 - 3.1 Disclosure
 - 3.2 Exterior Design Noise Levels
 - 3.3 Facade Upgrades
 - 3.4 Ventilation & Equipment
 - 3.5 Review of Construction
- 4.0 DISCUSSION
 - 4.1 Method of Evaluation
 - 4.2 Aircraft Noise
 - 4.3 Traffic Noise
 - 4.4 Canada Line SkyTrain Noise
 - 4.5 Interior Noise
- 5.0 CONCLUSION

APPENDIX



7960 ALDERBRIDGE WAY - ACOUSTICAL EVALUATION

1.0 INTRODUCTION

Brown Strachan Associates have been retained by Alderbridge Way LP to conduct an acoustical evaluation of the residential component of the proposed mixed-use development at 7960 Alderbridge Way, Richmond (DP 2016 740262), as designed by GBL Architects Inc. on drawings issued for DP 7/25/2018 (prints appended).

The terms of reference of this report are to assess YVR aircraft, traffic and Canada Line SkyTrain noise on the proposed development and to recommend facade upgrades satisfying interior noise level design criteria specified in the City of Richmond Official Community Plan (OCP, prints appended).

2.0 DESIGN CRITERIA

The development has been evaluated with respect to the following design criteria specified in section 14.4.7.B Aircraft Noise of the City of Richmond OCP (page 14-45, appended):

"... the noise level in those portions of the dwelling units listed below shall not exceed the noise level... set out in the corresponding right-hand column... The noise level utilized is an A-weighted 24-hour equivalent (Leq) sound level and will be defined simply as noise level in decibels.

<u>Portions of Dwelling Units</u>	<u>Noise Levels (decibels)</u>
Bedrooms	35
Living, dining, recreation rooms	40
Kitchen, bathrooms, hallways and utility rooms	45

The design criteria are also referenced in OCP 3.6.3 Noise Management for Aircraft Noise Sensitive Areas, OCP 14.4.7.A Traffic/Transit Noise and 5.17.3 of the Zoning Bylaw 8500 (prints appended). The design criteria adopted by Richmond are the indoor design criteria



recommended in the Canada Mortgage and Housing Corporation (CMHC) publication entitled "Road and Rail Noise: Effects on Housing" (NHA 5156 08/86, print appended).

3.0 RECOMMENDATIONS

The following are recommendations to satisfy the OCP interior design criteria, based on the 7/25/2018 drawings, and should be referenced in the tender documents. These recommendations may be revised based on the final building design, including window and door details, etc. Where necessary, the working drawings and window & door shop drawings should be reviewed with reference to this report and the appended Schedule. Other design considerations such as structural, thermal, etc., should be reviewed by other disciplines.

Notations should be included on the construction drawings indicating that the acoustical recommendations in this report will be incorporated into the final design and construction, as concurred with or amended by the City of Richmond.

3.1 Disclosure

Restrictive Covenants are required by the City of Richmond (ref. OCP page 3-68). In addition, disclosure should be made to prospective residents that the development site is subject to noise and vibration from aircraft, traffic and Canada Line SkyTrain activity, operating day and night, which may be annoying to some individuals. The City of Richmond, YVR, Translink and SkyTrain may have specific wording satisfying their requirements.

3.2 Exterior Design Noise Levels

Aircraft noise has been evaluated based on the Noise Exposure Forecast (NEF) contours on the City of Richmond Interactive Map and the OCP Aircraft Noise Sensitive Development Map (appended). At the most exposed location, the recommended exterior design level for aircraft noise is NEF 35, or $Leq(24) = 67$ dB (see 4.2 Aircraft Noise, below).

The recommended exterior design level for traffic noise is $Leq(24) = 69$ dB at the most exposed location (see 4.3 Traffic Noise, below).



The recommended exterior design level for SkyTrains on the Canada Line is $Leq(24) = 59$ dB at the most exposed location (see 4.4 Canada Line SkyTrain Noise, below).

3.3 Facade Upgrades

Recommended exterior wall, window and door upgrades are indicated on the appended "7960 Alderbridge Way - Facade Upgrade Schedule" (Schedule).

The window and door supplier(s) should provide fenestration test reports to ASTM E90 for their proposed assemblies, i.e. glazing including window frame and door assemblies, confirming specified OITC ratings are met, particularly assemblies meeting specified OITC 32 & 35 ratings. At substantial completion, the supplier(s) should confirm in writing that their rated assemblies, as installed on site, are equivalent to their tested assemblies and conform fully with this report and appended Schedule.

Wind loading, safety, structural, thermal requirements, visual specifications, etc., should be checked for all windows and doors, and may dictate thicker glazing than the appended Schedule, e.g. Code 4.3.6 & 9.6. Glazing may require strengthened glass to satisfy Code requirements and may have a size limitation to satisfy structural requirements, manufacturer's weight requirements, visual specifications, etc., i.e. mullions may be required. Good quality airtight weatherstrip should be specified for all exterior doors and windows. Windows should satisfy the A3 air-tightness standard in CSA A440, as referenced in the Code, e.g. 5.10.2 & 9.7.4.

Sound transmission through the exterior facade has been evaluated based on the indicated window and door areas and conventional exterior facade construction with finishes comparable to heavy pre-manufactured (Terracotta) panels, metal or spandrel panels and painted concrete (prints appended). Rooms requiring exterior wall upgrades are indicated on the appended Schedule.



3.4 Ventilation & Equipment

Sound transmission through the exterior facade considers windows and doors in the closed position, per Richmond's OCP (page 3-70, note 3). Ventilation details, thermal requirements, etc., should be designed by a mechanical consultant (OCP page 3-70, note 4). Equipment should be selected to satisfy Code acoustical requirements (e.g. Code 6.2.1.1 & 9.32.3.5), Richmond's standards for air conditioning systems and their alternatives and the Richmond Noise By-law #8856.

Where make-up air is required for ventilation, natural air leakage of the building envelope, corridor pressurization, etc., may be a consideration (design by mechanical). If make-up air ducts from the exterior are also required to satisfy ventilation requirements, the ducts must provide a minimum noise reduction of 50 dB for exterior noise, e.g. nominally 6ft. of 4" dia. acoustically lined ductwork or lined flexible connector. Proposed ductwork details penetrating the facade should be reviewed by BSA. Where Code related issues govern ductwork in areas such as bathrooms and kitchens, Code requirements should take precedence.

3.5 Review of Construction

The analyses in this report provide a detailed evaluation of aircraft, traffic and SkyTrain sound transmission through the exterior facade satisfying the OCP interior design criteria.

Coordination of Code requirements, acoustical recommendations, field reviews, letters of assurance, construction or occupancy certification requirements, etc., should be provided by the Registered Professional of Record. See appended Acoustical Evaluation Reports - Background Information.

4.0 DISCUSSION

4.1 Method of Evaluation

The method of evaluation used in this report gives detailed consideration of sound transmission referencing NRC's IBANA-Calc analysis software and related validation studies (see 4.5 Interior Noise, below). To determine facade upgrades necessary to satisfy the OCP design criteria, evaluation of the proposed buildings is based on Leq(24) aircraft, traffic and SkyTrain



sound transmission, windows and doors in the closed position, rooms with the greatest exposure to noise and the largest glazing and facade areas with respect to floor area.

4.2 Aircraft Noise

The development site is located in Area 2, defined as a High Aircraft Noise Area, with NEF contours of approximately NEF 30 to NEF 40 (prints appended).

As required by the City of Richmond Policy Planning Department, aircraft noise has been evaluated based on the NEF contours. The NEF contours are the Canadian noise metric used for airport noise assessment, based on peak planning day aircraft activity, i.e. the 95th percentile day in terms of volume or the average of the seven busiest days in each of the three busiest months, and cannot be directly measured (ref. YVR noise reports). Referencing the interpolation procedure in CMHC's "New Housing and Airport Noise" (print appended), the development site has been evaluated based on NEF 33-35 aircraft noise.

The OCP design criteria in 3.6.3 and 14.4.7 are based on $Leq(24)$ levels (see 2.0 Design Criteria, above). At the most exposed location, the recommended exterior design level for aircraft noise is $Leq(24) = 67$ dB, from $Leq(24) = NEF + 32$ (ref. IBANA-Calc, appended).

4.3 Traffic Noise

Future traffic noise exposure has been evaluated based on year 2032 forecasted a.m. + p.m. peak hour traffic volume data in the ISL Engineering and Land Services Traffic Impact Assessment Report (September 2017, prints appended). Peak hour data are considered equivalent to 13% of the daily total traffic (Richmond traffic data appended). To account for possible growth beyond 2032, and daily or seasonal variation, the ISL volumes have been increased by 10%. All roads in this area have a posted speed limit of 50 km/h.

Based on the ISL traffic forecasts, site observations and previous studies in the area, the following design volumes have been used to evaluate future traffic noise at the proposed development site:

	Vehicles per day	% Heavy vehicles
Alderbridge (E. Bnd/W. Bnd):	17,500/17,900	3
No. 3 Road (N.Bnd/S. Bnd):	15,600/15,700	3
New North-South Road:	6,000	3
New East-West Road:	6,500	3

Future traffic noise levels are derived from statistical tables, developed by NRC, in CMHC's "Road and Rail Noise: Effects on Housing". These tables have been used on numerous housing site assessments throughout Metro Vancouver, including recent studies in this area of Richmond, with good correlation between measured and calculated levels (typically +/-1 dB for normal traffic conditions). At the most exposed location, the recommended CMHC design level for traffic noise is $Leq(24) = 69$ dB (printouts appended).

To check that CMHC traffic noise calculations correlate with existing traffic flow in this area, measurements have been conducted at a test location approximately 6m west of the No. 3 Road curb and 64m south of the existing north property line. The average measured $Leq = 69$ dBA (Table 2 and Graph: SUMM, appended), including SkyTrain movements and aircraft takeoffs to the east. For the observed road traffic activity only, the CMHC calculated equivalent traffic noise level is $Leq(24) = 68$ dB (printout: Predict, appended).

4.4 Canada Line SkyTrain Noise

The elevated Canada Line guideway is on the east side of No. 3 Road and the closest buildings (D and F) are nominally 35m west of the guideway centerline (print appended). The Lansdowne Skytrain Station is to the south. For this section of the Canada Line, TransLink data indicate there are about 150 scheduled SkyTrain movements per weekday (each direction) or about 300 total movements per day (prints appended). For design, a total volume of 400 SkyTrain movements per day has been used.

Reference Canada Line SkyTrain measurements conducted north of the Marine Drive Station, near the Cambie Street portal, nominally 12m east of the guideway centerline and 2m above the

guideway parapet, indicate an average passby level of $Leq(10s) = 75$ dBA for northbound trains accelerating away from the station and 69 dBA for slower southbound trains approaching the station (Figure 1, appended). The measured data near the Marine Drive Station are considered representative of SkyTrain noise at the development site, i.e. near Lansdowne Station. Other reference SkyTrain data indicate a full speed passby level of $Leq(10s) = 79$ dBA at 8m (Figure 2, appended).

For design, SkyTrain noise has been evaluated based on the reference passby level of $Leq(10s) = 79$ dBA (each direction), which allows for some variation in SkyTrain noise at this site, e.g. maintenance cycle, etc. Based on 79 dBA and a total volume of 400 movements per day, the design SkyTrain noise level is $Leq(24) = 59$ dB at 35m.

4.5 Interior Noise

The suites have been evaluated referencing NRC's IBANA-Calc analysis software, related validation studies, IBANA aircraft, statistical traffic and SkyTrain source data, normalized to the design levels, and facade transmission loss data. Detailed calculations of sound transmission through the exterior facade are summarized in Tables 1A - 1H and include the absorption typical of furnished rooms, e.g. bed / furniture, carpet, etc. (printouts appended). These tables show the sound level transmitted by each sound path, such as windows, doors & exterior walls, and compare the total sound to the criterion.

Sound levels in suites can vary relative to calculated levels due to normal variation in transportation activity, maintenance cycle of SkyTrain, on-site performance of facade components, flanking sound transmission, room absorption, etc.

5.0 CONCLUSION

Provided the recommendations in this report are implemented, our evaluation indicates the design of the residential component of the proposed mixed-use development at 7960 Alderbridge Way satisfies the City of Richmond OCP interior design criteria for aircraft, traffic and SkyTrain noise.



APPENDIX



Brown Strachan Associates
Consulting Engineers in Acoustics

7960 ALDERBRIDGE WAY - FAÇADE UPGRADE SCHEDULE

This schedule forms part of the Brown Strachan Associates (BSA) acoustical report dated 27 August 2018 and should be read with the full report. It is the supplier's responsibility to ensure that the rated windows and doors, as installed on site, fully conform to this schedule and report (confirm in writing, when requested).

Unless otherwise indicated in table below, provide all residential windows and glazed doors rated OITC 29. Specified façade upgrades are applicable to all exterior walls, doors and windows in a given room.

Building	Level	Suite Type	Room	Window & Door	Exterior Wall
A, B & C	3 to 14	A1	Bed. #2 (two ext. walls)	OITC 32	
		ABC4	Bed. #2 (angled façade)	OITC 32	
D	3 to 14	D2 & D4	Bedrooms (both)	OITC 32	2x GWB
		D3	Bedroom	OITC 32	
E	3 to 13	E2	N.W Bed. (two ext. walls)	OITC 35	2x GWB
		E3	Bedroom	OITC 35	
		E4, E5, E7 & E12	Bedroom	OITC 32	
		E8	Master Bedroom	OITC 32	
	14	E2	N.W Bed. (two ext. walls)	OITC 35	2x GWB
		E3 & E7	Bedroom	OITC 35	
		E8	Master Bedroom	OITC 35	
F	3 to 6	AFF2	Bedroom	OITC 32	
		AFF3 & 5	Master Bedroom	OITC 35	2x GWB
			Bedroom #2	OITC 32	
		AFF4	Bedrooms (both) & L/R	OITC 32	
		AFF6	Master Bedroom	OITC 32	
			Bedroom #2	OITC 35	2x GWB
	AFF9 & 10	Bedroom	OITC 32		
	F7, 8, 29, 30 & 31	Bedroom	OITC 32		
	7 to 13	F2, 6, 7 & 8	Bedroom	OITC 32	
		F3 & F14	Master Bedroom	OITC 35	2x GWB
			Bed. #2 (north)	OITC 32	
		F5 & F16	Bedrooms (both) & L/R	OITC 32	
		F15, 17, 18, 19 & 20	Bedroom	OITC 32	
		F21	Master Bedroom & L/R	OITC 32	
		F25	Master Bedroom	OITC 35	2x GWB
			L/R	OITC 32	
	14	F2	Bedroom	OITC 35	
		F3	Master Bedroom	OITC 35	2x GWB
			Bed. #2 (north)	OITC 35	
		F5	Bedrooms (both)	OITC 35	
L/R			OITC 32		
F6, 7 & 8		Bedroom	OITC 35		
	F25	Master Bedroom	OITC 35	2x GWB	
		L/R	OITC 32		



7960 ALDERBRIDGE WAY - FAÇADE UPGRADE SCHEDULE (Cont'd)

Legend (including sliding and swing exterior doors):

- OITC 35: Stringent design requirement possibly requiring triple glazing and/or thick laminated glazing.
OITC 32: Typically laminated glazing, e.g. 6Lam-13-6 thermal glazing.
OITC 29: Typically conventional highrise thermal glazing, e.g. 6-13-4 or 6-13-6.
2x GWB: 2x interior GWB applied directly to exterior wall framing (exclude closets).

For all windows and doors, provide fenestration test reports to ASTM E90, as tested on representative assemblies. For all glazing in windows and doors, check wind loading, safety, structural requirements, visual specifications, etc. If necessary, provide thicker glazing than recommended above (subject to acoustical review by BSA). Glazing may require strengthened glass to satisfy Code requirements and may have size limitation to satisfy structural requirements, visual specifications, etc. (i.e. mullions may be required). Provide good quality airtight weatherstrip for all exterior doors and windows. Provide windows satisfying A3 air-tightness standard of CSA A440, as referenced in Code. See Acoustical Evaluation Reports - Background Information (appended to report).

Schedule based on drawings issued for DP 07/25/2018, received 13 August 2018.



July 24, 2018

City of Richmond
Attn: Ms. Janet Digby

Senior Planner / Urban Design
6911 No. 3 Road
Richmond, BC V6Y 2C1

Dear Janet,

CPTED 7960 Alderbridge Way

Natural Surveillance

1. Blind Corners
 - a) All pathways avoid sudden grade changes that would reduce sightlines.
 - b) In parking areas with blind corners, mirrors will be installed to allow users to see around the corner.
2. Siting and Building Layout
 - a) Residential entrances are located on prominent locations and have clear sight to multiple adjacent roadways/pathways.
 - b) Balconies are situated in the centre of the residential units to protect privacy. They are either separated by a vertical building element or a privacy screen.
 - c) The indoor amenities are located on multiple levels and open to the outdoor amenity spaces.
 - d) Visitor bicycle storage facilities are located around the building and close to lobbies for ease of access.
 - e) The commercial lobby is located in closest proximity to the Canada Line station with high visibility to No 3 Road.
 - f) Office and Retail spaces are clearly visible from No. 3 Road, New E-W Road, New N-S Road, Alderbridge Way and the public plaza.
 - g) End-of-trip facilities are located near the main parkade entrance next to the office elevator core.

GBL ARCHITECTS

139 EAST 8TH AVENUE
VANCOUVER, CANADA V6J 2C9
T 604 736 1156 INFO@GBLARCHITECTS.COM
F 604 731 5279 GBLARCHITECTS.COM



EMERGENT ARCHITECTURE



- h) Multiple exits are visible from all parking areas, as well as clear long clear sightlines across the parkades.
 - i) All parking levels will provide adequate and uniform levels of lighting.
 - j) Parking walls will be painted white or bright colours to reflect light
 - k) A signage program has been developed for the project, clearly identifying and colour-coding access to elevator cores, stairs, retail and office tenants as well as residential lobbies
 - l) Vestibules will have clear glazing.
 - m) Residential parking will be separated from public parking and accessed through gates with access control.
 - n) Access to the parkade is limited to two designated monitored entrances
 - o) The public plaza, and courtyard amenity spaces are easily observed by people from a multitude number of windows and locations.
3. Entrances
- a) Main entrances will have clear glazing to allow the viewer to see into them before entering.
 - b) Main entrances can be seen from the street and neighbours.
 - c) All entrances will provide adequate levels of lighting.
4. Landscaping
- a) Trees located on level 1 will have raise crowns to avoid a continuous barrier.
 - b) Low groundcover will be used along pedestrian pathways.
 - c) No landscaping will impede or conceal the building entrance from the street.
5. Lighting
- a) Inset and modulated spaces on the buildings façade, along access/egress routes, will be well lit.
 - b) All pedestrian pathways will include pedestrian scale lighting and direct light.
 - c) Areas not intended to be used at night will avoid lighting.
 - d) All lighting will be located away from walls to avoid climbing opportunities.

Territoriality

1. Public spaces at the amenity levels are separated through the use of landscaping and pavement treatments

2. Large areas, such as the outdoor courtyards, are separated into smaller areas through the use of landscaping, pavement treatments, and pedestrian walkways.
3. All public spaces have clear access and casual surveillance from adjacent premises and uses.
4. All public spaces avoid dead and ambiguous space.
5. Long blank facades are avoided to limit the sense of isolation.

Target Hardening

1. Full astragals will be used on all common exterior doors leading into the building or underground parkade.
2. Parkade gates will have narrowly spaced bars to prevent tampering.

Sincerely,
GBL Architects Inc.

Achim Charisius, Architect AIBC

gbl

EMERGENT ARCHITECTURE



No. DP 16-740262

To the Holder: 0989705 B.C. LTD.
Property Address: 7960 ALDERBRIDGE WAY AND 5333 & 5411 NO. 3 ROAD
Address: 200-1778 WEST 2ND AVENUE
VANCOUVER, BC V6J 1H6

1. This Development Permit is issued subject to compliance with all of the Bylaws of the City applicable thereto, except as specifically varied or supplemented by this Permit.
2. This Development Permit applies to and only to those lands shown cross-hatched on the attached Schedule "A" and any and all buildings, structures and other development thereon.
3. Subject to Section 692 of the Local Government Act, R.S.B.C.: buildings and structures; off-street parking and loading facilities; roads and parking areas; and landscaping and screening shall be constructed generally in accordance with Plans #1 to #80 attached hereto.
4. Sanitary sewers, water, drainage, highways, street lighting, underground wiring, and sidewalks, shall be provided as required.
5. As a condition of the issuance of this Permit, the City is holding the security in the amount of \$3,103,570.40 to ensure that development is carried out in accordance with the terms and conditions of this Permit. Should any interest be earned upon the security, it shall accrue to the Holder if the security is returned. The condition of the posting of the security is that should the Holder fail to carry out the development hereby authorized, according to the terms and conditions of this Permit within the time provided, the City may use the security to carry out the work by its servants, agents or contractors, and any surplus shall be paid over to the Holder. Should the Holder carry out the development permitted by this permit within the time set out herein, the security shall be returned to the Holder. The City may retain the security for up to one year after inspection of the completed landscaping in order to ensure that plant material has survived.
6. If the Holder does not commence the construction permitted by this Permit within 24 months of the date of this Permit, this Permit shall lapse and the security shall be returned in full.

Development Permit

No. DP 16-740262

To the Holder: 0989705 B.C. LTD.
Property Address: 7960 ALDERBRIDGE WAY AND 5333 & 5411 NO. 3 ROAD
Address: 200-1778 WEST 2ND AVENUE
VANCOUVER, BC V6J 1H6

7. The land described herein shall be developed generally in accordance with the terms and conditions and provisions of this Permit and any plans and specifications attached to this Permit which shall form a part hereof.

This Permit is not a Building Permit.

AUTHORIZING RESOLUTION NO.
DAY OF



ISSUED BY THE COUNCIL THE

DELIVERED THIS DAY OF

MAYOR



City of Richmond

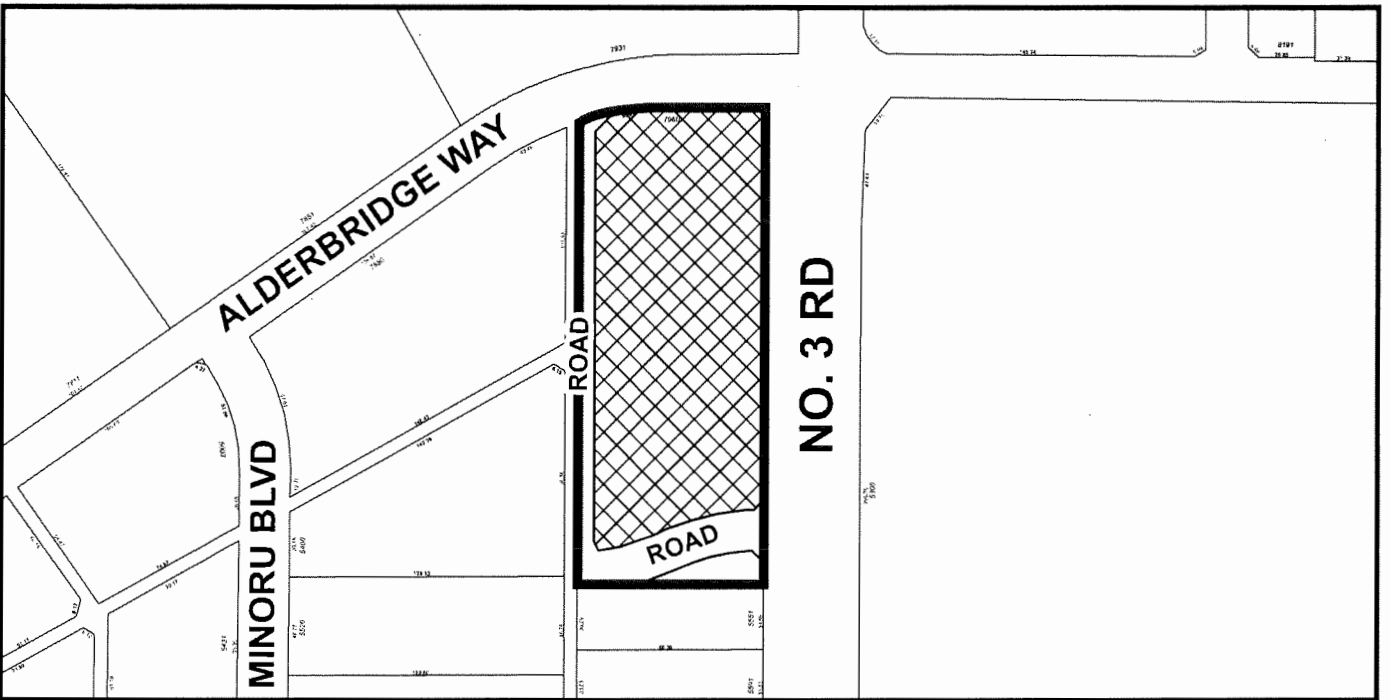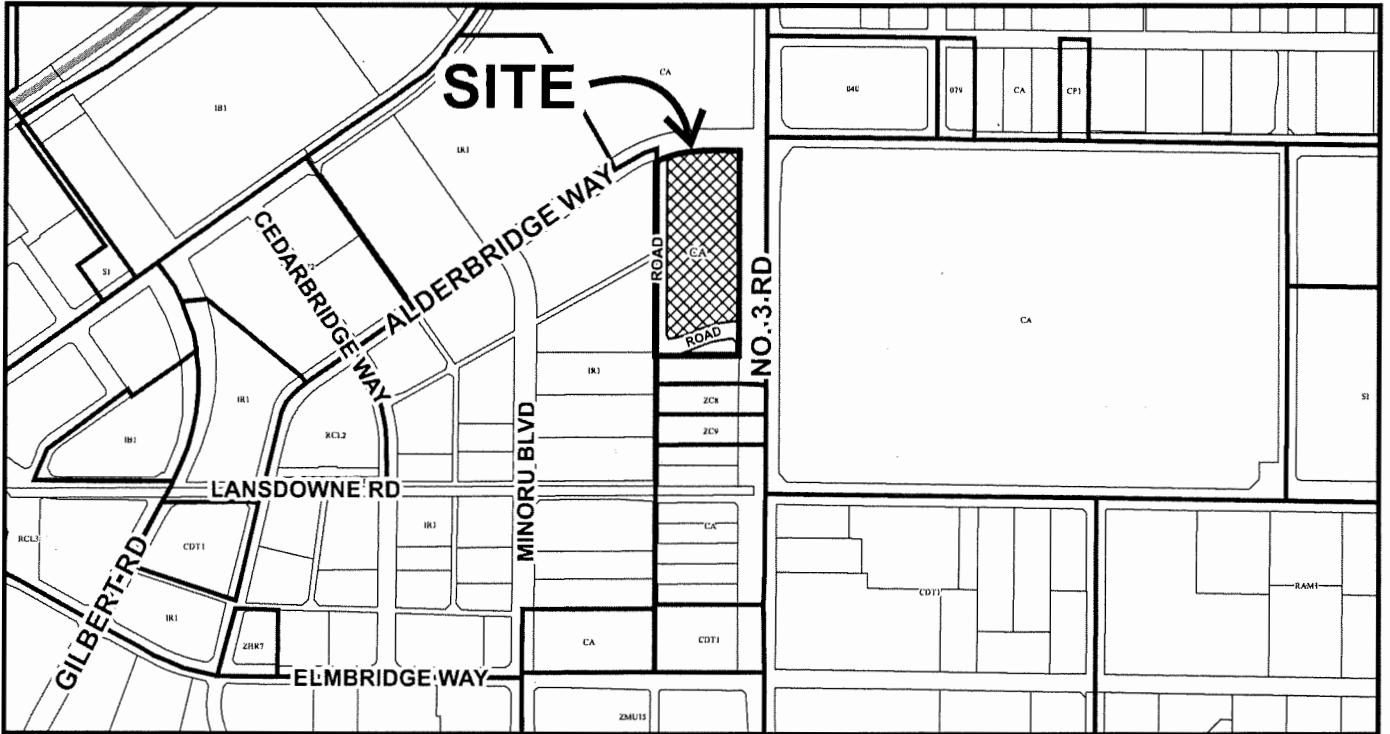


DP 16-740262 SCHEDULE "A"

Original Date: 08/18/16

Revision Date: 10/03/18

Note: Dimensions are in METRES

REVISIONS	DATE	DESCRIPTION	CONTRACTOR/ISSUED
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WAY

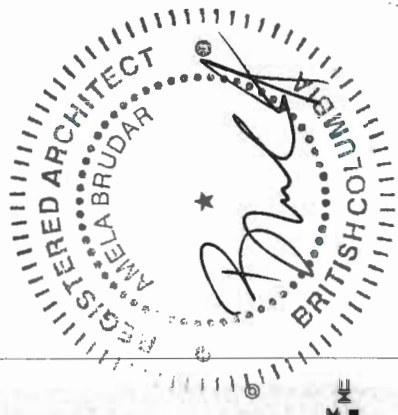
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A1.02

DP 16-740262 #1



EXISTING PROPERTY LINE

PROPERTY LINE
3m SETBACK

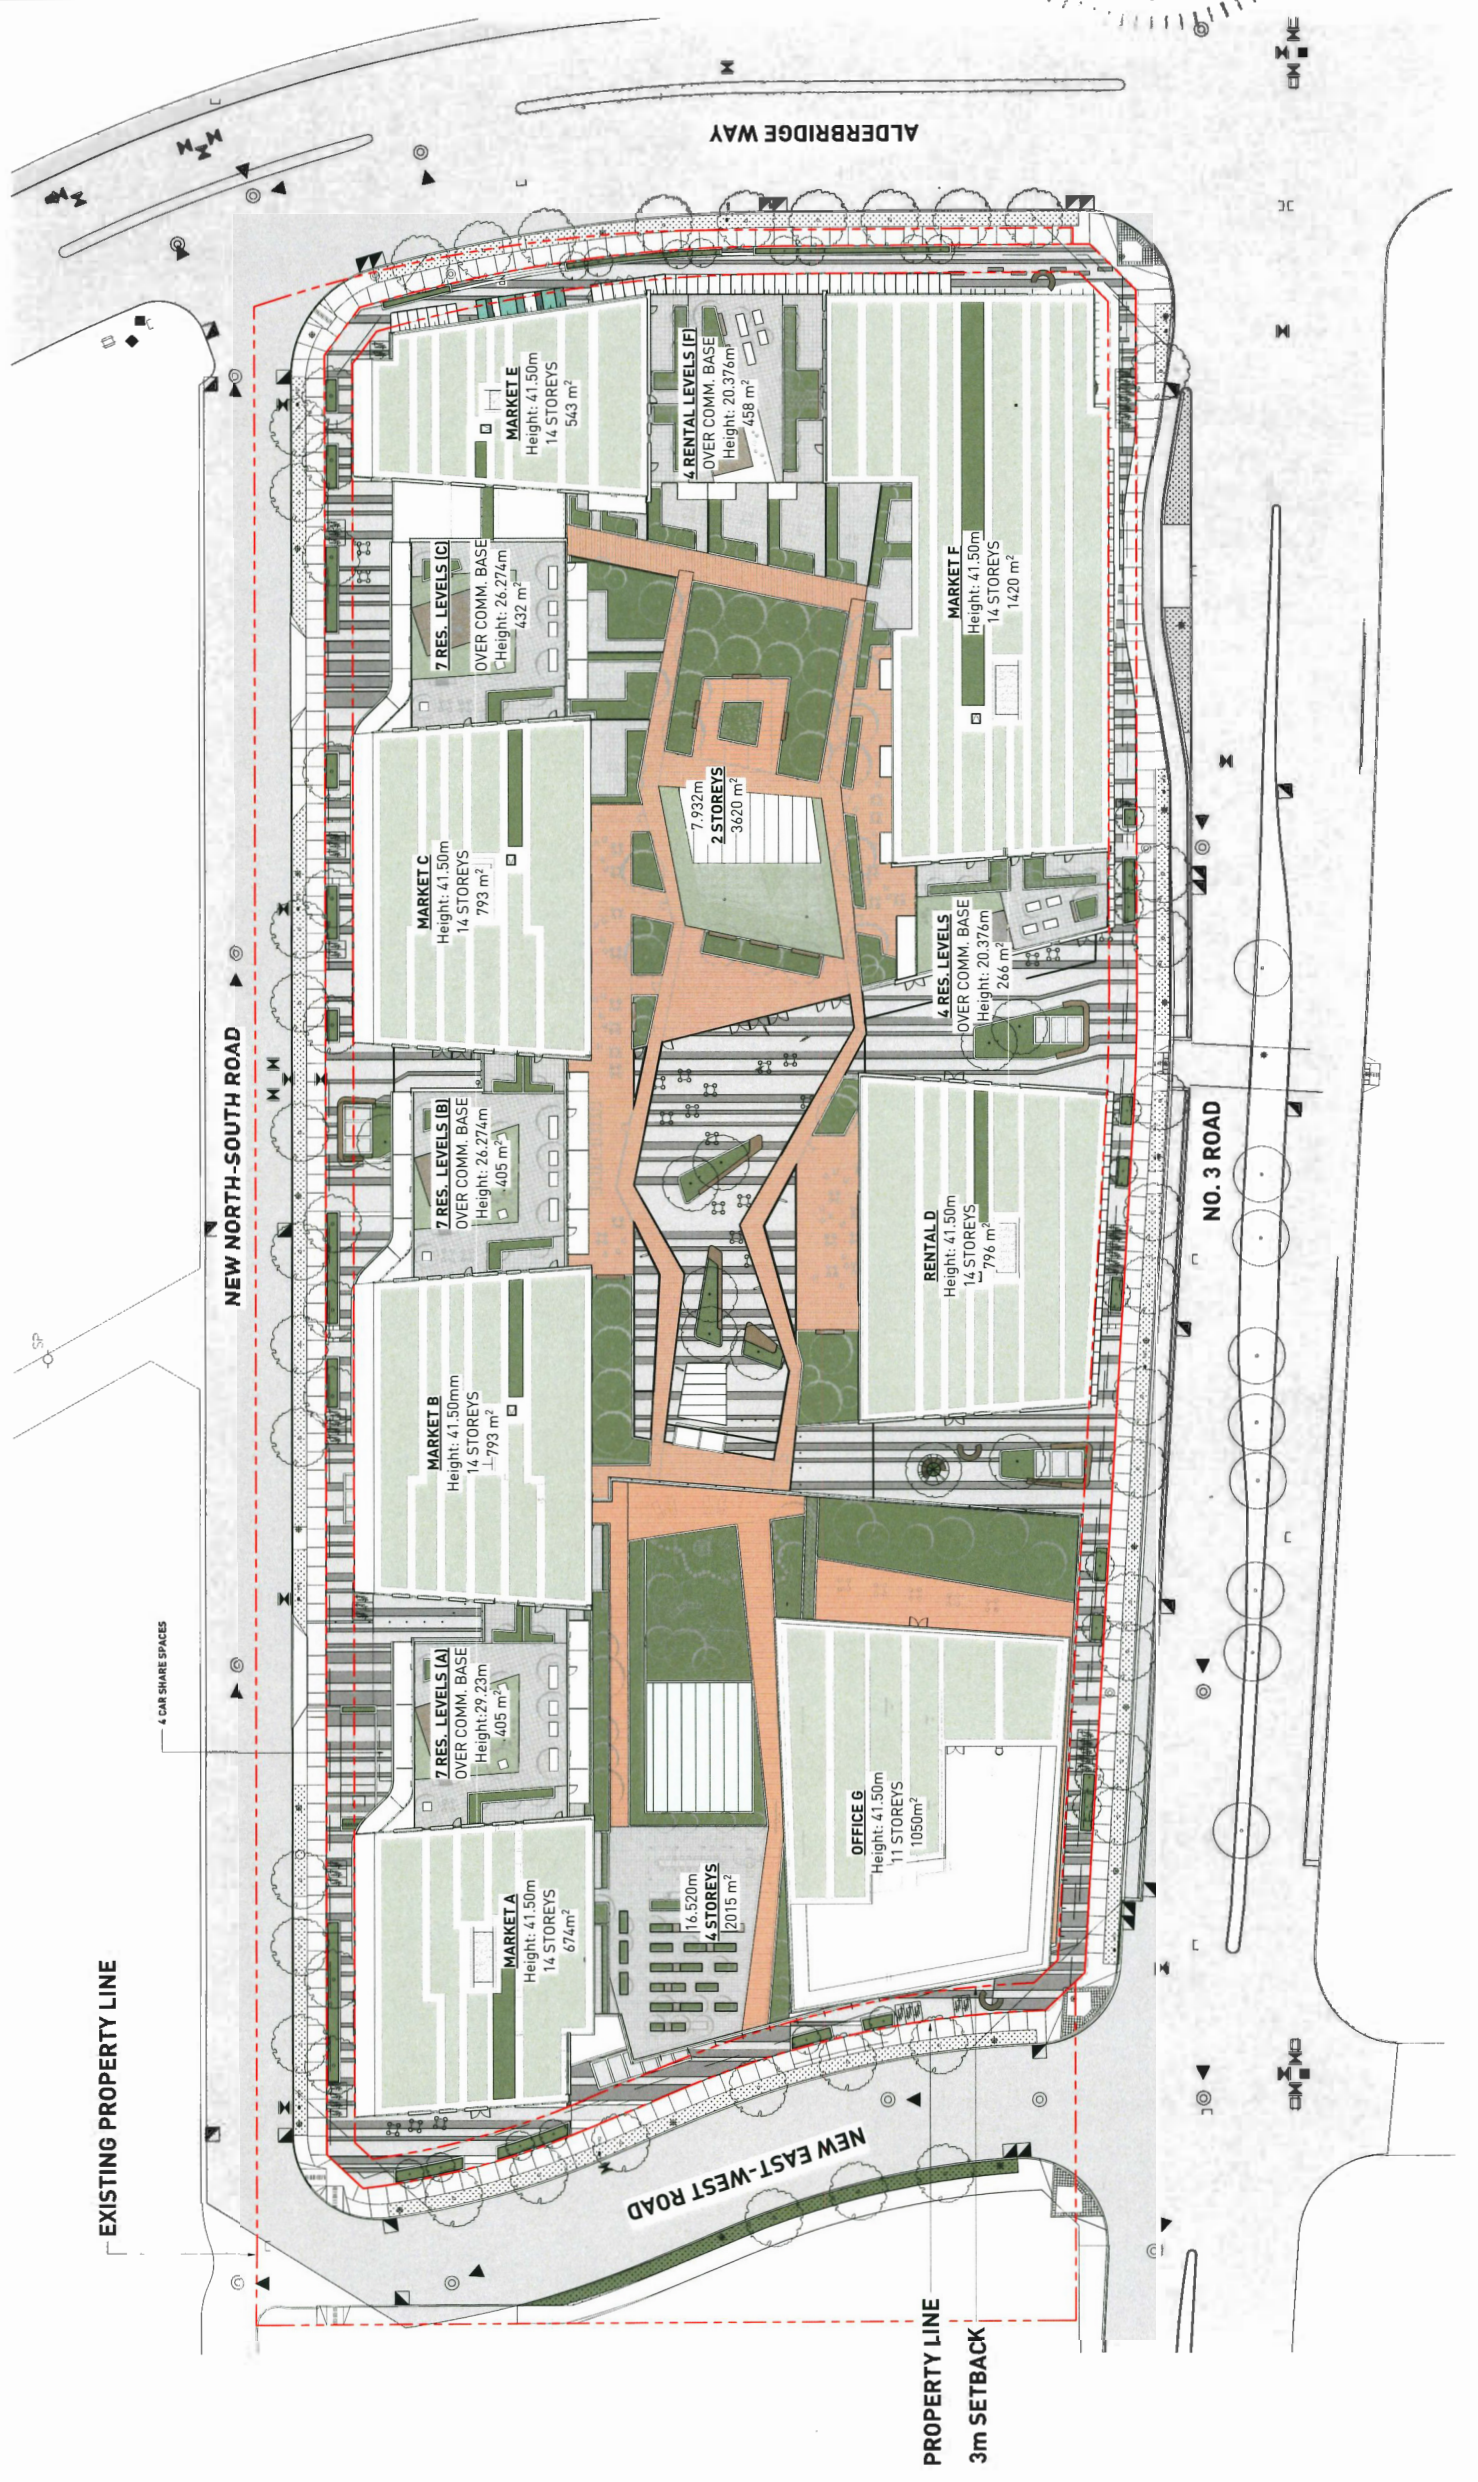

REVISIONS	DATE	DESCRIPTION
01	10/20/2018	ISSUED FOR CP



7960 ALDERBRIDGE WAY


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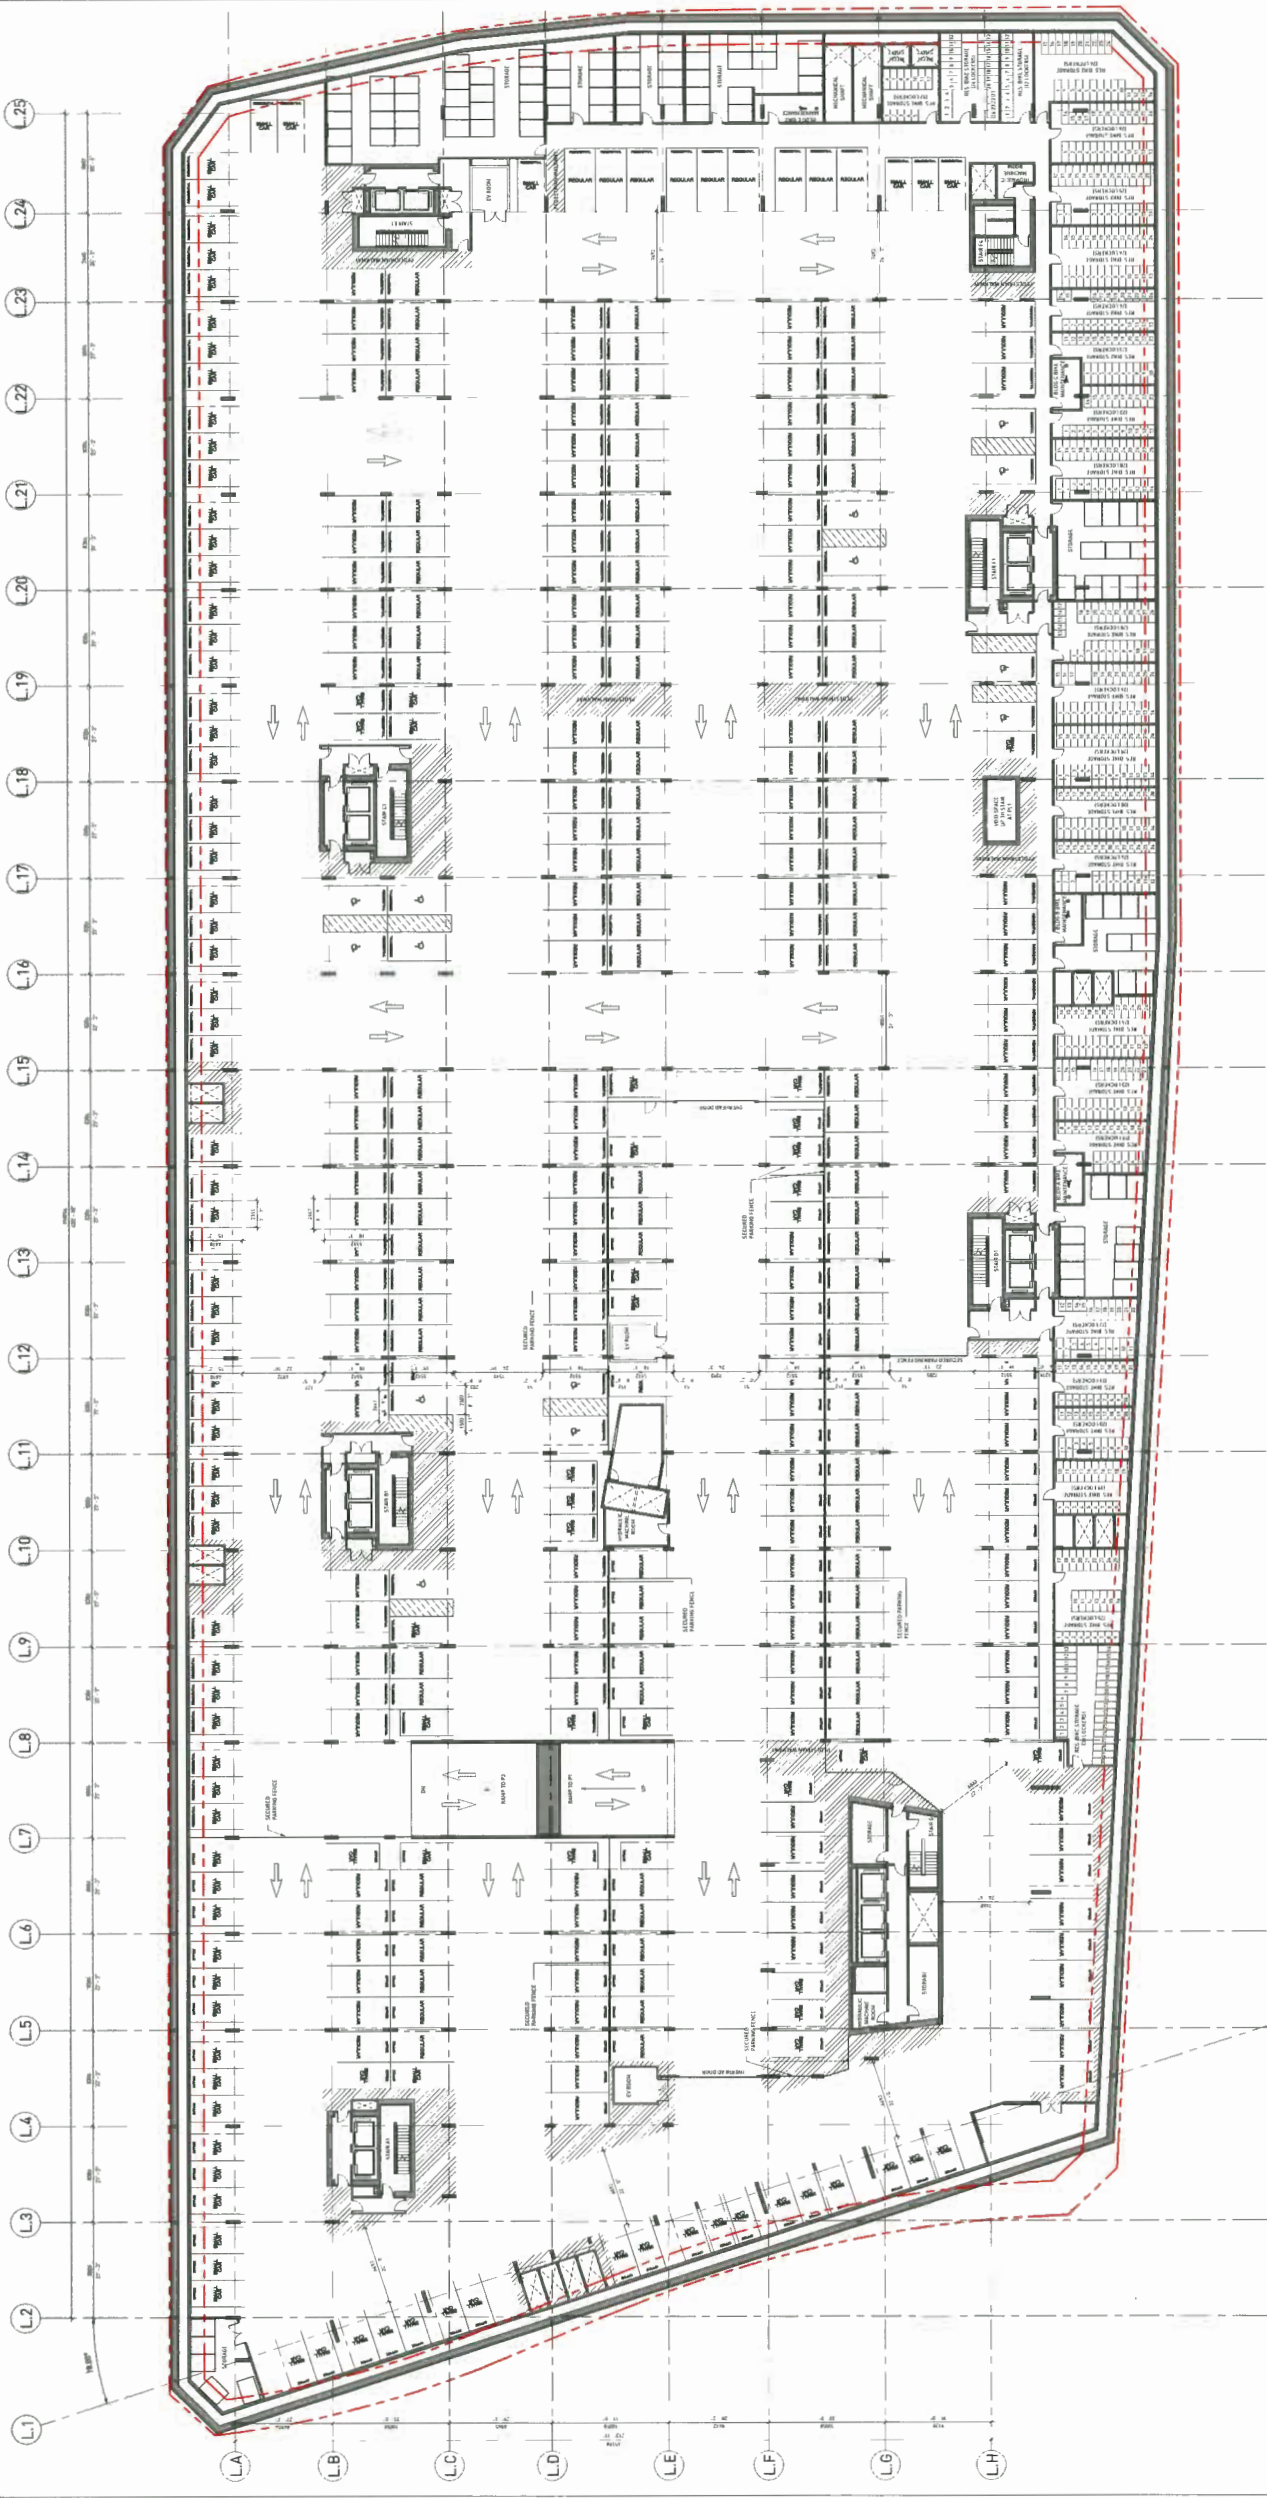
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DP 16-740262 #2





DP 16-740262 #3

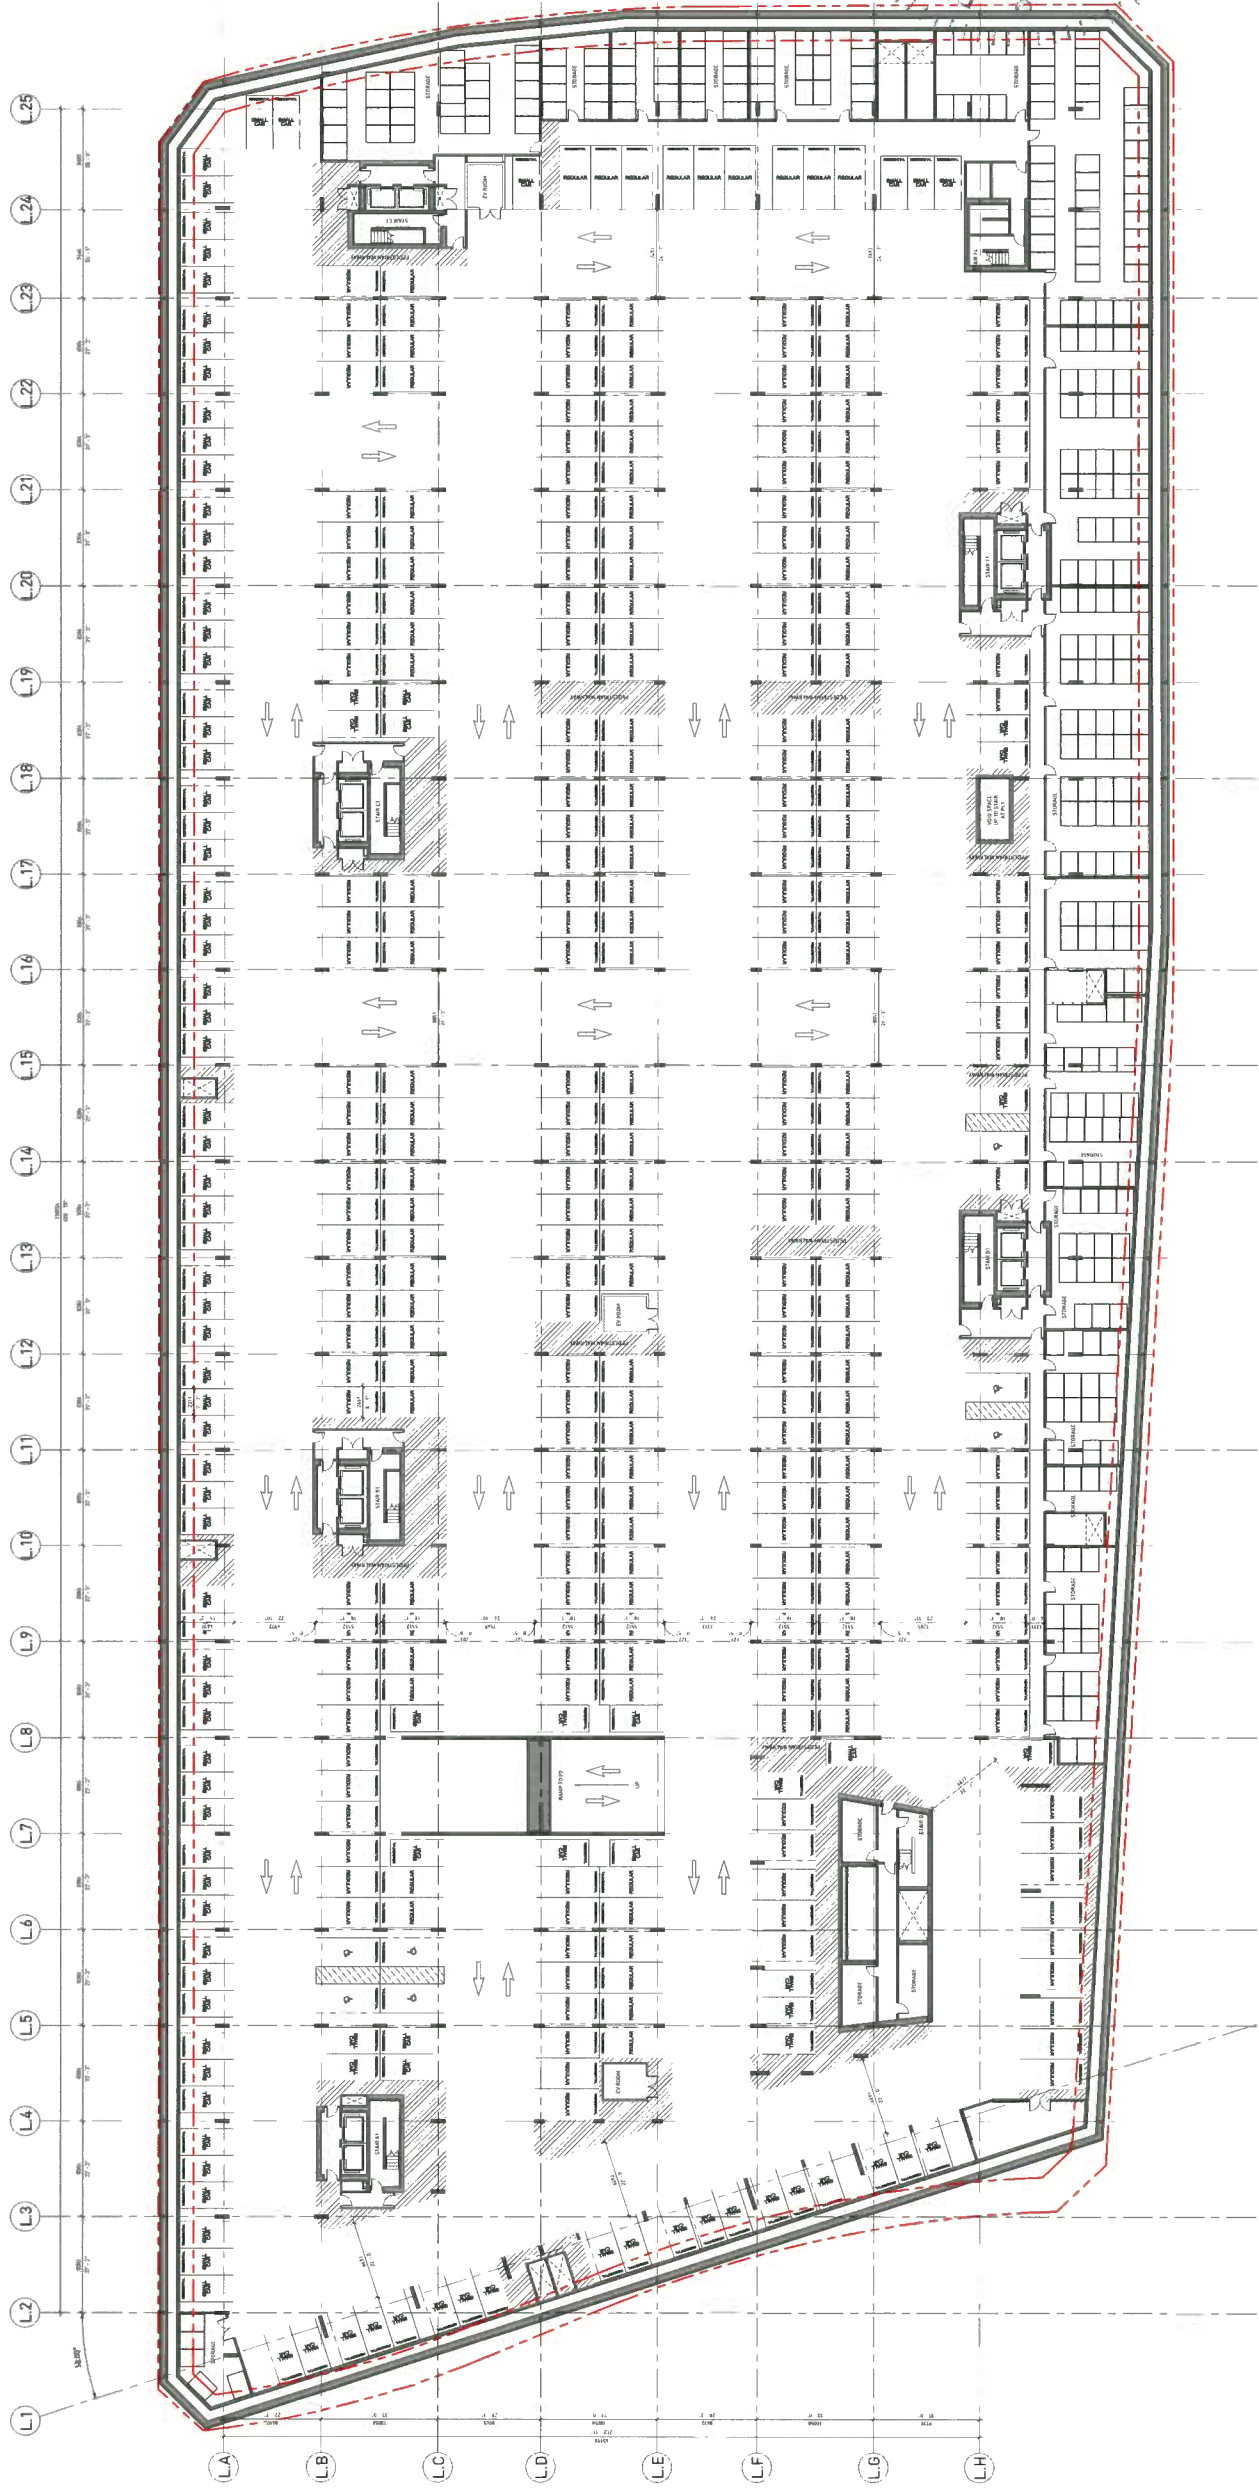

REVISIONS	DATE	DESCRIPTION	ISSUED FOR
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7960 ALDERBRIDGE
WAY
DEVELOPMENT PERMIT

LEVEL PL-2 PLAN

DATE: 10/09/2018
DRAWN BY: Amela Brudar
CHECKED BY: 11/18
JOB NUMBER: 17020

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REVISIONS	DATE	DESCRIPTION	DESIGNED BY
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7960 ALDERBRIDGE
 WAY


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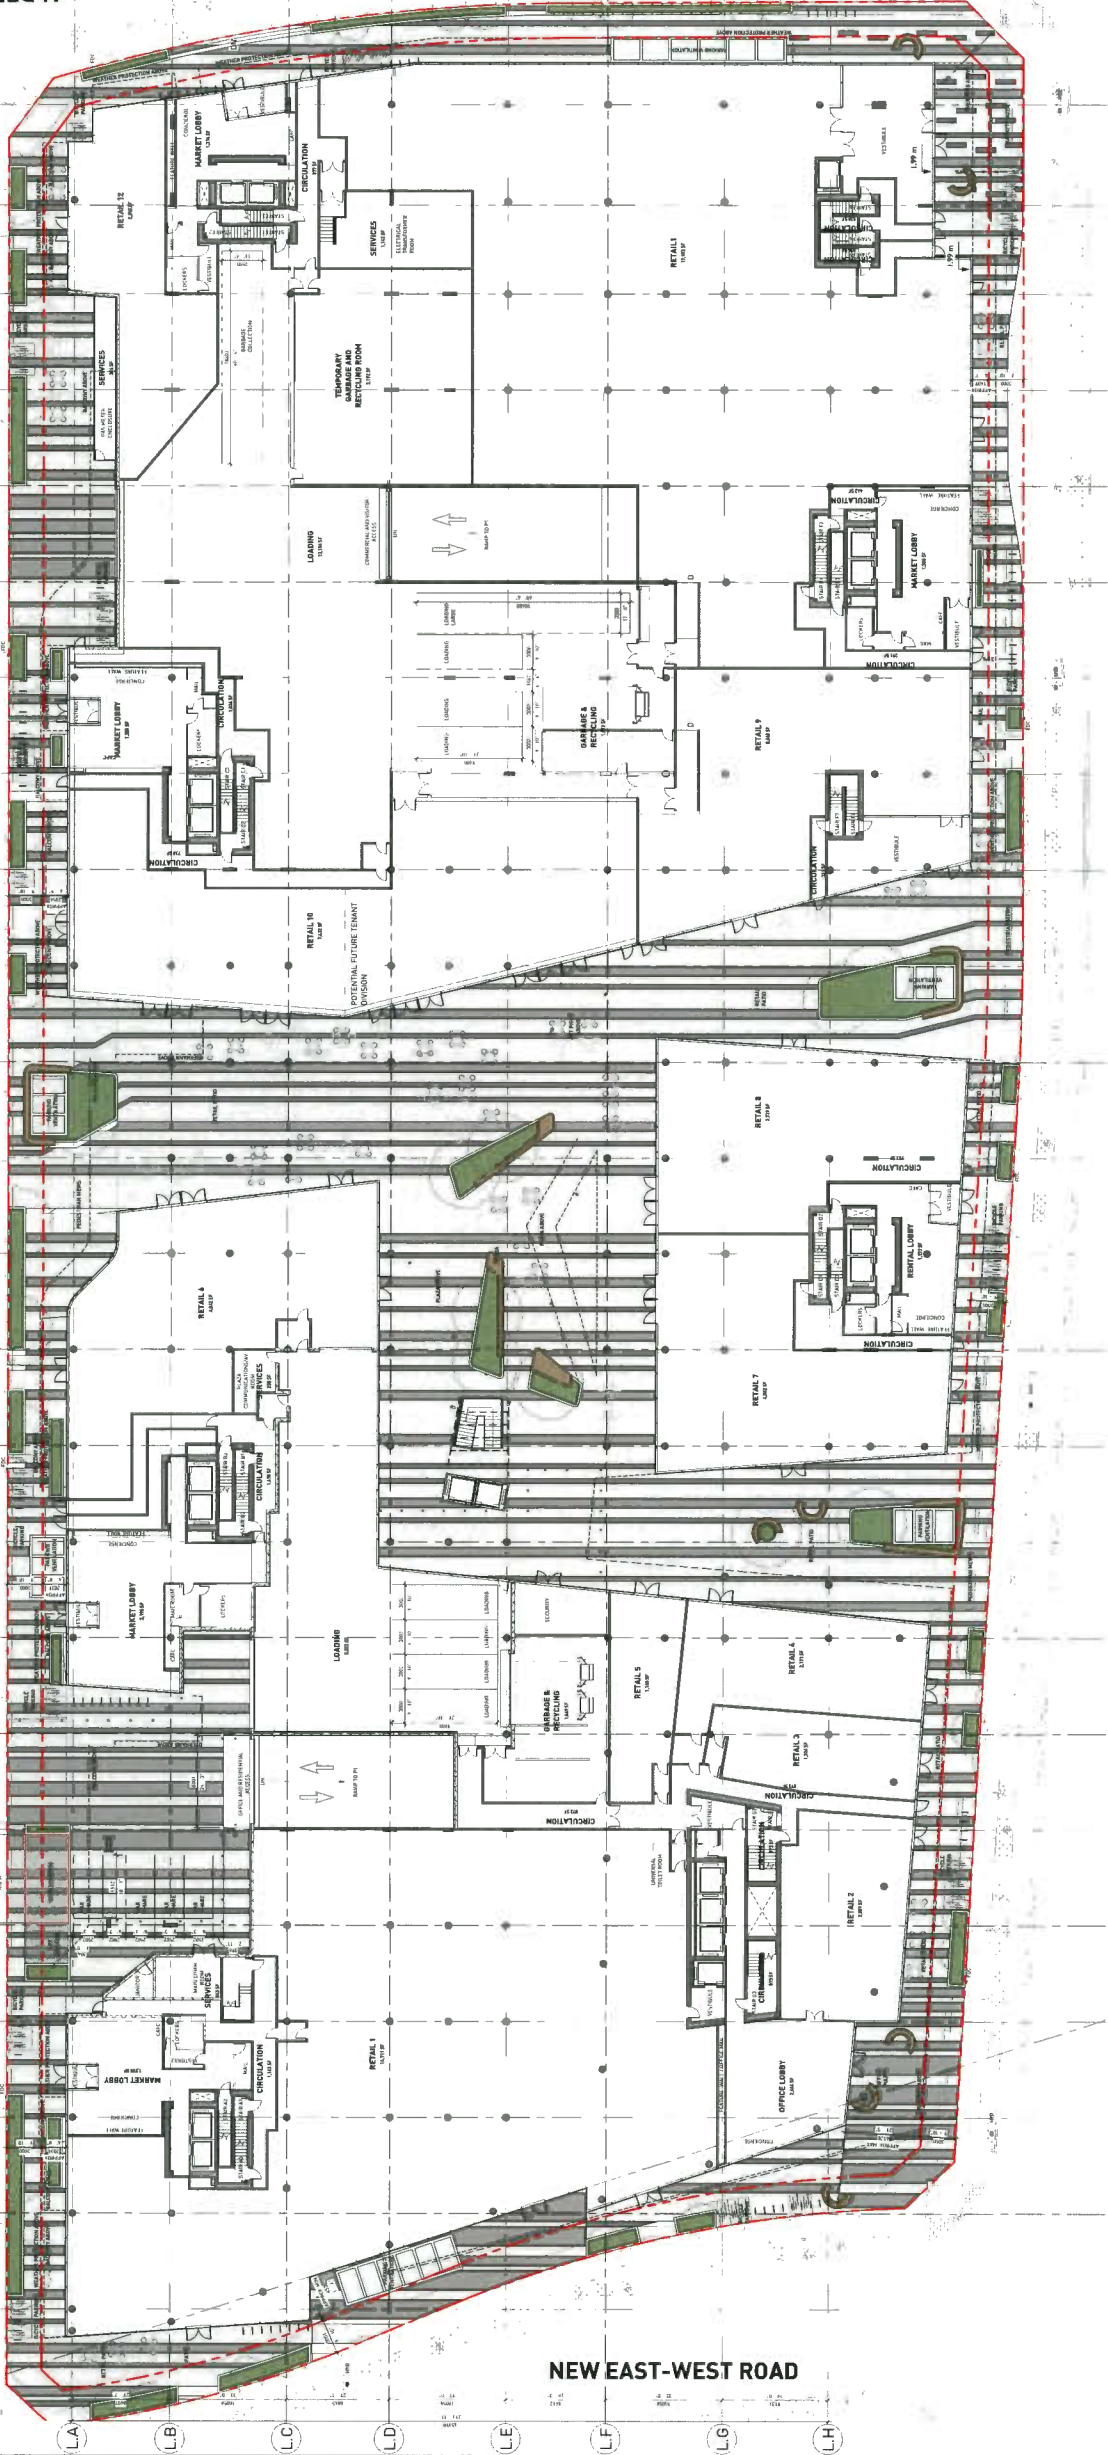
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DP 16-740262 #6

ALDERBRIDGE WAY

L1 L2 L3 L4 L5 L6 L7 L8 L9 L10 L11 L12 L13 L14 L15 L16 L17 L18 L19 L20 L21 L22 L23 L24 L25
 NEW NORTH-SOUTH ROAD



NO. 3 ROAD

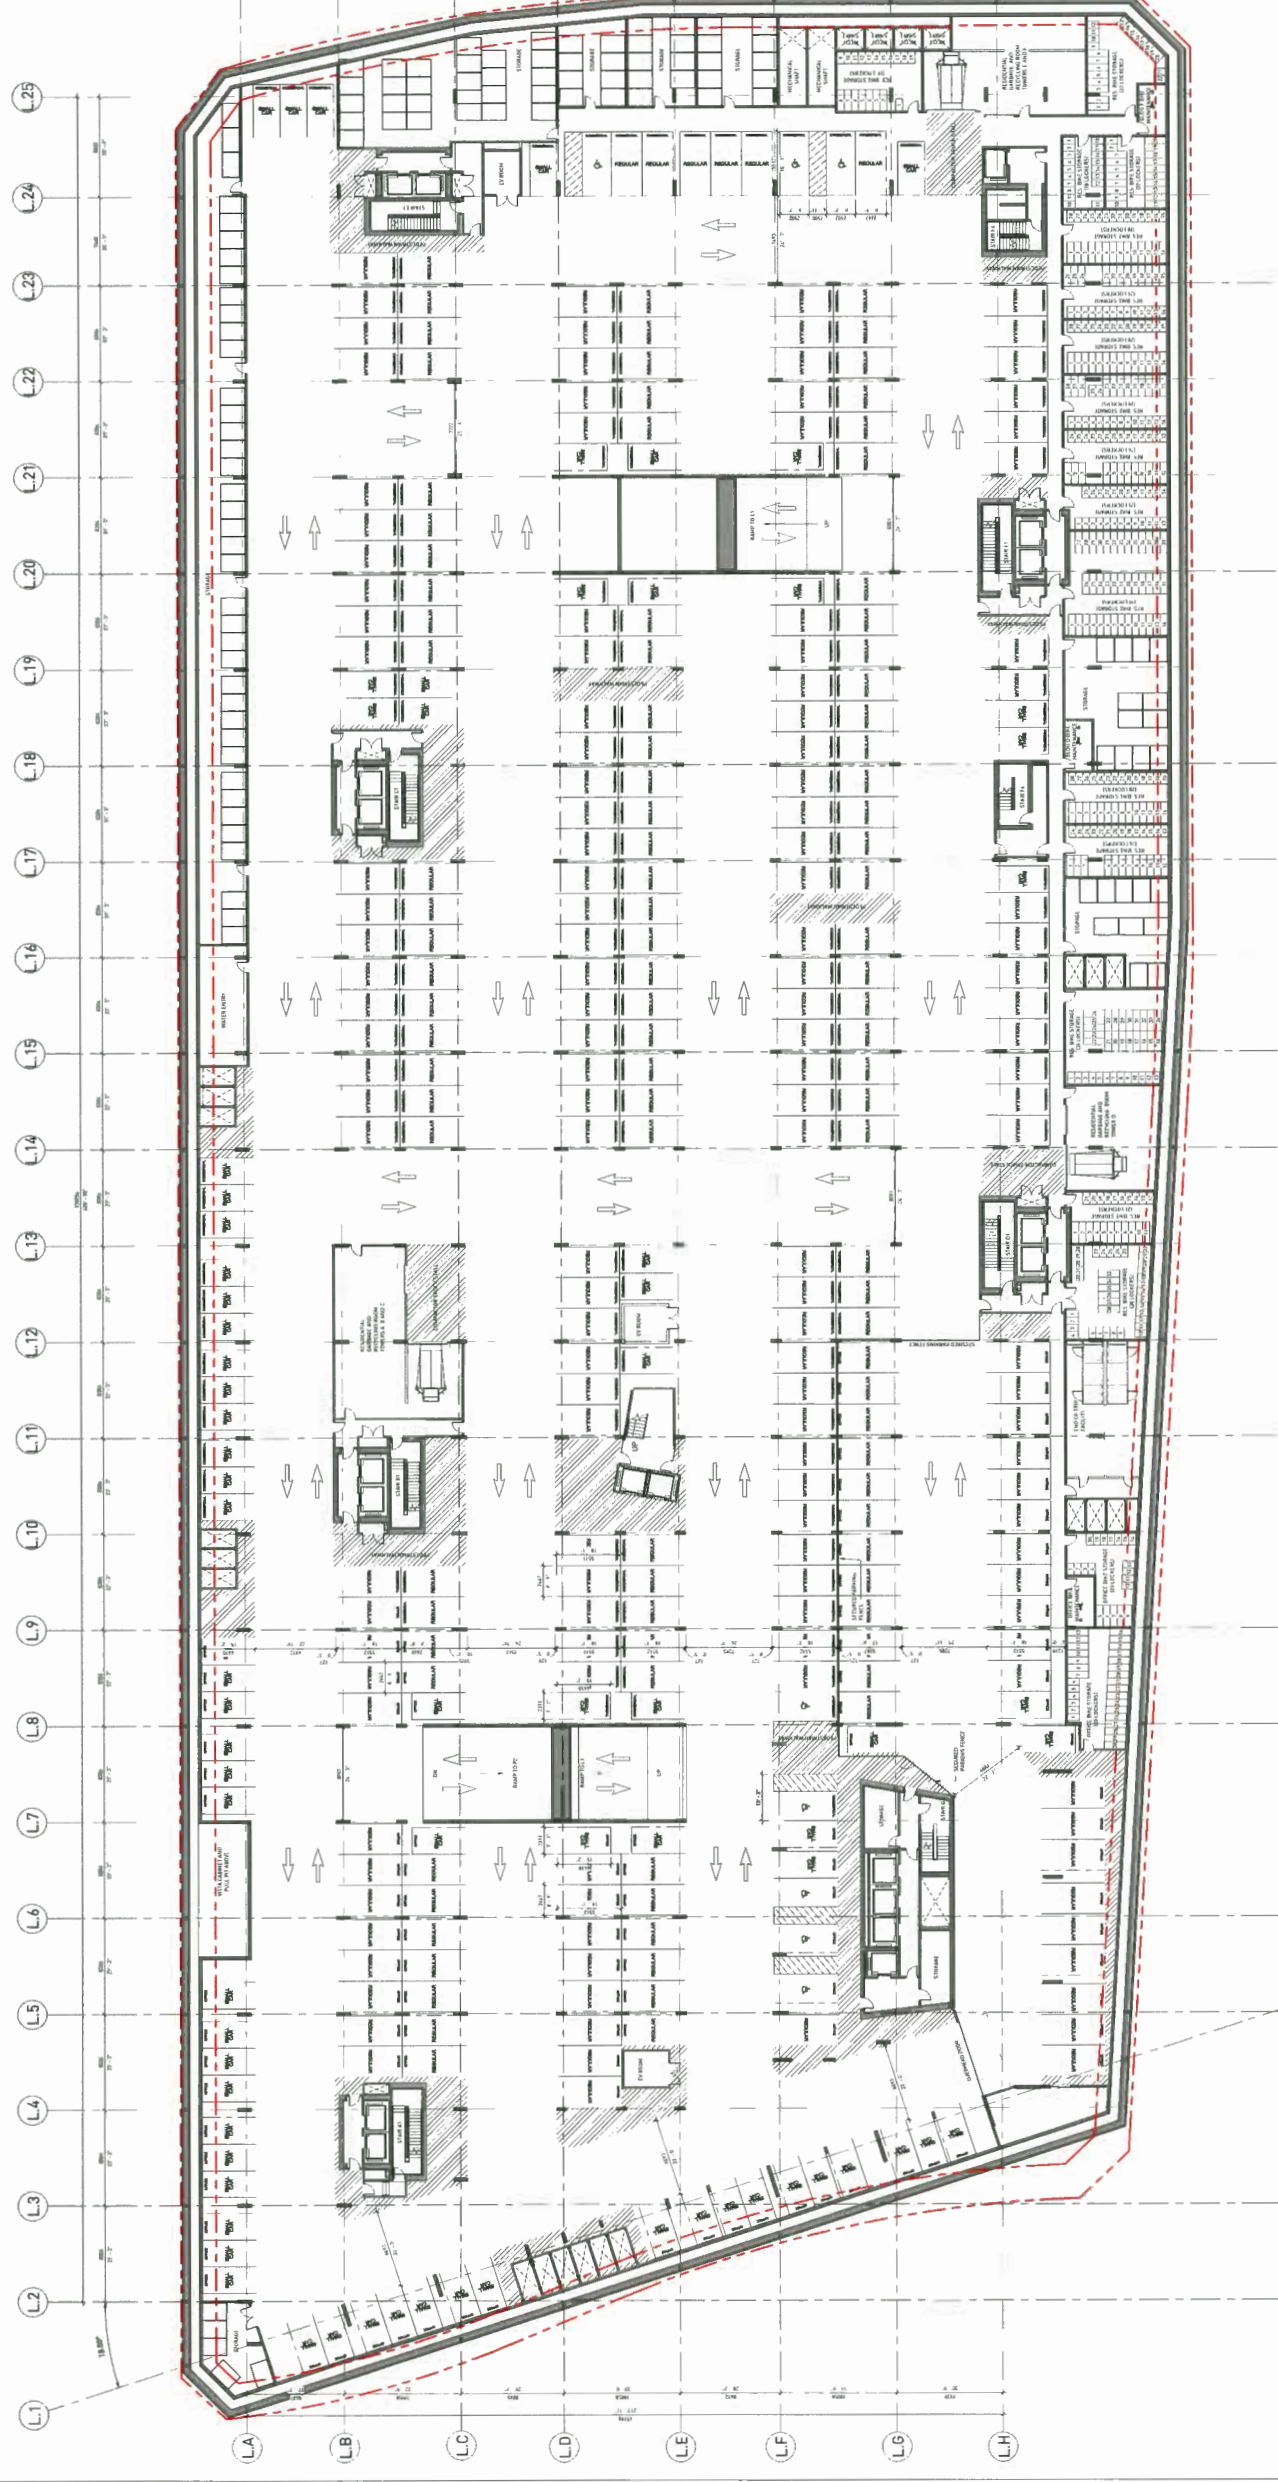NEW EAST-WEST ROAD

REVISIONS	DATE	DESCRIPTION	SUBMITTED
01	08/20/16	ISSUES	FOR I/P



7960 ALDERBRIDGE WAY


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DP 16-740262 #6



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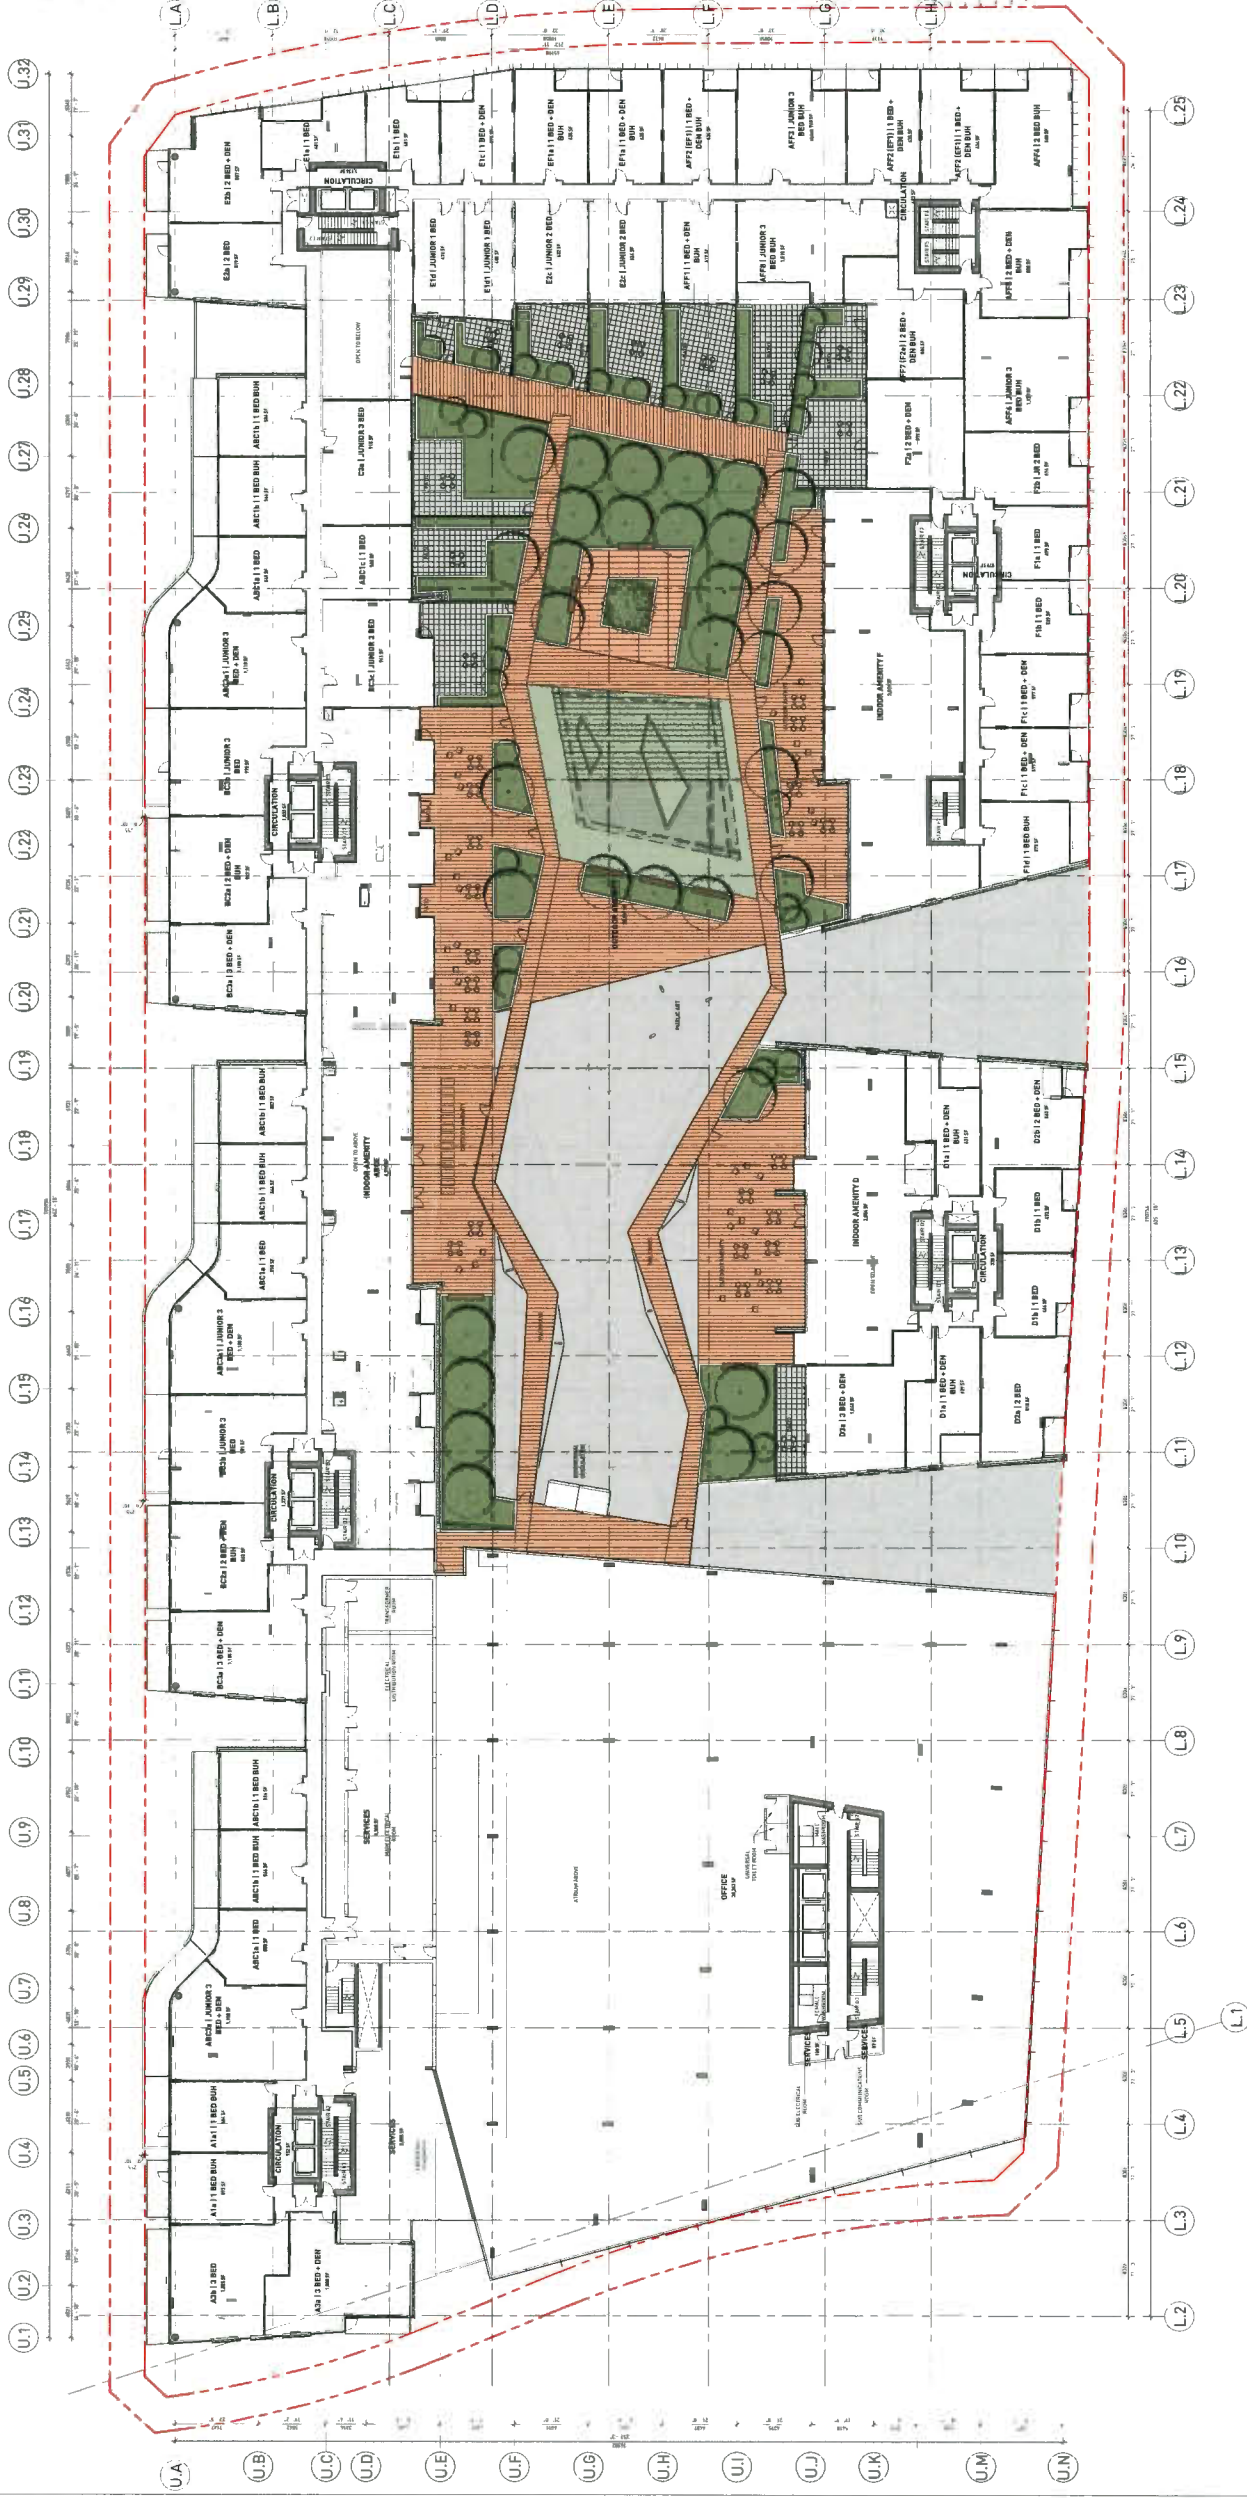
7960 ALDERBRIDGE
 WAY

DEVELOPMENT PERMIT

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DP 16-740262 #17

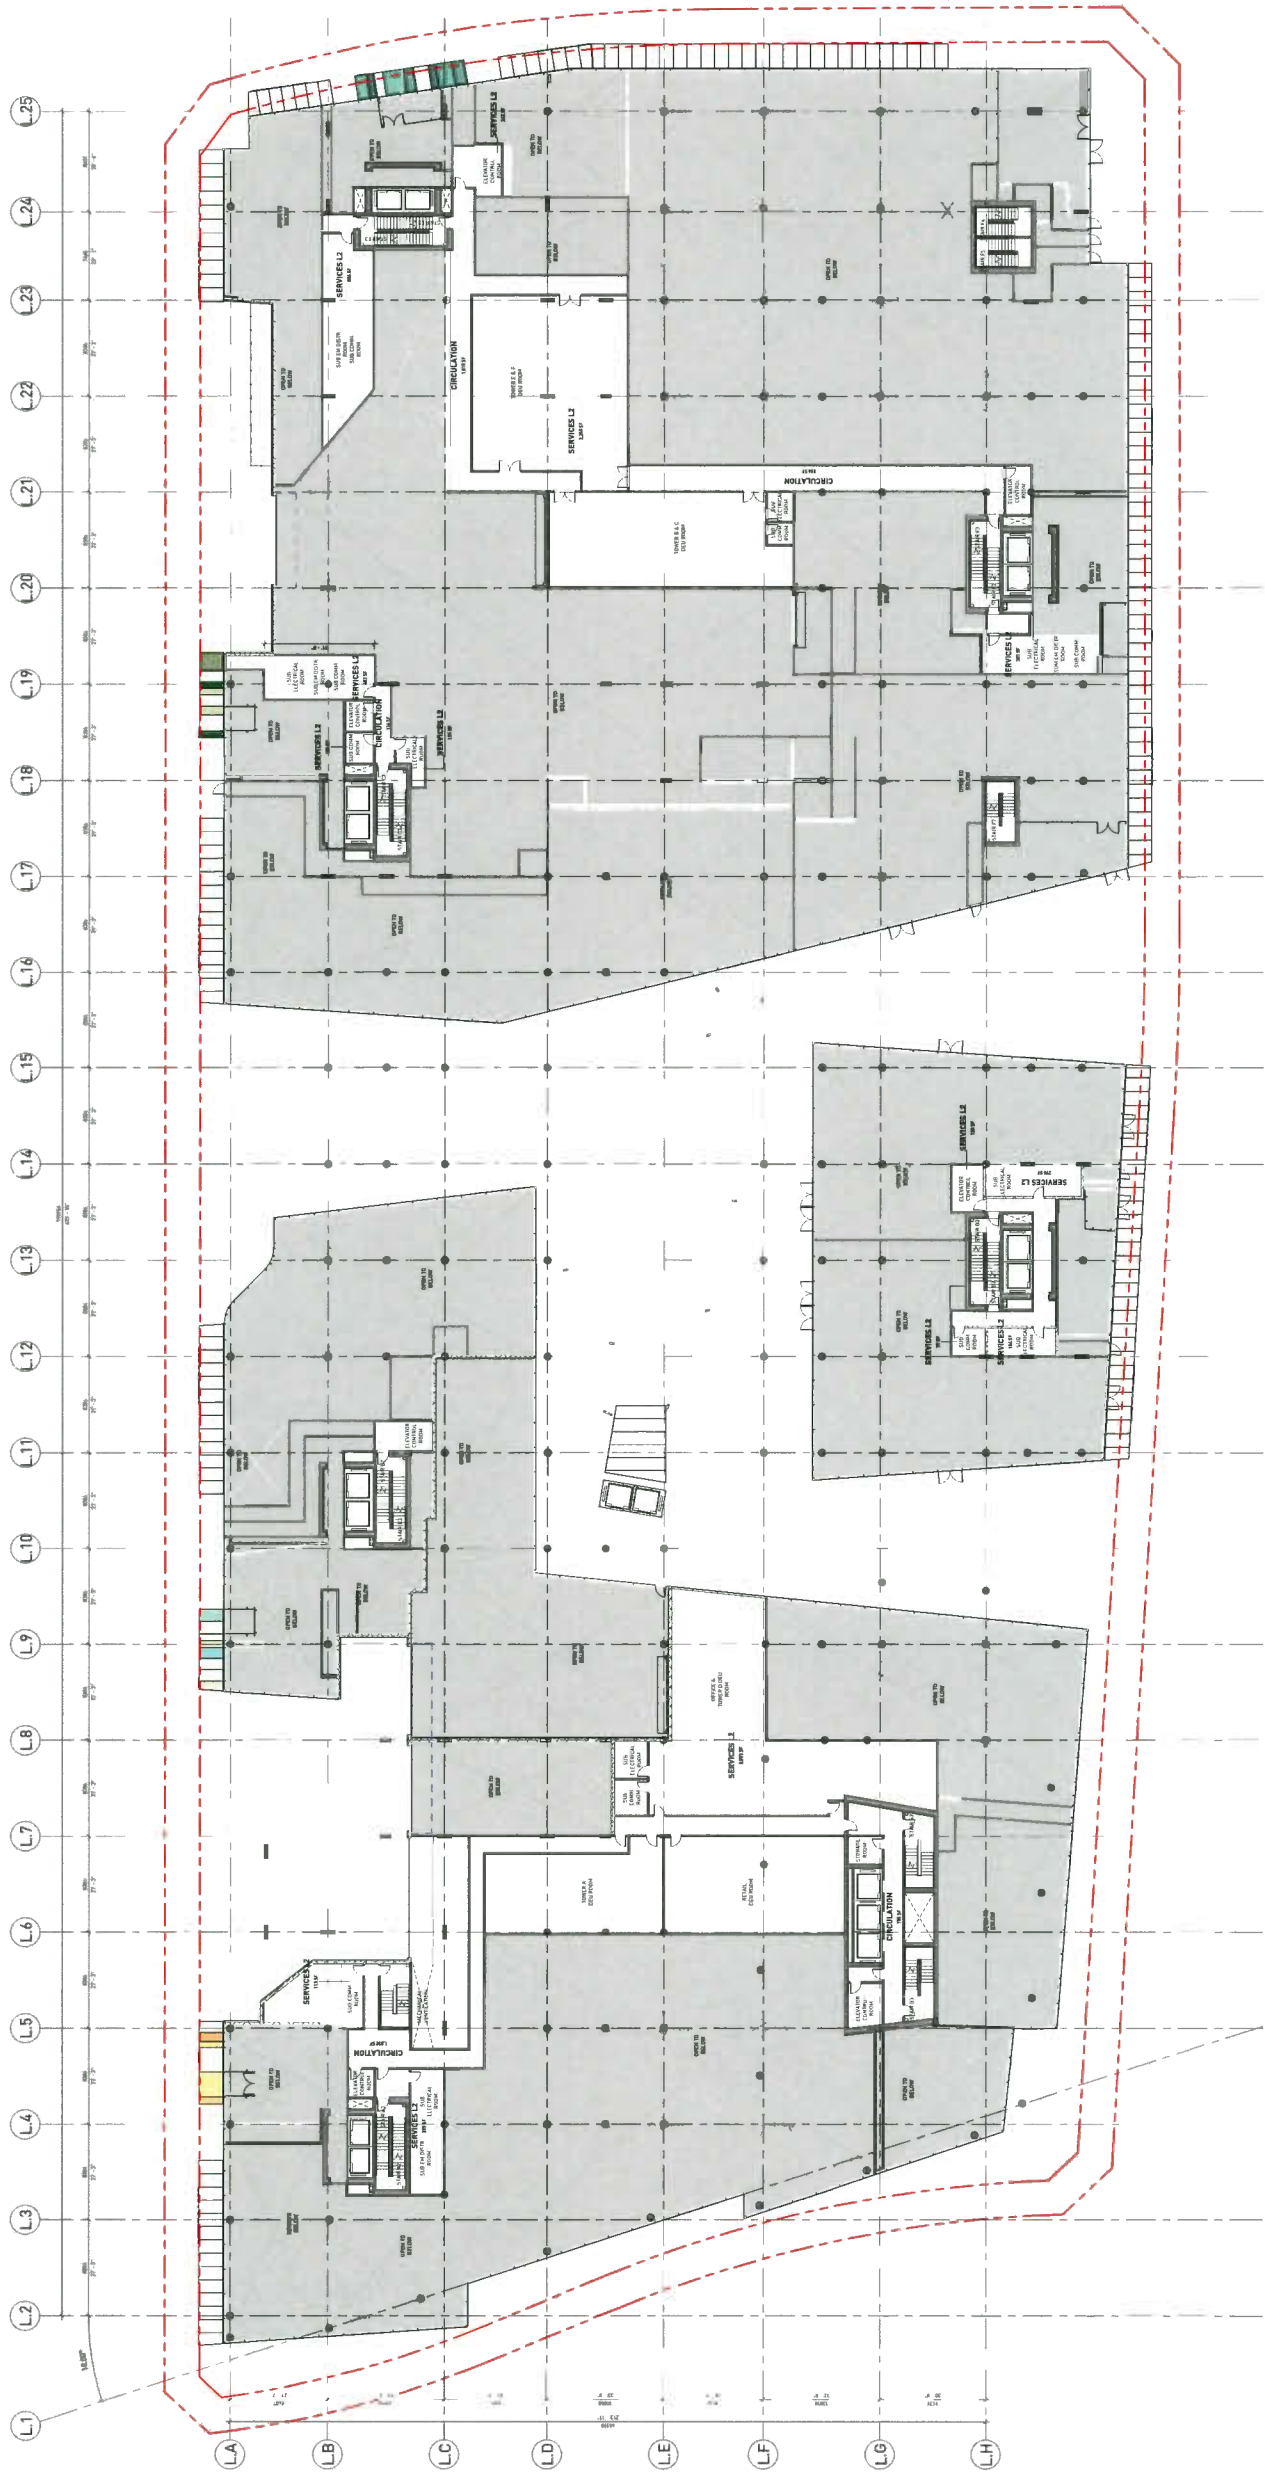

REVISIONS	NO.	DATE	DESCRIPTION	ISSUED FOR
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7960 ALDERBRIDGE WAY
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LEVEL 3 PLAN


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DP 16-740262 #8




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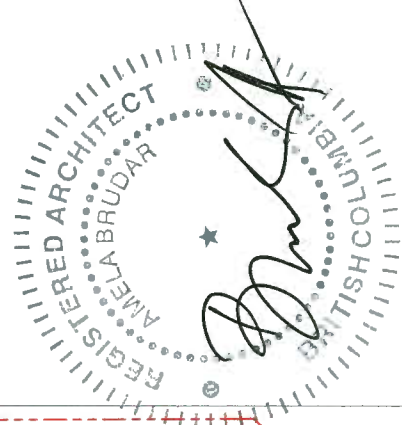
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DP 16-740262#1




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7960 ALDERBRIDGE
 WAY
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DP 16-740262#10

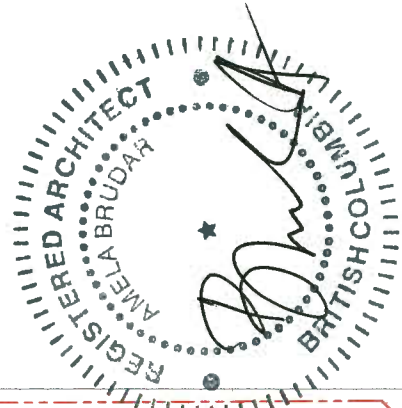

REVISIONS	NO.	DATE	DESCRIPTION	DESIGNED BY
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7960 ALDERBRIDGE
 WAY
 DEVELOPMENT PERMIT
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DP 16-740262 #12

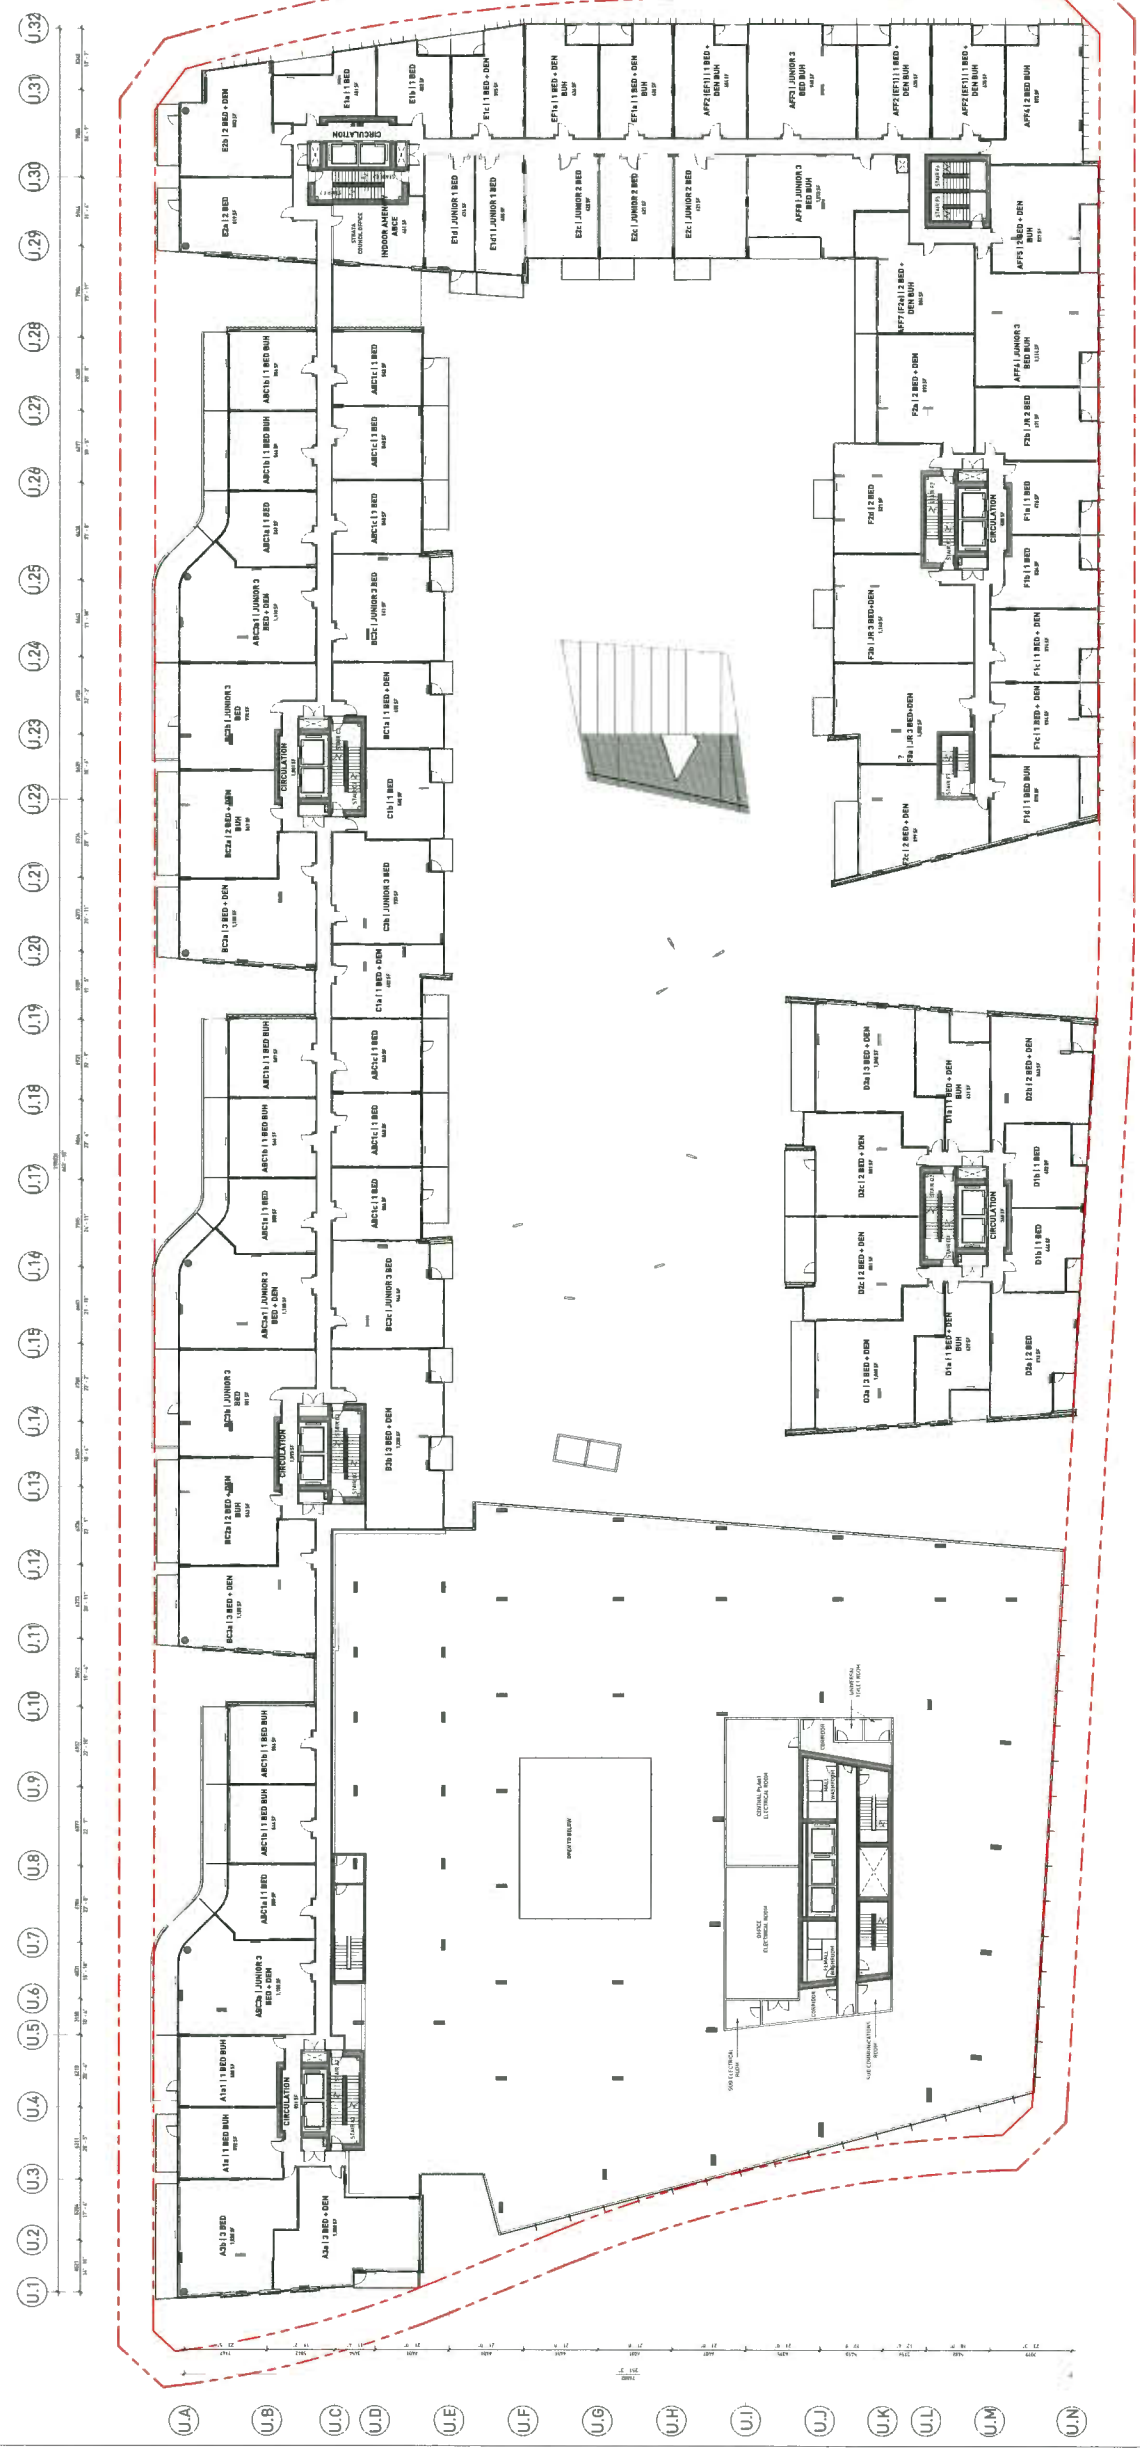REVISIONS	DATE	DESCRIPTION
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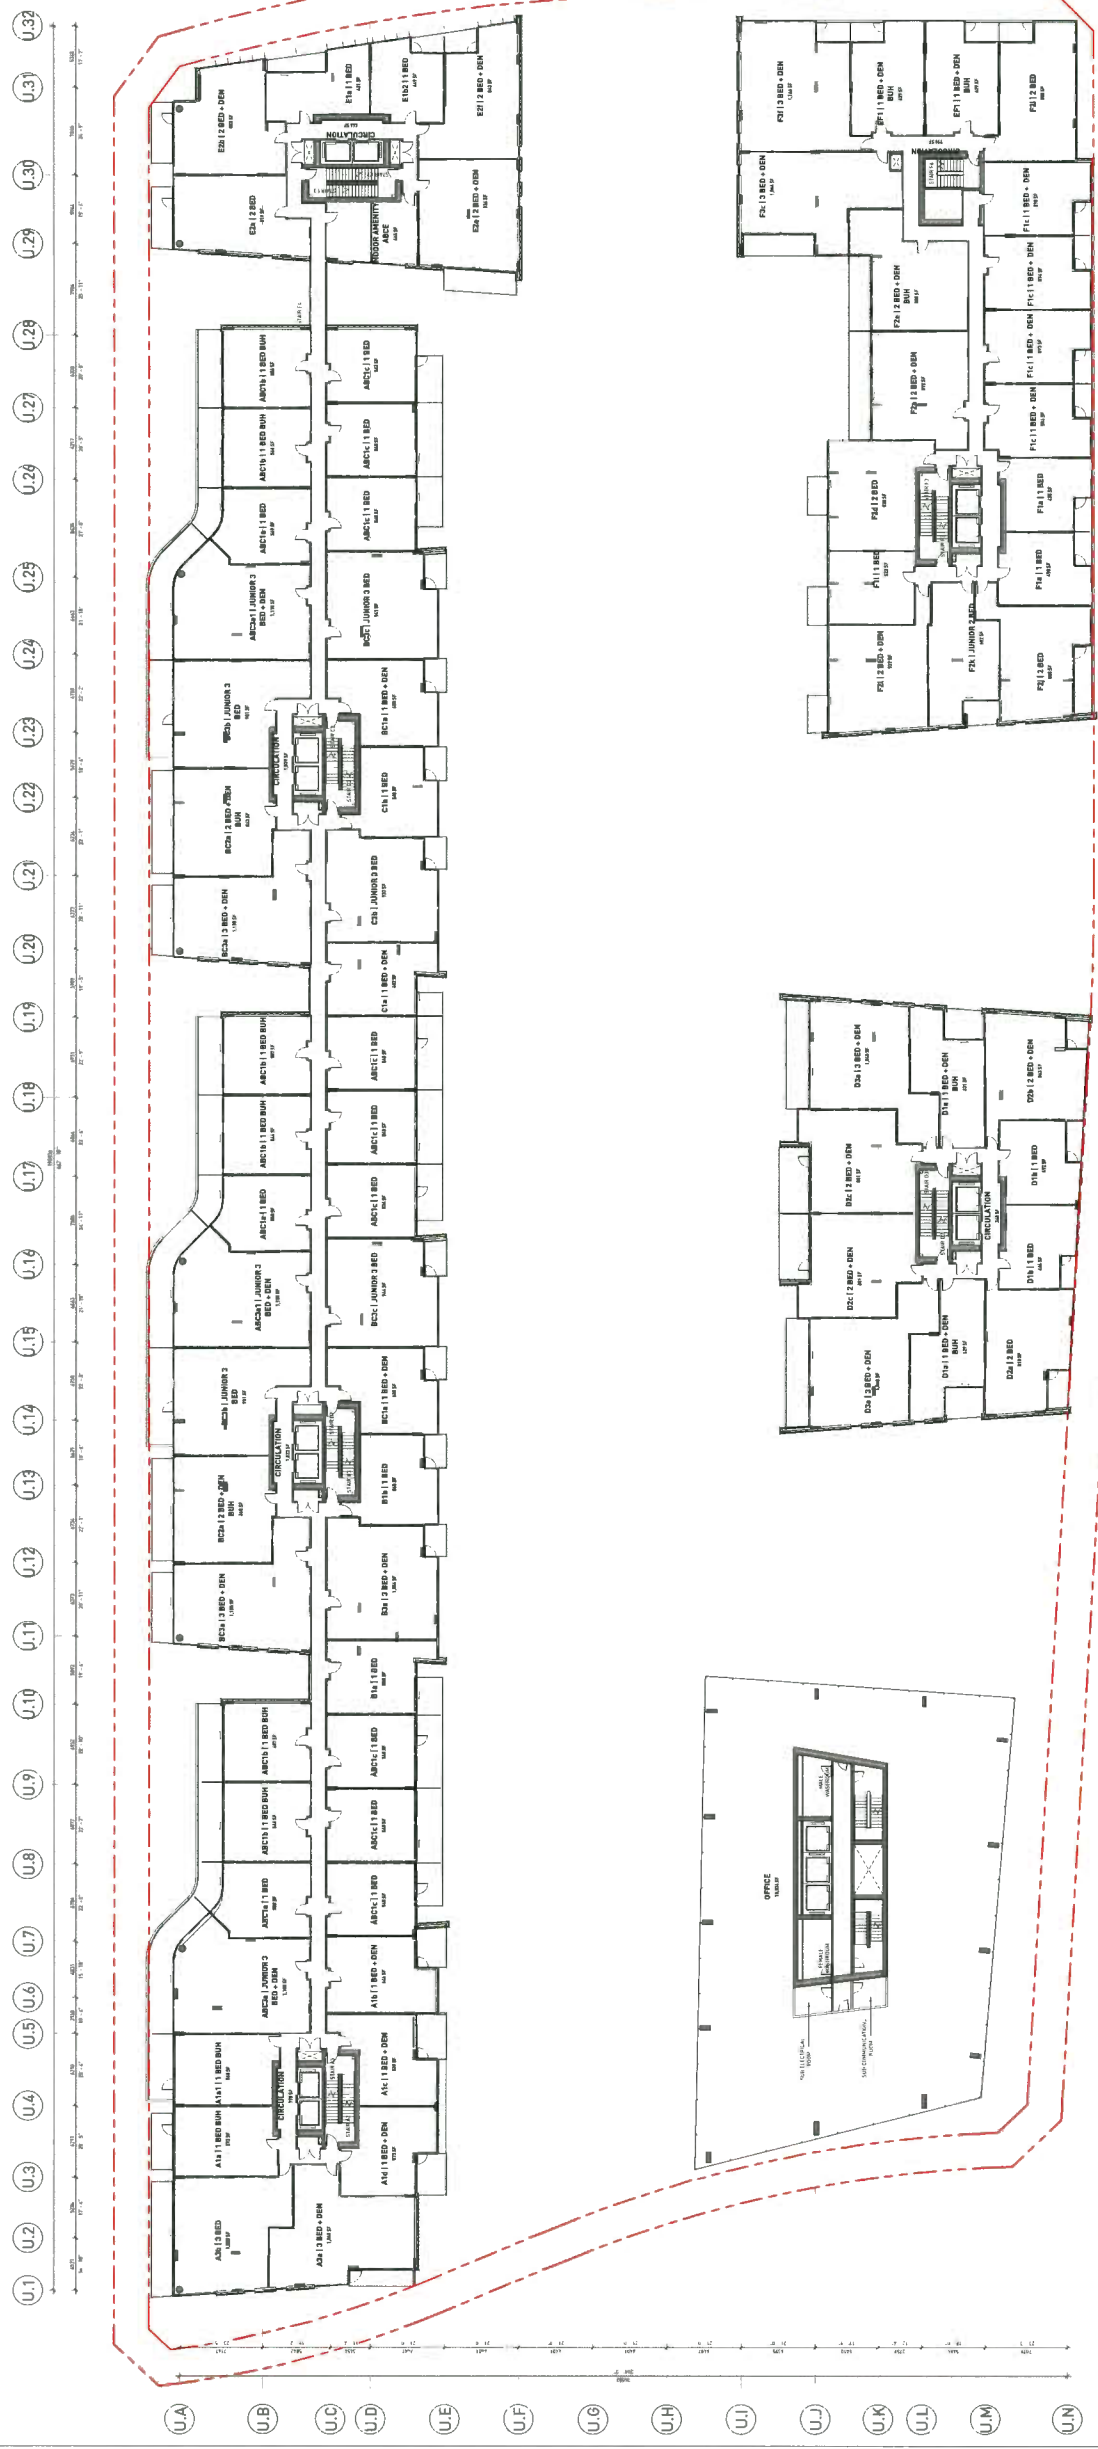
7960 ALDERBRIDGE
 WAY

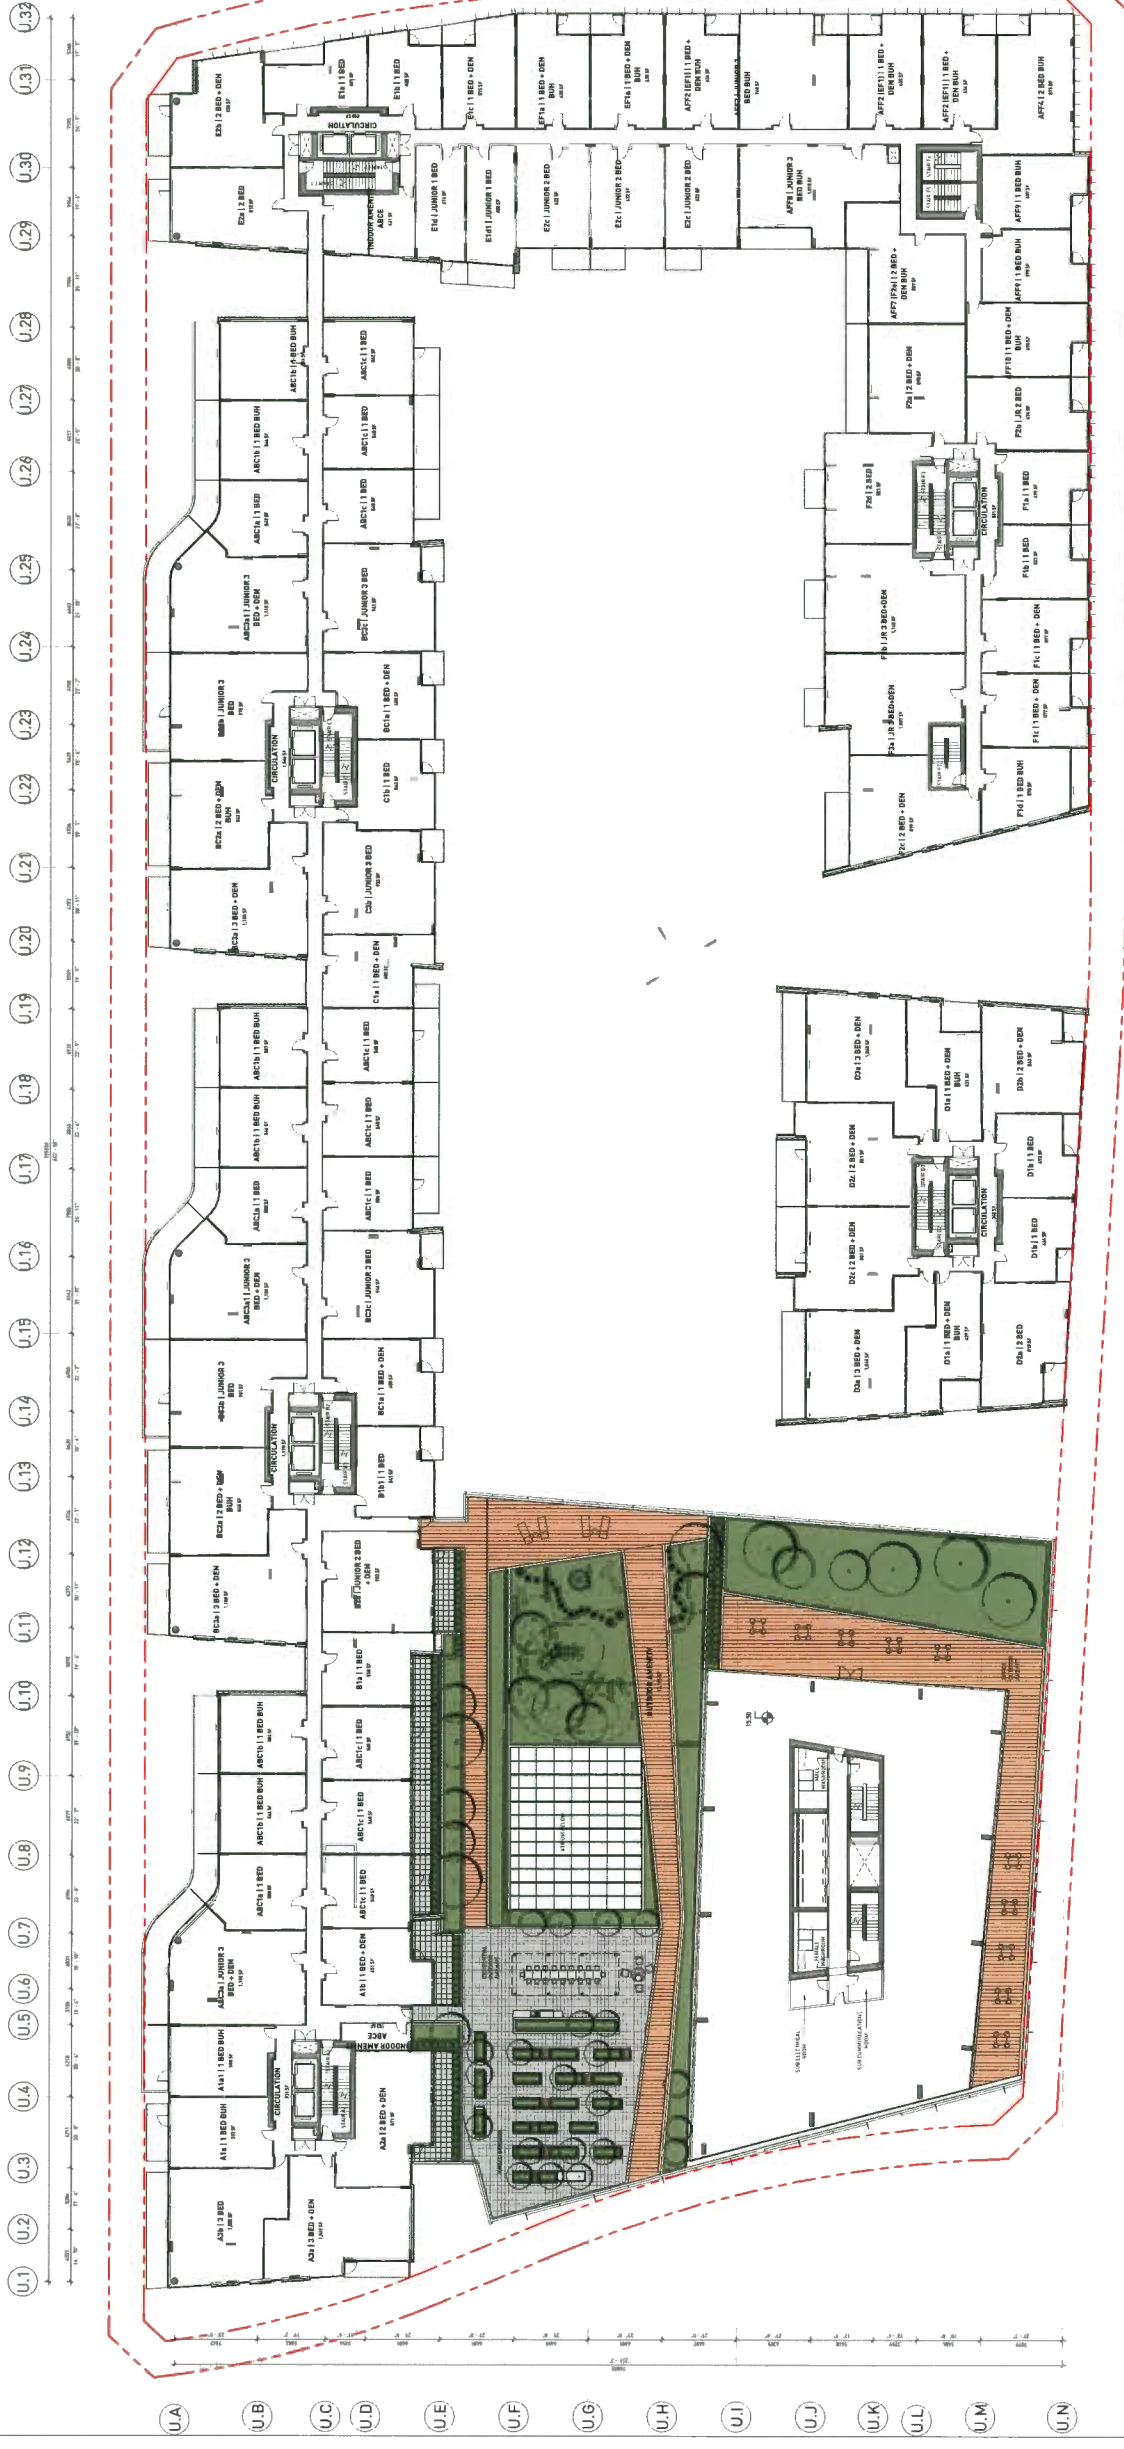DEVELOPMENT PERMIT


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A3.08



DP 16-740262 #13



REVISIONS	DATE	DESCRIPTION
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7960 ALDERBRIDGE WAY
 DEVELOPMENT PERMIT
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DP 16-740262 #4

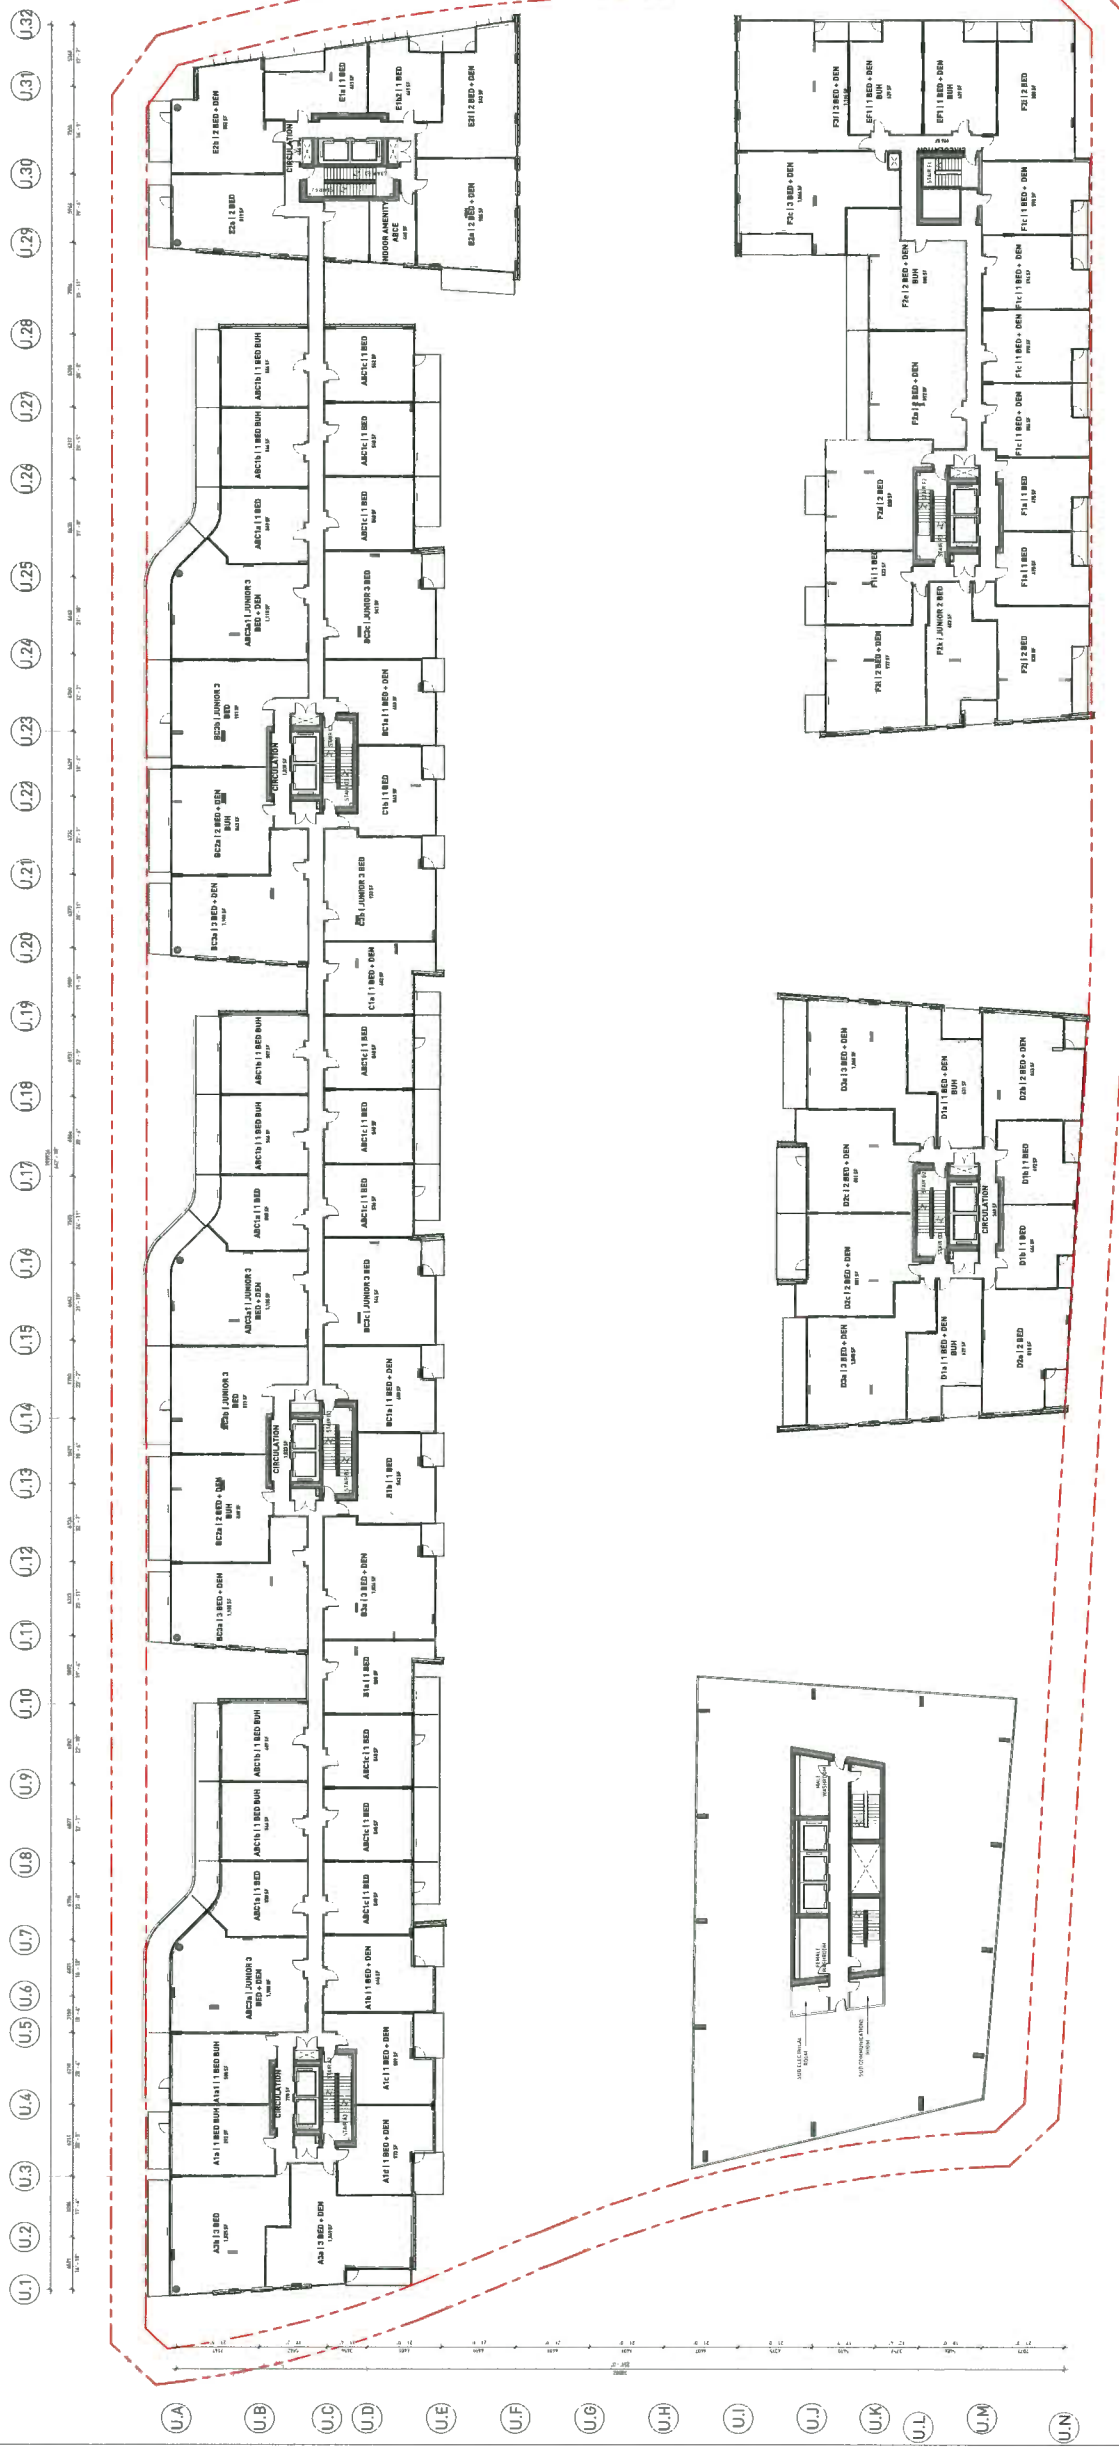


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7960 ALDERBRIDGE
 WAY
 DEVELOPMENT PERMIT
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DP 16-740262 #15



REVISIONS	NO.	DATE	DESCRIPTION
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7960 ALDERBRIDGE
 WAY
 DEVELOPMENT PERMIT
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 RESIDENTIAL PLAN
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DP 16-740262 #16



REVISIONS	NO.	DATE	DESCRIPTION
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7960 ALDERBRIDGE WAY

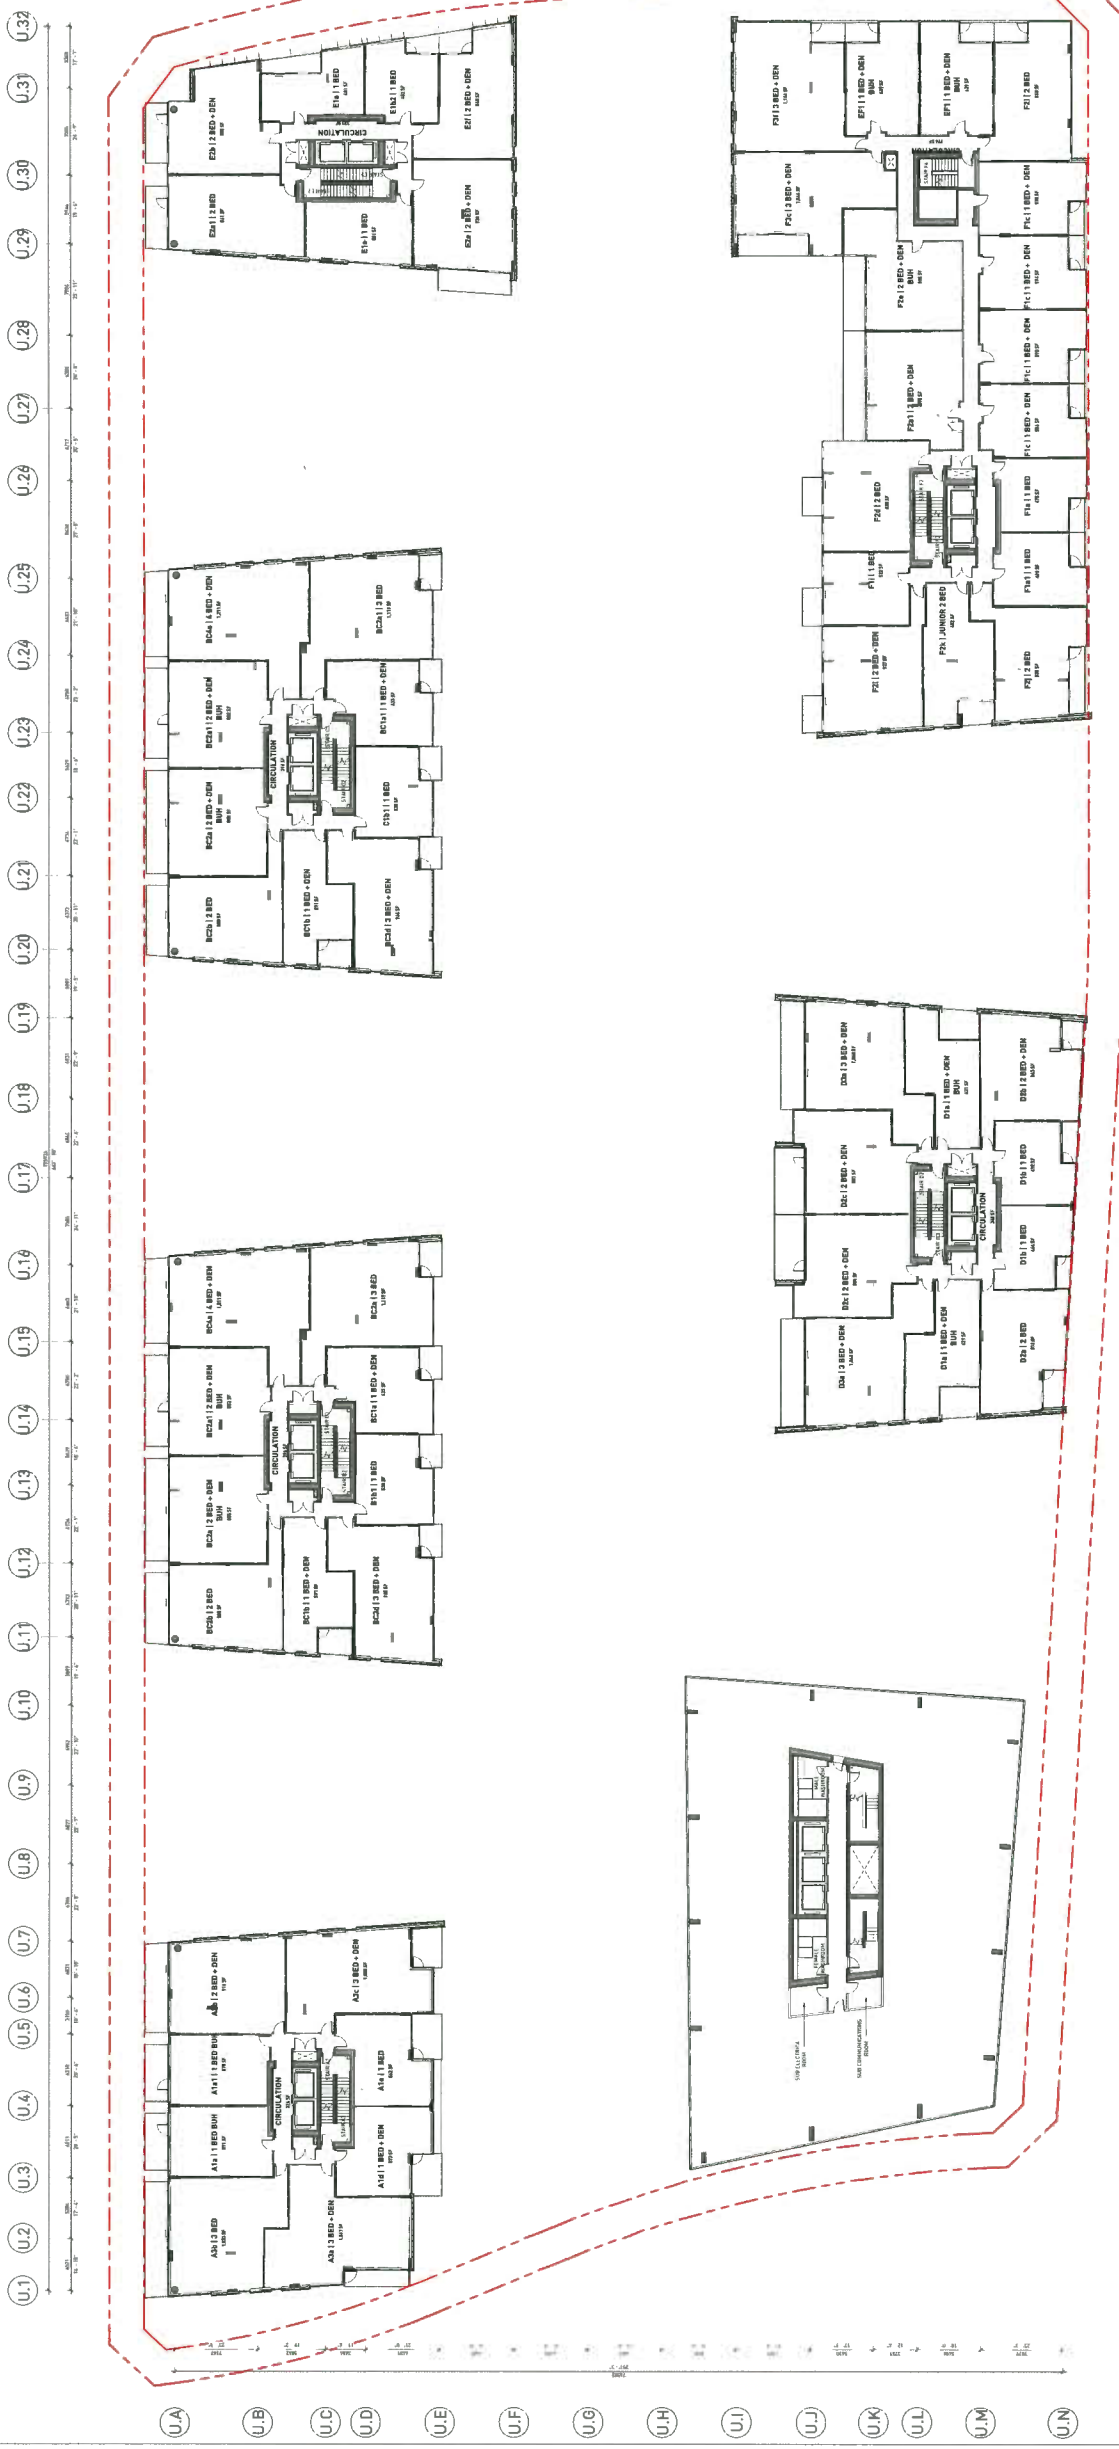
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LEVEL 12
RESIDENTIAL PLAN

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 CHECKED BY: Director
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DP 16-740262#17

U.1 U.2 U.3 U.4 U.5 U.6 U.7 U.8 U.9 U.10 U.11 U.12 U.13 U.14 U.15 U.16 U.17 U.18 U.19 U.20 U.21 U.22 U.23 U.24 U.25 U.26 U.27 U.28 U.29 U.30 U.31 U.32



REVISIONS	NO	DATE	DESCRIPTION
	01	10/02/2018	ISSUED FOR DP

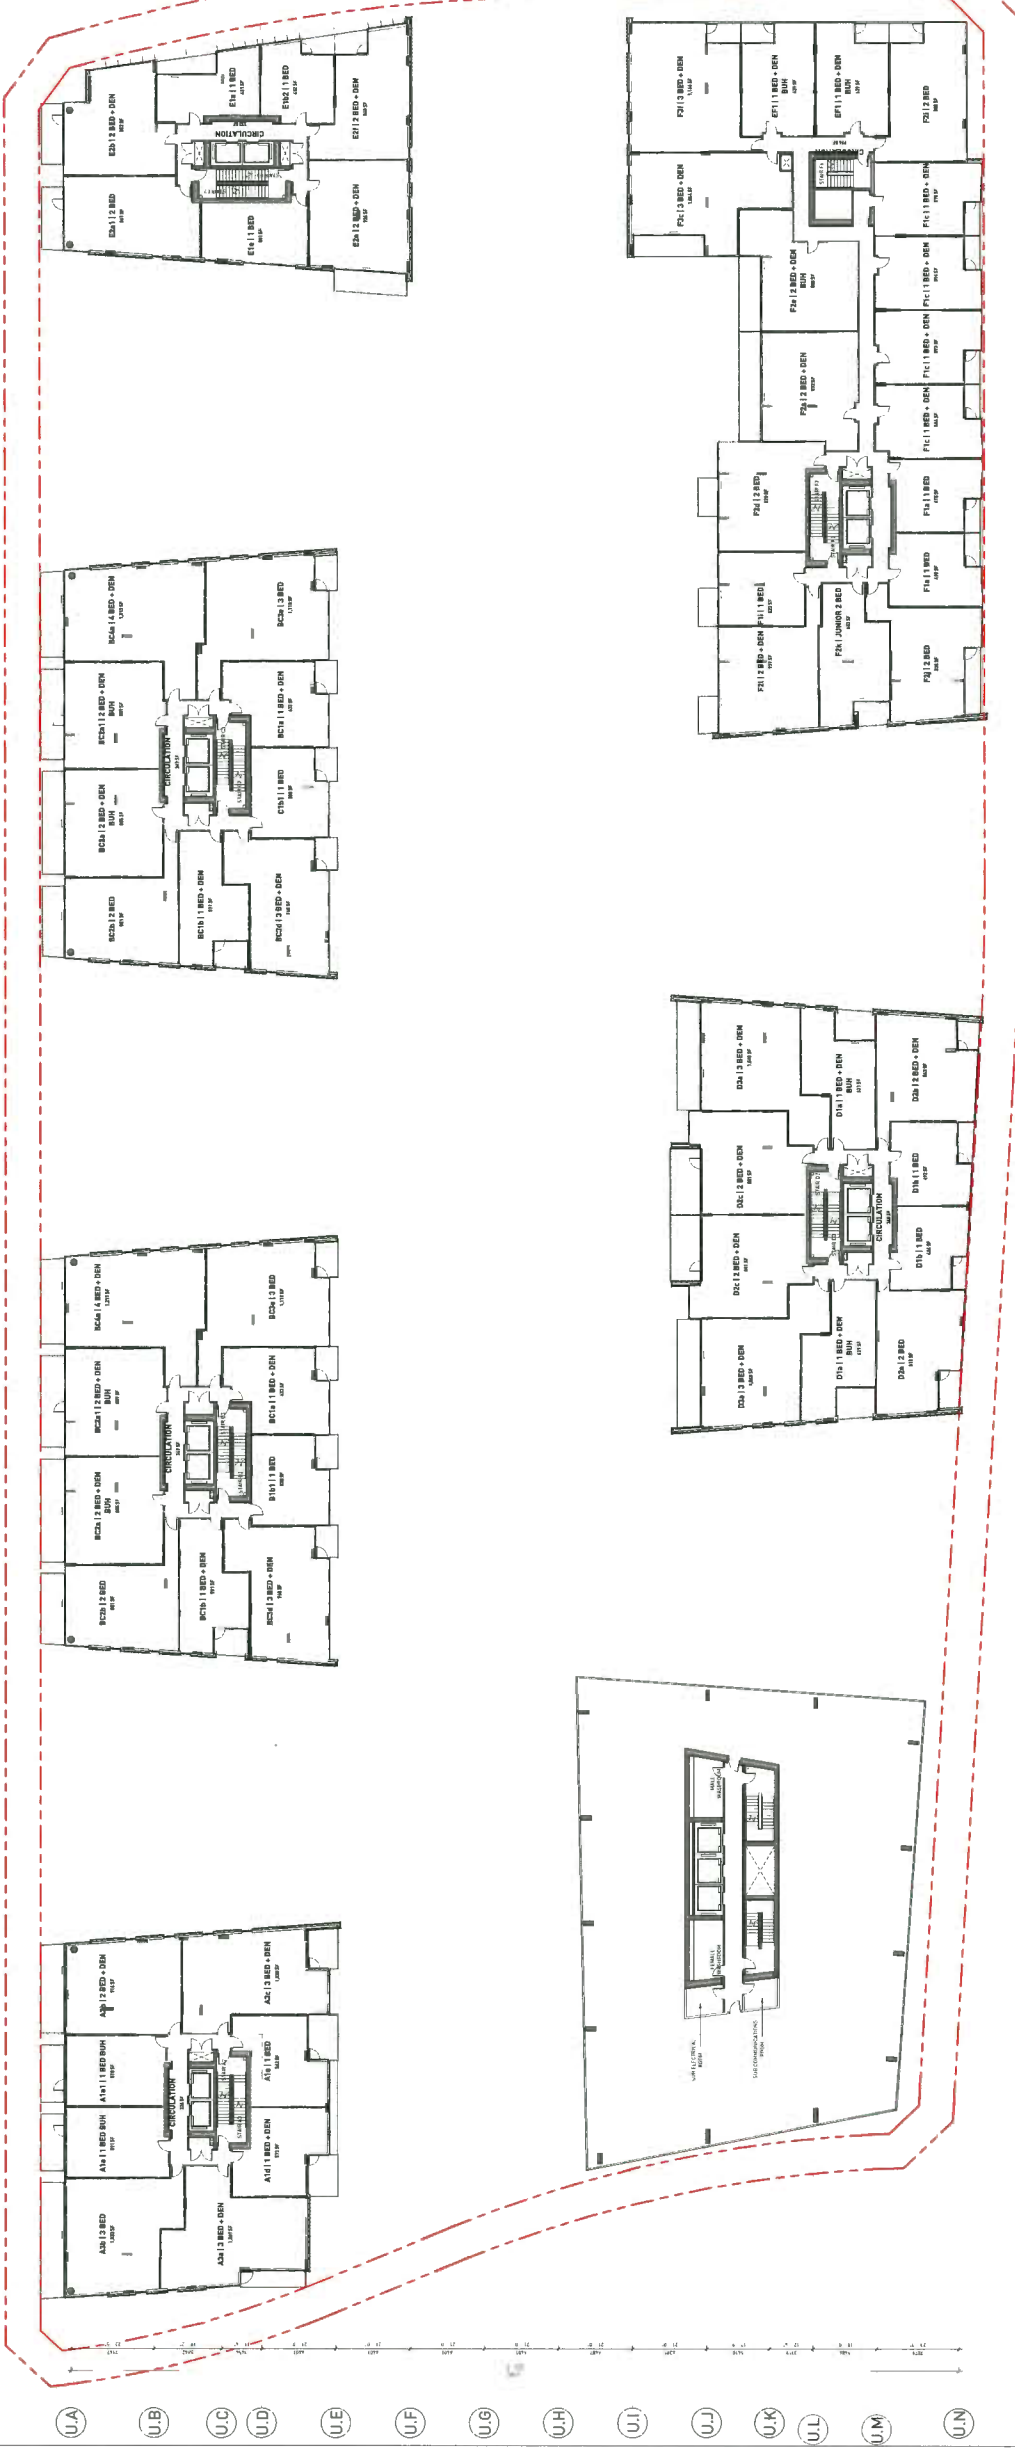

7960 ALDERBRIDGE
 WAY
 DEVELOPMENT PERMIT
 LEVEL 13
 RESIDENTIAL PLAN
 DATE: 10/02/2018
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 CHECKED BY: Designer
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 JOB NUMBER: 17020

DP 16-740262 #18




REVISIONS	DATE	DESCRIPTION
01		ISSUED FOR DP




7960 ALDERBRIDGE
 WAY
 DEVELOPMENT PERMIT
 LEVEL 14
 RESIDENTIAL PLAN
 DATE: 10/27/16
 DRAWN BY: [Signature]
 CHECKED BY: [Signature]
 SCALE: 1/8"=1'-0"
 JOB NUMBER: 17020

A3.14

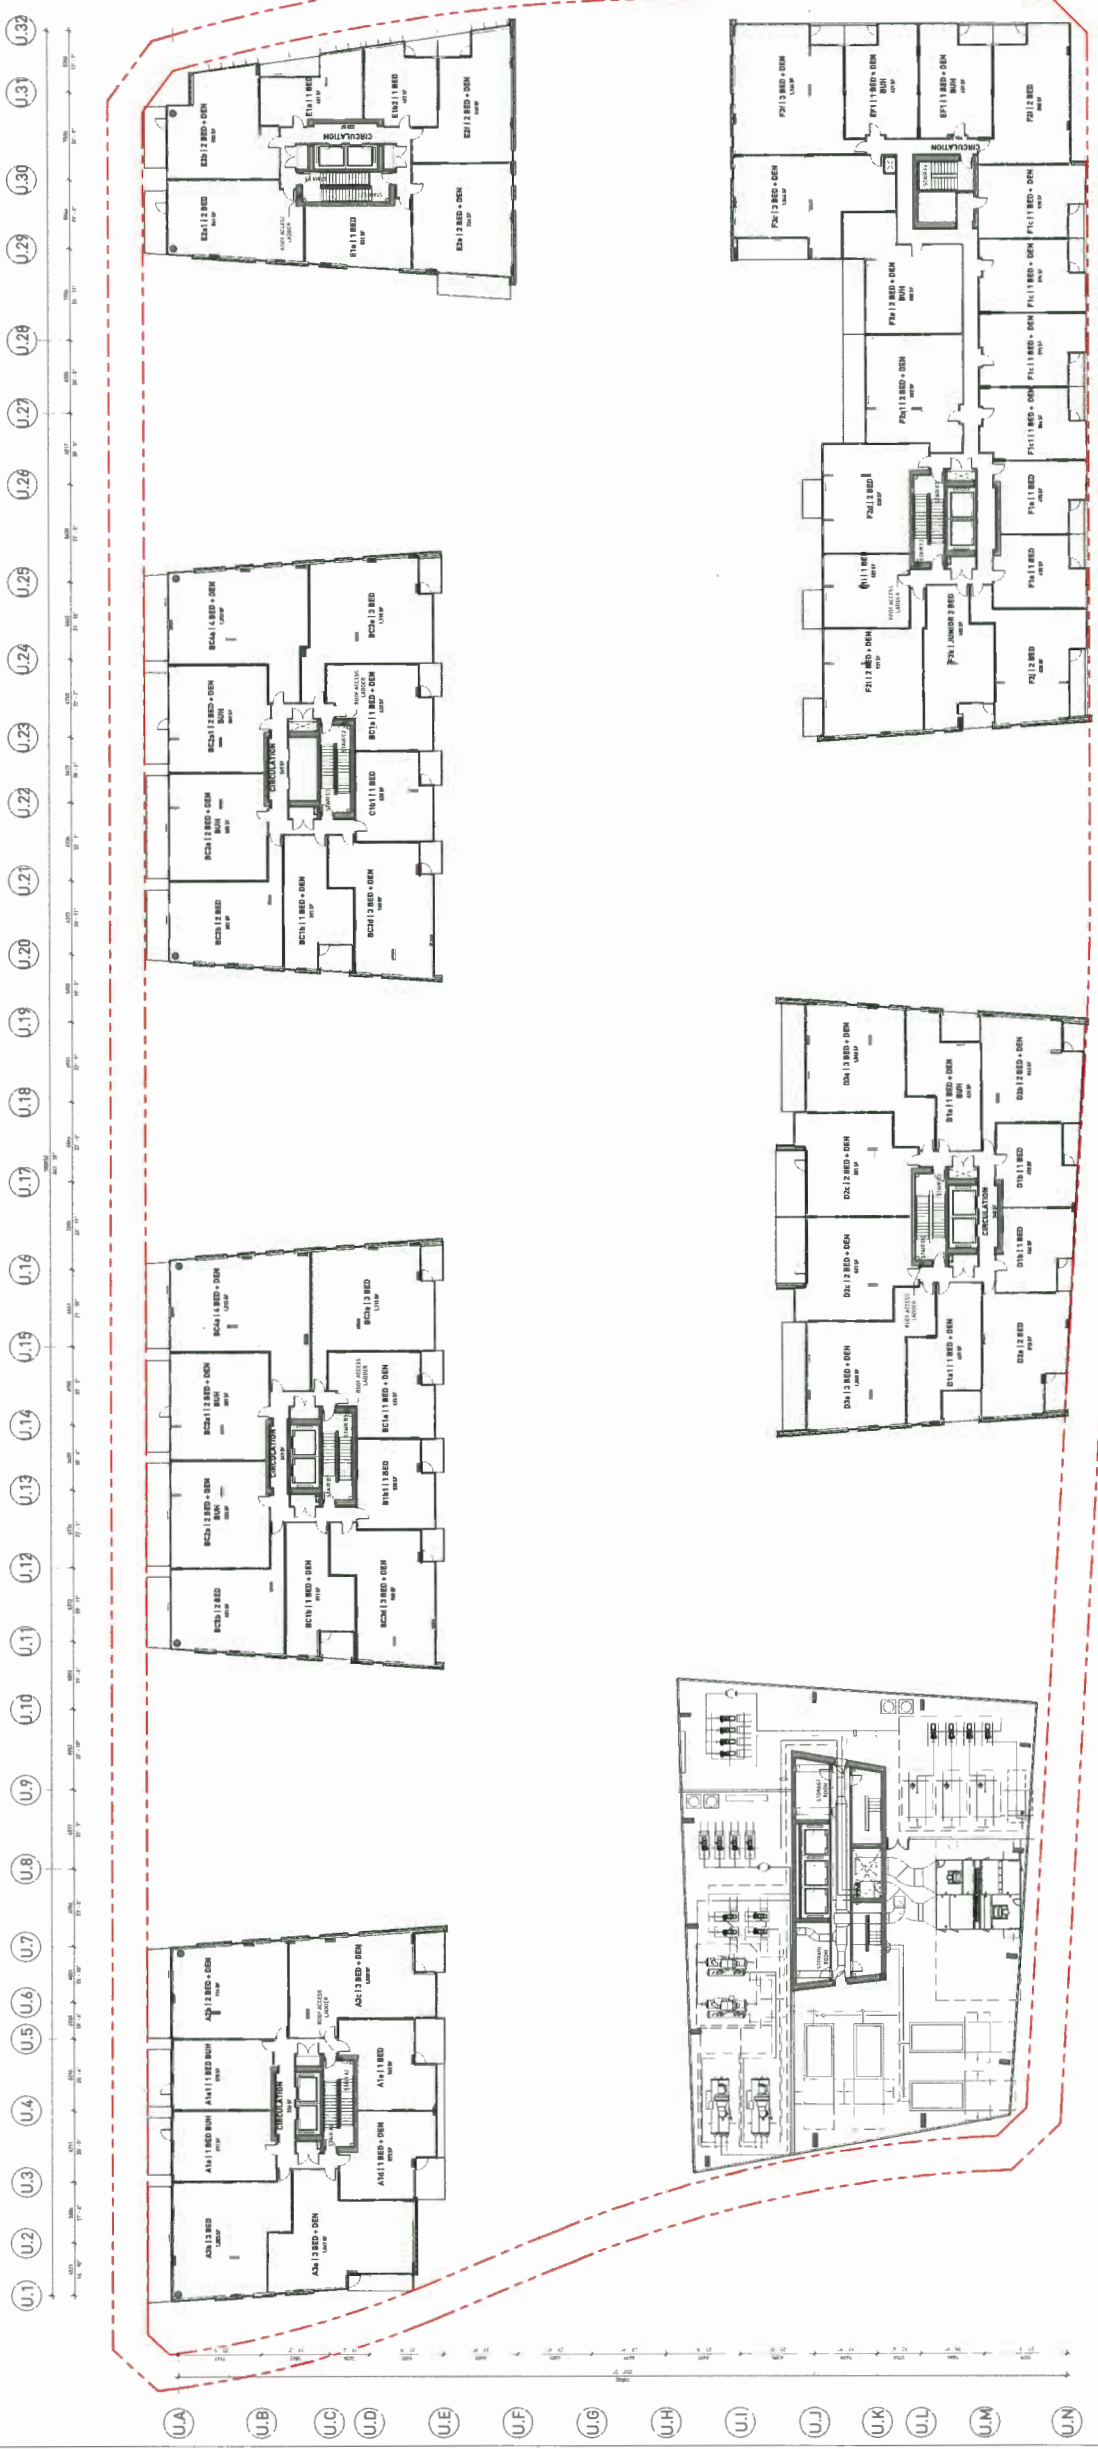



DP 16-740262 #M

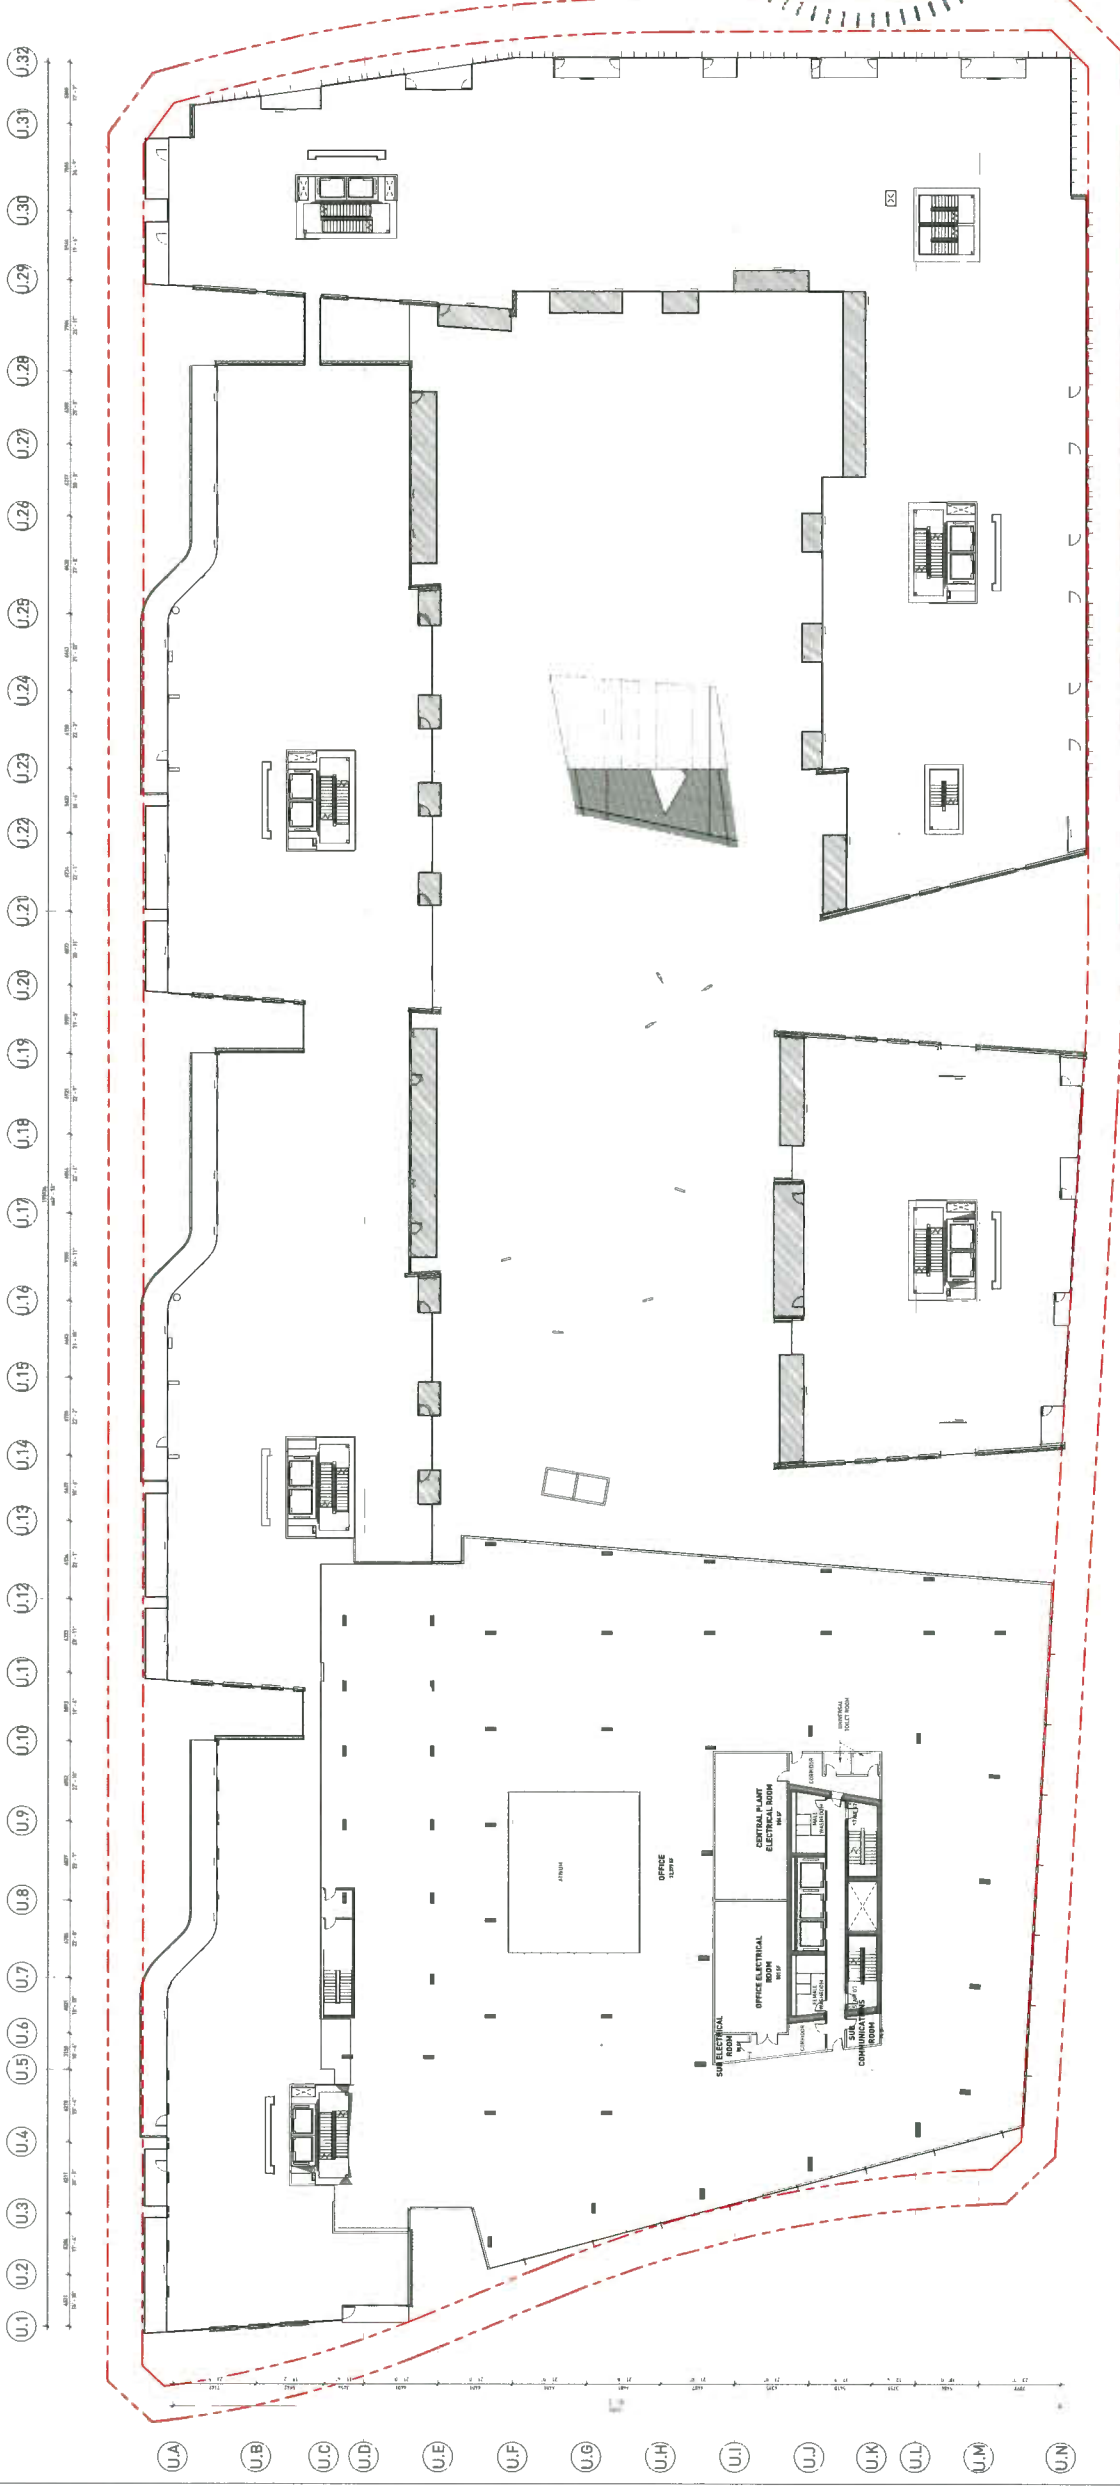

REVISIONS	DATE	DESCRIPTION
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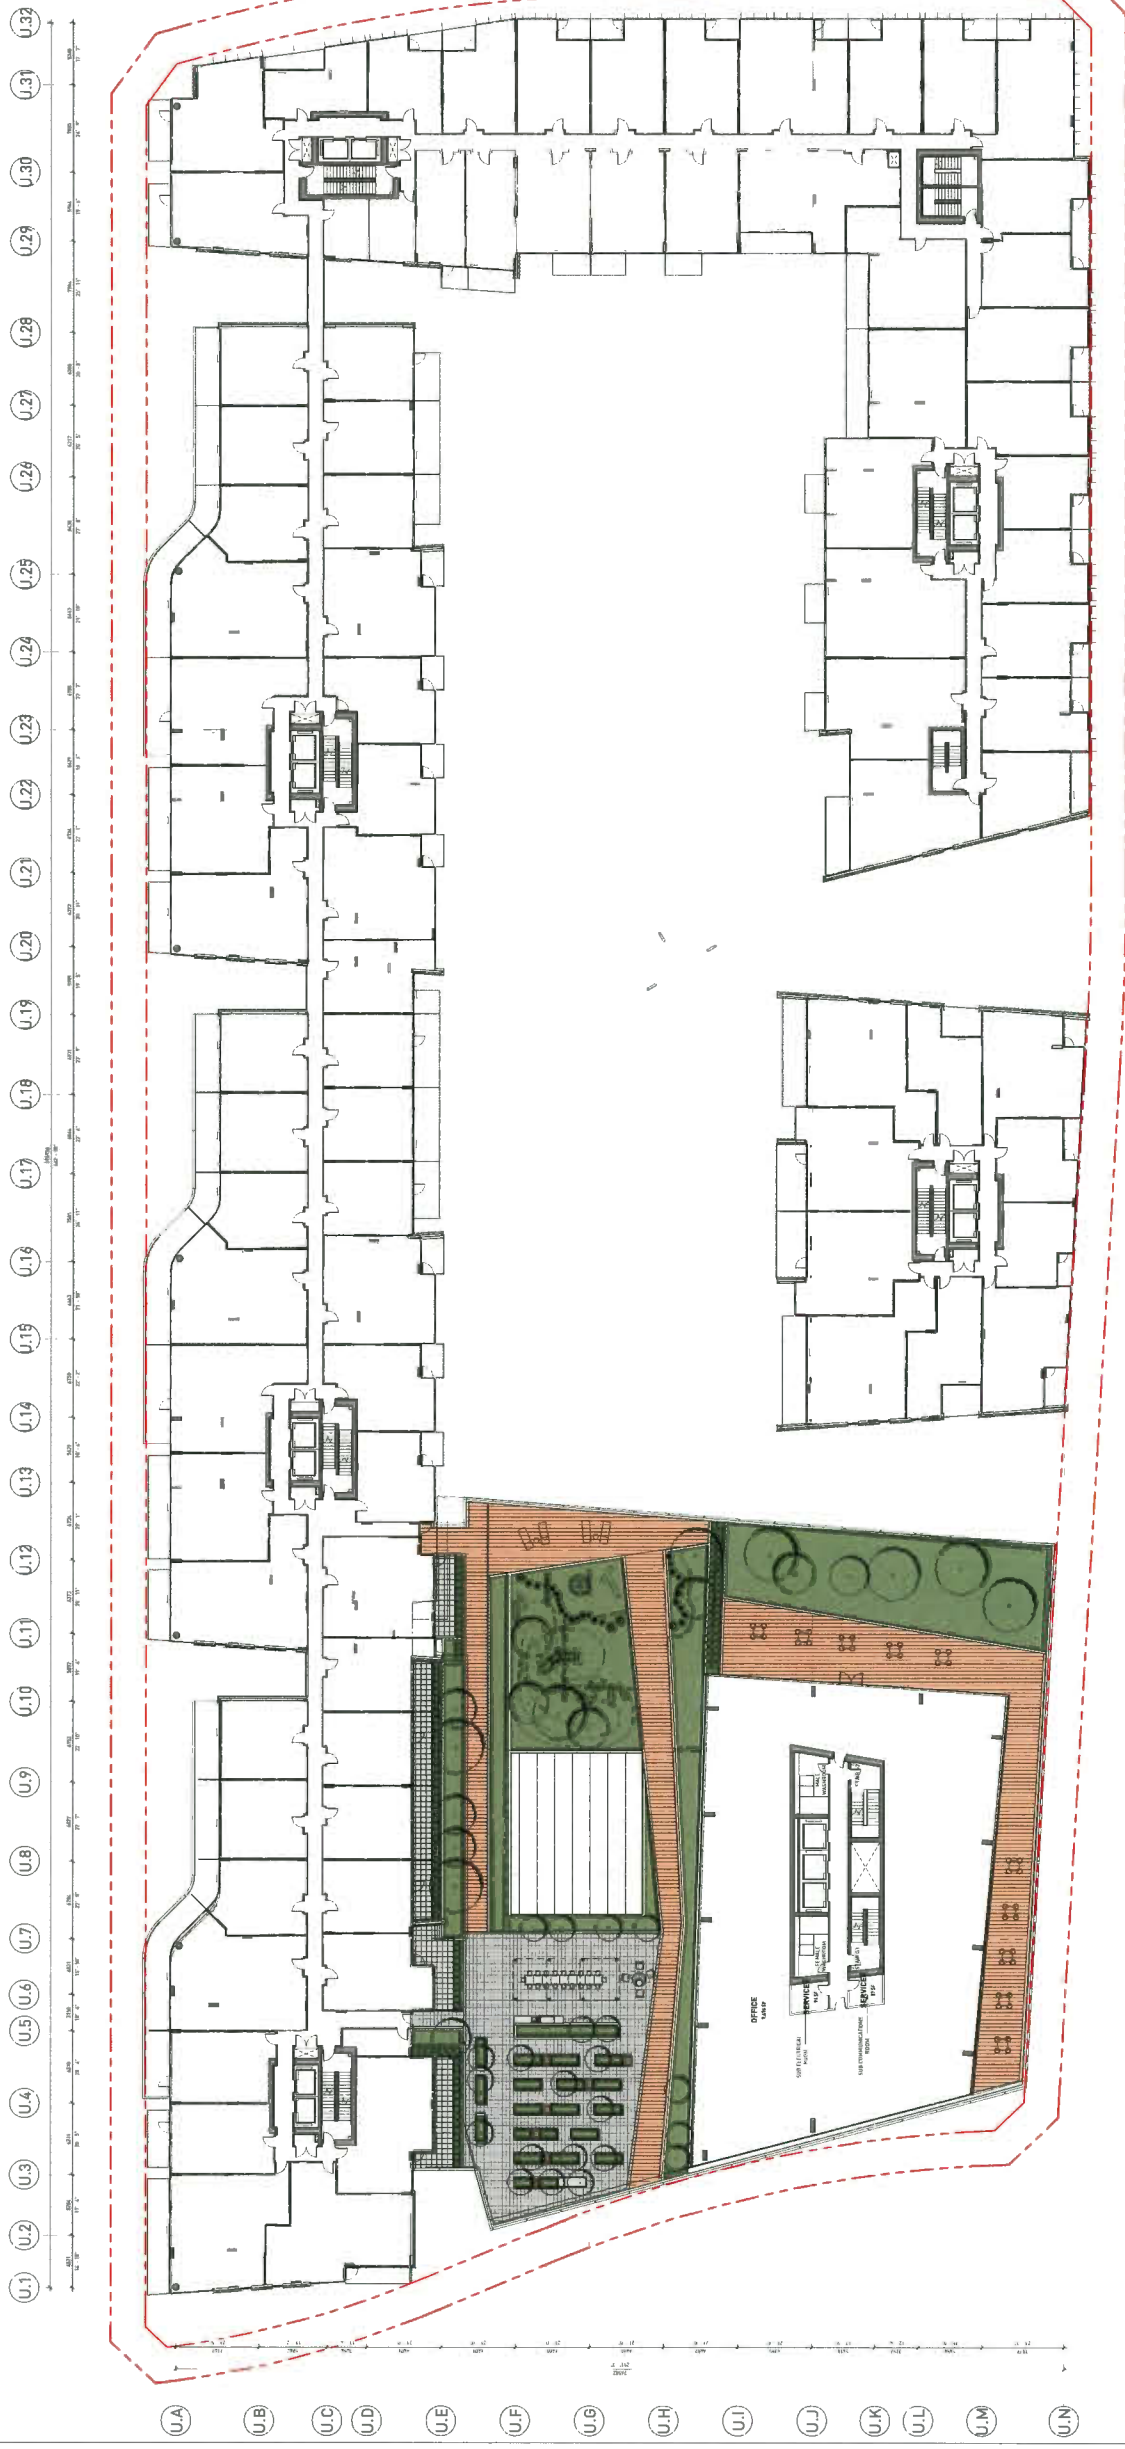


7960 ALDERBRIDGE WAY
DEVELOPMENT PERMIT

LEVEL 4 OFFICE PLAN

DATE: 10/20/15
DRAWN BY: [Signature]
CHECKED BY: [Signature]
SCALE: 1:100
JOB NUMBER: 17020

DP 16-740262#20



REVISIONS	NO.	DATE	DESCRIPTION
	01	10/20/19	ISSUED FOR DP




7960 ALDERBRIDGE
 WAY

DEVELOPMENT PERMIT

LEVEL 5 OFFICE
 PLAN

DATE: 10/20/19 1:08:18 PM
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 CHECKED BY: [Signature]
 SCALE: 1" = 30'
 JOB NUMBER: 17020

DP 16-740262 #21

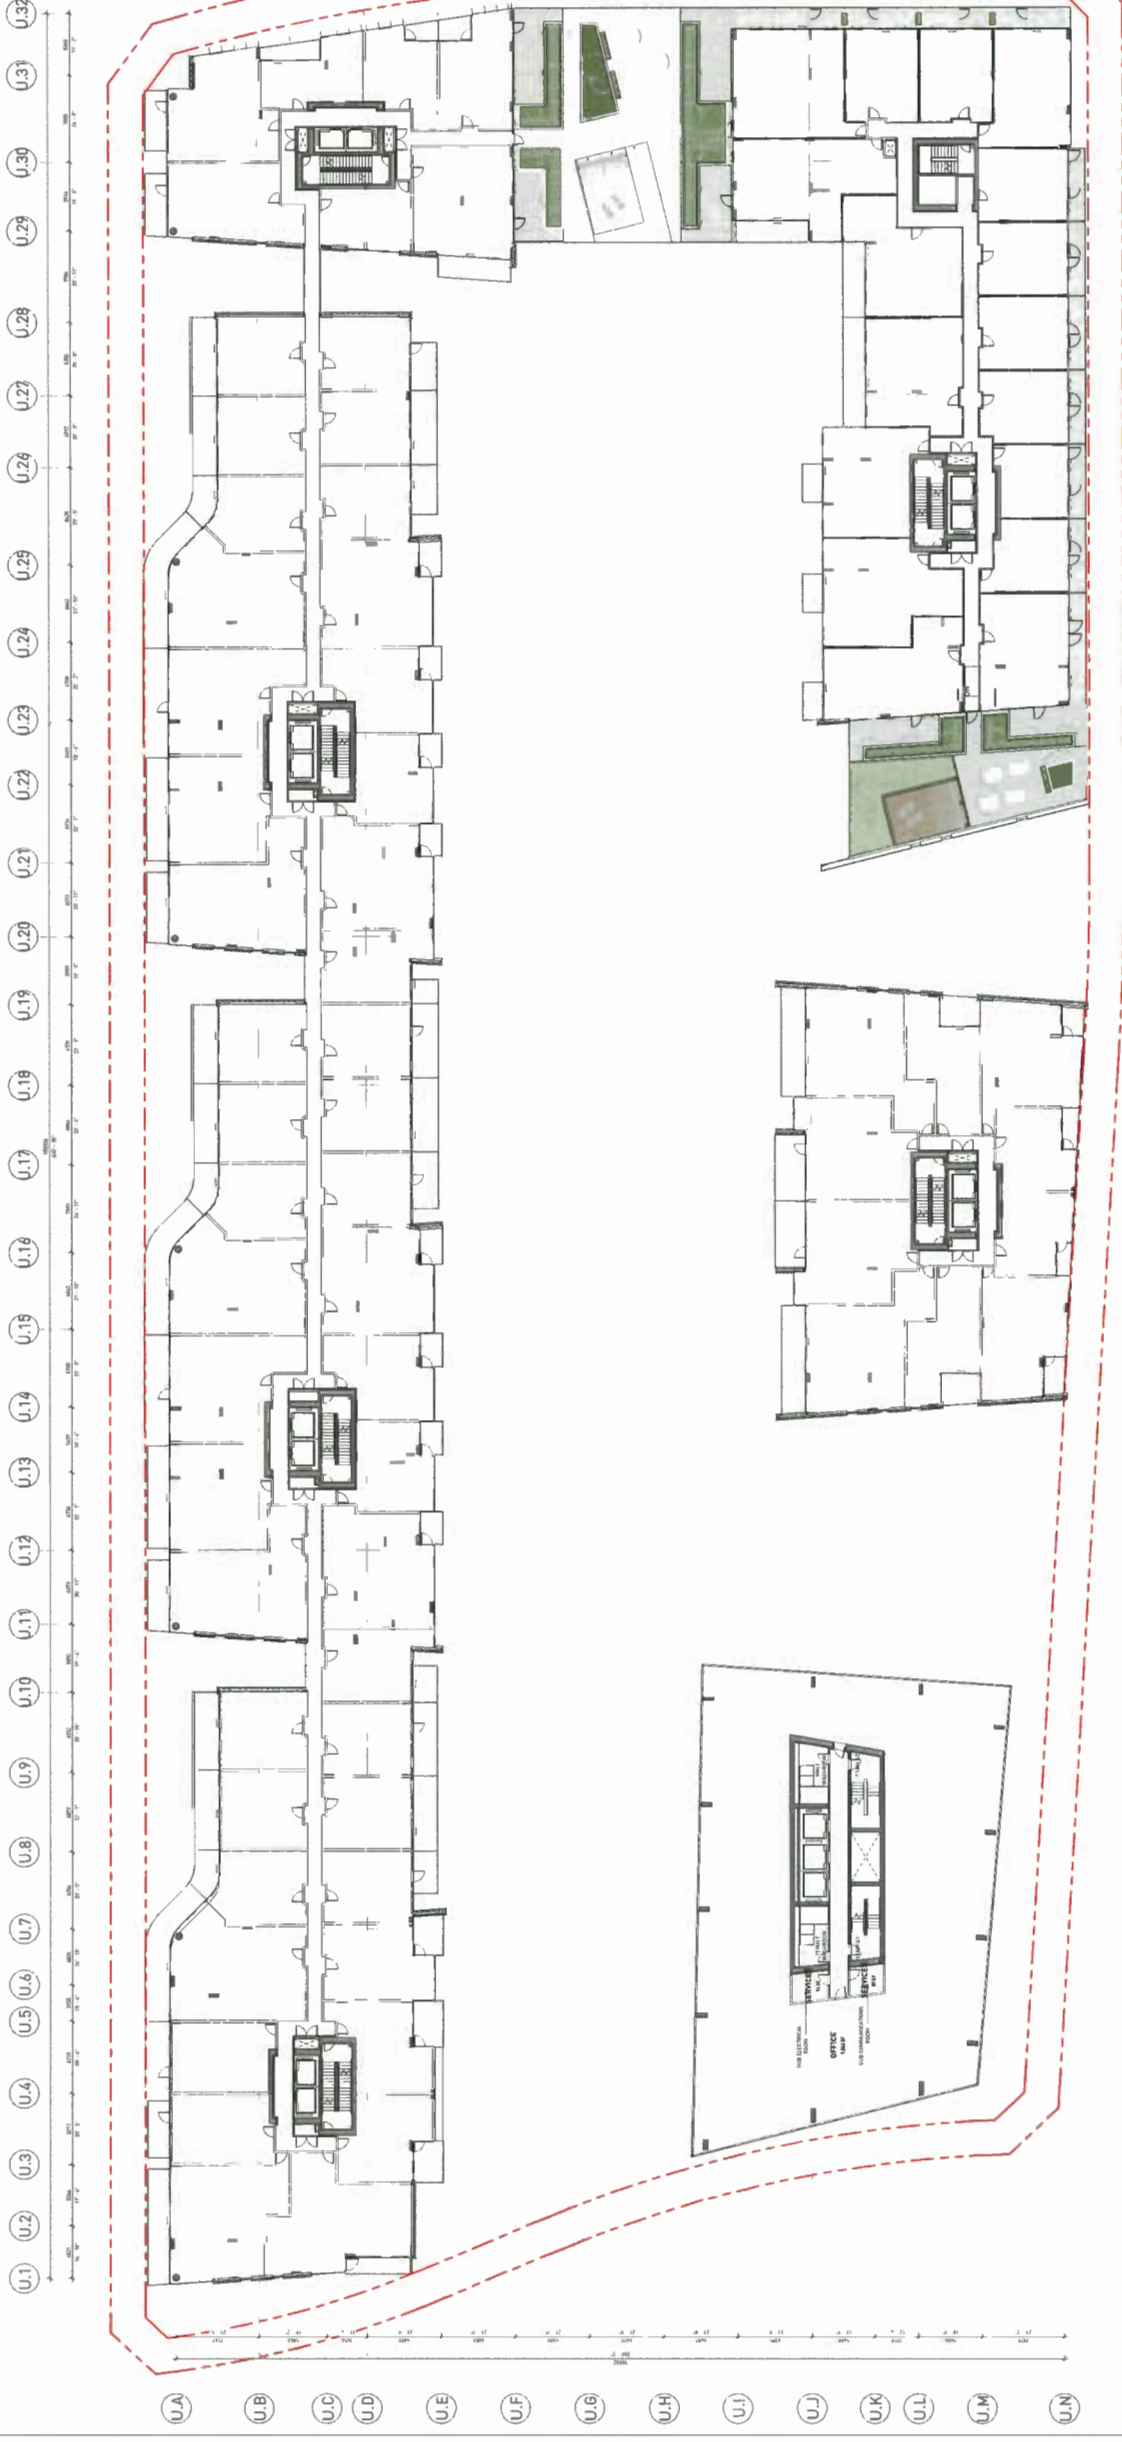


REVISIONS	NO	DATE	DESCRIPTION	DESIGNED FOR
	01	10/07/18		




7960 ALDERBRIDGE
 WAY
 DEVELOPMENT PERMIT
 LEVEL 6 OFFICE
 PLAN
 DATE: 10/07/18 10:41 AM
 DRAWN BY: [Signature]
 CHECKED BY: [Signature]
 SCALE: 1:100
 JOB NUMBER: 17020



DP 16-740262 #22

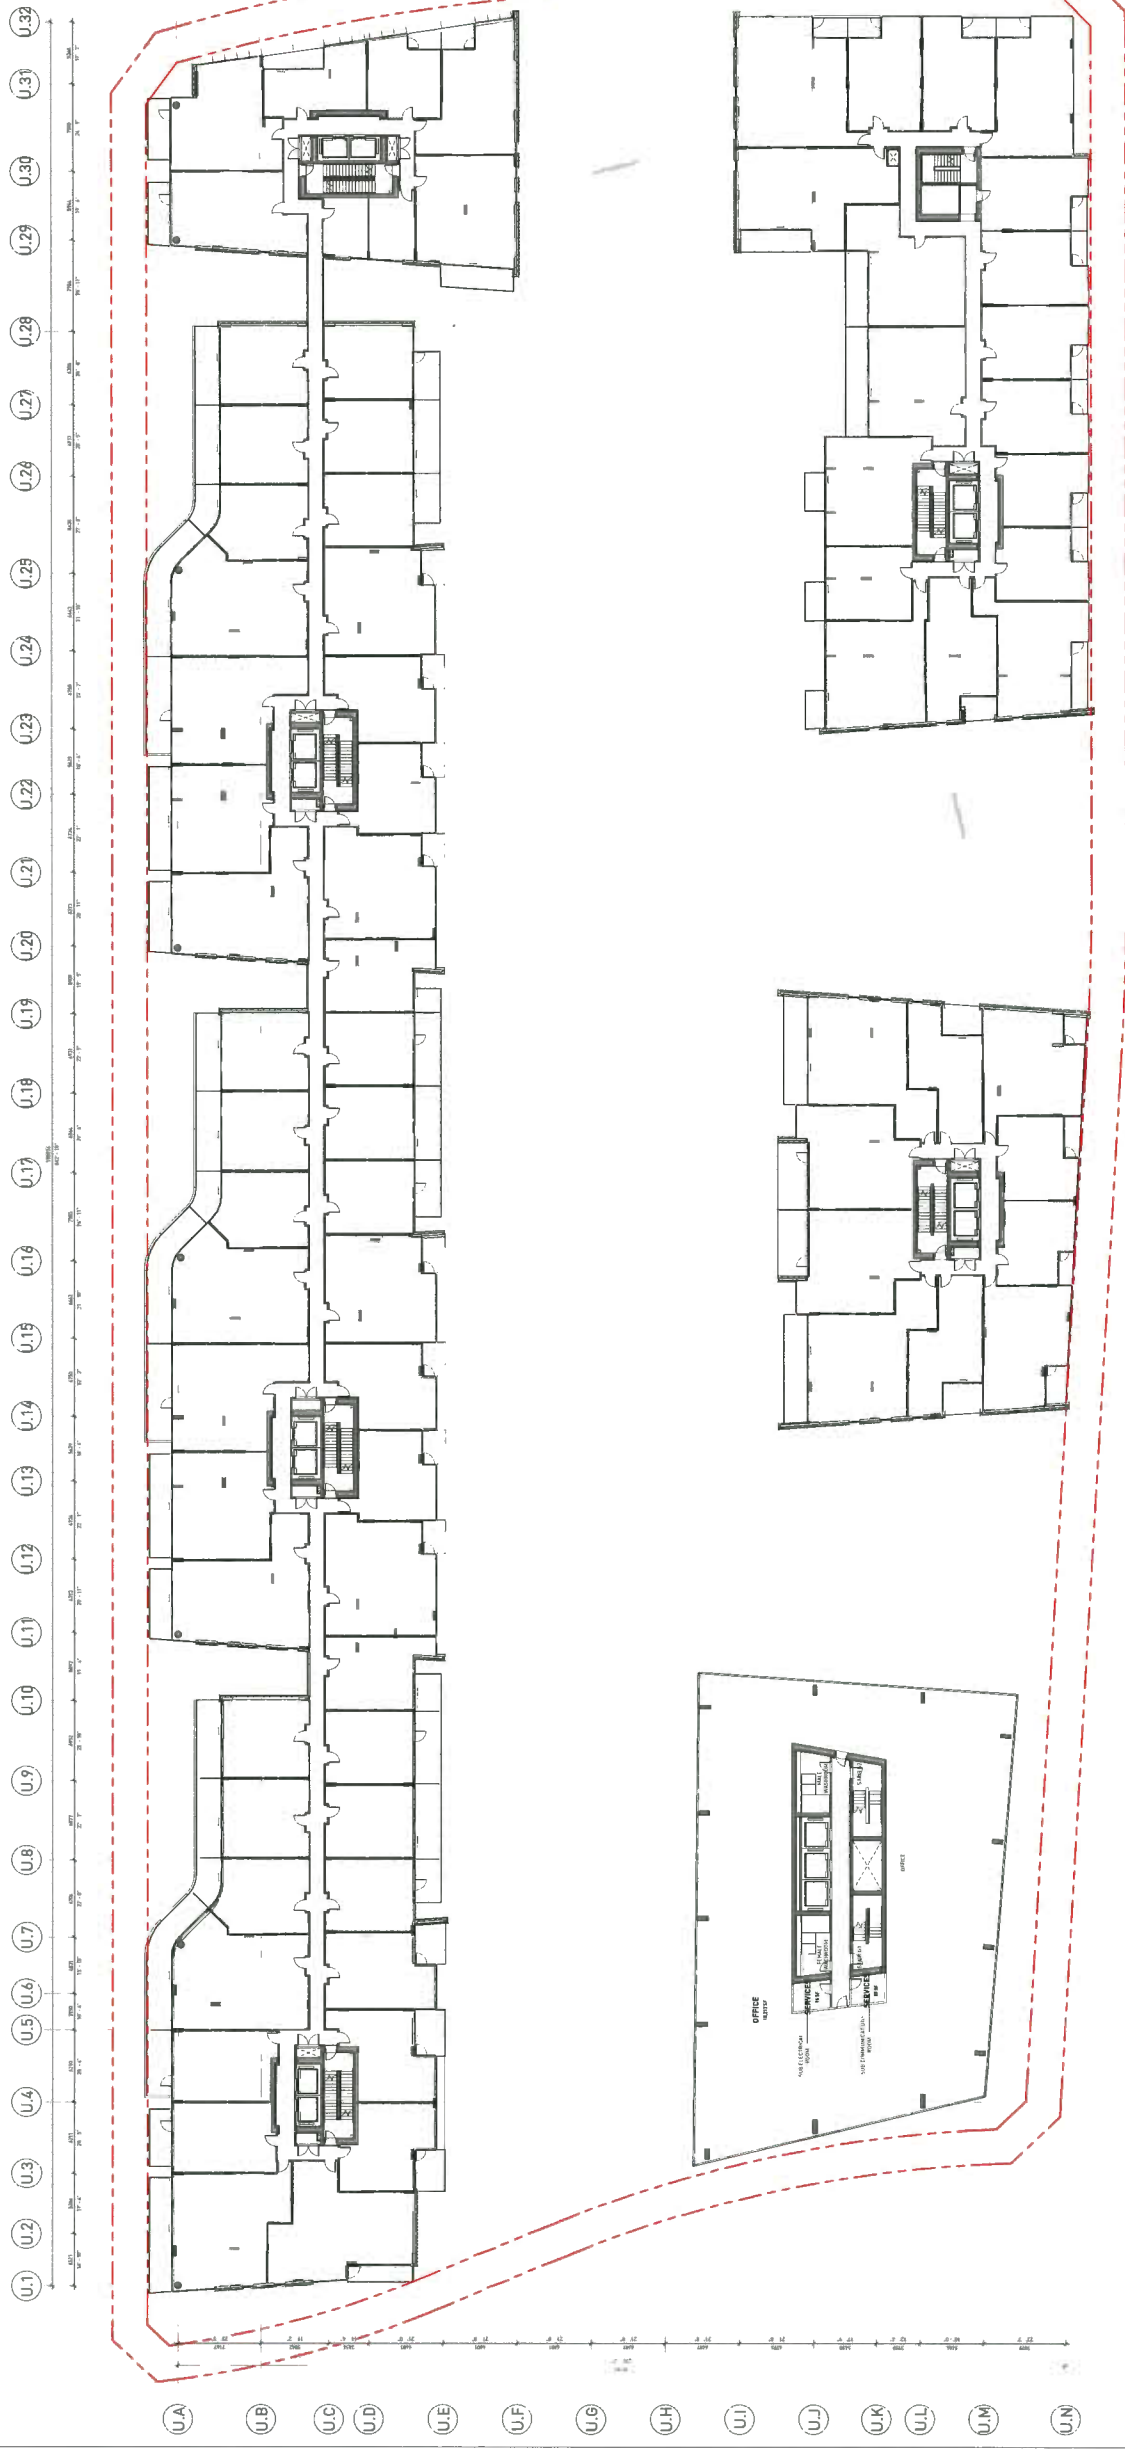

REVISIONS	NO.	DATE	DESCRIPTION	ISSUED FOR
	01	10/20/18		ISSUED FOR DP

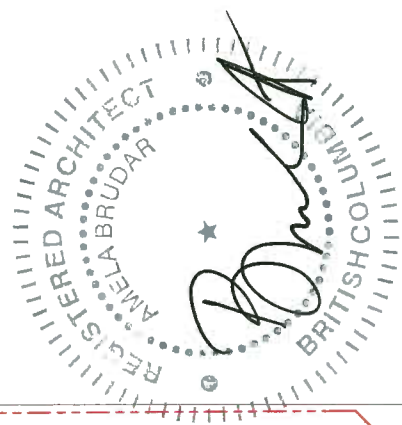

7960 ALDERBRIDGE
WAY

DEVELOPMENT PERMIT

LEVEL 7 OFFICE
PLAN

DATE: 10/20/18 1:07:54 PM
DRAWN BY: A.Brudar
CHECKED BY: A.Brudar
SCALE: 1:100
JOB NUMBER: 17020

DP 16-740262 #23



REVISIONS	DATE	DESCRIPTION
01	10/20/16	ISSUED FOR DP



7960 ALDERBRIDGE
WAY


DEVELOPMENT PERMIT

LEVEL 8 OFFICE
PLAN

DATE: 10/20/16
DRAWN BY: AM
CHECKED BY: CB
SCALE: 1/8"=1'-0"
JOB NUMBER: 17020



DP 16-740262#24

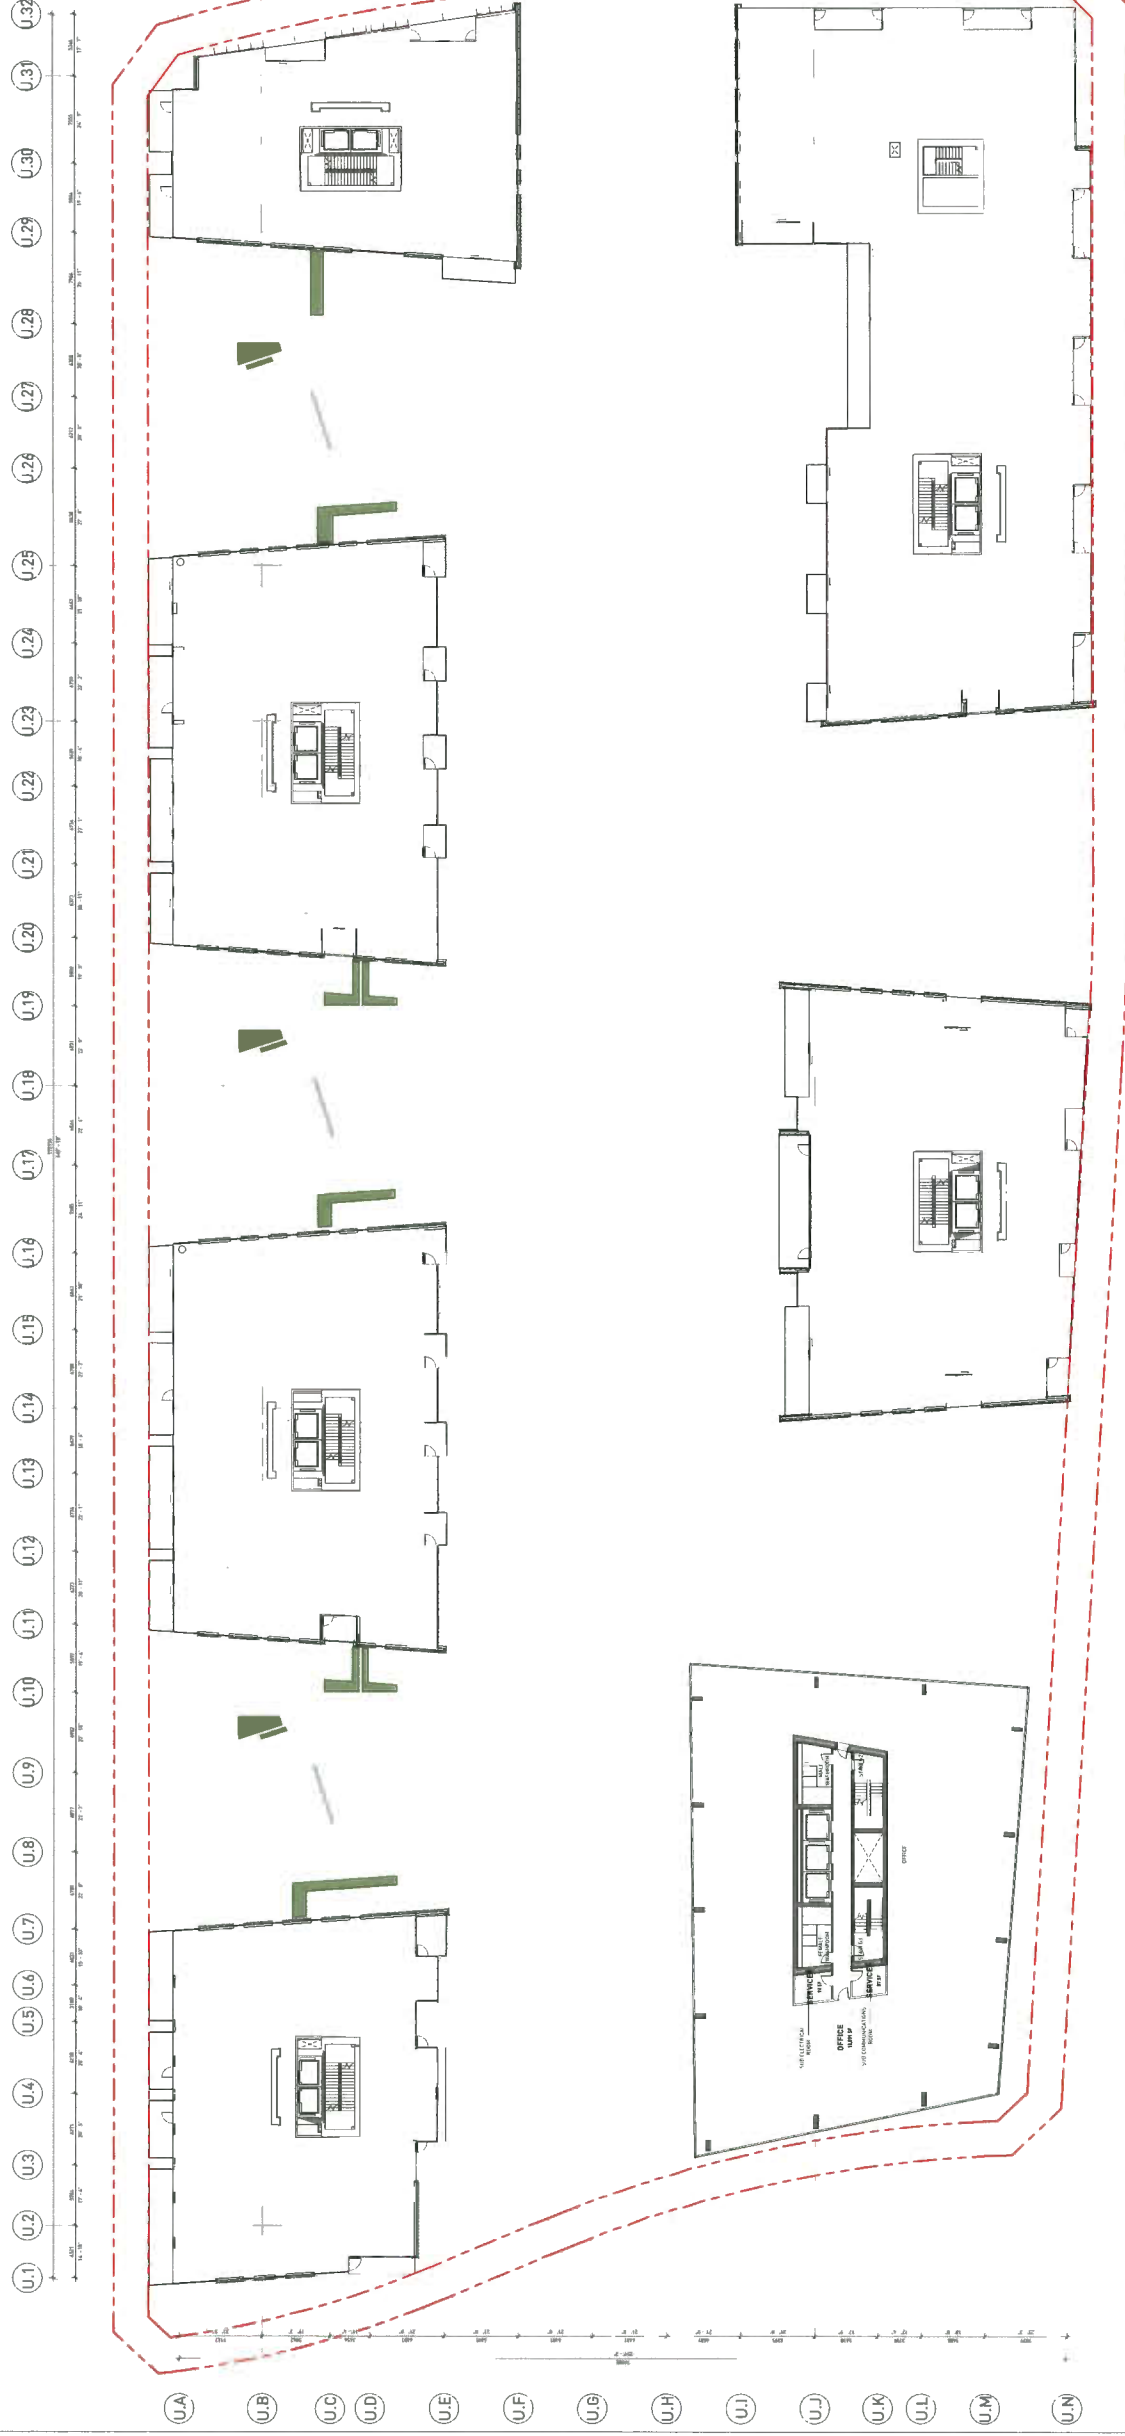

REVISIONS	NO	DATE	DESCRIPTION	DRAWN BY
	01	05/20/18	ISSUED FOR SP	



7960 ALDERBRIDGE
WAY


DEVELOPMENT PERMIT

LEVEL 9 OFFICE
PLAN

DATE: 05/20/18 10:27 PM
 DRAWN BY: [Signature]
 CHECKED BY: [Signature]
 SCALE: 1:100
 JOB NUMBER: 17020



DP 16-740262 #25

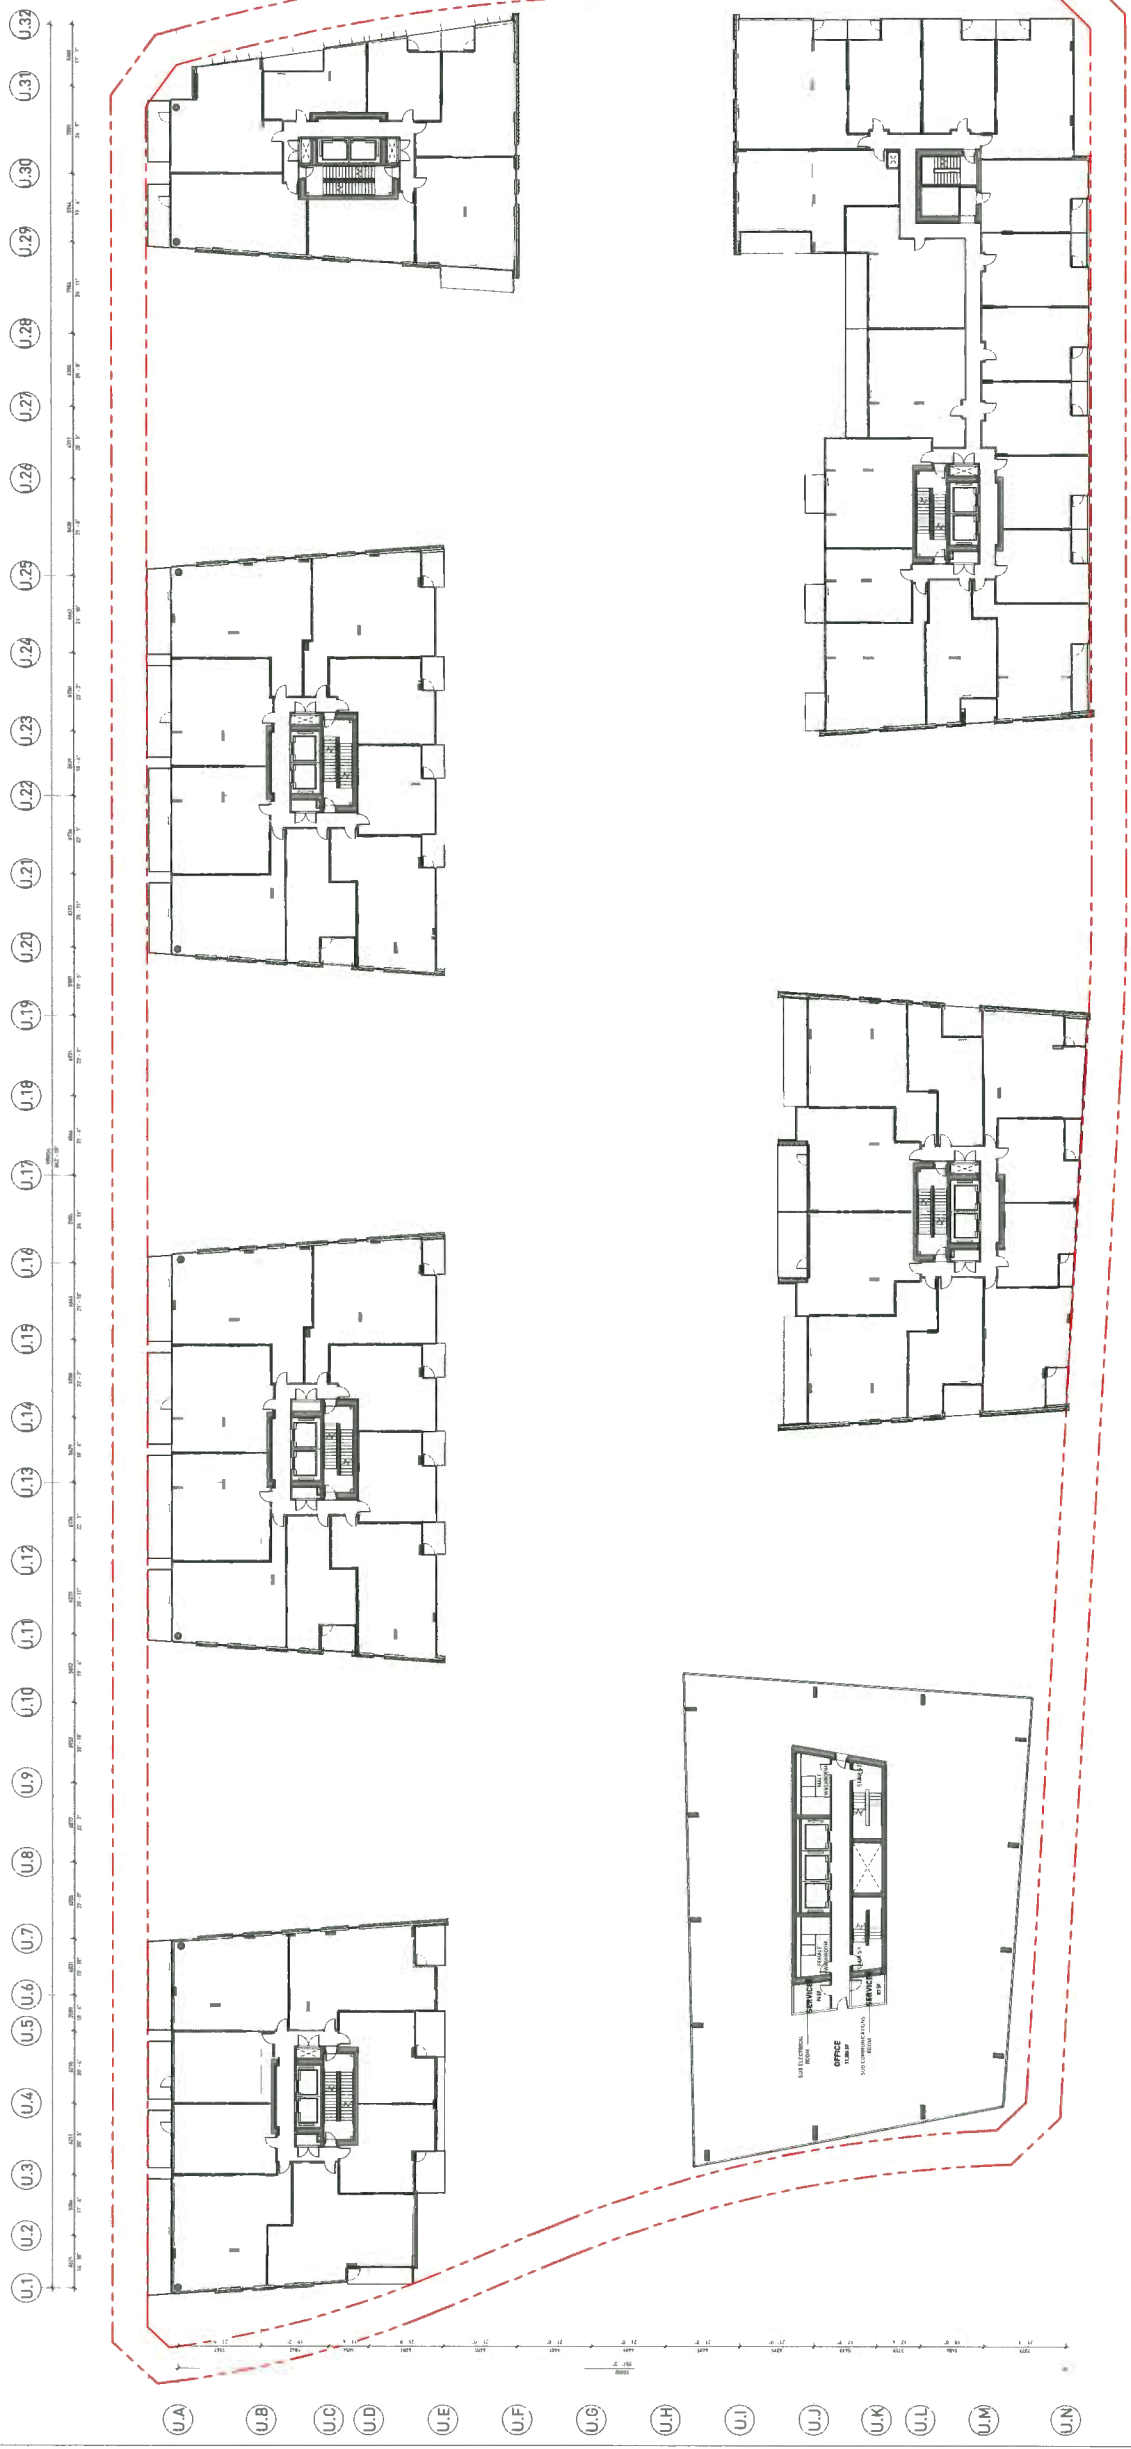

REVISIONS	DATE	DESCRIPTION	ISSUED FOR
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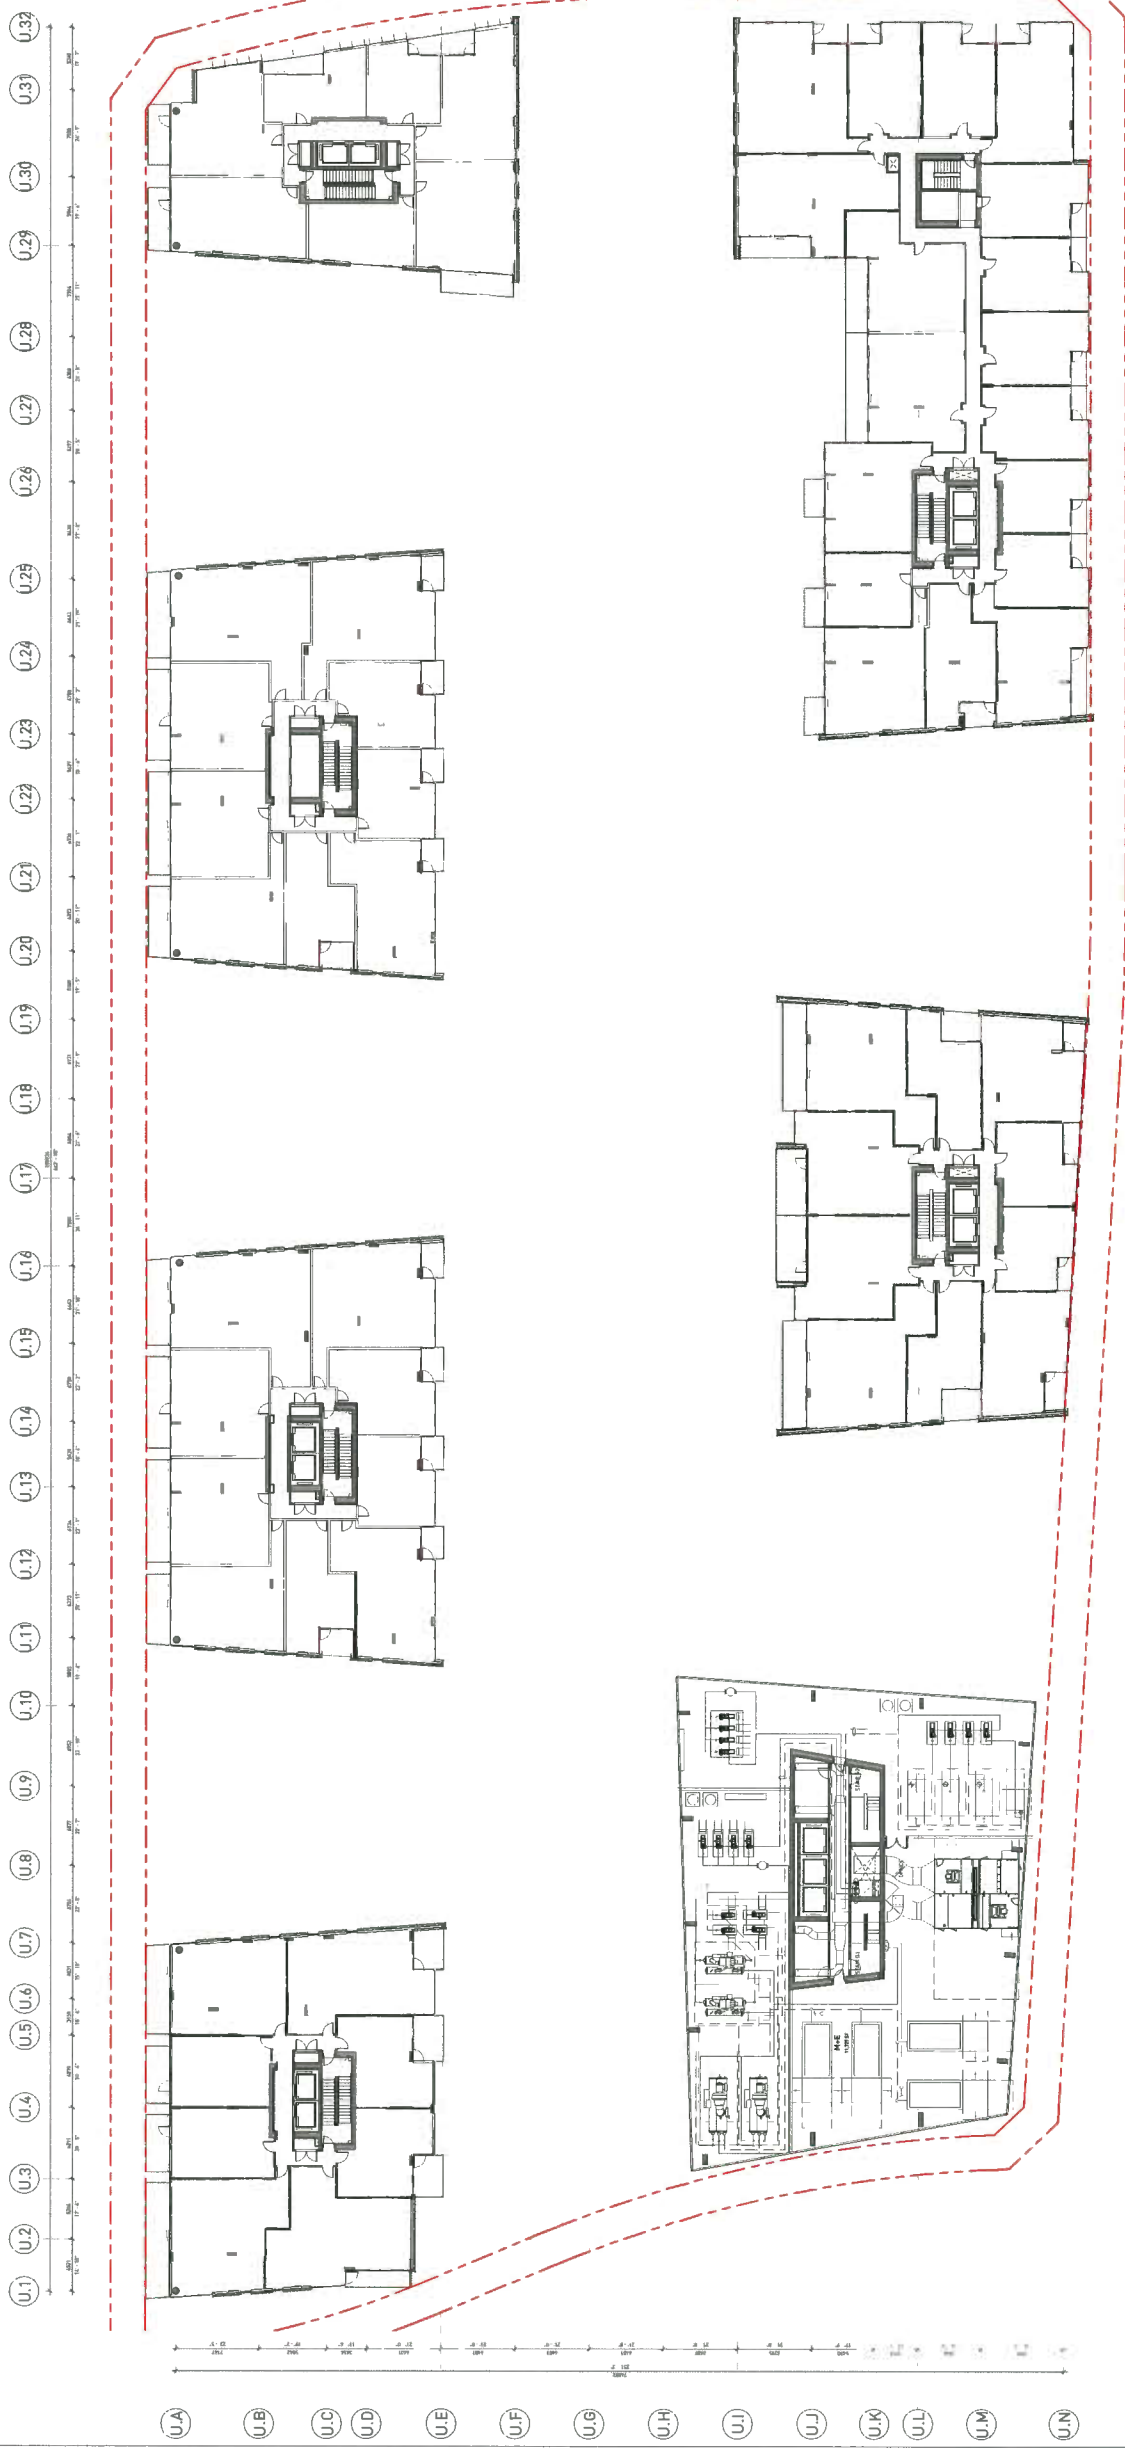
7960 ALDERBRIDGE
WAY

DEVELOPMENT PERMIT

LEVEL 10 OFFICE
PLAN

DATE: 10/25/2018 12:24 PM
DRAWN BY: [Signature]
CHECKED BY: [Signature]
SCALE: 1:100
JOB NUMBER: 17020

DP 16-740262 #26



REVISIONS	DATE	DESCRIPTION
01	10/20/08	COORDINATION



7960 ALDERBRIDGE
 WAY
 DEVELOPMENT PERMIT
 LEVEL 11 OFFICE
 PLAN
 DATE: 10/20/08
 DRAWN BY: [unintelligible]
 CHECKED BY: [unintelligible]
 SCALE: 1/32"
 JOB NUMBER: 17020



7960 ALDERBRIDGE
 WAY


DEVELOPMENT PERMIT

ROOFPLAN

DATE: 10/20/18
 DRAWN BY: [Signature]
 CHECKED BY: [Signature]
 SCALE: 1:200
 JOB NUMBER: 17020

A3.40


DP 16-740262 #27

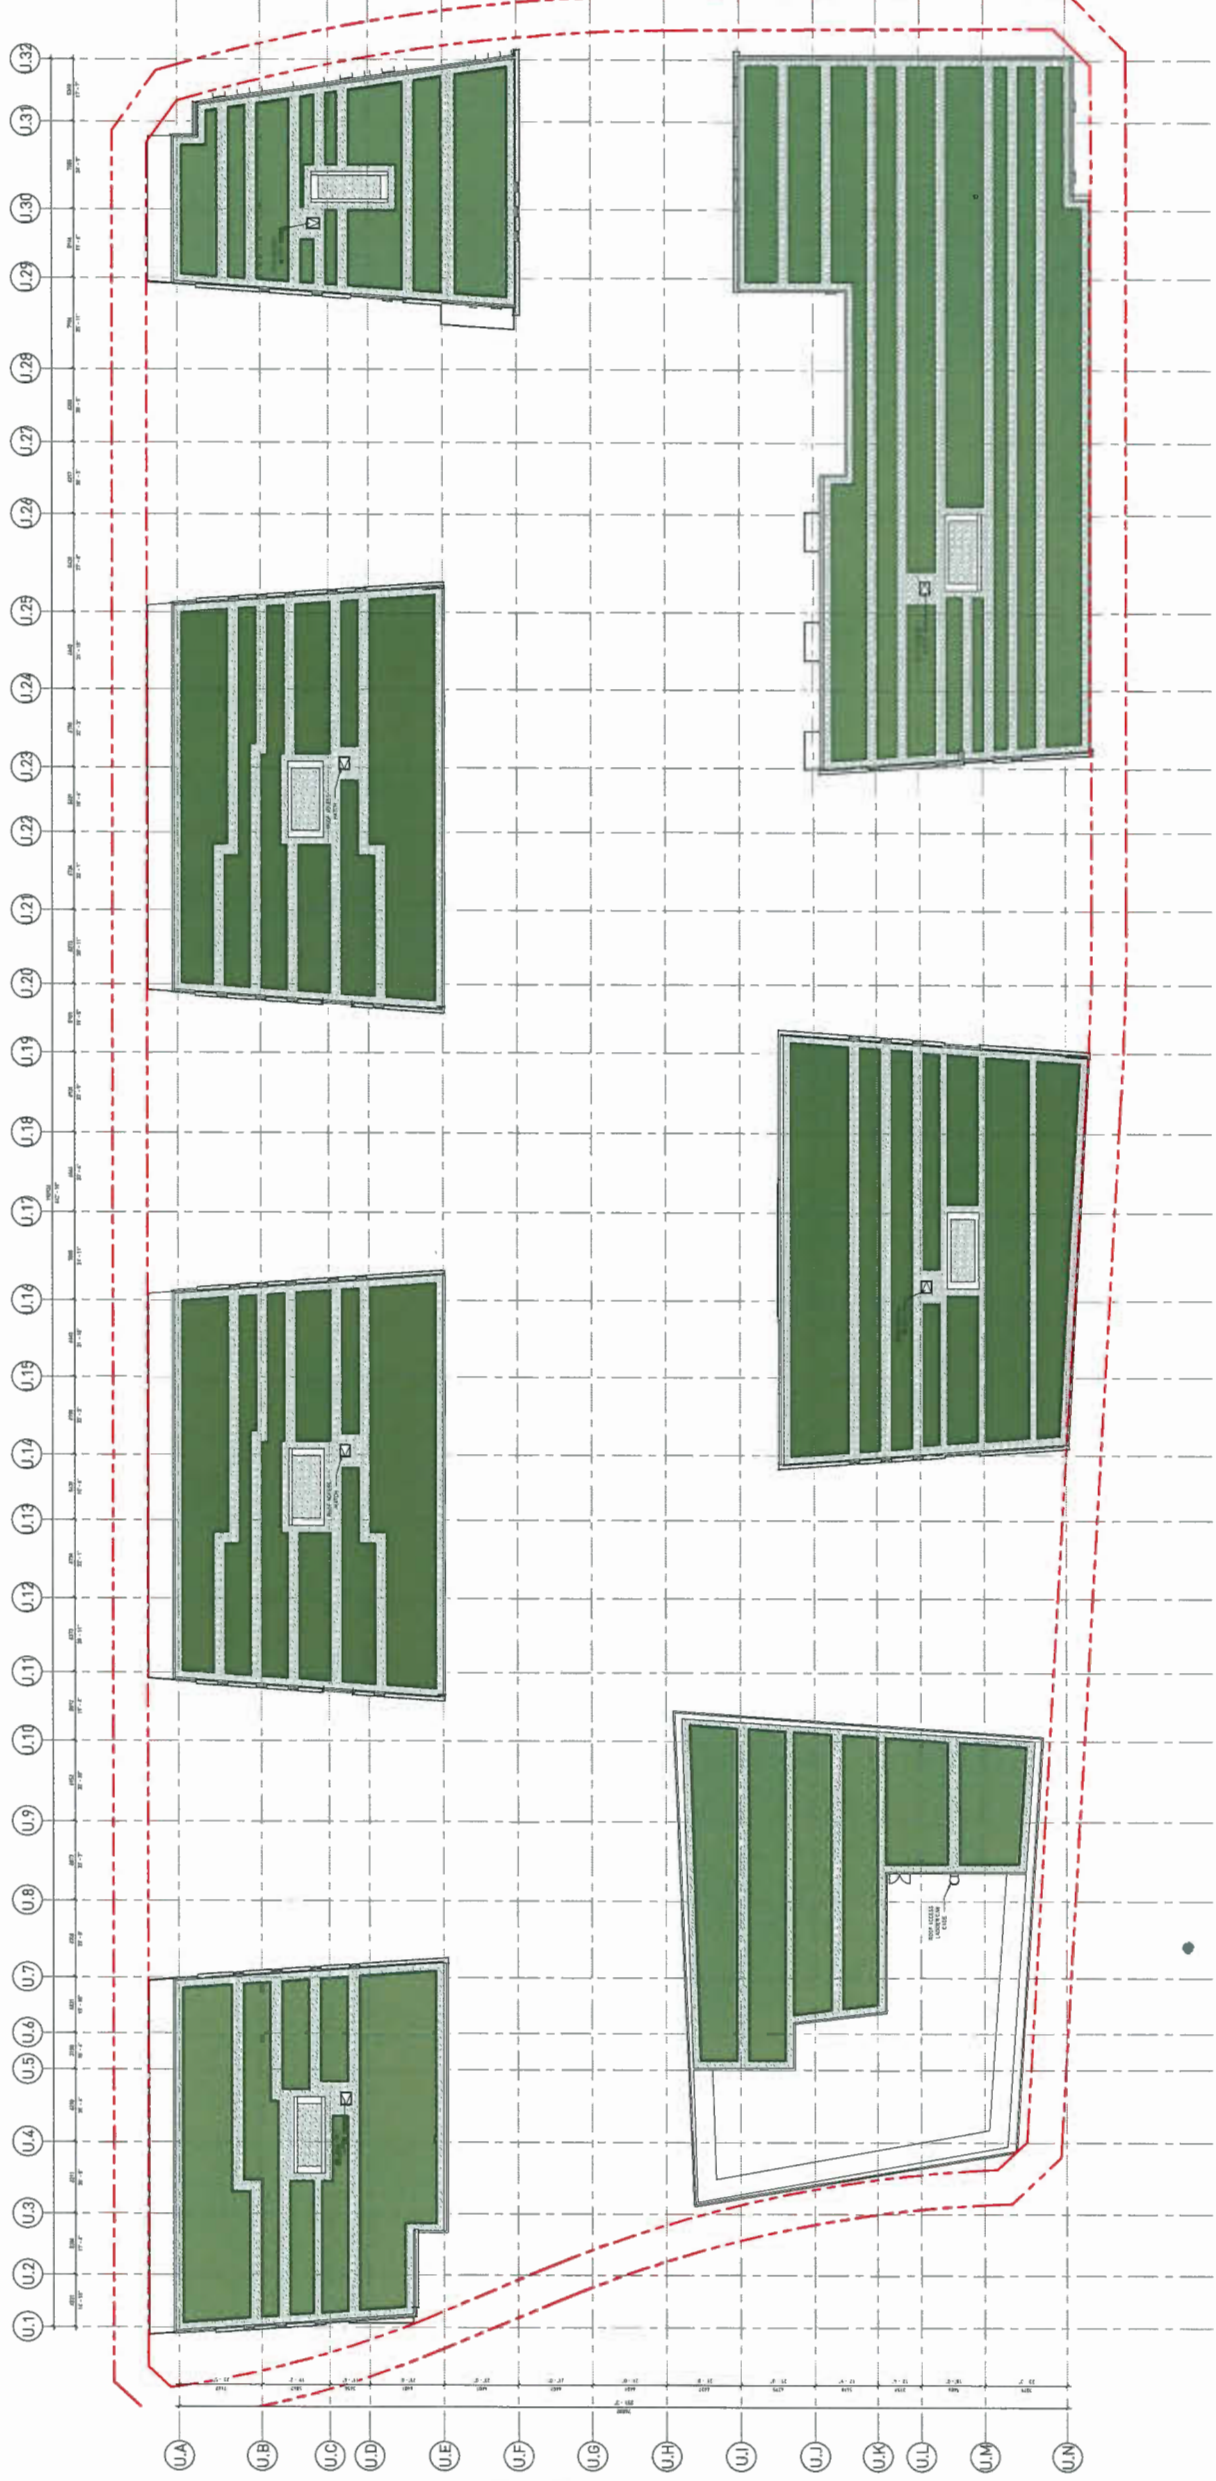


REVISIONS	NO.	DATE	DESCRIPTION	ISSUED FOR DP

DP 16-740262


#28

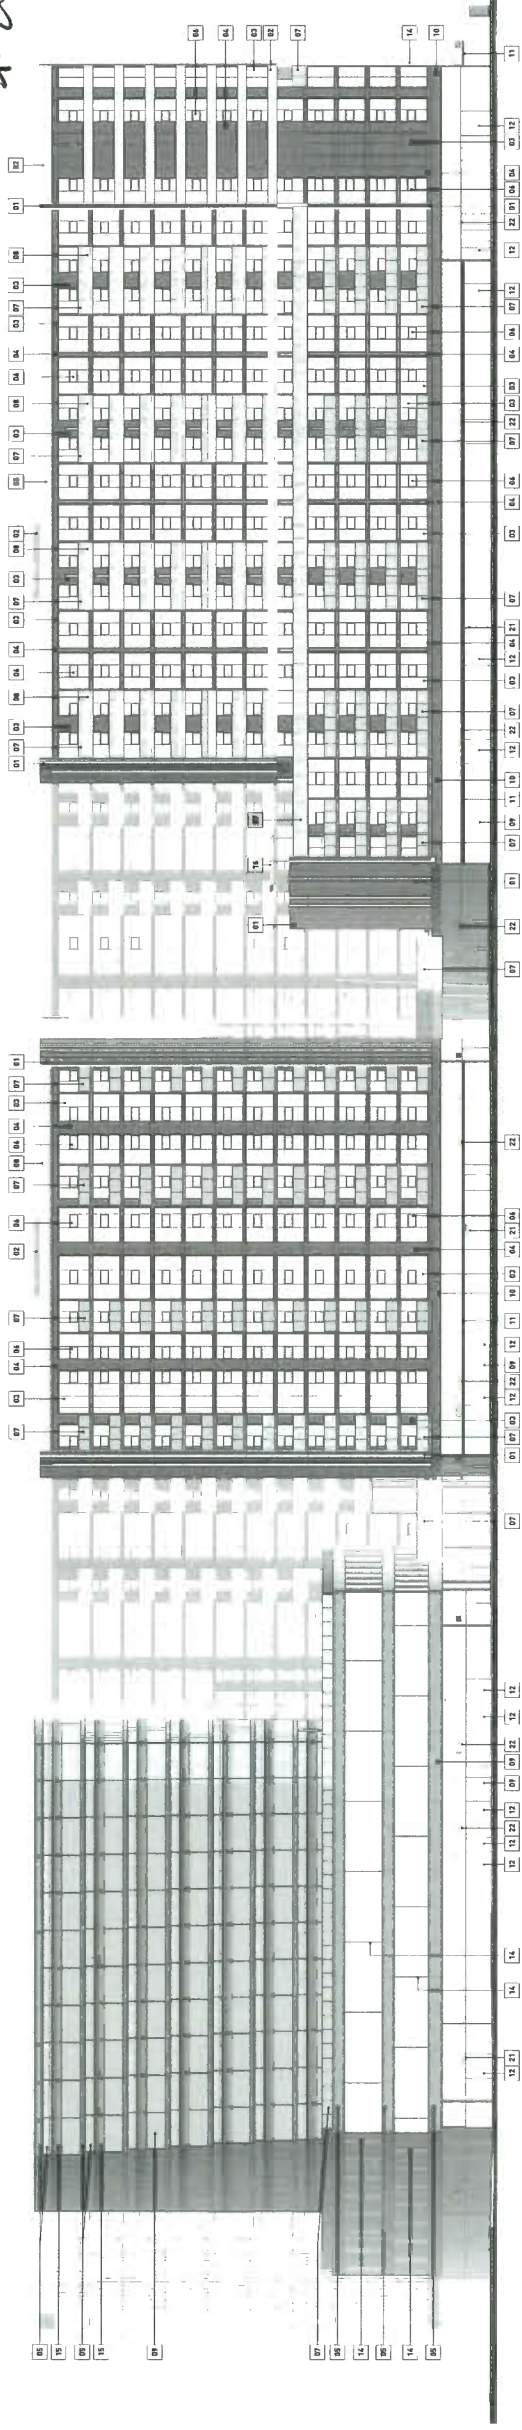

EAST ELEVATION

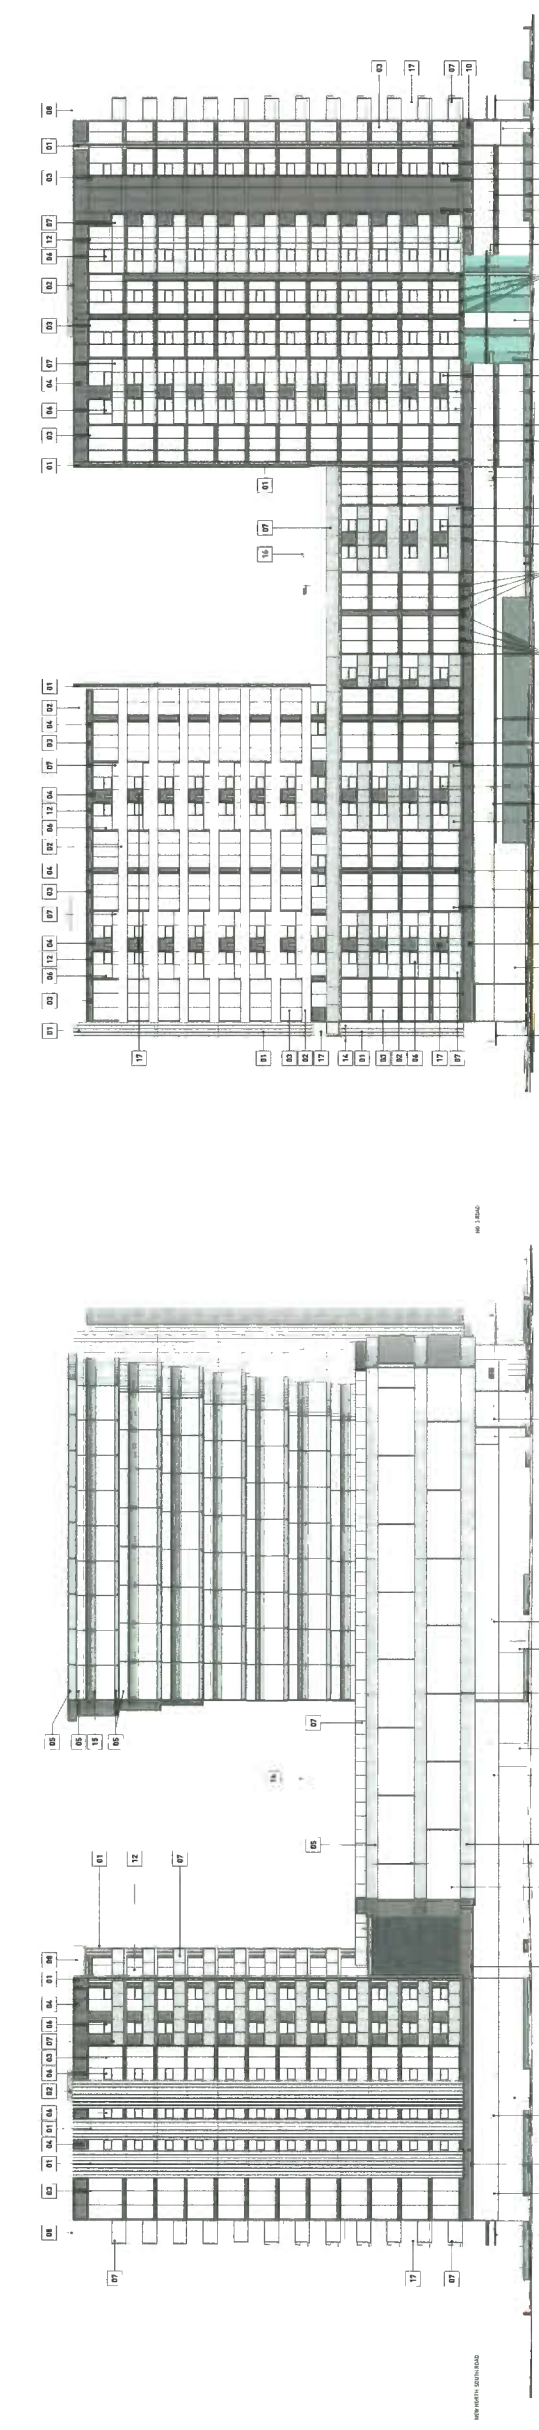

WEST ELEVATION

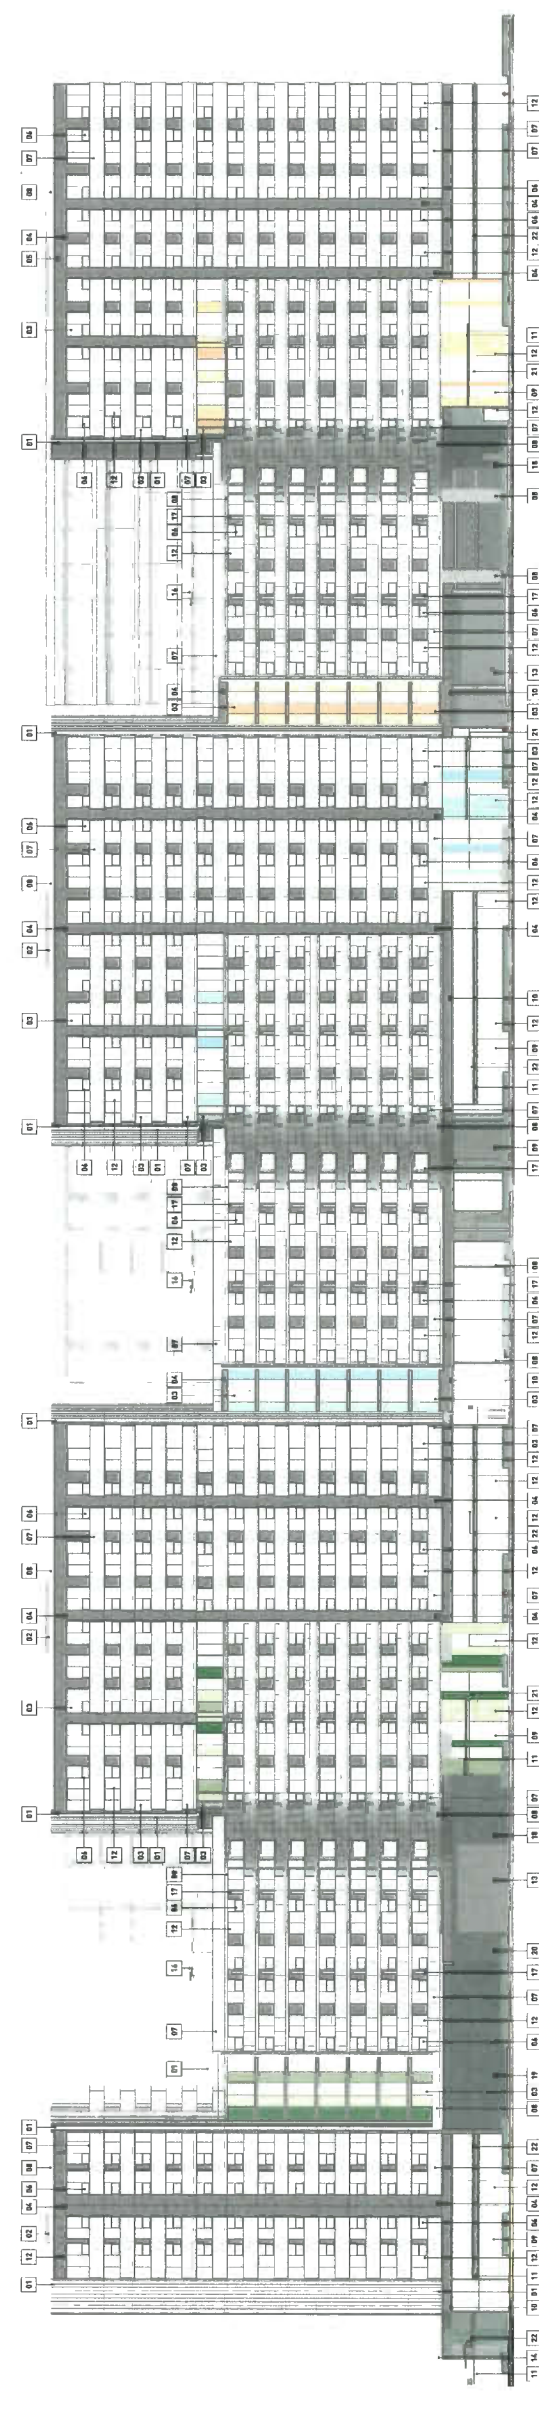


SOUTH ELEVATION

REVISIONS	DATE	DESCRIPTION	ISSUED FOR
1	10/20/16	ISSUED FOR SP	

#	Description	Color
01	Exterior Cladding	White (Glass)
02	Interior Paint	White
03	Exterior Window Sill	Charcoal
04	Exterior Window Frame	Charcoal
05	Exterior Window Pane	White
06	Interior Window Pane	White
07	Interior Window Frame	Charcoal
08	Interior Window Sill	Charcoal
09	Interior Window Pane	White
10	Interior Window Frame	Charcoal
11	Interior Window Sill	Charcoal
12	Interior Window Pane	White
13	Interior Window Frame	Charcoal
14	Interior Window Sill	Charcoal
15	Interior Window Pane	White
16	Interior Window Frame	Charcoal
17	Interior Window Sill	Charcoal
18	Interior Window Pane	White
19	Interior Window Frame	Charcoal
20	Interior Window Sill	Charcoal
21	Interior Window Pane	White
22	Interior Window Frame	Charcoal
23	Interior Window Sill	Charcoal
24	Interior Window Pane	White
25	Interior Window Frame	Charcoal
26	Interior Window Sill	Charcoal
27	Interior Window Pane	White
28	Interior Window Frame	Charcoal
29	Interior Window Sill	Charcoal
30	Interior Window Pane	White
31	Interior Window Frame	Charcoal

NOTE: SAMPLES SHOWN FOR CONCEPT ONLY. ALL SAMPLES SUBJECT TO DESIGN DEVELOPMENT.

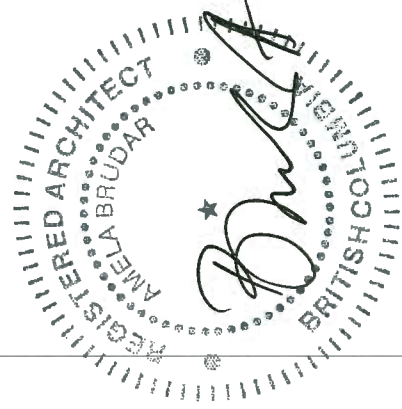

7960 ALDERBRIDGE WAY

DEVELOPMENT PERMIT


ELEVATIONS

DATE: 10/20/16
 CHECKED BY: [Signature]
 SCALE: 1:200
 JOB NUMBER: 17020

DP 16-740262 #29

gbl

G.B.L. ARCHITECTS INC.
151 EAST 10TH AVENUE
SUITE 200
DENVER, CO 80202
TEL: 303.733.1188
WWW.GBLARCHITECTS.COM

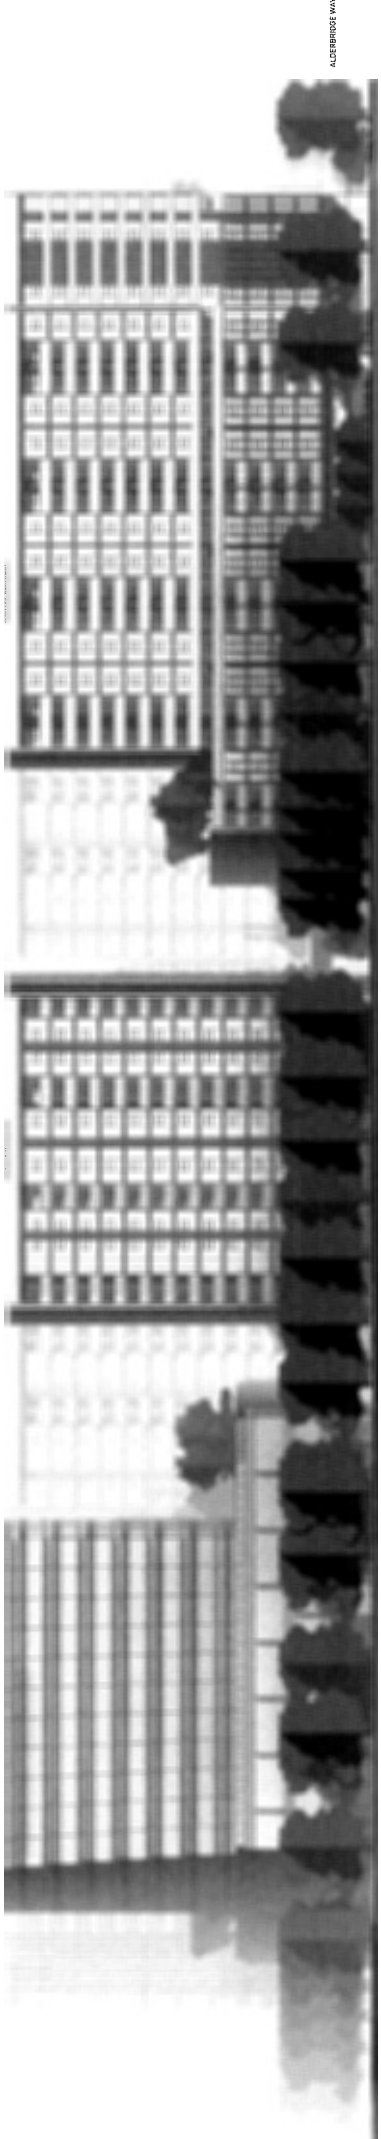


NEW EAST-WEST ROAD

ALDERBRIDGE WAY

EAST ELEVATION PLANTING
1:250

REVISIONS	NO.	DATE	DESCRIPTION	ISSUED FOR
	01	10/20/18		ISSUED FOR SP

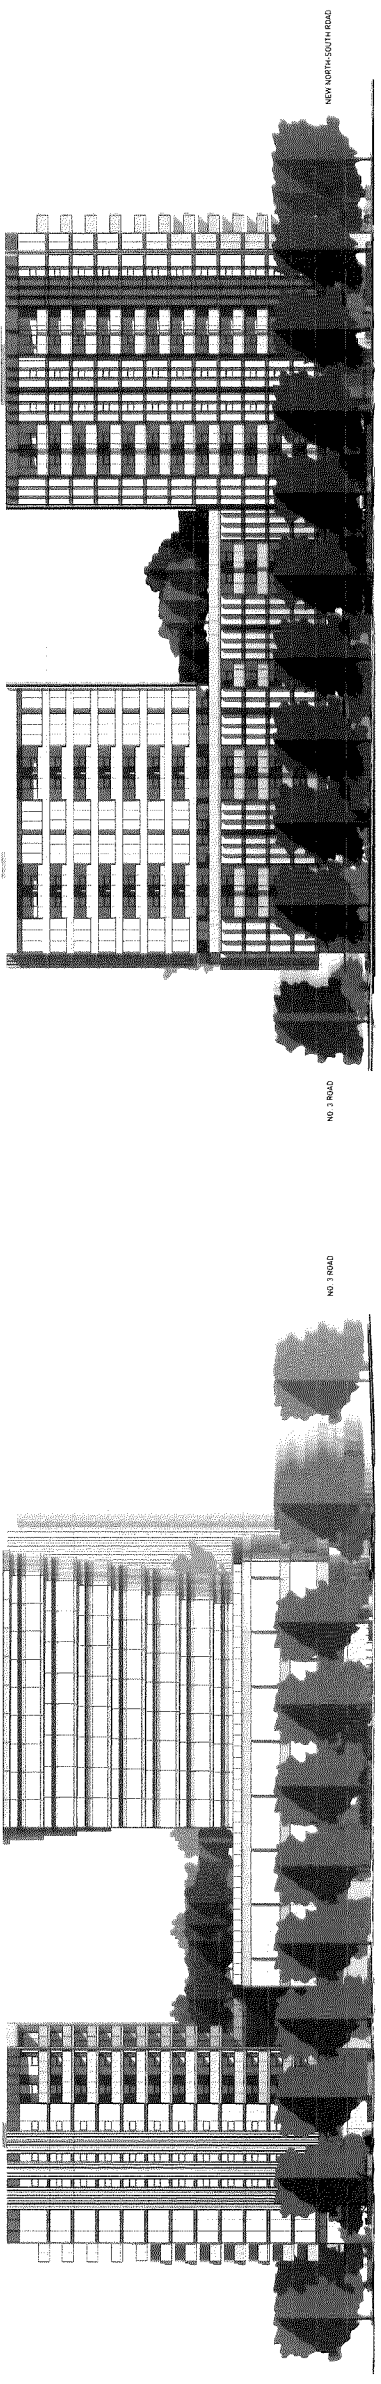

NEW NORTH-SOUTH ROAD

NO. 3 ROAD

NO. 3 ROAD

NEW NORTH-SOUTH ROAD

SOUTH ELEVATION PLANTING
1:250

NORTH ELEVATION PLANTING
1:250



7960 ALDERBRIDGE
WAY

DEVELOPMENT PERMIT

ELEVATIONS WITH
PLANTING


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DRAWN BY: Author
CHECKED BY: Checker
SCALE: 1:250
JOB NUMBER: 17020

A5.01

WEST ELEVATION PLANTING
1:250

ALDERBRIDGE WAY


EAST-WEST ROAD

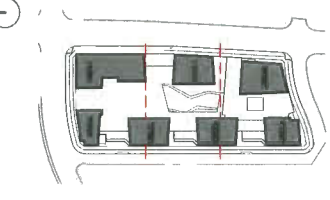

NO.	DATE	DESCRIPTION	DESIGNED BY
01	10/25/2018	COORDINATION	DP

#	Description	Color
01	White Gypsum	White (Gypsum)
02	White Gypsum	White (Gypsum)
03	Aluminum Framed Window Wall	Charcoal
04	Standard Panel	Charcoal
05	Aluminum Framed Window Wall	White
06	Aluminum Framed Window Wall	White
07	Aluminum Framed Window Wall	White
08	Aluminum Framed Window Wall	White
09	Aluminum Framed Window Wall	White
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96	Aluminum Framed Window Wall	White
97	Aluminum Framed Window Wall	White
98	Aluminum Framed Window Wall	White
99	Aluminum Framed Window Wall	White
100	Aluminum Framed Window Wall	White

NOTE: DIMENSIONS SHOWN FOR CONCEPT ONLY. ALL DIMENSIONS SUBJECT TO SHOP PRINTS AND APPLICATION PROCESS.

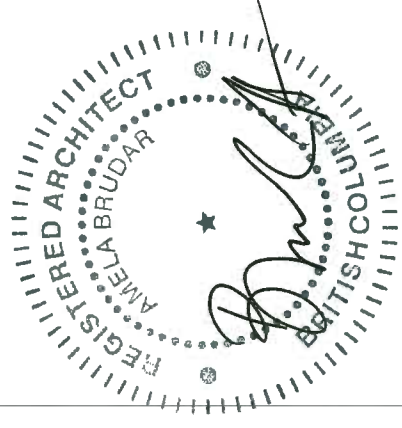







7960 ALDERBRIDGE WAY
DEVELOPMENT PERMIT

ELEVATIONS
TOWERS A AND B

DATE: 10/25/2018 10:27 AM
CHECKED BY: [Signature]
SCALE: 1:200
JOB NUMBER: 17020

A5.11

DP 16-740262 #20

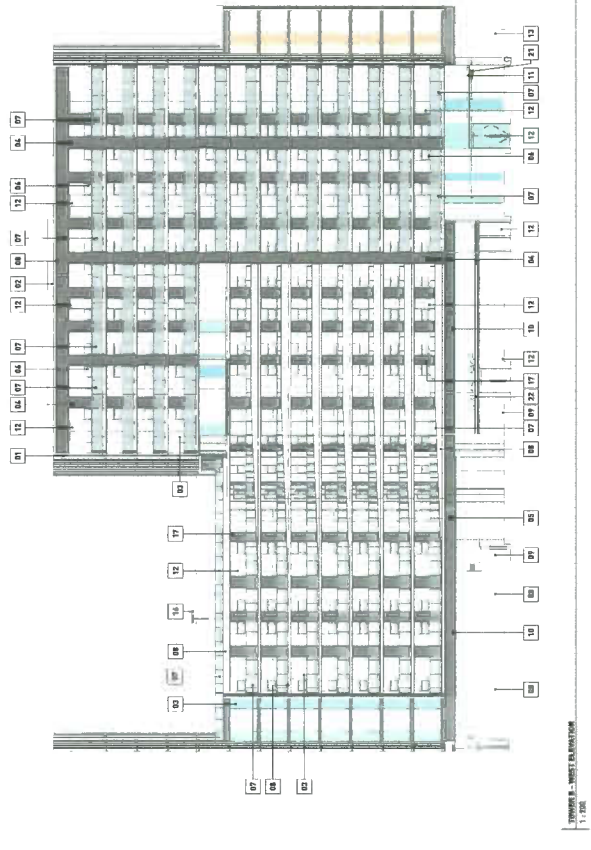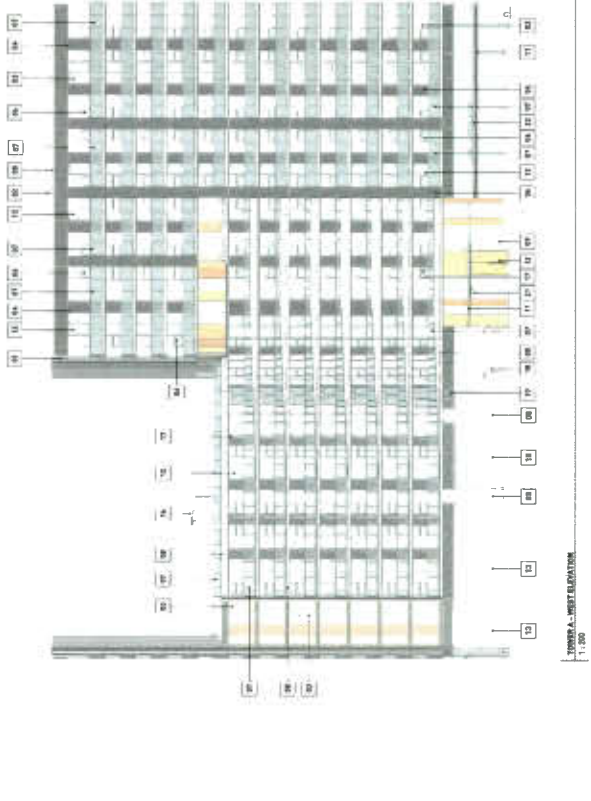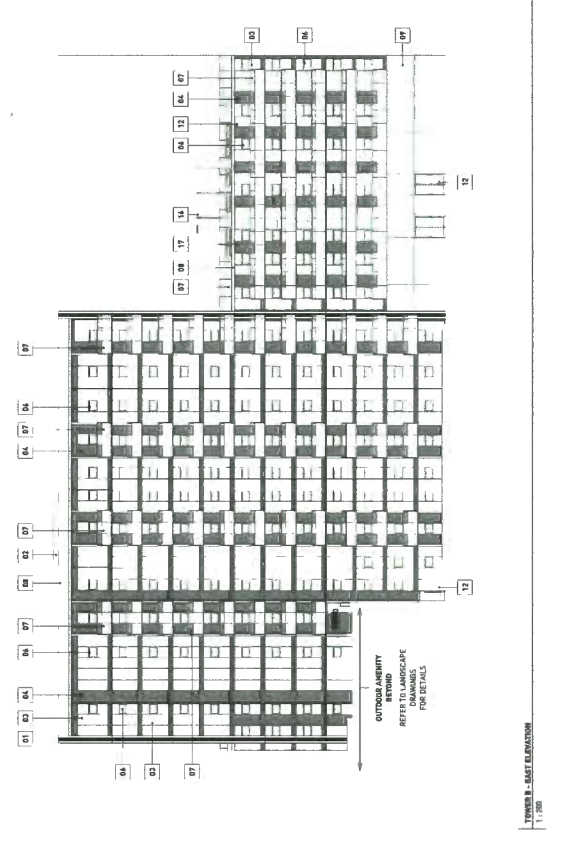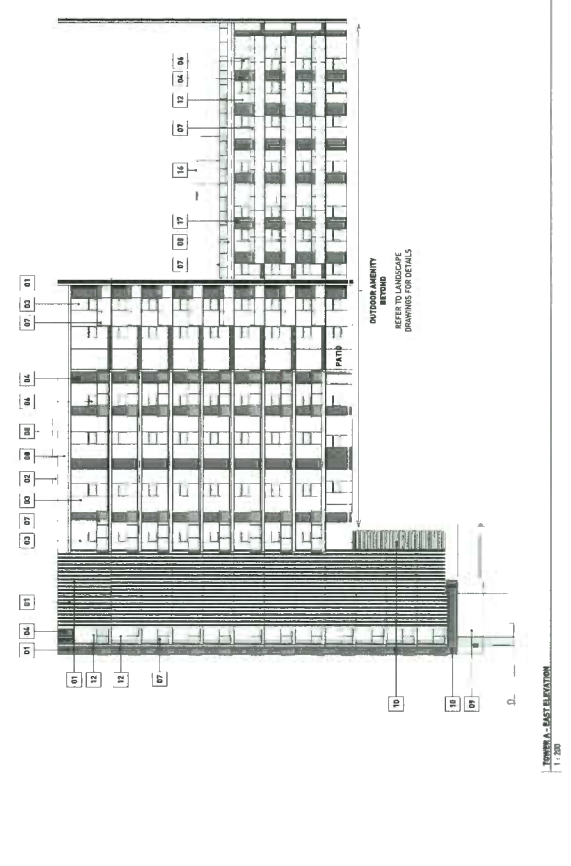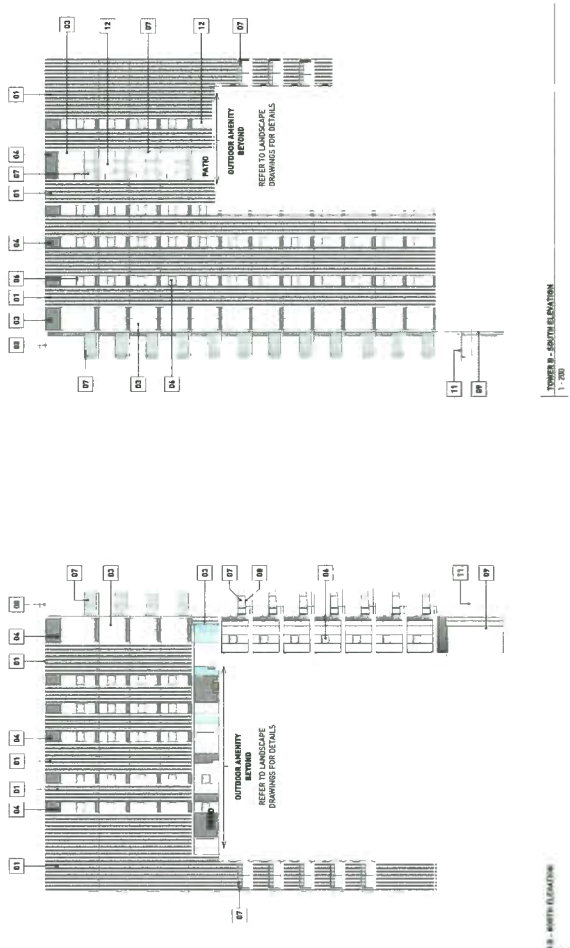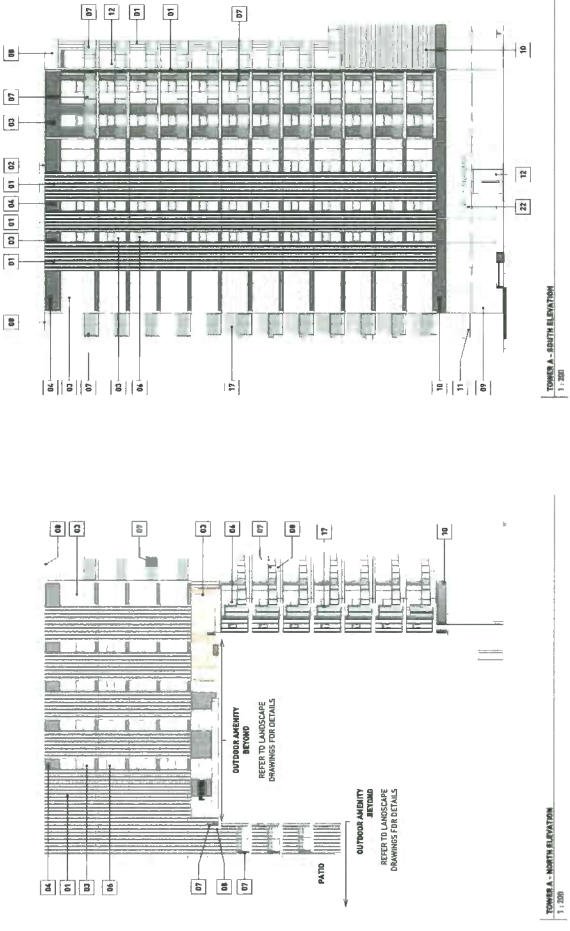


DP 16-740262 #21

gbi

GBI ARCHITECTS INC.
 174 EAST 87th AVENUE
 MANHATTAN, NY 10019
 TEL: 212 251 1156
 FAX: 212 251 1177
 WWW.GBIARCHITECTS.COM

KEY PLAN

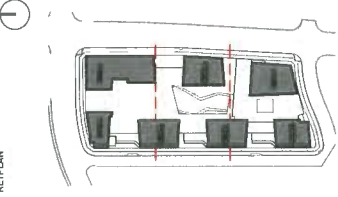

NO.	DATE	DESCRIPTION	SUBJECT FOR SP.
01	10/22/2016		

#	Description	Color
01	Exterior Cladding	White (Exterior)
02	Metal Panel	White
03	Aluminum Framed Window Wall	Charcoal
04	Aluminum Framed Window	Charcoal
05	Spandrel Panel	White
06	Aluminum Window	Charcoal
07	Aluminum Window Sill	Charcoal
08	Aluminum Window Head	Charcoal
09	Aluminum Window Frame	Charcoal
10	Aluminum Window Sill	Charcoal
11	Aluminum Window Head	Charcoal
12	Aluminum Window Frame	Charcoal
13	Aluminum Window Sill	Charcoal
14	Aluminum Window Head	Charcoal
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100	Aluminum Window Sill	Charcoal


NOTE: SPANSE SHOWN FOR CONCEPT ONLY. ALL MATERIALS TO BE DETERMINED BY ARCHITECT TO SURE PERMIT APPLICATION PROCESS.




7960 ALDERBRIDGE WAY
 DEVELOPMENT PERMIT
 ELEVATIONS
 TOWERS C AND D

DATE: 10/22/2016
 DRAWN BY: [Signature]
 CHECKED BY: [Signature]
 SCALE: 1" = 30'
 JOB NUMBER: 17020


A5.12

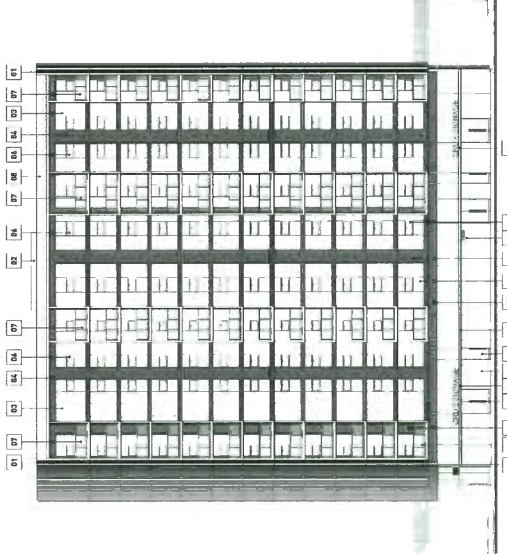


TOWER C - WEST ELEVATION
 1" = 30'

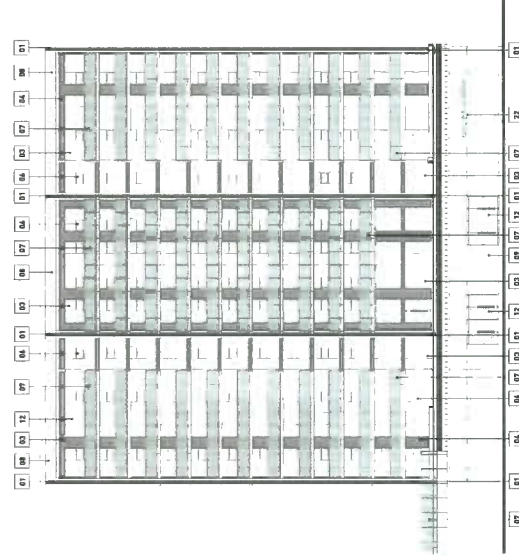


TOWER C - NORTH ELEVATION
 1" = 30'

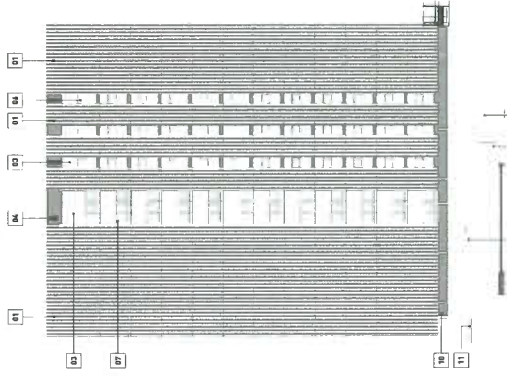

TOWER C - SOUTH ELEVATION
 1" = 30'

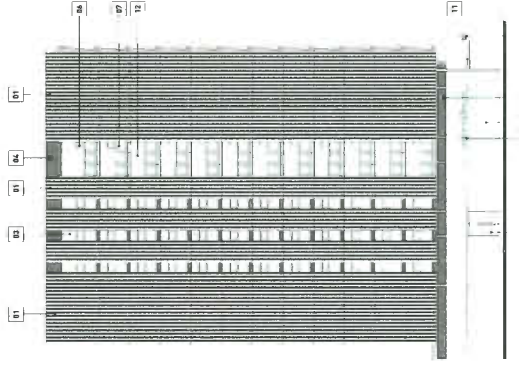


TOWER C - EAST ELEVATION
 1" = 30'

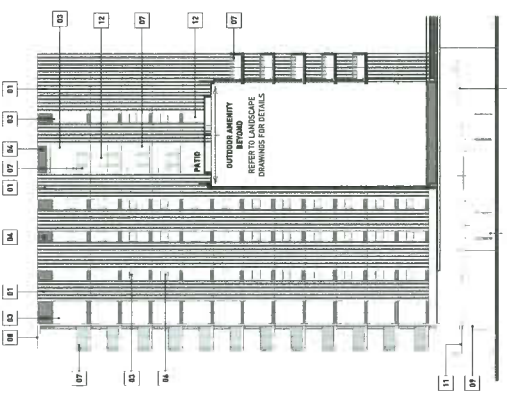


TOWER C - MARKET - SOUTH ELEVATION
 1" = 30'




TOWER C - MARKET - WEST ELEVATION
 1" = 30'

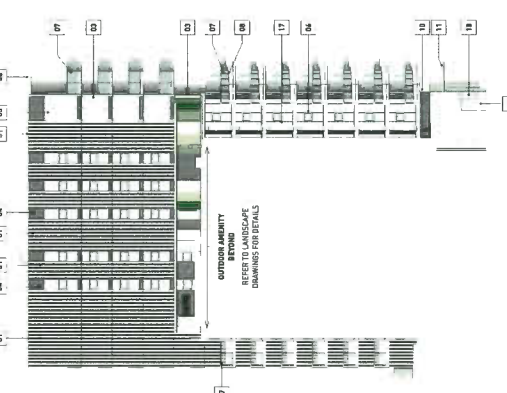

TOWER C - MARKET - NORTH ELEVATION
 1" = 30'

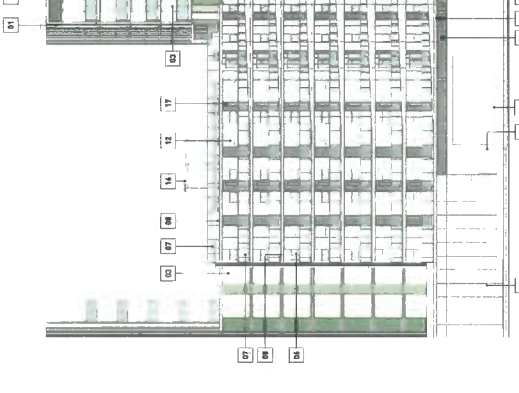

TOWER C - MARKET - EAST ELEVATION
 1" = 30'

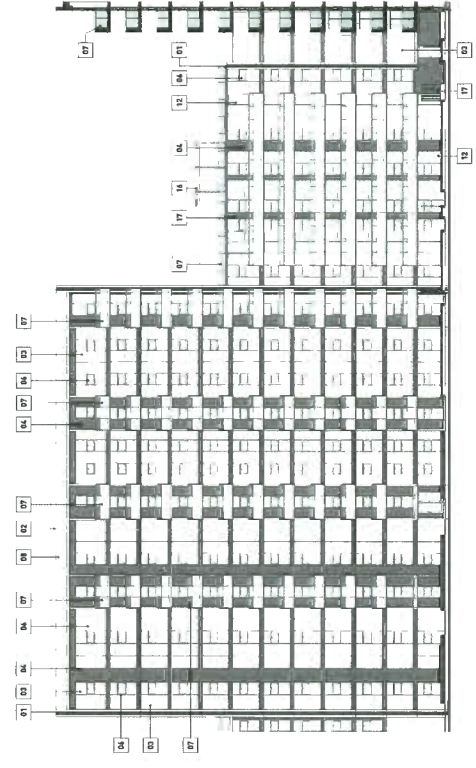

TOWER C - MARKET - WEST ELEVATION
 1" = 30'

OUTDOOR AMENITY
 REFER TO LANDSCAPE
 DRAWINGS FOR DETAILS

OUTDOOR AMENITY
 REFER TO LANDSCAPE
 DRAWINGS FOR DETAILS


OP 16-740262 #32

gbi

GBI ARCHITECTS INC.
 137 EAST 87th AVENUE
 NEW YORK, NY 10019
 TEL: (212) 751-1155
 FAX: (212) 751-1156
 WWW.GBIARCHITECTS.COM

KEY PLAN

1

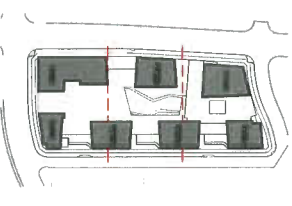

REVISIONS
 NO. DATE DESCRIPTION ISSUED FOR

01 10/20/18

#	Description	Color
01	Exterior Cladding	White Glazed
02	Marble Panel	White
03	Exterior Wall	Charcoal
04	Exterior Panel	Charcoal
05	Exterior Panel	White
06	Exterior Panel	White
07	Exterior Panel	White
08	Exterior Panel	White
09	Exterior Panel	White
10	Exterior Panel	White
11	Exterior Panel	White
12	Exterior Panel	White
13	Exterior Panel	White
14	Exterior Panel	White
15	Exterior Panel	White
16	Exterior Panel	White
17	Exterior Panel	White
18	Exterior Panel	White
19	Exterior Panel	White
20	Exterior Panel	White
21	Exterior Panel	White
22	Exterior Panel	White


NOTE: DIMENSIONS SHOWN FOR CONCRETE ONLY. ALL DIMENSIONS TO FACE UNLESS NOTED OTHERWISE.
 DIMENSIONS TO DIMENSION LINE UNLESS NOTED OTHERWISE.
 APPLICATION PROCESS




7960 ALDERBRIDGE WAY
 DEVELOPMENT PERMIT
 ELEVATIONS
 TOWERS E AND F

DATE: 10/20/18 1:25:43 PM
 DRAWN BY: [Signature]
 CHECKED BY: [Signature]
 SCALE: 1/8"=1'-0"
 JOB NUMBER: 17020


A5.13

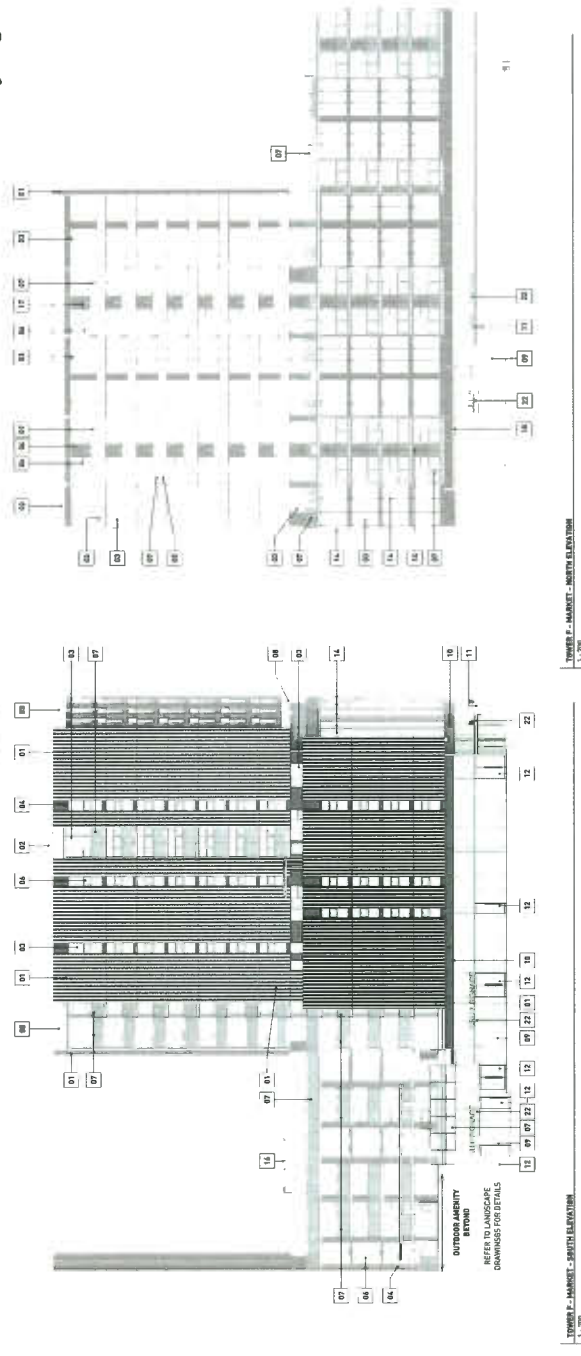


TOWER E - MARKET - WEST ELEVATION
 1/8"=1'-0"

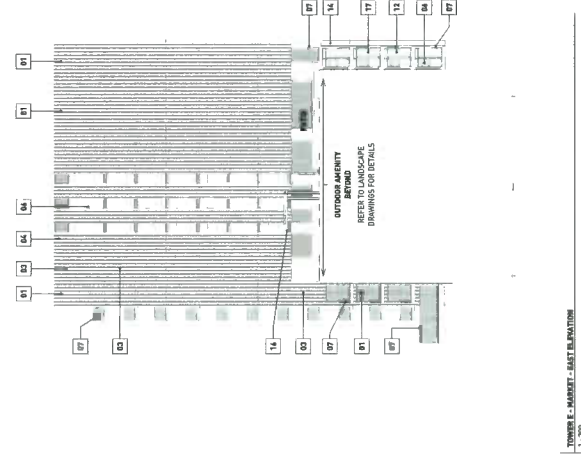


TOWER E - MARKET - EAST ELEVATION
 1/8"=1'-0"

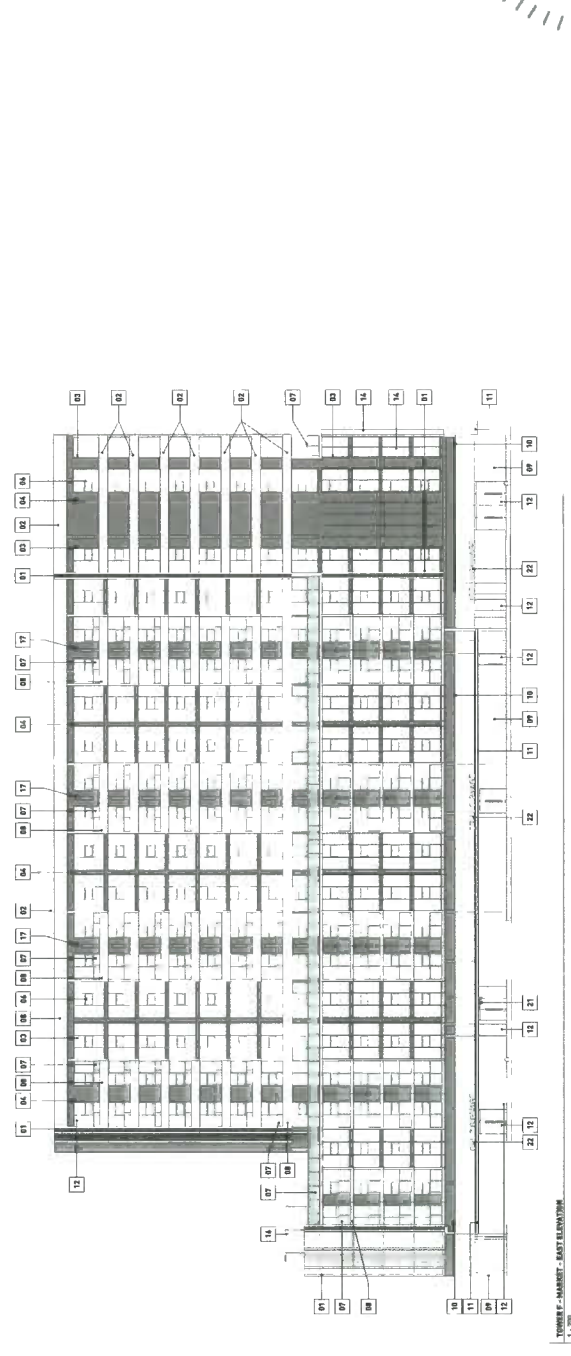


TOWER E - MARKET - NORTH ELEVATION
 1/8"=1'-0"

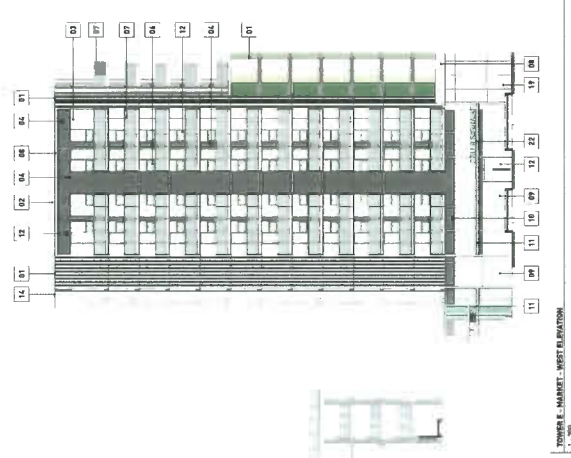


TOWER E - MARKET - SOUTH ELEVATION
 1/8"=1'-0"

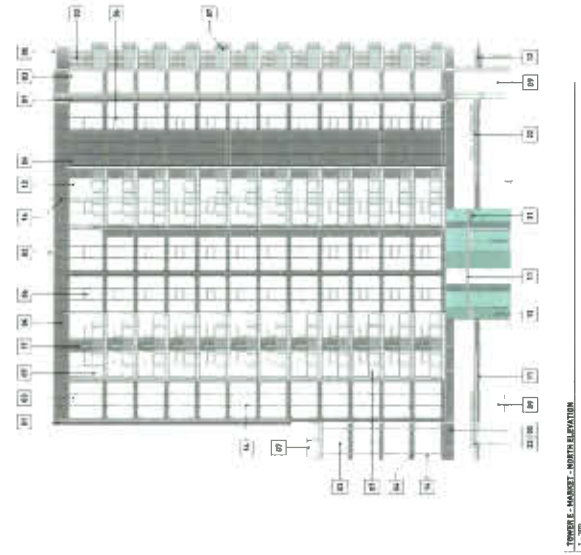


TOWER E - MARKET - WEST ELEVATION
 1/8"=1'-0"

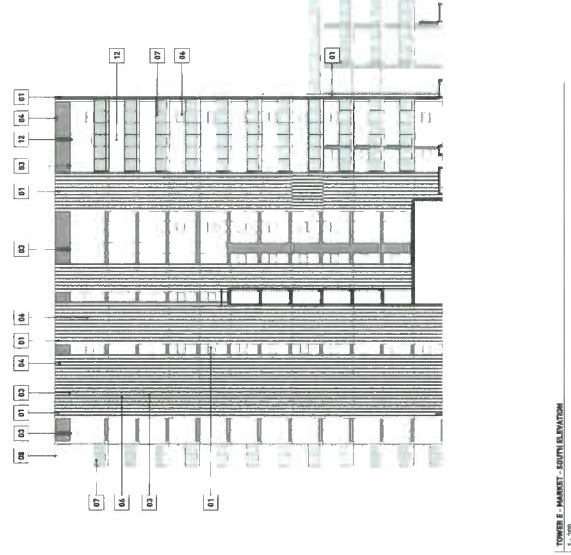

TOWER E - MARKET - EAST ELEVATION
 1/8"=1'-0"

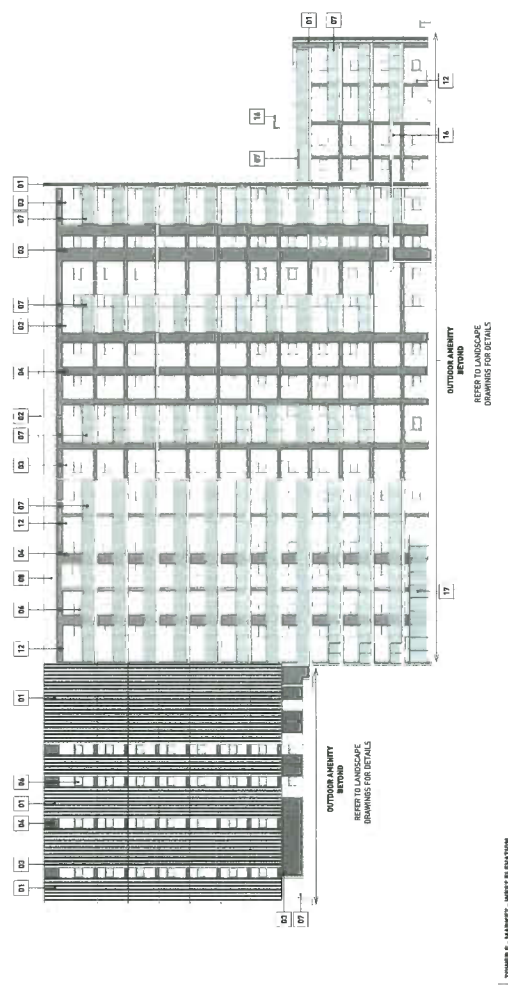

TOWER E - MARKET - WEST ELEVATION
 1/8"=1'-0"

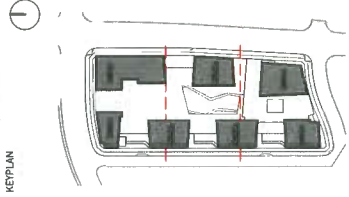

REVISIONS	NO.	DATE	DESCRIPTION	ISSUED FOR
	01	10/02/2018		ISSUED FOR IP


#	DESCRIPTION	COLOR
01	Exterior Cladding	White (Standard)
02	Window Panel	White
03	Aluminum Framed Window Wall	Charcoal
04	Aluminum Framed Window	White
05	Aluminum Panel	White
06	Aluminum Window Sill	White
07	Aluminum Window Sill	White
08	Aluminum Window Sill	White
09	Aluminum Window Sill	White
10	Aluminum Window Sill	White
11	Aluminum Window Sill	White
12	Aluminum Window Sill	White
13	Aluminum Window Sill	White
14	Aluminum Window Sill	White
15	Aluminum Window Sill	White
16	Aluminum Window Sill	White
17	Aluminum Window Sill	White
18	Aluminum Window Sill	White
19	Aluminum Window Sill	White
20	Aluminum Window Sill	White
21	Aluminum Window Sill	White
22	Aluminum Window Sill	White
23	Aluminum Window Sill	White
24	Aluminum Window Sill	White
25	Aluminum Window Sill	White
26	Aluminum Window Sill	White
27	Aluminum Window Sill	White
28	Aluminum Window Sill	White
29	Aluminum Window Sill	White
30	Aluminum Window Sill	White
31	Aluminum Window Sill	White
32	Aluminum Window Sill	White
33	Aluminum Window Sill	White
34	Aluminum Window Sill	White
35	Aluminum Window Sill	White
36	Aluminum Window Sill	White
37	Aluminum Window Sill	White
38	Aluminum Window Sill	White
39	Aluminum Window Sill	White
40	Aluminum Window Sill	White
41	Aluminum Window Sill	White
42	Aluminum Window Sill	White
43	Aluminum Window Sill	White
44	Aluminum Window Sill	White
45	Aluminum Window Sill	White
46	Aluminum Window Sill	White
47	Aluminum Window Sill	White
48	Aluminum Window Sill	White
49	Aluminum Window Sill	White
50	Aluminum Window Sill	White

NOTE: SHIMMER SHOWN FOR CONCEPT ONLY. ALL MATERIALS SUBJECT TO SIGN PERMIT APPLICATION PROCESS.




7960 ALDERBRIDGE WAY
 DEVELOPMENT PERMIT
 ELEVATIONS OFFICE
 TOWER G
 DATE: 10/02/2018 11:57 AM
 DRAWN BY: [Signature]
 CHECKED BY: [Signature]
 SCALE: 1:100
 JOB NUMBER: 17020


DP 16-740262#23

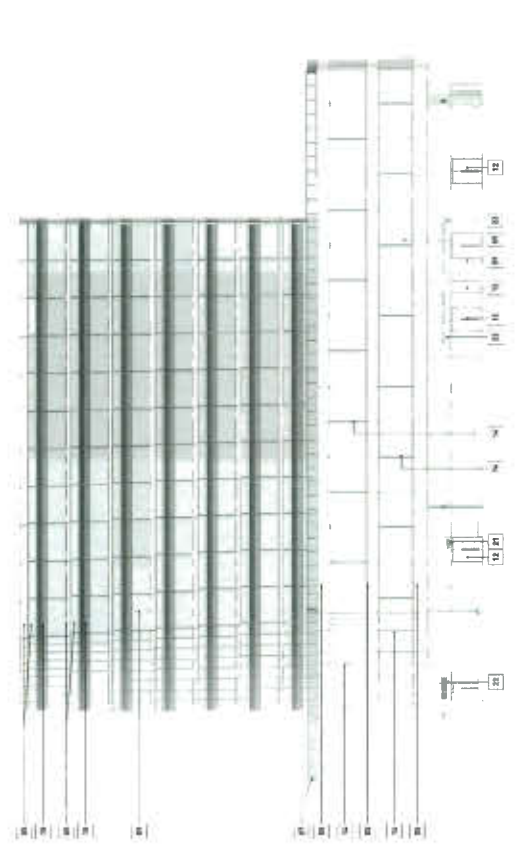


OFFICE TOWER - NORTH ELEVATION
1:100

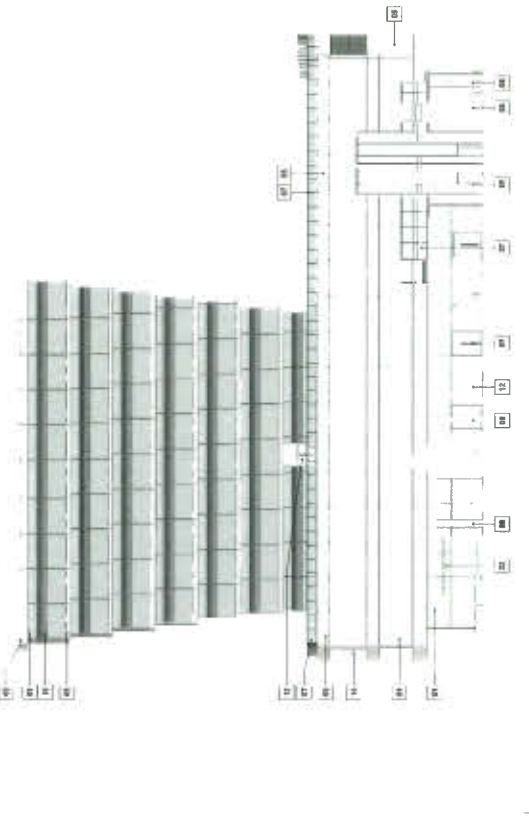

OFFICE TOWER - SOUTH ELEVATION
1:100

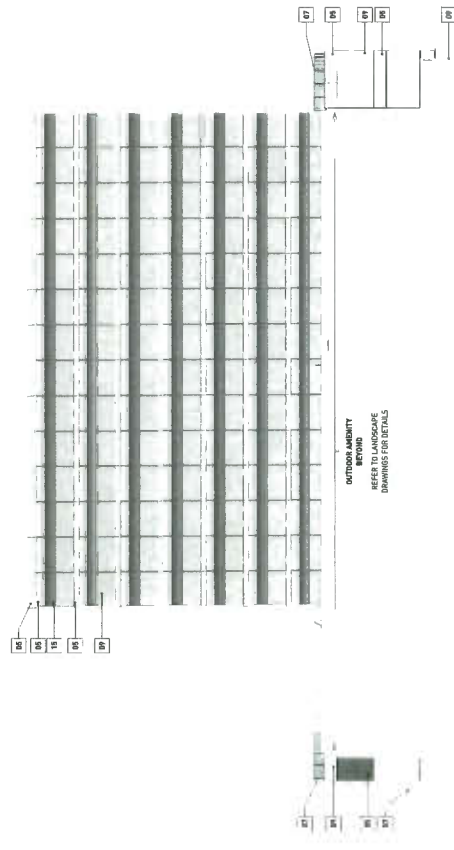


OFFICE TOWER - WEST ELEVATION
1:100

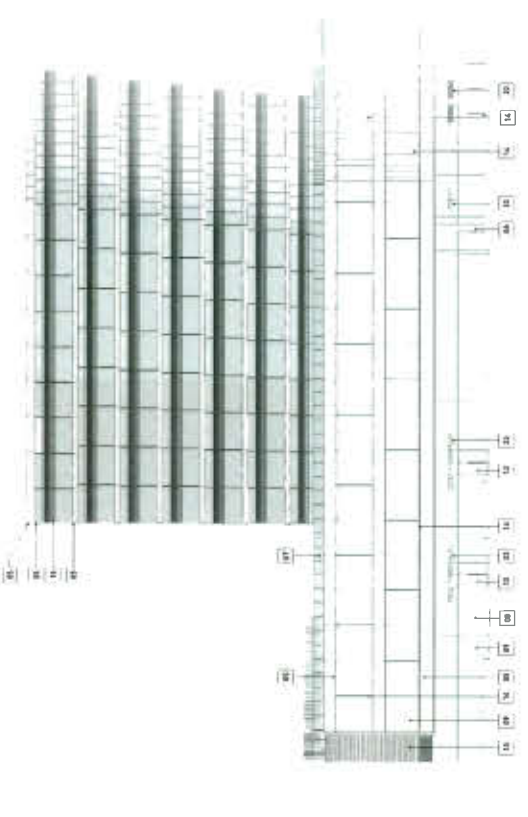

OFFICE TOWER - EAST ELEVATION
1:100

WINDOW SCHEDULE
 REFER TO LANDSCAPE DRAWINGS FOR DETAILS

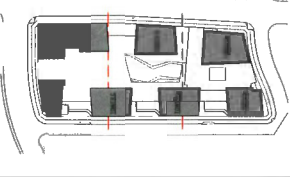

REVISIONS	NO.	DATE	DESCRIPTION	ISSUED FOR
	01	10/02/18		ISSUED FOR IP



7960 ALDERBRIDGE WAY




DEVELOPMENT PERMIT


BUILDING SECTIONS

DATE: 10/20/18 11:45 AM
 DRAWN BY: Amel
 CHECKED BY: Chantal
 SCALE: 1" = 20'-0"
 JOB NUMBER: 17020

A6.00

DP 740262 #34
 U.1 U.2 U.3 U.4 U.5 U.6 U.7 U.8 U.9 U.10 U.11 U.12 U.13 U.14 U.15 U.16 U.17 U.18 U.19 U.20 U.21 U.22 U.23 U.24 U.25 U.26 U.27 U.28 U.29 U.30 U.31 U.32

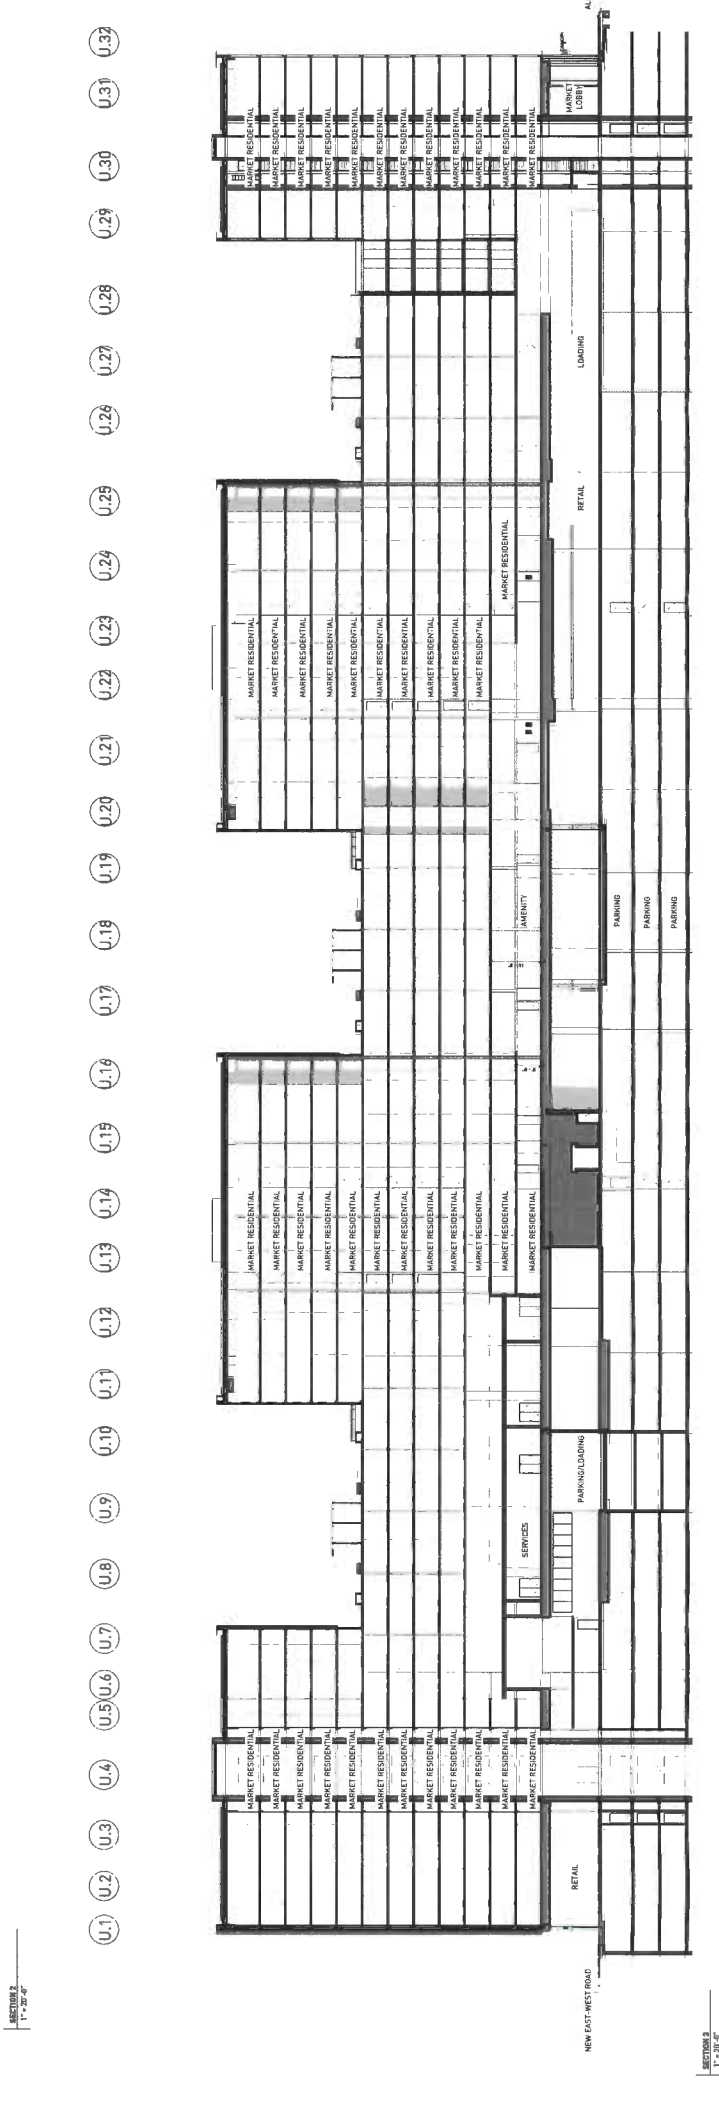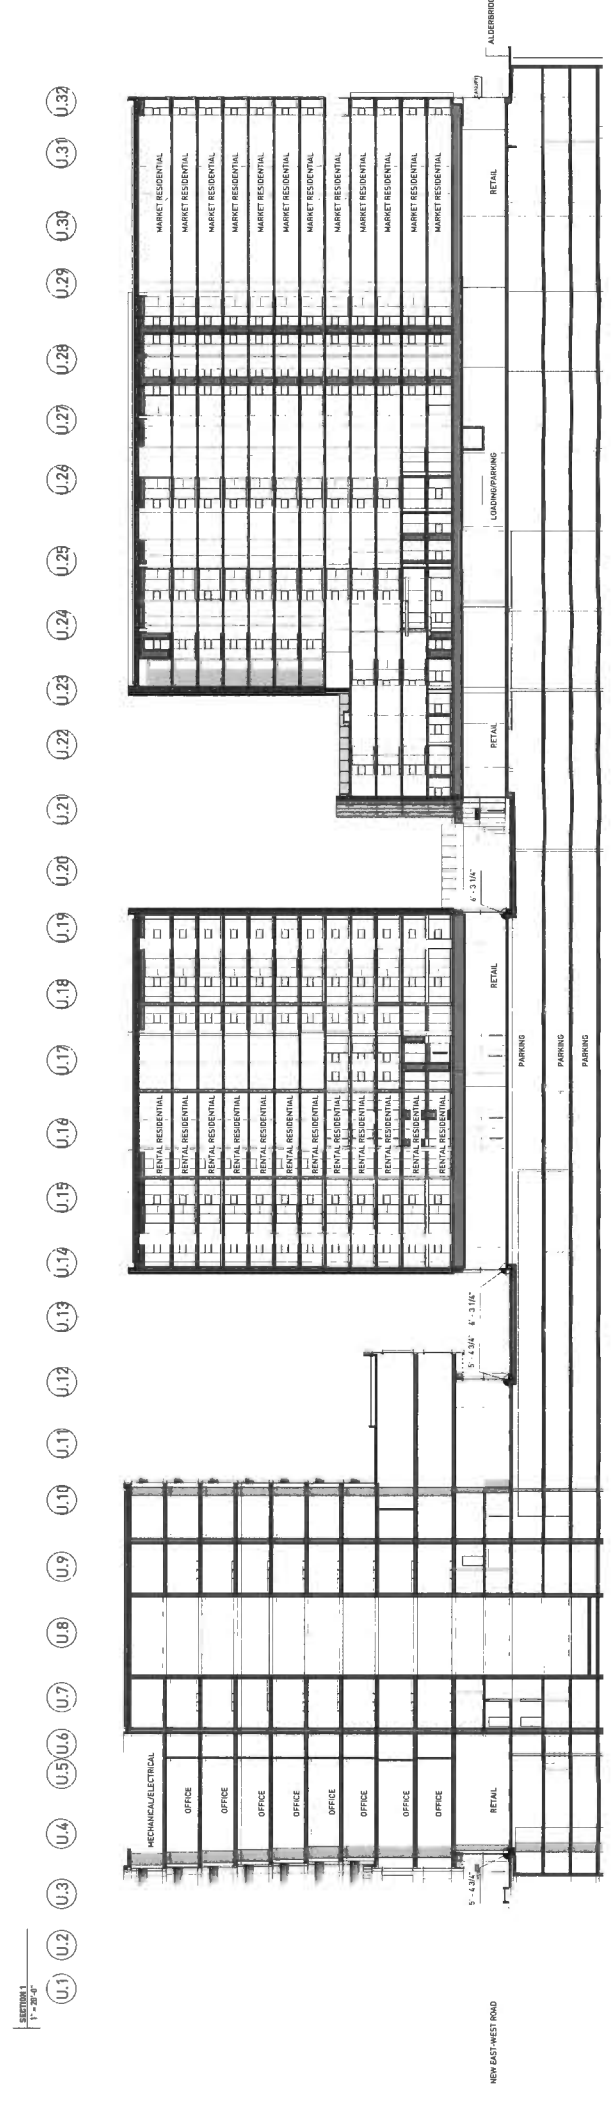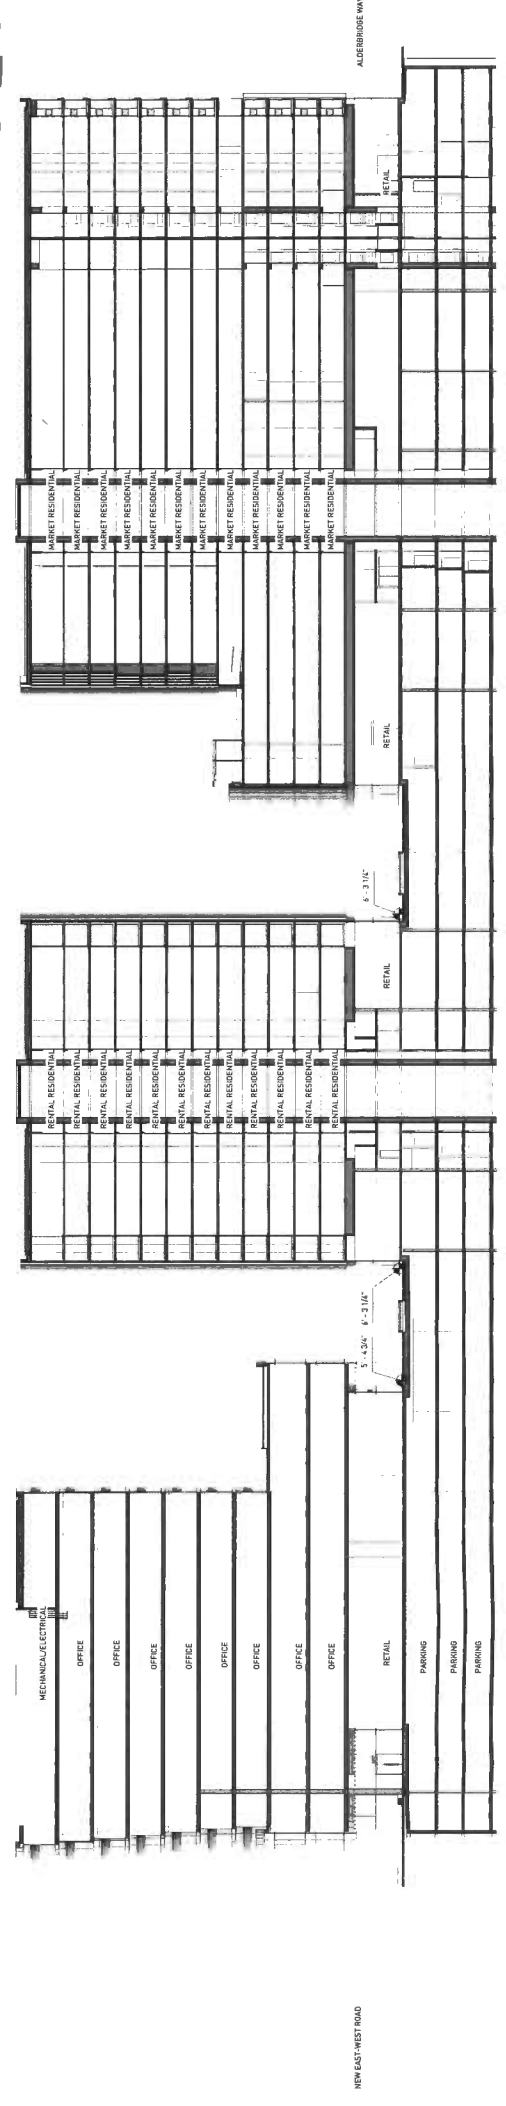


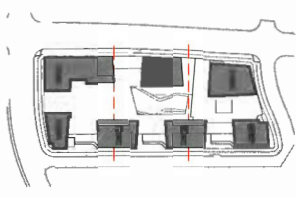

REVISIONS	DATE	DESCRIPTION
01	10/20/18	ISSUED FOR DP


DP 16-740262#35

- U.A
- U.B
- U.C
- U.D
- U.E
- U.F
- U.G
- U.H
- U.I
- U.J
- U.K
- U.L
- U.M
- U.N

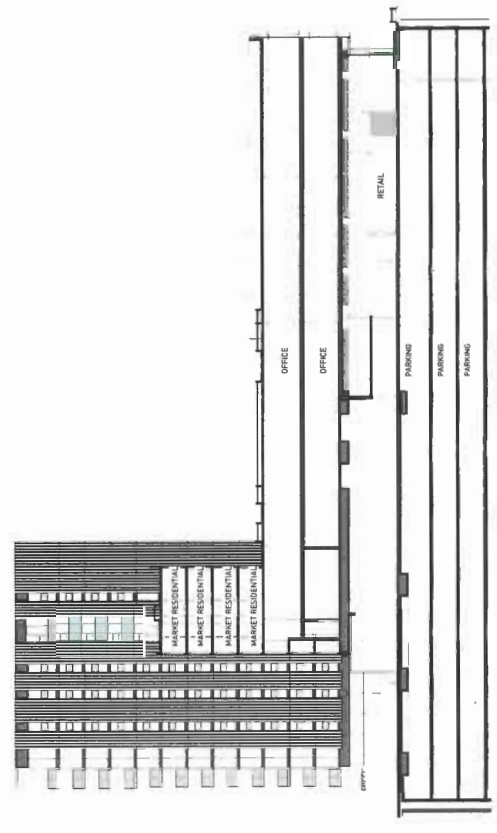


SECTION A
1" = 20' 0"

- U.A
- U.B
- U.C
- U.D
- U.E
- U.F
- U.G
- U.H
- U.I
- U.J
- U.K
- U.L
- U.M
- U.N

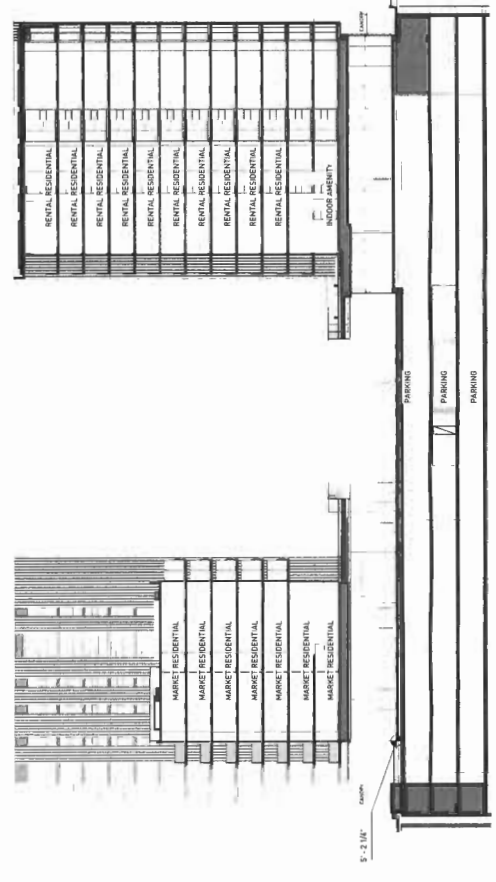

SECTION B
1" = 20' 0"

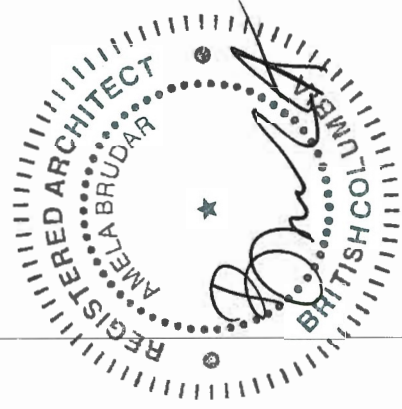

7960 ALDERBRIDGE WAY

DEVELOPMENT PERMIT

BUILDING SECTIONS

DATE: 10/20/18 12:17 PM
 DRAWN BY: Chahr
 CHECKED BY: 1" = 20' 0"
 SCALE: 17020
 JOB NUMBER: 17020



NO.	DATE	DESCRIPTION
1	2017-09-29	Issued for Reasoning
2	2017-11-14	Issued for Reasoning (Reubmission)
3	2017-11-14	Issued for DP
4	2018-07-18	Released for DP
5	2018-08-31	DD 80%
6	2018-09-21	Released for DP
7	2018-10-09	Released for DP

7960 ALDERBRIDGE WAY


COVER SHEET AND GENERAL NOTES

DATE: 10/09/2018
 DRAWN BY: MP/LL
 CHECKED BY: LL
 SCALE:
 JOB NUMBER: 17046

LG.01

OP 16-740262 #27

- GENERAL NOTES**
- GRIDLINES SHOWN ON LANDSCAPE DRAWINGS ARE AS PER ARCHITECTURAL LAYOUT.
 - DO NOT SCALE DRAWINGS. USE DIMENSIONAL INFORMATION AS NOTED IN DRAWINGS. CONTACT THE LANDSCAPE ARCHITECT IMMEDIATELY IF THERE IS ANY AMBIGUITY, LACK OF INFORMATION OR INCONSISTENCY, DISREGARD FOR THIS NOTE AND EXTRA COSTS INCURRED WILL NOT BE ACCEPTED.
 - LAYOUT AND MATERIALS DRAWINGS ARE TO BE READ IN CONJUNCTION WITH LANDSCAPE SPECIFICATIONS FOR COMPLIANCE.
 - LANDSCAPE DRAWINGS ARE TO BE READ IN CONJUNCTION WITH ARCHITECTURAL AND ENGINEERING DRAWINGS. REPORT ANY DISCREPANCIES TO THE CONSULTANT FOR REVIEW AND RESPONSE.
 - ALL LINES AND DIMENSIONS ARE PARALLEL OR PERPENDICULAR TO THE LINES FROM WHICH THEY ARE MEASURED UNLESS NOTED OTHERWISE.
 - VERIFY ALL DIMENSIONS WITH FIELD CONDITIONS. REPORT ANY DISCREPANCIES TO THE CONSULTANT FOR REVIEW AND RESPONSE.
 - UTILITY AND LIGHTING ARE INDICATED FOR REFERENCE ONLY. REFER TO ENG. DRAWINGS FOR LOCATIONS, DETAILS, AND SPECIFICATIONS.
 - REFER TO ENGINEERING DRAWINGS FOR SUBGRADE, AND REINFORCING OF ALL PAVED SURFACES IN ROADWAYS.
 - THE CONTRACTOR SHALL VERIFY DIMENSIONS SHOWN ON DRAWINGS AND NOTIFY THE LANDSCAPE ARCHITECT OF ANY DISCREPANCIES OR INCONSISTENCIES PRIOR TO CONSTRUCTION.
 - PROVIDE IRRIGATION FOR ALL SOFT LANDSCAPING INCLUDING GROUNDCOVERS, SHRUBS, AND GREENROOF. COLLECT RE-ESTABLISHMENT PLANTING AFTER ESTABLISHED SHALL NOT BE IRRIGATED.
 - PROVIDE ADEQUATE SUB-SURFACE DRAINAGE IN ALL PLANTED AREAS.
 - SEE CIVIL AND ARCHITECTURAL DRAWINGS FOR BUILDING PERIMETER AND ROADWAY GRADING.
 - ALL PLANT MATERIAL AND LANDSCAPE CONSTRUCTION TO CONFORM TO AALA STANDARDS.
 - ENSURE POSITIVE DRAINAGE.
 - PERIMETER ROADWAY TO BE RECONSTRUCTED FULLY IF DAMAGE.

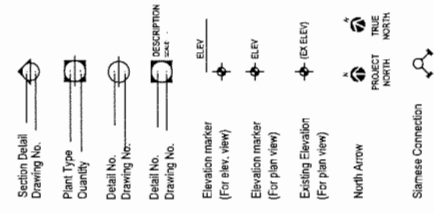

LANDSCAPE ARCHITECTURAL SYMBOLS

SYMBOL	DESCRIPTION
[Symbol]	Section Detail
[Symbol]	Plant Type
[Symbol]	Detail No.
[Symbol]	Elevation marker
[Symbol]	North Arrow
[Symbol]	Slashed Connection

DRAWING LIST


NO.	DESCRIPTION	DATE
1.	GENERAL	
2.	LANDSCAPE ARCHITECTURAL DRAWINGS	
3.	SITE PLAN	
4.	LEVEL 3 & LEVEL 6	
5.	LEVEL 7 & LEVEL 10	
6.	ROOFTOP	
7.	LANDSCAPE PLAN - GROUND LEVEL AREA 1	
8.	LANDSCAPE PLAN - GROUND LEVEL AREA 2	
9.	LANDSCAPE PLAN - GROUND LEVEL AREA 3	
10.	LANDSCAPE PLAN - GROUND LEVEL AREA 4	
11.	LANDSCAPE PLAN - LEVEL 3	
12.	LANDSCAPE PLAN - LEVEL 6	
13.	LANDSCAPE PLAN - LEVEL 7 & 10	
14.	LANDSCAPE PLAN - ROOFTOP	
15.	PLANTING PLAN - GROUND LEVEL - OVERALL	
16.	PLANTING PLAN - GROUND LEVEL AREA 1	
17.	PLANTING PLAN - GROUND LEVEL AREA 2 & 3	
18.	PLANTING PLAN - GROUND LEVEL AREA 4	
19.	PLANTING PLAN - GROUND LEVEL AREA 5	
20.	PLANTING PLAN - GROUND LEVEL AREA 6	
21.	PLANTING PLAN - GROUND LEVEL AREA 7	
22.	PLANTING PLAN - GROUND LEVEL AREA 8	
23.	PLANTING PLAN - LEVEL 3 - OVERBALL	
24.	PLANTING PLAN - LEVEL 3 AREA 1	
25.	PLANTING PLAN - LEVEL 3 AREA 2	
26.	PLANTING PLAN - LEVEL 3 AREA 3	
27.	PLANTING PLAN - LEVEL 6 - OVERBALL	
28.	PLANTING PLAN - LEVEL 6 AREA 1	
29.	PLANTING PLAN - LEVEL 6 AREA 2	
30.	PLANTING PLAN - LEVEL 7	
31.	PLANTING PLAN - LEVEL 10	
32.	PLANTING PLAN - ROOF TDP	
33.	LANDSCAPE LIGHTING PLAN - LEVEL 1	
34.	LANDSCAPE LIGHTING PLAN - LEVEL 3	
35.	LANDSCAPE LIGHTING PLAN - LEVEL 6	
36.	LANDSCAPE LIGHTING PLAN - LEVEL 7 & LEVEL 10	
37.	LANDSCAPE SECTIONS - GROUND LEVEL	
38.	LANDSCAPE SECTIONS - LEVEL 3	
39.	DETAILS - PAVING	
40.	DETAILS - PLANTING	
41.	DETAILS - PLANTING & FURNISHING	
42.	DETAILS - SITE FURNISHING	
43.	DETAILS - SITE FURNISHING	
44.	DETAILS - SITE FURNISHING	

7960 ALDERBRIDGE WAY

Richmond, BC


SYMBOL	DESCRIPTION	UNIT
AD	Area Drain	
ALT	Alternate	
ALUM	Aluminum	
ARCH	Architectural	
AVG	Average	
B	Bottom	
BC	Bottom of Curb Elevation	
BLOG	Building	
BOL	Bolled	
BP	Bottom of Pool	
BS	Bottom of Step/Slab Elevation	
BW	Between	
BW	Bottom of Wall Elevation	
CB	Catch Basin	
CV	Civil	
CJ	Control Joint	
COJ	Construction Joint	
COMP	Compacted	
CONC	Concrete	
DEG	Degree	
DEG	Rebar	
DET	Detail	
DA	Diameter	
DM	Dimension	
DN	Down	
DWG	Drawing	
EJ	Expansion Joint	
ENG	Engineer/Engineering	
EQ	Equal	
EX	Existing	
FC	Finish Curb	
FDN	Foundation	
FG	Finish Grade	
FN	Finish	
FTG	Footing	
FTN	Fountain	
GALV	Galvanized	
HEF	Horizontal Face	
HP	High Point	
HT	Height	
HWL	High Water Level	
ID	Inside Diameter/Dimension	
INCL	Included/Including	
JT	Joint	
LARCH	Landscape Architect	
LOW	Limit of Work	
LT	Light	
M	Meters/Metres	
MAX	Maximum	
MIN	Minimum	
MISC	Miscellaneous	
WF	Water Feature	
WJ	Water Jet	
WL	Water Level	
WP	Waterproofing	

NOTES

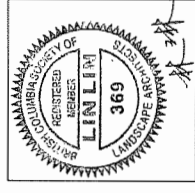



NO.	DATE	DESCRIPTION
1	2017-09-29	Issued for Re-zoning
2	2017-11-14	Issued for Re-zoning (Re-submission)
3	2017-11-14	Issued for DP
4	2018-07-18	Reissued for DP
5	2018-08-31	DD 80%
6	2018-09-21	Reissued for DP
7	2018-10-09	Reissued for DP

TREE MANAGEMENT PLAN	
DATE	10/09/2018
DRAWN BY	MP/LL
CHECKED BY	LL
SCALE	1/32" = 1'-0"
JOB NUMBER	17046

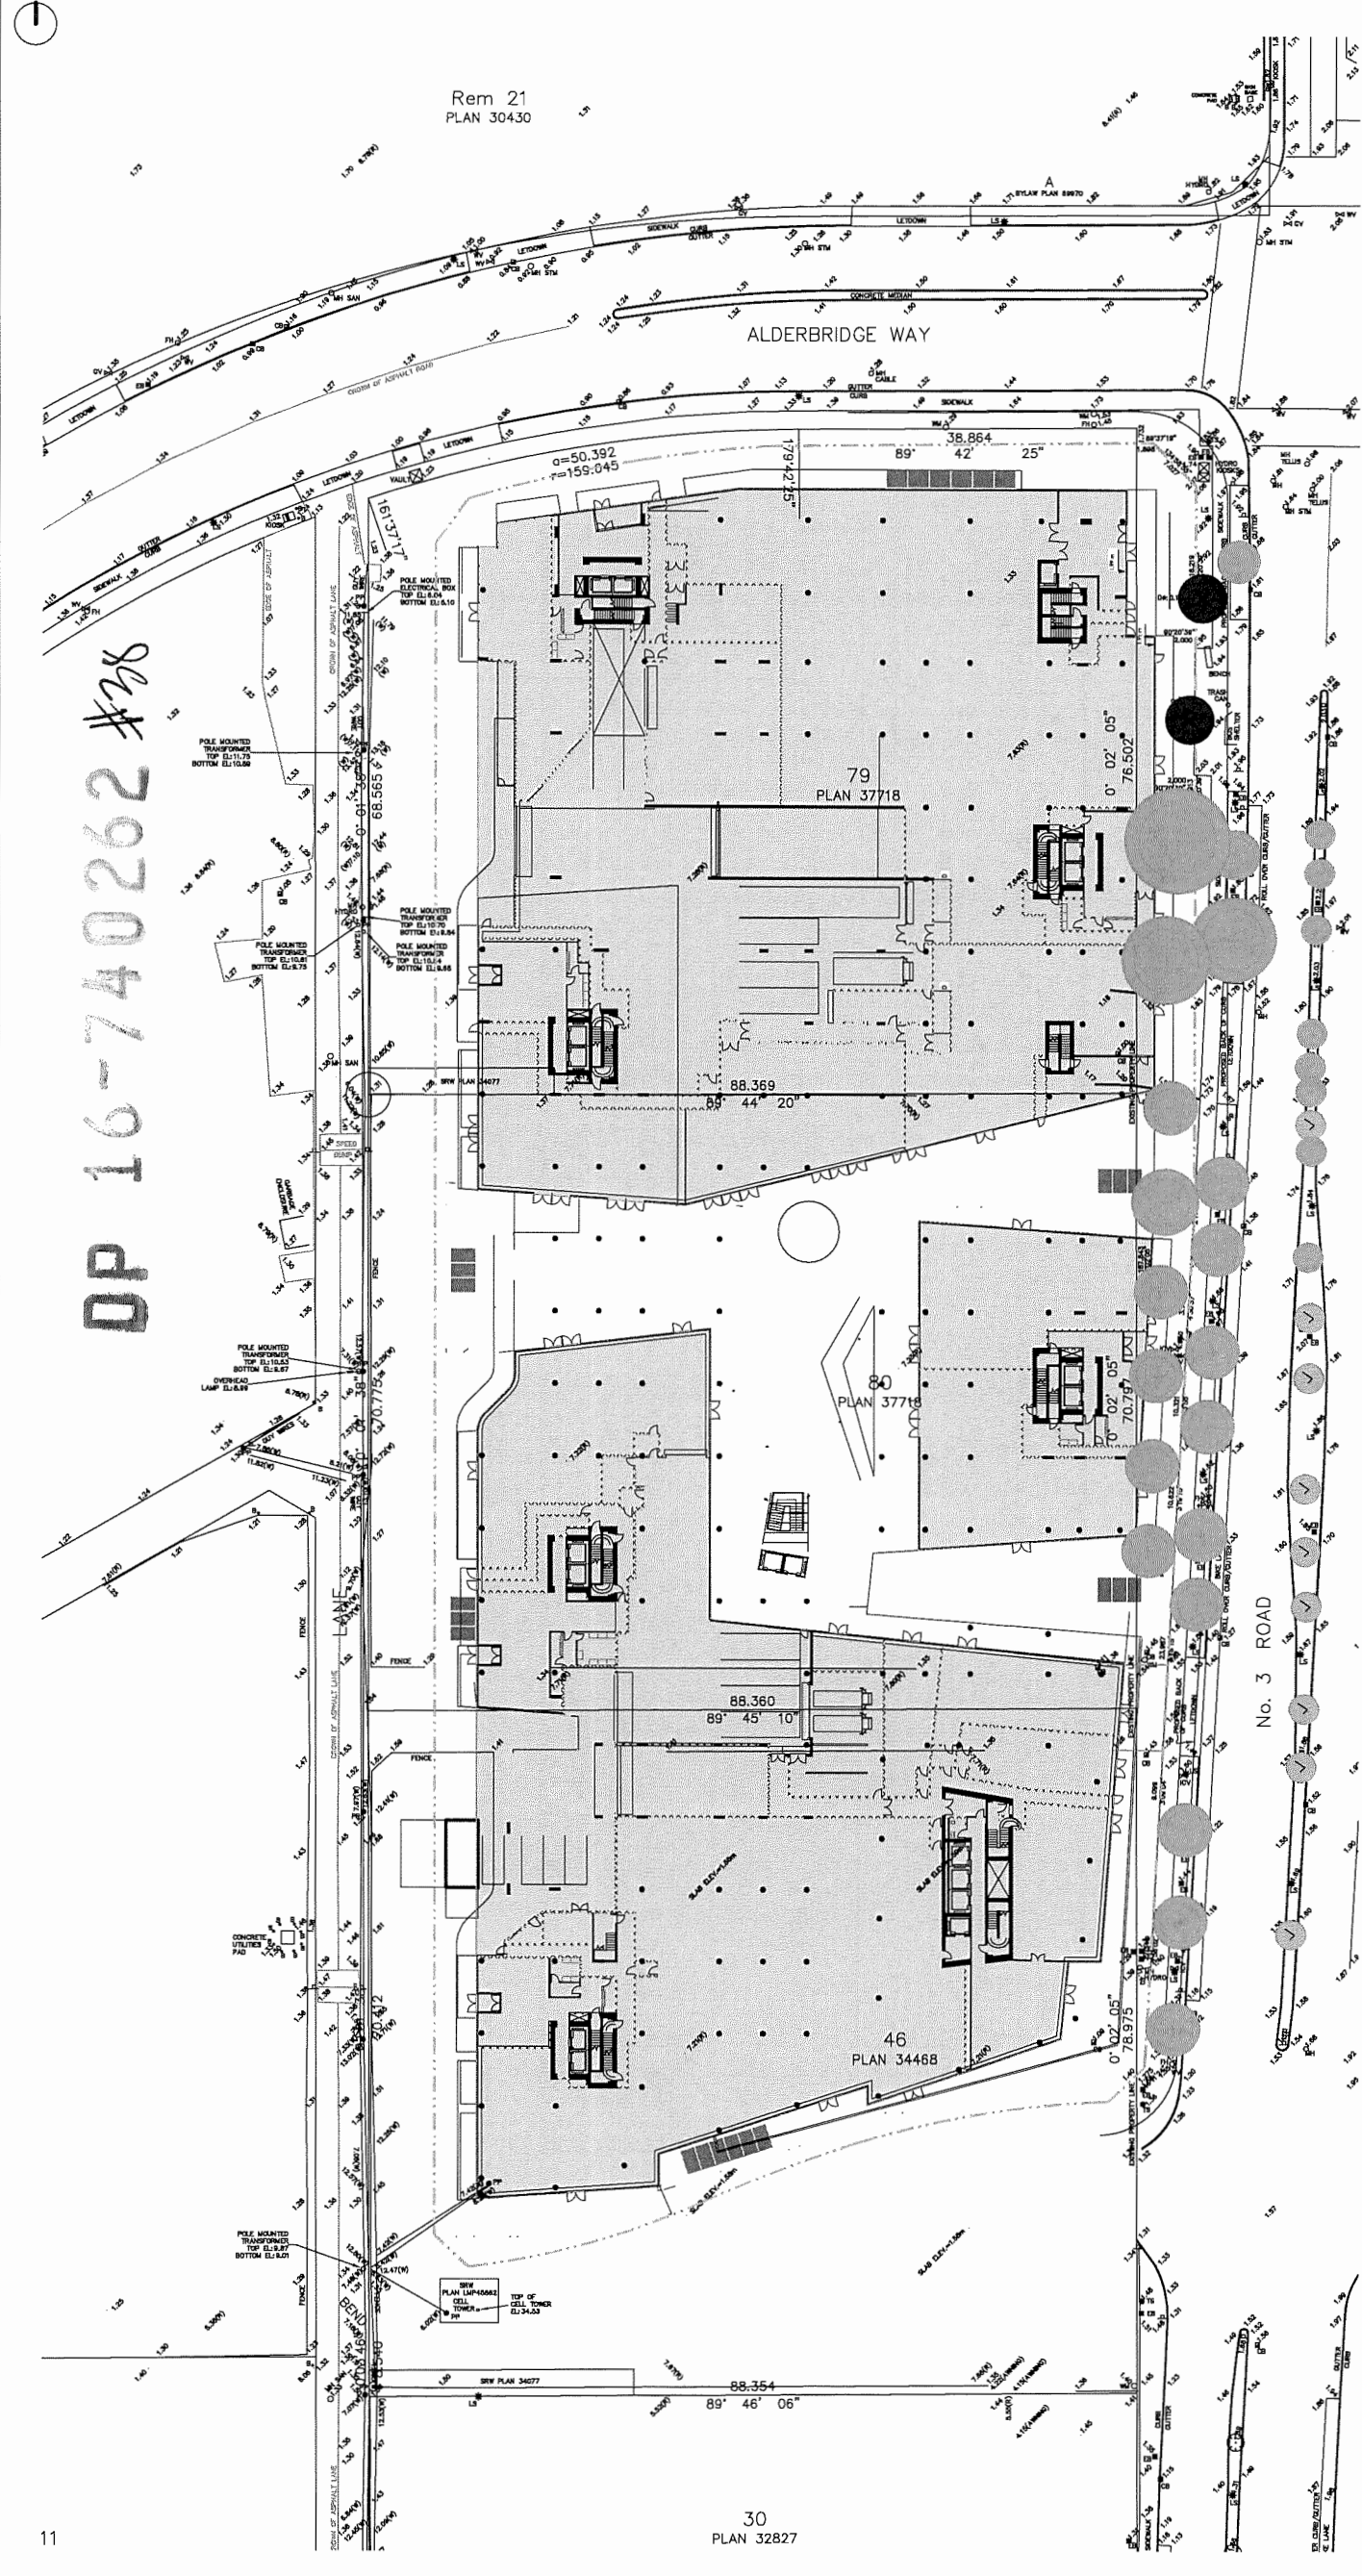

LEGEND


	EXISTING TREE TO BE REMOVED - TOTAL 2
	EXISTING TREE TO BE RELOCATED - TOTAL 28
	EXISTING TREE TO BE RETAINED - TOTAL 9
	PROPERTY LINE / LIMIT OF EXCAVATION
	TREE PROTECTION FENCING
	OUTLINE OF PROPOSED BUILDINGS

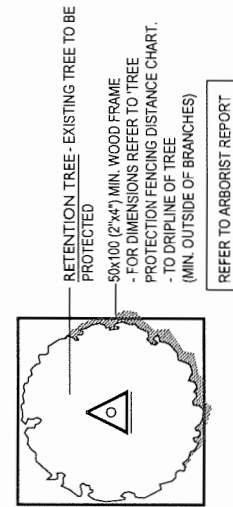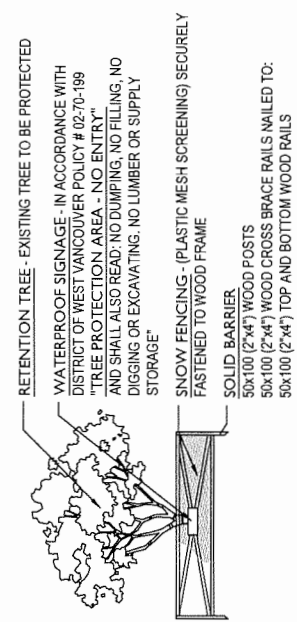

NOTE:
 THE CONTRACTORS SHOULD CONTACT MICHAEL GRIFFITH OR ALEX KURNICKI IN THE CITY OF RICHMOND WHEN THEY ARE READY TO REMOVE AND RELOCATE THE TREES.

1 TREE PROTECTION FENCING
 SCALE: 1/32"=1'0"

NOTES

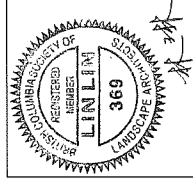


NO.	DATE	DESCRIPTION
1	2017-09-29	Issued for Rezoning
2	2017-11-14	Issued for Rezoning (Resubmission)
3	2017-11-14	Issued for DP
4	2018-07-18	DD 80%
5	2018-08-31	Released for DP
6	2018-09-21	Released for DP
7	2018-10-09	Reissued for DP

7960 ALDERBRIDGE WAY

SITE PLAN

DATE 10/09/2018
 DRAWN BY MP/LL
 CHECKED BY LL
 SCALE 1/32" = 1'-0"
 JOB NUMBER 17046


DP 16-740262 #24

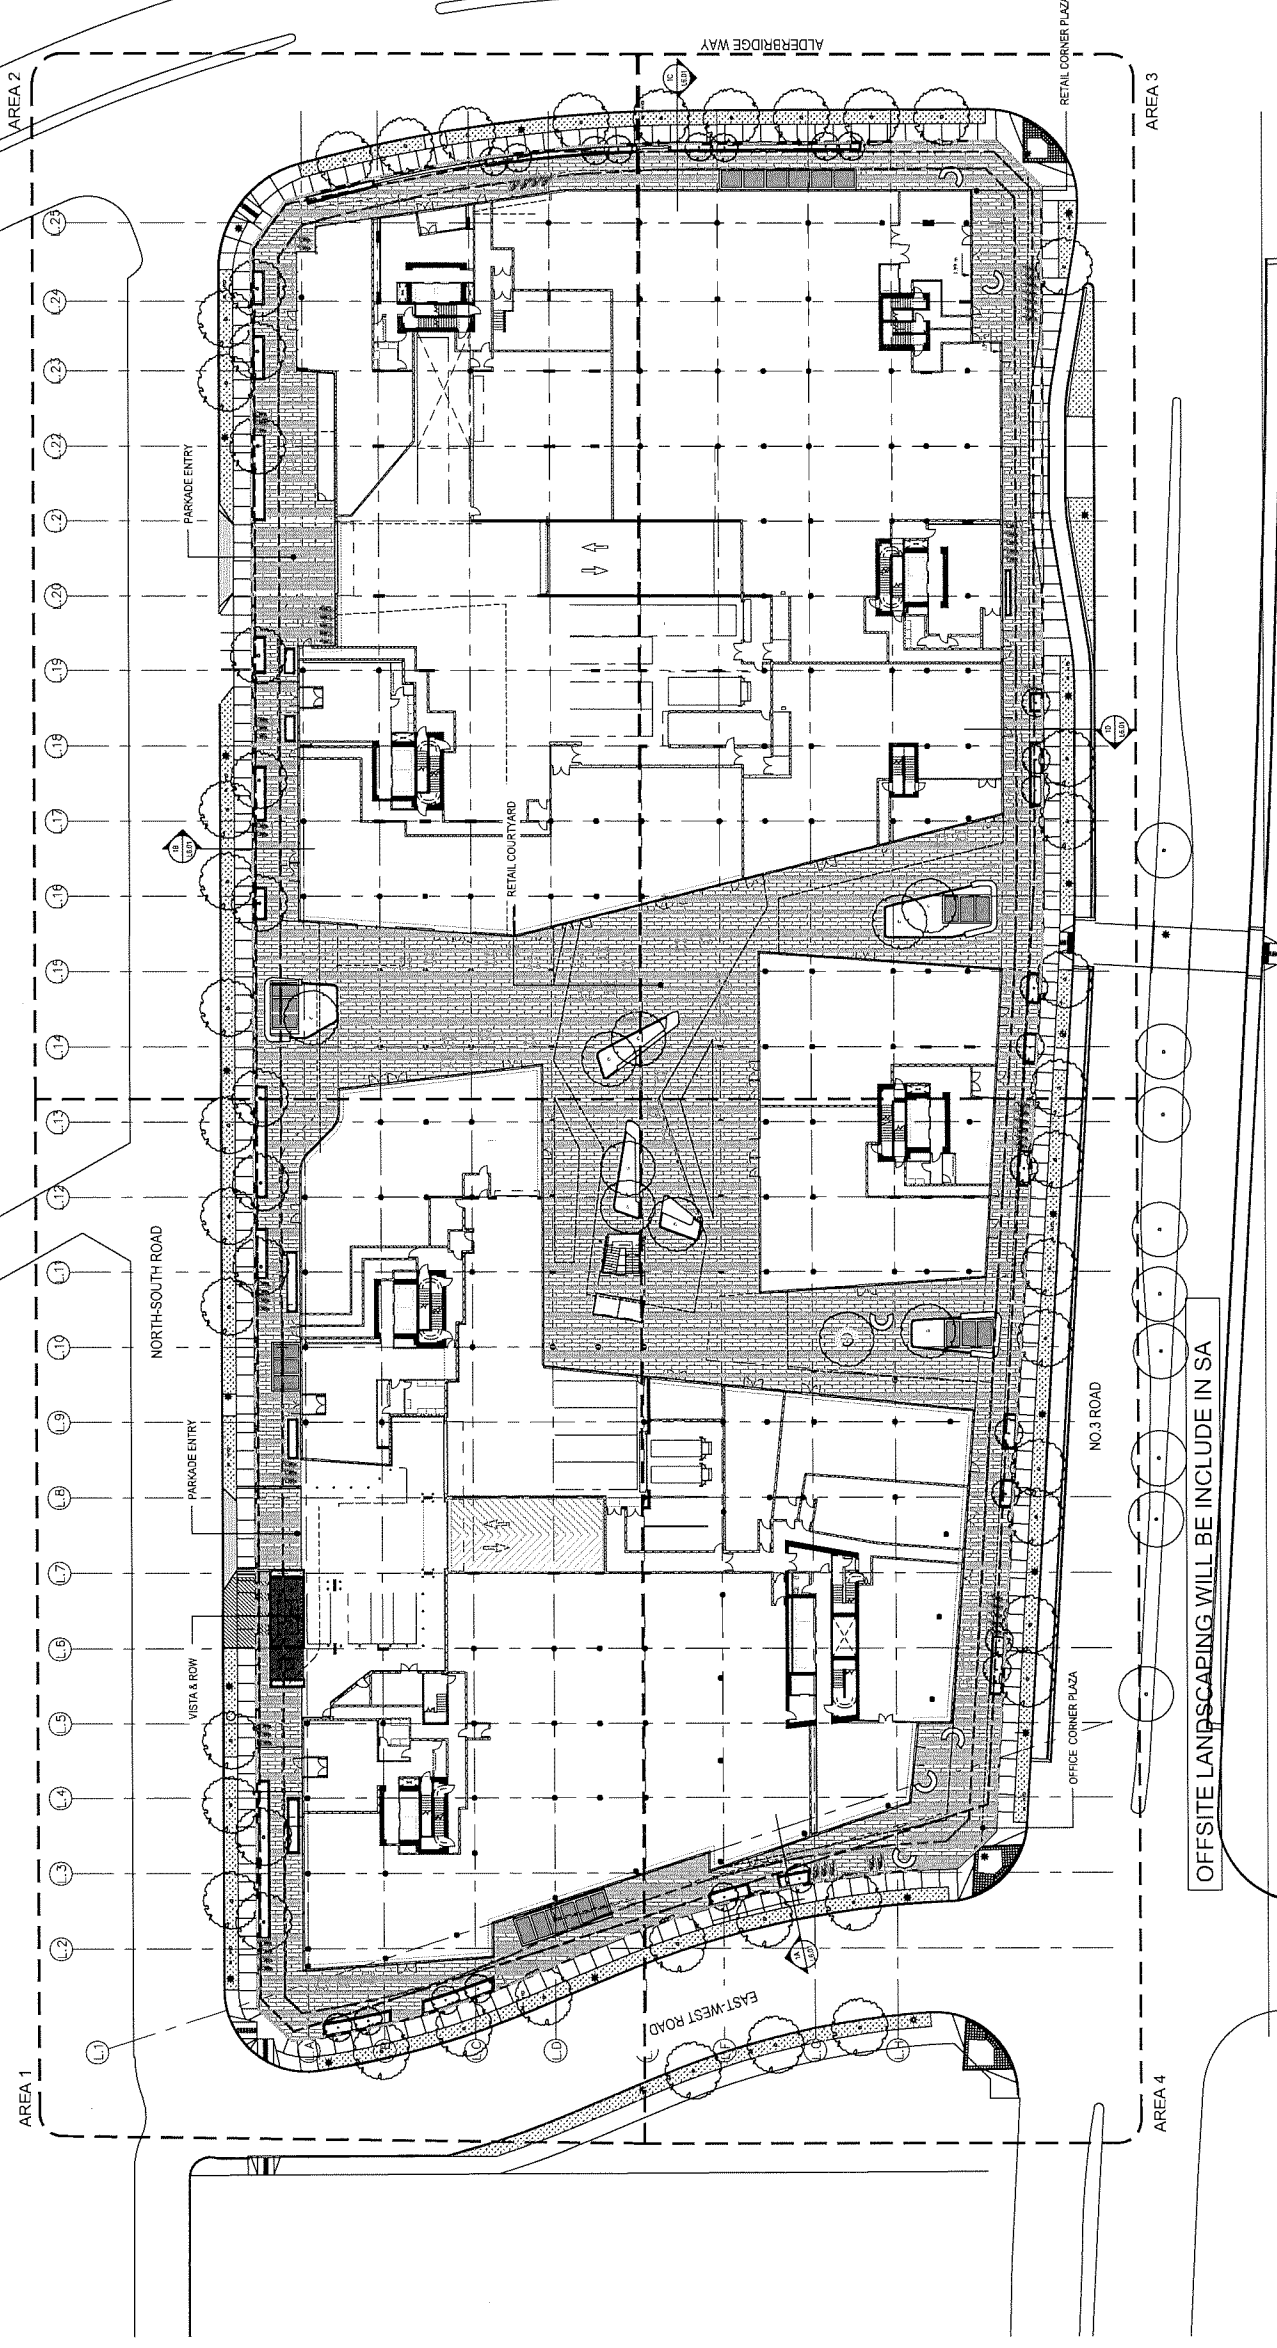

OFFSITE LANDSCAPING WILL BE INCLUDE IN SA

LEGEND


	PROPERTY LINE
	SETBACK LINE
	UNDERGROUND PARKING OUTLINE
	STRUCTURE ABOVE

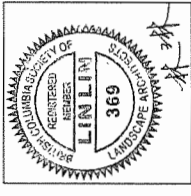


NO.	DATE	DESCRIPTION
1	2017-09-29	Issued for Rezoning
2	2017-11-14	Issued for Rezoning (Resubmission)
3	2017-11-14	Issued for DP
4	2018-07-18	Revised for DP
5	2018-08-31	DD 80%
6	2018-09-21	Revised for DP
7	2018-10-09	Revised for DP

NOTES

DP 16-740262
 #A

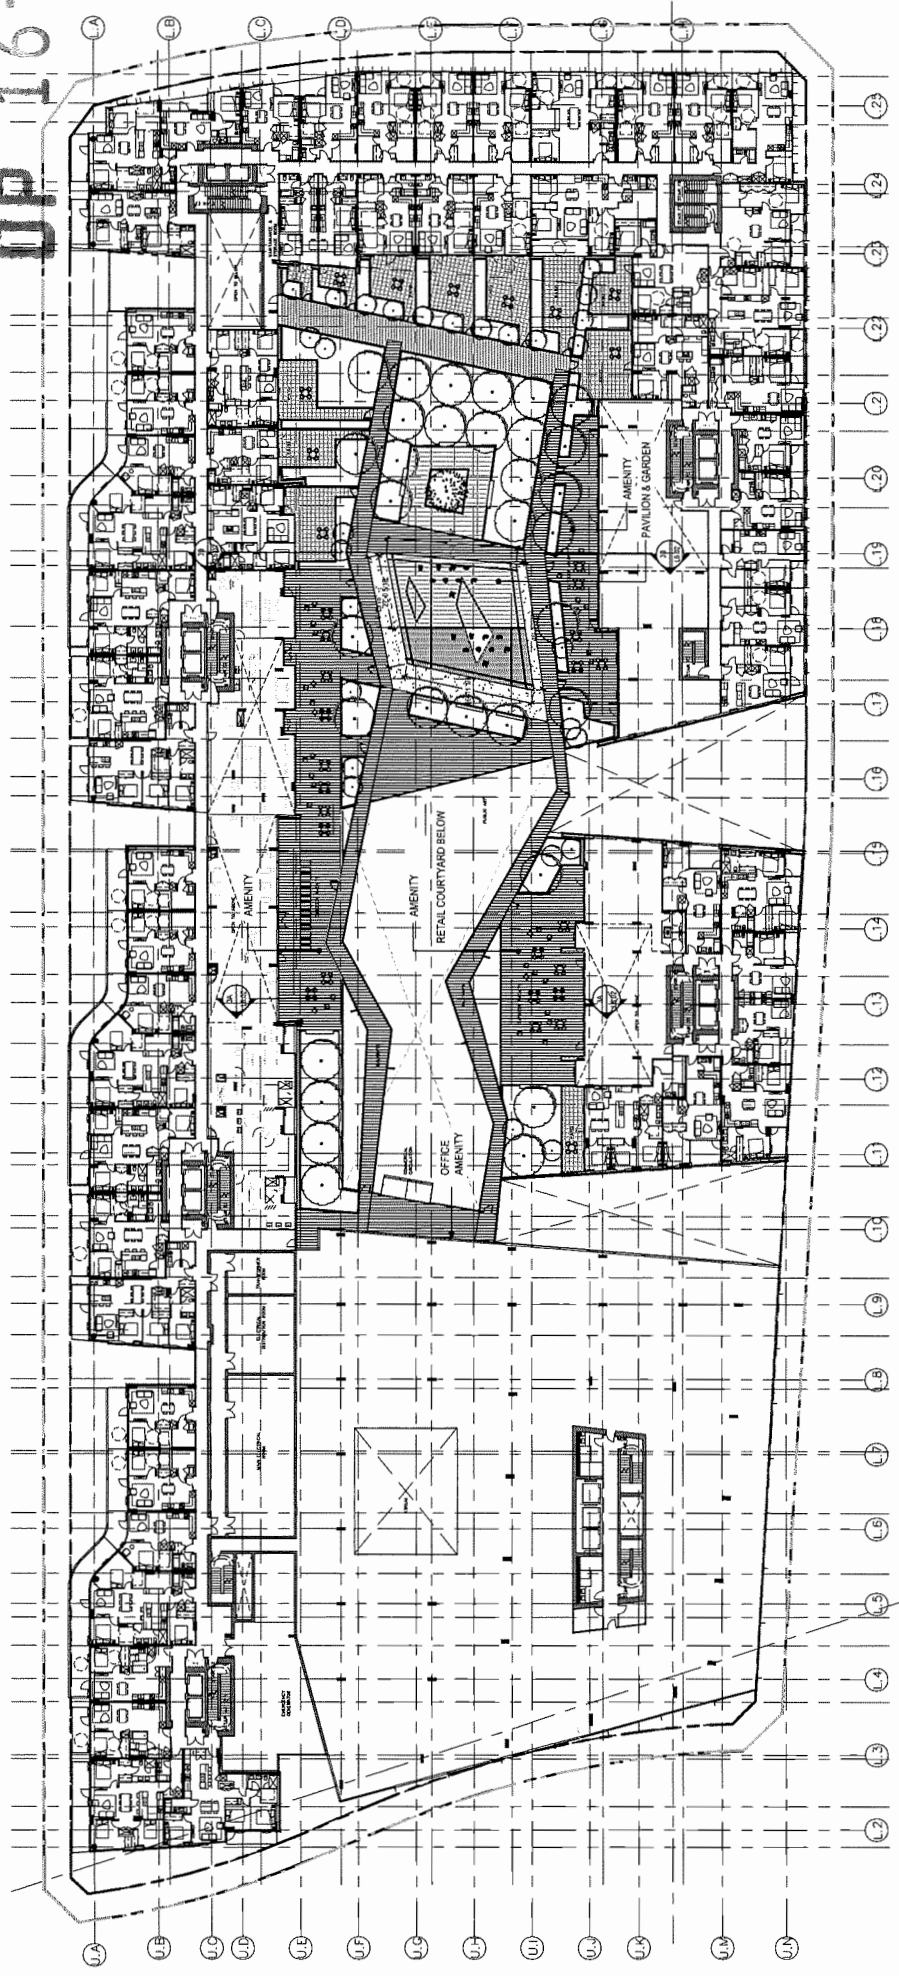

LEVEL 3

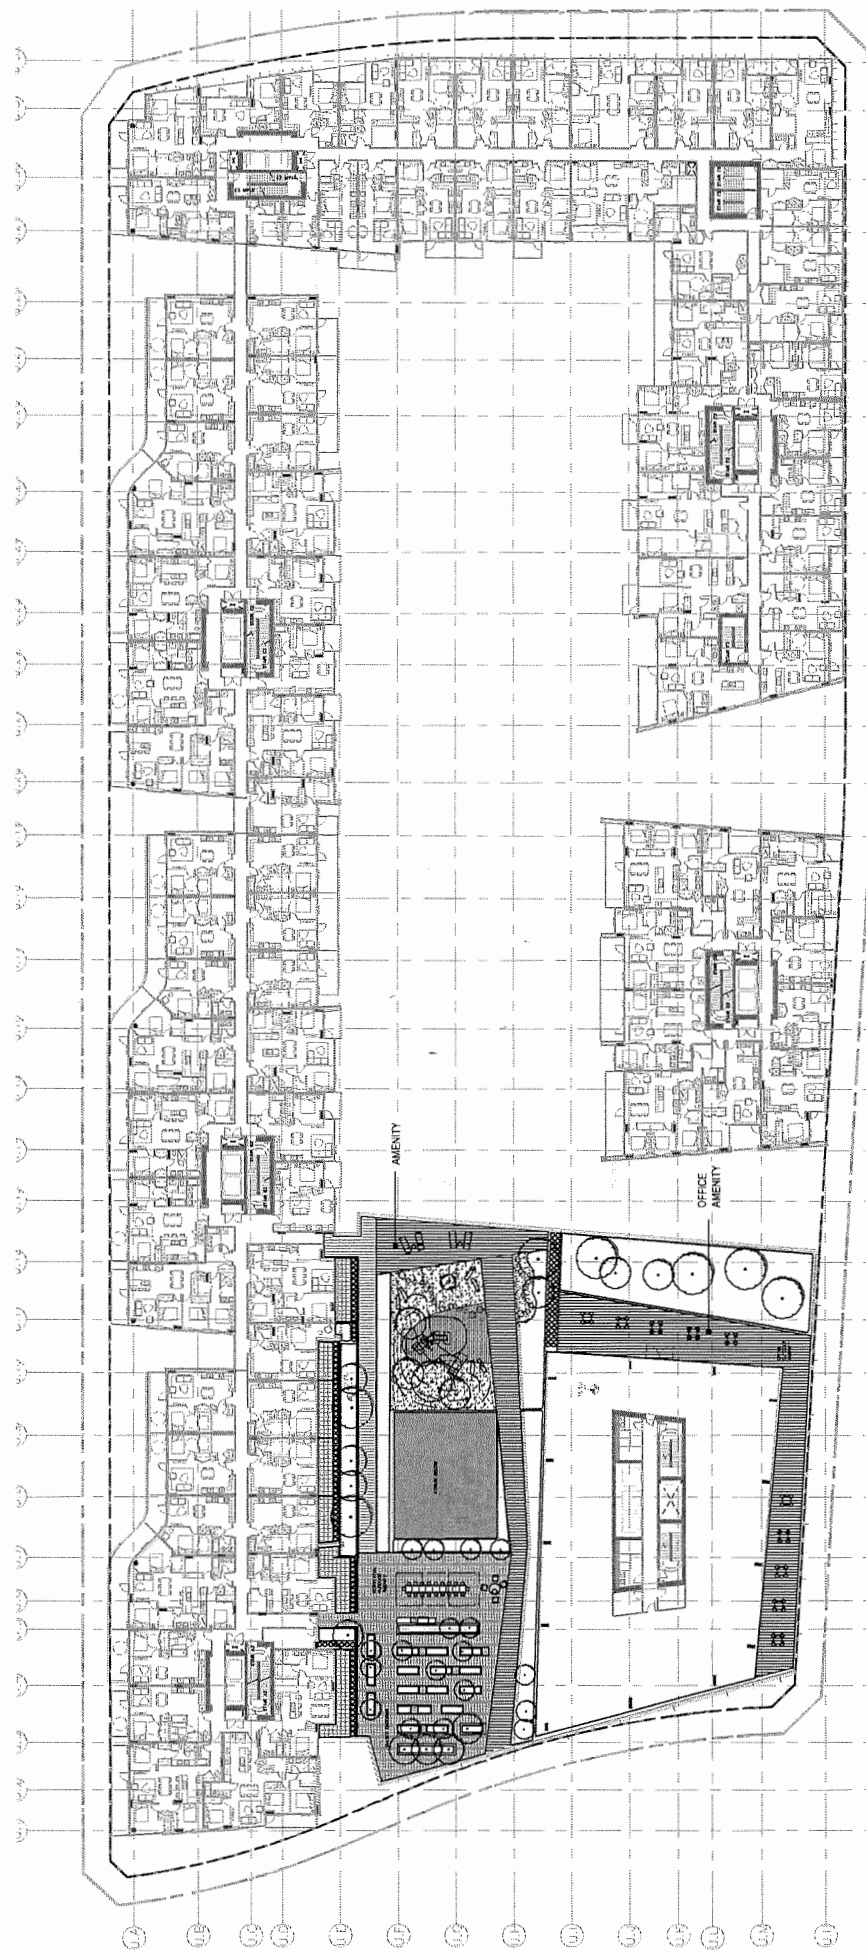

LEVEL 6

LEGEND

	PROPERTY LINE
	SETBACK LINE

7960 ALDERBRIDGE WAY

LEVEL 3 & LEVEL 6


DATE	10/09/2018
DRAWN BY	MPILL
CHECKED BY	LL
SCALE	1/32" = 1'-0"
JOB NUMBER	17046

OP 16-740262 #4



■ GBL ARCHITECTS INC.
 138 EAST 8TH AVENUE
 VANCOUVER, BC CANADA V6T 1R8
 TEL: 604 738 1155
 FAX: 604 731 9270
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 EMPLOYER. WE ENCOURAGE DIVERSITY IN OUR WORKPLACE.
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 WITHOUT THEIR WRITTEN CONSENT.

NOTES

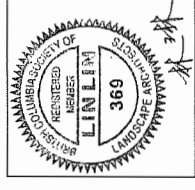

REVISIONS


NO.	DATE	DESCRIPTION
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2	2017-11-14	Issued for Rezoning (Resubmission)
3	2017-11-14	Issued for DP
4	2018-07-18	Revised for DP
5	2018-08-31	DD 80%
6	2018-09-21	Revised for DP
7	2018-10-09	Revised for DP

7960 ALDERBRIDGE WAY


LEVEL 7 & LEVEL 10

DATE: 10/09/2018
 DRAWN BY: MP/LL
 CHECKED BY: LL
 SCALE: 1/32" = 1'-0"
 JOB NUMBER: 17046

L2.03

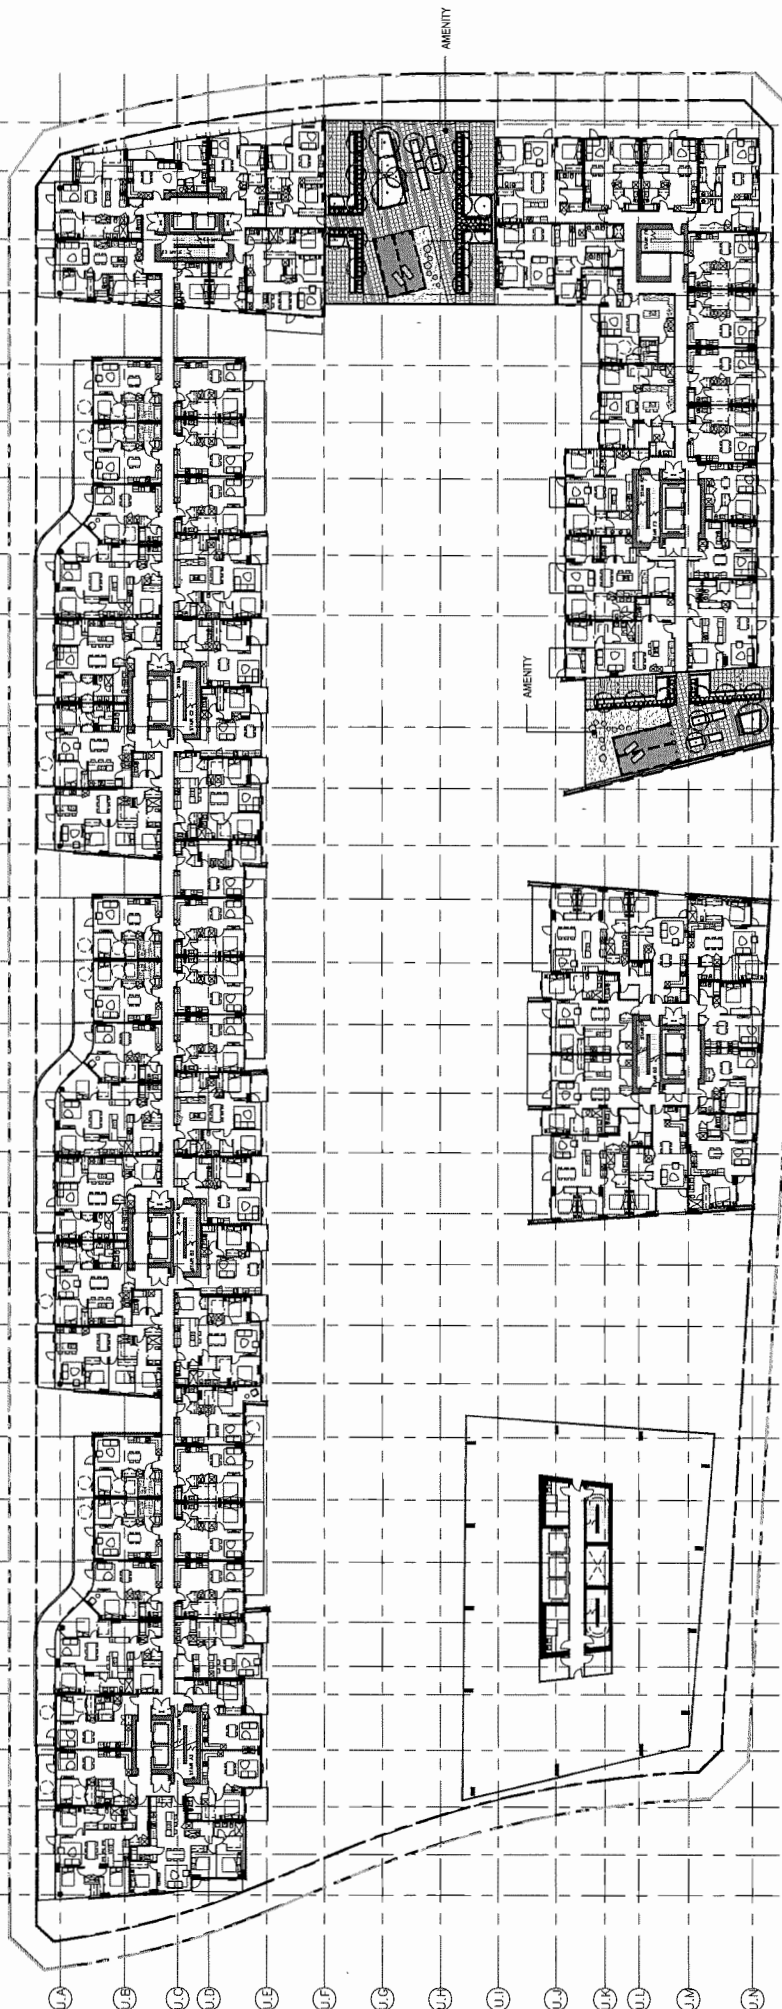


LEVEL 7

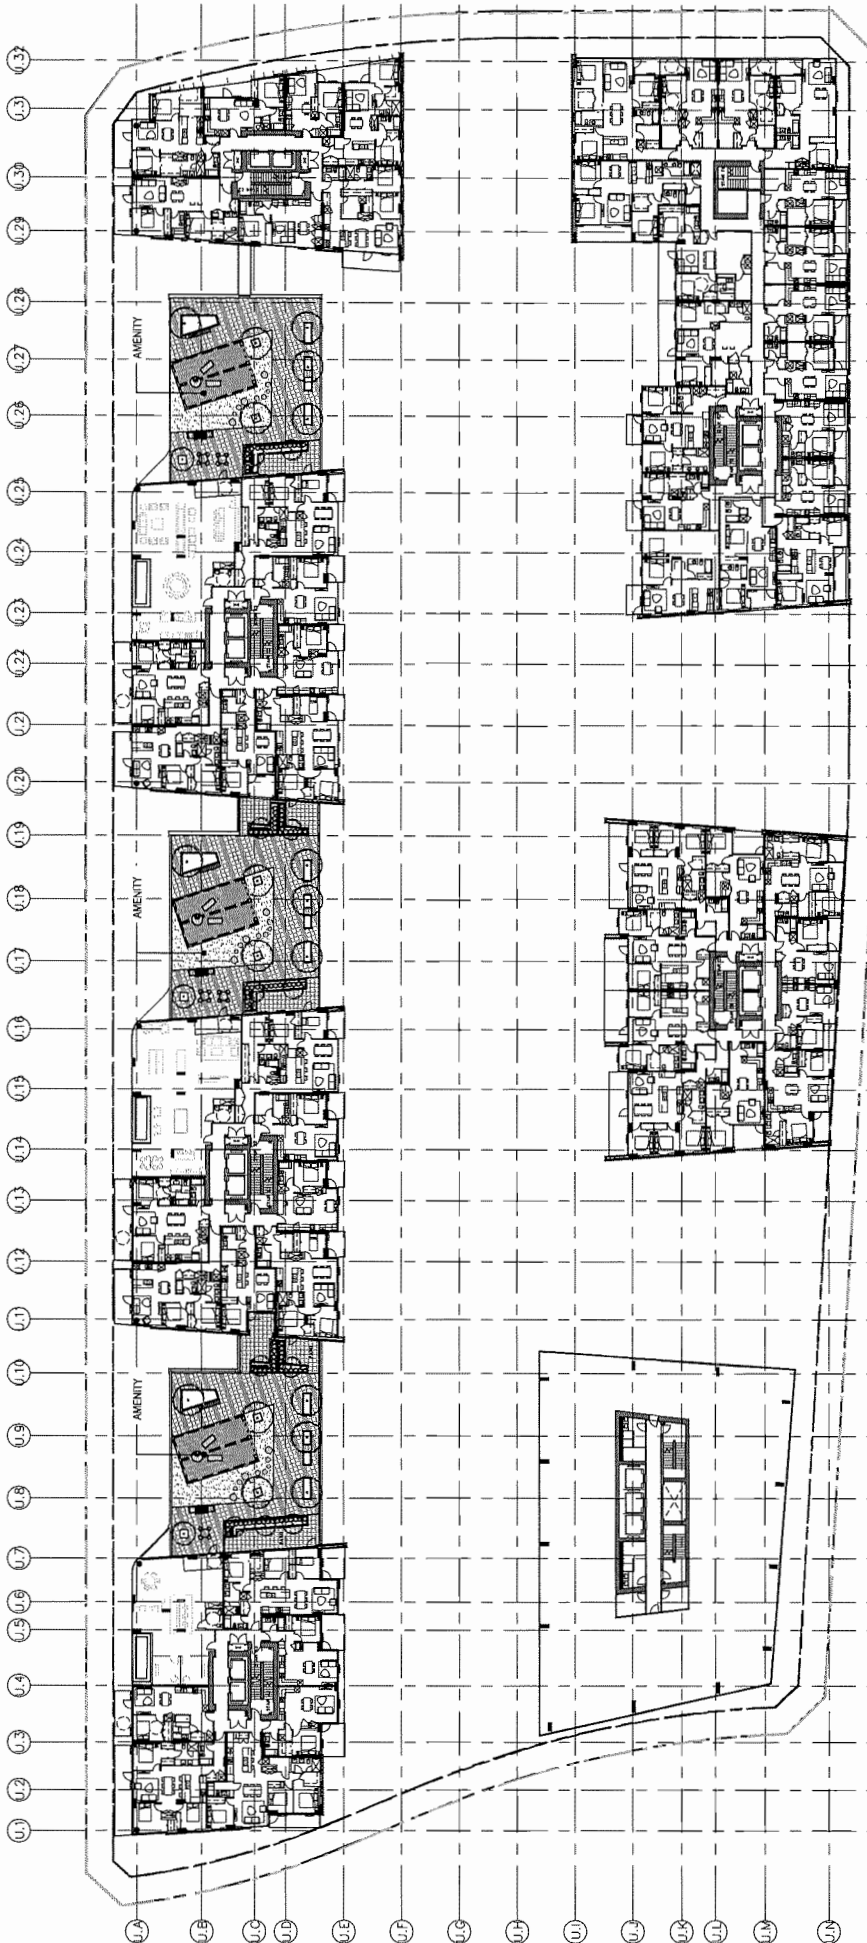

LEVEL 10

LEGEND
 --- PROPERTY LINE
 - - - - - SETBACK LINE

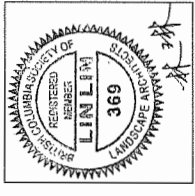

REVISIONS	NO.	DATE	DESCRIPTION
	1	2017-09-29	Issued for Rezoning
	2	2017-11-14	Issued for Rezoning (Resubmission)
	3	2017-11-14	Issued for DP
	4	2018-07-18	Reissued for DP
	5	2018-08-31	DD 80%
	6	2018-09-21	Reissued for DP
	7	2018-10-09	Reissued for DP

7960 ALDERBRIDGE WAY


ROOFTOP

DATE: 10/09/2018
 DRAWN BY: MP/LL
 CHECKED BY: LL
 SCALE: 1/32" = 1'-0"
 JOB NUMBER: 17046

L2.04

①

DP 16-740262 #42

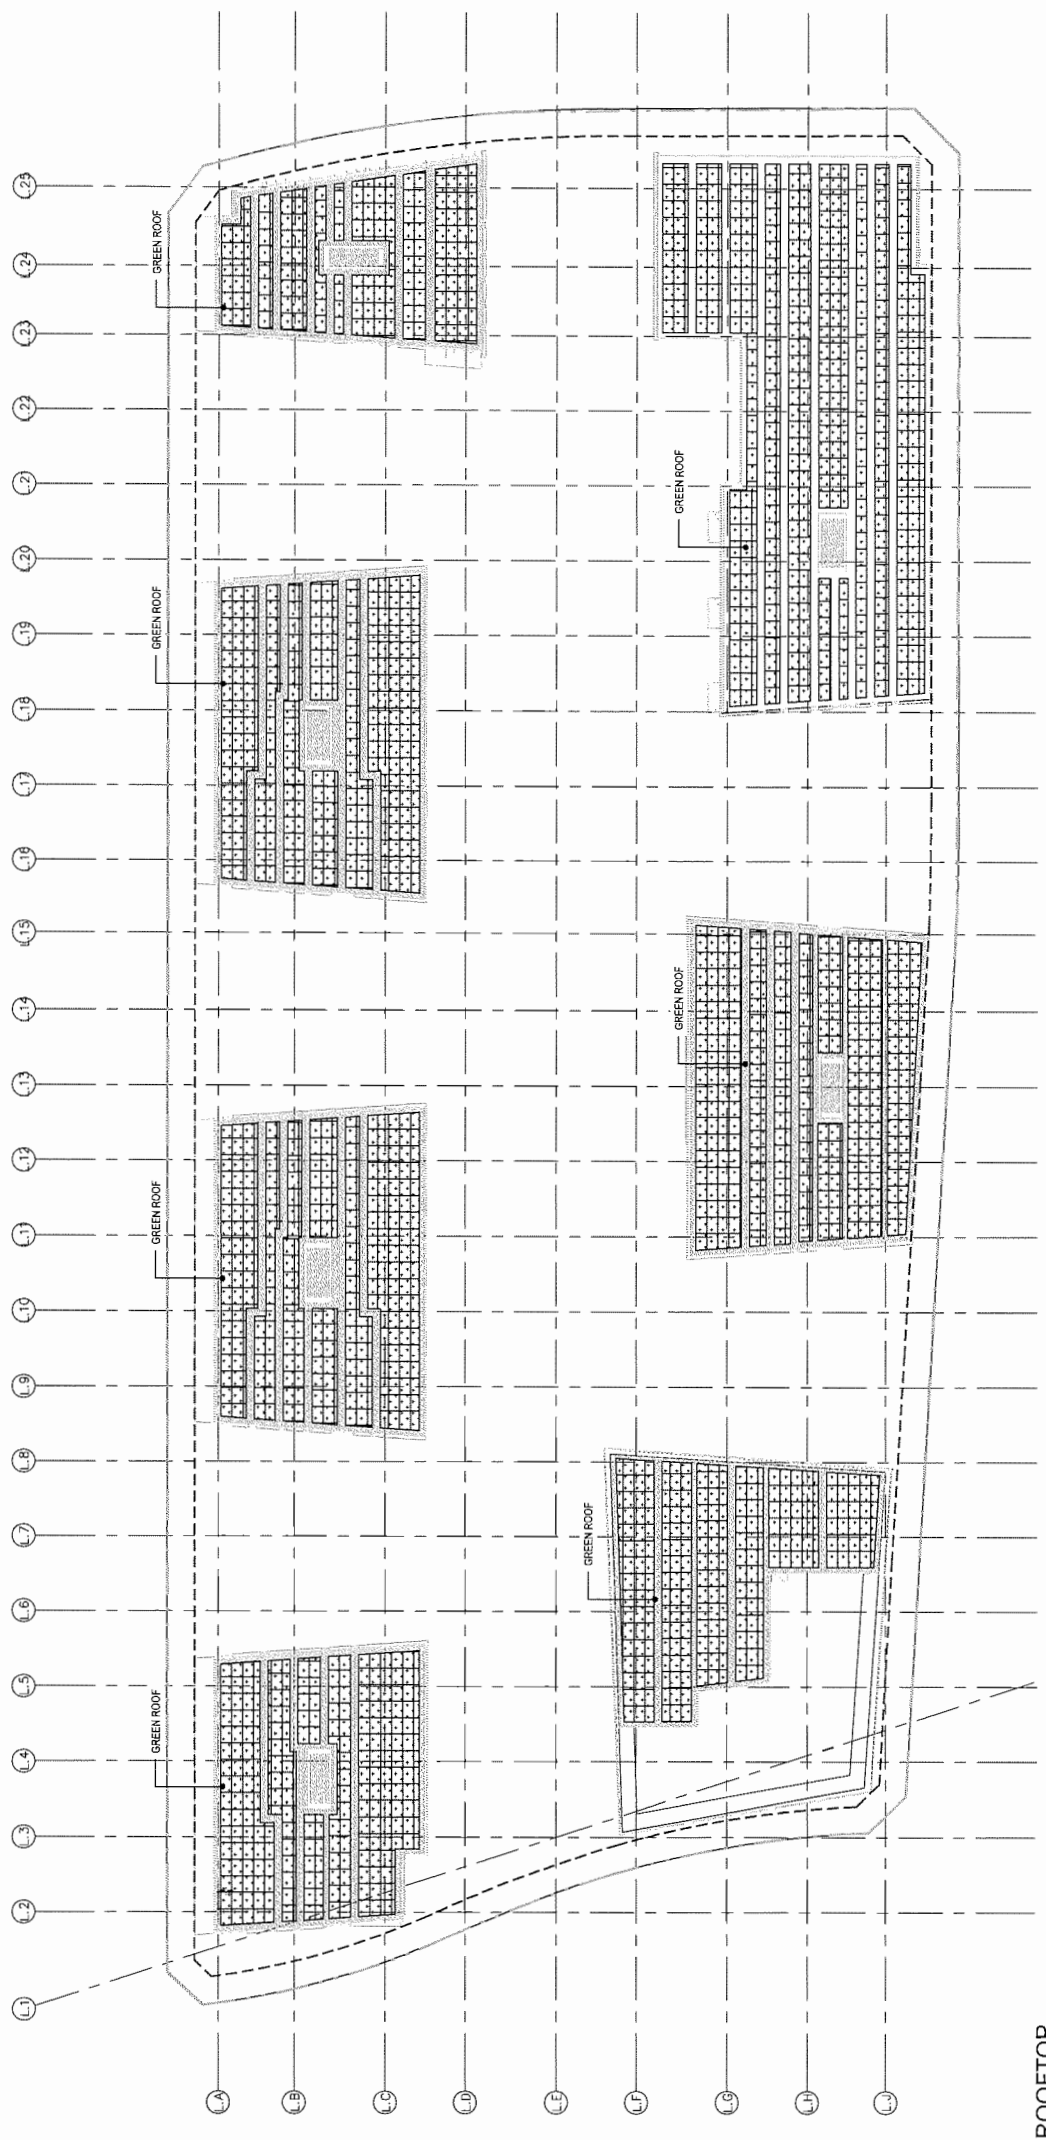

ROOFTOP


LEGEND
 ———— PROPERTY LINE
 - - - - - SETBACK LINE

DP 16-740262 #A3



GBL ARCHITECTS INC.
138 EAST 8TH AVENUE
VANCOUVER, BC CANADA V5T 1R8
TEL 604 738 1188
FAX 604 731 8279
CONTRACT AGREEMENT: THIS PLAN AND DESIGNATION ARE VALIDATED BY THE
MATERIALS LISTED IN THIS PLAN AND DESIGNATION ARE VALIDATED BY THE
MATERIALS LISTED IN THIS PLAN AND DESIGNATION ARE VALIDATED BY THE

PFS STUDIO
PLANNING - URBAN DESIGN - LANDSCAPE ARCHITECTURE
1777 West 7th Avenue
VANCOUVER, BC CANADA V6J 1V2
TEL 604 681 1111
FAX 604 681 1112

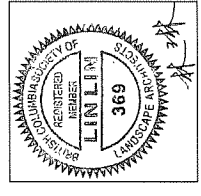


NO.	DATE	DESCRIPTION
1	2017-09-29	Issued for Rezoning
2	2017-11-14	Issued for Rezoning (Re-submission)
3	2017-11-14	Issued for DP
4	2018-07-18	Reissued for DP
5	2018-08-31	OD 80%
6	2018-09-21	Reissued for DP
7	2018-10-09	Reissued for DP

NOTES

7960 ALDERBRIDGE WAY
LANDSCAPE PLAN
- GROUND LEVEL AREA 1
DATE: 10/09/2018
DRAWN BY: MP/LL
CHECKED BY: LL
SCALE: 1/16" = 1'-0"
JOB NUMBER: 17046

L3.01

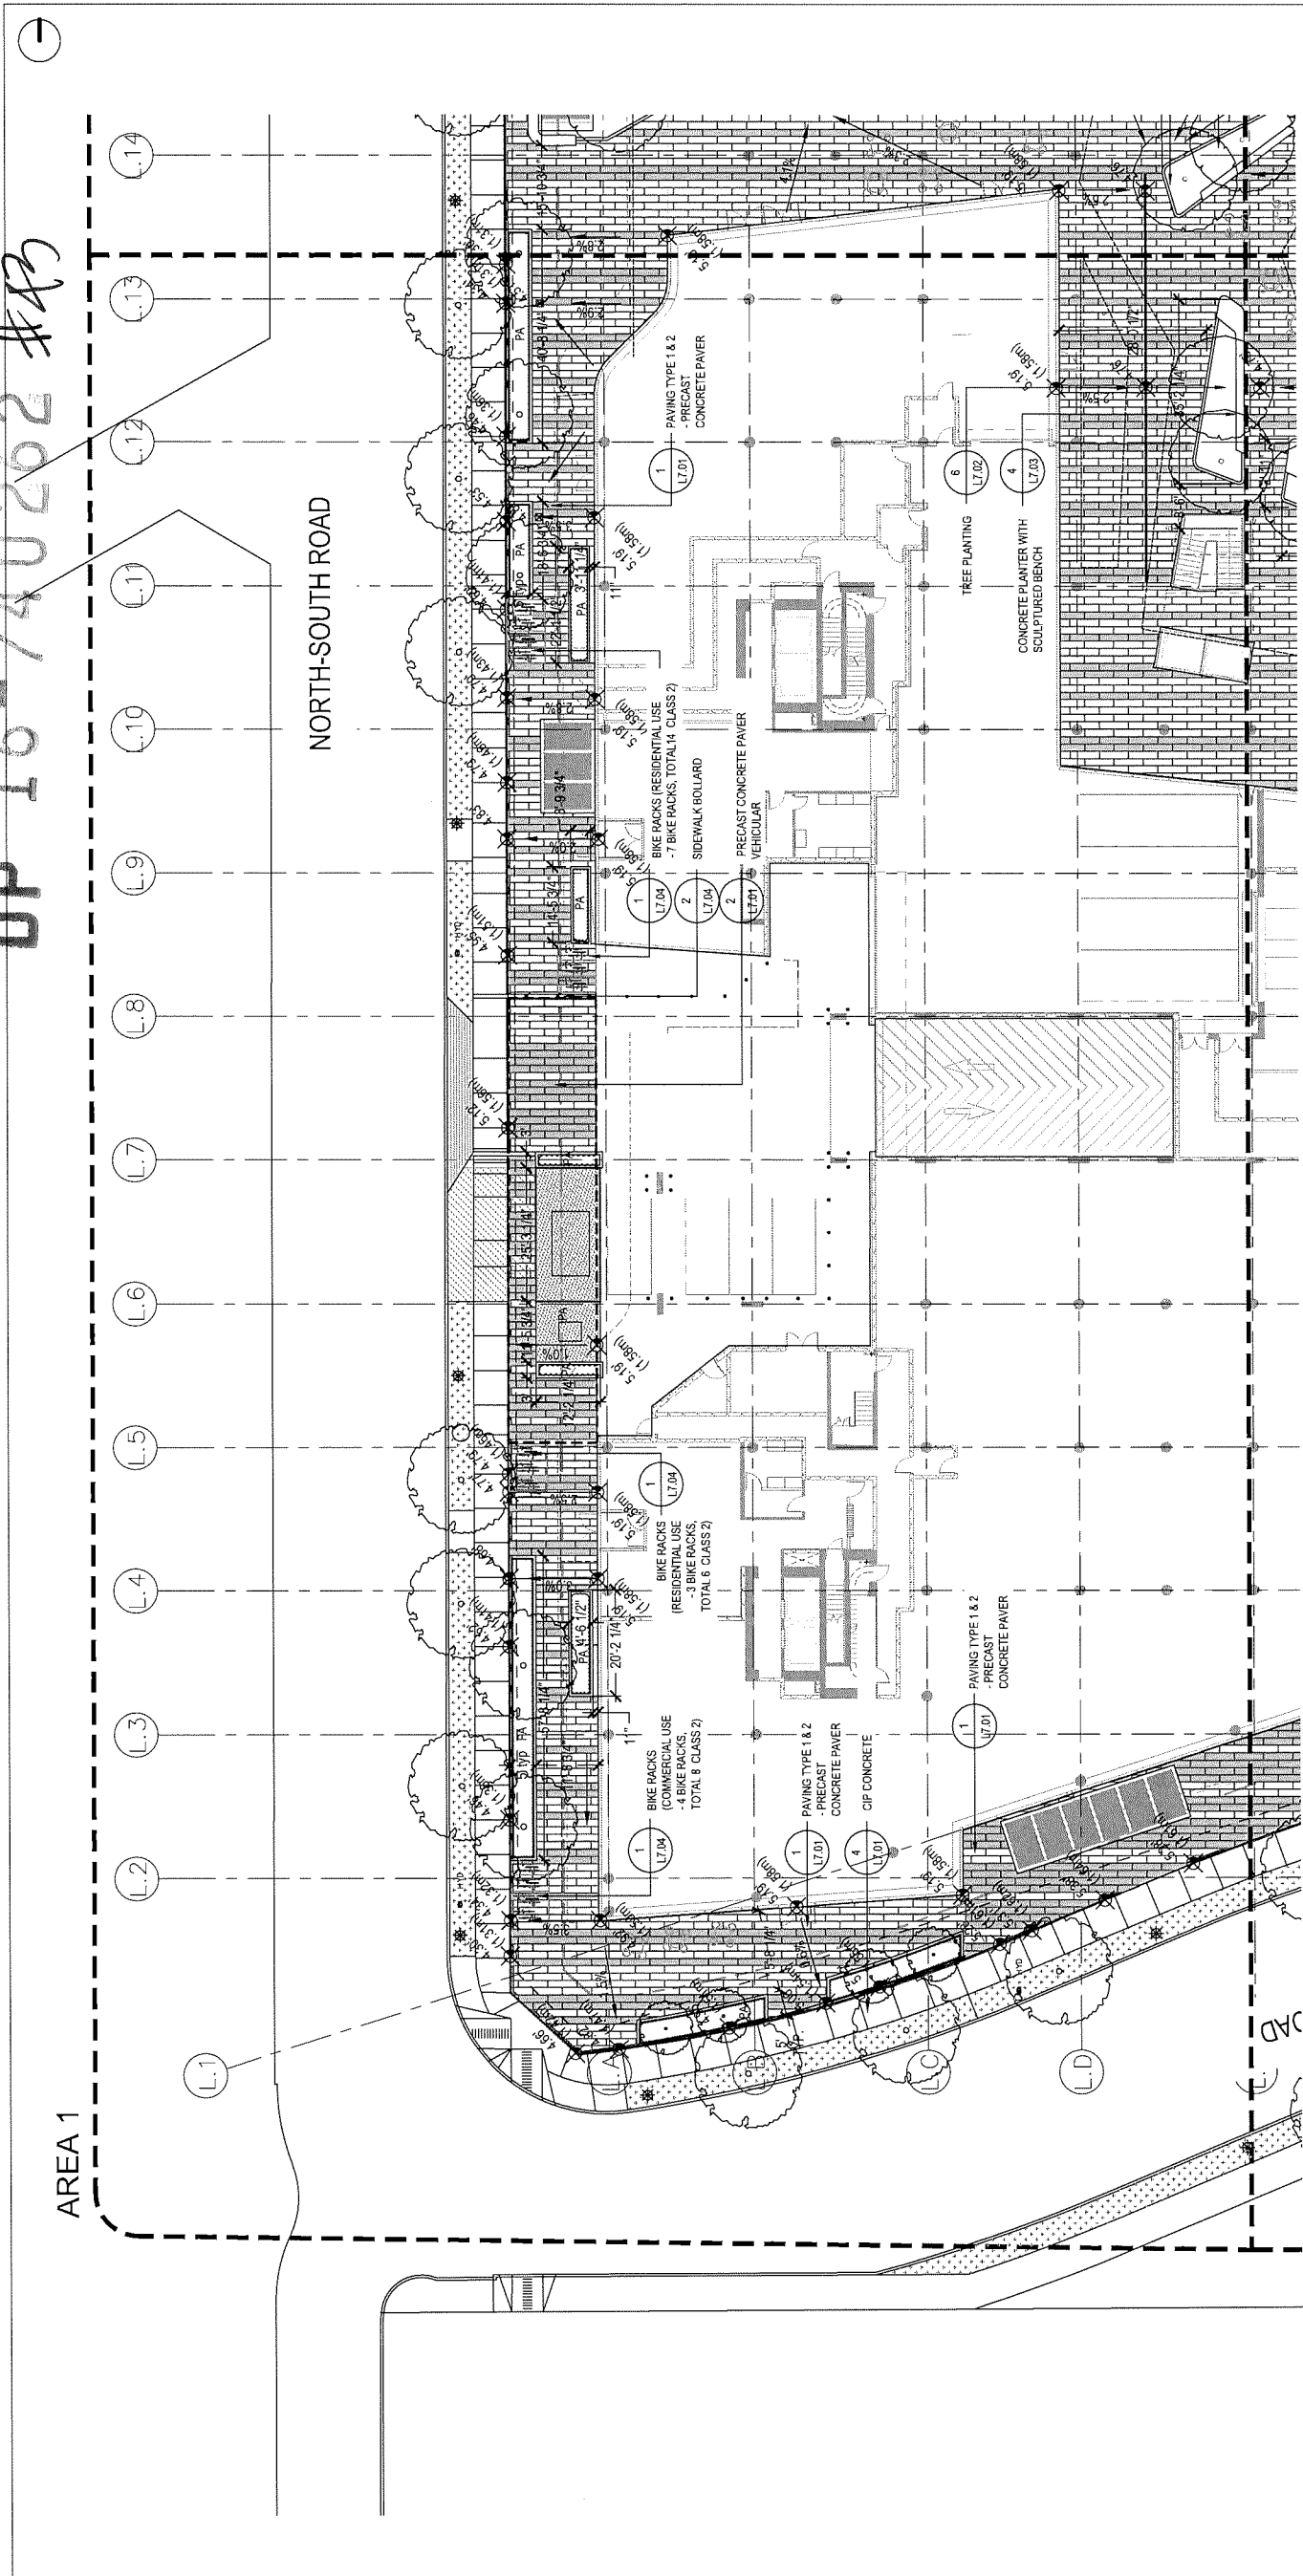


LAYOUT AND MATERIALS GENERAL NOTES

- DO NOT SCALE DRAWINGS. LAYOUT AS PER DIMENSIONS NOTED ON LANDSCAPE PLANS. REPORT ANY DISCREPANCIES TO THE CONSULTANT FOR REVIEW AND RESPONSE.
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- ENG. DRAWINGS FOR LOCATIONS, DETAILS, AND SPECIFICATIONS. REFER TO CIVIL ENGINEERS DRAWINGS FOR LAYOUT OF ROAD CURBS AND GUTTERS AND PEDESTRIAN LET-DOWNS.
- REFER TO ENGINEERING DRAWINGS FOR DETAILS, SUBGRADE, AND REINFORCING OF ALL PAVED SURFACES IN ROADWAYS.
- ALL STREET STREET DESIGN IS TO BE COORDINATED WITH CITY OF RICHMOND STREET ENGINEERING DEPARTMENT AND PLANTED UNDER SUPERVISION OF THE CITY OF RICHMOND PARK BOARD.
- REFER TO DETAILS AND SECTIONS FOR ALL LANDSCAPE IMPROVEMENTS. ALL DIMENSIONS ARE NOMINAL.
- VERIFY ALL DIMENSIONS WITH FIELD CONDITIONS. REPORT ANY DISCREPANCIES TO THE CONSULTANT FOR REVIEW AND RESPONSE.
- ALL MOVABLE FURNITURE WILL BE PROVIDED BY OWNERS.

MATERIALS LEGEND

	CIP CONCRETE OFFSITE REFERENCE ONLY		PRIVACY SCREEN FORMAL LEVEL - PAVING VIEWING PLATFORM LEVEL 3.6, 7.8, 10 SEE ARCH.
	PAVING TYPE 182 - PRECAST CONCRETE PAVEMENT STREET LEVEL TYPE 1 - CALIFORNIA SIZE: 19X8X3/4", COLOR: NATURAL TYPE 2 - CALIFORNIA SIZE: 19X8X3/4", COLOR: CHARCOAL		TRELLIS FORMAL LEVEL - PAVING VIEWING PLATFORM SEE ARCH.
	PAVING TYPE 3 - PORCELAIN WOOD LOOK SLABS LEVEL 3 - OUTDOOR AMENITY LEVEL 1.8 & 1.6 TYPE 1 - ANTI-SLIP - SIZE: 8" X 24" X 1/2", COLOR: REDDISH TYPE 2 - ANTI-SLIP - SIZE: 8" X 24" X 1/2", COLOR: REDDISH TYPE 3 - ANTI-SLIP - SIZE: 8" X 24" X 1/2", COLOR: REDDISH TYPE 4 - ANTI-SLIP - SIZE: 8" X 24" X 1/2", COLOR: REDDISH TYPE 5 - ANTI-SLIP - SIZE: 8" X 24" X 1/2", COLOR: REDDISH TYPE 6 - ANTI-SLIP - SIZE: 8" X 24" X 1/2", COLOR: REDDISH TYPE 7 - ANTI-SLIP - SIZE: 8" X 24" X 1/2", COLOR: REDDISH		CIP CONCRETE PLANTER WALL LEVEL 3.6, 7.8, 10 SEE ARCH.
	PAVING TYPE 4 & 5 - CONCRETE HYDRAPRESSED SLAB LEVEL 6, 7.8, 10 TYPE 1 - ANTI-SLIP - SIZE: 8" X 24" X 1/2", COLOR: REDDISH TYPE 2 - ANTI-SLIP - SIZE: 8" X 24" X 1/2", COLOR: REDDISH TYPE 3 - ANTI-SLIP - SIZE: 8" X 24" X 1/2", COLOR: REDDISH TYPE 4 - ANTI-SLIP - SIZE: 8" X 24" X 1/2", COLOR: REDDISH TYPE 5 - ANTI-SLIP - SIZE: 8" X 24" X 1/2", COLOR: REDDISH TYPE 6 - ANTI-SLIP - SIZE: 8" X 24" X 1/2", COLOR: REDDISH TYPE 7 - ANTI-SLIP - SIZE: 8" X 24" X 1/2", COLOR: REDDISH		WOOD POT LEVEL 6, 7.8, 10 - URBAN AGRICULTURE
	PAVING TYPE 6 - WOOD DECK LEVEL 7.8, 10		METAL PLANTER LEVEL 7.8, 10 - TREE PLANTER
	PAVING TYPE 7 - ARTIFICIAL TURF LEVEL 7.8, 10		BBQ COUNTER / FIRE PLACE LEVEL 6 - OUTDOOR DINING PATIO
	PAVING TYPE 8 - RUBBER SURFACE LEVEL 6		FIRE PIT LEVEL 6
	BIKE RACK GROUND LEVEL - ENTRANCES TOTAL 127		WOOD TOP BENCH TYPE B STREET LEVEL
	WOOD TOP BENCH TYPE A STREET LEVEL		WOOD TOP BENCH TYPE C STREET LEVEL - MID-PLAZA
	WOOD TOP BENCH TYPE B STREET LEVEL		WOOD TOP BENCH TYPE D LEVEL 3.1, 7.8, 10

NOTES

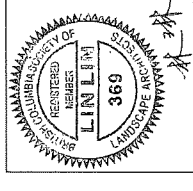


REVISIONS	NO.	DATE	DESCRIPTION
	1	2017-09-29	Issued for Reasoning (Resubmission)
	2	2017-11-14	Issued for DP
	3	2017-11-14	Issued for DP
	4	2018-07-18	DD 80%
	5	2018-08-31	Reissued for DP
	6	2018-09-21	Reissued for DP
	7	2018-10-09	Reissued for DP

7960 ALDERBRIDGE WAY

LANDSCAPE PLAN
- GROUND LEVEL AREA 2

DATE	10/09/2018
DRAWN BY	MP/LL
CHECKED BY	LL
SCALE	1/16" = 1'-0"
JOB NUMBER	17046

DP 16-740262 #44

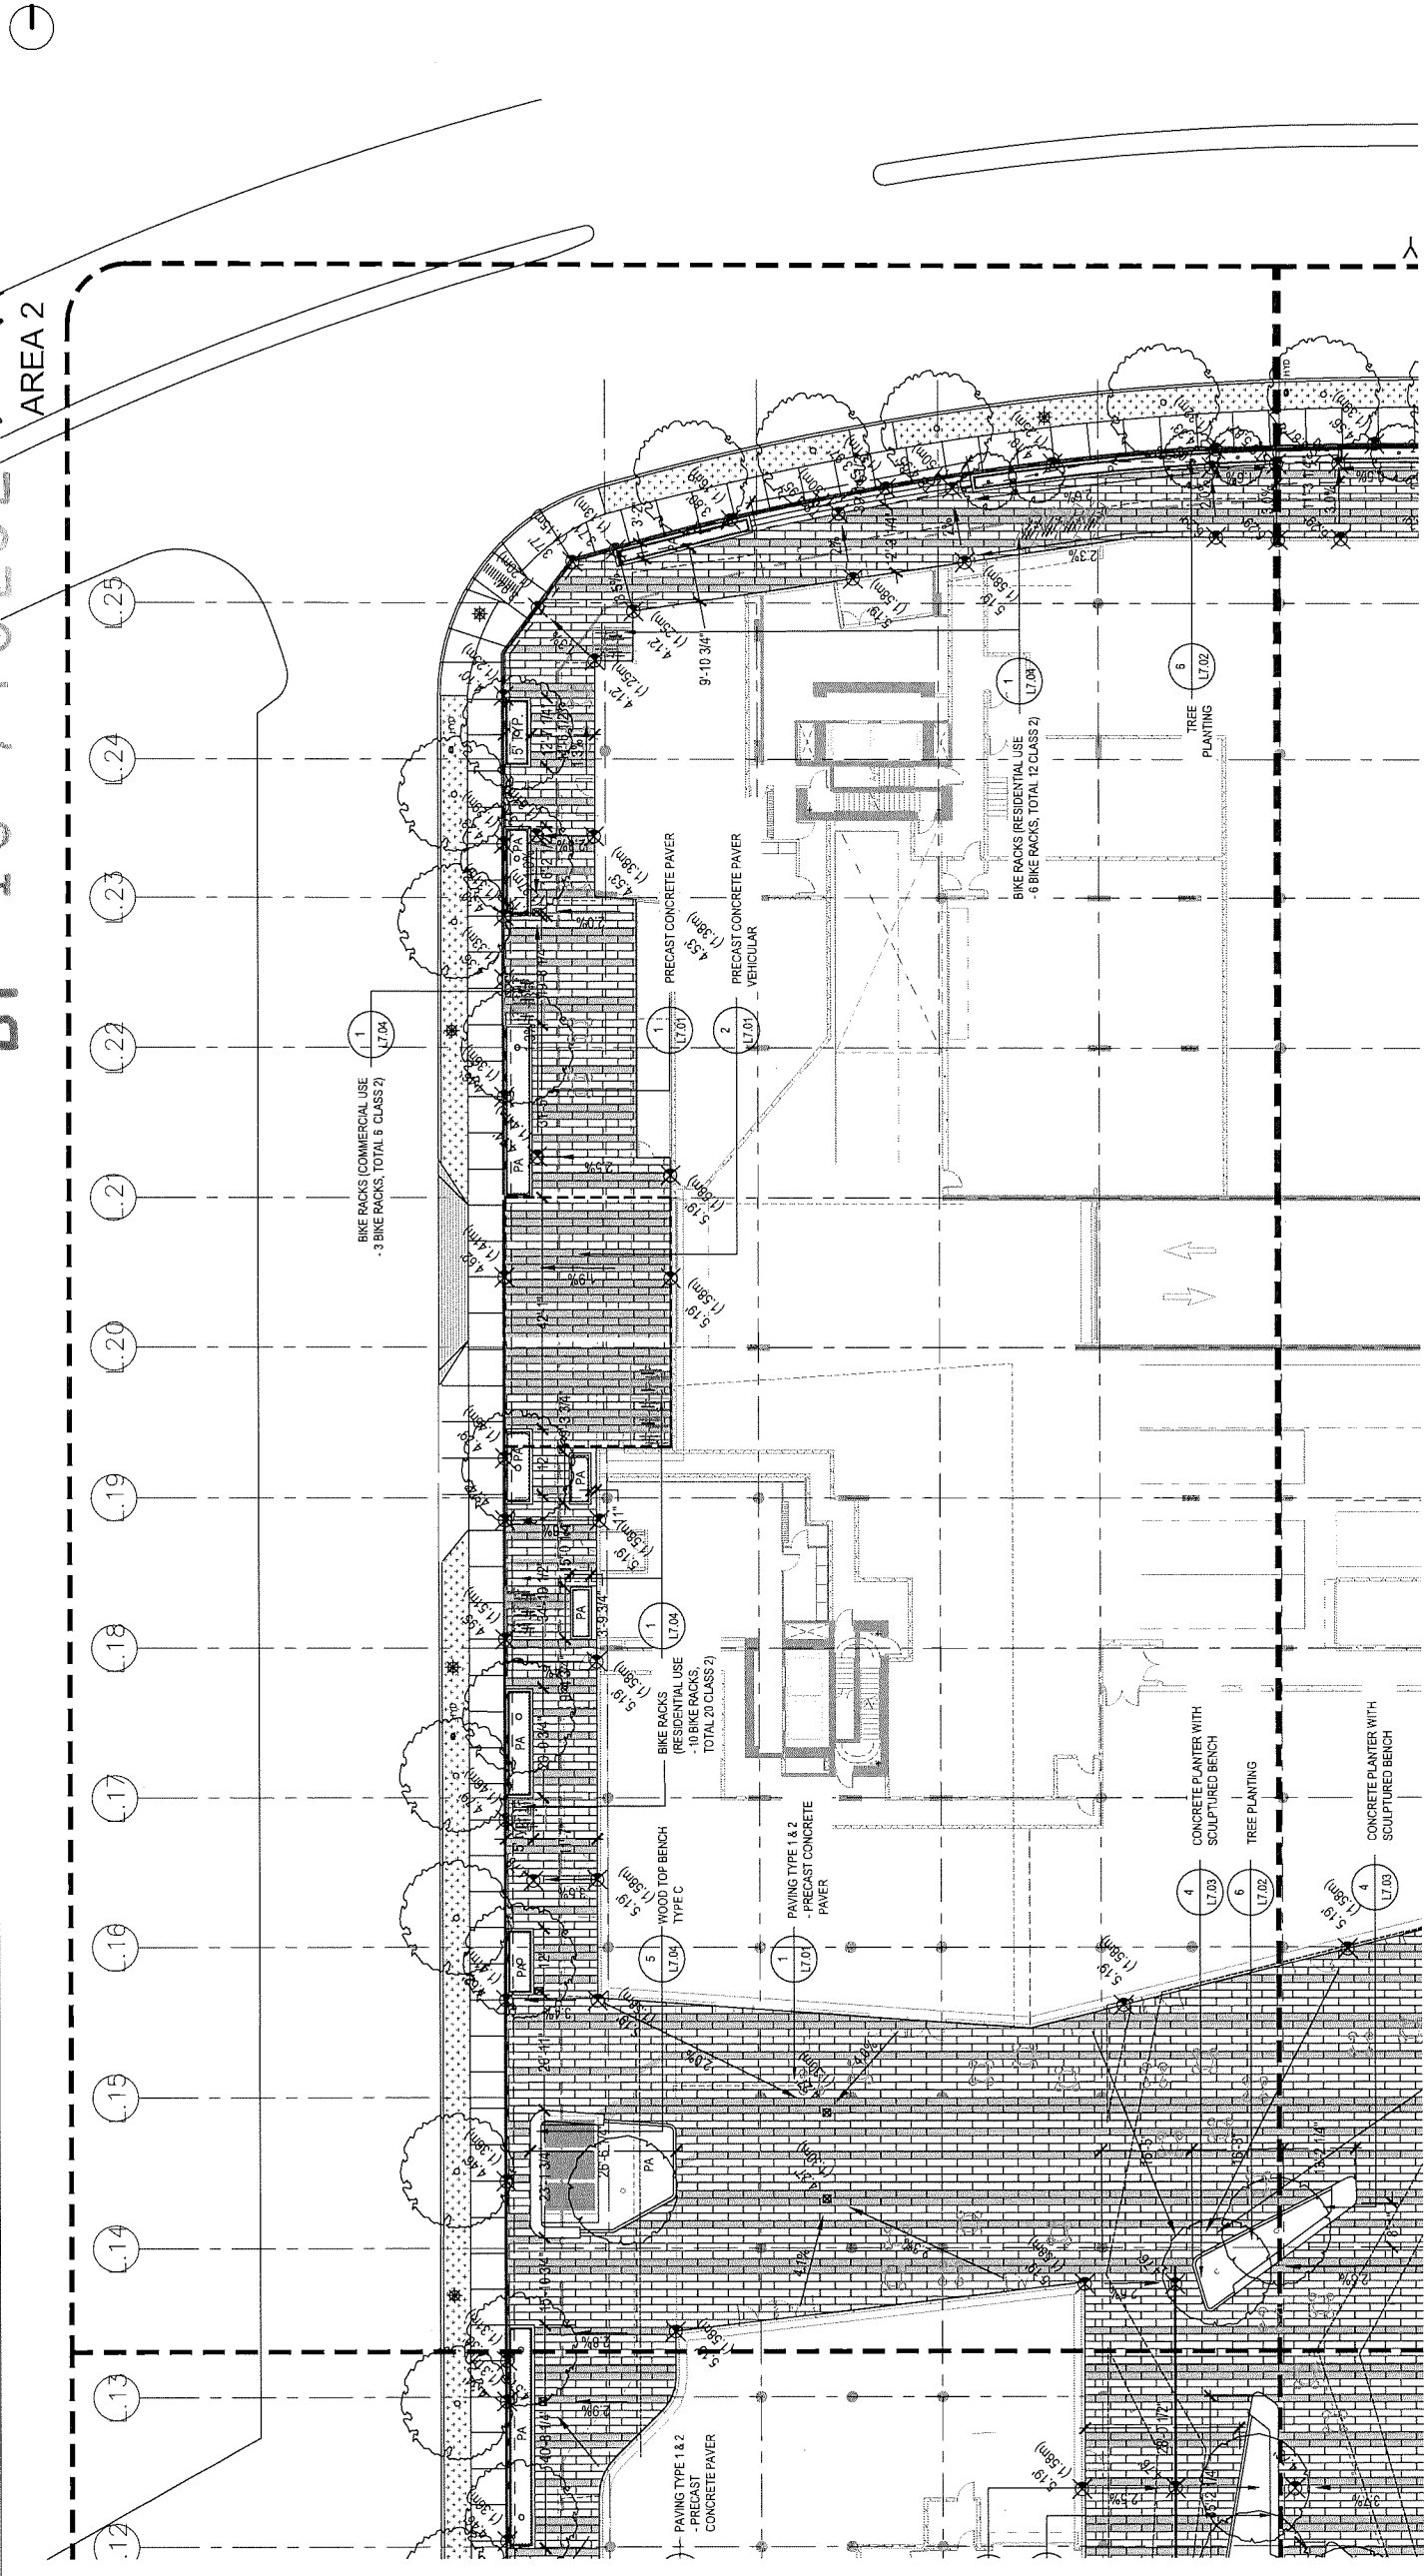


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- REFER TO THE LAYOUT AND MATERIALS DRAWINGS FOR LAYOUT OF ROAD CURBS AND REFER TO THE LAYOUT AND MATERIALS DRAWINGS FOR DETAILS, SUBGRADE, AND REINFORCING OF ALL PAVED SURFACES IN ROADWAYS.
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- REFER TO DETAILS AND SECTIONS FOR ALL LANDSCAPE IMPROVEMENTS. ALL DIMENSIONS ARE NOMINAL.
- VERIFY ALL DIMENSIONS WITH FIELD CONDITIONS. REPORT ANY DISCREPANCIES TO THE CONSULTANT FOR REVIEW AND RESPONSE.
- ALL MOVABLE FURNITURE WILL BE PROVIDED BY OWNERS.

MATERIALS LEGEND

	CIP CONCRETE OFF-SITE (REFERENCE ONLY)		PRIVACY SCREEN (1.1, 1.10 SEE ARCH.)
	PAVING TYPE 1&2 - PRECAST CONCRETE PAVER (STREET LEVEL, TYPE 1: CALIFORNIA, SIZE: 1200x34, COLOR: CHARCOAL)		TRELLIS (NORMAL LEVEL, PATIOS, VIEWING PLATFORM SEE ARCH.)
	PAVING TYPE 3 - PORCELAIN WOOD LOOK SLABS (LEVEL 3, OUTDOOR AMENITY LEVEL: 3.6, TYPE 3: PALMERA, SIZE: 87x33/2'x3', COLOR: SEDUCA)		CIP CONCRETE PLANTER WALL (LEVEL 3, 4, 1.10 SEE ARCH., NO SAND/SLAST FINISH)
	PAVING TYPE 4 & 5 - CONCRETE HYDRAPRESSED SLAB (TYPE 4: PALMERA, SIZE: 87x33/2'x3', COLOR: SEDUCA; TYPE 5: PALMERA, SIZE: 87x33/2'x3', COLOR: CHARCOAL)		WOOD POT (LEVEL 6, 7, 1.10 - URBAN AGRICULTURE)
	PAVING TYPE 6 - WOOD DECK (LEVEL 1, 1.10)		METAL PLANTER (LEVEL 7, 1.10 - TREE PLANTER)
	PAVING TYPE 7 - ARTIFICIAL TURF (LEVEL 1, 1.10)		BIO COUNTER / FIRE PLACE (LEVEL 6 - OUTDOOR DINING PATIO)
			FIRE PIT (LEVEL 6)
	PAVING TYPE 8 - RUBBER SURFACE (LEVEL 6)		CONCRETE PLANTER WITH SCULPTURED BENCH
	BIKE RACK (GROUND LEVEL - BIKERACKS TOTAL 122)		CONCRETE PLANTER WITH SCULPTURED BENCH
	WOOD TOP BENCH TYPE A (STREET LEVEL)		TREE PLANTING
	WOOD TOP BENCH TYPE B (STREET LEVEL)		
	WOOD TOP BENCH TYPE C (STREET LEVEL - 100' PADA)		
	WOOD TOP BENCH TYPE D (LEVEL 3, 7, 1.10)		


DP 16-740262 #45

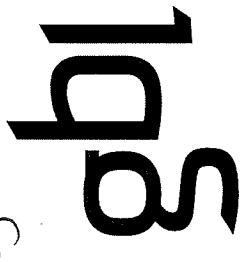

GBL ARCHITECTS INC.
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NOTES

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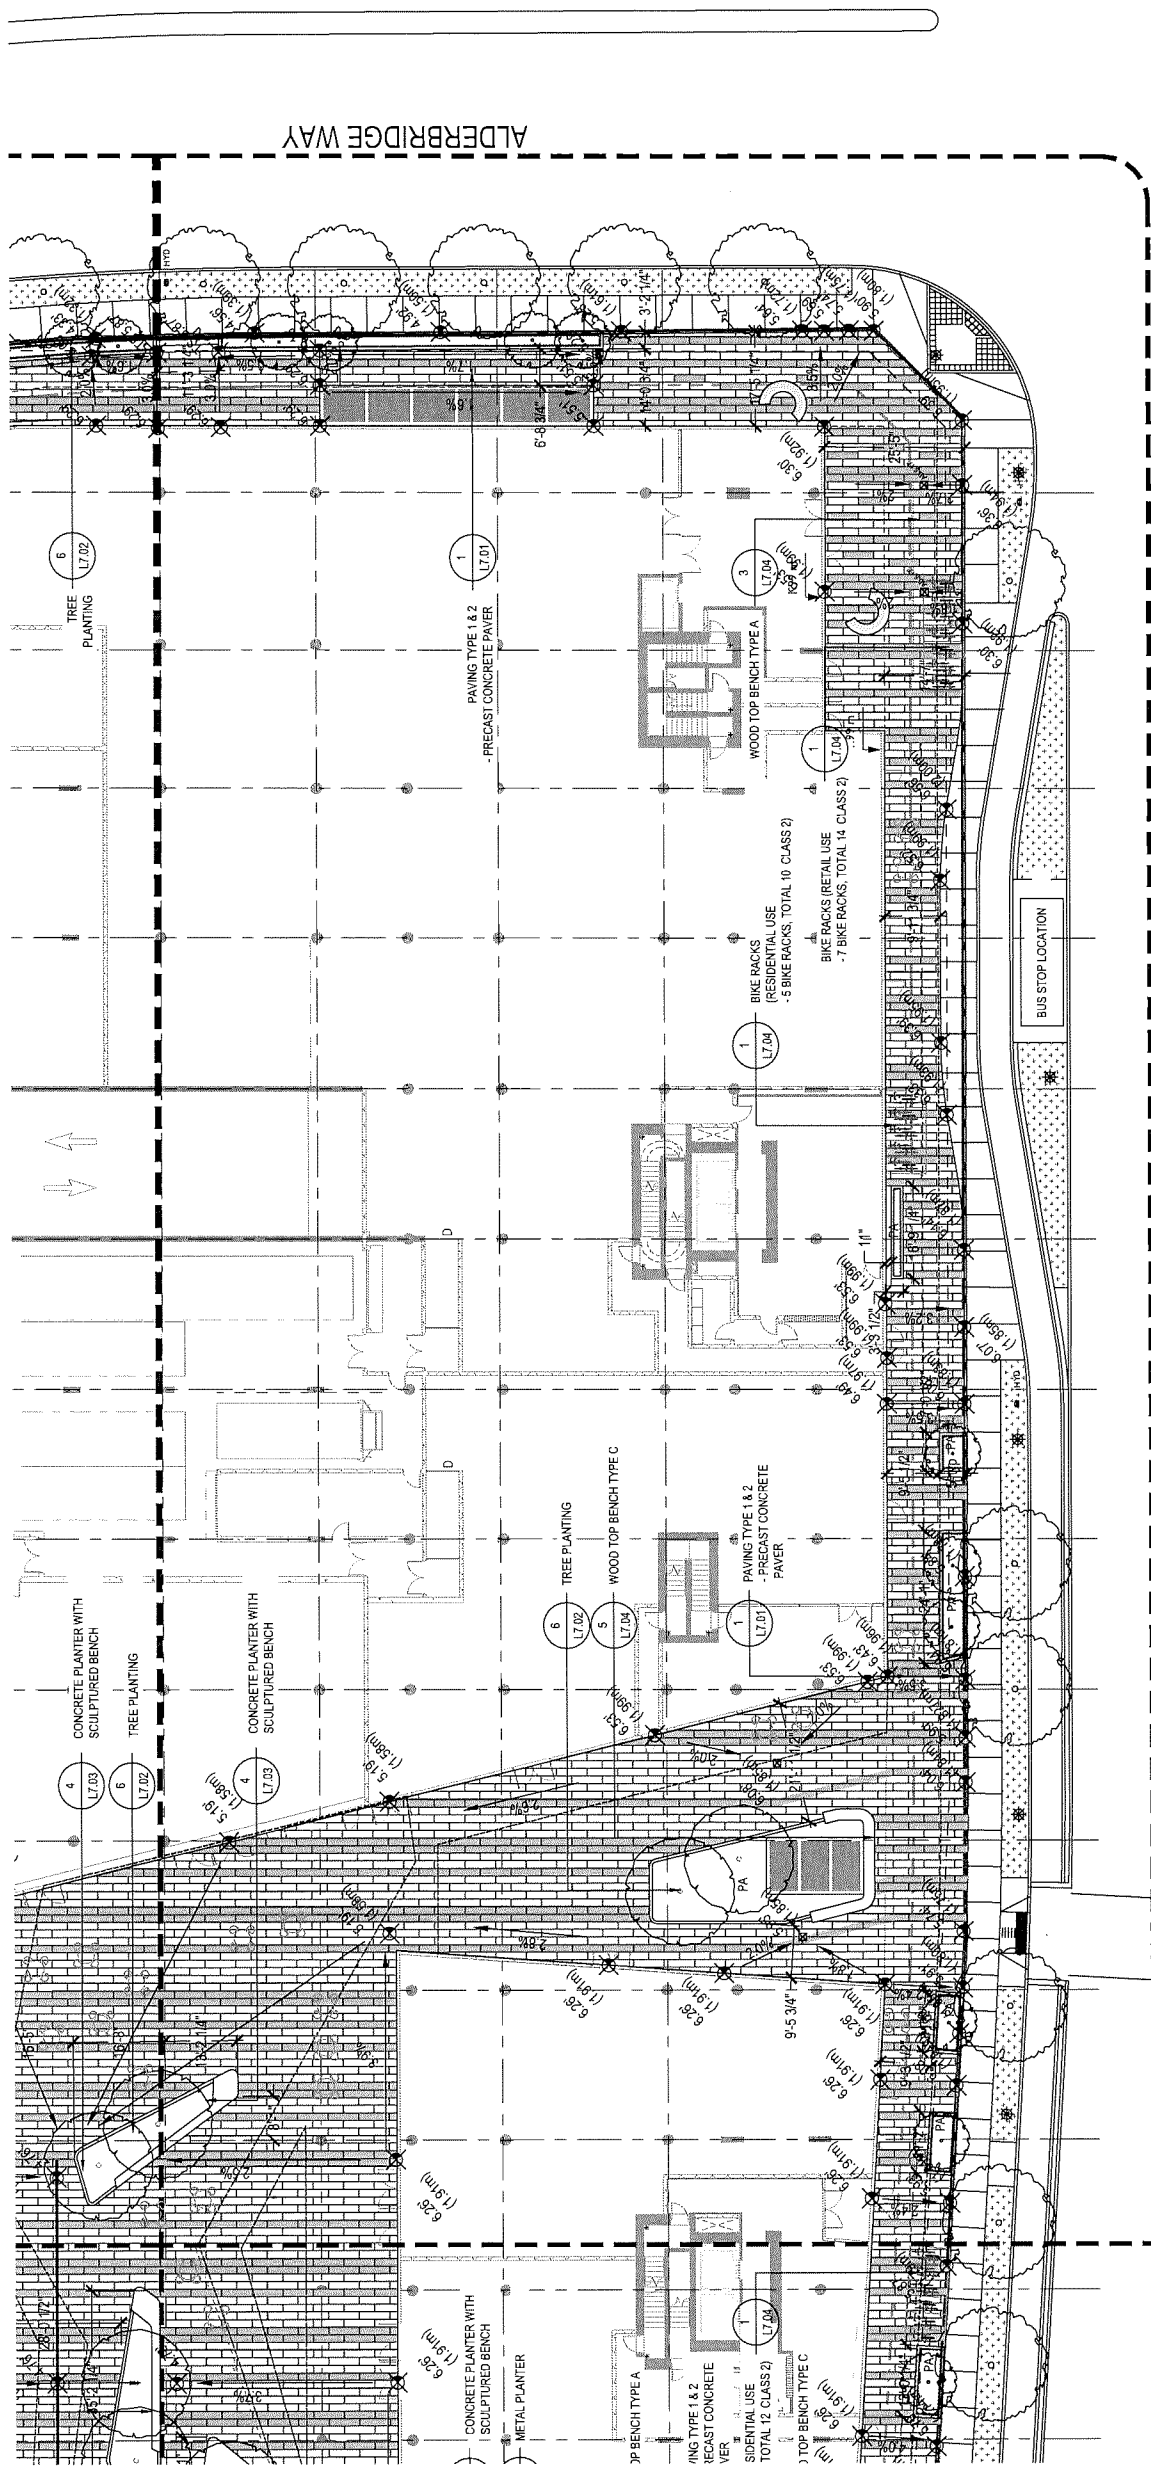


NO.	DATE	DESCRIPTION
1	2017-09-29	Issued for Rezoning
2	2017-11-14	Issued for Rezoning (Re-submission)
3	2017-11-14	Issued for DP
4	2018-07-18	Reissued for DP
5	2018-08-31	DD 80%
6	2018-09-21	Reissued for DP
7	2018-10-09	Reissued for DP

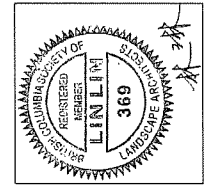7960 ALDERBRIDGE WAY

LANDSCAPE PLAN
- GROUND LEVEL AREA 3

DATE	10/09/2018
DRAWN BY	MP/LL
CHECKED BY	LL
SCALE	1/16" = 1'-0"
JOB NUMBER	17046



AREA 3


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- LANDSCAPE DRAWINGS ARE TO BE READ IN CONJUNCTION WITH ARCHITECTURAL DRAWINGS FOR MATERIALS, FINISHES, AND RESPONSE TO THE CONSULTANT FOR REVIEW AND RESPONSE.
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- ALL MOVABLE FURNITURE WILL BE PROVIDED BY OWNERS.

MATERIALS LEGEND

	GIP CONCRETE OFF-SITE (PERFORMANCE ONLY)		PRIVACY SCREEN FROMM LEVEL - FINISH, SEE ARCH. LEVEL 3.5, 7.4, 10
	PAVING TYPE 1&2 - PRECAST CONCRETE PAVER TYPE 1: CALIFORNIA SIZE: 125x93.8F, COLOR: NATURAL TYPE 2: CALIFORNIA SIZE: 125x93.8F, COLOR: CHARCOAL		TRELLIS FROMM LEVEL - FINISH, SEE ARCH. LEVEL 3.5, 7.4, 10
	PAVING TYPE 3 - PORCELAIN WOOD LOOK SLABS TYPE 1: GUDONKAWMENT LEVEL 2.8 & 3.0 TYPE 2: GUDONKAWMENT LEVEL 2.8 & 3.0 TYPE 3: GUDONKAWMENT LEVEL 2.8 & 3.0		CIP CONCRETE PLANTER WALL LEVEL 3.5, 7.4, 10 SEE ARCH. AND SANDBLAST FINISH
	PAVING TYPE 4 & 5 - CONCRETE HYDRAPRESSED SLAB TYPE 4: HYDRAPRESSED TYPE 5: HYDRAPRESSED		WOOD POT LEVEL 6, 7 & 9 - (PERMANENT) LEVEL 6, 7 & 9 - (PERMANENT)
	PAVING TYPE 6 - WOOD DECK LEVEL 7.8, 10		METAL PLANTER LEVEL 7.4, 9 - TREE PLANTER LEVEL 7.4, 9 - TREE PLANTER
	PAVING TYPE 7 - ARTIFICIAL TURF LEVEL 7.8, 10		BBG COUNTER/FIRE PLACE LEVEL 1 - OUTDOOR GRASS PITS
	PAVING TYPE 8 - RUBBER SURFACE LEVEL 6		FIRE PIT LEVEL 6
	BIKE RACK GROUND LEVEL - ENTRANCES TOTAL 122 STREET LEVEL		WOOD TOP BENCH TYPE A STREET LEVEL
	WOOD TOP BENCH TYPE B STREET LEVEL		WOOD TOP BENCH TYPE C STREET LEVEL - (100% ADA)
	WOOD TOP BENCH TYPE D LEVEL 3, 7 & 10		


DP 16-740262 #46

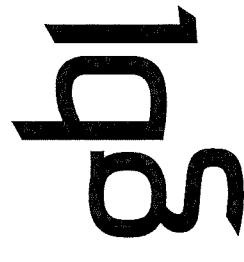


■ GBL ARCHITECT'S INC.
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VANCOUVER, BC CANADA V6H 2V6
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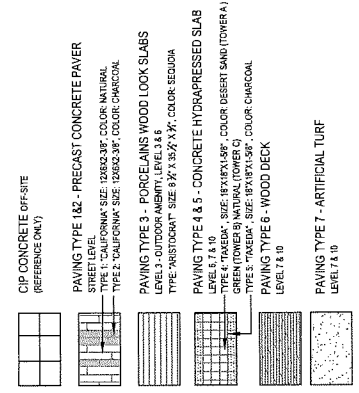
NO.	DATE	DESCRIPTION
1	2017-09-29	Issued for Rezoning (Reubmission)
2	2017-11-14	Issued for Rezoning (Reubmission)
3	2017-11-14	Issued for DP
4	2018-07-19	Released for DP
5	2018-08-31	DO 80%
6	2018-09-21	Released for DP
7	2018-10-09	Released for DP



NO.3 ROAD

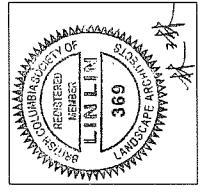AREA 4

MATERIALS LEGEND

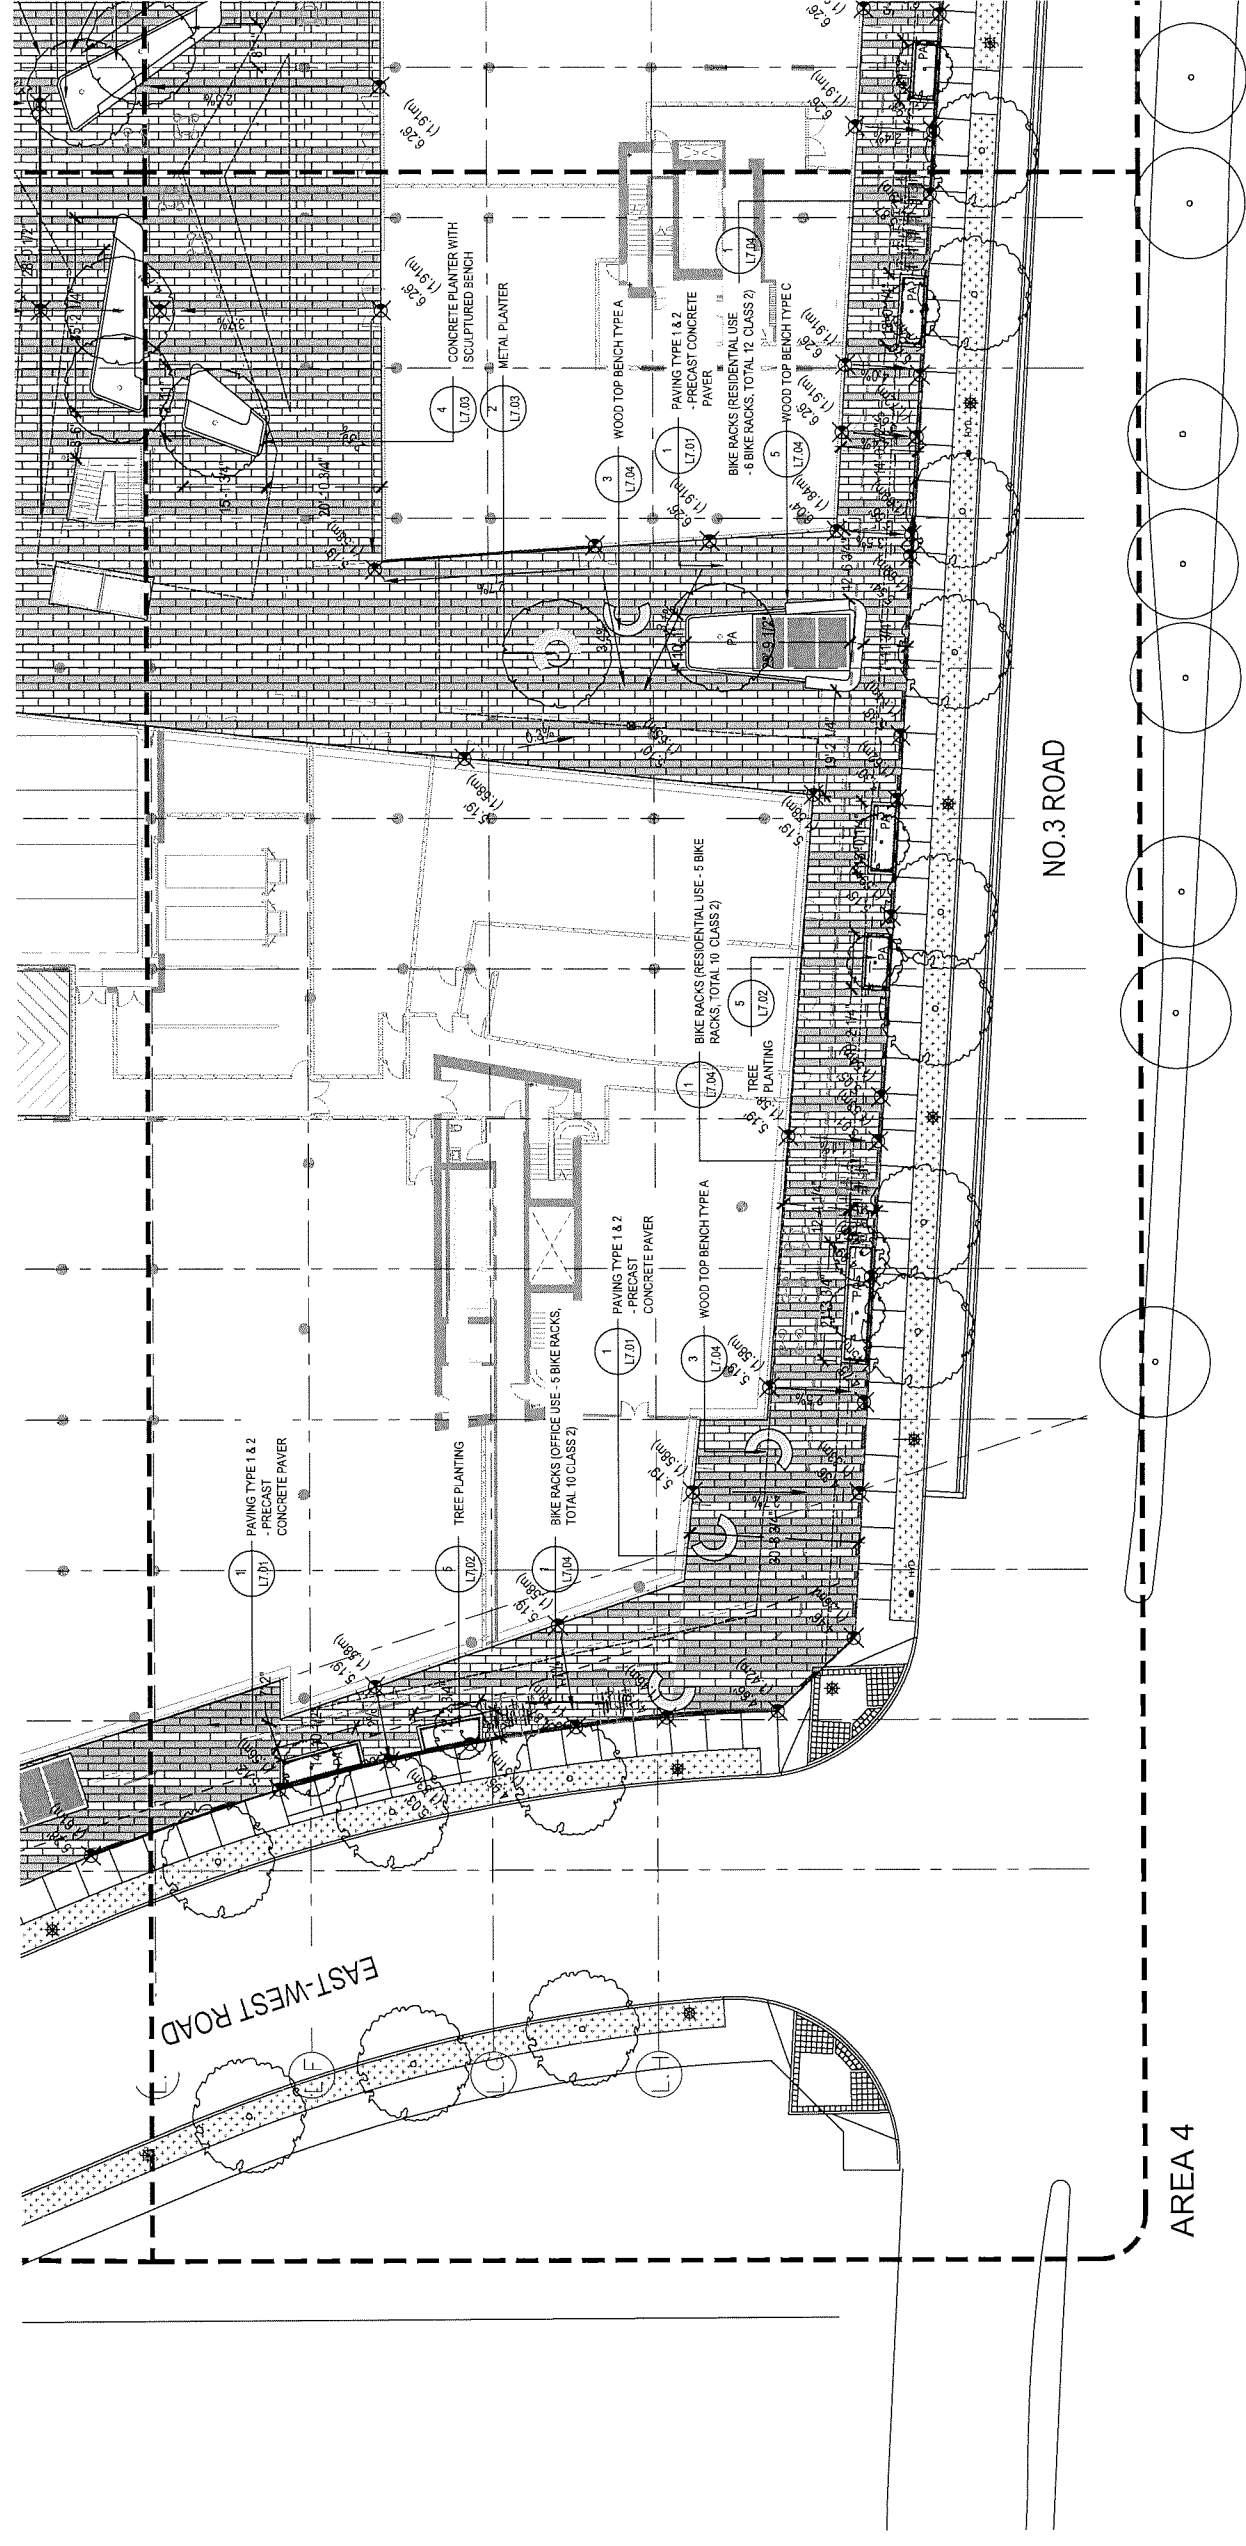

LAYOUT AND MATERIALS GENERAL NOTES

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7960 ALDERBRIDGE WAY

LANDSCAPE PLAN
- GROUND LEVEL AREA 4

DATE: 10/09/2018
DRAWN BY: MPILL
CHECKED BY: LL
SCALE: 1/16" = 1'-0"
JOB NUMBER: 17046

L3.04

DP 16-740262 #47




gbl ARCHITECTS INC.
139 EAST 5TH AVENUE
VANCOUVER, BC CANADA V5T 1R8
TEL: 604 735 1186
FAX: 604 731 8279
CONTACT: REBECCA.TAYLOR@GBLARCHITECTS.COM
REBECCA.TAYLOR@GBLARCHITECTS.COM
REBECCA.TAYLOR@GBLARCHITECTS.COM

NOTES

PFS STUDIO
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1077 West Pender Street
Vancouver, BC V6E 2E2
TEL: 604 681 1111
WWW.PFSSTUDIO.COM



NO.	DATE	DESCRIPTION
1	2017-09-29	Issued for Rezoning
2	2017-11-14	Issued for Rezoning (Re-submission)
3	2017-11-14	Issued for DP
4	2018-07-18	Released for DP
5	2018-08-31	DD 80%
6	2018-09-21	Released for DP
7	2018-10-09	Released for DP

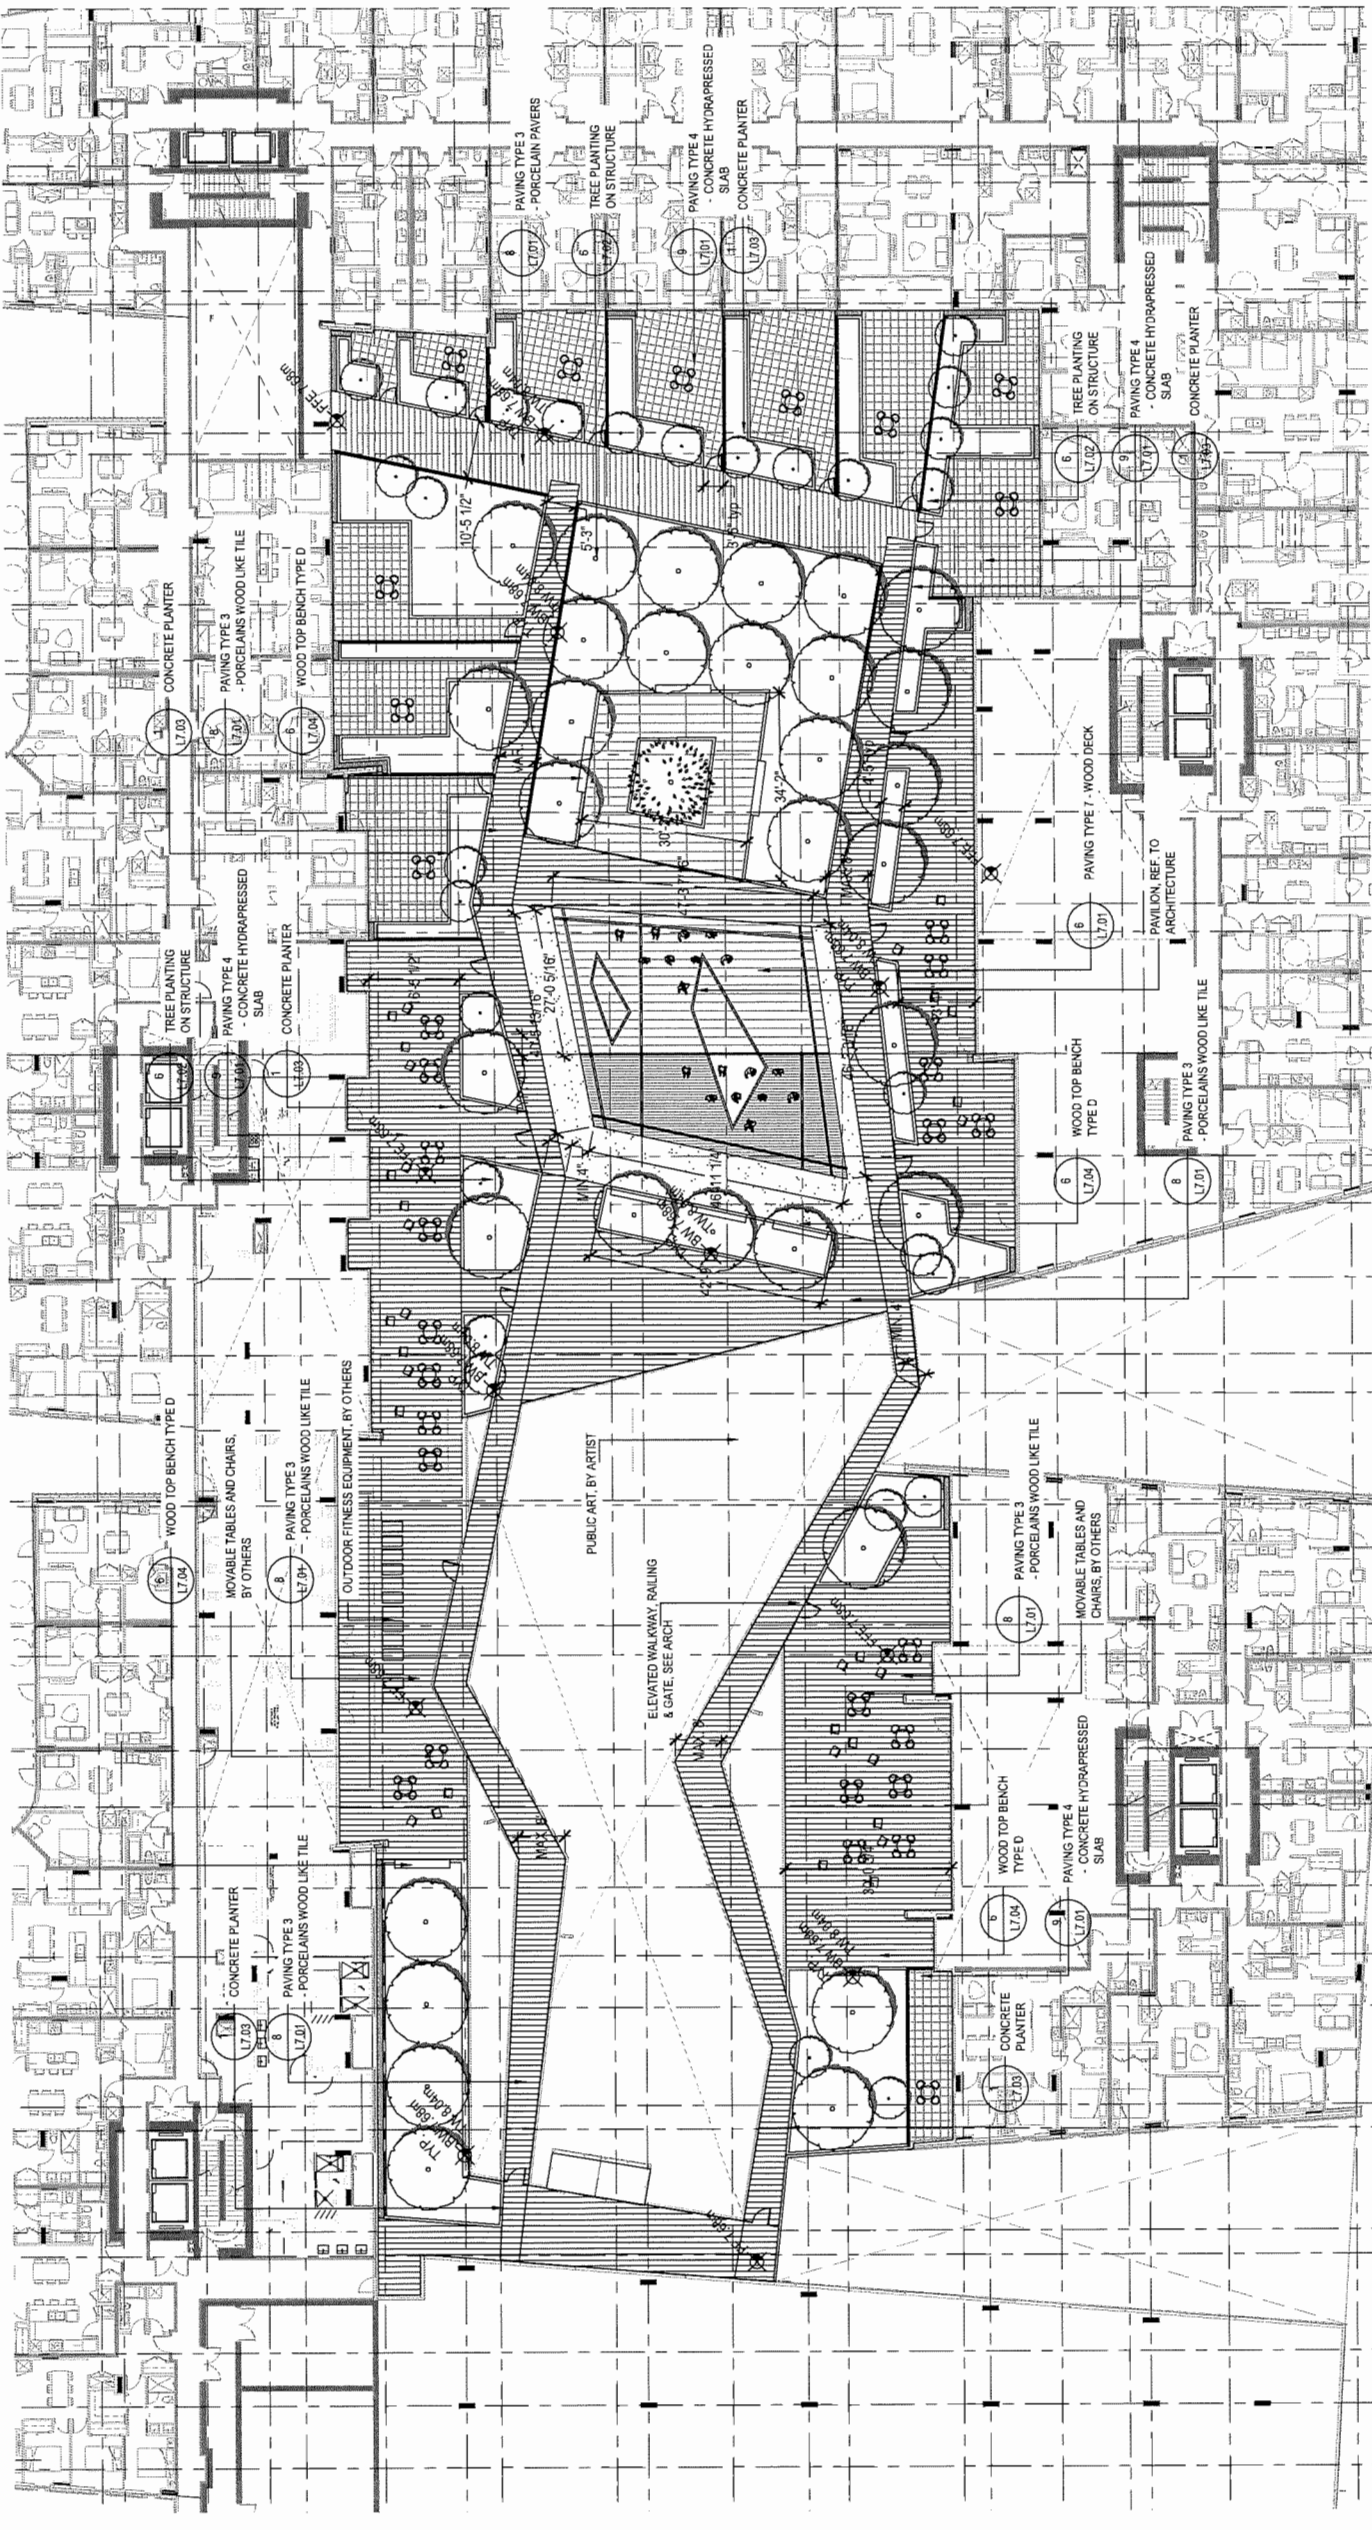

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 - ALL MOVABLE FURNITURE WILL BE PROVIDED BY OWNERS.

MATERIALS LEGEND

	CIP CONCRETE OFFSITE (REFERENCE ONLY)		PAVING TYPE 1:2 - PRECAST CONCRETE PAVER STREET LEVEL TYPE 1: 150x150x40mm, SIZE: 150x150x40mm, COLOR: NATURAL TYPE 2: 150x150x40mm, SIZE: 150x150x40mm, COLOR: CHARCOAL
	BIKE RACK GROUND LEVEL - ENTRANCES TOTAL 12		WOOD TOP BENCH TYPE A STREET LEVEL
	CONCRETE PLANTER		WOOD TOP BENCH TYPE B STREET LEVEL
	PAVING TYPE 3 - PORCELAIN WOOD LOOK SLABS LEVEL 3 - OFFICE/RECEPTION, LEVELS 4 & 5 - OFFICE/RECEPTION, LEVEL 6 - OFFICE/RECEPTION TYPE 1: 150x150x12mm, SIZE: 150x150x12mm, COLOR: ESCURIA TYPE 2: 150x150x12mm, SIZE: 150x150x12mm, COLOR: ESCURIA		WOOD TOP BENCH TYPE C STREET LEVEL - WOOD-PAVED
	PAVING TYPE 4: 4.5 - CONCRETE HYDRATED SLAB LEVELS 3, 4 & 5 TYPE 1: 150x150x12mm, SIZE: 150x150x12mm, COLOR: DESERT SAND (TOWER A) TYPE 2: 150x150x12mm, SIZE: 150x150x12mm, COLOR: CHAMICAL		WOOD TOP BENCH TYPE D LEVEL 3, 4 & 5
	PAVING TYPE 6 - WOOD DECK LEVEL 7, 8 & 9		PAVING TYPE 7 - ARTIFICIAL TURF LEVEL 7, 8 & 9
	PRIVACY SCREEN LEVELS 3, 6, 7, 8 & 9 SEE ARCH.		TRELLIS PODDIUM LEVEL - FIVE LEVEL PLATFORM SEE ARCH.
	PAVING TYPE 8 - RUBBER SURFACE LEVELS 3, 6, 7, 8 & 9		CIP CONCRETE PLANTER WALL LEVELS 3, 6, 7, 8 & 9 SEE ARCH. AND SMOKESTACK FINISH
	WOOD TOP BENCH TYPE E LEVEL 3, 6, 7, 8 & 9		WOOD POT LEVELS 7, 8 & 9 - URBAN AGRICULTURE
	METAL PLANTER LEVEL 7, 8 & 9 - TREE PLANTER		BBQ COUNTER/FIRE PLACE LEVEL 6 - OUTDOOR DINING PATIO
	FIRE PIT LEVEL 6		


7960 ALDERBRIDGE WAY

LANDSCAPE PLAN
- LEVEL 3

DATE: 10/09/2018
DRAWN BY: MP/LL
CHECKED BY: LL
SCALE: 1/16" = 1'-0"
JOB NUMBER: 17046

L3.05

NOTES

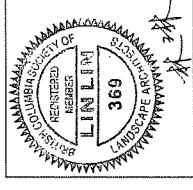


NO.	DATE	DESCRIPTION
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3	2017-11-14	Issued for DP
4	2018-07-18	Released for DP
5	2018-08-31	DD 80%
6	2018-09-21	Released for DP
7	2018-10-09	Released for DP

7960 ALDERBRIDGE WAY

**LANDSCAPE PLAN
- LEVEL 6**

DATE	10/09/2018
DRAWN BY	MP/LL
CHECKED BY	LL
SCALE	1/16" = 1'-0"
JOB NUMBER	17046

DP 16-740262 #46

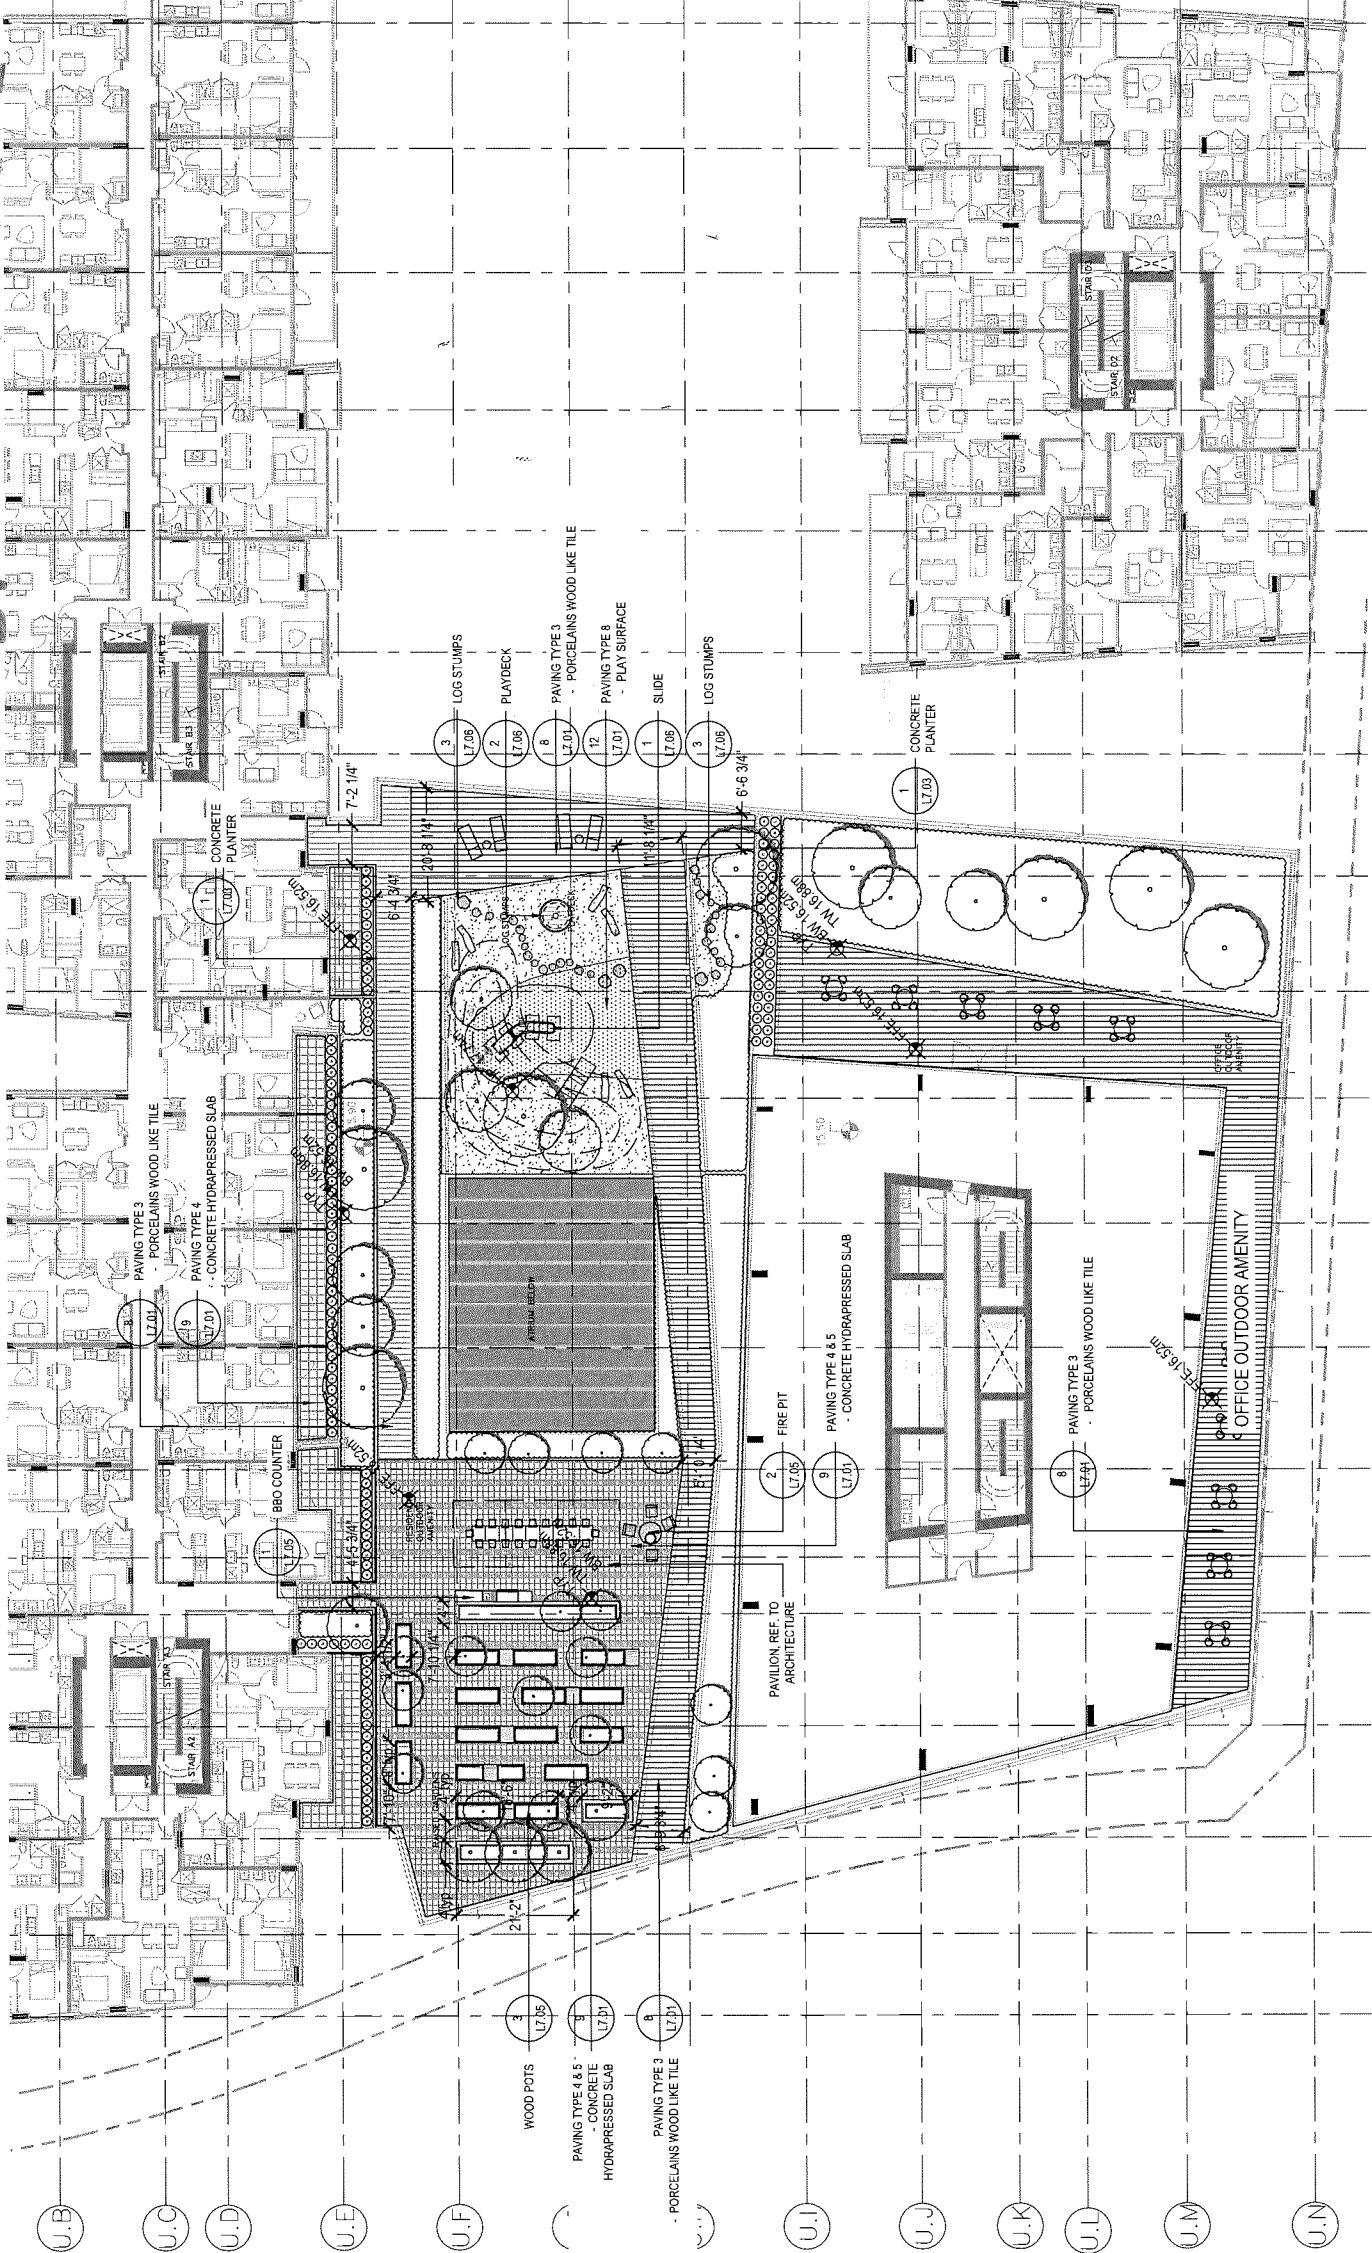


LAYOUT AND MATERIALS GENERAL NOTES

- DO NOT SCALE DRAWINGS. LAYOUT AS PER DIMENSIONS NOTED ON LANDSCAPE PLANS. REPORT ANY DISCREPANCIES TO THE CONSULTANT FOR REVIEW AND RESPONSE.
- LAYOUT AND MATERIALS DRAWINGS ARE TO BE READ IN CONJUNCTION WITH LANDSCAPE SPECIFICATIONS FOR COMPLIANCE.
- ARCHITECTURAL AND ENGINEERING DRAWINGS. REPORT ANY DISCREPANCIES TO THE CONSULTANT FOR REVIEW AND RESPONSE. REFER TO CIVIL ENGINEERS DRAWINGS FOR LAYOUT OF ROAD CURBS AND UTILITY AND LIGHTING ARE INDICATED FOR REFERENCE ONLY. REFER TO ENG. DRAWINGS FOR LOCATIONS, DETAILS, AND SPECIFICATIONS.
- REFER TO ENGINEERING DRAWINGS FOR DETAILS, SUBGRADE, AND REINFORCING OF ALL PAVED SURFACES IN ROADWAYS.
- ALL STREETSCAPE DESIGN IS TO BE COORDINATED WITH CITY OF RICHMOND STREET ENGINEERING DEPARTMENT AND PLANTED UNDER SUPERVISION OF THE CITY OF RICHMOND PARK BOARD.
- REFER TO DETAILS AND SECTIONS FOR ALL LANDSCAPE IMPROVEMENTS. ALL DIMENSIONS ARE NOMINAL.
- VERIFY ALL DIMENSIONS WITH FIELD CONDITIONS. REPORT ANY DISCREPANCIES TO THE CONSULTANT FOR REVIEW AND RESPONSE.
- ALL MOVABLE FURNITURE WILL BE PROVIDED BY OWNERS.

MATERIALS LEGEND

	CIP CONCRETE OFF-SITE (REFERENCE ONLY) LEVEL 1.1 & 1.0		PRIVACY SCREEN LEVEL 6.1 & 1.0 SEE ARCH.
	PAVING TYPE 12 - PRECAST CONCRETE PAVER STREET LEVEL TYPE 1 - CALIFORNIA, SIZE: 120x60x38, COLOR: NATURAL TYPE 2 - CALIFORNIA, SIZE: 120x60x38, COLOR: CHARCOAL		TRELLIS POSSIBLE LEVELS: PATIOS, VIEWING PLATFORM SEE ARCH.
	PAVING TYPE 3 - PORCELAINS WOOD LOOK SLABS LEVEL 1.1, OUTDOOR AMENITY, LEVEL 3 & 4 TYPE: "ARTISAN", SIZE: 18" x 33.5" x 3/4", COLOR: SEDONA		CIP CONCRETE PLANTER WALL LEVEL 6.1 & 1.0 SEE ARCH. AND SANDBLAST FINISH
	PAVING TYPE 4 & 5 - CONCRETE HYDRAPRESSED SLAB LEVEL 1.1 & 1.0 TYPE: "TRAVEN", SIZE: 18" x 18" x 3/4", COLOR: DESERT SAND (TOWER A) GREEN (TOWER B) SIZE: 18" x 18" x 3/4", COLOR: CHARCOAL		WOOD POT LEVEL 6.1 & 1.0 - URBAN AGRICULTURE
	PAVING TYPE 6 - WOOD DECK LEVEL 1.1 & 1.0		METAL PLANTER LEVEL 1.1 & 1.0 - TREE PLANTER
	PAVING TYPE 7 - ARTIFICIAL TURF LEVEL 1.1 & 1.0		BBC COUNTER / FIRE PLACE LEVEL 6 - OUTDOOR DINING PATIO
	PAVING TYPE 8 - RUBBER SURFACE LEVEL 6		FIRE PIT LEVEL 6
	BIKE RACK GROUND LEVEL - CIRCULARS TOTAL 12 STREET LEVEL		WOOD TOP BENCH TYPE A LEVEL 3.1 & 1.1 & 1.0 STREET LEVEL
	WOOD TOP BENCH TYPE B STREET LEVEL		WOOD TOP BENCH TYPE C LEVEL 1.1 & 1.0 STREET LEVEL - MID PLAZA
	WOOD TOP BENCH TYPE D LEVEL 3.1 & 1.0		

NOTES

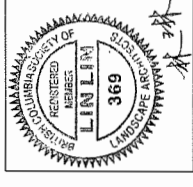

NO.	DATE	DESCRIPTION
1	2017-09-29	Issued for Rezoning
2	2017-11-14	Issued for Rezoning (Resubmission)
3	2017-11-14	Issued for DP
4	2018-07-18	Reissued for DP
5	2018-08-31	DD 80%
6	2018-09-21	Reissued for DP
7	2018-10-09	Reissued for DP


7960 ALDERBRIDGE WAY

LANDSCAPE PLAN
- LEVEL 7 & 10

DATE: 10/09/2018
DRAWN BY: MP/LL
CHECKED BY: LL
SCALE: 1/16" = 1'-0"
JOB NUMBER: 17046



DP 16-740262

#46

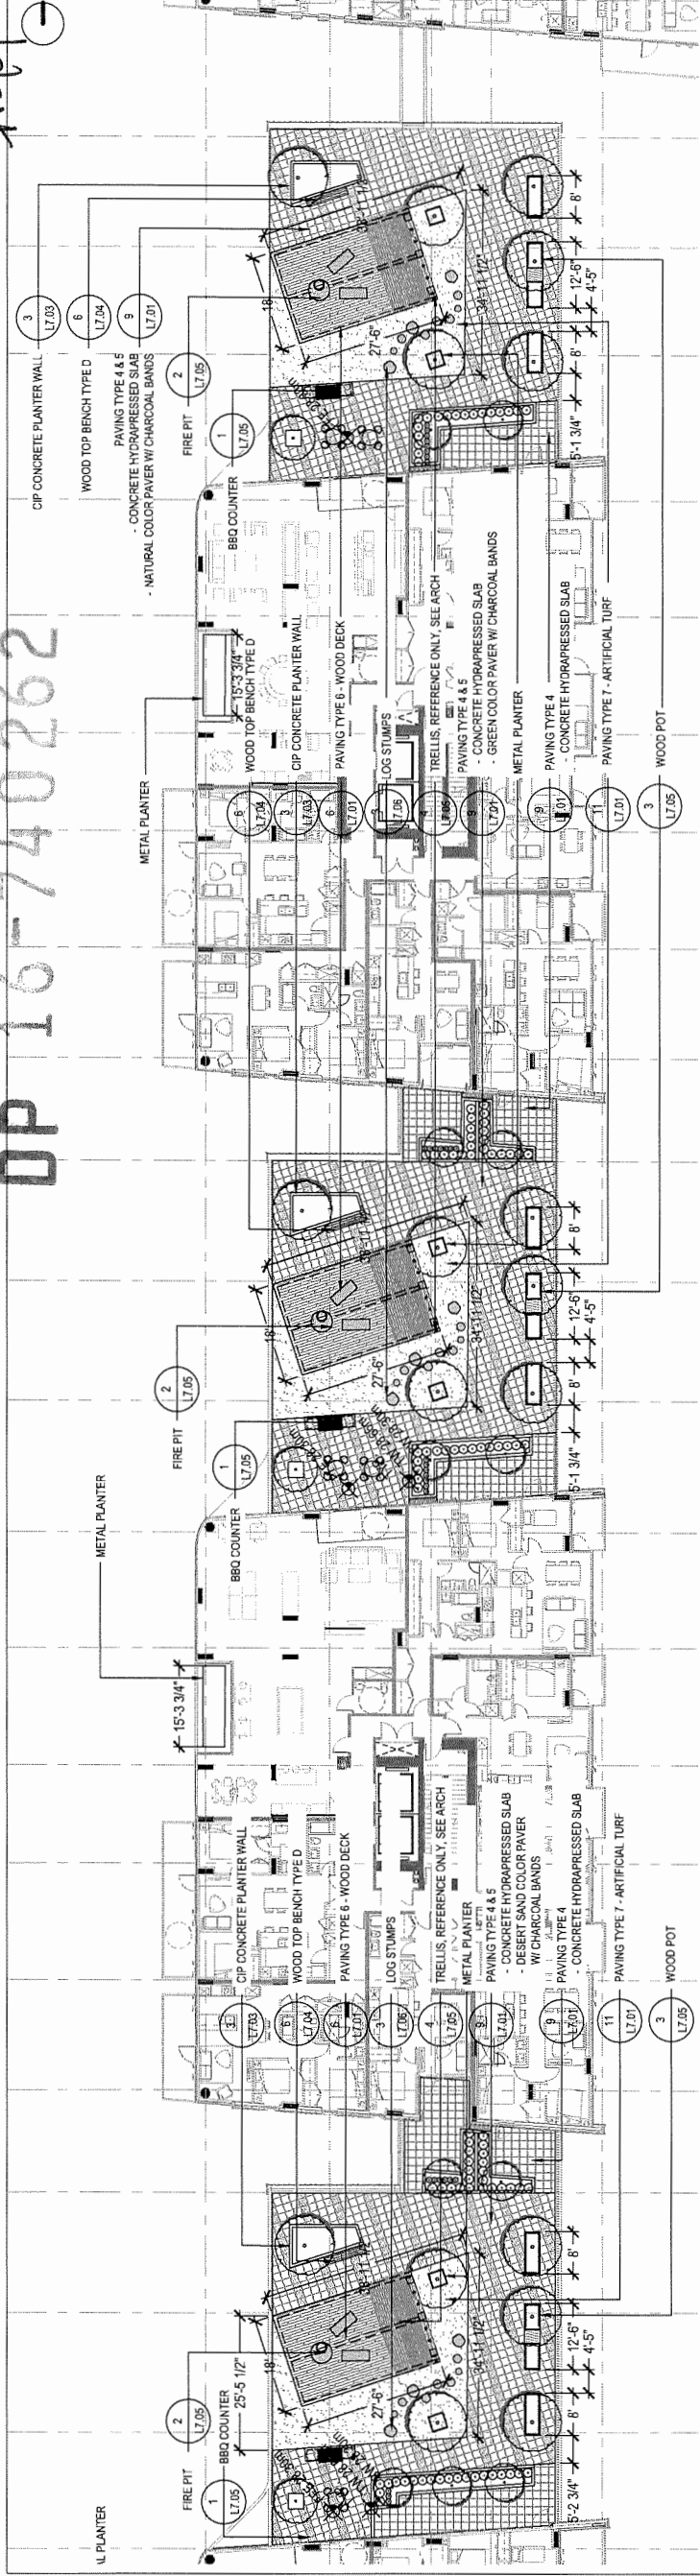

1 LEVEL 10
SCALE: 1/16" = 1'-0"


MATERIALS LEGEND

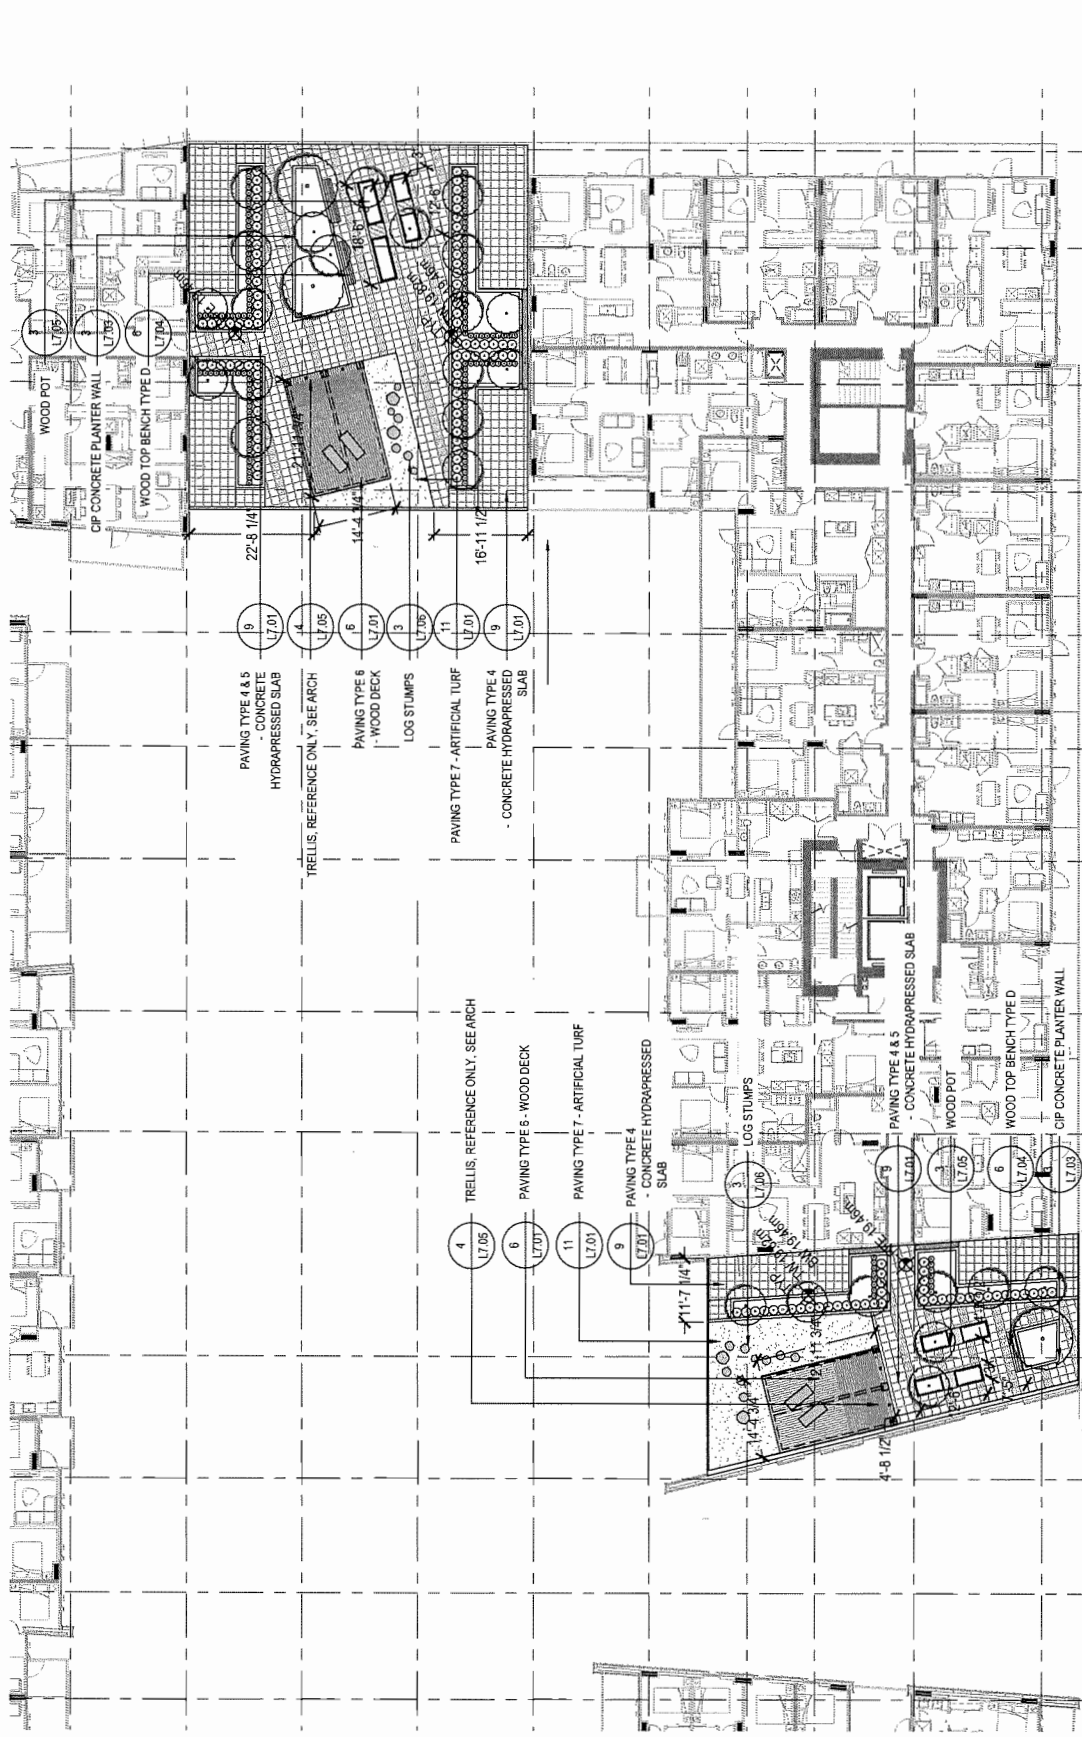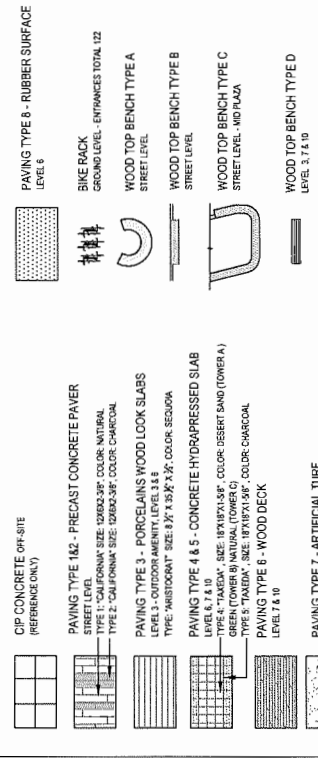

2 LEVEL 7
SCALE: 1/16" = 1'-0"


LAYOUT AND MATERIALS GENERAL NOTES

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- LAYOUT AND MATERIALS DRAWINGS ARE TO BE READ IN CONJUNCTION WITH LANDSCAPE SPECIFICATIONS FOR COMPLIANCE.
- ARCHITECTURAL AND ENGINEERING DRAWINGS: REPORT ANY RESPONSE TO UTILITY AND LEGAL NOTATIONS INDICATED FOR REFERENCE ONLY. REFER TO ENG. DRAWINGS FOR LOCATIONS, DETAILS AND SPECIFICATIONS.
- REFER TO CIVIL ENGINEERING DRAWINGS FOR LAYOUT OF ROAD CURBS AND GUTTERS AND PEDESTRIAN LET-DOWNS.
- REFER TO ENGINEERING DRAWINGS FOR DETAILS, SUBGRADE, AND REINFORCING OF ALL PAVED SURFACES IN ROADWAYS.
- ALL STREETSCAPE DESIGN IS TO BE COORDINATED WITH CITY OF RICHMOND STREET ENGINEERING DEPARTMENT AND PLANTED UNDER SUPERVISION OF THE CITY OF RICHMOND PARK BOARD.
- REFER TO DETAILS AND SECTIONS FOR ALL LANDSCAPE IMPROVEMENTS.
- ALL DIMENSIONS ARE NOMINAL.
- VERIFY ALL DIMENSIONS WITH FIELD CONDITIONS. REPORT ANY DISCREPANCIES TO THE CONSULTANT FOR REVIEW AND RESPONSE.
- ALL MOVABLE FURNITURE WILL BE PROVIDED BY OWNERS.

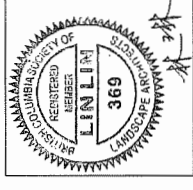

REVISIONS	NO.	DATE	DESCRIPTION
	1	2017-09-29	Issued for Reasoning
	2	2017-11-14	Issued for Reasoning (Resubmission)
	3	2017-11-14	Issued for DP
	4	2018-07-18	Released for DP
	5	2018-08-31	DD 80%
	6	2018-09-21	Released for DP
	7	2018-10-09	Released for DP

#50
DP 16-740262

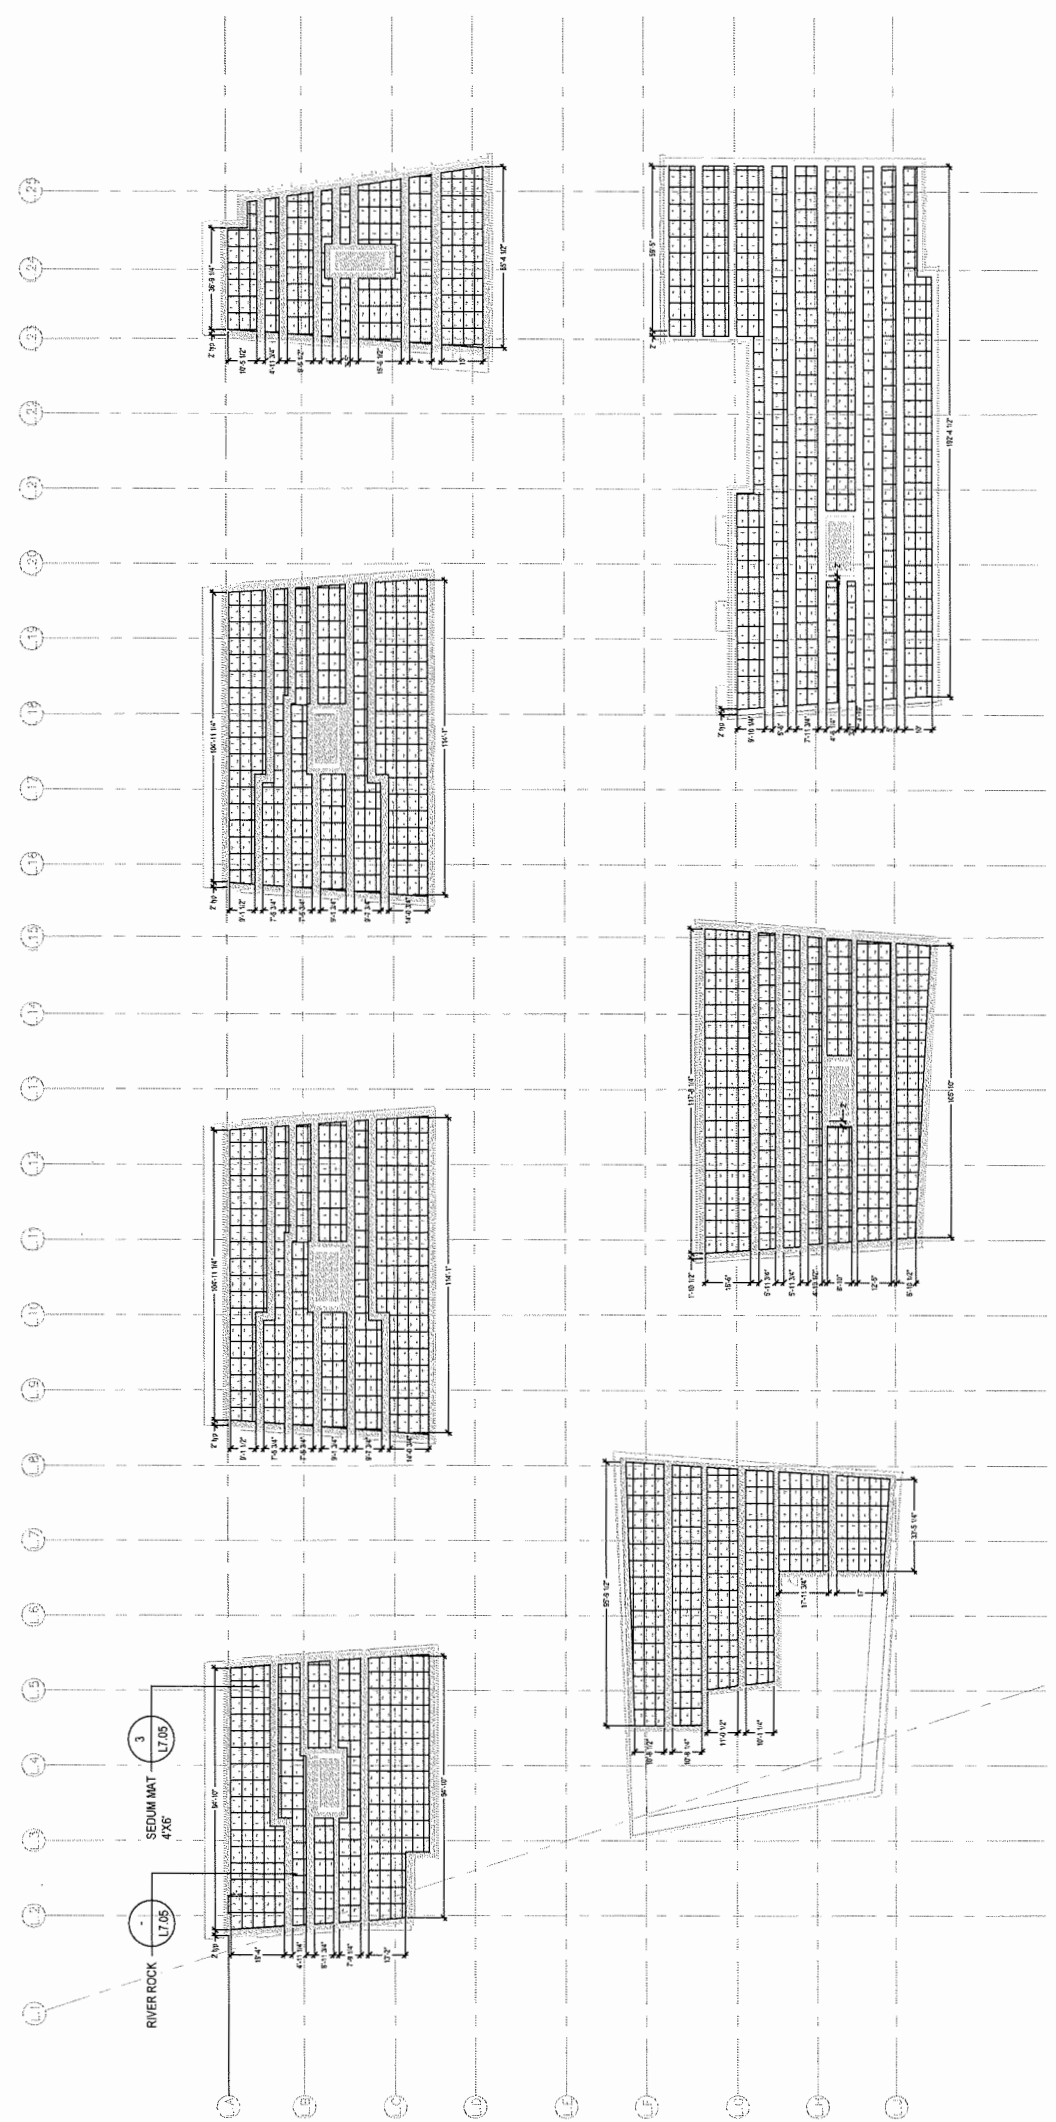

1 ROOFTOP
SCALE: 1/32" = 1'-0"

LAYOUT AND MATERIALS GENERAL NOTES


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- LANDSCAPE DRAWINGS ARE TO BE READ IN CONJUNCTION WITH ARCHITECTURAL AND ENGINEERING DRAWINGS. REPORT ANY DISCREPANCIES TO THE CONSULTANT FOR REVIEW AND RESPONSE.
- UTILITY AND LIGHTING ARE INDICATED FOR REFERENCE ONLY. REFER TO ENG. DRAWINGS FOR LOCATIONS, DETAILS, AND SPECIFICATIONS.
- REFER TO CIVIL ENGINEERS DRAWINGS FOR LAYOUT OF ROAD CURBS AND GUTTERS AND PEDESTRIAN LED-FLOWS.
- REFER TO BRONCHER DRAWINGS FOR DETAILS, SUBGRADE, AND REFER TO BRONCHER DRAWINGS FOR LIGHTING.
- ALL STREET DESIGN IS TO BE COORDINATED WITH CITY OF RICHMOND STREET ENGINEERING DEPARTMENT AND PLANTED UNDER SUPERVISION OF THE CITY OF RICHMOND PARK BOARD.
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7960 ALDERBRIDGE WAY

LANDSCAPE PLAN
- ROOFTOP

DATE	10/09/2018
DRAWN BY	MP/LL
CHECKED BY	LL
SCALE	1/32" = 1'-0"
JOB NUMBER	17046

NOTES

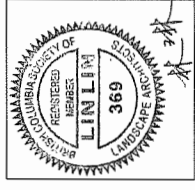


NO.	DATE	DESCRIPTION
1	2017-09-29	Issued for Reasoning
2	2017-11-14	Issued for Reasoning (Resubmission)
3	2017-11-14	Issued for DP
4	2018-07-18	Reissued for DP
5	2018-08-31	DD 80%
6	2018-09-21	Reissued for DP
7	2018-10-09	Reissued for DP

7960 ALDERBRIDGE WAY

PLANTING PLAN
 - GROUND LEVEL
 OVERALL

DATE	10/09/2018
DRAWN BY	MP/LL
CHECKED BY	LL
SCALE	1/32" = 1'-0"
JOB NUMBER	17046


OP 16-740262 #61

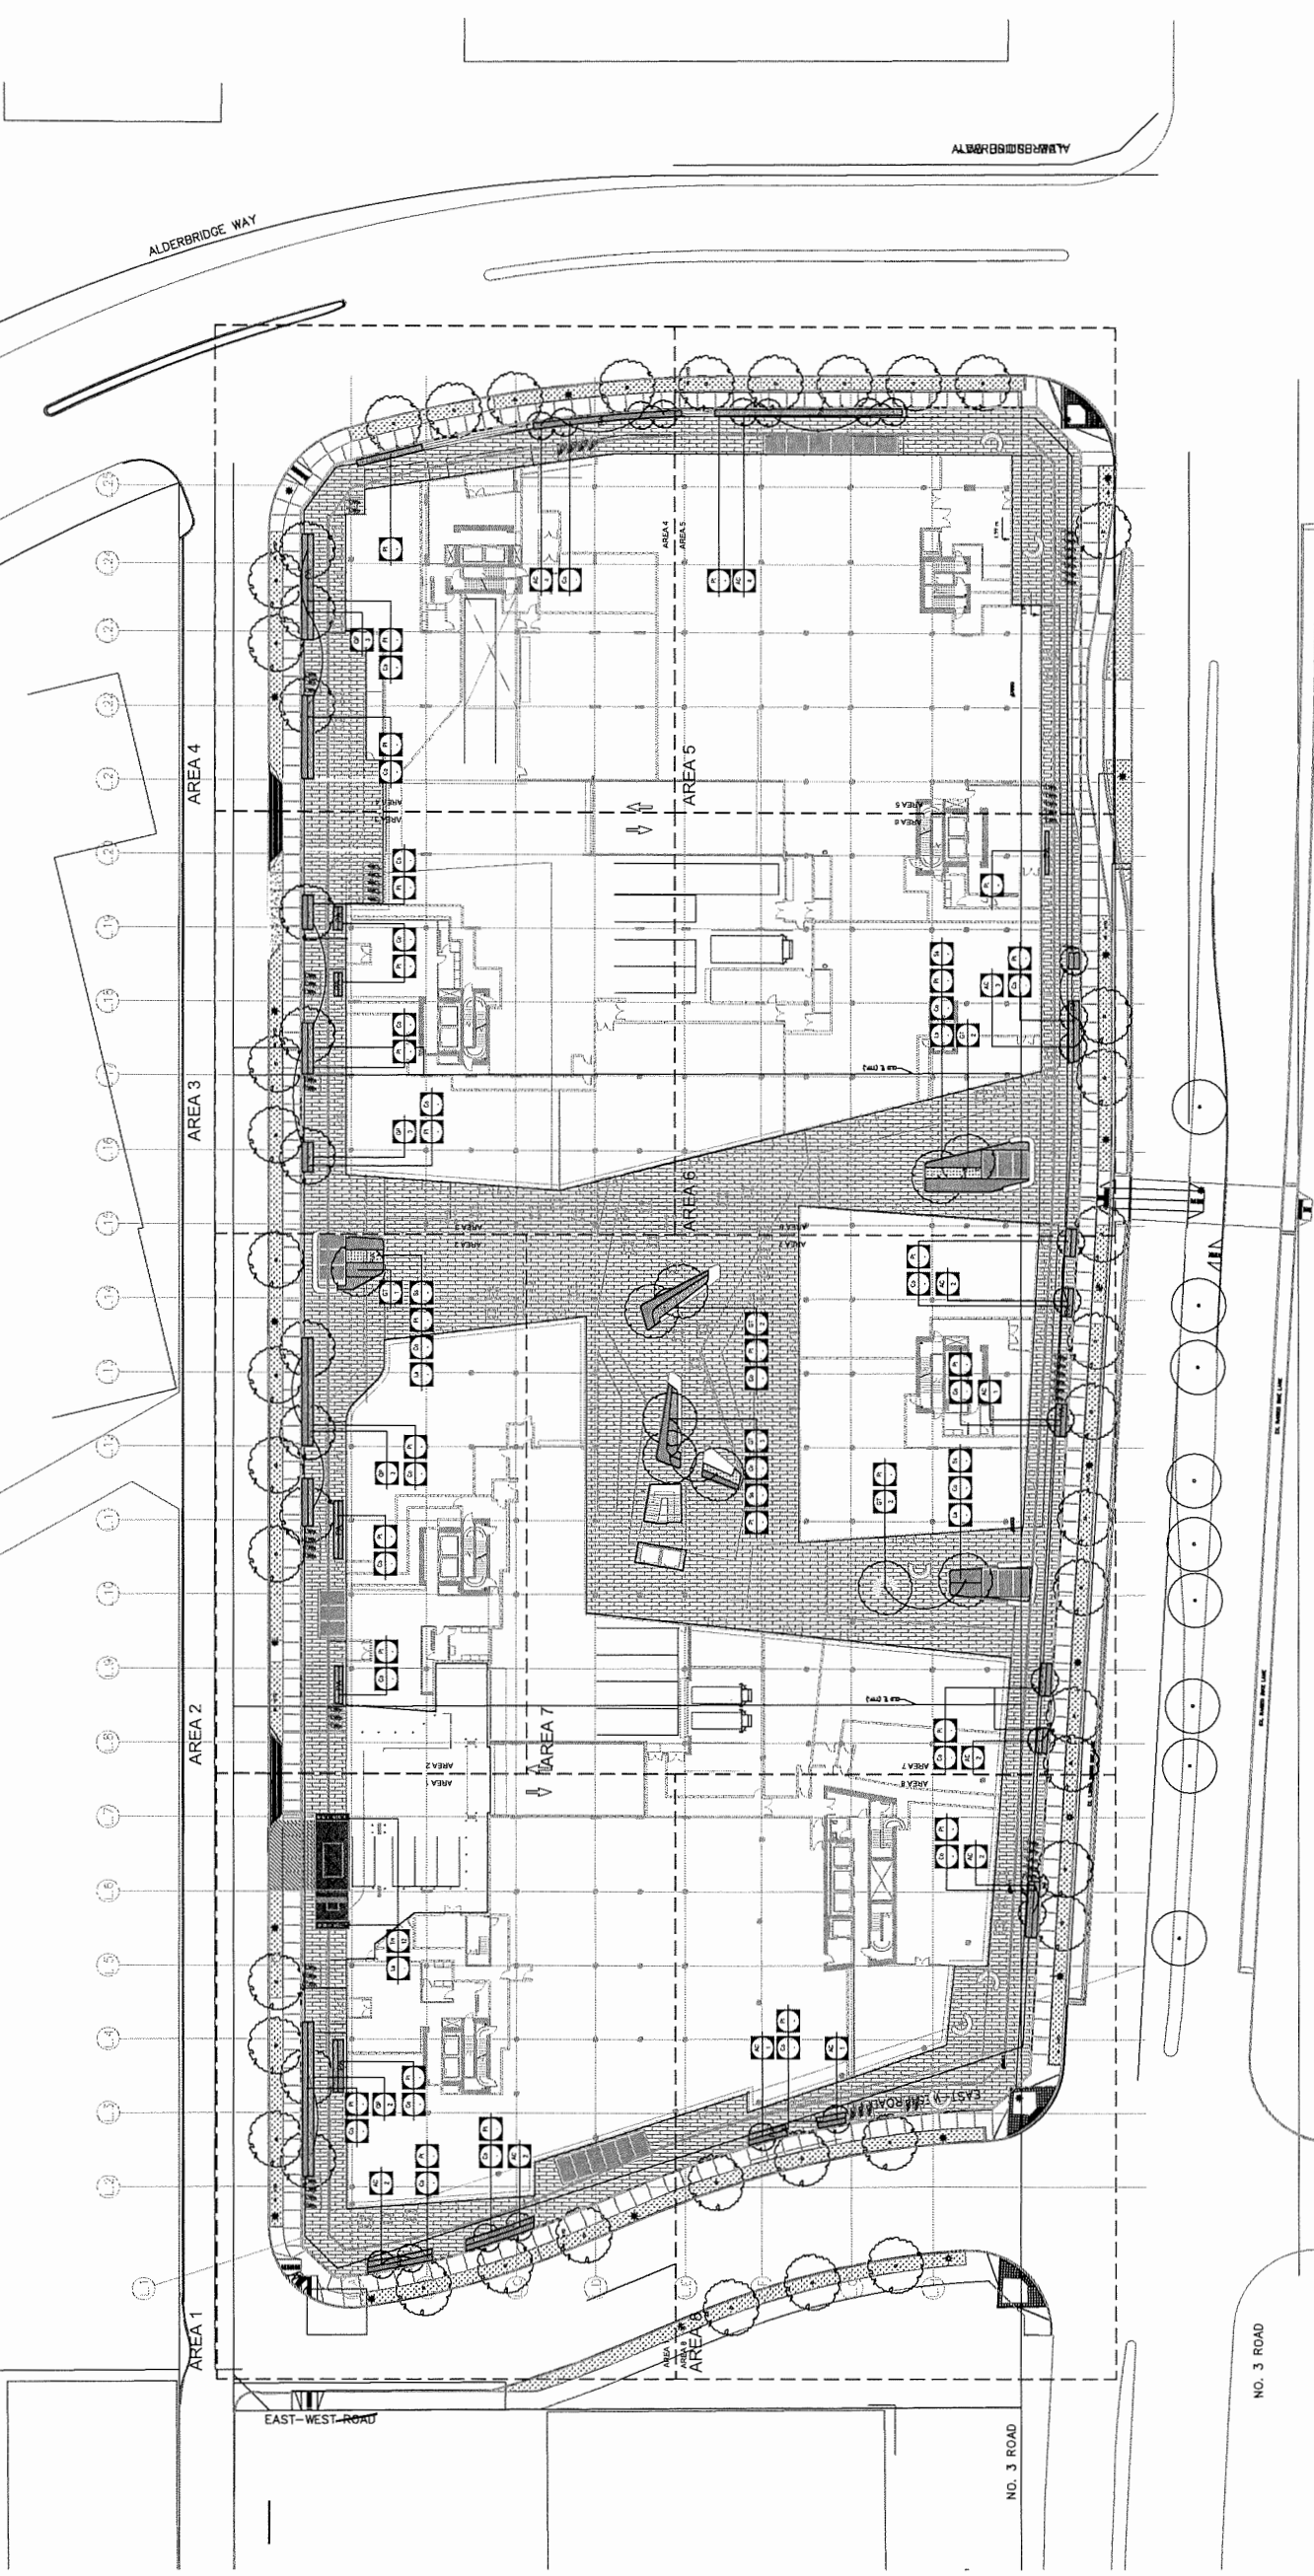

PLANTING GENERAL NOTES

1. ALL PLANT MATERIAL SHALL CONFORM TO THE STANDARD SPECIFIED IN THE CURRENT EDITION OF THE BC LANDSCAPE STANDARD. THIS STANDARD IS PUBLISHED JOINTLY BY THE BC SOCIETY OF LANDSCAPE ARCHITECTS (BCSLA) AND THE BC LANDSCAPE AND NURSERY ASSOCIATION (BCLNA).
2. SEARCH AREA FOR ALL PLANT MATERIAL SHALL INCLUDE ALL OF WESTERN NORTH AMERICA OR AS SPECIFIED.
3. PLANT MATERIAL SIZES SPECIFIED ARE THE MINIMUM ACCEPTABLE SIZES TO BE SUPPLIED TO THIS PROJECT.
4. ALL PLANT MATERIAL SIZES SHALL BE WELL ESTABLISHED AND UNIFORM IN SHAPES AND SIZE.
5. ALL PLANT MATERIAL SHALL BE NURSERY GROWN UNLESS OTHERWISE NOTED. ONLY CERTIFIED S.O.D. NURSERY STOCK WILL BE USED.
6. THE CONTRACTOR SHALL PROVIDE A GROWING MEDIUM ANALYSIS FOR REVIEW BY THE CONSULTANT - AS PER SPECIFICATIONS - PRIOR TO THE START OF CONSTRUCTION. GROWING MEDIUM SUPPLIED TO THE SITE OR INSTALLED ON SITE PRIOR TO CONSULTANT APPROVAL SHALL BE REJECTED AT NO COST TO THE OWNER.
7. THE CONTRACTOR SHALL CONFIRM PLANT QUANTITIES ON THE DRAWINGS CORRESPOND TO THOSE INDICATED ON THE PLANT LIST.
8. ANY DISCREPANCIES ARE TO BE VERIFIED BY THE CONSULTANT FOR REVIEW AND RESPONSE.
9. PRIOR TO THE START OF CONSTRUCTION, THE CONTRACTOR SHALL CONFIRM THE AVAILABILITY OF THE PLANT MATERIAL SPECIFIED AS PER SPECIFICATIONS, ALLOWING FOR ANY AND ALL REQUIRED APPROVALS. PLANT SUBSTITUTIONS NOT CONFIRMED AND APPROVED BY THE CONSULTANT WILL BE REJECTED.
10. PROVIDE IRRIGATION TO ALL PLANT MATERIAL AS SHOWN ON LANDSCAPE DRAWINGS AND PLANS.
11. HIGH EFFICIENT AUTOMATIC IRRIGATION SYSTEM WILL BE INSTALLED ON PLANTING AREAS.

KEY QTY	BOTANICAL NAME	COMMON NAME	SIZE	DESCRIPTION	KEY QTY	BOTANICAL NAME	COMMON NAME	SIZE	DESCRIPTION
1	ACER CIRCINATUM	VINE MAPLE	5CM CAL. WB	MULTI-STEMMED (3 MIN.) FULL	1	SHRUBS / GROUNDCOVERS	BLUE STAR	#2 POT	18" O.C.
5	ACER PALMATUM 'AO SHIME'	AO SHIME JAPANESE MAPLE	2.5M HT. WB	MULTI-STEMMED (3 MIN.) FULL	1	SHRUBS / GROUNDCOVERS	EVERGOLD SEDGE	#2 POT	12" O.C.
32	ACER PALMATUM 'OSAKAZUKI'	OSAKAZUKI JAPANESE MAPLE	3.5M HT. WB	MULTI-STEMMED (3 MIN.) FULL	1	SHRUBS / GROUNDCOVERS	MINSTEAD LAVENDER	#2 POT	18" O.C.
6	AMELANCHIER X GRANDIFLORA	SERVICEBERRY	10CM CAL. WB	MULTI-STEMMED (3 MIN.) FULL	1	SHRUBS / GROUNDCOVERS	HONEYBUCKLE	#2 POT	18" O.C.
9	GLEDITSIA TRICANTHOS	PYRAMIDAL EUROPEAN HORSEBEAM	7CM CAL. WB	FULL, UNIFORM SIZE AND QUALITY	1	SHRUBS / GROUNDCOVERS	JAPANESE SPURGE	#2 POT	12" O.C.
19	MAGNOLIA GRANDIFLORA 'LITTLE GEM'	EVERGREEN SOUTHERN MAGNOLIA	7CM CAL. WB	FULL, UNIFORM SIZE AND QUALITY	1	SHRUBS / GROUNDCOVERS	MAY NIGHT SAGE	#2 POT	12" O.C.
15	MALUS SYLVESTRIS	CRAB APPLE TREE	5CM CAL. WB	FULL, UNIFORM SIZE AND QUALITY	1	SHRUBS / GROUNDCOVERS	BEACH ROSE	#2 POT	12" O.C.
4	MAGNOLIA GALAXY	GALAXY MAGNOLIA	3M CAL. WB	SELECTED BY CONSULTANT	1	SHRUBS / GROUNDCOVERS	H.M. EDDIE YEW	40" HIGHMALE, FIELD GROWN	22-24" O.C.
1	PINUS CONTORTA	SHORE PINE	3M CAL. WB	SELECTED BY CONSULTANT	1	GRASSES / PERENNIALS	JAPANESE FOREST GRASS	#1 POT	12" O.C.
27	POPAULUS TREMULOIDES	TREMULING ASPEN	7CM CAL. WB	FULL, UNIFORM SIZE AND QUALITY	1	GRASSES / PERENNIALS	MEXICAN FEATHER GRASS	#2 POT	12" O.C.
10	PRUNUS SEROTINA 'KAZAZAKI'	JAPANESE FLOWERING CHERRY	7CM CAL. WB	FULL, UNIFORM SIZE AND QUALITY	1	GRASSES / PERENNIALS	BEACH GRASS	#2 POT	12" O.C.
11	PRUNUS SEROTINA 'WAR. TIBETICA'	TIBETAN CHERRY	8CM CAL. WB	FULL, UNIFORM SIZE AND QUALITY	1	GRASSES / PERENNIALS	AUTUMN JOY STONECROP	#2 POT	17" O.C.
7	QUERCUS PALustris	PINK OAK	8CM CAL. WB	FULL, UNIFORM SIZE AND QUALITY	1	SEDUM	SEDUM 'AUTUMN JOY'		
7	STRAX JAPONICUS 'OBASSA'	JAPANESE SNOWBELL TREE	7CM CAL. WB	FULL, UNIFORM SIZE AND QUALITY	1	SEDUM	ALL SEASONS SEDUM TILE		

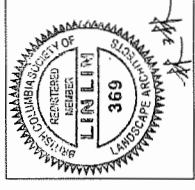


NO.	DATE	DESCRIPTION
1	2017-09-29	Issued for Rezoncing
2	2017-11-14	Issued for Rezoncing (Resubmission)
3	2017-11-14	Issued for DP
4	2018-07-18	DD 80%
5	2018-08-31	Reissued for DP
6	2018-09-21	Reissued for DP
7	2018-10-09	Reissued for DP

7960 ALDERBRIDGE WAY

LANDSCAPE
 PLANTING PLAN
 - GROUND LEVEL AREA 1


DATE: 10/09/2018
 DRAWN BY: MP/LL
 CHECKED BY: LL
 SCALE: 1/8" = 1'-0"
 JOB NUMBER: 17046

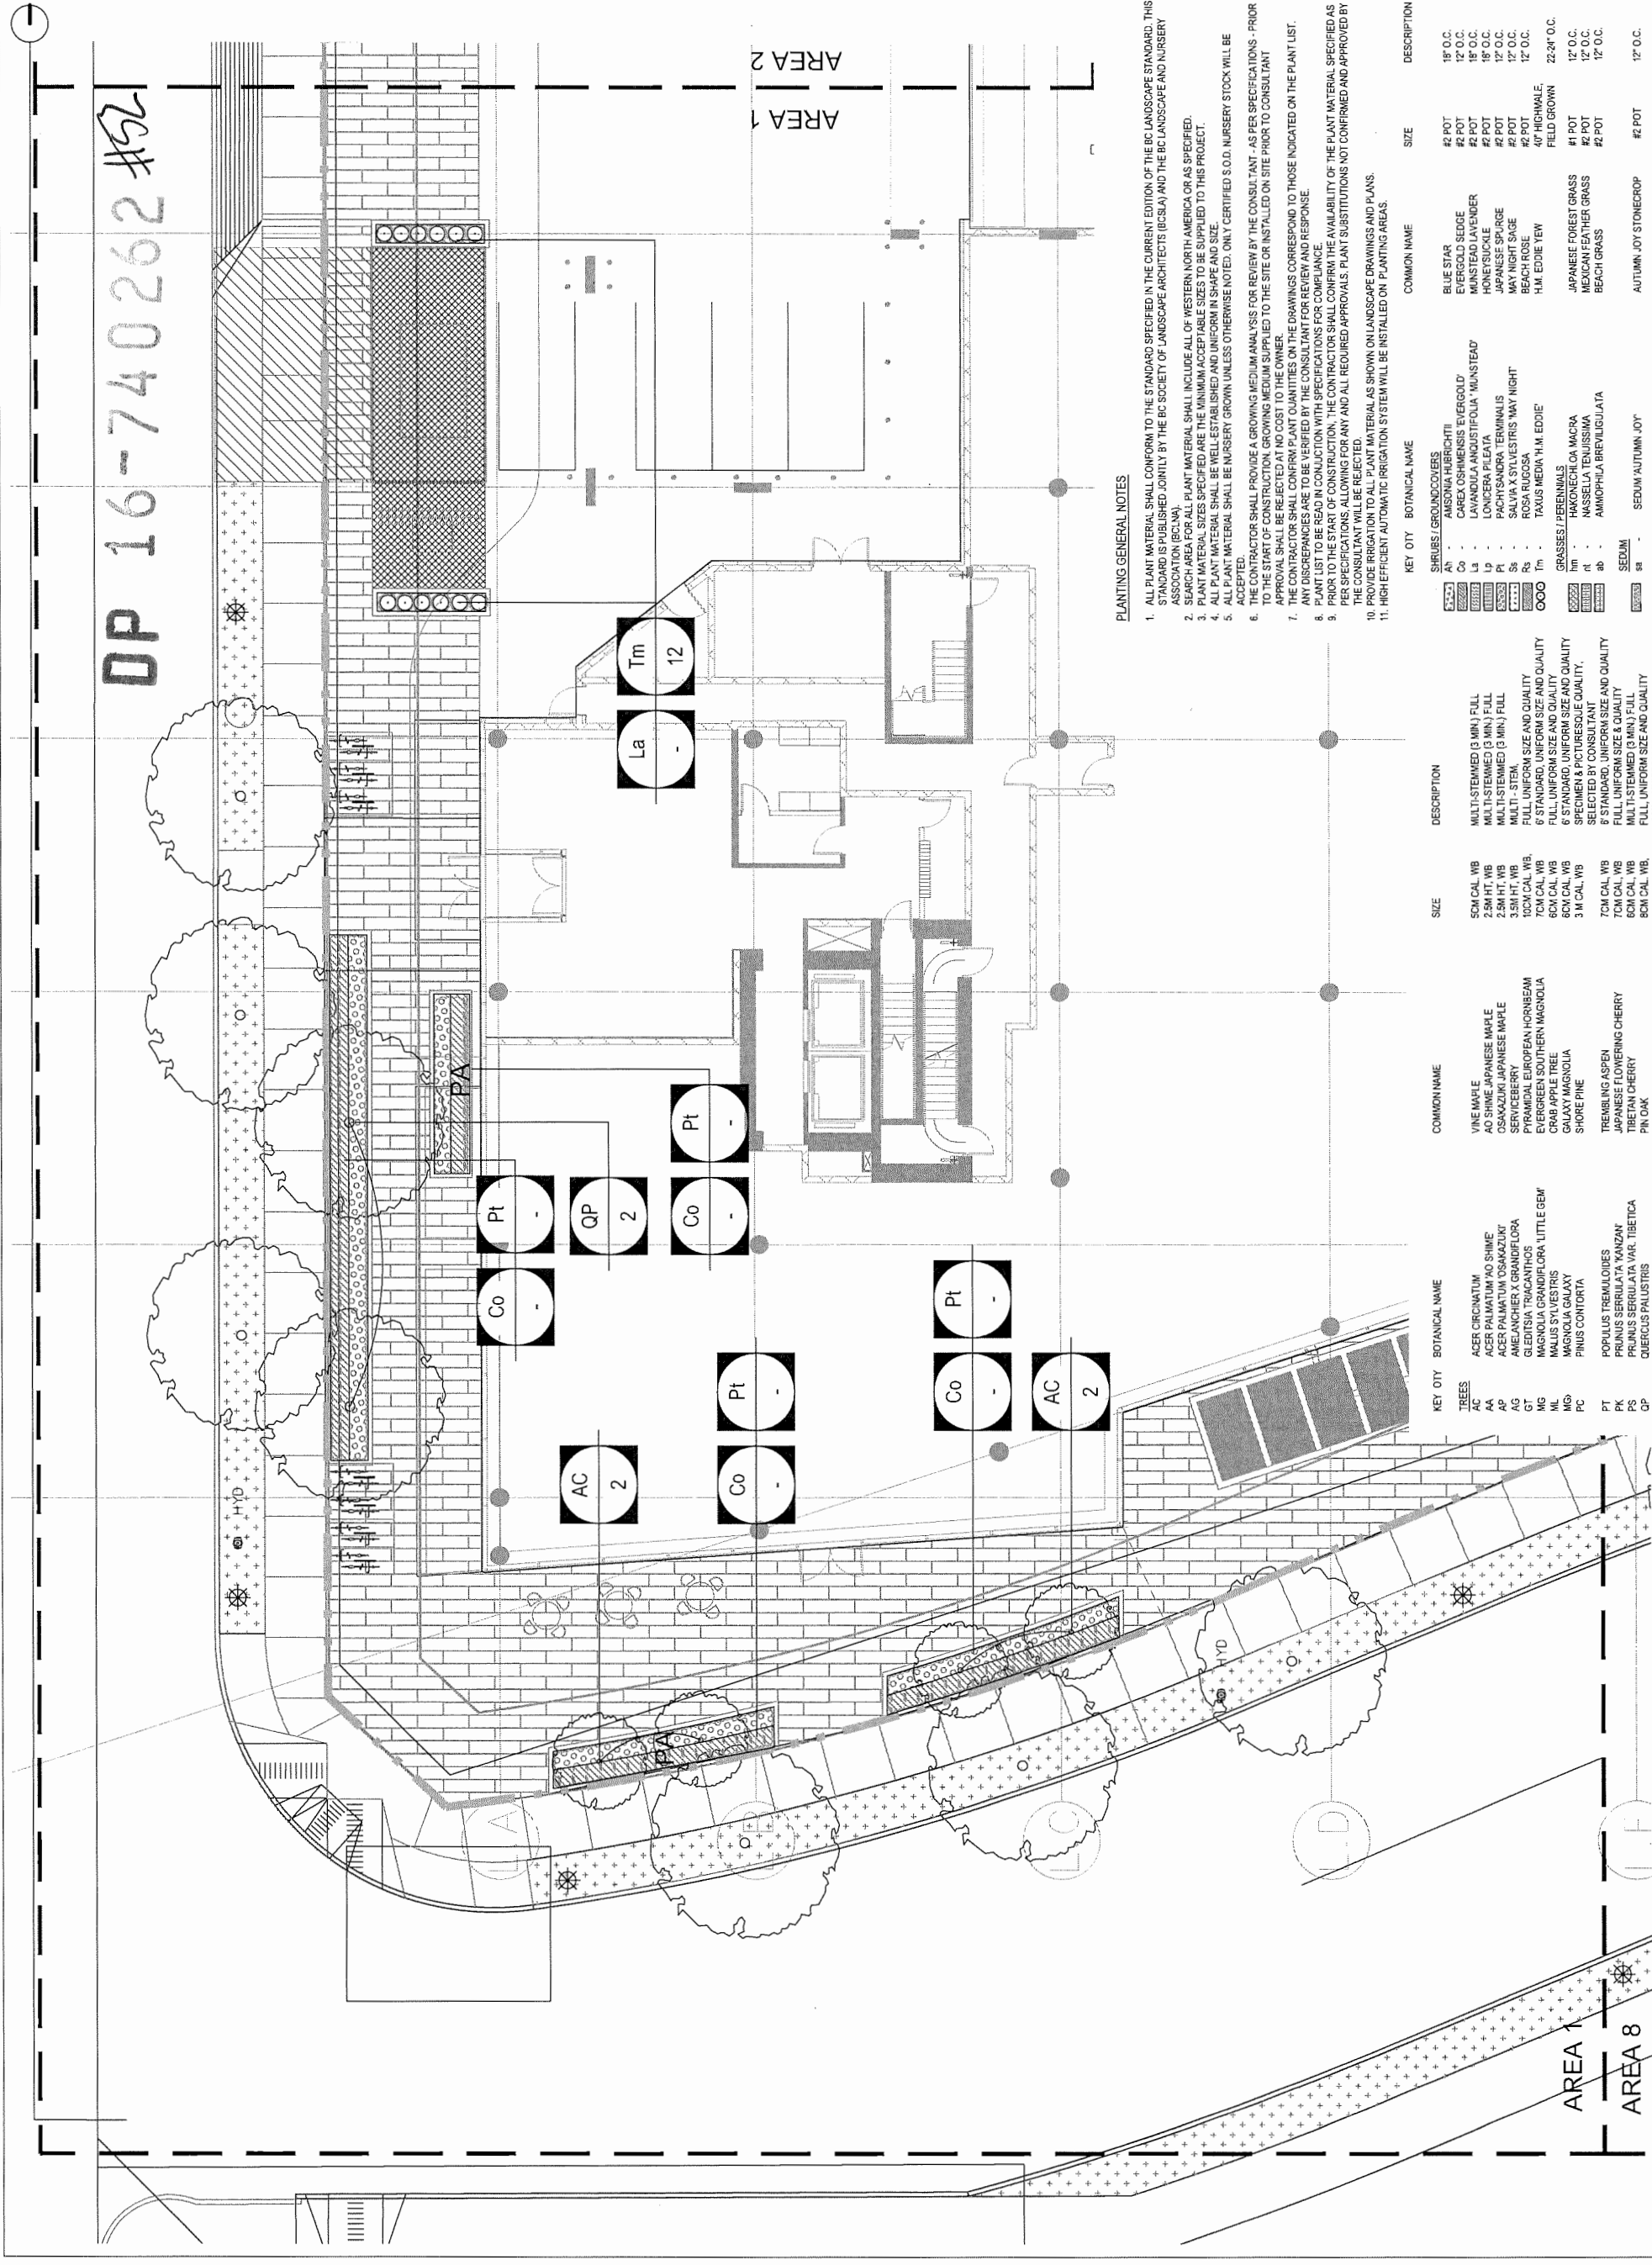

PLANTING GENERAL NOTES

1. ALL PLANT MATERIAL SHALL CONFORM TO THE STANDARD SPECIFIED IN THE CURRENT EDITION OF THE BC LANDSCAPE STANDARD. THIS STANDARD IS PUBLISHED JOINTLY BY THE BC SOCIETY OF LANDSCAPE ARCHITECTS (BCSLA) AND THE BC LANDSCAPE AND NURSERY ASSOCIATION (BCLNA).
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5. ALL PLANT MATERIAL SHALL BE NURSERY GROWN UNLESS OTHERWISE NOTED. ONLY CERTIFIED S.O.D. NURSERY STOCK WILL BE ACCEPTED.
6. THE CONTRACTOR SHALL PROVIDE A GROWING MEDIUM ANALYSIS FOR REVIEW BY THE CONSULTANT - AS PER SPECIFICATIONS - PRIOR TO THE START OF CONSTRUCTION. GROWING MEDIUM SUPPLIED TO THE SITE OR INSTALLED ON SITE PRIOR TO CONSULTANT REVIEW SHALL BE SUBJECT TO THE CONTRACTOR'S RISK. ALL PLANT MATERIALS SHALL BE SUPPLIED TO THE SITE WITH PROPER PLANT QUALITIES ON THE DRAWINGS CORRESPOND TO THOSE INDICATED ON THE PLANT LIST.
7. ANY DISCREPANCIES ARE TO BE VERIFIED BY THE CONSULTANT FOR REVIEW AND RESPONSE.
8. PLANT LIST TO BE READ IN CONJUNCTION WITH SPECIFICATIONS FOR COMPLIANCE.
9. PRIOR TO THE START OF CONSTRUCTION, THE CONTRACTOR SHALL CONFIRM THE AVAILABILITY OF THE PLANT MATERIAL SPECIFIED AS PER SPECIFICATIONS, ALLOWING FOR ANY AND ALL REQUIRED APPROVALS. PLANT SUBSTITUTIONS NOT CONFIRMED AND APPROVED BY THE CONSULTANT WILL BE REJECTED.
10. PROVIDE IRRIGATION TO ALL PLANT MATERIAL AS SHOWN ON LANDSCAPE DRAWINGS AND PLANS.
11. HIGH EFFICIENT AUTOMATIC IRRIGATION SYSTEM WILL BE INSTALLED ON PLANTING AREAS.

KEY	KEY CITY	BOTANICAL NAME	COMMON NAME	SIZE	DESCRIPTION	KEY CITY	BOTANICAL NAME	COMMON NAME	SIZE	DESCRIPTION
TREES	AC	ACER ORCINATUM	VINE MAPLE	50M CAL WB	MULTI-STEMMED (3 MIN.) FULL	SRUBS / GROUNDCOVERS	Co	CAREX OSHIMENSIS 'EVERGOLD'	#2 POT	BLUE STAR
	AK	ACER PALMATUM 'HO SHINE'	AD SHINE JAPANESE MAPLE	2.5M HT. WB	MULTI-STEMMED (3 MIN.) FULL		La	LAVANDULA ANGIUSTIFOLIA 'MUNSTEAD'	#2 POT	EVERGOLD SEDGE
	AP	ACER PALMATUM 'OSAZUKI'	OSAZUKI JAPANESE MAPLE	2.5M HT. WB	MULTI-STEMMED (3 MIN.) FULL		Ls	LANCERA PLEATA	#2 POT	MUNSTEAD LAVENDER
	AG	AMELANCHIER X GRANDIFLORA	SERVICEBERRY	3.5M HT. WB	MULTI - STEM		Pt	PACHY SANDRA TERMINALIS	#2 POT	HONEYBUCKLE
	GT	GLEDISIA TRICANTHOS	PYRAMIDAL EUROPEAN HORNBEEAM	10CM CAL. WB.	FULL UNIFORM SIZE AND QUALITY		Ss	SALVIA X SYLVESTRIS 'MAY NIGHT'	#2 POT	JAPANESE SPURGE
	MG	MAGNOLIA GRANDIFLORA 'LITTLE GEM'	EVERGREEN SOUTHERN MAGNOLIA	7CM CAL. WB	6' STANDARD. UNIFORM SIZE AND QUALITY		Rb	ROSA RUGOSA	#2 POT	MAY NIGHT SAGE
	ML	MALLUS SYLVESTRIS	CRAB APPLE TREE	6CM CAL. WB	FULL UNIFORM SIZE AND QUALITY		Tm	TAXUS MEDIA 'M. EDDIE'	#2 POT	BEACH ROSE
	MB	MAGNOLIA GALAXY	GALAXY MAGNOLIA	6CM CAL. WB	6' STANDARD. UNIFORM SIZE AND QUALITY		Gr	GRASSES / PERENNIALS	4P HIGHWALE	H.M. EDDIE TEW
	PC	PINUS CONTORTA	SHORE PINE	3 M CAL. WB	SPECIMEN & PICTURE QUALITY.		Gr	HAKONECHLOA MACRA	FIELD GROWN	JAPANESE FOREST GRASS
	PT	POPULUS TREMILOIDES	TREMBLING ASPEN	70M CAL. WB	6' STANDARD. UNIFORM SIZE AND QUALITY		Gr	MASSELLIA TENUISSIMA	#1 POT	MEXICAN FEATHER GRASS
	PK	PRUNUS SEROTINATA 'KANDAN'	JAPANESE FLOWERING CHERRY	70M CAL. WB	FULL UNIFORM SIZE AND QUALITY		Gr	AMMOPHILA BREVIJUGATA	#2 POT	BEACH GRASS
	CP	CERCOCARPUS	JIRICHI CHERRY	60M CAL. WB	MULTI-STEMMED (3 MIN.) FULL		Gr	SEDUM 'AUTUMN JOY'	#2 POT	AUTUMN JOY STONEDROP
	CP	CERCOCARPUS	PIR-CAN	80M CAL. WB	FULL UNIFORM SIZE AND QUALITY		Gr	ALL SEASONS SEDUM TILE	#2 POT	
	SI	STYRAX JAPONICUS 'OBASSIA'	JAPANESE SNOWBELL TREE	70M CAL. WB	6' STD. UNIFORM SIZE AND QUALITY					

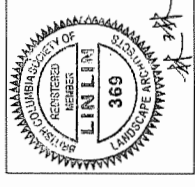


NO.	DATE	DESCRIPTION
1	2017-09-29	Issued for Rezoning
2	2017-11-14	Issued for Reopening (Re-submission)
3	2017-11-14	Issued for OP
4	2018-07-18	Released for DP
5	2018-08-31	DD 80%
6	2018-09-21	Released for DP
7	2018-10-09	Released for DP

NOTES

PLANTING GENERAL NOTES

1. ALL PLANT MATERIAL SHALL CONFORM TO THE STANDARD SPECIFIED IN THE CURRENT EDITION OF THE BC LANDSCAPE STANDARD, THIS STANDARD IS PUBLISHED JOINTLY BY THE BC SOCIETY OF LANDSCAPE ARCHITECTS (BCSLA) AND THE BC LANDSCAPE AND NURSERY ASSOCIATION (BCLNA).
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5. ALL PLANT MATERIAL SHALL BE NURSERY GROWN UNLESS OTHERWISE NOTED. ONLY CERTIFIED S.O.D. NURSERY STOCK WILL BE ACCEPTED.
6. THE CONTRACTOR SHALL PROVIDE A GROWING MEDIUM ANALYSIS FOR REVIEW BY THE CONSULTANT - AS PER SPECIFICATIONS - PRIOR TO THE START OF CONSTRUCTION. GROWING MEDIUM SUPPLIED TO THE SITE OR INSTALLED ON SITE PRIOR TO CONSULTANT REVIEW SHALL BE SUBJECT TO COST TO THE OWNER.
7. THE CONTRACTOR SHALL OBTAIN ALL NECESSARY PERMITS FROM ALL APPLICABLE AGENCIES ON THE DRAWINGS CORRESPOND TO THOSE INDICATED ON THE PLANT LIST.
8. ANY DISCREPANCIES ARE TO BE VERIFIED BY THE CONSULTANT FOR REVIEW AND RESPONSE.
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11. HIGH EFFICIENT AUTOMATIC IRRIGATION SYSTEM WILL BE INSTALLED ON PLANTING AREAS.

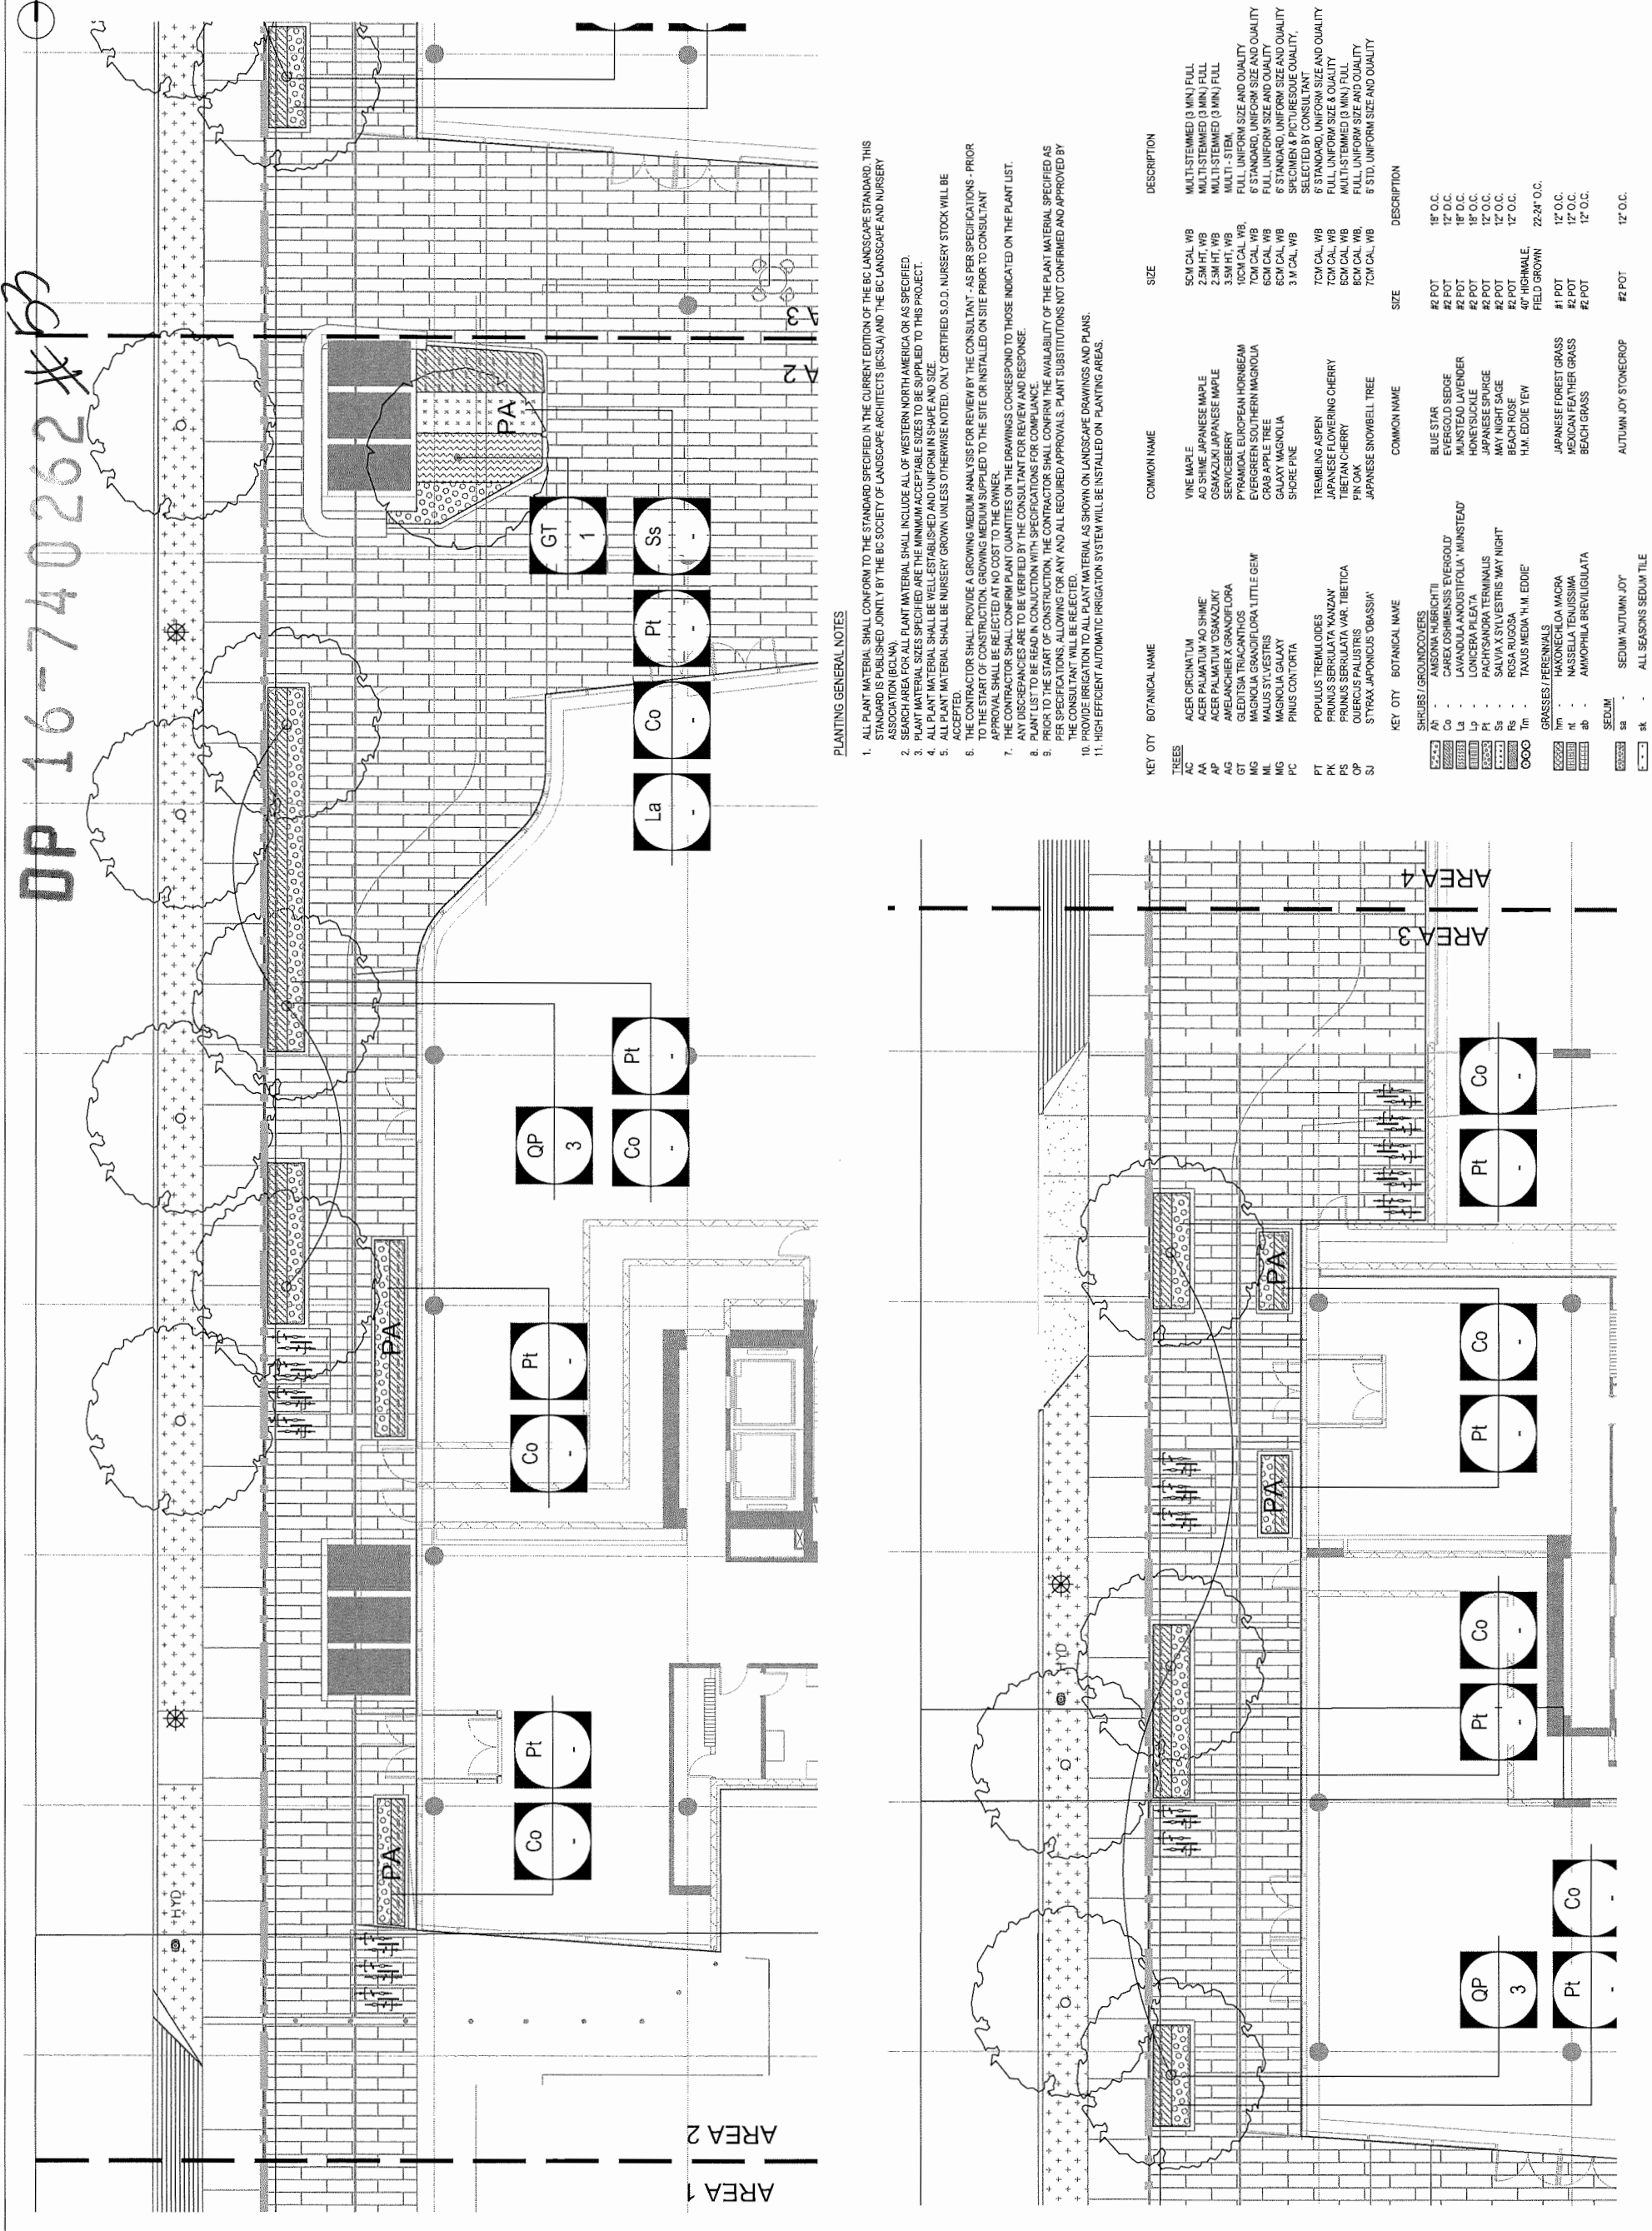

KEY	SYMBOL	BOTANICAL NAME	COMMON NAME	SIZE	DESCRIPTION
TREES	La	ACER CERCINATUM	VINE MAPLE	5CM CAL. WB	MULTI-STEMMED (3 MIN) FULL
	Co	ACER PALMATUM 'AO SHIME'	AO SHIME JAPANESE MAPLE	2.5M HT. WB	MULTI-STEMMED (3 MIN) FULL
	Pt	ACER PALMATUM 'OSAKAZUKI'	OSAKAZUKI JAPANESE MAPLE	2.5M HT. WB	MULTI-STEMMED (3 MIN) FULL
	Co	AMELANCHIER X GRANDIFLORA	SERVICEDRUM	3.5M HT. WB	MULTI-STEM
	GT	AMELANCHIER X GRANDIFLORA	SERVICEDRUM	10CM CAL. WB	FULL, UNIFORM SIZE AND QUALITY
	MG	GLEDITSIA TRIACANTHOS	PYRAMIDAL EUROPEAN HORSEBEAM	7CM CAL. WB	6' STANDARD, UNIFORM SIZE AND QUALITY
	ML	MAGNOLIA GRANDIFLORA 'LITTLE GEM'	EVERGREEN SOUTHERN MAGNOLIA	6CM CAL. WB	FULL, UNIFORM SIZE AND QUALITY
	MG	MALUS SYLVESTRIS	CRAB APPLE TREE	6CM CAL. WB	6' STANDARD, UNIFORM SIZE AND QUALITY
	PC	MAGNOLIA GALAXY	GALAXY MAGNOLIA	3" CAL. WB	SPECIMEN & PICTURESQUE QUALITY
	PT	SHORE PINE	SHORE PINE	3" CAL. WB	SPECIMEN & PICTURESQUE QUALITY
	PT	POPULUS TREMULOIDES	TREMBLING ASPEN	7CM CAL. WB	6' STANDARD, UNIFORM SIZE AND QUALITY
	PK	POPULUS SERRULATA 'VANZAN'	JAPANESE FLOWERING CHERRY	7CM CAL. WB	6' STANDARD, UNIFORM SIZE AND QUALITY
	CP	PRUNUS SP.	PINK CHERRY	8CM CAL. WB	6' STANDARD, UNIFORM SIZE AND QUALITY
	SU	QUERCUS PALUSTRIS	PINK OAK	8CM CAL. WB	6' STANDARD, UNIFORM SIZE AND QUALITY
		STYRAX JAPONICUS 'OBASSA'	JAPANESE SNOWBELL TREE	7CM CAL. WB	6' STD. UNIFORM SIZE AND QUALITY
KEY CITY BOTANICAL NAME					
SHRUBS / GROUNDCOVERS					
	Ah	AMSONIA HUBRICHTII	BLUE STAR	#2 POT	18" O.C.
	Co	CAREX OSHIMENSIS 'EVERGOLD'	EVERGOLD SEDGE	#2 POT	12" O.C.
	Lp	LAVANDULA ANOSTIFOLIA 'MUNSTEAD'	MUNSTEAD LAVENDER	#2 POT	18" O.C.
	Lp	LONGICERA PILEATA	HONEYBUCKLE	#2 POT	18" O.C.
	Pt	PACHYRANON TERMINALIS	JAPANESE SPURGE	#2 POT	12" O.C.
	Ss	SILVIA SYLVESTRIS 'MAY NIGHT'	MAY NIGHT SAGE	#2 POT	12" O.C.
	Rs	ROSEMOYNIUM 'SILVER GEM'	ROSEMOYNIUM	#2 POT	12" O.C.
	Tm	TARAXACUM 'M. EDDIE'	40" HIGHSIDE	FIELD GROWN	22-24" O.C.
GRASSES / PERENNIALS					
	Hm	HAKONECHLOA MACRA	JAPANESE FOREST GRASS	#1 POT	12" O.C.
	Nt	NASSELLA TENUSSIMA	MEXICAN FEATHER GRASS	#2 POT	12" O.C.
	Ab	AMPHIPHILA BREVILIGULATA	BEACH GRASS	#2 POT	12" O.C.
SEDUM					
	Ss	SEDUM AUTUMN JOY	AUTUMN JOY STONECROP	#2 POT	12" O.C.
	Sk	ALL SEASONS SEDUM TILE	ALL SEASONS SEDUM TILE		

PLANTING PLAN
- GROUND LEVEL AREA 2 & 3


DATE	10/09/2018
DRAWN BY	MP/LL
CHECKED BY	LL
SCALE	1/8" = 1'-0"
JOB NUMBER	17046

DP 16-740262 #5A



gbl ARCHITECTS INC.
139 EAST 4TH AVENUE
VANCOUVER, BC CANADA V5T 1R8
TEL 604 738 1195
FAX 604 731 9279
SALVATORE PROPERTY OF GBL ARCHITECTS INC. AND MAY NOT BE USED OR REPRODUCED WITHOUT THE WRITTEN CONSENT OF GBL ARCHITECTS INC.

PFS STUDIO
PLANNING - URBAN DESIGN - LANDSCAPE ARCHITECTURE
1777 West 7th Avenue
VANCOUVER, BC V6J 1M5
TEL 604 681 1111
FAX 604 681 1112

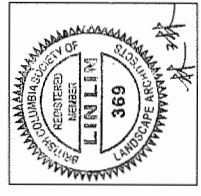


NOTES

KEY CITY	BOTANICAL NAME	COMMON NAME	SIZE	DESCRIPTION
TREES				
AC	ACER CIRCINATUM	VINE MAPLE	50M CAL. WB	MULTI-STEMMED (3 MIN.) FULL
AA	ACER PHLAIDATUM 'AQUARIUM'	AQUARIUM JAPANESE MAPLE	2.5M HT. WB	MULTI-STEMMED (3 MIN.) FULL
AG	ACER NIPONICUM	JAPANESE MAPLE	2.5M HT. WB	MULTI-STEMMED (3 MIN.) FULL
AS	AMELANCHIER X FRAXINOLORA	SPRINGBERRY	2.5M HT. WB	MULTI-STEMMED (3 MIN.) FULL
GT	GLEDITSIA TRACANTHOS	PYRAMIDAL EUROPEAN HORSEBEAM	10CM CAL. WB	FULL, UNIFORM SIZE AND QUALITY
MG	MAGNOLIA GRANDIFLORA 'LITTLE GEM'	EVERGREEN SOUTHERN MAGNOLIA	70M CAL. WB	5 STANDARD, UNIFORM SIZE AND QUALITY
ML	MALLUS SYLVESTRIS	CRAB APPLE TREE	60M CAL. WB	6 STANDARD, UNIFORM SIZE AND QUALITY
MGx	MAGNOLIA GALAXY	GALAXY MAGNOLIA	60M CAL. WB	6 STANDARD, UNIFORM SIZE AND QUALITY
PC	PINUS CONTORTA	SHORE PINE	3 M CAL. WB	SPECIMEN & PICTURESQUE QUALITY, SELECTED BY CONSULTANT
PT	POPULUS TREMULOIDES	TREMBLING ASPEN	70M CAL. WB	6 STANDARD, UNIFORM SIZE AND QUALITY
PK	PRUNUS SERRULATA 'KANZAN'	JAPANESE FLOWERING CHERRY	70M CAL. WB	6 STANDARD, UNIFORM SIZE AND QUALITY
PS	PRUNUS SERRULATA VAR. 'TIBETICA'	TIBETAN CHERRY	60M CAL. WB	MULTI-STEMMED (3 MIN.) FULL
QP	QUERCUS PALUSTRIS	PIN OAK	60M CAL. WB	MULTI-STEMMED (3 MIN.) FULL
SJ	STYRAX JAPONICUS 'OBASAKI'	JAPANESE SNOWBELL TREE	70M CAL. WB	6 STD. UNIFORM SIZE AND QUALITY

KEY CITY	BOTANICAL NAME	COMMON NAME	SIZE	DESCRIPTION
SHRUBS / GROUNDCOVERS				
AI	ANISONIA HIBERICHTII	BLUE STAR	#2 POT	18" O.C.
Co	ANEMONE 'EVERGOLD'	ANEMONE	#2 POT	18" O.C.
Co	ANEMONE 'LAVANILLA'	ANEMONE	#2 POT	18" O.C.
Co	ANEMONE 'MUNSTEAD'	MUNSTEAD ANEMONE	#2 POT	18" O.C.
Co	ANEMONE 'LONGERA PILEATA'	HONEY/SUCKLE	#2 POT	18" O.C.
Co	ANEMONE 'PACHYSAURA TERMINALIS'	JAPANESE SPIRGE	#2 POT	18" O.C.
Co	ANEMONE 'SALVIA X SYLVESTRIS MAY NIGHT'	MAY NIGHT SAGE	#2 POT	18" O.C.
Co	ANEMONE 'ROSA RUGOSA'	BEACH ROSE	#2 POT	18" O.C.
Co	ANEMONE 'TAXUS MEDIA 'H.M. EDDIE YEW'	H.M. EDDIE YEW	40" HIGH MALE, FIELD GROWN	22-24" O.C.
GRASSES / PERENNIALS				
Gr	GRASS (SPECIES)	JAPANESE FOREST GRASS	#1 POT	12" O.C.
Gr	GRASS (SPECIES)	MEXICAN FEATHER GRASS	#2 POT	12" O.C.
Gr	GRASS (SPECIES)	BEACH GRASS	#2 POT	12" O.C.
SEDUM				
Sa	SEDUM 'AUTUMN JOY'	AUTUMN JOY STONECROP	#2 POT	12" O.C.
SA	ALL SEASONS SEDUM TILE			

PLANTING GENERAL NOTES

1. ALL PLANT MATERIAL SHALL CONFORM TO THE STANDARD SPECIFIED IN THE CURRENT EDITION OF THE BC LANDSCAPE STANDARD, THIS STANDARD IS PUBLISHED JOINTLY BY THE BC SOCIETY OF LANDSCAPE ARCHITECTS (BCLSA) AND THE BC LANDSCAPE AND NURSERY ASSOCIATION (BCLNA).
2. SEARCH AREA FOR ALL PLANT MATERIAL SHALL INCLUDE ALL OF WESTERN NORTH AMERICA OR AS SPECIFIED.
3. PLANT MATERIAL SIZES SPECIFIED ARE THE MINIMUM ACCEPTABLE SIZES TO BE SUPPLIED TO THIS PROJECT.
4. ALL PLANT MATERIAL SHALL BE WELL-ESTABLISHED AND UNIFORM IN SHAPE AND SIZE.
5. ALL PLANT MATERIAL SHALL BE NURSERY GROWN UNLESS OTHERWISE NOTED. ONLY CERTIFIED S.O.D. NURSERY STOCK WILL BE ACCEPTED.
6. THE CONTRACTOR SHALL PROVIDE A GROWING MEDIUM ANALYSIS FOR REVIEW BY THE CONSULTANT - AS PER SPECIFICATIONS - PRIOR TO THE START OF CONSTRUCTION. GROWING MEDIUM SUPPLIED TO THE SITE OR INSTALLED ON SITE PRIOR TO CONSULTANT REVIEW SHALL BE REJECTED.
7. THE CONTRACTOR SHALL CONFIRM PLANT QUANTITIES ON THE DRAWINGS CORRESPOND TO THOSE INDICATED ON THE PLANT LIST.
8. ANY DISCREPANCIES ARE TO BE VERIFIED BY THE CONSULTANT FOR REVIEW AND RESPONSE.
9. PLANT LIST TO BE READ IN CONJUNCTION WITH SPECIFICATIONS FOR COMPLIANCE.
10. PRIOR TO THE START OF CONSTRUCTION, THE CONTRACTOR SHALL CONFIRM THE AVAILABILITY OF THE PLANT MATERIAL SPECIFIED AS PER SPECIFICATIONS, ALLOWING FOR ANY AND ALL REQUIRED APPROVALS. PLANT SUBSTITUTIONS NOT CONFIRMED AND APPROVED BY THE CONSULTANT WILL BE REJECTED.
11. PROVIDE IRRIGATION TO ALL PLANT MATERIAL AS SHOWN ON LANDSCAPE DRAWINGS AND PLANS.
12. HIGH EFFICIENT AUTOMATIC IRRIGATION SYSTEM WILL BE INSTALLED ON PLANTING AREAS.

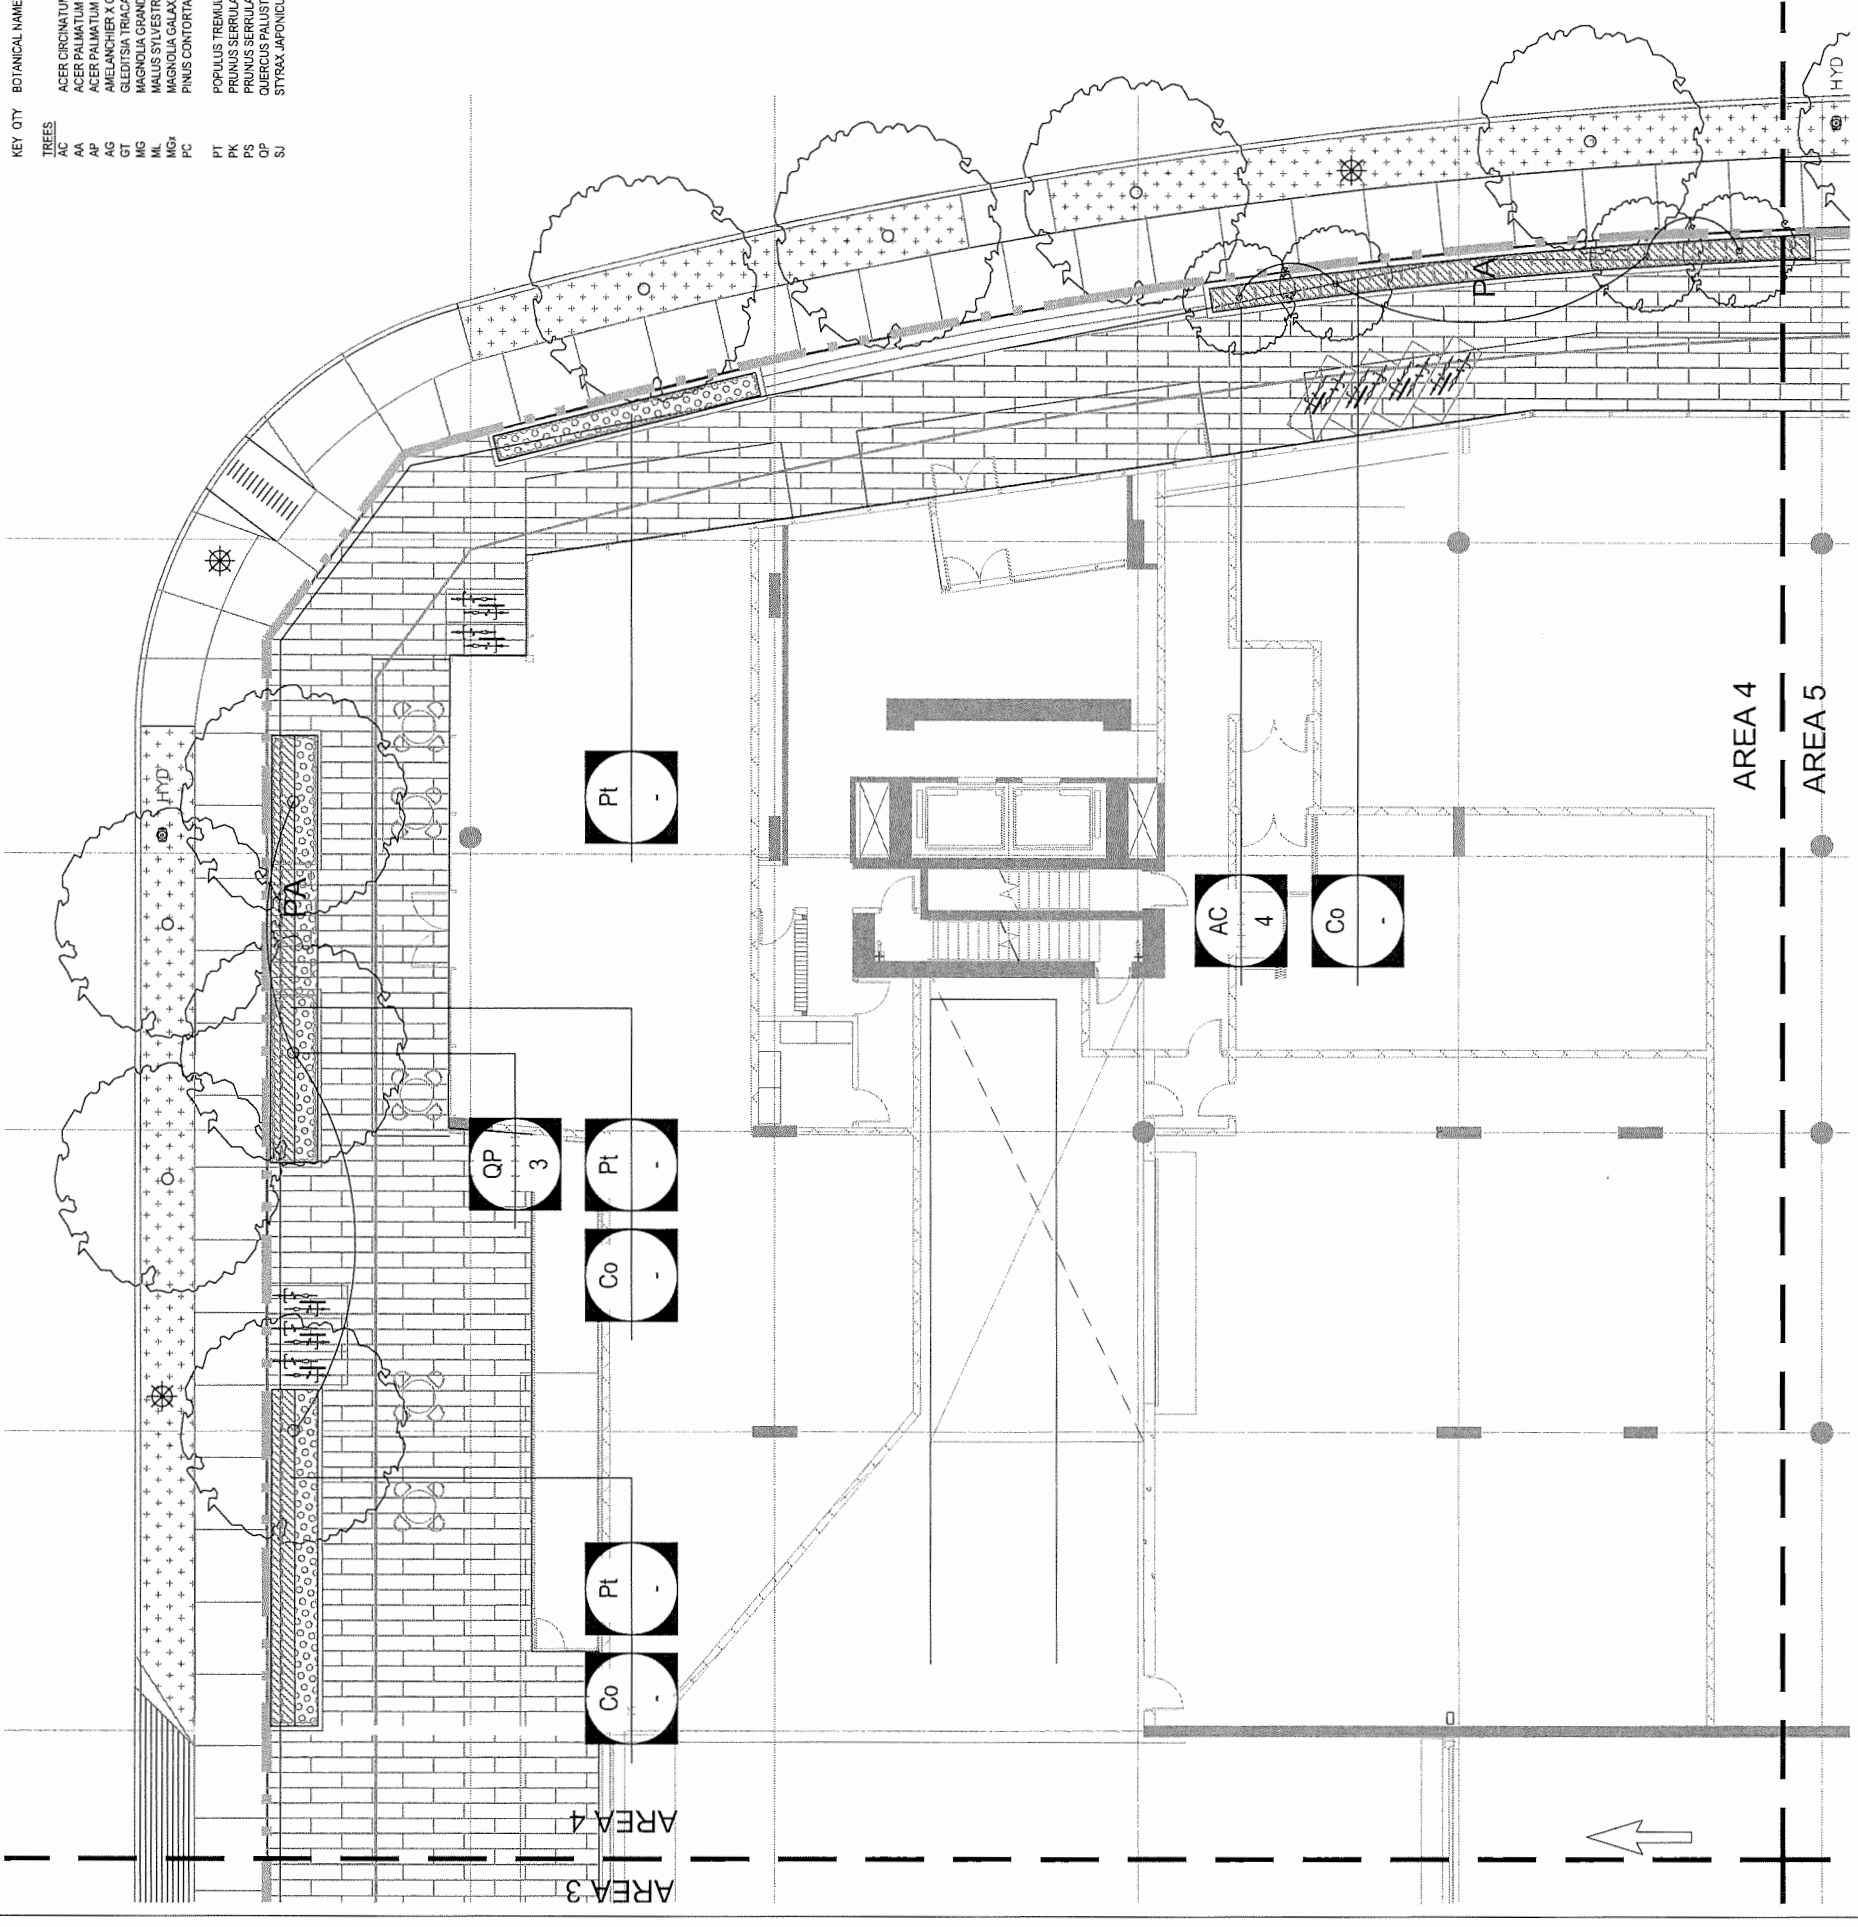

NO.	DATE	DESCRIPTION
1	2017-09-29	Issued for Re-zoning
2	2017-11-14	Issued for Re-zoning (Resubmission)
3	2017-11-14	Issued for DP
4	2018-07-18	DD 80%
5	2018-08-31	Reissued for DP
6	2018-09-21	Reissued for DP
7	2018-10-09	Reissued for DP


7960 ALDERBRIDGE WAY

PLANTING PLAN
- GROUND LEVEL AREA 4

DATE 10/09/2018
DRAWN BY MP/LL
CHECKED BY LL
SCALE 1/8" = 1'-0"
JOB NUMBER 17046

L4.04

NOTES

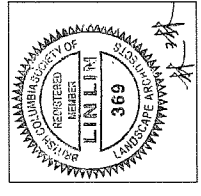


NO.	DATE	DESCRIPTION
1	2017-09-29	Issued for Rezoning
2	2017-11-14	Issued for Rezoning (Re-submission)
3	2017-11-14	Issued for DP
4	2018-07-18	Released for DP
5	2018-08-31	DD 80%
6	2018-09-21	Released for DP
7	2018-10-09	Released for OP

7960 ALDERBRIDGE WAY

PLANTING PLAN
- GROUND LEVEL AREA 5

DATE	10/09/2018
DRAWN BY	MP/LL
CHECKED BY	LL
SCALE	1/8" = 1'-0"
JOB NUMBER	17046

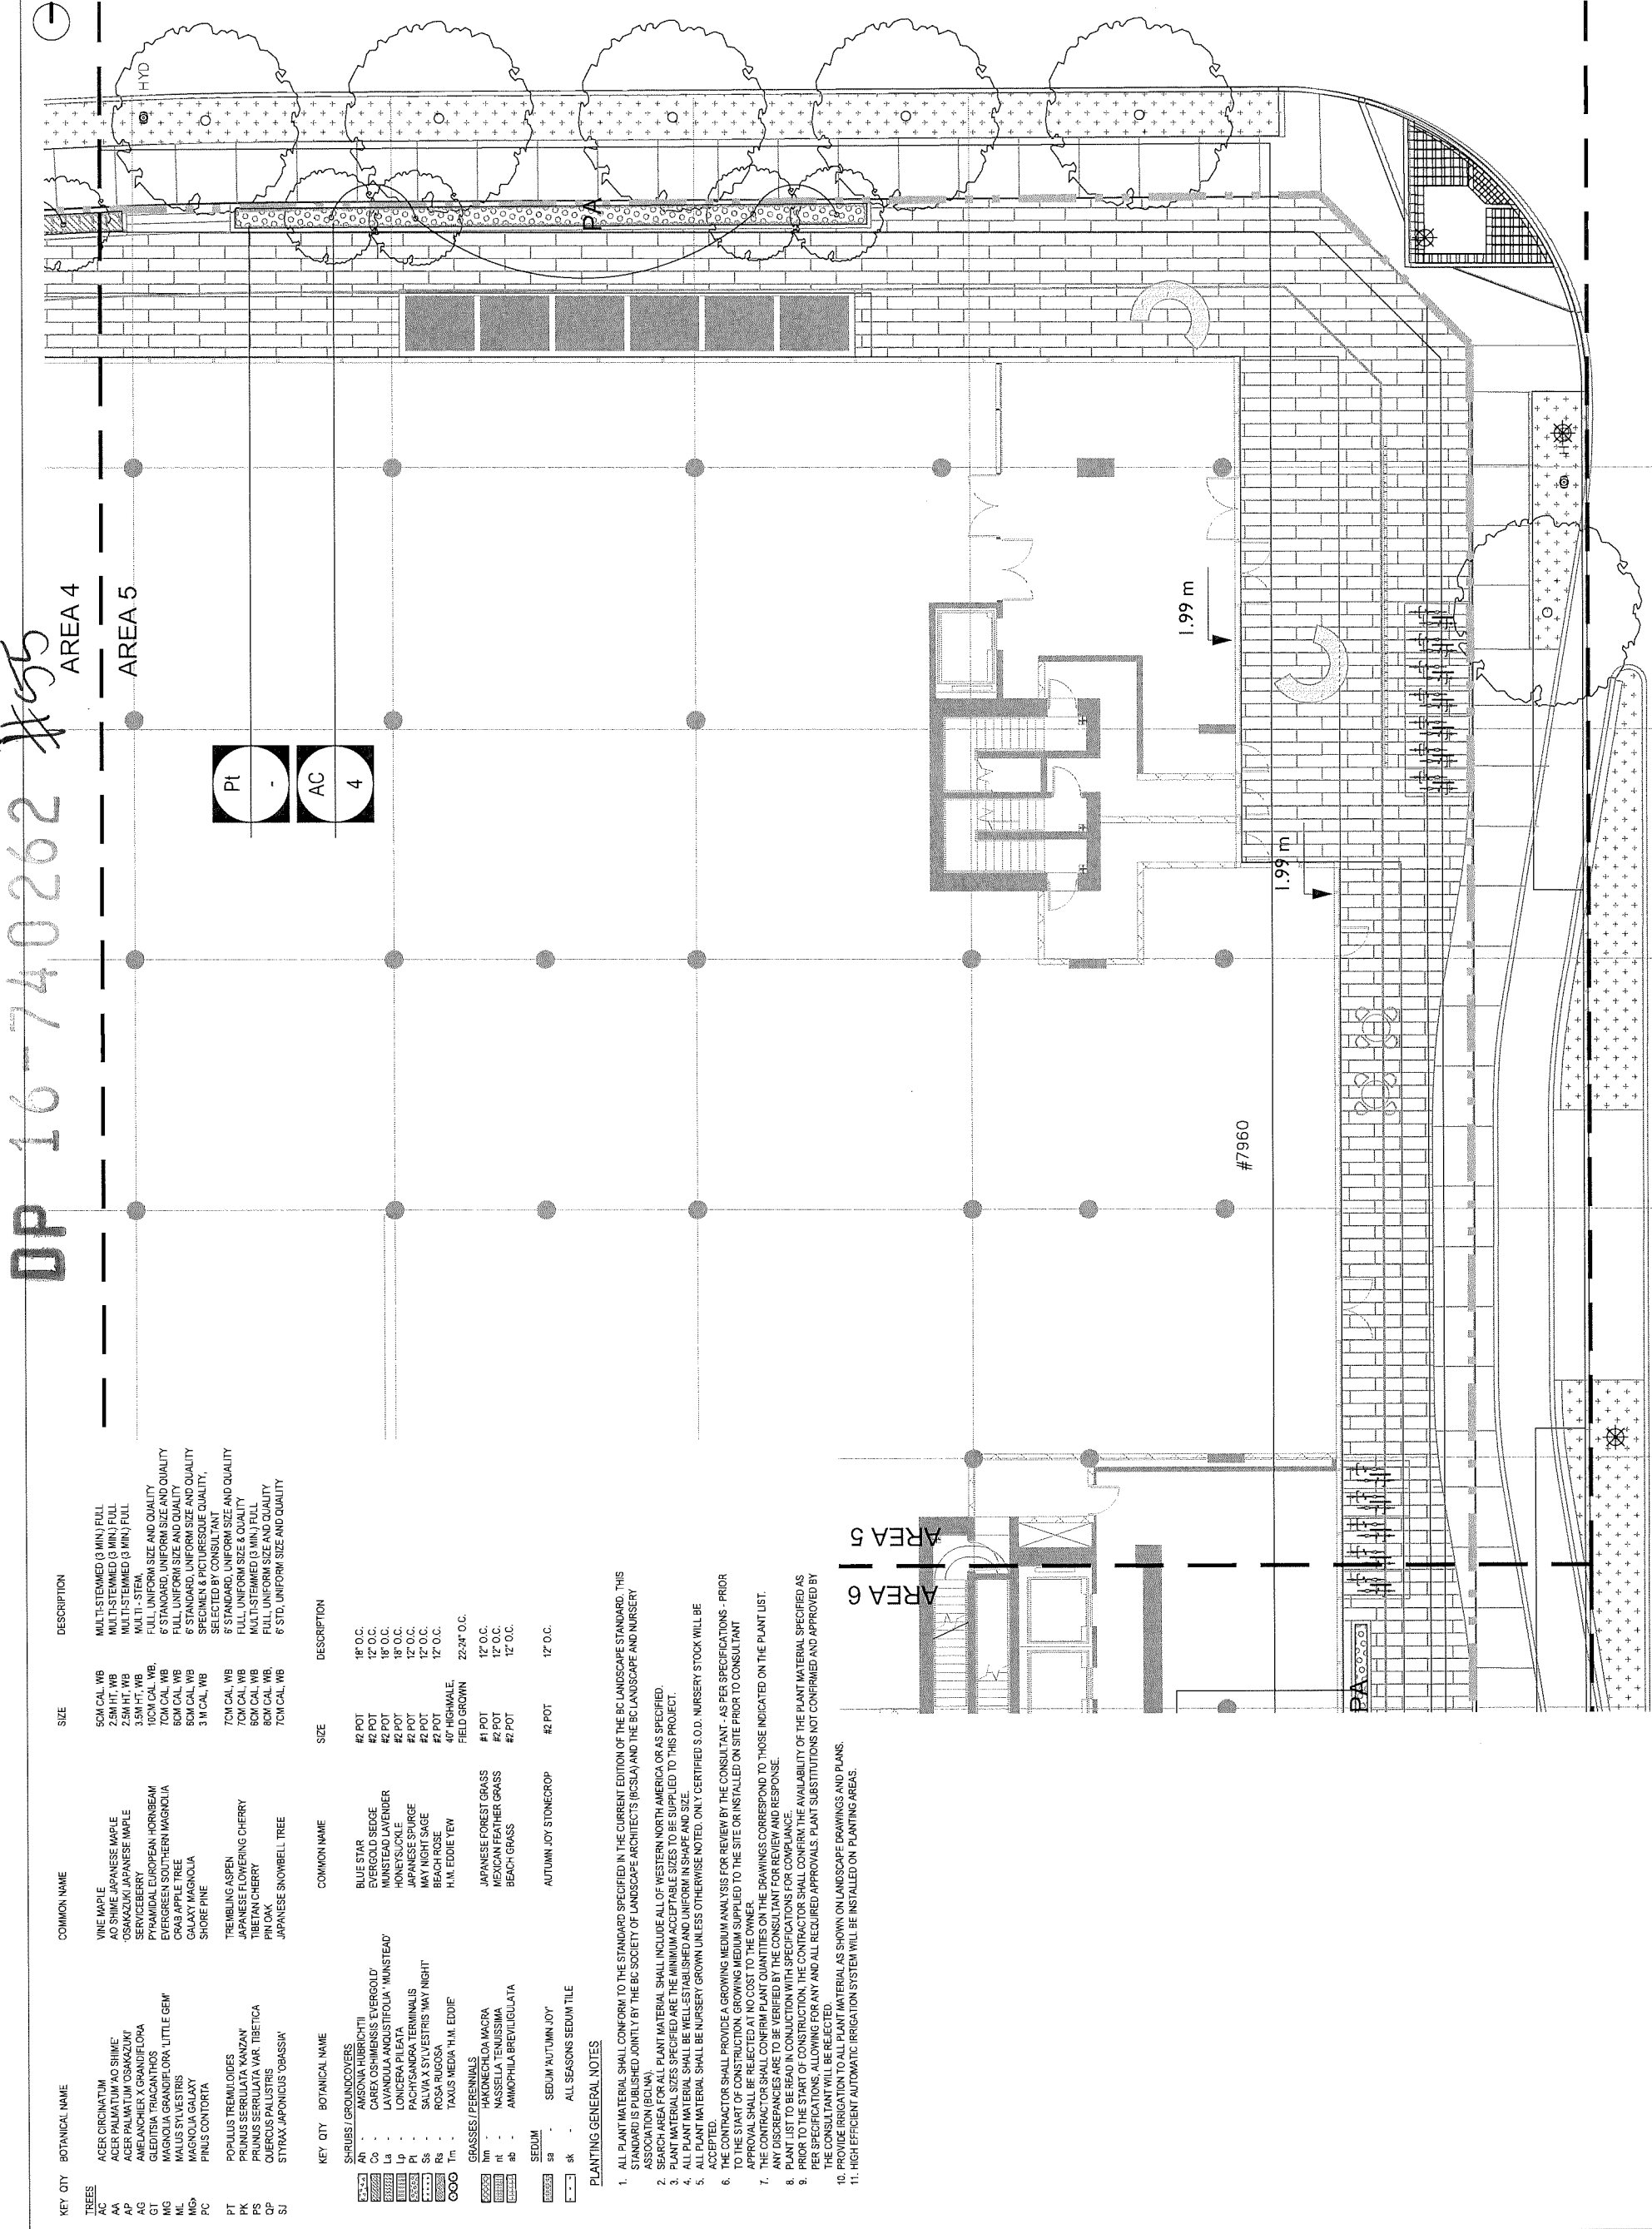


DP 16-740262 #55

KEY CITY	BOTANICAL NAME	COMMON NAME	SIZE	DESCRIPTION
AC	ACER CIRCINATUM	VINE MAPLE	5CM CAL. WB	MULTI-STEMMED (3 MIN.) FULL
AA	ACER PALMATUM 'AO SHIME'	AO SHIME JAPANESE MAPLE	2.5M HT. WB	MULTI-STEMMED (3 MIN.) FULL
AP	ACER PALMATUM 'OSAKAZUKI'	OSAKAZUKI JAPANESE MAPLE	2.5M HT. WB	MULTI-STEMMED (3 MIN.) FULL
AG	AMELANCHIER X GRANDIFLORA	SERVICEBERRY	15CM CAL. WB	MULTI-STEMMED (3 MIN.) FULL
GT	GLEDITSIA TRIACANTHOS	PIRAMIDAL EUROPEAN HORSEBEAM	70CM CAL. WB	FULL, UNIFORM SIZE AND QUALITY
MG	MAGNOLIA GRANDIFLORA 'LITTLE GEM'	EVERGREEN SOUTHERN MAGNOLIA	80CM CAL. WB	FULL, UNIFORM SIZE AND QUALITY
ML	MALUS SYLVESTRIS	CRAB APPLE TREE	80CM CAL. WB	FULL, UNIFORM SIZE AND QUALITY
Mb	MAGNOLIA GALAXY	SHORE PINE	3M CAL. WB	SPECIMEN & PICTURESQUE QUALITY
PC	PINUS CONTORTA	SHORE PINE	3M CAL. WB	SPECIMEN & PICTURESQUE QUALITY
PT	POPULUS TREMILOIDES	TREMBLING ASPEN	70CM CAL. WB	8 STANDARD, UNIFORM SIZE AND QUALITY
PK	PRUNUS SERRULATA 'KANZAN'	JAPANESE FLOWERING CHERRY	70CM CAL. WB	FULL, UNIFORM SIZE & QUALITY
PS	PRUNUS SERRULATA VAR. TIBETICA	TIBETAN CHERRY	80CM CAL. WB	MULTI-STEMMED (3 MIN.) FULL
QP	QUERCUS PALustris	PIN OAK	80CM CAL. WB	FULL, UNIFORM SIZE AND QUALITY
SJ	STRYAX JAPONICUS 'OBASSIA'	JAPANESE SNOWBELL TREE	70CM CAL. WB	8 STD., UNIFORM SIZE AND QUALITY

KEY CITY	BOTANICAL NAME	COMMON NAME	SIZE	DESCRIPTION
AR	ANDRONIA HIBRIDICHTI	BLUE STAR	#2 POT	18" O.C.
Co	CAREX OSHIMENSIS 'EVERGOLD'	EVERGOLD SEDGE	#2 POT	18" O.C.
La	LAVANDULA HINDUSTANICA 'MONSIEUR JACQUES'	FRANZ DEUTZ	#2 POT	18" O.C.
Ip	IPOMOEPA TERNATA	HONOLULU CLEOME	#2 POT	18" O.C.
Pa	PACHYSAURA TERMINALIS	JAPANESE SIBURGE	#2 POT	12" O.C.
Sa	SALVIA SYLVESTRIS 'MAY NIGHT'	MAY NIGHT SAGE	#2 POT	12" O.C.
Ra	ROSA RUGOSA	BEACH ROSE	#2 POT	12" O.C.
Tm	TAXUS MEDIA 'H.M. EDDIE'	H.M. EDDIE YEW	40" HIGHWALE, FIELD GROWN	22-24" O.C.
Gr	GRASSES / PERENNIALS	JAPANESE FOREST GRASS	#1 POT	12" O.C.
Mc	MACROPODUM APOCALYPTICUM	MACROPODUM APOCALYPTICUM	#2 POT	12" O.C.
Be	BELLA PERENNIALS	BEACH GRASS	#2 POT	12" O.C.
Se	SEDUM	AUTUMN JOY STONECROP	#2 POT	12" O.C.
Sk	ALL SEASONS SEDUM TILE			

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 - THE CONTRACTOR SHALL PROVIDE A GROWING MEDIUM ANALYSIS FOR REVIEW BY THE CONSULTANT - AS PER SPECIFICATIONS - PRIOR TO THE START OF CONSTRUCTION. GROWING MEDIUM SUPPLIED TO THE SITE OR INSTALLED ON SITE PRIOR TO CONSULTANT APPROVAL SHALL BE REJECTED AT NO COST TO THE OWNER.
 - THE CONTRACTOR SHALL CONFIRM PLANT QUANTITIES AND DRAWINGS CORRESPOND TO THOSE INDICATED ON THE PLANT LIST.
 - PLANT LIST TO BE RE-OPENED FOR REVIEW AND RESPONSE.
 - PLANT LIST TO BE RE-OPENED FOR REVIEW AND RESPONSE.
 - BEFORE THE START OF CONSTRUCTION, THE CONTRACTOR SHALL CONFIRM THE AVAILABILITY OF THE PLANT MATERIAL SPECIFIED AS PER SPECIFICATIONS. ALLOWING FOR ANY AND ALL REQUIRED APPROVALS. PLANT SUBSTITUTIONS NOT CONFIRMED AND APPROVED BY THE CONSULTANT WILL BE REJECTED.
 - PROVIDE IRRIGATION TO ALL PLANT MATERIAL AS SHOWN ON LANDSCAPE DRAWINGS AND PLANS.
 - HIGH EFFICIENT AUTOMATIC IRRIGATION SYSTEM WILL BE INSTALLED ON PLANTING AREAS.

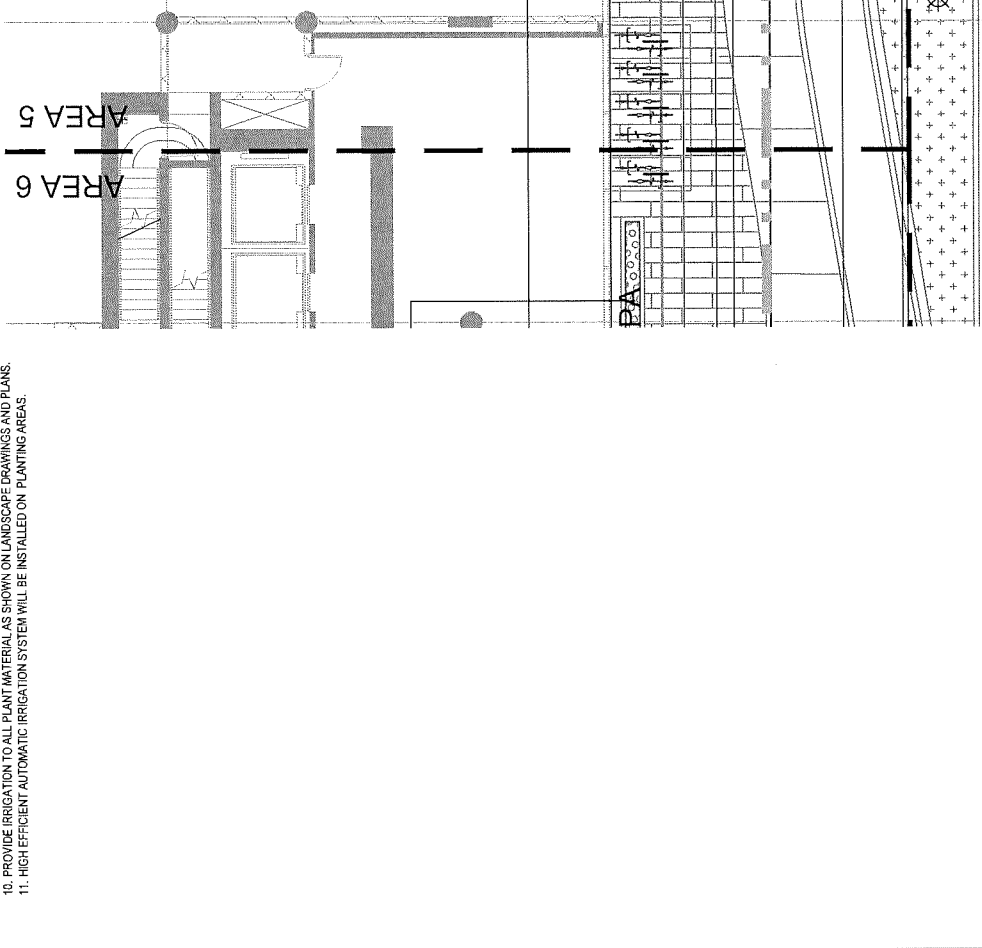




NO.	DATE	DESCRIPTION
1	2017-09-29	Issued for Reasoning
2	2017-11-14	Issued for Reasoning (Resubmission)
3	2017-11-14	Issued for DP
4	2018-07-18	Released for DP
5	2018-08-31	DD 80%
6	2018-09-21	Released for DP
7	2018-10-09	Released for DP

NOTES

7960 ALDERBRIDGE WAY

**PLANTING PLAN
- GROUND LEVEL AREA 6**

DATE	10/09/2018
DRAWN BY	MPILL
CHECKED BY	LL
SCALE	1/8" = 1'-0"
JOB NUMBER	17046

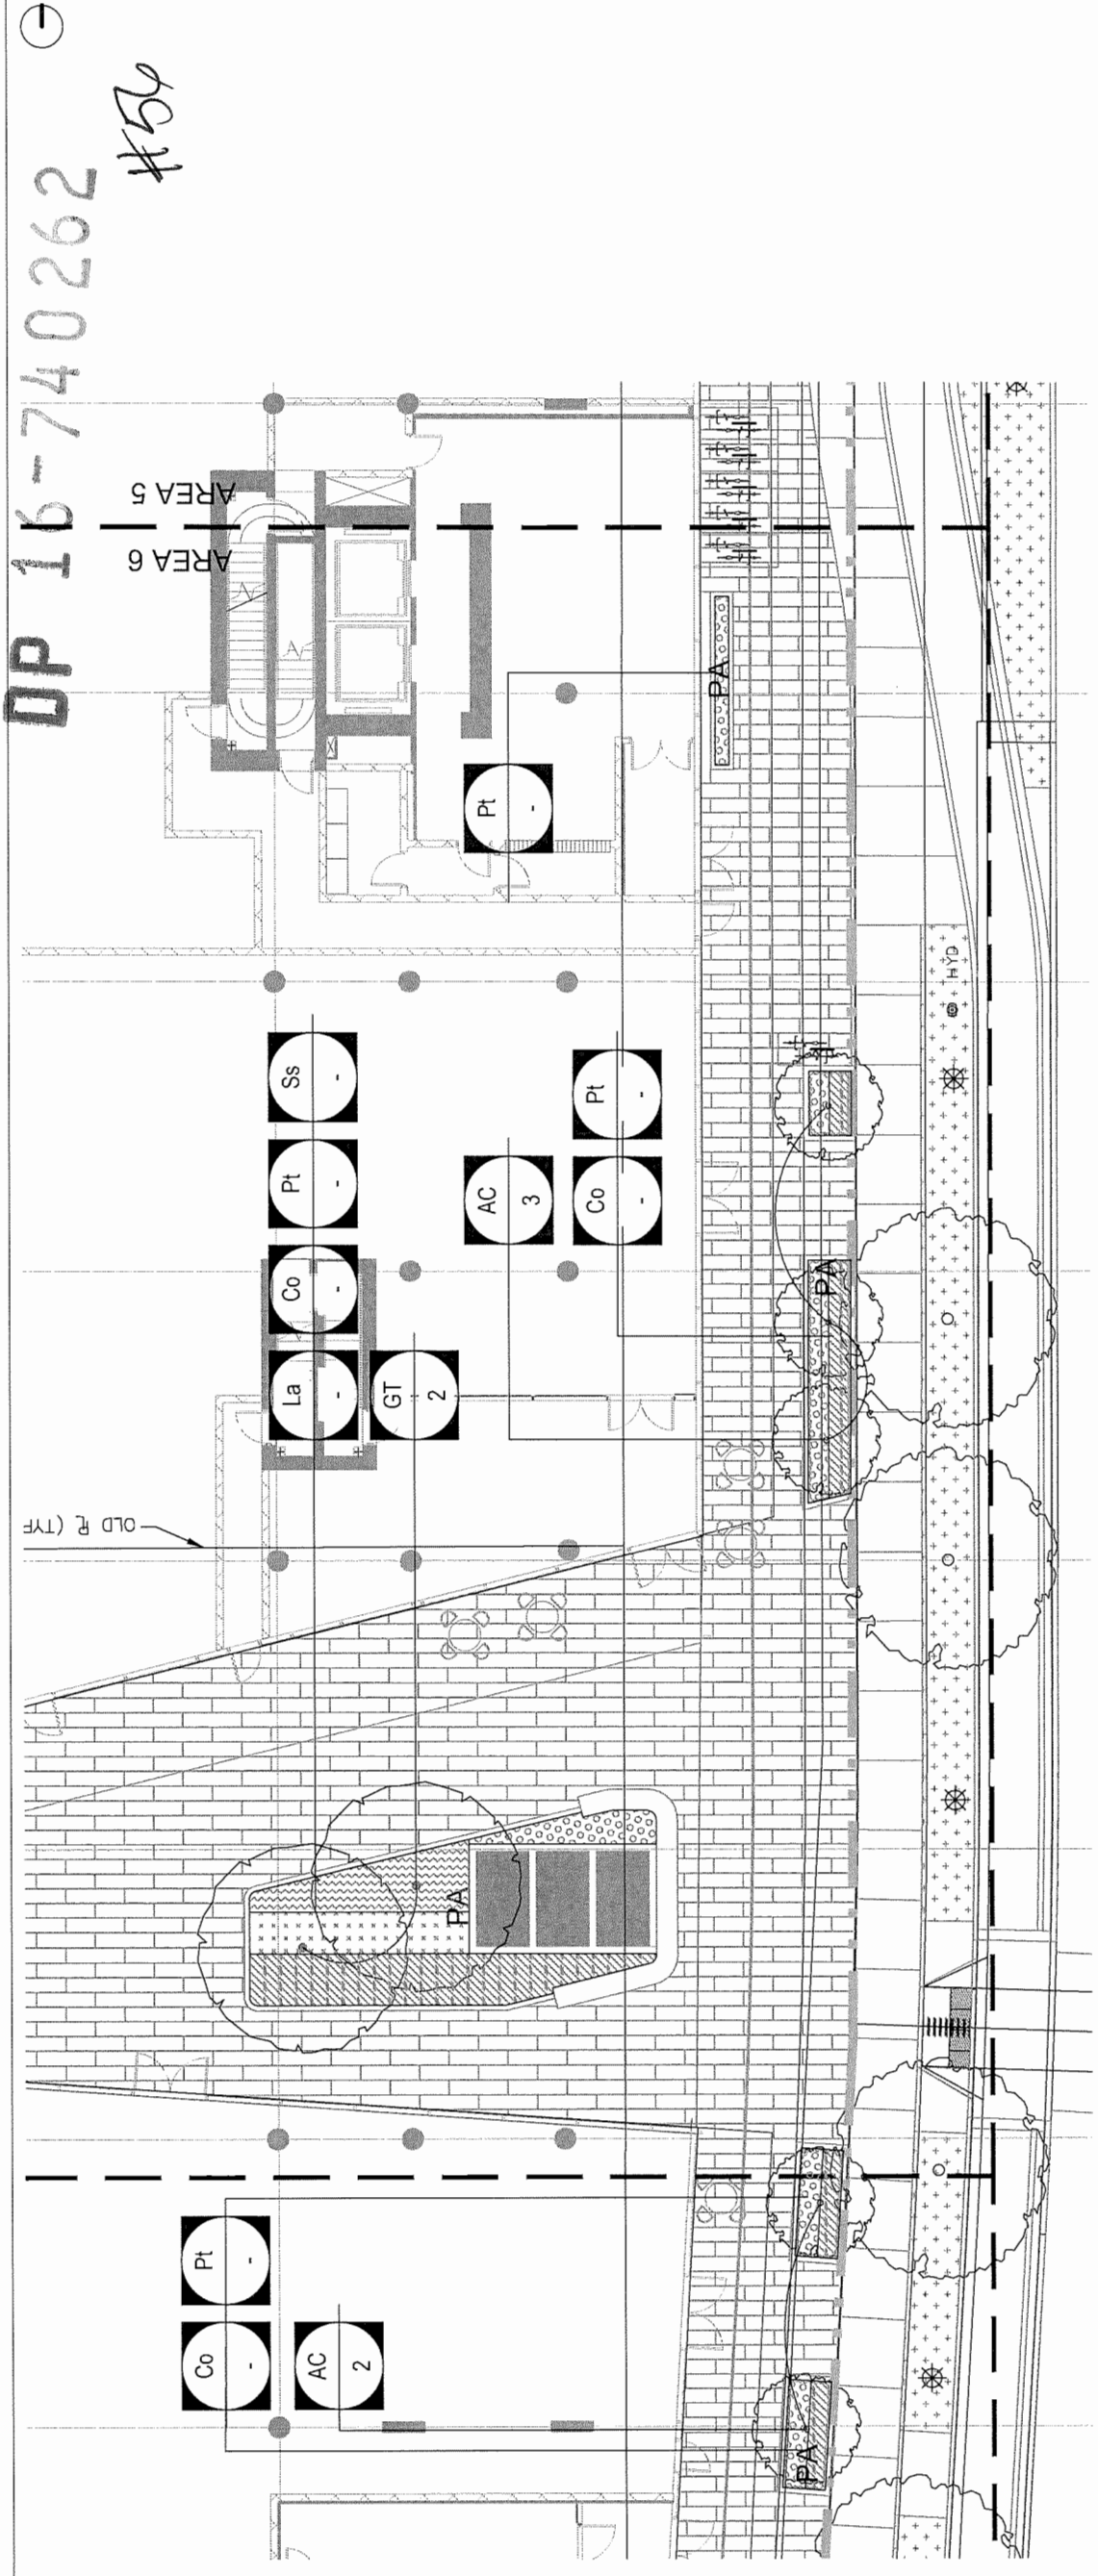


DP 16-740262
 #56

KEY QTY	BOTANICAL NAME	COMMON NAME	SIZE	DESCRIPTION	KEY QTY	BOTANICAL NAME	COMMON NAME	SIZE	DESCRIPTION	COMMON NAME	SIZE	DESCRIPTION
AC	ACER CIRCINATUM	VINE MAPLE	50M CAL. WB	MULTI-STEMMED (3 MIN.) FULL	AC	AMSONIA-HUBRICHTII	SHRUBS / GROUNDCOVERS	#2 POT	18" O.C.	BLUE STAR	#2 POT	18" O.C.
AA	ACER PALMATUM 'NO SHIME'	AO SHIME JAPANESE MAPLE	2.5M HT. WB	MULTI-STEMMED (3 MIN.) FULL	Co	CAREX OSHIMENSIS 'EVERGOLD'	EVERGOLD SEDGE	#2 POT	12" O.C.	MUNSTEAD LAVENDER	#2 POT	12" O.C.
AP	ACER PALMATUM 'OSAKAZUKI'	OSAKAZUKI JAPANESE MAPLE	2.5M HT. WB	MULTI-STEMMED (3 MIN.) FULL	La	LANANDELLA ANOSTIFOLIA 'MUNSTEAD'	MUNSTEAD LAVENDER	#2 POT	18" O.C.	HOMESUCKLE	#2 POT	18" O.C.
AG	AMEI-ANCHIER X GRANDIFLORA	SERVICEBERRY	3.3M HT. WB	MULTI-STEMMED (3 MIN.) FULL	Lp	LONGICERA PLEATA	LONGICERA PLEATA	#2 POT	18" O.C.	JAPANESE SAGE	#2 POT	18" O.C.
GT	GLIEDITSA TRICANTHOS	PYRAMIDAL EUROPEAN HORNBEAM	10CM CAL. WB	FULL, UNIFORM SIZE AND QUALITY	Pt	PACHYSPORA TERMINALIS	JAPANESE SAGE	#2 POT	12" O.C.	BEACH ROSE	#2 POT	12" O.C.
MG	WAGNOLIA GRANDIFLORA 'LITTLE GEM'	EVERGREEN SOUTHERN MAGNOLIA	8CM CAL. WB	FULL, UNIFORM SIZE AND QUALITY	Ra	ROSA RUGOSA	BEACH ROSE	#2 POT	12" O.C.	H/M EDDIE YEW	40" HIGH MALE	22.24" O.C.
ML	WALNUS SYLVESTRIS	BLACK WALNUT TREE	8CM CAL. WB	FULL, UNIFORM SIZE AND QUALITY	Tm	TAXUS MEDIA 'H.M. EDDIE'	H/M EDDIE YEW	FIELD GROWN	22.24" O.C.	JAPANESE FOREST GRASS	#1 POT	12" O.C.
MCp	WALNUS SYLVESTRIS 'GAY'	BLACK WALNUT TREE	8CM CAL. WB	FULL, UNIFORM SIZE AND QUALITY						MEXICAN FEATHER GRASS	#2 POT	12" O.C.
PC	PNUS COR CORA	SHORE PINE	3M CAL. WB	SPECIMEN & PICTURE QUALITY						BEACH GRASS	#2 POT	12" O.C.
PT	POPULUS TREMULOIDES	TREMBLING ASPEN	7CM CAL. WB	SELECTED BY CONSULTANT						AUTUMN JOY STONECROP	#2 POT	12" O.C.
PK	PRUNUS SERRULATA 'KANZAN'	JAPANESE FLOWERING CHERRY	7CM CAL. WB	STANDARD, UNIFORM SIZE AND QUALITY						ALL SEASONS SEDUM TILE		
PS	PRUNUS SERRULATA 'VAR. TIBETICA'	TIBETAN CHERRY	8CM CAL. WB	FULL, UNIFORM SIZE & QUALITY								
QP	QUERCUS PALustris	PIN OAK	8CM CAL. WB	MULTI-STEMMED (3 MIN.) FULL								
SJ	STYRAX JAPONICUS 'OBASSIA'	JAPANESE SNOWBELL TREE	7CM CAL. WB	STANDARD, UNIFORM SIZE AND QUALITY								

PLANTING GENERAL NOTES

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- HIGH EFFICIENT AUTOMATIC IRRIGATION SYSTEM WILL BE INSTALLED ON PLANTING AREAS.

NOTES

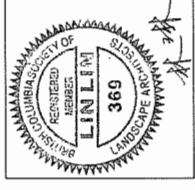


NO.	DATE	DESCRIPTION
1	2017-09-29	Issued for Re-zoning (Resubmission)
2	2017-11-14	Issued for DP
3	2017-11-14	Released for DP
4	2018-07-18	DO 80%
5	2018-08-31	Released for DP
6	2018-09-21	Released for DP
7	2018-10-09	Released for DP

7960 ALDERBRIDGE WAY

PLANTING PLAN
- GROUND LEVEL AREA 7


DATE 10/09/2018
 DRAWN BY MP/LL
 CHECKED BY LL
 SCALE 1/8" = 1'-0"
 JOB NUMBER 17046

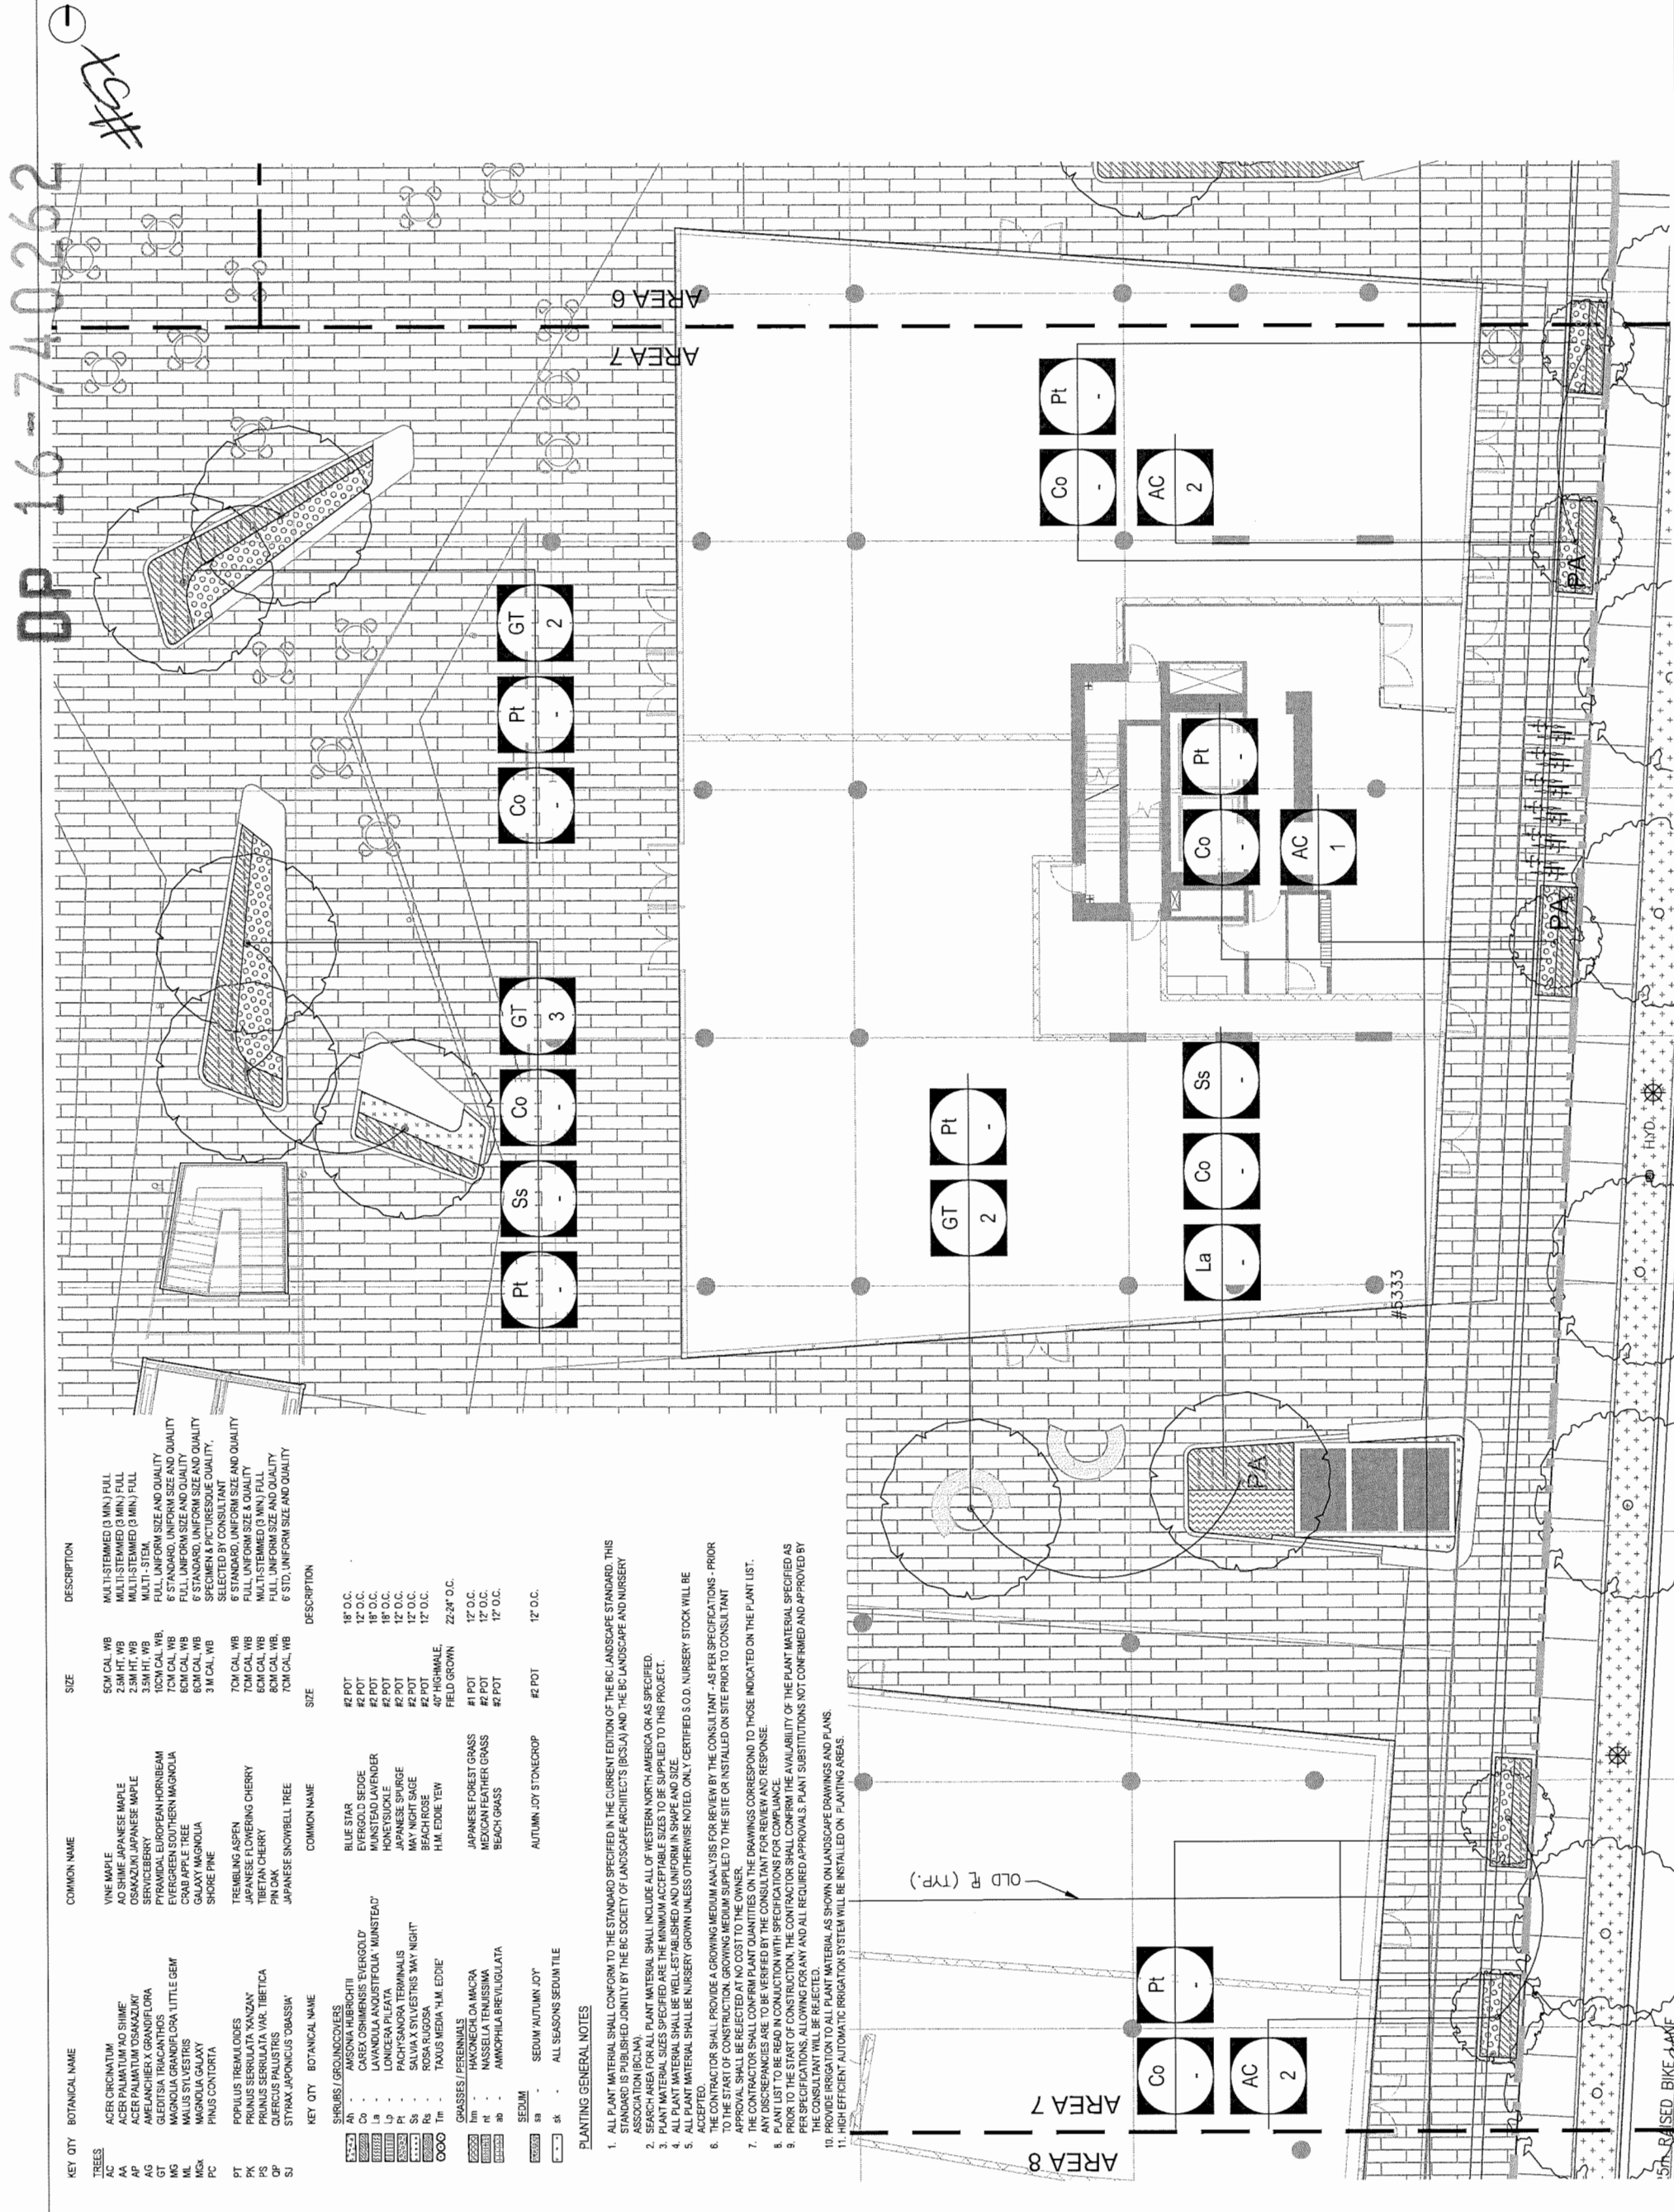

KEY QTY	BOTANICAL NAME	COMMON NAME	SIZE	DESCRIPTION
TREES				
AA	ACER CROCINATUM	VINE MAPLE	5CM CAL WB	MULTI-STEMMED (3 MIN.) FULL
AP	ACER PALMATUM 'KO SHIME'	AD SHIME JAPANESE MAPLE	2.5M HT. WB	MULTI-STEMMED (3 MIN.) FULL
AG	ACER PALMATUM 'OSAKAZUKI'	OSAKAZUKI JAPANESE MAPLE	3.5M HT. WB	MULTI-STEMMED (3 MIN.) FULL
GT	AMELANCHIER X 'GRANDIFLORA'	SERVICEBERRY	10CM CAL. WB.	FULL, UNIFORM SIZE AND QUALITY
MG	GLADIOSA TRIACANTHOS	PYRAMIDAL EUROPEAN HORNBEEAM	7CM CAL. WB.	6' STANDARD, UNIFORM SIZE AND QUALITY
ML	MAGNOLIA GRANDIFLORA 'LITTLE GEM'	EVERGREEN SOUTHERN MAGNOLIA	8CM CAL. WB.	FULL, UNIFORM SIZE AND QUALITY
MS	MALLUS SYLVESTRIS	CRAB APPLE TREE	6CM CAL. WB.	FULL, UNIFORM SIZE AND QUALITY
MCsk	MAGNOLIA GALAXY	GALAXY MAGNOLIA	3 M CAL. WB.	SPECIMEN & PICTURESQUE QUALITY.
PC	PINUS CONTORTA	SHORE PINE	7CM CAL. WB.	6' STANDARD, UNIFORM SIZE AND QUALITY
PT	POPULUS TREMULOIDES	TREMBLING ASPEN	7CM CAL. WB.	SELECTED BY CONSULTANT. UNIFORM SIZE AND QUALITY
PK	PRUNUS SERRULATA 'YANAZAKI'	JAPANESE FLOWERING CHERRY	6CM CAL. WB.	FULL, UNIFORM SIZE AND QUALITY
PS	PRUNUS SERRULATA 'VAR. TIBETICA'	PINK BLOSSOM CHERRY	6CM CAL. WB.	FULL, UNIFORM SIZE AND QUALITY
BT	SYTRAJA JAPONICUS 'OBASSA'	JAPANESE SNOWBELL TREE	7CM CAL. WB.	6' STD. UNIFORM SIZE AND QUALITY
SH				
SHUBS / GROUNDCOVERS				
Ah	AMSONIA HUBRICHTII	BLUE STAR	#2 POT	18" O.C.
Co	CAREX OSHIMENSIS 'EVERGOLD'	EVERGOLD SEDGE	#2 POT	12" O.C.
La	LAVANDULA ANOSTIFOLIA 'MUNSTEAD'	MUNSTED LAVENDER	#2 POT	18" O.C.
Ip	IPOMEOEA PULIFLORA	PORTULACA	#2 POT	12" O.C.
Pl	PLANTAGO SPURGE	JAPANESE SPURGE	#2 POT	12" O.C.
Sc	SALICIA SHAWANA 'TERMINALS'	SALICIA	#2 POT	12" O.C.
Sa	SALICIA SPURGE 'MAY NIGHT'	MAY NIGHT SAGE	#2 POT	12" O.C.
Ra	ROSA 'SLOTT'S MAY NIGHT'	BEACH ROSE	#2 POT	12" O.C.
Ta	TAXUS MEDIA 'H.M. EDIE'	H.M. EDDIE YEW	40" HIGHWALE, FIELD GROWN	22-24" O.C.
Grasses / Perennials				
Im	HAKONECHLOA MACRA	JAPANESE FOREST GRASS	#1 POT	12" O.C.
Rt	RIEGERIA TENISSIMIA	MEXICAN FETTER GRASS	#2 POT	12" O.C.
Ab	AMPHIPHILA BREVILIGULATA	BEACH GRASS	#2 POT	12" O.C.
Sedum				
Ss	SEDUM 'AUTUMN JOY'	AUTUMN JOY SEDUM	#2 POT	12" O.C.
Sk		ALL SEASONS SEDUM TILE		

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 - PLANT MATERIAL SPECIES SPECIFIED ARE THE MINIMUM ACCEPTABLE SIZES TO BE SUPPLIED TO THIS PROJECT.
 - ALL PLANT MATERIAL SHALL BE WELL ESTABLISHED AND UNIFORM IN SHAPE AND SIZE.
 - ALL PLANT MATERIAL SHALL BE NURSERY GROWN UNLESS OTHERWISE NOTED. ONLY CERTIFIED S.O.D. NURSERY STOCK WILL BE ACCEPTED.
 - THE CONTRACTOR SHALL PROVIDE A GROWING MEDIUM ANALYSIS FOR REVIEW BY THE CONSULTANT - AS PER SPECIFICATIONS - PRIOR TO THE START OF CONSTRUCTION. GROWING MEDIUM SUPPLIED TO THE SITE OR INSTALLED ON SITE PRIOR TO CONSULTANT APPROVAL SHALL BE REJECTED AT NO COST TO THE OWNER.
 - THE CONTRACTOR SHALL CONFIRM PLANT QUANTITIES ON THE DRAWINGS CORRESPOND TO THOSE INDICATED ON THE PLANT LIST.
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 - PLANT LIST TO BE READ IN CONJUNCTION WITH SPECIFICATIONS FOR COMPLIANCE.
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 - ALL PLANT MATERIAL AS SHOWN ON LANDSCAPE DRAWINGS AND PLANS.
 - HIGH EFFICIENT AUTOMATIC IRRIGATION SYSTEM WILL BE INSTALLED ON PLANTING AREAS.

#5333
 OLD PD (TRP.)
 AREA 7
 AREA 8
 AREA 9
 AREA 6
 RAISED BIKE LAKE
 HYD

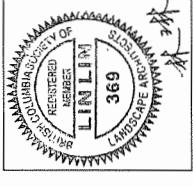


DP 16-740262

PLANTING GENERAL NOTES

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KEY CITY	BOTANICAL NAME	COMMON NAME	SIZE	DESCRIPTION
AC	ACER PALMATUM	VINE MAPLE	50M CAL, WB	MULTI-STEMMED (3 MIN) FULL
AA	ACER PALMATUM 'AO SHIME'	AO SHIME JAPANESE MAPLE	2.5M HT, WB	MULTI-STEMMED (3 MIN) FULL
AP	ACER PALMATUM 'OSAKAZUKI'	OSAKAZUKI JAPANESE MAPLE	2.5M HT, WB	MULTI-STEMMED (3 MIN) FULL
AG	AMELANCHIER X GRANDIFLORA	SERVICEBERRY	3.5M HT, WB	MULTI-STEM, FULL UNIFORM SIZE AND QUALITY
GT	GLEDTISIA TRICANTHOS	PYRAMIDAL EUROPEAN HORNBREAM	10CM CAL, WB	FULL UNIFORM SIZE AND QUALITY
MG	MAGNOLIA GRANDIFLORA LITTLE GEM	EVERGREEN SOUTHERN MAGNOLIA	70M CAL, WB	FULL UNIFORM SIZE AND QUALITY
ML	MALLUS SYLVESTRIS	CRAB APPLE TREE	60M CAL, WB	FULL UNIFORM SIZE AND QUALITY
MGK	MAGNOLIA GALAXY	GALAXY MAGNOLIA	60M CAL, WB	6' STANDARD, UNIFORM SIZE AND QUALITY
PC	PINUS CONTORTA	SHORE PINE	3M CAL, WB	6' STANDARD, UNIFORM SIZE AND QUALITY, SPECIMEN & PICTURED OF QUALITY, SELECTED BY CONSULTANT
PT	POPULUS TREMULOIDES	TREMBLING ASPEN	70M CAL, WB	6' STANDARD, UNIFORM SIZE AND QUALITY
PK	PRUNUS SEROTINATA	JAPANESE LOWERING CHERRY	70M CAL, WB	6' STANDARD, UNIFORM SIZE AND QUALITY
PS	PRUNUS SEROTINATA VAR. 'TIBETICA'	TIBETAN CHERRY	70M CAL, WB	6' STANDARD, UNIFORM SIZE AND QUALITY
CP	QUERCUS PALustris	PINK OAK	80M CAL, WB	FULL UNIFORM SIZE AND QUALITY
SJ	STYRAX JAPONICUS 'OBASSIA'	JAPANESE SNOEWELL TREE	70M CAL, WB	6' STD, UNIFORM SIZE AND QUALITY

KEY CITY	BOTANICAL NAME	COMMON NAME	SIZE	DESCRIPTION
SHRUBS / GROUNDCOVERS				
SH	BLUE STAR	BLUE STAR	#2 POT	18" O.C.
FG	FURGOLD SEDGE	FURGOLD SEDGE	#2 POT	12" O.C.
LS	LAVANDERA ANDRISTIFOLIA 'MUNSTEAD'	MUNSTEAD LAVENDER	#2 POT	18" O.C.
LS	LAVANDERA PULEGATA	HONEY/SUCKLE	#2 POT	18" O.C.
Pt	PACHY SANDRA TERMINALIS	JAPANESE SPURGE	#2 POT	12" O.C.
Ss	SALVIA X SYLVESTRIS 'MAY NIGHT'	MAY NIGHT SAGE	#2 POT	12" O.C.
Rb	ROSA RUGOSA	BEACH ROSE	#2 POT	12" O.C.
Tm	TAXUS MEDIA 'H.M. EDDIE'	H.M. EDDIE YEW	4P' HIGHWALE, FIELD GROWN	22-24" O.C.
GRASSES / PERENNIALS				
GR	JAPANESE FOREST GRASS	JAPANESE FOREST GRASS	#1 POT	12" O.C.
MT	MEXICAN FEATHER GRASS	MEXICAN FEATHER GRASS	#2 POT	12" O.C.
BE	BEACH GRASS	BEACH GRASS	#2 POT	12" O.C.
SEDUM				
SA	SEDUM 'AUTUMN JOY'	AUTUMN JOY SEDUM TILE	#2 POT	12" O.C.
SK	ALL SEASONS SEDUM TILE	ALL SEASONS SEDUM TILE	#2 POT	12" O.C.

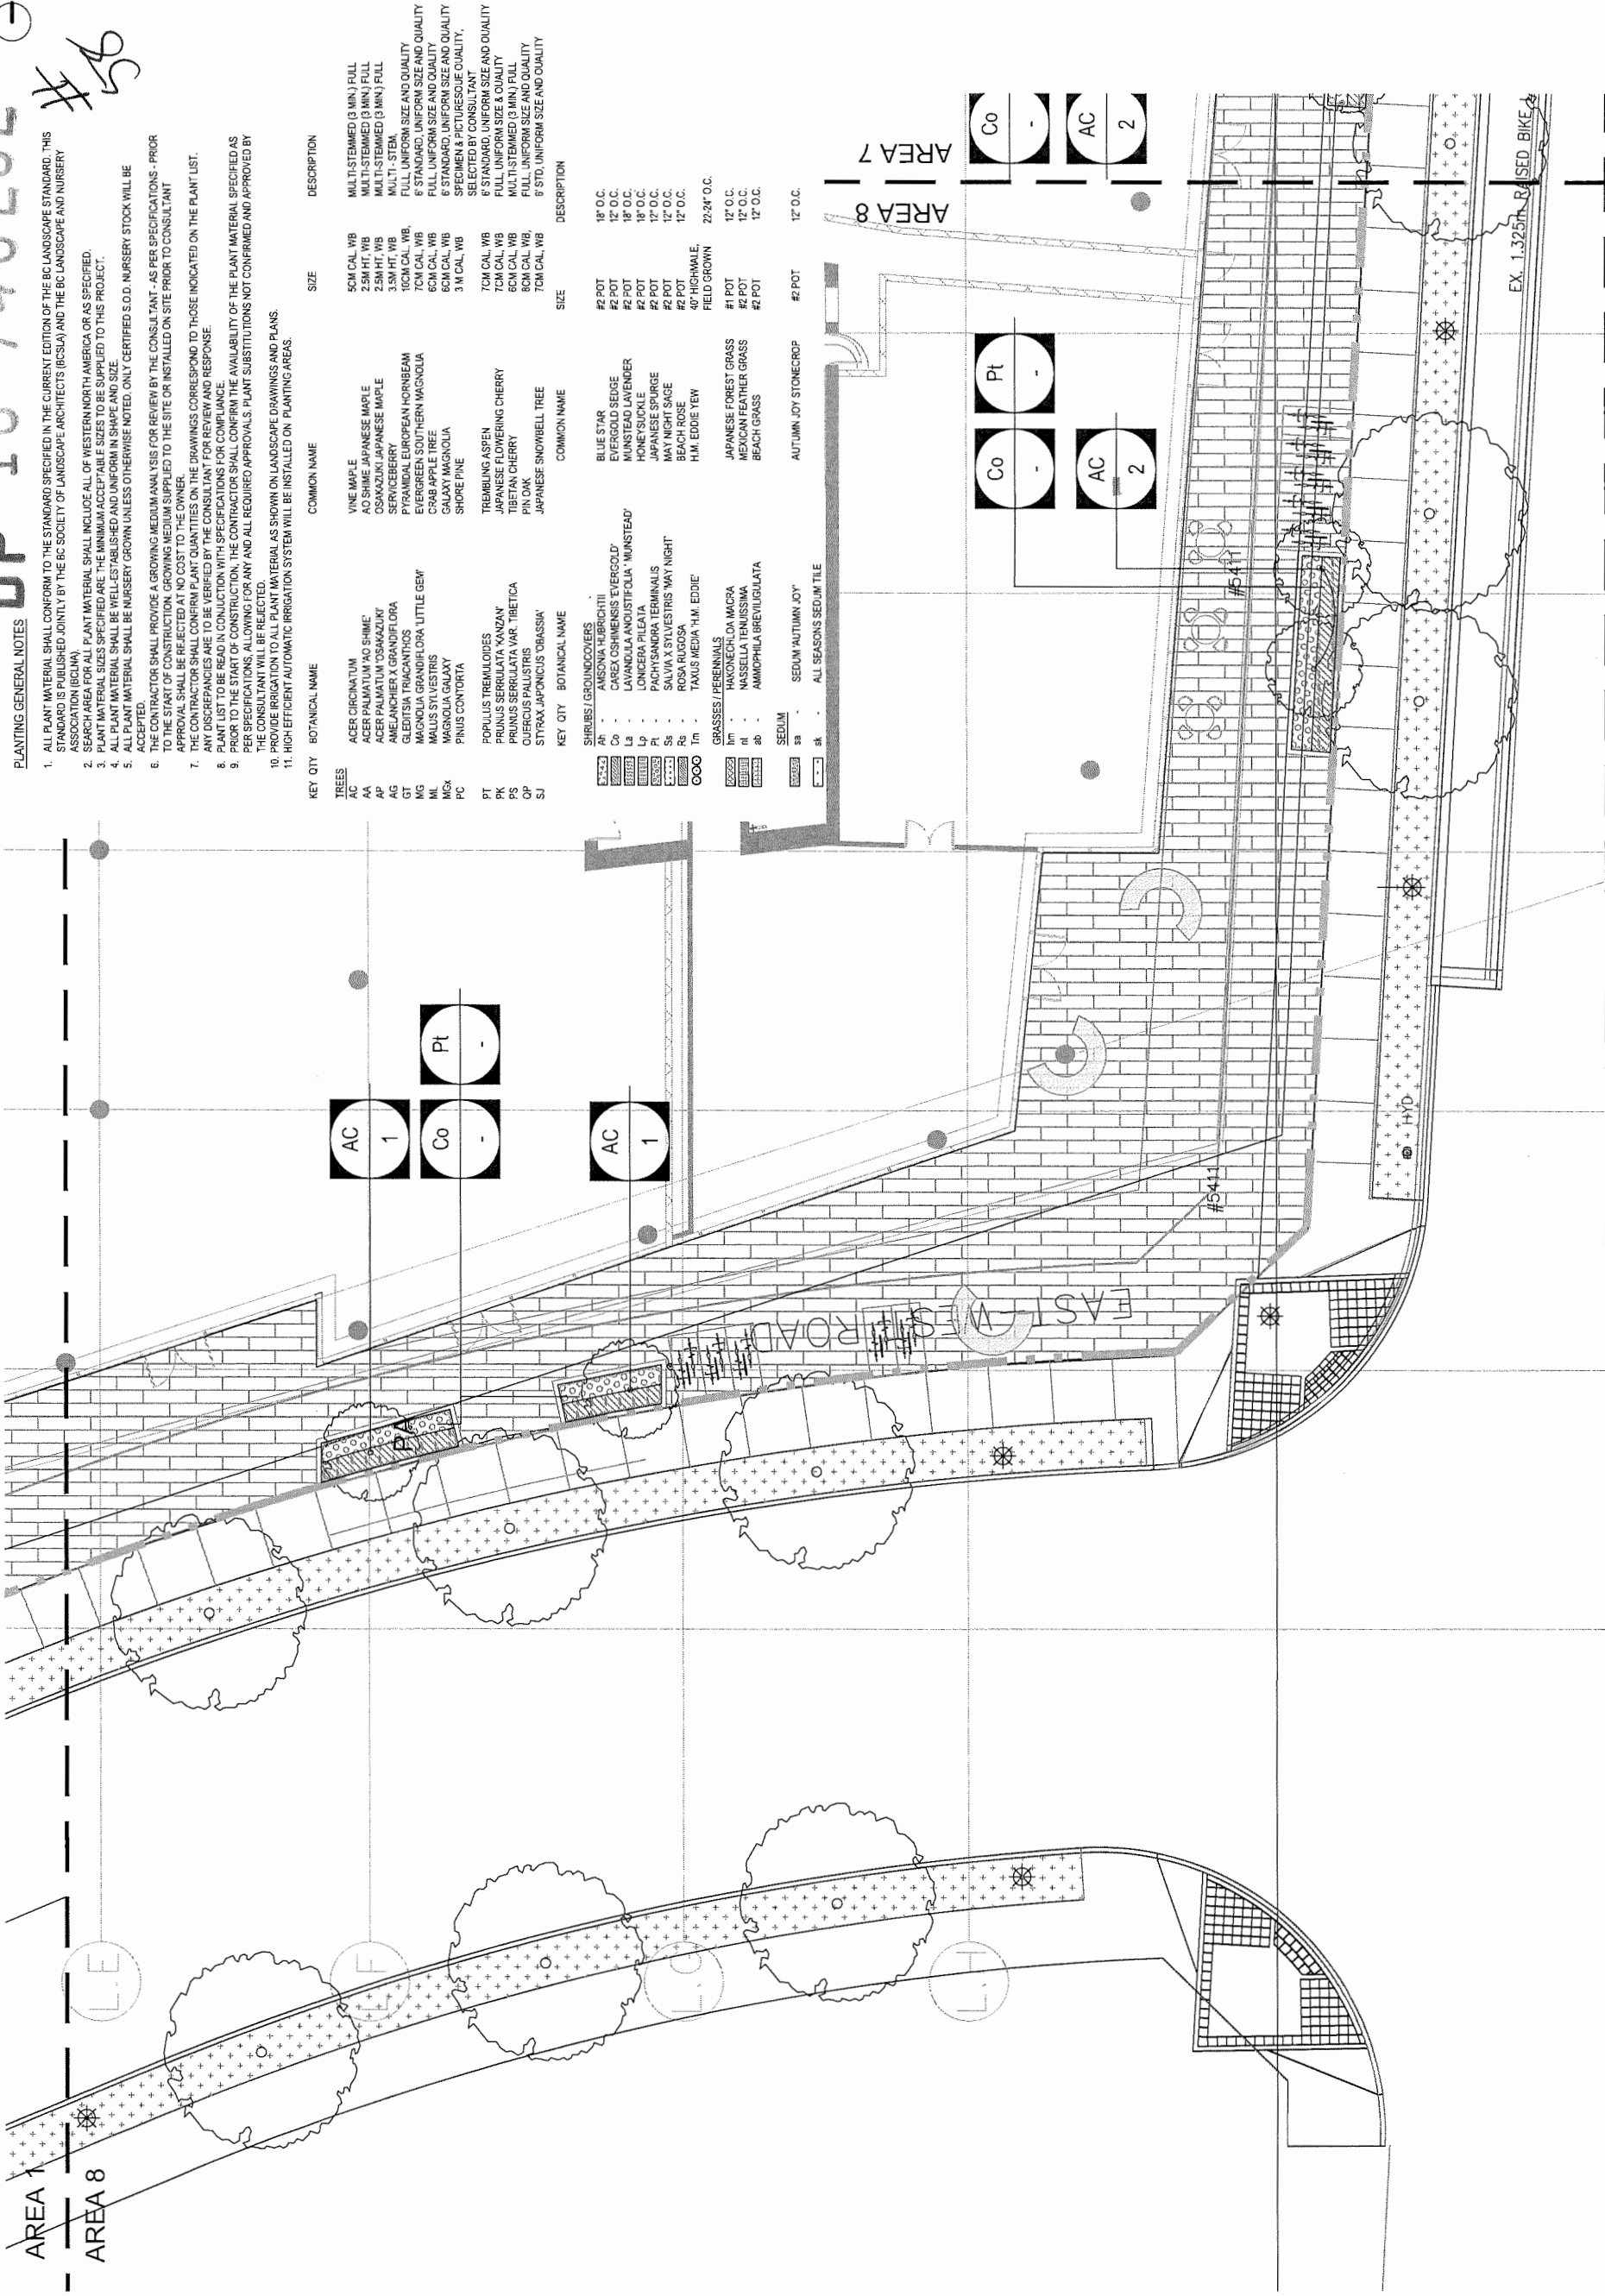


NO.	DATE	DESCRIPTION
1	2017-09-29	Issued for Rezoning
2	2017-11-14	Issued for Rezoning (Re-submission)
3	2017-11-14	Issued for OP (Re-submission)
4	2018-07-18	Reissued for OP
5	2018-08-31	OD 80%
6	2018-09-21	Reissued for OP
7	2018-10-09	Reissued for OP

7960 ALDERBRIDGE WAY

PLANTING PLAN
- GROUND LEVEL AREA 8

DATE	10/09/2018
DRAWN BY	MPILL
CHECKED BY	LL
SCALE	1/8" = 1'-0"
JOB NUMBER	17046

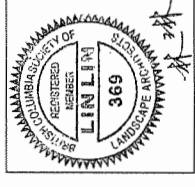


NO.	DATE	DESCRIPTION
1	2017-09-29	Issued for Reasoning
2	2017-11-14	Issued for Reasoning (Resubmission)
3	2017-11-14	Issued for DP
4	2018-07-18	DD 80%
5	2018-08-31	Released for DP
6	2018-09-21	Released for DP
7	2018-10-09	Released for DP

7960 ALDERBRIDGE WAY

**PLANTING PLAN - LEVEL 3
 OVERALL**

DATE	10/09/2016
DRAWN BY	MP/LL
CHECKED BY	LL
SCALE	1/32" = 1'-0"
JOB NUMBER	17046


DP 16-740262 #SA

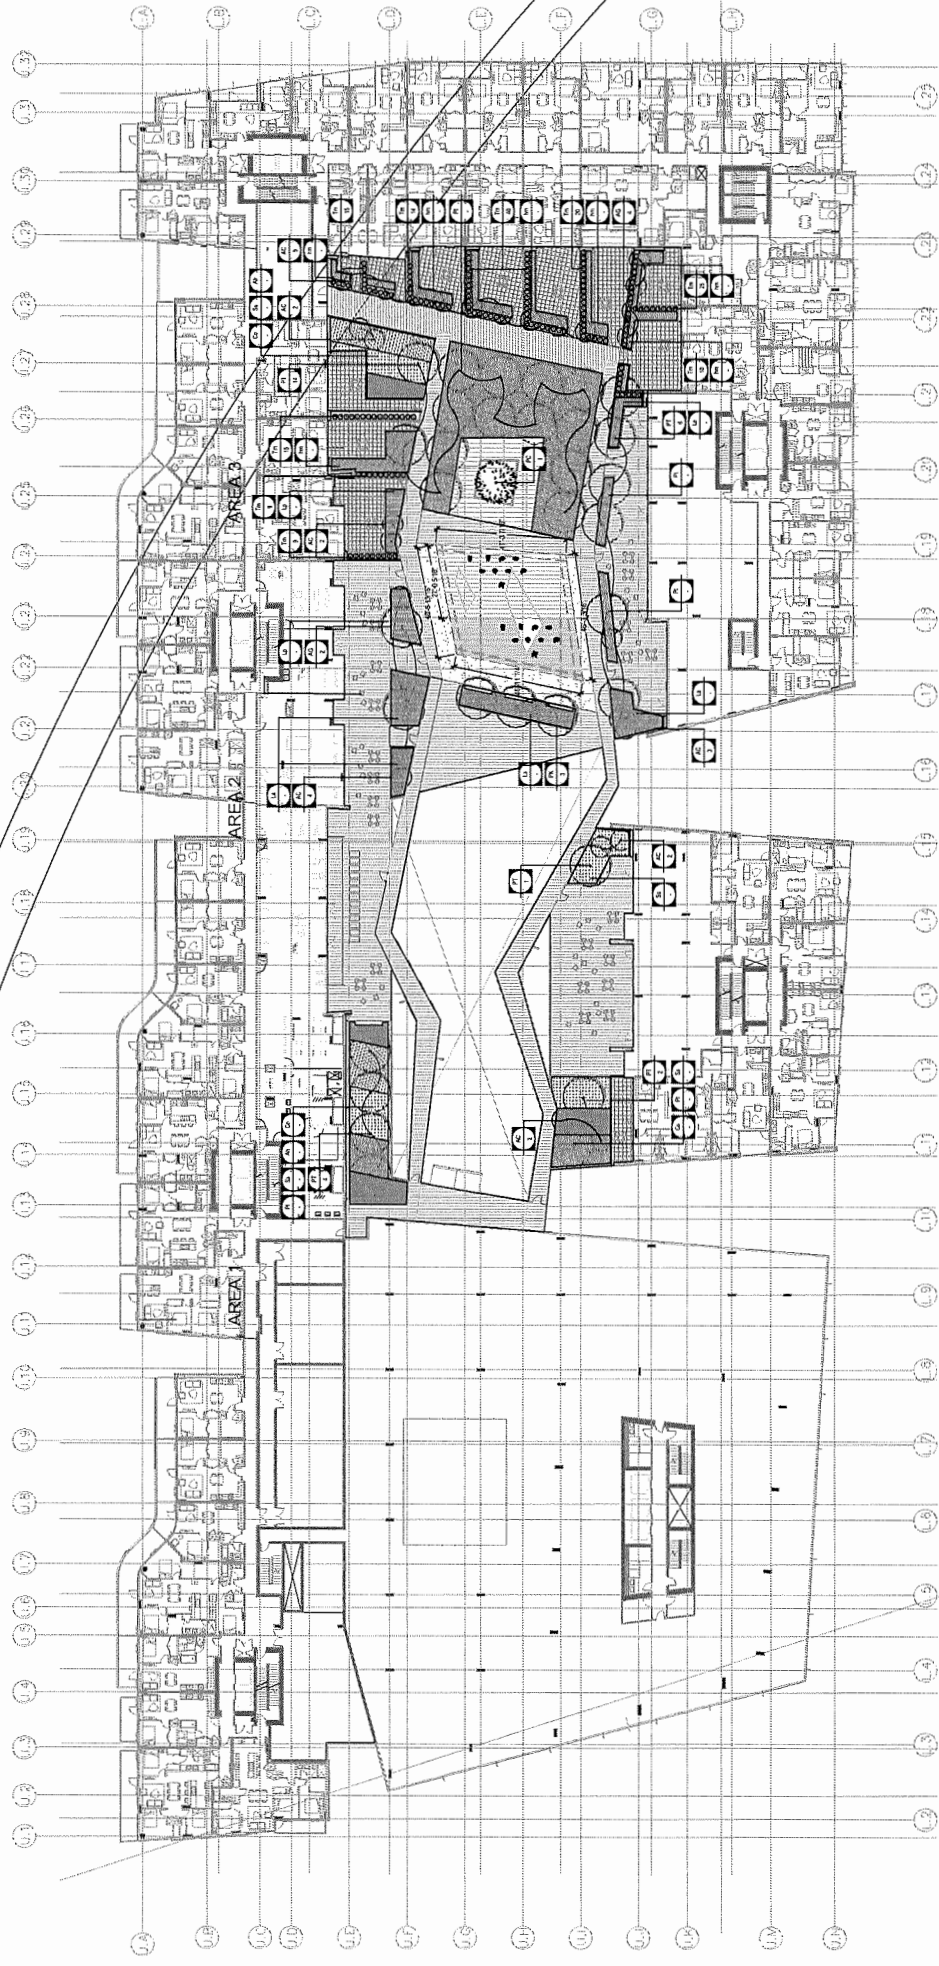

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KEY	OTY	BOTANICAL NAME	COMMON NAME	SIZE	DESCRIPTION	KEY	OTY	BOTANICAL NAME	COMMON NAME	SIZE	DESCRIPTION
AC	TREES	ACER CIRCINATUM	VINE MAPLE	5CM CAL. WB	MULTI-STEMMED (3 MIN.) FULL	AC	SHRUBS	ALBUCA HUBBARDII	BLUE STAR	#2 POT	18" O.C.
AA	TREES	ACER PALMATUM 'AO SHIME'	AO SHIME JAPANESE MAPLE	2.5M HT. WB	MULTI-STEMMED (3 MIN.) FULL	AA	SHRUBS	CAREX OSHIMENSIS EVERGOLD	EVERGOLD SEDGE	#2 POT	12" O.C.
AP	TREES	ACER PALMATUM 'OSAKAZUKI'	OSAKAZUKI JAPANESE MAPLE	2.5M HT. WB	MULTI-STEMMED (3 MIN.) FULL	AP	SHRUBS	LAVANDULA ANOSTIFOLIA 'MUNSTEAD'	MUNSTEAD LAVENDER	#2 POT	18" O.C.
AG	TREES	AMELANOCHER X GRANDIFLORA	SERVICEBERRY	3.5M HT. WB	MULTI-STEMMED (3 MIN.) FULL	AG	SHRUBS	LONGICERA PILEATA	HONEY SUCKLE	#2 POT	18" O.C.
GT	TREES	GLEDITSIA TRICANTHOS	PYRAMIDAL EUROPEAN HORNBEEAM	10CM CAL. WB	FULL, UNIFORM SIZE AND QUALITY	GT	SHRUBS	PACHYSAUNDRA TERMINALIS	JAPANESE SPIRGE	#2 POT	12" O.C.
MG	TREES	MAGNOLIA GRANDIFLORA 'LITTLE GEM'	EVERGREEN SOUTHERN MAGNOLIA	7CM CAL. WB	FULL, UNIFORM SIZE AND QUALITY	MG	SHRUBS	SALVIA X SYLVESTRIS 'MAY NIGHT'	MAY NIGHT SAGE	#2 POT	12" O.C.
ML	TREES	MALUS SYLVESTRIS	CRAB APPLE TREE	6CM CAL. WB	FULL, UNIFORM SIZE AND QUALITY	ML	SHRUBS	ROSA RUGOSA	BEACH ROSE	#2 POT	12" O.C.
MS	TREES	MAGNOLIA GALAXY	GALAXY MAGNOLIA	6CM CAL. WB	FULL, UNIFORM SIZE AND QUALITY	MS	SHRUBS	TAXUS MEDIA 'H.M. EDDIE'	H.M. EDDIE YEW	40" HIGH-MALE, FIELD GROWN	22-24" O.C.
PC	TREES	PINUS CONTOUR	SHORE PINE	3 M CAL. WB	SPECIMEN & PICTUREQUE QUALITY, SELECTED BY CONSULTANT	PC	GRASSES	PERENNIALS	JAPANESE FOREST GRASS	#1 POT	12" O.C.
PT	TREES	POPULUS TREMULOIDES	TREMULING ASPEN	7CM CAL. WB	FULL, UNIFORM SIZE AND QUALITY	PT	GRASSES	HAKONECHLOA MACRA	MEXICAN FEATHER GRASS	#2 POT	12" O.C.
PK	TREES	PRUNUS AUSTRIACA	SWEEPING CHERRY	8CM CAL. WB	FULL, UNIFORM SIZE AND QUALITY	PK	GRASSES	MASSELLA TENUISSIMA	BEACH GRASS	#2 POT	12" O.C.
PC	TREES	PRUNUS SEROTINA VAR. TIBETICA	TIBETAN CHERRY	8CM CAL. WB	FULL, UNIFORM SIZE AND QUALITY	PC	GRASSES	ANMOPIHILA BREVILOGLATA	AUTUMN JOY STONECROP	#2 POT	12" O.C.
CP	TREES	QUERCUS PALustris	PINOAK	7CM CAL. WB	FULL, UNIFORM SIZE AND QUALITY	CP	SEDUM	SEDUM 'AUTUMN JOY'			
SJ	TREES	STYRAX JAPONICUS 'OBASSA'	JAPANESE SNOWBELL TREE	7CM CAL. WB	FULL, UNIFORM SIZE AND QUALITY	SJ	SEDUM	ALL SEASONS SEDUM TILE			




NO.	DATE	DESCRIPTION
1	2017-09-29	Issued for Rezoning
2	2017-11-14	Issued for Rezoning (Resubmission)
3	2017-11-14	Issued for DP
4	2018-07-18	Released for DP
5	2018-08-31	DD: 80%
6	2018-09-21	Released for DP
7	2018-10-09	Released for DP

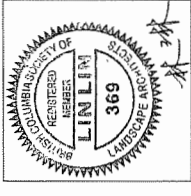7960 ALDERBRIDGE WAY

PLANTING PLAN - LEVEL 3
AREA 1

DATE	10/09/2018
DRAWN BY	MPILL
CHECKED BY	LL
SCALE	1/8" = 1'-0"
JOB NUMBER	17046

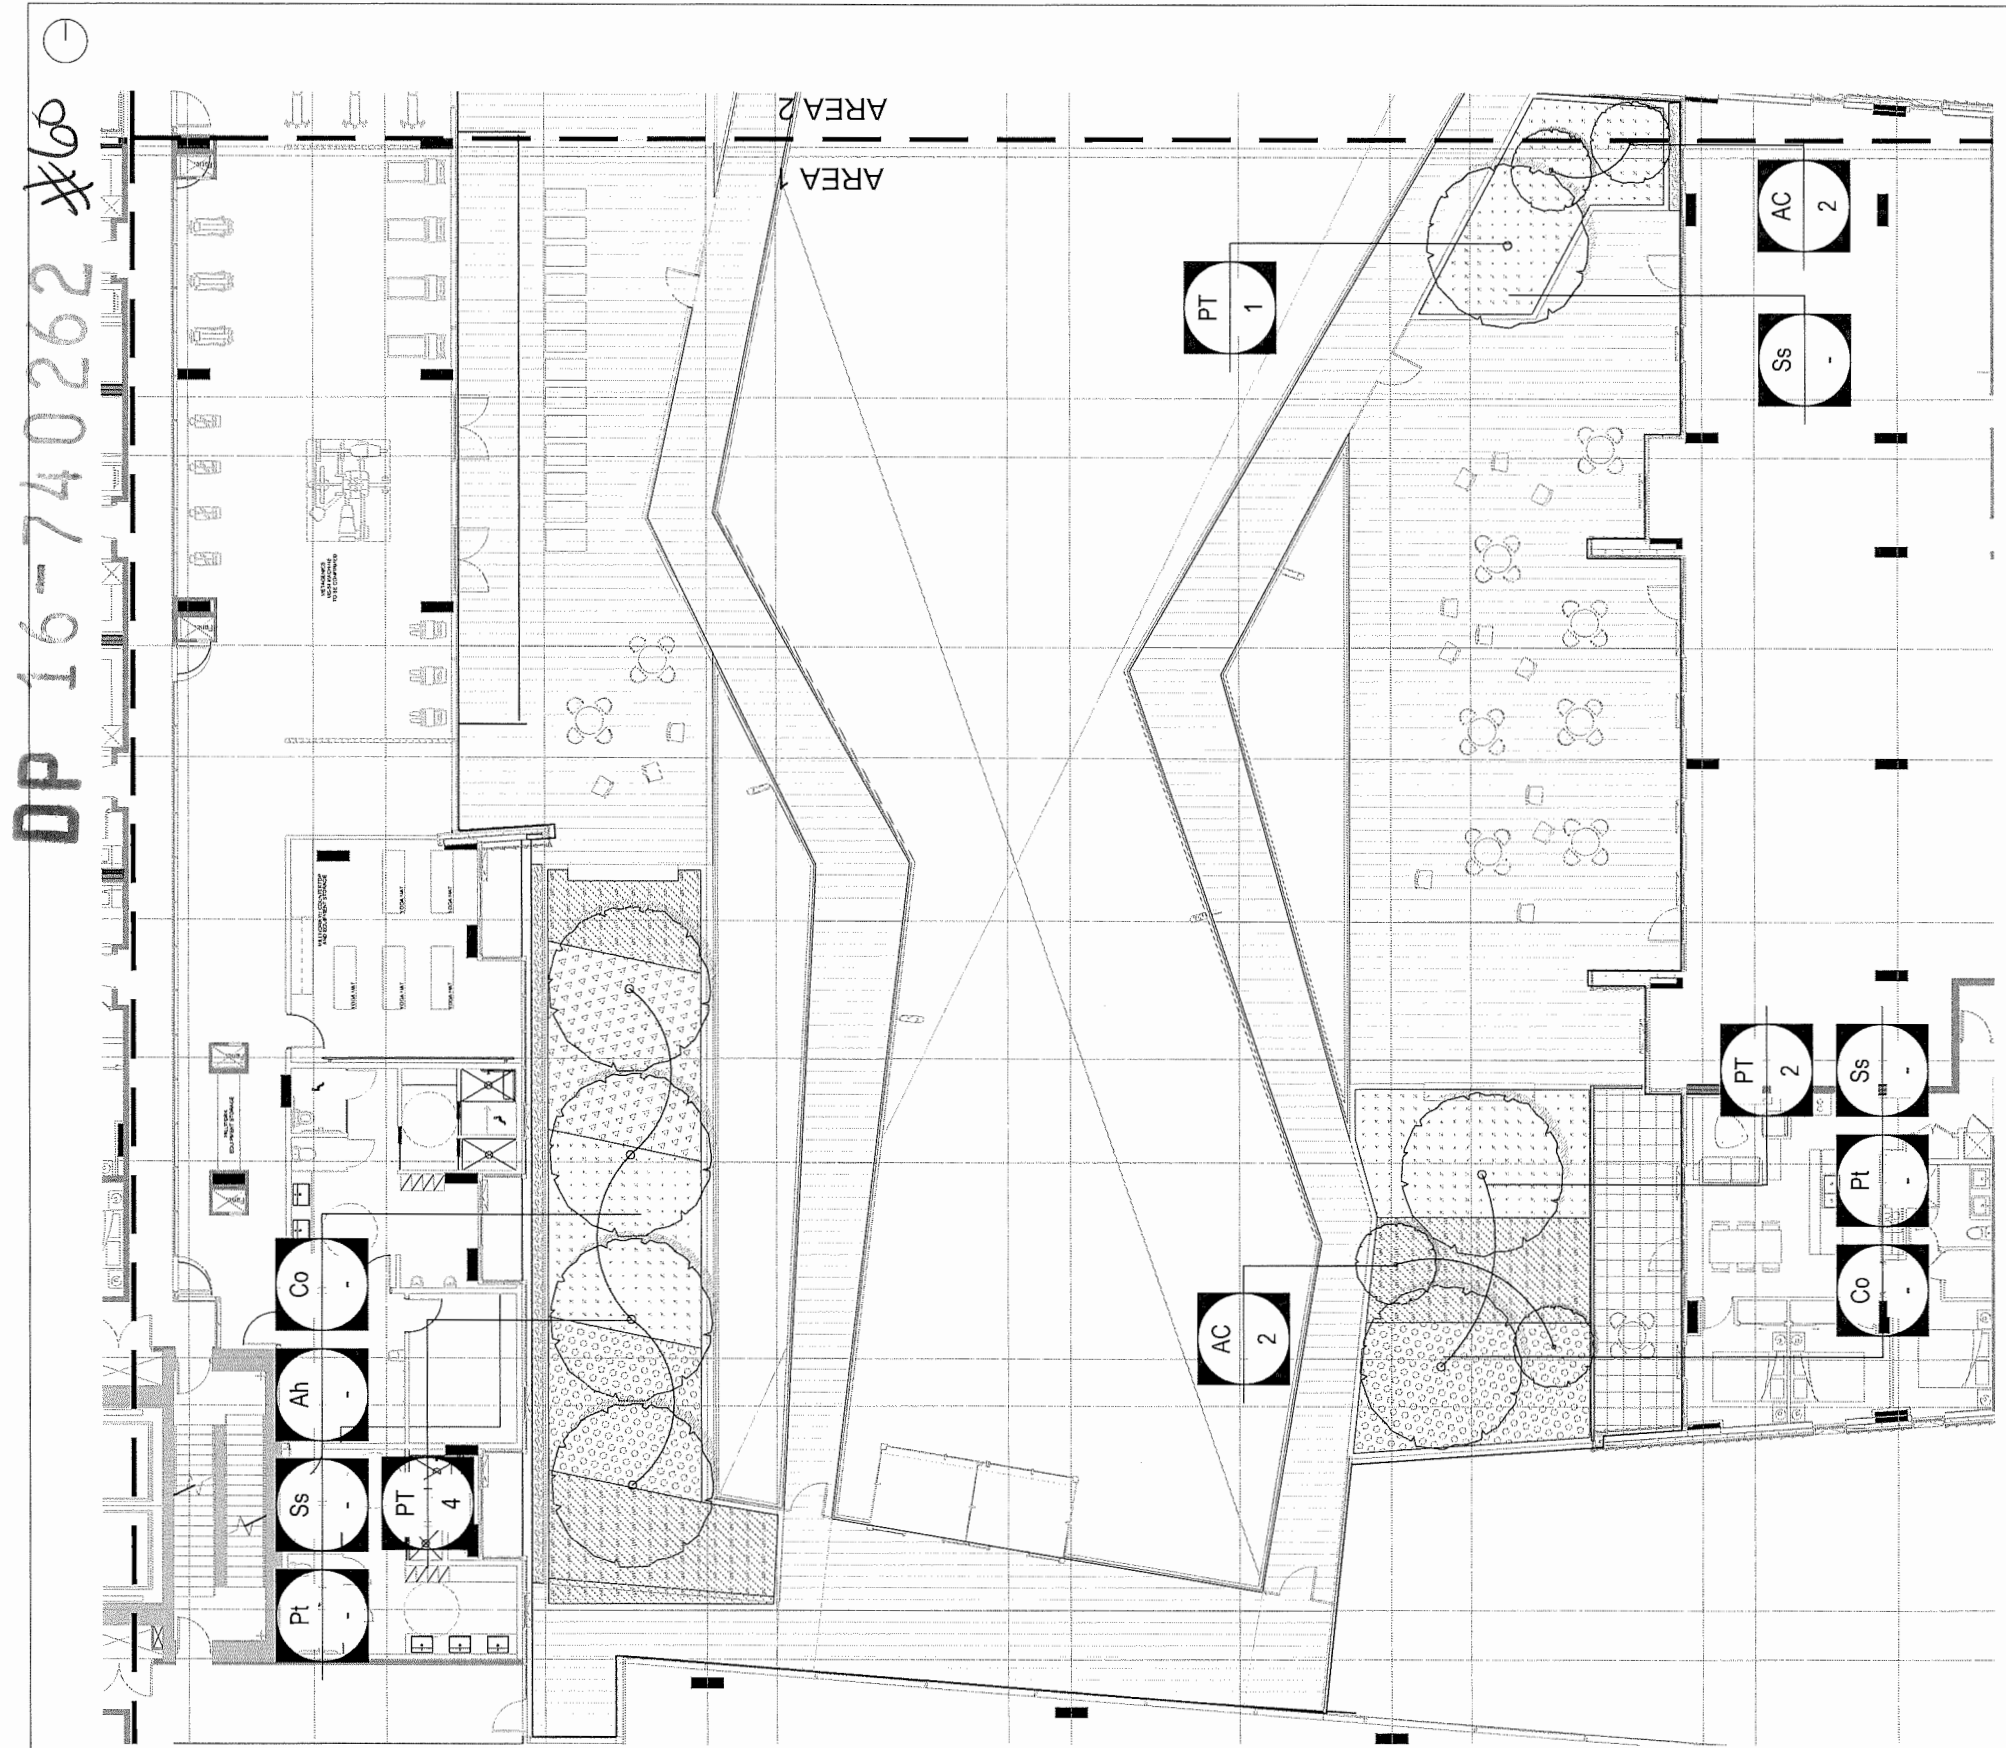

KEY	QTY	BOTANICAL NAME	COMMON NAME	SIZE	DESCRIPTION
TREES					
AC	50M CAL. WB	VINE MAPLE	MULTI-STEMMED (3 MIN.) FULL		
AP	2.5M HT. WB	AO SHAME JAPANESE MAPLE	MULTI-STEMMED (3 MIN.) FULL		
AG	3.5M HT. WB	OSAKAZUKI JAPANESE MAPLE	MULTI-STEMMED (3 MIN.) FULL		
GT	10CM CAL. WB.	SERVICEBERRY	MULTI-STEMMED		
MG	70M CAL. WB	PYRAMIDAL EUROPEAN HORNBEEAM	FULL, UNIFORM SIZE AND QUALITY		
ML	60M CAL. WB	EVERGREEN SOUTHERN MAGNOLIA	FULL, UNIFORM SIZE AND QUALITY		
MGX	60M CAL. WB	CRAB APPLE TREE	FULL, UNIFORM SIZE AND QUALITY		
PC	3M CAL. WB	GALAXY MAGNOLIA	6 STANDARD, UNIFORM SIZE AND QUALITY SPECIMEN & PICTURESQUE QUALITY, SELECTED BY CONSULTANT		
PT	70M CAL. WB	TREMBLING ASPEN	6 STANDARD, UNIFORM SIZE AND QUALITY		
PK	70M CAL. WB	JAPANESE FLOWERING CHERRY	6 STANDARD, UNIFORM SIZE AND QUALITY		
PS	60M CAL. WB	TIBETAN CHERRY	FULL, UNIFORM SIZE & QUALITY		
GP	60M CAL. WB	PIRENA CHERRY	FULL, UNIFORM SIZE & QUALITY		
SJ	70M CAL. WB	JAPANESE SNOWBELL TREE	6 STD, UNIFORM SIZE AND QUALITY		

KEY	QTY	BOTANICAL NAME	COMMON NAME	SIZE	DESCRIPTION
SHRUBS / GROUNDCOVERS					
Ah	18" O.C.	BLUE STAR	18" O.C.		
Co	#2 POT	EVERGOLD SEDGE	12" O.C.		
La	#2 POT	MUNSTEAD LAVENDER	18" O.C.		
Lp	#2 POT	HONEYBUCKLE	18" O.C.		
Pt	#2 POT	JAPANESE SPURGE	12" O.C.		
Ss	#2 POT	RAY SPURGE	12" O.C.		
St	#2 POT	8M ANEMONE	12" O.C.		
Tm	40" HIGH MALE	H.M. EDIE YEW	22.5M O.C.		
Grasses / Perennials					
Gr	#1 POT	JAPANESE FOREST GRASS	12" O.C.		
M	#2 POT	MEXICAN FEATHER GRASS	12" O.C.		
B	#2 POT	BEACH GRASS	12" O.C.		
Sedum					
Sa	#2 POT	AUTUMN JOY STONECROP	12" O.C.		
Sk		ALL SEASONS SEDUM TILE			

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DP 16-740262 #61



GBL ARCHITECTS INC.
139 EAST 8TH AVENUE
VANCOUVER, BC CANADA V6T 1R8
TEL: 604 236 1156
FAX: 604 231 8279

LANDSCAPE ARCHITECTS INC. (L.A.S.)
REGISTERED PROFESSIONAL LANDSCAPE ARCHITECTS
REGISTERED PROFESSIONAL ARCHITECTS



PFS STUDIO
PLANNING • URBAN DESIGN • LANDSCAPE ARCHITECTURE




NOTES

KEY CITY	BOTANICAL NAME	COMMON NAME	SIZE	DESCRIPTION
TR	ACER GRCINATUM	VINE MAPLE	50M CAL. WB	MULTI-STEAMED (3 MIN.) FULL
TR	ACER PALMATUM 'KID SHINE'	AD SHINE JAPANESE MAPLE	2.5M HT. WB	MULTI-STEAMED (3 MIN.) FULL
TR	ACER PALMATUM 'OSAZUKI'	OSAZUKI JAPANESE MAPLE	2.5M HT. WB	MULTI-STEAMED (3 MIN.) FULL
TR	AME ANCHER X GRANDIFLORA	SERVICEBERRY	3.5M HT. WB	MULTI-STEM
TR	GLEDTSA TRICANTHOS	PYRAMIDAL EUROPEAN HORNBEEAM	100M CAL. WB.	FULL, UNIFORM SIZE AND QUALITY
TR	MAGNOLIA GRANDIFLORA 'LITTLE GEM'	EVERGREEN SOUTHERN MAGNOLIA	70M CAL. WB	6' STANDARD, UNIFORM SIZE AND QUALITY
TR	MALLUS SYLVESTRIS	CRAB APPLE TREE	80M CAL. WB	FULL, UNIFORM SIZE AND QUALITY
TR	MAGNOLIA GALAXY	GALAXY MAGNOLIA	80M CAL. WB	6' STANDARD, UNIFORM SIZE AND QUALITY
TR	PNUS CONTORTA	SHORE PINE	3M CAL. WB	SELECTED BY CONSULTANT
TR	POPULUS TREMULOIDES	TREBUKING ASPEN	70M CAL. WB	FULL, UNIFORM SIZE AND QUALITY
TR	PRUNUS SEROTINA 'MAYNAN'	JAPANESE PINKER CHERRY	70M CAL. WB	FULL, UNIFORM SIZE AND QUALITY
TR	PRUNUS SEROTINA 'WAR. TIBETICA'	TIBETAN CHERRY	80M CAL. WB	FULL, UNIFORM SIZE AND QUALITY
TR	QUERCUS PALUSTRIS	PIN OAK	80M CAL. WB	FULL, UNIFORM SIZE AND QUALITY
TR	STYRAX JAPONICUS 'OBASSIA'	JAPANESE SNOWBELL TREE	70M CAL. WB	6' STD. UNIFORM SIZE AND QUALITY
SH	ARISAEMA VILBICHTII	BLUE STAR	#2 POT	18" O.C.
SH	CAREX OSHIMENSIS 'EVERGOLD'	EVERGOLD SEDGE	#2 POT	12" O.C.
SH	LAVANDULA ANGIUSTIFOLIA 'MUNSTEAD'	MUNSTEAD LAVENDER	#2 POT	18" O.C.
SH	LONGICHA PILEATA	HONEY/SUCKLE	#2 POT	18" O.C.
SH	PACHYSANDRA TERMINALIS	JAPANESE SPURGE	#2 POT	12" O.C.
SH	SALVIA X SYLVESTRIS 'MAY NIGHT'	MAY NIGHT SAGE	#2 POT	12" O.C.
SH	ROSA RUGOSA	BEACH ROSE	#2 POT	12" O.C.
SH	TAXUS MEDIA 'H.M. EDDIE'	H.M. EDDIE YEW	40" HIGH-MALE, FIELD GROWN	22'24" O.C.
GR	HAKONCHLOA MACRA	JAPANESE FOREST GRASS	#1 POT	12" O.C.
GR	MASSILLA TENUISSIMA	MEXICAN FEATHER GRASS	#2 POT	12" O.C.
GR	AMMOPHILA BREVILOGLATA	BEACH GRASS	#2 POT	12" O.C.
SED	SEDUM 'AUTUMN JOY'	AUTUMN JOY STONECROP	#2 POT	12" O.C.
SED	ALL SEASONS SEDUM TILE			

PLANTING GENERAL NOTES

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- PLANT MATERIAL SIZES SPECIFIED ARE THE MINIMUM ACCEPTABLE SIZES TO BE SUPPLIED TO THIS PROJECT.
- ALL PLANT MATERIAL SHALL BE WELL-ESTABLISHED AND UNIFORM IN SHAPE AND SIZE.
- ALL PLANT MATERIAL SHALL BE NURSERY GROWN UNLESS OTHERWISE NOTED. ONLY CERTIFIED S.O.D. NURSERY STOCK WILL BE ACCEPTED.
- THE CONTRACTOR SHALL PROVIDE A GROWING MEDIUM ANALYSIS FOR REVIEW BY THE CONSULTANT - AS PER SPECIFICATIONS - PRIOR TO THE START OF CONSTRUCTION. GROWING MEDIUM SUPPLIED TO THE SITE OR INSTALLED ON SITE PRIOR TO CONSULTANT APPROVAL SHALL BE REJECTED AND TO BE REPLACED WITH THE CORRECT MEDIUM. THE CONTRACTOR SHALL BE RESPONSIBLE FOR THE COST OF THIS ANALYSIS AND FOR THE COST OF ANY DISCREPANCIES ARE TO BE VERIFIED BY THE CONSULTANT FOR REVIEW AND RESPONSE.
- PLANT LIST TO BE READ IN CONJUNCTION WITH SPECIFICATIONS FOR COMPLIANCE.
- PRIOR TO THE START OF CONSTRUCTION, THE CONTRACTOR SHALL CONFIRM THE AVAILABILITY OF THE PLANT MATERIAL SPECIFIED AS PER SPECIFICATIONS, ALLOWING FOR ANY AND ALL REQUIRED APPROVALS. PLANT SUBSTITUTIONS NOT CONFIRMED AND APPROVED BY THE CONSULTANT WILL BE REJECTED.
- PROVIDE IRRIGATION TO ALL PLANT MATERIAL AS SHOWN ON LANDSCAPE DRAWINGS AND P.LANS.
- HIGH EFFICIENT AUTOMATIC IRRIGATION SYSTEM WILL BE INSTALLED ON PLANTING AREAS.

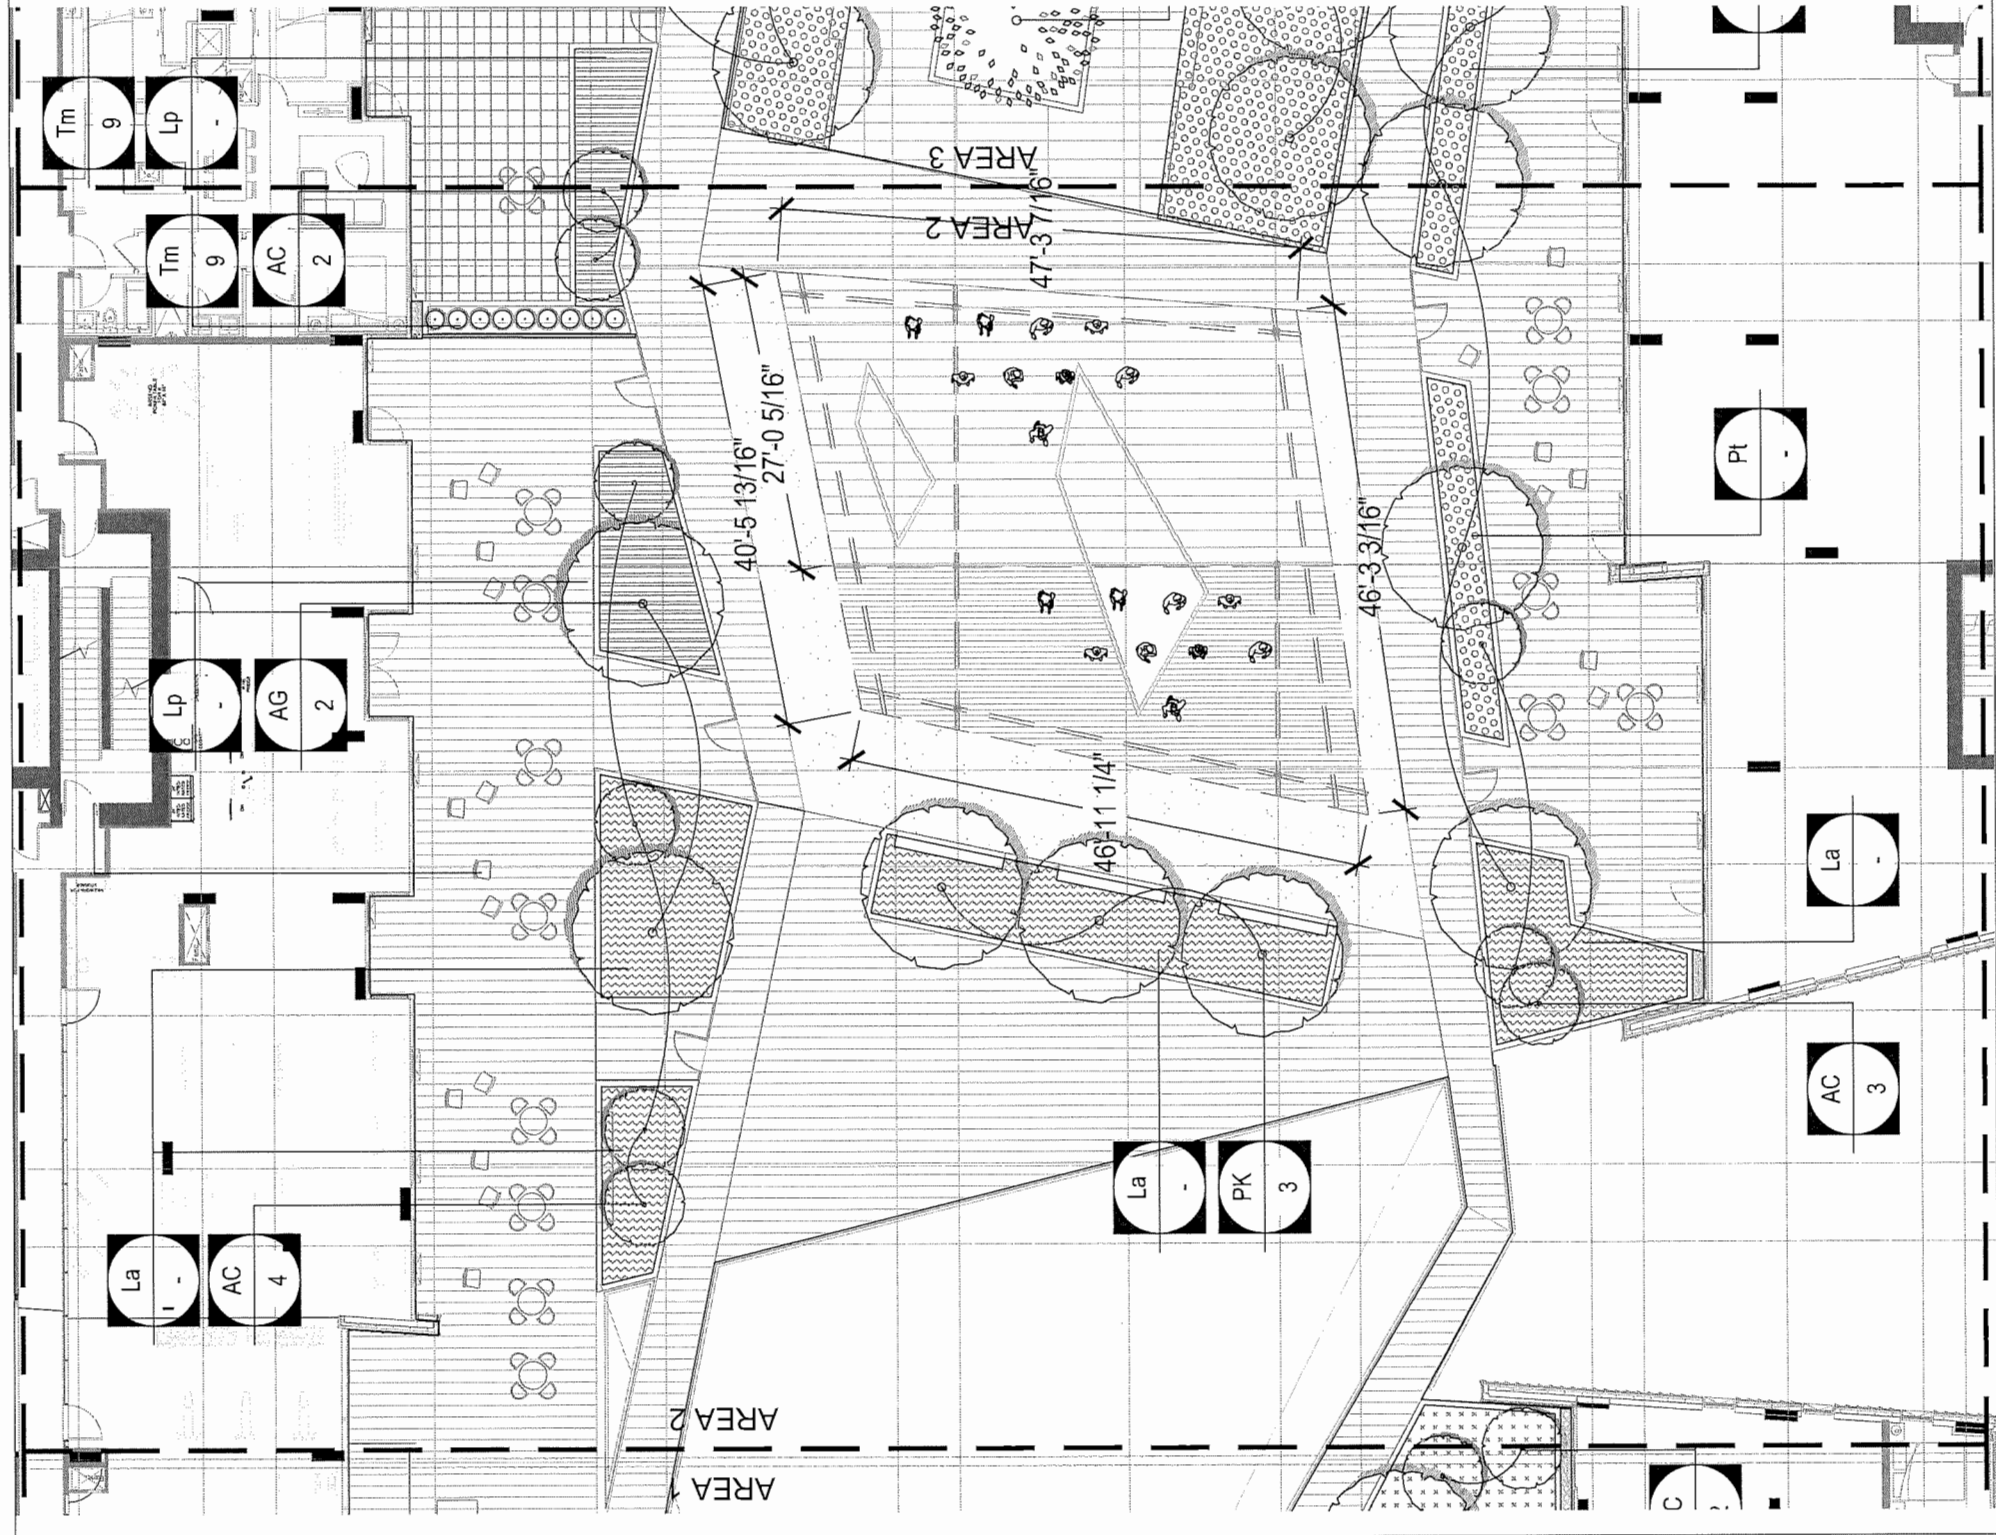

REVISIONS

NO.	DATE	DESCRIPTION
1	2017-09-29	Issued for Rezoning
2	2017-11-14	Issued for Rezoning (Resubmission)
3	2017-11-14	Issued for DP
4	2018-07-18	Reissued for OP
5	2018-08-31	DD 80%
6	2018-09-21	Reissued for DP
7	2018-10-09	Reissued for OP

7960 ALDERBRIDGE WAY

PLANTING PLAN - LEVEL 3
AREA 2

DATE: 10/09/2018
DRAWN BY: MP/LL
CHECKED BY: LL
SCALE: 1/8" = 1'-0"
JOB NUMBER: 17046

L4.11

DP 16-740262 #62




gbl ARCHITECTS INC.
139 EAST 8TH AVENUE
VANCOUVER, BC CANADA V6T 1R8
TEL: 604 736 1156
FAX: 604 731 8279

CONTRACT NUMBER: 7960 ALDERBRIDGE WAY
DATE: 10/09/2018

NOTES



PFS STUDIO
PLANNING - URBAN DESIGN - LANDSCAPE ARCHITECTURE

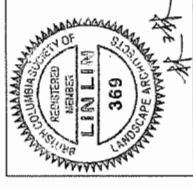

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7960 ALDERBRIDGE WAY

PLANTING PLAN - LEVEL 3
AREA 3

DATE: 10/09/2018
DRAWN BY: MP/LL
CHECKED BY: LL
SCALE: 1/8" = 1'-0"
JOB NUMBER: 17046


L4.12

KEY CITY	BOTANICAL NAME	COMMON NAME	SIZE	DESCRIPTION
TREES	ACER PALMATUM	VINE MAPLE	5CM CAL. WB	MULTI-STEMMED (3 MIN.) FULL
AA	ACER PALMATUM 'AD SHIME'	AD SHIME JAPANESE MAPLE	2.5M HT. WB	MULTI-STEMMED (3 MIN.) FULL
AP	ACER PALMATUM 'OSAKAZUKI'	OSAKAZUKI JAPANESE MAPLE	2.5M HT. WB	MULTI-STEMMED (3 MIN.) FULL
AG	AMELANCHIER X GRANDIFLORA	SERVICEBERRY	3.5M HT. WB	MULTI - STEM
GT	GLEDITSIA TRACANTHOS	PYRAMIDAL EUROPEAN HORNBREAM	10CM CAL. WB	FULL UNIFORM SIZE AND QUALITY
MG	MAGNOLIA GRANDIFLORA 'LITTLE GEM'	EVERGREEN SOUTHERN MAGNOLIA	6CM CAL. WB	FULL UNIFORM SIZE AND QUALITY
ML	MALUS SYLVESTRIS	CRAB APPLE TREE	6CM CAL. WB	FULL UNIFORM SIZE AND QUALITY
NG	MAGNOLIA GALAXY	GALAXY MAGNOLIA	6CM CAL. WB	FULL UNIFORM SIZE AND QUALITY
PC	PINUS CONTORTA	SHORE PINE	3 M CAL. WB	SPECIMEN & PICTURE QUALITY
PT	POPULUS TREMULOIDES	TREMBLING ASPEN	7CM CAL. WB	FULL UNIFORM SIZE AND QUALITY
PK	PRUNUS SEROTINATA 'KANZAN'	JAPANESE FLOWERING CHERRY	7CM CAL. WB	FULL UNIFORM SIZE AND QUALITY
PS	PRUNUS SEROTINATA VAR. 'TIBETICA'	TIBETAN CHERRY	7CM CAL. WB	FULL UNIFORM SIZE AND QUALITY
CP	QUERCUS PALAUSTRIS	PIN OAK	8CM CAL. WB	FULL UNIFORM SIZE AND QUALITY
SJ	STYRAX JAPONICUS 'OBASSIA'	JAPANESE SNOWBELL TREE	7CM CAL. WB	6" STD. UNIFORM SIZE AND QUALITY

KEY CITY	BOTANICAL NAME	COMMON NAME	SIZE	DESCRIPTION
SHRUBS / GROUNDCOVERS	AMSONIA HUBBICHTII	BLUE STAR	#2 POT	18" O.C.
Co	CAREX OSHIMENSIS 'EVERGOLD'	EVERGOLD SEDGE	#2 POT	12" O.C.
La	LAVANDULA ANGLUSTIFOLIA 'MAINSTEAD'	MAINSTEAD LAVENDER	#2 POT	12" O.C.
Lp	LONICERA FLEATA	HONEYSUCKLE	#2 POT	12" O.C.
Pt	PACHYSANDRA TERMINALIS	JAPANESE SPURGE	#2 POT	12" O.C.
Ss	SALVIA X SYLVESTRIS 'WAY NIGHT'	WAY NIGHT SAGE	#2 POT	12" O.C.
Rs	ROSA RUGOSA	BEACH ROSE	#2 POT	12" O.C.
Tm	TAXUS MEDIA 'H.M. EDDIE'	'H.M. EDDIE' TEN	#2 POT	12" O.C.
GRASSES / PERENNIALS	HAKONECHOLO MACRA	JAPANESE FOREST GRASS	#1 POT	12" O.C.
hm	MASSELLA TENJISSIMA	MEXICAN FEATHER GRASS	#2 POT	12" O.C.
ab	AMMOPHILA BREVILOQUATA	BEACH GRASS	#2 POT	12" O.C.
SEDUM	SEDUM AUTUMN JOY	AUTUMN JOY STONECROP	#2 POT	12" O.C.
sk	ALL SEASONS SEDUM TILE			


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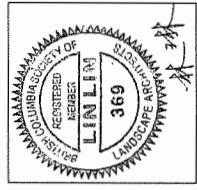
#63

DP 16-740262

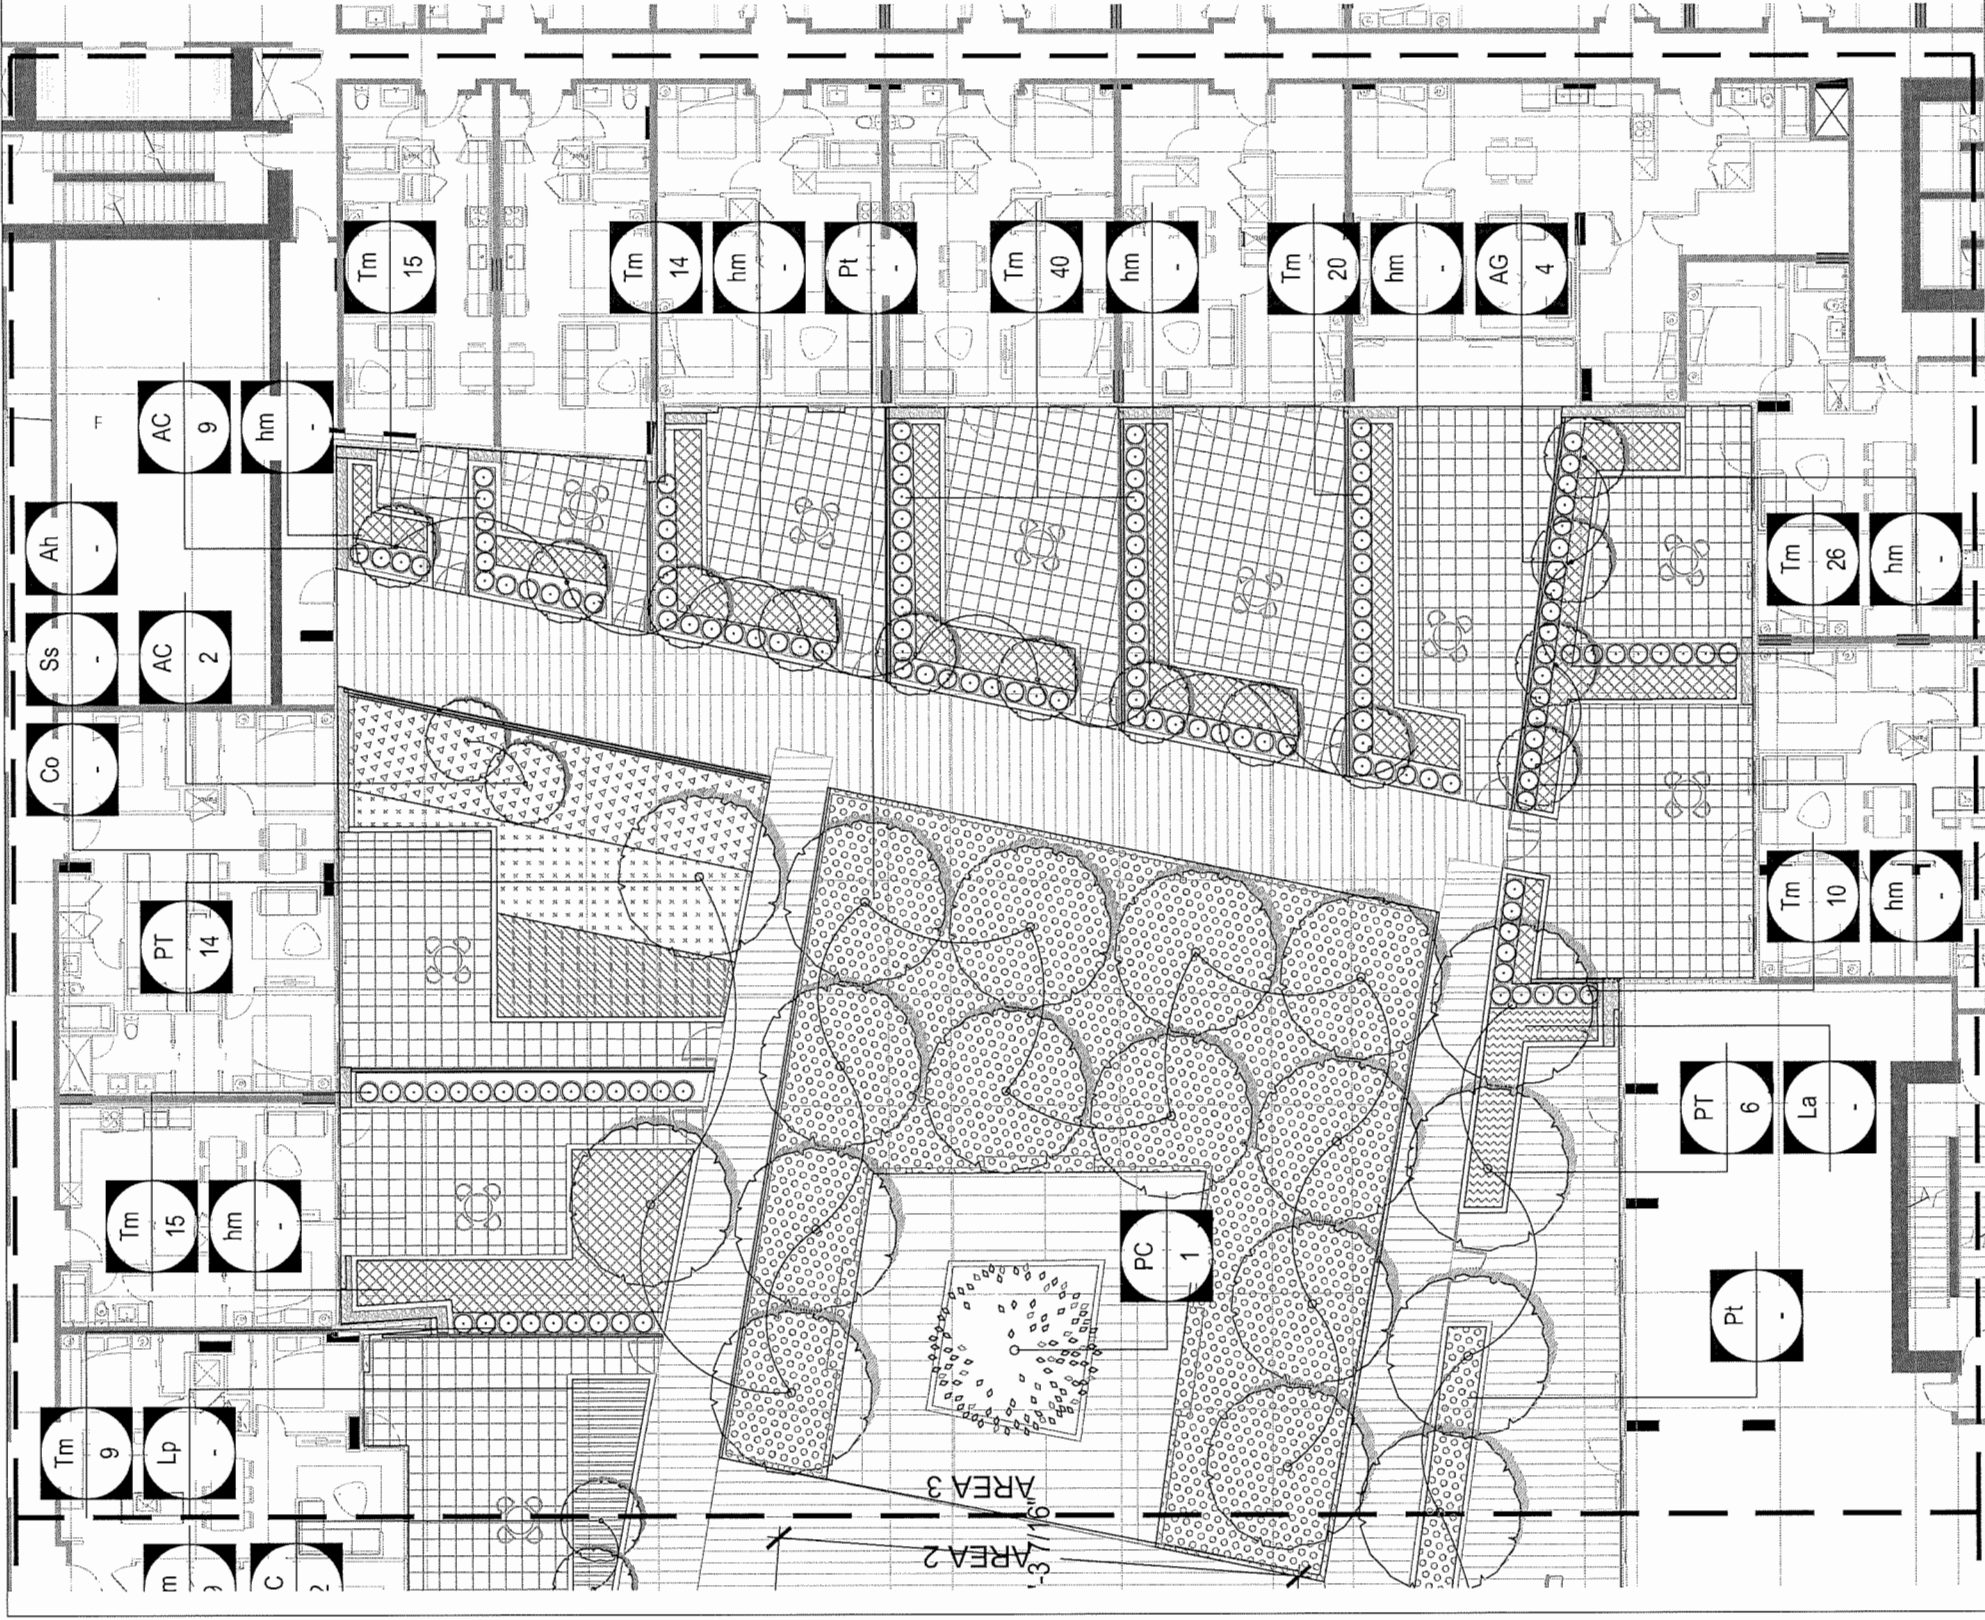

gbl ARCHITECTS INC.
138 EAST 7TH AVENUE
VANCOUVER, BC CANADA V6T 1R8
TEL: 604 738 1158
FAX: 604 731 9279
DISCLAIMER: THIS PLAN AND SPECIFICATIONS ARE PREPARED BY GBL ARCHITECTS INC. AND MAY NOT BE USED OR REPRODUCED WITHOUT THEIR WRITTEN CONSENT.

PFS STUDIO
PLANNING • URBAN DESIGN • LANDSCAPE ARCHITECTURE

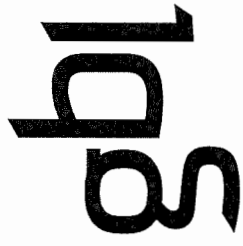


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7960 ALDERBRIDGE WAY

PLANTING PLAN
- LEVEL 6 OVERALL


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DRAWN BY: MP/LL
CHECKED BY: LL
SCALE: 1/32" = 1'-0"
JOB NUMBER: 17046



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KEY QTY	BOTANICAL NAME	DESCRIPTION	SIZE	COMMON NAME	KEY QTY	BOTANICAL NAME	COMMON NAME	SIZE	DESCRIPTION
100	ACER CIRCINATUM	6" STANDARD, UNIFORM SIZE AND QUALITY	6" CAL. WB	VINE MAPLE	SHRUBS / GROUNDCOVERS	AKOONIA HUBBICHTI	BLUE STAR	#2 POT	18" O.C.
100	ACER PALMATUM	6" STANDARD, UNIFORM SIZE AND QUALITY	6" CAL. WB	OSASHIME JAPANESE MAPLE	AKOONIA HUBBICHTI	AKOONIA HUBBICHTI	BLUE STAR	#2 POT	18" O.C.
100	AMELANCHIER X GRANDIFLORA	6" STANDARD, UNIFORM SIZE AND QUALITY	6" CAL. WB	OSASHIME JAPANESE MAPLE	AKOONIA HUBBICHTI	AKOONIA HUBBICHTI	BLUE STAR	#2 POT	18" O.C.
100	GLIEDISIA TRIACANTHOS	6" STANDARD, UNIFORM SIZE AND QUALITY	6" CAL. WB	OSASHIME JAPANESE MAPLE	AKOONIA HUBBICHTI	AKOONIA HUBBICHTI	BLUE STAR	#2 POT	18" O.C.
100	MAGNOLIA GRANDIFLORA	6" STANDARD, UNIFORM SIZE AND QUALITY	6" CAL. WB	OSASHIME JAPANESE MAPLE	AKOONIA HUBBICHTI	AKOONIA HUBBICHTI	BLUE STAR	#2 POT	18" O.C.
100	MALUS SYLVESTRIS	6" STANDARD, UNIFORM SIZE AND QUALITY	6" CAL. WB	OSASHIME JAPANESE MAPLE	AKOONIA HUBBICHTI	AKOONIA HUBBICHTI	BLUE STAR	#2 POT	18" O.C.
100	MAGNOLIA GALAXY	6" STANDARD, UNIFORM SIZE AND QUALITY	6" CAL. WB	OSASHIME JAPANESE MAPLE	AKOONIA HUBBICHTI	AKOONIA HUBBICHTI	BLUE STAR	#2 POT	18" O.C.
100	PNUS CONTORTA	6" STANDARD, UNIFORM SIZE AND QUALITY	6" CAL. WB	OSASHIME JAPANESE MAPLE	AKOONIA HUBBICHTI	AKOONIA HUBBICHTI	BLUE STAR	#2 POT	18" O.C.
100	POPULUS TREMILOIDES	6" STANDARD, UNIFORM SIZE AND QUALITY	6" CAL. WB	OSASHIME JAPANESE MAPLE	AKOONIA HUBBICHTI	AKOONIA HUBBICHTI	BLUE STAR	#2 POT	18" O.C.
100	PRUNUS SERRULATA	6" STANDARD, UNIFORM SIZE AND QUALITY	6" CAL. WB	OSASHIME JAPANESE MAPLE	AKOONIA HUBBICHTI	AKOONIA HUBBICHTI	BLUE STAR	#2 POT	18" O.C.
100	PRUNUS SERRULATA VAR. TIBETICA	6" STANDARD, UNIFORM SIZE AND QUALITY	6" CAL. WB	OSASHIME JAPANESE MAPLE	AKOONIA HUBBICHTI	AKOONIA HUBBICHTI	BLUE STAR	#2 POT	18" O.C.
100	QUERCUS PALustris	6" STANDARD, UNIFORM SIZE AND QUALITY	6" CAL. WB	OSASHIME JAPANESE MAPLE	AKOONIA HUBBICHTI	AKOONIA HUBBICHTI	BLUE STAR	#2 POT	18" O.C.
100	SITRAX JAPONICUS	6" STANDARD, UNIFORM SIZE AND QUALITY	6" CAL. WB	OSASHIME JAPANESE MAPLE	AKOONIA HUBBICHTI	AKOONIA HUBBICHTI	BLUE STAR	#2 POT	18" O.C.
100	SEDUM AUTUMN JOY	6" STANDARD, UNIFORM SIZE AND QUALITY	6" CAL. WB	OSASHIME JAPANESE MAPLE	AKOONIA HUBBICHTI	AKOONIA HUBBICHTI	BLUE STAR	#2 POT	18" O.C.
100	ALL SEASONS SEDUM TILE	6" STANDARD, UNIFORM SIZE AND QUALITY	6" CAL. WB	OSASHIME JAPANESE MAPLE	AKOONIA HUBBICHTI	AKOONIA HUBBICHTI	BLUE STAR	#2 POT	18" O.C.




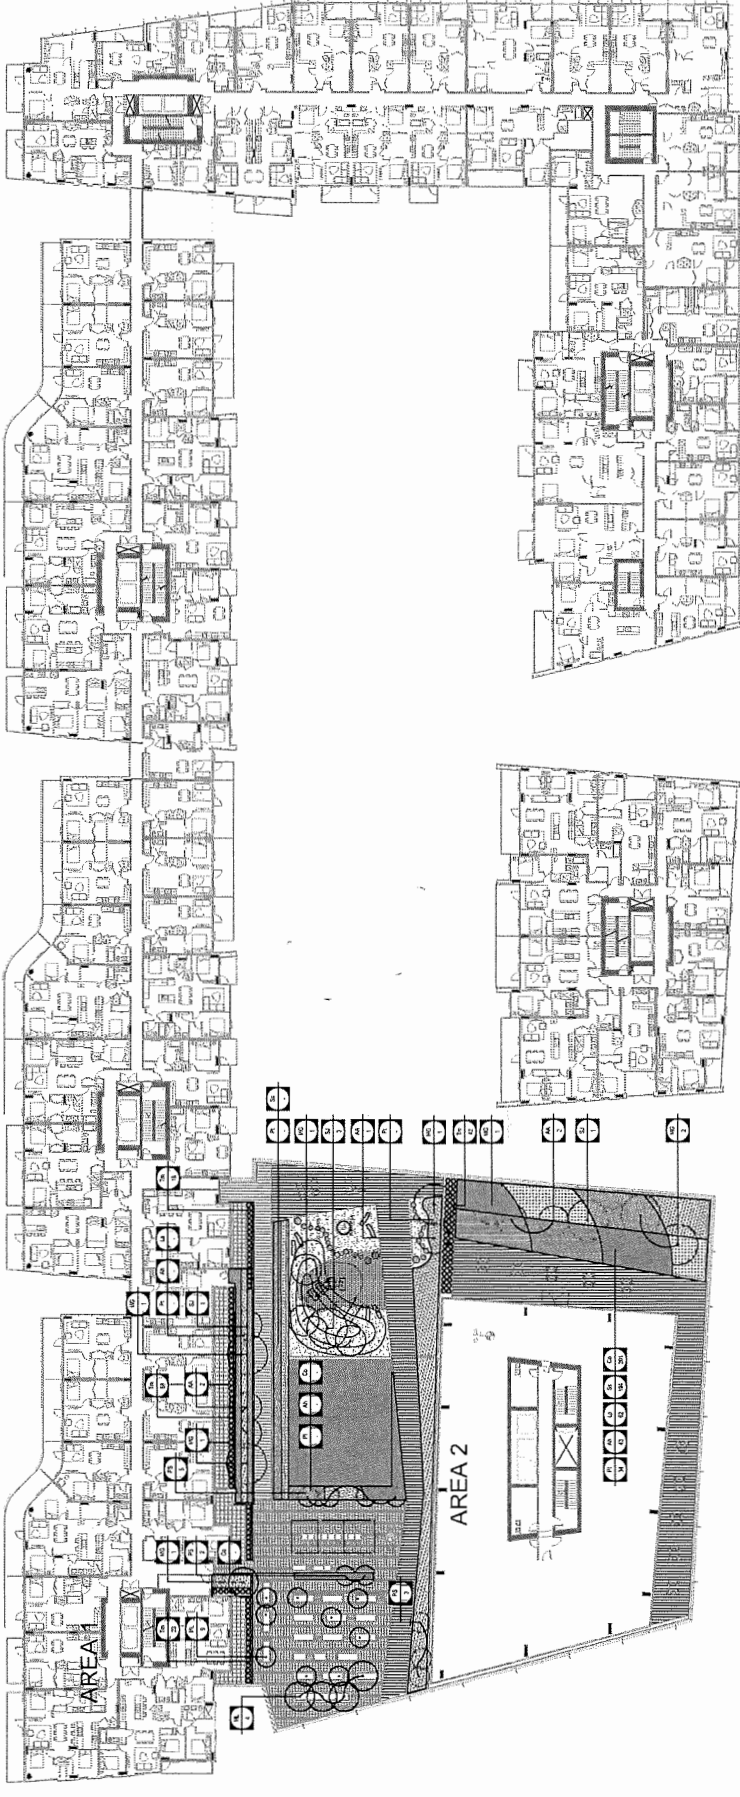
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NO.	DATE	DESCRIPTION
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DATE	10/09/2018
DRAWN BY	MP/LL
CHECKED BY	LL
SCALE	1/8" = 1'-0"
JOB NUMBER	17046

DP 16-740262
#65

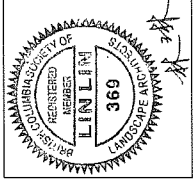

KEY	QTY	BOTANICAL NAME	COMMON NAME	SIZE	DESCRIPTION	KEY	QTY	BOTANICAL NAME	COMMON NAME	SIZE	DESCRIPTION
TREES		ACER GINONATUM	VINE MAPLE	50M CAL, WB	MULTI-STEMMED (3 MIN) FULL	Ar	1	AMBONIA HUBRICHII	SHRUBS / GROUNDCOVERS	#2 POT	18" O.C.
AC		ACER PALMATUM 'AO SHIME'	AO SHIME JAPANESE MAPLE	2.5M HT, WB	MULTI-STEMMED (3 MIN) FULL	Cu	1	CAREX OSHIMENSIS 'EVERGOLD'	EVERGOLD SEDGE	#2 POT	12" O.C.
AA		ACER PALMATUM 'OSAKAZUKI'	OSAKAZUKI JAPANESE MAPLE	2.5M HT, WB	MULTI-STEMMED (3 MIN) FULL	La	1	LAVANDULA ANQUISTIFOLIA 'MUNSTEAD'	MUNSTEAD LAVENDER	#2 POT	18" O.C.
AP		AMELANCHIER X GRANDIFLORA	SERVISCEBERRY	3.5M HT, WB	MULTI-STEMMED (3 MIN) FULL	Lp	1	LANCERA PLEATA	HONEYSUCKLE	#2 POT	18" O.C.
AG		AMELANCHIER X GRANDIFLORA	SERVISCEBERRY	3.5M HT, WB	MULTI-STEMMED (3 MIN) FULL	Lp	1	LANCERA PLEATA	HONEYSUCKLE	#2 POT	18" O.C.
GT		GLEDTISIA TRICANTHOS	PIRAMIDAL EUROPEAN HORNBREAM	100M CAL, WB	FULL, UNIFORM SIZE AND QUALITY	Pt	1	PACHYSANDRA TERMINALIS	JAPANESE SPURGE	#2 POT	12" O.C.
MG		MAGNOLIA GRANDIFLORA 'LITTLE GEM'	EVERGREEN SOUTHERN MAGNOLIA	70M CAL, WB	6 STANDARD, UNIFORM SIZE AND QUALITY	Ss	1	SALVIXA STYLVESTRIS 'MAY NIGHT'	MAY NIGHT SAGE	#2 POT	12" O.C.
ML		MALUS SYLVESTRIS	CRAB APPLE TREE	80M CAL, WB	6 STANDARD, UNIFORM SIZE AND QUALITY	Ss	1	SALVIXA STYLVESTRIS 'MAY NIGHT'	MAY NIGHT SAGE	#2 POT	12" O.C.
Mlx		MAGNOLIA GALATY	SHORE PINE	80M CAL, WB	6 STANDARD, UNIFORM SIZE AND QUALITY	Ss	1	SALVIXA STYLVESTRIS 'MAY NIGHT'	MAY NIGHT SAGE	#2 POT	12" O.C.
PC		PRUNUS SP.	SHORE PINE	3M CAL, WB	SPECIMEN & PICTURE QUALITY	Gr	1	GRASSES / PERENNIALS	H.M. EDDIE YEW	40" HIGHMALE FIELD GROWN	22-34" O.C.
PT		POPULUS TREMULOIDES	TREMBLING ASPEN	70M CAL, WB	6 STANDARD, UNIFORM SIZE AND QUALITY	Gr	1	GRASSES / PERENNIALS	H.M. EDDIE YEW	40" HIGHMALE FIELD GROWN	22-34" O.C.
PK		PRUNUS SERRULATA 'KANZAN'	JAPANESE FLOWERING CHERRY	70M CAL, WB	6 STANDARD, UNIFORM SIZE AND QUALITY	Gr	1	GRASSES / PERENNIALS	H.M. EDDIE YEW	40" HIGHMALE FIELD GROWN	22-34" O.C.
PS		PRUNUS SERRULATA VAR. 'TIBETICA'	TIBETAN CHERRY	60M CAL, WB	FULL, UNIFORM SIZE & QUALITY	Gr	1	GRASSES / PERENNIALS	H.M. EDDIE YEW	40" HIGHMALE FIELD GROWN	22-34" O.C.
OP		QUERCUS PALustris	PIN OAK	80M CAL, WB	FULL, UNIFORM SIZE AND QUALITY	Gr	1	GRASSES / PERENNIALS	H.M. EDDIE YEW	40" HIGHMALE FIELD GROWN	22-34" O.C.
SJ		STYRAX JAPONICUS 'OBASSIA'	JAPANESE SNOWBELL TREE	70M CAL, WB	6 STD, UNIFORM SIZE AND QUALITY	Gr	1	GRASSES / PERENNIALS	H.M. EDDIE YEW	40" HIGHMALE FIELD GROWN	22-34" O.C.
						SE	1	SEEDUM	AUTUMN JOY STONECROP	#2 POT	12" O.C.
						SA	1	SEASONALS	ALL SEASONS SEDUM TILE		

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KEY	QTY	BOTANICAL NAME	COMMON NAME	SIZE	DESCRIPTION
TREES					
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AA		ACER PALMATUM 'AO SHIME'	AO SHIME JAPANESE MAPLE	25WHIT WB	MULTI-STEMMED (3 MIN) FULL
AP		AMELANORHYZON	SHAMROCK MAPLE	25WHIT WB	MULTI-STEMMED (3 MIN) FULL
AS		AMELANORHYZON	SHAMROCK MAPLE	25WHIT WB	MULTI-STEMMED (3 MIN) FULL
CT		GLIEDISIA TRICANTHOS	PYRAMIDAL EUROPEAN HORNBREAM	10N CAL WB	FULL UNIFORM SIZE AND QUALITY
CG		MAGNOLIA GRANDIFLORA 'LITTLE GEM'	EVERGREEN SOUTHERN MAGNOLIA	10N CAL WB	FULL UNIFORM SIZE AND QUALITY
ML		MALLUS SYLVESTRIS	CRAB APPLE TREE	6N CAL WB	FULL UNIFORM SIZE AND QUALITY
MGX		MAGNOLIA GALAXY	GALAXY MAGNOLIA	6N CAL WB	FULL UNIFORM SIZE AND QUALITY
PC		FINUS CONTORTA	SHORE PINE	3 M CAL WB	SPECIMEN & PICTURESQUE QUALITY, SELECTED BY CONSULTANT
PT		POPULUS TREMULOIDES	TREMBLING ASPEN	70N CAL WB	6" STANDARD, UNIFORM SIZE AND QUALITY
PK		PRUNUS SERRULATA 'KANZAN'	JAPANESE FLOWERING CHERRY	70N CAL WB	6" STANDARD, UNIFORM SIZE AND QUALITY
PS		PRUNUS SERRULATA VAR. 'TIBETICA'	TIBETAN CHERRY	60N CAL WB	FULL UNIFORM SIZE & QUALITY
CP		QUERCUS PALUSTRIS	PIN OAK	60N CAL WB	FULL UNIFORM SIZE AND QUALITY
SJ		STYRAX JAPONICUS 'OBASAKI'	JAPANESE SNOWBELL TREE	70N CAL WB	6" STD, UNIFORM SIZE AND QUALITY

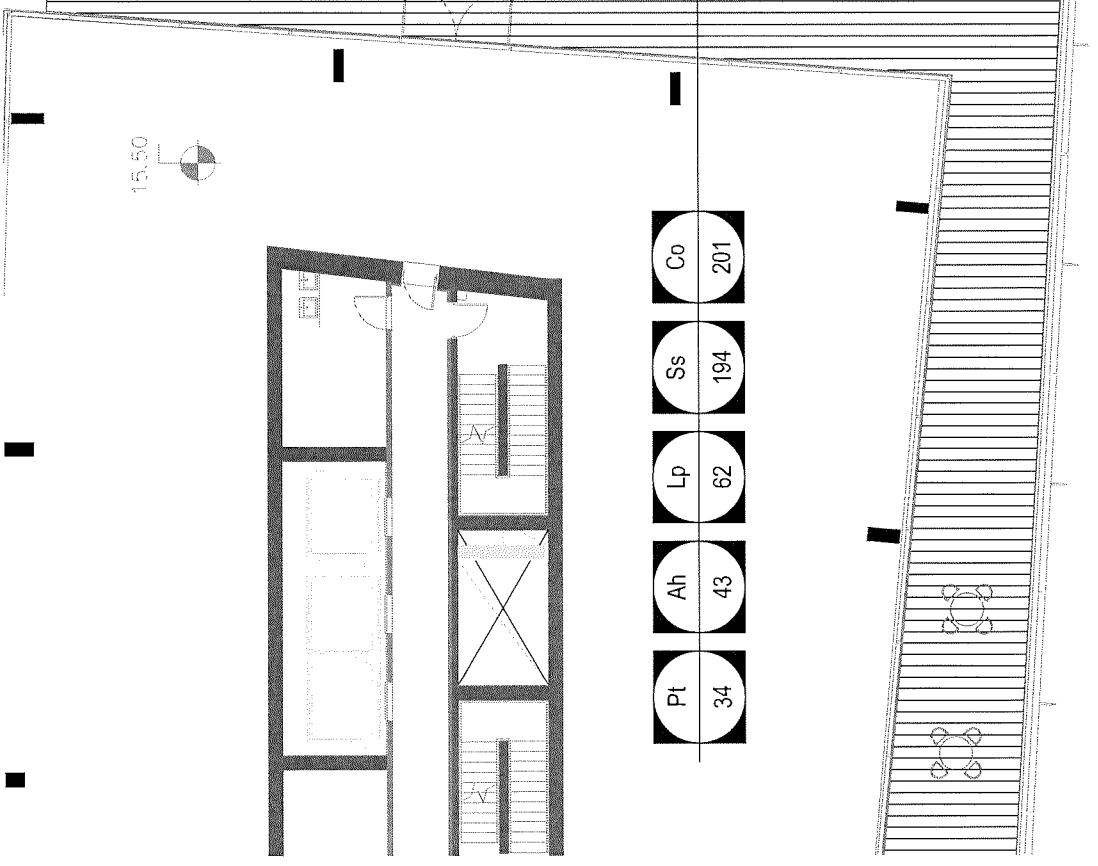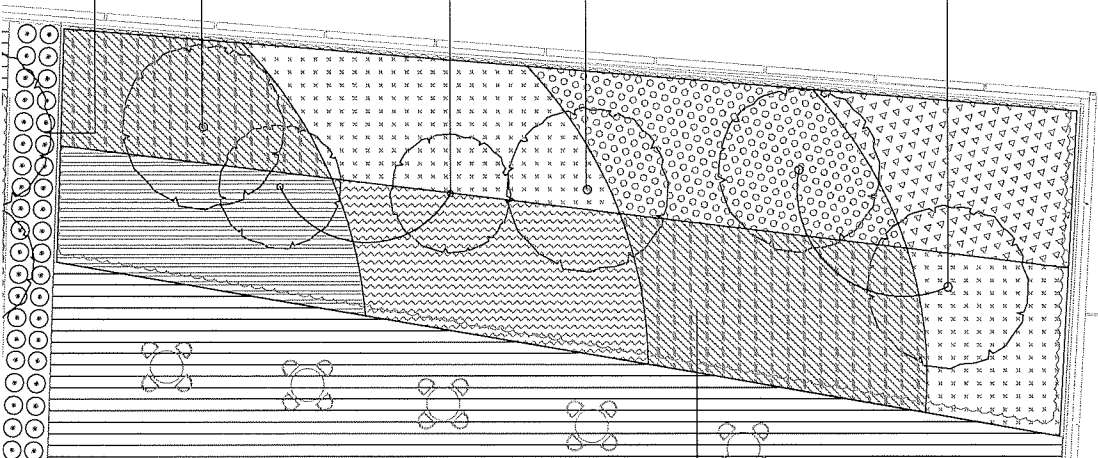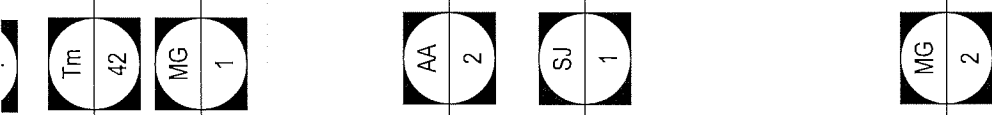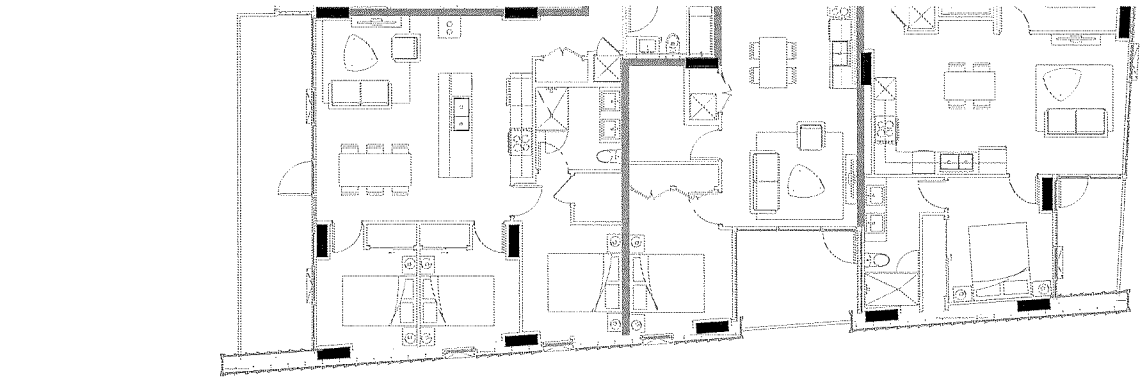KEY	QTY	BOTANICAL NAME	COMMON NAME	SIZE	DESCRIPTION
SHRUBS / GROUNDCOVERS					
Ah		ANSONIA HIBRICHITI	BLUE STAR	#2 POT	18" O.C.
Co		CAREX OSHIMENSIS 'EVERGOLD'	EVERGOLD SEDGE	#2 POT	12" O.C.
La		LAVANDULA ANOSTIFOLIA 'MUNSTED'	MUNSTED LAVENDER	#2 POT	18" O.C.
Li		LAVANDULA ANOSTIFOLIA 'MUNSTED'	MUNSTED LAVENDER	#2 POT	18" O.C.
Pa		PACHYSAURA TERMINALIS	JAPANESE SPURGE	#2 POT	12" O.C.
Pi		PACHYSAURA TERMINALIS	JAPANESE SPURGE	#2 POT	12" O.C.
Ss		SALVIA X SYLVESTRIS 'MAY NIGHT'	MAY NIGHT SAGE	#2 POT	12" O.C.
Ra		ROSA RUGOSA	BEACH ROSE	#2 POT	12" O.C.
Tm		TAXUS MEDIA 'M. EDDIE'	H.M. EDDIE YEW	40" HIGHWALE FIELD GROWN	22-34" O.C.
GRASSES / PERENNIALS					
Tm		TAXUS MEDIA 'M. EDDIE'	H.M. EDDIE YEW	40" HIGHWALE FIELD GROWN	22-34" O.C.
Gr		GRASSES / PERENNIALS			
Hk		HAKONECHLOA MACRA	JAPANESE FOREST GRASS	#1 POT	12" O.C.
Fe		FESTUCA TENUISSIMA	MEXICAN FEATHER GRASS	#2 POT	12" O.C.
Am		AMPHIPHILA BREVILIGULATA	BEACH GRASS	#2 POT	12" O.C.
SEDUM					
SJ		SEDUM 'AUTUMN JOY'	AUTUMN JOY SEDUM	#2 POT	12" O.C.

KEY	QTY	BOTANICAL NAME	COMMON NAME	SIZE	DESCRIPTION
Co		CAREX OSHIMENSIS 'EVERGOLD'	EVERGOLD SEDGE	#2 POT	12" O.C.
La		LAVANDULA ANOSTIFOLIA 'MUNSTED'	MUNSTED LAVENDER	#2 POT	18" O.C.
Li		LAVANDULA ANOSTIFOLIA 'MUNSTED'	MUNSTED LAVENDER	#2 POT	18" O.C.
Pa		PACHYSAURA TERMINALIS	JAPANESE SPURGE	#2 POT	12" O.C.
Pi		PACHYSAURA TERMINALIS	JAPANESE SPURGE	#2 POT	12" O.C.
Ss		SALVIA X SYLVESTRIS 'MAY NIGHT'	MAY NIGHT SAGE	#2 POT	12" O.C.
Ra		ROSA RUGOSA	BEACH ROSE	#2 POT	12" O.C.
Tm		TAXUS MEDIA 'M. EDDIE'	H.M. EDDIE YEW	40" HIGHWALE FIELD GROWN	22-34" O.C.
Gr		GRASSES / PERENNIALS			
Hk		HAKONECHLOA MACRA	JAPANESE FOREST GRASS	#1 POT	12" O.C.
Fe		FESTUCA TENUISSIMA	MEXICAN FEATHER GRASS	#2 POT	12" O.C.
Am		AMPHIPHILA BREVILIGULATA	BEACH GRASS	#2 POT	12" O.C.
SJ		SEDUM 'AUTUMN JOY'	AUTUMN JOY SEDUM	#2 POT	12" O.C.

KEY	QTY	BOTANICAL NAME	COMMON NAME	SIZE	DESCRIPTION
hm					
ML					
Tm					
MG					
MGX					
AP					
MS					
Ss					
Co					

KEY	QTY	BOTANICAL NAME	COMMON NAME	SIZE	DESCRIPTION
hm					
ML					
Tm					
MG					
MGX					
AP					
MS					
Ss					
Co					

KEY	QTY	BOTANICAL NAME	COMMON NAME	SIZE	DESCRIPTION
hm					
ML					
Tm					
MG					
MGX					
AP					
MS					
Ss					
Co					

KEY	QTY	BOTANICAL NAME	COMMON NAME	SIZE	DESCRIPTION
hm					
ML					
Tm					
MG					
MGX					
AP					
MS					
Ss					
Co					

KEY	QTY	BOTANICAL NAME	COMMON NAME	SIZE	DESCRIPTION
hm					
ML					
Tm					
MG					
MGX					
AP					
MS					
Ss					
Co					

KEY	QTY	BOTANICAL NAME	COMMON NAME	SIZE	DESCRIPTION
hm					
ML					
Tm					
MG					
MGX					
AP					
MS					
Ss					
Co					

KEY	QTY	BOTANICAL NAME	COMMON NAME	SIZE	DESCRIPTION
hm					
ML					
Tm					
MG					
MGX					
AP					
MS					
Ss					
Co					

PLANTING GENERAL NOTES

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- THE CONTRACTOR SHALL COMPLY WITH ALL REQUIREMENTS ON THE DRAWINGS CORRESPOND TO THOSE INDICATED ON THE PLANT LIST.
- PLANT LIST TO BE READ IN CONJUNCTION WITH SPECIFICATIONS FOR COMPLIANCE.
- PRIOR TO THE START OF CONSTRUCTION, THE CONTRACTOR SHALL CONFIRM THE AVAILABILITY OF THE PLANT MATERIAL SPECIFIED AS PER SPECIFICATIONS, ALLOWING FOR ANY AND ALL REQUIRED APPROVALS. PLANT SUBSTITUTIONS NOT CONFIRMED AND APPROVED BY THE CONSULTANT WILL BE REJECTED.
- PROVIDE IRRIGATION TO ALL PLANT MATERIAL AS SHOWN ON LANDSCAPE DRAWINGS AND PLANS.
- HIGH EFFICIENT AUTOMATIC IRRIGATION SYSTEM WILL BE INSTALLED ON PLANTING AREAS.

LEVEL 7 KEY PLAN

ROOF TOP 1

ROOF TOP 2

DP 16-740262

69

gbl


GBL ARCHITECTS INC.
139 EAST 8TH AVENUE
VANCOUVER, BC CANADA V5T 1R8
TEL: 604 236 1198
FAX: 604 231 9279

DESIGNER OF RECORD FOR THIS PROJECT AND MAY NOT BE USED OR REPRODUCED WITHOUT THE WRITTEN CONSENT OF GBL ARCHITECTS INC.

PFS STUDIO

PLANNING - URBAN DESIGN - LANDSCAPE ARCHITECTURE

1177 West 7th Avenue
VANCOUVER, BC V6H 1Y1
TEL: 604 681 1111
FAX: 604 681 1112

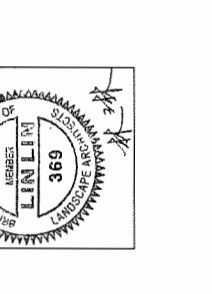

NO.	DATE	DESCRIPTION
1	2017-09-29	Issued for Rezoning
2	2017-11-14	Issued for Rezoning (Resubmission)
3	2017-11-14	Issued for DP
4	2018-07-18	Reissued for DP
5	2018-08-31	DD 80%
6	2018-09-21	Reissued for DP
7	2018-10-09	Reissued for DP

7960 ALDERBRIDGE WAY


PLANTING PLAN
- LEVEL 7

DATE: 10/09/2018
DRAWN BY: MP/LL
CHECKED BY: LL
SCALE: 1/8" = 1'-0"
JOB NUMBER: 17046

LEVEL 7 - ROOF TOP GARDEN 1
SCALE: 1/8" = 1'-0"

LEVEL 7 - ROOF TOP GARDEN 2
SCALE: 1/8" = 1'-0"

L4.16

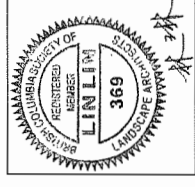


NO.	DATE	DESCRIPTION
1	2017-09-29	Issued for Rezoning (Resubmission)
2	2017-11-14	Issued for DP
3	2017-11-14	Issued for DP
4	2018-07-18	00 80%
5	2018-08-31	Released for OP
6	2018-09-21	Released for OP
7	2018-10-09	Released for OP

7960 ALDERBRIDGE WAY


PLANTING PLAN
- LEVEL 10

DATE: 10/09/2018
DRAWN BY: MP/LL
CHECKED BY: LL
SCALE: 1/8" = 1'-0"
JOB NUMBER: 17046


L4.17

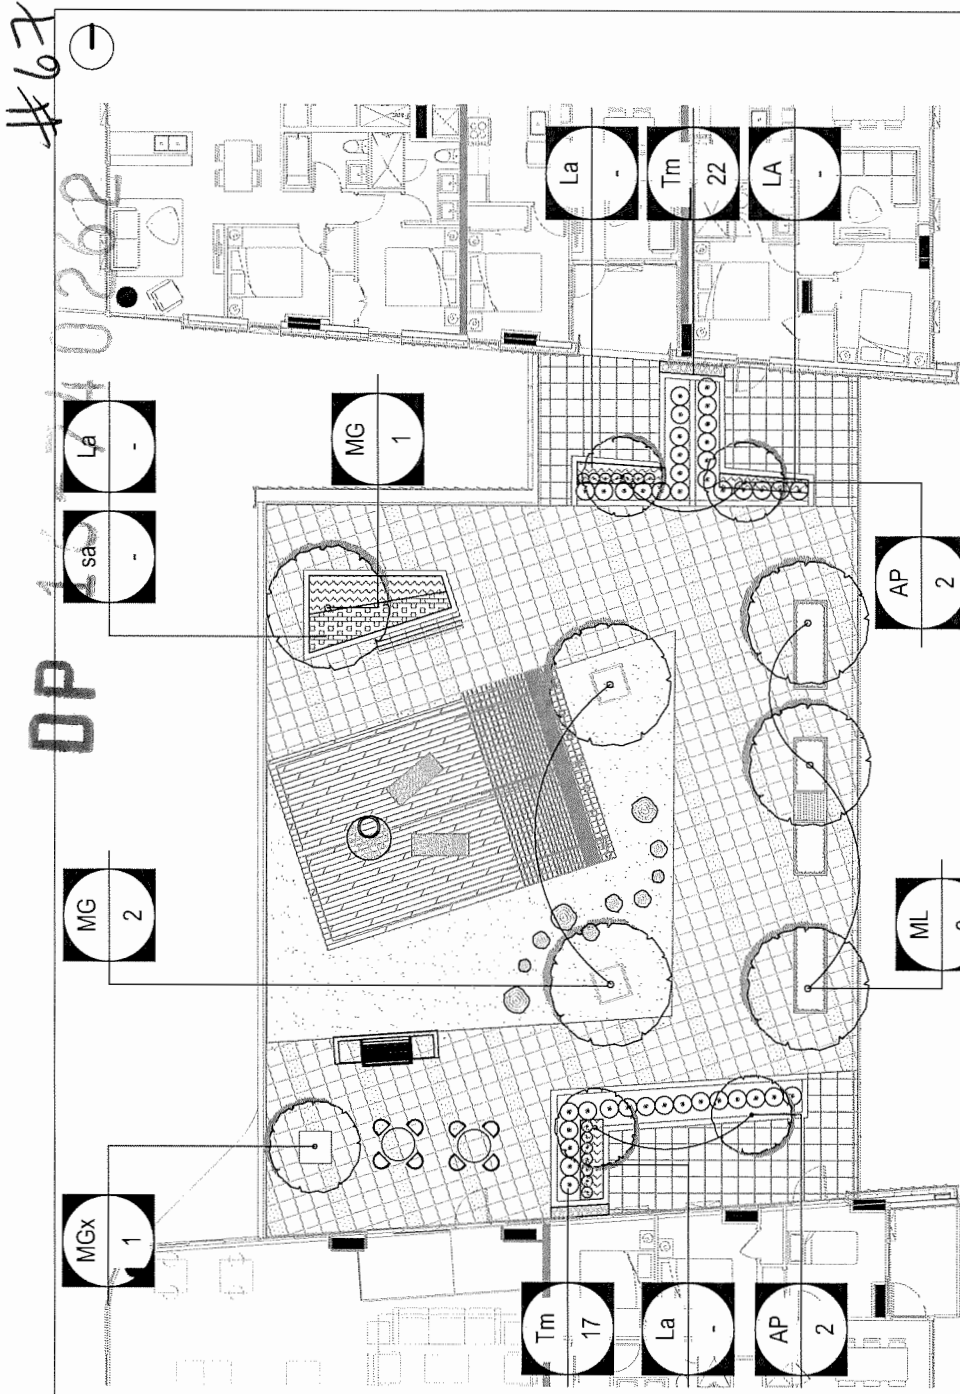

LEVEL 10 - ROOF TOP GARDEN 4
SCALE: 1/8" = 1'-0"

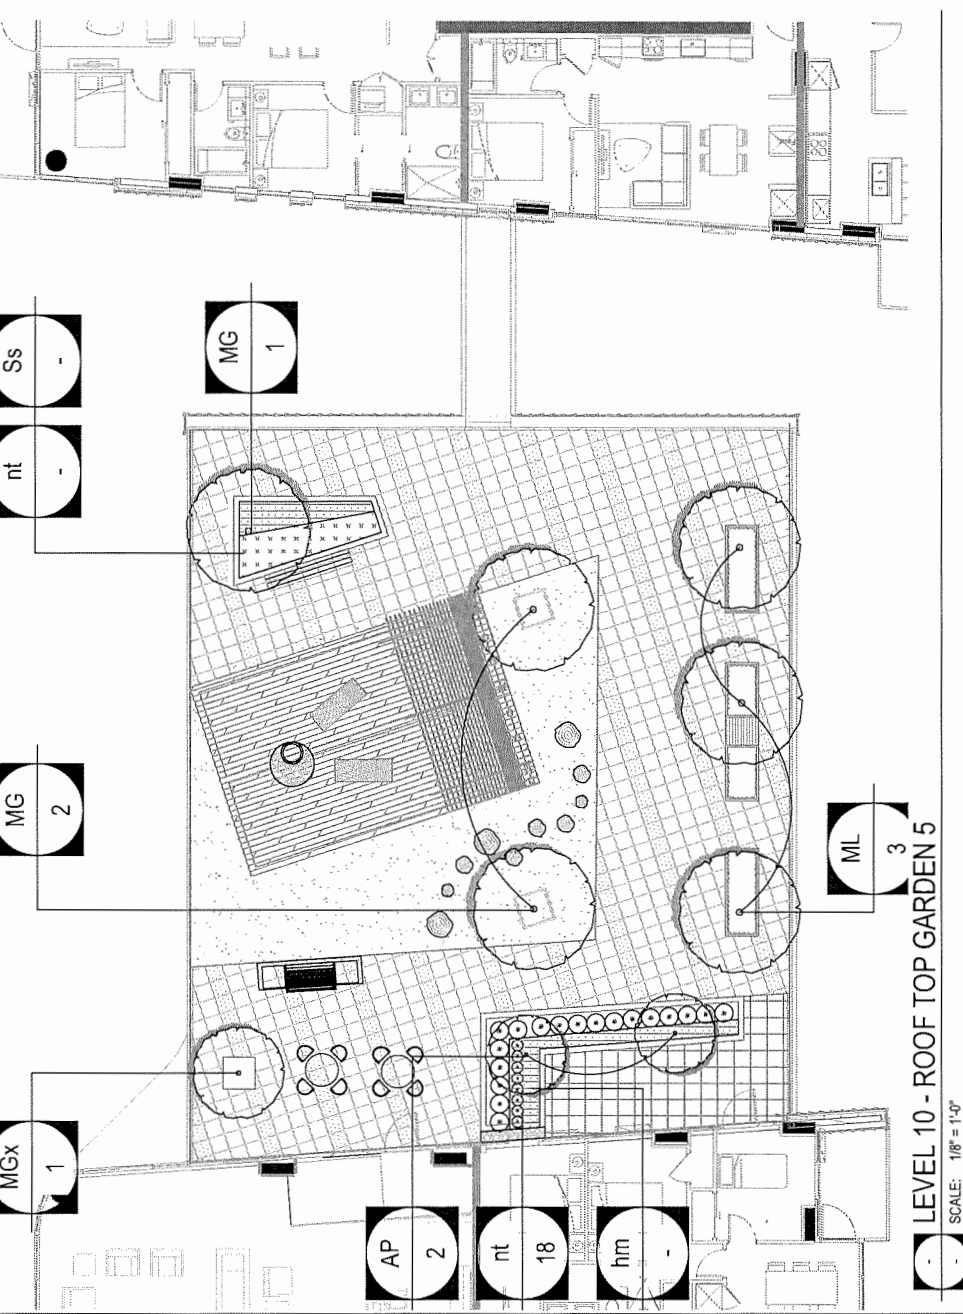

LEVEL 10 - ROOF TOP GARDEN 5
SCALE: 1/8" = 1'-0"

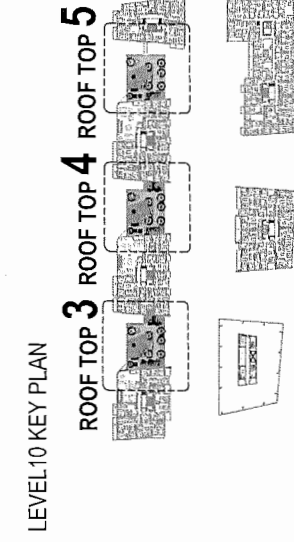


LEVEL 10 KEY PLAN

PLANTING GENERAL NOTES

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- ALL PLANT MATERIAL SHALL BE NURSERY GROWN UNLESS OTHERWISE NOTED. ONLY CERTIFIED S.O.D. NURSERY STOCK WILL BE ACCEPTED.
- THE CONTRACTOR SHALL PROVIDE A GROWING MEDIUM ANALYSIS FOR REVIEW BY THE CONSULTANT - AS PER SPECIFICATIONS - PRIOR TO THE START OF CONSTRUCTION. GROWING MEDIUM SUPPLIED TO THE SITE OR INSTALLED ON SITE PRIOR TO CONSULTANT APPROVAL SHALL BE REJECTED AT NO COST TO THE OWNER.
- THE CONTRACTOR SHALL CONFIRM PLANT QUANTITIES ON THE DRAWINGS CORRESPOND TO THOSE INDICATED ON THE PLANT LIST.
- ANY DISCREPANCIES ARE TO BE VERIFIED BY THE CONSULTANT FOR REVIEW AND RESPONSE.
- PLANT LIST TO BE READ IN CONJUNCTION WITH SPECIFICATIONS FOR COMPLIANCE.
- PRIOR TO THE START OF CONSTRUCTION, THE CONTRACTOR SHALL CONFIRM THE AVAILABILITY OF THE PLANT MATERIAL SPECIFIED AS PER SPECIFICATIONS. ALLOWING FOR ANY AND ALL REQUIRED APPROVALS. PLANT SUBSTITUTIONS NOT CONFIRMED AND APPROVED BY THE CONSULTANT SHALL BE AT THE CONTRACTOR'S RISK.
- PROVIDE IRRIGATION TO ALL PLANT MATERIAL AS SHOWN ON LANDSCAPE DRAWINGS AND PLANS.
- HIGH EFFICIENT AUTOMATIC IRRIGATION SYSTEM WILL BE INSTALLED ON PLANTING AREAS.

KEY QTY	BOTANICAL NAME	COMMON NAME	SIZE	DESCRIPTION
TREES				
AC	ACER GINOMATUM	VINE MAPLE	50M CAL. WB	MULTI-STEMMED (3 MIN.) FULL
AL	ALNUS MILANO SHINE	WHITE ALDER	40M HT. WB	MULTI-STEMMED (3 MIN.) FULL
AP	ACER PALMATHY 'OSAZAKI'	OSAZAKI JAPANESE MAPLE	2.5M HT. WB	MULTI-STEMMED (3 MIN.) FULL
AG	AMELANCHIER 'GRANDIFLORA'	SERVICE BERRY	1.5M HT. WB	MULTI-STEM
GT	GLEITSIA TRICANTHOS	PYRAMIDAL EUROPEAN HORNBEEAM	10CM CAL. WB	FULL UNIFORM SIZE AND QUALITY
MG	MAGNOLIA GRANDIFLORA 'LITTLE GEM'	EVERGREEN SOUTHERN WAGNOLIA	7CM CAL. WB	FULL UNIFORM SIZE AND QUALITY
ML	MALUS SYLVESTRIS	CRAB APPLE 'TREE'	8CM CAL. WB	FULL UNIFORM SIZE AND QUALITY
PC	MAGNOLIA GALAXY	GALAXY MAGNOLIA	8CM CAL. WB	SPECIMEN & PICTURESQUE QUALITY
	PNUS CONTORTA	SHORE PINE	3 M CAL. WB	SELECTED BY CONSULTANT
PT	POPULUS TREMULOIDES	TREMBLING ASPEN	7CM CAL. WB	6 STANDARD UNIFORM SIZE AND QUALITY
PK	PRUNUS SERRULATA 'KANZAN'	JAPANESE FLOWERING CHERRY	7CM CAL. WB	FULL UNIFORM SIZE & QUALITY
PS	PRUNUS SERRULATA 'VAR. TIBETICA'	TIBETAN CHERRY	8CM CAL. WB	MULTI-STEMMED (3 MIN.) FULL
OP	ODOROUS PALOUSTRIS	PIN OAK	8CM CAL. WB	FULL UNIFORM SIZE AND QUALITY
SJ	STYRA JAPONICUS 'UBASAKI'	JAPANESE SNOWBELL TREE	7CM CAL. WB	6 STD. UNIFORM SIZE AND QUALITY
		COMMON NAME		DESCRIPTION
SHRUBS / GROUNDCOVERS				
Ah	ANEMONA RUBRICRISTIS	BLUE STAR	#2 POT	18" O.C.
Co	CAREX OSHIMENSIS 'EVERGOLD'	EVERGOLD SEDGE	#2 POT	12" O.C.
La	LAVANDULA ANOSTIFOLIA 'MUNSTEAD'	WINTERED LAVENDER	#2 POT	18" O.C.
Ip	IPOMOEPA 'MAY NIGHT'	JAPANESE SPURGE	#2 POT	12" O.C.
Pt	PACHYSAURA TERMINALIS	MAY NIGHT SAGE	#2 POT	12" O.C.
Ss	SALVIA X SYLVESTRIS 'MAY NIGHT'	BEACH ROSE	#2 POT	12" O.C.
Ra	ROSA RUGOSA	H.M. EDDIE VEY	40" HIGH MALE	22-24" O.C.
Tm	TAXUS MEDIA 'H.M. EDDIE'	JAPANESE FOREST GRASS	#1 POT	12" O.C.
GRASSES / PERENNIALS				
hm	HAKONECHLOA MACRA	PACIFIC RIVER GRASS	#2 POT	12" O.C.
nl	NAUSEELLA TERUUSIMA	BEACH GRASS	#2 POT	12" O.C.
al	AMPHIPHILA BREVILIGULATA			
SEDUM				
sa	SEDUM 'AUTUMN JOY'	AUTUMN JOY STONECROP	#2 POT	12" O.C.
sk	ALL SEASONS SEDUM TILE			

NOTES

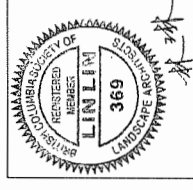

NO.	DATE	DESCRIPTION
1	2017-09-29	Issued for Reasoning
2	2017-11-14	Issued for Reasoning (Resubmission)
3	2017-11-14	Issued for DP
4	2018-07-18	Reissued for DP
5	2018-08-31	DD 80%
6	2018-09-21	Reissued for DP
7	2018-10-09	Reissued for DP


7960 ALDERBRIDGE WAY

PLANTING PLAN
- ROOFTOP

DATE	10/09/2018
DRAWN BY	MP/LL
CHECKED BY	LL
SCALE	1/32" = 1'-0"
JOB NUMBER	17046

L4.18

OP 10-14U262
#68

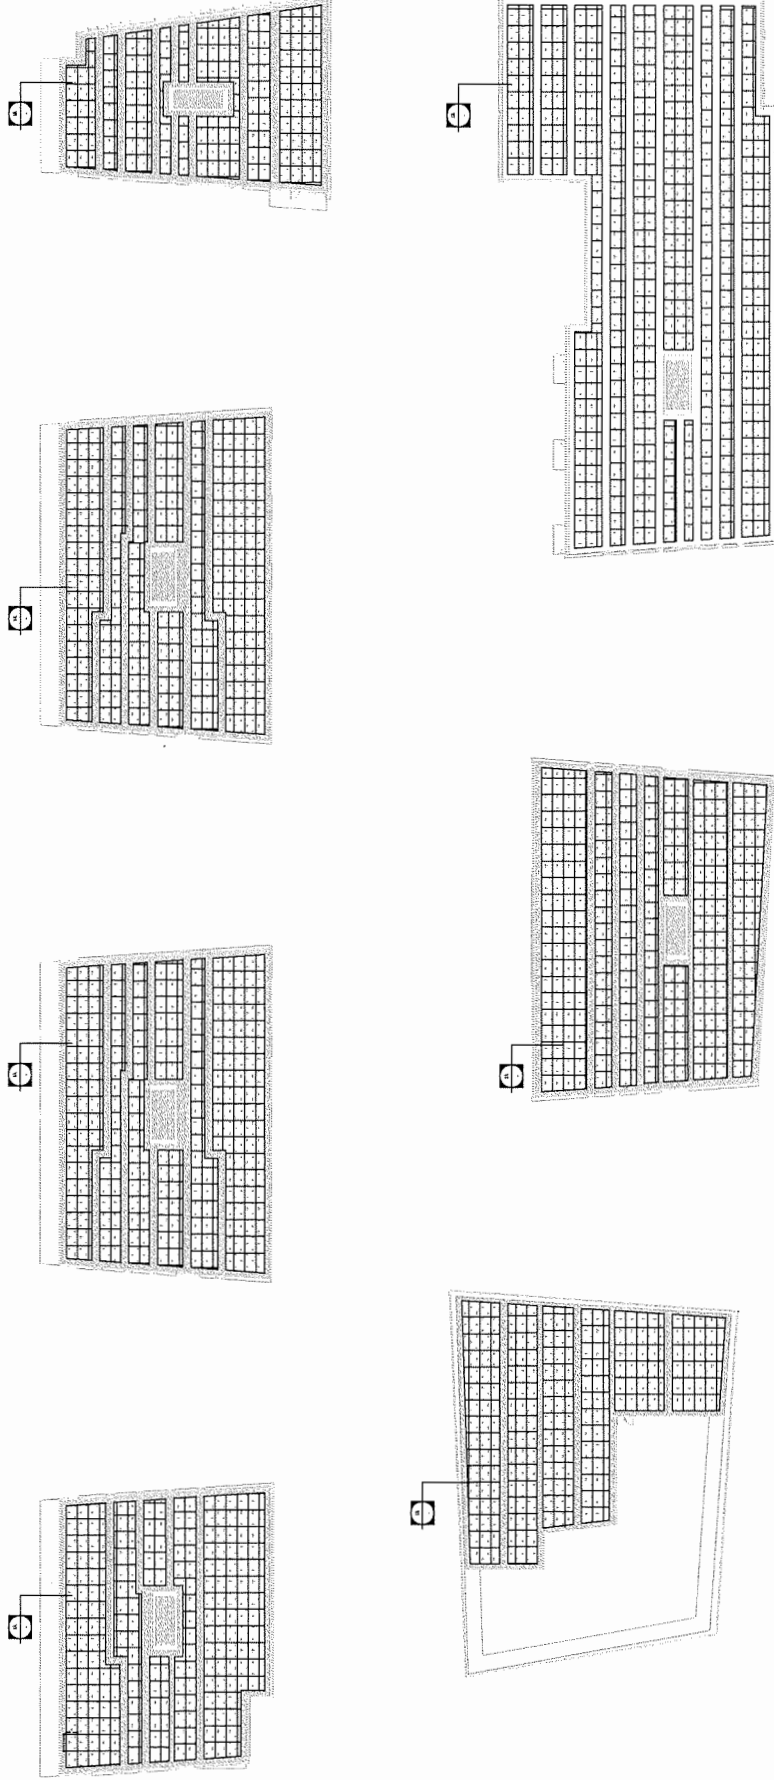


ROOFTOP
SCALE: 1/32" = 1'-0"

KEY QTY	BOTANICAL NAME	COMMON NAME	SIZE	DESCRIPTION
TREES				
AC	ACER CIRCINATUM	VINE MAPLE	50M CAL WB	MULTI-STEMMED (3 MN) FULL
AA	ACER PALMATUM 'AO SHIME'	AO SHIME JAPANESE MAPLE	2.5M HT. WB	MULTI-STEMMED (3 MN) FULL
AP	ACER PALMATUM 'OSAKAZUKI'	OSAKAZUKI JAPANESE MAPLE	2.5M HT. WB	MULTI-STEMMED (3 MN) FULL
AG	AMELANCHIER X GRANDIFLORA	SERVICEBERRY	10M CAL WB	MULTI-STEMMED (3 MN) FULL
GT	GLEDTISIA TRICANTHOS	PIRAMIDAL EUROPEAN HORNBEAM	10M CAL WB	FULL UNIFORM SIZE AND QUALITY
MG	MAGNOLIA GRANDIFLORA 'LITTLE GEM'	EVERGREEN SOUTHERN MAGNOLIA	5' STANDARD	UNIFORM SIZE AND QUALITY
ML	MALUS SYLVESTRIS	CRAB APPLE TREE	5' STANDARD	UNIFORM SIZE AND QUALITY
MOx	MORUS ALBA	SHORE PINE	3/4 CAL WB	5' STANDARD UNIFORM SIZE AND QUALITY
PC	PINUS CONTORTA	SHORE PINE	3/4 CAL WB	5' STANDARD UNIFORM SIZE AND QUALITY
PT	POPULUS TREMULOIDES	TREMULING ASPEN	7CM CAL WB	6' STANDARD UNIFORM SIZE AND QUALITY
PK	PRUNUS SERRULATA 'KANZAN'	JAPANESE FLOWERING CHERRY	7CM CAL WB	6' STANDARD UNIFORM SIZE AND QUALITY
PS	PRUNUS SERRULATA VAR. 'TIBETICA'	TIBETAN CHERRY	6CM CAL WB	FULL UNIFORM SIZE AND QUALITY
QP	QUERCUS PALUSTRIS	PIN OAK	6CM CAL WB	FULL UNIFORM SIZE AND QUALITY
SJ	STYRAX JAPONICUS 'OBASIA'	JAPANESE SNOWBELL TREE	7CM CAL WB	6' STD. UNIFORM SIZE AND QUALITY
SHRUBS / GROUNDCOVERS				
Ah	ANDROMEDA RUBRICRISTI	BLUE STAR	#2 POT	18" O.C.
Co	CAREX OSMENSIS	EVERGOLD SEDGE	#2 POT	12" O.C.
La	LOUISIANA IRIS	IRIS	#2 POT	18" O.C.
Li	LOUISIANA IRIS	IRIS	#2 POT	18" O.C.
Lo	LOUISIANA IRIS	IRIS	#2 POT	18" O.C.
Pa	PACHYSAURA TERMINALIS	WONDERBERRY	#2 POT	12" O.C.
Pl	PACHYSAURA TERMINALIS	WONDERBERRY	#2 POT	12" O.C.
Sa	SAIWA X SYLVESTRIS 'MAY NIGHT'	MAY NIGHT SAGE	#2 POT	12" O.C.
Ra	ROSA RUGOSA	BEACH ROSE	#2 POT	12" O.C.
Tm	TAXUS MEDIA 'H.M. EDDIE'	H.M. EDDIE YEW	40" HIGH MALE	22-24" O.C.
Grasses / Perennials				
Fl	FLORICOLA WAGRA	JAPANESE FOREST GRASS	#1 POT	12" O.C.
Hc	HIEROPHYSALIS	MEXICAN FLEETWING GRASS	#2 POT	12" O.C.
Be	BELLAIR	BEACH GRASS	#2 POT	12" O.C.
Sedum				
St	SEDUM 'AUTUMN JOY'	AUTUMN JOY STONECROP	#2 POT	12" O.C.
Sk	SK	ALL SEASONS SEDUM TILE		

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- LISTED PLANT SPECIFICATIONS WITH CONFLICTING OR UNUSUAL REQUIREMENTS SHALL BE CONFIRMED WITH THE CONSULTANT PRIOR TO THE START OF CONSTRUCTION. PLANT SUBSTITUTIONS SHALL CONFORM TO THE SPECIFICATIONS, ALLOWING FOR ANY AND ALL REQUIRED APPROVALS. PLANT SUBSTITUTIONS NOT CONFIRMED AND APPROVED BY THE CONSULTANT WILL BE REJECTED.
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- HIGH EFFICIENT AUTOMATIC IRRIGATION SYSTEM WILL BE INSTALLED ON PLANTING AREAS.

NOTES

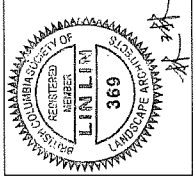


NO.	DATE	DESCRIPTION
1	2017-09-29	Issued for Rezoning
2	2017-11-14	Issued for Rezoning (Re-submission)
3	2017-11-14	Issued for DP
4	2018-07-18	Reissued for DP
5	2018-08-31	DD 80%
6	2018-09-21	Reissued for DP
7	2018-10-09	Reissued for DP

7960 ALDERBRIDGE WAY

LANDSCAPE LIGHTING PLAN
- LEVEL 1

DATE	10/09/2018
DRAWN BY	MPILL
CHECKED BY	LL
SCALE	1/16" = 1'-0"
JOB NUMBER	17046


OP 16-740262
 #6A

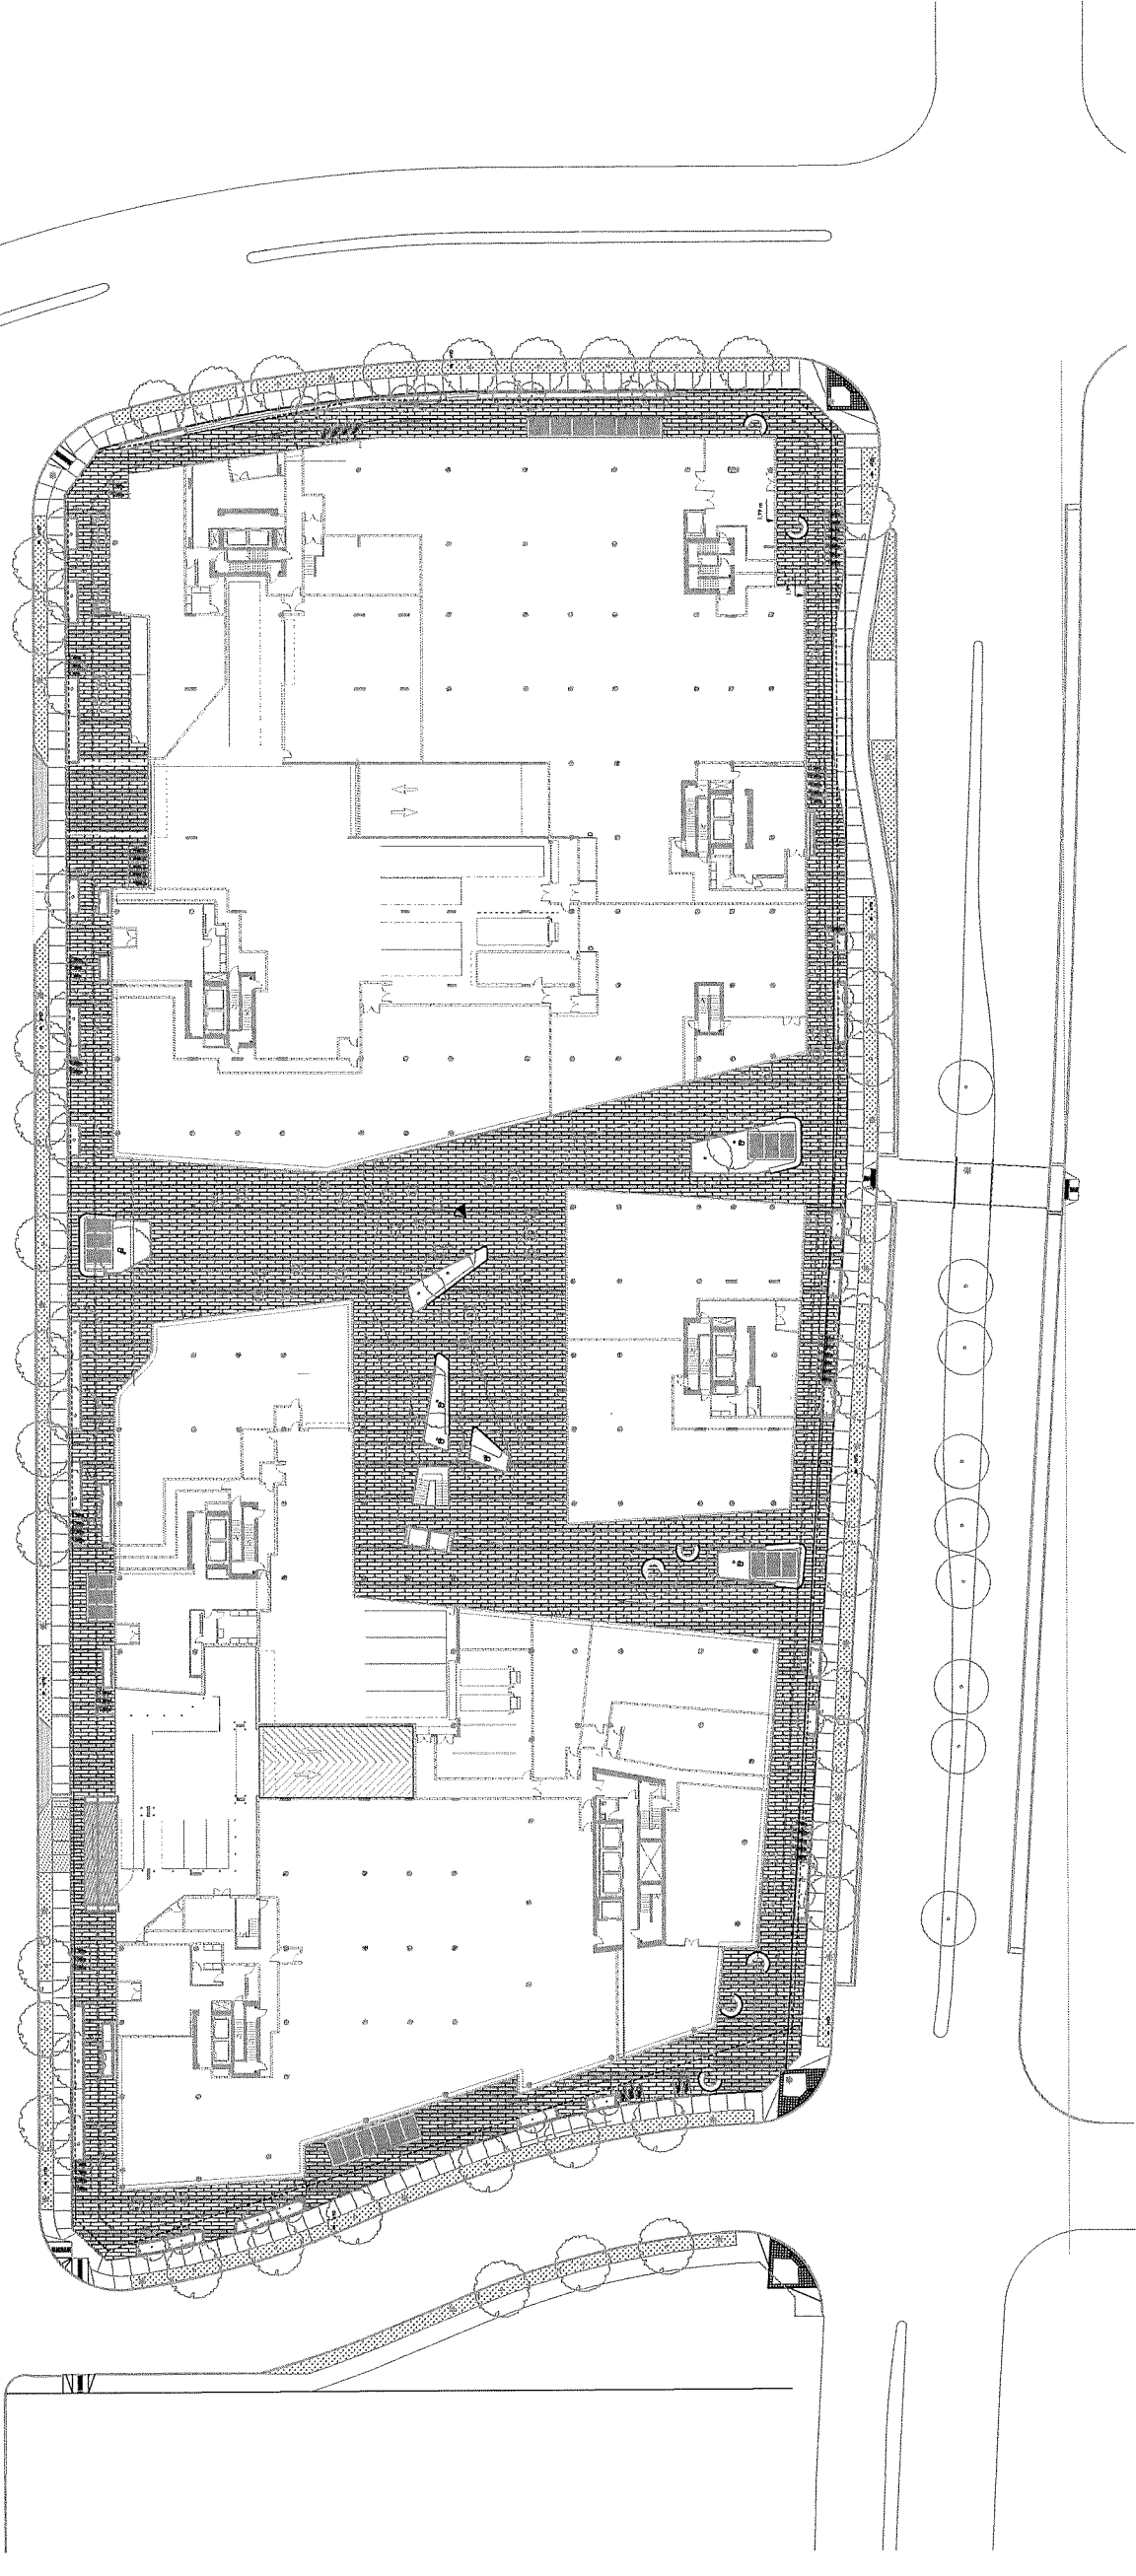

- LIGHTING LEGEND**
- BENCH STRING LIGHT - Type 'AA'; SEE ELECTRICAL
 - TREE UPLIGHT - Type 'BB'; SEE ELECTRICAL
 - ◊ PUBLIC ART UPLIGHT - Type 'CC'; SEE ELECTRICAL
 - CANOPY DOWN LIGHT - Type 'DD'; SEE ELECTRICAL
 - RECESSED WALL LIGHT - Type 'EE'; SEE ELECTRICAL
 - ◇ BOLLARD LIGHT - Type 'FF'; SEE ELECTRICAL
 - RAILING LED LIGHT - Type 'GG'; SEE ELECTRICAL

LIGHTING GENERAL NOTES
 THIS DRAWING IS FOR REFERENCE ONLY. SEE ELECTRICAL DRAWING FOR LIGHTING DESIGN.


OP 16-740262 #20

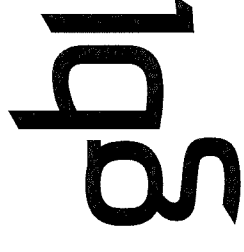

gbl ARCHITECTS INC.
138 EAST 8TH AVENUE
VANCOUVER, BC CANADA V5T 1S8
TEL: 604 238 1186
FAX: 604 231 5279
CORPORATE REGISTERED. THIS PLAN AND DESIGN ARE NOT VALID UNLESS REVIEWED
BY GBL ARCHITECTS INC. AND NOT BY ANY OTHER ARCHITECTS.

NOTES

PFS STUDIO
PLANNING - URBAN DESIGN - LANDSCAPE ARCHITECTURE

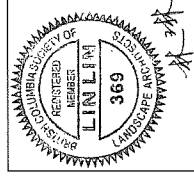


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5	2018-08-31	DD 80%
6	2018-09-21	Reissued for DP
7	2018-10-09	Reissued for DP

7960 ALDERBRIDGE WAY

LANDSCAPE LIGHTING PLAN
- LEVEL 3

DATE: 10/09/2018
DRAWN BY: MP/LL
CHECKED BY: LL
SCALE: 1/16" = 1'-0"
JOB NUMBER: 17046

L5.02

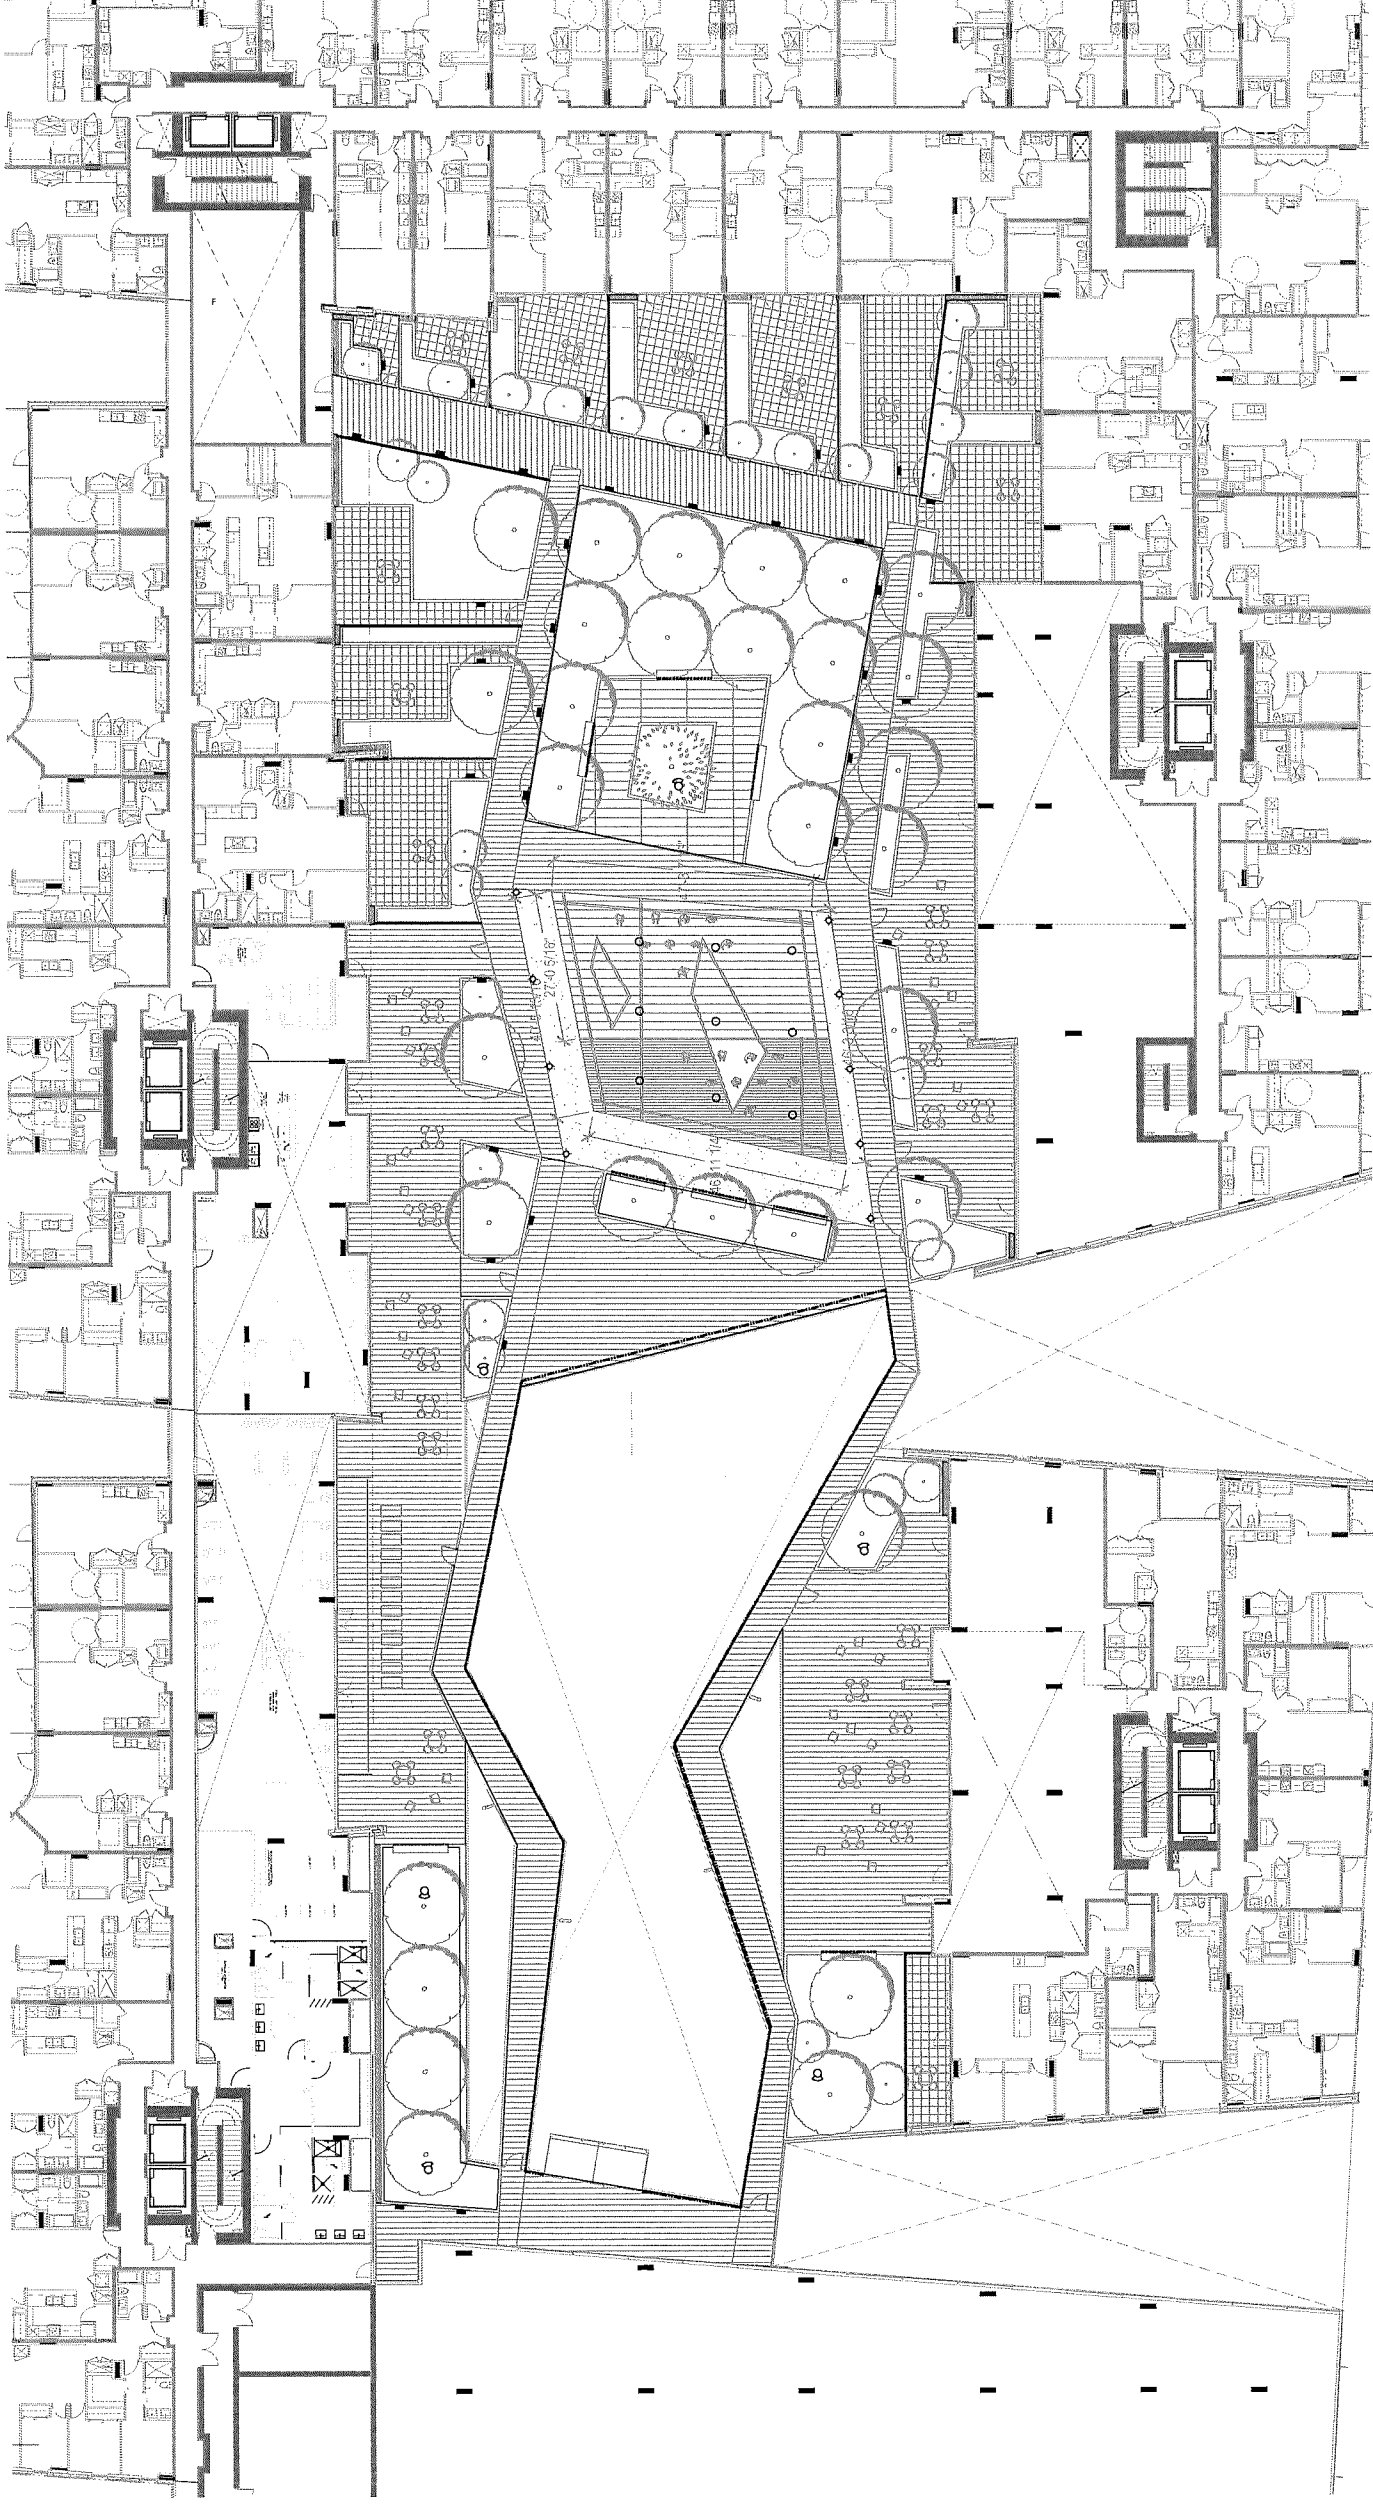

LIGHTING LEGEND
BENCH STRING LIGHT - Type 'AA':
SEE ELECTRICAL

TREE UP LIGHT - Type 'BB':
SEE ELECTRICAL

PUBLIC ART UP LIGHT - Type 'CC':
SEE ELECTRICAL

CANOPY DOWN LIGHT - Type 'DD':
SEE ELECTRICAL

RECESSED WALL LIGHT - Type 'EE':
SEE ELECTRICAL


BOLLARD LIGHT - Type 'FF':
SEE ELECTRICAL

RAILING LED LIGHT - Type 'GG':
SEE ELECTRICAL

LIGHTING GENERAL NOTES

THIS DRAWING IS FOR REFERENCE ONLY. SEE ELECTRICAL DRAWING FOR LIGHTING DESIGN.

NOTES

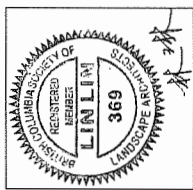



NO.	DATE	DESCRIPTION
1	2017-09-29	Issued for Rezoning
2	2017-11-14	Issued for Rezoning (Resubmission)
3	2017-11-14	Issued for DP
4	2018-07-18	Reissued for DP
5	2018-08-31	DD 80%
6	2018-09-21	Reissued for DP
7	2018-10-09	Reissued for DP

7960 ALDERBRIDGE WAY

**LANDSCAPE LIGHTING PLAN
- LEVEL 6**

DATE: 10/09/2018
 DRAWN BY: MP/LL
 CHECKED BY: LL
 SCALE: 1/16" = 1'-0"
 JOB NUMBER: 17046


OP 16-740262 #71

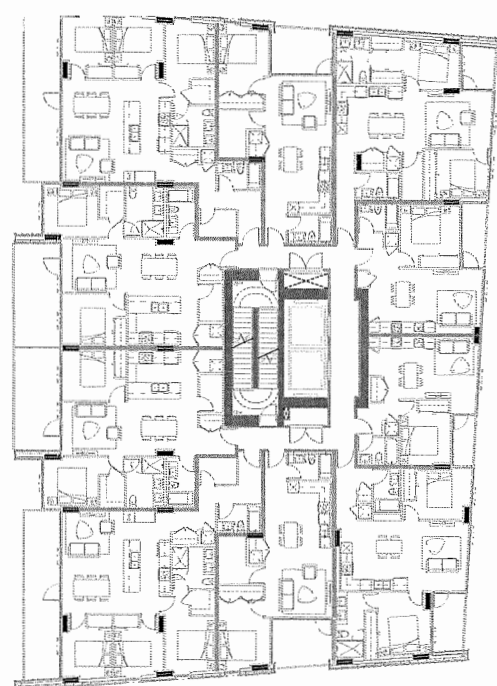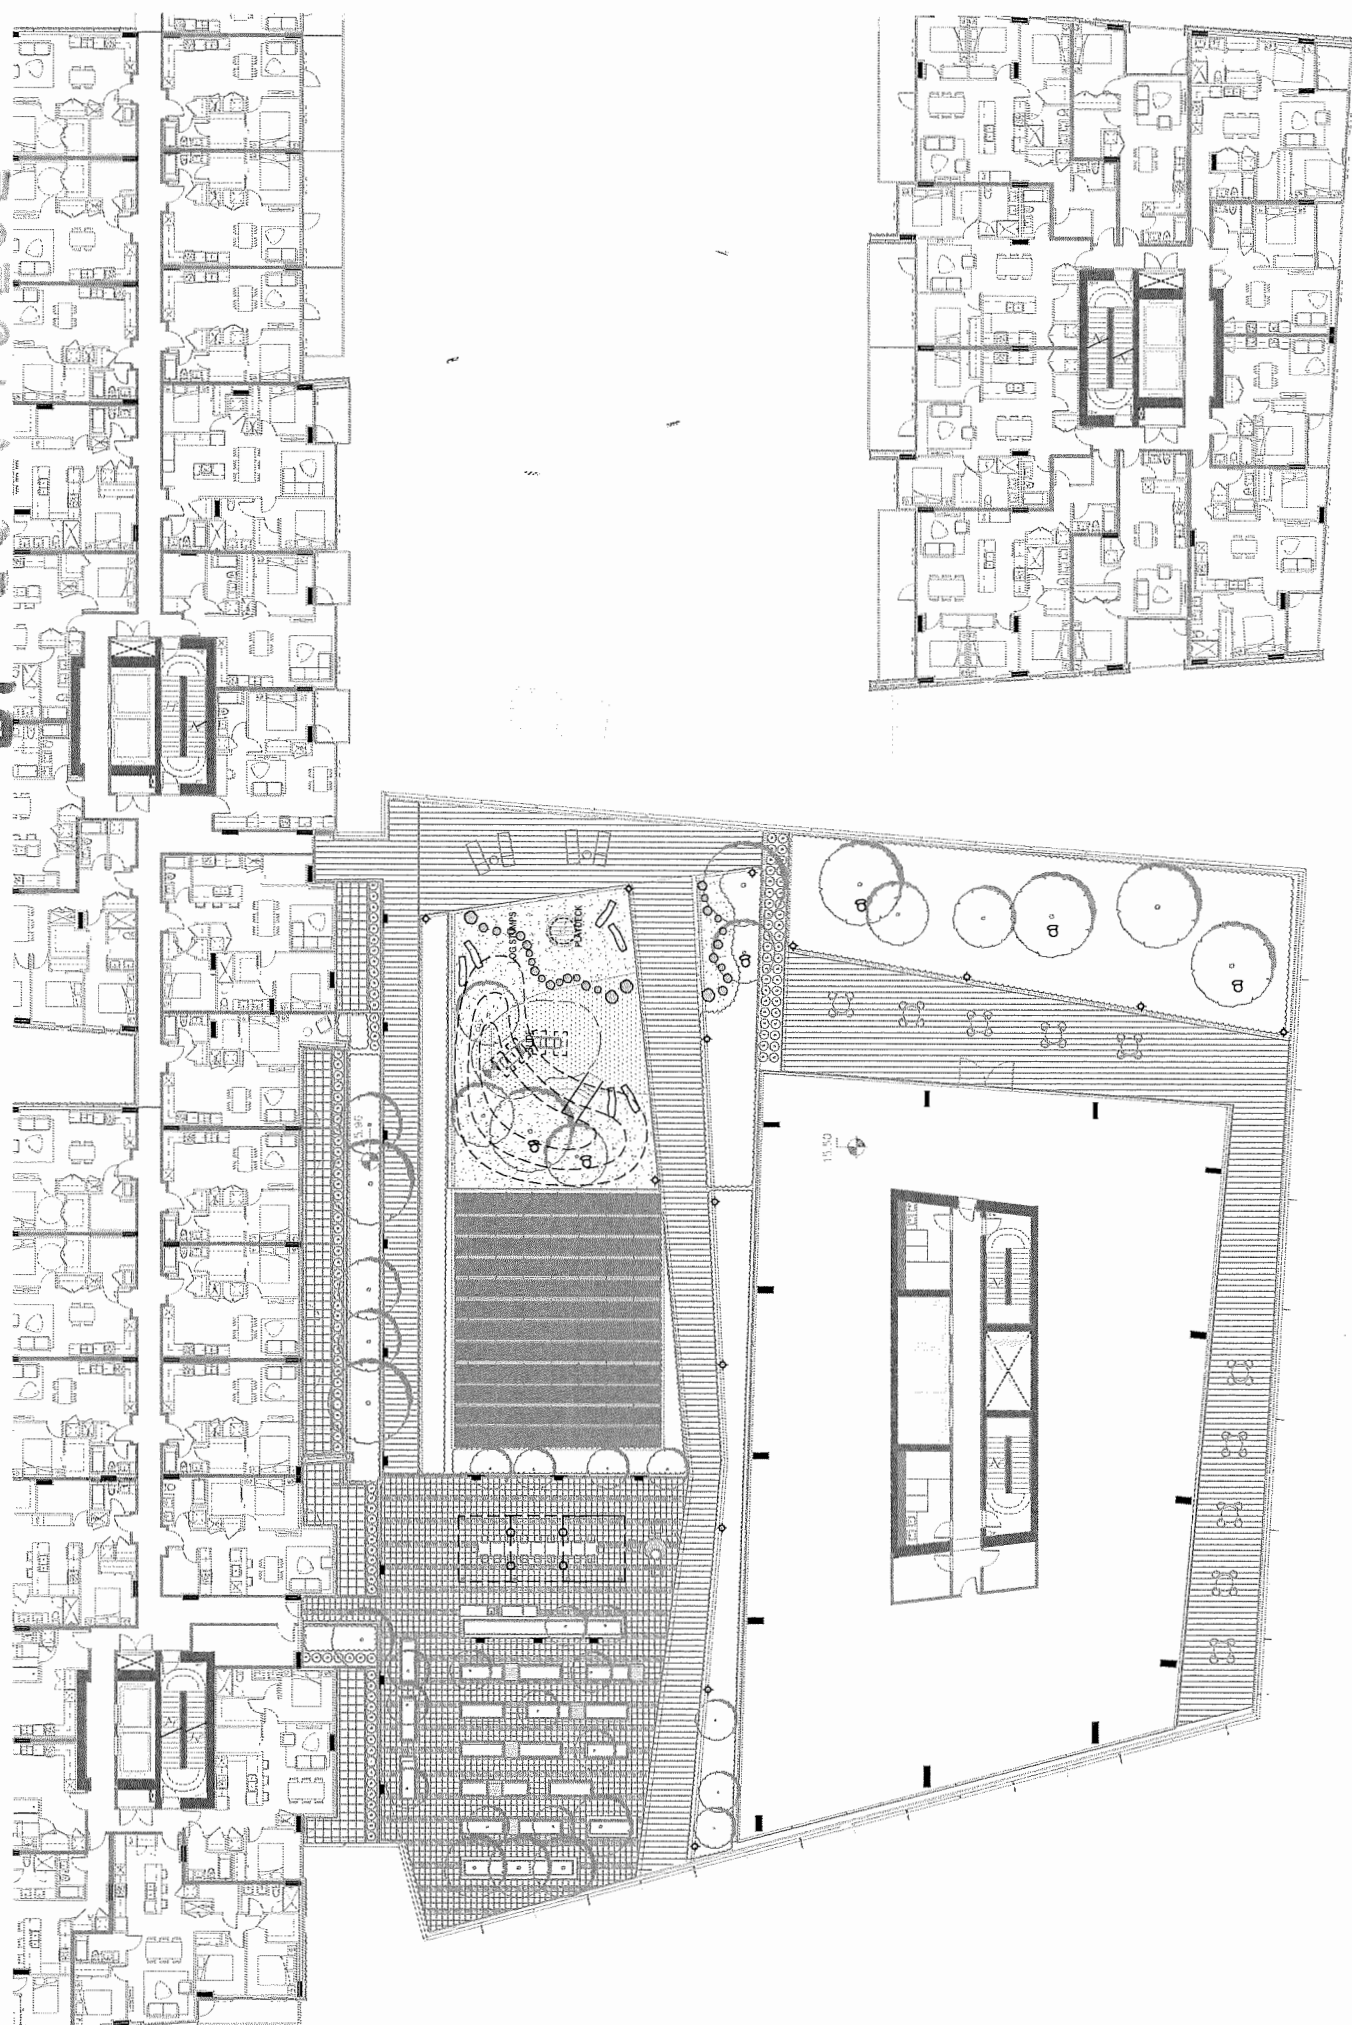

- LIGHTING LEGEND**
- BENCH STRING LIGHT - Type 'AA':
SEE ELECTRICAL
 - TREE LIGHT - Type 'BB':
SEE ELECTRICAL
 - ◀ PUBLIC ART UPLIGHT - Type 'CC':
SEE ELECTRICAL
 - CANOPY DOWN LIGHT - Type 'DD': SEE ELECTRICAL
 - RECESSED WALL LIGHT - Type 'EE':
SEE ELECTRICAL
 - ◇ BOLLARD LIGHT - Type 'FF':
SEE ELECTRICAL
 - RAILING LED LIGHT - Type 'GG':
SEE ELECTRICAL

LIGHTING GENERAL NOTES
 THIS DRAWING IS FOR REFERENCE ONLY. SEE ELECTRICAL DRAWING FOR LIGHTING DESIGN.

DP 16-740262 #22

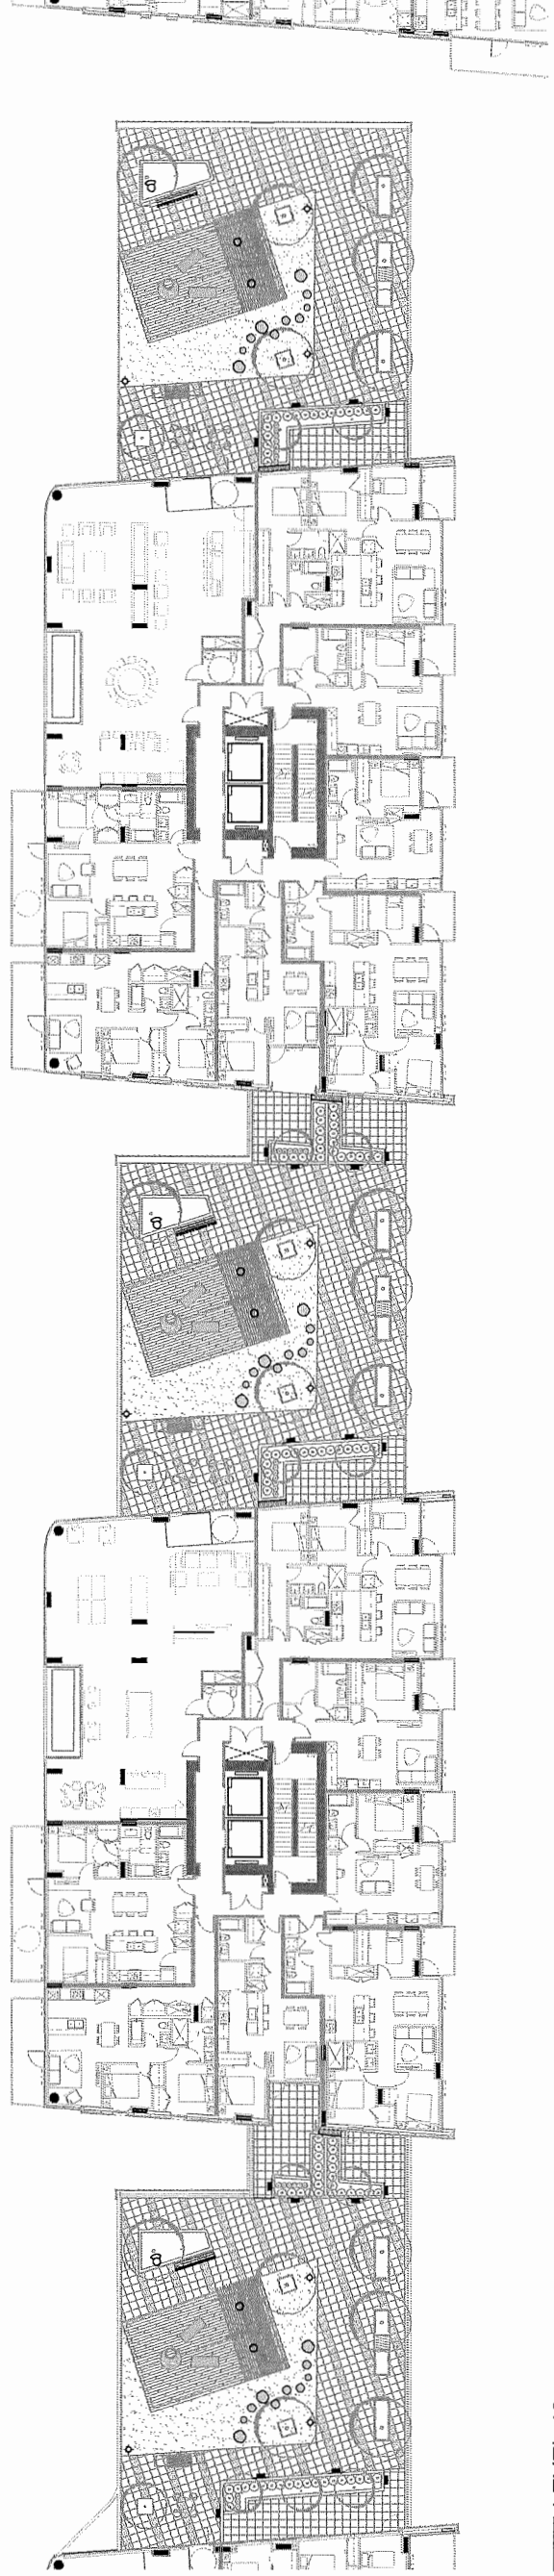

LEVEL 10
SCALE: 1/16" = 1'-0"


- LIGHTING LEGEND**
- BENCH STRING LIGHT - Type 'AA' - SEE ELECTRICAL
 - TREE UPLIGHT - Type 'BB' - SEE ELECTRICAL
 - ◇ PUBLIC ART UPLIGHT - Type 'CC' - SEE ELECTRICAL
 - CANOPY DOWN LIGHT - Type 'DD' - SEE ELECTRICAL
 - ▬ RECESSED WALL LIGHT - Type 'EE' - SEE ELECTRICAL
 - ◇ BOLLARD LIGHT - Type 'FF' - SEE ELECTRICAL
 - RAILING LED LIGHT - Type 'GG' - SEE ELECTRICAL

LIGHTING GENERAL NOTES
THIS DRAWING IS FOR REFERENCE ONLY. SEE ELECTRICAL DRAWING FOR LIGHTING DESIGN.

gbl

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REVISIONS


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3	2017-11-14	Issued for DP
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5	2018-08-31	DD 80%
6	2018-09-21	Reissued for DP
7	2018-10-09	Reissued for DP

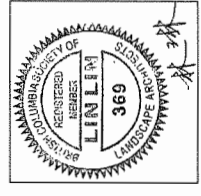7960 ALDERBRIDGE WAY

LANDSCAPE LIGHTING PLAN
- LEVEL 7 & 10

DATE: 10/09/2018
DRAWN BY: MP/LL
CHECKED BY: LL
SCALE: 1/16" = 1'-0"
JOB NUMBER: 17046


DP 16-740262 #13

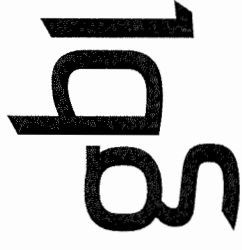


GBL ARCHITECTS INC.
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CONTRACT PROVIDED TO: TOWN OF VANCOUVER AND 7411 TOWN OF VANCOUVER
SIGNED AND SEALED FOR THE PROJECT BY: GBL ARCHITECTS INC. AND MAY NOT BE USED OR REPRODUCED
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NOTES


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3 SECTION 1A - EAST - WEST ROAD
SCALE: 3/16" = 1'-0"

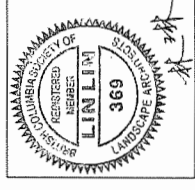

2 SECTION 1B - NORTH-SOUTH ROAD
SCALE: 3/16" = 1'-0"

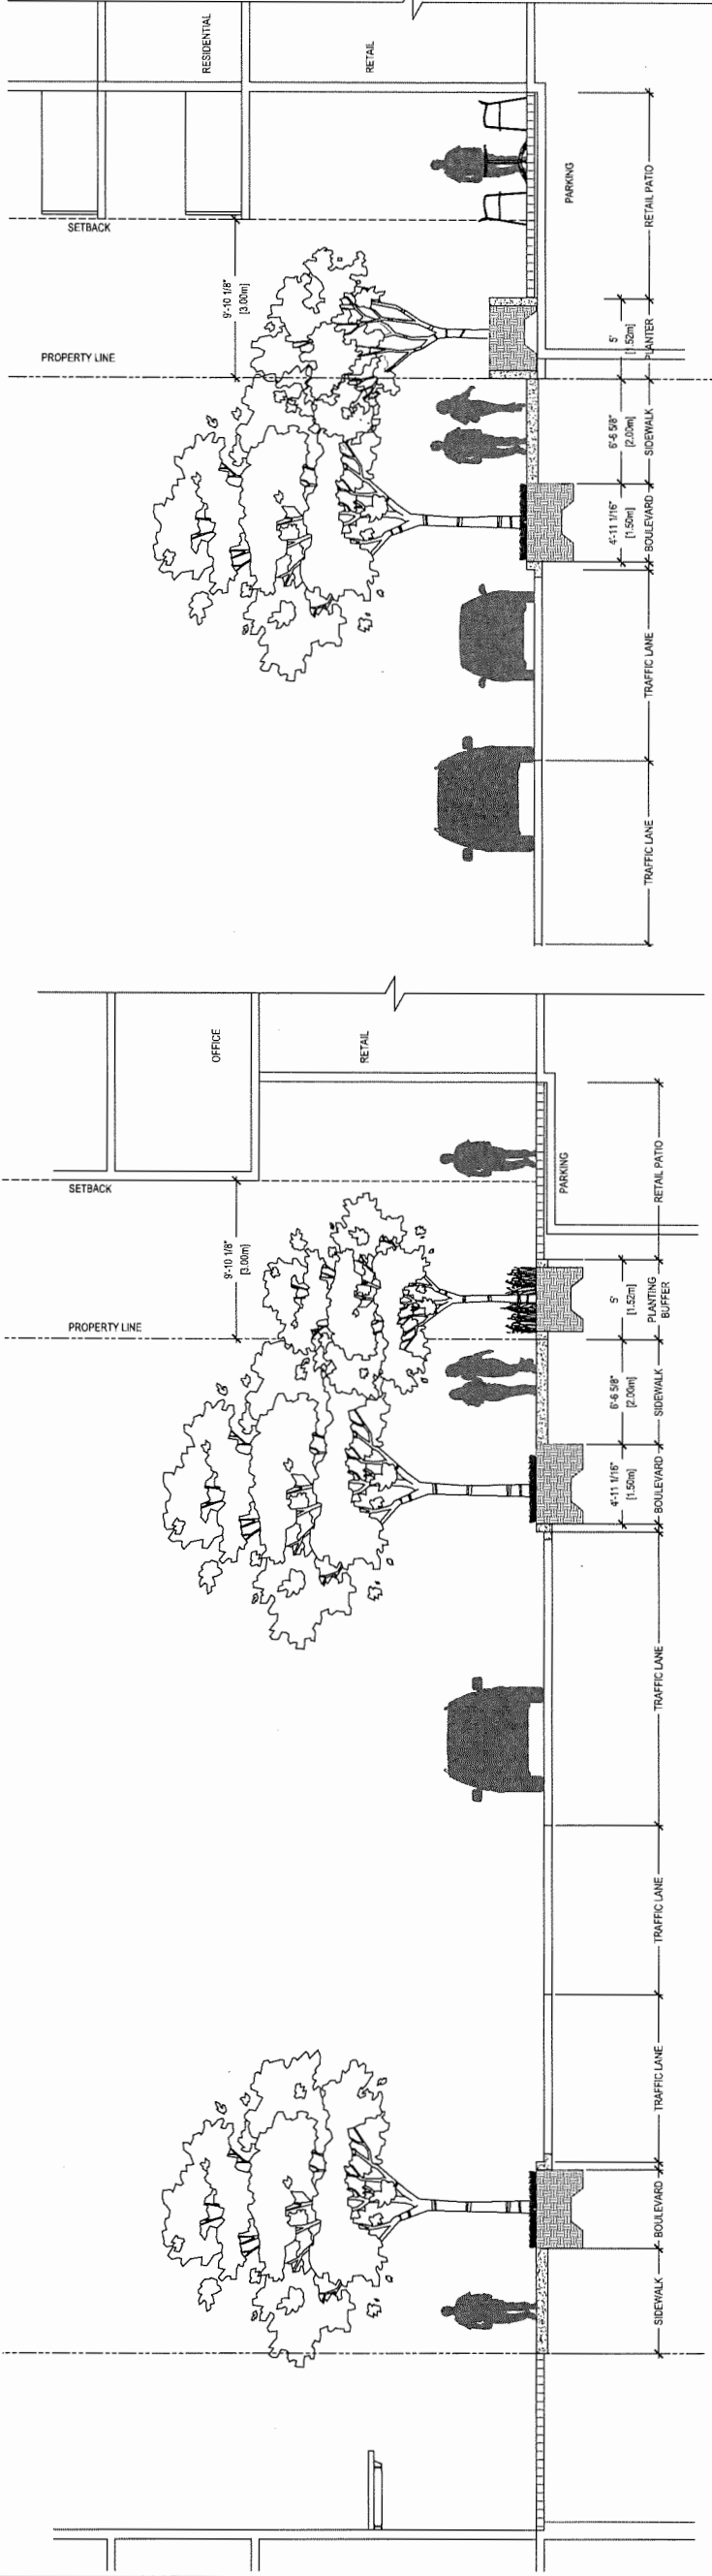

1 SECTION 1C - ALDERBRIDGE WAY
SCALE: 3/16" = 1'-0"

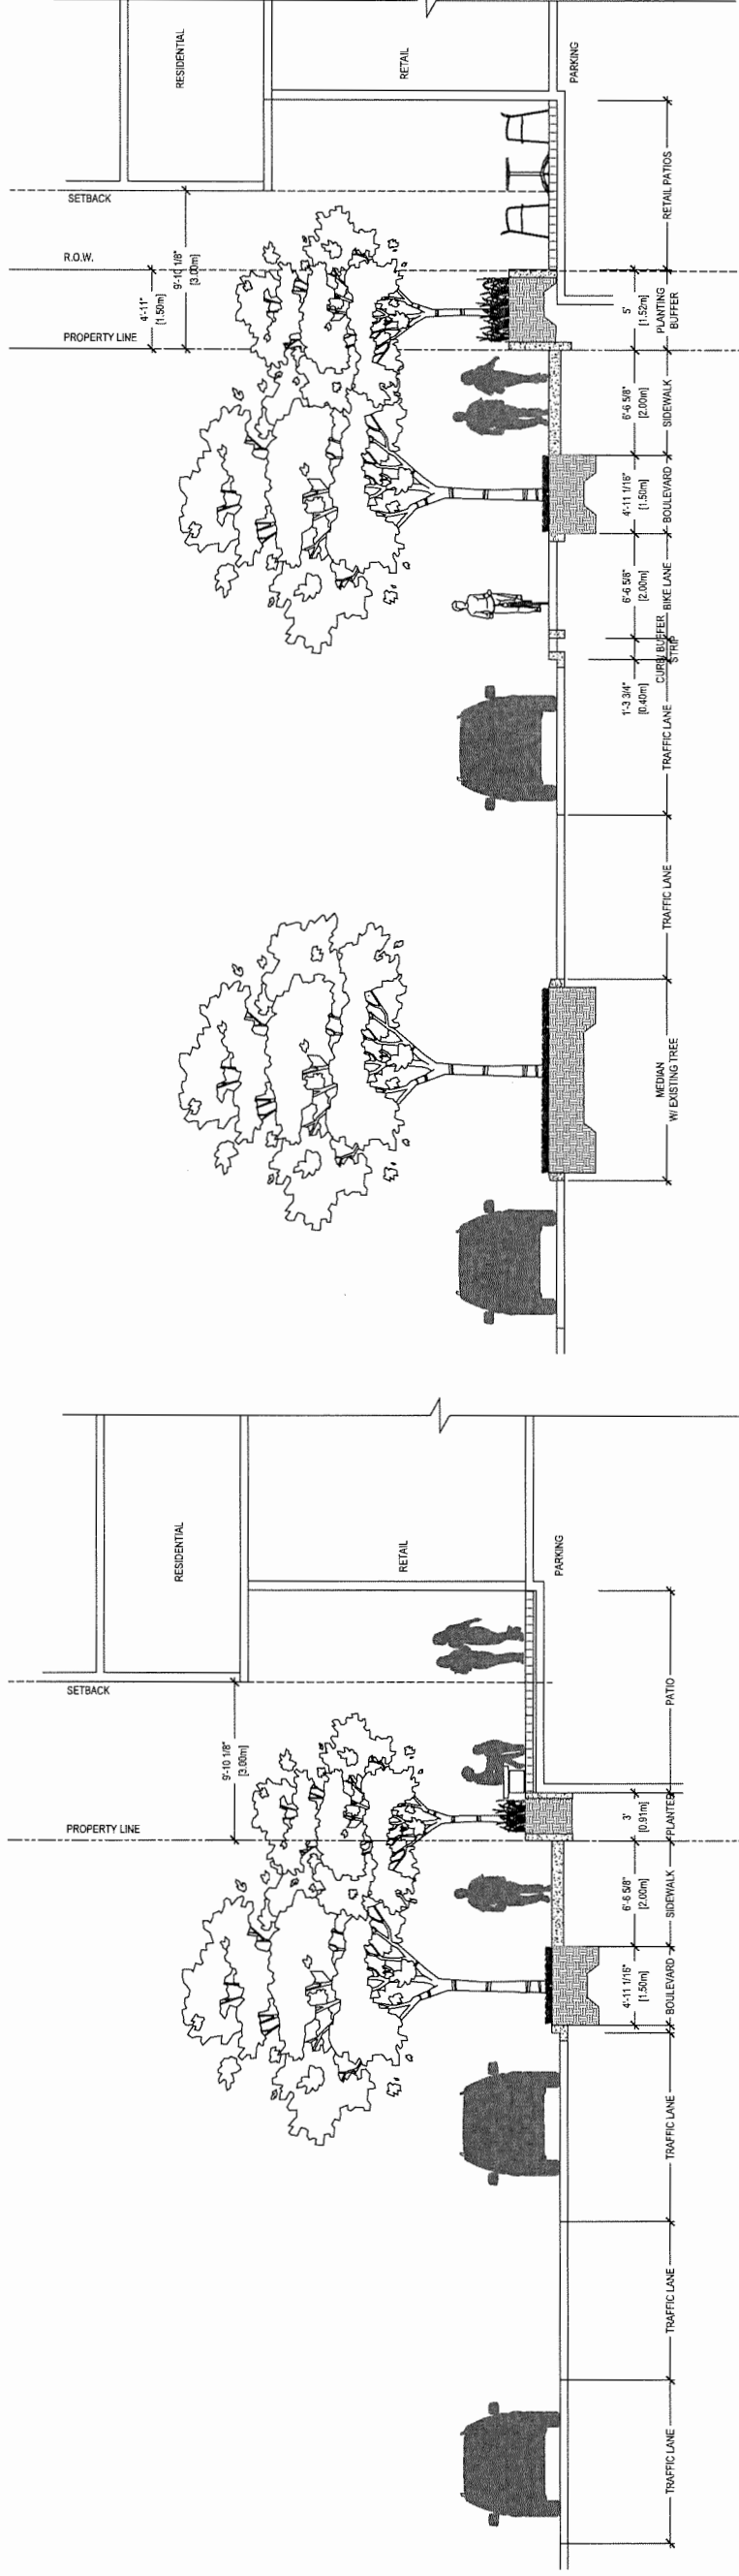4 SECTION 1D - NO 3 ROAD
SCALE: 3/16" = 1'-0"


NO.	DATE	DESCRIPTION
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6	2018-09-21	Released for DP
7	2018-10-09	Released for DP

7960 ALDERBRIDGE WAY

LANDSCAPE SECTIONS
- GROUND LEVEL


DATE: 10/09/2018
DRAWN BY: MP/LL
CHECKED BY: LL
SCALE: AS
JOB NUMBER: 170446

DP 16-740262 #24

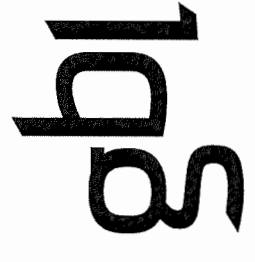

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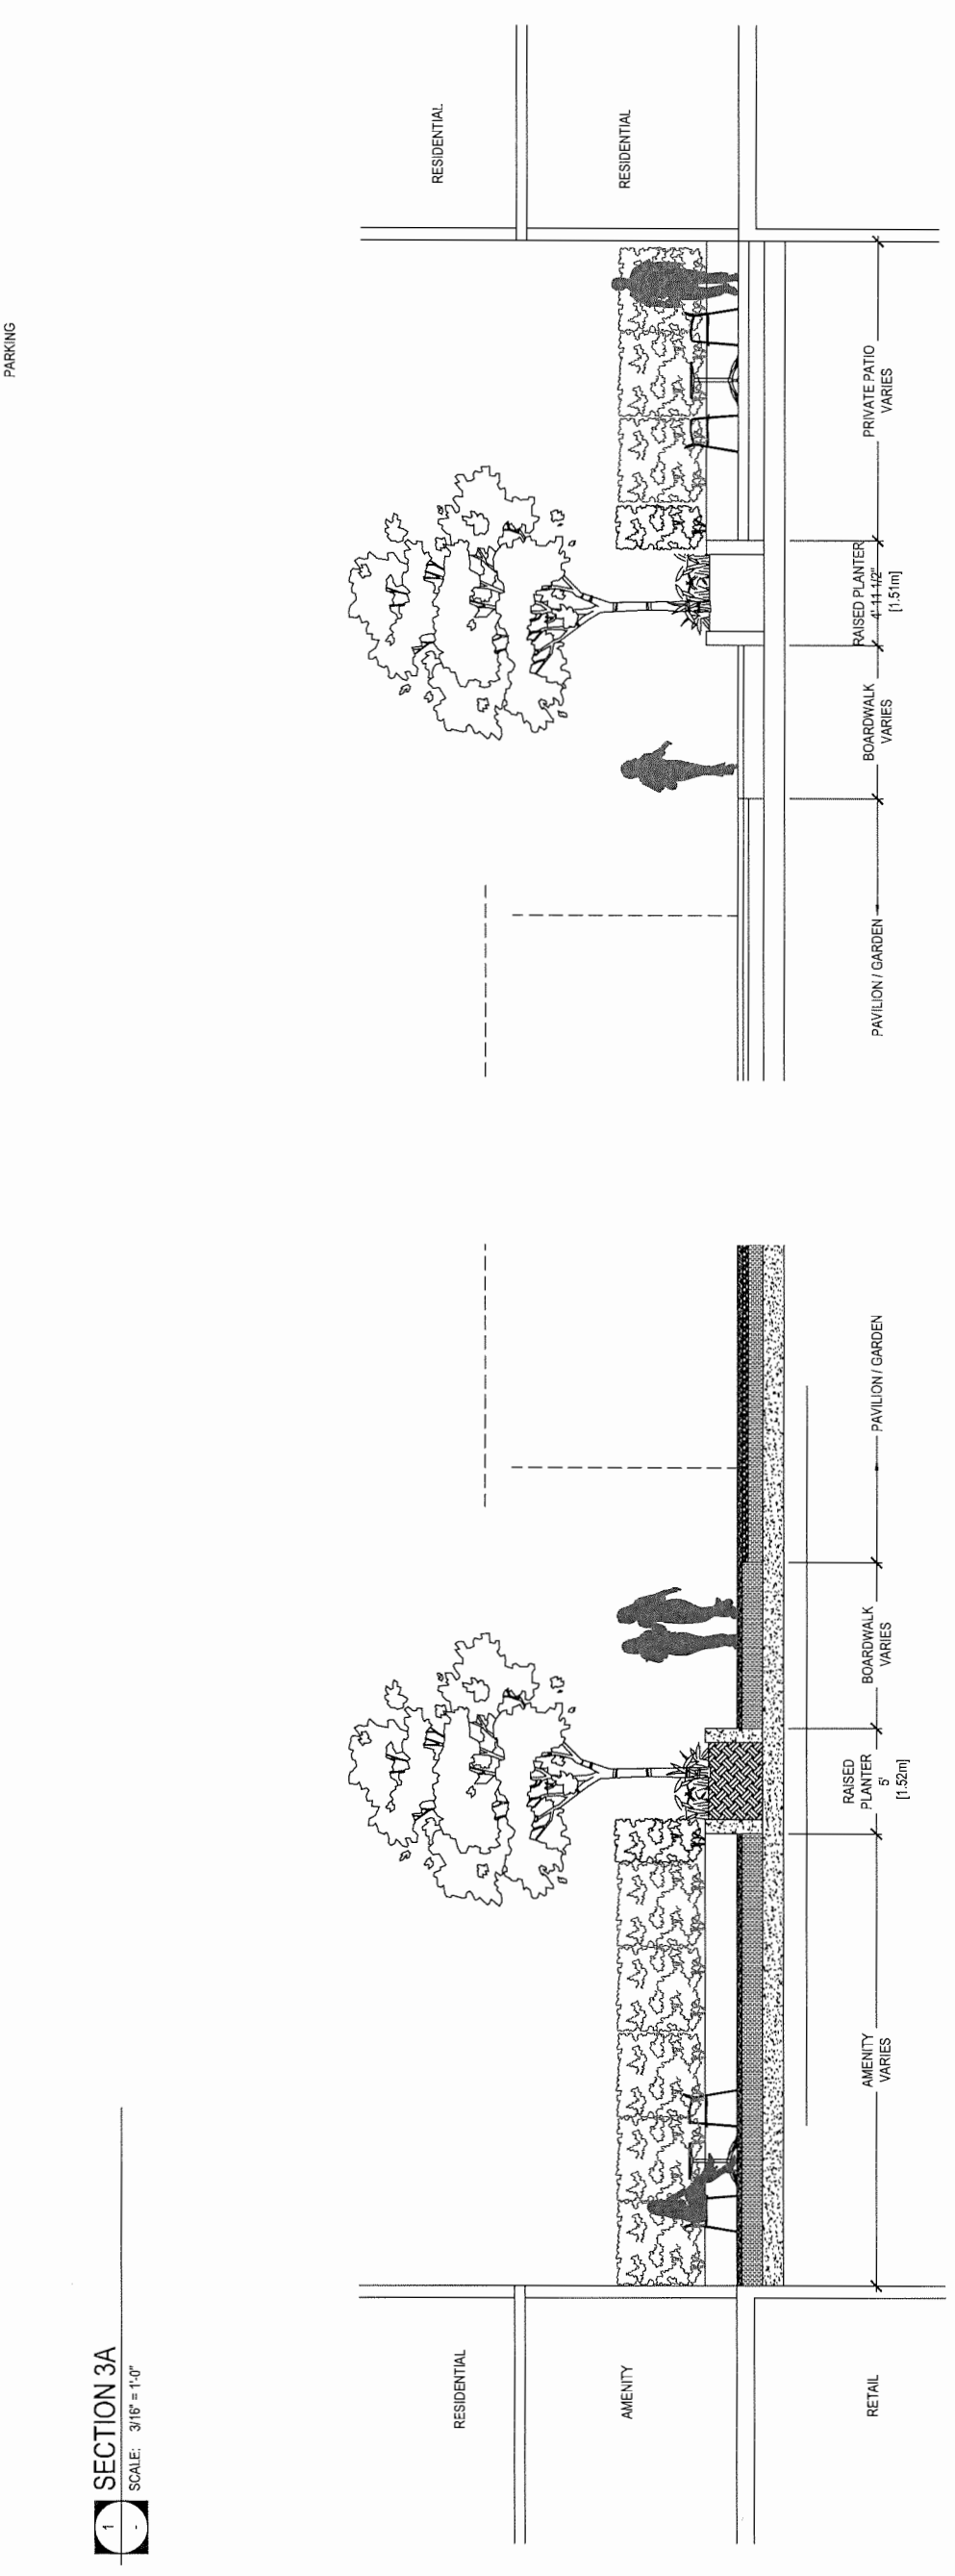
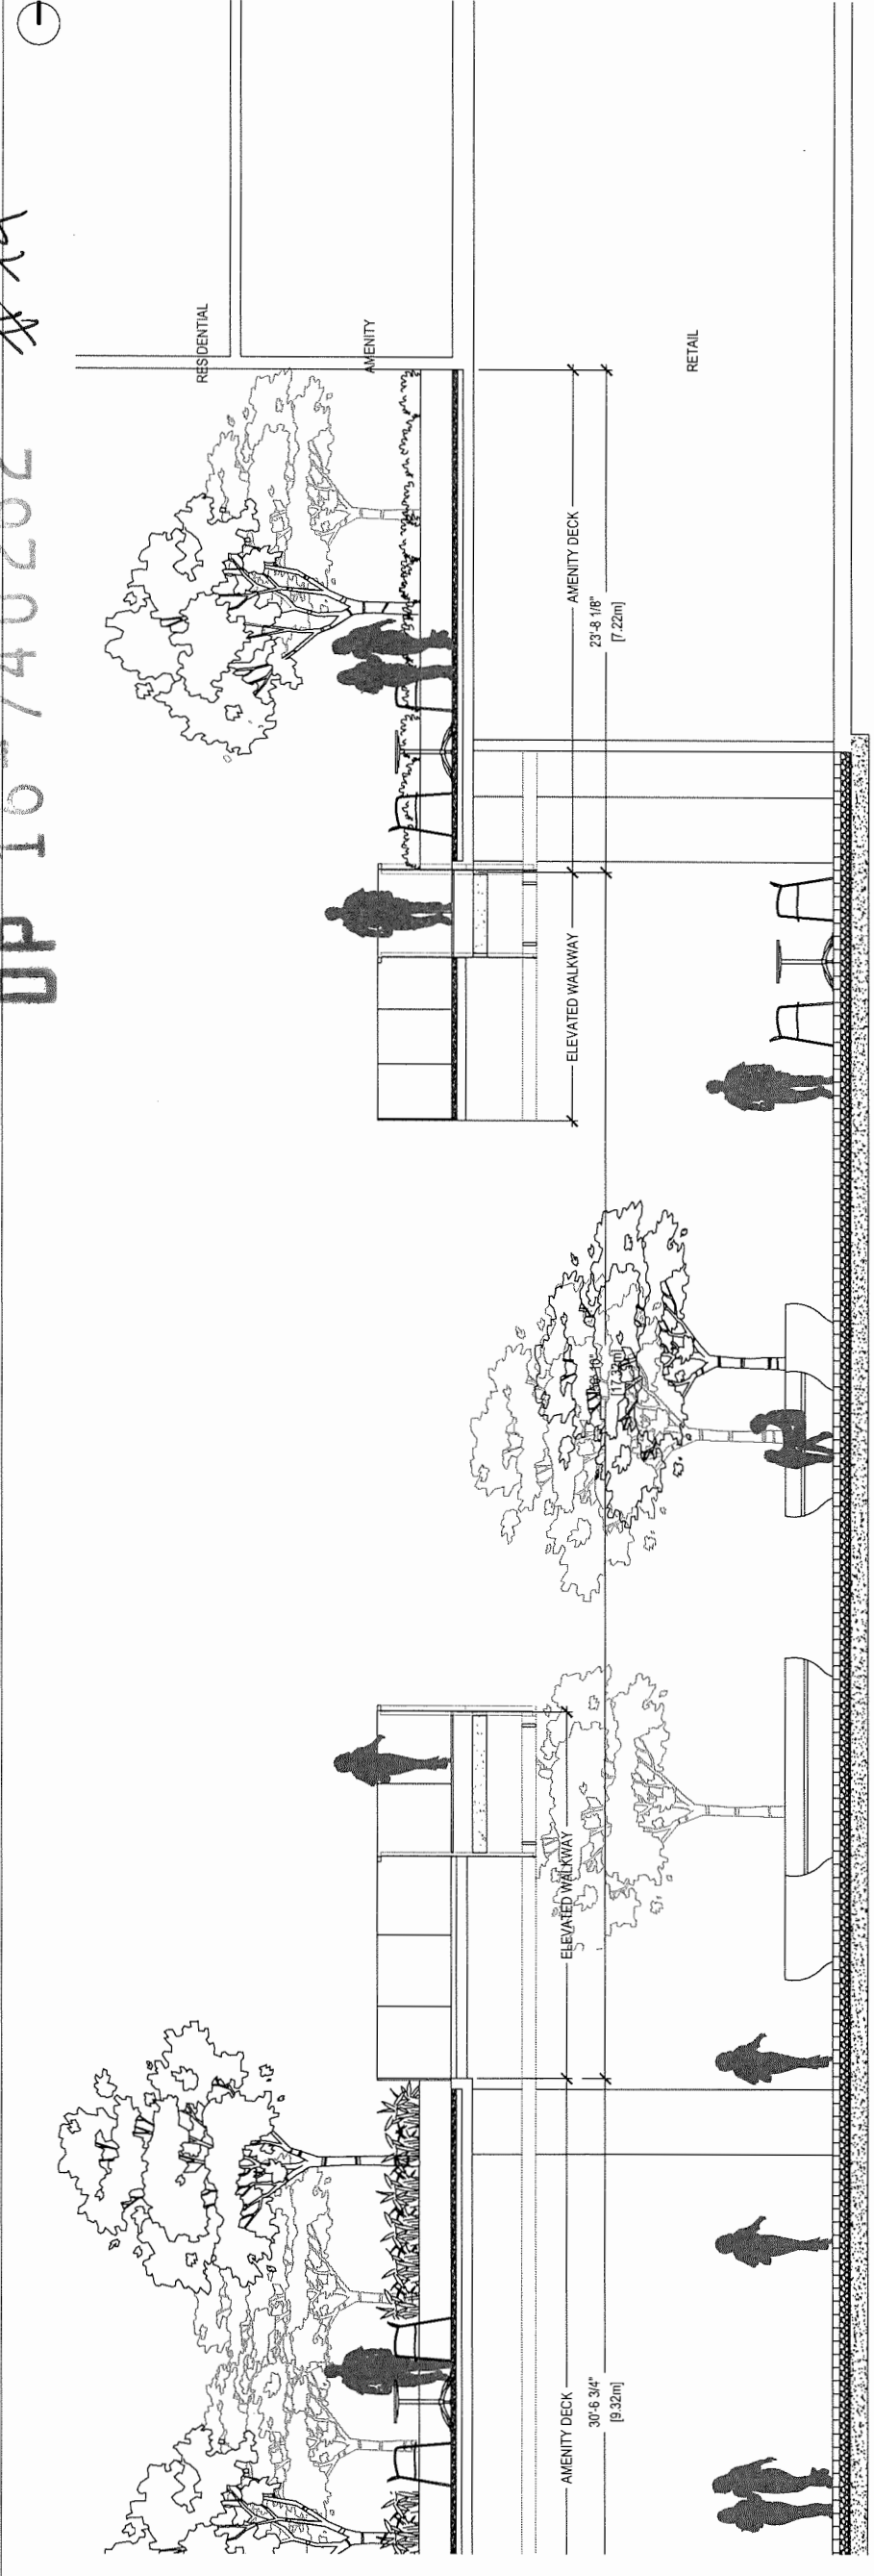
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1	2017-09-29	Issued for Rezoning
2	2017-11-14	Issued for Rezoning (Resubmission)
3	2017-11-14	Issued for DP
4	2018-07-18	Reissued for DP DD 80%
5	2018-08-31	Reissued for DP
6	2018-09-21	Reissued for DP
7	2018-10-09	Reissued for DP

7960 ALDERBRIDGE WAY

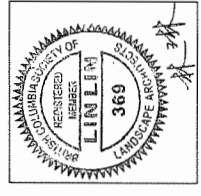LANDSCAPE SECTIONS
 - GROUND LEVEL

DATE	10/09/2018
DRAWN BY	MPILL
CHECKED BY	LL
SCALE	AS SHOWN
JOB NUMBER	17046

L6.01




DP 10-740262
#As



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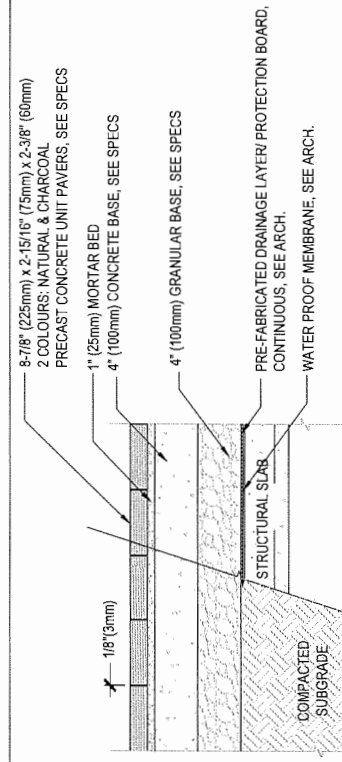
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2	2017-11-14	Issued for Rezonning (Resubmission)
3	2017-11-14	Issued for DP
4	2018-07-18	Reissued for DP
5	2018-08-31	DD 80%
6	2018-09-21	Reissued for DP
7	2018-10-09	Reissued for DP

7960 ALDERBRIDGE WAY

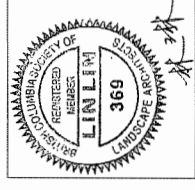
LANDSCAPE DETAILS
- PAVING

DATE 10/06/2018
DRAWN BY MP/LL
CHECKED BY LL
SCALE AS
JOB NUMBER 17046


L7.01




2 PRECAST CONCRETE UNIT PAVERS - VEHICULAR
SCALE: 1" = 1'-0"

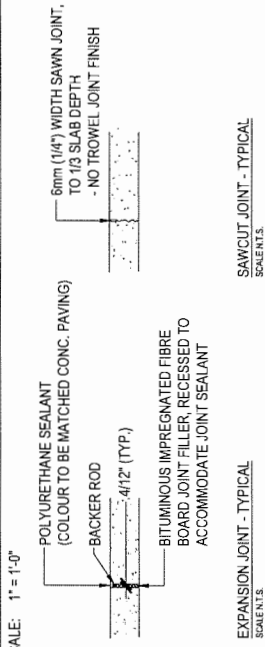


NOTES:
1. SAWCUT JOINTS TO BE LOCATED AT 9'-0" (3.0m) MAX. INTERVALS
2. EXPANSION JOINTS TO BE LOCATED AT 30'-0" (9.0m) MAX. INTERVALS AND WHERE CONCRETE PAVING ABUTS OTHER STRUCTURES OR BUILDINGS.

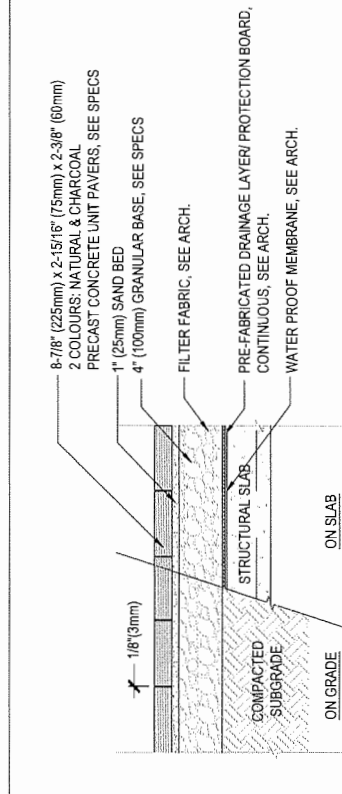


1 PRECAST CONCRETE UNIT PAVERS - PEDESTRIAN
SCALE: 1" = 1'-0"

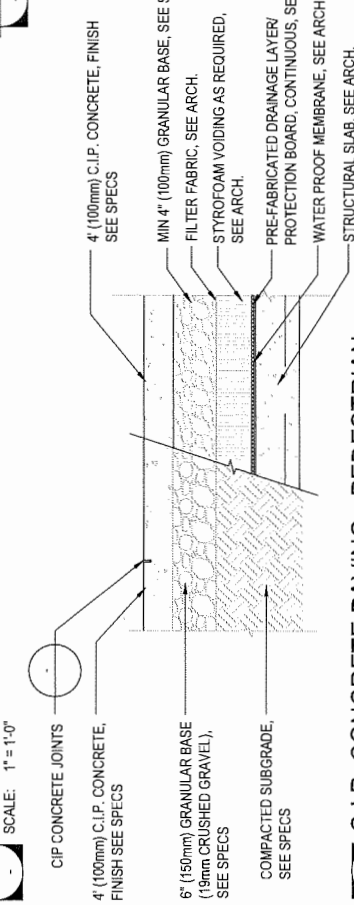


4 C.I.P. CONCRETE PAVING - PEDESTRIAN
SCALE: 1" = 1'-0"

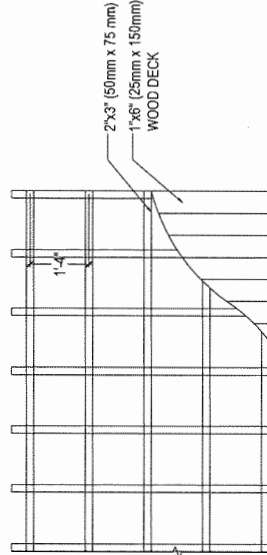


PLAN VIEW
SCALE: 1/2" = 1'-0"

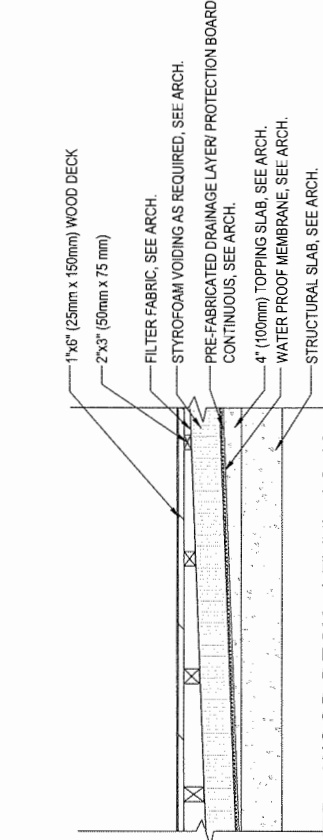


6 WOOD DECK - LEVEL 7 & 10
SCALE: 1" = 1'-0"

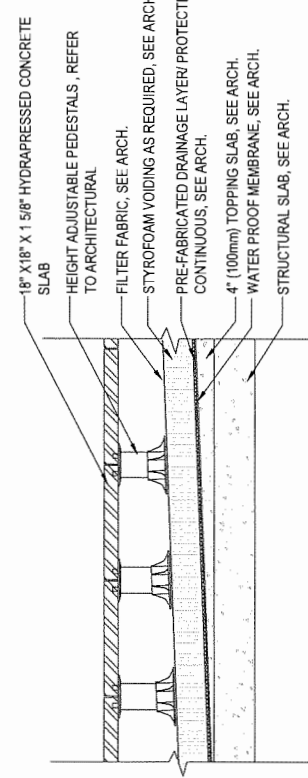


9 HYDRAPRESSED CONCRETE SLABS ON PEDESTALS - LEVEL 3, 5, 7 & 10
SCALE: 1" = 1'-0"

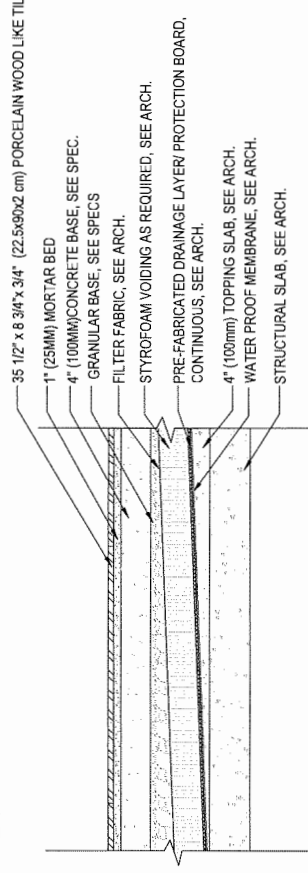

8 PORCELAIN PAVERS ON CONCRETE BASE - LEVEL 3 & 5
SCALE: 1" = 1'-0"

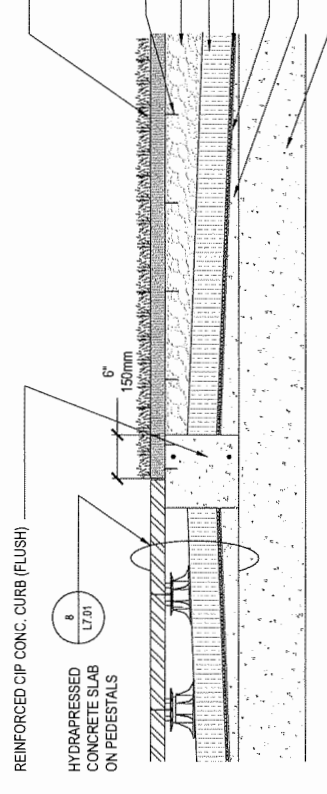

11 ARTIFICIAL TURF
SCALE: 1" = 1'-0"

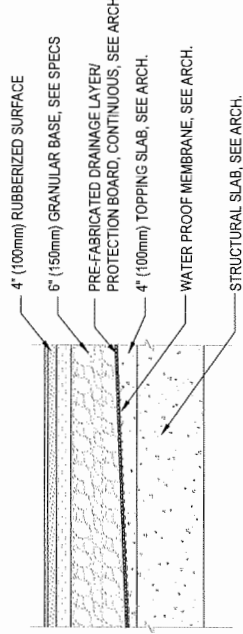

12 PLAY SURFACE - LEVEL 6
SCALE: 1" = 1'-0"

3 CONCRETE PAVERS RESTRAIN EDGE
SCALE: 1" = 1'-0"




DP 16-740262 #26



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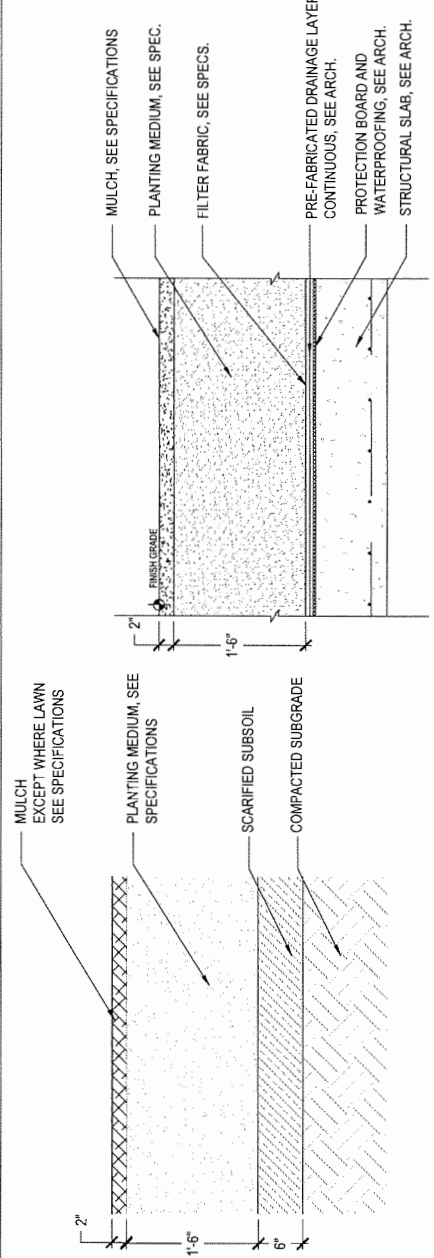
NO.	DATE	DESCRIPTION
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3	2017-11-14	Issued for DP
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5	2018-08-31	DD 80%
6	2018-09-21	Released for DP
7	2018-10-09	Released for DP

7960 ALDERBRIDGE WAY

LANDSCAPE DETAILS
 - PLANTING

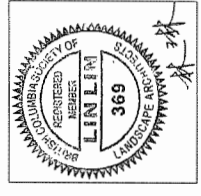
DATE	10/09/2018
DRAWN BY	MP/LL
CHECKED BY	LL
SCALE	AS
JOB NUMBER	17046

L7.02




1 SHRUB PLANTING ON GRADE

SCALE: 1" = 1'-0"

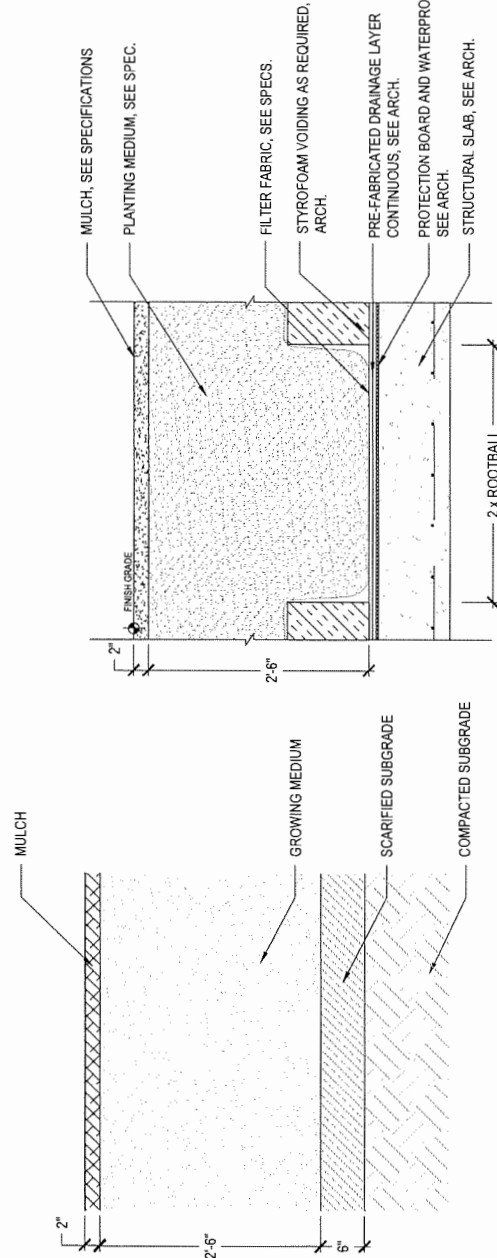


2 TREE PLANTING ON GRADE


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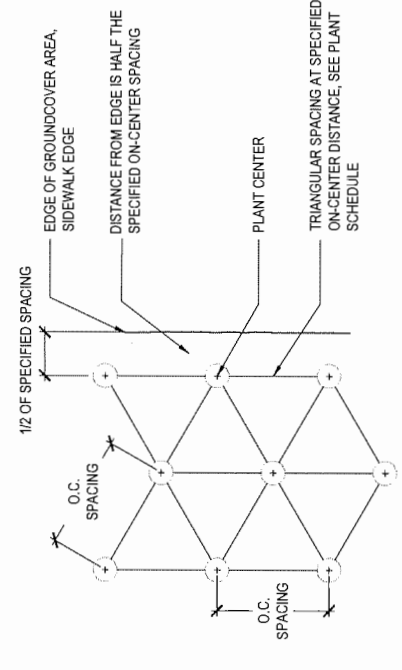
3 SHRUB PLANTING ON SLAB, WITH VOIDING

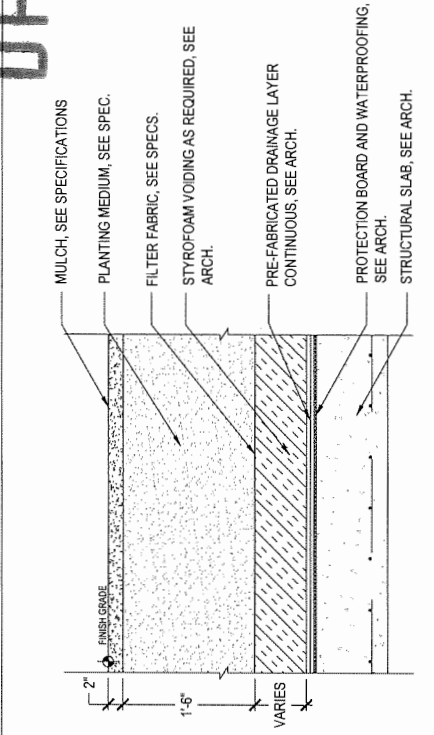

4 TREE PLANTING ON INSULATED SLAB

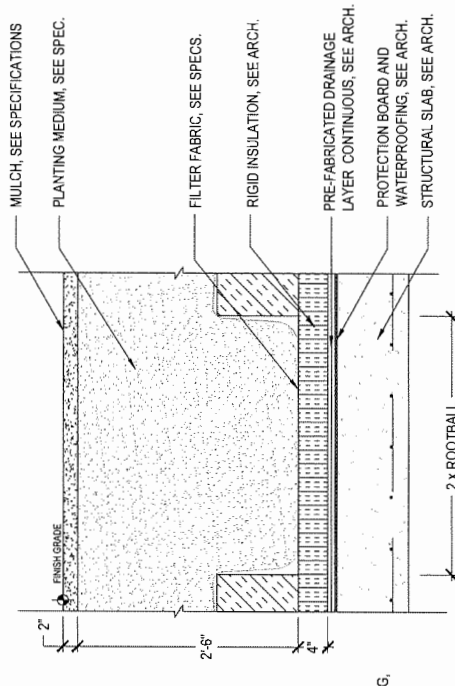


5 SHRUB PLANTING ON INSULATED SLAB

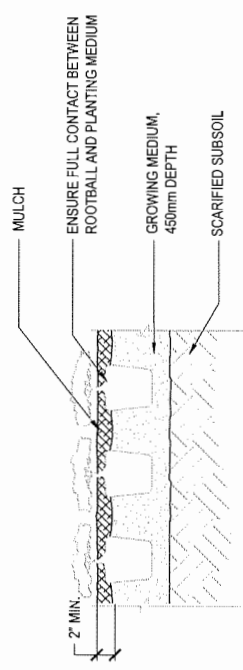


6 TREE PLANTING ON INSULATED SLAB

SCALE: 1" = 1'-0"

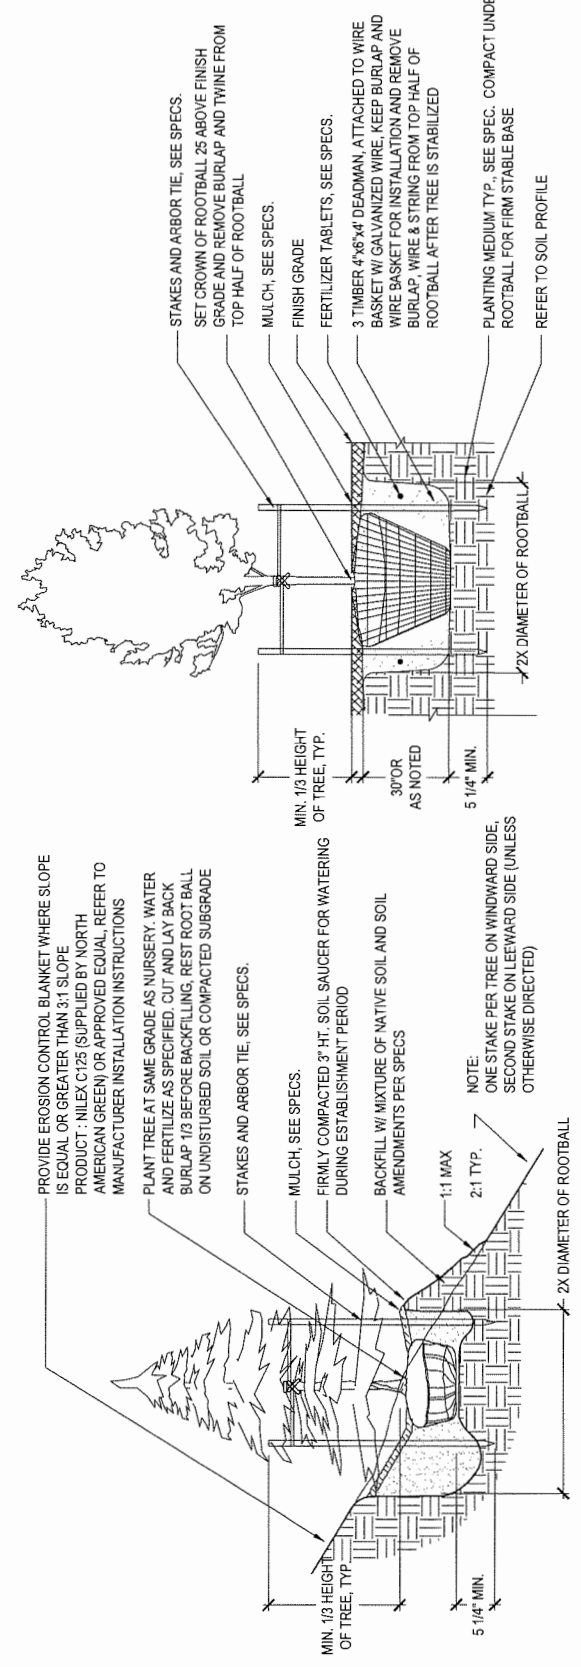

7 TREE PLANTING ON SLOPE

SCALE: 1" = 1'-0"

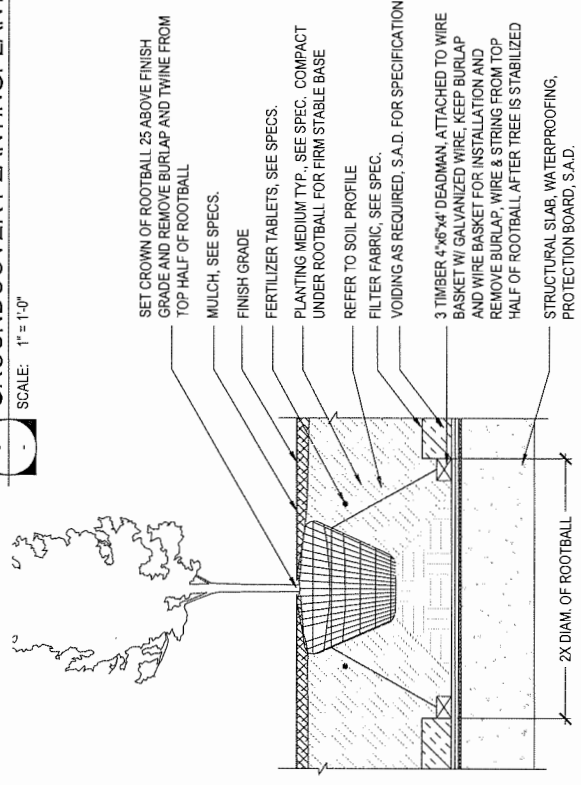


8 TREE PLANTING ON STRUCTURE

SCALE: 1" = 1'-0"


3 GROUND COVER PLANTING

SCALE: 1" = 1'-0"


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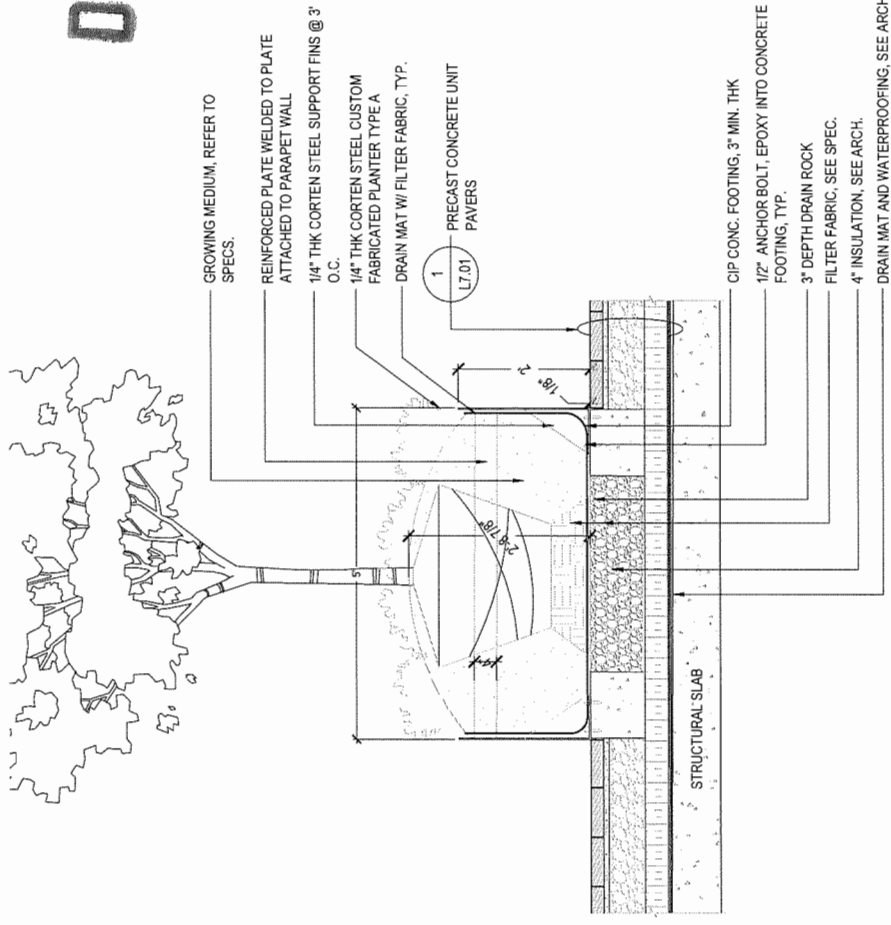
#22
 DP 16-740262

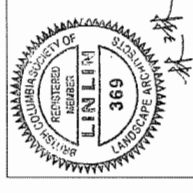


1 CONCRETE PLANTER - LEVEL 3
 SCALE: 3/4" = 1'-0"

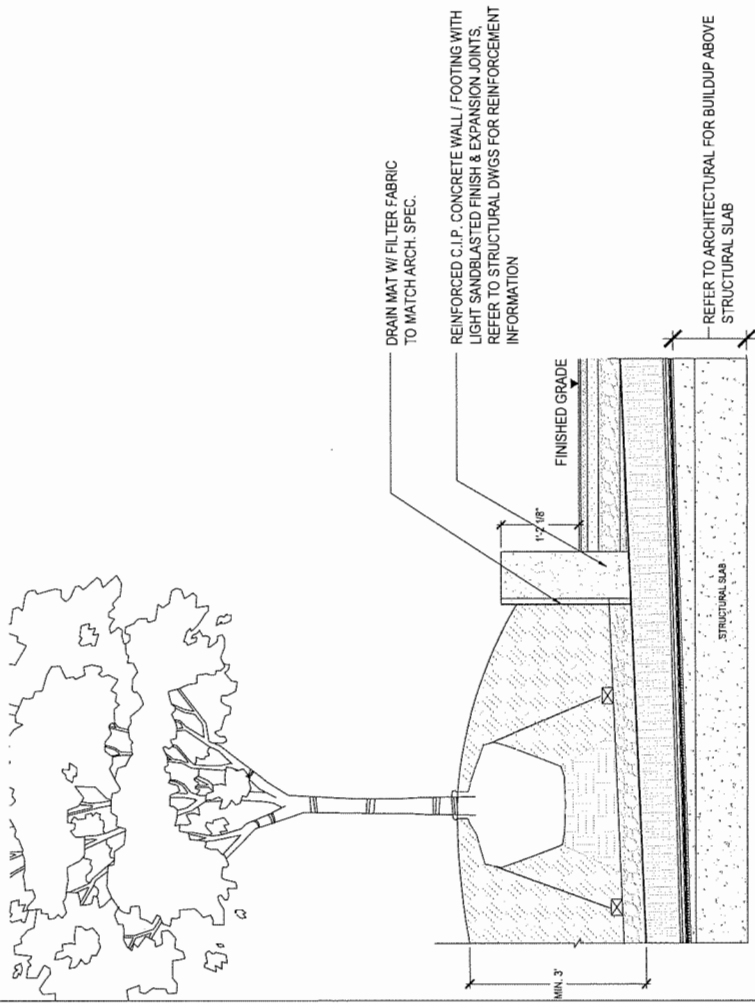


3 CONCRETE PLANTER - LEVEL 6, 7, 10
 SCALE: 3/4" = 1'-0"

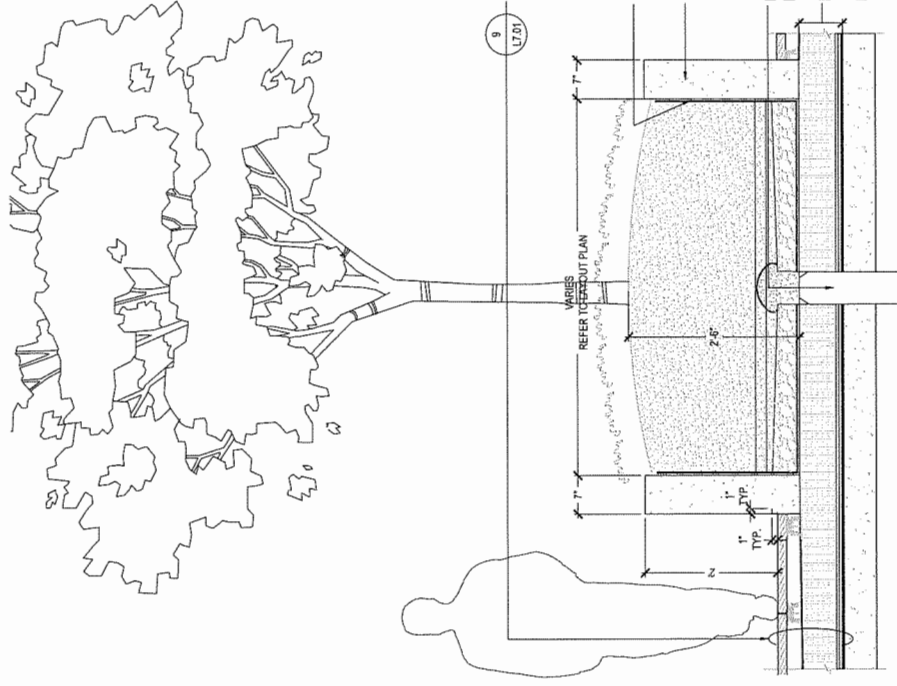

2 METAL PLANTER - LEVEL 1
 SCALE: 3/4" = 1'-0"

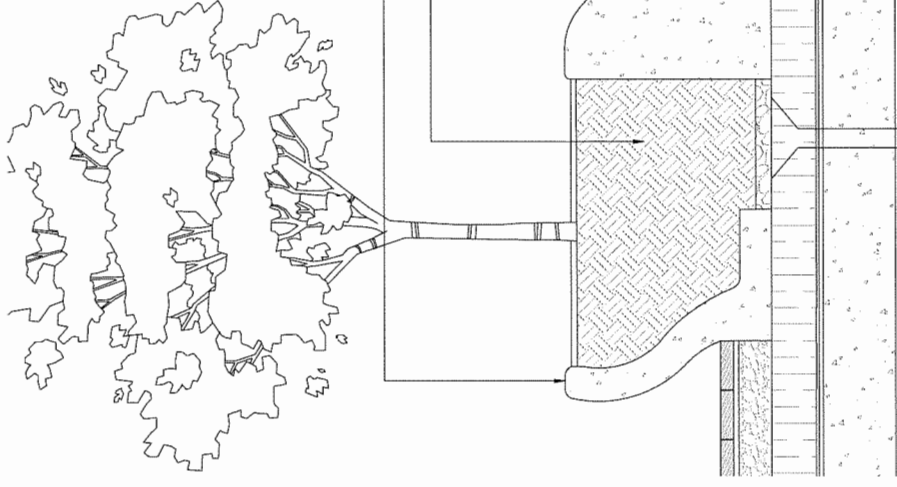

4 CONCRETE PLANTER - LEVEL 1 PLAZA
 SCALE: 3/4" = 1'-0"

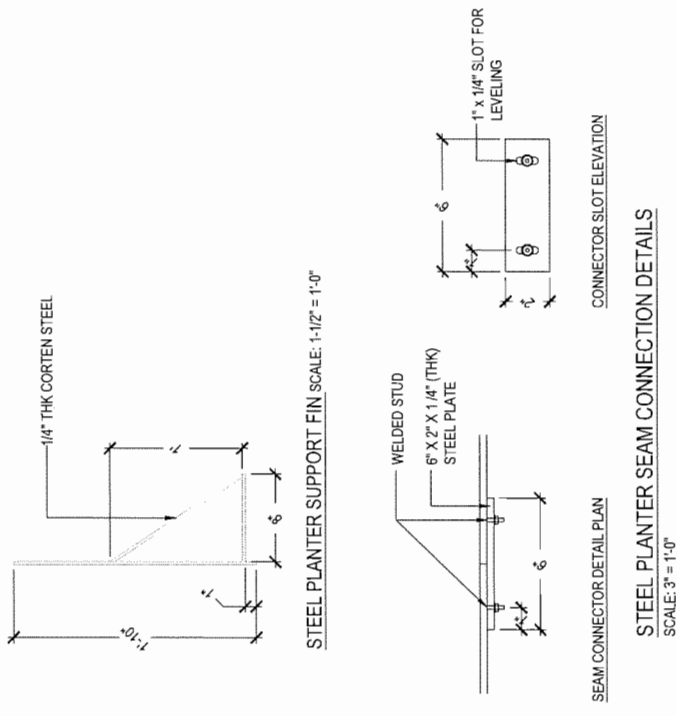

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6	2018-09-21	Reissued for DP
7	2018-10-09	Reissued for DP


7960 ALDERBRIDGE WAY

LANDSCAPE DETAILS
 - PLANTING & FURNISHING

DATE: 10/09/2018
 DRAWN BY: MP/LL
 CHECKED BY: LL/AS
 SCALE: AS
 JOB NUMBER: 17046

L7.03

NOTES

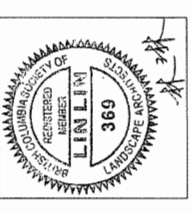


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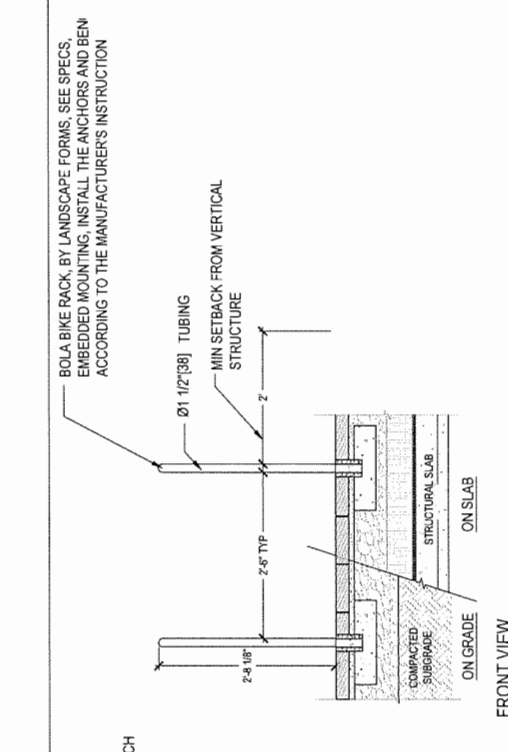
7960 ALDERBRIDGE WAY

LANDSCAPE DETAILS
- FURNISHING


DATE	10/09/2018
DRAWN BY	MP/LL
CHECKED BY	LL
SCALE	AS
JOB NUMBER	17046

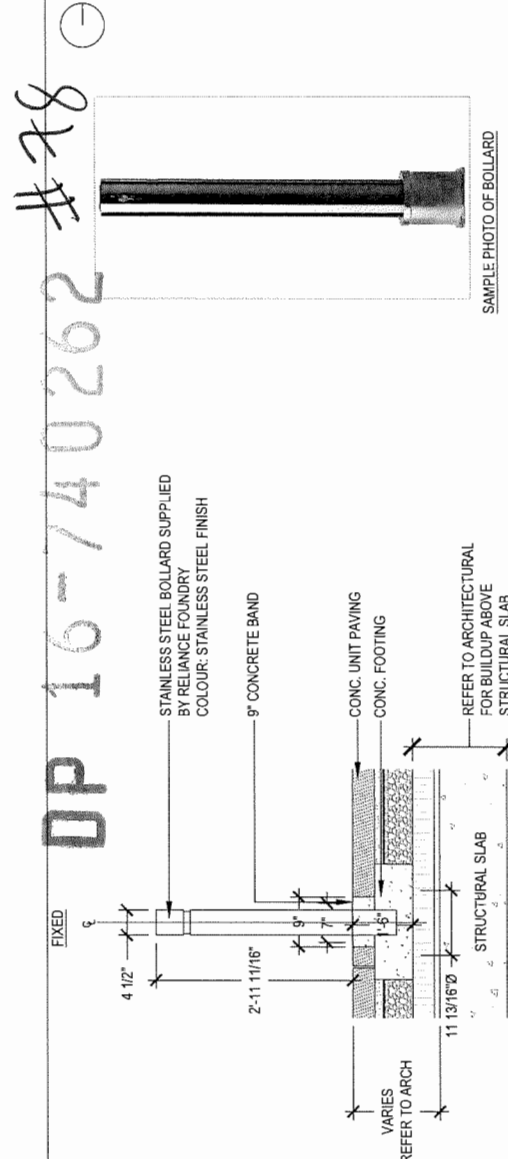


2 BOLLARD
SCALE: 3/4" = 1'-0"




1 BIKE RACK
SCALE: 3/4" = 1'-0"

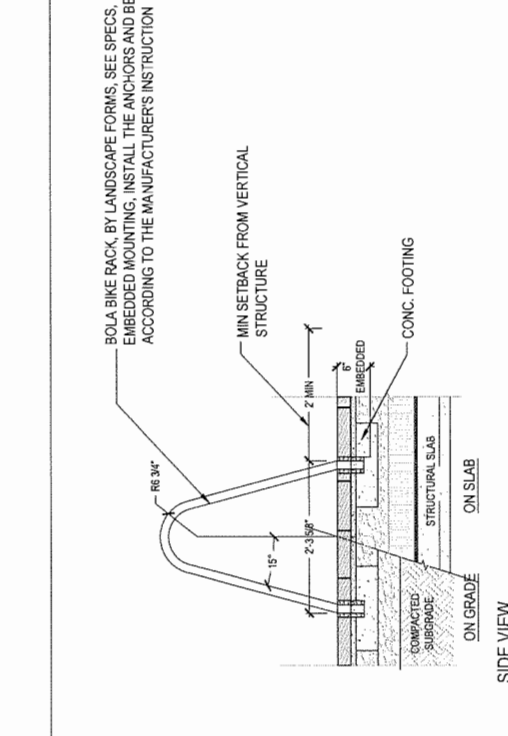


3 WOOD TOP BENCH TYPE A - STREET LEVEL
SCALE: 1/2" = 1'-0"

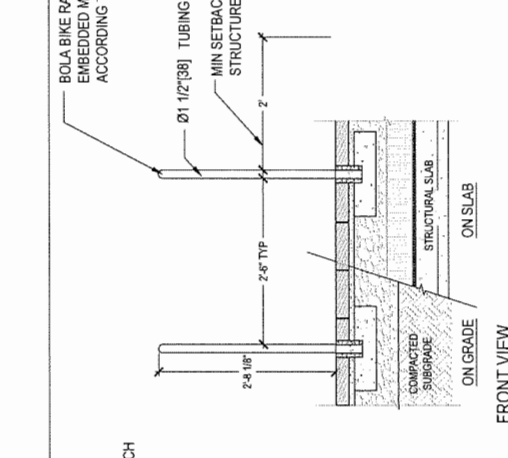


4 WOOD TOP BENCH TYPE B - STREET LEVEL
SCALE: 3/4" = 1'-0"

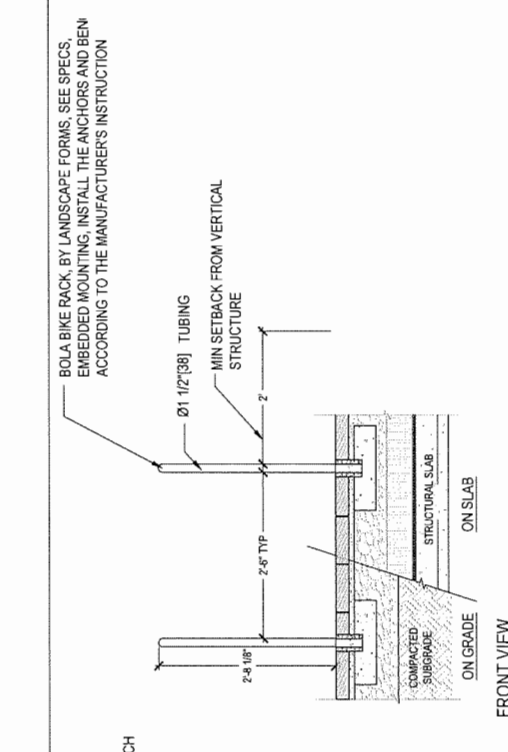


5 WOOD TOP BENCH TYPE C - STREET LEVEL
SCALE: 3/4" = 1'-0"

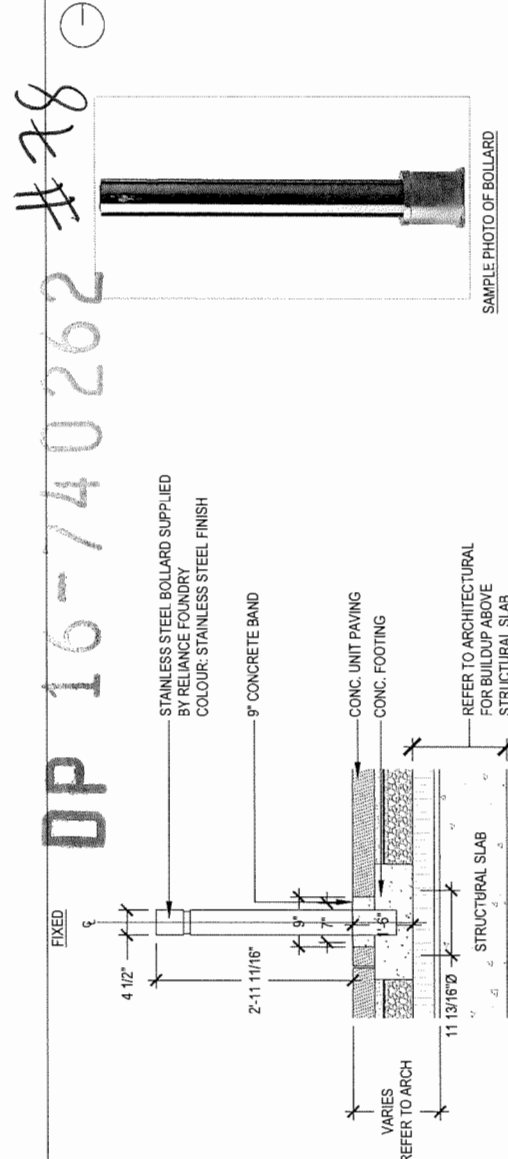


6 WOOD TOP BENCH TYPE D
SCALE: 3/4" = 1'-0"

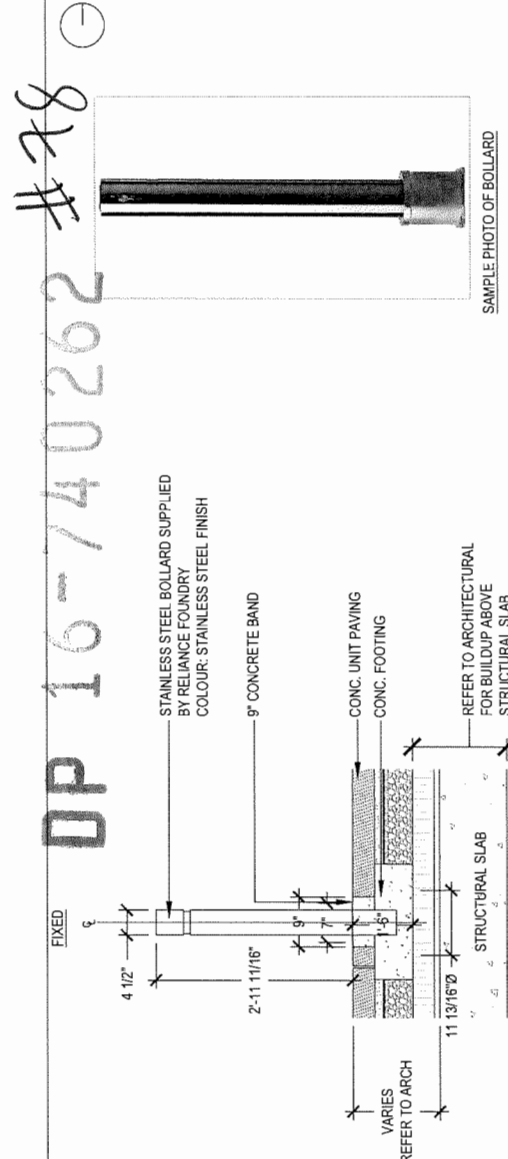


7 WOOD TOP BENCH TYPE E
SCALE: 3/4" = 1'-0"

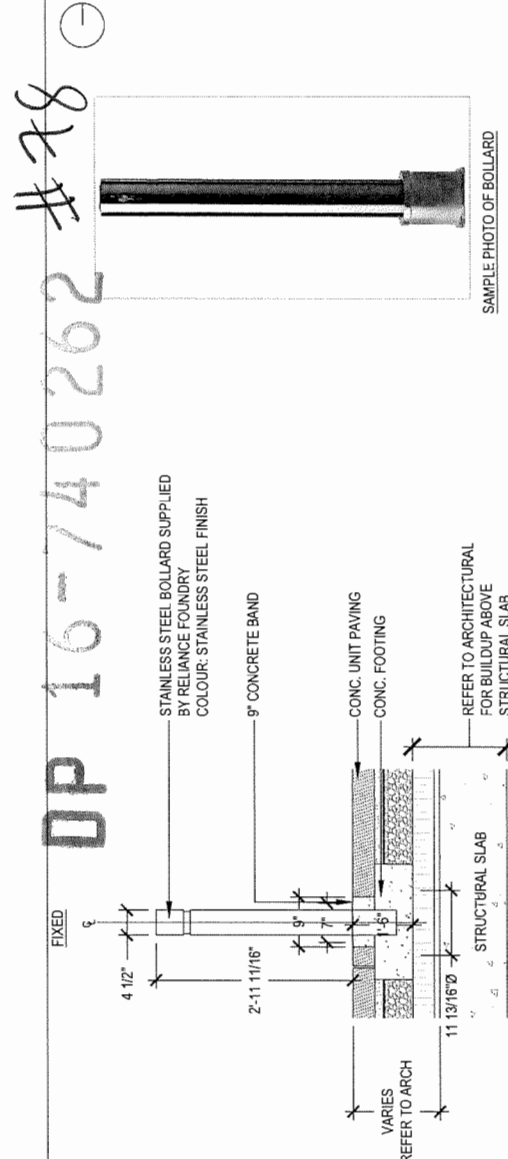


8 WOOD TOP BENCH TYPE F
SCALE: 3/4" = 1'-0"

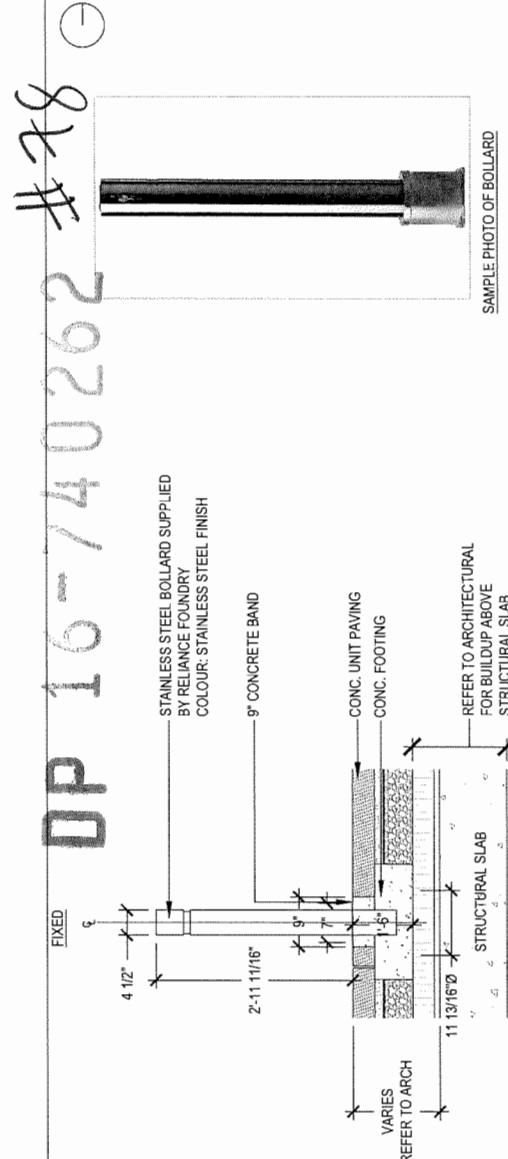


9 WOOD TOP BENCH TYPE G
SCALE: 3/4" = 1'-0"

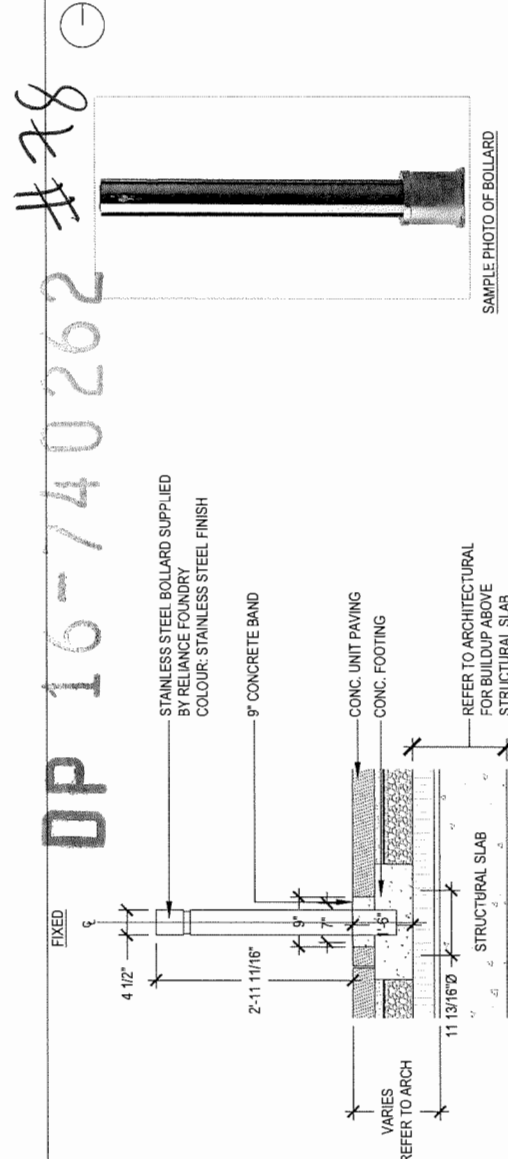


10 WOOD TOP BENCH TYPE H
SCALE: 3/4" = 1'-0"

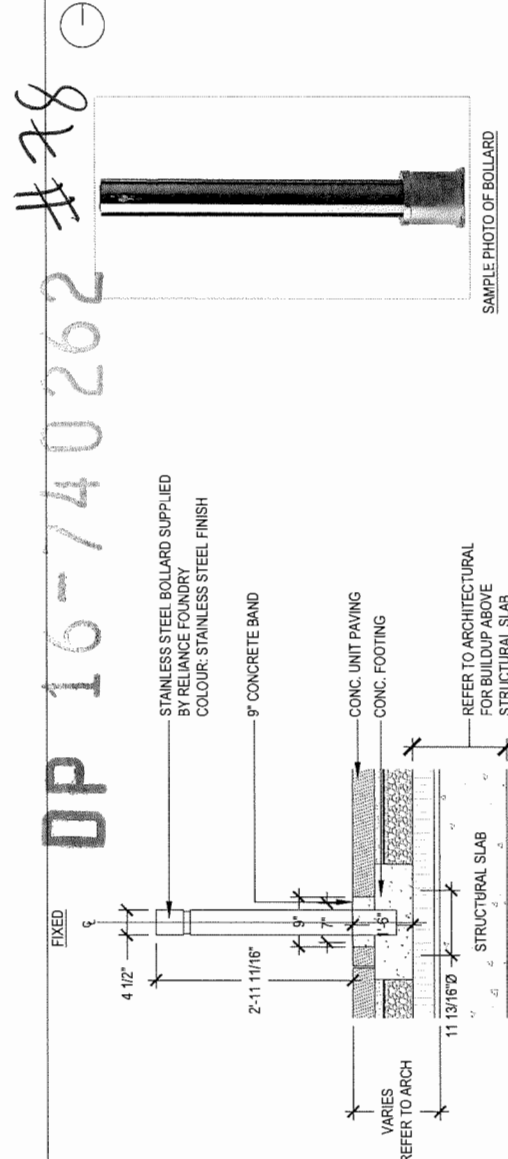


11 WOOD TOP BENCH TYPE I
SCALE: 3/4" = 1'-0"

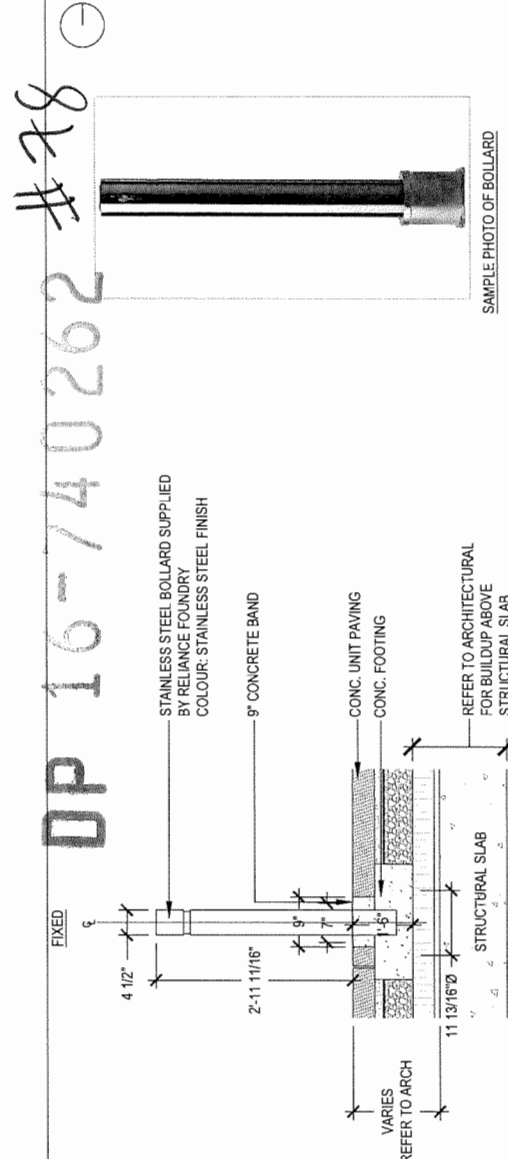


12 WOOD TOP BENCH TYPE J
SCALE: 3/4" = 1'-0"

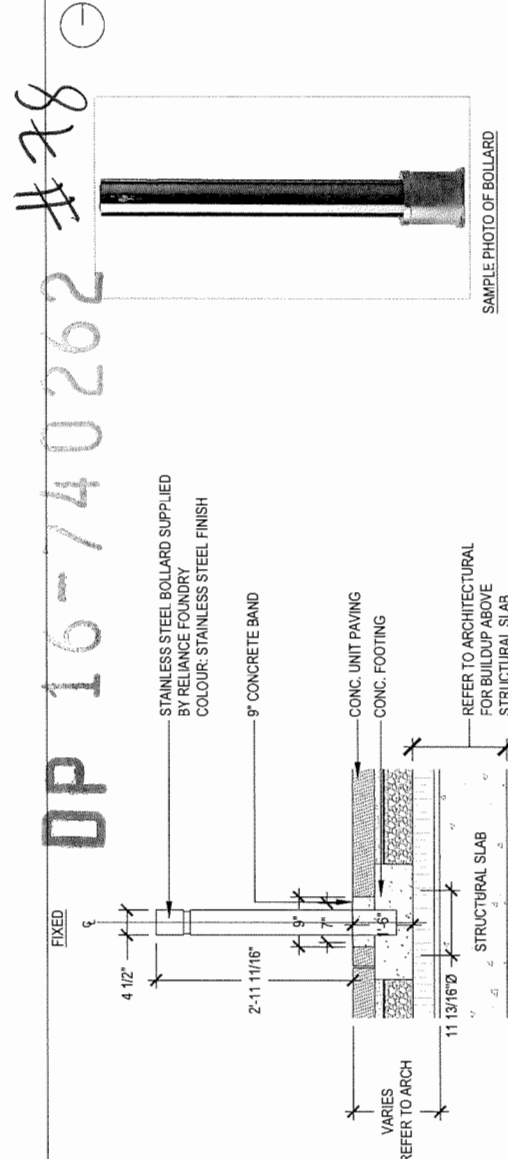


13 WOOD TOP BENCH TYPE K
SCALE: 3/4" = 1'-0"

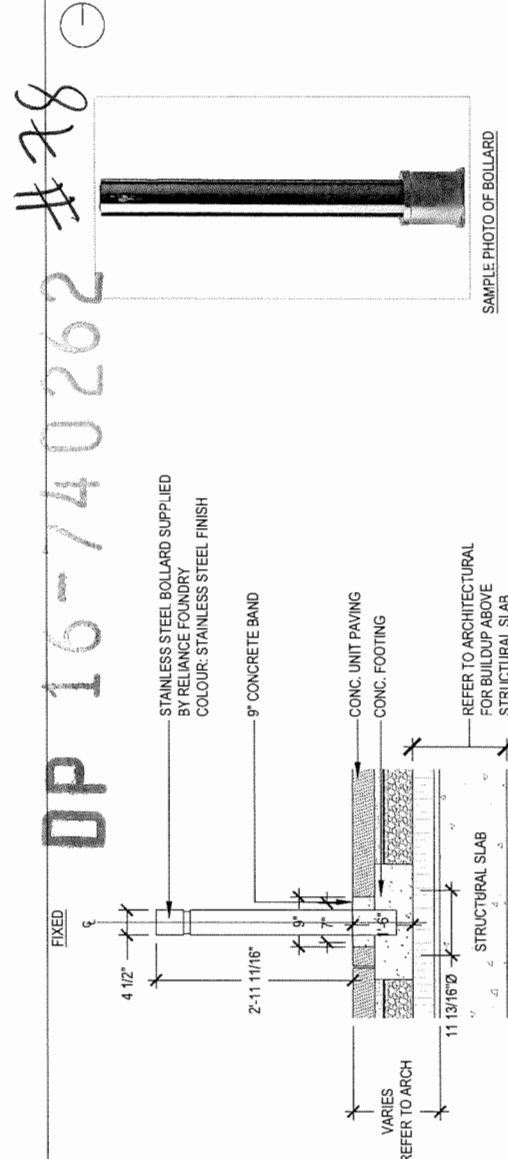


14 WOOD TOP BENCH TYPE L
SCALE: 3/4" = 1'-0"

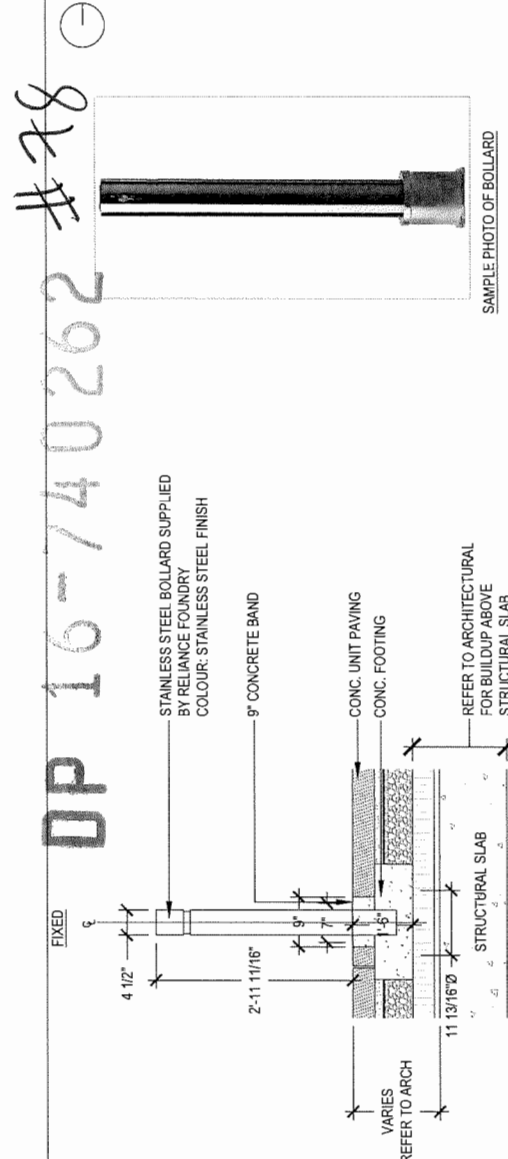


15 WOOD TOP BENCH TYPE M
SCALE: 3/4" = 1'-0"

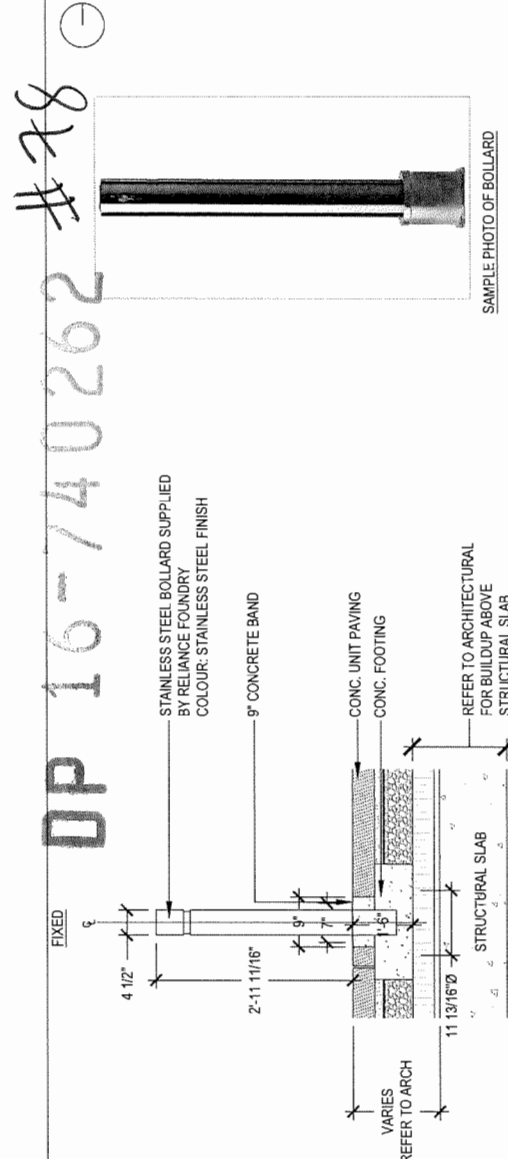


16 WOOD TOP BENCH TYPE N
SCALE: 3/4" = 1'-0"

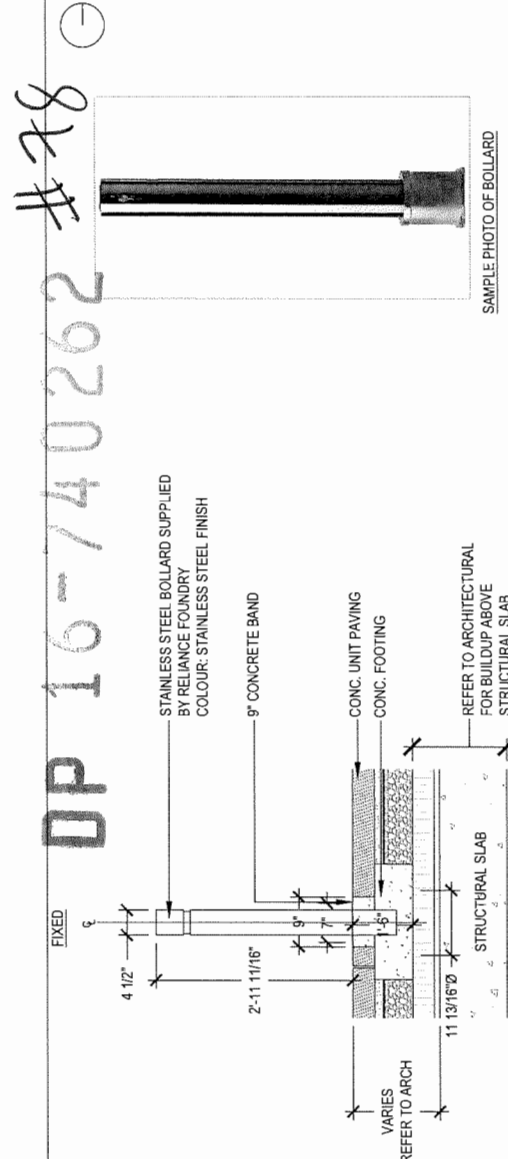


17 WOOD TOP BENCH TYPE O
SCALE: 3/4" = 1'-0"

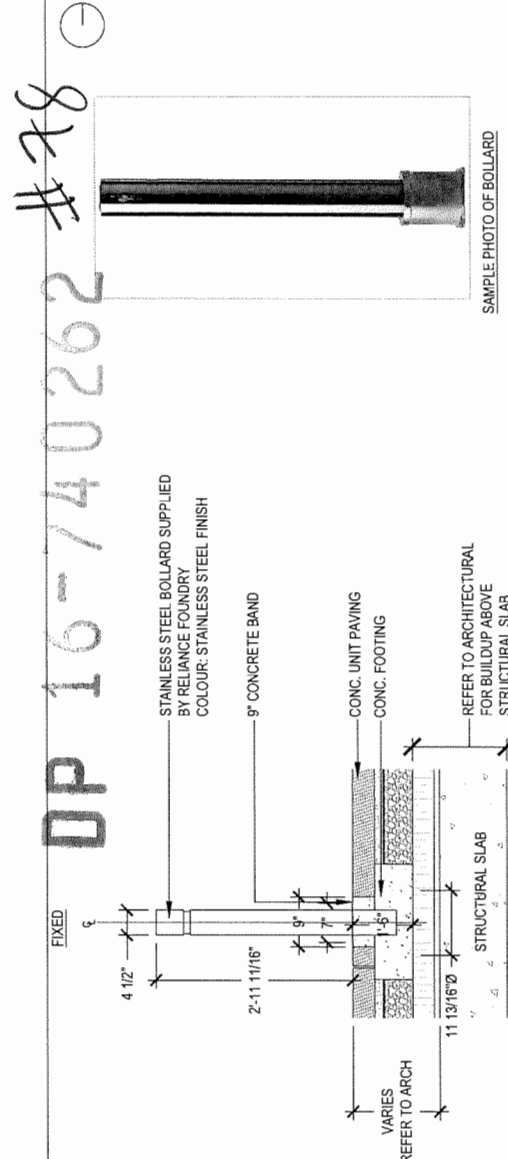


18 WOOD TOP BENCH TYPE P
SCALE: 3/4" = 1'-0"

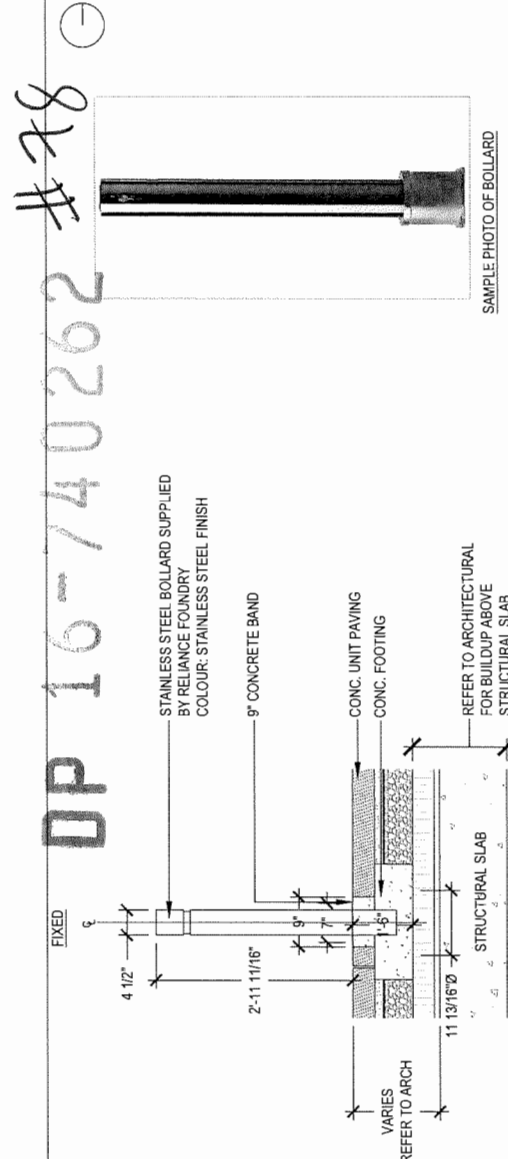


19 WOOD TOP BENCH TYPE Q
SCALE: 3/4" = 1'-0"

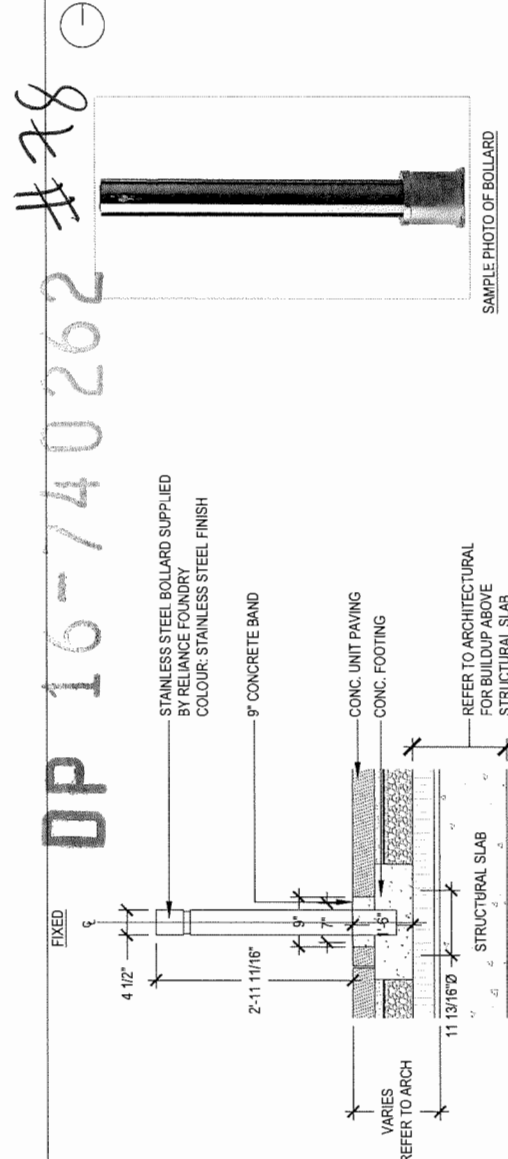


20 WOOD TOP BENCH TYPE R
SCALE: 3/4" = 1'-0"

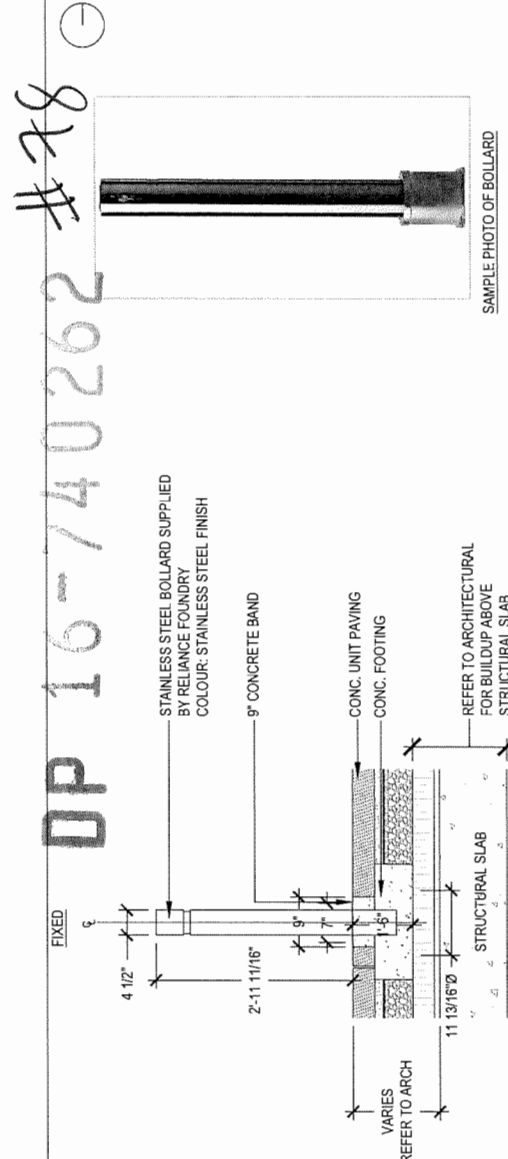


21 WOOD TOP BENCH TYPE S
SCALE: 3/4" = 1'-0"

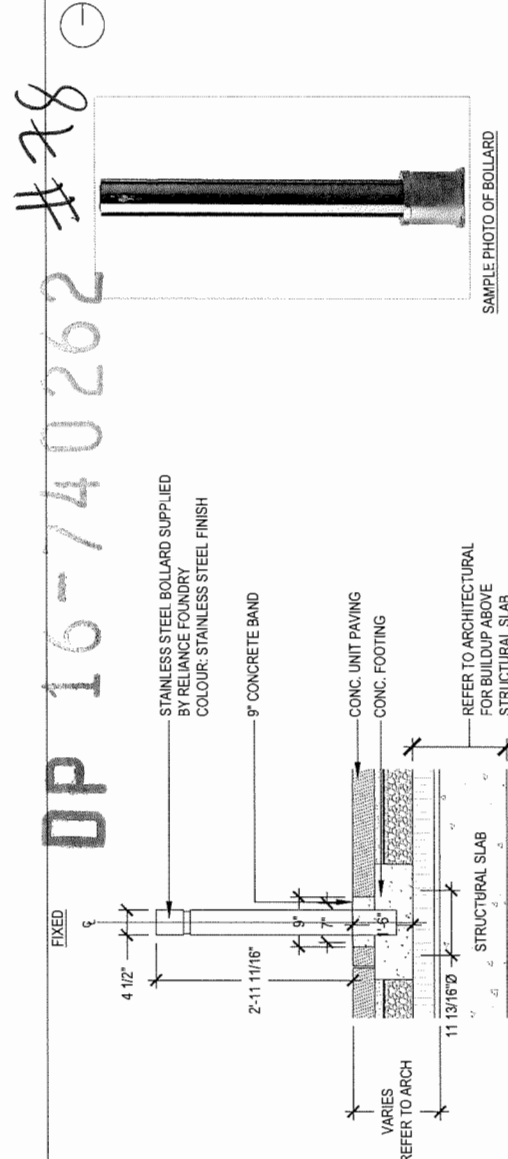


22 WOOD TOP BENCH TYPE T
SCALE: 3/4" = 1'-0"

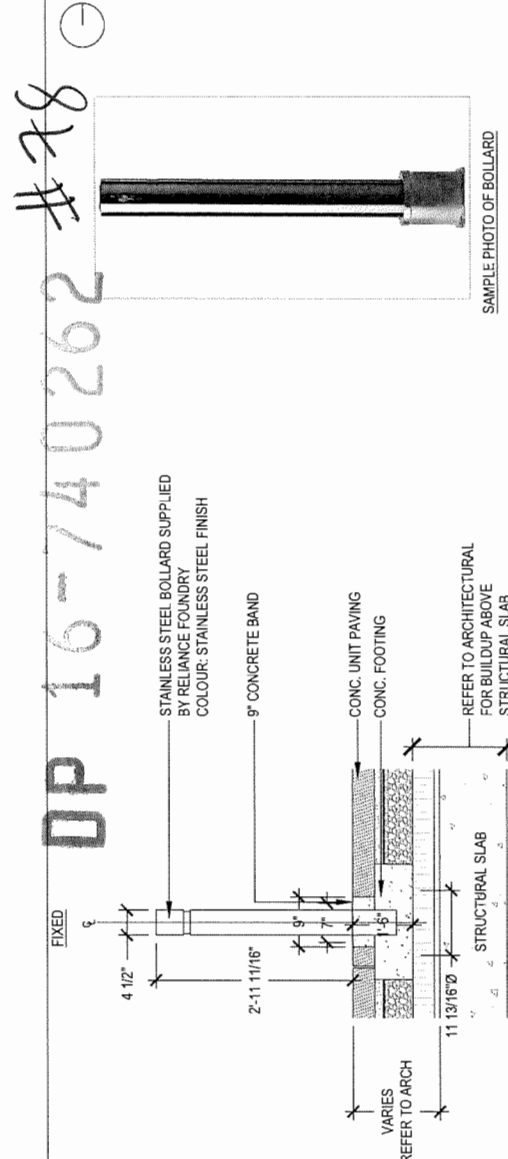


23 WOOD TOP BENCH TYPE U
SCALE: 3/4" = 1'-0"

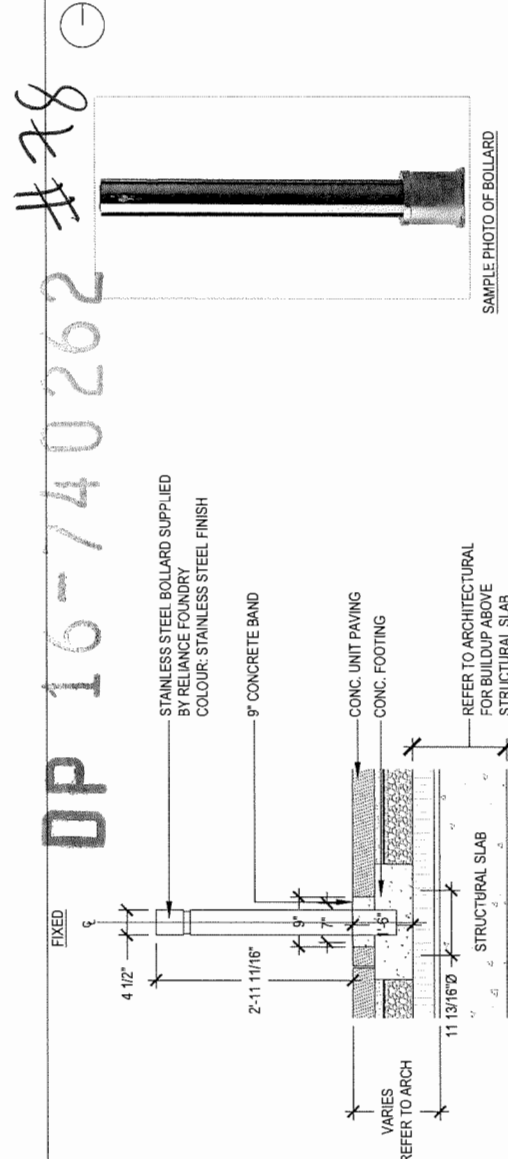


24 WOOD TOP BENCH TYPE V
SCALE: 3/4" = 1'-0"

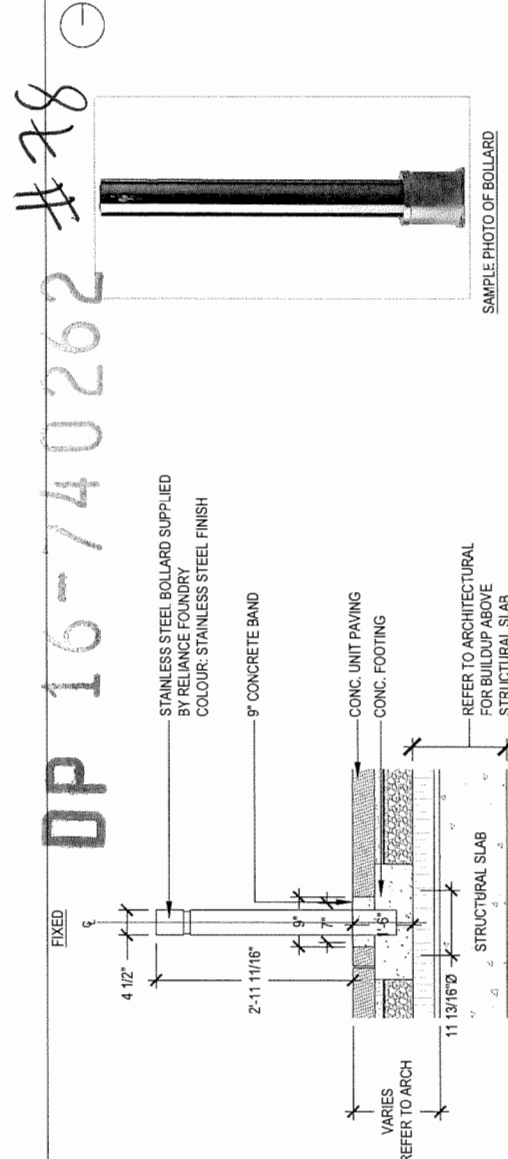


25 WOOD TOP BENCH TYPE W
SCALE: 3/4" = 1'-0"

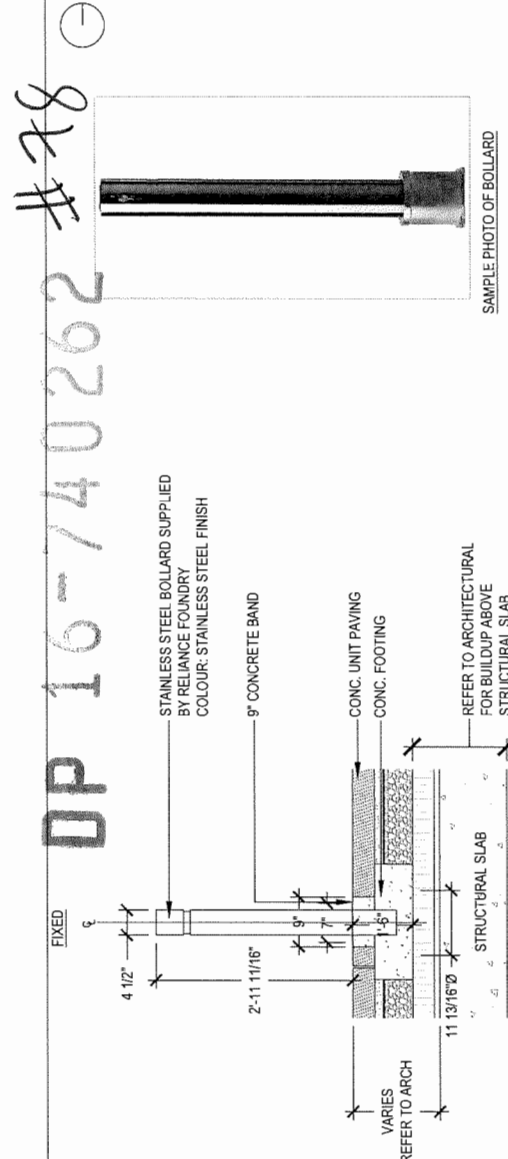


26 WOOD TOP BENCH TYPE X
SCALE: 3/4" = 1'-0"

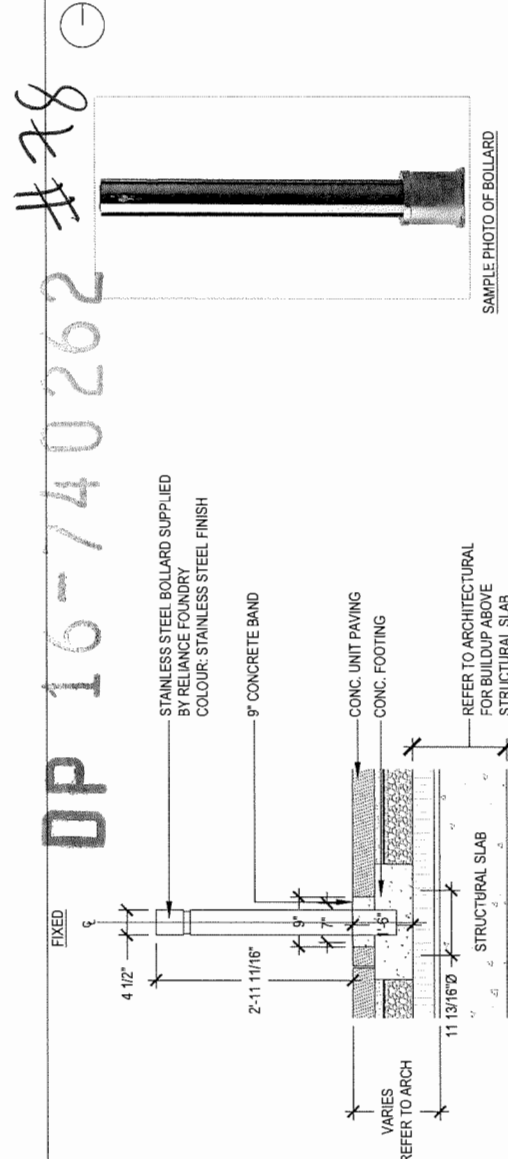


27 WOOD TOP BENCH TYPE Y
SCALE: 3/4" = 1'-0"

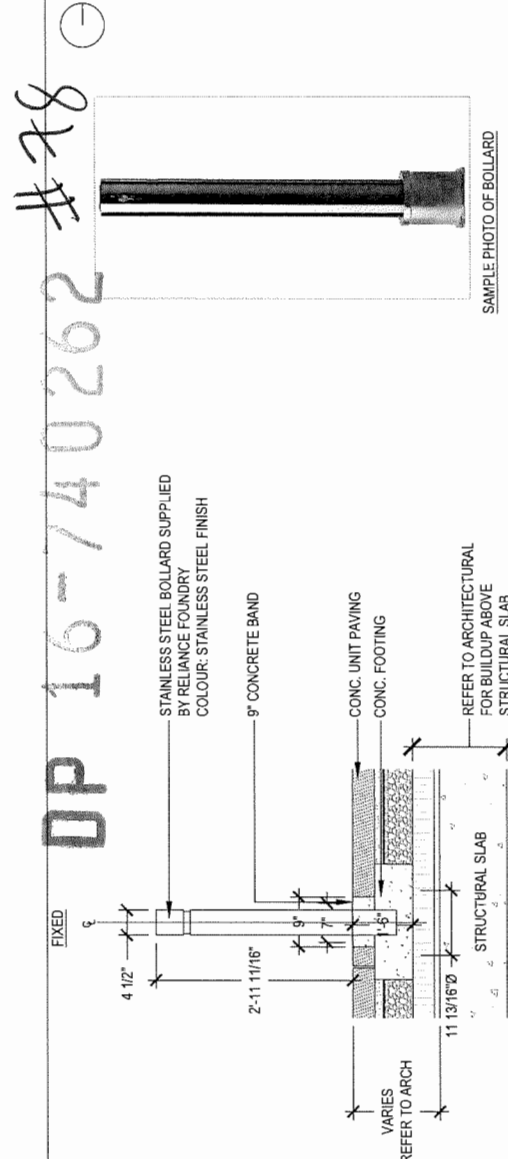


28 WOOD TOP BENCH TYPE Z
SCALE: 3/4" = 1'-0"

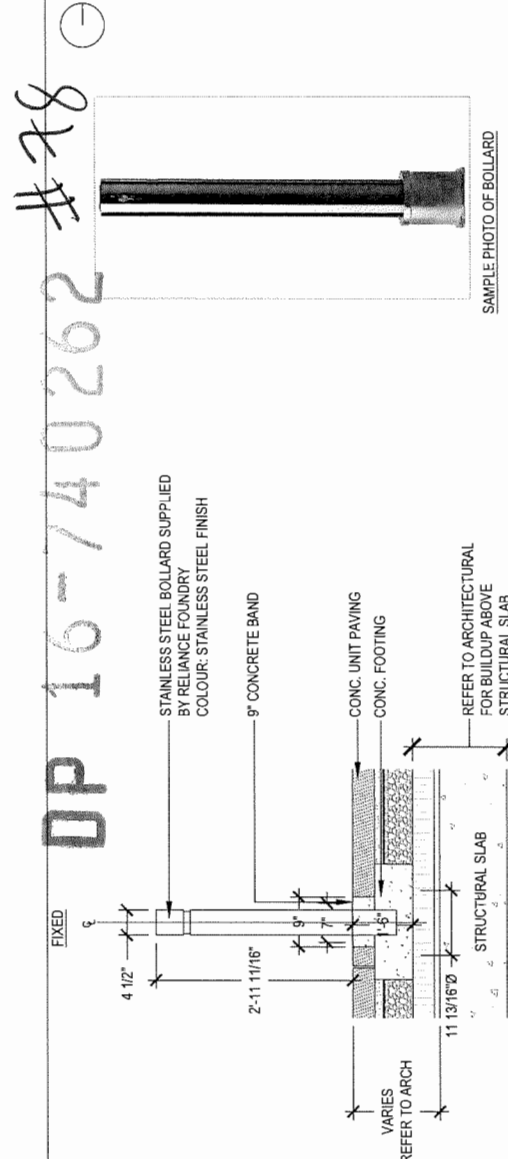


29 WOOD TOP BENCH TYPE AA
SCALE: 3/4" = 1'-0"

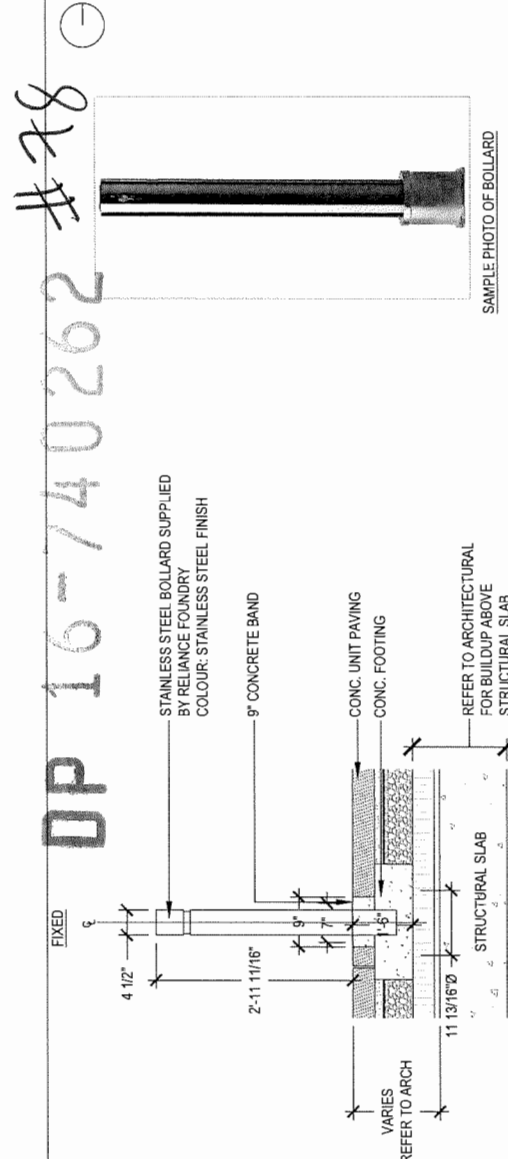


30 WOOD TOP BENCH TYPE AB
SCALE: 3/4" = 1'-0"

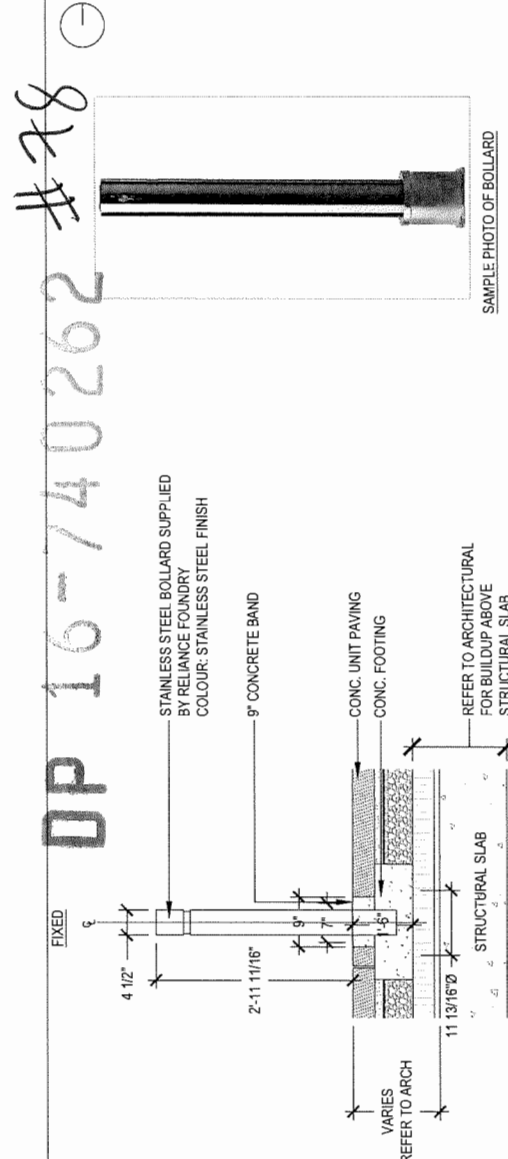


31 WOOD TOP BENCH TYPE AC
SCALE: 3/4" = 1'-0"

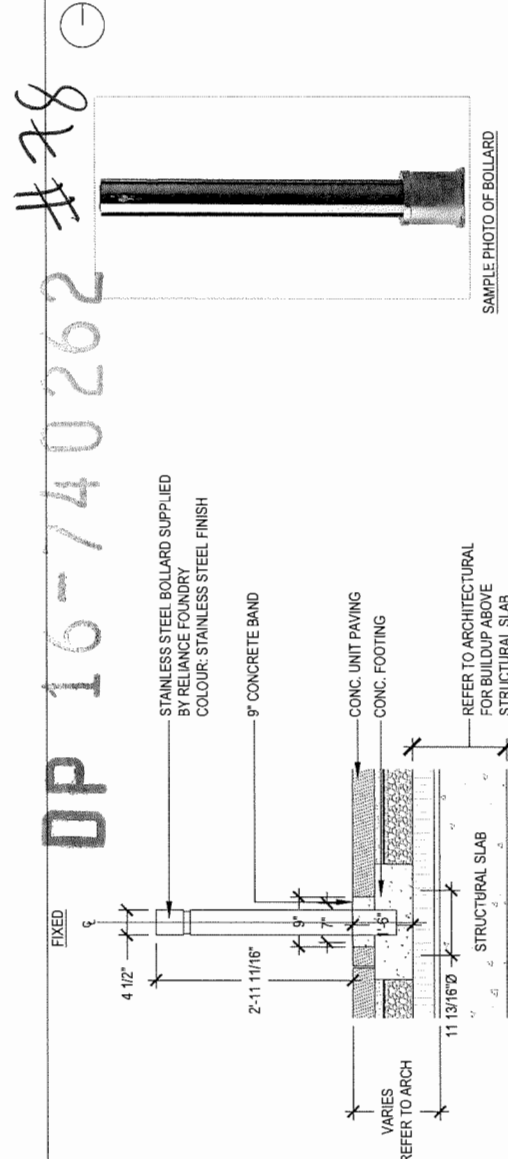


32 WOOD TOP BENCH TYPE AD
SCALE: 3/4" = 1'-0"

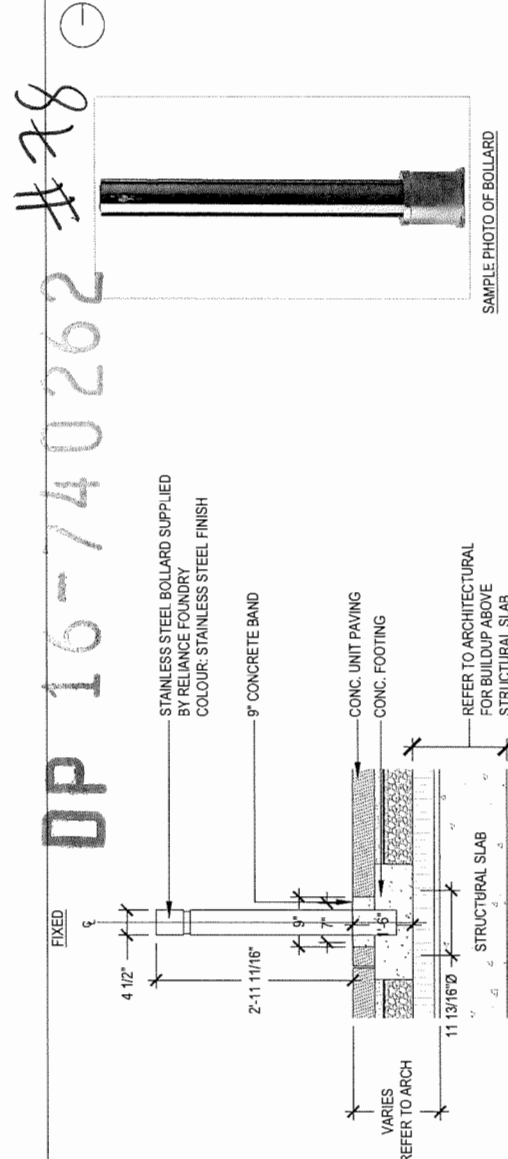


33 WOOD TOP BENCH TYPE AE
SCALE: 3/4" = 1'-0"

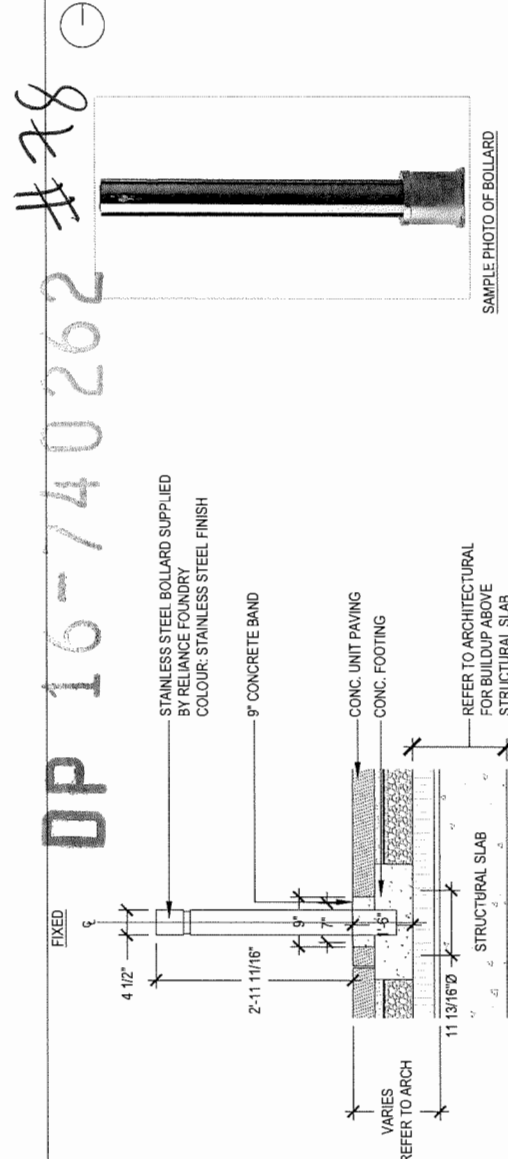


34 WOOD TOP BENCH TYPE AF
SCALE: 3/4" = 1'-0"

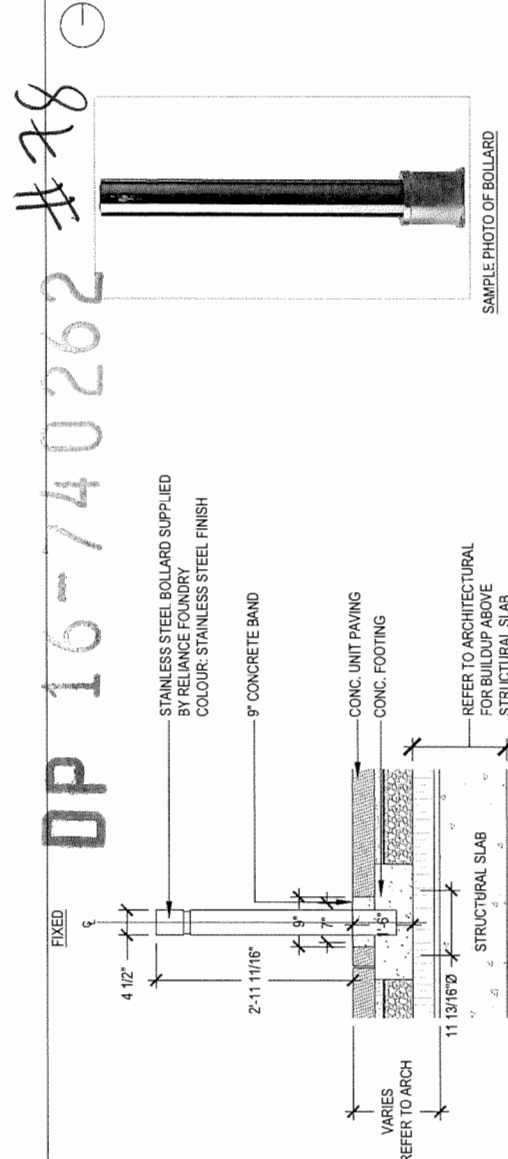


35 WOOD TOP BENCH TYPE AG
SCALE: 3/4" = 1'-0"

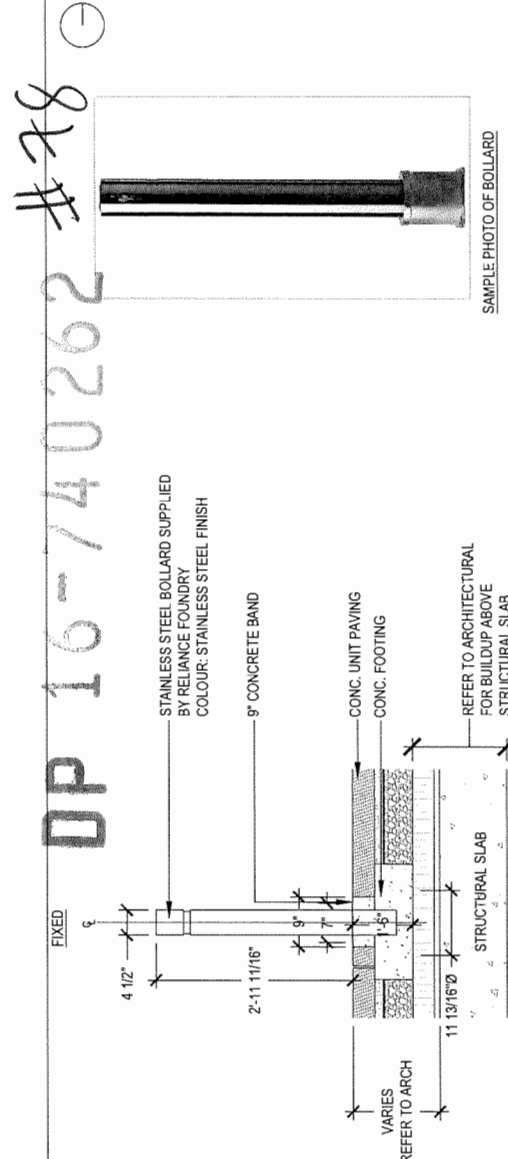


36 WOOD TOP BENCH TYPE AH
SCALE: 3/4" = 1'-0"

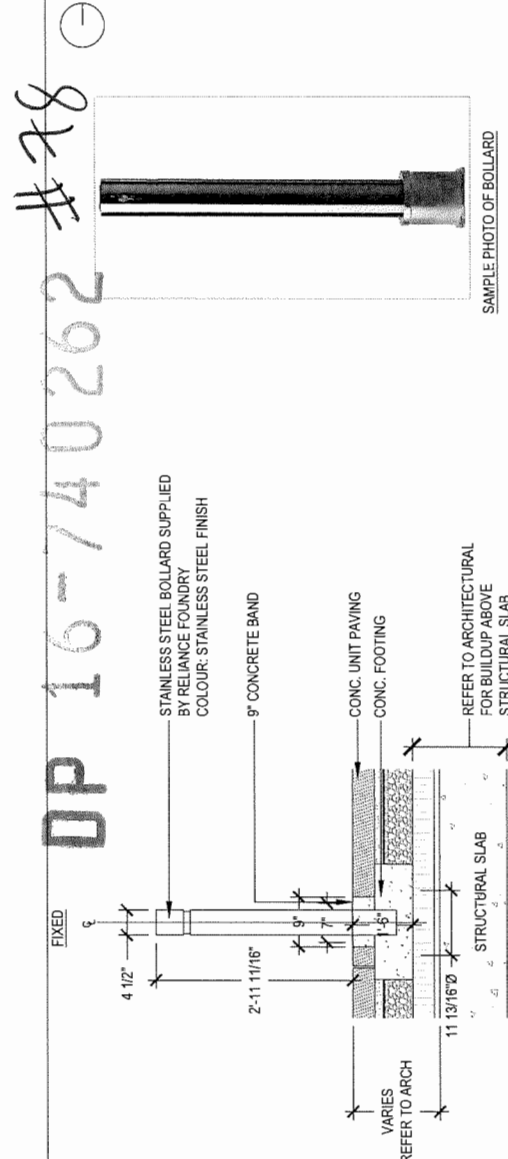


37 WOOD TOP BENCH TYPE AI
SCALE: 3/4" = 1'-0"

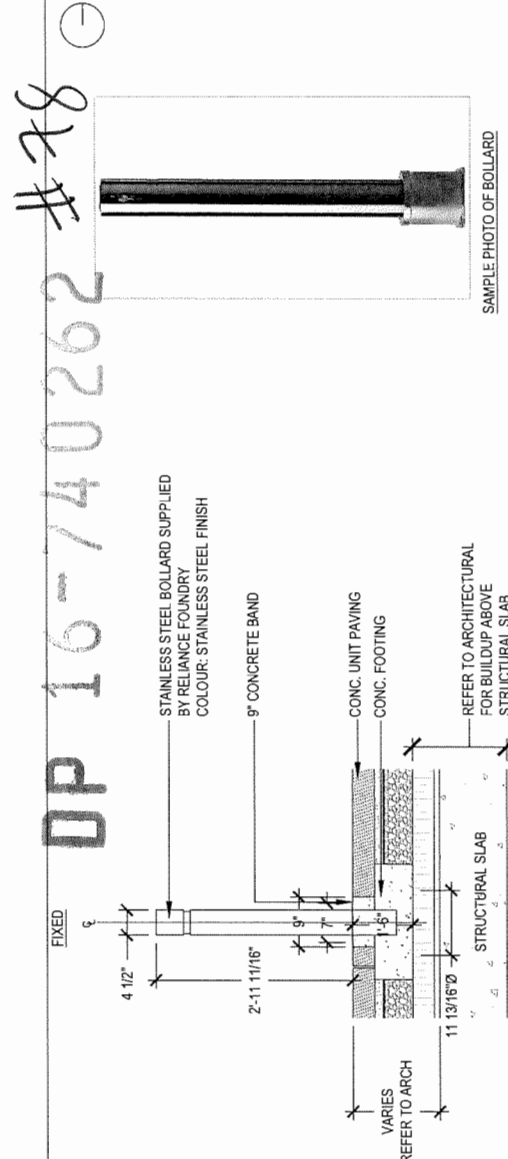


38 WOOD TOP BENCH TYPE AJ
SCALE: 3/4" = 1'-0"

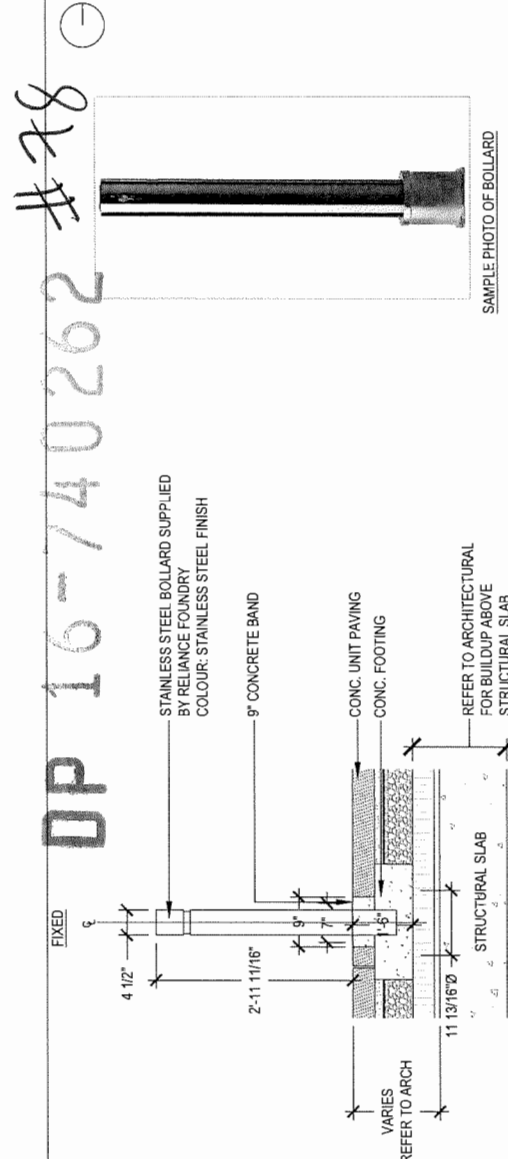


39 WOOD TOP BENCH TYPE AK
SCALE: 3/4" = 1'-0"

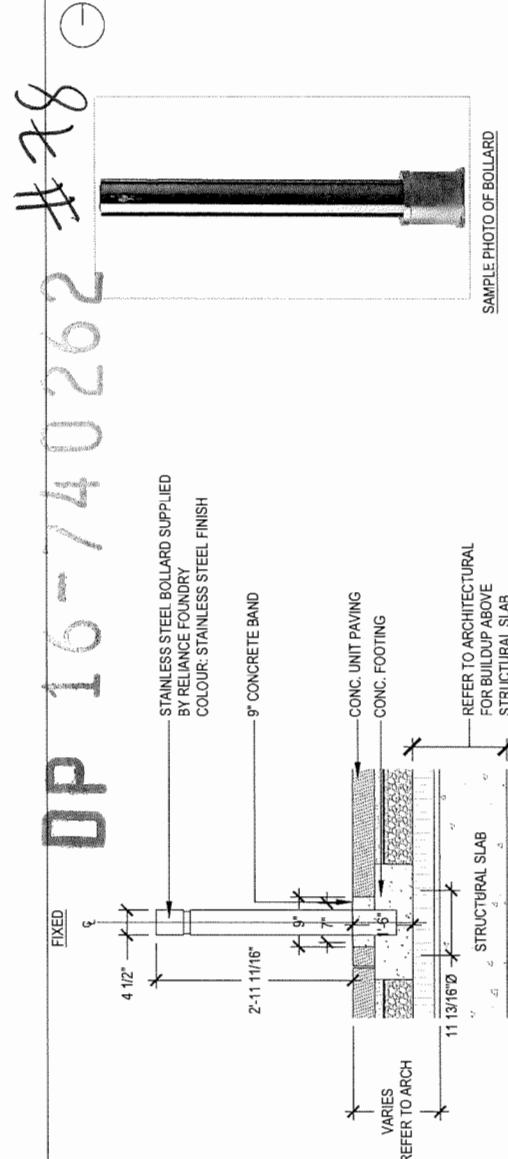


40 WOOD TOP BENCH TYPE AL
SCALE: 3/4" = 1'-0"

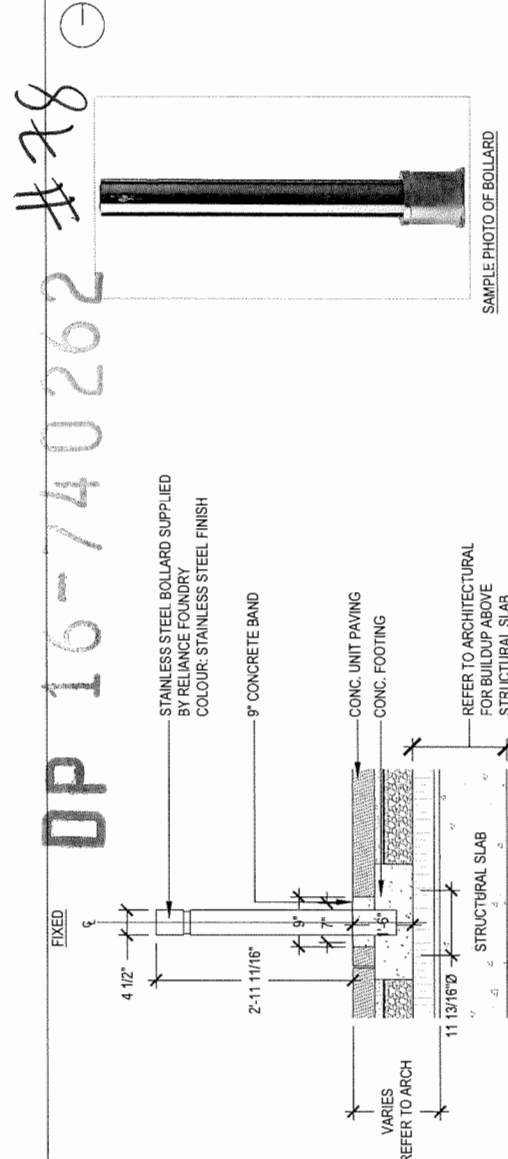


41 WOOD TOP BENCH TYPE AM
SCALE: 3/4" = 1'-0"

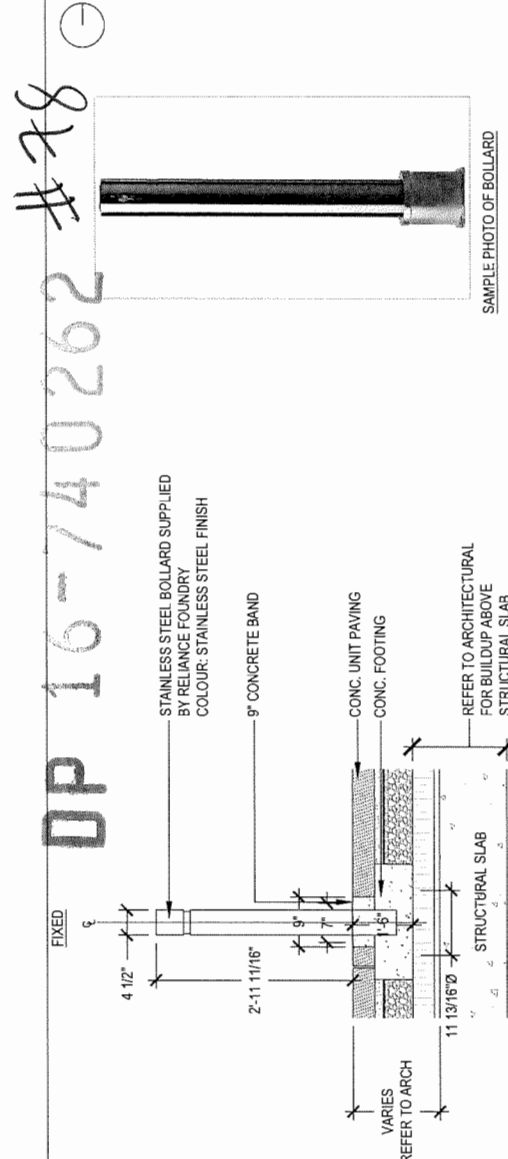


42 WOOD TOP BENCH TYPE AN
SCALE: 3/4" = 1'-0"

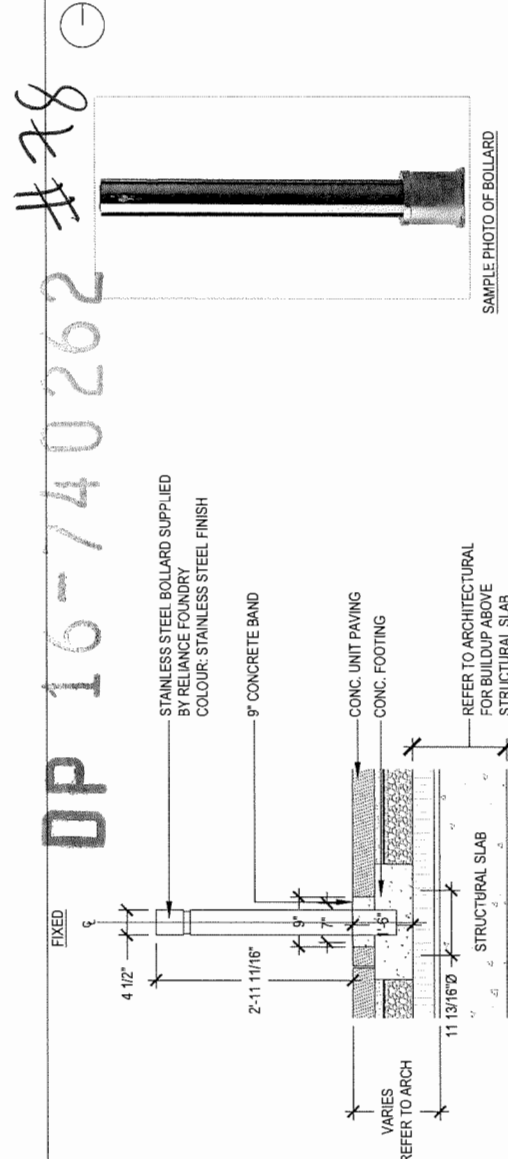


43 WOOD TOP BENCH TYPE AO
SCALE: 3/4" = 1'-0"

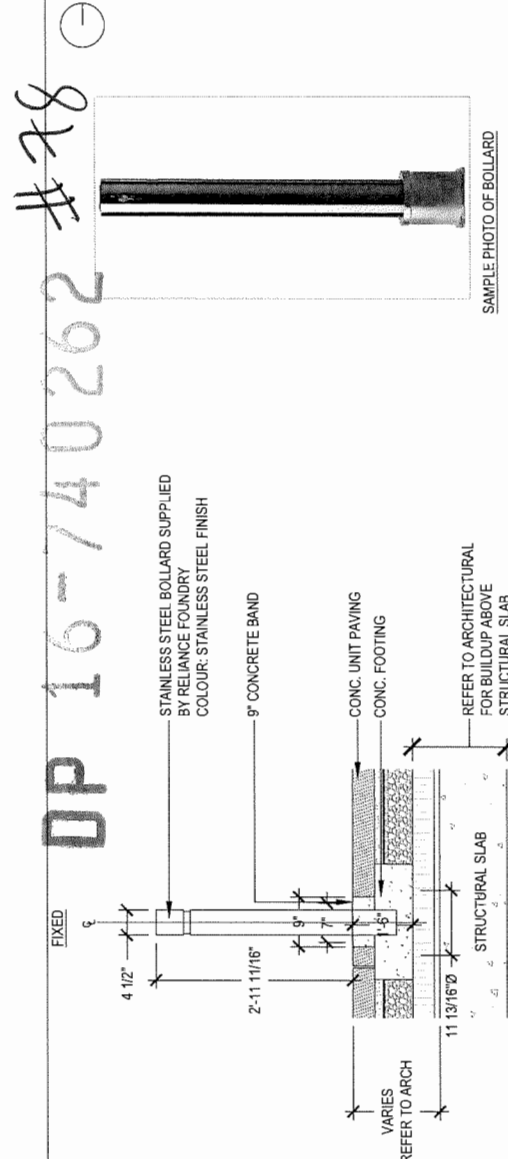


44 WOOD TOP BENCH TYPE AP
SCALE: 3/4" = 1'-0"

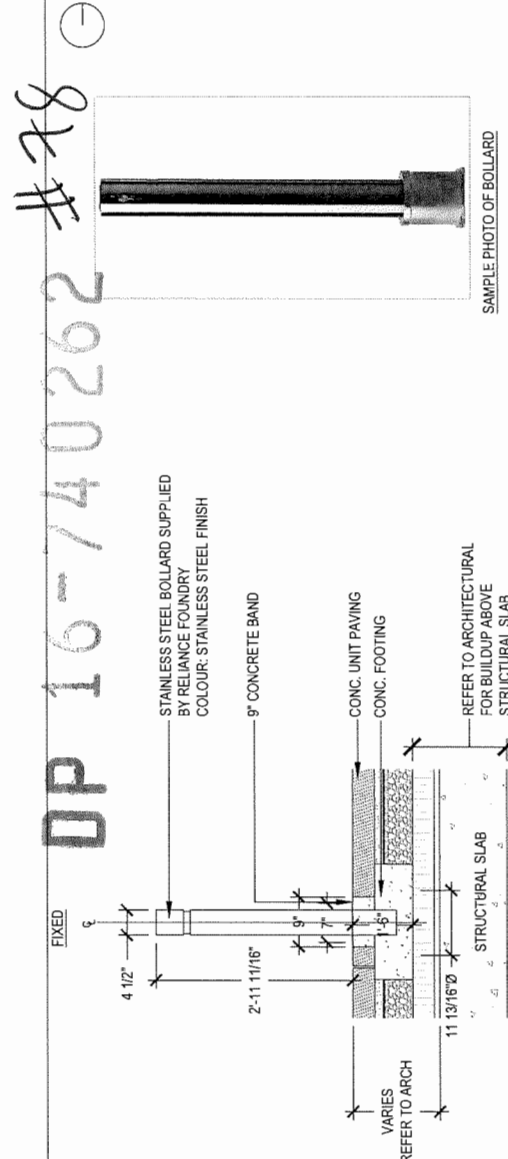


45 WOOD TOP BENCH TYPE AQ
SCALE: 3/4" = 1'-0"

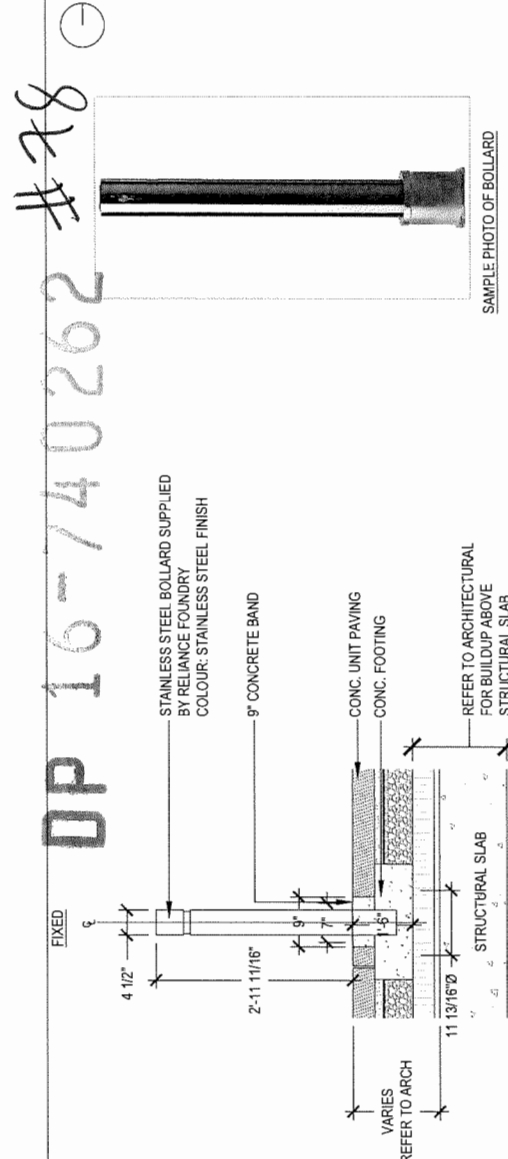


46 WOOD TOP BENCH TYPE AR
SCALE: 3/4" = 1'-0"

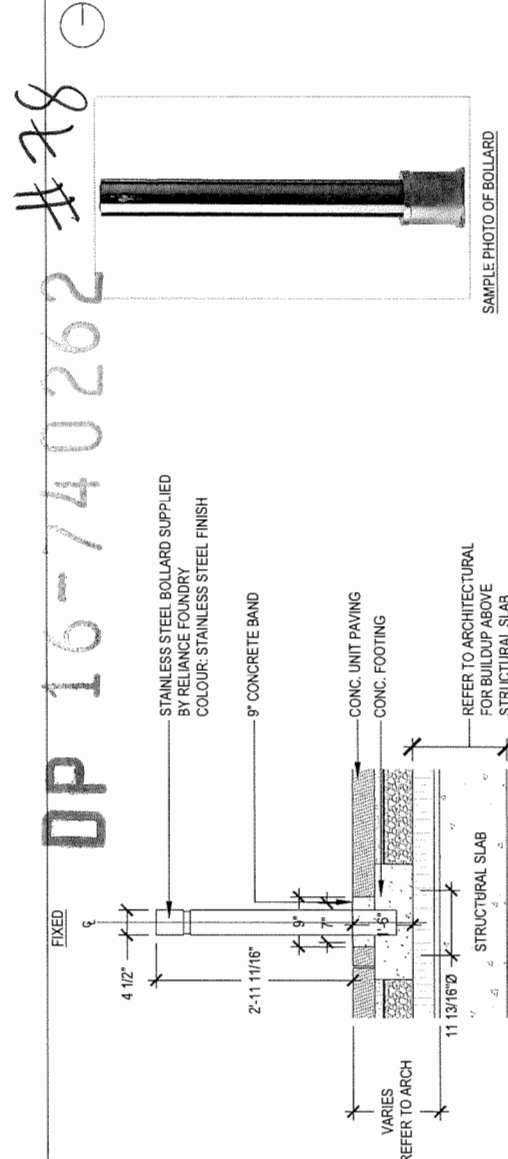


47 WOOD TOP BENCH TYPE AS
SCALE: 3/4" = 1'-0"

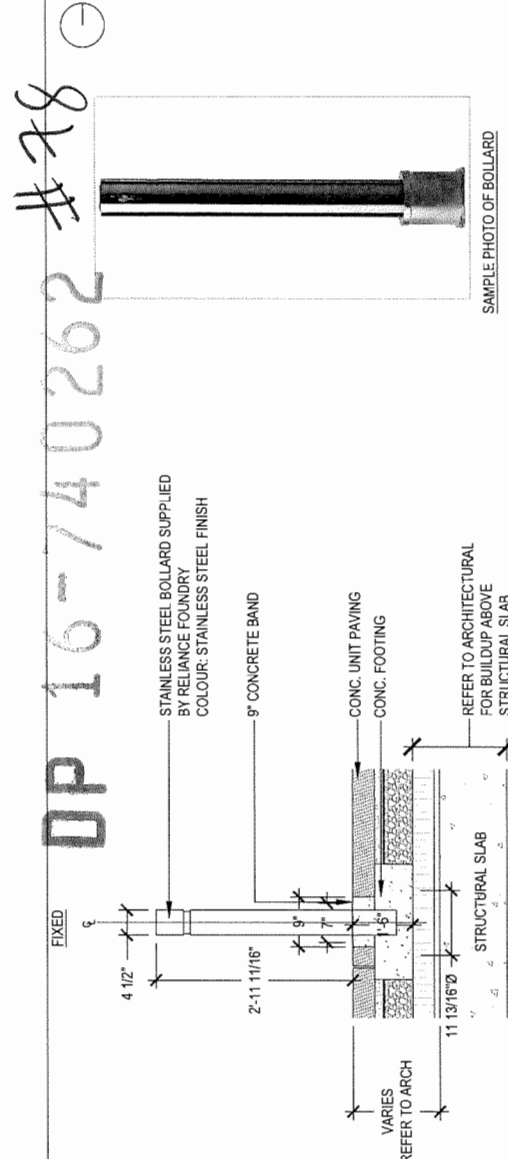


48 WOOD TOP BENCH TYPE AT
SCALE: 3/4" = 1'-0"

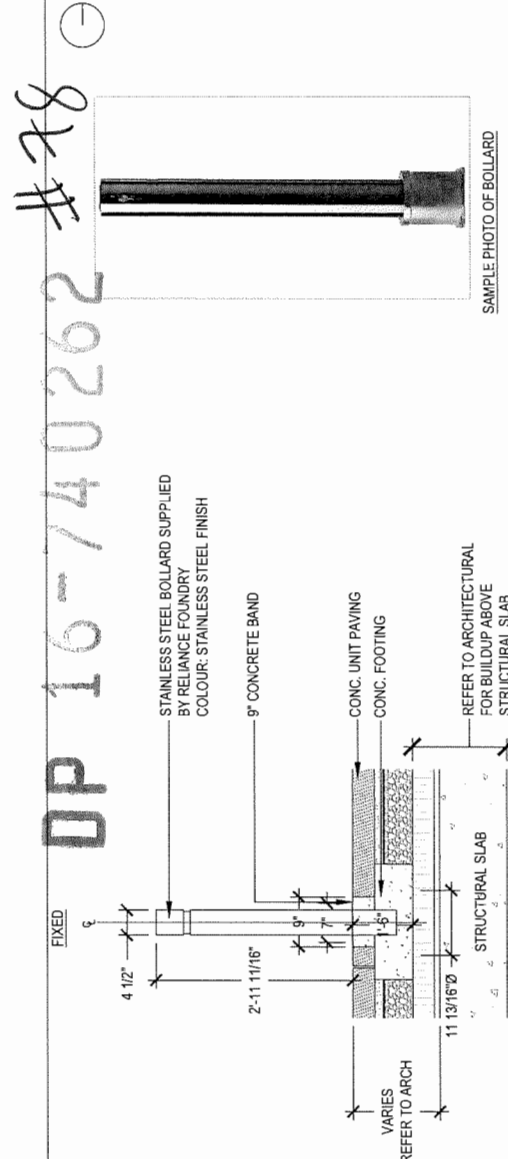


49 WOOD TOP BENCH TYPE AU
SCALE: 3/4" = 1'-0"

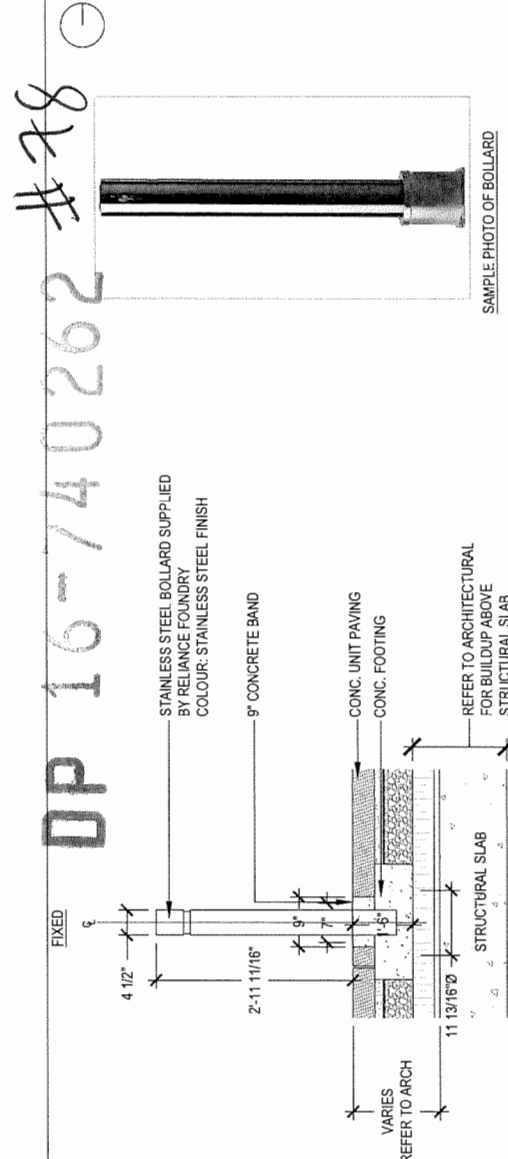


50 WOOD TOP BENCH TYPE AV
SCALE: 3/4" = 1'-0"

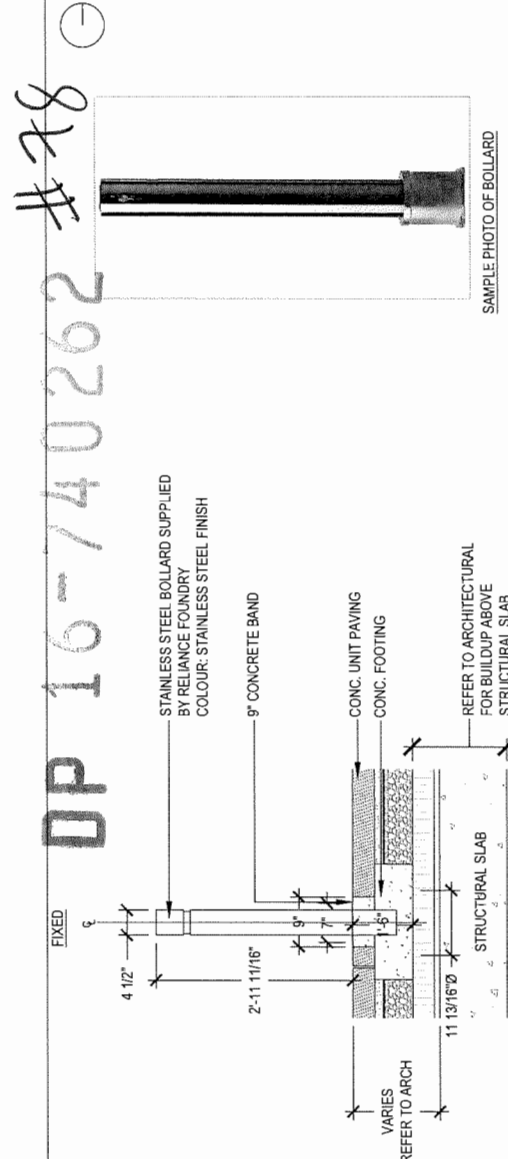


51 WOOD TOP BENCH TYPE AW
SCALE: 3/4" = 1'-0"

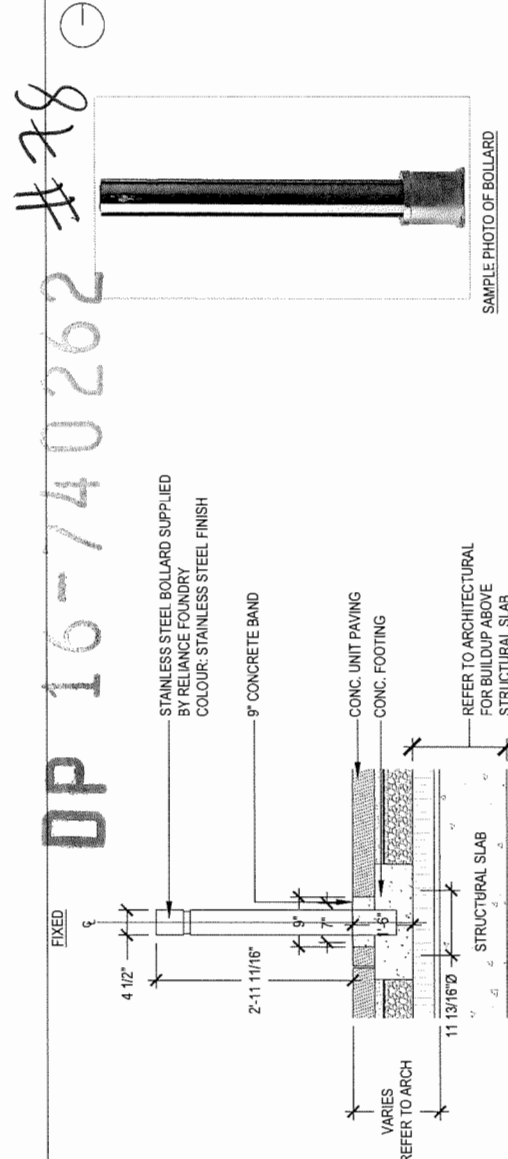


52 WOOD TOP BENCH TYPE AX
SCALE: 3/4" = 1'-0"

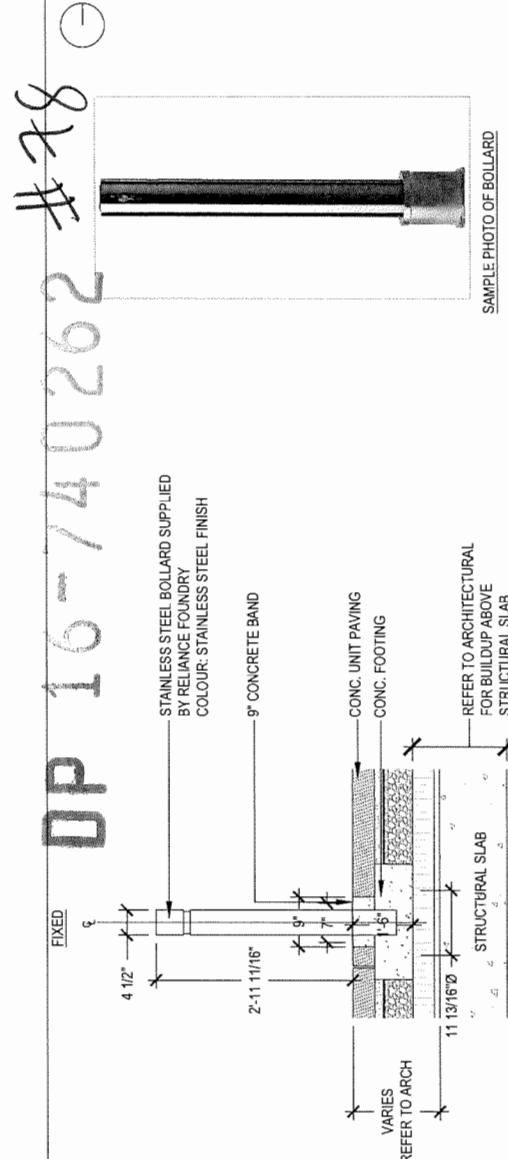


53 WOOD TOP BENCH TYPE AY
SCALE: 3/4" = 1'-0"

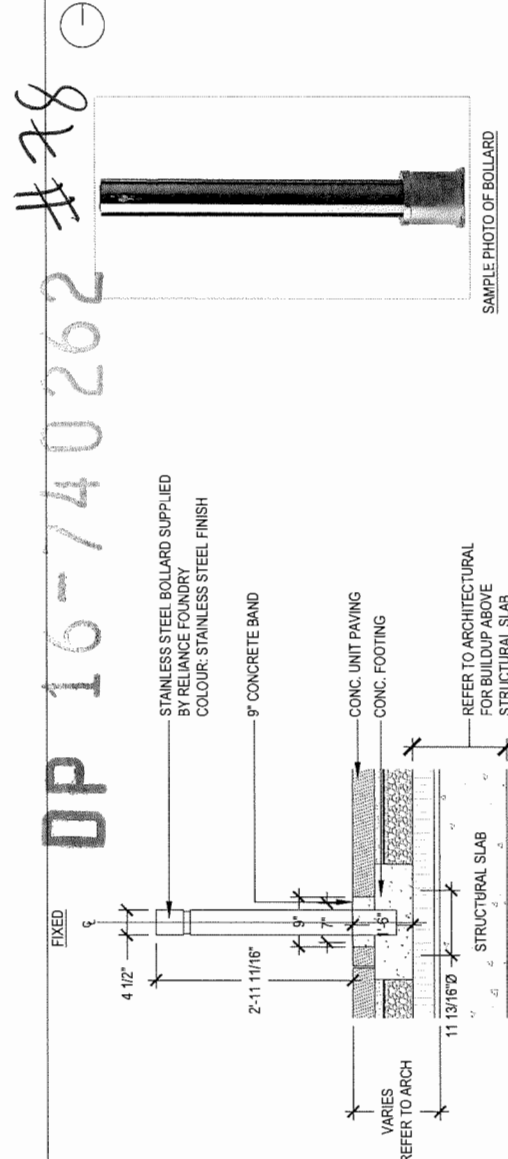


54 WOOD TOP BENCH TYPE AZ
SCALE: 3/4" = 1'-0"

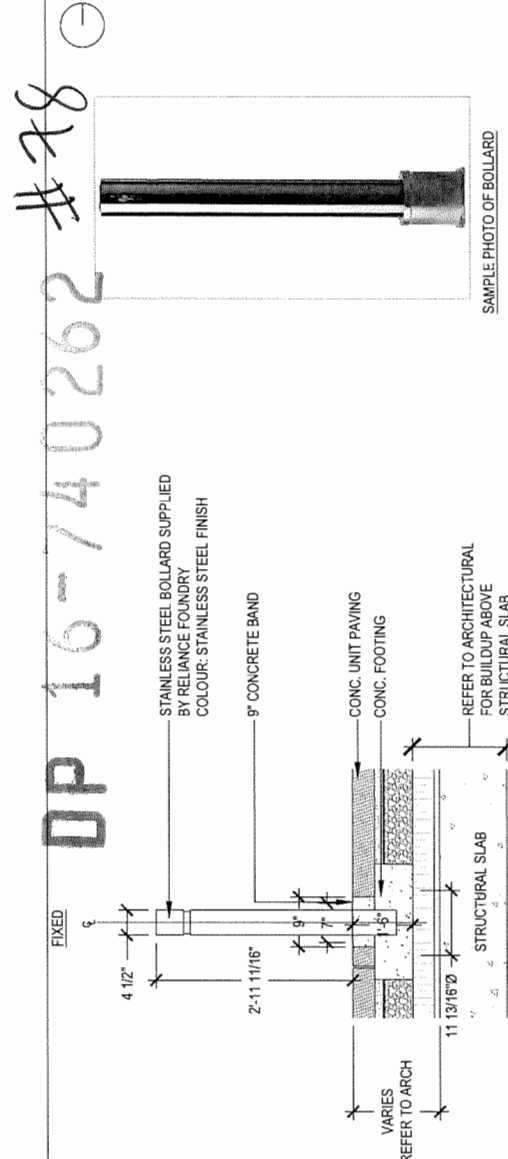


55 WOOD TOP BENCH TYPE BA
SCALE: 3/4" = 1'-0"

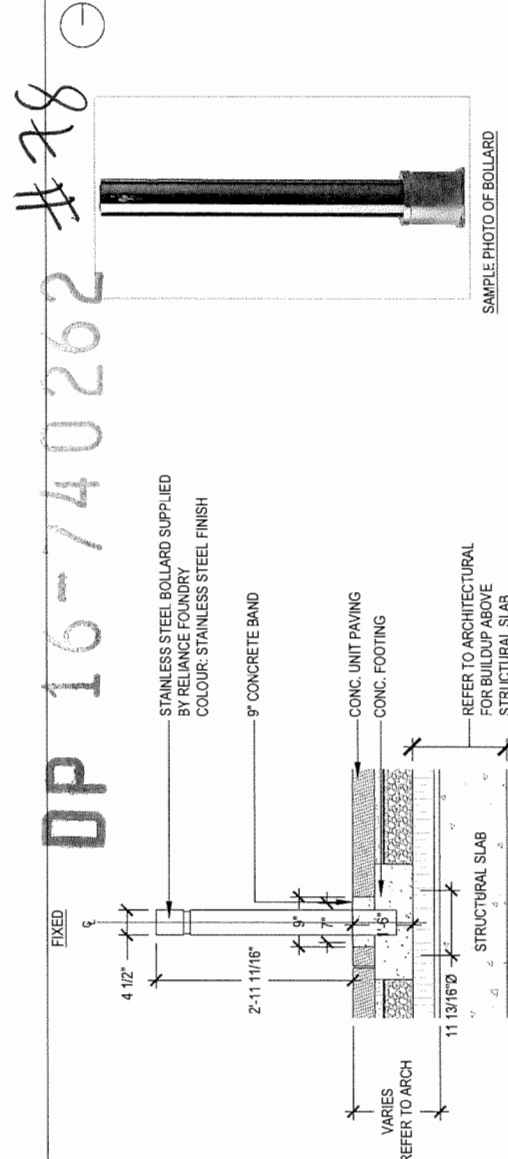


56 WOOD TOP BENCH TYPE BB
SCALE: 3/4" = 1'-0"

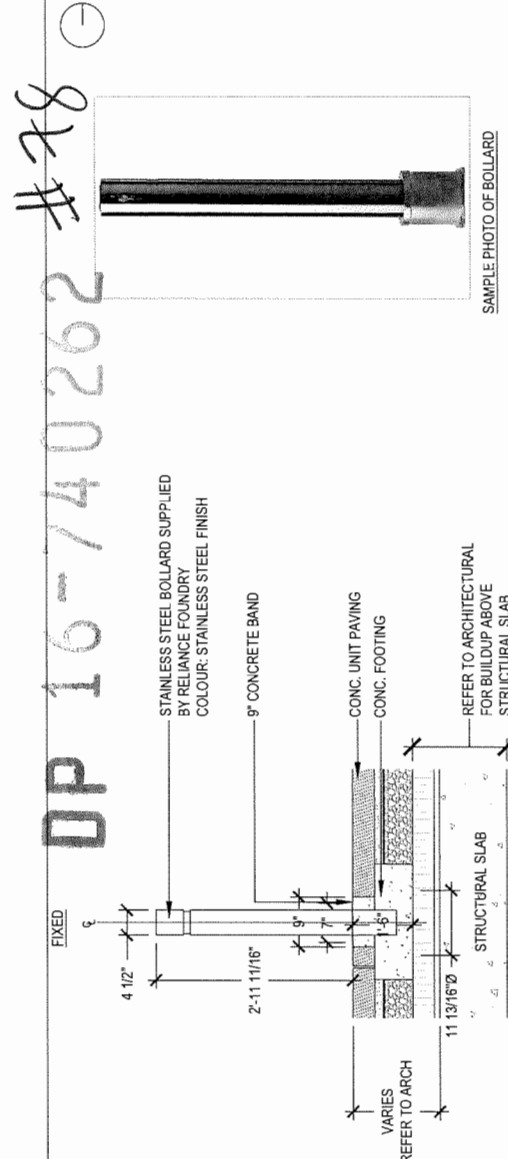


57 WOOD TOP BENCH TYPE BC
SCALE: 3/4" = 1'-0"

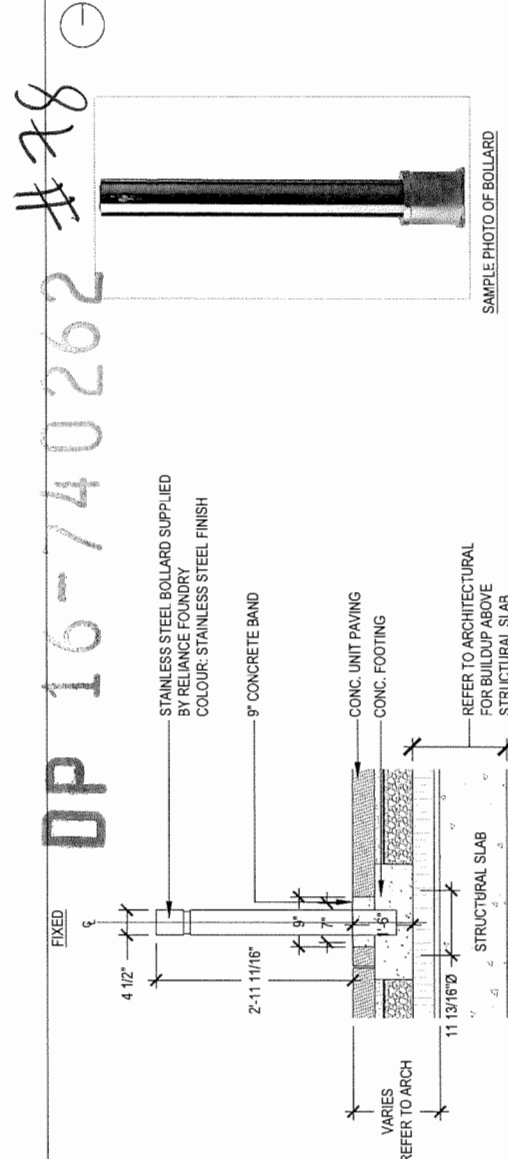


58 WOOD TOP BENCH TYPE BD
SCALE: 3/4" = 1'-0"

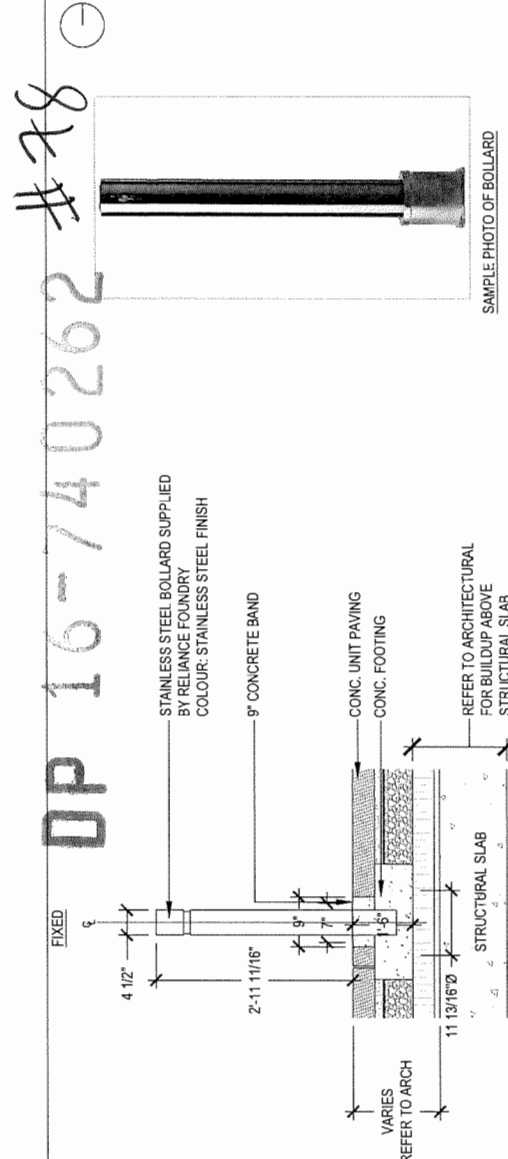


59 WOOD TOP BENCH TYPE BE
SCALE: 3/4" = 1'-0"

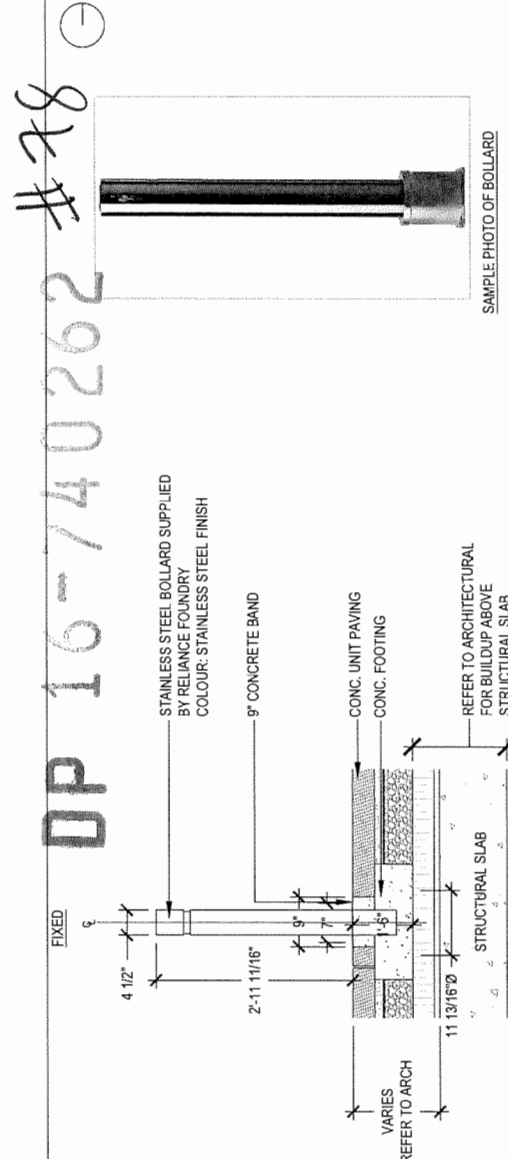


60 WOOD TOP BENCH TYPE BF
SCALE: 3/4" = 1'-0"

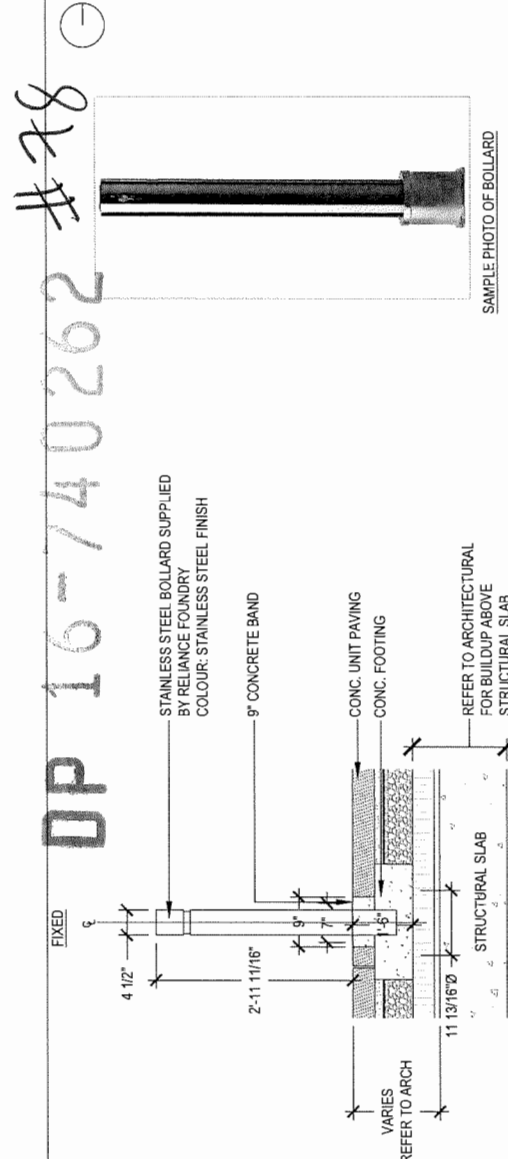


61 WOOD TOP BENCH TYPE BG
SCALE: 3/4" = 1'-0"

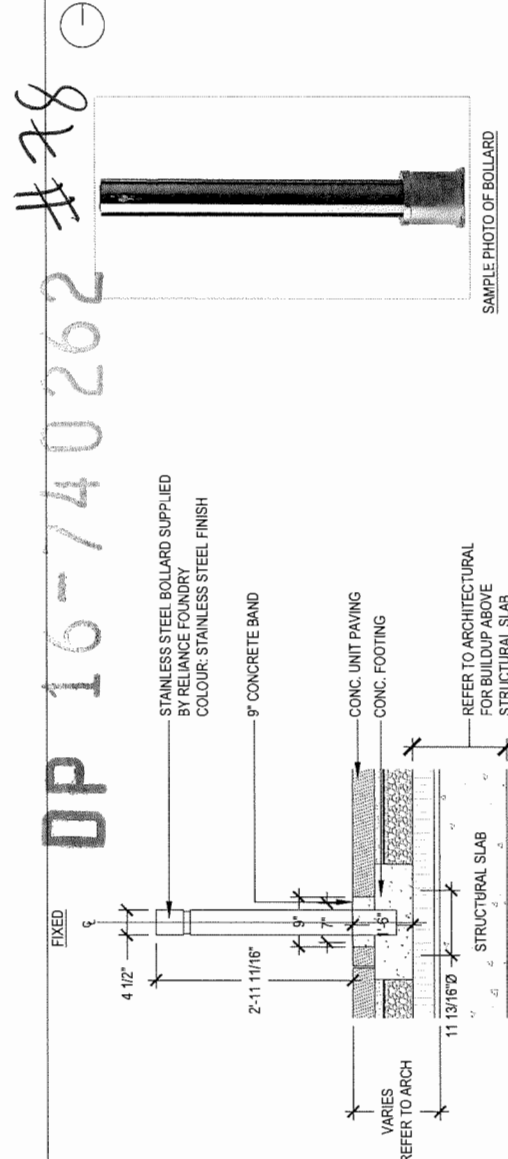


62 WOOD TOP BENCH TYPE BH
SCALE: 3/4" = 1'-0"

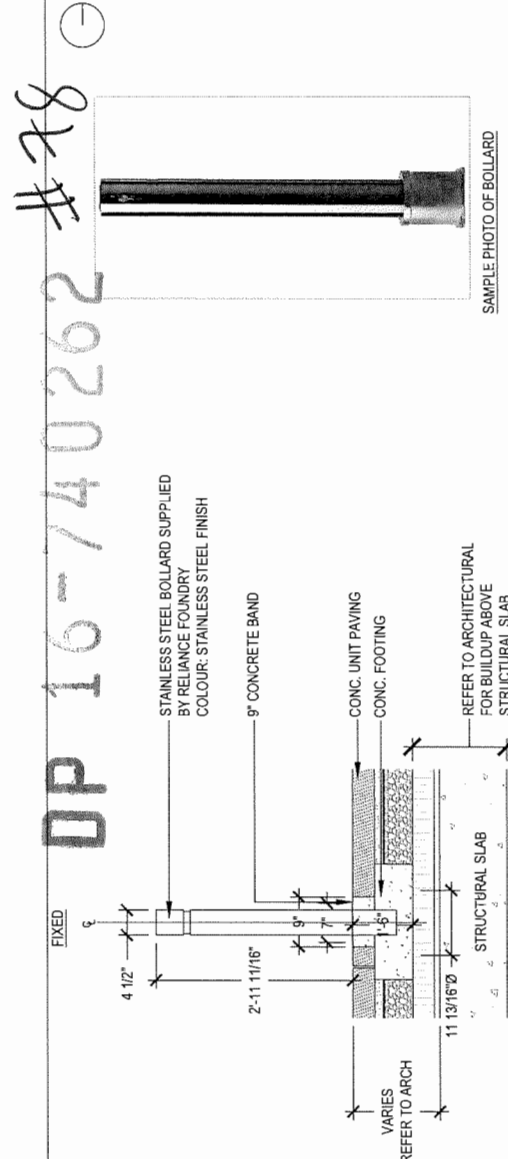


63 WOOD TOP BENCH TYPE BI
SCALE: 3/4" = 1'-0"

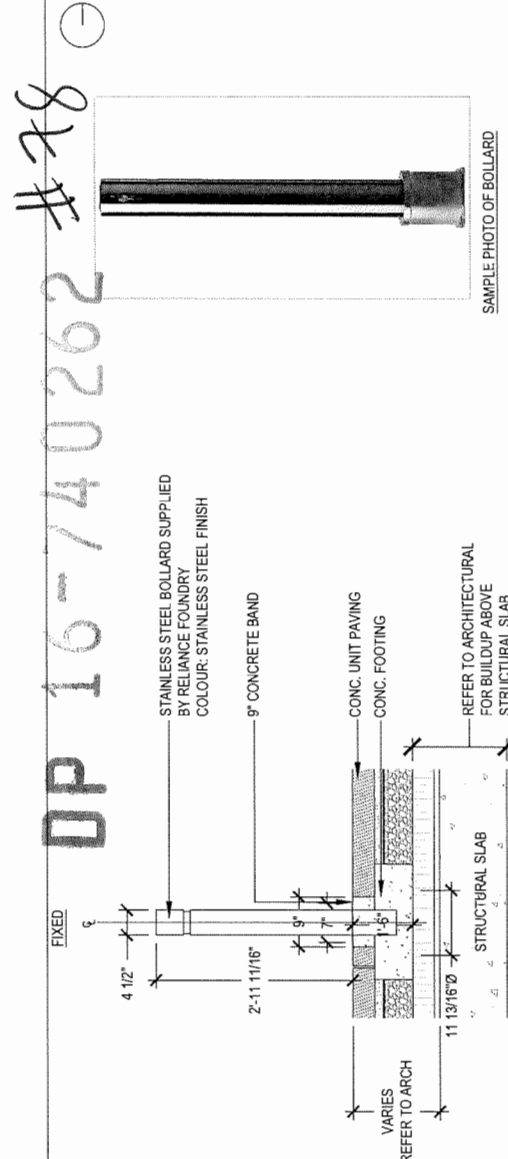


64 WOOD TOP BENCH TYPE BJ
SCALE: 3/4" = 1'-0"

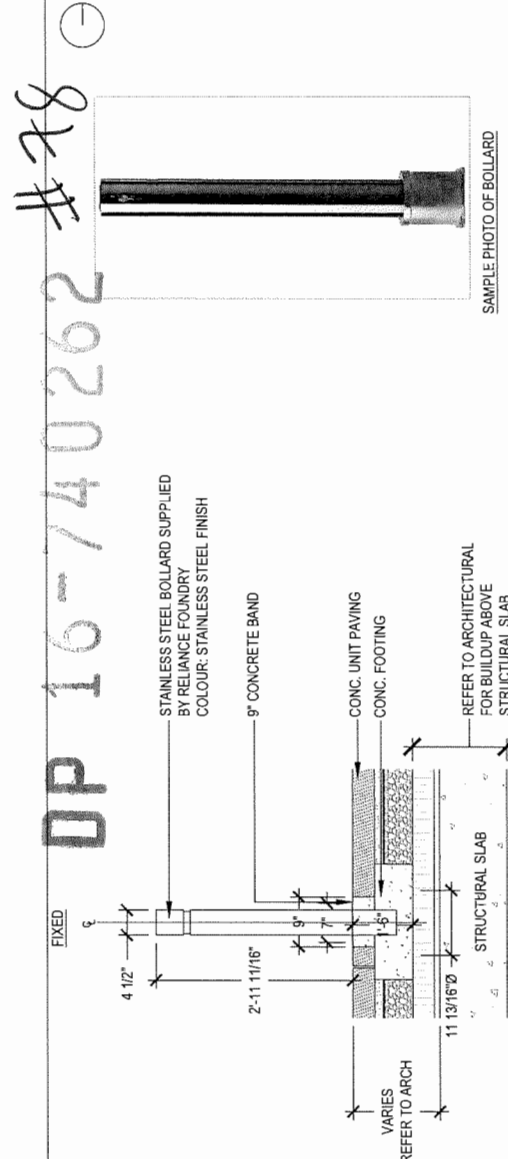


65 WOOD TOP BENCH TYPE BK
SCALE: 3/4" = 1'-0"

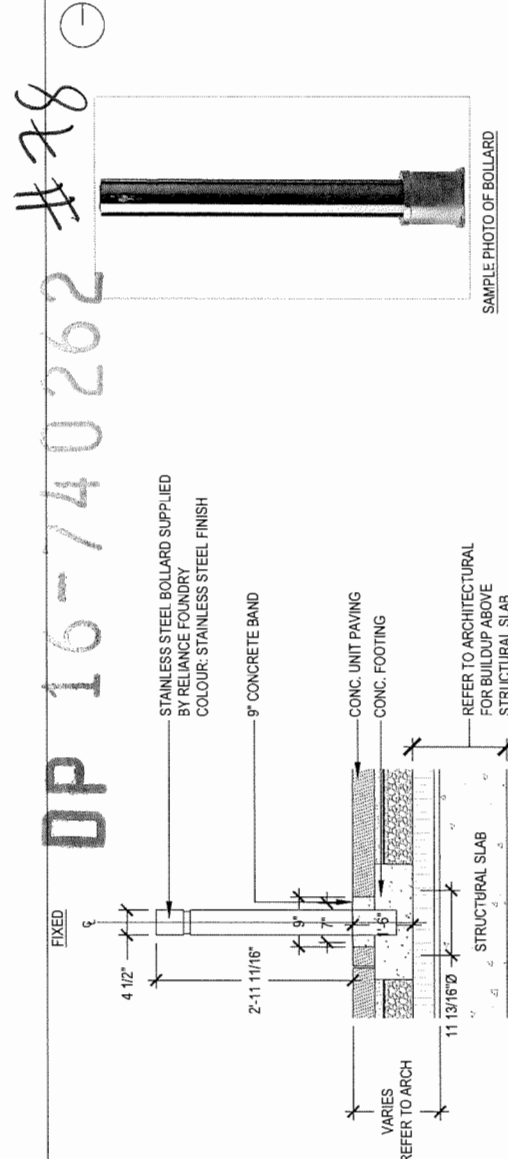


66 WOOD TOP BENCH TYPE BL
SCALE: 3/4" = 1'-0"

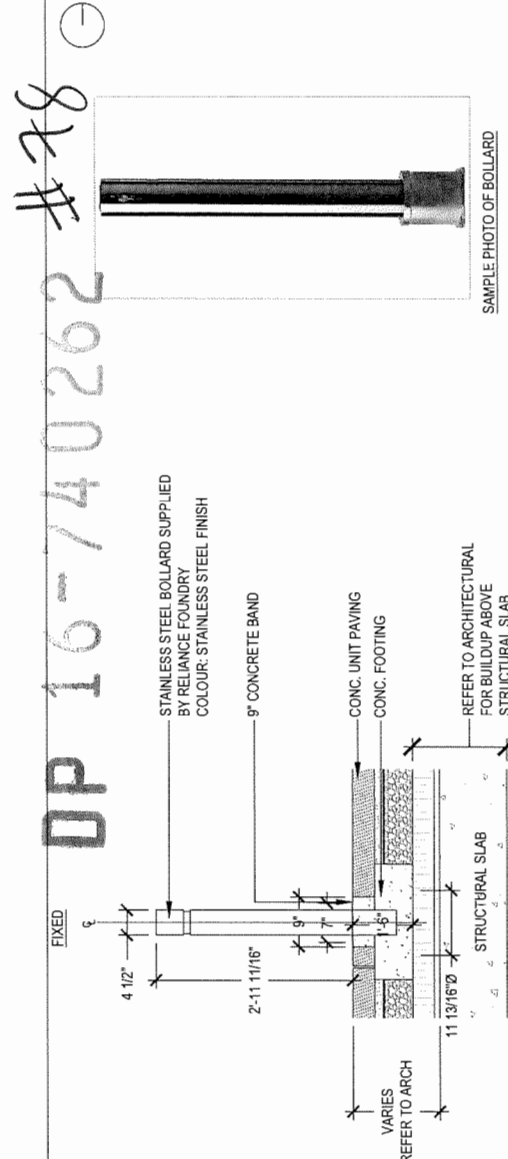


67 WOOD TOP BENCH TYPE BM
SCALE: 3/4" = 1'-0"

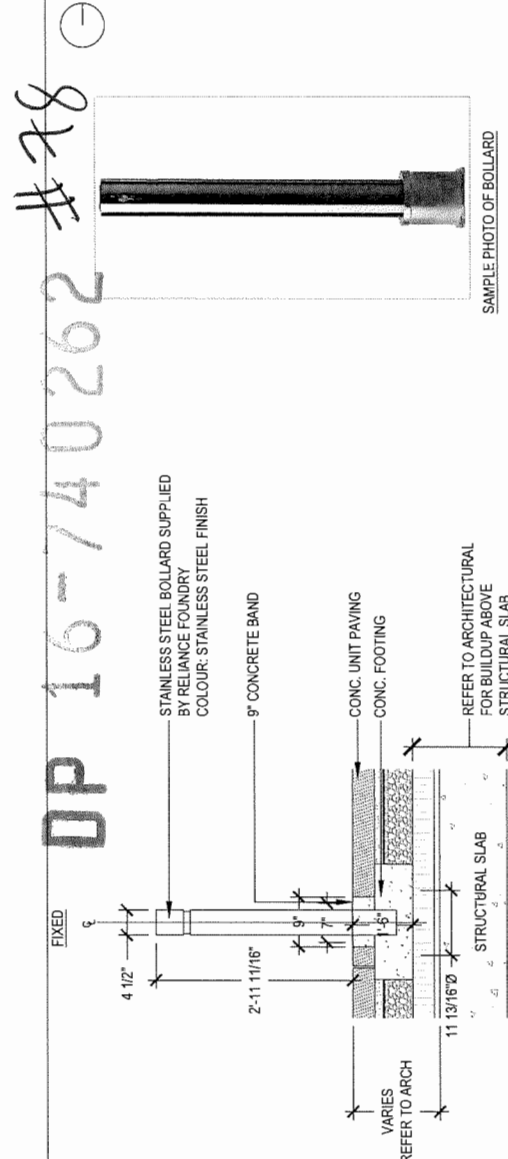


68 WOOD TOP BENCH TYPE BN
SCALE: 3/4" = 1'-0"

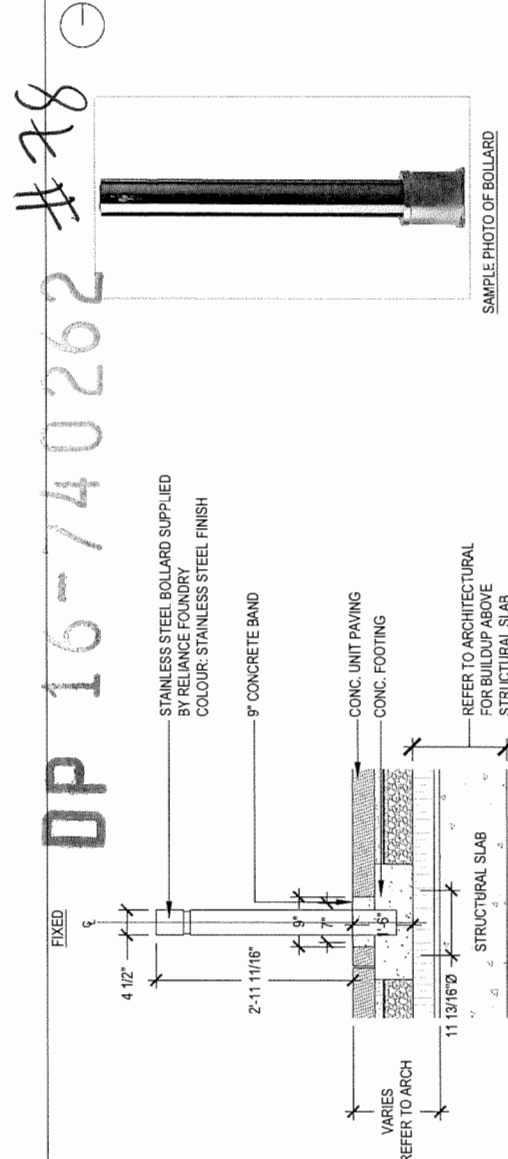


69 WOOD TOP BENCH TYPE BO
SCALE: 3/4" = 1'-0"

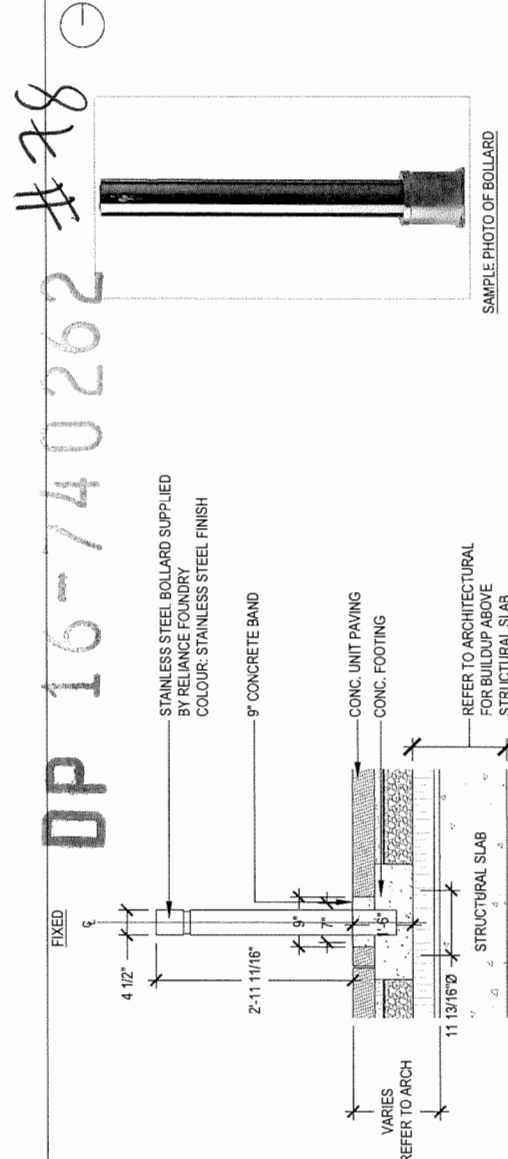


70 WOOD TOP BENCH TYPE BP
SCALE: 3/4" = 1'-0"

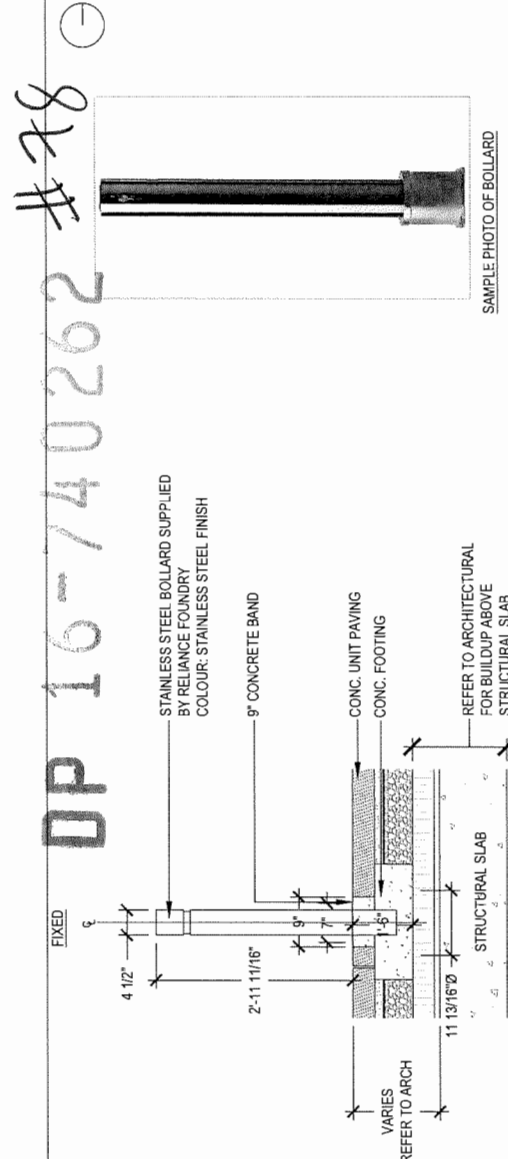


71 WOOD TOP BENCH TYPE BQ
SCALE: 3/4" = 1'-0"

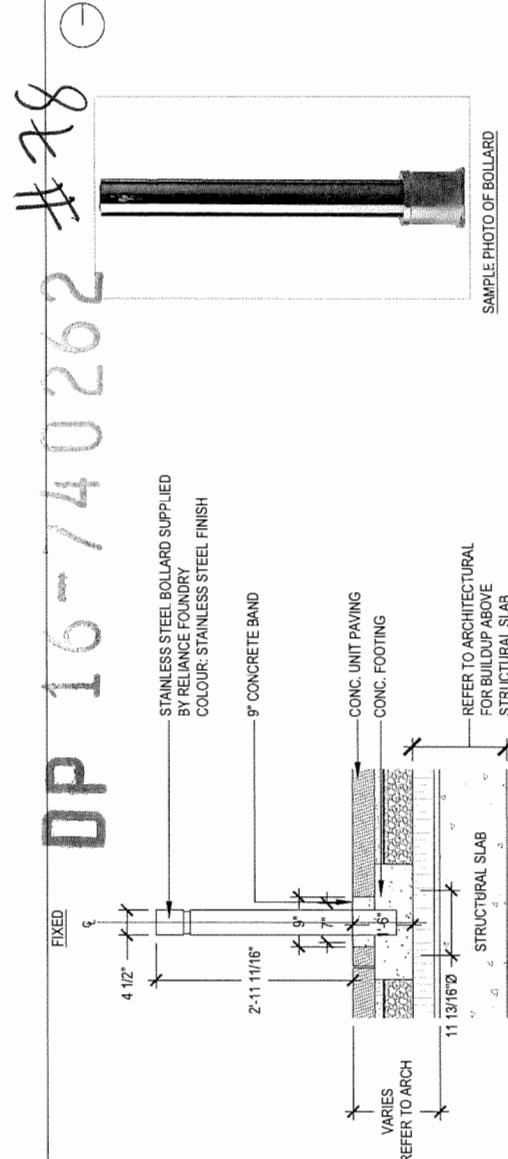


72 WOOD TOP BENCH TYPE BR
SCALE: 3/4" = 1'-0"

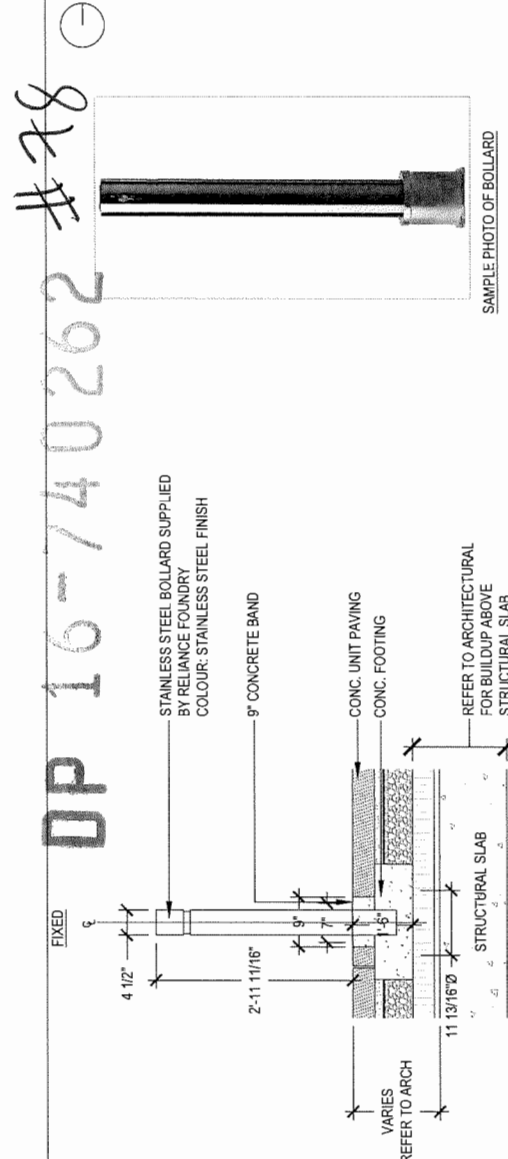


73 WOOD TOP BENCH TYPE BS
SCALE: 3/4" = 1'-0"

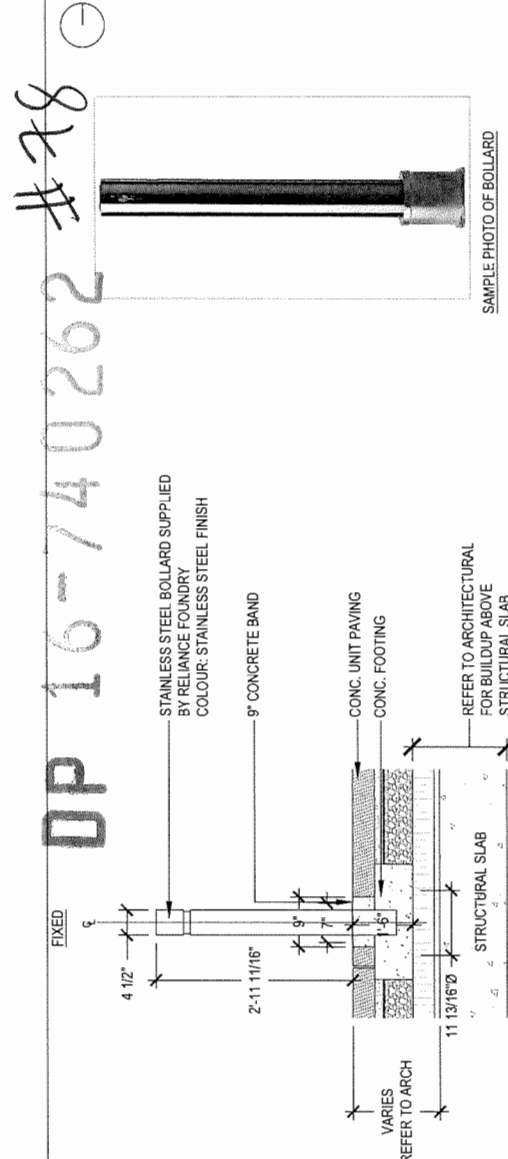


74 WOOD TOP BENCH TYPE BT
SCALE: 3/4" = 1'-0"

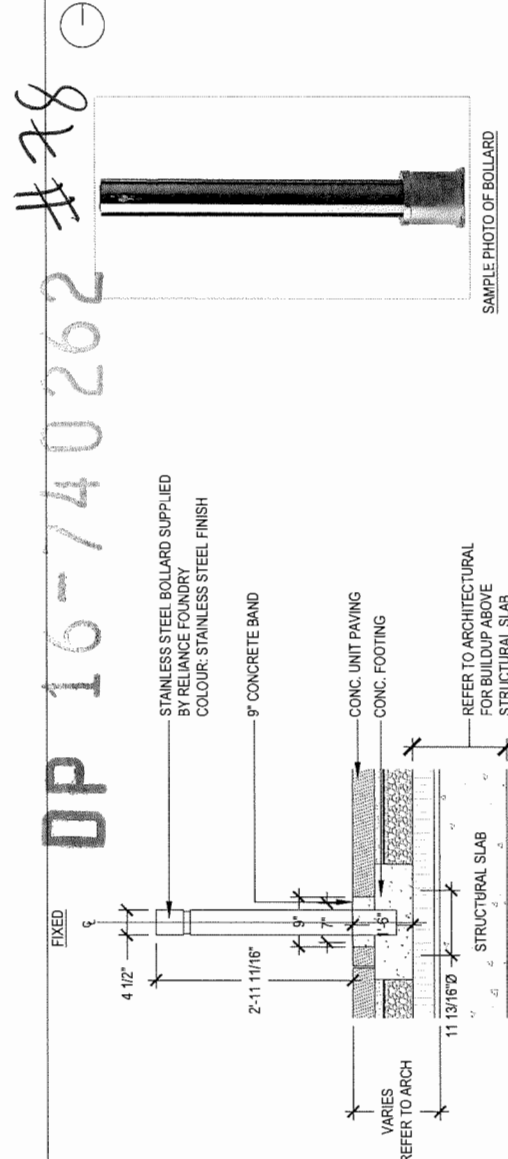


75 WOOD TOP BENCH TYPE BU
SCALE: 3/4" = 1'-0"

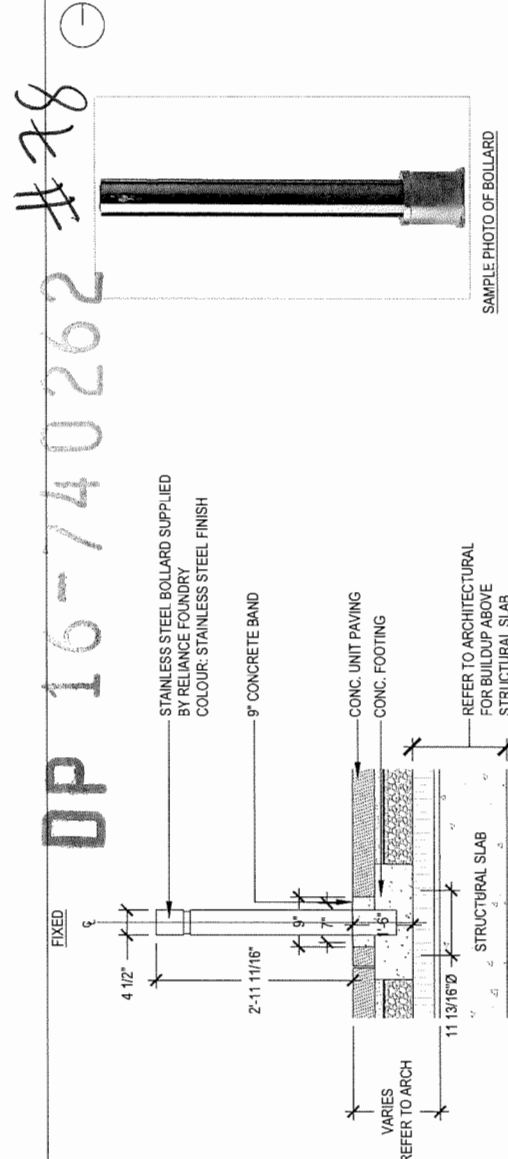


76 WOOD TOP BENCH TYPE BV
SCALE: 3/4" = 1'-0"

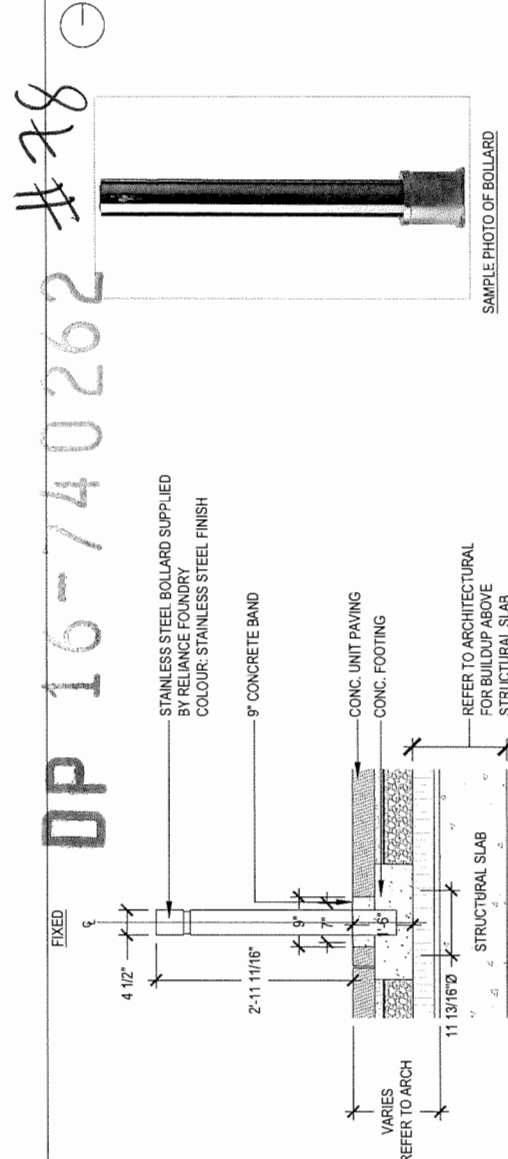


77 WOOD TOP BENCH TYPE BW
SCALE: 3/4" = 1'-0"

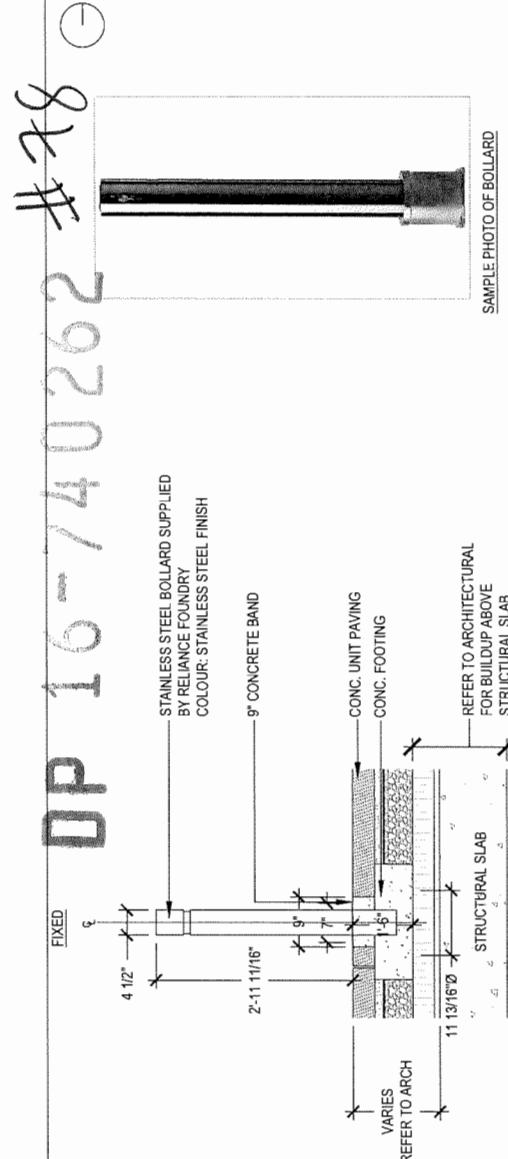


78 WOOD TOP BENCH TYPE BX
SCALE: 3/4" = 1'-0"

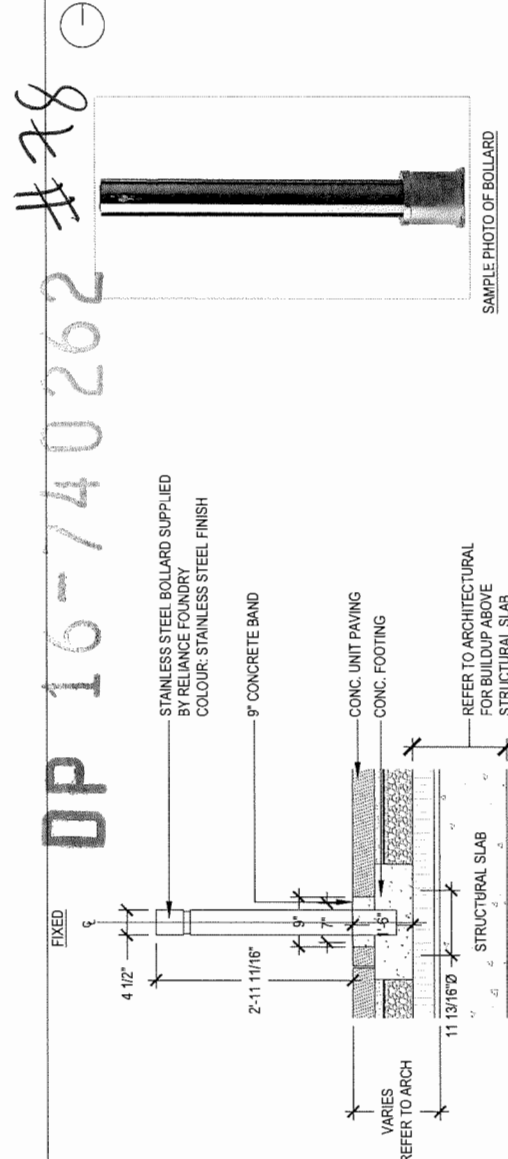


79 WOOD TOP BENCH TYPE BY
SCALE: 3/4" = 1'-0"

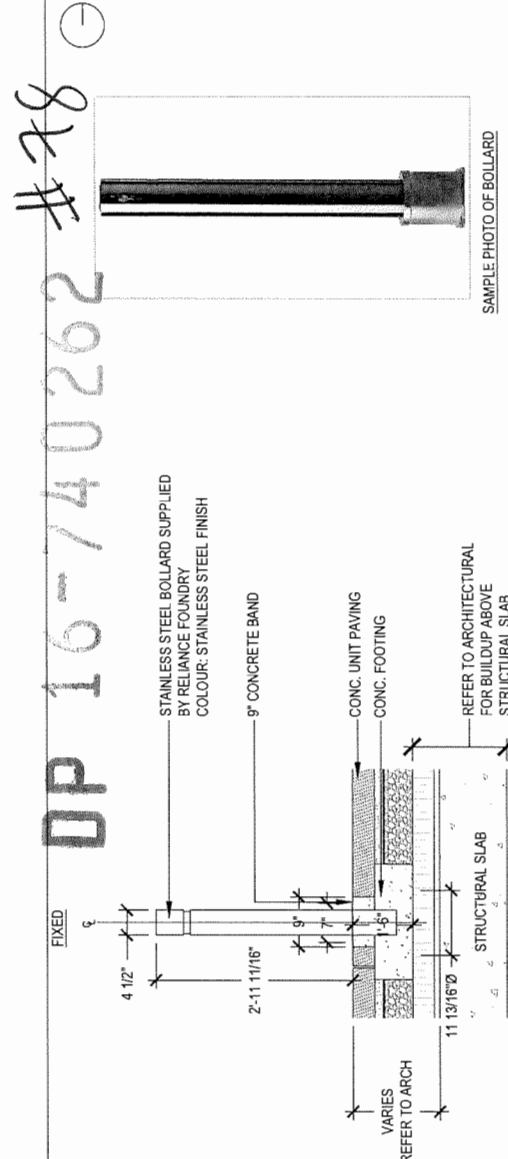


80 WOOD TOP BENCH TYPE BZ
SCALE: 3/4" = 1'-0"

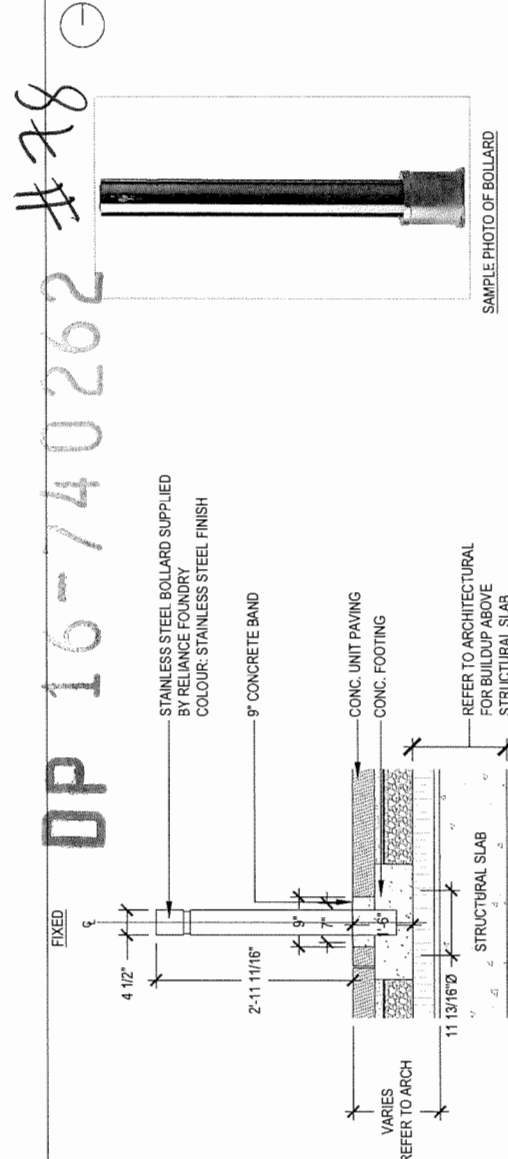


81 WOOD TOP BENCH TYPE CA
SCALE: 3/4" = 1'-0"

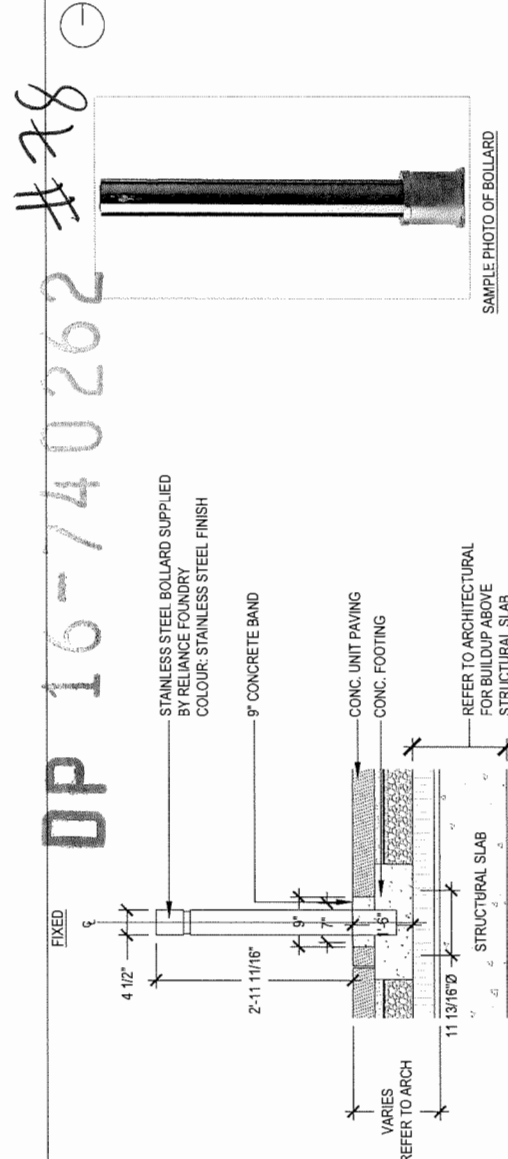


82 WOOD TOP BENCH TYPE CB
SCALE: 3/4" = 1'-0"

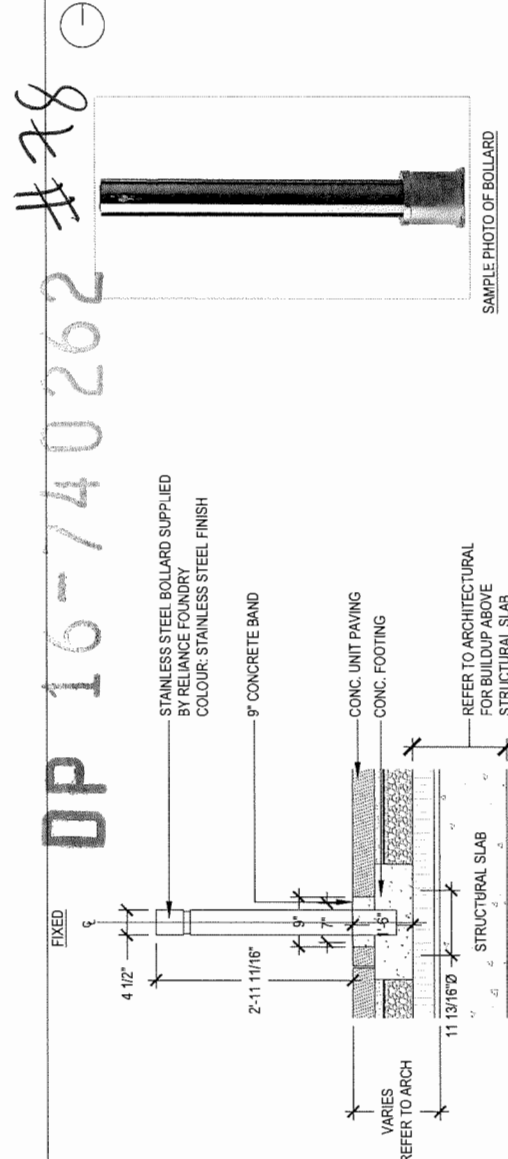

83 WOOD TOP BENCH TYPE CC
SCALE: 3/4" = 1'-0"

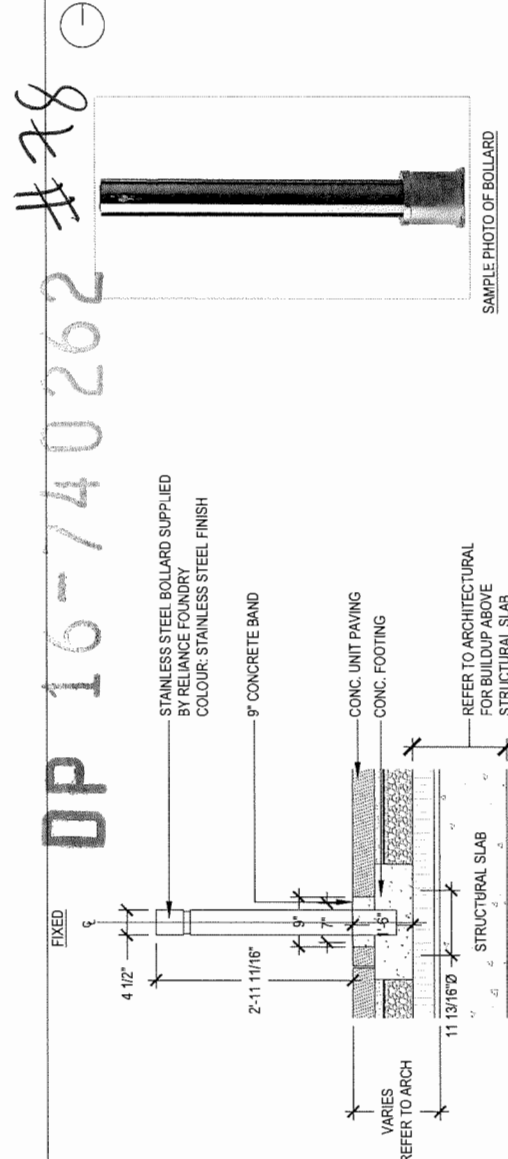

84 WOOD TOP BENCH TYPE CD
SCALE: 3/4" = 1'-0"

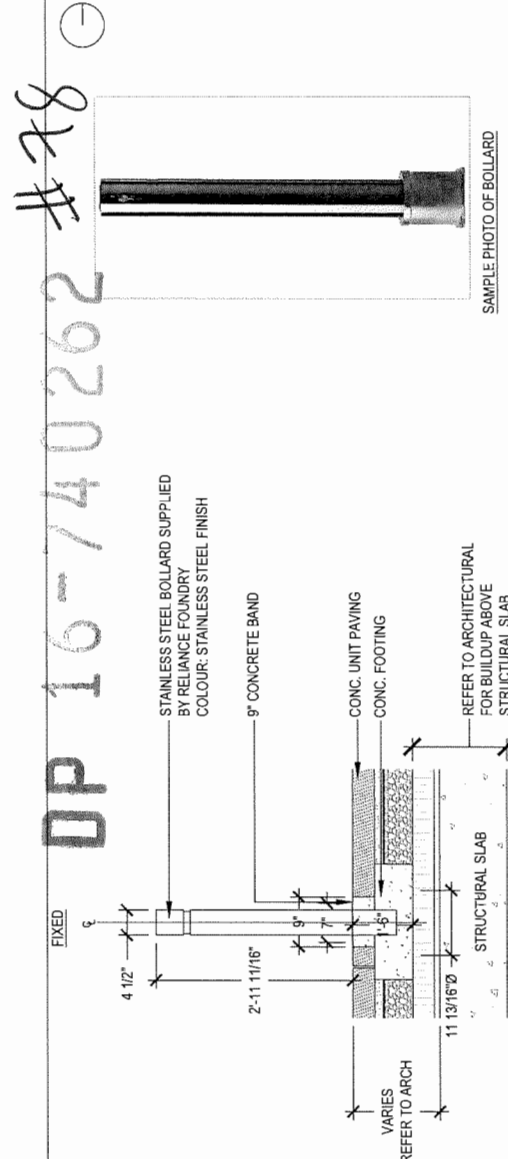

85 WOOD TOP BENCH TYPE CE
SCALE: 3/4" = 1'-0

DP 10-740202
#26



■ GBL ARCHITECTS INC.
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VANCOUVER, BC CANADA V5T 1R8
TEL: 604 738 1156
FAX: 604 731 5279
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PROJECT WITHOUT PERMISSION.

■ PFS STUDIO
PLANNING • URBAN DESIGN • LANDSCAPE ARCHITECTURE
1277 West 1st Avenue
VANCOUVER, BC V6E 2E6
TEL: 604 681 1111
FAX: 604 681 1112




NO.	DATE	DESCRIPTION
1	2017-09-29	Issued for Rezoning
2	2017-11-14	Issued for Rezoning (Resubmission)
3	2017-11-14	Issued for DP
4	2018-07-18	Reissued for DP
5	2018-08-31	DD 80%
6	2018-09-21	Reissued for DP
7	2018-10-09	Reissued for DP

7960 ALDERBRIDGE WAY


LANDSCAPE DETAILS
- FURNISHING

DATE: 10/09/2018
DRAWN BY: MPILL
CHECKED BY: LL
SCALE: AS
JOB NUMBER: 17046

L7.05


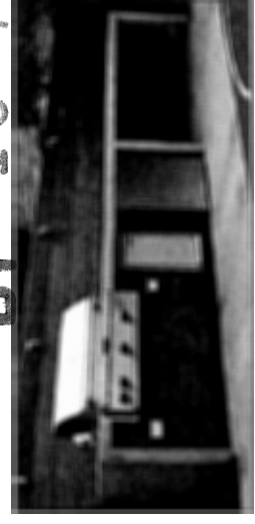


SAMPLE PHOTO OF BBQ & COUNTER

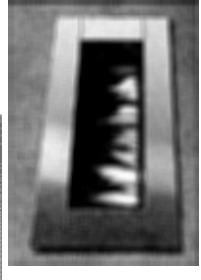


SAMPLE PHOTO OF FIREPLACE

NOTE:
1. ALL SHOWN WOOD CABINETS AND FRAMING ARE NOMINAL SIZE.
2. PROVIDE ENGINEER SIGNED AND SEALED SHOP DRAWINGS FOR BBQ AND FIREPLACE TO LANDSCAPE ARCHITECT FOR APPROVAL PRIOR TO INSTALLATION.

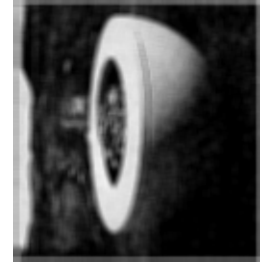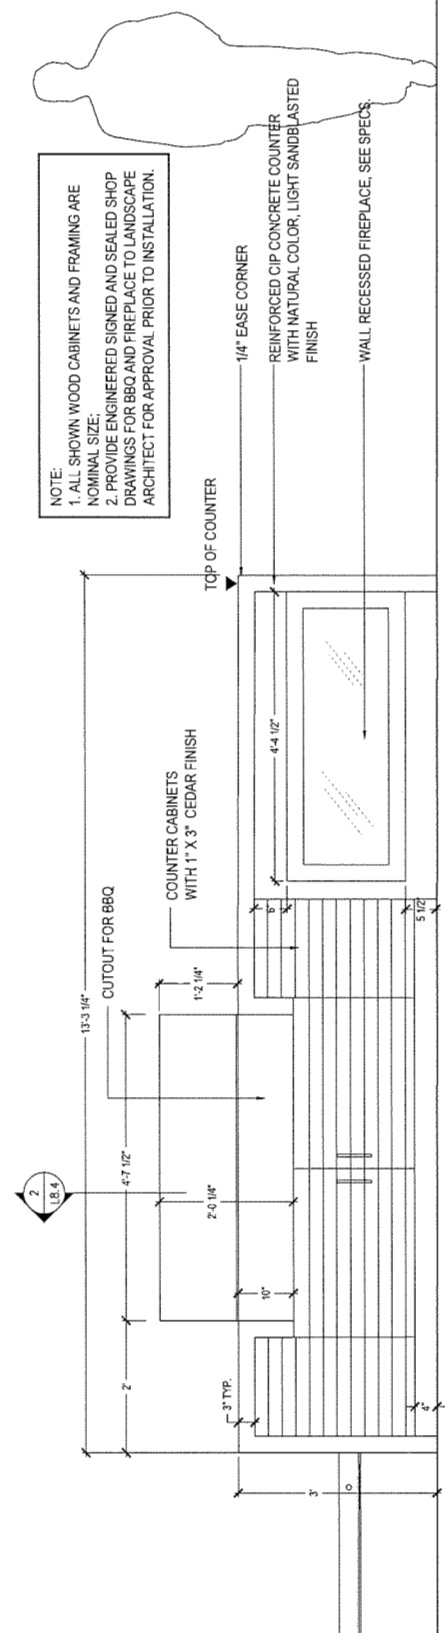


SAMPLE PHOTO



NOTE:
1. PROVIDE SHOP DRAWINGS TO LANDSCAPE ARCHITECT FOR APPROVAL PRIOR TO FABRICATION.
2. REFER TO LAYOUT PLANS FOR LOCATIONS

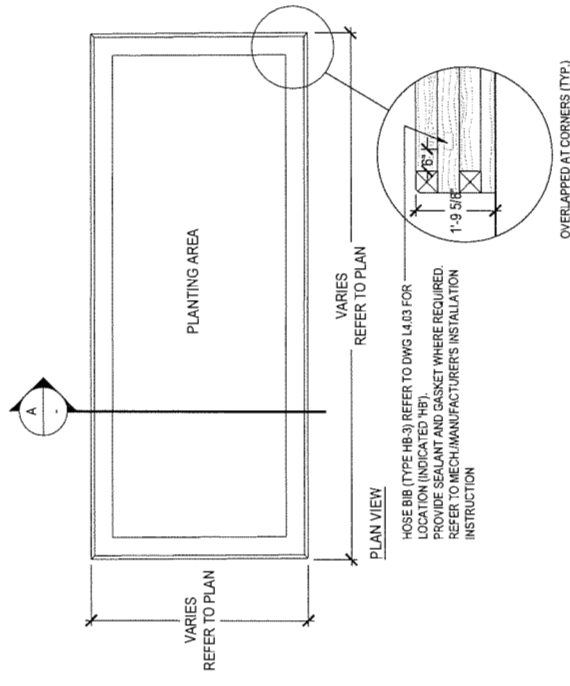

3 WOOD POT
SCALE: 1/2" = 1'-0"

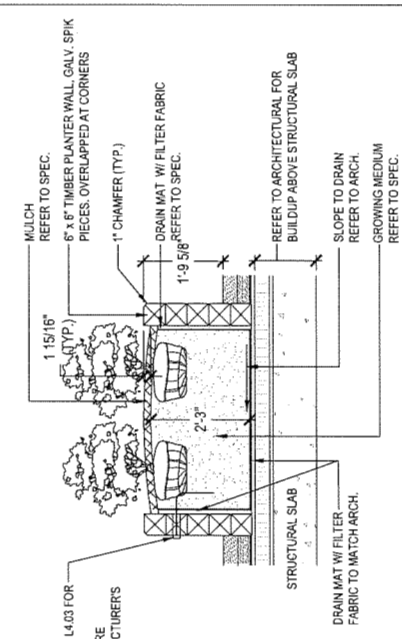

2 FIRE PIT
SCALE: 1/2" = 1'-0"

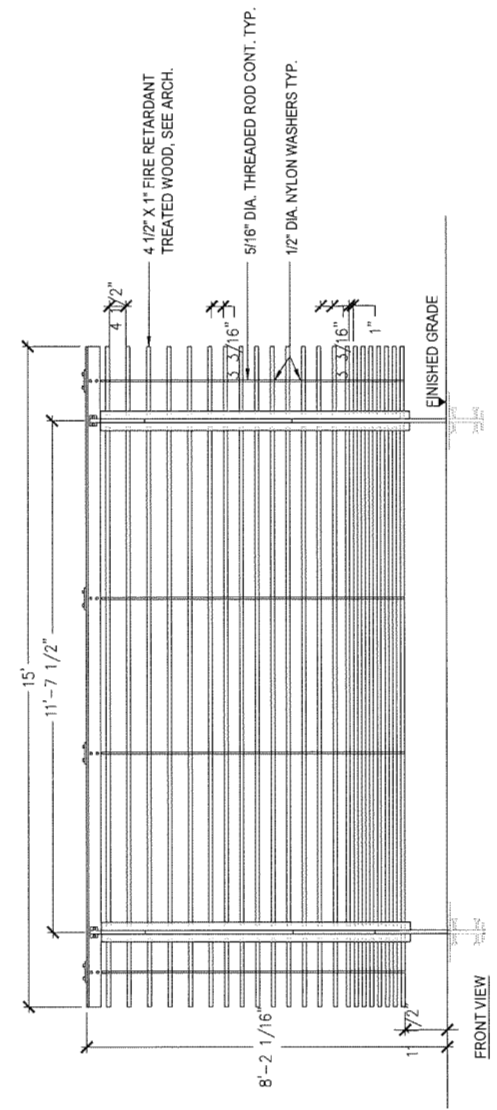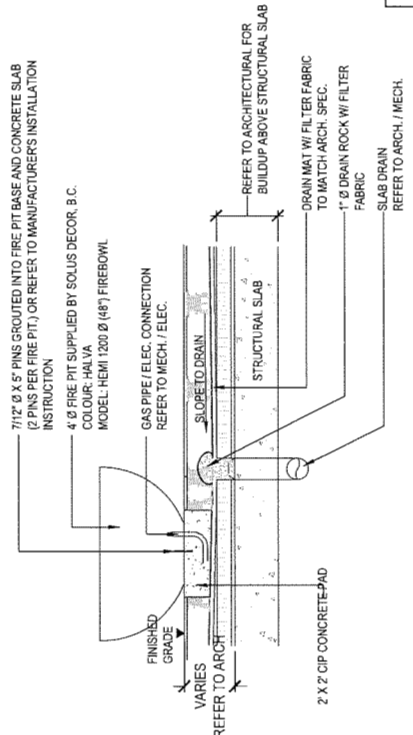

4 ROOFTOP TRELLIS, REFERENCE ONLY, SEE ARCH
SCALE: 1/2" = 1'-0"

NOTES:
1. ALL STEEL IS HOT-DIPPED GALVANIZED HSS UNLESS OTHERWISE INDICATED. GALVANIZED FINISH TO MATCH ARCHITECTURAL.
2. STAINLESS STEEL (S.S.) HARDWARE FINISH: POLISHED.
3. PROVIDE SHOP DRAWINGS FOR ALL SCREEN COMPONENTS. MINIMIZE WELDED JOINTS AND USE EXTRUDED COMPONENTS WHEREVER POSSIBLE.
4. REFER TO SPECIFICATIONS FOR WOOD FINISH SCHEDULE.
5. VERIFY IN THE FIELD ALL POST LOCATIONS AND ALIGN WITH STRUCTURAL BEAM LOCATIONS.
6. REFER TO STRUCTURAL FOR ANCHOR ASSEMBLY AND REINFORCING AT POSTS.

DP 10 740202


LL

gbl

■ GBL ARCHITECTS INC.
139 EAST 6TH AVENUE
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FAX: 604 731 8279
CONTACT: REBECCA, THE PLANNING DESIGN AND REAL ESTATE DIVISION
REBECCA@GBLARCHITECTS.COM
WWW.GBLARCHITECTS.COM

NOTES

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177 West Pender Street
VANCOUVER, BC V6C 3E8
PLANNING • URBAN DESIGN • LANDSCAPE ARCHITECTURE

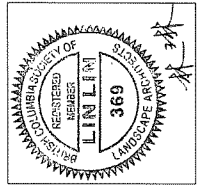


NO.	DATE	DESCRIPTION
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7960 ALDERBRIDGE WAY


LANDSCAPE DETAILS
- FURNISHING

DATE	10/09/2018
DRAWN BY	MP/LL
CHECKED BY	LL
SCALE	AS
JOB NUMBER	17046


L7.06

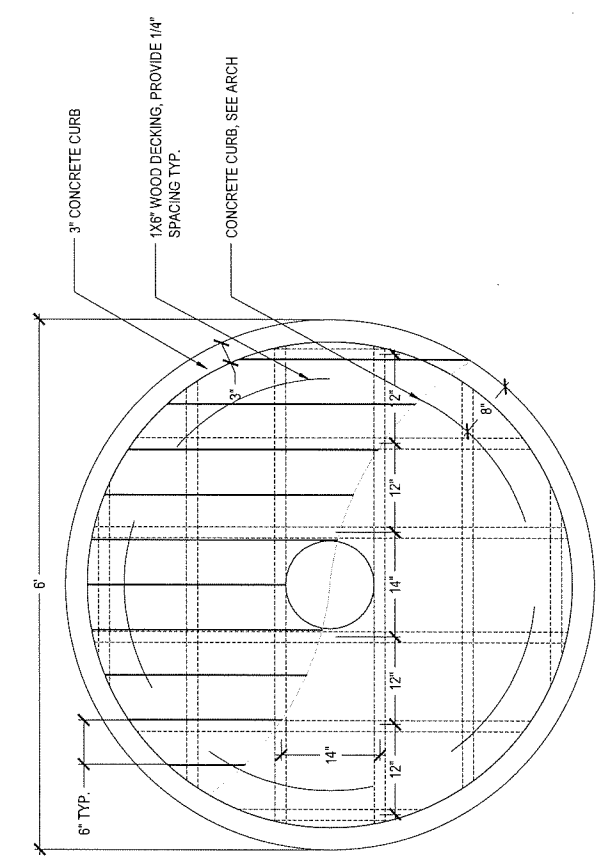

2 PLAY DECK - PLAN
SCALE: 1" = 1'-0"

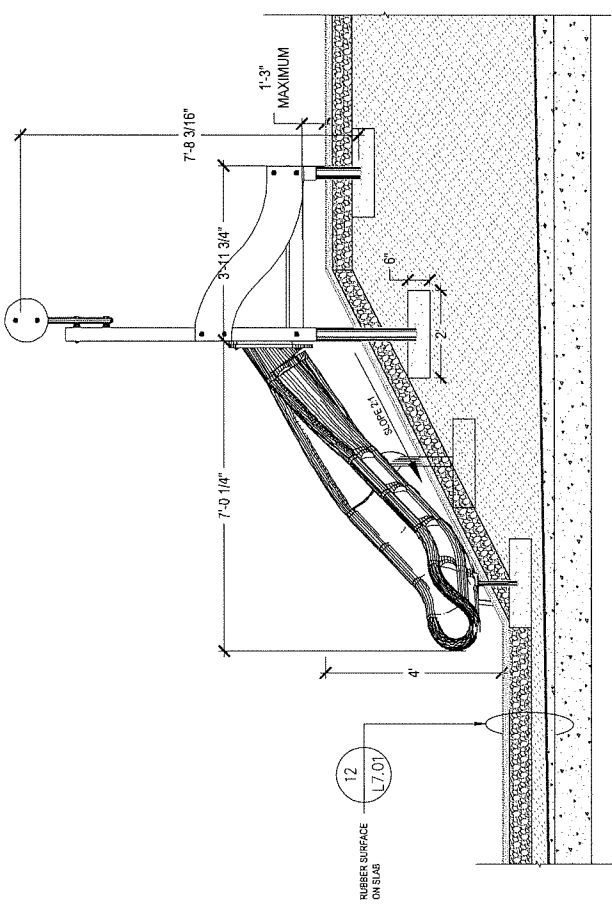

1 PLAY FEATURE - SLIDE
SCALE: 1/2" = 1'-0"

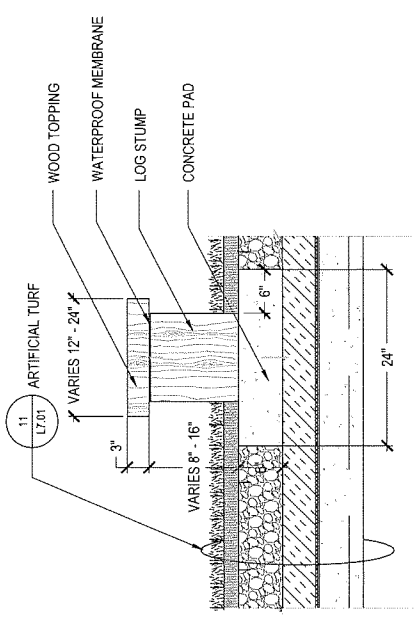

3 LOG STUMP
SCALE: 1" = 1'-0"

REFERENCE ONLY



GBI ARCHITECTS INC.
125 EAST 17TH AVENUE
VANCOUVER, BC CANADA V6T 1R6
TEL: 604.274.1154
FAX: 604.271.5279
WWW.GBIARCHITECTS.COM
KEYPLAN

REVISIONS	NO.	DATE	DESCRIPTION	DESIGNER/CP
	01	10/20/20		



WEST ELEVATION



EAST ELEVATION



7960 ALDERBRIDGE
WAY

DEVELOPMENT PERMIT

RENDERED
ELEVATIONS

DATE: 10/20/20 10:18 PM
DRAWN BY: [Signature]
CHECKED BY: [Signature]
SCALE:
JOB NUMBER: 17020

REFERENCE ONLY

gbl

GBL ARCHITECTS INC.
100 EAST PLYMOUTH
ANN ARBOR MI 48106
TEL: 734.769.1100
FAX: 734.769.1378
WWW.GBLARCHITECTS.COM
KEY PLAN

REVISIONS	NO	DATE	DESCRIPTION	ISSUED FOR
	01	10/22/2018		ISSUED FOR DP



7960 ALDERBRIDGE
WAY

DEVELOPMENT PERMIT

NORTHEAST
RENDER

DATE: 10/22/18 10:18:30 PM
DRAWN BY: Author
CHECKED BY: Chester
SCALE:
JOB NUMBER: 17020

A1.31



REVISIONS	NO.	DATE	DESCRIPTION	ISSUED FOR
	01	10/26/2018		ISSUED FOR PP



7960 ALDERBRIDGE
WAY
DEVELOPMENT PERMIT
NORTHWEST
RENDER

DATE: 10/26/2018
DRAWN BY: Anjela
CHECKED BY: Ochoa
SCALE:
JOB NUMBER: 17020

REFERENCE ONLY



REFERENCE ONLY

gbi

GBI ARCHITECTS INC.
TEL: 604.251.1156
101 EAST 5TH AVENUE
VANCOUVER, BC V6C 1K7
WWW.GBIARCHITECTS.COM
KEY PLAN

REVISIONS	NO	DATE	DESCRIPTION	ISSUED FOR
	01	10/05/2018		ISSUED FOR SP



7960 ALDERBRIDGE
WAY

DEVELOPMENT PERMIT

SOUTHWEST
RENDER

DATE: 10/05/2018 10:01:53 PA
DRAWN BY: Amber
CHECKED BY: Cheryl
SCALE:
JOB NUMBER: 17020

A1.33



REFERENCE ONLY



REVISIONS	DATE	DESCRIPTION	DESIGNED FOR: GP
01	10/20/2018		



7960 ALDERBRIDGE
 WAY

DEVELOPMENT PERMIT

COURTYARD AND
 PLAZA VIEWS

DATE: 10/20/18 10:02:22 PM
 DRAWN BY: ABrud'ar
 CHECKED BY: CBrud'ar
 SCALE:
 JOB NUMBER: 17020

REVISIONS	DATE	DESCRIPTION	ISSUED FOR
01	10/20/2019		



7960 ALDERBRIDGE
WAY

DEVELOPMENT PERMIT

OVERALL RENDER

DATE: 10/20/2019 10:52:24 AM
DRAWN BY: Amber
CHECKED BY: Orlan
SCALE:
JOB NUMBER: 17020

A1.36

REFERENCE ONLY

