



City of Richmond

Report to Committee

Staff Recommendation

That Richmond Zoning Bylaw 8500, Amendment Bylaw 9948, for a Zoning Text Amendment to the "Vehicle Sales (CV)" zone to increase the Floor Area Ratio to 0.82 at 13100 Smallwood Place, be introduced and given first reading.

Wayne Craig
Director, Development
(604-247-4625)

WC:dcb
Att. 5

REPORT CONCURRENCE
CONCURRENCE OF GENERAL MANAGER


Staff Report

Origin

Christopher Bozyk Architects Ltd. has applied for permission to amend the “Vehicle Sales (CV)” zone to increase the maximum Floor Area Ratio (FAR) to 0.82 at 13100 Smallwood Place.

A previous staff report was reviewed by Council at the meeting on November 13, 2018, and the application was referred back to staff. Council’s referral motion was as follows:

“That the application by Christopher Bozyk Architects for a Zoning Text Amendment to the “Vehicle Sales (CV)” Zone to Increase the Floor Area Ratio to 0.82 at 13100 Smallwood Place, be referred back to staff to examine options to:

(1) incorporate rooftop solar panels; and

(2) reduce building height;

and report back.”

In response to Council’s referral, the applicant worked with staff resulting in a number of revisions to their proposal including the addition of rooftop solar panels, reduction to the proposed building height, agreeing not to enclose the parkade and to monitor and address bird strike concerns. These proposed modifications and comments provided by the applicant are outlined in the subsequent text. A revised plan set and other supporting materials are incorporated into this submission.

To minimize repetition, the sections listed below have not been included in this report as their content remains unaffected by the proposed modifications to the design. Please refer to the original report from the Director, Development dated October 30, 2018 (in Attachment E), for details on the following topics:

- Location Maps
- Surrounding Development Analysis
- Official Community Plan/East Cambie Area Plan Policies
- Agricultural Land Reserve (ALR) Buffer Zone
- Floodplain Management Implementation Strategy
- Aircraft Noise Sensitive Development Policy
- Ministry of Transportation and Infrastructure (MOTI) Approval
- Ministry of Environment (MOE) Approval
- Existing Legal Encumbrances
- Transportation Analysis
- Tree Retention and Replacement
- Public Art Contributions
- Site Servicing and Frontage Improvements
- Development Permit Review
- Financial Impact or Economic Impact

Findings of Fact

A revised Development Application Data Sheet providing details about the development proposal is provided in Attachment A. The applicant's revised conceptual development plans are provided in Attachment B.

Applicant Response

The applicant's responses to Council's November 13, 2018, referral motion and related discussion are provided below. Staff's assessment on each issue is provided immediately following the applicant's comments.

1. Rooftop Solar Panels

Applicant Response: The applicant has modified the plans to accommodate approximately 107 solar panels in a 207.6 m^2 ($2,235 \text{ ft}^2$) of the building's lower rooftop level. The proposed location is shown highlighted in red in the Conceptual Development Plans in Attachment B on the plan labeled DP.007.

The solar panels are anticipated to have a maximum output of approximately 38.52 kW. The applicant has advised that "*the power generated would be connected to a grid tie invertor and connected to the building distribution system. The energy produced will help offset the power required for the parking lot lighting.*"

With respect to placing solar panels on the south façade of the building, the applicant has commented that "*we found that this may contribute to glare which was an issue brought up at the Advisory Design Panel Meeting and have been since advised that it may also affect birds impacting the building. An alternative location was found on the [second storey] rooftop which will be effective year round although somewhat reduced in winter months.*"

Staff Comment: The Zoning Text Amendment Considerations (see Attachment D) have been amended to include a requirement for the registration of a legal agreement on Title prior to bylaw adoption. The agreement will contain provisions that the solar panels will be installed to the satisfaction of the Director of Building Approvals, maintained for the life of the building and will not be removed without City approval.

2. Building Height Reduction

Applicant's Response: The applicant has investigated reducing the building's parapet height as well as reductions to the overall building height while retaining the two additional parkade floors. The property owner has also provided additional comment on their request for the two parkade floors.

Regarding the parapet height, the revised plan submission incorporates a reduction of the parapet by 0.71 m (2.33 ft.). As amended, the proposed parapet will be approximately 1.07 m (3.5 ft.) above the roof deck conforming to the BC Building Code requirements.

The applicant also revised the parkade plans to minimize the floor to floor heights in the proposed parkade addition from the original values of 2.75 m (level 4 to 5) and 2.89 m (level 3 to 4) to 2.64 m for both. Both the elevator overrun and the stair enclosure heights have been reduced by 0.51 m. Their revised plans have reduced the height of the roof deck by 0.36 m (1.18 ft.) and reduced both the stair tower and the elevator overrun by 0.51 m (1.67 ft.).

The applicant notes that the height reduction “*had to take into account drainage and plumbing falls, the slope of slabs and the provision of a dry sprinkler which requires a fall in the pipes. The dry system is required as this [is] not a heated space. The sprinkler system itself required 12 in. clearance below the [underside] of the roof/floor slab.*” Collectively, these technical requirements limit the amount of height reductions possible between the parkade floors.

The property owner, (OpenRoad) has provided the following background context information as their primary reasons for requiring the two additional parkade levels:

“As Toyota is a quality product at an accessible price point, car volumes and turnover are very high. It expected that between 350-400 cars will be sold here every month. The current showroom was designed to handle a fraction of this amount.

OpenRoad currently rent[s] land at two separate sites in Richmond; totaling 3.5 acres (152,000 ft²) for Toyota alone. They are forecast to require more in the future. The additional parkade along with the spaces already granted will eliminate this need and free up valuable [industrial] land which is acknowledged to be at a premium Richmond. The additional investment of this parkade will also eliminate the need for OpenRoad to rent this land. It is very difficult to find additional land if and when it is required.

There are also the logistics of transferring cars to and from these compounds to the showroom which creates unnecessary congestion for the city, extra emissions, and which cause logistical and time issues for OpenRoad.

If we are unable to build both additional parkade levels it will still necessitate renting land elsewhere. It will continue the current inefficient logistical situation at Toyota, described above, which is the reason a new showroom with larger inventory on site is required to begin with”.

Staff Comment: Regarding parapet height, section 3.3.1.18 of the BC Building Code requires a guard no less than 1.070 m (3.5 ft.) high to be provided around any roof to which access is provided for purposes other than maintenance. The revised parapet height, as shown in the attached plans, is now at the minimum height required by the BC Building Code and cannot be reduced further. Building Approval staff have advised that, to date, no equivalency proposals have been accepted for this code requirement since this is a safety issue.

The revised building heights, incorporating the proposed reductions, are included in the revised Conceptual Development Plans (Attachment B). The variances needed to accommodate these heights are listed in the “Variances Requested” section of this report.

3. Shadow Impact Analysis

Applicant’s Response: The applicant has provided a shadow study based on the reduced building height (see Attachment B-Plan DP.024). More detailed shadow diagrams for those periods where the shadows will extend to the Nature Park have been provided (see Attachment B – Plans DP.025 to DP.028).

Staff Comment: The primary building on the Toyota site is approximately 42.5m (139.4 ft.) to the east of the Richmond Nature Park. Based on the submitted shadow diagrams, shading of the periphery of the park will occur at several times through the year, limited to early morning hours. The diagrams indicate the duration of the shadowing to be typically short (on the order of an hour after sunrise at the extremes).

4. Future Enclosure of the Parkade

Applicant’s Response: *“OpenRoad are fully committed to providing humane measures preventing birds nesting in the building. It has been suggested that OpenRoad may try to enclose the building at a later date to prevent this; however it would require mechanical ventilation which is not something we wish to pursue. It would also require City and Council approval through the Development Permit process.”*

Staff Comment: The Zoning Text Amendment Considerations have been modified to include a requirement for the registration of an agreement on title ensuring that the parkade will not be enclosed unless the owner has successfully obtained a Development Permit issued by Council approving the enclosure and has also successfully obtained a Building Permit for the work.

5. Ornithologist Assessment

The applicant has submitted a report prepared by an ornithologist with CSR Environmental (report dated November 29, 2018 – see Attachment C) that undertakes a specific assessment of the Toyota building in terms of potential avian strike risk and mitigation options.

The report’s findings indicate that the proposed parkade addition does not pose a collision risk to birds because no glass or reflective material has been proposed in the addition.

Staff Comment: The applicant has agreed to engage a qualified environmental professional (QEP) to monitor the building for a year and to implement visual markers to the exterior of the glass at the lower levels should the QEP make that determination in the course of the monitoring.

The applicant has also indicated that no “up-lights” will be used in the project and that landscaping over 30 cm will be removed from within 10 m of the building.

The Zoning Text Amendment Considerations have been modified to include a requirement for the submission of a contract with a qualified environmental professional to monitor the facility for a minimum of 12 months post construction and to submit a report with recommendations and mitigation measures to the satisfaction of the Director, Development at the end of the monitoring period. The contract is to include the frequency of visits and an overview of how the findings will be presented.

Staff will review the landscaping plan through the Development Permit review to ensure that landscaping used within 10 m of the building will be no more than the recommended 30 cm in height.

Variances Requested

Based on the revised concept plans, the applicant will be requesting to vary the provisions of Richmond Zoning Bylaw 8500 at the Development Permit Application review stage to increase the maximum permitted building height. The table below shows the variances being requested and compares them to the applicant's previous variance request.

Area Affected	Previous Variance (m)	Revised Variance (m)
Parkade Rooftop Height	15.46 (rounded to 15.5)	15.1
Parapet Height	16.88 (rounded to 16.9)	16.17 (rounded to 16.2)
Stair Tower	18.51 (rounded to 18.6)	18.0
Elevator Over-Run	20.39 (rounded to 20.4)	19.88 (rounded to 19.9)

The variances requested reflect the overall reduction in height of between 0.36 m (1.2 ft. - roof deck) and 0.71 m (2.33 ft. - parapet) from the original submission reviewed by Council on November 13, 2018. The reduced parapet height would meet the Building Code minimum height of 1.07 m (3.5 ft.). The elevator and stair projections are cloud outlined in Attachment B on plan DP.009.

Development Permit Review

As noted earlier, this development is subject to a Development Permit review wherein further design development could occur. Through that process staff will be monitoring and verifying a number of elements as outlined in the previous report from the Director of Development (Attachment E). As a result of the modifications proposed, staff will also:

- Confirming building elevations and variances;
- Reviewing landscape modifications – particularly within 10 m of the building;
- Review the site lighting scheme including any use of “up-lighting”;
- Inclusion of any implementable avian mitigation measures.

Conclusion

Christopher Bozyk Architects Ltd. has applied for permission to amend the zoning district "Vehicle Sales (CV)" zone to increase the maximum Floor Area Ratio (FAR) to 0.82 at 13100 Smallwood Place.

In response to the Council referral on November 13, 2018, the applicant modified their submission by adding rooftop solar panels, reducing the overall building height and agreeing not to enclose the parkade. The applicant has also engaged an ornithologist to assess the overall building clarifying areas of concern and providing recommendations for minimizing bird strikes at the building. The applicant has committed to engaging a qualified environmental professional to monitor avian strikes with the building and to implementing the ornithologist's recommendations for visual marking of the glass along the west and northwest side of the building if required.

Based on the applicant's responses to Council's referral it is recommended that Richmond Zoning Bylaw 8500, Amendment Bylaw 9948 for a Zoning Text Amendment to the "Vehicle Sales (CV)" zone to increase the Floor Area Ratio to 0.82 at 13100 Smallwood Place, be introduced and given first reading.



David Brownlee
Planner 2
(604-276-4200)

DCB:blg

Attachment A: Revised Development Application Data Sheet

Attachment B: Revised Conceptual Development Plans

Attachment C: Report by CSR Environmental

Attachment D: Revised Zoning Text Amendment Considerations

Attachment E: Original Report from the Director of Development, dated October 30, 2018

Attachment A: Revised Development Application Data Sheet



City of Richmond

Development Application Data Sheet

Development Applications Department

ZT 18-818765

Attachment A

Address: 13100 Smallwood Place

Applicant: Christopher Bozyk Architects

Planning Area(s): East Cambie

	Existing	Proposed
Owner:	Multiland Pacific Holdings	Same
Site Size (m ²):	15,924 m ² (171,404.51 ft ²)	Same
Land Uses:	Auto Dealership And Service	Same
OCP Designation:	Commercial	Same
Area Plan Designation:	Commercial	Same
Zoning:	Vehicle Sales (CV)	Vehicle Sales (CV) with increased FAR to 0.82 at 13100 Smallwood Place

On Future Subdivided Lots	Bylaw Requirement	Proposed	Variance
Floor Area Ratio:	0.7 FAR	0.82 FAR	None permitted
Buildable Floor Area (m ²):*	11,146.8 m ² (119,983.2 ft ²)	12,996.3 m ² (139,891 ft ²)	None permitted
Lot Coverage (% of lot area):	Building: Max. 50%	Building: Max. 38%	None
Setback Front - North	Min 3.0 m	16.0 m	None
Setback Side – East	Min 3.0 m	20.38 m	None
Setback Side - West	Min 3.0 m	22.5 m Main Building 3.0 m Car Wash Building	None
Setback Rear - South	Min 3.0 m	10.63 m Main Building 3.0 m Garbage Enclosure	None
Height (m):	Max building height: 12.0 m with variance to 15.44 m at elevator overrun, stairway structures, storage and screened equipment as approved under DP 16-741123	Increased parkade rooftop height at 15.1 m, a parapet height of 16.17 m, a stair tower of 18.0 m and an elevator over-run of 19.88 m	Variance to be considered as part of DP18-818762
Off-street Parking Spaces – Staff and Visitor	281	296	None
Off-street Parking Spaces – Vehicle Inventory:	N/A	279	None

Other: _____

PLN - 55

Attachment B: Revised Conceptual Development Plans

DP.001

EAST ELEVATION

SCALE:
DATE:

2018.11.23

OpenRoad Toyota Richmond
PROJECT NUMBER: A10001
COPRIGHT NOTICE: All rights reserved. Any unauthorized duplication or distribution of this drawing, in whole or in part, is illegal. It is the property of Christou Architects Ltd. and is intended for the sole use of the client. It is to be returned to us or destroyed when no longer required. It is to be treated as a trade secret and is not to be shown to anyone outside the client's organization without our written permission in writing.

CHRISTOU ARCHITECTS LTD
JAN M. CHRISTOU, FAIA, LEED AP, NCARB, LEED AP, SITES
E: info@christouarchitects.com | W: www.christouarchitects.com | T: 604.541.5500

PAGE DATE: 11/20/2018 11:22:44 AM

PLN - 57





PLN - 58

OpenRoad Leyela Richimond

CHRISTOPHER PROJECTS LTD
10, BESIDE ST. MARY'S, MADURAI - 625 001
T: 0432 222 2222, F: 0432 222 2223

JUL 01 1964 AIR FORCE STAFF COLONEL JAMES W. BROWN
F-100 SUPER SABRE PILOT, USAF 25TH TFW

Electronic format: see the property of Christopher Black Architects Ltd., and
an Instrument of title that may not be used, forwarded to others,
35mm film: Downloaded or reproduced either in print or electronic format,
through the express written permission of the copyright owner.

NORTHWEST ELEVATION
SCALE

DATE: 2018-11-23

2018-11-23

DATE:



DP:003

VIEW FROM WESTMINSTER HIGHWAY


OpenRoad Toyota Richmond

CHRISTOPHER PROJECTS LTD
PROJECT NUMBER 214067

COPYRIGHT NOTICE. All rights reserved. All books, designs, drawings and reproductions either in print or on electronic formats, are the property of Barclay Architects Ltd., and are an infringement of same that may not be used, forwarded to others, transmitted, downloaded or reproduced either in print or electronic format, without the express written permission of the copyright owner.

VIEW INC
SCALE:
DATE: 2018.11.23

兩漢賦

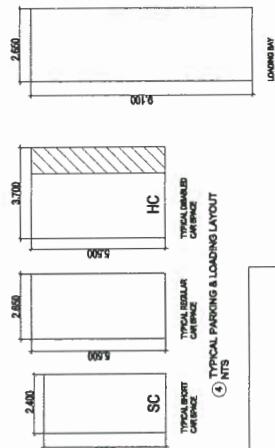


SECTION	DATE	ISSUED FOR DP
4	18/11/20	ISSUED FOR DP
3	18/11/20	ISSUED FOR DP
2	18/09/20	ISSUED FOR DP AMENDMENT
1	18/04/20	ISSUED FOR DP AMENDMENT

DESCRIPTION

REVISION

DATE

100

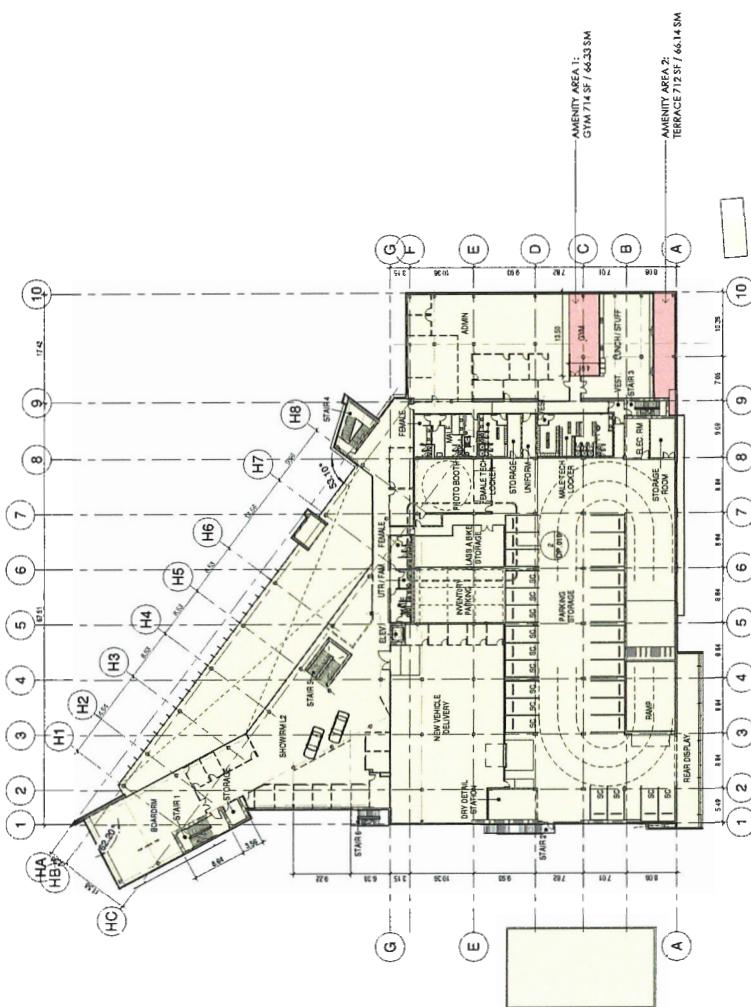

SECOND FLOOR PLAN

**PLAN #1B
DP.006**

DRANHUR
21400
DATE: 2028-11-01
PROJECT NUMBER
SCALE: 1: 3000
PLAN #1B


4	10/11/23	ISSUED FOR OP
3	10/11/08	ISSUED FOR OP
2	10/08/25	ISSUED FOR OP AMENDMENT
1	10/04/11	ISSUED FOR OP AMENDMENT
REVISION	DATE	DESCRIPTION

DP 18-818762

13100 SMALL WORDS

PLAN #1C
DP.007

OVERALL ROOF PLAN

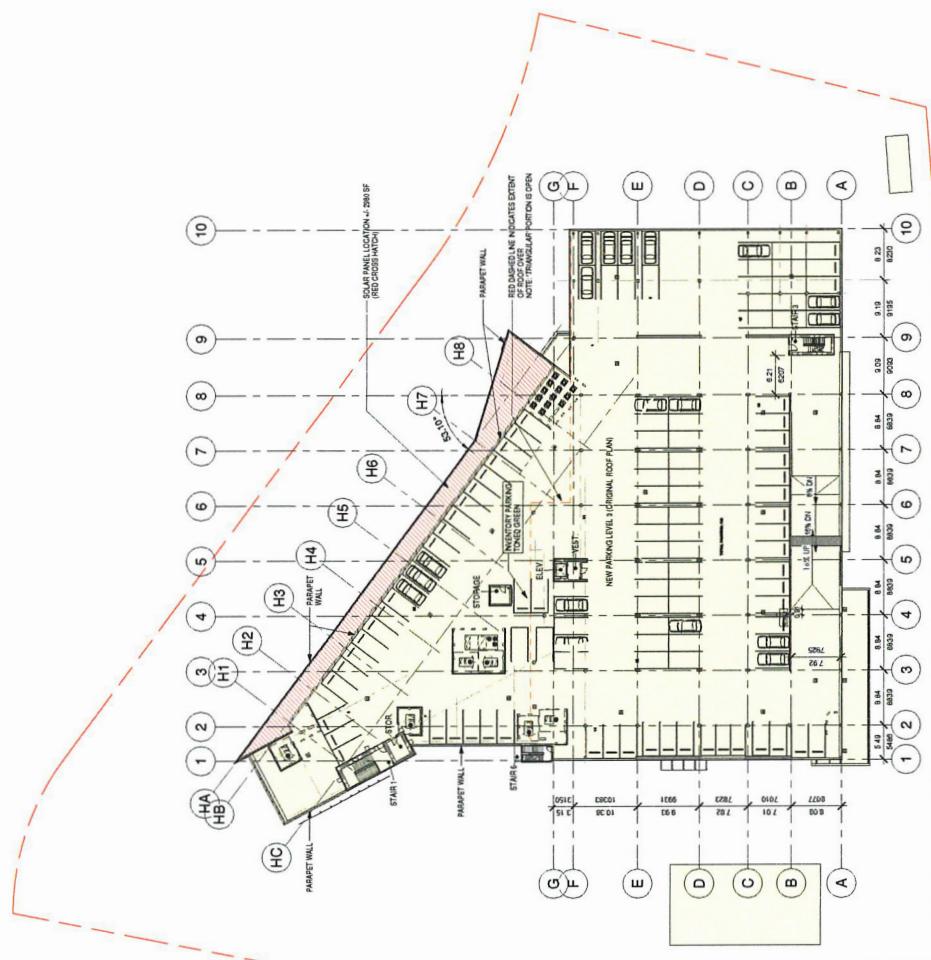

4	18 11 12	ISSUED FOR CP
3	18 11 08	ISSUED FOR DF
2	18 39 29	ISSUED FOR AMENDMENT
1	18 34 11	ISSUED FOR AMENDMENT
		DOCUMENTATION
		DATE
		CONTRACT NUMBER:

All rights reserved. All names, designs and representations either in print or in electronic format, are the property of Cartwright Design Australia Ltd, and are an infringement of a service that may not be used, forwarded to others, transmitted, downloaded or reproduced either in print or electronic format, without a written permission in a legal binding agreement.

DP 18-818762

LEVEL 4

PLAN #1D

DP.008

DATE: 2016-1-23

SCALE: 1" = 30'0"


PROJECT NUMBER:

DRAFTER:

REVISER:

APPROVING OFFICER:

ADDITIONAL PARKING LEVEL 1

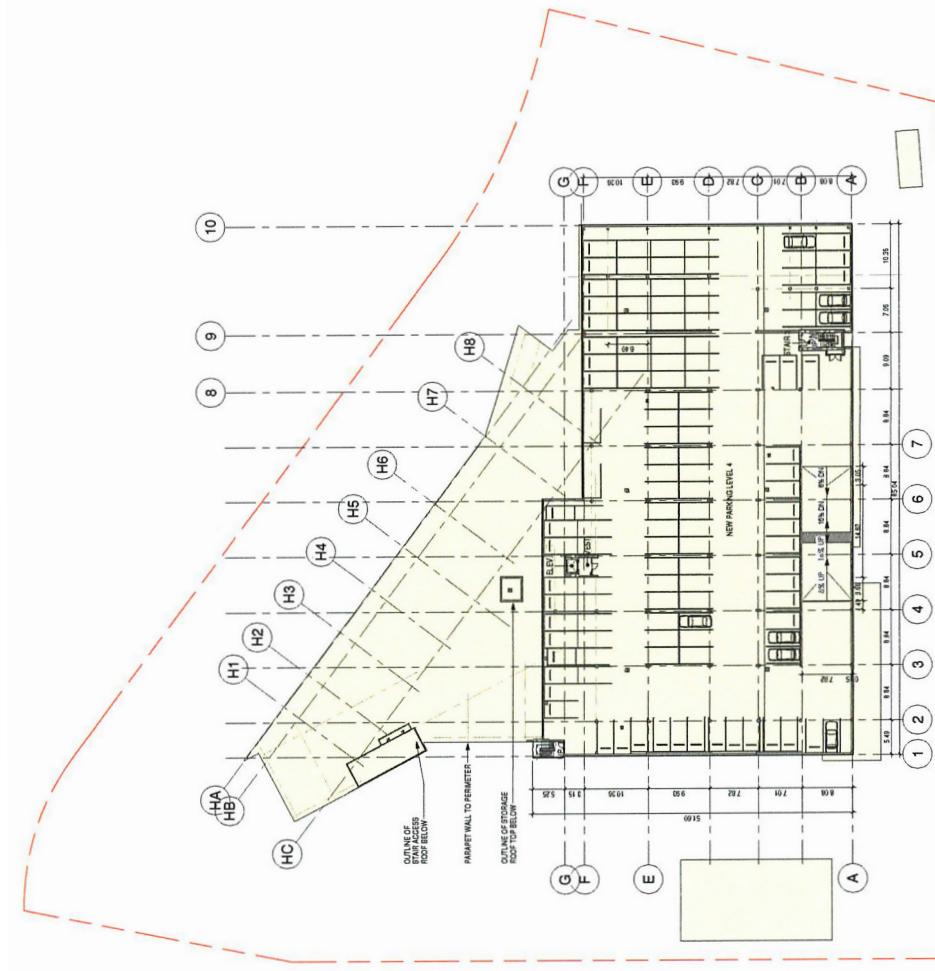

REVISION	DATE	DESCRIPTION
4	16/11/23	REvised FOR DP
3	16/11/09	REvised FOR DP
2	16/04/06	REvised FOR DP ENDMENT
1	16/04/11	REvised FOR DP AS ENDMENT

Contractor responsible for any resulting property work, and the cost of refection

OpenRoad Toyota Richmond

DP 18-818762

100 SMALL WOOD PLACE, RICHMOND, B.C.

בבבג

DRAFT NUMBER


卷之三



PLAN #1

DP.009
EAST MEET
TOKYO'S FUTURAM


1 ADDITIONAL PARKING LEVEL 2

Projections

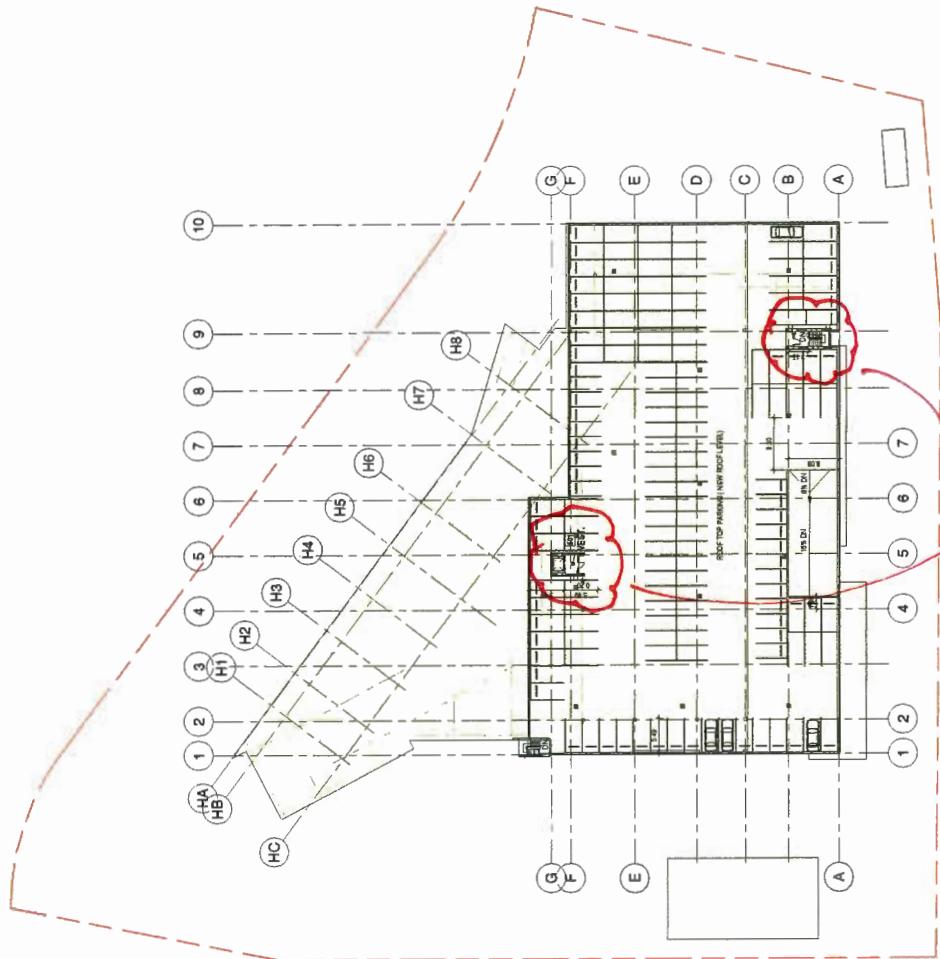


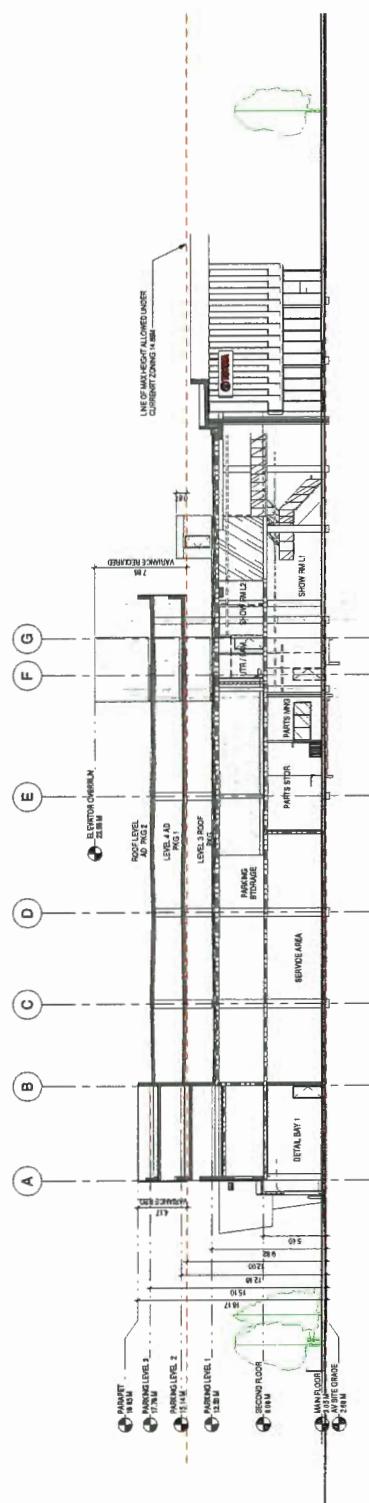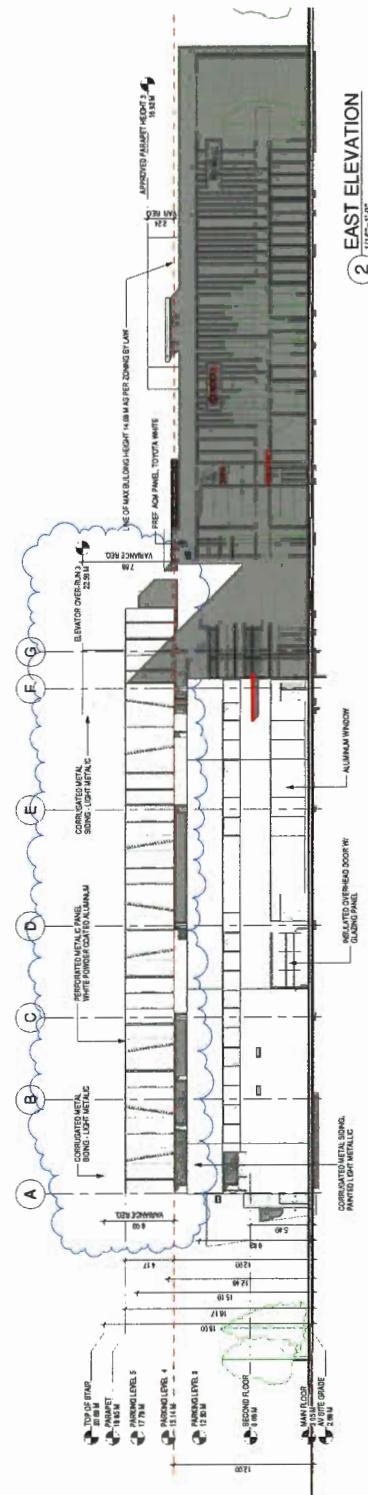

PLN - 66

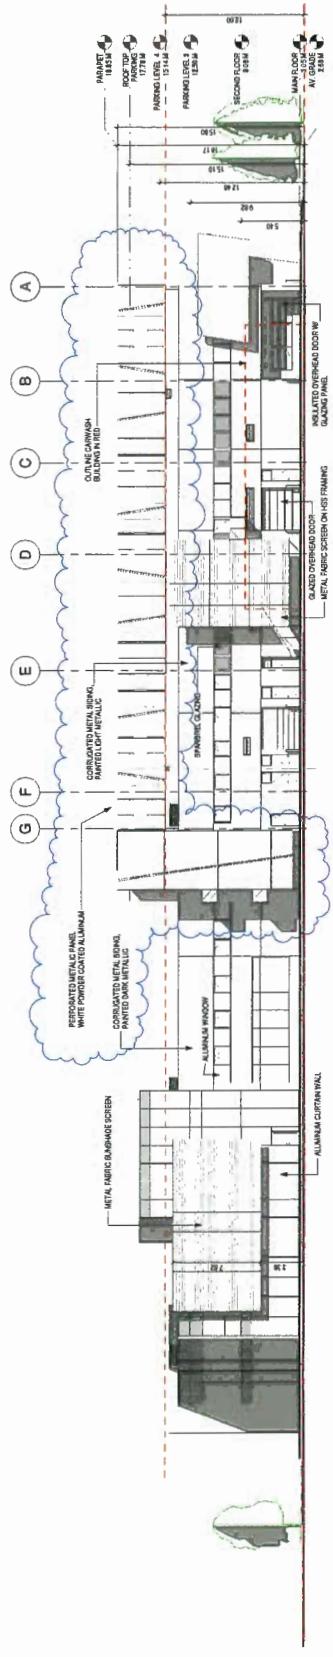

WEST ELEVATION

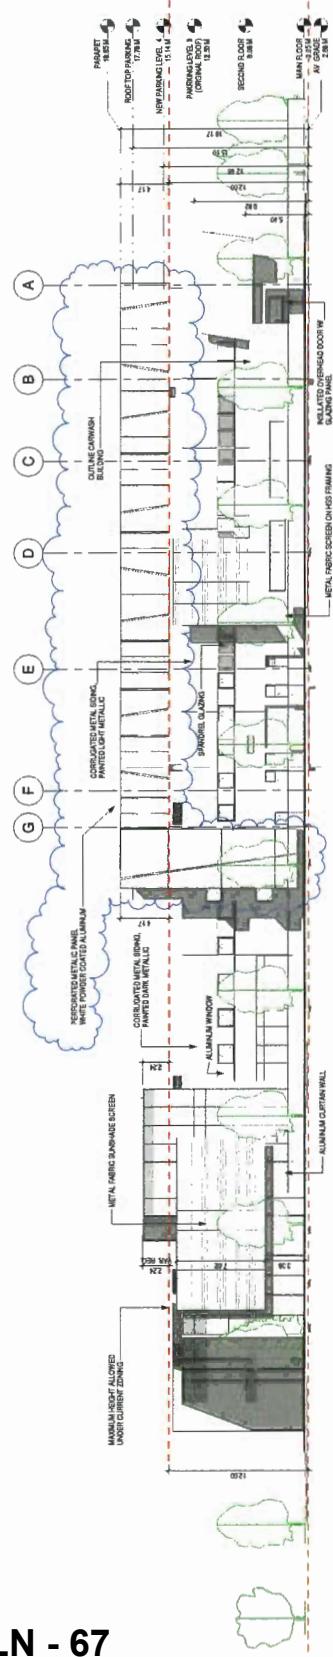


WEST ELEVATION WITH GARNISH LANDSCAPING AND FENCING SHOWN


PLN - 67

DP 18-818762
13100 SMALL WOOD PLACE, RICHMOND, BC
JACOMBS ROAD
ELEVATION

DRAWING

**PLAN #5
DP-011**

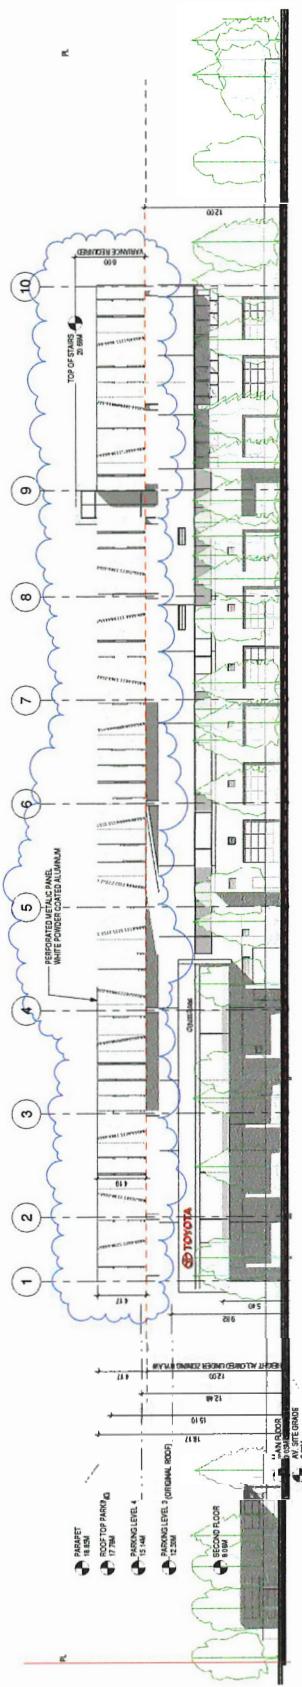

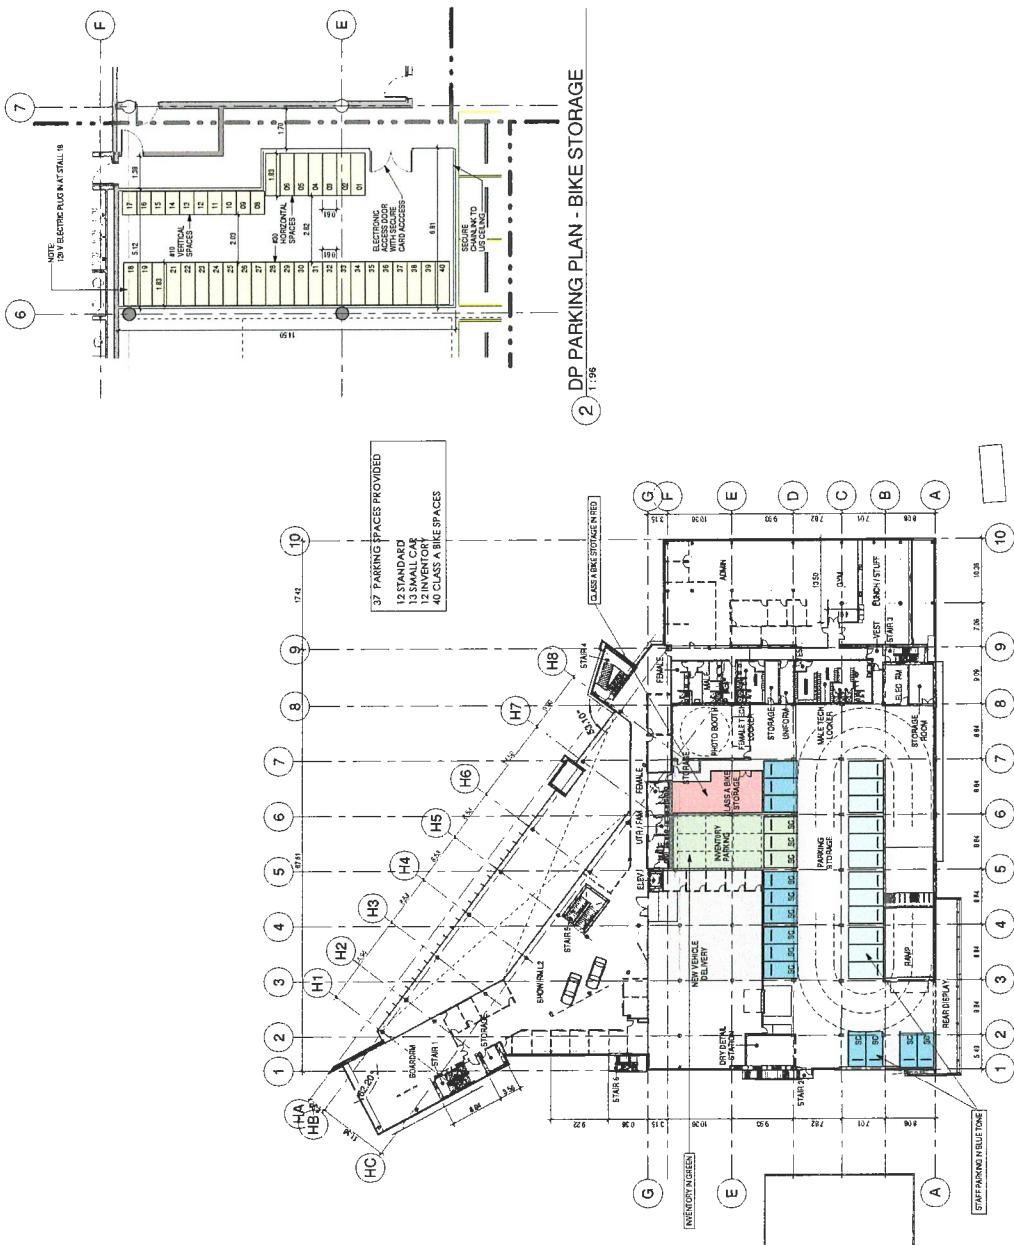

SECOND FLOOR PLAN

PLN - 70

10

02	18/11/22	05/06/22 FOR D2
02	18/11/20	05/06/22 FOR D2
01	18/06/20	05/06/22 FOR D2 AMENDMENT
REVISION	DATE	DESCRIPTION

Copyright notice. All rights reserved. No part of this document, including graphics and trademarks above or in the electronic form, are the property of Comptech English Authors Ltd., and are an indication of service or authorship and are not the work of third parties. Reproduction in whole or in part, unauthorised or authorised either to print or electronic form, without the express written permission of the copyright holder, is illegal.

Required certification of error, discrepancies, or outdated information contained in contract drawings and documents. Failure to obtain such certification renders the Contractor responsible for any resulting incomplete work and the cost of rectification.

OpenRoad Toyota Richmond
DP 18-818762
PARKING PLAN LEVEL 3
13100 SMALL WOOD PLACE, RICHMOND, BC

卷之三

DATE: 2019-11-22


PROBLEMI MATEMATICI


PLAN #2C

DP.020

PLUG DATA SUMMARY FOR THE AIR



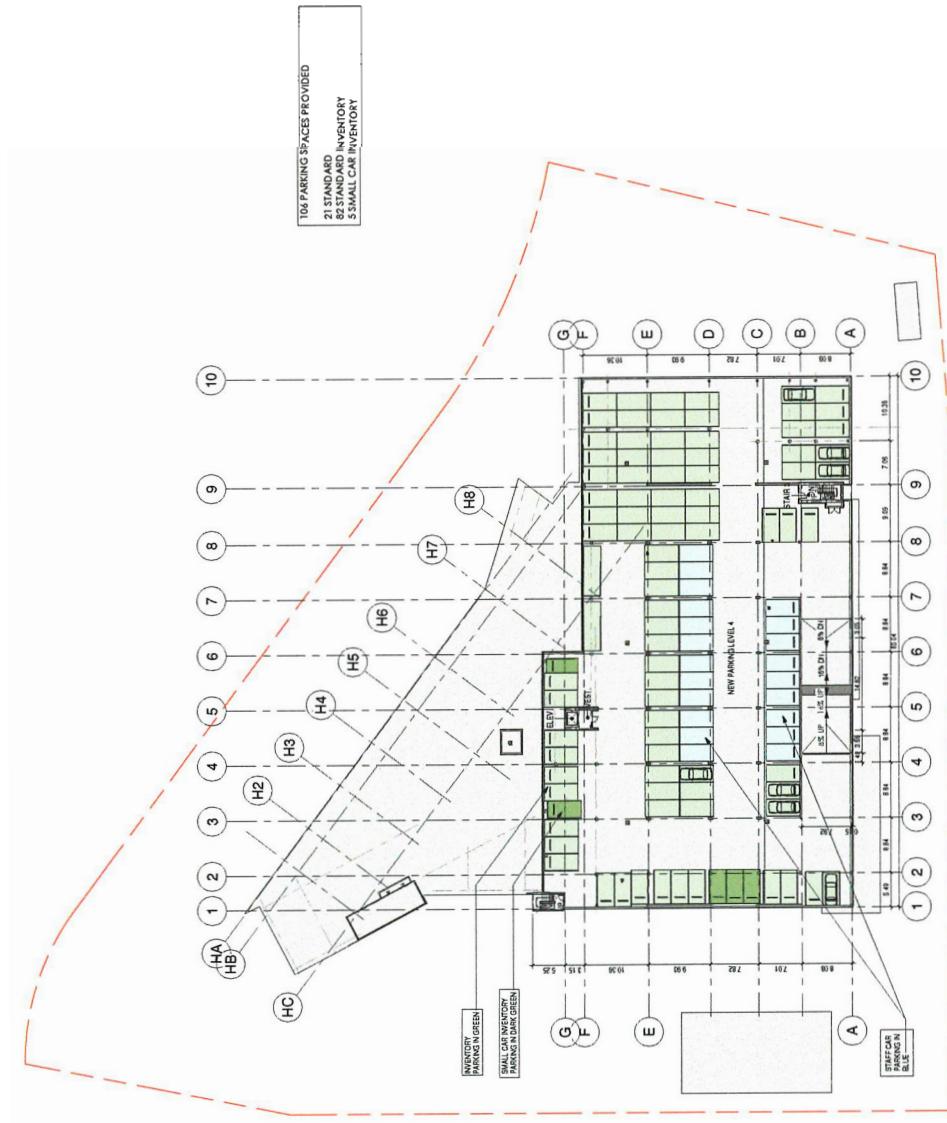

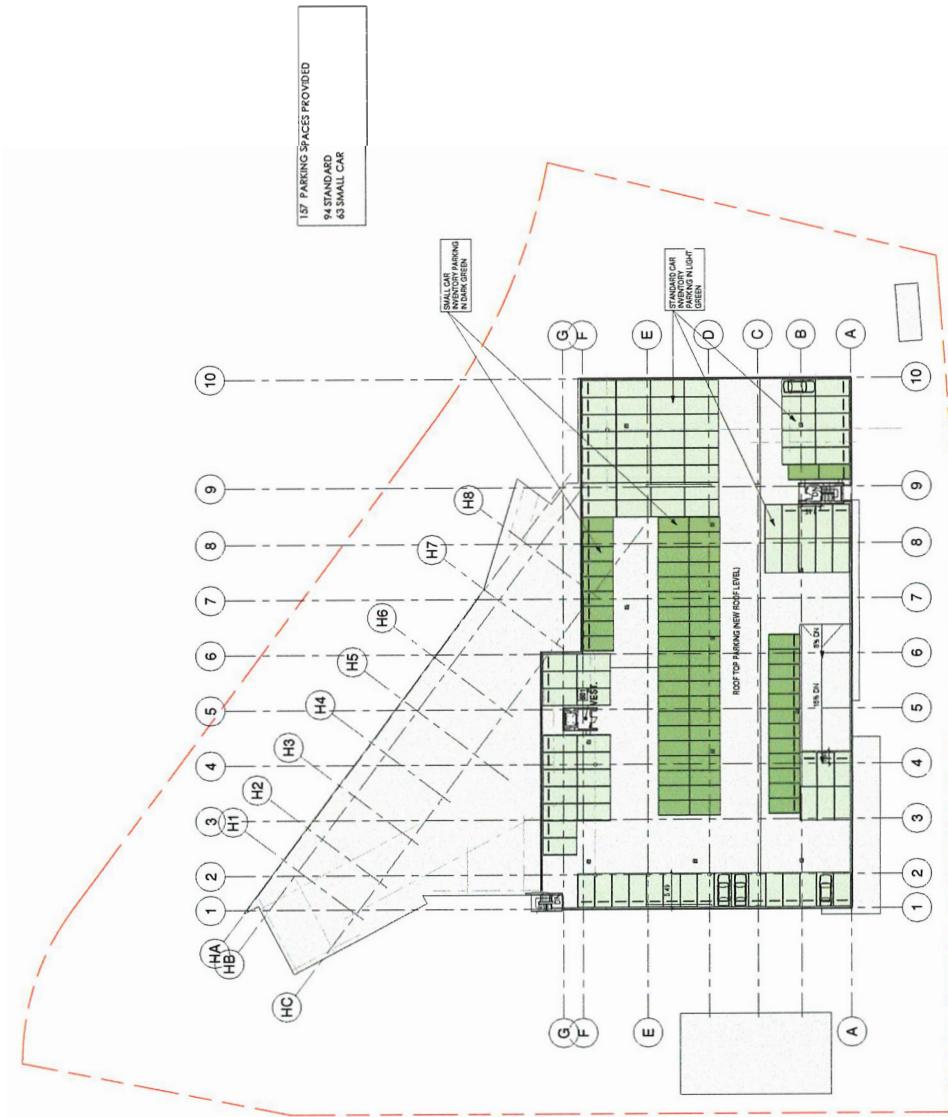

SECTION	DATE	ISSUED FOR DP	ISSUED FOR DP AND REVISION
12	18.11.28	158.20.04.29	
51	18.09.26		

REVISIONS

REVISIONS

REVISIONS

OpenRoad Toyota Richmond
DP 18-818762
13108 SWANLWOOD PLACE, RICHMOND, BC

PARKING PLAN LEVEL 5

SCALE 1" = 30'0"


ON THE 2006-1-2

PROJECT NUMBER


2400P

PLAN #2E

DP.022

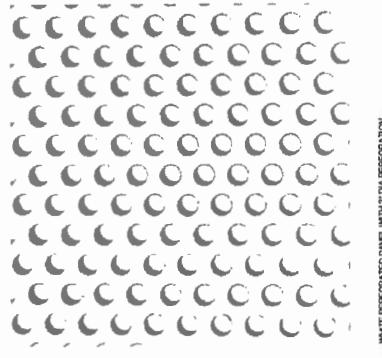

WHITE PERFORATED PANEL WITH 2" DIA PERFORATION

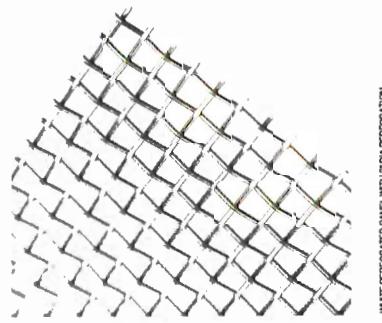

WHITE PERFORATED PANEL WITH 2" DIA PERFORATION



MILAN ANODIZED FINISH



GLAZING SPANGLE



GLAZING LONE

SECTION:	DATE:	DESCRIPTION:
1C	10.11.29	RELEASER FOR DP
01	10.11.08	RELEASED FOR DP

3110 SMALLWOOD PLACE, RICHMOND, BC	
MATERIAL SAMPLES	




CHARCOAL ACCENT ACM PANEL



RED ACCENT ACM PANEL



WHITE ACM PANEL

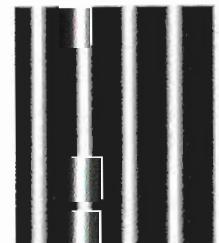


DARK METALLIC CORRUGATED FINISH



LIGHT METALLIC CORRUGATED FINISH

SCALE:	DATE:	DRAWN BY:
1:100	07/15/2016 11:23	ZAC


CHRISTOPHER
BOZYK ARCHITECTS LTD.
1611 W 110TH STREET, VANCOUVER BC, V6P 2G8
PHONE 604-251-9440 FAX 604-251-9441

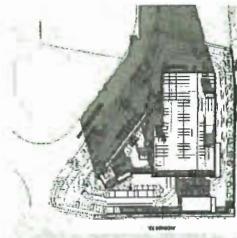


MARCH 20TH - 18.00




MARCH 20TH - 15.00

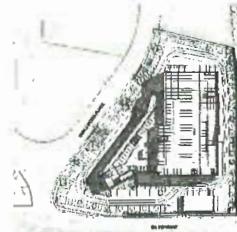

MARCH 20TH - 12.00

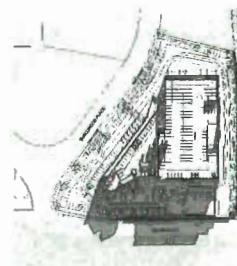

MARCH 20TH - 09.00

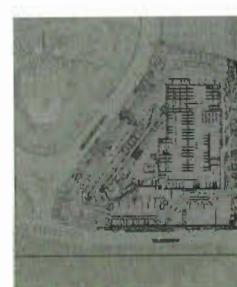

MARCH 20TH - 06.00

OpenRoad
AUTO GROUP

© 2012 OpenRoad Auto Group Inc.

PLN - 75

REVISION: 01/12 SIGNED FOR DP
DESCRIPTION:

CONFIDENTIAL NOTICE:
The drawings and related information shown
herein are the property of Christopher Bozyk
Architects Ltd. They are to be used only by the
parties involved in the project and are not to be
copied or distributed outside the project team
without the express written permission of the
architect. Any unauthorized copying or distribution
of these drawings and related documents, Confirms
right to sue for damages and other relief. All
rights reserved. No part of this document may be
reproduced without the express written permission
of Christopher Bozyk Architects Ltd. Failure
to do so will be interpreted as an infringement
of copyright and will be subject to legal action.
Christopher Bozyk Architects Ltd. reserves the
right to sue for damages and other relief. All
rights reserved. No part of this document may be
reproduced without the express written permission
of Christopher Bozyk Architects Ltd. Failure
to do so will be interpreted as an infringement
of copyright and will be subject to legal action.

1319 SMALL WOOD PLACE, RICHMOND, BC
SHADOW ANALYSIS

SCALE: 1:1200 DATE DRAWN: 11/12
PROJECT NUMBER: 2405

OpenRoad Toyota Richmond


1319 SMALL WOOD PLACE, RICHMOND, BC
SHADOW ANALYSIS

SCALE: 1:1200 DATE DRAWN: 11/12
PROJECT NUMBER: 2405


DEC 21ST - 18.00



JUNE 20TH - 18.00

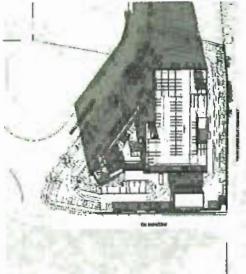


JUNE 21ST - 18.00

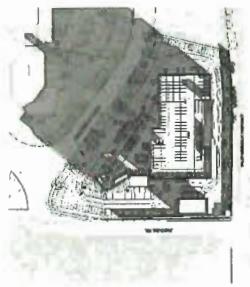


SEPT 22ND - 18.00




SEPT 22ND - 15.00

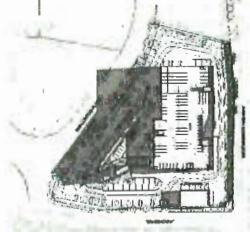


SEPT 22ND - 12.00

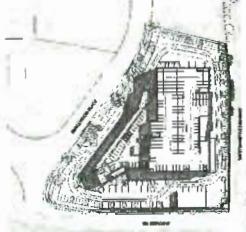

SEPT 22ND - 09.00

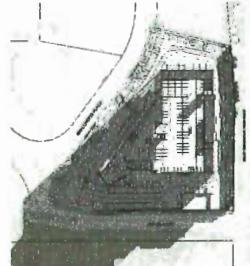

DEC 21ST - 12.00

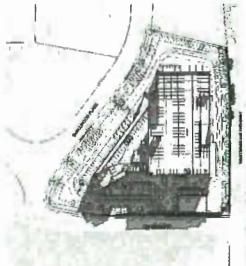

DEC 21ST - 09.00




DEC 21ST - 06.00




SEPTEMBER 22ND - 06.00

DP.024
REVISION: 01/12 SIGNED FOR DP
DESCRIPTION:

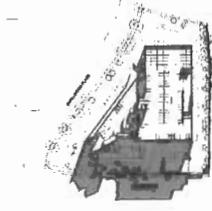

MARCH 20TH - 07:00

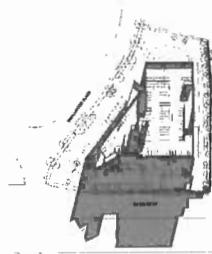

MARCH 20TH - 07:30



MARCH 20TH - 08:00



MARCH 20TH - 09:00




MARCH 20TH - 09:30




MARCH 20TH - 10:00




MARCH 20TH - 10:30

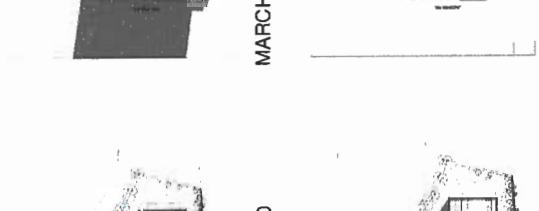

MARCH 20TH - 11:00

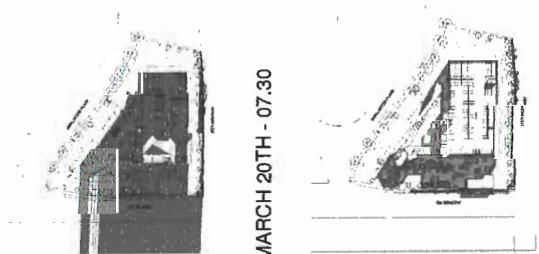

MARCH 20TH - 11:30

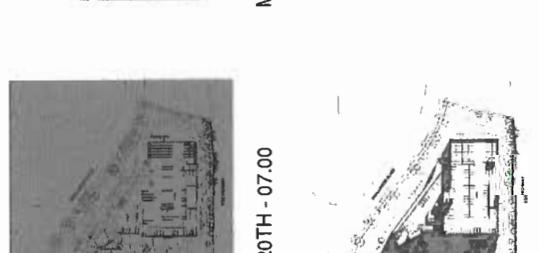

MARCH 20TH - 12:00

OpenRoad
AUTO GROUP

CHEV

POSITION	DATE	REASON FOR UP	DESCRIPTION
01	16/11/13		


Christopher Bozyk, Architect, is the proprietor of Christopher Bozyk Architects Ltd., a registered professional corporation. All rights reserved. No part of this document may be reproduced without written permission from the author. This document is intended for the sole use of the client and is not to be distributed to anyone else. It is the copyright of Christopher Bozyk, Architect, and may not be reproduced or distributed without his written permission. Christopher Bozyk, Architect, is not responsible for any damage or loss resulting from the unauthorized use of this document. Christopher Bozyk, Architect, is not responsible for any damage or loss resulting from the unauthorized use of this document. Christopher Bozyk, Architect, is not responsible for any damage or loss resulting from the unauthorized use of this document. Christopher Bozyk, Architect, is not responsible for any damage or loss resulting from the unauthorized use of this document.

OpenRoad Toyota Richmond


13109 SMALL WOOD PLACE, RICHMOND, BC
SHADOW STUDY - SPRING
EQUINOX MARCH 20TH

SCALE
PROJECT NUMBER
DRAWN BY / DATE DRAWN

DP.025

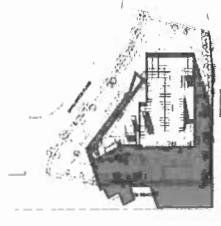


JUNE 21ST - 05.00

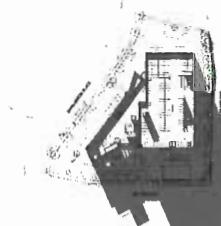


JUNE 21ST - 06.00



JUNE 21ST - 06.30

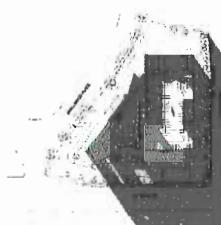


JUNE 21ST - 07.00

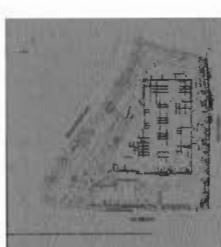


JUNE 21ST - 07.30




JUNE 21ST - 08.00

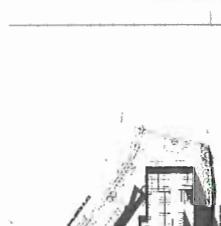

JUNE 21ST - 09.00

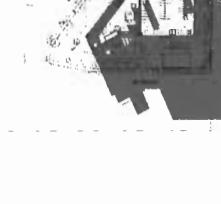

JUNE 21ST - 09.30

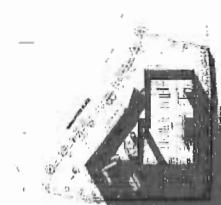

JUNE 21ST - 10.00



JUNE 21ST - 10.30



JUNE 21ST - 11.00



JUNE 21ST - 11.30



JUNE 21ST - 12.00


CHRISTOPHER
BOZYK ARCHITECTS LTD.
#6-1112 HOMER STREET, VICTORIA BC V8V 1E
PHONE 604.257.5487 FAX 604.257.5046



SEP 22ND - 09.00



SEP 22ND - 08.30

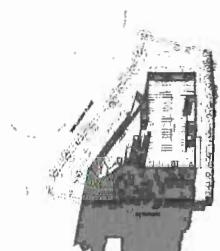


SEP 22ND - 08.00




SEP 22ND - 07.30




SEP 22ND - 07.00

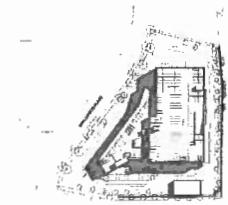

SEP 22ND - 11.00

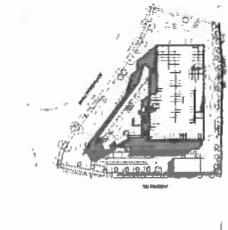

SEP 22ND - 10.30

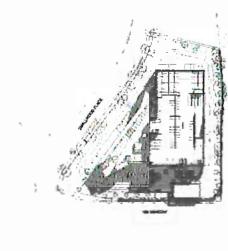

SEP 22ND - 10.00



SEP 22ND - 09.30



SEP 22ND - 12.00

OpenRoad
AUTO GROUP

CLEAR

SECTION	DATE	ISSUED FOR D/P
01	18/11/03	

CONFIDENTIAL
All plans contained in this document are the property of Christopher Bozyk Architects Ltd. They are to be treated as confidential information and must not be reproduced or disclosed to third parties without the written permission of Christopher Bozyk Architects Ltd. Any unauthorized disclosure of this information will result in the imposition of strict legal action against the offender. Christopher Bozyk Architects Ltd. reserves the right to sue for damages and/or injunctions for any unauthorized disclosure of this information. Christopher Bozyk Architects Ltd. reserves the right to sue for damages and/or injunctions for any unauthorized disclosure of this information. Christopher Bozyk Architects Ltd. reserves the right to sue for damages and/or injunctions for any unauthorized disclosure of this information. Christopher Bozyk Architects Ltd. reserves the right to sue for damages and/or injunctions for any unauthorized disclosure of this information.

OpenRoad Toyota Richmond

11109 SMALLWOOD PLACE, RICHMOND, BC
SHADOW STUDY AUTUMN
EQUINOX SEP 22ND

SCALE
PROJECT NUMBER
DRAWN BY
CHECKED BY
APPROVED BY
DATE 2003-11-3
2400F

DP.027

**CHRISTOPHER
BOZYK ARCHITECTS LTD**
414-011 ALEXANDER STREET V1V 1E1
PHONE (250) 251-5480 FAX (250) 251-2586




DEC 21ST - 10.00



DEC 21ST- 09.30




DEC 21 ST - 09.00

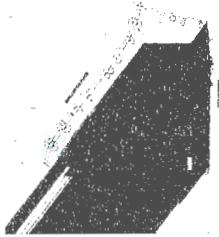


DEC 21ST- 08.30




DEC 21 ST - 08.00

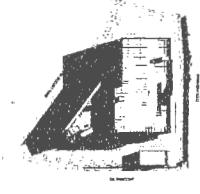

DEC 21ST - 11 30

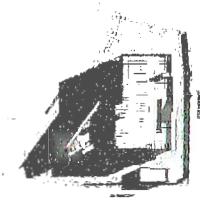

DEC 21 ST- 11 00

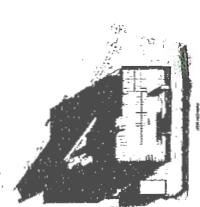

DEC 21 ST - 10 30

PLN - 79

13100 SMALL WOOD PLACE, RICHMOND, BC

**SHADOW STUDY WINTER
SOLSTICE DECEMBER 21ST**

SCALE DATE:2018-1-2 DRAWING NUMBER:
PROJECT NUMBER: 21-A007

DP.028

OpenRoad Toyota

LANDSCAPE ARCHITECTURAL SET — RE-ISSUED FOR DP

PROJECT INFORMATION

CLIENT:
 OPENROAD AUTO GROUP
 CONTACT NAME: SABRINA SUBAUNE
 EMAIL: MME.SABRINA@OPENROADAUTOGROUP.COM
 PH: 604.820.0202

LANDSCAPE ARCHITECT:
 CONNECT LANDSCAPE ARCHITECTURE INC.
 CONTACT NAME: KEN LARSSON
 ADDRESS: 2205 HELLICK STREET
 VANCOUVER, BRITISH COLUMBIA, V6H 2V4.
 PHONE: (604) 681-3203

LANDSCAPE DRAWING INDEX

SHEET No.	SHEET NAME
L.0.0	COVER SHEET AND DRAWING LIST
L.0.1	TREE MANAGEMENT PLAN
L.1.0	LANDSCAPE SITE PLAN
L.1.1	LANDSCAPE ENLARGEMENTS
L.1.2	LANDSCAPE LAYOUT PLAN
L.2.0	LANDSCAPE PLANT MATERIALS - NORTH
L.2.1	LANDSCAPE PLANT MATERIALS - SOUTH
L.3.0	LANDSCAPE DETAILS

GENERAL NOTES

- ALL LANDSCAPE ARCHITECTURAL DRAWINGS IN THIS PACKAGE SHALL BE READ IN CONJUNCTION WITH ALL OTHER CONSULTANT DRAWINGS, DETAILS, SPECIFICATIONS, AND CORRESPONDENCE THAT MAY BE ISSUED DURING THE COURSE OF THE CONTRACT.
- IF A DISCREPANCY OCCURS BETWEEN THE DRAWINGS AND THE SPECIFICATIONS OR ANY OTHER DOCUMENT ASSOCIATED WITH THE PROJECT, THE CONTRACTOR SHALL BE REPORTED IN WRITING TO THE LANDSCAPE ARCHITECT TO OBTAIN CLARIFICATION AND APPROVAL BEFORE PROCEEDING WITH WORKS.
- THE CONTRACTOR SHALL VISIT THE SITE TO VERIFY THE TRUE Existing CONDITIONS, AND UNCLEAR ISSUES SHALL BE CLARIFIED WITH THE LANDSCAPE ARCHITECT; NO CLAIM SHALL BE ALLOWED FOR EXTRAS WHICH MAY ARISE THROUGH NEGLECT OF THIS ADVICE.
- THE CONTRACTOR IS RESPONSIBLE FOR DETERMINING THE EXISTENCE, LOCATION, AND ELEVATION OF ALL UTILITIES, AND CONCEALED STRUCTURES, AND IS RESPONSIBLE FOR NOTIFYING THE APPROPRIATE COMPANY, DEPARTMENT OR PERSON(S) OF ITS INTENTION TO CARRY OUT ITS OPERATIONS.
- ALL EXISTING INFORMATION IS BASED ON AVAILABLE RECORDS AND SHALL NOT BE CONSTRUED TO BE COMPLETE OR ACCURATE.
- LAYOUT OF HARSCAPE, STREET FURNITURE, SOIL, PLANTING, AND ALL OTHER LANDSCAPE MATERIALS ARE TO BE STAKED OUT AND APPROVED BY THE LANDSCAPE ARCHITECT PRIOR TO INSTALLATION.
- ALL PUBLIC REALM DETAILS, AND FINAL SELECTION / APPROVAL OF ALL STREET TREES TO BE APPROVED BY THE MUNICIPALITY.

PLAN #3A


15	REFINED FOR DP	18:11:20
14	REFINED FOR DP	18:11:08
13	REFINED FOR DP	18:09:36
12	SHED FOR CONSTRUCTION	18:07:28
11	SHED FOR REVERSE BP	17:12:58
10	SOFTS FOR TERRAIN	17:12:06
9	REFINED FOR DP	17:06:29
8	SOFTS FOR KEP	17:06:47
7	REFINED FOR DP	17:05:20
6	REFINED FOR DP	17:05:19
5	SOFTS FOR BUDGETING	17:03:24
4	REFINED FOR DP	17:03:09
3	REFINED FOR DP	16:11:25
2	REFINED FOR DP	16:07:37
1	USED FOR CLIENT REVIEW	16:06:20

REVISIONS

OPENROAD TOYOTA

13100 Smallwood Place	AS SHOWN
Richmond, British Columbia	
Scale:	
Drawn:	KD
Reviewed:	KL
Project No.	06-490

LANDSCAPE COVER PAGE

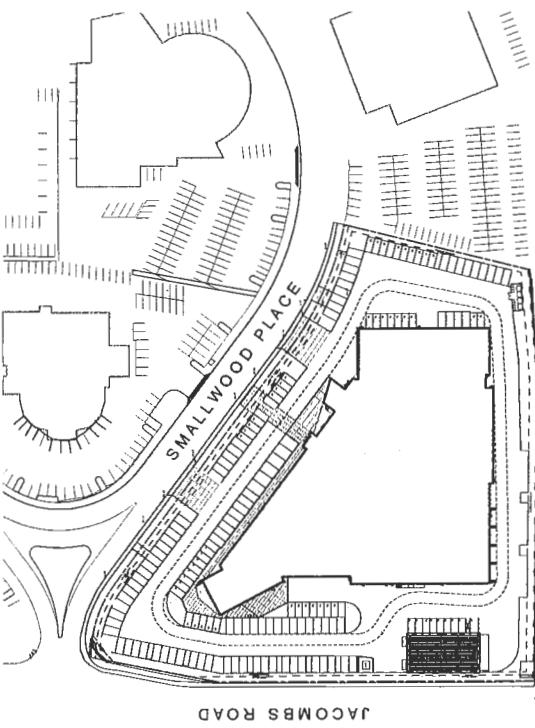

50 m ↑

connect

Landscape Architecture

CONNECT LANDSCAPE ARCHITECTURE INC. DOES NOT GUARANTEE THE DISTANCE, LOCATION, AND ELEVATION OF UTILITIES AND OR CONCEALED STRUCTURES AT THE PROJECT SITE.

THE CONTRACTOR IS RESPONSIBLE FOR DETERMINING THE EXISTENCE, LOCATION, AND ELEVATION OF ALL UTILITIES AND OR CONCEALED STRUCTURES AND IS RESPONSIBLE FOR NOTIFYING CONNECT LANDSCAPE ARCHITECTURE INC. AND ITS SUBCONTRACTORS OF THE EXISTENCE OF THESE UTILITIES AND OR CONCEALED STRUCTURES.

CHRISTOPHER ROZYK, ARCHITECTS

TREE MANAGEMENT LEGEND	
SYMBOL	DESCRIPTION
	EXISTING TREE TO BE REMOVED
	EXISTING TREE TO BE RETAINED
	TREE PROTECTION FENCING PER CITY OF RICHMOND

PER ARBORIST REPORT

TO BE REMOVED:

JACOBINS ROAD 13
SMALLWOOD PLACE 3
TOTAL 16

TO BE INSTALLED:

JACOBINS ROAD 18 (1@ 7.5cm CAL)
SMALLWOOD PLACE 3 (7.5cm CAL)
SOUTH PROPERTY LINE 4 (2@ 7.5cm CAL)
TOTAL 25 (3@ 7.5cm CAL)

SEE PLANTING PLAN 2.0 FOR NEW AND REPLACEMENT TREES

PLAN #3B

15	RE-SUBMIT FOR DP	18-11-20
14	RE-SUBMITTED FOR DP	18-11-08
13	RE-SUBMITTED FOR DP	18-09-26
12	ISSUED FOR CONSTRUCTION	18-02-28
11	ISSUED FOR REVISED BP	17-12-18
10	ISSUED FOR TENDER	17-11-20
9	RE-SUBMITTED FOR DP	17-06-29
8	ISSUED FOR BP	17-06-07
7	RE-SUBMITTED FOR DP	17-05-20
6	RE-SUBMITTED FOR DP	17-05-19
5	ISSUED FOR BUDGETING	17-05-24
4	RE-SUBMITTED FOR DP	17-04-09
3	ISSUED FOR BP	16-11-25
2	ISSUED FOR DP	16-07-27
1	ISSUED FOR CLIENT REVIEW	16-06-20

OPENROAD TOYOTA	13100 Smallwood Place	Richmond, British Columbia
		Scale:
		1:200

LO.1

50 m ↑

25

EXISTING TREE PROTECTION

WESTMINSTER HIGHWAY


(1) NOT TO SCALE

EXISTING OFFSITE TREES TO BE RETAINED


LANDSCAPE MANAGEMENT

PLAN 8-NET

DRAFT Landscape Architecture Site

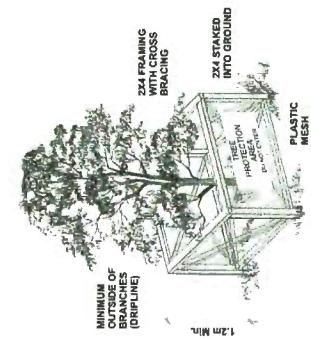

Tree Protection Distance Table					
		Minimum Projection Required Around Tree			
Tree Trunk Diameter	Distance from Trunk	Distance (in feet)	Distance (in meters)	Total Diameter	
20 cm	8 inches	0.6	1.2	3.9	2.60
25 cm	10 inches	0.8	1.5	4.9	3.25
30 cm	12 inches	1.0	1.8	5.9	3.90
35 cm	14 inches	1.2	2.1	6.9	4.55
40 cm	16 inches	1.3	2.4	7.8	5.20
45 cm	18 inches	1.5	2.7	8.7	5.75
50 cm	20 inches	1.6	3.0	9.6	6.30
55 cm	22 inches	1.8	3.3	10.5	6.95
60 cm	24 inches	2.0	3.6	11.5	7.50
75 cm	30 inches	2.5	4.5	14.5	8.75
90 cm	36 inches	3.0	5.0	16.4	10.00
100 cm	40 inches	3.3	6.0	18.7	13.00

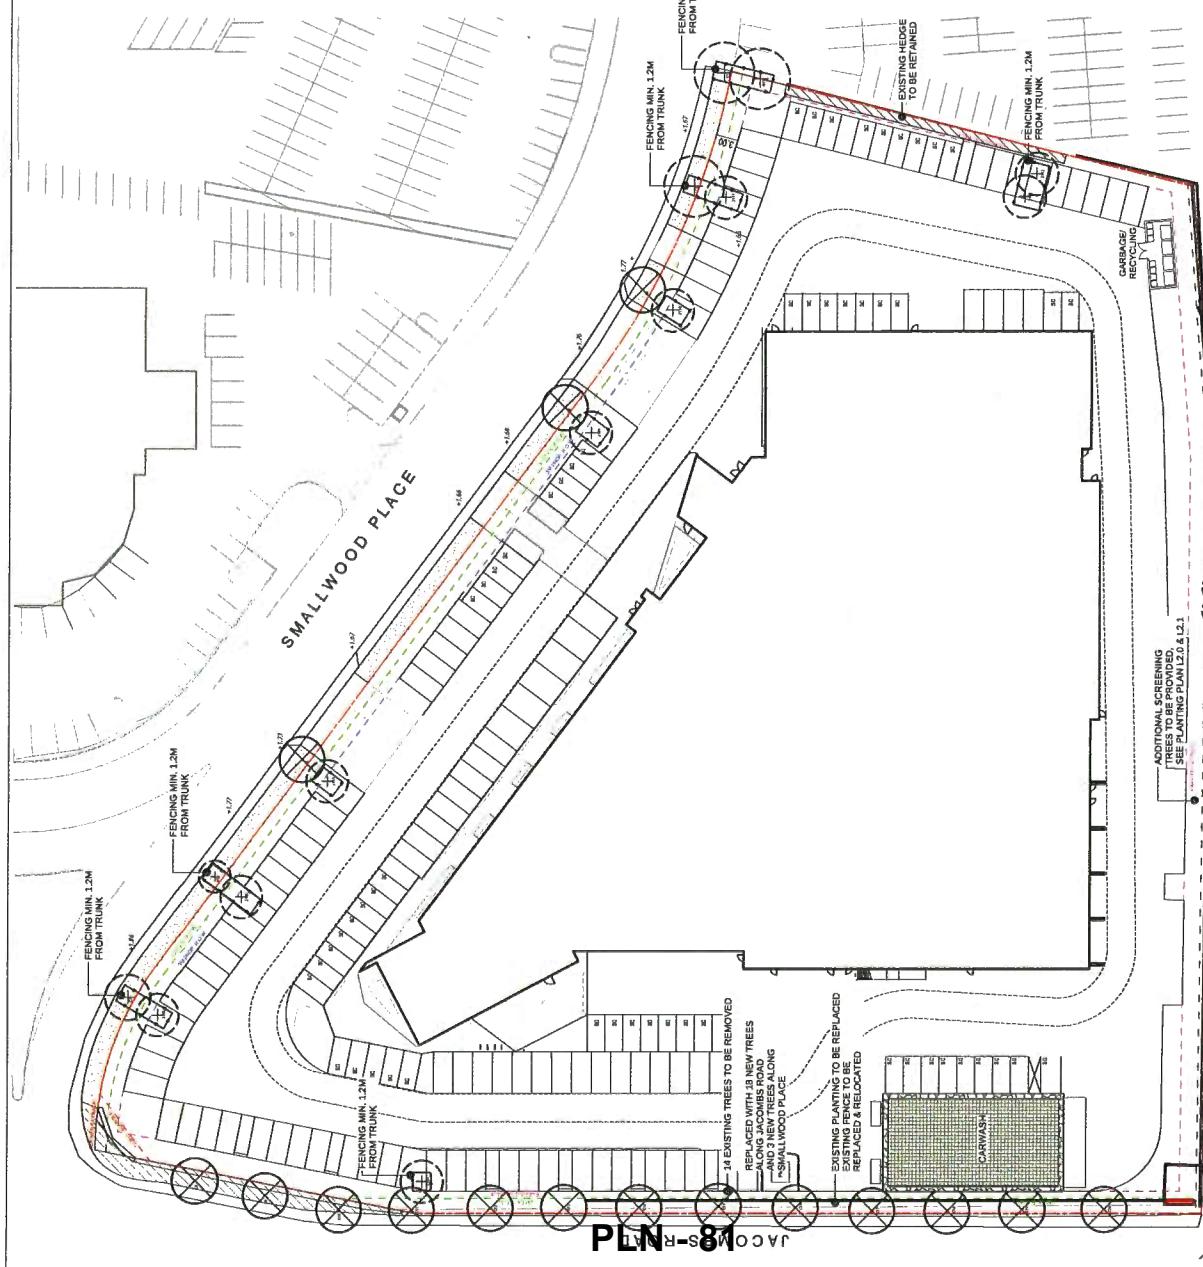

CONTRACTOR/LANDSCAPE ARCHITECTURE INC. DOES NOT GUARANTEE THE EXISTENCE, LOCATION, AND ELEVATION OF UTILITIES AND/OR CONCEALED STRUCTURES AT THE PROJECT SITE.

THE CONTRACTOR IS RESPONSIBLE FOR DETERMINING THE EXISTENCE, LOCATION, AND ELEVATION OF UTILITIES AND/OR CONCEALED STRUCTURES AND IS RESPONSIBLE FOR NOTIFYING THE APPROPRIATE COMPANY, ORPARTMENT OR PERSONS OF ITS INTENTION TO DRAIL OUT ANY OF ITS FEATURES.


CHRISTOPHER BOYKIN ARCHITECTS

AYOUT AND MATERIALS

SYMBOL	DESCRIPTION
	DECORATIVE GRAVEL WITH UPLIGHTING
	SAND CONCRETE PATTERN PER GUIDELINES
	PERMEABLE PAVERS PER PLAN AND DETAIL
	ROLL CURB PER PLAN AND DETAIL
	EXISTING PLANTING TO REMAIN
	EXISTING BOULEVARD TO REMAIN
	GREEN ROOF PLANTING PER PLAN AND DETAIL
	PROPOSED PLANTING PER PLANTING PLAN 12.0 & 12.1
	LANDSCAPE BOULEVARDES PER PLANS AND DETAILS
	BENCH BY BARNARD CONCRETE
	TRASH & RECYCLING BY EQUIPAC LANDSCAPE FORMS
	END OF BACK BY EQUIPAC

PLAN #3C

	REF ID	DESCRIPTION	CREATED BY	CREATED ON	LAST MODIFIED BY	LAST MODIFIED ON
34	R00000000000000000000000000000000	RELEASED FOR DP		16-11-08		
35	R00000000000000000000000000000000	RELEASED FOR DP		18-07-20		
36	R00000000000000000000000000000000	RELEASED FOR CONTRIBUTION		14-02-19		
37	R00000000000000000000000000000000	ISSUED FOR REVISED BP		17-12-18		
38	R00000000000000000000000000000000	ISSUED FOR FINGER		17-12-20		
39	R00000000000000000000000000000000	RELEASED FOR DP		17-08-29		
40	R00000000000000000000000000000000	RELEASED FOR ADP		18-06-29		
41	R00000000000000000000000000000000	RELEASED FOR DP		17-05-30		
42	R00000000000000000000000000000000	RELEASED FOR BUDGETING		17-05-18		
43	R00000000000000000000000000000000	ISSUED FOR DP		17-05-24		
44	R00000000000000000000000000000000	RELEASED FOR DP		17-05-24		
45	R00000000000000000000000000000000	RELEASED FOR DP		17-05-24		
46	R00000000000000000000000000000000	ISSUED FOR DP		18-11-25		
47	R00000000000000000000000000000000	ISSUED FOR DP		18-07-27		
48	R00000000000000000000000000000000	ISSUED FOR CLIENT REVIEW		18-06-20		
		REVISIONS				

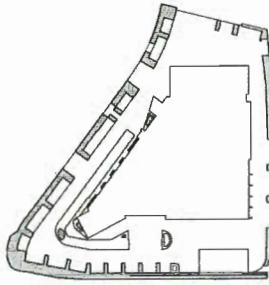

OPENROAD TOYOTA

13100 Smallwood Place
Richmond, British Columbia

1:300 Scale

Drewitt KB


KLT

Project No. 06-490

INDICES

LANDSCAPE SITE PLAN

10

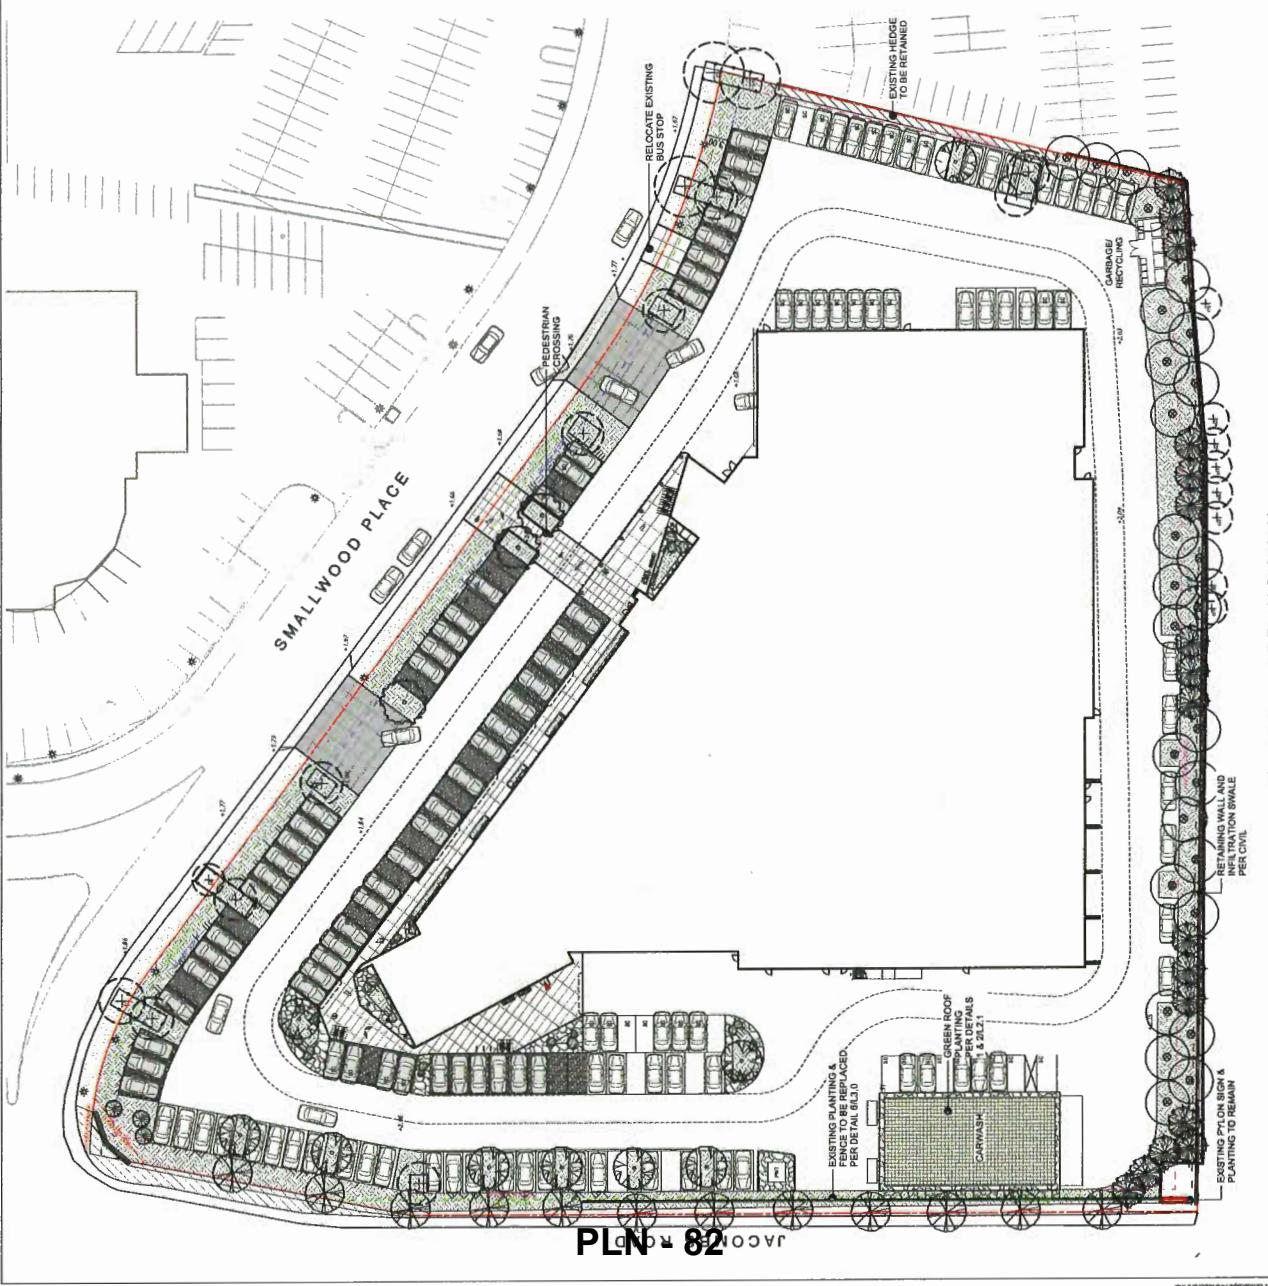

CONNECT LANDSCAPE ARCHITECTURE INC. DOES NOT OWN ANYTHING IN THE DESIGN, LOCATION, AND ENVIRONMENTAL TITLE IS AND IS CONSIDERED SUBJECT TO THE PROJECT SITE.
THE CONTRACTOR IS RESPONSIBLE FOR DETERMINING THE SURFACE, LOCATION, AND ELEVATION OF ALL UTILITIES AND OR CONCEALED STRUCTURES, AND IS RESPONSIBLE FOR NOTIFYING THE APPROPRIATE COMPANY, DEPARTMENT OR PERSON(S) OF ITS ATTENTION TO CARRY OUT ITS OPERATIONS.

ARCHITECT:

CHRISTOPHER BOZYK, ARCHITECT

PLAN #3D

TREE PROTECTION FENCING PER C.O.R
STANDARDS

DECORATIVE
GRAVEL WITH
PLANTING


ROLL CURB

PERMEABLE PAVING
AT FRONT STALLS

DISPLAY PLAZA

LOW PLANTING,
ROCK & BOULDERS,
FLUSH MOUNT
LIGHTING

SLEDDING DOORS
ALONG FRONT, TYP.

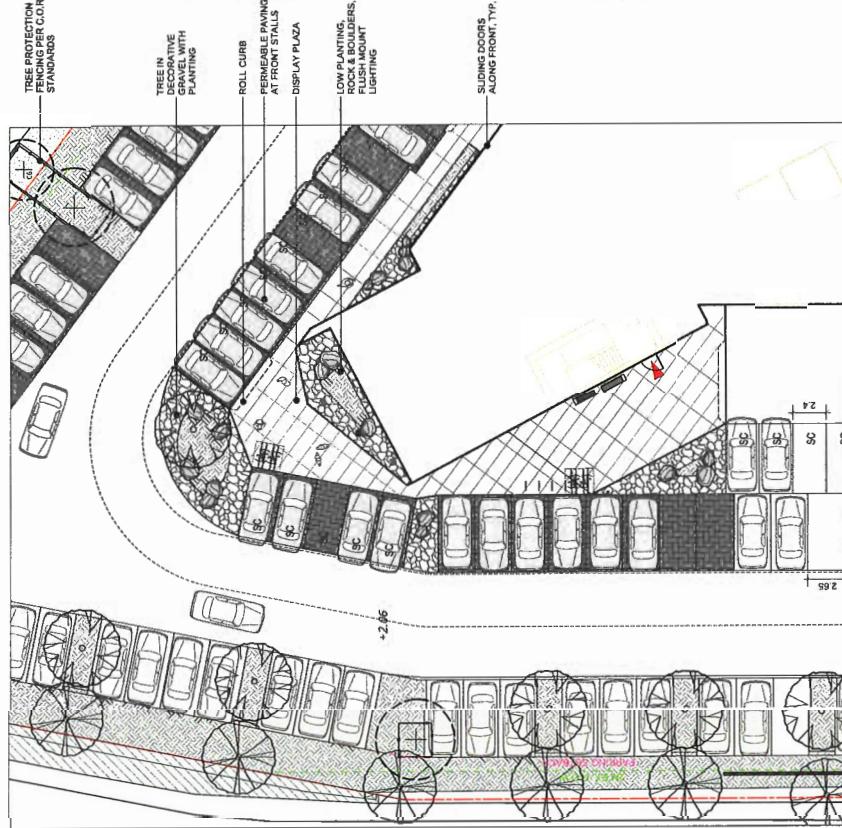


↑ 1' 0" 5' 10 m

L1.1

2 CORNER ENLARGEMENT PLAN

Scale: 1:160

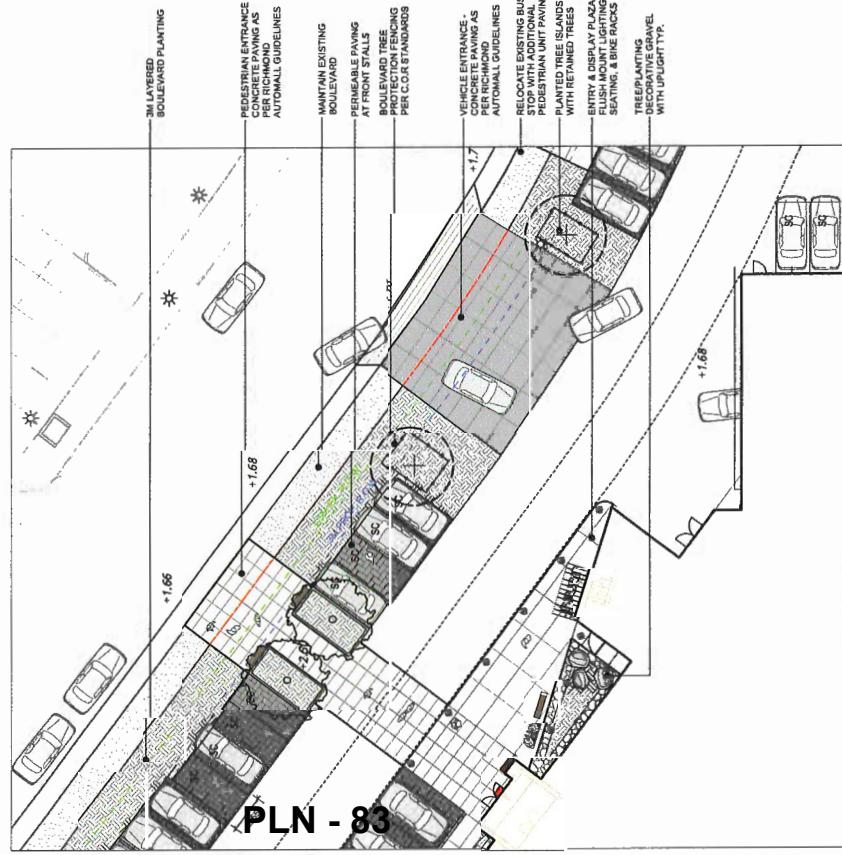

1 MAIN ENTRY ENLARGEMENT

Scale: 1:160

OPENROAD TOYOTA

13100 Smallwood Place
Richmond, British Columbia

Scale: 1:160

Drawn:

Reviewed:

Project No.

06-490

**LANDSCAPE
ENLARGEMENTS**

CONNECT LANDSCAPE ARCHITECTURE INC. DOES
NOT GUARANTEE THE EXISTENCE, LOCATION,
AND ELEVATION OF UTILITIES AND OR
CONCEALED STRUCTURES AT THE PROJECT SITE.
THE CONTRACTOR IS RESPONSIBLE FOR
DETERMINING THE EXISTENCE, LOCATION, AND
ELEVATION OF UTILITIES AND OR
CONCEALED STRUCTURES. NOT RESPONSIBLE
FOR DETERMINING THE APPROXIMATE LOCATION
DEPARTMENT OF FENCING OR TS'S ATTENTION
TO CARE OUT ITS OPERATIONS.

ARCHITECT:
CHRISTOPHER BOZYK, ARCHITECT, I.T.S.

PLAN #3E

- 15 REISSUED FOR DP 18-11-20
- 14 REISSUED FOR DP 18-11-20
- 13 REISSUED FOR DP 18-09-20
- 12 ISSUED FOR CONSTRUCTION 18-02-20
- 11 ISSUED FOR REVISED BP 17-12-19
- 10 ISSUED FOR REVISED 17-11-20
- 9 REISSUED FOR DP 17-06-20
- 8 ISSUED FOR KP 17-06-07
- 7 REISSUED FOR DP 17-05-20
- 6 REISSUED FOR DP 17-05-19
- 5 ISSUED FOR BUDGETING 17-03-24
- 4 RE-ISSUED FOR DP 17-03-20
- 3 ISSUED FOR BP 18-11-25
- 2 ISSUED FOR DP 16-03-27
- 1 ISSUED FOR CLIENT REVIEW 16-06-20

REVISIONS

OPENROAD TOYOTA

13100 Smallwood Place
Richmond, British Columbia


Scale: 1:25

Drawn: KD

Reviewed: KL

Project No.: 06-490

LANDSCAPE LAYOUT PLAN

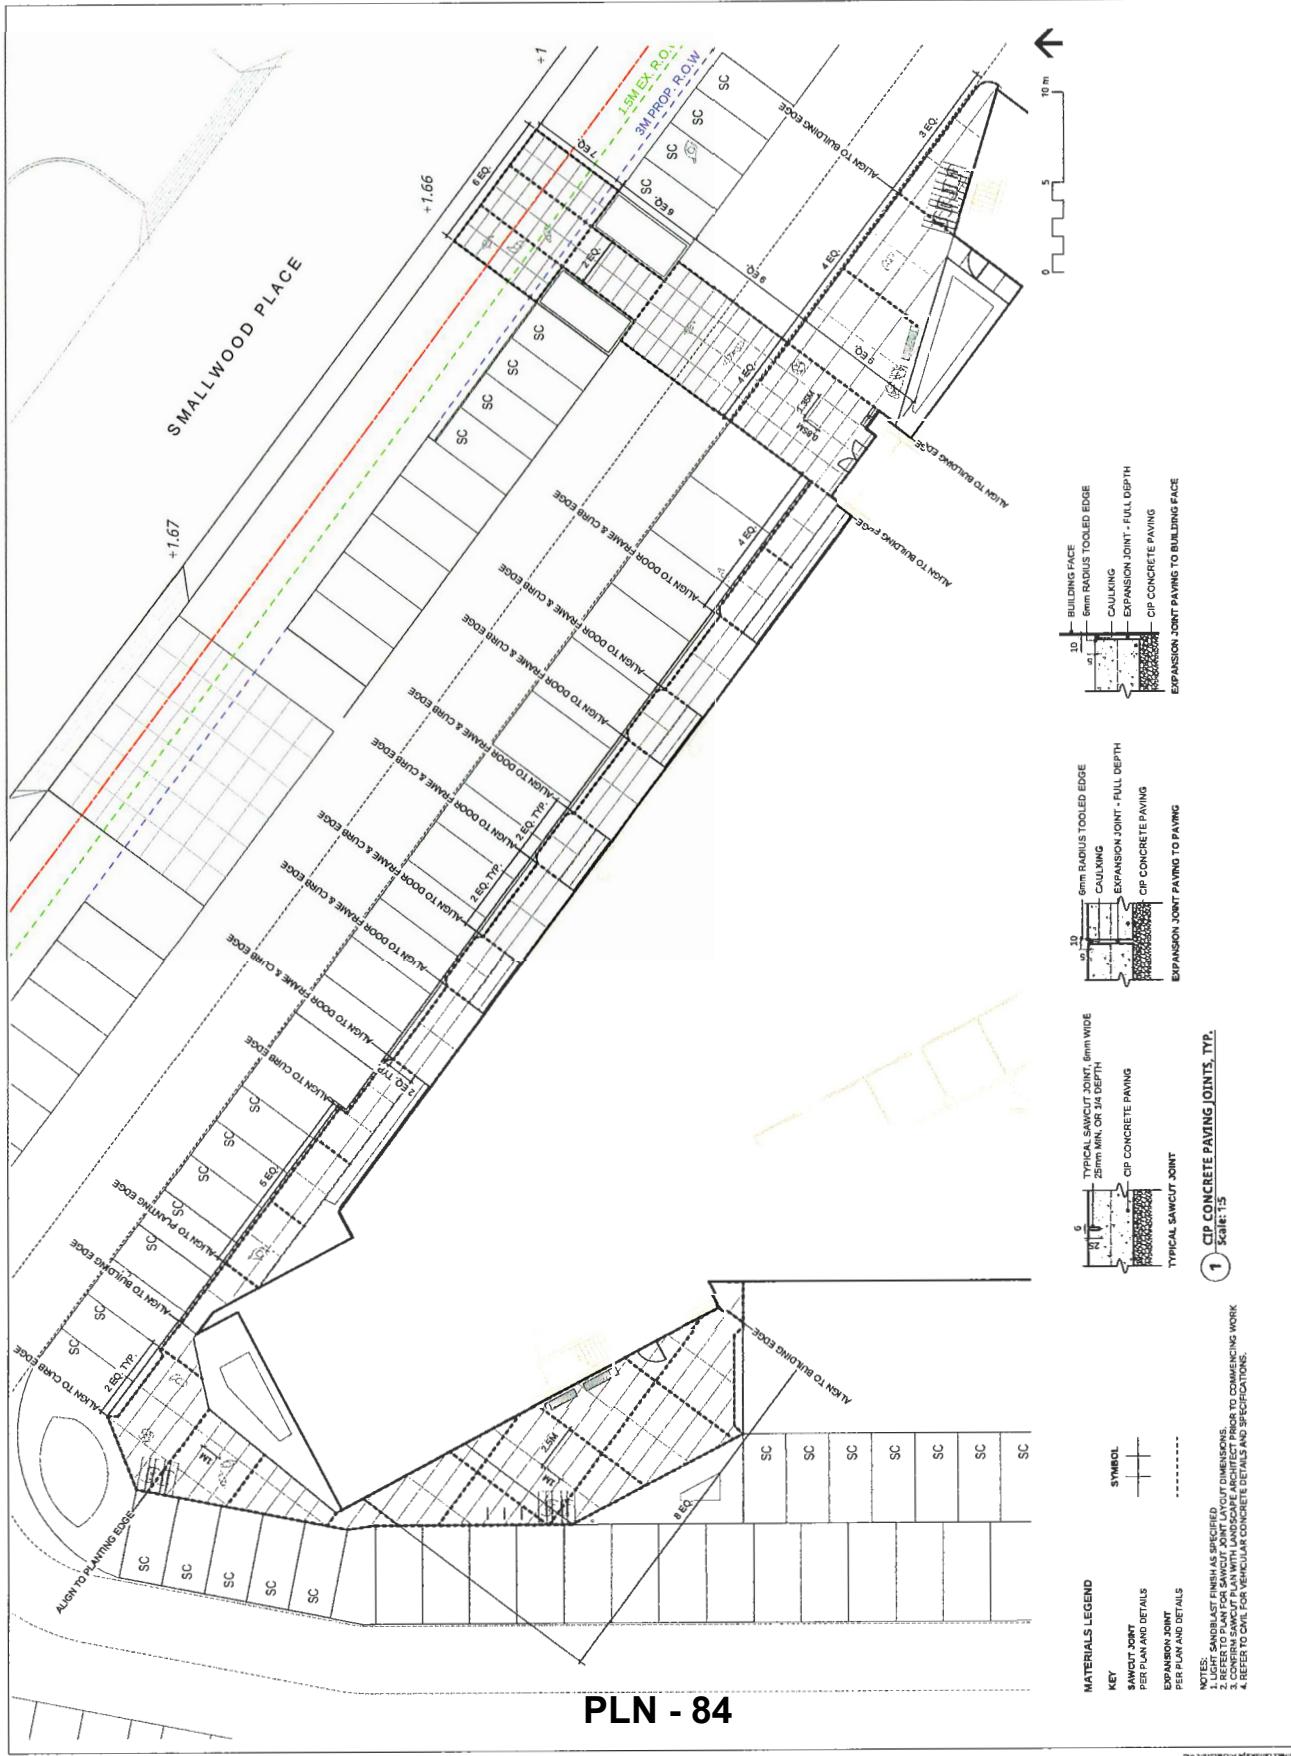

MATERIALS LEGEND

KEY	SYMBOL
SAW CUT JOINT	—
PER PLAN AND DETAILS	—
EXPANSION JOINT	—
PER PLAN AND DETAILS	—

- NOTES:
1. LIGHT SANDBLAST FINISH AS SPECIFIED
2. PAVING JOINTS ARE TO BE PLACED BY THE PAVING CONTRACTOR
3. REFER TO CIVIL FOR VEHICULAR CONCRETE DETAILS AND SPECIFICATIONS.
4. REFER TO VEHICLE CONCRETE DETAILS AND SPECIFICATIONS.

©2018 Connect Landscape Architecture Inc.

CONNECT LANDSCAPE ARCHITECTURE INC. DOES
NOT GUARANTEE THE EXISTENCE, LOCATION,
AND ELEVATION OF UTILITIES AND OR
CANDIDATE STRUCTURES AT THE PROJECT SITE.

THE CONTRACTOR IS RESPONSIBLE FOR
DETERMINING THE EXISTENCE, LOCATION, AND
ELEVATION OF ALL UTILITIES AND OR
CONCEALED STRUCTURES, AND IS RESPONSIBLE
FOR NOTIFYING THE APPROPRIATE COMPANY,
DEPARTMENT OR PERSON(S) OF ITS INTENTION
TO CARRY OUT ITS OPERATIONS


PLANT LIST

12. ALL IRRIGATION VALVE BOXES EQUIPPED WITH QUICK-COUPERS.

13. LANDSCAPE CONTRACTOR TO PROVIDE COMPLETE DESIGN-BUILD SERVICES FOR ALL AUTOMATIC SITE IrrIGATION SYSTEMS. TEMPORARY ESTABLISHMENT IRRIGATION TO BE PROVIDED AT GRADE WHERE NO AUTOMATIC IRRIGATION IS PRESCRIBED.

14. IRRIGATION CONTRACTOR PRESCRIBING THE WORK MUST HAVE MINIMUM 5-FIVE YEARS DOCUMENTED EXPERTISE, AND A MEMBER IN GOOD STANDING OF THE IRRIGATION INDUSTRY ASSOCIATION OF AMERICA.

15. IRRIGATION FOR CONFORMANCE TO ALL LOCAL PLUMBING AND ELECTRICAL CODE REQUIREMENTS. CONTRACTOR IS RESPONSIBLE FOR COORDINATION WITH MECHANICAL AND ELECTRICAL CONSULTANTS AND TRADES.

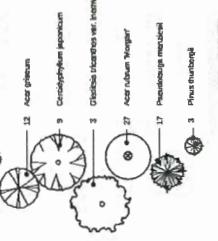

827 Bonus mācību

827	Bulbo micro-		
454	lato		
2531	Carex (cas)		
1058	Gaultheria		
504	Juncaginaceae		
609	Lamiales		
859	Mitchella		
308	Plantago		
309	Umbelliferae		
205	Ribes alpinum		
1516	Silene tenuissima		
454	Sympetrum		
284	Penstemon		
	Wetland		
	Existing P		

1

10

1

1

1

1

10

1

130

T

1

100

REVISIONS

OPENROAD TOYOTA

13100 Smalldwood Place

卷之三


Drawn: KB

Reviewed: _____

卷之三

PLANT MATERIALS
NORTH

12.0

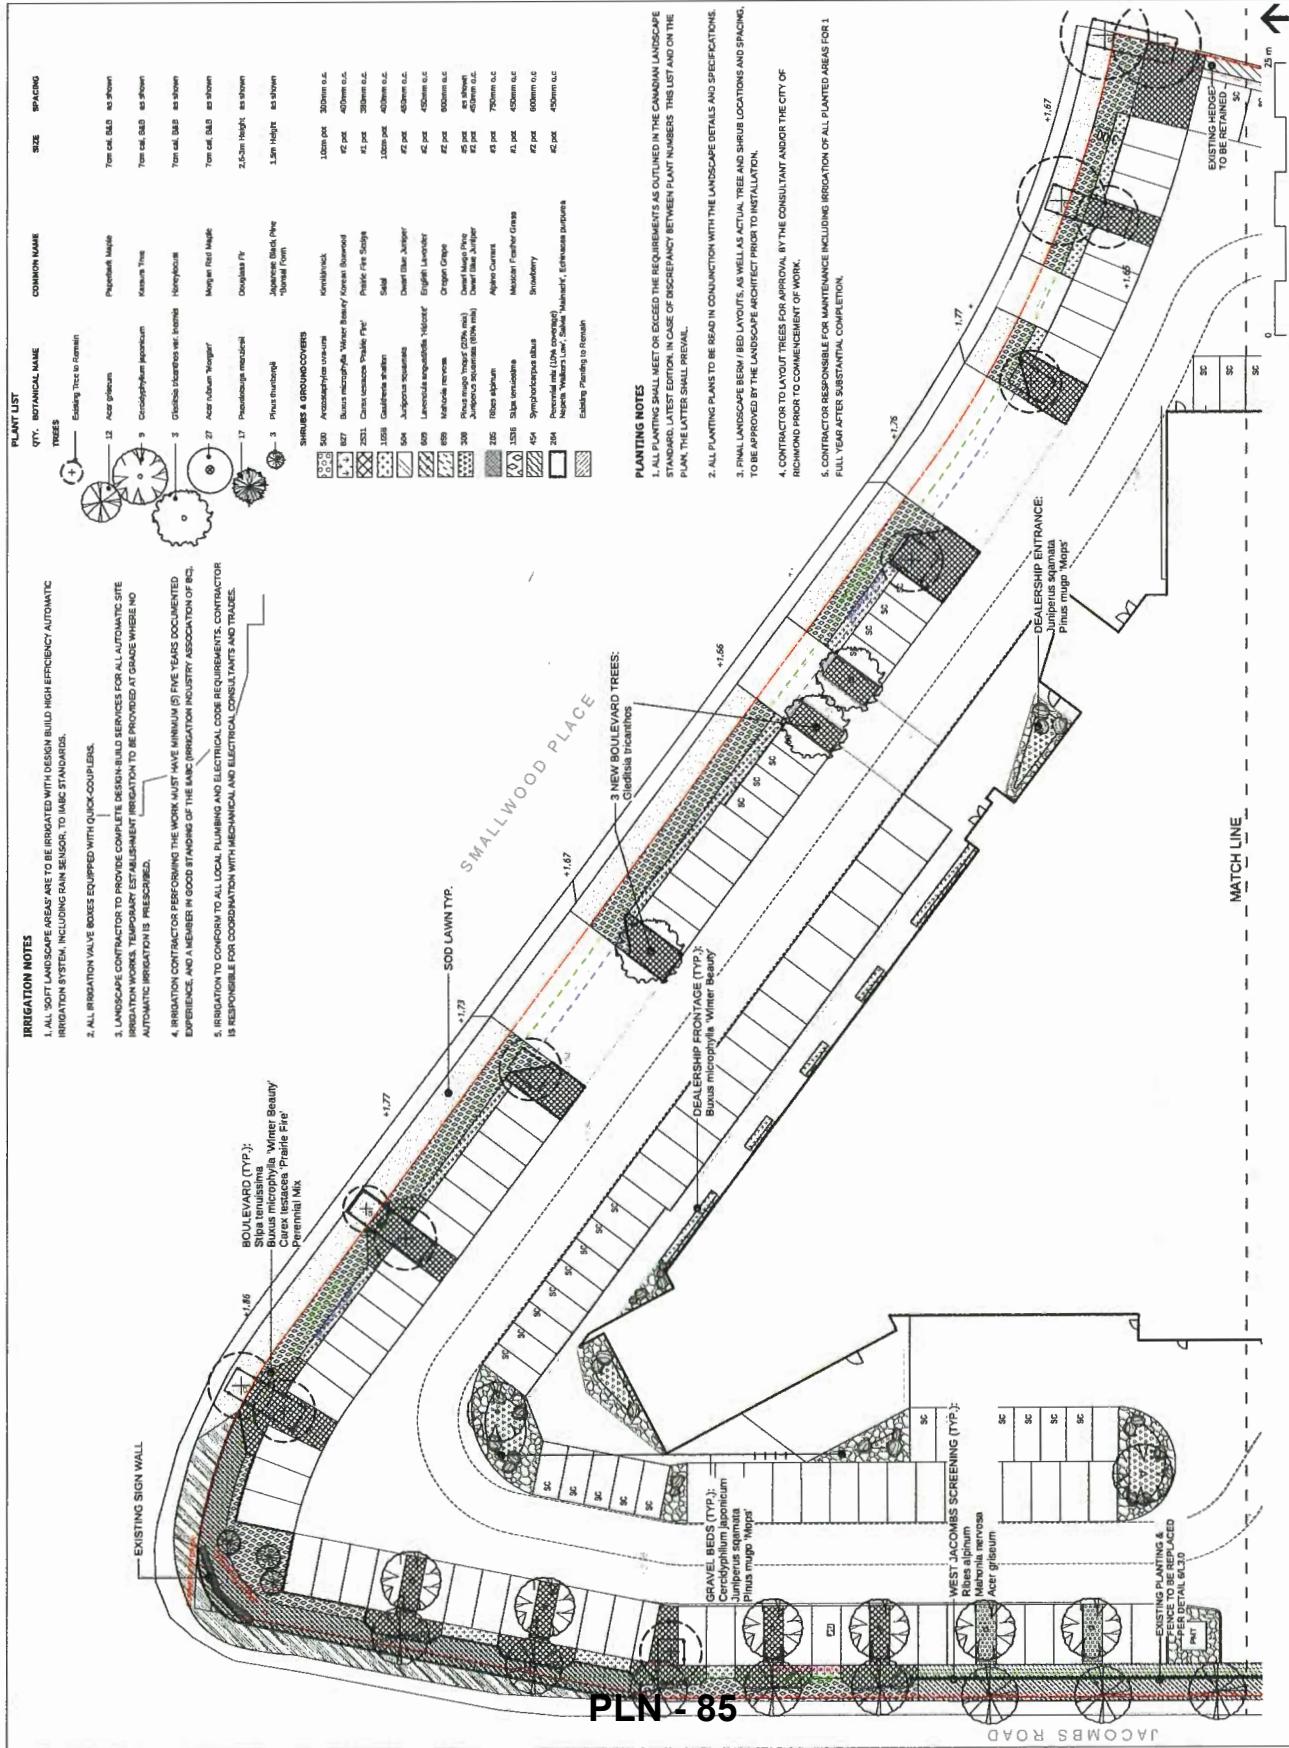

connect

LANDSCAPE ARCHITECTURE

REFER TO L2.0 FOR PLANT LIST.

PLANTING NOTES


1. ALL PLANTING SHALL MEET OR EXCEED THE REQUIREMENTS AS OUTLINED IN THE BC LANDSCAPE STANDARD, LATEST EDITION, IN CASE OF DISCREPANCY BETWEEN PLANT NUMBERS THIS LIST AND ON THE PLAN, THE LATTER SHALL PREDOMINATE.
2. ALL PLANTING PLANTS TO BE READ IN CONJUNCTION WITH THE LANDSCAPE DETAILS AND SPECIFICATIONS.
3. FINAL LANDSCAPE BERM BED LAYOUTS, AS WELL AS ACTUAL TREE AND SHRUB LOCATIONS AND SPACING, TO BE APPROVED BY THE LANDSCAPE ARCHITECT PRIOR TO INSTALLATION.
4. CONTRACTOR TO LAYOUT TREES FOR APPROVAL BY THE CONSULTANT AND/OR THE CITY OF RICHMOND PRIOR TO COMMENCEMENT OF WORK.
5. CONTRACTOR RESPONSIBLE FOR MAINTENANCE INCLUDING IRRIGATION OF ALL PLANTED AREAS FOR 1 FULL YEAR AFTER SUBSTANTIAL COMPLETION.

* SEE ARCHITECTURAL IS RESPONSIBLE FOR COORDINATION WITH MECHANICAL AND ELECTRICAL CONSULTANTS AND TRADES.

IRRIGATION NOTES

1. ALL SOFT LANDSCAPE AREA'S (INCLUDING OFFSITE, OFFSITE, AND GREEN ROOF AREAS) ARE TO BE IRRIGATED WITH DESIGN BUILD HIGH EFFICIENCY AUTOMATIC IRRIGATION SYSTEM, INCLUDING RAIN SENSOR, TO BACI STANDARDS.
2. ALL IRRIGATION VALVE BOXES EQUIPPED WITH QUICK COUPLERS.
3. LANDSCAPE CONTRACTOR TO PROVIDE COMPLETE DESIGN/BUILD SERVICES FOR ALL AUTOMATIC SITE IRRIGATION WORKS, TEMPORARY ESTABLISHMENT OF IRRIGATION TO BE PROVIDED AT GRADE WHERE NO AUTOMATIC IRRIGATION IS PRESCRIBED.
4. IRRIGATION CONTRACTOR PERFORMING THE WORK MUST HAVE MINIMUM (5) FIVE YEARS DOCUMENTED EXPERIENCE, AND A MEMBER IN GOOD STANDING OF THE IRRIGATION INDUSTRY ASSOCIATION (IBD).
5. IRRIGATION TO CONFORM TO ALL LOCAL PLUMBING AND ELECTRICAL CODE REQUIREMENTS. CONTRACTOR

* SEE ARCHITECTURAL IS RESPONSIBLE FOR COORDINATION WITH MECHANICAL AND ELECTRICAL CONSULTANTS AND TRADES.

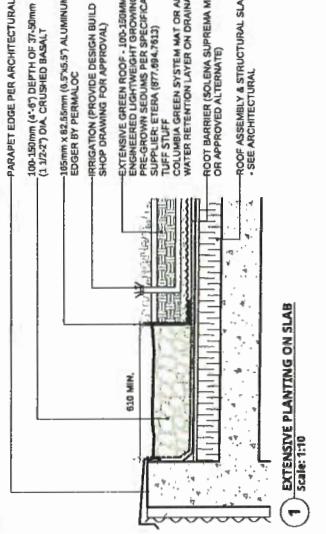

1 EXTENSIVE PLANTING ON SLAB

Scale: 1:10


EXTENSIVE PLANTING DRAIN

Scale: 1:10

PLN - 86

PLAN #3G

1	REISSUED FOR DP	16-51-30
14	REISSUED FOR BP	16-51-40
13	REISSUED FOR DP	16-09-26
12	REISSUED FOR CONSTRUCTION	16-02-26
11	REISSUED FOR REVISED BP	27-12-18
10	REISSUED FOR TENDER	27-12-20
9	REISSUED FOR DP	27-08-28
8	REISSUED FOR ADP	27-08-07
7	REISSUED FOR DP	27-06-30
6	REISSUED FOR DP	27-05-19
5	REISSUED FOR BUDGETING	27-03-24
4	REISSUED FOR DP	17-03-09
3	ISSUED FOR BP	16-31-25
2	ISSUED FOR DP	14-07-27
1	ISSUED FOR CLIENT REVIEW	16-06-20

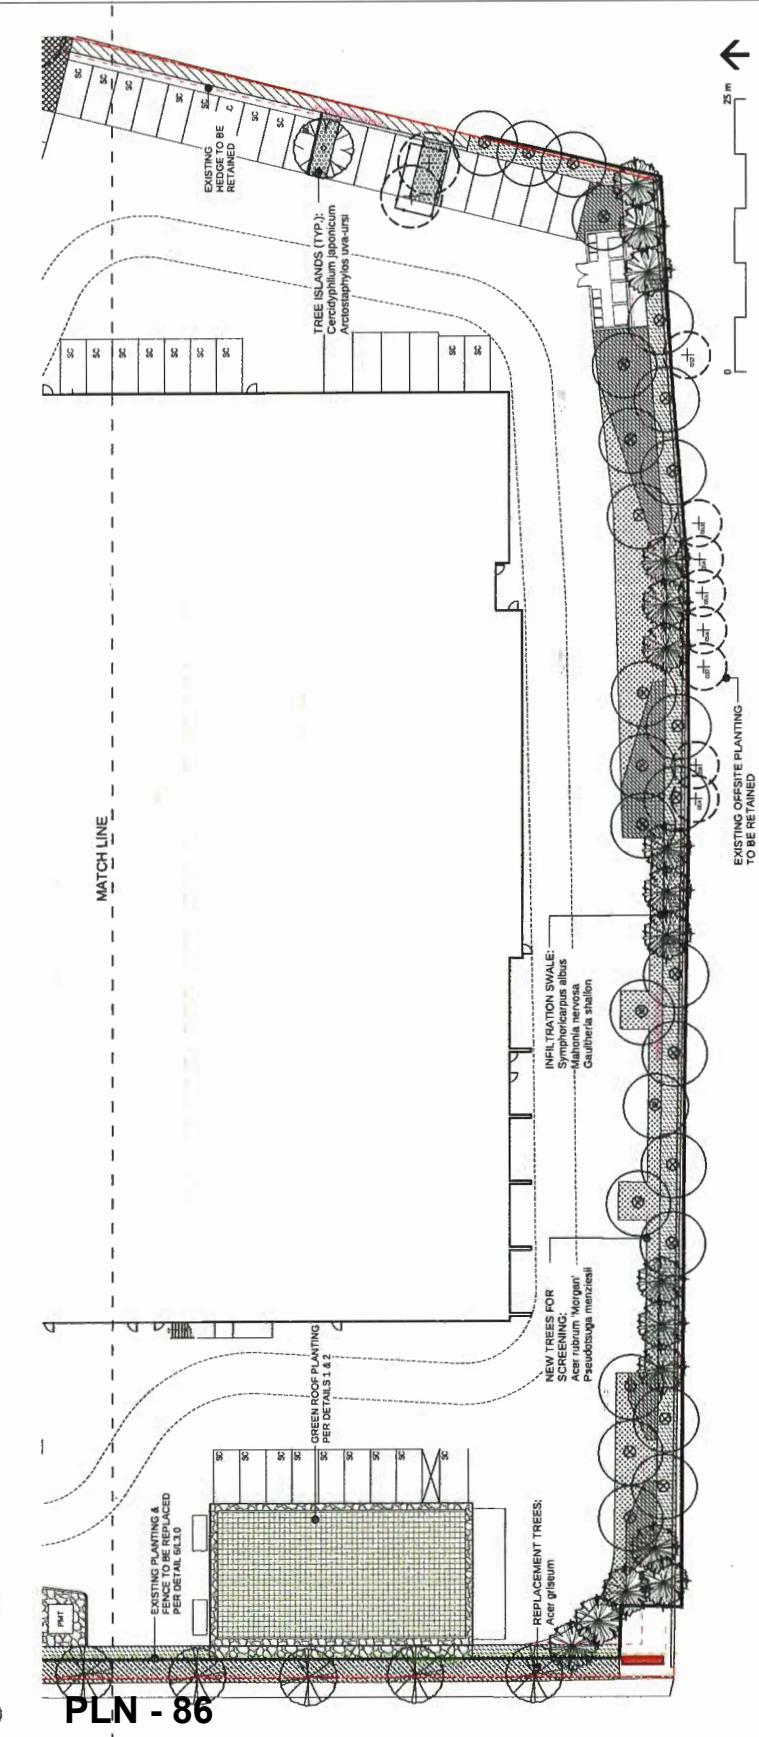

OPENROAD TOYOTA

13100 Smallwood Place

Richmond, British Columbia

Scale: 1:200

Drawn:

KD

Reviewed:

KL

Project No.

06-400

LANDSCAPE PLANT MATERIALS SOUTH

L2.1

Attachment C: Report by CSR Environmental



Your Project
Meets the
Environment

CSR ENVIRONMENTAL LTD.
113 – 408 E. Kent Avenue S.
Vancouver, BC, V5X 2X7
Phone: 604.559.7100
www.csrenviro.com

November 29, 2018

Christopher Bozyk Architects Ltd.
Suite 414 – 611 Alexander Street
Vancouver, BC V6A 1E1

Attention: Mr. Keiran Walsh
Via e-mail: keiran@bozyk.com

Reference: Avian Mitigation Measures
13100 Smallwood Place, Richmond, BC

Dear Mr. Walsh,

1.0 INTRODUCTION

CSR Environmental Ltd. (CSR Environmental) has been retained by Open Road Auto to provide a summary of potential strategies for avian mitigation in regard to the proposed development (the Project) at 13100 Smallwood Place in Richmond, BC (the Site). The summary is in response to comments provided by the City of Richmond (the City) Council on November 13, 2018.

1.1 BACKGROUND

A building permit has been previously acquired for the proposed development at the Site. The design of the proposed development has been completed to the satisfaction of the acquired building permit. An application for the addition of a parkade resulted in additional requested information from the City Council meeting which took place on November 13, 2018, in regard to modifications to the proposed development to reduce potential impact to birds and environmentally sensitive areas (File Ref. No. 12-8062-20-009948; ZT 18-818765, Section R18/19-8 (2)(iii)). The risk of bird collisions with glass windows on the first two floors of the Project are of particular concern. We understand as the building is in construction phase, implementing mitigation measures will be a challenging task.

On November 23, 2018, CSR Environmental conducted a Site visit and discussion with Mr. Keiran Walsh of Christopher Bozyk Architects Ltd. (Christopher Bozyk Architects) and Mr. Paul Bordingnon of Wales McLelland Construction (Wales McLelland). We identified risk of bird collision with glass surfaces on the west and northwest aspects of the building (see Figure 1).

1.2 APPLICABLE FEDERAL AND PROVINCIAL LEGISLATION

The following legislation prohibits unintentional injury or mortality to birds in British Columbia:

- BC Wildlife Act (§ 34);
- Migratory Birds Convention Act (§ 5 (a)); and
- Species at Risk Act (§ 32 (1)).

2.0 THREATS TO BIRDS AND ENVIRONMENTALLY SENSITIVE AREAS

CSR Environmental believes there is no collision risk to birds on the third floor of the Project because no glass or reflective material has been proposed.

CSR Environmental has identified the following threats to birds at the Project: window strikes, lighting, and open pipes and ventilation.

Building collisions account for the second highest human-caused mortality rate for birds in Canada, nearly 25 million birds annually¹. The problem is widespread, occurring at both commercial and residential buildings throughout the year. Fortunately, a variety of cost-effective mitigation options exist. Strategies to address this problem include bird-friendly design policy, implementation of mitigation options, and public education campaigns.

Birds collide with buildings because they either do not see glass or see vegetation reflected in glass rather than the surface of the glass. Impacts with glass occur during daytime and nighttime and can occur throughout the year. The highest risk of window strikes at the Site occur along the west face of the building, which is proposed to have extensive use of large, untreated windows that face the west and north. These surfaces occur within 40 meters of the Richmond Nature Park East, an environmentally sensitive area. The type of glass used in construction, the large expanse of glass windows on floors at or below tree canopy height (i.e. aboveground levels one through three), and vegetation reflected in glass are factors that contribute to collisions with windows.

CSR Environmental expects low risk of bird collision for glass surfaces on the northeast, east, and south aspects of the building facing Smallwood Place. We do not recommend mitigation for these surfaces, but we do recommend ongoing monitoring at these sites. If avian mortality is detected, post-construction mitigation options are available.

Placement of upward facing light can cause light pollution and may negatively influence nocturnal bird migration. Open pipes and ventilation are small openings that can trap birds and cause mortality.

¹ Machtans, C. S., Wedeles, C. H. R., and Bayne, E. M. 2013. A first estimate for Canada of the number of birds killed by colliding with building windows. Avian Conservation and Ecology 8(2): 6. <http://dx.doi.org/10.5751/ACE-00568-080206>

3.0 MITIGATION STRATEGIES

The City of Vancouver Planning and Development Services has a document titled *Bird Friendly Design Guidelines – Considerations for Development Permit*, adopted by City of Vancouver Council in January 2015, effective April 24, 2015². Mitigation strategies that are related to the Site are outlined in the following subsections.

3.1 WINDOWS

For the purpose of preventing bird strikes against windows, the use of mirrored glass on the west and northwest side of the proposed development is not recommended. Portions of the glass on the northwest corner of the proposed development will be screened by a metal mesh. The parkade addition will be clad in a matte finish perforated steel against a dark background. Approximate surface areas occupied by glass on the west and northwest faces are presented here:

Total façade area of the west and northwest faces: 1,440 m²

Total façade area with glass: 557 m² (38.8% of total façade area)

- Unobstructed glazing: 375 m² (26% of façade area with glass)
- Fritted/screened glass: 182 m² (12.8% of façade area with glass)

Total glass area belonging to the northwest face: 424 m² (76% of façade area with glass)

- Unobstructed glazing: 246 m² (58% of northwest face)
- Fritted/screened glass: 178 m² (42% of northwest face)

The area of glass with unobstructed glazing is approximately 375 square meters, which is approximately 26% of the surface area of the west and northwest faces of the proposed development. CSR

Environmental recommends adding visual markers to this area on the west and northwest aspects of the building.

Visual markers should be placed on the outside surface of the glass in the form of frit, etching, or ultraviolet treatments, in order to disrupt the reflection of light from the glass surface. Markers should be spaced to increase visibility to birds: maximum 2 inches (in) or 5 centimetres (cm) of horizontal distance and 4 in or 10 cm of vertical distance between markers. Markers should be lines or dots of at least 0.25 in or 0.64 cm in width and should provide enough contrast to be visible under varying light conditions.

Markers should cover unobstructed glass surfaces up to 20 m above grade.

Visual marker products that have been recommended by the City of Vancouver *Bird Friendly Design Guidelines – Considerations for Development Permit* include:

² City of Vancouver. 2015. *Bird Friendly Design Guidelines – Considerations for Development Permit*. Retrieved from <https://vancouver.ca/files/cov/appendix-a-bird-friendly-design-guidelines-rts-10847.pdf>.

- **Ceramic frit:** Highly durable glass enamel applied to the outside surface of the glass prior to installation. *Recommended product: Garibaldi Glass.*
- **Acid etching:** Multiple textures and patterns available; solar control glass coatings available. *Recommended product: Walker Glass' Aviprotek.*
- **Ultraviolet options:** Visible to birds but not visible to humans, however the ultraviolet layer is not applied to the outside of glass and therefore does not completely reduce risk of window strikes. *Recommended product: Ornilux Mikado.*
- **Exterior laminates:** These options are **not** recommended for commercial applications due to poor longevity of materials. Avian collision risk will remain constant through the life of the building, and as such, the mitigation option selected needs to last for the life of the building. Exterior laminates are suitable for post-construction mitigation only.

Where visual markers are not possible or cost prohibitive, physical barriers can be used in front of reflective surfaces to mitigate collision risk. Metal cladding, architectural grillwork or decorative grills could be installed in front of windows with reflective properties. Further, canopies and sunshades can be used to minimize reflections on the external surface of small windows but are only effective if reflection is completely obstructed during daylight conditions.

3.2 LIGHTING

The City of Vancouver Outdoor Lighting Strategy³ contains recommendations for placement of lighting to improve outdoor environment during nighttime, including to minimize ecological impacts. We recommend that upward facing lighting be limited for the Project. Further, lighting spillover to adjacent environmentally sensitive areas should be prevented. Lighting can be shielded to effectively light desired areas without adversely effecting nearby areas. Light can be used judiciously to maintain nighttime safety while minimizing impacts to wildlife. CSR Environmental understands that upward facing lighting has not been suggested for this development.

3.3 LANDSCAPING

Natural vegetation between the proposed development and natural areas on Jacombs Road should be reduced to limit wildlife corridors which lead to the Site and immediate surrounding area. To facilitate this, CSR Environmental does not recommend planting any vegetation over 30 cm on the west and northwest side of the property. CSR Environmental also recommends refraining from use of ornamental plants inside the building that are visible from the outside, such as potted trees and indoor vegetation which can entice birds to fly toward windows.

3.4 PIPES AND VENTILATION

CSR Environmental recommends caps and screen on open pipes and ventilation systems to limit wildlife entry. Voids greater than 2.5 in or 7 cm square should be covered.

³ City of Vancouver. 2018. *Outdoor Lighting Strategy Consultation Paper*. Retrieved from <https://vancouver.ca/files/cov/outdoor-lighting-strategy-consultation-paper.pdf>.

4.0 MONITORING

Mitigation measures must be monitored to ensure success. Bird collisions occur throughout the year, although in southwestern BC collisions peak during fall, winter, and spring. Daily monitoring of glass surfaces by an independent biologist would be cost prohibitive. Hence, we recommend an Open Road Auto Group representative at the Site conduct weekly monitoring to document any bird mortality between September 15th through May 1st each year. Monitoring should involve a visual search of the ground underneath glass surfaces around the entire building to a distance of 8 meters from the building. The location of all mortalities should be documented (using GPS or by noting a unique window identifier). Although collision risk is highest along the west and northwest aspects, the entire building should be monitored for the first season. CSR Environmental will review the monitoring findings every three-months and revise the monitoring plan if warranted. If bird mortality exceeds five in any week, CSR Environmental will be contacted. Mortalities should be submitted to the Global Birds Collision Mapper⁴.

CSR Environmental will also conduct an annual follow-up Site visit to review avian protection activities, effectiveness of mitigation measures, and results of the weekly monitoring activities.

5.0 CLOSURE

In summary, bird collisions with the proposed development are possible at the Site considering proximity to environmentally sensitive areas. Approximately 26 percent of the west and northwest faces of the proposed development will be glass with unobstructed glazing which should be treated with visual markers such as ceramic frit, acid etching, ultraviolet options, or physical obstructions. Placement of lighting, strategic landscaping, and protecting openings to pipes and ventilation are other measures which should be implemented. Following the recommendations provided by CSR Environmental and conducting regular monitoring of mitigation measures should reduce potential impact to birds and environmentally sensitive areas.


We trust this letter satisfies your requirements at this time. Should you have questions regarding this summary or require our assistance on other tasks, please do not hesitate to contact me at 604.559.7100 or via email at mamoud@csrenviro.com at your convenience. Thank you.

Yours sincerely,

CSR Environmental Ltd.



Patrick Burke, BA
Avian Biologist

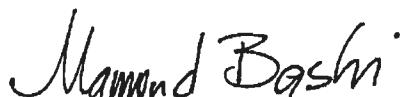

Mamoud G. Bashi, MBA, PEng
Principal and Environmental Engineer

⁴ BirdSafe and FLAP Canada. 2018. Global Bird Collision Mapper [Geographical information system]. Retrieved from <https://birdmapper.org/app/>.

Attachment D: Revised Zoning Text Amendment Considerations



City of Richmond

ATTACHMENT D
Rezoning Considerations
Development Applications Department
6911 No. 3 Road, Richmond, BC V6Y 2C1

Address: 13100 Smallwood Place

File No.: ZT 18-818765

Prior to final adoption of Richmond Zoning Bylaw 8500, Amendment Bylaw 9948, the developer is required to complete the following:

1. Provincial Ministry of Transportation & Infrastructure Approval.
2. The submission and processing of a Development Permit* completed to a level deemed acceptable by the Director of Development.
3. City acceptance of the developer's offer to voluntarily contribute \$0.45 per buildable square foot (e.g. \$38,432) to the City's Public Art fund.
4. Registration of an agreement on Title, prior to Bylaw adoption, ensuring that the proposed 107 rooftop solar panels will be installed to the Director of Building Approval's satisfaction and will be maintained for the life of the building and will not be removed unless otherwise agreed to by the City of Richmond.
5. Registration of an agreement on Title ensuring that the development's parkade will not be enclosed unless the owner has successfully obtained a Development Permit issued by Council approving the enclosure and has also successfully obtained a Building Permit for the work.
6. Submission of a contract with a qualified environmental professional (QEP) to monitor bird strikes to the building for a minimum of 12 months post construction and to submit a report with recommendations and mitigation measures to the satisfaction of the Director , Development at the end of the monitoring period. The contract is to include the frequency of visits and an overview of how the findings will be presented.

Prior to Building Permit* Issuance, the developer must complete the following requirements:

1. Submission of a Construction Parking and Traffic Management Plan to the Transportation Department. Management Plan shall include location for parking for services, deliveries, workers, loading, application for any lane closures, and proper construction traffic controls as per Traffic Control Manual for works on Roadways (by Ministry of Transportation) and MMCD Traffic Regulation Section 01570.
2. Installation of appropriate tree protection fencing around all trees to be retained as part of the development prior to any construction activities, including building demolition, occurring on-site.
3. Incorporation of accessibility measures in Building Permit (BP) plans as determined via the Rezoning and/or Development Permit processes.
4. Obtain a Building Permit (BP) for any construction hoarding. If construction hoarding is required to temporarily occupy a public street, the air space above a public street, or any part thereof, additional City approvals and associated fees may be required as part of the Building Permit. For additional information, contact the Building Approvals Department at 604-276-4285.

Note:

- * This requires a separate application.
- Where the Director, Development deems appropriate, the preceding agreements are to be drawn not only as personal covenants of the property owner but also as covenants pursuant to Section 219 of the Land Title Act.

All agreements to be registered in the Land Title Office shall have priority over all such liens, charges and encumbrances as is considered advisable by the Director, Development. All agreements to be registered in the Land Title Office shall, unless the Director of Development determines otherwise, be fully registered in the Land Title Office prior to enactment of the appropriate bylaw.

The preceding agreements shall provide security to the City including indemnities, warranties, equitable/rent charges, letters of credit and withholding permits, as deemed necessary or advisable by the Director, Development. All agreements shall be in a form and content satisfactory to the Director, Development.

- Additional legal agreements, as determined via the subject development's Servicing Agreement(s) and/or Development Permit(s), and/or Building Permit(s) to the satisfaction of the Director of Engineering may be required including, but not limited to, site investigation, testing, monitoring, site preparation, de-watering, drilling, underpinning, anchoring, shoring, piling, pre-loading, ground densification or other activities that may result in settlement, displacement, subsidence, damage or nuisance to City and private utility infrastructure.
- Applicants for all City Permits are required to comply at all times with the conditions of the Provincial *Wildlife Act* and Federal *Migratory Birds Convention Act*, which contain prohibitions on the removal or disturbance of both birds and their nests. Issuance of Municipal permits does not give an individual authority to contravene these legislations. The City of Richmond recommends that where significant trees or vegetation exists on site, the services of a Qualified Environmental Professional (QEP) be secured to perform a survey and ensure that development activities are in compliance with all relevant legislation.

[Signed original in file]

Signed

Date

Attachment E: Original Report from the Director of Development,
dated October 30, 2018



City of Richmond

Report to Committee

To: Planning Committee

Date: October 30, 2018

From: Wayne Craig
Director, Development

File: ZT 18-818765


Re: Application by Christopher Bozyk Architects for a Zoning Text Amendment to the "Vehicle Sales (CV)" Zone to Increase the Floor Area Ratio to 0.82 at 13100 Smallwood Place.

Staff Recommendation

That Richmond Zoning Bylaw 8500, Amendment Bylaw 9948, for a Zoning Text Amendment to the "Vehicle Sales (CV)" zone to increase the Floor Area Ratio to 0.82 at 13100 Smallwood Place, be introduced and given first reading.


Wayne Craig
Director, Development
(604-247-4625)

WC:dcb
Att. 6

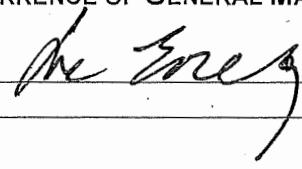REPORT CONCURRENCE
CONCURRENCE OF GENERAL MANAGER


Staff Report**Origin**

Christopher Bozyk Architects Ltd. has applied for permission to amend the “Vehicle Sales (CV)” zone to increase the maximum Floor Area Ratio (FAR) to 0.82 at 13100 Smallwood Place.

The intent of the application is to modify the previously approved Toyota automobile dealership development, to accommodate additional gross floor area associated with two additional levels of parking and vehicle inventory storage overtop of the dealership building, which is currently under construction. The subject site is within the Richmond Auto Mall in the East Cambie planning area. A location map and the East Cambie Area Plan map showing the site's location are provided in Attachments 1 and 2 respectively.

Toyota's original development applications (ZT 16-754143 and DP 16-741123) were adopted/issued by Council on October 23, 2017. These applications were to accommodate the construction of a two-storey building with rooftop parking. The approved Zoning Text Amendment increased the maximum FAR from 0.5 to 0.7. Building permits were issued for this construction and the buildings are currently under construction.

The current application proposes to increase the maximum Floor Area Ratio (FAR) to accommodate the additional two storeys of parking and vehicle inventory storage on top of the approved building; resulting in a four-storey building with rooftop parking, with one of the objectives to eliminate the need for off-site storage elsewhere. The current proposal will result in an additional 2,154.3 m² (23,188 ft²) of floor space to the building over the previous approved proposal (ZT 16-754143 and DP 16-741123). Requested height variances are identified in this Staff Report, but will be addressed through a separate Development Permit application (DP 18-818762).

Findings of Fact

A Development Application Data Sheet providing details about the development proposal is provided in Attachment 3.

Surrounding Development

The subject property at 13100 Smallwood Place, is located within the Richmond Auto Mall at the northeast corner of the intersection of Westminster Highway and Jacombs Road. The site has been cleared of structures and construction of the approved dealership building is currently ongoing.

Existing land uses and development immediately surrounding the subject site are as follows:

- To the North, immediately across Smallwood Place, is an existing Hyundai dealership on a site zoned “Vehicle Sales (CV)” within the Richmond Auto Mall at 13171 Smallwood Place. A Zoning Text Amendment (ZT 18-810720) and a Development Permit application (DP 18-810720) have been received from Kasian Architecture Interior Design & Planning,

with the objective of redeveloping that property to accommodate a new Porsche dealership building. These applications are currently under review by staff.

- To the South, across Westminster Highway and a frontage road further south, are large properties zoned “Agriculture (AG1)” in the Agricultural Land Reserve (ALR), which contain single-family dwellings and accessory buildings.
- To the East, is an existing Nissan dealership on a site zoned “Vehicle Sales (CV)” within the Richmond Auto Mall at 13220 Smallwood Place.
- To the West, across Jacombs Road, is the “Richmond Nature Park East” on a site zoned “School & Institutional Use (SI)” at 5991 Jacombs Road. The Nature Park East is designated as an Environmentally Sensitive Area (ESA).

Related Policies & Studies

Official Community Plan/East Cambie Area Plan

The subject site is designated “Commercial” in both the Official Community Plan (OCP) and the East Cambie Area Plan (Attachment 2). As a commercial use, the proposed auto dealership at the subject site is consistent with the OCP and Area Plan land use designations.

Agricultural Land Reserve (ALR) Buffer Zone

Where there is an intervening road between ALR lands and non-ALR lands, the OCP encourages an appropriate landscaping buffer on the non-ALR lands through the Rezoning and Development Permit processes. This situation was reviewed under the original Zoning Text Amendment application (ZT 16-754143) and it was noted that the applicant’s proposal was consistent with the land use considerations in the OCP in that:

- “The Agricultural Land Reserve (ALR) is located to the south of the site and to the west (Richmond Nature Park). The site is separated from the ALR by existing roads (Jacombs Road and Westminster Highway). Formal landscaping plans to adequately buffer the site from the ALR will be a requirement of the forthcoming Development Permit [DP 16-741123] for the proposed auto dealership.” (A covenant was registered on Title through the previous zoning application (ZT 16-754143) to ensure that the landscaping within the ALR buffer along the southern property boundary would be retained.)
- “There is an existing 1.8 m high solid fence along the south property line next to Westminster Highway and the applicant proposes a row of new trees, a 3 m setback to on-site surface parking, and a setback of approximately 15 m to the south building façade.”
- “The applicant also proposes to retain the existing planting and 1.8 m high solid fence along the west property next to Jacombs Road, replace the existing London Plane trees (which are in poor condition) with a new row of Ginkgo Biloba trees, and to provide a minimum 3 m setback to on-site surface parking and proposed buildings.”

The current application will improve upon the above responses by further removing 12 of the previously approved parking spaces along the southern property boundary and replacing them with additional tree and shrub planting. The parking spaces will now be located within the parkade. The additional tree planting in this area will provide additional visual screening of the building from Westminster Highway as the trees eventually grow to mature height.

An additional eight previously approved parking spaces, generally along the western property boundary, are proposed to be relocated from grade to the internal parkade. These spaces will be replaced with new vegetation strips with trees. These changes are shown on the attached conceptual landscaping plans (Attachment 4) but will be addressed in greater detail through the separate Development Permit application (DP 18-818762).

Floodplain Management Implementation Strategy

The proposed development must meet the requirements of the Richmond Flood Plain Designation and Protection Bylaw 8204. A flood indemnity covenant was been registered on Title under the previous Zoning Text Amendment application (ZT 16-754143). The proposed addition will have no effect on the registered flood covenant.

Aircraft Noise Sensitive Development Policy

The OCP's Air Noise Sensitive Development (ANSO) Policy applies to the subject site, which is located within the "Restricted Area (Area 1B)". The proposed auto dealership at the subject site is consistent with the ANSO Policy as it is not a residential use.

An aircraft noise indemnity covenant has been registered on Title as required under the previous Zoning Text Amendment application (ZT 16-754143). No changes to the existing aircraft noise covenant as a result of the proposed addition.

Ministry of Transportation and Infrastructure (MOTI) Approval

As the subject site is located within 800 m of an intersection of a Provincial Limited Access Highway and a City road, the Zoning Text Amendment proposal was referred to MOTI for review and comment. The Zoning Text Amendment considerations include a requirement for MOTI approval prior to bylaw adoption.

Ministry of Environment (MOE) Approval

As the Site Profile submitted by the applicant for the current application identified Schedule 2 activities have occurred on-site, the Site Profile was submitted to the Ministry of Environment (MOE) in accordance with the Provincial Contaminated Sites Regulation. MOE has subsequently provided a letter dated May 16, 2018, allowing the City to proceed with approval of the Zoning Text Amendment and Development Permit applications.

Analysis

Built Form and Architectural Character

As proposed, the redevelopment will result in a two storey dealership office and sales facility with a four storey parkade. The concept plans for the proposed modifications to auto dealership building and the landscaping are provided in Attachment 4. The most significant areas proposed to change have been cloud outlined on the drawing package. Further review of the design aspects shown in the preliminary concept plans will be undertaken through the separate Development Permit review process to ensure general compliance with the Official Community Plan Development Permit Guidelines and assess the requested variances outlined in the next section.

Generally, the modifications include:

- Modifications to exterior cladding over portions of the building in part to mitigate the additional massing created by the addition of the two parkade levels.
- The addition of the two extra floors of parkade over top of the previously approved building. Staff have been advised that the initial building construction (currently underway) was designed to be able to accommodate future additional parkade floors above.
- Relocation of 20 at-grade parking spaces to the inside of the parkade.
- Restriping of the 6 accessible parking spaces (see Transportation section for more detail).
- Addition of trees and other landscaping to fill the spaces left by relocating the 20 parking spaces.
- Relocation of the garbage and recycling facility to the south-east corner of the site to allow additional vegetation screening of the car wash facility located in the south-west corner of the site. This also facilitates more efficient garbage collection.

Existing Legal Encumbrances

A Title summary prepared by Terra Law, dated October 19, 2019, was submitted for this application. The subject site carries a series existing legal encumbrances including

- Statutory rights of way agreements for utilities;
- Statutory building schemes with the Richmond Auto Mall Association;
- Vancouver Airport Authority noise indemnification covenants;
- Agricultural Land Reserve setback covenants;
- A covenant requiring the design, installation and maintenance of three electric vehicle charging stations on the site; and
- A flood indemnity covenant.

Terra Law's Title summary report advises that none of these encumbrances will affect the current application and they can remain on Title.

Transportation

Transportation staff have reviewed and assessed the potential traffic impacts associated with the proposed development. As the proposal is to provide space primarily for vehicle inventory

storage, it is anticipated that the associated traffic impacts would be minimal and can be accommodated within existing road infrastructure.

As part of this application review, staff have requested and the client has agreed, to restripe the six accessible parking spaces in accordance with the recent Zoning Bylaw Amendment on accessible parking (Section 7.5.15). This adjustment will be addressed through the Development Permit application review.

The Zoning Text Amendment considerations include a requirement that prior to the issuance of the Building Permit, a construction parking and traffic management plan to be provided to the Transportation Division.

Tree Retention and Replacement

No additional existing trees will be removed from the site as a result of the current proposal; however, an additional 45 more on-site trees are included in the conceptual landscape plans over the original landscape plan (DP 16-741123). These trees will help provide additional edge screening for the site.

No changes or additional protection is required for existing trees, as all the tree protection barriers are currently in place given the on-going construction at the site. Tree survival securities for both on-site and off-site have been addressed through the previously approved Zoning Text Amendment application (ZT 16-754143).

Public Art

Under the previous Development Permit (DP 16-741123) the Public Art contribution for the commercial use was assessed as \$51,762, which was contributed to the Public Art Reserve Fund. The Public Art Planner has advised that the proposed addition will result in an additional Public Art contribution of \$38,432, based on the 2018 rate of \$0.45/SF. The additional contribution has been included in the Zoning Text Amendment considerations and are required prior to final adoption, with the funds to be directed to the Public Art Reserve Fund.

Variances Requested

Based on the proposed preliminary concept plans, the applicant will be requesting to vary the provisions of Richmond Zoning Bylaw 8500 at the Development Permit Application review stage to increase the maximum permitted building height to accommodate:

- An increased parkade rooftop height from 12.0 m to 15.46 m (rounded to 15.5 m).
- A new parapet height of 16.88 m (rounded to 16.9 m).
- A stair tower of 18.51 m (rounded to 18.6 m).
- An elevator over-run of 20.39 m (rounded to 20.4 m).

The current proposal has been reviewed by the Richmond Auto Mall Association (RAMA) which has provided a letter (Attachment 5) in support of the proposed density increase to 0.82 FAR, as well as the requested variances.

Noting the special context and operating characteristics within the Richmond Auto Mall, staff believe the requested variances are supportable. Staff note that this is an overall trend observed within the Auto Mall to increase the on-site storage capacity and reduce land holding costs off-site. This specific request does not increase the building's footprint (site coverage), but will result in increased permeability of the site as a result of the vegetation improvements. The details of the quality of the proposed finishes, cladding materials, vegetation selections and height variances will be reviewed and analyzed further through the Development Permit Application review.

Site Servicing and Frontage Improvements

All the site servicing and frontage improvements were addressed under the previous Zoning Text Amendment application (ZT 16-754143). The proposed modifications to the building, site plan and landscaping will not result in any additional site servicing requirements or new frontage improvements.

Development Permit Review

As noted previously, the proposed development will undergo a separate design review via the Development Permit application (DP 18-818762). Specific issues to be addressed will include:

- Assessing compliance with the Official Community Plan Development Permit Guidelines.
- A review of the proposed landscape plant/tree selections, sizes, locations and rationale.
- Additional landscape securities will be calculated to address the landscaping additions.
- A review of the proposed exterior materials and colours as they relate to the proposed parkade floor additions.
- A review of vehicle parking spaces to ensure compliance with the parking requirements in the Zoning Bylaw No. 8500.
- Restriping of the six accessible parking spaces.
- A review of the height variances requested.
- An assessment of the garbage and recycling facility to ensure it is sufficiently sized and located to address the needs of the site. A waste management overlay will be required.

Financial Impact or Economic Impact

As all the servicing and frontage works were addressed under the previous Zoning Text Amendment application (ZT 16-754143) no additional Operational Budget Impacts (OBI) for off-site City infrastructure are anticipated as a result of this application. The previous application noted only insignificant operational impacts.

Conclusion

Christopher Bozyk Architects Ltd. has applied for permission to amend the zoning district "Vehicle Sales (CV)" zone to increase the maximum Floor Area Ratio (FAR) to 0.82 at 13100 Smallwood Place. The intent is to modify the previously approved Toyota automobile dealership development in order to accommodate two additional levels of parking and vehicle inventory storage overtop of the dealership building, which is currently under construction. Site

plan changes will result in fewer cars parked at grade and additional landscaping being added to the site.

It is recommended that Richmond Zoning Bylaw 8500, Amendment Bylaw 9948, be introduced and given first reading.



David Brownlee

Planner 2

(604-276-4200)

DCB:blg

Attachment 1: Location Map

Attachment 2: East Cambie Land Use Map

Attachment 3: Development Application Data Sheet


Attachment 4: Conceptual Development Plans

Attachment 5: Letter from Richmond Auto Mall Association

Attachment 6: Zoning Text Amendment Considerations




City of Richmond

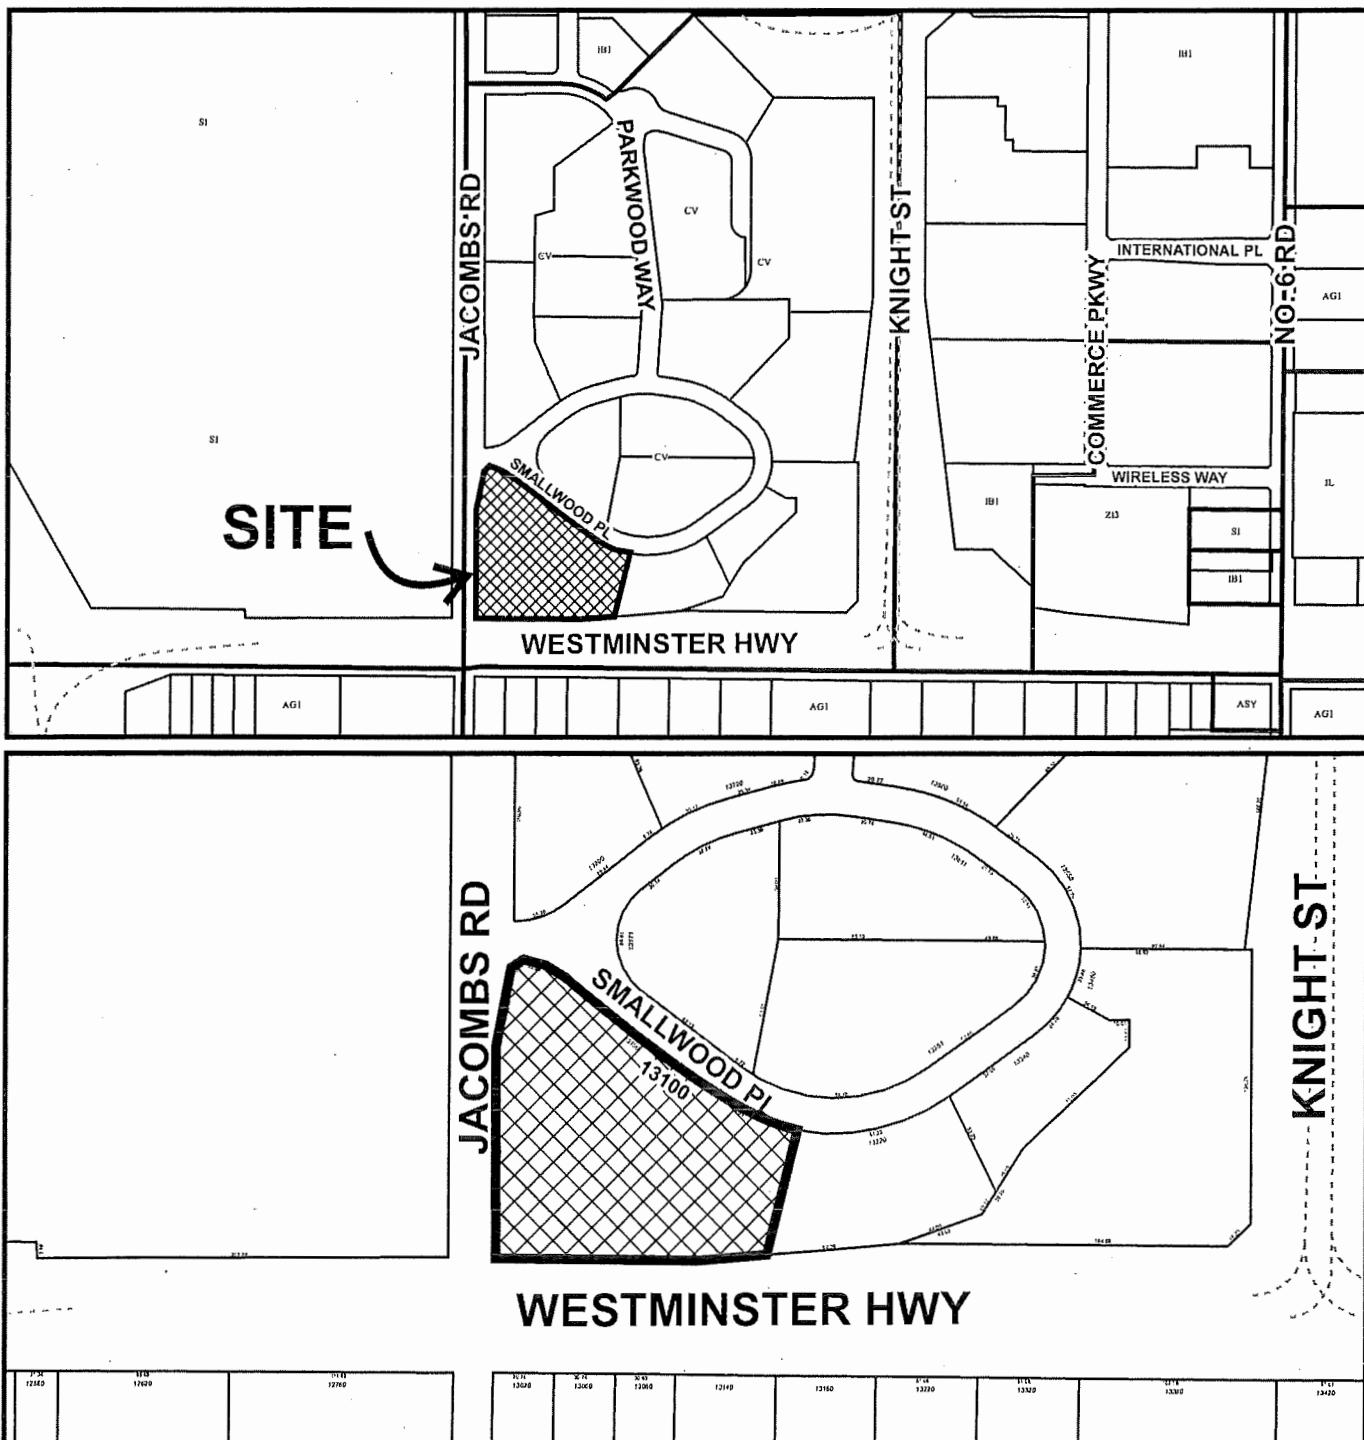

	ZT 18-818765	Original Date: 05/09/18 Revision Date: Note: Dimensions are in METRES
--	--------------	---



City of Richmond

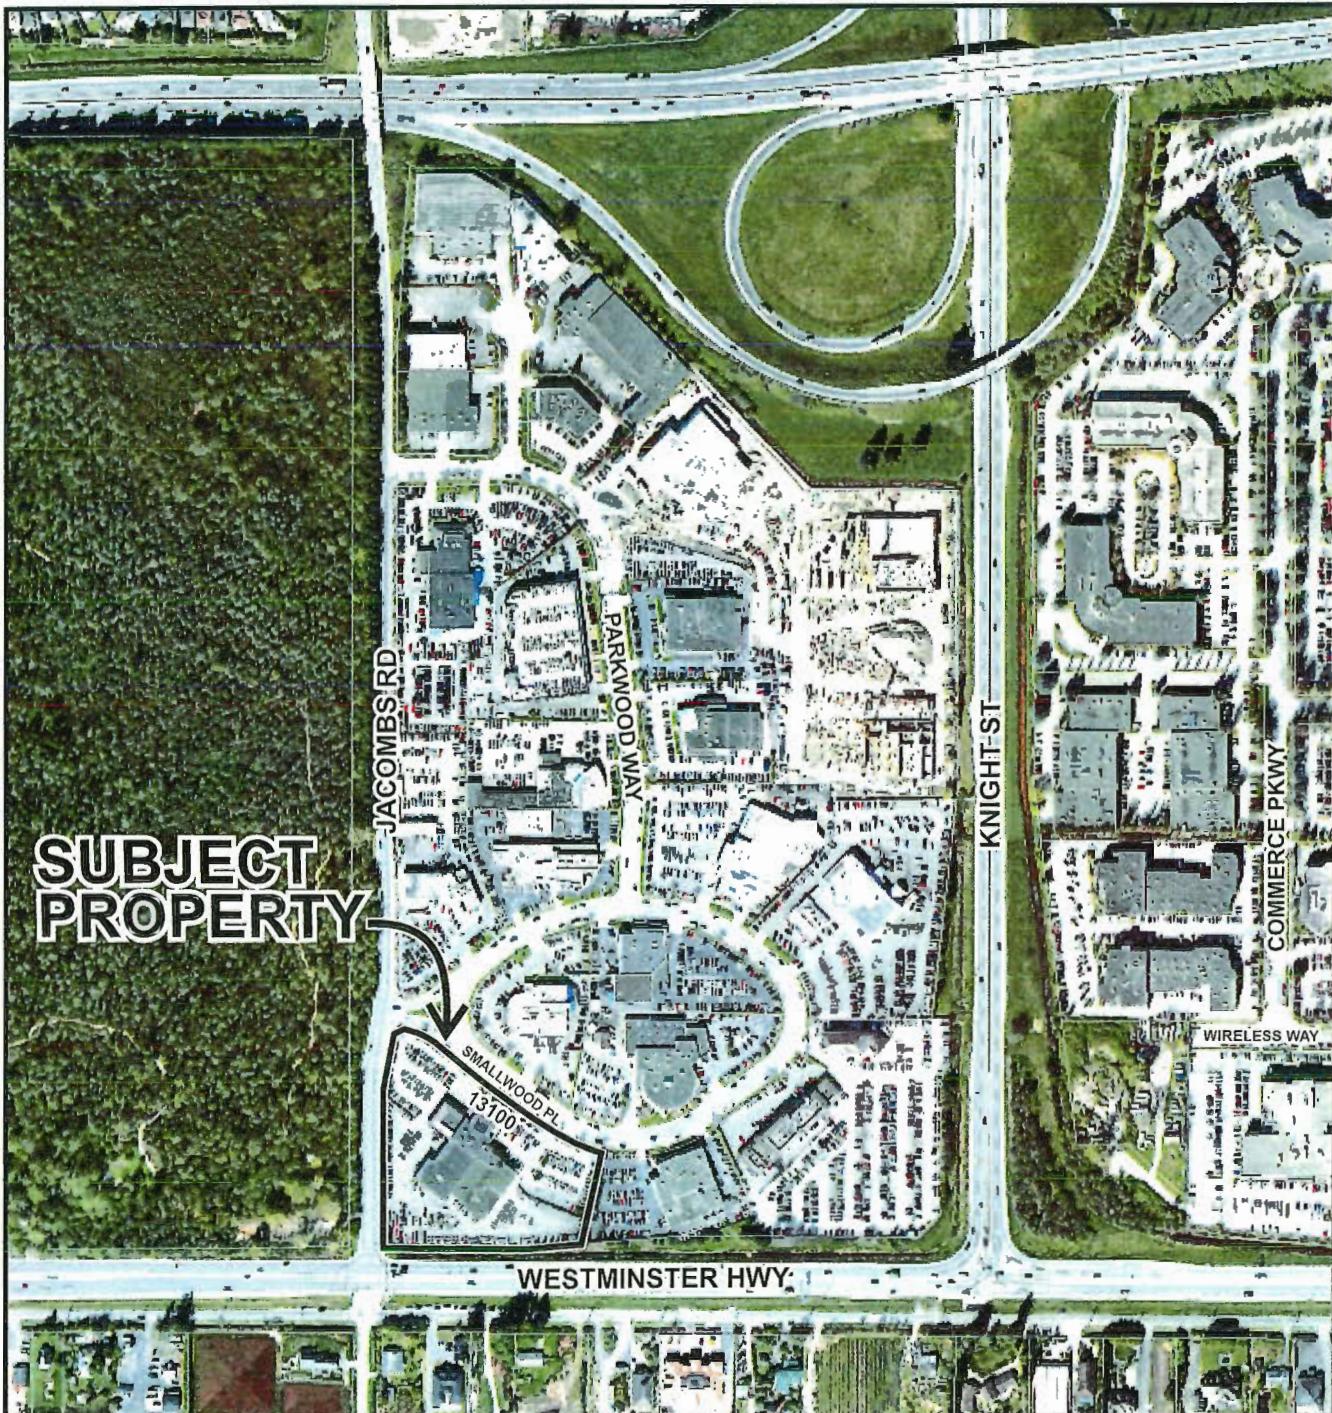

ZT 18-818765

PLN - 108

Original Date: 10/26/18


Revision Date:

Note: Dimensions are in METRES

City of Richmond

Land Use Map

Bylaw 8948
2016/10/24

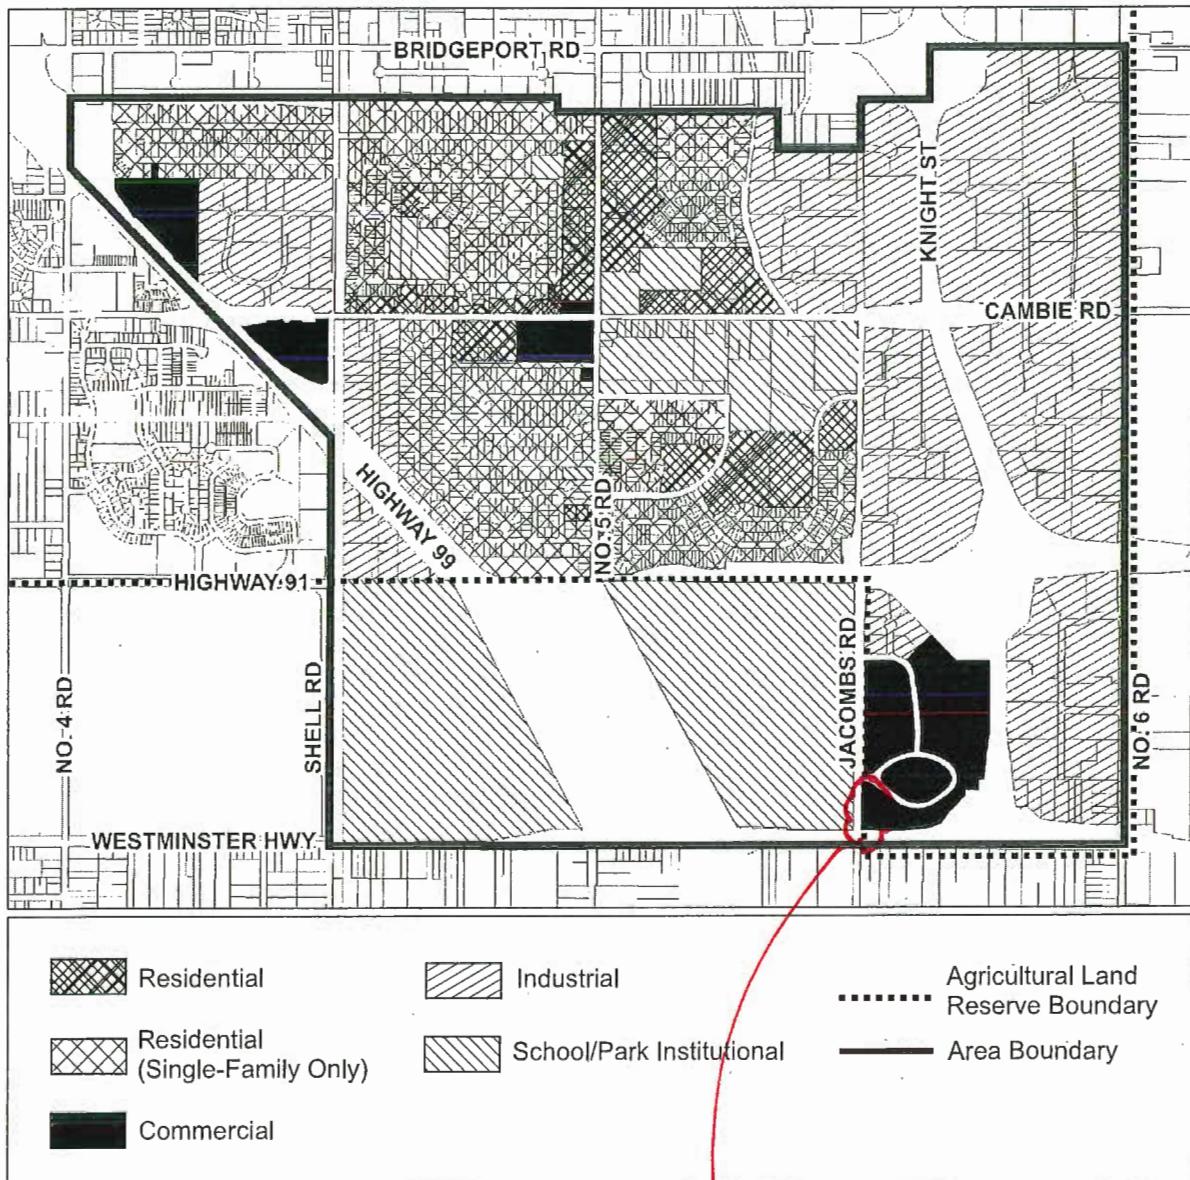



**City of
Richmond**

Development Application Data Sheet
Development Applications Department

ATTACHMENT 3

ZT 18-818765

Attachment 3

Address: 13100 Smallwood Place

Applicant: Christopher Bozyk Architects

Planning Area(s): East Cambie

	Existing	Proposed
Owner:	Multiland Pacific Holdings	Same
Site Size (m²):	15,924 m ² (171,404.51 ft ²)	Same
Land Uses:	Auto Dealership And Service	Same
OCP Designation:	Commercial	Same
Area Plan Designation:	Commercial	Same
Zoning:	Vehicle Sales (CV)	Vehicle Sales (CV) with increased FAR to 0.82 at 13100 Smallwood Place

On Future Subdivided Lots	Bylaw Requirement	Proposed	Variance
Floor Area Ratio:	0.7 FAR	0.82 FAR	None permitted
Buildable Floor Area (m ²):*	11,146.8 m ² (119,983.2 ft ²)	12,996.3 m ² (139,891 ft ²)	None permitted
Lot Coverage (% of lot area):	Building: Max. 50%	Building: Max. 38%	None
Setback Front - North	Min 3.0 M	16.0 M	None
Setback Side – East	Min 3.0m	20.38m	None
Setback Side - West	Min 3.0m	22.5m Main Building 3.0m Car Wash Building	None
Setback Rear - South	Min 3.0m	10.63m Main Building 3.0m Garbage Enclosure	None
Height (m):	Max building height: 12.0 m with variance to 15.44 m at elevator overrun, stairway structures, storage and screened equipment as approved under DP 16-741123	Increased parkade rooftop height at 15.46 m, a parapet height of 16.88 m, a stair tower of 18.51 m and an elevator over- run of 20.39 m	Variance to be considered as part of DP18-818762
Off-street Parking Spaces – Staff and Visitor	281	296	none
Off-street Parking Spaces – Vehicle Inventory:	N/A	279	none

Other: _____



PLN - 111



PLN - 112

OpenRoad Toyota Richmond

CHRISTOPHER ROZYK ARCHITECTS LTD
PROJECT NUMBER 0214007
416 51 FAZAKERLEY STREET VANCOUVER BC V6A 1E1
TEL 604 541 0000 FAX 604 541 0001
E-MAIL: info@christopherrozyk.com
URL: www.christopherrozyk.com

Copyright notice:
All rights reserved. All design, design drawings, and architectural drawings, plans, and specifications, either partially or entirely, contained in this document are the sole and exclusive property of Christopher Rozyk Architects Ltd. They are to be used only by the client and his architect and are not to be reproduced, copied, or distributed without the prior written consent of Christopher Rozyk Architects Ltd. Any unauthorized use, reproduction, copying, or distribution of these documents will result in criminal prosecution.

NORTH WEST ELEVATION

SCALE: 1:200
DATE: SEPT 26, 2018

DP.002



PLN - 113

OpenRoad Toyota Richmond

PROJECT NUMBER: 21000

CHRISTOPHER BOZYK ARCHITECTS LTD
100 GLENMAGGIES STREET VANCOUVER BC V6A 1E1
TEL: 604.541.1000 FAX: 604.541.1001

PIC DATE: 09/26/2011 11:37 AM

COPYRIGHT NOTICE:
All rights reserved. All rights, designs, drawings and other information, either of print or electronic form, contained in this drawing or any part thereof, is the sole and exclusive property of OpenRoad Toyota Richmond Ltd., and is protected by law.
Unauthorized copying or reproduction of the entire plan or any portion thereof, is prohibited.

VIEW FROM WESTMINSTER HIGHWAY

SCALE:

DATE:


SEPT 26, 2018

DP.003

CHRISTOPHER
BOZYK ARCHITECTS LTD

44-41 ALDERMAN STREET VICTORIA BC V8W 1H1

PHONE (250) 513-5494 FAX (250) 513-5494

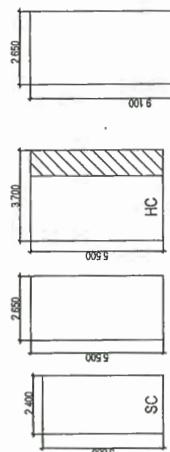

④ TYPICAL PARKING & LOADING LAYOUT
NTS

PROPERTY STATISTICS:	
PROJECT NAME:	OPENROAD TOYOTA SHOWROOM
CIVIC ADDRESS:	13100 SMALLWOOD PLACE, RICHMOND BC V6V 1W8
LEGAL ADDRESS:	Unit 7-8 & Blk 4 N New Rd, Richmond, BC V6V 7Z8
ZONING:	CV
AUTHORITY:	CITY OF RICHMOND
USES:	CAR SHOWROOM
LOT AREA:	15,922.14 m ²
FLOOR AREA:	PROPOSED
MAIN FLOOR:	PREVIOUS
2ND FLOOR:	5,055.31 m ²
3RD FLOOR:	4,823.15 m ²
4TH FLOOR:	3,935.12 m ²
5TH FLOOR:	786.54 m ²
CAR WASH:	3,176.01 m ²
TOTAL:	17,915.12 m ²
LOT COVERAGE:	12,986.21 m ²
MAIN FLOOR:	16,10,25 16,10,25 16,10,25
GARBAGE ENCL:	16,10,25 16,10,25 16,10,25
CAR WASH:	16,10,25 16,10,25 16,10,25
% TOTAL:	27.77%
FAR:	1.0
% LANDSCAPE:	9.14% (1,456.8 m ²)
SETBACKS:	15.0M - GARBAGE ENCL, 3.0M SOUTH: 10.15M - GARBAGE ENCL, 3.0M EAST: 20.38M - GARBAGE ENCL, 3.0M WEST: 22.5M - GARBAGE ENCL, 3.0M
BIKE PARKING:	36 CLASS I + 36 CLASS 2
VEHICULAR PARKING:	SURFACE PARKING: 157 INCL 6 DISABLED PARKING SPACES AND SMALL SPACES
LOADING SPACES:	4 REQUIRED, 1 PROVIDED, VARIANCE PER PREVIOUS DP APP
CONSTRUCTION:	1 PROVIDED, VARIANCE PER PREVIOUS DP APP
DISPOSITION:	1 PROVIDED, VARIANCE PER PREVIOUS DP APP

PLAN #1
DP0.04

PROJECT NUMBER: DP-18-818752

SCALE: 1" = 20'-0"

DATE: Jan. 1, 2014

DRAWN BY: J. H. BROWN

REVIEWED BY: J. H. BROWN

APPROVED BY: J. H. BROWN

PLANNED BY: J. H. BROWN

DESIGNED BY: J. H. BROWN

MADE BY: J. H. BROWN

PRINTED BY: J. H. BROWN

RECORDED BY: J. H. BROWN

FILED BY: J. H. BROWN

SEARCHED BY: J. H. BROWN

INDEXED BY: J. H. BROWN

COPIED BY: J. H. BROWN

FILED BY: J. H. BROWN

SEARCHED BY: J. H. BROWN

INDEXED BY: J. H. BROWN

COPIED BY: J. H. BROWN

FILED BY: J. H. BROWN

SEARCHED BY: J. H. BROWN

NUMBER	DATE	DESCRIPTION
1	10/10/00	RECEIVED FOR APPROVAL
2	10/10/00	RECEIVED FOR APPROVAL

CONTRACT NOTICE:
Architectural drawings, including all floor plans, sections, elevations, details, and other drawings, are the property of Christopher Boztk Architects Ltd. They are to be used only by the architect or his/her firm, or by the client, as part of the services furnished by the architect. Any unauthorized use, sale, or distribution of the drawings, or any portion thereof, without the express written permission of the architect, will result in legal action.


OpenRoad Toyota Richmond
DP 18-818762
11100 SMALL WOOD PLACE, RICHMOND, BC

LEVEL 1
1 GROUND FLOOR PLAN
1' = 30'-0"

SCALE: 1" = 25'-0"
DATE: SEP/78 2010
PROJECT NUMBER:
11100 SMALL WOOD PLACE, RICHMOND, BC

PLAN #1A
DP.005

1 GROUND FLOOR PLAN
1' = 30'-0"

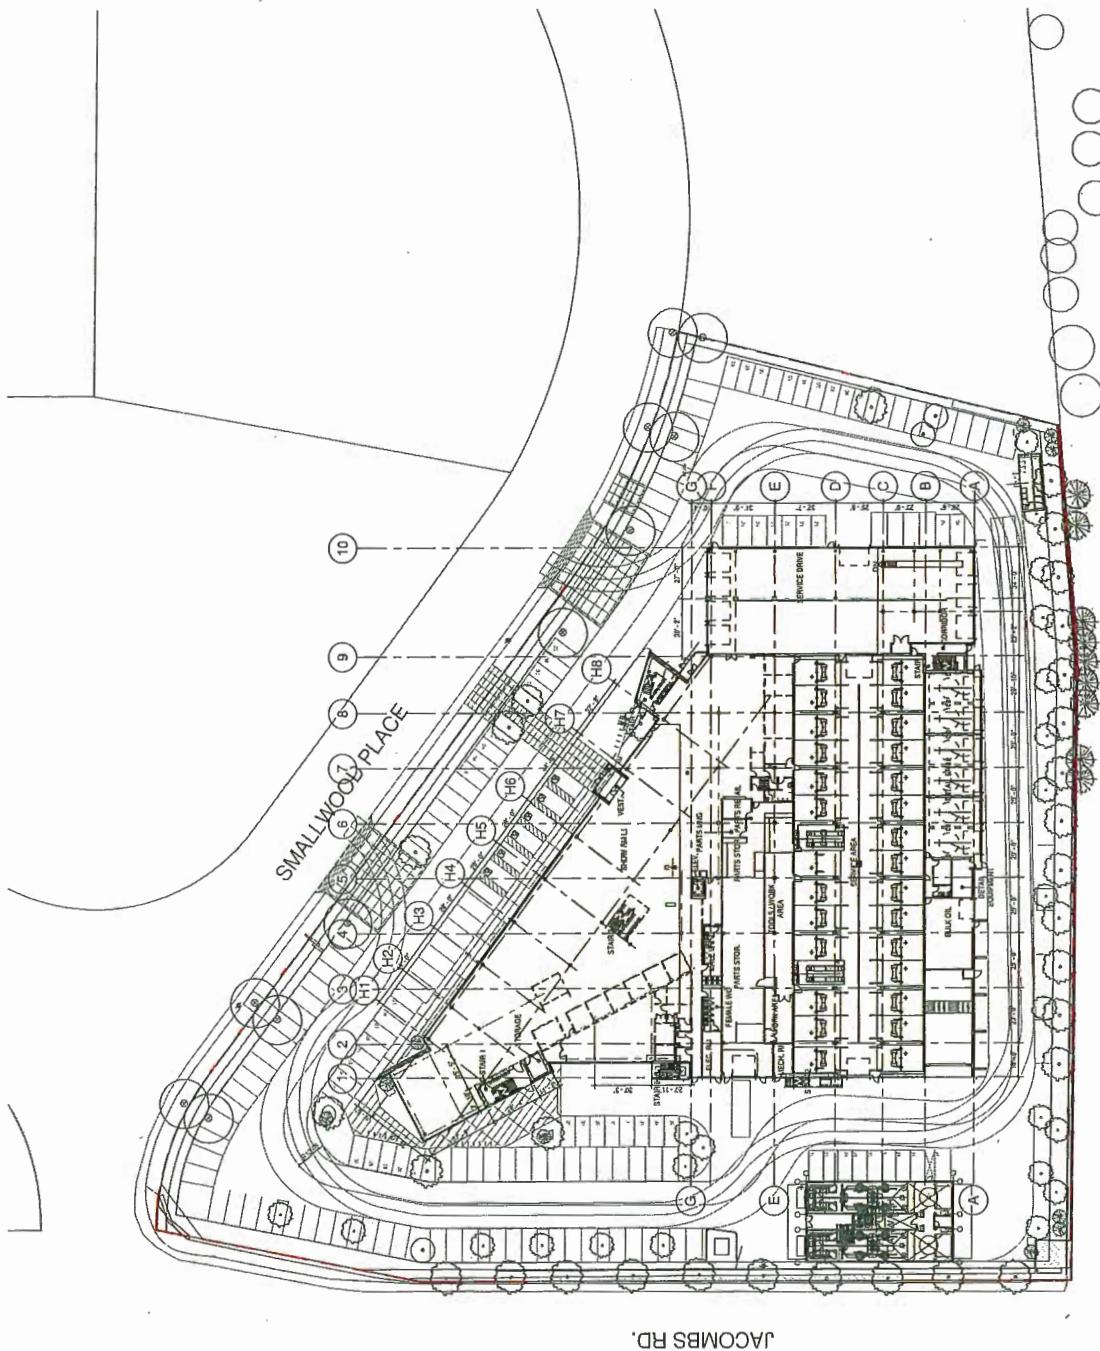


PLAN #1B


DP.006

DATE: SEPTEMBER 2015
SCALE: 1" = 10' 0"
PROJECT NUMBER:
DRAFTER: [Signature]
REVIEWER: [Signature]

1 SECOND FLOOR PLAN

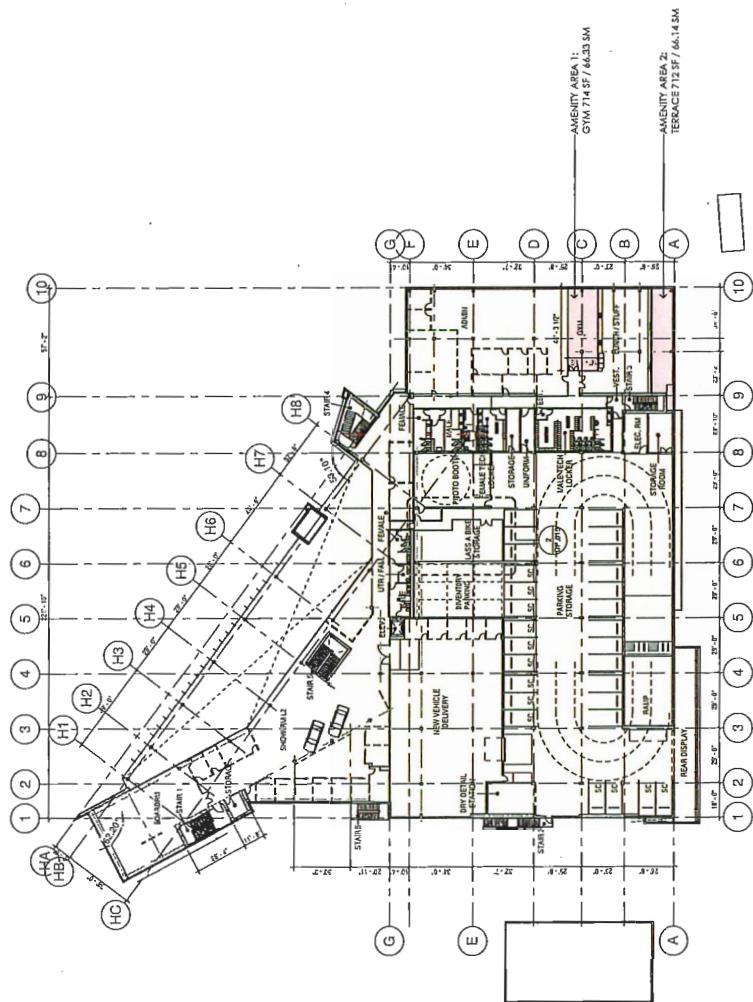

PLAN #1C
DP.007

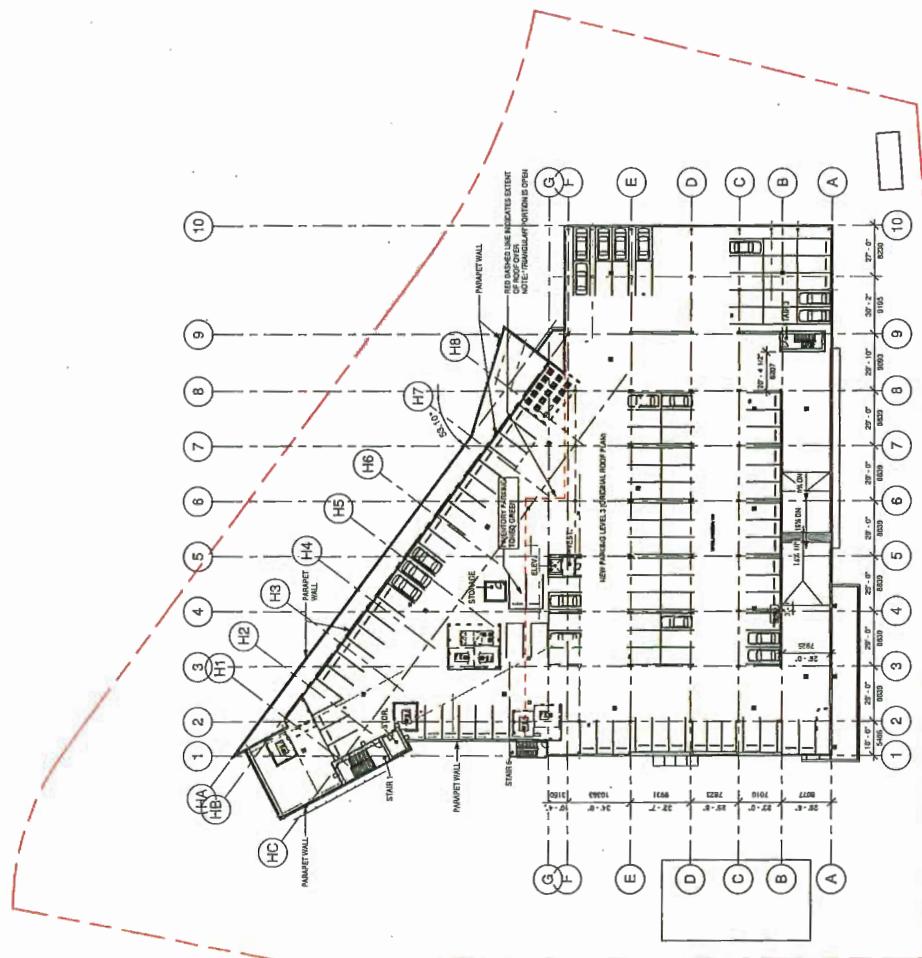

REASON FOR DISMISSEMENT	
REASON	DATE
1. 16.05.25 CORPORATE NOTICE.	15.06.11 ISSUED FOR DISMISSEMENT

Corporate Notice. At Name, during and throughout a period of time from 16.05.25 to 15.06.11, you have been employed by us as an employee of our company. However, as of today, I hereby terminate, discharge and release you from your employment with us. Please note that you are responsible to report any information to your tax office.

Corporate Notice. We provide all relevant information, conditions and rules of employment to all documents and contracts you have signed with us. If you have any questions or comments about the job, you can contact us at any time. We will do our best to answer your questions and help you. If you have any concerns or complaints, please let us know. We will do our best to resolve them. Thank you for your hard work and dedication. We hope you will find success in your future endeavors.

OpenRoad Toyota Richmond

DP 18-818762

1310 WOOD PLACE, RICHMOND, BC

OpenRoad Toyota Richmond


DP 18-818762

13100 SMALL WORLD

DATE: SEPT 27, 2018
SCALE: 1' = 10'-0"
PROJECT NAME: _____

PLAN #1D

DP-008

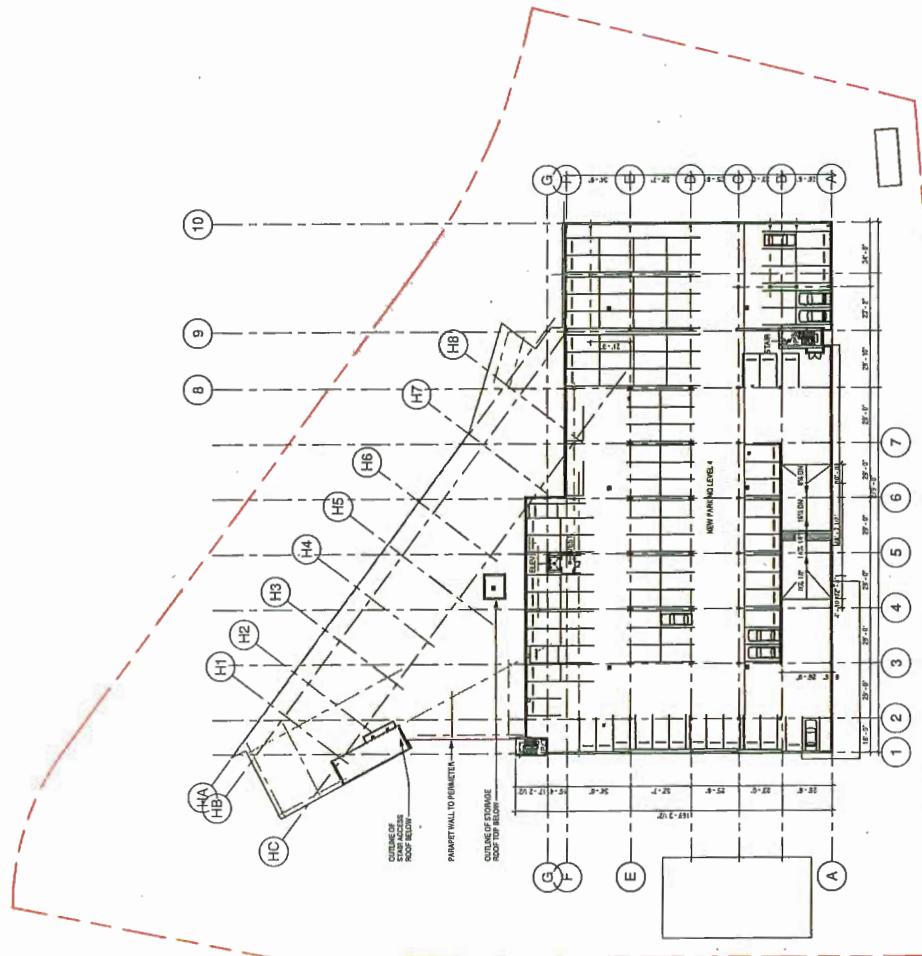

1 ADDITIONAL PARKING LEVEL 1

POSITION	DATE	DESCRIPTION
2	11.06.19	RECEIVED DRAWING FOR APPROVAL
1	11.06.19	SIGNED DRAWING FOR APPROVAL

POSITION	DATE	DESCRIPTION
1	11.06.19	RECEIVED DRAWING FOR APPROVAL
2	11.06.19	SIGNED DRAWING FOR APPROVAL

POSITION	DATE	DESCRIPTION
1	11.06.19	RECEIVED DRAWING FOR APPROVAL
2	11.06.19	SIGNED DRAWING FOR APPROVAL

POSITION	DATE	DESCRIPTION
1	11.06.19	RECEIVED DRAWING FOR APPROVAL
2	11.06.19	SIGNED DRAWING FOR APPROVAL


POSITION	DATE	DESCRIPTION
1	11.06.19	RECEIVED DRAWING FOR APPROVAL
2	11.06.19	SIGNED DRAWING FOR APPROVAL



POSITION	DATE	DESCRIPTION
1	11.06.19	RECEIVED DRAWING FOR APPROVAL
2	11.06.19	SIGNED DRAWING FOR APPROVAL

PLAN #1E
DP.009


1 ADDITIONAL PARKING LEVEL 2

1 ADDITIONAL PARKING LEVEL 2

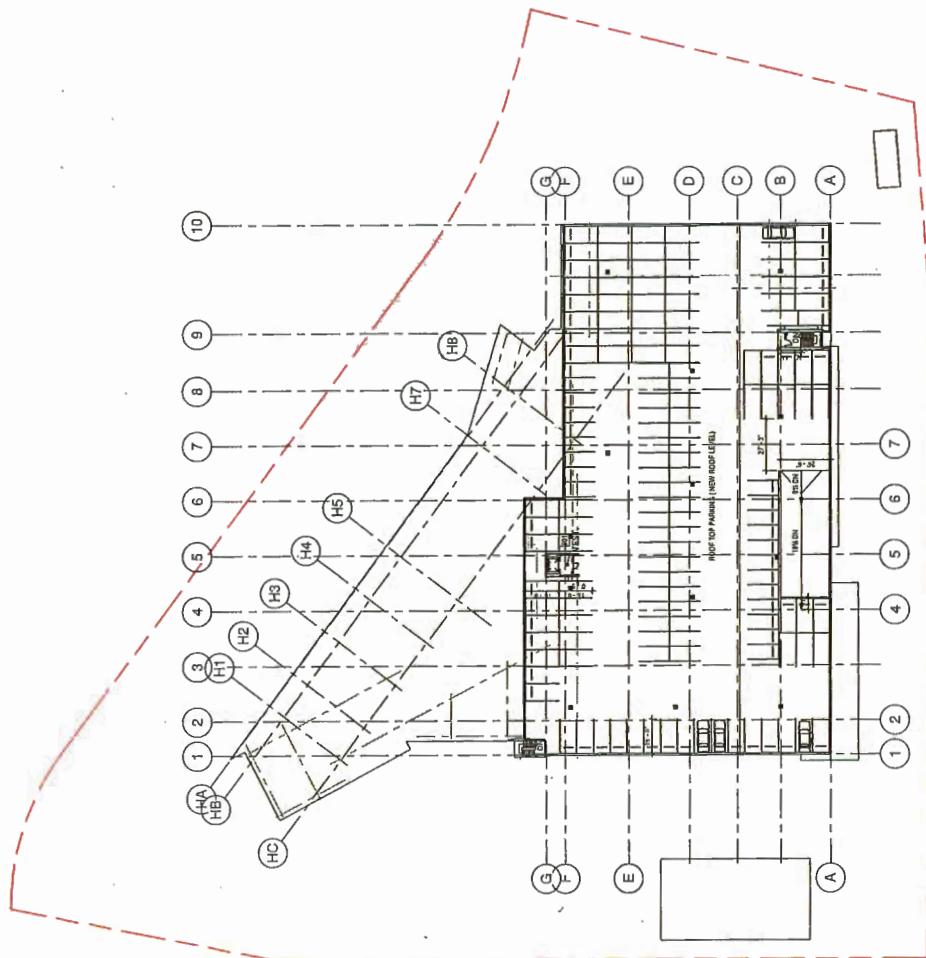


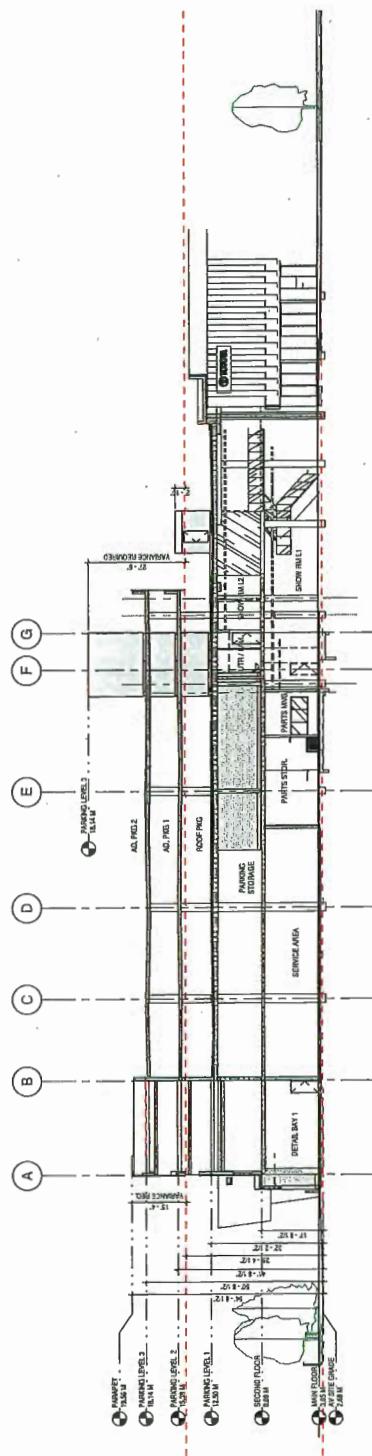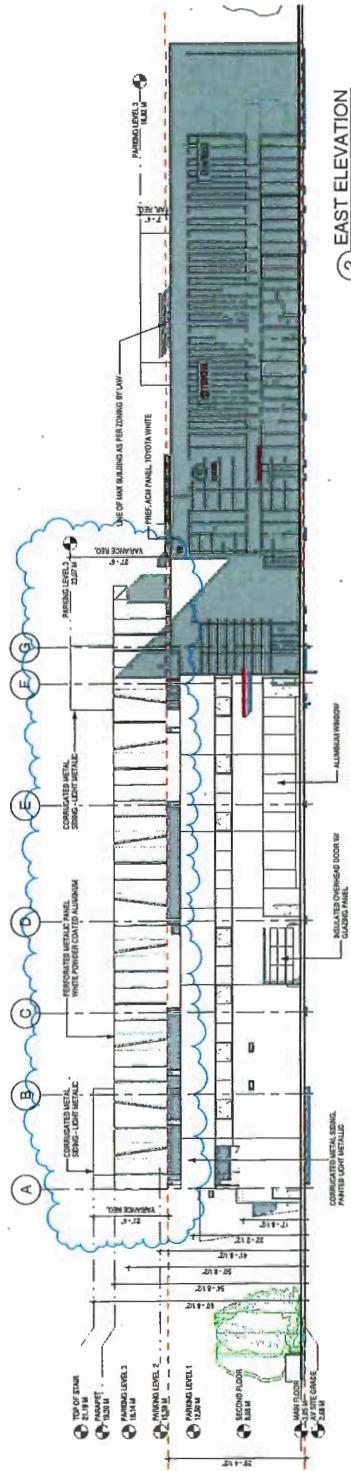

PLN - 120

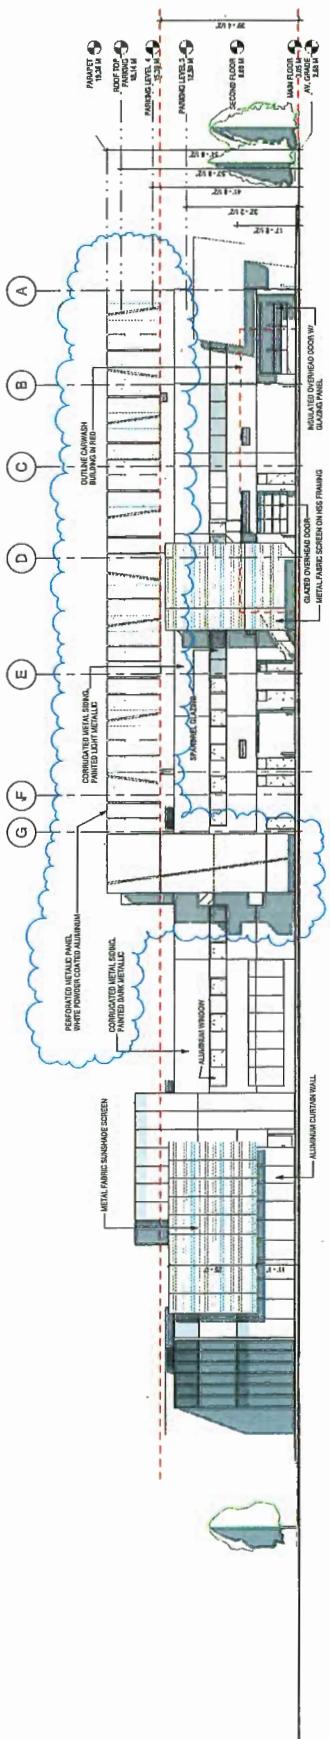

PLN - 121

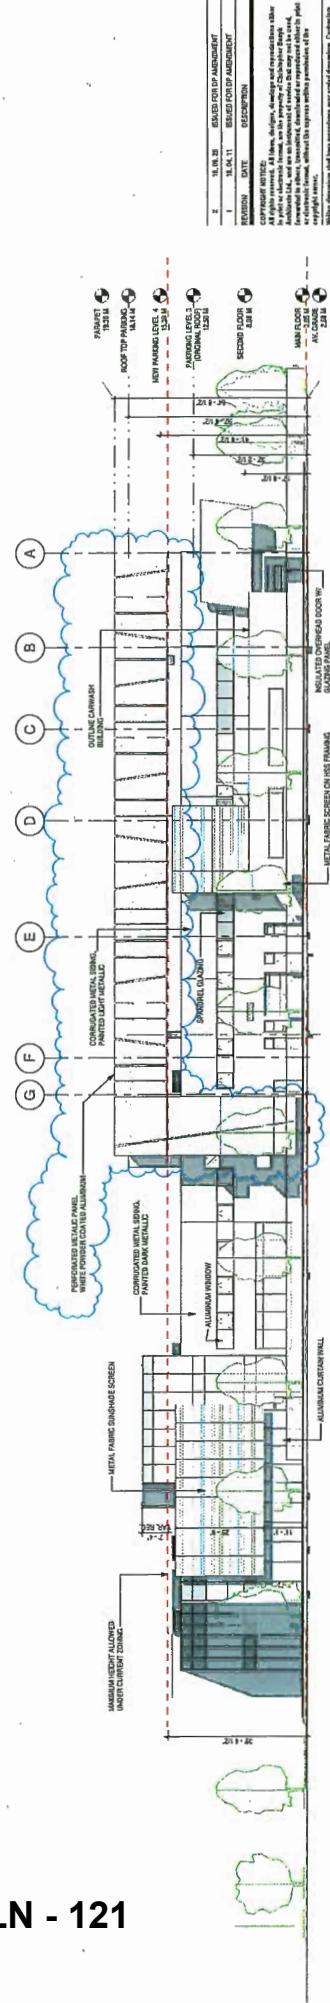

OpenRoad
TOYOTA RICHMOND

DP 18-818762

JACOBI'S ROAD
ELEVATION

DATE: SEP 7, 2014

PROJECT NUMBER: 2007



SCALE: 1/16'-0"

DP 18-818762

DATE: SEP 7, 2014

PROJECT NUMBER: 2007

**PLAN #5
DP.011**

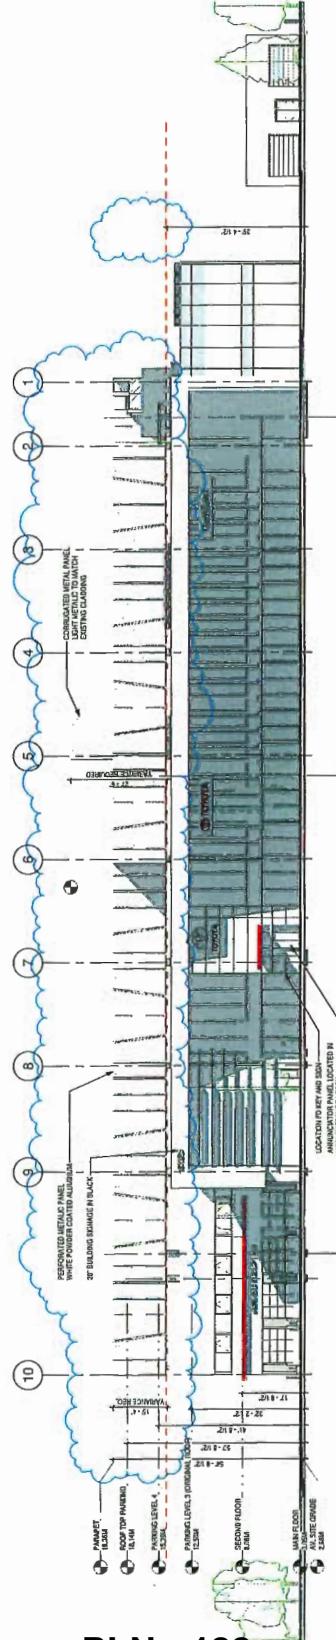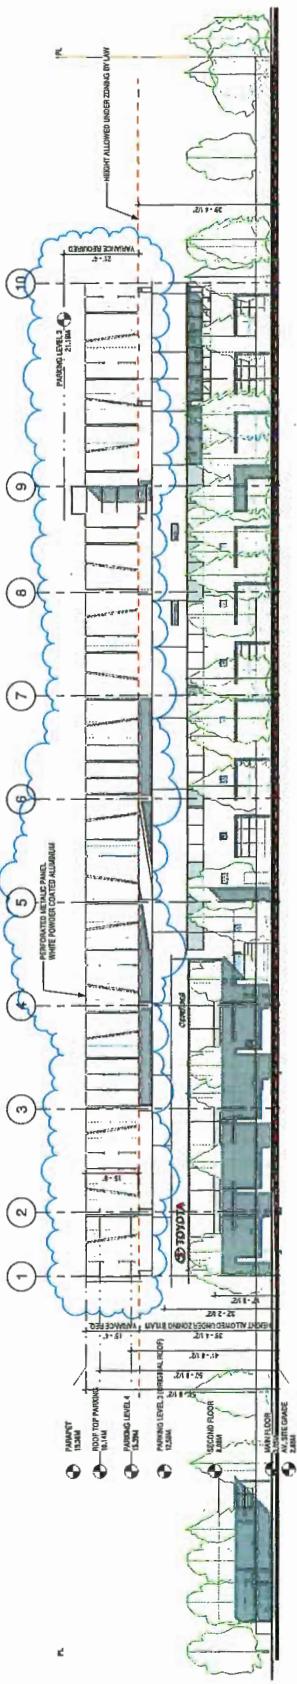

PLN - 122

OpenRoad
AUTO GROUP

AUTO GROUP

		18.09.05	ISSUED FOR DP AMENDMENT
	NAME	DATE	ISSUED FOR DP AMENDMENT
1		18.04.11	
COPYRIGHT NOTICE:			
All rights reserved. All items, documents and reproductions either in whole or in part, are the copyright of the Commonwealth of Australia. They may not be reproduced without the prior written consent of the Commonwealth of Australia.			

Within a democratic and free press system, journalists and their sources are responsible for documents and comments on the job; they must be held accountable for errors, discrepancies, or libelous information contained in them.

OpenRoad Toyota Richmond
DP 18-818762

13100 SMALL WOOD PLACE, RICHMOND, BC


**ELEVATIONS AND
SECTIONS**

SCALE: VIII" = 1'-0" DATE: SEP 28, 1918 DRAWN BY
PROJECT NAME: DR. ANTHONY #6
21407

PLAN #0 DP-012


FBI Lab Report - 11-02-2004

SECTION THROUGH RAMP

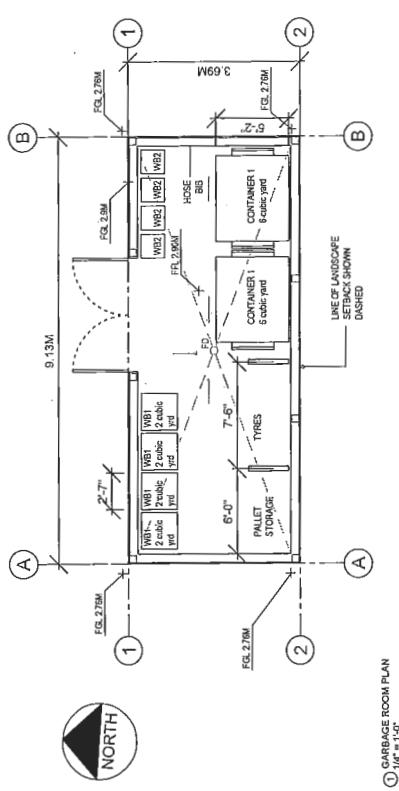


① GARBAGE ROOM PLAN


PLN - 124

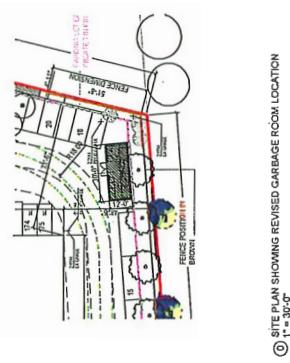


© SITE PLAN SHOWING REVISED GARBAGE ROOM LOCATION
④ 1'-30"-0"

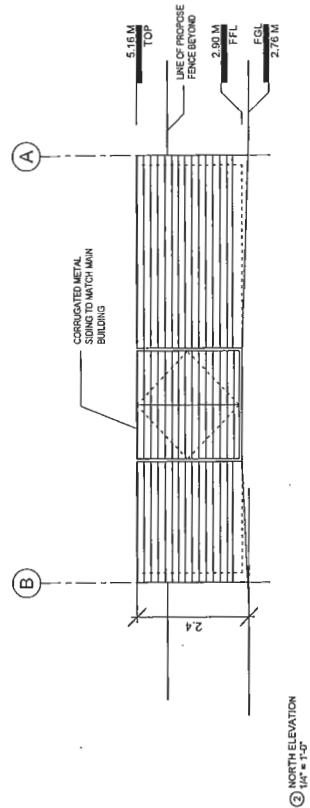


(2) NORTH ELEVATION

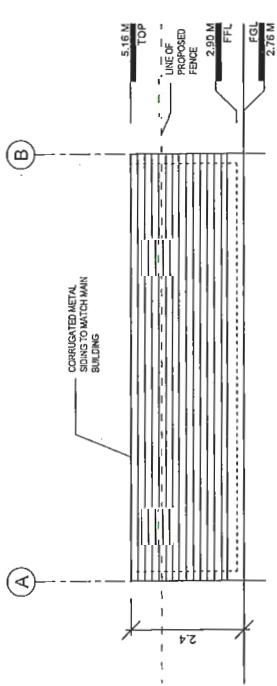

(3) SOUTH ELEVATION
1/4" = 1'-0"

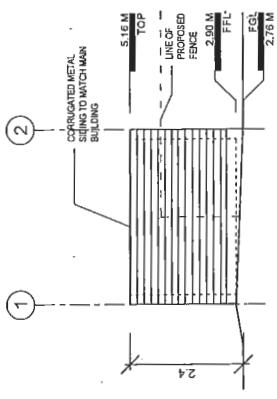

(5) WEST ELEVATION
1/4" = 1' 0"

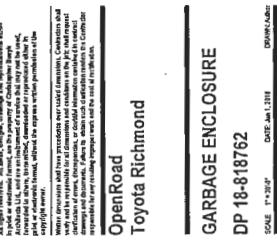

0001!

DP0.31

CONNETI LANDSCAPE ARCHITECTURE INC. DOES NOT GUARANTEE THE EXISTENCE, LOCATION, AND ELEVATION OF UTILITIES AND/OR CONCEALED STRUCTURES AT THE PROJECT SITE.

THE CONTRACTOR IS RESPONSIBLE FOR DETECTING THE EXISTENCE, LOCATION, AND ELEVATION OF ALL UTILITIES AND/OR

CHRISTOPHER BOZYK ARCHITECTS


PLAN #3B

	ISSUED FOR DP	ISSUED FOR AP	ISSUED FOR BH	ISSUED FOR PIP	ISSUED FOR AP	ISSUED FOR BH	ISSUED FOR PIP
11	RE-ISSUED FOR DP	18-05-24					
12	ISSUED FOR CONSTRUCTION	18-05-24					
13	FOR CREDIT REFERRED BP	17-05-19					
14	ISSUED FOR REBATE	17-11-20					
15	ISSUED FOR BUDGETING	17-05-24					
16	ISSUED FOR DPH	17-05-24					
17	ISSUED FOR DP	17-05-07					
18	RE-ISSUED FOR AP	12-05-20					
19	RE-ISSUED FOR BH	17-05-19					
20	RE-ISSUED FOR PIP	17-05-24					
21	ISSUED FOR BUDGETING	17-05-24					
22	ISSUED FOR DPH	18-11-25					
23	ISSUED FOR AP	18-05-24					
24	ISSUED FOR BH	18-05-24					
25	ISSUED FOR PIP	18-05-24					
26	ISSUED FOR AP	18-05-24					
27	ISSUED FOR BH	18-05-24					
28	ISSUED FOR PIP	18-05-24					

OPENROAD TOYOTA

Scale:	1:300
Drawn by:	KL
Reviewed by:	
Project No.	06-490
LANDSCAPE	
TREE MANAGEMENT	

101

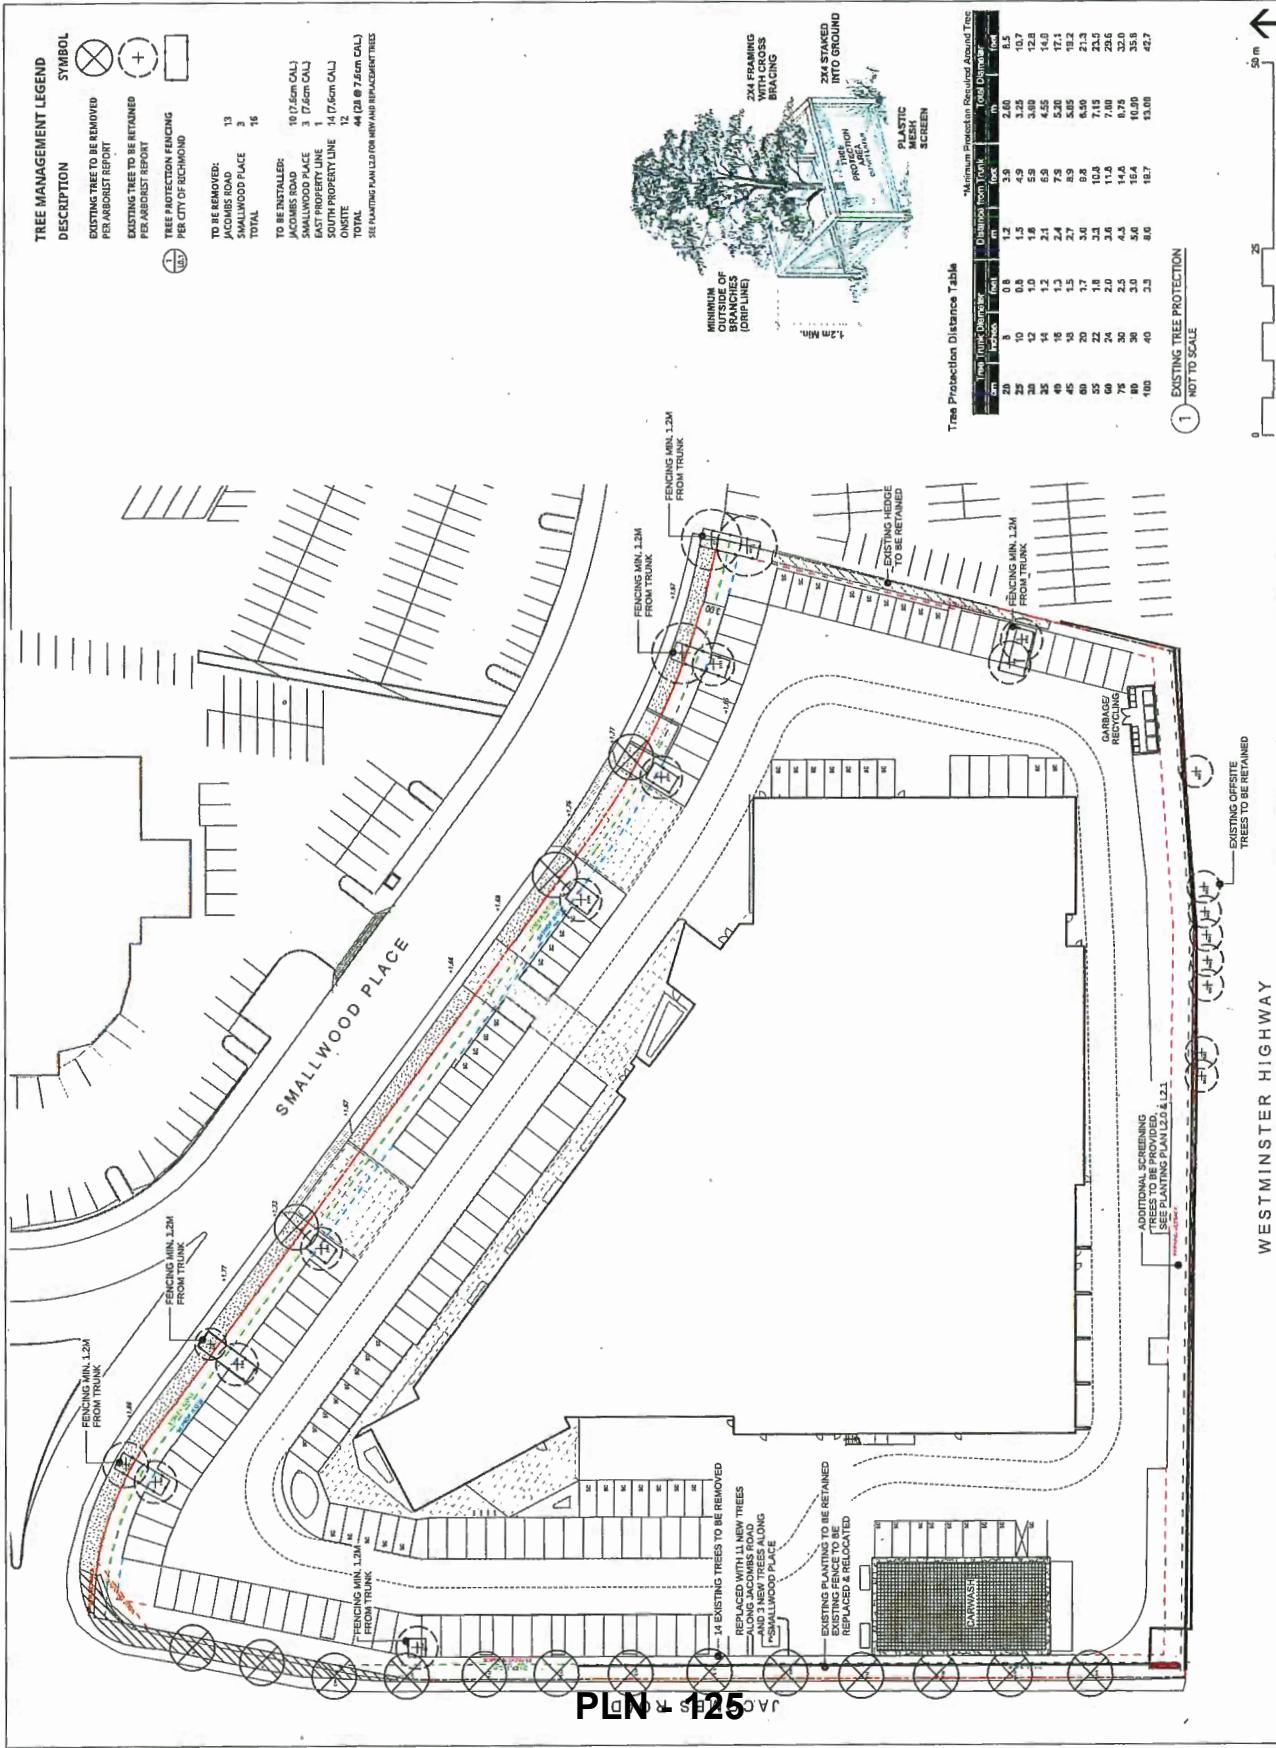


CONNECT LANDSCAPE ARCHITECTURE INC. DOES NOT GUARANTEE THE EXISTENCE, LOCATION, ELEVATION OF UTILITIES AND/OR CONCEALED STRUCTURES AT THE PROJECT SITE.

THE CONTRACTOR IS RESPONSIBLE FOR DETERMINING THE EXISTENCE, LOCATION, AND ELEVATION OF ALL UTILITIES AND / OR CONCEALED STRUCTURES, AND IS RESPONSIBLE

FOR NOTIFYING THE APPROPRIATE COMPANY,
DEPARTMENT OR PERSON(S) OF ITS INTENTION
TO CARRY OUT ITS OPERATIONS.

ARCHITECT:
CHRISTOPHER BOZYSK ARCHITECTS

PLAN #3C

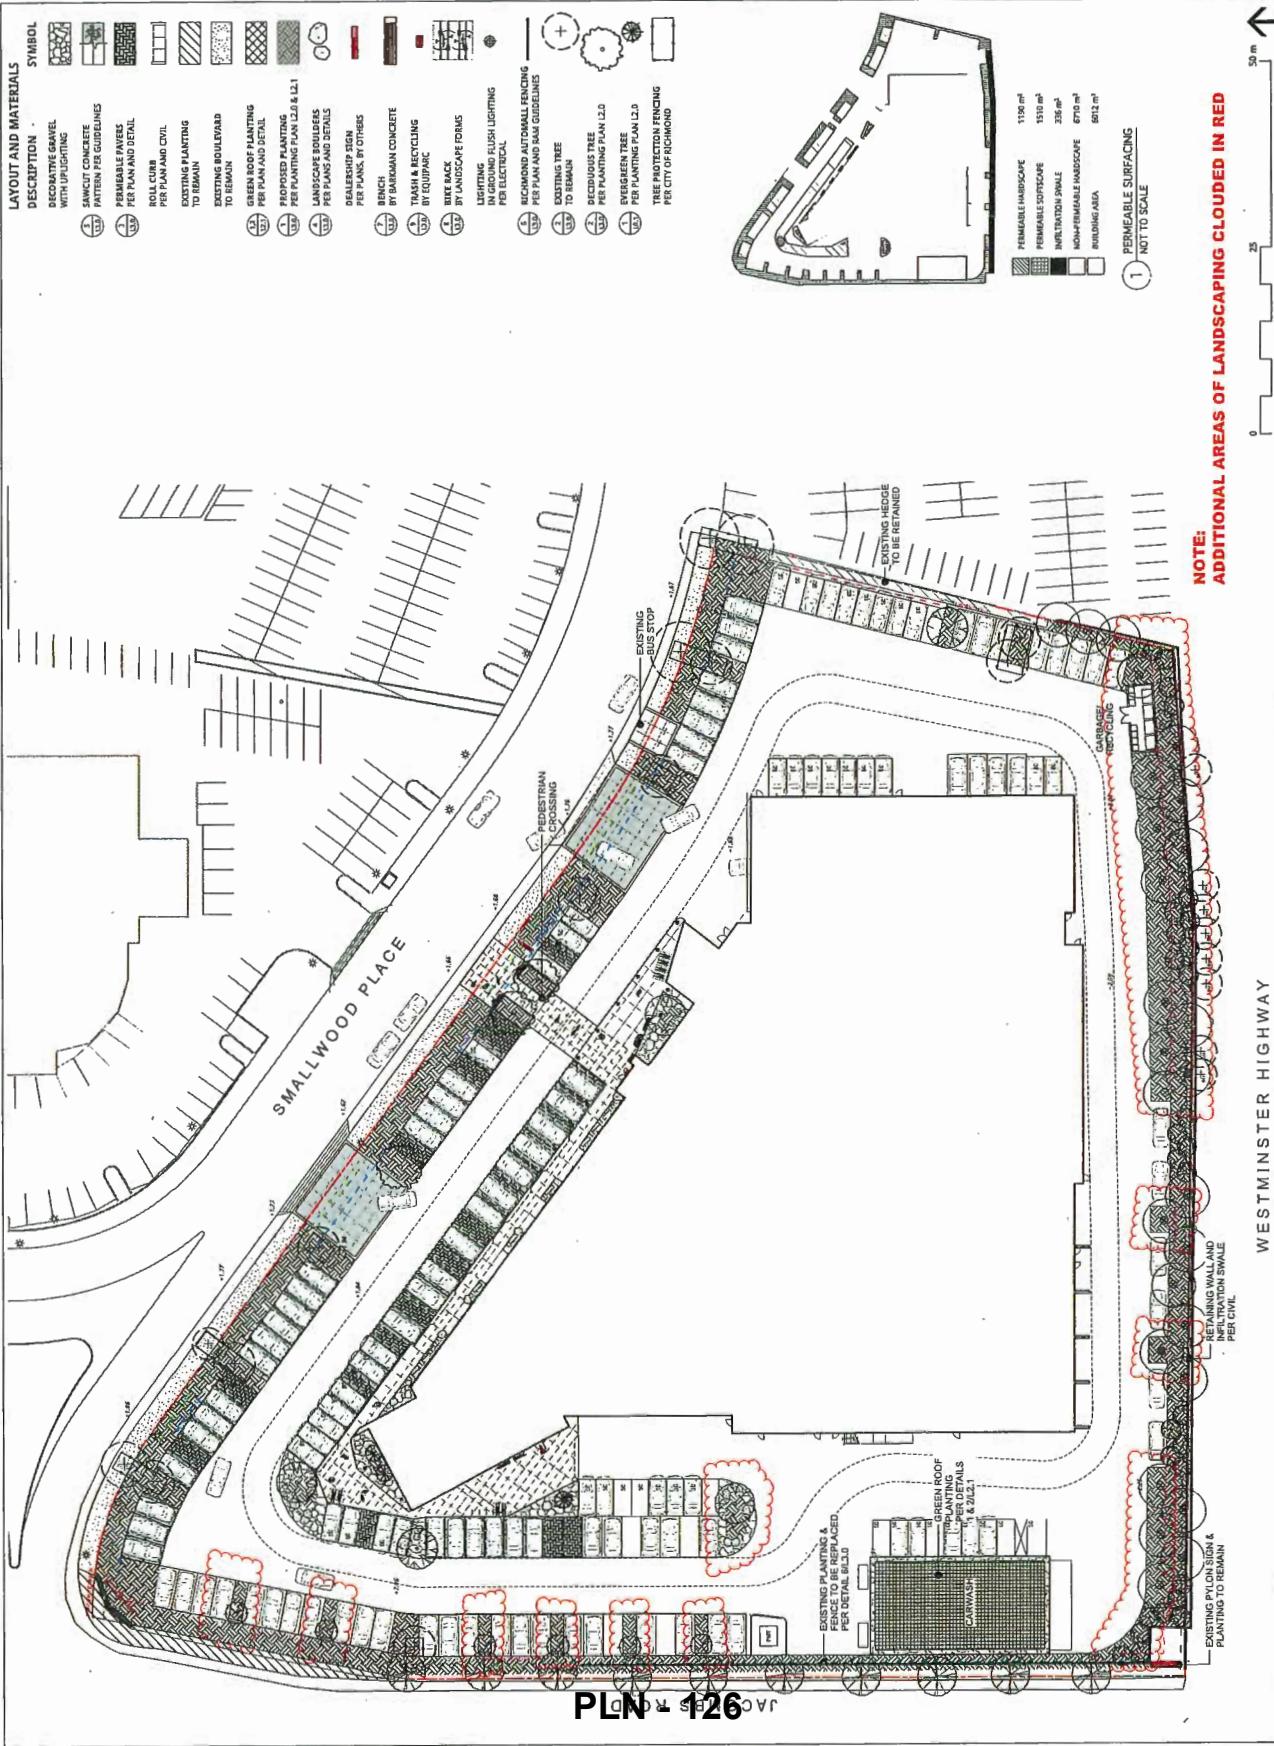

CONNECT LANDSCAPE ARCHITECTURE INC. DOES NOT GUARANTEE THE EXISTENCE, LOCATION, AND RELATION OF UTILITIES AND OR CONCEALED STRUCTURES AT THE PROJECT SITE.
THE CONTRACTOR IS RESPONSIBLE FOR DETERMINING THE EXISTENCE, LOCATION, AND ELEVATION OF ALL UTILITIES AND OR CONCEALED STRUCTURES, AND IS RESPONSIBLE FOR NOTIFYING THE APPROPRIATE COMPANY, DEPARTMENT OR PERSONS OF ITS INTENTION TO CARRY OUT ITS OPERATIONS.

ARCHITECT:
CHRISTOPHER BOZYK, ARCHITECTS

PLAN #3D

13	REISSUED FOR DP	14-05-26
12	ISSUED FOR CONSTRUCTION	18-02-23
31	ISSUED FOR REVISED RP	27-12-13
10	ISSUED FOR TRADE	12-11-20
9	REISSUED FOR DP	17-05-29
8	ISSUED FOR RP	17-05-07
7	REISSUED FOR DP	17-05-20
6	REISSUED FOR DP	17-05-19
5	ISSUED FOR MARKETING	17-05-24
4	REISSUED FOR DP	17-05-20
3	ISSUED FOR RP	18-11-25
2	ISSUED FOR DP	16-07-27
1	ISSUED FOR CLIENT REVIEW	16-06-20
	REVISIONS	

OPENROAD TOYOTA

13100 -Smallwood Place
Richmond, British Columbia
Scale: 1:150
Drawn: KD
Reviewed: KL
Project No.: 06-490
LANDSCAPE ENLARGEMENTS

L1.1



2 CORNER ENLARGEMENT PLAN

Sale: 1:160

1 MAIN ENTRY ENLARGEMENT

Scale: 1:160

PLN - 127

CONCIE LANDSCAPE ARCHITECTURE INC. DOES
NOT GUARANTEE THE EXISTENCE, LOCATION,
AND LOCATION OF UTILITIES AND OR
CONCEALED STRUCTURES AT THIS PROJECT SITE.
THE CONTRACTOR IS RESPONSIBLE FOR
DETERMINING THE EXISTENCE, LOCATION, AND
LOCATION OF UTILITIES AND OR
CONCEALED STRUCTURES, AND IS RESPONSIBLE
FOR NOTIFYING THE APPROPRIATE COMPANY,
DEPARTMENT OR PERSON(S) OF ITS INTENTION
TO CARRY OUT ITS OPERATIONS.


ARCHITECT:
CHRISTOPHER BOZYK, ARCHITECTS

PLAN #3E

13	REISSUED FOR DP	28-05-26
12	ISSUED FOR CONSTRUCTION	18-05-26
11	ISSUED FOR REVESS BP	17-12-13
10	ISSUED FOR TENDER	12-11-20
9	ISSUED FOR DP	17-06-26
8	ISSUED FOR ADP	17-06-27
7	REISSUED FOR DP	17-05-20
6	REISSUED FOR DP	17-05-19
5	ISSUED FOR JUDGING	27-03-24
4	REISSUED FOR DP	17-03-09
3	ISSUED FOR BP	18-11-26
2	ISSUED FOR DP	16-01-27
1	ISSUED FOR CLIENT REVIEW	14-06-23


OPENROAD TOYOTA

13100 Smallwood Place	Richmond, British Columbia
Scale:	1:125
Drawn:	KD
Reviewed:	XL
Project No.:	06-090
Landscape	LANDSCAPE LAYOUT PLAN

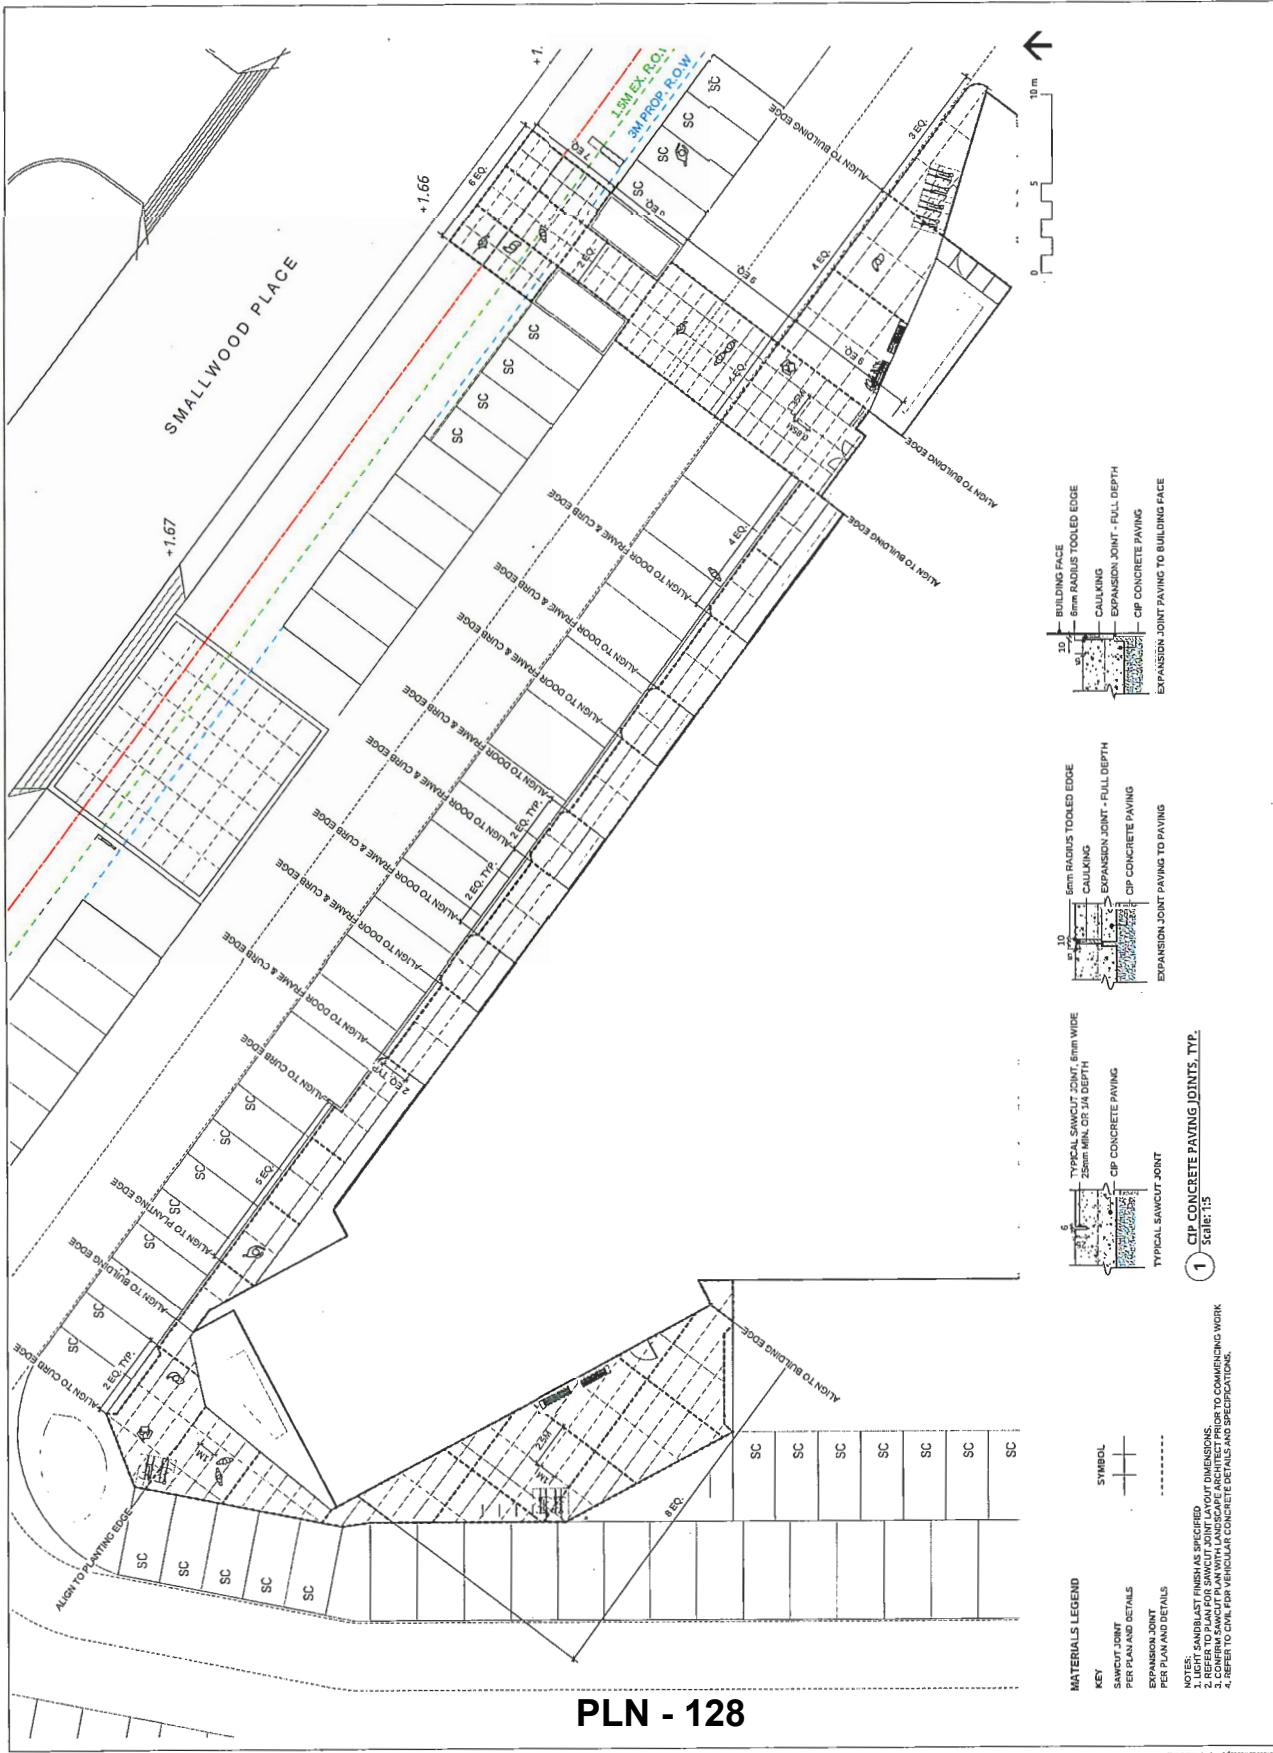

IRRIGATION NOTES

1. ALL SOFT LANDSCAPE AREAS ARE TO BE IRRIGATED WITH DESIGN BUILD HIGH EFFICIENCY AUTOMATIC IRRIGATION SYSTEM INCLUDING RAIN SENSORS, TO IAC STANDARDS.
2. ALL IRRIGATION VALVE BOXES EQUIPPED WITH QUICK-CLEANERS.
3. LANDSCAPE CONTRACTOR TO PROVIDE COMPLETE DISCHARGEABLE SERVICES FOR ALL AUTOMATIC SITE IRRIGATION WORKS, TEMPORARY ESTABLISHMENT IRRIGATION TO BE PROVIDED AT GRADE WHERE NO AUTOMATIC IRRIGATION IS PRESCRIBED.
4. IRRIGATION CONTRACTOR PERFORMING THE WORK MUST HAVE MINIMUM @ FIVE YEARS DOCUMENTED EXPERIENCE AND MEMBER IN GOOD STANDING OF THE IAC IRIGATION INDUSTRY ASSOCIATION OR BCI.
5. IRRIGATION TO CONFORM TO ALL LOCAL PLUMBING AND ELECTRICAL CODE REQUIREMENTS. CONTRACTOR IS RESPONSIBLE FOR COORDINATION WITH MECHANICAL AND ELECTRICAL CONSULTANTS AND TRADES.

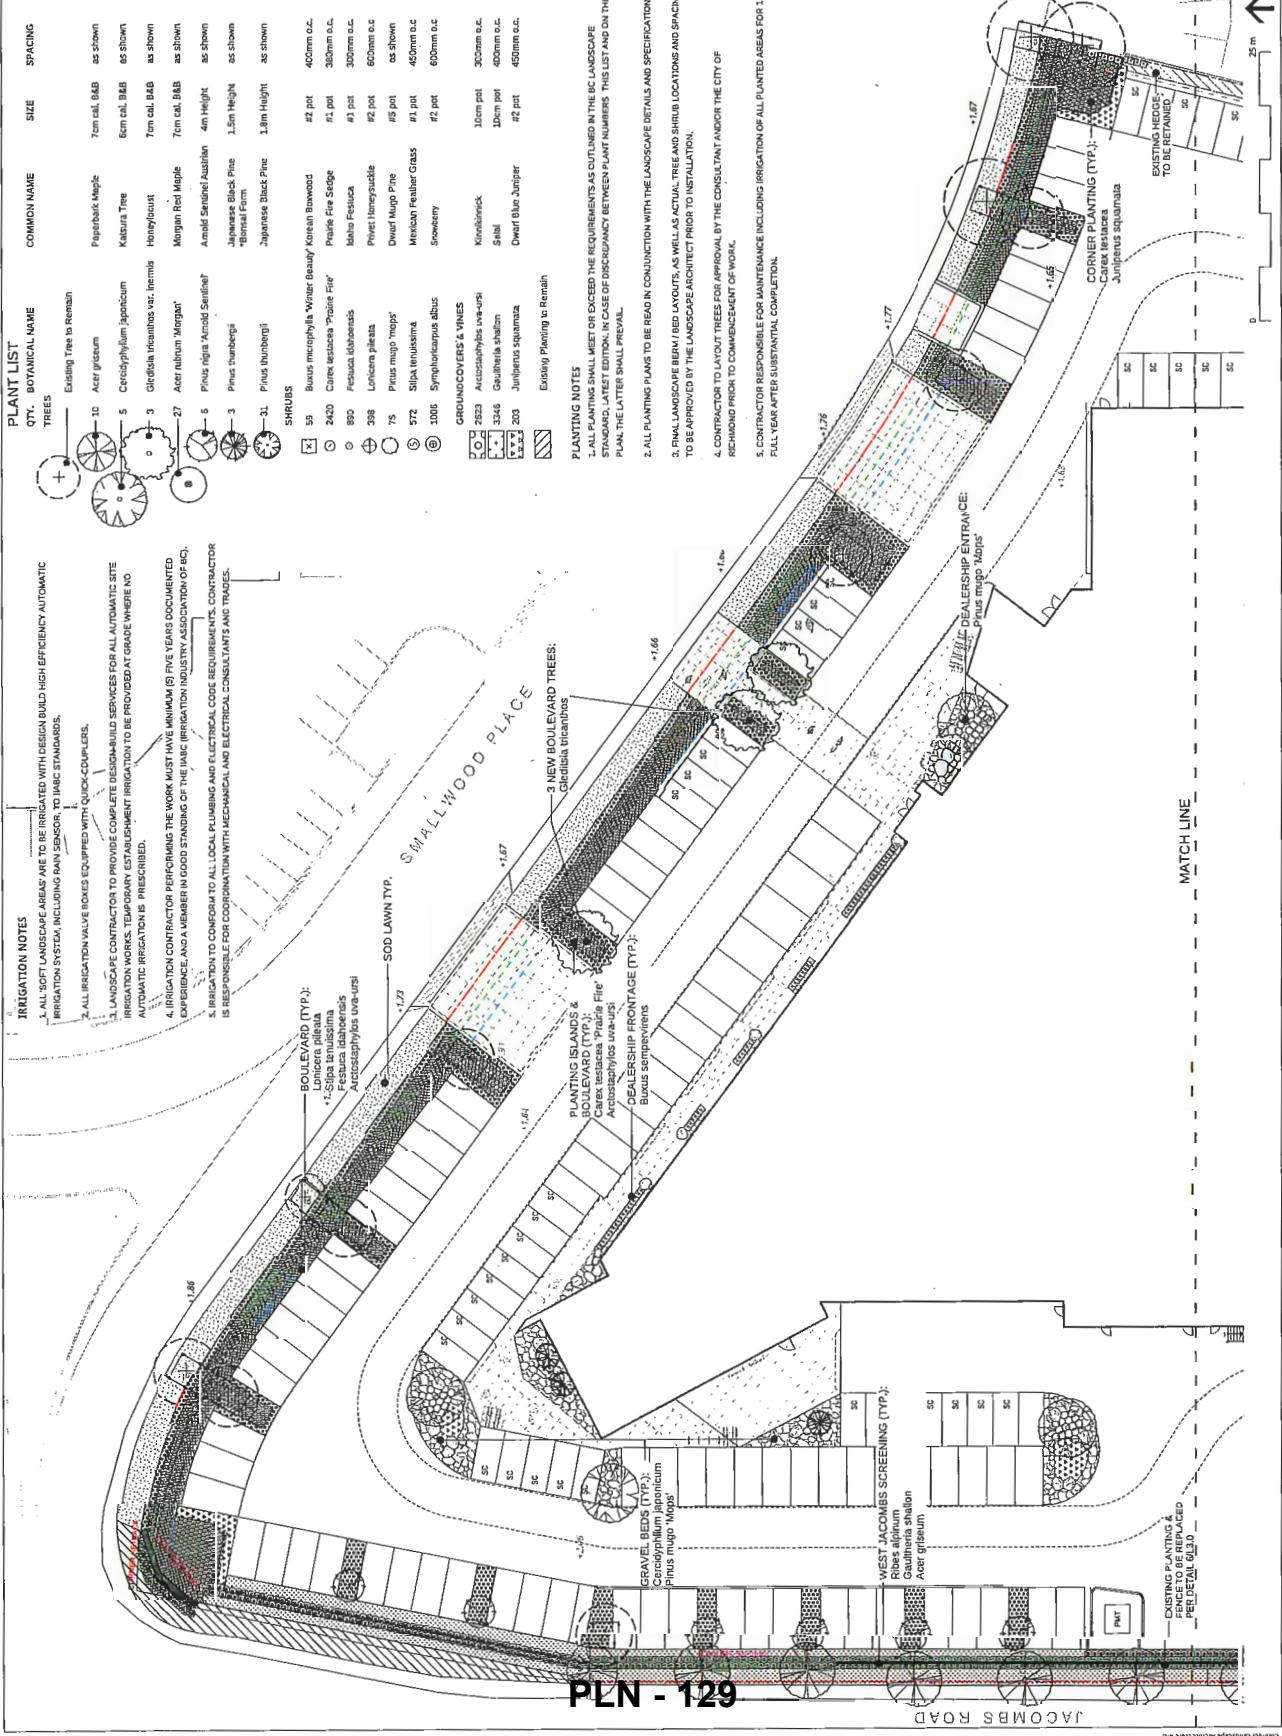

REFER TO L2.0 FOR PLANT LIST.

IRRIGATION NOTES

1. ALL PLANTING AREAS INCLUDING GREEN ROOF AREAS ARE TO BE IRRIGATED WITH DESIGN BUILD HIGH EFFICIENCY AUTOMATIC IRRIGATION SYSTEM, INCLUDING RAIN SENSOR, TO IBC STANDARDS.

2. ALL IRRIGATION VALVE BOXES EQUIPPED WITH QUICK-COUPLE ERS.

3. LANDSCAPE CONTRACTOR TO PROVIDE COMPLETE DESIGN AND SERVICES FOR ALL AUTOMATIC SITE IRRIGATION WORKS, TEMPORARY ESTABLISHMENT IRRIGATION TO BE PROVIDED AT GRADE WHERE NO AUTOMATIC IRRIGATION IS PRESCRIBED.

4. IRRIGATION CONTRACTOR PERFORMING THE WORK MUST HAVE MINIMUM 15 FIVE YEARS DOCUMENTED EXPERIENCE, AND A MEMBER IN GOOD STANDING OF THE IRRIGATION INDUSTRY ASSOCIATION (INC).

5. IRRIGATION TO CONFORM TO ALL LOCAL PLUMBING AND ELECTRICAL CODE REQUIREMENTS. CONTRACTOR IS RESPONSIBLE FOR COORDINATION WITH MECHANICAL AND ELECTRICAL CONSULTANTS AND TRADES.

PLANTING NOTES

1. ALL PLANTING SHALL MEET OR EXCEED THE REQUIREMENTS AS OUTLINED IN THE BC LANDSCAPE STANDARD, LATEST EDITION. IN CASE OF DISCREPANCY BETWEEN PLANT NUMBERS THIS LIST AND ON THE PLAN, THE LATTER SHALL PREDOMINATE.

2. ALL PLANTING PLANS TO BE READ IN CONJUNCTION WITH THE LANDSCAPE DETAILS AND SPECIFICATIONS.

3. FINAL LANDSCAPE BED LAYOUTS, AS WELL AS ACTUAL TREE AND SHRUB LOCATIONS AND SPACING, TO BE APPROVED BY THE LANDSCAPE ARCHITECT PRIOR TO INSTALLATION.

4. CONTRACTOR TO LAYOUT TREES FOR APPROVAL BY THE CONSULTANT AND/OR THE CITY OF RICHMOND PRIOR TO COMMENCEMENT OF WORK.

5. CONTRACTOR RESPONSIBLE FOR MAINTENANCE INCLUDING IRRIGATION OF ALL PLANTED AREAS FOR 1. FULL YEAR AFTER SUBSTANTIAL COMPLETION.

PARAPET EDGE PER ARCHITECTURAL

100x150mm (4") DEPTH OF 31.5mm
(1.22x7') 1/4" CHISELISHED BASE ALUMINUM

EDGED BY PERMALOC
SHOP DRAWING FOR DESIGN BUILD

EXTENSIVE GREEN ROOF - 100x150mm (4") DEEP DECK
ENGINEERED DOWNTIME GROWING MEDIUM WITH
SUPPLIER ETBIA 107.6M, 63%

ROOF BARRIER (ISOLINA SUPREMA MICROFAB
OR APPROVED ALTERNATE)

-ROOF ASSEMBLY & STRUCTURAL SLAB
-SEE ARCHITECTURAL

1. ALL PLANTING SHALL MEET OR EXCEED THE REQUIREMENTS AS OUTLINED IN THE BC LANDSCAPE STANDARD, LATEST EDITION. IN CASE OF DISCREPANCY BETWEEN PLANT NUMBERS THIS LIST AND ON THE PLAN, THE LATTER SHALL PREDOMINATE.

2. ALL PLANTING PLANS TO BE READ IN CONJUNCTION WITH THE LANDSCAPE DETAILS AND SPECIFICATIONS.

3. FINAL LANDSCAPE BED LAYOUTS, AS WELL AS ACTUAL TREE AND SHRUB LOCATIONS AND SPACING, TO BE APPROVED BY THE LANDSCAPE ARCHITECT PRIOR TO INSTALLATION.

4. CONTRACTOR TO LAYOUT TREES FOR APPROVAL BY THE CONSULTANT AND/OR THE CITY OF RICHMOND PRIOR TO COMMENCEMENT OF WORK.


5. CONTRACTOR RESPONSIBLE FOR MAINTENANCE INCLUDING IRRIGATION OF ALL PLANTED AREAS FOR 1. FULL YEAR AFTER SUBSTANTIAL COMPLETION.

1 EXTENSIVE PLANTING ON SLAB

Scale: 1:10

2 INTENSIVE PLANTING DRAIN

Scale: 1:10

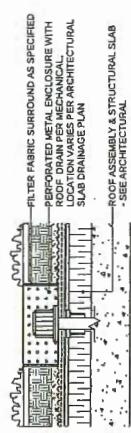

1 EXTENSIVE PLANTING ON SLAB
2 INTENSIVE PLANTING DRAIN

PLAN #3G

Scale: 1:100

PLN - 130

13	REISSUED FOR DP	18-09-26
14	ISSUED FOR CONSTRUCTION	18-09-26
15	ISSUED FOR PEVED IP	17-12-19
16	REISSUED FOR TOWER	12-12-20
9	REISSUED FOR DP	17-08-29
8	ISSUED FOR DP	17-08-29
7	REISSUED FOR DP	17-05-20
6	REISSUED FOR RP	17-05-19
5	ISSUED FOR BUDGETING	17-03-24
4	REISSUED FOR RP	21-03-20
3	ISSUED FOR RP	18-12-15
2	ISSUED FOR DP	18-01-27
1	ISSUED FOR CLIENT REVIEW	18-06-20

REVISIONS

OPENROAD TOYOTA

13100 Smallwood Place	Richmond, British Columbia	Scale: 1:200
Reviewed:	KD	
Project No.	06-080	
Landscape	Plant Materials	SOUTH

L2.1

EXISTING OFFSITE PLANTING
TO BE RETAINED

25 m ↑

CONNECT LANDSCAPE ARCHITECTURE INC. DOES NOT GUARANTEE THE EXISTENCE, LOCATION, OR LEVEL OF UTILITIES AND OR CONCEALED STRUCTURES AT THE PROJECT SITE.


THE CONTRACTOR IS RESPONSIBLE FOR DETERMINATION OF THE EXISTENCE, LOCATION, AND LEVEL OF ALL UTILITIES AND OR CONCEALED STRUCTURES, AND IS RESPONSIBLE, E. G., IN NOTIFYING THE APPROPRIATE COMPANY, DEPARTMENT OR PERSON(S) OF ITS INTENTION TO WORK IN THE AREA.

CHRISTOPHER NOOK ARCHITECTS


PLAN #3H





CONCRETE BENCH

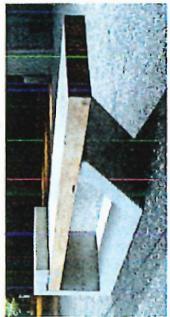



CONCRETE BEN

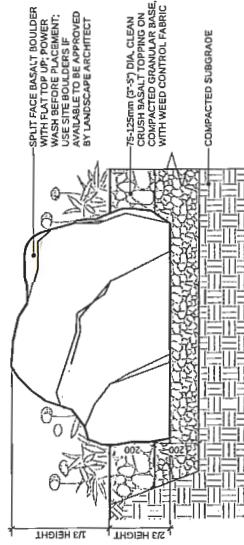


4 LANDSCAPE BOULDER
Scale: 1:10

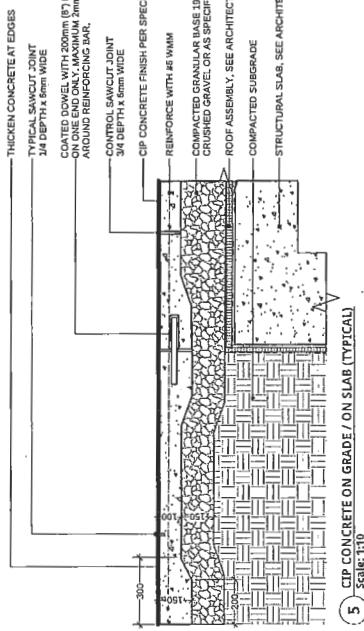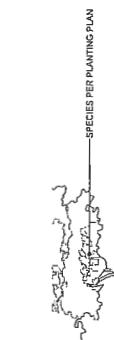

CIP CONCRETE ON GRADE / ON SLAB (

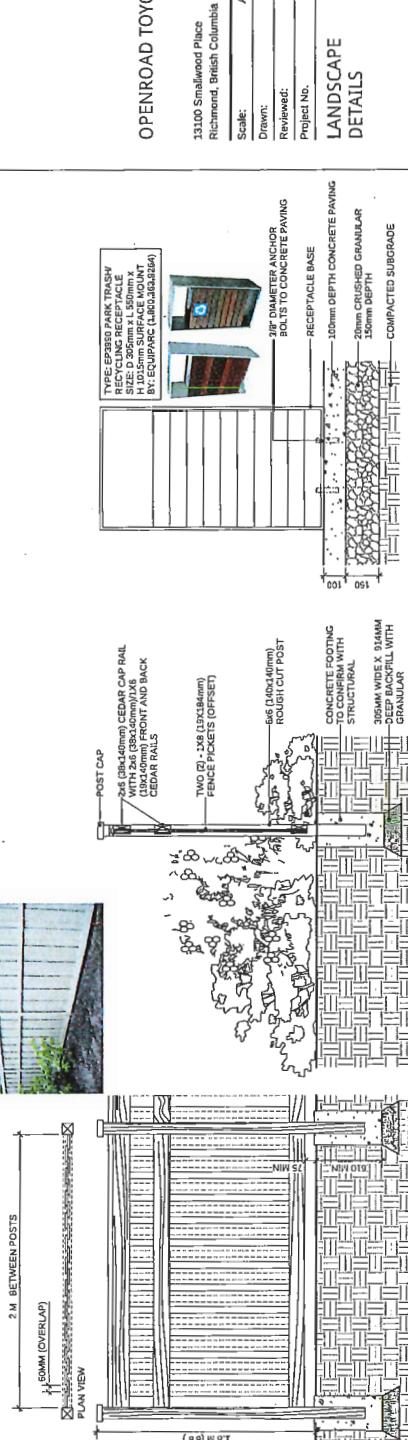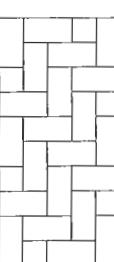

PERIMETER WOOD FENCE

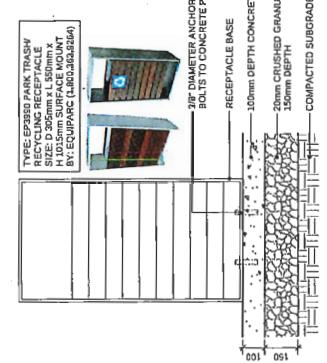

9 TRASH/RECYCLING RECEPTACLE
Scale: 1:10



OPENROAD TOYOTA

Scale:	AS SHOWN
Drawn:	KD
Reviewed:	KL
Project No.	06-190

LANDSCAPE

3



October 12, 2018

MEMO TO: Christian Chia, OpenRoad Toyota Richmond

FROM: RAMA Board of Directors

RE: OpenRoad Toyota Richmond Development Permit Application-
Car Parking Addition

Dear Christian,

This letter is to inform you that your revised building design application submitted April, 2018 for the new OpenRoad Toyota Richmond dealership in the Richmond Auto Mall has been approved by RAMA's Board of Directors.

We note that the maximum Floor Area Ratio of 0.82 is higher than the municipal bylaw of .5 and that the proposed: roof height 15.46M, parapet height of 16.88M, stair tower 18.51M and elevator over-run of 20.39M exceed the bylaw maximum of 12M. Based on the variances granted on the recent Audi and Jaguar LandRover applications on these same two issues, the Board has also approved the variances on your application.

If you have any questions, please don't hesitate to call. On behalf of the Directors and myself, we wish you the very best with your new facility.

Kind regards,

A handwritten signature in black ink, appearing to read 'Gail Terry'.

Gail Terry

General Manager, Richmond Auto Mall Association

CC: RAMA Board of Directors, Bibiane Dorval



City of Richmond

ATTACHMENT 6

Rezoning Considerations

Development Applications Department
6911 No. 3 Road, Richmond, BC V6Y 2C1

Address: 13100 Smallwood Place

File No.: ZT 18-818765

Prior to final adoption of Richmond Zoning Bylaw 8500, Amendment Bylaw 9948, the developer is required to complete the following:

1. Provincial Ministry of Transportation & Infrastructure Approval.
2. The submission and processing of a Development Permit* completed to a level deemed acceptable by the Director of Development.
3. City acceptance of the developer's offer to voluntarily contribute \$0.45 per buildable square foot (e.g. \$38,432) to the City's public art fund.

Prior to Building Permit* Issuance, the developer must complete the following requirements:

1. Submission of a Construction Parking and Traffic Management Plan to the Transportation Department. Management Plan shall include location for parking for services, deliveries, workers, loading, application for any lane closures, and proper construction traffic controls as per Traffic Control Manual for works on Roadways (by Ministry of Transportation) and MMCD Traffic Regulation Section 01570.
2. Installation of appropriate tree protection fencing around all trees to be retained as part of the development prior to any construction activities, including building demolition, occurring on-site.
3. Incorporation of accessibility measures in Building Permit (BP) plans as determined via the Rezoning and/or Development Permit processes.
4. Obtain a Building Permit (BP) for any construction hoarding. If construction hoarding is required to temporarily occupy a public street, the air space above a public street, or any part thereof, additional City approvals and associated fees may be required as part of the Building Permit. For additional information, contact the Building Approvals Department at 604-276-4285.

Note:

- * This requires a separate application.
- Where the Director of Development deems appropriate, the preceding agreements are to be drawn not only as personal covenants of the property owner but also as covenants pursuant to Section 219 of the Land Title Act.
All agreements to be registered in the Land Title Office shall have priority over all such liens, charges and encumbrances as is considered advisable by the Director of Development. All agreements to be registered in the Land Title Office shall, unless the Director of Development determines otherwise, be fully registered in the Land Title Office prior to enactment of the appropriate bylaw.

The preceding agreements shall provide security to the City including indemnities, warranties, equitable/rent charges, letters of credit and withholding permits, as deemed necessary or advisable by the Director of Development. All agreements shall be in a form and content satisfactory to the Director of Development.

- Additional legal agreements, as determined via the subject development's Servicing Agreement(s) and/or Development Permit(s), and/or Building Permit(s) to the satisfaction of the Director of Engineering may be required including, but not limited to, site investigation, testing, monitoring, site preparation, de-watering, drilling, underpinning, anchoring, shoring, piling, pre-loading, ground densification or other activities that may result in settlement, displacement, subsidence, damage or nuisance to City and private utility infrastructure.
- Applicants for all City Permits are required to comply at all times with the conditions of the Provincial *Wildlife Act* and Federal *Migratory Birds Convention Act*, which contain prohibitions on the removal or disturbance of both birds and their nests. Issuance of Municipal permits does not give an individual authority to contravene these legislations. The City of Richmond recommends

that where significant trees or vegetation exists on site, the services of a Qualified Environmental Professional (QEP) be secured to perform a survey and ensure that development activities are in compliance with all relevant legislation.

Signed

Date



City of Richmond

Bylaw 9948

Richmond Zoning Bylaw 8500 Amendment Bylaw 9948 (ZT 18-818765) 13100 Smallwood Place

The Council of the City of Richmond, in open meeting assembled, enacts as follows:

1. Richmond Zoning Bylaw 8500, section 10.7 entitled “Vehicle Sales (CV)”, is amended by deleting subsection 10.7.4.1 d) in its entirety and replacing with the following:
 - d) 0.82
13100 Smallwood Place
P.I.D. 000-955-574
Lot 7 Section 5 Block 4 North Range 5 West New Westminster District Plan
68775 Except Plan EPP72489
2. This Bylaw may be cited as **“Richmond Zoning Bylaw 8500, Amendment Bylaw 9948”**.

FIRST READING



PUBLIC HEARING

SECOND READING

THIRD READING

MINISTRY OF TRANSPORTATION APPROVAL

OTHER CONDITIONS SATISFIED

ADOPTED

MAYOR

CORPORATE OFFICER