



City of  
Richmond

## Report to Development Permit Panel

---

**To:** Development Permit Panel

**Date:** October 4, 2018

**From:** Wayne Craig  
Director of Development

**File:** DP 17-794280

**Re:** **Application by Ciccozzi Architecture Inc. for a Development Permit at 4008  
Stolberg Street**

---

### Staff Recommendation

That a Development Permit be issued which would permit the construction of a 196-unit apartment complex at 4008 Stolberg Street on a site zoned "Low Rise Apartment (ZLR22) – Alexandra Neighbourhood (West Cambie)".

Wayne Craig  
Director of Development

WC:mm

Att. 2

## Staff Report

### Origin

Ciccozzi Architecture Inc. has applied to the City of Richmond for permission to develop a 196-unit apartment complex comprised of two (2) four-storey buildings located over a single level parkade at 4008 Stolberg Street on a site zoned “Low Rise Apartment (ZLR22) – Alexandra Neighbourhood (West Cambie)”. The site is currently vacant.

The site was rezoned to the current ZLR22 zone in 2009 (RZ 07-366342). A Development Permit (DP 08-431155) was issued for this site in March, 2014 and lapsed in March, 2016.

Servicing works were constructed as part of the requirements for this project under a Servicing Agreement for the previous rezoning. These include 2.0 m (6.6 ft.) wide concrete sidewalks along with boulevards consisting of grass and street trees facing Stolberg Street, Cambie Road and McKim Way. Prior to Building Permit issuance, the applicant is required to pay for the replacement of street trees and grass as needed, modification of the driveway let-down on Stolberg Street, and removal of the let-down on McKim Way under a City Work Order.

### Development Information

Please refer to attached Development Application Data Sheet (**Attachment 1**) for a comparison of the proposed development data with the relevant Bylaw requirements.

### Background

Development surrounding the subject site is as follows:

To the north, across Cambie Road, there is an established single family neighbourhood zoned “Single Detached (RS1/B)”;

To the south, across McKim Way, there is a four storey apartment zoned “Low Rise Apartment (ZLR24) – Alexandra Neighbourhood (West Cambie)”;

there are also three large lots zoned “Single Detached (RS1/F)” which are designated in the Area Plan for future low-rise apartment developments;

To the east, there is a four storey apartment zoned “Low Rise Apartment (ZLR24) – Alexandra Neighbourhood (West Cambie)” currently under construction (DP 10-557521); and

To the west, across Stolberg Street, there is a six-storey apartment building with a childcare facility zoned “Low Rise Apartment (ZLR22) – Alexandra Neighbourhood (West Cambie)”.

### Staff Comments

The proposed scheme attached to this report has satisfactorily addressed the urban design issues and other staff comments identified as part of the review of the subject Development Permit application. In addition, it complies with the intent of the applicable sections of the Official Community Plan and is generally in compliance with the West Cambie Area Plan. The proposal is also in compliance with Zoning Bylaw 8500.

## **Advisory Design Panel Comments**

The Advisory Design Panel was in favour of the proposed project. A copy of the relevant excerpt from the Advisory Design Panel Minutes from the June 20, 2018 meeting is attached for reference (**Attachment 2**). The design response from the applicant has been included immediately following the specific Design Panel comments and is identified in '*bold italics*'.

## **Analysis**

### ***Conditions of Adjacency***

- The 1.92 m (6.3 ft.) grade difference between the ground floor of the building and the Cambie Road and McKim Way Street frontages has been necessitated by the high water table and engineering considerations that do not allow the building to be lowered. However, 6.0 m (20.0 ft.) building setbacks to each of these streets has allowed for three levels of landscaping from street level to the main floor level. These building setbacks exceed the minimum zoning setbacks of 4.5 m (14.7 ft.) for Cambie Road and 3.0 m (9.8 ft.) for McKim Way.
- Along these street frontages, there are two retaining walls separating three landscaped levels which effectively obscure the parkade located below the buildings. The brick and concrete retaining walls are punctuated by stairways leading from street level to individual units. The retaining walls nearest the streets range from 1.0 m (3.3 ft.) to 1.2 m (4.0 ft.) in height and are setback a minimum of 1.0 m (3.3 ft.) from the adjacent public sidewalks while the upper retaining walls are less than 0.60 m (2.0 ft.) in height.
- The above-noted retaining walls extend around the site corners onto Stolberg Street, progressively becoming lower until the on-site landscaping becomes level with the street at the middle of the block. The project's driveway at the middle of the block is aligned with the driveway of the existing building on the west side of the street.
- The 6.9 m (23 ft.) building setback to east property line combined with the 6.0 m (20 ft.) setback for the adjacent building to the east provide an overall 12.9 m (43 ft.) separation between the buildings. The abutting parkade podiums are both at the same elevation with raised landscape planters along the east side of the subject property to provide for an attractive landscape transition.

### ***Access and Parking***

- The main pedestrian entrances to the buildings are provided near the middle of the block of the Stolberg Street frontage.
- There is an existing mid-block crosswalk on Stolberg Street with curb extensions on each side that provide for a narrower pedestrian crossing distance.
- The parkade will be accessed by a driveway adjacent to this mid-block crosswalk and between the two buildings. This driveway is located near the driveway proposed for the previously approved project (DP 08-431115).
- The one loading space is located adjacent to the driveway with provision for truck maneuvering on-site.
- The project includes 296 resident parking spaces in excess of the 294 required spaces. Approximately 10% of the resident parking or 30 spaces are in tandem format which is

below the maximum 50% permitted. There is a Tandem Parking Covenant (LTO #BB1161265) registered on title ensuring that each pair of tandem spaces are sold or assigned to the same unit.

- The parkade includes the required 40 visitor parking spaces.
- The Development Permit plans include a notation specifying that all parking spaces are provided with 120 volt electrical (Level 1) outlets as required under the City's Zoning Bylaw.
- The residents will be provided with 284 Class 1 (Resident) bicycle parking spaces within the parkade which is in excess of the 245 required parking spaces. Bike racks will be provided to accommodate the required 40 Class 2 (Visitor) bicycle parking spaces.

### ***Urban Design and Site Planning***

- Stolberg Street forms the functional front of the project with the parkade entrance, and off-street loading bay and both building lobbies located near the middle of the block. At this point, the street level rises to the level of the main floor of both buildings, thus providing level pedestrian access to the building lobbies.
- Cambie Road is an arterial road located 1.92 m (6.3 ft.) grade below the project's main floor level. There is a large building setback of 6.0 m (20.0 ft.) and parkade setback of 4.7 m (15.4 ft.), well in excess of the respective minimum setbacks of 4.5 m (14.7 ft.) and 1.5 m (4.9 ft.) under the Zoning Bylaw. There is no vehicle access and one small pedestrian access to the podium amenity space for residents.
- McKim Way is a local road also located 1.92 m (6.3 ft.) grade below the project's main floor level. There is a large building setback of 6.0 m (20.0 ft.) and parkade setback of 3.0 m (9.8 ft.), well in excess of the respective minimum setbacks of 3.0 m (9.8 ft.) and 1.5 m (4.9 ft.) under the Zoning Bylaw. There is no vehicle access and one small pedestrian access to the podium amenity space for residents.

### ***Architectural Form and Character***

- The two buildings have "L" and "U" shaped footprints and are located on one large common concrete podium parkade that covers most of the site. The buildings' wings face the adjacent streets and open out onto one common central courtyard located between the buildings.
- The west elevation of the project facing Stolberg Street includes an approximately 20 m (66 ft.) separation between the building wings while there is an approximately 31 m (104 ft.) separation between the buildings on the project's east elevation.
- Each of the buildings includes a colonnaded walkway adjacent to the large outdoor planters and the parkade entrance providing attractive pedestrian accesses from Stolberg Street to the podium courtyard amenity space.
- The buildings' façades are articulated with regularly spaced recesses occupied by banks of covered balconies at approximately every 6.0 m (20 ft.) to 8.0 m (24.5 ft.) of building frontage.
- The first floor apartment units include patios with individual walkways leading onto the surrounding public streets to access and to animate the street frontages.

- The majority of the bottom two floors of the buildings' façades are clad in red brick with concrete lintels with this treatment extending to the third floor around the building lobbies facing Stolberg Street.
- The majority of the remainder of the building façades are clad with white hardi panel interspersed with grey painted wood trim. The recessed areas of building façades include brown hardi panel and wood trim to accentuate the depth of the recesses.
- The flat roofs are trimmed with large cornices with larger raised roof sections at each building corner facing Stolberg Street.
- Smaller pop-up roofs punctuate the rooflines above each section of the buildings that contain banks of balconies.

### ***Landscape Design, Open Space Design and Amenity Space***

- Along the street frontages, there are two retaining walls separating three landscaped levels which effectively obscure the parkade located below the buildings. These walls are broken-up by stairways leading from street level to individual units.
- The landscape walls at street level range from 1.0 m (3.3 ft.) to 1.2 m (4.0 ft.) with on-site shrubs and trees adjacent to the Cambie Road sidewalk and grass along the McKim Way sidewalk. These walls extend around the site corners onto Stolberg Street, progressively becoming lower until the on-site landscaping becomes level with the street at the middle of the block.
- The middle terrace is heavily landscaped on all street frontages while the upper terrace includes unit patios and landscaping.
- The large central courtyard located on top of the parkade podium includes a water feature, common patios, grassed areas, seating areas and large glass-covered trellises. The outdoor amenity space has a total area of 1,565.5 m<sup>2</sup> (16,845.5 ft<sup>2</sup>) which complies with the OCP Development Permit Area guidelines.
- The 653.7m<sup>2</sup> (7,036 ft<sup>2</sup>) play area includes a long slide on a raised landscape mound and rope spinner surrounded outdoor rubber play surface which complies with the OCP Development Permit Area guidelines.
- There are community garden plots and a common garden shed provided within the podium courtyard that are provided with hose bibs.
- There are two large irrigated lawns within the courtyard and that allow for passive recreation.
- Along the east side of the central courtyard, there are beech and pine trees, and a fence at the edge of the podium to provide a buffer to the abutting apartment building podium courtyard being constructed at same level to the east.
- Each of the ground floor units facing the central courtyard and adjacent streets are provided with a large private patios.
- The applicant will be required to provide a landscaping security of \$877,459.12 prior to Development Permit issuance.

- There is a total of 627.4 m<sup>2</sup> (6,753.3 ft<sup>2</sup>) of indoor recreation space within the two buildings and which includes a gym, taiji room, lounge, a party room and mah-jong rooms. Each building includes more than the 100 m<sup>2</sup> (1,076 ft<sup>2</sup>) minimum required under the OCP Development Permit Area guidelines.
- These common amenity spaces have direct access to the interior courtyard and colonnaded walkways noted above.

### ***Crime Prevention Through Environmental Design***

- The outdoor amenity area is located within the internal courtyard with limited access points to the adjacent public streets.
- There is a comprehensive lighting plan with bollard lighting and subdued wall-mounted lighting within the central courtyard and along the perimeter of the project facing the public streets.
- The external street frontages and internal courtyards provide significant resident surveillance due to the design of the building and landscaping.

### ***Accessible Housing***

- The proposed development includes 20 basic universal housing units that are designed to be easily renovated to accommodate a future resident in a wheelchair. These single-storey units are required to incorporate all of the accessibility provisions listed in the Basic Universal Housing Features section of the City's Zoning Bylaw, and are permitted a density exclusion of 1.86 m<sup>2</sup> (20 ft<sup>2</sup>) per unit.
- All of the proposed units incorporate aging in place features to accommodate mobility constraints associated with aging. These features include:
  - stairwell hand rails;
  - lever-type handles for plumbing fixtures and door handles; and
  - solid blocking in washroom walls to facilitate future grab bar installation beside toilets, bathtubs and showers.

### ***Energy and Sustainability***

- The project will be connected to the West Cambie District Energy Utility (DEU).
- There is utilization of energy efficient lighting, heating, mechanical systems and appliances as noted in the applicant's Design Rationale.
- There is use of drought-tolerant and native landscape species where possible.

### ***Affordable Housing***

Affordable housing units were provided for the subject site at 4008 Stolberg Street within the building on the adjacent site to the west at 9388 Cambie Road as part of the affordable housing contributions applicable to both sites being rezoned to the ZLR22 zone in 2009 (RZ 07-366342).

### ***Alexandra Beautification Contribution***

The applicant will provide the Alexandra Area Beatification Contribution at a rate of \$0.60/ft<sup>2</sup> or \$108,069.48 prior to Development Permit issuance for this site.

Other Alexandra Amenity Area contributions were previously paid at the rezoning stage for this site.

### ***OCP Aircraft Noise Policy***

Prior to issuance the Development Permit, the applicant will be required to provide final reports from acoustical and mechanical engineers to the satisfaction of the City that meet the OCP policy requirements for:

- Meeting the ASHRAE 55 “Thermal Environmental Conditions for Human Occupancy standards for interior living spaces”. In that regard, it should be noted that all units will be air conditioned.
- Confirming that the building has been designed and constructed to achieve the CMHC guidelines for interior noise levels.

### **Conclusions**

As the proposed development would meet applicable policies and Development Permit Guidelines, staff recommend that the Development Permit be endorsed, and issuance by Council be recommended.



Mark McMullen  
Senior Coordinator - Major Projects

MM:rg

The following are to be met prior to forwarding this application to Council for approval:

- Receipt of a Letter-of-Credit for landscaping in the amount of \$877,459.12
- Receipt of the Alexandra Beatification Contribution at a rate of \$0.60/ft<sup>2</sup> or \$108,069.48 (based on the net floor area of 118,115.8 ft<sup>2</sup>) prior to Development Permit issuance for this site.
- An assignment and assumption agreement with the City, whereby the Owner acknowledges, agrees to and assumes all of the covenants and obligations under the City documents registered on title relating to RZ 07-366342 and DP 08-431155 as if the Owner had originally signed them, including but not limited to an acknowledgment and assumption of the existing agreements and all covenants and obligations of the owner thereunder, including the:
  - District Energy Covenant (LTO #CA3923897)
  - Airport Noise Covenant & SRW (LTO #BB1104464 & #BB1104465)
  - Flood Covenant (LTO #BB1104468)
  - Tandem Parking Covenant (LTO #BB1161265)
- The acoustical and mechanical reports are to be prepared and submitted to the satisfaction of the City as set out in the OCP including:
  - Submission of a final report from the project mechanical P.Eng. confirming that the building has designed to meet the ASHRAE 55 “Thermal Environmental Conditions for Human Occupancy standards for interior living spaces”; and
  - Submission of a final report from an acoustical engineer confirming that the building has been designed and constructed to achieve the CMHC guidelines for interior noise levels as indicated in the chart below:

Portions of Dwelling Units	Noise Levels (decibels)
Bedrooms	35 decibels
Living, dining, recreation rooms	40 decibels
Kitchen, bathrooms, hallways, and utility rooms	45 decibels

Prior to future Building Permit issuance, the developer is required to complete the following:

- The applicant will pay for the replacement of any trees and grass within the adjacent boulevards that are dead, dying or otherwise need to be replaced, the modification the driveway let-down on Stolberg Street, removal of the let-down on McKim Way, installation of any City service and DEU connections, and new fire hydrant(s), all to the satisfaction of City Staff under a City Work Order; the applicant may need to engage a civil engineering consultant to assist with the design of these works.
- Payment of latecomer agreement charges, plus applicable interest associated with eligible latecomer works which include:
  - Stolberg Street Drainage (Oris) Latecomer Agreement SA 08-434616D
  - Stolberg Street Sanitary Sewer (Oris) Latecomer Agreement SA 08-464616S
  - Alexandra/West Cambie Latecomer Agreement
- The applicant is required to obtain a Building Permit for any construction hoarding associated with the proposed development. If construction hoarding is required to temporarily occupy a street, or any part thereof, or occupy the air space above a street or any part thereof, additional City approvals and associated fees may be required as part of the Building Permit. *For further information on the Building Permit, please contact Building Approvals Department at 604-276-4285.*
- Submission of a construction traffic and parking management plan to the satisfaction of the City's Transportation Department (<http://www.richmond.ca/services/ntp/special.htm>).

Prior to future Building Permit issuance or approval of the Phased Strata Plan Declaration, the developer is required to complete the following:

- Submit a Building Code Analysis addressing the phasing of the construction to the satisfaction of the City, receive approval or approval-in-principal of the Phased Strata Declaration (Form P) from the Approving Officer, and register any covenants, easements or other documents required to facilitate the Phased Strata and the phasing of construction as determined by the City and Approving Officer.



**DP 17-794280**

**Attachment 1**

Address: 4008 Stolberg Street

Applicant: Ciccozzi Architecture Inc.

Owner: 168899 Holding Inc.

Planning Area(s): West Cambie (Alexandra)

Floor Area Gross: 17,886.6 m<sup>2</sup>

Floor Area Net: 16,733.0 m<sup>2</sup>

	<b>Existing</b>	<b>Proposed</b>	
<b>Site Area:</b>	11,022.3 m <sup>2</sup>	11,022.3 m <sup>2</sup>	
<b>Land Uses:</b>	Vacant	Apartment complex	
<b>OCP Designation:</b>	Apartment Residential	Apartment Residential	
<b>Zoning:</b>	Low Rise Apartment (ZLR22) – Alexandra Neighbourhood (West Cambie)	Low Rise Apartment (ZLR22) – Alexandra Neighbourhood (West Cambie)	
<b>Number of Units:</b>	None	196 units	
	<b>Bylaw Requirement</b>	<b>Proposed</b>	<b>Variance</b>
Floor Area Ratio:	1.52	1.52	none permitted
Lot Coverage:	65%	45.4%	none
Setback – Stolberg Street:	2.85 m	4.0 m	none
Setback – Cambie Road:	4.5 m	6.0 m	none
Setback – McKim Way:	3.0 m	6.0 m	none
Setback – Side Yard:	3.2 m (Building) 0.0 (Parkade)	6.9 m (Building) 0.0 (Parkade)	none
Height (m):	Max. 24.0 m	15.9 m	none
Lot Size:	None	None	none
Off-street Parking Spaces – Regular/Visitor:	294 / 40	296 / 40	none
Off-street Parking Spaces – Accessible (included above):	7	8	none
Total off-street Spaces:	334 (Max.)	336	none
Tandem Parking Spaces	167	30	none
Amenity Space – Indoor:	Min. 200 m <sup>2</sup>	627.4 m <sup>2</sup> in both buildings	none
Amenity Space – Outdoor:	Min. 1,182 m <sup>2</sup>	1,565.5 m <sup>2</sup>	none

Excerpt from the Minutes from  
**The Design Panel Meeting**

Wednesday, June 20 – 4:00 p.m.  
Rm. M.1.003  
Richmond City Hall

**DP 17-794280 - TWO FOUR-STOREY RESIDENTIAL BUILDINGS OVER  
SHARED PARKADE WITH 196 APARTMENTS**

ARCHITECT: Ciccozzi Architecture

PROPERTY LOCATION: 4008 Stolberg Street

**Applicant's Presentation**

Otto Lejeune, Ciccozzi Architecture, and Daryl Tyacke, ETA Landscape Architecture, presented the project and answered queries from the Panel on behalf of the applicant.

**Panel Discussion**

*Comments from Panel members were as follows:*

- appreciate the applicant for considering public art; the applicant is encouraged to coordinate with the City's public art planner regarding the location of public art in the project;

*Although Public Art is not required as part of this development application, we have provided a number of design features to enhance the public experience. We have incorporated a plazalike feel at the loading area by incorporating a distinct paving patter to delineate the space. We have also included both trellises and colonnades to help soften and animate the space.*

- appreciate the articulation of the brick walls as it helps in breaking down the massing and length of the building; brown wood reveals setback also help clarify the language of the building;

*Acknowledged.*

- consider a different colour for the ground level of the gray-coloured three levels at the east elevation (courtyard) to make it more pedestrian-friendlier;

*Considered and incorporated.*

- consider further articulation to the west entrance of the outdoor amenity area facing Stolberg Street to enhance its gateway feel; applicant could consider differentiating it from the rest of the building;

*Expanded space between buildings facing Stolberg Street more than 20' (from 49' to 70') by redesign of corner units; setting back balconies from street by 5.5'/13.8'; and introducing a FEATURE COLONNADE on both sides of the loading/parkade entry plaza to improve pedestrian accessibility and special quality. As well, the opening facing the courtyard has been increased to more than 70' at ground level (to inside wall of colonnade), and an additional 2', to 51.5', for the building above. Refer to Architectural drawing A1.2*

- appreciate the applicant's efforts to provide landscaping and accessibility to pedestrians, e.g. stairways into the mews on the back-east side of the development;

*Acknowledged.*

- consider accentuating the main entrance along Stolberg Street, e.g. introducing a different texture on the ground could help delineate a pedestrian pathway into the gate; stairway could also be wider;

*Considered. See Landscape drawings for added ground treatment.*

- appreciate the higher language of the entry foyer for each building; consider further strengthening the gateway language at the corners of both buildings to provide stronger definition to the pedestrian entry;

*Acknowledged.*

- appreciate the overall landscaping and articulation for the project;

*Acknowledged.*

- parkade entrance on Stolberg Street appears to be a service entrance due to the location of the garbage and recycling pick-up at the main entrance; consider looking at McKim Way as potential underground parkade entrance;

*Considered. Current layout improved to creates a welcoming sense and togetherness for residents in/out of parkade and take advantage of service area open space with good visual connection to courtyard outdoor amenity area from street and parkade entry.*

- no problem with the location and articulation of spaces; however, investigate opportunities for widening the gap between the two buildings along Stolberg Street; look at the possibility for a modified U-shape for Building 1 (north building);

*Considered. Widened opening facing Stolberg Street >20' to 70' and >2' to 51' facing courtyard at ground level. Compared building shapes and current layout scheme to offer better quality for units and overall outdoor space.*

- consider interrupting the long, continuous corridors on the ground floor of the two buildings to allow natural daylight to the corridors and open up more views to the main courtyard spaces to provide a reference point to pedestrians, e.g. through introducing glazing or doorways;

*Acknowledged.*

- review and confirm the total number of adaptable units in A6.4 of the package;

*Confirmed.*

- consider installing an outward opening door in lieu of an inward opening door for the den adjacent to the entry foyer for adaptable unit types A1 and Unit A for more efficient use of floor space;

*Considered and incorporated.*

- Unit type A2 has an awkward space off the dining room; person using the bedroom is required to go out into the living room to get to the adjacent bathroom; consider design development;

*Reviewed and revised.*

- Unit type B1 has good access;

*Acknowledged.*

- consider an outward opening door for the powder room in unit types B2 and C;

*Acknowledged.*

- consider installing a pocket door to the doorway of the master bedroom to the washroom in unit type C to enhance usability;

*Acknowledged.*

- consider the installation of lazy susans to enhance the use of kitchen cabinet space under the counters;

*Reviewed and revised.*

- consider an outward opening door for the powder room in Unit C1; also consider installing a pocket door in the ensuite bathroom in the master bedroom to make it more usable;

*Reviewed and revised.*

- reconsider the lay-out for unit type C1 as the living room and bedroom require access through a corridor into the master bedroom to get to a powder room; also consider the same for unit type C1A

*Reviewed and revised.*

- living room, bedroom and master bedroom in unit type C3 are all relying on one door to the bathroom;

*Reviewed and revised.*

- not concerned with building frontages; increasing the building setbacks on Cambie Street and McKim Way helps provide a buffer from the street; appreciate the applicant's efforts to soften the transition from the street level to the ground level units;

*Acknowledged.*

- main entry points are clear in terms of wayfinding; however, secondary entries need to be more clearly defined for both buildings, in particular the building entry off McKim Way; consider providing a connecting path off McKim Way directly or provide a mid-block connecting point to provide direct access;

*Acknowledged; there is no entrance off McKim.*

- main building lobbies are well-expressed and clear;

*Acknowledged.*

- support comments for the applicant to beautify the parkade ramp and staging area for the garbage pick-up; consider creating a plaza-like feel with appropriate ground materials and provide temporary screening for the garbage and recycling bins;

*Considered. Added trellis over parkade entry ramp; new planters and colonnades along both sides. At front of the garbage/recycle bins staging area, a nature screen and visual barrier for the garbage and recycle bins.*

- consider continuing the trellis connecting the two amenity areas to also cover the driveway ramp to soften the space and make it more welcoming;

*Considered. Please see Architectural & landscape revised drawings.*

- appreciate the significant amount of contiguous indoor and outdoor amenity spaces for the subject project not typically seen in other similar projects;

*Acknowledged.*

- consider a double height ceiling for a portion of the north amenity (where the party room is located) to allow more daylight into the space given the size and scale of the amenity space;

*Acknowledged.*

- in general, lay-out of unit types are functional; however, investigate opportunities to allow more natural daylight into the living room spaces of the internal corner units, i.e. unit types A2 and A2A;

*Acknowledged.*

- appreciate the alignment of the driveways of the subject development and the building to the west side of Stolberg Street; however, question the symmetrical harmony of the shape of the subject buildings with respect to the adjacent building to the east;

*Acknowledged.*

- appreciate the proposed outdoor amenity area for the project; nice to see that the programming of the generous amount of outdoor amenity space is not overly prescriptive;

*Acknowledged.*

- materials palette is well-handled; building frontages are broken up with the brick base; good balance of materials and colours; alternating roof lines help in breaking down the visual mass of the buildings;

*Acknowledged.*

- City staff is advised to encourage applicants of development projects to consider architectural styles other than those found in the projects' immediate site context to provide diversity of architectural styles in the neighbourhood;

*Acknowledged.*

- appreciate the applicant's presentation of the project; proposed development is stately-looking and elegant; massing is well-handled and visually broken down;

*Acknowledged.*

- the model presented by the applicant makes the project easier to understand;

*Acknowledged.*

- solar aspect of the interior landscape is excellent; applicant has minimized the presence of deeply shaded patios; support the choice of small deciduous trees;

- reconsider the choice of poplars on concrete slab and consider columnar beech trees in lieu;

*Considered. See revised Landscape drawing.*

- consider introducing a five percent slope on the glass cover of the trellis feature for easier maintenance;

*Considered. See revised Landscape drawing. See sheet L-e.1*

- applicant should have included grading information in the package provided to Panel; would have been helpful in reviewing the project in advance;

*Considered. See revised Landscape drawing.*

- appreciate the dog run in the central courtyard; consider installing a hose bib dedicated to the dog run area;

*Acknowledged. HB indicated on L-b.5*

- consider installing a large Douglas fir tree in the central courtyard considering the size of the landscaped area;

*Acknowledged. One of the Pines has been replaced with a Fir*

- appreciate the applicant's presentation and the model;

*Acknowledged.*

- concerned with the loading area; consider design development of the loading area to allow some breathing room and visual and pedestrian permeability; consider relocating some of the columnar trees down the sides of the loading area or wrap the trellis around the side of the building to emphasize the pedestrian circulation beside the loading area;

*Acknowledged. Expanded loading area around 3' at driver side and added planters to separate pedestrian walkway/colonnade at building ground level, greatly improving pedestrian accessibility and loading plaza space quality.*

- the courtyard is well- programmed; solar exposure is great; concerned with the large trees shading the courtyard; would be nice to have some sunny areas in the courtyard;

*Other than the Doug Fir requested in the courtyard, none of the trees are large growing. In addition, the trees have been spaced out a bit more to make the courtyard feel more open*

- appreciate the mounding but too much of it will change the character of the landscape;

*The mounding is part of the character and is intended to be part of the children's play throughout the project.*

- support the comment that it would have been helpful if the applicant had provided a grading plan to help understand the sense of the landscape and public realm;

*Acknowledged- a grading plan has been added*

- overall, appreciate the treatment of the public realm; also appreciate how the bricks are brought down; nice façade along Cambie Road; appreciate how the landscaping is integrated into the building; and

*Acknowledged.*

- overall, the project is nicely done.

*Acknowledged.*

#### **Panel Decision**

It was moved and seconded

*That DP 17-794280 be supported to move forward to the Development Permit Panel subject to the applicant giving consideration to the comments of the Advisory Design Panel.*

**CARRIED**



No. DP 17-794280

To the Holder: 168899 Holding Inc.  
Property Address: 4008 Stolberg Street  
Address: 335 – 8120 Granville Avenue  
Richmond, BC V6Y 1P3

---

1. This Development Permit is issued subject to compliance with all of the Bylaws of the City applicable thereto, except as specifically varied or supplemented by this Permit.
2. This Development Permit applies to and only to those lands shown cross-hatched on the attached Schedule "A" and any and all buildings, structures and other development thereon.
3. Subject to Section 692 of the Local Government Act, R.S.B.C.: buildings and structures; off-street parking and loading facilities; roads and parking areas; and landscaping and screening shall be constructed generally in accordance with Plans #DP17-794280-1 to #DP17-794280-62 attached hereto.
4. Sanitary sewers, water, drainage, highways, street lighting, underground wiring, and sidewalks, shall be provided as required.
5. As a condition of the issuance of this Permit, the City is holding the security in the amount of \$877,459.12 to ensure that development is carried out in accordance with the terms and conditions of this Permit. Should any interest be earned upon the security, it shall accrue to the Holder if the security is returned. The condition of the posting of the security is that should the Holder fail to carry out the development hereby authorized, according to the terms and conditions of this Permit within the time provided, the City may use the security to carry out the work by its servants, agents or contractors, and any surplus shall be paid over to the Holder. Should the Holder carry out the development permitted by this permit within the time set out herein, the security shall be returned to the Holder. The City may retain the security for up to one year after inspection of the completed landscaping in order to ensure that plant material has survived.
6. If the Holder does not commence the construction permitted by this Permit within 24 months of the date of this Permit, this Permit shall lapse and the security shall be returned in full.

**Development Permit**  
**No. DP 17-794280**

To the Holder: 168899 Holding Inc.  
Property Address: 4008 Stolberg Street  
Address: 335 – 8120 Granville Avenue  
Richmond, BC V6Y 1P3

---

7. The land described herein shall be developed generally in accordance with the terms and conditions and provisions of this Permit and any plans and specifications attached to this Permit which shall form a part hereof.

This Permit is not a Building Permit.

AUTHORIZING RESOLUTION NO.  
DAY OF

ISSUED BY THE COUNCIL THE



DELIVERED THIS DAY OF

---

MAYOR



# City of Richmond

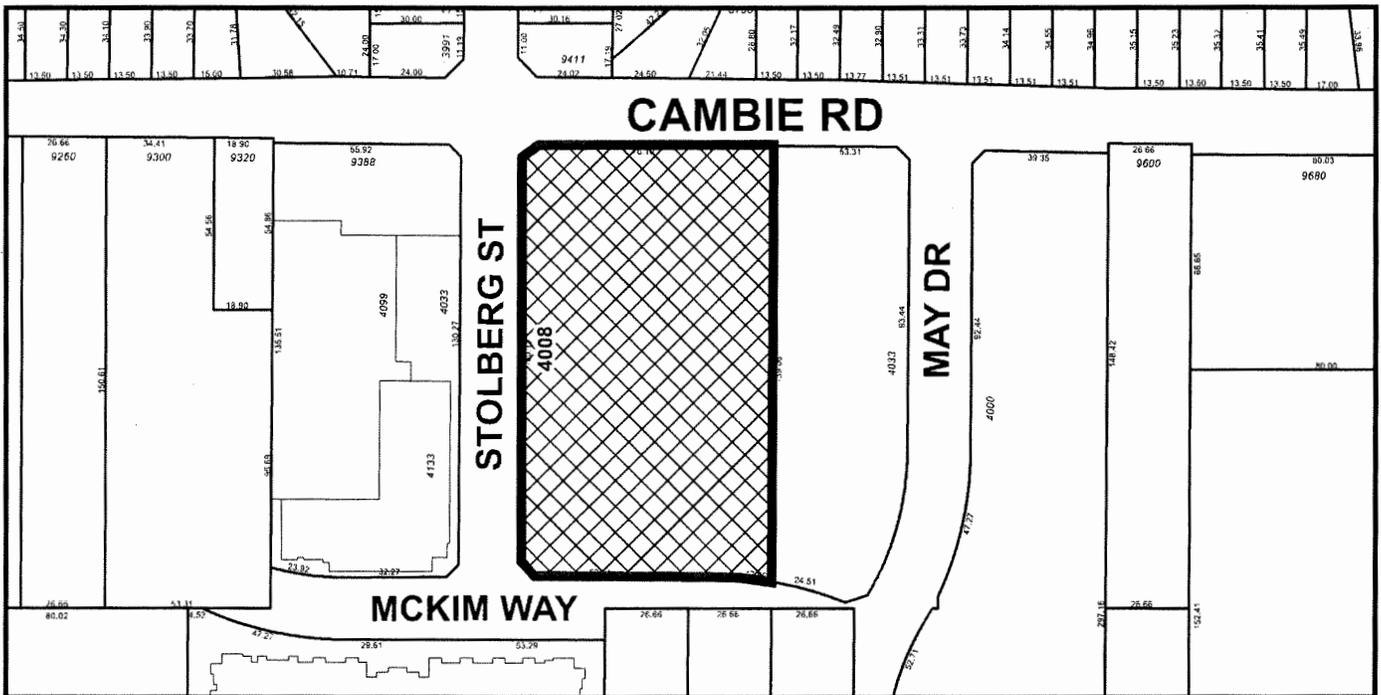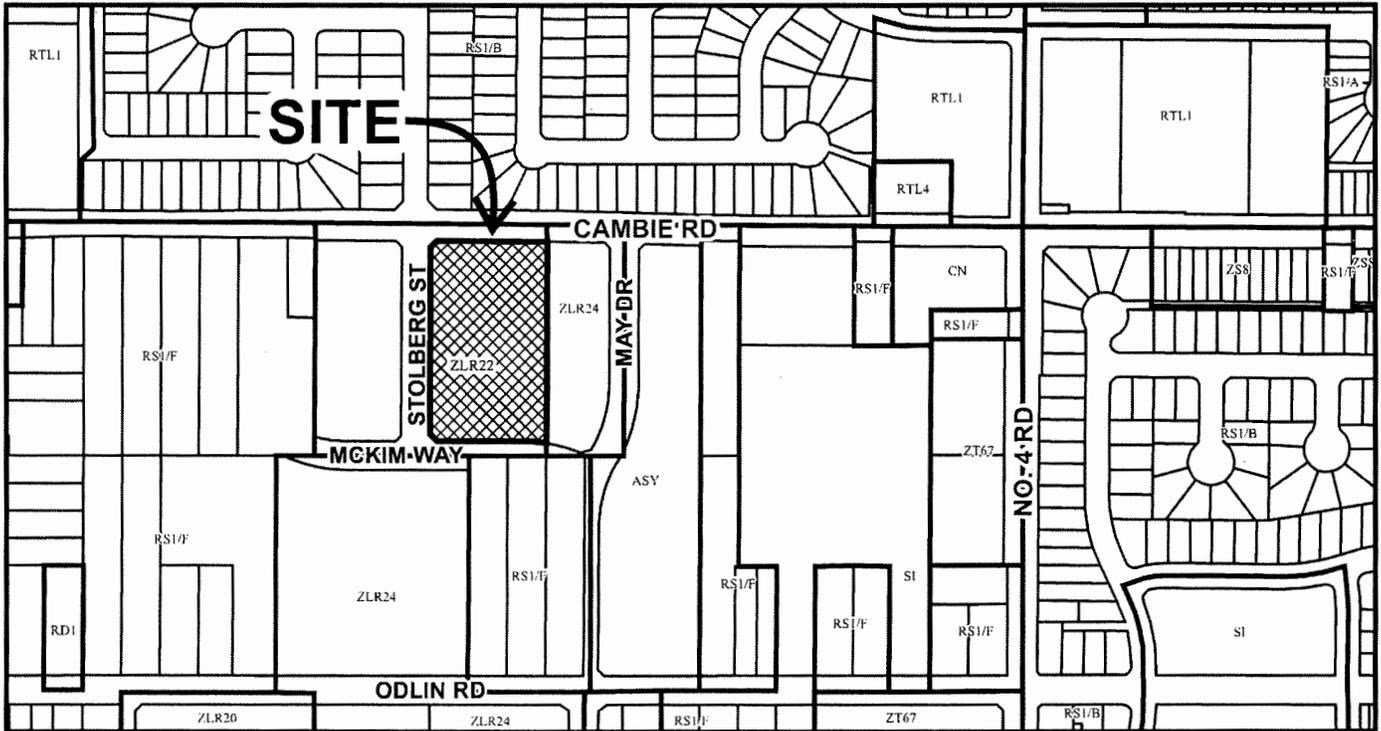

**DP 17-794280**  
**SCHEDULE "A"**

Original Date: 01/09/18

Revision Date:

Note: Dimensions are in METRES

4008, 4018 STOLBERG STREET RESIDENTIAL DEVELOPMENT

MULTI-FAMILY RESIDENTIAL PROPOSAL

CIVIC ADDRESS: 4008, 4018 STOLBERG ST, RICHMOND BC

LEGAL DESCRIPTION: LOT B SECTION 34, BLOCK 5 NORTH RANGE 6 WEST NWD BCP42345

DEVELOPMENT PERMIT RESUBMISSION

SEPT. 20, 2018

COPYRIGHT RESERVED. THIS DRAWING MUST NOT BE SCALED. VARIATIONS AND MODIFICATIONS TO WORK SHALL BE MADE BY THE ARCHITECT OR ARCHITECTS WITHOUT WRITTEN PERMISSION FROM THE ARCHITECTS. THIS DRAWING IS THE EXCLUSIVE PROPERTY OF CICOZZI ARCHITECTURE INC. AND ON BE REPRODUCED ONLY WITH THEIR WRITTEN PERMISSION.

REVISIONS table with columns for DATE, DESCRIPTION, and ISSUED FOR



PROJECT STATISTICS

Table containing project statistics: CIVIC ADDRESS, LEGAL DESCRIPTION, SITE AREA, ZONING, DENSITY F.S.R., LOT COVERAGE, BUILDING HEIGHT, SETBACKS, BUILDING AREA, NET BUILDING AREA, AMENITY CALC, and OUTDOOR AMENITY.

UNIT & PARKING STATISTICS BY PHASE

Table with columns for PHASE, UNIT SUMMARY, RESIDENT, VISITOR, TOTAL, REQUIRED, PROVIDED, and other metrics for parking stalls.

Table showing BIKE PARKING BREAKDOWN - CLASS ONE (Long-term / Resident) with columns for PHASE ONE, PHASE TWO, and TOTAL.


DRAWING LIST

Table listing architectural drawings: A00 COVER SHEET, A01 DESIGN RATIONALE, A02 CONTEXT PHOTOS, A03 MATERIAL BOARD, A04 SHADOW STUDY, A10 SITE PLAN, A11 PARKADE PLAN, A12 GARBAGE WASTE MANAGEMENT PLAN, A13 RECYCLING WASTE MANAGEMENT PLAN, A20 BUILDING 1 - MAIN LEVEL PLAN, A21 BUILDING 1 - 2ND LEVEL PLAN, A22 BUILDING 1 - 3RD LEVEL PLAN, A23 BUILDING 1 - 4TH LEVEL PLAN, A24 BUILDING 2 - MAIN LEVEL PLAN, A25 BUILDING 2 - 2ND LEVEL PLAN, A26 BUILDING 2 - 3RD LEVEL PLAN, A27 BUILDING 2 - 4TH LEVEL PLAN, A28 ROOF PLAN, A29 BUILDING 1 - MAIN LEVEL OVERLAY, A30 BUILDING 1 - 2ND/3RD/4TH LEVEL OVERLAY, A31 BUILDING 2 - MAIN LEVEL OVERLAY, A32 BUILDING 2 - 2ND/3RD/4TH LEVEL OVERLAY, A40 ELEVATIONS, A41 ELEVATIONS, A42 COURTYARD ELEVATIONS, A43 COURTYARD ELEVATIONS, A50 BUILDING SECTIONS, A51 BUILDING SECTIONS, A52 BUILDING SECTIONS, A60 UNIT A PLANS, A61 UNIT B PLANS, A62 UNIT C PLANS, A63 UNIT C PLANS, A64 UNIT SUMMARY.

CLIENT: EVERWELL GROUP HOLDING LTD PARTNERSHIP
CONTACT: BARBY SAVAGE
ARCHITECT: CICOZZI ARCHITECTURE INC.
LANDSCAPE: ETA LANDSCAPE ARCHITECTURE

RESIDENTIAL DEVELOPMENT
4008 & 4018 STOLBERG ST
RICHMOND, BC

COVER SHEET

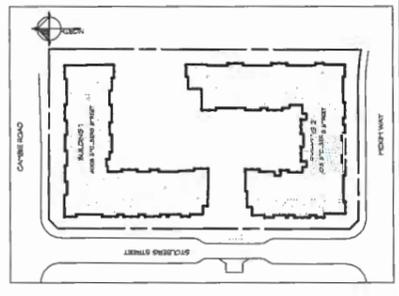

OP 11 / 17420U - 1

COPYRIGHT RESERVED. THIS DRAWING MUST NOT BE SCALED. VARIATIONS AND MODIFICATIONS TO WORK SHOWN ON THESE DRAWINGS SHALL NOT BE CARRIED OUT WITHOUT WRITTEN PERMISSION FROM THE ARCHITECT. THIS DRAWING IS THE PROPERTY OF CICCOCCHI ARCHITECTURE INC. AND CAN BE REPRODUCED ONLY WITH THEIR WRITTEN PERMISSION.

REVISION:	
NO.	DESCRIPTION:

ISSUE:	
DATE:	DESCRIPTION:
22.12.2027	DP SUBMISSION
06.04.2028	FINAL DP RESUBMISSION
2.03.2029	DP RESUBMISSION
06.06.2029	REBID FOR DP
24.03.2030	REBID FOR DP



# CICCOZZI

ARCHITECTURE

200 - 2339 COLUMBIA STREET  
VANCOUVER, B.C.  
CANADA V5Y 3Y3  
TEL: (604) 687-4741

PROJECT:	
RESIDENTIAL DEVELOPMENT	
4008 STOLBERG ST	RICHMOND, BC

DRAWING:	
NO.	DESCRIPTION:

SHEET TITLE:	
DESIGN RATIONAL	

SHEET NO.:	
A0.01	

## 4008 STOLBERG STREET - A MULTI-FAMILY RESIDENTIAL DEVELOPMENT PROPOSAL

### DESIGN RATIONALE

The Stolberg project site is located on the 4000 block of Stolberg Street south of Cambie Road Road, in the Alexandra neighborhood of West Cambie. The site is bounded by Stolberg Street to the west, Cambie Road to the north, Adjacent site to the east, and McKim Way to the south. The area is primarily a residential neighborhood. To the West and southwest of the site are existing 4-story multi-family residential buildings to the north, are existing 2-story townhomes complex, to the east, a new 4-story multi-family residential site nearing completion.

The project site proposes two 4-story residential buildings over a single-level parkade. Externally, the buildings are sited to create a strong urban edge along the perimeter with higher massing to hold the corners and breaks in the north-south homages at the mid-block location. Internally, the site opens up to a formal landscaped courtyard with outdoor amenities such as walking paths, edible landscape, children's play area and dog park. The ground level will have direct access from their suite to either the fronting street, internal courtyard or living/greenway.

The building indoor amenity, which has a more active area includes a Tall room, Yoga room, Gym and craft room is located within the southern building. And a passive area includes community lounge, party room and kitchen is located within the northern building footprint, both feature direct access from Stolberg Street and to the central courtyard. Locating the amenity in the mass of the building created a larger, uninterrupted central courtyard with greater programming opportunities.

Architecturally, the contemporary east coast brownstone style fits well in the context created by the existing buildings. The buildings are articulated to read as a series of smaller facades by stepping back the building face in some areas and increasing the roof height in others. Breaks between the two buildings provide relief to the street wall and provide a visual connection to the inner landscaped courtyard. Lobbies are centrally and prominently located on Stolberg Street and create a focal point for each building.

Extensive use of masonry on the buildings is a feature of the east coast style and is in keeping with other developments in the area. The top floor is detailed with board and batten siding as a consistent material on all elevations. Punched window openings with detailed fenestration are highlighted with decorative metal railing and concrete inlets and sills. Roof overhangs are detailed with dentils and corner brackets to add character and identity. Loggias are over height volumes, characterized by brick clad entry columns, custom lighting fixtures and glass and steel entry canopies.

The landscape design for the development provides for an inviting, formal, lush landscaped residential project. It attracts residents, neighbors, and visitors through a friendly street frontage with lush stepping paths, and residential patios. Well-defined pathways lead to the generous internal courtyard and amenity green which is defined into a series of outdoor rooms. These outdoor rooms provide the residents and visitors with a multitude of outdoor active and passive recreational opportunities. Trees and formal planting divide the space into open multifunctional lawns, a central gathering space with linear water feature, lawn bowling area, natural play area with climbing wall, urban agriculture with communal herb gardens, and a patio with BBQ off the amenity building. The open and formal courtyard space with low plantings and formally organized walkways have open views throughout the space which is inviting and allows for easy way finding. All season interest in the planting palette and the native and adaptive plant species, as well as quality hardscape materials will ensure the landscape can be enjoyed all year round for years to come.

### DEVELOPMENT PERMIT CRITERIA

#### MULTI-FAMILY DEVELOPMENTS

##### Protestion-Oriented Streetscapes

- The building siting orients the main facade parallel to the street, creating a desired residential street wall.
- The streetscapes have been designed to animate the street, with the stepped planters and exterior staircases up to the main floor, to provide high level of pedestrian interest along the street edges.
- Windows and doors are oriented toward the street, to animate the building facade, and provide a "human-scale" to the project and added security for the neighborhood.
- The two building entrances from the adjacent streets and are directly accessible from the public sidewalks. Indoor waiting areas are provided along with outdoor weather protection with an identifiable entrance canopy design.

##### Building Massing, Scale and Form

- The development includes a variety of unit types and sizes, providing social diversity and opportunities for architectural interest
- The residential character is designed to be unique while at the same time being compatible in the neighborhood.
- The building mass is articulated through the use of projections, recesses, solids and voids, varying roof heights and attention to architectural detailing and decorative elements at the roof line.
- The building facade 'breaks' along the east and west facades, providing views into the interior garden court from street level.
- Exterior cladding materials include brick, horizontal and vertical hard-siding, and metal detailing at framed openings, cornice and soffit detailing. The materials are architecturally detailed and placed within the facades to provide visual interest and identity in the various elevations.
- The elevations have been articulated to break the massing with smaller elements designed as vertical components to express a rhythm and interest in the buildings' overall length.

##### Facade Articulation

- Balconies and decks are designed as integral parts of the building massing and facade composition, maintaining "hard corners" and continuity of the building face with framed openings, rather than open recesses.
- "Punctured" windows in brick veneer are dominant on the lower portions of the building, reducing apparent building mass and height.
- Upper level windows are aligned, extending vertical articulation to the building facade in a well ordered and simple configuration.

#### Public and Private Views:

"Maintain views wherever possible, public off-site views as well as private on-site views"

- The buildings were sited to maximize views both off-site. Immediate views toward existing parks to the north and south, and east along a new parkway greenway. New internal views were created to maximize views between the two buildings, creating a sense of place and identity and a landmark in the landscape.
- Views from existing developments were protected with the design of this low-rise development and shadowed with a visual connection from off site to the classically designed landscaped podium.
- Impacts on on-site open space are minimized with the generous setbacks between the two buildings, providing light and views onto the site and the large open internal courtyard. The site perimeter is adjacent to city streets on 3 sides, and a pedestrian walkway on the 4<sup>th</sup>, minimizing shadow impact on any neighbouring properties.
- Views are preserved through view corridors with the setback of the building face along the public greenway, enhancing the public open spaces.
- Opportunities are created for views of adjacent parks, gardens, and landscaped areas for residents.
- Siting of the buildings with the wide openings through to internal the landscape provides shared views between developments, providing opportunities for views through and past the site.
- The thoughtful design of the development itself adds value to the existing neighbourhood and creates a good view for other developments.
- The landscaped podium has been designed to provide a variety of activities, both active and passive and provides opportunities to take advantage of internal and exterior views and sun.

#### Public Realm and Pedestrian Amenity: "Create a high-quality, vibrant and pedestrian friendly public realm."

- Sunlight Penetration: The height, massing, and siting of the development allows for adequate sunlight penetration to both the adjacent streets and private open space with adequate setbacks, and breaks (approximately 40') between the two buildings, and the open internal courtyard area.
- Weather Protection - Rain and Sun Protection: Weather protection is provided with an entry canopy at the common lobby/entry feature, fronting the public sidewalk. The entry design also provides good daylighting into the lobby area with the double height proportion with upper level glazing.
- Wind Protection: The outdoor amenity area is located within the building courtyard, providing areas of wind protection to enhance enjoyment of the outdoors, and to extend the seasonal duration of outdoor activities.

#### Site Landscaping

"...Enhancing the image of the City of Richmond as the Garden City..."

- Although there were not any eligible trees for preservation on this site, the project includes an abundant landscape design with new landscaping at the perimeter and a fully landscaped podium level.
- The landscape design defines the public space with new boulevard trees that also provide shade as needed.
- The internal courtyard design provides planted areas and minimizes impervious surfaces areas.
- The selected plantings include species that will attract birds, enhancing biodiversity and creating soundscapes.
- Drought resistant plant material is used in order to reduce long-term maintenance requirements and water consumption.
- A variety of trees (deciduous and evergreen) are provided for seasonal color, texture and variety.
- Species have been chosen to provide shade, wind protection, and improve air quality. Ecologically sound, appropriate for the existing and future site conditions and suitable for all seasons.
- Trees have been "clustered" or aligned to create "outdoor rooms" or define smaller, more intimate areas for people to gather in.
- Trees are placed to frame building elevations and to add visual interest, with low planting material along edges to soften building elevations, maintain a pedestrian scale and provide definition to public walkways and open spaces.
- Public seating is provided where walkways intersect public streets.
- Deciduous trees are provided on the south elevation to reduce summer building heat loads and maximize winter building heat gain.
- Surface Treatment: A variety of colour and textures has been proposed for patios, walkways and open areas.

#### Public Art

"Promote and facilitate the integration of public art... that expresses the lives of artists and the community..."

- A contribution will be made as required to Richmond's Public Art Reserve.

#### Vehicle Access and Circulation:

"... Provide safe and efficient circulation for vehicles without compromising the pedestrian environment..."

- The parkade entrance is located on a local street, midway between the intersections to the north and south, providing a clear access point to property to the west, to maximize safety in the pedestrian realm.
- Garbage and recycling collection is located on site, adjacent to the parkade entry. The area is designed for the vehicle to exit the site in a forward motion, minimizing interface with pedestrian traffic and public vehicular access.

#### Accessibility (Universal Design Principles): Site Accessibility/Circulation

"... ensure that the design of a development enables all people, including people with disabilities, to have full and unrestricted access to every part of a project"

- The main entry lobbies to both buildings are accessible directly from the pedestrian sidewalk along the fronting streets.
- All parking spaces allocated for people with disabilities are located in the parkade, close to the elevator lobbies of each building.
- Accessible access to the outdoor amenity space is provided through both buildings through the upper level lobbies.
- The ground courtyard area is fully accessible with walkways accessing all outdoor amenity areas.

Crime Prevention Through Environmental Design (CPTED)  
"...through the use of CPTED principles, opportunities for crime are minimized and a sense of security is promoted."

#### Natural Access Control

- We have provided clearly-defined pedestrian entries and separation of vehicle access to create safe routes for pedestrians.
- Formal site access points are limited to the two building lobbies and two site access stairs.
- Edges and corners are defined with low landscaping, low planters, low permeable fencing, columns and elevation changes.
- Building signage will be designed into the entry lobbies at the two access points.
- Semi-private open spaces are situated around the building perimeter to maximize resident access, surveillance and enjoyment.
- Illuminated walkways with site lines maintained are provided on the podium garden court.

#### Natural Surveillance

- A strong orientation between buildings and the street is established in the siting of the buildings around the site perimeter.
- Surveillance or "eyes on the street" opportunities are provided with garden entries with windows and patio doors to all main level homes to allow people to enjoy private outdoor space while easily viewing what is happening around them, on the streets and in the garden courtyard.
- Clear, unobstructed views of entry lobbies are illuminated, clearly visible and easily accessible from the public street.
- Outdoor amenity areas are grouped and designed so that each area will allow for passive observation from other users and adjacent homes.
- Public and semi-public spaces are defined from private spaces landscape elements such as changes in elevation, paving, vegetation, low wall and raised planters.

#### Green Buildings and Sustainable Infrastructure:

"... undertake where feasible, green building and sustainable infrastructure... and help reduce the demand for energy and resources."

- Energy Efficiency: The building is designed with the following considerations to help minimize the use of energy and reduce Greenhouse Gas Emissions:
  - Provision of high performance windows, walls and roofs to reduce energy consumption;
  - Use of day lighting and natural ventilation with generous window sizes;
  - Utilizing energy efficient lighting, heating, mechanical systems and appliances;
  - Connected to the district energy system, with an individual heat pumps located in each suite;
  - Eliminating the use of ozone depleting chemicals wherever possible

Water Conservation: The building and site infrastructure is designed to use less potable water by considering the following:

- Installation of plumbing fixtures that conserve water.
- Utilizing high efficiency irrigation and drought tolerant plants for landscape areas to minimize the need for watering and maintenance.

#### Building Materials: The design incorporates sustainable building materials by using:

- Recycled and renewable building materials when possible;
- Material such as brick and hard siding that have long-life, low maintenance properties to extend the lifespan of the building;

#### Rainwater Management

- The project has been designed with a large landscaped roof over the parkade to help manage as much rainwater on site as possible and reduce the impact on City drainage systems

Waste Reduction: Measures to reduce the generation of waste through careful design and construction practice will be provided as feasible by:

- Supporting educational recycling programs for construction workers and site occupants;
- Providing facilities to encourage three stream waste separation and recycling.

Health and Air Quality: Helping to improve indoor air quality, and minimize noise, noxious emissions, and dust by:

- Planting trees where possible to improve air quality and mitigate heat island effects;
- Selecting and encouraging green materials (e.g., paints, adhesives that minimize toxic chemicals and gases)

#### Urban Agriculture

- Provision of onsite urban agriculture.

DP 17-194280-2

COPYRIGHT RESERVED. THIS DRAWING MUST NOT BE SCALED. VARIATIONS AND MODIFICATIONS TO WORK SHOWN ON THESE DRAWINGS SHALL NOT BE CARRIED OUT WITHOUT WRITTEN PERMISSION FROM THE ARCHITECT. THIS DRAWING IS THE PROPERTY OF CICCOTZI ARCHITECTURE INC. AND CAN BE REPRODUCED ONLY WITH THEIR WRITTEN PERMISSION.

REVISION:	
NO.	DESCRIPTION:

ISSUE:	
DATE:	DESCRIPTION:
22.12.2017	DP SUBMISSION
06.04.2018	PARTIAL DP RE-SUBMISSION
13.09.2018	DP RESUBMISSION
06.06.2018	RE-SUBMITTED FOR DP
28.09.2018	RE-SUBMITTED FOR DP



**CICCOTZI**  
ARCHITECTURE  
200 - 2339 COLUMBIA STREET  
VANCOUVER, B.C.  
CANADA V5T 3Y3  
TEL: (604) 687-4741

PROJECT:  
**RESIDENTIAL DEVELOPMENT**  
4008E-4018 STOLBERG ST  
RICHMOND, BC


OWNER:	CLIENT:	PROJECT NO.:

SCALE:	PROJECT NO.:
1:1000	564

SHEET TITLE:  
**MATERIAL BOARD**

REVISION NO.:	SHEET NO.:
-	A0.2

**BUILDING CHARACTER**

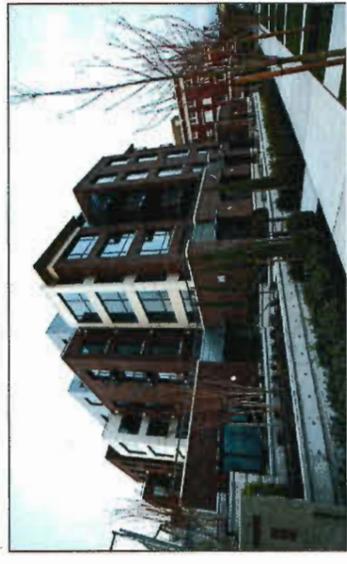

**PAINTED WOOD TRIM**  
BENJAMIN MOORE  
HC-167 ANTHEAST GREY



**G**

**ALUMINIUM RAILINGS**  
PRE-FINISHED ALUMINIUM  
BLACK



**H**

**ALUMINIUM WINDOWS & CURTAINWALL STOREFRONT**  
AKZO NOBEL - INTERPON  
IRON MOUNTAIN GREY BL257-03000 / 61007-0101



**J**

**BRICK CLADDING**  
MUTUAL MATERIALS  
INCA MISSION



**D**

**CAST IN PLACE CONCRETE**  
UNPAINTED SMOOTH FINISH



**E**

**PRECAST CONCRETE**  
UNPAINTED SMOOTH FINISH



**F**

**HARDIE HORIZONTAL SIDING**  
BENJAMIN MOORE  
HC-166 YENDALL CHARCOAL



**A**

**HARDIE HORIZONTAL SIDING**  
BENJAMIN MOORE  
OC-19 'SEAPEARL'



**B**

**HARDIE PANEL SIDING W/ WOOD BATTENS**  
BENJAMIN MOORE  
OC-19 'SEAPEARL'/HC-75 'MARTYVILLE BROWN'



**C**



DP 17-17420-3

CONTRACTOR: THESE DRAWINGS MUST NOT BE  
SCALED, REPRODUCED OR MODIFICATIONS TO WORK  
SHOWN ON THESE DRAWINGS SHALL NOT BE CARRIED  
OUT WITHOUT WRITTEN PERMISSION FROM THE  
ARCHITECTS. THIS DRAWING IS THE EXCLUSIVE  
PROPERTY OF CICCOZZI ARCHITECTURE AND ON-  
LINE. IT IS TO BE USED ONLY WITH THE WRITTEN  
PERMISSION.

REVISION:	DATE:	DESCRIPTION:

ISSUE:	DATE:	DESCRIPTION:
08.04.2017	DP SUBMISSION	
08.04.2018	PARTIAL DP RESUBMISSION	
12.07.2018	DP RESUBMISSION	
08.08.2018	RE-BUILD FOR DP	
09.20.2018	RE-BUILD FOR DP	
20.09.2018	RE-BUILD FOR DP	




**CICCOZZI**  
ARCHITECTURE  
200 - 2339 COLUMBIA STREET  
VANCOUVER, B.C.  
CANADA V5Y 3Y3  
TEL: (604) 687-4741

PROJECT:  
**RESIDENTIAL  
DEVELOPMENT**  
40084018 STOLBERG ST  
RICHMOND, BC

DRAWN:	REV:	CHECKED BY:	INC
SCALE:	1/8" = 1'-0"	PROJECT NO.:	5664
SHEET TITLE:			<b>SITE PLAN</b>

REVISION NO.:	-	SCALE:	A1.0
---------------	---	--------	------

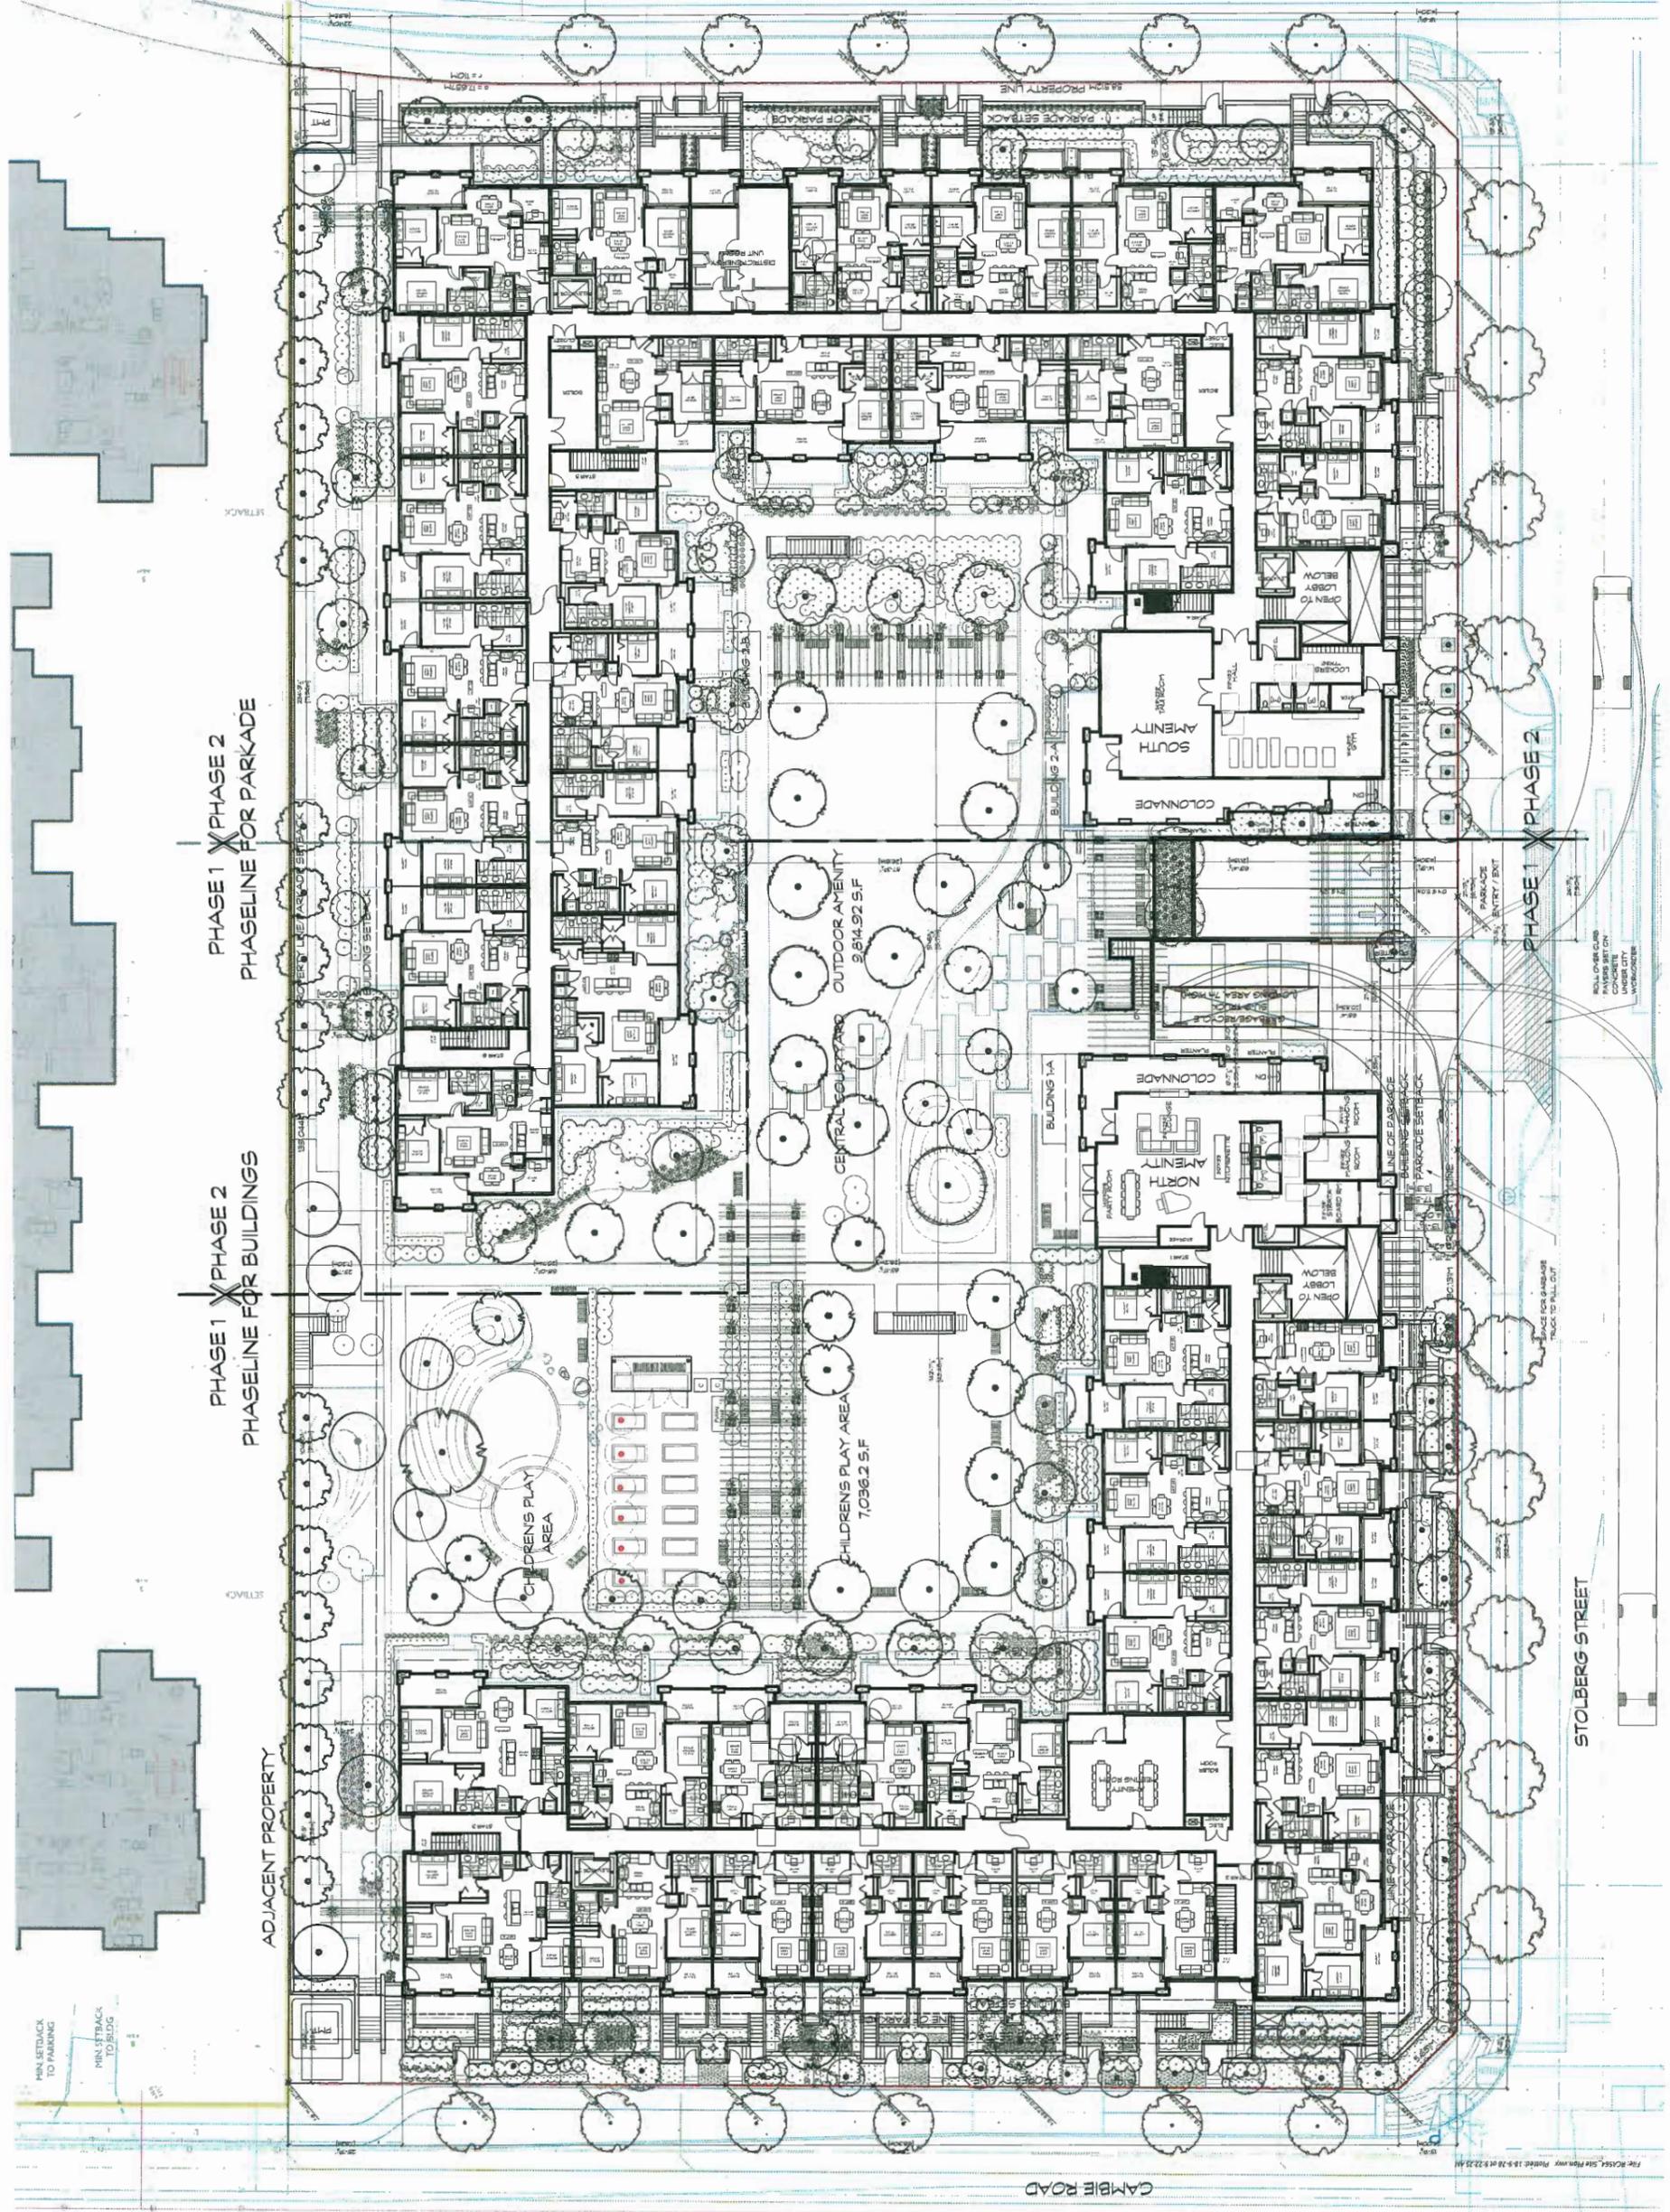

OP 17-19420U-0

COPYRIGHT RESERVED. THIS DRAWING MUST NOT BE REPRODUCED OR TRANSMITTED IN ANY FORM OR BY ANY MEANS, ELECTRONIC OR MECHANICAL, INCLUDING PHOTOCOPYING, RECORDING, OR BY ANY INFORMATION STORAGE AND RETRIEVAL SYSTEM, WITHOUT WRITTEN PERMISSION FROM THE ARCHITECTS. THIS DRAWING IS THE EXCLUSIVE PROPERTY OF CICCOTZI ARCHITECTURE INC. AND CAN BE REPRODUCED ONLY WITH THEIR WRITTEN PERMISSION.

REVISION:	DATE:	DESCRIPTION:

**ISSUE:**  
**DATE:** 23.03.2018  
**DESCRIPTION:** CP SUB-MISSON  
 CALCULATION PARTIAL CP RESUB-MISSON  
 12.07.2018 CP RESUB-MISSON  
 CALCULATION RE-ISSUED FOR CP  
 28.03.2018 RE-ISSUED FOR CP



**CICCOZZI**  
 ARCHITECTURE  
 200 - 2339 COLUMBIA STREET  
 VANCOUVER, B.C.  
 CANADA V5Y 3Y3  
 TEL: (604) 687-4741

**RESIDENTIAL DEVELOPMENT**  
 40064018 STOLBERG ST  
 RICHMOND, BC


DRAWN:	KJV	CHECKED BY:	RC
SCALE:	1/8" = 1'-0"	PROJECT NO.:	564
SHEET TITLE: <b>PARKADE PLAN</b>			

SHEET NO.:	A1.1
DATE:	-

MCKM WAY

PHASE 1 PHASE 2  
 PHASELINE FOR PARKADE

PHASE 1 PHASE 2  
 PHASELINE FOR BUILDINGS

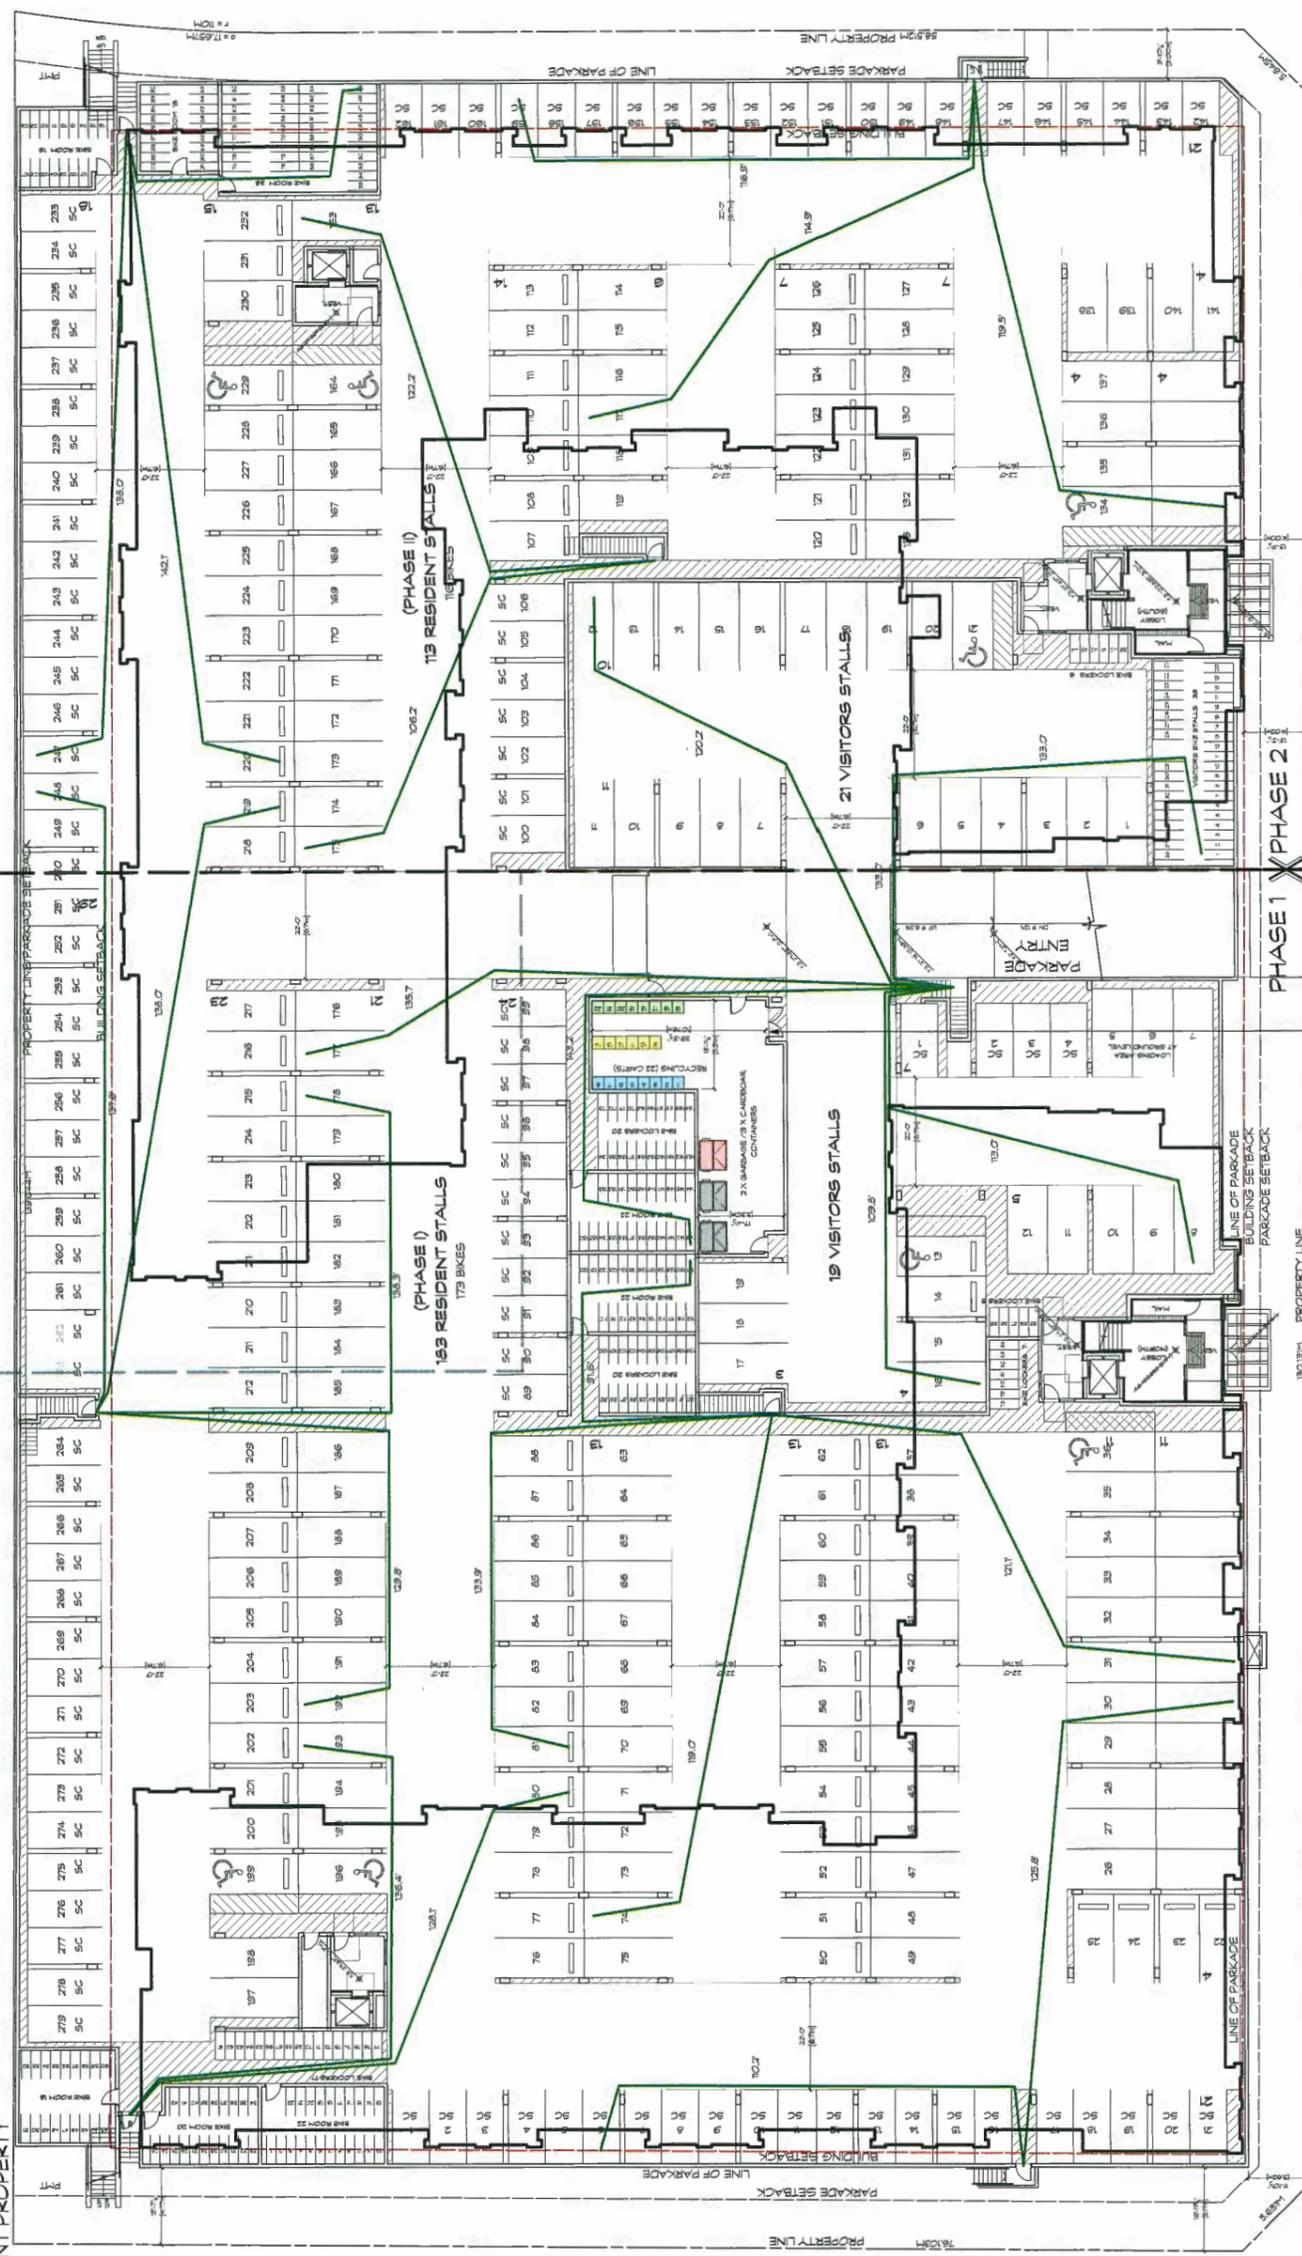

**LEGEND:**  
 S.C. SMALL CAR STALL  
 TRAVEL DISTANCE


**BIN TYPES:**  
 GARBAGE FRONT END CONTAINER  
 CARDBOARD FRONT END CONTAINER  
 FOOD SCRAP CART  
 PAPER RECYCLING CART  
 MIXED CONTAINERS RECYCLING CART

VEHICULAR PARKING BREAKDOWN	RESIDENT	VISITOR	TOTAL	HC / ACCESSIBLE	SMALL CARS
PHASE ONE	153	19	202 stalls	4	68
PHASE TWO	113	21	134 stalls	2.0 % (min. 2 %)	33.7 % (max. 50 %)
FULL BUILDOUT	296	40	336 stalls	3.0 % (min. 2 %)	46 % (max. 50 %)
PHASE ONE	166	0	166	0.0%	166
PHASE TWO	116	0	116	0.0%	116
FULL BUILD OUT	284	0	284	0.0%	284

NOTE: INCLUDING 11 TENDAM PARKING STALLS & 7 EV. STALLS (EV. 80-99)  
 INCLUDING 4 TENDAM PARKING STALLS  
 INCLUDING TOTAL 15 TENDAM PARKING STALLS  
 LEVEL 2 (NOV) ELECTRICAL CHARGING FOR ALL STALLS  
 \* BIKE PARKING BREAKDOWN - CLASS ONE (Long-term/ Resident)  
 (No. of Bicycle Parking Spaces in Parkade)

PHASE	HORIZONTAL	VERTICAL	VERTICAL % (33% max.)	TOTAL
PHASE ONE	166	0	0.0%	166
PHASE TWO	116	0	0.0%	116
FULL BUILD OUT	284	0	0.0%	284

NOTE: ONE 120V ELECTRIC PLUG-IN FOR EACH BIKE STORAGE ROOM

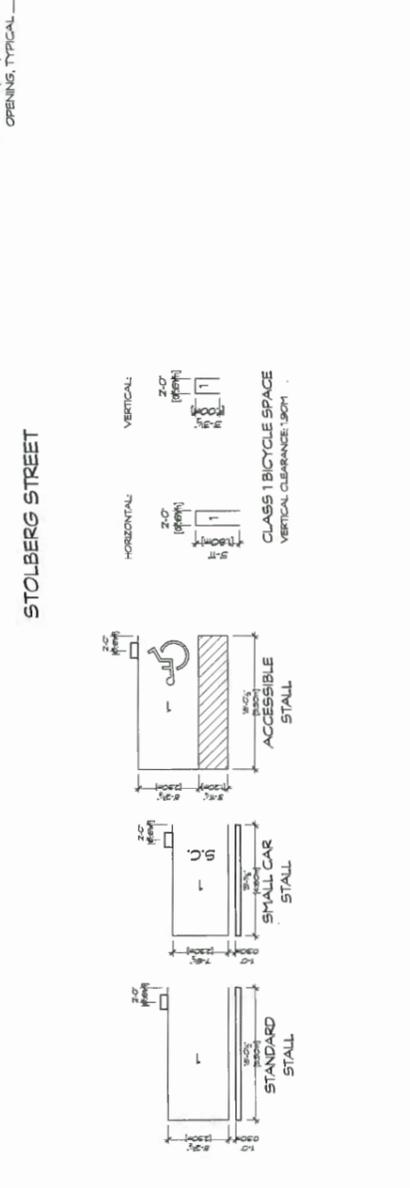

OP 17-18-20-5

COPYRIGHT RESERVED. THIS DRAWING MUST NOT BE REPRODUCED, COPIED, REPRODUCED, OR TRANSMITTED IN ANY FORM OR BY ANY MEANS, WITHOUT WRITTEN PERMISSION FROM THE ARCHITECTS. THIS DRAWING IS THE EXCLUSIVE PROPERTY OF CICOZZI ARCHITECTURE INC. AND CAN BE REPRODUCED ONLY WITH THEIR WRITTEN PERMISSION.

NO.	DATE	DESCRIPTION


ISSUE:	DATE:	DESCRIPTION:



**CICOZZI**  
ARCHITECTURE

200 - 2339 COLUMBIA STREET  
VANCOUVER, B.C.  
CANADA V5Y 3Y3  
TEL: (604) 687-4741

MCKIM WAY

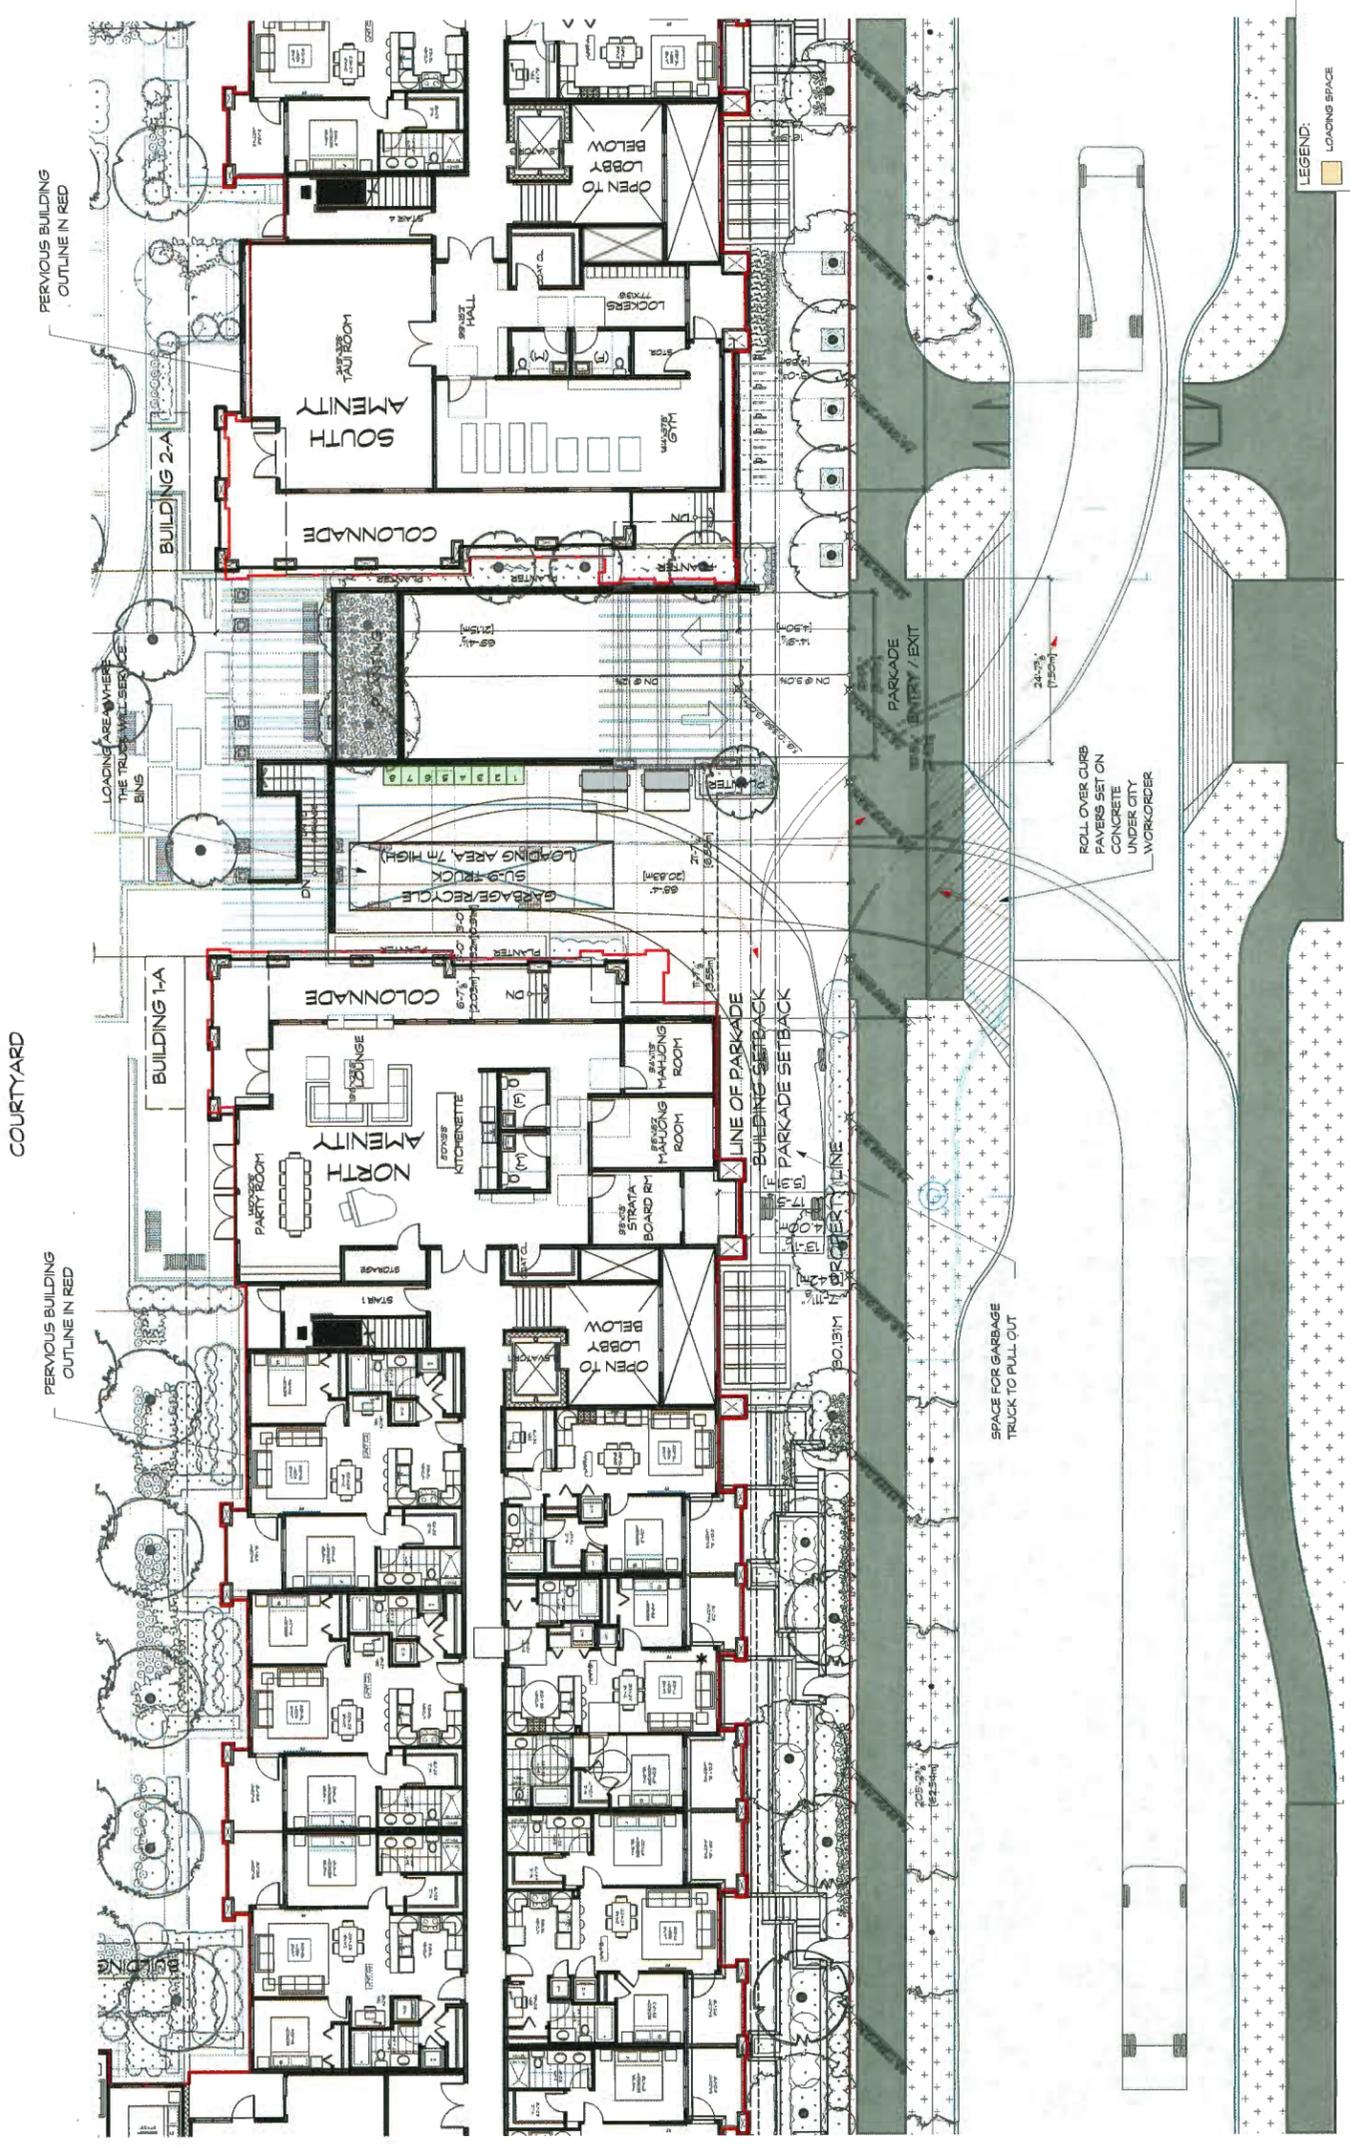

**LEGEND:**

- LOADING SPACE
- TRUCK ACCESS

**BIN TYPES:**

- GARBAGE FRONT END CONTAINER
- CARDBOARD FRONT END CONTAINER
- FOOD SCRAP'S CART
- PAPER RECYCLING CART
- MIXED CONTAINERS RECYCLING CART

PROJECT:  
**RESIDENTIAL DEVELOPMENT**  
400884018 STOLBERG ST  
RICHMOND, BC

DRAWN: KJV	CHECKED BY: RC
SCALE: 1/8" = 1'-0"	PROJECT NO.: 564
SHEET TITLE: <b>GARBAGE WASTE MANAGEMENT PLAN</b>	

INTERIOR NO.: -	SHEET NO.: <b>A1.2</b>
-----------------	------------------------

CONTRACTOR ADVISED. THE DRAWING MUST NOT BE SCALED. VARIATIONS AND MODIFICATIONS TO WORK SHOWN ON THESE DRAWINGS SHALL NOT BE CARRIED OUT WITHOUT WRITTEN PERMISSION FROM THE ARCHITECT. THIS DRAWING IS THE EXCLUSIVE PROPERTY OF CICCOZZI ARCHITECTURE AND CAN BE REPRODUCED ONLY WITH THEIR WRITTEN PERMISSION.

NO.	DATE	DESCRIPTION

ISSUE:	DATE:	DESCRIPTION:
20.12.2017	DP SUBMISSION	
01.04.2018	PARTIAL DP RE-SUBMISSION	
12.07.2018	DP RE-SUBMISSION	
01.03.2018	RE-SUBMITTED FOR DP	
28.09.2018	RE-SUBMITTED FOR DP	




**CICCOZZI**  
ARCHITECTURE

200 - 2339 COLUMBIA STREET  
VANCOUVER, B.C.  
CANADA V5Y 3Y3  
TEL: (604) 687-4741

MCKIM WAY

COURTYARD

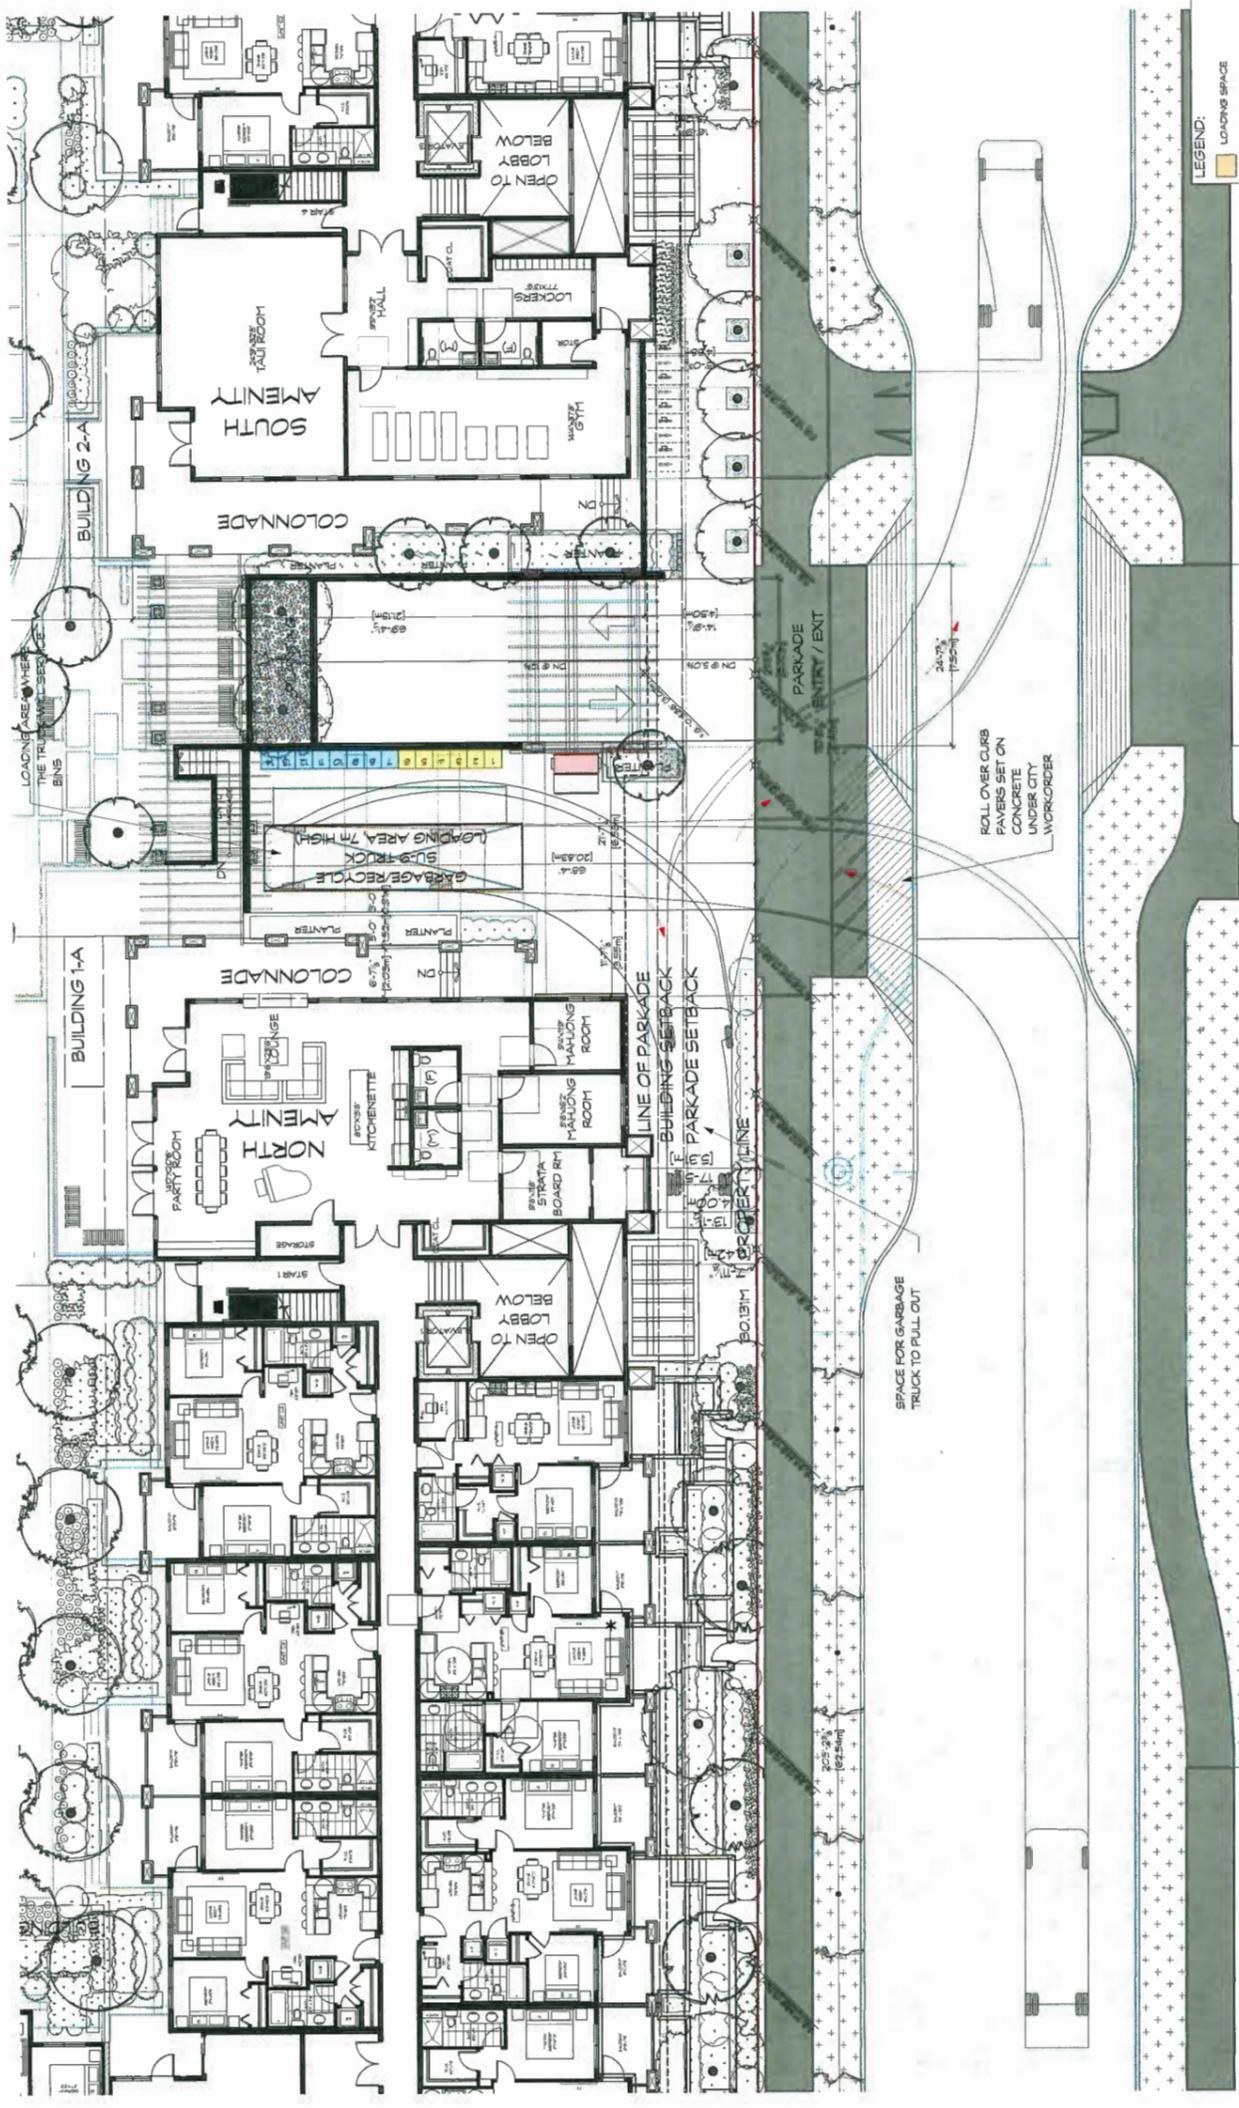

**LEGEND:**

- LOADING SPACE
- TRUCK ACCESS

**BIN TYPES:**

- GARBAGE FRONT END CONTAINER
- CARDBOARD FRONT END CONTAINER
- FOOD SCRAPS CART
- PAPER RECYCLING CART
- MIXED CONTAINERS RECYCLING CART

PROJECT: RESIDENTIAL DEVELOPMENT  
40084018 STOLBERG ST  
RICHMOND, BC

DATE:	REV:	DESCRIPTION:

PROJECT NO.: 5614  
SHEET TITLE: **RECYCLING WASTE MANAGEMENT PLAN**

DATE:	REV:	DESCRIPTION:

SHEET NO.: A1.3

OP 17-794 280-7

COPYRIGHT RESERVED. THIS DRAWING MUST NOT BE SCALED. VARIATIONS AND MODIFICATIONS TO WORK SHALL BE INDICATED BY DIMENSIONS AND NOTED OUT WITHOUT WRITTEN PERMISSION FROM THE ARCHITECT. THIS DRAWING IS THE EXCLUSIVE PROPERTY OF CICCOTZI ARCHITECTURE INC. AND CAN BE REPRODUCED ONLY WITH THEIR WRITTEN PERMISSION.

REVISION:	
NO.	DESCRIPTION

ISSUE:	
DATE	DESCRIPTION
10.13.17	CP SUBMISSION
12.07.2018	CP REVISION
04.08.2018	RE-DESIGN FOR CP
26.03.2018	RE-DESIGN FOR CP



**CICCOTZI**  
ARCHITECTURE

200 - 2339 COLUMBIA STREET  
VANCOUVER, B.C.  
CANADA V5Y 3Y3  
TEL: (604) 687-4741

**RESIDENTIAL DEVELOPMENT**  
4008 BELGIA ST. COLLETS ST  
RICHMOND, BC

DRAWN: KJV	CHECKED: EC
SCALE: 3/32" = 1'	PROJECT NO: 2684
SHEET TITLE: BUILDING 1 MAIN LEVEL PLAN	

SHEET NO.: -	SHEET TITLE: A2.0
--------------	-------------------




**MEASURES PROVIDED FOR RICHMOND BASIC UNIVERSAL HOUSING UNITS (AS NOTED):**

- ROUGH WORK WILL BE PROVIDED AT SUITE ENTRY DOOR TO PROVIDE FOR FUTURE INSTALLATION OF AN AUTOMATIC DOOR OPENER.
- DOOR IN SUITE (KITCHEN OR BATHROOM) SHALL BE ACCESSIBLE BATHROOM AND DOOR CLEARANCES SHALL BE PROVIDED AT ONE BEDROOM AND ONE BATHROOM FOR ALL UNITS CONTAINING 2 OR MORE BEDROOMS.
- FLOOR SURFACES WITHIN SUITE (AND THROUGH BUILDING INTERIOR) SHALL HAVE NO abrupt change in level and flush thresholds (MAX. 3/16" HEIGHT) DOORS TO SUITE SHALL BE ACCESSIBLE WITHIN SUITE.
- MINIMUM ONE ACCESSIBLE WINDOW IN BOTH ONE BEDROOM AND LIVING AREA PROVIDE A WINDOW HEIGHT THAT CAN BE OPERATED WITH ONE HAND WITHOUT TIGHT GRASPING, PINCHING OR TWISTING.
- ELECTRICAL POINTING HEIGHTS SHALL CONFORM TO THE FOLLOWING (ALL NOTED ABOVE HEIGHTS ARE TO FACE):
  - LIGHT SWITCHES AND ELECTRICAL PANELS: 800 MM TO 1000 MM
  - INTERCOMS: 175 MM ELECTRICAL & CABLE OUTLETS: PHONE JACKS: 455 MM TO 1200 MM
  - THERMOSTATS: 800 MM TO 1000 MM
  - ALL CONTROLS REQUIRE 750 MM (30") CLEARANCE AREA
  - ALL CONTROLS SHALL BE ACCESSIBLE WITH ONE HAND
  - AT LEAST ONE BATHROOM SHALL HAVE:
    - TOILET WITH CLEARANCES 420 MM TO 460 MM FROM SIDE WALL ON WHICH A FUTURE GRAB BAR CAN BE INSTALLED 510 MM CLEARANCE TO ANY OBSTRUCTION ON THE OPPOSITE SIDE, AND 800 MM CLEARANCE IN FRONT.
    - A CLEARANCE OF 760 MM TO THE SINK OF 760 MM X 1220 MM, CENTERED AND POSITIONED FOR A PARALLEL APPROACH.
    - A MINIMUM CLEAR AREA OF 510 MM ALONG FULL LENGTH OF BATHUB
    - EASY TO GRASP (ES LEVER STYLE) FAUCETS
  - THE KITCHEN SHALL PROVIDE:
    - SOME USABLE COUNTER AND CUPBOARDS SPACE THAT CAN EASILY BE ACCESSIBLE WITH ONE HAND
    - CUPBOARDS WITH 25 CONTINUOUS COUNTER BETWEEN SINK AND STOVE (ADJUSTABLE SHELVES ETC)
    - EASY TO GRASP (ES LEVER STYLE) FAUCETS
    - EASY TO GRASP (ES J OR D STYLE) HANDLES ON CUPBOARDS
    - TASK LIGHTING AT SINK, STOVE AND KEY WORK AREAS
    - PLUMBING AND UTILITY PIPES PROVIDE 80 MM UNDER COUNTERS
    - CLEARANCES AT SINK TO ALLOW ACCESSIBLE KNEE SPACE FOR FUTURE CONVERSION OF SINK.
    - AT LEAST ONE BEDROOM SHALL PROVIDE A TURNING DIAMETER OF 150 MM ON ONE SIDE OF A DOUBLE BED AND A CLOSET WHICH HAS A CLEAR OPENING OF 800 MM BELOW TO 1000 MM
    - ALL SUITES SHALL HAVE A MINIMUM DIMENSION OF 3000 MM X 1800 MM AND BE ACCESSIBLE BY A DOOR WITH A MINIMUM CLEAR OPENING OF 800 MM

**AGING IN PLACE FEATURES (APPLIES TO ALL UNITS) INCLUDE:**

1. SOLID BLOCKING IN BATHROOMS FOR FUTURE GRAB BAR INSTALLATION
2. LEVER HANDLES ON SUITE DOOR HARDWARE
3. 34" CLEAR OPENING TO SUITE ENTRY DOORS

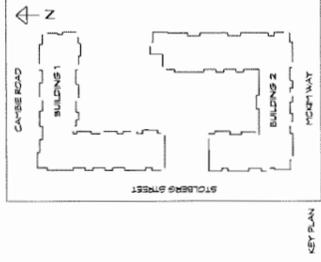

File: RICH154\_500 Main Plan - Floors 1B-9 2018.04.22.25.M

OP 17-794280-8

COPYRIGHT RESERVED. THIS DRAWING MUST NOT BE REPRODUCED OR TRANSMITTED IN ANY FORM OR BY ANY MEANS, ELECTRONIC OR MECHANICAL, INCLUDING PHOTOCOPYING, RECORDING, OR BY ANY INFORMATION STORAGE AND RETRIEVAL SYSTEM, WITHOUT THE WRITTEN PERMISSION OF THE ARCHITECT. THIS DRAWING IS THE EXCLUSIVE PROPERTY OF CICCOTZI ARCHITECTURE INC. AND CAN BE REPRODUCED ONLY WITH THEIR WRITTEN PERMISSION.

NO.	DATE	DESCRIPTION

ISSUE:	NO.	DATE	DESCRIPTION



**CICCOTZI**  
ARCHITECTURE

200 - 2339 COLUMBIA STREET  
VANCOUVER, B.C.  
CANADA V5Y 3Y3  
TEL: (604) 687-4741

PROJECT:  
**RESIDENTIAL DEVELOPMENT**  
400664018 STOLBERG ST  
RICHMOND, BC


OWNER:	
DESIGNER:	
DATE:	
SCALE:	3/32" = 1'0"
SHEET TITLE:	<b>BUILDING 1 2ND LEVEL PLAN</b>
CHECKED BY:	BC
PROJECT NO.:	564

THEET NO.:  
A2.1

**MEASURES PROVIDED FOR RICHMOND BASIC UNIVERSAL HOUSING UNITS (AS NOTED):**

- ROUGH WIRING WILL BE PROVIDED AT SUITE ENTRY DOOR TO PROVIDE FOR FUTURE INSTALLATION OF AN AUTOMATIC DOOR OPENER.
- DOORS IN SUITE (AT LEAST ONE BEDROOM, ONE ACCESSIBLE BATHROOM, AND LIVING AREA) SHALL PROVIDE A CLEAR OPENING OF NOT LESS THAN 800 MM (32").
- DOOR CLEARANCES SHALL BE PROVIDED AT ONE BEDROOM AND ONE BATHROOM.
- DOOR CLEARANCES SHALL BE PROVIDED AT ONE BATHROOM AND ONE BATHROOM.
- FLOOR SURFACES WITHIN SUITE (AND THROUGH BUILDING INTERIOR) SHALL HAVE NO ABRUPT CHANGE IN LEVEL AND FLUSH THRESHOLDS (MAX. 13MM HEIGHT). DOORS TO BALCONIES, PATIOS, DECKS ARE EXEMPT FROM THIS REQUIREMENT.
- MINIMUM ONE ACCESSIBLE WINDOW IN BOTH ONE BEDROOM AND LIVING AREA.
- ACCESSIBLE WINDOW SHALL HAVE A STILL HEIGHT NOT EXCEEDING 750 MM (30") AND SHALL BE OPERATED WITH ONE HAND WITHOUT THE OTHER HAND BEING ON THE WINDOW.
- ELECTRICAL MOUNTING HEIGHTS SHALL CONFORM TO THE FOLLOWING (ALL NOTED ABOVE FINISHER FLOOR LEVEL):
  - LIGHT SWITCHES
  - ELECTRICAL PANELS: 900 MM TO 1200 MM
  - INTERCOMS: 1375 MM - ELECTRICAL & CABLE OUTLETS: PHONE JACKS: 485 MM TO 1200 MM
  - RECEPTACLES: 800 MM TO 1200 MM
  - ALL CONTROLS REQUIRE 760 MM (30") CLEAR FLOOR AREA
  - LIGHT SWITCHES TO BE ROCKER OR PADDLE STYLE
  - AT LEAST ONE BATHROOM SHALL HAVE:
    - TOILET WITH CLEARANCES 400 MM TO 460 MM FROM SIDE WALL ON WHICH A FUTURE BARRIER OR GUARDRAIL COULD BE INSTALLED TO ANY OBSTRUCTION ON THE OPPOSITE SIDE AND 400 MM CLEARANCE IN FRONT.
    - A CLEAR FLOOR AREA AT ONE END OF 760 MM X 1200 MM, CENTERED AND POSITIONED FOR A PARALLEL APPROACH
    - A MINIMUM CLEAR AREA OF 510 MM ALONG FULL LENGTH OF BATHTUB
    - EASY TO GRASP (ES LEVER STYLE) FAUCETS
  - THE KITCHEN SHALL HAVE ONE ACCESSIBLE COUNTER AND CLEARANCES SPACE THAT CAN EASILY BE ACCESSED BY PEOPLE WITH DISABILITIES (SS CONTINUOUS COUNTER BETWEEN SINK AND STOVE, ADJUSTABLE SHELVES, ETC.)
  - EASY TO GRASP (ES, J OR D STYLE) HANDLES ON CUPBOARDS
  - TASK LIGHTING AT SINK, STOVE AND COUNTERS
  - TURNABLE COUNTERS WITH A MINIMUM CLEARANCE OF 800 MM UNDER COUNTERS
  - CLEARANCE AT SINK TO ALLOW ACCESSIBLE KNEE SPACE FOR FUTURE CONVERSION OF SINK.
  - AT LEAST ONE BEDROOM SHALL PROVIDE A TURNING DIAMETER OF 1500 MM ON ONE SIDE OF A DOUBLE BED AND A CLOSET WHICH HAS A CLEAR OPENING OF 800 MM (BETWEEN CLOSET DOOR AND WALL) AND A CLOSET HANGER THAT CAN BE ADJUSTED TO A MINIMUM OF 1500 MM.
  - THE BALCONY OR PATIO SHALL HAVE A MINIMUM DIMENSION OF 1500 MM X 1800 MM AND BE ACCESSED BY A DOOR WITH A MINIMUM CLEAR OPENING OF 800 MM.

- AGING IN PLACE FEATURES (APPLIES TO ALL UNITS) INCLUDE:**
1. SOLID BLOCKING IN BATHROOMS FOR FUTURE GRAB BAR INSTALLATION
  2. LEVER HANDLES ON SUITE DOOR HARDWARE
  3. 34" CLEAR OPENING TO SUITE ENTRY DOORS

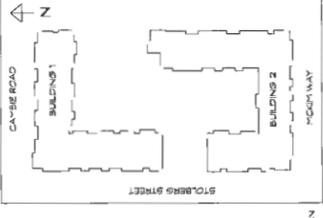

CONTRACT RECEIVED. THIS DRAWING MUST BE SCALED. VARIATIONS AND MODIFICATIONS TO WORK SHOWN ON THESE DRAWINGS SHALL NOT BE CARRIED OUT WITHOUT WRITTEN PERMISSION FROM THE ARCHITECT. THIS DRAWING IS THE EXCLUSIVE PROPERTY OF CICCOTZI ARCHITECTURE INC. AND CAN BE REPRODUCED OR COPIED ONLY WITH THEIR WRITTEN PERMISSION.

NO.	DATE	DESCRIPTION

ISSUE:	DATE:	DESCRIPTION:



**CICCOTZI**  
ARCHITECTURE

200 - 2339 COLUMBIA STREET  
VANCOUVER, B.C.  
CANADA V5T 3T3  
TEL: (604) 687-4741

PROJECT:  
**RESIDENTIAL DEVELOPMENT**  
400854015 STOLBERG ST  
RICHMOND, BC


DESIGNED BY:	KW	CHECKED BY:	RC
SCALE:	3/32" = 1/8"	PROJECT NO.:	564
SHEET TITLE: <b>BUILDING 1 3RD LEVEL PLAN</b>			

SHEET NO.:	A2.2
------------	------

**MEASURES PROVIDED FOR RICHMOND BASIC UNIVERSAL HOUSING UNITS (AS NOTED):**

- ROUGH WIRING WILL BE PROVIDED AT SUITE ENTRY DOOR TO PROVIDE FOR FUTURE INSTALLATION OF AN AUTOMATIC DOOR OPENER.
- DOORS IN SUITE (AT LEAST ONE BEDROOM, ONE ACCESSIBLE BATHROOM AND LIVING AREA) SHALL PROVIDE A CLEAR OPENING OF NOT LESS THAN 800 MM (32").
- ONE (1) ACCESSIBLE BATHROOM AND ONE BATHROOM FOR EACH SUITE CONTAINING 2 OR MORE BEDROOMS.
- FLOOR SURFACES WITHIN SUITE (AND THROUGH BUILDING INTERIOR) SHALL HAVE NO ABRUPT CHANGE IN LEVEL AND FLUSH THRESHOLDS (MAX. 19MM HEIGHT). DOORS TO BALCONIES, PATIOS, DECKS ARE EXEMPT FROM THIS REQUIREMENT.
- MINIMUM ONE ACCESSIBLE WINDOW IN BOTH ONE BEDROOM AND LIVING AREA.
- ALL SUITE ENTRY DOORS SHALL BE OPERATED WITH ONE HAND WITHOUT PROCEES GRASPING MECHANISM THAT CAN BE OPERATED WITH ONE HAND WITHOUT TIGHT GRASPING MECHANISM.
- ELECTRICAL PLACING HEIGHTS SHALL CONFORM TO THE FOLLOWING (ALL NOTED ABOVE FINISHED FLOOR LEVEL):
  - LIGHT SWITCHES AND ELECTRICAL PANELS: 900 MM TO 1200 MM
  - INTERCOMS: 175 MM - ELECTRICAL CABLE OUTLETS: PHONE JACKS: 465 MM TO 525 MM
  - THERMOSTATS: 900 MM TO 1200 MM.
  - ALL CONTROLS REQUIRE 750 MM (30") CLEAR FLOOR AREA
  - LIGHT SWITCHES TO BE ROCKER OR PADLE STYLE
  - AT LEAST ONE BATHROOM SHALL HAVE:
    - TOILET WITH CLEARANCE 800 MM TO 860 MM FROM SIDE WALL ON WHICH A FUTURE TOILET WITH CLEARANCE 800 MM TO 860 MM CLEARANCE TO ANY OBSTRUCTION ON THE OPPOSITE SIDE AND 800 MM CLEARANCE IN FRONT.
    - A CLEAR FLOOR AREA AT ONE END OF 760 MM X 1220 MM, CENTERED AND POSITIONED FOR A PARALLEL APPROACH
    - A MINIMUM CLEAR AREA OF 910 MM ALONG FULL LENGTH OF BATHUB
    - EASY TO GRASP (80 LEVER STYLE) FAUCETS
    - THE KIT: SINK, STOVE, REFRIGERATOR AND CUPBOARDS SPACE THAT CAN EASILY BE ACCESSSED BY PEOPLE WITH DISABILITIES (S.S. CONTIGUOUS COUNTER BETWEEN SINK AND STOVE, ADJUSTABLE SHELVES, ETC)
    - EASY TO GRASP (80 LEVER STYLE) FAUCETS
    - EASY TO GRASP (80 J OR D STYLE) HANDLES ON CUPBOARDS
    - ALL HANDLES AND CONTROLS TO BE 480 MM TO 520 MM FROM SIDE WALL
    - PIPING AND UTILITY PIPES PROVIDE 80 MM UNDER COUNTERS
    - CLEARANCE AT SINK TO ALLOW ACCESSIBLE KNEE SPACE FOR FUTURE CONVERSION OF SINK.
    - AT LEAST ONE BEDROOM SHALL PROVIDE A TURNING DIAMETER OF 150 MM ON ONE SIDE OF A DOUBLE BED AND A CLOSET WHICH HAS A CLEAR OPENING OF 800 MM BELOW BED TO 1200 MM OF 750 MM X 1200 MM; AND A CLOTHES HANGER THAT CAN BE LOWERED TO 1200 MM.
    - THE BALCONY OR PATIO SHALL HAVE A MINIMUM DIMENSION OF 900MM X 1500 MM AND BE ACCESSIBLE BY A DOOR WITH A MINIMUM CLEAR OPENING OF 800 MM.

- AGING IN PLACE FEATURES (APPLIES TO ALL UNITS) INCLUDE:**
1. SOLID BLOCKING IN BATHROOMS FOR FUTURE GRAB BAR INSTALLATION
  2. LEVER HANDLES ON SUITE DOOR HARDWARE
  3. 3% CLEAR OPENING TO SUITE ENTRY DOORS

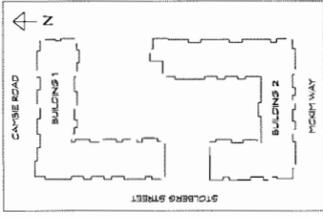

08 17 2014 201 - 10

COPYRIGHT RESERVED. THIS DRAWING MUST NOT BE REPRODUCED OR TRANSMITTED IN ANY FORM OR BY ANY MEANS, ELECTRONIC OR MECHANICAL, INCLUDING PHOTOCOPYING, RECORDING, OR BY ANY INFORMATION STORAGE AND RETRIEVAL SYSTEM, WITHOUT THE WRITTEN PERMISSION OF THE ARCHITECTS. THIS DRAWING IS THE EXCLUSIVE PROPERTY OF CICCOTZI ARCHITECTURE INC. AND CAN BE REPRODUCED ONLY WITH THEIR WRITTEN PERMISSION.

REVISIONS:	
NO.	DATE / DESCRIPTION

ISSUE:	
DATE	DESCRIPTION
20.03.2018	DP SUB-MISSON
08.09.2018	DP REV-B-MISSON
20.09.2018	RE-BUILD FOR DP
20.09.2018	RE-BUILD FOR DP



**CICCOTZI**  
ARCHITECTURE

200 - 2339 COLUMBIA STREET  
VANCOUVER, B.C.  
CANADA V5V 3Y3  
TEL: (604) 687-4741

PROJECT:  
**RESIDENTIAL DEVELOPMENT**  
400864018 STOLBERG ST  
RICHMOND, BC

DRAWN:	CHKD BY:
ENV	RC
SCALE:	PROJECT NO.:
3/32" = 1'-0"	564
SHEET TITLE:	
<b>BUILDING 1 4TH LEVEL PLAN</b>	

REVISION NO.:	SHEET NO.:
-	A2.3




**MEASURES PROVIDED FOR RICHMOND BASIC UNIVERSAL HOUSING UNITS (AS NOTED):**

- ROUGH WIRING WILL BE PROVIDED AT SUITE ENTRY DOOR TO PROVIDE FOR FUTURE INSTALLATION OF AN AUTOMATIC DOOR OPENER.
- ALL COACHES, REFRIGERATORS, AND ACCESSIBLE BATHROOM AND LIVING AREA SHALL PROVIDE A CLEAR OPENING OF NOT LESS THAN 800 MM (31.5").
- DOOR CLEARANCES SHALL BE PROVIDED AT ONE BEDROOM AND ONE BATHROOM FOR ALL LH UNITS CONTAINING 2 OR MORE BEDROOMS.
- FLOOR SURFACES WITHIN SUITE (AND THROUGH BUILDING INTERIOR) SHALL HAVE NO CURBS OR THRESHOLDS (WITHIN SUITE) OR THRESHOLDS (BETWEEN SUITES) DOORS TO BALCONIES, PATIO DECKS ARE EXCEPT FROM THIS REQUIREMENT.
- MINIMUM ONE ACCESSIBLE WINDOW IN BOTH ONE BEDROOM AND LIVING AREA ACCESSIBLE WINDOW SHALL HAVE A STILL HEIGHT NOT EXCEEDING 200 MM (8.0") AND PROVIDE A OPENING MECHANISM THAT CAN BE OPERATED WITH ONE HAND WITHOUT TIGHT GRASPING, PULLING OR TWISTING.
- ALL ELECTRICAL UNITS SHALL CONFORM TO THE FOLLOWING (ALL NOTED ABOVE FINISHED FLOOR LEVEL):
  - LIGHT SWITCHES: 1775 MM - ELECTRICAL & CABLE OUTLETS, PHONE JACKS: 455 MM TO 1220 MM.
  - THERMOSTATS: 800 MM TO 1200 MM.
  - ALL COACHES, REFRIGERATORS, AND STOVE SHALL BE 600R AREA.
  - LIGHT SWITCHES TO BE ROCKER OR PADLE STYLE.
  - AT LEAST ONE BATHROOM SHALL HAVE:
    - TOILET WITH CLEARANCES 420 MM TO 450 MM FROM SIDE WALL ON WHICH A FUTURE GRAB BAR CAN BE INSTALLED; 80 MM CLEARANCE TO ANY OBSTRUCTION ON THE OPPOSITE SIDE; AND 80 MM CLEARANCE IN FRONT.
    - SINK OF 165 MM TO 1220 MM, CENTERED AND POSITIONED FOR A PARALLEL APPROACH.
    - A MINIMUM CLEAR AREA OF 80 MM ALONG FULL LENGTH OF BATH-TUB.
    - EASY TO GRASP (EG LEVER STYLE) FAUCETS.
  - THE KITCHEN SHALL PROVIDE:
    - CLEARANCE AT SUITE ENTRY DOOR AND CORRIDOR SPACE THAT CAN EASILY BE ACCESSED BY PEOPLE WITH MOBILITY CHALLENGES (EG CONTRASTS COUNTER BETWEEN SINK AND STOVE, ADJUSTABLE SHELVES, ETC).
    - EASY TO GRASP (EG LEVER STYLE) FAUCETS.
    - EASY TO GRASP (EG J OR D STYLE) HANDLES ON CUPBOARDS.
    - TASK LIGHTING AT SINK, STOVE AND KEY WORK AREAS.
    - TURNABLE AND ADJUSTABLE WORK SURFACES TO ACCOMMODATE VARIOUS CLEARANCES AT SINK TO ALLOW ACCESSIBLE KNEE SPACE FOR FUTURE CONVERSION OF SINK.
  - AT LEAST ONE BEDROOM SHALL PROVIDE A TURNING DIAMETER OF 900 MM ON ONE SIDE OF A DOUBLE BED AND A CLOSET WHICH HAS A CLEAR OPENING OF 900 MM (88) CLEAR FLOOR SPACE OF 50 MM X 1200 MM AND A CLOTHES HANGER THAT CAN BE OPENED FROM THE SUITE ENTRY DOOR.
  - THE BALCONY OR PATIO SHALL HAVE A MINIMUM DIMENSION OF 3000 MM X 1500 MM AND BE ACCESSED BY A DOOR WITH A MINIMUM CLEAR OPENING OF 800 MM.

**AGING IN PLACE FEATURES (APPLIES TO ALL UNITS) INCLUDE:**

- SOLID BLOCKING IN BATHROOMS FOR FUTURE GRAB BAR INSTALLATION
- LEVER HANDLES ON SUITE DOOR-HANDWARE
- 3.34 CLEAR OPENING TO SUITE ENTRY DOORS

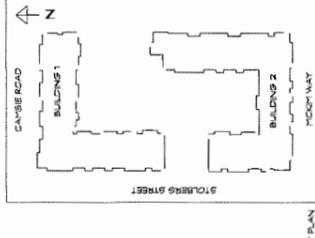

DP 17-794280-11



COPYRIGHT RESERVED. THESE DRAWINGS MUST NOT BE SCALED, REPRODUCED, COPIED, OR MODIFIED IN ANY MANNER WITHOUT THE WRITTEN PERMISSION OF THE ARCHITECTS. THE ARCHITECTS' LIABILITY IS LIMITED TO THE PROFESSIONAL SERVICES PROVIDED AND DOES NOT INCLUDE ANY OTHER SERVICES OR PRODUCTS. THESE DRAWINGS ARE THE PROPERTY OF CICCOTZI ARCHITECTURE INC. AND CAN BE REPRODUCED ONLY WITH THEIR WRITTEN PERMISSION.

NO.	DATE	DESCRIPTION

DATE	DESCRIPTION
12.12.17	CP SUBMISSION
12.27.2018	CP RESUBMISSION
01.08.2019	RE-DESIGNED FOR CP
24.09.2018	RE-DESIGNED FOR CP



**CICCOZZI**  
ARCHITECTURE

200 - 2339 COLUMBIA STREET  
VANCOUVER, B.C.  
CANADA V5Y 3Y3  
TEL: (604) 687-4741

PROJECT:  
**RESIDENTIAL DEVELOPMENT**  
400854018 STOLBERG ST  
RICHMOND, BC

OWNER:	BC
DESIGNER:	BCA
DATE:	3.22.17
SHEET TITLE:	<b>BUILDING 2 2ND LEVEL</b>


SHEET NO.:  
**A2.5**

**MEASURES PROVIDED FOR RICHMOND BASIC UNIVERSAL HOUSING UNITS (AS NOTED):**

- ROUGH WIRING WILL BE PROVIDED AT SUITE ENTRY DOOR TO PROVIDE FOR FUTURE INSTALLATION OF AN AUTOMATIC DOOR OPENER.
- DOORS IN SUITE (AT LEAST ONE BEDROOM, ONE ACCESSIBLE BATHROOM, AND LIVING AREA) SHALL PROVIDE A CLEAR OPENING OF NOT LESS THAN 800 MM (32").
- DOOR CLEARANCES SHALL BE 750 MM FOR BATHROOMS, 800 MM FOR OTHER ROOMS.
- FLOOR SURFACES WITHIN SUITE (AND THROUGH-BUILDING INTERIORS) SHALL HAVE NO ABUPT CHANGES IN LEVEL AND FLUSH THRESHOLDS (MAX. 13MM HEIGHT). DOORS TO BALCONIES, PATIOS, DECKS ARE EXCEPT FROM THIS REQUIREMENT.
- MINIMUM ONE ACCESSIBLE WINDOW IN BOTH ONE BEDROOM AND LIVING AREA.
- ACCESSIBLE WINDOW SHALL HAVE A STILL HEIGHT NOT EXCEEDING 2500 MM (82") AND SHALL BE OPERABLE WITH ONE HAND.
- TEST BRASSING, PAINTING OR TREATING SHALL BE OPERATED WITH ONE HAND WITHOUT ABOVE FINISHED FLOOR LEVEL.
- ELECTRICAL PANELS SHALL CONFORM TO THE FOLLOWING (ALL NOTED ABOVE FINISHED FLOOR LEVEL):
  - LIGHT SWITCHES AND ELECTRICAL PANELS 900 MM TO 1200 MM
  - INTERCOMS 1875 MM, ELECTRICAL CABLE OUTLETS PHONE JACKS 455 MM TO 1200 MM
  - THERMOSTATS 800 MM TO 1200 MM
- ALL CONTROLS REQUIRE 750 MM (30") CLEAR FLOOR AREA
- LIGHT SWITCHES TO BE ROCKER OR PADLE STYLE
- AT LEAST ONE BATHROOM SHALL HAVE:
  - A TUB OR SHOWER WITH CLEARANCES 620 MM TO 860 MM FROM SIDE WALL ON WHICH A TUB OR SHOWER IS INSTALLED TO PROVIDE 800 MM TO ANY OBSTRUCTION ON THE OPPOSITE SIDE AND 800 MM CLEARANCE IN FRONT.
  - A CLEAR FLOOR AREA AT ONE END OF 760 MM X 1200 MM, CENTERED AND POSITIONED FOR A PARALLEL APPROACH.
  - A MINIMUM CLEAR AREA OF 510 MM ALONG FULL LENGTH OF BATHTUB
  - EASY TO GRASP (E5 LEVER STYLE) FAUCETS
- THE KITCHEN USABLE COUNTERTOPS AND CUPBOARDS SPACE THAT CAN EASILY BE ACCESSED BY PEOPLE WITH DISABILITIES (55" CONTIGUOUS COUNTERTOP BETWEEN SINK AND STOVE, ADJUSTABLE SHELVES, ETC)
  - EASY TO GRASP (E5 LEVER STYLE) FAUCETS ON CUPBOARDS
  - EASY TO GRASP (E5, J OR D STYLE) HANDLES ON CUPBOARDS
  - KITCHEN AND BATHROOM COUNTERS SHALL PROVIDE 800 MM UNDER COUNTERS CLEARANCE AT SINK TO ALLOW ACCESSIBLE KNEE SPACE FOR FUTURE CONVERSION OF SINK.
- AT LEAST ONE BEDROOM SHALL PROVIDE A TURNING DIAMETER OF 900 MM ON ONE SIDE OF A DOUBLE BED AND A CLOSET WHICH HAS A CLEAR OPENING OF 800 MM (E5). CLEAR FLOOR SPACE OF 1500 MM X 1200 MM AND A CLOTHES HANGER THAT CAN BE USED BY A PERSON WITH A MINIMUM DIMENSION OF 1500 MM X 1500 MM
- THE BALCONY OR PATIO SHALL HAVE A MINIMUM DIMENSION OF 1500 MM X 1500 MM AND BE ACCESSED BY A DOOR WITH A MINIMUM CLEAR OPENING OF 800 MM.

**AGING IN PLACE FEATURES (APPLIES TO ALL UNITS) INCLUDE:**

- SOLID BLOCKING IN BATHROOMS FOR FUTURE GRAB BAR INSTALLATION
- LEVER HANDLES ON SUITE DOOR HARDWARE
- 34" CLEAR OPENING TO SUITE ENTRY DOORS

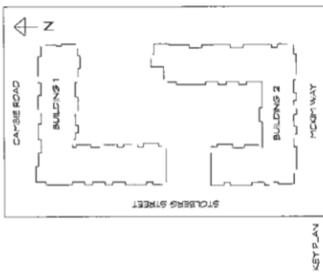

COPYRIGHT RESERVED. THIS DRAWING MUST NOT BE SCALED, VARIATIONS AND MODIFICATIONS TO WORK SHALL BE MADE BY THE ARCHITECT OR ENGINEER WITHOUT WRITTEN PERMISSION FROM THE ARCHITECTS. THIS DRAWING IS THE EXCLUSIVE PROPERTY OF CICCOTZ ARCHITECTURE INC. AND CAN BE REPRODUCED ONLY WITH THEIR WRITTEN PERMISSION.

REVISION:	
NO.	DESCRIPTION

ISSUE:	
DATE	DESCRIPTION
13.11.17	DP SUB-MISSION
17.12.17	DP REVISION
06.08.2018	RE-SSUED FOR DP
28.09.2018	RE-SSUED FOR DP



**CICCOTZ**  
ARCHITECTURE

200 - 2339 COLUMBIA STREET  
VANCOUVER, B.C.  
CANADA V5V 3Y3  
TEL: (604) 687-4741

PROJECT:  
**RESIDENTIAL DEVELOPMENT**  
400854018 STOLBERG ST  
RICHMOND, BC

DRAWN: KJV  
SCALE: 3/32" = 1'-0"  
SHEET TITLE:  
**BUILDING 2  
3RD LEVEL PLAN**


CHECKED BY: RC  
PROJECT NO.: 564  
REVISIONING: -  
SHEET NO.: **A2.6**

**MEASURES PROVIDED FOR RICHMOND BASIC UNIVERSAL HOUSING UNITS (AS NOTED):**

- SLOSH WINDOWS WILL BE PROVIDED AT SUITE ENTRY DOOR TO PROVIDE FOR FUTURE INSTALLATION OF AN AUTOMATIC DOOR OPENER.
- DOORS IN SUITE (AT LEAST ONE BEDROOM, ONE ACCESSIBLE BATHROOM, AND LIVING AREA) SHALL PROVIDE A CLEAR OPENING OF NOT LESS THAN 800 MM (31").
- DOOR CLEARANCES SHALL BE PROVIDED AT ONE BEDROOM AND ONE BATHROOM FOR ALL UNITS CONTAINING 2 OR MORE BEDROOMS.
- ALL SUITE ENTRY DOORS AND INTERIOR DOORS SHALL HAVE A 180° TURNING RANGE AND SHALL BE OPERATED BY ONE HAND WITHOUT EXCESSIVE FORCE.
- BALCONY PATIO DECKS ARE EXEMPT FROM THIS REQUIREMENT.
- MINIMUM ONE ACCESSIBLE WINDOW IN BOTH ONE BEDROOM AND LIVING AREA. ACCESSIBLE WINDOW SHALL HAVE A STILL HEIGHT NOT EXCEEDING 150 MM (6") AND PROVIDE A OPENING MECHANISM THAT CAN BE OPERATED WITH ONE HAND WITHOUT EXCESSIVE FORCE.
- ELECTRICAL SWITCHES AND OUTLETS SHALL CONFORM TO THE FOLLOWINGS (ALL NOTED ABOVE FINISHED FLOOR LEVEL):
  - LIGHT SWITCHES - 175 MM - ELECTRICAL & CABLE OUTLETS, PHONE JACKS, 655 MM TO 1200MM.
  - INTERCOMS, 800 MM TO 1300 MM.
  - ALL CONTROLS REQUIRE 120 MM (5") CLEAR FLOOR AREA.
  - AT LEAST ONE BATHROOM SHALL HAVE:
    - TOILET WITH CLEARANCES 420 MM TO 460 MM FROM SIDE WALL ON WHICH A FUTURE GRAB BAR CAN BE INSTALLED 510 MM CLEARANCE TO ANY OBSTRUCTION ON THE OPPOSITE SIDE AND 800 MM CLEARANCE IN FRONT.
    - TOILET SEAT HANGERS SHALL BE POSITIONED AT 180 MM TO 220 MM, CENTERED AND POSITIONED FOR A PARALLEL APPROACH.
    - A MINIMUM CLEAR AREA OF 510 MM ALONG FULL LENGTH OF BATH-TUB.
    - EASY TO GRASP (E.G. LEVER STYLE) FAUCETS.
  - THE KITCHEN SHALL PROVIDE:
    - 50% USABLE COUNTER AND CUPBOARD SPACE THAT CAN EASILY BE REACHED BY A PERSON USING A WALKER (E.G. CONTINUOUS COUNTER BETWEEN SINK AND STOVE, ADJUSTABLE SHELVES, ETC).
    - EASY TO GRASP (E.G. LEVER STYLE) FAUCETS.
    - EASY TO GRASP (E.G. J OR D STYLE) HANDLES ON CUPBOARDS.
    - TASK LIGHTING AT SINK, STOVE AND KEY WORK AREAS.
  - PLUMBING AND UTILITY PIPES PROVIDE 800 MM UNDER COUNTERS CLEARANCE AT SINK TO ALLOW ACCESSIBLE KITCHEN FOR FUTURE CONVERSION OF SINK.
  - AT LEAST ONE BEDROOM SHALL PROVIDE A TURNING DIAMETER OF 180 MM ON ONE SIDE OF A DOUBLE BED AND A CLOSET WHICH HAS A CLEAR OPENING OF 800 MM BELOWED TO 1200 MM.
  - THE ACCENT OR HALL SHALL HAVE A MINIMUM CLEARANCE OF 800MM X 1200 MM AND BE ACCESSIBLE BY A DOOR WITH A MINIMUM CLEAR OPENING OF 800 MM.

**AGING IN PLACE FEATURES (APPLIES TO ALL UNITS) INCLUDE:**


- SOLID BLOCKS IN BATHROOMS FOR 6. FIRE GRAB BAR INSTALLATION
- LEVER HANDLES ON SUITE DOOR HARDWARE
- 3.5% CLEAR OPENING TO SUITE ENTRY DOORS

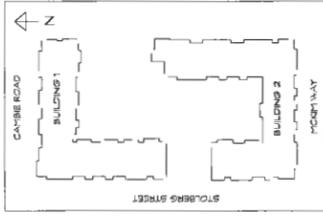

COPYRIGHT RESERVED. THIS DRAWING MUST NOT BE REPRODUCED OR TRANSMITTED IN ANY FORM OR BY ANY MEANS, ELECTRONIC OR MECHANICAL, INCLUDING PHOTOCOPYING, RECORDING, OR BY ANY INFORMATION STORAGE AND RETRIEVAL SYSTEM, WITHOUT THE WRITTEN PERMISSION OF THE ARCHITECT. THIS DRAWING IS THE EXCLUSIVE PROPERTY OF CICCOTZI ARCHITECTURE INC. AND CAN BE REPRODUCED ONLY WITH THEIR WRITTEN PERMISSION.

NO.	DATE	DESCRIPTION

ISSUE	DATE	DESCRIPTION

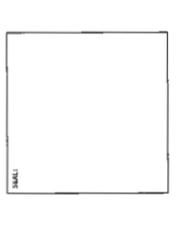

**CICCOTZI**  
ARCHITECTURE

200 - 2339 COLUMBIA STREET  
VANCOUVER, B.C.  
CANADA V5Y 3Y3  
TEL: (604) 687-4741

PROJECT:  
**RESIDENTIAL DEVELOPMENT**  
400854018 STOLBERG ST  
RICHMOND, BC


OWNER: KIV	ORDERED BY: RC
SCALE: 3/32" = 1'	PROJECT NO: B64
SHEET TITLE: <b>BUILDING 2 4TH LEVEL PLAN</b>	

REVISION NO: -	SHEET NO: A2.7
----------------	----------------

**MEASURES PROVIDED FOR RICHMOND BASIC UNIVERSAL HOUSING UNITS (AS NOTED):**

- ROLLS AWAY WILL BE PROVIDED AT SUITE ENTRY DOOR TO PROVIDE FOR FUTURE INSTALLATION OF AN AUTOMATIC DOOR OPENER.
- DOORS IN SUITE (AT LEAST ONE BEDROOM, ONE ACCESSIBLE BATHROOM, AND LIVING AREA) SHALL PROVIDE A CLEAR OPENING OF NOT LESS THAN 600 MM (24").
- DOOR CLEARANCES SHALL BE PROVIDED AT ONE BEDROOM AND ONE BATHROOM FOR ALL UNITS CONTAINING 2 OR MORE BEDROOMS.
- ALL SUITE ENTRY DOORS SHALL BE PROVIDED WITH A MINIMUM CLEARANCE OF 1800 MM (70") ABOVE FINISHED FLOOR LEVEL.
- BALCONY PATIOS DECKS ARE EXEMPT FROM THIS REQUIREMENT.
- MINIMUM ONE ACCESSIBLE WINDOW IN BOTH ONE BEDROOM AND LIVING AREA.
- ACCESSIBLE WINDOW SHALL HAVE A STILL HEIGHT NOT EXCEEDING 750 MM (30") PROVIDES A OPENING MECHANISM THAT CAN BE OPERATED WITH ONE HAND WITHOUT THE USE OF TOOLS.
- ELECTRICAL PANELS SHALL CONFORM TO THE FOLLOWINGS (ALL NOTED ABOVE FINISHED FLOOR LEVEL):
  - LIGHT SWITCHES AND ELECTRICAL PANELS 200 MM TO 1200 MM FROM FINISHED FLOOR.
  - INTERCOM'S 175 MM - ELECTRICAL & CABLE OUTLETS PHONE JACKS: 455 MM TO 1200MM.
  - ALL INTERCOM'S 200 MM TO 1200 MM.
  - ALL CONTROLS REQUIRE 750 MM (30") CLEAR FLOOR AREA.
  - LIGHT SWITCHES TO BE ROCKER OR PADLE STYLE.
  - AT LEAST ONE BATHROOM SHALL HAVE:
    - TOILET WITH CLEARANCES 420 MM TO 460 MM FROM SIDE WALL ON WHICH A FUTURE GRAB BAR CAN BE INSTALLED 500 MM CLEARANCE TO ANY OBSTRUCTION ON THE OPPOSITE SIDE AND 300 MM CLEARANCE TO THE SIDE WALL.
    - AT LEAST ONE BATHROOM SHALL HAVE AT ONE END OF THE BATH A MINIMUM CLEARANCE OF 1200 MM TO THE CENTERED AND POSITIONED FOR A PARALLEL APPROACH.
    - A MINIMUM CLEAR AREA OF 610 MM ALONG FULL LENGTH OF BATH TUB.
    - EASY TO GRASP (ES LEVER STYLE) FAUCETS.
  - THE KITCHEN SHALL PROVIDE:
    - SOMEWHAT COUNTERS AND CUPBOARDS BRACE THAT CAN EASILY BE ACCESSIBLE UNDER COUNTERS (ES. CONTIGUOUS COUNTERS BETWEEN SINK AND STOVE ADJUSTABLE SHELVES ETC).
    - EASY TO GRASP (ES LEVER STYLE) FAUCETS ON CUPBOARDS.
    - EASY TO GRASP (ES J OR D STYLE) HANDLES ON CUPBOARDS.
    - TASK LIGHTING AT SINK, STOVE AND KEY WORK AREAS.
    - PLUMBING AND UTILITY PIPES PROVIDE 800MM UNDER COUNTERS CLEARANCES AT SINK TO ALLOW ACCESSIBLE KNEE SPACE FOR FUTURE CONNECTION OF SINK.
    - AT LEAST ONE BEDROOM SHALL PROVIDE A TURNING DIAMETER OF 1500 MM ON ONE SIDE OF A DOUBLE BED AND A CLOSET WHICH HAS A CLEAR OPENING OF 800 MM (31.5"). CLEAR FLOOR SPACE OF 750 MM X 1200 MM AND A CLOTHES HANGER THAT CAN BE LOWERED TO 1200 MM.
    - THE BATHROOM SHALL HAVE A MINIMUM CLEARANCE OF 1500MM X 1200 MM AND BE ACCESSIBLE BY A DOOR WITH A MINIMUM CLEAR OPENING OF 600 MM.

- AGING IN PLACE FEATURES (APPLIES TO ALL UNITS) INCLUDE:**
1. 500 BLOCOS IN BATHROOMS FOR BUBBLE GRAB BAR INSTALLATION
  2. LEVEL HANDLES ON SUITE DOOR-HARDWARE
  3. 33" CLEAR OPENING TO SUITE ENTRY DOORS

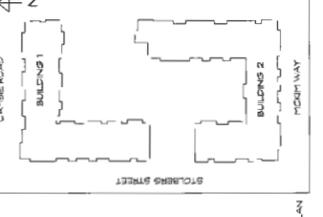

CONTRACTOR: REFER TO THE DRAWINGS FOR ALL NOTES AND SPECIFICATIONS. THIS DRAWING IS THE PROPERTY OF CICCOZZI ARCHITECTURE. ANY REVISIONS TO THIS DRAWING MUST BE APPROVED BY CICCOZZI ARCHITECTURE IN WRITING. THIS DRAWING IS NOT TO BE REPRODUCED OR COPIED IN ANY MANNER WITHOUT THE WRITTEN PERMISSION OF CICCOZZI ARCHITECTURE.

NO.	DATE	DESCRIPTION

DATE	DESCRIPTION
23.12.2021	DP SUBMISSION
05.04.2024	PARTIAL DP RESUBMISSION
13.07.2024	DP RESUBMISSION
05.03.2024	RE-DESIGNED FOR DP
24.09.2024	RE-DESIGNED FOR DP



**CICCOZZI**  
ARCHITECTURE

200 - 2339 COLUMBIA STREET  
VANCOUVER, B.C.  
CANADA V5Y 3Y3  
TEL: (604) 687-4741


PROJECT:  
**RESIDENTIAL DEVELOPMENT**  
4008E4075 STOLBERG ST  
RICHMOND, BC

DRAWN	DATE	CHECKED BY	DATE

SCALE	PROJECT NO.
1/8" = 1'-0"	5654

SHEET TITLE
ROOF PLAN

REVISION NO.	SHEET NO.
-	A2.8

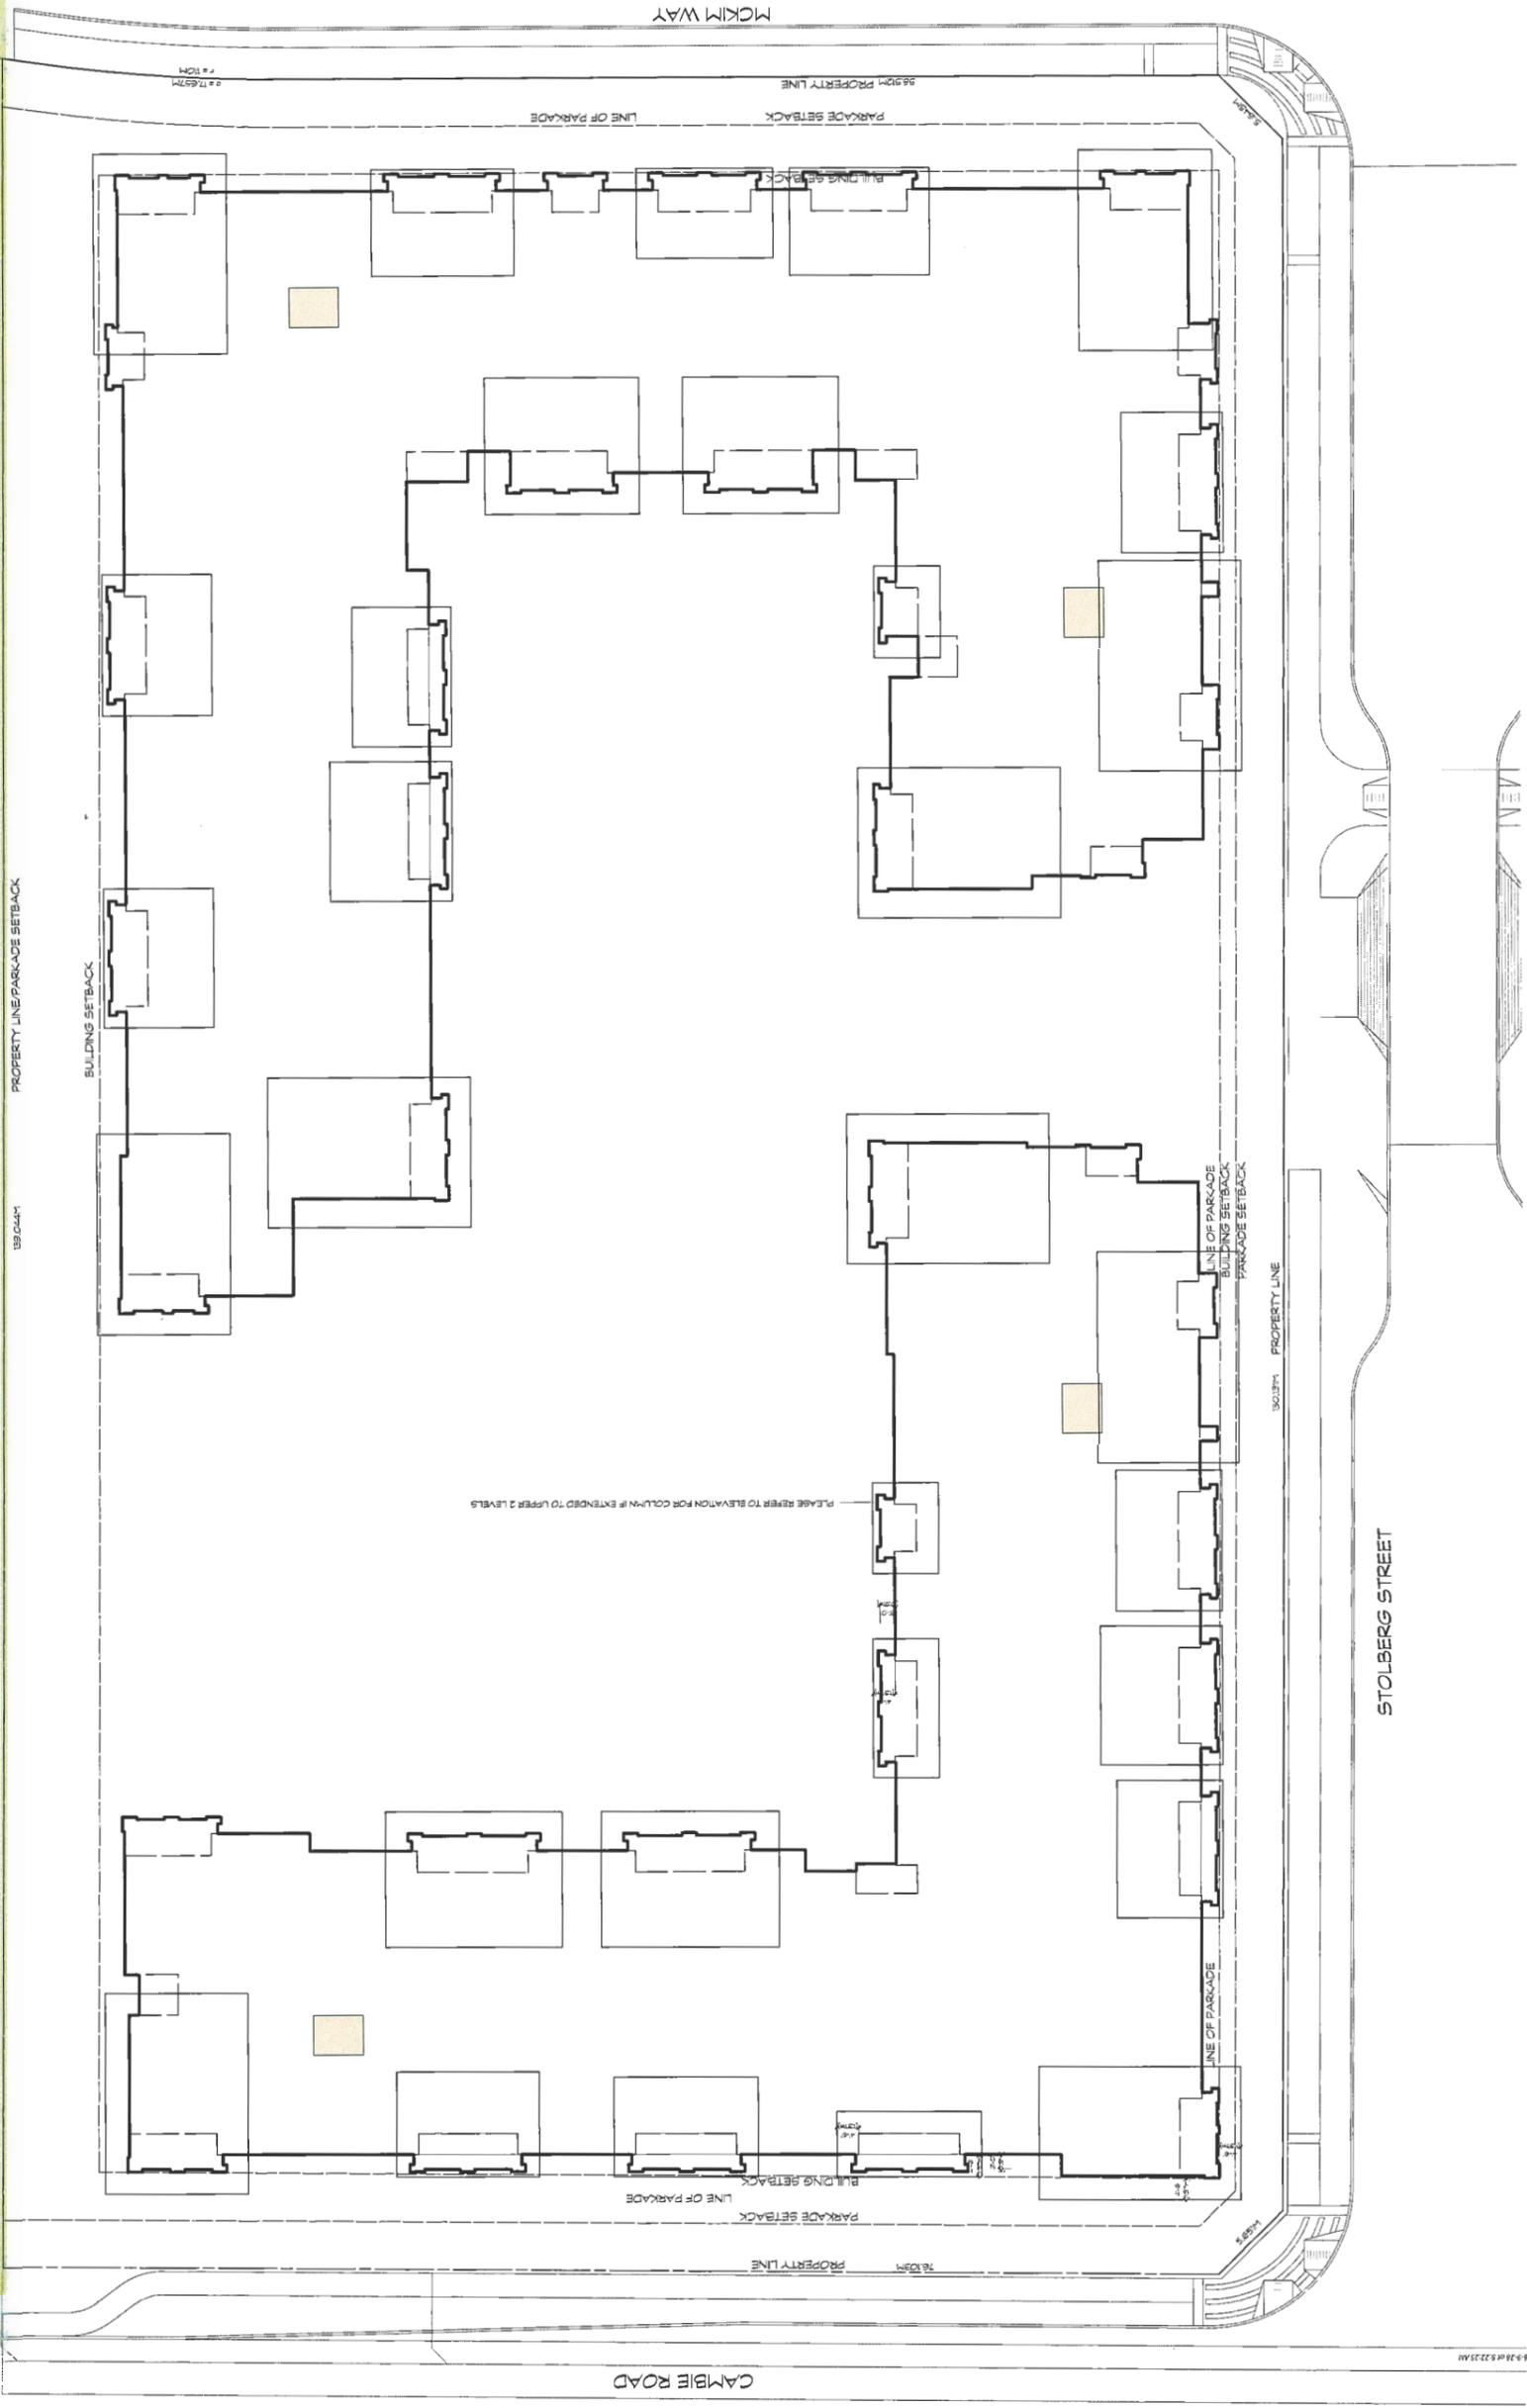

ADJACENT PROPERTY

TRACK

TRACK

DP 17-794-100-1

COPYRIGHT RESERVED. THIS DRAWING MUST NOT BE REPRODUCED OR TRANSMITTED IN ANY FORM OR BY ANY MEANS, ELECTRONIC OR MECHANICAL, WITHOUT WRITTEN PERMISSION FROM THE ARCHITECTS. THIS DRAWING IS THE EXCLUSIVE PROPERTY OF CICOZZI ARCHITECTURE INC. AND CAN BE REPRODUCED ONLY WITH THEIR WRITTEN PERMISSION.

NO.	DATE	DESCRIPTION

ISSUE:	DATE:	DESCRIPTION:




**CICOZZI**  
ARCHITECTURE

200 - 2339 COLUMBIA STREET  
VANCOUVER, B.C.  
CANADA V5Y 3Y3  
TEL: (604) 687-4741

PROJECT:  
**RESIDENTIAL DEVELOPMENT**  
40086408 STOLBERG ST  
RICHMOND, BC

DESIGNED BY:	BC
PROJECT NO.:	ESGA
SCALE:	3/32" = 1'
SHEET TITLE:	AREA OVERLAY BUILDING 1 MAIN LEVEL


PROJECT NO.:	-
SHEET NO.:	A2.9

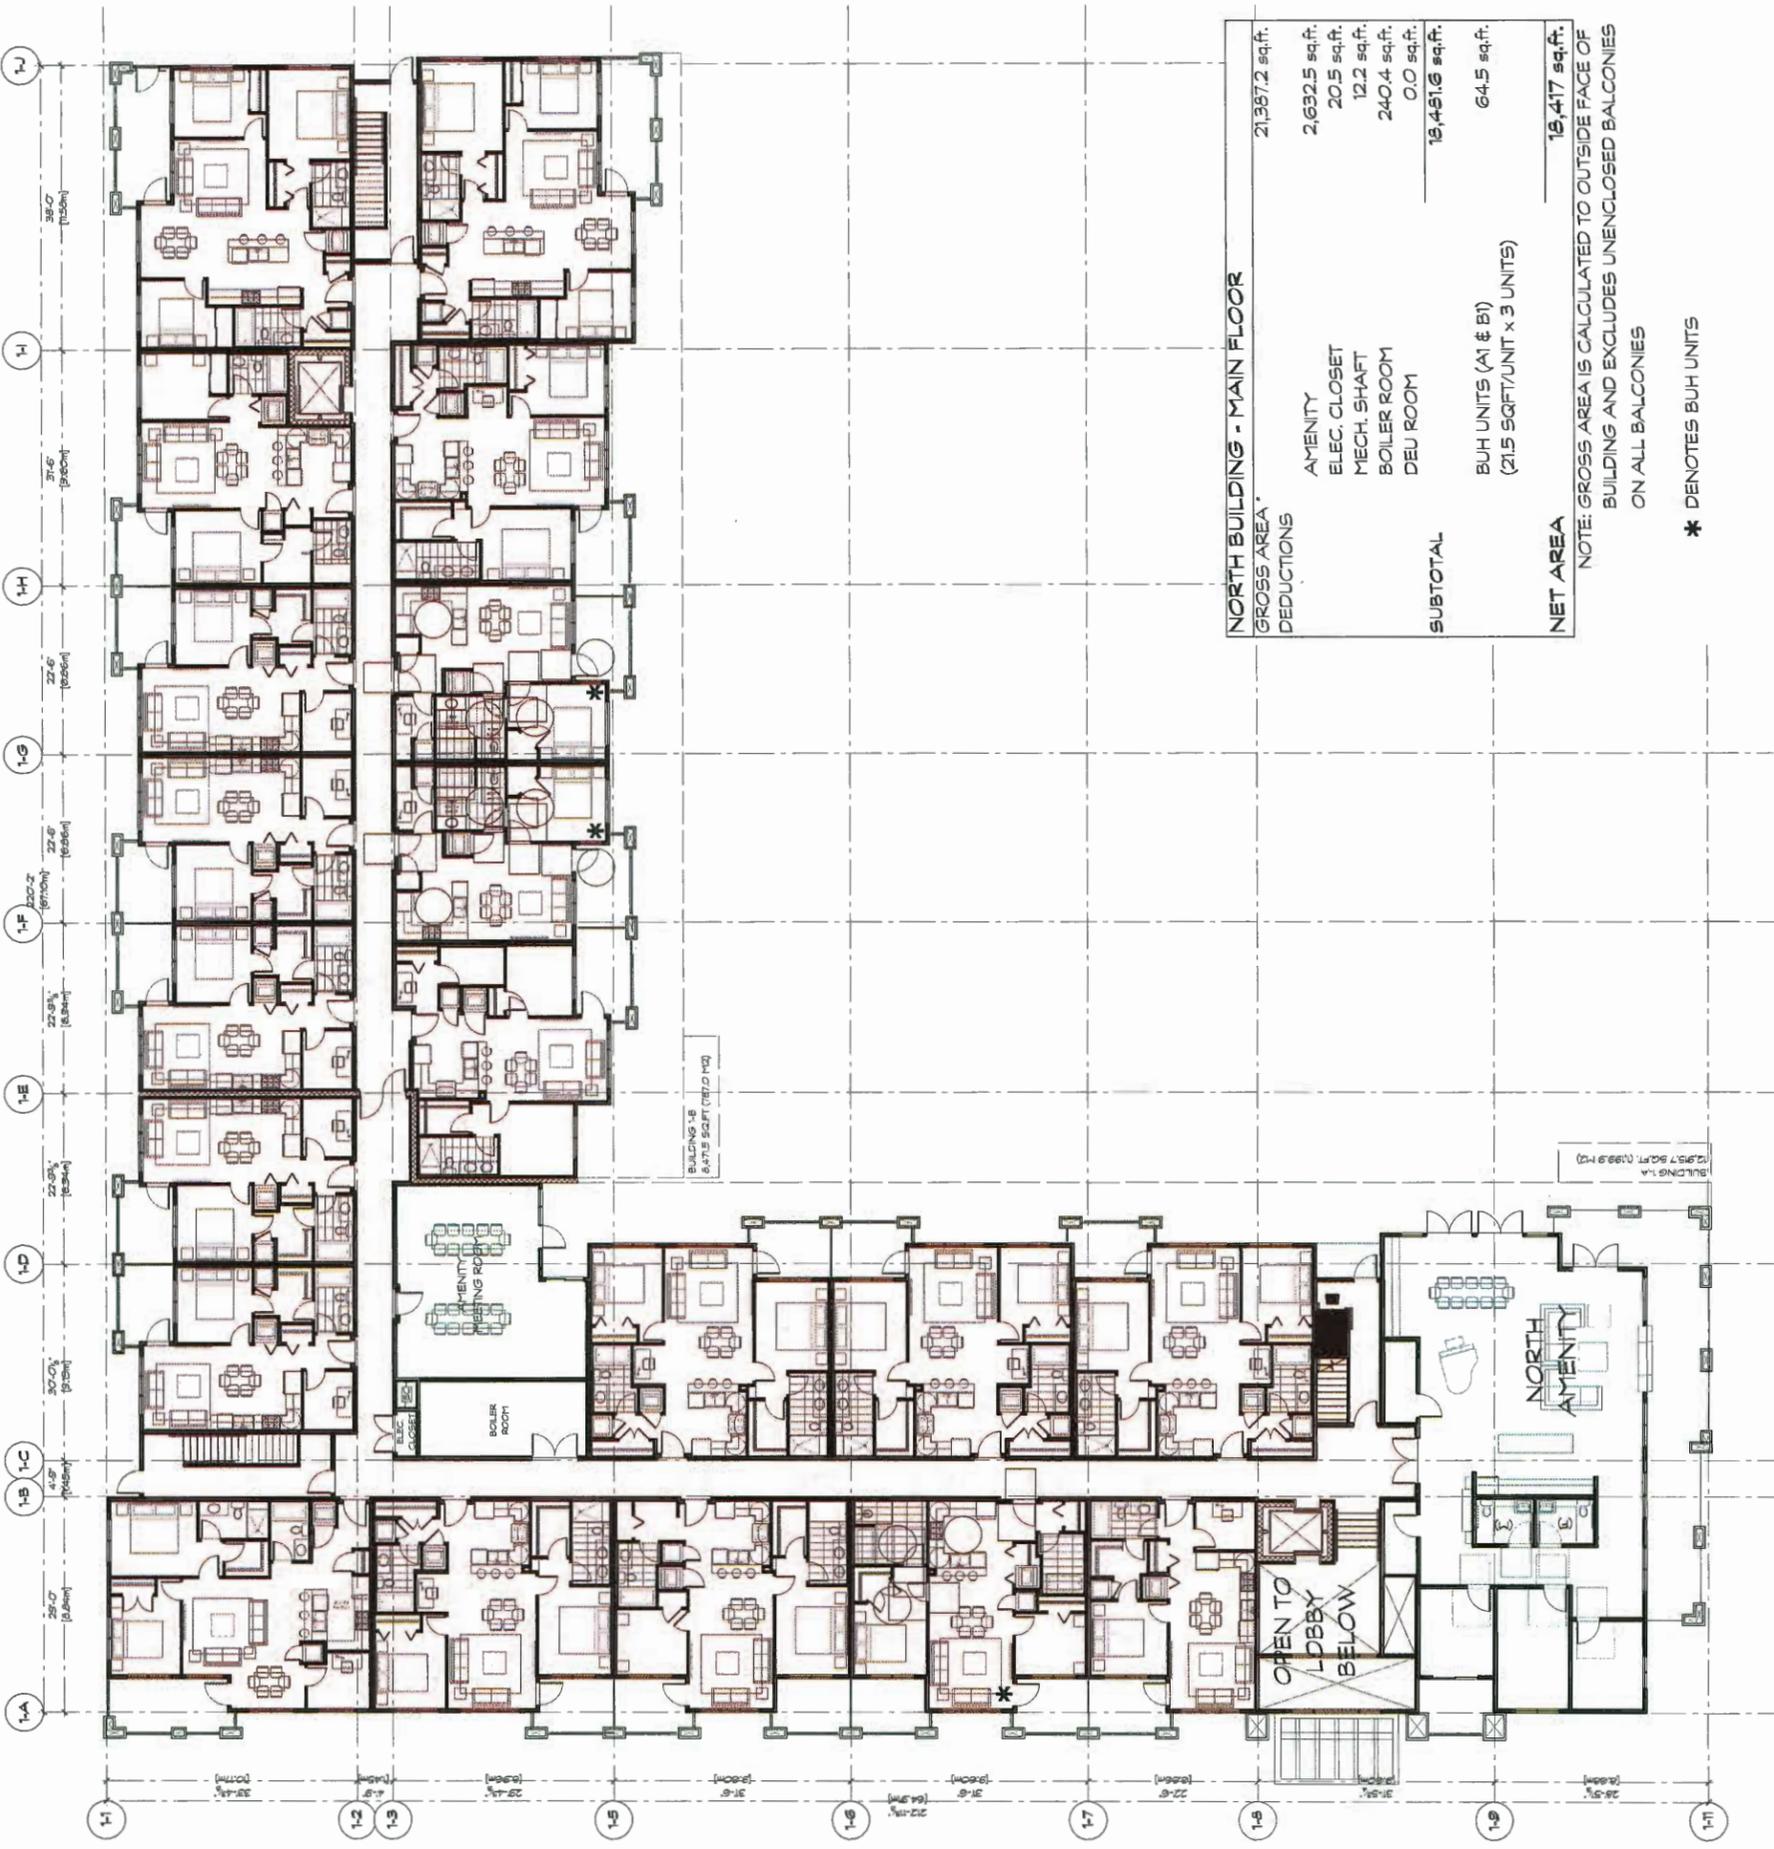

NORTH BUILDING - MAIN FLOOR	
GROSS AREA	21,387.2 sq.ft.
DEDUCTIONS	
AMENITY	2,632.5 sq.ft.
ELEC. CLOSET	20.5 sq.ft.
MECH. SHAFT	12.2 sq.ft.
BOILER ROOM	240.4 sq.ft.
DEU ROOM	0.0 sq.ft.
<b>SUBTOTAL</b>	<b>18,451.6 sq.ft.</b>
BUH UNITS (A1 & B1)	64.5 sq.ft.
(21.5 SQFT/UNIT x 3 UNITS)	
<b>NET AREA</b>	<b>18,417 sq.ft.</b>

NOTE: GROSS AREA IS CALCULATED TO OUTSIDE FACE OF BUILDING AND EXCLUDES UNENCLOSED BALCONIES ON ALL BALCONIES

\* DENOTES BUH UNITS

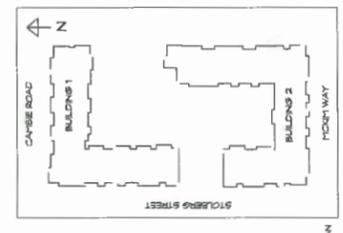

NET PLAN

00 17-79/280-17

COPYRIGHT RESERVED. THIS DRAWING MUST NOT BE SCALED. VARIATIONS AND MODIFICATIONS TO WORK SHOWN ON THESE DRAWINGS SHALL NOT BE CARRIED OUT WITHOUT THE WRITTEN PERMISSION OF THE ARCHITECTS. THIS DRAWING IS THE EXCLUSIVE PROPERTY OF CICCOTZI ARCHITECTURE INC. AND CAN BE REPRODUCED ONLY WITH THEIR WRITTEN PERMISSION.

NO.	DATE	DESCRIPTION

DATE	DESCRIPTION
21.12.2017	DP SUB-MISSION
21.12.2017	DP SUB-MISSION
06.04.2018	PARTIAL DP RE-SUB-MISSION
12.07.2018	DP RE-SUB-MISSION
06.08.2018	RE-SUBMITTED FOR DP
26.09.2018	RE-SUBMITTED FOR DP




**CICCOZZI**  
ARCHITECTURE  
200 - 2335 COLUMBIA STREET  
VANCOUVER, B.C.  
CANADA V5Y 3Y3  
TEL: (604) 687-4741

PROJECT:  
**RESIDENTIAL DEVELOPMENT**  
4008&4015 STOLBERG ST  
RICHMOND, BC

DRAWN:	ENV	CHECKED BY:	RC
SCALE:	3/32" = 1'0"	PROJECT NO.:	564
SHEET TITLE: <b>AREA OVERLAY BUILDING 1 LEVEL 2ND/3RD/4TH</b>			


REVISION NO.:	-	SHEET NO.:	A2.10
---------------	---	------------	-------

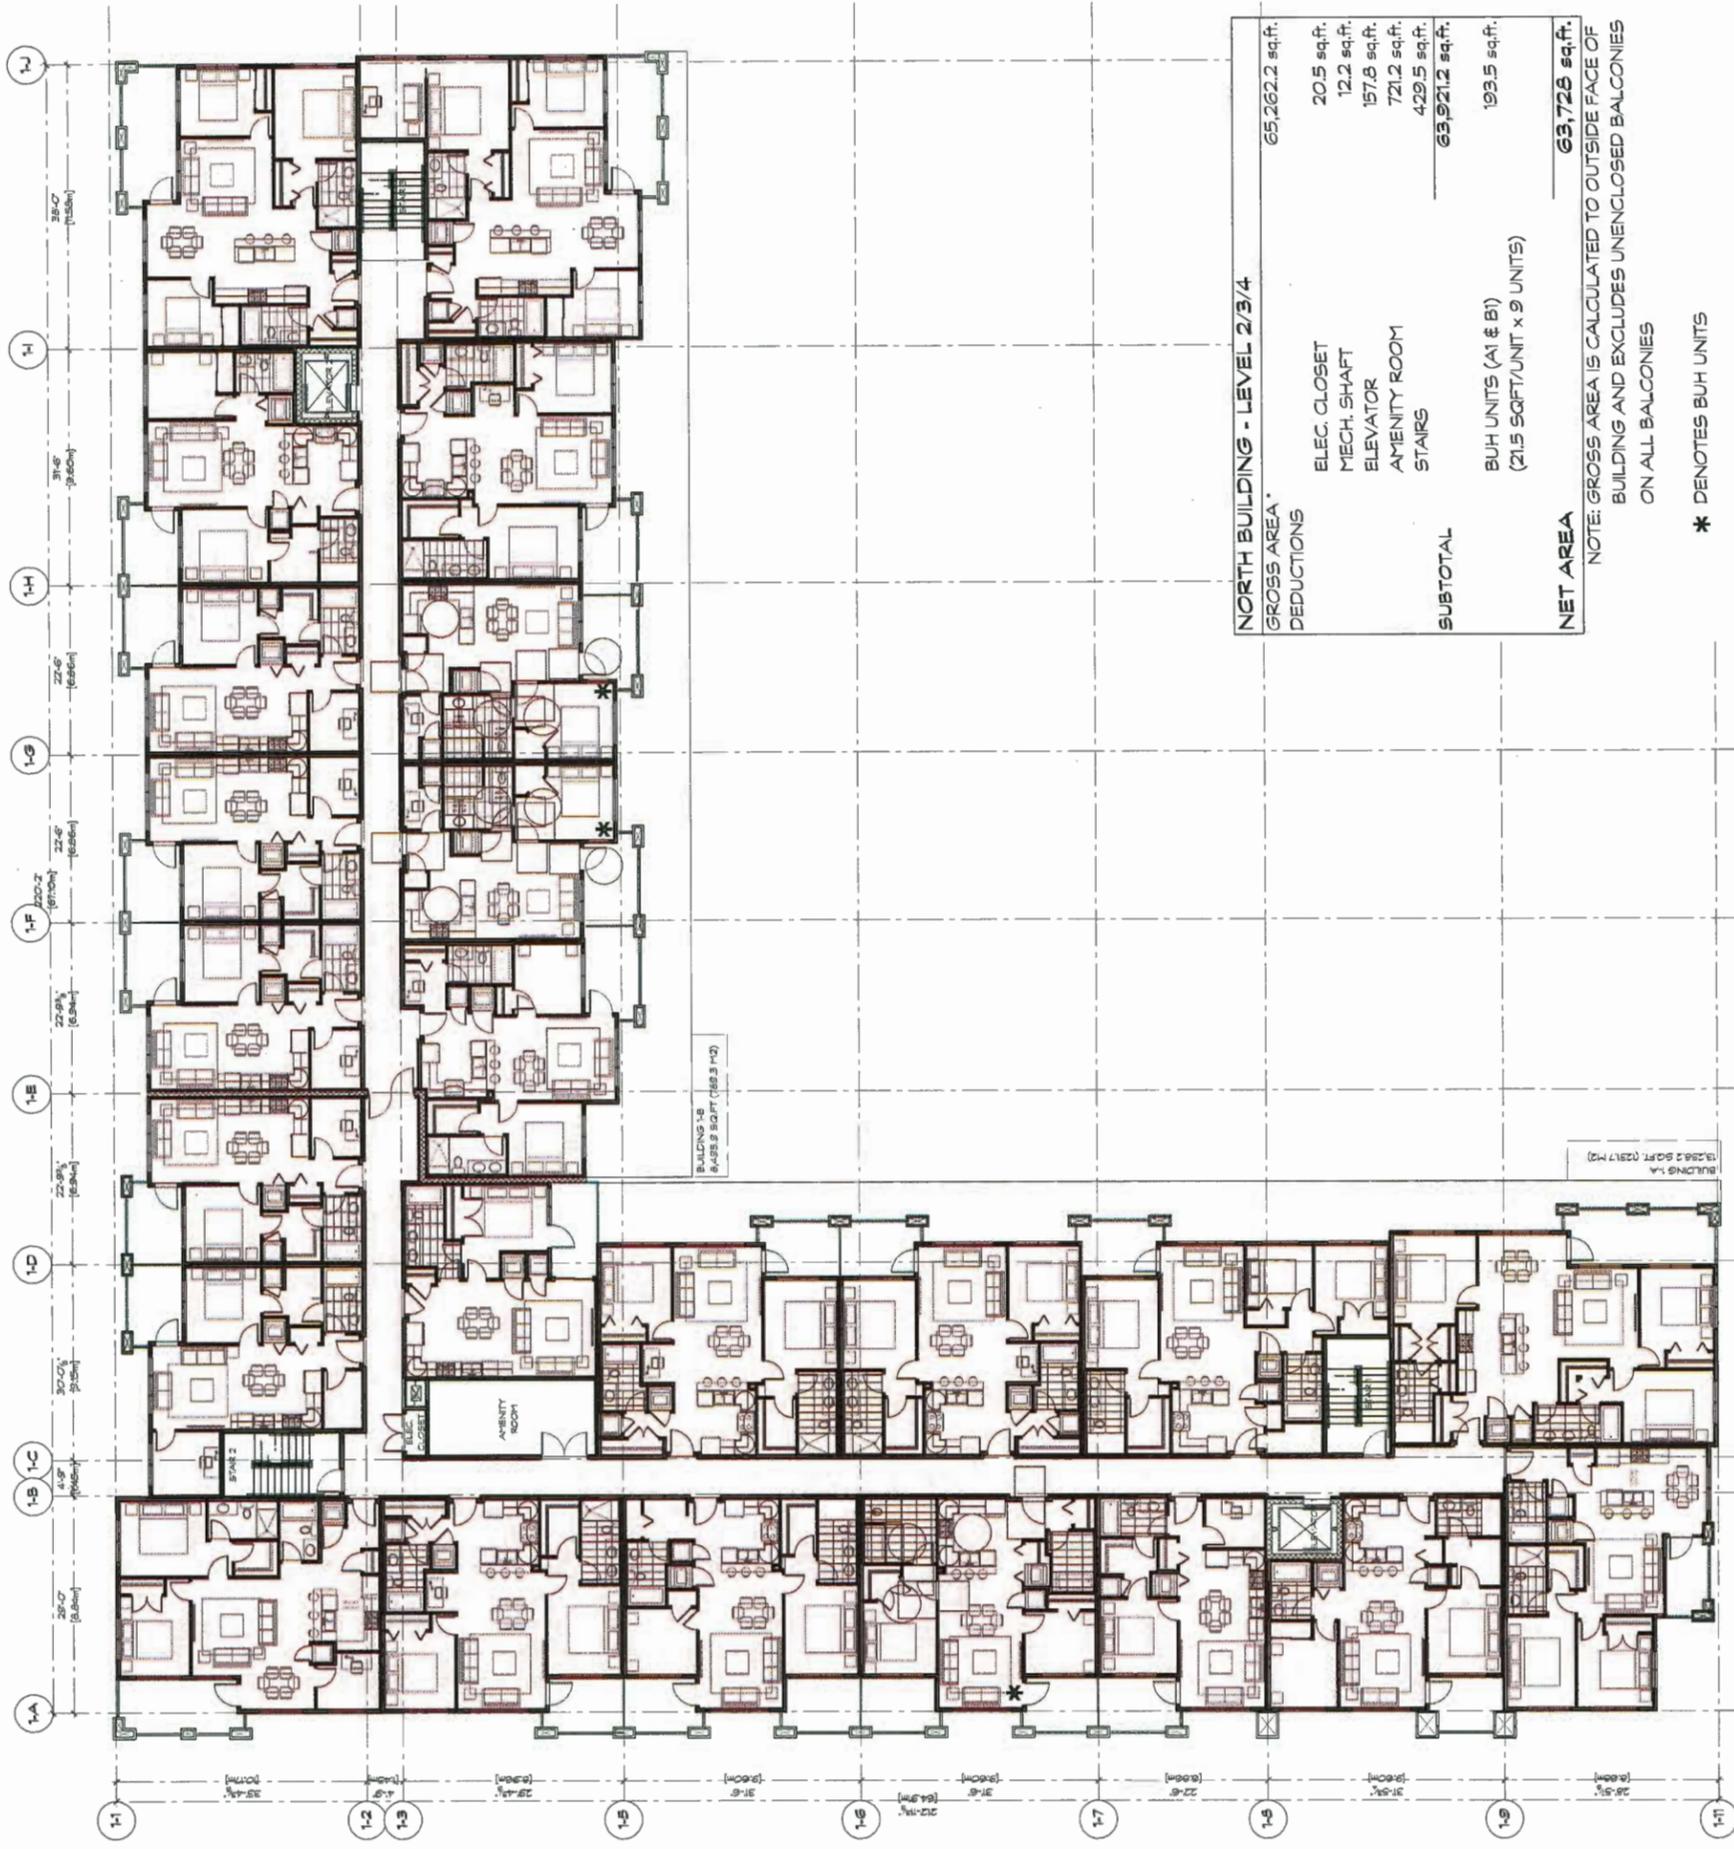

NORTH BUILDING - LEVEL 2/3/4	
GROSS AREA*	65,262.2 sq.ft.
DEDUCTIONS	
ELEC. CLOSET	20.5 sq.ft.
MECH. SHAFT	12.2 sq.ft.
ELEVATOR	157.8 sq.ft.
AMENITY ROOM	721.2 sq.ft.
STAIRS	429.5 sq.ft.
<b>SUBTOTAL</b>	<b>63,921.2 sq.ft.</b>
BUH UNITS (A1 & B1) (21.5 SQFT/UNIT x 9 UNITS)	193.5 sq.ft.
<b>NET AREA</b>	<b>63,728 sq.ft.</b>

NOTE: GROSS AREA IS CALCULATED TO OUTSIDE FACE OF BUILDING AND EXCLUDES UNENCLOSED BALCONIES ON ALL BALCONIES

\* DENOTES BUH UNITS

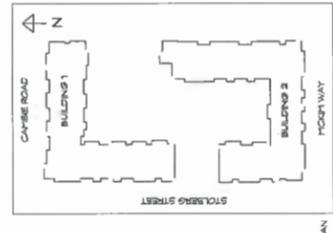

KEY PLAN

COPYRIGHT RESERVED. THIS DRAWING MUST NOT BE SCALED. VARIATIONS AND MODIFICATIONS TO WORK SHOWN ON THESE DRAWINGS SHALL NOT BE REQUIRED UNLESS SPECIFICALLY NOTED OTHERWISE. THESE DRAWINGS ARE THE EXCLUSIVE PROPERTY OF CICCOTZI ARCHITECTURE INC. AND CAN BE REPRODUCED ONLY WITH THEIR WRITTEN PERMISSION.

NO.	DATE	DESCRIPTION

ISSUE	DATE	DESCRIPTION



**CICCOZZI**  
ARCHITECTURE



200 - 2339 COLUMBIA STREET  
VANCOUVER, B.C.  
CANADA V5Y 3Y3  
TEL: (604) 687-4741

PROJECT:  
**RESIDENTIAL DEVELOPMENT**  
400864018 STOLBERG ST  
RICHMOND, BC

NAME:	KVY	CHECKED BY:	RC
SCALE:	3/32" = 1'-0"	PROJECT NO.:	564
SHEET TITLE:	AREA OVERLAY BUILDING 2 MAIN LEVEL		

REGION NO.:	-	SHEET NO.:	A2.11
-------------	---	------------	-------

**COLOR LEGEND:**  
 BUILDING AREA  
 EXCLUSIONS

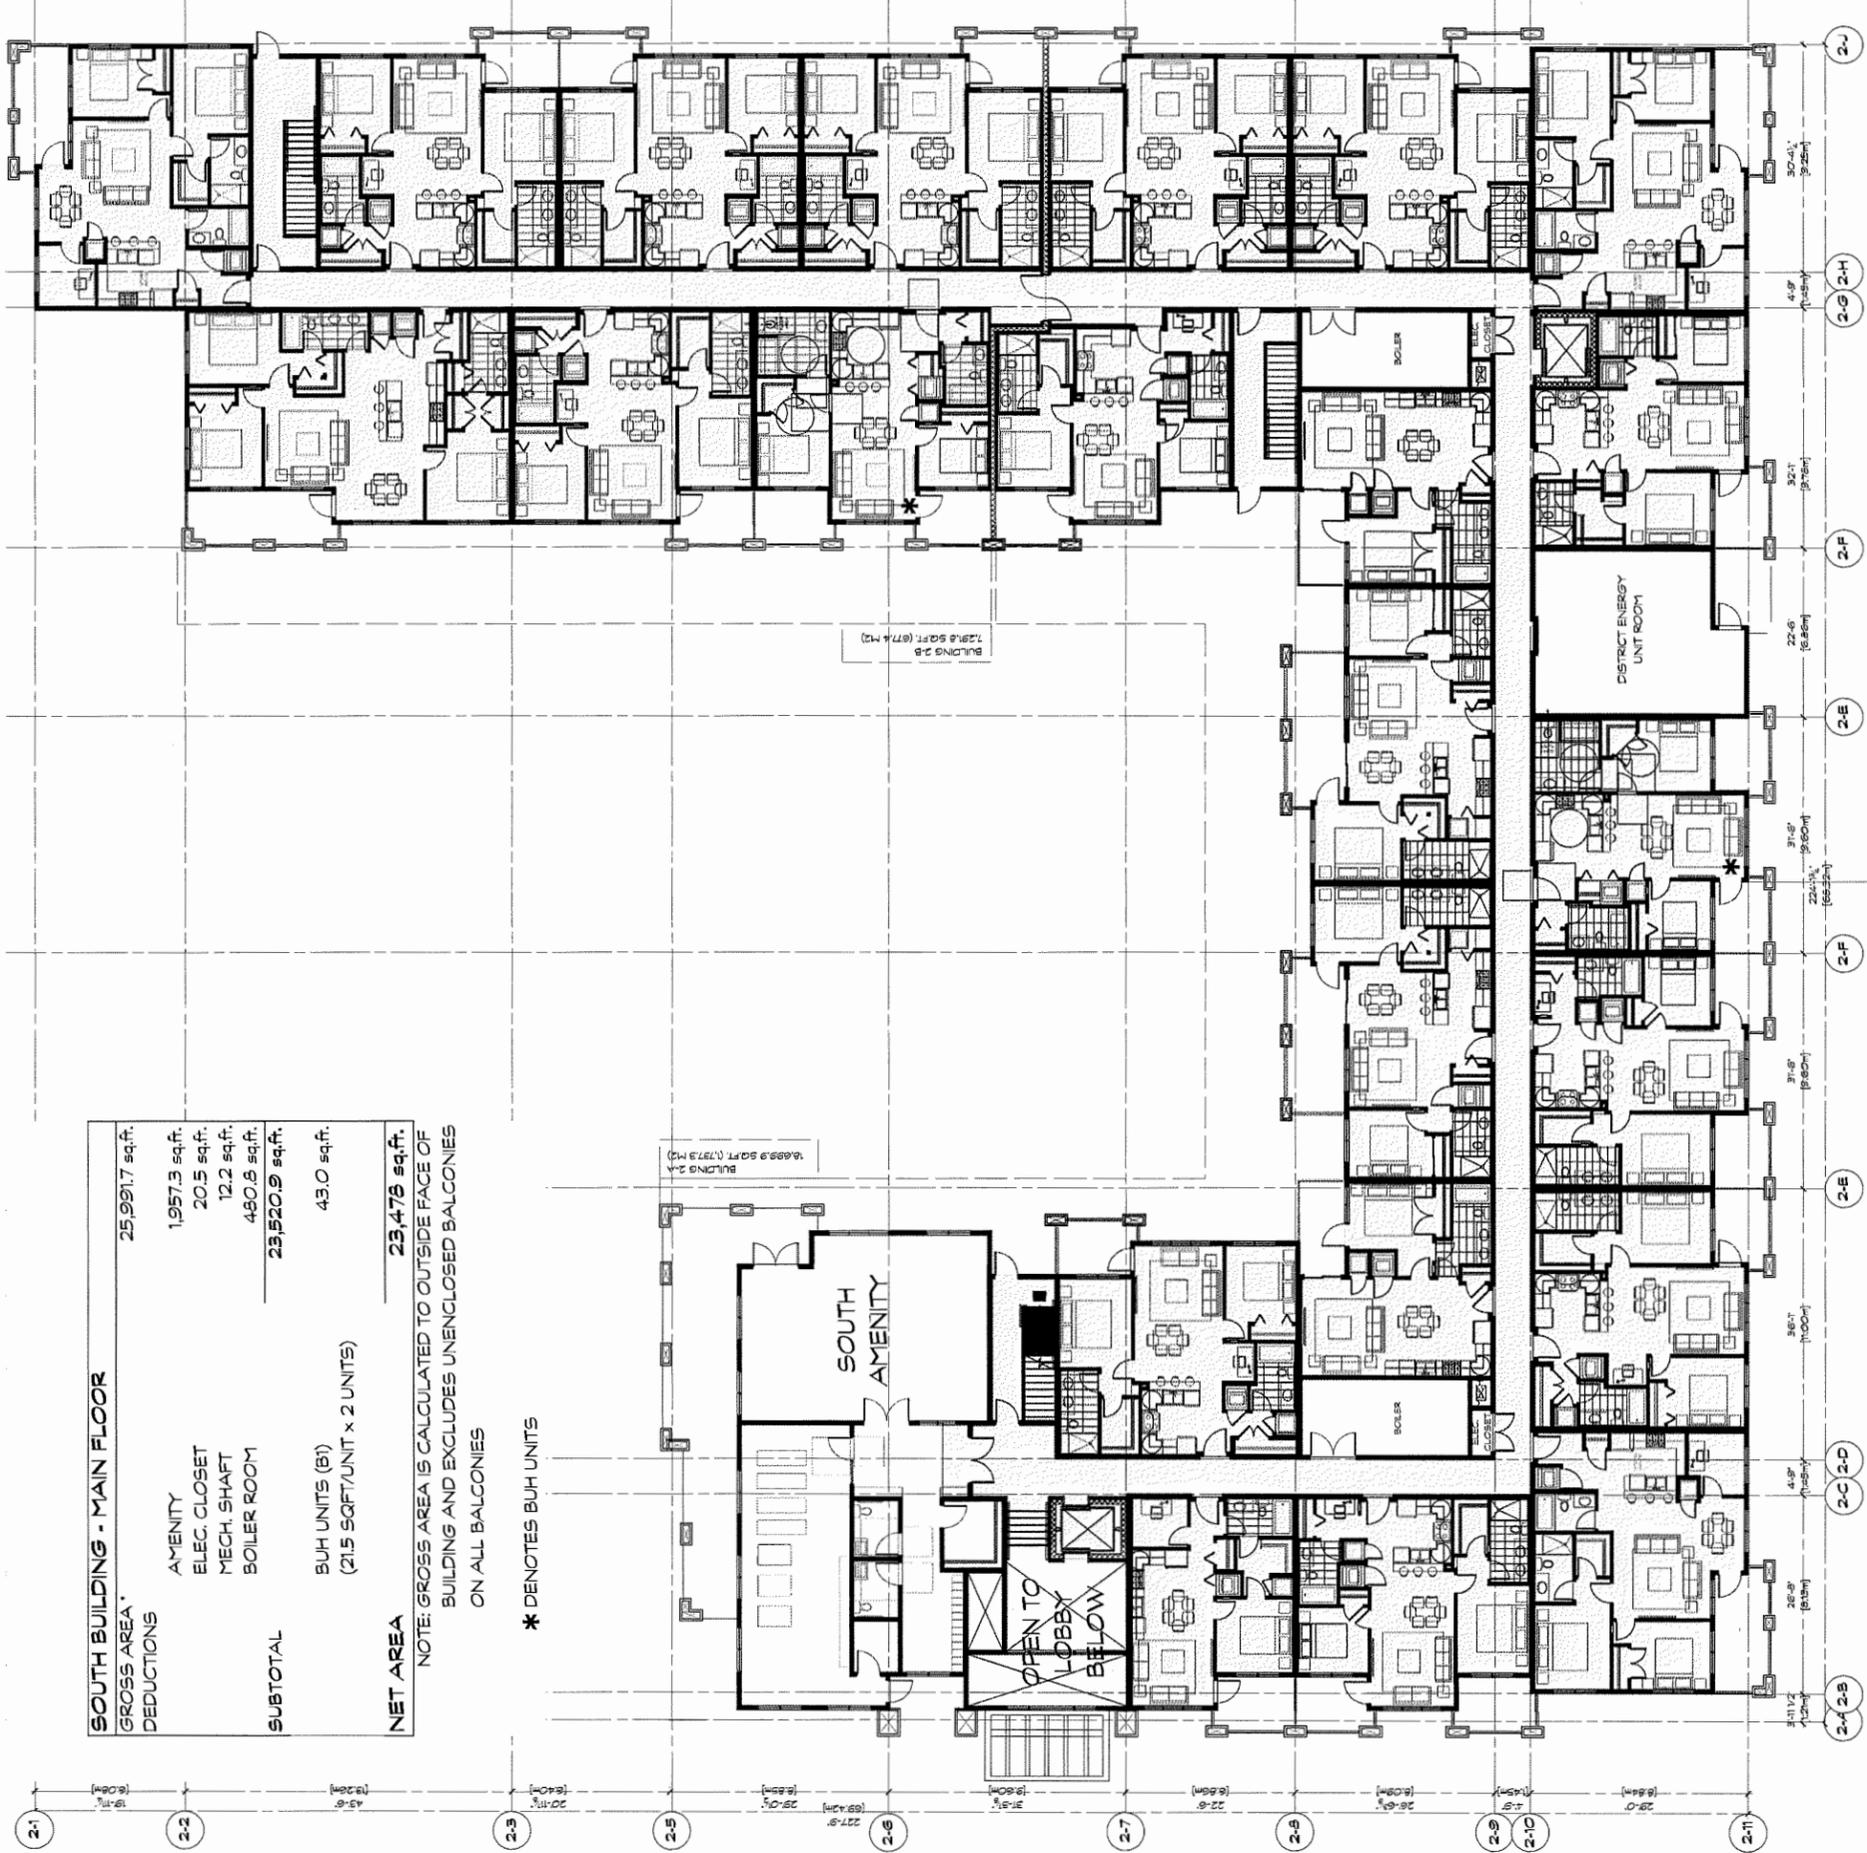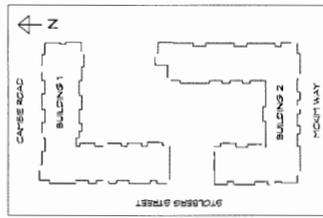

SOUTH BUILDING - MAIN FLOOR	
GROSS AREA*	25,991.7 sq.ft.
DEDUCTIONS	
AMENITY	1,957.3 sq.ft.
ELEC. CLOSET	20.5 sq.ft.
MECH. SHAFT	12.2 sq.ft.
BOILER ROOM	480.8 sq.ft.
<b>SUBTOTAL</b>	<b>23,520.9 sq.ft.</b>
BUH UNITS (B1) (21.5 SQFT/UNIT x 2 UNITS)	43.0 sq.ft.
<b>NET AREA</b>	<b>23,478 sq.ft.</b>

NOTE: GROSS AREA IS CALCULATED TO OUTSIDE FACE OF BUILDING AND EXCLUDES UNENCLOSED BALCONIES ON ALL BALCONIES

\* DENOTES BUH UNITS

COPYRIGHT RESERVED. THIS DRAWING MUST NOT BE REPRODUCED OR TRANSMITTED IN ANY FORM OR BY ANY MEANS, ELECTRONIC OR MECHANICAL, INCLUDING PHOTOCOPYING, RECORDING, OR BY ANY INFORMATION STORAGE AND RETRIEVAL SYSTEM, WITHOUT THE WRITTEN PERMISSION FROM THE ARCHITECTS. THIS DRAWING IS THE EXCLUSIVE PROPERTY OF CICOZZI ARCHITECTURE INC. AND CAN BE REPRODUCED ONLY WITH THEIR WRITTEN PERMISSION.

NO.	DATE	DESCRIPTION

ISSUE	DATE	DESCRIPTION



**CICOZZI**  
ARCHITECTURE


200-2339 COLUMBIA STREET  
VANCOUVER, B.C.  
CANADA V5Y 3Y3  
TEL: (604) 687-4741

PROJECT:  
**RESIDENTIAL DEVELOPMENT**  
400854018 STOLBERG ST  
RICHMOND, BC

DESIGNER	KJV	CHECKED BY	BC
SCALE	3/32" = 1'0"	PROJECT NO.	564
SHEET TITLE	AREA OVERLAY BUILDING 2 LEVEL 2ND/3RD/4TH		

DATE	-
SHEET NO.	A2.12

**COLOR LEGEND:**  
 BUILDING AREA  
 EXCLUSIONS

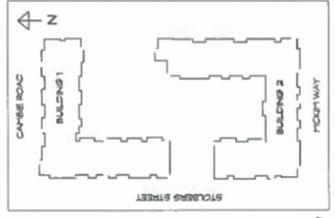

KEY PLAN



<b>SOUTH BUILDING - LEVEL 2/3/4</b>	
GROSS AREA*	79,006.5 sq.ft.
DEDUCTIONS	
ELEC. CLOSET	61.4 sq.ft.
MECH. SHAFT	36.5 sq.ft.
ELEVATOR	157.8 sq.ft.
AMENITY ROOM	1,442.4 sq.ft.
STAIRS	429.5 sq.ft.
<b>SUBTOTAL</b>	<b>76,579.0 sq.ft.</b>
BUH UNITS (B1) (21.5 SQFT/UNIT x 6 UNITS)	129.0 sq.ft.
<b>NET AREA</b>	<b>76,750 sq.ft.</b>


NOTE: GROSS AREA IS CALCULATED TO OUTSIDE FACE OF BUILDING AND EXCLUDES UNENCLOSED BALCONIES ON ALL BALCONIES

\* DENOTES BUH UNITS

COPYRIGHT RESERVED. THIS DRAWING MUST NOT BE SCALED. VARIATIONS AND MODIFICATIONS TO WORK SHOWN ON THESE DRAWINGS SHALL NOT BE CARRIED OUT WITHOUT THE WRITTEN PERMISSION OF THE ARCHITECTS. THIS DRAWING IS THE EXCLUSIVE PROPERTY OF CICCOTZI ARCHITECTURE INC. AND CAN BE REPRODUCED ONLY WITH THEIR WRITTEN PERMISSION.

REVISION:	
NO.	DESCRIPTION


ISSUE:  
DATE: 08/03/2018  
DESCRIPTION: RE-SUBMITTED FOR DP  
DATE: 28/03/2018  
DESCRIPTION: RE-SUBMITTED FOR DP

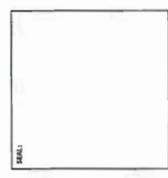

1 NORTH ELEVATION (CAMBIE ROAD)  
ALD01 / SCALE 1/8" = 1'-0"



2 WEST ELEVATION (STOLBERG STREET)  
ALD02 / SCALE 1/8" = 1'-0"

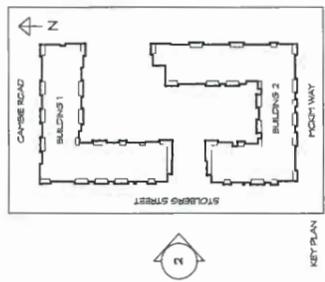

**CICCOZZI**  
ARCHITECTURE  
200 - 2339 COLUMBIA STREET  
VANCOUVER, B.C.  
CANADA V5Y 3Y3  
TEL: (604) 687-4741

PROJECT:  
**RESIDENTIAL DEVELOPMENT**  
4008&4018 STOLBERG ST  
RICHMOND, BC

DATE:	CHECKED BY:
SCALE:	PROJECT NO.:
1/8" = 1'-0"	564
SHEET TITLE:	
<b>ELEVATIONS</b>	

REVISION NO.:	SHEET NO.:
-	A4.0

DP 17-194280-2

COPYRIGHT RESERVED. THIS DRAWING MUST NOT BE SCALED. VARIATIONS AND MODIFICATIONS TO WORK SHOWN ON THESE DRAWINGS SHALL NOT BE CARRIED OUT WITHOUT THE WRITTEN PERMISSION OF THE ARCHITECT. ANY CHANGES TO THE DRAWING SHALL BE THE PROPERTY OF CICCOTZI ARCHITECTURE INC. AND CAN BE REPRODUCED ONLY WITH THEIR WRITTEN PERMISSION.

REVISION:	
NO.	DESCRIPTION

ISSUE:	
DATE	DESCRIPTION
28.09.2018	RE-DESIGNED FOR DP
28.09.2018	RE-DESIGNED FOR DP

SCALE

**CICCOZZI**  
ARCHITECTURE

200 - 2339 COLUMBIA STREET  
VANCOUVER, B.C.  
CANADA V5Y 3Y3  
TEL: (604) 687-4741


PROJECT:  
**RESIDENTIAL DEVELOPMENT**  
4008&4016 STOLBERG ST  
RICHMOND, BC

DATE:	CHECKED BY:
SCALE: 1/8" = 10'-0"	PROJECT NO.: 564
SHEET TITLE: <b>ELEVATIONS</b>	


SHEET NO.:  
A4.1



1 SOUTH ELEVATION (MCKIM WAY)  
AL003 SCALE 1/8" = 10'

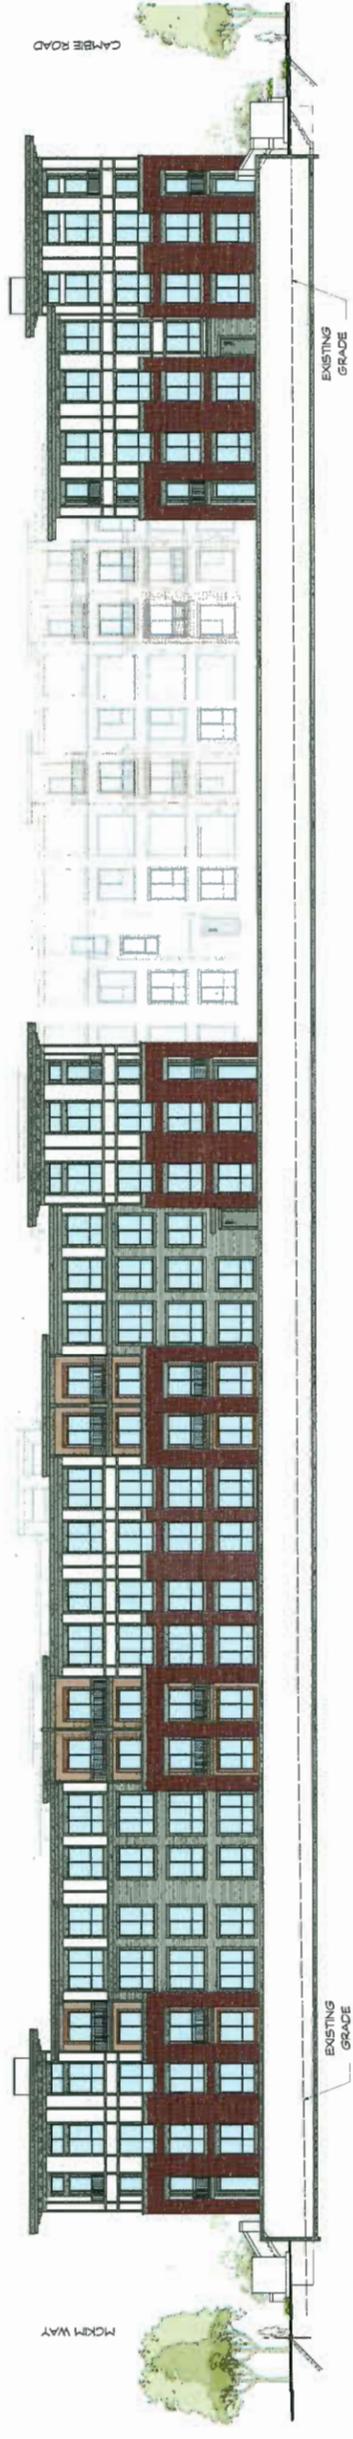

2 EAST ELEVATION (ADJACENT PROPERTY)  
AL003 SCALE 1/8" = 10'

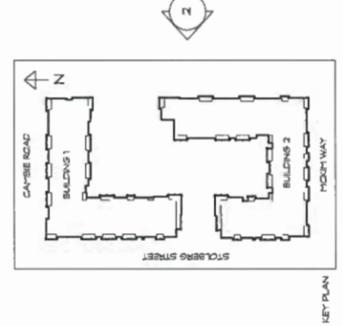

KEY PLAN

COPYRIGHT RESERVED. THIS DRAWING MUST NOT BE SCALED. VARIATIONS AND MODIFICATIONS TO WORK SHALL BE INDICATED BY CHANGES TO THE DRAWING WITHOUT WRITTEN PERMISSION FROM THE ARCHITECTS. THIS DRAWING IS THE EXCLUSIVE PROPERTY OF CICOZZI ARCHITECTURE INC. AND CAN BE REPRODUCED ONLY WITH THEIR WRITTEN PERMISSION.

REVISION:	
NO.	DESCRIPTION


**ISSUE:**  
**DATE:** 26.09.2018  
**DESCRIPTION:** RE-SUBMITTED FOR DP  
 26.09.2018 RE-SUBMITTED FOR DP



1 COURTYARD-NORTH ELEVATION  
 A1003/3 SCALE 1/8" = 1'-0"



2 EAST ELEVATION (COURTYARD)  
 A1003/3 SCALE 1/8" = 1'-0"

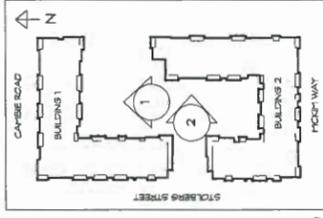

KEY PLAN

**CICOZZI**  
 ARCHITECTURE  
 200 - 2339 COLUMBIA STREET  
 VANCOUVER, B.C.  
 CANADA V5Y 3Y3  
 TEL: (604) 687-4741

PROJECT:  
**RESIDENTIAL DEVELOPMENT**  
 4008&4016 STOLBERG ST  
 RICHMOND, BC


NAME:	CICOZZI/TH
SCALE:	1/8" = 1'-0"
PROJECT NO.:	564
SHEET TITLE: <b>ELEVATIONS</b>	

ANTHONY BUI	SHEET NO.:
-	A4.2

COPYRIGHT RESERVED. THIS DRAWING MUST NOT BE REPRODUCED OR TRANSMITTED IN ANY FORM OR BY ANY MEANS, ELECTRONIC OR MECHANICAL, INCLUDING PHOTOCOPYING, RECORDING, OR BY ANY INFORMATION STORAGE AND RETRIEVAL SYSTEM, WITHOUT THE WRITTEN PERMISSION FROM THE ARCHITECTS. THIS DRAWING IS THE EXCLUSIVE PROPERTY OF CICCOTZI ARCHITECTURE INC. AND CAN BE REPRODUCED ONLY WITH THEIR WRITTEN PERMISSION.

REVISION:	
NO.	DESCRIPTION


ISSUE:	
DATE	DESCRIPTION
06/02/2018	REISSUED FOR CD
28/09/2018	REISSUED FOR CD

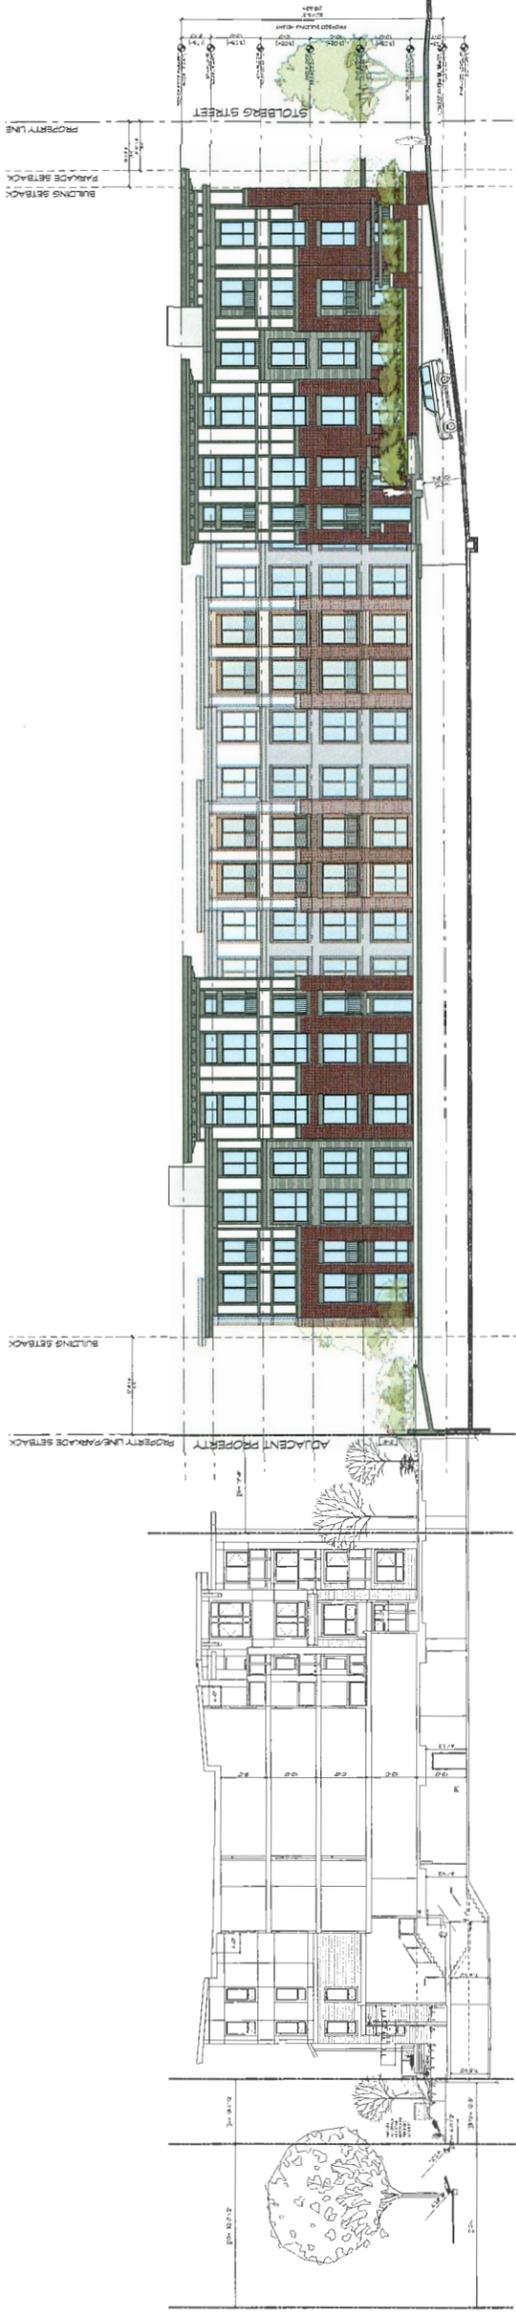

1 COURTYARD- SOUTH ELEVATION  
ALCOA SCALE: 1/8" = 1'-0"



2 WEST ELEVATION (COURTYARD)  
ALCOA SCALE: 1/8" = 1'-0"

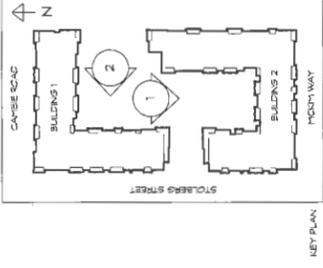

KEY PLAN

**CICCOTZI**  
ARCHITECTURE  
200 - 2339 COLUMBIA STREET  
VANCOUVER, B.C.  
CANADA V5Y 3Y3  
TEL: (604) 687-4741

PROJECT:  
**RESIDENTIAL DEVELOPMENT**  
4008&4018 STOLBERG ST  
RICHMOND, BC

DATE	DESCRIPTION


DATE:	PROJECT NO.:
SCALE: 1/8" = 1'-0"	564
SHEET TITLE:	
<b>ELEVATIONS</b>	

REVISION NO.:	SHEET NO.:
-	<b>A4.3</b>


COPYRIGHT RESERVED. THIS DRAWING MUST NOT BE SCALED. VARIATIONS AND MODIFICATIONS TO WORK SHOWN ON THESE DRAWINGS SHALL NOT BE CARRIED OUT WITHOUT WRITTEN PERMISSION FROM THE ARCHITECT. THIS DRAWING IS THE PROPERTY OF CICCOTZI ARCHITECTURE INC. AND CAN BE REPRODUCED ONLY WITH THEIR WRITTEN PERMISSION.

REVISION:	
NO.	DESCRIPTION

ISSUE:	
DATE	DESCRIPTION
08.03.2018	RE-ISSUED FOR CPP
28.09.2018	RE-ISSUED FOR CPP

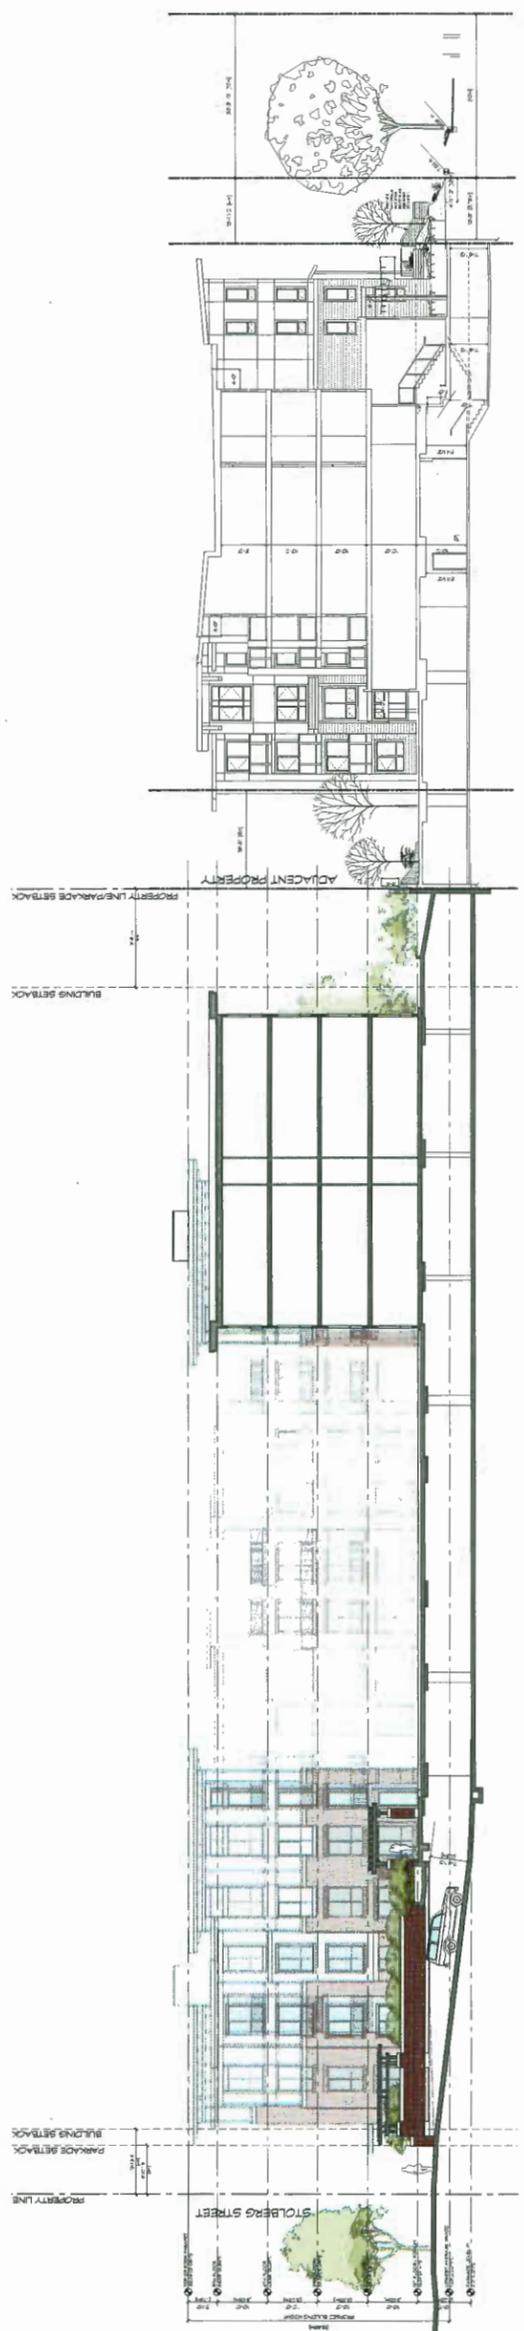

**A SECTION A**  
A1/231 / SCALE 1/8" = 1'-0"

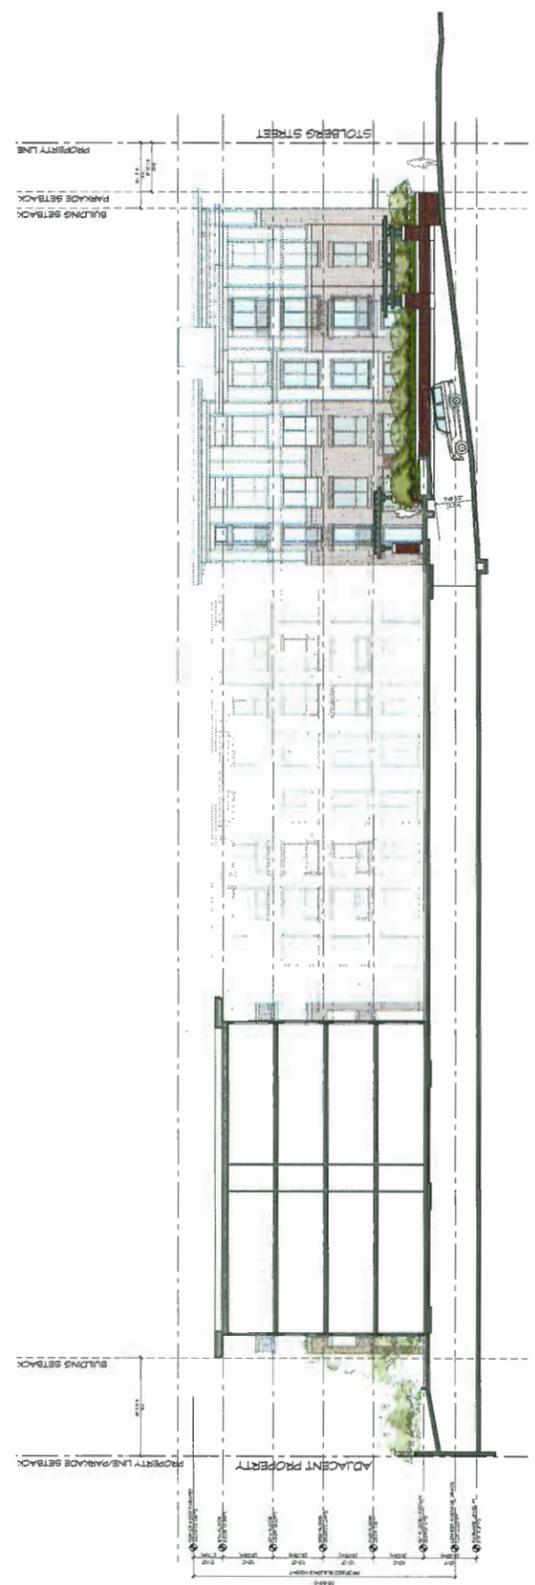



**B SECTION B**  
A1/231 / SCALE 3/32" = 1'-0"

**CICCOZZI**  
ARCHITECTURE  
200 - 2339 COLUMBIA STREET  
VANCOUVER, B.C.  
CANADA V5Y 3V3  
TEL: (604) 687-4741

PROJECT:  
**RESIDENTIAL DEVELOPMENT**  
400284018 STOLBERG ST  
RICHMOND, BC

DRAWN: [ ] CHECKED BY: [ ]  
SCALE: 1/8" = 1'-0" PROJECT NO.: 5634  
SHEET TITLE: **SITE SECTIONS**

REVISION NO.: - SHEET NO.: **A5.0**

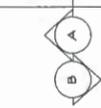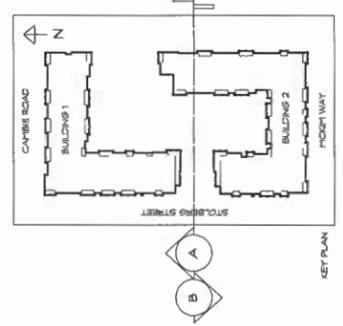


DB 1/17/18 11:28 AM - 25

COPYRIGHT RESERVED. THIS DRAWING MUST NOT BE SCALED. VARIATIONS AND MODIFICATIONS TO WORK SHOWN ON THESE DRAWINGS SHALL NOT BE CARRIED OUT WITHOUT WRITTEN PERMISSION FROM THE ARCHITECT. THIS DRAWING IS THE PROPERTY OF CICCOTZI ARCHITECTURE INC. AND CAN BE REPRODUCED ONLY WITH THEIR WRITTEN PERMISSION.

REVISION	
NO.	DESCRIPTION

ISSUE	DESCRIPTION
01	PRELIMINARY
02	REVISED FOR LP
03	REVISED FOR LP

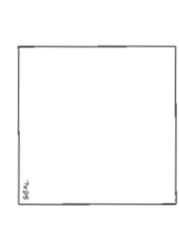

**CICCOTZI**  
ARCHITECTURE  
200 - 2339 COLUMBIA STREET  
VANCOUVER, B.C.  
CANADA V5T 3T3  
TEL: (604) 687-4741


PROJECT  
**RESIDENTIAL DEVELOPMENT**  
40084018 STOLBERG ST  
RICHMOND, BC

DRAWN		CHECKED BY	
SCALE	3/16" = 1'-0"	PROJECT NO.	584
SHEET TITLE		SITE SECTIONS	

REVISION NO.	-
PRINTING	A5.1

PROPERTY LINE  
BUILDING SETBACK  
PACKAGE SETBACK


18'-1 1/2" [4m]  
9'-10 1/8" [3m]

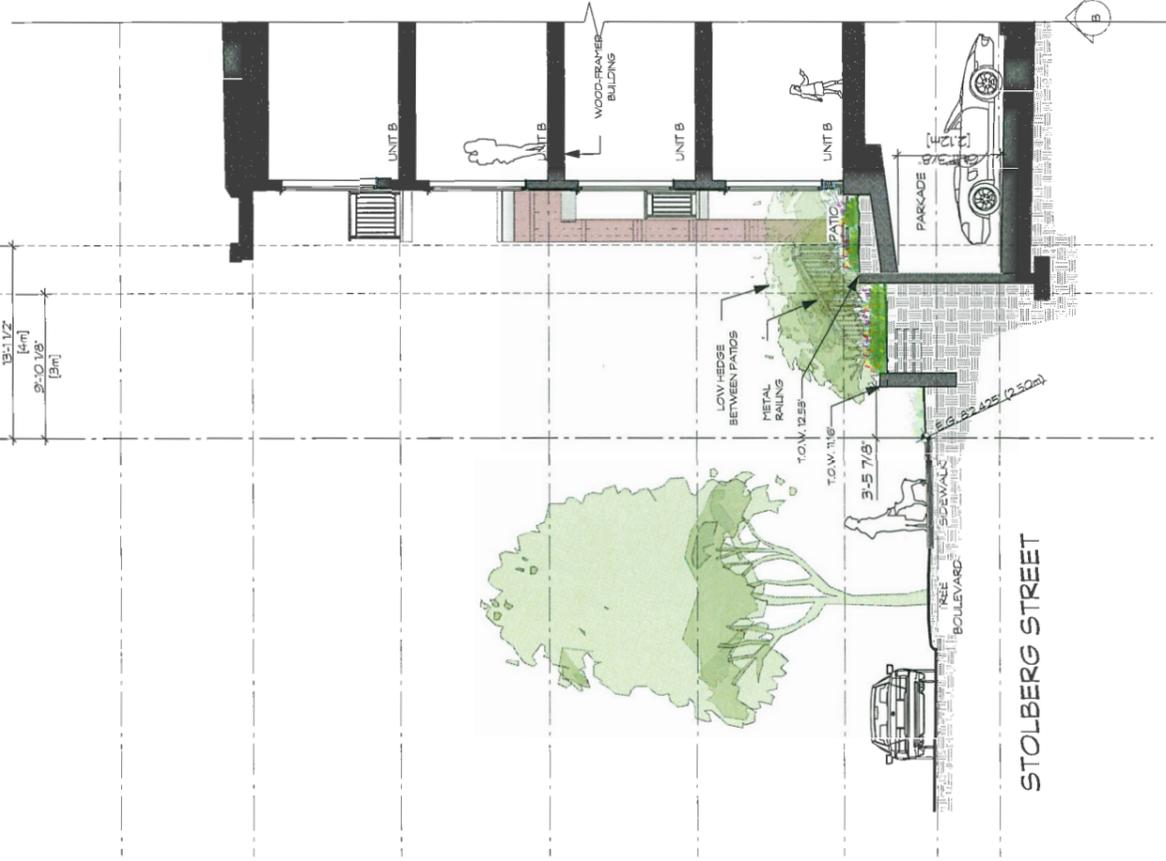

**B SECTION B-STOLBERG STREET**  
SCALE: 3/8" = 1'-0"

PROPERTY LINE  
PACKAGE SETBACK  
BUILDING SETBACK

18'-4 1/4" [4m]  
9'-10 1/8" [3m]

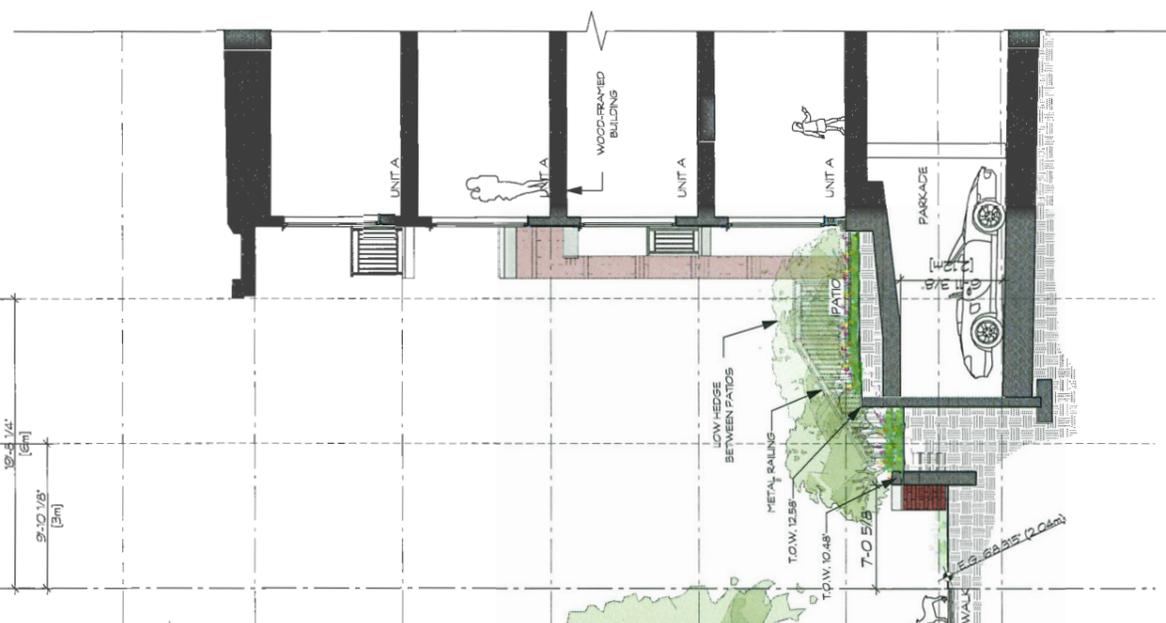

**A SECTION A-CAMBIE ROAD**  
SCALE: 3/8" = 1'-0"

PROPOSED BUILDING HEIGHT [5.69m]


TOP OF ROOF/PARAPET	62.55 (19.03m)	5'-10"	[1.78m]
5TH FLOOR	53.55 (16.34m)	10'-0"	[3.05m]
4TH FLOOR	43.55 (13.29m)	10'-0"	[3.05m]
3RD FLOOR	33.55 (10.24m)	10'-0"	[3.05m]
2ND FLOOR	23.55 (7.19m)	10'-0"	[3.05m]
1ST FLOOR/PODIUM	15.55 (4.74m)	10'-0"	[3.05m]
LOWEST AVERAGE GRADE	7.25 (2.22m)	0'-7"	[0.23m]
PARKADE LEVEL PL	3.0 (0.91m)		

DP 11174 CW - 26

COPYRIGHT RESERVED. THIS DRAWING MUST NOT BE SCALED. VARIATIONS AND MODIFICATIONS TO WORK SHALL BE MADE BY THE ARCHITECT OR ARCHITECTS WITHOUT WRITTEN PERMISSION FROM THE ARCHITECTS. THIS DRAWING IS THE EXCLUSIVE PROPERTY OF CICCOTZI ARCHITECTURE INC. AND CAN BE REPRODUCED ONLY WITH THEIR WRITTEN PERMISSION.

REVISION NO.	DATE	DESCRIPTION

ISSUE	DATE	DESCRIPTION
08.08.2018	24.05.2018	REVISED FOR DP
28.09.2018	14.05.2018	REVISED FOR DP

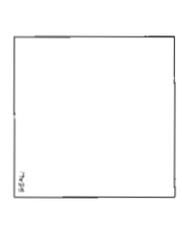


**CICCOTZI**  
ARCHITECTURE  
200 - 2339 COLUMBIA STREET  
VANCOUVER, B.C.  
CANADA V5Y 3Y3  
TEL: (604) 687-4741

PROJECT  
**RESIDENTIAL DEVELOPMENT**  
4008540'S STOLBERG ST  
RICHMOND, BC

DRAWN BY	CHECKED BY
SCALE	PROJECT NO.
3/16" = 1'-0"	564
SHEET TITLE	
<b>SITE SECTIONS</b>	

REVISION NO.	SHEET NO.
-	A5.2

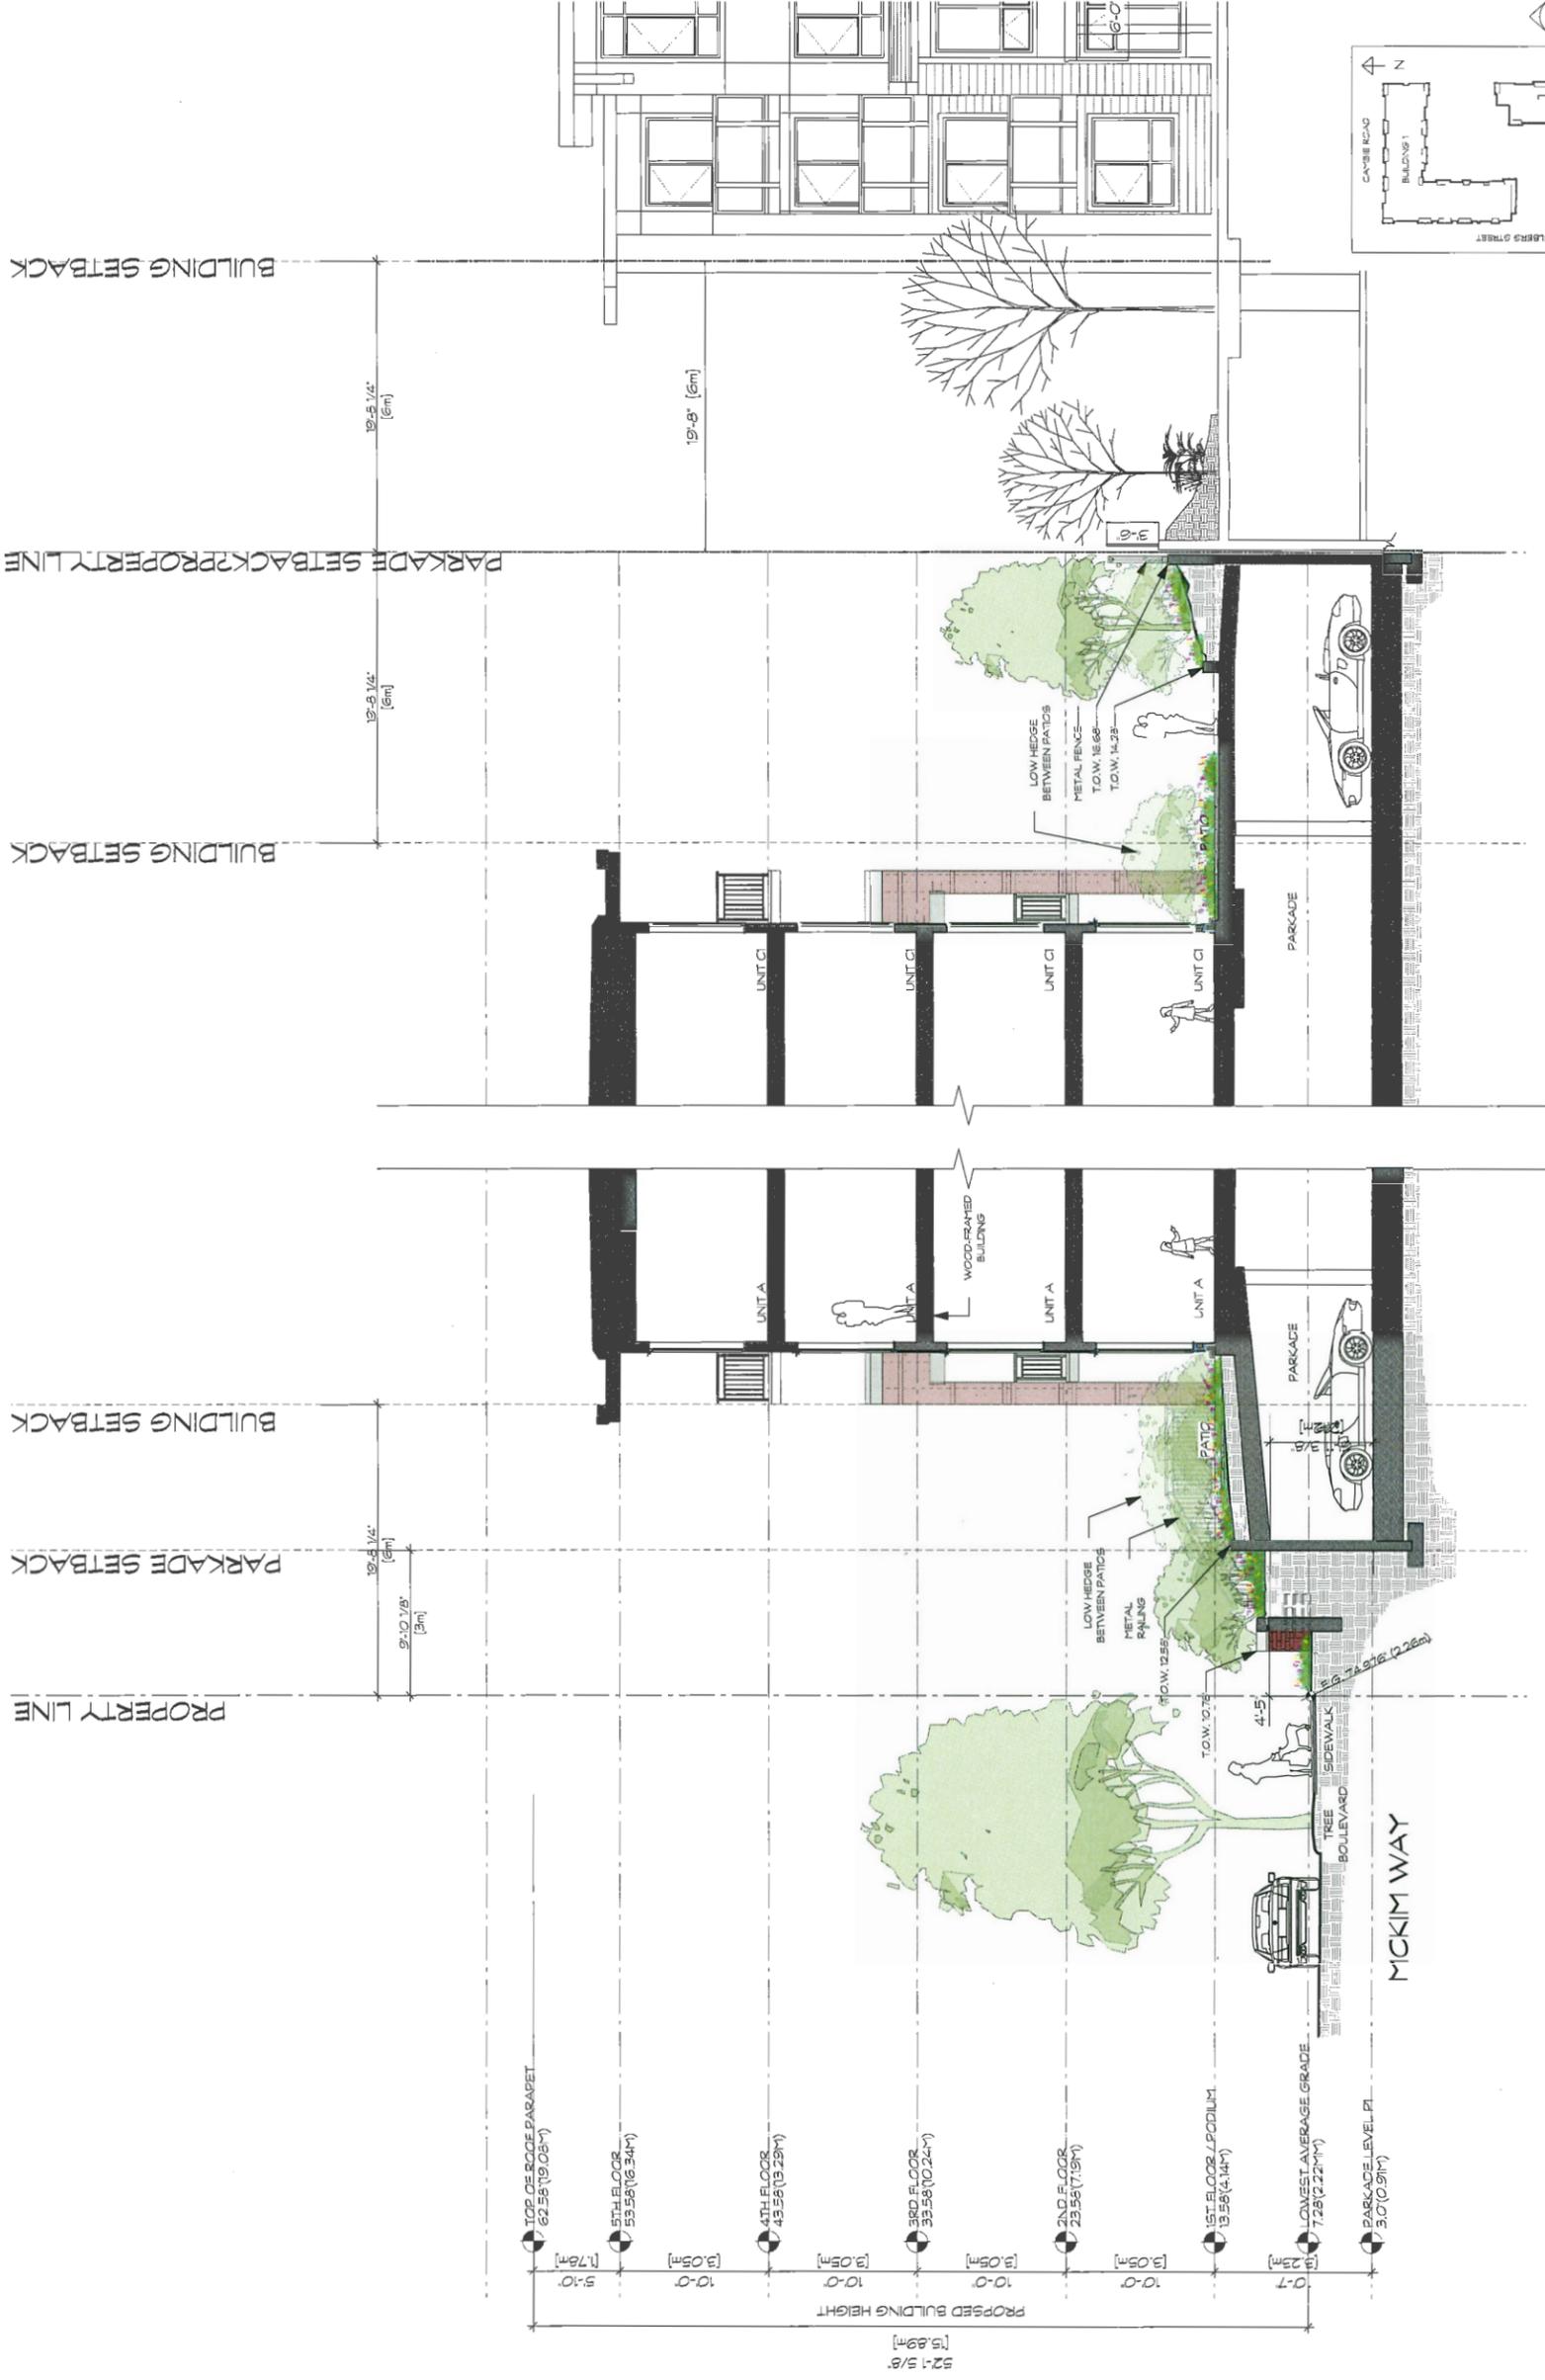

D SECTION D - ADJACENT SITE  
SCALE: 3/16" = 1'-0"


C SECTION C - MICKIM WAY  
SCALE: 3/16" = 1'-0"

DP 10000000 - 27

COPYRIGHT RESERVED. THIS DRAWING MUST NOT BE SCALED. VARIATIONS AND MODIFICATIONS TO WORK SHOWN ON THESE DRAWINGS SHALL NOT BE CARRIED OUT WITHOUT THE WRITTEN PERMISSION OF THE ARCHITECT. THE DRAWINGS ARE THE PROPERTY OF CICCOTZI ARCHITECTURE INC. AND CAN BE REPRODUCED ONLY WITH THEIR WRITTEN PERMISSION.

NO.	DATE	DESCRIPTION

**ISSUE:**  
 DATE: 09/21/21  
 DESCRIPTION: DP SUBMISSION  
 DRAWINGS REVISIONS FOR DP  
 28.09.2021 REVISIONS FOR DP



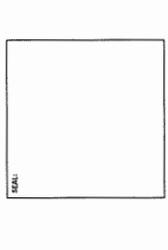


**CICCOTZI**  
 ARCHITECTURE  
 200 - 2339 COLUMBIA STREET  
 VANCOUVER, B.C.  
 CANADA V5Y 3Y3  
 TEL: (604) 687-4741


**RESIDENTIAL DEVELOPMENT**  
 40084018 STOLBERG ST  
 RICHMOND, BC

FORM: CIV	CREATED: RC
SCALE: 1/4" = 1'-0"	PROJECT: 564
SHEET TITLE: UNIT A PLANS	


REVISION NO.: -	SHEET NO.: A6.0
-----------------	-----------------

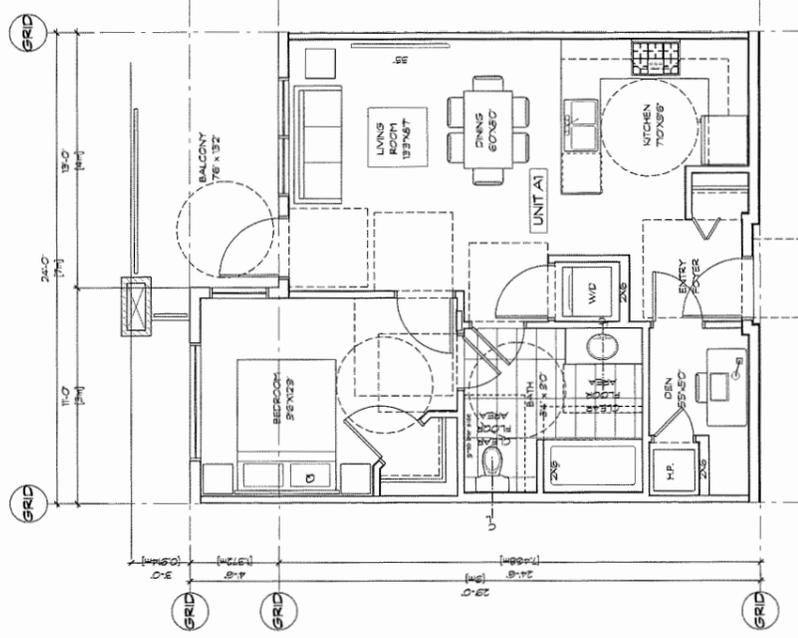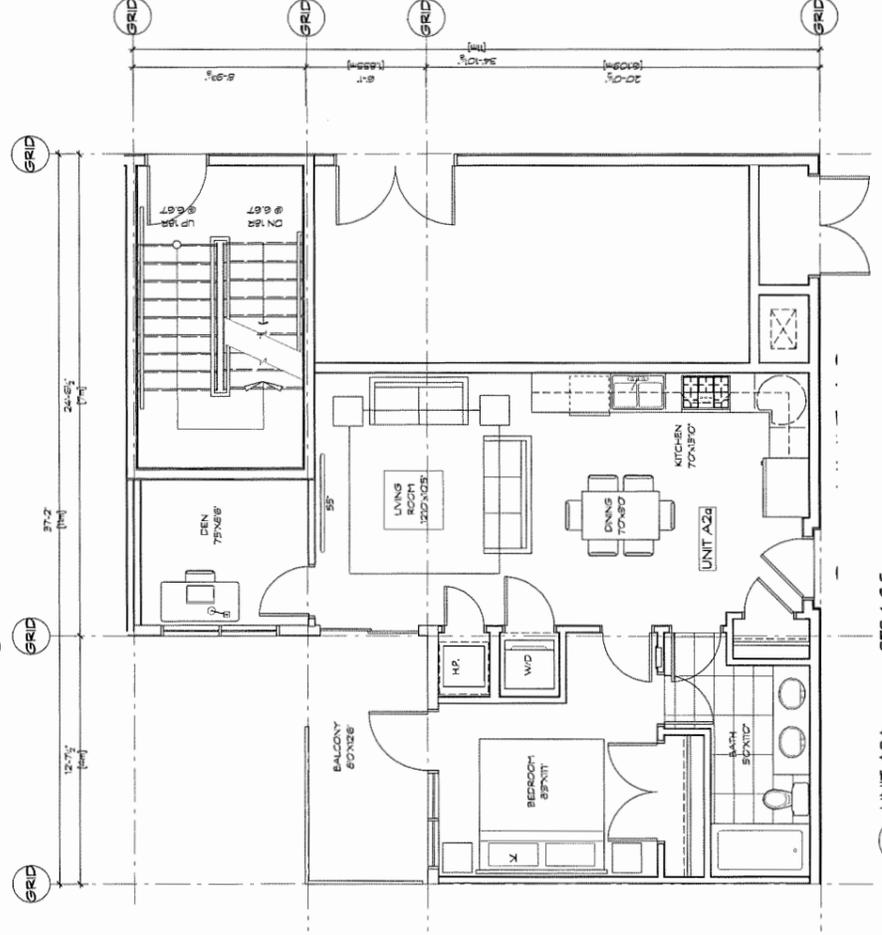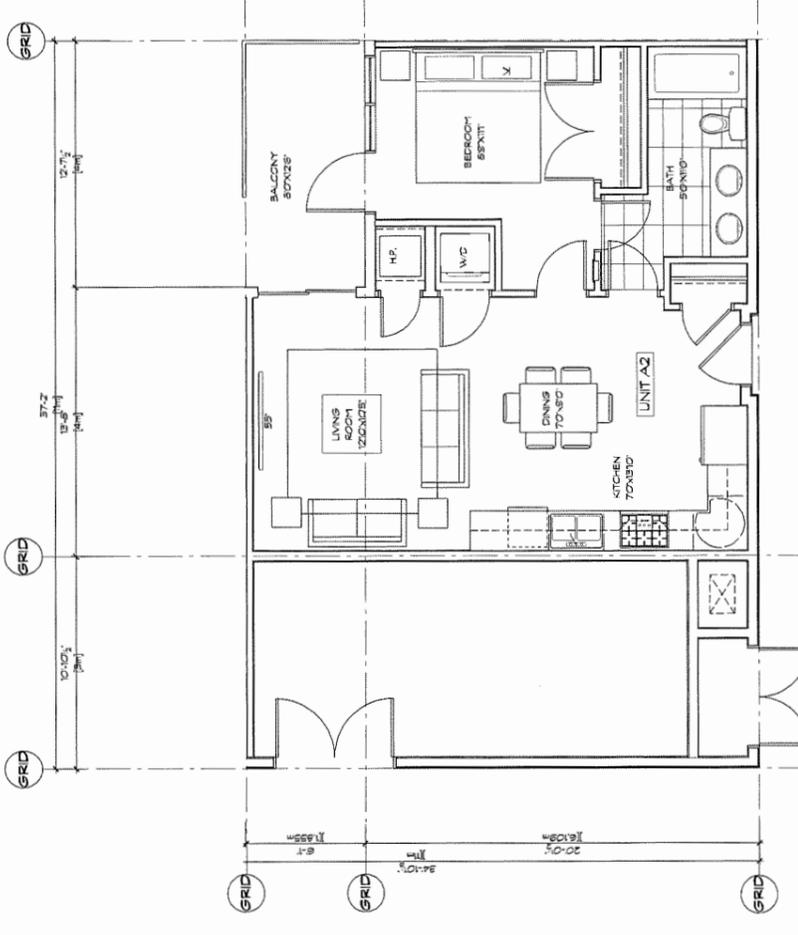

**2 UNIT A1**  
 SCALE: 1/4" = 1'-0"  
 629.1 S.F. (8 UNITS)

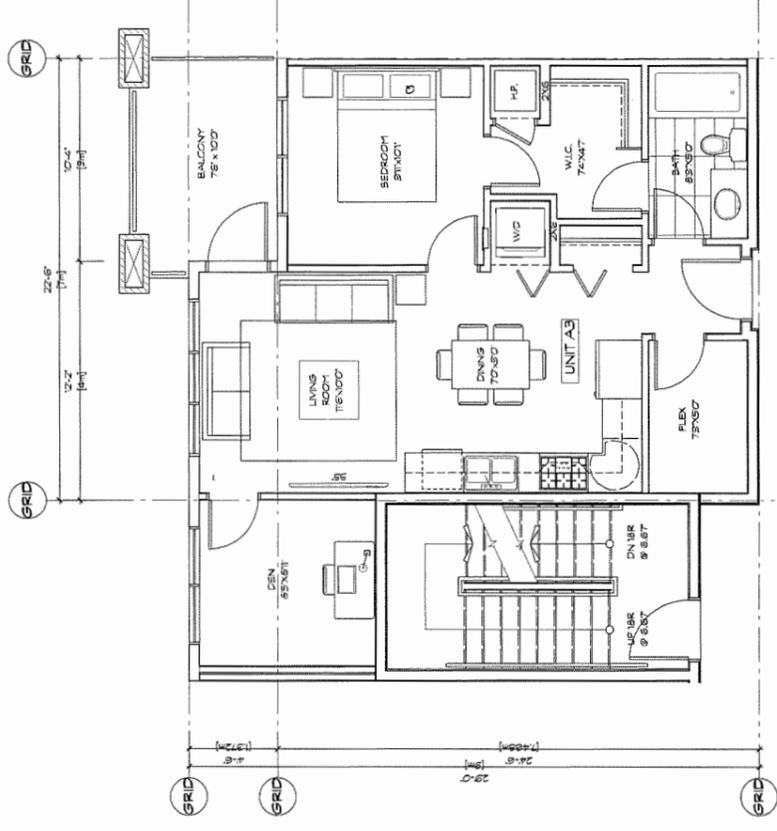

**4 UNIT A3**  
 SCALE: 1/4" = 1'-0"  
 662.1 S.F. (3 UNITS)

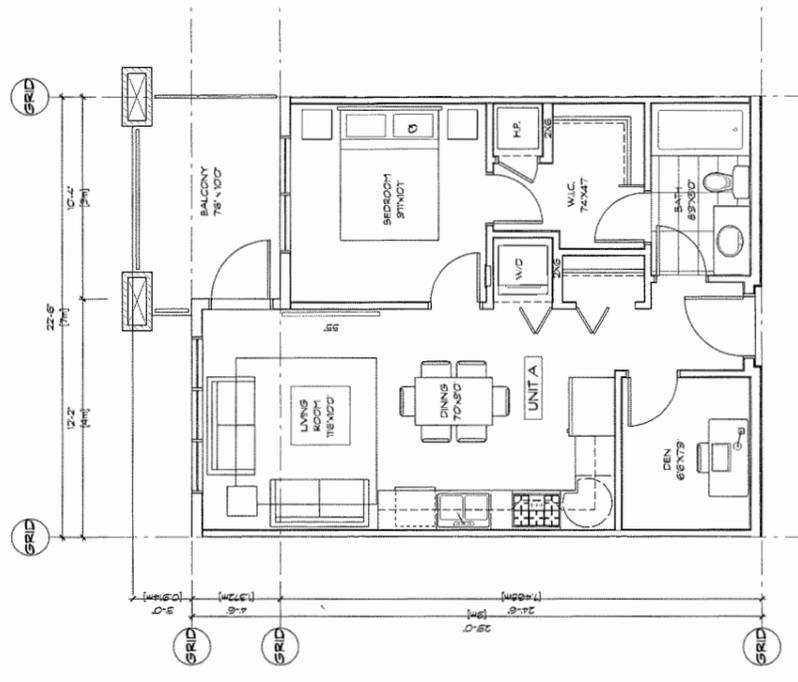


**1 UNIT A**  
 SCALE: 1/4" = 1'-0"  
 598.4 S.F. (23 UNITS)

COPYRIGHT RESERVED. THIS DRAWING MUST NOT BE SCALED. VARIATIONS AND MODIFICATIONS TO WORK SHOWN ON THESE DRAWINGS SHALL NOT BE CARRIED OUT WITHOUT WRITTEN PERMISSION FROM THE ARCHITECT. THIS DRAWING IS THE PROPERTY OF CICCOTZI ARCHITECTURE INC. AND CAN BE REPRODUCED ONLY WITH THEIR WRITTEN PERMISSION.

NO.	DATE	DESCRIPTION

ISSUE:  
 DATE: 25.03.2018  
 DESCRIPTION: DP 5.0 - REVISION  
 DATE: 06.08.2018  
 DESCRIPTION: RE-DESIGNED FOR DP  
 DATE: 25.03.2018  
 DESCRIPTION: RE-DESIGNED FOR DP

MAIL

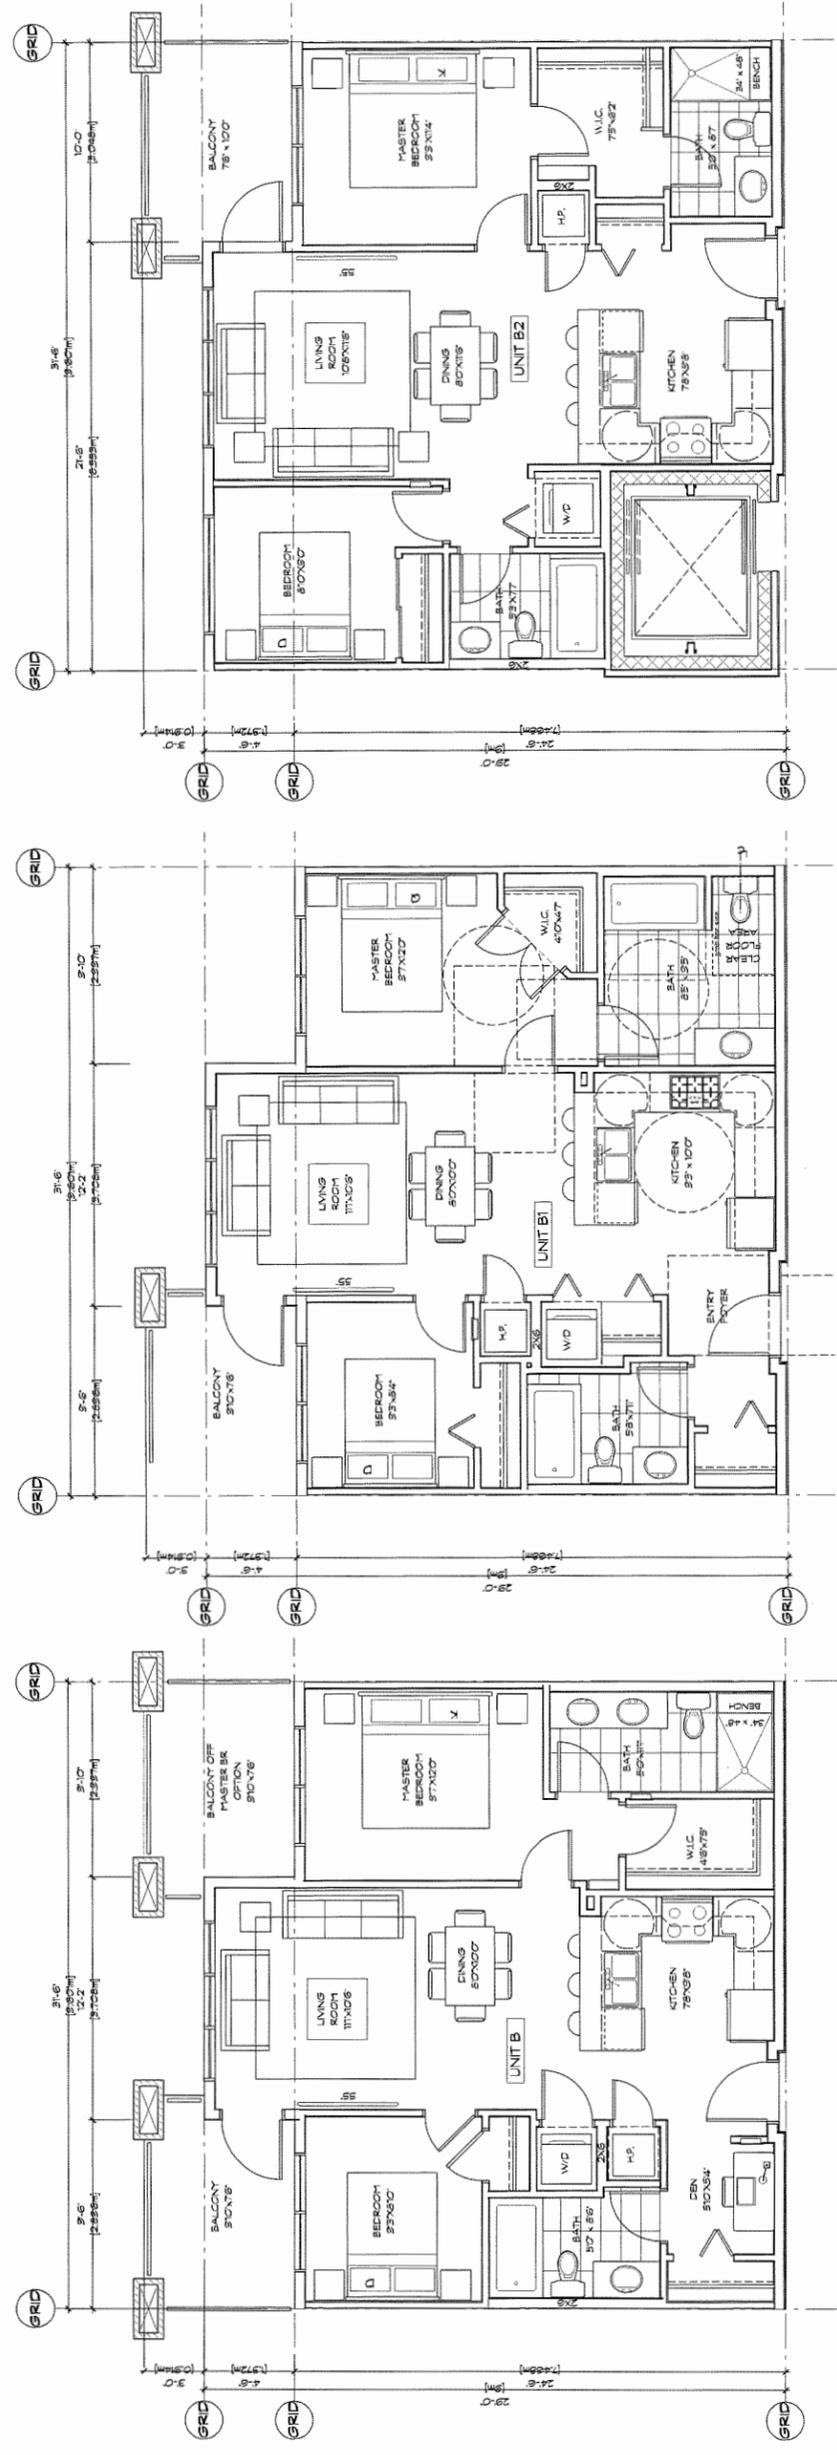

1 UNIT B 815.8 SF. (12 UNITS)  
 SCALE: 1/8" = 1'-0"

2 UNIT B1 815.1 SF. (12 UNITS)  
 SCALE: 1/8" = 1'-0"

3 UNIT B2 774.4 SF. (12 UNITS)  
 SCALE: 1/8" = 1'-0"


**CICCOTZI**  
 ARCHITECTURE

200 - 2339 COLUMBIA STREET  
 VANCOUVER, B.C.  
 CANADA V5Y 3Y3  
 TEL: (604) 687-4741

PROJECT:  
**RESIDENTIAL DEVELOPMENT**  
 400884018 STOLBERG ST  
 RICHMOND, BC

DRAWN:	CHKD BY:	RC
SCALE:	PROJECT NO.:	564
SHEET TITLE: <b>UNIT B PLANS</b>		

REVISION NO.: -  
 SHEET NO.: AG.1

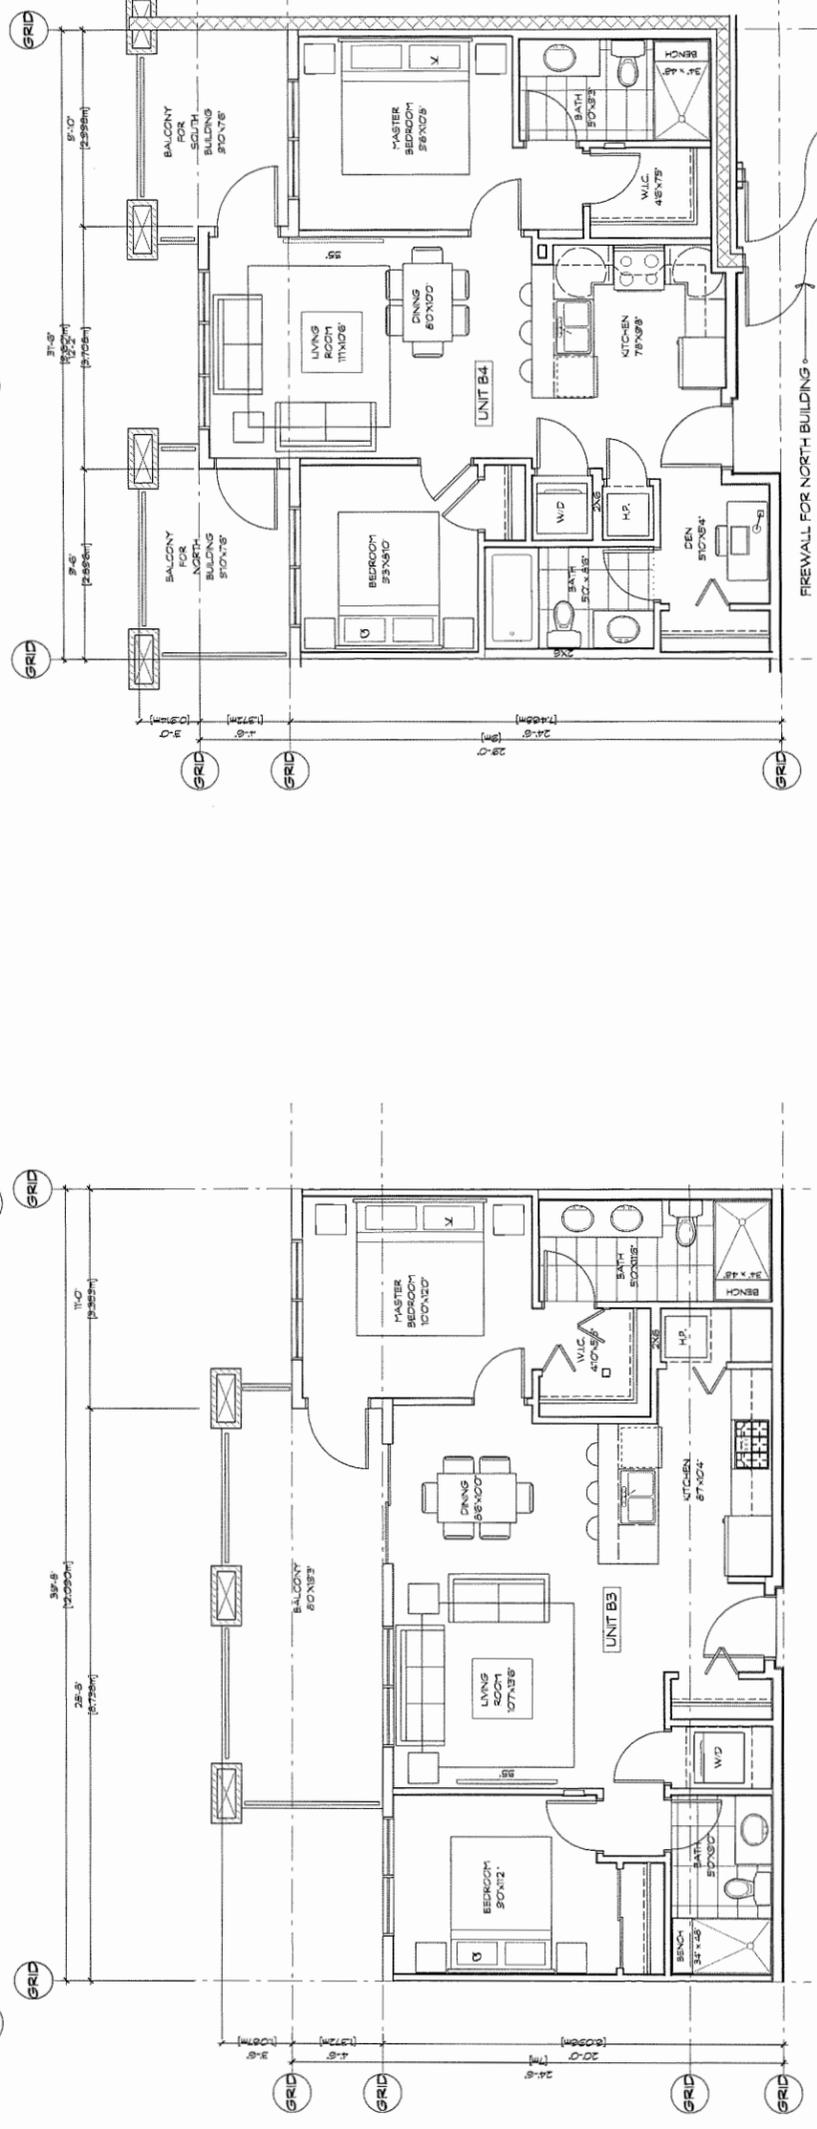

4 UNIT B3 829.1 SF. (8 UNITS)  
 SCALE: 1/8" = 1'-0"

5 UNIT B4 760.2 SF. (8 UNITS)  
 SCALE: 1/8" = 1'-0"

OP 17-794280-29

COPYRIGHT RESERVED. THIS DRAWING MUST NOT BE REPRODUCED OR TRANSMITTED IN ANY FORM OR BY ANY MEANS, ELECTRONIC OR MECHANICAL, INCLUDING PHOTOCOPYING, RECORDING, OR BY ANY INFORMATION STORAGE AND RETRIEVAL SYSTEM, WITHOUT THE WRITTEN PERMISSION FROM THE ARCHITECTS. THIS DRAWING IS THE EXCLUSIVE PROPERTY OF CICCOTZI ARCHITECTURE INC. AND CAN BE REPRODUCED ONLY WITH THEIR WRITTEN PERMISSION.

NO.	DATE	DESCRIPTION

**ISSUE:**  
 DATE: 08.03.2018  
 DESCRIPTION: DP SUBMISSION  
 DATE: 28.09.2018  
 DESCRIPTION: REISSUED FOR DP  
 DATE: 28.09.2018  
 DESCRIPTION: REISSUED FOR DP




**CICCOTZI**  
 ARCHITECTURE

200 - 2339 COLUMBIA STREET  
 VANCOUVER, B.C.  
 CANADA V5Y 3Y3  
 TEL: (604) 687-4741


PROJECT:  
**RESIDENTIAL DEVELOPMENT**  
 400854018 STOLBERG ST  
 RICHMOND, BC

TEAM:	KJV	CREATED BY:	BC
SCALE:	1/2" = 1'-0"	PROJECT NO.:	564
SHEET TITLE: <b>UNIT C PLANS</b>			


REVISION NO.:	-	SHEET NO.:	A6.2
---------------	---	------------	------

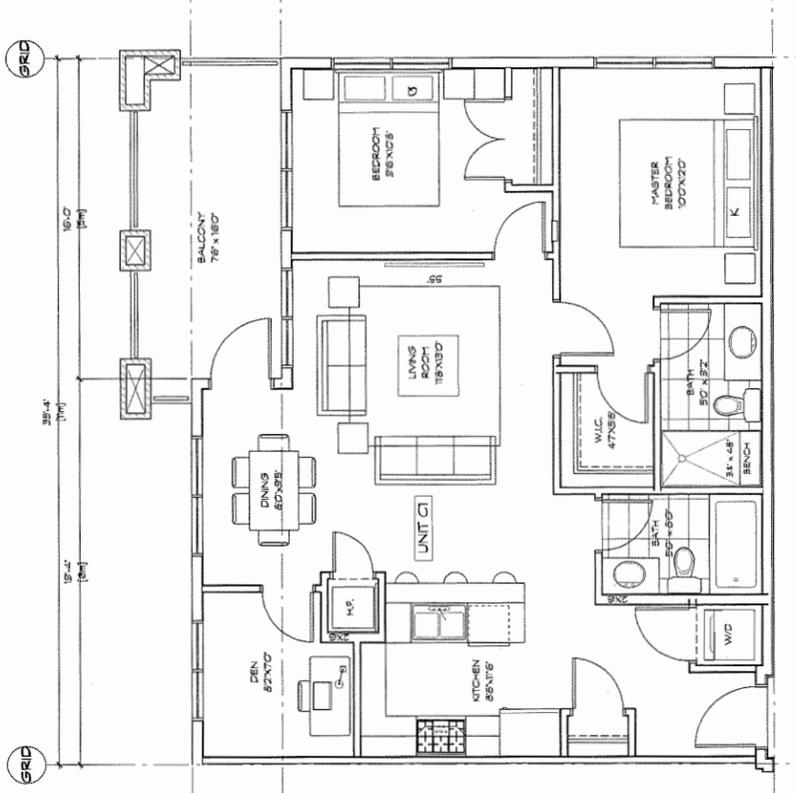

① UNIT C1 940.5 S.F.  
 SCALE: 1/4" = 1'-0" (9 UNITS)

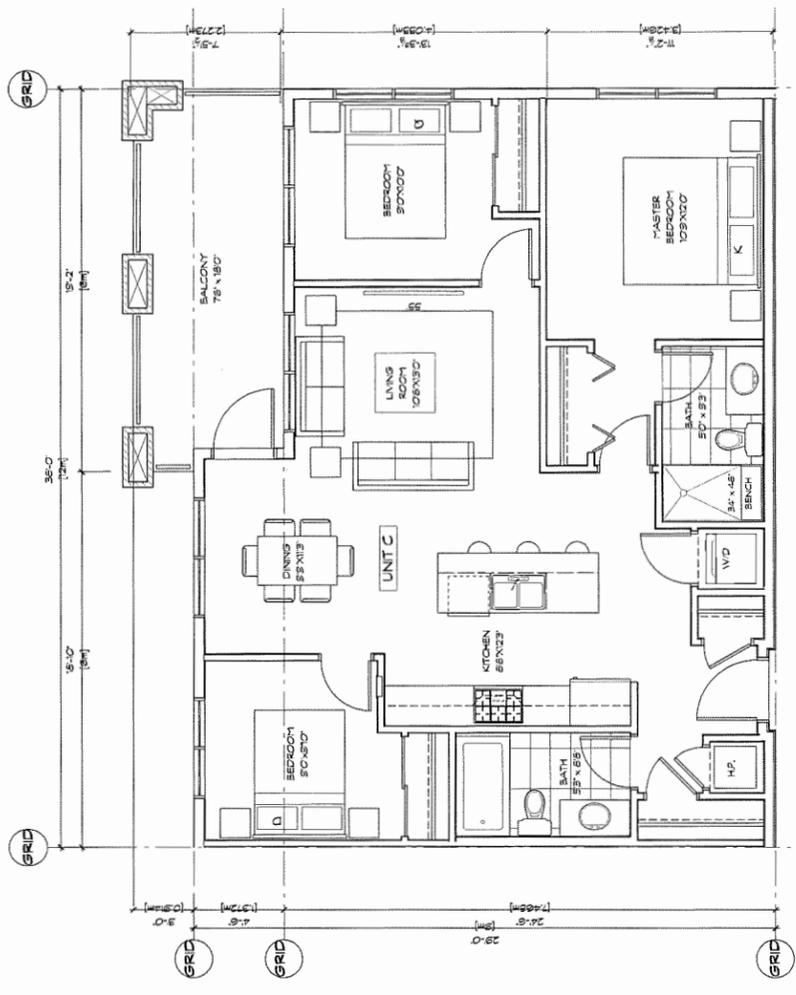

② UNIT C 1008.0 S.F.  
 SCALE: 1/4" = 1'-0" (8 UNITS)

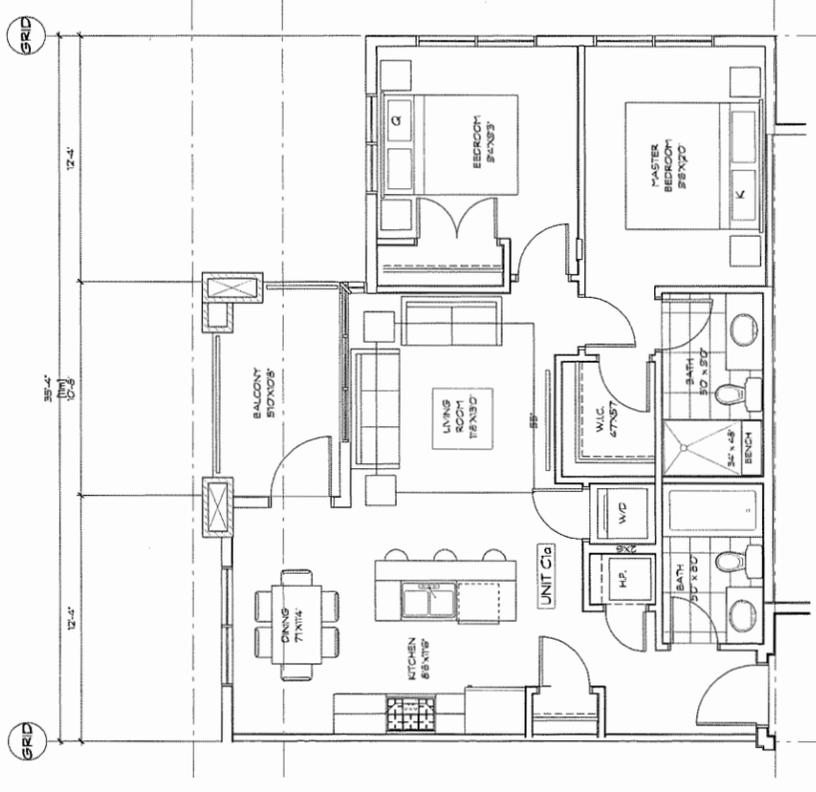


③ UNIT C1A 903.8 S.F.  
 SCALE: 1/4" = 1'-0" (3 UNITS)

DB 17/01/200-20

COPYRIGHT RESERVED. THIS DRAWING MUST NOT BE REPRODUCED OR TRANSMITTED IN ANY FORM OR BY ANY MEANS, ELECTRONIC OR MECHANICAL, INCLUDING PHOTOCOPYING, RECORDING, OR BY ANY INFORMATION STORAGE AND RETRIEVAL SYSTEM, WITHOUT THE WRITTEN PERMISSION OF THE ARCHITECTS. THIS DRAWING IS THE EXCLUSIVE PROPERTY OF CICCOTZI ARCHITECTURE INC. AND CAN BE REPRODUCED ONLY WITH THEIR WRITTEN PERMISSION.


REVISION:	
NO.	DESCRIPTION

ISSUE:	
DATE	DESCRIPTION
06.06.2018	DP SUB-BEEN
28.09.2018	RE-SUB-1D FOR DP
28.09.2018	RE-SUB-1D FOR DP

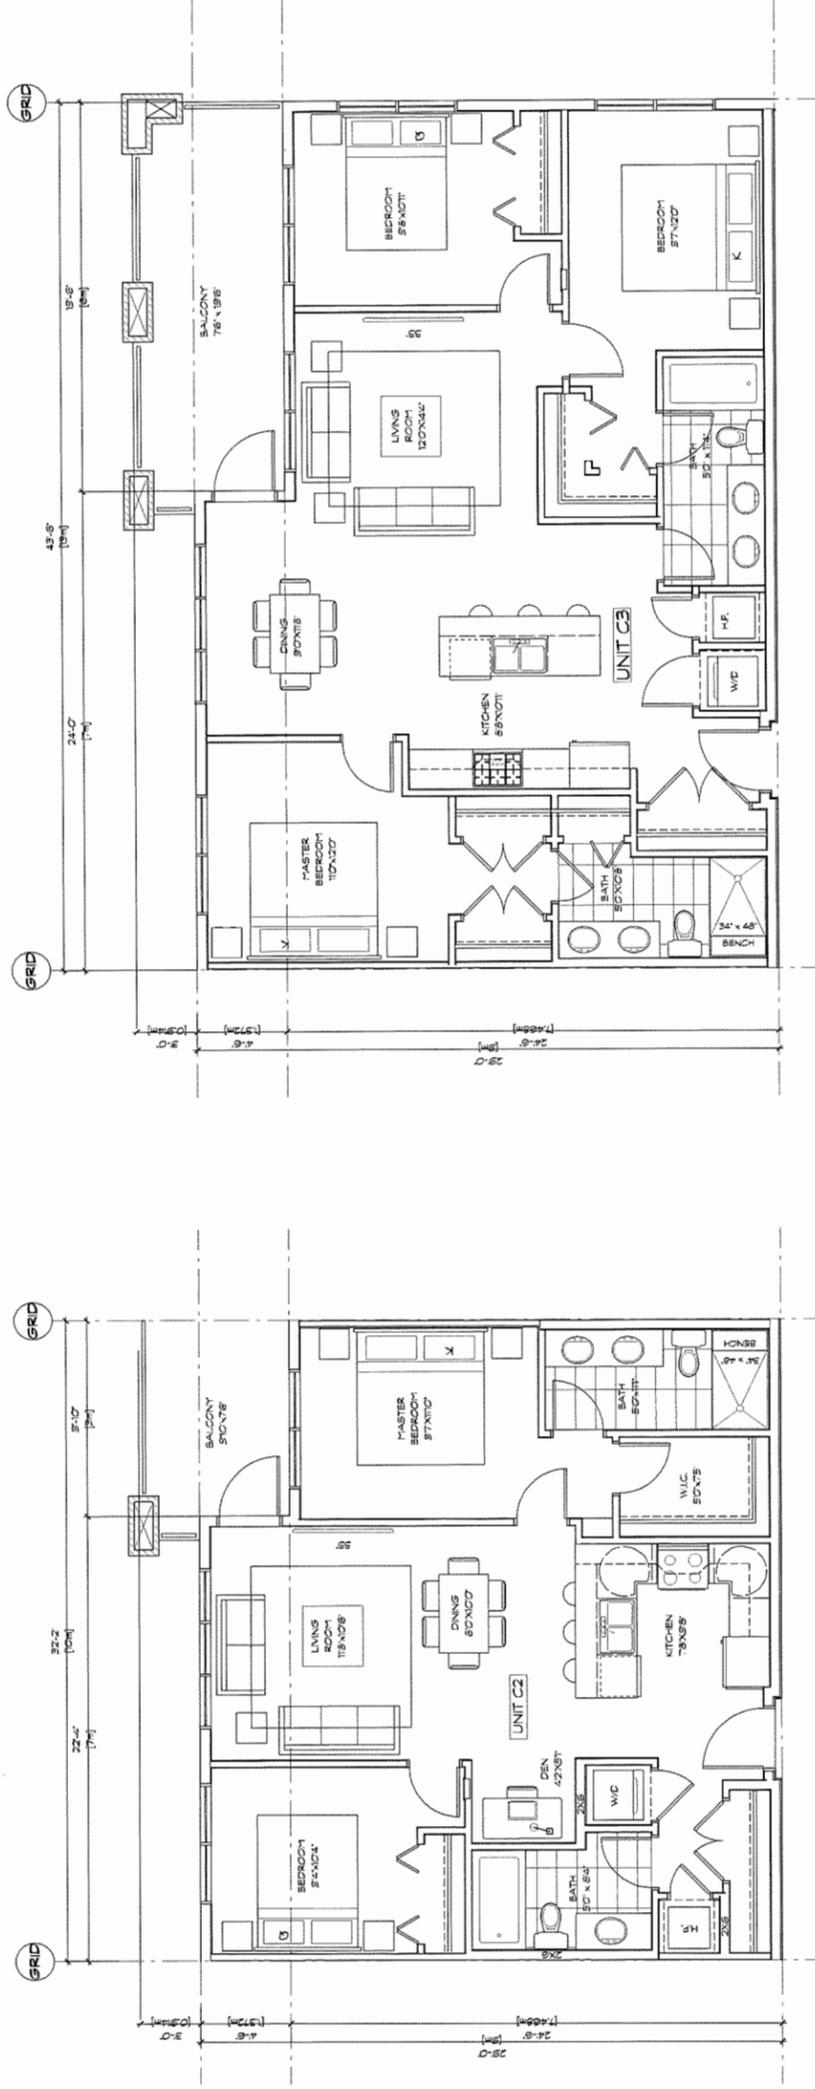

1 UNIT C2 878.5 S.F. (46 UNITS)  
SCALE: 1/4" = 1'-0"

2 UNIT C3 1189.6 S.F. (10 UNITS)  
SCALE: 1/4" = 1'-0"

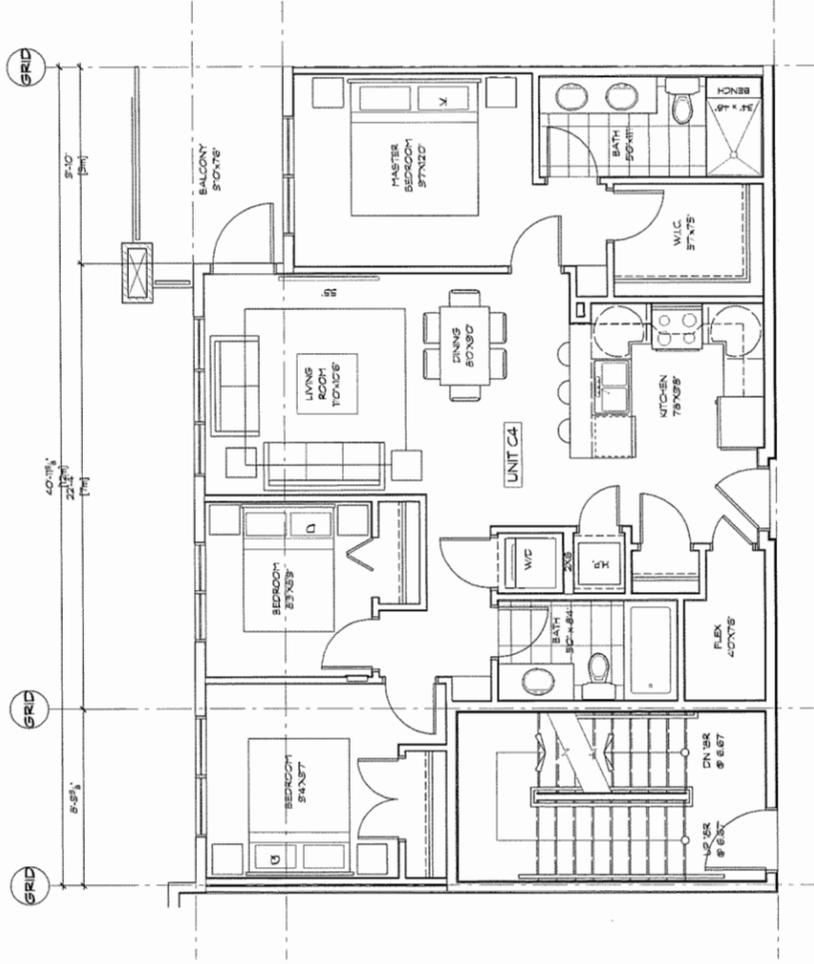

3 UNIT C4 988.0 S.F. (8 UNITS)  
SCALE: 1/4" = 1'-0"

**CICCOTZI**  
ARCHITECTURE

200 - 2339 COLUMBIA STREET  
VANCOUVER, B.C.  
CANADA V5Y 3Y3  
TEL: (604) 687-4741

PROJECT:  
**RESIDENTIAL DEVELOPMENT**  
400864018 ST. CLBERG ST  
RICHMOND, BC


OWNER:	KV	CREATED BY:	BC
SCALE:	1/4" = 1'-0"	PROJECT NO.:	864
SHEET TITLE: <b>UNIT C PLANS</b>			

REVISION NO.:	-	SHEET NO.:	A6.3
---------------	---	------------	------

COPYRIGHT RESERVED. THIS DRAWING MUST NOT BE REPRODUCED OR TRANSMITTED IN ANY FORM OR BY ANY MEANS, ELECTRONIC OR MECHANICAL, INCLUDING PHOTOCOPYING, RECORDING, OR BY ANY INFORMATION STORAGE AND RETRIEVAL SYSTEM, WITHOUT THE WRITTEN PERMISSION FROM THE ARCHITECTS. THIS DRAWING IS THE EXCLUSIVE PROPERTY OF CICCOTZI ARCHITECTURE INC. AND CAN BE REPRODUCED ONLY WITH THEIR WRITTEN PERMISSION.

REVISION:	
NO.	DESCRIPTION

ISSUE:	
DATE	DESCRIPTION
20.12.2017	DP SUB-MISSON
08.03.2018	RE-REVISION FOR DP
28.03.2018	RE-REVISION FOR DP

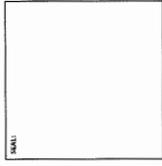

**CICCOTZI**  
ARCHITECTURE  
200 - 2339 COLUMBIA STREET  
VANCOUVER, B.C.  
CANADA V5Y 3Y3  
TEL: (604) 687-4741

PROJECT:  
**RESIDENTIAL DEVELOPMENT**  
4008/4018 STOLBERG ST  
RICHMOND, BC

DRAWN:	
NO.	NAME

CHECKED BY:	
NO.	NAME

SHEET TITLE:	
NO.	DESCRIPTION

REVISION NO.:  
-  
SHEET NO.:  
A6.4

DP 17-794280-32

4008/4018 STOLBERG STREET, RICHMOND, UNIT SUMMARY

UNIT TYPE	FLOOR AREA SQ.FT.	BUILDING LEVELS				TOTAL UNITS	TOTAL AREA PER UNIT TYPE	PERCENTAGE %
		LEVEL 1	LEVEL 2	LEVEL 3	LEVEL 4			
UNIT A:	598.4 SQ.FT.	7	7	7	7	28 UNITS	16,754.6 SQ.FT.	14.3%
UNIT A1:	629.1 SQ.FT.	2	2	2	2	8 UNITS	5,032.7 SQ.FT.	4.1%
UNIT A2:	599.7 SQ.FT.	2	2	2	2	8 UNITS	4,797.3 SQ.FT.	4.1%
UNIT A2R:	672.4 SQ.FT.	0	1	1	1	3 UNITS	2,017.3 SQ.FT.	1.5%
UNIT A3:	682.1 SQ.FT.	0	1	1	1	3 UNITS	2,046.3 SQ.FT.	1.5%
UNIT B:	819.9 SQ.FT.	3	3	3	3	12 UNITS	9,789.8 SQ.FT.	6.1%
UNIT B1:	815.1 SQ.FT.	3	3	3	3	12 UNITS	9,751.3 SQ.FT.	6.1%
UNIT B2:	714.4 SQ.FT.	2	4	4	4	14 UNITS	10,841.9 SQ.FT.	7.1%
UNIT B3:	829.1 SQ.FT.	2	2	2	2	8 UNITS	6,633.1 SQ.FT.	4.1%
UNIT B4:	760.2 SQ.FT.	2	2	2	2	8 UNITS	6,081.8 SQ.FT.	4.1%
UNIT C:	1,008.0 SQ.FT.	2	2	2	2	8 UNITS	8,063.8 SQ.FT.	4.1%
UNIT C1:	940.5 SQ.FT.	2	2	2	2	8 UNITS	7,166.6 SQ.FT.	4.1%
UNIT C1R:	821.0 SQ.FT.	0	1	1	1	3 UNITS	2,483.0 SQ.FT.	1.5%
UNIT C2:	878.9 SQ.FT.	13	11	11	11	46 UNITS	40,409.1 SQ.FT.	23.5%
UNIT C3:	1,359.9 SQ.FT.	1	3	3	3	10 UNITS	11,586.6 SQ.FT.	5.1%
UNIT C4:	988.0 SQ.FT.	0	2	2	2	6 UNITS	5,927.8 SQ.FT.	3.1%
NET SALEABLE FLOOR AREA:		TOTAL UNITS:				196 UNITS	160,107.4 SQ.FT.	100.0%

UNIT TYPE	UNIT NUMBER	PERCENTAGE
BUH UNIT TYPES	20	10.2%
** REQUIRED 10% OF TOTAL UNITS BY THE CITY OF RICHMOND		
UNIT TYPE	UNIT NUMBER	PERCENTAGE
A, A1, A2, A2R, A3	50	25.5%
B, B1, B2, B3, B4, C1, C1R, C2	122	62.2%
C, C3, C4	24	12.2%
TOTAL:	196 UNITS	100.0%

4008 STOLBERG STREET, RICHMOND (NORTH BUILDING) UNIT SUMMARY

UNIT TYPE	FLOOR AREA SQ.FT.	BEDROOM NUMBER	BUILDING LEVELS				TOTAL UNITS	TOTAL AREA PER UNIT TYPE	PERCENTAGE %
			LEVEL 1	LEVEL 2	LEVEL 3	LEVEL 4			
UNIT A:	598.4 SQ.FT.	1 BEDROOMS	5	5	5	5	20 UNITS	10,976 SQ.FT.	21.0%
UNIT A1:	629.1 SQ.FT.	1 BEDROOMS	2	2	2	2	8 UNITS	5,032.7 SQ.FT.	6.8%
UNIT A2:	599.7 SQ.FT.	1 BEDROOMS	0	1	1	1	3 UNITS	1,799.0 SQ.FT.	3.3%
UNIT A2R:	672.4 SQ.FT.	0 BEDROOMS	0	0	0	0	0 UNITS	0.0 SQ.FT.	0.0%
UNIT A3:	682.1 SQ.FT.	1 BEDROOMS	0	1	1	1	3 UNITS	2,046.3 SQ.FT.	3.3%
UNIT B:	819.9 SQ.FT.	2 BEDROOMS	1	1	1	1	4 UNITS	3,263.3 SQ.FT.	4.4%
UNIT B1:	815.1 SQ.FT.	2 BEDROOMS	1	1	1	1	4 UNITS	3,360.9 SQ.FT.	4.4%
UNIT B2:	714.4 SQ.FT.	2 BEDROOMS	1	2	2	2	7 UNITS	5,430.8 SQ.FT.	1.7%
UNIT B3:	829.1 SQ.FT.	2 BEDROOMS	0	0	0	0	0 UNITS	0.0 SQ.FT.	0.0%
UNIT B4:	760.2 SQ.FT.	2 BEDROOMS	1	1	1	1	4 UNITS	3,040.9 SQ.FT.	4.4%
UNIT C:	1,008.0 SQ.FT.	3 BEDROOMS	2	2	2	2	8 UNITS	8,063.8 SQ.FT.	6.8%
UNIT C1:	940.5 SQ.FT.	2 BEDROOMS	1	1	1	1	4 UNITS	3,761.9 SQ.FT.	4.4%
UNIT C1R:	821.0 SQ.FT.	2 BEDROOMS	0	1	1	1	3 UNITS	2,483.0 SQ.FT.	3.3%
UNIT C2:	878.9 SQ.FT.	2 BEDROOMS	5	4	4	4	17 UNITS	14,933.8 SQ.FT.	9.7%
UNIT C3:	1,359.9 SQ.FT.	3 BEDROOMS	0	1	1	1	3 UNITS	3,479.8 SQ.FT.	3.3%
UNIT C4:	988.0 SQ.FT.	3 BEDROOMS	0	1	1	1	3 UNITS	2,893.8 SQ.FT.	3.3%
NET SALEABLE FLOOR AREA:		TOTAL UNITS:		51 UNITS	71,871 SQ.FT.	100.0%			

4018 STOLBERG STREET, RICHMOND (SOUTH BUILDING) UNIT SUMMARY

UNIT TYPE	FLOOR AREA SQ.FT.	BEDROOM NUMBER	BUILDING LEVELS				TOTAL UNITS	TOTAL AREA PER UNIT TYPE	PERCENTAGE %
			LEVEL 1	LEVEL 2	LEVEL 3	LEVEL 4			
UNIT A:	598.4 SQ.FT.	1 BEDROOMS	2	2	2	2	8 UNITS	4,797.3 SQ.FT.	1.8%
UNIT A1:	629.1 SQ.FT.	1 BEDROOMS	0	0	0	0	0 UNITS	0.0 SQ.FT.	0.0%
UNIT A2:	599.7 SQ.FT.	1 BEDROOMS	2	1	1	1	5 UNITS	2,229.3 SQ.FT.	4.8%
UNIT A2R:	672.4 SQ.FT.	0 BEDROOMS	0	1	1	1	3 UNITS	2,017.3 SQ.FT.	2.9%
UNIT A3:	682.1 SQ.FT.	1 BEDROOMS	0	0	0	0	0 UNITS	0.0 SQ.FT.	0.0%
UNIT B:	819.9 SQ.FT.	2 BEDROOMS	2	2	2	2	8 UNITS	6,526.6 SQ.FT.	7.8%
UNIT B1:	815.1 SQ.FT.	2 BEDROOMS	2	2	2	2	8 UNITS	6,821.0 SQ.FT.	7.8%
UNIT B2:	714.4 SQ.FT.	2 BEDROOMS	1	2	2	2	7 UNITS	5,430.8 SQ.FT.	6.7%
UNIT B3:	829.1 SQ.FT.	2 BEDROOMS	2	2	2	2	8 UNITS	6,633.1 SQ.FT.	7.8%
UNIT B4:	760.2 SQ.FT.	2 BEDROOMS	1	1	1	1	4 UNITS	3,040.9 SQ.FT.	3.8%
UNIT C:	1,008.0 SQ.FT.	3 BEDROOMS	0	0	0	0	0 UNITS	0.0 SQ.FT.	0.0%
UNIT C1:	940.5 SQ.FT.	2 BEDROOMS	3	4	4	4	15 UNITS	14,058.9 SQ.FT.	14.3%
UNIT C1R:	821.0 SQ.FT.	2 BEDROOMS	0	0	0	0	0 UNITS	0.0 SQ.FT.	0.0%
UNIT C2:	878.9 SQ.FT.	2 BEDROOMS	6	7	7	7	28 UNITS	25,479.3 SQ.FT.	27.8%
UNIT C3:	1,359.9 SQ.FT.	3 BEDROOMS	1	2	2	2	7 UNITS	8,178.8 SQ.FT.	6.7%
UNIT C4:	988.0 SQ.FT.	3 BEDROOMS	0	1	1	1	3 UNITS	2,893.8 SQ.FT.	2.9%
NET SALEABLE FLOOR AREA:		TOTAL UNITS:		108 UNITS	88,803 SQ.FT.	100.0%			

# 4008 STOLBERG STREET

for Everwell Group Holding Ltd. Partnership.

Civic Address: 4008 Stolberg Street, Richmond BC  
 Legal Address: \*\*\*\*



1690 West 2nd Avenue  
 Vancouver . BC . Canada . V6J 1H4  
 t | 604.683.1456 f | 604.683.1459 w | www.etal.ca

### CONSULTANT TEAM

OWNER: Everwell Group Holding Ltd. Partnership.  
 ARCHITECT: RCA Architects  
 LANDSCAPE: ETA Landscape Architecture

ISSUED FOR RE-DP: Sept 28, 2018

### DRAWING LIST


La.1	Landscape Concept Plan
Lb.0	Landscape Key Plan
Lb.1	Landscape Materials: Plan 1
Lb.2	Landscape Materials: Plan 2
Lb.3	Landscape Materials: Plan 3
Lb.4	Landscape Materials: Plan 4
Lb.5	Landscape Materials: Children's Play
Lb.6	Landscape Grading: Plan 1
Lb.7	Landscape Grading: Plan 2
Lb.8	Landscape Grading: Plan 3
Lb.9	Landscape Grading: Plan 4
Lc.1	Landscape Planting: Plan 1
Lc.2	Landscape Planting: Plan 2
Lc.3	Landscape Planting: Plan 3
Lc.4	Landscape Planting: Plan 4
Lc.5	Landscape Irrigation: Plan 1
Lc.6	Landscape Irrigation: Plan 2
Lc.7	Landscape Irrigation: Plan 3
Lc.8	Landscape Irrigation: Plan 4
Ld.1	Landscape Lighting: Plan 1
Ld.2	Landscape Lighting: Plan 2
Ld.3	Landscape Lighting: Plan 3
Ld.4	Landscape Lighting: Plan 4
Ld.5	Landscape Lighting: Specifications
Le.1	Landscape Sections
Le.2	Landscape Sections
Lf.1	Landscape Details - Softscape
Lf.2	Landscape Details - Hardscape
Lf.3	Landscape Details - Site Furnishings

SITE FURNISHINGS			
ID	DESCRIPTION	SIZE	QTY
A1	TIMBER ARBOUR	Varies	3
B1	LAKESIDE PICKET FENCE BENCH - 67"	Wood slat	27
B2	WOODEN BENCH	Varies	-
C4	COMPOST BINS	TBD	2
P1	POTTLING TABLE	Custom	1
F1	FENCE	Aluminum	-
F2	SCREEN FENCE	WRC	-
G1	GATE	Steel	-

MATERIALS			
ID	DESCRIPTION	SIZE	QTY
AB	ALLAN BLOCK WALL	Standard	-
CE	CONCRETE EDGE	Cast-In-Place	-
Gr	PEA GRAVEL	<1/2"	-
P1	UNIT PAVER	Boardwalk	-
P2	CONCRETE WALKWAY	Cast-In-Place	-
P3	CONCRETE STAIRS	Custom	-
P4	CONCRETE STAIRS	Custom	-
P5	VEHICULAR CONCRETE	3' x 18' x 4"	-
P6	GARDEN PAVER	10' x 35' x 2" Bridgwood	-
P7	PAVERS 1	24' x 24"	-
P8	PAVERS 2	Plazza	-
R1	RUBBER PLAY SURFACE	Pour-In-Place	-

PLANT LIST	ID	QTY	LATIN NAME	COMMON NAME	SPACING	SCHEDULED SIZE	NOTES
TREES	Ag	4	Acer griseum	paperbark maple	as shown	15' full height	full, bushy plants
	Apo	3	Acer palmatum 'Osakazuki'	Japanese maple	as shown	#7 cont.	multistemmed/ bushy plants
	Bn	11	Betula nigra	river birch	as shown	3-4m specimen/ B&B	low branching/ very heights
	Ccf	22	Cercis canadensis forest pansy	Eastern redbud	as shown	5cm cal/ B&B	2m standard/ full crown
	Dt	1	Davidia involucrella	dove tree	as shown	5cm B&B	Full, bushy plants
	Ffd	19	Fagus sylvatica dewyck gold	golden beech	as shown	4m ht. B&B	full/ bushy plants
	Fpc	10	Pinus cembra	Swiss Stone Pine	as shown	3.5m ht/ B&B	full/ bushy canopies
	Pse	1	Pseudotsuga menziesii	Douglas Fir	as shown	2.5m ht/ B&B	full/ bushy canopies
	Sil	39	Shyrax japonica	Japanese snowbell	as shown	6cm B&B	full/ dense crown
SHRUBS	Al	191	Azalea japonica 'Hino White'	white evergreen azalea	20' #2 cont.		full/ bushy plants
	Azs	73	Azalea schlippenbachii	royal azalea	25' #2 cont.		full/ bushy plants
	Cod	279	Cotoneaster dammeri	barberry cotoneaster	20' #2 cont.		full/ bushy plants
	Cr	3	Cornus canadensis	Trumpet creeper	30' #2 cont/ staked		full/ bushy plants
	Csp	9	Chaenonelax spicifera	flowering quince	40' #5 cont.		bushy plants
	Fm	4	Fragaria virginiana	Fragrant Daylily	30' #2 cont.		full/ bushy plants
	Em	94	Echinacea purpurea	purple coneflower	15' #2 cont.		full/ bushy plants
	Gs	94	Gaultheria shallon	salal	20' #2 cont.		full/ bushy plants
	Hd	172	Hydrangea paniculata 'Little Lime'	LimeLight Hardy Hydrangea	45'70' #5 cont.		full/ bushy plants
	Icc	20	Ilex crenata compacta	Japanese Holly	15' #5 cont.		full/ bushy plants
	Icc	191	Ilex crenata compacta	Japanese Holly	15' #2 cont.		full/ bushy plants
	Las-1	112	Liriodie muscari 'Majestic'	Majestic Lilyturf	40' #2 cont.		full/ bushy plants
	Lp	22	Lonicera pileolata	box leaf honeysuckle	610' #3 cont.		full/ bushy plants
	Mis	569	Miscanthus sinensis 'Morning Light'	morning light maiden grass	20' #3 cont.		full/ bushy plants
	Mis	569	Miscanthus sinensis 'Morning Light'	morning light maiden grass	20' #3 cont.		full/ bushy plants
	Mr	94	Mahonia repens	Creeping Oregon grape	20' #2 cont.		full/ bushy plants
	Pa	49	Pennisetum alopecuroides	Fountain Grass	25' #4 cont.		full/ bushy
	Pot	49	Physocarpus opulifolius	ninebark	15' #2 cont.		full/ bushy plants
	Ps	563	Potentilla fruticosa	Alaska Fern	10' #3 cont.		full/ bushy plants
	Rt	50	Rubus occidentalis	white rose	30' #2 cont.		full/ bushy plants
	Rm	113	Rosa 'Alba Meiland'	Meiland Rose	10' #2 cont.		full/ bushy plants
	Rub	94	Rubus 'Goldstrut'	Goldstrut	10' #2 cont.		full/ bushy plants
	Ru	94	Rosa rugosa 'Mellozaure'	Common Rosemary	15' #2 cont.		full/ bushy plants
	Rr	94	Rosa rugosa 'Mellozaure'	Prick Mongolian Stonecrop	30' #2 cont.		full/ bushy plants
	Saw	108	Sedum everali	sweet box	15' #1 cont.		Full, bushy plants
	Sh	458	Sarcococca hookeriana	Mexican sedum	15' #1 cont.		Full, bushy plants
	Sk	108	Sedum kimmachi	Gray Stonecrop	15' #1 cont.		Full, bushy plants
	Spa	108	Sedum pachyclados	hardhack	25' #2 cont.		full/ bushy plants
	Spd	64	Spiraea douglasii	Two-row stonecrop 'Pink Jewel'	15' #1 cont.		full/ bushy plants
	Spe	108	Sedum spurium 'Pink Jewel'	Two-row stonecrop 'Pink Jewel'	15' #1 cont.		full/ bushy plants
	Spl	108	Sedum spaldingii	October Daphne	15' #1 cont.		full/ bushy plants
	Ssp	108	Sedum spurium 'Green Mantle'	Two-row stonecrop	15' #1 cont.		full/ bushy plants
	Tbr	30	Taxus baccata 'Repandens'	swart English yew	30' 1m ht/ B&B		full and bushy
	Tj	9	Trachelospermum jasminoides	star jasmine	15' #2 cont.		staked
	Vh	72	Vaccinium hickelii	Andropogon fawn	15' #2 cont.		full/ bushy plants
	Vl	303	Viburnum acerifolium	Amur viburnum	20' #2 cont.		full/ bushy plants
	Vn	16	Viburnum opulus 'Roseum'	Amur viburnum	15' #2 cont.		full/ bushy plants
	Vtr	15	Viburnum opulus 'Roseum'	snowball tree	35' 1m high B&B		full/ bushy plants
	Vvb	27	Viburnum plicatum f. tomentosum	douglas viburnum	35' 1m high B&B		full/ bushy plants
	Vva	10	Vitis vinifera atropurpurea	Purple Leaf Grape	30' #2 cont/ staked		full/ bushy plants
	Vvc	10	Vitis vinifera concord	Concord Grape	0' #2 cont.		staked
		0			0'		
	GROUNDCOVERS/ PERENNIALS						
LAWN			Non-Netted, grown on sand				
NOTES:							
1. ALL LANDSCAPE TO CONFORM TO THE CURRENT EDITION OF THE BC LANDSCAPE STANDARDS FOR LEVEL 2 'GROOMED LANDSCAPE TREATMENT' IN THE EVENT OF A DISCREPANCY BETWEEN THE PLANT LIST AND THE PLANTING PLAN, THE PLANTING PLAN TAKES PRECEDENCE.							
2. SEARCH AREA TO INCLUDE BRITISH COLUMBIA, WASHINGTON, AND OREGON							

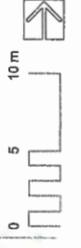

Roll over curb  
 Pavers set on concrete under City of Richmond work order

Property Line  
 Outline of parkade below

PMT

7.8 m

CHILDREN'S PLAY AREA  
 7,036.2 S.F.

OUTDOOR AMENITY  
 CENTRAL COURTYARD  
 9,814.92 S.F.

CHILDREN'S PLAY AREA

Let-down to be removed under City of Richmond work order

Project Name: 4008 Stolberg Street


Project No.: 21746  
 Date: 07/12/2017  
 Drawing No.: 1200  
 Drawing No.: La.1 of 30

Design Firm: eta landscape architecture  
 1690 West 2nd Avenue  
 Vancouver, BC - Canada, V6L 1H4  
 604.683.1456  
 604.683.1459  
 www.etalandscape.com

No.	Date	Zone	Approvals	No.	Date	Issue Notes
C	18-6-26					Issued for R2CP addressing ADP comments
B	18-6-20					Issued for R2CP
A	18-6-7					Issue for ADP

All Rights Reserved by eta landscape architecture Inc. This drawing is the property of eta landscape architecture Inc. and is not to be reproduced, stored in a retrieval system, or transmitted in any form or by any means, electronic, mechanical, photocopying, recording, or by any information storage and retrieval system, without the prior written permission of eta landscape architecture Inc. The information contained herein is for general informational purposes only and does not constitute an offer of any financial product or service. eta landscape architecture Inc. is not a financial institution and is not licensed to provide financial services. eta landscape architecture Inc. is not a registered dealer or advisor under the Securities Act (R.S.C. 1985, c. S-37) or the Securities Act (S.B.C. 1996, c. 49). eta landscape architecture Inc. is not a registered dealer or advisor under the Securities Act (S.B.C. 1996, c. 49). eta landscape architecture Inc. is not a registered dealer or advisor under the Securities Act (S.B.C. 1996, c. 49).

DP 17-794280-34

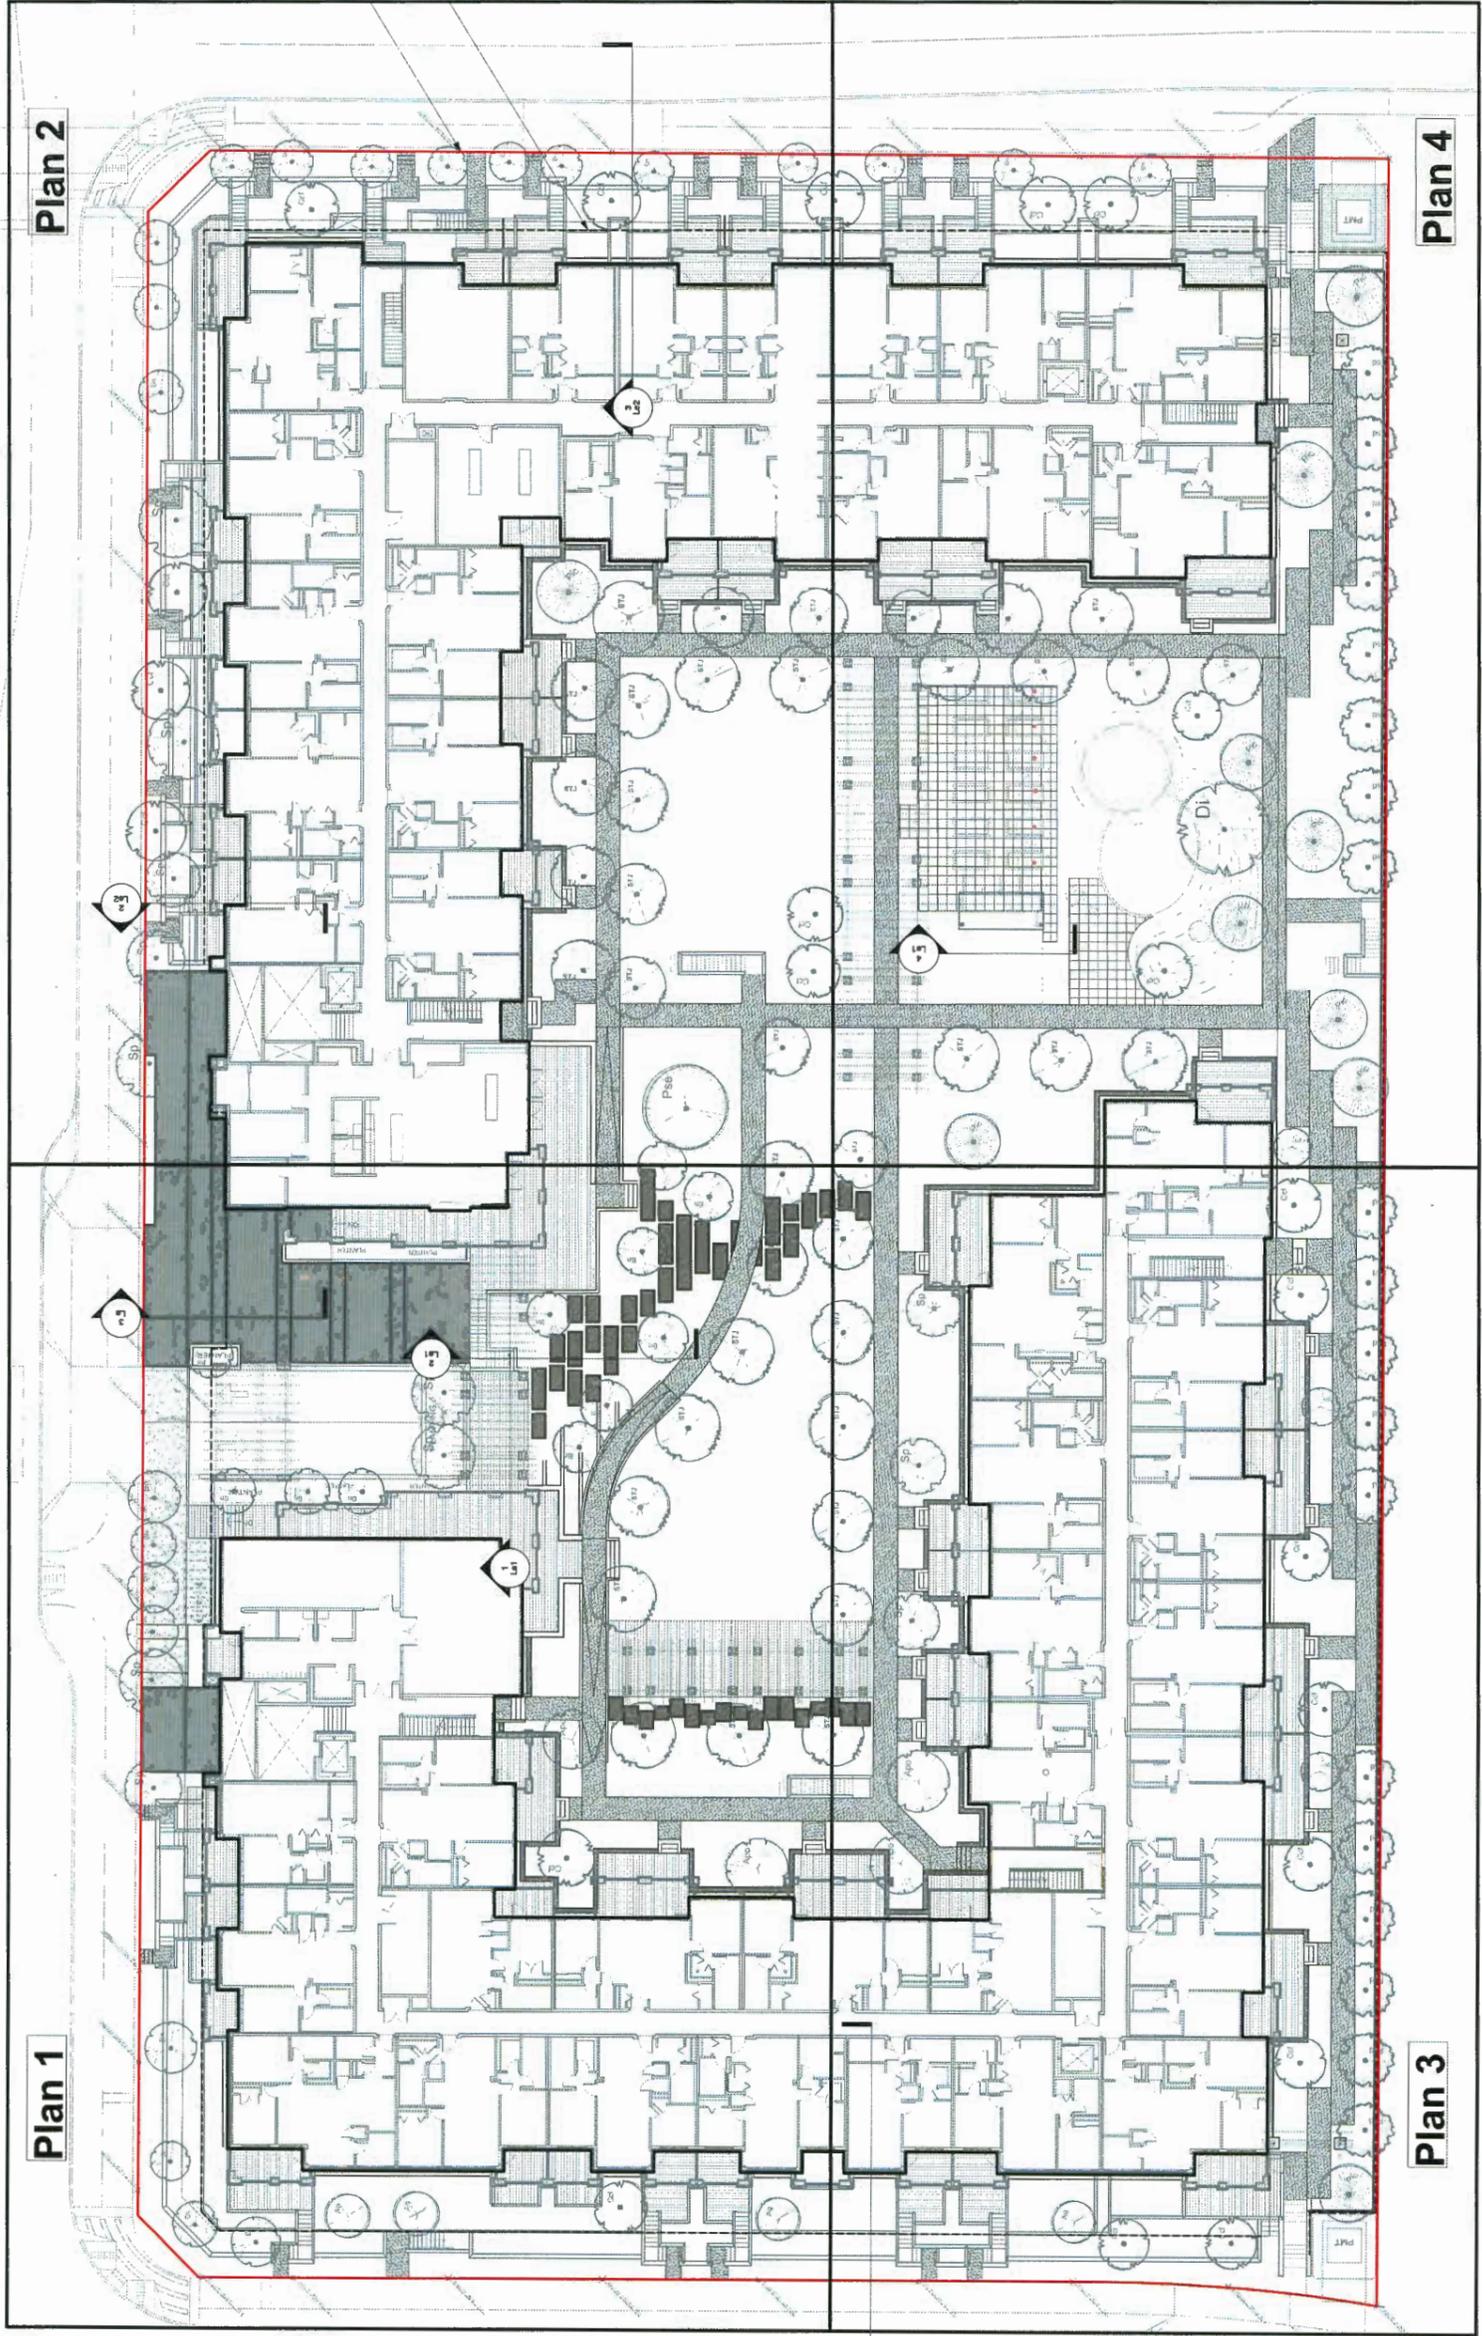

Property Line  
 Outline of parkade below



Plan 2

Plan 4

Plan 1

Plan 3

4008 Stolberg Street

eta  
 landscape architecture  
 1890 West 2nd Avenue  
 Vancouver, BC, Canada V6L 1H4  
 | 604.683.1456  
 | 604.683.1459  
 | www.etalandscape.ca


No.	Date	Revision Notes	Zone	Approvals	No.	Date	Issue Notes
C	18-9-28	Issued for RCP addressing ADP comments					
B	18-9-20	Issued for RCP					
A	18-8-7	Issue for ADP					

All Rights Reserved for all trademarks and/or logos. The information contained in this document is the property of the Client. It is to be used only for the project and site for which it was prepared. It is not to be used for any other project or site without the written consent of the Client. The information contained herein is for informational purposes only and does not constitute an offer of any financial product or service. The information contained herein is not intended to be used as a substitute for professional advice. The information contained herein is not intended to be used as a substitute for professional advice.

Project No. 21746  
 Design Team NTS  
 Date 05/12/2017  
 Project 174280-3

Lb.0  
 of 30

DP 1 / 174280-3

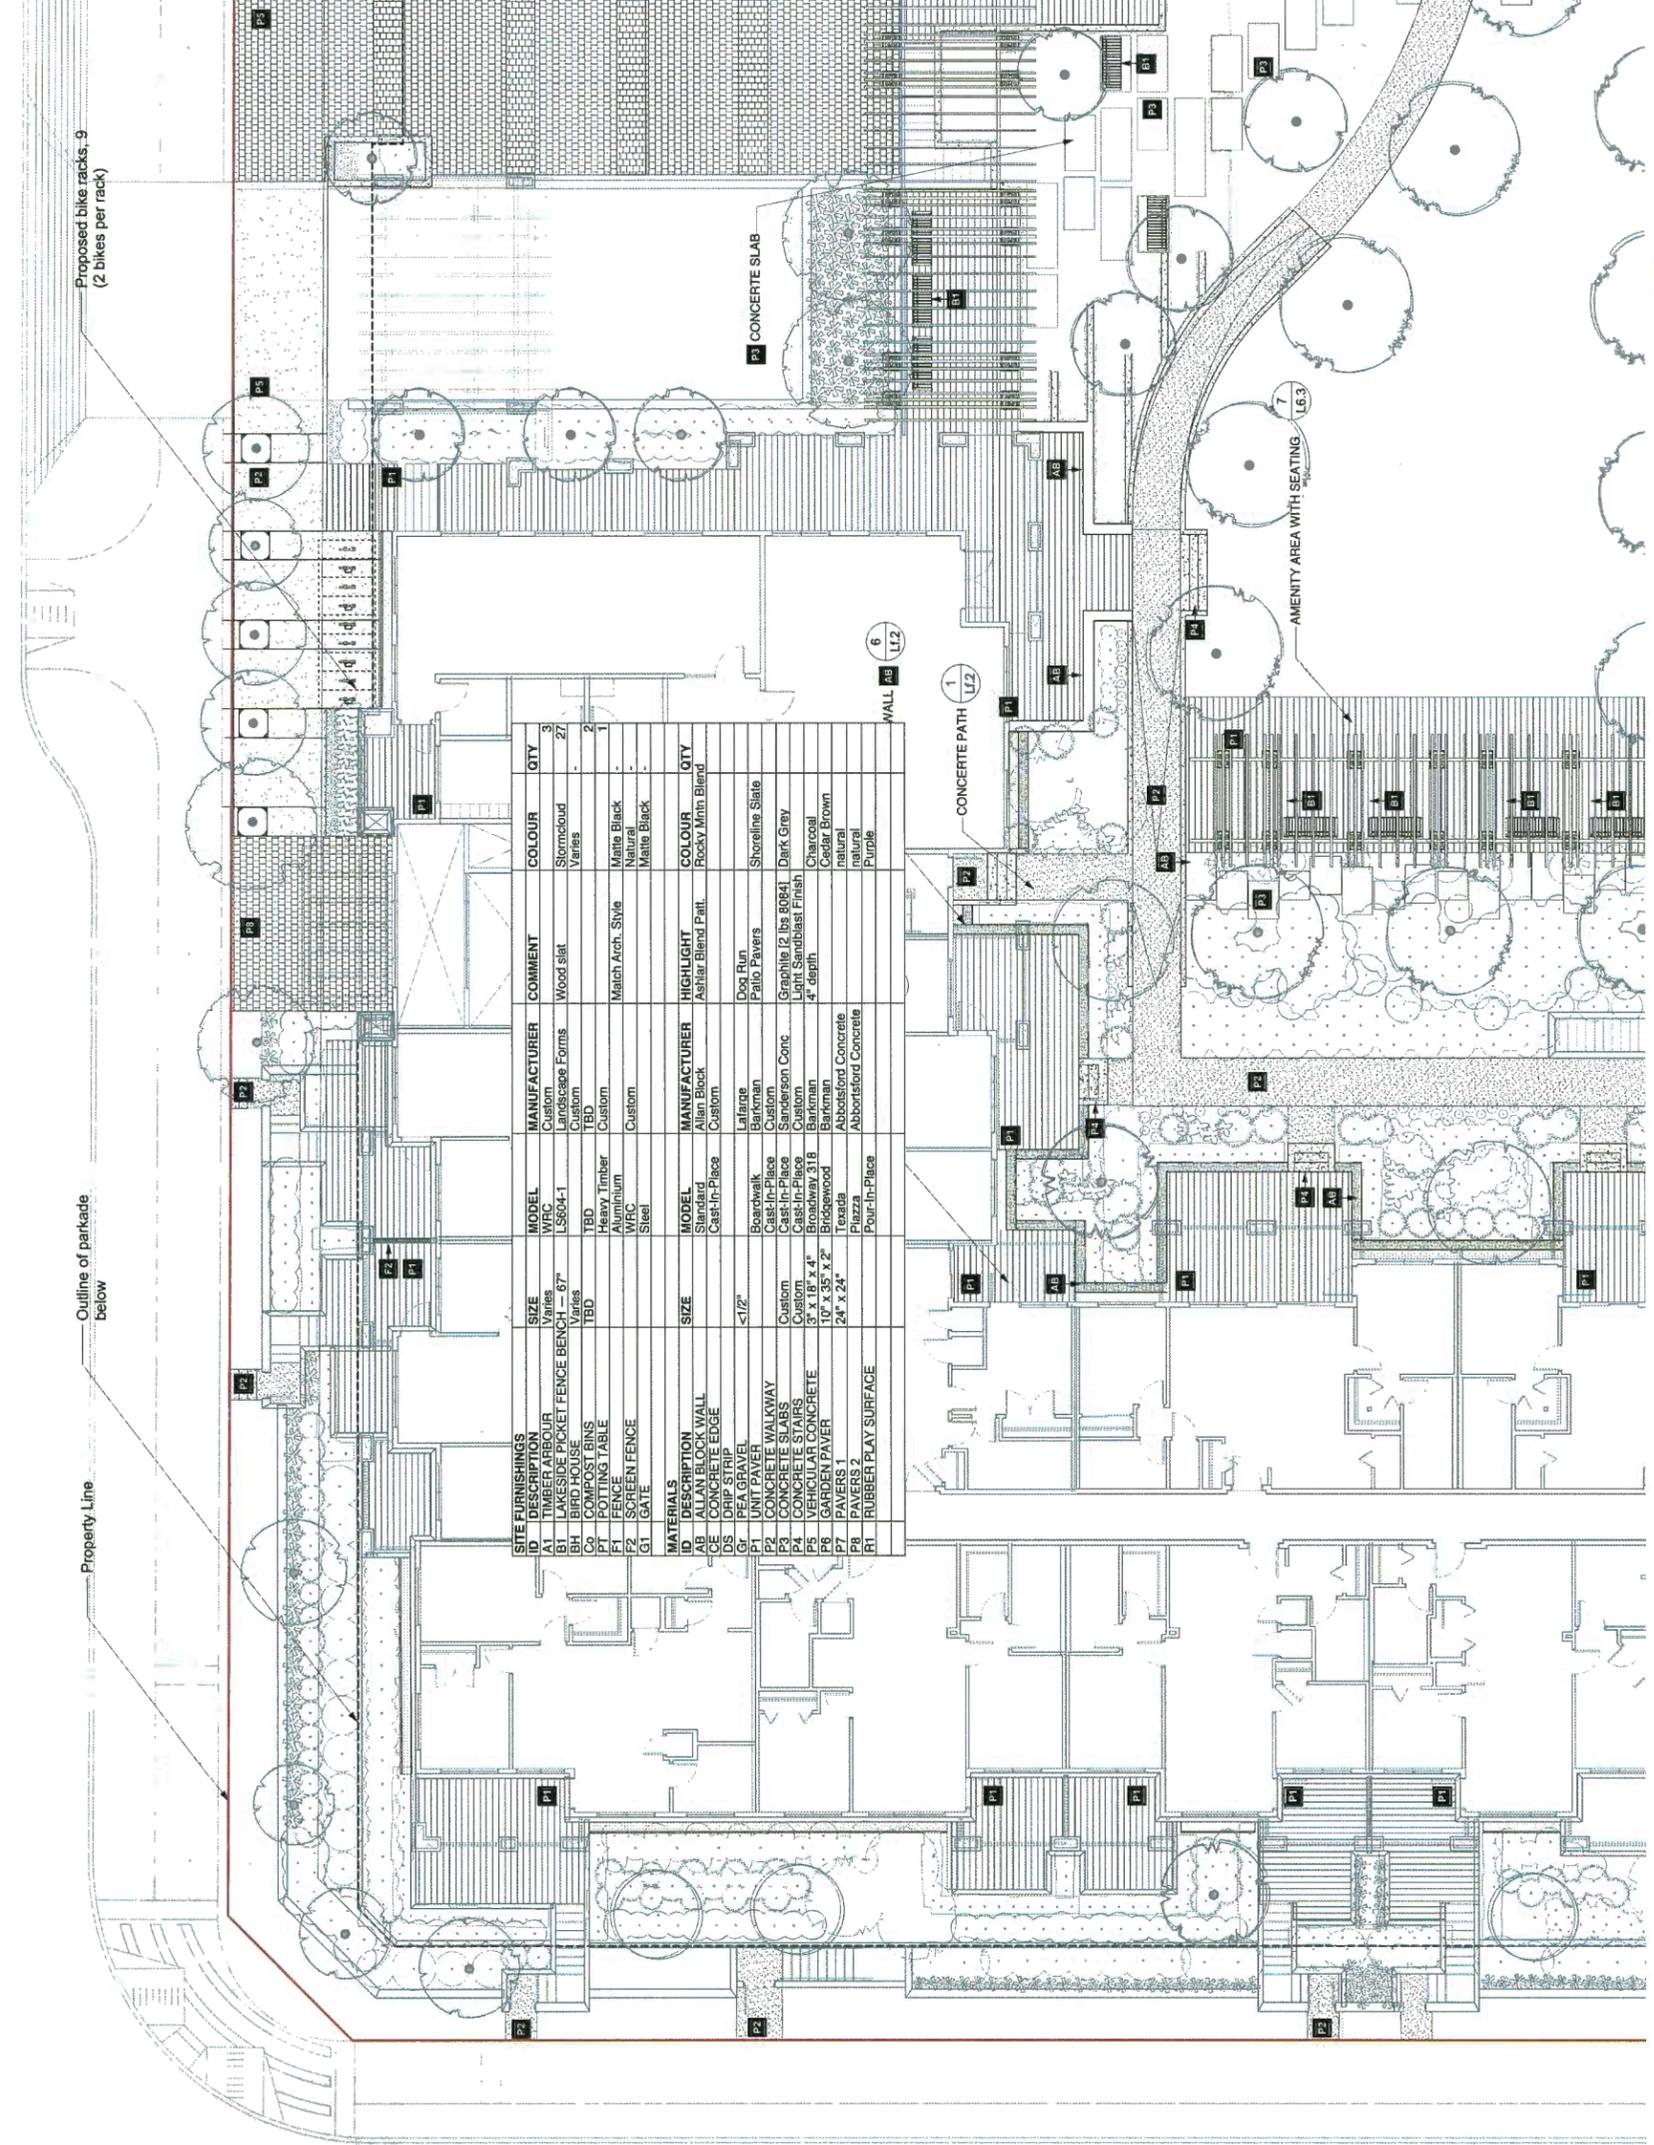

NOTE:  
Refer to Materials Schedule on Cover Sheet



Project No. 21748  
 Drawing No. DT  
 Scale 1:100  
 Date 06/12/2017  
 Project Name 4008 Stolberg Street  
 Designer DT  
 Checker DT  
 Approver DT  
 Project Manager DT

Revision Notes

No.	Date	Zone	Approvals	No.	Date
C	18-0-28				
B	19-0-20				
A	18-0-7				

Issued for RDP addressing ADP comments  
 Issued for RDP  
 Issued for ADP


eta  
 1650 West 2nd Avenue  
 Vancouver, BC, Canada V6J 1H4  
 1 604.683.1456  
 1 604.683.1459  
 www.eta.ca

Project No. 4008 Stolberg Street  
 Drawing No. Landscape Materials  
 Plan 1  
 Scale 1:100  
 Date 06/12/2017  
 Project Name 4008 Stolberg Street

All Rights Reserved by eta landscape architecture inc.  
 Information contained on these drawings is the property of eta landscape architecture inc. and is to be used only for the project and site for which it was prepared. eta landscape architecture inc. is not responsible for any errors or omissions on these drawings. eta landscape architecture inc. is not responsible for any damage or injury resulting from the use of these drawings.

DP 17-794 280-36

Lb.1  
 of  
 30

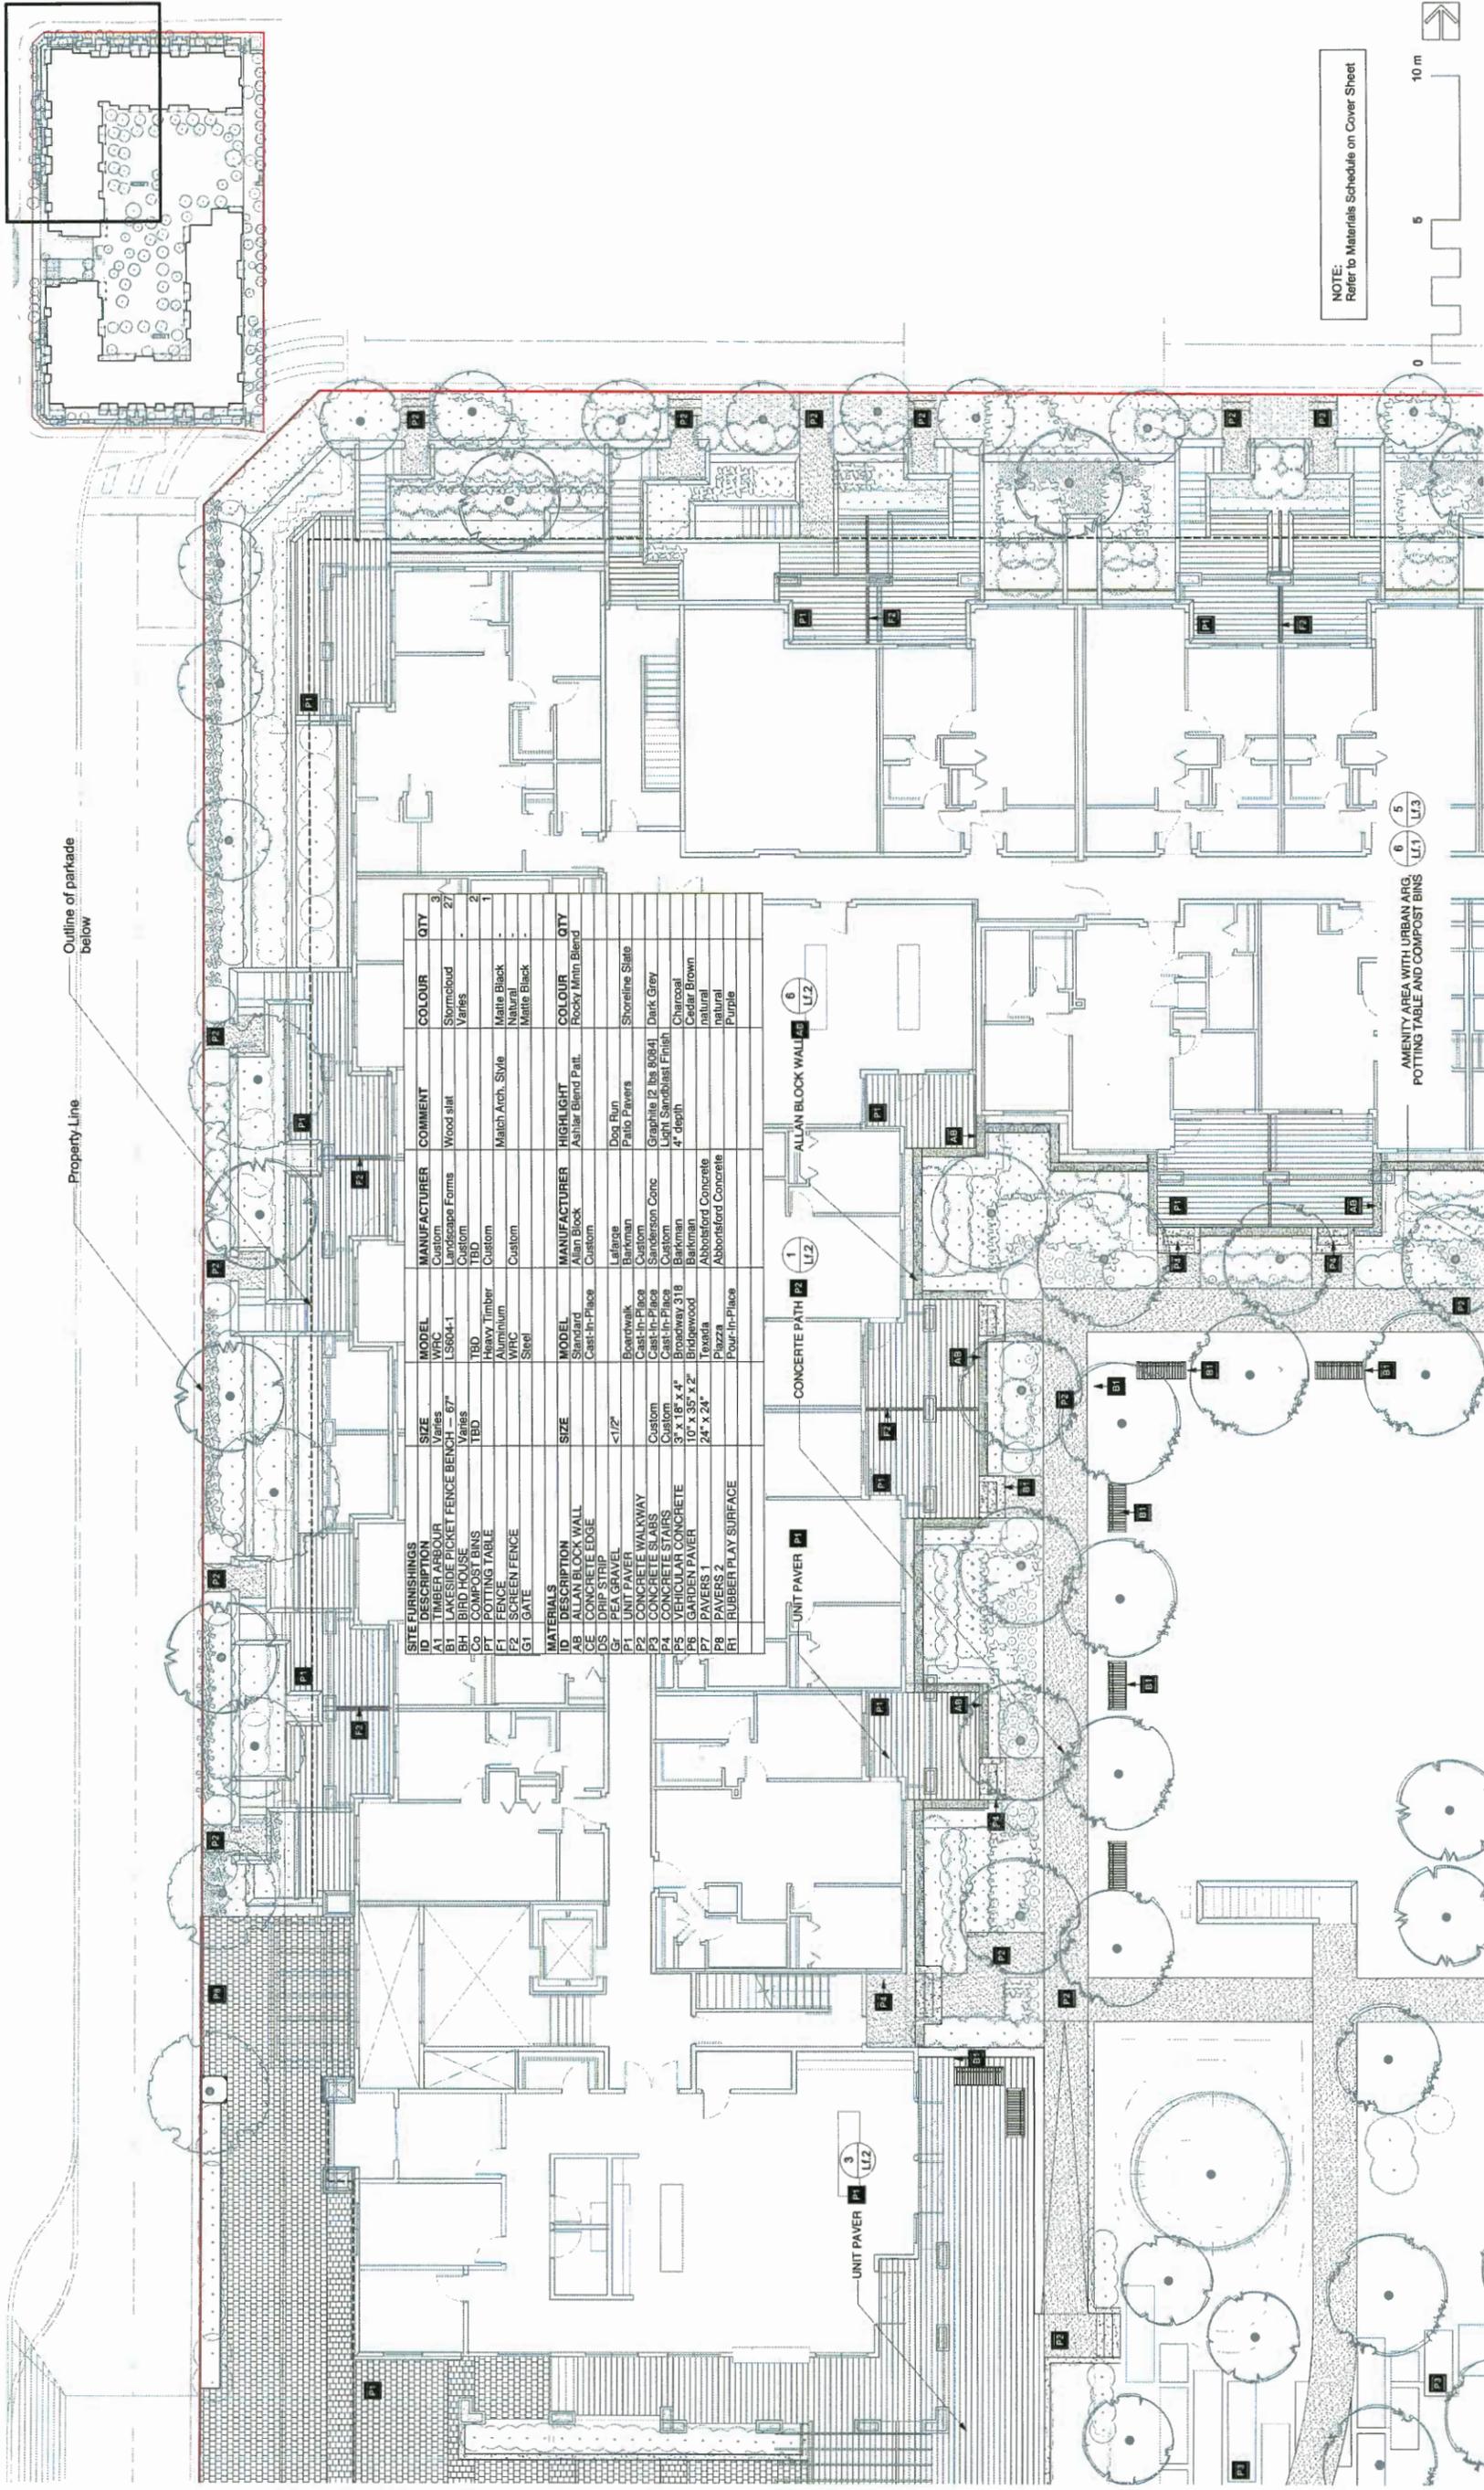

Property Line  
Outline of parkade  
below

SITE FURNISHINGS		MATERIALS	
ID	DESCRIPTION	DESCRIPTION	ID
A1	TIMBER ARBOUR	ALAN BLOCK WALL	AB
B1	LAKESIDE PICKET FENCE BENCH - 67"	CONCRETE EDGE	CE
BH	BIRD HOUSE	PEA GRAVEL	GS
C6	COMPOST BINS	UNIT PAVER	P1
FT	POTTING TABLE	CONCRETE WALKWAY	P2
F1	SCREEN FENCE	CONCRETE SLABS	P3
G1	GATE	CONCRETE STAIRS	P4
		VEHICULAR CONCRETE	P5
		PAVERS 1	P6
		PAVERS 2	P7
		RUBBER PLAY SURFACE	P8

NOTE:  
Refer to Materials Schedule on Cover Sheet



No.	Date	Revision Notes
C	18-9-26	Issued for ReDP addressing ADP comments
B	18-9-20	Issued for ReDP
A	18-6-7	Issue for ADP

Zone	Approvals	No.	Date	Issue Notes

**eta** landscape architecture  
1690 West 2nd Avenue  
Vancouver, BC, Canada V6J 1Y4  
T 604.683.1455  
F 604.683.1459  
www.etalandscape.com

Project Title: 4008 Stolberg Street

Project No. 21748  
Drawn By: DT  
Checked By: DT  
Reviewed By: DT  
Date: 06/12/2017  
Project Name: 4008 Stolberg Street

Project Title: Landscape Materials  
Plan 2

Project No. 21748  
Drawn By: DT  
Checked By: DT  
Reviewed By: DT  
Date: 06/12/2017  
Project Name: 4008 Stolberg Street


Project No. 21748  
Drawn By: DT  
Checked By: DT  
Reviewed By: DT  
Date: 06/12/2017  
Project Name: 4008 Stolberg Street

DP 17-794280-37

Lb.2  
of  
30



Property Line  
Outline of parkade  
below

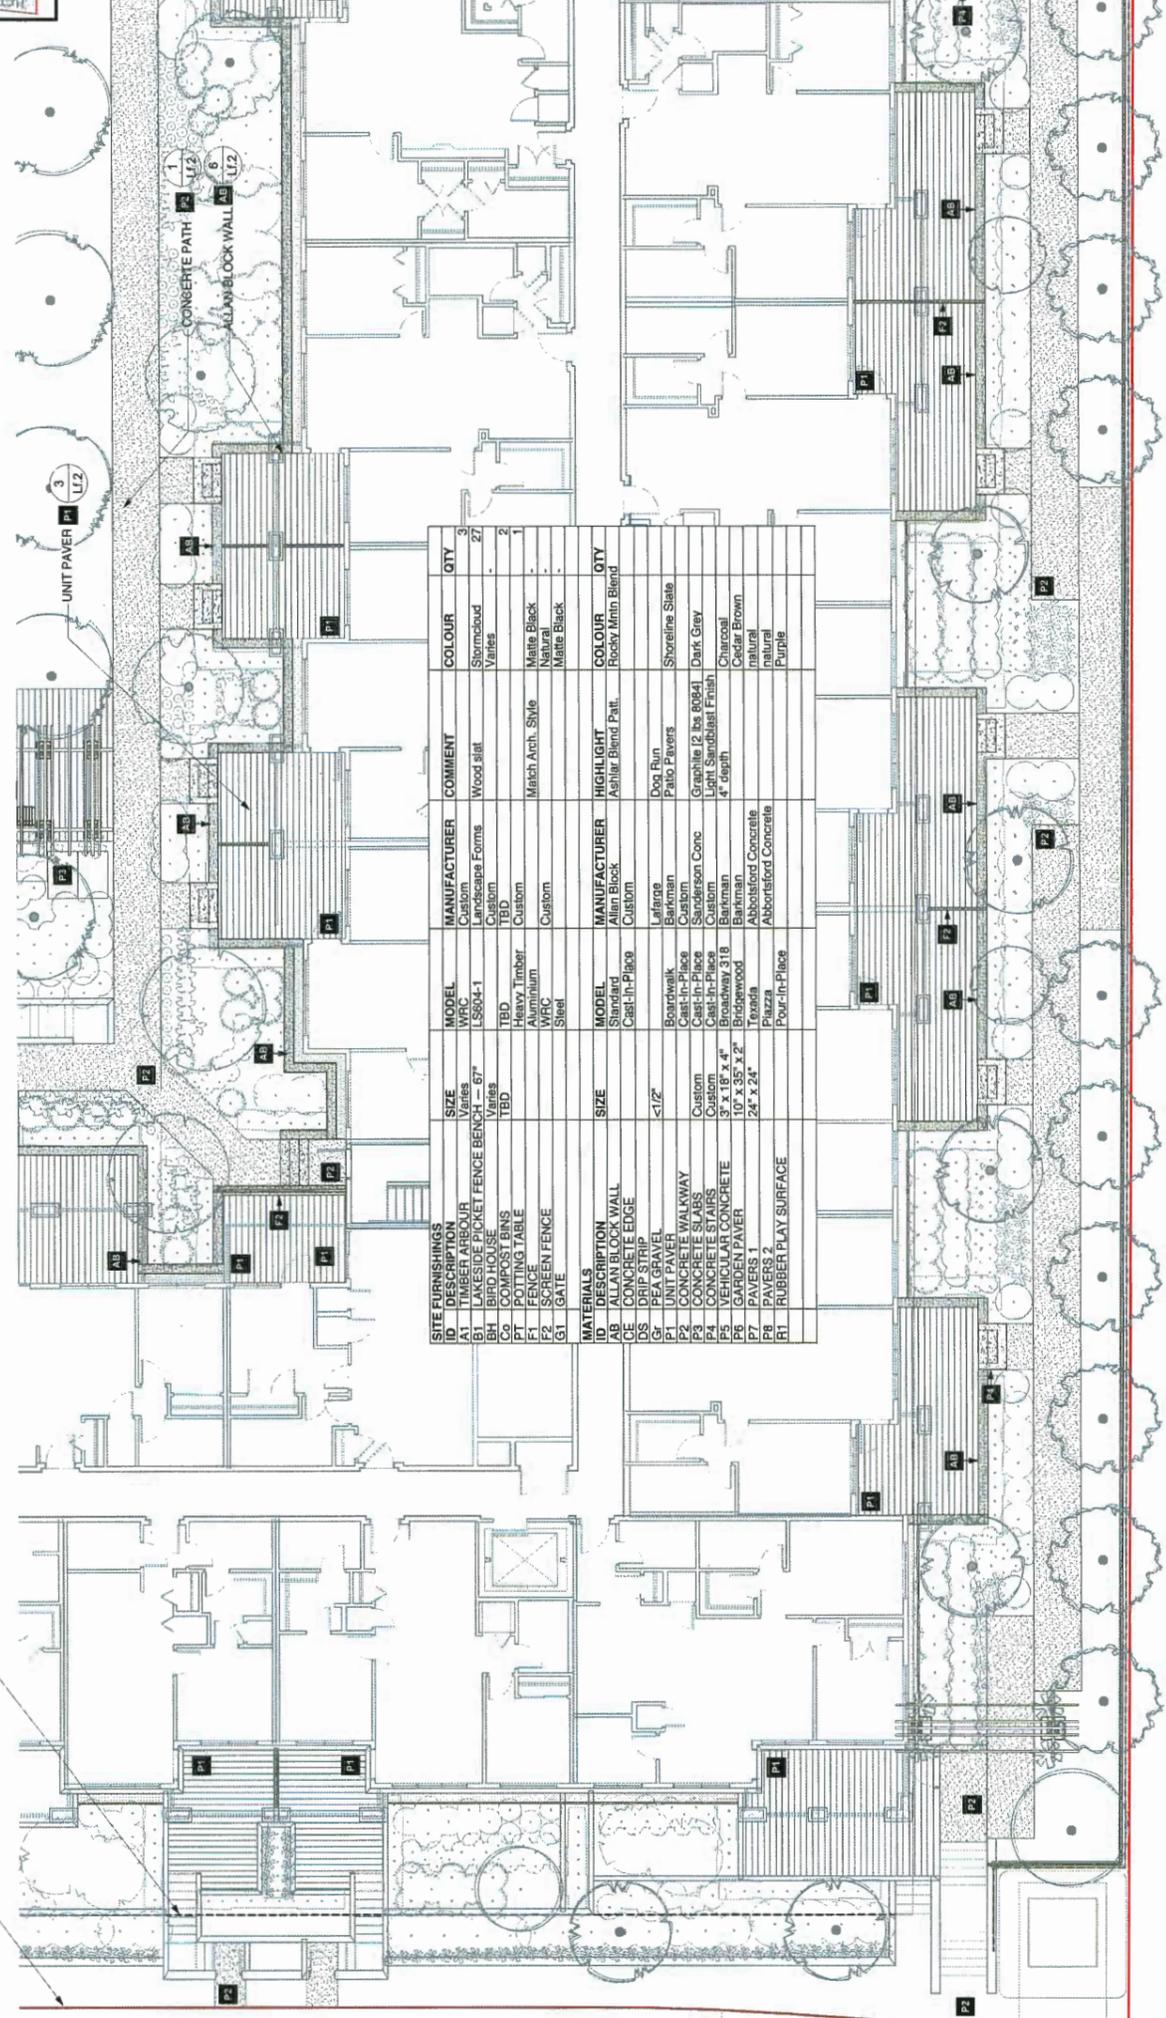

SITE FURNISHINGS			
ID	DESCRIPTION	SIZE	MANUFACTURER
A1	TIMBER ARBOUR	Varies	Custom
B1	LAKESIDE PICKET FENCE BENCH - 67"	Varies	LS804-1
BH	BIRDHOUSE	Varies	Custom
C0	COMPOST BINS	TBD	BD
F1	FENCE TABLE	Aluminum	Custom
F2	SCREEN FENCE	WRC	Custom
G1	GATE	Steel	Custom
MATERIALS			
ID	DESCRIPTION	SIZE	MANUFACTURER
CE	CONCRETE WALL		Alu Block
CE	CONCRETE EDGE		Custom
DS	DRIP STRIP		Cast-In-Place
G1	PEA GRAVEL	<1/2"	Lafarge
P1	UNIT PAVER		Barkman
P2	CONCRETE WALKWAY		Custom
P3	CONCRETE SLABS		Cast-In-Place
P4	CONCRETE CURB	3" x 18" x 4"	Custom
P4	VEHICULAR CONCRETE	5" x 18" x 4"	Barkman
P6	GARDEN PAVER	10" x 35" x 2"	Barkman
P7	PAVERS 1	24" x 24"	Abbotsford Concrete
P8	PAVERS 2		Abbotsford Concrete
R1	RUBBER PLAY SURFACE		Pour-In-Place

NOTE: Refer to Materials Schedule on Cover Sheet



4008 Stolberg Street

Landscape Materials  
Plan 3


**eta** landscape architecture  
1890 West 2nd Avenue  
Vancouver, BC, Canada V6J 1H4  
1 (604) 683.1459  
1 (604) 683.1459  
www.eta.ca

No.	Date	Revision Notes
C	18-9-28	Issued for R4DP addressing ADP comments
B	18-9-20	Issued for R4DP
A	18-5-7	Issue for ADP

Project No: 21748  
Drawn By: DT  
Checked By: DT  
Date: 06/12/2017  
Scale: 1:100  
Drawing No: Lb.3 of 30  
Project Name: 4008 Stolberg Street

DP 1/1-1/24 280-38

SITE FURNISHINGS			
ID	DESCRIPTION	SIZE	QTY
A1	TIMBER ARBOUR	Varies	3
B1	LAKESIDE PICKET FENCE BENCH	67"	27
BH	BIRD HOUSE	Varies	-
Co	COMPOST BINS	TBD	2
F1	FOLYING TABLE	Heavy Timber	-
F2	SCREEN FENCE	Aluminum	-
G1	GATE	Steel	-
MATERIALS			
ID	DESCRIPTION	SIZE	QTY
AB	ALLAN BLOCK WALL	Standard	-
CE	DRIP STRIP EDGE	Cast-In-Place	-
G2	PEA GRAVEL	<1/2"	-
P1	UNIT PAVEMENT	Boardwalk	-
P2	CONCRETE WALKWAY	Cast-In-Place	-
P3	CONCRETE SLABS	Cast-In-Place	-
P4	CONCRETE STAIRS	Cast-In-Place	-
P5	VEHICULAR CONCRETE	3" x 18" x 4"	-
P6	UNIT PAVEMENT	Bridgwood	-
P7	PAVERS 1	24" x 24"	-
P8	PAVERS 2	Four-In-Place	-
R1	RUBBER PLAY SURFACE	Four-In-Place	-

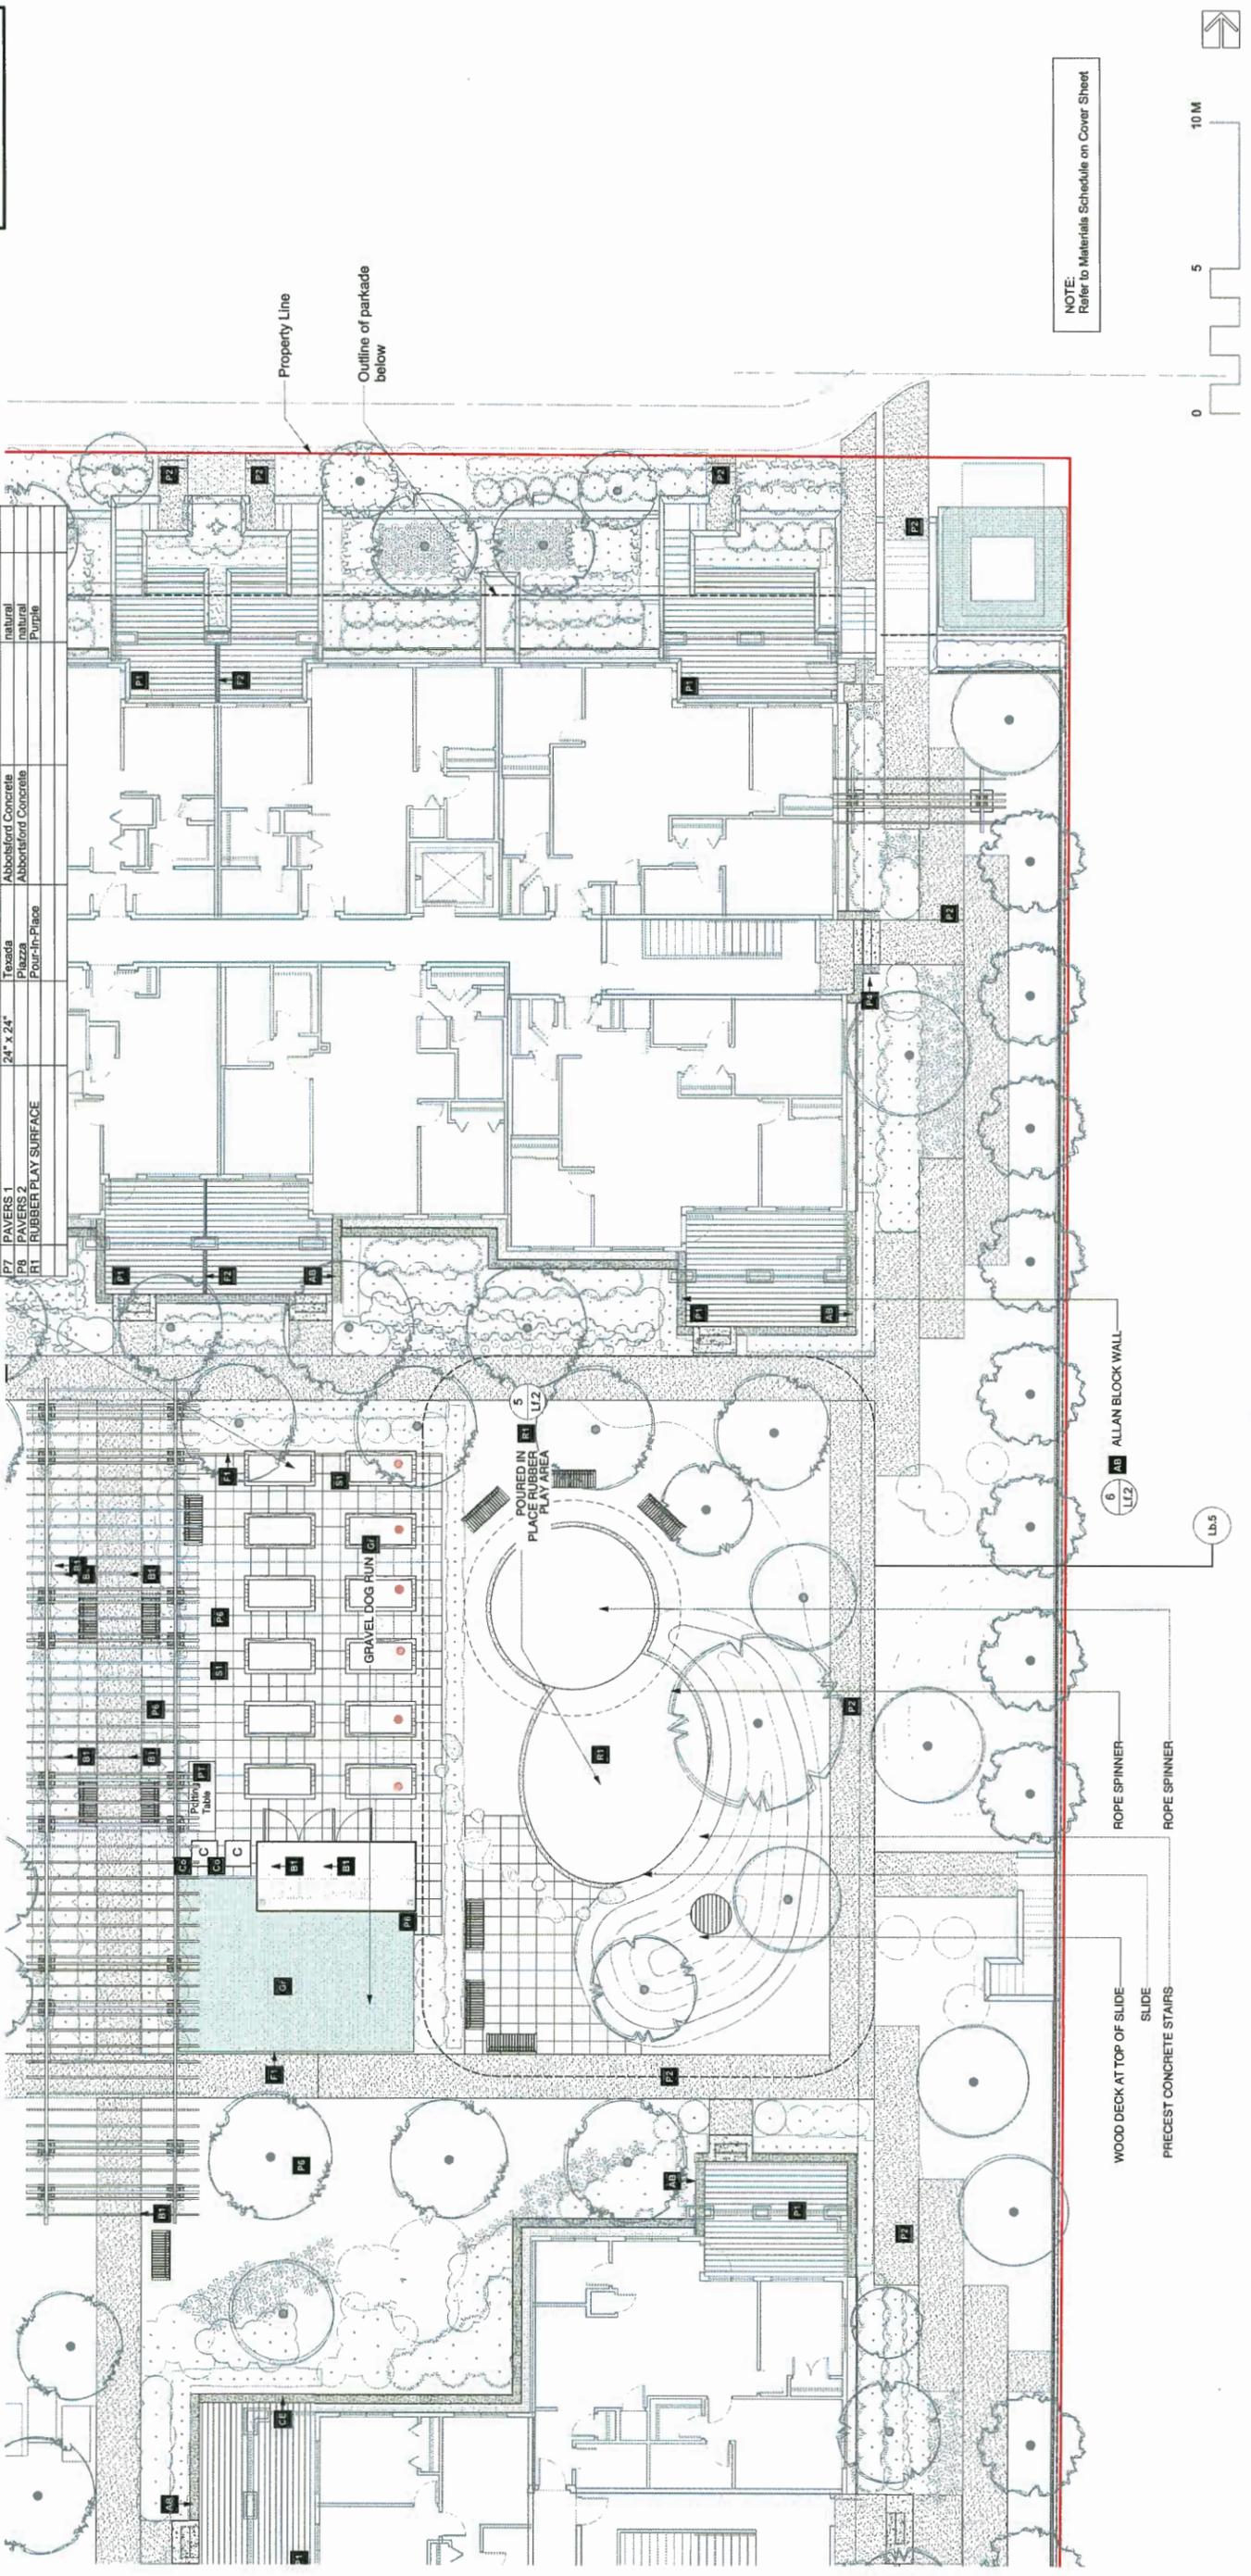

NOTE:  
Refer to Materials Schedule on Cover Sheet

Project No: 4008 Stolberg Street

Project Name: 4008 Stolberg Street

Project ID: 21748

Client: DT

Designer: DT

Scale: 1:100

Date: 06/12/2017

Drawn by: PH, 2018 Sep 28

Checked by: DT, 2018 Sep 28

Project Location: 4008 Stolberg Street

Revision Notes

No.	Date	Zone	Approvals	No.	Date	Issue Notes
C	18-9-28					Issued for R4DP addressing ADP comments
B	18-9-20					Issued for R4DP
A	18-6-7					Issue for ADP

eta landscape architecture

1690 West 2nd Avenue  
Vancouver, BC, Canada - V6J 1H4  
Tel: 604.683.1456  
Fax: 604.683.1459  
www.eta.ca

Project Title: Landscape Materials Plan 4

Drawing Title: Landscape Materials Plan 4

Project No: 4008 Stolberg Street

Project Name: 4008 Stolberg Street

Project ID: 21748

Client: DT

Designer: DT

Scale: 1:100

Date: 06/12/2017

Drawn by: PH, 2018 Sep 28

Checked by: DT, 2018 Sep 28

Project Location: 4008 Stolberg Street

Revision Notes


No.	Date	Zone	Approvals	No.	Date	Issue Notes
C	18-9-28					Issued for R4DP addressing ADP comments
B	18-9-20					Issued for R4DP
A	18-6-7					Issue for ADP

eta landscape architecture

1690 West 2nd Avenue  
Vancouver, BC, Canada - V6J 1H4  
Tel: 604.683.1456  
Fax: 604.683.1459  
www.eta.ca

OP 17-794280-39

Lb.4 of 30

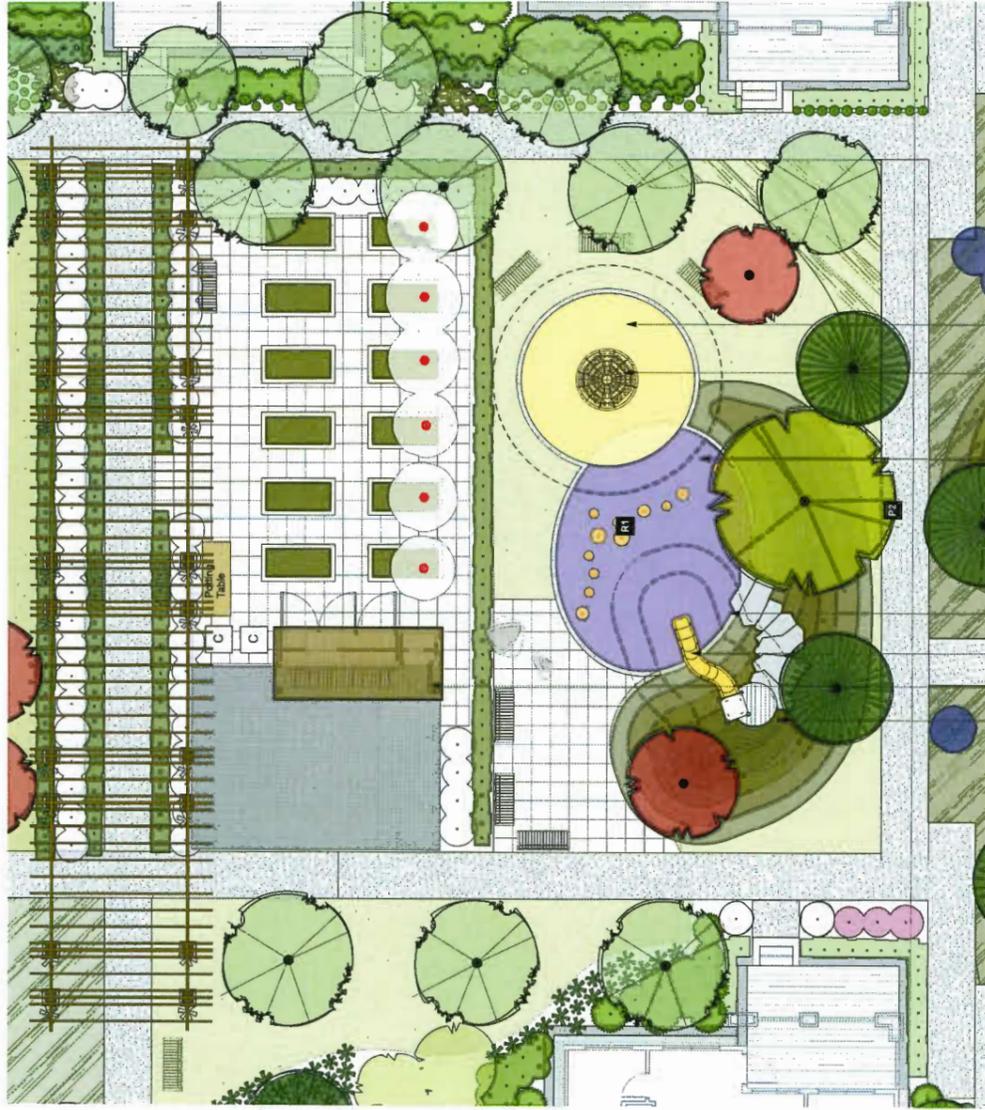

WOOD DECK AT TOP OF SLIDE  
PROVIDE A HOSE BIB AT SHED FOR USE  
IN DOG RUN

PRECAST CONCRETE STAIRS

SLIDE

ROPE SPINNER

SITTING STUMPS

POURED IN PLACE RUBBER  
PLAY AREA

5  
U12

**PRODUCT SPECIFICATION**



<b>Product Name</b>	Mini Apollo™
<b>Product Number</b>	DX-1200
<b>Size - Diameter</b>	2.00 m / 6' 7"
<b>Size - Height</b>	2.44 m / 8' 0"
<b>Shipping Weight</b>	485 kg / 1069.2 lb
<b>Shipping Volume</b>	4.18 m³ / 147.6 ft³
<b>Foundations</b>	1
<b>Concrete Volume</b>	0.27 m³ / 9.5 ft³

<b>ASTM F-1487</b>	2 years - 5 years
<b>Capacity</b>	15
<b>Use Zone - Diameter</b>	3.66 m / 12' 0"
<b>Fall Height</b>	1.45 m / 4' 9"


  

<b>CSA Z614</b>	18 months - 5 years
<b>Capacity</b>	15
<b>Use Zone - Diameter</b>	3.60 m / 11' 8"
<b>Fall Height</b>	1.45 m / 4' 9"

<b>EN 1176</b>	2 years - 6 years
<b>Capacity</b>	15
<b>Use Zone - Diameter</b>	6.00 m / 19' 8"
<b>Fall Height</b>	1.45 m / 4' 9"

\*These Concretes must be minimum 3500 PSI / 25MPa.

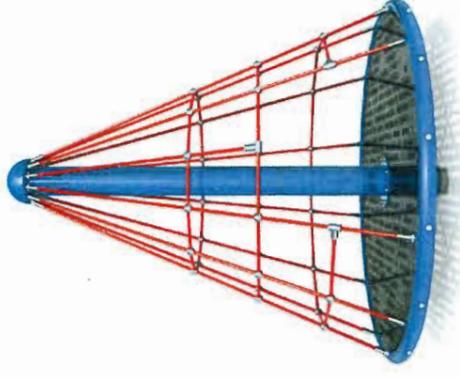


**Grape 1216**  
Poured in Place Rubber play surface



Compost Bin and Potting Table



**KOMPAN!**  
PCM110103 - Embankment Slide - Curved

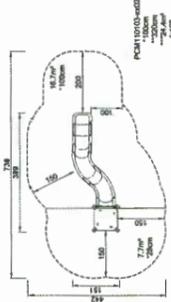

Sitting Stumps





Roman Steps up to Slide



Lakeside Picket Fence Bench

NOTE:  
Refer to Materials Schedule on Cover Sheet



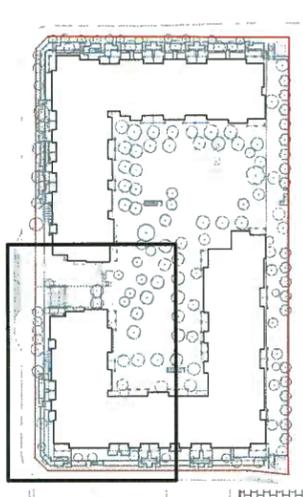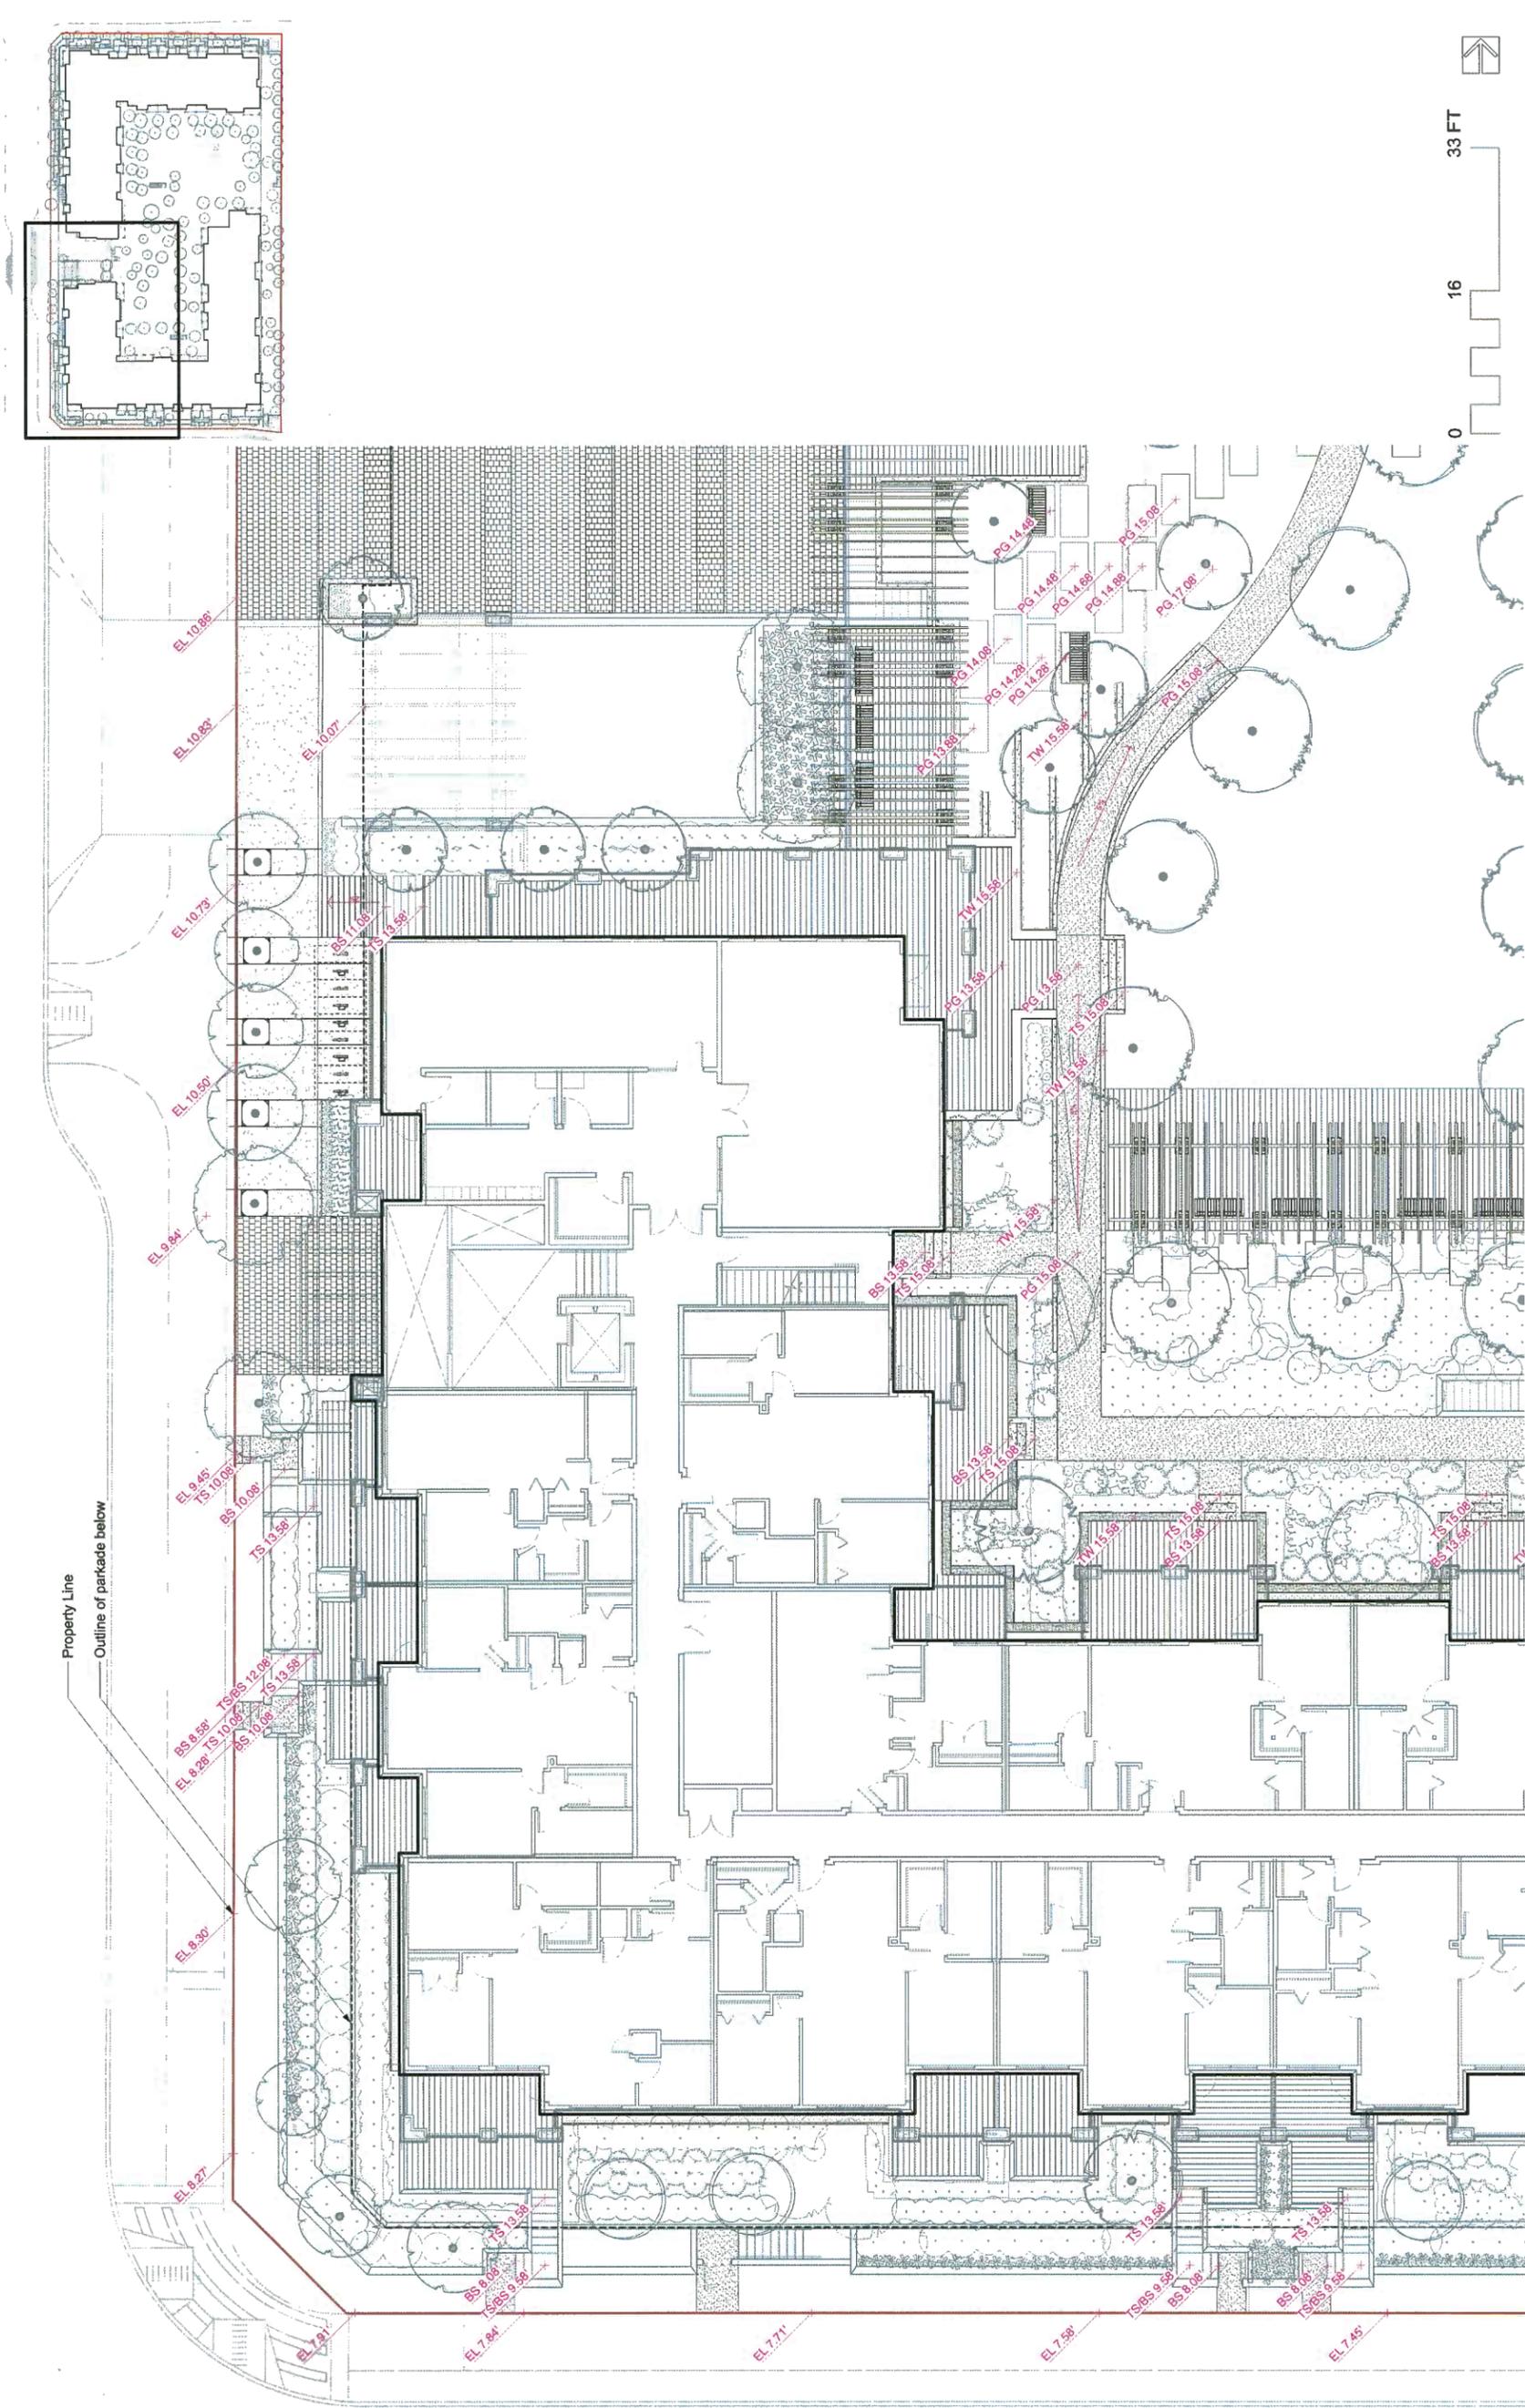


Property Line  
Outline of parkade below

Project No. 21748  
 Date 08/12/2017  
 Scale 1:100  
 Drawing No. Lb.6 of 30  
 Project Name 4008 Stolberg Street  
 Drawing Title Landscape Grading Plan 1  
 Designer etda landscape architecture  
 1690 West 2nd Avenue  
 Vancouver, BC, Canada V6J 1H4  
 Tel: 604.683.1456  
 Fax: 604.683.1459  
 www.etda.ca

No.	Date	Revision Notes	Zone	Approvals	No.	Date	Issue Notes
C	18-9-28	Issued for ReDP addressing ADP comments					
B	18-9-20	Issued for ReDP					
A	18-6-7	Issue for ADP					

All Rights Reserved for site landscape architecture Inc.  
 Information contained in these documents is part of the Confidentiality Agreement entered into between the Client and the Designer. No part of these documents shall be used for any purpose other than that intended by the Client. The Designer shall not be responsible for the construction of the site, which shall be the responsibility of the Client. The Designer shall not be responsible for the construction of the site, which shall be the responsibility of the Client.

DP 17-194280-41

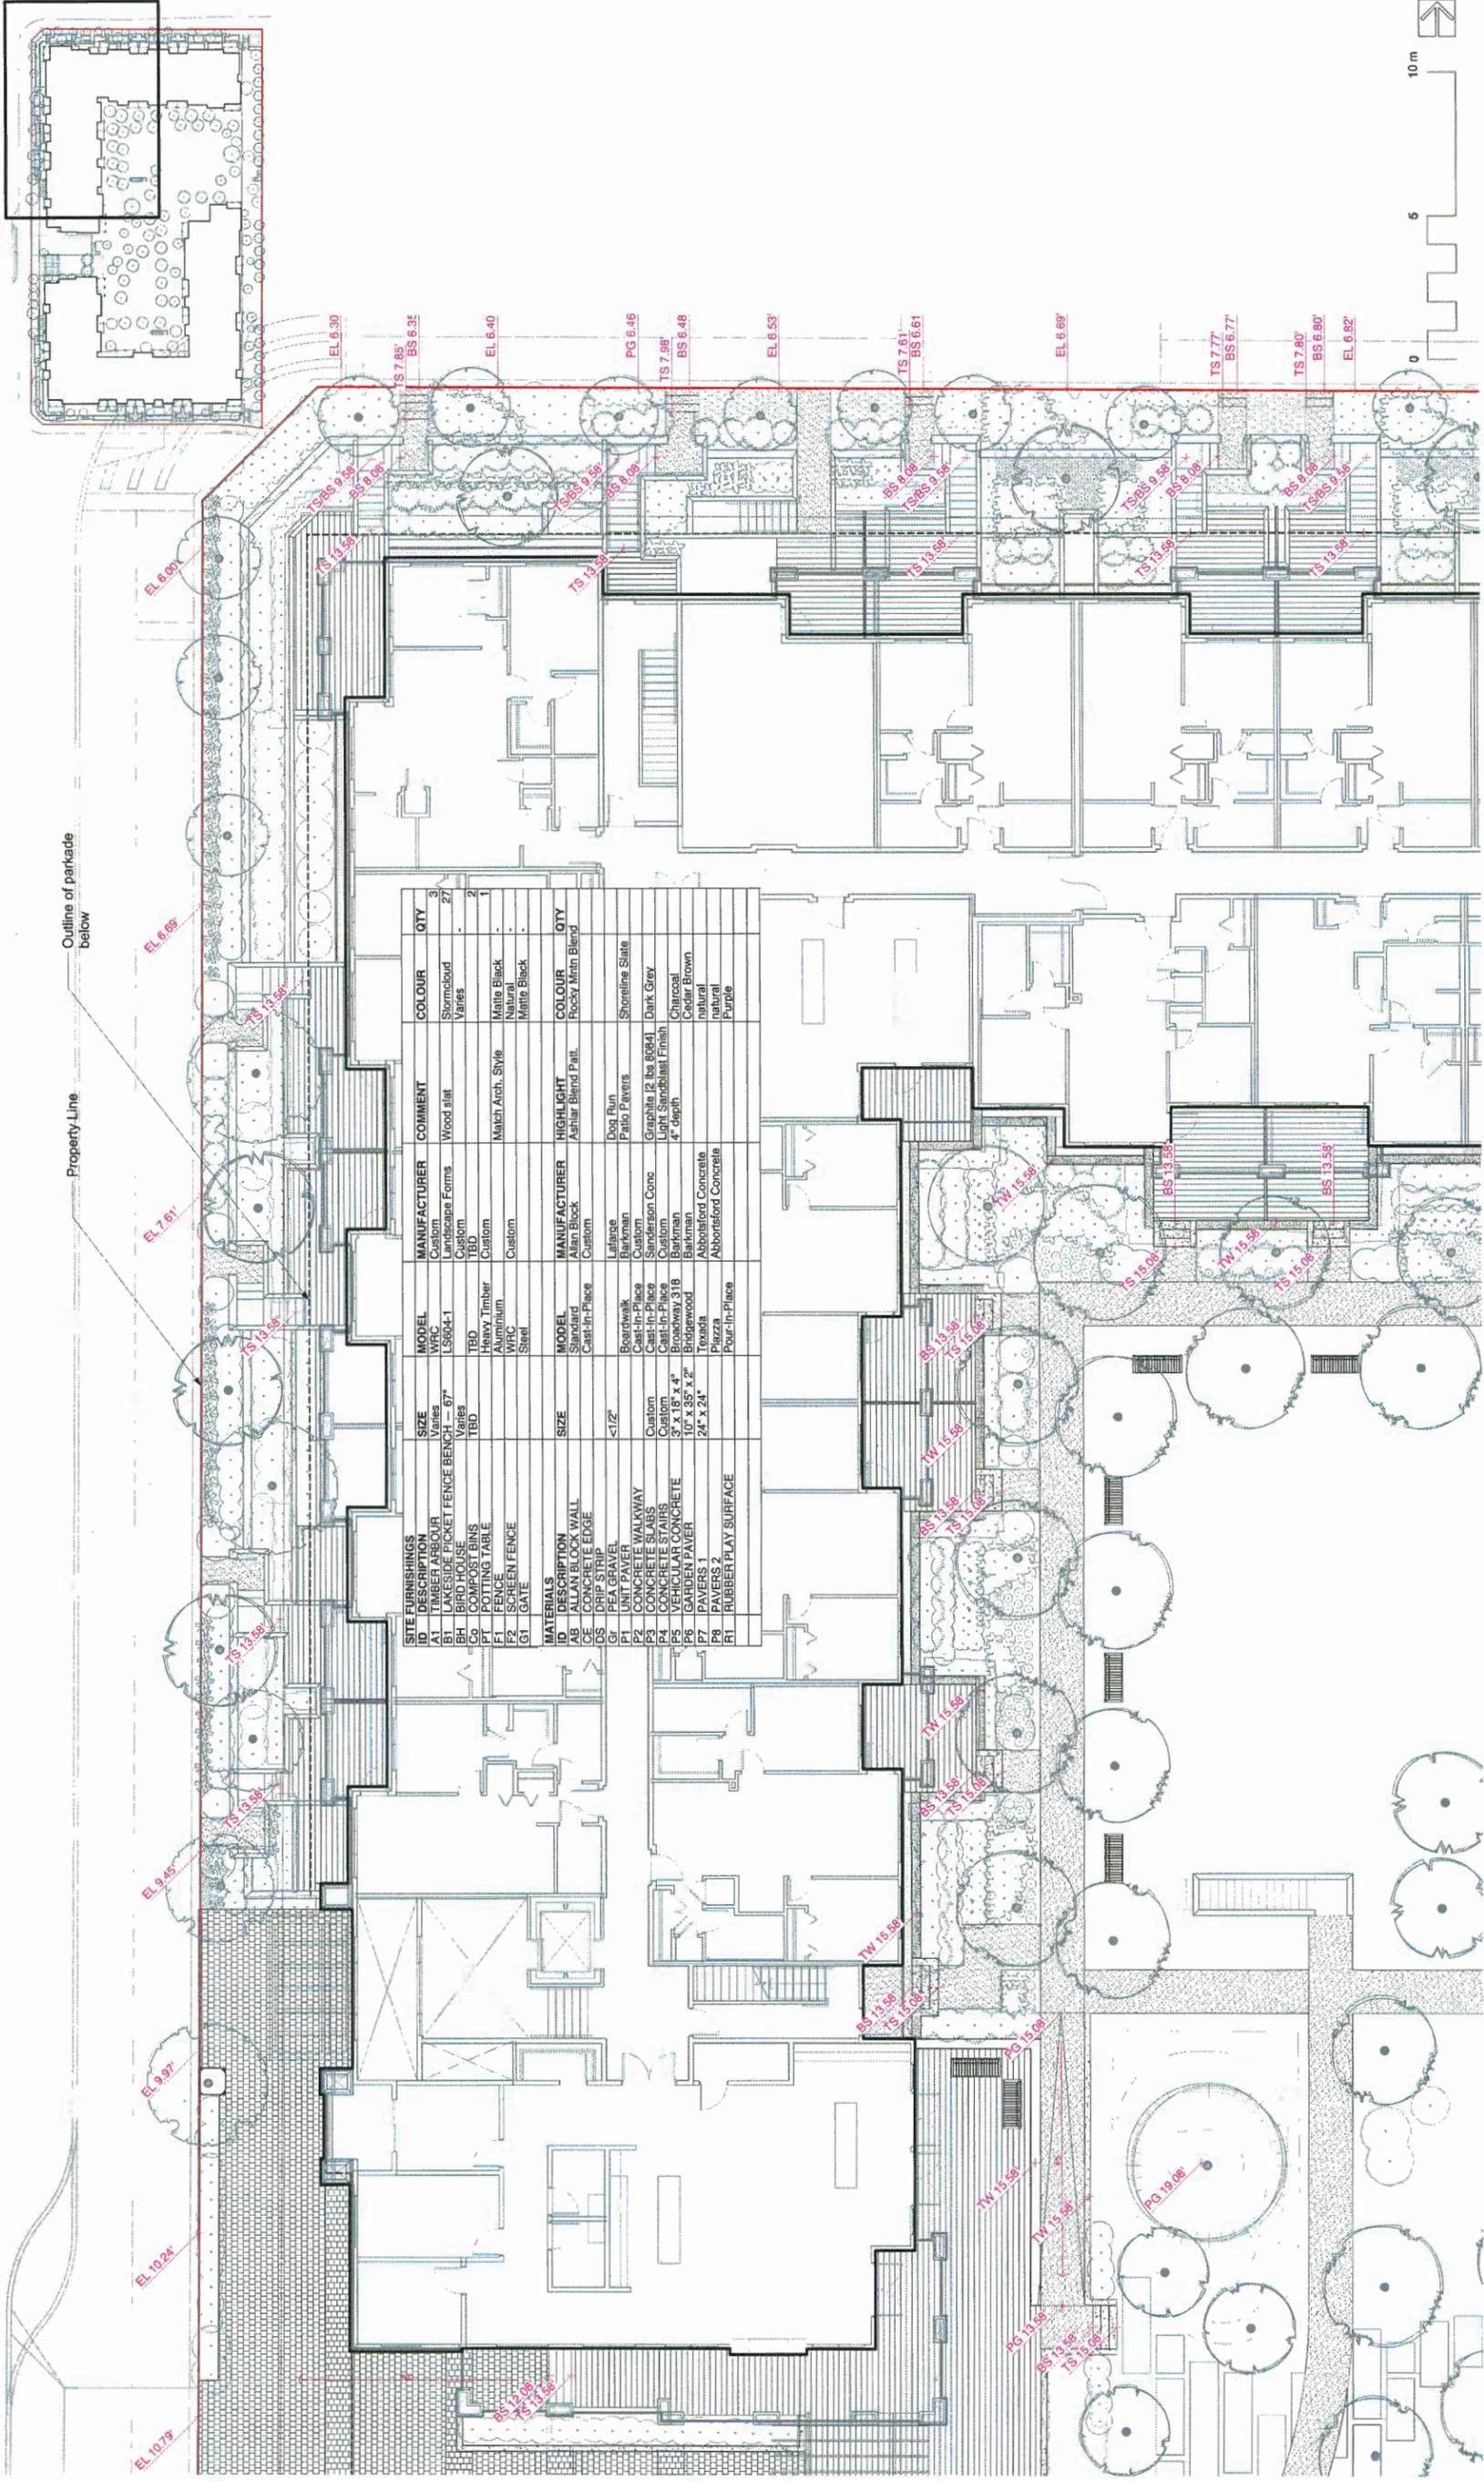

Property Line  
Outline of parkade  
below

SITE FURNISHINGS		MATERIALS	
ID	DESCRIPTION	ID	DESCRIPTION
A1	TIMBER ARBOUR	AB	ALLAN BLOCK WALL
B1	LAKE SIDE PICKET FENCE BENCH - 67"	AS	ASPHALT DRIVE
BH	BIRD HOUSE	DS	DRIP STRIP
C0	COMPOST BINS	G0	PEA GRAVEL
F1	FEEDING TABLE	P1	UNIT PAVES
F2	SCREEN FENCE	P2	CONCRETE WALKWAY
G1	GATE	P3	CONCRETE SLABS
		P4	CONCRETE STAIRS
		P5	CIRCULAR CONCRETE
		P6	PAVERS 1
		P7	PAVERS 2
		P8	PAVERS 3
		P9	PAVERS 4
		R1	RUBBER PLAY SURFACE

No.	Date	Revision Notes
C	18-9-28	Issued for RDP addressing ADP comments
B	18-9-20	Issued for RDP
A	18-6-7	Issue for ADP

Zone	Approvals	No.	Date	Issue Notes

**eta** landscapes architecture  
 1550 West 2nd Avenue  
 Vancouver, B.C. Canada, V6J 1H4  
 | 1 604.653.1458  
 | 1 604.653.1459  
 | www.eta.ca


Project Name: 4008 Stolberg Street  
 Drawing Title: Landscape Grading Plan 2

Project Number: 21748  
 Date: 08/12/2017  
 Drawing No: 30  
 Lb.7 of 30

DP 17-174280-42



Property Line  
Outline of parkade  
below

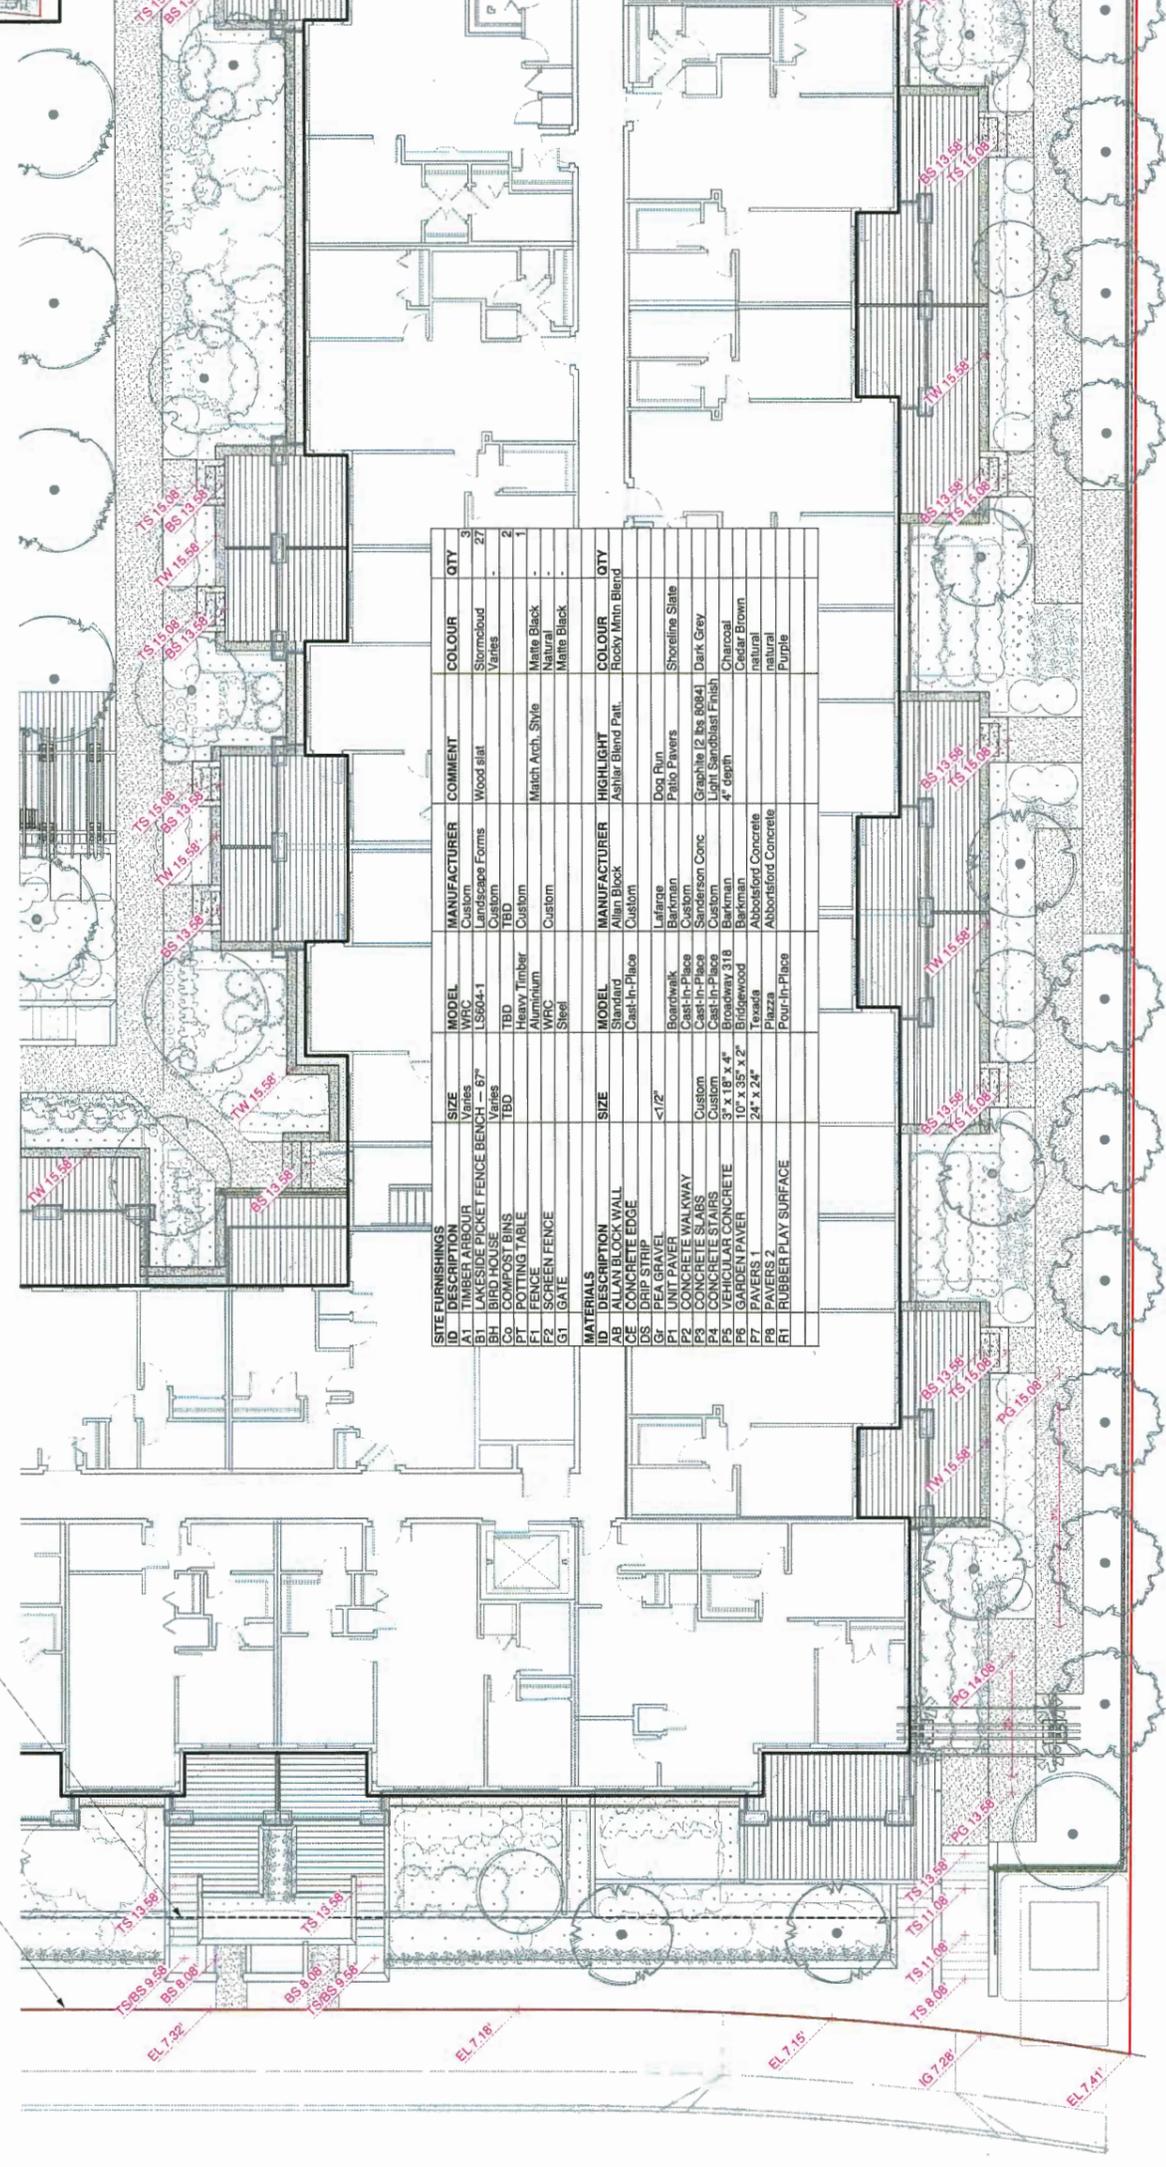

SITE FURNISHINGS			
ID	DESCRIPTION	SIZE	QTY
A1	TIMBER ARBOUR	Varies	3
B1	LAKE-SIDE PICKET FENCE BENCH - 67"	Varies	27
BH	BIRD HOUSE	Varies	27
C0	COMPOST BINS	TBD	2
CT	POTTING TABLE	TBD	1
F1	SCREEN FENCE	Heavy Timber	1
F2	SCREEN FENCE	WPC	1
G1	GATE	Steel	1
MATERIALS			
ID	DESCRIPTION	SIZE	QTY
AB	ALLAN BLOCK WALL	Standard	Rocky Minn Blend
DE	DECKING	Cast-In-Place	Custom
DS	DRIP STRIP	Cast-In-Place	Custom
GA	GRAVEL	1/2"	Dog Run
P1	UNIT PAVEMENT	Boardwalk	Patio Pavers
P2	CONCRETE WALKWAY	Cast-In-Place	Shoreline Slate
P3	CONCRETE SLABS	Cast-In-Place	Dark Grey
P4	CONCRETE STAIRS	Cast-In-Place	Graphite (2 lbs. 8064)
P5	CONCRETE	Cast-In-Place	Light Sandblast Finish
P6	GARDEN PAVEMENT	10' x 1.5' x 4"	4" depth
P7	PAVERS 1	Brickwood	Charcoal
P8	PAVERS 2	Tessera	Cedar Brown
R1	RUBBER PLAY SURFACE	24' x 24'	natural
		Pour-In-Place	Purple



Project Name: 4008 Stolberg Street  
 Project No.: 21748  
 Drawing No.: 11100  
 Date: 08/12/2017  
 Drawn By: VG  
 Checked By: VG  
 Project Manager: VG  
 Client: 21748 4008 Stolberg Ave

Revision Notes

No.	Date	Zone	Approvals	No.	Date	Issue Notes
C	18-9-23					Issued for RCDP addressing ADP comments
B	18-9-20					Issued for RCDP
A	18-6-7					Issue for ADP


Design Firm: **eta** landscape architecture  
 1690 West 2nd Avenue  
 Vancouver, BC, Canada, V6J 1Y4  
 T 604.833.1459  
 F 604.833.1459  
 W www.eta.ca

Contract No.:  
 Drawing Title: Landscape Grading  
 Plan 3  
 Sheet No.: Lb.8 of 30

DP 17-194200-4



SITE FURNISHINGS			
ID	DESCRIPTION	SIZE	QTY
A1	TIMBER ARBOUR	Varies	3
B1	LAKE SIDE PICKET FENCE BENCH — 67"	Varies	27
BH	BIRO HOUSE	TBD	2
C0	COMPOST BINS	TBD	1
PT	POTTING TABLE	Custom	-
F1	FENCE	Heavy Timber	-
F2	SPRINKLER FENCE	Aluminum	-
G1	GATE	Aluminum	-
G2	GATE	Aluminum	-
G3	GATE	Aluminum	-
MATERIALS			
ID	DESCRIPTION	SIZE	QTY
AB	ALLAN BLOCK WALL	Standard	Rocky Mtn Blend
CE	CONCRETE EDGE	Cast-In-Place	Asphlar Blend Pat.
IS	GRAVEL	1/2"	-
IS	GRAVEL	1/2"	-
P1	UNIT PAVER	Boardwalk	Dark Run
P2	CONCRETE WALKWAY	Custom	Patio Pavers
P3	CONCRETE SLABS	Cast-In-Place	Graphite (2 lbs 8084)
P4	CONCRETE STAIRS	Cast-In-Place	Light Sandblast Finish
P5	VEHICULAR CONCRETE	3' x 18' x 4"	Charcoal
P6	PAVER	3' x 18' x 4"	Ceasar Brown
P7	PAVER	24' x 24'	natural
P8	PAVER 2	24' x 24'	purple
R1	RUBBER PLAY SURFACE	Pour-In-Place	-

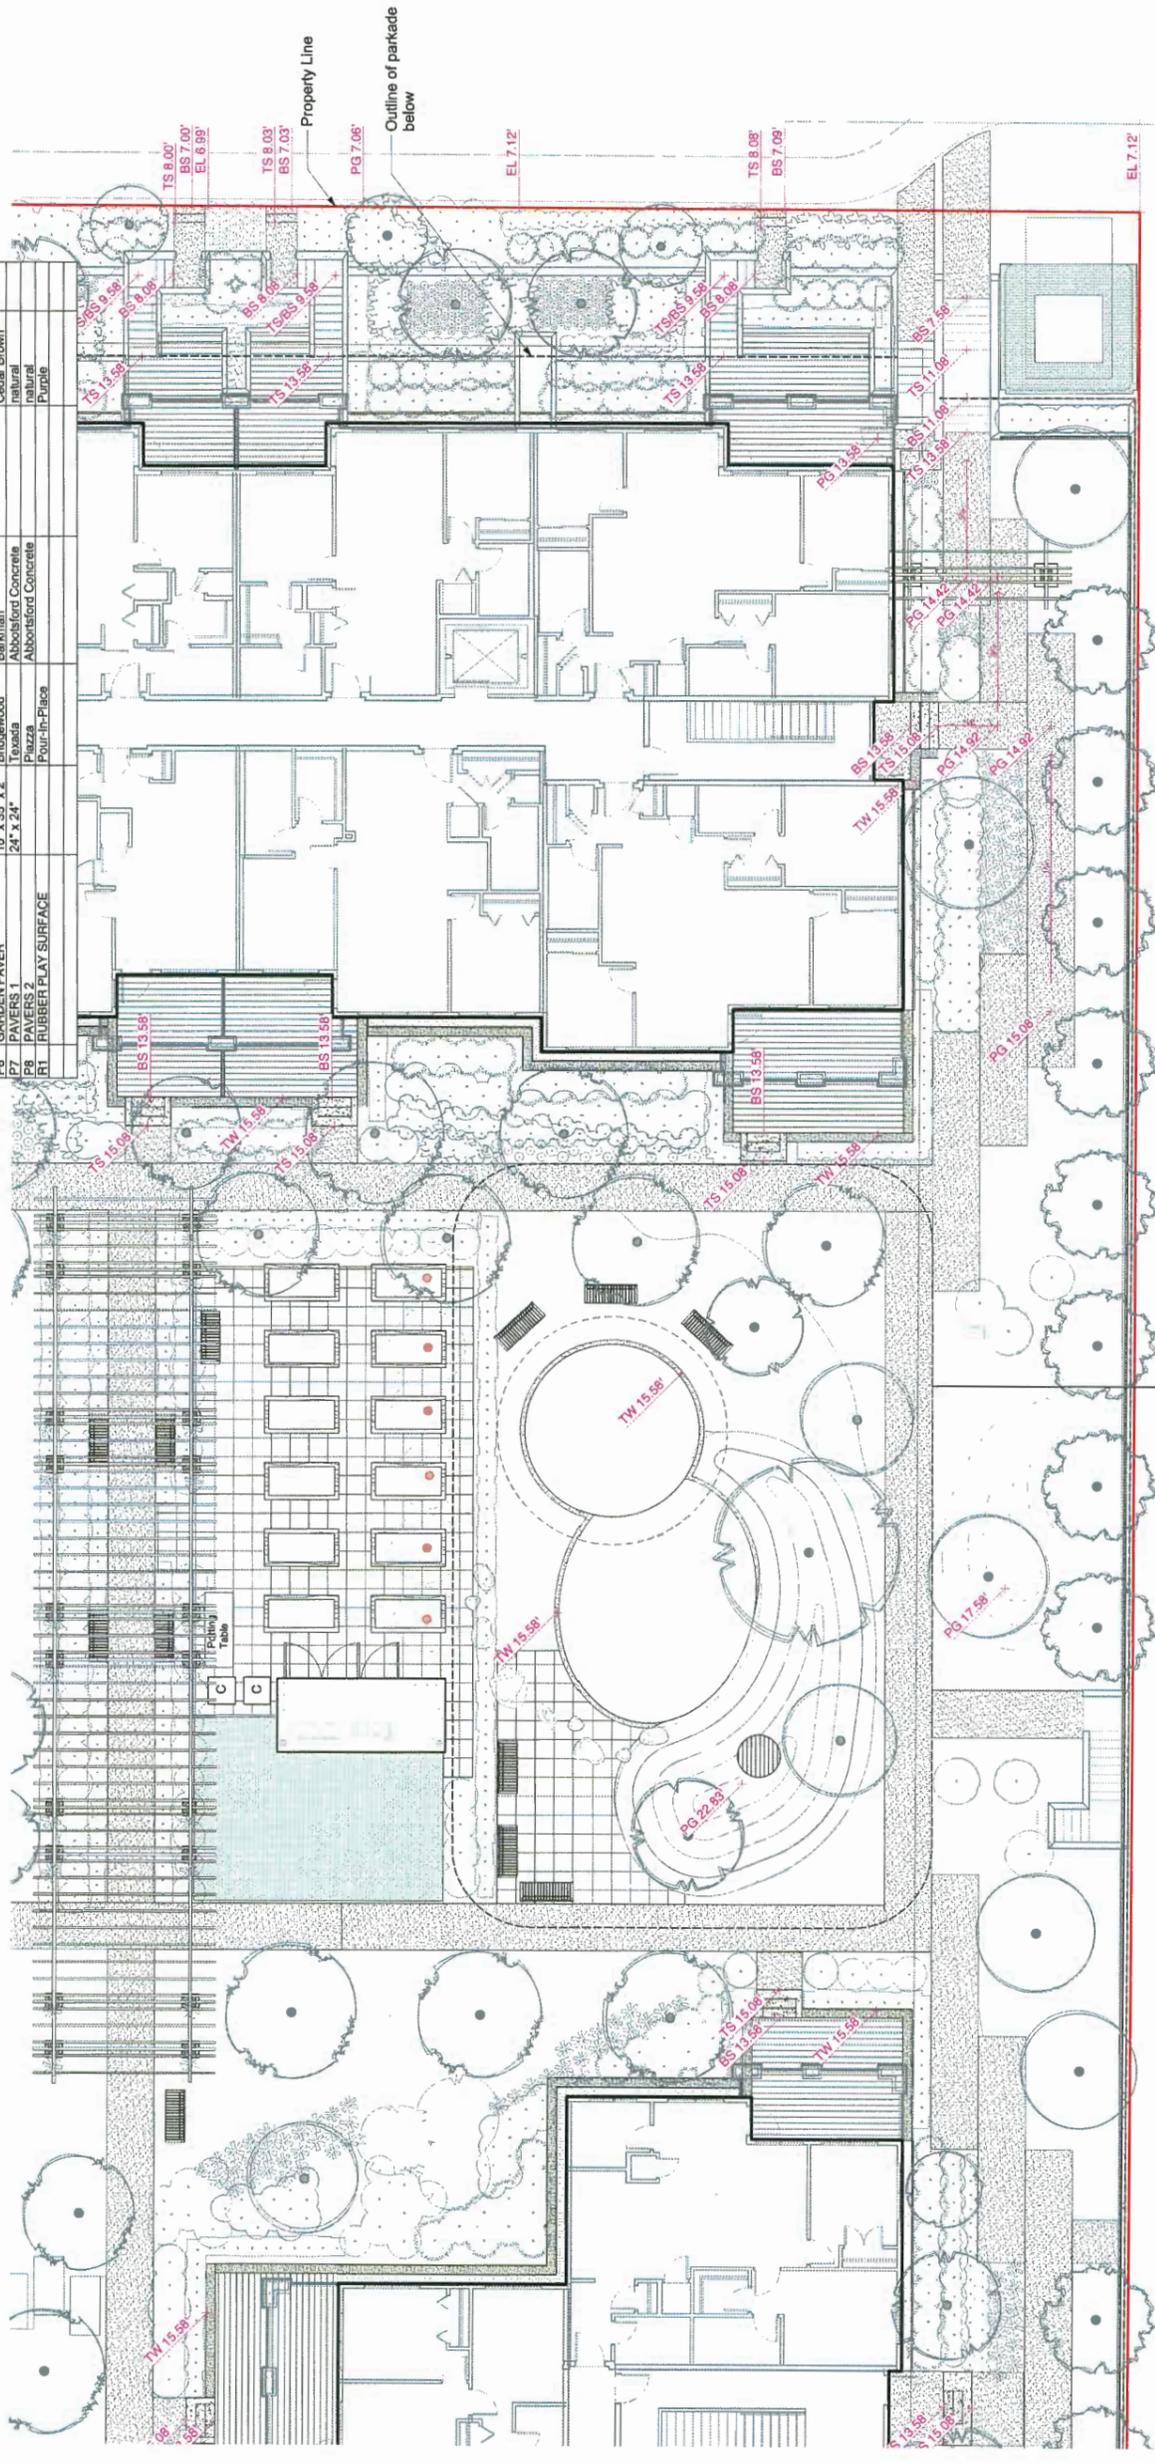

4008 Stolberg Street

### Landscape Grading Plan 4

eta landscape architecture  
1600 West 2nd Avenue  
Vancouver, BC, Canada V6J 1H4  
T 604.683.1458  
F 604.683.1459  
www.eta.ca


No.	Date	Revision Notes
C	18-5-28	Issued for RFP addressing ADP comments
B	18-5-20	Issued for RFP
A	18-6-7	Issue for ADP

No.	Date	Revision Notes

Project No. 21748  
Issue No. 1:100  
Drawing No. Lb.9

Prepared By: VG  
Checked By: VG  
Date: 06/22/2017  
Project: 4008 Stolberg Street

Lb.9 of 30  
DP 17-794280-

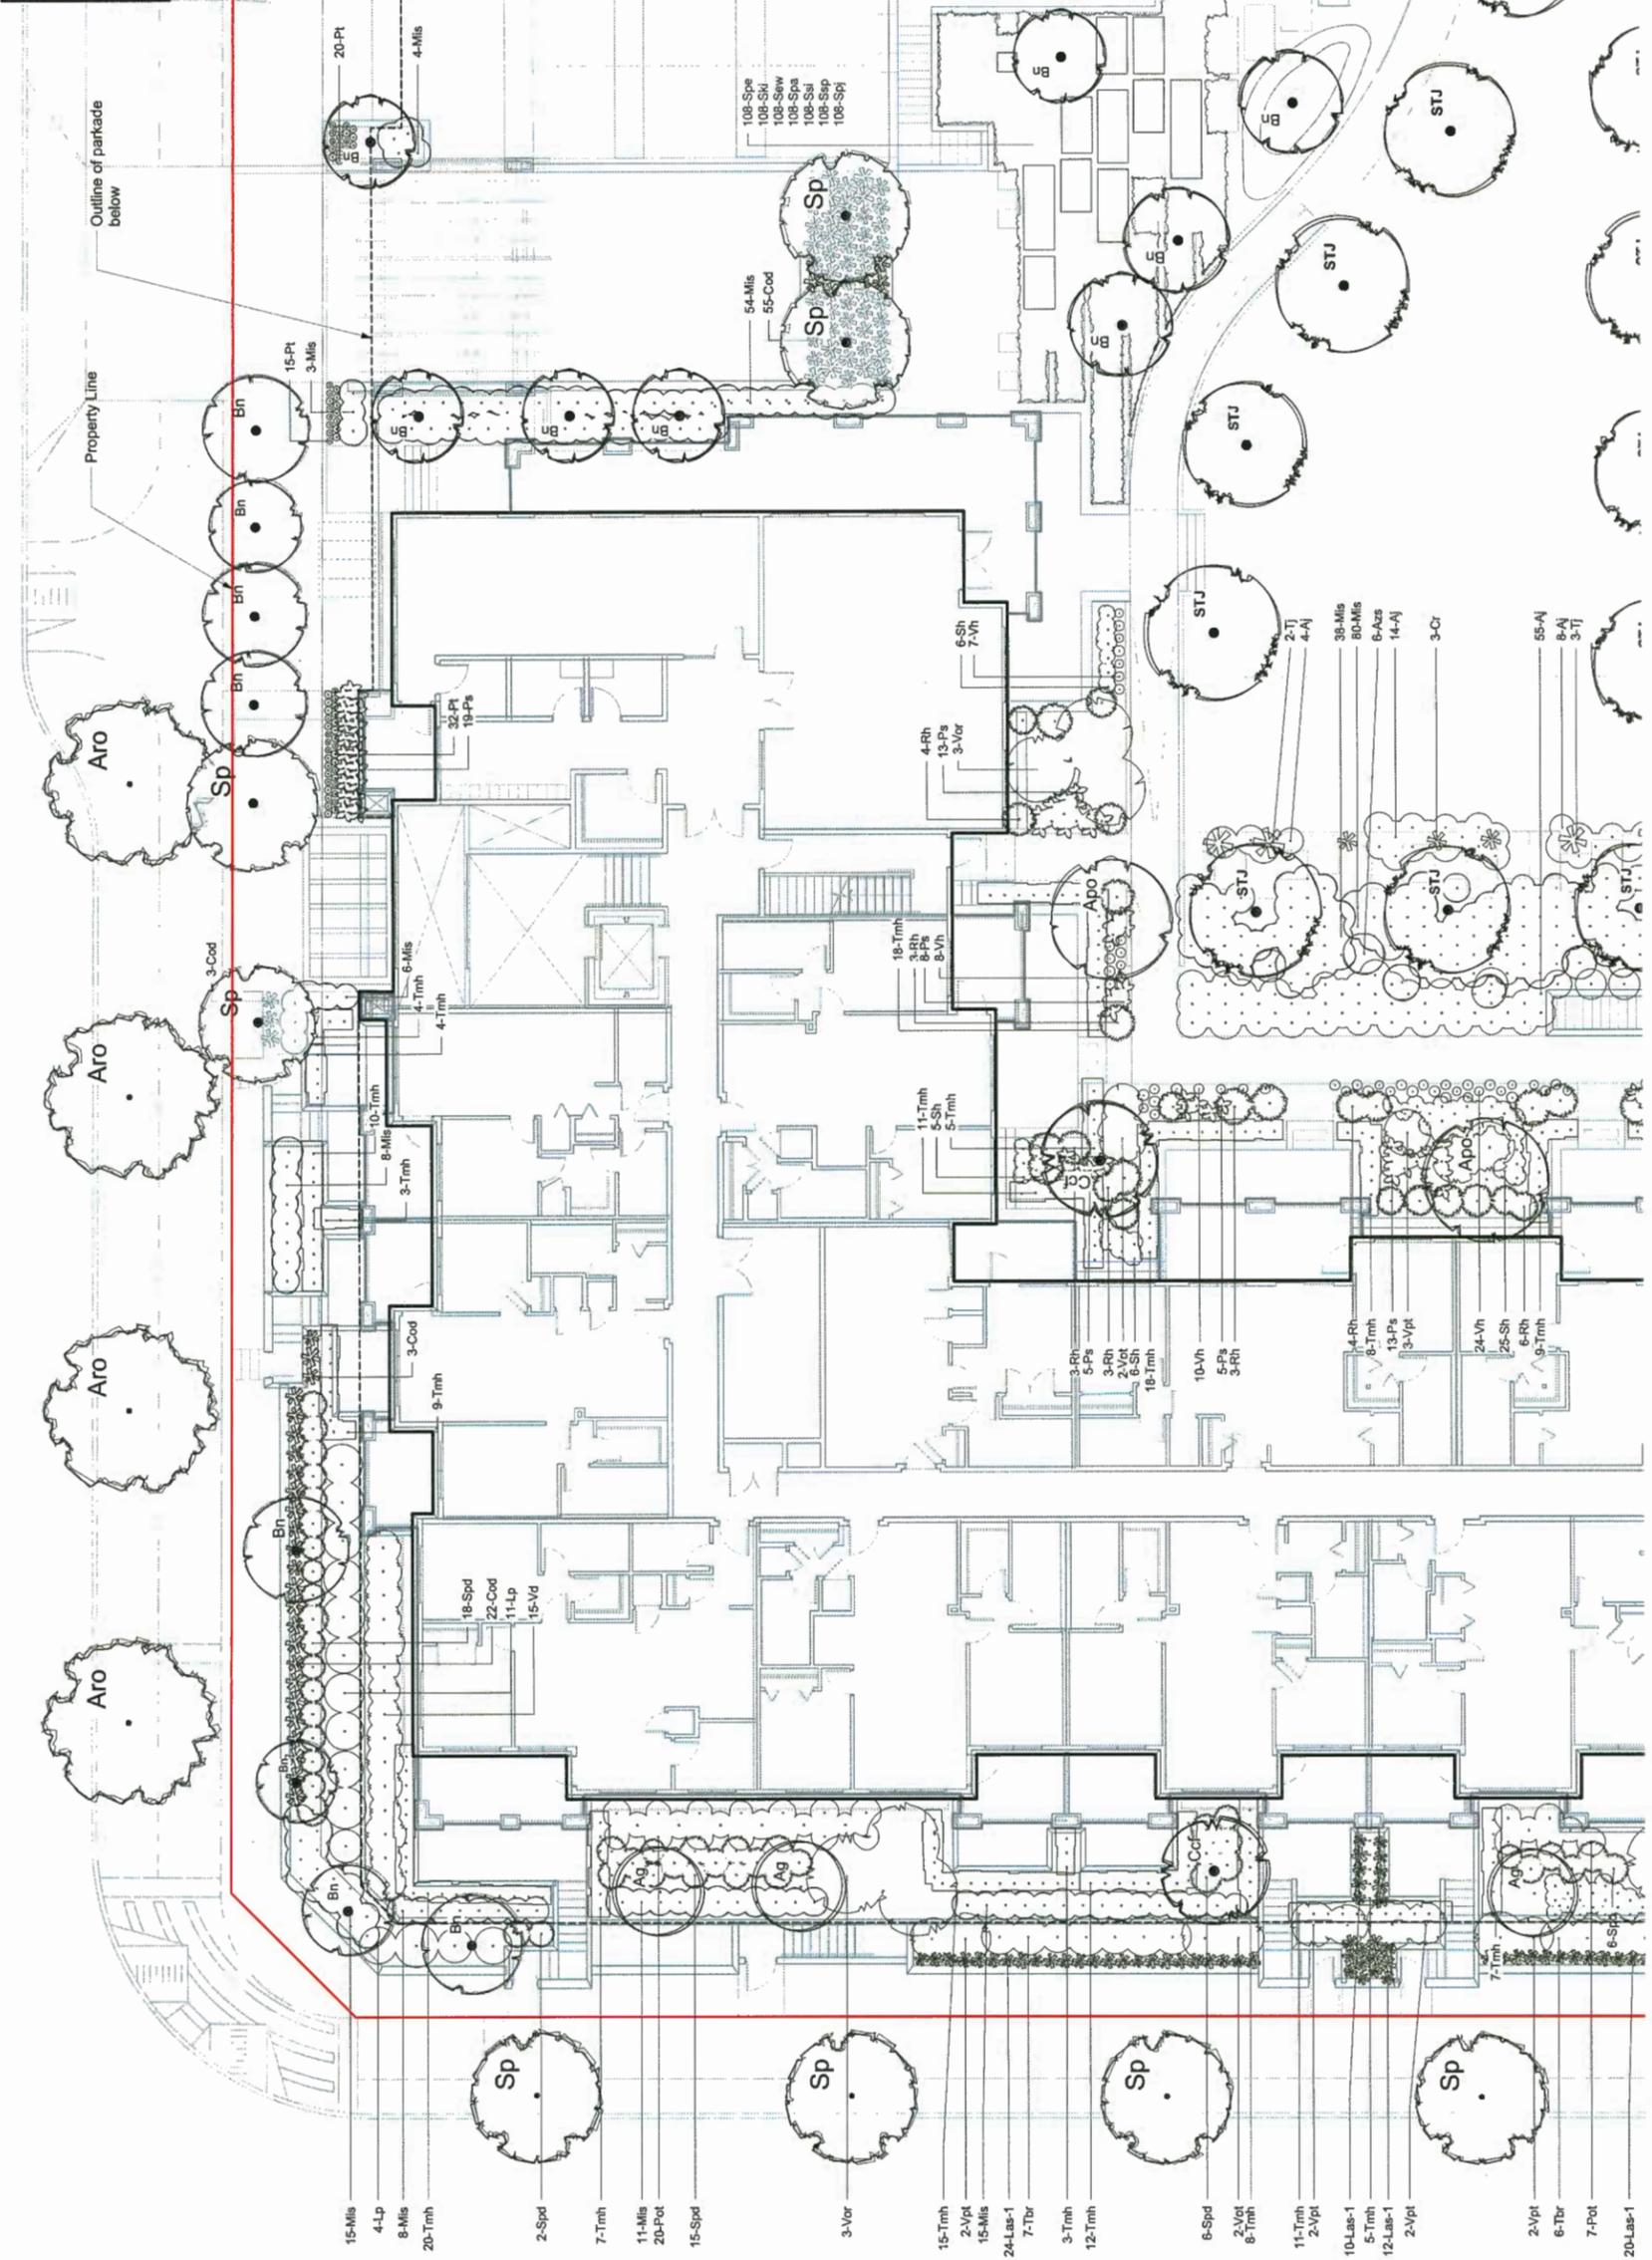

NOTE: Refer to Plant List on Cover Sheet



Project Name: 4008 Stolberg Street  
Landscape architect: eta  
1600 West 2nd Avenue  
Vancouver, BC, Canada, V6U 1H4  
Tel: (604) 683.1168  
Fax: (604) 683.1169  
www.eta.ca

No.	Date	Revision Notes	Zone	Apprvals	No.	Date	Issue Notes
C	18-6-28	Issued for RDP addressing ADP comments					
B	18-6-20	Issued for RDP					
A	18-6-7	Issue for ADP					

eta LANDSCAPE ARCHITECTURE


All Rights Reserved by eta landscape architecture. No part of this document may be reproduced or transmitted in any form or by any means electronic or mechanical, including photocopying, recording, or by any information storage and retrieval system, without the prior written permission of eta landscape architecture.

Project Title: Landscape Planting Plan 1

Project Number: 21748  
Date: 09/12/2017  
Drawing No.: 1:100

LC-1 of 30

DP 17-794280-45

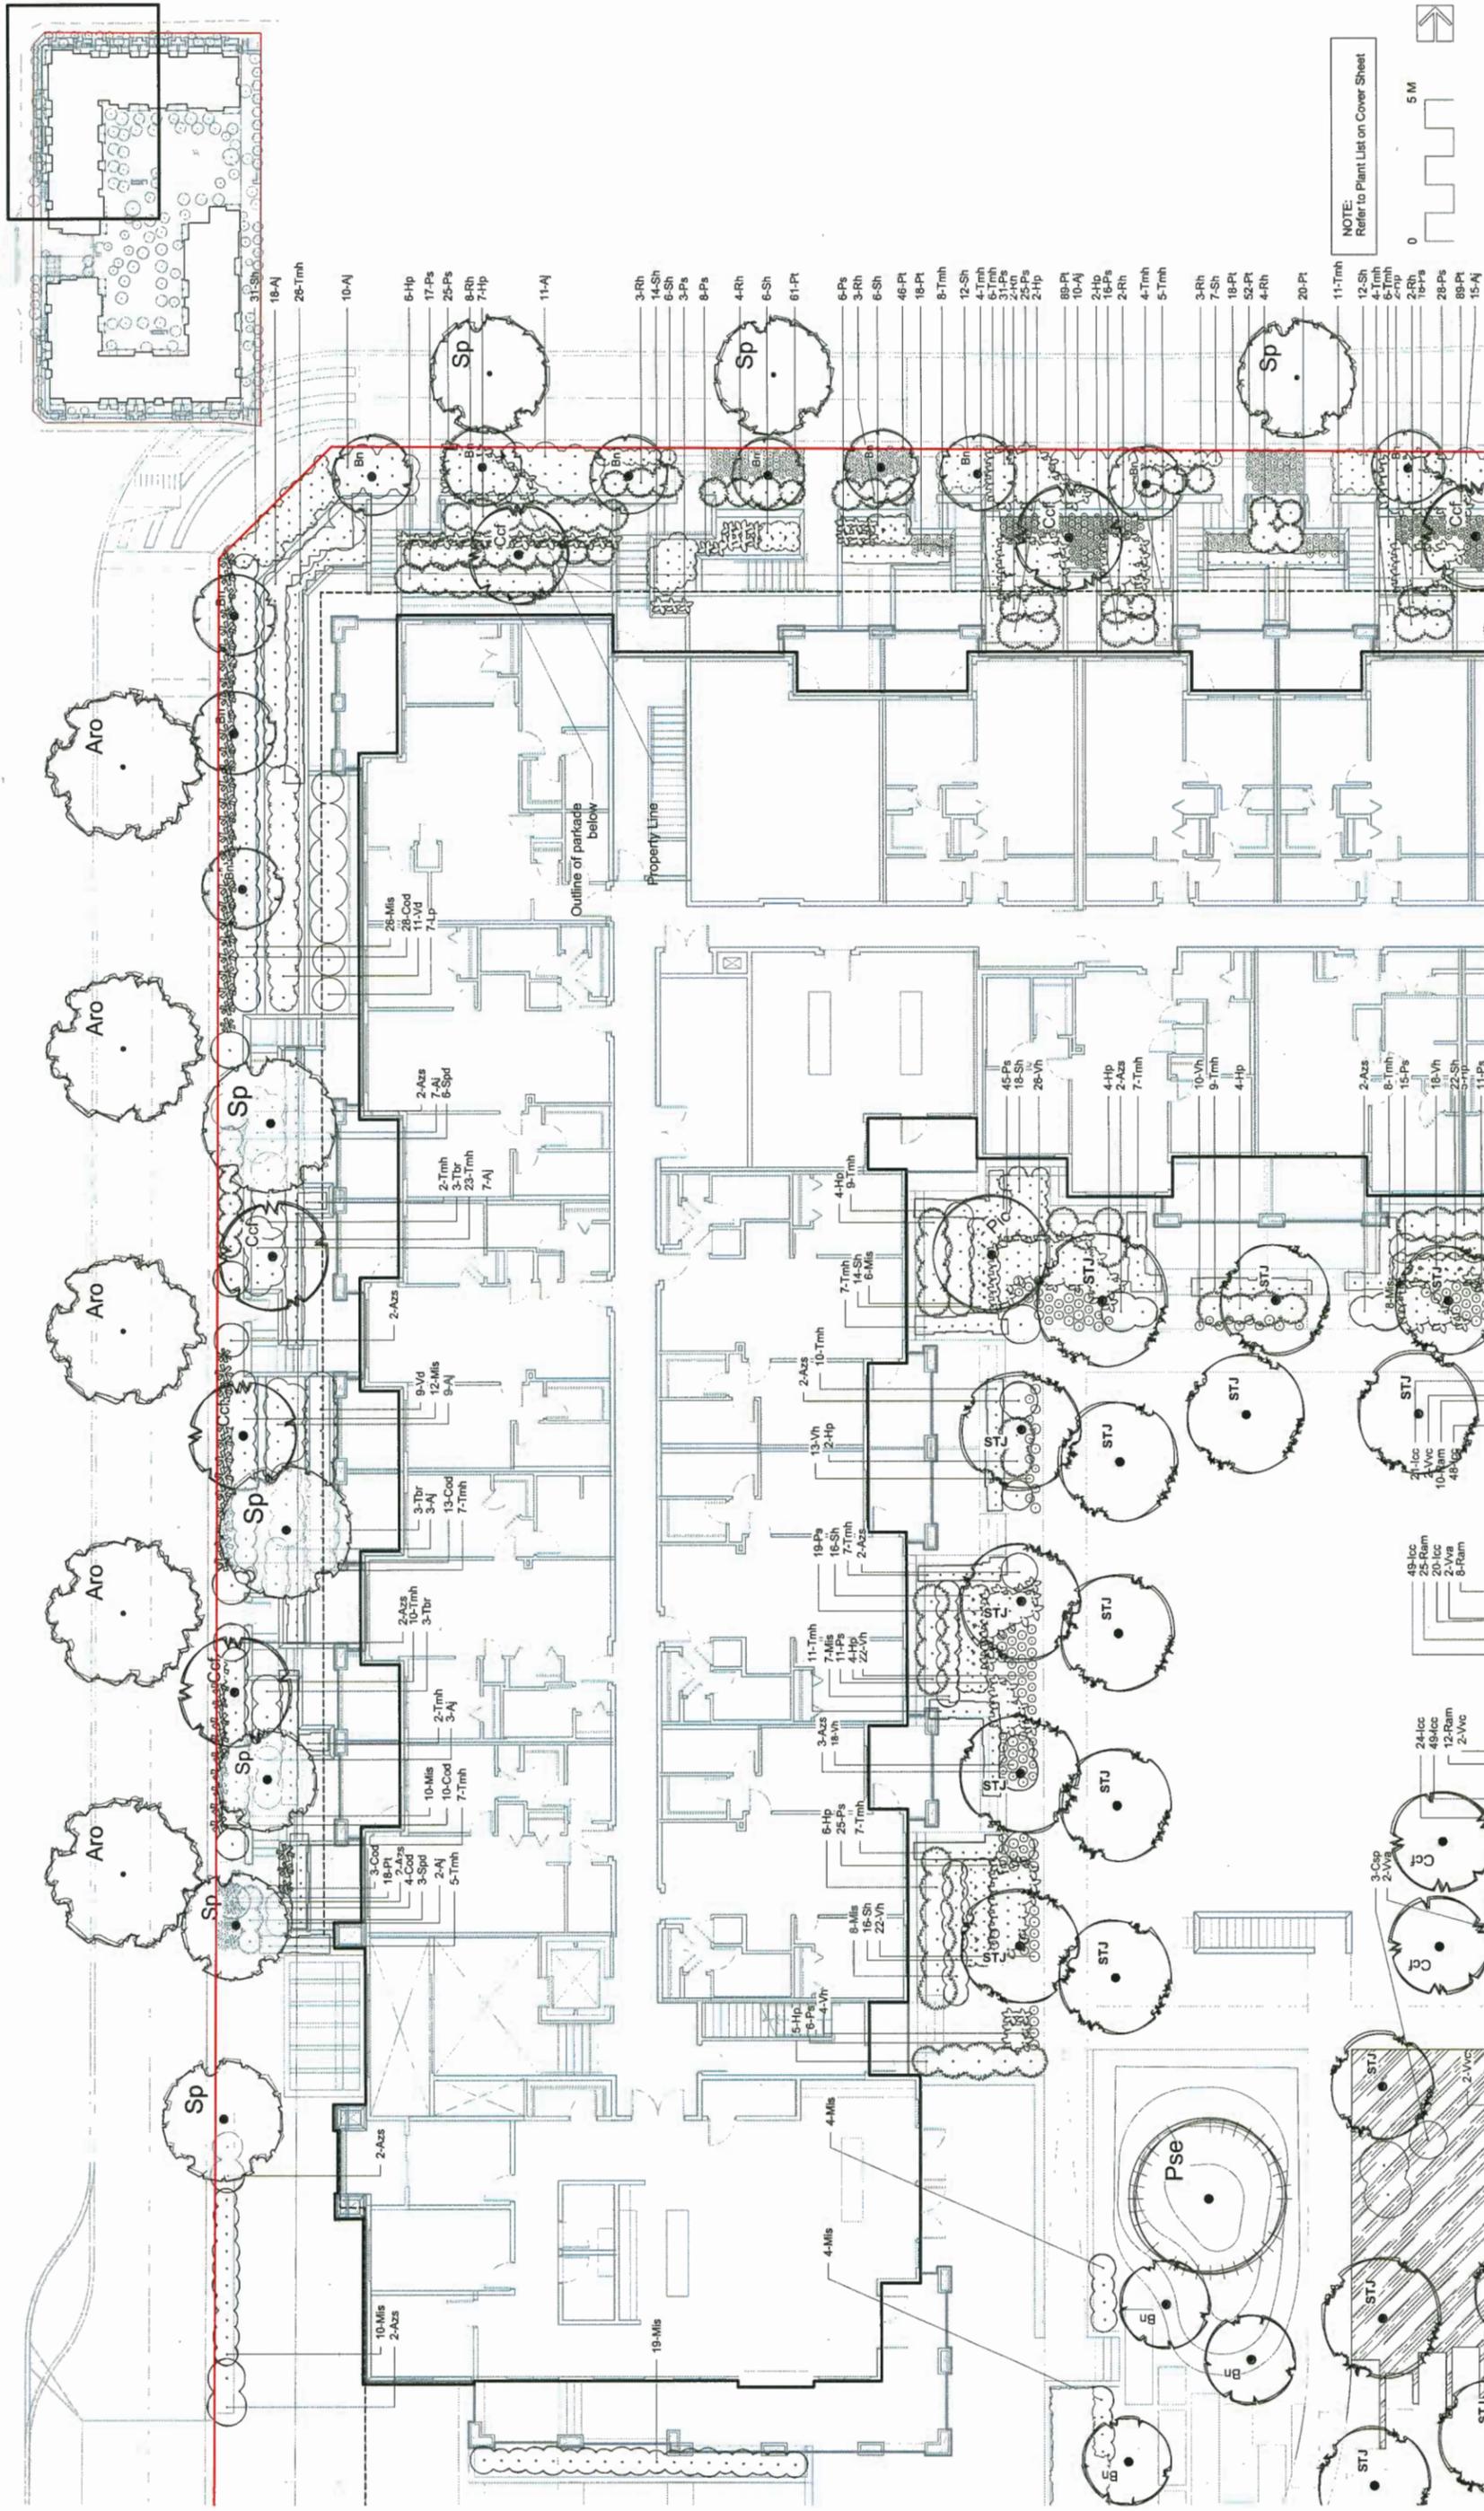

Project Name: 4008 Stolberg Street  
 Drawing No: 21748  
 Scale: 1:100  
 Date: 08/12/2017  
 Project No: 1747420U-46

Author: DT  
 Designer: DT  
 Checker: DT

Revision Notes

No.	Date	Zone	Approvers	No.	Date	Issue Notes
C	18-9-28					Issued for RIGP addressing ADP comments
B	18-9-20					Issued for RIGP
A	18-6-7					Issue for ADP

Project Title: Landscape Planning Plan 2

Client: 4008 Stolberg Street

Site Address: 4008 Stolberg Street

City: Vancouver, BC, Canada - V6J 1H4

Phone: (604) 683-1456

Website: www.eta.ca

ETA Landscape Architecture

18-08-28  
 18-09-20  
 18-06-07


OP 1 / 1747420U-46

LC-2

of 30



Property Line  
Outline of parkade  
below

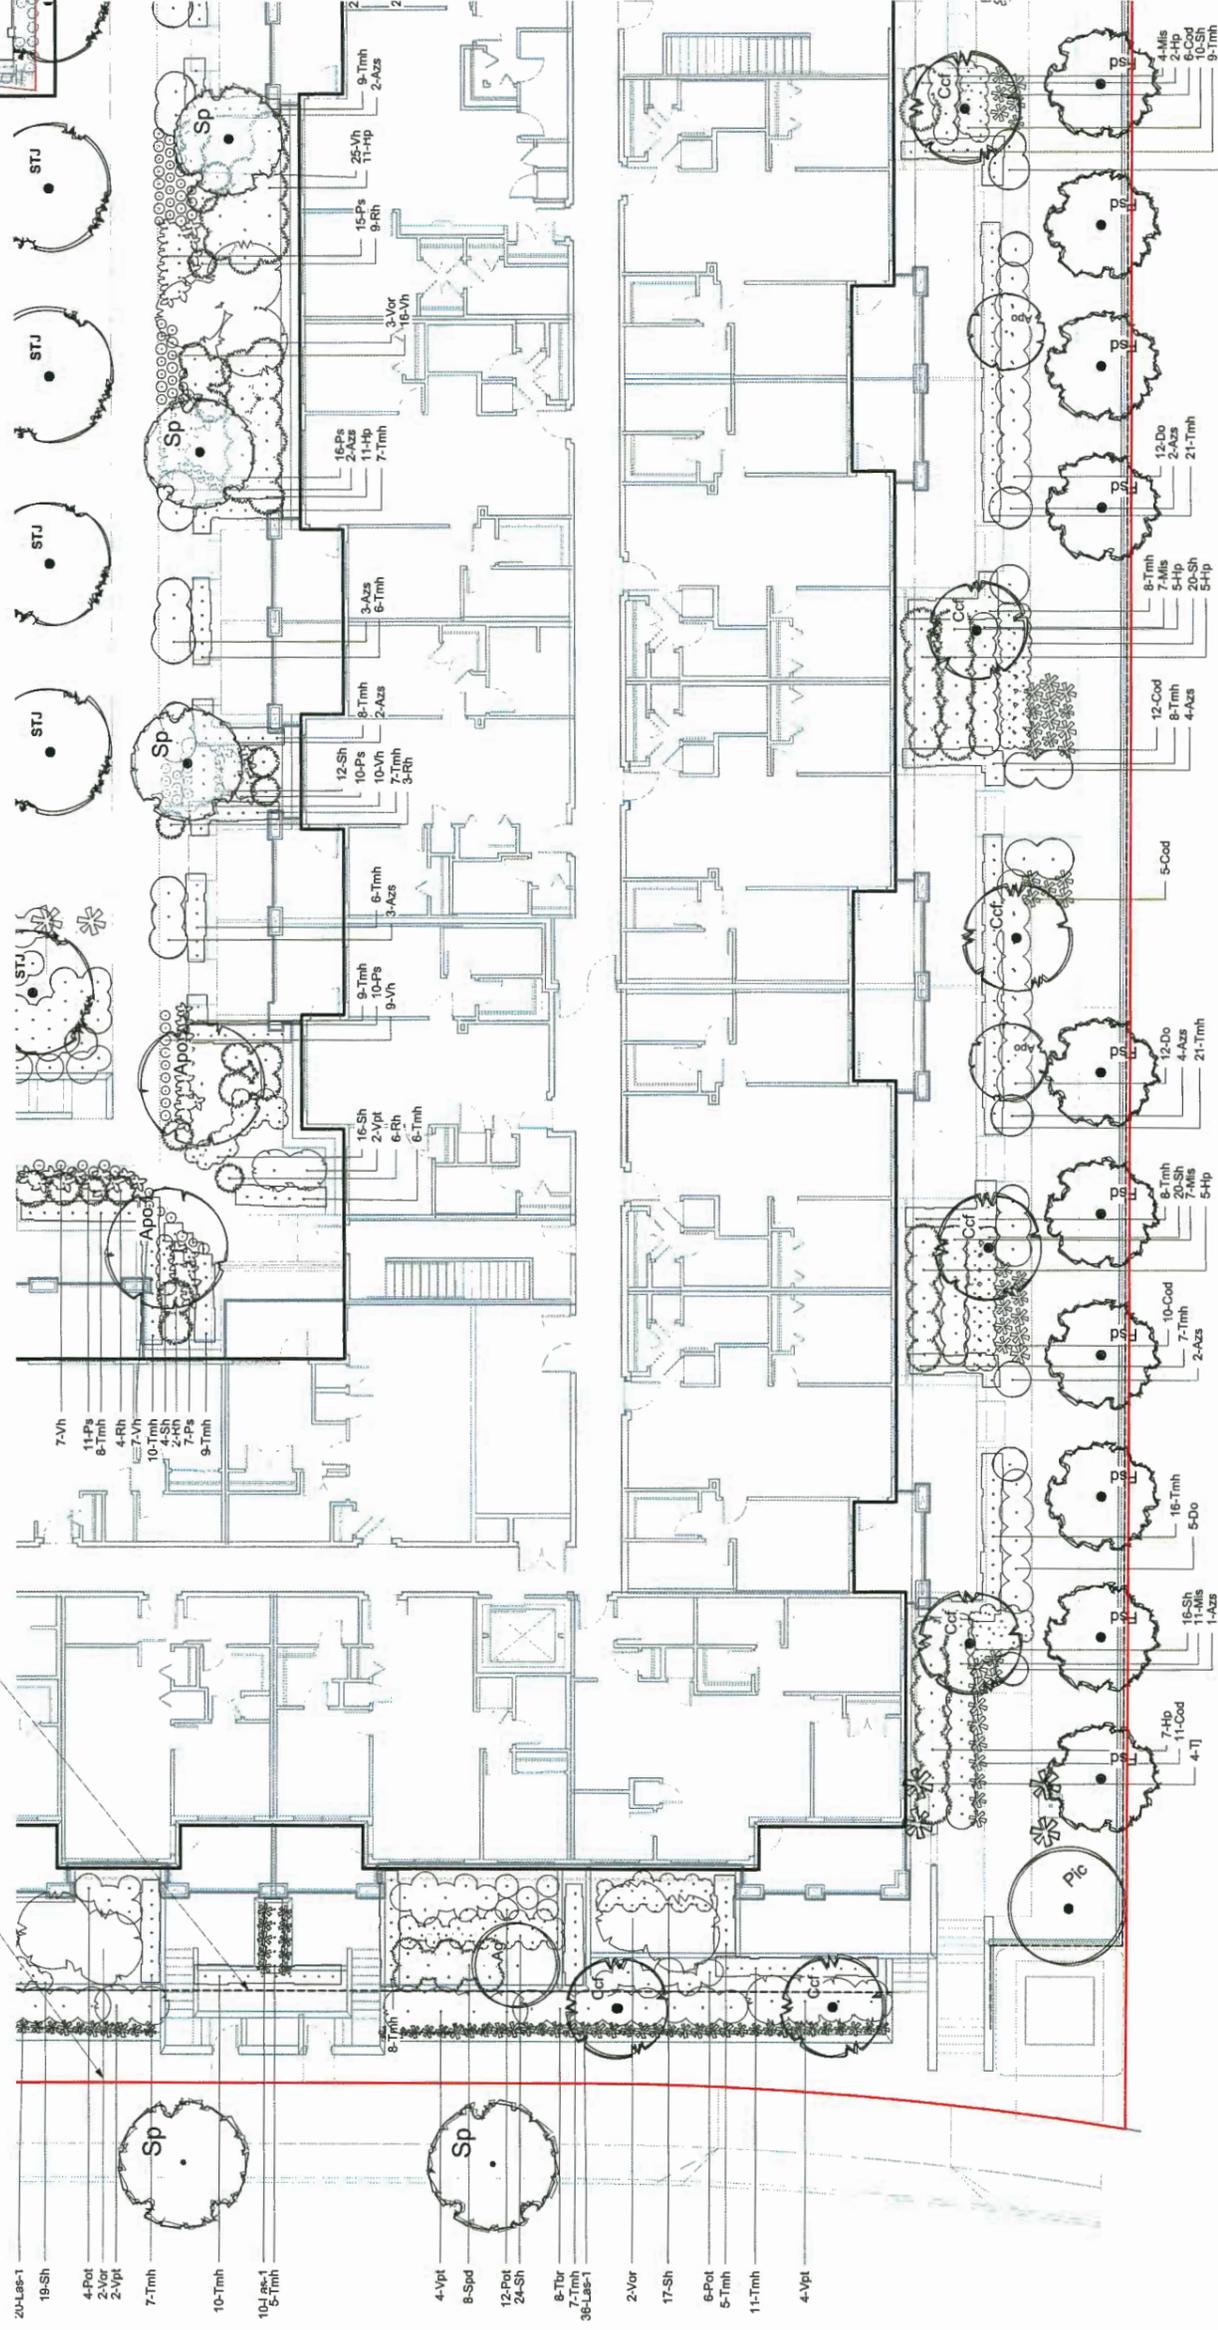

NOTE:  
Refer to Plant List on Cover Sheet



Project No. 21746  
Date 06/12/2017  
Drawing No. LC.3  
of 30


4008 Stolberg Street

Landscape Planting  
Plan 3

eta landscape architecture  
1890 West 2nd Avenue  
Vancouver, BC, Canada, V6J 1H4  
604.683.1456  
www.eta.ca

No.	Date	Revision Notes	Zone	Apprvals	No.	Date	Issue Notes
C	18-9-28	Issued for RNDP addressing ADP comments					
B	18-9-20	Issued for RNDP					
A	18-6-7	Issue for ADP					

DP 11-194280-47

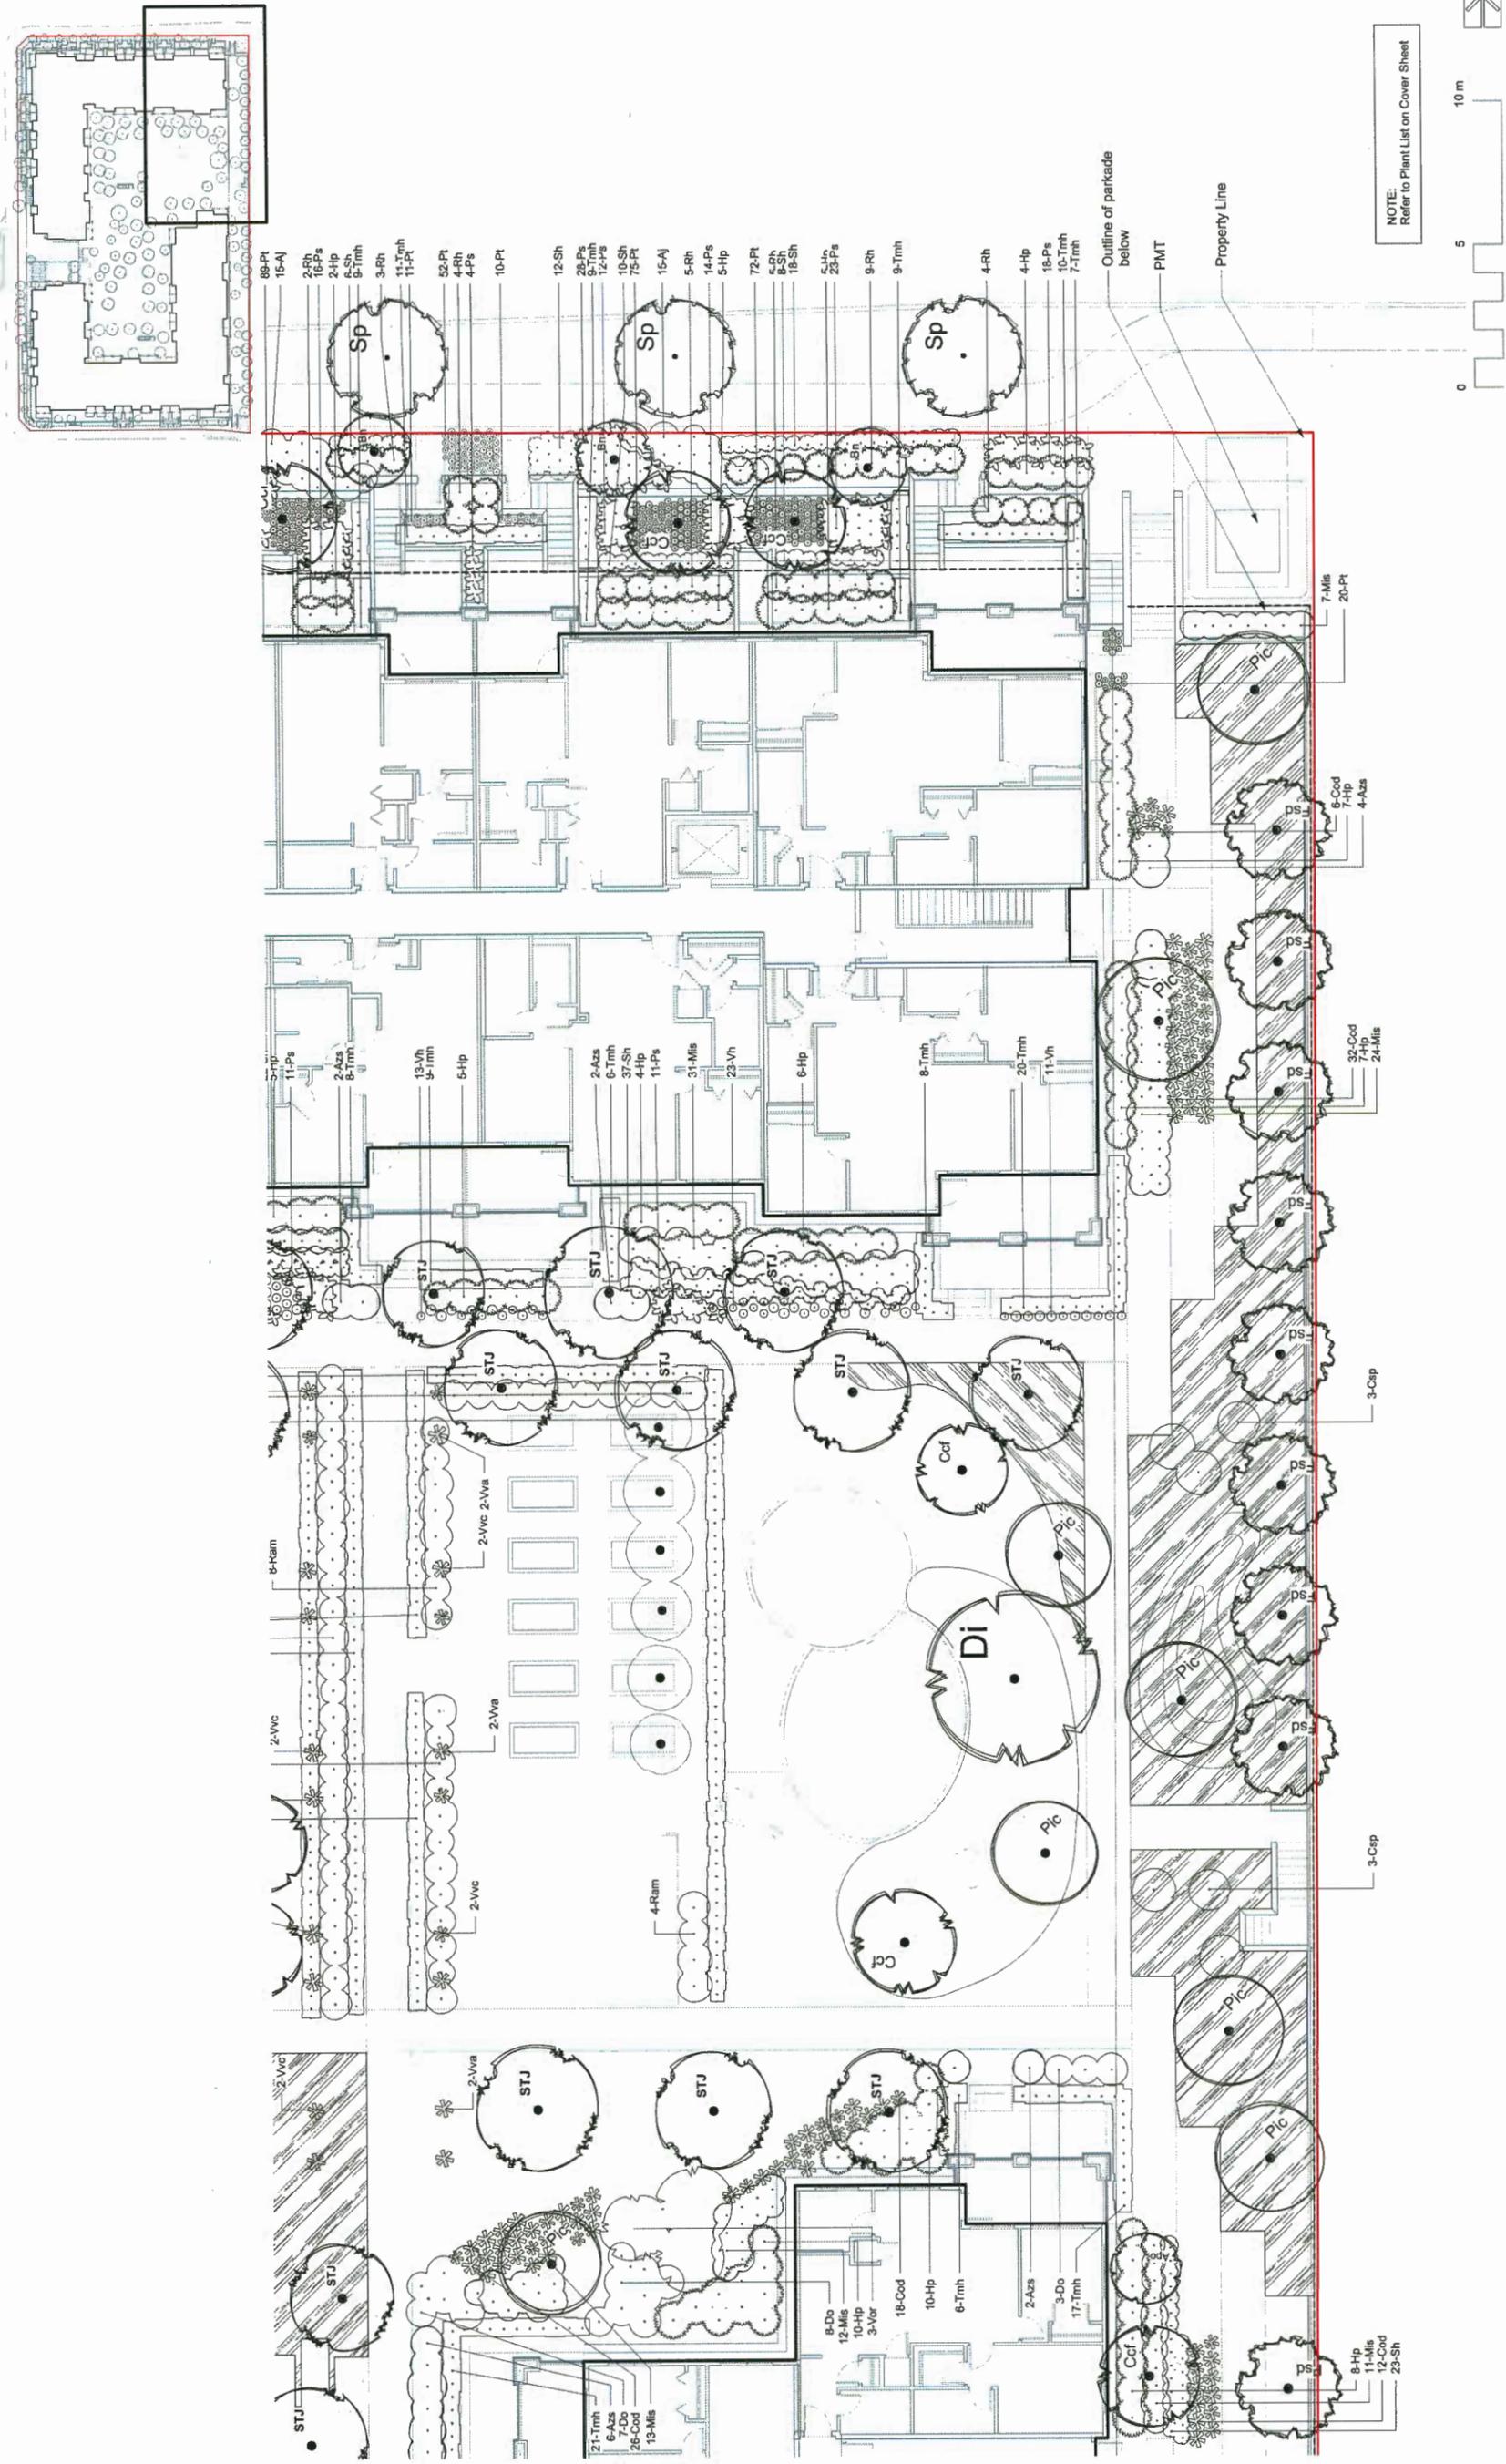

Project No. 21748  
 Date: 06/12/2017  
 Drawing No. 30

Project Name: 4008 Stolberg Street  
 Drawing Title: Landscape Planning Plan 4

Client: eta landscape architecture  
 1690 West 2nd Avenue  
 Vancouver, BC, Canada, V6J 1H4  
 Tel: 604.683.1456  
 Fax: 604.683.1459  
 www.eta.ca

Revision Notes

No.	Date	Zone	Approvals	No.	Date	Issue Notes
C	19-9-28					Issued for RldP addressing ADP comments
B	18-9-20					Issued for RldP
A	18-6-7					Issue for ADP

Project Manager: DT  
 Designer: DT  
 Drafter: DT

Project No. 21748  
 Date: 06/12/2017  
 Drawing No. 30


Project Name: 4008 Stolberg Street  
 Drawing Title: Landscape Planning Plan 4

Client: eta landscape architecture  
 1690 West 2nd Avenue  
 Vancouver, BC, Canada, V6J 1H4  
 Tel: 604.683.1456  
 Fax: 604.683.1459  
 www.eta.ca

DP 17-794280-48

LC-4 of 30



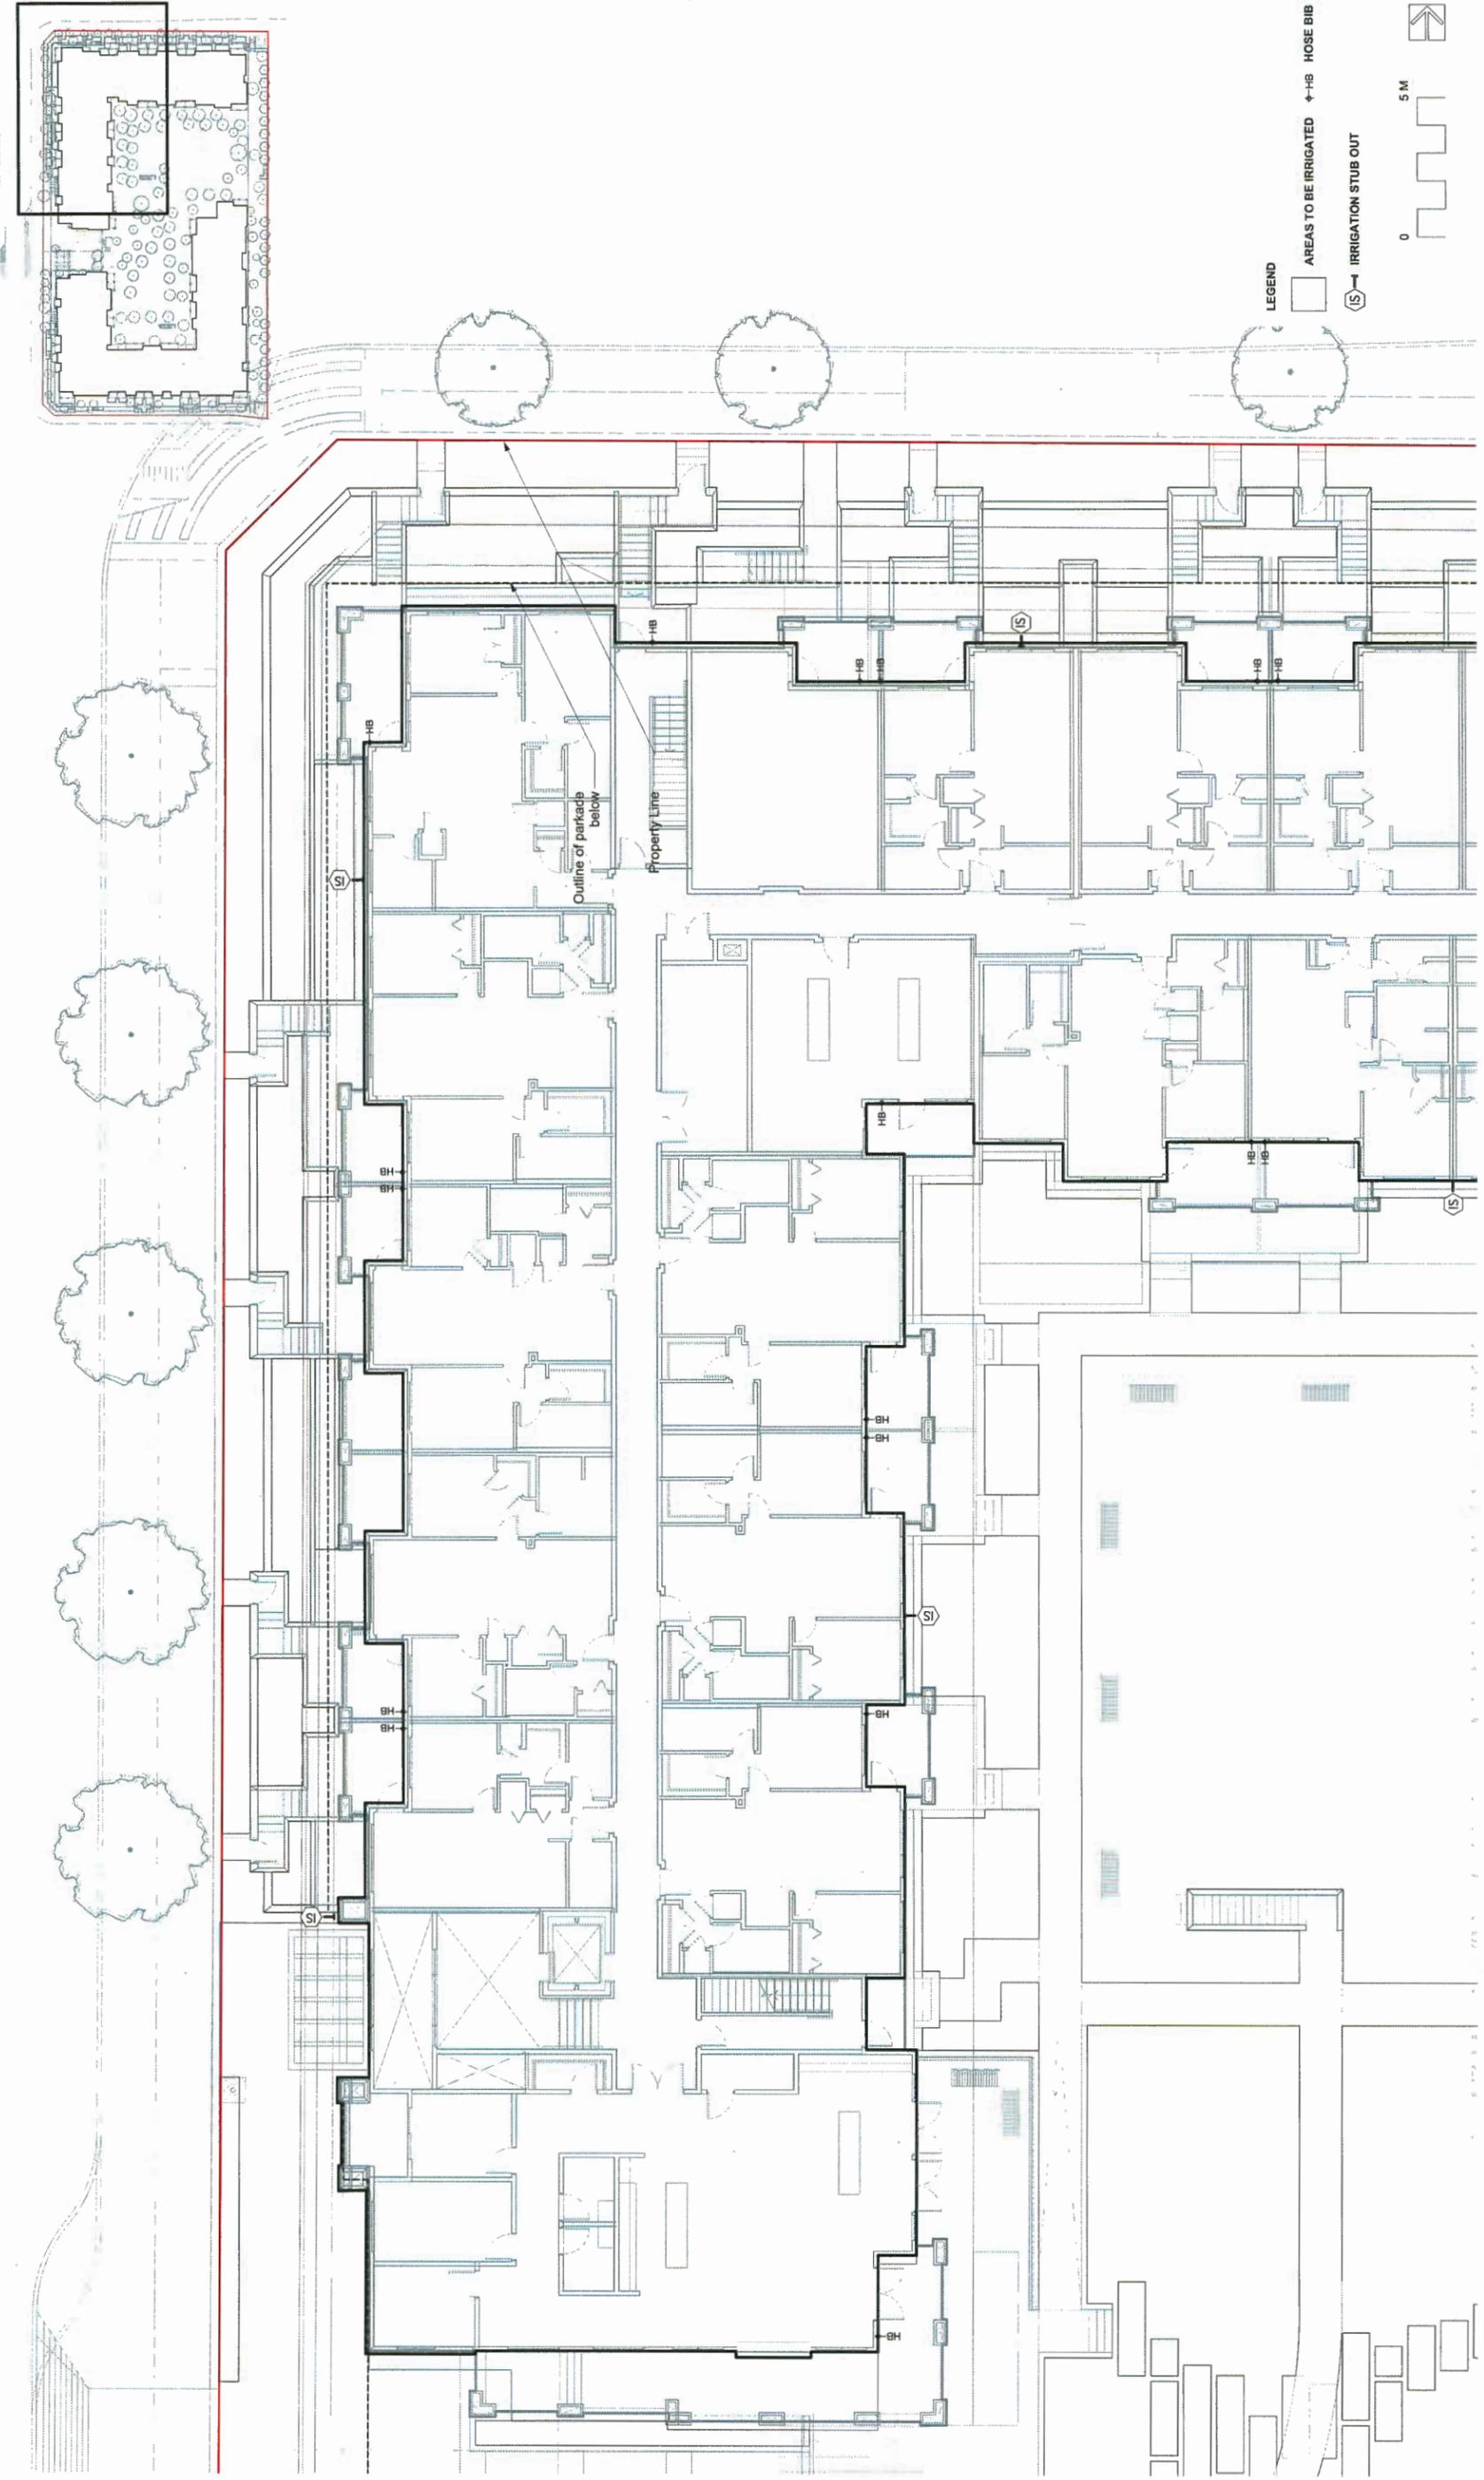

Project Name: 4008 Stolberg Street  
 Project No.: 21748  
 Scale: 1:100  
 Drawing No.: LC.6  
 Date: 08/12/2017  
 Project Manager: DT  
 Designer: VG  
 Draftsman: VG  
 Date: 08/12/2017  
 Project: 21748 Stolberg St  
 Drawing: 21748-006 Landscape Irrig

Project No.: 4008 Stolberg Street  
 Drawing Title: Landscape Irrigation Plan 2


**eta** landscape architecture  
 1890 West 20th Avenue  
 Vancouver, BC, Canada, V6J 1H4  
 | (604) 683-1456  
 | (604) 683-1459  
 | www.etalab.ca

No.	Date	Revision Notes	Zone	Approvals	No.	Date	Issue Notes
C	18-5-28	Issued for RCP addressing ADP comments					
B	18-9-20	Issued for RCP					
A	18-8-7	Issue for ADP					

OP 17174280-50



Property Line  
Outline of parkade below

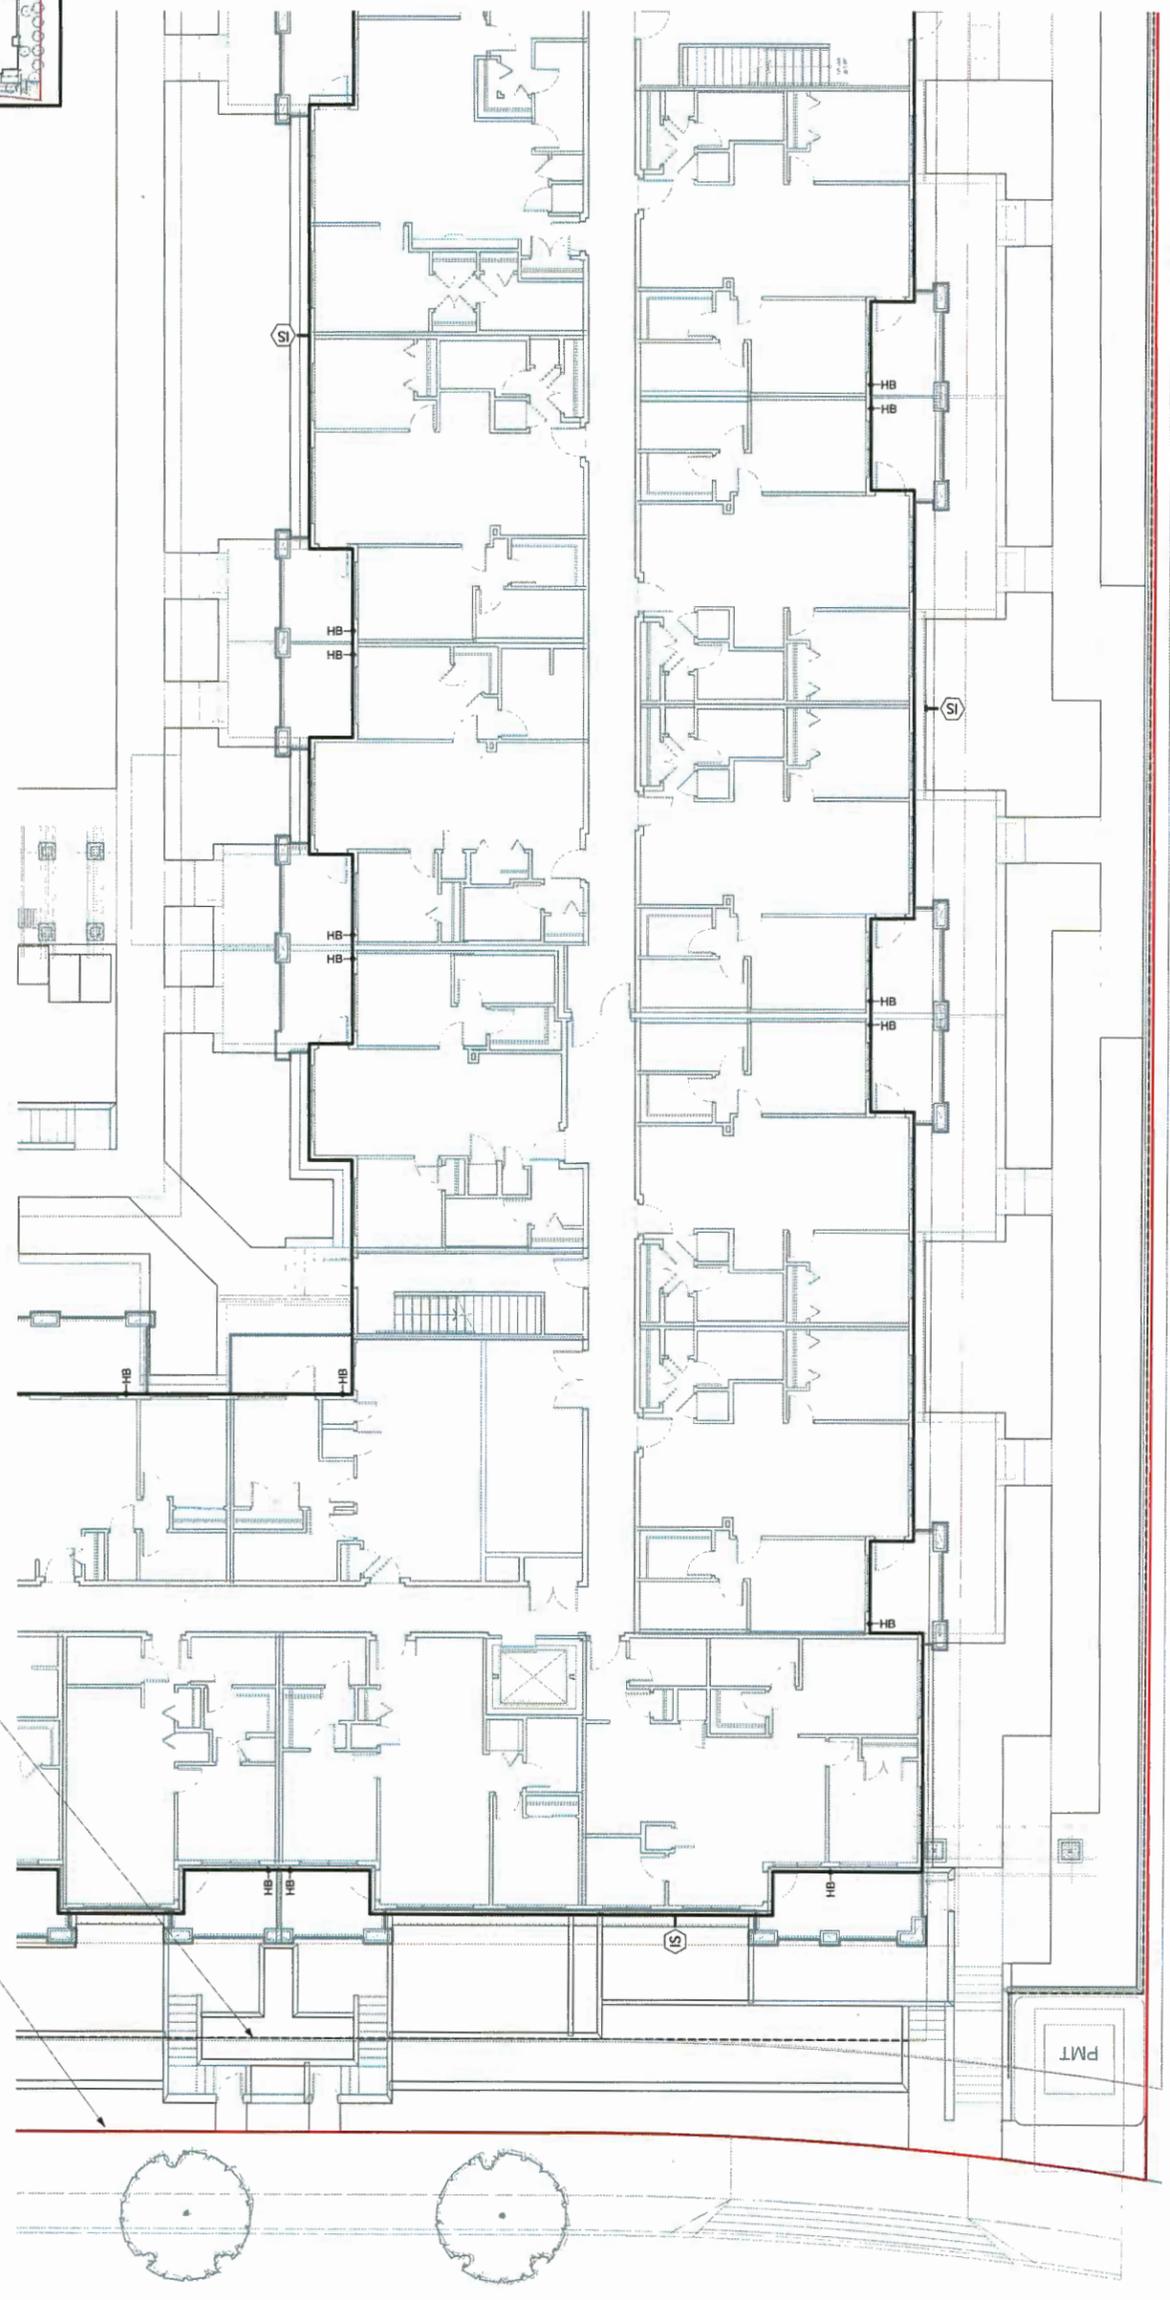

**LEGEND**  
 [ ] AREAS TO BE IRRIGATED  
 → HB HOSE BIB  
 (S) IRRIGATION STUB OUT



**eta** landscape architecture  
 1690 West 2nd Avenue  
 Vancouver, BC, Canada V6J 1Y4  
 T 604.683.1456  
 F 604.683.1459  
 W www.eta.ca

No.	Date	Revision Notes	Zone	Approvals	No.	Date	Issue Notes
C	18-9-28	Issued for RCDP addressing ADP comments					
B	18-9-20	Issued for RCDP					
A	18-6-7	Issue for ADP					

Project Title: 4008 Stolberg Street  
 Drawing Title: Landscape Irrigation Plan 3


All Rights Reserved. No part of this drawing may be reproduced, stored in a retrieval system, or transmitted in any form or by any means, electronic, mechanical, photocopying, recording, or by any information storage and retrieval system, without the prior written permission of the author. The author shall not be held liable for any errors or omissions in this drawing.

Project Number: 21748  
 Drawn By: VG  
 Checked By: DT  
 Date: 06/12/2017  
 Scale: 1:100  
 Drawing No.: 10  
 Project Name: 4008 Stolberg Ave

OP 17-174280-51

Lc.7

of 30

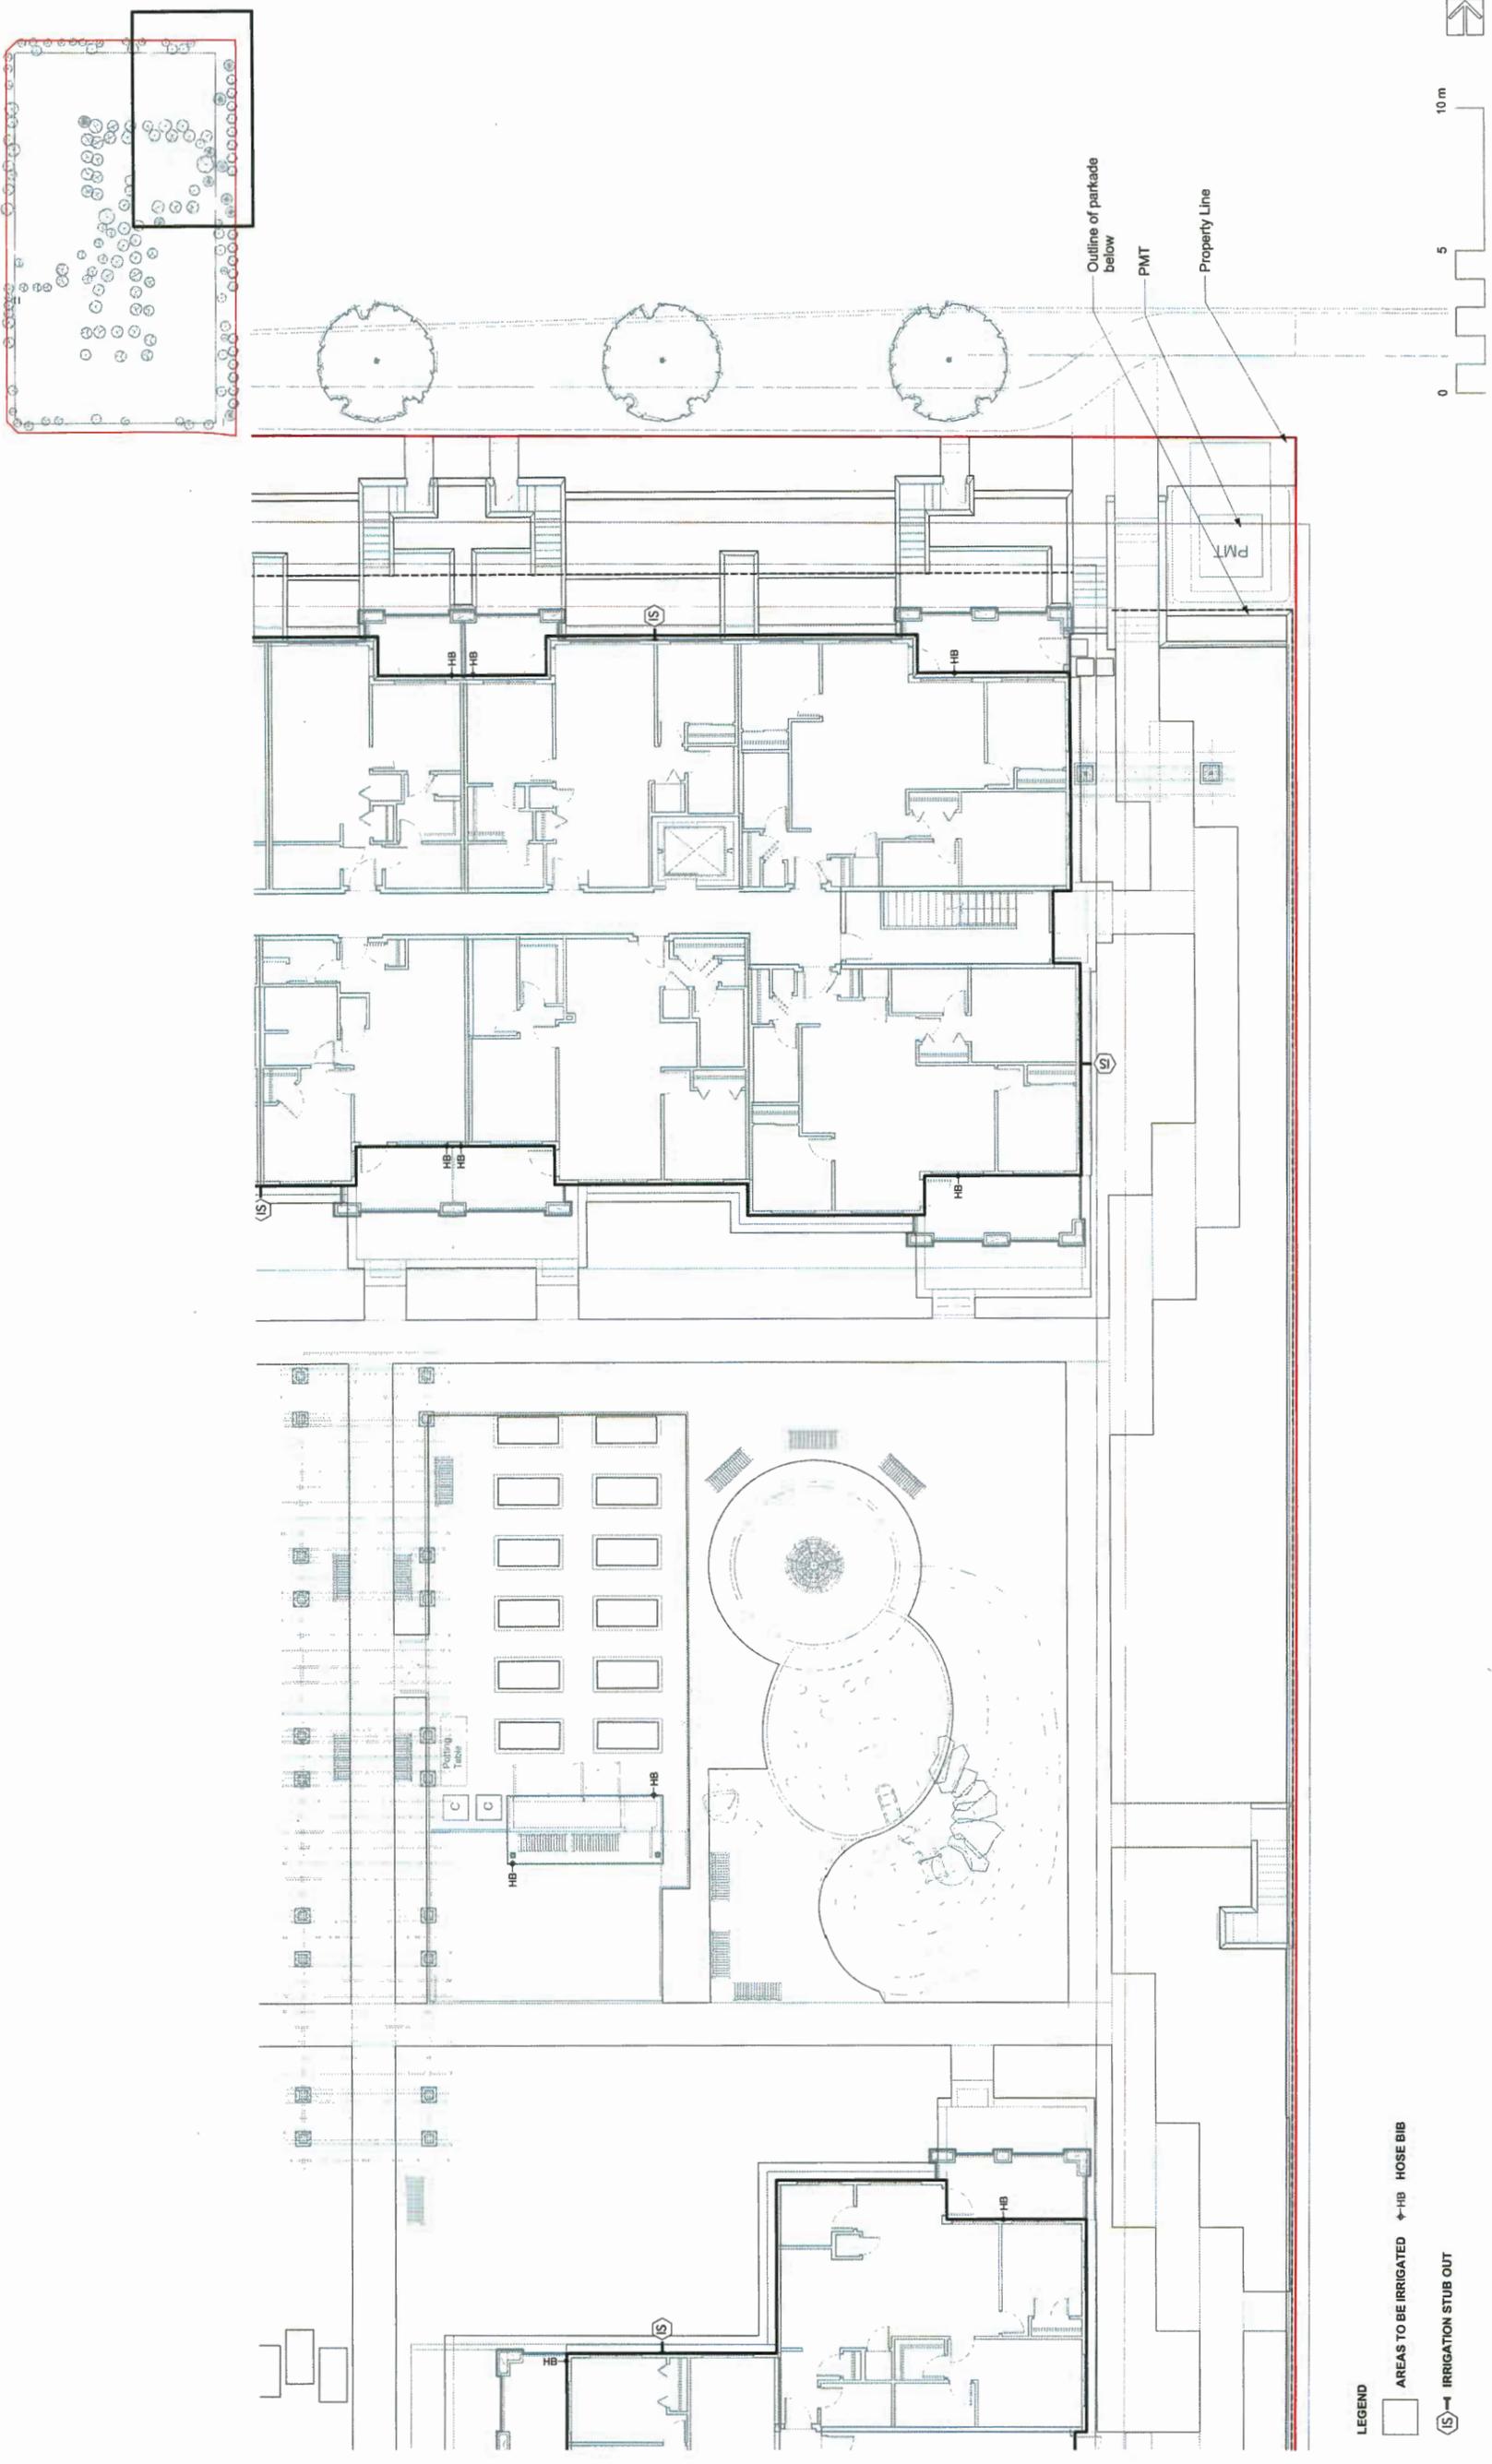

**LEGEND**  
 □ AREAS TO BE IRRIGATED  
 ← HB HOSE BIB  
 (S) IRRIGATION STUB OUT

4008 Stolberg Street

Irrigation Planning  
 Plan 4


**eta** LANDSCAPE ARCHITECTURE  
 1890 West 3rd Avenue  
 Vancouver, BC, Canada V6J 1Y4  
 | (604) 683-1456  
 | (604) 683-1459  
 | www.eta.ca

No.	Date	Revision Notes	Zone	Approvals	No.	Date	Issue Notes
C	18-9-28	Issued for RxDP addressing ADP comments					
B	18-9-20	Issued for RxDP					
A	18-8-7	Issue for ADP					

Project No. 21748  
 Date: 06/12/2017  
 Scale: 1:100  
 Drawing No. LC-8  
 of 30  
 Project Name: PM, 2016 Sep 28  
 Location: 21748 4008 Stolberg Ave

All Rights Reserved by eta landscape architecture inc. eta landscape architecture inc. is not responsible for the construction of the irrigation system. eta landscape architecture inc. is not responsible for the construction of the irrigation system. eta landscape architecture inc. is not responsible for the construction of the irrigation system.

OP 17-794280-52

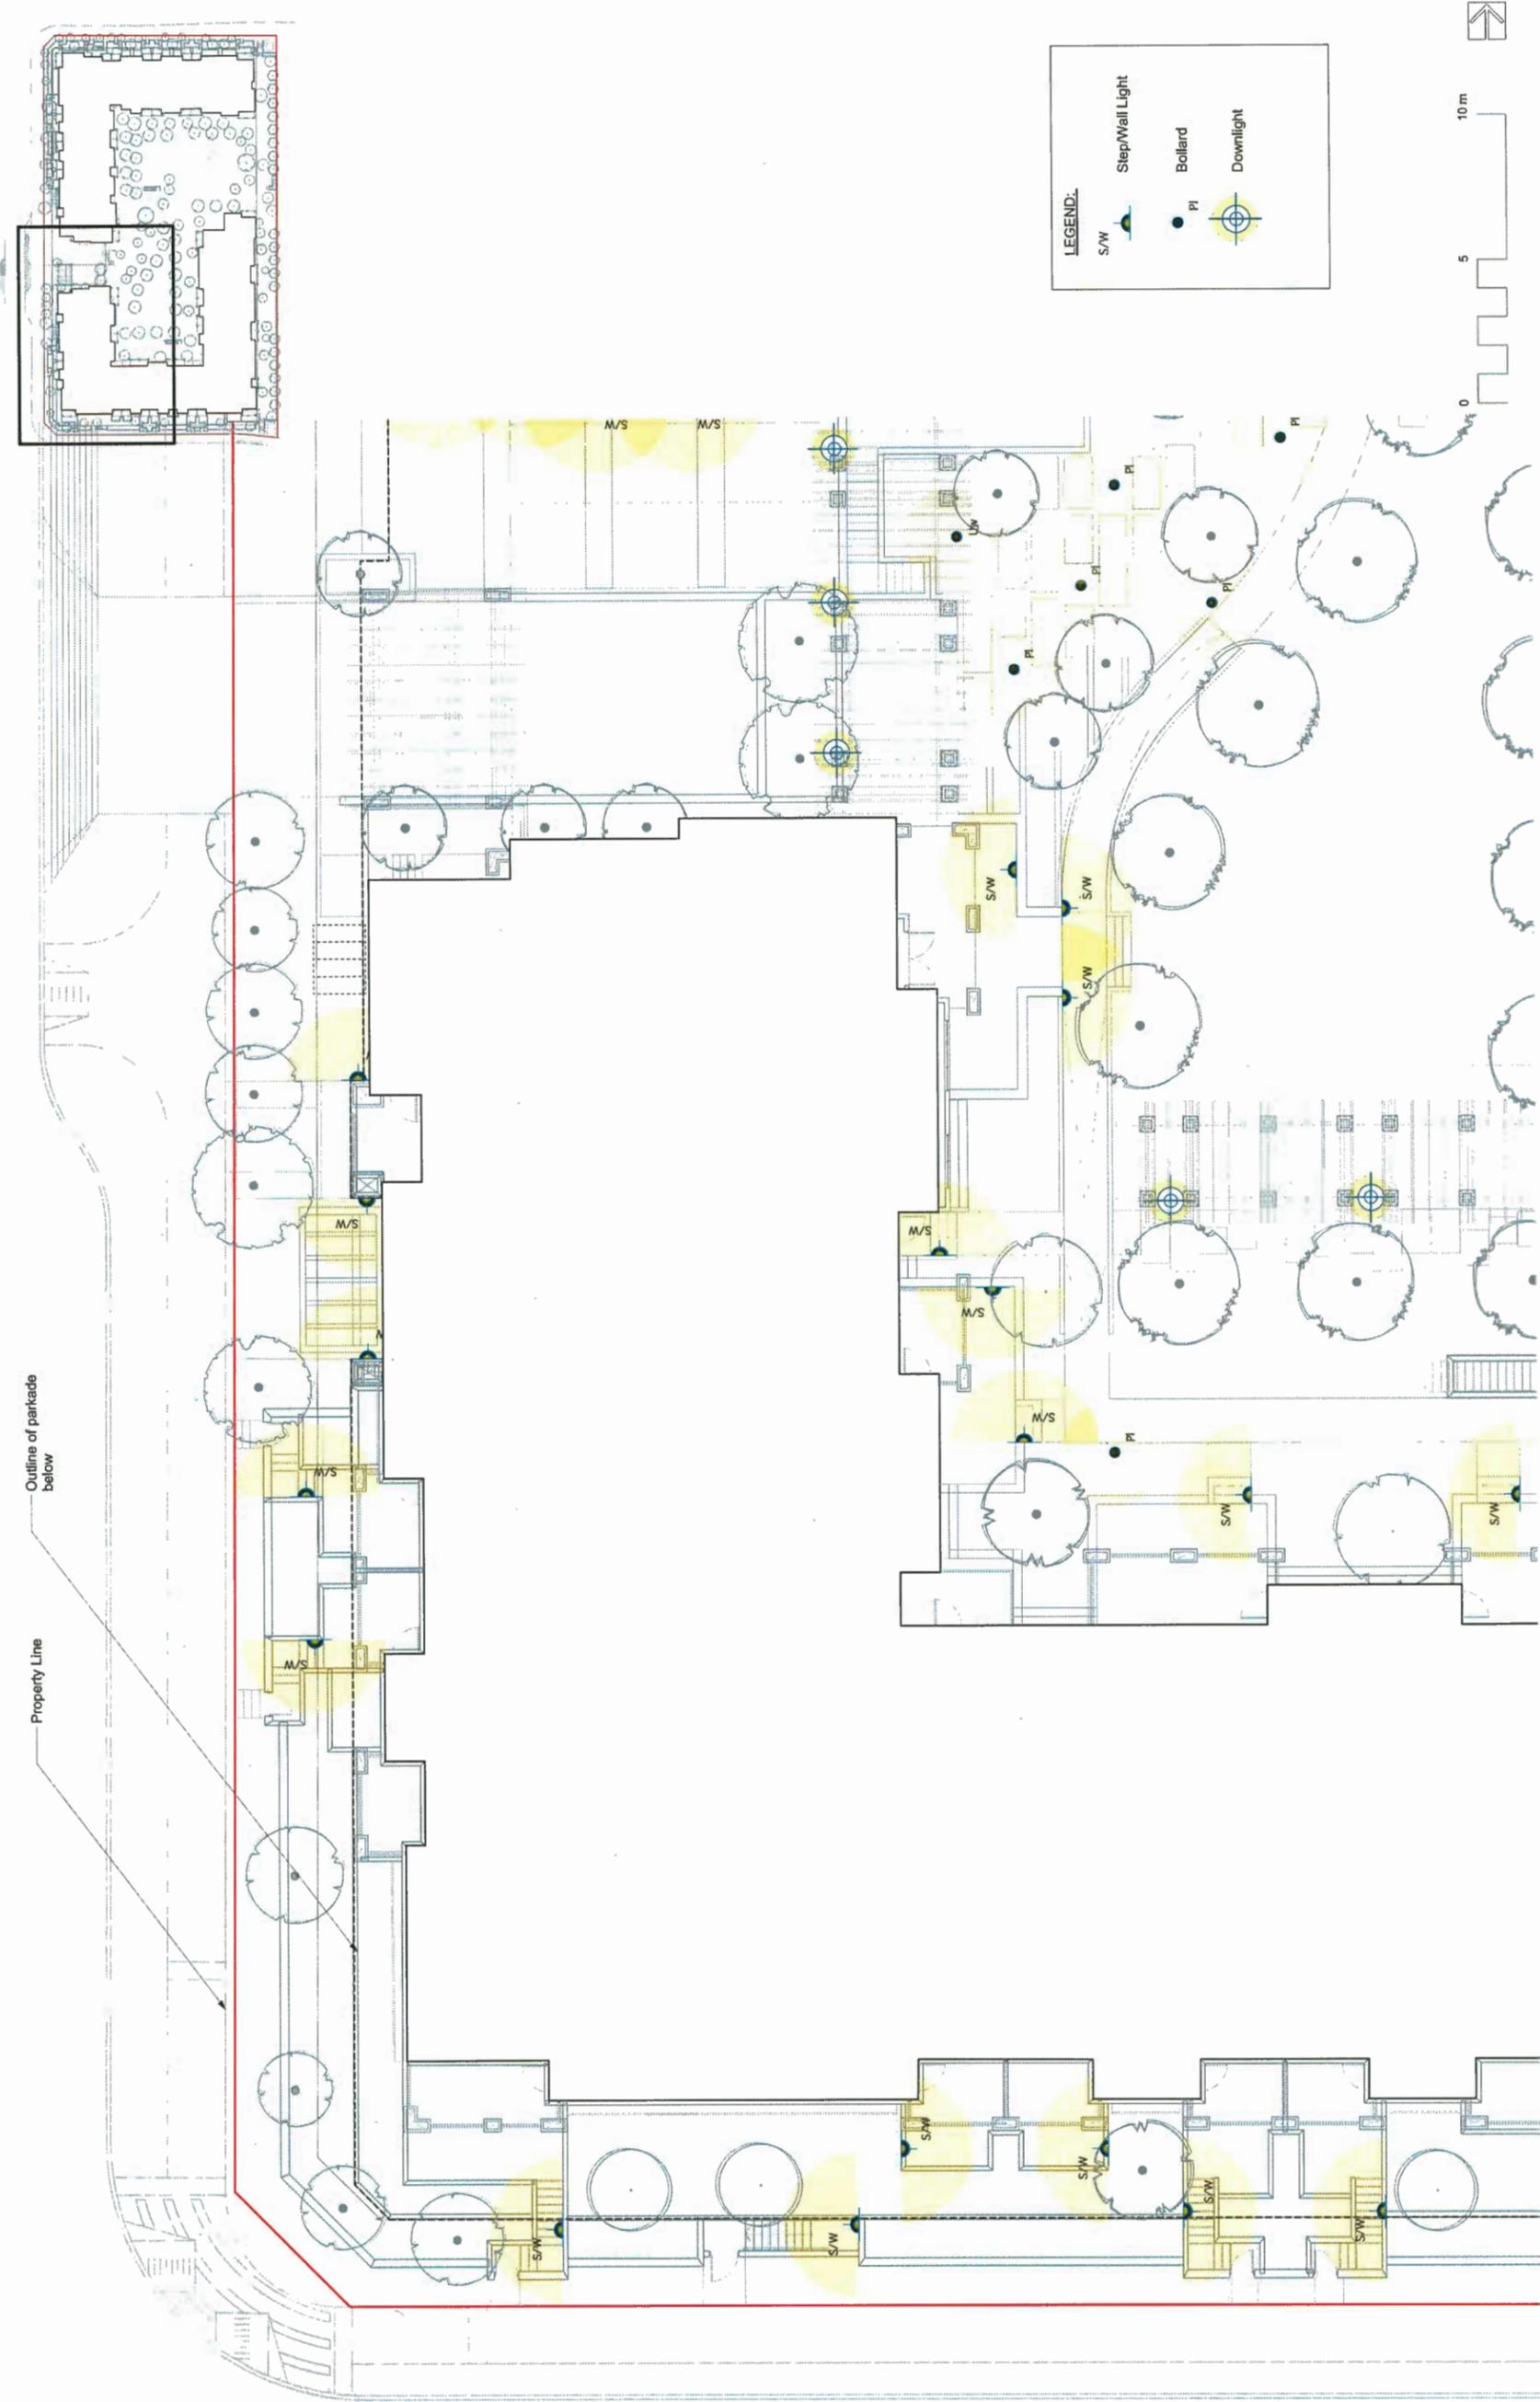

Project No: 21748  
 Project Name: 4008 Stolberg Street  
 Drawing No: Landscape Lighting Plan 1  
 Date: 06/12/2017  
 Scale: 1:100  
 Drawing By: DT  
 Checked By: DT  
 Project Manager: DT  
 Client: DT


Revision Notes:

No.	Date	Zone	Approvals	No.	Date	Issue Notes
C	18-9-28					Issued for RCP addressing ADP comments
B	18-6-20					Issued for RCP
A	18-6-7					Issue for ADP

etra landscape architecture  
 1890 West 2nd Avenue  
 Vancouver, BC, Canada, V6J 1H4  
 T | 604.683.1458  
 F | 604.683.1459  
 W | www.etra.ca


All Rights Reserved for all trademarks and/or service marks contained in this document are the property of their respective owners. The information contained in this document is for informational purposes only and is not intended to constitute an offer of any financial product or service. The information contained in this document is subject to change without notice. The information contained in this document is not intended to constitute an offer of any financial product or service. The information contained in this document is not intended to constitute an offer of any financial product or service.

Ld.1  
 of  
 30  
 DP 11-174280-53

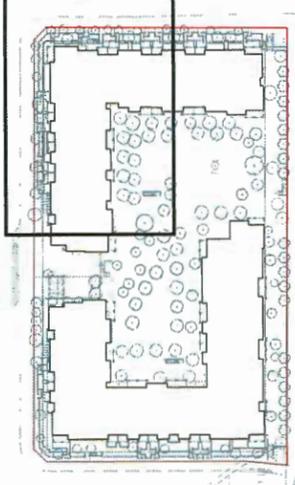

Property Line

Outline of parkade below

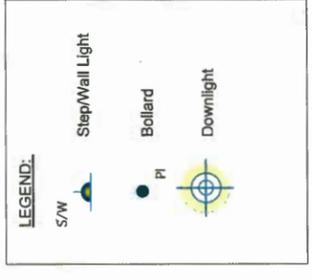

4008 Stolberg Street

landscape architecture

**eta**

1890 West 2nd Avenue  
Vancouver, BC, Canada, V6J 1H4  
T (604) 683-1456  
F (604) 683-1459  
www.eta.ca

All Rights Reserved for the Intellectual Property of the Firm. This drawing is the property of the Firm and is not to be reproduced, copied, or used in any way without the written consent of the Firm.

Landscape Lighting  
Plan 2

Issue Notes

Zone Approvals No. Date

Revision Notes

No. Date

Project No. 21748

Scale 1:100

Drawn by DT

Checked by DT

Approved by

Ld.2


of

30




Date 08/12/2017

Project Name 4008 Stolberg Street

DP 17 174280-54

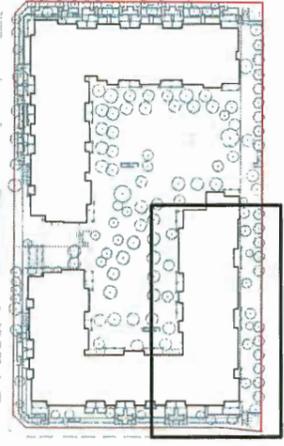

Property Line  
Outline of parkade below

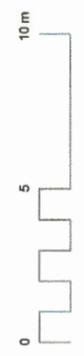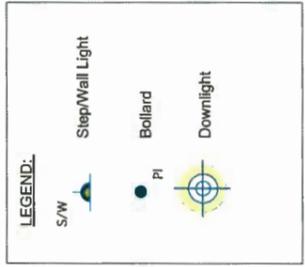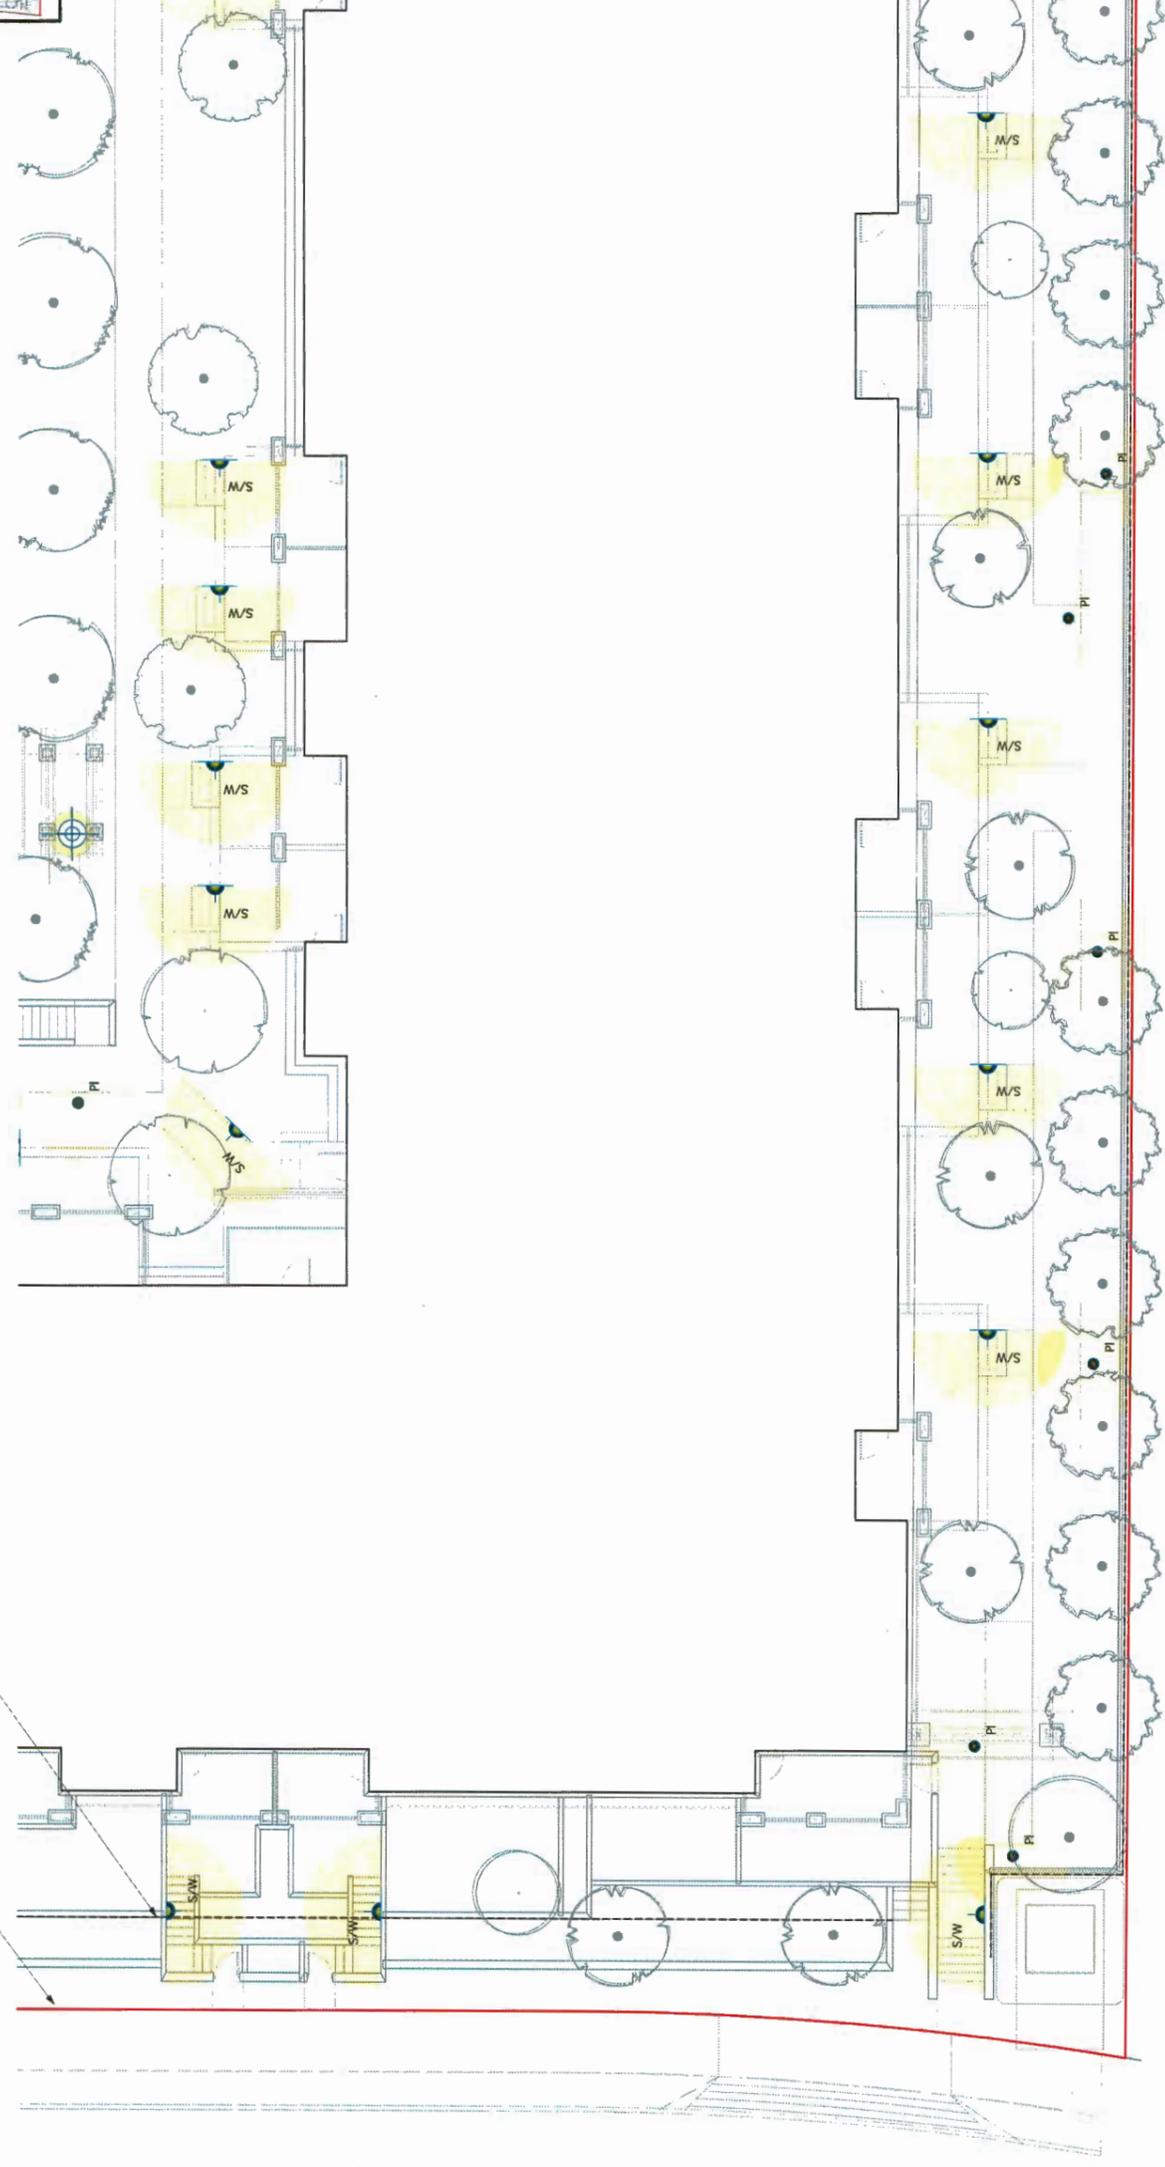

Project Title: 4008 Stolberg Street

Project No.: 21748  
 Date: 11/00  
 Drawing No.:  
 Designer:  
 Date: 06/12/2017  
 Designer: DT  
 Project: 4008 Stolberg Street

eta landscape architecture  
 1800 West 2nd Avenue  
 Vancouver, BC, Canada V6J 1H4  
 1 (604) 683-1459  
 1 (604) 683-1459  
 www.eta.ca

No.	Date	Zone	Approvals	No.	Date	Revision Notes
C	18-5-26					Issued for RfDP addressing ADP comments
B	18-5-26					Issued for RfDP
A	18-6-7					Issue for ADP

Issue Notes

Revision Notes

No. Date

Issue Notes


No. Date

Issue Notes

OP 17-794280-SS  
 Ld.3  
 of  
 30



Property Line  
Outline of parkade below

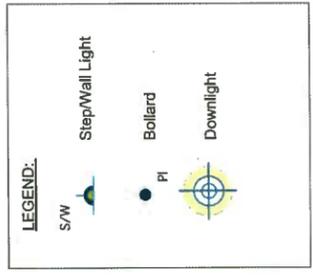

Project No. 21748  
 Drawing No. 1:100  
 Date: 08/12/2017  
 Drawn By: DT  
 Checked By: DT  
 Reviewed By: DT  
 Project: 4008 Stolberg Street  
 Drawing Title: Landscape Lighting Plan 4  
 Revision Notes:  
 C 18-9-28 Issued for RldP addressing ADP comments  
 B 18-9-20 Issued for RldP  
 A 18-6-7 Issue for ADP  
 No. Date  
 Zone Approvals No. Date  
 Issue Notes


eta landscape architecture  
 1890 West 2nd Avenue  
 Vancouver, BC, Canada V6J 1H4  
 T 604.683.1456  
 F 604.683.1459  
 www.eta.ca

Professional Engineer  
 Project No. 4008 Stolberg Street  
 Drawing Title: Landscape Lighting Plan 4  
 Date: 08/12/2017  
 Drawn By: DT  
 Checked By: DT  
 Reviewed By: DT  
 Project: 4008 Stolberg Street  
 Drawing No. 1:100  
 Issue No. 30 of 30  
 Ld.4


DP 17-174280-56



Glass cover  
3x8 rafters  
4x10" beams  
4x8" beams  
6x6" posts

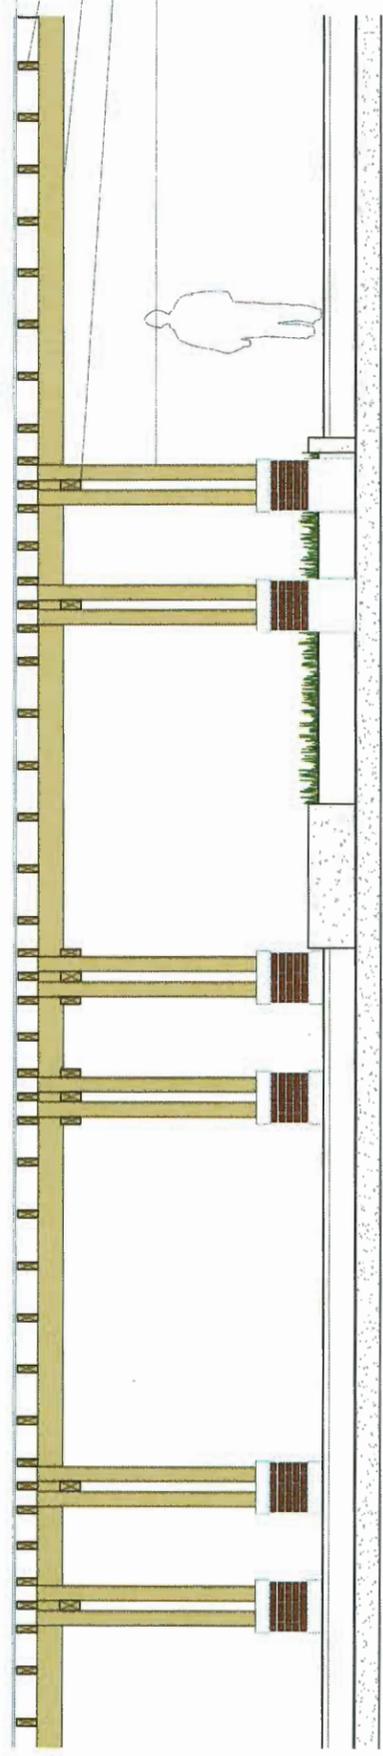


1 Section: West Courtyard and Trellis  
Scale: 3/8" = 1'-0"

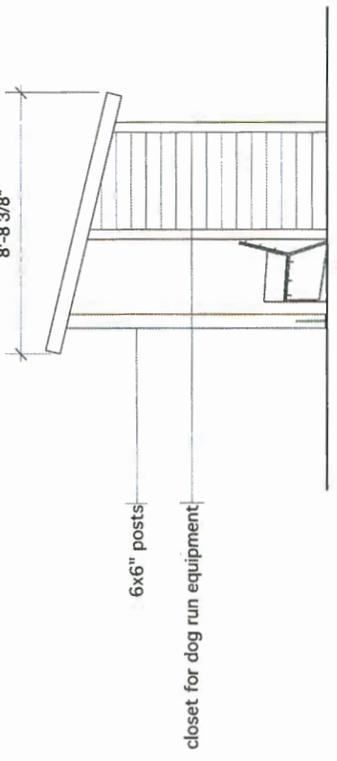

6x6" posts  
closet for dog run equipment


8'-8 3/8"

Glass cover, 5% slope  
3x6 rafters  
4x10" beams  
4x8" beams  
6x6" posts

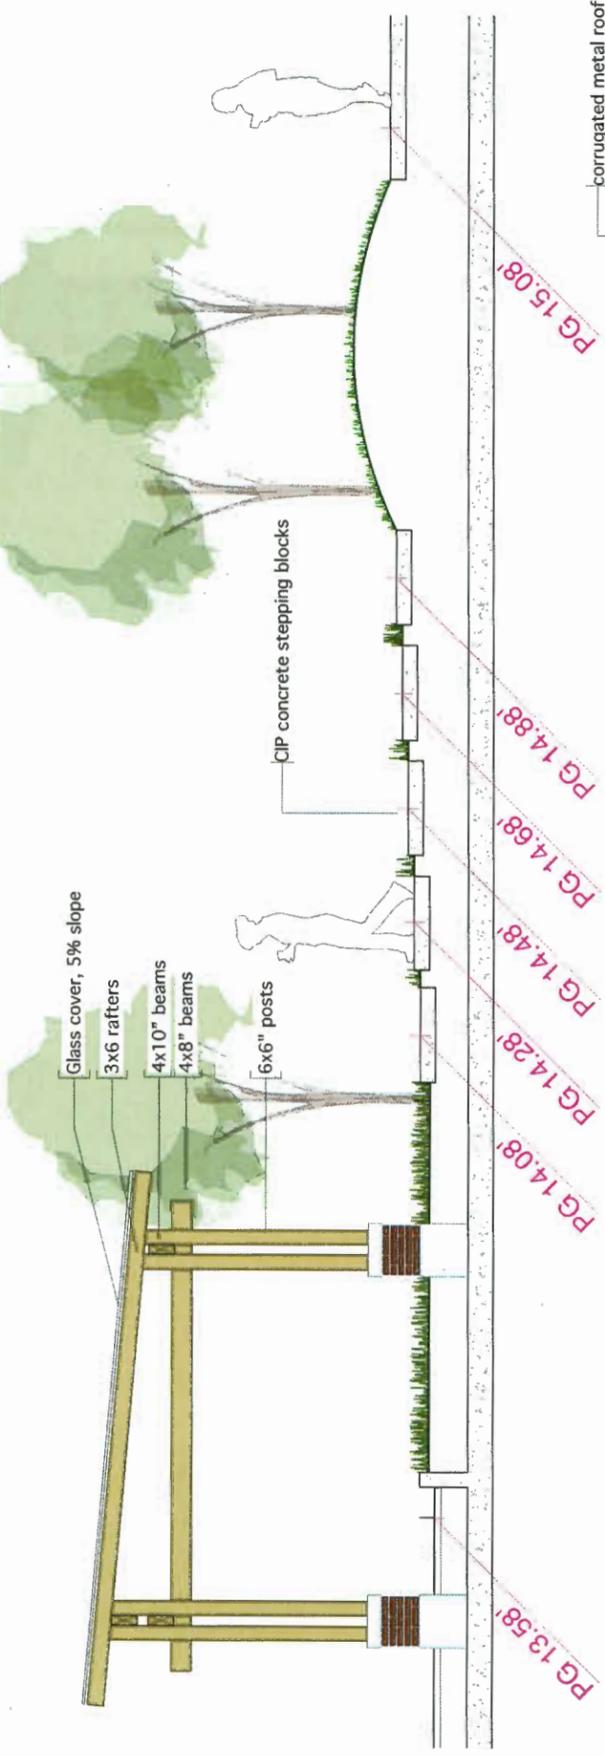

2 North Courtyard and Trellis  
Scale: 3/8" = 1'-0"


NOTE:  
Other arbours to be detailed similarly.

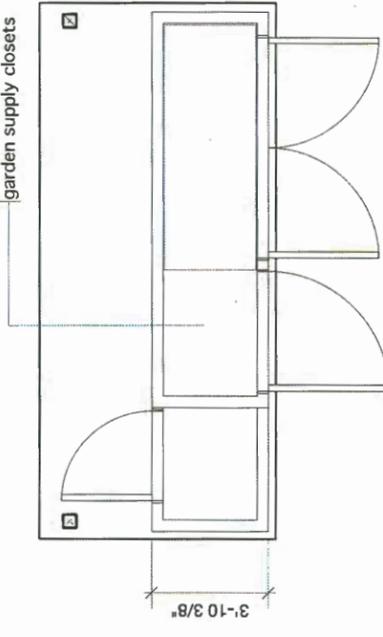

garden supply closets

3'-10 3/8"

17'-9 7/8"

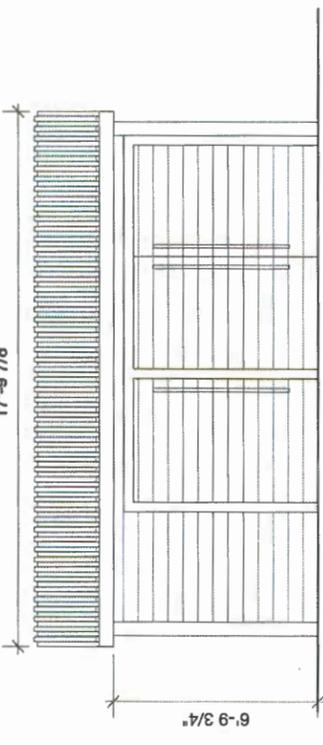

6'-9 3/4"

3 Elevation: Garden Storage Shed  
Scale: 3/8" = 1'-0"

etara landscape architecture

1890 West 2nd Avenue  
Vancouver, BC, Canada V6U 1H4  
Tel: 604.683.1456  
Fax: 604.683.1459  
www.etara.ca

18-5-26 Issued for RCP addressing ADP comments  
18-5-20 Issued for RCP  
18-6-7 Issue for ADP

No.	Date	Zone	Approvals	No.	Date	Issue Notes
C						
B						
A						

Project Site: 4008 Stolberg Street









Drawings Title: Landscape Sections


All Rights Reserved by etara landscape architecture Inc. This drawing is the property of etara landscape architecture Inc. and is not to be reproduced, stored in a retrieval system, or transmitted in any form or by any means, electronic, mechanical, photocopying, recording, or by any information storage and retrieval system, without the prior written permission of etara landscape architecture Inc.

Project Manager: DT  
Designer: DT  
Drawings No.:


Date: 06/12/2017  
Project: 171474200 - 58  
Drawing No. 30

DP 171474200-58

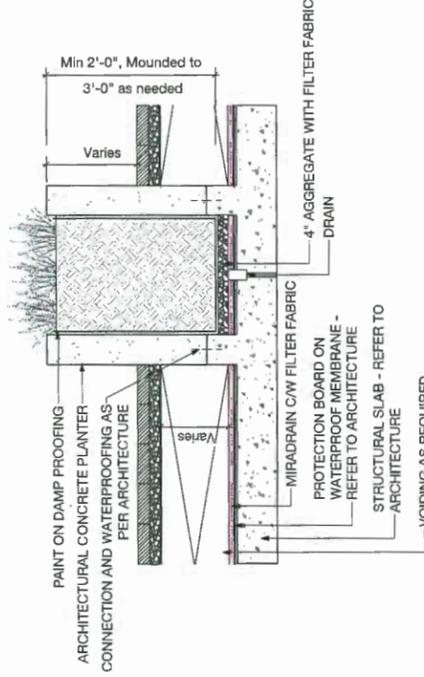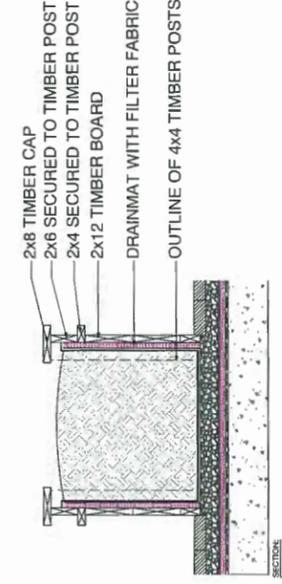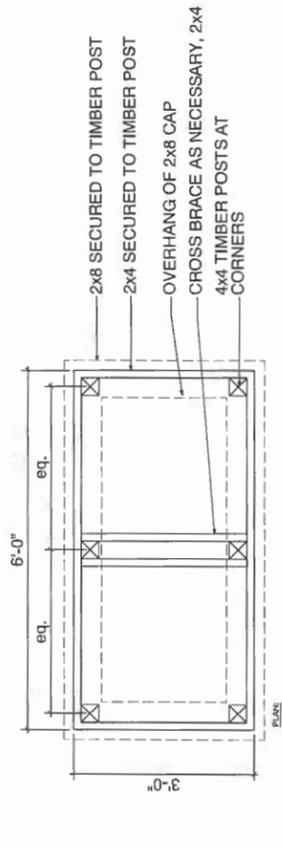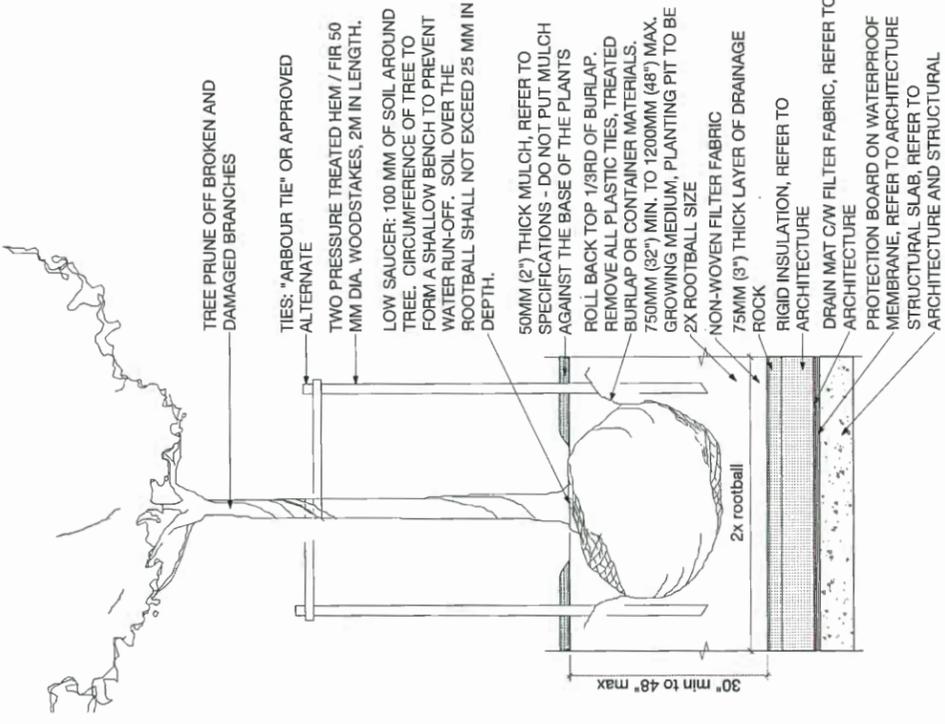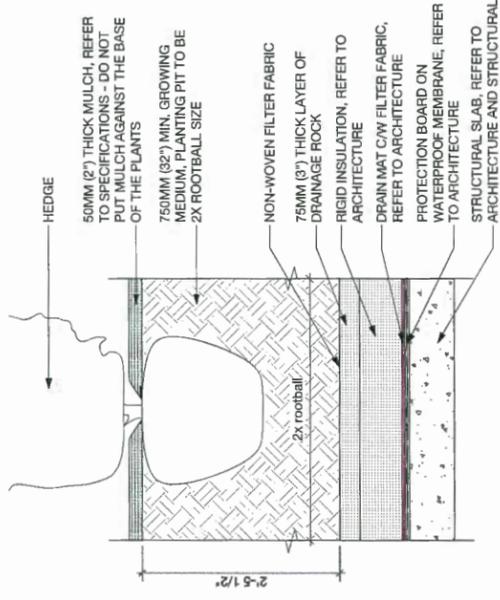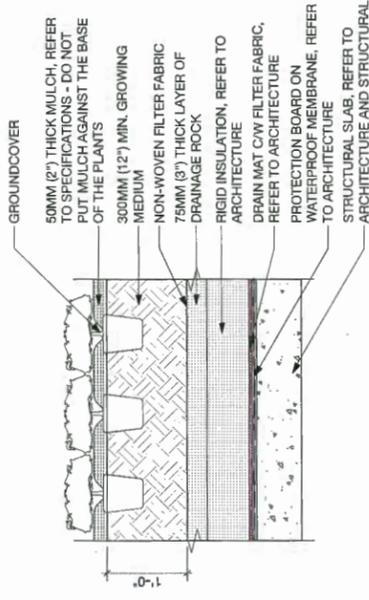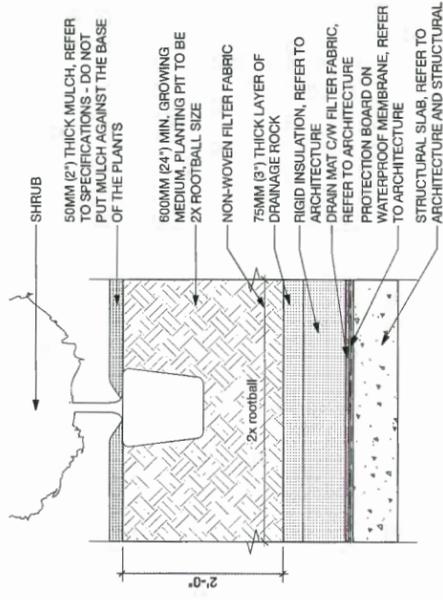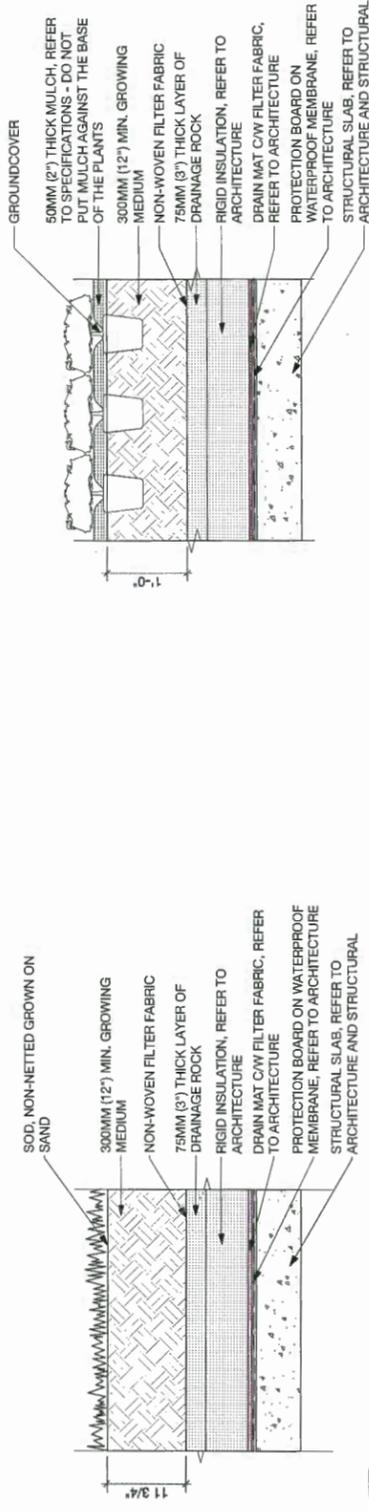


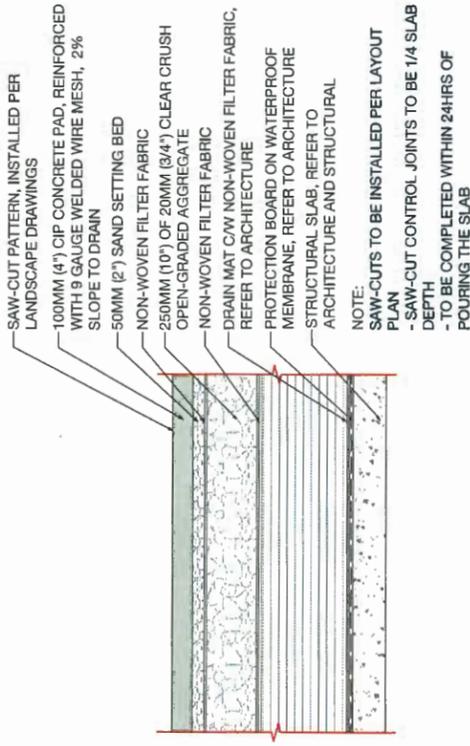


1 Detail: Pedestrian Concrete on Slab, No Insulation  
Scale: 3/4" = 1'-0"

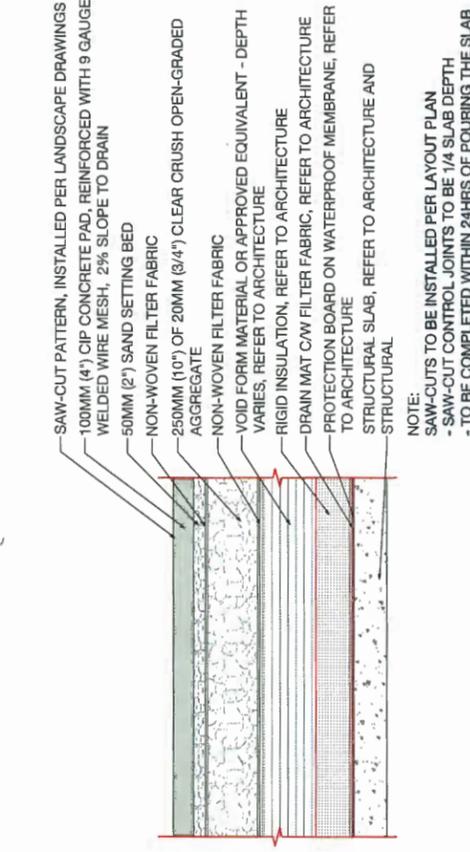


2 Detail: Pedestrian Concrete on Slab, on Insulation  
Scale: 3/4" = 1'-0"

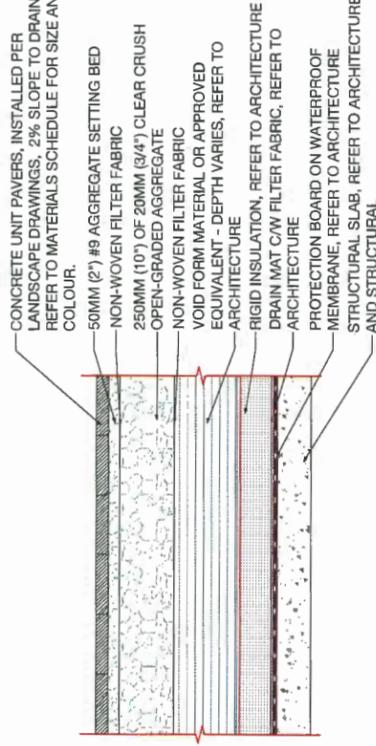


3 Detail: Pedestrian Unit Paver Concrete on Slab, No Insulation  
Scale: 3/4" = 1'-0"

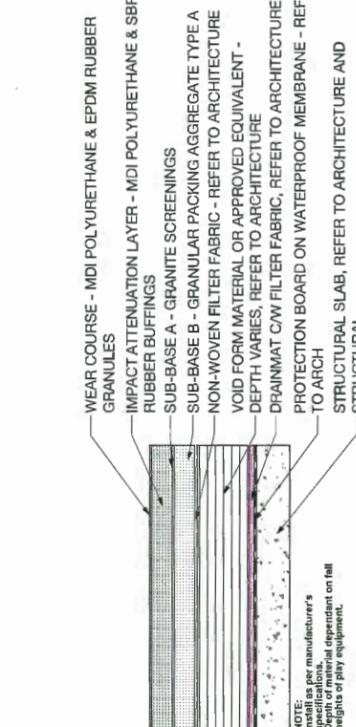


4 Detail: Drip Strip  
Scale: 3/4" = 1'-0"

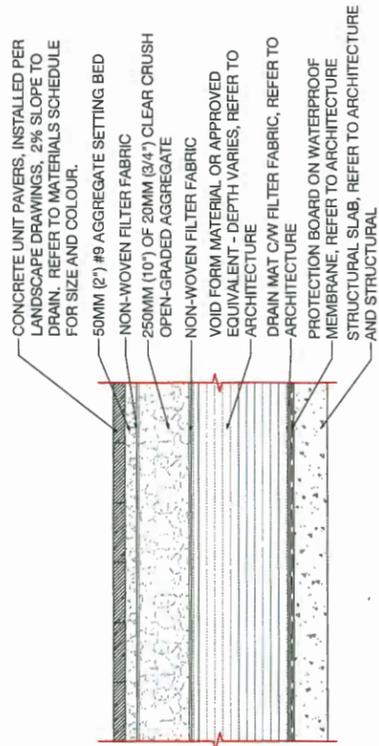


5 Detail: Pedestrian Unit Paver Concrete on Slab, No Insulation  
Scale: 3/4" = 1'-0"

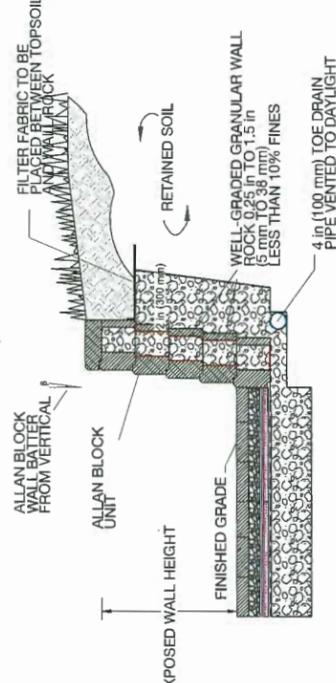


6 Detail: Allan Block Wall  
Scale: 3/4" = 1'-0"

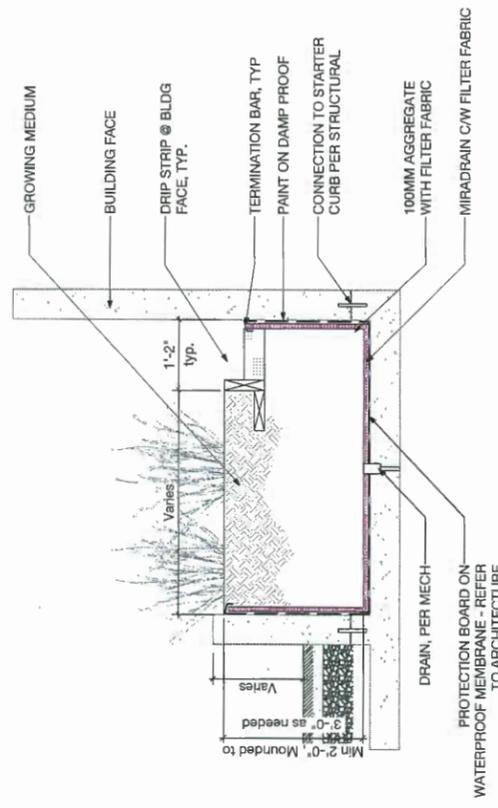


7 Detail: Drip Strip  
Scale: 3/4" = 1'-0"

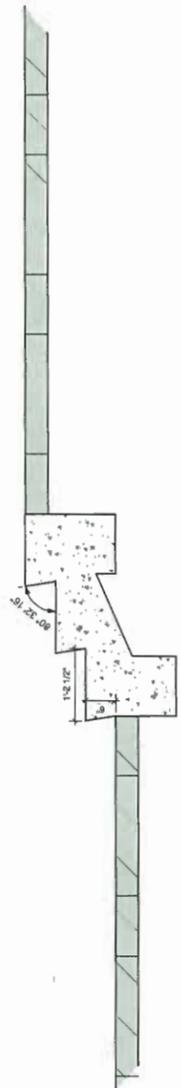


8 Detail: Stairs  
Scale: 3/4" = 1'-0"

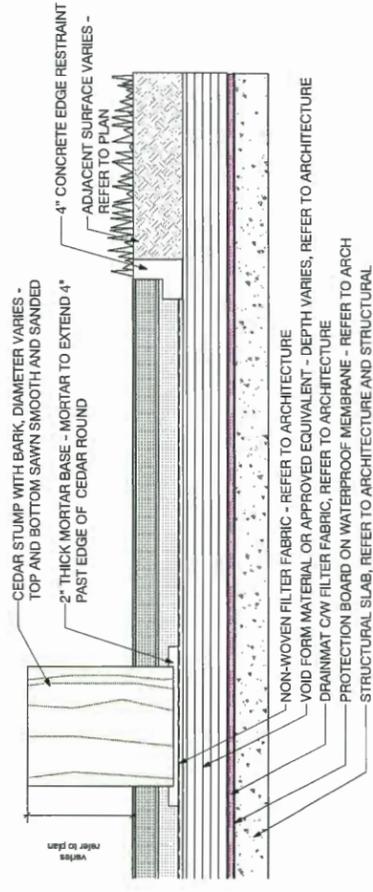


3 Detail: Pour-In-Place Resilient Surfacing w/ Cedar Stump and Edge Restraint  
Scale: 3/4" = 1'-0"

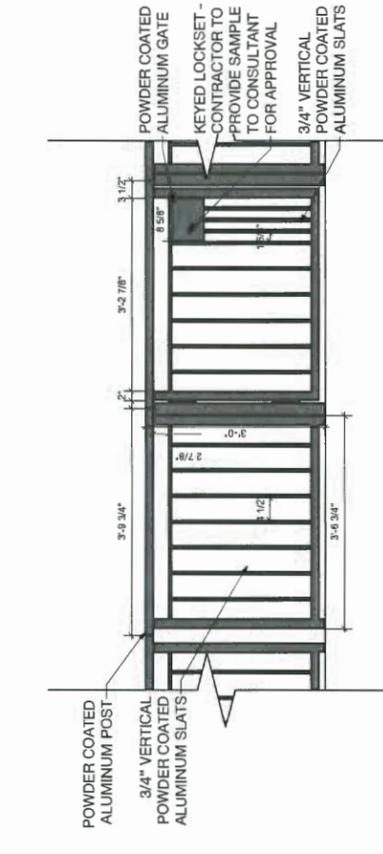


4 Detail: Aluminum Fence w/ Gate  
Scale: 3/4" = 1'-0"

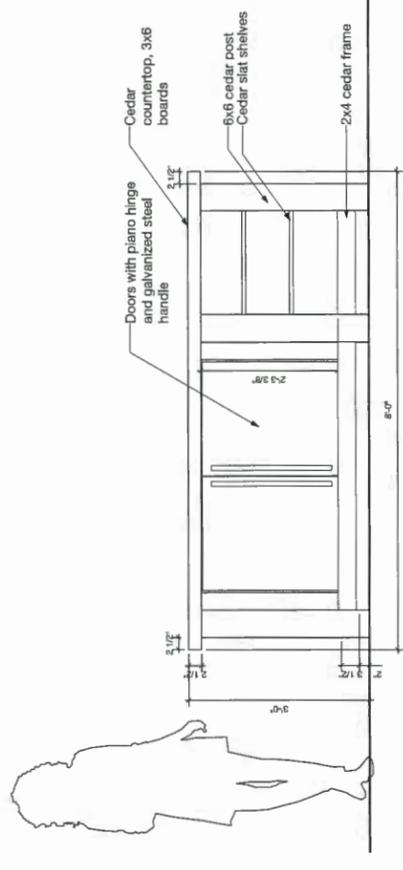


5 Detail: Potting Table  
Scale: 3/4" = 1'-0"

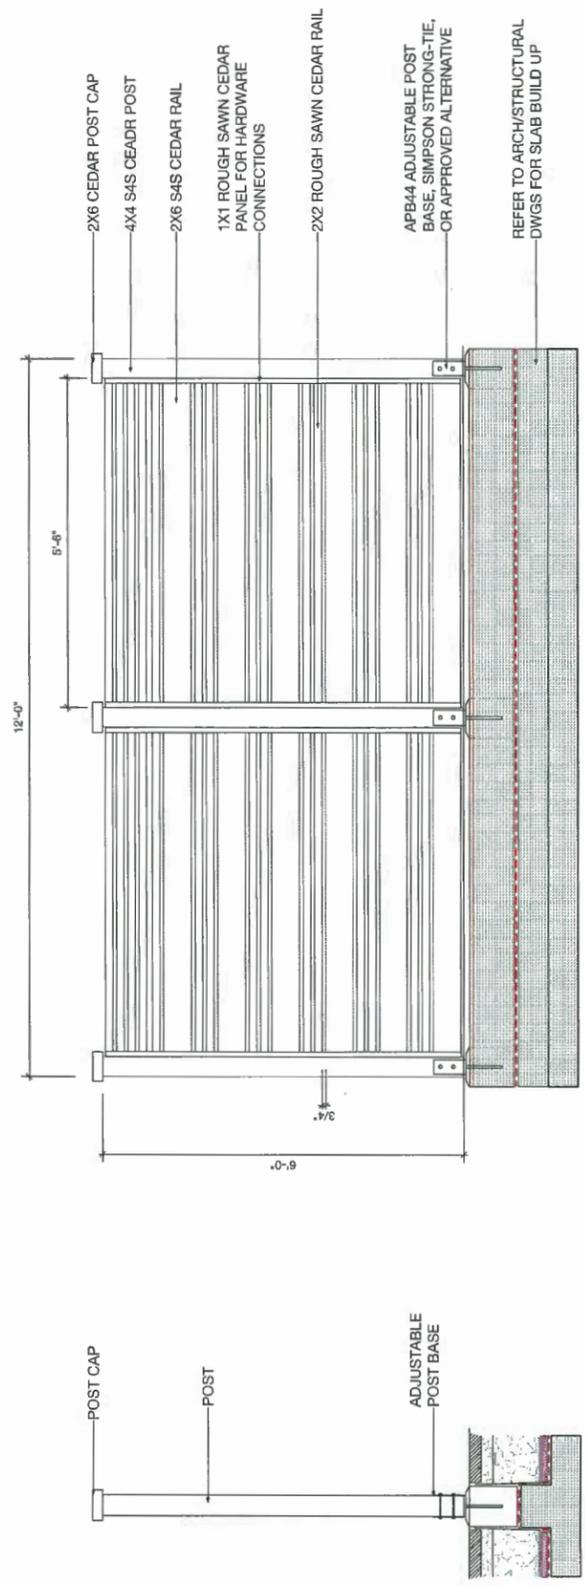


7 Detail: Western Red Cedar Screen Fence  
Scale: 3/4" = 1'-0"

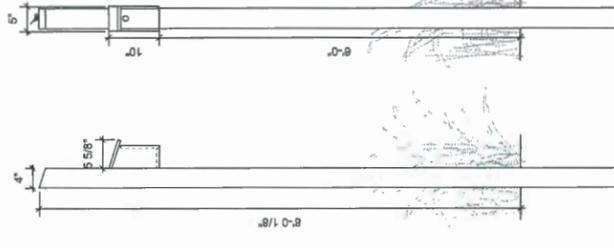

6 Detail: Bird Houses  
Scale: 3/4" = 1'-0"

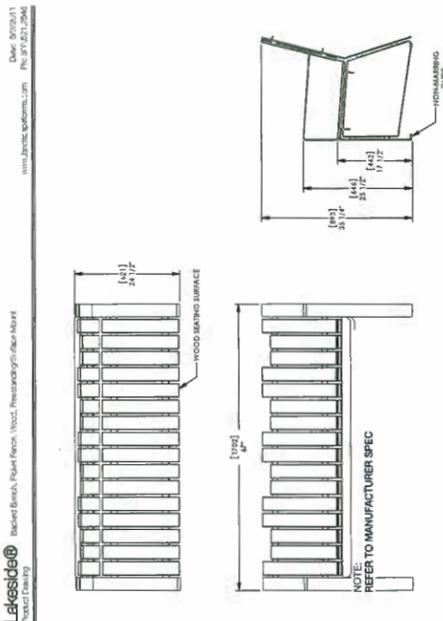

8 Detail: Lakeside Bench  
Scale: 3/4" = 1'-0"

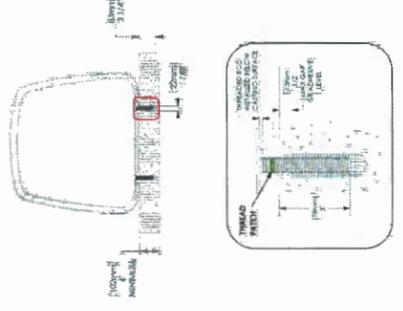

9 Detail: Ride Bike Rack  
Scale: 3/4" = 1'-0"

COPYRIGHT RESERVED. THIS DRAWING MUST NOT BE REPRODUCED OR TRANSMITTED IN ANY FORM OR BY ANY MEANS, ELECTRONIC OR MECHANICAL, INCLUDING PHOTOCOPYING, RECORDING, OR BY ANY INFORMATION STORAGE AND RETRIEVAL SYSTEM, WITHOUT THE WRITTEN PERMISSION FROM THE ARCHITECTS. THIS DRAWING IS THE EXCLUSIVE PROPERTY OF CICOZZI ARCHITECTURE INC. AND CAN BE REPRODUCED ONLY WITH THEIR WRITTEN PERMISSION.

NO.	DATE	DESCRIPTION

DATE	DESCRIPTION
22.02.2017	DP SUBMISSION
06.04.2016	PARTIAL DP REVISION
12.05.2016	DP REVISION
06.06.2016	RE-SIGNED POE DP
26.09.2016	RE-SIGNED POE DP

NO.	DATE	DESCRIPTION

**CICOZZI**  
ARCHITECTURE  
200 - 2339 COLUMBIA STREET  
VANCOUVER, B.C.  
CANADA V5Y 3Y3  
TEL: (604) 687-4741

PROJECT  
**RESIDENTIAL DEVELOPMENT**  
400864018 STOLBERG ST  
RICHMOND, BC

DATE	2/10/20
SCALE	1/1000
PROJECT NO.	564
CHECKED BY	BC
DRAWN BY	
SHEET TITLE	CONTEXT PHOTOS

REVISION NO.	-
SHEET NO.	AO.1



LOOKING SOUTH - WEST FROM CAMBIE ROAD



LOOKING SOUTH - WEST FROM CAMBIE ROAD



LOOKING SOUTH - EAST FROM CAMBIE ROAD



LOOKING SOUTH - EAST FROM CAMBIE ROAD



LOOKING SOUTHEAST FROM CAMBIE ROAD




LOOKING SOUTH FROM STOLBERG STREET



LOOKING NORTH - EAST FROM CAMBIE ROAD



LOOKING WEST FROM CAMBIE ROAD

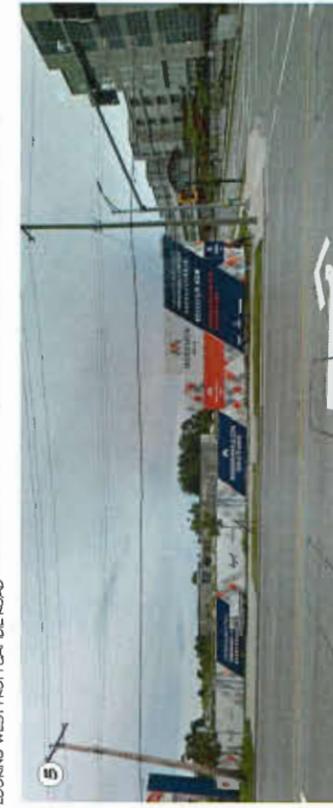

LOOKING SOUTH FROM CAMBIE ROAD



SITE CONTEXT & VICINITY PLAN



DP 11-194280 - Reference