



City of Richmond

Report to Development Permit Panel

To: Development Permit Panel

Date: April 15, 2019

From: Wayne Craig
Director, Development

File: DP 17-792077

Re: **Application by Konic Development for a Development Permit at
9851, 9891 Steveston Highway and 10931 Southgate Road**

Staff Recommendation

That a Development Permit be issued which would:

1. Permit the construction of 11 townhouses at 9851, 9891 Steveston Highway and 10931 Southgate Road on a site zoned “Low Density Townhouses (RTL4)”; and
2. Vary the provisions of Richmond Zoning Bylaw 8500 to:
 - a) Allow seven resident vehicle parking spaces to be small-sized; and
 - b) Reduce the minimum front yard on Southgate Road and the exterior side yard on Steveston Highway from 6.0 m to 5.0 m.



Wayne Craig

Director, Development
(604-247-4625)

WC:cl

Att. 3

Staff Report

Origin

Konic Development has applied to the City of Richmond for permission to develop 11 townhouses at 9851, 9891 Steveston Highway and 10931 Southgate Road on a site zoned “Low Density Townhouses (RTL4)”, with vehicle access from Steveston Highway (Attachment 1). The site is currently vacant.

The site is being rezoned from the “Single Detached (RS1/E)” zone to the “Low Density Townhouses (RTL4)” zone for this project under Bylaw 9659 (RZ 10-552879). The Bylaw was given Third Reading at the Public Hearing held on March 20, 2017, and the applicant is working to complete all of the Rezoning considerations.

Off-site works required as part of the proposed development include boulevard and storm sewer upgrades along Steveston Highway and Southgate Road, which will be undertaken as part of a Servicing Agreement to be entered into prior to issuance of a Building Permit.

Development Information

Please refer to the attached Development Application Data Sheet for a comparison of the proposed development data with the relevant Bylaw requirements (Attachment 2).

Background

Existing development immediately surrounding the subject site is as follows:

- To the north, are single-family dwellings fronting Southgate Road and Southgate Place on lots zoned “Single Detached (RS1/E)”.
- To the south, immediately across Steveston Highway, are large lots zoned “Agriculture (AG1)” that are in the Agricultural Land Reserve (ALR) at 9660 Steveston Highway and 11111 No. 4 Road, one of which contains a single detached dwelling.
- To the east, immediately across Southgate Road, is a small commercial plaza on lots zoned “Community Commercial (CC)” and “Gas and Service Station (CG2)” at 10811 and 10991 No. 4 Road, which contain a group daycare/preschool, a learning centre, and a carwash/oil change facility.
- To the west, is an existing dwelling on a lot zoned “Single Detached (RS1/E)” at 9835 Steveston Highway.

Rezoning and Public Hearing Results

During the rezoning process, staff identified the following design issues to be resolved at the Development Permit stage:

- Showing finalized locations for aboveground utility infrastructure required to service the proposed development.
- Addressing transitions in lot grading at the property lines within tree protection zones.

- Enhancing on-site permeability and highlighting the drive-aisle's dual-purpose for both vehicle and pedestrian circulation through the use of varied materials.
- Refinement to landscape design as it relates to tree sizes, abundance of shrubs/ground cover on-site along Steveston Highway, and providing clearance next to visitor parking.
- Improvements to upper storeys and roof forms where the buildings step down to two-storeys.
- Design development to further articulate facades and break up the building mass.
- Review of the proposed colour palette and exterior building materials.
- Demonstrating that all of the relevant accessibility features are incorporated into the design of the proposed Convertible Unit, and that aging-in-place features will be incorporated into all units.
- Reviewing the applicant's design response to the principles of Crime Prevention Through Environmental Design (CPTED).

Through the review of this Development Permit application, staff has worked with the applicant to address these issues to staff satisfaction and to ensure that the proposed architectural form and character is consistent with the design guidelines contained within the Official Community Plan (OCP). The applicant has made the following modifications to their proposal to address the urban design issues identified:

- The location for the aboveground utility infrastructure required to service the townhouses are demonstrated on the Site Plan and have been confirmed to be acceptable by the private utility service providers. Impact of the infrastructure on the public realm is minimized by locating the Shaw and Telus kiosks in an enclosed electrical room on-site, and through proposed landscaping/screening for the hydro kiosk at the east end of the internal drive-aisle.
- Significant effort and review was undertaken by the applicant, the project Arborist, and City staff of the proposed lot grading in tree protection zones at shared property lines to arrive at an acceptable outcome (i.e., using a terraced approach to maintaining the lot grade in the tree protection zone for Tree # 11 to the northwest at 9835 Steveston Highway, while using permeable pavers and varied layers of bedding course and sub-base in the tree protection zone of Tree # 7 to the northeast, shared with 10911 Southgate Road).
- On-site permeability has been enhanced with the expanded use of permeable pavers over the internal drive-aisle from the site entry all the way to the central outdoor amenity space to highlight its' shared use for both vehicle and pedestrian circulation.
- The landscape design has been refined to include a mix of deciduous and coniferous trees of various sizes, the height and abundance of shrubs on-site along Steveston Highway has been clarified, and shrubs have been removed next to visitor parking spaces to ensure adequate clearance for door opening.
- Design improvements have been made to upper storeys and roof forms where the buildings step down to two-storeys, to reflect a more subtle transition.

- Significant design development has been made to provide façade articulation and break up the building mass such that each individual unit is well-defined.
- The proposed material and colour scheme has been enhanced, is of a high-quality and will be compatible with that of adjacent single-family development.
- Aging-in-place features are proposed in all units, as noted on the plans, and the Convertible Unit proposed at the west end of Building A is designed to meet all of the guidelines in the Official Community Plan (OCP).
- Information on how the proposal responds to the principles of CPTED is summarized in the “Analysis” section below.

The Public Hearing for the rezoning of this site was held on March 20, 2017. At the Public Hearing, the neighbouring property owner at 10911 Southgate Road raised questions regarding the expected timeframe for the start of construction, when the applicant would attempt to contact the neighbouring property owner, and whether the joint consent of neighbouring property owners is required to remove trees.

In response to the neighbour’s questions, staff advised that if a tree is jointly owned, the joint consent is required for tree removal. The applicant also identified that construction would begin as soon as all permits are obtained, and that action was taken in January, 2017 to enquire about the owner’s interest in selling their property and to advise of the development plans in the event that the owner did not wish to sell.

Bylaw 9659 for the rezoning of the subject site was given Third Reading at the Public Hearing.

Following Third Reading of Bylaw 9659 and to enable demolition of the dwellings on the subject site, a valid Tree Removal Permit was obtained in June 2017 to remove of the trees agreed-upon during the Rezoning Application review process, including removal of the two trees on the shared property line of the subject site and 10911 Southgate Road.

The applicant has since reached out to the property owners at 10911 Southgate Road to provide an update on the anticipated timeline for construction on-site and to address any concerns they may have. City staff has not received further correspondence from the neighbouring property owner at 10911 Southgate Road in response to the Development Permit application.

Staff Comments

The proposed scheme attached to this Report (Plans # 1.a to # 4.f, and Reference Plans) has satisfactorily addressed the significant urban design issues and other staff comments identified as part of the review of the subject Development Permit application. In addition, it complies with the intent of the applicable sections of the OCP and is generally in compliance with the “Low Density Townhouses (RTL4)” zone, except for the zoning variances noted below.

Zoning Compliance/Variances (staff comments in *bold italics***)**

As identified at Rezoning stage, the applicant requests to vary the provisions of Richmond Zoning Bylaw 8500 to:

- a) Allow seven resident vehicle parking spaces to be small-sized.

Staff is supportive of this variance for the following reasons:

- *Richmond Zoning Bylaw 8500 allows small car parking spaces (up to a maximum of 50%) where more than 31 parking spaces are proposed on-site. The City's Transportation Department staff support the proposed variance as the seven small car parking spaces (approximately 32 %) meet the intent of the Zoning Bylaw as it would otherwise comply if the proposed parking contained more than 31 spaces. Also, the use of the small car parking spaces enables all of the required resident parking spaces to be provided in a side-by-side arrangement within the garages of each unit.*

- b) Reduce the minimum front yard on Southgate Road and the exterior side yard on Steveston Highway from 6.0 m to 5.0 m.

Staff is supportive of this variance request for the following reasons:

- *A reduction in the building setback from the south property line along Steveston Highway and from the east property line along Southgate Road enables wider setback to be provided from the north and west property lines, resulting in a more sensitive interface with the existing single-family housing to the north and west.*
- *The frontage improvements along both Steveston Highway and Southgate Road that are required with rezoning enable a more desirable boulevard alongside the street-fronting units, complete with grass and trees between the property line and the existing curb of the road, as compared with the current condition along these frontages. The resulting distance between the curb of Steveston Highway and the building face is approximately 9.0 m, and approximately 9.5 m between the curb and building face on Southgate Road. Prior to final adoption of the rezoning bylaw, a restrictive covenant is required to be registered on title to ensure that noise attenuation is required to be incorporated into dwelling unit design and construction. The applicant has submitted an acoustical and thermal report and recommendations, prepared by a registered professional, confirming that dwelling unit design complies with the Canadian Mortgage and Housing Corporation (CMHC) guidelines for interior noise levels and the ASHRAE 55-2004 "Thermal Environmental Conditions for Human Occupancy" standard for interior living spaces.*
- *The proposal maintains consistency with the private outdoor space guidelines in the OCP through the provision of larger yards for all units as well as the provision of additional private outdoor spaces in the form of uncovered decks off the main living area on the second floor of some of the units.*

Advisory Design Panel Comments

The Advisory Design Panel review of the proposal was held on December 20, 2018, and was supported to move forward to the Development Permit Panel subject to the applicant giving consideration to the comments identified at the meeting. A copy of the relevant excerpt from the Advisory Design Panel Minutes is attached for reference (Attachment 3). The design response from the applicant has been included immediately following the specific Advisory Design Panel comments and is identified in '***bold italics***'.

Analysis

Conditions of Adjacency

- The proposed townhouses at the subject site are designed with consideration of the adjacent single-family context to the north and west.
- The proposed buildings along the interface with the rear yards of adjacent single-family lots (Buildings C and D) are a maximum of two-storeys in height and are in a duplex form.
- The proposed three-storey buildings along Steveston Highway (Buildings A and B) have been designed to step down to two-storeys along the interface with the side yard of adjacent single-family lots, and the physical separation to the adjacent single-family lot to the north is at least 6.7 m due to the proposed east-west drive-aisle.
- The applicant has provided a preliminary concept showing how the property at 10911 Southgate Road could redevelop for townhouses in the future, a copy of which is on file. To enable potential future shared use of facilities at the subject site by 10911 Southgate Road, legal agreements for public access over the entire drive-aisle and shared access to the garbage and recycling room are required to be registered on title prior to rezoning.
- Consistent with the OCP guidelines for sites located across an intervening road from ALR lands, a legal agreement is required to be registered on title prior to rezoning to secure a 4.0 m wide landscape buffer on-site (as measured from the south property line) along the Steveston Highway frontage and to indicate that the subject site is potentially subject to impacts of noise, dust, and odour resulting from active agricultural operations.

Site Planning, Access, and Parking

- This proposal is to develop 11 townhouse units on a site that will be approximately 2,506 m² (26,980 ft²) in area after the required corner cut road dedication.
- The proposed site layout consists of:
 - Two buildings on the south portion of the site along Steveston Highway, which are three-storeys in height, each stepping down to two-storeys at either end (Buildings A and B).
 - Two duplex buildings on the north portion of the site, which are two-storeys in height (Buildings C and D).
 - An east-west internal drive-aisle that bisects the site.

- The siting of the buildings enables:
 - The common outdoor amenity space to be provided in a visible and centrally-located portion of the site opposite the main vehicle access point.
 - Easier on-site vehicle manoeuvring.
 - A treed and landscaped yard along Southgate Road, which provides for a more visually interesting public realm.
- Site access was reviewed as part of the Rezoning Application review process and supported by the City's Transportation Department. A single vehicle access point to the site is proposed from Steveston Highway, and is positioned approximately mid-block. The proposed townhouse development is anticipated to generate a manageable amount of traffic that can be accommodated within the existing geometry and capacity of the adjacent road network. The site access configuration was developed in consideration of spacing to the adjacent streets and signalized intersections on Steveston Highway. The access point and internal east-west drive-aisle on-site is intended to provide shared access to future developments to the northeast and to the west, avoiding the need for additional access points in this block between Southgate Road and Southridge Road in the future. A Statutory Right-of-Way (SRW) for Public Right-of-Passage (PROP) over the internal drive-aisle is required to be registered on title prior to final adoption of the rezoning bylaw. On the basis of these considerations, a full movement access to the site is supported.
- Pedestrian access to the site is proposed in two locations: from a walkway off Southgate Road and from the vehicle entry point on Steveston Highway. The decorative and permeable surface treatment of the drive-aisle at the site entry has been carefully designed to highlight its' shared use by both pedestrians and vehicles.
- The main pedestrian entries to the units in Buildings A and B are proposed to front onto Steveston Highway, while the main unit entries to the units in Buildings C and D are proposed to front the internal drive-aisle. Individual garages are arranged along the internal drive-aisle.
- The proposed number of resident and visitor vehicle and bike parking spaces is consistent with the parking requirements in Richmond Zoning Bylaw 8500. Resident vehicle and bike parking spaces are proposed in individual garages, all of which vehicles are in a side-by-side arrangement. Visitor vehicle parking spaces are provided adjacent to buildings and are screened from public view by landscaping. A rack for three visitor bicycle parking spaces is proposed within the common outdoor amenity space.

Open Space and Landscape Design

Outdoor Amenity Space

- A common outdoor amenity space of 89.25 m² in size is proposed on-site in a central location that is visible from the main site entry point, and exceeds the minimum size specified in the OCP guidelines (i.e., minimum 66 m²).
- A children's playhouse is proposed within the outdoor amenity area, which features interactive play activities like a working telescope, mailbox, spinning flowers, as well as countertops, pass-through windows, and seating for social play. In addition to the playhouse,

boulders, balance beams, and stepping logs are also proposed within the outdoor amenity area for natural play, as well as a dry stream bed and bridge, bench seating, a mail kiosk, and bike rack. The area is also to contain two Japanese Maple trees, a variety of shrubs, and lawn.

- A smaller passive common outdoor space containing bench seating, shrubs, and lawn is also provided on-site within a portion of the east yard, off Southgate Road (60.87 m^2 in size).

Private Open Space

- Private outdoor space for each of the units is proposed primarily in the form of yards at grade, and exceeds the minimum size guidelines in the OCP. Additional private outdoor spaces are also proposed for some of the units in the form of small uncovered decks off the main living area on the second floor.

Landscaping

- On-site tree retention and removal was assessed as part of the Rezoning Application, at which time the City's Tree Preservation Coordinator concurred with the applicant's proposal to: retain Tree # 11 off-site to the northwest at 9835 Steveston Highway and Tree # 7 to the northeast, shared with 10911 Southgate Road; and to remove a total of 16 trees (including hedges) on-site/on shared property lines due to poor and hazard condition, as well as conflict with the building envelope and proposed lot grading. The property owner at 9860 Southgate Place obtained a permit to remove Tree # 9 located on their property, which was identified as a hazard tree during the Rezoning process. Following Third Reading of the rezoning bylaw, the applicant obtained a Tree Removal Permit to remove the on-site/shared trees in June 2017 to enable demolition and site preparation, and an interim replacement security for these trees was collected and will be held until after the final Landscaping Security is submitted by the applicant prior to Development Permit issuance.
- Consistent with the 2:1 tree replacement ratio in the OCP, the applicant is required to plant and maintain a minimum of 32 replacement trees on-site, with the understanding that the City will accept a contribution from the applicant in the amount of \$500/tree for any replacement trees that cannot be accommodated on-site.
- The proposed Landscape Plan includes a mix of 25 deciduous and coniferous trees, as well as a variety of shrubs, perennials, grasses and groundcover. In-lieu of planting the remaining required seven replacement trees on-site, the applicant is required to submit a contribution to the City's Tree Compensation Fund in the amount of \$3,500 (\$500/tree) prior to issuance of the Development Permit.
- The tree and plant species proposed in the Landscape Plan include: Cypress, Dogwood, Hornbeam, Maple, and Spruce, as well as Azalea, Daylily, Fountain Grass, Hosta, Mock Orange, Laurel, Viburnum, Victoria California Lilac, and Yew hedges.
- The proposed on-site landscaping treatment along Steveston Highway, within the 4.0 m wide ALR landscaped buffer is proposed to include grass, trees, and shrubs, while the off-site boulevard treatment will contain a new sidewalk, grass and trees. At rezoning stage, the proposal was presented to the Agricultural Advisory Committee, and was supported unanimously.

- To define the street edge along Steveston Highway and Southgate Road, low decorative metal fencing with pedestrian gates is proposed, while 1.8 m high solid wood fencing is proposed elsewhere around the perimeter of the site. A variety of other fencing types are proposed elsewhere on-site to enable screening and definition between yards.
- A variety of hardscape materials and colours are proposed on-site to distinguish between pedestrian and vehicle areas, provide visual interest and assist with surface permeability. Specifically: a mix of asphalt and permeable pavers over the internal drive-aisle and visitor parking spaces, broom-brushed concrete pedestrian pathways from the public sidewalk on Steveston Highway to individual unit entries, a stepping stone pathway from Southgate Road, and permeable pavers for patios in the individual yards of units in Buildings C and D.
- The Landscape Plan requires that all soft landscaped areas be irrigated consistent with industry standards. To ensure on-going maintenance, the installation of an automated irrigation system is proposed.

Indoor Amenity Space

- Consistent with the OCP, the applicant proposes to submit a contribution to the City prior to rezoning bylaw adoption in-lieu of the provision of common indoor amenity space on-site. Since the associated rezoning bylaw was in-stream and received Third Reading by Council prior to City Council updating the contribution rates in the OCP on February 19, 2018, the former contribution rates apply (i.e., \$1,000/unit, for a total of \$11,000).

Architectural Form and Character

- The proposal contains elements of the Tudor architectural style, using gable roofs, entry porches with columns, two tones of brick cladding at the ground level, and a combination of light and dark composite cement panels, siding, and shake at 2nd and 3rd levels.
- There is an architectural rhythm to the units through the use of vertical bays that accentuate individual units along the dominant frontage on Steveston Highway. The east side elevation facing Southgate Road has been designed to include more articulation and an additional entry porch to simulate the character of single-family housing.
- Consistent with the design guidelines in the Arterial Road Land Use Policy, the rear buildings along the rear yard interface with adjacent single-family housing to the north are proposed in duplex form and are limited to two storeys. The architectural style of the duplex buildings are consistent with the Tudor style proposed for the street-fronting buildings along Steveston Highway.

Accessible Housing

- All of the proposed units incorporate aging-in-place features to accommodate mobility constraints associated with aging. These features include:
 - Stairwell hand rails.
 - Lever-type handles for plumbing fixtures and door handles.
 - Solid blocking in washroom walls to facilitate future grab bar installation beside toilets, bathtubs and showers.

- As demonstrated on the Site Plan and Reference Plans (Plan # 1.e, and Drawing No. A5.0 and A 5.0B), the proposed development includes one Convertible Unit in Building A that is designed with the potential to be easily renovated to accommodate a future resident in a wheelchair (i.e., Unit Type A1). The potential conversion of this unit will require the installation of a vertical lift (e.g., elevator).

Sustainability

- On July 16, 2018, Richmond City Council adopted the BC Energy Step Code requirements for new residential developments. These new requirements apply to most Building Permit applications filed on or after September 1, 2018, except for developments with: a) a valid Development Permit; or b) an acceptable Development Permit application submitted to the City by July 16, 2018. Since the associated rezoning bylaw received Third Reading by Council and the associated Development Permit application was received prior to July 16, 2018, this project may be constructed to meet the City's previous Townhouse Energy Efficiency and Renewable Energy Policy, so long as an acceptable Building Permit application for the development is submitted to the City by December 31, 2019. If this deadline is not met, the development will be required to meet the City's Energy Step Code requirements.
- Consistent with the previous Townhouse Energy Efficiency and Renewable Energy Policy, the applicant has committed to achieving an EnerGuide Rating System (ERS) score of 82 and to providing pre-ducting for solar hot water heating for the proposed development. Prior to rezoning bylaw adoption, a legal agreement is required to be registered on Title specifying that all units are to be built and maintained to an ERS score of 82 or higher, and that all units are to be solar hot water ready.
- The applicant has submitted an acceptable evaluation report by a Certified Energy Advisor, which confirms that the proposed townhouse units are designed to achieve an ERS 82 score of 82. The key technical elements that enable this rating to be achieved will be specified in the legal agreement registered on Title to ensure that they are included in the building design at Building Permit stage.
- The applicant has also identified the following features are proposed to be provided in all units:
 - Low E double glazed windows.
 - Energy Star appliances and light bulbs.
 - An energized outlet in all garages to enable Level 2 electric vehicle charging, consistent with the Zoning Bylaw.

Crime Prevention Through Environmental Design (CPTED)

- The applicant has identified that the proposal responds to the following principles of CPTED, as encouraged in the design guidelines contained within the OCP:

Natural Access Control

- A single and visible vehicle entry point is proposed to the site from Steveston Highway, with decorative surface used to highlight the dual-use of the entry point for both vehicles and pedestrians, and the secondary pedestrian entry point to the site off

Southgate Road is clearly defined through the use of a trellis structure/gate that has a direct sightline and requires a key to enter. Low fencing with perimeter trees is used to delineate the public versus private space.

Natural Surveillance

- The common outdoor amenity space is centrally-located and highly visible implying informal supervision throughout the site. Front yard-facing windows in Buildings A and B provide for “eyes on the street”. Bench seating is proposed in both the common outdoor amenity space and passive outdoor space along Southgate Road. Landscape design considered CPTED principles to inform plant species selection.

Territoriality/Defensible Space

- Impersonal spaces such as the internal drive-aisle and surface parking spaces are personalized through the use of varied soft and hard landscape materials. Landscaping, screening, and varied fence types are appropriate to the spaces they intend to define. Exterior building-mounted lighting is proposed to illuminate entries.

Site Servicing & Off-site Improvements

- Servicing requirements and off-site improvements to support the proposed development were identified as part of the Rezoning Application, and include:
 - A 4 m x 4 m corner cut road dedication at the southeast corner of the subject site and \$20,000 contribution towards the future installation of a special crosswalk at the intersection of Southgate Road and Steveston Highway, all prior to rezoning bylaw adoption.
 - Entering into a Servicing Agreement prior to Building Permit issuance for the design and construction of the required water, storm and sanitary service connections, as well as boulevard and storm sewer upgrades along Steveston Highway and Southgate Road.

Conclusion

This proposal is for an 11-unit townhouse development at 9851, 9891 Steveston Highway and 10931 Southgate Road, with vehicle access from Steveston Highway.

The applicant has addressed the design issues identified through the rezoning process, as well as additional staff comments regarding site planning, urban design, architectural form and character, and landscape design identified as part of the Development Permit Application review process. The proposal provides an appropriate response to the surrounding single-family context and conforms to the applicable design guidelines contained within the OCP.

The development proposal complies with the requirements of the “Low Density Townhouses (RTL4)” zone, with the exception of the zoning variances discussed.

On this basis, staff recommends that the Development Permit be endorsed, and issuance by Council be recommended.



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Attachment 1: Location Map

Attachment 2: Development Application Data Sheet

Attachment 3: Excerpt from the December 20, 2018 Advisory Design Panel Meeting minutes and Applicant's design response

The following are to be met prior to forwarding this application to Council for approval:

- Submission of a contribution to the City's Tree Compensation Fund in the amount of \$3,500 in-lieu of planting the seven remaining required replacement trees on-site.
- Receipt of a Letter-of-Credit or other form of security acceptable to the City for landscaping in the amount of \$119,943.29 (100% of the cost estimate provided by the Landscape Architect, including all materials, labour, and a 10% contingency).

Prior to future Building Permit* issuance, the applicant is required to complete the following:

- Incorporation of accessibility measures (e.g., Aging-in-place features in all units, and Convertible Unit features in one unit) in Building Permit plans as determined via the Rezoning and Development Permit applications.
- Incorporation of energy efficiency measures and pre-ducting for solar hot water heating in Building Permit plans to achieve an ERS score of 82, as specified in the legal agreement that is required via the Rezoning and Development Permit applications.
- Incorporation of noise mitigation measures in Building Permit plans as outlined in the acoustical and thermal report and recommendations prepared by the appropriate registered professional as part of the Development Permit application, which demonstrates that the interior noise levels and noise mitigation standards comply with the City's Official Community Plan and Noise Bylaw requirements (as per the noise covenant registered on Title prior to rezoning).
- Entrance into a Servicing Agreement* for the design and construction of off-site improvements, as well as water, storm, and sanitary service connections. Works include, but are not limited to:

Water Works

- Using the OCP Model, there are 518 L/s of water available at 20 psi residual at the hydrant at the south side of Steveston Highway and 284 L/s of water available at 20 psi residual at the hydrant at the northwest corner of the Steveston Highway and Southgate Road intersection. Based on the proposed development, the site requires a minimum fire flow of 220 L/s. At Building Permit stage, the applicant is required to submit Fire Underwriter Survey (FUS) or International Organization for Standardization (ISO) fire flow calculations to confirm the development has adequate fire flow for on-site fire protection. Calculations must be signed and sealed by a Professional Engineer and be based on Building Permit Stage designs.
- At the applicant's cost, the City will:
 - Cut and cap at the main the existing water service connections at the Steveston Highway frontage.
 - Install a new water connection to service the proposed development. Connection to the existing 500 mm diameter watermain along the north side of Steveston Highway is not permitted. Details of the new water service shall be finalized via the Servicing Agreement design review process.

- Relocate the existing fire hydrant at the northwest corner of Steveston Highway and Southgate Road intersection to match the required frontage improvements (as identified by the City's Transportation Department).

Storm Sewer Works

- o The applicant is required to upgrade the existing ditch along Southgate Road to a single 1050 mm storm sewer at road centerline. The length of the ditch upgrade shall match the extent of the required frontage improvements (as identified by the City's Transportation Department). Tie-ins of the proposed 1050 mm storm sewers shall be as follows:
 - The south end of the new 1050 mm storm sewer at Southgate Road centerline shall tie-in to the existing storm sewer alignment along the north side of Steveston Highway via a new manhole.
 - The north end of the new 1050 mm storm sewer shall tie-back to the existing drainage systems along the east and west sides of Southgate Road via new manholes and/or storm sewer inlet structures.
- o The applicant is required to upgrade the existing 525 mm diameter storm sewer to 750 mm diameter (approximately 102 m long) along Steveston Highway from the proposed site's west property line to the existing manhole STHM2902 (located at the northeast corner of Steveston Highway and Southgate Road). The storm sewer upgrade along Steveston Highway shall include (but is not limited to) the following:
 - Removal of existing manholes STHM2801 and STHM2803.
 - Provide new manholes at the west property line and at the junction of the proposed 750 mm diameter storm sewer along Steveston Highway with the proposed 1050 mm diameter storm sewer along Southgate Road.
- o The applicant is required to upgrade the existing 600 mm diameter storm sewer to 1050 mm diameter (approximately 8 m long) from the new manhole at the junction of Steveston Highway and Southgate Road and tie-in to the existing manhole STHM2902 via a reducer. Existing manhole STHM2902 shall be replaced if it is found to be in poor condition.
- o The applicant is required to install a new storm sewer connection to service the proposed site. Details of the new storm service shall be finalized via the Servicing Agreement design review process.
- o At the applicant's cost, the City will:
 - Extend the existing drainage connections at the Southgate Road frontage of 10811 No. 4 Road to Southgate Road centerline and connect it to the new 1050 mm storm sewer.
 - Plug the existing pipe opening at the north side of manhole STHM2902.

Sanitary Sewer Works

- o The applicant is required to provide a sanitary service connection to the proposed site off of the existing sanitary main at Southgate Road.
- o At the applicant's cost, the City will cap at the property line the existing sanitary service connections for 9851 and 9891 Steveston Highway and 10931 Southgate Road.

Frontage Improvements

- o The applicant is required to coordinate with BC Hydro, Telus, and other private communication service providers to:
 - Underground the existing overhead service lines along the Steveston Highway frontage.
 - Pre-duct for future hydro, telephone and cable utilities along all road frontages.
 - Locate all above ground utility cabinets and kiosks required to service the proposed development within the developments site (see list below for examples). A functional plan showing conceptual locations for such infrastructure shall be included in the Development Permit application design review process. Please coordinate with the respective private utility companies and the project's lighting and traffic signal consultants to confirm the right-of-way dimensions and the locations for the aboveground structures. If a private utility company does not require an aboveground structure, that company shall

confirm this via a letter to be submitted to the City. The following are examples that shall be shown in the functional plan and registered prior to Servicing Agreement design approval:

BC Hydro PMT – 4 m W X 5 m (deep)	Traffic signal UPS – 2 m W X 1.5 m (deep)
BC Hydro LPT – 3.5 m W X 3.5 m (deep)	Shaw cable kiosk – 1 m W X 1 m (deep)
Street light kiosk – 1.5 m W X 1.5 m (deep)	Telus FDH cabinet – 1.1 m W X 1 m (deep)
Traffic signal kiosk – 1 m W X 1 m (deep)	

- The applicant is required to upgrade the boulevard along Steveston Highway to the ultimate condition, including (but not limited to) installation of a treed/grass boulevard at the existing curb and a 1.5 m wide concrete sidewalk at or near the south property line of the subject site.
- The applicant is required to upgrade the road and boulevard along Southgate Road, including (but not limited to): road widening to achieve a minimum pavement width of 11.2 m (note: examination of the existing road base is also required to determine if new road base construction is required); installation of curb and gutter, a 1.5 m wide treed/grass boulevard, and a 1.5 m wide concrete sidewalk at or near the east property line of the subject site. The curb return at the southeast corner of the subject site is to have a 9.0 m radius. .
- The applicant is required to provide street lighting along Steveston Highway and Southgate Road frontages.

General Items

- If pre-load is required, the applicant is required to:
 - Provide, prior to pre-load installation, a geotechnical assessment of preload and soil preparation impacts on the existing utilities fronting or within the development site (e.g., existing sanitary mains along the north property line and existing 150 mm diameter watermain along Southgate Road frontage), proposed utility installations, the existing houses along the north property line, and provide mitigation recommendations. The mitigation recommendations shall be incorporated into the first Servicing Agreement design submission or prior to pre-load.
- Additional legal agreements, as determined via the subject development's Servicing Agreement(s) and/or Development Permit(s), and/or Building Permit(s) to the satisfaction of the Director of Engineering may be required, including, but not limited to, site investigation, testing, monitoring, site preparation, de-watering, drilling, underpinning, anchoring, shoring, piling, pre-loading, ground densification or other activities that may result in settlement, displacement, subsidence, damage or nuisance to City and private utility infrastructure.
- The applicant is required to obtain a Building Permit for any construction hoarding associated with the proposed development. If construction hoarding is required to temporarily occupy a street, or any part thereof, or occupy the air space above a street or any part thereof, additional City approvals and associated fees may be required as part of the Building Permit. *For further information on the Building Permit, please contact Building Approvals Department at 604-276-4285.*
- Submission of a Construction Parking and Traffic Management Plan to the satisfaction of the City's Transportation Department (<http://www.richmond.ca/services/ttp/special.htm>). The Management Plan shall include location for parking for services, deliveries, workers, loading, application for any lane closures, and proper construction traffic controls as per Traffic Control Manual for works on Roadways (by Ministry of Transportation and Infrastructure) and MMCD Traffic Regulation Section 01570.

Notes:

- * This requires a separate application.
- Where the Director of Development deems appropriate, the preceding agreements are to be drawn not only as personal covenants of the property owner, but also as covenants pursuant to Section 219 of the Land Title Act.

All agreements to be registered in the Land Title Office shall have priority over all such liens, charges and encumbrances as is considered advisable by the Director of Development. All agreements to be registered in

the Land Title Office shall, unless the Director of Development determines otherwise, be fully registered in the Land Title Office prior to enactment of the appropriate bylaw.


The preceding agreements shall provide security to the City including indemnities, warranties, equitable/rent charges, letters of credit and withholding permits, as deemed necessary or advisable by the Director of Development. All agreements shall be in a form and content satisfactory to the Director of Development.

- Additional legal agreements, as determined via the subject development's Servicing Agreement(s) and/or Development Permit(s), and/or Building Permit(s) to the satisfaction of the Director of Engineering may be required including, but not limited to, site investigation, testing, monitoring, site preparation, de-watering, drilling, underpinning, anchoring, shoring, piling, pre-loading, ground densification or other activities that may result in settlement, displacement, subsidence, damage or nuisance to City and private utility infrastructure.
- Applicants for all City Permits are required to comply at all times with the conditions of the Provincial *Wildlife Act* and Federal *Migratory Birds Convention Act*, which contain prohibitions on the removal or disturbance of both birds and their nests. Issuance of Municipal permits does not give an individual authority to contravene these legislations. The City of Richmond recommends that where significant trees or vegetation exists on site, the services of a Qualified Environmental Professional (QEP) be secured to perform a survey and ensure that development activities are in compliance with all relevant legislation.



City of Richmond

Attachment 1

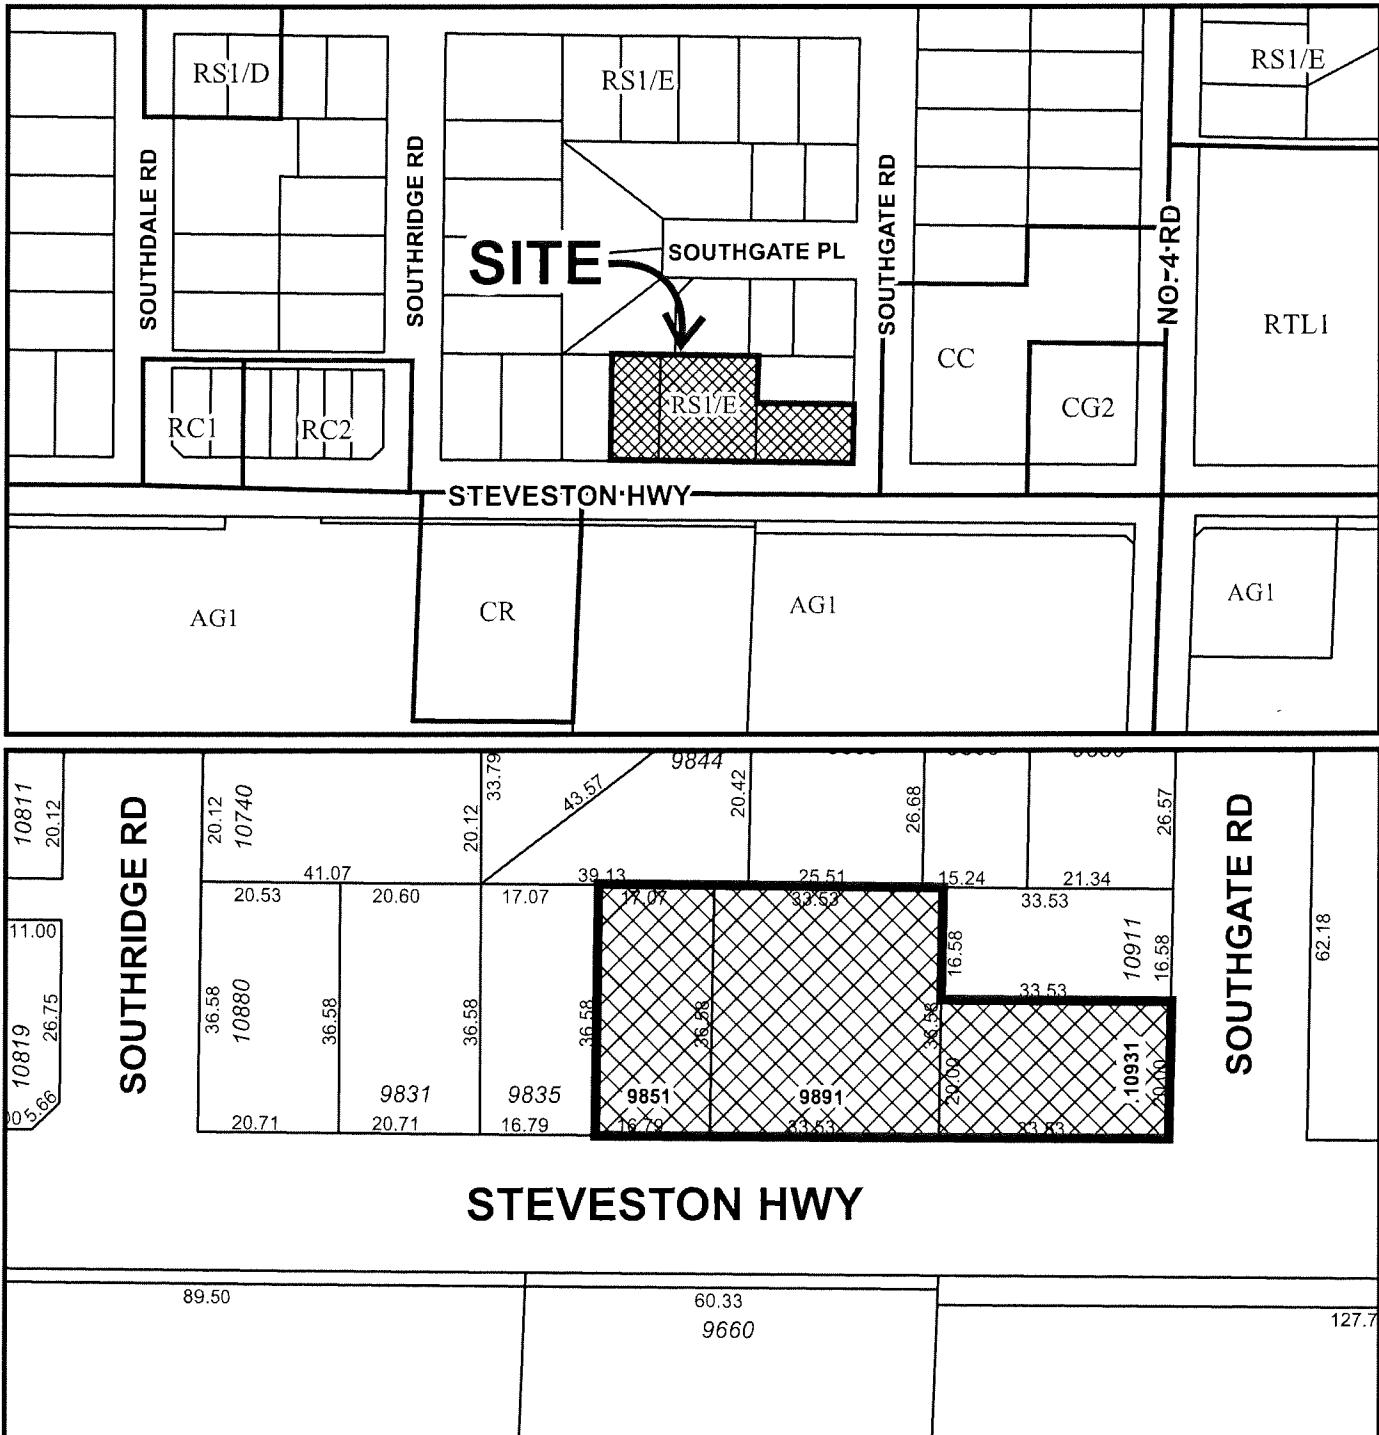

2	DP 17-792077	Original Date: 11/27/17 Revision Date: Note: Dimensions are in METRES
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**City of
Richmond**

Attachment 2

Development Application Data Sheet
Development Applications Department

DP 17-792077

Address: 9851, 9891 Steveston Highway and 10931 Southgate Road

Applicant: Konic Development Owner: 1002397 BC Ltd.

Planning Area(s): Broadmoor

	Existing	Proposed
Site Area:	2,515 m ² (27,071.21 ft ²)	2,506 m ² (26,974.33 ft ²)
Land Uses:	Vacant Land (previously single-family and duplex housing)	Townhousing
OCP Designation:	Neighbourhood Residential	No change
Zoning:	Single Detached (RS1/E)	Low Density Townhouses (RTL4)
Number of Units:	Previously 4	11

	Bylaw Requirement/ OCP Guideline	Proposed	Variance
Floor Area Ratio:	Max. 0.60	0.60	none permitted
Buildable Floor Area (m ²)	Max. 1,503.55 m ² (16,184.60 ft ²)	1,503.37 m ² (16,182.62 ft ²)	none
Lot Coverage – Buildings (% of lot area):	Max. 40%	37.88%	none
Lot Coverage – Buildings, Structures, and Non-Porous Surfaces:	Max. 65%	55.88%	none
Lot Coverage – Live Plant Material:	Min. 25%	26.59%	none
Setback – Front Yard (east):	Min. 6.0 m	5.03 m	To reduce from 6.0 m to 5.0 m
Setback – Interior Side Yard (north):	Min. 3.0 m	4.55 m	none
Setback – Exterior Side Yard (south):	Min. 6.0 m	5.00 m	To reduce from 6.0 m to 5.0 m
Setback – Rear Yard (west):	Min. 3.0 m	3.29 m	none
Building Height (m):	Max. 12.0 m	11.95 m (3 storey buildings)	none
		8.79 m (2 storey buildings)	

	Bylaw Requirement/ OCP Guideline	Proposed	Variance
On-site Vehicle Parking Spaces (Resident):	Min. 22 spaces (2/unit)	22 spaces	none
On-site Vehicle Parking Spaces (Visitor):	Min. 3 spaces (0.2/unit; min. 1 space must be Accessible)	3 spaces (of which 1 space is Accessible)	
On-site Vehicle Parking Spaces – Total:	Min. 25 spaces	25 spaces	none
Tandem Parking Spaces:	Max. 50% of resident parking spaces	N/A	none
Standard Parking Spaces:	Min. 100% for sites with less than 31	68% (15 spaces)	To allow 7 small car parking spaces
Small Parking Spaces:	N/A	32% (7 spaces)	
Amenity Space – Indoor:	Min. 70 m ²	Cash-in-lieu	N/A
Amenity Space – Outdoor:	Min. 66 m ²	Main space - 89.25 m ² Passive space – 60.87 m ²	N/A

Attachment 3

Annotated Excerpt from the Minutes to the Advisory Design Panel Meeting

**Thursday, December 20, 2018 – 4:00 p.m.
Rm. M.1.003
Richmond City Hall**

4. DP 17-792077 – 11-UNIT TOWNHOUSE DEVELOPMENT

ARCHITECT: Imperial Architecture

LANDSCAPE ARCHITECT: M2 Landscape Architects

PROPERTY LOCATION: 9851, 9891 Steveston Highway and 10931 Southgate Road

Applicant's Presentation

Jiang Zhu, Imperial Architecture, and Meredith Mitchell, M2 Landscape Architects, presented the project and answered queries from the Panel on behalf of the applicant.

Panel Discussion

Comments from Panel members were as follows:

- appreciate the applicant contributing to the City's Public Art Fund; applicant is encouraged to consider incorporating public art into the project, particularly at the corner of Steveston Highway and Southgate Road; *Noted. A contribution in-lieu of the provision of public art on-site was already determined through the Rezoning Application.*
- differentiation of units in Buildings C and D is needed to break down the massing of these buildings; consider introducing different colours and materials and a differentiating architectural feature between units; *Revised the elevation designs for back buildings. More architectural elements such as covered porches and bay windows with dormer roof above were introduced in order to add more details and break up the massing.*
- support the installation of the trellis feature to define the common space from private space for the east end unit; *Noted.*
- consider further articulation of the east end unit of Building B, e.g. carrying down the white pattern language down to the second floor to further highlight the corner as a gateway; *Revised the second floor bay window profile (on east end of south elevation) to correspond the wood patterns and rhythm of the main architectural treatment/language used on Building B.*

- support the pedestrian walkway articulation on the internal drive aisle; consider adding a matching permeable pathway along the south side of the internal drive aisle for pedestrian circulation to Buildings A and B; also consider adding pedestrian connections with a different paving pattern or colour treatment from the main sidewalk to the interior pedestrian networks; *Decorative paving at site entry extended to east-west pedestrian pathway on internal drive aisle to provide connection to outdoor amenity area. Additional matching permeable pathway along the south side of the internal drive-aisle is proposed. Paving pattern/colour treatment for interior network is different than main sidewalk as requested.*
- support the proposed sustainability features of the project; appreciate the level of information regarding the project's sustainability strategy included in the package provided by the applicant; *Noted.*
- appreciate the applicant's presentation of the project; commend the applicant for providing a plant list with larger fonts; *Noted.*
- concerned that the pedestrian treatment on the internal drive aisle may be underused by pedestrians and has potential maintenance issues; *Decorative paving at site entry extended to 3' wide east-west pedestrian pathways on both the north and south sides of the internal drive aisle to provide connection to outdoor amenity area; this will encourage pedestrian usage throughout the site and promote entry to the outdoor amenity space. Maintenance should not be a concern as decorative paving within drive-aisles is common.*
- from an urban design view, support the proposed plantings in the portion of the front yard facing Steveston Highway which serve as a vegetative buffer to lands within the Agricultural Reserve on the south side of Steveston Highway; *Size for Victoria California Lilac and Photinia revised to #2 pot; 40cm to ensure that mature height will not exceed 1.2m; will still provide a vegetative buffer.*
- screening for the exposed facades on Buildings A and B at visible locations is not adequate; consider installing a trellis and/or higher and more vertical planting on building facades, i.e. on blank brick walls, on either side of the main entrance to the site; *Planting has been revised to provide larger/taller/more vertical shrubs to screen exposed facades on Buildings A and B.*
- the outdoor amenity area is sited in a good location; however, the area is very narrow; needs to have an adequate play area; *Trellis at amenity area entry provides greater sense of arrival. Trellis has been made wider so that the mail kiosk, pathway, and bike rack are all underneath the trellis.*

- the trellis feature and bicycle racks at the entry to the outdoor amenity area separate/isolate the area from the rest of the development and block sunlight into the area; consider opening up the entry to the outdoor amenity area; *Trellis at amenity area entry provides greater sense of arrival. Trellis has been made wider so that the mail kiosk, pathway, and bike rack are all underneath the trellis. The wider structure will also allow for more circulation through the area and the total number of overall wood members has been decreased in order to allow for more sunlight into the area.*
- concerned that the sod area under the play elements may not work; *This is not believed to be an issue, the only area with sod under the play element is with the playhouse. With proper maintenance and irrigation, the sod should be healthy. Climbing rock, stepping logs, balance beams will not be an issue as these features are sitting on grade with no grass underneath.*
- consider rearranging the play elements in the outdoor amenity area to under accentuate the linearity of the space; also, the bench is not located in the best location; *Trellis at amenity area entry provides greater sense of arrival. Trellis has been made wider so that the mail kiosk, pathway, and bike rack are all underneath the trellis. The wider structure will also allow for more circulation through the area. Play elements have been rearranged and spaced out to provide more room down the middle of the area. The elements are arranged to promote continuity and a theme/linearity from one feature to another. Allows for children to work their way through the space from south to north. Bench within central amenity area has been relocated. It is not intended to be set in cast-in-place concrete, rather installed within the planting bed; this is not an uncommon practice.*
- appreciate the applicant's efforts to retain the existing tree adjacent to Unit 111; however, the applicant is cautioned on the survivability of the retained tree considering its proximity to the townhouse unit; *Details of construction around existing tree illustrated on tree management plan and landscape detail/section.*
- consider relocating the PMT to provide continuity to the east-west internal drive aisle up to Southgate Road; *Several alternate PMT location options were proposed during design stage and the current location is the only option which was agreed by city and approved by BC Hydro.*
- the tree management plan provided by the applicant needs more coherence and could have been better presented; *Adequate detail and descriptions have been provided on the tree management plan.*
- appreciate the model giving clarity to the proposed scheme; *Noted.*
- unfortunate that the PMT is located at the east terminus of the east-west internal drive aisle; if it could not be relocated elsewhere, consider a more significant landscape on the east terminus as a transition buffer; *1.20m high Hicks yew hedge screen provides adequate transition buffer to amenity area; space is limited as is.*

- consider increasing the size of the outdoor amenity space; also consider design development of the roofscape of adjacent townhouse units to allow more daylight into the amenity space; *The "L" shape site and rear setback requirements caused by historical subdivision layout created challenges on the design especially enlarging the outdoor amenity area by reducing building footprints. A shadow analysis was conducted to compare the shadow effect between two different roof profiles. The study indicated the roof slope profiles have minimum difference on amount of sunlight or shadow over the amenity area. In consideration of consistency of the architectural treatment and language used in each building, we propose to maintain the gable roof profile for back buildings.*
- appreciate the lineal and more urban expression along Steveston Highway; *Noted.*
- duplex units could benefit from the small shift in the alignment of the internal driveway; investigate opportunities for accentuating the jogging so the duplex units can split; *This option was considered during design stage. The jogging driveway is one of the townhouse design guidelines in OCP part 14.*
- agree with the Panel comment that the outdoor amenity space is narrow and there is a lot going on in the limited space; consider reducing the setback to the west property line and take away some of the adjacent private lawn area to widen the amenity space; *This option was reviewed at design stage, however, the width requirement on visitor parking stall and clearance on both sides to vertical barriers (wall or fence) make the option of narrower west yard setback not valid. Also reducing the west yard setback further creates concerns on privacy to the neighbor next door.*
- also agree with Panel comment to eliminate the trellis as it would hide the amenity space and make it feel more constrained; *Trellis at amenity area entry provides greater sense of arrival. Trellis has been made wider so that the mail kiosk, pathway, and bike rack are all underneath the trellis. The wider structure will also allow for more circulation through the area.*
- consider extending the permeable paving treatment on the site entry up to the intersection and connect to the outdoor amenity space to enhance on-site pedestrian experience; *East-west pathway along north side of internal drive-aisle has been maintained, and additional matching permeable pathway along the south side has been proposed. Decorative paving at site entry extended to east-west pedestrian pathway on internal drive aisle to provide connection to outdoor amenity area; this will encourage pedestrian usage and promote entry to the outdoor amenity space.*
- the package provided to the Panel was helpful; *Noted.*
- overall architectural style is dated but contextual; simple and well done; *Noted.*

- consider replacing the vinyl shake with the more durable and higher quality pre-painted hardie which is more appropriate to an arterial road development; ***Revised exterior finish schedule to replace vinyl shake with suggested Hardie shake.***
- appreciate that the applicant is putting a lot of thought on the retention of the large tree; however, agree with concerns regarding its survivability; ***Noted.***
- agree with the suggestion to relax the setback to the west property line as it would provide breathing room around the outdoor amenity space; ***This option was reviewed at design stage, however, the width requirement on visitor parking stall and clearance on both sides to vertical barriers (wall or fence) make the option of narrower west yard setback not valid. Also reducing the west yard setback further creates concerns on privacy to the neighbor next door.***
- appreciate the design of the convertible units; the units are spacious and the elevator is well designed; ***Noted.***
- proposed location of the PMT negatively impacts the exterior amenity area; ***Several alternate PMT location options were proposed during design stage and the current location is the only option which was agreed by city and approved by BC Hydro.***
- agree with Panel comments that there is a lot going on in the central outdoor amenity space; investigate opportunities for simplifying its design and relocating the mailbox; ***Design at entry of central outdoor amenity area has been simplified, trellis provides greater sense of arrival at the entry into the area. Trellis has been made wider so that the mail kiosk, pathway, and bike rack are all underneath the trellis. The wider structure will also allow for more circulation through the area.***
- proposed treatment of the north side of the internal drive aisle with permeable pavers to define on-site pedestrian circulation could either be maintained or eliminated due to potential maintenance issues; ***East west pathway along north side of internal drive aisle has been maintained, additional matching permeable pathway along the south side is proposed. Decorative paving at site entry extended to these pathways to provide connection to outdoor amenity area; this will encourage pedestrian usage and promote entry to the outdoor amenity space.***

- and, support the proposal from the Panel to extend the permeable paving treatment at the site entry through the intersection up to the outdoor amenity area to bring the amenity area out into the street to highlight the area and allow more play opportunities for children. *Decorative paving at site entry extended through the intersection up to the outdoor amenity area, and connected to the 3' wide east-west pedestrian pathways on both the north and south sides of internal drive-aisle to provide connection to outdoor amenity area; this will encourage pedestrian usage throughout the site and promote entry to the outdoor amenity area while bringing the amenity area out towards the street to highlight the area and allow additional play opportunities.*

Panel Decision

It was moved and seconded

That DP 17-792077 be supported to move forward to the Development Permit Panel subject to the applicant giving consideration to the comments of the Advisory Design Panel.

CARRIED



City of Richmond

Development Permit

No. DP 17-792077

To the Holder: KONIC DEVELOPMENT

Property Address: 9851, 9891 STEVESTON HIGHWAY AND
10931 SOUTHGATE ROAD

Address: C/O 1135 - 13700 MAYFIELD PLACE
RICHMOND, BC V6V 2E4

1. This Development Permit is issued subject to compliance with all of the Bylaws of the City applicable thereto, except as specifically varied or supplemented by this Permit.
2. This Development Permit applies to and only to those lands shown cross-hatched on the attached Schedule "A" and any and all buildings, structures and other development thereon.
3. The "Richmond Zoning Bylaw 8500" is hereby varied to:
 - a) Allow seven resident vehicle parking spaces to be small-sized; and
 - b) Reduce the minimum front yard on Southgate Road and the exterior side yard on Steveston Highway from 6.0 m to 5.0 m.
4. Subject to Section 692 of the Local Government Act, R.S.B.C.: buildings and structures; off-street parking and loading facilities; roads and parking areas; and landscaping and screening shall be constructed generally in accordance with Plans # 1.a to # 4.f attached hereto.
5. Sanitary sewers, water, drainage, highways, street lighting, underground wiring, and sidewalks, shall be provided as required.
6. As a condition of the issuance of this Permit, the City is holding the security in the amount of \$119,943.29 to ensure that development is carried out in accordance with the terms and conditions of this Permit. Should any interest be earned upon the security, it shall accrue to the Holder if the security is returned. The condition of the posting of the security is that should the Holder fail to carry out the development hereby authorized, according to the terms and conditions of this Permit within the time provided, the City may use the security to carry out the work by its servants, agents or contractors, and any surplus shall be paid over to the Holder. Should the Holder carry out the development permitted by this permit within the time set out herein, the security shall be returned to the Holder. The City may retain the security for up to one year after inspection of the completed landscaping in order to ensure that plant material has survived.
7. If the Holder does not commence the construction permitted by this Permit within 24 months of the date of this Permit, this Permit shall lapse and the security shall be returned in full.

Development Permit
No. DP 17-792077

To the Holder: KONIC DEVELOPMENT

Property Address: 9851, 9891 STEVESTON HIGHWAY AND
10931 SOUTHGATE ROAD

Address: C/O 1135 - 13700 MAYFIELD PLACE
RICHMOND, BC V6V 2E4

8. The land described herein shall be developed generally in accordance with the terms and conditions and provisions of this Permit and any plans and specifications attached to this Permit which shall form a part hereof.

This Permit is not a Building Permit.

AUTHORIZING RESOLUTION NO.
DAY OF ,


ISSUED BY THE COUNCIL THE

DELIVERED THIS DAY OF ,


MAYOR



City of Richmond

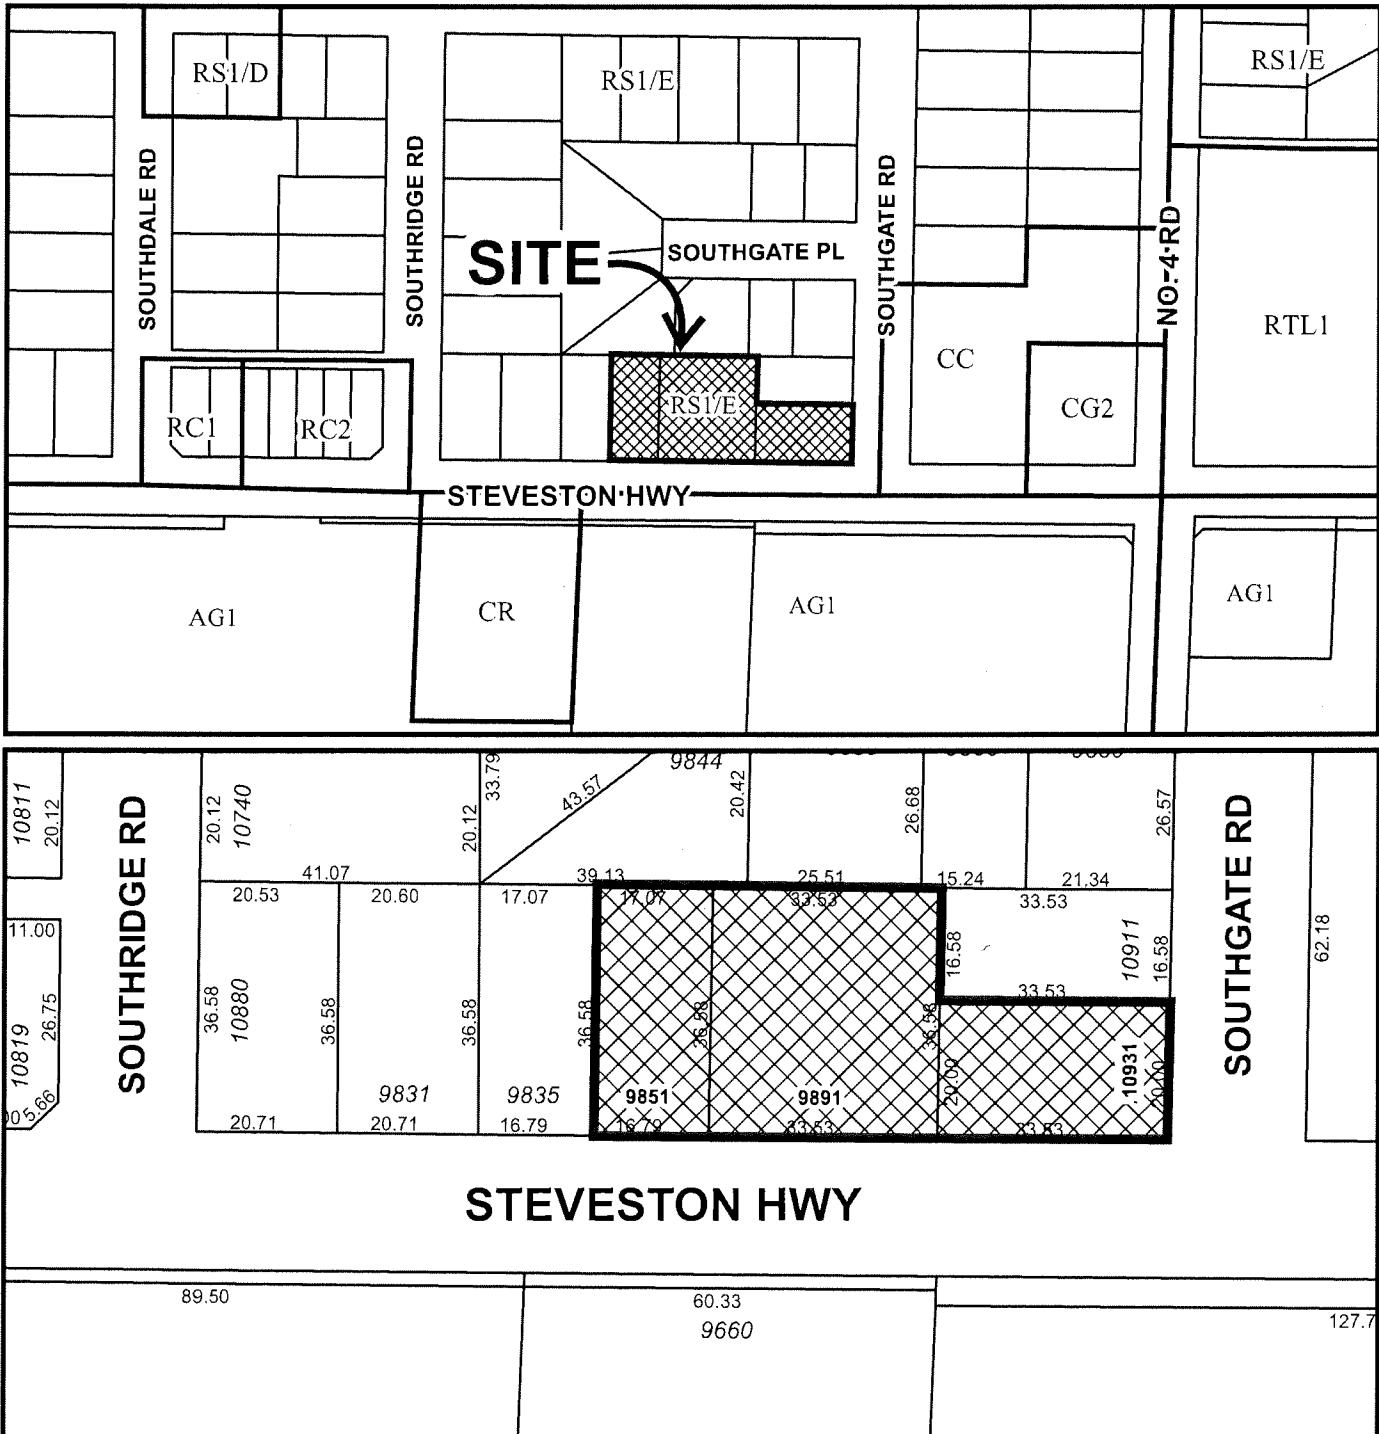

	DP 17-792077 SCHEDULE "A"	Original Date: 11/27/17 Revision Date: Note: Dimensions are in METRES
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ARCHITECTURE
INTERIOR
DESIGN
PLANNING

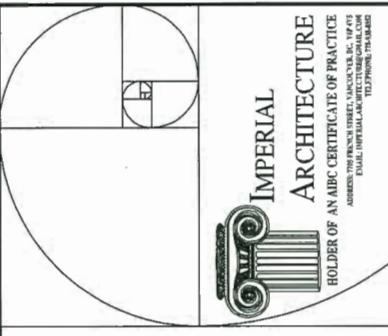HOLDER OF AN ABC CERTIFICATE OF PRACTICE


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KEY PLAN

SOUTH GATE ROAD

STEVESTON HIGHWAY

17-792077

PLAN # 1.a

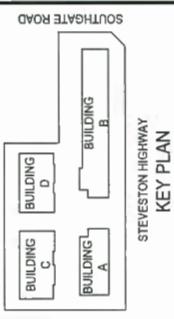ISSUED DP
RESUBMISSION
2019-04-23

ClientProject:
STEVESTON TOWNHOUSE
DEVELOPMENT (DP 17-792077) FOR
KONIC INC.
9851 1989 STEVESTON HWY &
10931 SOUTHGATE ROAD, RICHMOND, BC

Title

COVER SHEET /
COLOR RENDERINGS

Project No. #8127

Date N.T.S.

Drawing No. Sheet

Position

A 0.0

TOWNHOUSE DEVELOPMENT (DP 17-792077) AT 9851, 9891 STEVESTON HIGHWAY & 10931 SOUTHGATE ROAD, RICHMOND, BC

DP

ARCHITECTURE:
AT 9851, 9891 STEVESTON HIGHWAY & 10931 SOUTHGATE ROAD, RICHMOND, BC
ISSUED FOR DP RESUBMISSION 2019-04-23



CONTACT LIST

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DEVELOPMENT DIRECTOR
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IMPERIAL ARCHITECTURE
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FAX: 604-439-9189
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CAPTURE ENERGY
5811 COONEY RD #205,
RICHMOND, BC V6X 3M1
CONTACT: SCOTT SILVERTHORN
TEL: 604-787-1982
EMAIL: SCOTT@CAPTURE-ENERGY.CA

LANDSCAPE:
#220 FLOOR PLANS & ROOF PLAN
BLDG A FLOOR PLANS
BLDG B FLOOR PLANS & ROOF PLAN
BLDG C FLOOR PLANS & ROOF PLAN
BLDG D FLOOR PLANS & ROOF PLAN
LANDSCAPE PLAN
LOT COVERAGE PLAN
GRADING PLAN
LANDSCAPE DETAILS
LANDSCAPE SPECIFICATIONS
SURVEY:
S1 TOPOGRAPHIC SURVEY PLAN

BUILDING SECTIONS
A4.1 BUILDING SECTIONS

UNIT TYPE A1 PLANS
A5.0 UNIT TYPE A1 AREA CALCULATION DIAGRAM
A5.0.A UNIT TYPE A1 AREA CALCULATION DIAGRAM
A5.0.B MANUFACTURER'S SPECIFICATION

UNIT TYPE A2 PLANS
A5.1 UNIT TYPE A2 PLANS

UNIT TYPE A2 AREA CALCULATION DIAGRAM
A5.1.A UNIT TYPE A2 AREA CALCULATION DIAGRAM
A5.1.B UNIT TYPE A2 AREA CALCULATION DIAGRAM

UNIT TYPE B1 PLANS
A5.2 UNIT TYPE B1 PLANS

UNIT TYPE B1 AREA CALCULATION DIAGRAM
A5.2.A UNIT TYPE B1 AREA CALCULATION DIAGRAM
A5.2.B UNIT TYPE B1 AREA CALCULATION DIAGRAM

UNIT TYPE B2 PLANS
A5.3 UNIT TYPE B2 PLANS

UNIT TYPE C1 / C2 PLANS
A5.4 UNIT TYPE C1 / C2 PLANS

UNIT TYPE C1 / C2 AREA CALCULATION DIAGRAM
A5.5 UNIT TYPE C1 / C2 AREA CALCULATION DIAGRAM
A5.5.A UNIT TYPE C1 / C2 AREA CALCULATION DIAGRAM

UNIT TYPE D1 / D2 PLANS
A5.6 UNIT TYPE D1 / D2 PLANS

UNIT TYPE D1 / D2 AREA CALCULATION DIAGRAM
A5.7 UNIT TYPE D1 / D2 AREA CALCULATION DIAGRAM
A5.7.A UNIT TYPE D1 / D2 AREA CALCULATION DIAGRAM

UNIT TYPE D1 / D2 AREA CALCULATION DIAGRAM
A5.8 UNIT TYPE D1 / D2 AREA CALCULATION DIAGRAM
A5.8.A UNIT TYPE D1 / D2 AREA CALCULATION DIAGRAM

UNIT TYPE D1 / D2 PLANS
A5.9 UNIT TYPE D1 / D2 PLANS

UNIT TYPE D1 / D2 AREA CALCULATION DIAGRAM
A5.10 UNIT TYPE D1 / D2 AREA CALCULATION DIAGRAM
A5.10.A UNIT TYPE D1 / D2 AREA CALCULATION DIAGRAM

UNIT TYPE D1 / D2 AREA CALCULATION DIAGRAM
A5.11 UNIT TYPE D1 / D2 AREA CALCULATION DIAGRAM
A5.11.A UNIT TYPE D1 / D2 AREA CALCULATION DIAGRAM

UNIT TYPE D1 / D2 PLANS
A5.12 UNIT TYPE D1 / D2 PLANS

UNIT TYPE D1 / D2 AREA CALCULATION DIAGRAM
A5.13 UNIT TYPE D1 / D2 AREA CALCULATION DIAGRAM
A5.13.A UNIT TYPE D1 / D2 AREA CALCULATION DIAGRAM

UNIT TYPE D1 / D2 AREA CALCULATION DIAGRAM
A5.14 UNIT TYPE D1 / D2 AREA CALCULATION DIAGRAM
A5.14.A UNIT TYPE D1 / D2 AREA CALCULATION DIAGRAM

UNIT TYPE D1 / D2 PLANS
A5.15 UNIT TYPE D1 / D2 PLANS

UNIT TYPE D1 / D2 AREA CALCULATION DIAGRAM
A5.16 UNIT TYPE D1 / D2 AREA CALCULATION DIAGRAM
A5.16.A UNIT TYPE D1 / D2 AREA CALCULATION DIAGRAM

UNIT TYPE D1 / D2 AREA CALCULATION DIAGRAM
A5.17 UNIT TYPE D1 / D2 AREA CALCULATION DIAGRAM
A5.17.A UNIT TYPE D1 / D2 AREA CALCULATION DIAGRAM

UNIT TYPE D1 / D2 PLANS
A5.18 UNIT TYPE D1 / D2 PLANS

UNIT TYPE D1 / D2 AREA CALCULATION DIAGRAM
A5.19 UNIT TYPE D1 / D2 AREA CALCULATION DIAGRAM
A5.19.A UNIT TYPE D1 / D2 AREA CALCULATION DIAGRAM

UNIT TYPE D1 / D2 AREA CALCULATION DIAGRAM
A5.20 UNIT TYPE D1 / D2 AREA CALCULATION DIAGRAM
A5.20.A UNIT TYPE D1 / D2 AREA CALCULATION DIAGRAM




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DESIGN
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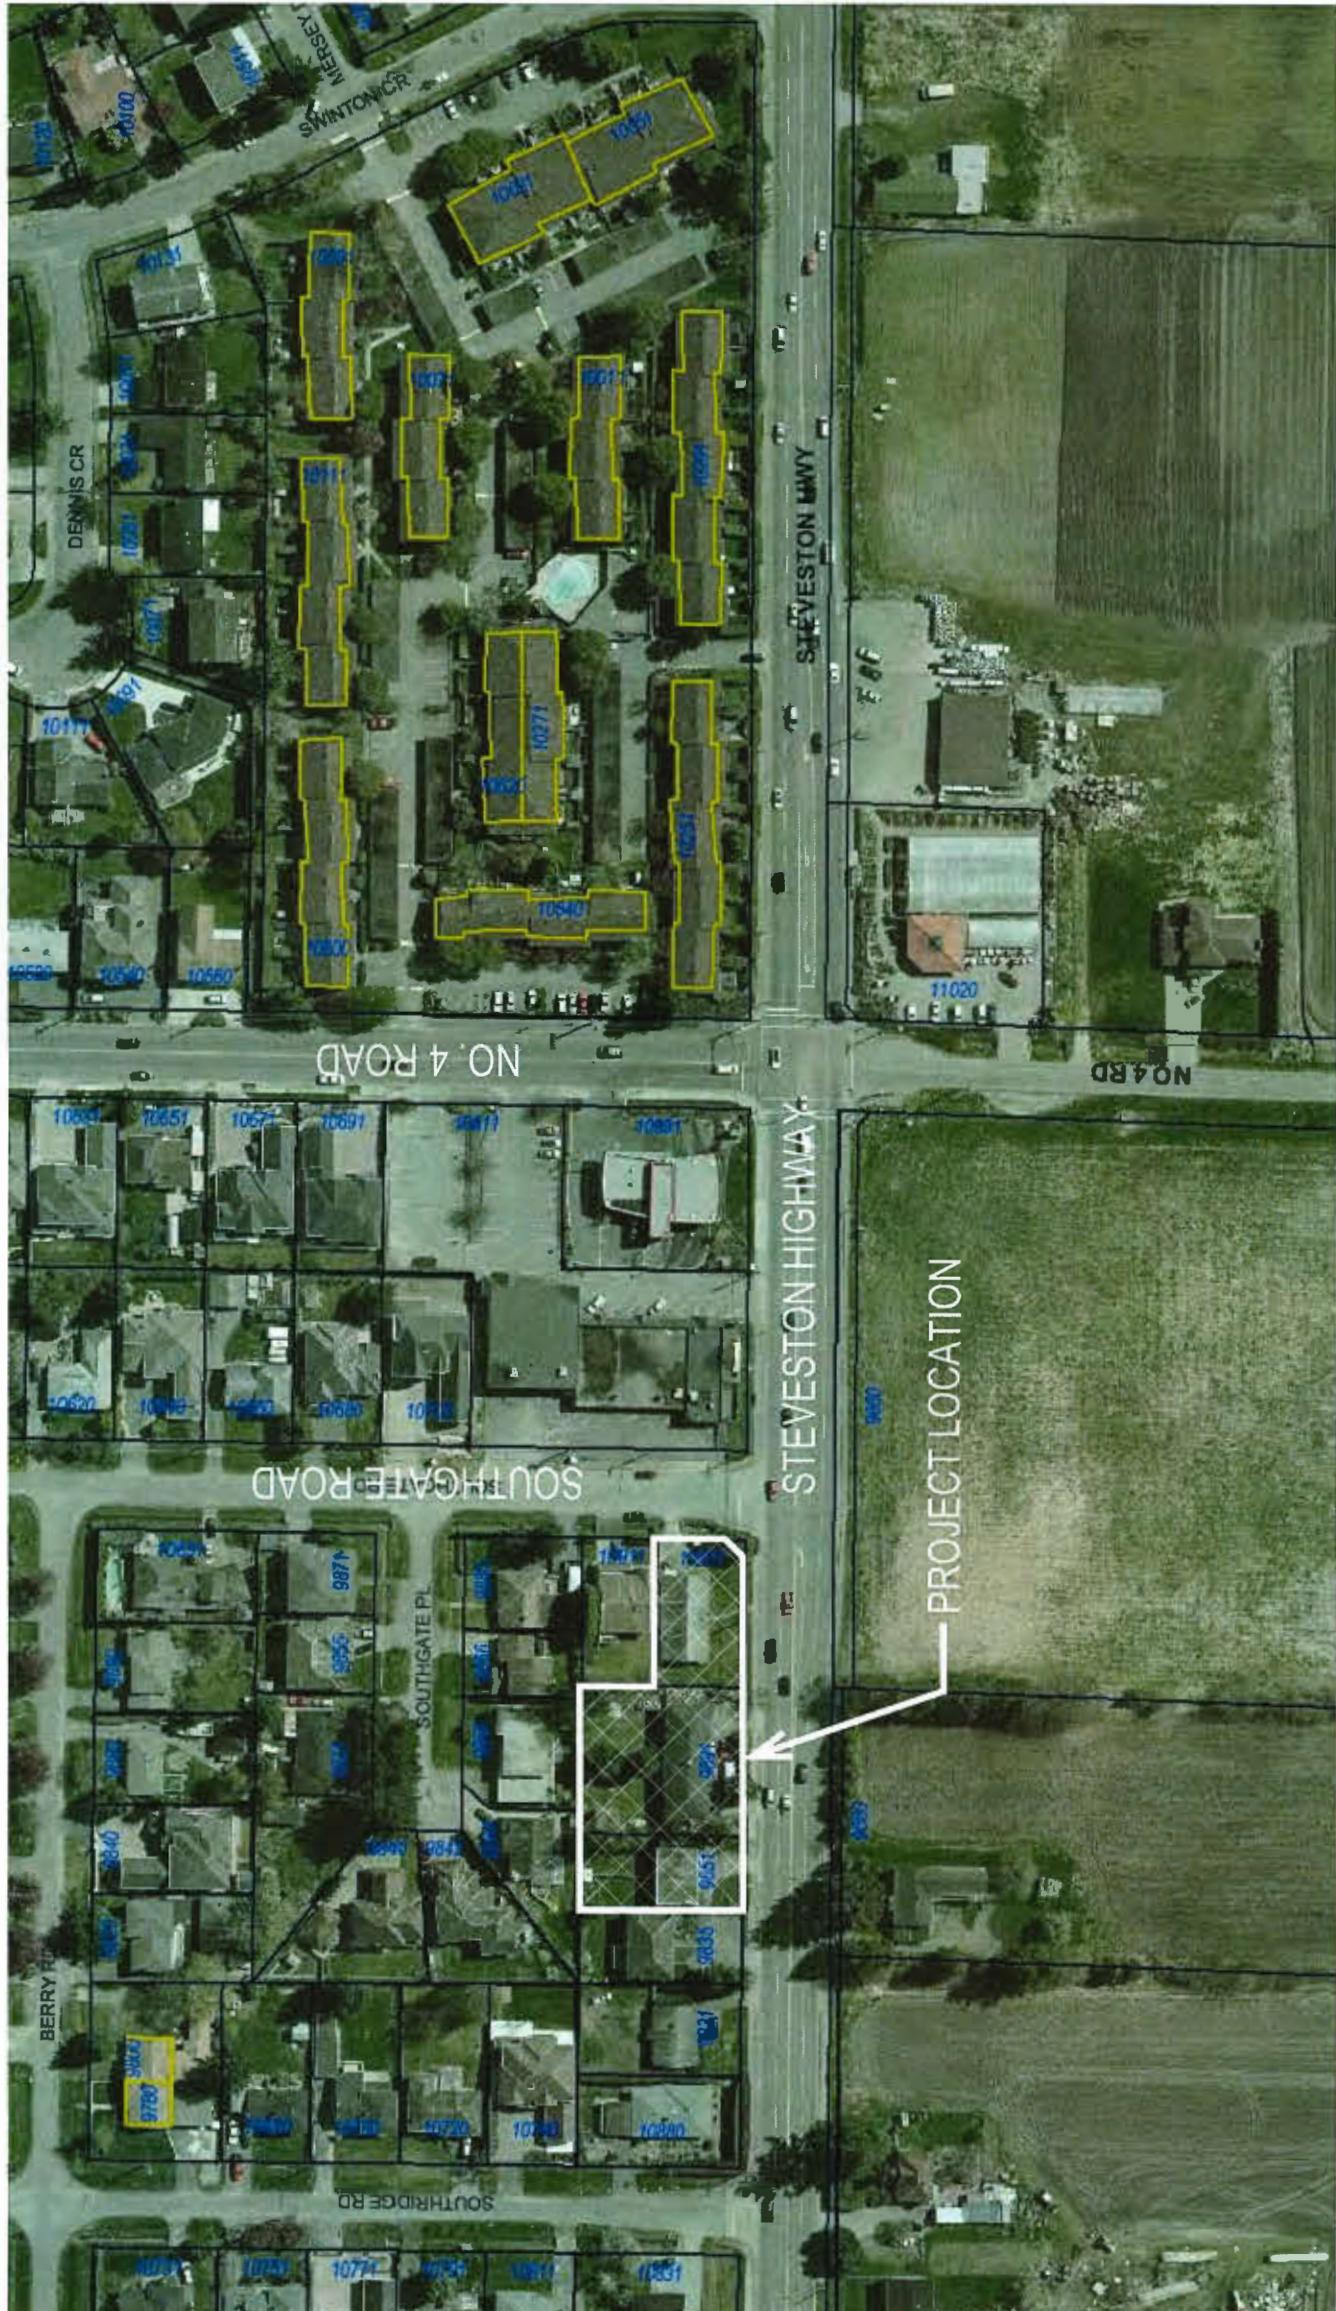




ISSUED DP
RESUBMISSION
2019-04-23

ClientProject
STEVESTON TOWNHOUSE
DEVELOPMENT (DP 17-792077) FOR
KONIC
9851 9801 STEVESTON HWY &
10921 SOUTHGATE ROAD, RICHMOND, BC

Site Aerial Photo

Project No.
#8127
Scale
N.T.S.
Drawing No.
Sheet
Revision
A 0.3

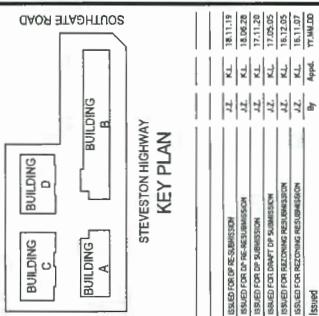

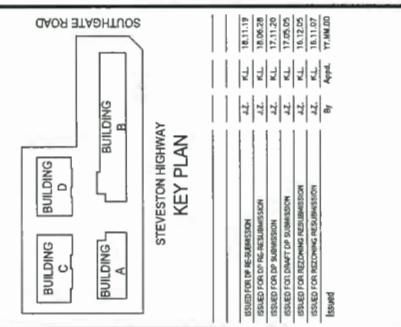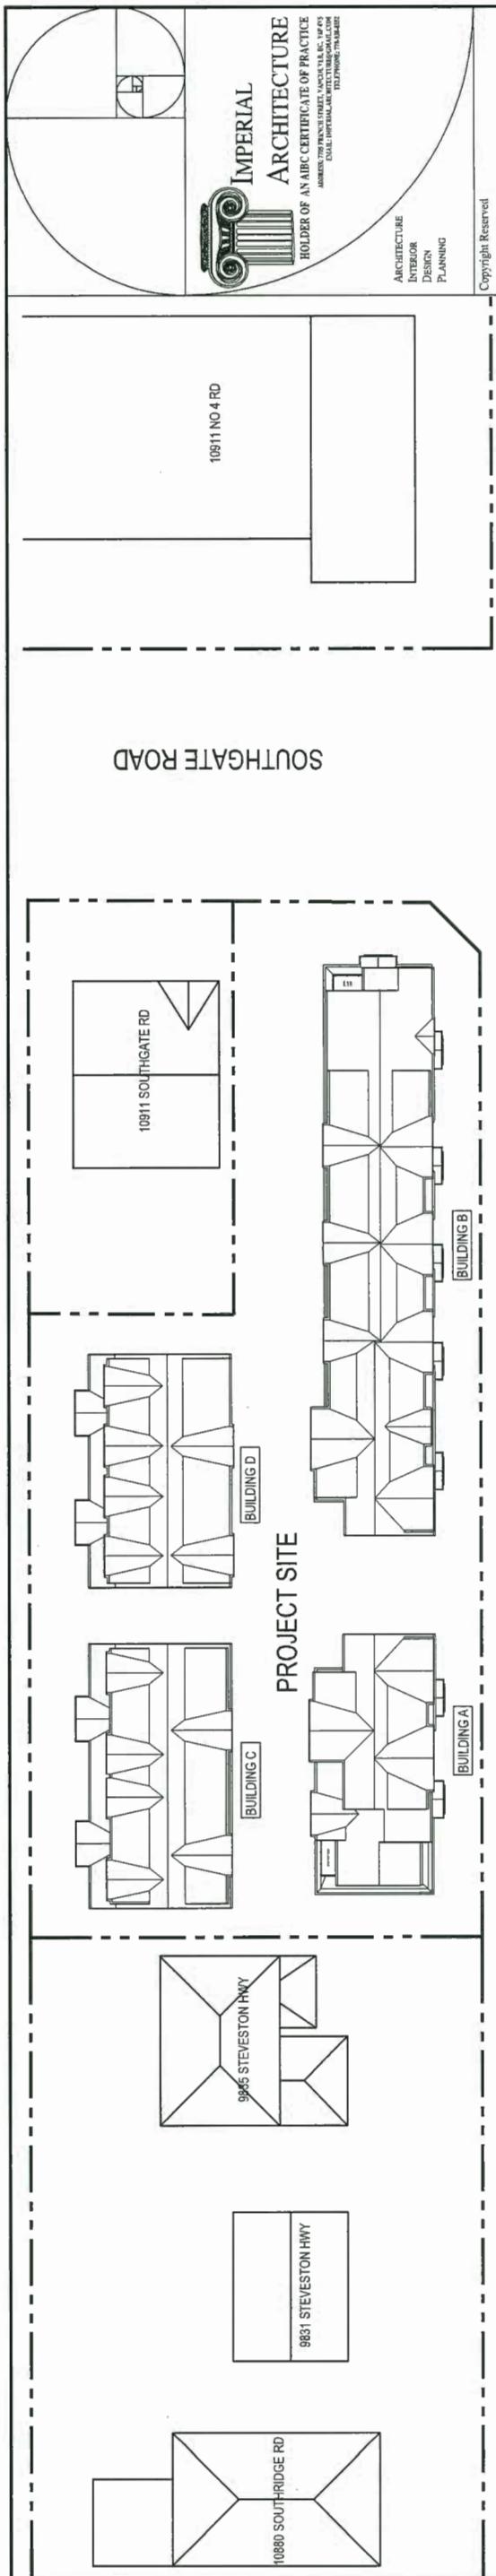

PLAN # 1.C

ISSUED DP
RESUBMISSION
2019-04-23

Project No.	#8127	Drawing No.	A05
Scale	1"=20'-0"	Sheet	of
		Revision	



EXISTING SITE INTEGRATION (SITE BHOST)

EXISTING SOUTH



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E-MAIL: info@imperialarch.com
WEBSITE: www.imperialarch.com

Project Statistics		Civic Address		Legal Description		PID		Building A		Building B		Building C		Building D		Total Units		
Lot	Unit	9851 Stevenson Highway, Richmond, BC	B SEC 34 BLKAN RIGGM PL NWP79459	012-213-471		Unit #	Unit 1	Unit 2	Unit 3	Unit 4	Unit 5	Unit 6	Unit 7	Unit 8	Unit 9	Unit 10	Unit 11	Total Units
Lot 1		9851 Stevenson Highway, Richmond, BC	43 SEC 34 BLKAN RIGGM PL NWP79459	004-871-715		Unit Type	A1	A2	B1	B2	C1	C2	D1	D2	E	F	G	Unit Types
Lot 2		9851 Stevenson Highway, Richmond, BC	42 SEC 34 BLKAN RIGGM PL NWP79459	000-614-688		Private Yard (SM)												
Lot 3		10951 Southgate Road, Richmond, BC	42 SEC 34 BLKAN RIGGM PL NWP79459	50 METRES		Uncovered Deck / Open Balcony (SF)												
Planning Area						Uncovered Deck / Open Balcony (SM)												
Gross Site Area						114.41	549.63	465.96	465.96	465.96	465.96	465.96	569.92	513.84	547.73	510.82	954.69	
Road Dedication						98.97	465.51	468.08	476.26	476.26	476.26	476.26	500.71	467.40	768.17	500.71	7084.17	SM
Net Site Area						91.88	44.97	39.60	39.60	39.60	39.60	39.60	77.68	46.52	43.42	77.65	658.14	SM
Max. FSU Allowed (RLT-4 Zone)						63.46	40.87	40.87	40.87	40.87	40.87	40.87	82.76				227.75	
Floor Area Allowed						114.41	549.63	465.96	465.96	465.96	465.96	465.96	569.92	513.84	547.73	510.82	954.69	
Total Net Floor Area Provided						16182.63 SF	0.00 SF	0.00 SF	0.00 SF	0.00 SF	0.00 SF	0.00 SF	7.69				21.18	SM
Total FSU Provided						16182.63 SF	0.00 SF	0.00 SF	0.00 SF	0.00 SF	0.00 SF	0.00 SF	3.80				7.69	SM

Private Outdoor Area Calculation

Outdoor Amenity Area Calculation

Total Amount of Unit



Regulated Outdoor Amenity Area Ratio

Total Outdoor Amenity Area Required

Provided Outdoor Amenity Area A1

Provided Outdoor Amenity Area A2

Total Outdoor Amenity Provided

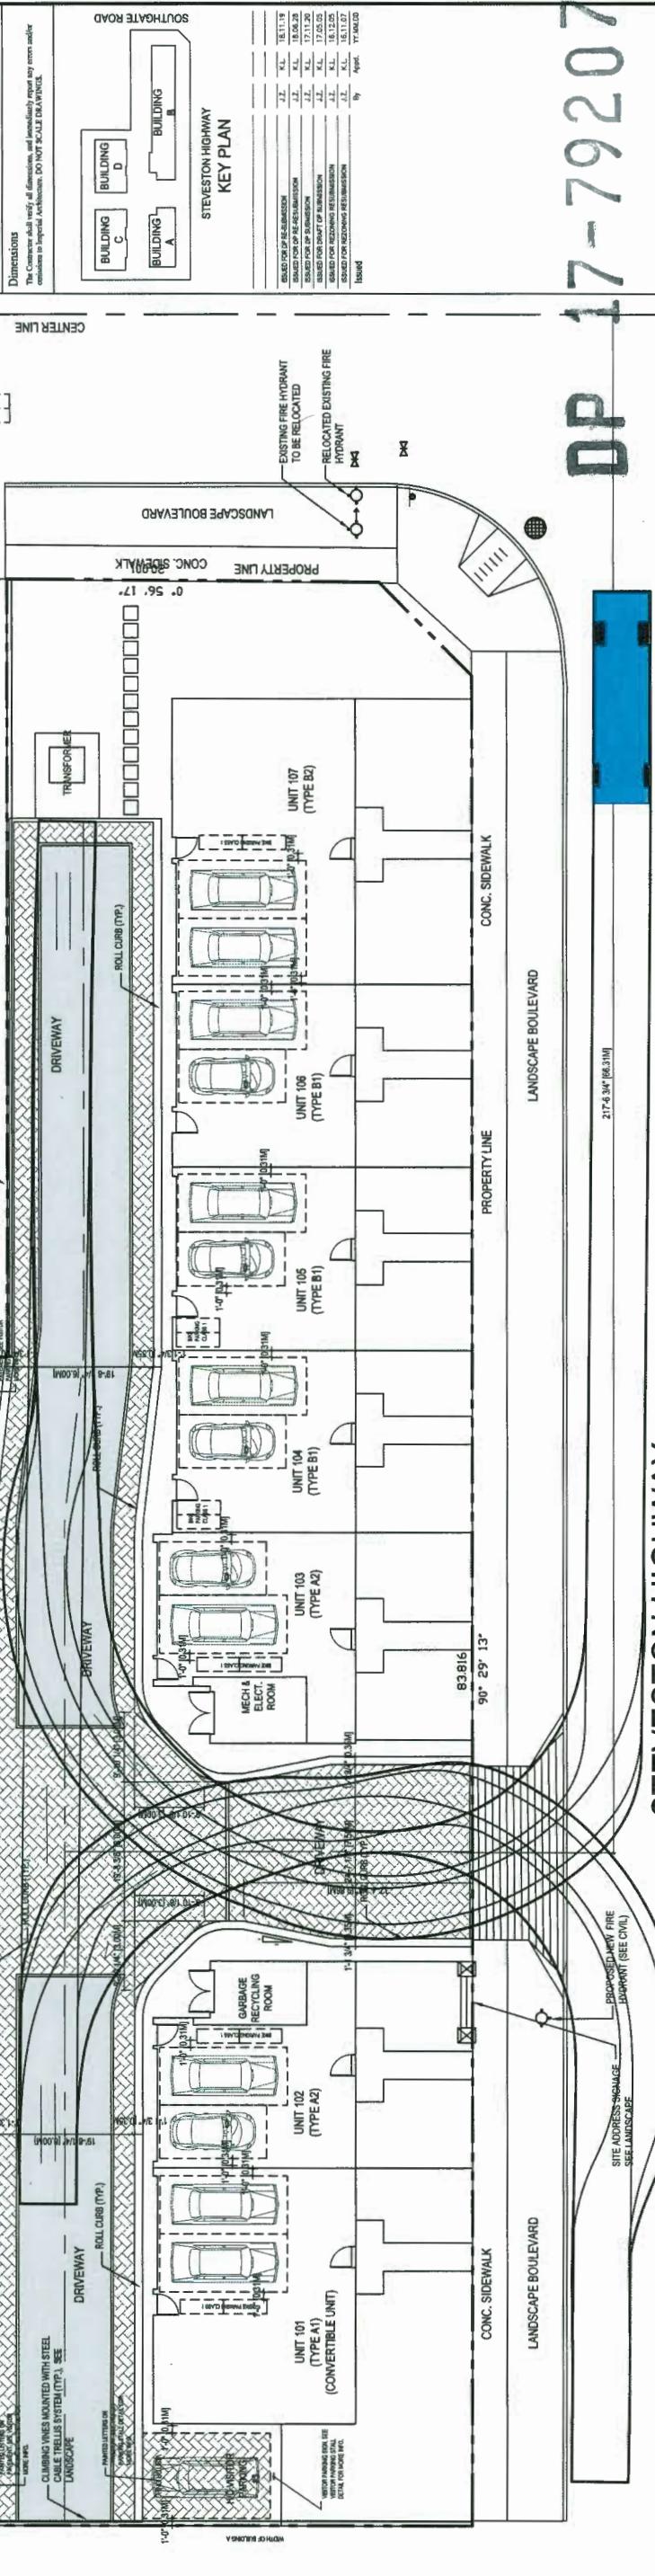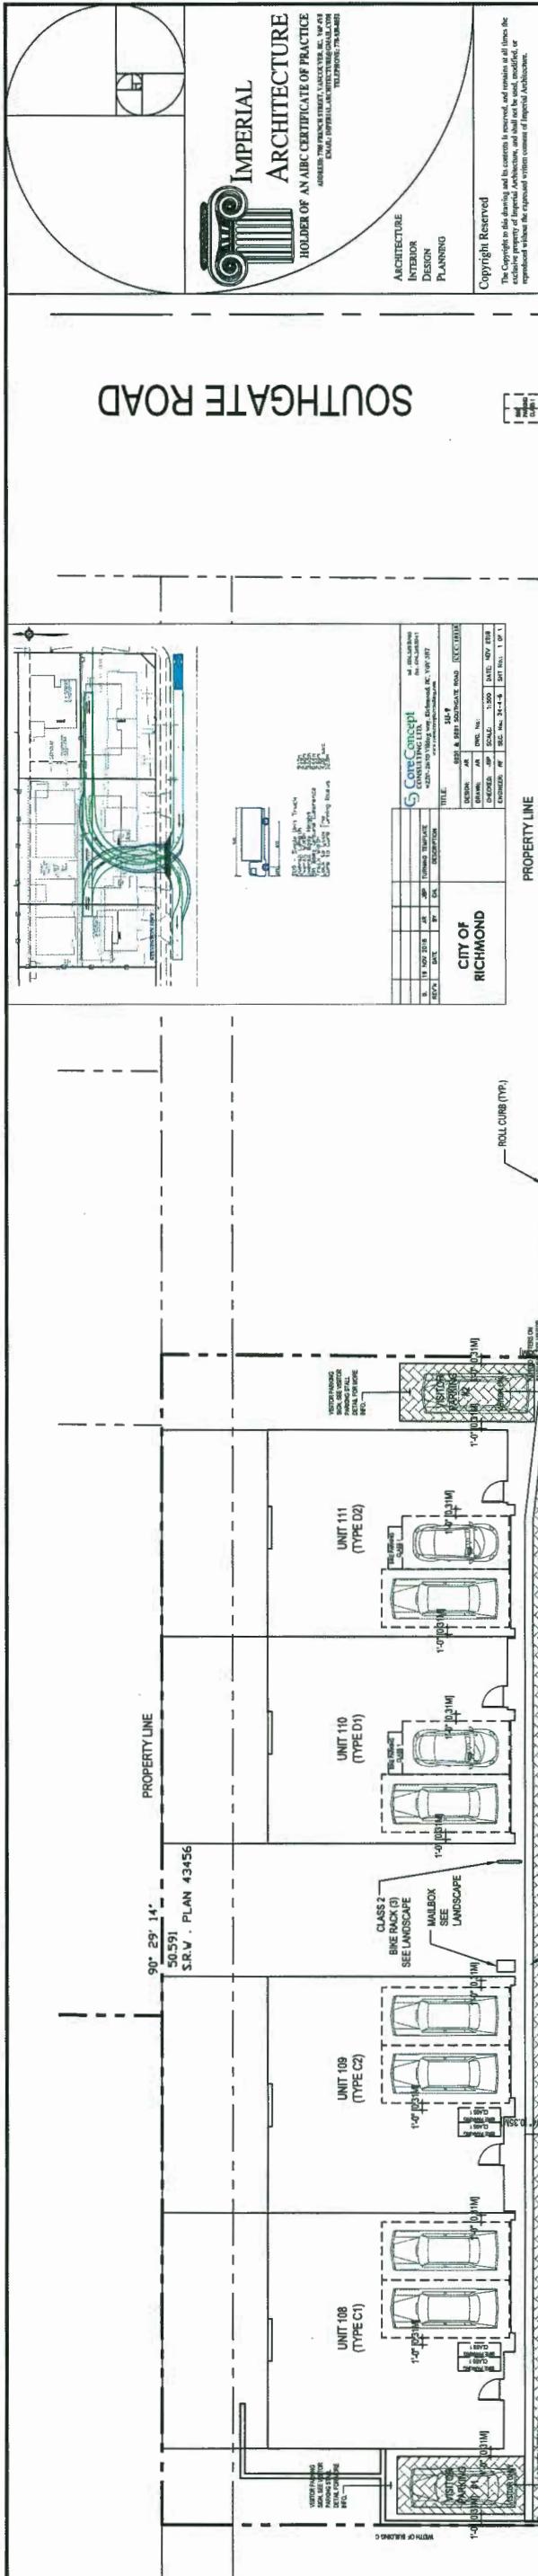

PLAN # 2.a

ISSUED DP
RESUBMISSION
2019-04-23

Client/Project STEVESTON TOWNHOUSE
DEVELOPMENT (DP 17-79207) FOR
KENSIE

This image shows an architectural drawing titled "PARKING PLAN" for the address 10931 Southgate Road, Richmond, BC. The drawing includes a map of the site, dimensions for the parking areas, and a legend for symbols like trees and sidewalks. A scale bar indicates distances up to 100 meters.

PLAN # 2.a

ISSUED DP
RESUBMISSION
2019-04-23

9851,9891 STEVESTON HWY &
10931 SOUTHGATE ROAD, RICHMOND, BC

VISITOR PARKING STALL DETAILS

CENTER LINE

PARKING PLAN 3/32" = 1'-0"


A1.1 SCALE

SUPPORT FIRE TRUCK @ 80,000 LBS

STEVEN SWAN

Building Calculation by Unit												
Building Type	Building A			Building B			Building C			Building D		
	Unit 1	Unit 2	Unit 3	Unit 4	Unit 5	Unit 6	Unit 7	Unit 8	Unit 9	Unit 10	Unit 11	Total
Residential Parking (Standard)	A1	A2	A3	B1	B2	B3	C1	C2	C3	D1	D2	8 Units
Residential Parking (Small Car)	0	2	1	3	1	1	1	2	2	0	1	7 Units

Residential Parking Provided	Including Standard Stalls including Some Stalls	1 Stall	13 Stalls	Reserve Required
Business Parking Required	Business Parking Provided	X	11 Unit	2 Stalls
			=	3 Stalls (including 14°C stall)
Visitor Parking Required	Visitor Parking Provided			1 Stall
				1 Stall
Bike Storage Required	Bike Storage Provided			13.75 Spaces
				20 Spaces
Bike Parking Required	Bike Parking Provided			2.5 Spaces
				3 Spaces

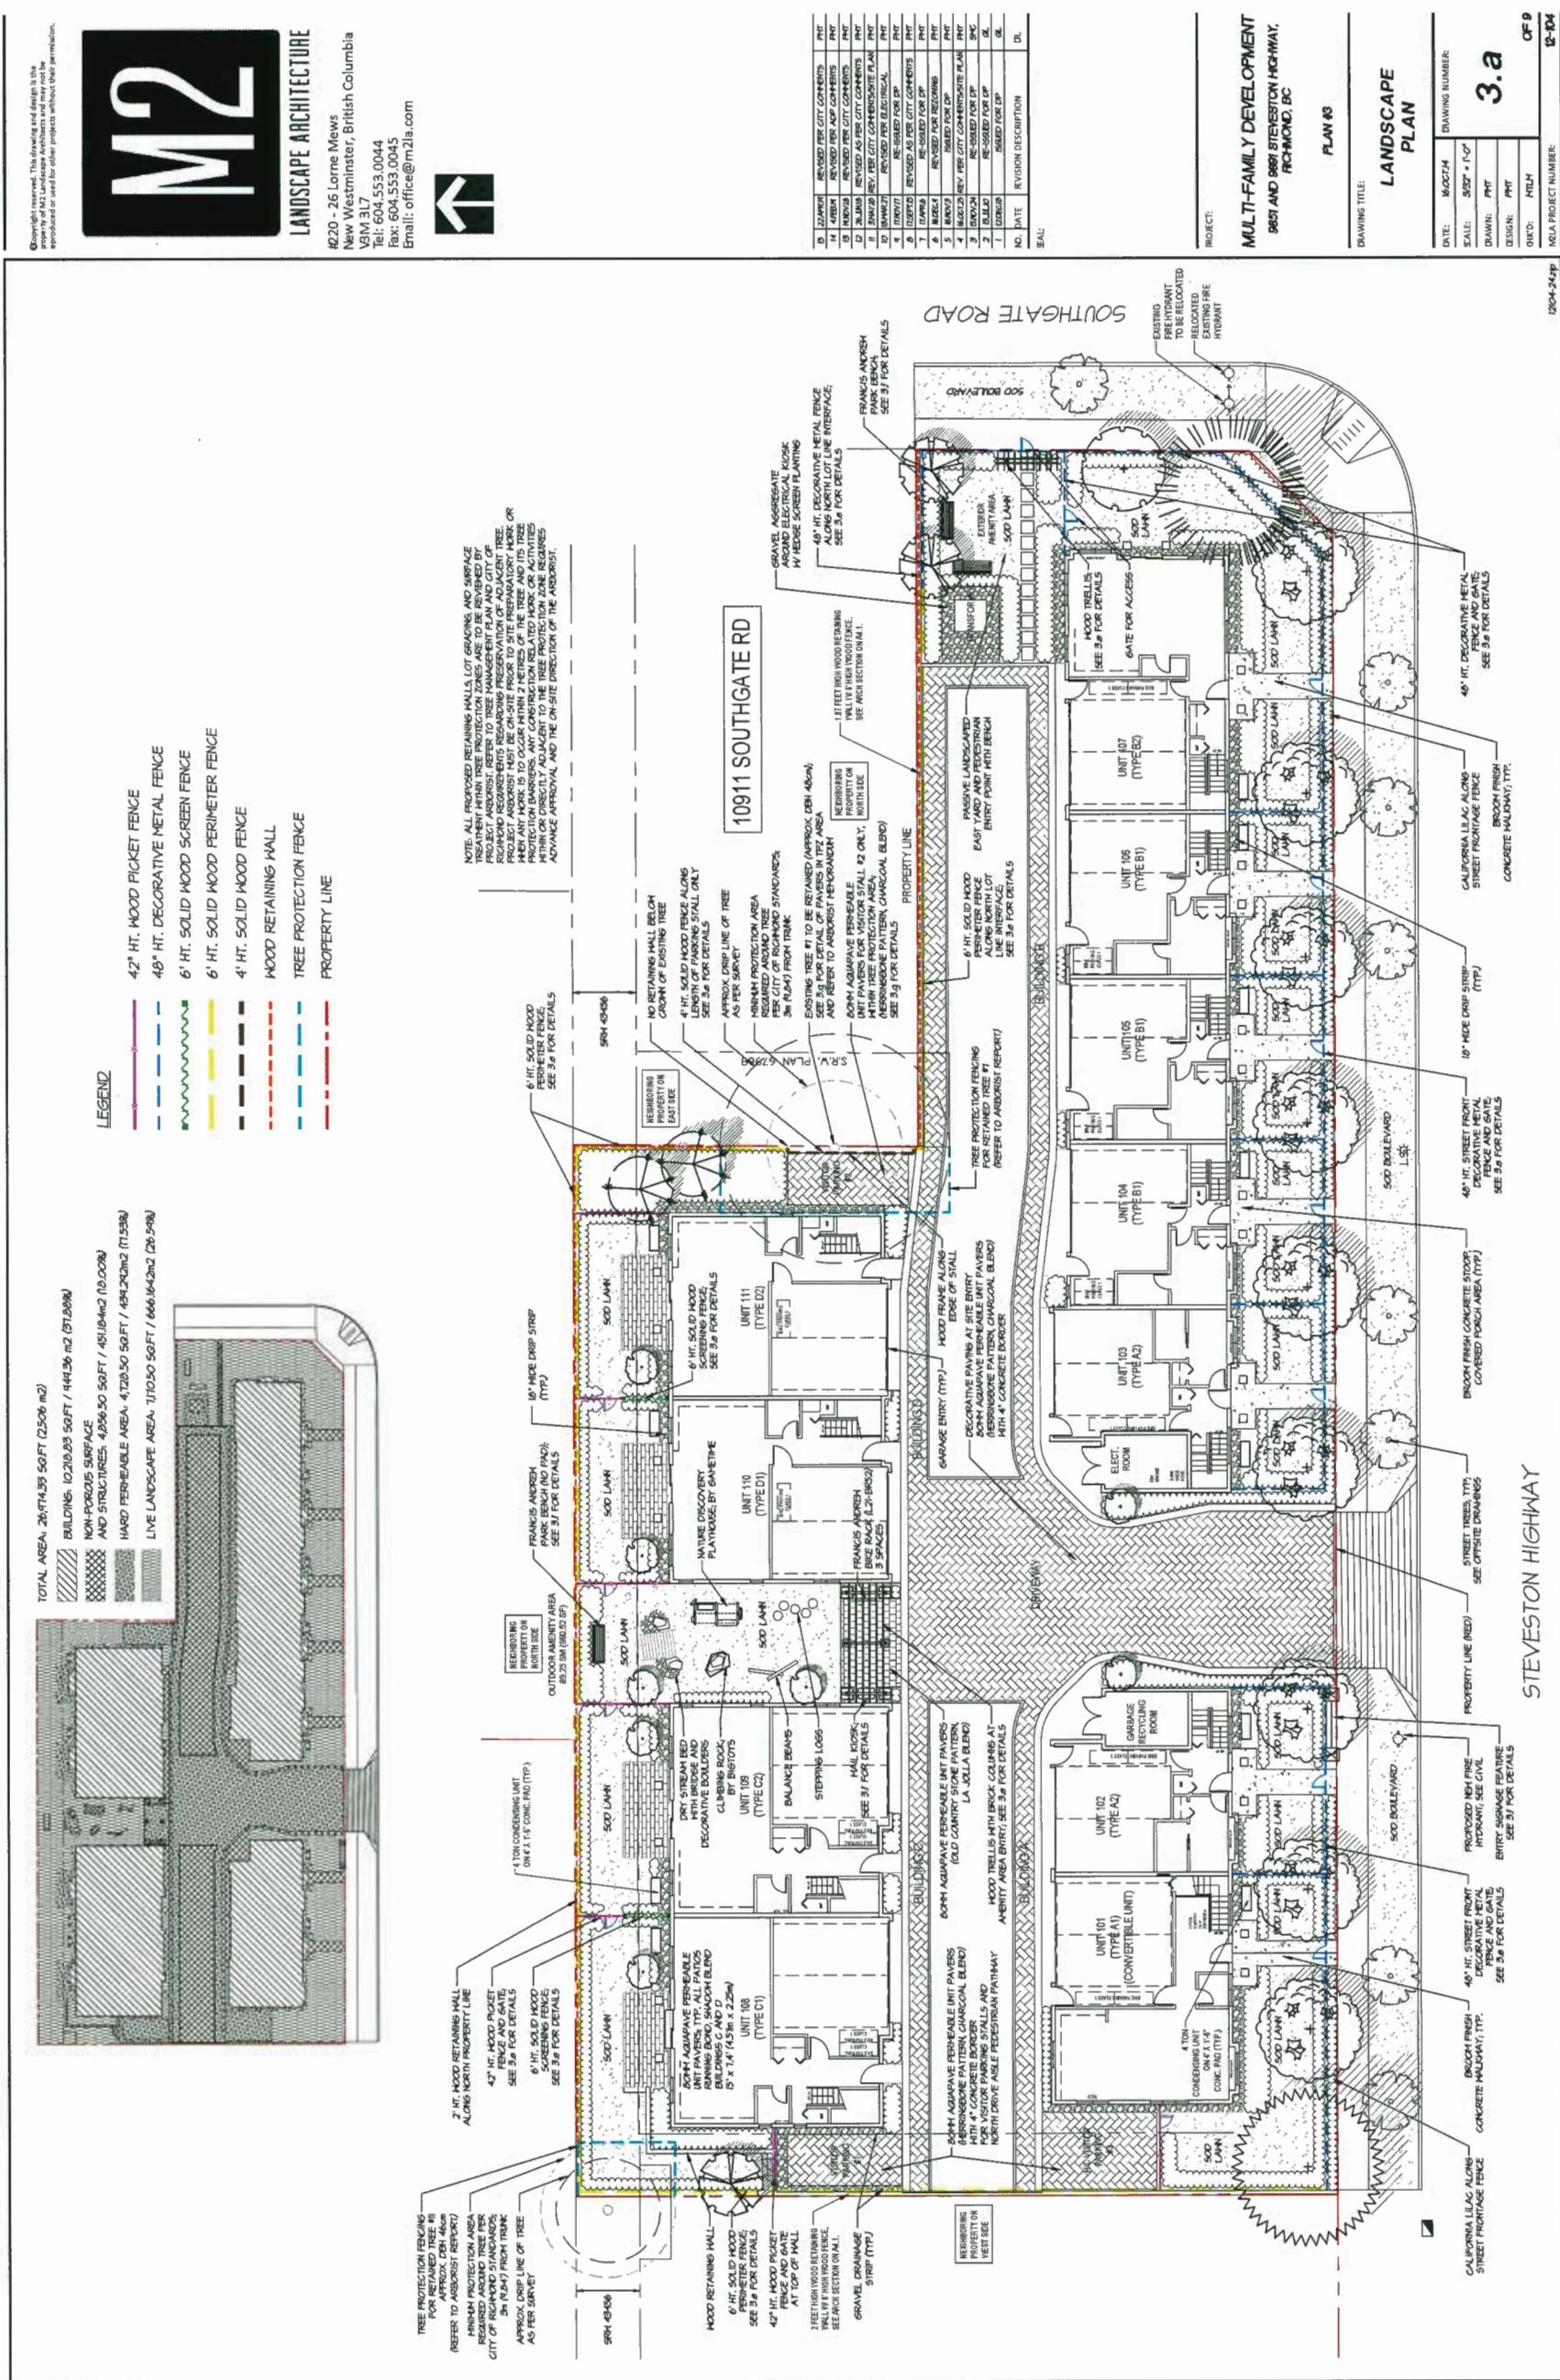

PLAN # 3.b

DRAFTER: 12-044
DRAWING NUMBER: 3.b
SCALE: 3'0" x 1'-0"
DRAWN: PHF
DESIGN: PHF
C.H.O.: MTLM
C.R.F.: OF 9
PROJECT NUMBER: 12-044

STEVESTON HIGHWAY

LANDSCAPE ARCHITECTURE
M2

MULTI-FAMILY DEVELOPMENT
95TH AND 96TH STEVESTON HIGHWAY,
FARMOND, BC

PLAN #3

SHRUB
PLAN

PROJECT:

PLAN:

SHEET:

SCALE:

DATE:

REV:

REVISION:




LANDSCAPE ARCHITECTURE

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fax: 604.553.0045
email: office@m2a.com


1

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NOTE: REFER TO CIVIL DRAWINGS FOR LOT GRADING AND DRAINAGE INFRASTRUCTURE DESIGN

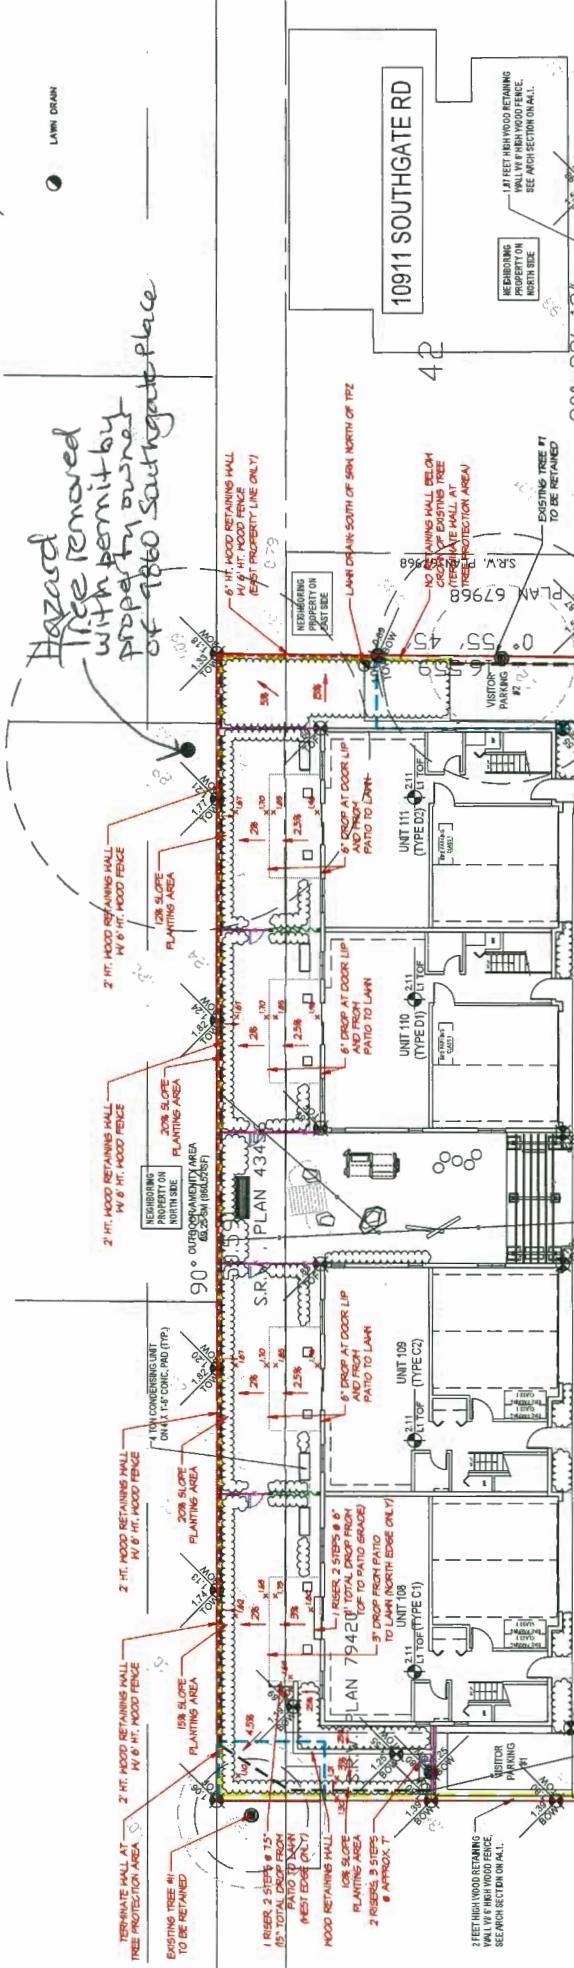

SOUTHEGATE ROAD

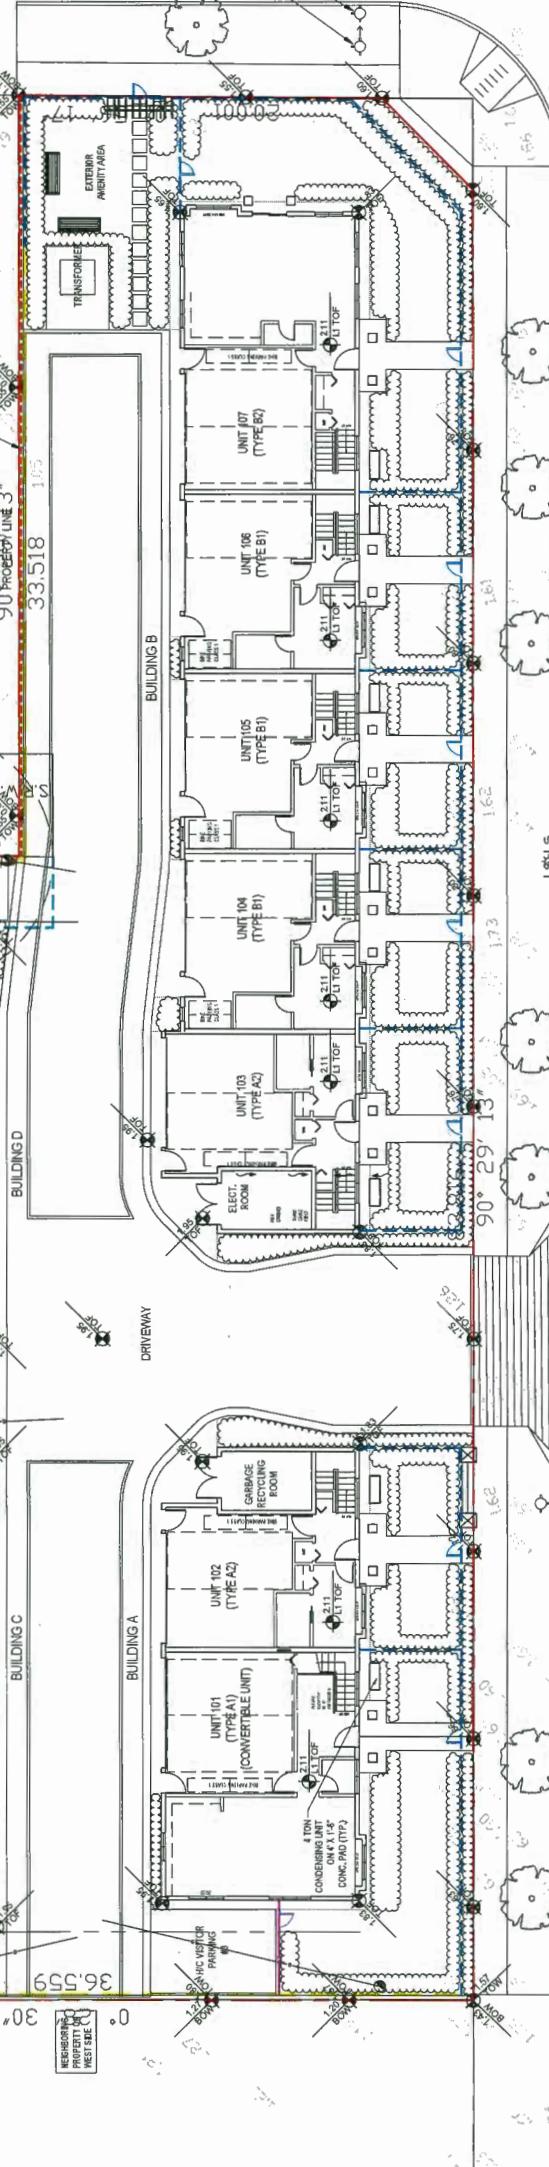

CONVECTION VORTICITY

MULTI-FAMILY DEVELOPMENT
9851 AND 9881 STEVESTON HIGHWAY,
RICHMOND, BC

ANS

GRADING PLAN

PLAN

DATE:	16 OCT 74
SCALE:	3/8" = 1'-0"
DRAWN:	PMT
DESIGN:	PMT

DRAWING NUMBER:
3.C

OP 17-792077

PLAN # 3.f

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Fax: 604.553.0045
Email: office@m2la.com

ROOFING DOCUMENT FACT SHEET

Typical Construction Details

Basic Series 2

Frances Andrew Site Furnishings Ltd

Dimensions:

General Specifications:

Options:

Accessories:

LETTERING STYLE AND SIZE PER ARCH

WOOD BRIDGE AT AMENITY AREA

SCALE : 3/8" = 1'-0"

ENTRANCE SIGNAGE FEATURE

SCALE : 1/2" = 1'-0"

**PROJECT: MULTI-FAMILY DEVELOPMENT
9851 STEVESTON HIGHWAY,
RICHLAND, BC**

PLAN #3

DRAWING TITLE: LANDSCAPE DETAILS

DATE: 16/07/14 DRAWING NUMBER: 3.f OF 9

SCALE: AS SHOWN DRAWN: PHT DESIGN: PHT DIVID: HCN

INLA PROJECT NUMBER: 12/104

1204-24-4P

CANADA POST MAIL KIOSK

STEPPING STONES

CLIMBING ROCK by BigRock

DRY STREAM BED

BALANCE BEAMS

PROJECT: CANADA POST MAIL KIOSK

15 WOOD TRELLIS AND MAIL KIOSK WITH BRICK COLUMNS AT AMENITY AREA ENTRY

SCALE : 3/8" = 1'-0"

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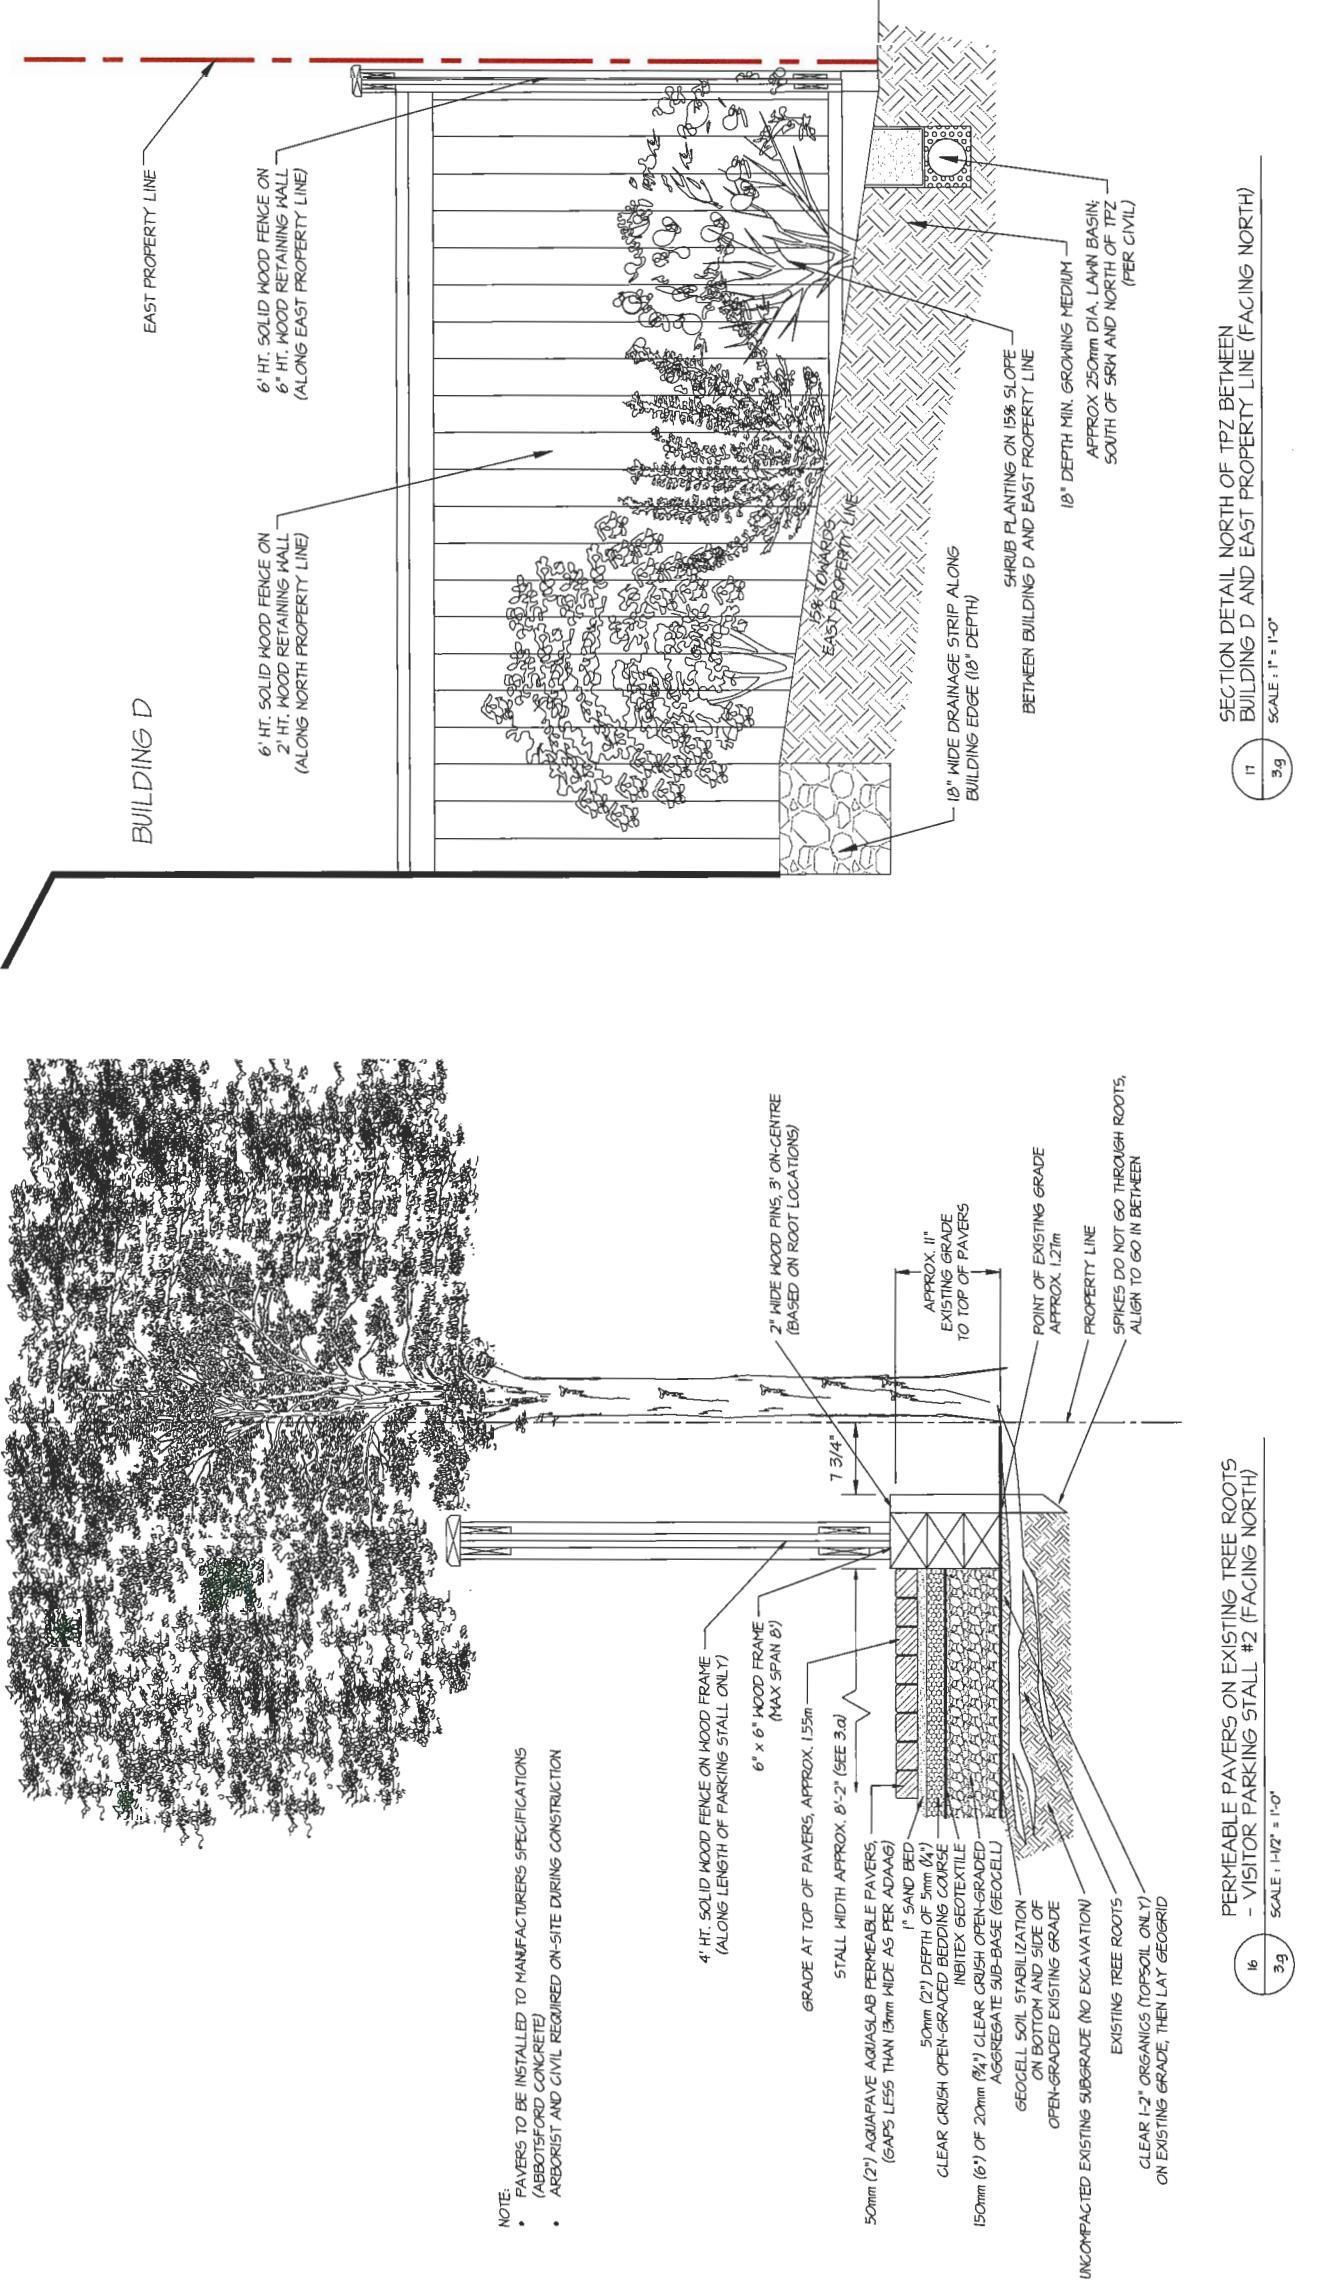
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PLAN # 3.9


DP 11-12077



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Email: office@m2ia.com

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EXISTING TREE #1 AREA ALONG EAST PROPERTY LINE
(FACING WEST)

1b
3h

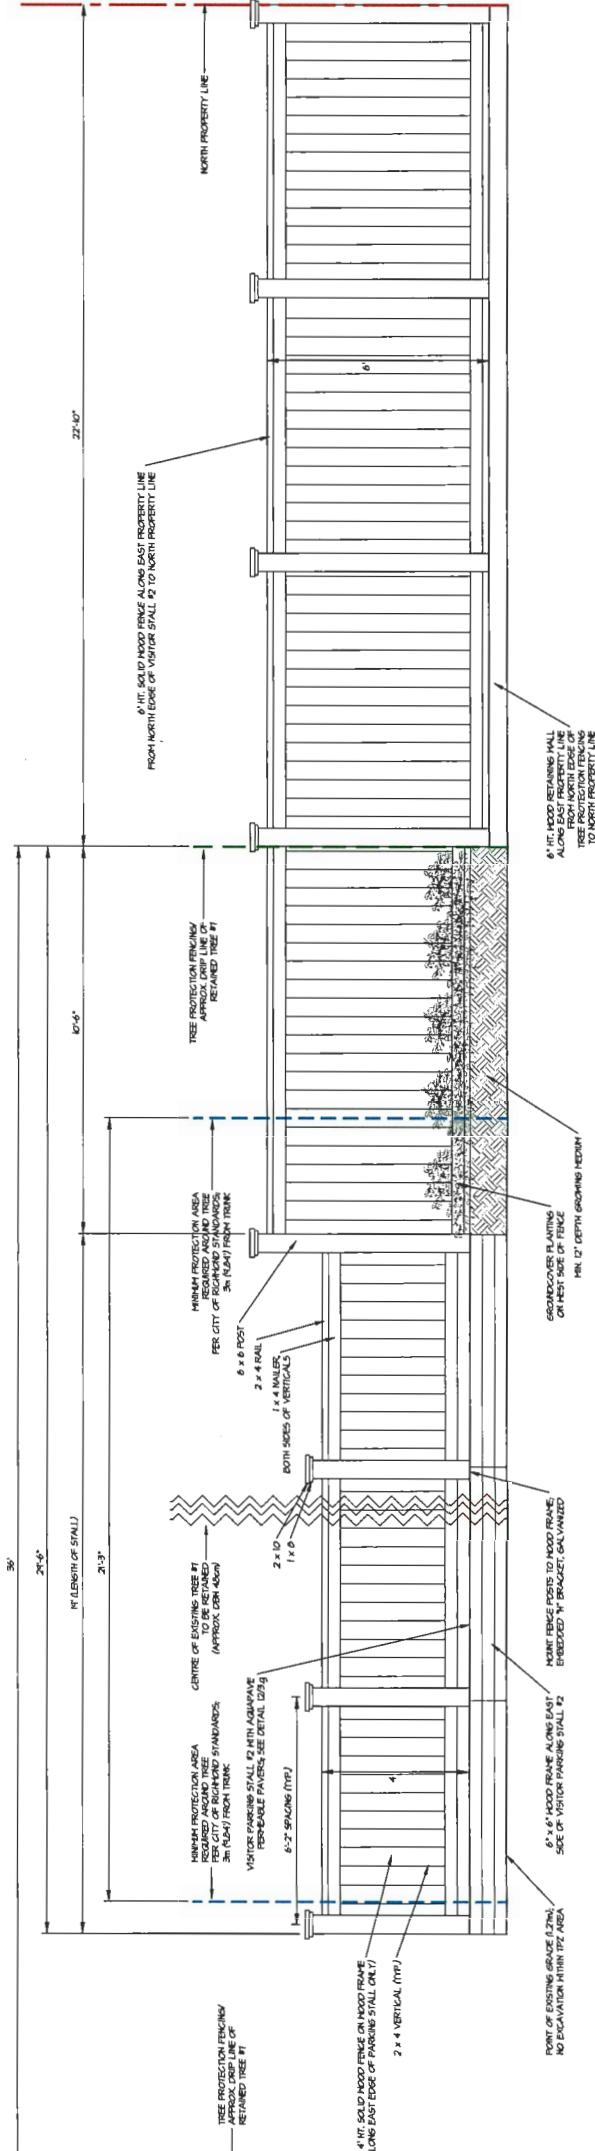SCALE : 1/2" = 1'-0"

PROJECT:
MULTI-FAMILY DEVELOPMENT
9851 AND 9851 STEVENSON HIGHWAY,
RICHLAND, BC


PLAN #8


DRAWING TITLE:
LANDSCAPE
SECTIONS

DATE:	16-OCT-14	BALWING NUMBER:	
SCALE:	AS SHOWN		
DRAWN:	PHOT		
DESIGN:	PHOT		
CHKO:	PHOT	OP 9	
MLA PROJECT NUMBER:	12-104		

DP 1772077

PLAN # 3.h

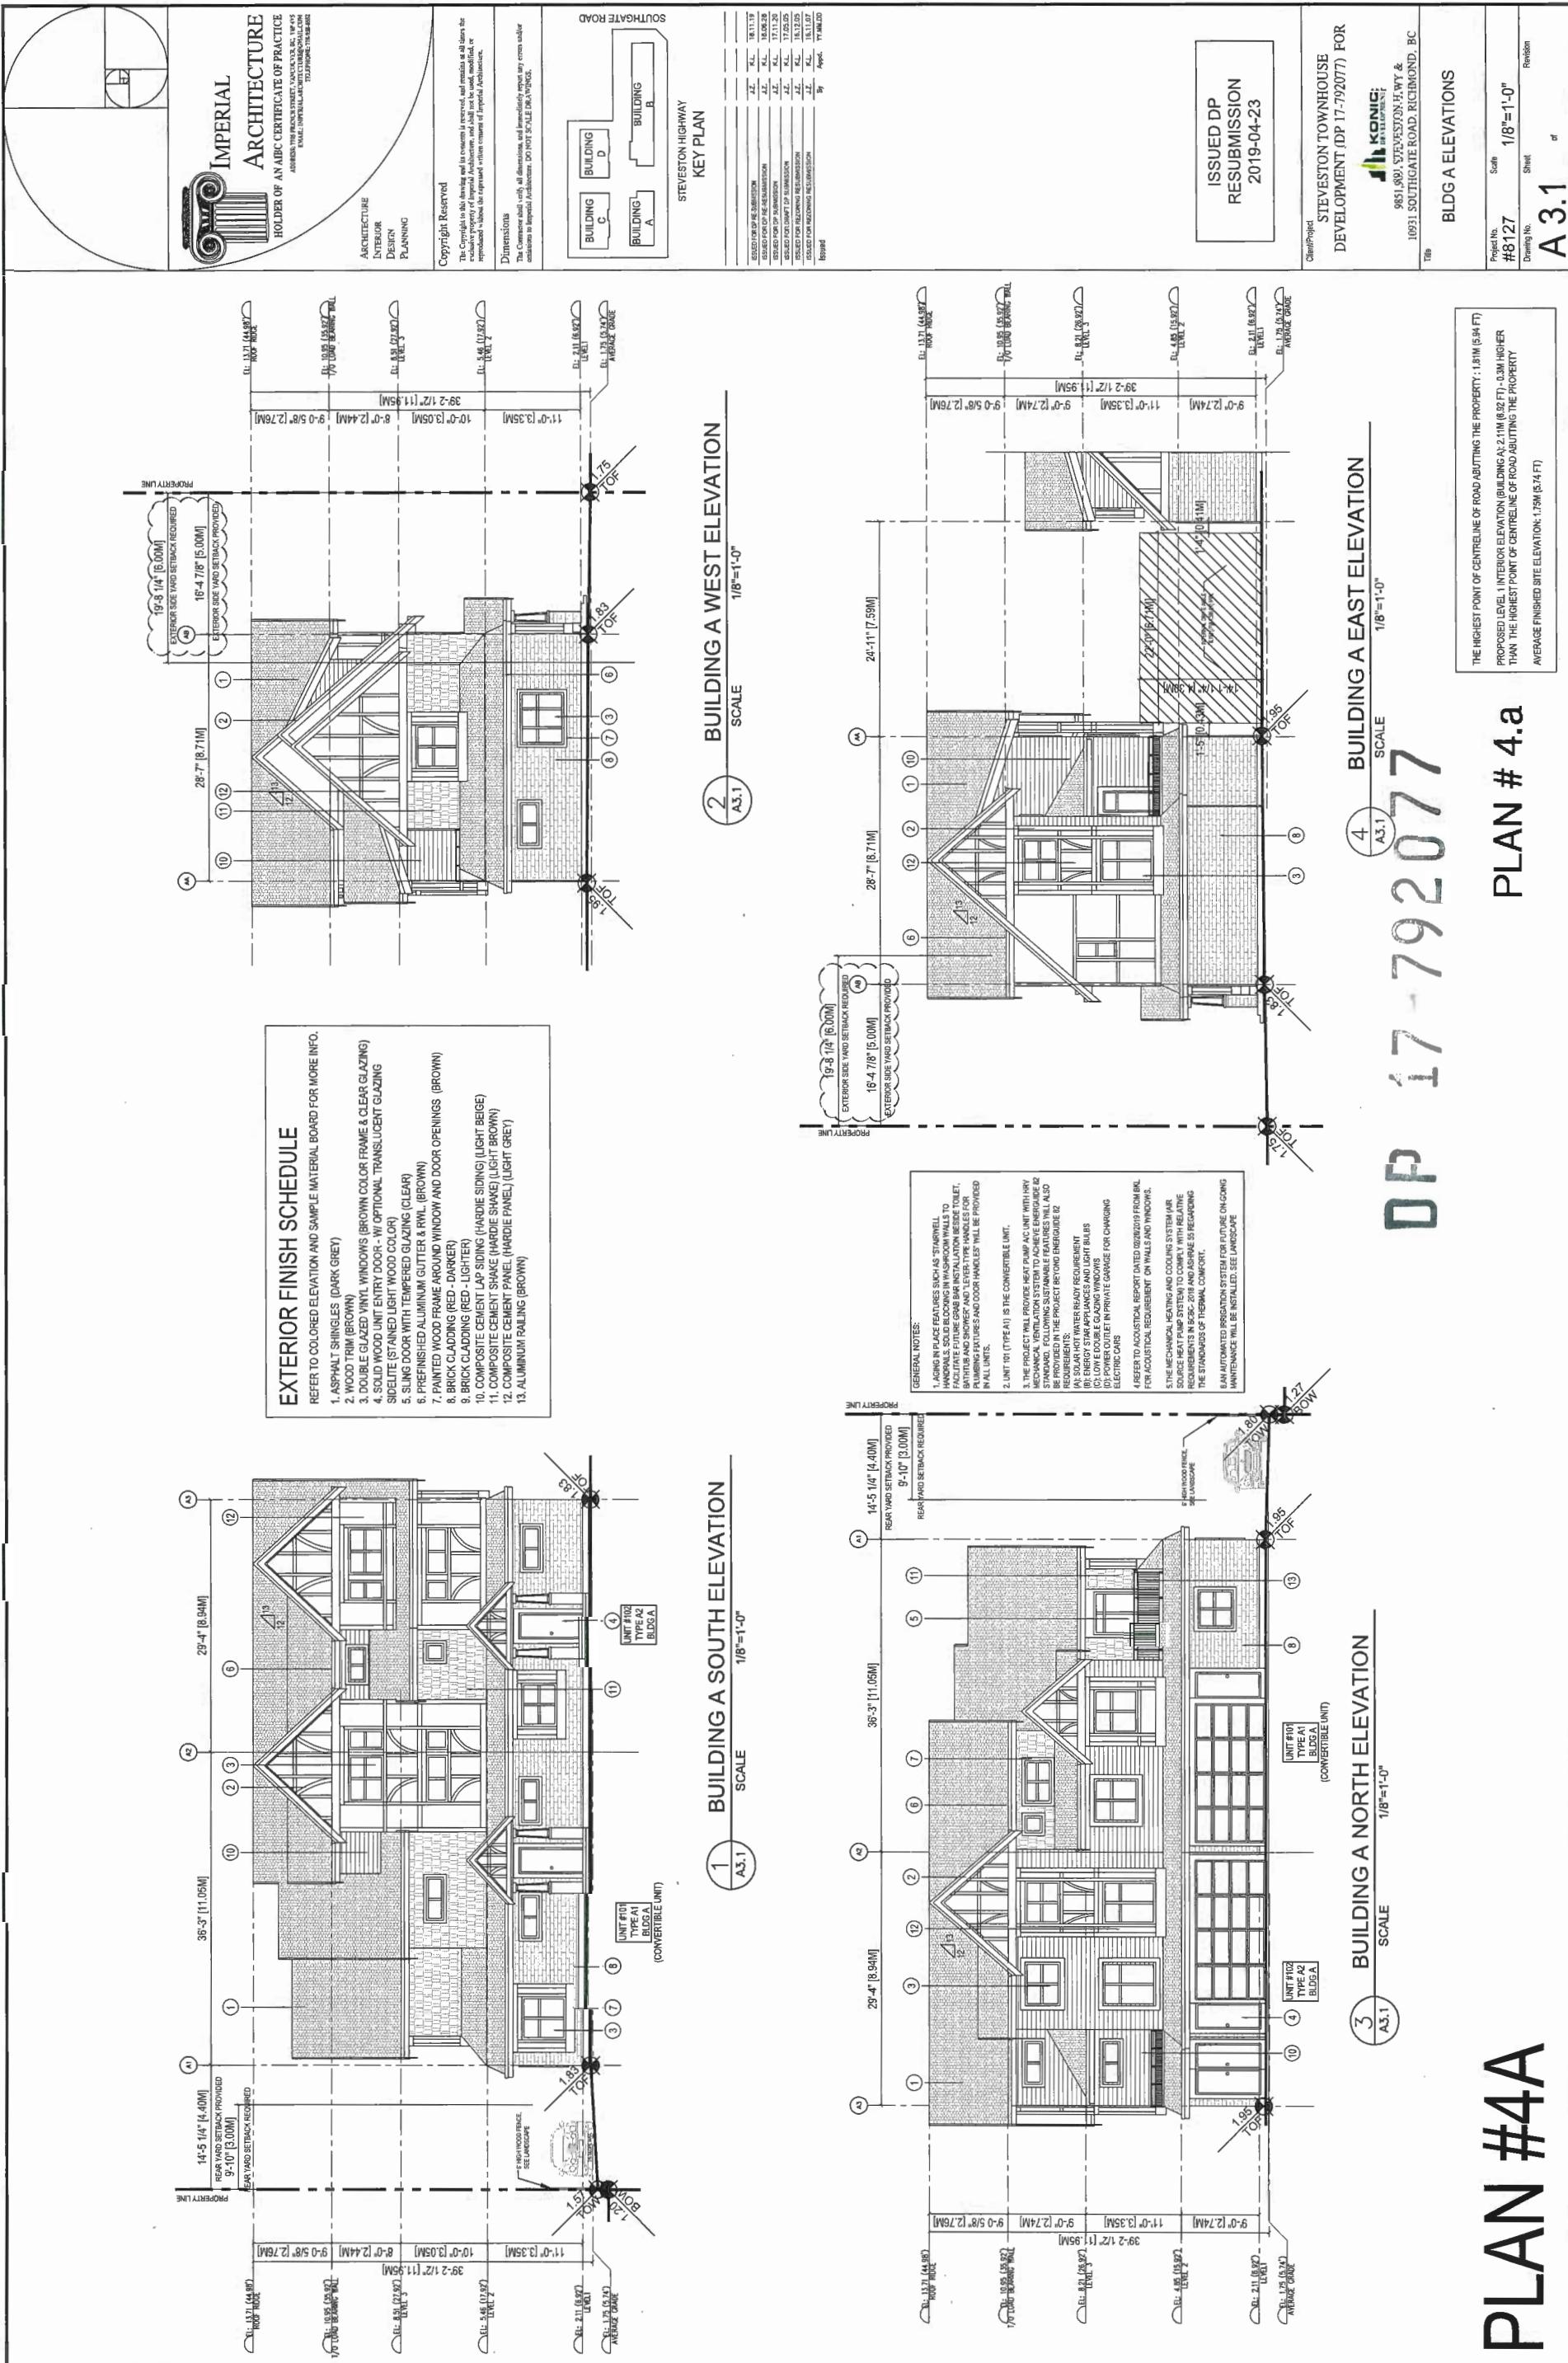


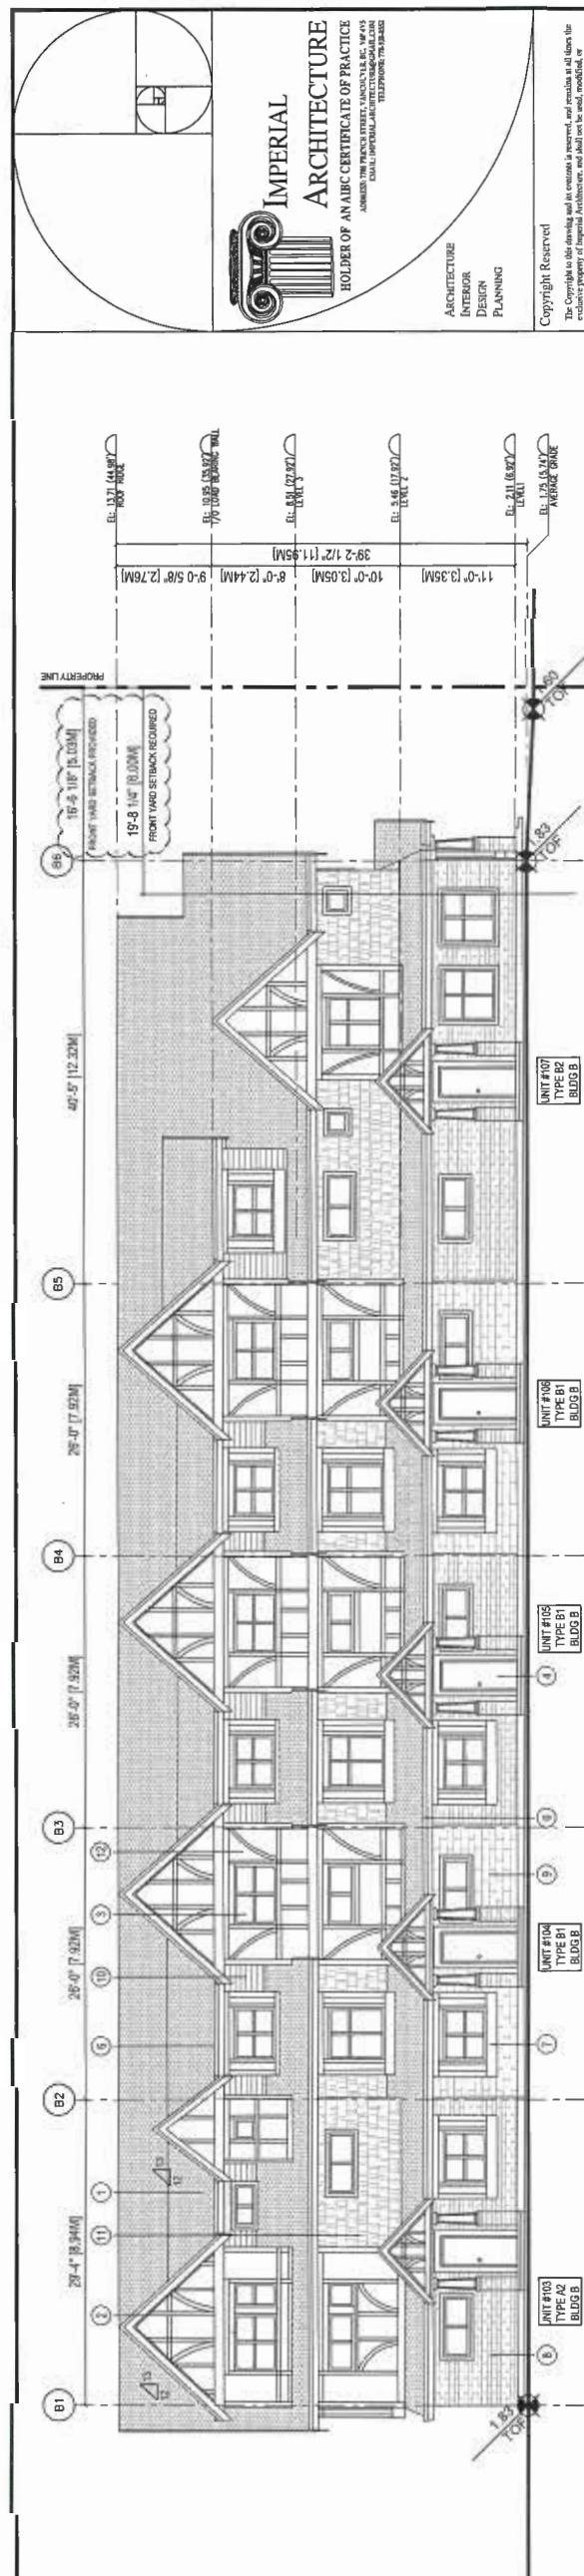

BUILDING B SOUTH ELEVATION

SCALE
1/8"=1'-0"

NOTE:
HIGHEST POINT OF ADJACENT ROAD: 1.9M GSC
GROUND FLOOR ELEVATION: 2.1M GSC
GROUND LEVEL & 1st ELEVATION IS 0.2M HIGHER THAN THE HIGHEST POINT OF ADJACENT ROAD

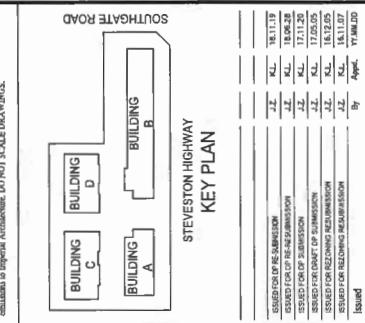

KEY PLAN

SOUTHEAST ROAD

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Interior
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TELEPHONE: 778.545.0888

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ARCHITECTURE

17-792077

PLAN # 4.b


ISSUED DP
RESUBMISSION
2019-04-23

Client/Project
DEVELOPMENT (DP 17-792077) FOR
9851 98A STEVESTON HWY &
10931 SOUTHGATE ROAD, RICHMOND, BC

BLDG B ELEVATIONS

1/8"=1'-0"
Scale
Drawing No. #8127
Title

A 3.2
of

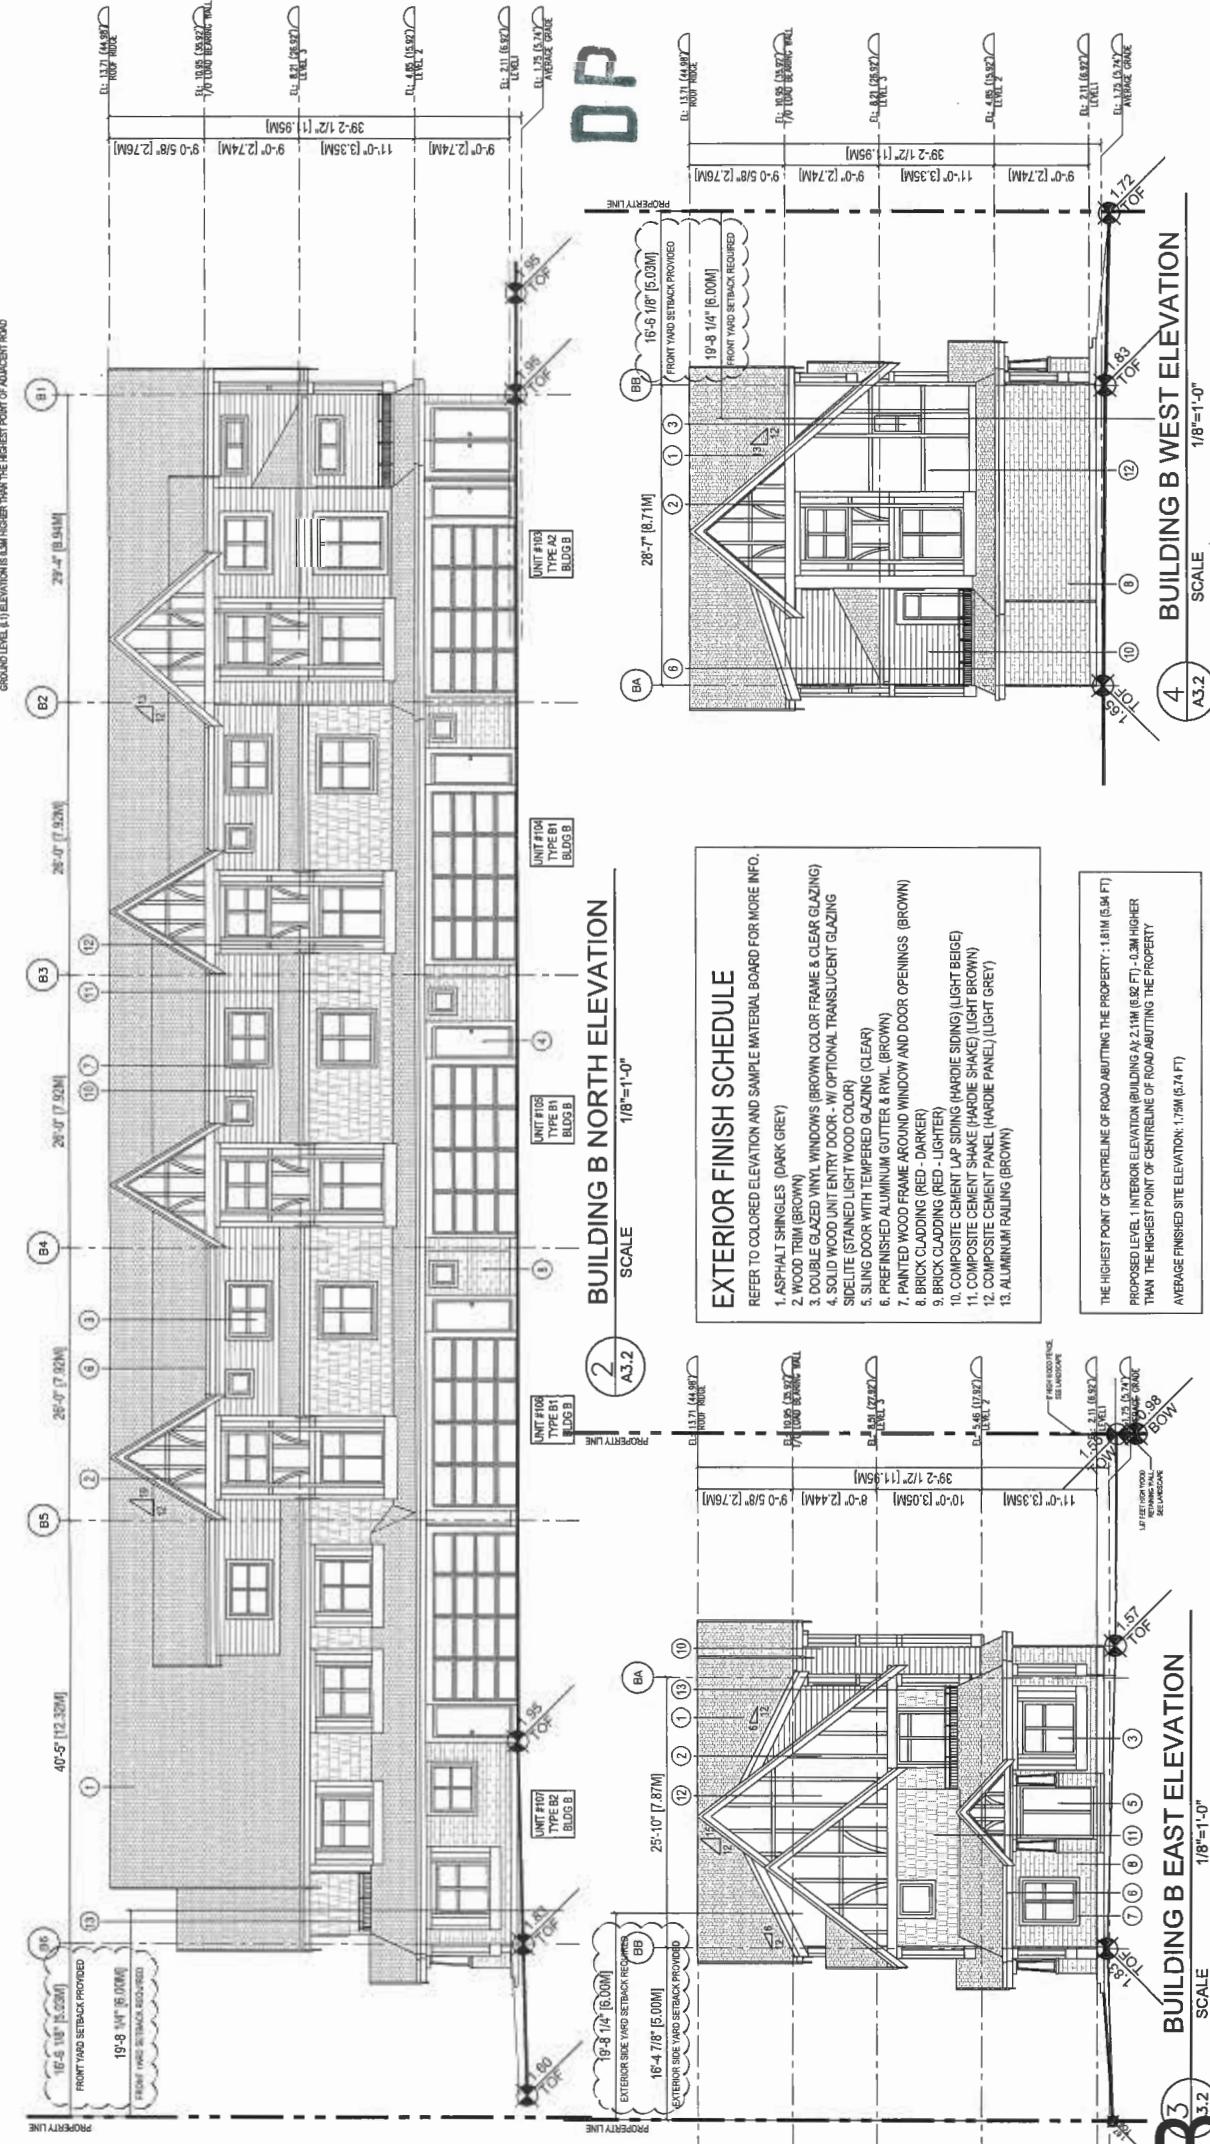

GENERAL NOTES:

1. GABLES IN THESE FEATURES SIGNIFICANT STRENGTH, HANGERS, SOLID DOOR COVERS AND INSULATION WALLS TO FACILITATE FUTURE GRAB BAR INSTALLATION BEHIND TOILET, BATHTUB AND SHOWER AND LEVER-TYPE HANLES FOR PLUMBING FIXTURES AND DOOR HANLES WILL BE PROVIDED IN ALL UNITS.
2. UNIT 101 (TYPE A) IS THE CONVERTIBLE UNIT.
3. THE PROJECT WILL PROVIDE HEAT PUMP AC UNIT WITH NEW MECHANICAL VENTILATION SYSTEM TO ACHIEVE ENERGUIDE & STANDARD, ALLOWING SUSTAINABLE FEATURES LIKE ENERGY STAR RATED APPLIANCES, ENERGY STAR RATED REFRIGERATORS, ENERGY STAR RATED WATER HEATERS, ENERGY STAR RATED (A) SOLAR READY REQUIREMENT (B) LOW ENERGY STAR APPLIANCES AND LIGHT BULBS (C) LOW DOUBLE GLAZING WINDOWS (D) POWER OUTLET IN PRIVATE GARAGE FOR CHARGING ELECTRIC CARS
4. REFER TO ACOUSTICAL REPORT D02/2019 FROM IRNL FOR ACoustICAL REQUIREMENT ON WALLS AND DOORS.
5. THE MECHANICAL HEATING AND COOLING SYSTEM (AIR SOURCE HEAT PUMP SYSTEM) TO COMPLY WITH RELATIVE REQUIREMENTS IN ICBC-2016 AND ASHRAE 90.1 REGARDING THE STANDARDS OF THERMAL COMFORT.
6. AN AUTOMATIC IRRIGATION SYSTEM FOR FUTURE ONGOING MAINTENANCE WILL BE INSTALLED SEE LANDSCAPE

BUILDING B NORTH ELEVATION

SCALE
1/8"=1'-0"

UNIT #103
TYPE B1
BLDG B

UNIT #108
TYPE B2
BLDG B

UNIT #104
TYPE B1
BLDG B

UNIT #105
TYPE B1
BLDG B

UNIT #106
TYPE B2
BLDG B

UNIT #107
TYPE B1
BLDG B

UNIT #108
TYPE B2
BLDG B

UNIT #109
TYPE B1
BLDG B

UNIT #110
TYPE B2
BLDG B

UNIT #111
TYPE B1
BLDG B

UNIT #112
TYPE B2
BLDG B

UNIT #113
TYPE B1
BLDG B

UNIT #114
TYPE B2
BLDG B

UNIT #115
TYPE B1
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UNIT #116
TYPE B2
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UNIT #117
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UNIT #118
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UNIT #120
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UNIT #121
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UNIT #124
TYPE B2
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TYPE B1
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TYPE B1
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UNIT #148
TYPE B2
BLDG B

UNIT #149
TYPE B1
BLDG B

UNIT #150
TYPE B2
BLDG B

UNIT #151
TYPE B1
BLDG B

UNIT #152
TYPE B2
BLDG B

UNIT #153
TYPE B1
BLDG B

UNIT #154
TYPE B2
BLDG B

UNIT #155
TYPE B1
BLDG B

UNIT #156
TYPE B2
BLDG B

UNIT #157
TYPE B1
BLDG B

UNIT #158
TYPE B2
BLDG B

UNIT #159
TYPE B1
BLDG B

UNIT #160
TYPE B2
BLDG B

UNIT #161
TYPE B1
BLDG B

UNIT #162
TYPE B2
BLDG B

UNIT #163
TYPE B1
BLDG B

UNIT #164
TYPE B2
BLDG B

UNIT #165
TYPE B1
BLDG B

UNIT #166
TYPE B2
BLDG B

UNIT #167
TYPE B1
BLDG B

UNIT #168
TYPE B2
BLDG B

UNIT #169
TYPE B1
BLDG B

UNIT #170
TYPE B2
BLDG B

UNIT #171
TYPE B1
BLDG B

UNIT #172
TYPE B2
BLDG B

UNIT #173
TYPE B1
BLDG B

UNIT #174
TYPE B2
BLDG B

UNIT #175
TYPE B1
BLDG B

UNIT #176
TYPE B2
BLDG B

UNIT #177
TYPE B1
BLDG B

UNIT #178
TYPE B2
BLDG B

UNIT #179
TYPE B1
BLDG B

UNIT #180
TYPE B2
BLDG B

UNIT #181
TYPE B1
BLDG B

UNIT #182
TYPE B2
BLDG B

UNIT #183
TYPE B1
BLDG B

UNIT #184
TYPE B2
BLDG B

UNIT #185
TYPE B1
BLDG B

UNIT #186
TYPE B2
BLDG B

UNIT #187
TYPE B1
BLDG B

UNIT #188
TYPE B2
BLDG B

UNIT #189
TYPE B1
BLDG B

UNIT #190
TYPE B2
BLDG B

UNIT #191
TYPE B1
BLDG B

UNIT #192
TYPE B2
BLDG B

UNIT #193
TYPE B1
BLDG B

UNIT #194
TYPE B2
BLDG B

UNIT #195
TYPE B1
BLDG B

UNIT #196
TYPE B2
BLDG B

UNIT #197
TYPE B1
BLDG B

UNIT #198
TYPE B2
BLDG B

UNIT #199
TYPE B1
BLDG B

UNIT #200
TYPE B2
BLDG B

UNIT #201
TYPE B1
BLDG B

UNIT #202
TYPE B2
BLDG B

UNIT #203
TYPE B1
BLDG B

UNIT #204
TYPE B2
BLDG B

UNIT #205
TYPE B1
BLDG B

UNIT #206
TYPE B2
BLDG B

UNIT #207
TYPE B1
BLDG B

UNIT #208
TYPE B2
BLDG B

UNIT #209
TYPE B1
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UNIT #210
TYPE B2
BLDG B

UNIT #211
TYPE B1
BLDG B

UNIT #212
TYPE B2
BLDG B


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TYPE B1
BLDG B

UNIT #214
TYPE B2
BLDG B


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TYPE B1
BLDG B

UNIT #216
TYPE B2
BLDG B

UNIT #217
TYPE B1
BLDG B</

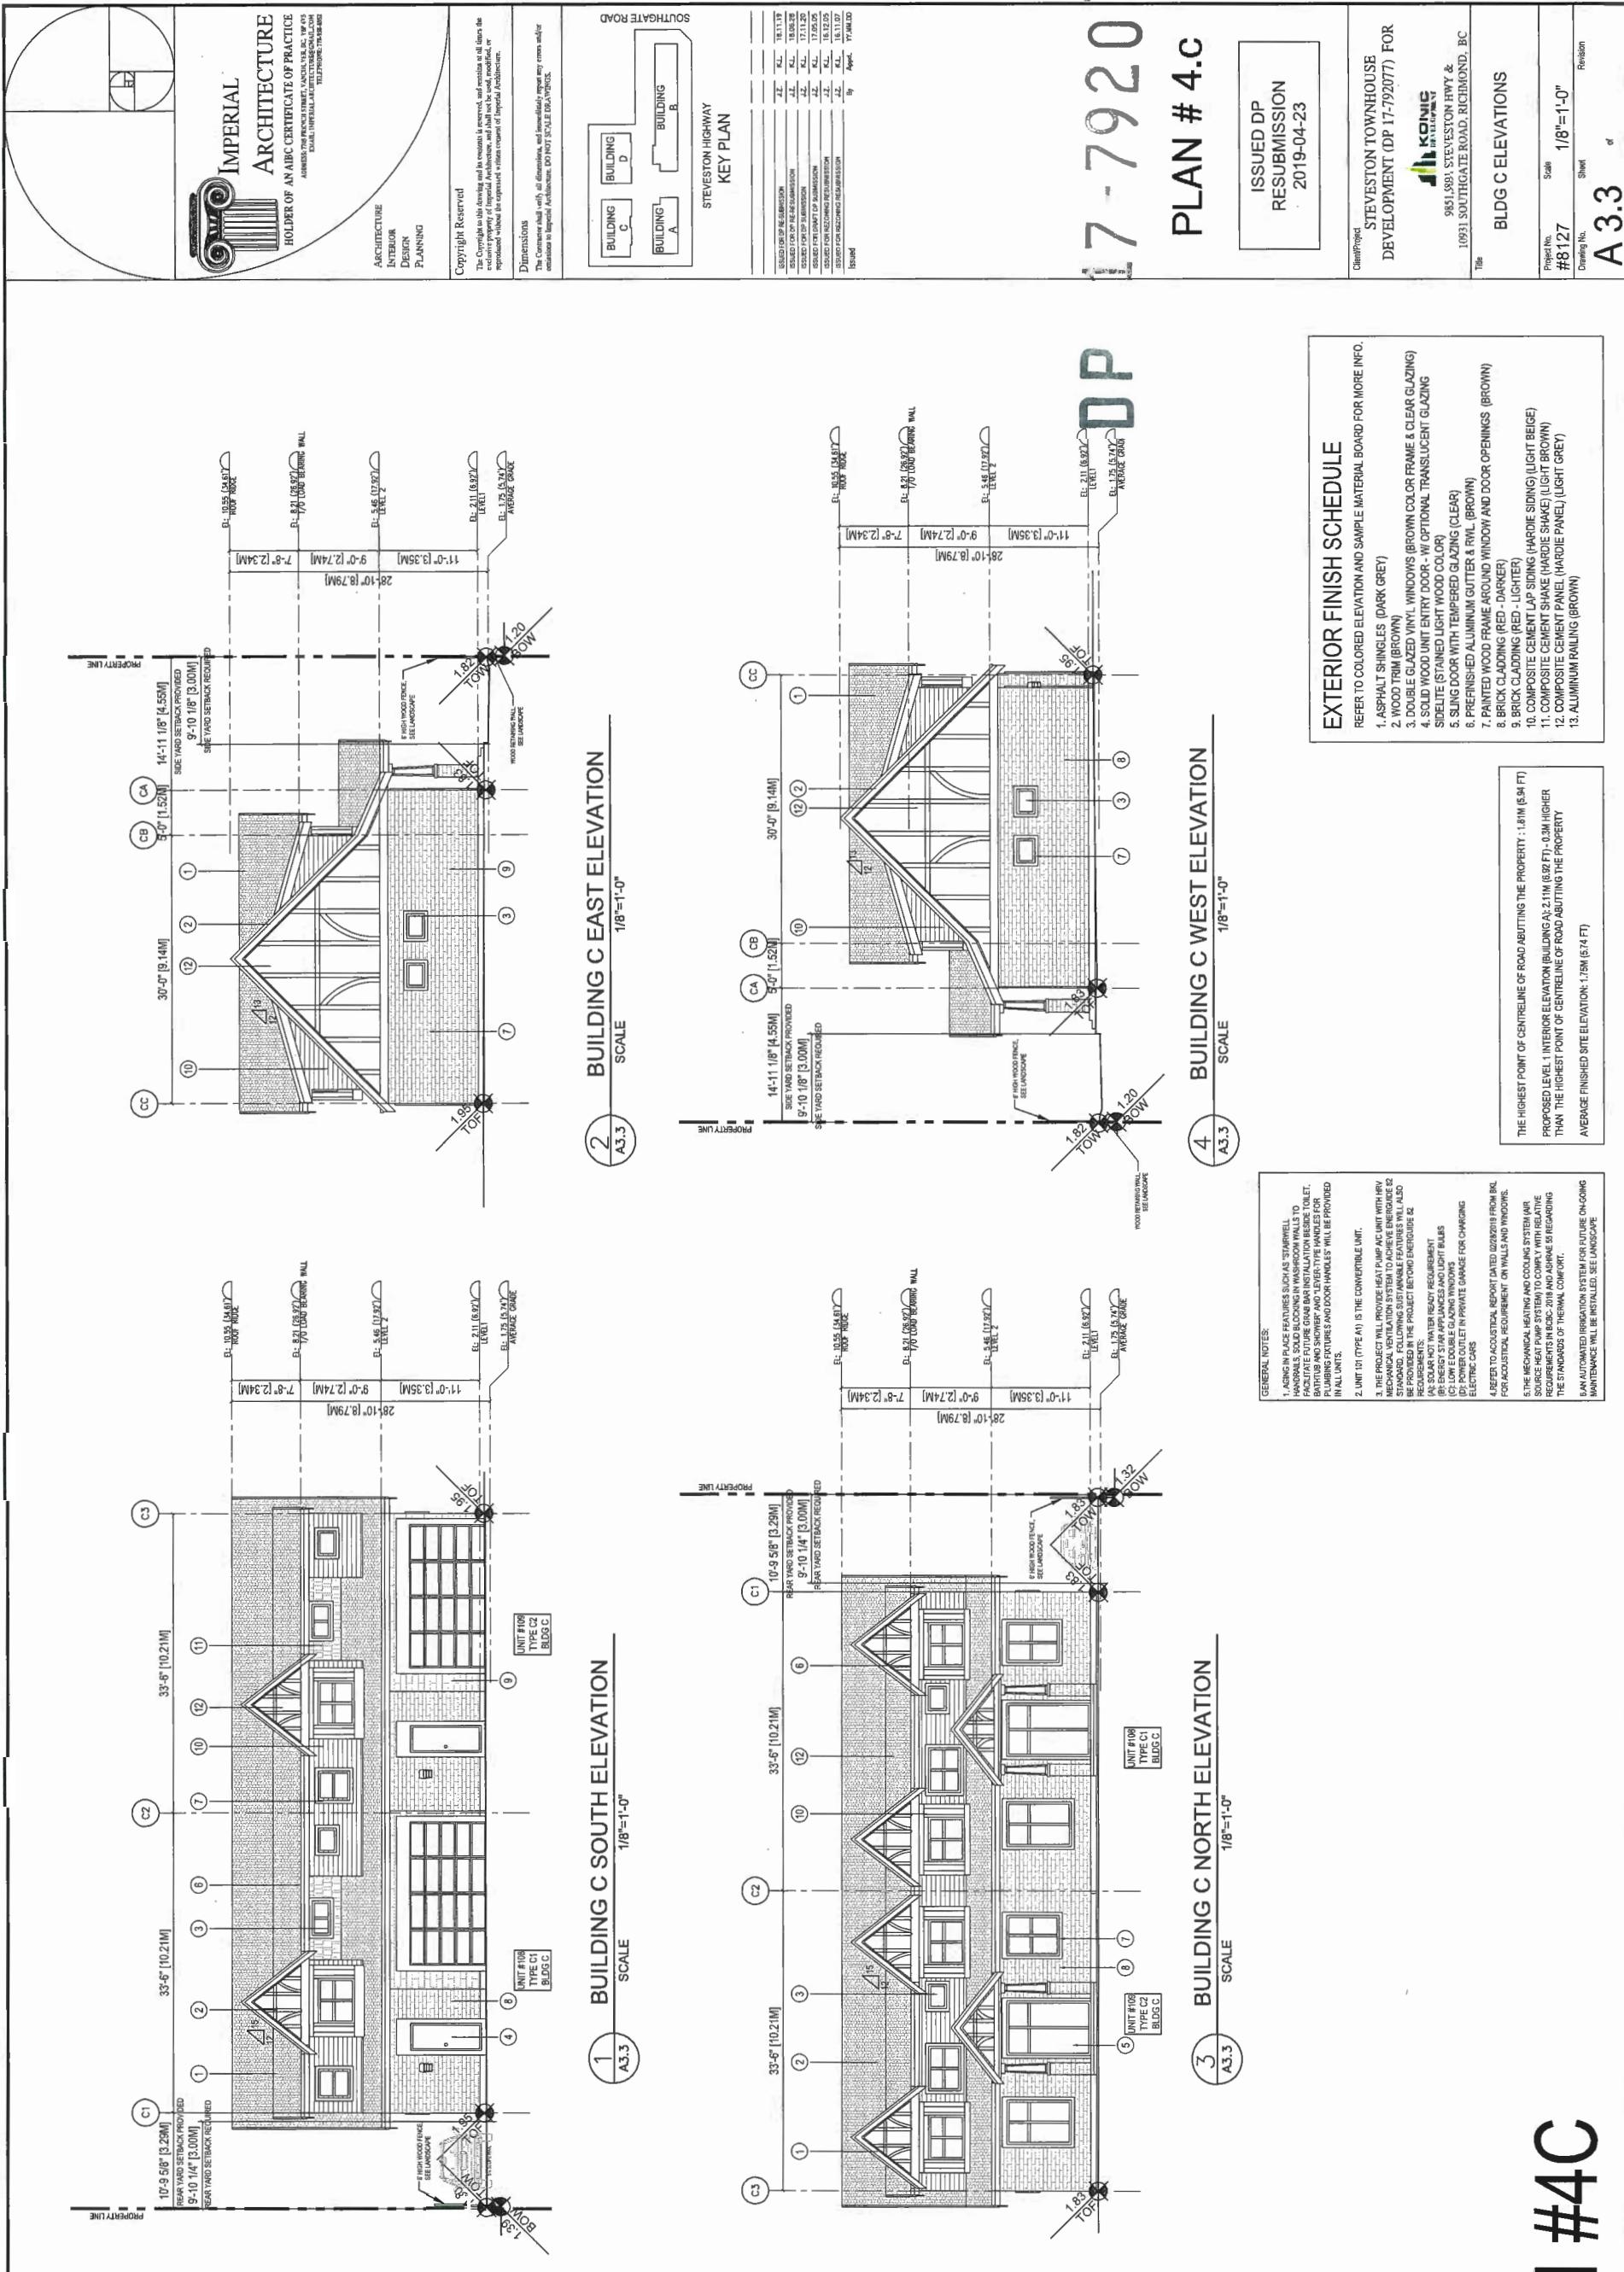

PLAN #4C

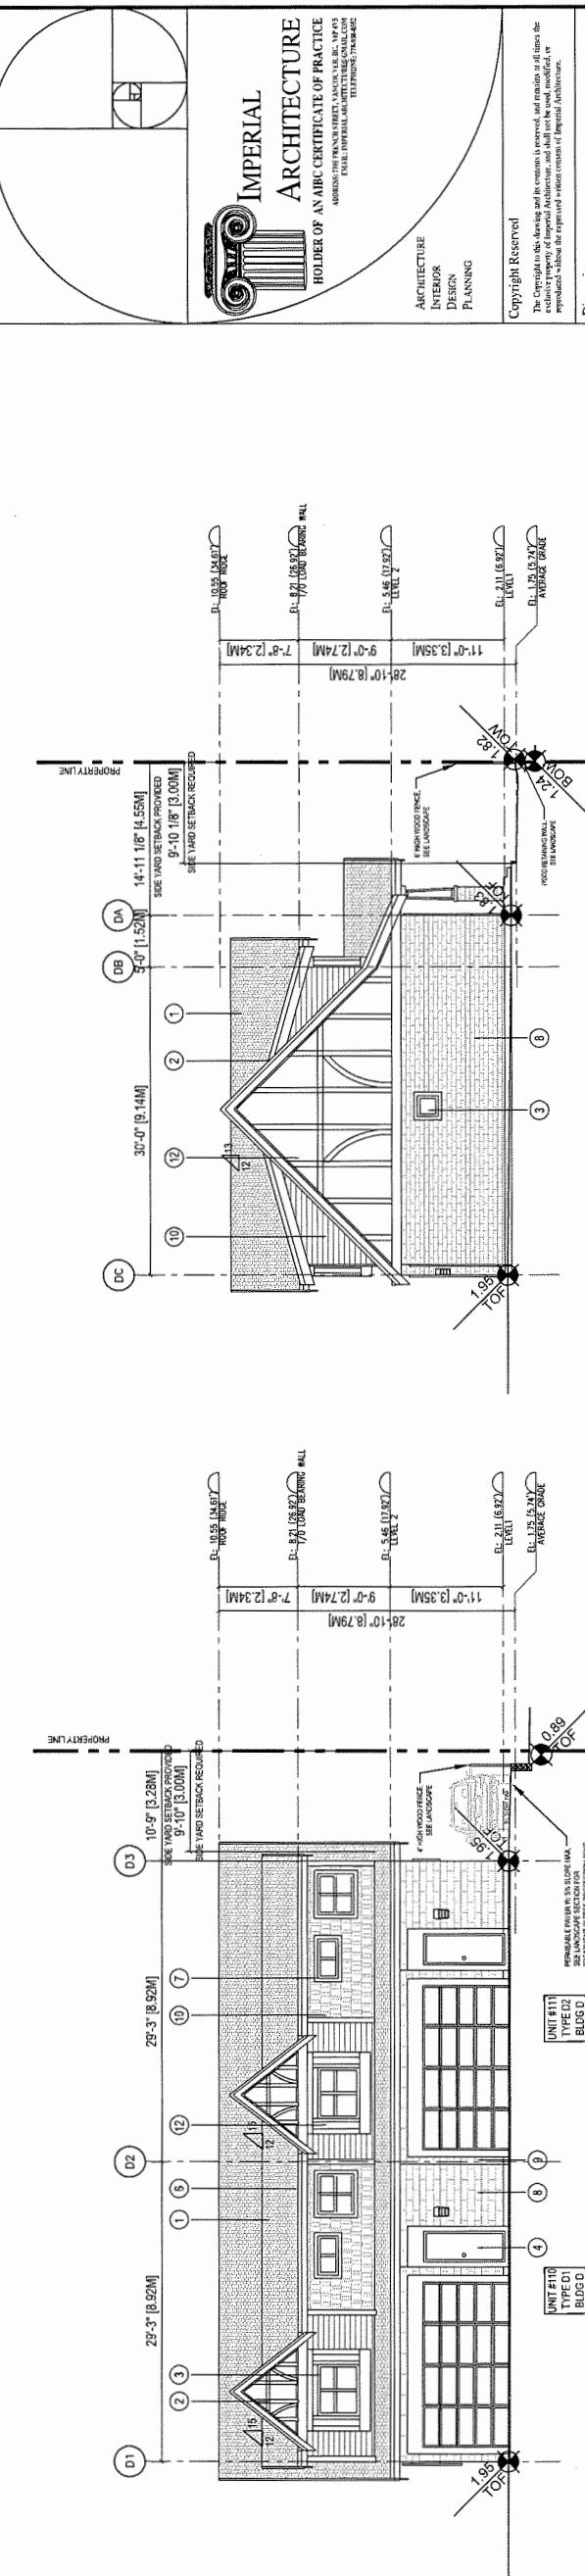


BUILDING D EAST ELEVATION

A3.4 SCALE 1/8"=1'-0"

BUILDING D KEY PLAN

A3.4 SCALE 1/8"=1'-0"

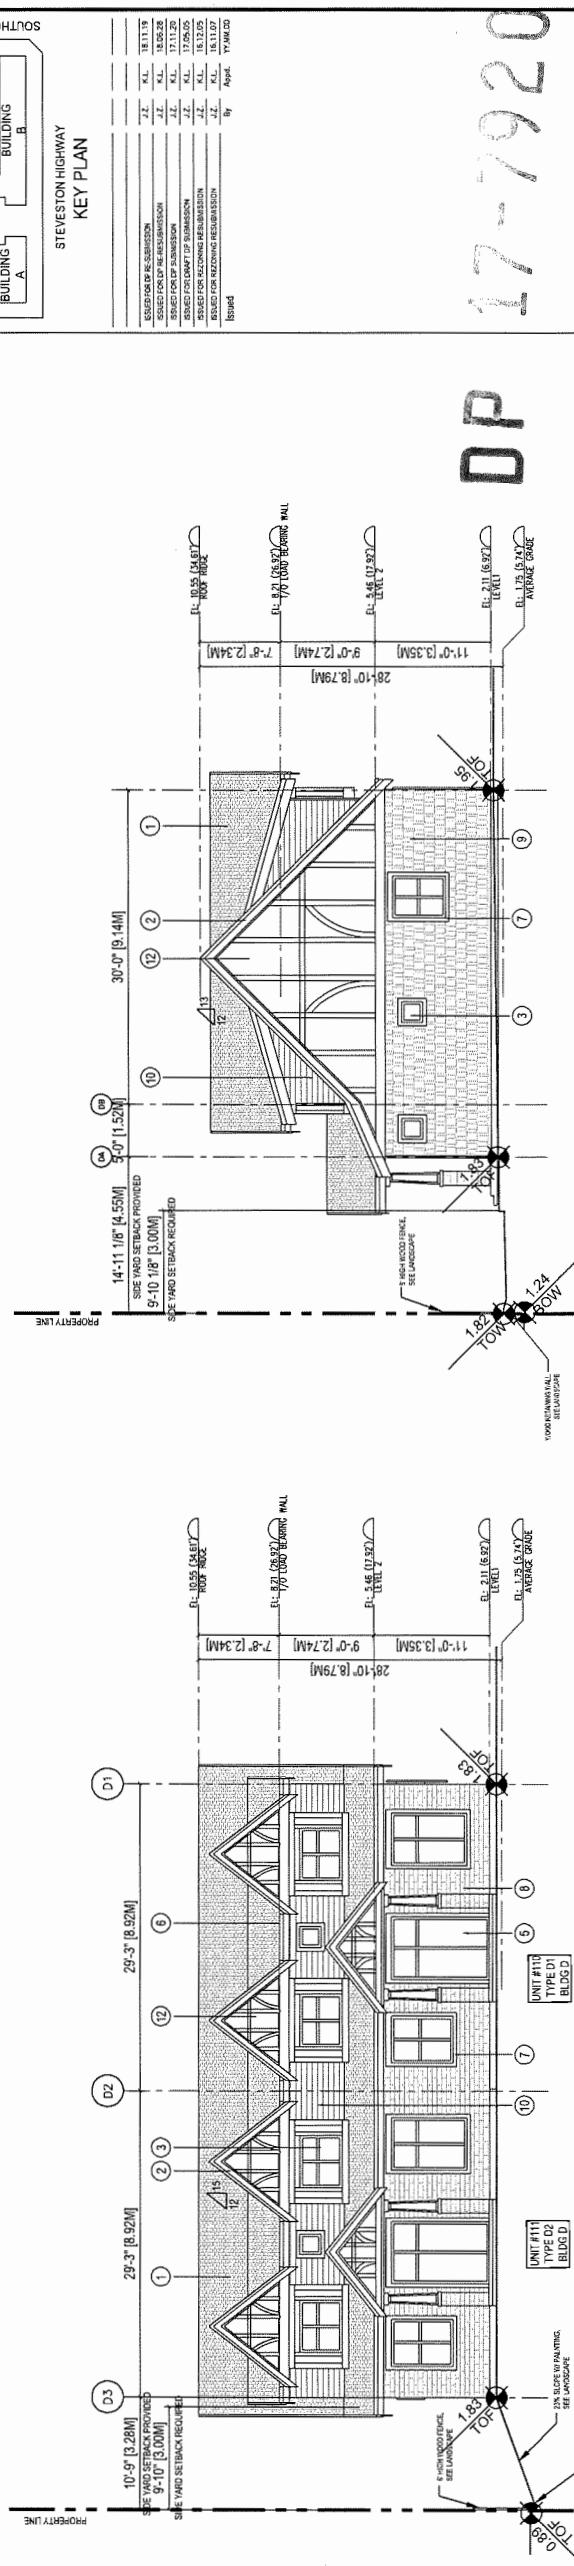


BUILDING D WEST ELEVATION

A3.4 SCALE 1/8"=1'-0"

PLAN # 4.d

ISSUED DP
RESUBMISSION
2019-04-23

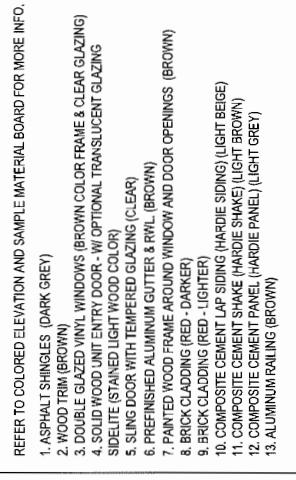

EXTERIOR FINISH SCHEDULE

- REFER TO COLORED ELEVATION AND SAMPLE MATERIAL BOARD FOR MORE INFO.
1. ASPHALT SHINGLES (DARK GREY)
 2. WOOD TRIM (BROWN)
 3. DOUBLE GLAZED VINYL WINDOWS (BROWN COLOR FRAME & CLEAR GLAZING)
 4. SOLID WOOD UNIT ENTRY DOOR, WI OPTIONAL TRANSLUCENT GLAZING
 5. SIDELITE STAINED LIGHT WOOD COLOR
 6. SLING DOOR WITH TEMPERED GLAZING (CLEAR)
 7. PAINTED ALUMINUM GUTTER & RAIL, (BROWN)
 8. BRICK CLADDING (RED, LIGHTER)
 9. BRICK CLADDING (RED, LIGHTER)
 10. COMPOSITE CEMENT SHAKE (HARDIE SIDING) (LIGHT BROWN)
 11. COMPOSITE CEMENT SHAKE (HARDIE SHAKE) (LIGHT BROWN)
 12. COMPOSITE CEMENT PANEL (HARDIE PANEL) (LIGHT GREY)
 13. ALUMINUM RAILING (BROWN)

Client/Project STEVESTON TOWNHOUSE
DEVELOPMENT (DP 17-792077) FOR
KONIC
9851-9891 STEVESTON HWY &
10931 SOUTHGATE ROAD, RICHMOND, BC

Title BLDG D ELEVATIONS



Project No. Sale #8127
Drawing No. Sheet 1/8"=1'-0"
Revision A 3.4 of

The HIGHEST POINT OF CENTRELINE OF ROAD ABUTTING THE PROPERTY 18M (5.94 FT)
PROPOSED LEVEL INTERIOR ELEVATION BUILDING A: 2.1M (6.92 FT) - 0.3M HIGHER
THAN THE HIGHEST POINT OF CENTRELINE OF ROAD ABUTTING THE PROPERTY
AVERAGE FINISHED SITE ELEVATION: 1.7M (5.74 FT)



PLAN #4D


GENERAL NOTES:

1. KING PLATE FEATURES SUCH AS STARVELL HANDRAIL, SOLID BULKING IN WASHDOWN WALLS TO FACILITATE SPARE BAR INSULATION BEIDE TOILET, BATHROOM, KITCHEN, AND LAUNDRY. FEATURES ON BATHROOM EXTERIOR AND KITCHEN EXTERIOR ARE CONSIDERED AS PART OF THE BULKING FEATURES. THESE FEATURES WILL BE PROVIDED IN ALL UNITS.
2. UNIT 101 (TYPE A) IS THE CONVERTIBLE UNIT.
3. THE PROJECT WILL PROVIDE A LEAK RAMP ACROSS UNIT BOUNDARY. MECHANICAL VENTILATION SYSTEM TO ACHIEVE ENERGUIDE 12 STANDARD FOLLOWING SUSTAINABLE FEATURES. THIS WILL ALSO BE PROVIDED IN THE PROJECT BEYOND ENERGUIDE 12 REQUIREMENTS.
4. SOLAR PANELS AND THERMAL ENERGY RECOVERY SYSTEMS WILL BE PROVIDED IN ALL UNITS. THESE FEATURES WILL BE PROVIDED IN ALL UNITS.
5. MECHANICAL HEATING AND COOLING SYSTEM AND SOURCE WATER PUMP SYSTEM TO COMPLY WITH RELATIVE REQUIREMENTS OF B.C. 2018 AND ASRAE 59 REGARDING THE STANDARDS OF THERMAL COMFORT.
6. POWER OUTLET IN PRIVATE GARAGE FOR CHARGING ELECTRIC CARS.
7. A LEER TO DESIGN REPORT DATED 02/20/09 FROM BUL FOR ACOUSTICAL REQUIREMENT, OVERWALL AND Windows.
8. THE MECHANICAL HEATING AND COOLING SYSTEM AND SOURCE WATER PUMP SYSTEM TO COMPLY WITH RELATIVE REQUIREMENTS OF B.C. 2018 AND ASRAE 59 REGARDING THE STANDARDS OF THERMAL COMFORT.
9. AN AUTOMATED IRRIGATION SYSTEM FOR FUTURE ON-GROUND MAINTENANCE WILL BE INSTALLED. SEE LANDSCAPE

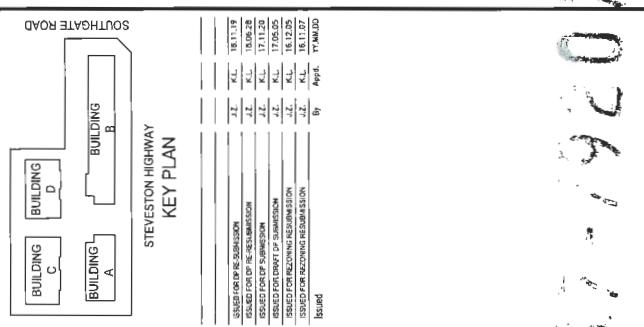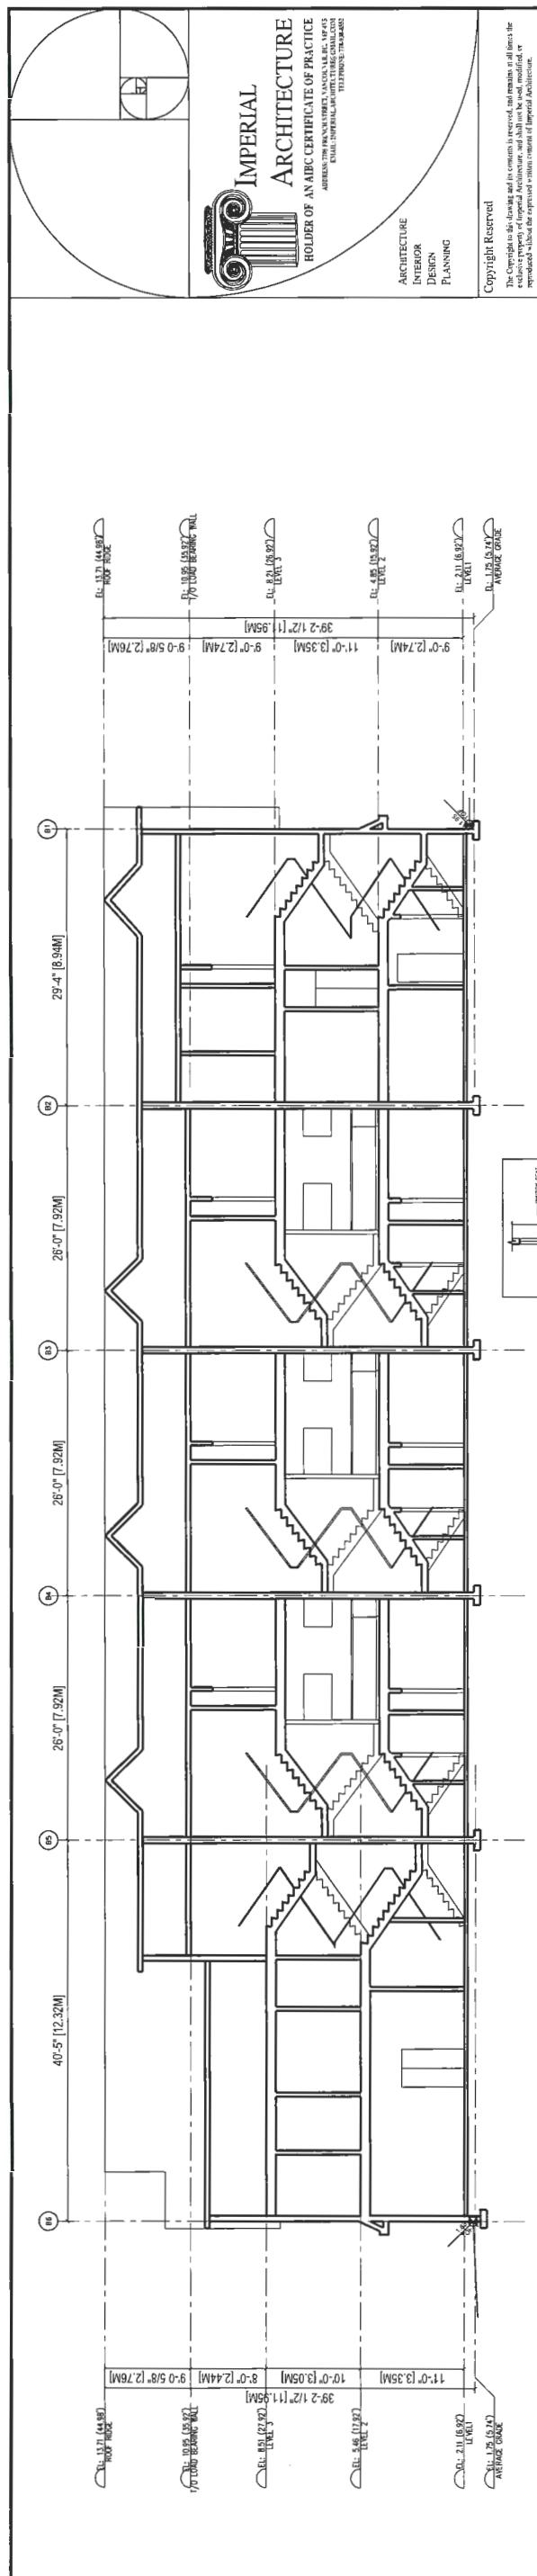

PLAN # 4.e

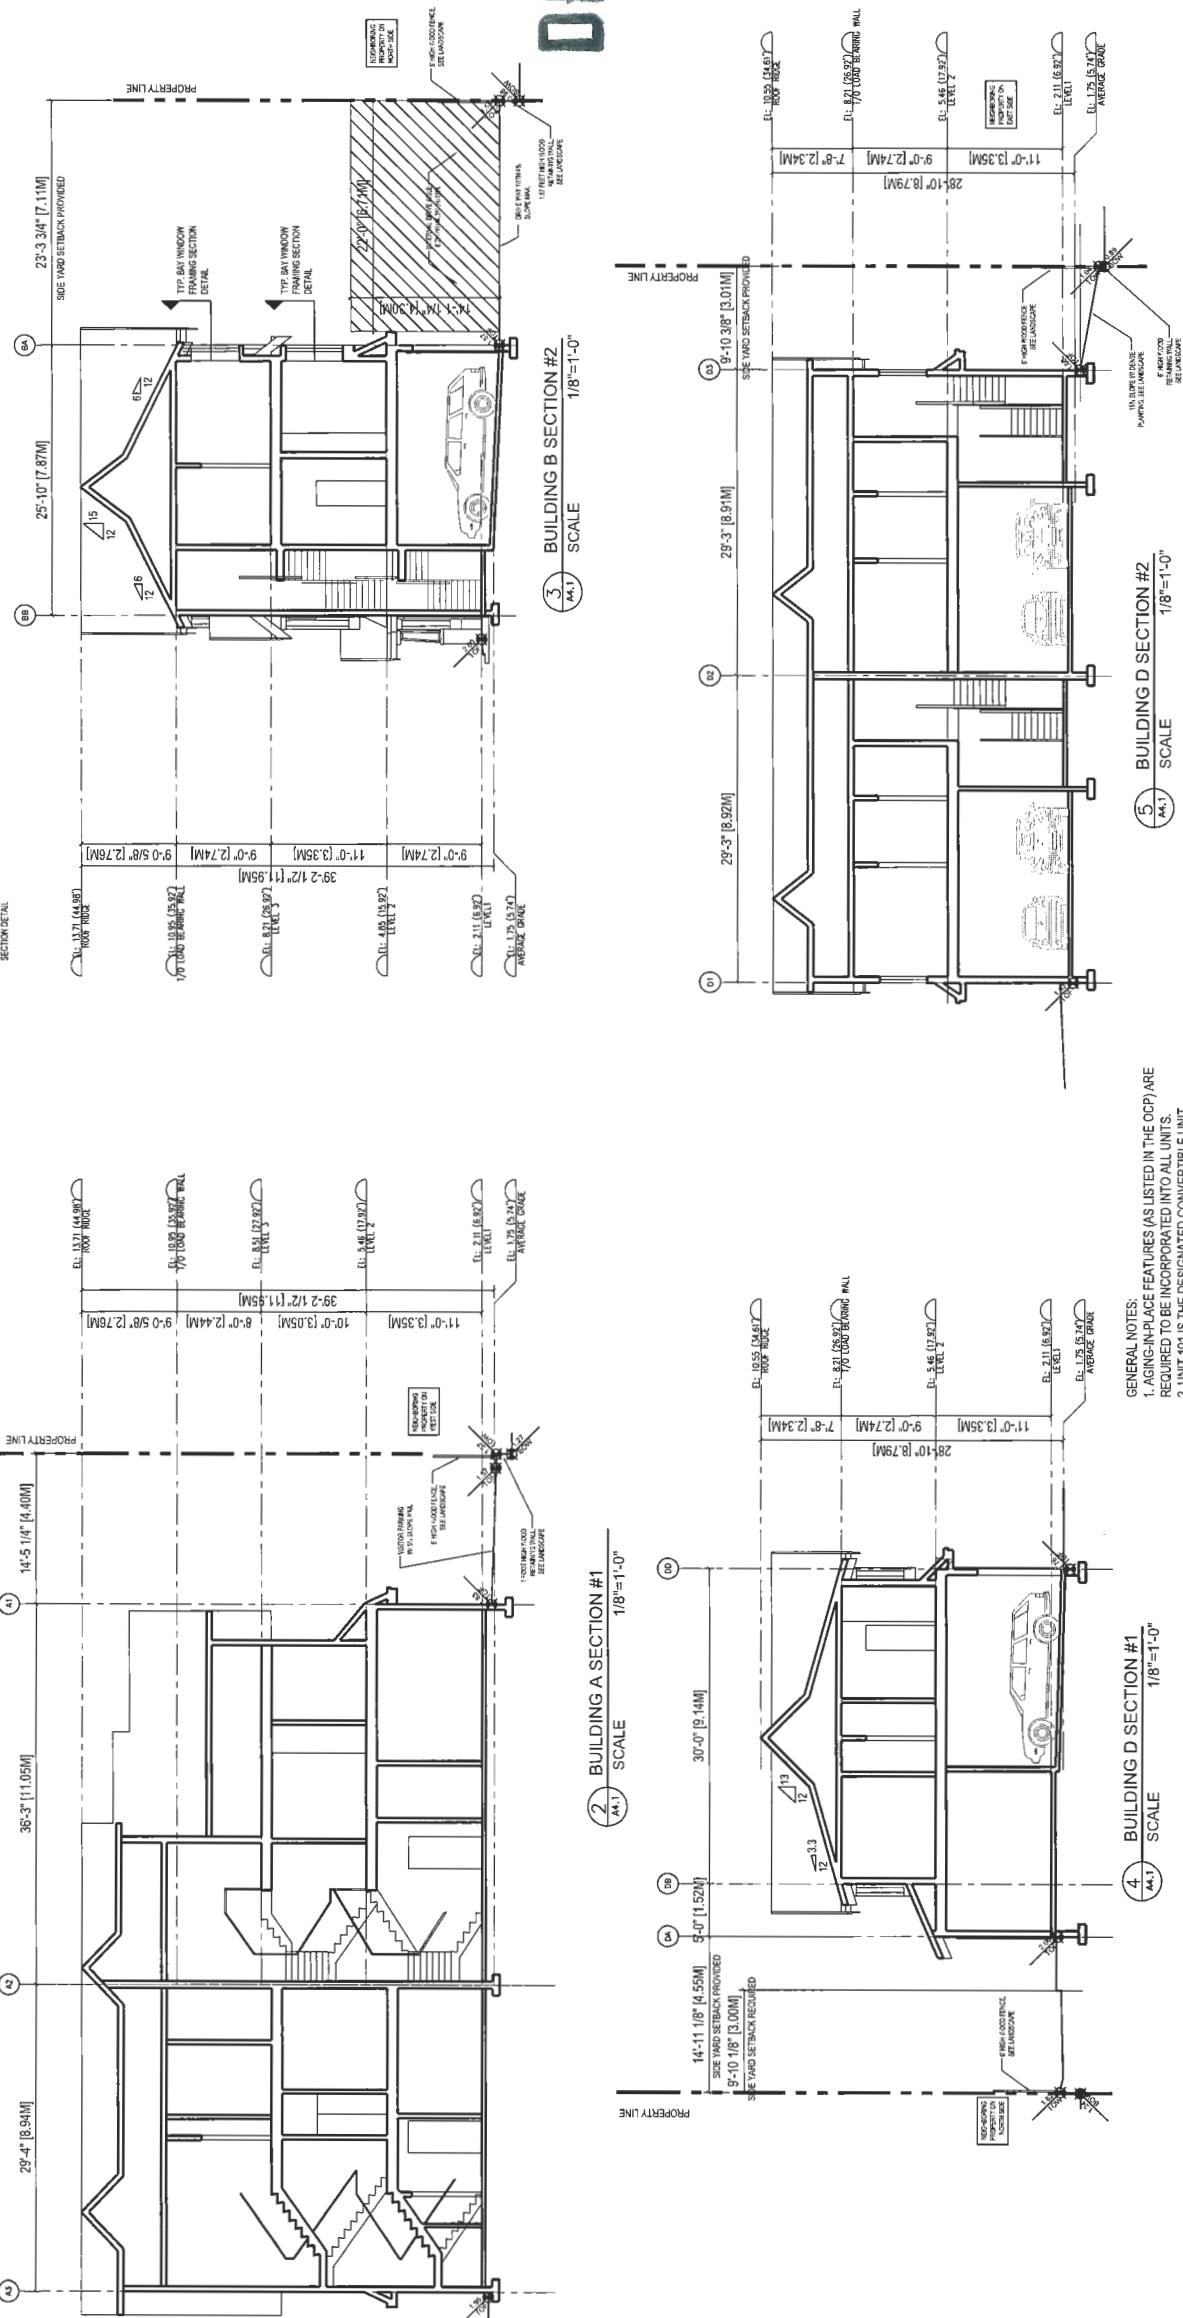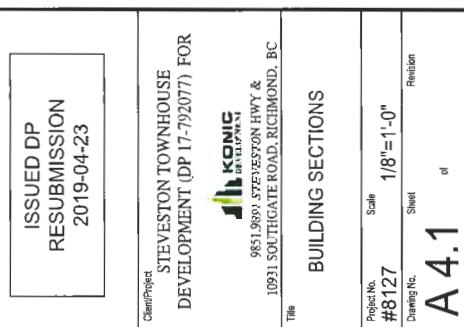


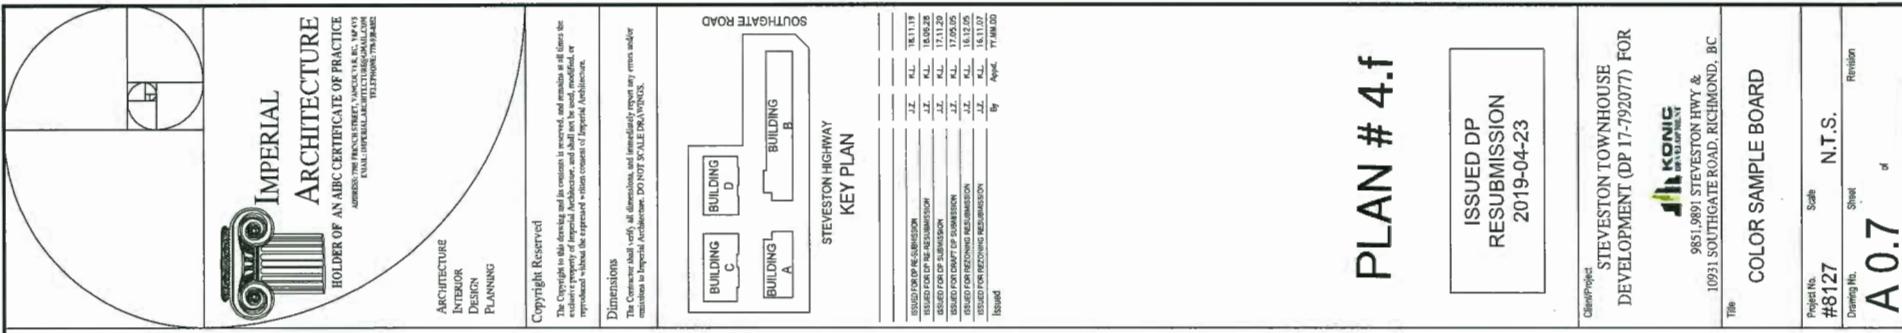


EXTERIOR FINISH SCHEDULE

REFER TO COLORED ELEVATION AND SAMPLE MATERIAL BOARD FOR MORE INFO.

1. ASPHALT SHINGLES (DARK GREY)
2. WOOD TRIM (BROWN)
3. DOUBLE GLAZED VINYL WINDOWS (BROWN COLOR FRAME & CLEAR GLAZING)
4. SOLID WOOD UNIT ENTRY DOOR. W/ OPTIONAL TRANSLUCENT GLAZING
5. SLING DOOR WITH TEMPERED GLAZING (CLEAR)
6. PREFINISHED ALUMINUM GUTTER & RWL (BROWN)
7. PAINTED WOOD FRAME AROUND WINDOW AND DOOR OPENINGS (BROWN)
8. BRICK CLADDING (RED - LIGHTER)
9. BRICK CLADDING (RED - DARKER)
10. COMPOSITE LAP SIDING (HARDIE SIDING) (LIGHT BEIGE)
11. COMPOSITE CEMENT SHAKE (HARDIE SHAKE) (LIGHT BROWN)
12. COMPOSITE CEMENT PANEL (HARDIE PANEL) (LIGHT GREY)
13. ALUMINUM RAILING (BROWN)

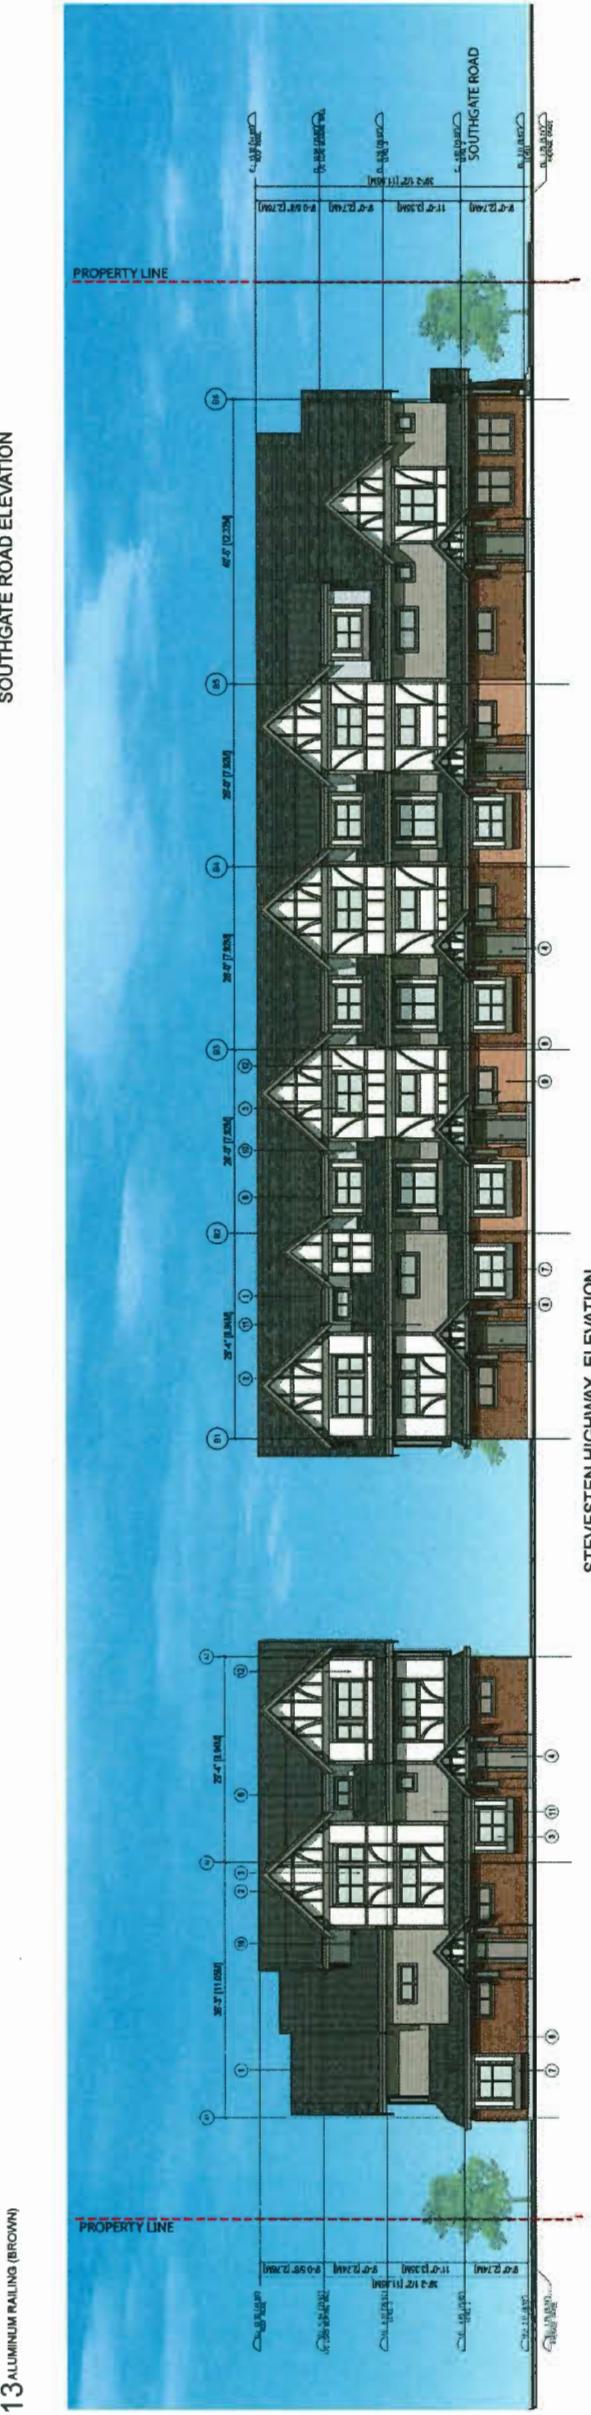

9851, 9891 STEVESTON HIGHWAY AND 10931 SOUTHGATE ROAD, RICHMOND, BC

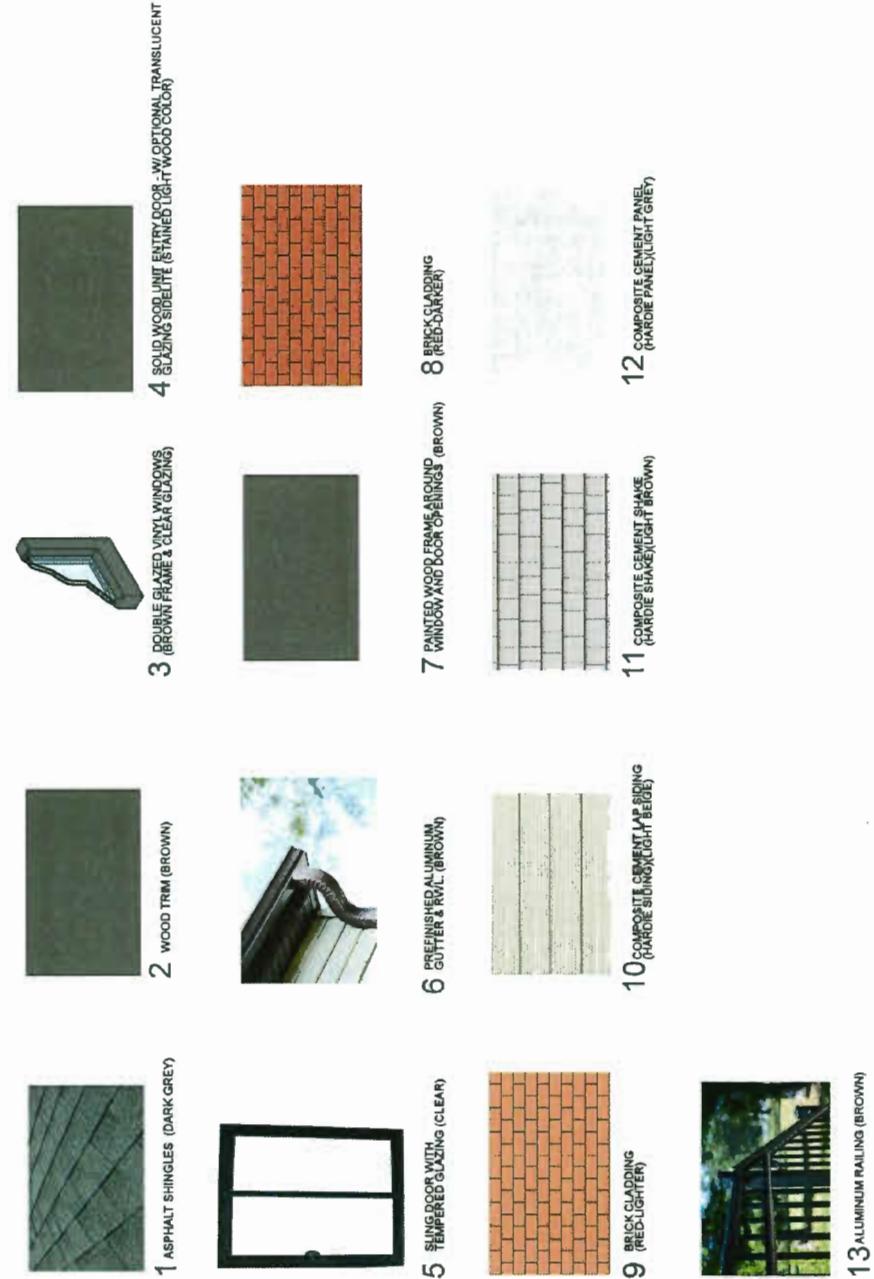


DP 17-792077

PLAN # 4.f

ISSUED DP
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2019-04-23

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DEVELOPMENT (DP 17-792077) FOR
9851, 9891 STEVESTON HWY &
10931, SOUTHGATE ROAD, RICHMOND, BC.
The COLOR SAMPLE BOARD

Project No. #8127
Scale N.T.S.
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A 0.7 of

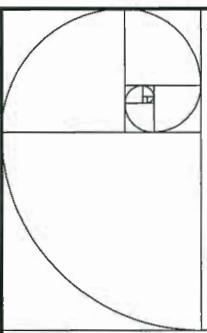

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FAX: 604-541-1222
ELECTRONIC MAILBOX: 10921 SOUTHGATE ROAD, RICHMOND, BC, V6V 1Z3


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STEVESTON HIGHWAY
KEY PLAN

SOUTHGATE ROAD	
BUILDING C	BUILDING D
BUILDING A	BUILDING B

ISSUED DP
RESUBMISSION
2019-04-23

ClientProject
STEVESTON TOWNHOUSE
DEVELOPMENT (OP 17-792077) FOR
KONIC
9851 1801 STEVESTON HWY &
10921 SOUTHGATE ROAD, RICHMOND, BC


Color Rendering
BIRD-EYE VIEW
Title
A 0.1
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Project No.
#8127
Drawing No.
Sheet
N.T.S.
Revision
d
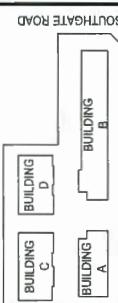
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D P 17-792077





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SOUTHGATE ROAD		
BUILDING A	BUILDING B	BUILDING C
BUILDING D		
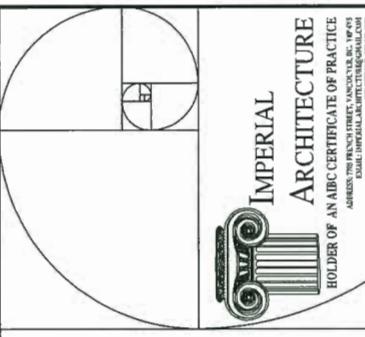
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ClientProject
STEVESTON TOWNHOUSE
DEVELOPMENT (DP 17-792077) FOR


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9851 19891 STEVESTON HWY &
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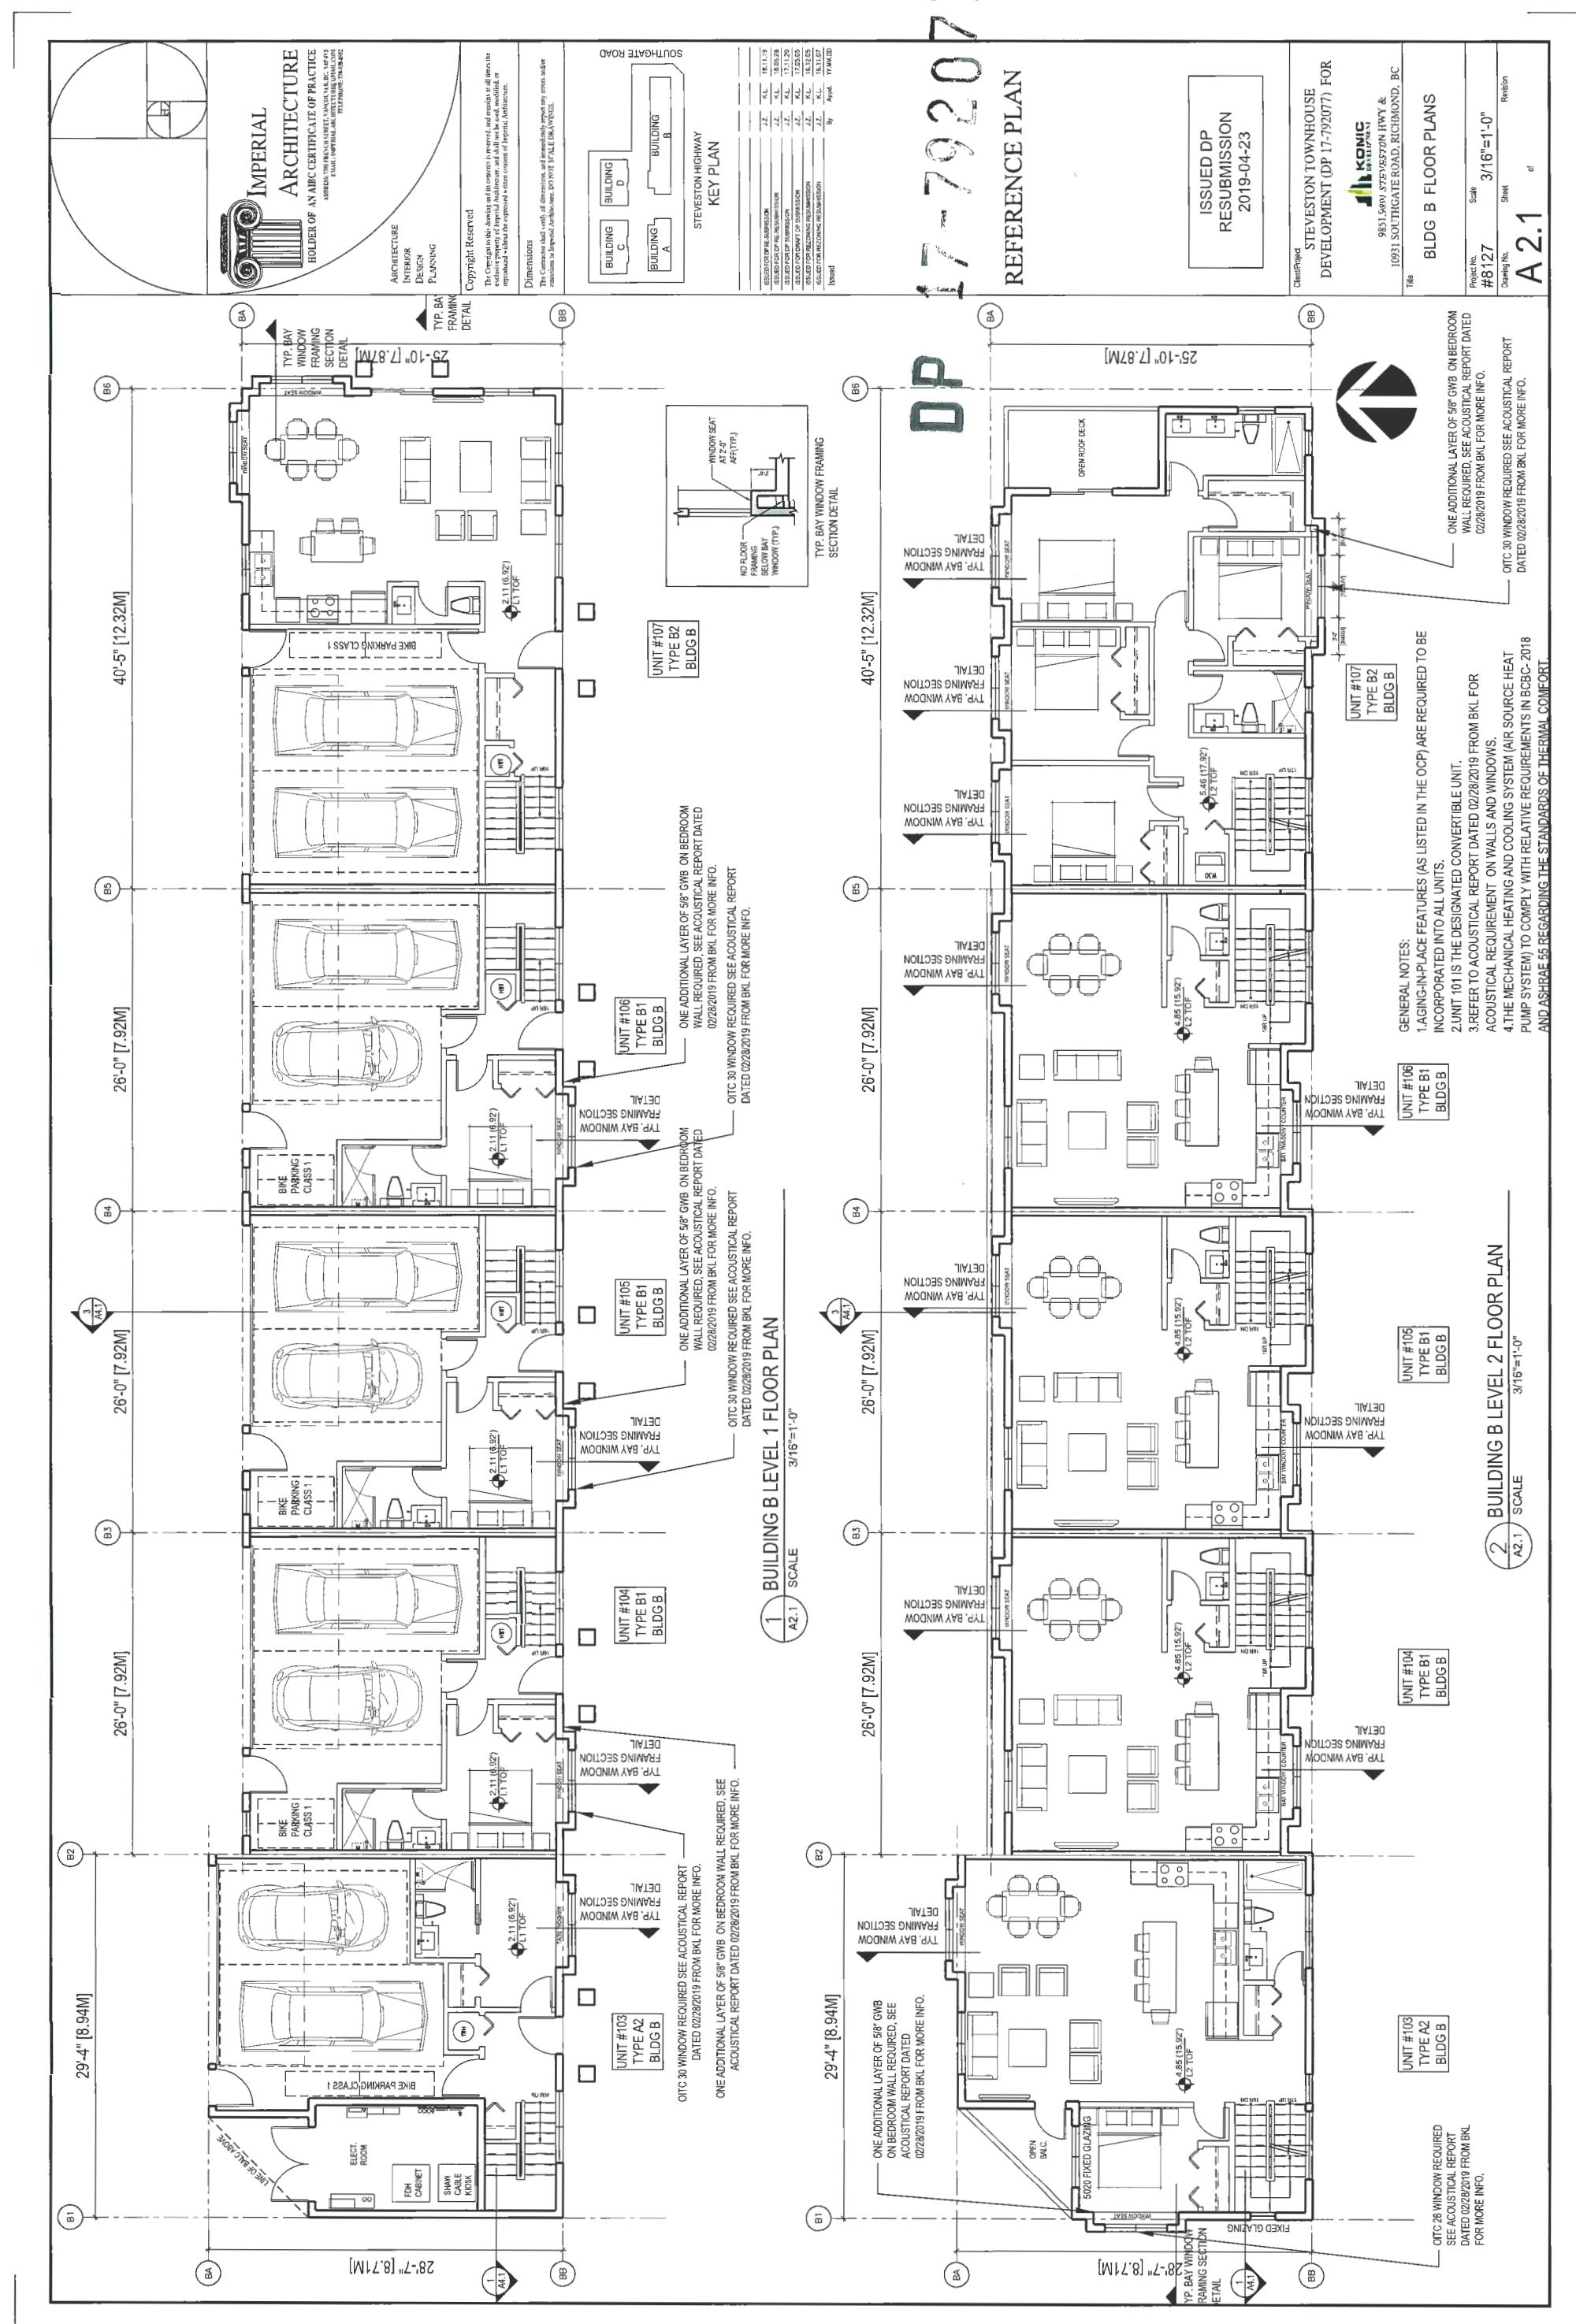
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COLOR RENDERING
EYE LEVEL STREETSCAPE VIEWS
#8127 Scale N.T.S.
Drawing No. Sheet Revision
A 0.2 d


DP 17-792077

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WESTON HIGHWAY
KEY PLAN

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2019-04-23

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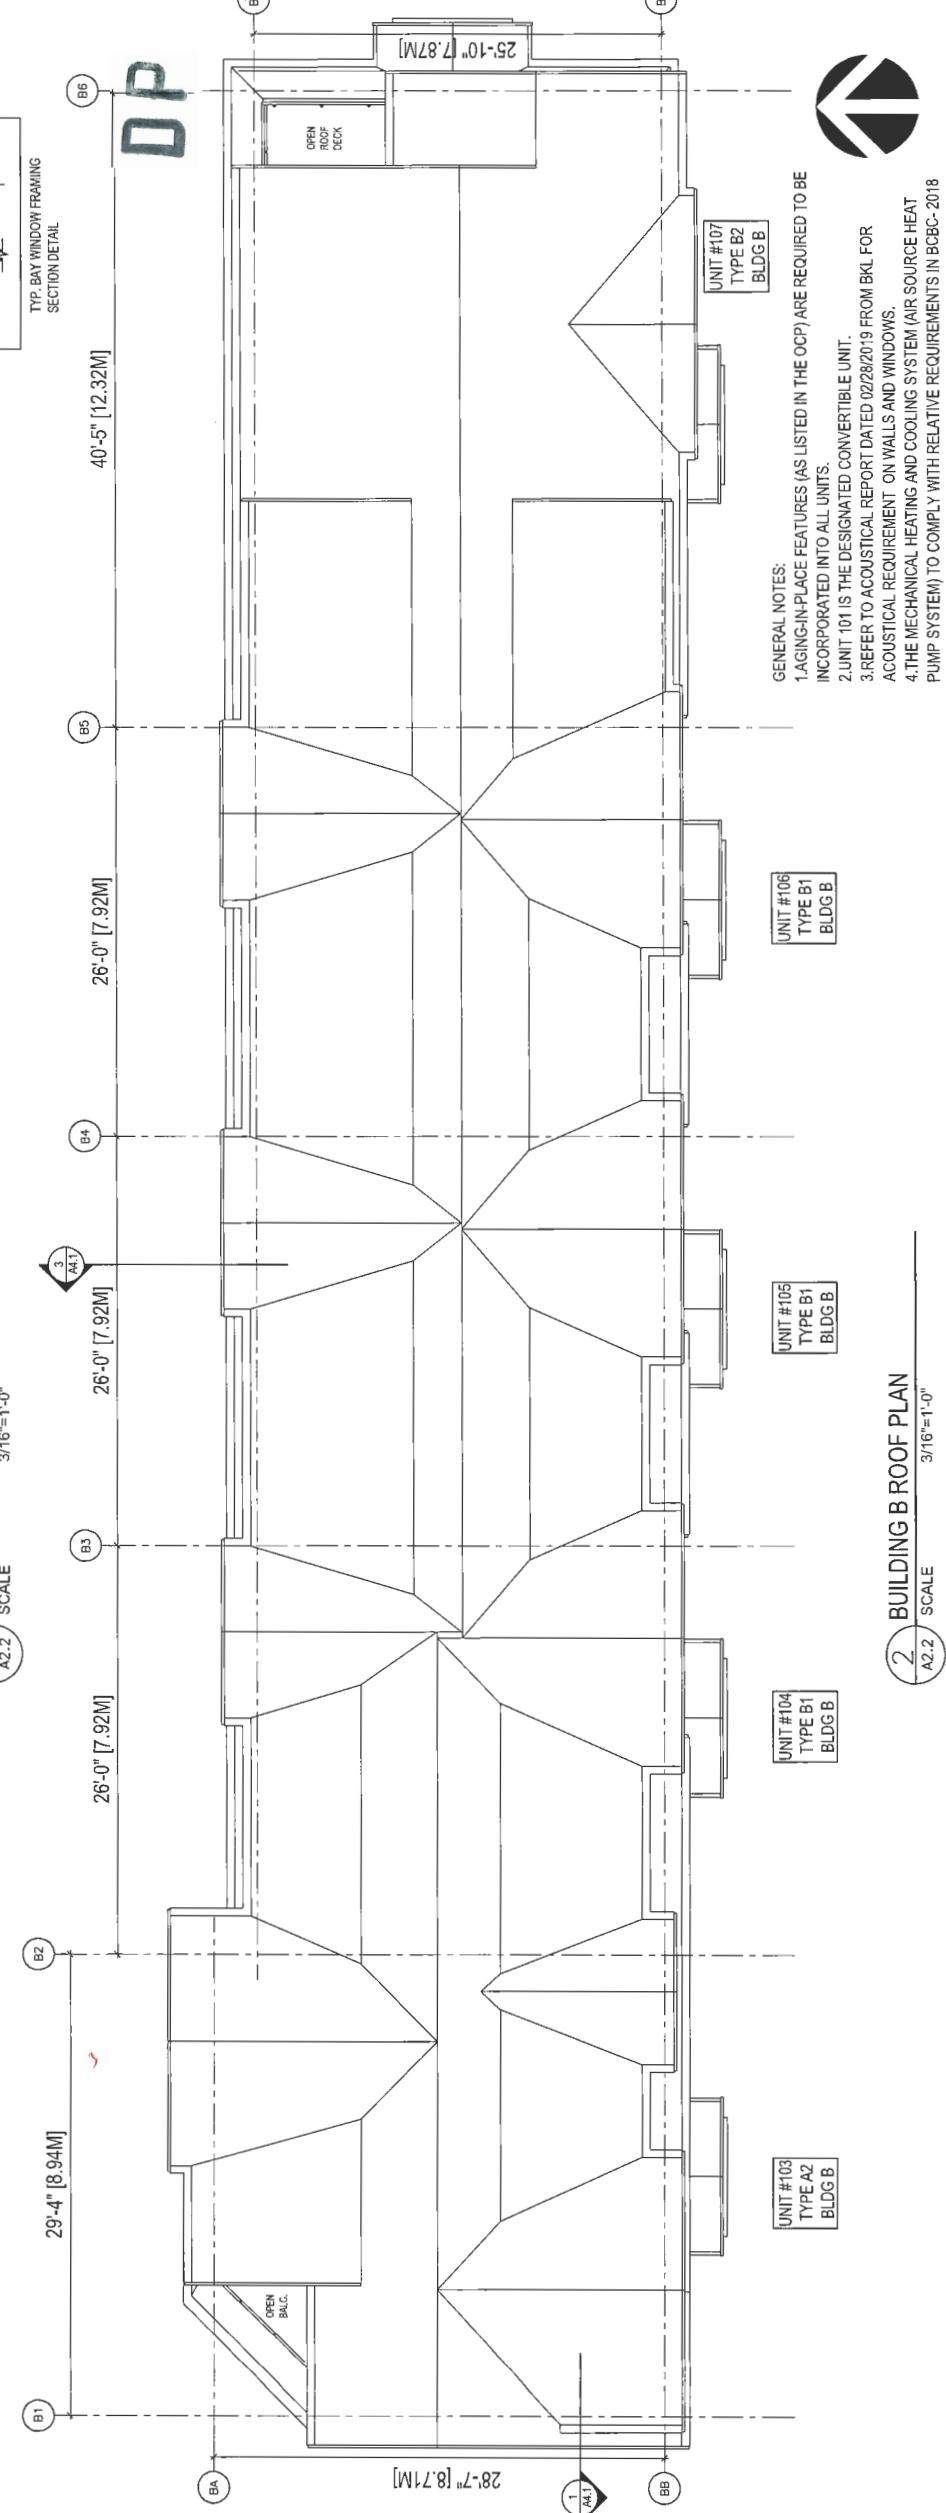
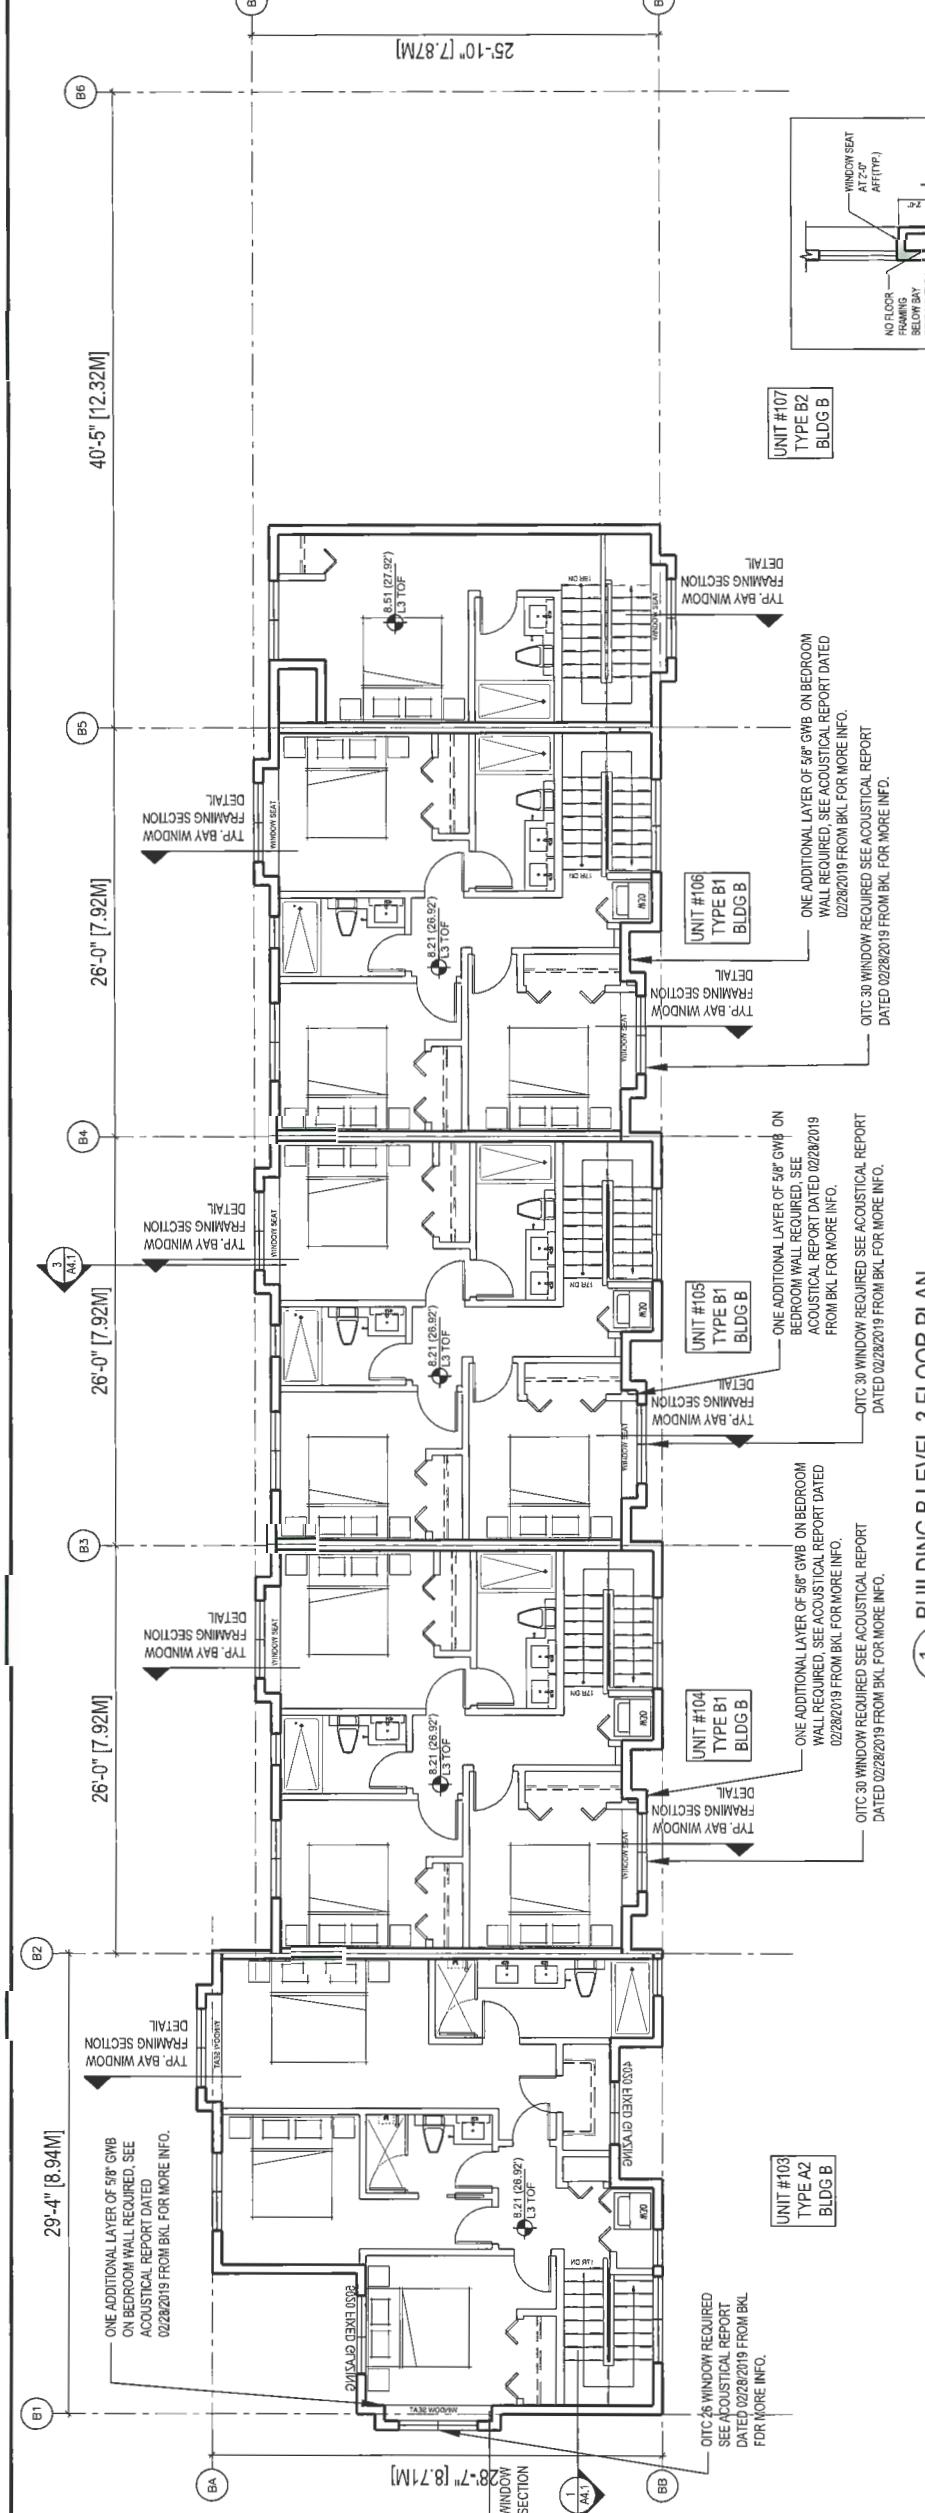
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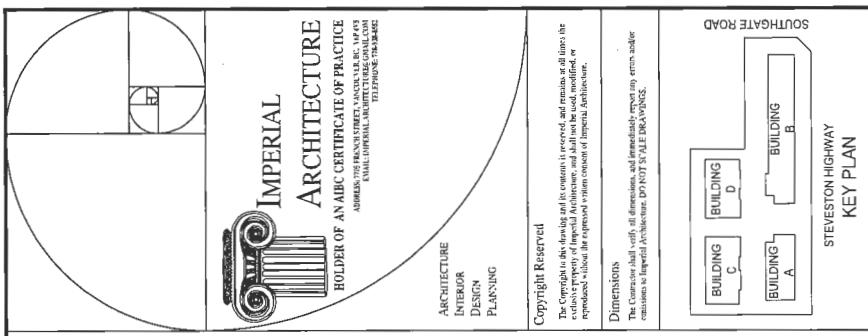
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Sheet 22
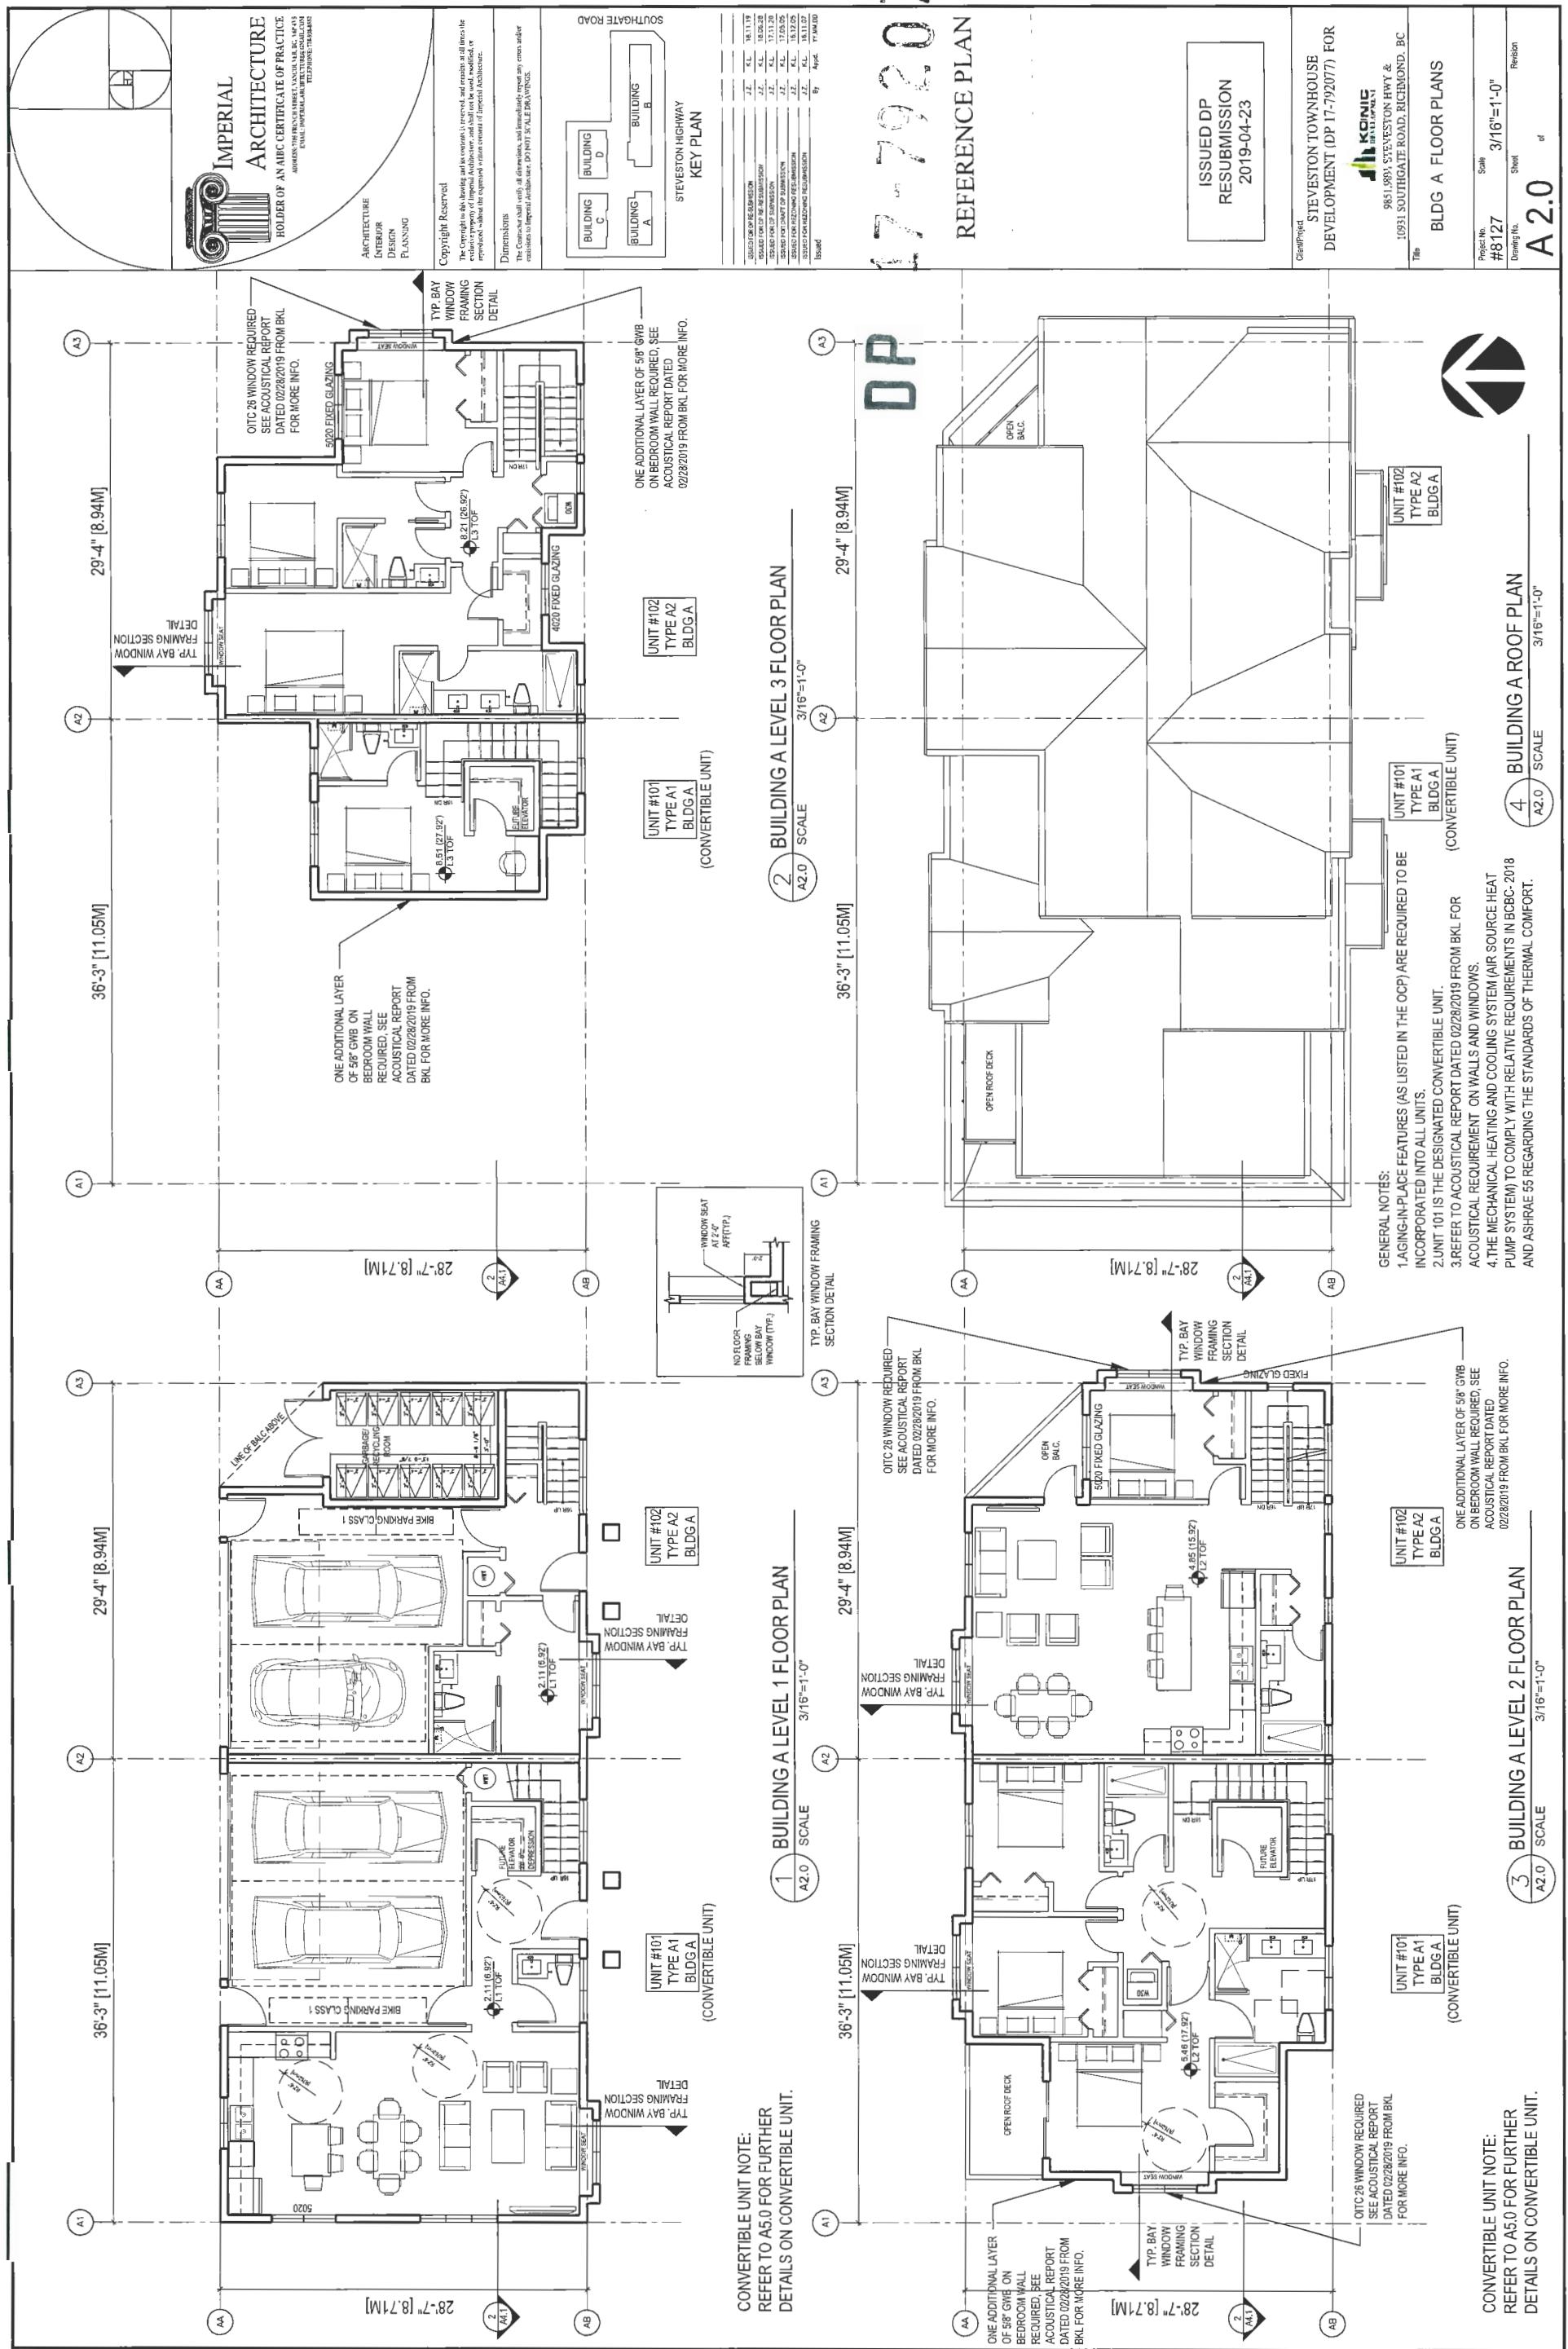
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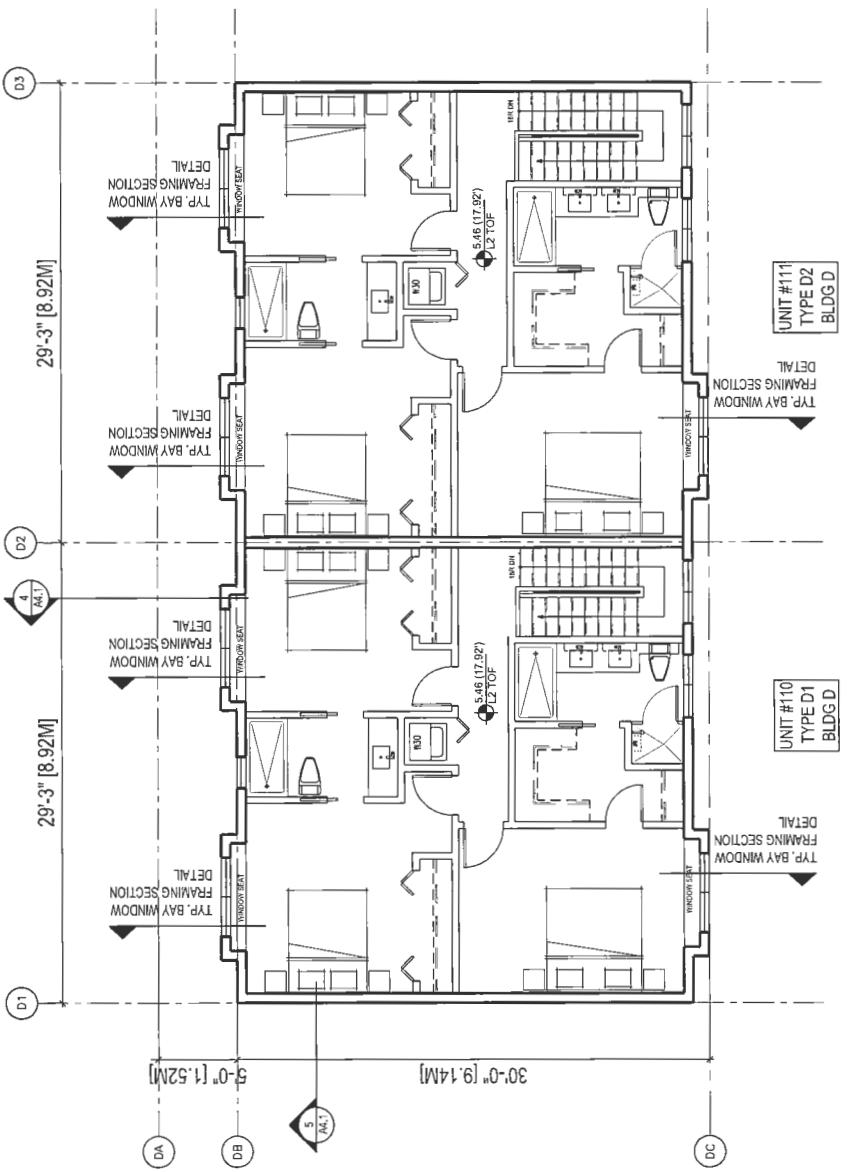
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**STEVESTON TOWNHOUSE
DEVELOPMENT (DP 17-792077) FOR**
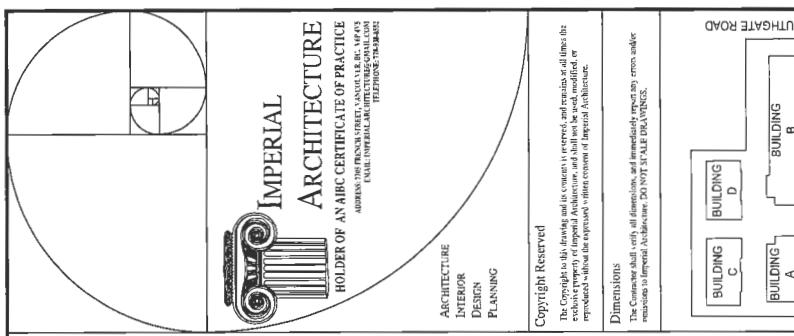
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9831-9832 SOUTHGATE HWY &
10931 SOUTHGATE ROAD, RICHMOND.

Revis
of
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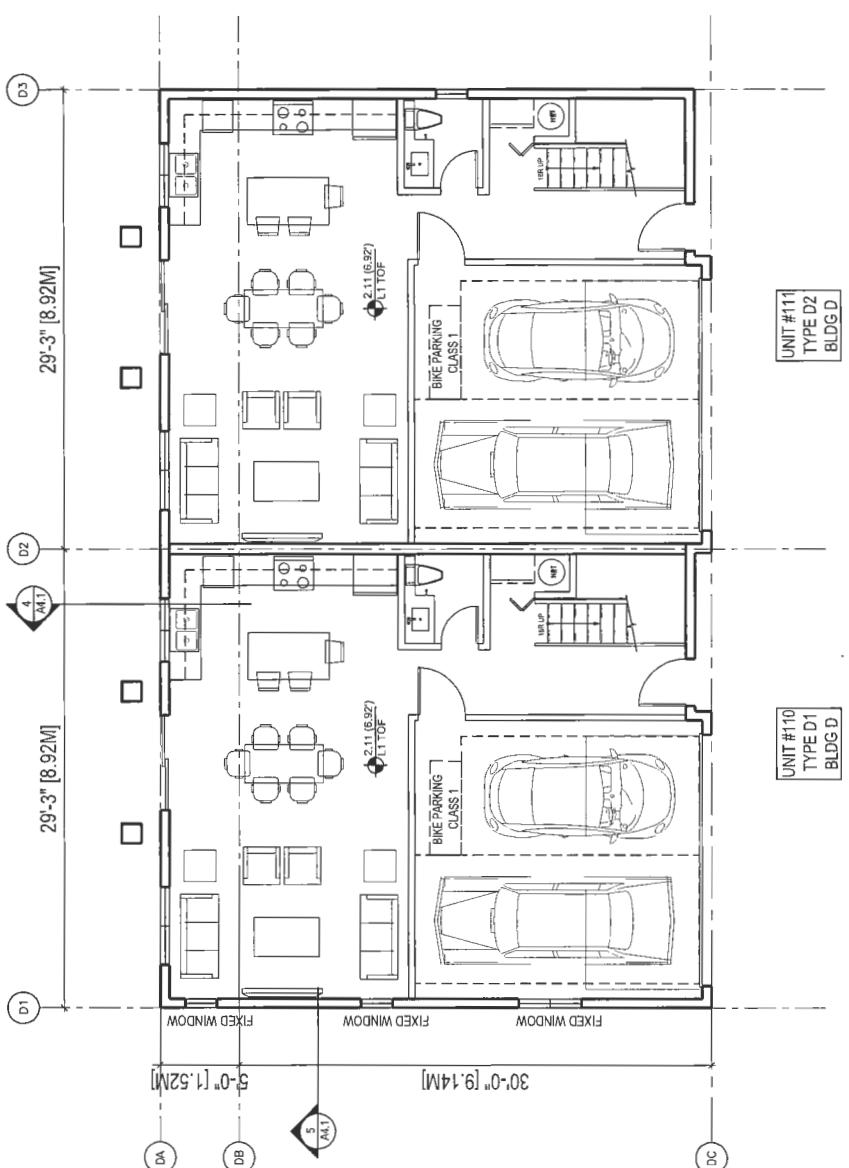
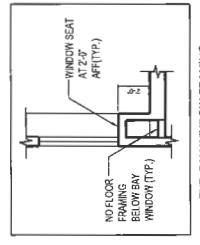


BUILDING D LEVEL 2 FLOOR PLAN


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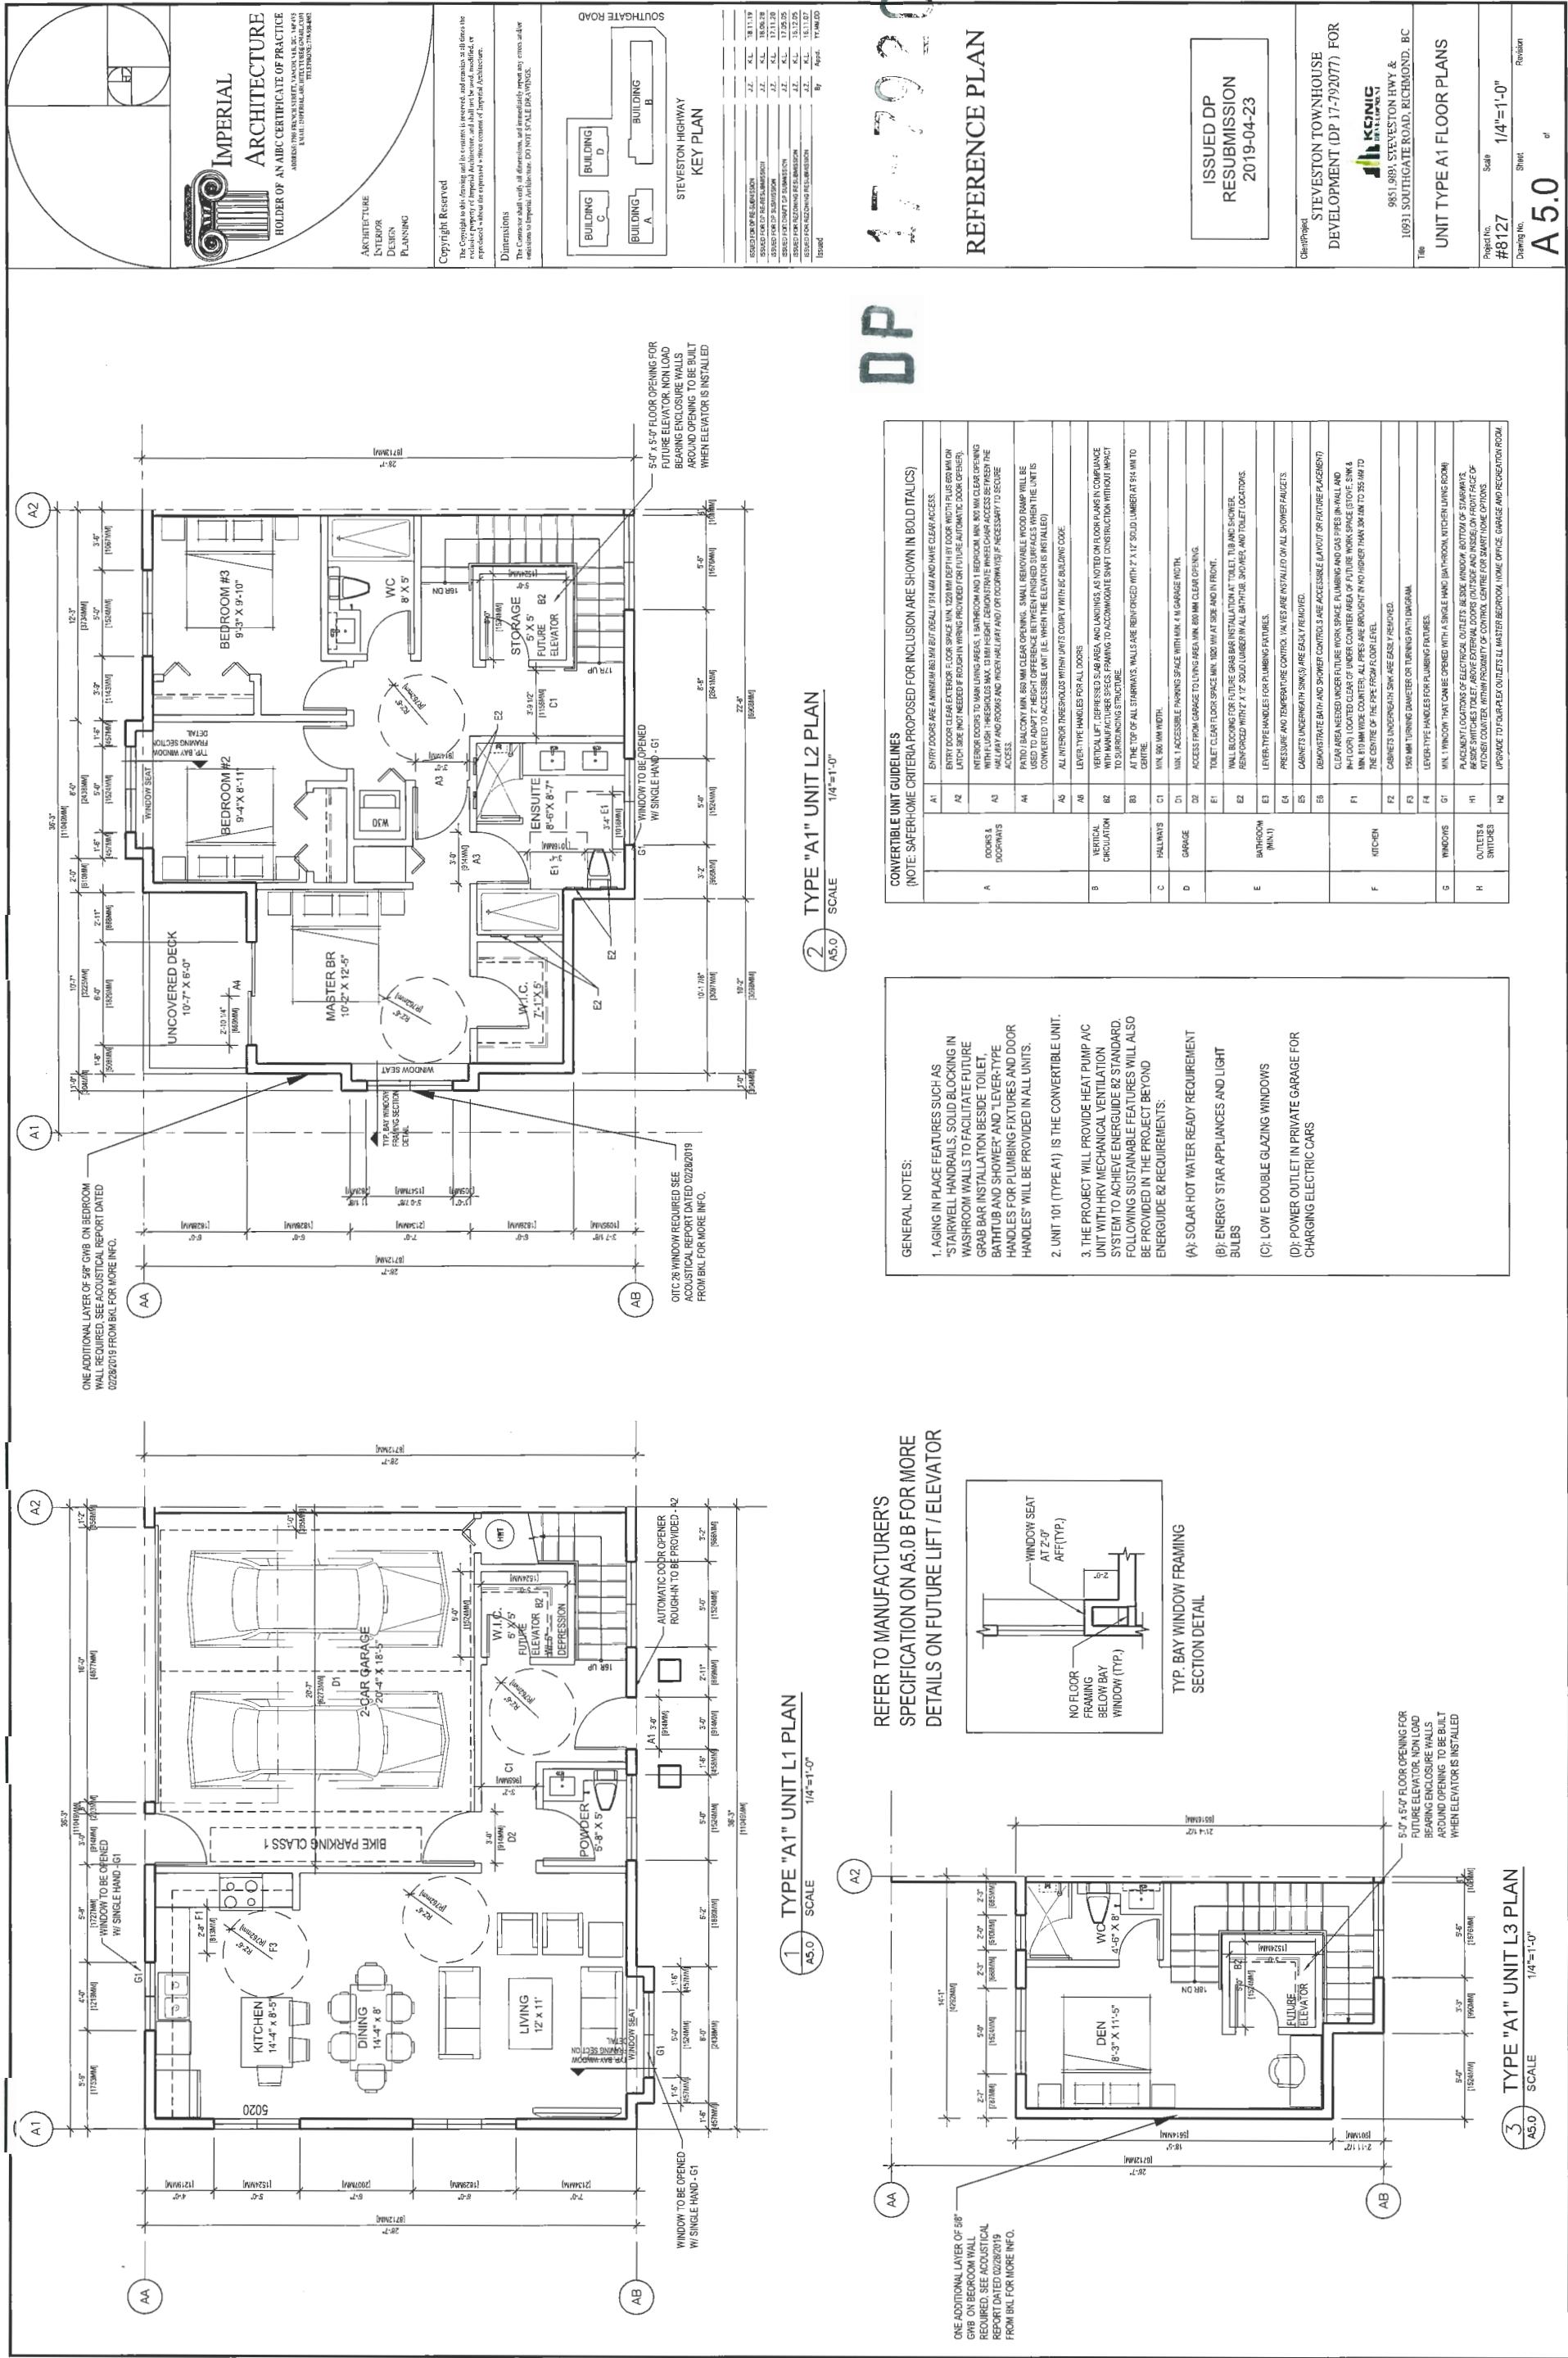
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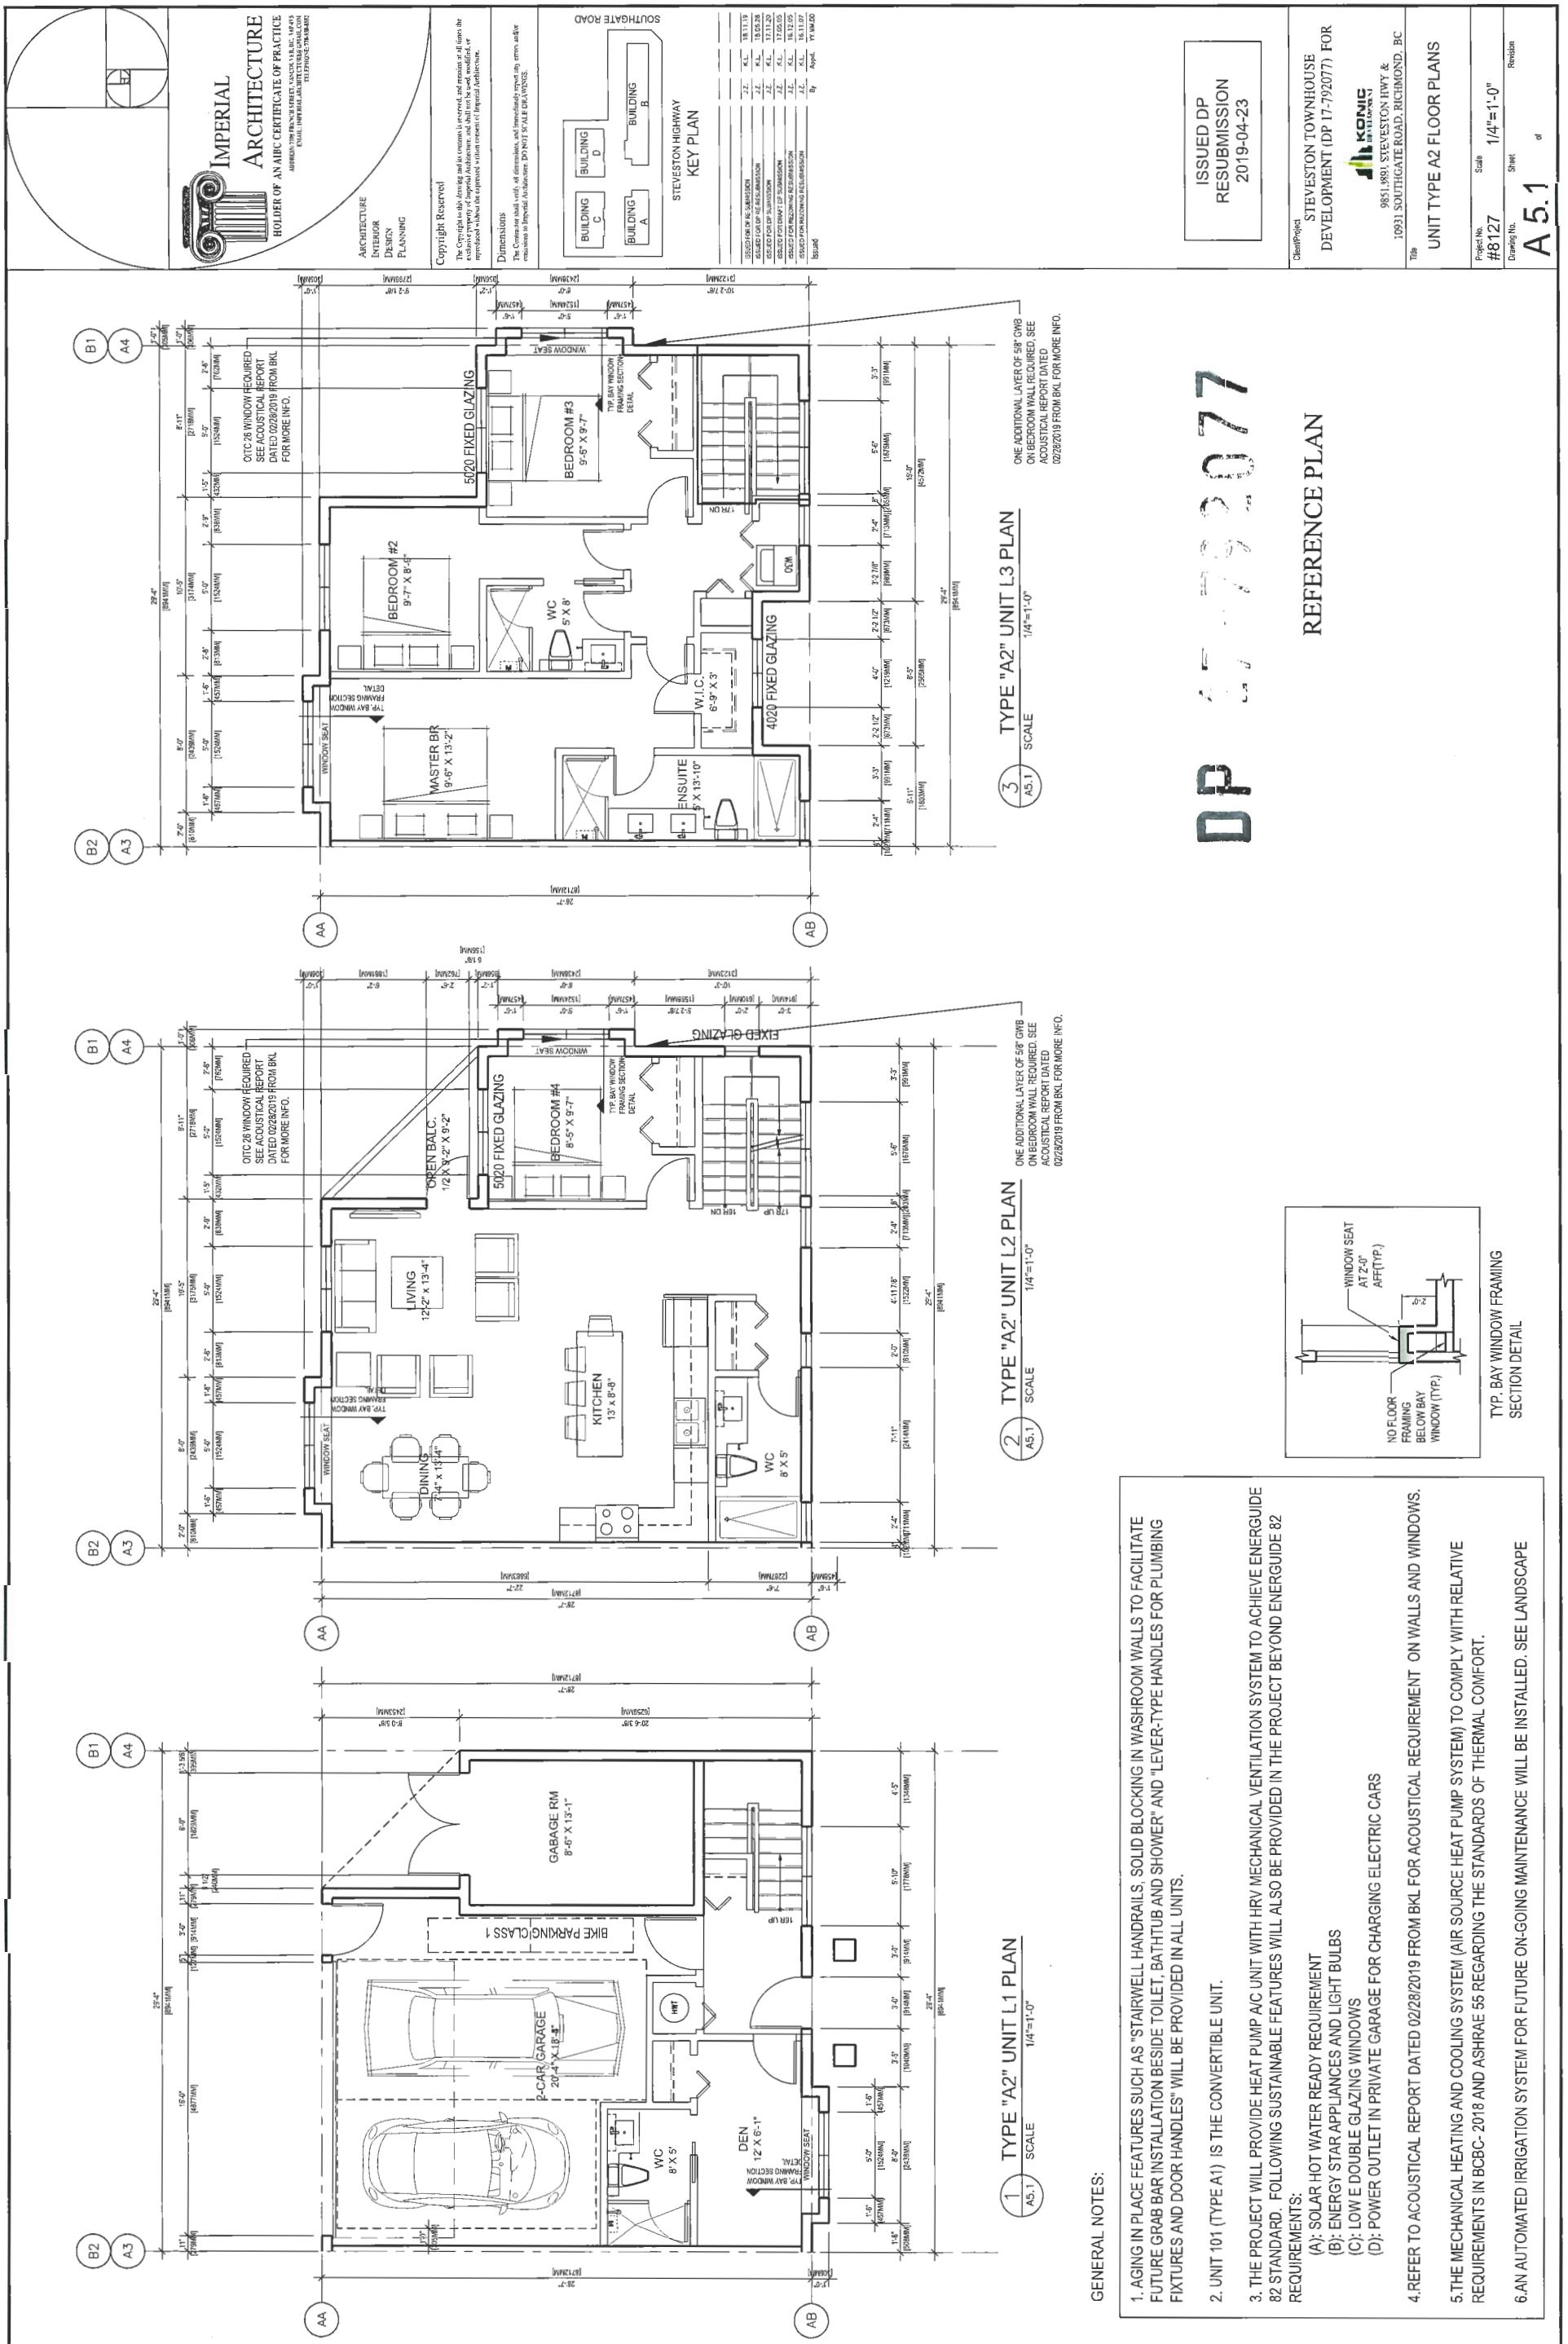
1. AGING IN PLACE FEATURES SUCH AS "STAIRWELL HANDRAILS SOLID BLOCKING IN WASHROOM WALLS TO FACILITATE FUTURE GRAB BAR INSTALLATION BESIDE TOILET, BATHTUB AND SHOWER" AND "LEVER-TYPE HANDLES FOR PLUMBING FIXTURES AND DOOR HANDLES" WILL BE PROVIDED IN ALL UNITS.
2. UNIT 101 (TYPE A1) IS THE CONVERTIBLE UNIT.
3. THE PROJECT WILL PROVIDE HEAT PUMP AC UNIT WITH HRV MECHANICAL VENTILATION SYSTEM TO ACHIEVE ENERGYGUIDE 82 BE PROVIDED IN THE PROJECT BEYOND ENERGYGUIDE 82 REQUIREMENTS:
 - (A): SOLAR HOT WATER READY REQUIREMENT
 - (B): ENERGY STAR APPLIANCES AND LIGHT BULBS
 - (C): LOW E DOUBLE GLAZING WINDOWS
 - (D): POWER OUTLET IN PRIVATE GARAGE FOR CHARGING ELECTRIC CARS
4. REFER TO ACOUSTICAL REPORT DATED 02/28/2019 FROM BKL FOR ACOUSTICAL REQUIREMENT ON WALLS AND WINDOWS.
5. THE MECHANICAL HEATING AND COOLING SYSTEM (AIR SOURCE HEAT PUMP SYSTEM) TO COMPLY WITH RELATIVE REQUIREMENTS IN BCSC-2018 AND ASHRAE 55 REGARDING THE STANDARDS OF THERMAL COMFORT.
6. AN AUTOMATED IRRIGATION SYSTEM FOR FUTURE ON-GOING MAINTENANCE WILL BE INSTALLED SEE LANDSCAPE




BUILDING D LEVEL 1 FLOOR PLAN





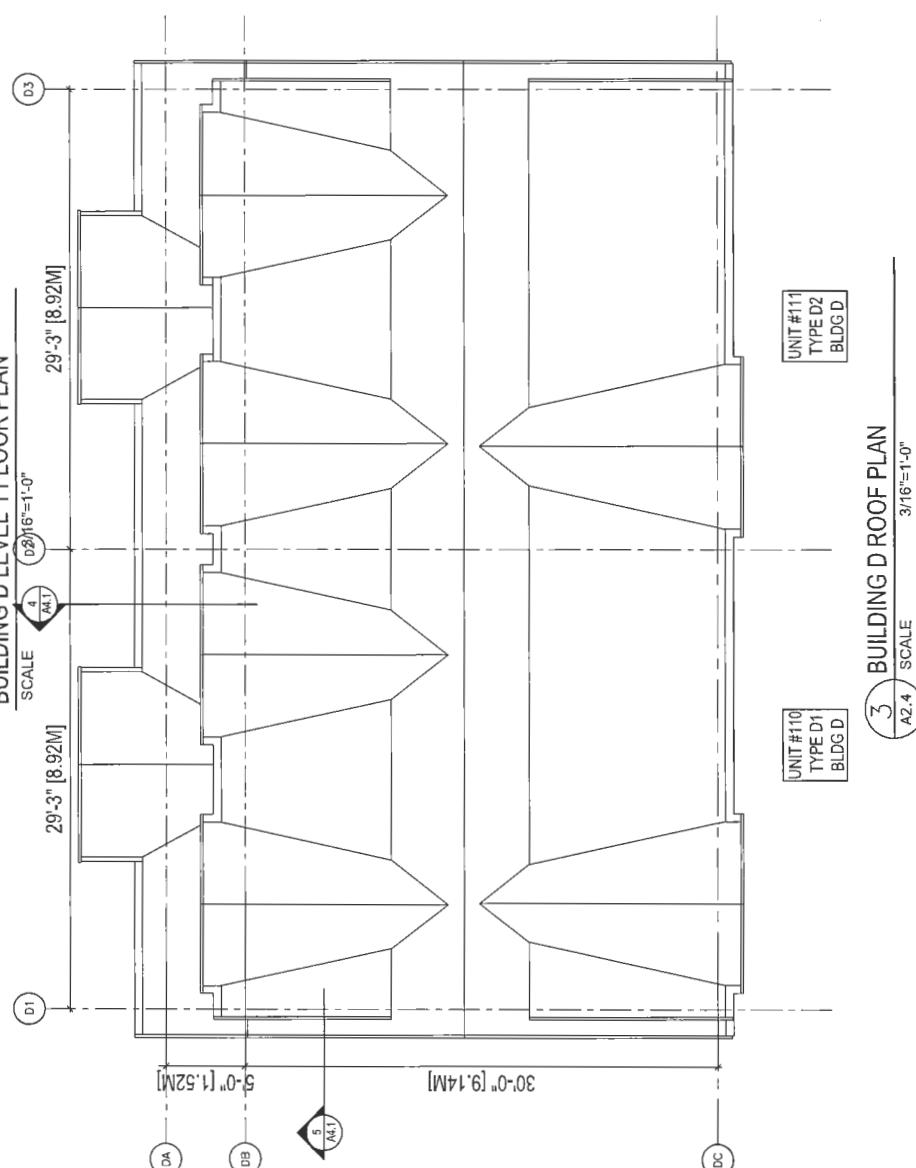

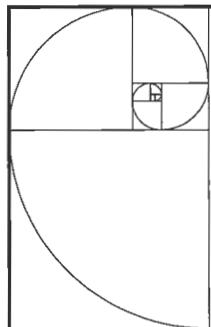

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SOUTHGATE ROAD
STEVESTON HIGHWAY
KEY PLAN

BUILDING C
BUILDING D
BUILDING A
BUILDING B

Issued: Apr 2019

By: [Signature]

Date: April 2019

File No: 10931



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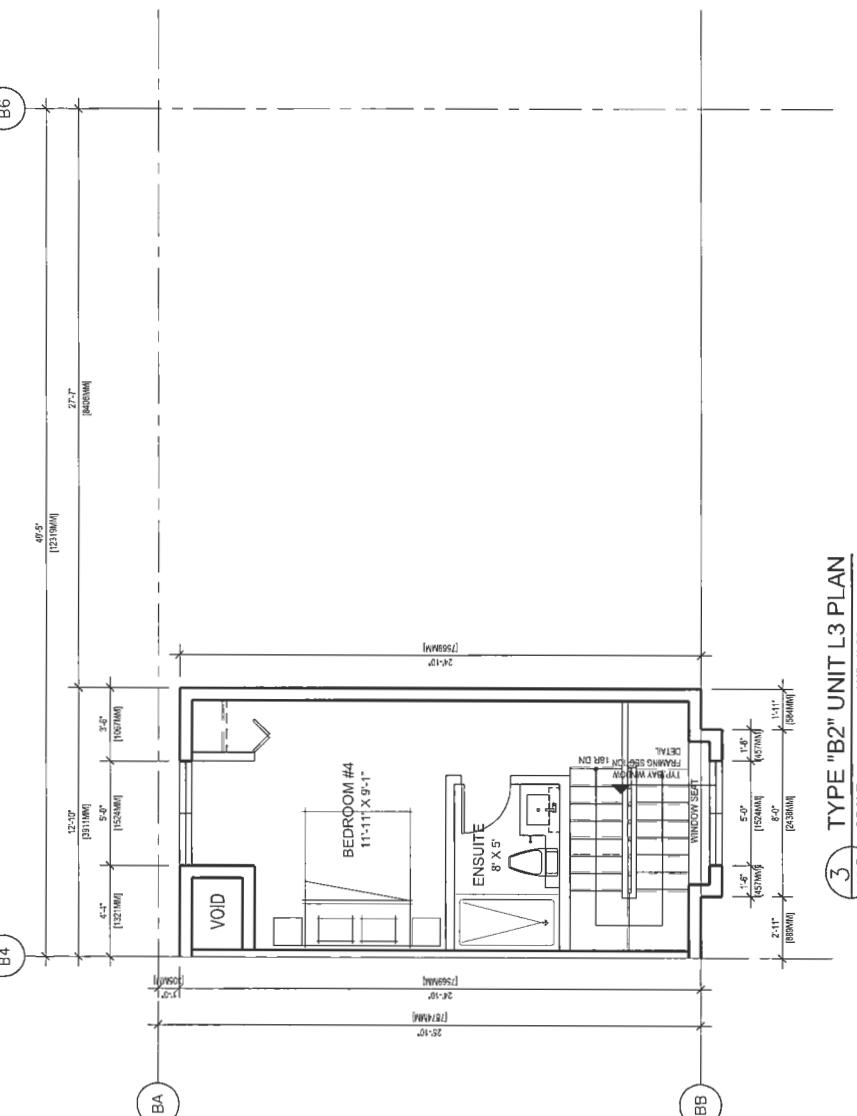
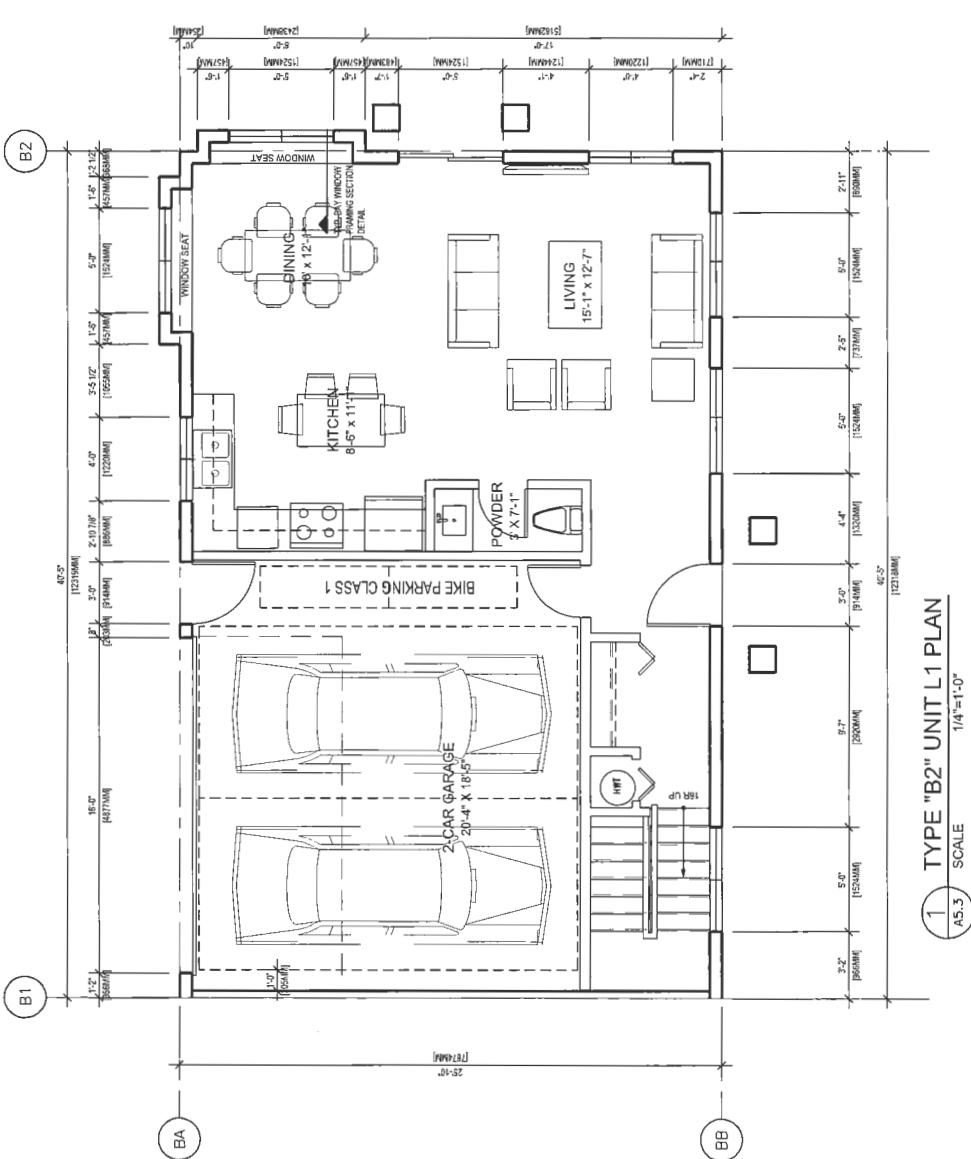
Client Project:
STEVESTON TOWNSHOUSE
DEVELOPMENT (DP 17/792077) FOR
9851 9890 STEVESTON HWY &
10931 SOUTHGATE ROAD, RICHMOND, BC


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Drawing No.: Sheet
A 5.3 of



TYP. BAY WINDOW FRAMING
SECTION DETAIL

- GENERAL NOTES:
- 1 AGING IN PLACE FEATURES SUCH AS "STAIRWELL HANDRAILS, SOLID BLOCKING IN WASHROOM WALLS TO FACILITATE FUTURE GRAB BAR INSTALLATION BESIDE TOILET, BATHTUB AND SHOWER" AND "LEVER-TYPE HANDLES FOR PLUMBING FIXTURES AND DOOR HANDLES" WILL BE PROVIDED IN ALL UNITS.
 2. UNIT 101 (TYPE A1) IS THE CONVERTIBLE UNIT.
 3. THE PROJECT WILL PROVIDE HEAT PUMP A/C UNIT WITH HRV MECHANICAL VENTILATION SYSTEM TO ACHIEVE ENERGUIDE 82 STANDARD. FOLLOWING SUSTAINABLE FEATURES WILL ALSO BE PROVIDED IN THE PROJECT BEYOND ENERGUIDE 82 REQUIREMENTS:
 - (A): SOLAR HOT WATER READY REQUIREMENT
 - (B): ENERGY STAR APPLIANCES AND LIGHT BULBS
 - (C): LOW E DOUBLE GLAZING WINDOWS
 - (D): POWER OUTLET IN PRIVATE GARAGE FOR CHARGING ELECTRIC CARS
 4. REFER TO ACoustical REPORT DATED 02/28/2019 FROM BKL FOR acoustical REQUIREMENT ON WALLS AND WINDOWS.
 5. THE MECHANICAL HEATING AND COOLING SYSTEM (AIR SOURCE HEAT PUMP SYSTEM) TO COMPLY WITH RELATIVE REQUIREMENTS IN BCBC-2018 AND ASHRAE 55 REGARDING THE STANDARDS OF THERMAL COMFORT.
 6. AN AUTOMATED IRRIGATION SYSTEM FOR FUTURE ON-GOING MAINTENANCE WILL BE INSTALLED. SEE LANDSCAPE

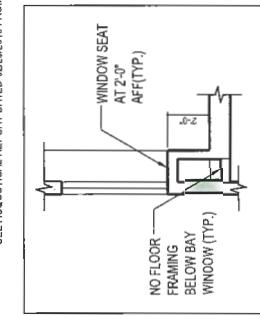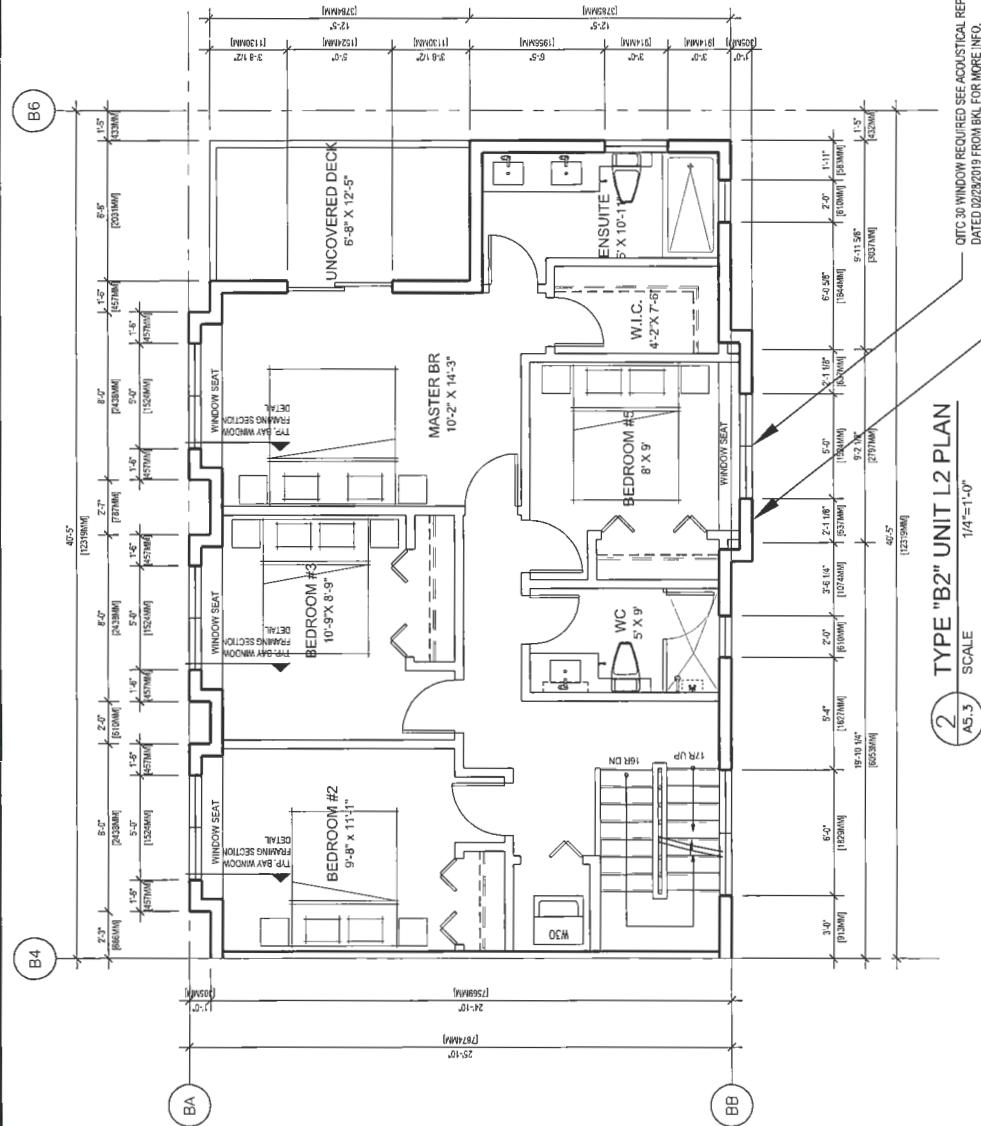

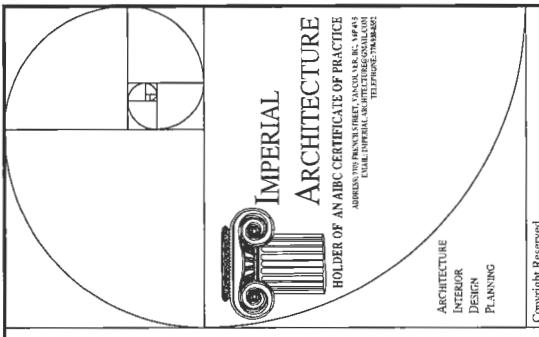

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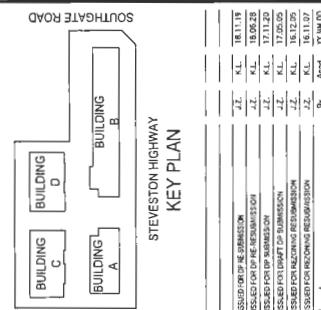
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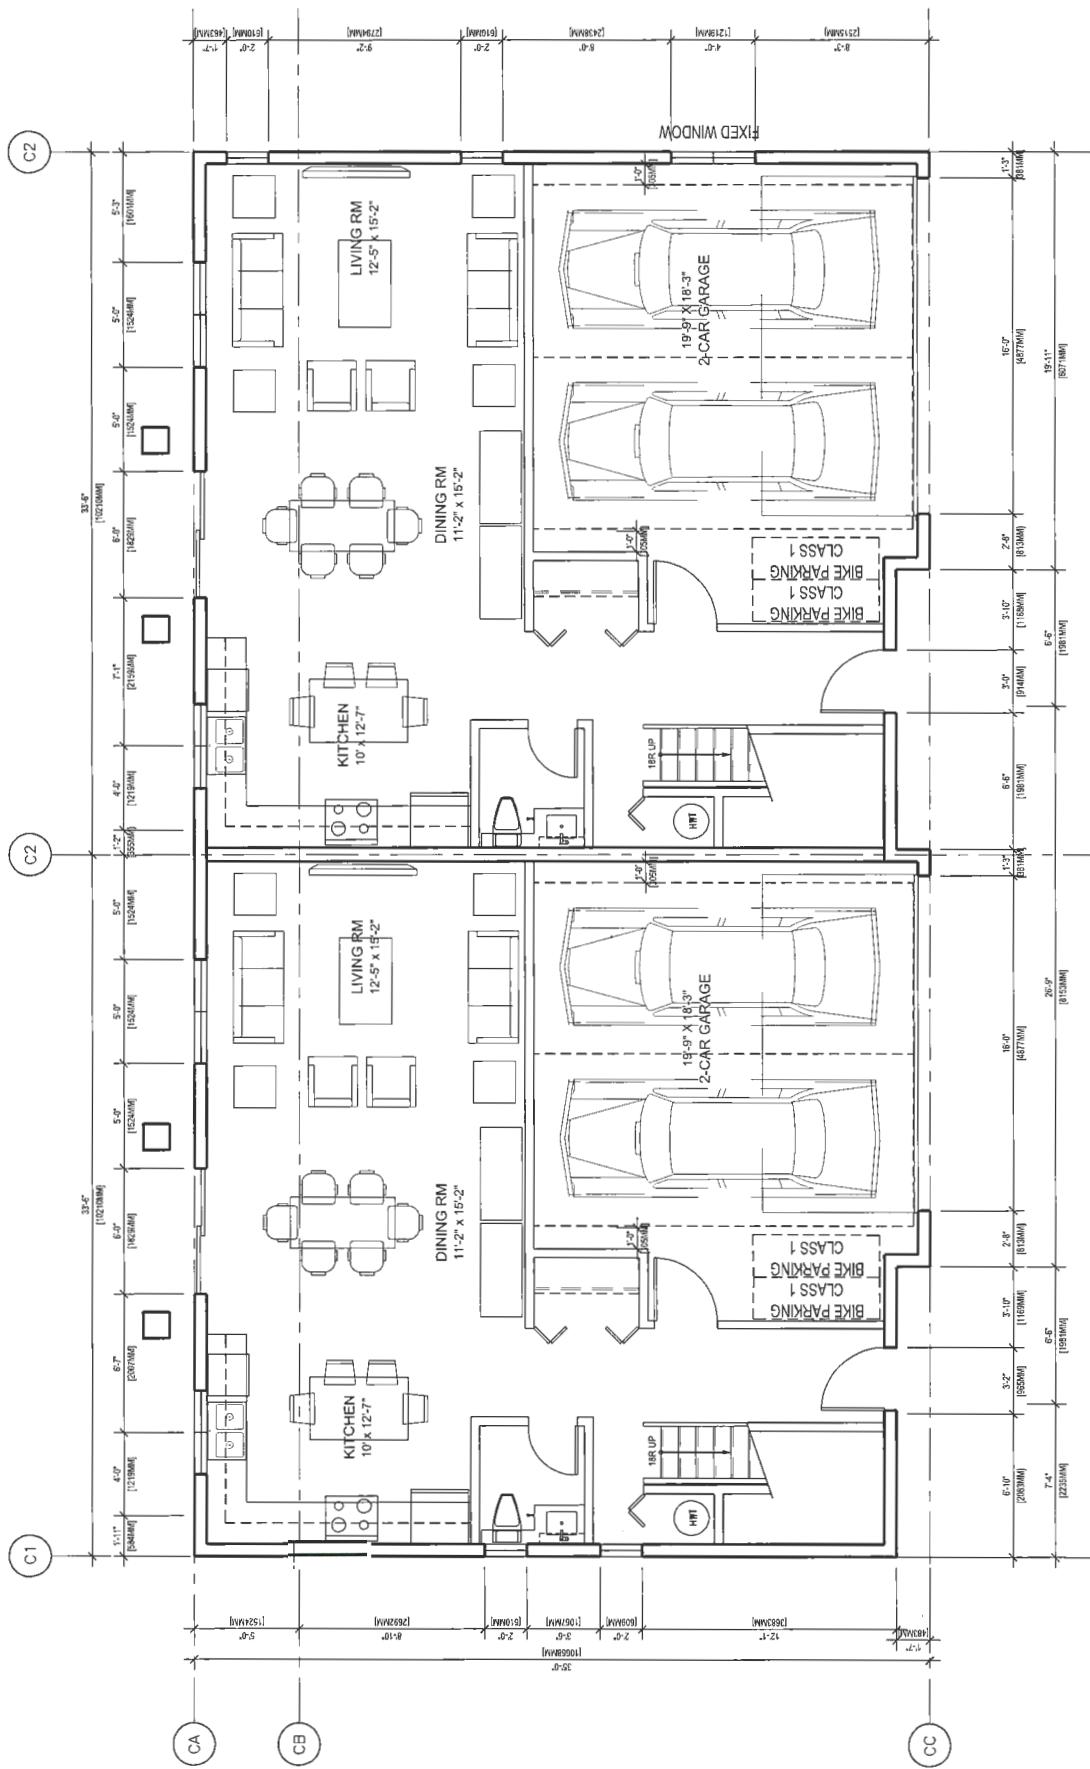
77
7920
DP

REFERENCE PLAN

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DEVELOPMENT (DR17-720277) FOR
9851 188A STEVESTON HWY &
10931 SOUTHGATE ROAD, RICHMOND, BC

Project No.: #8127
Scale: 1/4"=1'-0"
Drawing No.: A5.4
Sheet: 1
Revision:



DP
TYP. BAY WINDOW FRAMING
SECTION DETAIL

GENERAL NOTES:


1. AGING IN PLACE FEATURES SUCH AS "STAIRWELL HANDRAILS, SOLID BLOCKING IN WASHROOM WALLS TO FACILITATE FUTURE GRAB BAR INSTALLATION BESIDE TOILET, BATHTUB AND SHOWER" AND "LEVER-TYPE HANDLES FOR PLUMBING FIXTURES AND DOOR HANDLES" WILL ALSO BE PROVIDED IN THE PROJECT BEYOND ENERGUIDE 82 REQUIREMENTS.
2. UNIT 101 (TYPE A1) IS THE CONVERTIBLE UNIT.
3. THE PROJECT WILL PROVIDE HEAT PUMP A/C UNIT WITH HRV MECHANICAL VENTILATION SYSTEM TO ACHIEVE ENERGUIDE 82 STANDARD. FOLLOWING SUSTAINABLE FEATURES WILL ALSO BE PROVIDED IN THE PROJECT BEYOND ENERGUIDE 82 REQUIREMENTS:
 - (A): SOLAR HOT WATER READY REQUIREMENT
 - (B): ENERGY STAR APPLIANCES AND LIGHT BULBS
 - (C): LOW E DOUBLE GLAZING WINDOWS
 - (D): POWER OUTLET IN PRIVATE GARAGE FOR CHARGING ELECTRIC CARS

4. REFER TO ACOUSTICAL REPORT DATED 02/28/2019 FROM BKL FOR ACOUSTICAL REQUIREMENT ON WALLS AND WINDOWS.
5. THE MECHANICAL HEATING AND COOLING SYSTEM (AIR SOURCE HEAT PUMP SYSTEM) TO COMPLY WITH RELATIVE REQUIREMENTS IN BCBC-2018 AND ASHRAE 55 REGARDING THE STANDARDS OF THERMAL COMFORT.
6. AN AUTOMATED IRRIGATION SYSTEM FOR FUTURE ON-GOING MAINTENANCE WILL BE INSTALLED. SEE LANDSCAPE

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A 5.4



ARCHITECTURE
INTERIOR
DESIGN
PLANNING
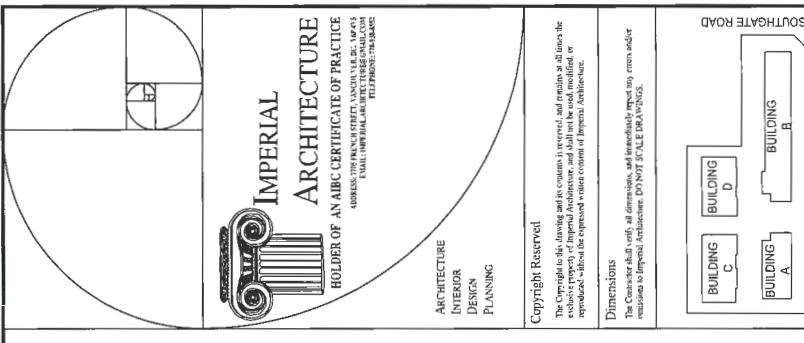
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SOUTHGATE ROAD
STEVENSON HIGHWAY
KEY PLAN


BUILDING C	BUILDING D
BUILDING A	BUILDING B

REFERENCE PLAN

ISSUED DP
RESUBMISSION
2019-04-23


Project No.
#8127
Title
STEVENSON TOWNHOUSE
DEVELOPMENT (DP 17-792077) FOR
9851 90th STEVENSON HWY &
10931 SOUTHGATE ROAD, RICHMOND, BC

UNIT TYPE C1/C2
LEVEL 2 FLOOR PLANS
Project No.
#14127
Title
1/4"=1'-0"
Sheet
Revision

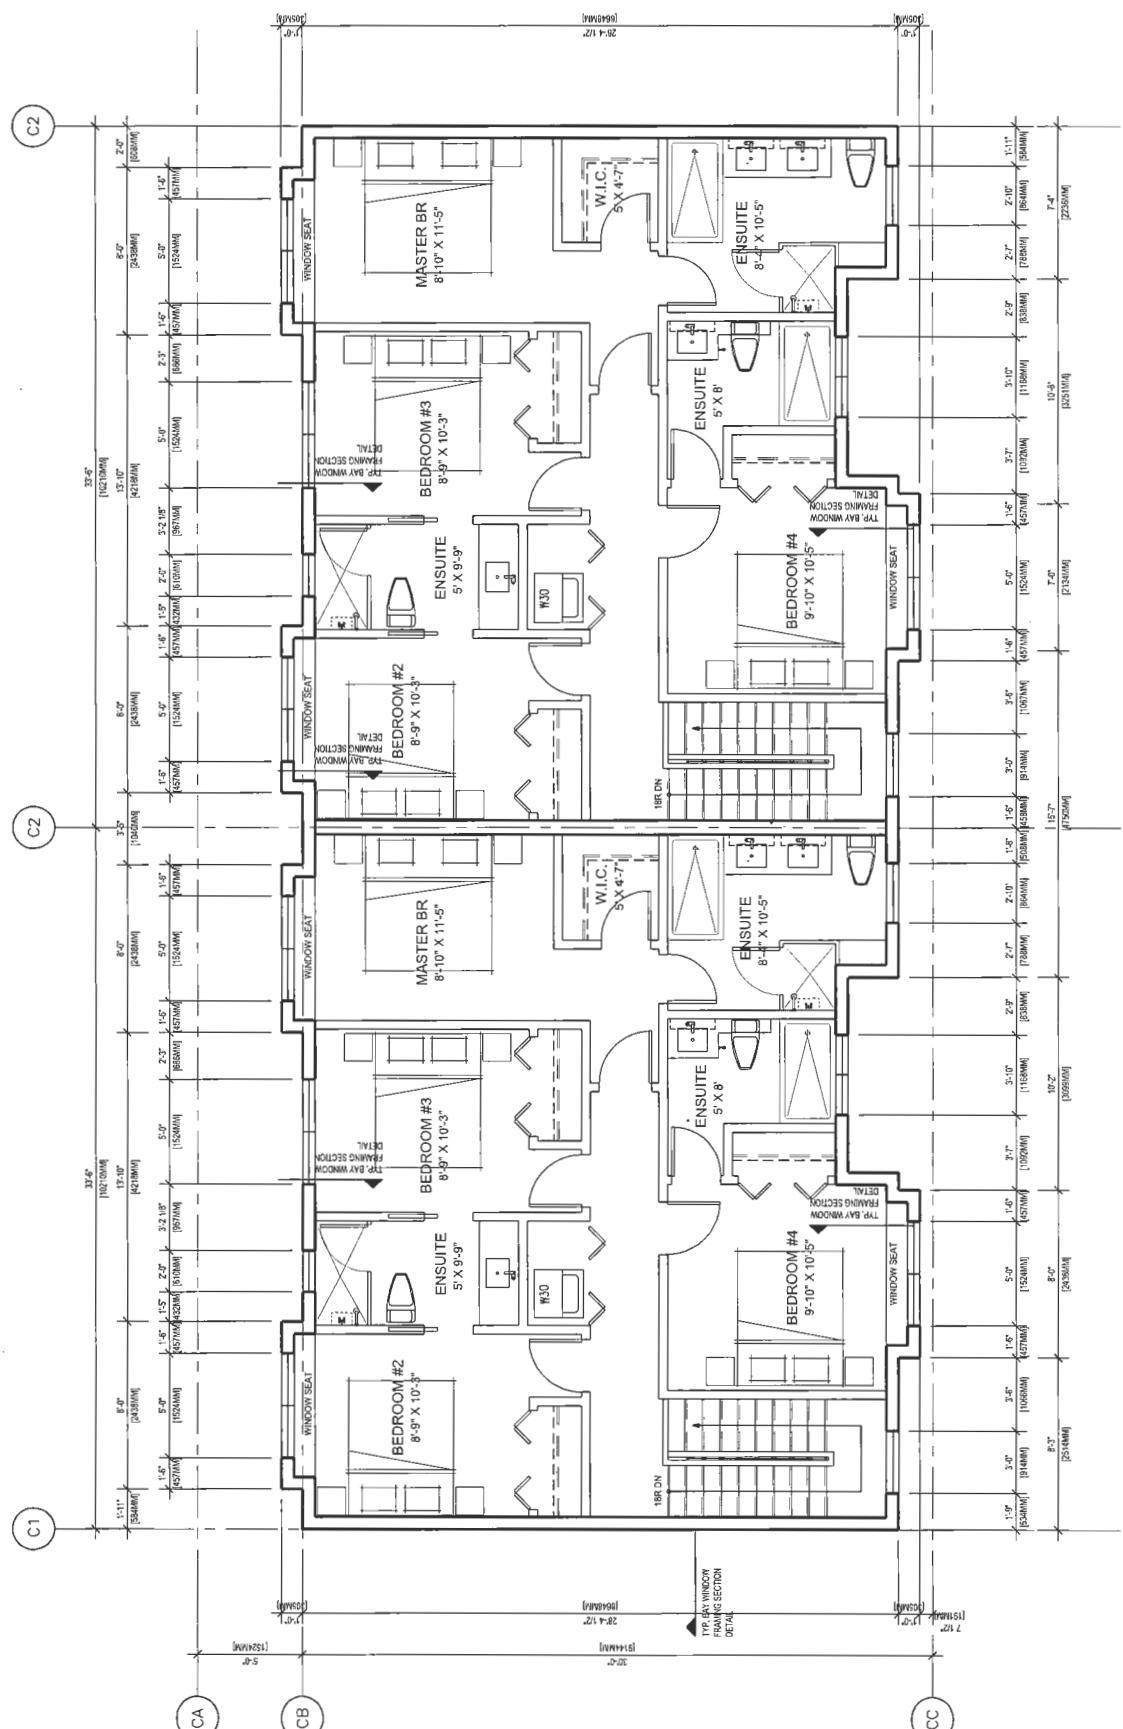

2 TYPE "C2" UNIT L2 PLAN
AS.5 SCALE 1/4"=1'-0"

TYP. BAY WINDOW FRAMING
SECTION DETAIL

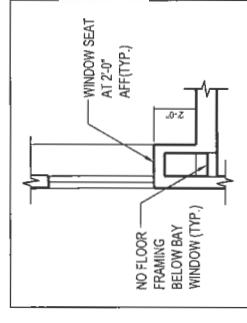


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ISSUED DP
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2019-04-23


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Title
STEVENSON TOWNHOUSE
DEVELOPMENT (DP 17-792077) FOR
9851 90th STEVENSON HWY &
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UNIT TYPE C1/C2
LEVEL 2 FLOOR PLANS
Project No.
#14127
Title
1/4"=1'-0"
Sheet
Revision



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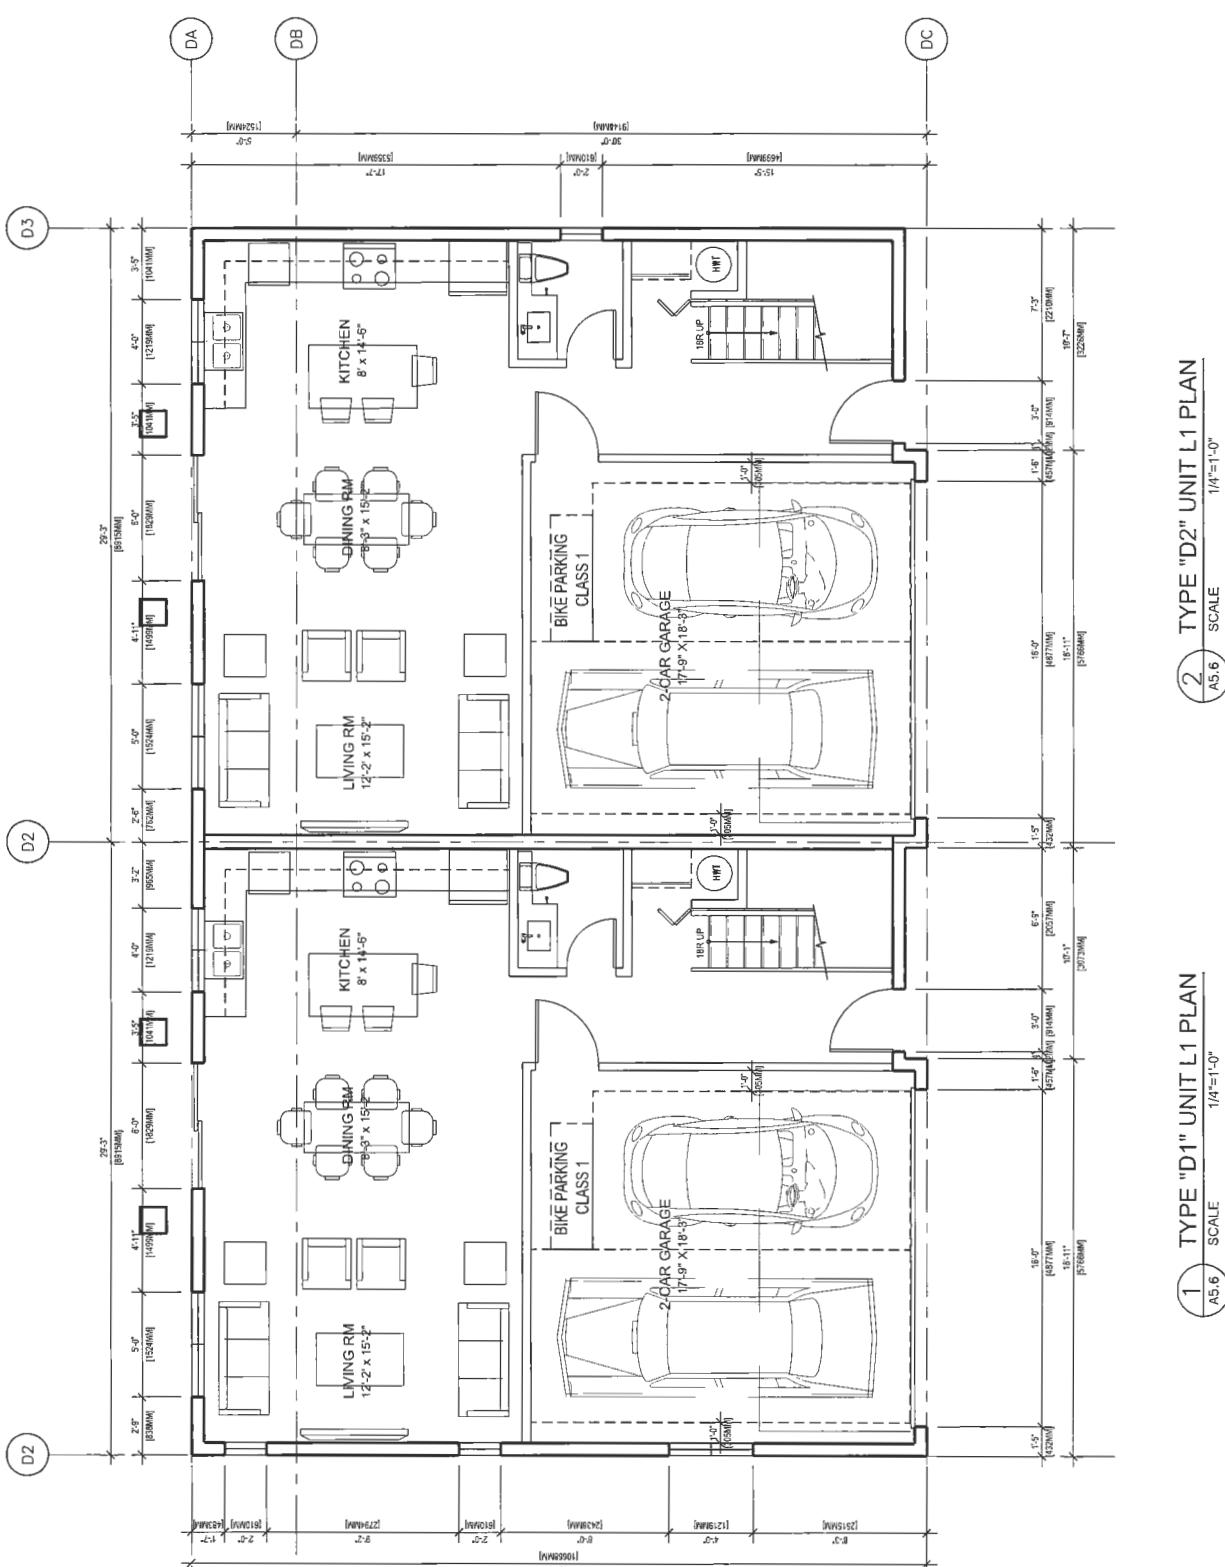
Issued

REFERENCE PLAN

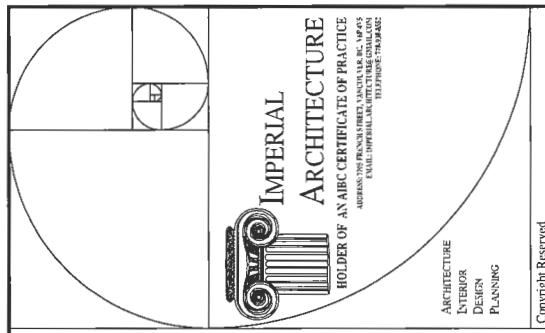ISSUED DP
RESUBMISSION
2019-04-23

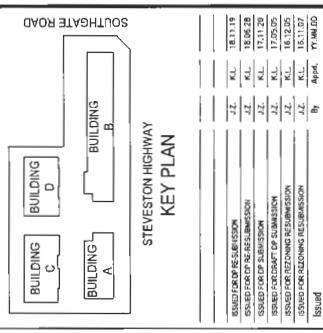Client/Project
STEVESTON TOWNHOUSE
DEVELOPMENT (DP 17/792077) FOR
9851 168th STEVESTON HWY &
10931 SOUTHGATE ROAD, RICHMOND, BC

UNIT TYPE D1/D2
LEVEL 1 FLOOR PLANS
Project No. #8127
Scale 1/4"=1'-0"
Drawing No. A 5.6
Sheet 1 of 1
Revision



1 TYPE "D1" UNIT L1 PLAN
A5.6 SCALE 1/4"=1'-0"


GENERAL NOTES:

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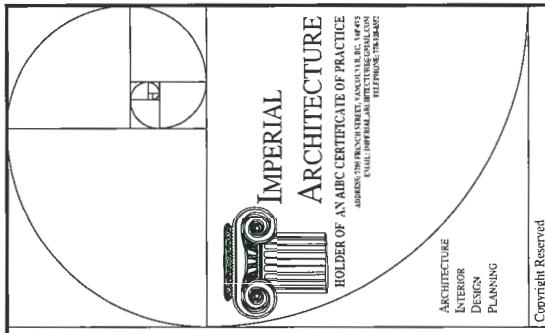
2 TYPE "D2" UNIT L1 PLAN
A5.6 SCALE 1/4"=1'-0"

TYP. BAY WINDOW FRAMING
SECTION DETAIL



REFERENCE PLAN

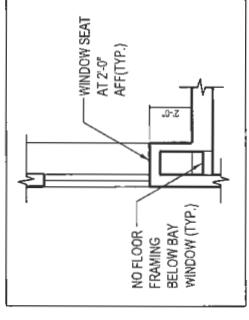77




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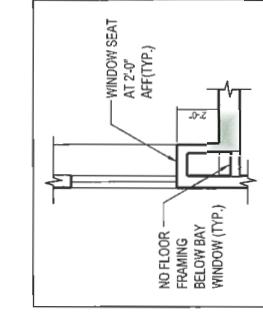
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TYP. BAY WINDOW FRAMING
SECTION DETAIL

REFERENCE PLAN

ISSUED DP
RE-SUBMISSION
2019-04-23

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STEVESTON TOWNHOUSE
DEVELOPMENT (DP17-792077) FOR
KONIC
9851 58th ST STEVESTON, BC V4A 1Z2
10931 SOUTHGATE ROAD, RICHMOND, BC

UNIT TYPE D1/D2
LEVEL 2 FLOOR PLANS

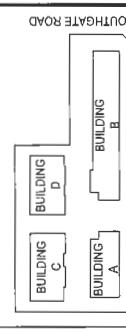
Project No. #8127
Scale 1/4"=1'-0"
Drawing No. Sheet A 5.7
Revision d

77

20

DP

77

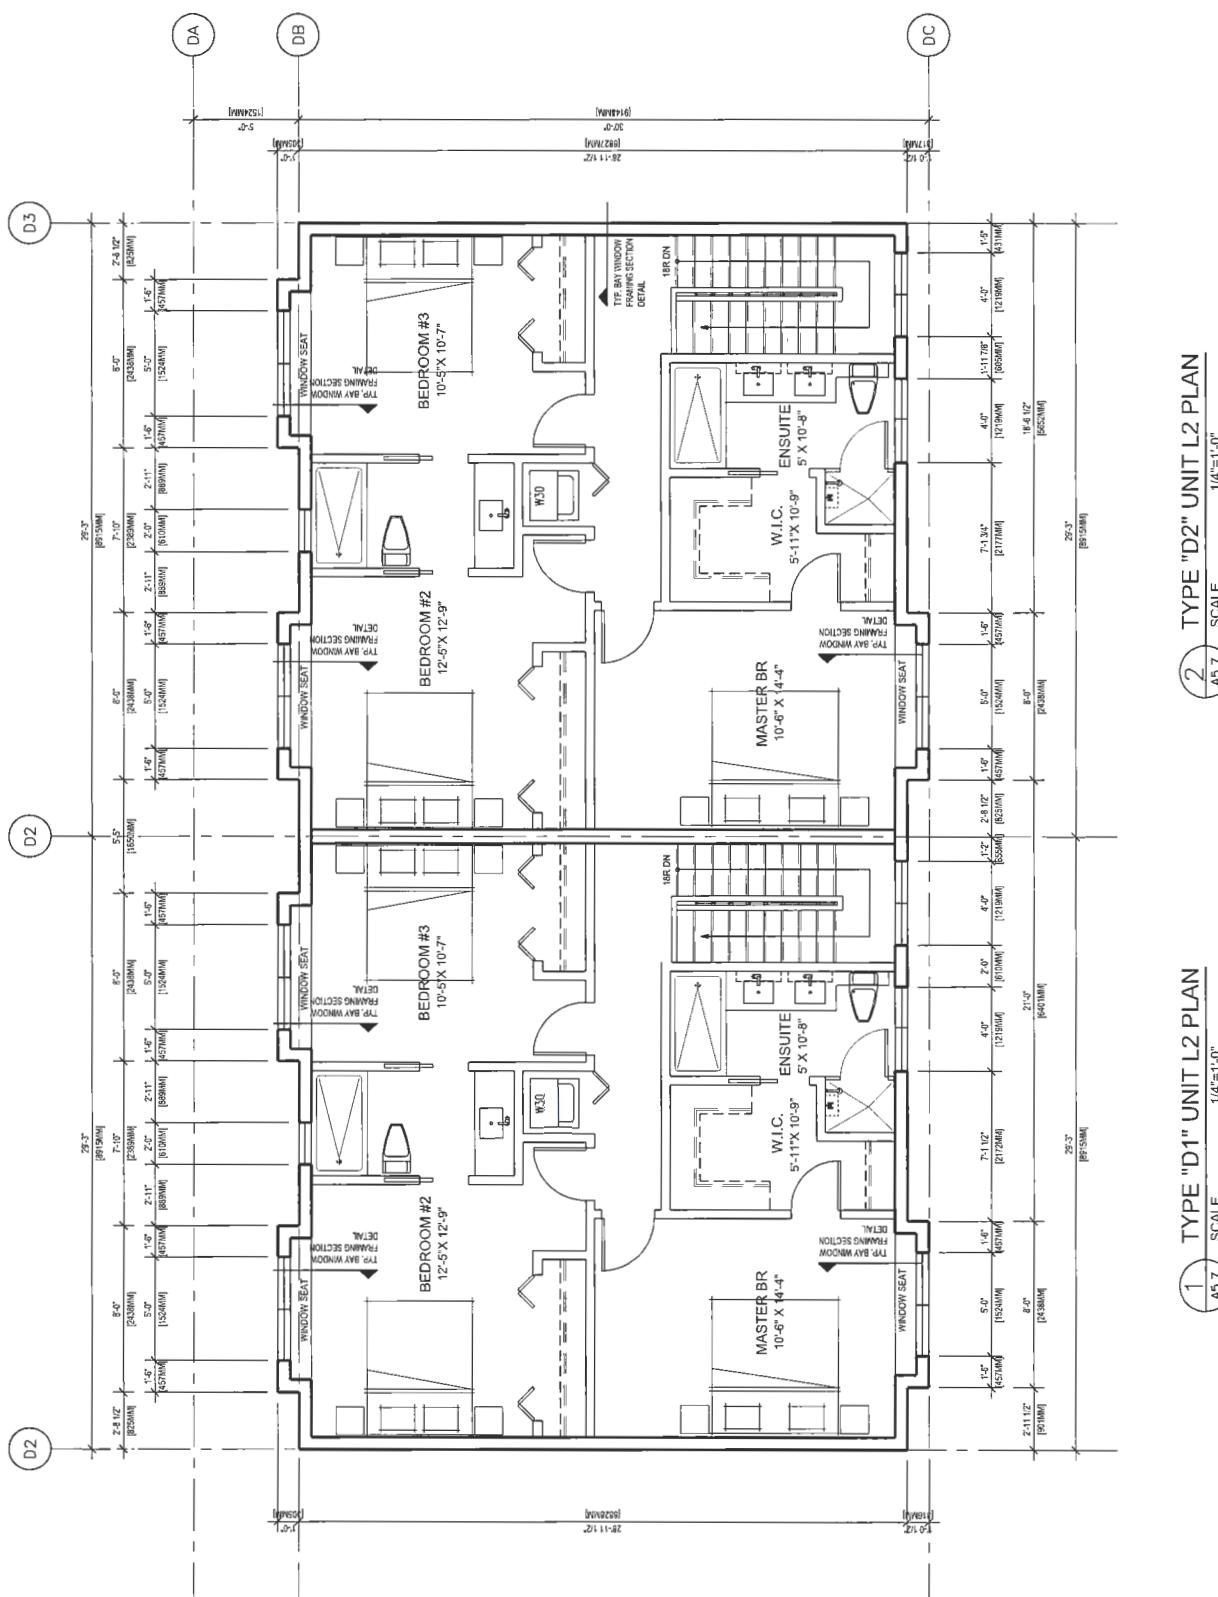

1 TYPE "D1" UNIT L2 PLAN
A5.7 SCALE 1/4"=1'-0"

GENERAL NOTES:

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