



City of Richmond

Report to Development Permit Panel

To: Development Permit Panel

Date: January 23, 2019

From: Wayne Craig
Director of Development

File: DP 18-831623

Re: **Application by W.T. Leung Architects, Inc. on behalf of Grand Long Holdings Canada Ltd. for a Development Permit at 8071 and 8091 Park Road**

Staff Recommendation

That a Development Permit be issued which would permit the construction of two residential towers and one office-residential tower on a podium with street-oriented commercial and retail uses at ground level at 8071 and 8091 Park Road on a site zoned "High Density Mixed Use (ZMU39) – Brighouse Village (City Centre).



Wayne Craig
Director of Development

WC:nd

Att. 6

Staff Report

Origin

W.T. Leung Architects Inc., on behalf of Grand Long Holdings Canada Ltd. has applied to the City of Richmond for permission to develop two residential towers and one office-residential tower on a podium with street-oriented commercial and retail uses fronting Park Road and Buswell Street at ground level and concealed parking at 8071 and 8091 Park Road.

The proposed mixed use development includes a total floor area of approximately 39,410 m² (424,211 ft²) comprised of approximately:

- 5,461 m² (58,780 ft²) of office space within proposed Tower A (3rd-7th storey of the building);
- 29,893 m² (321,766 ft²) of residential space within proposed Tower A, B, and C, including twenty one (21) Low End Market Rental (LEMR) Affordable Housing (AH) units that will be secured with a legal agreement as a condition of rezoning bylaw adoption;
- 4,057 m² (43,671 ft²) of retail/restaurant space; and
- 1,069 m² (11,505 ft²) of indoor and 3,558 m² (38,295 ft²) of outdoor common amenity space.

The site is being rezoned from “Downtown Commercial (CDT1)” to “High Density Mixed Use (ZMU39)-Brighouse Village (City Centre)” zone under Bylaw 9878 (RZ 17-779229), which received third reading on July 16, 2018. Considerations of rezoning include:

- Registration of right of ways to secure supplementary public space at ground level (i.e. proposed Park Road plaza, north/south public pedestrian connection through the parking podium).
- Transportation and infrastructure improvements in accordance with the City’s standard Servicing Agreement process. Works include but are not limited to road dedications and frontage improvements (along Park Road, Buswell Street and both adjacent lanes), installation of a new traffic signal at the Park Road/Buswell Street intersection, installation of a new mid-block pedestrian crossing signal, undertaking improvements to the existing traffic signal at the No. 3 Road/Park Road intersection, and water, storm sewer and sanitary sewer improvements.
- Design, construction and transfer of ownership to the City of an on-site energy plant.
- Provision of cash in lieu of contributions for childcare and community amenity space consistent with City Centre Area Plan (CCAP) density bonusing provisions.
- Participation in the City’s Public Art Program and introduction of public art on-site.

Development Information

The subject site is comprised of two lots that are located at the northwest intersection of Park Road and Buswell Street and bound by existing north/south and east/west lanes (Attachment 1). There are currently no residential uses on the site. The existing one and two storey commercial buildings and associated surface parking are currently vacant.

Surrounding Development

The subject site is located in the Brighouse Village in the City Centre Area Plan (CCAP) and is in an area that is designated “Urban Core T6 (45m)” and “Village Centre Bonus (VCB)” (Attachment 2). The applicant’s proposal to rezone the site to take advantage of the CCAP supported density for the site, which includes provisions to permit up to 1.0 Floor Area Ratio (FAR) of additional non-residential density, is at third reading. Development surrounding the subject site is as follows:

- To the North: An existing lane that will be widened as a condition of rezoning bylaw adoption, existing commercial buildings and a new fifteen storey mixed use (residential/commercial) tower at 6511 Buswell Street, at the intersection of Buswell Road and Cook Road, that is currently under construction (DP 13-634111). The properties are zoned “Downtown Commercial (CDT1)” and designated “Urban Core T6 (45 m)” and “Village Centre Bonus” in the Brighouse Village in the CCAP.
- To the South: Park Road and existing single storey commercial buildings with surface parking within the front yard setback and a fourteen storey mixed use (residential/commercial) tower at the intersection of Park Road and Buswell Street (6733 Buswell Street). The properties are zoned “Downtown Commercial (CDT1)” and designated “Urban Core T6 (45 m)” and “Village Centre Bonus” in the Brighouse Village in the CCAP.
- To the East: Buswell Street and an existing low rise apartment building zoned “Medium Density Low Rise Apartments (RAM1)” and designated “Urban Centre T5 (25 m)” in the Brighouse Village in the CCAP.
- To the West: An existing lane that will be widened as a condition of rezoning bylaw adoption and existing one and two storey commercial buildings that front No. 3 Road and provide vehicle parking in both the front and rear yard setback (No. 3 Road and lane setback). 6560, 6600, 6640 and 6700 No. 3 Road are under application (RZ 15-694855, DP 16-754761) to rezone to the “High Density Mixed Use (ZMU36)- Brighouse Village (City Centre)” zone to permit development of a mixed-use building (residential/ commercial/office). This development proposal has Third Reading and issuance of the Development Permit is pending. The properties are designated “Urban Core T6 (45 m)” and “Village Centre Bonus” in the Brighouse Village in the CCAP.

Rezoning and Public Hearing Results

The Public Hearing for the rezoning of this site was held on July 16, 2018. At the Public Hearing, there were no written submissions or submissions from the floor. No concerns about the proposed rezoning were expressed.

Staff Comments

The proposed development scheme attached to this report complies with the provisions of the proposed “High Density Mixed Use (ZMU39)-Brighouse Village (City Centre)” zone. The applicant has satisfactorily addressed the urban design form and character objectives of the

Official Community Plan (OCP) and City Centre Area Plan (CCAP) and associated Development Permit Guidelines. The attached Development Application Data Sheet (Attachment 3) provides a comparison of the proposed development data with the relevant Bylaw requirements.

Advisory Design Panel Comments

The Advisory Design Panel (ADP) reviewed the proposal on August 22, 2018 and again on October 17, 2018. Subsequent to the applicant revising the proposal in response to the ADP's initial comments, the Panel was supportive of the proposed form and character subject to further design development in response to their comments. The current proposal incorporates changes in response to comments from the ADP including:

- Design development of the building elevations, including the building elevations that abut the proposed Park Road plaza area.
- Design development of the landscape plan including enhancements to the north/south pedestrian corridor and public plaza, and the podium level common outdoor amenity area.
- Architectural and landscape updates to improve on-site wayfinding (i.e. wayfinding by design including building materials, colour, illumination).

A copy of the relevant excerpt from the most recent ADP Minutes from October 17, 2018 is attached for reference (Attachment 4). The design response from the applicant has been included immediately following the specific comments from members of the Advisory Design Panel and is identified in '***bold italics***'.

Analysis

Proposal Description

The proposed development includes three towers and stepped mid-rise buildings over a podium with ground level, street-oriented commercial and retail uses fronting Park Road and Buswell Street, and concealed parking. The CCAP supports the proposed mix of land uses at the site, which includes residential, office and commercial uses as well as supplementary public space at the ground level (i.e. proposed Park Road plaza, north/south public pedestrian connection through the parking podium).

The proposal is a single phase development. The applicant intends to create four airspace parcels and a remainder (three residential air space parcels, one office air space parcel, one commercial and parking remainder).

Conditions of Adjacency

The proposed development is designed to minimize impacts on both existing and future surrounding development.

- The subject site is surrounded by City streets and lanes and does not abut a private property.
- The proposed siting of the towers is consistent with CCAP tower separation guidelines and considers both separations between proposed on-site towers and tower setbacks from the property line.
- Stepped mid-rise building forms are proposed. The proposed mid-rise building massing:

- Increases the separation between the west side of Tower C and the east side of Tower A, which increases sun penetration into the common outdoor amenity area, minimizes overlook between residents and office workers, and maintains a view of the north shore mountains for some properties that are south of the subject site.
- Includes angled building corners (for Building C and A mid-rise storeys) that maximize sun access to the outdoor amenity space, preserve through views, and articulate mid-rise building façades.

Urban Design and Site Planning

Streetscape/Public Realm

- Through the associated rezoning process, a series of dedications and improvements will be undertaken to enhance the public realm. These measures include road and lane widening, installation of a pedestrian push button crosswalk on Park Road that is aligned with the proposed Park Road plaza and north/south pedestrian connection, upgrades to the intersection of Park Road and Buswell Street from the current four way stop configuration into a signalized intersection that also includes upgrades on the north side of Park Road along the subject site's frontage.
- The proposed development would contribute to activity and animation along its road frontages:
 - The proposed building massing is consistent with CCAP guidelines that encourage a "human-scaled streetscape" (concealed parking and servicing, weather protection for street level uses, varied building setbacks along road frontages, and a series of commercial retail units and lobbies to on-site residences and offices that are oriented to support pedestrian access from the sidewalk or the proposed Park Road Plaza).
 - To minimize the impact of the proposed development on the City's roadways and interruption of the pedestrian realm by vehicle accesses, all access to the site will be via the existing east/west and north/south laneways, which will be widened.
- The proposed redevelopment must meet the requirements of the Richmond Flood Plain Designation and Protection Bylaw 8204. Registration of a flood indemnity covenant on Title is required prior to final adoption of the rezoning bylaw.

Site and Functional Planning

The site's location at the intersection of Park Road and Buswell Street, proximity to No. 3 Road and the proposed mix of on-site uses influence the proposed site and functional planning.

Pedestrians

- The site is bound by lanes and roads with active uses and weather protection lining the property's road frontages.
- Supplementary public outdoor amenity spaces would be secured by right of ways as a consideration of the associated rezoning application.
 - The proposed Park Road plaza would interrupt and animate the development's long Park Road frontage and support pedestrian connectivity between Park Road, commercial uses (including a planned grocery store at the ground level in Building A), on-site enclosed parking, a proposed at grade north/south public pedestrian connection through the building, and a proposed new Park Road mid-block signalized pedestrian crossing. The space includes area that is both open to above and covered by second storey building area that provides weather protection.

- A north/south pedestrian connection through the building that connects Park Road, the proposed Park Road public plaza, and the east/west lane is proposed. Inclusion of a pedestrian connection is consistent with the CCAP's objective to introduce smaller block pedestrian connections (at 100 m intervals) to provide more access options and linkages for pedestrians. To encourage its use by pedestrians and to maximize both the pedestrian experience and safety, the proposed building podium design includes light wells (vertical shafts with openings at the podium level) to facilitate natural light penetration from the podium level to the north/south pedestrian connection, wall mounted and flush with the ground linear ground lighting, continuation of colour tiles and materials used at the plaza throughout the corridor, continuation of the façade treatment to the ceiling of the opening to the pedestrian pathway for continuity, visual interest and wayfinding, and landscaping.

Vehicle Access

- To minimize the impact of development on the City's roadways, all access to the site will be via the existing east/west and north/south laneways, which will be widened. Three parkade accesses are proposed. Two way access for both residential and non-residential uses would be located from the north/south lane. The east/west lane would provide two points of access including two way access for residential use and an exit only opening for both residential and non-residential uses.

Parking and on-site car share provisions

- The proposed vehicle, bicycle and truck parking is consistent with the site specific bylaw (ZMU39). Consistent with provisions in the Zoning Bylaw, as a condition of rezoning bylaw adoption, an agreement will be registered on Title to secure 153 parking spaces for shared use by retail and restaurant uses and residential visitors.
- Although the development proposal meets on-site parking requirements, car share vehicles that are available for public use would be provided on-site as a supplementary Transportation Demand Management (TDM) amenity. Unenclosed, designated car share parking would be secured on-site through the associated rezoning application and accessed from the north/south lane. The car share provider would initially introduce one car share vehicle on-site. A second vehicle would be introduced when there is public demand for the service. The applicant would contribute \$25,000/stall (total \$50,000) to the car share operator for the provision of car share vehicles.

Cyclists

- Commercial/office and residential bicycle storage is located in secure rooms within the parkade and end of trip facilities are located within close proximity of the on-site plaza on the ground level. Bicycle maintenance and repair facilities are provided for each of the three buildings (Tower A facilities are at the submerged parking level, Tower B and C facilities are located at the uppermost parking level). Short term bicycle parking is provided at lobby entrances, adjacent to the plaza and within and at entries to the north/south pedestrian connection through the parking podium.

Loading/Collection

- Six on-site medium size (SU-9) loading spaces are proposed. All spaces would be secured as shared spaces as a condition of rezoning bylaw adoption and a covenant would be registered on Title to prohibit access/service by large (WB-17) vehicles.

- There are six waste storage areas that provide separate spaces for the on-site uses. The spaces are either directly accessible from an adjacent loading space or a designated holding area is provided that is directly accessible from an adjacent loading space.

Wayfinding

- The development proposal includes a signage and wayfinding strategy; however, a separate Sign Permit Application would be required to install commercial signage. The signage strategy is supplementary to site planning, building massing and building materials (colours, textures, illumination), which were designed to safely guide people through and to the various on-site uses.

Common indoor amenity space

- A total 794 m^2 (8545 ft^2) of residential common indoor amenity space and 275 m^2 ($2,960 \text{ ft}^2$) of office indoor amenity space is proposed, which meets CCAP guidelines. The residential common indoor amenity space is distributed between the three buildings. The spaces would be equally accessible to all residents and amenities include meeting and party rooms, exercise facilities and an indoor pool. Each of the spaces have direct access to the adjacent residential common outdoor amenity space.

Affordable Housing (AH) Strategy

- As a condition of rezoning bylaw adoption, twenty-one Low End Market Rental (LEMR) Affordable Housing (AH) units will be secured on the third and fourth storey of Building B and C. The subject application was received prior to July 24, 2017 and is proceeding in accordance with in-stream provisions that were in process at the time Council adopted amendments to the Affordable Housing (AH) Strategy in July 2017 (i.e. 5% of the permitted residential floor area will be secured as AH units). Family-friendly units comprise 57% of the total number of units and the total combined unit floor area is $1,536 \text{ m}^2$ [$16,534 \text{ ft}^2$]).
- Registration of an AH agreement on Title is a condition of rezoning bylaw adoption. The agreement includes provisions to:
 - Secure access to and use of all residential indoor and outdoor amenities for the occupants of AH units.
 - Ensure the AH units are managed and operated by a non-profit organization that is acceptable to the City.

Table 1: Affordable Housing Summary

| Unit Type | Number of Units | Proposed Unit Area | % of Unit Mix | Unit Location |
|-----------|-----------------|--|---------------|---|
| 1 bedroom | 9 | 49 m^2 to 61.5 m^2 (535 to 662 ft^2) | 43% | 3 rd floor: 7 units 4 th floor: 2 units |
| 2 bedroom | 7 | 79.8 to 102.6 m^2 (860 - $1,105 \text{ ft}^2$) | 33% | 3 rd floor: 5 units 4 th floor: 2 unit |
| 3 bedroom | 5 | 92.8 to 102.7 m^2 (999 - $1,106 \text{ ft}^2$) | 24% | 3 rd floor: 3 units 4 th floor: 2 units |
| Total | 21 | | | |

Architectural Form and Character

Massing

- Stepped mid-rise buildings are proposed. The proposed building massing accommodates the CCAP supported density for the site while limiting the number of proposed on-site towers

and softening the transition between the podium and tower building elements. The proposed stepped mid-rise building design would vary streetwall heights and floorplate shapes.

- The building includes varied building setbacks along the road frontages, building entries and lobbies are recessed, and the Buswell Street elevation is pulled back mid-block.
- The development supports porosity at ground level by incorporating a public plaza at the midpoint of the site's Park Road frontage that connects to a north/south pedestrian connection through the building's parkade. Angled textured walls define the Park Road plaza space and direct views and pedestrians to the north/south pathway.
- The development would include a full level of below grade parking, which reduces the mass of the parking podium. The remaining above grade parking podium structure is wrapped with commercial uses and building lobby entrances at ground level and commercial and residential uses above along the site's Park Road and Buswell Street frontages. The exposed parking podium elevations along the building's lane frontages are articulated using aluminium louvers, painted concrete with reveals, corrugated metal panels, vertical slat screening, and ground level commercial uses and windows wrap around the building corners.
- The proposed tower floorplates are generally consistent with CCAP design guidelines. The development's proposed stepped tower design is characterized by incrementally reduced tower floorplate sizes.
 - Tower A's podium includes office uses (4th to 7th storey), and proposes larger floorplates, with residential uses above.
 - Tower B has tower floorplates that are less than 650 m² (6,996 ft²).
 - Tower C similarly proposes a slim profile tower with floorplates that are less than 650 m² (6,996 ft²) for the upper 6 storeys of the tower.

Building Articulation

- The building is characterized by angles and an orthogonal character. The building's horizontal character is articulated with the use of varied façade materials in muted hues that are punctuated with colour and materials including:
 - Translucent burgundy tinted glass screens;
 - Gold, grey and black hued spandrel panels;
 - Metal screen panels; and
 - A vertical slat screen applied to the indoor amenity bridging element between Tower A and Tower C, and to the lane elevation to identify access to the north/south pathway
- Colour and materials are used to differentiate on-site uses and to introduce a strong vertical character to Tower C at the southeast corner of the site (i.e. a series of vertical gold hued spandrel panels set the office component of the development apart from the residential uses, gold hued spandrel panels and omission of horizontal building slabs between building floors create a vertical statement at the southeast corner of Tower C at the Park Road and Buswell Street intersection).

Landscape and Open Space Design

Ground level: A distinct porcelain paver pattern would be installed to identify entries to building lobbies and these areas would be lined with metal planters and wood benches. The materials and pattern are repeated to identify the Park Road plaza area and to emphasize the building's recess from Buswell Street. The pavers continue through the building to define the north/south

pedestrian connection. The lightwells that would be incorporated into the parking podium design to facilitate the penetration of natural light to the north/south pedestrian connection would also support the long term survival of the shrubs and ferns that are proposed in planters. A columnar tree (Hedge Maple) would be planted at the building's Buswell Street recess and the Park Road plaza design includes a feature (Katsura) tree. Two shades of concrete are proposed at ground level. The darker hue would be used to establish a regular pattern of bands that align with building columns and that draw attention to the entries to commercial ground level uses.

Office common open space: Located above the parking podium and accessed from the fourth storey office indoor amenity area, a designated office outdoor amenity area, which is finished with unit pavers and perimeter landscaping, is proposed at the northwest corner of the building's podium.

Residential common outdoor space: The common residential outdoor amenity space would be located above the parking podium and includes active and passive spaces including urban agriculture gardens and associated amenities, curvilinear pathways, outdoor patio spaces with direct access to common indoor amenity spaces, a long table next to a gas barbecue and associated sink and counter, a central water feature, seating benches and walls, and children's play areas. Raised planters with suitable soil volume to support landscaping that includes trees would be introduced throughout the outdoor amenity area and used to separate common outdoor amenity space from outdoor spaces associated with private residences. The proposal includes 3,558 m² (38,297 ft²) of outdoor amenity space, which exceeds CCAP guidelines.

Children's play area: The landscape design includes two areas that are specifically designed to encourage children's play and to suit a variety of development stages including:

- A conventional designated play area with a large prefabricated play structure that includes climbing, hanging and sliding play equipment on a poured in place rubber surface.
- "Natural play" areas with boulders and logs to encourage exploratory and imaginative play. One of the natural play areas features a slide that is integrated into the landscaped mound and a tunnel this is comprised of individual wood frames and associated stepping stones.

Green roof: With the exception of the tower rooftops, irrigated sedum green roofs are proposed at building rooftops that are not private or common outdoor amenity space. Planting the terraced building rooftops contributes to the proposal's on-site sustainability features.

Landscape Letter of Credit (LOC): As a consideration of Development Permit issuance, the applicant will provide a LOC for \$1,579,121.27.

Tree Retention and Replacement: A survey submitted by the applicant confirms that there are no existing bylaw trees on or adjacent to the subject site. No tree replacement or protection is required.

Public Art: During the associated rezoning application review process, the applicant committed to participate in the City's Public Art Program (Policy 8703). A possible location for public art is identified within the Park Road plaza area. A public art plan for this site was considered and supported by the Public Art Committee on October 16, 2018.

Sustainability

BC Energy Step Code: In June 2018, City Council amended the Building Regulation Bylaw to include BC Energy Step Code requirements. The subject development is designed and would be constructed to comply with Step 2 requirements, which combined with provision of an on-site energy plant, is consistent with the updated Building Regulation Bylaw (Attachment 5).

District Energy Utility (DEU): As a consideration of rezoning, the applicant will design, construct and transfer ownership of an on-site energy plant to the City. Seventy percent of space heating, space cooling and domestic hot water will be from a non-carbon energy source (air source heat recovery system). Sustainability staff have received preliminary design information. Should changes affecting the form and character of the development be required as a result of ongoing development of the energy plant design, a General Compliance application may be required.

LEED & Step Code: The subject application will target LEED (version 4) silver equivalency and a 51% window to wall ratio to improve building energy efficiency. The preliminary equivalency scorecard is attached to this report (Attachment 6).

Electric Vehicle (EV) Charging Infrastructure

In December 2017, City Council amended the Richmond Zoning Bylaw to support electric vehicle (EV) charging infrastructure for all residential parking spaces. In accordance with the bylaw, all residential parking spaces will be provided with an energized outlet (Level 2 EV charging). The development also provides charging infrastructure for commercial and visitor parking spaces and for secured bicycle parking (Attachment 3).

Livability

Accessibility: All of the proposed units would incorporate aging in place features to accommodate mobility constraints associated with aging. These features include stairwell handrail; lever-type handles for plumbing fixtures and door handles; and solid blocking in washroom walls to facilitate future grab bar installation beside toilets, bathtubs and showers. Barrier-free access to the building lobbies and indoor and outdoor amenity spaces is provided throughout the building.

Basic Universal Housing (BUH): Sixteen percent of the proposed 353 units proposed, including all 21 AH units, which will be secured through the concurrent rezoning application, would be constructed to be fully accessible in accordance with the Basic Universal Housing (BUH) features outlined in Section 4.16 of the Zoning Bylaw. The Zoning Bylaw supports a density exclusion of 1.86 m^2 (20 ft^2) per BUH unit; however, the applicant does not propose to apply this exemption.


Noise Mitigation: The site is affected by OCP Airport Noise Contours and traffic noise. The applicant has provided an acoustical evaluation report and a mechanical thermal report, which were both prepared by a qualified professional, to study interior noise levels and noise mitigation standards to ensure compliance with the City's OCP interior noise guidelines and Noise Regulation Bylaw (8856). The acoustical report suggest suitable window glazing standards and installation of weather stripping on exterior doors. In addition, all units would have air conditioning; therefore, it would not be necessary for residents to open windows during warm weather. The mechanical thermal report confirms that operation of the mechanical system will not only be energy efficient but also comply with the Noise Regulation Bylaw.

Crime Prevention through Environmental Design (CPTED): The applicant has provided a summary of feature CPTED measures which focus on:

- Encouraging passive surveillance through design (i.e. an open parkade layout, installation of transparent glazing at elevator lobbies, activating public spaces, street oriented store fronts); and
- Creating well defined spaces (i.e. design with wayfinding in mind, distinguish between public, semi-private and private spaces, integrate signage and lighting strategies).

Conclusions

As the proposed development would meet applicable policies and Development Permit Guidelines, staff recommend that the Development Permit be endorsed, and issuance by Council be recommended.

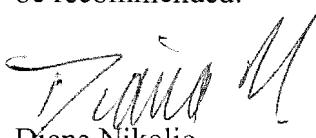

Diana Nikolic
Senior Planner/Urban Design

Attachment 1: Location Map

Attachment 2: Brighouse Village Specific Land Use Map

Attachment 3: Development Application Data Sheet

Attachment 4: Advisory Design Panel Minutes & Applicant Responses (inserted in bold italics)

Attachment 5: Letter from Project Architect: Construction of Step 2 Building

Attachment 6: LEED Equivalency List (provided by applicant)

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The following are to be met prior to forwarding this application to Council for approval:


- Receipt of a Letter-of-Credit for landscaping in the amount of \$1,579,121.27.

Prior to future Building Permit issuance, the developer is required to complete the following:


- The applicant is required to obtain a Building Permit for any construction hoarding associated with the proposed development. If construction hoarding is required to temporarily occupy a street, or any part thereof, or occupy the air space above a street or any part thereof, additional City approvals and associated fees may be required as part of the Building Permit. *For further information on the Building Permit, please contact Building Approvals Department at 604-276-4285.*
- Submission of a construction traffic and parking management plan to the satisfaction of the City's Transportation Department (<http://www.richmond.ca/services/ttp/special.htm>).
- Confirmation that the recommendations identified in the acoustic evaluation report by Brown Strachan Associates, dated December 7, 2018, and in the mechanical thermal report by Williams Engineering, dated December 10, 2018, or equivalent measures, have been incorporated in the construction plans.
- Confirmation that the design of the proposed development will meet Step 2 of the BC Energy Step Code.



City of
Richmond

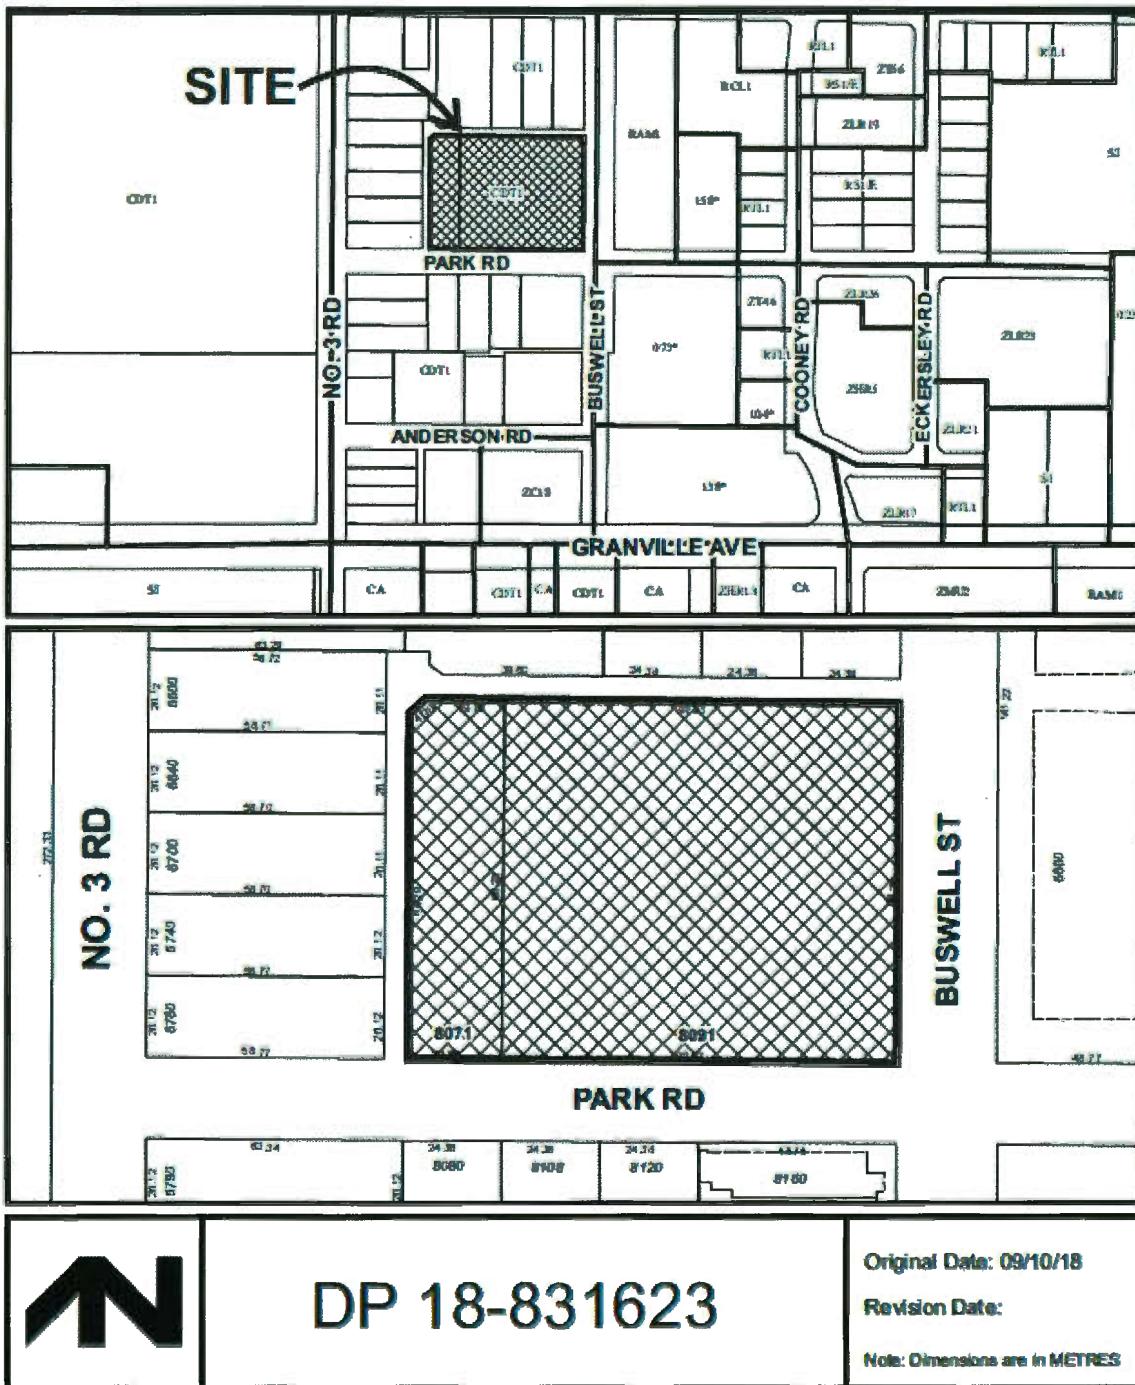

Specific Land Use Map: Brighouse Village (2031)

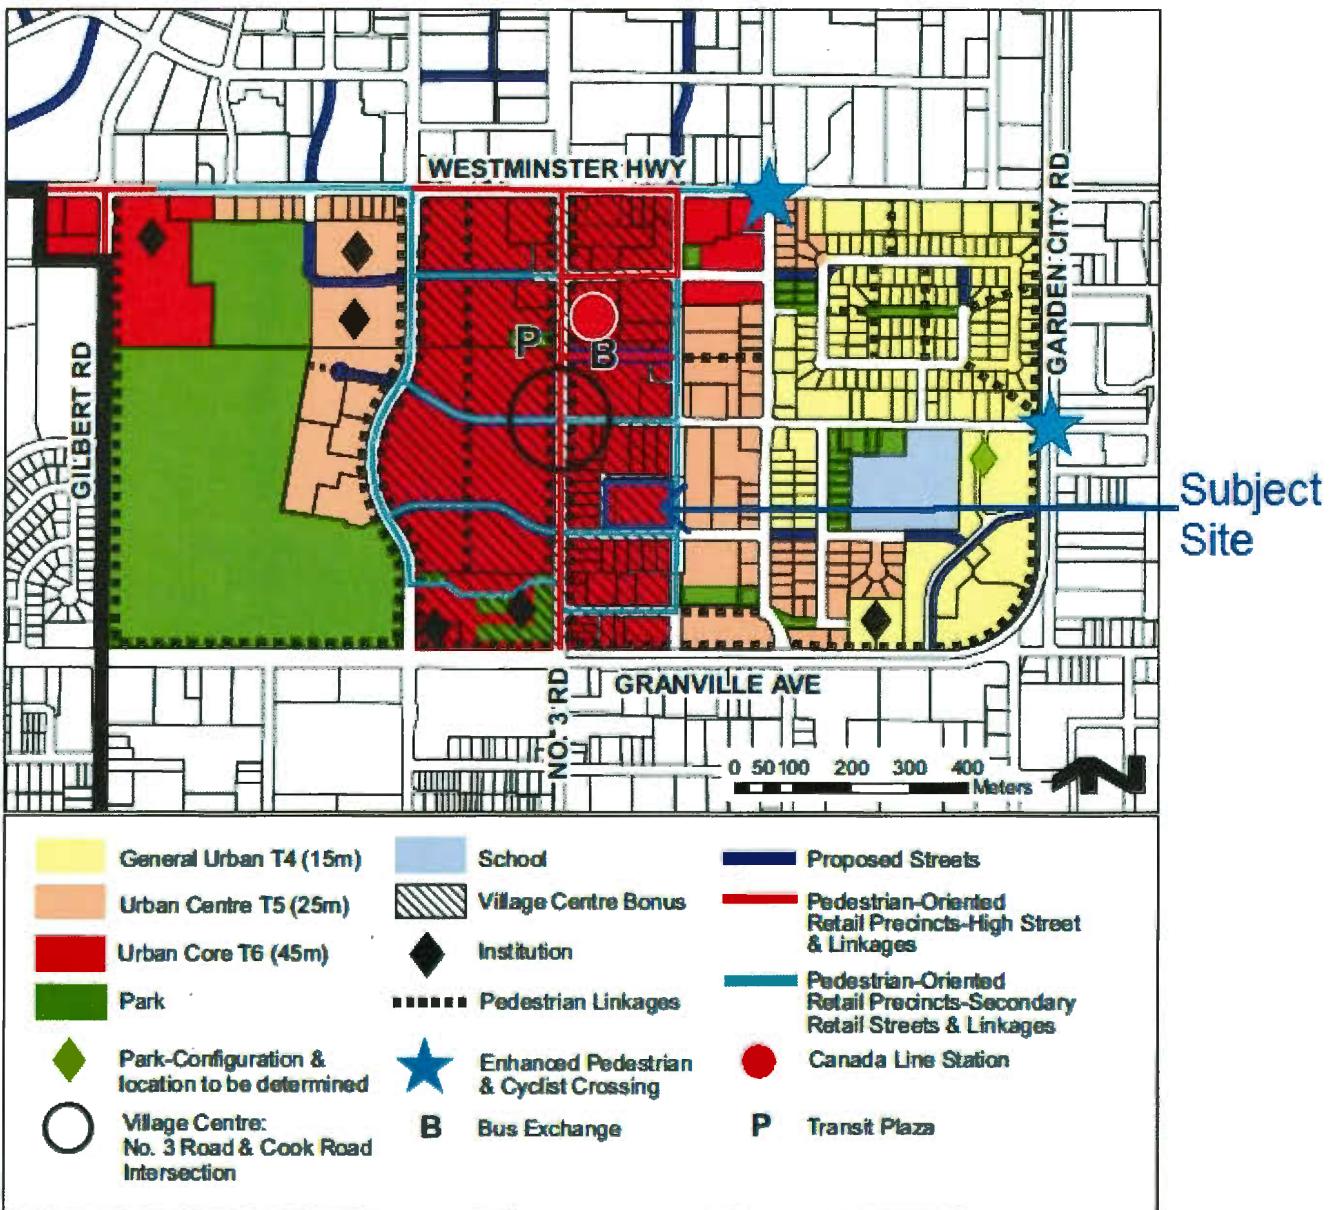



**City of
Richmond**

Development Application Data Sheet
Development Applications Department

RZ 17-779229

Attachment 3

Address: 8071 and 8091 Park Road

Applicant: W.T. Leung Architects, Inc. on behalf of Grand Long Holdings Canada Ltd.

Planning Area(s): City Centre Area Plan (Brighouse Village)

| | Existing | Proposed |
|-------------------------------------|---|---|
| Owner: | Grand Long Holdings Canada Ltd. Inc. No. BC1168849 | Grand Long Holdings Canada Ltd. Inc. No. BC1168849 |
| Site Size (m²): | 10,621.61 m ² (114,333 ft ²) | 10,216 m ² (109,969 ft ²) |
| Land Uses: | Commercial, restaurant | Office, commercial, restaurant, residential |
| OCP Designation: | Downtown Mixed Use | Downtown Mixed Use |
| Area Plan Designation: | Urban Core T6 (45 m), Village Centre Bonus | Urban Core T6 (45 m), Village Centre Bonus |
| Zoning: | Downtown Commercial (CDT1) | High Density Mixed Use (ZMU39) – Brighouse Village (City Centre) |
| Number of Residential Units: | 0 | Market housing: 332 residential units AH:21 Total: 353 |

| On Future Subdivided Lots | Proposed ZMU39 Bylaw Requirement | Proposed | Variance |
|--|--|--|-----------------|
| Floor Area Ratio: | 2.0 FAR increased to a higher density of 3.0 FAR conditional to complying with the City's affordable housing objectives | Net: 3.86 FAR | |
| Buildable Floor Area (m ²):* | 3.0 FAR increased to a higher density of 4.0 FAR conditional to the lot being located within a VCB designated area and complying with VCB terms | Residential: 2.93 FAR Non-residential: 0.93 | none permitted |
| Lot Coverage (% of lot area): | 90% for buildings | 62.7% | none |
| Lot Size: | CCAP minimum: 4,000 m ² | 10,216 m ² (109,965 ft ²) | none |
| Lot Dimensions (m): | Width: 45 m minimum Depth: 40 m minimum | Width: 85-88 m Depth: 117-120 m | none |

| On Future Subdivided Lots | Proposed ZMU39 Bylaw Requirement | Proposed | Variance |
|---|---|--|---|
| Setbacks (m): | <ul style="list-style-type: none"> ▪ Park Road and Buswell Street: 3m minimum that may be reduced to 2.2m subject to conditions ▪ Rear: Min. 0 m ▪ Side: Min. 0 m | <ul style="list-style-type: none"> ▪ Park Road: Min. 3 m ▪ Buswell Street: Min. 2.2 to 3.0 m ▪ Rear (west): Min. 1.45 m ▪ Side (north): Min. 1.5 m | none |
| Permitted setback projections: | <ul style="list-style-type: none"> ▪ Balconies: 1/3 of required setback (0.73 m to 1.0 m) ▪ Architectural features: 0.6 m ▪ Awnings: to the property line (as approved through the DP) ▪ Cantilevered roofs: 1.2 m ▪ Above ground utilities: 0.6 m | <p>Balconies: Park Road: 0.72 m Buswell Street: 0.72 m</p> <p>Awnings: Park Road: 1.98 m Buswell Street: 1.98 m and extending to the property line in some locations as shown in the DP plans</p> | none |
| Height (m): | 47 m geodetic | <p>Tower A: 46.93 m (15 storeys) Tower B & C: 46.88 m (16 storeys)</p> | none |
| Parking Spaces – Total (Zone 1) | <p>Total: 565</p> <p>Residential: 337 Non-residential: -Commercial/restaurant: 153 (shared with residential visitors) -Office: 75</p> | <p>Total: 622</p> <p>Residential: 379 Non-residential: -Commercial/restaurant: 159 (Of which <u>153 would be shared with residential visitors</u> and secured with an agreement on Title as a condition of rezoning bylaw adoption.) -Office: 84</p> | none |
| Parking Spaces – Residential (City Centre Zone 1) Applied rates: Residential: 1/unit AH: 0.9/unit Shared visitor/commercial parking (no exclusive use) | <p>Total: 337</p> <p>Residential: 332 AH: 19 Visitor: 71 spaces shared with commercial</p> | <p>379</p> <p>(no TDM relaxation requested or required)</p> | none |
| Parking Spaces – Non-Residential Applied rates: 3.75/100m ² (on 1 st 2 floors) + [1.5/100m ² (above 1 st 2 floors) – 15%] | <p>Total: 228</p> <p>Commercial/restaurant: 153 (shared with residential visitors) Office: 75</p> | <p>Total: 243</p> <p>Commercial/restaurant: 159 (shared with residential visitors) Office: 84</p> <p>no TDM relaxation requested or required</p> | no TDM relaxation requested or required |
| Tandem Parking | 50% max for market residential spaces (maximum permitted: 159) | 72 parking stalls in tandem arrangement (36 tandem stalls) | none |
| Accessible Parking | 2% of required parking spaces (12 stalls) | 14 Commercial: 6 Residential: 8 | none |

| On Future Subdivided Lots | Proposed ZMU39 Bylaw Requirement | Proposed | Variance |
|--|---|--|-----------------|
| Loading | 6 shared medium truck loading spaces No large on-site truck (WB17) parking | 6 shared medium truck loading spaces | none |
| Class 1 Bike Storage (Secure) Applied rates: Residential: (1.25/unit) Commercial: (0.27/100m ² gross leasable area greater than 100 m ²) | Total: 449 Residential: 424 Commercial: 25 | Total: 563 Residential: 481 Commercial: 82 | none |
| Class 2 Bike Storage (Unsecure) Applied rates: Residential: (0.1/unit) Commercial: (0.1/100m ² gross leasable area greater than 100m ²) | Total: 44 Residential: 34 Commercial: 10 | Total: 53 Residential: 35 Commercial: 18 | none |
| Electric Vehicle (EV) Charging Equipment | All residential parking spaces (excluding) visitor parking spaces to feature energized outlet (minimum Level 2 charging) 20% of stalls with 120 V electric vehicle charging receptacle (i.e. 46 stalls) 25% of stalls with roughed in conduit for future installation of charging receptacle (i.e. 57 stalls) | Residential: 100% EV ready Commercial/visitor parking spaces: ▪ 49 EV ready ▪ 61 EV roughed in conduit | none |
| Electric Vehicle (EV) Charging Equipment - bicycle | 10% of spaces: 48 | 49 | none |
| Amenity Space – Indoor: | 2 m ² /unit: 678 m ² (ZMU39 permits 0.1 FAR additional floor area provided it is used entirely to accommodate indoor amenity space [1,078 m ²]) | Total: 1,069 m ² (Residential: 794 m ² , Office: 275 m ²) Tower A: Residential: 145 m ² , Office: 275 m ² Tower B: Residential: 523 m ² Tower C: Residential: 126 m ² Amenity area exceeds Bylaw permitted exemption; therefore, 57 m ² of indoor amenity is included in the proposed FAR) | none |
| Amenity Space – Outdoor: | OCP: Min. 6.0 m ² /unit, including 600 m ² for children's play space: 2,118 m ² based on 353 units CCAP: Min. 10% of net site: (1,021 m ² based on 10,215 m ²) | Total: 3,558 m ² Office: 605 m ² Residential: 2,953 m ² , including 604 m ² children's play area | none |
| Basic Universal Housing (BUH) | All AH units (21) | Total 56 AH: 21 Market: 35 | none |

Advisory Design Panel

Wednesday, October 17, 2018

...

1. DP 18-831623 – 3-TOWER CITY CENTRE MIXED USE COMMERCIAL, OFFICE AND RESIDENTIAL DEVELOPMENT

ARCHITECT: W.T. Leung Architects Inc.

LANDSCAPE Durante Kreuk Ltd.

ARCHITECT:

PROPERTY LOCATION: 8071 and 8091 Park Road

Applicant's Presentation

Konning Tam, W.T. Leung Architects, Inc., and Stephen Vincent, Durante Kreuk Ltd., presented the project and together with Wing Ting Leung, W.T. Leung Architects, Inc., answered queries from the Panel on behalf of the applicant.

Panel Discussion

Comments from Panel members were as follows:

- appreciate the improved package provided to the Panel which addresses many of the comments that were previously expressed by the Panel;
- appreciate the project targeting BC Energy Code Step 2 for energy efficiency;
- the project is targeting the City requirement for LEED Silver Equivalency in terms of sustainability; however, the applicant is using a LEED 2009 scorecard which is no longer applicable; the applicant is advised to submit a LEED Version 4 scorecard; **Applicant: Noted.**
- the applicant needs to indicate the location of required vestibules for large CRUs in the floor plans; **Applicant: Vestibules have been added to entrances to the large CRU space annotated as "GROCERY". The remaining CRU spaces are intended to smaller units.**

- the applicant is advised to consider different indoor temperature condition requirements for residential, office, and commercial spaces in determining design parameters for the project's heating, ventilation and air conditioning system (HVAC); review indoor design condition for residential spaces indicated in the package provided to the Panel; *Applicant: Noted.*
- appreciate the proposed use of low-carbon energy sources for the project; however, the applicant is advised to review the requirements for the Low Carbon Energy Building System in terms of the maximum limit for CO₂ use; *Applicant: Noted.*
- consider increasing the height of the slab at the podium level and follow the organic/curvilinear forms in the overall landscape concept for the podium level (including the shape of the light wells) to avoid the rectangular box canyon visual experience from the pedestrian connection looking above the openings at the podium; *Applicant: The slab elevation of the podium cannot be raised further as it will affect the heights of the towers above. The straight edges of the openings were informed by the desire to provide weather protection to the parking levels below. However, the openings have been adjusted to be slightly larger.*
- consider spilling some of the landscaping on the podium level over the edge to reinforce the south-facing plaza, e.g. introducing a south-facing green wall; *Applicant: Consideration had been given to introducing a planted green wall. However, it was determined proper maintenance and irrigation would be technically challenging and costly.*
- size of proposed tree at the south plaza should be large enough to provide a significant feature at the plaza; *Applicant: The tree within the plaza is specified as a Katsura, which is a medium to large sized tree upon maturity. We feel this is an appropriate size and species as a focal point of the plaza. The planter has been adequately sized to support long-term health and growth of the tree.*
- investigate further opportunities to animate the plaza in view of the applicant's decision to eliminate the stairs leading up to the restaurant; *Applicant: Along with the focal Katsura tree, public art will be installed within the plaza. A generous amount of bench seating encourages people to gather. Various outdoor activities are also envisioned to help animate the plaza such as outdoor café-style seating, grocery produce & floral displays, and seasonal cart vendors.*
- consider a focal point that is anchored in one area in the proposed paving pattern on the plaza and decreasing the visual links in the parkade; *Applicant: The plaza design has been revised to decrease a visual link towards the parkade and improve the focus on the central Katsura tree / planter and Public Art.*

- applicant needs to provide details on the lighting plan for the plaza, e.g. low level lighting, lighting on the soffits, and other relevant details; *Applicant: Linear in-ground lighting has been added to the ground plane of the plaza and the pedestrian walkway in a random pattern to illuminate the area in soft light. There are wall sconces (up and down lighting) along the sides of the plaza and extends along the full length of the walkway. Linear soffit lights, integrated with the ceiling soffit slats, extend the full length of the walkway as well.*
- in general, appreciate the proposed improvements on the project;
- agree with the positive comments regarding the improvements on the project in response to Panel comments, particularly on the articulation of the entry plaza;
- the diagram on page 23 in the package provides a clearer articulation and stronger identity to the entry plaza in terms of colour and façade treatment as opposed to the model presented to the Panel;
- appreciate the colour and texture of the underside of the bridge connecting Buildings A and C; however, the height of the entry to the pedestrian connection is low and should be reconsidered given the scale of the project; *Applicant: The soffit is approximately 17 ft. [5.18m] above the plaza floor. We believe this height is an appropriate proportion for the size of the plaza.*
- also appreciate the use of white colour to animate the bridge;
- applicant is advised to reconsider the installation of picture windows above the entry to the pedestrian connection as they take away from the simplicity of the entry; consider continuing the vertical slat treatment over the windows all the way up the entire entry façade to create a single gesture; *Applicant: The punched windows have been replaced with a single, linear clerestory window. The extent of the vertical slat treatment has been increased to create a more monumental frontage facing the plaza.*
- consider bringing back the stairway leading to the restaurant considering the new design of the plaza; *Applicant: Given the size of the plaza, we believe there is not enough room for a staircase of proper significance. Instead, focus is on the central planter / tree and public art.*
- consider identifying the location of the proposed public art in the plaza as it will affect the design of the plaza, treatment of the structural walls at the plaza corners, entry to the pedestrian connection and pedestrian circulation within the plaza; *Applicant: Noted. The intention is for the public artwork to be integrated with the plaza. A "place holder" location is shown on the drawings. A separate Public Art Plan has been submitted. A presentation was made to the Richmond Public Art Committee and committee members generally supported the idea of having a flexible location for the Art depending on the resulting artists' proposals.*
- appreciate the more thorough presentation package provided by the applicant to the Panel;

- applicant is advised to give more thought to the proposed landscape and architecture materials as there appears to be lot going on in the plaza; *Applicant: Noted. The plaza design and use of materials have been simplified and refined. A lighting design has also been incorporated.*
- appreciate the grand gestures in the plaza; however, would appreciate if the vertical slat treatment on the façade above the entry to the pedestrian connection could extend upwards; *Applicant: The vertical slats are extended to the parapet tops of the bridge form over the walkway entry.*
- structural walls in the plaza are an important part of the entryway; consider incorporating architectural or landscape treatment on the walls, e.g., green wall treatment or installing metal panelling; however, signage should not be incorporated into the walls as it would not be visually appealing; *Applicant: Board-formed concrete is being considered for the walls at the plaza corners for texture and materiality. Box planters have been added within the plaza that would allow climbing vines to be incorporated.*
- design of the paving treatment on the plaza and the pedestrian connection needs refinement; ensure that the paving concept/approach is fully expressed and carried through; also look at better integration of the paving treatment on the entryway and the sidewalk; *Applicant: The plaza design and paving treatment have been revised to better integrate the plaza, pedestrian walkway and sidewalks. Along the walkway, coloured bandings align with columns and architectural façade panel locations. In-ground lighting has also been incorporated.*
- the applicant should consider incorporating landscape/architectural treatment to animate the corner of the plaza and not rely on the future tenant; applicant could consider installing metal panels on solid walls at the plaza corners which echo the facades of the building; *Applicant: Noted. Board-formed concrete is being considered for the walls at the plaza corners for texture and materiality. Moveable box planters have been added within the plaza, allowing a potential flexible approach to meet the needs of future tenant(s).*
- appreciate the applicant's move to remove the skylights over the lightwells; ensure adequate soil volume to ensure survivability of vines coming down from planters; *Applicant: The planter depths are generally minimum 24" deep and will support plant growth and health. Soil volume references are included in the drawings.*
- appreciate the comprehensive package provided by the applicant to the Panel and the applicant's responses to Panel comments in the previous consideration of the project which have addressed most of the primary concerns of the Panel;
- appreciate the applicant's approach to use mostly architectural and landscaping treatments in lieu of signage for wayfinding;

- consider a more pedestrian-friendly entry to the north-south pedestrian connection from the north lane similar to the approach to the entry at the south side; also look at and address the potential conflict between pedestrians and vehicles at the north lane; *Applicant: Revisions have been made to further differentiate and separate the walkway opening and the adjacent vehicle access opening. The two have been separated so that they are not on the same plane in plan.*
- the applicant is advised to bring in a signage consultant considering the size of the project; *Applicant: Noted.*
- appreciate the applicant's efforts to reduce the project's window-to-wall ratio; consider installing more insulated walls for the office portion of Tower A and incorporate more vertical wall elements on residential units to further reduce the window-to-wall ratio and the mechanical loads on these spaces; *Applicant: Noted.*
- consider introducing solar shading for office spaces on the south side; *Applicant: Horizontal sunshades have been added to south-facing facades of the office levels.*
- consider increasing the depth of the canopy above the pedestrian connection entry from five feet to at least seven or eight feet considering the scale of the development; and *Applicant: Canopy projections have been increased to 6'-6" for improved weather protection.*
- appreciate the different architectural treatment of the bridge's facade above the pedestrian connection entry; however, consider reducing the punched effect of the windows in the amenity space overlooking the plaza. *Applicant: The punched windows have been replaced with a single, linear clerestory window. The extent of the vertical slat treatment has been increased to create a more monumental frontage facing the plaza.*

Panel Decision

It was moved and seconded

That DP 18-831623 be supported to move forward to the Development Permit Panel subject to the applicant giving consideration to the comments of the Advisory Design Panel.

CARRIED

ATTACHMENT 5

W.T. LEUNG ARCHITECTS INC.

Suite 300 - 973 West Broadway, Vancouver, British Columbia , Canada V5Z 1K3 Tel (604) 736-9711 Fax (604) 736-7991

January 11, 2019

Diana Nikolic, Senior Planner (Urban Design)
City of Richmond
Policy Planning Department
6911 No. 3 Road
Richmond, BC V6Y 2C1
Canada

Dear Ms. Nikolic:

RE: 8071 – 8091 Park Road
Development Permit DP 18-831623

We are writing to confirm that the design of the proposed development at 8071 – 8091 Park Road will meet **Step 2** of the BC Energy Step Code with regards to energy efficiency requirements. The proposed development will also be designed to include a low carbon energy plant onsite, ready to connect to the City Centre District Energy Utility (DEU) system once such system is available for connection.

Yours truly,

W.T. LEUNG ARCHITECTS, INC.



Wing Ting Leung



Sustainability Scorecard: v4 Multifamily Metrics

Project Checklist

Project Name: 8071-8091 Park Road
Date: 10/01/2016 **City:** San Jose, CA **Zip:** 95126

ATTACHMENT 6



City of Richmond

Development Permit

No. DP 18-831623

To the Holder: W.T. Leung Architects, Inc. on behalf of Grand Long Holdings Canada Ltd. Inc. No. BC1168849

Property Address: 8071 and 8091 Park Road

Address: c/o W.T. Leung Architects, Ltd.
#300 - 973 West Broadway
Vancouver, BC V5Z 1K3

1. This Development Permit is issued subject to compliance with all of the Bylaws of the City applicable thereto, except as specifically varied or supplemented by this Permit.
2. This Development Permit applies to and only to those lands shown cross-hatched on the attached Schedule "A" and any and all buildings, structures and other development thereon.
3. Subject to Section 692 of the Local Government Act, R.S.B.C.: buildings and structures; off-street parking and loading facilities; roads and parking areas; and landscaping and screening shall be constructed generally in accordance with Plans #1a to #11b attached hereto.
4. Sanitary sewers, water, drainage, highways, street lighting, underground wiring, and sidewalks, shall be provided as required.
5. As a condition of the issuance of this Permit, the City is holding the security in the amount of \$1,579,121.27 to ensure that development is carried out in accordance with the terms and conditions of this Permit. Should any interest be earned upon the security, it shall accrue to the Holder if the security is returned. The condition of the posting of the security is that should the Holder fail to carry out the development hereby authorized, according to the terms and conditions of this Permit within the time provided, the City may use the security to carry out the work by its servants, agents or contractors, and any surplus shall be paid over to the Holder. Should the Holder carry out the development permitted by this permit within the time set out herein, the security shall be returned to the Holder. The City may retain the security for up to one year after inspection of the completed landscaping in order to ensure that plant material has survived.
6. If the Holder does not commence the construction permitted by this Permit within 24 months of the date of this Permit, this Permit shall lapse and the security shall be returned in full.

Development Permit
No. DP 18-831623

To the Holder: W.T. Leung Architects, Inc. on behalf of Grand Long Holdings
Canada Ltd. Inc. No. BC1168849

Property Address: 8071 and 8091 Park Road

Address: W.T. Leung Architects, Ltd.
#300 - 973 West Broadway
Vancouver, BC V5Z 1K3

7. The land described herein shall be developed generally in accordance with the terms and conditions and provisions of this Permit and any plans and specifications attached to this Permit which shall form a part hereof.

This Permit is not a Building Permit.

AUTHORIZING RESOLUTION NO.
DAY OF ,

ISSUED BY THE COUNCIL THE

DELIVERED THIS DAY OF ,

MAYOR

**W. T. LEUNG
ARCHITECTS
INC.**

125

| | | | |
|------------------|---|-------------------|-------------------------------------|
| Uses | Existing Commercial & Mixed-Use (Convenience, Petrol, Gas, Laundry, Office, Dining, etc.) | | |
| Proposed: | Mixed Residential & Multi-Family Residential | | |
| Existing: | 114,333 SF | [10,822 - 61 SHL] | Pet Survey by J.C. Tam & Associates |
| Post-Deductions: | 109,995 SF | [10,215.8 SHL] | |
| Allowable: | FAH 401(3.0 base + 1.0 Village Centre Bonus) | | (Convenience, Comm'l Use Only) |
| Proposed: | FAR 3.67 | | |
| Allowable: | 90% Maximum | | |
| Proposed: | 62.7% | | |
| Lot Coverage | | | |

AREA SUMMARY

| RESIDENTIAL UNIT SUMMARY | | STUDIO | | |
|---------------------------------------|--|---------------------|----------------------|-----------------------|
| Unit Type | 4-BR | 2-BR | 1-BR | |
| Commercial-Retail | 33,356.55 SF | 137,22 SF | 33,351.73 SF | 33,356.22 SF |
| Commercial-Restaurant | 10,717.00 SF | 22,160 SF | 10,652.13 SF | 10,659.55 SF |
| Commercial-Office (G/F-3/F) | 3,191.78 SF | 9,445.47 SF | 2,247.31 SF | - |
| Commercial-Office (Twr. A, 4/F-7/F) | 61,410.13 SF | 4,874.32 SF | 56,533.81 SF | 56,580.10 SF |
| Tower A Residential | 81,065.13 SF | 6,748.92 SF | 74,031.21 SF | - |
| Tower B Residential | 119,654.87 SF | 10,675.45 SF | 108,979.67 SF | - |
| Tower C Residential | 110,233.59 SF | 6,753.05 SF | 138,479.74 SF | - |
| Affordable Housing (3/F-L, Twr B-4/F) | Incl. | Incl. | 16,729.65 SF | - |
| Total Building Area | 455,556.64 SF | 31,355.04 SF | 424,221.60 SF | [39,410.19 SF] |
| Total Commercial Area | [42,323.07 SF] | [2,912.88 SF] | [39,410.19 SF] | - |
| Total Residential Area | [108,632.05 SF] | [5,738.86 SF] | [102,564.98 SF] | - |
| Total Residential Area | [10,099.02 SF] | [5,738.86 SF] | [9,516.07 SF] | - |
| Affordable Housing Strategy | 5% of max. permitted residential density: Proposed: | 16,161.60 SF | [1,532.37 SF] | - |
| Commercial FAR | 0.99 Gross | 0.93 Net | - | - |
| Residential FAR | 3.16 Gross | 2.92 Net | - | - |
| Combined FAR | 4.14 Gross | 3.66 Net | - | - |

בְּנֵי־עַמִּים

| PARKING ANALYSIS | | Proposed | |
|---|-------------------------------------|------------|-----------------------|
| Car | Parking Commercial | Required | Allowed w/ TDM (-10%) |
| Retail | Retail/Restaurant: 3.75/100SM L1/L2 | 153 | 159 |
| Office | 1.5/100SM per Section 7.9.4 Zone 1 | 75 | 84 |
| Small Car Seats (max. 5%) | 5% Reduction L1+ 12% (max.) | 75 | 82 |
| EV-Charging Ready | - | 49 | 49 |
| EV-Charging Capable (Future) | 20% of Seats Provided | 61 | 61 |
| Total Seats (Commercial) | 25% of Seats Provided | 228 | 243 |
| Car | Parking Residential | | |
| Section 7.9.3 - Zone 1 | (332) Units @ 1.0 per Dwelling Unit | 332 | 360 |
| Section 7.9.3 - Zone 1 | (21) AHU @ 0.9 per AHU | 19 | 19 |
| Small Car Seats (max. 5%) | 0.2 Visitor per Dwelling Unit | 71 | Shared w/ Comm'l |
| Tandem Seats | (36) Sets | 70 (max.) | 8 |
| Total Seats (Residential) | | 351 | 379 |
| Gross Parking Seats (Commercial+Residential) | | 579 | 622 |
| Bicycle Parking Commercial | | | |
| Sanction 7.14-10 Class 1 | 0.27/100SM over 100SM | 26 | 82 |
| Sanction 7.14-10 Class 2 | 0.1/100SM over 100SM | 10 | 18 |
| Sanction 7.14-10 Class 3 | 33% Max. Req'd @ Vertical Spaces | 8 | 0 |
| Electric Charging Capable | 10% Min. | 8 | 10 |
| Bicycle Parking Residential | | | |
| Section 7.14-10 Class 1 | 1.25 per Dwelling Unit | 441 | 481 |
| Sanction 7.14-10 Class 2 | 0.1 per Dwelling Unit | 35 | 35 |
| Sanction 7.14-15 | 33% Max. Req'd @ Vertical Spaces | 146 | 81 |
| Electric Charging Capable | 10% Min. | 48 | 49 |
| Seating Space Commercial | | | |
| Section 7.13.6 | 5 M+2 L | | 4. Medium |

PROJECT DATA,
2011

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DP 188 1623


DEC 11 2018

**PARK ROAD &
BUSWELL STREET**
DP 18-831623
8071-8091 PARK ROAD
RICHMOND, BC


**SITE DEFINITION
DIAGRAMS**



Job No. 16-03
Drawn KT
Date 07 DEC 2018
Scale 1/32" = 1'-0"
Drawing No. DP 18-831623

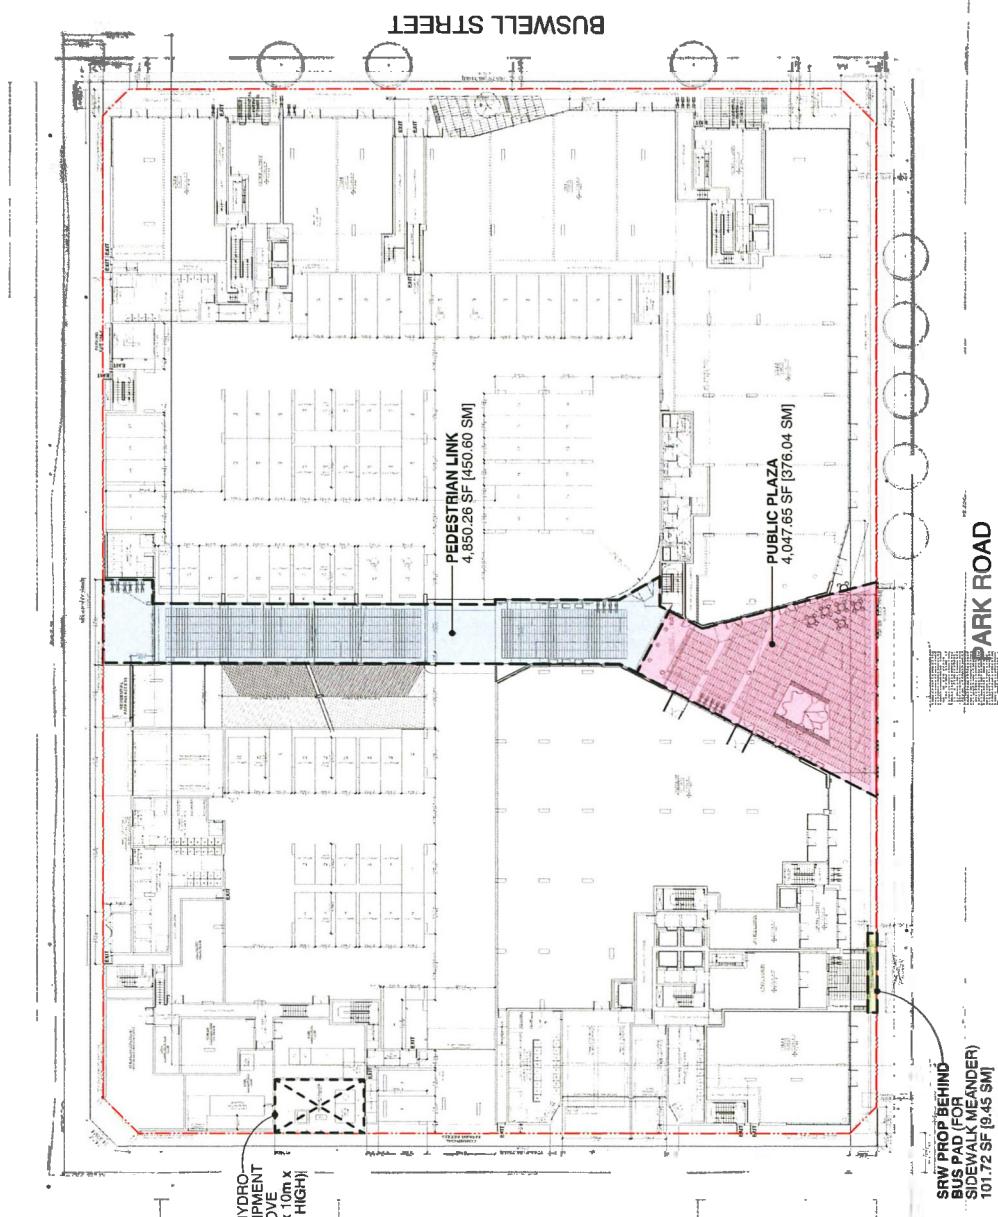

STATUTORY RIGHT-OF-WAY (SRW) & RIGHT-OF-WAY (ROW) DIAGRAMS

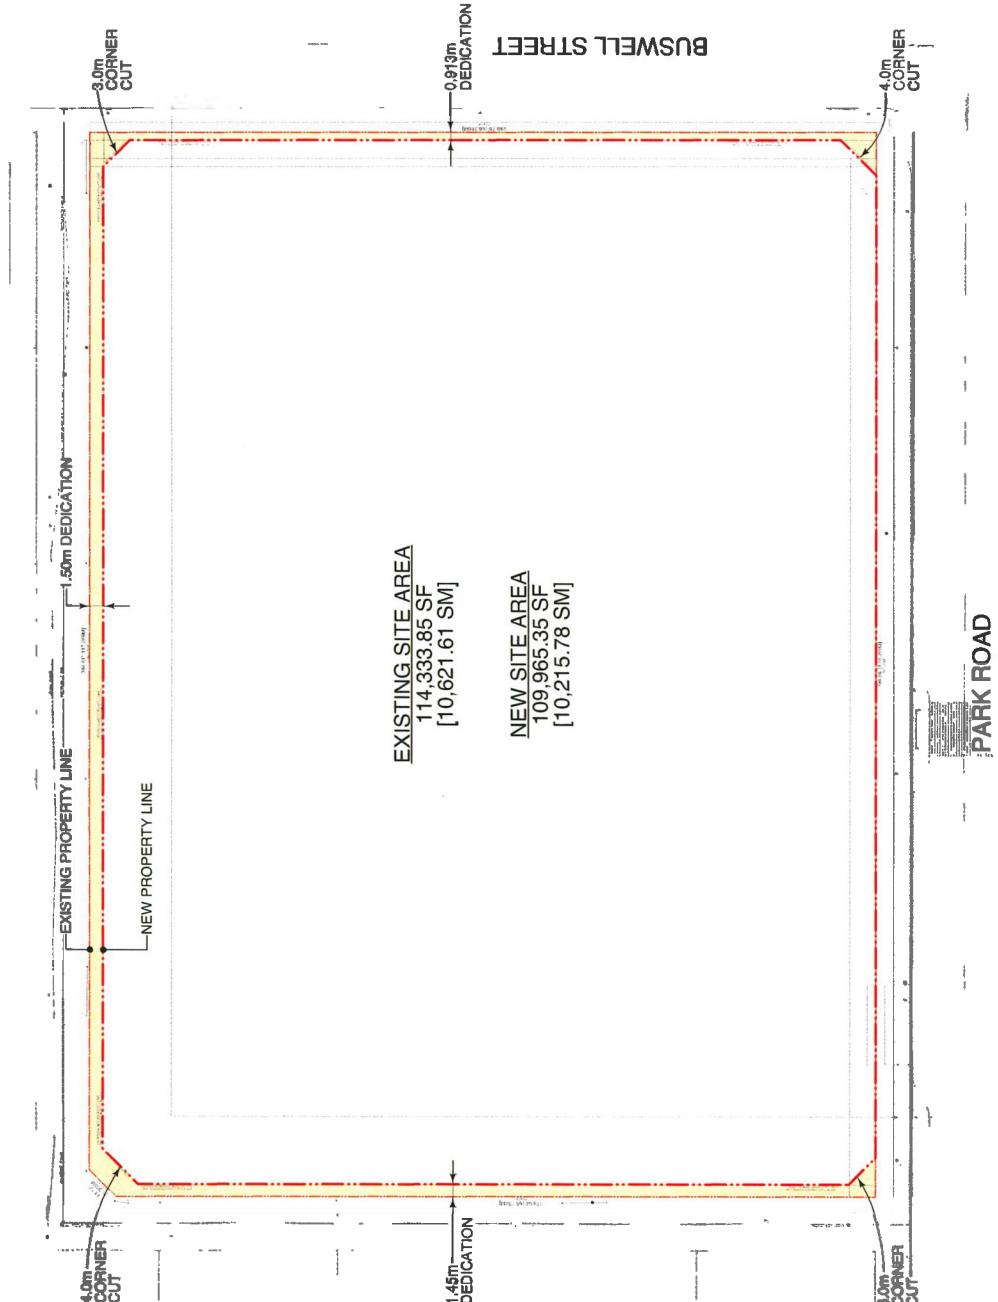


ROAD DEDICATION DIAGRAM


DP 18-831623

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BUSWELL STREET

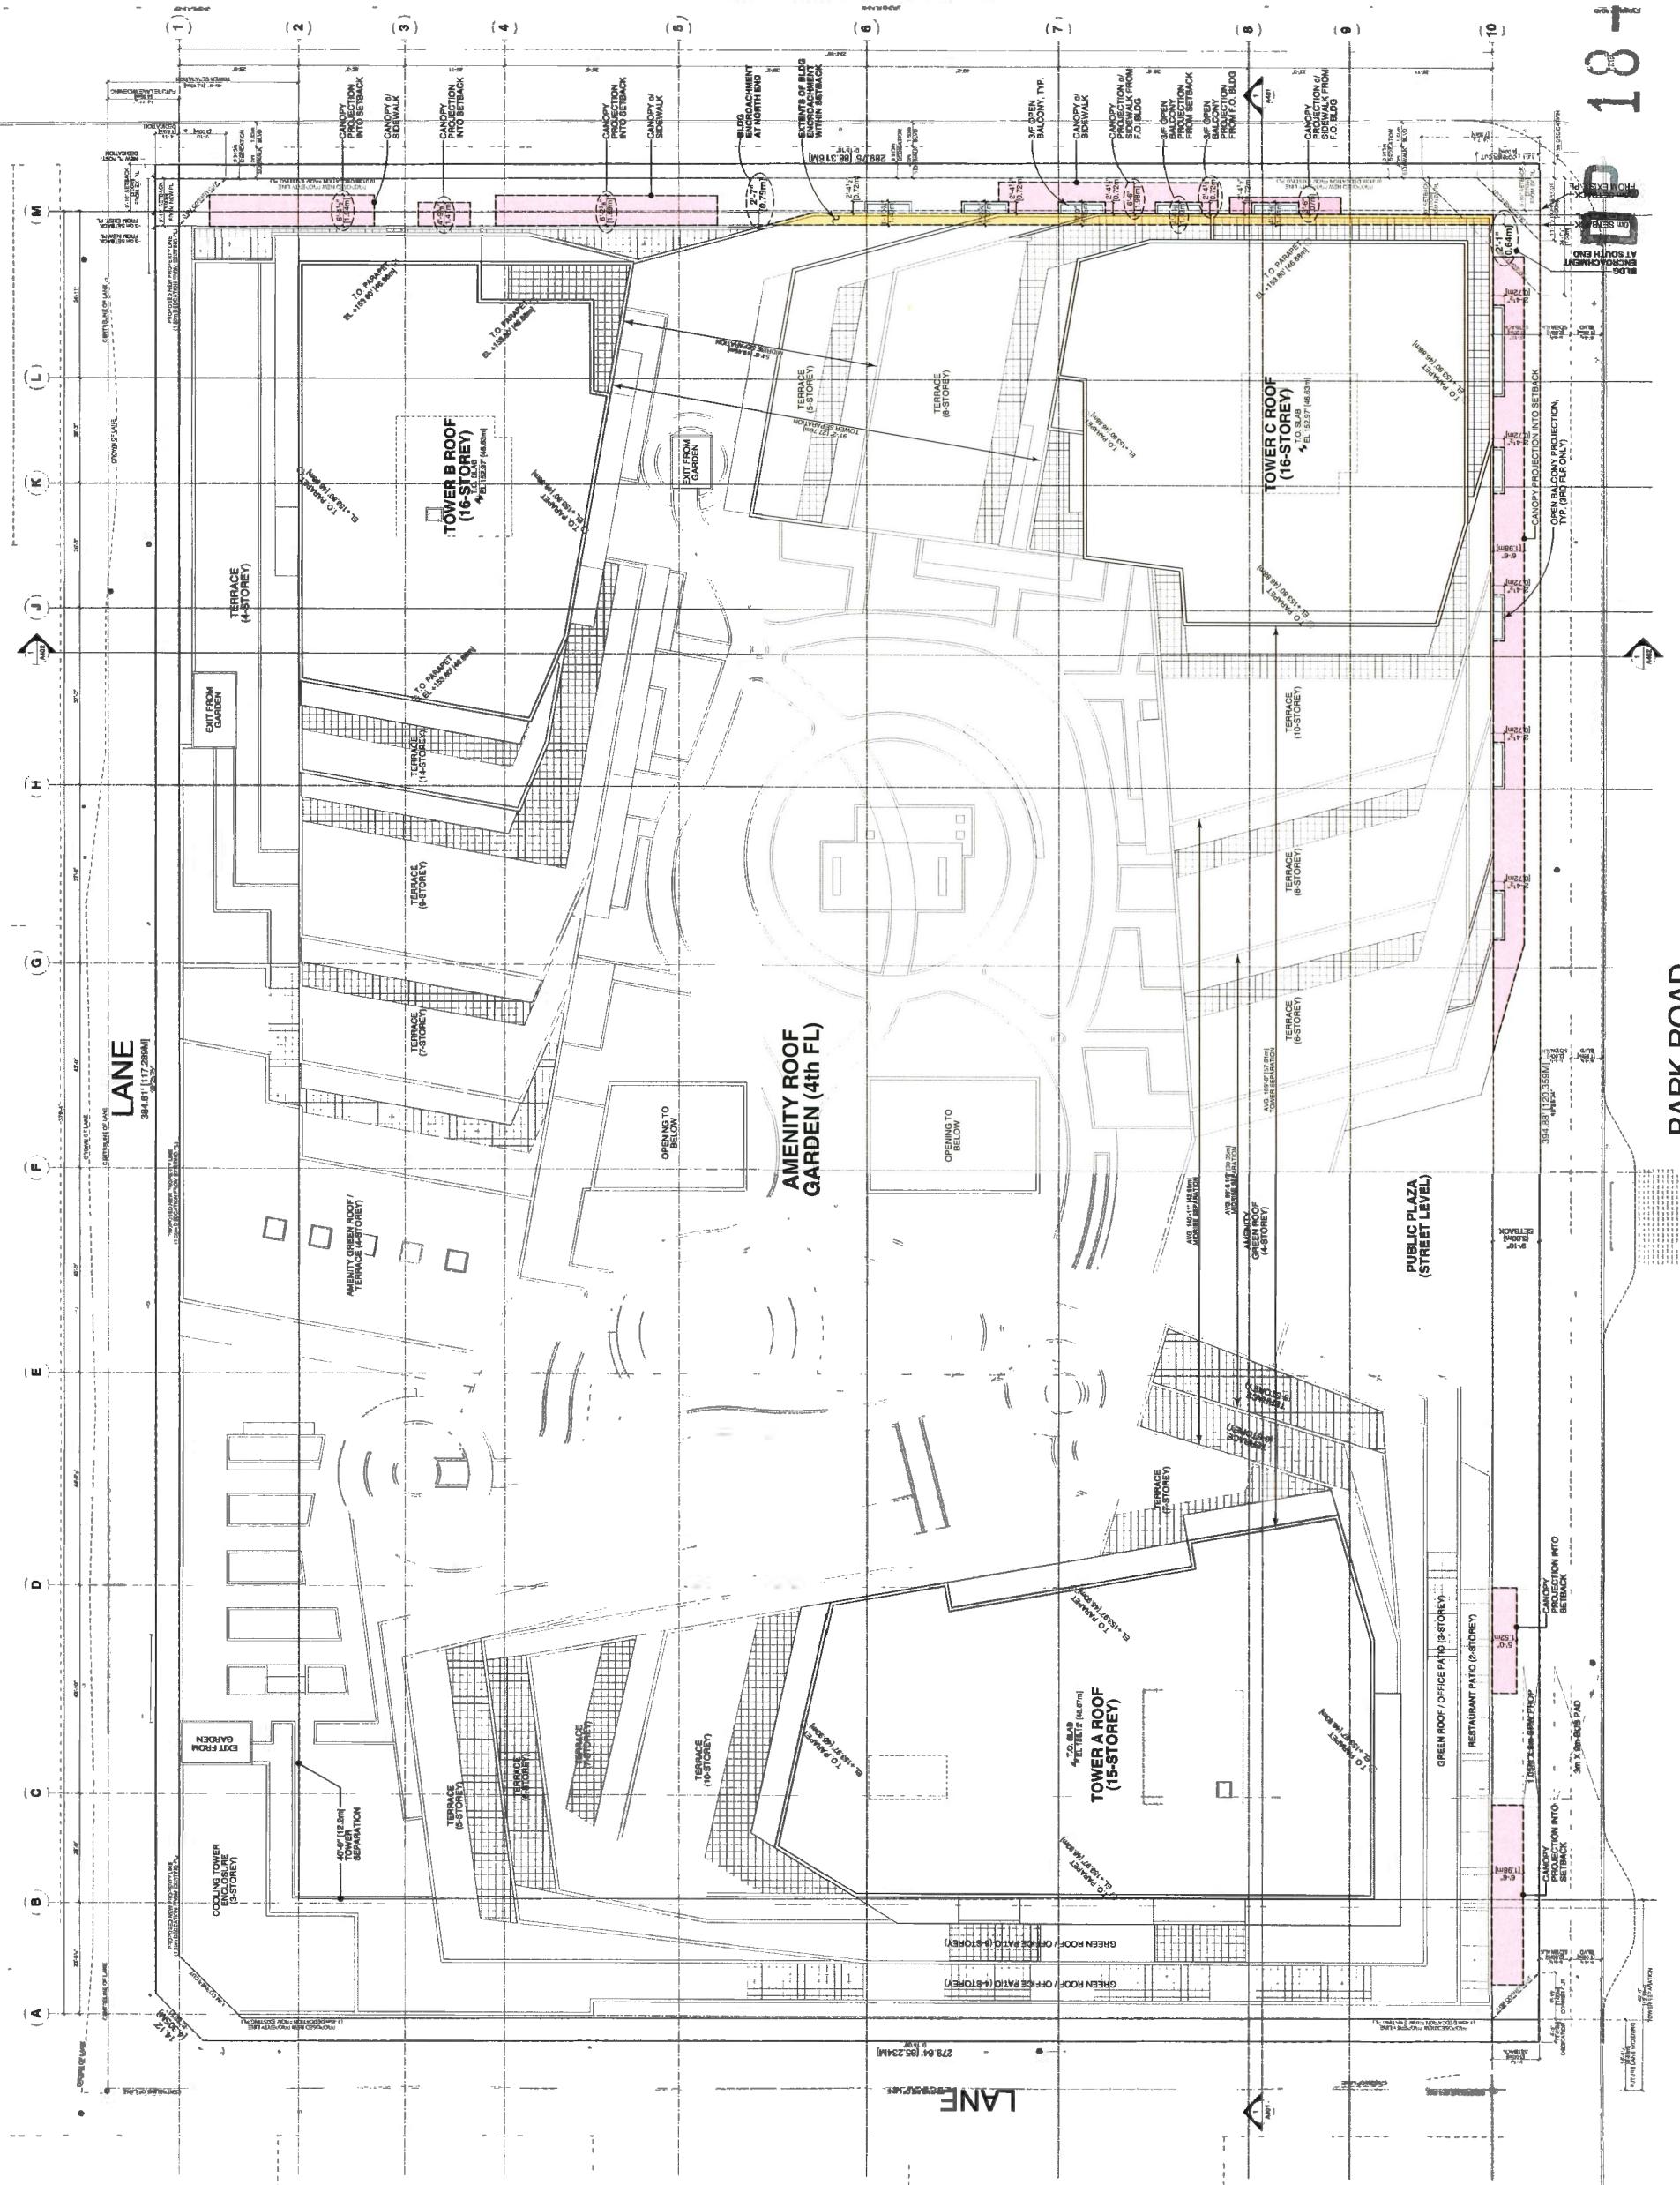

Plan #1C

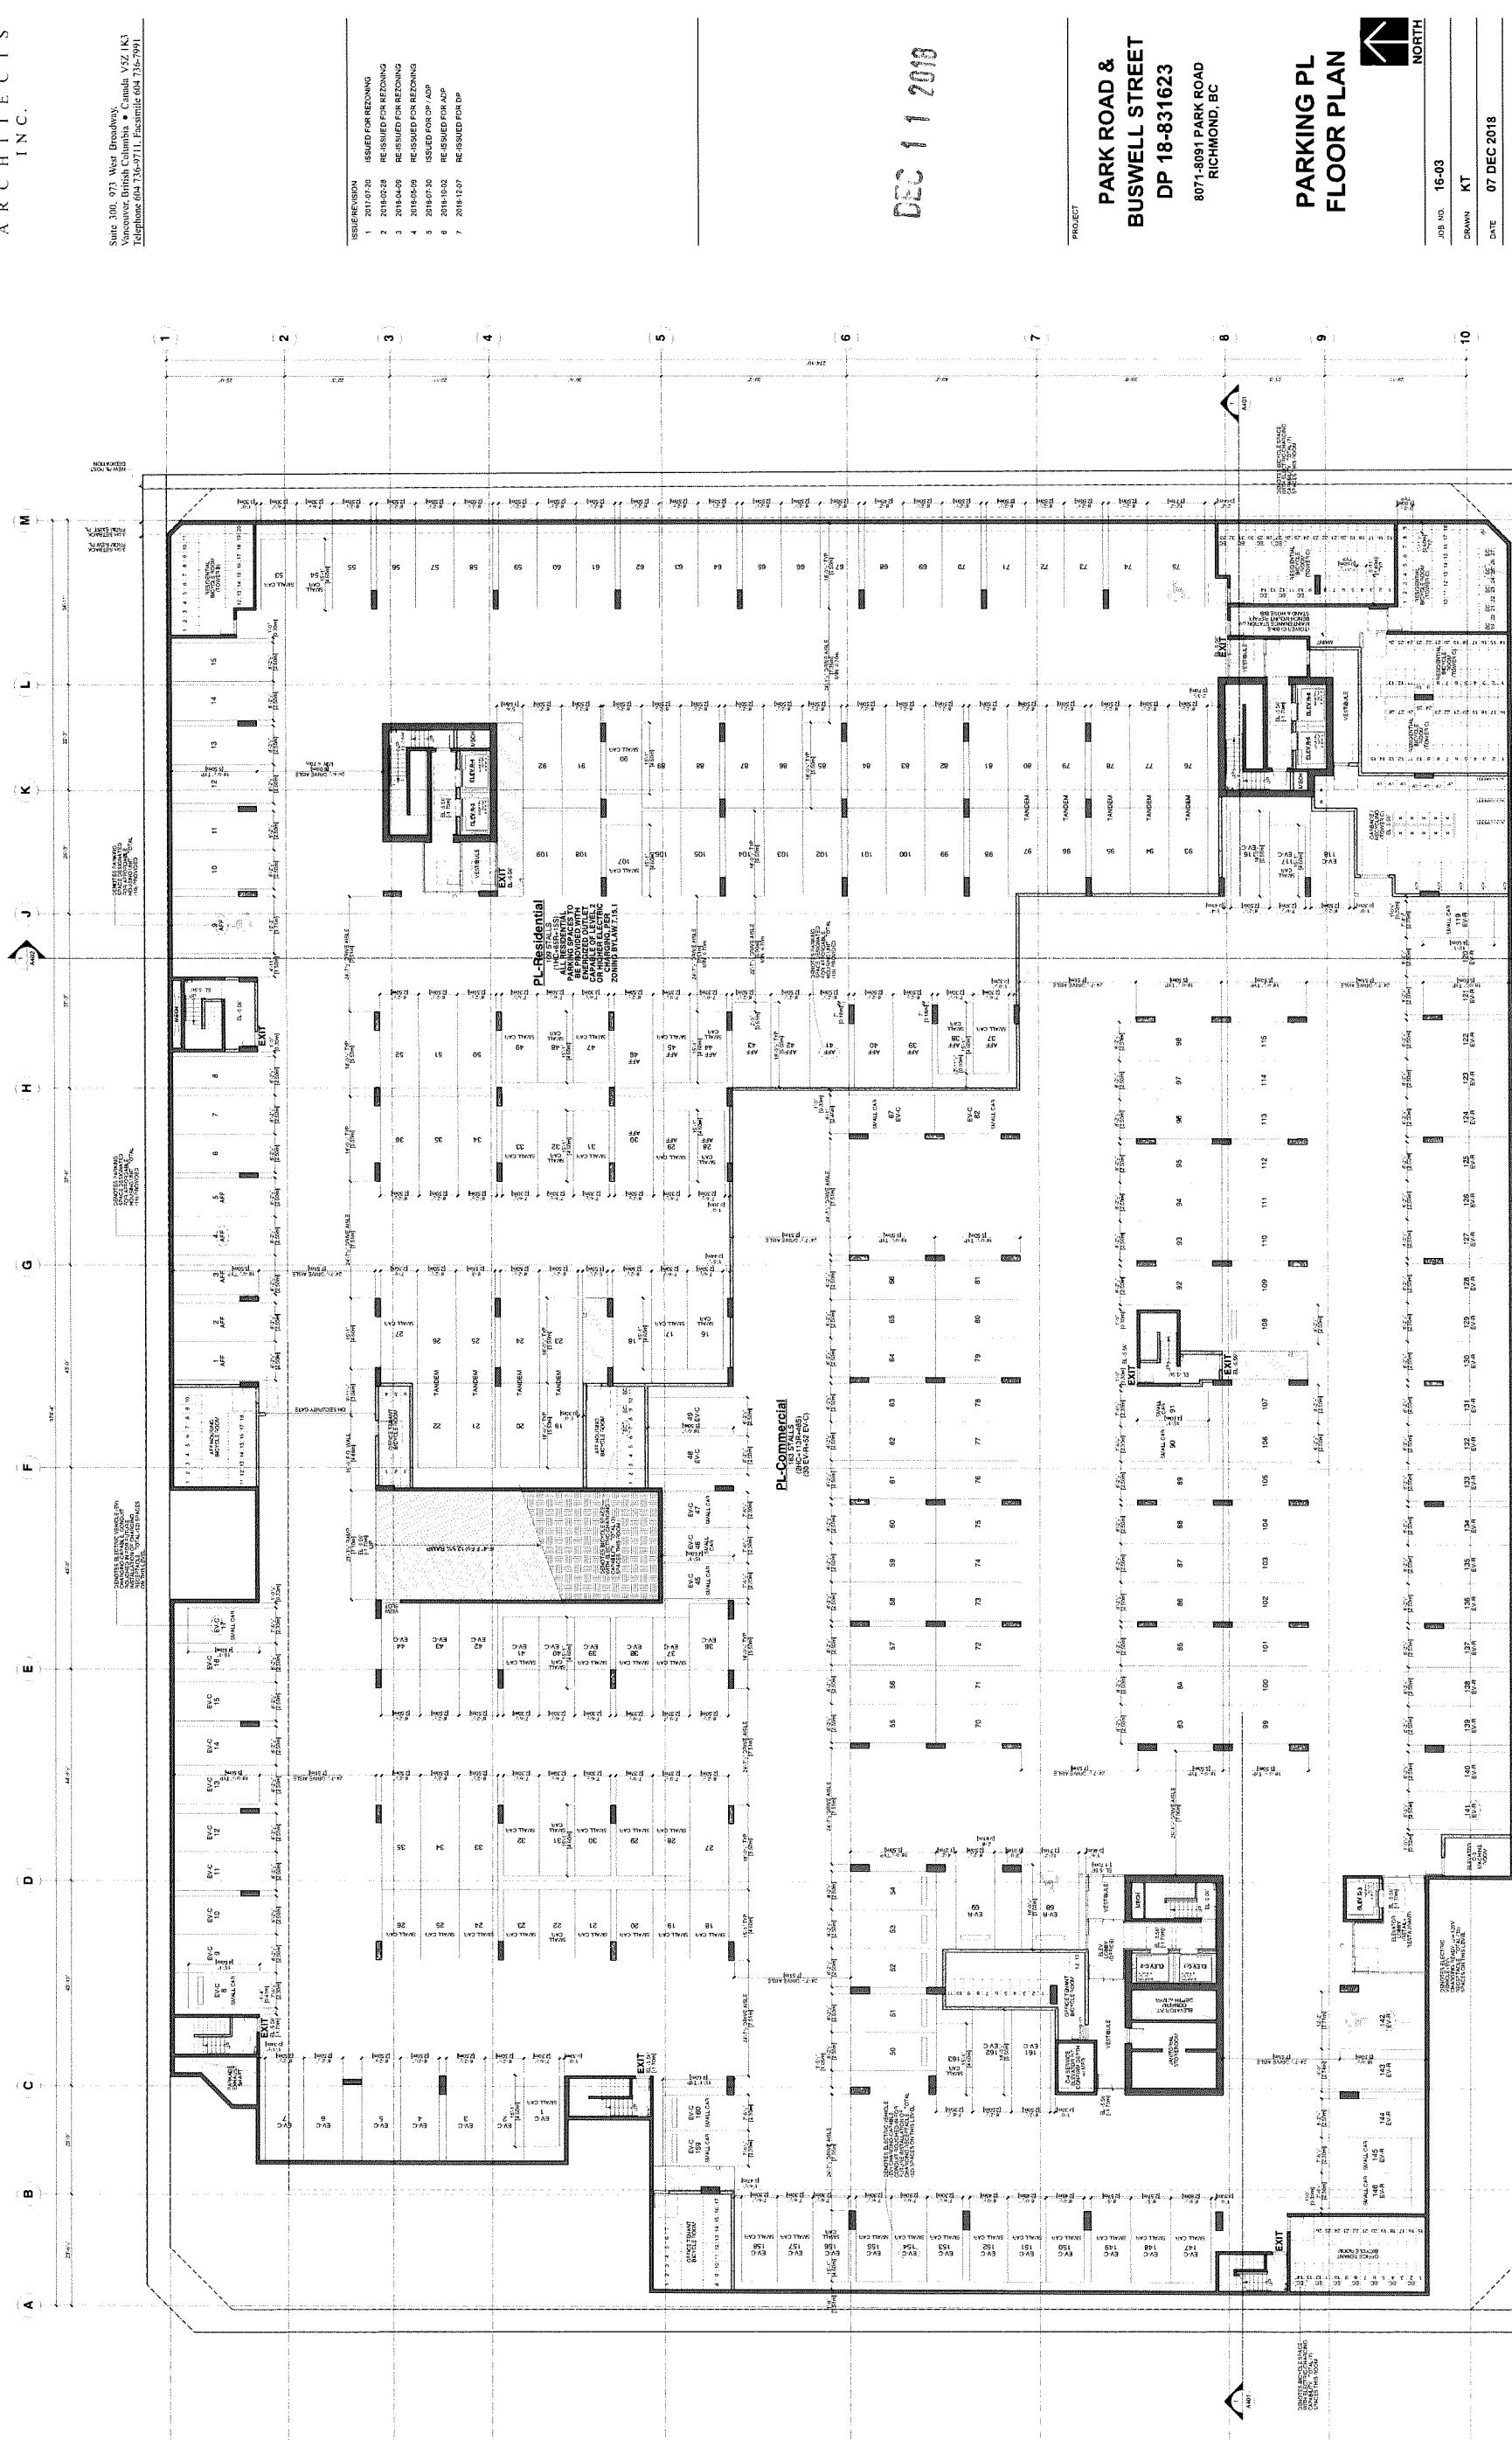


Plan #2a



W. T. LEUNG
ARCHITECTS
INC.

Suite 300, 973 West Broadway,
Vancouver, British Columbia • Canada V5Z 1K3
Telephone (604) 736-9711, Facsimile 604 736-7991

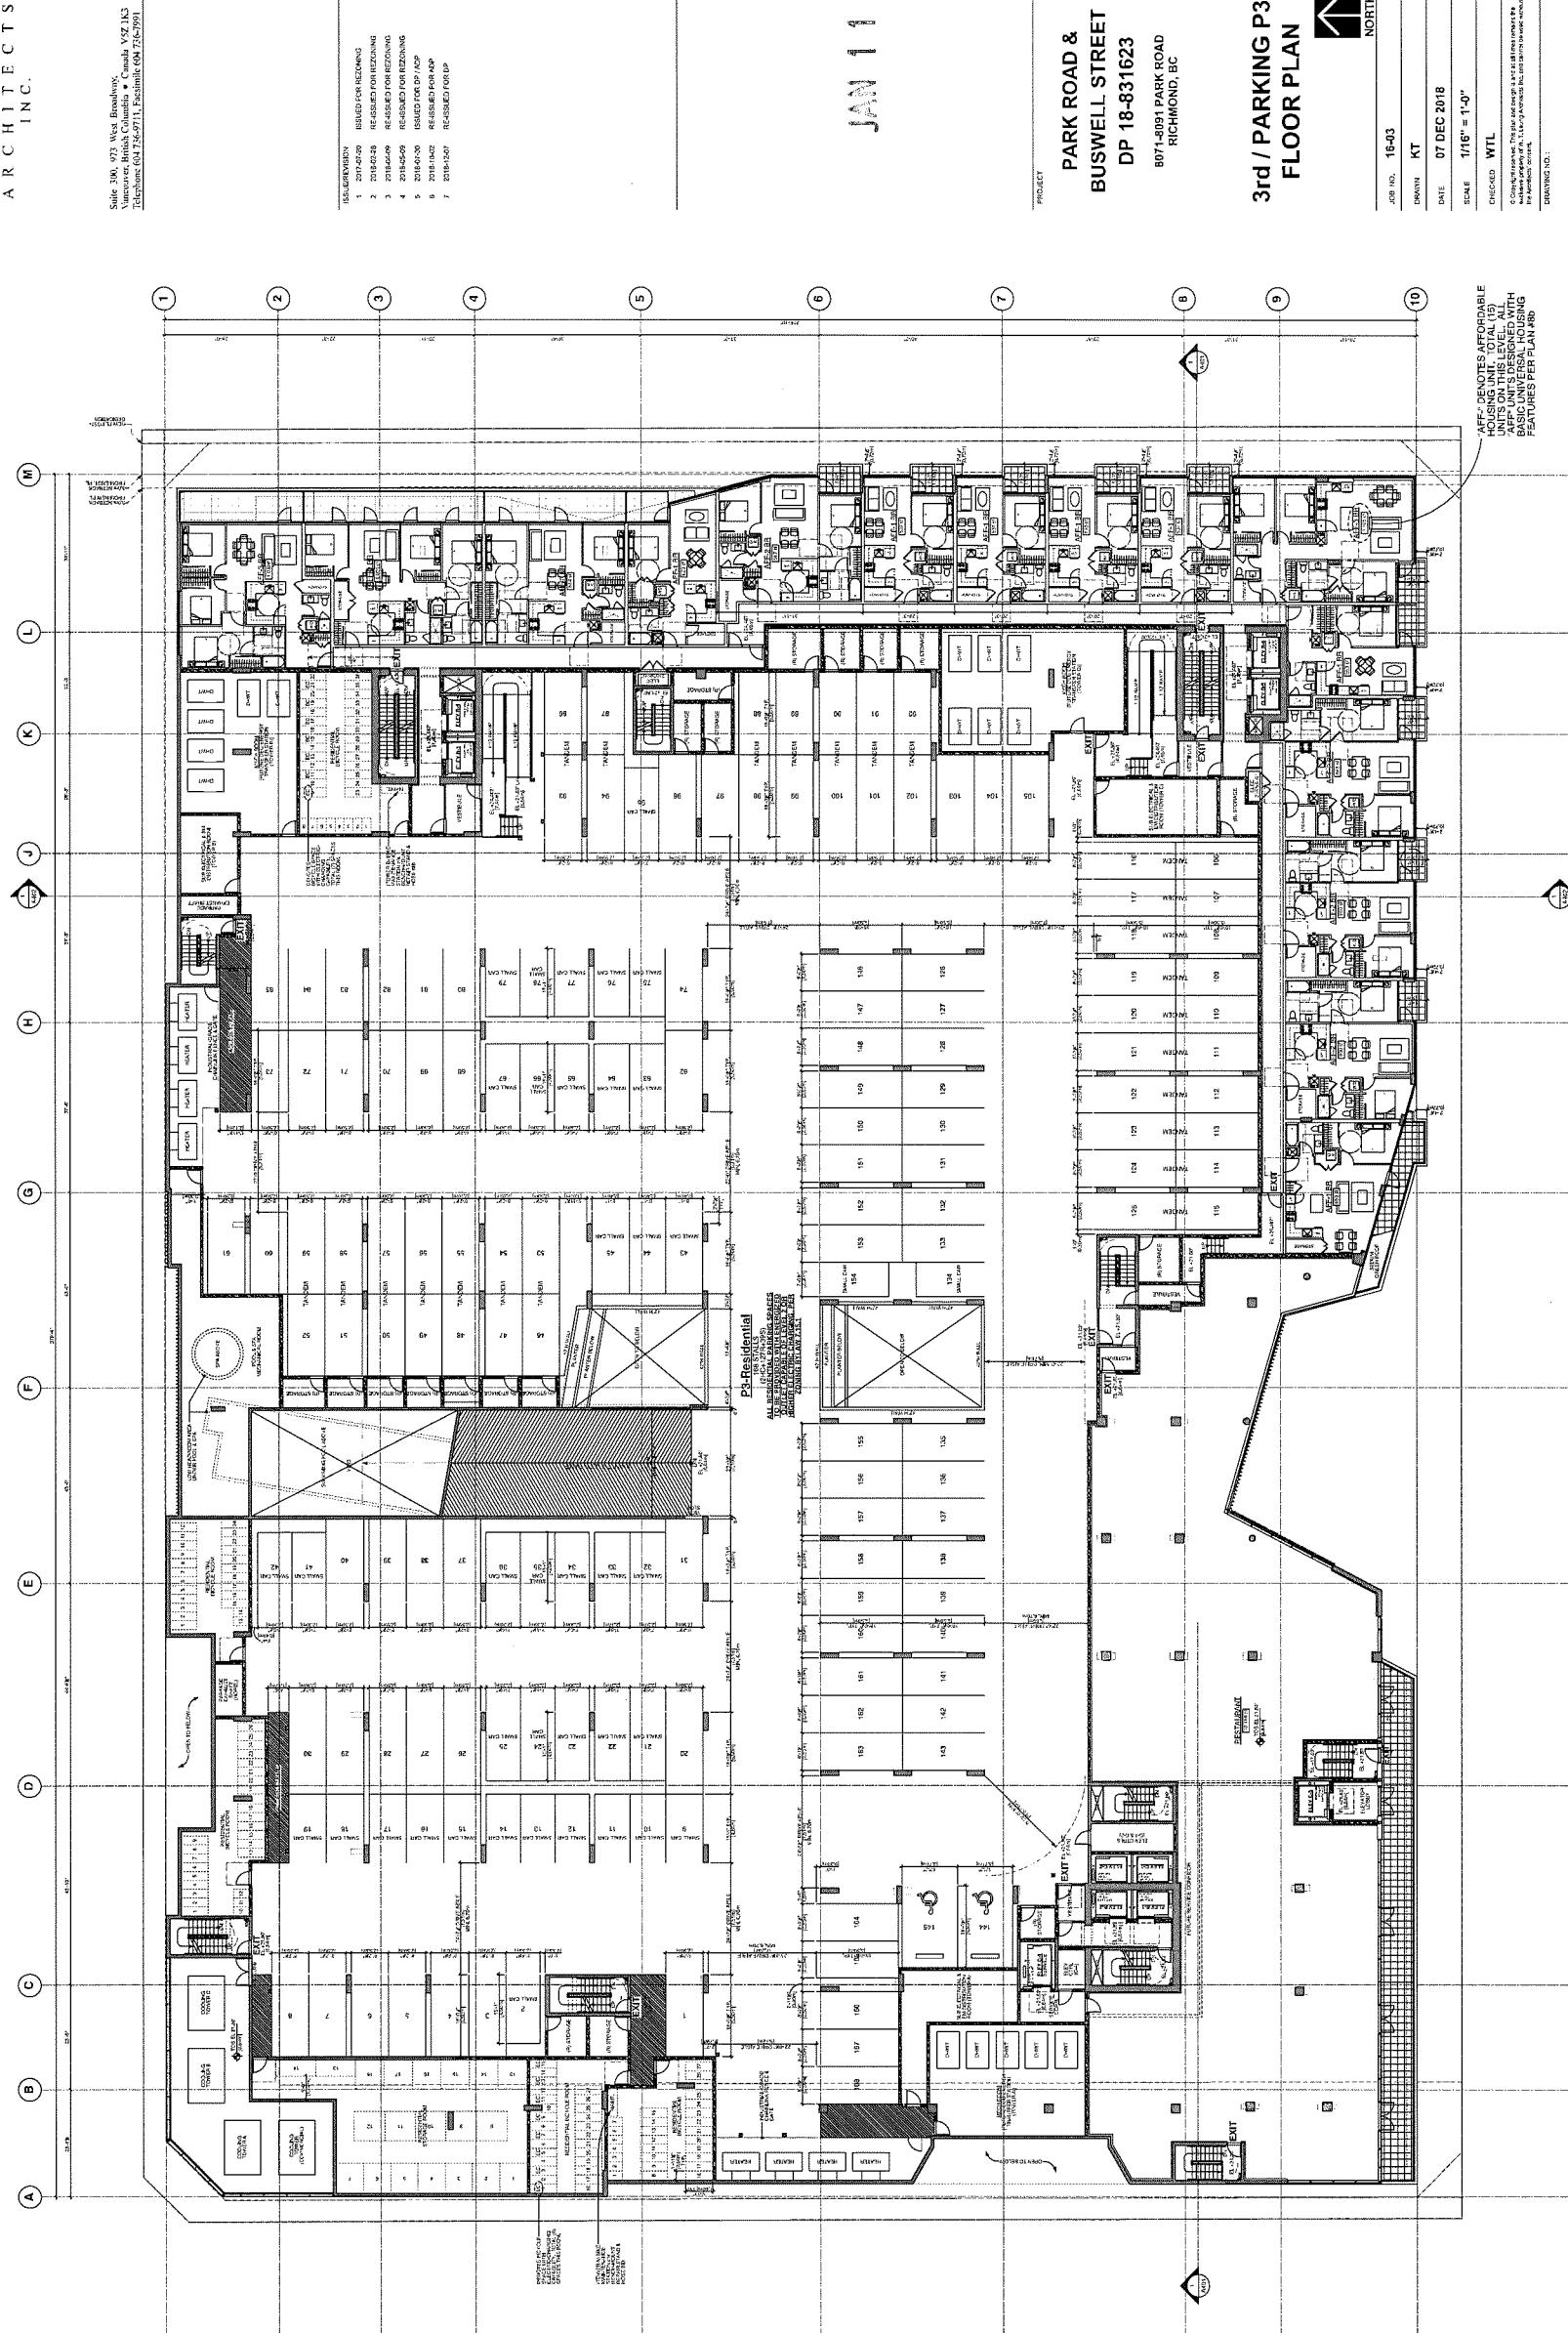


Plan #2d

$$\begin{array}{r} 123 \\ - 85 \\ \hline 38 \end{array}$$

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W. T. LEUNG
ARCHITECTS
INC.

Suite 300, 973 West Broadway,
Vancouver, British Columbia • Canada V6H 1K3
Telephone 604-736-0711 • Telecopier 604-735-3931

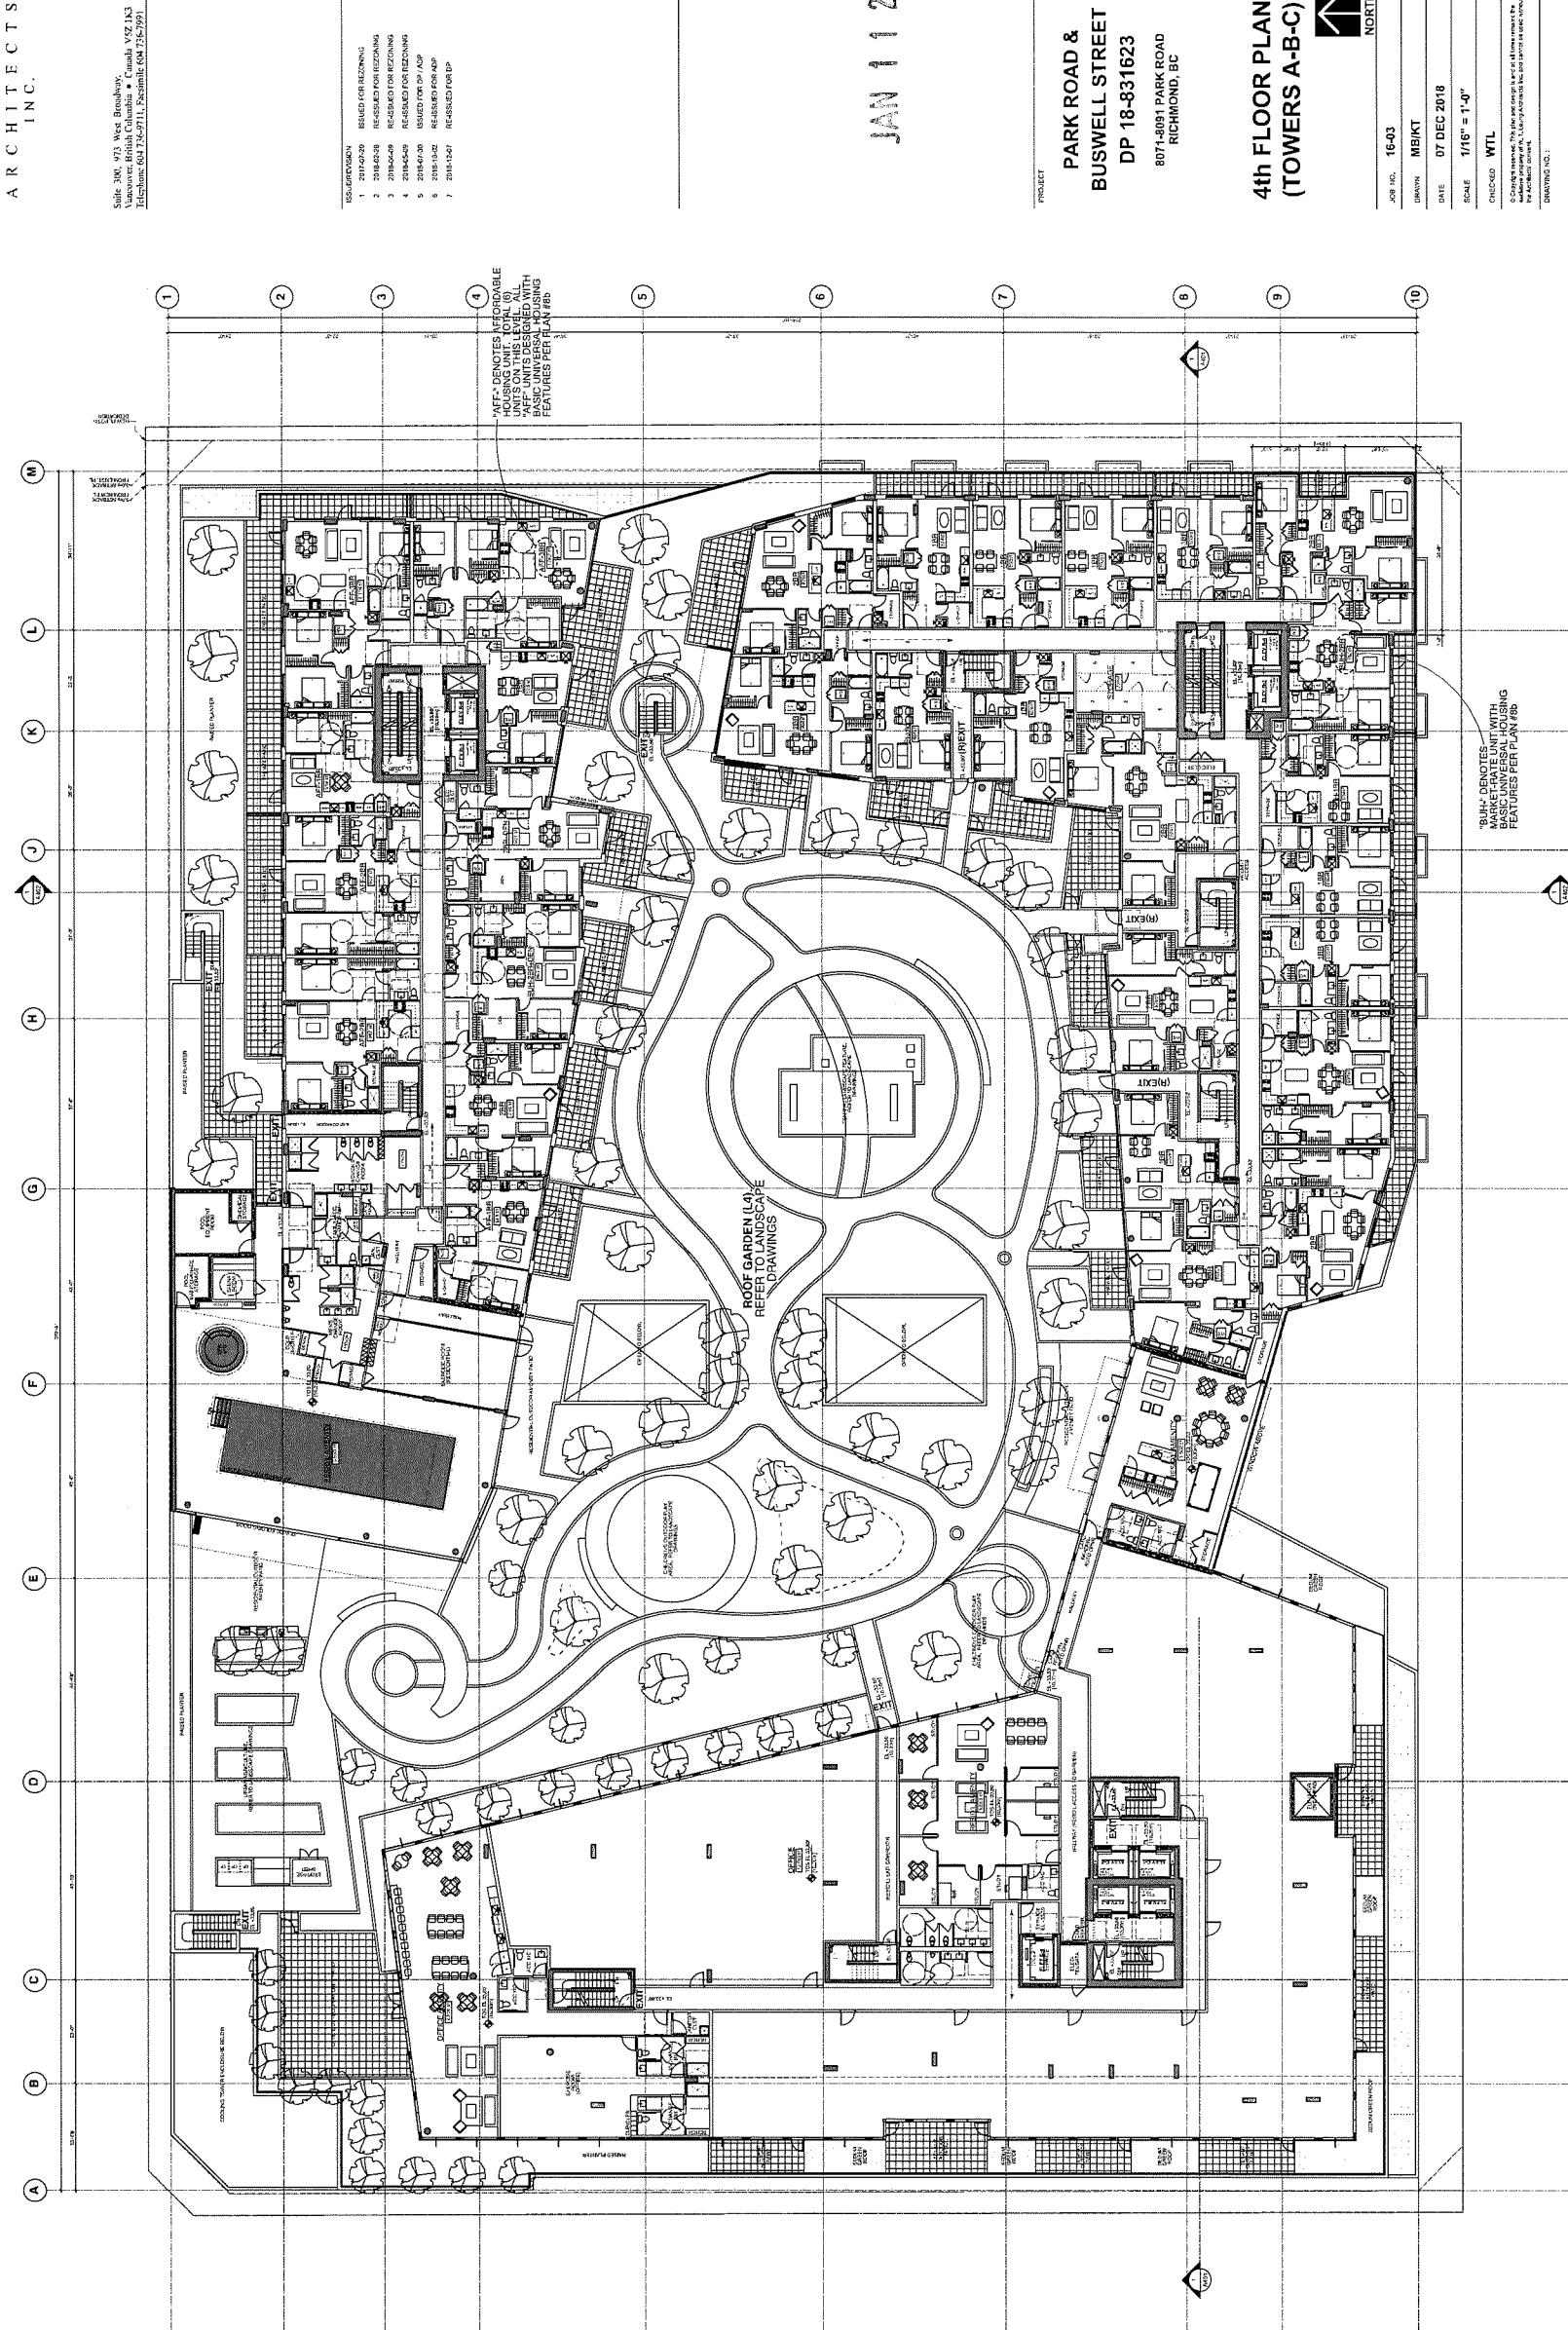

Plan #2e

DP 18-831623

W. T. LEUNG
ARCHITECTS
INC.

Suite 300, 1713 West Broadway,
Vancouver, British Columbia V6J 1K3
Tel: 604-524-9711; fax: 604-524-7791


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2 2315-02-24
RE-ISSUED FOR RECORDING
3 2315-02-09
4 2315-02-09
RE-ISSUED FOR RECORDING
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MAINT'D BY DP
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6 2315-02-09
RE-ISSUED FOR APP
7 2315-02-09

JAN 11 2019

PROJECT
PARK ROAD &
BUSWELL STREET
DP 18-831623
807-8091 PARK ROAD
RICHMOND, BC

5th FLOOR PLAN
(TOWERS A-B-C)

NORTH
JOB NO. 16-03
DRAWN MBK/T
DATE 07 DEC 2018
SCALE 1/16" = 1'-0"
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FOR APPROVAL OR COMMENT
BY ARCHITECTURE DEPARTMENT
DRAWING NO. 1

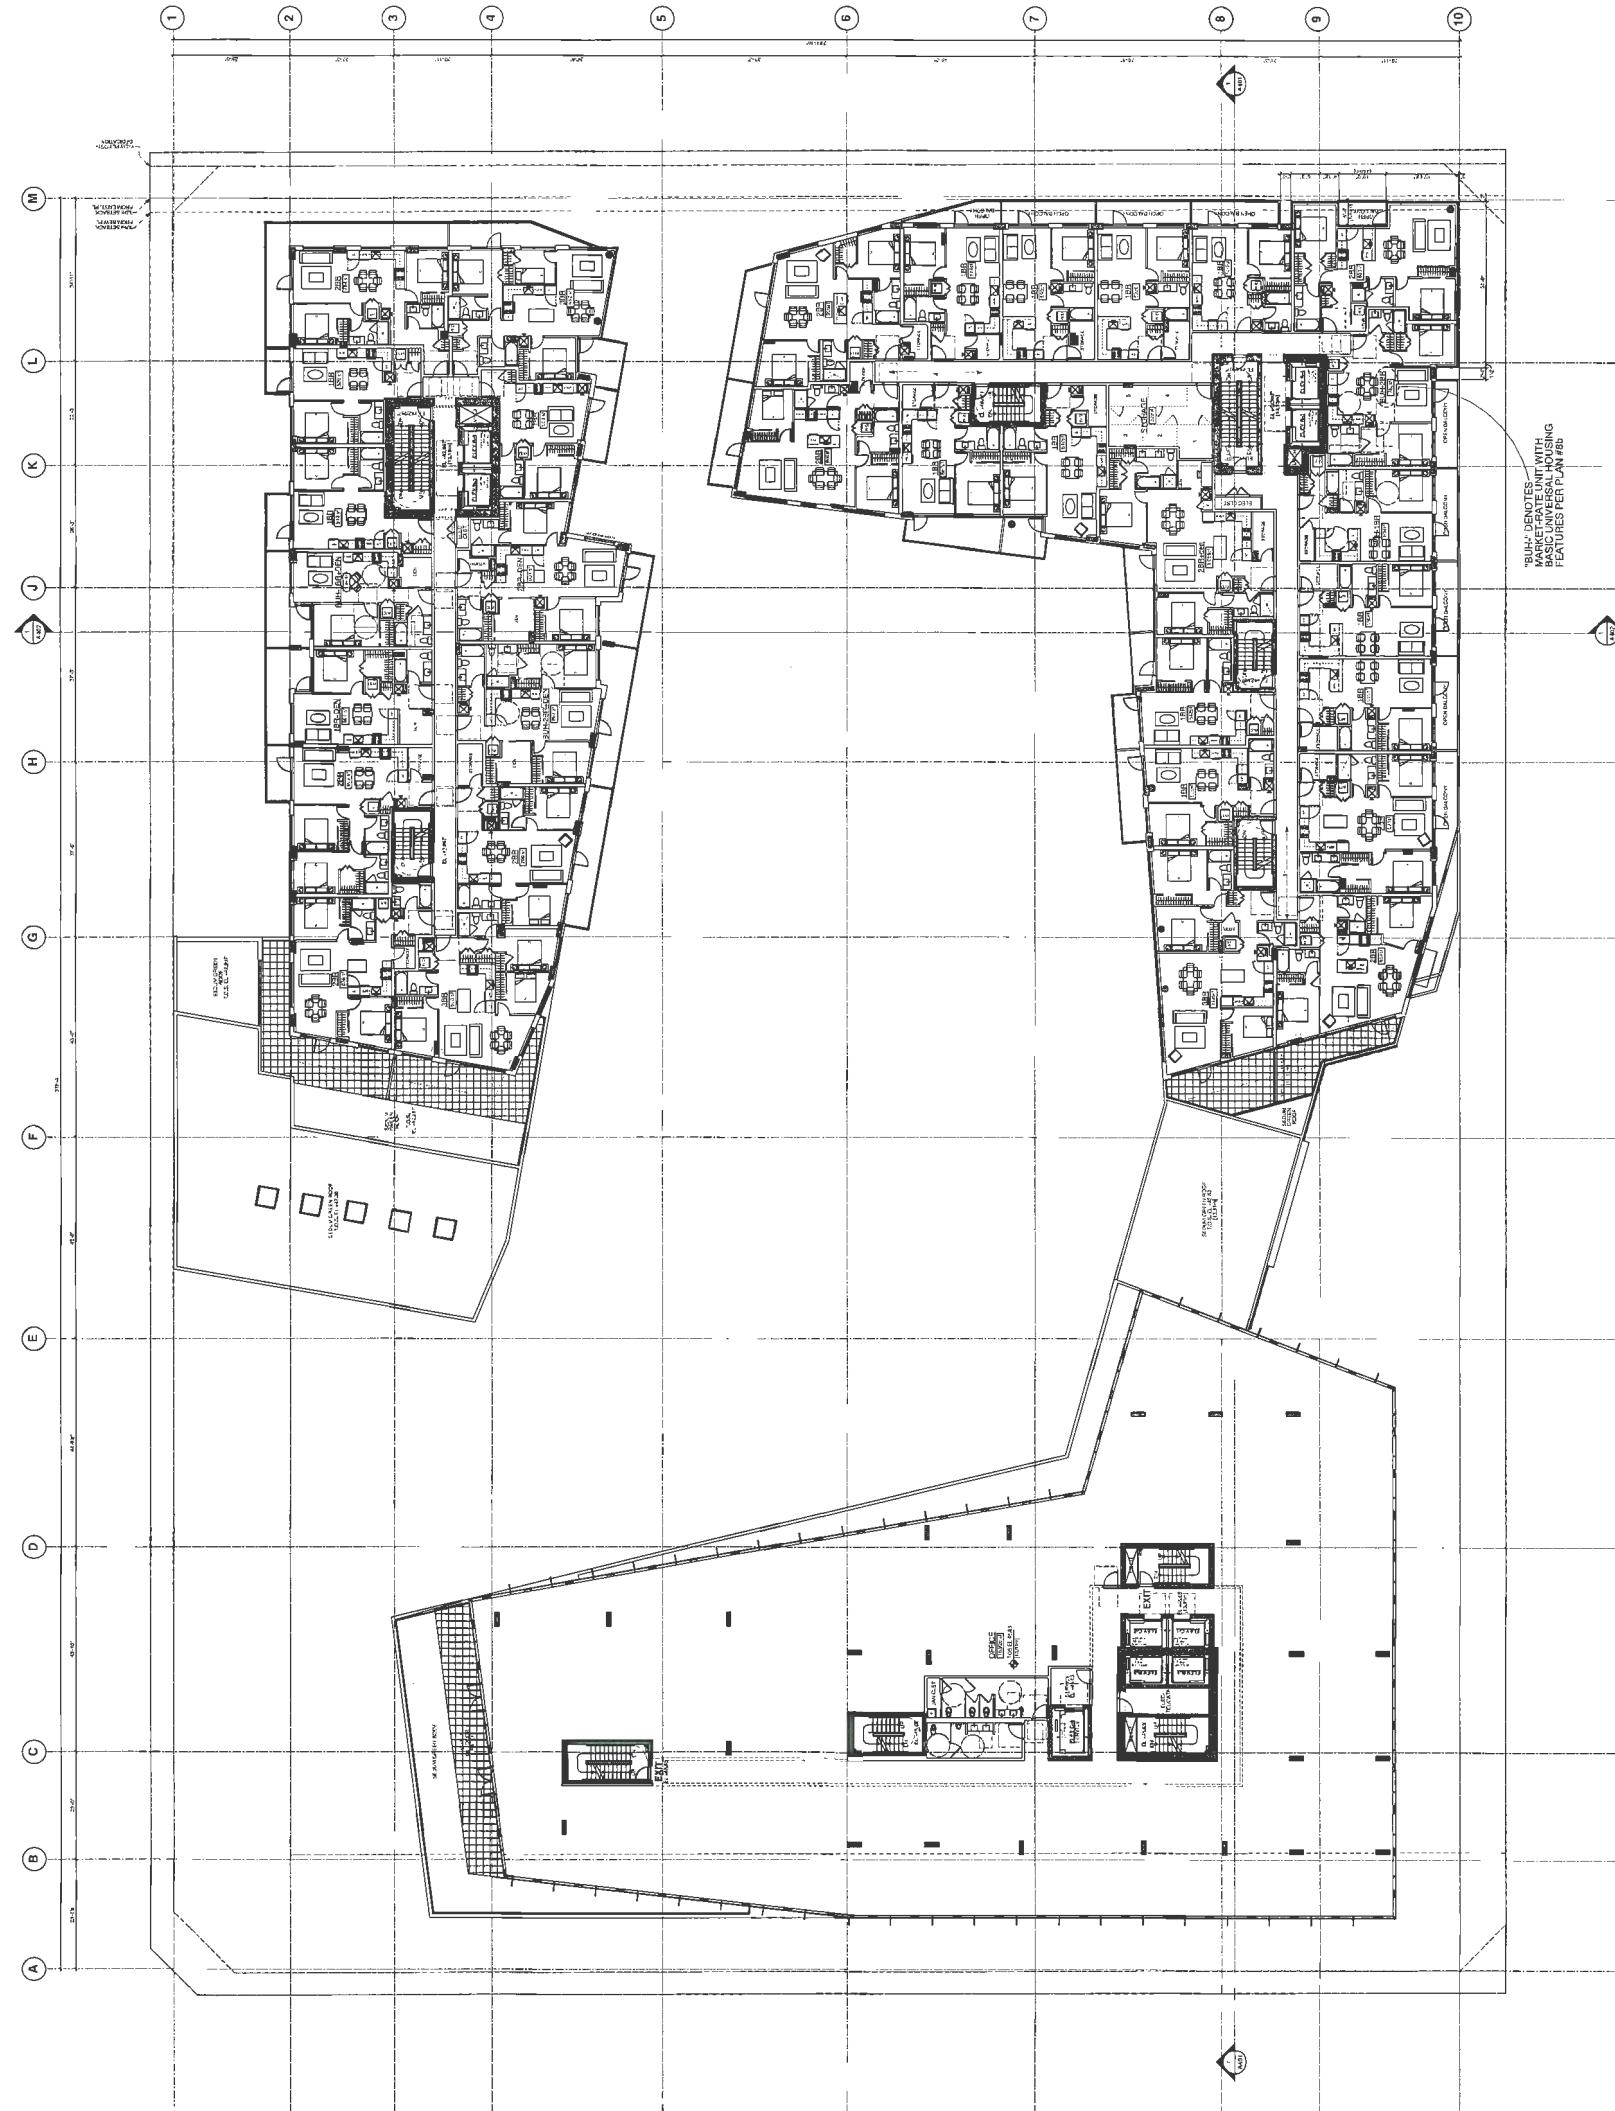

Plan #2f

DP 18-831623

W. T. LEUNG
A R C H I T E C T S
I N C

Suite 300, 973 West Broadway,
Vancouver, British Columbia • Canada V5Z 1K3
Telephone 604 736-9711, Facsimile 604 736-7991

| ISSUE/EXTENSION | ISSUED FOR READING |
|-----------------|-------------------------|
| 1 | 2017-07-20 |
| 2 | RE-ISSUED FOR READING |
| 3 | 2018-04-29 |
| 4 | RE-ISSUED FOR READING |
| 5 | 2018-04-29 |
| 6 | ISSUED FOR D/P & ADP |
| 7 | RE-ISSUED FOR D/P & ADP |
| 8 | 2018-12-07 |

1 JAN 1981

**PARK ROAD &
JUSWELL STREET
DP 18-831623
8071-8091 PARK ROAD**

6th FLOOR PLAN
(TOWERS B-C)

←

| | | | | |
|--|---------|-------------|---------------|---------|
| 16-03 | MBIKT | 07 DEC 2018 | 1116' = 1'-0" | WTL |
| ACB INC. | ORANAYA | DATE | SOURCE | CHECKED |
| This form is to be used. | | | | |

Plan #2d

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**W. T. LEUNG
ARCHITECTS
INC.**

Suite 300, 173 West Broadway,
Vancouver, BC, Canada V6E 1K3
Telephone: 604-569-7111 Facsimile: 604-569-7391


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RE-ISSUED FOR ZONING
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6 2014-04-30
7 2014-04-27
RE-ISSUED FOR APP
RE-ISSUED FOR DP
RE-ISSUED FOR DPA

JAN 11 2019

PROJECT
PARK ROAD &
BUSWELL STREET
DP 18-831623
807-8091 PARK ROAD
RICHMOND, BC

TOWER A 6/F
TOWERS B-C 7/F
PLANS ↑
NORTH

JOB NO. 16-03
DRAWN MBIKT
DATE 07 DEC 2018
SCALE 1IN=1'-0"
CHECKED WTL
DRAWN BY: *[Signature]*
Comments: This drawing is to be used for construction purposes only. It is the responsibility of the user to verify that all applicable codes and regulations are met.
DRAFTING CO.: *[Signature]*

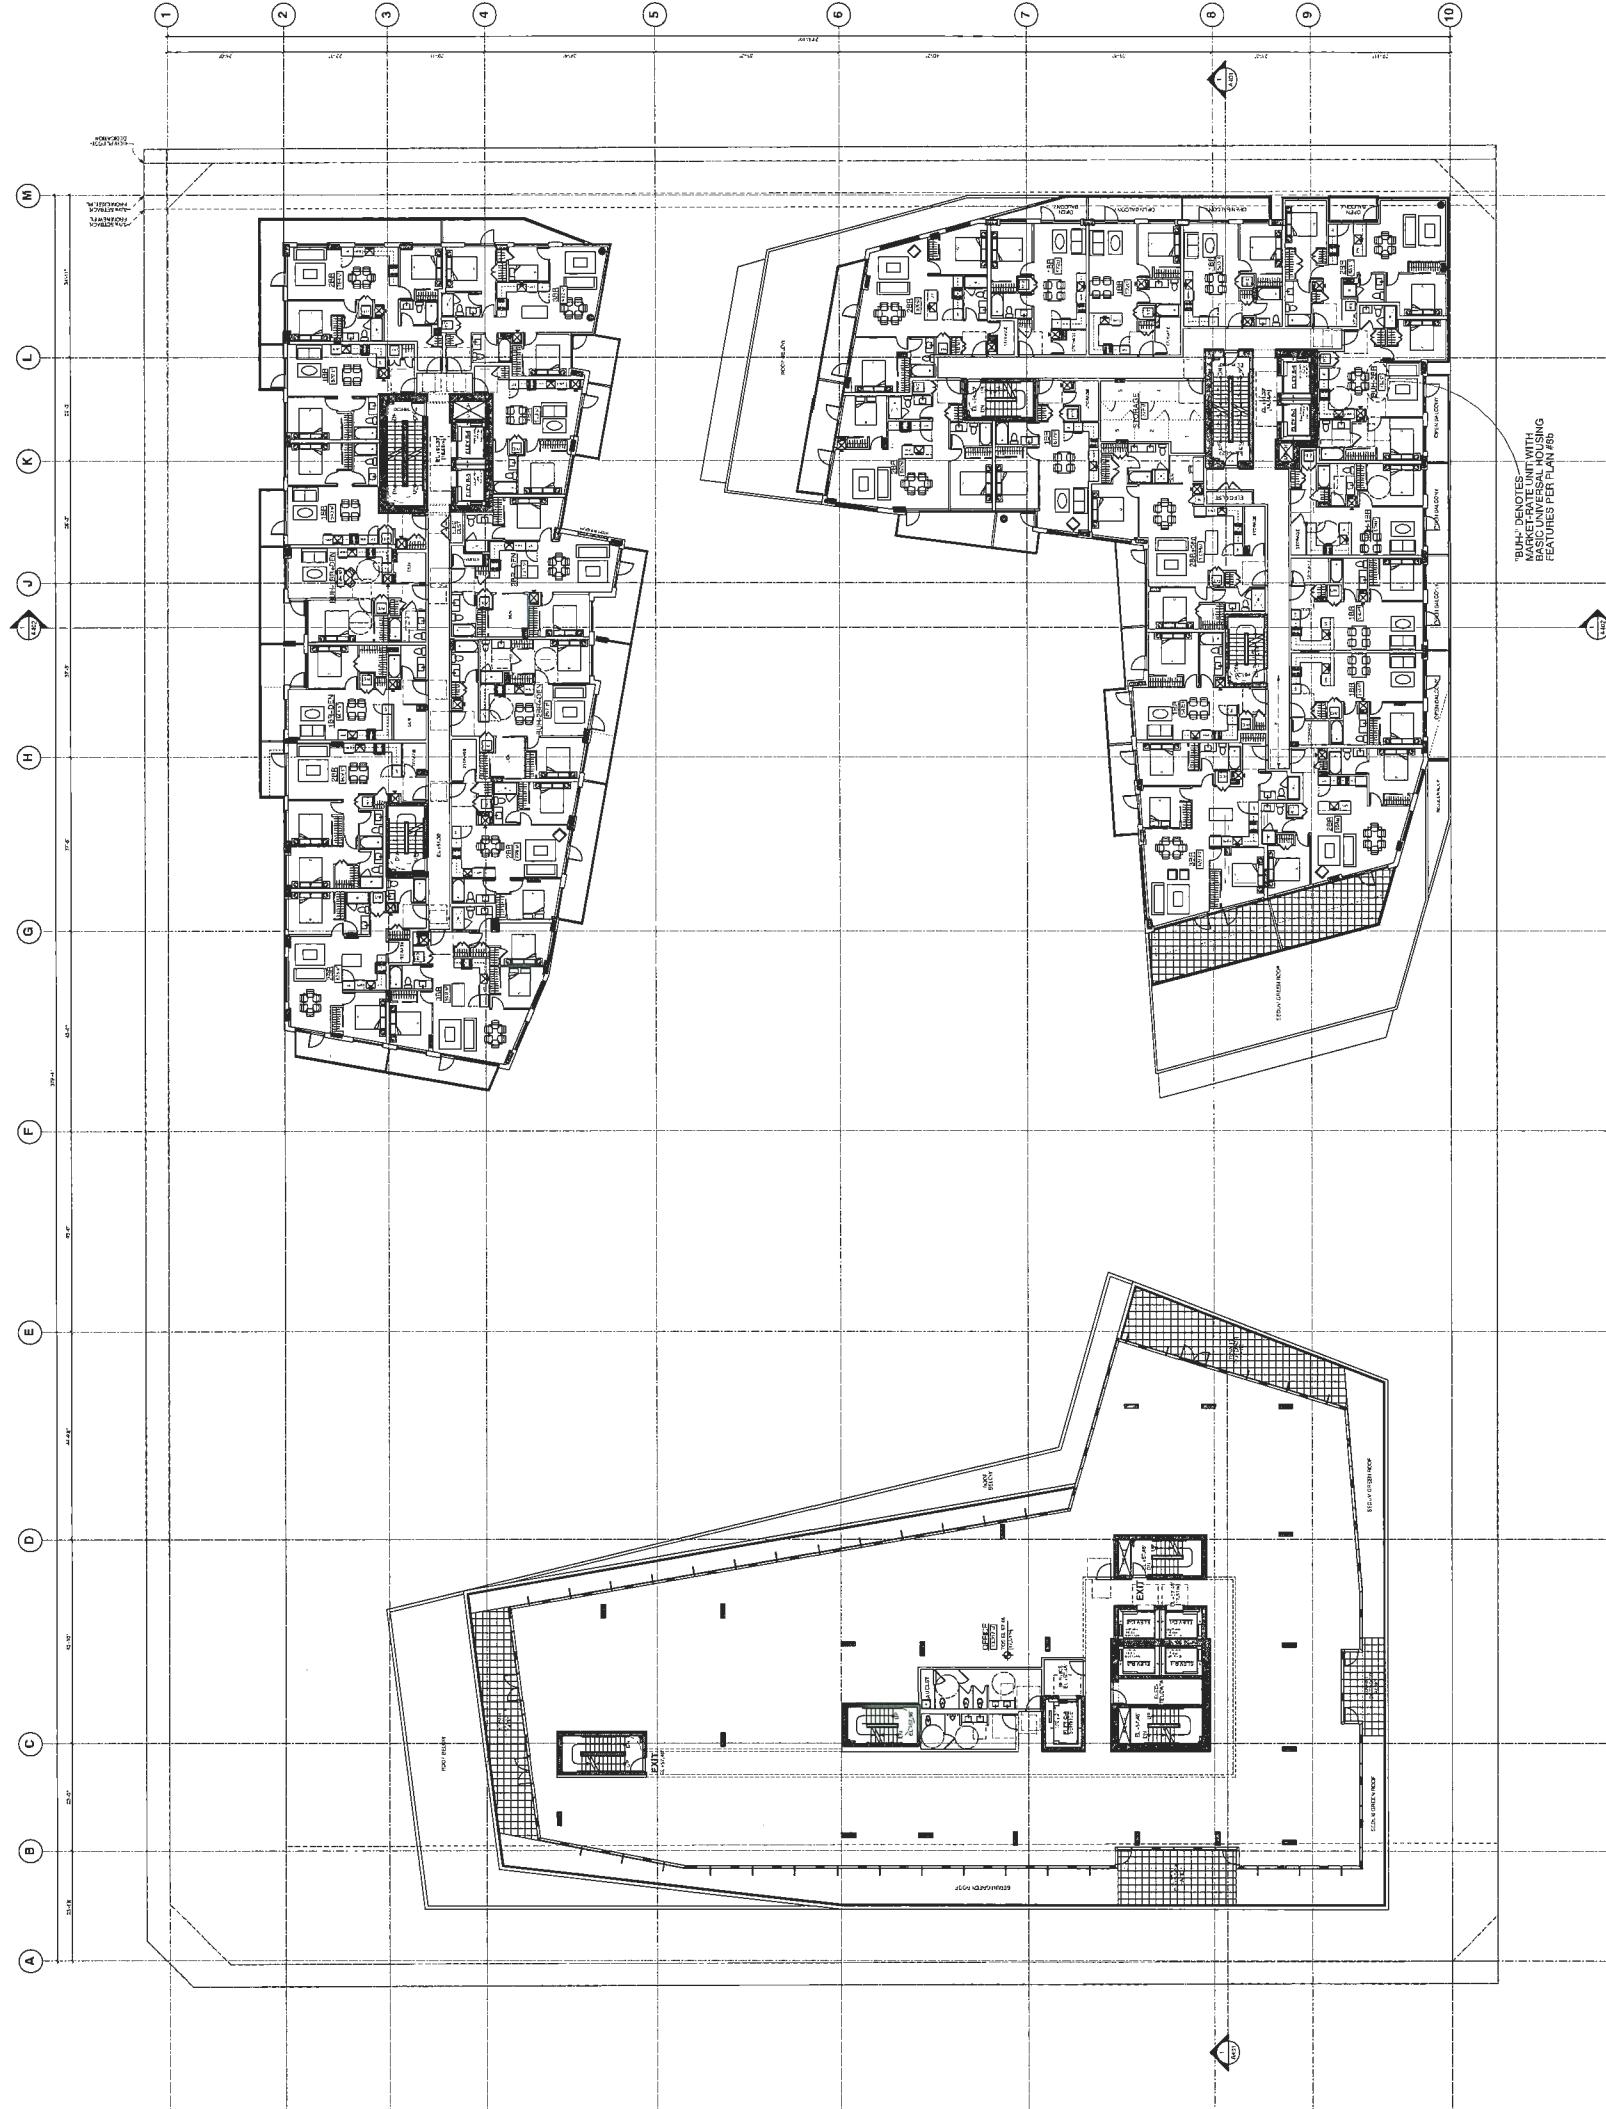

Plan #2h

1623
831623
DOP

W. T. LEUNG
ARCHITECTS
INC.

Suite 300, 973 West Broadway
Vancouver, British Columbia • Canada V6Z 1K3
Telephone 604 736-9711, Facsimile 604 735-7991

2019
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14


TOWER A 7/F,
TOWERS B-C 8/F
PLANS

**PARK ROAD &
JUSWELL STREET**
DP 18-831623
8071-8091 PARK ROAD
RICHMOND, BC

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W. T. LEUNG
ARCHITECTS INC.

Suite 300, 973 West Broadway,
Vancouver, British Columbia • Canada V6H 1K3
Telephone 604 568-5111; facsimile 604 736-5391

ISSUED FOR RECORDING
1 2018-02-20 RE-ISSUED FOR RECORDING
2 2018-02-28 RE-ISSUED FOR RECORDING
3 2018-03-09 RE-ISSUED FOR RECORDING
4 2018-03-09 RE-ISSUED FOR DP / AP
5 2018-03-20 RE-ISSUED FOR DP / AP
6 2018-03-20 RE-ISSUED FOR DP / AP
7 2018-03-27 RE-ISSUED FOR DP / AP

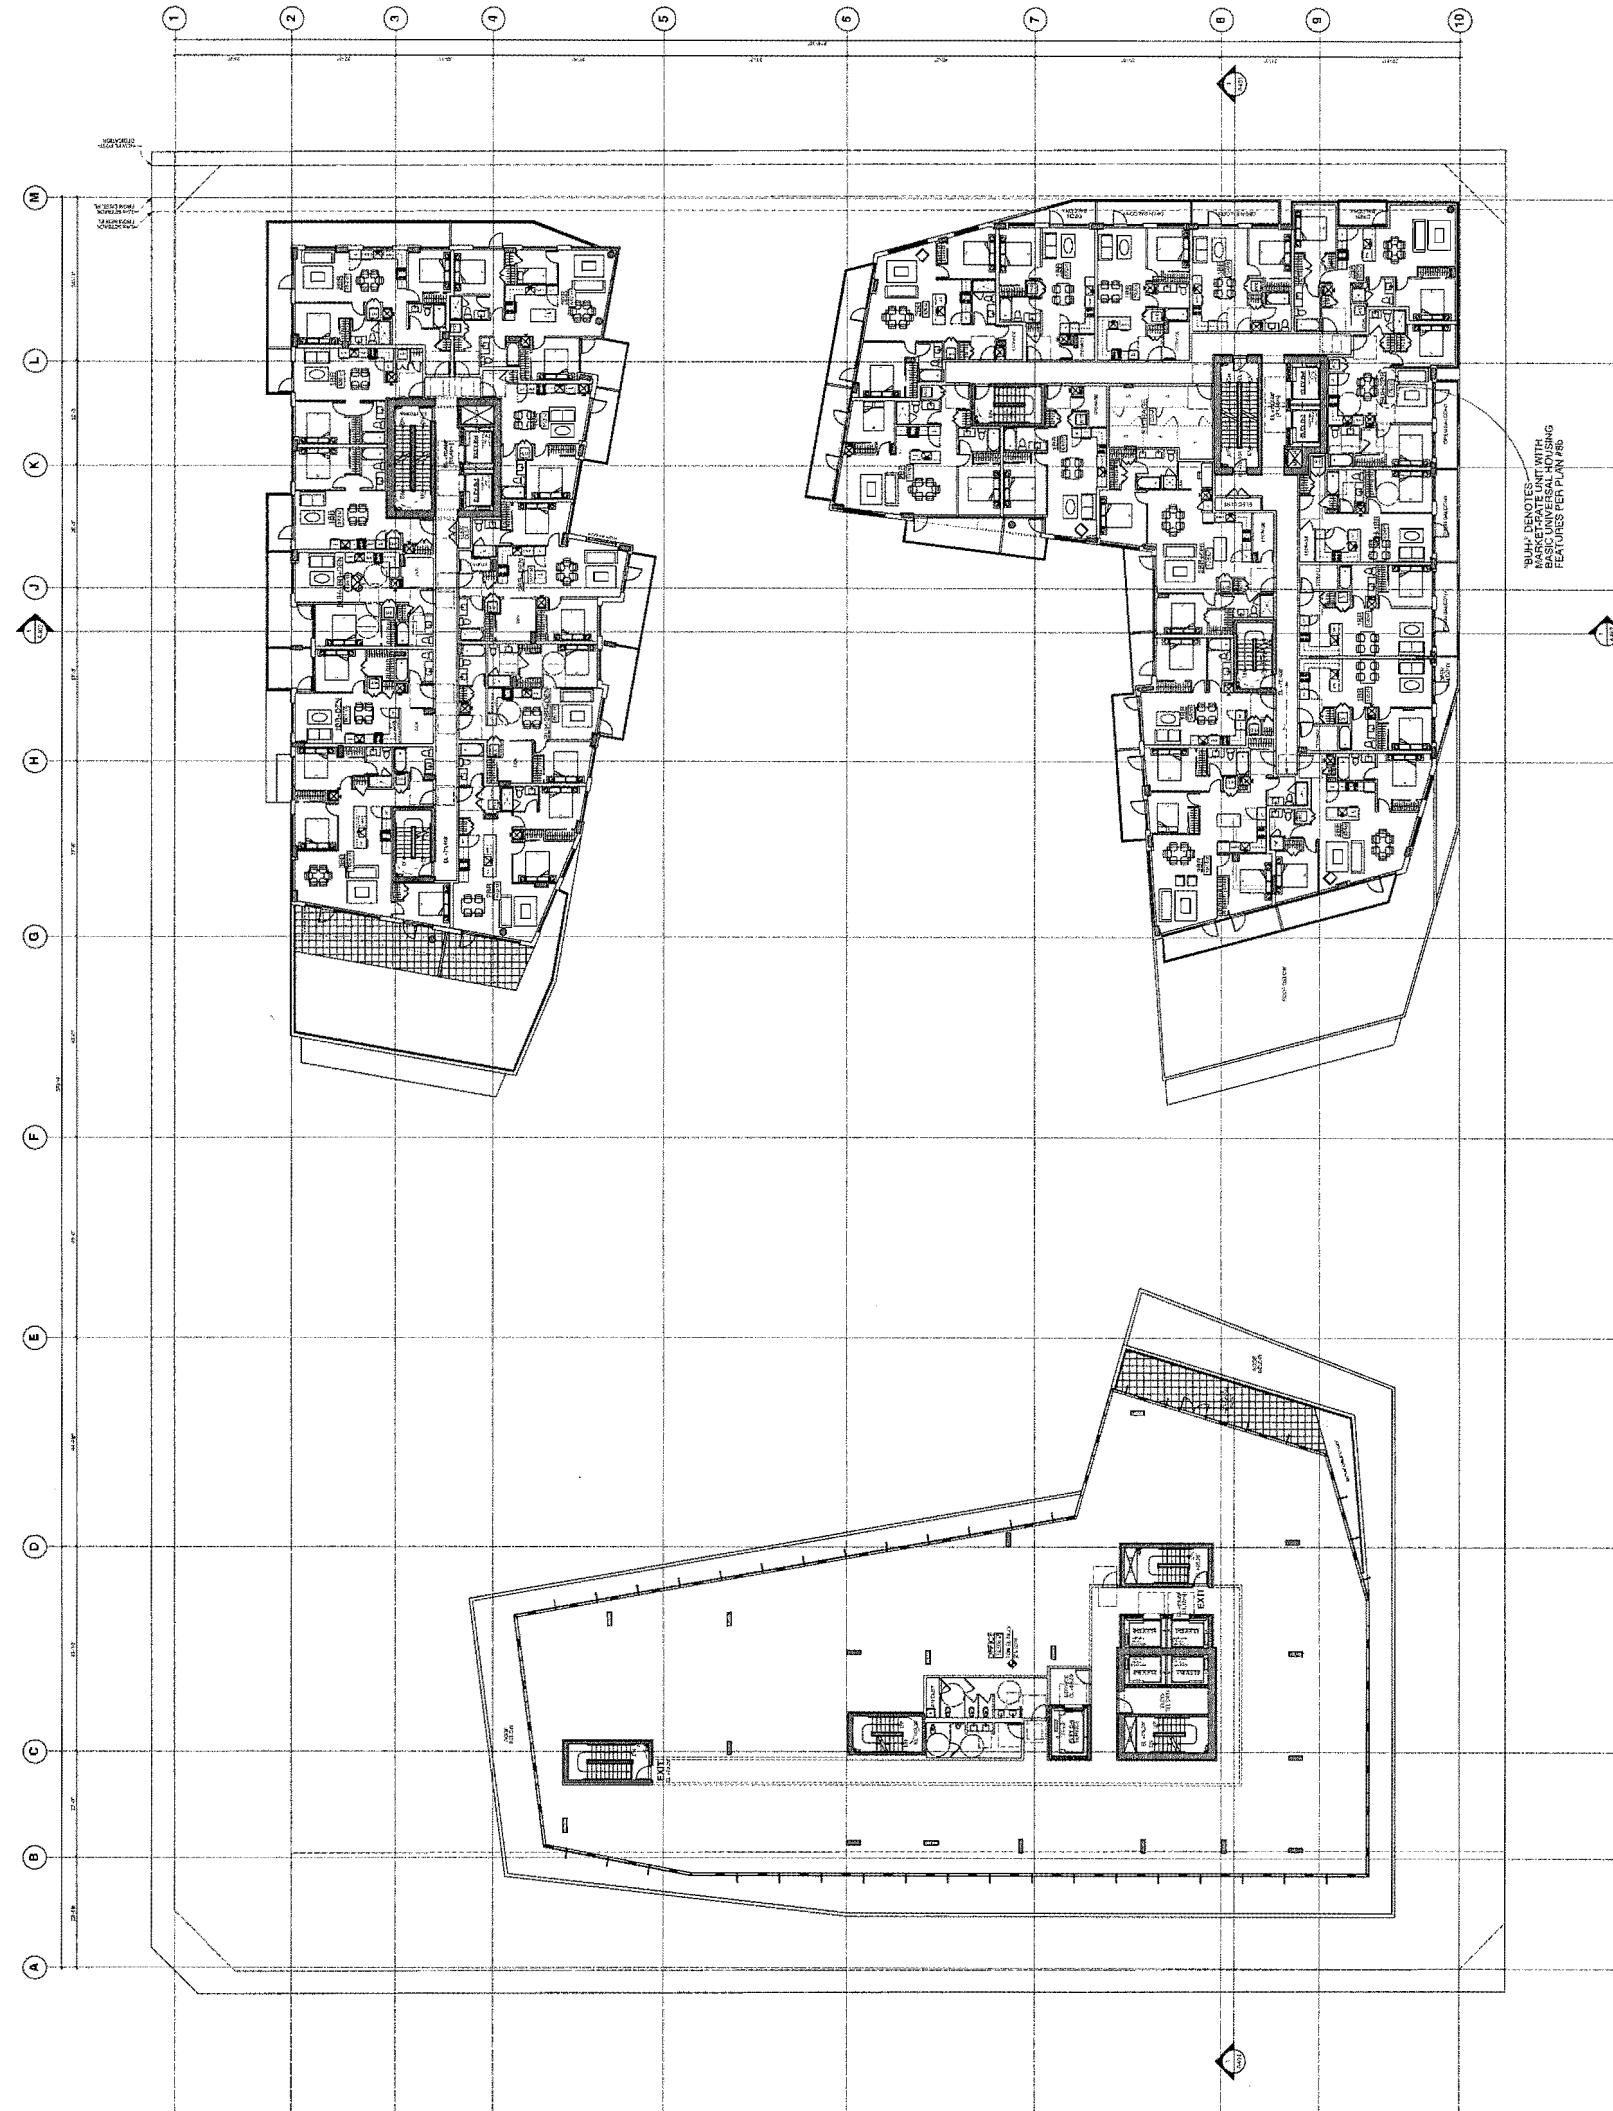JAN 11 2019


PROJECT
PARK ROAD &
BUSWELL STREET
DP 18-831623
807-8091 PARK ROAD
RICHMOND, BC

TOWER A 8/F,
TOWERS B-C 9/F

PLANS ↑

NORTH
16-03
DRAWN BY MIKLT
DATE 07 DEC 2018
SCALE 1/16" = 1'-0"
CHECKED WTL
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Plan #2j

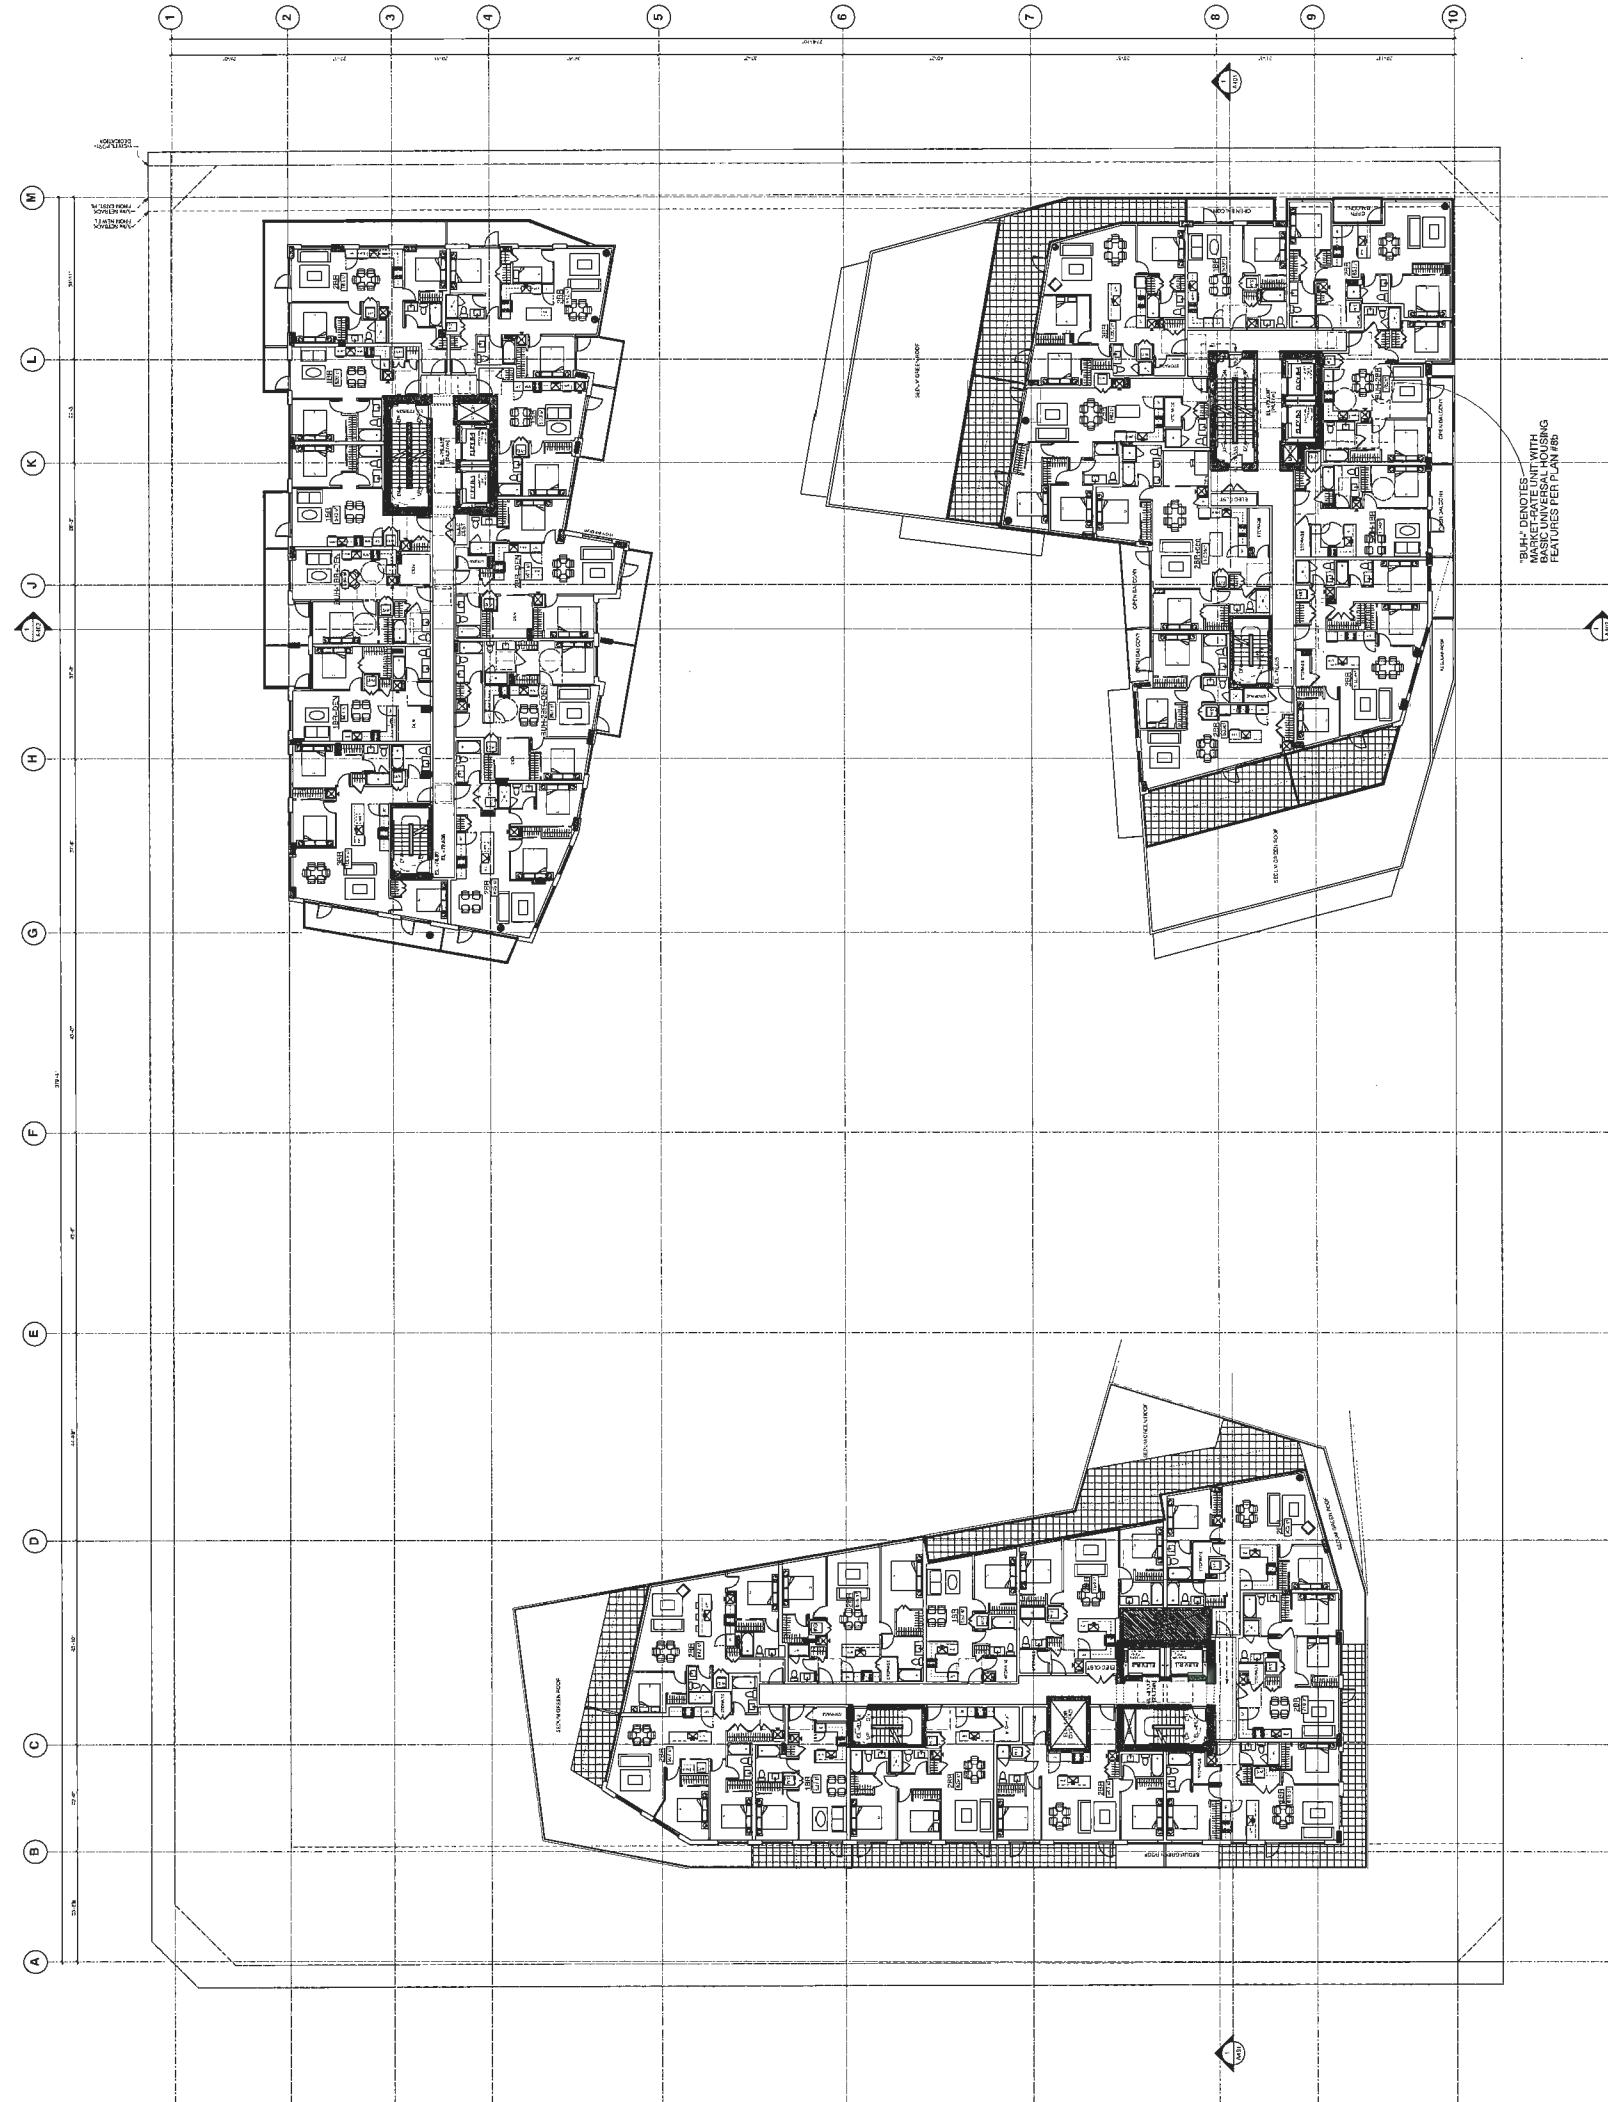

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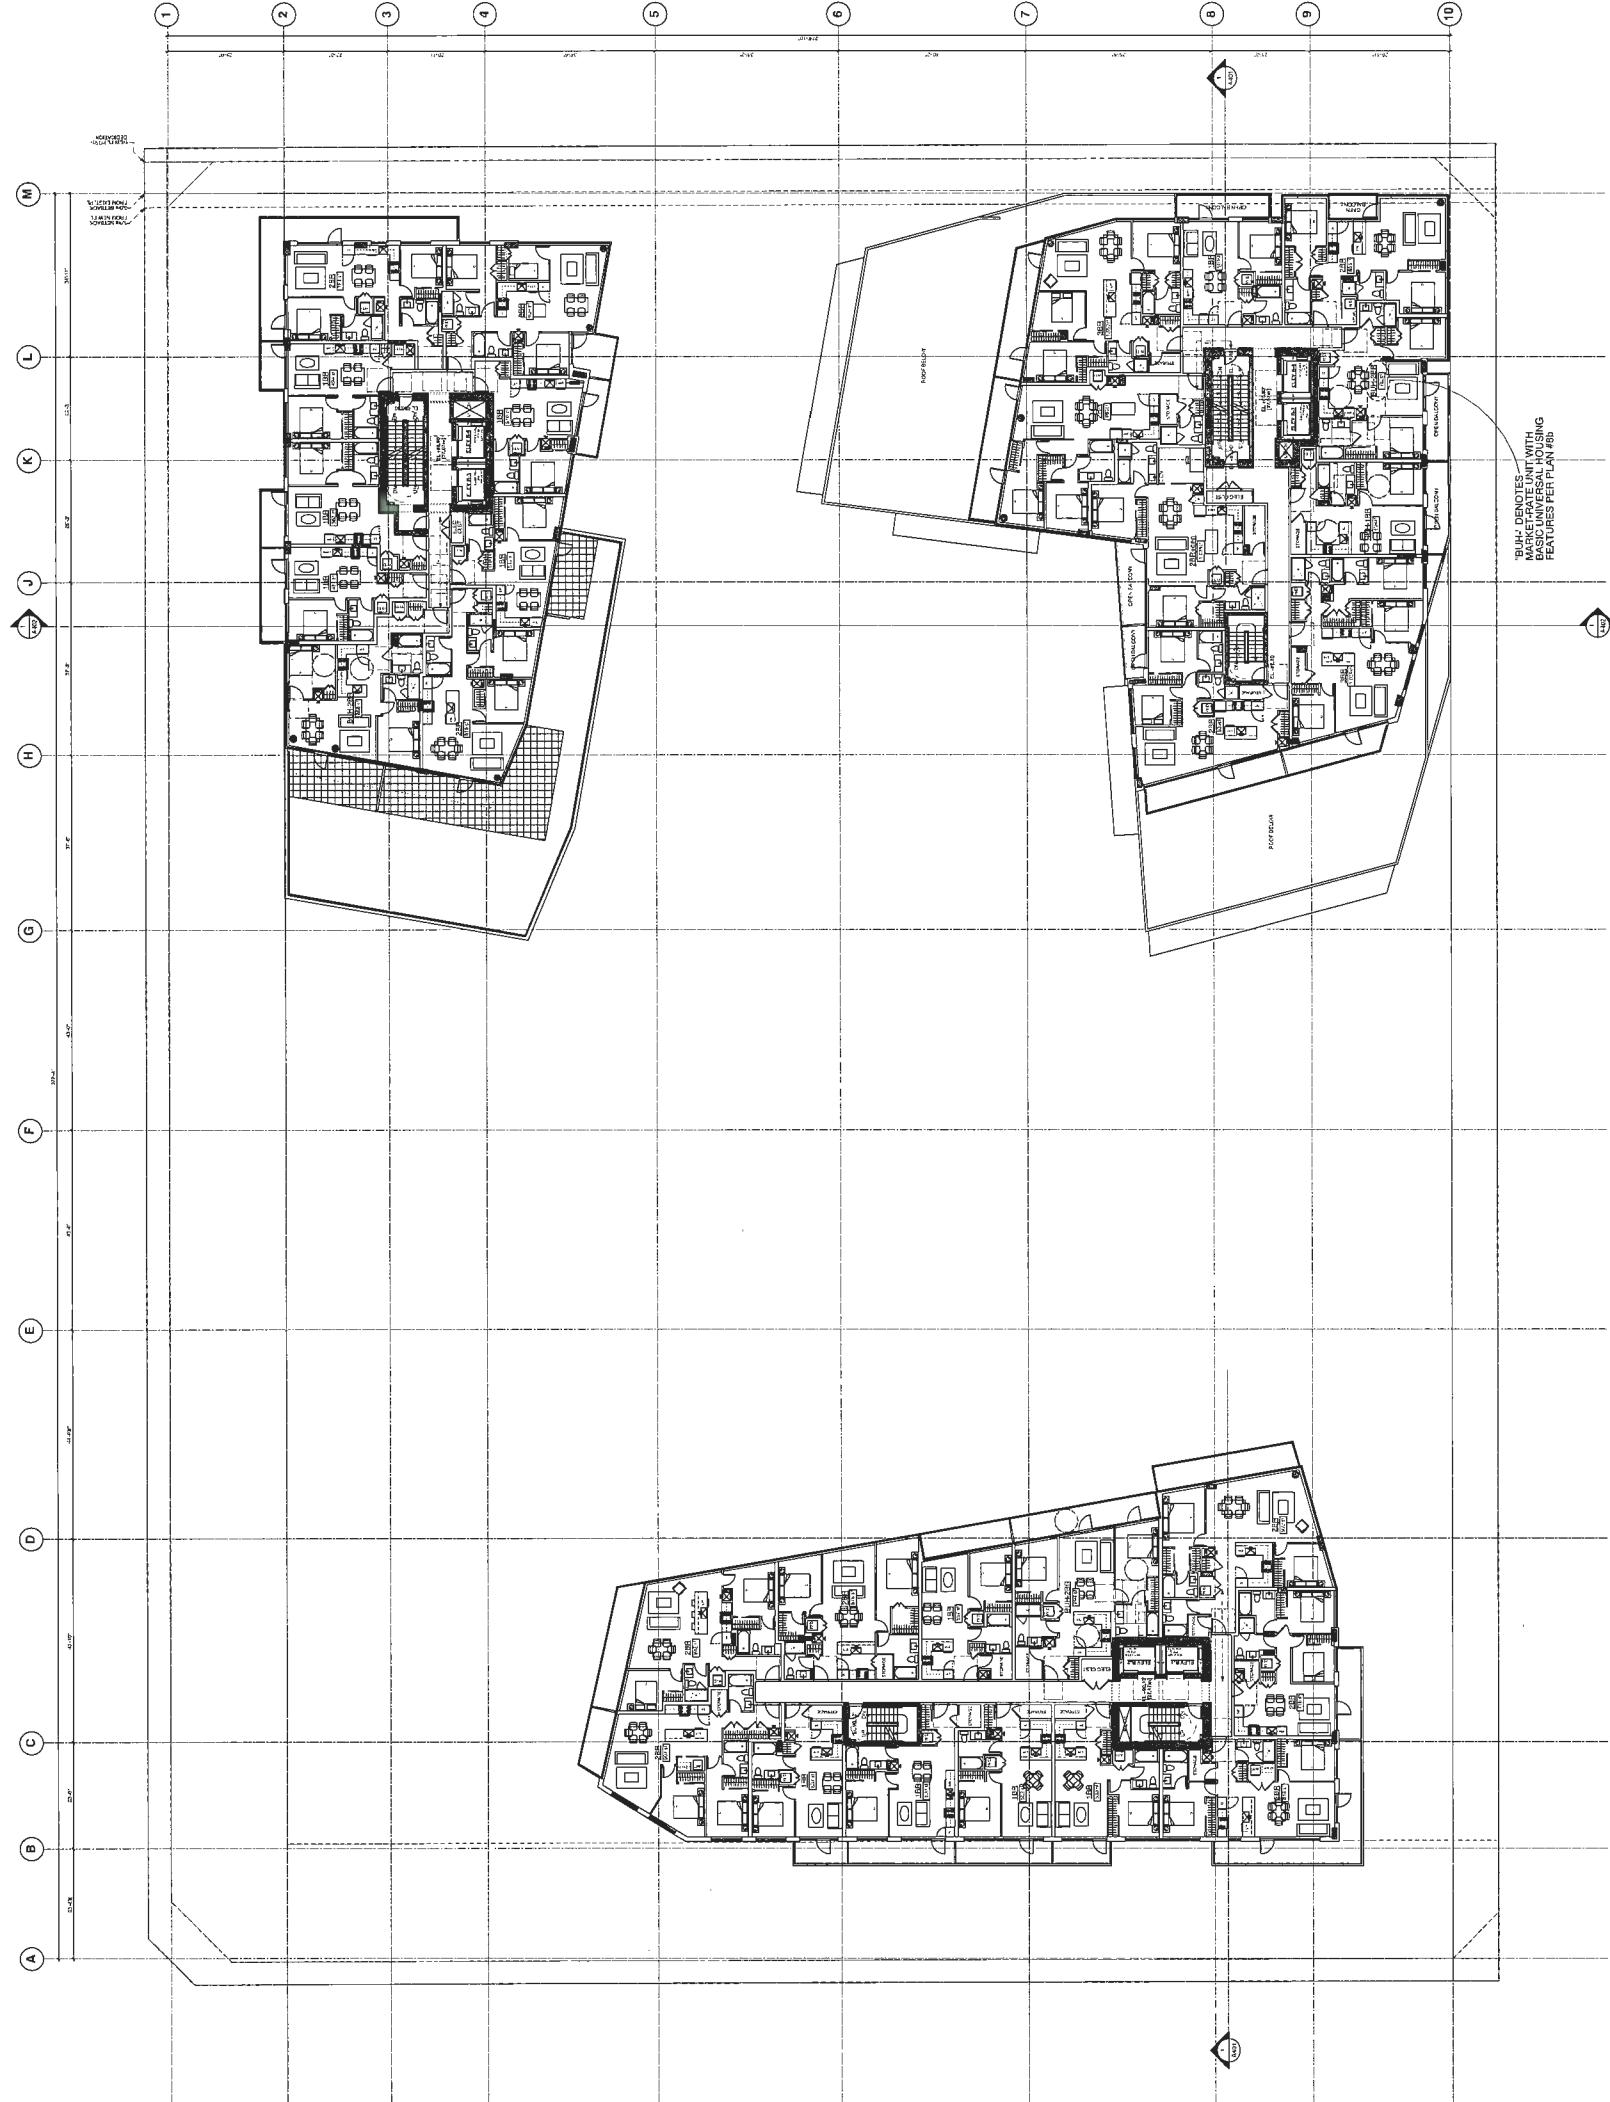
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1 2011-02-20
2 2011-02-26
3 RE-ISSUED FOR ZONING
4 2011-04-29
5 ISSUED FOR DP/APP
6 2011-05-09
7 RE-ISSUED FOR DP
8 2011-04-20
9 2011-04-20

JAN 11 2019

PROJECT
PARK ROAD &
BUSWELL STREET
DP 18-831623
807-8091 PARK ROAD
RICHMOND, BC

TOWER A 9/F,
TOWERS B-C 10/F
PLANS 

NORTH
JOB NO. 18-Q3
DRAWN MB/KT
DATE 07 DEC 2018
SCALE 1/16" = 1'-0"
CHECKED WTL
APPROVED BY: 
Comments: This plan is based on the information provided by the client and is subject to review by the City of Richmond. It is the responsibility of the client to ensure that all requirements of the City of Richmond are met.
Engineering Co.: 



Plan #2k

DP 18-831623

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L N C.

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Vancouver, British Columbia • Canada V5Z 1K3
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**PARK ROAD &
BUSWELL STREET**
DP 18-831623
8071-891 PARK ROAD
RICHMOND, BC

**TOWER A 10/F,
TOWERS B-C 11/F**

PLANS

| | |
|--|------------------------|
| NORTH | |
| 16-03 AUG 16, 2016 | MBIKT |
| CHAYNIN | DATE 07 DEC 2016 |
| | SCALE 1/16" = 1'-0" |
| CHECKED | WTL |
| Check and signed by _____, I have performed the work described above in accordance with the plans and specifications of the project. I further declare that the work was done in accordance with the applicable codes and standards. | |
| F. A. Nichols Co., Inc. | |
| Drawing No.: _____ | |

Plan #2

001 - 31623

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Vancouver, British Columbia • Canada V5Z 1K5
Telephone: 604-736-9711, Facsimile 604-736-7991


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| | | RE-ISSUED FOR RECEIVING |
| 4 | 2018-05-09 | RE-ISSUED FOR RECEIVING |
| 5 | 2018-07-20 | ISSUED FOR DP/ACP |
| | | RE-ISSUED FOR DP/ACP |
| 6 | 2018-09-27 | RE-ISSUED FOR DP |

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| | | |
|---|---|---|
| PARK ROAD & BUSWELL STREET DP 18-311623 8071-809A PARK ROAD RICHMOND, BC | TOWER A 11/F, TOWERS B-C 12/F PLANS  NORTH | 16-33 MENKT 17 DEC 2018 11/16" = 1'-4" SCALE WTL <small>CHANGED</small> |
|---|---|---|

Plan #27

$$\begin{array}{r} 23 \\ \underline{- 16} \\ \hline 7 \end{array}$$

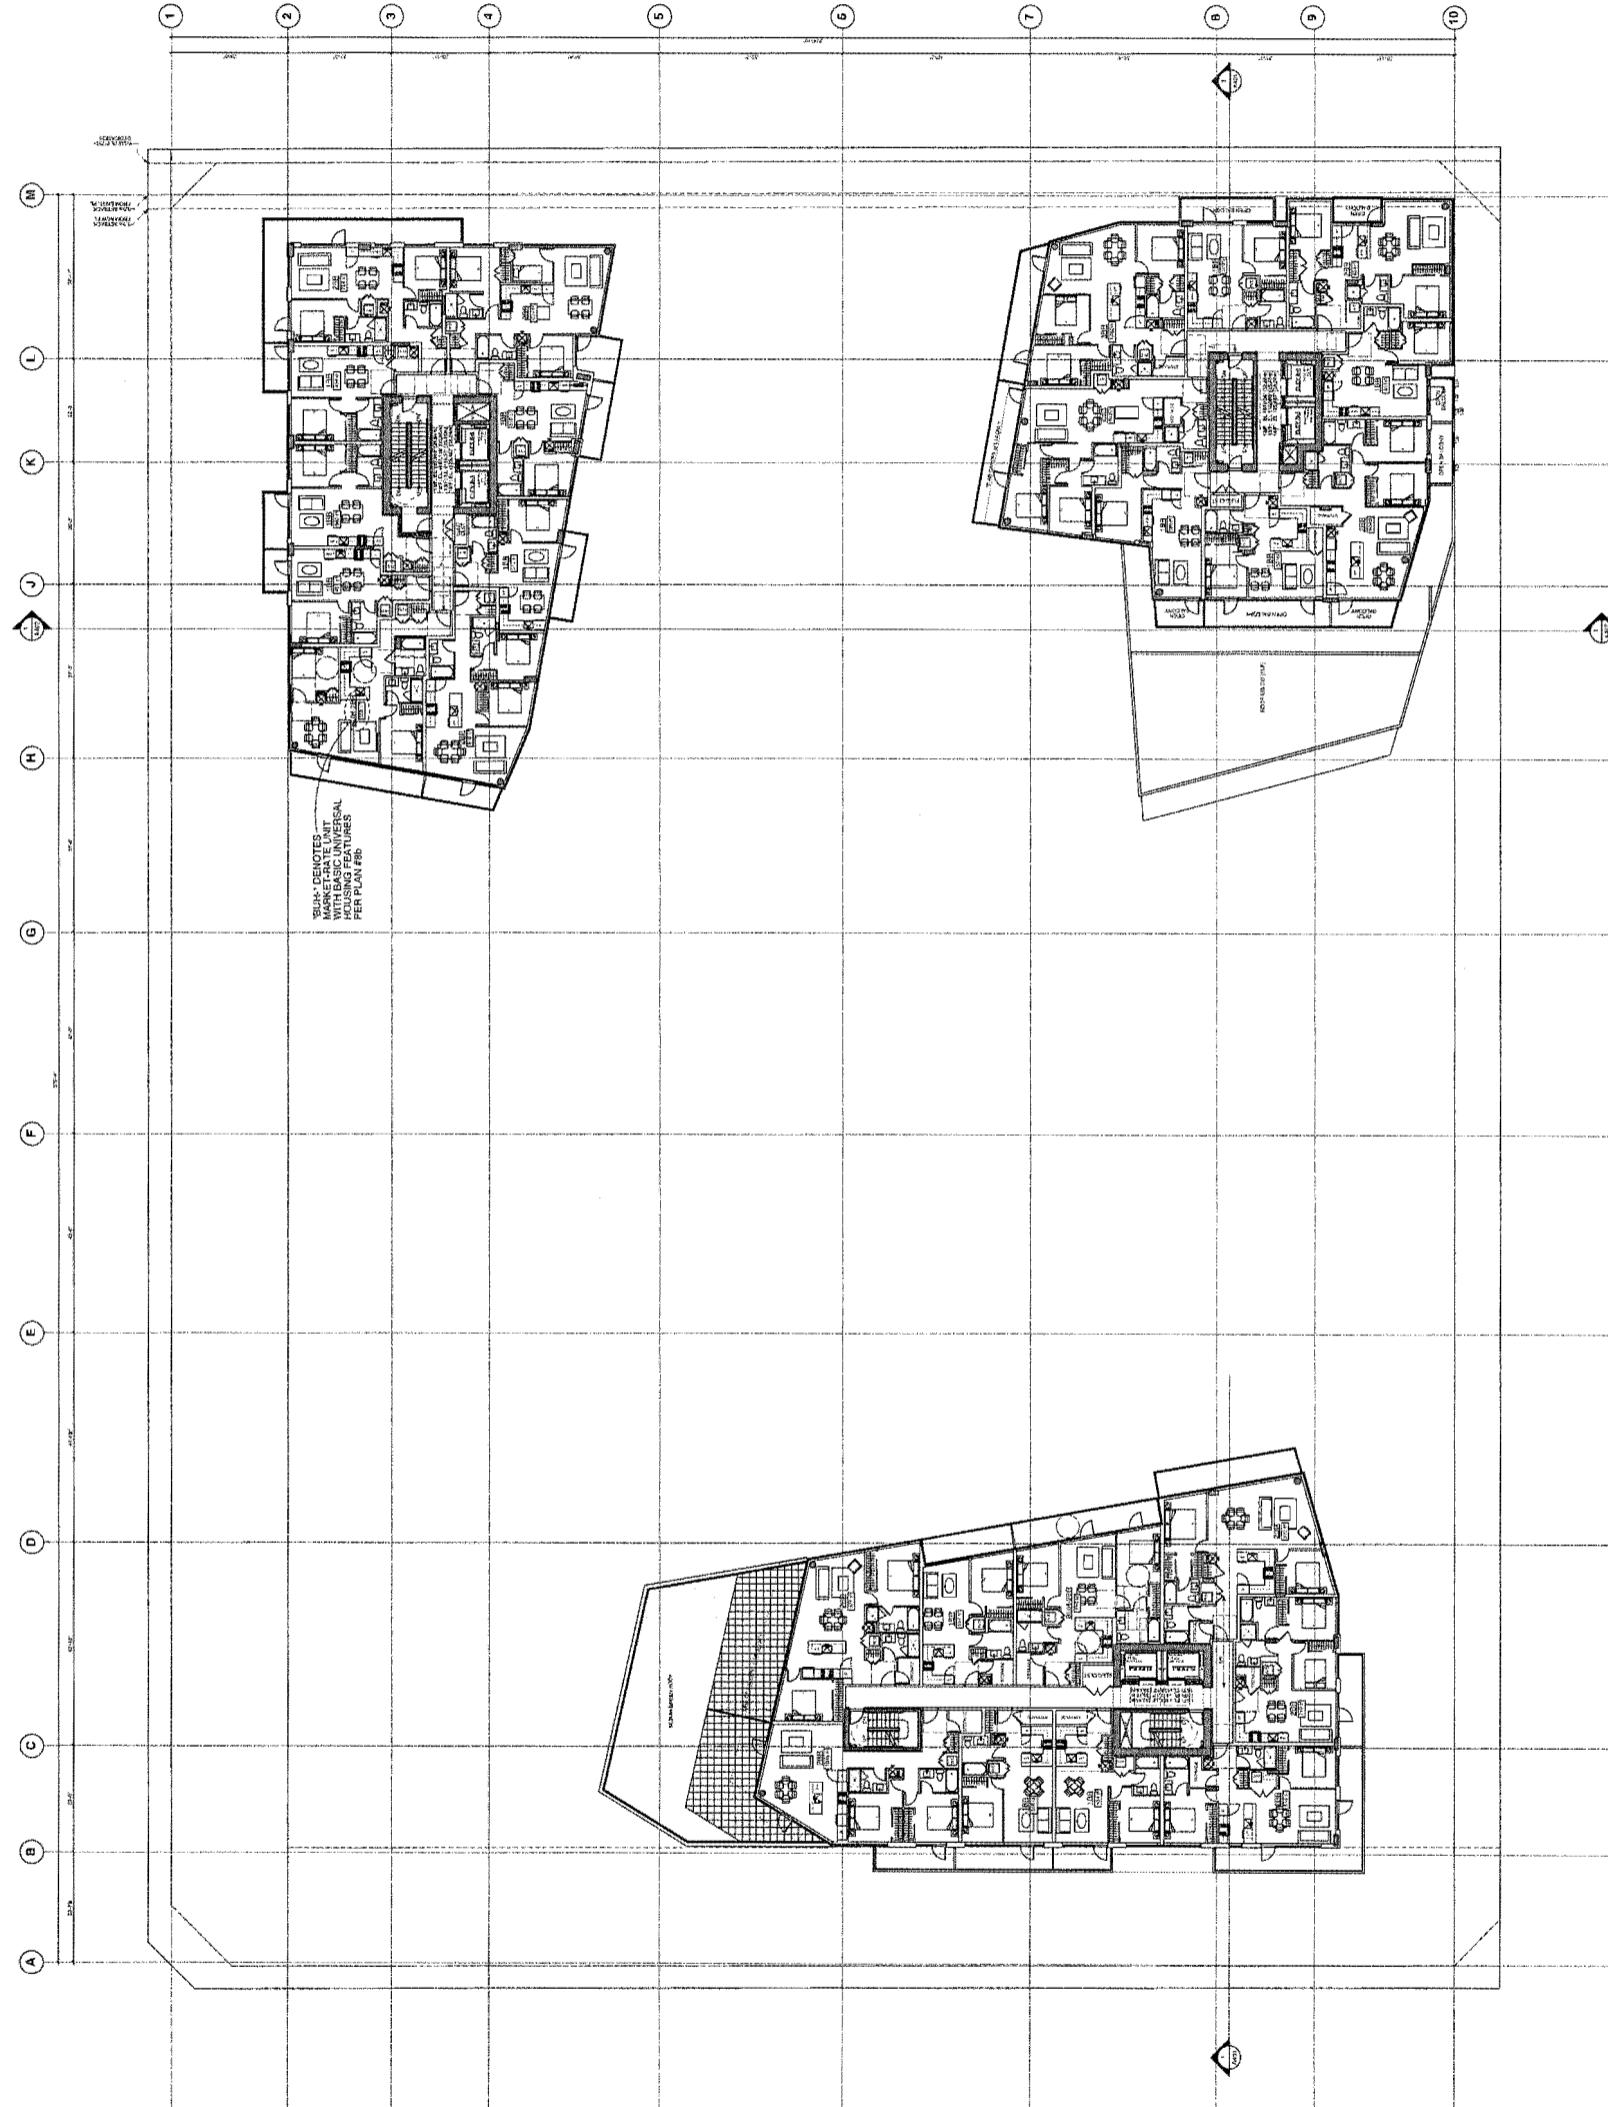


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ISSUED FOR RECORDING
RE-ISSUED FOR RECORDING

1 2016-07-07
2 2016-07-08
3 2016-07-09
4 2016-07-09
5 2016-07-09
6 2016-07-09
7 2016-07-09

JAN 11 2019



PROJECT
PARK ROAD &
BUSWELL STREET
DP 18-831623
807-809 PARK ROAD
RICHMOND, BC

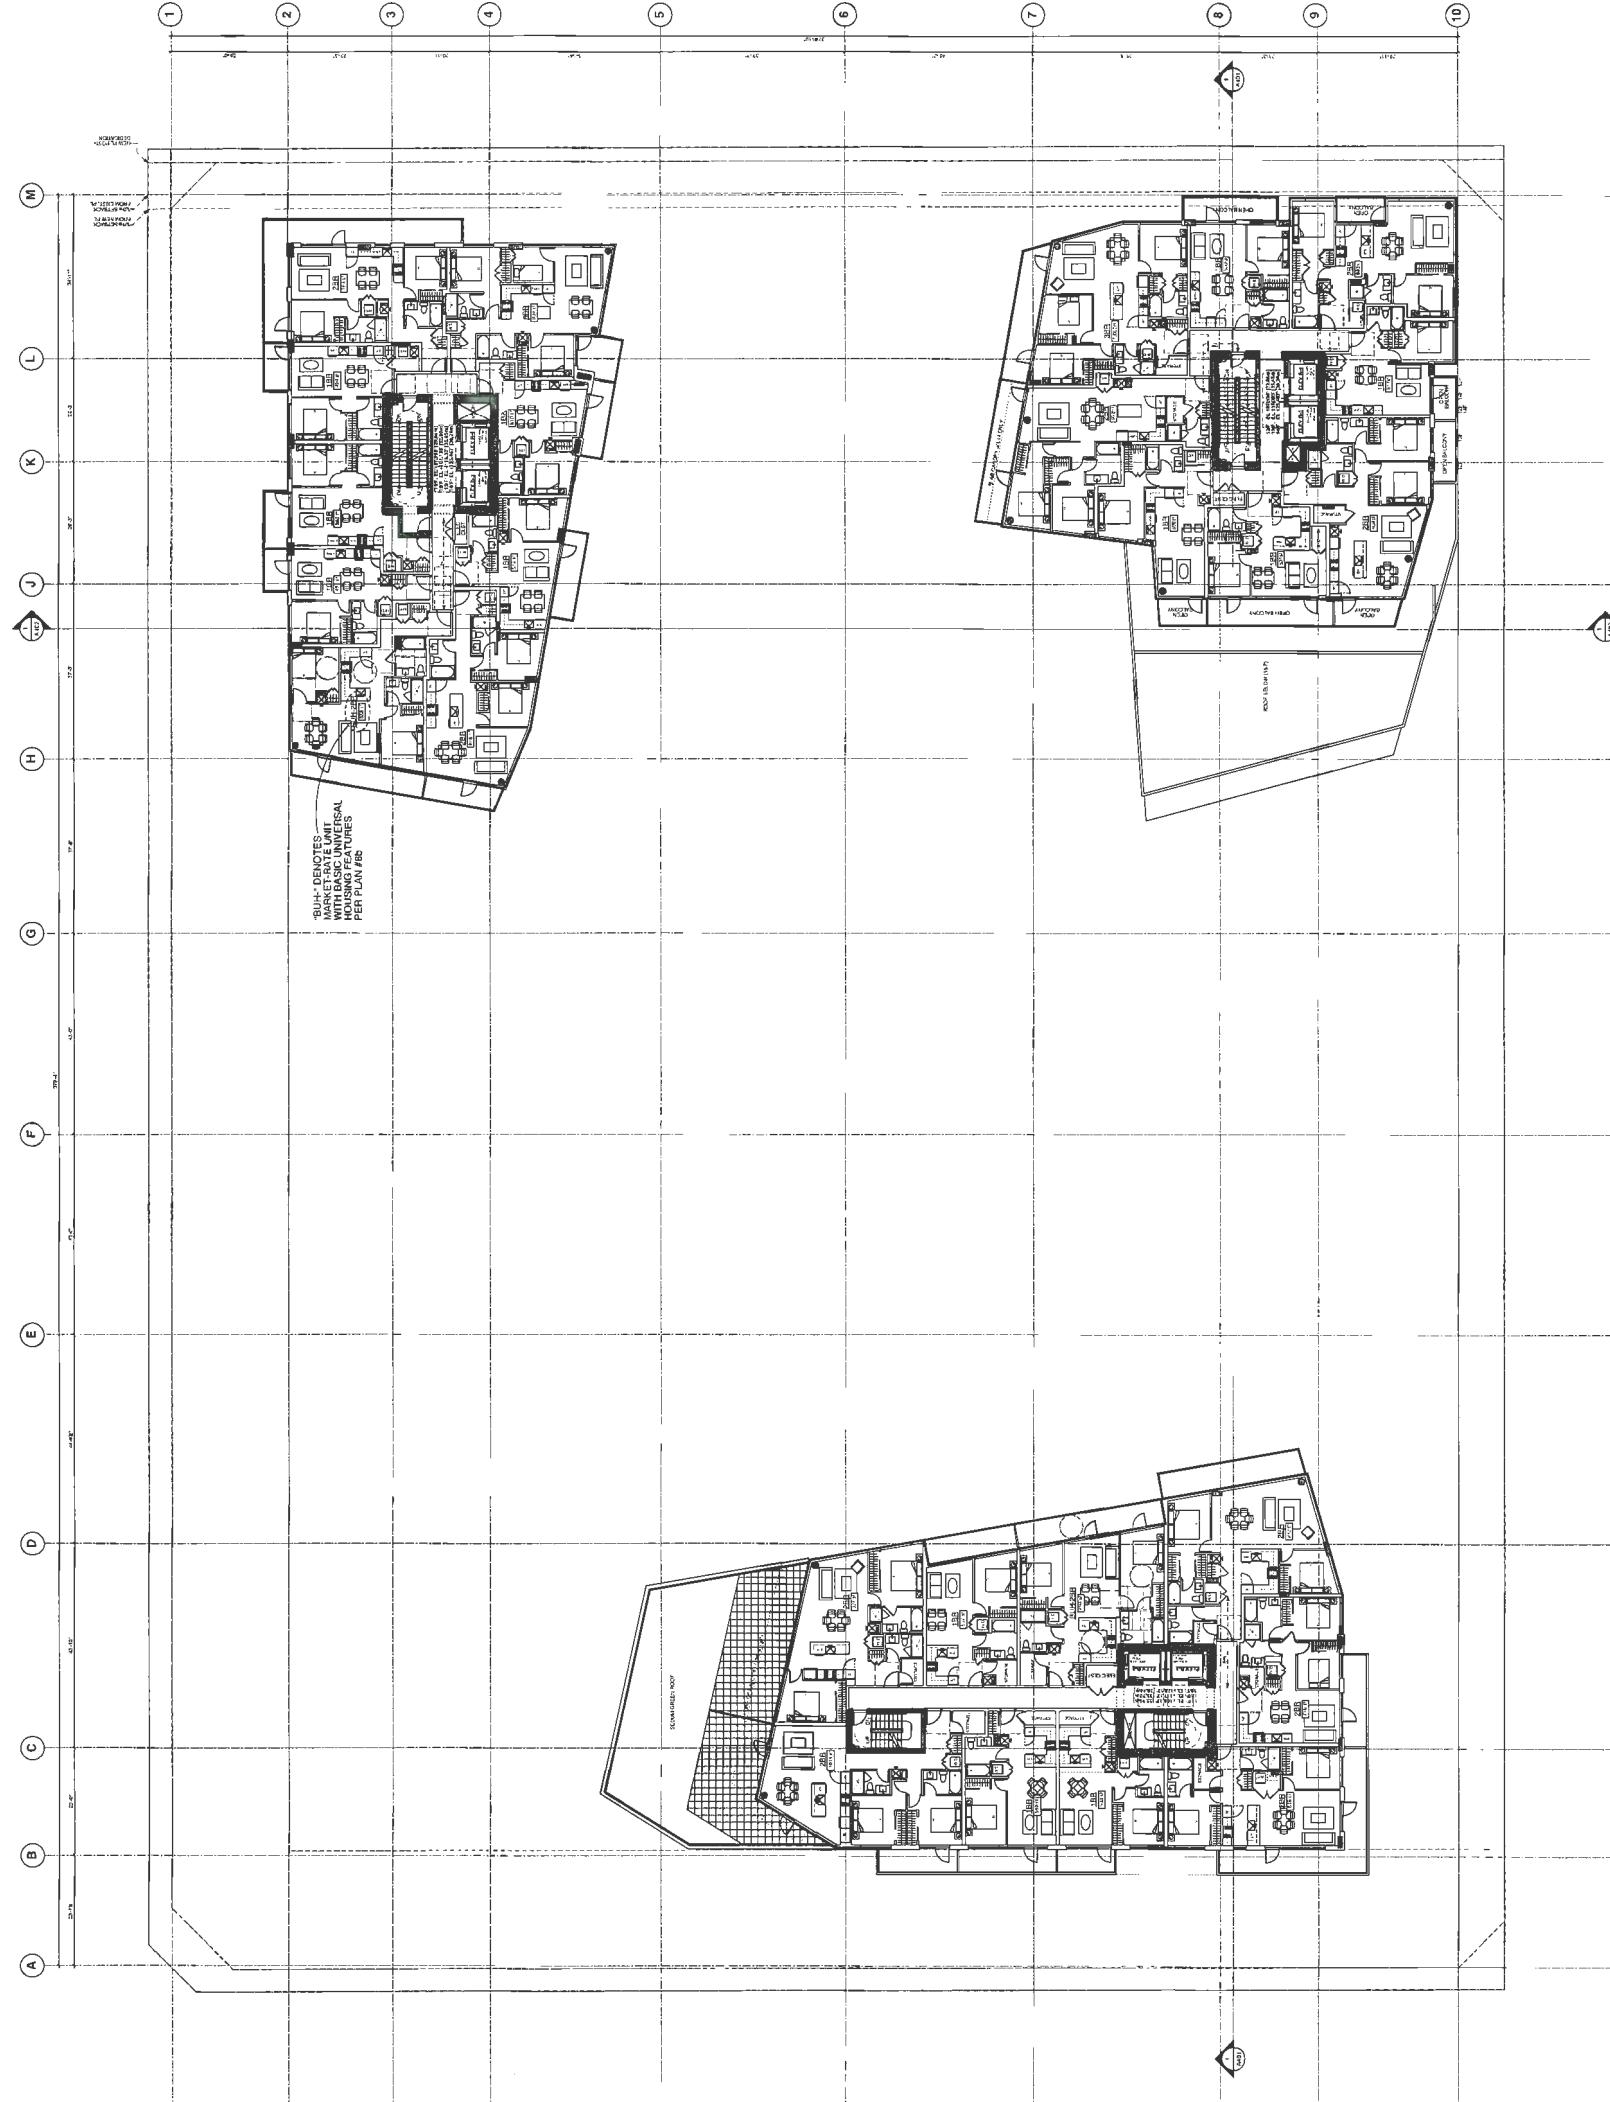TOWER A 12/F,
TOWERS B-C 13/F

PLANS 

NORTH

DRAWN BY: MIKLT

DATE: 07 DEC 2018

SCALE: 1/16" = 1'-0"

CHECKED BY: WTL

APPROVED BY: JASPER

FOR ARCHITECTURE

BY: W.T. LEUNG ARCHITECTS INC.

PRINTED BY: W.T. LEUNG ARCHITECTS INC.


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Plan #2n

DD 10 03 03 1623

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I N C.

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Vancouver, British Columbia • Canada V6Z 1K3
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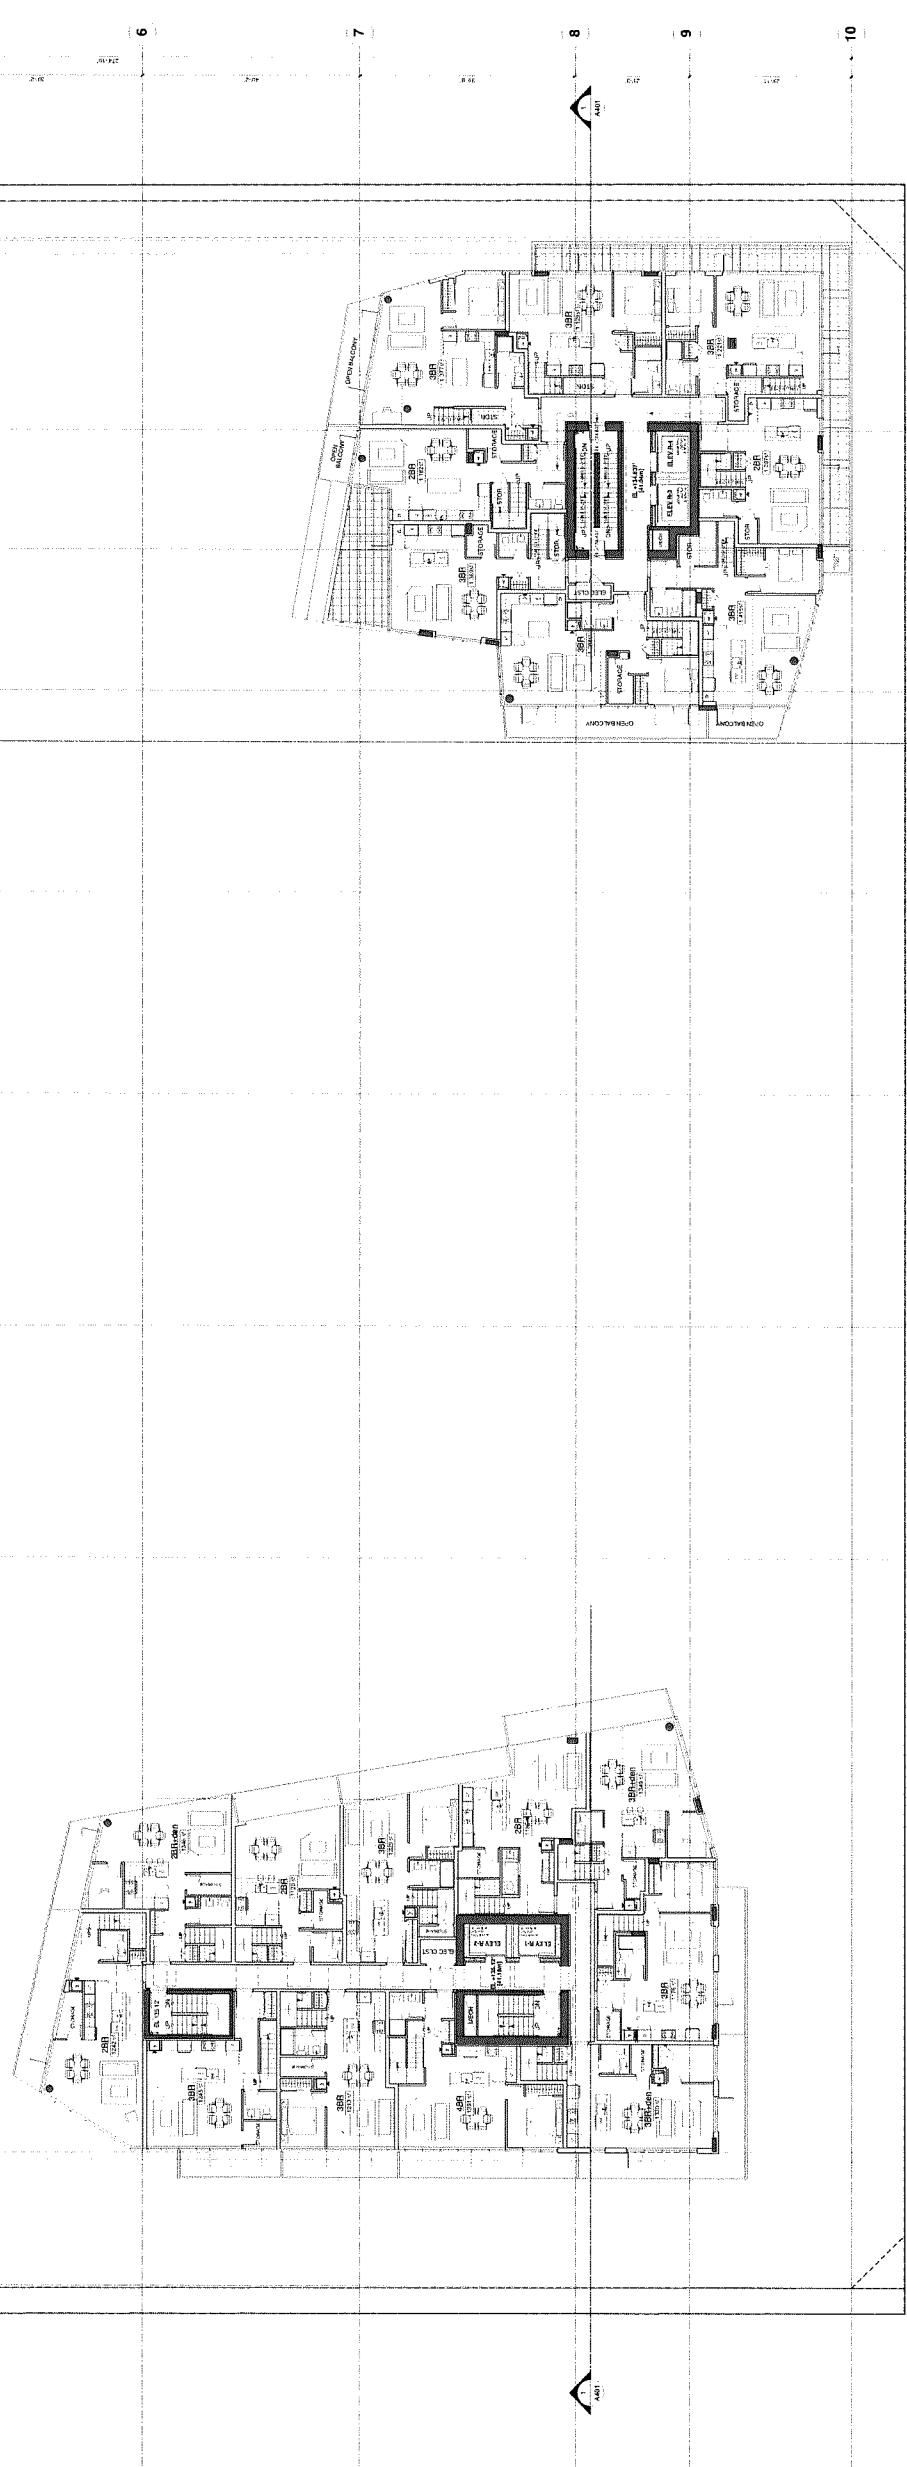
DEC 11 2018

PROJECT
**PARK ROAD &
BUSWELL STREET**
DP 18-831623
8071-8091 PARK ROAD
RICHMOND, BC

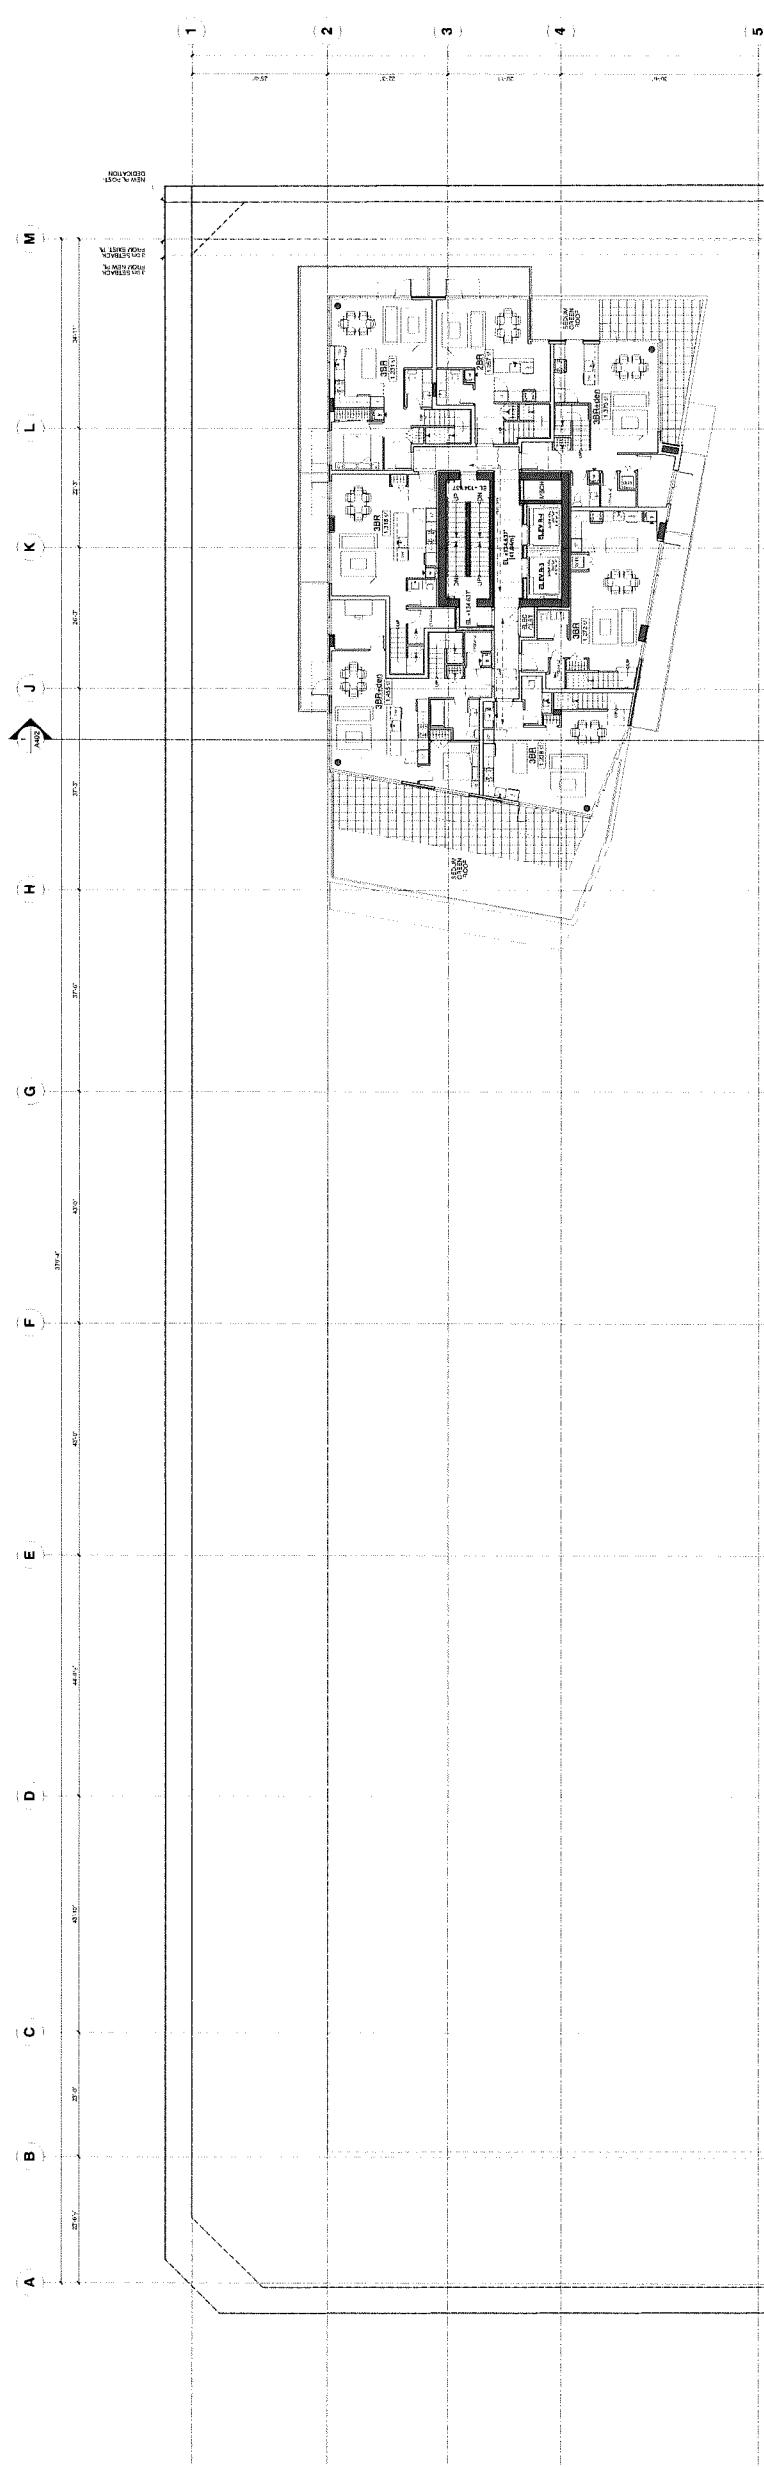**TOWER A 14/F,
TOWERS B-C 15/F**
PLANS

NORTH

JOB NO. 16-03
DRAWN MB/KT
DATE 07 DEC 2018
SCALE 1/16" = 1'-0"
CHECKED WTL
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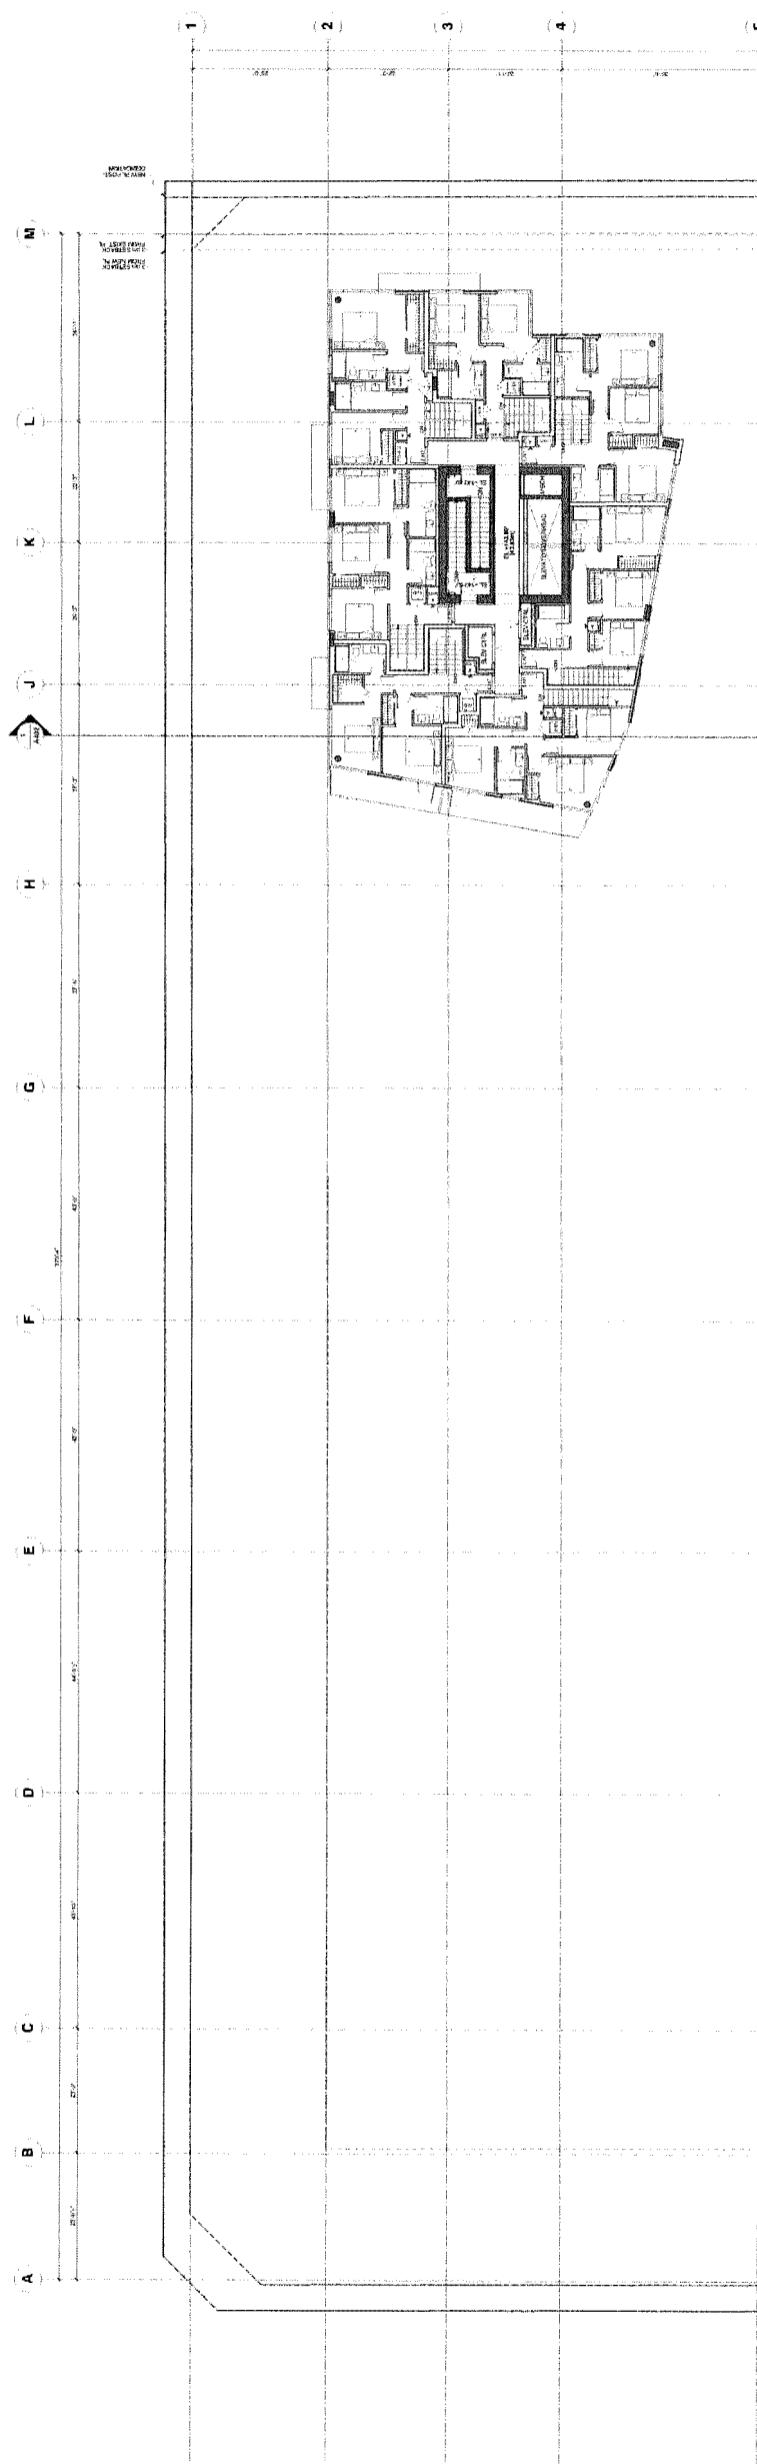


DP 18-831623

Plan #2p

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INC.

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Vancouver, British Columbia • Canada V5Z 1K3
Telephone 604 736-9711; Facsimile 604 736-7991



| REF ID/VERSION | ISSUED FOR REZONING |
|----------------|----------------------|
| 1 | 2016-01-20 |
| 2 | 2016-02-26 |
| 3 | REFUSED FOR REZONING |
| 4 | 2016-04-06 |
| 5 | REFUSED FOR REZONING |
| 6 | 2016-05-30 |
| 7 | ISSUED FOR D/P - APP |
| 8 | 2016-10-02 |
| 9 | REFUSED FOR APP |

DEC 1964

**PARK ROAD &
BUSWELL STREET
DP 18-831623**

TOWER A 15/F,
TOWERS B-C 16/F
PLANS

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MB/KT

DRAWN **DATE** **07 DEC 2018**

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COURT OF COMMON PLEAS
CLERK'S OFFICE
100 N. MARKET ST.
HARRISBURG, PA.
JULY 25, 1953

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CLERK'S OFFICE
COURT OF COMMON PLEAS
HARRISBURG, PA.


Plan #2q

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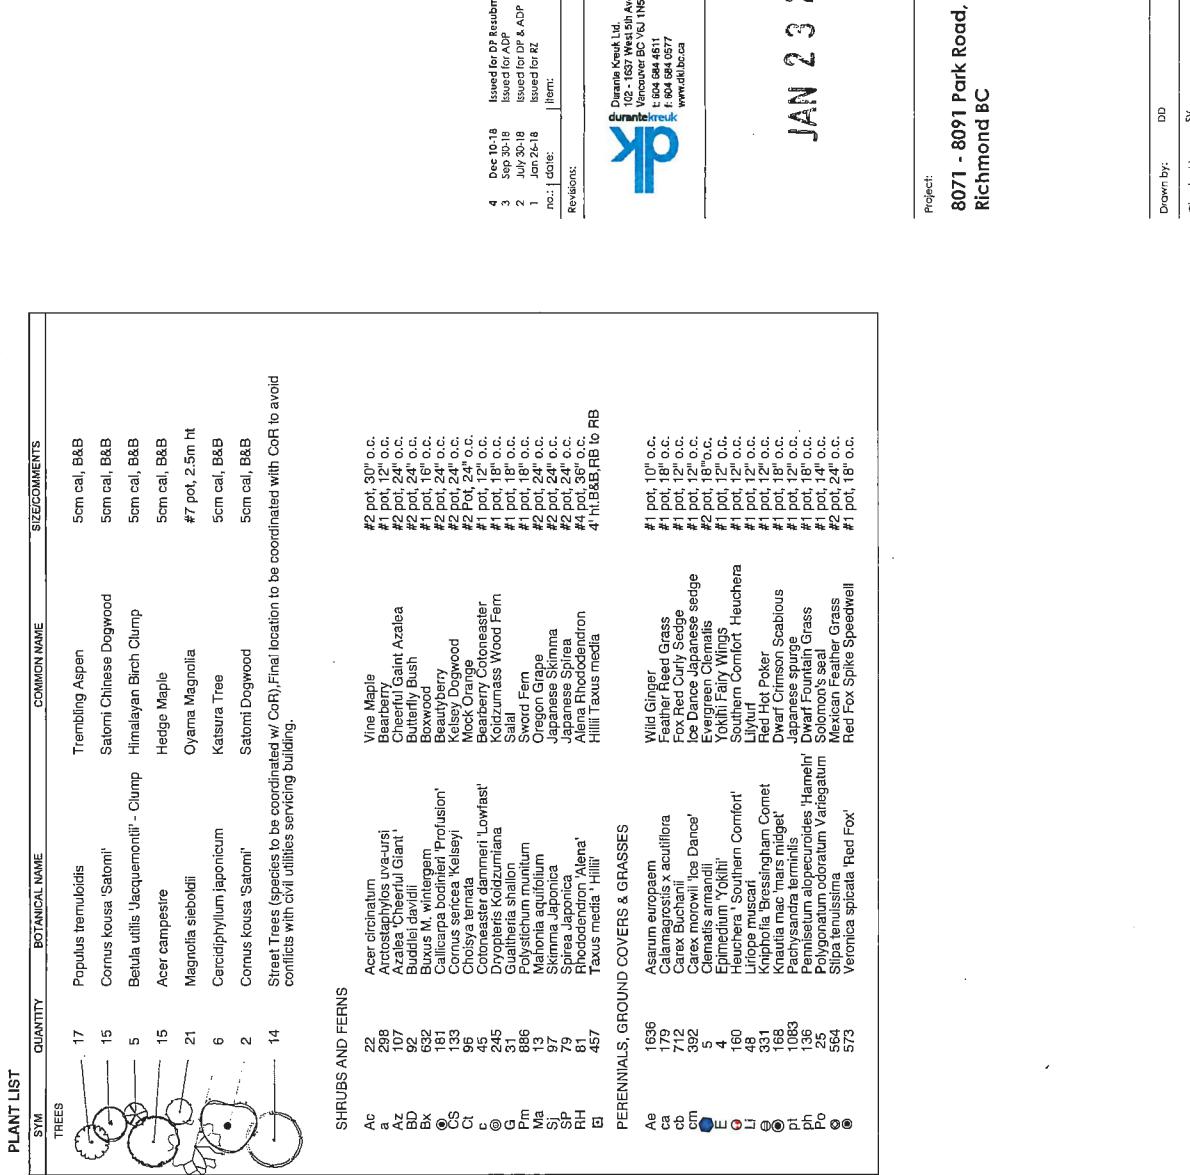
ANSWER

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| GENERAL NOTES: | |
|--|--------------------------------------|
| 1. Refer to Architectural drawings for all concrete work details including, but not limited to stairs, planter walls etc... | |
| 2. Refer to Architectural drawings for all planter wall details and elevations. | |
| 3. Hose bibs shall be provided for all patios over 100 sq. ft. and for all common amenity roof decks. Additional hose bibs shall be provided on any locations where there are garden plots. Exact and final location per Mechanical drawings. | |
| 4. Irrigation stub-up shall be provided as noted on plans. Refer to Mechanical drawings for all final locations. | |
| 5. Outdoor lighting symbols shown for reference only. Refer to Electrical drawings for all placement and connections. | |
| PUBLIC REALM NOTES: | |
| 1. All public realm design to the approval of the General Manager of Engineering. | |
| 2. This plan is not for construction of any public property facilities. A minimum of 8 weeks prior to the start of any construction on public property a landscape plan must be submitted to Engineering Services for review. No work on public property may begin until such plans receive "For Construction" approval and related permits are issued. | |
| OFFSITE PLANTING NOTES: | |
| 1. Street tree final location to the approval of CoR Engineering. | |
| 2. Final spacing, quantity and tree species to the satisfaction of the General Manager of Engineering Services. | |
| 3. Approved root border to be installed per CoR standard. | |
| GENERAL PLANTING NOTES: | |
| 1. All work shall meet or exceed the requirements as outlined in the current Edition of the B.C. Landscape Standard. | |
| 2. Plant sizes and related container classes are specified according to the current B.C. Landscape Standard Edition. For container classes #3 and smaller, plant sizes shall be as shown in the plant list and the Standard; for all other plants, both plant size and container class shall be as shown in the plant list. Specifically, when the plant list call for #5 class containers, these shall be as defined in the BCNTA (ANS) Standard. | |
| 3. Irrigation: All Soft Landscape Areas are to be irrigated with high-efficiency automatic irrigation system, including rain sensor, to ILAC Standards. | |
| 5. All irrigation valve boxes equipped with quick-couplers. | |
| 6. Provide irrigation stub outs in locations shown on plan. 50 gpm at 50 psi. Irrigation to be Design / Build Process. See Specifications. | |
| 7. Planting Pallets include many bird friendly native species, including evergreen and perennials creating year round interest, and adding habitat value. | |
| DRAWING LIST | |
| 00 | Landscape Rationale |
| Legend#3 | Precedent Images |
| Plan #3o | Overall Landscape Plan, Ground Level |
| Plan #3b | NW Planting Plan, Ground Level |
| Plan #3c | SW Planting Plan, Ground Level |
| Plan #3d | NE Planting Plan, Ground Level |
| Plan #3e | SE Planting Plan, Ground Level |
| Plan #3g | Level 2 Planting Plan |
| Plan #3h | Level 3 Planting plan |
| Plan #3j | Overall Landscape Plan, Level 4 |
| Plan #3k | NW Planting Plan, Level 4 |
| Plan #3l | SE Planting Plan, Level 4 |
| Sections #3m | Landscape Sections |
| Sections #3n | Landscape Sections |
| Sections #3o | Landscape Sections/Details |
| Sections #3p | Landscape Sections/Details |
| Sections #3q | Landscape Sections/Details |



| PLANT LIST | | SYN | QUANTITY | BOTANICAL NAME | COMMON NAME | SIZE/COMMENTS | | | |
|-------------------------------------|---|---|----------|--|------------------------|-----------------|--|--|--|
| TREES | | | | | | | | | |
| (P) | CIP Concrete (offsite) | 10mm thick. Saw cut as per plan. Colour: Natural | 17 | Populus tremuloides | Trembling Aspen | 5cm cal, B&B | | | |
| (P) | CIP Concrete (offsite) | 10mm thick. Saw cut as per plan. Colour: Charcoal | 15 | Cornus kousa 'Satomi' | Satomi Chinese Dogwood | 5cm cal, B&B | | | |
| (P) | CIP Concrete | 10mm thick. Saw cut as per plan. Colour: Natural | 5 | Betula utilis 'Jacquemontii' - Clump | Himalayan Birch Clump | 5cm cal, B&B | | | |
| (P) | CIP Concrete | 10mm thick. Saw cut as per plan. Colour: Charcoal | 15 | Acer campestre | Hedge Maple | 5cm cal, B&B | | | |
| (P) | CIP Concrete | 10mm thick. Saw cut as per plan. Colour: Charcoal | 21 | Magnolia sieboldii | Oyama Magnolia | #7 pot, 2.5m ht | | | |
| (P) | Porcelain pavers, 900 x300 x 5mm, mortared on concrete. | | 6 | Cercidiphyllum japonicum | Katsura Tree | 5cm cal, B&B | | | |
| (P) | Interlocking Paving Stones 600x100 x 100mm. Colour: Charcoal | | 2 | Cornus kousa 'Satomi' | Satomi Dogwood | 5cm cal, B&B | | | |
| (P) | Interlocking Paving Stones 600x100 x 100mm. Colour: Granite | | 14 | Street Trees (species to be coordinated w/ CoR), Final location to be coordinated with CoR to avoid conflicts with civil utilities servicing building. | | | | | |
| <hr/> | | | | | | | | | |
| SHRUBS AND FERNS | | | | | | | | | |
| (Ac) | Acer circinatum | | | | | | | | |
| (Az) | Arctostaphylos uva-ursi | | | | | | | | |
| (Bz) | Azalea 'Cheerful Giant' | | | | | | | | |
| (Bx) | Buddleia davidii | | | | | | | | |
| (C) | Buxus M. wintergem | | | | | | | | |
| (CS) | Callicarpa bodinieri 'Profusion' | | | | | | | | |
| (Cr) | Comus sericea 'Kelseyi' | | | | | | | | |
| (Ct) | Chrysanthemum 'Termina' | | | | | | | | |
| (C) | Cotoneaster dammeri 'Lowfast' | | | | | | | | |
| (D) | Dyosurus Koldzumiana | | | | | | | | |
| (G) | Gaultheria shallon | | | | | | | | |
| (G) | Polystichum munitum | | | | | | | | |
| (Ma) | Mahonia aquifolium | | | | | | | | |
| (Sp) | Skimmia Japonica | | | | | | | | |
| (RH) | Spiraea Japonica | | | | | | | | |
| (H) | Rubus spectabilis 'Alena' | | | | | | | | |
| (T) | Taxus media 'Hillii' | | | | | | | | |
| <hr/> | | | | | | | | | |
| PERENNIALS, GROUND COVERS & GRASSES | | | | | | | | | |
| (Ae) | Asarum europaeum | | | | | | | | |
| (ca) | Calochortus x acutiflora | | | | | | | | |
| (cb) | Carex buchanani | | | | | | | | |
| (cm) | Carex morrowii 'Ice Dance' | | | | | | | | |
| (E) | Clematis armandii | | | | | | | | |
| (E) | Epimedium 'Tokill' | | | | | | | | |
| (L) | Heuchera 'Southern Comfort' | | | | | | | | |
| (Li) | Liriope muscari | | | | | | | | |
| (L) | Kniphofia 'Bressingham Comet' | | | | | | | | |
| (O) | Knautia mac 'mars midget' | | | | | | | | |
| (O) | Pachysandra terminalis | | | | | | | | |
| (P) | Pennisetum aequalis 'Henne' | | | | | | | | |
| (P) | Polygonatum odoratum 'Variegatum' | | | | | | | | |
| (Po) | Silpha tenuissima | | | | | | | | |
| (S) | Veronica spicata 'Red Fox' | | | | | | | | |
| (S) | Mexican Feather Grass | | | | | | | | |
| (S) | Red Fox Spike Speedwell | | | | | | | | |
| <hr/> | | | | | | | | | |
| WALLS, FENCING & HARDSCAPE | | | | | | | | | |
| (D) | Patio Entry Gate | | | | | | | | |
| (B) | Bike Racks | | | | | | | | |
| (B) | Beta Bike Racks | | | | | | | | |
| (W) | Wood Bench | | | | | | | | |
| (W) | Wall mount exterior lighting | | | | | | | | |
| (S) | Scrapers Seating block | | | | | | | | |
| (S) | Outdoor Fire Place | | | | | | | | |
| (M) | Movable outdoor furniture | | | | | | | | |
| (W) | Wall mounted lighting | | | | | | | | |
| <hr/> | | | | | | | | | |
| PLAY EQUIPMENT | | | | | | | | | |
| (P) | Play Equipment NR2012 (On Slop) | | | | | | | | |
| (P) | Stanch: XX11 Contact: Reclec Industries (604) 940 0067 Jeff Kubay | | | | | | | | |
| (P) | Kids Play Equipment - Spring Chair | | | | | | | | |
| (P) | Balance logs | | | | | | | | |
| (P) | Discovery Path-Stepping stones with Wood Frame tunnel | | | | | | | | |
| <hr/> | | | | | | | | | |

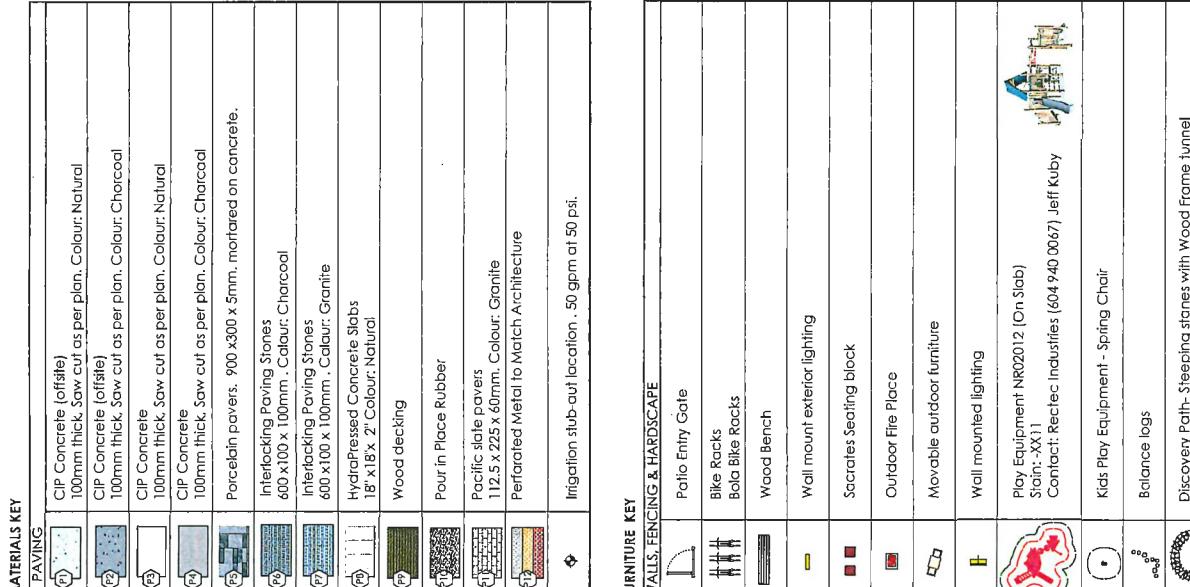

Project No.:
17054

Date: September 2018

Scale: NTS

Drawing Title:
Landscape Legend

Legend #3

DP 18-021623

Sheet No.: 17054

Overall Landscape plan
Ground level

Drawing title:

Project No.:

Date:

Scale:

Checked by:

Drawn by:


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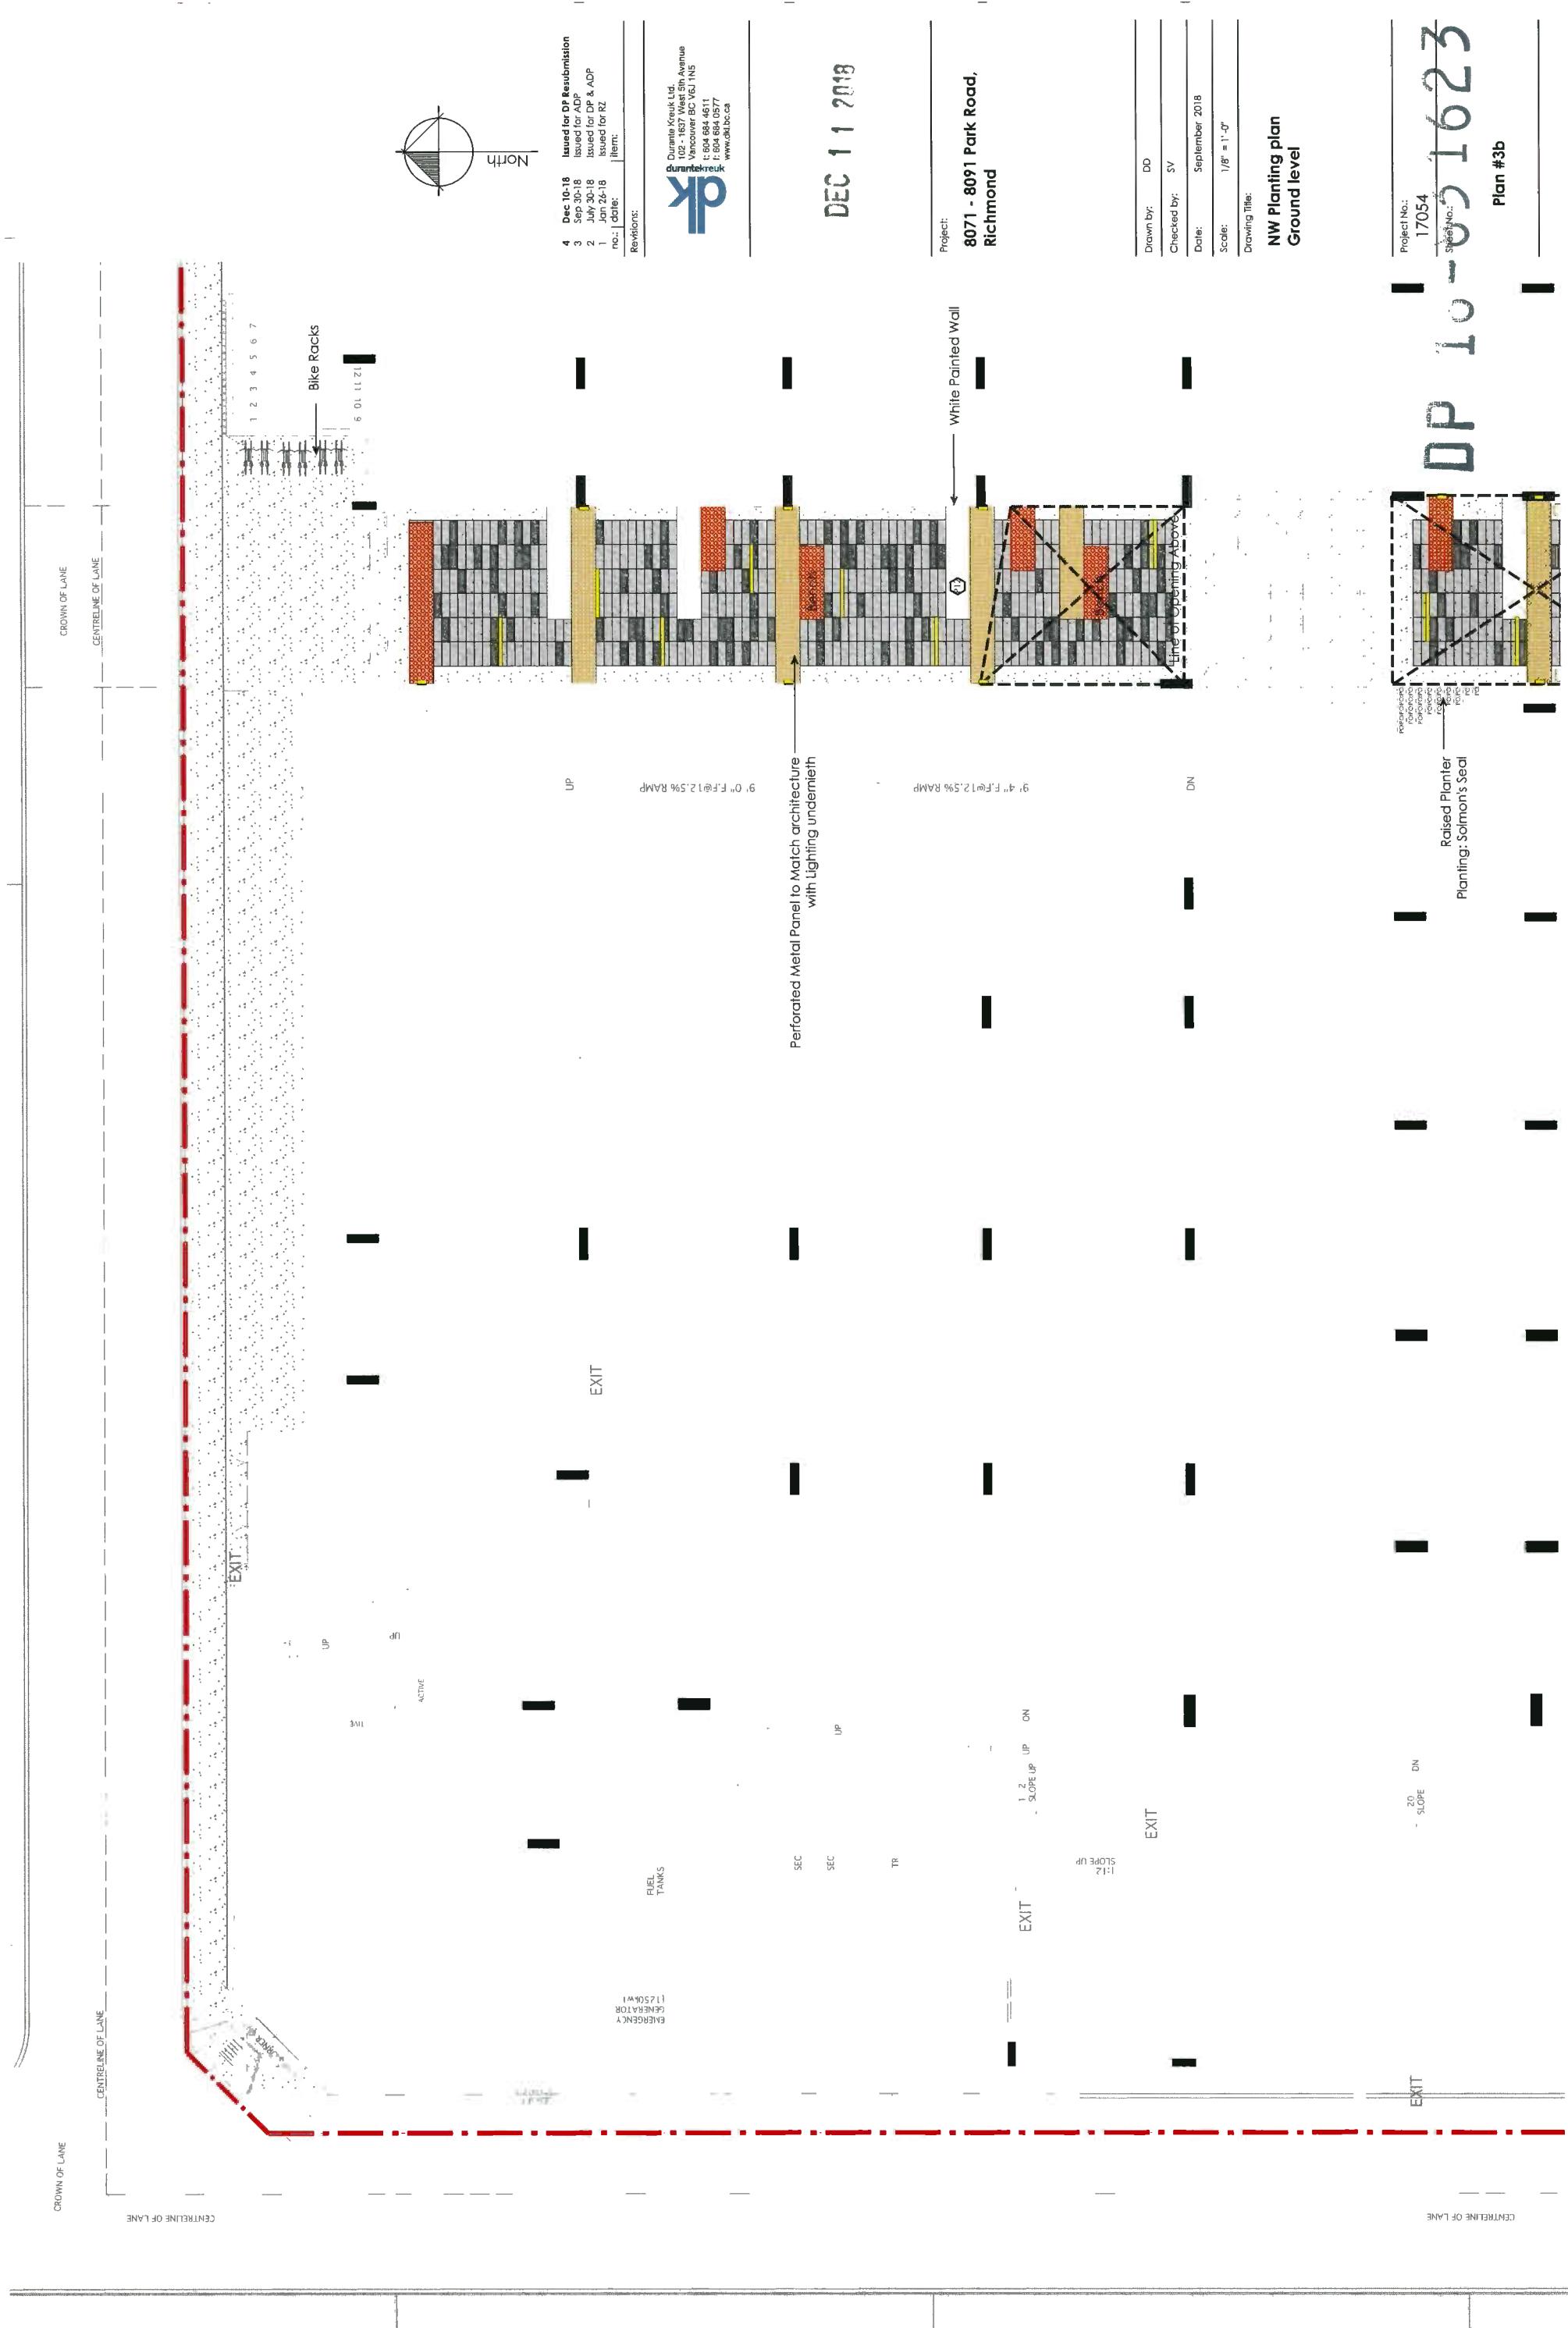
Project: 8071 - 8091 Park Road,
Richmond BC


DEC 11 2018


Durand Creek Ltd.
102 - 1517 West 5th Avenue
Vancouver BC V6J 1N5
604 684 4611
604 684 0577
www.dckl.ca

Issued for DP Resubmission
4 Dec 10-18
3 Sep 30-18
2 July 30-18
1 Jan 26-18
Item: date:
Revisions:



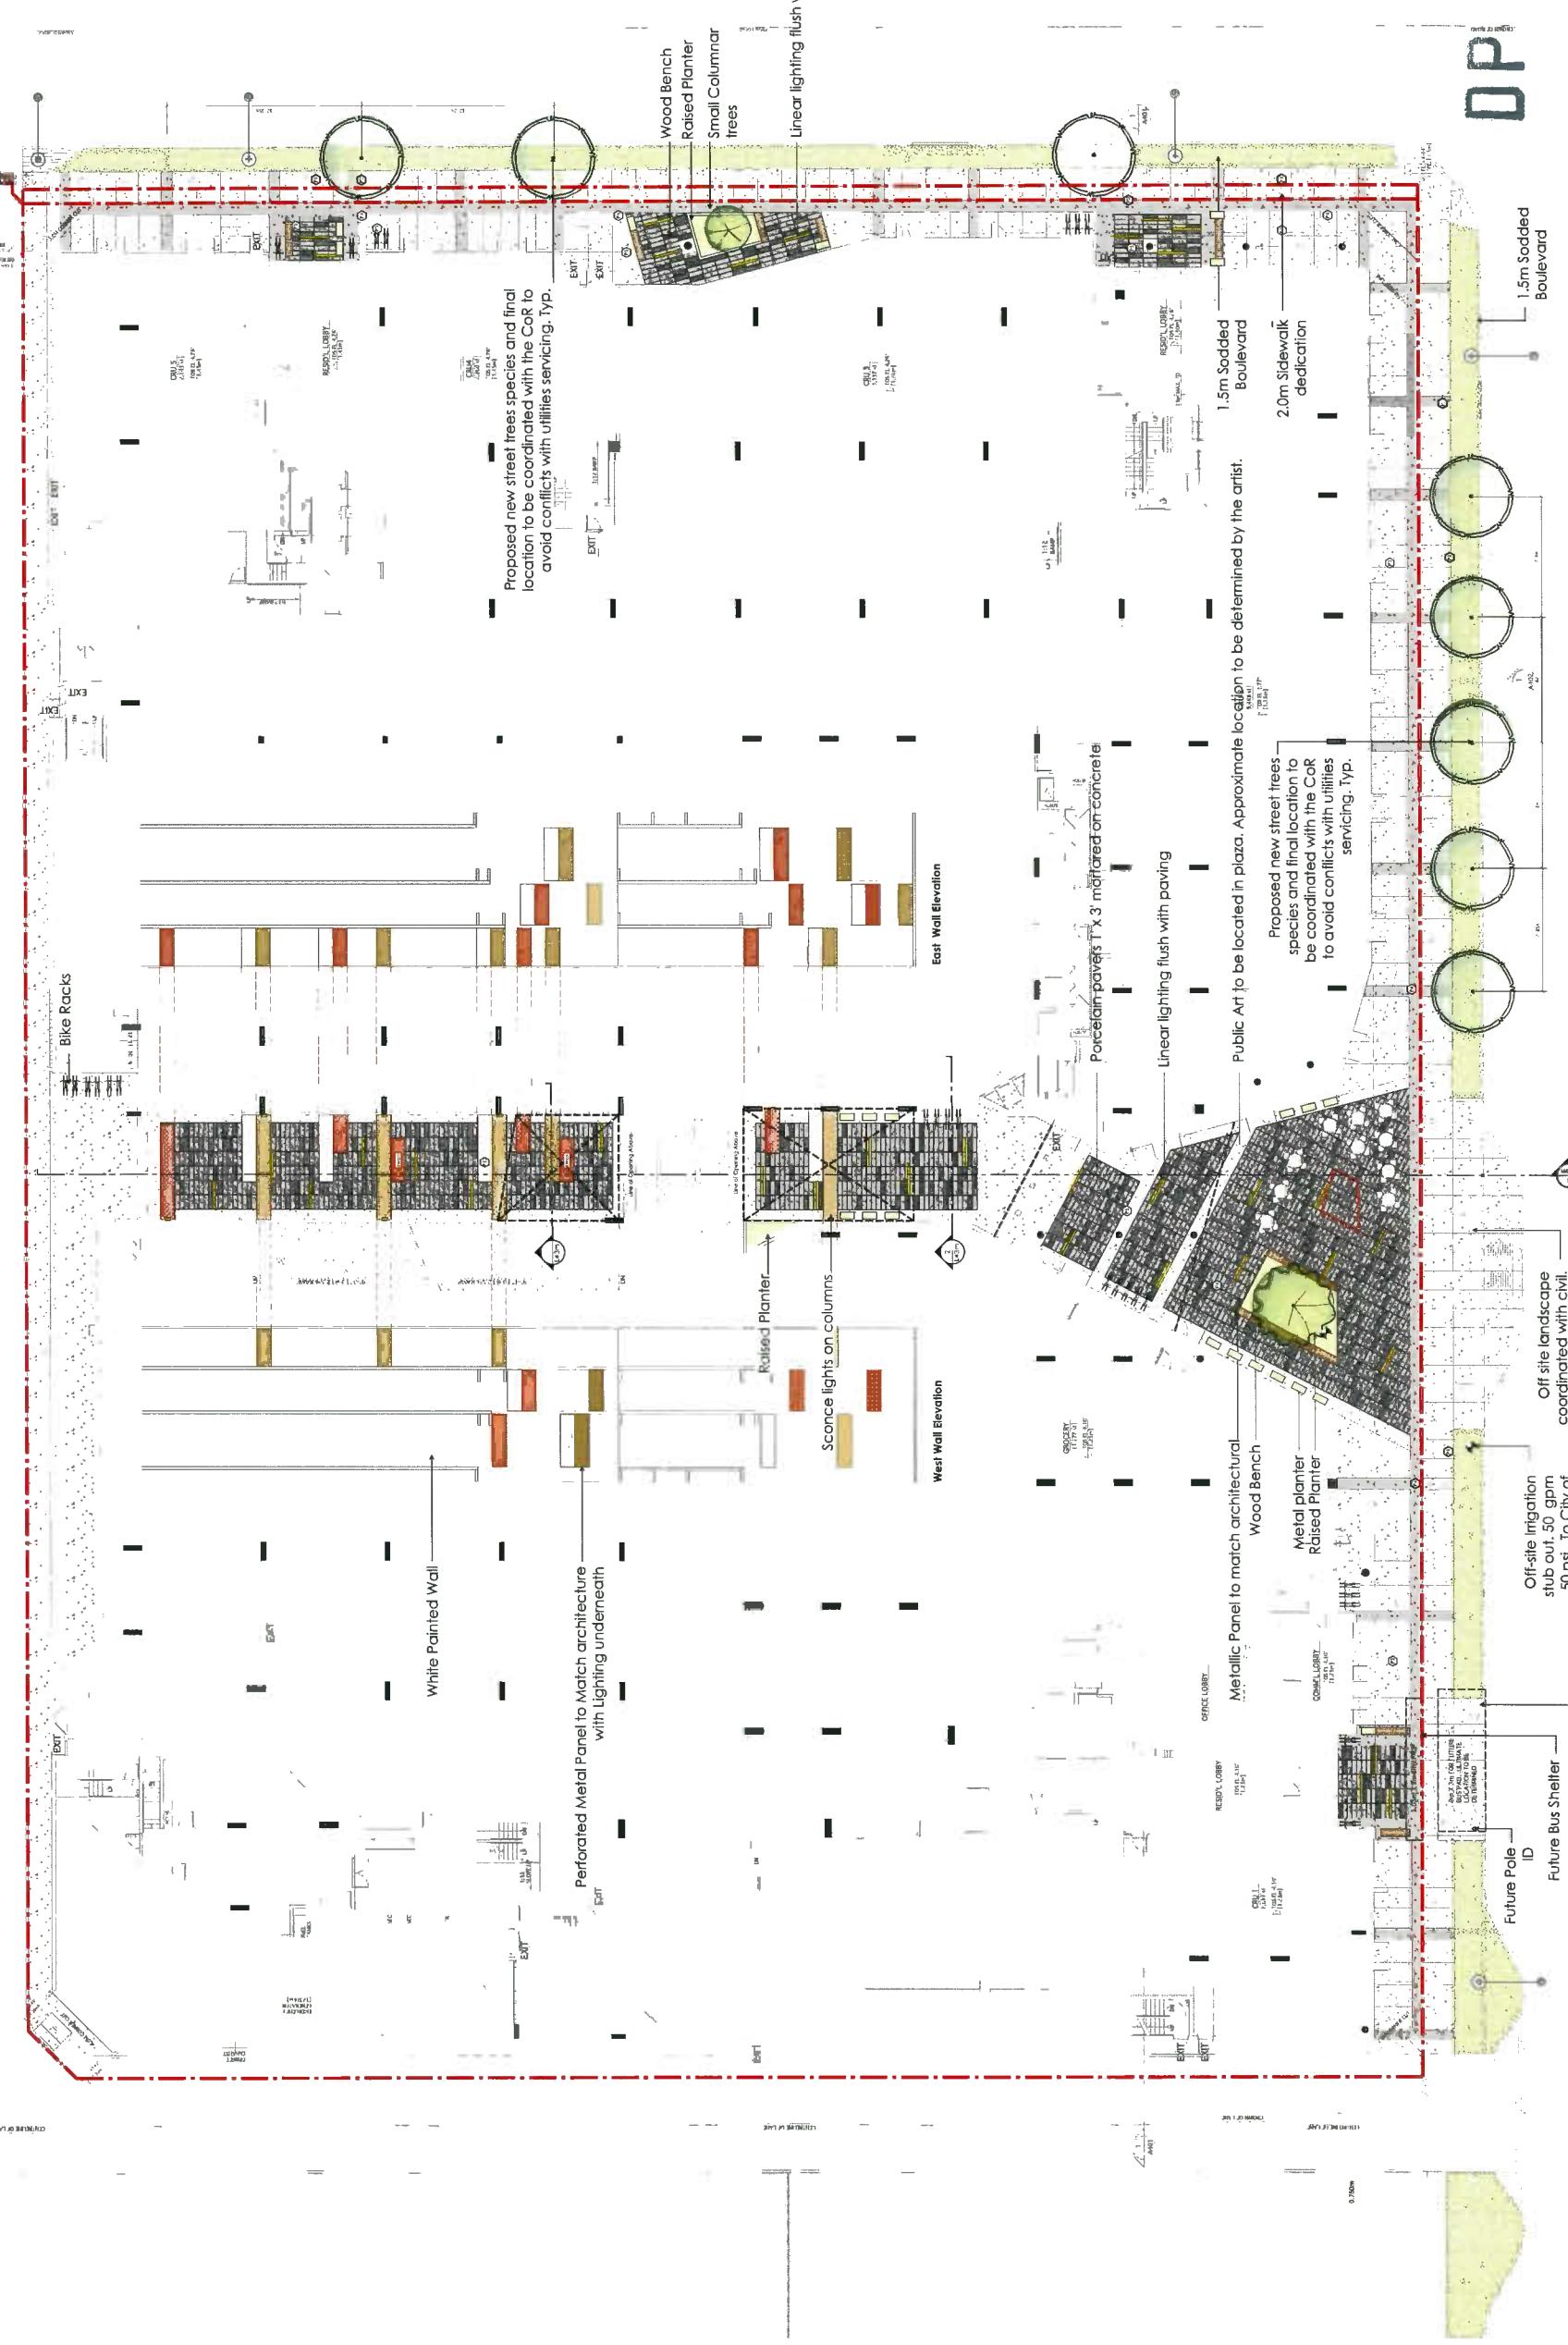

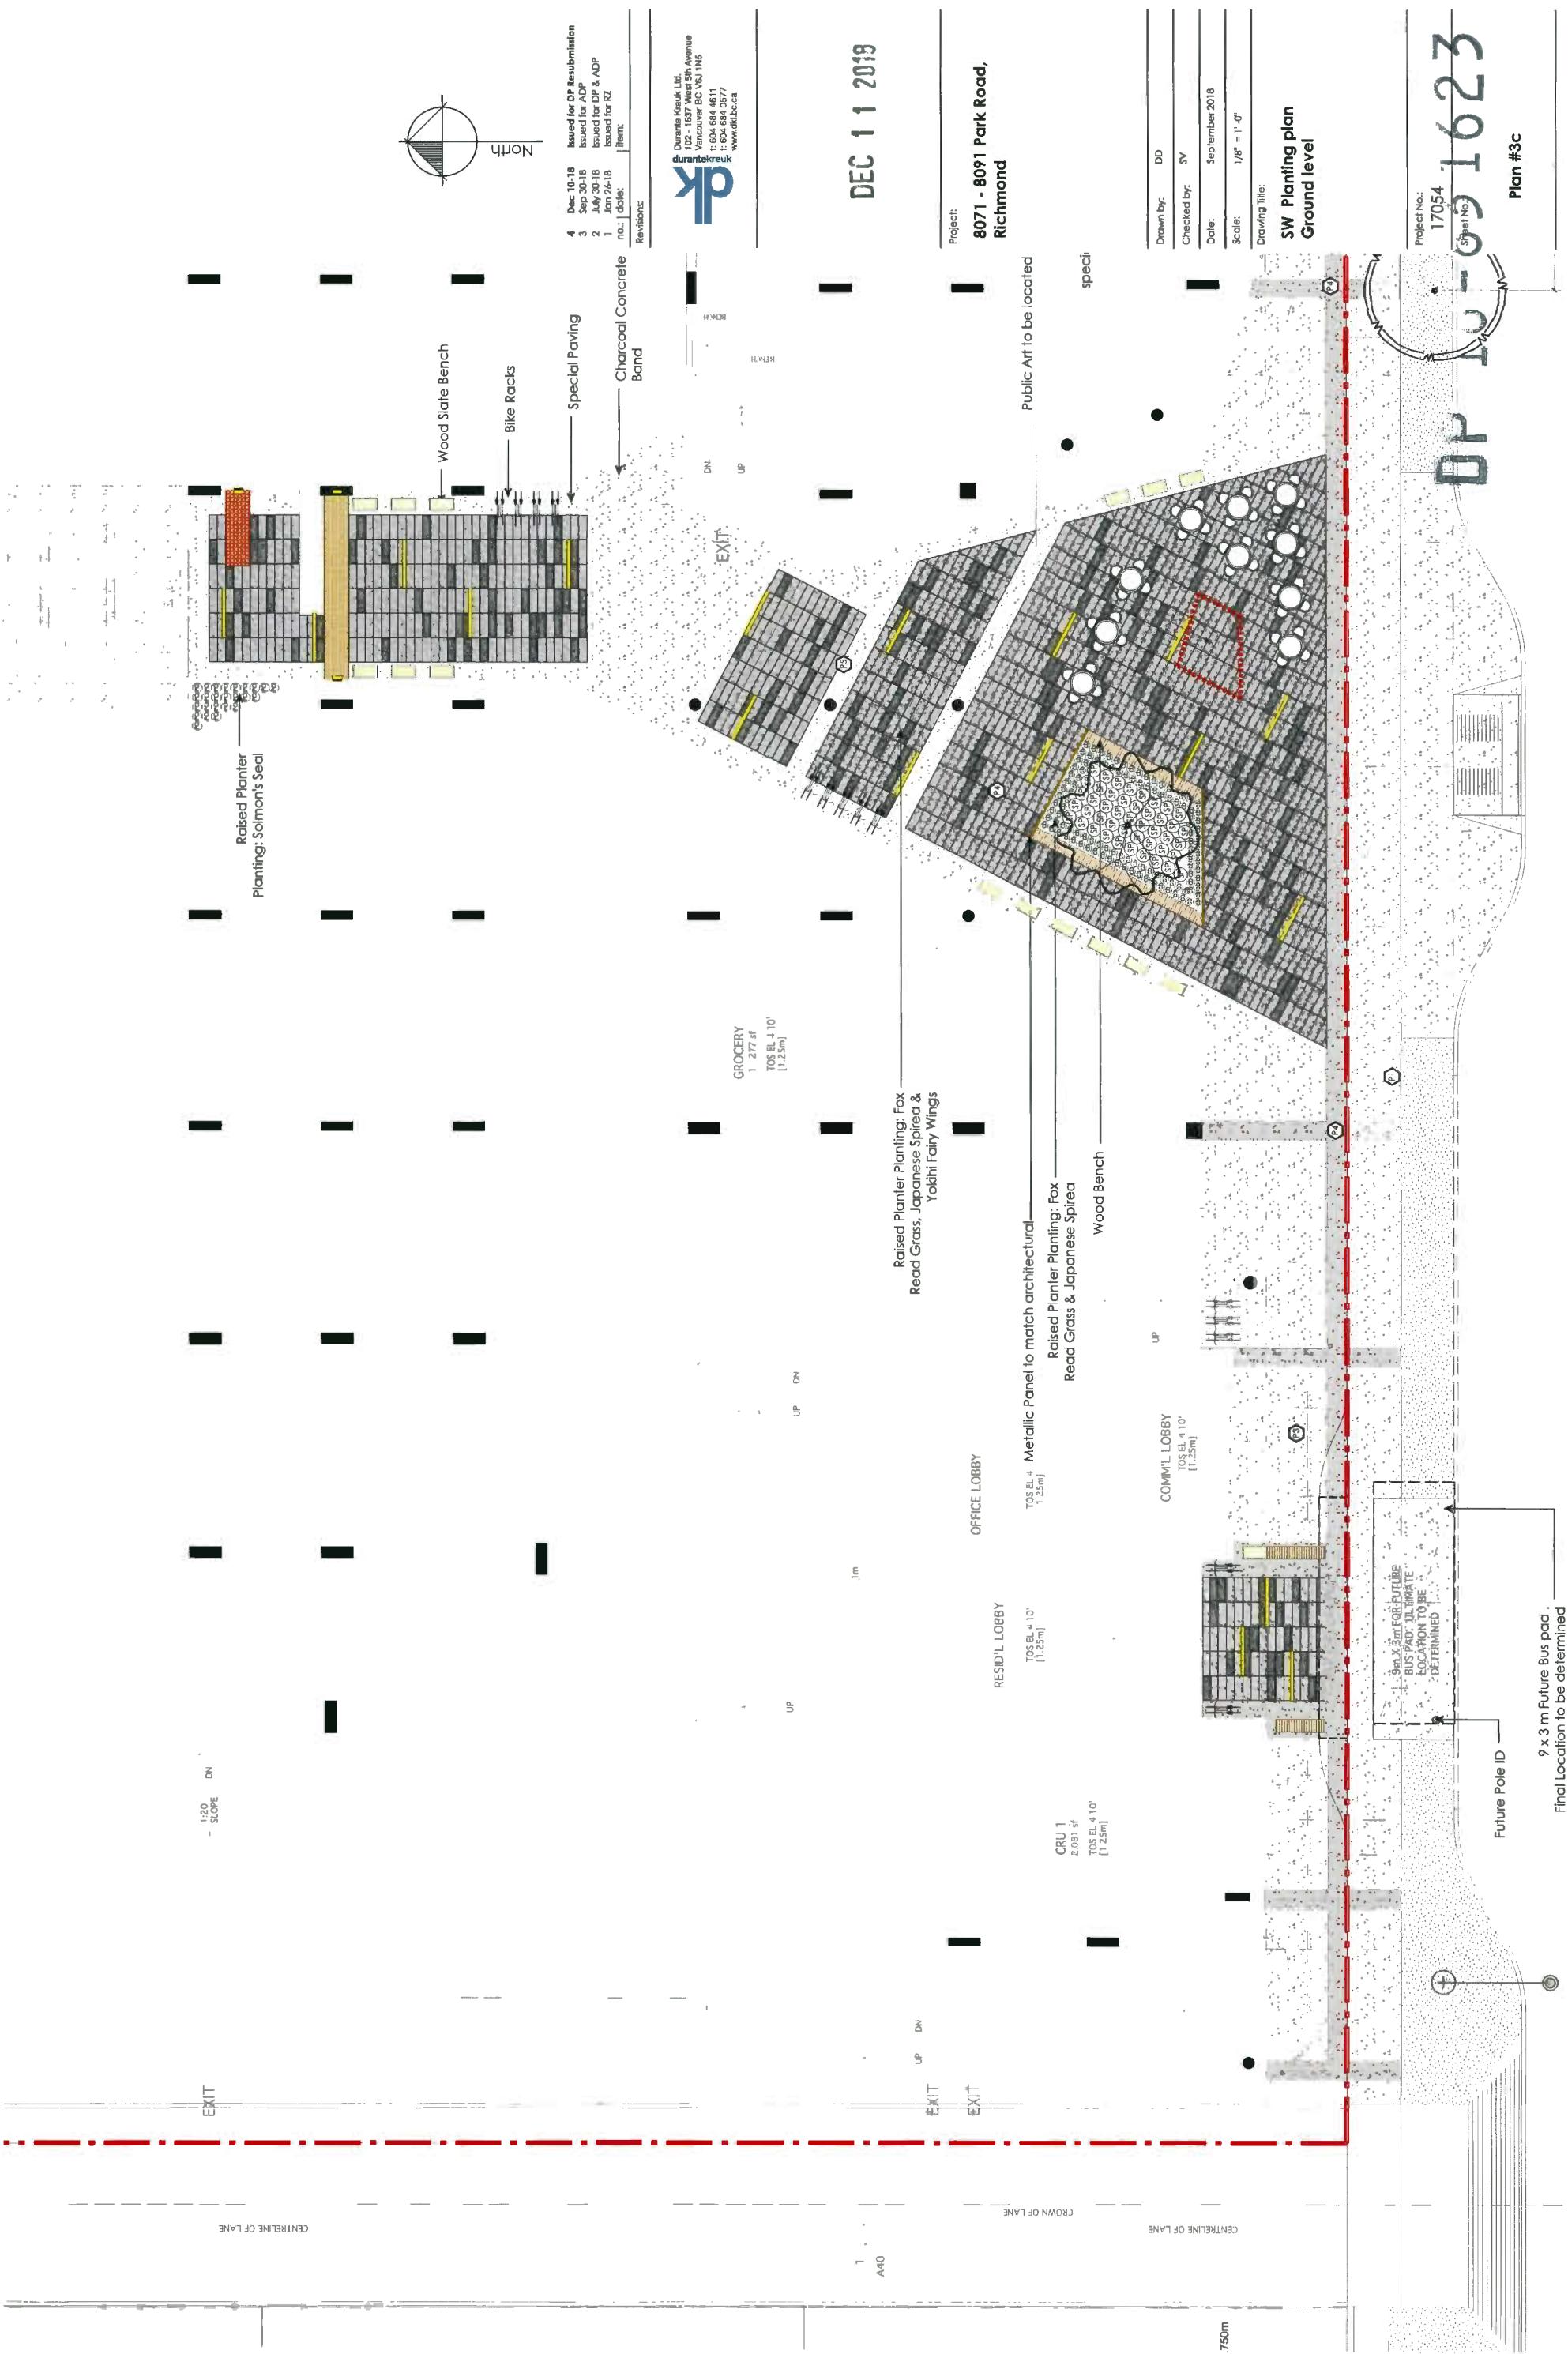


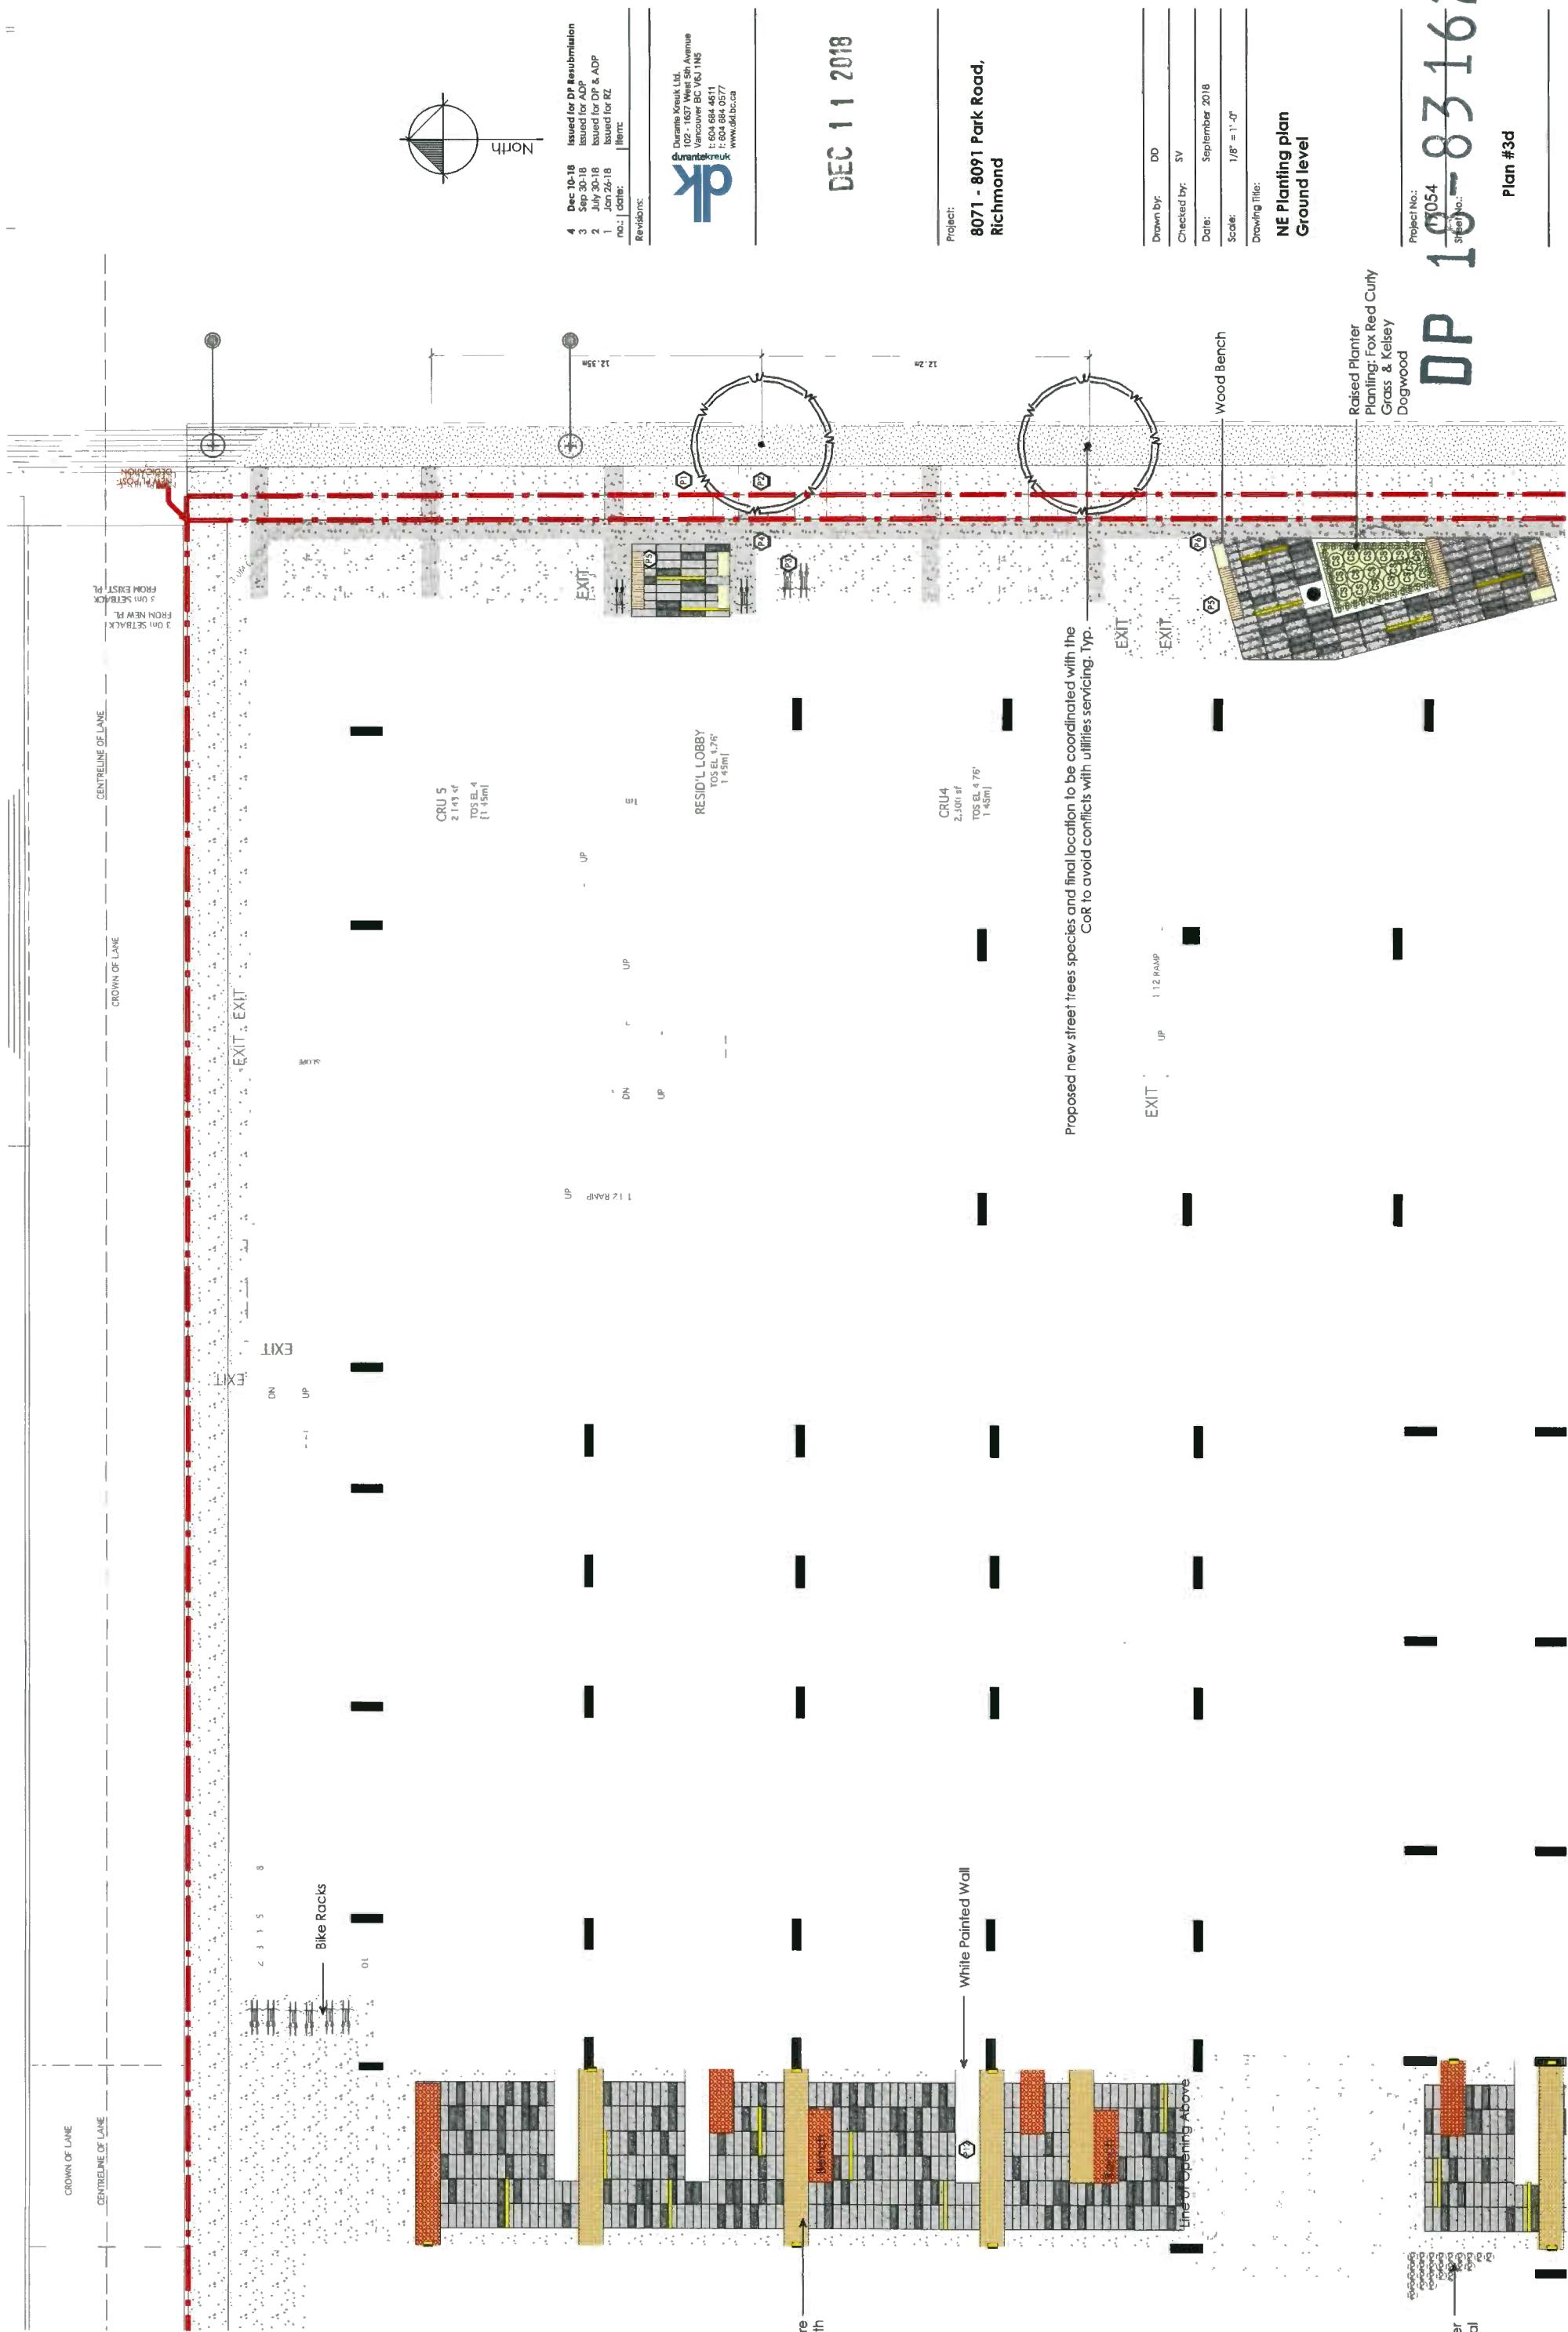

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Project No.: 110-1654
Shelf No.: 831623

Plan #3e

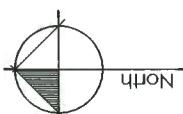


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| 2 | Sep 30- 18 | Issued for ADP |
| 2 | July 30- 18 | Issued for DP & ADP |
| 1 | Jan 26-18 | Issued for RZ |
| no.: | date: | Item: |
| | | Revisions: |

DEC 1 1 2018

**8071 - 8091 Park Road,
Richmond**

| | |
|--|----------------|
| Drawn by: | DD |
| Checked by: | SV |
| Date: | September 2018 |
| Scale: | 1/8" = 1'-0" |
| Drawing Title: SE Planting plan Ground level | |

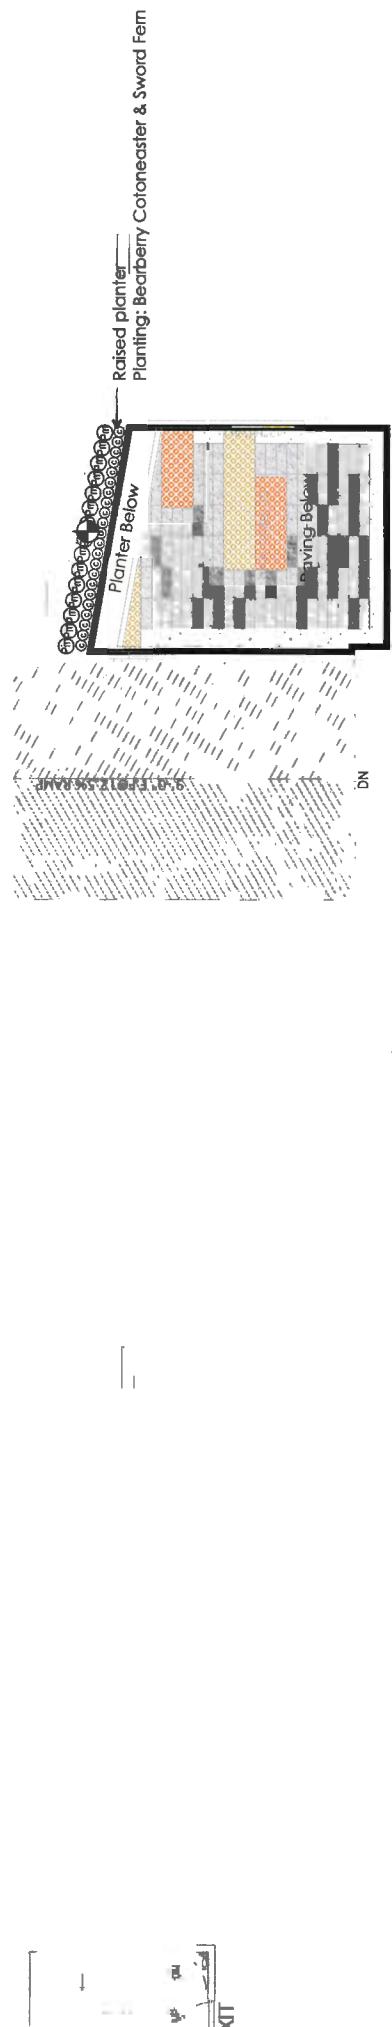

4 Dec 10-18 Issued for DP Resubmission
3 Sep 30-18 Issued for ADP
2 July 30-18 Issued for DP & ADP
1 Jan 26-18 Issued for R2
no.: Item:
Revisions:

Durante Kreuk Ltd.
102 - 1637 West 5th Avenue
Vancouver BC V6J 1N5
604 684 4611
www.dklbc.ca

DEC 11 2019


Project:
8071 - 8091 Park Road,
Richmond

Drawn by: DD
Checked by: SV
Date: September 2018
Scale: 1/8" = 1'-0"

Planting plan
Level 3


Project No: 17054
Sheet No: 1
Drawing Title: Plan #39
18031623

Plan #39

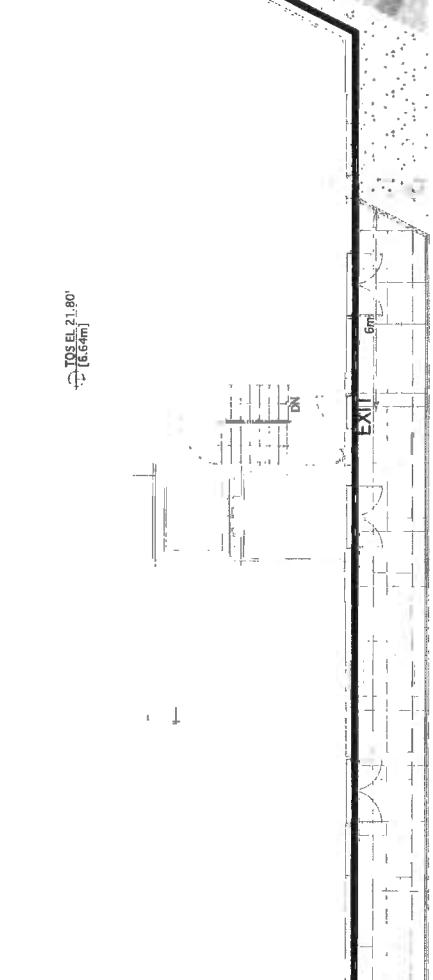

DP 18-80543 **1623**
Project No. **80543** **1623**
Sheer No.:

Plan #3h

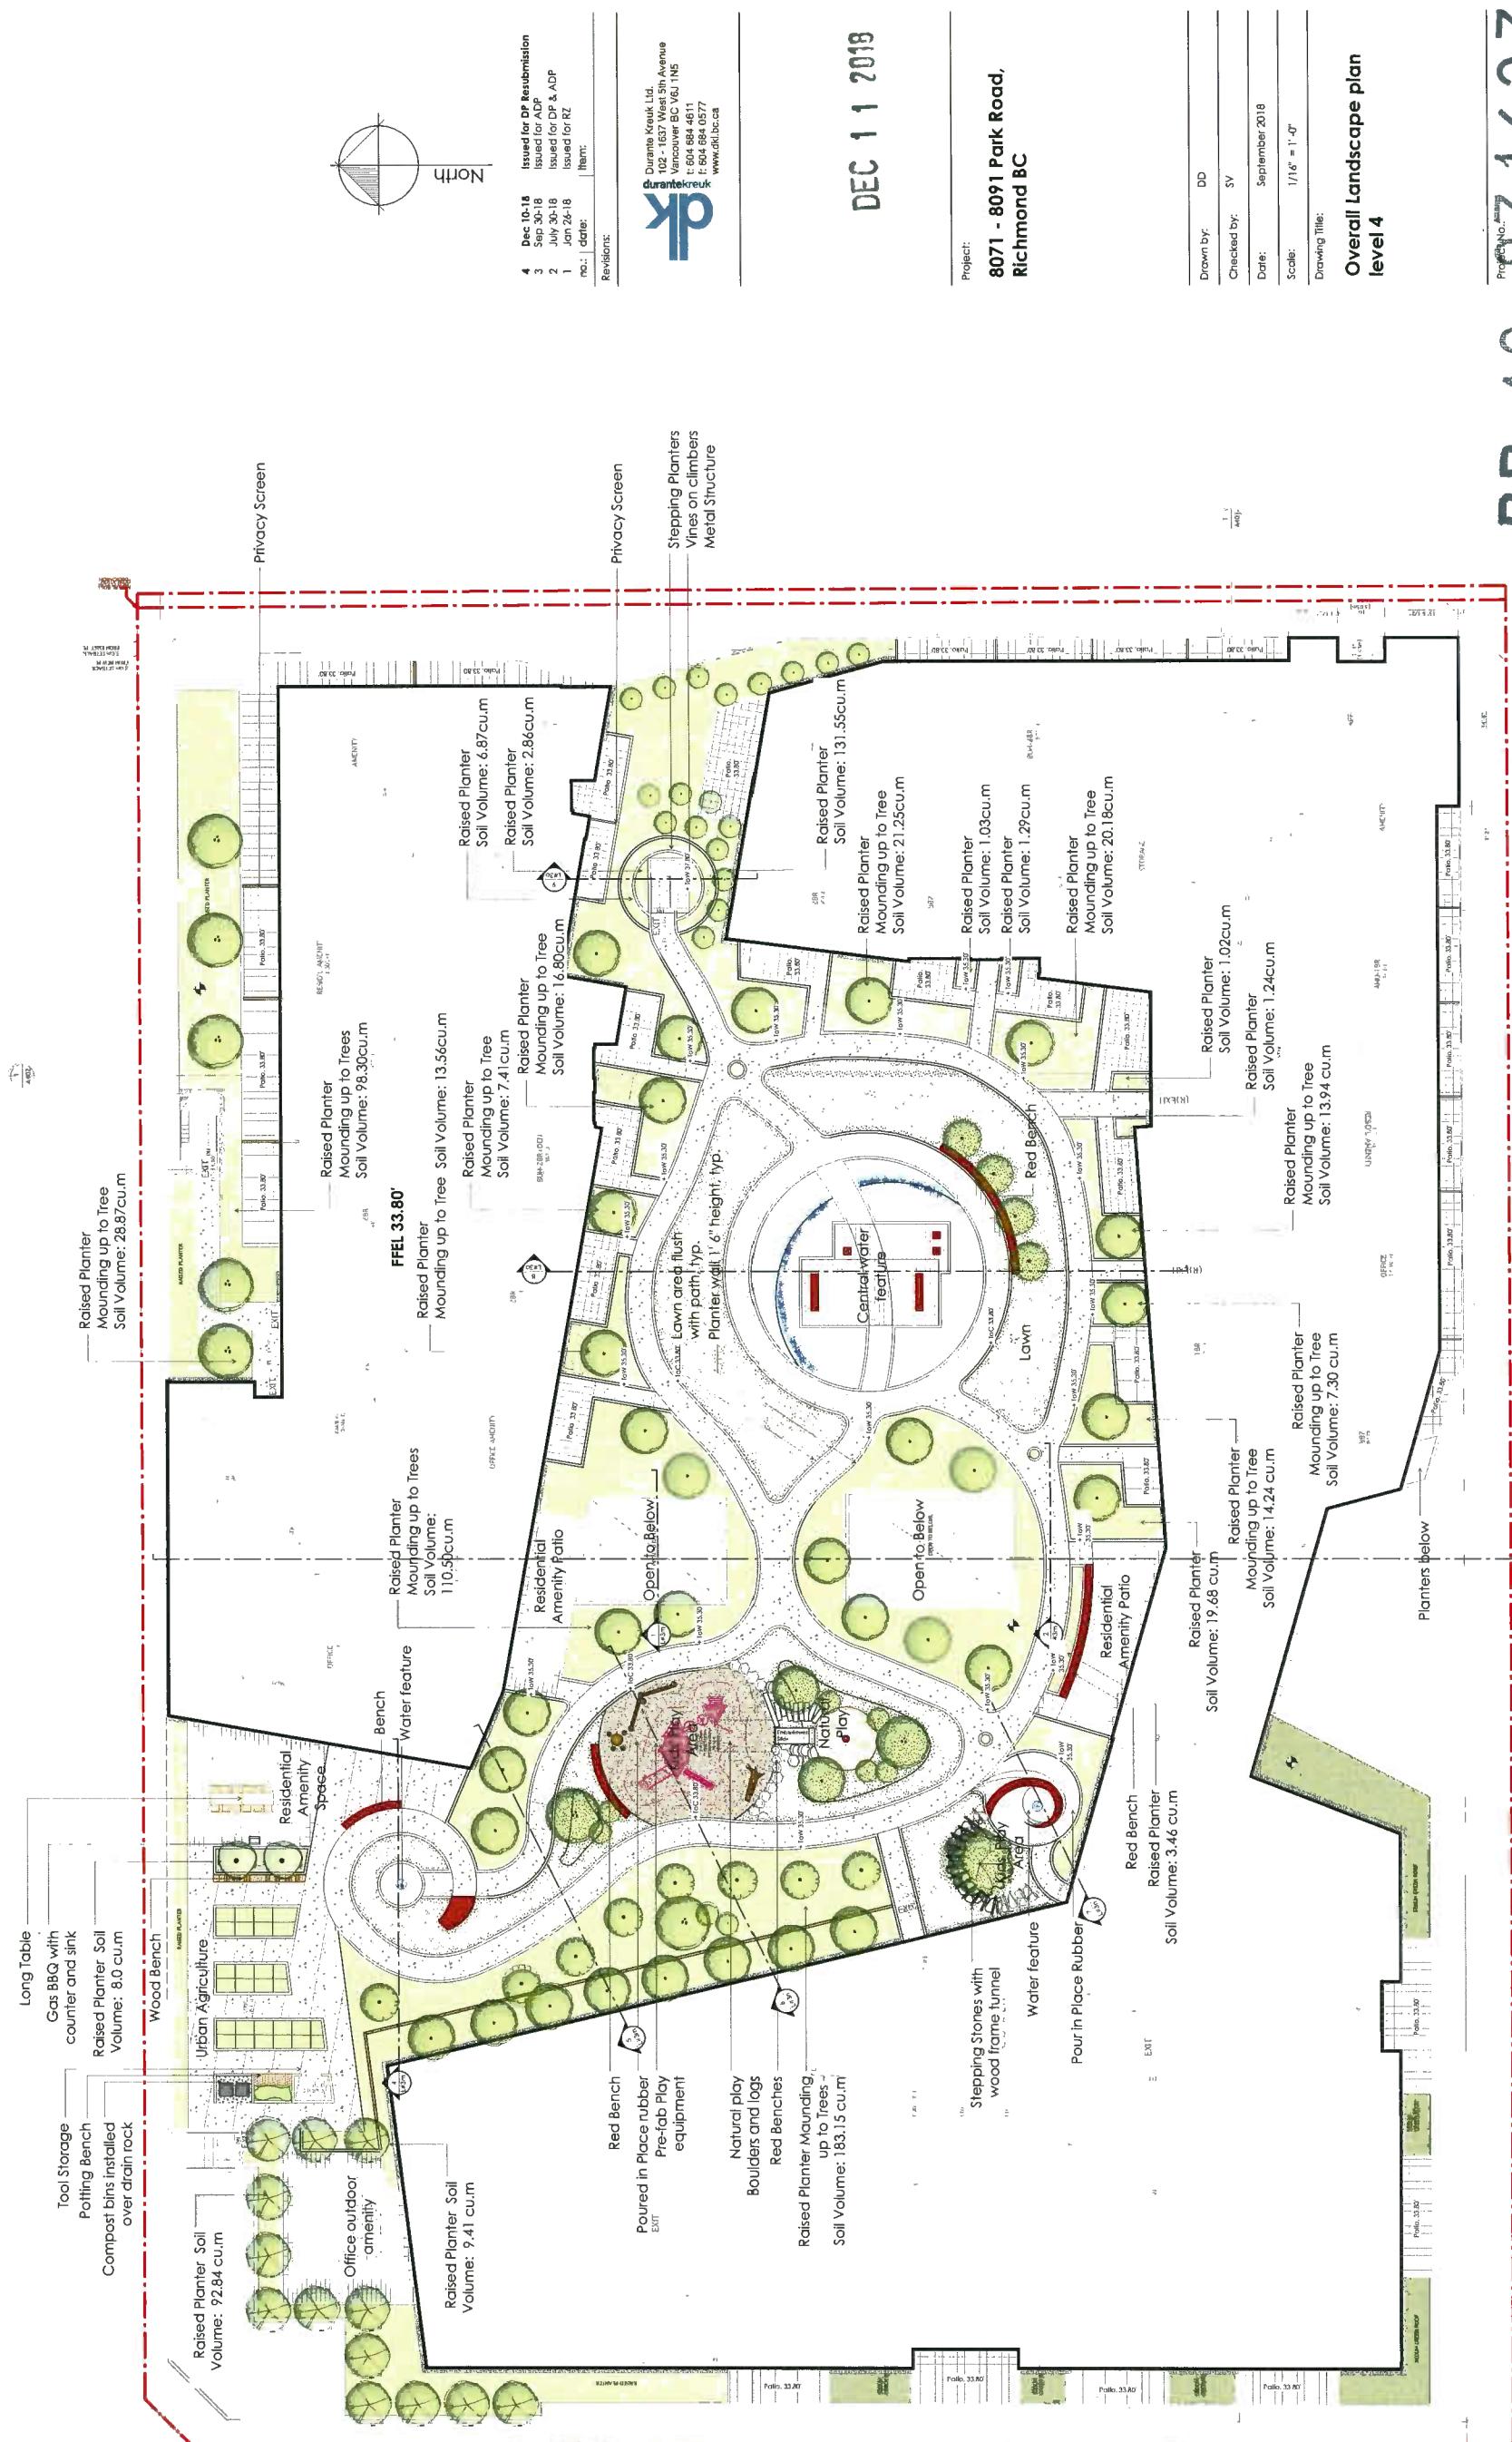


| | | | |
|--|---|------------|--|
| Raised Planter | Soil Volume: 17.88 cu.m Planting: Butterfly bush | Long Table | Gas BBQ with counter and sink |
| Tool Storage | | | |
| Potting Bench | | | Raised Planter Soil Volume: 8.0 cu.m Planting: Butterfly bush & Bearberry |
| Compost bins installed over drain rock | | | |




DP 18 - 8054-1623

Plan #31

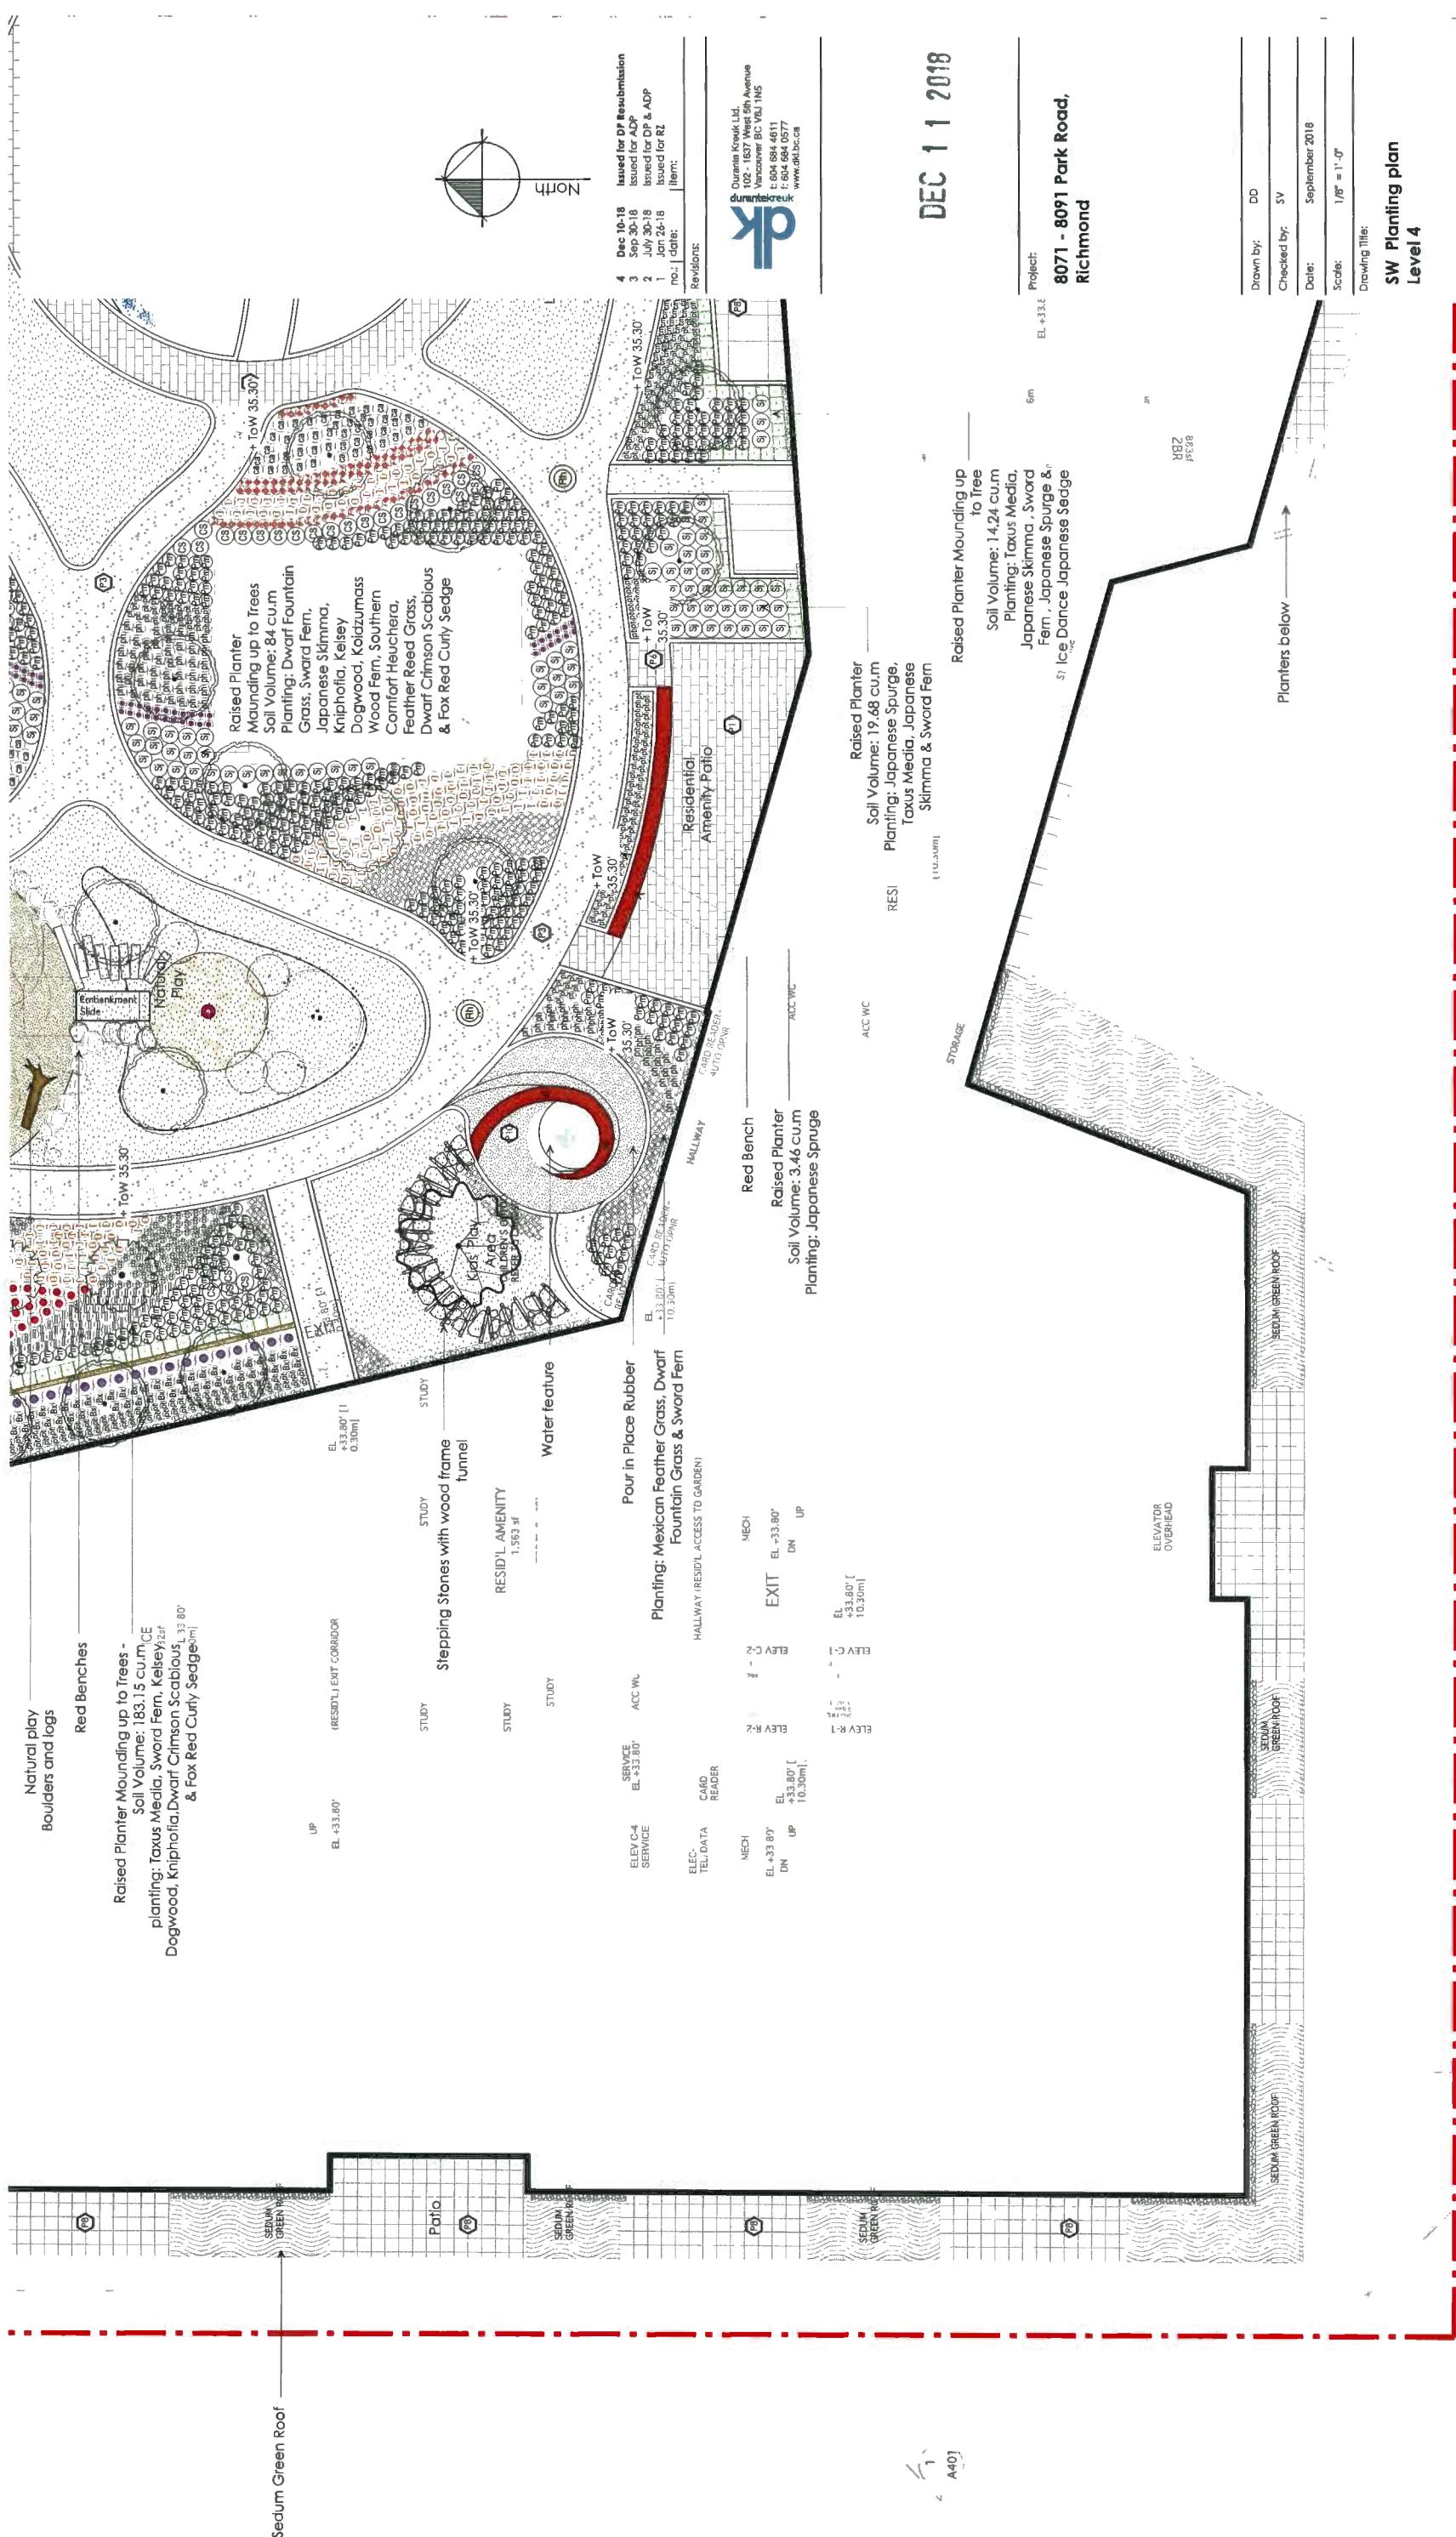

DP 18 - 831623

Plan #31

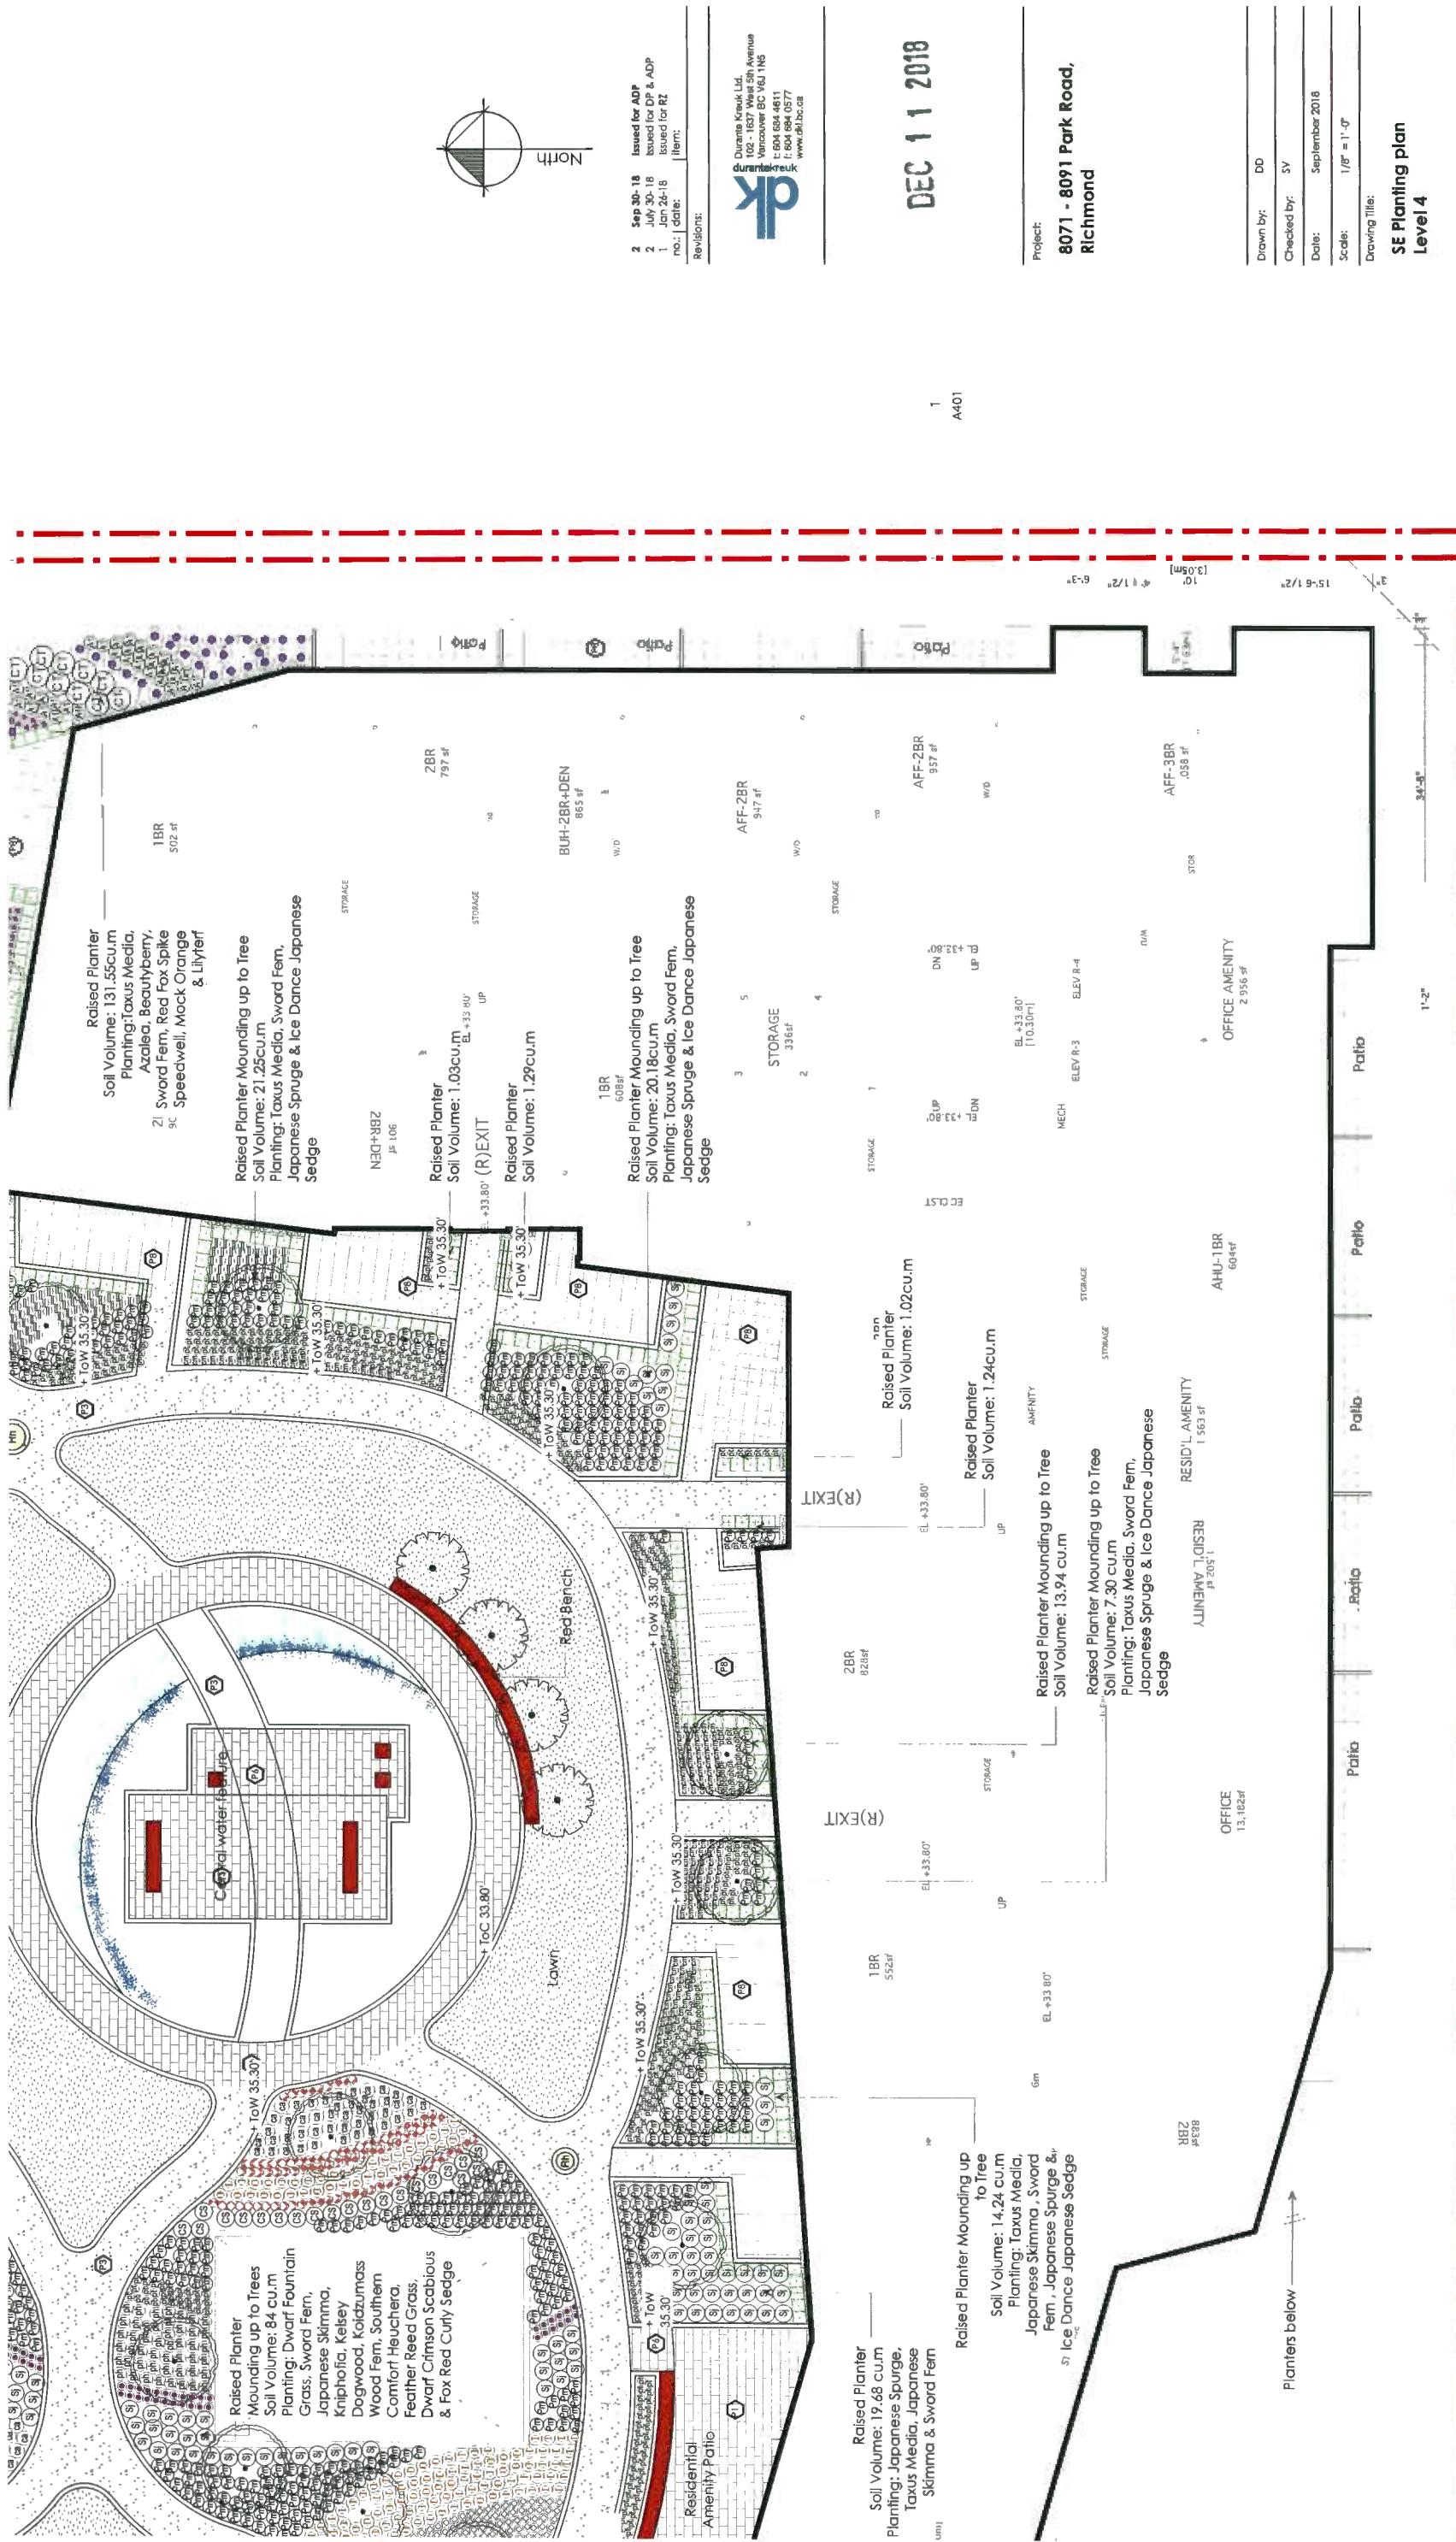

Section A : Section through Pedestrian Path

Scale: 1/8" = 1'

This section shows a pedestrian path with raised planters containing trees and shrubs. A lightwell is located between the planters. Residential amenity spaces are shown above the planters. A proposed location for public art is indicated. Labels include: Raised Planter, Residential Amenity Space, Lightwell, and Proposed Location for Public Art.

Section 1 : Section through Light well

Scale: 3/16" = 1'

This section shows a lightwell with a perforated metal panel. Residential amenity spaces are shown above the lightwell. Labels include: Perforated Metal Panel to Match architectural, Bench - Match architecture, and Perforated Metal Panel to Match architectural with lighting underneath.

Section 2 : Section through light well

Scale: 3/16" = 1'

This section shows a lightwell with a perforated metal panel. Residential amenity spaces are shown above the lightwell. Labels include: Perforated Metal Panel to Match architectural, Bench - Match architecture, and Perforated Metal Panel to Match architectural with lighting underneath.

Section 3 : Section through Pedestrian Path

Scale: 1/16" = 1'

This section shows a pedestrian path with raised planters containing trees and shrubs. A lightwell is located between the planters. Residential amenity spaces are shown above the planters. Labels include: Raised Planter, Residential Amenity Space, Lightwell, and Bench.

Elevational Perspective: Mid-Block Connection

NTS

Landscape Sections

Project: 8071 - 8091 Park Road,
Richmond BC

Drawn by: DO
Checked by: SY
Date: September 2018
Scale: As shown
Drawing Title: Landscape Sections

Project No.: 17054
Sheet No.: 1

Elevational Perspective of the pedestrian passage


OP 18-831623

DP 18 - 837051623


Section 5 : Section through path between buildings
Scale: 1/4" = 1'


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|---------------------------|----------------|
| Project No.: | |
| 47051623 | |
| Drawing Title: | |
| Landscape Sections | |
| Drawn by: | DD |
| Checked by: | SV |
| Date: | September 2018 |
| Scale: | As shown |

DEC 11 2018

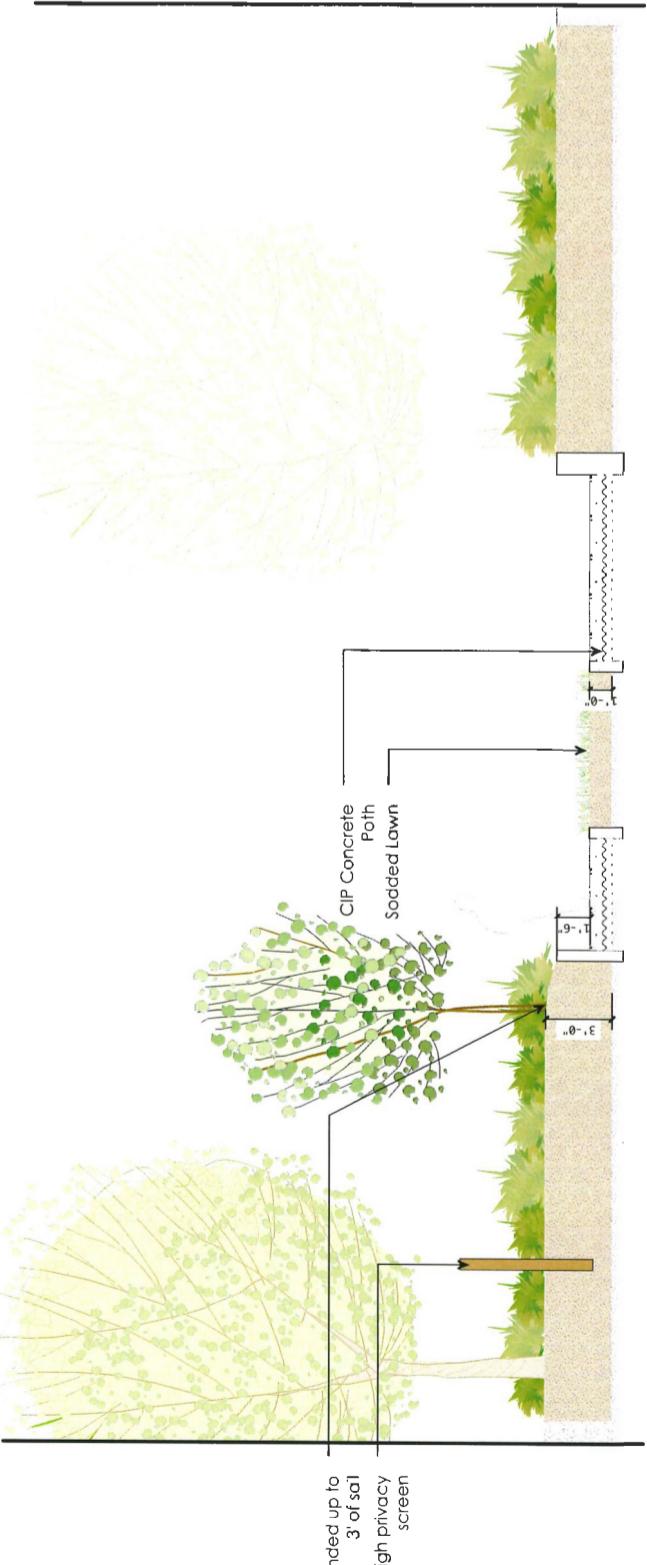

Section 4 : Section through water feature and amenity area
Scale: 1/4" = 1'

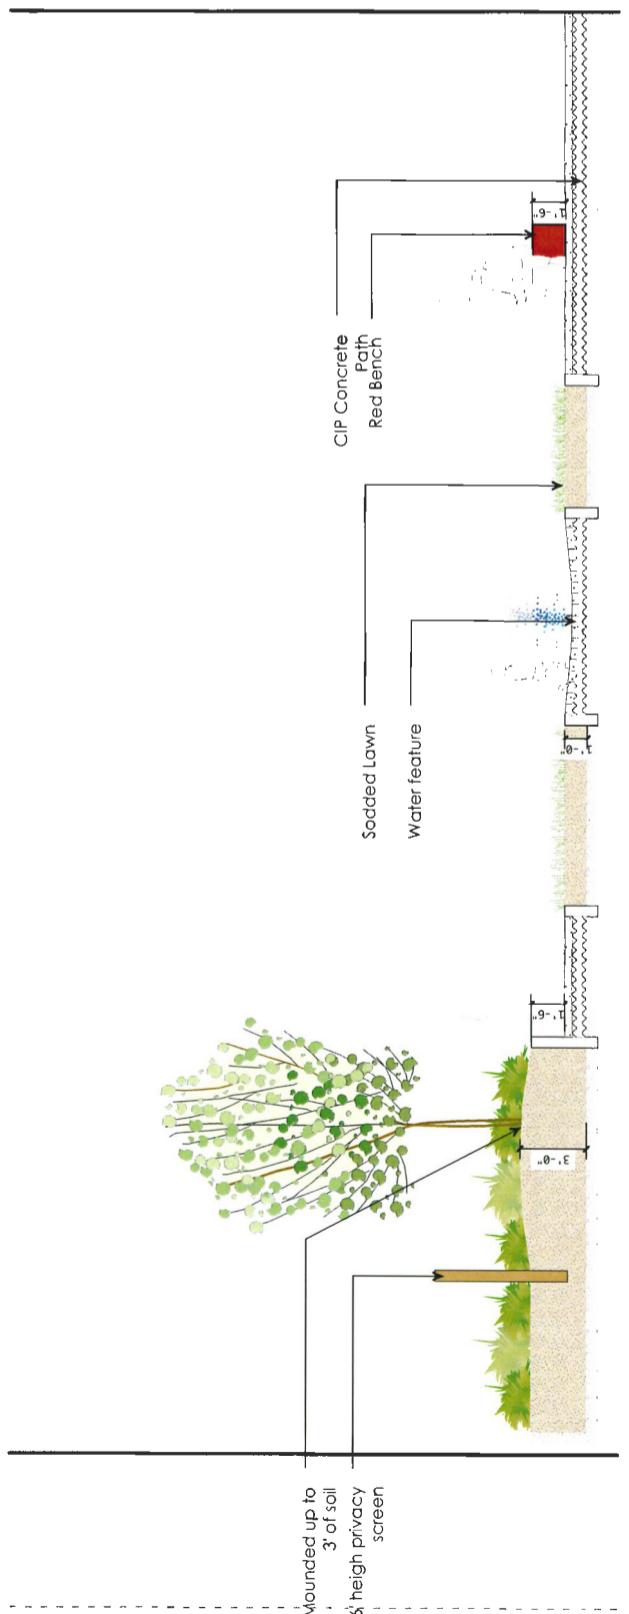

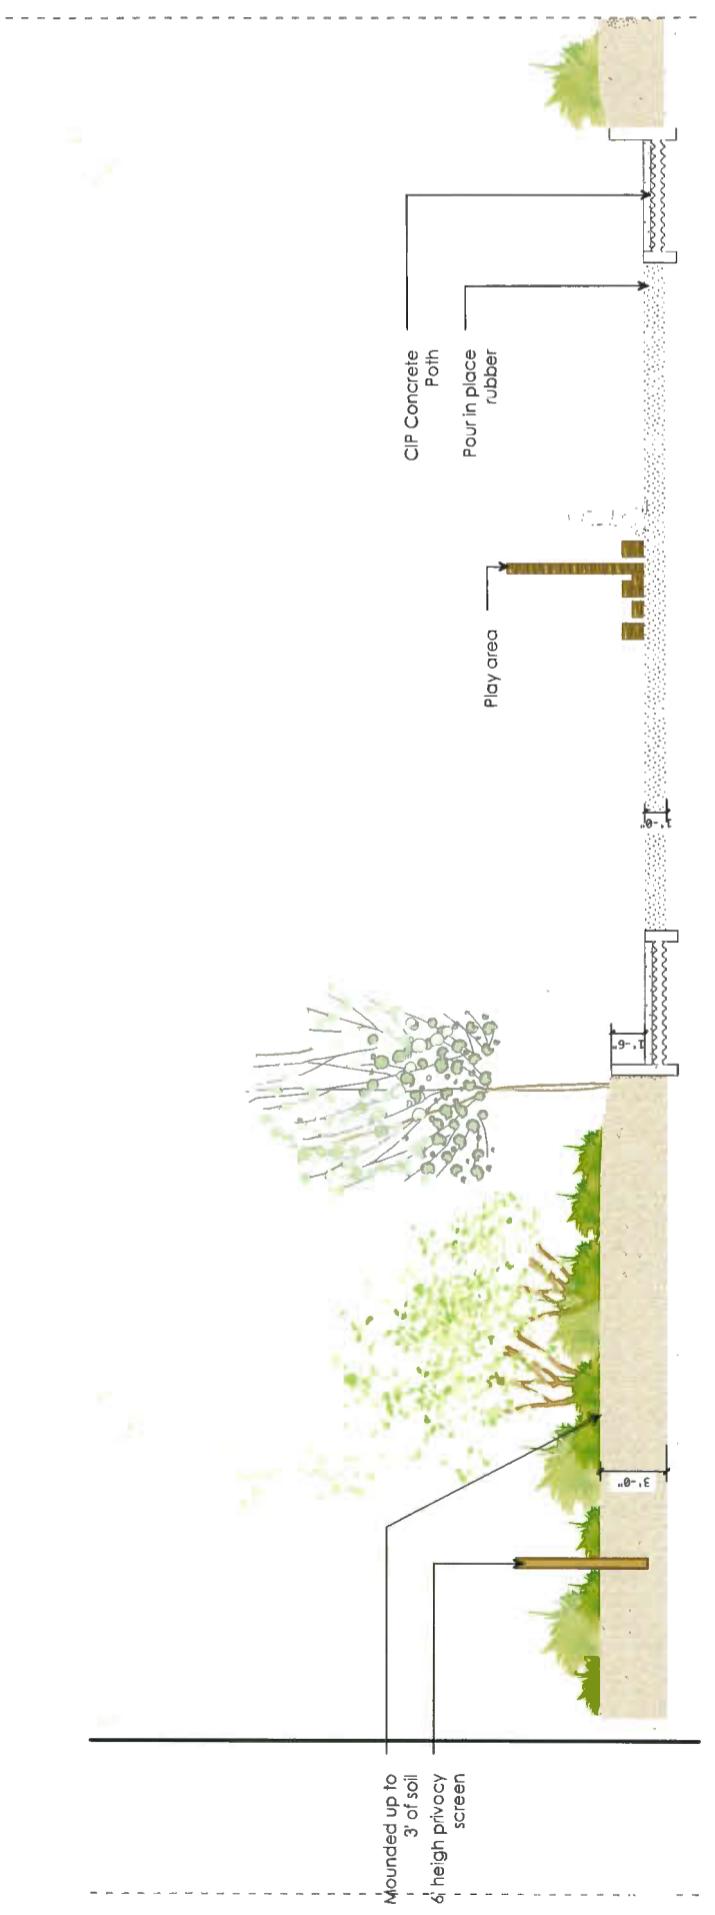

4 Dec 10-18 Issued for DR Resubmission
3 Sep 30-18 Issued for ADP
2 July 30-18 Issued for DP & ADP
1 Jun 26-18 Issued for RZ
no: date: | here:
Revisions:

Durante Kreuk Ltd.
102 1537 West 5th Avenue
Vancouver BC V6J 1NS
t: 604 684 4611
l: 604 684 0577
www.dklbc.ca


dk



DEC 11 2010

Project:
8071 - 8091 Park Road,
Richmond BC


Drawn by: DD
Checked by: SV
Date: September 2018
Scale: As shown
Drawing Title: Landscape sections

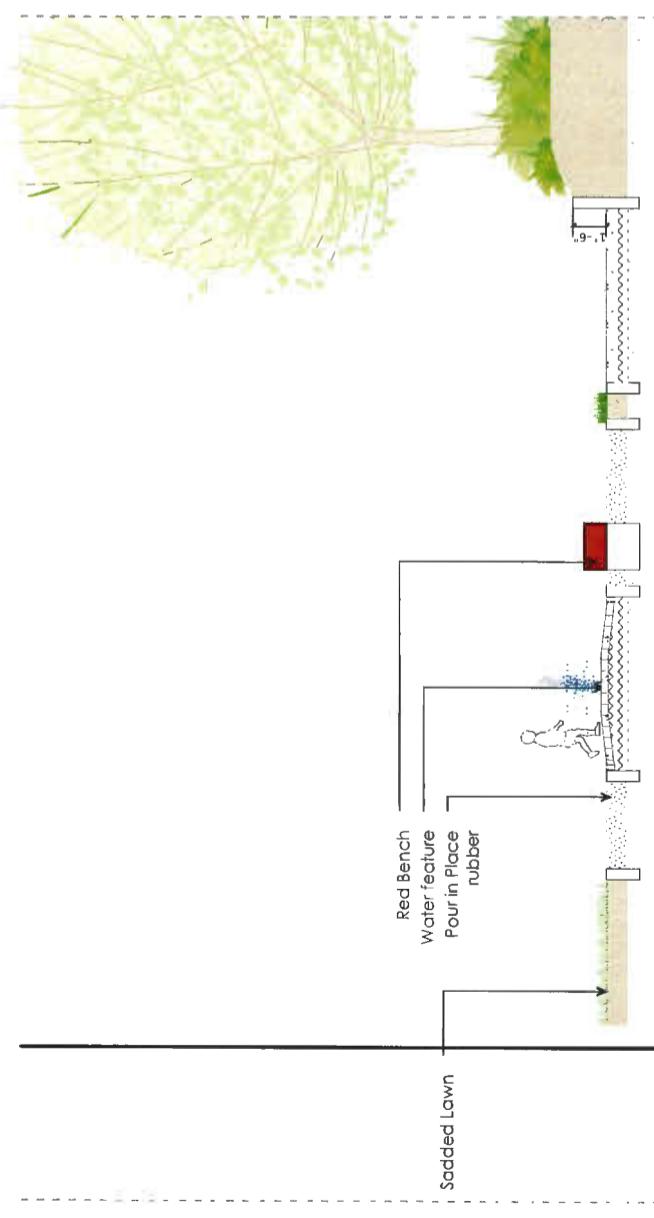


Project No.: 17054
Sheet No.: 1623

Sections #30

DP 13

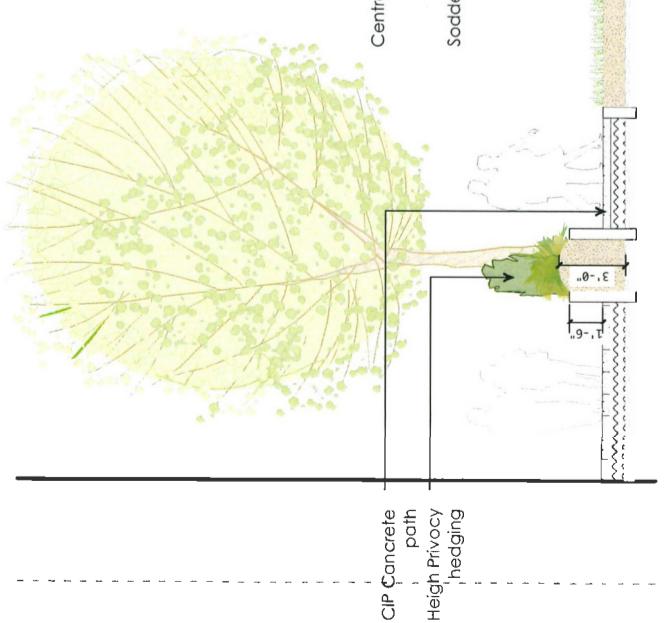

Section 8 : Section through central water feature
Scale: 1/4" = 1'

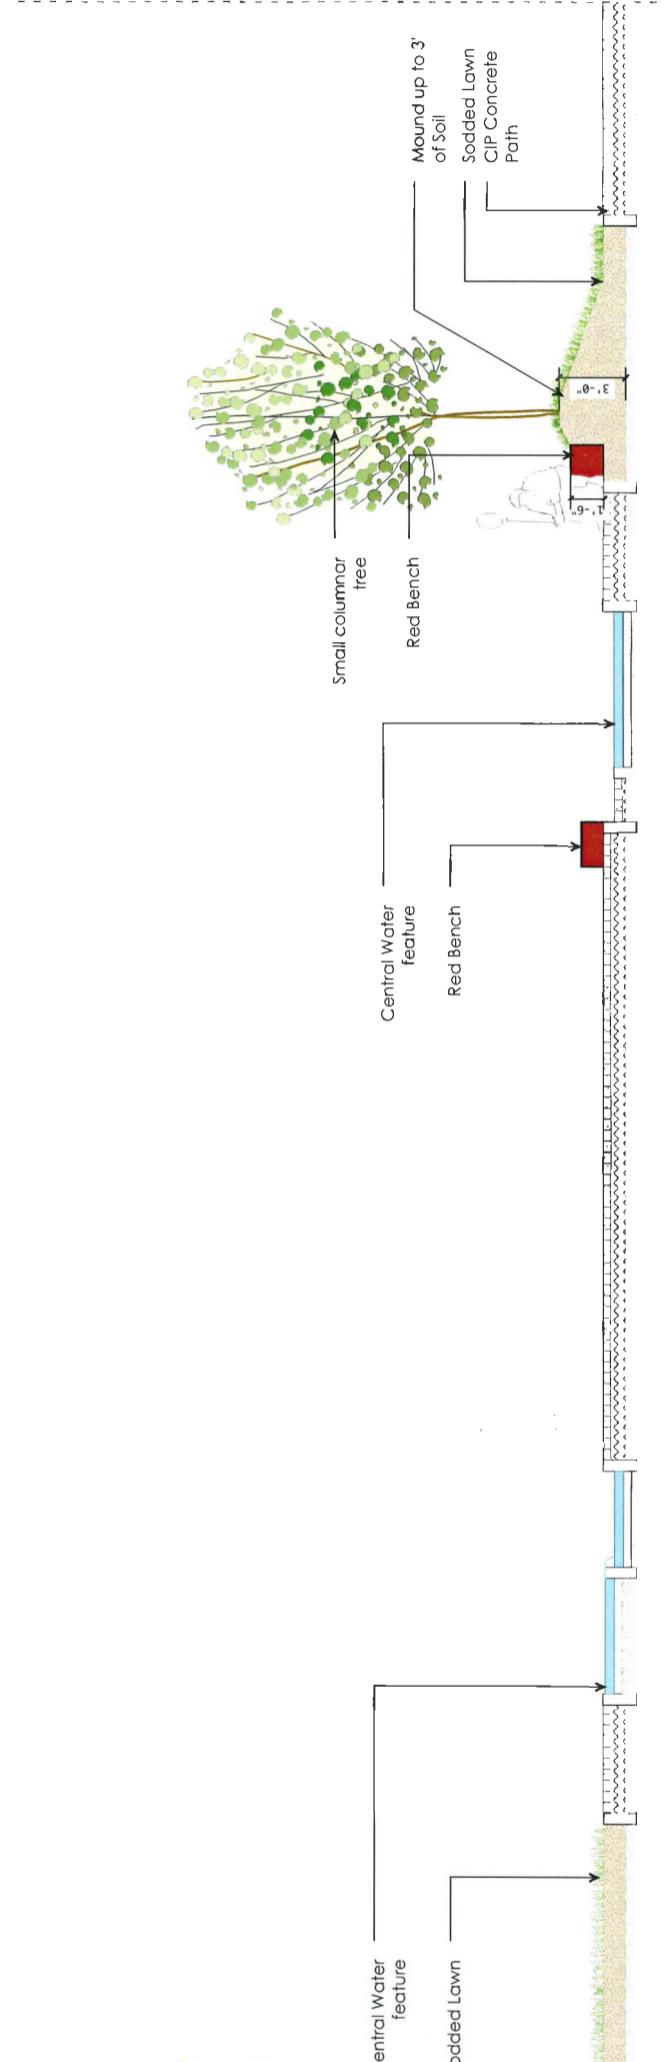

Section 8 : Section through central water feature
Scale: 1/4" = 1'



Section 9 : Section through access to parkade between buildings
Scale: 1/4" = 1'

DEC 11 2018

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Vancouver BC V6J 1N5
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f: 604 684 0577
www.dkrc.ca

**Project:
8071 - 8091 Park Road,
Richmond BC**

Drawn by: DD
Checked by: SV
Date: September 2018
Scale: As shown
Drawing file: Landscape Sections/Details

Project No.: 8070541623
Sheet No.: 8
Date:

Green Roof Detail

Cut line between Mix varieties.

DP 108

Scale: 1" = 1'

Scale: 1/4" = 1'

Sections #3p



DEC 11 2018

PROJECT
**PARK ROAD &
BUSWELL STREET**
DP 18-831623
8071-8091 PARK ROAD
RICHMOND, BC


STREETSCAPES

JOB NO. 16-03
DRAWN KT
DATE 07 DEC 2018
SCALE 1/32" = 1'-0"
DRAWING INC.

831623 - 0103 - 023



Plan #4a

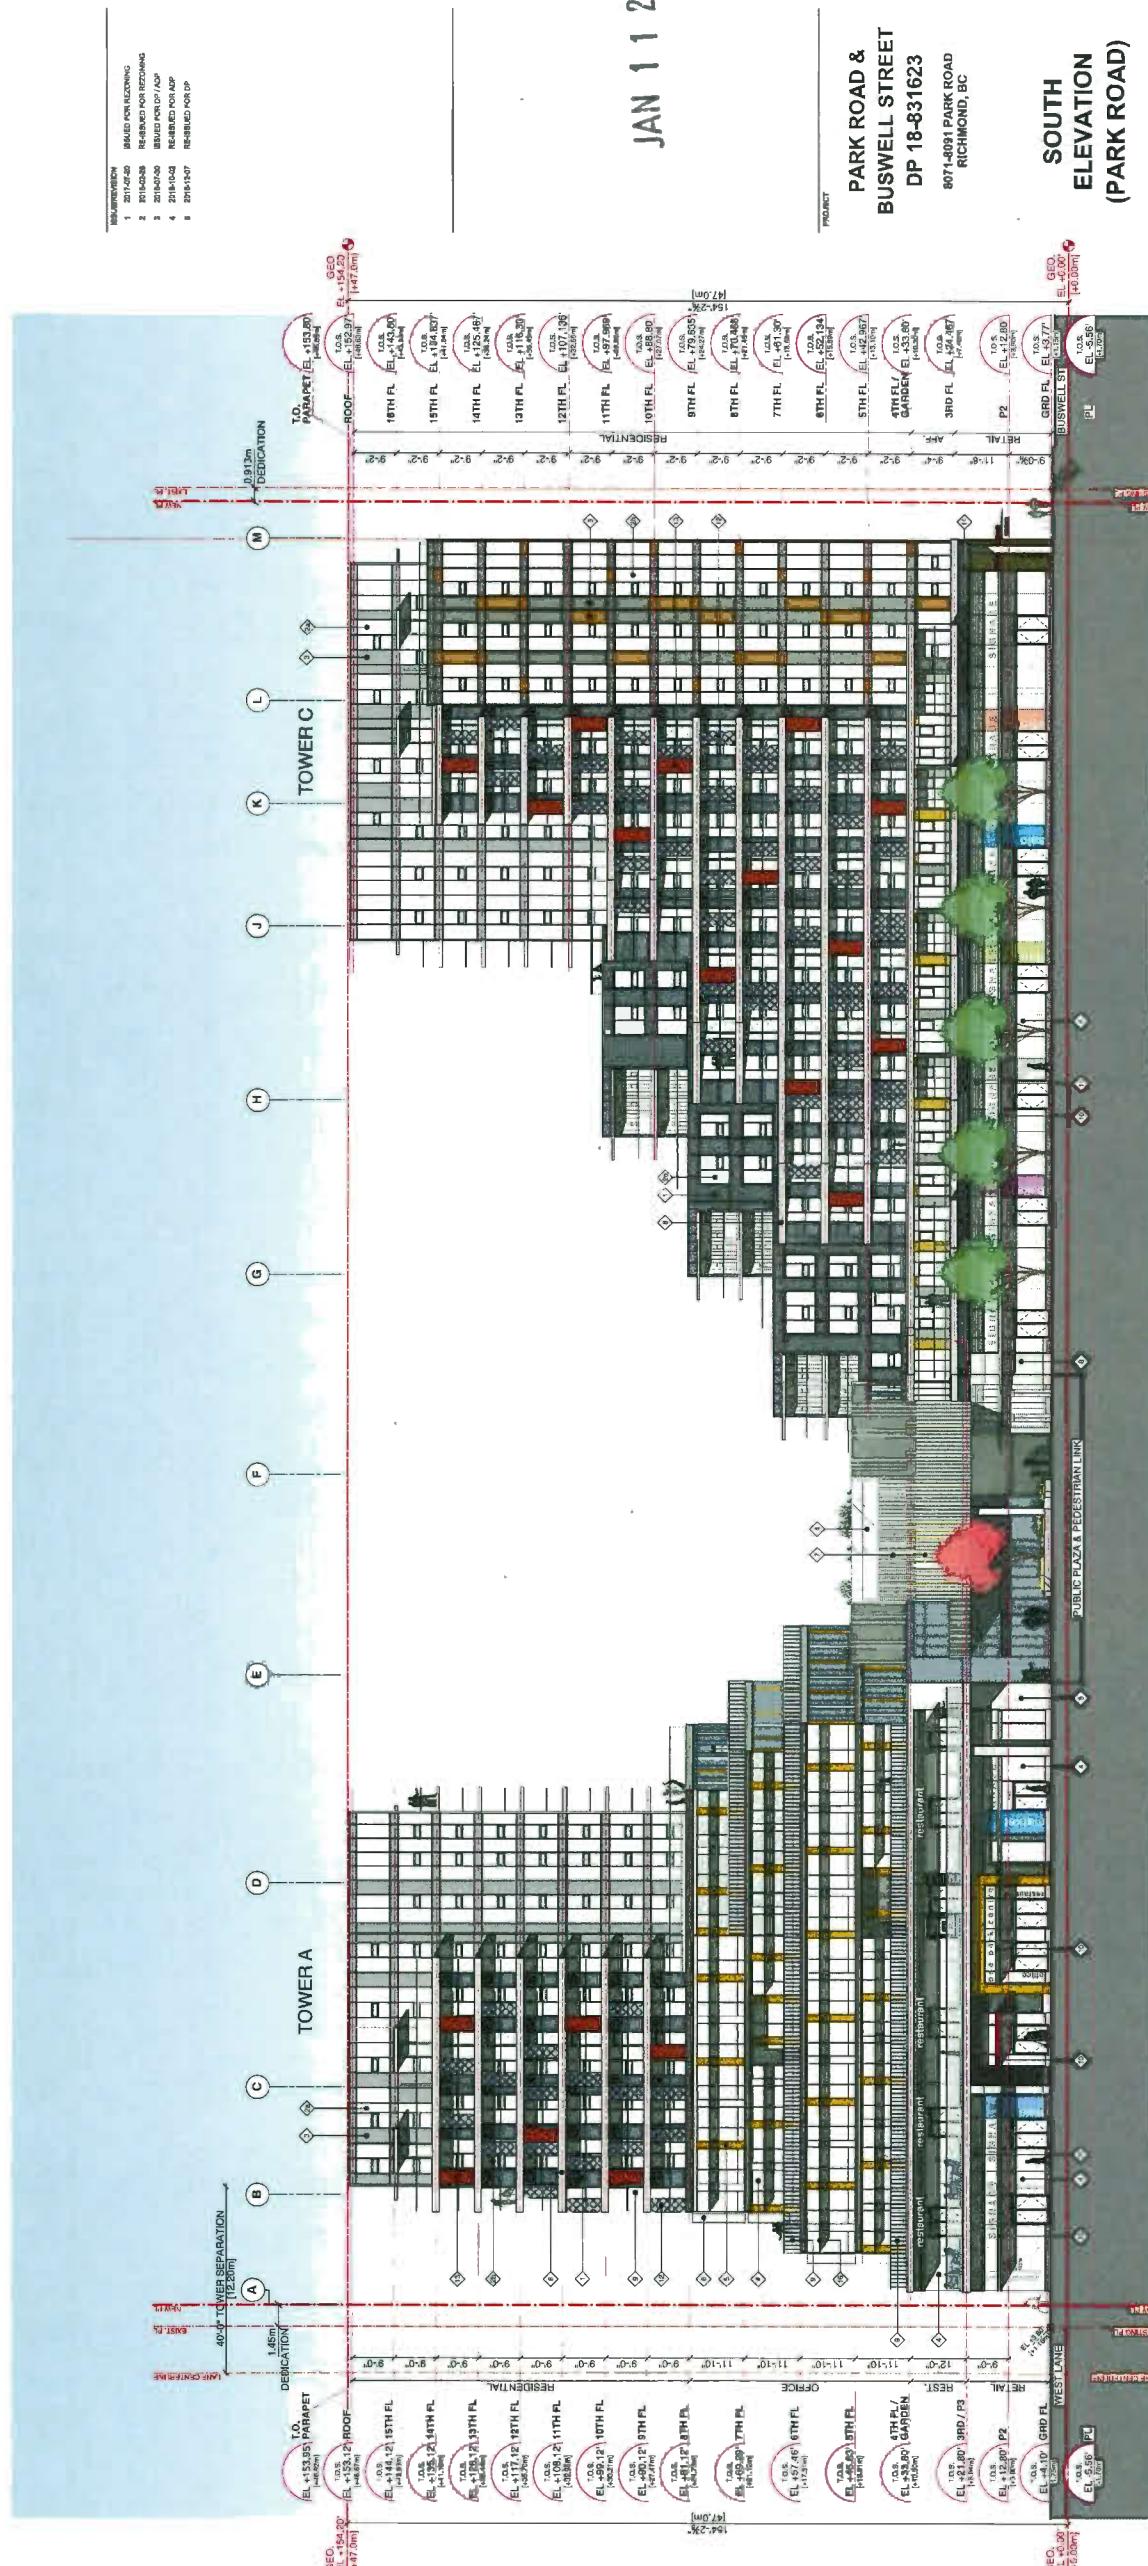

JAN 1 2019

**PARK ROAD &
BUSWELL STREET
DP 18-831623**

**SOUTH
ELEVATION
(PARK ROAD)**

17

DP 18-831623

| ISSUE/REVISION | ISSUED FOR REZONING | ISSUED FOR READING | ISSUED FOR DP / ADP | ISSUED FOR ADP |
|----------------|---------------------|------------------------|---------------------|----------------|
| 1 | 2017-07-20 | | | |
| 2 | 2018-02-28 | RE-ISSUED FOR READING | | |
| 3 | 2018-07-30 | RE-ISSUED FOR DP / ADP | | |
| 4 | 2018-10-02 | RE-ISSUED FOR ADP | | |
| 5 | 2018-12-07 | RE-ISSUED FOR DP | | |

DEC 1 1 2013

PARK ROAD &
BUSWELL STREET
DP 18-831623

8071-8091 PARK ROAD
RICHMOND, BC


WEST ELEVATION (WEST LANE) 3

• 01 M 16-03

DRAWN MB/KT/JB

DATE 8/ DEC 2018
SCALE 1/16" = 11-0"
CHECKED WTL

Plan #AC

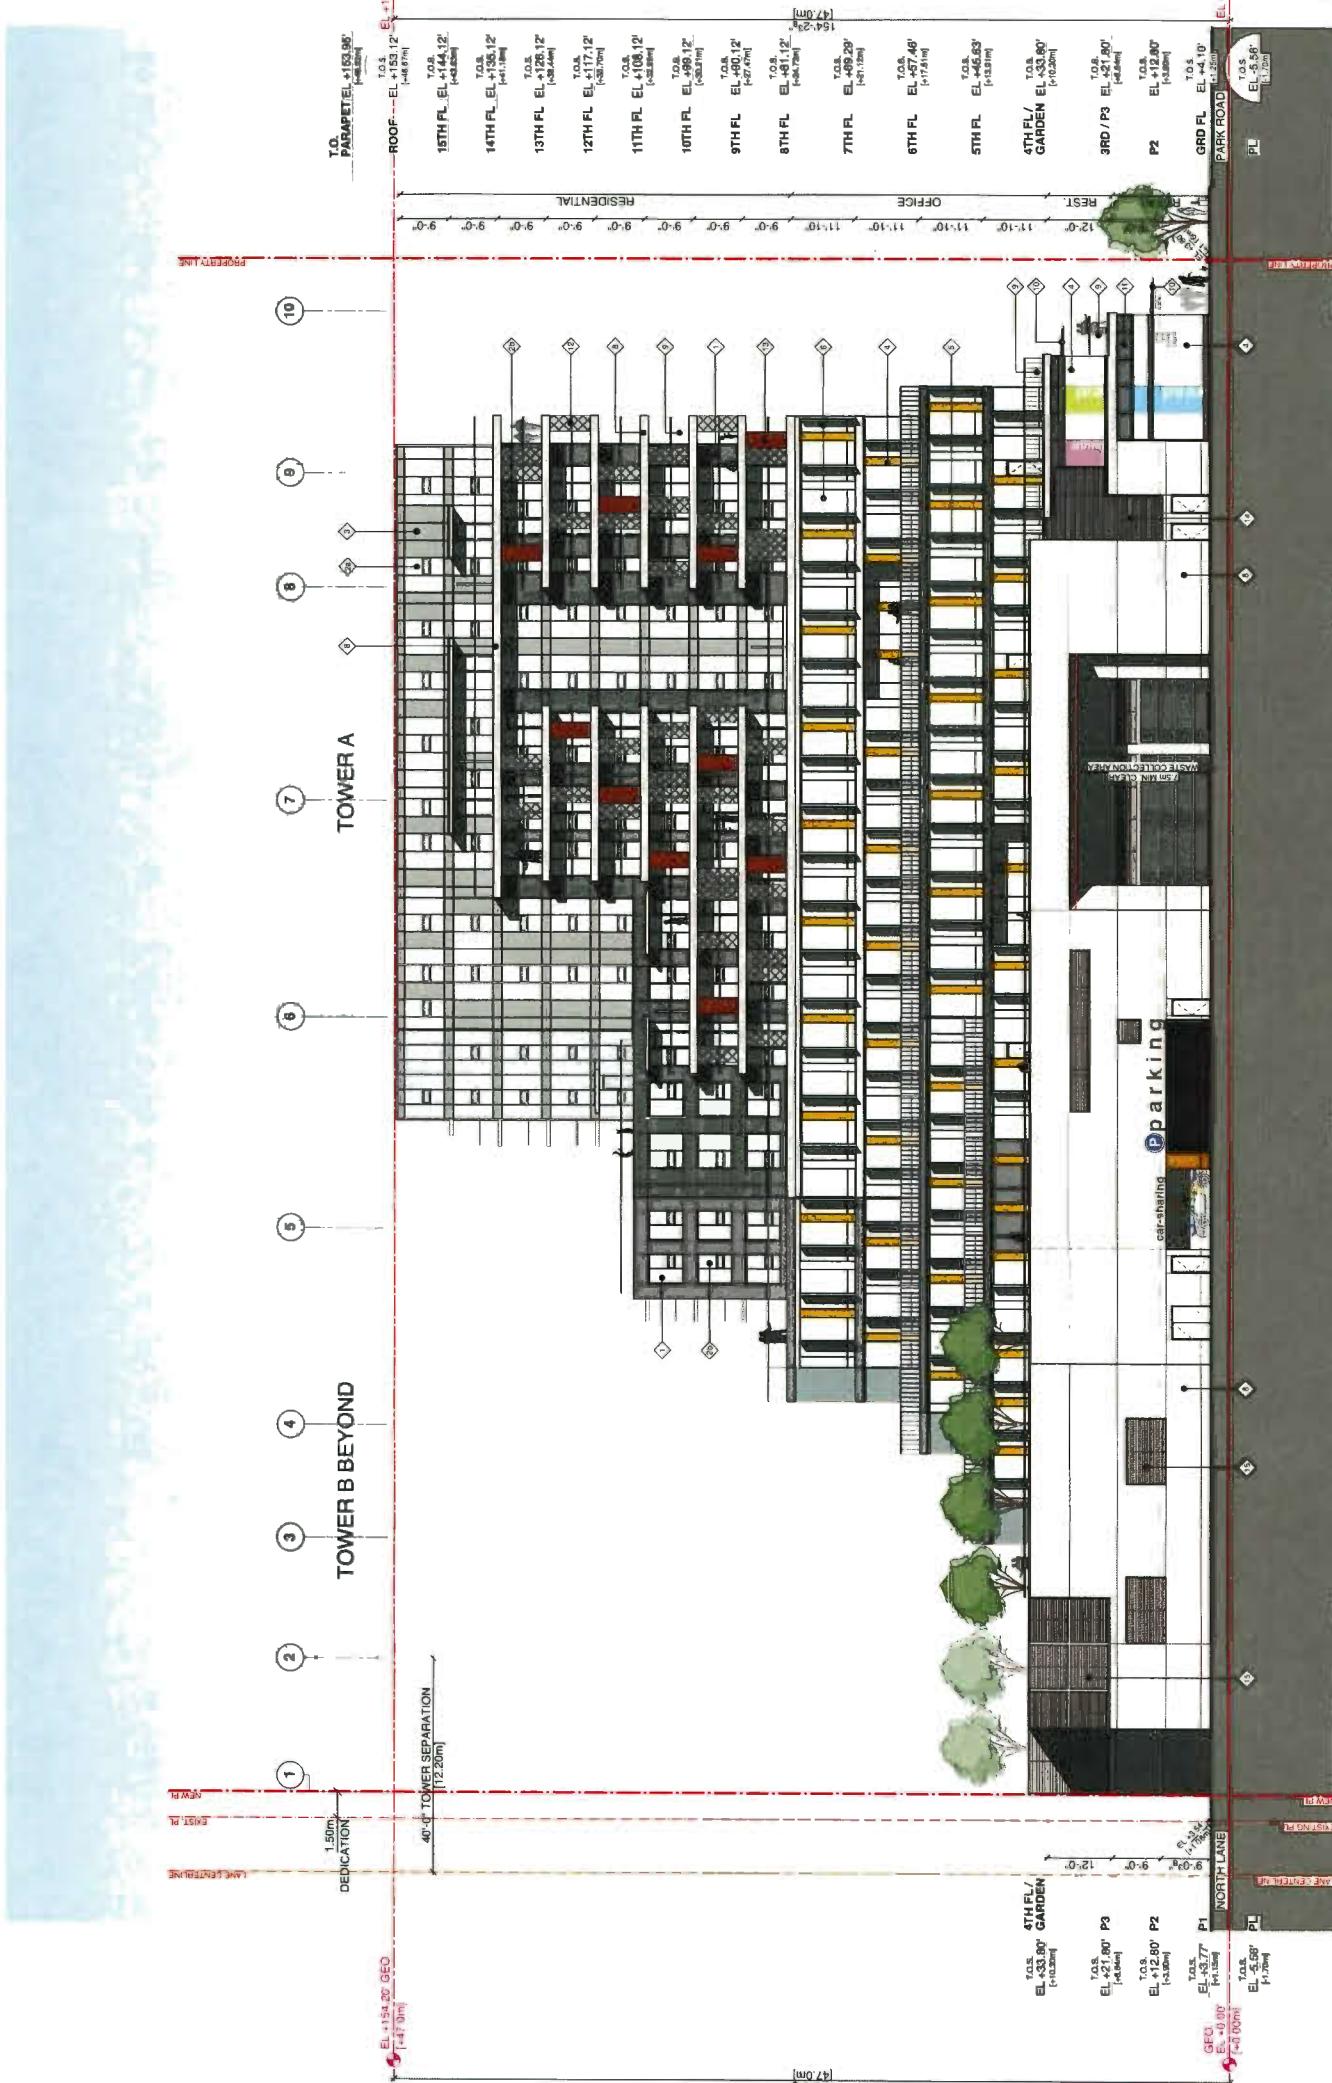

| REVISION | DATE | DESCRIPTION |
|----------|------------|------------------------|
| 1 | 2017-07-20 | ISSUED FOR REZONING |
| 2 | 2018-02-26 | RE-ISSUED FOR REZONING |
| 3 | 2018-07-30 | ISSUED FOR DP / AOP |
| 4 | 2018-10-02 | RE-ISSUED FOR AOP |
| 5 | 2018-12-07 | RE-ISSUED FOR AOP |


DEC 1 1 2013

**PARK ROAD &
BUSHWELL STREET
DP 18-831623**

EAST
ELEVATION
(BUSWEIL ST.)

MB/KT/.


Plan #4d

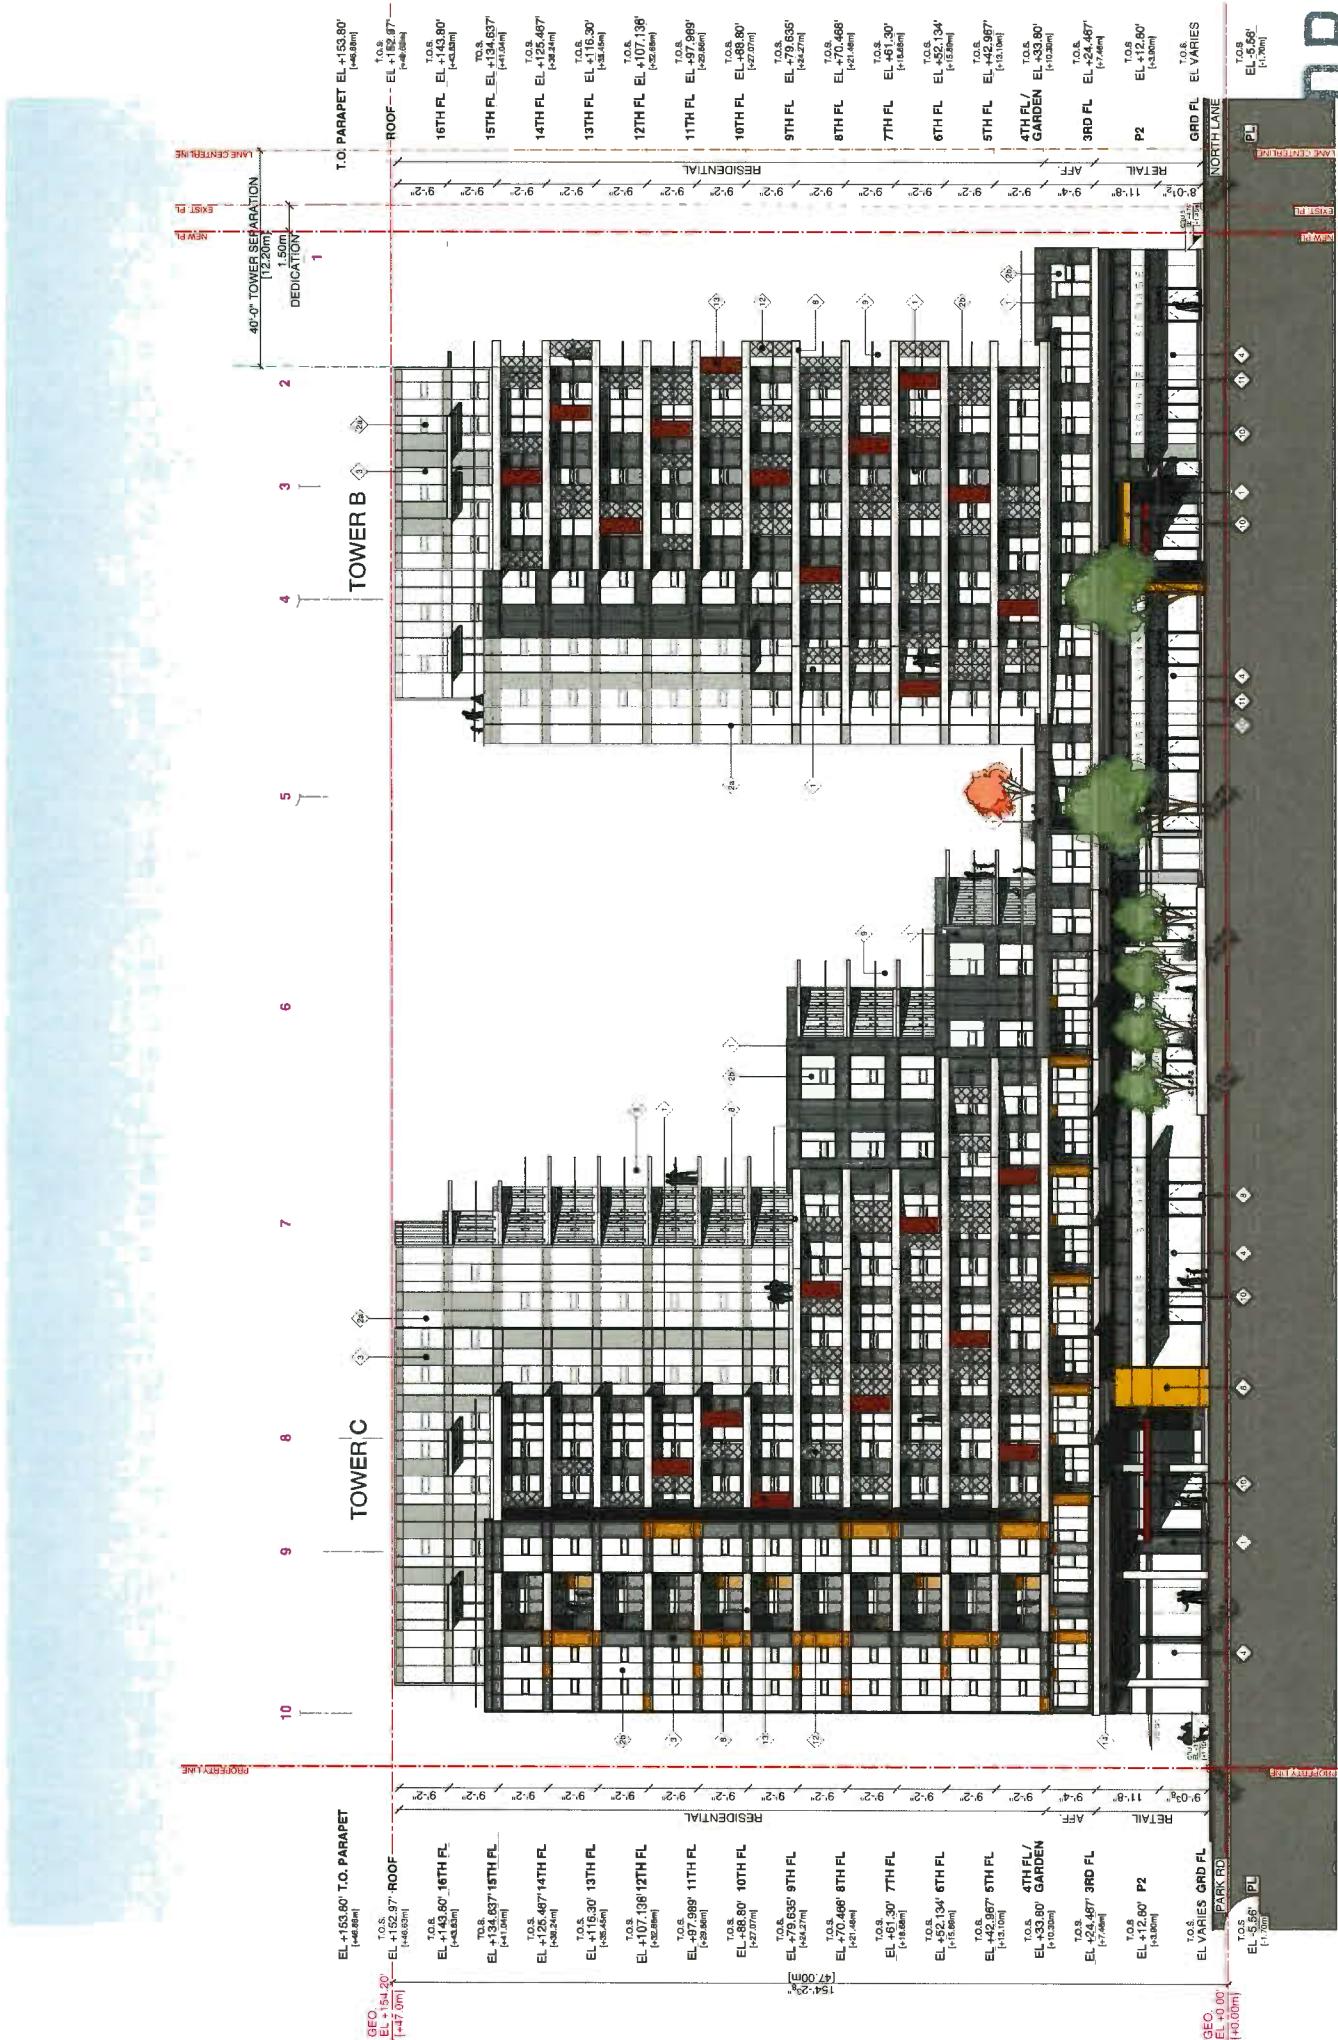

| FINISH MATERIAL LEGEND | |
|------------------------|--|
| 1 | FIBRE CEMENT CLADDING |
| 2 | STAINLESS STEEL REFLX BLACK VELVET 921° |
| 3 | PREFINISHED ALUMINUM WINDOW WALL SPANDREL PANEL (GLAZED) |
| 4 | PREFINISHED ALUMINUM CURTAIN WALL SYSTEM |
| 5 | PREFINISHED ALUMINUM CURTAIN WALL SPANDREL PANEL (GLAZED 1 METAL) |
| 6 | VERMICULITE INSULATION SYSTEM - VERTICAL SLAT SCREEN FROM PRE-FINISHED METAL |
| 7 | PAINTED ARCHITECTURAL CONCRETE (ELASTOMERIC COATING) |
| 8 | PREFINISHED ALUMINUM GLASS RAILING TO MATCH WINDOW |
| 9 | METAL & GLASS CANOPY |
| 10 | PREFINISHED ALUMINUM GRILLE (CURTAIN WALL INFL) COLOUR TO MATCH WINDOW |
| 11 | PREFINISHED METAL SCREEN. COLOUR TO MATCH RAILING |
| 12 | TRANSLUCENT GLASS PANEL |
| 13 | COLOR TO PAINT PANTONE 23-37-C |
| 14 | COATING COLOR TO MATCH WINDOW |
| 15 | PREFINISHED ALUMINUM SIGHTSCREEN TO MATCH CURTAIN WALL |

CHECKED W/L
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the Architect's consent.

Suite 300, 973 West Broadway,
Vancouver, British Columbia • Canada V5Z 1K3
Telephone 604 736-9711; Facsimile 604 736-7991

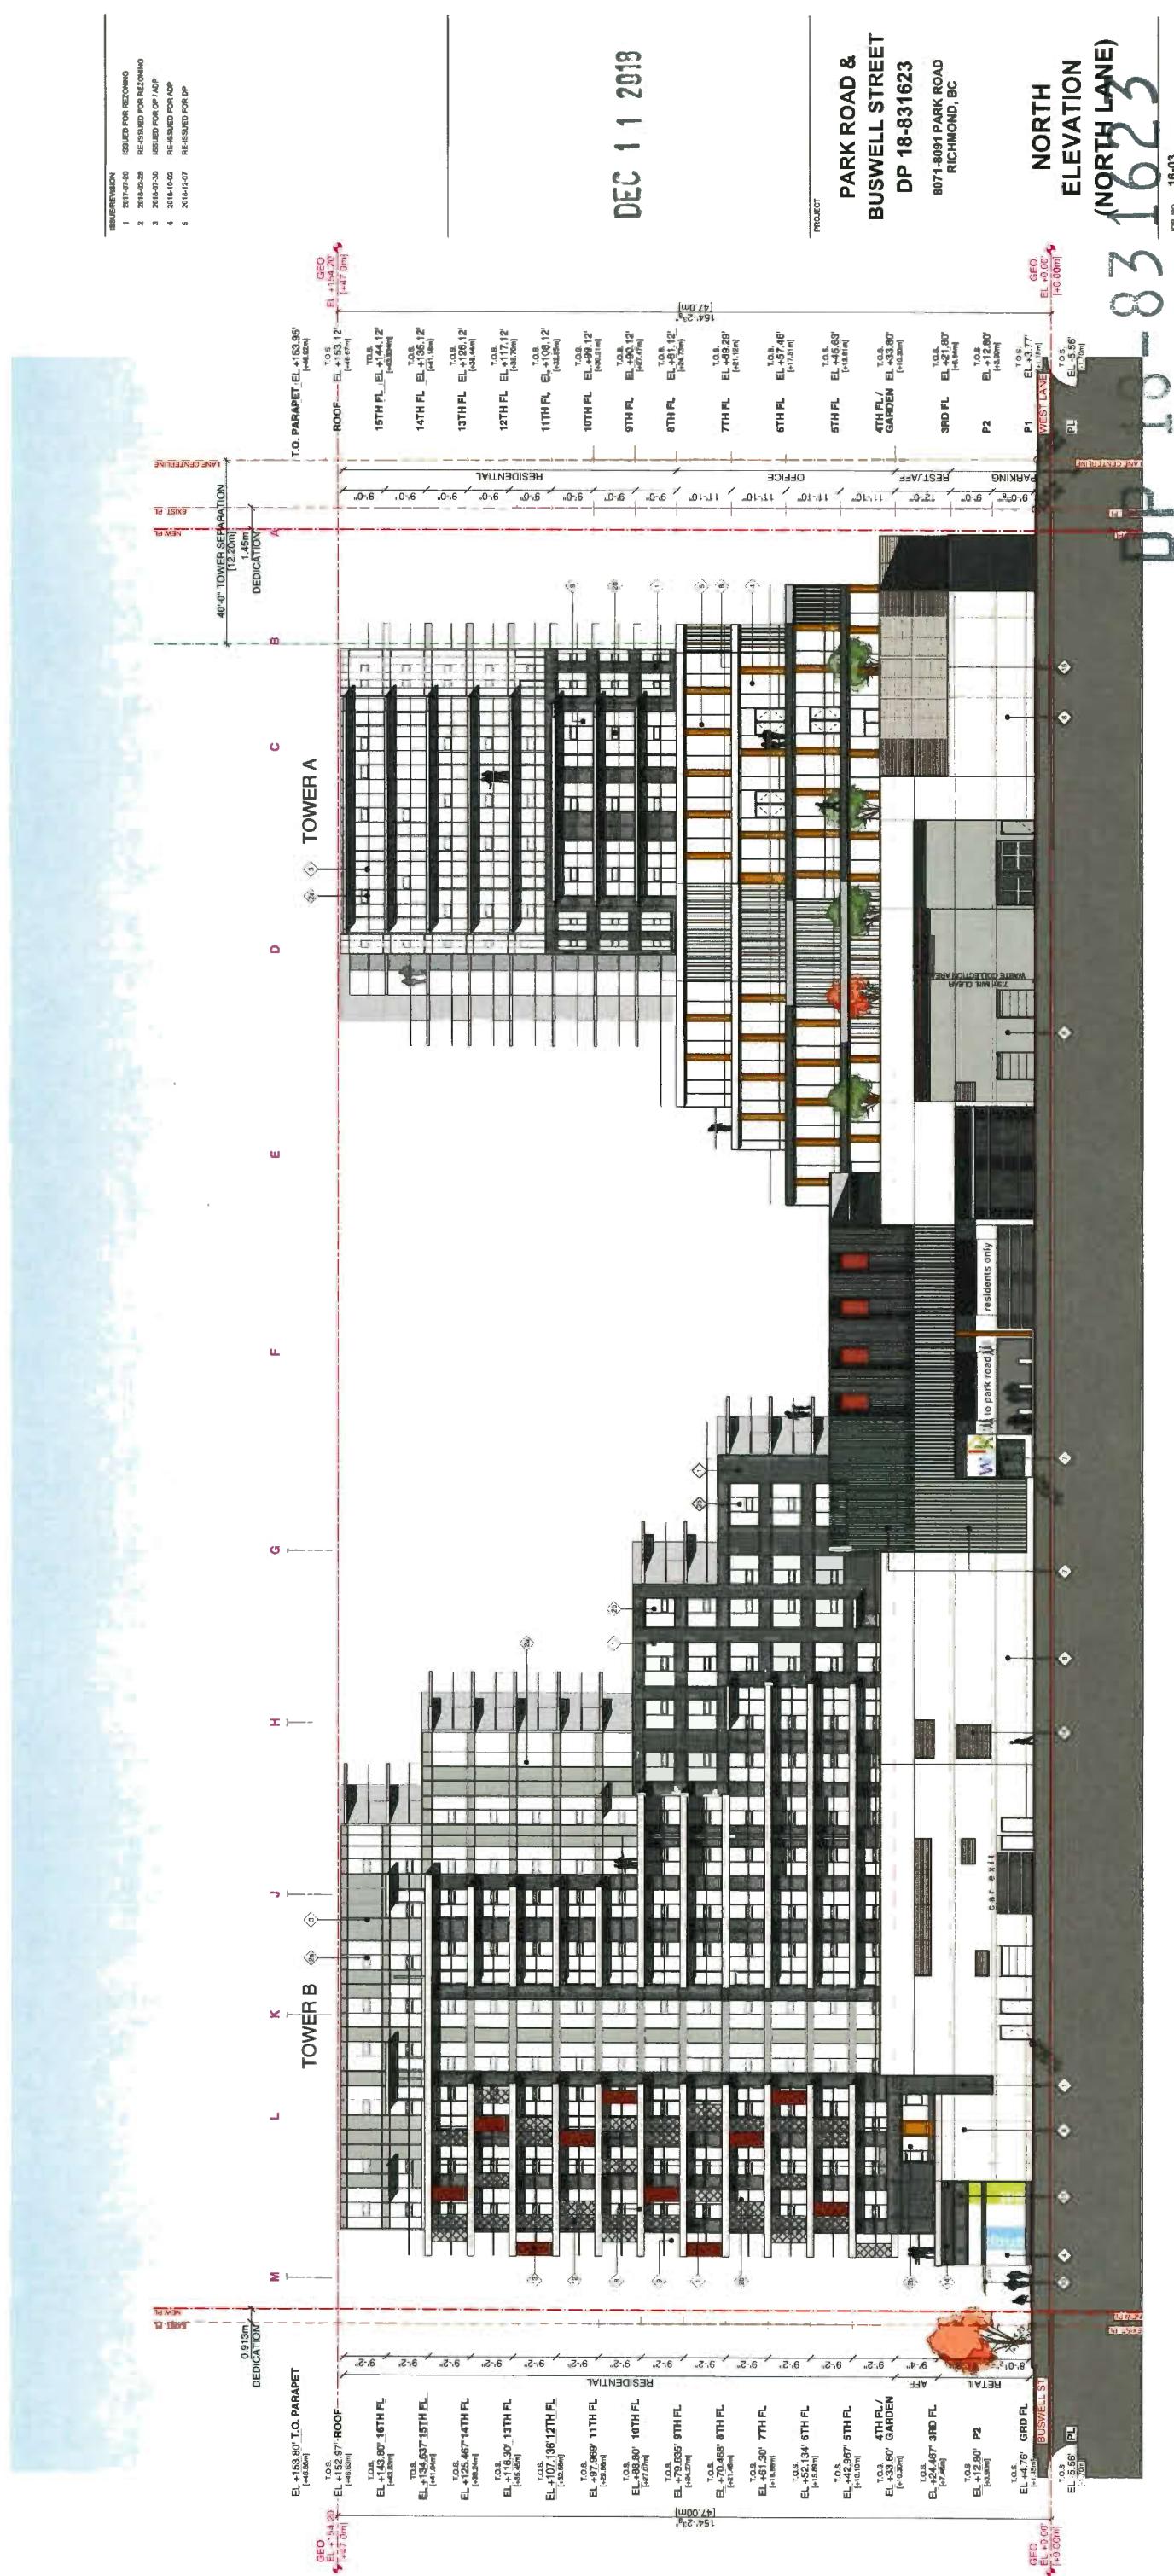


Plan #4e

| | | |
|---|---------------|--|
| DRAWN: | MBK/TJB | |
| DATE: | 07 DEC 2018 | |
| SCALE: | 1/16" = 1'-0" | |
| CROSSED OUT: | | |
| W.T.L. | | |
| DRAFTED/RECHECKED: This plan was developed in and or altered pursuant to the executive authority of Mr. T. Loring Archibald, and approved by the same official in the authority of Council. | | |
| DRAWING NO.: | | |

ISSUED FOR DP

ISSUED FOR DP

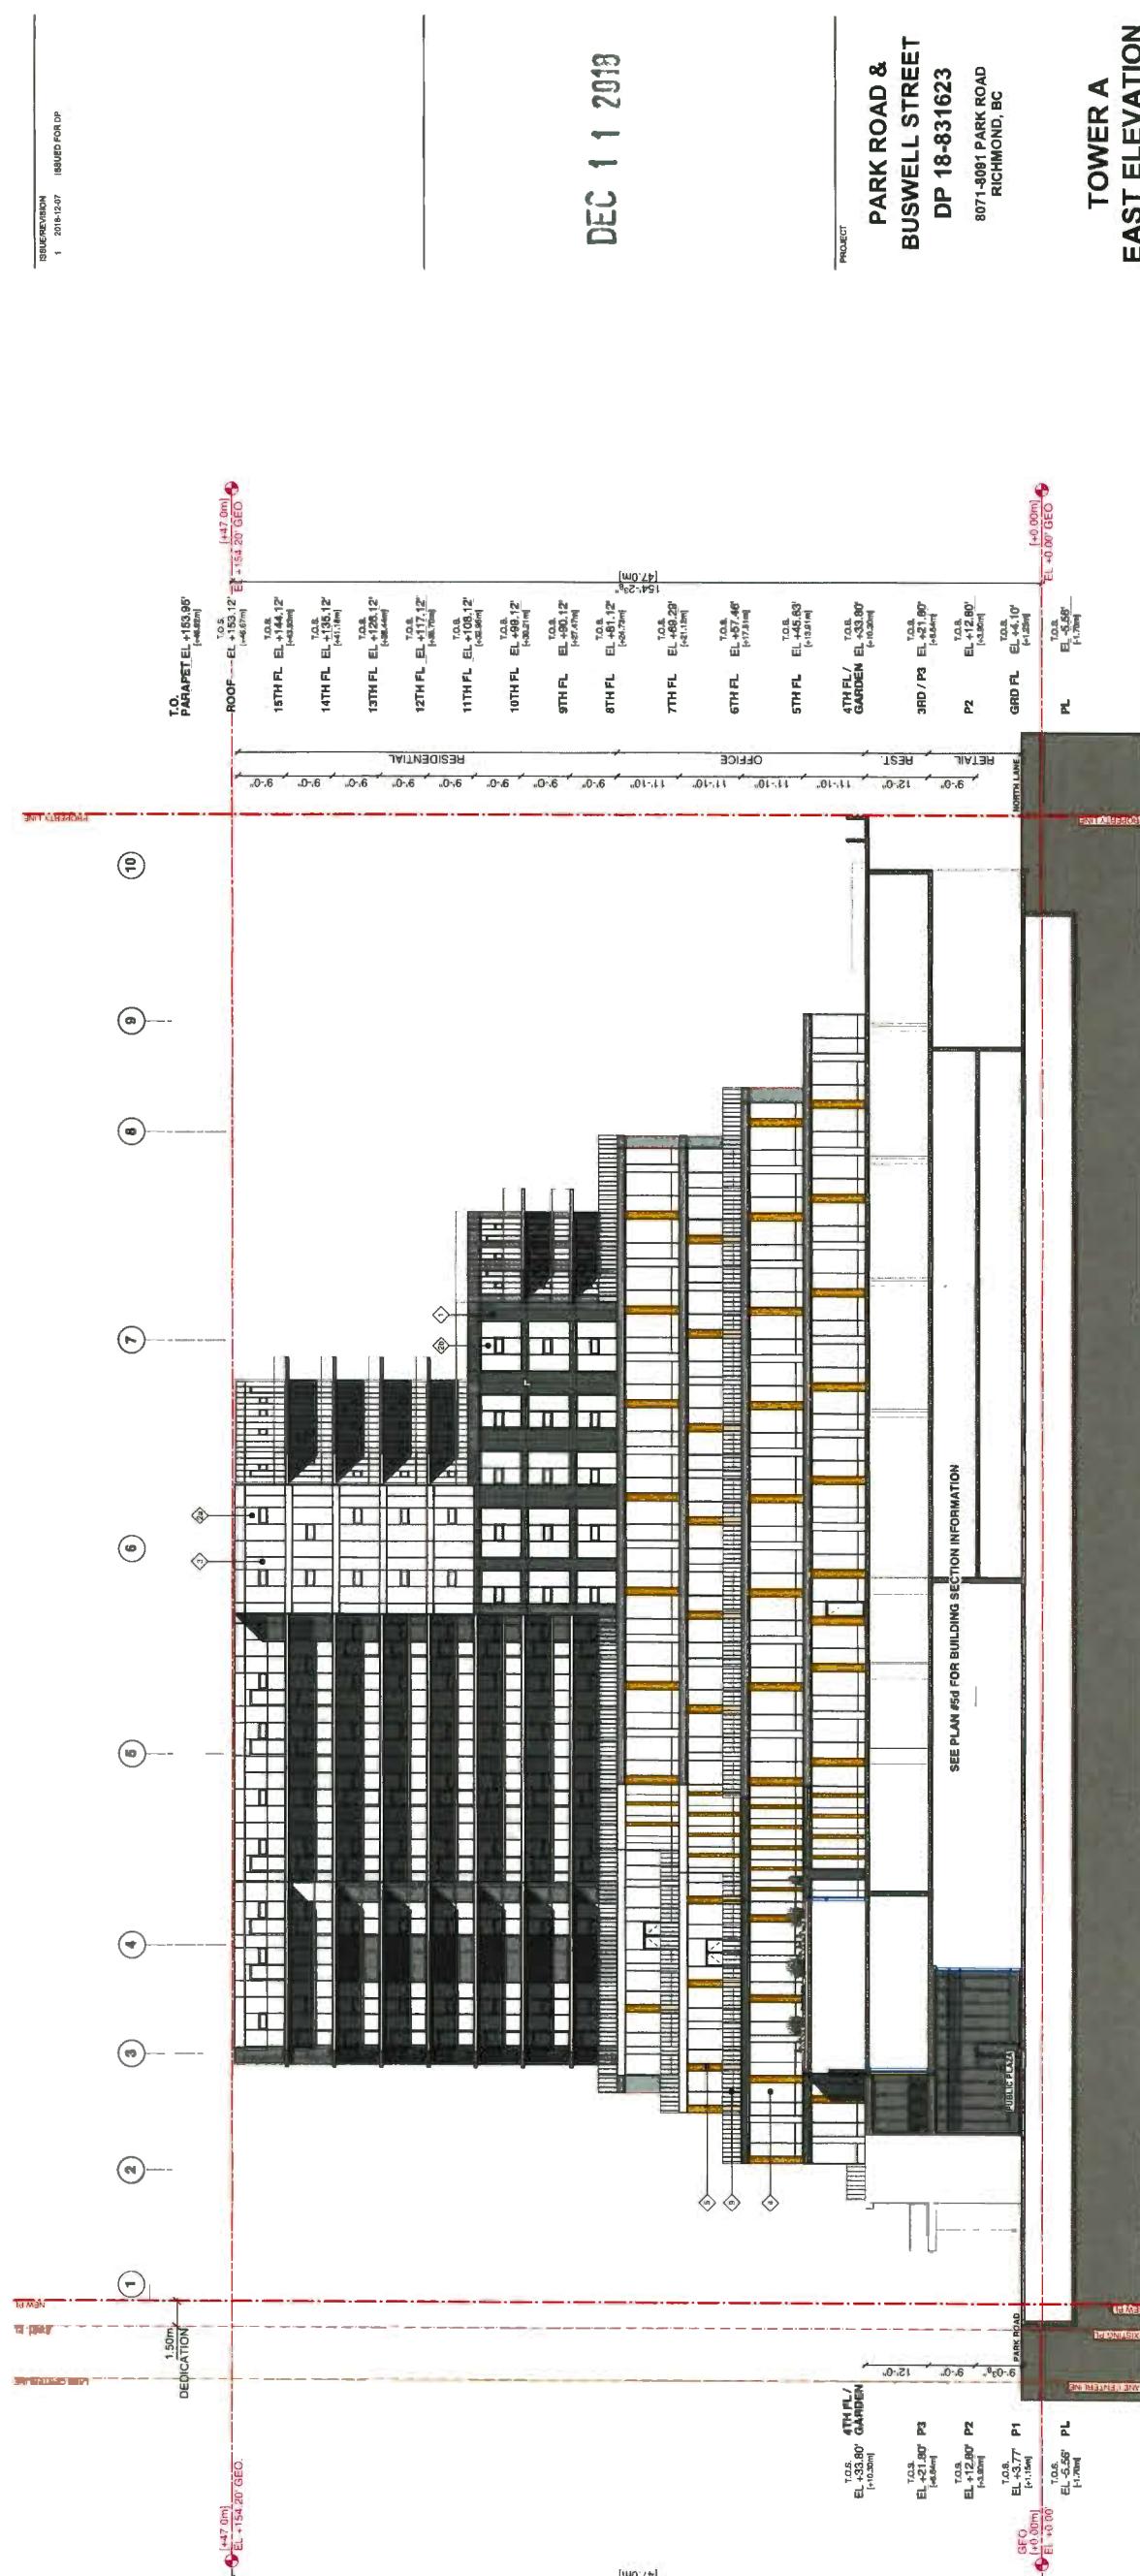

DEC 11 2018


**PARK ROAD &
BUSWELL STREET
DP 18-831623**

**TOWER A
EAST ELEVATION**

GROUP GARDEN

卷之三

Plan #4f

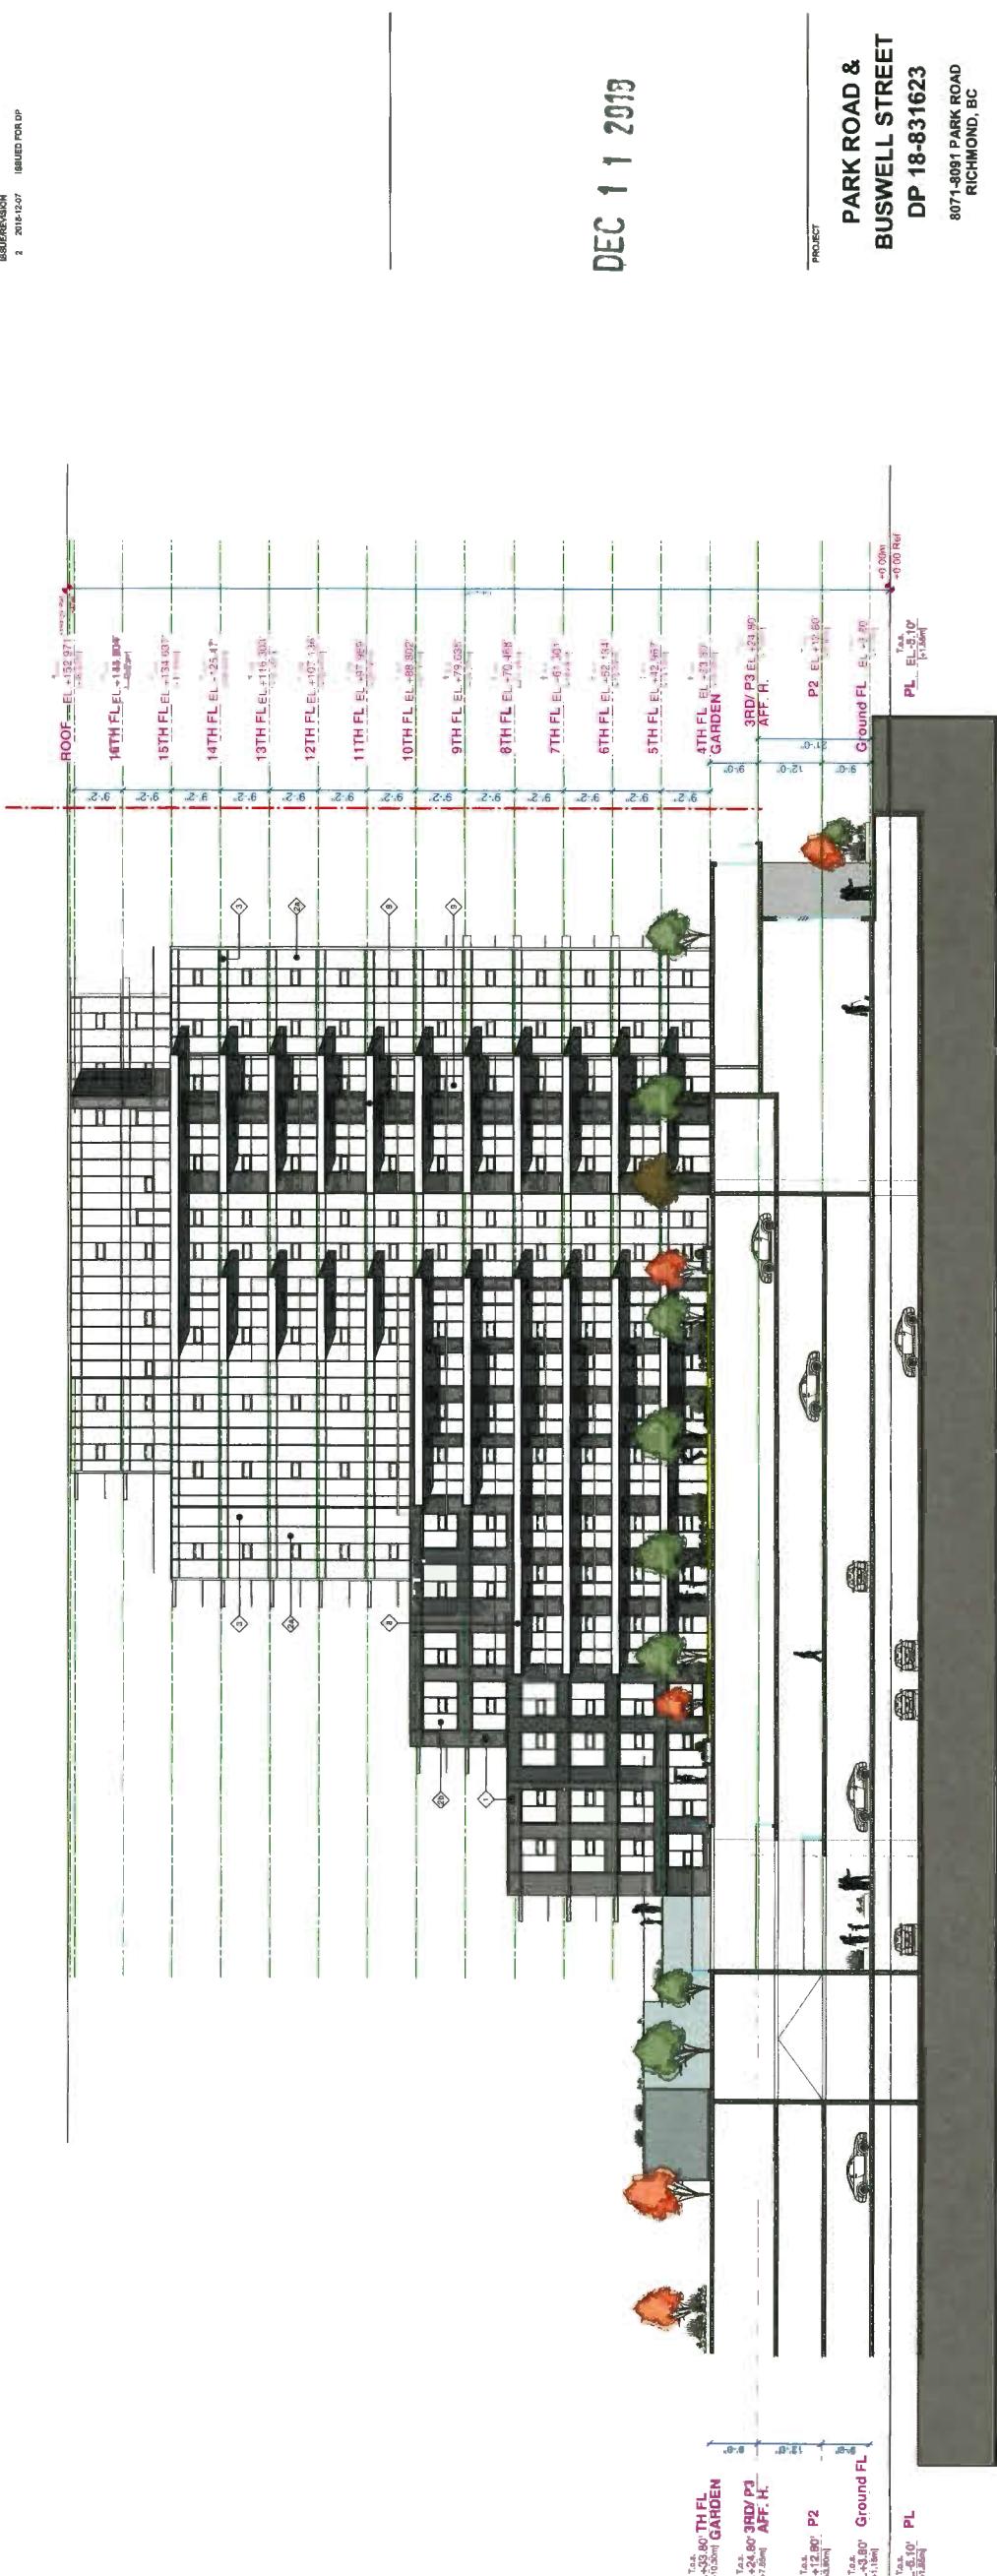

**TOWER B
SOUTH ELEVATION
(ROOF GARDEN)**

DP 18-831623

WTL

CHECKED

DRAWN MB/JB

DATE 07 DEC 2018

SCALE 1/16" = 1'-0"

BRUSH MATERIAL LEGEND

(Detailed description of symbols and their meanings for brush material legend)

Plan #4g

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DEC 11 2019

PROJECT
PARK ROAD &
BUSWELL STREET
DP 18-831623
8071-8081 PARK ROAD
RICHMOND, BC

**TOWER C
NORTH ELEVATION
(ROOF GARDEN)**

JOB NO. 16-03

DRAWN MB/JB


DATE 07 DEC 2018

SCALE 1/16" = 1'-0"

CHECKED WTL

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PRE-FINISHED WINDOWS:
"CHARCOAL GREY"
7a

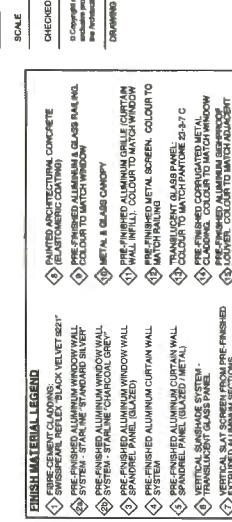

PRE-FINISHED WINDOWS & RAILINGS:
"STANDARD SILVER"
7b



PAINTED CONCRETE:
Benjamin Moore OC-25 "Cloud Cover"
6

DEC 11 2018

PROJECT
**PARK ROAD &
BUSWELL STREET**
DP 18-831623
8071-8091 PARK ROAD
RICHMOND, BC



18 - 8 MATERIALS 3




CEMENT COMPOSITE PANEL:
SWISSPEARL REFLEX "BLACK VELVET 9221"
4


VERTICAL SUNSHADE:
WHITE DIFFUSED GLASS PANEL
5

PRE-FINISHED METAL SCREEN,
COLOUR "BLACK WINDOW,
"STANDARD SILVER"
2


TINTED GLASS SCREEN:
PANTONE 201 C
1

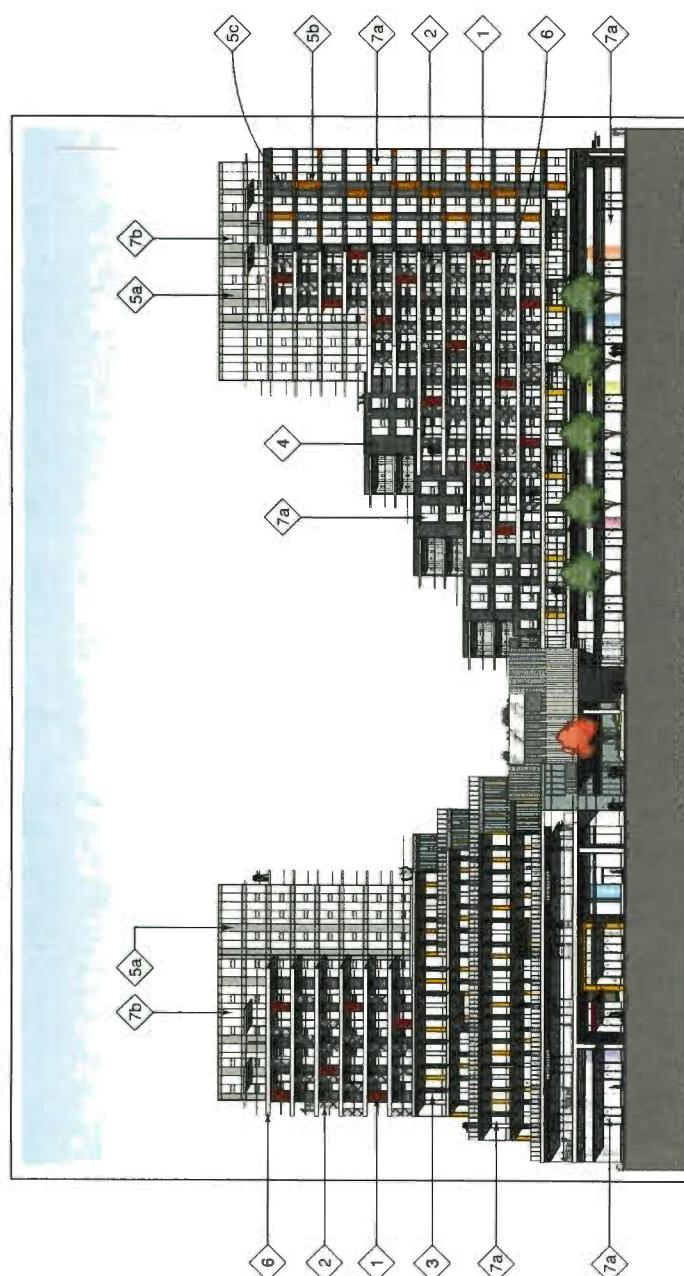

PARK ROAD ELEVATION
1/32" = 1'-0"

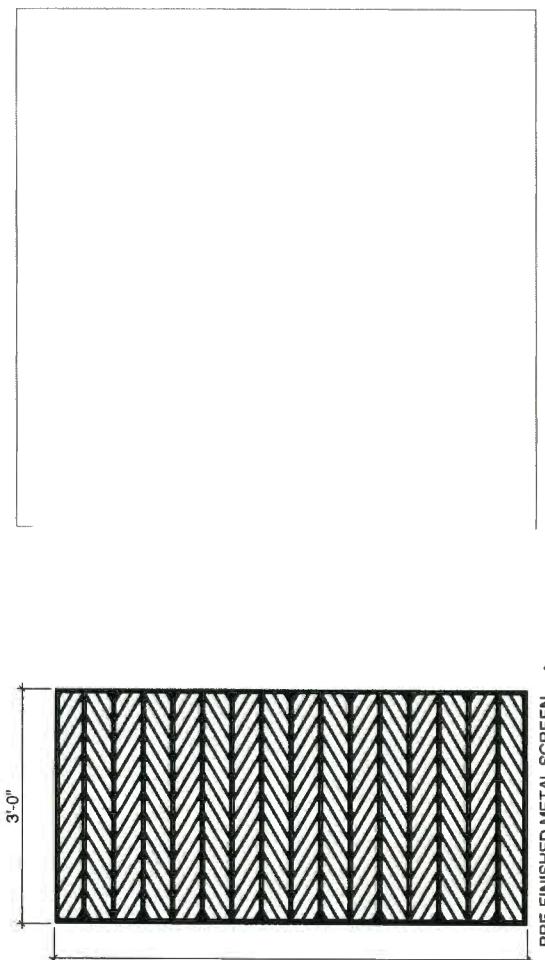


| ISSUE/REVISION | DATE | DESCRIPTION |
|----------------|------------|------------------------|
| 1 | 2017-07-20 | ISSUED FOR REZONING |
| 2 | 2018-02-28 | RE-ISSUED FOR REZONING |
| 3 | 2018-01-10 | ISSUED FOR OPT ADP |
| 4 | 2018-10-22 | RE-ISSUED FOR ADP |

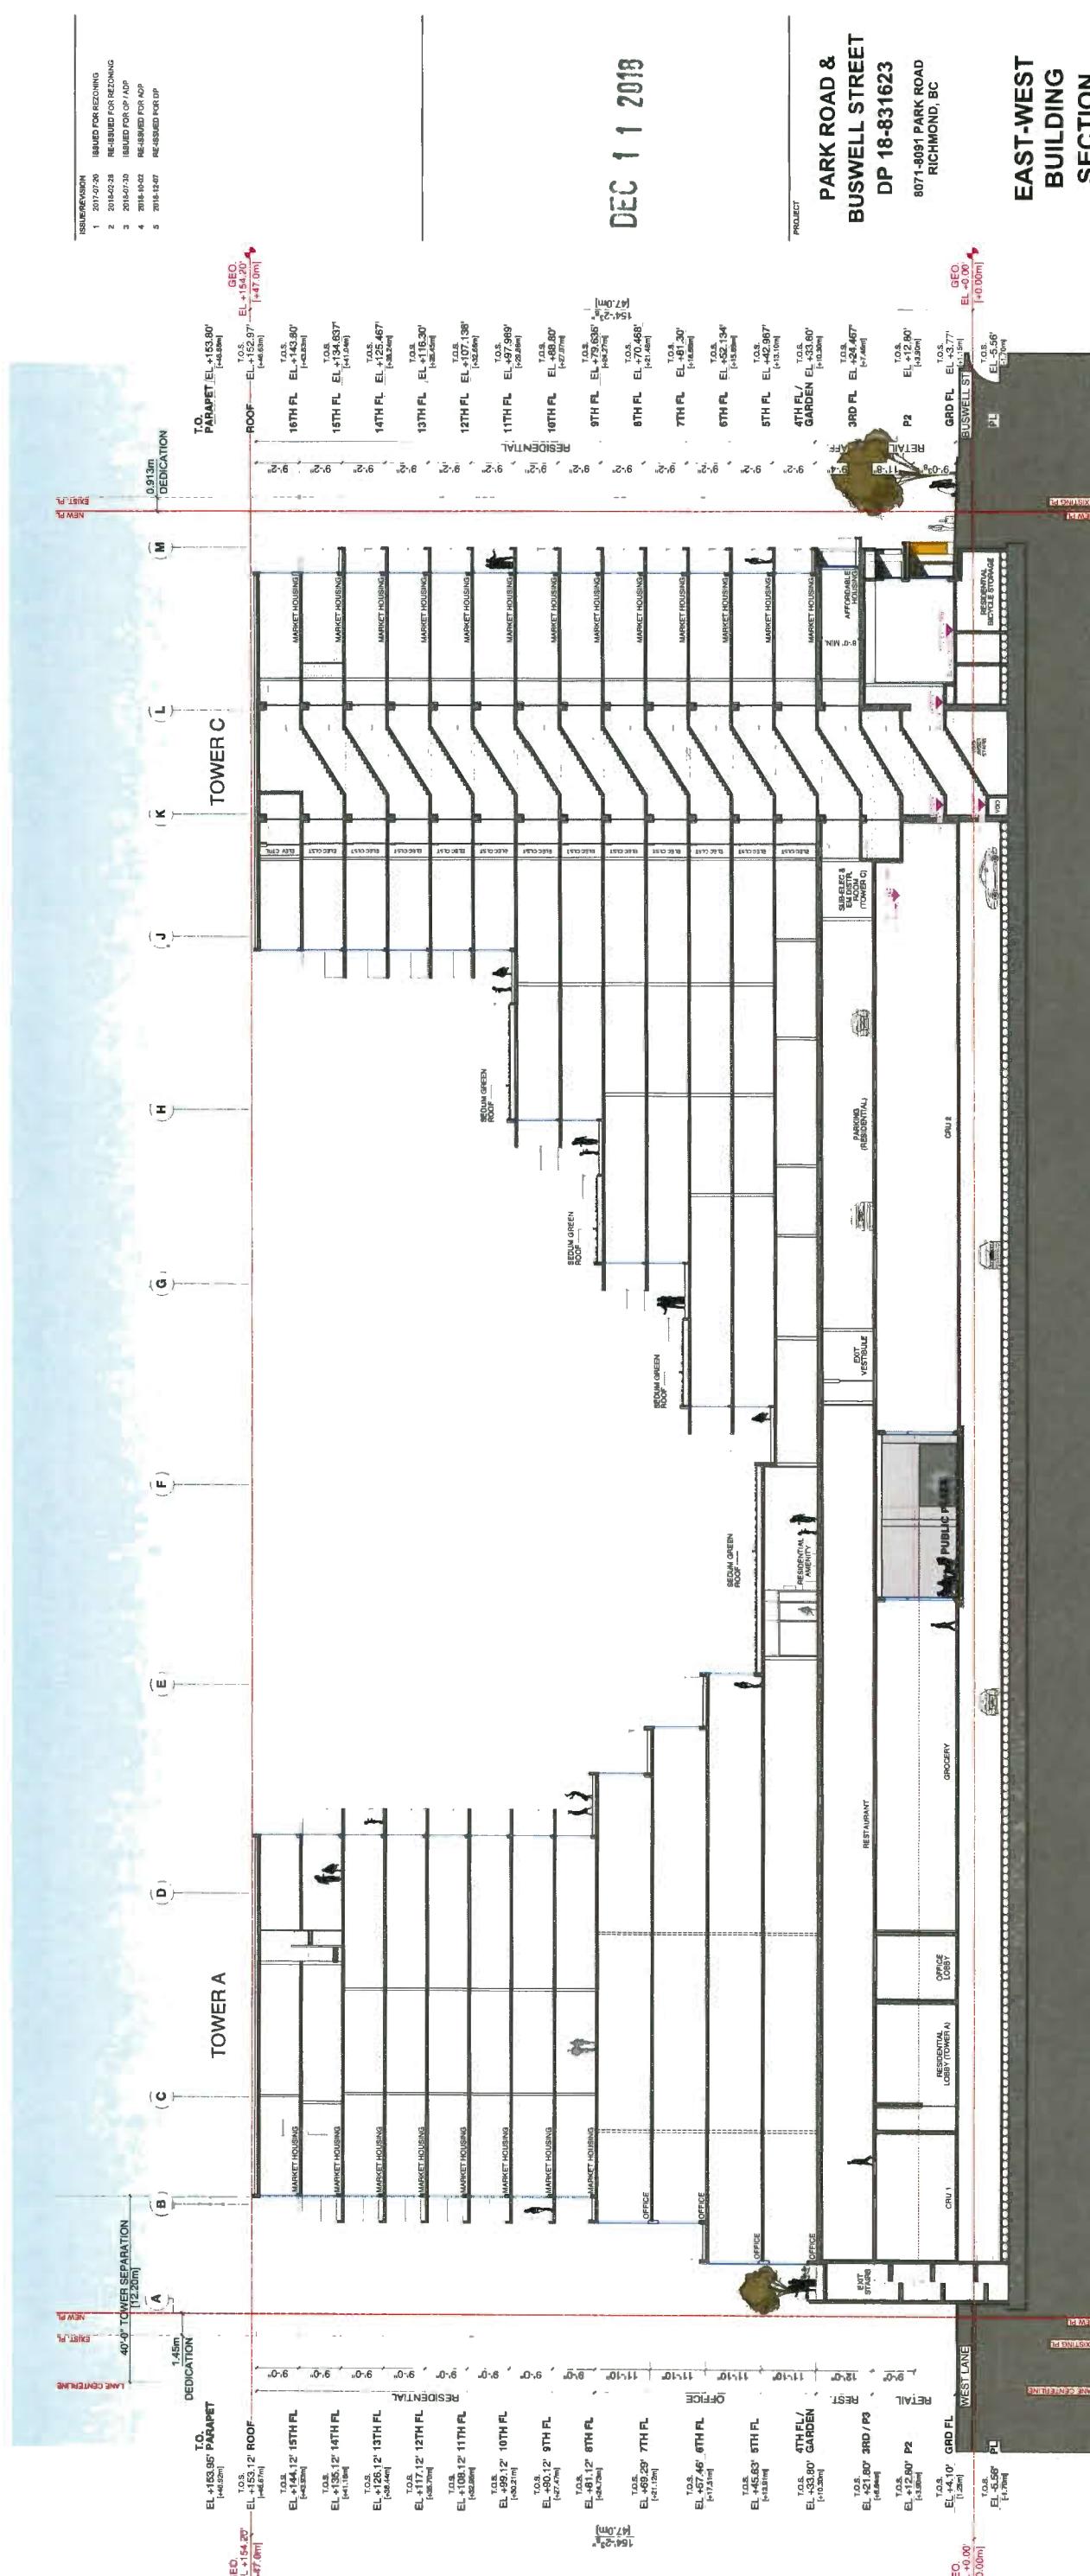

| | |
|-----------------------|----------------------|
| JOB NO. | 16-33 |
| DRAWN BY | MB / KIT |
| DATE | 07 DEC 2018 |
| SCALE | 1/16" = 1'-0" |
| CHEMED | WTL |
| DRAWN BY : 362 | |

Plan #5a

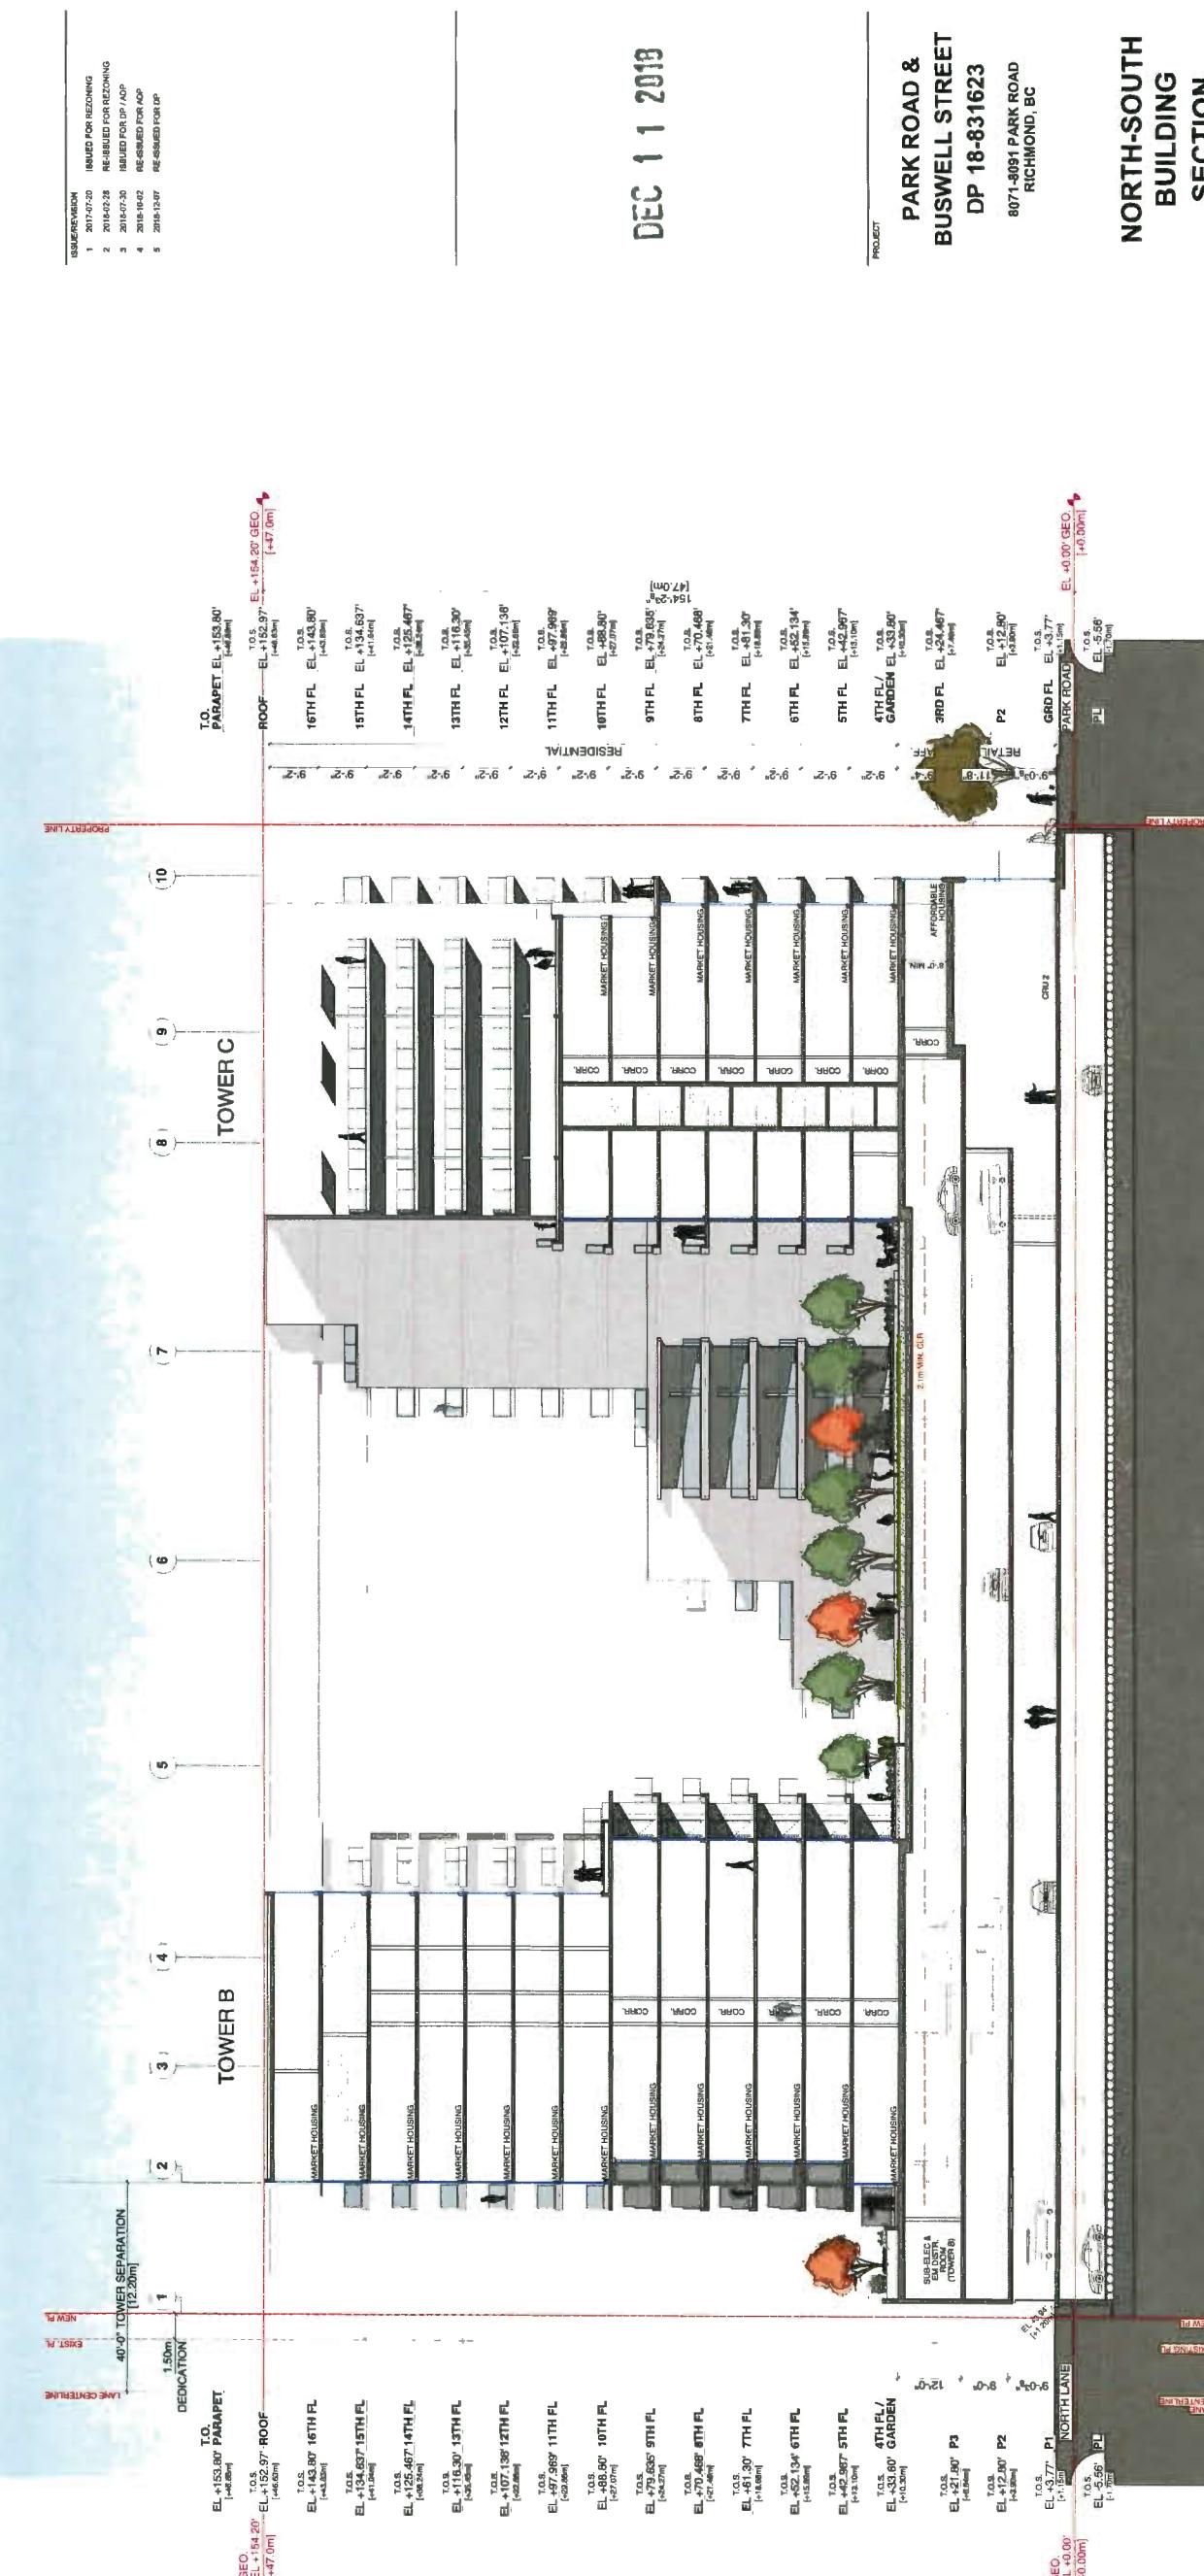

JOB NO. 16-03
DRAWN MB / KT
DATE 07 DEC 2018
SCALE 1/16" = 1'-0"
CHECKED WTL
REVISIONS
1. Initial drawing.
2. Minor changes to building sections.
3. Final version.

DP 18-831623

| ISSUE/REVISION | ISSUED FOR REZONING |
|----------------|-----------------------------------|
| 1 | 2017-07-20 ISSUED FOR REZONING |
| 2 | 2018-02-28 RE-ISSUED FOR REZONING |
| 3 | 2018-07-30 ISSUED FOR DP / ADP |
| 4 | 2018-10-16 RE-ISSUED FOR ADP |
| 4 | 2018-12-07 DE-LISTED FOR ADP |
| 4 | 2019-01-07 DE-LISTED FOR ADP |



DEC 11 2018

**PARK ROAD &
BUSWELL STREET
DP 18-831623**

8071-8091 PARK ROAD
RICHMOND, BC

N-S BLDG SECTION THRU
WALKWAY

6-03

6

7 DEC 2018

16" = 1'.0"

۷۱

— This plan and chart
of Ticonderoga

Bias #E9

W. T. LEUNG
ARCHITECTS
INC.

Suite 300, 973 West Broadway,
Vancouver, British Columbia • Canada V5Z 1K5
Telephone 604 736-9711, Facsimile 604 736-7991


| ISS-REF# | ISS-DESCRIPTION |
|----------|--------------------------------------|
| 1 | 2014-07-30 RE-SUED FOR REWORKING |
| 2 | 2014-07-30 RE-ASSED FOR REWORKING |
| 3 | 2014-07-30 RE-SUED FOR ACP |
| 4 | 2014-07-30 RE-SUED FOR ACP |
| 5 | 2014-12-07 RE-SENT FOR REP |

JAN 1 2019

PROJECT PARK ROAD &
BUSWELL STREET
DP 18-031623
8091-0091 PARK ROAD
RICHMOND, BC
N-S BLDG
SECTION THRU
WALKWAY

| | |
|----------|--------------------|
| JOB NO. | 16-03 |
| CHAVAN | JB |
| | 07 DEC 2018 |
| SCREENER | 1156 - 1-AJ |
| CHECKED | WTL |

G First interview. The man emerged as a tall, thin male, wearing a light-colored shirt, dark trousers, and a dark cap. He had short hair and was wearing glasses.

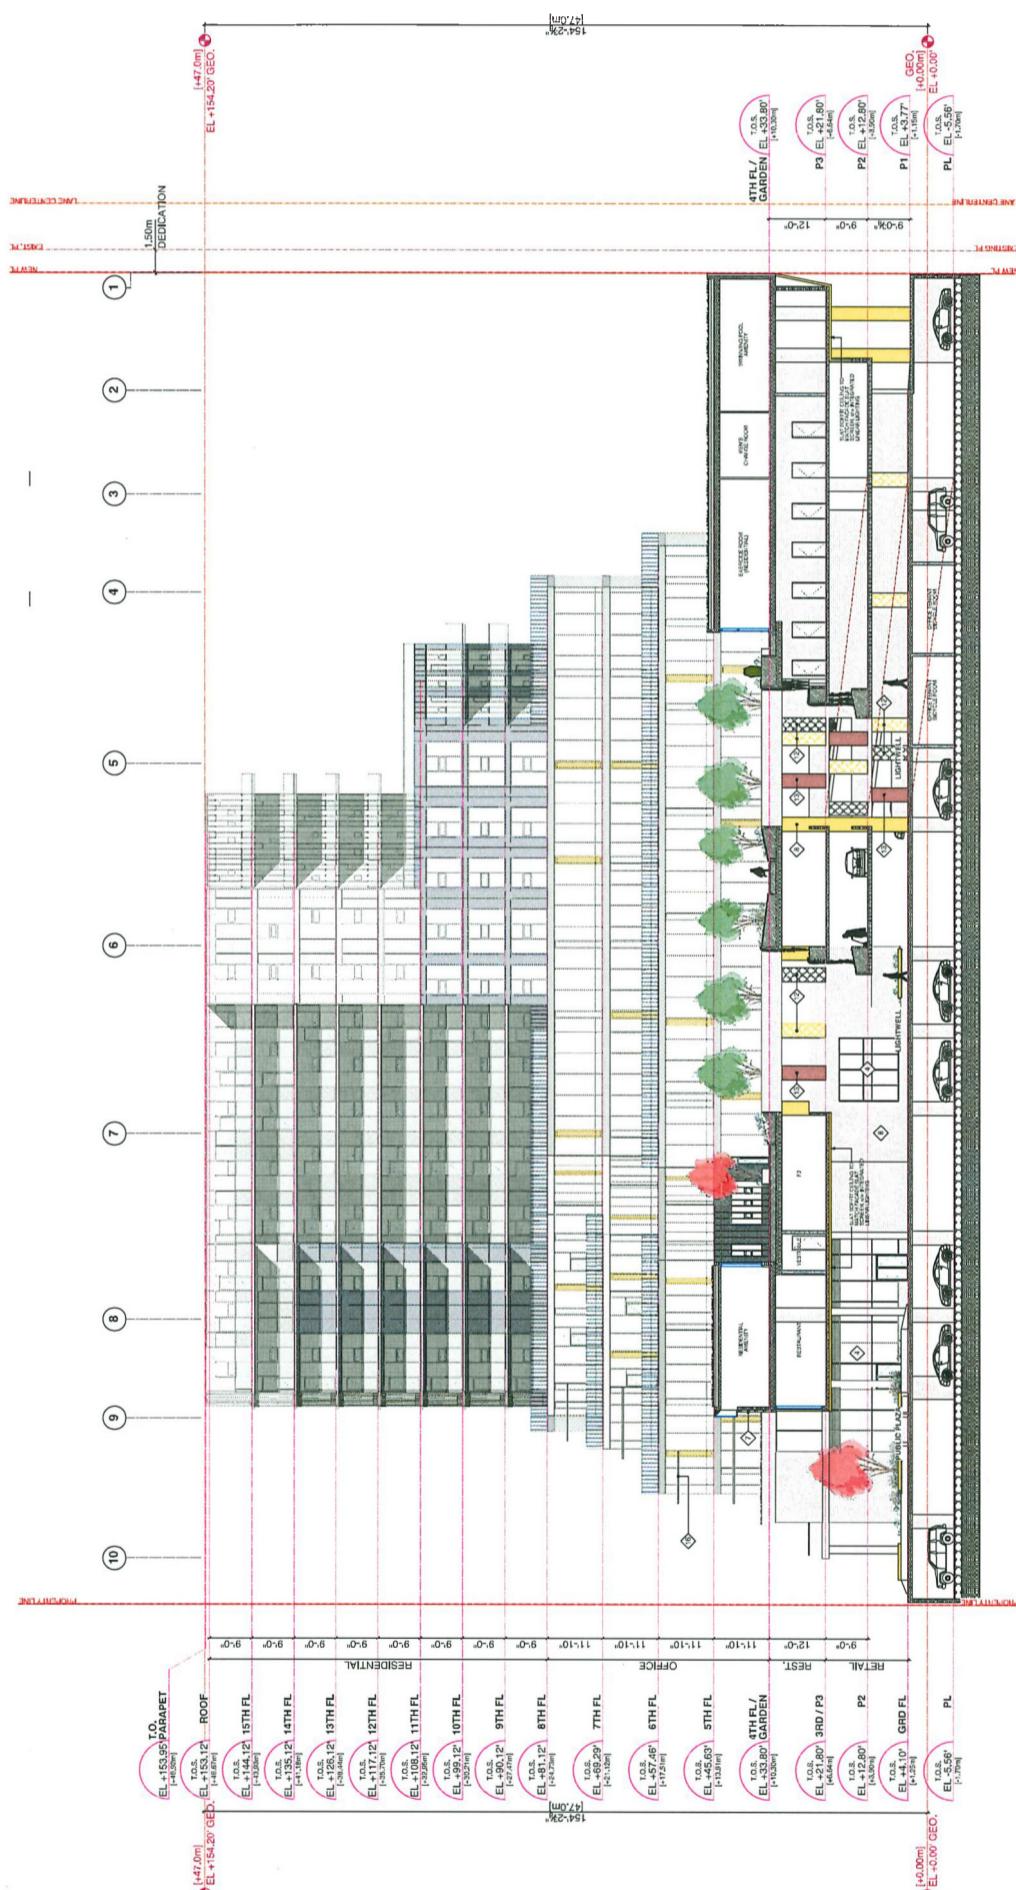

דוחות

2 0 2 3 1 6 3

ISSUE NUMBER: 6
ISSUED FOR REVIEWING
1 2016-07-20
2 2016-09-08
RE-SUBMITTED FOR REVIEWING
3 2016-04-09
4 2016-05-09
RE-SUBMITTED FOR REVIEWING
5 2016-07-30
SUBMITTED FOR DP ADP
6 2016-12-07
RE-ASSIGNED FOR DP

DEC 11 2013

PROJECT
PARK ROAD &
BUSWELL STREET
DP 18-831623
8071-8091 PARK ROAD
RICHMOND, BC

PROJECT
RENDERINGS
831623

JOB NO. 16-03
DRAWING NO. JB
DATE 07 DEC 2016
SCALE NO SCALE
CHECKED WTL
SOLVED
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penalties under Canadian law.


Plan #6a




LOOKING NORTHWEST



LOOKING SOUTHWEST

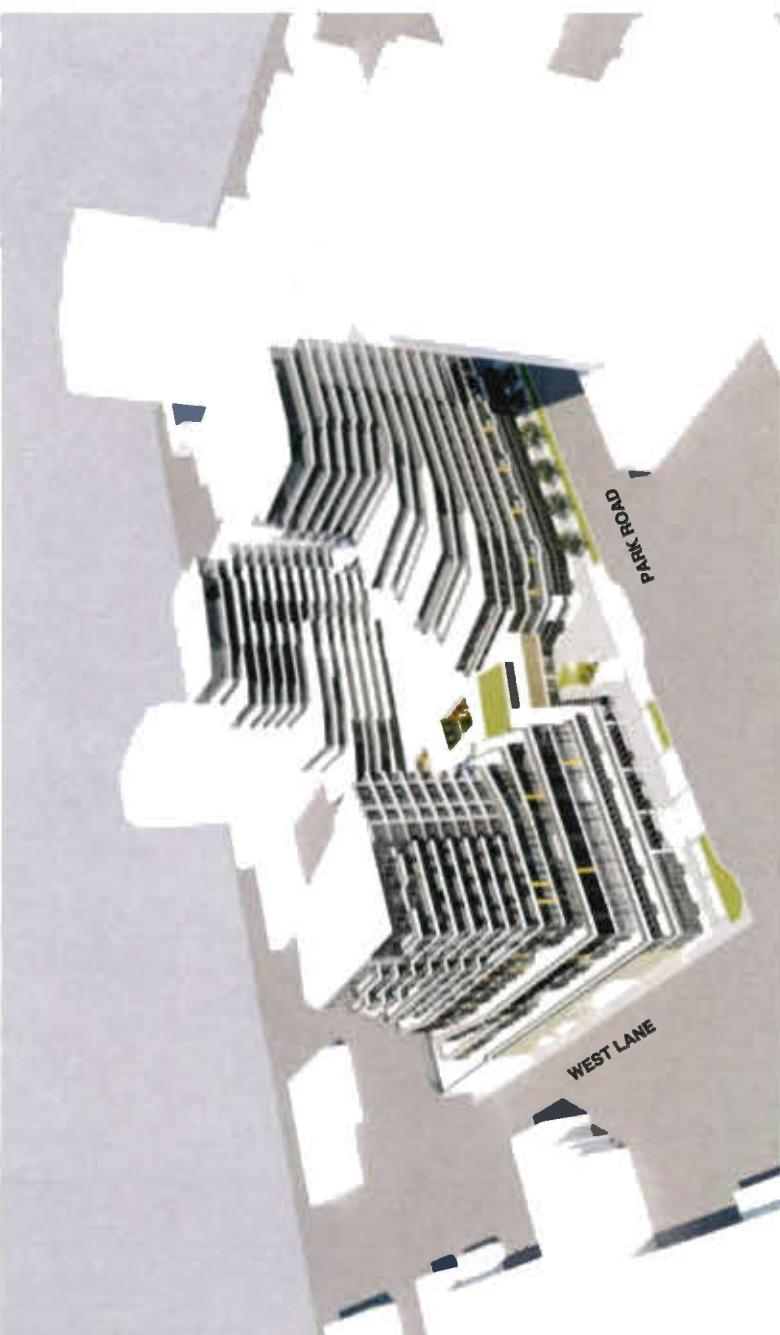

LOOKING NORTHEAST

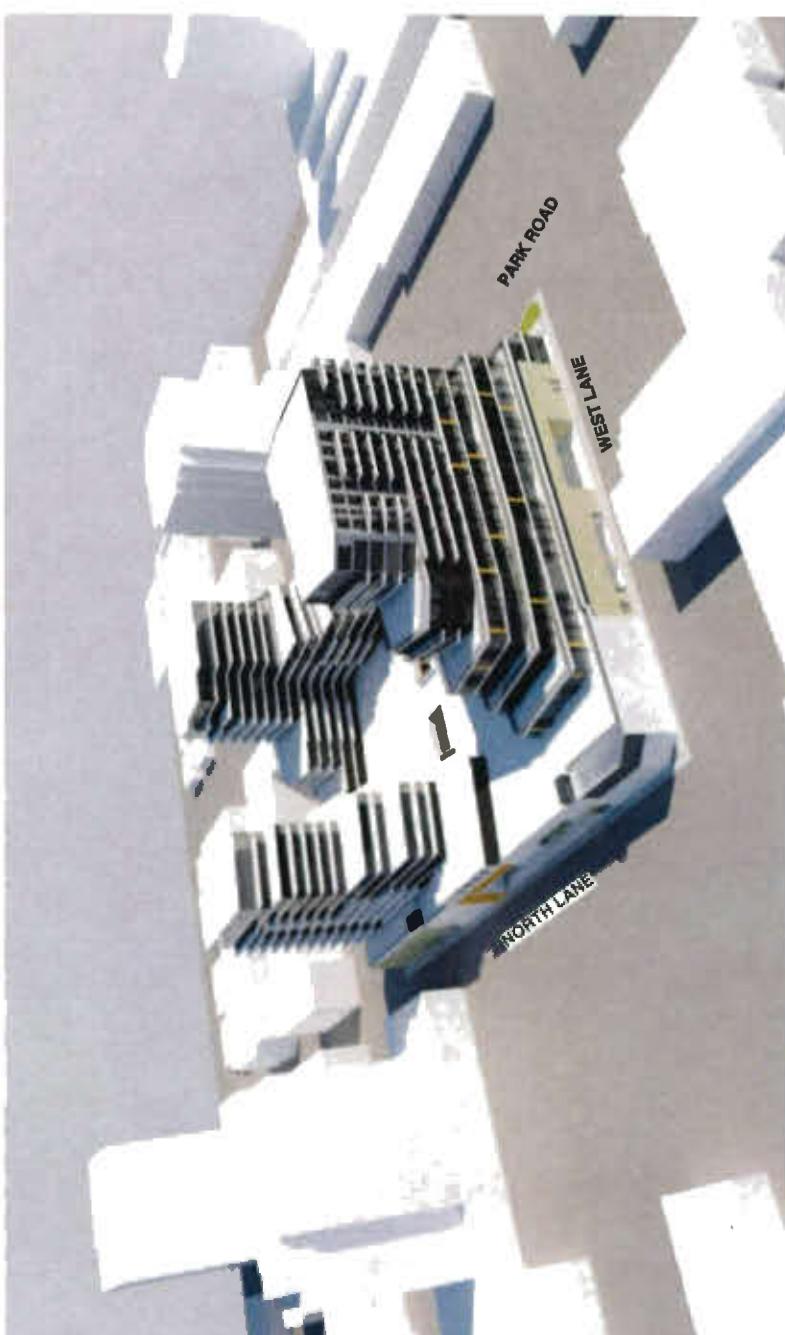

LOOKING SOUTHEAST




PUBLIC PLAZA AND PEDESTRIAN CONNECTION FROM PARK ROAD



DEC 11 2018

LOOKING NORTH WITHIN THE PEDESTRIAN CONNECTION

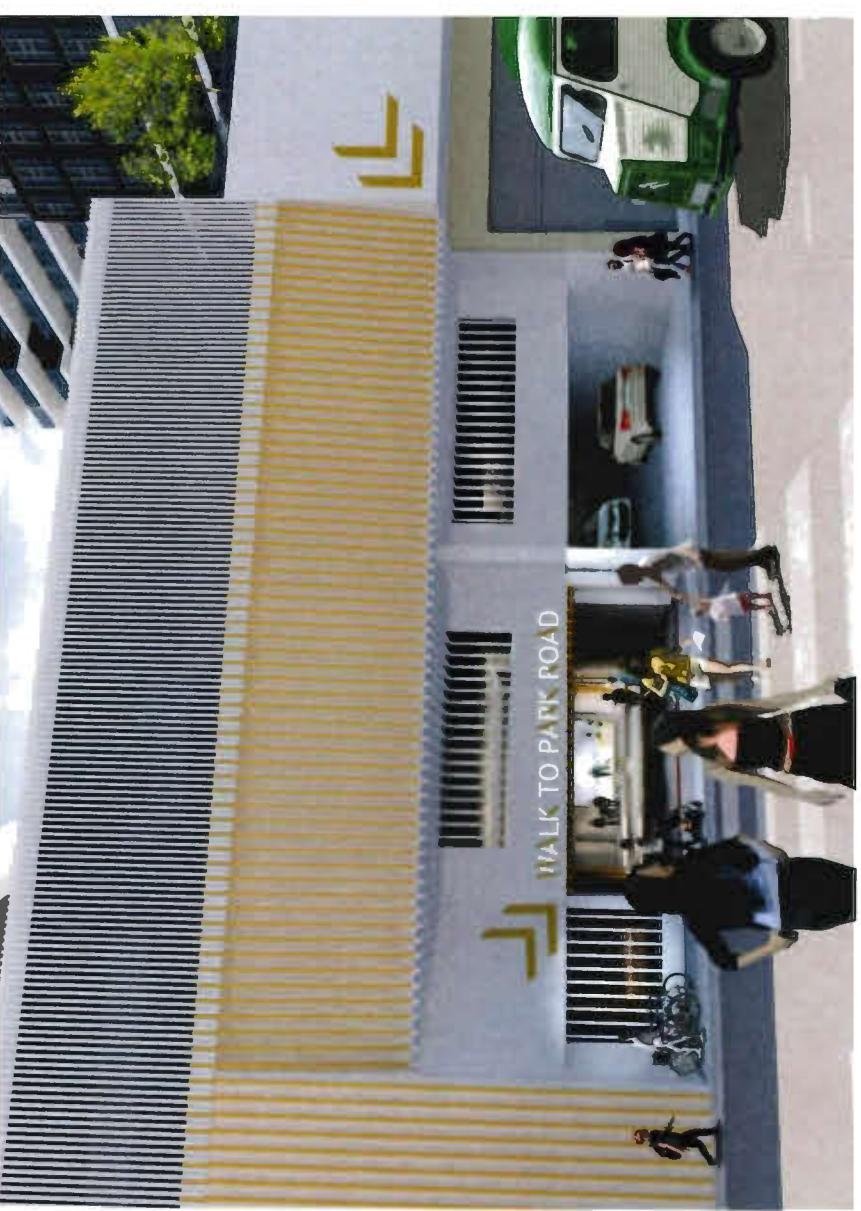

PEDESTRIAN CONNECTION FROM THE NORTH LANE



LOOKING WEST ALONG PARK ROAD

W. T. LEUNG
A R C I T E C T S
I N C.

200-201 10th Street
Vancouver, British Columbia V6C 0G9
(604) 541-5511, Fax (604) 541-5501


REF. NO. 10000000000000000000000000000000
1. SIDE A 2. SIDE B
3. FRONT 4. BACK
5. HORIZONTAL
6. VERTICAL




MARCH 21 @ 10AM



MARCH 21 @ 12PM

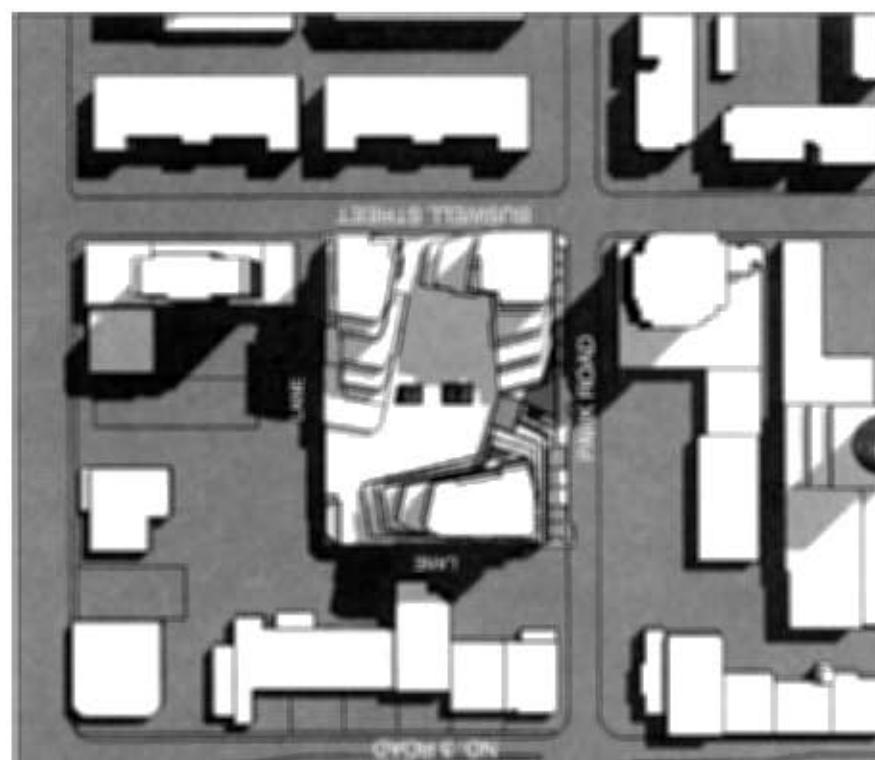

MARCH 21 @ 2PM

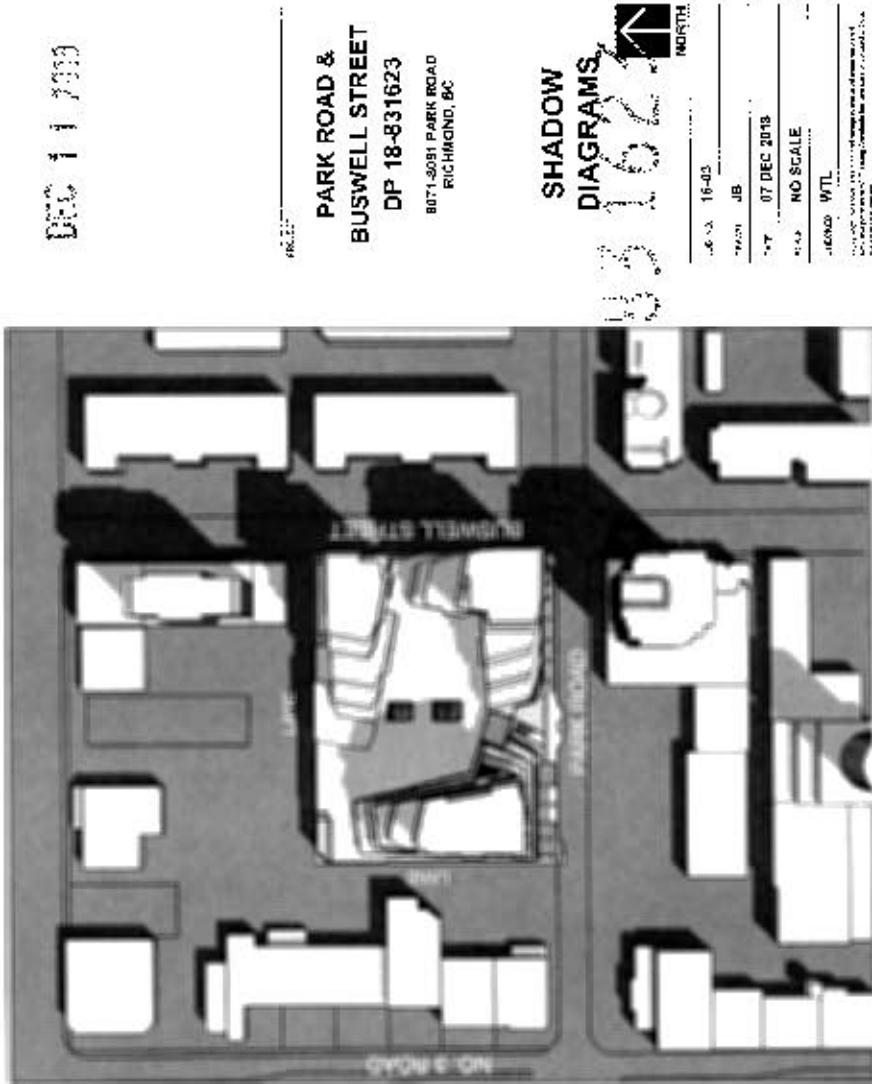

SEPTEMBER 21 @ 10AM



SEPTEMBER 21 @ 12PM




SEPTEMBER 21 @ 2PM

PARK ROAD &
BUSWELL STREET
DP 18-831623
8071-9081 PARK ROAD
RICHLAND, BC

SHADOW
DIAGRAMS
16
NORTH
16-03
JB
07 DEC 2013
NO SCALE
WTL



16-03
JB
07 DEC 2013
NO SCALE
WTL

Plan #7

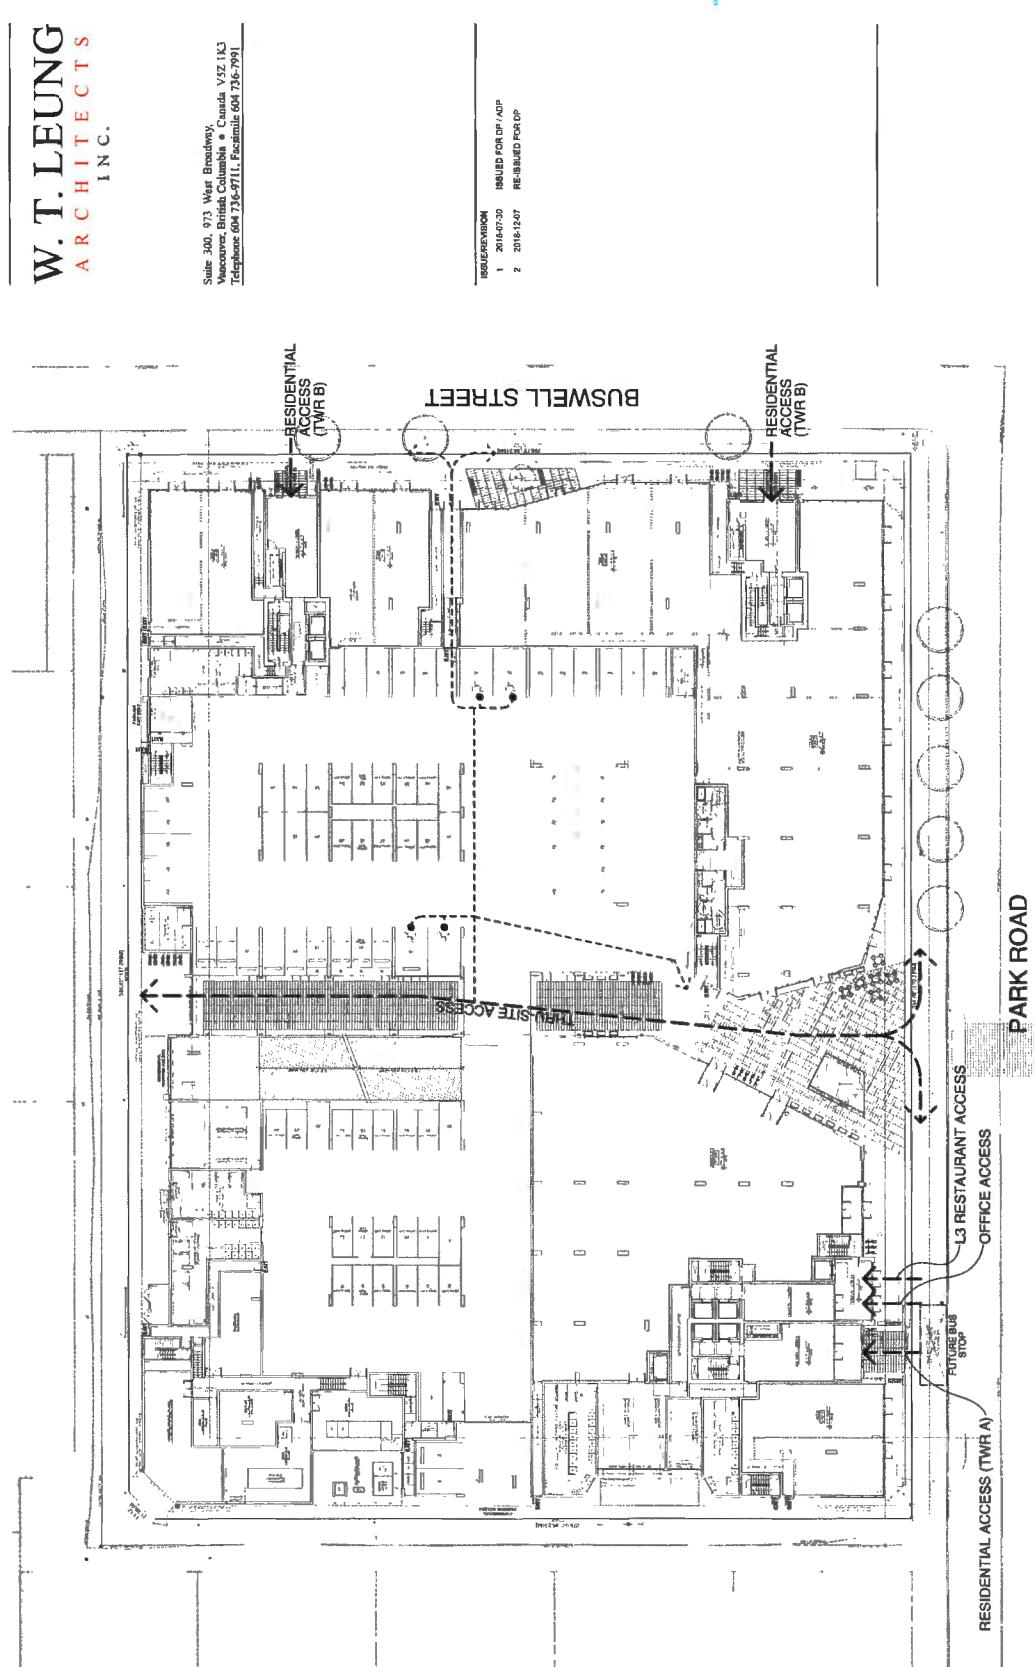


DEC 11 2019

**PARK ROAD
ACCESSIBILITY ROUTE ON GROUND FLOOR**

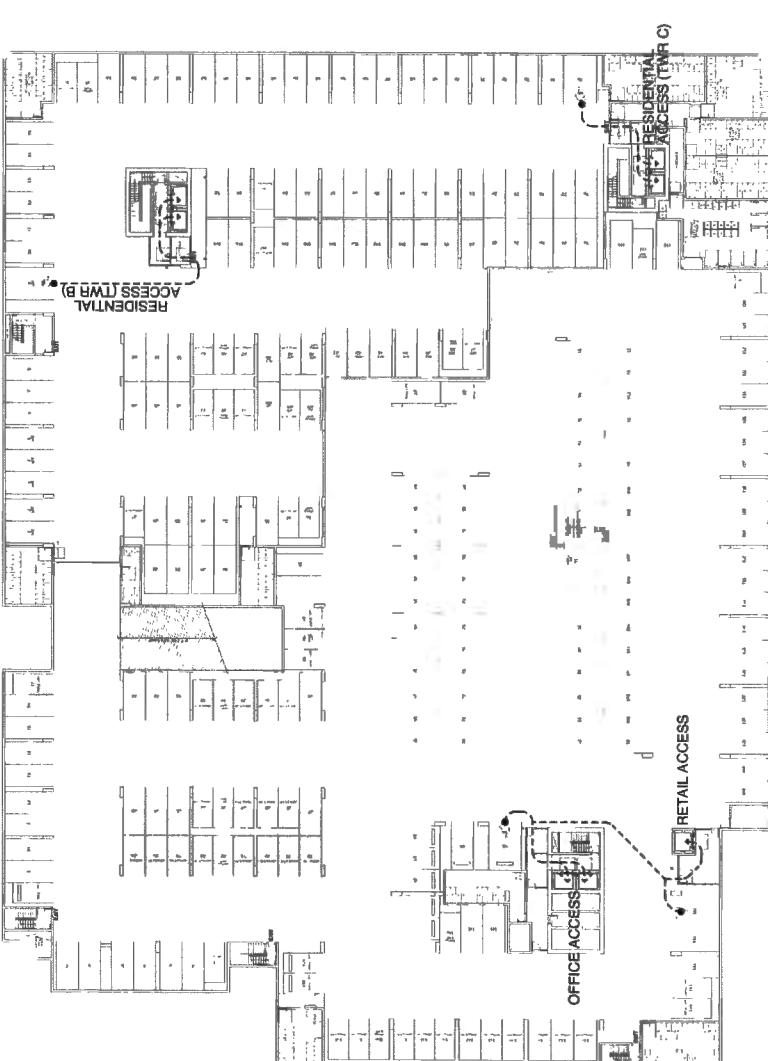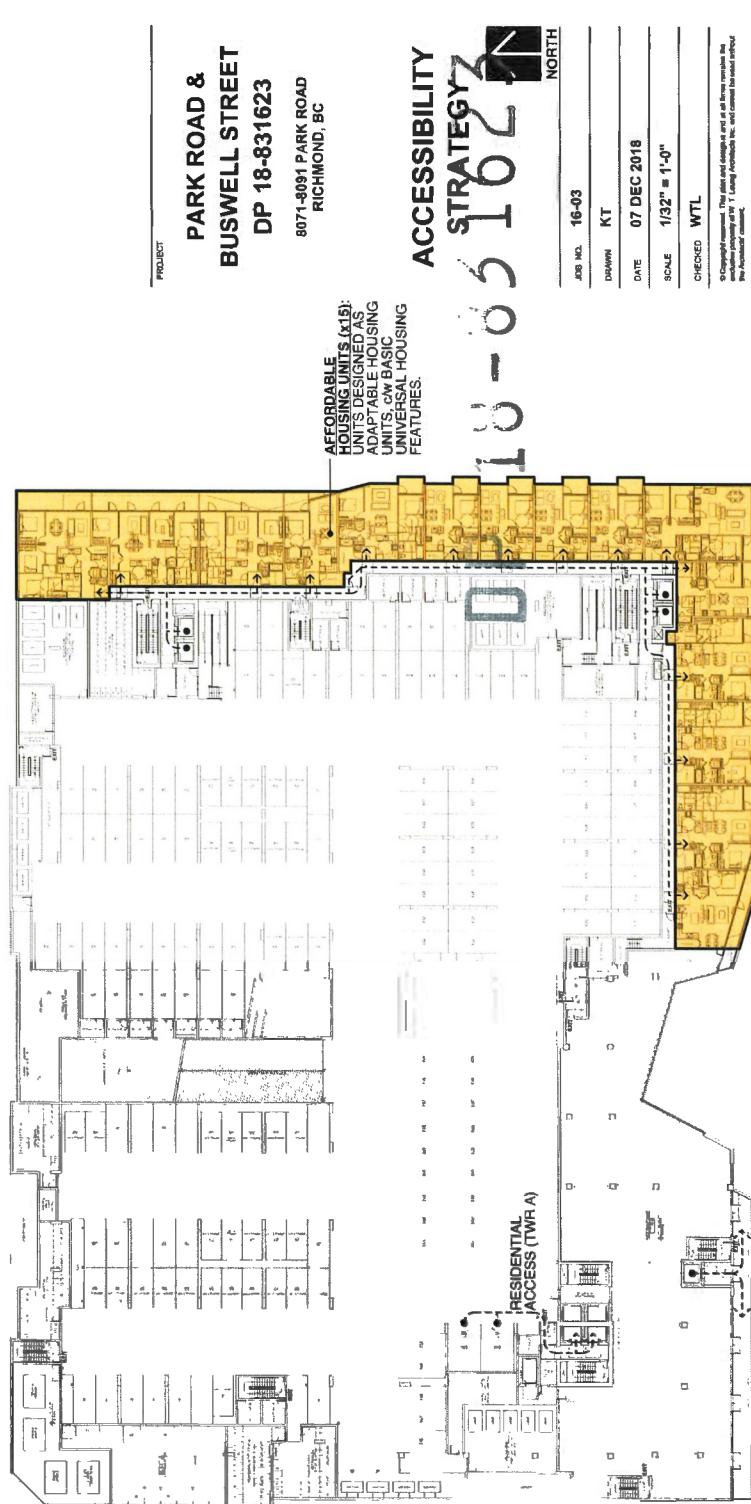


ACCESSIBILITY ROUTE ON LEVEL PL

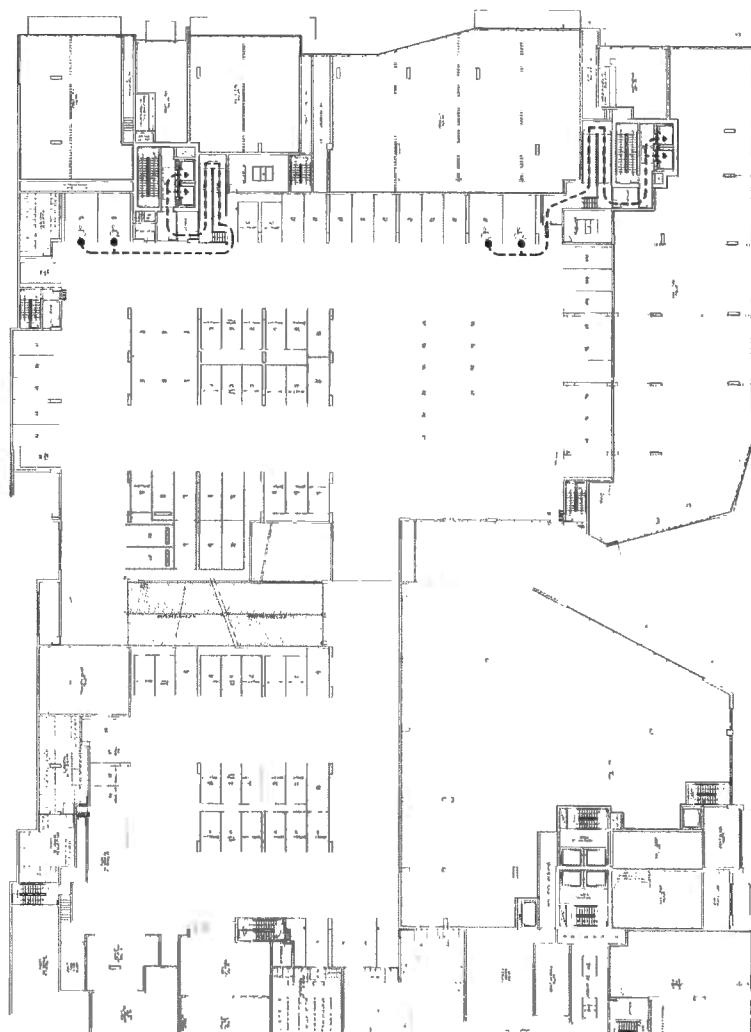


ACCESSIBILITY ROUTE ON LEVEL P3/3RD FL.(AFFORDABLE HOUSING UNITS)

ACCESSIBILITY ROUTE ON LEVEL P2


Plan #8a

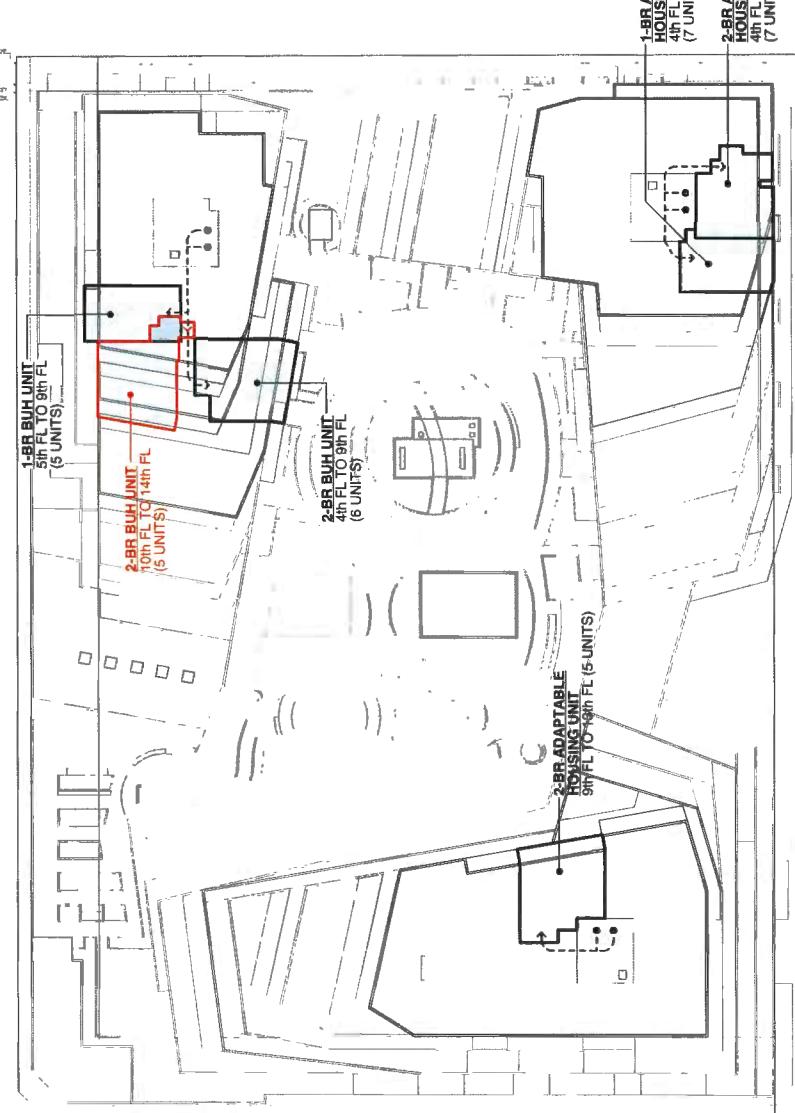


ACCESSIBILITY ROUTES & LOCATIONS OF BASIC UNIVERSAL HOUSING (BUH) UNITS

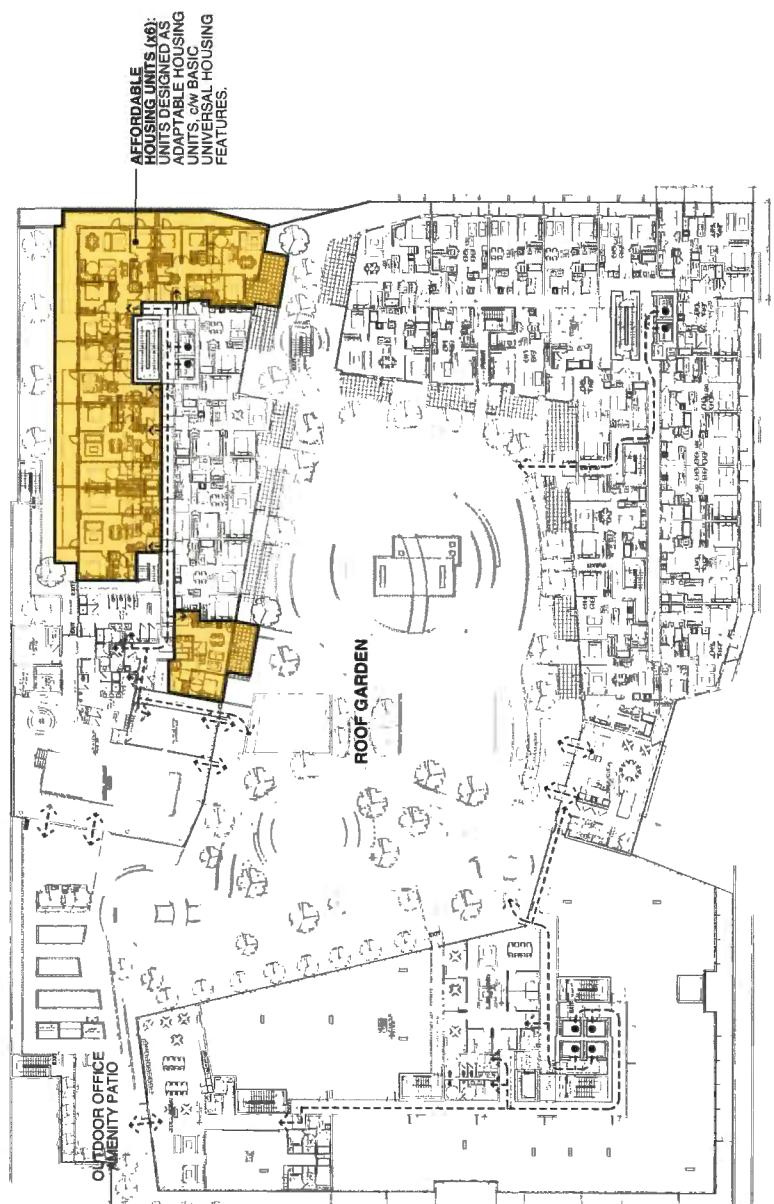

ACCESSIBILITY ROUTE ON 4th FLOOR (AMENITIES & ROOF GARDEN)

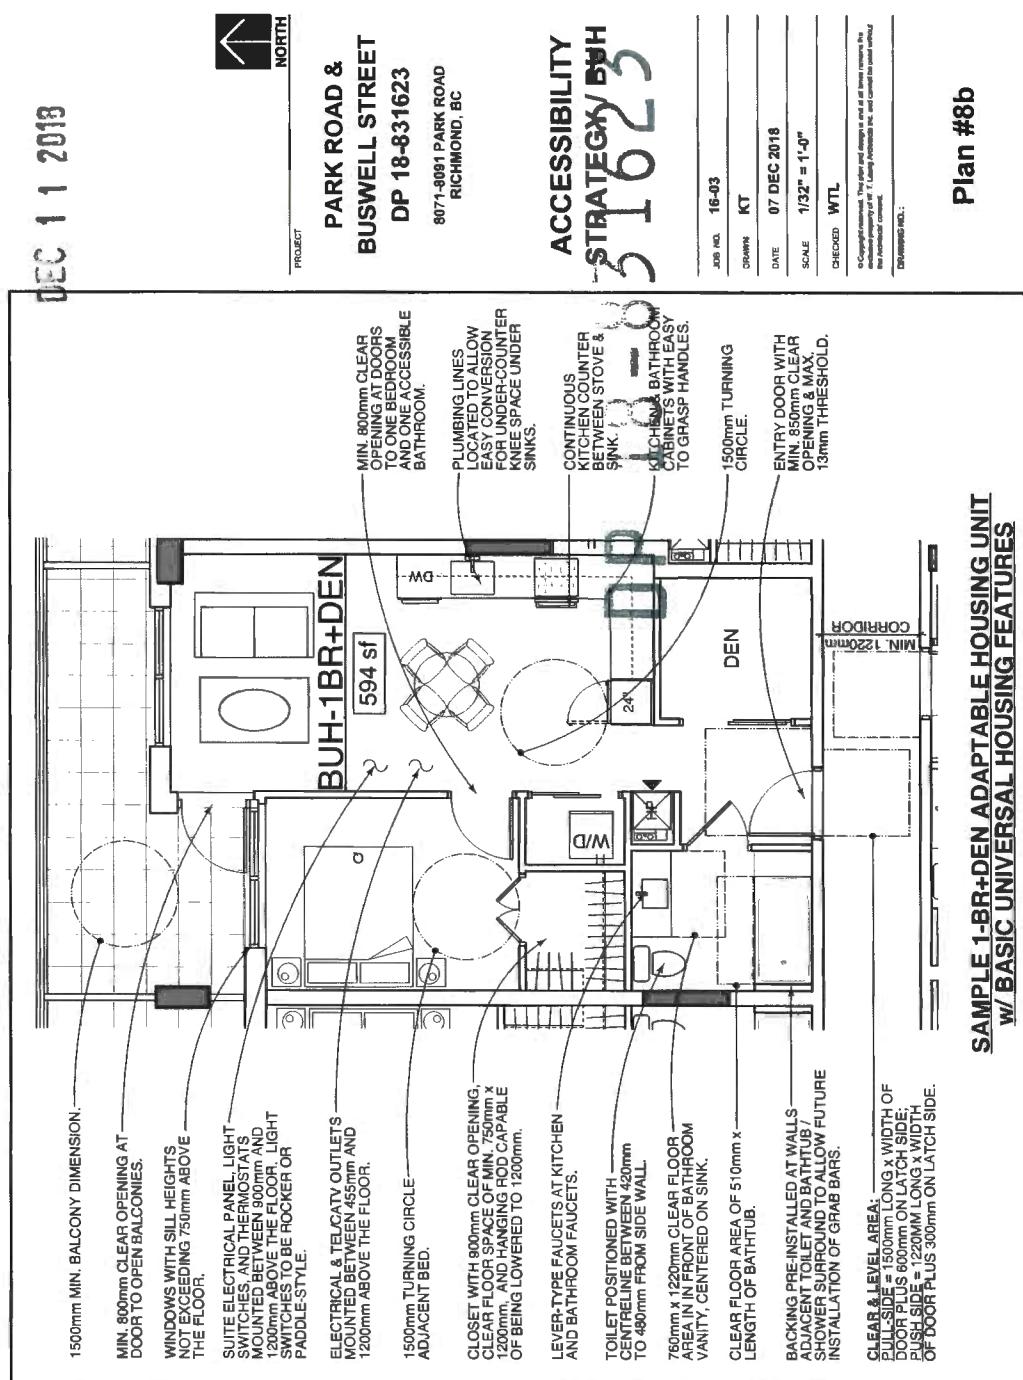

ACCESSIBILITY ROUTE ON 4th FLOOR (AMENITIES & ROOF GARDEN)

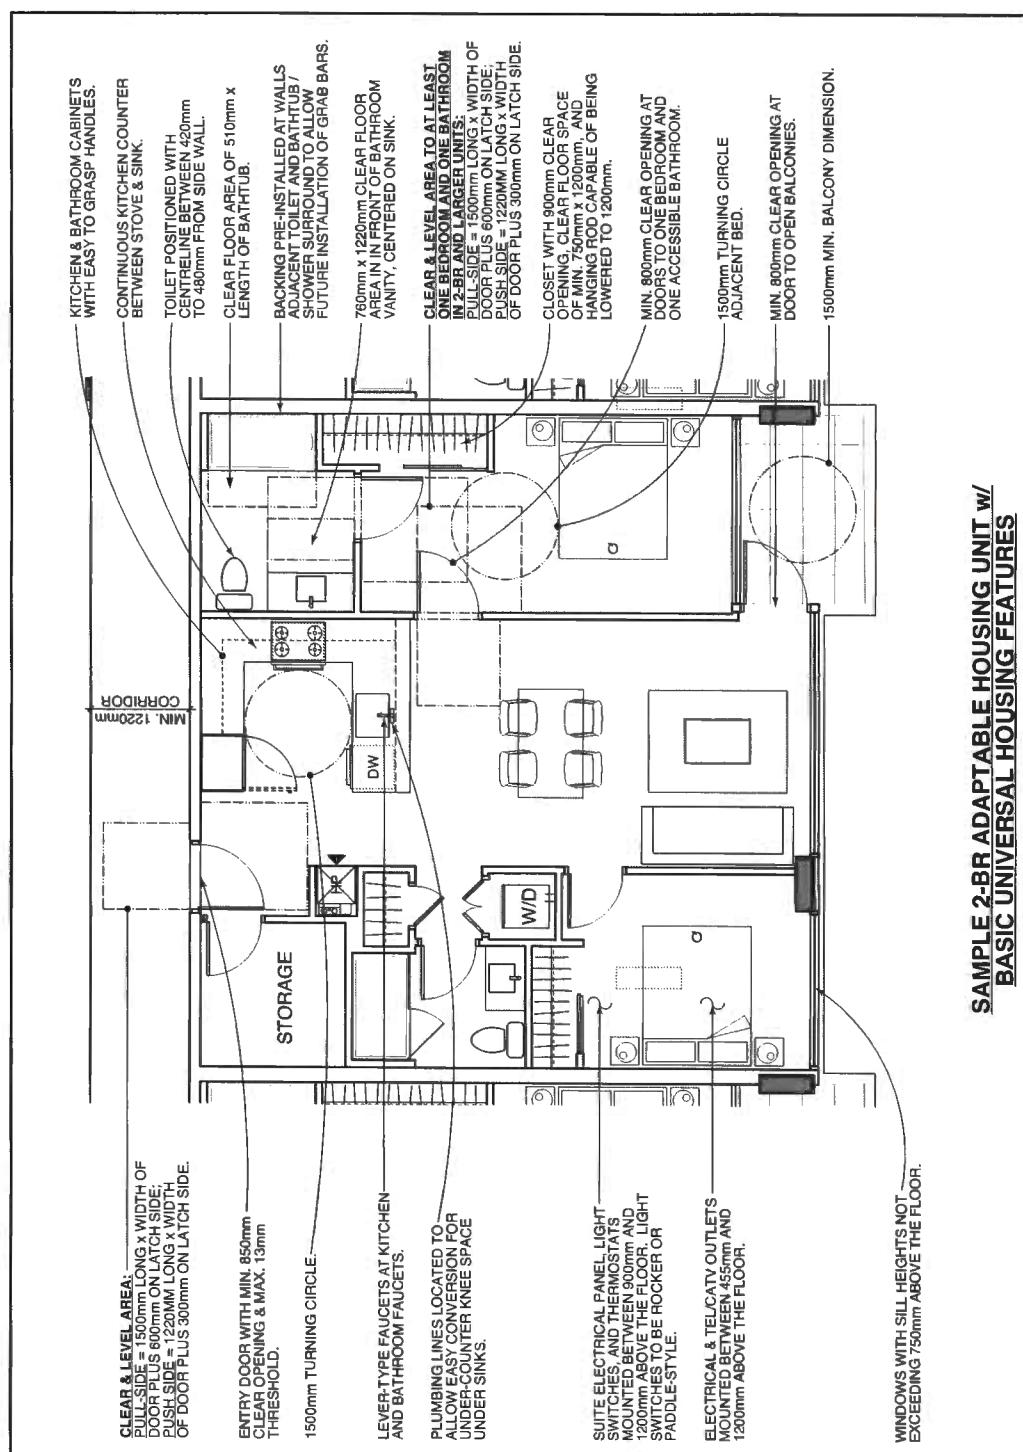

SAMPLE 1-BR+DEN ADAPTABLE HOUSING UNIT W/ BASIC UNIVERSAL HOUSING FEATURES

Plan #8b

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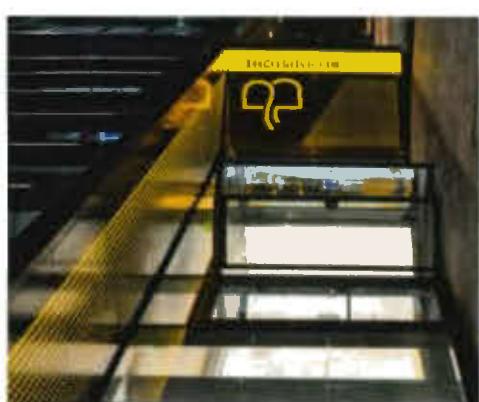
4



DEC 11 2013

↑
NORTH
PROJECT

PARK ROAD &
BUSWELL STREET
18-831623
18-831623
PARK ROAD
RICHMOND, BC



3



2



1



PROPOSED WAYFINDING & SIGNAGE STRATEGIES

COMMERCIAL / RETAIL SIGNAGES ARE PROPOSED TO BE LOCATED ALONG GROUND LEVEL RETAIL FRONTAGES. SIMILAR SIGNAGE STRATEGIES MAY BE PROPOSED FOR RESTAURANT TENANTS ON THE 3rd FLOOR.

1

OVERALL PROJECT WAYFINDING

WAYFINDING POSTS WITH DIRECTIONAL ARROWS AND SITE MAPPING AT THE PUBLIC PLAZA, NORTH LANE ACCESS OF THE PEDESTRIAN LINK, AND BUSWELL STREET ACCESS.

2

RESIDENTIAL ENTRANCE

CANPIES PAINTED WITH COLOURS USED ON RESIDENTIAL FLOORS FOR VISUAL LINKAGE. BOLD STREET ADDRESS NUMBERS AND NAMES OF THE RESIDENTIAL DEVELOPMENT.

3

OFFICE ENTRANCE

PORTAL WITH COLOUR USED ON OFFICE FLOORS FOR VISUAL LINKAGE. CAST ALUMINUM NAME OF OFFICE DEVELOPMENT AND CIVIC ADDRESSING.

4

PARKING AND PEDESTRIAN WAYFINDING

PAINTED SIGNAGE IN OVERSIZED SYMBOLS AND BOLD COLOURS.

5

RETAIL SIGNAGE

TENANT NAME & LOGO ATTACHED ON LEADING EDGE OR ON TOP OF PROJECTING METAL & GLASS CANPIES.
FOR PEDESTRIAN SCALE, SMALL DROP-DOWN SIGNAGE SUSPENDED JUST BELOW THE CANOPY, PERPENDICULAR TO THE STOREFRONTS



WAYFINDING &
SIGNAGE
STRATEGY

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Job No. 16-03
Drawn JB
Date 07 DEC 2018
Scale 1/16" = 1'-0"
Checked WTL
DRAFTING INC.

The image shows a detailed architectural floor plan of a building, likely a multi-story structure. The vertical axis on the left is labeled with letters A through M from bottom to top. The horizontal axis at the top is labeled with numbers 1 through 5 from left to right. The plan includes numerous rooms, hallways, and exits. Key features include a central staircase, several rooms labeled 'OFFICE' and 'WORKSTATION', and various other functional areas. A dashed line indicates a boundary or path across the middle of the building. Numerous room numbers are scattered throughout the plan, such as 1, 2, 3, 208, 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RICHMOND, B.C.**

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**WASTE MGMT
PLAN
(1/EVEI PI)**

WASTE MGMT PLAN (1/EVEI BI)

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| NO. | 16-03 | NAME | KT | DATE | 07 DEC 2016 | TIME | 1116 ^E = 1 ⁰ 0 ^W | WIND DIRECTION | WTL |
| REMARKS | The above information is given to you by the Bureau of Meteorology and will be issued whenever the Bureau receives it. It is the responsibility of the user to verify the accuracy of the information contained in this document. | | | | | | | | |

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