



# City of Richmond

## Report to Development Permit Panel

**To:** Development Permit Panel

**Date:** December 14, 2020

**From:** Wayne Craig  
Director of Development

**File:** DP 18-829236

**Re:** Application by 1132865 BC Ltd. for a Development Permit at 7464, 7480, 7500,  
7520, 7540, 7560/7580 and 7600 No. 1 Road

### Staff Recommendation

That a Development Permit be issued which would:

1. Permit the construction of 30 townhouse units at 7464, 7480, 7500, 7520, 7540, 7560/7580 and 7600 No. 1 Road on a site zoned “Medium Density Townhouses (RTM2)”; and
2. Vary the provisions of Richmond Zoning Bylaw 8500 to reduce the front yard setback along No. 1 Road from 6.0 m to 4.5 m.



Wayne Craig  
Director of Development

WC:el  
Att.3

## Staff Report

### Origin

1132865 BC Ltd. (Incorporation number: BC1132865; Director: Jun Ning, Lin Xiong Chen, and Brian Wah Tak Tsang) has applied to the City of Richmond for permission to develop 30 townhouse units at 7464, 7480, 7500, 7520, 7540, 7560/7580 and 7600 No. 1 Road. Three of the 30 townhouse units are proposed to contain a ground-level secondary suite.

The site is being rezoned from the “Single Family Detached (RS1/E)” zone and “Two Unit Dwelling (RD1)” zone to “Medium Density Townhouse (RTM2)” zone for this project under Bylaw 9983 (RZ 17-794287), which received Third Reading following the Public Hearing on June 17, 2019. The site currently contains six single-family homes and one duplex, which will be demolished.

Frontage improvements including beautification works, installation of a new fire hydrant, and upgrades to a nearby bus stop were secured through the rezoning process and will be constructed through a separate Servicing Agreement (SA 19-873682). The Servicing Agreement must be entered into prior to final adoption of the rezoning bylaw.

### Development Information

Please refer to attached Development Application Data Sheet (Attachment 1) for a comparison of the proposed development data with the relevant Bylaw requirements.

### Background

Development surrounding the subject site is as follows:

- To the north and south, large lot single family residential zoned “Single Detached (RS1/E)”;
- To the east, behind four of the subject lots are three large lots zoned “Two-Unit Dwellings (RD1)” containing three duplex dwellings fronting Burton Avenue. To the east of the three remaining subject lots are three large single family residential lots zoned “Single Detached (RS1/E)” fronting Amundsen Place; and
- To the west, across No. 1 Road are three lots (7471, 7491 and 7531 No. 1 Road) zoned “Low Density Townhouses (RTL1)”. The lots vary in size from 0.18 ha (0.43 ac) to 2.28 ha (5.64 ac) in area. The dwellings are typically two storeys in height.

### Rezoning and Public Hearing Results

The Public Hearing for the rezoning of this site was held on June 17, 2019. At the Public Hearing, concern related to the development potential of the adjacent orphan lot was raised.

Staff confirm that this concern was considered at Rezoning stage. The adjacent property to the north at 7460 No. 1 Road has a frontage of approximately 20 m along No. 1 Road and has a new (four year old) home on it. The proposed site assembly will leave 7460 No. 1 Road as a residual development site that will not meet the minimum 50 m site frontage requirement for a stand alone arterial road townhouse development. The applicant advised staff that they have made attempts to acquire the adjacent property, but cannot reach an agreement with the owners.

While the proposed development would create an orphan site situation on the north side of the subject site, staff support the proposed development based on:

- The developer has provided a development concept plan for the adjacent site to the north (on file);
- The developer has agreed to provide vehicle access to future townhouse development at 7460 No. 1 Road; a Public Rights-of-Passage (PROP) Statutory Right-of-Way (SRW) over the entry driveway on the subject site has been secured at Rezoning;
- The developer has agreed to provide garbage/recycling collection facilities and additional outdoor amenity space on-site to allow the shared use of these facilities with future townhouse development at 7460 No. 1 Road;
  - the outdoor amenity area proposed on site exceeds the minimum required to serve the proposed development; and
  - Environment Services staff confirmed that the sizes and configurations of the two garbage and recycling enclosures proposed on site will be able to accommodate the needs of the proposed townhouse development on site and future townhouse development at 7460 No. 1 Road;

A cross-access easement/agreement will be registered on Title of the subject site prior to Development Permit issuance in order to secure this arrangement.

### **Staff Comments**

The proposed scheme attached to this report has satisfactorily addressed the significant urban design issues and other staff comments identified as part of the review of the subject Development Permit application. In addition, it complies with the intent of the applicable sections of the Official Community Plan and is generally in compliance with the “Medium Density Townhouse (RTM2)” except for the zoning variance noted below.

### **Zoning Compliance/Variance (staff comments in **bold**)**

The applicant requests to vary the provisions of Richmond Zoning Bylaw 8500 to reduce the front yard setback along No. 1 Road from 6.0 m to 4.5 m.

*(Staff supports the proposed variance as it is consistent with the OCP Development Permit Guidelines for Townhouses on arterial roads, which support front yard setbacks at 4.5m (14.8 ft.) where a 6 m (19.7 ft.) rear yard setback to both the ground and second floors of the rear units is provided. The result will provide a wider space between the rear units of the subject development and the single family and duplex units that back onto the subject site. It will also provide a larger buffer to accommodate tree retention along the rear property line.*

*The resulting distance from the back of curb to the building face would be approximately 7.74 m. The reduced front yard setback does not compromise tree preservation or tree planting opportunity along the site frontage. The proposed architectural design provides appropriate building articulation and interface with neighbouring properties.*

***To address the road traffic noise from No. 1 Road, the project acoustical engineer confirmed that the proposed development is designed to meet the interior noise limits as per the CMHC standards.***

***This variance was identified at rezoning stage, and no concerns were identified at that time.)***

### **Advisory Design Panel Comments**

The Advisory Design Panel (ADP) has reviewed the project and supports it. A copy of the relevant excerpt from the Advisory Design Panel Minutes from Thursday, December 19, 2019 is attached for reference (Attachment 2). The design response from the applicant has been included immediately following the specific Design Panel comments and is identified in '***bold italics***'.

### **Analysis**

#### ***Conditions of Adjacency***

- The proposed form, massing, and orientation of the buildings are compatible to the existing adjacent developments on the block.
- While three-storey units are proposed along No. 1 Road, the building height is stepped down to one storey along the north property line to provide appropriate transition to the adjacent single-family home.
- A 7.56 m setback to the south property line is proposed to accommodate tree retention and a landscape buffer between the proposed three-storey building and the adjacent single family home to the south.
- Two-storey units in duplex form as well as the outdoor amenity area are proposed along the rear (east) property line to minimize privacy and overlook concerns.
- Deeper rear yards (6.0m instead of 4.5m) are proposed in order to enhance rear yard buffering.
- The existing site grade along the rear (east) property line will be maintained to provide an appropriate transition to the adjacent single-family properties to the east. A 1.8 m tall wood fence will be installed along the rear property line to protect the privacy of the neighbouring single-family homes.
- The site grade of the back yards of Units #10 to #15 will be raised to provide a barrier free outdoor private space to these units, which include three convertible units (i.e., Unit #10, #12 and #14). A set of tiered retaining walls will be installed to the west of the existing sanitary SRW (within the rear yards) and to provide a gradual transition and planting opportunities.
- A number of existing trees will be retained and a variety of new trees will be planted along the rear and side property lines to enhance the interfaces between the proposed townhouse development and the existing adjacent residential developments.
- The site grade along the north property line will be raised to match the existing site grade of the adjacent single family development to the north. No new retaining wall will be required.
- The site grade along the south property line will be raised. The height of the proposed retaining wall will range from 0.42 m to 1.24 m. A 1.2 m tall wood fence will be installed on top of the wall.

- A wood trellis (at approximately 2.5 m tall) is proposed at the ends of the drive aisle to provide a landscaped visual screen.
- Perimeter drainage will be required as part of the Building Permit to ensure storm water is managed and addressed through the development and will not impact the neighbouring properties.
- Adjacent properties to the north and south have future potential for redevelopment as townhouses. A statutory right-of-way (SRW) allowing access to/from the adjacent future development sites through the subject site (over the internal drive aisle) has been secured at rezoning.
- A signage indicating that the driveway on the subject site may connect to the future adjacent townhouse developments is proposed to be installed at each end of the drive aisle so that future residents/owners/strata of the subject development are aware that they may be required to provide access to the north and south.

### ***Urban Design and Site Planning***

- The site layout includes 12 two-storey units and 18 three-storey units in 10 clusters.
- The layout of the townhouse units is oriented around a single driveway, providing access to the site from No. 1 Road and a north-south internal manoeuvring aisle providing access to the unit garages.
- Vehicle access will be limited to right-in/right-out only. Registration of a right in/right out only covenant on Title is required prior to Development Permit Issuance. A raised island will be required to channelize and enforce the no left turn access restrictions.
- Units along No. 1 Road are designed to have a strong street presence with individual front entrances and yards; units along the rear (east) property line will have access from the internal drive aisle.
- Three of the three-storey townhouse units (i.e., Units #1, #22 and #30) will each contain a ground-level secondary suite of approximately 25.3 m<sup>2</sup> (272 ft<sup>2</sup>) in size.
- All units will have two vehicle parking spaces in a side-by-side double car garage. No additional parking stall is required for the proposed secondary units since the required parking spaces for the units containing a secondary suites are provided in a side-by-side arrangement.
- A total of six visitor parking spaces, including two accessible visitor parking spaces, will be provided throughout the site. The number of visitor parking spaces proposed is in compliance with the minimum bylaw requirement.
- Both internal and external bicycle parking spaces have been incorporated into the proposal and are in compliance with the zoning bylaw requirements.
- The provision of private outdoor spaces complies with the Development Permit Guidelines of the OCP. All units will have private outdoor spaces consisting of a front or a rear yard; the three-storey units will also have deck/balcony spaces on the second floor facing the internal drive aisle and on the third floor facing No. 1 Road.
- Outdoor amenity space is proposed opposite to the site entry for maximum casual surveillance opportunity and sun exposure. The size and location of the outdoor amenity

space is appropriate in providing open landscape and amenity space convenient to all units. A mailbox kiosk will be provided in the outdoor amenity space.

- No indoor amenity space is proposed on site. A \$65,600 cash-in-lieu contribution has been secured as a condition of rezoning approval, consistent with the OCP.
- Two garbage, recycling and organic waste storage enclosures are proposed. The enclosures have been incorporated into the design of the Buildings #1 and #10 to minimize the visual impact.

#### ***Architectural Form and Character***

- The design of this project follows the West Coast tradition of simple forms and clean lines.
- A pedestrian scale is generally achieved along No. 1 Road and the internal drive aisle through the inclusion of variation in building projections, recesses, varying material/colour combinations, landscape features, and the use of individual unit entrances.
- Individuality of units is expressed through private landscaped patio/yards with gates at front units, bold numbering and stoop lighting at all unit entry doors, and dynamic roof lines.
- The impact of blank garage doors has been mitigated with panel patterned doors, transom windows, unit entrances, and planting islands along the drive aisle.
- The proposed building materials (fiber cement panel siding and lap siding, fiberglass asphalt roof shingles, solid wood doors, etc.) are generally consistent with the Official Community Plan (OCP) Guidelines.
- A palette of earth tone colours with white accents is proposed. Some metal and glass elements are selected to enhance the “west coast modern” aesthetic.

#### ***Tree Retention and Replacement***

- Tree preservation was reviewed at rezoning stage; a total of 32 bylaw-sized trees were identified on site, eight trees were noted on the neighbouring properties, and two trees were noted on a shared property line with the neighbour.
- Ten trees (tag# 716, 726, 750, 751, 752, 753, 754, 755, 756 and 757) on neighbouring properties or shared property lines are identified to be retained and protected.
- In order to retain the Sycamore Maple tree (tag #726) located along the south property line of the subject site, the south side yard setback at the southwest corner of the site has been increased from 3.0 m to 7.56 m, and the existing site grade within the tree protection area will be maintained.
- Tree protection fencing is required to be installed as per the Arborist Report recommendations prior to any construction activities (including demolition) occurring on-site. A survival security for the two shared trees (#716 and # 726) in the amount of \$10,000 has been secured at Rezoning.
- The applicant has agreed to the relocation of the Japanese Maple tree (tag # 734). This tree will be relocated to the proposed outdoor amenity area. A survival security of \$1,000 has been secured at Rezoning. In addition, submission of a proof of a contract with a company specializing in tree relocation to undertake the transplant of this tree is required prior to Development Permit issuance.

- A total of 31 trees on-site were identified for removal. The majority of these trees are located in three groupings. Overall, the majority of these trees are either dead, dying (sparse canopy foliage), have been previously topped or exhibit structural defects such as cavities at the main branch union and co-dominant stems with inclusions. As a result, these trees are not good candidates for retention and should be replaced.
- Based on the 2:1 tree replacement ratio stated in the Official Community Plan (OCP), 62 replacement trees are required. The applicant is proposing to plant 62 replacement trees on-site, including 13 conifers and 49 deciduous trees.

### ***Landscape Design and Open Space Design***

- The street edge along No. 1 Road will be defined with landscaping including various trees, shrubs and ground covers. A low 42 in. tall transparent aluminum fence with gates and architectural concrete columns will be installed along the road frontage to accommodate visually interesting plant species.
- Each unit will have a private front yard with an outdoor patio to generate animation along the streetscape. The front yards will be separated with low aluminum fence with landscaping to provide privacy for individual units. All units will have a private yard with a patio, shade tree, shrub/groundcover planting and open lawn area.
- Landscape pockets with shrubs and grasses will be provided along the main north-south internal drive aisle. Trellis will be provided at the ends of the internal drive aisle to provide visual interests at the terminuses.
- An on-site irrigation system is proposed to ensure continued maintenance of live landscaping.
- The location of outdoor amenity space provides easy access and visual transparency and surveillance for the townhouse residents.
- Two multi-functional play structures and natural play elements such as flat boulders and balance logs are proposed within the outdoor amenity area. These play structures/elements are chosen to fit into the provided space and to allow multiple children to play at the same time. The equipment provides different play opportunities for the development of social, imagination, balance, and motor skills. Benches are also proposed near the children's play area for caregivers.
- Permeable pavers with decorative pattern will be used at the vehicle entrance, at the ends of the internal drive aisle, and on all surface parking spaces to break up the expansive paved surface on-site.
- In order to ensure that the proposed landscaping works are completed, the applicant is required to provide a landscape security of \$269,620.74 in association with the Development Permit.

### ***Crime Prevention Through Environmental Design***

- The site plan and individual unit layout create opportunity for passive surveillance.
- The sidewalk and internal drive aisle edges will have well-defined landscaped edges, clearly defining the areas for public pedestrian use.
- Front entries are not deeply set back, and will be well-lit with wall sconces or bollards lights.

- Bollard lighting will be provided between buildings and at visitor parking spaces.
- The outdoor amenity and children's play area is centrally located and contained on three sides, with high visibility to the site entry.

### ***Sustainability***

- At the rezoning stage, the applicant committed to achieving an EnerGuide rating of 82 for the proposed town houses and to pre-ducting all units for solar hot water heating. The proposal meets the grandfathering provisions for Energy Step Code approved by Council.
- A Certified Energy Advisor has confirmed that the proposed townhouse units will be designed to achieve an EnerGuide rating of 82. The report prepared by the Energy Advisor is on file and will be utilized through the Building Permit review process to ensure these measures are incorporated in the Permit drawings.
- The architect advised that low-flow toilets and showers, energy-efficient LED lighting and Energy Star appliances will also be incorporated into the development.

### ***Accessible Housing***

- The proposed development includes three convertible units that are designed with the potential to be easily renovated to accommodate a future resident in a wheelchair. The potential conversion of these units will require installation of a chair lift (where the staircase has been dimensioned to accommodate this in "Bc" units) in the future, if desired.
- All of the proposed units incorporate aging in place features to accommodate mobility constraints associated with aging. These features include:
  - stairwell hand rails;
  - lever-type handles for plumbing fixtures and door handles; and
  - solid blocking in washroom walls to facilitate future grab bar installation beside toilets, bathtubs and showers.

### **Conclusions**

The applicant has satisfactorily addressed staff's comments regarding conditions of adjacency, site planning and urban design, architectural form and character, and landscape design. The applicant has presented a development that fits into the existing context. On this basis, staff recommend support of this Development Permit application.



Edwin Lee  
Planner 2

EL:cas

Attachment 1: Development Application Data Sheet

Attachment 2: Excerpt from Advisory Design Panel Meeting Minutes (April 24, 2019)

Attachment 3: Development Permit Considerations



**City of  
Richmond**

**Development Application Data Sheet**  
Development Applications Department

**DP 18-829236**

**Attachment 1**

Address: 7464, 7480, 7500, 7520, 7540, 7560/7580 and 7600 No. 1 Road

Applicant: 1132865 BC Ltd. Owner: 1132865 BC Ltd.

Planning Area(s): Seafair

Floor Area Gross: 5,362.64 m<sup>2</sup> Floor Area Net: 3,760.34 m<sup>2</sup>

	<b>Existing</b>	<b>Proposed</b>
<b>Site Area:</b>	5,820.0 m <sup>2</sup>	5,820.0 m <sup>2</sup>
<b>Land Uses:</b>	Single-Family Residential/Two-Family Residential	Multiple-Family Residential
<b>OCP Designation:</b>	Single-Family Residential	Multiple-Family Residential
<b>Zoning:</b>	Single Detached (RS1/E) and Two-Unit Dwelling (RD1)	Medium Density Townhouses (RTM2)
<b>Number of Units:</b>	6 single-family homes + 2 duplex units	30 townhouse units + 2 secondary suites

	<b>Bylaw Requirement</b>	<b>Proposed</b>	<b>Variance</b>
Floor Area Ratio:	Max. 0.65	0.65	none permitted
Lot Coverage – Building:	Max. 40%	39.6%	none
Lot Coverage – Non-porous Surfaces:	Max. 65%	64%	none
Lot Coverage – Landscaping:	Min. 25%	27.9%	none
Setback – Front Yard (m):	Min. 6.0 m	4.50 m	<b>Variance Requested</b>
Setback – North Side Yard (m):	Min. 3.0 m	3.15 m	none
Setback – South Side Yard (m):	Min. 3.0 m	3.49 m	none
Setback – Rear Yard (m):	Min. 3.0 m	6.04 m	none
Height (m):	Max. 12.0 m (3 storeys)	10.31 m (3 storeys) 7.51 m (2 storeys)	none
Lot Width:	Min. 50.0 m	137 m	none
Lot Depth:	Min. 35.0 m	41 m	none
Off-street Parking Spaces – Regular (R) / Visitor (V):	2 (R) and 0.2 (V) per unit	2 (R) and 0.2 (V)	none
Off-street Parking Spaces – Total:	60 (R) and 6 (V)	60 (R) and 6 (V)	none

Tandem Parking Spaces:	Max. 50% of proposed residential spaces in enclosed garages (56 x Max. 50% = 28)	0	none
Small Car Parking Spaces	Max. 50% when 31 or more spaces are provided on-site (66 x Max. 50% = 33)	19	none
Handicap Parking Spaces:	Min. 2% when 11 or more spaces are required (66 x 2% = 2 spaces)	2	none
Bicycle Parking Spaces – Class 1 / Class 2:	1.25 (Class 1) and 0.2 (Class 2) per unit	1.3 (Class 1) and 0.23 (Class 2) per unit	none
Off-street Parking Spaces – Total:	38 (Class 1) and 6 (Class 2)	39 (Class 1) and 7 (Class 2)	none
Amenity Space – Indoor:	Min. 70 m <sup>2</sup> or Cash-in-lieu	Cash-in-lieu	none
Amenity Space – Outdoor:	Min. 6 m <sup>2</sup> x 30 units = 180 m <sup>2</sup>	206 m <sup>2</sup>	none

## Attachment 2

### Excerpt from the Minutes from The Design Panel Meeting

Thursday, December 19, 2019 – 4:00 p.m.  
Rm. M.1.003  
Richmond City Hall

#### 1. DP 18-829236 – 30-UNIT ARTERIAL ROAD TOWNHOUSE DEVELOPMENT

ARCHITECT: Interface Architecture  
LANDSCAPE ARCHITECT: PMG Landscape Architects Ltd.  
PROPERTY LOCATION: 7464, 7480, 7500, 7520, 7540, 7560/7580 and 7600 No. 1 Road

#### Applicant's Presentation

Kenneth Chow, Interface Architecture Inc., and Mary Chan Yip, PMG Landscape Architects, presented the project and answered queries from the Panel on behalf of the applicant.

#### Panel Discussion

*Comments from Panel members present were as follows:*

- appreciate the provision of aging-in-place features for all townhouse units;  
*Noted.*
- for the convertible units, consider installing pocket doors for all washrooms, ensuite walk-in closet and Level 1 powder room; proposed inward-swinging doors for washrooms are not appropriate for a person in wheelchair in terms of accessibility;  
*Level 1 powder room: door now to swing outward;*  
*Ensuite walk-in closet: door can be removed if conversion required;*  
*Access hall to ensuite washroom & closet now widened from 3'2 to 3'6.*
- proposed stairlift for the convertible units is challenging for people with disabilities, e.g. people using walkers and in wheelchairs would require one on each floor; consider accommodating a vertical lift in lieu of a stairlift;  
*Vertical lift considered, but no change. A straight run stairlift is a good solution for convertibility.*
- appreciate the larger size of the proposed convertible units;  
*Noted.*

- appreciate the provision of side-by-side parking as opposed to tandem parking in the garages of townhouse units;  
*Noted.*
- appreciate the design of the project;  
*Noted.*
- the project is fairly compact and well designed;  
*Noted.*
- consider incorporating roof drains/rainwater leaders in the design of the building at this stage of the project to ensure that the pipe placement is aligned with the building design;  
*The roof drains & rainwater leaders are shown on the A2 series of plans and elevations.*
- consider a lighter colour for the vertical fins that run from the ground up to the roof level with a canopy on top to mitigate its heavy appearance;  
*The colour of the vertical fins were reviewed, some options identified (i.e. versions of gray and white), and the owners selected the white colour (providing a clean Modern look).*
- hardie trims would work better with lighter colours;  
*Fins now white in colour, instead of dark gray.*
- consider extending the permeable paving treatment throughout the internal drive aisle;  
*Have now added sections to permeable pavers at the ends of the drive aisle (visually indicates the ends of internal drive aisle).*
- consider increasing the size of the play area to accommodate larger play structures;  
*Children's play area substantially increased in size, and added 2nd play structure.*
- applicant could have provided a larger image of the proposed play equipment which would have been more useful to the Panel;  
*Added 2nd play structure.*
- consider installing more conifers on site;  
*More conifer trees have been proposed on-site. Six extra pines – replaces 2 japanese maples, 1 magnolia, 2 sourwood, 1 japanese snowbell.*
- consider installing fewer but larger trees;  
*No change in number of trees, trees have been upsized. Japanese maples, magnolias, sourwoods, snowbells: from 6cm to 8cm; pines from 3.5m ht to 4.0m ht.*

- consider installing more permeable pavers on the internal drive aisle to break up the large expanse of asphalt paving;  
*Added approx 20'x20' areas of permeable pavers at both ends of drive aisles. They indicate the ends of the drive aisle, and if later extended into the adjacent properties, indicate the transition across PL's.*
- appreciate the applicant contributing to the City's Public Art Fund; however, the applicant is encouraged to consider incorporating public art into the project as it would enhance the public realm;  
*Noted.*
- investigate opportunities for introducing additional architectural elements in addition to vertical fins to further break down the scale of the townhouse buildings;  
*We have reviewed all building elevation drawings and analyzed the model from different angles and view heights. We believe that there is sufficient building articulation and human scale in the architectural elements.*
- consider an additional set of colour scheme for the rear townhouse units to avoid repetition of unit designs;  
*The ABAB rhythm is sufficient. This will provide sufficient colour contrast between adjacent units. No changes proposed.*
- permeable paving treatment at the centre of the drive aisle helps create a sense of entry and provide a gateway feel;  
*Noted.*
- consider further articulation to the corner unit in Building 2 adjacent to the large private outdoor space as it is prominent from the street; consider installing wider or more windows;  
*The Level 1 office/den (Building 2, south end) is now provided with a larger window, replacing the previous high slot window.*
- consider installing garbage room mechanical ventilation to address potential odour issues;  
*After reviewing this option, we've opted to replace the solid doors with open slat, black metal swing doors. The metal slat doors will have integrated acrylic panels. This project allows door-to-door pickup of garbage and recycle bins, so with this scenario, the central garbage and recycle depots may be used for common (strata-managed) storage of seasonal items such as lawn/garden maintenance and snow removal equipment for the time being until the strata would like to have central garbage and recycling pick up.*
- the applicant is advised to be mindful of potential sightline issues for the large tree in the outdoor amenity area at the centre of the site; the tree could block the view of garbage trucks backing out and children coming out from the outdoor amenity area;  
*Yes, that issue is valid, but the large tree helps to identify a high traffic area.*

- not sure if the applicant has achieved a sense of individuality for the townhouse units or successfully broken down the sameness of units;  
*hard to explain, but a degree of sameness is a feature of the Modernist heritage.*
- consider breaking down the symmetry of units on both sides of the entry driveway to mitigate the repetitiveness of unit designs; and  
*First, there is nothing wrong with symmetry; it is a good organizing principle that formalizes the 'gateway' into our project. We feel that the added vertical & horizontal fins already create a dynamic interplay of lines and shadows which alleviates any concerns of repetitiveness. With just 4 frontage buildings, the symmetry does not seem overdone.*
- consider introducing soft landscaping on the internal drive aisle so it will read as intended for shared use, i.e. for vehicular circulation and play/gathering space for residents; the applicant could design the internal drive aisle with a grass surface in between hard surfaces in lieu of a monolithic hard surface treatment.  
*The proposed landscape design already introduces as much soft landscaping as possible along the internal drive aisle. The surface treatment recognizes that the hard surface between rollover curbs also functions as an informal, durable play surface. After the ADP, additional sections of permeable pavers have been added to the ends of the drive aisle to visually mark its terminus and, in the future, as transitions to adjacent development.*

*The following comments were submitted by Jubin Jalili and read into the record by Sara Badyal:*

- the project is showing compliance with EnerGuide rating of 82 by use of air source heat pumps;  
*Noted.*
- according to the design rationale report, the outdoor units are proposed to be installed in the pathway between the buildings; however, installation details such as support structure, acoustic enclosure (if any) and refrigerant pipe routing to individual townhomes need to be detailed; and  
*BP will note that installation will comply with manufacturer's specifications.*
- grouping the outdoor units may have adverse noise impact to the adjacent townhomes with need to be reviewed by an acoustic consultant.  
*After consultation with the acoustic consultant and the construction manager, we are able to relocate the individual outdoor mech (condensing) units from the front yards to the level 2 rear decks of the same units.*

**Panel Decision**

It was moved and seconded

*That DP 18-829236 be supported to move forward to the Development Permit Panel subject to the applicant giving consideration to the comments of the Advisory Design Panel.*

**CARRIED**



**City of  
Richmond**

## **Development Permit Considerations**

Development Applications Department  
6911 No. 3 Road, Richmond, BC V6Y 2C1

**Address:** 7464, 7480, 7500, 7520, 7540, 7560/7580 and 7600 No 1 Road

**File No.:** DP 18-829236

**Prior to approval of the Development Permit, the developer is required to complete the following:**

1. Final adoption of the Zoning Amendment Bylaw 9983.
2. Registration of a cross-access easement agreement over the garbage/recycling collection facilities and outdoor amenity space on-site (design as per Development Permit DP 18-829236), in favour of the future residential (townhouse) development at 7460 No. 1 Road, allowing shared use of these facilities on the subject site with future townhouse development at 7460 No. 1 Road.
3. Registration of a legal agreement on Title identifying that the proposed development must be designed and constructed in a manner that mitigates potential traffic noise from No. 1 Road to the proposed dwelling units. Dwelling units must be designed and constructed to achieve:

- a) CMHC guidelines for interior noise levels as indicated in the chart below:

Portions of Dwelling Units	Noise Levels (decibels)
Bedrooms	35 decibels
Living, dining, recreation rooms	40 decibels
Kitchen, bathrooms, hallways, and utility rooms	45 decibels

- b) The ASHRAE 55-2004 "Thermal Environmental Conditions for Human Occupancy" standard for interior living spaces.
4. Registration of a legal agreement on title to restrict access to the property to right in/right out movements only.
5. Submission of a Contract entered into between the applicant and a company specializing in tree relocation to undertake the transplant of a Japanese Maple tree (tag # 734) with proper removal, storage, and replanting techniques. The Contract should include the scope of work to be undertaken and a provision for the Arborist to submit a post-construction assessment report to the City for review.
6. Receipt of a Letter of Credit for landscaping in the amount of \$ 269,620.74 (based on the costs estimate provided by a CSLA registered landscape Architect including 10% contingency).

**Prior to Building Permit Issuance, the developer must complete the following requirements:**

1. Submission of a Construction Parking and Traffic Management Plan to the Transportation Department. Management Plan shall include location for parking for services, deliveries, workers, loading, application for any lane closures, and proper construction traffic controls as per Traffic Control Manual for works on Roadways (by Ministry of Transportation) and MMCD Traffic Regulation Section 01570.
2. Incorporation of energy efficiency, CPTED, sustainability, and accessibility measures in Building Permit (BP) plans as determined via the Rezoning and/or Development Permit processes.
3. Obtain a Building Permit (BP) for any construction hoarding. If construction hoarding is required to temporarily occupy a public street, the air space above a public street, or any part thereof, additional City approvals and associated fees may be required as part of the Building Permit. For additional information, contact the Building Approvals Department at 604-276-4285.

**Note:**

- \* This requires a separate application.
- Where the Director of Development deems appropriate, the preceding agreements are to be drawn not only as personal covenants of the property owner but also as covenants pursuant to Section 219 of the Land Title Act.  
All agreements to be registered in the Land Title Office shall have priority over all such liens, charges and encumbrances as is considered advisable by the Director of Development. All agreements to be registered in the Land Title Office shall, unless the

Initial: \_\_\_\_\_

Director of Development determines otherwise, be fully registered in the Land Title Office prior to enactment of the appropriate bylaw.

The preceding agreements shall provide security to the City including indemnities, warranties, equitable/rent charges, letters of credit and withholding permits, as deemed necessary or advisable by the Director of Development. All agreements shall be in a form and content satisfactory to the Director of Development.

- Additional legal agreements, as determined via the subject development's Servicing Agreement(s) and/or Development Permit(s), and/or Building Permit(s) to the satisfaction of the Director of Engineering may be required including, but not limited to, site investigation, testing, monitoring, site preparation, de-watering, drilling, underpinning, anchoring, shoring, piling, pre-loading, ground densification or other activities that may result in settlement, displacement, subsidence, damage or nuisance to City and private utility infrastructure.
- Applicants for all City Permits are required to comply at all times with the conditions of the Provincial *Wildlife Act* and Federal *Migratory Birds Convention Act*, which contains prohibitions on the removal or disturbance of both birds and their nests. Issuance of Municipal permits does not give an individual authority to contravene these legislations. The City of Richmond recommends that where significant trees or vegetation exists on site, the services of a Qualified Environmental Professional (QEP) be secured to perform a survey and ensure that development activities are in compliance with all relevant legislation.

---

Signed

---

Date



# City of Richmond

## Development Permit

No. DP 18-829236

To the Holder: 1132865 BC Ltd.

Property Address: 7464, 7480, 7500, 7520, 7540, 7560/7580 and 7600 No. 1 Road

Address: 1132865 BC Ltd.  
c/o Interface Architecture Inc.  
Suite 230 - 11590 Cambie Road  
Richmond, BC V6X 3Z5

1. This Development Permit is issued subject to compliance with all of the Bylaws of the City applicable thereto, except as specifically varied or supplemented by this Permit.
2. This Development Permit applies to and only to those lands shown cross-hatched on the attached Schedule "A" and any and all buildings, structures and other development thereon.
3. The "Richmond Zoning Bylaw 8500" is hereby varied to reduce the front yard setback along No.1 Road from 6.0 m to 4.5 m.
4. Subject to Section 692 of the Local Government Act, R.S.B.C.: buildings and structures; off-street parking and loading facilities; roads and parking areas; and landscaping and screening shall be constructed generally in accordance with Plans #1 to #4 attached hereto.
5. Sanitary sewers, water, drainage, highways, street lighting, underground wiring, and sidewalks, shall be provided as required.
6. As a condition of the issuance of this Permit, the City is holding the security in the amount of \$ 269,620.74 to ensure that development is carried out in accordance with the terms and conditions of this Permit. Should any interest be earned upon the security, it shall accrue to the Holder if the security is returned. The condition of the posting of the security is that should the Holder fail to carry out the development hereby authorized, according to the terms and conditions of this Permit within the time provided, the City may use the security to carry out the work by its servants, agents or contractors, and any surplus shall be paid over to the Holder. Should the Holder carry out the development permitted by this permit within the time set out herein, the security shall be returned to the Holder. The City may retain the security for up to one year after inspection of the completed landscaping in order to ensure that plant material has survived.
7. If the Holder does not commence the construction permitted by this Permit within 24 months of the date of this Permit, this Permit shall lapse and the security shall be returned in full.

**Development Permit**  
**No. DP 18-829236**

To the Holder: 1132865 BC Ltd.

Property Address: 7464, 7480, 7500, 7520, 7540, 7560/7580 and 7600 No. 1 Road

Address: 1132865 BC Ltd.  
c/o Interface Architecture Inc.  
Suite 230 - 11590 Cambie Road  
Richmond, BC V6X 3Z5

---

8. The land described herein shall be developed generally in accordance with the terms and conditions and provisions of this Permit and any plans and specifications attached to this Permit which shall form a part hereof.

This Permit is not a Building Permit.

AUTHORIZING RESOLUTION NO.  
DAY OF , .



ISSUED BY THE COUNCIL THE

DELIVERED THIS DAY OF , .

MAYOR



# City of Richmond

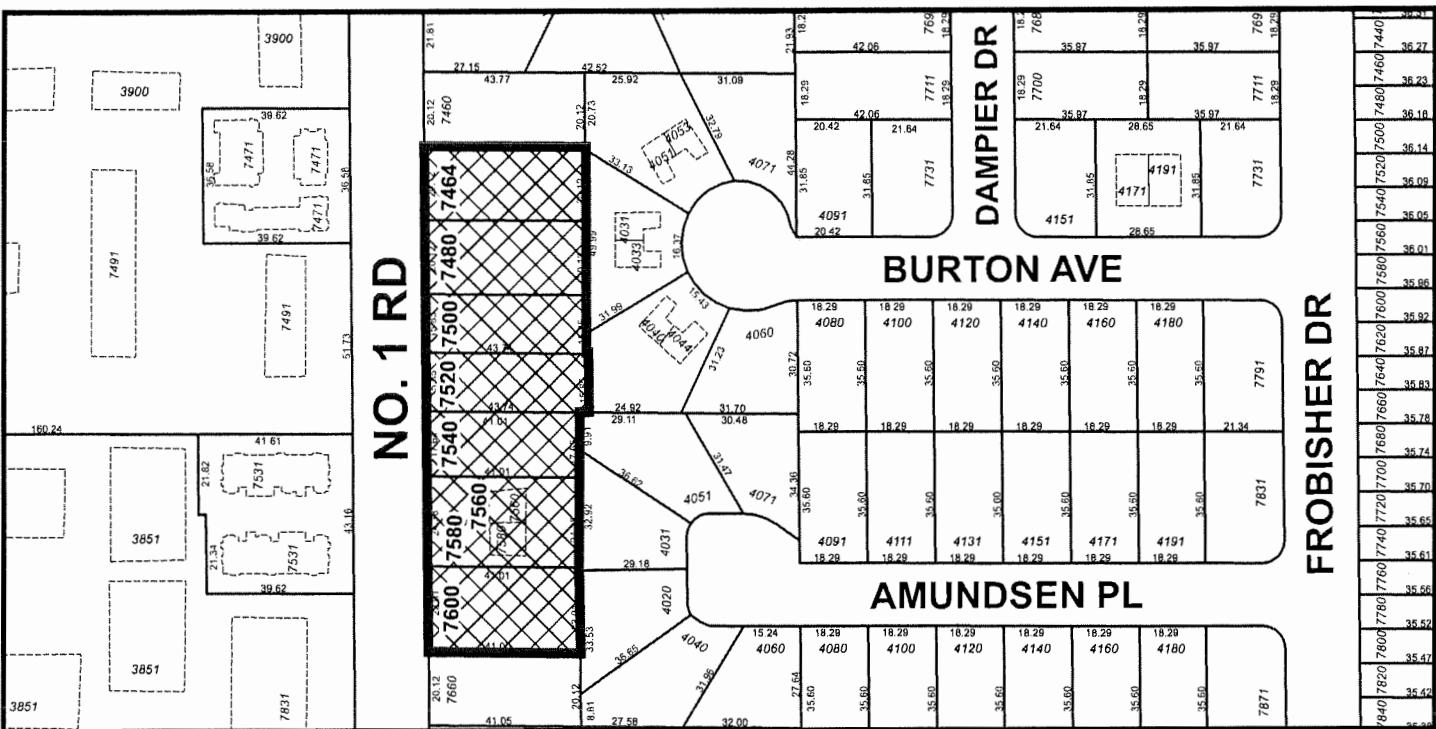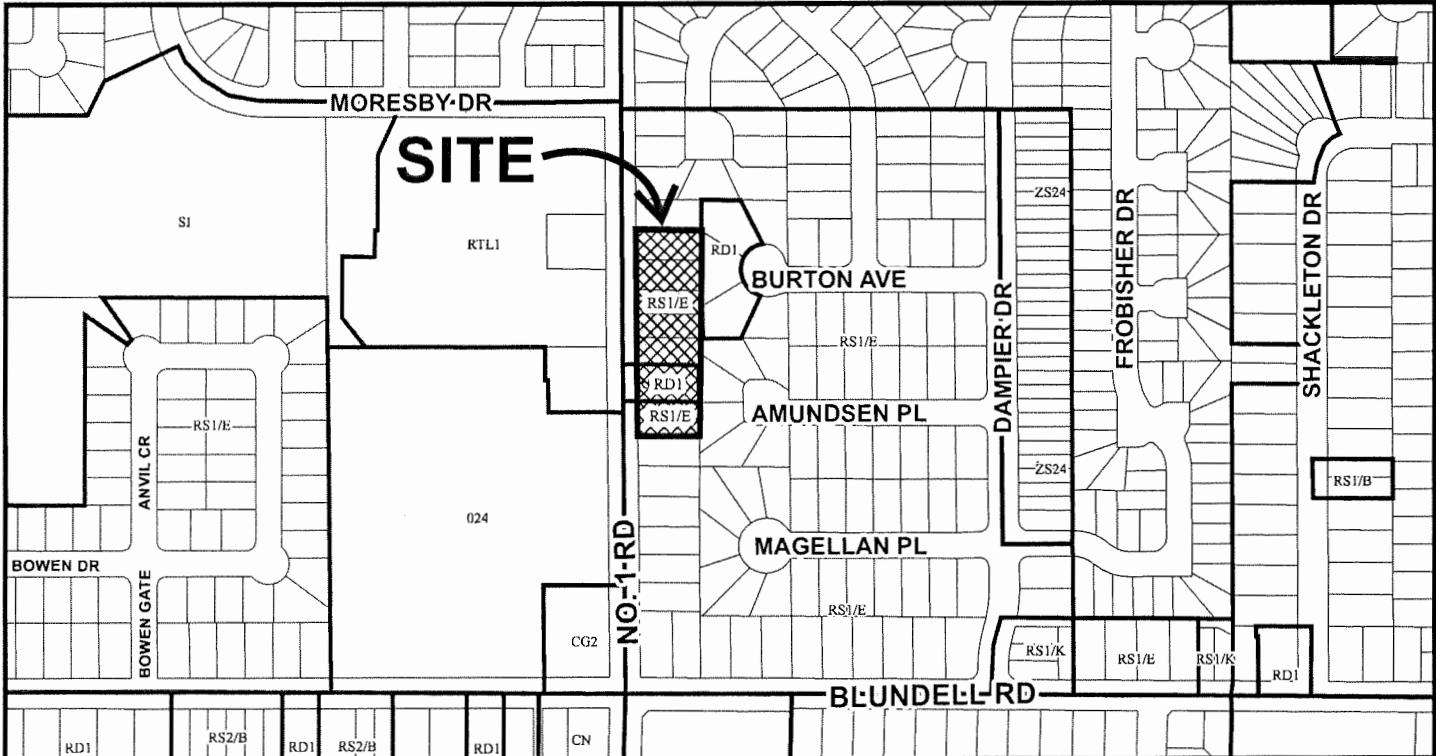

**DP 18-829236  
SCHEDULE "A"**

Original Date: 10/25/18

Revision Date:

Note: Dimensions are in METRES

# DEVELOPMENT PERMIT SUBMISSION - DECEMBER 8, 2020

## 30-UNIT TOWNHOUSE DEVELOPMENT 7464, 7480, 7500, 7520, 7540, 7560, 7580, AND 7600 NUMBER 1 ROAD, RICHMOND BC

REVISIONS	DEC 08, 2020 DPB RESUBMISSION	NOV 27, 2020 DPS RESUBMISSION	JUNE 03, 2020 DP RESUBMISSION	DEC 23, 2019 BP SUBMISSION	DEC 02, 2019 ADP SUBMISSION	APR 26, 2019 RZ RESUBMISSION	JULY 16, 2018 DP APPLICATION	DEC 12, 2017 RZ APPLICATION
CONSULTANTS								

CONTACTS	
Architect	INTERFACE ARCHITECTURE INC. #220 - 1580 CAMPBIE ROAD RICHMOND, BC V6X 3Z5 Tel: 604-821-1102 Fax: 604-821-1146 Email: karen@interfacearchitecture.com
Surveyor	J.C. TAM AND ASSOCIATES #115 - 8833 COLIN CRESCENT RICHMOND, BC V6X 3Z7 Tel: 604-214-8928 Fax: 604-214-8929 Email: office@jctam.com
Civil	CORE CONCEPTS CONSULTING #220 - 2839 YOUNG WAY RICHMOND, BC V6V 3P7 Tel: 604-249-5040 Fax: 604-249-5041 Email: boudy@coreconceptconsulting.com
Landscape Architect	PNG LANDSCAPE ARCHITECTS SITE C100 - 4186 STICK CREEK DRIVE BURNABY, BC V5C 1G8 Tel: 604-284-0011 Fax: 604-284-0022 Email: merv@pnglandscape.com
Arborist	FROGGERS GREEK TREE CONSULTANTS 7233 MCGREGOR AVENUE BURNABY, BC V5J 4H4 Tel: 604-771-6002 Fax: 604-437-6970 Email: gavin@froggertree.ca
Energy	CAPTURE ENERGY 8070 HUDSON STREET VANCOUVER, BC V6P 4M1 Tel: 604-492-2892 Email: eric@capture-energy.ca
Acoustical	B&P Acoustics Ltd. #122-2271 ST. JOHNS STREET PORT MOODY, BC V3H 2Z5 Tel: 604-492-3157 Email: eric@bpacoustics.ca
Electrical	LIEW ENGINEERING Ltd. 108-11311 HORSESHOE WAY RICHMOND, BC V7A 5G7 Tel: 604-277-3157 Email: lieveng@live.ca

DRAWING LIST	
Architectural	<p>A1.0 COVER SHEET</p> <p>A1.1 PROJECT DATA &amp; SITE PLAN</p> <p>A1.2 PARKING/TRUCK TURNING PLAN</p> <p>&amp; FIRE ACCESS PLAN</p> <p>A1.3 PERMEABILITY, AMENITY AREA OVERLAYS</p> <p>FAR OVERLAY BY BUILDING 1, 2, 9, &amp; 10</p> <p>A1.4 PLANS; BUILDING 1, 4, 5, 6, 7, &amp; 8</p> <p>A2.1 PLANS; BUILDING 1 &amp; 2</p> <p>ELEVATIONS BUILDING 1 &amp; 2</p> <p>A2.2 PLANS; BUILDING 5-8</p> <p>A2.3 ELEVATIONS BUILDING 3-6</p> <p>A2.4 ELEVATIONS BUILDING 8-9</p> <p>A2.5 PLANS; BUILDING 6-8</p> <p>A2.6 ELEVATIONS BUILDING 6-8</p> <p>A2.7 PLANS; BUILDING 9 &amp; 10</p> <p>A2.8 ELEVATIONS BUILDING 9 &amp; 10</p> <p>A2.9 FLOOR PLANS; CONFIDENTIAL UNIT (Re)</p> <p>A3.1 STREETSCAPES &amp; SITE SECTION S1</p> <p>A3.2 SITE SECTIONS: S2, S3, &amp; S4</p> <p>A3.3 SITE SECTIONS: S5, S6, &amp; S7</p> <p>A3.4 MATERIAL BOARD</p> <p>A3.5 SHADOW STUDY</p> <p>A3.6 PERSPECTIVES</p> <p>Landscape</p> <p>L1 LANDSCAPE PLAN</p> <p>L2A SHRUB AND GRADING PLAN</p> <p>L2B GRADING PLAN</p> <p>L3 GRADING PLAN</p> <p>L4 LANDSCAPE DETAILS</p> <p>L5 TREE MANAGEMENT PLAN</p> <p>L6 LANDSCAPE SPECIFICATIONS</p> <p>Survey</p> <p>SURVEY DATED OCTOBER 23, 2019</p>
Arborist	REPORT DATED JUNE 02, 2020
Energy	
Acoustical	
Electrical	

**INTERFACE:**

Sub 1-20  
11580 Cambie Road  
Richmond BC  
Canada V6X 2Z5  
T 604 821 1142  
F 604 821 1146  
www.interfacearchitecture.com

**PROJECT:**  
Proposed 30-Unit  
Townhouse Development  
LOT ASSEMBLY  
7464 / 7480 / 7500 / 7520 /  
7540 / 7560 / 7580 / 7600  
NO. ROAD  
RICHMOND, BC

**PROJECT NO.**  
1717RUMI

**SCALE:**  
As Nailed

**DATE:**  
JULY 16, 2017

**DRAWN BY:**  
KYC, SRS, XY

**CHECKED BY:**  
KYC

**SHEET TITLE:**  
COVER SHEET

**DRAWING:**  
DRAWING

**A1.0**

**RZ17-794287**  
**DP18-829236**

**7471 No. 1 ROAD**

**7460 No. 1 ROAD**

**7491 No. 1 ROAD**

**7531 No. 1 ROAD**

**7831 No. 1 ROAD**

**CONTEXTUAL MAP**

**7460 No. 1 ROAD**

**7491 No. 1 ROAD**

**7531 No. 1 ROAD**

**CONTEXTUAL PHOTOS OF ADJACENT DEVELOPMENTS**

**7471 No. 1 ROAD**

**7460 No. 1 ROAD**

**7491 No. 1 ROAD**

**7531 No. 1 ROAD**

**7831 No. 1 ROAD**

**10-829236**

# A 1.1


DP 18-829236 PLAN #1  
PLAN #1A

Scale: 1/16"-1'-0" DP 14 2020

\*NOTE: LEVEL 2 EV ENERGIZED OUTLET TO BE PROVIDED IN EACH BUILDING FACE (DO NOT ENCROACH INTO FRONT YARD SETBACK) NO.1 ROAD

\*NOTE: AT FRONT BUILDINGS, BOX WINDOWS PROJECT 6'0"-15" FROM CENTER LINE OF FACING TOWNHOUSE SITE ACCESS

\*NOTE: RIGHT IN, RIGHT OUT SITE ACCESS SUBJECT TO FINAL CITY ENGINEERING & SERVICING AGREEMENT.

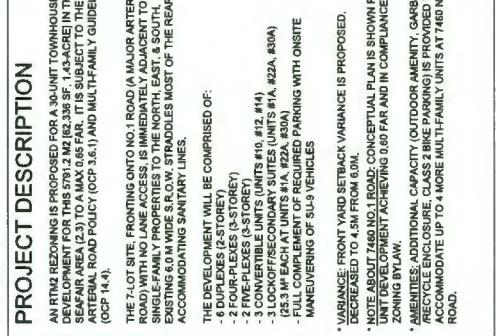

## DP RESUBMISSION

REVISIONS

DEC 08, 2020 DP RESUBMISSION  
NOV 27, 2020 DP RESUBMISSION

JUNE 03, 2020 DP RESUBMISSION  
DEC 23, 2019 BP SUBMISSION  
DEC 02, 2019 ADP SUBMISSION

APR 06, 2019 RZ RESUBMISSION

JULY 16, 2018 DP APPLICATION

DEC 22, 2017 RZ APPLICATION

CONSULTANTS

All units are subject to the requirements of the Residential Project Plan (RPP) and Residential Project Plan (RPP) Addendum. The RPP and RPP Addendum are available at [www.vancouver.ca](http://www.vancouver.ca). The RPP and RPP Addendum are available at [www.vancouver.ca](http://www.vancouver.ca).

**INTERFACE:**  
11500 Cambie Road  
Richmond BC  
Canada V6X 3Z5  
T 604 821 1162  
F 604 821 1146  
[www.interfacearchitects.com](http://www.interfacearchitects.com)

PROJECT  
Proposed 30-Unit  
Townhouse Development  
7.LOT ASSEMBLY  
7860  
11500 Cambie Road  
Richmond BC  
Canada V6X 3Z5  
T 604 821 1162  
F 604 821 1146  
[www.interfacearchitects.com](http://www.interfacearchitects.com)

SCALE  
As Nailed

DATE  
JUNE 21, 2017

DRAWN BY  
KYO, SRS, XY


CHECKED BY  
KYO

SHEET TITLE  
PROPOSED SITE PLAN

PROJECT DATA,  
SITE PLAN

DRAWING

		AVERAGE FINISHED GRADE CALCULATION										
		ZONING										
		PARCEL ID	LEGAL DESCRIPTIONS:									
MIN. LOT SIZE:	50m (W) X 55m (D)	(1) REM. LOT 5, PLAN 10114 (2) #7464 (3) REM. LOT 6, PLAN 10114 (4) #7480 (5) #7500 (6) #7520 (7) #7540 (8 & 7) STRATA PLAN NW5381 (9) PCLA EXP PLAN 16239 (10) ALL OF SECTION 14 LN RNG 7W NWD	RS1/E (2) RS1/E (3) RS1/E (4) RS1/E (5) RS1/E (6) RS1/E (7) RD1 (8) RD1 (9) RS1/E	BLDG 1 BLDG 2 BLDG 3 BLDG 4 BLDG 5 BLDG 6 BLDG 7 BLDG 8 BLDG 9 BLDG 10 BLDG 11 BLDG 12 BLDG 13 BLDG 14 BLDG 15 BLDG 16 BLDG 17 BLDG 18 BLDG 19 BLDG 20 BLDG 21 BLDG 22 BLDG 23 BLDG 24 BLDG 25 BLDG 26 BLDG 27 BLDG 28 BLDG 29 BLDG 30 BLDG 31 BLDG 32 BLDG 33 BLDG 34 BLDG 35 BLDG 36 BLDG 37 BLDG 38 BLDG 39 BLDG 40 BLDG 41 BLDG 42 BLDG 43 BLDG 44 BLDG 45 BLDG 46 BLDG 47 BLDG 48 BLDG 49 BLDG 50 BLDG 51 BLDG 52 BLDG 53 BLDG 54 BLDG 55 BLDG 56 BLDG 57 BLDG 58 BLDG 59 BLDG 60 BLDG 61 BLDG 62 BLDG 63 BLDG 64 BLDG 65 BLDG 66 BLDG 67 BLDG 68 BLDG 69 BLDG 70 BLDG 71 BLDG 72 BLDG 73 BLDG 74 BLDG 75 BLDG 76 BLDG 77 BLDG 78 BLDG 79 BLDG 80 BLDG 81 BLDG 82 BLDG 83 BLDG 84 BLDG 85 BLDG 86 BLDG 87 BLDG 88 BLDG 89 BLDG 90 BLDG 91 BLDG 92 BLDG 93 BLDG 94 BLDG 95 BLDG 96 BLDG 97 BLDG 98 BLDG 99 BLDG 100 BLDG 101 BLDG 102 BLDG 103 BLDG 104 BLDG 105 BLDG 106 BLDG 107 BLDG 108 BLDG 109 BLDG 110 BLDG 111 BLDG 112 BLDG 113 BLDG 114 BLDG 115 BLDG 116 BLDG 117 BLDG 118 BLDG 119 BLDG 120 BLDG 121 BLDG 122 BLDG 123 BLDG 124 BLDG 125 BLDG 126 BLDG 127 BLDG 128 BLDG 129 BLDG 130 BLDG 131 BLDG 132 BLDG 133 BLDG 134 BLDG 135 BLDG 136 BLDG 137 BLDG 138 BLDG 139 BLDG 140 BLDG 141 BLDG 142 BLDG 143 BLDG 144 BLDG 145 BLDG 146 BLDG 147 BLDG 148 BLDG 149 BLDG 150 BLDG 151 BLDG 152 BLDG 153 BLDG 154 BLDG 155 BLDG 156 BLDG 157 BLDG 158 BLDG 159 BLDG 160 BLDG 161 BLDG 162 BLDG 163 BLDG 164 BLDG 165 BLDG 166 BLDG 167 BLDG 168 BLDG 169 BLDG 170 BLDG 171 BLDG 172 BLDG 173 BLDG 174 BLDG 175 BLDG 176 BLDG 177 BLDG 178 BLDG 179 BLDG 180 BLDG 181 BLDG 182 BLDG 183 BLDG 184 BLDG 185 BLDG 186 BLDG 187 BLDG 188 BLDG 189 BLDG 190 BLDG 191 BLDG 192 BLDG 193 BLDG 194 BLDG 195 BLDG 196 BLDG 197 BLDG 198 BLDG 199 BLDG 200 BLDG 201 BLDG 202 BLDG 203 BLDG 204 BLDG 205 BLDG 206 BLDG 207 BLDG 208 BLDG 209 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A business card for Core Concept Consulting Ltd. The card features a large stylized 'G' logo followed by the company name 'Core Concept' in a bold, serif font. Below this is 'CONSULTING LTD.' and a phone number. To the right is a large 'DP' logo with the text 'ENRICH DEVELOPMENT' above it. The bottom right corner contains project information.
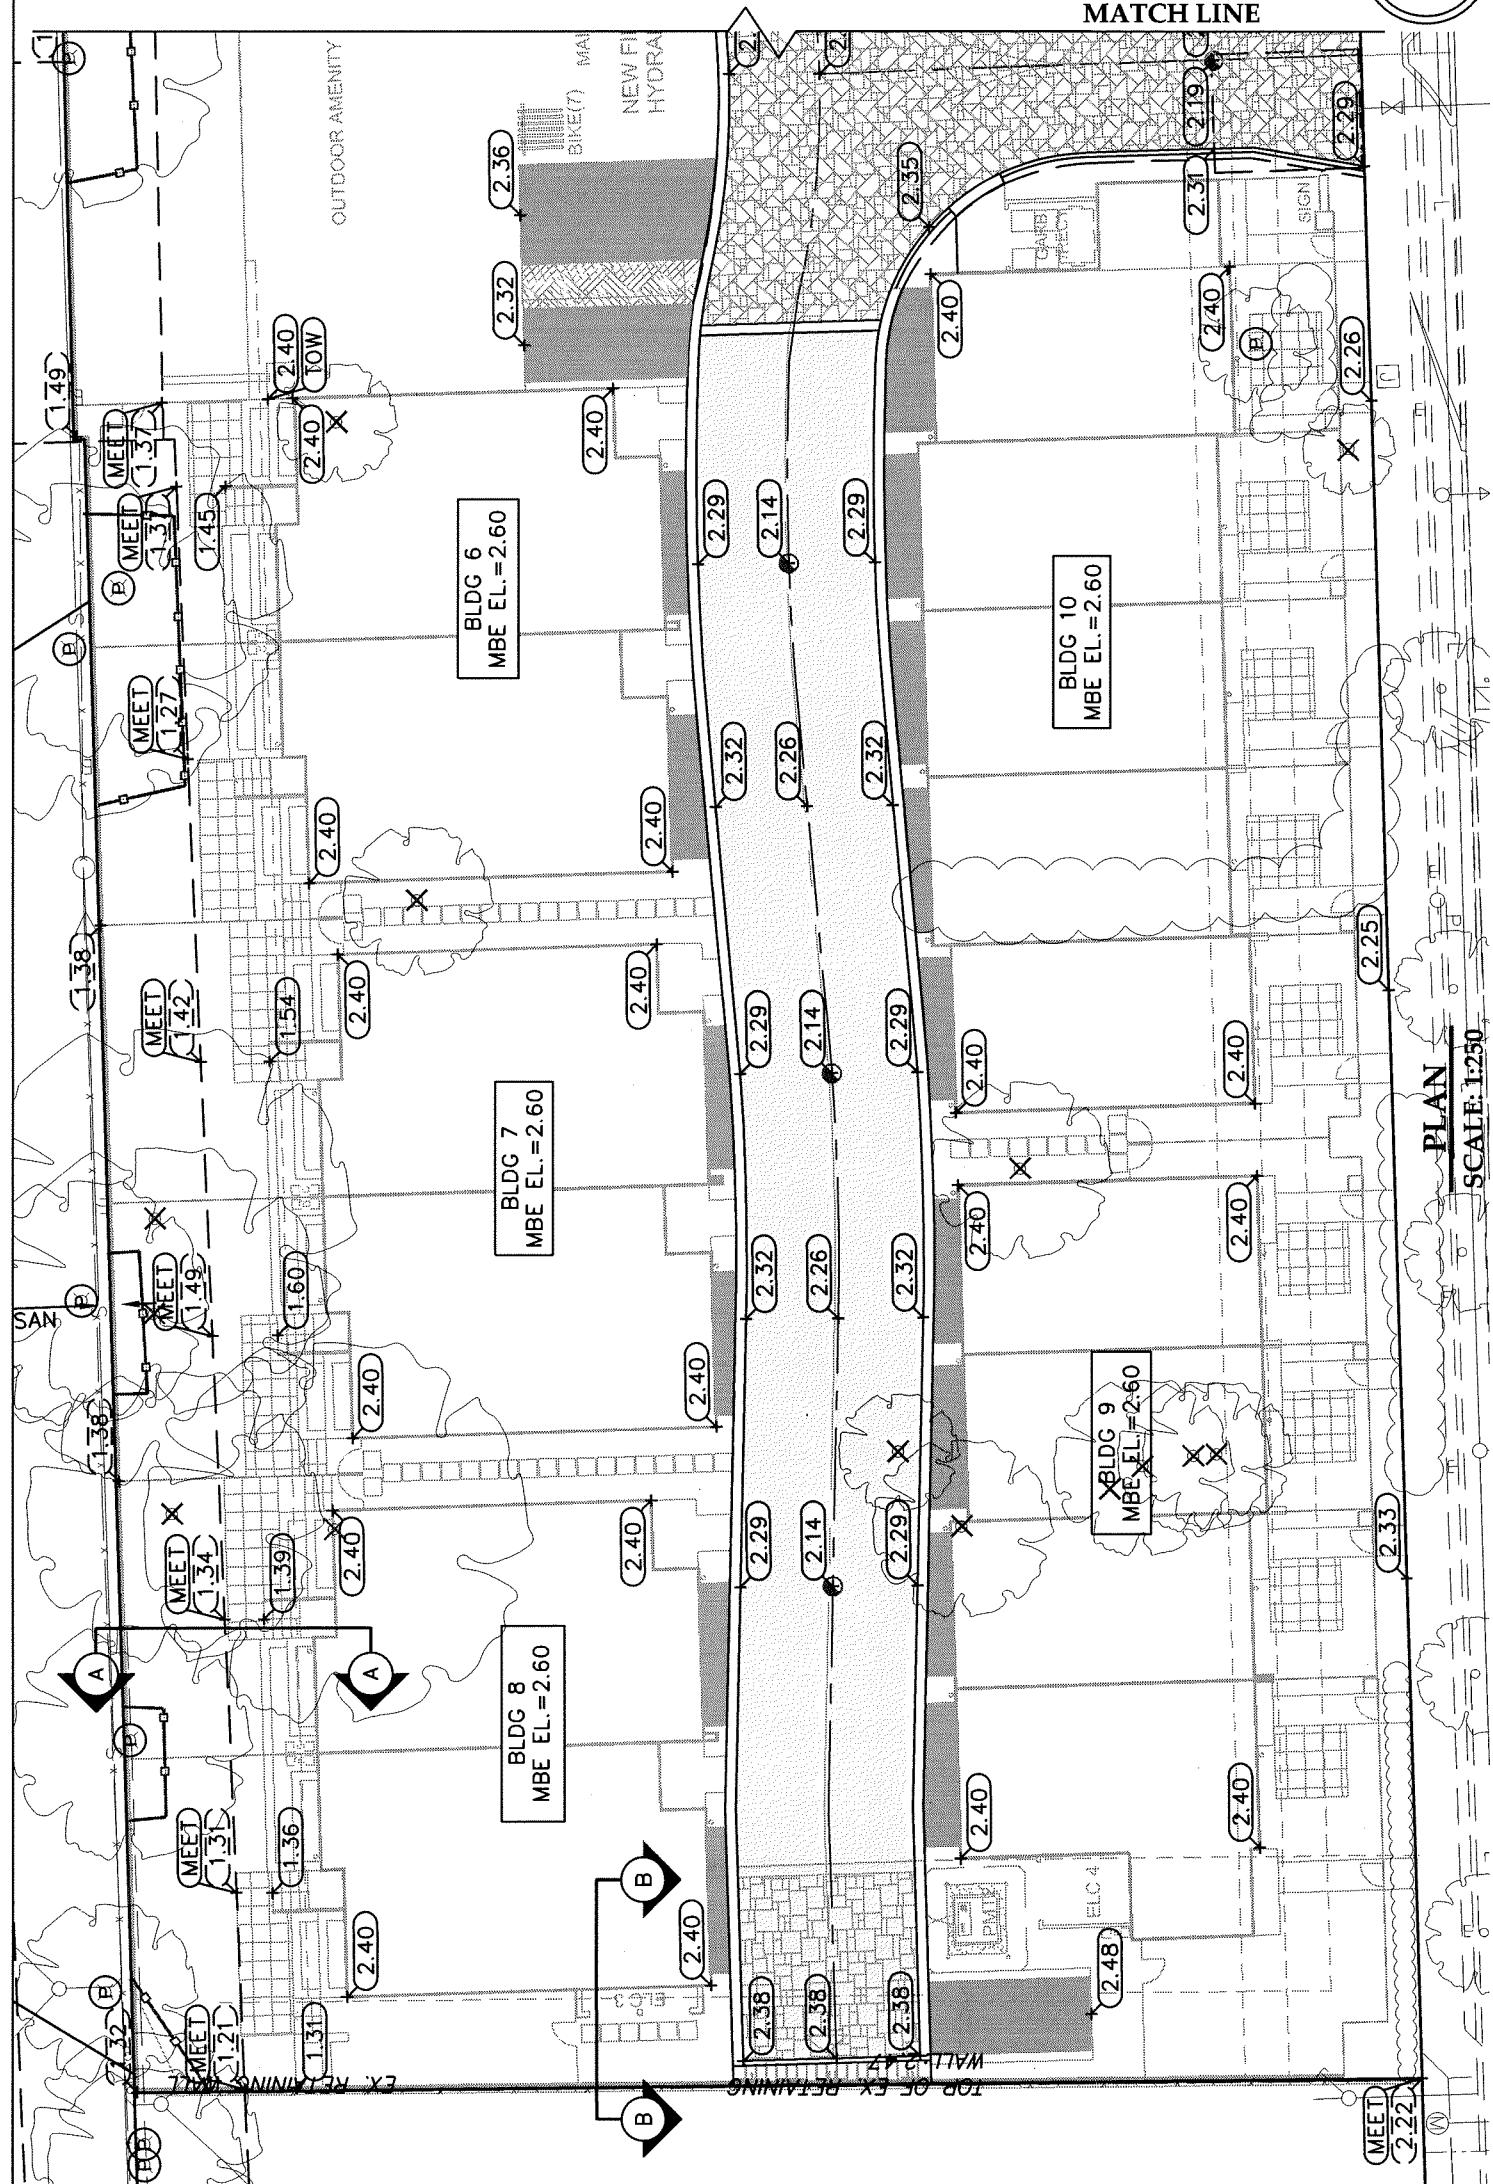
## LOT GRADING

TITLE:

7464-7600 NO.1 RD  
PENNSYLVANIA  
2028

Plan #1B

**CITY FILE:**


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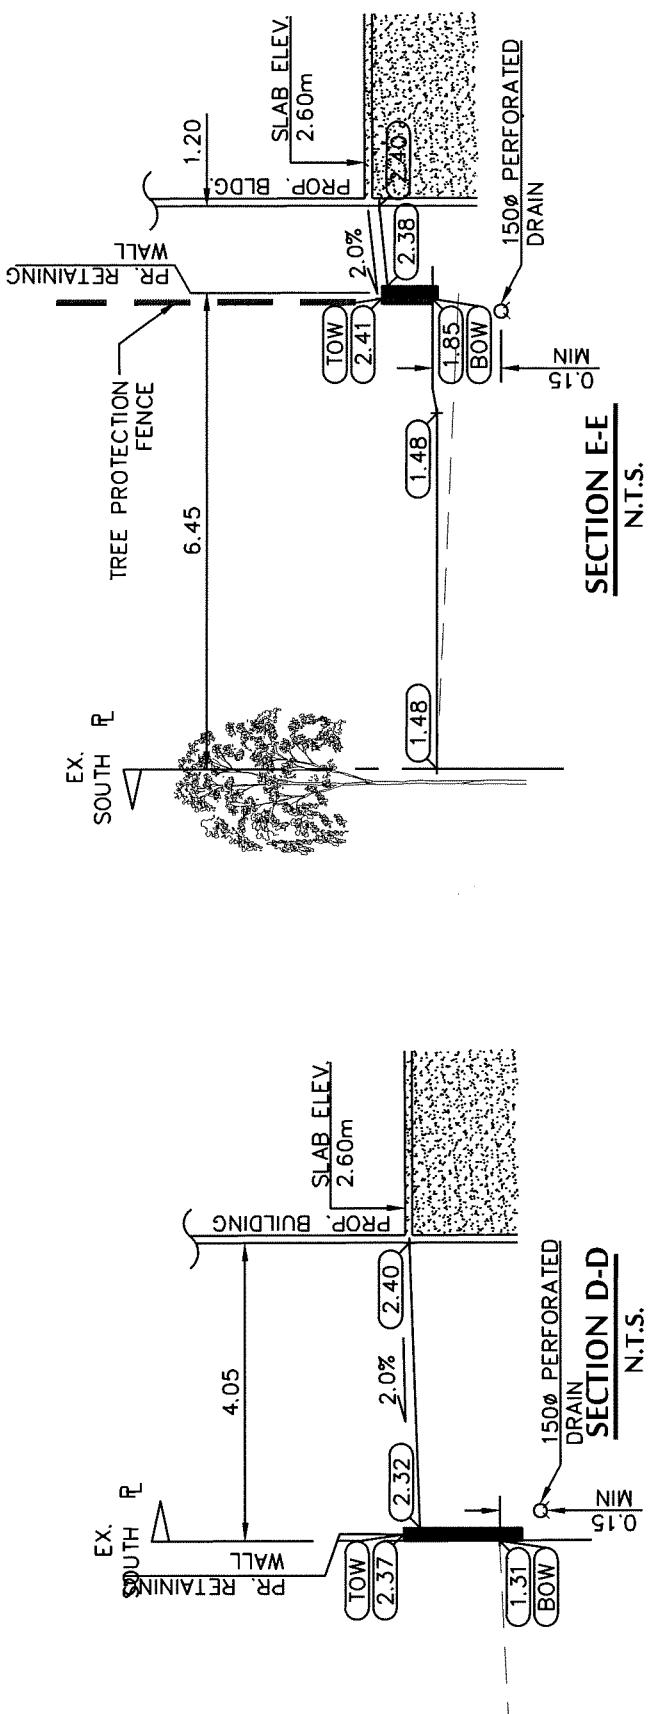
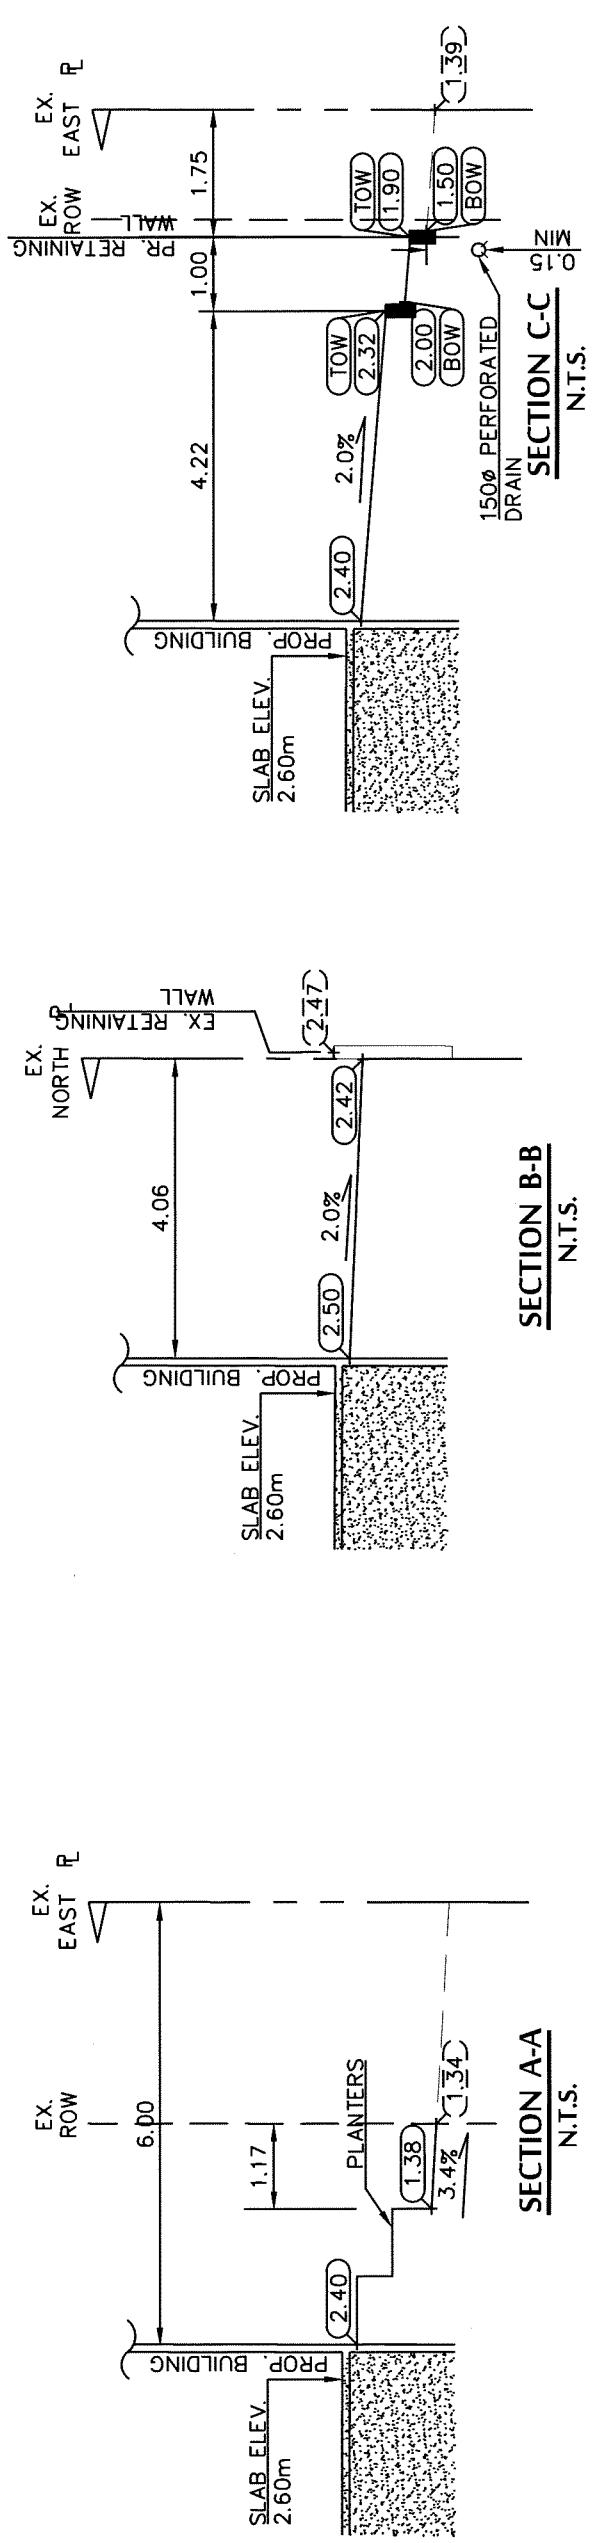
7464-7600 NO.1 RD

DESIGN:	DRK	DRAWN:	DRK	DWG.
CHECKED:	TS	SCAL.		
ENCINDED.	TS			SEC.

CONSTRUCTION  
27 NOV 2020

REV'N	DATE	BY	CH.	DESCRIPTION	REVISIONS
2.	08 DEC 2020	AR	TS	RE-ISSUED FOR DP	
1.	27 NOV 2020	AR	TS	RE-ISSUED FOR DP	
0.	29 MAY 2020	SP	BTR	ISSUED FOR DP	



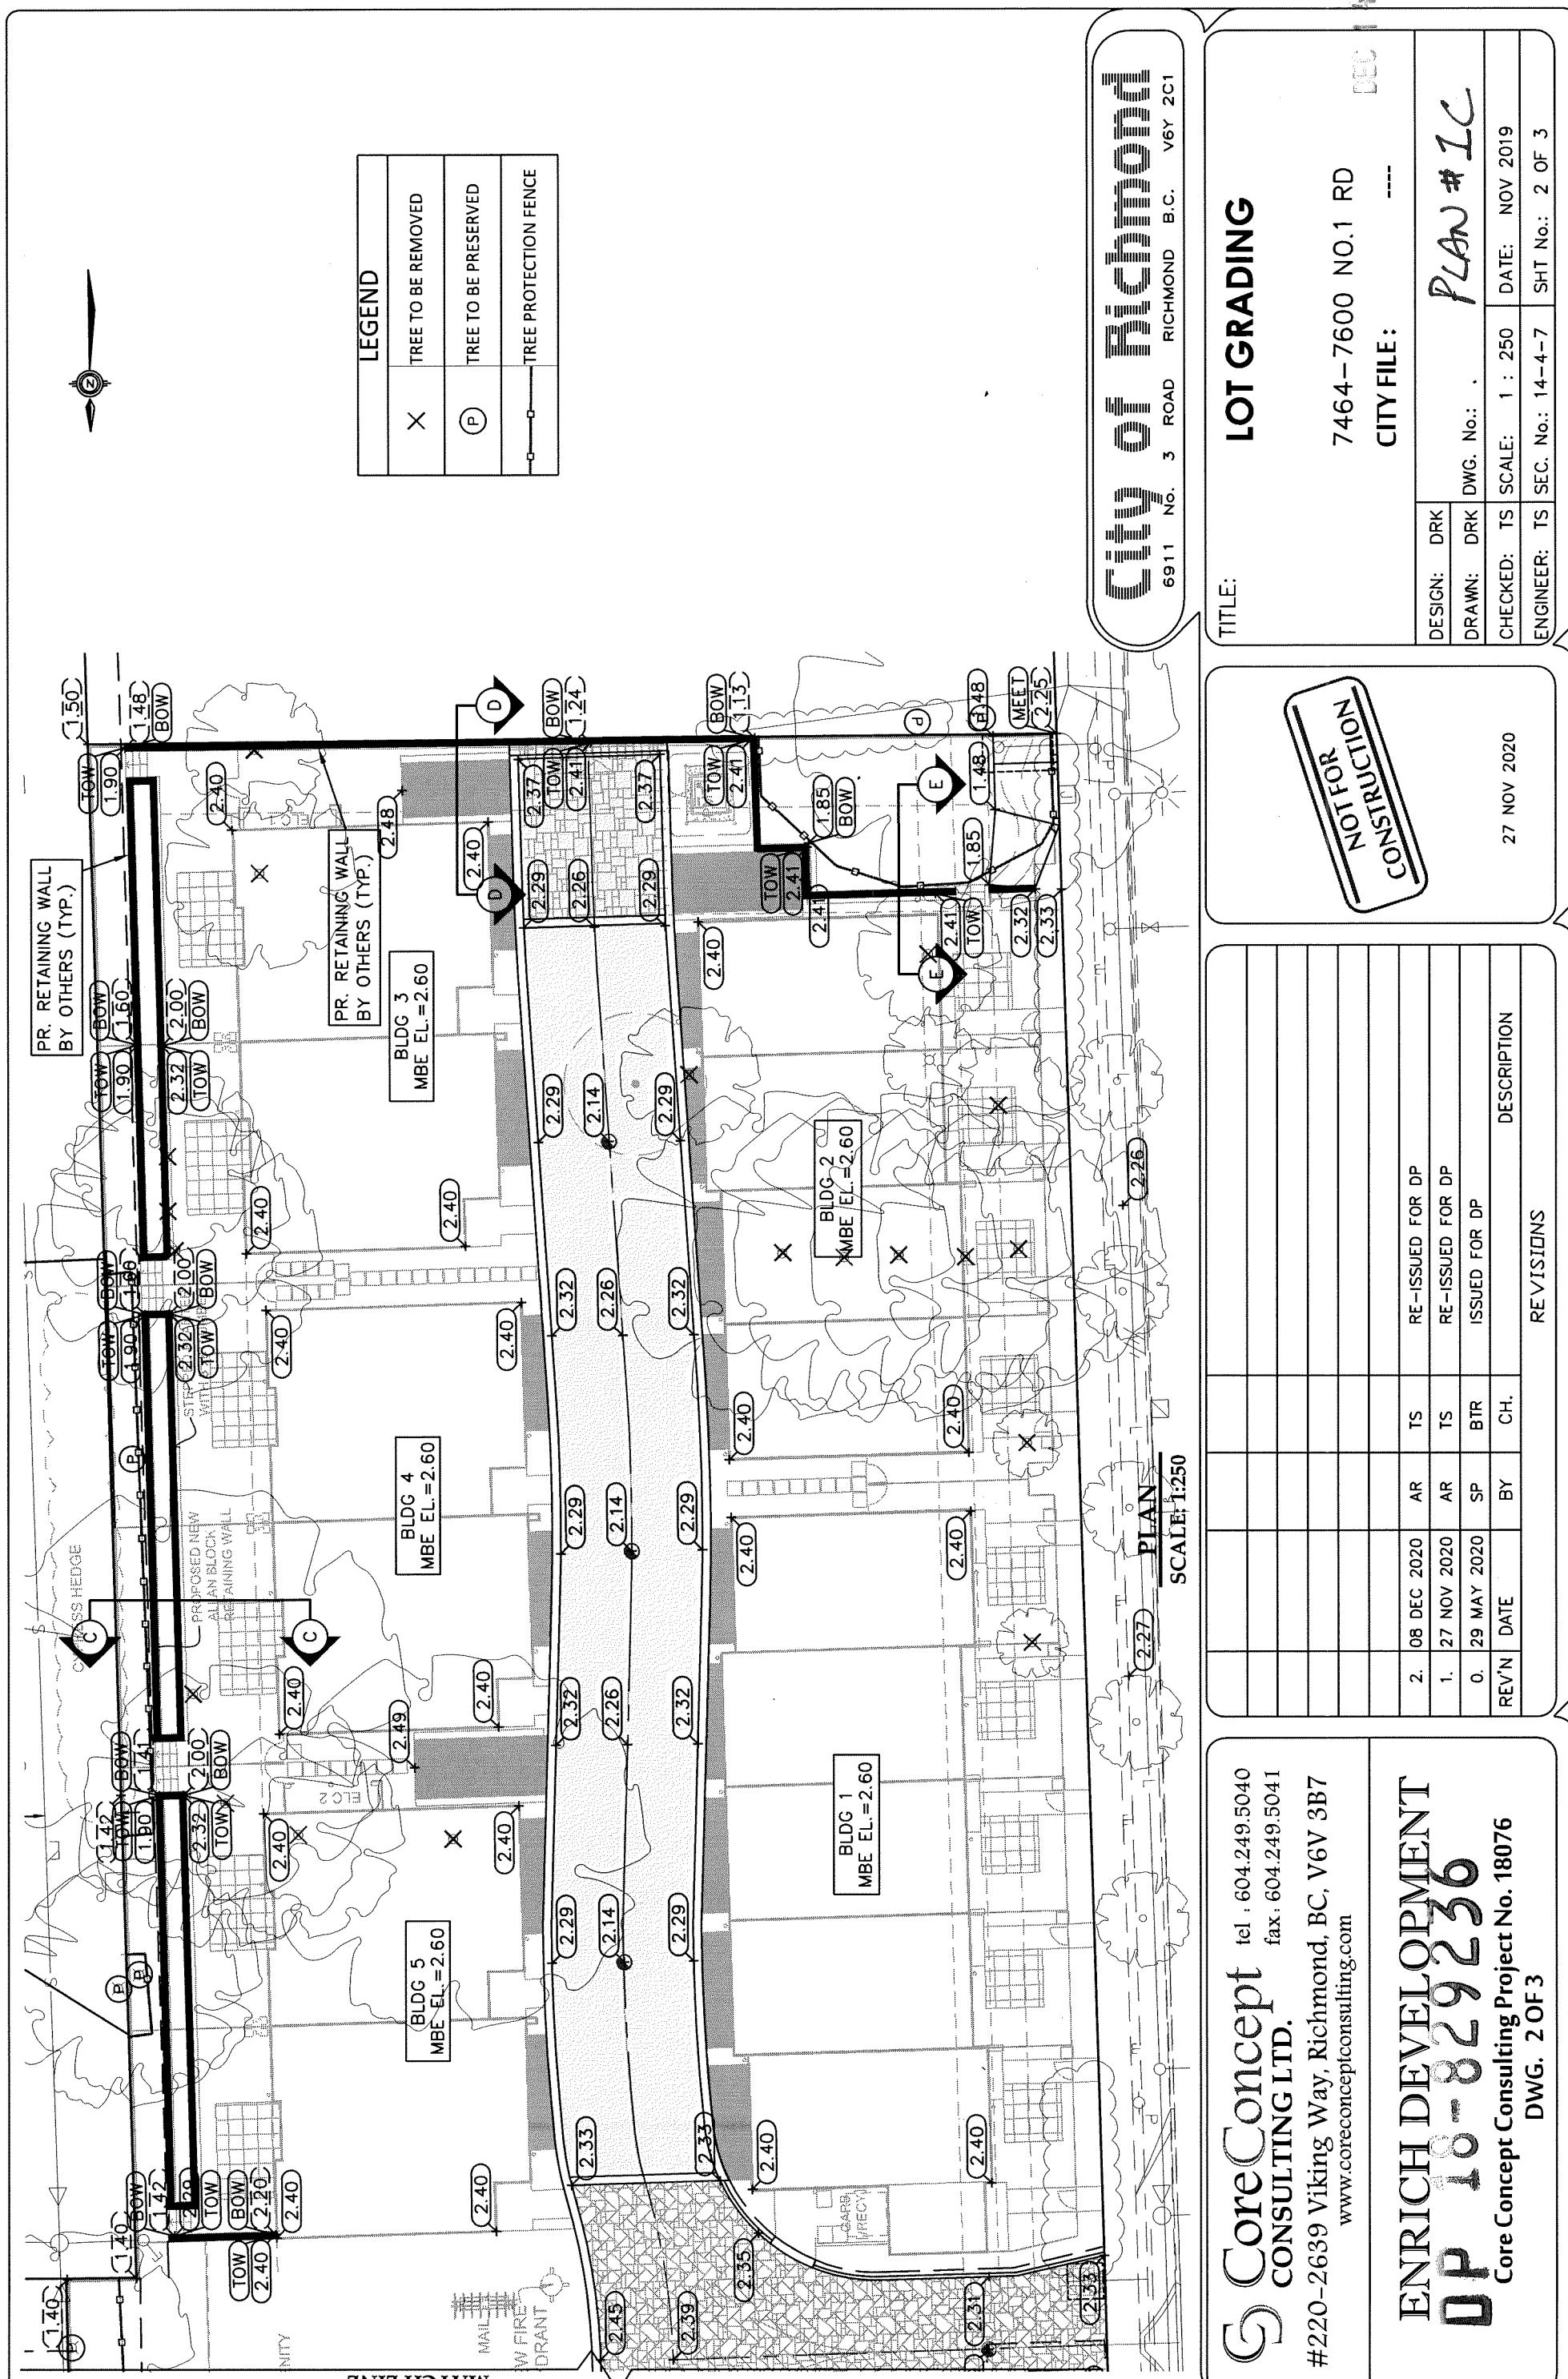

**CITY OF RICHMOND**  
6911 No. 3 ROAD RICHMOND B.C. V6Y 2C1

**LOT GRADING**

REF 14 2020

7464-7600 NO.1 RD

CITY FILE: ----

DESIGN:	DRK	DATE:	NOV 2019
DRAWN:	DRK	DWG. No.:	PLAN # 1D
CHECKED:	TS	SCALE:	1 : 250
ENGINEER:	TS	SEC. No.: 14-4-7	SHT No.: 3 OF 3

NOT FOR CONSTRUCTION

27 NOV 2020

REVN	DATE	BY	CH.	DESCRIPTION
				REVISIONS

**Core Concept** tel : 604.249.5040  
CONSULTING LTD. fax: 604.249.5041  
#220-2639 Viking Way, Richmond, BC, V6V 3B7  
www.coreconceptconsulting.com

**ENRICH DEVELOPMENT**  
**18-829236**


Core Concept Consulting Project No. 18076  
DWG. 3 OF 3

REVISIONS	DEC 08, 2020	DP& RESUBMISSION
NOV 27, 2020	DP& RESUBMISSION	
JUNE 03, 2020	DP RESUBMISSION	
DEC 23, 2019	BP SUBMISSION	
DEC 02, 2019	ADP SUBMISSION	
APR 26, 2019	RZ RESUBMISSION	
JULY 16, 2018	DP APPLICATION	
DEC. 22, 2017	RZ APPLICATION	
CONSULTANTS		

*All applications and other documents submitted to the City of Richmond must be submitted in English. Submissions in other languages will not be accepted. Applications must be submitted to the City of Richmond at the address listed below. No faxed or emailed applications will be accepted.*

*The drawing shall not be negotiable without written permission from the City of Richmond. Any drawings or plans which have been altered and/or changed by anyone other than the original designer or architect, or any other person, shall be rejected. Any alterations or changes made to the original design or plan shall be subject to review by the City of Richmond. Any such changes shall be submitted to the City of Richmond for review and approval before any work is performed.*

**SEAL**

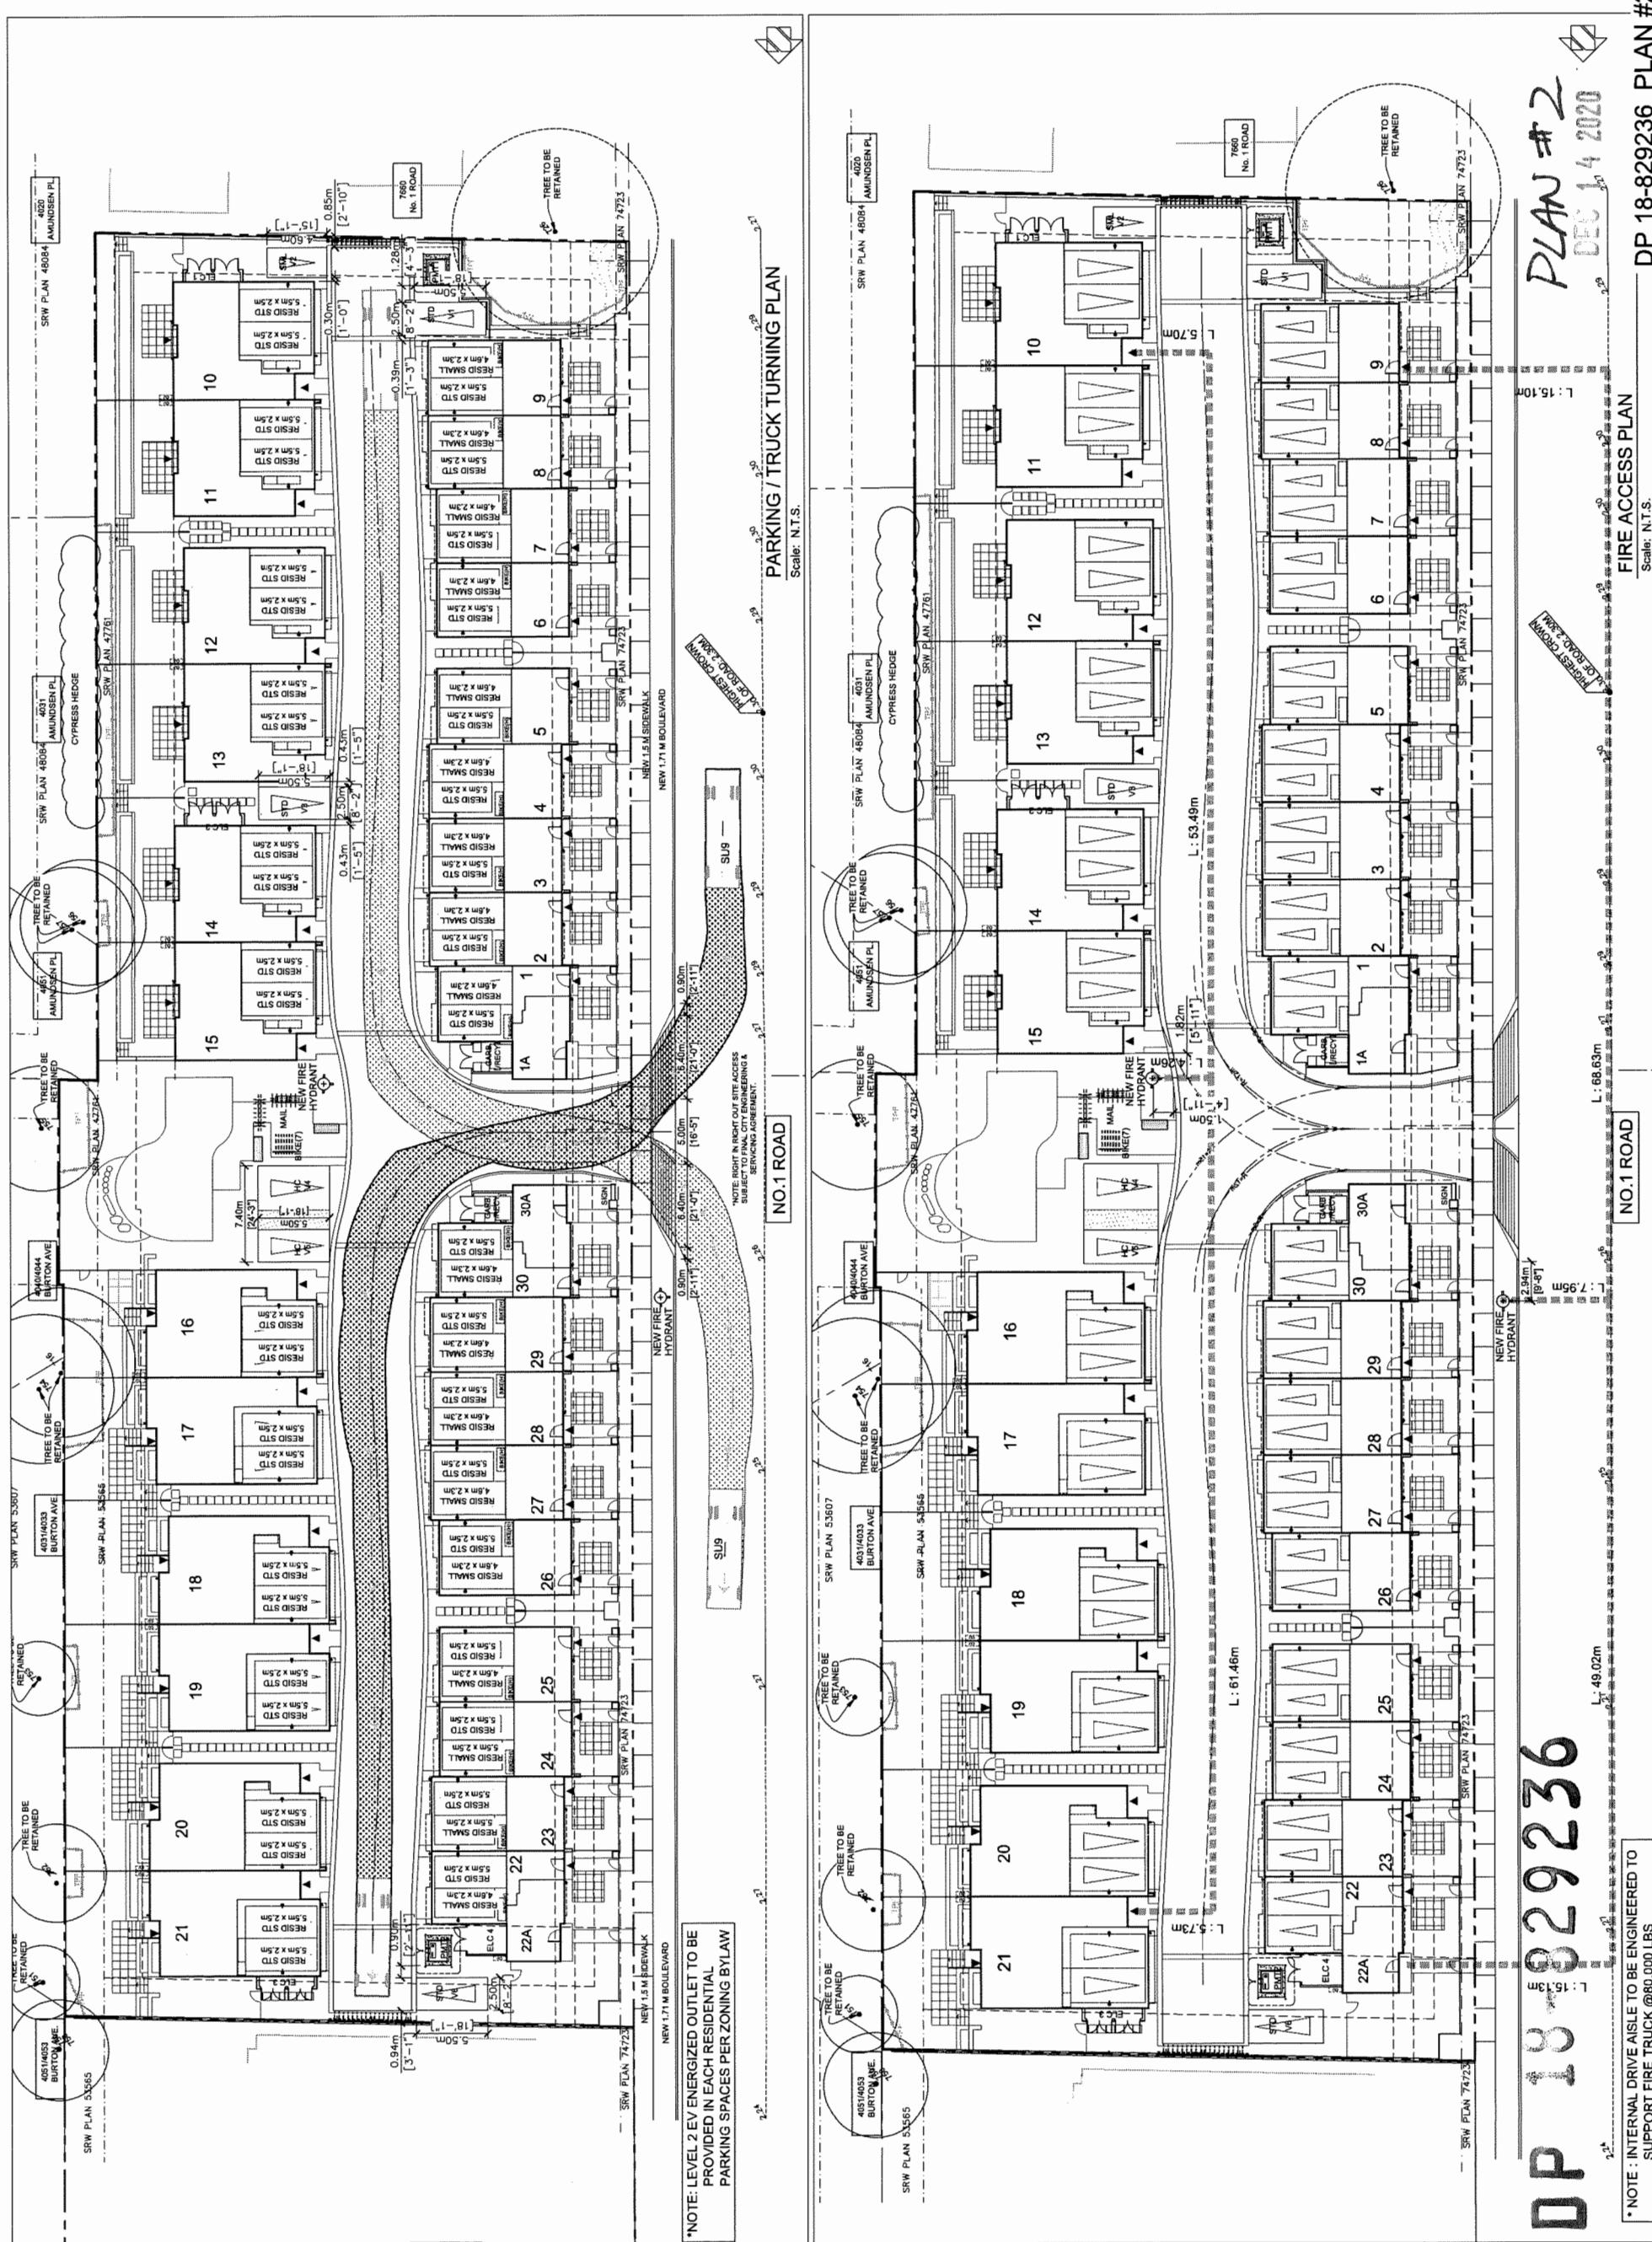


**NO LOCK BLOCKS OR GRADE CHANGES  
INSIDE PROTECTION ZONE OF RETAINED  
TREES**

DP 18-829236

NO.1 ROAD

PLAN #3

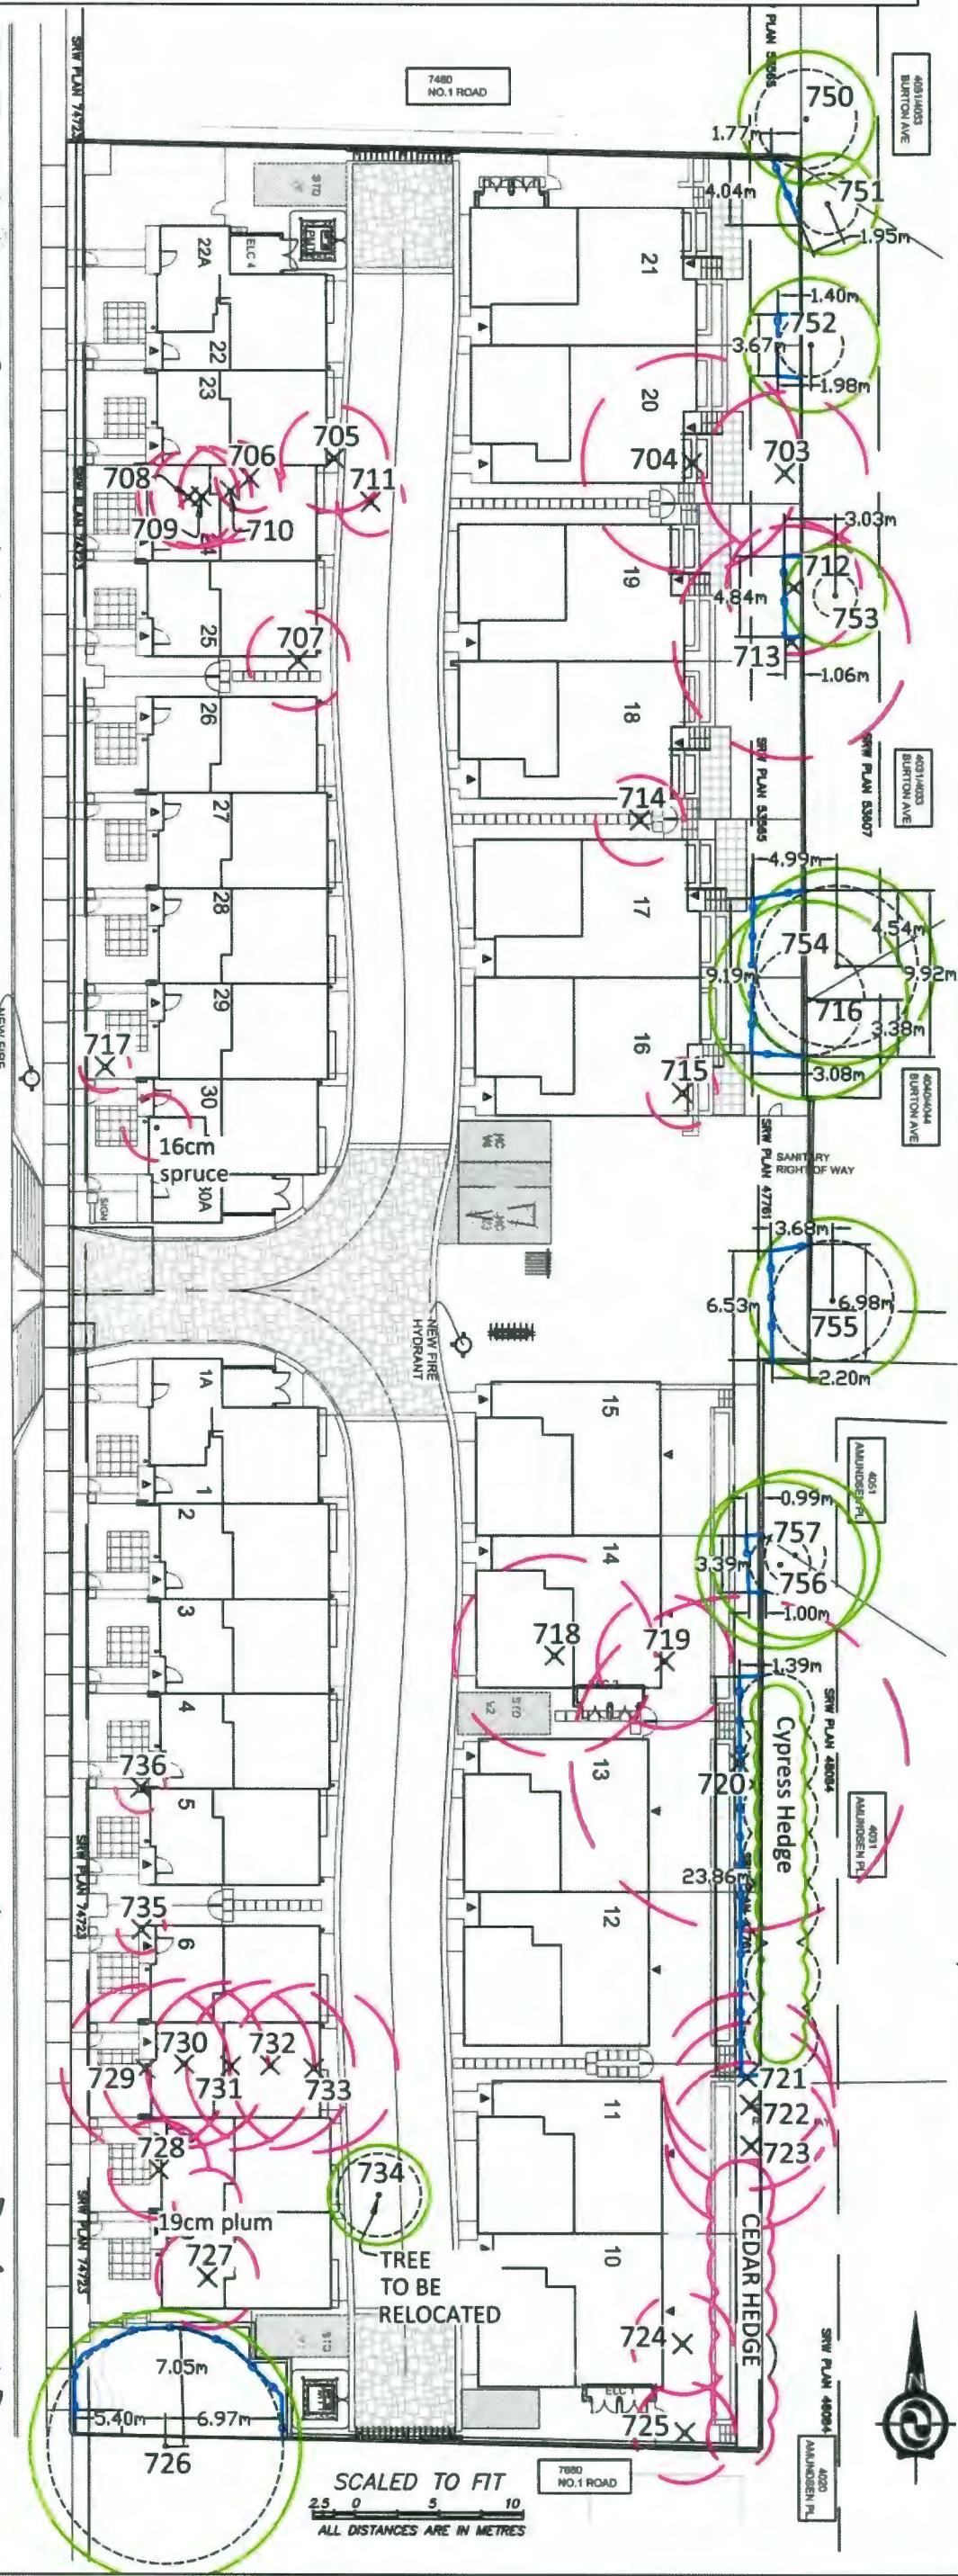

## **APPENDIX 3**

### **TREE MANAGEMENT PLAN**

## **TREE INVENTORY**

#	Type	Action	DBH	MPZ
703	Portuguese Laurel	Remove	35/28/25cm	3.0m
704	Cherry	Remove	90cm	5.4m
705	Portuguese Laurel	Remove	28cm	1.7m
706	Portuguese Laurel	Remove	20cm	1.2m
707	Apple	Remove	18/18cm	1.8m
708	Western Redcedar	Remove	27cm	1.6m
709	Cherry	Remove	26cm	1.6m
710	Western Redcedar	Remove	42cm	2.5m
711	Lawson Cypress	Remove	38cm	2.3m
712	Purple Plum	Remove	35cm	2.1m
713	Norway Maple	Remove	51cm	3.1m
714	Cherry	Remove	27/20cm	2.0m
715	Mountain Ash	Remove	20cm	1.2m
716	Norway Maple	Retain	55cm	3.3m
717	Norway Spruce	Remove	28cm	1.7m
718	Cherry	Remove	80cm	4.8m
719	Portuguese Laurel	Remove	20/19cm	1.8m
720	English Walnut	Remove	58cm	3.5m
721	Deodar Cedar	Remove	49cm	2.9m
722	Deodar Cedar	Remove	51cm	3.1m
723	Deodar Cedar	Remove	40cm	2.4m
724	Lombardy Poplar	Remove	110cm	6.6m
725	Lombardy Poplar	Remove	110/90cm	7.0m
726	Sycamore Maple	Retain	75/75/75cm	7.0m
727	Purple Plum	Remove	28cm	1.7m
728	Purple Plum	Remove	30cm	1.8m
729	Laburnum	Remove	28cm	1.7m
730	Laburnum	Remove	25/20cm	2.0m
731	Laburnum	Remove	45cm	2.7m
732	Laburnum	Remove	32cm	1.9m
733	Laburnum	Remove	30cm	1.8m
734	Japanese Maple	Relocate	22/12/12cm	2.5m
735	Lawson Cypress	Remove	30cm	1.8m
736	Blue Spruce	Remove	25cm	1.5m
	Cedar Hedge	Remove	30cm	2.5m
750	Western Redcedar	Retain	35/35cm	3.0m
751	Western Redcedar	Retain	15/15cm	1.8m
752	Cherry	Retain	32cm	1.9m
753	Western Redcedar	Retain	22cm	1.3m
754	Western Redcedar	Retain	80cm	4.8m
755	Western Redcedar	Retain	60cm	3.6m
756	Lawson Cypress	Retain	28cm	1.7m
757	Lawson Cypress	Retain	30cm	1.8m
	Cypress Hedge	Retain	20 to 35cm	2.2m

**DBH- trunk diameter, MPZ- protection zone**

# **TREE PROTECTION FENCING**

## **Minimum Radial Distance from trunk**


#	Type	DBH	Metres	Feet
716	Norway Maple	55cm	3.3m	10.8ft
726	Sycamore Maple	75/75/75cm	7.0m	23.0ft
750	Western Redcedar	35/35cm	3.0m	9.8ft
751	Western Redcedar	15/15cm	1.8m	5.9ft
752	Cherry	32cm	1.9m	6.3ft
753	Western Redcedar	22cm	1.3m	4.3ft
754	Western Redcedar	80cm	4.8m	15.7ft
755	Western Redcedar	60cm	3.6m	11.8ft
756	Lawson Cypress	28cm	1.7m	5.5ft
757	Lawson Cypress	30cm	1.8m	5.9ft
	Cypress Hedge	20 to 35cm	2.2m	7.2ft

---

**LEGEND**

TREE PROPOSED  
FOR REMOVAL

**TREE PROPOSED  
FOR RETENTION**

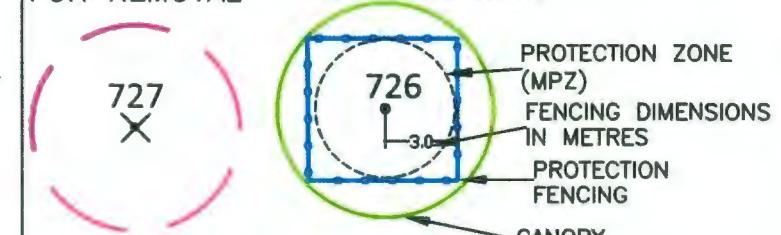

**NOTES:**  
1. SITE LAYOUT  
INFORMATION AND TREE  
SURVEY DATA PER  
SUPPLIED DRAWING

**2. REFER TO  
ATTACHED TREE  
PROTECTION REPORT  
FOR INFORMATION  
CONCERNING TREE  
SPECIES, STEM  
DIAMETER, HEIGHT,  
CANOPY SPREAD AND  
CONDITION.**

3. ALL MEASUREMENTS  
ARE METRIC

**Froggers Creek  
Tree Consultant**

*7763 McGregor Avenue Burnaby BC V5J 4H4  
Telephone: 604-721-6002 Fax: 604-437-0970*

7500 No 1 Road Richmond

**TREE MANAGEMENT DRAWING**  
THE DRAWING PLOTS ALL TREES, PROPOSED FOR  
RETENTION, REMOVAL, THEIR CANOPIES,  
PROTECTION ZONES AND PROTECTION FENCING IN  
RELATION TO PROPOSED LAYOUT










LANDSCAPE  
ARCHITECTS

Suite C100 - 4185 Still Creek Drive

Burnaby, British Columbia, V5C 6S9

P: 604.254.0011 | F: 604.254.0022

SEAL:


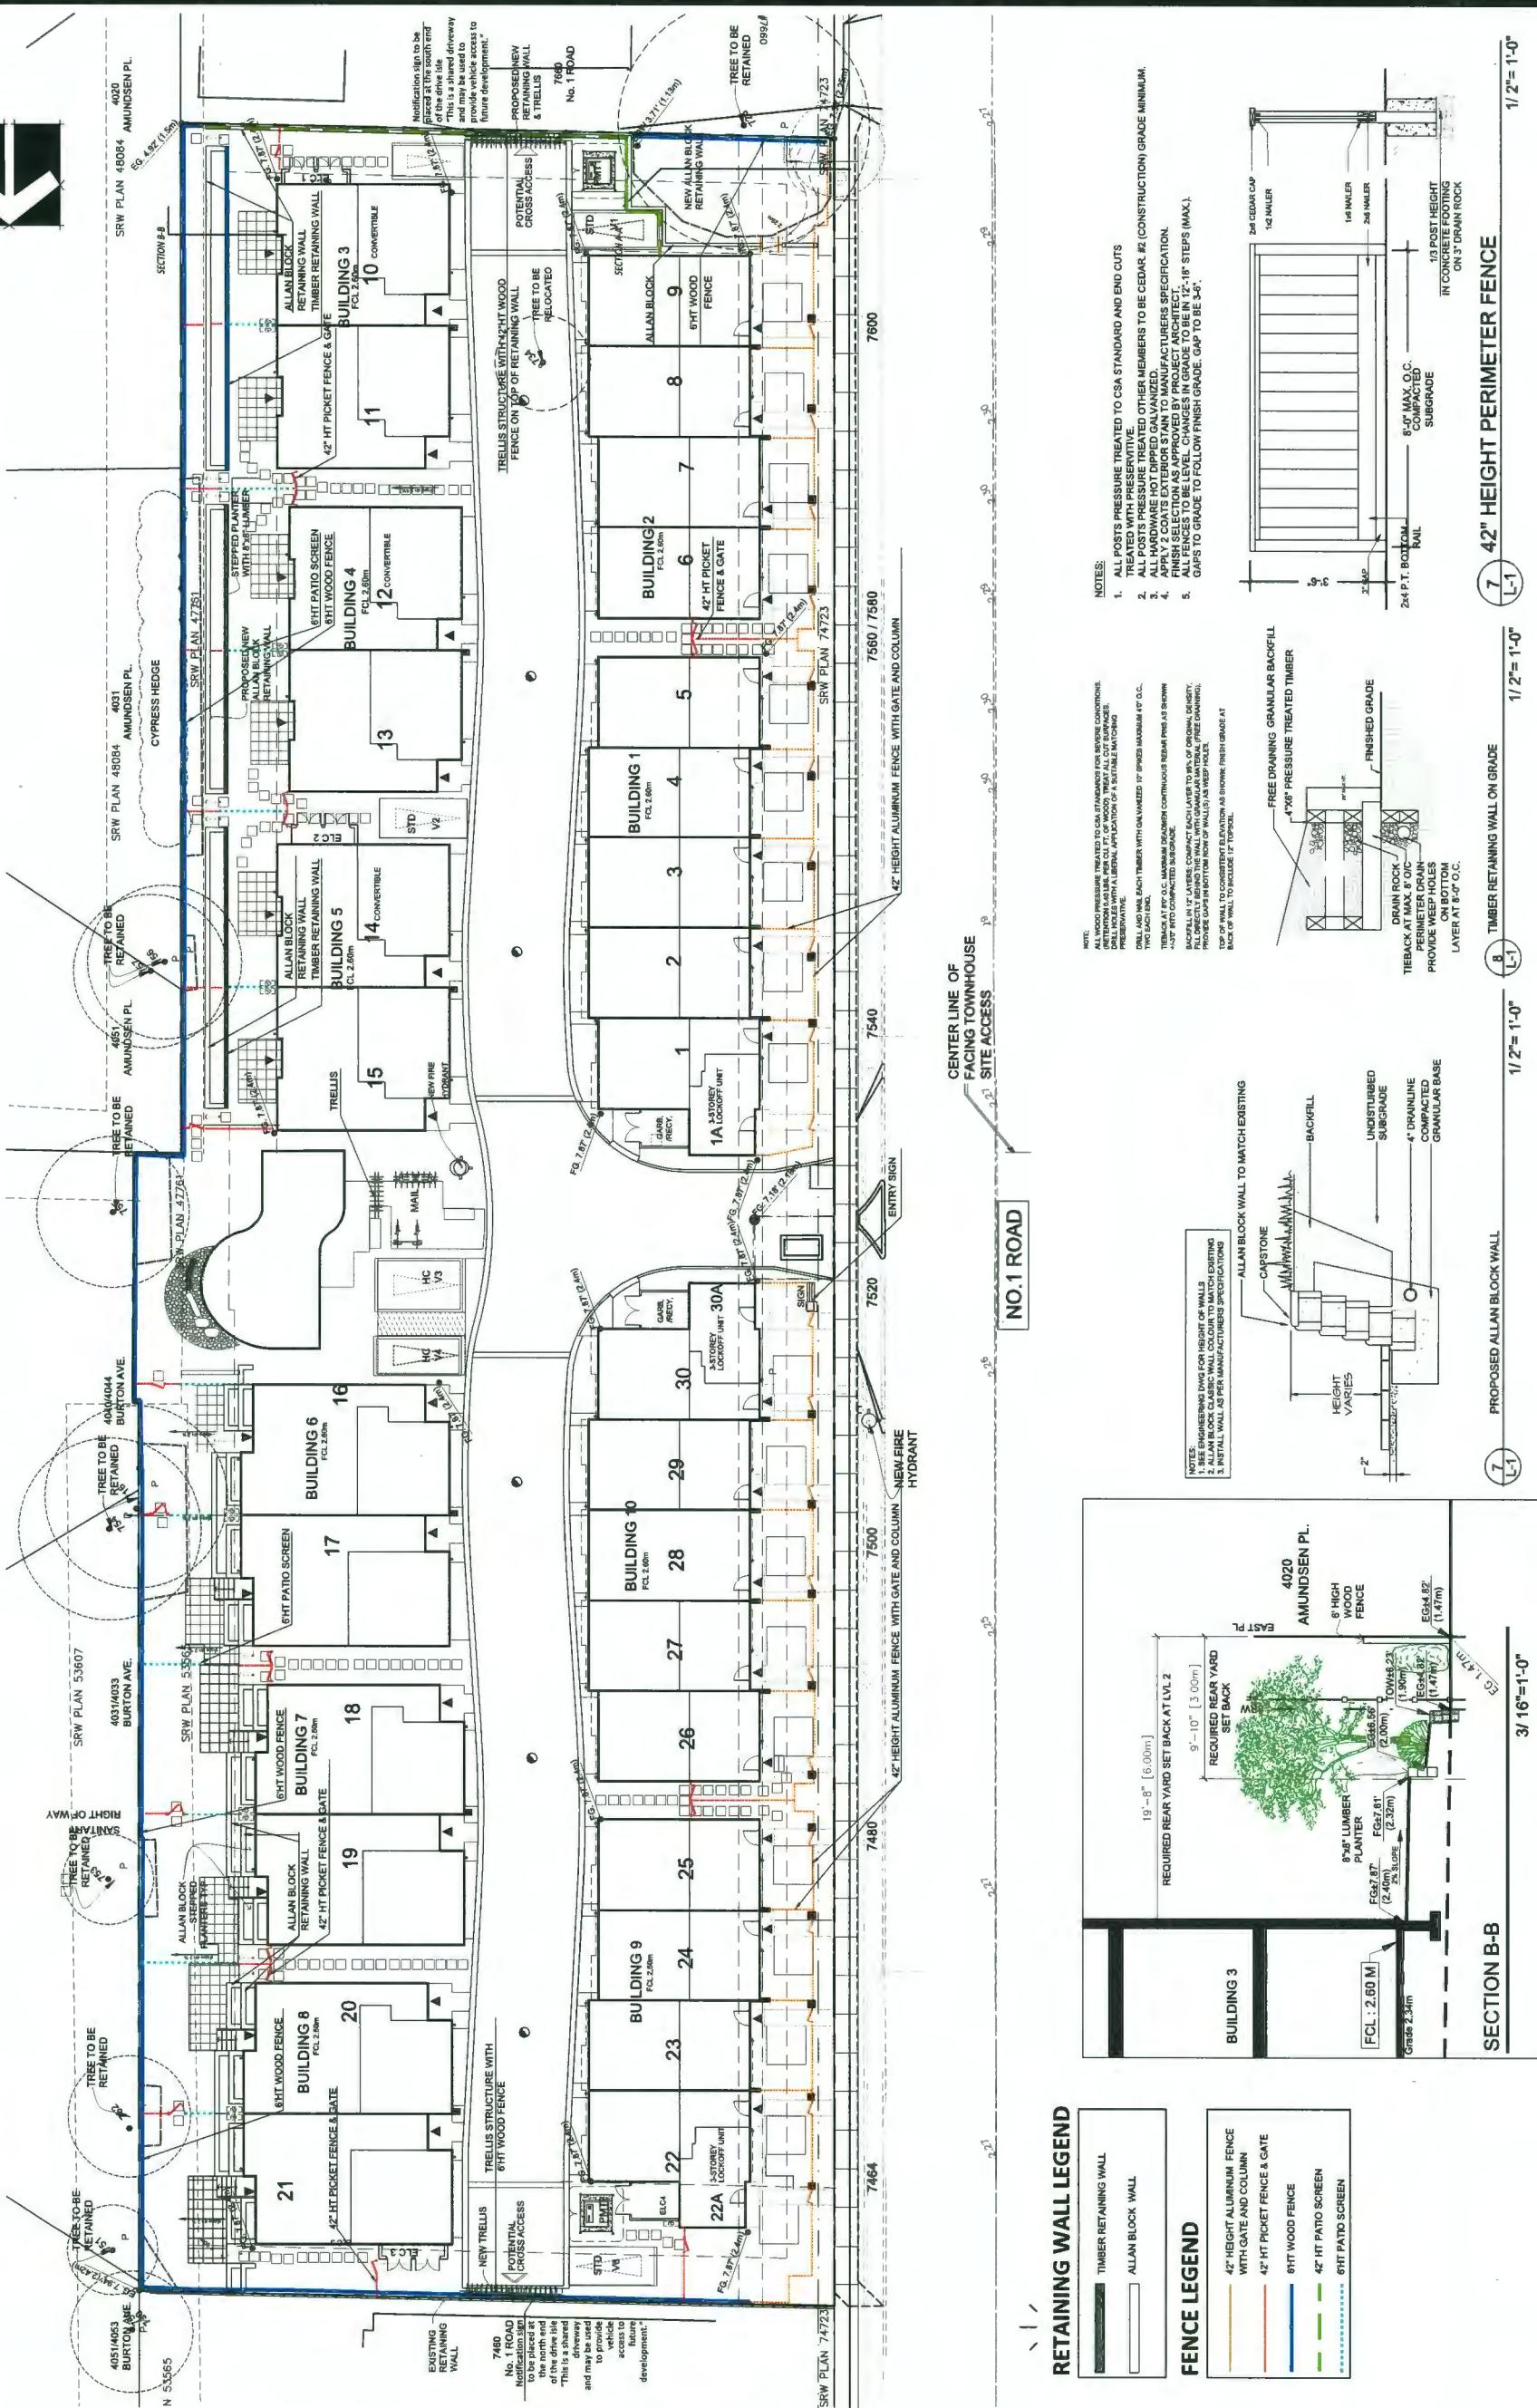







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ARCHITECTS  
Suite C100 - 4185 Still Creek Drive  
Burnaby, British Columbia, V5C 6G9  
p: 604 284-0011 : f: 604 284-0022

SEAL:

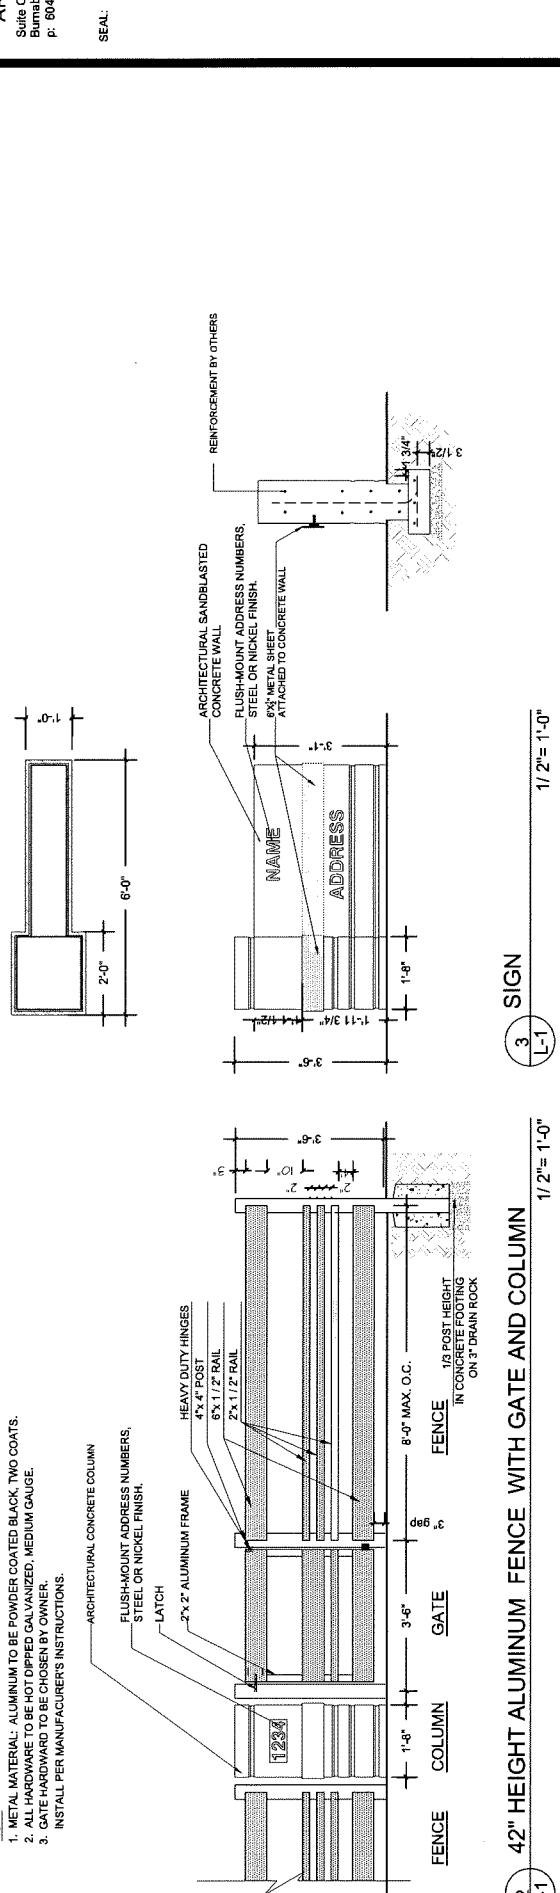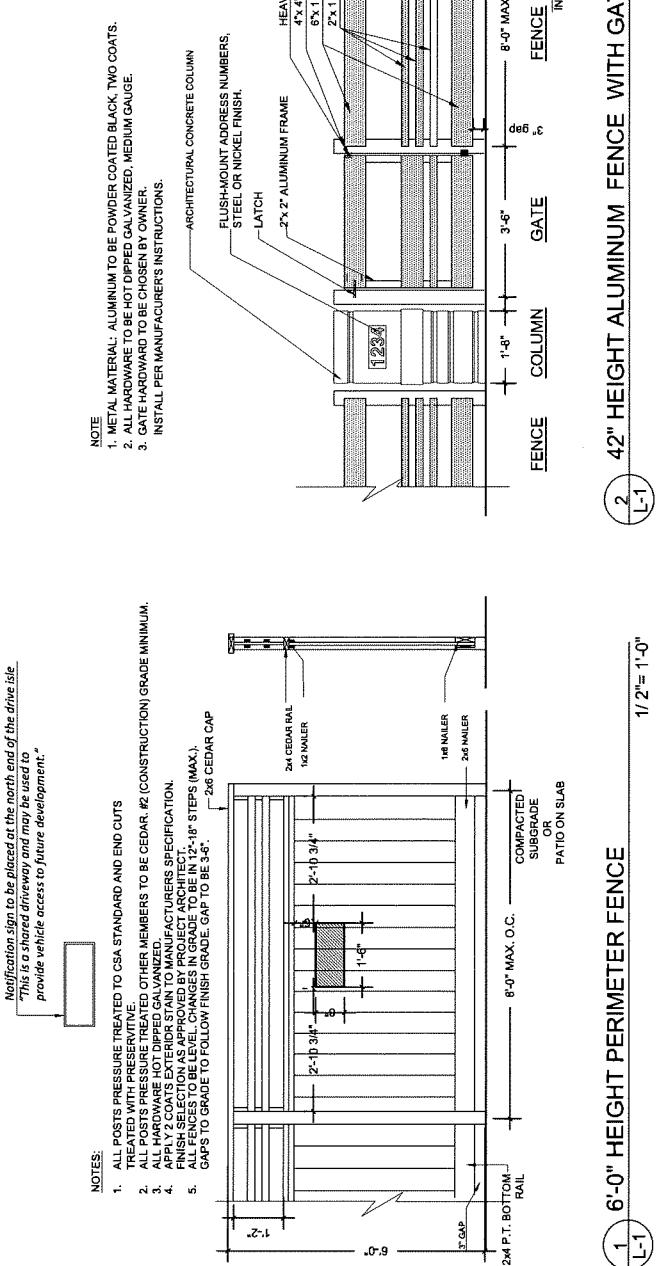

### PLANT SCHEDULE

KEY	QTY	BOTANICAL NAME	COMMON NAME	PLANTED SIZE / REMARKS
SHRUB	1	ABELIA 'EDWARD GOUCHER'	PINK ABELIA	#2 POT; 30CM
(A)	21	AZALEA 'JAPONICA HINO CRIMSON'	AZALEA (SINGLE DEEP CRIMSON)	#2 POT
(B)	2	BERBERIS THUNBERGII 'MONOMBO'	CHERRY BOMB BARBERRY	#2 POT
(C)	21	BLIXIUS MICROPHYLLA 'WINTER GEM'	LITTLE-LEAF BOX	#2 POT; 25CM
(D)	17	CHOISYA TERNATA	MEXICAN MOCK ORANGE	#3 POT; 50CM
(E)	3	CORNUS SERICEA	FRED OSIER DOGWOOD	#2 POT; 40CM
(F)	10	FOETHERGILLA GARDENII	DAWRF FOETHERCILLA	#3 POT; 80CM
(G)	38	HYDRANGEA M. 'ENDLESS SUMMER'	ENDLESS SUMMER BIGLEAF HYDRANGEA	#3 POT; 50CM
(H)	24	KALMIA LATIFOLIA 'ELF'	DAWRF MOUNTAIN LAUREL	#3 POT; 50CM
(I)	103	PLERIS JAPONICA 'VALLEY FIRE'	VALLEY FIRE PIERIS	#2 POT; 50CM
(J)	8	PRUNUS LAUROCEPRAUS 'ZABELIANA'	ZABLE'S LAUREL	#2 POT; 30CM
(K)	101	ROSA 'SCARLET MEDILAND'	SCARLET MEIDLAND ROSE	#2 POT; 30CM
(L)	78	SKIMMIA JAPONICA (10% MALE)	SKIMMIA SKIMMIA	#2 POT
(M)	110	SKIMMIA REEVESIANA	HICKS' YEW	1.0M BAB
(N)	167	TAXUS X MEDIA 'HICKSF'	DAVID'S VIBURNUM	#2 POT; 30CM
(O)	107	VIBURNUM DAVIDI	MARIE'S DOUBLE FILE VIBURNUM	1.0M HT; B&B
(P)	3	VIBURNUM P.T. 'MARIESII'		#1 POT; FULL
GRASS	348	CAREX COLCHOSTACHYA 'KAGA NISHIKI'	GOLD FOUNTAIN SEDGE	#1 POT; HEAVY
(Q)	4	CAREX MORROWII 'AUREO VARIEGATA'	GOLDEN VARIGATED JAPANESE SEDGE	#2 POT
(R)	54	MISCANTHUS SINensis 'MORNING LIGHT'	MORNING LIGHT JAP. SILVER GRASS	#1 POT
(S)	284	PENNSETUM ALOPECUROIDES 'HAMLIN'	DWARF FOUNTAIN GRASS	#2 POT; 60CM; STAKED
(T)	10	STIPA TENUISSIMA	MEXICAN FEATHER GRASS	
VINE	2	CLEMATIS ARMANDII	EVERGREEN CLEMATIS	#2 POT; 5 EYE OR LARGER
(U)	90	ASTILBE X 'ETNA'	ETNA FALSE SPIRAEA (RED)	15CM POT
(V)	93	LIRIOPE MUSCARI	BLUE LILY-TURF	#1 POT; 25CM
(W)	2	EUONYMUS JAPONICA 'EMERALD GAIETY'	EUONYMUS; SILVER VARIEGATED	#1 POT; 20CM
(X)	294	POLYSTICHUM MUNIMUM	WESTERN SWORD FERN*	

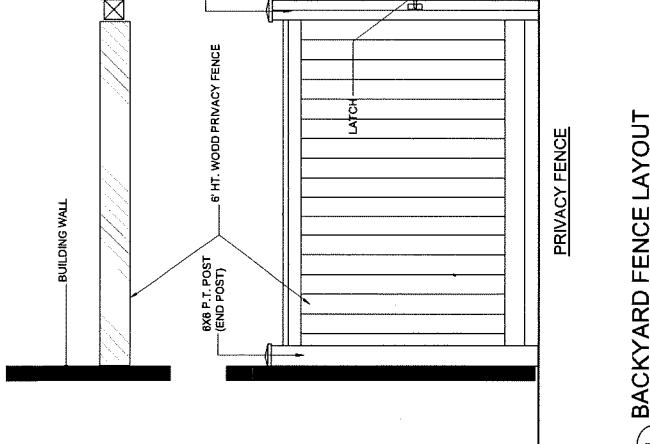

NO. DATE	REVISION DESCRIPTION	DR.
1	NEW SITE PLAN	DR.
2	REVISION AS PER CITY COMMENTS	DR.
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REVISIONS
DEC 06, 2020 DP RESUBMISSION
NOV 27, 2020 DP RESUBMISSION
JUNE 03, 2020 DP RESUBMISSION
DEC 23, 2019 BP SUBMISSION
DEC 02, 2019 ADP SUBMISSION
APR 26, 2019 RZ RESUBMISSION
JULY 16, 2018 DP APPLICATION
DEC 22, 2017 RZ APPLICATION
CONSULTANTS

**INTERFACE:**

Suite 230  
11600 Cambie Road  
Richmond BC  
Canada V6X 3Z5  
T 604 821 1182  
F 604 821 1146  
[www.interfacearchitecture.com](http://www.interfacearchitecture.com)

PROJECT	Proposed 30-Unit Townhouse Development
7.LOT ASSEMBLY	7.1600 Cambie Road / 7500 / 7510 / 7540 / 7560 / 7580 / 7600 NO. 1 ROAD / RICHMOND, BC
PROJECT NO.	1717NJM1
SCALE	As Noted
DATE	JUNE 21, 2017
DRAWN BY	KYC, SRS, XY
CHECKED BY	KYC
SHEET TITLE	PERSPECTIVES
PERIODIC	

NOTE: NO LANDSCAPING IS SHOWN.  
SEE THE LANDSCAPE DRAWINGS FOR FURTHER INFORMATION



**PERSPECTIVE IMAGE - END OF DRIVE AISLE LOOKING NORTH**



**PERSPECTIVE IMAGE - END OF DRIVE AISLE LOOKING NORTH**



**PERSPECTIVE IMAGE - BIRD EYE VIEW LOOKING NORTH-EAST**



**PERSPECTIVE IMAGE - LOOKING SITE ENTRY**

NOTE: NO LANDSCAPING IS SHOWN.  
SEE THE LANDSCAPE DRAWINGS FOR FURTHER INFORMATION

**DP 18-8229236**

**A9.3**  
PLAN #4  
DEC 14 2020

A9.1

PLAN #4A

DEC 14 2020

Scale: 1/16=1'-0"

DP 18-829236

REVISIONS  
DEC 06, 2020 DP6 RESUBMISSION  
NOV 27, 2020 DPS RESUBMISSION  
JUNE 03, 2020 DP RESUBMISSION  
DEC 23, 2019 BP SUBMISSION  
DEC 02, 2019 ADP SUBMISSION  
APR 26, 2019 RZ RESUBMISSION  
DEC 22, 2017 DP APPLICATION  
JULY 16, 2018 RZ APPLICATION  
CONSULTANTS

DRAWING

PROJECT  
Proposed 30-Unit  
Townhouse Development  
7.LOT ASSEMBLY  
7464 / 7480 / 7500 / 7520 /  
7540 / 7560 / 7580 / 7600  
NO. 2 ROAD  
RICHMOND, BC  
PROJECT NO.  
1717NUH1

SCALE

As Nailed

DATE

JUNE 21, 2017

DRAWN BY

KYC, SRS, XY

CHECKED BY

KYC

SHEET TITLE

STREETSCAPES &  
SITE SECTIONS


INTERFACE:  
Suite 230  
11590 Cambie Road  
Richmond BC  
Canada V6X 3Z5  
T 604 821 1182  
F 604 821 1146  
www.interfacearchitcture.com

DRAWING



STREETSCAPE ALONG NO 1 ROAD  
Scale: 1/16=1'-0"

KEY PLAN

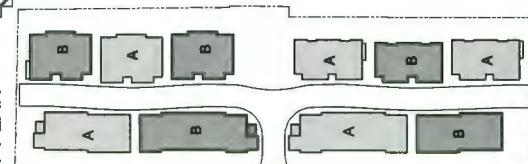


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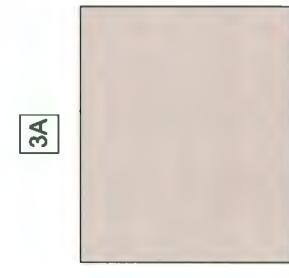
FIBER CEMENT LAP SIDING  
HARDIEPLANK (SELECT CEDARMILL)  
COLOUR: Nut Brown



FIBER CEMENT PANEL SIDING  
HARDIEARTISAN (V-GROOVE SIDING)  
COLOUR: Evening Blue




FIBER CEMENT PANEL SIDING  
HARDIEPANEL (SMOOTH)  
COLOUR: Iron Gray

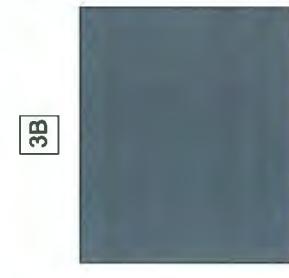

FIBER CEMENT PANEL SIDING  
HARDIEPANEL (SMOOTH)  
COLOUR: Arctic White



FIBER CEMENT PANEL (SMOOTH)  
HARDIEARTISAN (V-GROOVE)  
COLOUR: Pearl Gray

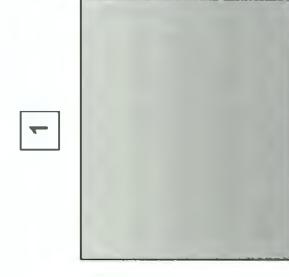

FIBER CEMENT PANEL SIDING  
HARDIEARTISAN (V-GROOVE)  
COLOUR: Kendal Charcoal



6: DOUBLE GLAZED VINYL WINDOW  
7: DOUBLE GLAZED VINYL SLIDING  
DOOR  
Colour: BM HC166 (Kendall Charcoal)



8: ENTRY SOLID WOOD DOOR  
14: BUILT UP POST  
Door Colour: Light Walnut Stain  
Colour: BM HC166 (Kendall Charcoal)



9: ALUMINUM FASCIA GUTTER  
10: METAL FLASHED EYE BROW ROOF  
Colour: BM HC166 (Kendal Charcoal)



11: OVERHEAD METAL GARAGE DOOR  
17: ELECTRICAL ROOM DOOR  
Colour: BM HC-172 (Revere Pewter)



12: METAL FLASHED EYE BROW ROOF  
Colour: BM HC166 (Kendal Charcoal)



13: METAL FLASHED EYE BROW ROOF  
Colour: BM HC166 (Kendal Charcoal)



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Colour: BM HC166 (Kendal Charcoal)



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49: METAL FLASHED EYE BROW ROOF  
Colour: BM HC166 (Kendal Charcoal)



50: METAL FLASHED EYE BROW ROOF  
Colour: BM HC166 (Kendal Charcoal)



51: METAL FLASHED EYE BROW ROOF  
Colour: BM HC166 (Kendal Charcoal)



52: METAL FLASHED EYE BROW ROOF  
Colour: BM HC166 (Kendal Charcoal)



53: METAL FLASHED EYE BROW ROOF  
Colour: BM HC166 (Kendal Charcoal)



54: METAL FLASHED EYE BROW ROOF  
Colour: BM HC166 (Kendal Charcoal)



55: METAL FLASHED EYE BROW ROOF  
Colour: BM HC166 (Kendal Charcoal)



56: METAL FLASHED EYE BROW ROOF  
Colour: BM HC166 (Kendal Charcoal)



57: METAL FLASHED EYE BROW ROOF  
Colour: BM HC166 (Kendal Charcoal)






58: METAL FLASHED EYE BROW ROOF  
Colour: BM HC166 (Kendal Charcoal)





REVISIONS	
DEC 08, 2020	D/P RESUBMISSION
NOV 27, 2020	D/P RESUBMISSION
JUNE 03, 2020	D/P RESUBMISSION
DEC 23, 2019	BP SUBMISSION
DEC 02, 2019	A/D SUBMISSION
APR 26, 2019	RZ RESUBMISSION
JULY 16, 2018	D/P APPLICATION
DEC. 22, 2017	RZ APPLICATION
CONSULTANTS	

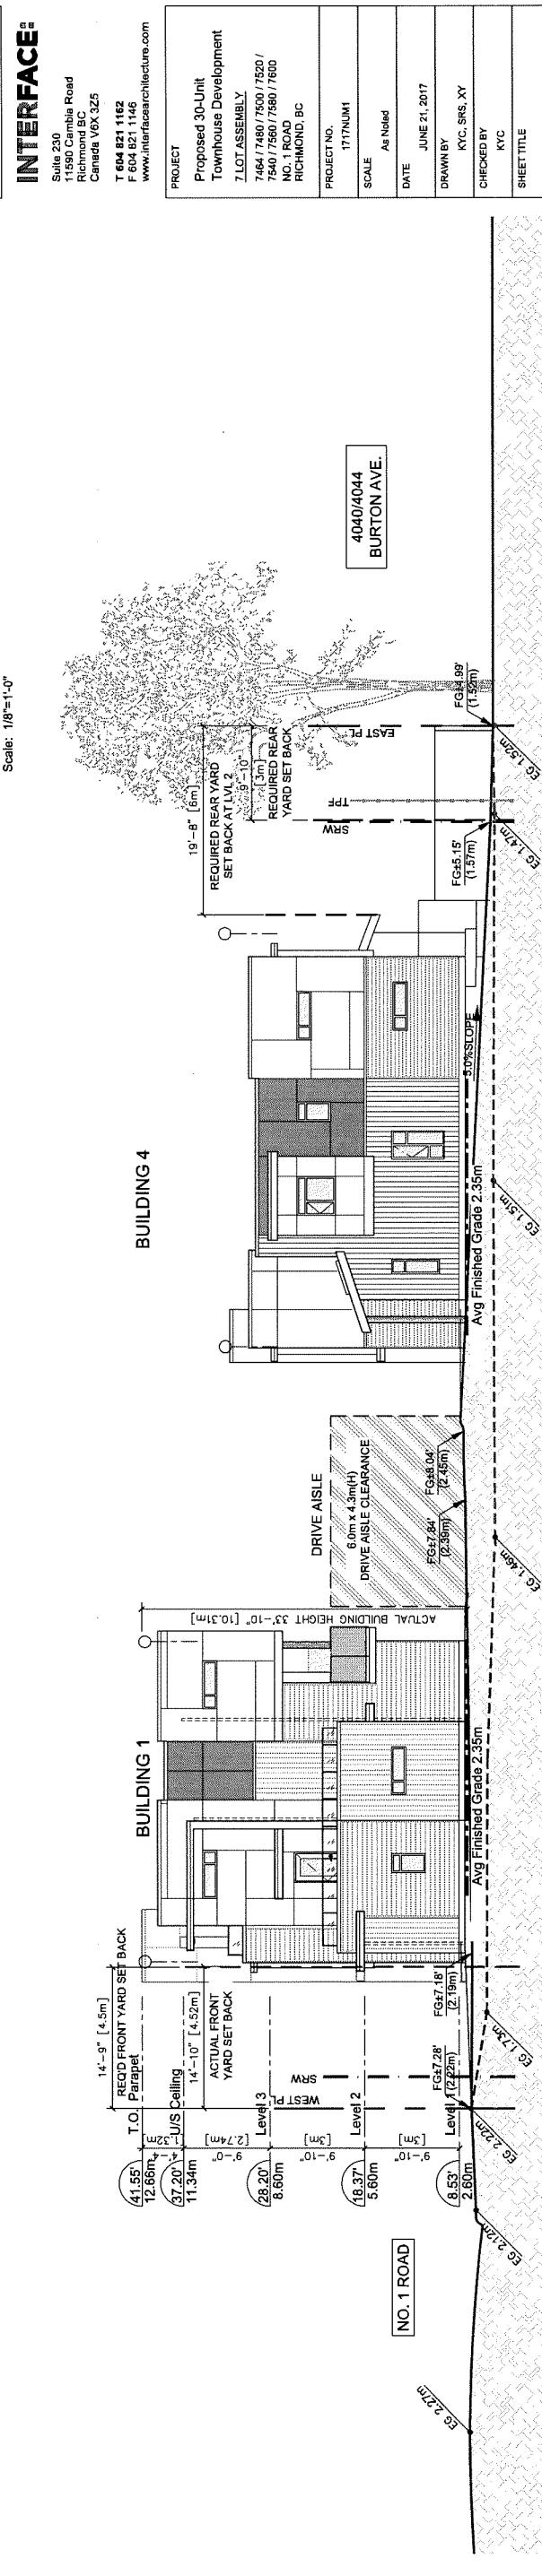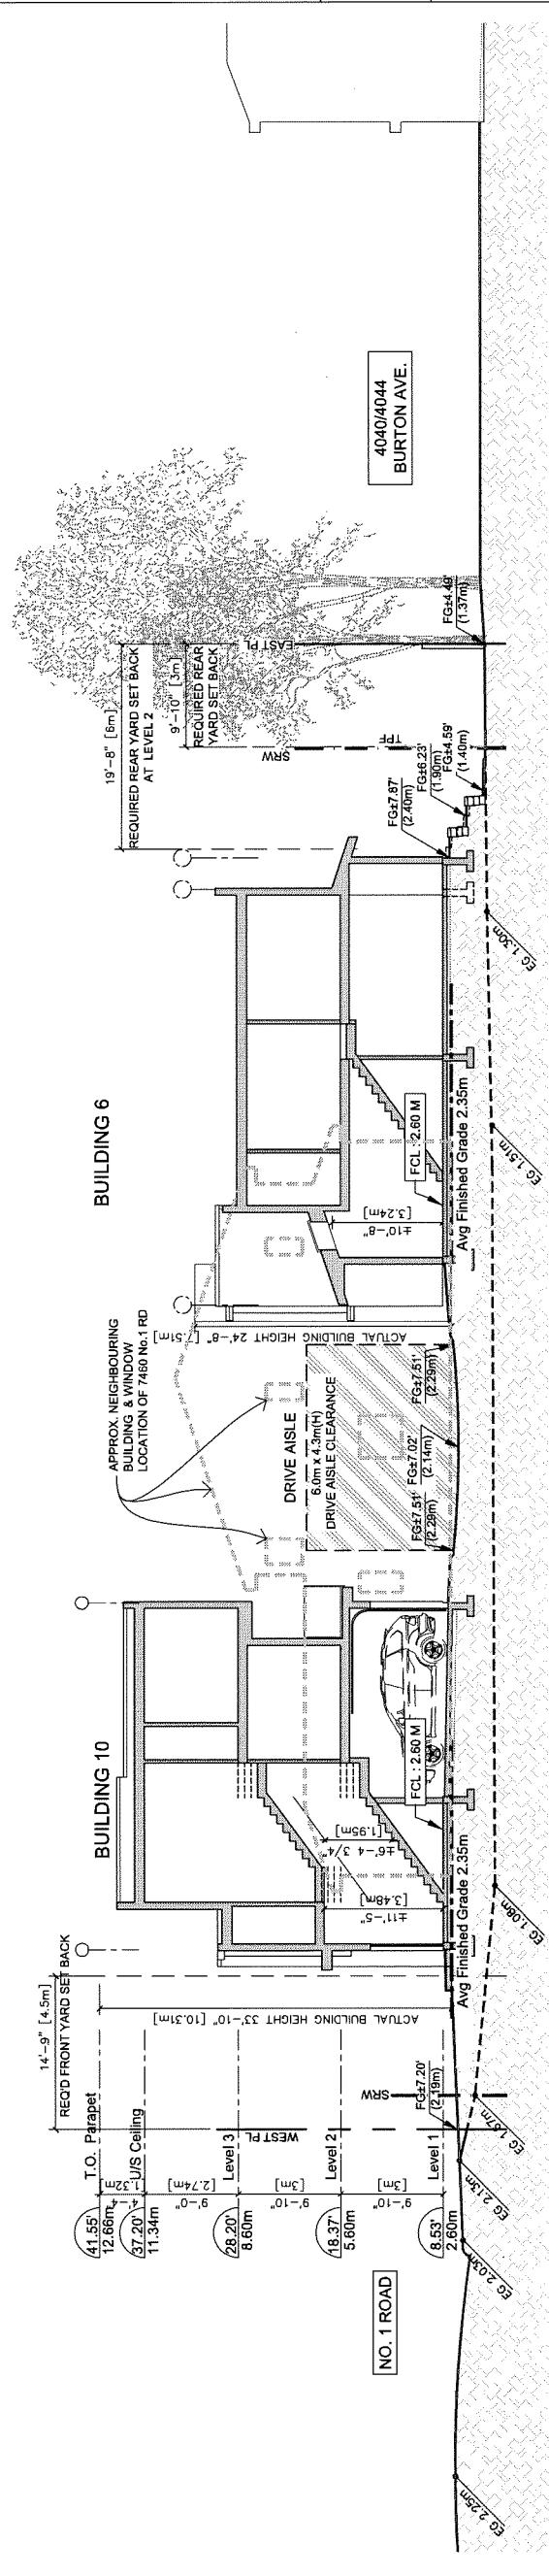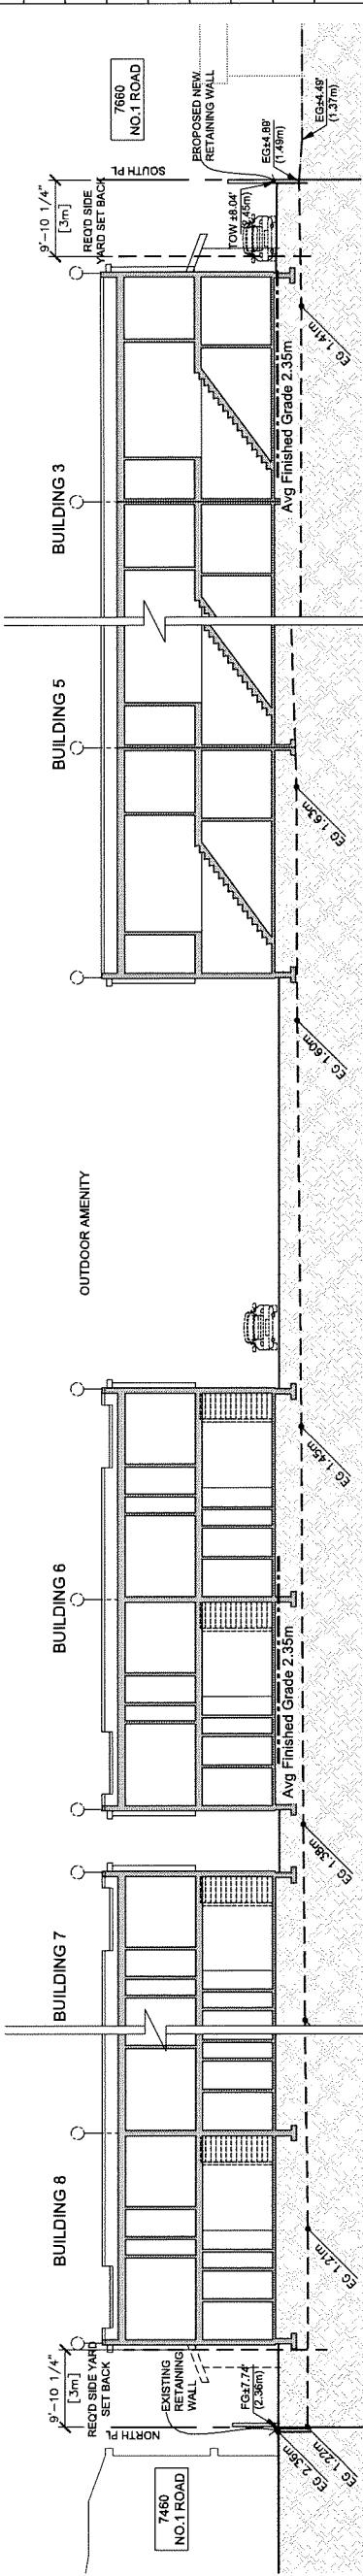

**DP 18-829236**

**SITE SECTIONS-1**

DRAWING

**A5.2**

**Plan #4C**

14/02/2020

REVISIONS	
DEC 08, 2020	DP8 RESUBMISSION
NOV 27, 2020	DP9 RESUBMISSION
JUNE 03, 2020	DP RESUBMISSION
DEC 23, 2019	BP SUBMISSION
DEC 02, 2019	ADP SUBMISSION
APR 26, 2019	RZ RESUBMISSION
JULY 16, 2018	DP APPLICATION
DEC. 22, 2017	RZ APPLICATION
CONSULTANTS	

### INTERFACE:


PROJECT  
Proposed 30-Unit  
Townhouse Development  
7.LOT ASSEMBLY  
7454 1/4860 / 7560 / 7520 /  
7540 1/7560 / 7560 / 7600  
NO. 1 ROAD  
Richmond BC  
Canada V6X 3Z5  
T 604 821 1162  
F 604 821 1146  
www.interfacearchitects.com


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REVISIONS	
DEC 08, 2020	DP5 RESUBMISSION
NOV 27, 2020	DP5 RESUBMISSION
JUNE 03, 2020	DP RESUBMISSION
DEC 23, 2019	BP SUBMISSION
DEC 02, 2019	ADP SUBMISSION
APR 26, 2019	RZ RESUBMISSION
JULY 16, 2018	DP APPLICATION
DEC 22, 2017	R2 APPLICATION
CONSULTANTS	


## INTERFACE

PROJECT	Proposed 30-Unit Townhouse Development
T.LOT ASSEMBLY	7464/7480/7500/7520 / NO. 1 ROAD RICHMOND, BC
T	604 821 1182
F	604 821 1146
www	www.interfacearchitects.com
PROJECT NO.	1771NUM1
SCALE	As Noted
DATE	JUNE 21, 2016
DRAWN BY	KYC, SRS, XY
CHECKED BY	KYC
SHEET TITLE	
ELEVATIONS:	BUILDING 1 & 2
DRAWING	



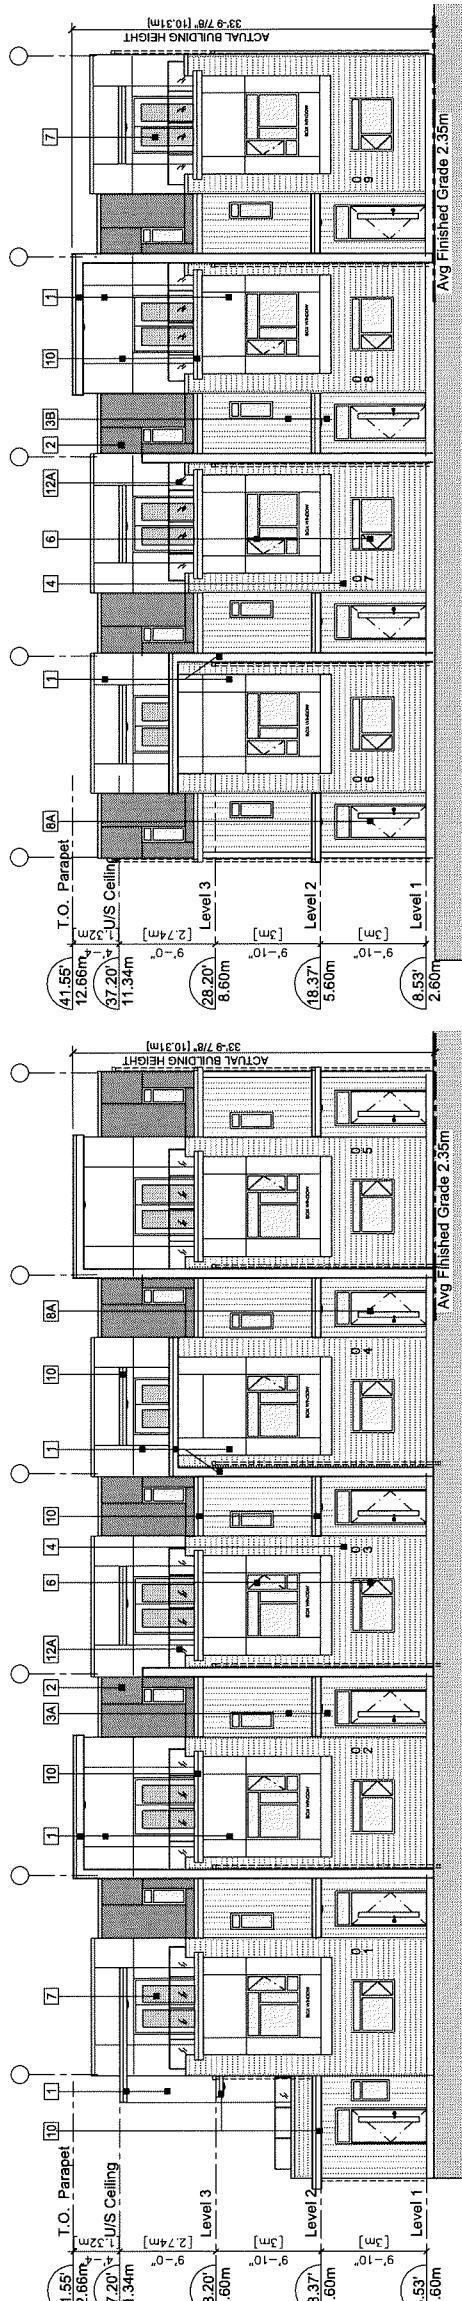

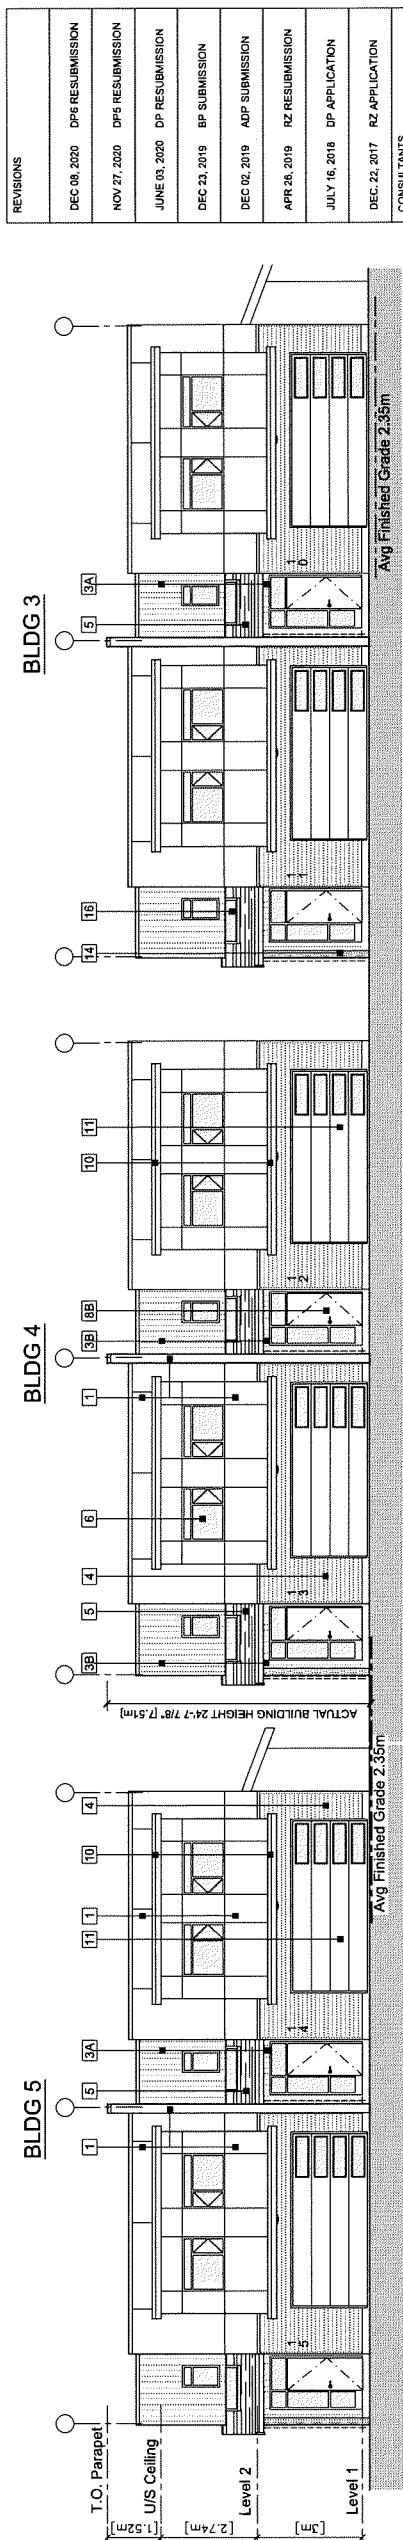
DRIVE AISLE ELEVATION (WEST): BUILDING 3, 4 & 5

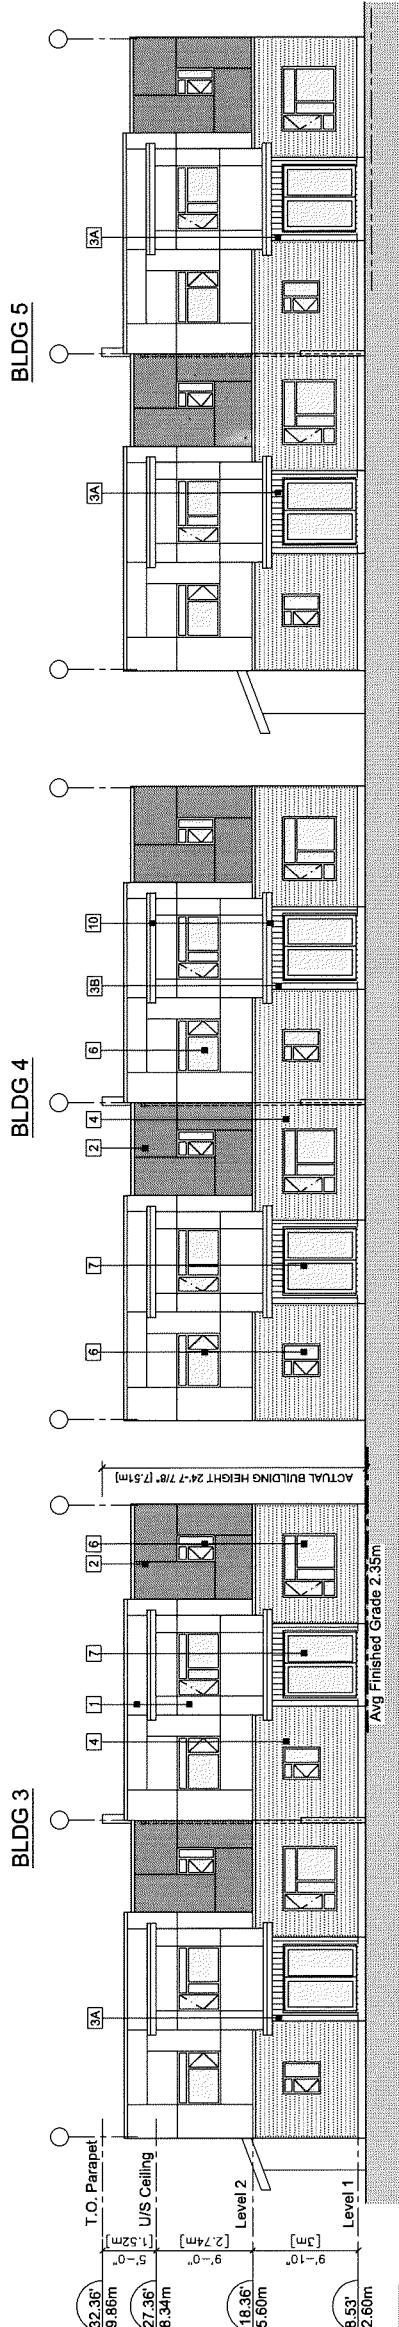


EXTERIOR FINISHES

- [1] FIBER CEMENT PANEL SIDING  
Colour: Arctic White
- [2] FIBER CEMENT PANEL SIDING  
Colour: Ion Gray
- [3] FIBER CEMENT PANEL SIDING  
HARDIEARTAN (V-GROOVE SIDING)  
Colour: A - Pearl Gray  
B - Evening Blue
- [4] FIBER CEMENT LAP SIDING (6" EXPOSURE)  
HARDIEPLANK (SELECT CEDAR MILL)  
Colour: Nut Brown
- [5] FIBERGLASS ASPHALT ROOF SHINGLES  
Colour: Dark Gray (Multicolour, Textured)
- [6] VINYL-FRAMED DOUBLE-GLOZED WINDOWS  
Colour: BH-HC166 (Kendall Charcoal)
- [7] DOUBLE-GLOZED VINYL SLIDING DOOR  
Colour: BH-HC166 (Kendall Charcoal)
- [8] ENTRY SOLID WOOD DOOR  
A - WITH CLEAR GLASS TRANSOM  
B - WITH FROSTED GLASS SIDE LITE  
Door Colour: Light Walnut Stain
- [9] ALUMINUM FASIA GUTTER  
Colour: BH-HC166 (Kendall Charcoal)
- [10] METAL FLASHED BROW ROOF  
Colour: BH-HC166 (Kendall Charcoal)
- [11] OVERHEAD METAL GARAGE DOOR  
Colour: BH-HC172 (Revere Pewter)
- [12] METAL RAILING W/ GLASS  
A - CLEAR GLASS  
B - FROSTED GLASS  
Metal Colour: Dark Gray
- [13] HIGH FROSTED GLASS PARTITION  
TO MATCH RAILING SYSTEM
- [14] BUILT UP POST  
Colour: Light Walnut Stain
- [15] GARBAGE RECYCLE DEPOT  
METAL GRILL DOOR  
Colour: BH-HC166 (Kendall Charcoal)
- [16] SKY LIGHT
- [17] ELECTRICAL ROOM DOOR  
Colour: BH-HC172 (Revere Pewter)


REAR YARD ELEVATION (EAST): BUILDING 3, 4 & 5

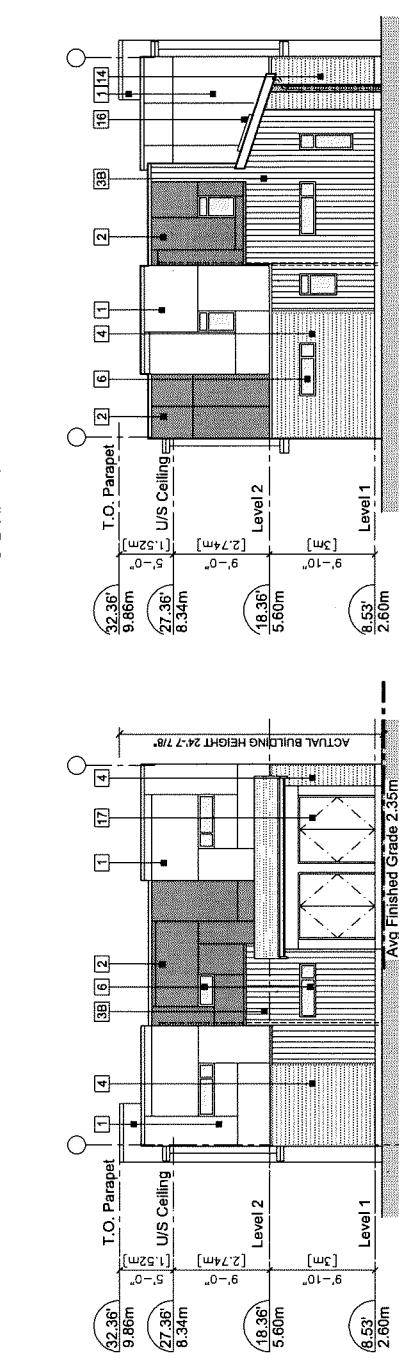

SIDE ELEVATION - NORTH : BUILDING 3 & 5

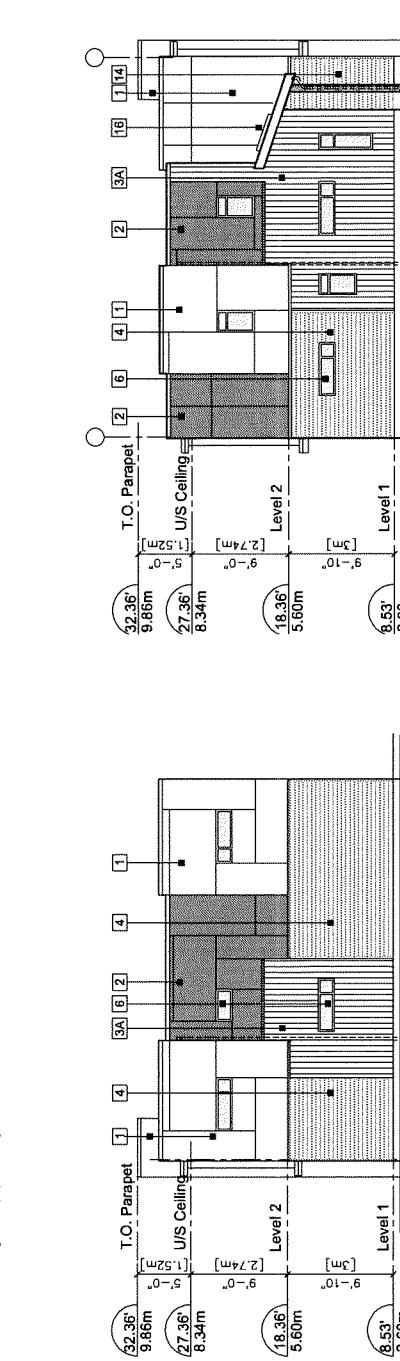

SIDE ELEVATION - NORTH : BUILDING 3 & 5

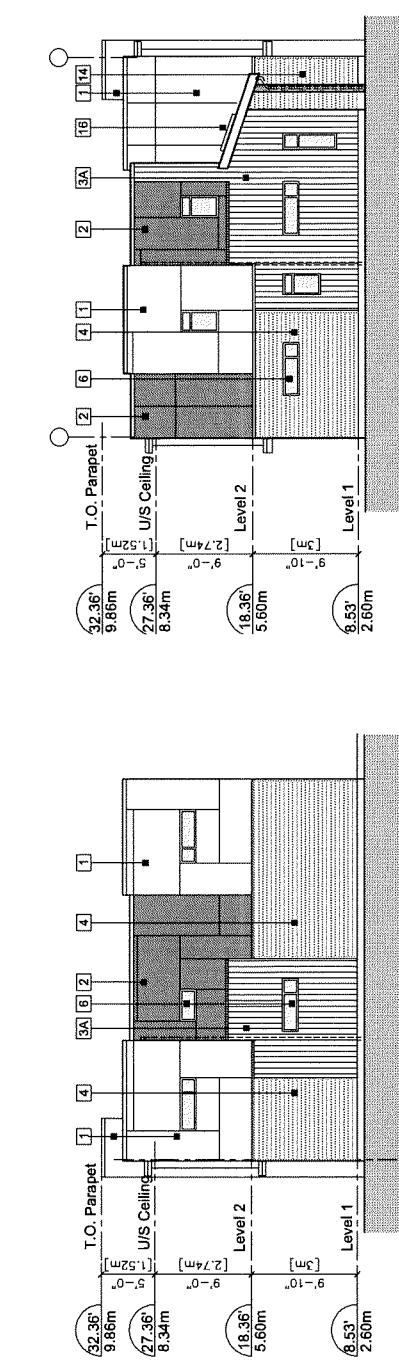

SIDE ELEVATION - NORTH : BUILDING 4



DP 18-829236 PLAN #5

A2.4

REVISIONS	
DEC 08, 2020	DPS RESUBMISSION
NOV 27, 2020	DPS RESUBMISSION
JUNE 03, 2020	DP RESUBMISSION
DEC 23, 2019	BP SUBMISSION
DEC 02, 2019	ADP SUBMISSION
APR 26, 2019	R2 RESUBMISSION
JULY 16, 2018	DP APPLICATION
DEC. 22, 2017	R2 APPLICATION






CONSULTANTS	
INTERFACE	

Project: Proposed 30-Unit Townhouse Development  
Lot Assembly: 7464 / 7480 / 7560 / 7520 / 7540 / 7560 / 7560 / 7600 / NO 1 ROAD / RICHMOND, BC  
Project No.: 1771NUM1  
Scale: As Noted  
Date: JUNE 21, 2016  
Drawn By: KYC, SRS, XY  
Checked By: KYC  
Sheet Title: BUILDING 3 & 5 PLANS & ELEVATIONS  
Drawing: DRAWING

DP 18-829236 PLAN #5




A2.4

REVISIONS	
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NOV 27, 2020	DPS RESUBMISSION
JUNE 03, 2020	DP RESUBMISSION
DEC 23, 2019	BP SUBMISSION
DEC 02, 2019	ADP SUBMISSION
APR 26, 2019	RZ RESUBMISSION
JULY 16, 2018	DP APPLICATION
DEC 22, 2017	RZ APPLICATION
	CONSULTANTS

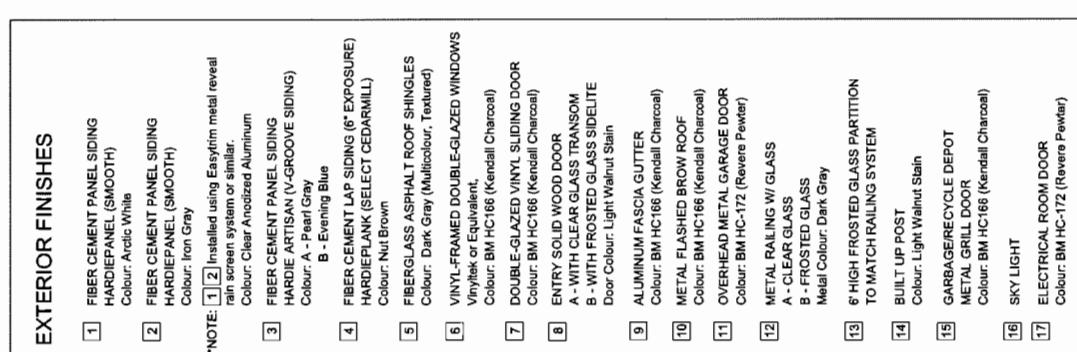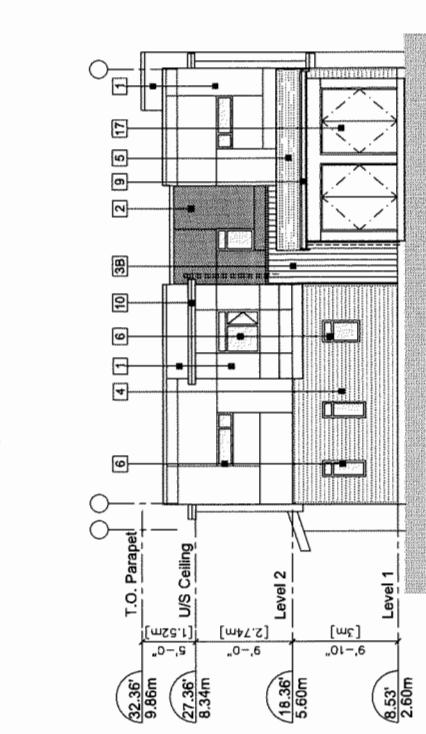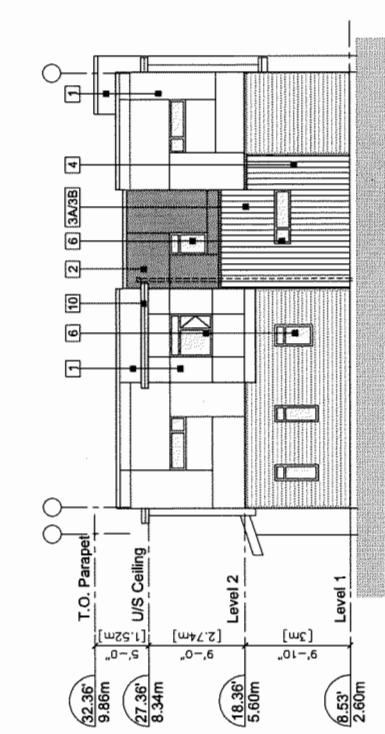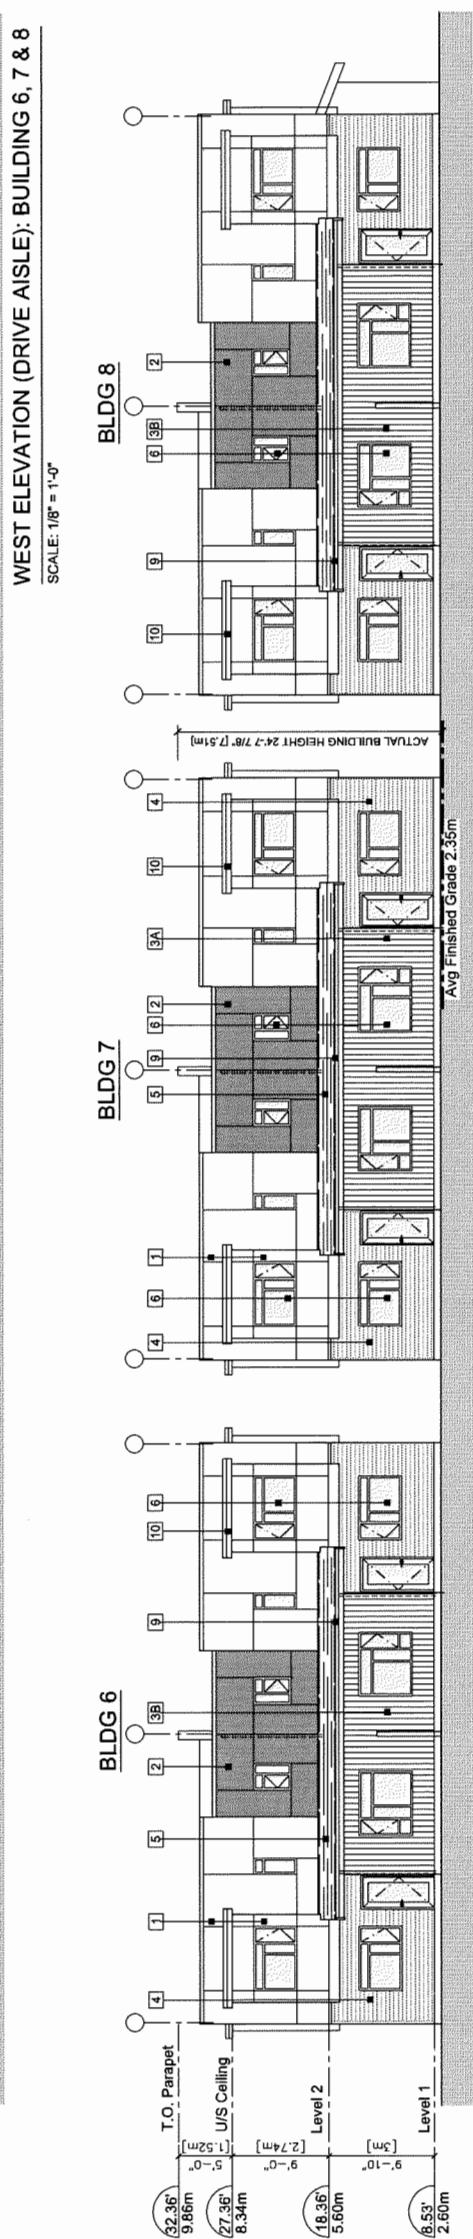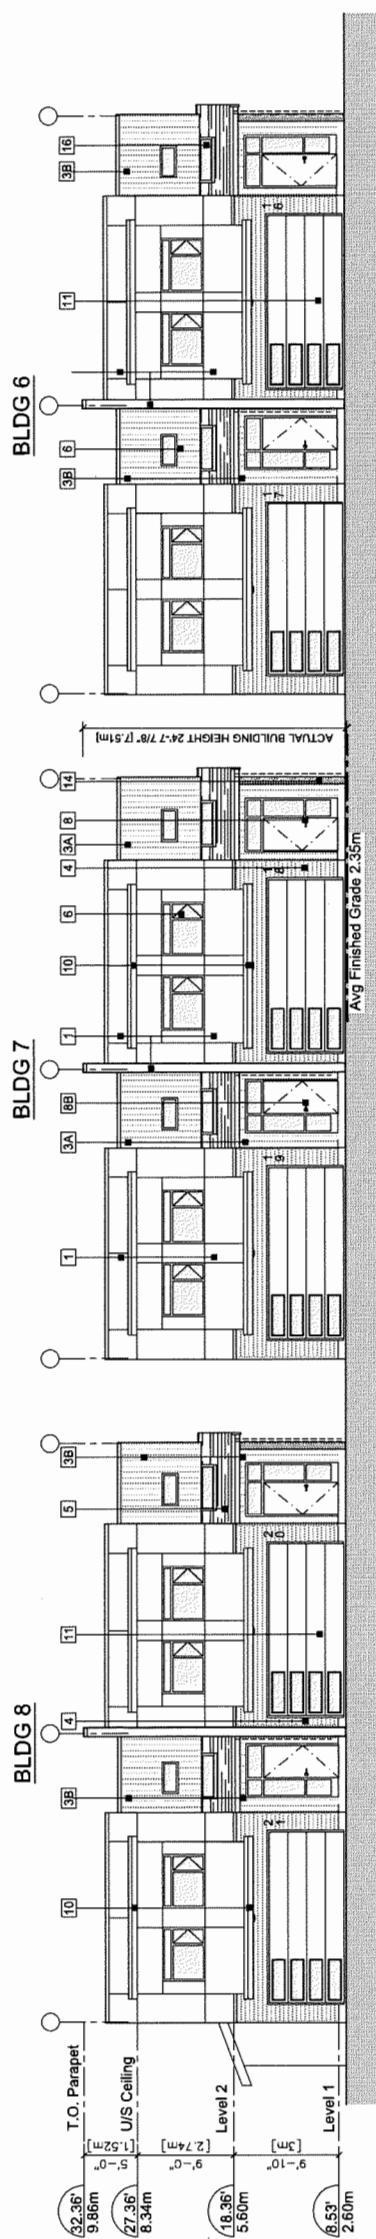

418-829236

2

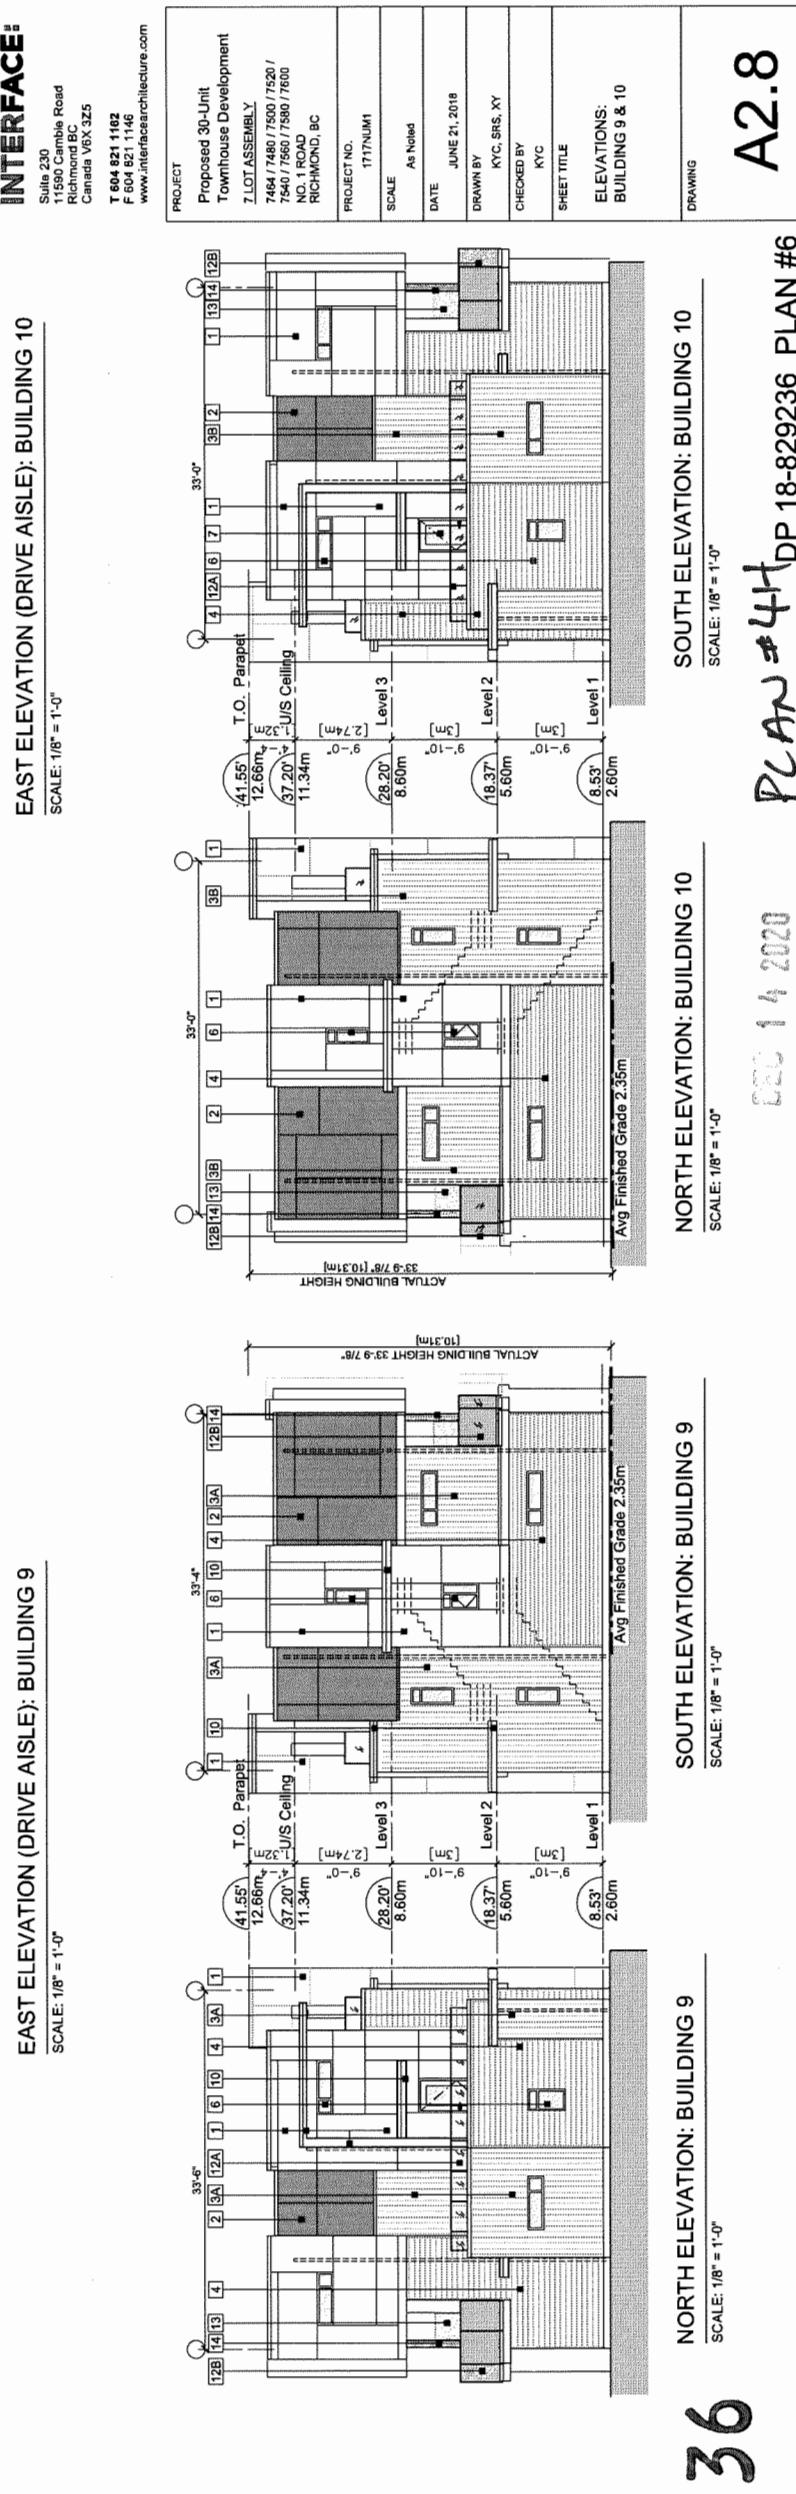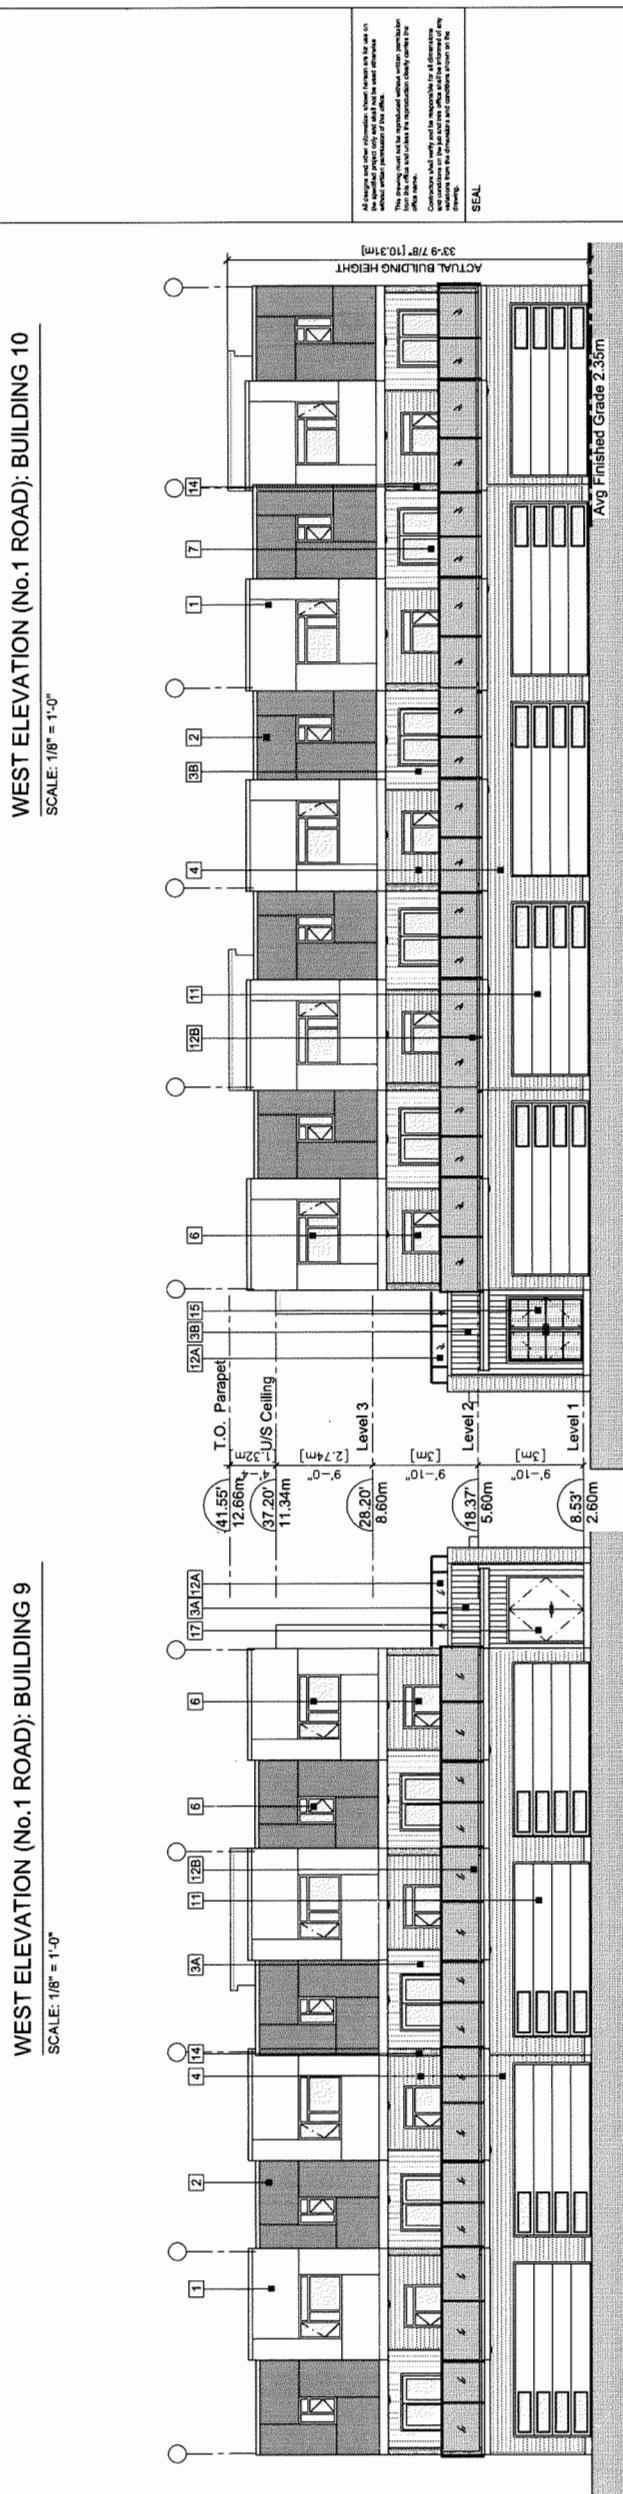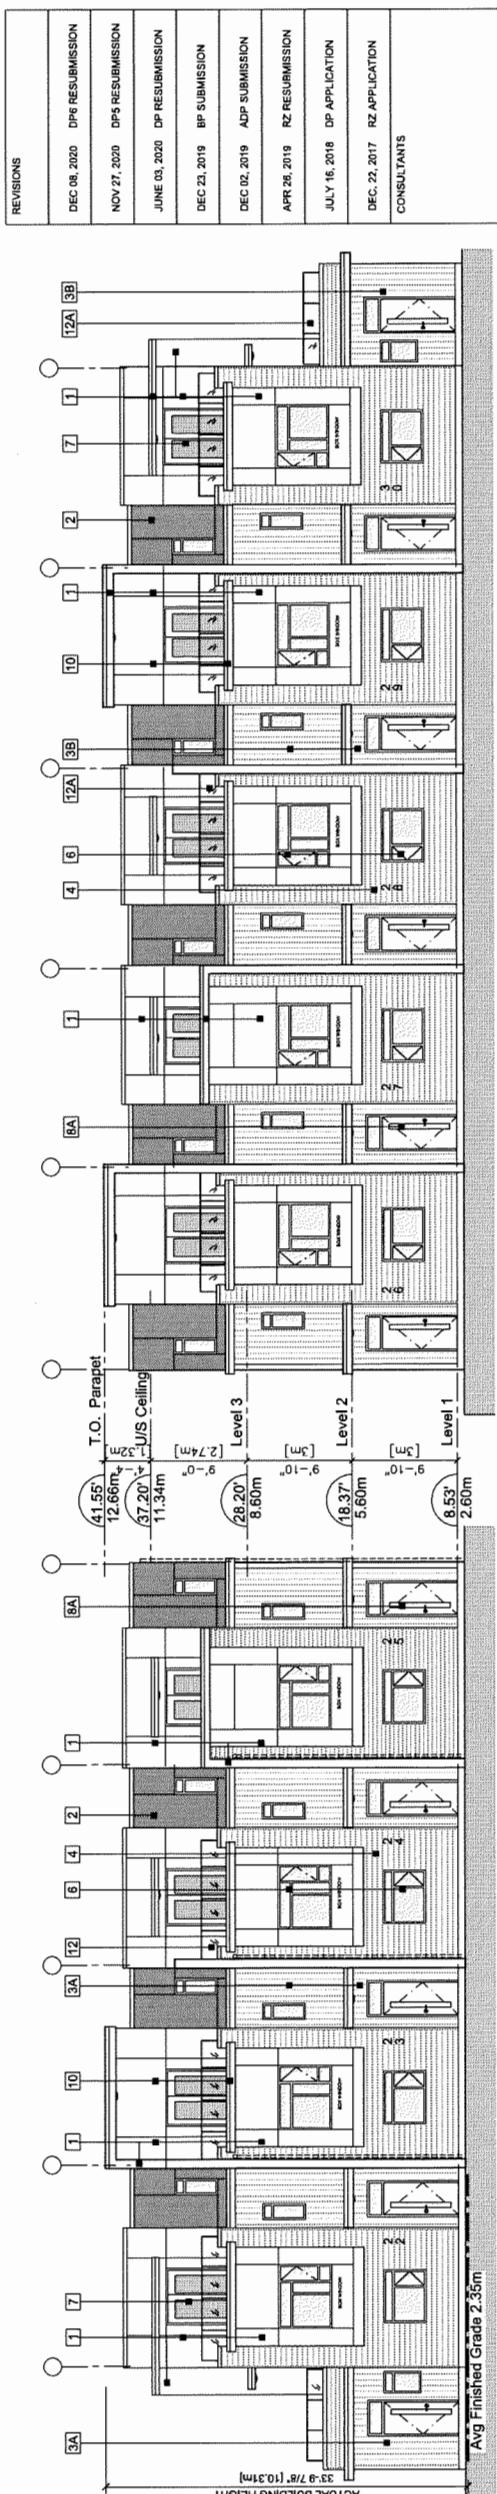

EXTERIOR FINISHES	
1	FIBER CEMENT PANEL SIDING HARDIEPANEL (SMOOTH) Colour: Arctic White
2	FIBER CEMENT PANEL SIDING HARDIEPANEL (SMOOTH) Colour: Iron Gray
3	FIBER CEMENT PANEL SIDING HARDIE ARTISAN (V-GROOVE SIDING) Colour: A - Pearl Gray B - Evening Blue
4	FIBER CEMENT LAP SIDING (6" EXPOSURE) HARDIEPLANK (SELECT CEDAR MILL) Colour: Nut Brown
5	FIBERGLASS ASPHALT ROOF SHINGLES Colour: Dark Gray (Multicolour, Textured)
6	VINYL-FRAMED DOUBLE-GLAZED WINDOWS Vinylak or Equivalent.
7	DOUBLE-GLAZED VINYL SLIDING DOOR Colour: BM HC166 (Kendall Charcoal)
8	ENTRY SOLID WOOD DOOR A - WITH CLEAR GLASS TRANSOM B - WITH FROSTED GLASS Sidelite Door Colour: Light Walnut Stain
9	ALUMINUM FASCIA GLITTER Colour: BM HC166 (Kendall Charcoal)
10	METAL FLASHED BROW ROOF Colour: BM HC166 (Kendall Charcoal)
11	OVERHEAD METAL GARAGE DOOR Colour: BM HC172 (Revere Pewter)
12	METAL RAILING w/ GLASS A - CLEAR GLASS B - FROSTED GLASS
13	HIGH FROSTED GLASS PARTITION TO MATCH RAILING SYSTEM
14	BUILT UP POST Colour: Light Walnut Stain
15	GARBAGE RECYCLE DEPOT METAL GRILL DOOR Colour: BM HC166 (Kendall Charcoal)
16	SKY LIGHT
17	ELECTRICAL ROOM DOOR Colour: BM HC172 (Revere Pewter)

**D P**

**SOUTH ELEVATION: BUILDING 9**  
SCALE: 1/8" = 1'-0"

**NORTH ELEVATION: BUILDING 9**  
SCALE: 1/8" = 1'-0"

**SOUTH ELEVATION: BUILDING 10**  
SCALE: 1/8" = 1'-0"

**NORTH ELEVATION: BUILDING 10**  
SCALE: 1/8" = 1'-0"

**A2.8**

REVISIONS	
DEC 08, 2020	DPB RESUBMISSION
NOV 27, 2020	DPS RESUBMISSION
JUNE 03, 2020	DP RESUBMISSION
DEC 23, 2019	BP SUBMISSION
DEC 02, 2019	ADP SUBMISSION
APR 26, 2019	RZ RESUBMISSION
JULY 16, 2018	DP APPLICATION
DEC. 22, 2017	RZ APPLICATION
CONSULTANTS	








INTERFACE:	Suite 230 11580 Cambie Road Richmond BC V6X 4Z5
PROJECT	Proposed 30-Unit Townhouse Development
LOT ASSEMBLY	7464 / 7480 / 7500 / 7520 / 7540 / 7560 / 7580 / NO. 1 ROAD
LOCATION	RICHMOND, BC
PROJEC NO.	1717NUM1
SCALE	As Nodred
DATE	JUNE 21, 2017
DRAWN BY	KYC, SRS, XY
CHEKED BY	KYC
SHEET TITLE	SHADOW STUDY
DRAWING	

A9.2

PLAN #41


SEPTEMBER 14, 2020

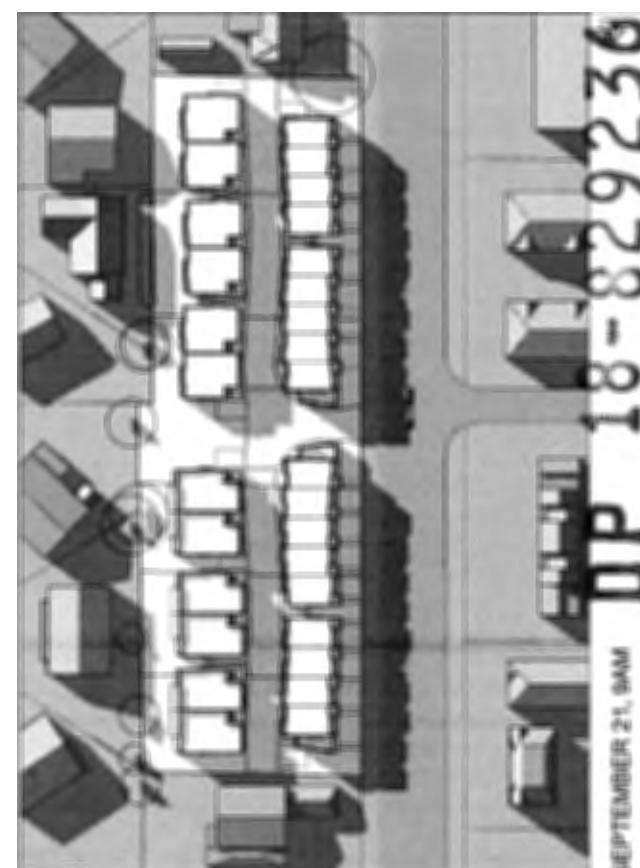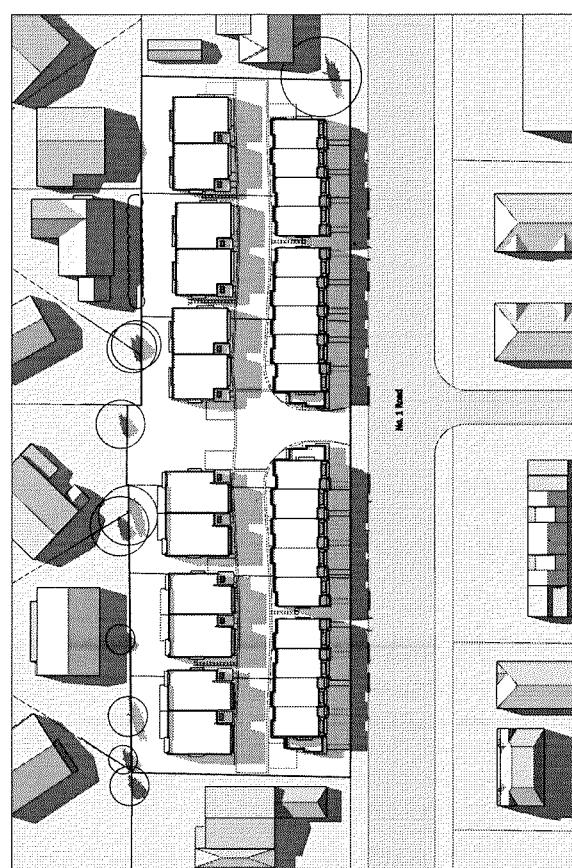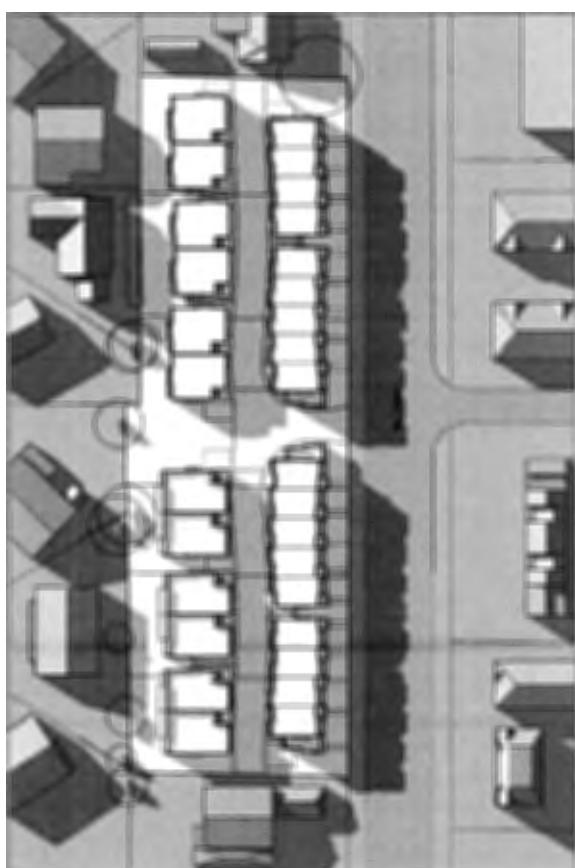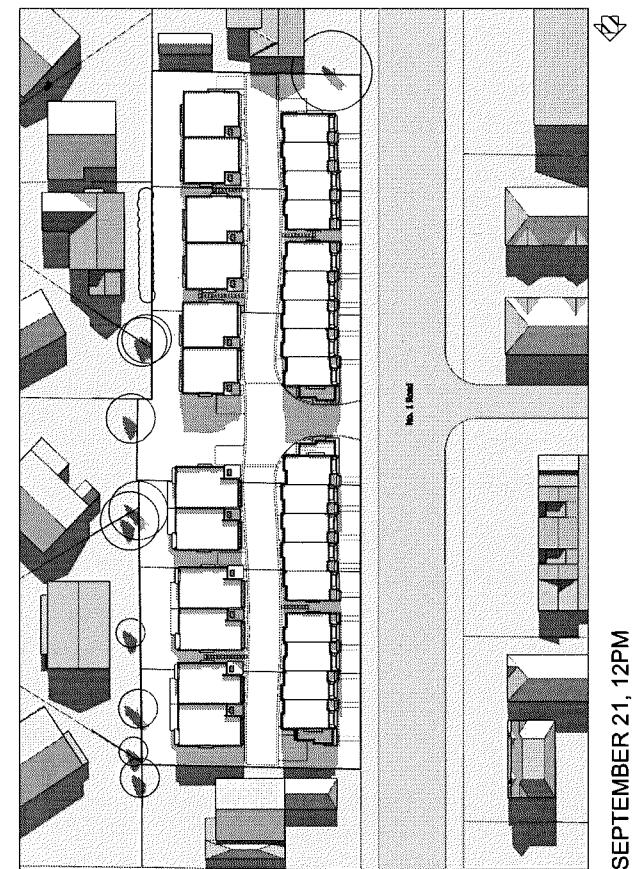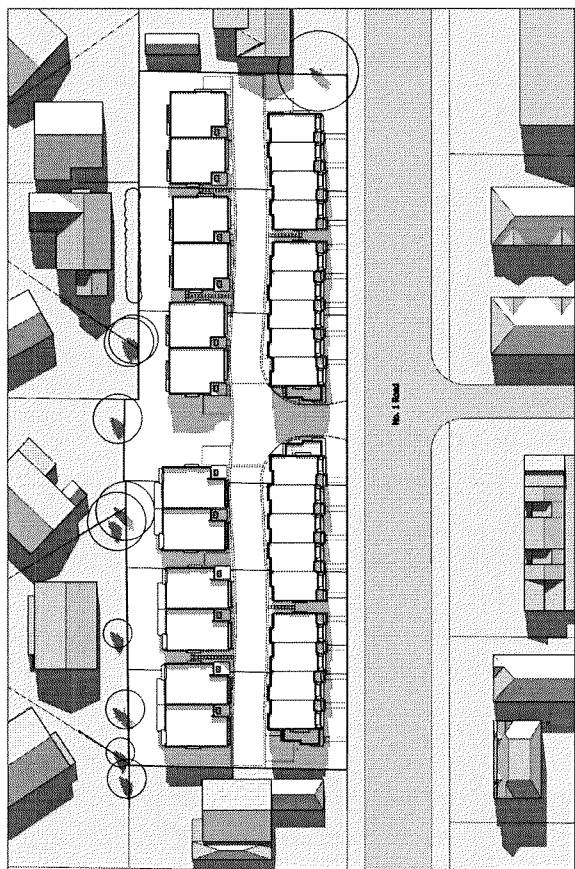


18-829236

SEPTEMBER 21, 9AM


REVISIONS	
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NOV 27, 2020	DPS RESUBMISSION
JUNE 03, 2020	DP RESUBMISSION
DEC 23, 2019	BP SUBMISSION
DEC 02, 2019	ADP SUBMISSION
APR 26, 2019	RZ RESUBMISSION
JULY 16, 2016	DP APPLICATION
DEC. 22, 2017	RZ APPLICATION
CONSULTANTS	

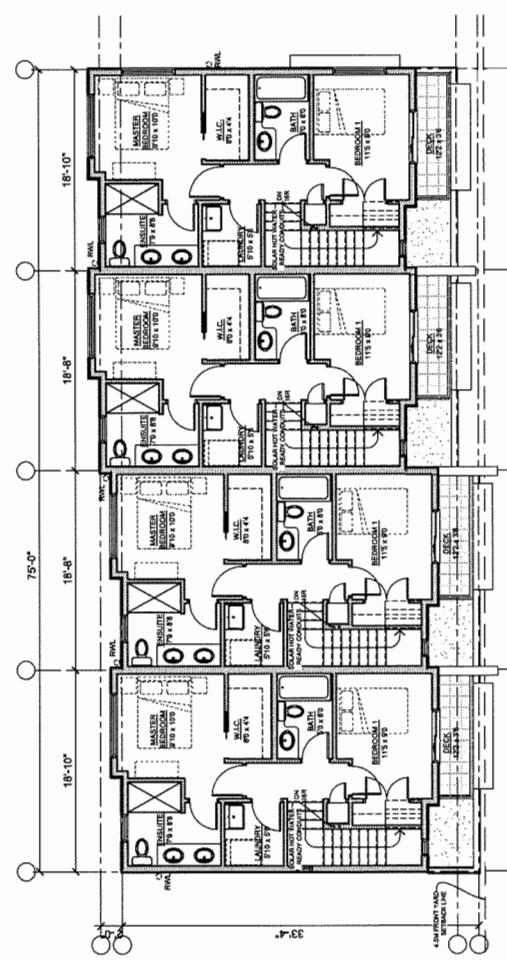


FLOOR PLAN - LEVEL 3, BUILDING 2  
SCALE: 1/8" = 1'-0"

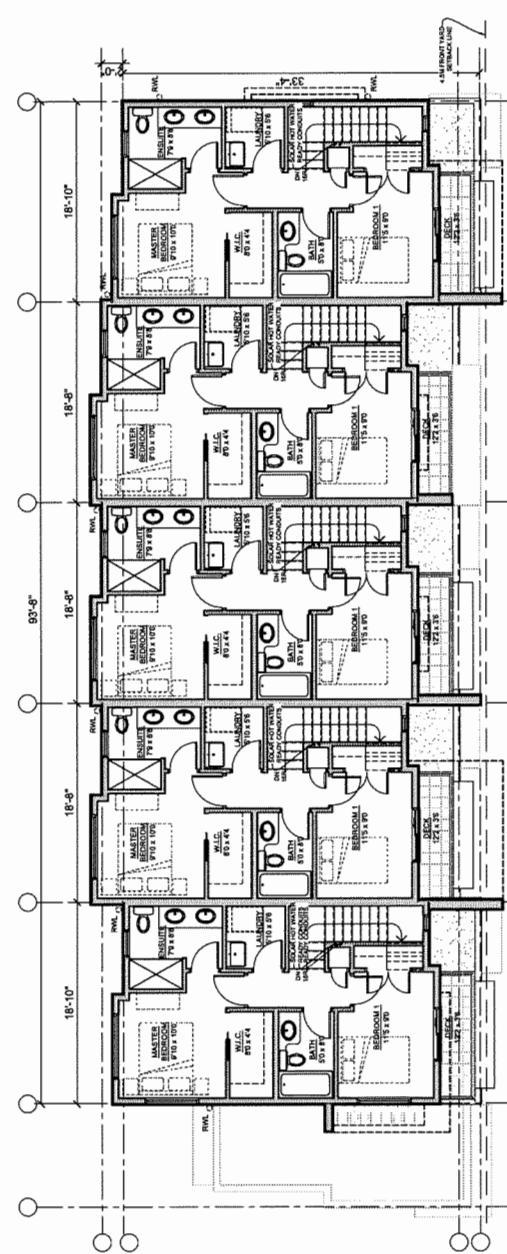


FLOOR PLAN - LEVEL 1, BUILDING 1  
SCALE: 1/8" = 1'-0"

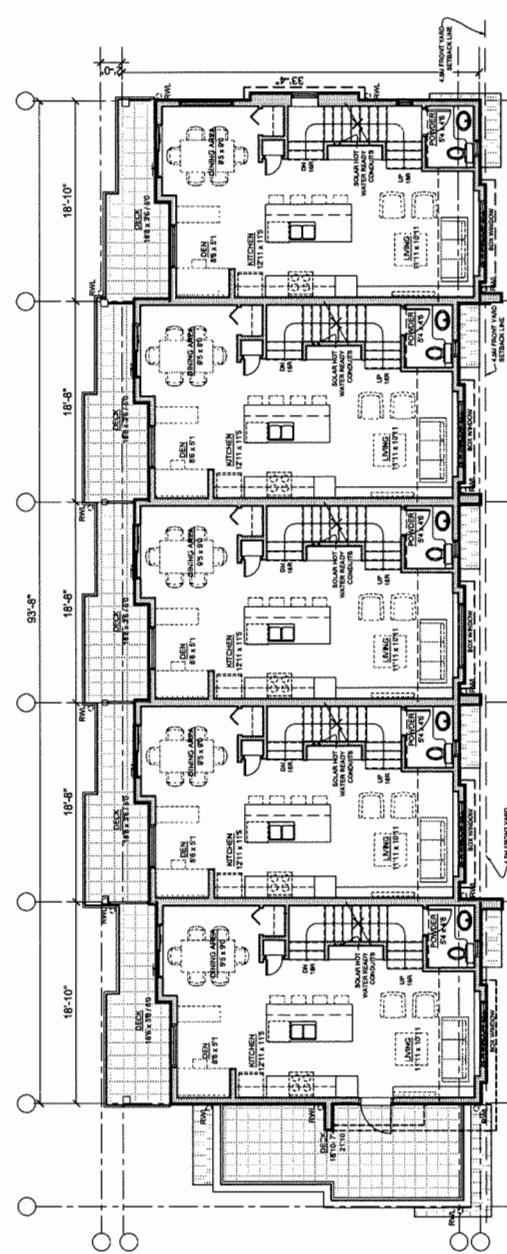


FLOOR PLAN - LEVEL 1, BUILDING 1  
SCALE: 1/8" = 1'-0"

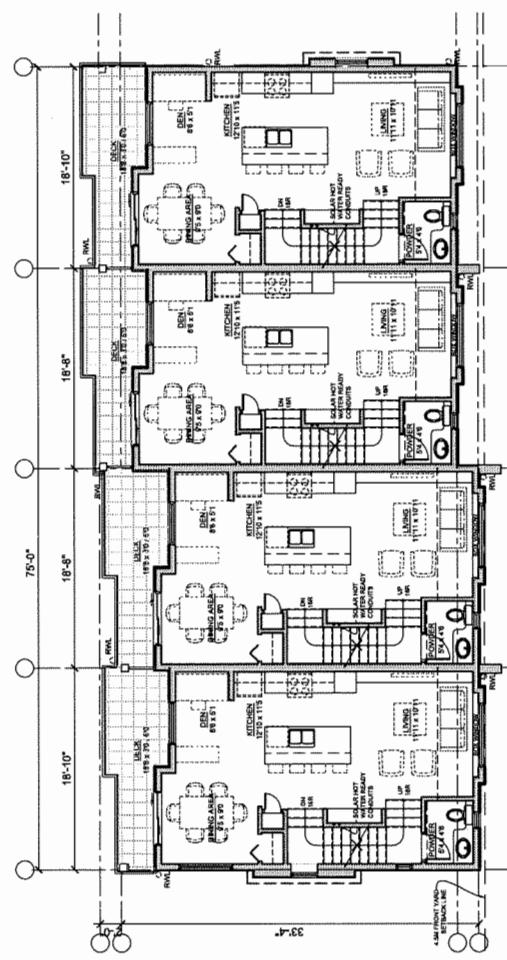

FLOOR PLAN - LEVEL 2, BUILDING 2  
SCALE: 1/8" = 1'-0"

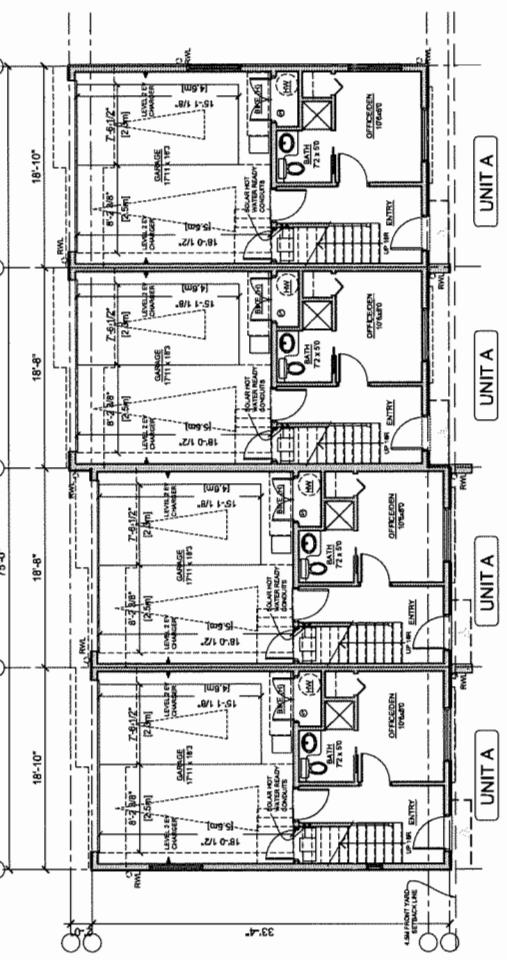

FLOOR PLAN - LEVEL 2, BUILDING 1  
SCALE: 1/8" = 1'-0"

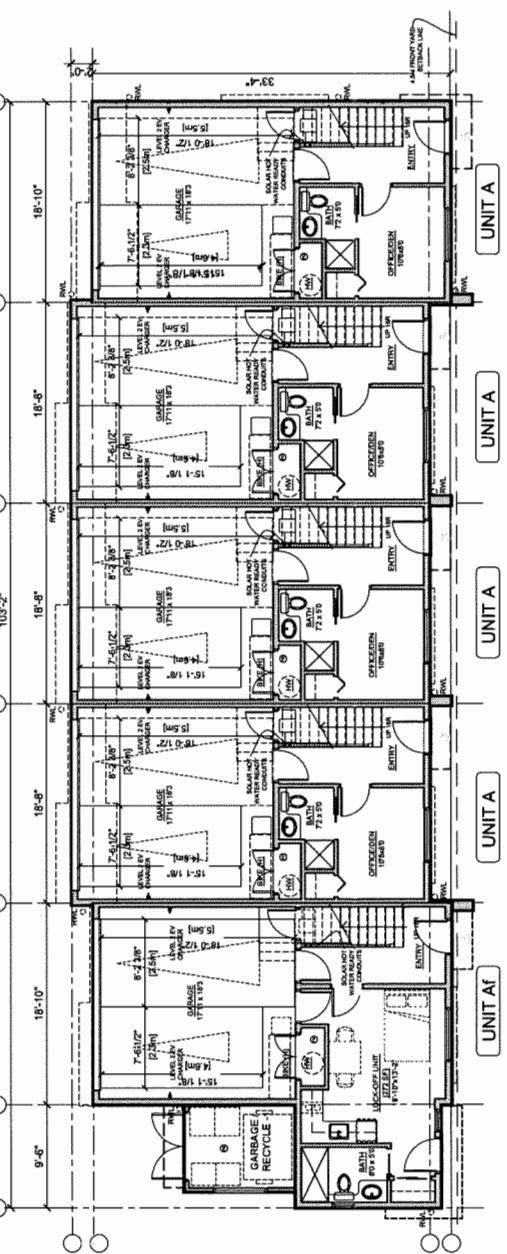

FLOOR PLAN - LEVEL 1, BUILDING 2  
SCALE: 1/8" = 1'-0"



INTERFACE:  
Suite 230  
11580 Cambie Road  
Richmond BC V6X 3Z5  
T 604 821 1162  
F 604 821 1146  
www.interfacearchitecture.com

PROJECT  
Proposed 30-Unit  
Townhouse Development  
LOT ASSEMBLY  
7480/7560/7560/7520 /  
NO. 1 ROAD / 7600  
RICHMOND, BC  
PROJECT NO.  
1171NUM1  
SCALE  
As Noted  
DATE  
JUNE 21, 2016  
DRAWN BY  
XYC, SRS, XY  
CHECKED BY  
XYC  
SHEET TITLE  
FLOOR PLANS:  
BUILDING 1&2  
UNIT A  
DRAWING



FLOOR PLAN - LEVEL 1, BUILDING 2  
SCALE: 1/8" = 1'-0"



FLOOR PLAN - LEVEL 2, BUILDING 2  
SCALE: 1/8" = 1'-0"




REFERENCE PLAN  
DEC 14 2020  
\*NOTE: LEVEL 2 EV ENERGIZED OUTLET TO BE PROVIDED IN EACH  
RESIDENTIAL PARKING SPACES PER ZONING BY-LAW

DP 18-829236

REVISIONS	DEC 08, 2020	OPS RESUBMISSION
	NOV 27, 2020	OPS 5 RESUBMISSION
	JUNE 03, 2020	OP RESUBMISSION
INTERFACe	DEC 23, 2019	BP SUBMISSION
	DEC 02, 2019	ADP SUBMISSION
	APR 26, 2019	RZ RESUBMISSION
CONSULTANTS	JULY 16, 2018	DP APPLICATION
	OEC, 22, 2017	RZ APPLICATION

AGING-IN-PLACE MEASURES (ALL UNITS)	
ALL ROOMS	LARGE TOGGLE-TYPE ELECTRICAL SWITCHES
	LEVER TYPE DOOR HANDLES
	MINIMIZE THRESHOLD HEIGHTS (LESS THAN 12") WHERE POSSIBLE
STAIRS & LANDINGS	WALL BLOCKING FOR FUTURE ADDITIONAL HANDRAIL INSTALLATION
	INTERMEDIATE STAIR LANDINGS WHENEVER POSSIBLE
	LESS STEEP RISER/Run DIMENSIONS WHERE POSSIBLE
BATHROOMS	WALL BLOCKING FOR FUTURE GRAB BAR INSTALLATION (AT BATHTUB, TOILET)
	INTERMEDIATE STAIR LANDINGS WHENEVER POSSIBLE
	LESS STEEP RISER/Run DIMENSIONS WHERE POSSIBLE
KITCHEN	WALL BLOCKING FOR FUTURE GRAB BAR INSTALLATION (AT BATHTUB, TOILET)
	LEVER HANDLE TAPS AND FAUCETS
HALLWAYS	24"- SLIDING DOORS WHERE POSSIBLE
	LEVER HANDLE TAPS AND FAUCETS
	MIN. 900 MM WIDTH

CONVERTIBLE UNIT FEATURES CHECKLIST	
DOORS & DOORWAYS	ENTRY DOORS MIN. 863 MM BUT IDEALLY 914MM AND HAVE CLEAR ACCESS ENTRY DOOR CLEAR EXTERIOR FLOOR SPACE MIN. 1220 MM DEPTH BY DOOR WIDTH PLUS 600 MM LATCH SIDE (NOT NEEDED IF ROUGH IN WIRING PROVIDED FOR FUTURE AUTOMATIC DOOR OPENER)
	INTERIOR DOORS TO MAIN LIVING AREAS, 1 BATHROOM AND 1 BEDROOM, MIN. 860 MM CLEAR OPENING WITH FLUSH THRESHOLDS (MAX 13MM HEIGHT). DEMONSTRATE WHEELCHAIR ACCESS BETWEEN HALLWAY AND ROOMS AND OVER A HALLWAY AND/OR CORRIDORS IF NECESSARY TO SECURE ACCESS
	PATIO/BALCONY MIN. 860 MM CLEAR OPENING, ACCESSED FROM REAR DOOR AT GROUND FLOOR.
	ALL INTERIOR THRESHOLDS WITHIN UNITS COMPLY WITH BCSC.
LEVER-TYPE HANDLES FOR ALL DOORS	STAR LIFT STAIRCASE WIDTH, FRAMING SUPPORT, AND LANDINGS, AS NOTED ON FLOOR PLANS IN COMPLIANCE WITH MANUFACTURER SPECIFICATIONS.
VERTICAL CIRCULATION	SPEC. NOTE: BRUNO RAIL STAR LIFT (EITA CURVE PRG-2110) MAX. LOAD: 400 LB, POWER: 24VDC, COMPRISED (2) 1AH 12V BATTERIES *** PROVISION FOR - UNIT B (BUILDING 3, 4 & 5) ***
HALLWAYS	VERTICAL LIFT (FUTURE): DEPRESSED LAB AREA, AND LANDINGS, AS NOTED ON FLOOR PLANS IN COMPLIANCE WITH MANUFACTURER SPEC. FRAMING TO ACCOMMODATE SHAFT CONSTRUCTION WITHOUT IMPACT TO SURROUNDING STRUCTURE. AT THE TOP OF ALL STAIRWAYS, WALLS ARE REINFORCED WITH 2X12" SOLID LUMBER AT 14 MM TO CENTRE.
GARAGE	MIN. 860 MM WIDTH ACCESS FROM GARAGE TO LIVING AREA MIN. 800 MM CLEAR OPENING

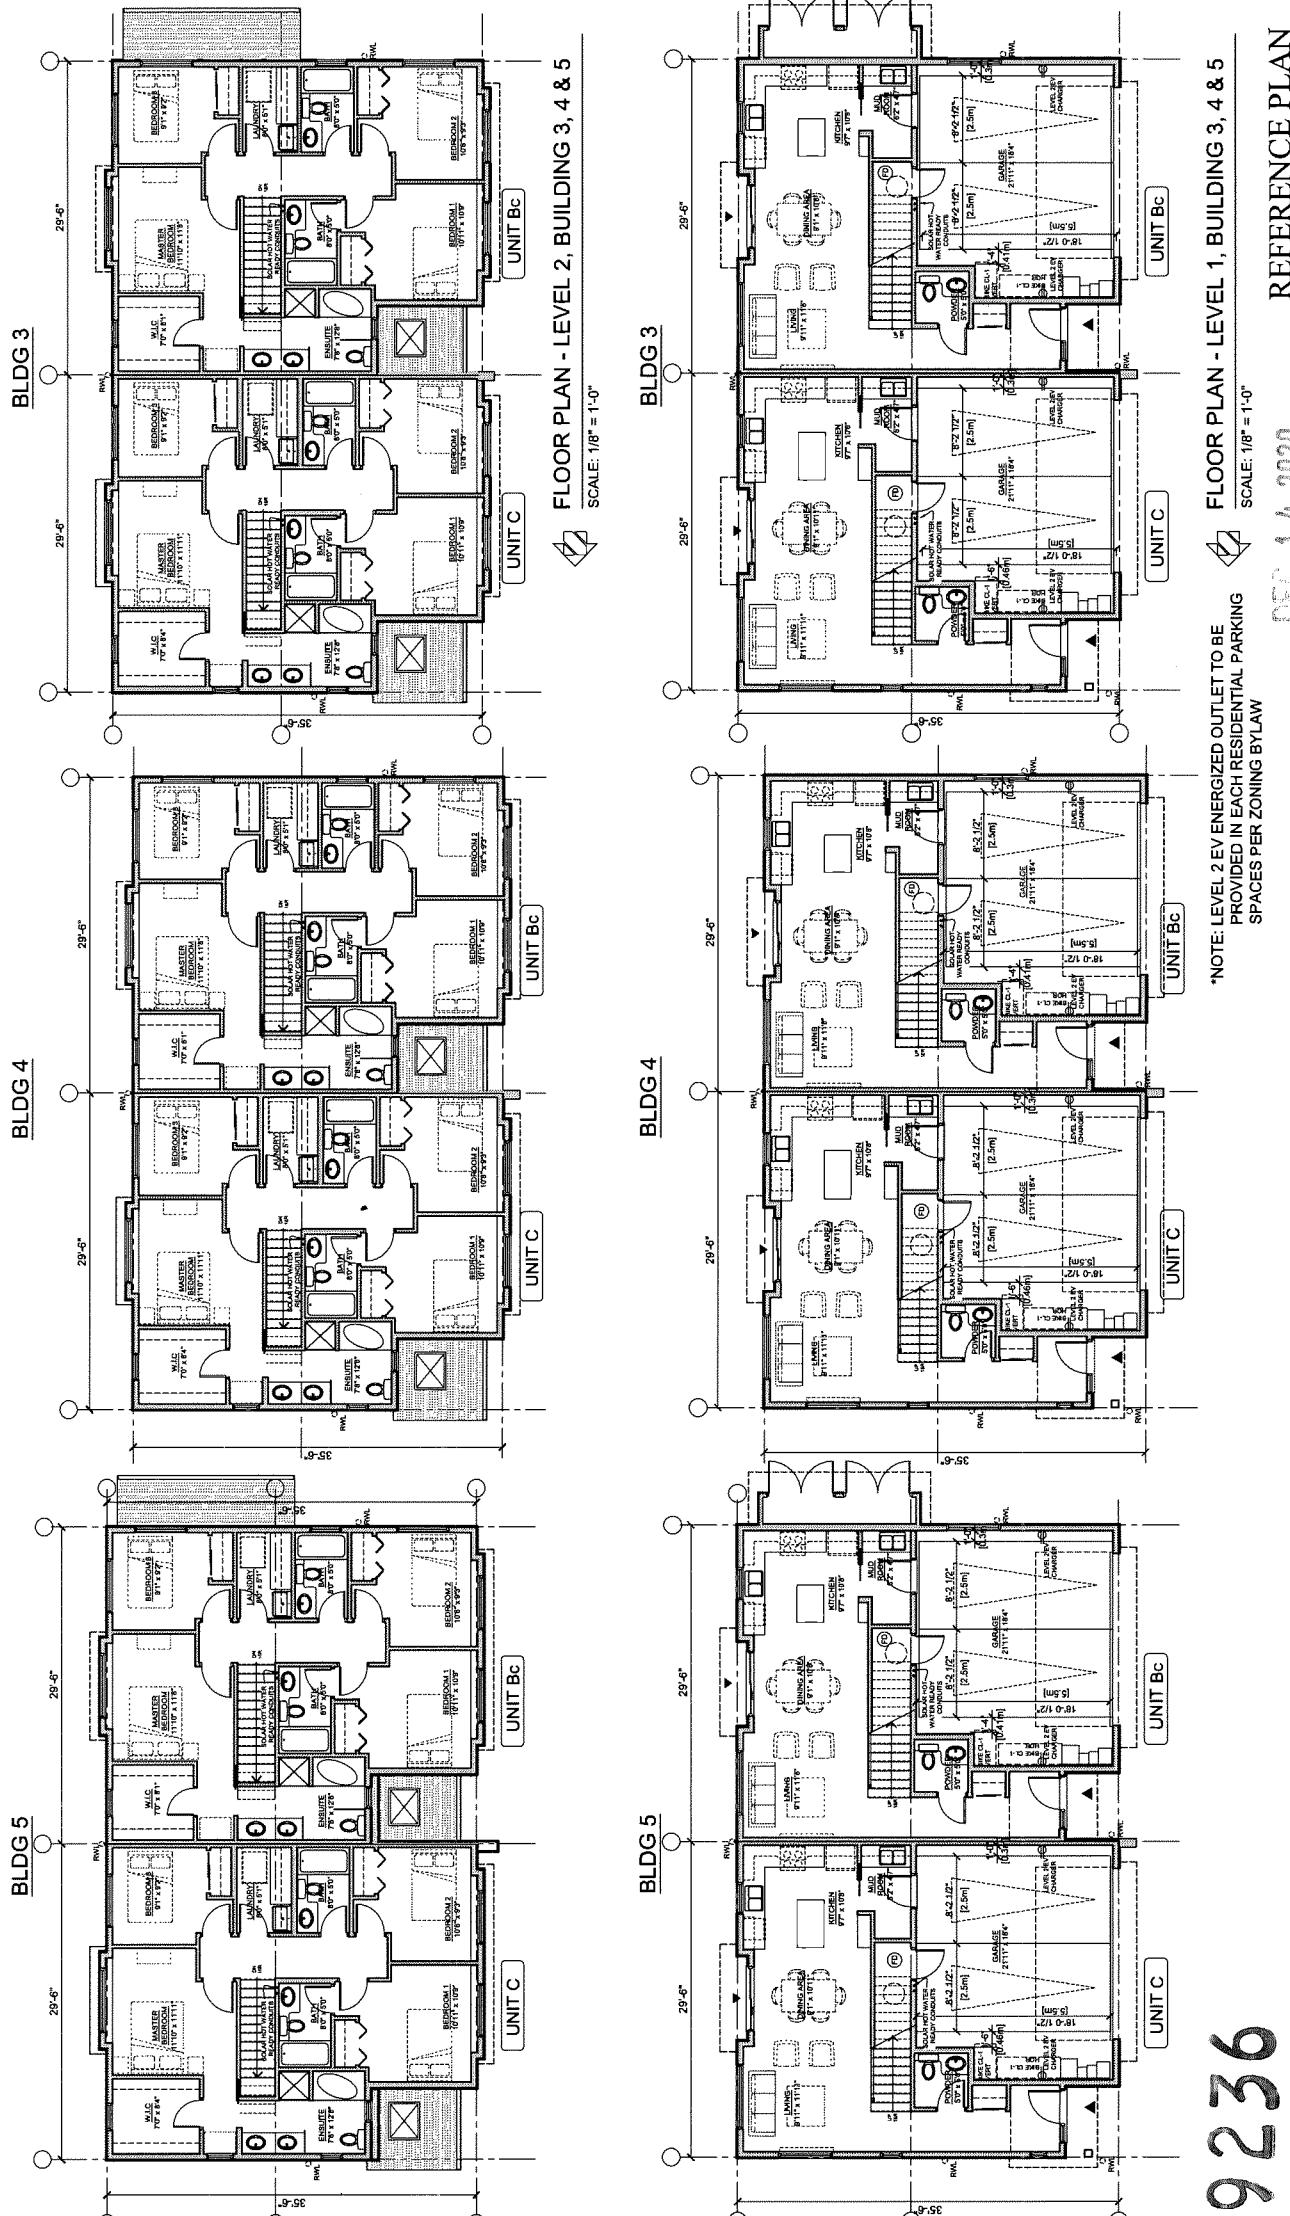

A2.3

REFERENCE PLAN


DRAFT DATE: JUNE 21, 2018  
DRAWN BY: KYC, SRS, XY  
CHECKED BY: KYC  
SHEET TITLE: FLOOR PLANS: BUILDING 3, 4 & 5  
DRAWING

10-829236

D P

REVISIONS	
DEC 08, 2020	DPS RESUBMISSION
NOV 17, 2020	DPS RESUBMISSION
JUNE 03 2020	DPS RESUBMISSION
DEC 23, 2019	BP SUBMISSION
DEC 02, 2019	AP SUBMISSION
APR 26, 2019	RZ RESUBMISSION
JULY 16, 2018	DP APPLICATION
DEC. 22, 2017	RZ APPLICATION
CONSULTANTS	

AGING-IN-PLACE MEASURES (ALL UNITS)	
ALL ROOMS	LARGE TOGGLE-TYPE ELECTRICAL SWITCHES
	LEVER TYPE DOOR HANDLES
	MINIMIZE THRESHOLD HEIGHTS (LESS THAN 1/2") WHERE POSSIBLE
STAIRS & LANDINGS	WALL BLOCKING FOR FUTURE ADDITIONAL HANDRAIL INSTALLATION
	INTERMEDIATE STAIR LANDINGS WHENEVER POSSIBLE
BATHROOMS	LESS STEEP RISE/RUN DIMENSIONS WHERE POSSIBLE
	WALL BLOCKING FOR FUTURE GRAB BAR INSTALLATION (AT BATHTUB, TOILET)
KITCHEN	INTERMEDIATE STAIR LANDINGS WHENEVER POSSIBLE
	LESS STEEP RISE/RUN DIMENSIONS WHERE POSSIBLE
HALLWAYS	WALL BLOCKING FOR FUTURE GRAB BAR INSTALLATION (AT BATHTUB, TOILET)
	LEVER HANDLE TAPS AND FAUCETS
	24° SLIDING DOORS WHERE POSSIBLE
	LEVER HANDLE TAPS AND FAUCETS
	MIN. 900 MM WIDTH

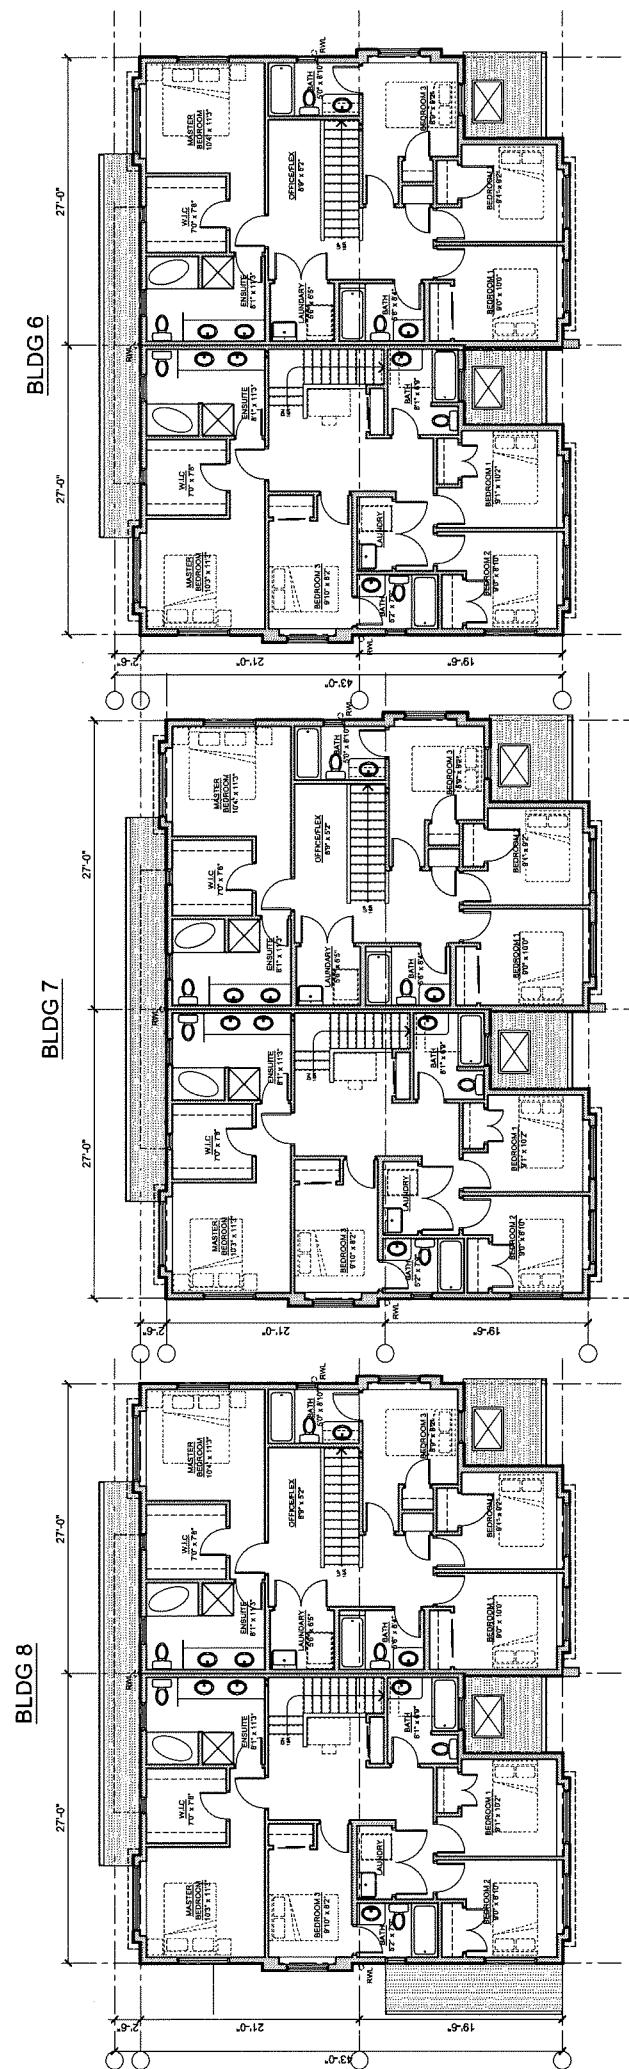

### INTERFACE

Suite 230  
11580 Cambie Road  
Richmond BC  
Canada V6X 3Z5  
T 604 821 1162  
F 604 821 1146  
www.interfacearchitecture.com

PROJECT  
Proposed 30-Unit  
Townhouse Development  
LOT ASSEMBLY  
7454 / 7480 / 7500 / 7520 /  
7540 / 7560 / 7580 / 7600  
NO. 1 ROAD  
RICHMOND, BC

PROJECT NO.  
171TRUM1

SCALE  
As Noted


DATE  
JUNE 21, 2018

DRAWN BY  
KTC, SRS, XY

CHECKED BY  
KTC

SHEET TITLE  
FLOOR PLANS:  
BUILDING 6, 7 & 8

DRAWING  
14 JUN 2018

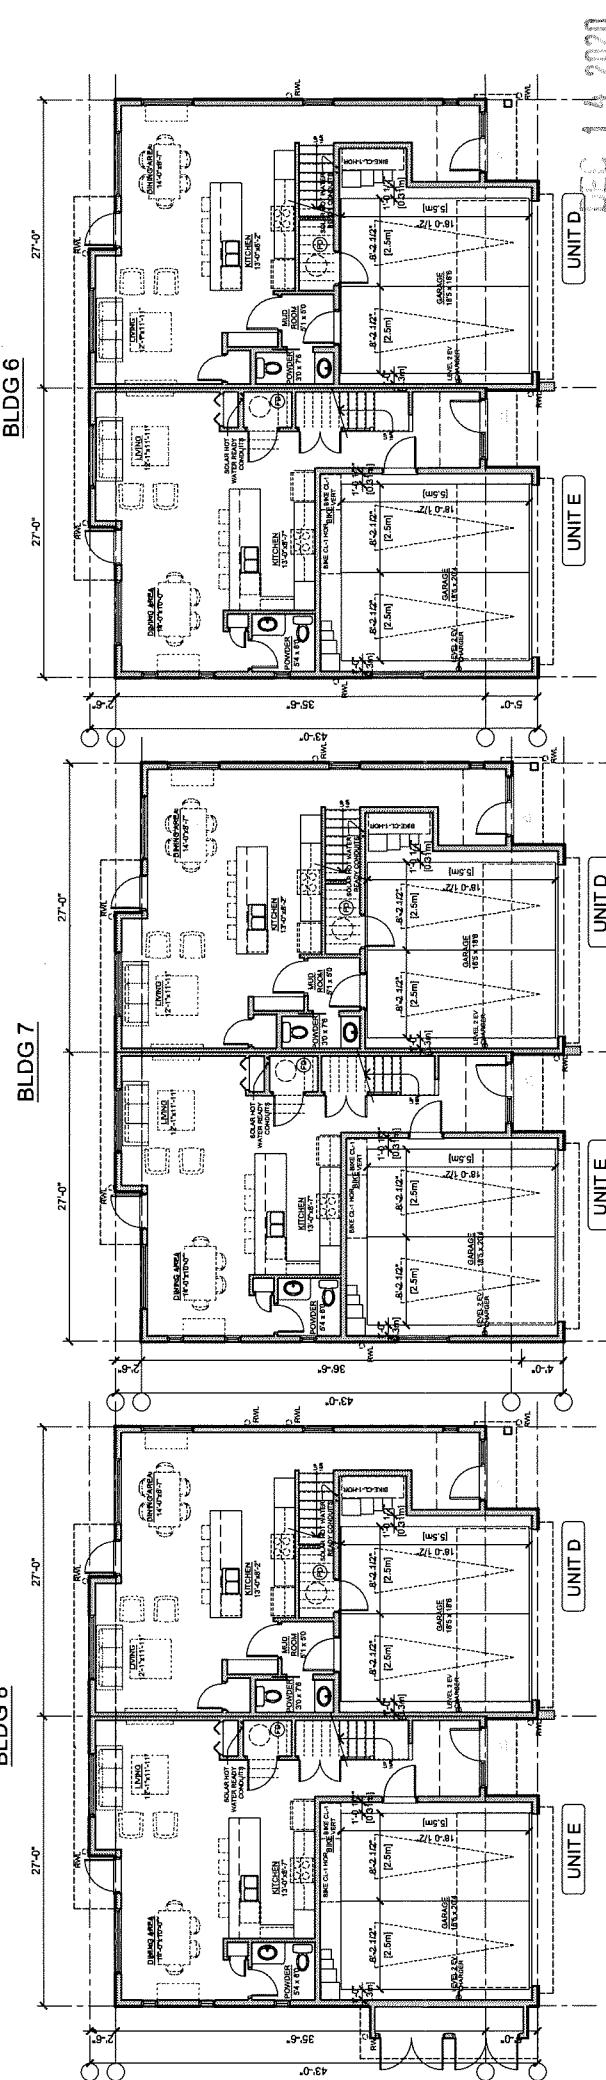

FLOOR PLAN - LEVEL 2, BUILDING 6, 7 & 8  
SCALE: 1/8" = 1'-0"  
  
\*NOTE: LEVEL 2 EV ENERGIZED OUTLET TO BE PROVIDED IN EACH RESIDENTIAL PARKING SPACES PER ZONING BY LAW


A2.5

DP 18-829236


REVISIONS	
DEC 08, 2020	DPR RESUBMISSION
NOV 27, 2020	DPR RESUBMISSION
JUNE 03, 2020	DPR RESUBMISSION
DEC 23, 2019	BP SUBMISSION
DEC 02, 2019	ADP SUBMISSION
APR 26, 2019	RZ RESUBMISSION
JULY 16, 2018	DP APPLICATION
DEC. 22, 2017	RZ APPLICATION
CONSULTANTS	

**INTERFACE®**


Suite 230  
11580 Cambie Road  
Richmond BC  
Canada V6X 3Z5  
T 604.821.1162  
F 604.821.1146  
[www.interfacearchitects.com](http://www.interfacearchitects.com)

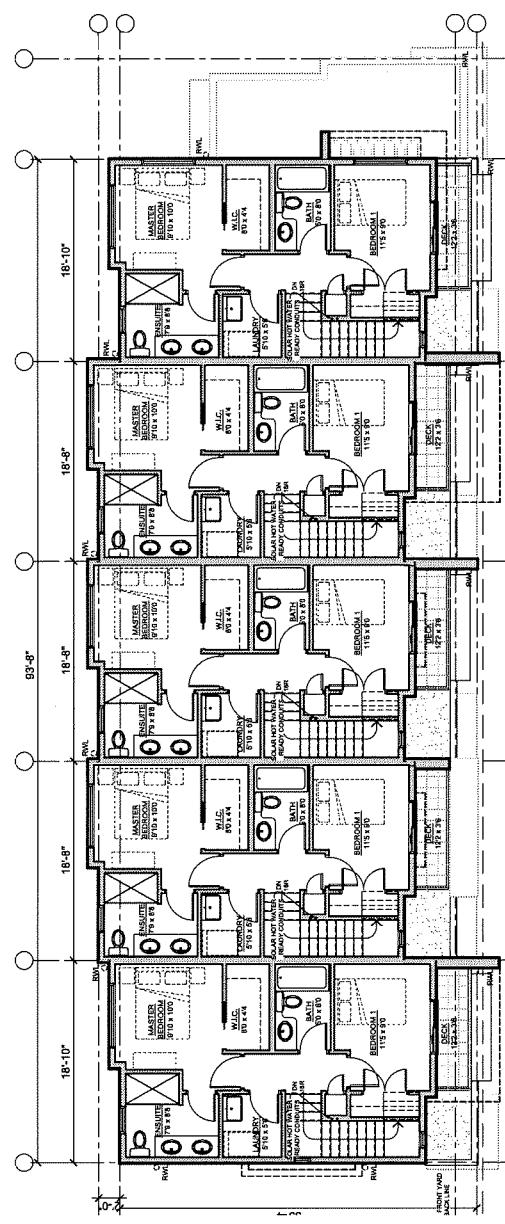


**FLOOR PLAN - LEVEL 3, BUILDING 10**  
SCALE: 1/8" = 1'-0"

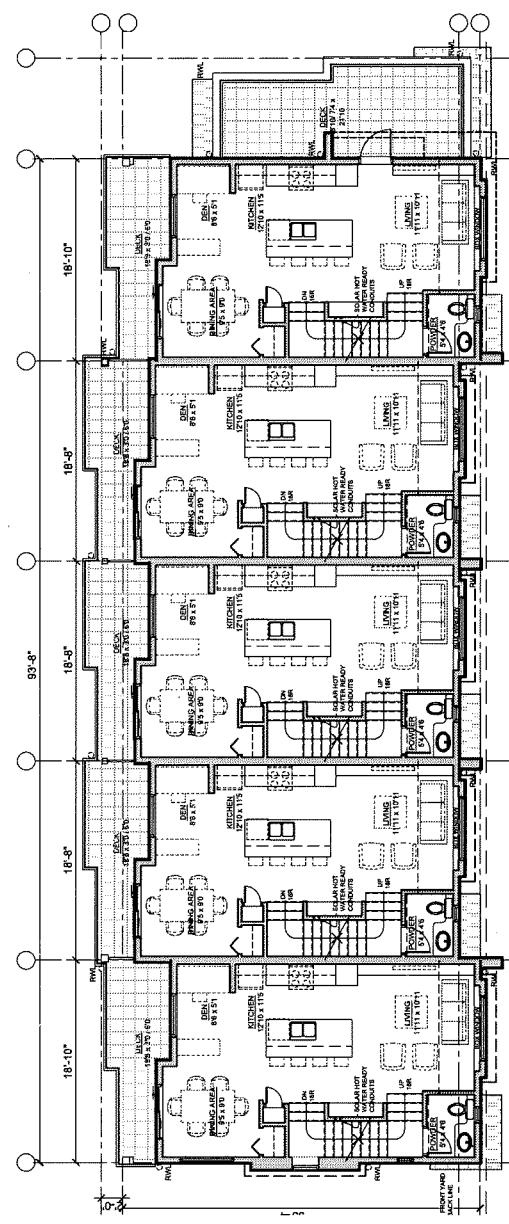


**FLOOR PLAN - LEVEL 2, BUILDING 10**  
SCALE: 1/8" = 1'-0"

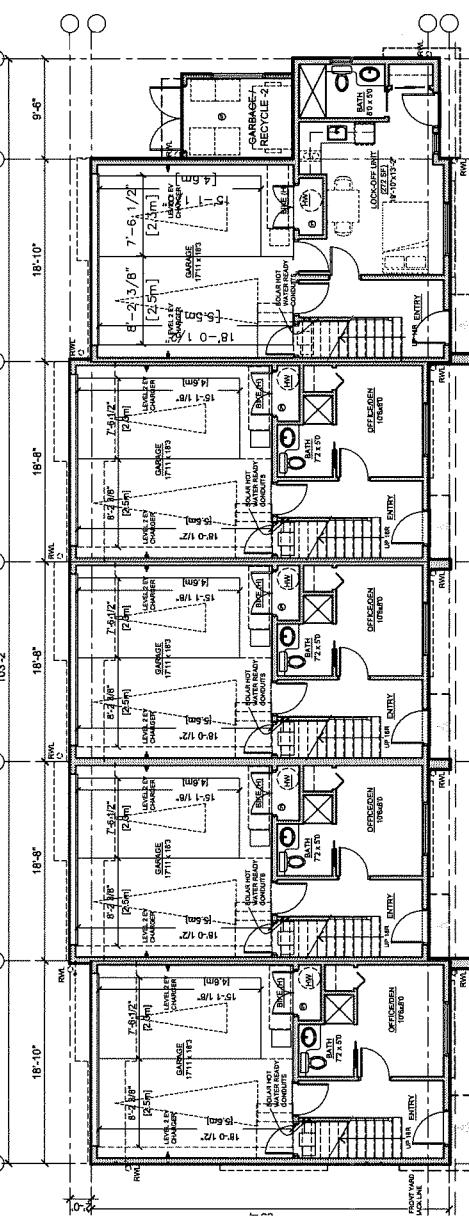


**FLOOR PLAN - LEVEL 1, BUILDING 10**  
SCALE: 1/8" = 1'-0"

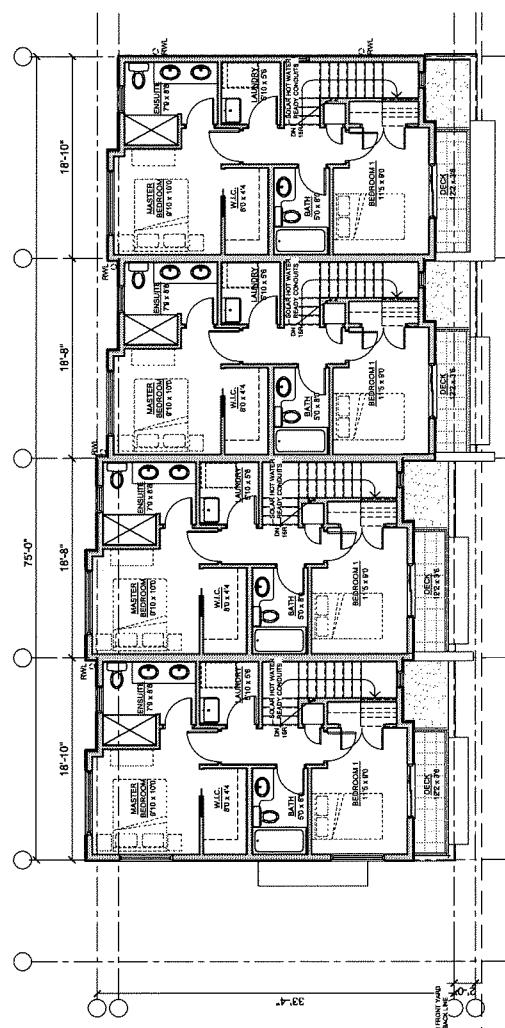

**FLOOR PLAN - LEVEL 3, BUILDING 9**  
SCALE: 1/8" = 1'-0"

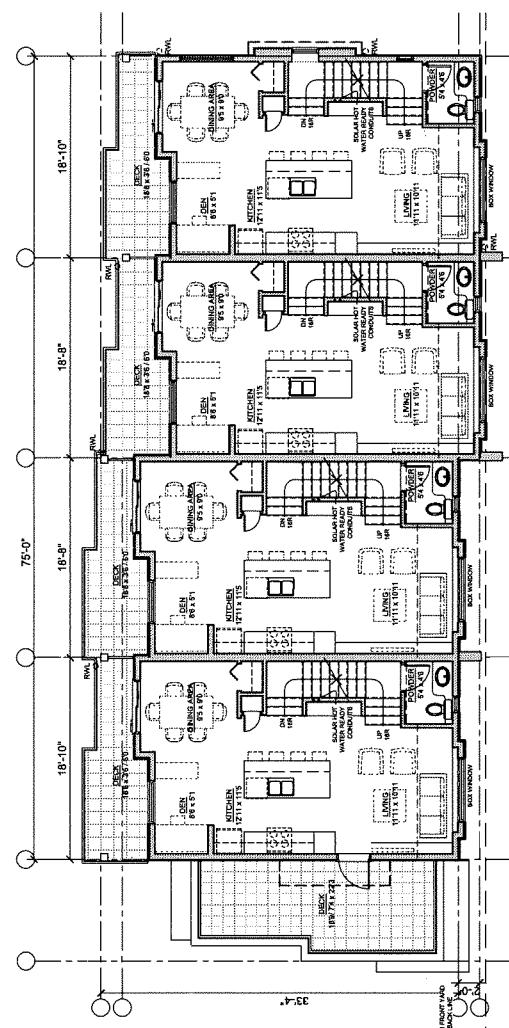

**FLOOR PLAN - LEVEL 2, BUILDING 9**  
SCALE: 1/8" = 1'-0"

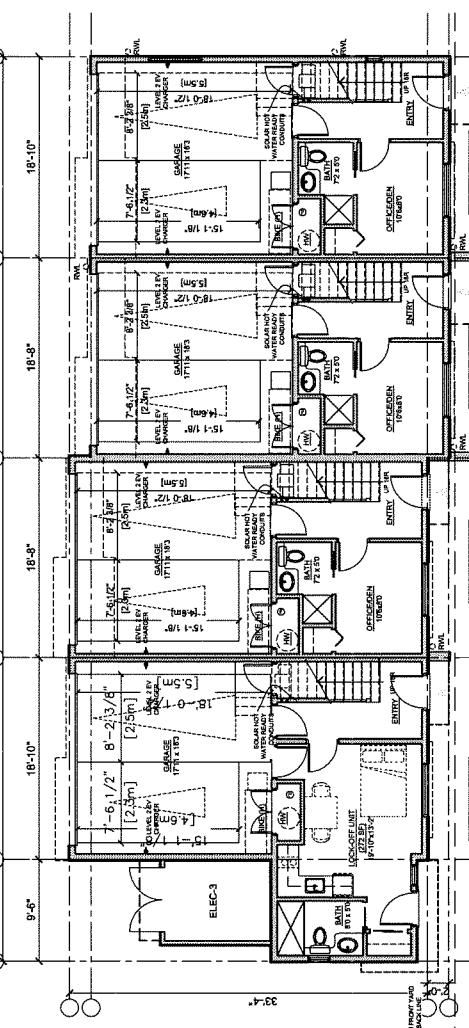

**FLOOR PLAN - LEVEL 1, BUILDING 9**  
SCALE: 1/8" = 1'-0"

**NOTE: LEVEL 2 EV ENERGIZED OUTLET TO BE PROVIDED IN EACH RESIDENTIAL PARKING SPACES PER ZONING BYLAW**

**REFERENCE PLAN**  
DRAFT DATE: JUN 21, 2018  
DRAWN BY: KYC, SRS, XY  
CHECKED BY: KYC  
SHEET TITLE: FLOOR PLANS: BUILDINGS 9 & 10  
DRAWING: DRAFT 1442020

**A2.7**

**NOTE: LEVEL 2 EV ENERGIZED OUTLET TO BE PROVIDED IN EACH RESIDENTIAL PARKING SPACES PER ZONING BYLAW**

**829236**

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REVISIONS	
DEC 08, 2020	DPS RESUBMISSION
NOV 27, 2020	DPS RESUBMISSION
JUNE 03, 2020	DP RESUBMISSION
DEC 23, 2019	BP SUBMISSION
DEC 02, 2019	ADP SUBMISSION
APR 26, 2019	RZ RESUBMISSION
JULY 16, 2018	DP APPLICATION
OEC. 22, 2017	RZ APPLICATION
CONSULTANTS	

## INTERFACE:

PROJECT Proposed 30-Unit Townhouse Development  
LOT ASSEMBLY Suite 230 11580 Camille Road Richmond BC Canada V6X 3Z5 T 604 621 1162 F 604 621 1146 www.interfacearchitecte.com

DATE JUNE 21, 2018


DRAWN BY KTC, SRS, XY

SCALE 1:4" = 1'-0"

SHEET TITLE FLOOR PLANS: CONVERTIBLE UNIT (Bc)


DRAWING

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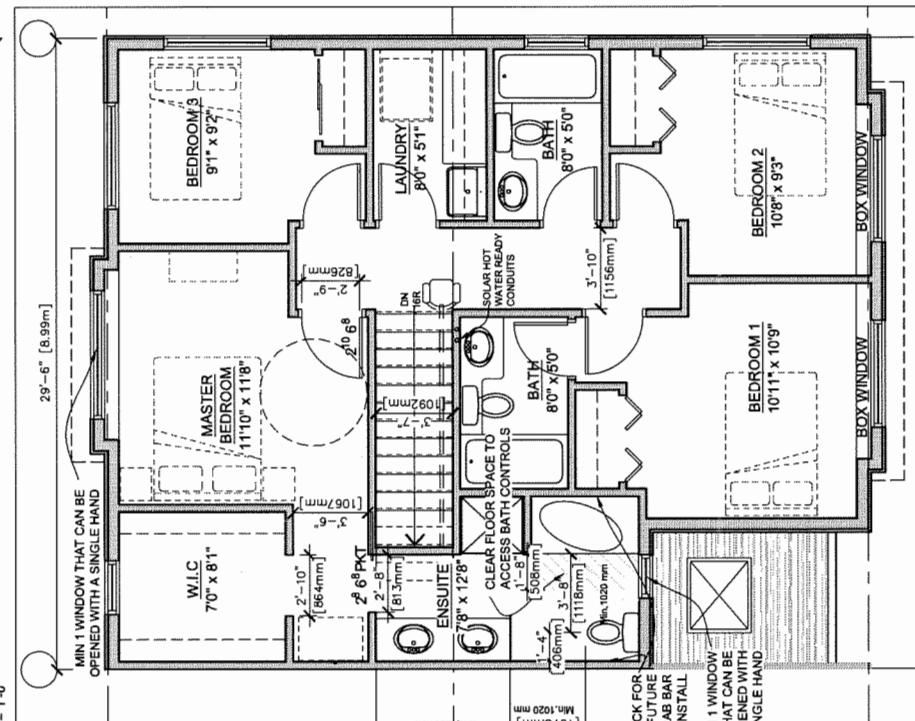
FLOOR PLAN: CONVERTIBLE UNIT Bc ( BEFORE CONVERSION )

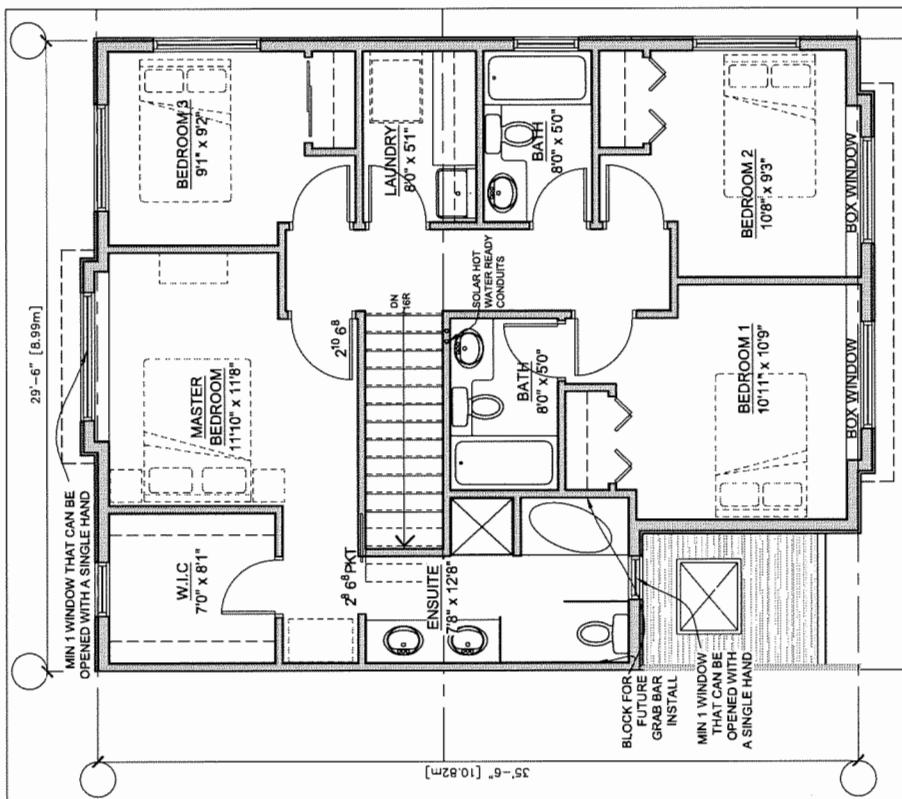SCALE: 1/4" = 1'-0"




\*NOTE: LEVEL 2 EV ENERGIZED OUTLET TO BE PROVIDED IN EACH RESIDENTIAL PARKING SPACES PER ZONING BY LAW

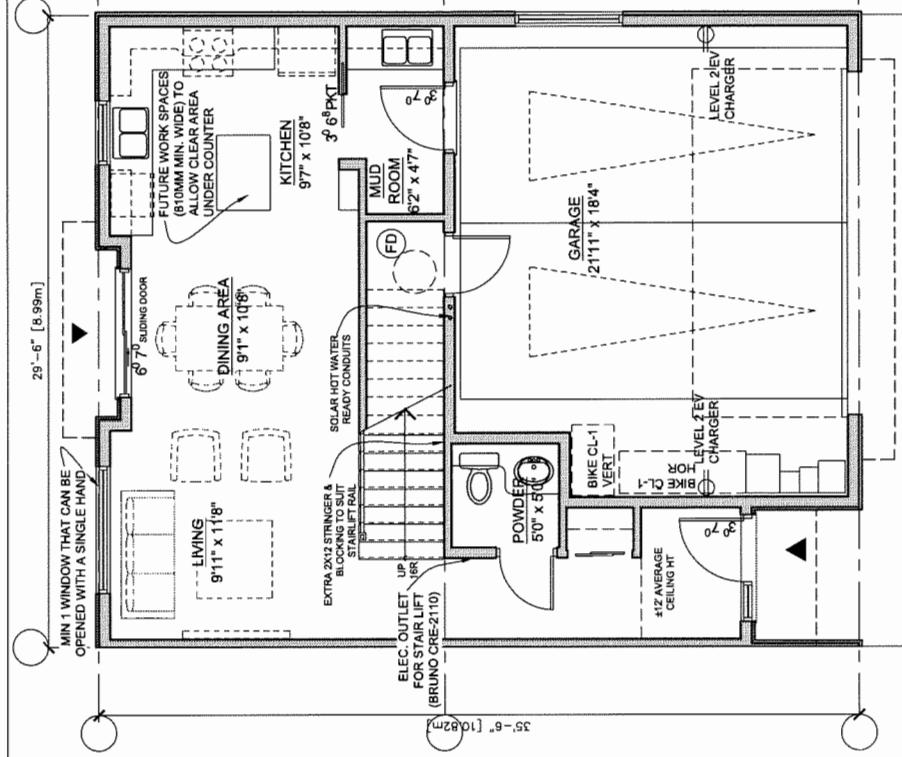SCALE: 1/4" = 1'-0"




FLOOR PLAN: CONVERTIBLE UNIT Bc ( AFTER CONVERSION )

SCALE: 1/4" = 1'-0"

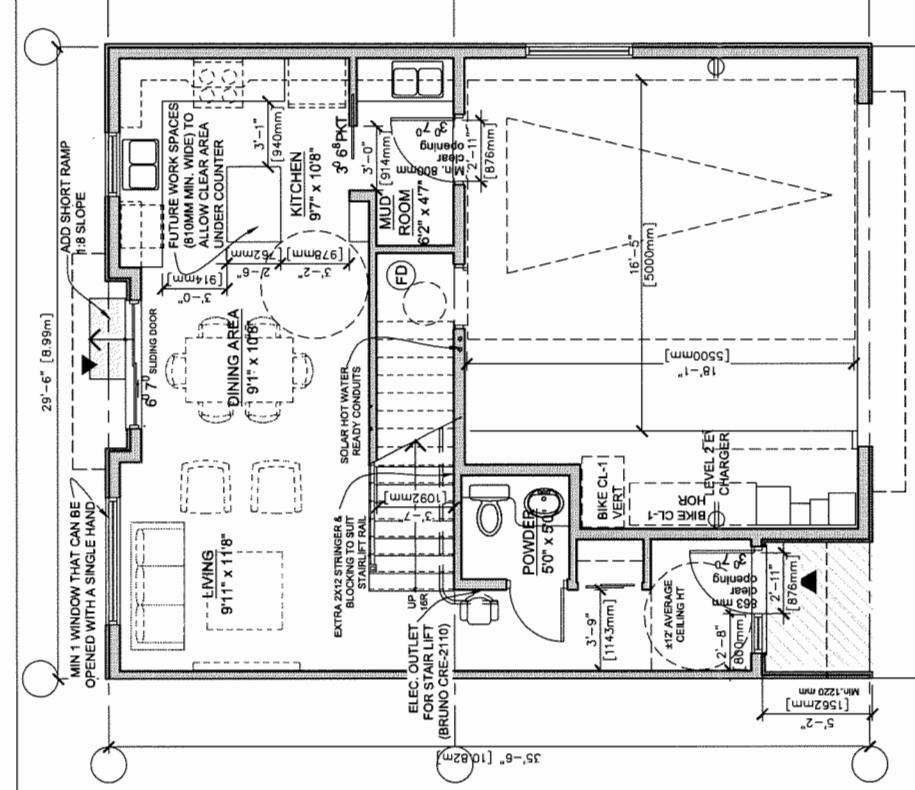

FLOOR PLAN: CONVERTIBLE UNIT Bc ( AFTER CONVERSION )

SCALE: 1/4" = 1'-0"

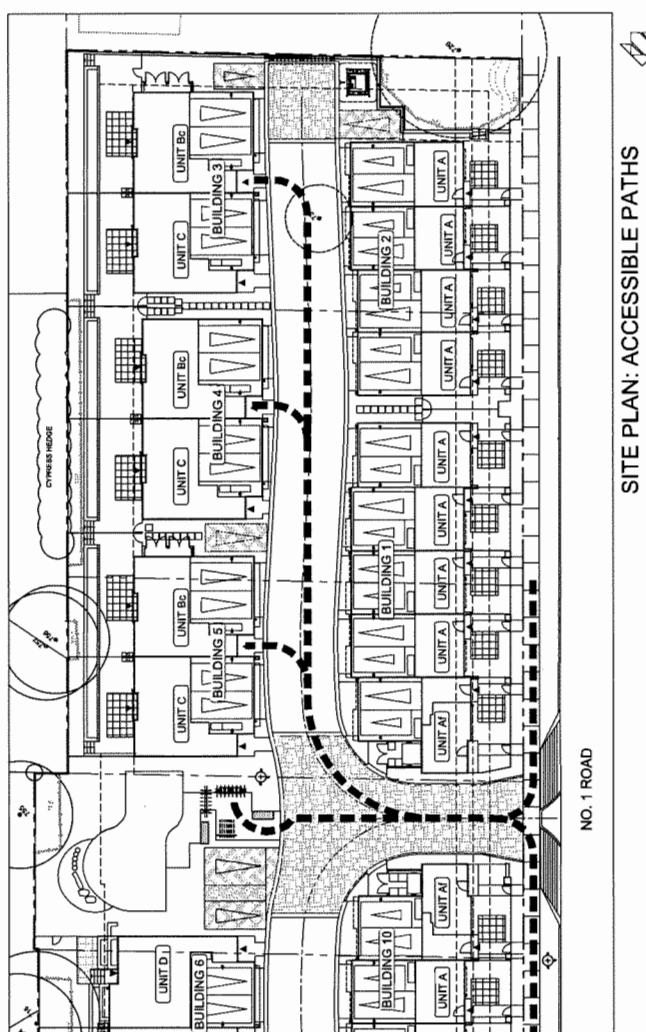

SITE PLAN: ACCESSIBLE PATHS

SCALE: NTS

## CONVERTIBLE UNIT FEATURES CHECKLIST

- DOORS & DOORWAYS**
- ENTRY DOORS MIN. 865 MM BUT IDEALLY 914MM AND HAVE CLEAR ACCESS
  - ENTRY DOOR CLEAR EXTERIOR FLOOR SPACE MIN 1220 MM DEPTH BY DOOR WIDTH PLUS 800 MM LATCH SIDE (NOT NEEDED IF ROUGH IN WIRING PROVIDED FOR FUTURE AUTOMATIC DOOR OPENER)
  - INTERIOR DOORS TO MAIN LIVING AREAS, BATHROOM AND 1 BEDROOM, MIN. 860 MM CLEAR OPENING WITH FLUSH THRESHOLD MAX 13 MM HEIGHT, DEMONSTRATE WHEELCHAIR ACCESS BETWEEN HALLWAY AND ROOMS AND WIDEN HALLWAY AND/OR DOORWAYS IF NECESSARY TO SECURE ACCESS
  - PATIO/BALCONY MIN. 860 MM CLEAR OPENING, ACCESSED FROM REAR DOOR AT GROUND FLOOR.
  - ALL INTERIOR THRESHOLDS WITHIN UNITS COMPLY WITH BCBC.
  - LEVER-TYPE HANDLES FOR ALL DOORS
- VERTICAL CIRCULATION**
- STAIR/LIFT STAIRCASE, WIDTH, FRAMING SUPPORT, AND LANDINGS, AS NOTED ON FLOOR PLANS IN COMPLIANCE WITH MANUFACTURER SPECIFICATION.
  - SPEC NOTE: BRUNO RAIL STAIR LIFT (ELITE CURVE CRE-2110) MAX. LOAD: 400LBS, POWER: 24VDC COMPRISED (2) 7AH 12V BATTERIES \*\*\* PROVISION FOR IN UNIT B (BUILDING 3 & 5) \*\*\*
  - ON FLOOR PLANS FOR FUTURE GRAB BARS AT TOILET, TUB AND SHOWER, REINFORCED WITH 2X12 SOLID LUMBER IN ALL BATH/TUB, SHOWER, AND TOILET LOCATIONS.
  - LEVER-TYPE HANDLES FOR PLUMBING FIXTURES.
  - PRESSURE AND TEMPERATURE CONTROL VALVES ARE INSTALLED ON ALL SHOWER FAUCETS.
  - CABINETS UNDERNEATH SINK ARE EASILY REMOVED.
  - DEMONSTRATE BATH AND SHOWER CONTROLS ARE ACCESSIBLE (LAYOUT OR FIXTURE PLACEMENT).
  - CLEAR AREA NEEDED UNDER FUTURE WORKSPACE, PLUMBING AND GAS PIPES (IN-WALL AND IN FLOOR) LOCATED CLEAR OF UNDER COUNTER AREA OF FUTURE WORKSPACE (STOVE, SINK & M/N 810 MM WIDE COUNTER) ALL PIPES ARE BROUGHT IN NO HIGHER THAN 304 MM TO THE CENTRE OF THE PIPE FROM FLOOR LEVEL.
  - 1500 MM TURNING DIAMETER OR TURNING PATH DIAGRAM
  - LEVER-TYPE HANDLES FOR PLUMBING FIXTURES.
- KITCHEN**
- MIN. 1' WINDOW THAT CAN BE OPENED WITH A SINGLE HAND (BATHROOM, KITCHEN, LIVING ROOM)
  - OUTLETS & SWITCHES PLACEMENT LOCATIONS OF ELECTRICAL OUTLETS: BESIDE WINDOW, BOTTOM OF SHELVES AND SEASIDE FOR RANGE EXTRACTOR, DOORS ON ISLAND, AND INSIDE ON VENTILATION FOR KITCHEN COUNTER AREA OF KITCHEN, SINK & M/N 810 MM WIDE COUNTER, WITH PROXIMITY OF CONTROL CENTRE FOR SMART HOME OPTIONS.
  - UPGRADE TO FOURPLEX OUTLETS IN MASTER BEDROOM, HOME OFFICE, GARAGE, AND RECREATION ROOM.

\*NOTE: LEVEL 2 EV ENERGIZED OUTLET TO BE PROVIDED IN EACH RESIDENTIAL PARKING SPACES PER ZONING BY LAW

FLOOR PLAN: REFERENCE PLAN

SCALE: 1/4" = 1'-0"

DP 18-829236