

July 26, 2021 DP 18-829233

To:	Development Permit Panel	Date:
From:	Wayne Craig Director of Development	File:

Re: Application by 1085948 BC Ltd for a Development Permit at 10671, 10691, and 10751 Bridgeport Road

Staff Recommendation

That a Development Permit be issued which would:

- 1. Permit the construction of 24 townhouses at 10671, 10691, and 10751 Bridgeport Road on a site zoned "Low Density Townhouses (RTL4)"; and
- 2. Vary the provisions of Richmond Zoning Bylaw 8500 to reduce the minimum front yard along Bridgeport Road from 6.0 m to 5.2 m.

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Wayne Craig Director of Development

WC:cl Att.

Staff Report

Origin

1085948 BC Ltd (Director: Mr. Xin Bo Mao), has applied to the City of Richmond for permission to develop 24 townhouses at 10671, 10691, and 10751 Bridgeport Road on a site zoned "Low Density Townhouses (RTL4)", with right-in/right-out vehicle access from Bridgeport Road (Attachment 1). The site is currently vacant.

The site is being rezoned from the "Single Detached (RS1/D)" zone to the "Low Density Townhouses (RTL4)" zone for this project under Bylaw 9935 (RZ 17-771592). The Bylaw was given Third Reading at the Public Hearing held December 17, 2018, and the Applicant is working to complete all of the Rezoning considerations.

A Servicing Agreement (SA) is required as a condition of rezoning bylaw adoption and includes, but is not limited to, design and construction of the following improvements (SA 19-875791):

- Water, storm, and sanitary service connections, water meter and fire hydrant installation;
- Storm and sanitary sewer system upgrades along portions of McKessock Avenue and Bridgeport Road; and
- Road upgrades to accommodate the raised barrier curb island to restrict vehicle access to right-in/right-out movements, as well as construction of a new treed/grass boulevard at the curb and concrete sidewalk at the new property line after road dedication, with transition to the existing sidewalk to the east and west of the subject site.

Development Information

Please refer to attached Development Application Data Sheet for a comparison of the proposed development data with the relevant Bylaw requirements (Attachment 2).

Background

The subject site is located on the north side of Bridgeport Road, between McKessock Avenue and Shell Road. Existing development immediately surrounding the subject site is as follows:

- To the north are the rear portions of lots zoned "Single Detached (RS1/D)" that front McKessock Avenue and Shell Road, which are the subject of an active rezoning application to the "Single Detached (RS2/B)" zone and the "Low Density Townhouses (RTL4)" zone that is currently under staff review (RZ 20-916003 at 2408 McKessock Avenue, 2751, and 2755 Shell Road);
- To the south, across Bridgeport Road, is a lot zoned "Town Housing (ZT17) Bridgeport Road (Bridgeport Area)" at 3088 Airey Drive, containing two-storey townhouses. In addition, there are three lots zoned "Single Detached (RS1/F)" at 10760, 10780 Bridgeport Road and 3033 Shell Road, which are the subject of active rezoning and Development Permit (DP) applications to permit townhouses on a lot to be zoned "Medium Density Townhouses (RTM3)" (RZ 16-754158/DP 18-828900). The proposed rezoning bylaw received Third Reading at the Public Hearing held on September 4, 2018, and the DP application was endorsed by the Development Permit Panel on April 14, 2021;

- To the east are two lots zoned "Single Detached (RS1/D)" at 10811 and 10891 Bridgeport Road; and
- To the west is one lot zoned "Single Detached (RS1/D)" at 10651 Bridgeport Road.

Rezoning and Public Hearing Results

During the rezoning process, staff identified the following design issues to be resolved at the DP stage:

- Refinement of the pattern and use of non-porous surface materials to enhance on-site permeability and strengthen on-site pedestrian circulation and future public pedestrian connectivity;
- Refinement of the proposed fencing/screening on-site;
- Demonstrating that all of the relevant accessibility features are incorporated into the design of the proposed Convertible Units, and that aging-in-place features will be incorporated into all units;
- Consideration of alternate locations for some of the proposed replacement trees to ensure no conflict with the vehicle drive-aisle in close proximity to the site's entry;
- Exploring additional design development to provide adequate building massing articulation along Bridgeport Road;
- Review of the proposed colour palette and exterior building materials;
- Reviewing the Applicant's design response to the principles of Crime Prevention Through Environmental Design (CPTED);
- Gaining a better understanding of the proposed sustainability features to be incorporated into the project; and
- Refining the concept for the off-site boulevard improvements along Bridgeport Road.

Through the review of this DP application, staff worked with the Applicant to address the design issues to staff's satisfaction and to ensure that the proposed architectural form and character is consistent with the intent of the design guidelines contained within the Official Community Plan (OCP). The Applicant has made the following modifications to their proposal to address the design issues identified:

- The amount of porous surface material has been increased by 10% to enhance site permeability and the paving stone pattern to highlight on-site pedestrian circulation has been simplified;
- The proposed on-site fencing and screening concept has been clarified and refined to include: perimeter privacy fencing of varied heights based on adjacent lot grading (i.e., from 1.2 m on top of retaining walls to 1.8 m at grade), low transparent fencing along the Bridgeport Rd frontage and between yards of individual units, and privacy screening in strategic locations such as between adjacent patios and entries;
- It is demonstrated on the floor plans that aging-in-place features are incorporated into the design of all units and that all Convertible Units features are incorporated into the design of the two convertible units proposed in the northeast corner of the site (AC9 and AC10 in Building 3);

- The locations of the proposed columnar trees in close proximity to the drive-aisle near the site entry are confirmed by the project Arborist to be suitable;
- The design of the buildings along Bridgeport Road has been revised significantly to improve building mass articulation while clearly defining each unit with a visually interesting motif;
- The proposed colour palette and exterior building materials have been finalized and are summarized below in the "Architectural Form and Character" section of this report;
- Information on how the proposal responds to the principles of CPTED, and the proposed sustainability features to be incorporated into the project, are summarized below in the "Analysis" section of this report; and
- Since the design of the off-site boulevard treatment is being reviewed as part of the SA process, an interim concept is shown on the architectural and landscape plans.

The Public Hearing for the rezoning of this site was held on December 17, 2018. At the Public Hearing, members of the public provided comments about the need for shared vehicle access to adjacent properties to the north fronting McKessock Avenue and Shell Road, and raised concerns about the servicing of sewer lines, the potential for flooding in the area, and the need for repairs to boulevards and lighting. In response to the concerns, staff advised that:

- the adjacent properties to the north could be developed into single-family homes or townhouses with access to McKessock Avenue and Shell Road (consistent with the policies in the Bridgeport Area Plan); and,
- the water, storm, and sanitary sewer lines to the proposed development will be from Bridgeport Road.

Bylaw 9935 for the rezoning of the subject site was given Third Reading at the Public Hearing.

Public Input during the DP Review Process

Subsequent to the Public Hearing, the neighbouring property owner to the west at 10651 Bridgeport Road raised concerns about the status of the subject development site, the condition of the site in the interim, and city infrastructure in the neighbourhood (e.g., maintenance and construction of sidewalks, storm drainage, road).

Staff worked with the applicant to advance the Development Permit application to arrive at a form and character that is consistent with the guidelines in the OCP, and reached out to the applicant to address the concerns about the conditions of the property. The applicant took steps to clean up the property and trim back vegetation when requested by City staff, to engage security to patrol the site, and to demolish the dwellings after they had been vacated by tenants. The applicant intends to proceed with construction as soon as the development applications and permits are approved.

Concerns regarding maintenance and construction of the sidewalk along a portion of Bridgeport Road, as well as storm drainage and a pothole on McKessock Avenue were referred to the City's Engineering and Public Works department and action was taken in response to investigation of the issues raised. Specifically: the sidewalk along a portion of Bridgeport Road was repaired; a new storm drain was installed in the boulevard and the shoulder/pothole repaired along McKessock Avenue in the fall of 2019; and staff continued to monitor the situation and implemented additional drainage improvements in consultation with the property owner.

Staff Comments

The proposed scheme attached to this report (Plans # 1.A to # 3.L, and Reference Plans) has satisfactorily addressed the significant urban design issues and other staff comments identified as part of the review of the subject DP application. In addition, it complies with the intent of the applicable sections of the OCP and is generally in compliance with the RTL4 zone, except for the zoning variances noted below.

Zoning Compliance/Variances (staff comments in bold italics)

The Applicant requests to vary the provisions of Richmond Zoning Bylaw 8500 to reduce the minimum front yard along Bridgeport Road from 6.0 m to 5.2 m.

(Staff supports the proposed variance for the following reasons:

- Road dedication is being provided along Bridgeport Road for improvements to the public realm and future road widening. The required improvements enable a more pedestrian-oriented environment in front of the units along Bridgeport Road, complete with a treed and grass boulevard between the new property line and the existing curb of the road;
- A reduction to the front yard setback enables a deeper rear yard setback to be provided at the north of the site along the interface with existing adjacent single-family housing.
- Although the front yard setback is reduced, the proposal maintains consistency with the minimum private outdoor space guidelines in the OCP through the provision of second floor balconies for the units fronting Bridgeport Road, which face north off the main living area, in addition to the front yards; and
- The Applicant has made adjustments to the Site Plan since the Rezoning review stage to reduce the scope of the variance. At that time, the proposed variance was to reduce the front yard setback from 6.0 m to 4.7 m, whereas the scope of the variance has now diminished to 5.2 m. The distance between the existing curb face and building face is 10.6 m. Although this distance will be reduced slightly with future road widening upon potential redevelopment of the neighbouring properties to the east (i.e., 8.4 m), the remaining treed and grass boulevard is an improvement over the current condition and the resulting distance is acceptable to staff as it is still greater than it would otherwise be if a single-family dwelling was constructed on-site under the existing zoning without road dedication.
- The applicant's acoustic report confirms that the units will achieve the CMHC interior noise standards identified in the OCP when considering traffic and aircraft noise.

Advisory Design Panel Comments

The Advisory Design Panel review of the proposal was held on December 19, 2019, and was supported to move forward to the Development Permit Panel subject to the Applicant giving consideration to the comments identified at the meeting. A copy of the relevant excerpt from the Advisory Design Panel meeting minutes is attached for reference (Attachment 3). The design response from the Applicant has been included immediately following the specific Design Panel comments and is identified in '*bold italics*'.

Analysis

Conditions of Adjacency

- The proposed townhouses at the subject site have been designed with consideration of the surrounding single-family context, with side and rear yard setbacks well beyond those required in the RTL4 zone.
- The proposed buildings along the rear yard interface with existing single-family housing to the north (Buildings 3 to 6) are two-storeys in height, are in a duplex form, and are set back from the shared property line a minimum of 4.5 m to the ground floor and 6.0 m to the second floor.
- The proposed three-storey buildings along Bridgeport Road and in the middle of the site (Buildings 1, 2, 7 and 8) are set back from the shared property lines with existing single-family housing to the east and west by at least 7.5 m and up to 10.5 m. Also, the existing large Douglas Fir that is to be retained in the southwest corner of the site acts as a vegetative buffer that screens the proposed development from the west.
- Exposed side and rear building elevations are visually interesting, well articulated, and have limited small windows to minimize potential overlook.
- Privacy fencing is proposed around the perimeter of the site to screen the development at ground level from the north, east and west, while responding appropriately to lot grade differences through varied fence heights.
- As part of the Rezoning Application review process the Applicant submitted preliminary concept plans showing how the neighbouring properties to the north, east, and west of the subject site could potentially redevelop in the future consistent with the Bridgeport Area Plan, a copy of which is on file. To enable shared vehicle access through the subject site to potential future townhouse developments to the east and west, a SRW for public-right-of-passage is required to be registered on title of the subject site prior to rezoning bylaw adoption. The proposed Landscape Plan and Perspectives shows where signage is to be placed on perimeter fencing at the east and west ends of the drive-aisle notifying future townhouse residents at the subject site of potential drive-aisle extension.

Site Planning, Access, and Parking

- The proposal is to develop 24 townhouse units on a site of approximately 4,264 m² (45,899 ft²) in area after the required 2.3 m road dedication along the Bridgeport Road frontage.
- The proposed site layout consists of:
 - Two three-storey buildings (each containing four units) along Bridgeport Road and in the middle of the site (Buildings 1, 2, 7 and 8); and

- Four two-storey buildings along the north end of the site (Buildings 3 to 6).
- All buildings have a north-south orientation and are arranged in east-west rows. The main unit entries for all buildings are proposed to face south, either onto Bridgeport Road or onto the internal drive-aisles.
- Vehicle access to the site was reviewed as part of the Rezoning Application review process and supported by the City's Transportation Department. A single vehicle access point to the site is proposed from Bridgeport Road, and is positioned approximately midblock between McKessock Avenue and Shell Road. The proposed driveway crossing will be constructed with a triangular-shaped raised barrier curb island within the boulevard to physically restrict vehicle movements to the site to right-in/right-out only.
- To accommodate the raised barrier curb island and for future road widening, a 2.3 m road dedication along the entire south property line on Bridgeport Road is required prior to rezoning bylaw adoption. The design and construction of the required works will be reviewed as part of the SA that must be entered into prior to rezoning bylaw adoption.
- The vehicle access point and internal drive-aisle on-site is intended to provide shared access to future potential townhouses developments to the east and west, avoiding the need for additional vehicle access points in this block between McKessock Avenue and Shell Road in the future. To secure the future shared vehicle access, a Statutory Right-of-Way (SRW) for public-right-of-passage over the internal drive-aisle is required to be registered on title prior to rezoning bylaw adoption.
- Pedestrian access to the site is proposed via a pathway in the southeast corner of the site, as well as via a clearly-defined pathway adjacent to the vehicle entry point on Bridgeport Road that is treated with decorative and permeable pavers that differentiate it from the driving surface. Continued use of the same decorative permeable paver pattern is proposed to highlight north-south circulation through the site via a pathway that is ultimately intended to provide a public pedestrian connection between Bridgeport Road and McKessock Place upon potential redevelopment of adjacent properties to the north in the future, consistent with the Bridgeport Area Plan. To secure the future connection, a SRW for public-right-of-passage is required to be registered on title prior to rezoning bylaw adoption.
- Pedestrian unit entries are provided on the south side of all buildings, which are accessed from pathways leading from the public sidewalk on Bridgeport Road for Buildings 1 and 8; and from the internal drive-aisles for Buildings 2 to 7.
- On-site parking and loading is provided consistent with Richmond Zoning Bylaw 8500. Resident vehicle and bike parking spaces are proposed in individual garages, all of which vehicles are proposed in a side-by-side arrangement. Vehicle parking spaces for visitors are located adjacent to buildings and screened from public view, and includes one vanaccessible space. A rack for five visitor bike parking spaces is proposed within one of the open spaces in the north portion of the site. The internal drive-aisle has been designed to accommodate the required undesignated medium-sized loading space.
- Door-to-door service is proposed for garbage, recycling, and organics service, and the garages of each unit have been designed to accommodate the storage of the required receptacles.

Open Space Design and Landscape Design

Outdoor Amenity Space

- The proposed siting of the buildings enables the main common Outdoor Amenity Space to be located in the center of the site in a visible location opposite the main vehicle access point. The space contains a mail kiosk softened by a trellis structure, bollard lighting, seating, timber blocks of varying height for climbing, and a playhouse and whale tail bench within a poured in place rubber surface coloured to reflect the Applicant's desired maritime theme (i.e., green land, sandy beach, and blue water). The width of the play area alongside the required north-south pedestrian pathway through the site cannot accommodate the fall zone requirement associated with alternative equipment of equal play value.
- Three other passive Outdoor Amenity Areas are also proposed on-site:
 - one with seating on either side of the pedestrian pathway in the north portion of the site;
 - one with seating alongside a pathway into the site from the public sidewalk along Bridgeport Road in the southeast portion of the site; and
 - one in the southwest portion of the site, which has been designed to facilitate retention of the large Douglas Fir tree, complete with informal seating at existing grade and a 15' x 15' wood deck elevated above existing grade to enable semi-active use (e.g., Tai-Chi).

Private Outdoor Space

- Private outdoor space for each of the units is proposed as follows, consistent with the size guidelines in the OCP:
 - South-facing front yards are provided at grade for Buildings 1, 2, 7, and 8, along with balconies provided on upper floors; and
 - North-facing rear yards are provided at grade for Buildings 3 to 6.

Landscaping

- On-site tree retention and removal was assessed as part of the Rezoning Application, at which time the City's Tree Preservation Coordinator concurred with the Applicant's proposal to:
 - retain the large Douglas Fir (Tree # 958) in the southwest corner of the subject site and the three trees located on neighbouring properties to the north (Trees # 001, 002, 003); and
 - remove a total of 20 trees on-site due to poor condition, and conflict with the building envelope and proposed lot grading [Trees # 959, 960, 961, 965; 963 (a row of four trees); 964 (a row of three trees); and 967 (a row of nine trees)].

The Landscape Plan includes the proposed Tree Management Plan showing the trees to be retained and removed.

• Consistent with the 2:1 tree replacement ratio goal in the OCP, the Applicant is required to plant and maintain a minimum of 40 replacement trees on-site. The Landscape Plan shows that a mix of 42 deciduous and coniferous replacement trees of various sizes are

proposed to be planted and maintained on-site, along with a variety of shrubs, perennials, grasses and groundcover.

- Tree and plant species proposed as part of the Landscape Plan include: Maples, Nootka Cypress, Beech, Ginkgo, Sweet Gum, Pine, Cherry, Pear, Pin Oak, Boxwood, Hydrangea, Holly, Rhododendron, Rose, Skimmia, Spirea, Viburnum, Yew and Cedar Hedges, Dwarf Fountain Grass, Daylily, Ferns, and Salal.
- The Landscape Plan requires that all soft landscaped areas be irrigated through installation of an automated system consistent with industry standards.
- A variety of decorative paving treatments is proposed on-site to distinguish between pedestrian and vehicle areas, provide visual interest and assist with surface permeability. Specifically: a mix of asphalt and permeable pavers at strategic locations within the internal drive-aisle and visitor parking spaces; and a mix of broom-finished concrete, both permeable and standard paving stones, and flagstones for pathways and patios.
- To define the street edge along Bridgeport Road and other front yard areas within the subject site, low transparent fencing with pedestrian gates is proposed, while solid privacy fencing is proposed around the site perimeter ranging in height from 1.2 m on top of retaining walls to 1.8 m at grade depending on adjacent lot grading.
- To ensure that the Landscape Plan is adhered to, the Applicant is required to submit a Landscaping Security in the amount of 100% of a cost estimate prepared by the Registered Landscape Architect (including installation and a 10% contingency) prior to DP issuance.

Indoor Amenity Space

• Consistent with the OCP, and as considered at the time of rezoning, the Applicant proposes to submit a contribution to the City prior to rezoning bylaw adoption in-lieu of the provision of common indoor amenity space on-site.

Architectural Form and Character

- The Applicant has indicated that the architectural vocabulary is identifiable with some elements from two eclectic styles: Tudor (i.e., front facing gables) and French (i.e., upturned eaves) with the aim of achieving an interesting residential identity.
- The residential character of the development is enhanced with small-scale elements such as multi-paned windows, metal flowerbox frames, and covered/recessed entry porches.
- The proposed colour palette and building materials consist of alternating white, grey, and warm ivory colours of horizontal Hardie lap siding, Hardie panel vertical siding, brick cladding, wood beams, posts, barge board and trim, black and charcoal metal railings and flower box frames, and asphalt shingle roofing;

Accessible Housing

• The proposed development includes two convertible units in one of the two-storey duplex buildings (Building 3), which are designed with the potential to be easily renovated to accommodate a future resident in a wheelchair. The proposed stair width, framing support, and landings as noted on floor plans for these units enable potential conversion to include installation of a stair lift, consistent with the lift manufacturer's specifications.

The list of convertible unit features and floor plans before and after conversion are included in the Reference Plans to the DP.

- All of the 24 proposed units incorporate aging-in-place features to accommodate mobility constraints associated with aging. These features include:
 - stairwell hand rails;
 - lever-type handles for plumbing fixtures and door handles; and
 - solid blocking in washroom walls to facilitate future grab bar installation beside toilets, bathtubs and showers.

Sustainability

- At the rezoning stage, the applicant committed to achieving an EnerGuide rating of 82 for the proposed townhouses and to pre-ducting all units for solar hot water heating. The proposal meets the Council-adopted grandfathering criteria to proceed on this basis.
- The Applicant has submitted an acceptable evaluation report by an Energy Advisor which confirms that the proposed townhouse units are designed to achieve an EnerGuide rating of 82. The key technical elements that enable this rating to be achieved include air source heat pumps (for both heating and cooling), ductless heating distribution, and heat recovery ventilation systems. The heat pumps for the duplex buildings (Buildings 3 to 6), are proposed to be located in the rear yard, and for the 4-unit buildings (Buildings 1, 2, 7, 8) they are proposed to be located on the 2nd floor decks. The applicant's acoustic report confirms that noise associated with operation of the pumps will comply with the City's Noise Regulation Bylaw due to the incorporation of noise control measures (i.e., neoprene vibration sleeves and isolators). Prior to rezoning bylaw adoption, a legal agreement is required to be registered on title to secure the commitments to install the energy-efficiency upgrade measures identified in the evaluation report and that all units are to be solar hot water ready.
- Consistent with Zoning Bylaw requirements, an energized outlet capable of providing Level 2 EV charging is proposed for all residential vehicle parking spaces.

Crime Prevention Through Environmental Design (CPTED)

The Applicant has identified that the proposal responds to the following principles of CPTED, as encouraged in the design guidelines contained within the OCP:

Natural Access Control

- Pedestrian circulation on-site has landscaped edges, clearly defining the areas for public and private use, and clear wayfinding signage is planned for in both directions along the north-south pedestrian path through the site (to be installed when the ultimate pathway connecting Bridgeport Road and McKessock Place is completed), which is well-lit with bollard lighting.
- All unit entries are clearly visible from the street and internal drive-aisle, and are to be well-lit.

Natural Surveillance

- Window placement on all buildings provide for passive surveillance at pathways, common outdoor amenity areas, visitor parking spaces, main unit entries and garages, and into the passive outdoor space under the canopy of the retained Tree # 958.
- The main common Outdoor Amenity Space is centrally located with good passive surveillance, and includes bollard lighting, low plantings, and site furnishings.

Territoriality/Defensible Space

- Front yards along the street and internal drive-aisle animate semi-private and semi-public outdoor spaces.
- Areas of visual interest at the drive-aisle entry and through the site have decorative surface treatments for additional pedestrian safety and to promote territoriality.

Site Servicing & Off-site Improvements

- Servicing requirements and off-site improvements to support the proposed development were identified during the Rezoning Application review process, and include:
 - A 2.3 m road dedication along the entire Bridgeport Road frontage prior to rezoning bylaw adoption to accommodate the required raised barrier curb island to restrict vehicle movements at the site access point, new treed/grass boulevard at the curb and concrete sidewalk at the new property line after road dedication, with transition to the existing sidewalk to the east and west of the subject site, and future road improvements; and
- Entering into a SA prior to rezoning bylaw adoption (SA 19-875791) for the design and construction of water, storm, and sanitary service connections, water meter and fire hydrant installation, storm and sanitary sewer system upgrades along portions of McKessock Avenue and Bridgeport Road, and the road upgrades described above. The existing sanitary service connections to the site are to be discontinued in favour of the installation of the new sanitary sewer along Bridgeport Road and McKessock Avenue to service the subject site. The existing SRW for the sanitary sewer must remain on-site for continued access to the existing sanitary sewers providing service to the adjacent properties.

Conclusion

This proposal is for a 24-unit townhouse development at 10671, 10691, and 10751 Bridgeport Road, with right-in/right-out vehicle access from Bridgeport Road.

The Applicant has addressed the design issues identified through the Rezoning Application review process, as well as additional staff comments regarding site planning, urban design, architectural form and character, and landscape design identified as part of the DP application review process. The proposal as designed provides an appropriate response to the surrounding single-family context and conforms to the applicable policies and design guidelines contained within the OCP.

The proposed development complies with the requirements of the RTL4 zone, with the exception of the zoning variances discussed.

On this basis, staff recommends that the DP be endorsed, and issuance by Council be recommended.

Cynthia Lussier Planner 2 (604-276-4108)

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Attachment 1: Location Map
Attachment 2: Development Application Data Sheet
Attachment 3: Excerpt from the December 17, 2018 Advisory Design Panel meeting minutes and Applicant's design response

The following are to be met prior to forwarding this application to Council for issuance:

- Final adoption of Richmond Zoning Bylaw 8500, Amendment Bylaw 9935.
- Receipt of a Letter-of-Credit or other form of security acceptable to the City for landscaping in the amount of \$328,219.10 (100% of the cost estimate provided by the Registered Landscape Architect, including all materials, installation, and a 10% contingency).

Prior to future Building Permit¹ issuance, the Applicant is required to complete the following:

- Incorporation of accessibility measures in Building Permit plans and construction, as determined via the Rezoning and Development Permit applications (e.g., Aging-in-Place features in all units; and Convertible Unit features in the two Units AC).
- Incorporation of energy efficiency measures and pre-ducting for solar hot water heating in Building Permit plans to meet or exceed an EnerGuide score of 82, as specified in the legal agreement that is required via the Rezoning and Development Permit applications.
- Incorporation of noise mitigation measures in Building Permit plans and construction, as outlined in the acoustical/thermal reports and recommendations prepared by the appropriate registered professional via the Rezoning and Development Permit applications, which demonstrate that the interior noise levels and noise mitigation standards comply with the City's Official Community Plan and Noise Regulation Bylaw (as per the noise-related covenant(s) registered on title prior to rezoning bylaw adoption).
- Obtain a Building Permit for any construction hoarding associated with the proposed development. If construction hoarding is required to temporarily occupy a street, or any part thereof, or occupy the air space above a street or any part thereof, additional City approvals and associated fees may be required as part of the Building Permit. For further information on the Building Permit, please contact Building Approvals Department at 604-276-4285.
- Submission of a Construction Traffic and Parking Management Plan to the satisfaction of the City's Transportation Department (http://www.richmond.ca/services/ttp/special.htm). The Management Plan shall include location for parking for services, deliveries, workers, loading, application for any lane closures, and proper construction traffic controls as per Traffic Control Manual for works on Roadways (by Ministry of Transportation and Infrastructure) and MMCD Traffic Regulation Section 01570.

¹ This requires a separate application.

Notes:

• Where the Director of Development deems appropriate, the preceding agreements are to be drawn not only as personal covenants of the property owner, but also as covenants pursuant to Section 219 of the Land Title Act.

All agreements to be registered in the Land Title Office shall have priority over all such liens, charges and encumbrances as is considered advisable by the Director of Development. All agreements to be registered in the Land Title Office shall, unless the Director of Development determines otherwise, be fully registered in the Land Title Office prior to enactment of the appropriate bylaw.


The preceding agreements shall provide security to the City including indemnities, warranties, equitable/rent charges, letters of credit and withholding permits, as deemed necessary or advisable by the Director of Development. All agreements shall be in a form and content satisfactory to the Director of Development.

- Additional legal agreements, as determined via the subject development's Servicing Agreement(s) and/or Development
 Permit(s), and/or Building Permit(s) to the satisfaction of the Director of Engineering may be required including, but not
 limited to, site investigation, testing, monitoring, site preparation, de-watering, drilling, underpinning, anchoring, shoring,
 piling, pre-loading, ground densification or other activities that may result in settlement, displacement, subsidence, damage
 or nuisance to City and private utility infrastructure.
- Applicants for all City Permits are required to comply at all times with the conditions of the Provincial *Wildlife Act* and
 Federal *Migratory Birds Convention Act*, which contain prohibitions on the removal or disturbance of both birds and their
 nests. Issuance of Municipal permits does not give an individual authority to contravene these legislations. The City of
 Richmond recommends that where significant trees or vegetation exists on site, the services of a Qualified Environmental
 Professional (QEP) be secured to perform a survey and ensure that development activities are in compliance with all
 relevant legislation.

ATTACHIAENT 1



City of Richmond

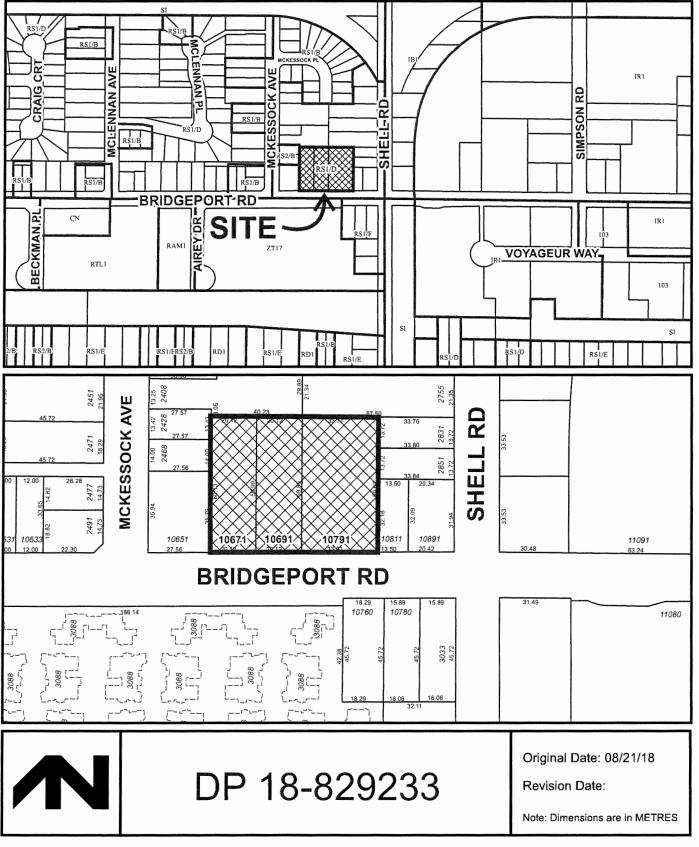



DP 18-829233					
Address:	10671, 10691, 10751 Bridgeport R	oad			
Applicant:	1085948 BC Ltd (Mr. Xin Bo Mao)		Owner:	1085948 BC Ltd (Mr. Xin Bo Mao)	
Planning Area(s): Bridgeport					
		Existing		Proposed	
Cite Annual 4,264.1 m ²					

Site Area:	4,434.7 m ²	4,264.1 m ² (after 170.6 m ² road dedication)
Land Uses:	Vacant Land (previously single-family housing)	Townhouses
OCP Designation:	Neighbourhood Residential	No change
Bridgeport Area Plan Designation:	Residential Area 2 (subject to the policies described in Section 3.1 and 4.0) of the Area Plan	No change
Zoning:	Single Detached (RS1/D)	Low Density Townhouses (RTL4)
Number of Units:	Previously 3 dwelling units	24 dwelling units

	Zoning Bylaw/OCP Requirement	Proposed	Variance
Floor Area Ratio:	0.60	0.60	None permitted
Buildable Floor Area:	2,558.46 m ² (27,539.03 ft ²)	2,550.85 m ² (27,457.12 ft ²)	None permitted
Lot Coverage - Building:	Max. 40%	36.9%	None
Lot Coverage – Non-porous Surfaces:	Max. 65%	51.5%	None
Lot Coverage – Live Landscaping:	Min. 25%	25.0%	None
Minimum Lot Size:	2,500 m ²	4,264.1 m ²	N/A
Minimum Lot Width – Bridgeport Road:	50 m	74 m	None
Setback – Front Yard (South):	Min. 6.0 m	5.2 m	Variance Requested
Setback – Side Yard (East):	Min. 3.0 m	Building 1 - 7.5 m Building 2 - 10.6 m Building 3 - 3.6 m	None
Setback – Side Yard (West):	Min. 3.0 m	Building 6 - 3.3 m Building 7 - 10.4 m Building 8 - 7.5 m	None
Setback – Rear Yard (North):	Min. 3.0 m	Ground Floor – Min. 4.5 m 2 nd Floor - 6.0 m	None



	Zoning Bylaw/OCP Requirement	Proposed	Variance
Height (m):	Max. 12.0 m (3 storeys)	Buildings 1, 2, 7, 8 - 11.8 m (3 storey) Buildings 3, 4, 5, 6, - 8.97 m (2 storey)	None
On-site Vehicle Parking Spaces: Regular (R) 2.0/unit Visitor (V) 0.2/unit	Min. 48 (R) Min. 5 (V)	48 (R) 5 (V)	None
Small Size (Max. 50%):	24 (R) 2 (V)	24 (R) 2 (V)	None
Tandem Vehicle Parking Spaces (Max. 50%):	24 (R)	N/A	None
On-site Accessible Parking Spaces (Min. 2%):	1 Van Accessible	1 Van Accessible	None
Total:	53	53	None
On-site Bicycle Parking Spaces:	Class 1 (1.25/unit) - 30 Class 2 (0.2/unit) - 5	Class 1 - 32 Class 2 - 5	None
Vertical Spaces (Max. 33%):	9	8	None
On-site Loading Space:	1 medium-size (can manoeuvre on-site; designated space not required)	1 medium size (can manoeuvre on-site; designated space not required)	None
Amenity Space – Indoor:	Min. 70 m ²	Cash-in-Lieu	N/A
Amenity Space – Outdoor:	Min. 6 m ² (i.e., 144 m ²)	250.4 m ²	N/A

Excerpt from the Minutes of The Advisory Design Panel Meeting

Thursday, December 19, 2019 – 4:00 p.m. Rm. M.1.003 Richmond City Hall

1. DP 18-829233 – 24-UNIT TOWNHOUSE DEVELOPMENT

ARCHITECT:	Interface Architecture
LANDSCAPE ARCHITECT:	PMG Landscape Architects Ltd.
PROPERTY LOCATION:	10671, 10691 and 10751 Bridgeport Road

Applicant's Presentation

Kenneth Chow, Interface Architecture Inc., and Mary Chan Yip, PMG Landscape Architects, presented the project and answered queries from the Panel on behalf of the Applicant.

Panel Discussion

Comments from Panel members present were as follows:

- consider relocating the proposed accessible parking stall, i.e. V2, to visitor parking stall V3 as it is closer to the convertible units; *Idea considered earlier but not possible because both V3 and V4 cannot accommodate the wider width required for the accessible parking space. Visitor accessible space V2 has also since been further widened to be van-accessible.*
- consider installing a vertical lift in lieu of a stair lift for the convertible units as it is easier for people using walkers and in wheelchairs than providing equipment on each floor; A vertical lift would have functional advantages, but would require additional space; a straight-run stair lift is good solution for these smaller units.
- appreciate the provision of pocket doors for ground floor powder room, second floor ensuite washrooms and walk-in closets; consider installing outward swinging doors with the hinge on the right to enhance accessibility; *The master bedroom door can be altered and replaced with an out-swinging door upon conversion, however kept as-is pre-conversion to avoid the need for excessive resident movement at top of stairs.*
- consider installing an outward swinging door with the hinge on the right side of the garage door entrance to provide more accessibility; The door swings into the unit from the garage in Unit Ac have been retained because an outswinging door may conflict with the parking space. The swing (i.e. hinge at front door side) would presumably aid access from the garage to the interior of the unit.

- consider raising the pedestrian crossing for the north-south pedestrian walkway at the centre of the rear internal drive aisle to enhance the safety of pedestrians; *The pavered sections north & south of the amenity area, will be raised 2" c/w rollover curbs.*
- concerned about the narrowness of the 20-foot wide separation between the two threestorey buildings in the middle of the site; The gap between Buildings 2 & 7 is oriented north-south which results in direct sunlight penetration during mid-day hours. The roofs of both buildings are hipped (i.e. rather than gabled) to reduce shadowing into this area. The pedway design has been simplified for a less cluttered feel in this amenity area. Also, the amenity area has an aspect ratio of less than 3:1 so it should not feel 'narrow'.
- consider installing permeable pavers across the drive aisles adjacent to the end units of the three-storey buildings in the middle of the site (i.e., Unit 8 in Building 2 and Unit 17 in Building 7) to announce the motorist's arrival into a different area; *Done*.
- reconsider the curved shallow furred out portions of the front facades as these appear forced and could give rise to detail issues; The detailing of the curved furred out portions of the front facades of Buildings 1 & 8 has been revised and reviewed by the envelope engineer. The top of the furred out portions are now protected by pre-made metal flashing instead of roof shingles. Furthermore, the furred portions were made slightly thicker (from 3 ½" to 6"). The curves are an architectural device that helps unify the front facade of Buildings 1 & 8, and provides motif that is used (to a lesser extent) to create an identity to the 3 rows of buildings. The intent is for the curved flashing to be dimensioned and painted to match the exterior corner trims of the cement board cladding.
- stoops in the three-storey front buildings facing Bridgeport Road appear out of scale relative to the gable size; the urban character of the stoops in the middle three-storey buildings are more balanced to the three-storey buildings; Noted. No changes were made because, on the contrary, we feel the ground level gables help create a strong building 'base' (i.e. tripartite façade design) and enhances the visual engagement with passersby at the ground level.
- a recreation area which could include a tai-chi space in lieu of the proposed passive play area may make more sense in the proposed development; *The passive play area in the SW corner has been re-designed and is ideal for this activity.*
- consider installing a play boat in lieu of a play house in the central outdoor amenity area which is more consistent with the proposed whale tail bench; The Landscape architect has not recommended this option because the required safety zone around play boats of equal play value that were explored is minimum 6 ft, which cannot be accommodated in the central outdoor amenity area. The design concept for this space is that of coloured play surfaces with rubber balls for climbing and a play house. The only alternatives to these pieces that can be accommodated within the space are play panels, which do not provide equal play value to the pieces selected.
- the openness of the north-south public pathway in the middle of the site is an appropriate approach as it provides a sense of orientation and direction for residents in the neighbourhood; *Yes, that was the intention*.

- consider installing a special landscape feature at the north entrance to the north-south pedestrian walkway to identify it as a public entry for residents in the immediate neighbourhood; Added wood trellis feature as a visual terminus just clear of the sewer right-of-way (until the public pathway is eventually opened up to the north properties), which is both a practical and visual improvement in the north amenity area (i.e., more centrally positioned as a hard landscape element to be experienced from both sides).
- ensure that the proposed bollard and wall lighting along the north-south pedestrian walkway will provide adequate lighting for pedestrians; Bollard lighting clearly shown on L1, L2, and partial plans. Lighting positions are coordinated with benches and mailbox. Will ensure engineer to design additional pedway lighting (i.e. area lights on wall or lamp standards) if appropriate.
- support the different paving patterns over portions of the drive aisle as these would enhance the landscaping on the site; *Noted*.
- sidewalks along both edges of the driveway entrance help create a pedestrian territory along the driveway; consider continuing this approach throughout the internal drive aisle; Sidewalks primarily intended for pedestrian safety at site entry and through the north-south central pathway. Due to the tight layout, not possible to add sidewalks throughout the entire drive aisle loop.
- consider installing vertical buffers along the east and west ends of the internal drive aisle to mitigate the impact of headlight glare on adjacent single-family homes; 6' high fences will already adequately serve this function, and the east and west ends of the drive-aisle should remain as unobstructed as possible by vegetation to facilitate potential future extension of the drive-ailse to neighbouring sites in the future.
- proposed design of the north-south pedestrian walkway does not read as a public walkway due to the location of the outdoor amenity area adjacent to the pedestrian walkway; Improvements have been made: (i) changed Paver Pattern 'A' to 'C' for a visually continuous pedway surface treatment, (ii) removed the playful concrete slab insets which may be confusing, (iii) shifted the north end trellis structure southward to be visually closer to Bridgeport Rd, and (iv) coordinated the placement of the required 3 pedway signs.
- the outdoor amenity area at the southwest corner of the site is underutilized; consider utilizing a portion of the area for a semi-active play space; This SW area is redesigned to be a more usable passive and semi-active area, complete with log and boulder seating, sod lawn, and added a 15' x 15' wood deck at the north end of this area for tai-chi.
- active and passive play areas should be usable by residents; Understood.
- consider enhancing the landscaping including tree planting to anchor the southeast corner of the site and balance the large protected tree in the landscaping in the southwest corner of the site; *The landscaping of the common SE open area has been improved to make it more usable by adding a bench for seating and shifting the proposed coniferous tree to the south to help visually anchor the line of trees along the streetfront year round.*

- end units of Buildings 1 and 8 facing the entry driveway need further architectural treatment; the Applicant should not rely only on landscaping for corner treatments; *The two facades facing the driveway now have a picture window at the living rooms, complete with shed roof over, to create a more articulated end unit corner.*
- the curved shallow furred out portions of the front facades may no longer be necessary considering that the circumstances which forced the proposed design are no longer applicable; *The shallow furred out portions create a visually interesting motif for the overall development and also enables cladding transitioning.*
- consider relocating the play area to the southeast corner of the site which is currently underused; Several locations for the outdoor play area were proposed early in the design process, but a front yard location is not acceptable as it is inconsistent with the Design Guidelines in the OCP due to proximity to Bridgeport Road. The play area as proposed is more desirable as it is centrally-located, provides more visual interest opposite the main site entry, and is located further away from Bridgeport Road.
- support the proposed curvilinear piece on the front facades which is a clever move; however, the vertical Hardie cladding furred out 3 ½ inches proud of the horizontal siding is not enough; consider adding more depth to at least 18 inches to create a more attractive building elevation and to avoid detailing issues over the long term; *Ideally, an increased depth is preferred, however the front yard setback was increased well into the project design, and limited our building depths. The detail has been finetuned, both visually and technically, and the furred out portions were made slightly thicker (from 3 ½ to 6").*
- review the use of brick on the front façade of the buildings facing Bridgeport Road; consider a stronger use of brick along the base of the front buildings other than on the front facade; and *This was considered by the design team and the owner, but the intent was to use brick to accentuate the entry gable elements, and let the coloured vertical Hardie siding read continuously from the roof soffitts down to grade.*
- consider installing a raised deck around the significant tree at the southwest corner of the site; the Applicant could work with the project's arborist to ensure that the retained tree will be protected. A wood deck that is elevated from the existing grade (to enable tree retention) is now proposed to enable semi-active use of this southwest outdoor area, such as tai-chi.

The following comments were submitted by Jubin Jalili and read into the record by Sara Badyal:

- the project is showing compliance with EnerGuide rating of 82 by use of air source heat pumps and the owner has committed to the use of heat recovery units which is a great energy savings feature for the project; *Correct.*
- per architectural drawings (i.e., Drawing A1.2) provided by the Applicant, the outdoor units are proposed to be installed in the pathways between the townhomes at the back, on the balconies for the middle row and beside the property walkway for the front units; the installation details, such as support structure, acoustic enclosure (if any) and the refrigerant pipe routing to individual townhomes need to be detailed; and *The installation details will be incorporated into the Building Permit drawings.*

grouping the outdoor units may have adverse noise impact to the adjacent townhomes and needs to be reviewed by the acoustic consultant. When asked for a review of the outdoor units, our acoustic consultant immediately suggested that they should not be grouped between townhomes. The mech units are now relocated to the decks and rear yards and noise mitigation measures are proposed consistent with the acoustic report (neoprene vibration sleeves and isolators). See the supplemental acoustic report assessing the outdoor condensing units.



Development Permit

No. DP 18-829233

To the Holder:	1085948 BC Ltd
Property Address:	10671, 10691, 10751 Bridgeport Road
Address:	2143 West 36th Avenue Vancouver BC V6M 1L3

- 1. This Development Permit is issued subject to compliance with all of the Bylaws of the City applicable thereto, except as specifically varied or supplemented by this Permit.
- 2. This Development Permit applies to and only to those lands shown cross-hatched on the attached Schedule "A" and any and all buildings, structures and other development thereon.
- 3. The "Richmond Zoning Bylaw 8500" is hereby varied to reduce the minimum front yard along Bridgeport Road from 6.0 m to 5.2 m.
- 4. Subject to Section 692 of the Local Government Act, R.S.B.C.: buildings and structures; off-street parking and loading facilities; roads and parking areas; and landscaping and screening shall be constructed generally in accordance with Plans # 1.A to # 3.L and Reference Plans, attached hereto.
- 5. Sanitary sewers, water, drainage, highways, street lighting, underground wiring, and sidewalks, shall be provided as required.
- 6. As a condition of the issuance of this Permit, the City is holding the security in the amount of \$328,219.10. to ensure that development is carried out in accordance with the terms and conditions of this Permit. Should any interest be earned upon the security, it shall accrue to the Holder if the security is returned. The condition of the posting of the security is that should the Holder fail to carry out the development hereby authorized, according to the terms and conditions of this Permit within the time provided, the City may use the security to carry out the work by its servants, agents or contractors, and any surplus shall be paid over to the Holder. Should the Holder carry out the development permitted by this permit within the time set out herein, the security shall be returned to the Holder. The City may retain the security for up to one year after inspection of the completed landscaping in order to ensure that plant material has survived.
- 7. If the Holder does not commence the construction permitted by this Permit within 24 months of the date of this Permit, this Permit shall lapse and the security shall be returned in full.

Development Permit No. DP 18-829233

To the Holder:	1085948 BC Ltd
Property Address:	10671, 10691, 10751 Bridgeport Road
Address:	2143 West 36th Avenue Vancouver BC V6M 1L3

8. The land described herein shall be developed generally in accordance with the terms and conditions and provisions of this Permit and any plans and specifications attached to this Permit which shall form a part hereof.

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This Permit is not a Building Permit.


AUTHORIZING RESOLUTION NO. DAY OF , .

ISSUED BY THE COUNCIL THE

DELIVERED THIS DAY OF

MAYOR



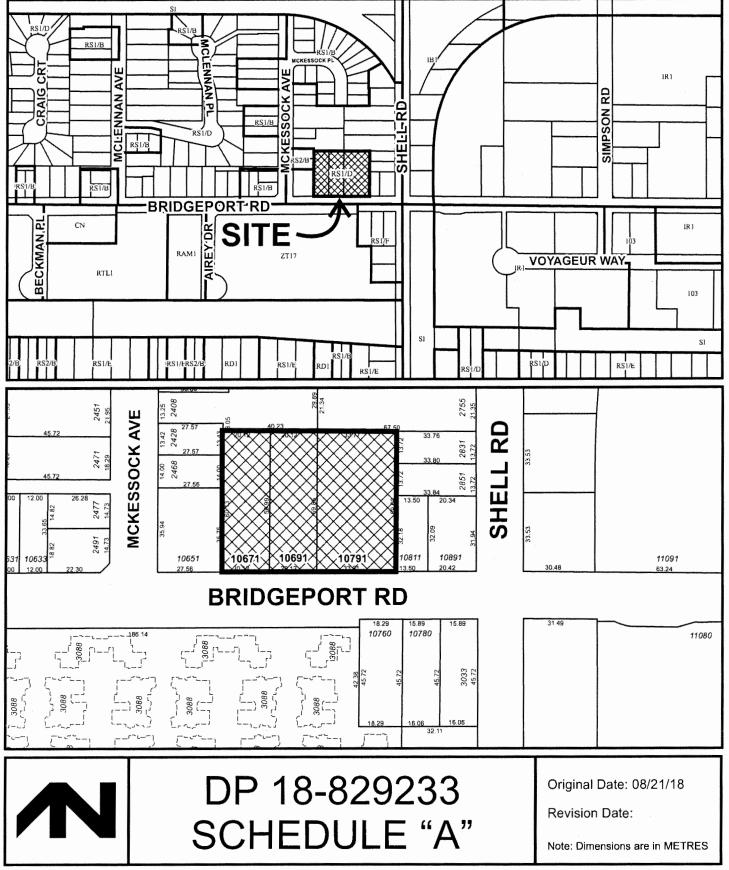

DEVELOPMENT PERMIT RESUBMISSION - 19 JULY 2021

PROPOSED 24-UNIT TOWNHOUSE DEVELOPMENT 10671, 10691, 10751 BRIDGEPORT ROAD




NOTE: MINOR REVISIONS TO SIDE ELEVATIONS OF BUILDING 1 & 8

VIEW ALONG BRIDGEPORT ROAD

RZ17-771592 DP18-829233 **PLAN # 1.A**

REVISIONS	
JULY 29, 2021	DP RE-SUBMISSION
MAR 28, 2021	DP RE-SUBMISSION
AUG 19, 2020	DP RE-SUBMISSION
DEC 19, 2019	ADP SUBMISSION
OCT 4, 2019	DP RE-SUBMISSION
NOV 9, 2018	RZ RE-SUBMISSION
SEPT 21, 2018	RZ RE-SUBMISSION
JULY 16, 2018	DP SUBMISSION
	RE-SUBMISSION
MAY 14, 2018	
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CONTEXT PLAN 43

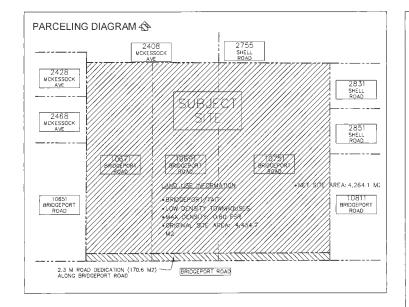



CONTACTS Architect

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Civil Engineer (onsite/offsite) CORE CONCEPT CONSULTING LTD.

#220 - 2639 VIKING WAY RICHMOND, B.C. V6V 387 Alth: BRUCE DUFFY Tel: 604-249-5040 Fax: 604-249-5041 Email: bcduffy@coreconce

Landscape Architect

PMG LANDSCAPE ARCHITECTS SUITE C100 - 4186 STILL CREEK DRIVE BURNABY, BC V5C 6G9 Tel: 604-294-0011 Attn: Mary Chan-Yip Fax: 604-294-0022 Email: Mary@pmglandsca

Arbourist

ARBORTECH CONSULTING LTD. #200 - 3740 CHATHAM STREET RICHMOND, BC V7E 2Z3 Tel: 604-275-3484 Attn: Norm Hol

Fax: 604-275-9554 Email: norm@aclgroup.ca Transportation

ISL ENGINEERING AND LAND SERVICES #200 -8506 200th STREET LANGLEY, 8C V2Y OM1 Tel: 604-371-0091 Mol: 778-788-2132 Attn: Borg Chan Email: bchan@islenginee

Energy CAPTURE ENERGY 8070 HUDSON STREET VANCOUVER, BC V6P 4M1 Attn: Scott Silverthorn Tel: 604-787-1952 Email: scott@capture-ener Acoustical

BAP Acoustics Ltd. #122-2227 St. JOHNS STREET PORT MOODY, BC V3H 2A6

Attn: Eric de Santís Tel: 604-492-2992 Email: eric@bapacoustics.e Electrical

LIEW ENGINEERING Ltd.

108-11121 HORSESHOE WAY RICHMOND, BC V7A 5G7 Tel: 604-277-3157 Attn: Adrien Ng Email: rliewengltd@telus.ne

ENGINEERING ISSUES

Human Comfort

TO MEET COMFORT LEVELS PER ASHRAE 55-2004 (I.E. SUFFICIEN VENTILATION/FRESH AIR WHEN WINDOWS ARE CLOSED DUE TO N CONDITIONING SYSTEM WILL BE INSTALLED TO PROVIDING HEAT Acoustic

TO MEET CMHC NOISE CRITERIA FOR RESIDENTIAL PROJECTS WI TO MEET CMHC NOISE CRITERIA FOR RESIDENTIAL PROJECTS WIT POLICY AREA. NOISE MITOCATION MEASURES AREA PROPOSED AT A (PER INTERIOR ENVIRONMENTAL NOISE CONTROL STUDY, MARCH "WINDOWS - SLE2 DOUBLE GUAZED WINDOWS AT ALL BEDROORDS "SOUTH FACING EXTERIOR WALLS AT BULLING 1 & B MASTER BEC 2X6 INTERIOR FRAMING, SHEATHING, AND EXTERIOR 2 × 6 FRAMI "CELLING SAT LIVEL'S BEDROORDS, USE RESILIENT METAL CHANNE LAYERS OF 5/8° GYPSUM WALLBOARD

TO ASSESS COMPLIANCE WITH NOISE BYLAW NO.8856, SEE ACOU MARCH 24, 2021 (ASSESSMENT OF CONDENSING UNITS: * OUTDOOR CONDENSING UNITS MAX RATED SOUND LEVEL OUTPUT 53dBA al 1m * USE NEOPRENE VIBRATION SLEEVES AND ISOLATORS (SEE REPORT)

CONSULT TWO ACOUSTIC REPORTS FOR THE FULL REQUIREMENTS

Energy

TO MEET ENERGUIDE 82 CRITERIA, THE CEA REPORT (DATED OCT. 8, 2019) SPECIFIES THE MECHANICAL SPECIFICATION DETAILS OUTLINED BELOW: SOLAR HOT WATER READY (2) PIERS TO FUTURE PANELS) AIR SOLRCE HEAT PUMP, PROVIDING BOTH DUCTED HEATING AND COOLING PROJECT MECHANICAL ENGINEER TO PROVIDE LETTER TO CITY OF RICHMAND CONFIRMING THAT THE EOUIPMENT COMPLIES WITH NOISE REG BYLAW NO. 8856

TO MEET THE CITY'S ELECTRIC VEHICLE CHARGING BYLAW: • ALL RESIDENTIAL PARKING SPACES, EXCLUDING VISITOR PARKING SPACES, SHALL FEATURE EV CHARGING OUTLETS CAPABLE OF PROVIDING 'LEVEL 2' EV CHARGING

LEVEL 2 EV: VOLTAGE 208 V TO 240 V. 15A TO 80A

	PROJECT DESCRIPTION
hitecture.com	A 24-UNIT TOWNHOUSE DEVELOPMENT IS PROPOSED FOR THIS 4434.7 M2 (1) 10 ACRE) SITE IN THE BRIDGEPORTITAIT NEIGHBOURHOOD. THE 3 EXISTING PARCELS (APPROX, 242 COMBINED FRONTAGE) ARE CURRENTLY 20NER SITE AND ARE SUBJECT TO THE BRIDGEPORTITAIT OCP AREA PLAN. MAIN FRONTAGE FACES BRIDGEPORT (AN ARTERIAL ROAD). SIDE AND REAR ABUTTING RESIDENTIAL SINGLE FAMILY LOTS THE PROJECT COMPRISES OF 24 UNITS IN 8 BUILDINGS (4 DUPLEXES AND FOUR 4-PLEXES).
	THE PROJECT INCLUDES TWO CONVERTIBLE UNITS (UNIT #9, #10), AND ALL UNITS CONTAIN AGING-IN-PLACE FEATURES.
	ONE SIGNIFICANT ON-SITE TREE IS TO BE PROTECTED AND RETAINED AT SW CORNER (TREE #958, DOUGLAS-FIR).
	THE TARGET ZONING IS RTL4, WHICH PERMITS UP TO FAR 0.60 + FAR 0.1 FOR ANY INDOOR AMENITY SPACE, SUBJECT TO:
eptconsulting.com	1. CONTRIBUTION TO THE AFFORDABLE HOUSING RESERVE.
	2. COMPLIANCE WITH THE OCP MULTI-FAMILY DESIGN GUIDELINES.
	 PROVISION OF A 2.3M ROAD DEDICATION ALONG THE ENTIRE BRIDGEPORT ROAD FRONTAGE.
ape.com	 PROVISION OF PUBLIC-RIGHT-OF PASSAGE (PROP) CONNECTING McKESSOCK PLACE TO BRIDGEPORT ROAD: a. VIA A PEDESTRIAN WALKWAYS THROUGH THE SITE
	b. VIA THE INTERNAL DRIVE AISLE LOOP
	ONE ZONING VARIANCE IS REQUESTED:
	1. FRONT BUILDING SETBACK FROM 6.0 M TO 5.2 M
	DRAWING LIST
	Architectural
	A0.0 COVER SHEET A1.0 PROJECT DATA
	A1.1 SITE PLAN
ring.com	A1.2 FIRE ACCESS PLAN, PARKING/TRUCK TURNING PLAN A1.3 AMENITY OVERLAY
	A1.4 LOT COVERAGE OVERLAY
	A1.5 PERMEABILITY OVERLAY: NON-POROUS SURFACE A1.6 PERMEABILITY OVERLAY: POROUS SURFACE &
	LIVE PLANT MATERIAL
ergy.ca	A1.7 FAR BREAKDOWN, FAR OVERLAY BY UNIT TYPES A1.8 FAR OVERLAY BY BUILDINGS: BUILDINGS 1-6
	A1.9 FAR OVERLAY BY BUILDINGS: BUILDINGS 7 & 8
	A1.10 NEIGHBOURHOOD DEVELOPMENT SCENARIOS #1,#2
	A1.11 CONCEPTUAL LIGHTING PLAN A2.1 CONVERTIBLE UNIT AC BEFORE & AFTER
	A2.2 UNIT A PLANS
com	A2.3 UNIT B & C PLANS A3.1 PLANS: BUILDINGS 1 & 8
	A3.2 PLANS: BUILDINGS 2 & 7
	A3.3 PLANS: BUILDINGS 3 & 4
	A3.4 PLANS: BUILDINGS 5 & 6 A3.5 ELEVATIONS: BUILDINGS 1 & 8
	A3.6 ELEVATIONS: BUILDINGS 2 & 7
et	A3.7 ELEVATIONS: BUILDINGS 3 & 4
	A3.8 ELEVATIONS: BUILDINGS 5 & 6 A4.1 DETAIL: FRONT FACADE OF BUILDINGS
	A4.2 FRAMING DETAIL OF BOX WINDOWS
	A5.1 STREETSCAPE 1, 2, 3 & SITE SECTION A A5.2 SITE SECTIONS B, C, D & E
	A5.3 PARTIAL SITE SECTION F& G: INTERIM AND ULTIMATE
	FRONTAGE CONCEPT A6.1 3D VIEWS ALONG BRIDGEPORT FRONTAGE
л	A6.2 3D AERIAL VIEW, VIEW OF DUPLEXES
NOISE), AN AIR ING/COOLING.	A9.1 EXTERIOR MATERIAL & COLOUR
	A9.2 SHADOW STUDY
ITHIN THE ANSD	Landscape Architect
ALL BEDROOMS	L1 LANDSCAPE PLAN
CH 26, 2021): MS	L2 PLAN SCHEDULE AND KEY PLAN
EDROOMS: WITH	L3 PLANTING AND GRADING PLAN L4 PLANTING AND GRADING PLAN
MING, SHEATHING	L5 PLANTING AND GRADING PLAN
INELS WITH 2	L6 PLANTING AND GRADING PLAN
	L7 PLANTING AND GRADING PLAN L8 TREE MANAGEMENT PLAN
USTIC REPORT,	L8 TREE MANAGEMENT PLAN L9 LANDSCAPE DETAILS

- LANDSCAPE DETAILS L9
- L10 LANDSCAPE DETAILS
- L11 LANDSCAPE ENLARGEMENTS L12 LANDSCAPE SPECIPICATIONS

BLDG NO.	NO. UNIT	BLDG GROSS	BLDG EXEMPT	BLDG FAR AREA (SF)	BLDG FAR AREA (M2)
1	4 x B	6,658 sf	(2,333 sf)	4,325 sf	401.79 M2
2	4 x C	7.092 sf	(2,536 sf)	4,556 sf	423.25 M2
3	2 x Ac	3,445 sf	(1,021 sf)	2,424 sf	225.19 M2
4	2 x A	3,406 sf	(982 sf)	2,424 sf	225.19 M2
5	2 x A	3,406 sf	(982 sf)	2,424 sf	225.19 M2
6	2 x A	3,445 sf	(1,021 sf)	2,424 sf	225.19 M2
7	4 x C	7,092 sf	(2,536 sf)	4,556 sf	423.25 M2
8	4 × B	6,601 sf	(2,276 sf)	4,325 sf	401.79 M2
TOTAL				27,458sf	2,550.85 M2

ZONING SUMMARY

	CIVIC ADDRESS: LEGAL DESCRIPTION:	10671/ 10691/ 10751 BRIDGEPO CURRENTLY LOTS 190, 101, PL
	LOT SIZE (3-LOTS):	ALL OF SECTION 23, BLOCK 5 M ORIGINAL SITE: 4,4 2.3m ROAD DEDICATION: 170
	HERIT/ALR/ESA/NEF:	NET SITE: 4,26 NO / NO / NO / YES (ANSD ARE/ EXCEPT NEW SINGLE-FAMILY)
	AREA PLAN / OCP:	BRIDGEPORT AREA PLAN 2.12
		PERMITTED
	LOT ZONING:	RTL4 (CURR: RS1/D)
	MINIMUM LOT SIZE:	50M WIDTH
	DENSITY (MAX):	FAR 0.6 + FAR 0.1 AMENITY (WITH CONDITIONS)
	LOT COVERAGE:	40% MAX FOR BLDGS
	LOT PERMEABILITY:	65% MAX NON-POROUS 25% MIN LANDSCAPED
	YARD SETBACKS:	6 0 M [18 69] MIN
	FRONT YARD (S) SIDE YARD 1 (E)	6.0 M [19.69'] MIN 3.0 M [9.84'] MIN;
	SIDE TARD I (E)	7.5 M [24.58'] MIN AT LEV. 3
	SIDE YARD 2 (W)	3.0 M [19.69'] MIN;
		7.5 M [24.58'] MIN AT LÉV. 3
	REAR YARD (N)	3.0 M [19.69'] MIN
		LEV 1: 4.5M - OCP 14.4.13 LEV 2: 6.0M - OCP 14.4.13
	YARD PROJECTIONS:	LEV 2. 0.00 - 00P 14:4:13
	PRINCIPAL BLDG	MAX 1.5M [4.92'] FRONT YD
	BAY WINDOWS	1.0M [3.28] FRONT
		0.6M [1.97] SIDE
	BALCONIES PERGOLAS ETC	1.5M[4.92'] BUT NOT AT SIDE BY CASE
	ELEC. RM ETC	0.6M [2'] REAR, SIDE YD
	ELEC. RM ETC	0.6M [2'] REAR, SIDE YD
	BUILDING HEIGHT:	12.0M MAX/3-STOREY - FRONT 9.0M MAX/ 2-STOREY - SIDE 9.0M MAX/ 2-STOREY - REAR
	FLOODPLAIN C.L.	TOP OF HAB FLR AT 0.3M MIN ABOVE RD CROWN
ĺ	PARKING REQUIRED:	48 (2.0/UNIT RESIDENTS) 4.8 (0.2/UNIT VISITORS)
	SMALL CARS	MIN 50% STANDARD
l	TANDEM SPACES H/C SPACES	MAX 50% OF UNITS 2% OF SPACES MIN.
	BICYCLE PARKING:	278 OF SFACES WIN.
	CLASS 1	30 (1.25 PER UNIT) MAX, 33% PLACED VERT.
l	CLASS 2	5 (0.2 PER UNIT)
l	AMENITY SPACE:	
l	COMMON OUTDR	144 M2 (6 M2/UNIT x 24)
	PRIVATE OUTDR	30 M2 (323 SF)/UNIT MIN 70 M2 OR PAY-IN-LIEU
l	GARBAGE [IN UNIT]:	DOOR TO DOOR PICKUP
l	GARBAGE CART	1 x 120 Litres
l	FOOD SCRAPS	1 x GREEN CART
		1 x KITCHEN CONT.
	MIXED CONT. MIXED PAPER	1 x CONTAINER 1 x CONTAINER
l	GLASS	1 x CONTAINER
	ON-SITE LOADING:	MEDIUM SIZE SPACE
Ľ		1

* ZONING VARIANCE REQUIRED

AVERAGE GRADE CALCULATION


	SITE	BLDG 1	BLDG 2	BLDG 3	BLDG 4	BLDG 5	BLDG 6	BLDG 7	BLDG 8	TOTAL AVG.
CORNER 1	1.29	1.95	1.95	1.95	1.95	1.95	1.95	1.95	1.95	
CORNER 2	1.22	1.95	1.95	1.95	1.95	1.95	1.95	1,95	1.95	
CORNER 3	1.60	1.95	1.95	1.95	1.95	1.95	1.95	1.95	1.95	
CORNER 4	1,14	1.95	1.95	1.95	1.95	1.95	1.95	1.95	1.95	
AVG GRD	1.31m	1.95m	1.95m	1,95m	1.95m	1.95m	1.95m	1.95m	1.95m	1.88m


Zoning Bylaw No. 8500


ORT ROAD, RICHMOND BC 2LAN 33687, AND WEST HALF LOT 101 PLAN 8212 NORTH, RANGE 6 WEST NWD 434.7 M2 [47,735 SF] [1.10 ACRES] 0.6 M2 [1,837 SF] 264.1 M2 (45.898 SF1 (1.05 ACRES) EA 2 - ALL USE TYPES MAY BE CONSIDERED 2 / TAIT 3.1 PROJECT SPECIFICS (PROPOSED) RTL4 (LOW DENSITY TOWNHOUSES) 74,18M [243,4'] (W) X 57.82M [189.7'] (D) FAR 0.60 (2.550.85 M2 / 4,264.1 M2) 36.9% (1,574.8 M2/4264.1 M2) 51.5% (2,193.3 M2/4264.1 M2) 25.0% (1,067.5 M2 / 4264.1 M2) 5.2M [17.06'] * BUIEDING 1: 7.5 M [24.61] BUILDING 2: 10.59 M (34.75') BUILDING 3: 3.62 M [11.92'] BUILDING 6: 3.31 M [10.86'] BUILDING 7: 10.4 M [34.25'] BUILDING 8: 7.51 M [24.43'] LEV 1: 4.5M [14.76'] LEV 2: 6.0M [19.69] 0.92M [3'] (ENTRY CANOPIES) 0.18M (0.58] SIDE N/A 0.13M [0.42'] SIDE YD (E) 0.44M [1.44'] SIDE YD (W) 11.8M [38.72'] - 3-STOREY N/A - EXCEED 7.5M FROM PL 8.97M [29.43'] - 2-STOREY 2.16M [7.09] FCL (=1.86M + 0.3M) 48 RESIDENT SPACES (24 STD, 24 SML) 5 VISITOR SPACES (2 STD, 2 SML, 1 H/C) 49% (26 SMALL / 53 SPACES) PROVIDE 1 H/C VISITOR SPACE 32 PROVIDED IN 24 UNITS 25% VERT. (8 OUT OF 32) 5 PROVIDED (OUTDOOR) 250.4 M2 [2695 SF] SHOWN PROVIDE 30.4 M2 [327 SF] MIN. PER UNIT PAY-IN-LIEU DOOR TO DOOR PICKUP 1 x 120 Litres 1 x GREEN CART x KITCHEN CONTAINER 1 x CONTAINER x CONTAINER 1 x CONTAINER N/A - CAN MANOEUVRE ON SITE

DP18-829233 PLAN # 1.B


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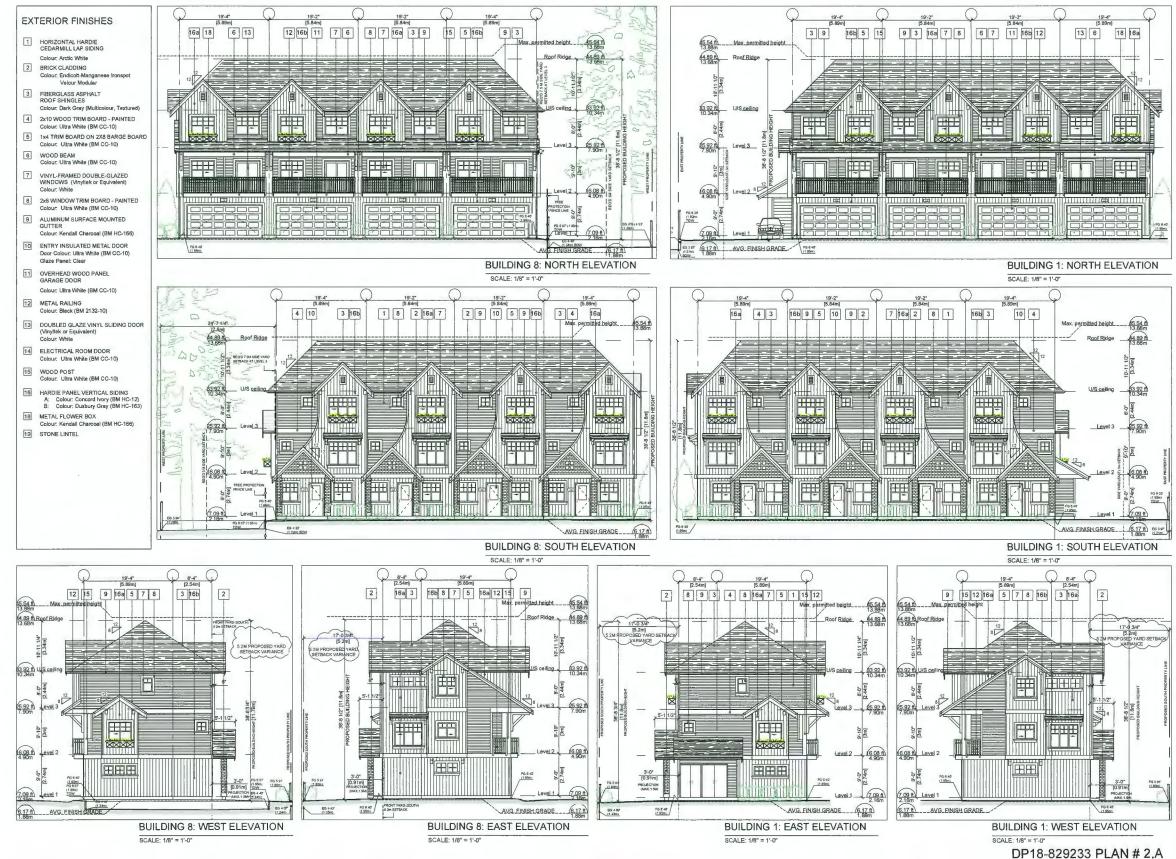


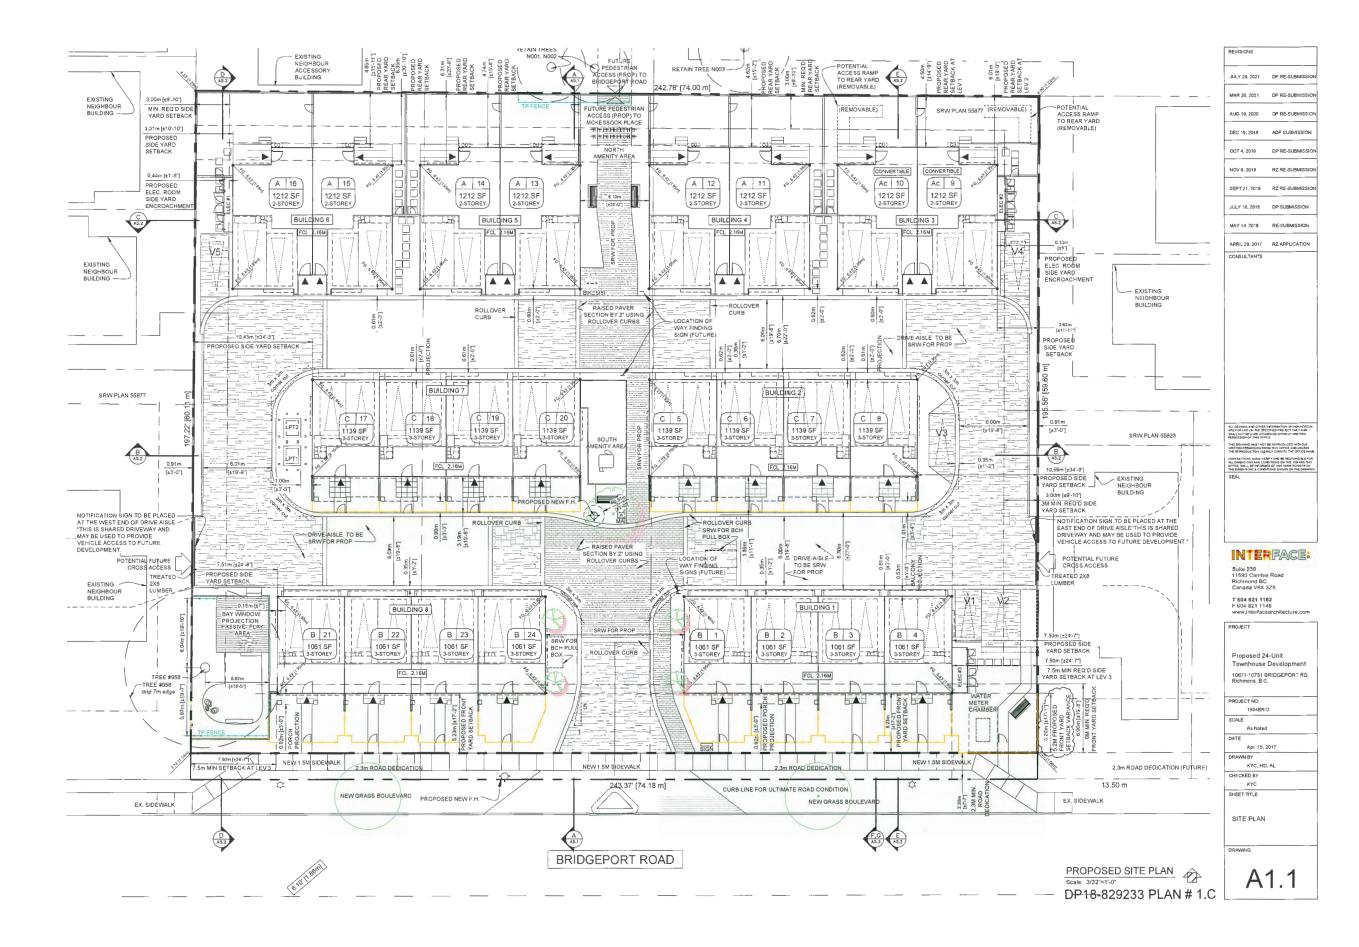

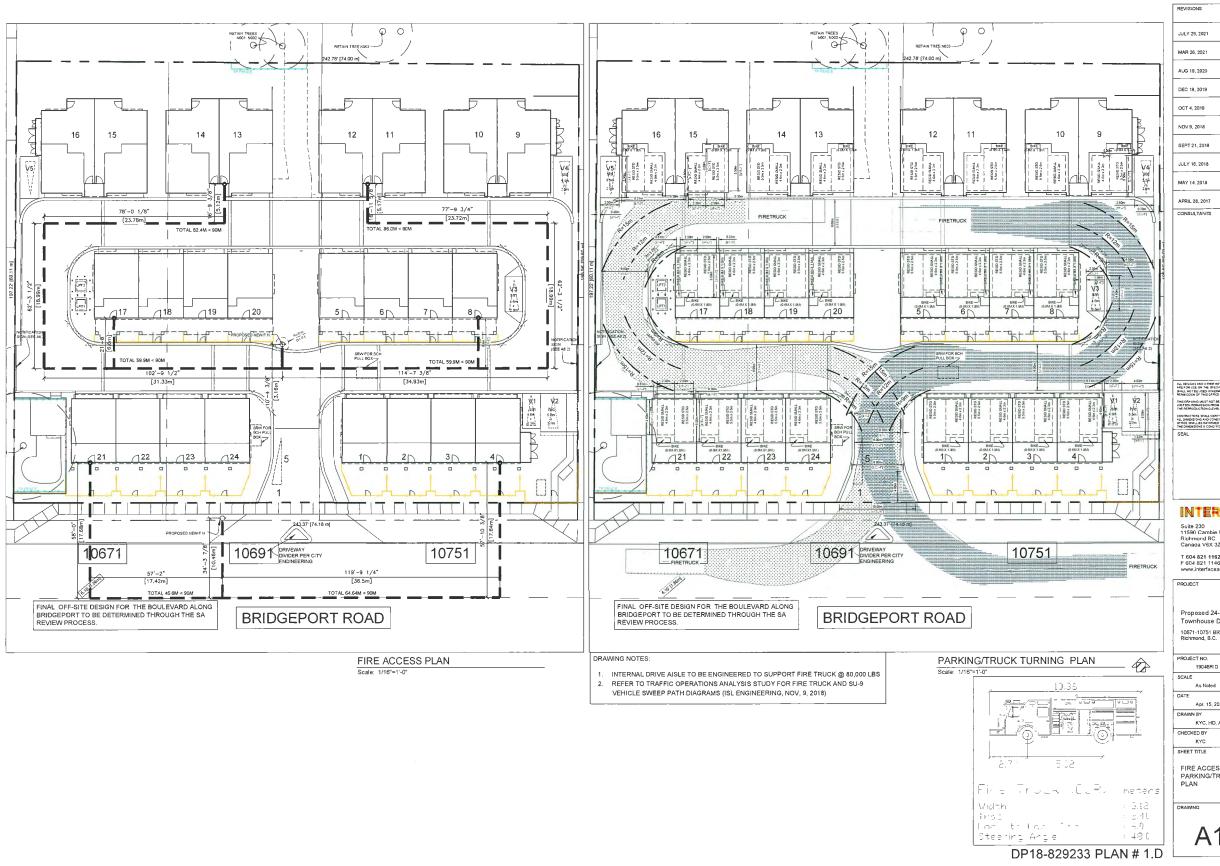
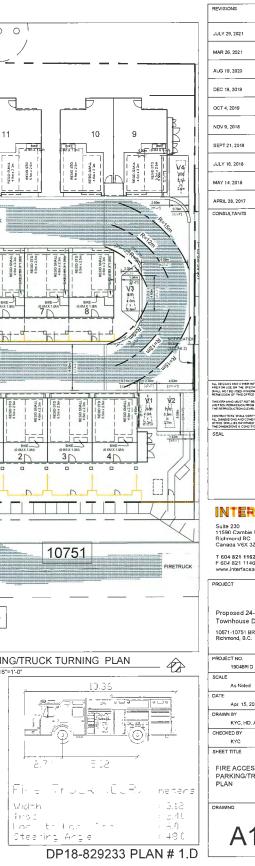
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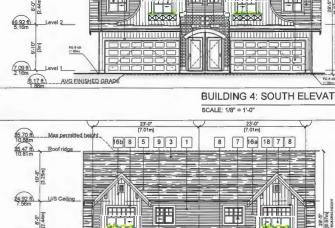


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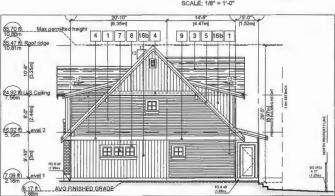


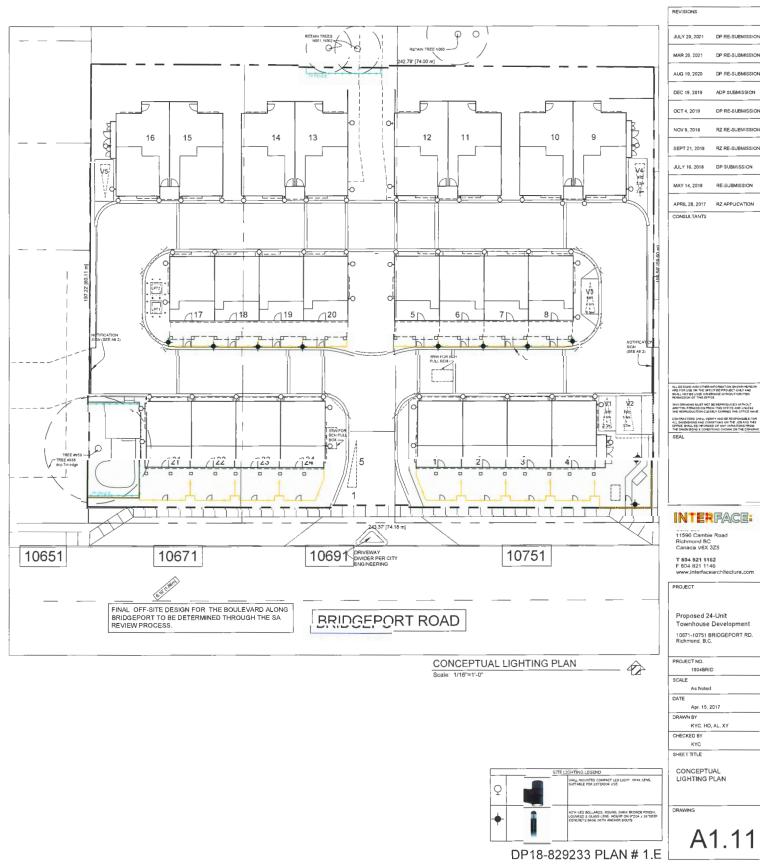
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10.81m Roof ridge

24.92 th U/S Ceiling





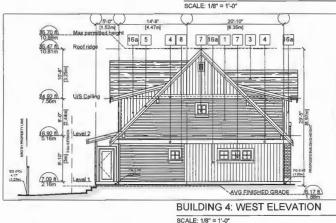


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EXTERIOR FINISHES

1 HORIZONTAL HARDIE CEDARMILL LAP SIDING Colour: Arctic White 2 BRICK CLADDING Colour: Endicott-Manganese Velour Modular 3 FIBERGLASS ASPHALT ROOF SHINGLES Colour: Dark Gray (Multicolour, Textured) 4 2x10 WOOD TRIM BOARD - PAINTED Colour: Ultra White (BM CC-10) 5 1x4 TRIM BOARD ON 2X8 BARGE BOARD Colour: Ultra White (BM CC-10) 6 WOOD BEAM Colour: Ultra White (BM CC-10) 7 VINYL-FRAMED DOUBLE-GLAZED WINDOWS (Vinyltek or Equivalent) Colour: White 8 2x6 WINDOW TRIM BOARD - PAINTED Colour: Ultra White (BM CC-10) 9 ALUMINUM SURFACE MOUNTED GUTTER Colour: Kendall Charcoal (BM HC-166) 10 ENTRY INSULATED METAL DOOR Door Colour: Ultra White (BM CC-10) Glaze Panel: Clear 11 OVERHEAD WOOD PANEL GARAGE DOOR Colour: Ultra White (BM CC-10) 12 METAL RAILING Colour: Black (BM 2132-10) 13 DOUBLED GLAZE VINYL SLIDING DOOR (Vinytlek or Equivalent) Colour: White 14 ELECTRICAL ROOM DOOR Colour: Ultra White (BM CC-10) 15 WOOD POST Colour: Ultra White (BM CC-10) 16 HARDIE PANEL VERTICAL SIDING A: Colour: Concord Ivory (BM HC-12) B: Colour: Duxbury Gray (BM HC-163) 18 METAL FLOWER BOX Colour: Kendall Charcoal (BM HC-166) 19 STONE LINTEL

18-829233	PLAN	#	2.C
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REVISIONS
JULY 29, 2021 DP RE-SUBMISSION
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INTERFACE:
11590 Cambie Road
Richmond BC Canada V6X 3Z5
T 604 821 1162 F 604 821 1146 www.interfacearchitecture.com
PROJECT
Proposed 24-Unit Townhouse Development
10671-10751 BRIDGEPORT RD. Richmond, B.C.
PROJECT NO.
1904BRID SCALE
As Noted DATE
Apr. 15, 2017 DRAWN BY
KYC, HD, AL CHECKED BY
KYC SHEET TITLE
ELEVATIONS: BUILDING 3 & 4
DRAWING
A3.7





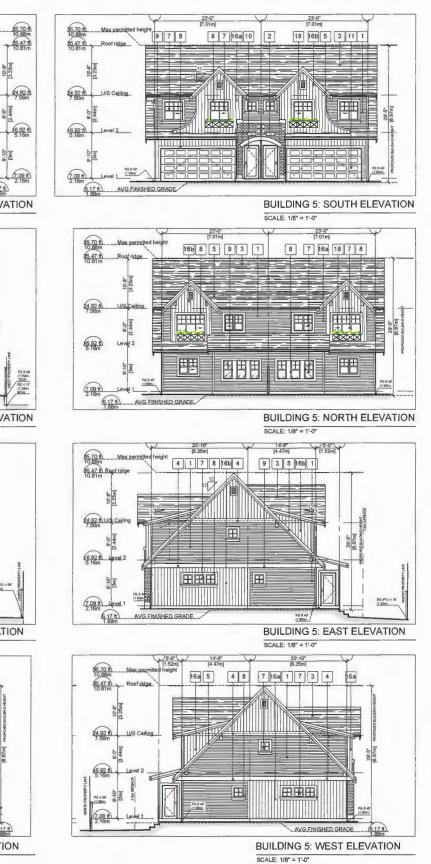





SCALE: 1/8" = 1'-0"







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15	WOOD POST Colour: Ultra White (BM CC-10)
16	HARDIE PANEL VERTICAL SIDING A: Colour: Concord Ivory (BM HC-12) B: Colour: Duxbury Gray (BM HC-163)
18	METAL FLOWER BOX Colour: Kendall Charcoal (BM HC-165)
19	STONE LINTEL


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As Noted	
Apr. 15, 2017	
KYC, HD, AL	
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DP18-829233 PLAN # 2.F

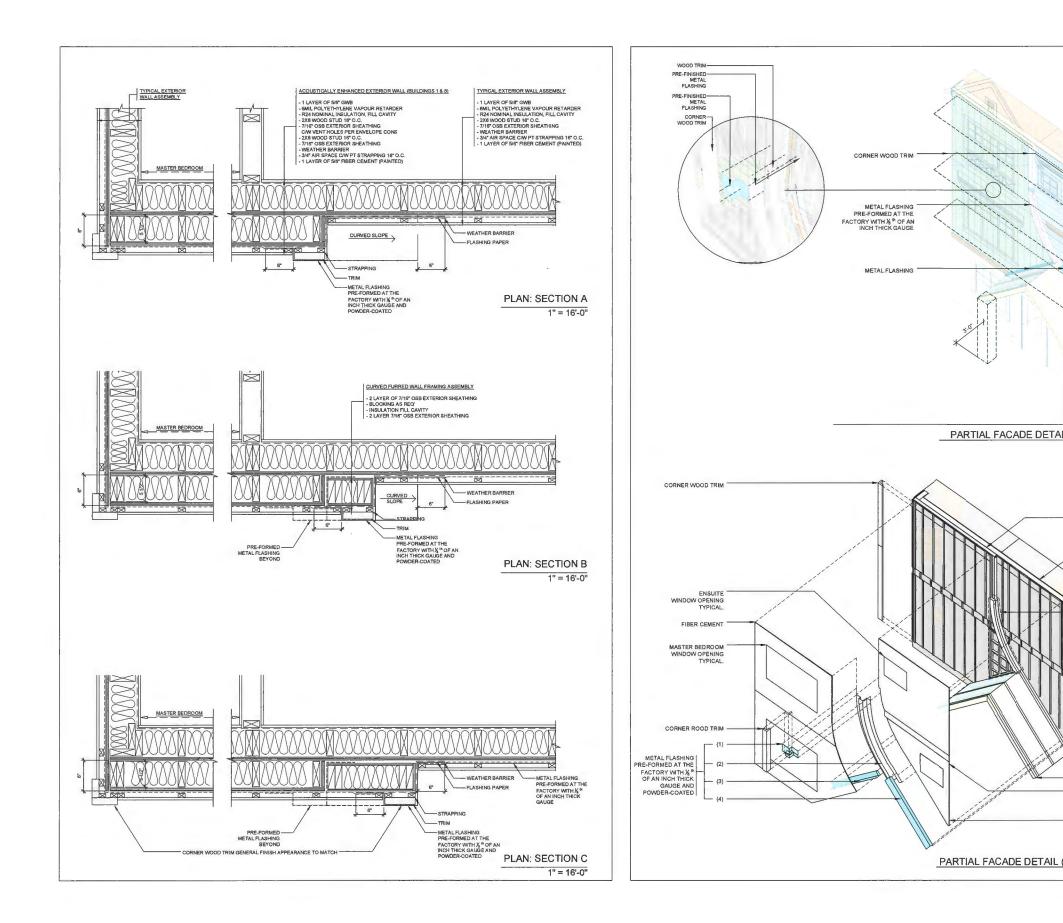


BUILDING 7 BUILDING 2 FG 5.25' (1.60m) FG 6.40 FG 4.40' ' (1.34m) BW (1.95m FG 6.40' (1.95m) _ _ _ _ . 2468 MCKESSOCK AVE STREETSCAPE 2: ALONG THE SOUTH PART OF INNER DRIVING AISLE LOOP (LOOKING NORTH)

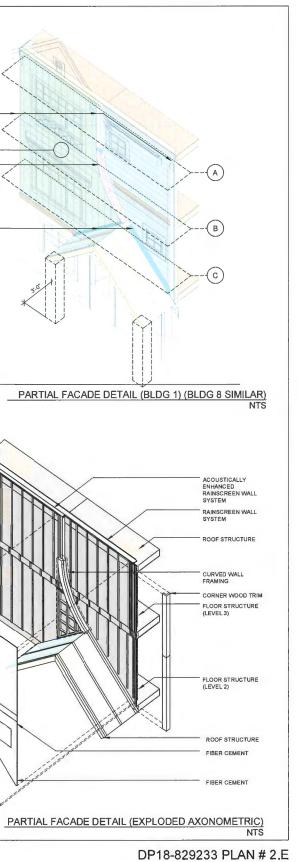



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INTER FACE: Suite 230
11590 Cambie Road Richmond BC Canada V6X 3Z5
T 604 821 1162 F 604 821 1146
www.interfacearchitecture.com
PROJECT
Proposed 24-Unit Townhouse Development
10671-10751 BRIDGEPORT RD. Richmond, B.C.
PROJECT NO.
19048RID SCALE
As Noted DATE
Apr. 15, 2017 DRAWN BY
KYC, HD CHECKED BY
KYC SHEET TITLE
STREETSCAPE 1, 2 & 3 AND SITE SECTION A
DRAWING
A5.1

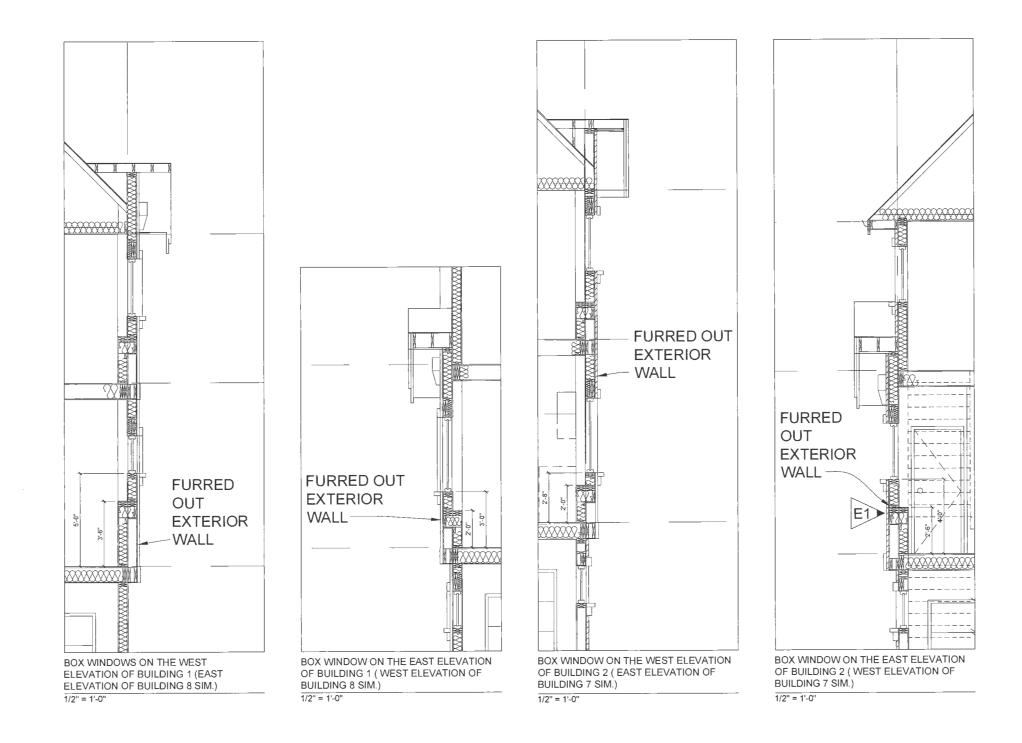

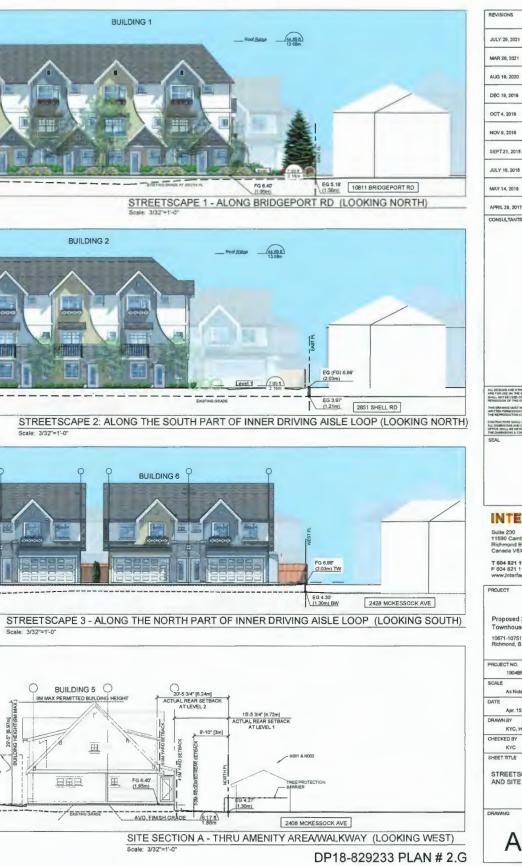



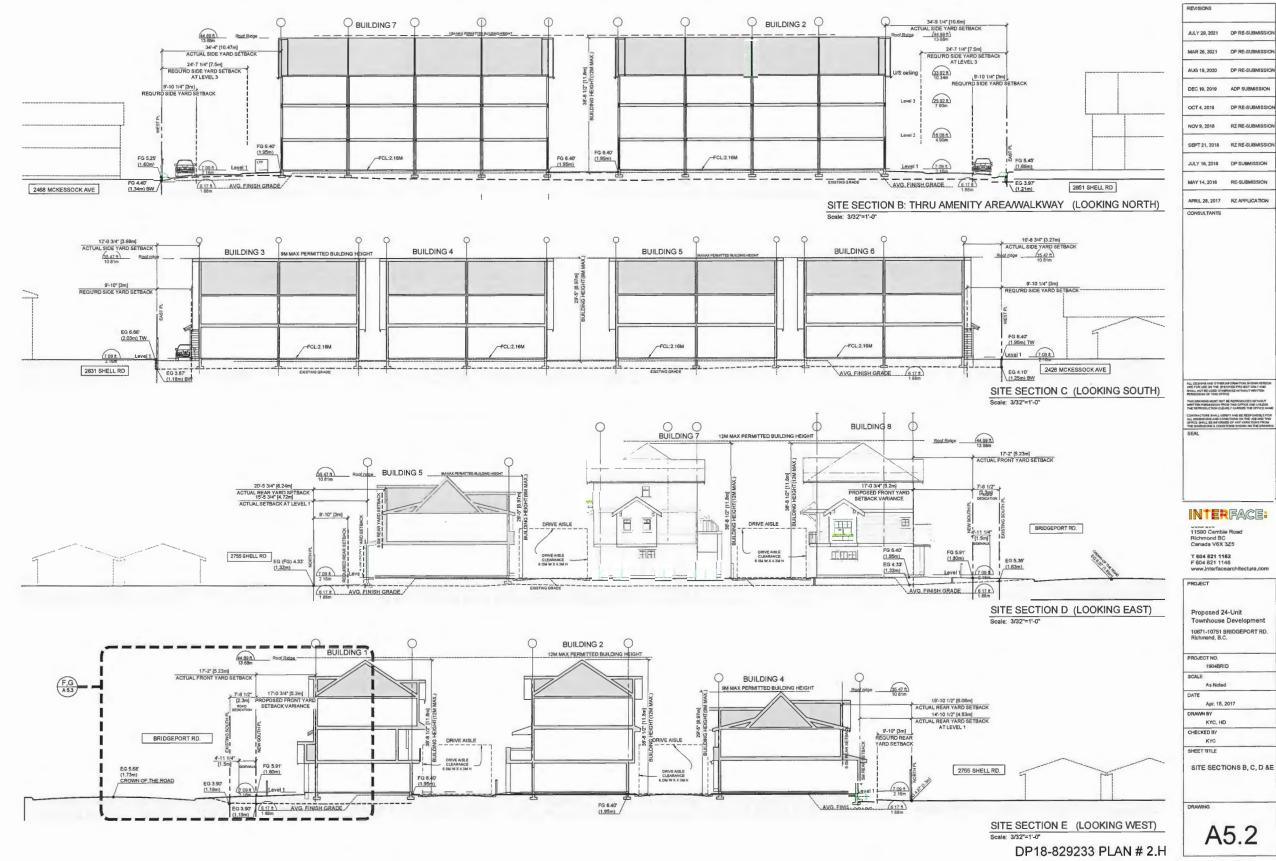

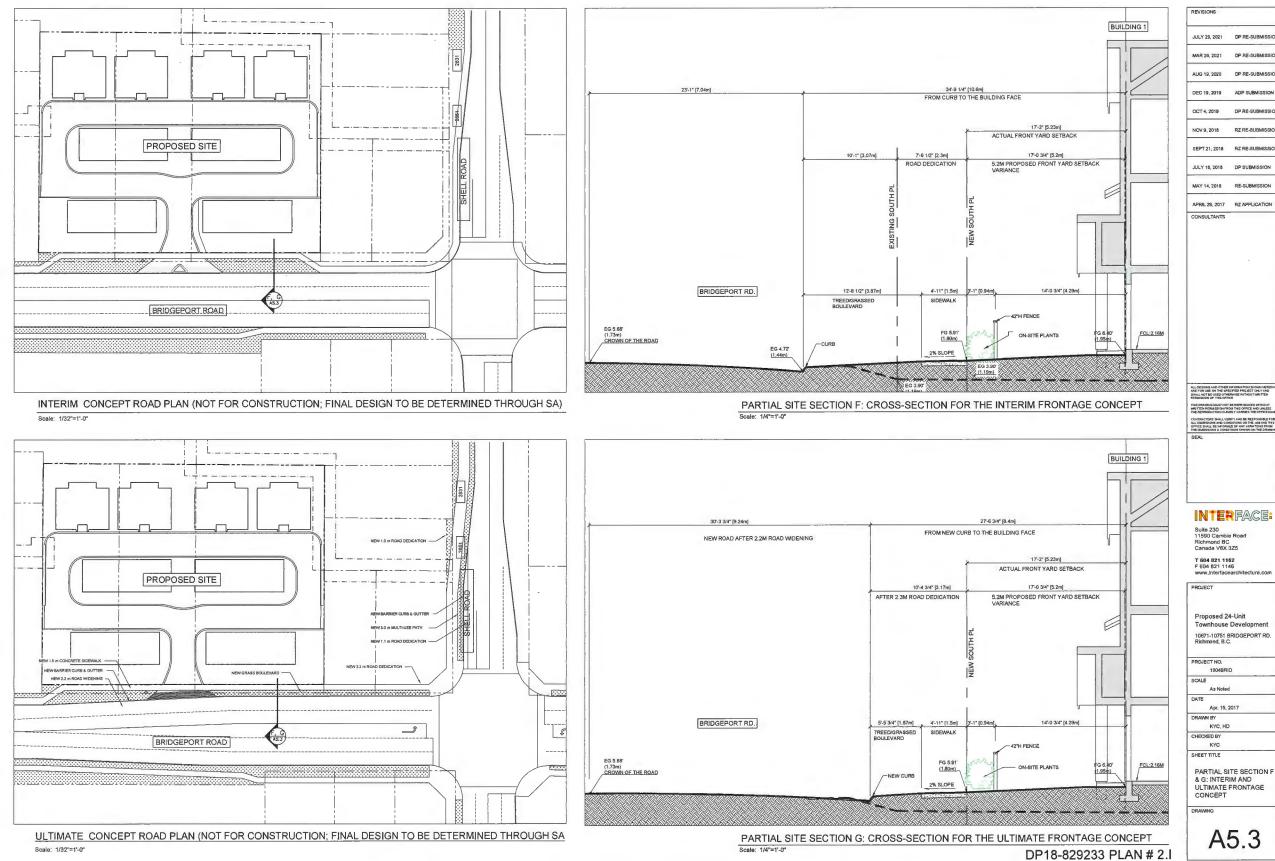ALONG BRIDGEPORT RD (LOOKING NORTH)

DP18-829233 PLAN # 2.J

REVISIONS	
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MAR 26, 2021	OP RE-SUBMISSION
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APRIL 28, 2017	RZ APPLICATION
CONSULTANTS	

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INTERFACE:

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T 604 821 1162 F 604 821 1146 www.interfacearch PROJECT

Proposed 24-Unit Townhouse Development 10671-10751 BRIDGEPORT RD. Richmond, B.C.

PROJECT NO. 1904BRID

SCALE As Noted

DATE Apr. 15, 2017

DRAWN BY KYC, HD CHECKED BY KYC SHEET TITLE

3D VIEWS ALONG BRIDGEPORT FRONTAGE

MING

A6.1



AERIAL VIEW (LOOKING NORTH WEST)



PERSPECTIVE VIEW OF DUPLEX BUILDINGS (LOOKING NORTH WEST)



PERSPECTIVE IMAGE - END OF DRIVE AISLE LOOKING WEST N.T.S.



PERSPECTIVE IMAGE - END OF DRIVE AISLE LOOKING EAST N.T.S.

REVISIONS	
JULY 29, 2021	OP RE-SUBMISSION
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CONSULTANTS	

DP18-829233 PLAN # 2.K

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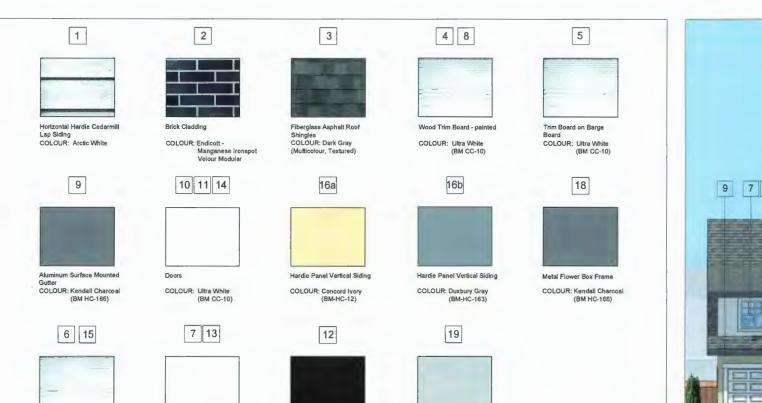
Apr. 15, 2017 RAWNBY

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PERSPECTIVES





Stone Lintel





Vinyl-Framed Double-Glazed Windows or Sliding Doors (Vinyltek or Equivalent) COLOUR: White

Wood Beams & Posts

COLOUR: Ultra White (BM CC-10)

Metal Railing

COLOUR: Black (BM 2132-10)




BUILDING 1: SOUTH ELEVATION SCALE: 1/8" = 1'-0"

BUILDING 2: SOUTH ELEVATION SCALE: 1/8" = 1'-0" DP18-829233 PLAN # 2.L

BUILDING 1: SOUTH ELEVATION SCALE: 1/8" = 1'-0"

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INTER Suite 230 11580 Cambie Richmond Stat F 604 821 116 F 604 821 114 www.interfaces PROJECT Proposed 24 Townhouse I 10671-10751 BF Richmond, B.C. 1904BRID SCALE As Noted DATE As Noted DATE Apr. 15, 25 DRAWN BY KYC, HD CHECKED KYC	Road Z5 2 -Unit Development RIDGEPORT RD.
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INTER Suite 230 T1590 Cambie Richmond BC Caneda V6X 3 T 604 821 1161 F 804 821 11	Road Z5 2 Garchitecture.com -Unit Development RIDGEPORT RD.

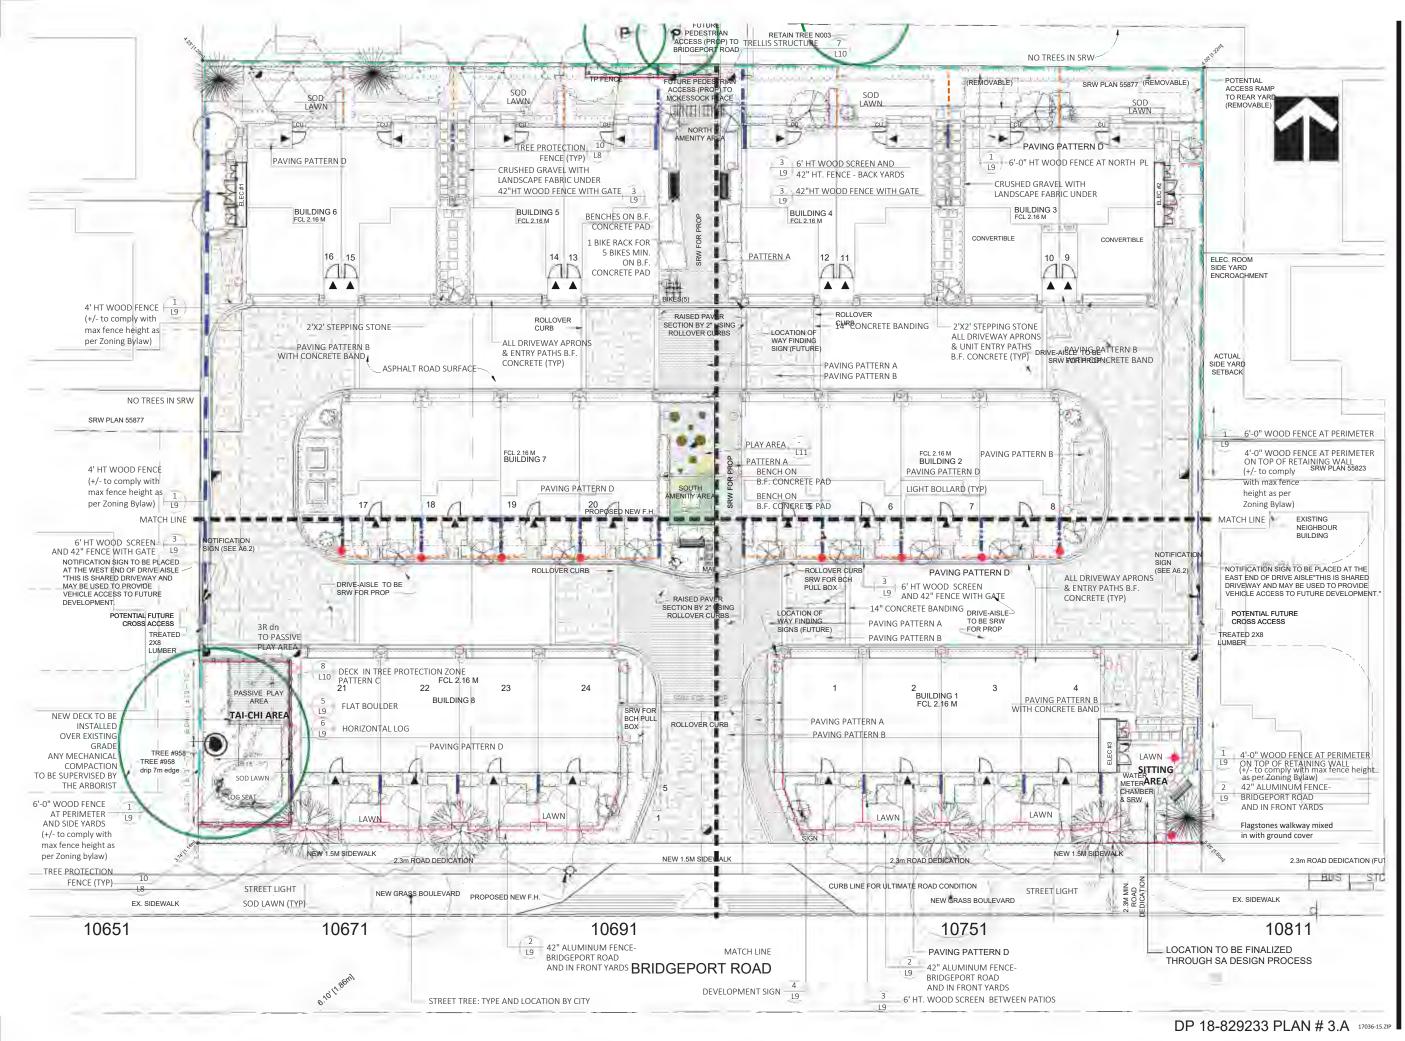

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SEAL

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1	17.MAY.04	RZ Application	DD
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15	21.JUL.26	REVISION AS PER CITY COMMENTS	DD

CLIENT: MFL Development Ltd

PROJECT: 24 UNIT TOWNHOUSE DEVELOPMENT

10671-10751 BRIDGEPORT ROAD RICHMOND

DP 18-829233 PLAN DRAWING TITLE:



DATE: April 27, 2017 SCALE: 1/16"=1'-0" DRAWN: DD DESIGN: DD CHK'D: MCY DRAWING NUMBER:

L1

OF 12

PMG PROJECT NUMBER:

PLANT SCHEDULE PMG PROJECT NUMBER: 17-03			PMG PROJECT NUMBER: 17-036	
KEY	QTY	BOTANICAL NAME	COMMON NAME	PLANTED SIZE / REMARKS
+ TREE	2	STREET TREE	LOCATION AND TYPE BY CITY	7CM CAL; 2M STD; B&B

NOTES: * PLANT SIZES IN THIS LIST ARE SPECIFIED ACCORDING TO THE BC LANDSCAPE STANDARD AND CANADIAN LANDSCAPE STANDARD. LATEST EDITION. CONTAINER SIZES SPECIFIED AS PER CNLA STANDARD. BOTH PLANT SIZE AND CONTAINER SIZE ARE THE MINIMUM ACCEPTABLE SIZES. * REFER TO SPECIFICATIONS FOR DEFINED CONTAINER MEASUREMENTS AND OTHER PLANT MATERIAL REQUIREMENTS. * SEARCH AND REVIEW: MAKE PLANT MATERIAL AVAILABLE FOR OPTIONAL REVIEW BY LANDSCAPE ARCHITECT AT SOURCE OF SUPPLY. AREA OF SEARCH TO INCLUDE LOWER MAINLAND AND FRASER VALLEY. * SUBSTITUTIONS: OBTAIN WRITTEN APPROVAL FROM THE LANDSCAPE ARCHITECT PRIOR TO MAKING ANY SUBSTITUTIONS TO THE SPECIFIED MATERIAL. UNAPPROVED SUBSTITUTIONS WILL BE REJECTED. ALLOW A MINIMUM OF FIVE DAYS PRIOR TO DELIVERY FOR REQUEST TO SUBSTITUTE. SUBSTITUTIONS ARE SUBJECT TO BC LANDSCAPE STANDARD AND CANADIAN LANDSCAPE STANDARD - DEFINITION OF CONDITIONS OF AVAILABILITY. * ALL LANDSCAPE MATERIAL AND WORKMANSHIP MUST MEET OR EXCEED BC LANDSCAPE STANDARD AND CANADIAN LANDSCAPE STANDARD LATEST EDITION. * ALL PLANT MATERIAL MUST BE PROVIDED FROM CERTIFIED DISEASE FREE NURSERY. * BIO-SOLIDS NOT PERMITTED IN GROWING MEDIUM UNLESS AUTHORIZED BY LANDSCAPE ARCHITECT.

PLAN	<u>11 S</u>	CHEDULE		PMG PROJECT NUMBER: 17-036
KEY	QTY	BOTANICAL NAME	COMMON NAME	PLANTED SIZE / REMARKS
TREE				
2/2	5	ACER GRISEUM	PAPERBARK MAPLE	6CM CAL; 1.8M STD; B&B
````````````````````````````````	1	ACER PALMATUM 'ATROPURPUREUM'	RED JAPANESE MAPLE	3.5M HT MULTISTEM; B&B
But	2	AMELANCHIER C.'SNOWCLOUD'	SNOWCLOUD SERVICEBERRY	6CM CAL; 1.8M HT; B&B
Vez	5	CHAMAECYPARIS NOOTK. 'VAN DEN AKKER'	VAN DEN AKKER NOOTKA CYPRESS	4.0M HT; B&B
	4	FAGUS SYLVATICA 'DAWYCKII PURPLE'	PURPLE FASTIGIATE BEECH	6CM CAL; 1.8M STD, B&B
\$¥.}	2	GINKGO BILOBA 'PRINCETON SENTRY'	PRINCETON SENTRY MAIDENHAIR	10CM CAL; 2M STD; B&B
Brok	4	LIQUIDAMBAR ST. 'SLENDER SILHOUETTE'	SLENDER SILHOUETTE SWEET GUM	6CM CAL; 2M STD; B&B
M	3	PINUS FLEXILIS 'VANDERWOLF'S PYRAMID'	VANDERWOLF'S PYRAMIDAL LIMBER PINE	5.0M HT; B&B
2010	12	PRUNUS SERRULATA 'AMANOGAWA'	AMANOGAWA CHERRY	6CM CAL; 1.5M STD; B&B
XA	2	PYRUS CALLERYANA 'CHANTICLEER'	CHANTICLEER PEAR	10CM CAL; 2.0M STD; B&B
NA/	2	QUERCUS PALUSTRIS 'GREEN PILLAR'	GREEN PILLAR PIN OAK	9CM CAL; 2M STD; B&B
1				

SPECIFIED AS PER CNLA STANDARD. BOTH PLANT SIZE AND CONTAINER SIZE ARE THE MINIMUM ACCEPTABLE SIZES. * REFER TO SPECIFICATIONS FOR DEFINED CONTAINER MEASUREMENTS AND OTHER PLANT MATERIAL REQUIREMENTS. * SEARCH AND REVIEW: MAKE PLANT MATERIAL AVAILABLE FOR OPTIONAL REVIEW BY LANDSCAPE ARCHITECT AT SOURCE OF SUPPLY. AREA OF SEARCH TO INCLUDE LOWER MAINLAND AND FRASER VALLEY. * SUBSTITUTIONS: OBTAIN WRITTEN APPROVAL FROM THE LANDSCAPE ARCHITECT PRIOR TO MAKING ANY SUBSTITUTIONS TO THE SPECIFIED MATERIAL. UNAPPROVED SUBSTITUTIONS WILL BE REJECTED. ALLOW A MINIMUM OF FIVE DAYS PRIOR TO DELIVERY FOR REQUEST TO SUBSTITUTE. SUBSTITUTIONS ARE SUBJECT TO BC LANDSCAPE STANDARD AND CANADIAN LANDSCAPE STANDARD - DEFINITION OF CONDITIONS OF AVAILABILITY. * ALL LANDSCAPE MATERIAL AND WORKMANSHIP MUST MEET OR EXCEED BC LANDSCAPE STANDARD AND CANADIAN LANDSCAPE STANDARD LATEST EDITION. * ALL PLANT MATERIAL MUST BE PROVIDED FROM CERTIFIED DISEASE FREE NURSERY. * BIO-SOLIDS NOT PERMITTED IN GROWING MEDIUM UNLESS AUTHORIZED BY LANDSCAPE ARCHITECT.

PAVER: 'ECO PRIORI' PERMEABLE PAVERS, 80mm TH SUPPLIER: MUTUAL MATERIALS COLOUR: CHARCOAL PATTERN: RUNNING BOND, ALIGNED AS SHOWN	
PATTERN B: ROADWAY/ VISITOR PARKING PAVER: 'ECO PRIORI' PERMEABLE PAVERS, 80mm TH SUPPLIER: MUTUAL MATERIALS COLOUR: SUMMIT BLEND PATTERN: COMBINATION #2, ALIGNED AS SHOWN	
PATTERN C: DECK	
PATTERN D: PATIOS	
PAVER: VANCOUVER BAY ARCHITECTURAL SLABS 24 SUPPLIER: MUTUAL MATERIALS COLOUR: NATURAL PATTERN: STACKED BOND, ALIGNED AS SHOWN	X24

MODENA PARK BENCH; MODEL NUMBER: MAL-5 BY WISHBONE SITE FURNISHINGS ALUMINUM METAL SLATS, POWDER COAT BLACK LONG LASTING STAINLESS STEEL HARDWARE



PAVING MATERIAL NOTES:

PMG PROJECT NUMBER: 17-036

**PAVING PATTERN KEY** 

- 1. INTERNAL ROADWAY TO BE ASPHALT UNLESS NOTED OTHERWISE
- 2. UNIT ENTRY PATHWAYS AND INTERNAL DRIVEWAY APRONS TO BE BROOM FINISH CONCRETE, UNLESS NOTED OTHERWISE.

MIN. 3" THICK B.F. CONCRETE PAD.

PHONE: 604 626 0476

FENCE PATTERN KEY		
<u> </u>	42"HT ALUMINUM FENCE AND GATE - BRIDGEPORT AVENUE	2 L9
	6' HT WOOD SCREEN	3 L9
	42" HT. FENCE - INTERNAL STREET AND BACK YARDS	3 L9
	6'-0" HT WOOD FENCE AT PERIMETER 4'-0" HT WOOD FENCE AT PERIMETER (+/- to comply with max fence height as per Zonin	1 L9 ng Bylaw)
	RETAINING WALL	



<b>PLA</b>	N I 3	CHEDULE		PMG PROJECT NUMBER: 17-036
KEY	QTY	BOTANICAL NAME	COMMON NAME	PLANTED SIZE / REMARKS
SHRUE	3			
(AB)	34	ABELIA X 'EDWARD GOUCHER'	EDWARD GOUCHER ABELIA	#3 POT
a)	10	AUCUBA JAPONICA 'MR. GOLDSTRIKE'	MR. GOLDSTRIKE AUCUBA	#3 POT; 50CM
AR	16	AUCUBA JAPONICA 'ROZANNIE'	ROZANNIE AUCUBA	#3 POT; 50CM
ä	8	BERBERIS THUNGBERGII 'MONOMB'	CHERRY BOMB BARBERRY	#3 POT
8	211	BUXUS SEMPERVIRENS 'GREEN VELVET'	GREEN VELVET BOXWOOD	#3 POT
X	16	HYDRANGEA M. 'ENDLESS SUMMER'	ENDLESS SUMMER BIGLEAF HYDRANGEA	#3 POT; 80CM
ä	5	HYDRANGEA PANICULATA 'LITTLE QUICK FIRE'	LITTLE QUICK FIRE HYDRANGEA	#3 POT
SPH .	7	ILEX 'SKY PENCIL'	SKY PENCIL HOLLY	1.2M HT, B&B
X	86	ILEX CORNUTA 'BURFORDII'	BURFORD HOLLY	#3 POT; 60CM
- X	6	MAHONIA AQUIFOLIUM 'COMPACTA'	COMPACT OREGON GRAPE HOLLY*	#3 POT; 50CM
X	23	PIERIS JAPONICA 'VALLEY FIRE'	VALLEY FIRE PIERIS	#3 POT; 50CM
H A	10	RHODODENDRON 'CHRISTMAS CHEER'	CHRISTMAS CHEER RHODODENDRON	#3 POT; 50CM
g	4	RHODODENDRON 'HOTEI'	HOTEI RHODODENDRON	#2 POT; 30CM
a	2	RHODODENDRON 'NAOMI'	NAOMI RHODODENDRON	#3 POT; 50CM
8	2	RHODODENDRON 'P.J.M. ELITE'	P.J.M. ELITE RHODODENDRON	#3 POT
X	21	ROSA 'KNOCKOUT RADRAZZ'	RADRAZZ KNOCKOUT ROSE	#3 POT
ä	40	ROSA MEIDELAND 'MEIMODAC'	ROYAL BONICA ROSE	#2 POT; 40CM
ä	15	SARCOCOCCA HOOKERANA 'RUSCIFOLIA'	FRAGRANT SARCOCOCCA	#2 POT
æ	17	SKIMMIA JAPONICA (10% MALE)	JAPANESE SKIMMIA	#2 POT; 30CM
ä	57	SKIMMIA REEVESIANA	DWARF SKIMMIA	#2 POT
8	5	SPIRAEA X BUMALDA 'LIMEMOUND'	LIMEMOUND SPIREA	#3 POT
X	14	TAXUS X MEDIA 'DENSIFORMIS'	DWARF YEW	#3 POT, SHEARED
X	126	TAXUS X MEDIA 'HICKSII'	HICK'S YEW	1.2M HT, B&B
ĿĿĿ	29	THUJA OCCIDENTALIS 'FASTIGIATA'	PYRAMIDAL CEDAR	1.8M HT, B&B
- 8	4	THUJA OCCIDENTALIS 'SMARAGD'	EMERALD GREEN CEDAR	2.5M HT; B&B
	3	VIBURNUM DAVIDII	DAVID'S VIBURNUM	#3 POT
(vb)	2	VIBURNUM X 'BURKWOODII'	BURKWOOD VIBURNUM	1.0M HT, B&B TREE FORM
GRASS	3			
(KE)	100	CALAMAGROSTIS X A. 'KARL FOERSTER'	KARL FOERSTER FEATHEREED GRASS	#2 POT, HEAVY
(KF) (HA)	221	HAKONECHLOA MACRA 'ALLGOLD'	ALLGOLD JAPANESE FOREST GRASS	#1 POT
a	74	PENNISETUM ALOPECUROIDES 'HAMLIN'	DWARF FOUNTAIN GRASS	#1 POT; HEAVY
PÈRÉN	INIAL			
(HE)	12	HEMEROCALLIS 'STELLA D'ORO'	STELLA D'ORO DAYLILY	#1 POT; 1-2 FAN
æ	4	HEUCHERA 'PALACE PURPLE'	PALACE PURPLE CORAL BELLS	15CM POT
H B J E S	128	LIRIOPE MUSCARI	BLUE LILY-TURF	#1 POT
a	39	MATTEUCIA STRUTHIOPTERIS	OSTRICH FERN	#2 POT
(NM)	32	NEPETA RACEMOSA 'WALKER'S LOW'	WALKER'S LOW CATMINT	#1 POT
(ST)	32	STACHYS BYZNATINA	LAMB'S EAR	#1 POT
GC				
	90	ADIANTUM PEDATUM	MAIDENHAIR FERN	#2 POT; 35CM
(E2)	34	EUONYMUS JAPONICA 'EMERALD GAIETY'	EMERALD GAIETY EUONYMUS	#1 POT; 25CM
X EZ G F	5	GAULTHERIA SHALLON	SALAL*	#1 POT; 20CM
F	102	POLYSTICHUM MUNITUM	WESTERN SWORD FERN*	#1 POT
NOTES:	* PLANT	SIZES IN THIS LIST ARE SPECIFIED ACCORDING TO	THE BC LANDSCAPE STANDARD AND CANADIAN LANDS	CAPE STANDARD, LATEST EDITION. CONTAINER SIZ

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NOTE

PLANT SCHEDULE



SURF BIKE RACK; SFBRGP-5 BY WISHBONE SITE FURNISHINGS POWDER COAT BLACK METAL

NOTE: ALL BENCHES AND BIKE RACKS TO BE INSTALLED PER MANUFACTURER'S SPECIFICATIONS, SURFACE MOUNTED, ON

SITE LI	GHTING LEGEND
	WALL MOUNTED COMPACT LED LIGHT. OPAL LENS, SUITABLE FOR EXTERIOR USE.
	42"H LED BOLLARDS, ROUND, DARK BRONZE FINISH, LOUVRED & GLASS LENS. MOUNT ON 9"DIA x 36"DEEP CONCRETE BASE WITH ANCHOR BOLTS.

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15	21.JUL.26	REVISION AS PER CITY COMMENTS	DD
14	21.MAR.26	NEW SITE& CIVIL PLANS	DD
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CLIENT: MFL Development Ltd'

#### PROJECT

#### **24 UNIT TOWNHOUSE** DEVELOPMENT

10671-10751 BRIDGEPORT ROAD RICHMOND


DP 18-829233 PLAN RAWING TITLE

#### PLANT SCHEDULE **AND KEY PLAN**

DATE: April 27, 2017 SCALE DRAWN: DD DESIGN: DD CHK'D: MCY

OF 12

DP 18-829233 PLAN # 3.B 17036-15.ZIP MG PROJECT NUMBER:

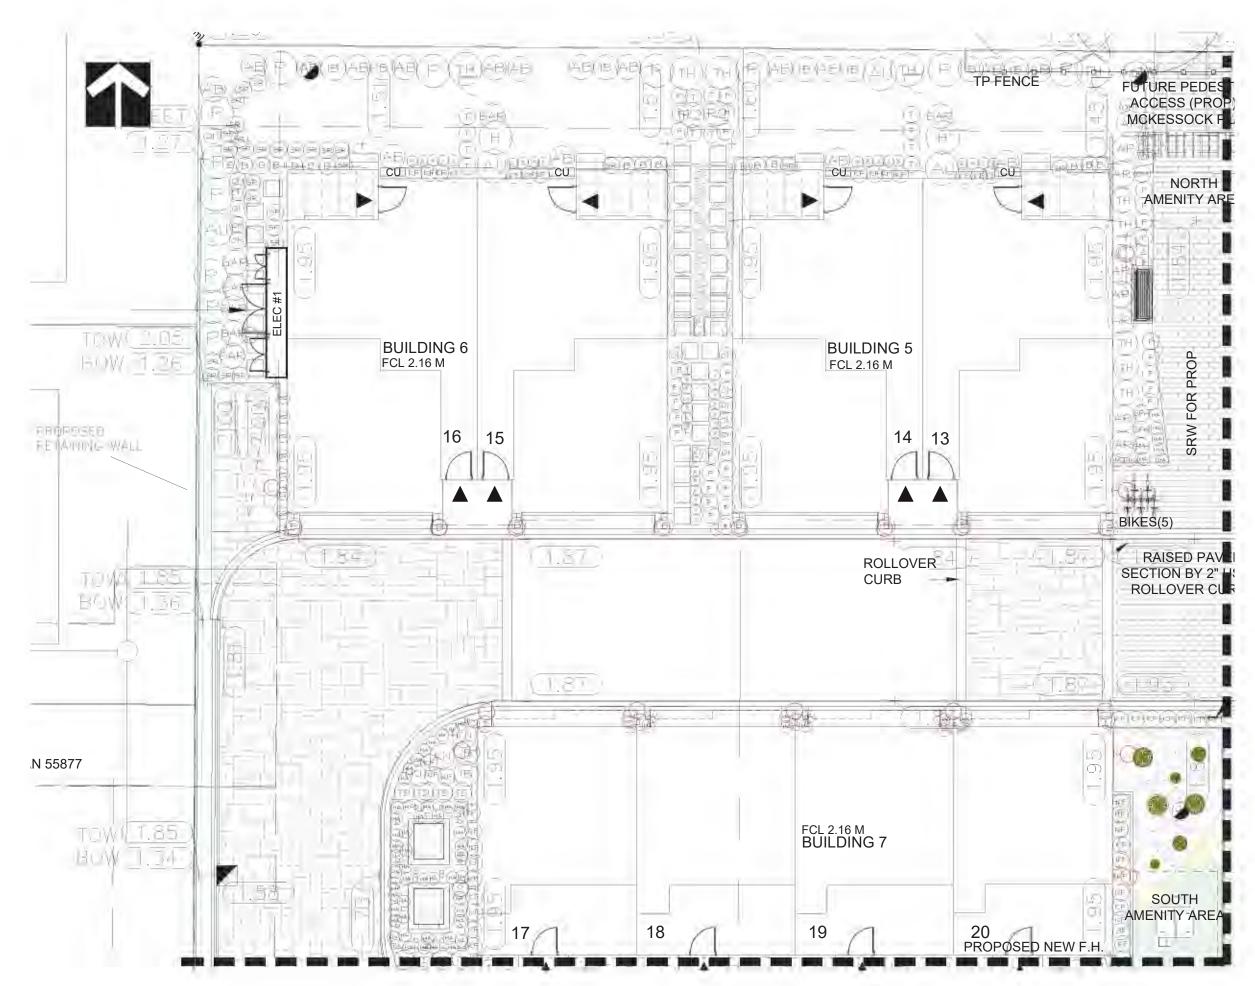

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#### PROJECT **24 UNIT TOWNHOUSE** DEVELOPMENT

10671-10751 BRIDGEPORT ROAD RICHMOND

DP 18-829233 PLAN DRAWING TITLE:


#### **PLANTING AND GRADING PLAN**

DATE: April 27, 28:5EP.19 SCALE: 3 /16"=1'-0" DRAWN: DD DESIGN: DD CHK'D: MCY

DRAWING NUMBER:

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#### PROJECT **24 UNIT TOWNHOUSE** DEVELOPMENT

10671-10751 BRIDGEPORT ROAD RICHMOND

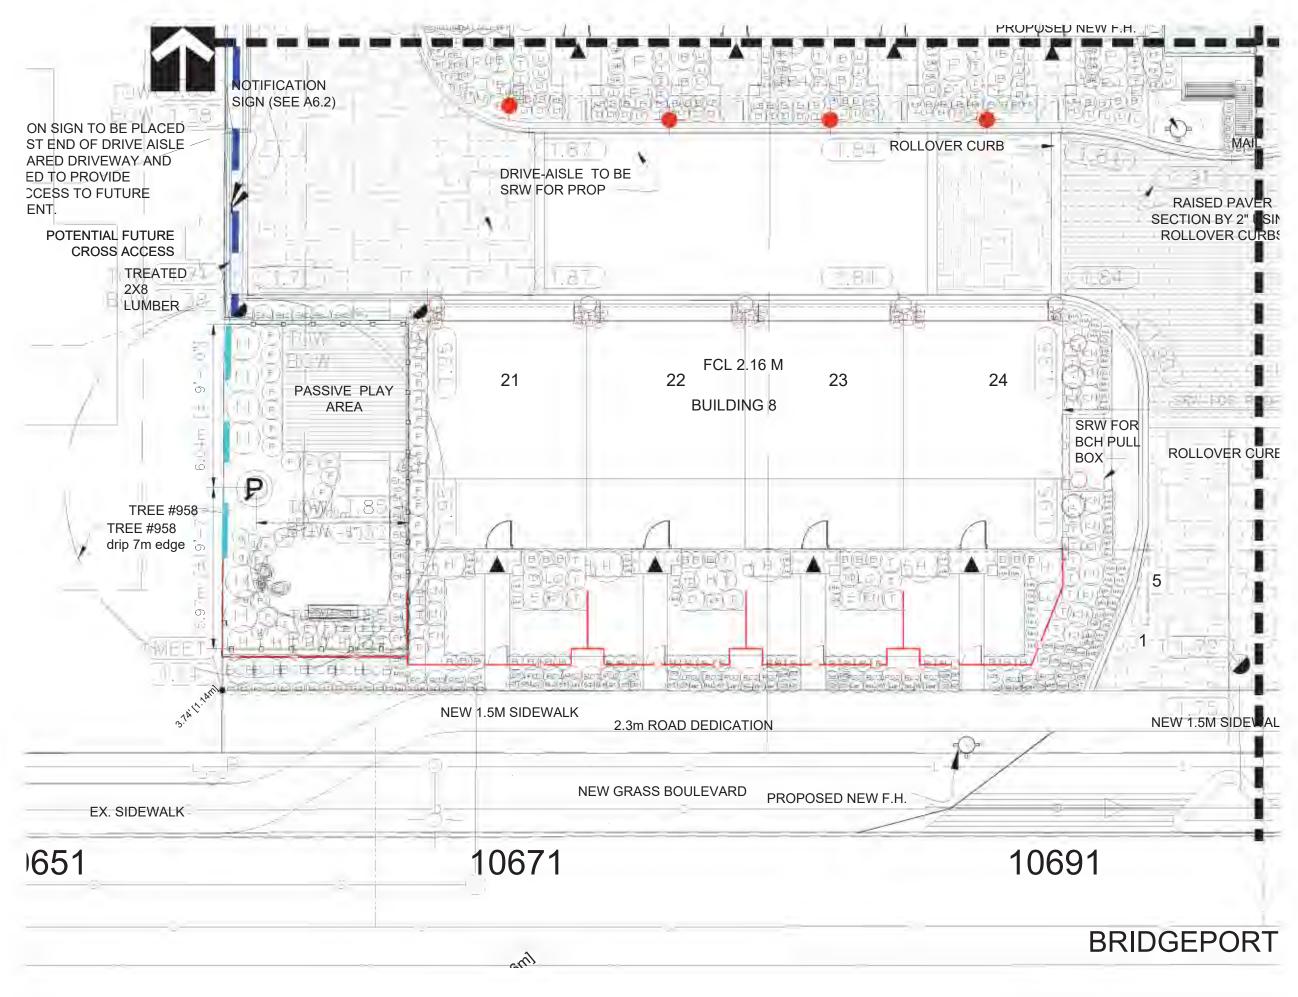DP 18-829233 PLAN DRAWING TITLE:

#### **PLANTING AND GRADING PLAN**


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DRAWING NUMBER

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OF 12

PMG PROJECT NUMBER



DP 18-829233 PLAN # 3.E 17036-15.2/P MG PROJECT NUMBER
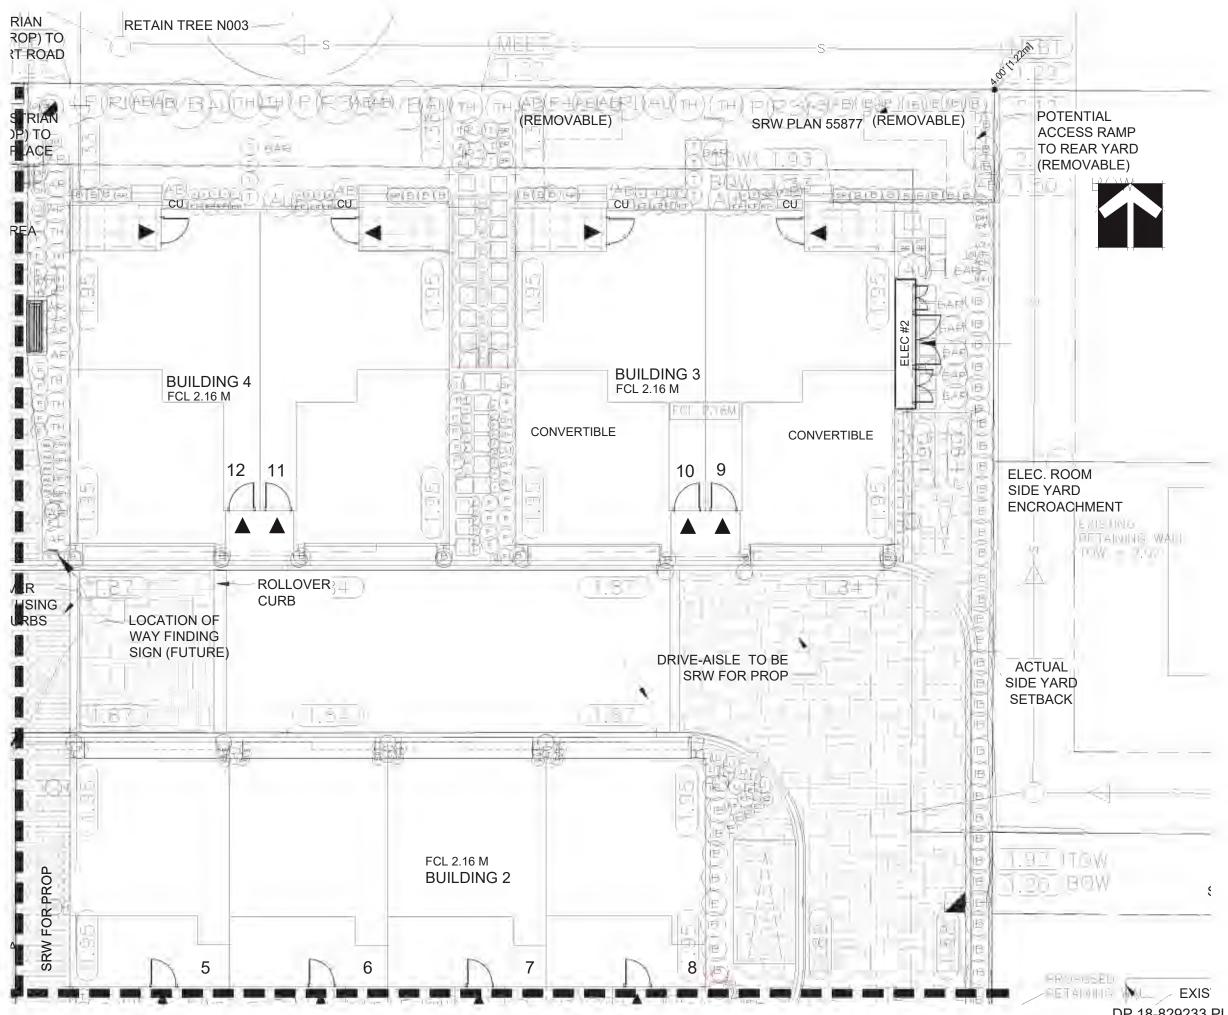
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CLIENT: MFL Development Ltd'

## PROJECT

#### **24 UNIT TOWNHOUSE** DEVELOPMENT

10671-10751 BRIDGEPORT ROAD RICHMOND

DP 18-829233 PLAN DRAWING TITLE:


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**L5** 

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#### PROJECT: 24 UNIT TOWNHOUSE DEVELOPMENT

10671-10751 BRIDGEPORT ROAD RICHMOND


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## PLANTING AND GRADING PLAN

DATE: April 27, **28:5E**P.19 SCALE: 3 /16"=1'-0" DRAWN: DD DESIGN: DD CHK'D: MCY DRAWING NUMBER:
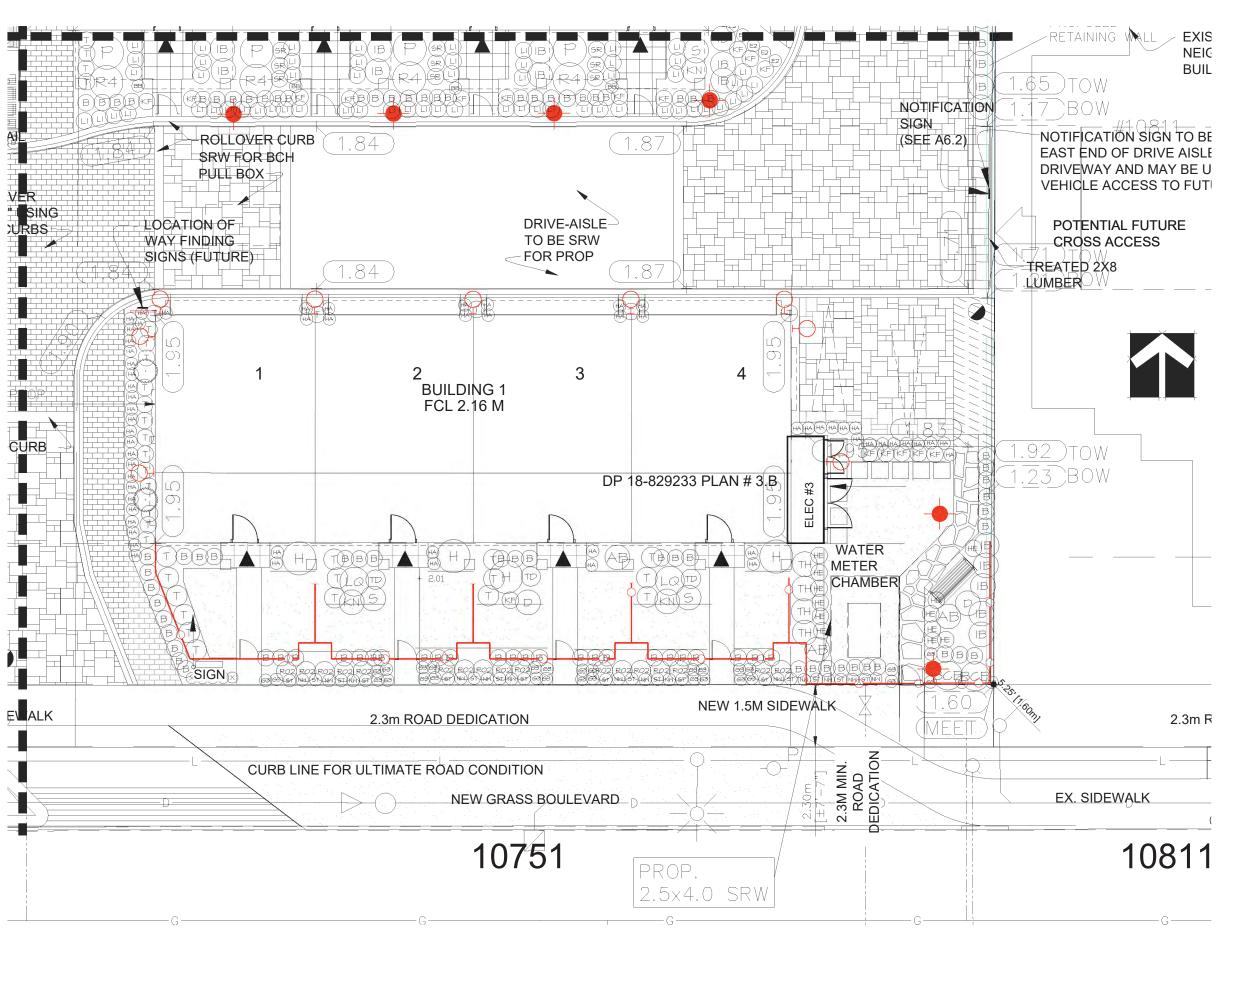
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DP 18-829233 PLAN # 3.F 17036-15.ZIP PMG PROJECT NUMBER:



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#### LANDSCAPE ARCHITECTS uite C100 - 4185 Still Cre

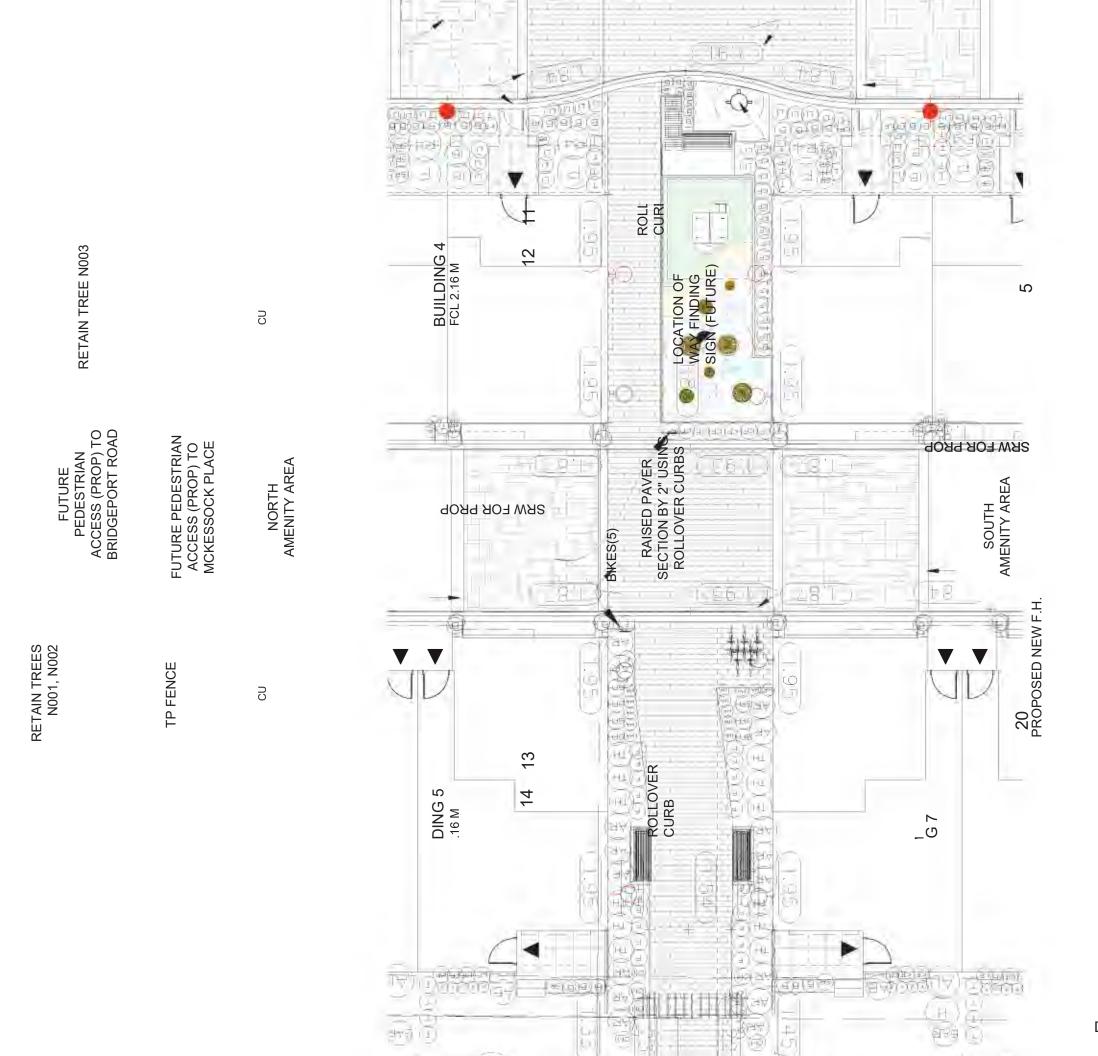Suite C100 - 4185 Still Creek Drive Burnaby, British Columbia, V5C 6G9 p: 604 294-0011 ; f: 604 294-0022

SEAL

ROLLOVER CL	SRW FOR BCH	PULL BOX	OCATION OF	WAY FINDING	SIGNS (FUTURE)
			ŏ	۸A	SIG

MAIL

# RAISED PAVER SECTION BY 2" USING ROLLOVER CURBS

15	21.JUL.26	REVISION AS PER CITY COMMENTS	DD
14	21.MAR.26	NEW SITE& CIVIL PLANS	DD
13	21.FEB.25	NEW SITE PLAN & CITY COMMENTS	DD
11	20.AUG.18	NEW SITE PLAN	DD
10	20.JUL.15	NEW SITE&CIVIL PLANS AND CITY COMMENTS	DD
9	19.NOV.27	NEW SITE PLAN	DD
8	19.SEP.13	NEW SITE PLAN	DD
7	19.AUG.23	NEW SITE PLAN	DD
6	18.NOV.09	REV. PER ARCH. COMMENTS	DD
5	18.NOV.08	REV. PER CITY COMMENTS	BJ
4	18.SEP.20	PRELIMINARY SUBMISSION TO CONSULTANTS	BJ
-	18.JUL.16	ISSUED FOR DP	DD
3	18.MAY.11	REVISION AS PER CITY REQUEST	DD
2	18.MAY.11	NEW SITE PLAN/ RZ RESUBMISSION	DD
1	17.MAY.04	RZ Application	DD
NO	DATE	REVISION DESCRIPTION	DR

CLIENT: MFL Development Ltd'

#### PROJECT: 24 UNIT TOWNHOUSE DEVELOPMENT

10671-10751 BRIDGEPORT ROAD RICHMOND

DP 18-829233 PLAN DRAWING TITLE:

#### PLANTING AND GRADING PLAN

 DATE:
 April 27, 28.5EP.19

 SCALE:
 3 /16"=1'-0"

 DRAWN: DD
 DESIGN: DD


 CHK/D:
 MCY

DRAWING NUMBER:

L7 0F 12

DP 18-829233 PLAN # 3.G 17036-15.ZIP

PMG PROJECT NUMBER:

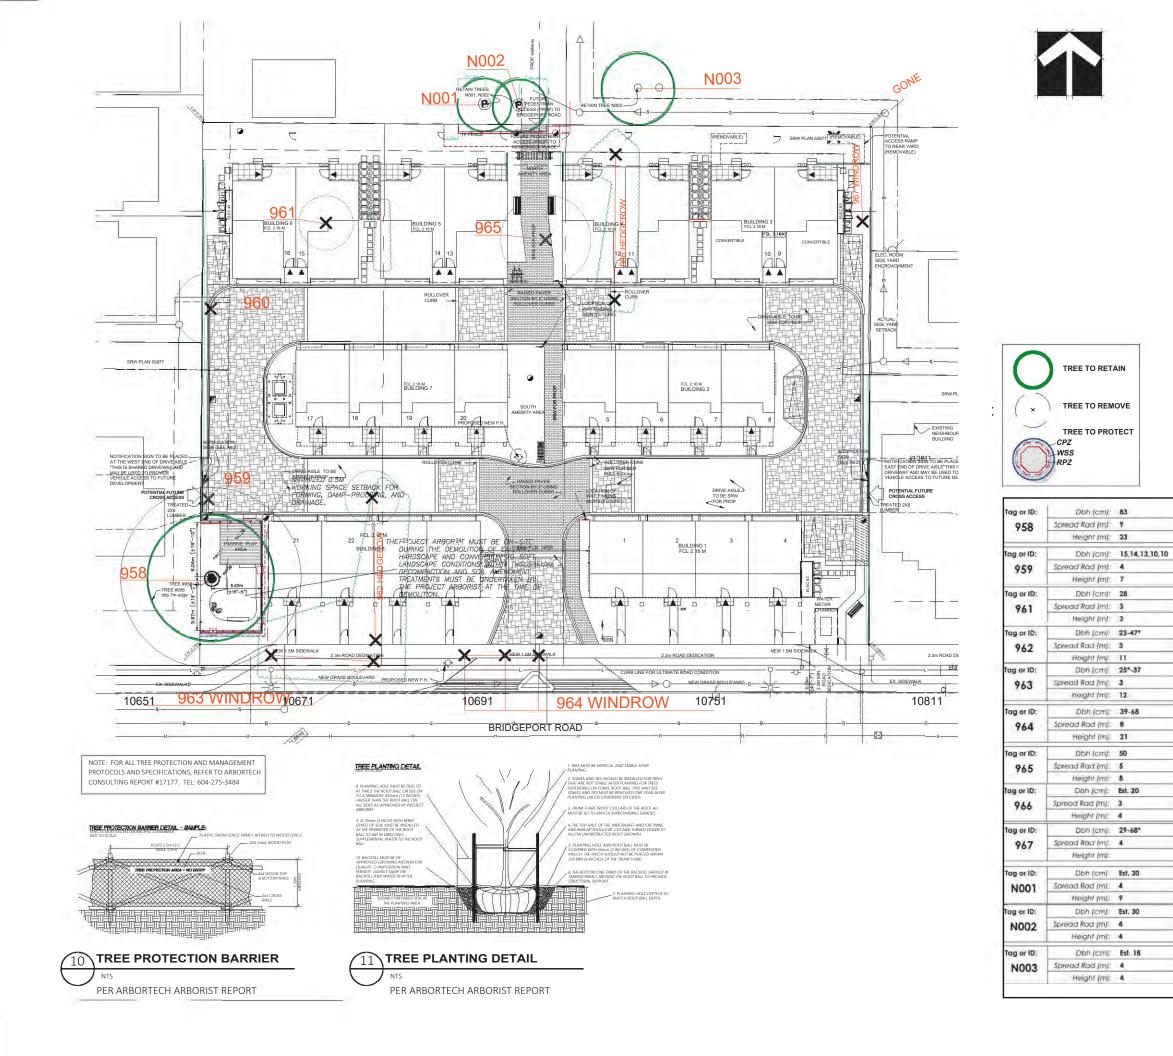

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SEAL

species.	Douglas-In (Pseu	luoisuga menzie	2011
Struc Class:	Open	Condition	Fair
Age Closs:	Moture	Ownership:	On-Sife
Species	Golden chain	Labumum sp.)	
Struc Class	Open	Condition	Very Poor
Age Class	Mature	Ownership:	On-Site
Species:	Flowering cherry	(Prunus serrular	a)
Struc Class,	Open	Condition:	Very Poor
Age Class.	Mature	Ownership:	On-Site
Specier	Mixed confierous	species	
Struc Class.	Open	Condition:	Very Poor
Age Class:	Mature	Ownership:	On-Site
Species:	Mixed coniferou	\$	
Struc Class.	Open	Condition	Very Poor
Age Class:	Mature	Ownership:	On-Sile
Species:	Douglas-fir (Psec	idolsugo menzi	esi)
Struc Class:	Open	Condition:	Fair
Age Closs.	Mature	Ownership	On-Sile
Species:	Flowering cherry		
Struc Class:	Open	Condition:	Very Poor
Age Closs	Mature	Ownership:	On-Sife
Species:	Western redcedo	r (Thuja plicata)	
Struc Class	Орел	Condition;	Very Poor
Age Class.	Malure	Ownership:	On-Site
Species:	Sawata cypress	(Chamaecypari	s pisitera)
Struc Class:	Open	Condition:	Very Poor
Age Class:	Mature	Ownership:	On-Site
Species:	Flowering cherry	(Prunus serviata,	1
Struc Class:	Open	Condition:	Fair
Age Class	Mature	Ownership	OII-Site
Species:	Flowering cherry	(Prunus serulato	0
Struc Class.	Open	Condition.	Very Poor
Age Class:	Mature	Ownership.	Off-Sile
Species:	Pear (Pyrus sp.)		
Struc Class:	Open	Condition	Very Poor
Age Class:	Malure	Ownership	Off-Site

Species: Doualas-fir (Pseudofsuga menziesi)

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1	17.MAY.04	RZ Application	DD
NO	DATE	REVISION DESCRIPTION	DR

CLIENT: MFL Development Ltd'

#### PROJECT:

#### 24 UNIT TOWNHOUSE DEVELOPMENT

10671-10751 BRIDGEPORT ROAD RICHMOND

DP 18-829233 PLAN DRAWING TITLE:


#### TREE MANAGEMENT PLAN

DATE: April 27, 2017 SCALE: 1/16"=1'-0" DRAWN: DD DESIGN: DD CHK'D: MCY DRAWING NUMBER:

**L8** 

OF 12

DP 18-829233 PLAN # 3.H 17036-15.ZIP MIG PROJECT NUMBER:

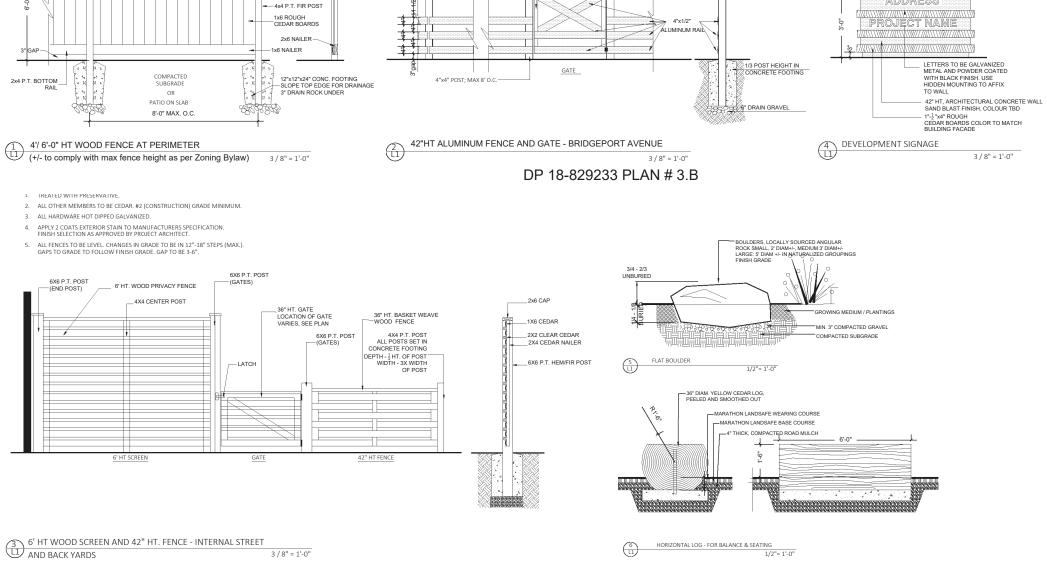

- 2. ALL OTHER MEMBERS TO BE CEDAR. #2 (CONSTRUCTION) GRADE MINIMUM. 3. ALL HARDWARE HOT DIPPED GALVANIZED. 4. APPLY 2 COATS EXTERIOR STAIN TO MANUFACTURERS SPECIFICATION. FINISH SELECTION AS APPROVED BY PROJECT ARCHITECT.
- 5. ALL FENCES TO BE LEVEL. CHANGES IN GRADE TO BE IN 12"-18" STEPS (MAX.). GAPS TO GRADE TO FOLLOW FINISH GRADE. GAP TO BE 3-6".

1. ALL POSTS PRESSURE TREATED TO CSA STANDARD AND END CUTS TREATED WITH PRESERVITIVE.

-2x6 CEDAR CAP

2x4 CEDAR RAIL -

3 / 8" = 1'-0"

1x2 NAILER -

2"x2" METAL FRAME

8'-0" MAX. O.C.

- 5. APPLY 2 COATS EXTERIOR STAIN TO MANUFACTURERS SPECIFICATION. FINISH SELECTION AS APPROVED BY PROJECT ARCHITECT.
- 4. ALUMINIUM FENCE TO BE POWDERCOATED CONFIRM COLOUR

- INSTALL PER MANUFACURER'S INSTRUCTIONS.
- 3. GATE HARDWARD TO BE CHOSEN BY OWNER.

- 2. ALL HARDWARE TO BE HOT DIPPED GALVANIZED, MEDIUM GAUGE.
- 1. METAL MATERIAL: ALUMINUM TO BE POWDER COATED BLACK, TWO COATS.
- ALUMINUM FENCE NOTES:

丰

NOTE

ŝТ

1/2"= 1'-0"

Mature landscaping to not obscure project sign.
 Letters to be of contrasting colours to the background'

— 5'-0" —

ADDRESS

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SEAL

15	21.JUL.26	REVISION AS PER CITY COMMENTS	DD
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11	20.AUG.18	NEW SITE PLAN	DE
10	20.JUL.15	NEW SITE&CIVIL PLANS AND CITY COMMENTS	DD
9	19.NOV.27	NEW SITE PLAN	DE
8	19.SEP.13	NEW SITE PLAN	DE
7	19.AUG.23	NEW SITE PLAN	DE
6	18.NOV.09	REV. PER ARCH. COMMENTS	DE
5	18.NOV.08	REV. PER CITY COMMENTS	B.
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-	18.JUL.16	ISSUED FOR DP	DE
3	18.MAY.11	REVISION AS PER CITY REQUEST	DE
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1	17.MAY.04	RZ Application	DI
NO.	DATE	REVISION DESCRIPTION	DF

CLIENT: MFL Development Ltd'

PROJECT

#### **24 UNIT TOWNHOUSE** DEVELOPMENT

10671-10751 BRIDGEPORT ROAD RICHMOND

DP 18-829233 PLAN DRAWING TITLE:


#### LANDSCAPE DETAILS

DATE: April 27, 28:5EPT.19 SCALE: DRAWN: DD DESIGN: DD CHK'D: MCY

DRAWING NUMBER:

**L9** 

OF 12

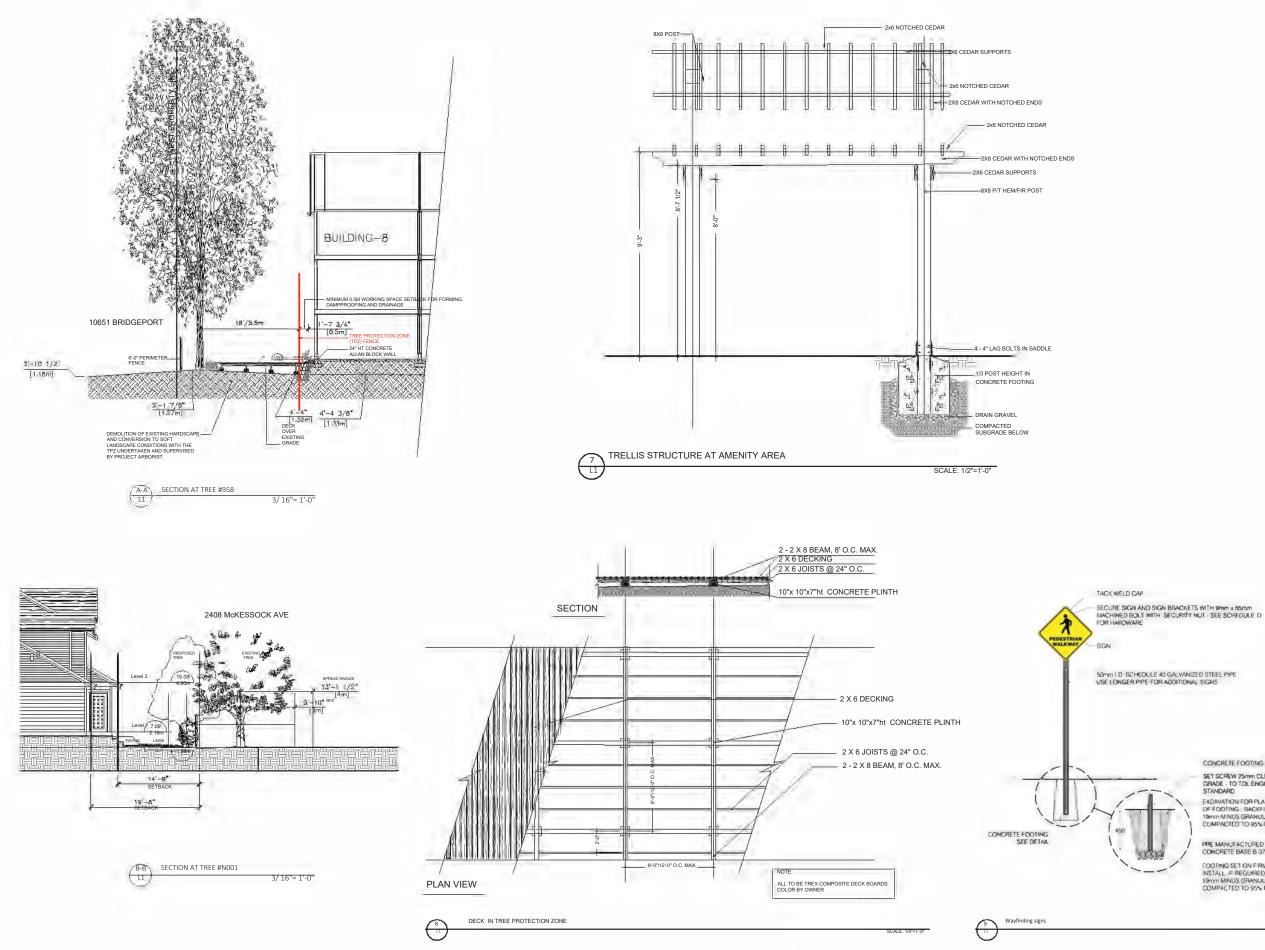

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SEAL

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1	17.MAY.04	RZ Application	DD
10.	DATE	REVISION DESCRIPTION	DR

CLIENT: MFL Development Ltd'

PROJECT

10671-10751 BRIDGEPORT ROAD

24 UNIT TOWNHOUSE

RICHMOND

DEVELOPMENT

DP 18-829233 PLAN

LANDSCAPE

DRAWING TITLE:

DETAILS

DATE: April 27, 2017

AS NOTED

SCALE:

DRAWN: DD DESIGN: DD

CHK'D: MCY


CONCRETE FOOTING DETAIL SET SCREW 25mm CLEAR OF GRADE - TO TOL ENGINEERING STANDARD EXCAVATION FOR PLACEMENT OF FOOTING BACKFIEL WITH 19mm MINUS GRANULAR BASE COMPACTED TO 95% MPD

PRE MANUFACTURED PYRAMIDA CONCRETE BASE B 37 KG

FOOTING SET ON F RM BASE INSTALL IF REGUIRED 100mm OF 19mm MINUS GRANULAR BASE COMPACTED TO 95% MPD

DRAWING NUMBER:

**L10** 

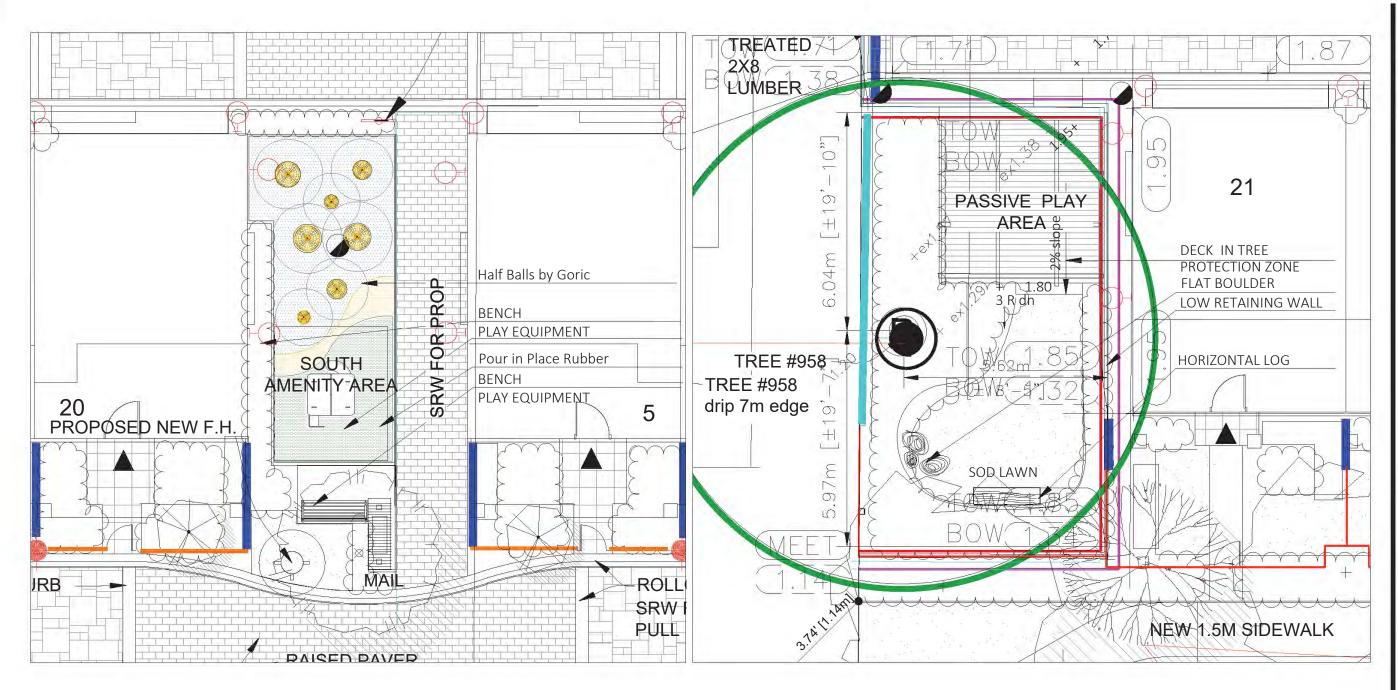


## PLAY AREA FURNITURE



EUROFLEX[®] Half Balls by Goric Granulated recycled rubber

RED PLAY HOUSE-M7000 by Kompan

**PLAYFALL SURFACING** 

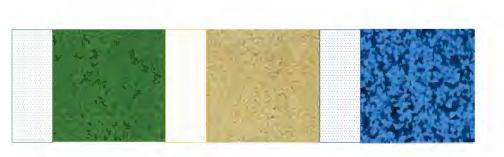

Pour in Place Rubberby Marathon surfaces

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SEAL

10	DATE	REVISION DESCRIPTION	DR
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15	21.JUL.26	REVISION AS PER CITY COMMENTS	DD

CLIENT: MFL Development Ltd'

PROJECT

#### **24 UNIT TOWNHOUSE** DEVELOPMENT

10671-10751 BRIDGEPORT ROAD RICHMOND

DP 18-829233 PLAN DRAWING TITLE:

#### LANDSCAPE **ENLAGREMTS**

DATE: April 27, 2017 SCALE: AS NOTED DRAWN: DD DESIGN: DD CHK'D: MCY

DRAWING NUMBER

L11

OF 12

#### DP 18-829233 PLAN # 3.K 17036-15.ZIP MIG PROJECT NUMBER:

				1	3	
PART ONE GENERAL I	REQUIREMENTS			PART THREE SOFT LANDSCAPE DEVELOPMENT	PART THREE SOFT LANDSCAPE DEVELOPMENT - CONT	PART THREE SOFT LANDSCAPE DEVELOPMENT - COL
1.1 REFERENCES .1 CCDC Doc 2 2008				3.1 RETENTION OF EXISTING TREES .1. Prior to any vork on site - protect individual trees or plant groupings indicated as retained on landscape plans as vegetation retention areas.	.8-Application Rate: .8.1 Silved Mixture: 136 kg/ha (125 lks/acre)	.18.4 For all plant material, the Landscape Architect reserves the right to extend the Co and growth is not sufficient to ensure future satisfactory growth.
	eral Conditions of Contract in conjunction with H	his section unless superseded by other Contract	t Documents.	<ol> <li>In some instances the Landscape Architect will tag trees or areas to remain. Discuss tree retention areas at a start-up meeting with the Landscape Architect.</li> <li>A physical barrier must be installed to delineate cleaning boundaries. Refer to physical barrier defail. If detail not provided, comply with local municipal requirements.</li> </ol>	.8.2 Fertilizer≻402 kg/ha (110 lbs/acre) .8.3 Coastal WildflöwecMin: Where specified, apply [31 lbs/acre] (1/4 lb.: 1 lb. of grass seed	.18.5 Where the Owner is responsible for plant maintenance and has not provided adequa The Landscape Architect shall determine whether maintenance has been satisfactory using
<ol> <li>Canadian Landscape Standard, L and materials shall neet standards</li> </ol>	latest edition, prepared by the Canadian Societ s as set out in the Canadian Landscape Standari	y of Landscape Architects and the Canadian Lan d unless superseded by this specification or as	dscape & Nursery Association, jointly, All work directed by Landscape Architect with written	<ol> <li>A projecta darmer musi de inicaled to darmare deaning podnanies, letter i o projecta darmer de lai, in certa noi provideo, convy wini toca instruptic requirements.</li> <li>No nachine fravel through or within vegetation referition areas or under crowns of trees to be related is allowed.</li> </ol>	.8.4 Notes: .8.4.1 At the time of Tender provide, a complete chart of all components of the mix proposed including mulch, tackifier, water etc. Sloped sites require tackifier.	naintenance standard is a minimum of Level Three - Medium. Refer to Section 3.11, Establi 18.6 The Landscape Contractor is responsible to replace any plant material or repair any the Certificate of Concellion.
instruction.				.4 Do not stockpile soil, construction materials, or excavated materials within vegetation retention areas.	8.4.2 Fertilizer:     8.4.2 Nord Grass: It a soil analysis is available, comply with results.     8.4.2.2 Law: Where hydroseeding is approved, comply-with soil analysis recommendations.	The Certificate of Completion. 18.7 Deviation from the specifications may require extension of the Warranty Period as
Association, and the Municipal Engine		ared by the Consulting Engineers of British Colu	mora, incladoutoer's and meavy construction	.5 Do not park, fuel or service vehicles within vegetation retention areas.	.9 Accurately neasure the quantities of each of the materials to be-charged into the tank either by nass or by a commonly accepted system of mass-calibrated volume	3.10 INSTALLING LANDSCAPE ON STRUCTURES
	RIGATION SYSTEM, 2008: Prepared by the Irriga	ation Industry Association of British Columbia.		.6 No debris fires, clearing fires or trash burning shall be permitted within vegetation retention areas.	measurements. The materials shall be added to the tank while it is being TMed with water, in the following sequence; seed, tertilizer. Thoroughly mix into a honogenous slurry. After charging, add no water or other material to the nixture. Do not leve slurry-to the tank for more than four (41 hours.	Verity that drainage and protection material is completely installed and acceptable be     Coordinate under the complexity of allochan and allochan devices
.5 MUNICIPAL BYLAWS AND ENGINE	REERING SPECIFICATIONS WHERE NOTED.			.7 No excavations, drain or service trenches nor any other discuption shall be permitted within vegetation retention areas without a review of the proposed encroachment by the Landscape Architect.	.10 Distribute slurry uniformly over the surface of the area to be hydroseeded. Blend application into previous applications and existing grass areas to form uniform surfaces.	<ol> <li>Coordinate work with construction-of planters and planter drainage.</li> <li>Verify that planter drains are in place Bink-positive drainage to roof drains is presented.</li> </ol>
.1 A current [not more than one mo	nonth  test for all growing medium to be used or	n this site is required. Provide and pay for testi	ing by an independent testing facility	.8 Do not cut branches or roots of retained trees without the approval of the Landscape Architect.	.11 Elean up: Renove all materials and other debris resulting from seeding operations from the jdb site.	3 Provide clean out at all through-slab drain locations . Use 309wp min. dia. PVC Pipe fil
pre-approved by the Landscape Ard Medium Testing for procedure.	chitect. Deliver growing medium test results to	) Landscape Architect for review and approval p	rior to placement. Refer to Section 3.4 Growing	.9 Any datage to existing vegetation intended for preservation will be subject to evaluation by an I.S.A. Certified Arborist using the "Guide for Plant Appraisal", Eighth Edition, 1907	.12 Maintenance: Begin maintenance inmediately after seeding and continue for 60 days after Substantial Completion and until accepted by the Owner. Re-seed at three week intervals where gernination has failed. Protect seeded areas from danage with temporary wire or twine ferces complete with Signage until grass area is Taken over by the	A Install drain rack evenly to a minimum depth of 4" (100mm)or alternate sheet drain.) 1
.2 Owner reserves the right to tes	est or re-test materials. Contractor responsibl	le to pay for testing if materials do not meet sp	ecification.	9.74. 9.1 Replacement planting of equivalent value to the disturbance will be required. The cost of the evaluation and of the replacement planting will be the responsibility of the General Contractor and or the personial responsible for the disturbance.	Owner. Water in sufficient quantities to ensure deep penetration and at frequent intervals to maintain vigorous growth until grass is taken over by the Owner. It is the Owner's responsibility to supply water at no extra cost to the Contract.	<ol> <li>Cover drain rock (or alternate sheet drain if specified on drawing details) with filter f placing growing medium.</li> </ol>
13 SUBMITTALS			N	10 In nunicipalities with specific true retention/replacement bylaws ensure compliance to bylaws.	.13 Acceptance of the Rough Grass Areas: Proper germination of all specified grass species is the responsibility of the Landscape Contractor. The grain-shall be reasonably well established, with no apparent dead or bare spots and shall be reasonably free of veeds (to Canadan Landscape Standard, Section 13 Maintenance Lavel 4. (Doeg space)	.6 Place an even layer of 25 - 50mm clean washed pump sand over filter fabric.
	Any alternale products differing from that contained in the contract documents must be pre-approved by the Landscape Architect.     Subnittais to consist of product sample or manufacturer's product description.			.11 In situations where required construction may disturb existing vegelation intended for preservation, contact Landscape Architect for review prior to commencing	Sixty days after substantial completion, areas needing the conditions above will be taken over by the Quner. Areas seeded in Fall will be accepted in Spring one nonfirst(tr starty days after substantial completion, areas needing the conditions above will be taken over by the Quner. Areas seeded in Fall will be accepted in Spring one nonfirst(tr start of growing seasor, provided that the above conditions to except ance are cold taken.	3: Place growing medium to depths specified in Section 3.5 above for various surface tree Use Styrotoan block over drain rock shaped to provide smooth surface transition at edge
14 SITE REVIEW	cr seigne or menorectories s product descriptio	n.		anstruction.	38 LAWI AFFAS - SOUDINS	nigrating downward.
.1 Under the terms of the Landsca	ape Architect's Contract with the Owner and wh air minime to confirm conformance to the plans a	tere the Landscape Architect is the designated i and specifications. Contact Owners Represental	reviewer, the Landscape Architect will observe five to arrange for site observation at the	3.2 services .1 Ensure subgrade is prepared to conform to depths specified in Section 35, Growing Nedure Supply, below. Where planting is indicated close to existing trees, prepare suitable planting pockets for material indicated on the planting plan. Shape subgrade to eliminate free shanding valer and conform to the site grading and drainage plan.	38 LAWN ANCAS - SUILUNDS .1 General: Treat all areas defined as lawn areas on the landscape plan between all property lines of the project including all boulevards to edge of roads and lanes.	3.11 ESTABLISHMENT MAINTENANCE (Provide a separate price for this section)
appropriate times. Allow two days n	notice. Observation schedule may include but wi	ill not be limited to the following: eting with the general contractor to review tree		2. On slopes in excess of 34 trench suborade across slope to 150mm (61 initiation at 15m (5 H) intervals minimum.	.2 Growing Medium: Comply with Section 2.2.1, Growing Medium. Prior to sodding, request an inspection of the finished grade, and depth and condition of growing medium by the	<ol> <li>Intent: The intent of "establishment" maintenance is to provide sufficient care to new the long term success of the planting. The objective is the adaptation of plants to a new</li> </ol>
and municipal requirements. .1.2 Start Up Site Meeting, Landsca	cape Contract (it separate): At the start of wor	k with Owner's Representative, Site Superinten	dent and Landscape Contractor; a meeting is to	3 Scarify the entire subgrade immediately prior to placing growing nedium. Re-cultivate where vehicular traffic results in compaction during the construction procedures.	Landscape Architect. 3 Time of Soddino: Sod from April 1st to October 1st. Further extensions may be obtained on concurrence of the Landscape Architect.	failure and unnecessary work associated with improper establishment. Establishment of m turfgrass areas and new trees and shrubs.
for this meeting.		nd general site conditions to the Landscape Con brough the course of the work. Review of ditte		Ensure that all planting areas are smoothly contoured after light compaction to finished grades. 4. Eliminate standing water from all finished grades. Provide a smooth, firm and even surface and conform to grades shown on the Landscape Gravings. Do not exceed	<ol> <li>Sind Supply: Enriement all conditions of Canadian Landscape Standard, Socilion 8, RC. Standard for Turtgrass Sod.</li> </ol>	<ol> <li>Maintenance Period: Provide maintenance of installed landscaping for 12 months follow</li> </ol>
any single visit. Such elements may	r include: Site Layout, Rough Grading, Growing M	fedun - quality, depths, tinish grading; Drainage , plant sizes, quality, quantity, planting practice	and Drainage Materials; Lawns or Grass areas;	A commerce standing water into all informed grades. Franke a stident, tima and even surrace and controls to grades shown on the Landscape Uravings. To not exceed maximum and winimum gradents defined by the Canadian Landscape Standard.	.5 Specified Turfgrass by area: Refer to Table 2 below.	3 Related Standards and Legislation: Canadian Landscape Standard, latest edition; Fert
Systems, Play Equipment; Site Furni Fencing, Non-structural walls and sl	niture; and other elements of the site developm	ent where the Landscape Architect is the design	nated reviewer such as: Pedestrian Paving,	.5 Construct swales true to line and grade, smooth and tree of sags or high points. Minimum slope 2%, maximum side slopes 10%. Assure positive drainage to collection points.	TABLE 2 SPECIFED TURFGRASS BY AREA	A Site Review: In addition to the inspections at substantial completion, at final progress reviews during the 12 months attended by the Einstractor and a designated representative designated representative.
.1.5 Certificate of Completion: Upor	on the declaration of Substantial Performance, :	, deletions; plant counts, preparations of deficie a recommendation for the issuance of the Certif	ency list, and recommendations for completion. icate of Completion will be made to the Payment	.6 Slope not to exceed the following maximums: Rough Grass 34, Lawn 4-1, Landscape plantings 2-1.	Area Description Quality Grade Major Species (LASS 1 Lawn, all areas noted on drawings as lawn in urban No. 1 Prenium Kentucky Blue for sun, Fescues for shafe	<ol> <li>Scheduling: Prepare a schedule of anticipated visits and submit to designated representation.</li> </ol>
	e completion of the holdback period, check for o	completion of deficiencies. Once completed, a Sc		.7 Finished soll/mulch elevation at building to comply with municipal requirements.	development sites including boulerand grass ELASS 2 Grass - public parks, inclustrial and institutional sites No. 2 Standard same	the growing season between March 1st and November 30th, however visits at other times of
.1.7 Warranty Review: Prior to the recommendations for waranty replace	e completion of the waranty period l+/- 11 mont acement.	hs after issuance of the Certificate of Completi	on), review all waranty material and report	Inform Landscape Architect of completion of finish grade prior to plaxement of seed, sod, plants or molch.     33 LANDSLAPE DRAMAGE	ELASS 3 Rough Grass see hydroseeding SPECIAL	.6 Maintenance Level: Comply with B. C. Landscape Standard, Section 14, Table 14.2, Maint
15 WORKMANSHIP	the Destand Days (1997)		and fashering Dirich in the state	3.3 LANUSLAPE UKANNOE .1. Related Work: Growing medium and Finish Grading, Grass areas, Trees Shrubs and Groundcovers, Planters, Crib Walls.		<ol> <li>Materials: Comply with Part Two of this specification.</li> <li>3:1 Fertilizers: To the requirements of the Canadian Landscape Standard. Formulations</li> </ol>
<ol> <li>Unless otherwise instructed in t constitutes acceptance of the subgr</li> </ol>	rne contract Llocuments, the preparation of the grade by the Landscape Contractor. Any subsec	e subgrade shall be the responsibility of the Ge quent corrections to the subgrade required are	neral contractor. Placement of growing medium the responsibility of the Landscape Contractor.	.2 Wink Included. Site finish grading and surface drainage. Installation of any drainage systems detailed on Landscape plans. Note: Eatch basins shown on Landscape plans for coordination only, confirm scope of work prior to bid.	6 Line: The line shall be as defined in Section 22.3, Materials. Apply at rates recommended in required soil test. Reter to Section 3.4 for method. 7 Fertilizer: Reter to Section 2.2.2 Materials. Apply specified fertilizer at rates shown in the required soil. test. Apply with a mechanical spreader. Cultivate into growing	<ol> <li>Plant Material Establishment:</li> <li>B.1. Watering: During the first growing season, water new plants at least every ten (10)</li> </ol>
.2 All work and superintendence st current license issued by the approp	shall be performed by personnel skilled in lands opriate authorities.	scape contracting. In addition, all personnel appl	iying herbicides and/or pesticides shall hold a	.2.1 Coordinate all landscape drainage work with rest of site drainage, Refer to engineering drawings and specifications for connections and other drainage work2.2 Determine exact location of all existing utilities and structures and underground utilities prior to commencing work, which may not be located on drawings and conduct work.	.7 Fertilizen Refer to Section 2.2.2 Materials. Apply specthed fertilizen at rates shown in the required soil fest. Apply with a mechanical spreader. Cultivate into growing medium 40 hours prior to sodding. Apply separately from line.	81 Watering: Uuring the first growing season, water new plants at least every ren (IU) and September 19th. Minimu 25 gallons per free per application. During the second growi and once between August fits and September 31st. Apply water at a rate and duration such
	oprare astronomes. me faniliar with site conditions before bidding a	and before start of work.		so as to prevent interruption of service or damage to them. Protect existing structures and utility services and be responsible for damage caused. .2.3 Planter drains on slab: Refer to Section 3.10, Installing Landscapes on Structures.	8 Sodding: Prepare a smooth, firm, even surface for laying sod. Lay sod staggered with sections closely betted, without overlapping or gaps, smooth and even with adjoining areas and roll lightly. Water to obtain moisture penetration of 3" to 4" (7 - Non). Comply with requirements of Canadian Landscape Standard Section 8, BC Standard for	nedium. Apply water again when the water content reaches 25% of tield capacity. Provid or has not been completely installed. Scheduled applications of water shall be missed only
.4 Confirm location of all services	· · · · · · · · · · · · · · · · · · ·			3 Execution     31 Do trenching and backfilling in accordance with engineering defails and specifications.	Turtgrass Sod.	8.2 Mulch: Maintain mulches in the original areas and to the original depths. 8.3 Weed Control: Renove all weeds from all areas at least once per month during the innovement but housen the behaviore.
.5 Notify Landscape Architect of a	any discrepancies. Obtain approval from Lands	cape Architect prior to deviating from the plans		3.2 Lay drains on prepared bed, true to line and grade with inverts smooth and tree at sags or high points. Ensure barrel of each pipe is in contact with bed throughout full tength.	.9 Naintenance. Begin maintenance immediately after sodding and continue for 60 days after Substantial Completion and until accepted by the Owner. Protoct sodded areas from damage with temporary wire or haine tenees complete with dispage until law to be the Norter. Water to oktain noticiture generation of 3" to 4." IT-1001 at intervals receivers to maintain sufficient rows. He can areas of the height of tenees areas of the Norter. Provide adventure presentation of 3" to 4." IT-1001 at intervals receivers to maintain sufficient rows. He can areas of the height of tenees at the Norter of Adventure and the notice of the Norter.	necessary, by the use of herbicles. .8.4 Pest and Disease Control: Inspirct all planted areas for pests and diseases periodic person. Carry out freatment for pests or diseases promptly and consistently for maximum
.6 Take appropriate measures to a quidelines	avoid environmental damage. Do not dunp any	waste naterials into water bodies. Conform with	h all tederal, provincial and local statutes and	3.3 Commence laying pipe at outlet and proceed in upstream direction. 3.4 Lay perforated pipes with perforations at 8pm and 4pm positions.	Intervals necessary to nanitalis sufficient growth. Reeg grass cut at height of between 1-V2? (Arm) and 2? (Srn). Provide adequate protection of sodded areas spans tomage until the turt has been taken over by Owner. Repair any damaged areas, ne-grade as necessary. Aeralinn may be required if in the Landscape Architect's opinion, drainage through the sod base nection is impaired.	person, carry our recarment for peers or orecases promptly and consistently for meaning 8.5 Tree Support: Maintain stakes, guy wires and fies one full growing season. Check f bark. Loosen, repair or replace fies as necessary. Renove all stakes guy wires and lies.
.7 Collect and dispose of all debris	is and/or excess material from landscape opera	ations. Keep paved surfaces clean and repair da	mage resulting from landscape work. Repairs	3.5 Make joints tight in accordance with manufacturer's directions. 3.6 Do not allow water to flow through the pipes during construction except as approved by Engineer.	100 Ogn ine box vace records is imparted.	the opinion of the Landscape Architect. All Hagging of guy wires shall be visible and in go 8.6 Pruning: Inspect all trees and shrubs at least every two months during the growing
are to be completed prior to final ac				<ol> <li>Hate waterlight connections to existing drains, new an existing manholes or calchlasins where indicated or as directed by Landscape Architect.</li> <li>Piug upstream exist of pipe with xaterlight clean out caps.</li> <li>Sumund and cover bow ith drain note in uniform from Javers to various dealths e stative in details. Initiana 100nn.</li> </ol>	Landscape Standard, Section 13 Maintenance Level 2 (Appearance). Use herbicides if necessary for weed renoval unless other conditions of contract forbid their use. After the lawn has been cut at least fuice, areas neeting the conditions above will be taken over by the Owner.	of the plant. Carry out clipping or shaping only if required in the maintenance contract for 8.7 Fertilizing: Once during the twelve north period of establishment maintenance fertil
	1 existing, and where existing work is altered, m	ake good to match existing undisturbed condition	n	3.3 Surround and cover pipe wind and include main rule in unit in dealine adjects to various deplans as shown in version, minimum docume. 3.10 Cover drain rock with non-scoven filter cloth lap all edges and seans minimum 150mm. 3.11 Assure positive drainage.		.9 Grass Areas Establishment:
1.6 WARRANTIES .1 Guarantee all naterials and wor	arkmanship for a minimum period of one full year	r from the date of Certificate of Completion.		3.12 Back fål remainder of french as indicated. 3.13 Protect subdrains from floatation during installation.	3.9 PLANTS AND PLANTING .1 Conform to planting layout as shown on Landscape Plane.	9.1 Watering: Use hoses and sprinklers, irrigation systems or other nethods to apply w Lawns and Grasses) such that the grass is maintained in a furgid condition. Supply and im installation at no expense to the owner. Apply water to prevent packing or crossion of the
.2 Refer to individual sections for				3.4 GROWING MEDIUM TESTING	2. Obtain approval of Landscape Architect for layout and preparation of planting prior to commencement of planting operations.	nedium reaches field capacity to the full depth of the growing medium. Apply water again 9.2 Weed, Insect and Disease Control. Inspect grass areas each time they are moved to
PART TWO SCOPE OF				.1 Submit representative sample of growing medium proposed for use on this project to an independent laboratory. Provide test results to Landscape Architect prior to placing. Test results to include: 11. Physica properties, 2: context of growel, sand, sith, clay and arganics.	.3 Nake edge of beds with smooth clean defined lines.	manual methods, or by the use of chemicals in compliance with the B.C.S.L.A./B.C.L.N.A. Law application of a suitable herbicide if the weed population exceeds 10 Broadleaf weeds or 51
21 SCOPE OF WORK				<ol> <li>And the provide a second of the second of the</li></ol>	4 Time et Planting: 4.1 Plant trees, shrubs and groundcovers only during periods that are normal for such work as determined by local weather conditions when seasonal conditions are likely to	the weed population to zero. .9.3 Fertilizing: According to soil analysis. .9.4 Lining According to soil analysis
.1 Other conditions of Contract ma	3. Other conditions of Contract may apply. Confirm Scope of Work at time of tender.			1.1.4 Carbon/Altragen level. 35 GROWING MEDIUM SUPPLY AND PLACEMENT	ensure successful adaptation of plants to their new location.	.9.4 Uting according to sole analysis .9.5 Maving and Trimming – All areas: The first four cuts shall be a sharp rotary type in with a sharp reel or rotary nower when the grass reaches a height of 60mm. Now to a height of 60mm. Now to a height of 60mm. Now to a height of 60mm.
<ol> <li>Work includes supply of all rela- consists of the following:</li> </ol>	2. Work includes supply of all related items and performing all operations necessary to complete the work in accordance with the drawings and specifications and generally			<ol> <li>Supply all growing nedium required for the performance of the Contract. Do not load, transport or spread growing nedium when it is so wet that its structure is likely to be damaged.</li> </ol>	.5 Standards: .5.1 All plant material shall conform to the requirements of the Canadian Landscape Standard, Latest edition, unless exceeded by drawing Plant Schedule or this specification.	Remove all grass clippings atter each cut. 
.2.1 Retention of Existing Trees wh				2 Supply all growing medium admixtures as required by the soil test. Anended growing medium nust meet the specification for growing medium as defined in Table One for the	5.11 Refer to Canadian Landscape Standard, Section 9, Plants and Planting and in Section 12, BCLNA Standard for Container Errown Plants for minimum standards. 5.12 Refer to Ran's Schedule for specific plant and container sizes and comply with requirements.	depth of 100mm. (4"), and remove cores. 9.7 Repairs: Re-grade, re-seed or re-sod when necessary to restore damaged or failing
.2.2 Finish Grading and Landscape .2.3 Supply and placement of grow	wing medium.			various areas. .2.1 Thoroughly nix required anendments into the full depth of the growing medium. .2.2 Special mixes may be required for various situations. Refer to drawing notes for instructions.	5.2 Plant material obtained from areas with less severe climatic conditions shall be grown to withstand the site climate.	throughout the growing season. Re-seed between Aprik 1st and April 15th or between Sep nowing.
2.4 Testing of imported growing m 2.5 Supply and incorporation of ac 2.6 Presention of all action hole	medium and/or site topsoil, additives to meet requirements of soil test and ;, supply of plant material and planting.	Table One.		3.2.2 opecan incesting ye required for an industrial and an interference of a minimum of the minimum occurs.	.6.1 Review at the source of supply and/or collection point does not prevent subsequent rejection of any or all planting stock at the site.	
	areas, supply of materials and seeding.			standing water.	<ol> <li>Availability:</li> <li>7.1 Area of search includes the Lower Mainland and Fraser Valley. Reter to Plant Schedule for any extension of area.</li> </ol>	
.2.9 Supply and placement of bark .2.10 Maintenance of planted and s	k nulch. seeded/sodded areas until accepted by Dwner.			A Minimum depits of proving needium placed and comparted to 80%     A.1 Dn-gradie     A1 So-gradie     A1 So-gradie     A1 So-gradie	.7.2 Supply proof of the availability of the specified plant material within 30 days of the award of the Contract. 8 Substitution:	
.2.11 SEPARATE PRICE Establishme .2.12 Other work: Work other Han	nent Naintenance, Section 3.11. n this list, not specified by Landscape Architect	h.		A.11 Seeked and sedde lawn	<ol> <li>Substitution:</li> <li>8.1 Obtain written approval of the Landscape Architect prior ro making any substitutions to the specified material. Non-approved substitutions will be rejected.</li> <li>8.2 Allor a minimum of 5 days prior to delivery for request to substitution.</li> </ol>	
2.2 MATERIALS				A.1.4 Tree & large shrub pits	.8.3 Substitutions are subject to Canadian Landscape Standard - definition of Conditions of Availability.	
	nadian Landscape Standard for definitions of in NUMS MEDIUM FOR LEVEL 2 SPROMED AND LEVEL	aported and on-site topsoil. Refer to Table One	belaw.	.4.2.0n-Slab: .4.2.1 trigated lawn	<ol> <li>Plant Species &amp; Location:</li> <li>S1 Plants shall be true to name and of the height, caliper and size of root ball as shown on the landscape/site plan plant schedule. Caliper of trees is to be taken &amp;" (IScm)</li> </ol>	
Canadian System of Soil Classifica	cation Textural Class: "Loany Sand" to "Sandy L	Loam".		4.2.2 Groundover areas	above grade. .9.2 Plant all specified species in the location as shown on the Landscape drawings. Notity Landscape Architect if conflicting rock or underground/overhead services are necountered.	
Applications	Low Traffic Areas. Trees and Large Shrubs	High Traffic Lawn Areas	Planting Areas and Planters	4.2.6 Shrub & groundcover areas	.9.3 Deviation of given planting location will only be allowed after review of the proposed deviation by the Landscape Architect.	
Growing Medium Types	21.	2H Boscost Of Deu Meichl of Tabul Gouvies Me	2P	4.2.7 Maximum 19" depth growing medium except where mounded for trees over column points.	.10 Excavation: .10.1 Trees and large structs: Excavate a saucer shaped tree pit to the depth of the rootball and to at least twice the width of the rootball. Assure that thished grade is at	
Coarse Gravel:	0 - 1%	Percent Of Dry Weight of Total Growing Me 0 - 1%	0 - 1%	5 Manually spread grawing nedium/planting soil around existing trees, shrubs and obstacles.	the original grade the tree was grown at:	
larger than 25mm All Gravel:	0 - 5%	0 - 5%	0 - 5%	.6 In perimeter seeded grass areas, feather growing medium out to nothing at edges and blend into existing grades.	If: Drainage of Rahling Hules.     In Drainage of Rahling Hules.     In Drainage of planting pits where required, is on stoped conditions, break out the side of the planting pit to allow drainage down slope, and in flat conditions, mound     to raise the randball above topervises layer. Motify the Landscape Architect where the drainage of planting holes is limited.	
larger than 2mm		Percent Of Dry Weight of Growing Medium Exclud		7 Finished grades shall conform to the elevations shown on landscape and site plans.     3.6 ROUGH GRASS AREA - SEEDING		
Sand: Langer than 0.05mm	50 - 80%	78 - 90%	40 - 80%	<ol> <li>Nonvoir General mice - accurate 1. General: Rough grass areas are noted on the drawings as "Rough Grass". Treat all areas defined as rough grass between all property lines of the project including all bollevands to deep of rough and Lanes.</li> </ol>	12.1 Plant all trees and sinvise with the roots placed in their natural growing position. It burtapped, loosen around the top of the ball and cut away or fold under. Bo not pull burlap from under the ball. Carefully remove containers without injuring the rootballs. After settled in place, cut twine. For wire baskets, clip and remove top three rows of	
smaller than 2.0mm Silts				2 Preparation of Surfaces: To Canadian Landscape Standard Class 3 Areas (Rough grass) Section 7.113	vine. 12.2 Filthe planting holes by gently firming the growing nedium around the root system in 6° (15cm) layers. Settle the soli with water. Add soil as required to neet thish	
larger than 0.002mm smaller than 0.05mm	10 - 25%	0 - 15%	10 - 25%	.2.1 Clean existing soil by mechanical means of debris over 50mm in any dimension. .2.2 Roughly grade surfaces to allow for maintenance specified and for positive drainage.	prode. Leave no air voids. When 2/5 of the topsoil has been placed, apply fertilizer as recommended by the required soil test at the specified rates. .42.3. Where plant has indicated adjacent to existing press, assigned, acre to avoid disturbance of the root system on natural grades at such trees. .12.4. Where these are in law manas, provide a class of an advaced and the such advaced and the root system on advaced grades at such trees. .12.4. Where these are in law manas, provide a class of an advaced system. This distributive determined on the tree.	
Clay: smaller than 0.002mm	B - 25%	0 - 15%	0 - 25%	3 Time of Seeding: Seed from early spring (generally April 1st) to late tall (September 15th) of each year. Further extensions may be obtained on concurrence of the Landscape Architect.	.12.4 where trees are in save areas, provide a clean out muched 500mm (3.11.) wanteer ordio centered on the tree13 Staking of Trees.	
Clay and Silt Combined	naxinun 35%	maximum 15%	maximun 35%	Architect. 4 Seed Supply & Testing: All seed must be obtained from a recognized seed supplier and shall be I/o. 1 grass mixture delivered in containers bearing the following information:	.13.1 Use two 2*x2*x5* stakes, unless superseded by municipal requirements. Set stakes minimum 2.11; in soil. Do not drive stake through rootball. .13.2 Leave the tree carefully vertical.	
Organic Content (coast): Organic Content (interior):	3 - 10%	3 - 5%	10 - 20% 15 - 20%	A seek supply a name; in see inside obtained includiare seek suppler and shart be two. I gross include derivere in centaries bearing ine notaveng monitaritie: A1 Analysis of the seed historie A2 Processing of each seed type	19.3 The vith pre-approved commercial, fitat waven polypropylene fabric belt, invinum width 19nn (374*). Approved product: Arbor Tie - available from DeepRoot. 19.4 Conferences Three over 6 ft. height: Guy with three 2-strand wires ft1 gauge). Drive three stakes equidistant around the tree completely below grade.	
Acidity (pH)	6,0 - 7,0	6.0 - 7.0	45-65	.5 Seed Micture: All varieties shall be rated as strong performers in the Pacific Northwest and are subject to client approval.	.B5 Trees 6 ft+ on Wood or Concrete Decks: Guy as above using three deadmen (nin. 2x2*x4*) buried to the maximum possible depth instead of stakes. .B.6 Mark all guy wires with visible flagging material.	
Drainage:	Percolation shall be such that no standin	ig water is visible 60 minutes atter at least 10 m	inutes of noderate to heavy rain or irrigation.	70% Creeping Ref Fescue 20% Annual Rye F F S that Departure for Music	16. Proming 16.1 Linit proving to the ninitrum necessary to remove dead or injured branches. Preserve the natural character of the plants, do not cut the leader. Use only clean, sharp	
	2 Fertilizer: An organic and/or incrganic compound containing Nitrogen (NI), Phosphate (25), and Potash (soluble 2) in proportions required by soil test.			5% Salarin Perenaila Bye 5% Kentudy Bleggras Fun Wildhever Areas use a nichure of WildIbvers with Hard Fescues  Terralink Coastal WildIbvers) with Hard Fescue or pre-approved alternate.	.16.1 Limit pruning to the minimum necessary to rehove dead on injured branches. Preserve the natural diarecter of the plants, so not cut the leader, use only clean, sharp tools. Make all cuts clean and cut to the branch collar leaving no studs. Shape affected areas so us not to retain water. Remove damaged material.	
	3 Line: Ground agricultural linestone. Heel requirements of the Canadan Landscape Standard			ran withtnown Areas use a northe of withtnowns with Hard rescues () enratink Loasta withtnowns with hard rescue of pre-approved attentiate. .6 Fertilizen: Mechanical seeding: Apply a complete synthetik slow-release tertilizen with naxinum 35% water soluble nitrogen and a formulation ratio of 18-18-18 - 50%	15 Molching: .15.1 Molch all planting areas with an even layer of molch to 2-1/2 - 3" (65 - 35mm) depth. Eantirm placement of molch in areas labeled "Groundcover Area" on drawings. Mulch a	
.4 Organic Additives Commercial con Recommended suppliers: The Answer	4 Brganic Additive Commercial compost product to the requirements of the Canadian Landscape Standard, Latest edition and pre-approved by the Landscape Architect. Recommended suppliers: The Answer Garden Products, Fraser Richmond Scilis & Faire, Stream Organics Management.			sulphur unea coated , 112 kg/hal/100bs/acre) using a mechanical spreader.	3 ft. (900mm) diameter circle arcound trees in Lawn areas, Leave a clean edge.	
.5 Sand: Clean, washed pump sand	d to meet requirements of the Canadian Landsc	ape Standard.		.7 Seeding: Apply seed at a rate of 112X/H 110ULs / acrel with a mechanical spreader. Incorporate seed into the top 1/4" (Isma) of soil and lightly compact.	.16 Acceptance: .16.1 The establishment of all plant material is the responsibility of the Landscape Contractor.	
.6 Composited Bark Mulch: 10mn  3 extraneous matter. Fresh orange in		ree of chunks and sticks, dark brown in colour a	nd free of all soil, stones, roots or other	A cceptance: Provide adequele protection of the seeded areas until conditions of acceptance have been met. Comply with Section 3.7 Hydroseeding.     37 HzQR0SEEDING	. 17 Plant Material Maintenance . 17.1 Maintain all plant naterial for 69 days after landscape work has received a Certificate of Completion.	
.7 Herbicides and Pesticides: If used, must conform to all federal, provincial and local statutes. Appliers must hold current licenses issued by the appropriate authorities in				3.7"HZURDSEEDING .1. May beaused as an alternate to mechanical seeding in rough grass areas.	.17.2 Watering: Conform to Canadan Landscape Standard, Section 1932 - Watering and generally as follows: .17.2.1 Water to supplement natural raintall such that the soil moisture content is kept to 50% to 100% of field capacity. Water to the full depth of the root zone each time.	
the area.				.2 May not be used in areas, at lawn unless pre-approved by the Landscape Architect prior to bidding.	The Owner is responsible to supply water at no extra cost to the Contract. Confirm source of water prior to beginning work. .17.3 Use appropriate measures to combat pests or diseases damaging plant material. Comply with all local governing statutes and guidelines for chemical control.	
.8 Filter Fabric A non biodegradable blanket or other tiltering membrane that vill allow the passage of water but not time sol particles. ISuch as MRAFI 14.0 NL, EEDLON IN40 OR AMICR 4545 or alternate product pre-approved by the Landscape Architect.)				.3. Preparation and Growing Medium: .3.1. In areas of Rough Grass: Comply with Section-34, Rough Grass.	.17.4 Plant material which fails to survive shall be replaced in the next appropriate season as determined by the Landscape Architect. .17.5 Repair tree guards, stakes, and guy wires, when necessary.	
.9 Drainage Piping if required: Scho	hedule 40 PVE nominal sizes.			.3.2 Where approved for use in areas of lawn, comply with Section 3.8 Lawn Areas: Sodding.	.17.6 Häntäin äreäs relatiively veed free. JAppearance level 2, Canadian Landscape Standard, Chapter 13). .17.7 Häntäin mulch to specified depths.	
	t, durable, and have a naximum size of 19nm an			4. Protection: Ensure that fertilizer in solution does not come in contact-with the foliage of any trees, shrubs, on other susceptible vegetation. Do not spray seed or nuclei on objects and expendent to grow grass. Protect existing site equipment, readways, linksupping, reference points, monuments, markers and structures from damage. Where experiments and expendent of the contact damage is the mark expendent damage. The mark expendent damage is the damage of the damage is the damage of the damage. Where experiments and expendent damage. Where	<ol> <li>Plant Warranty:</li> <li>Replace all unsatisfactory plant material except those designated "Specimes" for a period of one 19 year after the Certificate of Constellion. Replace all unsatisfactory</li> </ol>	
.11 Plant Material: To the requirem free nursery. Provide proof of cert	ements of the Canadian Landscape Standard. Re rtification.	efer to 3.9, Plants and Planting. All plant mater	ial must be provided from a certified disease	contamination occurs, renove seeding storry to satistaction of and by means approved by The Landscape Architect 5. Notch shall consist of virgin wood fibre or recycled paper fibre designed for hydraulic seeding and dyed tos ease of nonitoring application. If using recycled paper material	plant material designated "Specimen" for a period of two (2) years after the Cerlificate of Completion. Replace all unsatisfactory trees and knrubs and continue to replace these until the specified number is complete and satisfactory to the Landscape Architect. Such replacement shall be subject to the notification, inspection and approval as	
.12 Sod: Refer to individual section	ions in this specification.			for wood fibre substitute use 135% (by weight). Conform to Eanadian Landscape Standard for much requirements.	specified for the original planting, and shall not constitute an extra to the Contract. .18.2 Those Plants, identified as hardy within one zone of the Canada Department of Agriculture tonal class for the area, specified by the Landscape Architect and installed by	
		ngs for all walls: signed and sealed drawings for d and signed off by Certified Professional Engin		.6 Water: Shall be free of any importities that may have an injurious effect on the success of seeding or may be harmful to the environment.	the Landscape Contractor which are killed through below normal temperatures (below the average of the extreme ninium temperatures officially recorded in the area concerned, in the last 10 years), will not be replaced without cosh of replacement burne by the Owner.	
combinations of walls collectively in Tender price.	- COLOR OF ALM, INSTANDIOUS MUST BE FEVIENE	la ana wyneu orr wy cerrinieu riforessional Engin	co, mouse coar or engineering services in	7 Equipment: Use industry standard hydraulic seeder/muldher equipment with the tark volume certified by an identification plate on striker afficied to plate view on the equipment. The hydraulic seeder/muldher shall be capable of sufficient against in the nativitation to a knowprocess start with the start start and the support of the multitive start and the support of the m	.183 A review may be requested during the latter part of the warranty growing season. All plant material showing well developed foliage, healthy growth and lood forming, will then be taken over.	
.14 Miscellaneous: Any other mate	terial necessary to complete the project as sho	ivn in the drawings and described herein.		unin in supplied. The discharge pumps and gun nozzies shall be capable of applying the naterials uniformity over the designated area.	]	

CONT

the Contractor's responsibility for another growing season if, in his opinion, leat development

adequate naintenance, the plant replacenest section of the contract may be declared void. ry using the Canadian Landscape Standard, Section 19, Maintenance as the guide. The required Schälahnent Mintenance. pär any construction included in the Contract that is damaged or stoles until the issuance of riod as determined by the Landscape Architect.

table before beginning work. Contact Landscape Architect for instructions if not in place.

s present prior to placing any drain rock or soil.

Pipe filled with drain rock unless specific drawing detail shown.

PainLt specified. Install sheet drain as per manufacturer's recommendations. filter fabric lapping # (150nm) at all edges. Obtain approval of drainage system prior to

e treatments. Refer to Drawing details for any light weight hill<del>er required to</del> alter grade. edges. Butt each plece tightly together and cover with filter fabric to prevent soil from

to newly installed plant material for a relatively short period of time to ensure or increase a new site in order to obtain the desired effect from the planting while reducing the rate of th of maintenance procedures apply to all new and retained vegetation including cultivated

following substantial completion.

on; Fertilizer Code., B.C. Pesticide Control Act. progress draw application, and at the end of the guarantee period, there should be three other entative of the Owner. Maintain a Logbook and reporting procedures and submit to the

epresentative at start-up. Maintenance operations shall be carried out predominately during times of the year may be required.

2, Maintenance Level 2 "Groomed".

lations and rates as required by soil testing.

in fül dags between April fist and July 31st, and every twenty (20) dags between August 1st growing seasem, water new plants at least every twenty dags between April 1 and July 31 on with that the water context resolver faild copycity 1 fine late depth of the given tronde and ringite with water in the event that any automatic infigition system nationations of unity when statistic be generated the user fully as required.

ing the growing season by hoeing or cultivation to a maximum depth of Bümm, hand-pulling, or, if

protocolly and at least every two months during the graving season by as experienced maximum affectiveness. Longity with all R. Perlinde Carriel Act and municipal regurements, and the structure that regulation and the flags and recarding a depression is have only and the structure that regulation and the flags and recarding a depression is have and appendix and the correct and the structure structure containing any environ in any approximation and any approximation and any approximation in the structure that receive all add quarks of structure structure containing any environ and approximation and any approximation and any approximation and any approximation and the approximation and approximation approximation and approximation and approximation and approximation approximation and approximation and approximation and approximation approximation approximation approximation and approximation approximation approximation approximation and approximation approximatio

apply writer to Class 1 and Class 2 grassed areas (Emation Landscape Standard, Section 7, y and impairs with water in the revent of any impairs system mallustrition, or incomplete on the soal. Apply works at a rate and devators to that the vater content in the growing endpoint between the vater content result. Since the system content in the growing with revents, market in a different and the system content in the growing of the system between the vater content result. Since the system content is the system of the revents, market is and different the system content in the growing of the system of the vater content result. Since the system content is the system of the system content of the system content in the system content is a system of the system of the system content of the system content is the system content in the system content is designed by the system content of the system netices. This application shall reduce

Type mower. Excess grass clipping shall be removed after each cut. Mow all grassed areas to a height of 40mm. Edge with a mechanical vertical cutting edger once per year in March.

he second growing season, aerate in early May with a suitable mechanical corer. Core to a

r failing grass areas. Match the grass varieties in the surrounding area. Re-sod, if required, een September 1st and September 15hb. Protect re-seeded areas and keep moist until the first

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SEAL:

14         21.MAR.26         NEW SITE& CIVIL PLANS         D           13         21.FR.25         NEW SITE PLAN & CITY COMMENTS         D           12         20.AUG.38         NEW SITE PLAN & CITY COMMENTS         D           12         20.AUG.38         NEW SITE PLAN         D           12         20.AUG.38         NEW SITE PLAN         D           12         20.AUG.38         NEW SITE PLAN         D           13         31.SEP.31         NEW SITE PLAN         D           14         34.SEP.20         RELIMINARY SUBMISSION TO CONSULTANTS         E           18.AUG.49         REV.2ER ARCH COMMENTS         D         18.UUG.45           18.AUG.40         NEW SITE PLAN         D         D           18.AUG.40         REV.PER ARCH COMMENTS         E           18.AUG.40         REV.PER ARCH COMMENTS         E           18.AUG.41         SEVENDIASION TO CONSULTANTS         E           18.AUG.41         REVISION AS PER CITY REQUEST         D           18.AUG.41         REVSIDE FOR OF P         D           18.AUG.41         REVSIDE FOR REPERSUBMISSION         D           18.AUG.41         REVSIDE FOR REPERSUBMISSION         D           18.AUG.44         REV Applicat				
13         21.FEB.25         NEW STE PLAN & CITY COMMENTS         D           11         20.AUG.18         NEW STE PLAN         D           12         20.AUG.18         NEW STE PLAN         D           13         20.AUG.18         NEW STE PLAN         D           14         20.AUG.18         NEW STE PLAN         D           15         20.AUG.15         NEW STE PLAN         D           16         18.NOV.20         NEW STE PLAN         D           16         18.NOV.09         REV.PER ARCH, COMMENTS         D           16         18.NOV.08         REV.PER ARCH, COMMENTS         D           17         18.SEP.20         REV.NER CITY COMMENTS         D           18         18.SEP.20         REVISION NO CONSULTANTS         D           18         18.SUED FOR DP         D         D           18         18.VL16         ISUED FOR DP         D           18         18.NUL16         NEW STE PLAN RESUBSISION         D           18         18.NUL16         ISUED FOR DP         D           18         18.NUL16         ISUED FOR DP         D           18         18.NUL16         ISUED FOR RESUBUSINSION         D           1	15	21.JUL.26	REVISION AS PER CITY COMMENTS	DD
11         20.AUG.18         NEW STE PLAN         D           10         20.JUL.15         NEW STE PLAN         D           11         20.JUL.15         NEW STE PLAN         D           12         3.NOV.27         NEW STE PLAN         D           13         JS.259.13         NEW STE PLAN         D           14         3.529.13         NEW STE PLAN         D           15         18.NOV.09         REV. PER ACH COMMENTS         D           18.JUL.16         ISSUED FOR DP         D           18.JUL.26         ISSUED FOR DP         D           18.JUL.16         ISSUED FOR DP         D           18.JUL.16         IRSUER CIT'R REQUISITS         D           18.JUL.16         ISSUED FOR DP	14	21.MAR.26	NEW SITE& CIVIL PLANS	DD
10         20.JUL15         NEW SITE&CVIL PLANS AND CITY COMMENTS           11         20.JUL15         NEW SITE PLAN         D           12         30.VC 27         NEW SITE PLAN         D           13         31.SEP 31.3         NEW SITE PLAN         D           15         31.SEP 31.3         NEW SITE PLAN         D           15         18.NOV.08         REV. PER ACH COMMENTS         D           1         18.LP2.09         RELINIARY SUBMISSION 10 CONSULTANTS         D           1         18.LUL 56         SUSE DFOR OP         D           1         18.MU-10         SUSE DOR AS PER CITY REQUEST         D           1         18.MU-11         REVISION AS PER CITY REQUEST         D           1         18.MU-11         NEW SITE PLAN REQUEST         D           1         18.MU-11         NEW SITE PLAN REQUEST         D           1         18.MU-11         NEW SITE PLAN REQUEST         D           1         18.MU-10         REQUEST         D	13	21.FEB.25	NEW SITE PLAN & CITY COMMENTS	DD
9         19.NOV 27         NEW SITE PLAN         D           8         19.5FP.13         NEW SITE PLAN         D           19.AUG 23         NEW SITE PLAN         D           6         18.NOV.09         REV. PER ARCH. COMMENTS         D           5         18.NOV.08         REV. PER ARCH. COMMENTS         E           4         18.5FP.200         PRELIMARY SUBMISSION TO CONSULTANTS         E           1         18.AUA.11         REVISION AS FER.CTIT REQUEST         D           1         18.MAV.11         REVISION AS FER.CTIT REQUEST         D           1         18.MAV.11         REVISION AS FER.CTIT REQUEST         D           1         18.MAV.14         REVISION AS FER.CTIT REQUEST         D           1         17.MAY.04         REA.Application         D	11	20.AUG.18	NEW SITE PLAN	DD
8         19.5EP.13         NEW STE PLAN         D           7         15.AUG.23         NEW STE PLAN         D           1         18.NUV.08         REV. PER ACH.COMMENTS         D           5         18.NUV.08         REV. PER ACH.COMMENTS         D           4         18.5EP.20         RELININARY SUBMISSION TO CONSULTANTS         D           1         18.JUL.16         ISSUE D'OR OP         D           3         18.MAY.11         REVSTOR AS FER CIT'R REQUISTS         D           1         18.MVS         NEW STE PLAN.REQUISTS         D           1         18.MVS         NEW STE PLAN.REQUISTS         D           1         18.MVF         NEW STE PLAN.REQUISTS         D           1         18.70% AF ZE ADMINGTON AS FER CIT'R REQUISTS         D           1         17.MAY.04         RZ Application         D	10	20.JUL.15	NEW SITE&CIVIL PLANS AND CITY COMMENTS	DD
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6         18.NOV.09         REV.PER.ARCH.COMMENTS         D           5         18.NOV.08         REV.PER.ARCH.COMMENTS         E           4         18.SEP.200         PRELIMINARY SUMBASSION TO CONSULTANTS         E           5         18.NUL16         ISSUED FOR DP         D           1         18.AVL11         REVISION AS FER.CTT REQUEST         D           1         18.MAV.11         REVISION AS FER.CTT REQUEST         D           1         18.MAV.11         REVISION AS FER.SUMMISSION         D           1         17.MAY.04         R2.Application         D	8	19.SEP.13	NEW SITE PLAN	DE
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4         18.5EP.20         PRELIMINARY SUBMISSION TO CONSULTANTS         E           -         18.10L16         ISSUED FOR DP         D           3         18.MAY.11         REVISION AS PER CITY REQUEST         D           2         18.MAY.11         NEW STEP LAW RERUSION         D           1         17.MAY.04         RZ Application         D	6	18.NOV.09	REV. PER ARCH. COMMENTS	DD
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	2	18.MAY.11	NEW SITE PLAN/ RZ RESUBMISSION	DE
NO. DATE REVISION DESCRIPTION D	1	17.MAY.04	RZ Application	DD
	NO.	DATE	REVISION DESCRIPTION	DF

CLIENT: MFL Development Ltd'

PROJECT:

#### **24 UNIT TOWNHOUSE** DEVELOPMENT

10671-10751 BRIDGEPORT ROAD RICHMOND

DP 18-829233 PLAN DRAWING TITLE:

#### LANDSCAPE SPECIFICATIONS


DATE: April 27, 2017 SCALE: DRAWN: DD DESIGN: DD CHK'D: MCY


DRAWING NUMBER:

L12

OF 12

DP 18-829233 PLAN # 3.L 17036-15.ZIP MG PROJECT NUMBER:

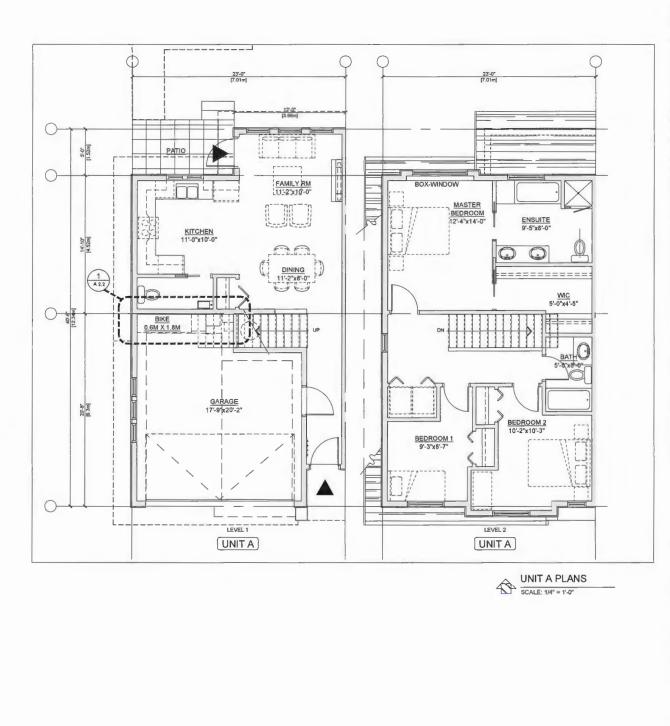

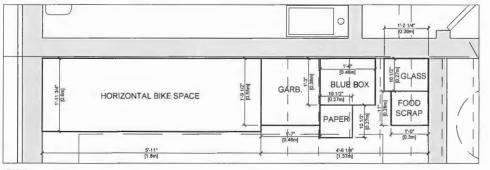

LEGEND:

 GARB.:
 120 LITRE GARBAGE CART (SIZE: 19" X 21.5")

 FOOD SCRAP:
 46.5 LITRE ORGANICS CART (SIZE: 12" X 11")

 BLUE BOX:
 BLUE CONTAINER RECYCLING BIN (BIZE: 15" X 18")

 GLASS:
 GREY GLASS RECYCLING BIN (SIZE: 11" X 14")


 PAPER:
 YELLOW PAPER RECYCLING BAG (SIZE: 18" X 18")

AREA FOR GARBAGE AND RECYCLING BINS 1 AREA FOR A2.2 SCALE: 1" = 1'-0"



DP18-829233 REFERENCE PLANS




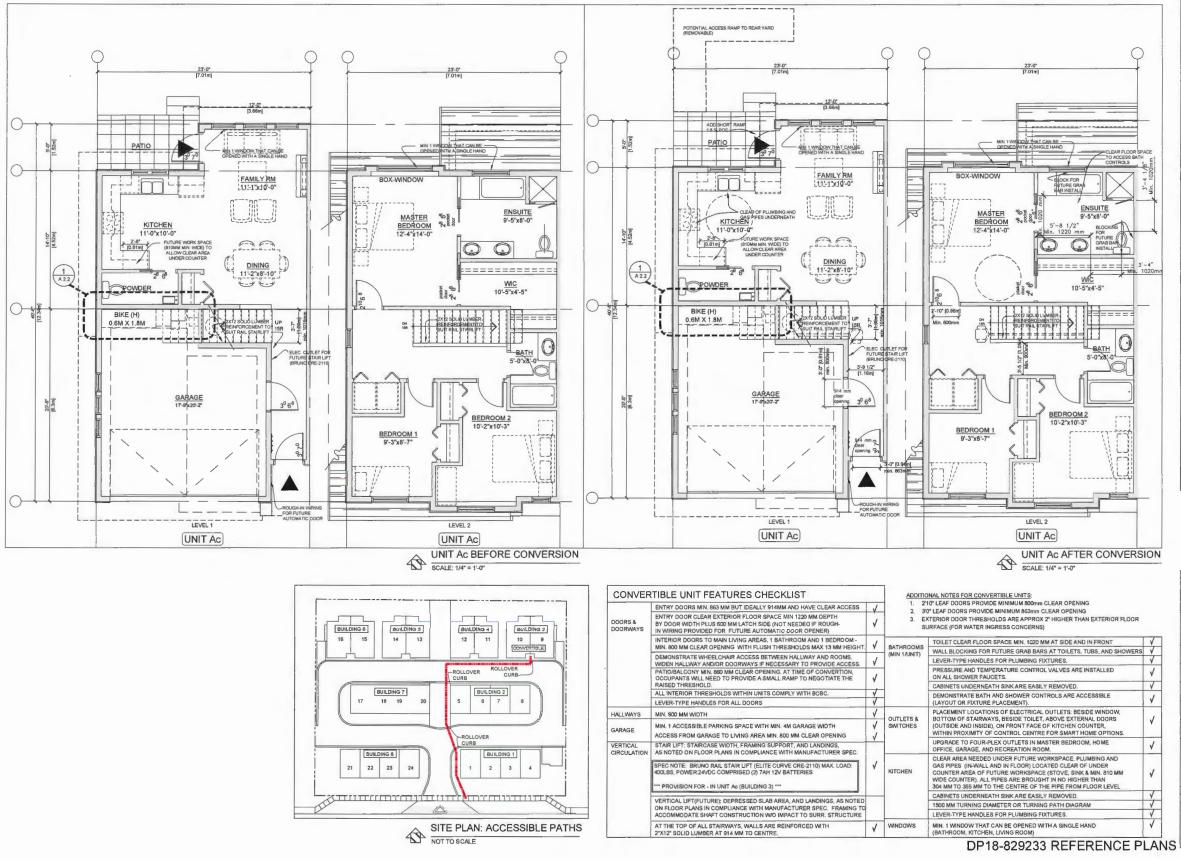





OULOILOI			THE HOTEOTON CONTENTIOLE ONTO	
DEALLY 914MM AND HAVE CLEAR ACCESS	J		0" LEAF DOORS PROVIDE MINIMUM 800mi " LEAF DOORS PROVIDE MINIMUM 863mm	
LOOR SPACE MIN 1220 MM DEPTH TCH SIDE (NOT NEEDEO IF ROUGH- RE AUTOMATIC DOOR OPENER)		3. EX		
AREAS, 1 BATHROOM AND 1 BEDROOM -	1	BATHROOMS	TOILET CLEAR FLOOR SPACE MIN. 1020	
	,	(MIN 1/UNIT)	WALL BLOCKING FOR FUTURE GRAB BA	
CESS BETWEEN HALLWAY AND ROOMS. WAYS IF NECESSARY TO PROVIDE ACCESS.	1	(	LEVER-TYPE HANDLES FOR PLUMBING	
AR OPENING. AT TIME OF CONVERTION, /IDE A SMALL RAMP TO NEGOTIATE THE		1	PRESSURE AND TEMPERATURE CONTR ON ALL SHOWER FAUCETS.	
			CABINETS UNDERNEATH SINK ARE EAS	
HIN UNITS COMPLY WITH BCBC.	4	-	DEMONSTRATE BATH AND SHOWER CO (LAYOUT OR FIXTURE PLACEMENT).	
	V		PLACEMENT LOCATIONS OF ELECTRICA	
CE WITH MIN. 4M GARAGE WIDTH		✓ OUTLETS & SWITCHES	BOTTOM OF STAIRWAYS, BESIDE TOILE (OUTSIDE AND INSIDE), ON FRONT FACI WITHIN PROXIMITY OF CONTROL CENT	
G AREA MIN. 800 MM CLEAR OPENING	V		UPGRADE TO FOUR-PLEX OUTLETS IN N	
RAMING SUPPORT, AND LANDINGS, OMPLIANCE WITH MANUFACTURER SPEC.			OFFICE, GARAGE, AND RECREATION RC	
IFT (ELITE CURVE CRE-2110) MAX. LOAD: ED (2) 7AH 12V BATTERIES UILDING 3) ***	1	KITCHEN	CLEAR AREA NEEDED UNDER FUTURE V GAS PIPES (IN-WALL AND IN FLOOR) LO COUNTER AREA OF FUTURE WORKSPAY WIDE COUNTER), ALL PIPES ARE BROUG 304 MM TO 355 MM TO THE CENTRE OF	
	_	-	CABINETS UNDERNEATH SINK ARE EAS	
SED SLAB AREA, AND LANDINGS, AS NOTED E WITH MANUFACTURER SPEC. FRAMING TO			1500 MM TURNING DIAMETER OR TURNI	
JCTION W/O IMPACT TO SURR. STRUCTURE			LEVER-TYPE HANDLES FOR PLUMBING	
WALLS ARE REINFORCED WITH TO CENTRE.	1	WINDOWS	MIN. 1 WINDOW THAT CAN BE OPENED ( (BATHROOM, KITCHEN, LIVING ROOM)	
			DD10 00000	

REVISIONS	
JULY 29, 2021	DP RE-SUBMISSION
MAR 28, 2021	DP RE-SUBMISSION
AUG 19, 2020	DP RE-SUBMISSION
DEC 19, 2019	ADP SUBMISSION
OCT 4, 2019	OP RE-SUBMISSION
NOV 9, 2018	RZ RE-SUBMISSION
SEPT 21, 2018	RZ RE-SUBMISSION
JULY 16, 2018	DP SUBMISSION
MAY 14, 2018	RE-SUBMISSION
APRIL 28, 2017	RZ APPLICATION
CONSULTANTS	
ALL DESIGNS AND OTHER IN	FORMATION SHOWN HEREON
ARE FOR USE ON THE SPEC BHALL NOT BE USED OTHER PERMISSION OF THE OFRO THIS ORAWING MUST NOT 8	FIED PROJECT ONLY AND WISE WITHOUT WRITTEN E
WRITTEN PERMISSION PRO THE REPRODUCTION CLEAR CONTRACTORS SHALL VERE ALL DIMENSIONS AND CONC	IT THE OFFICE AND UNLESS ILY CARRIES THE OFFICE NAME FY AND BE RESPONSIBLE FOR XITCHS ON THE JOB AND THE
OFACE SHALL BE INFORME THE DIMENSIONS & CONDITI SEAL	D OF ANY VARIATIONS FROM IONS SHOWN ON THE DRAWING
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Suite 230 11590 Cambie Richmond BC Canada V6X 3 T 604 821 116 F 804 821 114	Road Z5
Suite 230 11590 Cambie Richmond BC Canada V6X 3 T 604 821 116 F 604 821 114 www.interface	Road 25 2 6
Suite 230 11590 Cambie Richmond BC Canada V6X 3 T 604 821 116 F 804 821 114 www.interface PROJECT Proposed 24	Road Z5 2 architecture.com
Suite 230 11580 Cambie Richmond BC Canada V8X 3 T 604 821 116 F 804 821 114 www.interface: PROJECT Proposed 24 Townhouse I	Road Z5 2 architecture.com
Suite 230 11580 Cambia Richmond BC Canada V6X 3 T 604 821 114 WWW Jntarface PROJECT Proposed 24 Townhouse I 10671-10751 BI	Road Z5 2 6 6 architecture.com
Suite 230 11580 Camber Richmond BC Canada V&X3 F 604 821 114 F 804 821 114 www.interface PROJECT Proposed 24 Townhouse 1 10671-10751 BI Richmond, B.C. PROJECT NO. 1904BRID	Road 25 2 architecture.com -Unit Development alogePORT RD.
Suite 230 11580 Cambie Richmond BC Canada VEX 3 F 604 821 116 www.interface: PROJECT Proposed 24 Townhouse I 10671-10751 BJ Richmond, B.C. 1904BRD SCALE As Noted	Road 25 2 architecture.com -Unit Development alogePORT RD.
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Suite 230 11580 Camber Richmond BC Canada VEX 3 F 604 821 116 9 ROJECT PROJECT Proposed 24 Proposed 24 10671-10751 BI Richmond, B.C. 1904BRD SCALE AN Noted DATE Apr. 15, 21 DRAWN BY KYC, HD,	Road Z5 2 srchitecture.com Unit Development RIDGEPORT RD.
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Suite 230 11580 Cambie Richmond VXX3 T 504 821 116 F 604 821 117 Www.Interface: PROJECT Proposed 24 Townhouse I 10671-10751 BI Richmond, B.C. PROJECT NO. 1904BRID SCALE As Noted DATE As Noted DATE CHECKED SHEET TITLE CONVERTIE BEFORE & A	Road Z5 Z5 sarchitecture.com -Unit Development RIDGEPORT RD

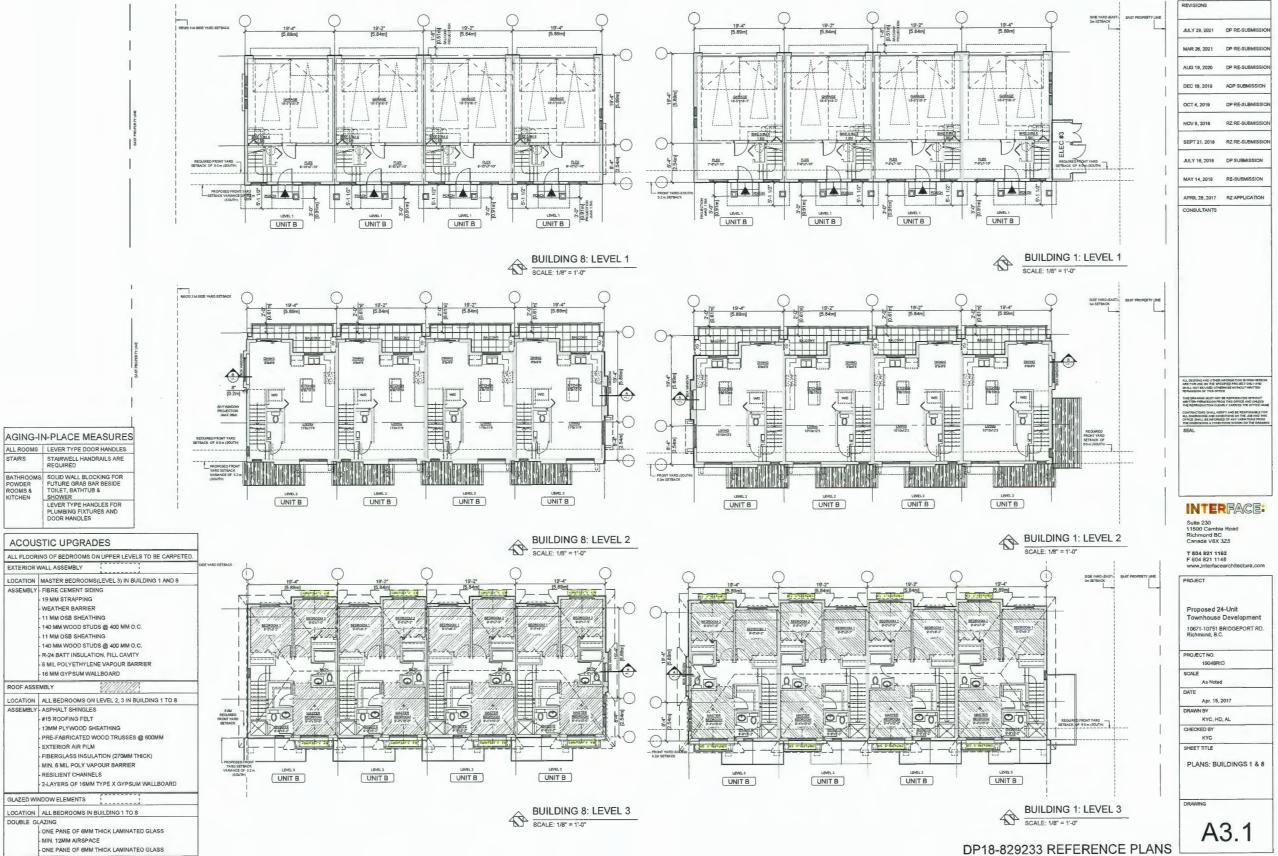

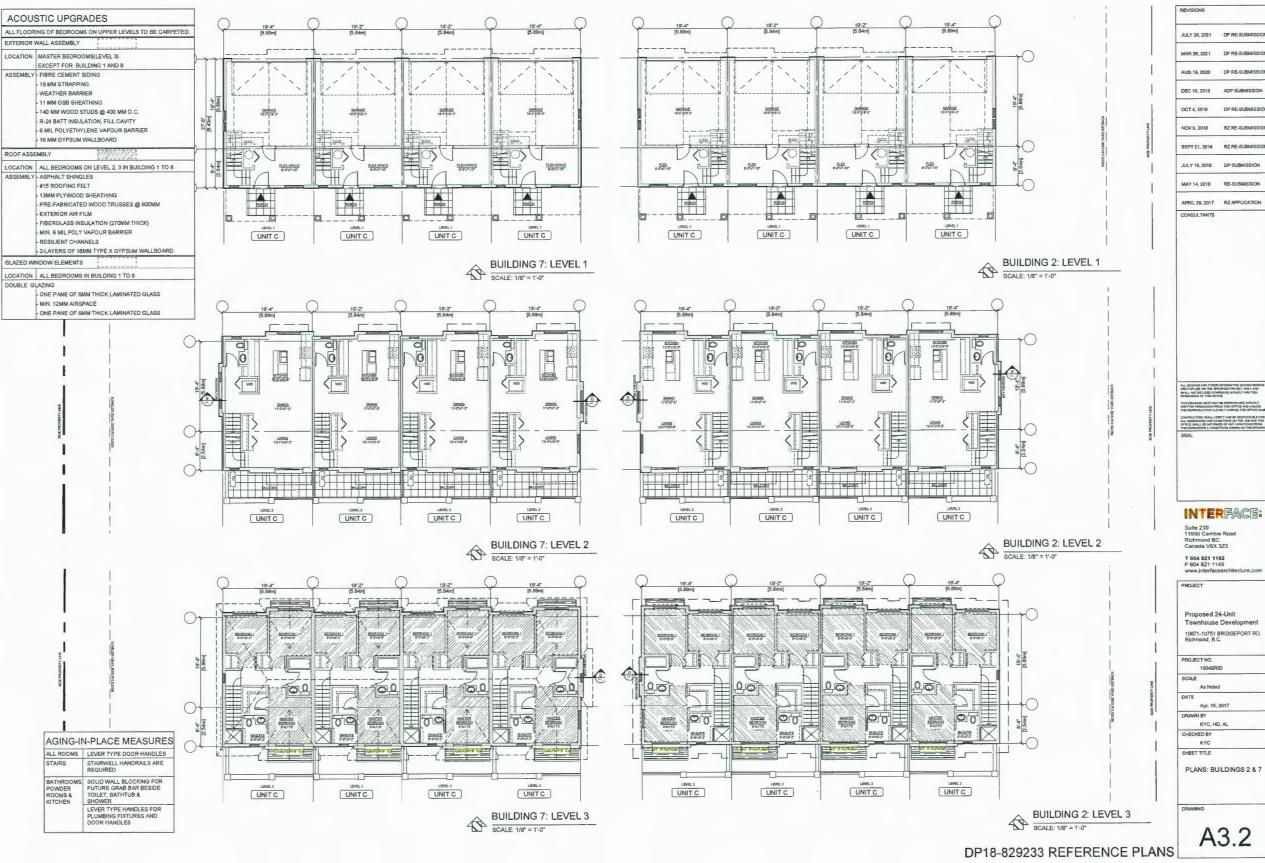


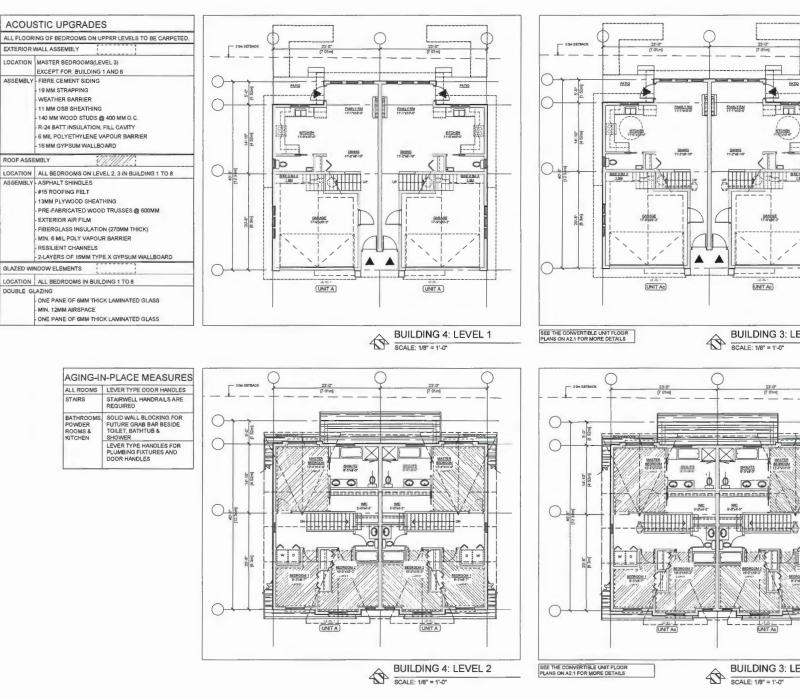



DP18-829233 REFERENCE PLANS

REVISIONS
JULY 29, 2021 OP RE-SUBMISSION
MAR 26, 2021 DP RE-SUBMISSION
AUG 19, 2020 DP RE-SUBMISSION
DEC 19, 2019 ADP SUBMISSION
OCT 4, 2019 DP RE-SUBMISSION
NOV 9, 2018 RZ RE-SUBMISSION
SEPT 21, 2018 RZ RE-SUBMISSION
JULY 16, 2018 DP SUBMISSION
MAY 14, 2018 RE-SUBMISSION
APRIL 28, 2017 RZ APPLICATION
CONSULTANTS
SEAL
INTER FACE: Suite 230 11590 Cambie Road Richmond BC Canada V5K 325 T 604 821 1162 F 604 821 1145 www.interfacearchilecture.com
Proposed 24-Unit Townhouse Development 10871-10751 BRIDGEPORT RD. Richmond, B.C.
PROJECT NO.
1904BRID SCALE
As Noted DATE
Apr. 15, 2017 DRAWN BY
KYC, HD CHECKED BY
SHEET TITLE
PLANS: BUILDINGS 3 & 4
DRAWING
A3.3

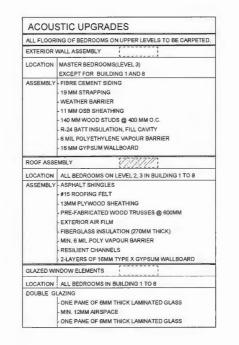



AGING-IN-PLACE MEASURES


ALL ROOMS LEVER TYPE DOOR HANDLES STAIRS STAIRWELL HANDRAILS ARE


BATHROOMS SOUD WALL BLOCKING FOR POWDER ROOMS & TOILET, BATHTUB & KITCHEN LEVER TYPE HANDLES FOR PLUMBING FUTURES AND DOOR HANDLES


STAIRWELL HANDRAILS ARE REQUIRED

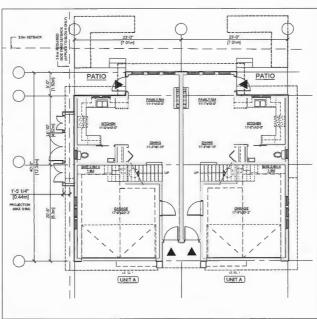

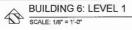

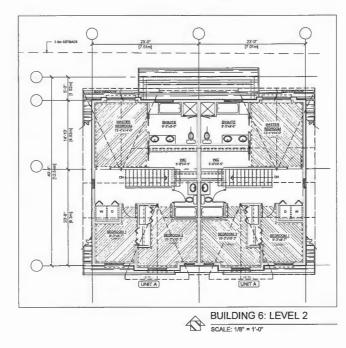

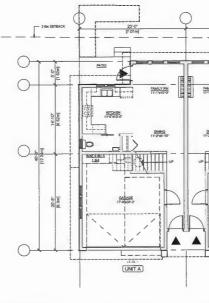

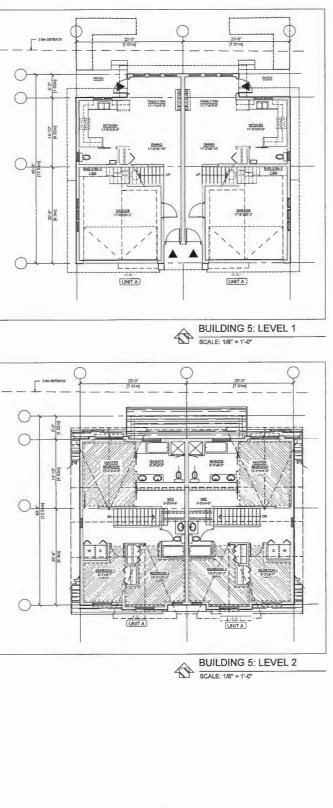

DP18-829233 REFERENCE PLANS

JULY 29, 2021 DP RE-SUBM MAR 26, 2021 DP RE-SUBMI AUG 19, 2020 DP RE-SUBMISS DEC 19, 2019 ADP SUBMISS OCT 4, 2019 DP RE-SUBMISS NOV 9, 2018 RZ RE-SUBMISS SEPT 21, 2018 RZ RE-SUBMIS JULY 16, 2018 DP SUBMISSION MAY 14, 2018 RE-SUBMISSION APRIL 28, 2017 RZ APPLICATION CONSULTANTS ALL DESCARS AND OTHER INFORMATION SHOWN HERE ARE FOR URE ON THE SPECIFIC PROJECT ONLY AND SHALL NOT BEUSED OTHERWISE WITHOUT WRITTEN PERMISSION OF THIS OFFICE. THIS DRAWING MUST NOT BE REPRODUCED WITHOUT WRITTEN FEMALSSION PROM THIS OFFICE AND UNLESS THE ASTRODUCTION CLEARLY CARRIES THE OFFICE NA CONTRACTORS SHALL ALL DIMENSIONS AND OFFICE SHALL BE HE THE DIMENSIONS A C INTERFACE: 11590 Cambie Road Richmond BC Canada V6X 3Z5 T 504 821 1162 F 604 821 1146 www.interfacearchited PROJECT Proposed 24-Unit Townhouse Development 10571-10751 BRIDGEPORT RD. Richmond, B.C. PROJECT NO. 1904BRID SCALE As Noted Apr. 15, 2017 KYC, HD CHECKED BY KYC HEET TITLE PLANS: BUILDINGS 5 & 6 WING A3.4

REVISION









MARCH 21, 9AM

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JUNE 21, 12PM

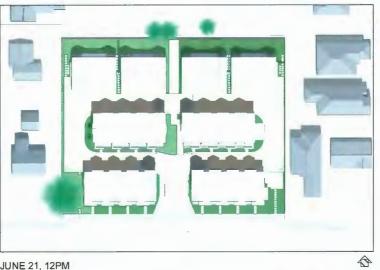



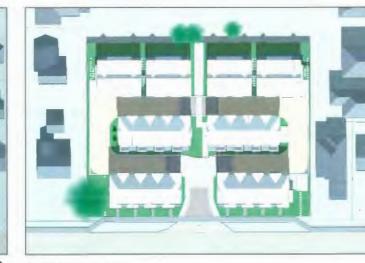

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SEPTEMBER 21, 9AM

SEPTEMBER 21, 12PM

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Townhouse Development 10571-10751 BRIDGEPORT RD. Richmond, B.C.