



City of Richmond

Report to Development Permit Panel

To: Development Permit Panel

Date: January 22, 2019

From: Wayne Craig
Director, Development

File: DP 18-827622

Re: **Application by Matthew Cheng Architect Inc. for a Development Permit at
8280/8282 and 8300/8320 No. 3 Road**

Staff Recommendation

That a Development Permit be issued which would permit the construction of 10 townhouse units and one secondary suite at 8280/8282 and 8300/8320 No. 3 Road on a site zoned “Low Density Townhouses (RTL4)”.



Wayne Craig
Director, Development
(604-247-4625)

WC:el
Att. 2

Staff Report

Origin

Matthew Cheng Architect Inc. has applied to the City of Richmond for permission to develop 10 townhouse units at 8280/8282 and 8300/8320 No. 3 Road. One of the 10 townhouse units is proposed to contain a ground-level secondary suite and one unit will be a convertible unit. The site is being rezoned from “Two-Unit Dwellings (RD1)” zone to “Low Density Townhouses (RTL4)” zone for this project under Bylaw 9856 (RZ 16-733565), which received Third Reading following the Public Hearing on May 22, 2018. The site is currently vacant, but previously contained two duplexes. A Servicing Agreement for frontage upgrades and service connections is required prior to Building Permit issuance.

Development Information

Please refer to the attached Development Application Data Sheet (Attachment 1) for a comparison of the proposed development data with the relevant bylaw requirements.

Background

Development surrounding the subject site is as follows:

To the North: An existing duplex on a lot zoned “Two-Unit Dwellings (RD1)”; which is identified for townhouse development under the Arterial Road Land Use Policy, and a public walkway between No. 3 Road and Luton Road.

To the South: Existing single-family homes on lots zoned “Single Detached (RS1/E)”; which are identified for townhouse development under the Arterial Road Land Use Policy.

To the East: Existing single-family dwellings and duplexes on lots zoned “Single-Detached (RS1/E)” and “Two-Unit Dwellings (RD1)”.

To the West: Across No. 3 Road, existing single-family homes on lots zoned “Single Detached (RS1/E)”, “Single Detached (RS1/B)”, and “Compact Single Detached (RC1)”; which are identified for compact lot single detached development under the Arterial Road Land Use Policy.

Rezoning and Public Hearing Results

The Public Hearing for the rezoning of this site was held on May 22, 2018. No concerns regarding the rezoning application were expressed at the Public Hearing.

Staff Comments

The proposed scheme attached to this report has satisfactorily addressed the significant urban design issues and other staff comments identified as part of the review of the subject Development Permit application. In addition, it complies with the intent of the applicable sections of the Official Community Plan (OCP) and is generally in compliance with the “Low Density Townhouses (RTL4)” zone.

Advisory Design Panel Comments

The subject application was not presented to the Advisory Design Panel (ADP) on the basis that this small project generally meets all the applicable Development Permit Guidelines, and the overall design and site plan have adequately addressed staff comments.

Analysis

Conditions of Adjacency

- The proposed height, siting and orientation of the buildings generally address the massing of the surrounding residential developments.
- While three-storey units are proposed along No. 3 Road, the building height and setbacks are articulated to address potential shadowing over the adjacent duplexes to the north.
- Two pairs of two-storey duplexes and the outdoor amenity area are proposed along the rear (east) property line to minimize privacy and overlook concerns.
- The existing site grade within the rear yards along the east property line will be maintained to facilitate tree preservation and provide an appropriate transition to the adjacent single-family properties to the east.
- The site grade of the proposed outdoor amenity space at the southeast corner of the site will be raised approximately 0.8 m to match the proposed site grade of the internal drive aisle. A retaining wall is proposed along the east property line. The proposed change of site grade in the outdoor amenity area would enhance passive surveillance opportunity over the space and provide a more functional children's play area with play equipment on a relatively flat area.
- Privacy for adjacent residential developments will be maintained by a 1.8 m high wood fence with lattice and landscaping with trees along the three interior property lines. Fence height along the east property line within the outdoor amenity space will be reduced to approximately 1.0 m (on top of the 0.8 m high retaining wall) to provide a consistent overall fence height looking from the neighbouring property.
- Perimeter drainage will be required as part of the Building Permit to ensure storm water is managed and addressed through the development and will not impact the neighbouring properties.
- Properties to both north and south of the subject site are designated for townhouse development. A statutory right-of-way (SRW) allowing access to/from the adjacent future development sites through the subject site (over the entry driveway and internal drive aisle) has been secured at rezoning.

Urban Design and Site Planning

- Main vehicular access to this new townhouse project is to be from No. 3 Road through a new driveway at the southern edge of the site, with future connections to the neighbouring properties to the north and south, secured by a SRW.
- An on-site turnaround will be provided opposite to the entry driveway on the east side of the internal drive aisle. It is expected that, when the adjacent property to the south is redeveloped into a townhouse development, on-site turnaround would be accommodated by a T-intersection over the two sites. At that time, the on-site turnaround area located adjacent to the outdoor amenity area will no longer be warranted and can be used as an extended outdoor amenity space. This arrangement has been secured through a legal agreement at rezoning.

- The layout of the townhouse units is oriented around the north-south internal manoeuvring aisle, providing access to the unit garages.
- Units along No. 3 Road will have direct pedestrian access from the street and units along the rear (east) property line will have access from the internal drive aisle.
- One of the units will contain a ground-level secondary suite (studio) of approximately 28 m² (299 ft²) in size. An additional surface parking stall will be assigned to the secondary suite.
- All townhouse units will have two vehicle parking spaces in a double car garage. The proposal will feature four units with a total of eight spaces in a tandem arrangement (40% of total required residential parking spaces), which is consistent with the maximum 50% of tandem parking provision of Richmond Zoning Bylaw 8500. A restrictive covenant to prohibit the conversion of the tandem garage area into habitable space has been secured at rezoning.
- A total of two visitor parking spaces will be provided throughout the site. The number of visitor parking spaces proposed is in compliance with the minimum bylaw requirement.
- Both internal and external bicycle parking spaces have been incorporated into the proposal and are in compliance with the Zoning Bylaw requirements.
- The provision of private outdoor spaces complies with the Development Permit Guidelines (30 m² per unit) of the OCP. All units will have private outdoor spaces consisting of a front or a rear yard; the three-storey units will also have a covered deck on the second floor facing the internal drive aisle.
- Outdoor amenity space is proposed opposite to the site entry for maximum casual surveillance opportunity and sun exposure. The size and location of the outdoor amenity space is appropriate in providing open landscape and amenity space convenient to all units.
- The required garbage, recycling and organic waste storage enclosures, as well as the covered mailbox kiosk, has been incorporated into the design of the street fronting building to minimize the visual impact. The proposed location will also be convenient to all of the units.

Architectural Form and Character

- The proposed building form is contemporary with simple rectilinear building mass of rectangular shapes, stacked to create varying projections. This contemporary design approach does reference existing examples of other buildings along arterial roads that demonstrate use of flat roof lines and strong vertical elements.
- The overall contemporary form and modern architectural expression of the proposal provides for enhanced architectural and built form variation of the No. 3 Road streetscape.
- The street fronting units will have individual canopies and stoops identifying the entry doors. A pedestrian scale is generally achieved along the public streets and internal drive aisle through the inclusion of variation in building projections, recesses, variety of materials/colours and landscape features.
- The impact of blank garage doors has been mitigated with panel patterned doors, transom windows, unit entrances, and planting islands along the drive aisle.
- The proposed building materials (fibre-cement panel, woodprint channeled hollow core vinyl siding, brick veneer) are generally consistent with the Official Community Plan (OCP) Guidelines.
- A palette of earthly colours such as gray and brown, with white as an accent colour on the main cladding materials, are generally consistent with the contemporary design of the project.

Landscape Design and Open Space Design

- Tree preservation was reviewed at rezoning stage; 23 trees on-site were identified for removal. Based on the 2:1 tree replacement ratio stated in the Official Community Plan (OCP), 46 replacement trees are required. The applicant is proposing to plant 24 replacement trees on-site, including five conifers and 19 deciduous trees. The applicant has agreed to provide a voluntary contribution of \$11,000 to the City's Tree Compensation Fund in lieu of planting the remaining 22 replacement trees. A voluntary contribution of \$5,000 has been secured at the Rezoning stage; an additional voluntary contribution of \$6,000 will be provided prior to issuance of the Development Permit.
- The proposal provides for a pedestrian-oriented streetscape fronting No. 3 Road with a landscaped edge treatment including a new tree in each front yard, lawn and patio areas, low metal fencing, and metal gate to each street fronting unit.
- All units along the rear (east) property line will have a private yard with a patio and a lawn area. Various hedges, shrubs and ground covers, as well as perennials and grasses have been selected to ensure the landscape treatment remains interesting throughout the year.
- Landscaping will be provided along the north-south internal drive aisle between entry doors/garage doors to provide vertical green to soften the internal streetscape. A trellis will be provided at the north end of the internal drive aisle to provide visual interests at the terminus.
- A children's play area is proposed for the outdoor amenity area, and play equipment has been chosen to fit into outdoor amenity space and to provide different play opportunities (i.e., climbing, social, imagination, balance, motor skills) that can be used by different age groups and for multiple purposes. A bench is also provided for caregivers.
- The vehicle entrance, on-site turnaround area, surface parking spaces and designated walkways on-site will be treated with permeable pavers for better water infiltration and variety in paving surfaces.
- Pavers will also be used to highlight pedestrian routes along the main north-south drive aisle.
- In order to ensure that the proposed landscaping works are completed, the applicant is required to provide a landscape security of \$90,745.24 in association with the Development Permit.
- Indoor amenity space is not proposed on-site. A \$10,000 cash-in-lieu contribution (\$1,000 per unit) has been secured as a condition of rezoning approval, consistent with the OCP.
- It is expected that, when the adjacent property to the south is redeveloped into a townhouse development, on-site turnaround would be accommodated on the entry driveway and the internal aisle. At that time, the on-site turnaround area located adjacent to the outdoor amenity area will no longer be warranted. In order to ensure that the on-site turnaround area will be used as outdoor amenity when the on-site turnaround area becomes unwarranted, as per the SRW documents secured at rezoning stage, a conceptual landscape plan for this area has been included in the landscaping drawings.

Crime Prevention Through Environmental Design

- Site lighting and clear site lines provide unobstructed views of surrounding area; plantings near residential entries are low to maximize views and casual surveillance opportunities.

- Expansive glazing for each unit increases the visual presence and surveillance along No. 3 Road, the amenity area, as well as internal drive aisle. All entrances are visible and overlooked by pedestrians or by neighbour's windows.
- Exterior lights will be provided along drive aisle, as well as in visitor parking, outdoor amenity, and private yard areas; wall mount illuminated lights will be installed on building faces.

Sustainability

- A Certified Energy Advisor has confirmed that the proposed townhouse units will be designed to achieve an EnerGuide rating of 82. The report prepared by the Energy Advisor is on file and will be utilized through the Building Permit review process to ensure these measures are incorporated in the Permit drawings.
- The architect advised that the following design/features are incorporated into the proposal:
 - Water efficient plumbing fixtures.
 - Durable siding materials (such as Sagiwall and Hardie panel) as the main cladding material to achieve sustainable building practices.
 - Drought tolerant landscaping.

Accessible Housing

- The proposed development includes one convertible unit that is designed with the potential to be easily renovated to accommodate a future resident in a wheelchair. The potential conversion of this unit will require installation of a vertical lift in the stacked storage space (which has been dimensioned to allow for this in Unit #7) in the future, if desired.
- All of the proposed units incorporate aging in place features to accommodate mobility constraints associated with aging. These features include:
 - Stairwell hand rails.
 - Lever-type handles for plumbing fixtures and door handles.
 - Solid blocking in washroom walls to facilitate future grab bar installation beside toilets, bathtubs and showers.

Conclusions

As the proposed development would meet applicable policies and Development Permit Guidelines, staff recommend that the Development Permit be endorsed, and issuance by Council be recommended.



Edwin Lee
Planner 1
(604-276-4121)

EL:blg

Attachment 1: Development Application Data Sheet
Attachment 2: Development Permit Considerations



City of Richmond

Development Application Data Sheet

Development Applications Department

DP 18-827622

Attachment 1

Address: 8280/8282 and 8300/8320 No. 3 Road

Applicant: Matthew Cheng Architect Inc. Owner: Chislon (No. 3) Development Corp.

Planning Area(s): Broadmoor

Floor Area Gross: 1,877.01 m² Floor Area Net: 1,289.28 m²

	Existing	Proposed
Site Area:	2,140 m ²	No Change
Land Uses:	Duplex	Multiple-Family Residential
OCP Designation:	Low-Density Residential	No Change
Zoning:	Two-Unit Dwellings (RD1)	Low Density Townhouses (RTL4)
Number of Units:	4	10

	Bylaw Requirement	Proposed	Variance
Floor Area Ratio:	Max. 0.60	0.60	none permitted
Lot Coverage – Building:	Max. 40%	39.67%	none
Lot Coverage – Non-porous Surfaces:	Max. 65%	59.52%	none
Lot Coverage – Landscaping:	Min. 25%	25.29%	none
Setback – Front Yard (m):	Min. 6.0 m	6.1 m Min.	none
Setback – North Side Yard (m):	Min. 3.0 m	3.13 m Min.	none
Setback – South Side Yard (m):	Min. 3.0 m	7.84 m	none
Setback – Rear Yard (m):	Min. 3.0 m	6.1 m Min. with 50% ground floor projection (at 4.5 m)	none
Height (m):	Max. 12.0 m (3 storeys)	9.83 m (3 storeys) along No. 3 Road & 7.39 m (2 storeys) along east property line	none
Lot Width:	Min. 50.0 m	50.25 m	none
Lot Depth:	Min. 35.0 m	42.67 m	none
Off-street Parking Spaces – Regular (R) / Visitor (V):	2 (R) and 0.2 (V) per unit + 1 (R) per secondary suite	2 (R) and 0.2 (V) per unit + 1 (R) per secondary suite	none
Off-street Parking Spaces – Total:	21 (R) and 2 (V)	21 (R) and 2 (V)	none

Tandem Parking Spaces:	Max. 50% of proposed residential spaces in enclosed garages (20 x Max. 50% = 10)	8	none
Small Car Parking Spaces	None when fewer than 31 spaces are provided on site	0	none
Handicap Parking Spaces:	None when fewer than 3 visitor stalls are required	0	none
Bicycle Parking Spaces – Class 1 / Class 2:	1.25 (Class 1) and 0.2 (Class 2) per unit	1.7 (Class 1) and 0.2 (Class 2) per unit	none
Off-street Bicycle Parking Spaces – Total:	13 (Class 1) and 2 (Class 2)	17 (Class 1) and 2 (Class 2)	none
Amenity Space – Indoor:	Min. 70 m ² or Cash-in-lieu	Cash-in-lieu	none
Amenity Space – Outdoor:	Min. 6 m ² x 10 units = 60 m ²	77.81 m ²	none



**City of
Richmond**

ATTACHMENT 2

Development Permit Considerations

Development Applications Department
6911 No. 3 Road, Richmond, BC V6Y 2C1

Address: 8280/8282 and 8300/8320 No. 3 Road

File No.: DP 18-827622

Prior to approval of the Development Permit, the developer is required to complete the following:

1. Final adoption of the Zoning Amendment Bylaw 9856.
2. Receipt of a Letter-of-Credit for landscaping and tree survival security in the amount of \$90,745.24. No Landscape Letter of Credit will be returned until
 - a) the post-construction assessment report, confirming the protected trees survived the construction, prepared by the Arborist, and
 - b) the Letter of Assurance, confirming the landscaping are installed as per the Development Permit, prepared by the Landscape Architect,are reviewed by staff.
3. City acceptance of the developer's offer to voluntarily contribute \$6,000.00 to the City's Tree Compensation Fund for the planting of 12 replacement trees within the City.

Note: Should the applicant wish to begin site preparation work after third reading of the rezoning bylaw, but prior to final adoption of the rezoning bylaw and issuance of the Development Permit, the applicant will be required to obtain a Tree Permit and submit landscaping security (i.e. \$25,000 in total) to ensure the replacement planting will be provided.

Prior to Building Permit Issuance, the developer must complete the following requirements:

1. Installation of appropriate tree protection fencing around all trees to be retained as part of the development prior to any construction activities, including building demolition, occurring on-site.
2. Submission of a Construction Parking and Traffic Management Plan to the Transportation Department. Management Plan shall include location for parking for services, deliveries, workers, loading, application for any lane closures, and proper construction traffic controls as per Traffic Control Manual for works on Roadways (by Ministry of Transportation) and MMCD Traffic Regulation Section 01570.
3. Incorporation of accessibility, CPTED and sustainability measures in Building Permit (BP) plans as determined via the Rezoning and/or Development Permit processes.
4. Enter into a Servicing Agreement* for the design and construction of engineering infrastructure improvements. Works include, but may not be limited to:

Water Works

- Using the OCP Model, there is 1001 L/s of water available at a 20 psi residual at the No. 3 Road frontage. Based on your proposed development, your site requires a minimum fire flow of 220 L/s.
- The Developer is required to:
 - Submit Fire Underwriter Survey (FUS) or International Organization for Standardization (ISO) fire flow calculations to confirm the development has adequate fire flow for on-site fire protection. Calculations must be signed and sealed by a Professional Engineer and be based on Building Permit Stage Building designs.
- At the Developers cost, the City is to:
 - Install one new water service connection, off of the existing 400 mm AC watermain on No. 3 Road. Meter will be placed on site (i.e. mechanical room).
 - Cut and cap at main, the two existing water service connections at the No. 3 Road frontage.

Initial: _____

Storm Sewer Works

- At Developer's cost, the City is to:
 - Install a new storm service connection off of the existing box culvert along No. 3 Road complete with inspection chamber.
 - Cut, cap and remove the existing service connection and inspection chamber STIC59019.

Sanitary Sewer Works

- The Developer is required to:
 - Not start on-site building construction prior to completion of rear yard sanitary works.
- At Developer's cost, the City is to:
 - Install a new sanitary service connection off of the existing manhole SMH2399 at the northeast corner of the subject site. The manhole will serve as the inspection chamber.
 - Cut and cap the existing sanitary service leads along the east property line of the development site.

Frontage Improvements

- The Developer is required to:
 - Remove the existing sidewalk behind the curb and backfill the area to provide a minimum 1.5 m wide grass/treed boulevard (width of the boulevard is exclusive of the 0.15 m wide top of curb).
 - Construct a new 1.5 m wide concrete sidewalk behind the new boulevard and next to the property line. The new sidewalk is to transition to connect to the existing sidewalk north and south of the subject site.
 - The new sidewalk may have to be designed to go around trees that have been identified for retention. Consult Parks on the design of the new sidewalk to ensure that tree root systems are not compromised and natural irrigation can be maintained.
 - The frontage improvements identified under above are to be extended across the frontage of 8260/8266 No. 3 Road.
 - Road dedication would be required if the existing width between the curb and the property line is not sufficient to accommodate the required minimum frontage improvements noted above.
 - All existing driveways along the subject site's No. 3 Road frontage are to be closed permanently and replaced by a single driveway.
 - Remove the existing driveway crossings and replace with barrier curb/gutter, boulevard and sidewalk per standards described above. The applicant is responsible for the design and construction of curb/gutter, sidewalk and boulevard as part of the driveway closure works in addition to other required frontage improvements.
 - Design new driveway to City design standards (6.7 m driveway width at the property line, with 0.9 m flares at the curb and 45° offsets to meet existing grade of sidewalk/boulevard).
 - Coordinate with BC Hydro, Telus and other private communication service providers
 - To underground Hydro service lines.
 - When relocating/modifying any of the existing power poles and/or guy wires within the property frontages.
 - To determine if above ground structures are required and coordinate their locations (e.g. Vista, PMT, LPT, Shaw cabinets, Telus Kiosks, etc.). These should be located on-site.

General Items

- The Developer is required to:
 - Enter into, if required, additional legal agreements, as determined via the subject development's Servicing Agreement(s) and/or Development Permit(s), and/or Building Permit(s) to the satisfaction of the Director of Engineering, including, but not limited to, site investigation, testing, monitoring, site preparation, de-watering, drilling, underpinning, anchoring, shoring, piling, pre-loading, ground densification or other activities that may result in settlement, displacement, subsidence, damage or nuisance to City and private utility infrastructure.

Initial: _____

- Provide, prior to soil densification and preload installation, a geotechnical assessment of preload and soil densification impacts on the existing utilities surrounding the development site and provide mitigation recommendations.
- 5. If applicable, payment of latecomer agreement charges, plus applicable interest associated with eligible latecomer works.
- 6. Obtain a Building Permit (BP) for any construction hoarding. If construction hoarding is required to temporarily occupy a public street, the air space above a public street, or any part thereof, additional City approvals and associated fees may be required as part of the Building Permit. For additional information, contact the Building Approvals Department at 604-276-4285.

Note:

- * This requires a separate application.
- Where the Director of Development deems appropriate, the preceding agreements are to be drawn not only as personal covenants of the property owner but also as covenants pursuant to Section 219 of the Land Title Act.
All agreements to be registered in the Land Title Office shall have priority over all such liens, charges and encumbrances as is considered advisable by the Director of Development. All agreements to be registered in the Land Title Office shall, unless the Director of Development determines otherwise, be fully registered in the Land Title Office prior to enactment of the appropriate bylaw.
The preceding agreements shall provide security to the City including indemnities, warranties, equitable/rent charges, letters of credit and withholding permits, as deemed necessary or advisable by the Director of Development. All agreements shall be in a form and content satisfactory to the Director of Development.
- Additional legal agreements, as determined via the subject development's Servicing Agreement(s) and/or Development Permit(s), and/or Building Permit(s) to the satisfaction of the Director of Engineering may be required including, but not limited to, site investigation, testing, monitoring, site preparation, de-watering, drilling, underpinning, anchoring, shoring, piling, pre-loading, ground densification or other activities that may result in settlement, displacement, subsidence, damage or nuisance to City and private utility infrastructure.
- Applicants for all City Permits are required to comply at all times with the conditions of the Provincial *Wildlife Act* and Federal *Migratory Birds Convention Act*, which contains prohibitions on the removal or disturbance of both birds and their nests. Issuance of Municipal permits does not give an individual authority to contravene these legislations. The City of Richmond recommends that where significant trees or vegetation exists on site, the services of a Qualified Environmental Professional (QEP) be secured to perform a survey and ensure that development activities are in compliance with all relevant legislation.

Signed

Date



City of Richmond

Development Permit

No. DP 18-827622

To the Holder: MATTHEW CHENG ARCHITECT INC.

Property Address: 8280/8282 AND 8300/8320 NO. 3 ROAD

Address: C/O #202 - 670 EVANS AVENUE
VANCOUVER, BC V6A 2K9

1. This Development Permit is issued subject to compliance with all of the Bylaws of the City applicable thereto, except as specifically varied or supplemented by this Permit.
2. This Development Permit applies to and only to those lands shown cross-hatched on the attached Schedule "A" and any and all buildings, structures and other development thereon.
3. Subject to Section 692 of the Local Government Act, R.S.B.C.: buildings and structures; off-street parking and loading facilities; roads and parking areas; and landscaping and screening shall be constructed generally in accordance with Plans #1 to #4 attached hereto.
4. Sanitary sewers, water, drainage, highways, street lighting, underground wiring, and sidewalks, shall be provided as required.
5. As a condition of the issuance of this Permit, the City is holding the security in the amount of \$90,745.24 to ensure that development is carried out in accordance with the terms and conditions of this Permit. Should any interest be earned upon the security, it shall accrue to the Holder if the security is returned. The condition of the posting of the security is that should the Holder fail to carry out the development hereby authorized, according to the terms and conditions of this Permit within the time provided, the City may use the security to carry out the work by its servants, agents or contractors, and any surplus shall be paid over to the Holder. Should the Holder carry out the development permitted by this permit within the time set out herein, the security shall be returned to the Holder. The City may retain the security for up to one year after inspection of the completed landscaping in order to ensure that plant material has survived.
6. If the Holder does not commence the construction permitted by this Permit within 24 months of the date of this Permit, this Permit shall lapse and the security shall be returned in full.

Development Permit
No. DP 18-827622

To the Holder: MATTHEW CHENG ARCHITECT INC.
Property Address: 8280/8282 AND 8300/8320 NO. 3 ROAD
Address: C/O #202 - 670 EVANS AVENUE
VANCOUVER, BC V6A 2K9

7. The land described herein shall be developed generally in accordance with the terms and conditions and provisions of this Permit and any plans and specifications attached to this Permit which shall form a part hereof.

This Permit is not a Building Permit.

AUTHORIZING RESOLUTION NO.
DAY OF ,


ISSUED BY THE COUNCIL THE

DELIVERED THIS DAY OF ,

MAYOR



City of Richmond

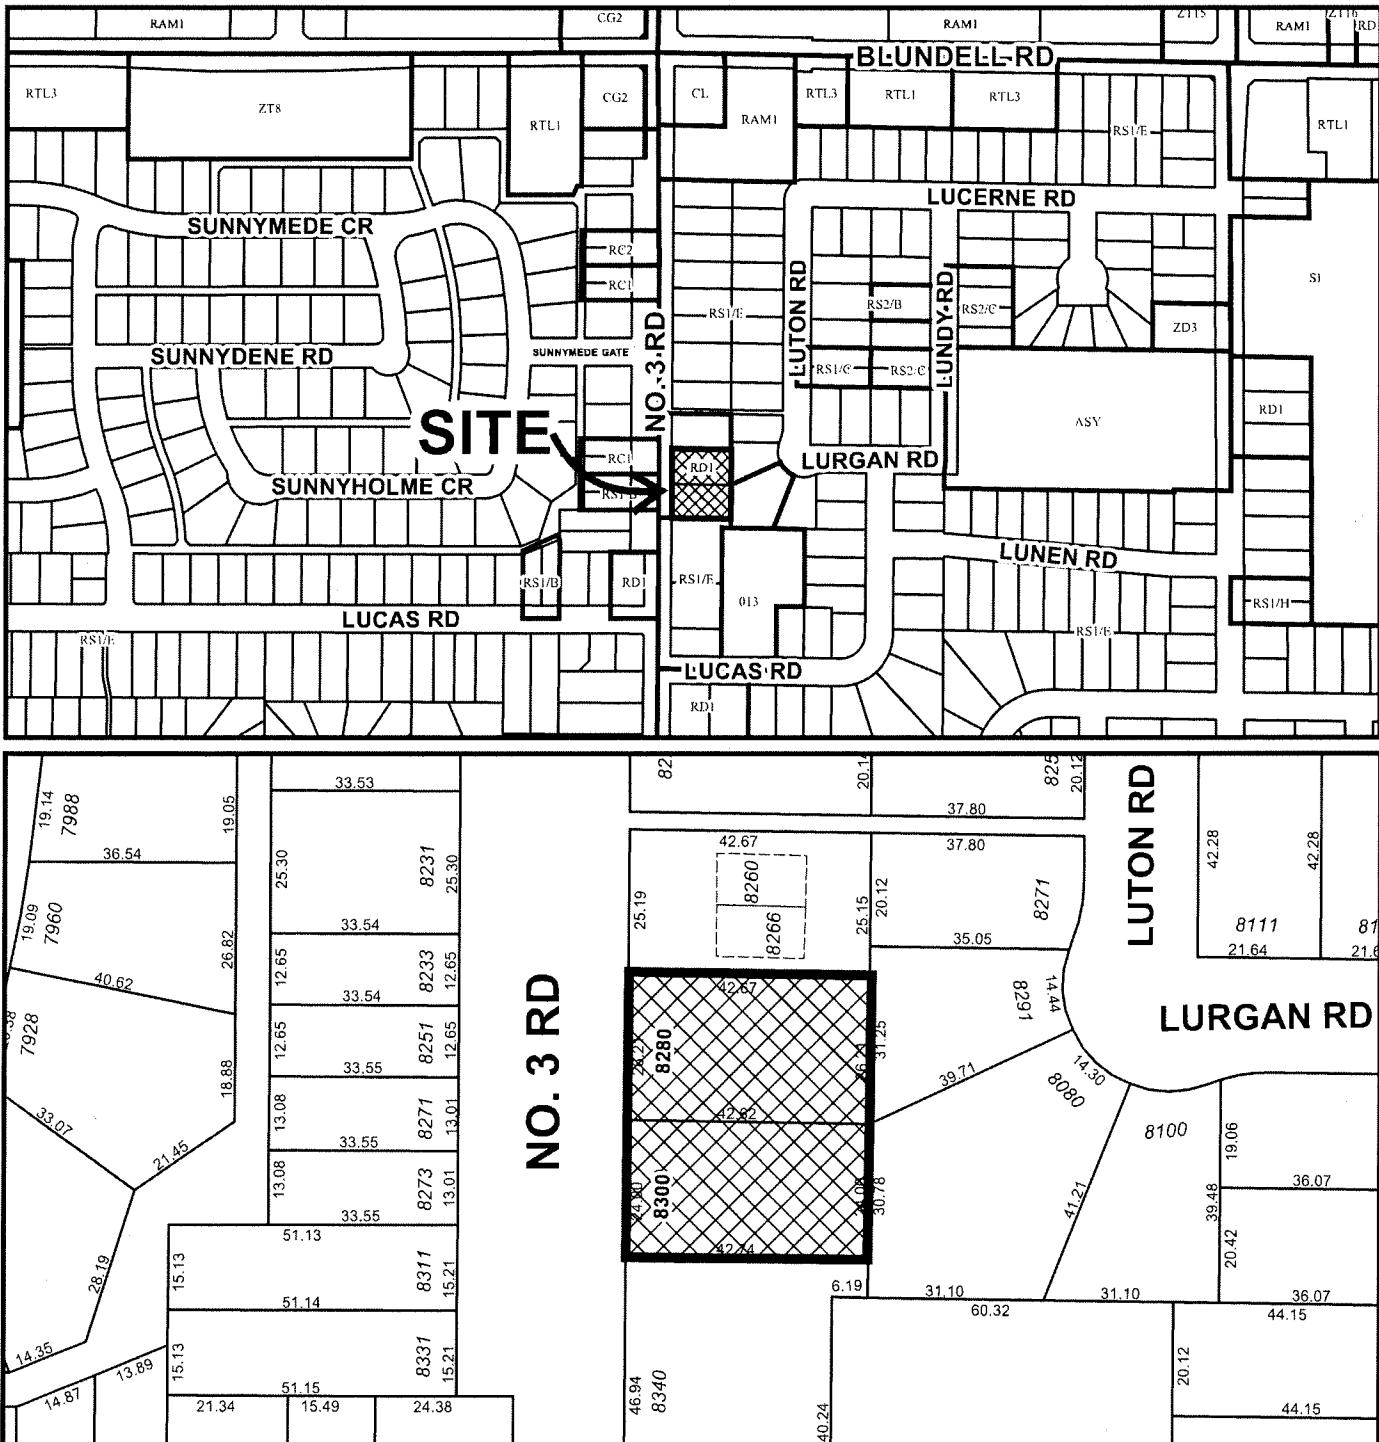


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DP 18-827622
SCHEDULE "A"

Original Date: 08/09/18

Revision Date:

Note: Dimensions are in METRES

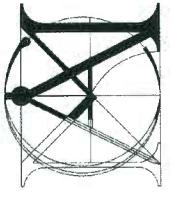

Matthew Cheng
Architect Inc.

Unit 202 - 670 EVANS AVENUE
VANCOUVER, BC V6A 2K9
Tel: (604) 731-3012 / Fax: (604) 731-3908
Cel: (604) 649-0669 / Email: matthew@mcafee.ca

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Revision:	2018-12-19	ISSUE FOR DPP STAFF REVIEW
	2019-01-10	RE-ISSUE FOR DPP STAFF REVIEW
	2019-01-15	RE-ISSUE FOR DPP STAFF REVIEW

Consultant

PROJECT FILE
8280 NO. 3
ROAD,
RICHMOND,
B.C.

JAN 22 2019

Location	RJU
Checked By	MC
Scale	As indicated
Project Number	16RTH01
Revision	Dwg.
Date	20/03/17

AGING-IN-PLACE FEATURES

PROVIDE AGING-IN-PLACE FEATURES ON ALL UNITS:

- FOR STAIRWALLS:**
AT THE TOP OF ALL STAIRWAYS, WALLS ARE REINFO
SOLID LUMBER AT 914 MM TO CENTRE.
- PROVIDE LEVER TYPE HANDLES FOR:**
 - PLUMBING FIXTURES
 - ALL DOOR HANDLES
- PROVIDE SOLID BLOCKING IN WASHROOM WALLS FOR:**
 - BESIDE TOILET, BATH/TUB AND SHOWER.
- CROSS HATCH AREA DENOTES TREE PROTECTION ZONE**
 - NO EXCAVATION FOR THE BUILDING AND SITE CONSTRUCTION OR COLOCATING OF EQUIPMENT INTO THE TZ2 MUST BE SUPERVISED BY C
EEFER TO TREE MANAGEMENT PLAN FOR DETAILED N
OVELTY CHANGES ARE TO OCCUR WITH
BSOLUTELY NO GRADE CHANGES ARE TO OCCUR WITH
- SRW AREA DENOTES SRW ZONE AS PER**
 - SURVEY DRAWING

SITE PLAN HATCH LEGEND


CROSS HATCH AREA DENOTES TREE PROTECTION ZONE (TPZ).
ANY EXCAVATION FOR THE PROPOSED BUILDING MUST BE CONDUCTED WITHIN THE TPZ AND STARVOGE THAT ENCROACHES INTO THE TPZ MUST BE SURVEYED BY CERTIFIED ARBORIST.
REFER TO TREEMANAGEMENT PLAN FOR DETAILED INSTRUCTION.
ABSOLUTELY NO GRADE CHANGES ARE TO OCCUR WITHIN THESE ZONES.


SURVEY PLAN UNDERLAY LEGEND

DP 18-827622

SITE PLAN

JAN 22 2019

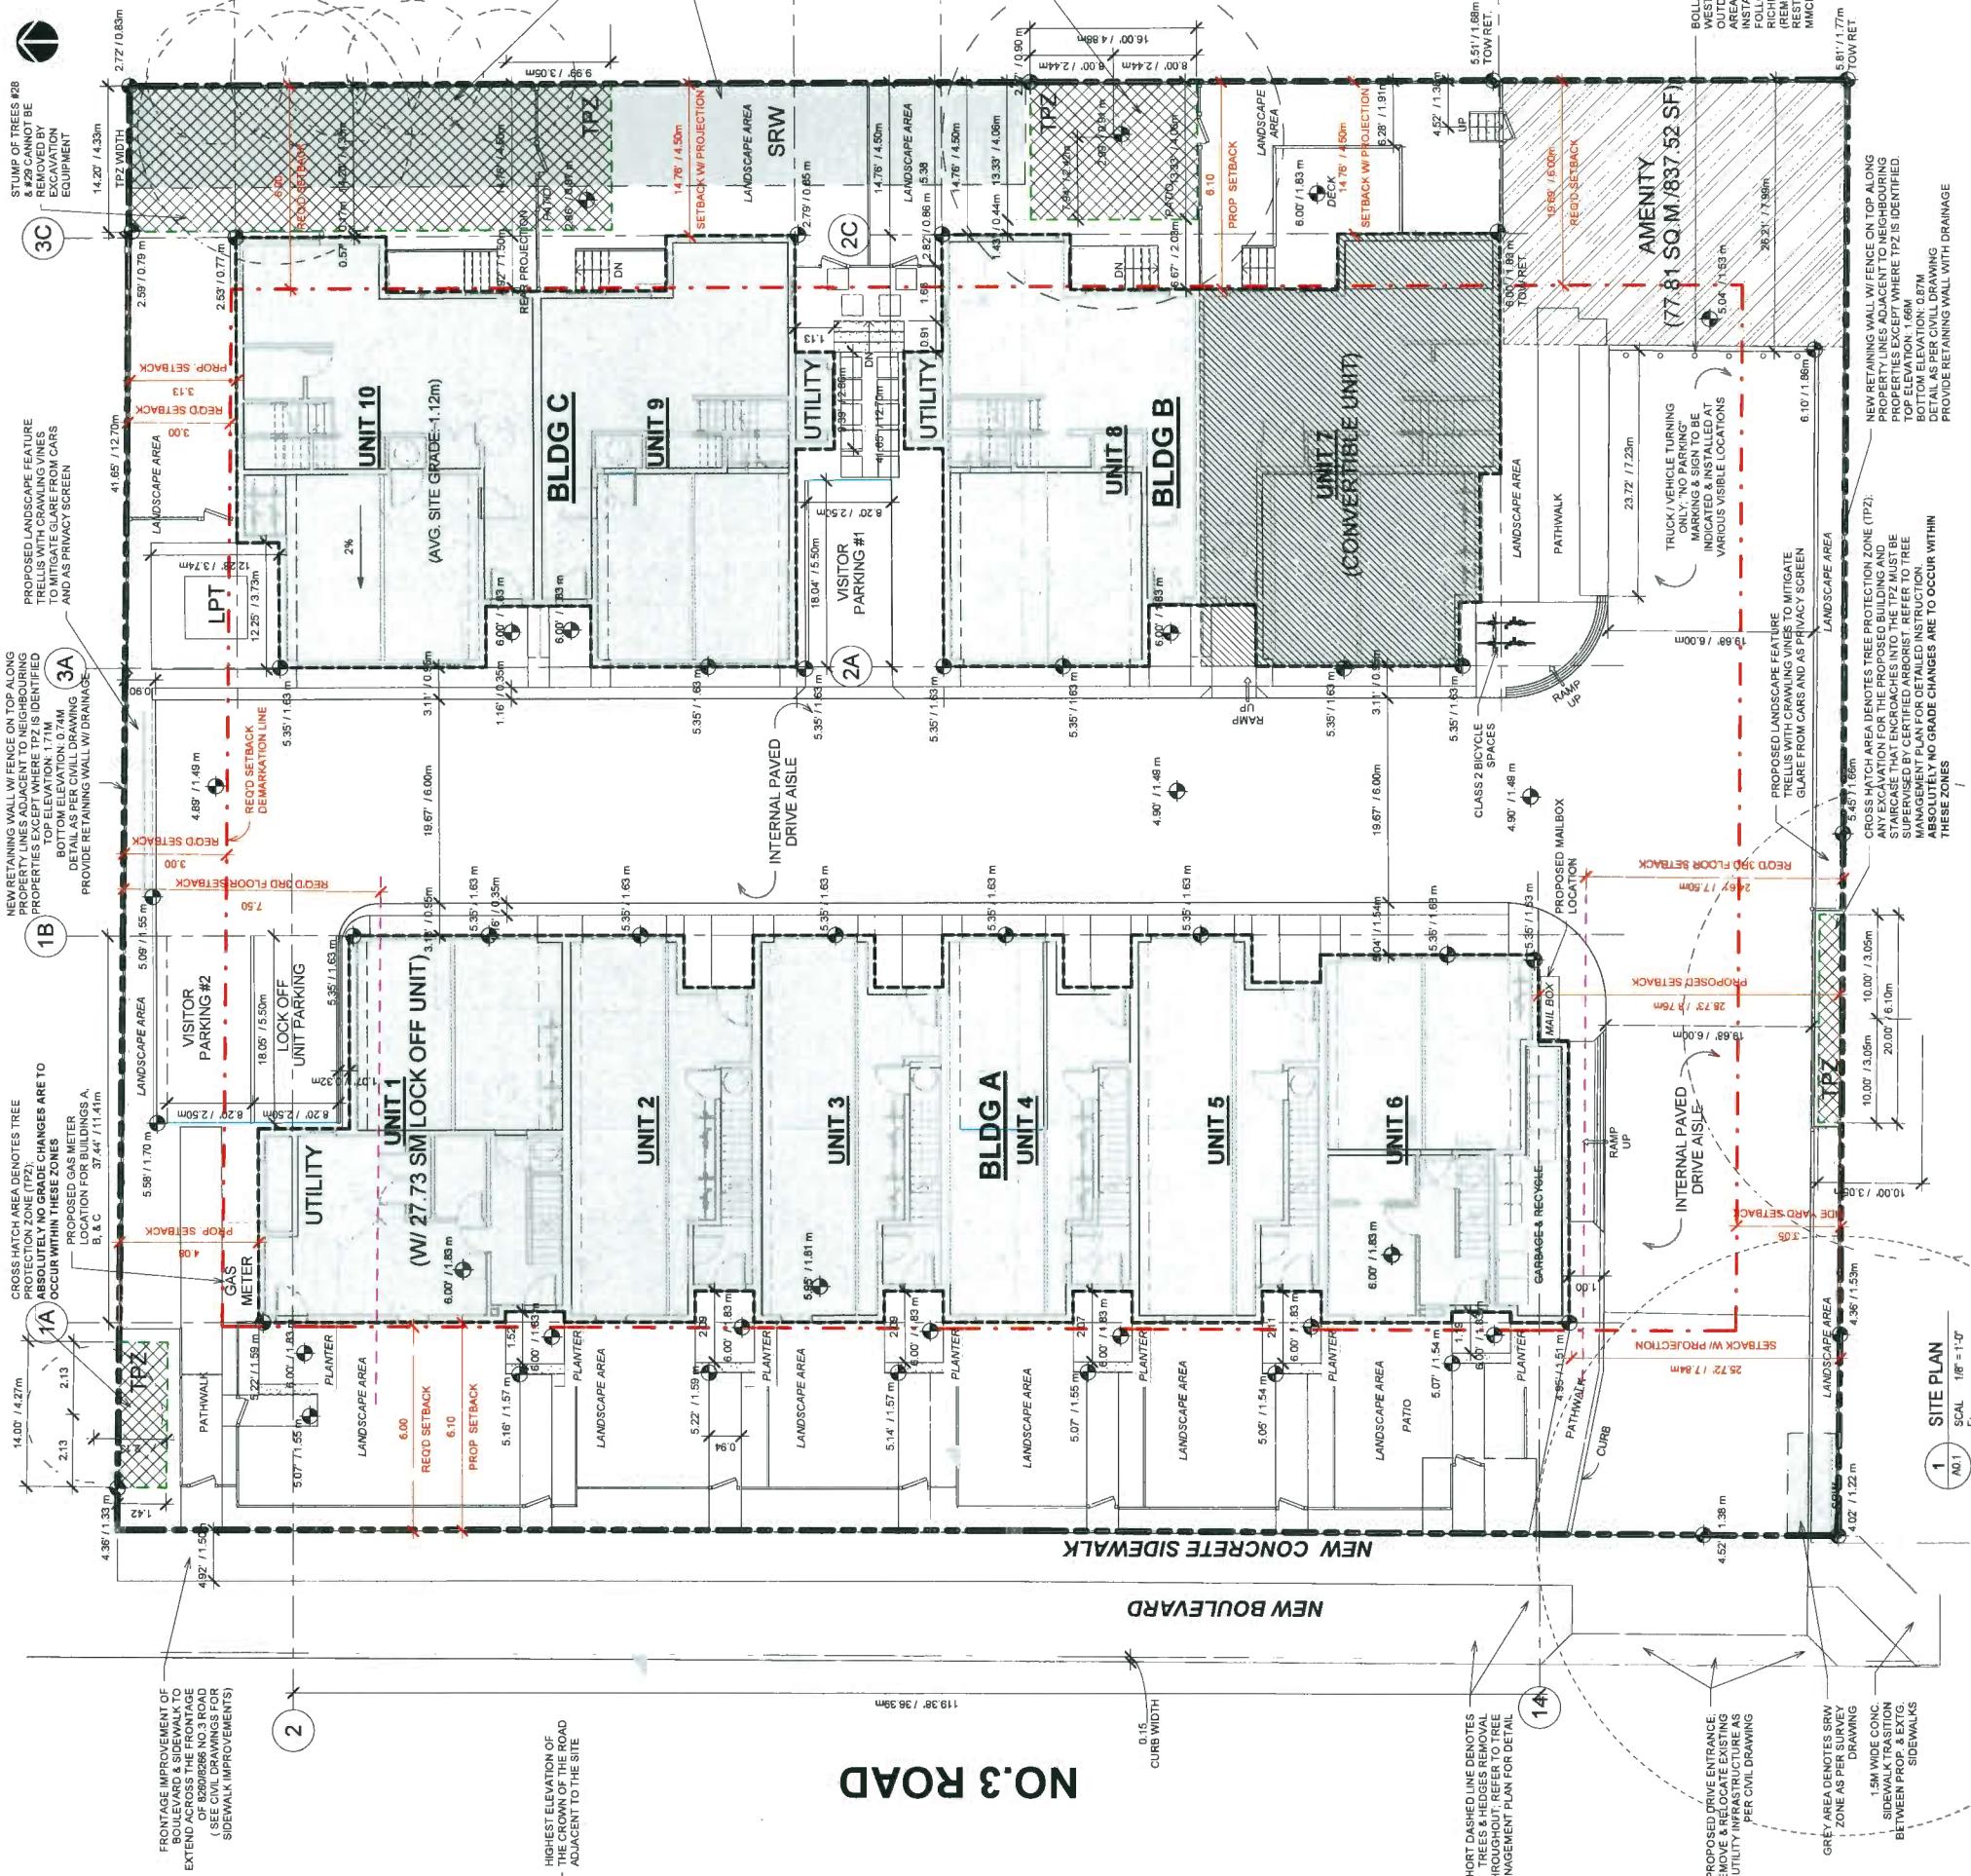

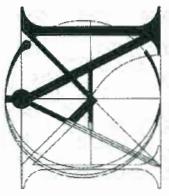

3 CONTEXT REAR ELEVATION
AO.4 SCAL 1" = 20'-0"
E

Matthew Cheng
Architect Inc.
Unit 202 - 670 EVANS AVENUE
VANCOUVER, BC V6A 2K9
Tel: (604) 731-3012 / Fax: (604) 731-3908
Cell: (604) 649-0669 / Email: matthew@matc.ca

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Revision: 2018-12-19
Issue for DPP Staff Review
2019-01-10
Re-issue for DPP Staff Review

1 CONTEXT FRONT ELEVATION
AO.4 SCAL 1" = 20'-0"
E

Consultants

8220 NO.3 ROAD



2 CONTEXT PLAN
AO.4 SCAL 1" = 20'-0"
E

Consultants

8220 NO.3 ROAD



3 CONTEXT REAR ELEVATION
AO.4 SCAL 1" = 20'-0"
E

Consultants

8220 NO.3 ROAD



4 SITE PROFILE - NORTH
AO.4 SCAL 1/4" = 1'-0"
E

Project Title
8280 NO.3
ROAD,
RICHMOND,
B.C.

Sheet File
CONTEXT PLAN
& ELEVATIONS

Drawn: RK
Checked: MC
Scale: As indicated
Project Number: 16RTH01
Revision: Dwg.
Print Date: 2019/01/10

5 SITE PROFILE - EAST P.L.
AO.4 SCAL 1/4" = 1'-0"
E

Project Title
8280 NO.3
ROAD,
RICHMOND,
B.C.

Sheet File
CONTEXT PLAN
& ELEVATIONS

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Checked: MC
Scale: As indicated
Project Number: 16RTH01
Revision: Dwg.
Print Date: 2019/01/10

6 SITE PROFILE - NORTH
AO.4 SCAL 1/4" = 1'-0"
E

Project Title
8280 NO.3
ROAD,
RICHMOND,
B.C.

Sheet File
CONTEXT PLAN
& ELEVATIONS

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Project Number: 16RTH01
Revision: Dwg.
Print Date: 2019/01/10

7 SITE PROFILE - EAST P.L.
AO.4 SCAL 1/4" = 1'-0"
E

Project Title
8280 NO.3
ROAD,
RICHMOND,
B.C.

Sheet File
CONTEXT PLAN
& ELEVATIONS

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Project Number: 16RTH01
Revision: Dwg.
Print Date: 2019/01/10

8 SITE PROFILE - SOUTH
AO.4 SCAL 1/4" = 1'-0"
E

Project Title
8280 NO.3
ROAD,
RICHMOND,
B.C.

Sheet File
CONTEXT PLAN
& ELEVATIONS


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Project Number: 16RTH01
Revision: Dwg.
Print Date: 2019/01/10


9 SITE PROFILE - WEST P.L.
AO.4 SCAL 1/4" = 1'-0"
E

Project Title
8280 NO.3
ROAD,
RICHMOND,
B.C.

Sheet File
CONTEXT PLAN
& ELEVATIONS

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Scale: As indicated
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Matthew Cheng
Architect Inc.
Unit 202 - 670 EVANS AVENUE
VANCOUVER, BC V6A 2K9
Tel: (604) 731-3012 / Fax: (604) 731-3908
Cell: (604) 649-0669 / Email: matthew@zmc.ca
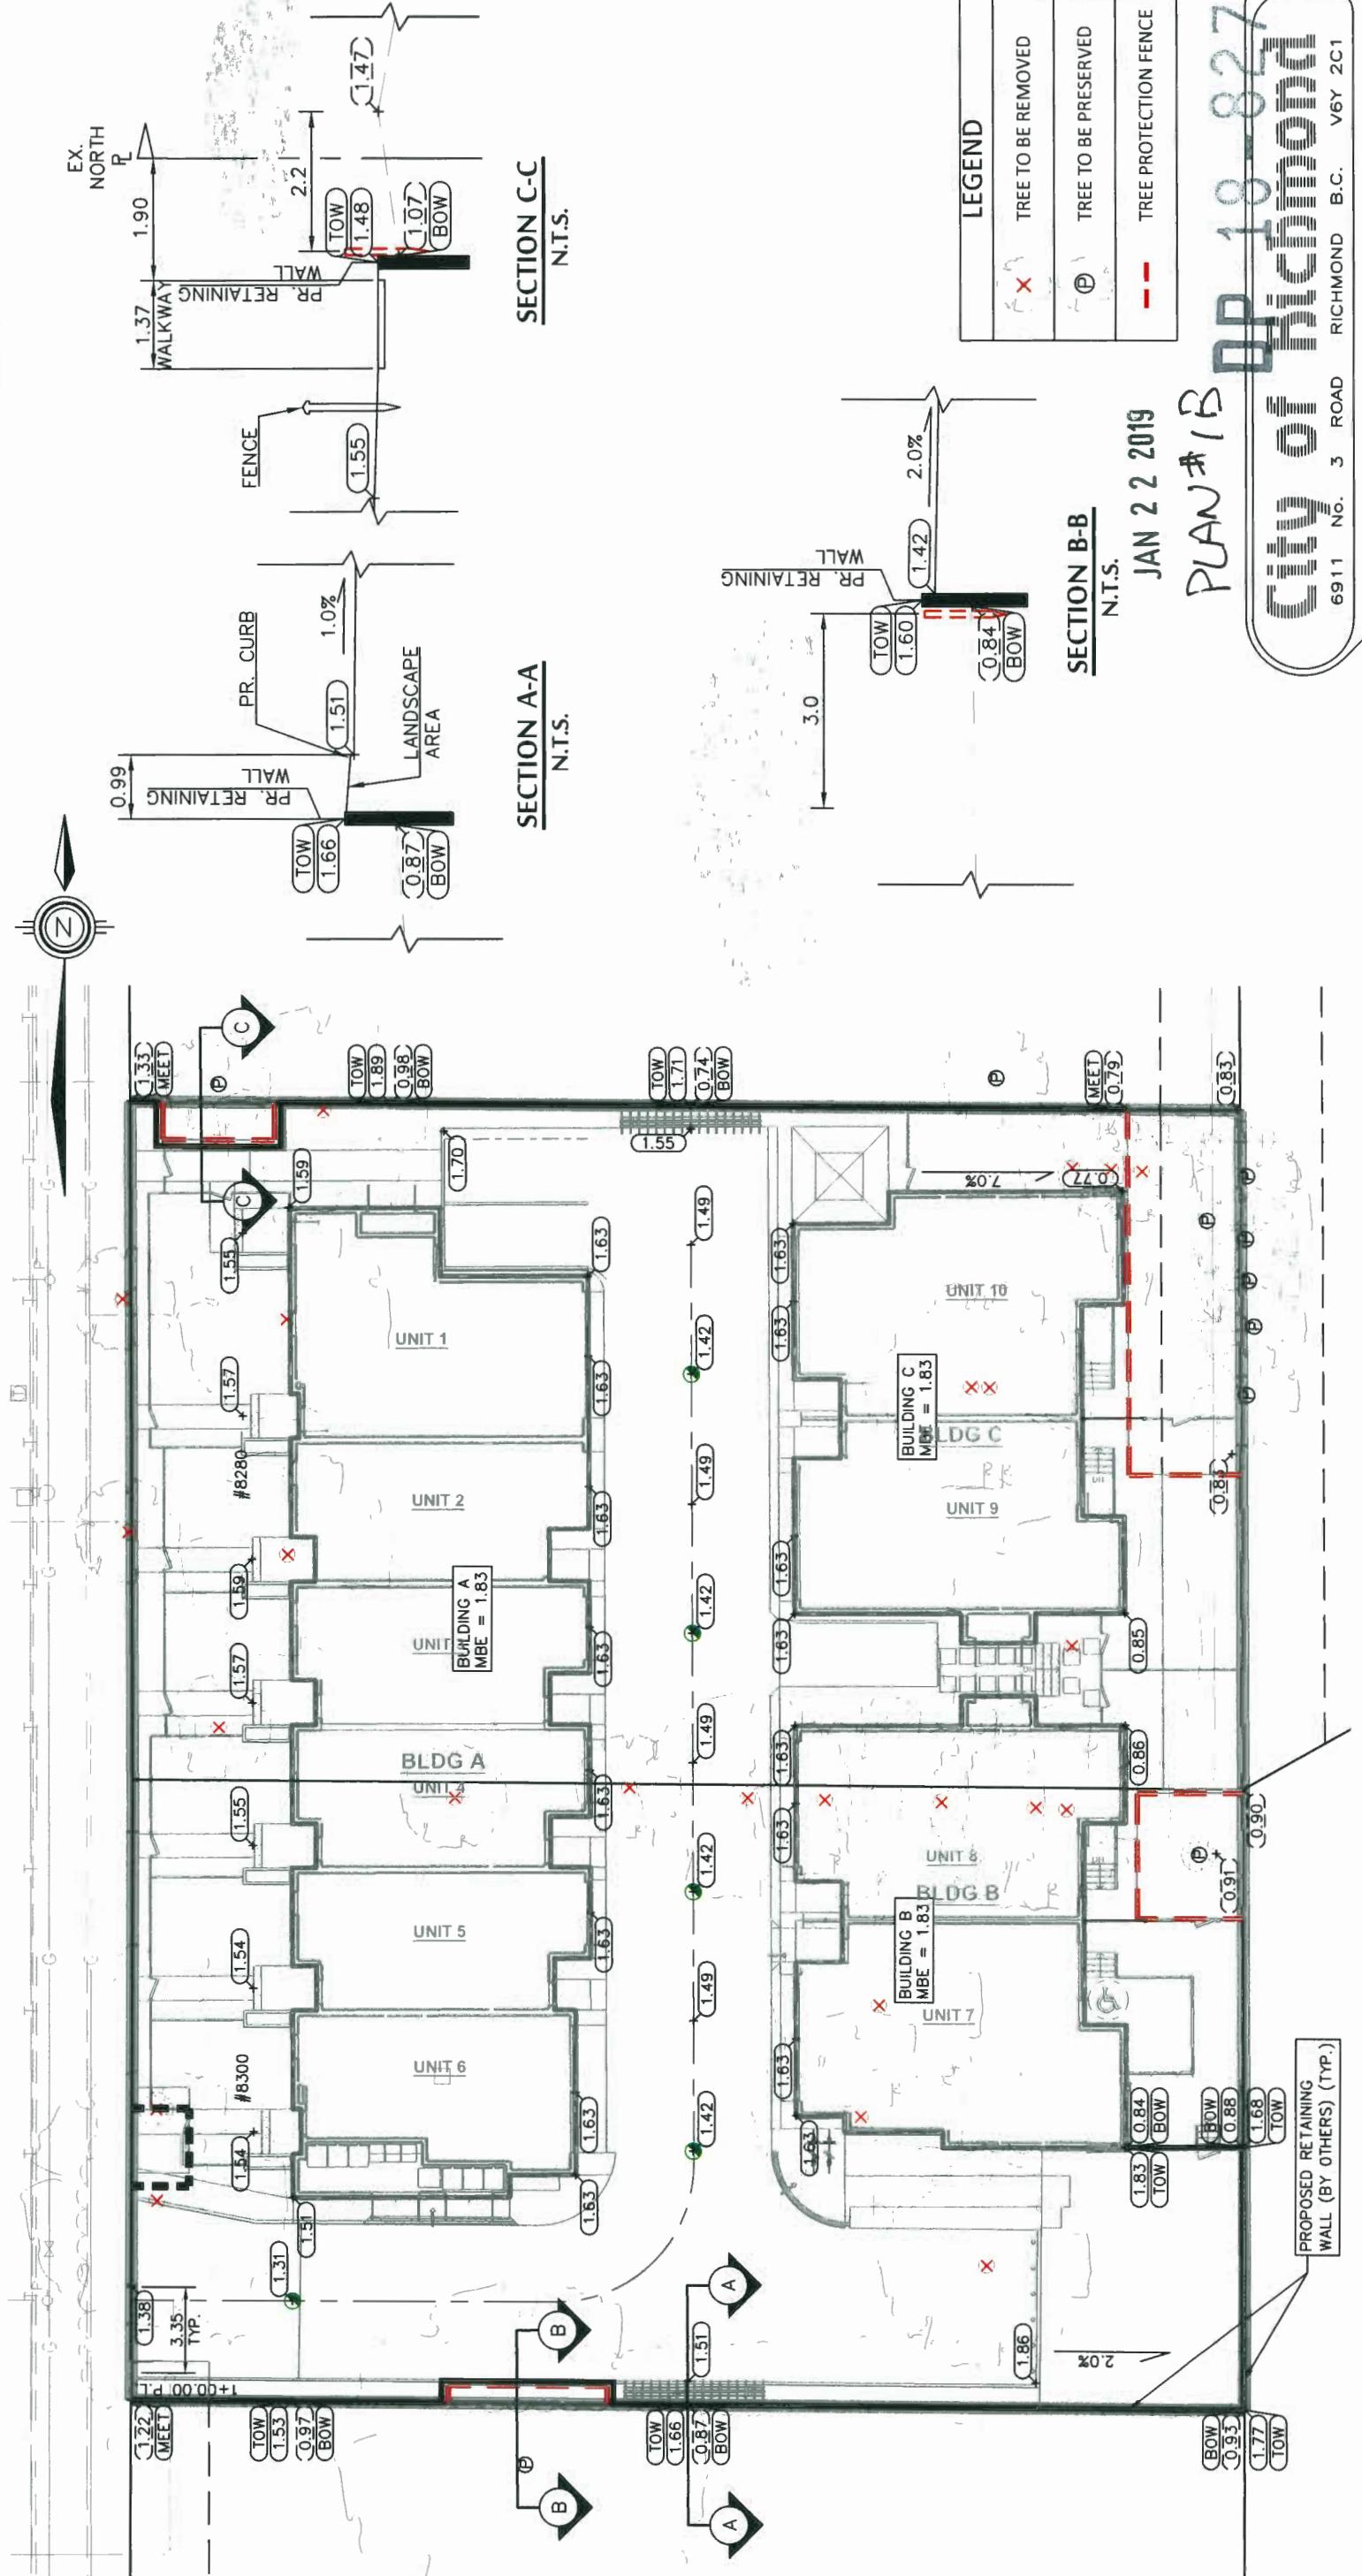
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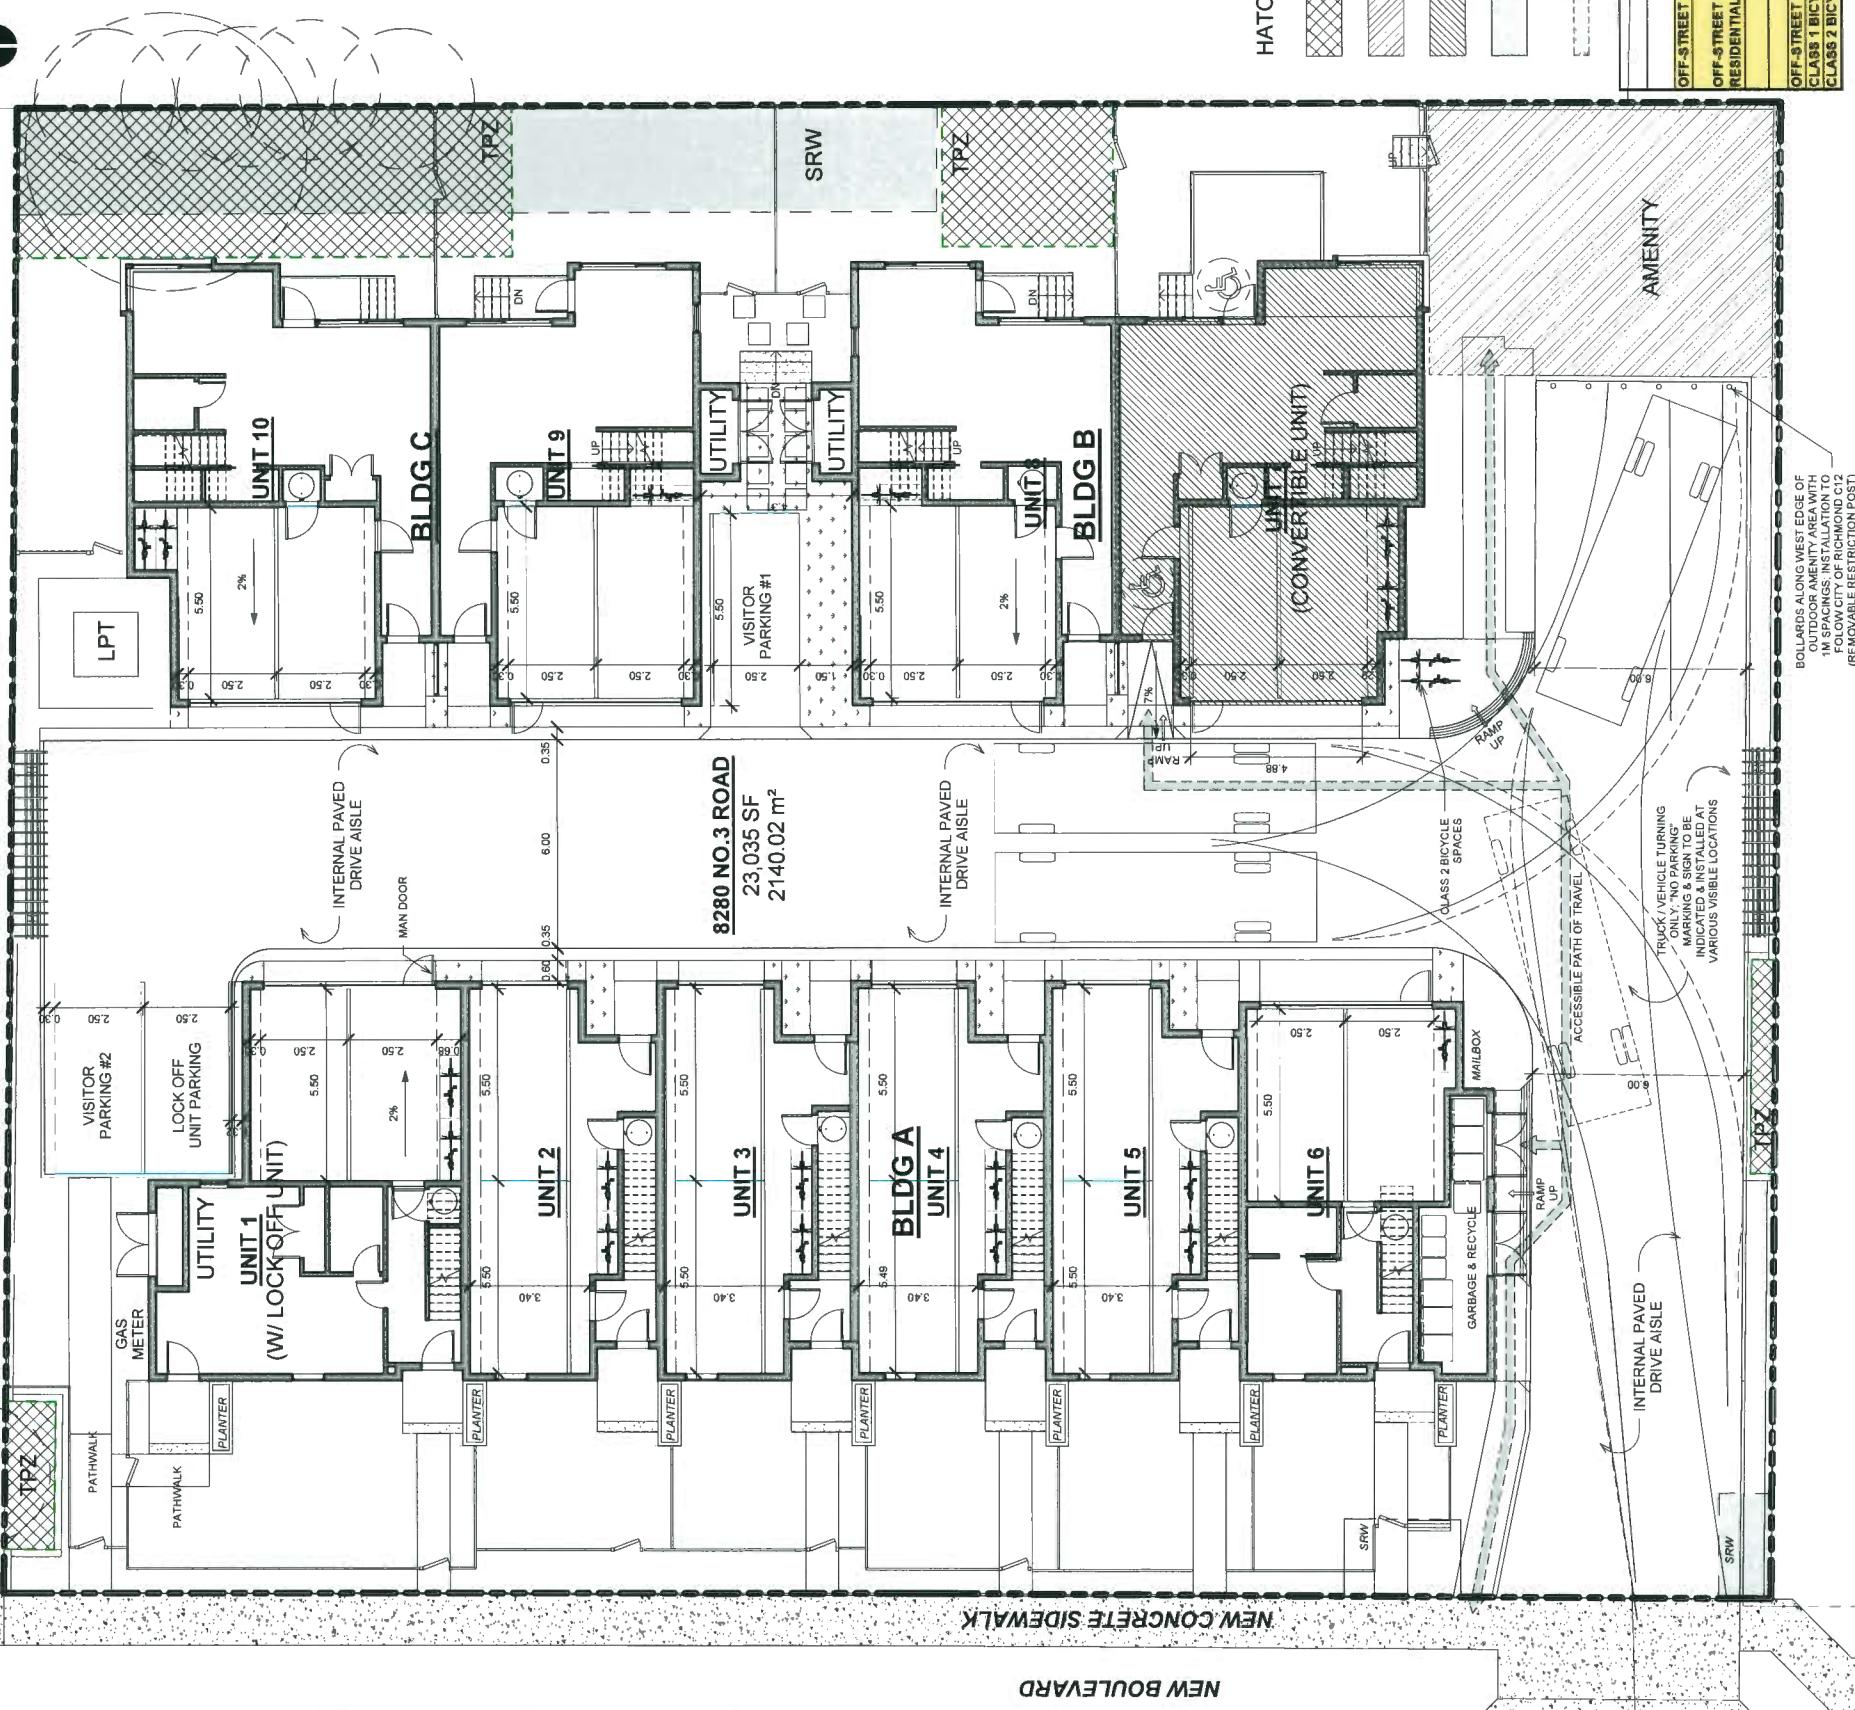
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8280 NO.3
ROAD,
RICHMOND,
B.C.

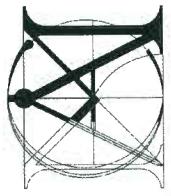Sheet Title
PARKING PLAN


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Checked MC
Scale: 1/8" = 1'-0"
Project Number: 16RTH01
Revision: Draft
Print Date: 20180110

DP 18-827622

PLAN #2
JAN 22 2019
ACCESSED PATH OF TRAVEL



NO.3 ROAD

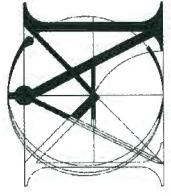

Matthew Cheng
Architect Inc.
Unit 202 - 670 EVANS AVENUE
VANCOUVER, BC V6A 2J9
Tel: (604) 731-3012 / Fax: (604) 731-3908
Cell: (604) 639-4669 / Email: matthew@amca.ca

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Revision:	2018-12-19	ISSUE FOR DPP STAFF REVIEW
	2019-01-10	RE-ISSUE FOR DPP STAFF REVIEW

Consultants

Project Title
**8280 NO.3
ROAD,
RICHMOND,
B.C.**


**FIRE TRUCK
ACCESS**


DP 18-827622

JAN 22 2019

RK

Scale: 1/8" = 1'-0"
Project Number: 16RTH01
Revision: Dwg: _____
Print Date: 2019/01/10

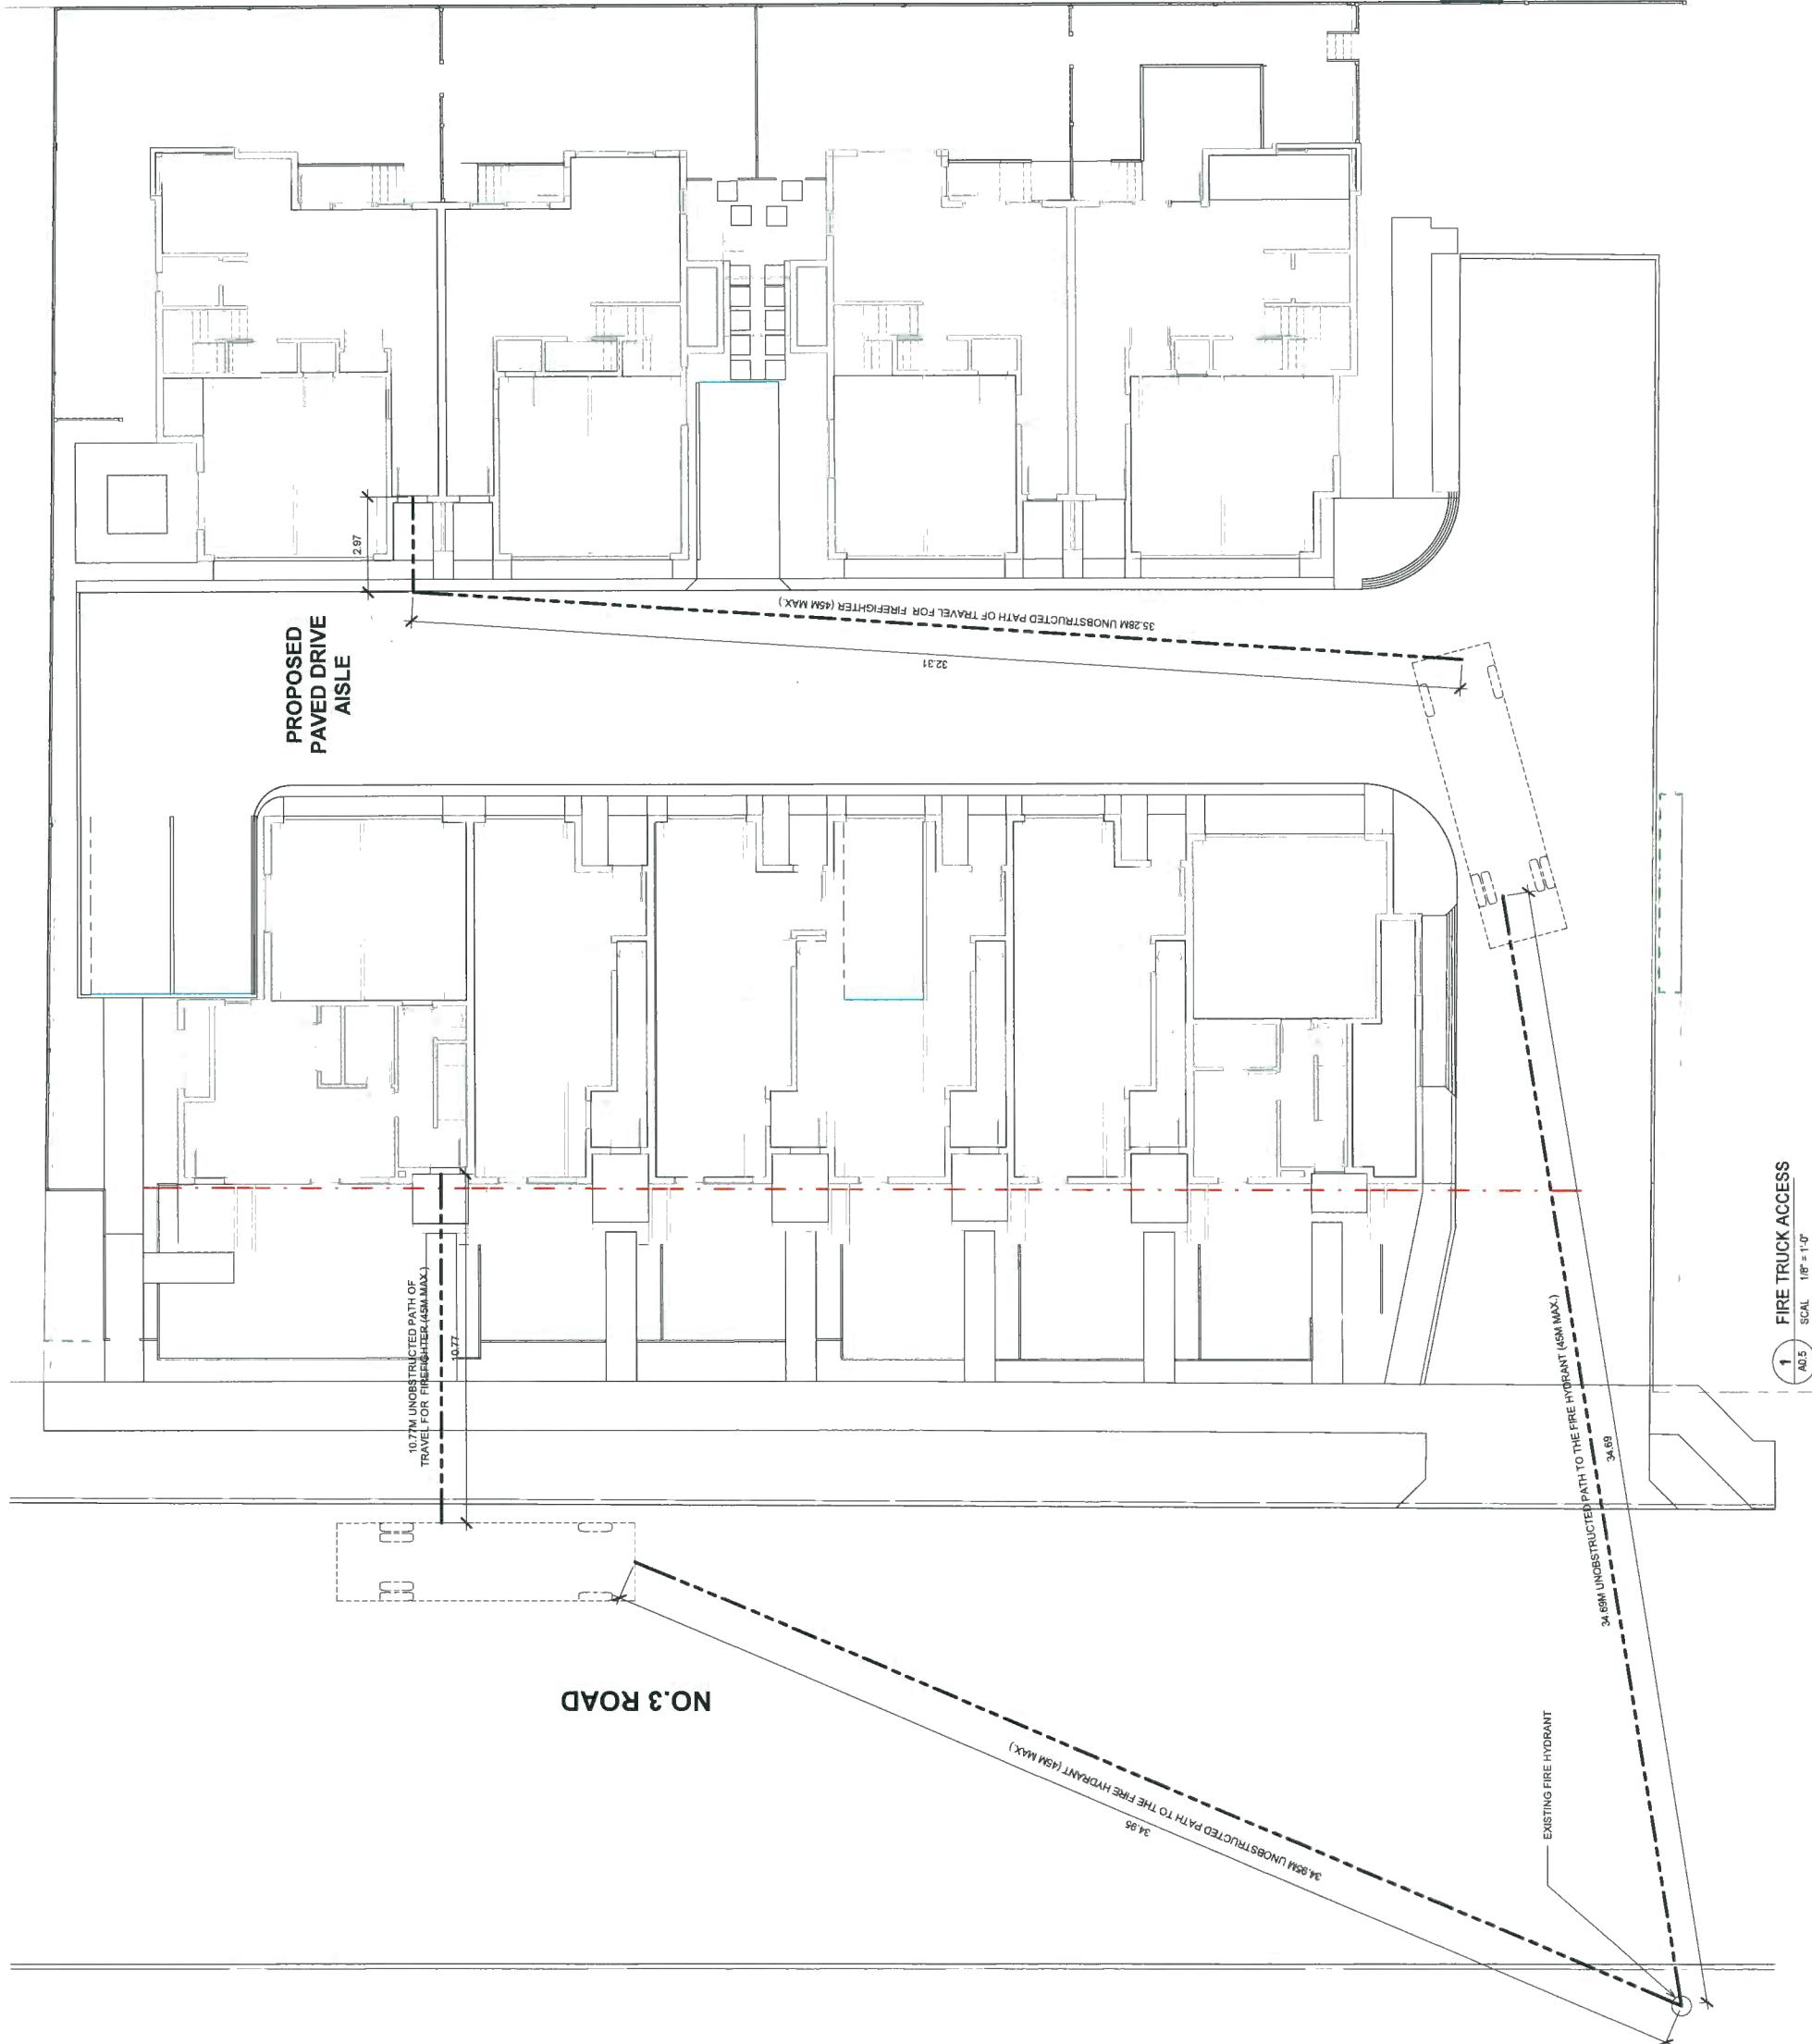

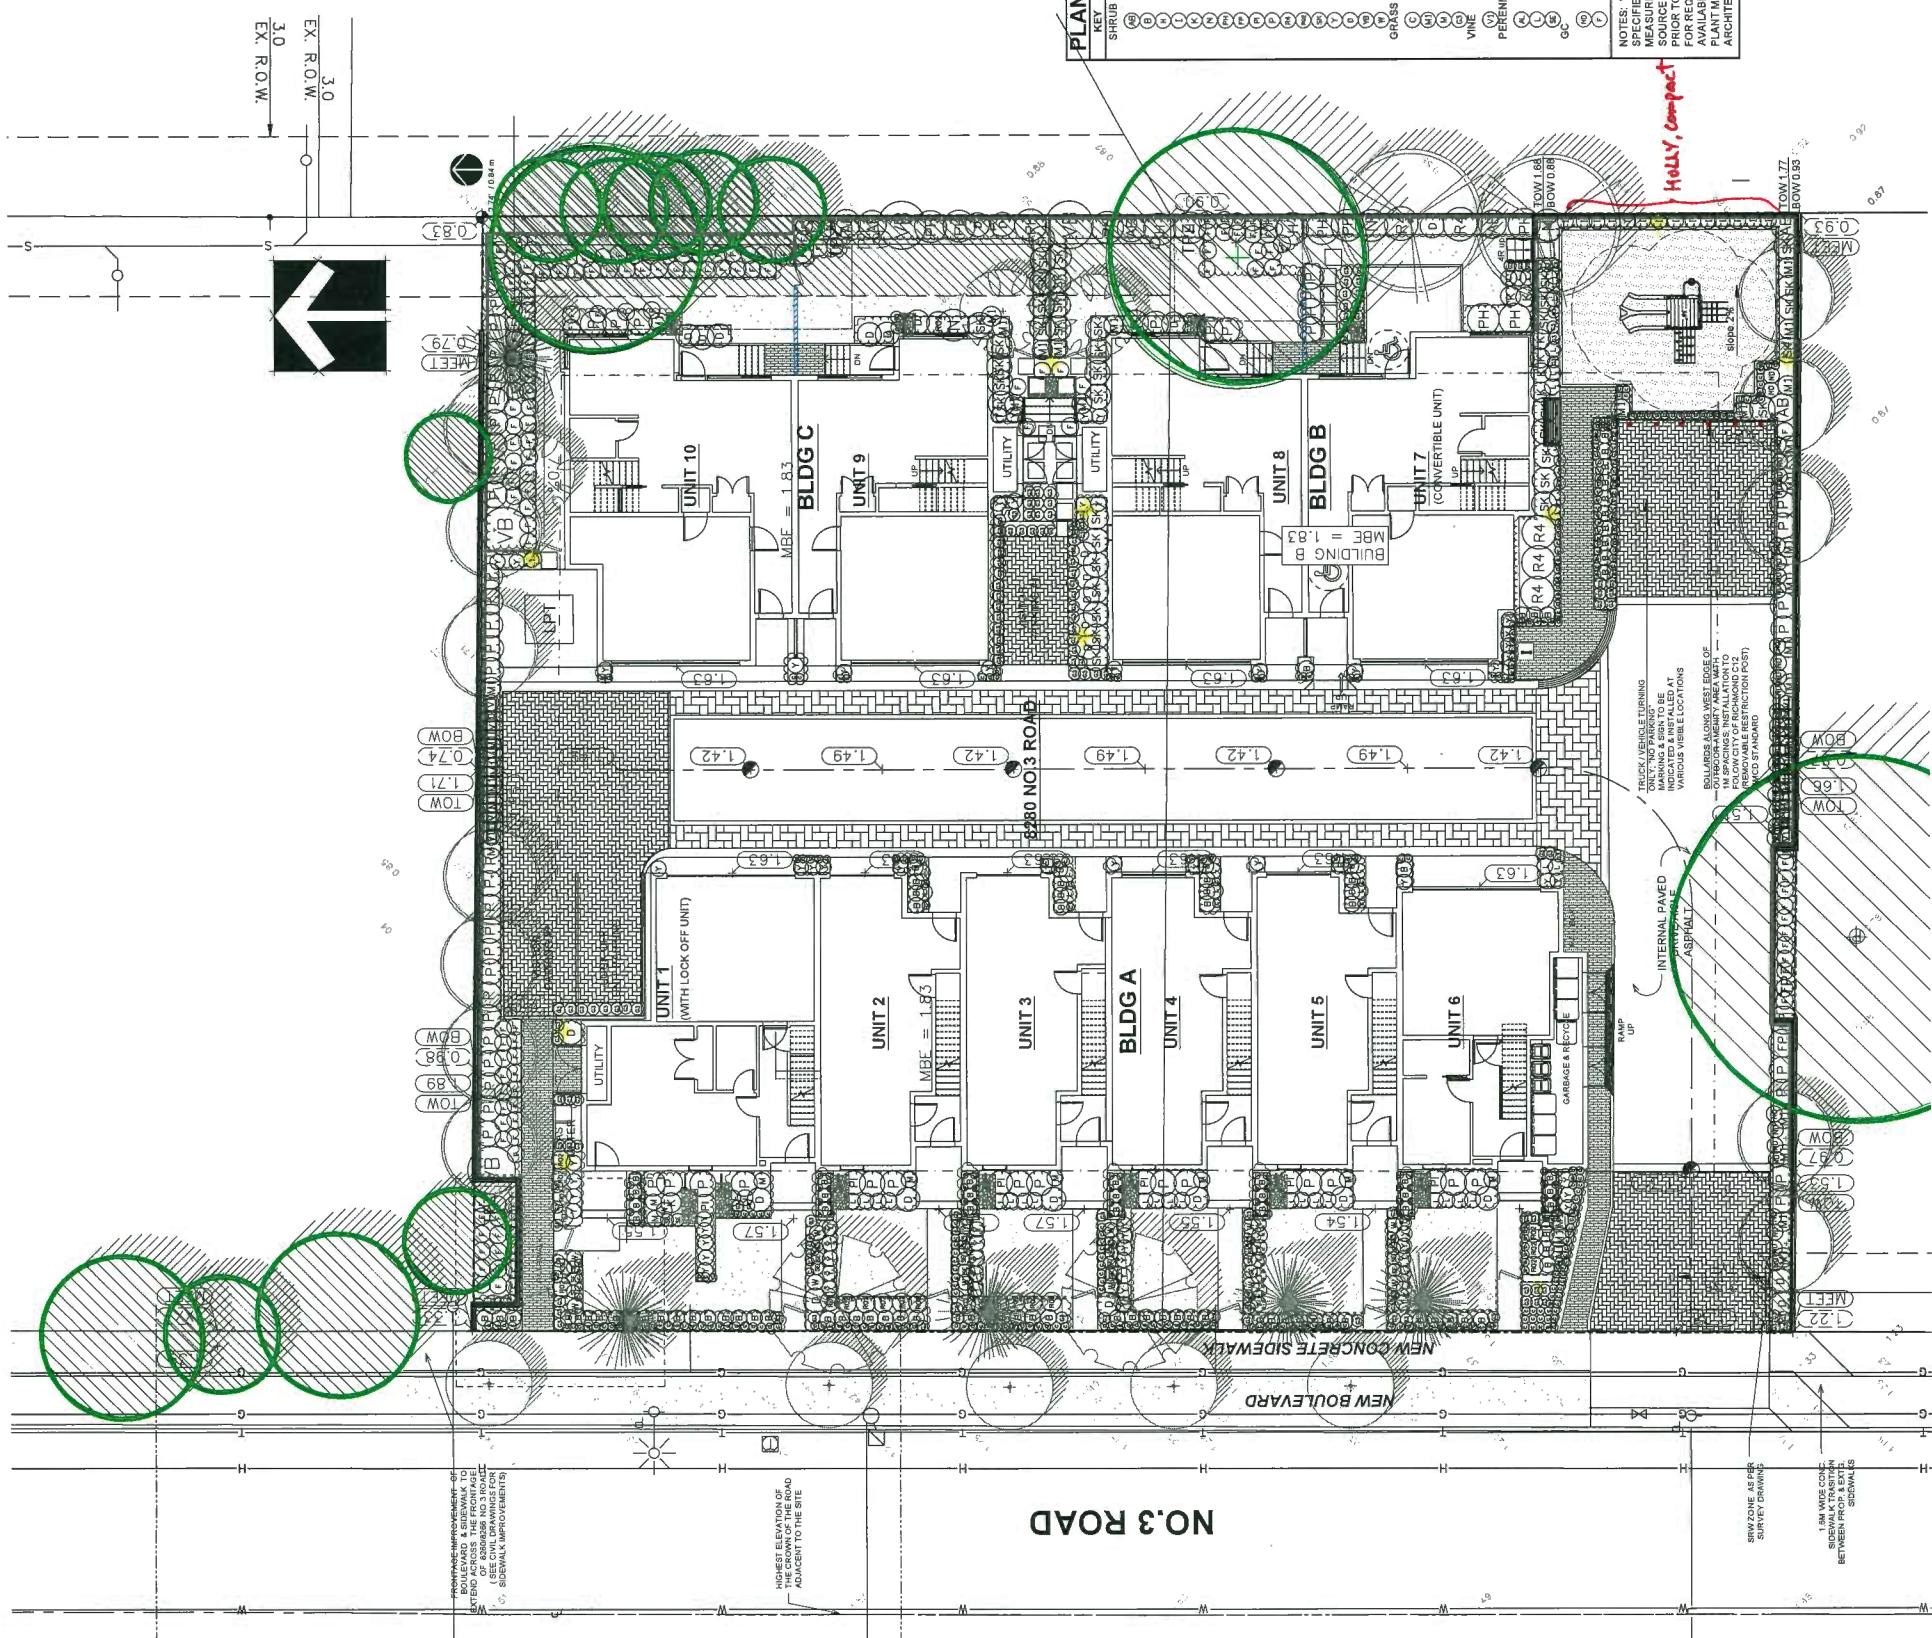

PLANT SCHEDULE				PING PROJECT NUMBER: 17-423
KEY	QTY	BOTANICAL NAME	COMMON NAME	PLANTED SIZE / REMARKS
SIRUB	6	ABELIA EDWARD GOUCHER ^(A)	PINK ABELIA	#2 POT; 30CM
	108	BUXUS MICROPHYLLA 'WINTER GEM' ^(B)	LITTLE LEAF BOX	#2 POT; 25CM
	3	HYDRANGEA M. 'ENDLESS SUMMER'	ENDLESS SUMMER BIGLEAF HYDRANGEA	#3 POT; 90CM
	14	ILEX CRENATA 'GREEN THUMB' ^(C)	HOLLY; COMPACT	#3 POT; 50CM
	7	KALMIA LATIFOLIA 'ELF' ^(D)	DWARF MOUNTAIN LAUREL	#3 POT; 50CM
	3	NANDINA DOMESTICA ^(E)	HEAVENLY BAMBOO	#3 POT; 50CM
	9	PHILADELPHUS LENSII ^(F)	MOCK ORANGE [*]	#2 POT; 50CM
	2	PHOTINIA X FRASERI ^(G)	FRASER PHOTINIA	1.6M HT
	6	PICEA GLAUCA 'CONICA' ^(H)	DWARF ALBERTA SPRUCE	#3 POT; 50CM
	60	PERISIA GLAUCA 'VALLEY FIRE' ^(I)	CHRISTMAS CHEER RHODODENDRON	#3 POT; 50CM
	5	RHODODENDRON 'CHRISTMAS CHEER'	SCARLET MEIDLAND ROSE	#2 POT; 40CM
	23	ROSA 'SCARLET MEIDLAND' ^(J)	JAPANESE ROSE	#2 POT; 30CM
	39	SKIMMIA JAPONICA (10% MALE) ^(K)	HICKS YEW	1M + POT
	79	TAXUS X MUNIFICENTIS ^(L)	DAVID'S BURNUM	#2 POT; 30CM
	27	VIBURNUM DAVIDI ^(M)	BURKNWOOD VIBURNUM	#3 POT; 50 CM
	4	VIBURNUM X BURKWOODII ^(N)	DWARF WEIGELA	#2 POT; 40CM
	13	WEIGELA FLORIDA 'MIDNIGHT WINE' ^(O)	FROSTED SEDGE	#1 POT
GRASS	403	CAREX 'ICE DANCE' ^(P)	COMPACT MAIDEN GRASS	#1 POT
	39	MISCANTHUS SINensis 'LITTLE KITTEN'	YAKU JIMA LAF. SILVER GRASS	#2 POT
	8	MISCANTHUS SINensis 'YAKU JIMA'	DWARF FOUNTAIN GRASS	#1 POT; HEAVY
	147	PENNISETUM ALOPECUROIDES 'HAMLIN' ^(Q)	EVERGREEN CLEMATIS	
VINE	6	CLEMATIS ARMANDII ^(R)	COMMON THRIFT	SCM POT; 15CM POT
	21	ARMERIA MARITIMA ^(S)	ENGLISH LAVENDER	#1 POT
	44	LAVENDULA ANGUSTIFOLIA 'HIDCOTE BLUE' ^(T)	AUTUMN JOY STONECROP	9CM POT
	21	SEDMUM TELEPHUM 'HERBSTFREUDE' ^(U)	HARBOUR DWARF NANDINA	#1 POT
GRO	32	NANDINA DOMESTICA 'HARBOUR DWARF'	WESTERN SWORD FERN	#1 POT; 20CM
	152	POLYSTICHUM MUNIMUM ^(V)		

DP 18-827622
P/A 1#3A JAN 22 2019


17072

DRAWING NUMBER:
12

DRAWING NUMBER:
12

2

17-023
PROJECT NUMBER:

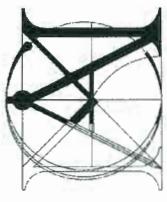

Matthew Cheng
Architect Inc.

Unit 202 - 670 EVANS AVENUE
VANCOUVER, BC V6A 2K9
Tel: (604) 731-3012 / Fax: (604) 731-3908
Cell: (604) 649-0669 / Email: matthewc@mac.com

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Revision: 2018-12-19 Issue for DPP Staff Review
2019-01-10 Re-issue for DPP Staff Review
2019-01-15

Consultants

Project Title: 8280 NO.3
ROAD,
RICHMOND,
B.C.

Sheet No: PERSPECTIVES

Drawn: RO
Checked: MC
Saled:

Project Number: 16RTH01
Revision: A2.6
Print Date: 2019/01/16



BUILDING A VIEW ALONG NO. 3 ROAD



BUILDING A REAR VIEW



PERSPECTIVE OF BUILDING A & ENTRANCE TO INTERNAL ROAD PLAN #4
JAN 22 2019 DPP 18-827622

PLAN #4
JAN 22 2019 DPP 18-827622



Matthew Cheng
Architect Inc.

Unit 202 - 610 EVANS AVENUE
VANCOUVER, BC V6A 2K9
Tel: (604) 731-3008 Fax: (604) 731-3908
Cell: (604) 649-0669 Email: matthewc@mail.ca

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2019-01-15 Re-issue for DPP Staff Review

Consultants

Project Title: 8280 NO.3
Road,
Richmond,
B.C.
Sheet Title: PERSPECTIVES

Drawn: RO
Checked: MC
Scale:
Project Number: 16RTH01
Revision: 20190116

Dwg: A2.7
Print Date: 2019-01-16



PERPETIVE TOWARDS NORTHWEST VIEW




PERSPECTIVE VIEW TOWARDS SOUTHWEST
JAN 22 2019 PLAN #4A



BUILDING B & C PERSPECTIVE FROM INTERNAL AISLE DRIVE

DP 18-827622
JAN 22 2019

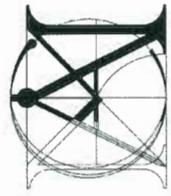

Matthew Cheng
Architect Inc.

**Matthew Cheng
Architect Inc.**
Unit 202 - 670 EVANS AVENUE
VANCOUVER, BC V6A 2K9
Tel: (604) 731-3012 (FAX: (604) 731-3547)
Cel: (604) 649-0669 Email: matthew@qwest.net

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	2019-01-15	RE-ISSUE FOR DPP STAFF REVIEW
	2019-01-15	RE-ISSUE FOR DPP STAFF REVIEW

Comments

8280 NO.3
ROAD,
RICHMOND
B.C.

Sheet Title EXTERIOR WALL FINISHES

Drawn RO
Checked MC

Project Number:	16RTH01
Revision:	Dmg
Print Date:	2019/01/15

EXTERIOR MATERIALS AND COLOURS:

- Vertical Vinyl Siding:** BY SAGINAW (REF 9 - CARAMEL ZEBRAWOOD)
- Hardie Panel Paint Finish:** BY BENJAMIN MOORE (2116-70 MIRAGE WHITE)
- Metal Trims and Reveals:** FINISH TO MATCH WALL PAINT COLOUR
- Roof Fascia, White Paint Finish:** BY BENJAMIN MOORE (2116-70 MIRAGE WHITE)
- Hardie Panel Paint Finish:** BY BENJAMIN MOORE (2116-70 MIRAGE WHITE)
- Clear Glass Casement Window:** WINDOW FRAME FINISH TO MATCH DARK GRAY WALL PANELS (BENJAMIN MOORE 2116-30 EBONY SLATE)
- Hardie Panel Paint Finish:** BY BENJAMIN MOORE (2116-70 MIRAGE WHITE)
- Metal Trims and Reveals:** FINISH TO MATCH WALL PAINT COLOUR
- Roof Fascia, White Paint Finish:** BY BENJAMIN MOORE (2116-70 MIRAGE WHITE)
- Hardie Panel Paint Finish:** BY BENJAMIN MOORE (2116-70 MIRAGE WHITE)
- Metal Trims and Reveals:** FINISH TO MATCH WALL PAINT COLOUR
- Clear Glass Casement Window:** WINDOW FRAME FINISH TO MATCH DARK GRAY WALL PANELS (BENJAMIN MOORE 2116-30 EBONY SLATE)
- Hardie Panel Paint Finish:** BY BENJAMIN MOORE (2116-70 MIRAGE WHITE)
- Metal Trims and Reveals:** FINISH TO MATCH WALL PAINT COLOUR
- Clear Glass Wall Frame to Match Dark Ebony Slate:** CLEAR GLASS WALL FRAME TO MATCH DARK GRAY WALL PANELS (BENJAMIN MOORE 2116-30 EBONY SLATE)
- Horizontal Vinyl Bindings:** BY SASHWALL (REF # - CARAMEL ZEBRAWOOD)
- Railing Structure:** CLEAR GLASS PANEL WITH STAINLESS STEEL PIPE HANDRAIL AND BLACK PAINTED BALUSTERS AND RAILS
- Roof Facia, Hardie Panel Paint Finish:** BY BENJAMIN MOORE (2116-70 MIRAGE WHITE)
- Brick Veneer:** PEWTER COLOUR BY L-XL MASONRY

Typical Finishes for Building A

LIST OF EXTERIOR FINISHES:



HARDIE PANEL PAINT FINISH BY
BENJAMIN MOORE
(2116-70 MIRAGE WHITE)


HARDIE PANEL PAINT FINISH BY
BENJAMIN MOORE
(2118-10 EBONY SILATE)

VERTICAL OR HORIZONTAL
VINYL SIDINGS BY SAGIWALL
(REF. 9 - CABAMEI ZEBRAWOOD)

**BRICK VENEER
PEWTER COLOUR BY I-XI MASONRY**

327622
MAY 22 2010

מוציאים מושגים

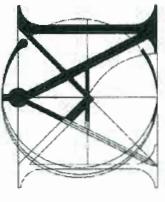

**Matthew Cheng
Architect Inc.**
Unit 202 - 670 EVANS AVENUE
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2016-12-19	ISSUE FOR DPP STAFF REVIEW
2019-01-01	RE-ISSUE FOR DPP STAFF REVIEW
2019-01-15	RE-ISSUE FOR DPP STAFF REVIEW

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Project Title
828 RO RIC B.C

NORTH AND
SOUTH
ELEVATIONS


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A22
Dwg. No.
Print Date:


BUILDING A

18

BUILDING C

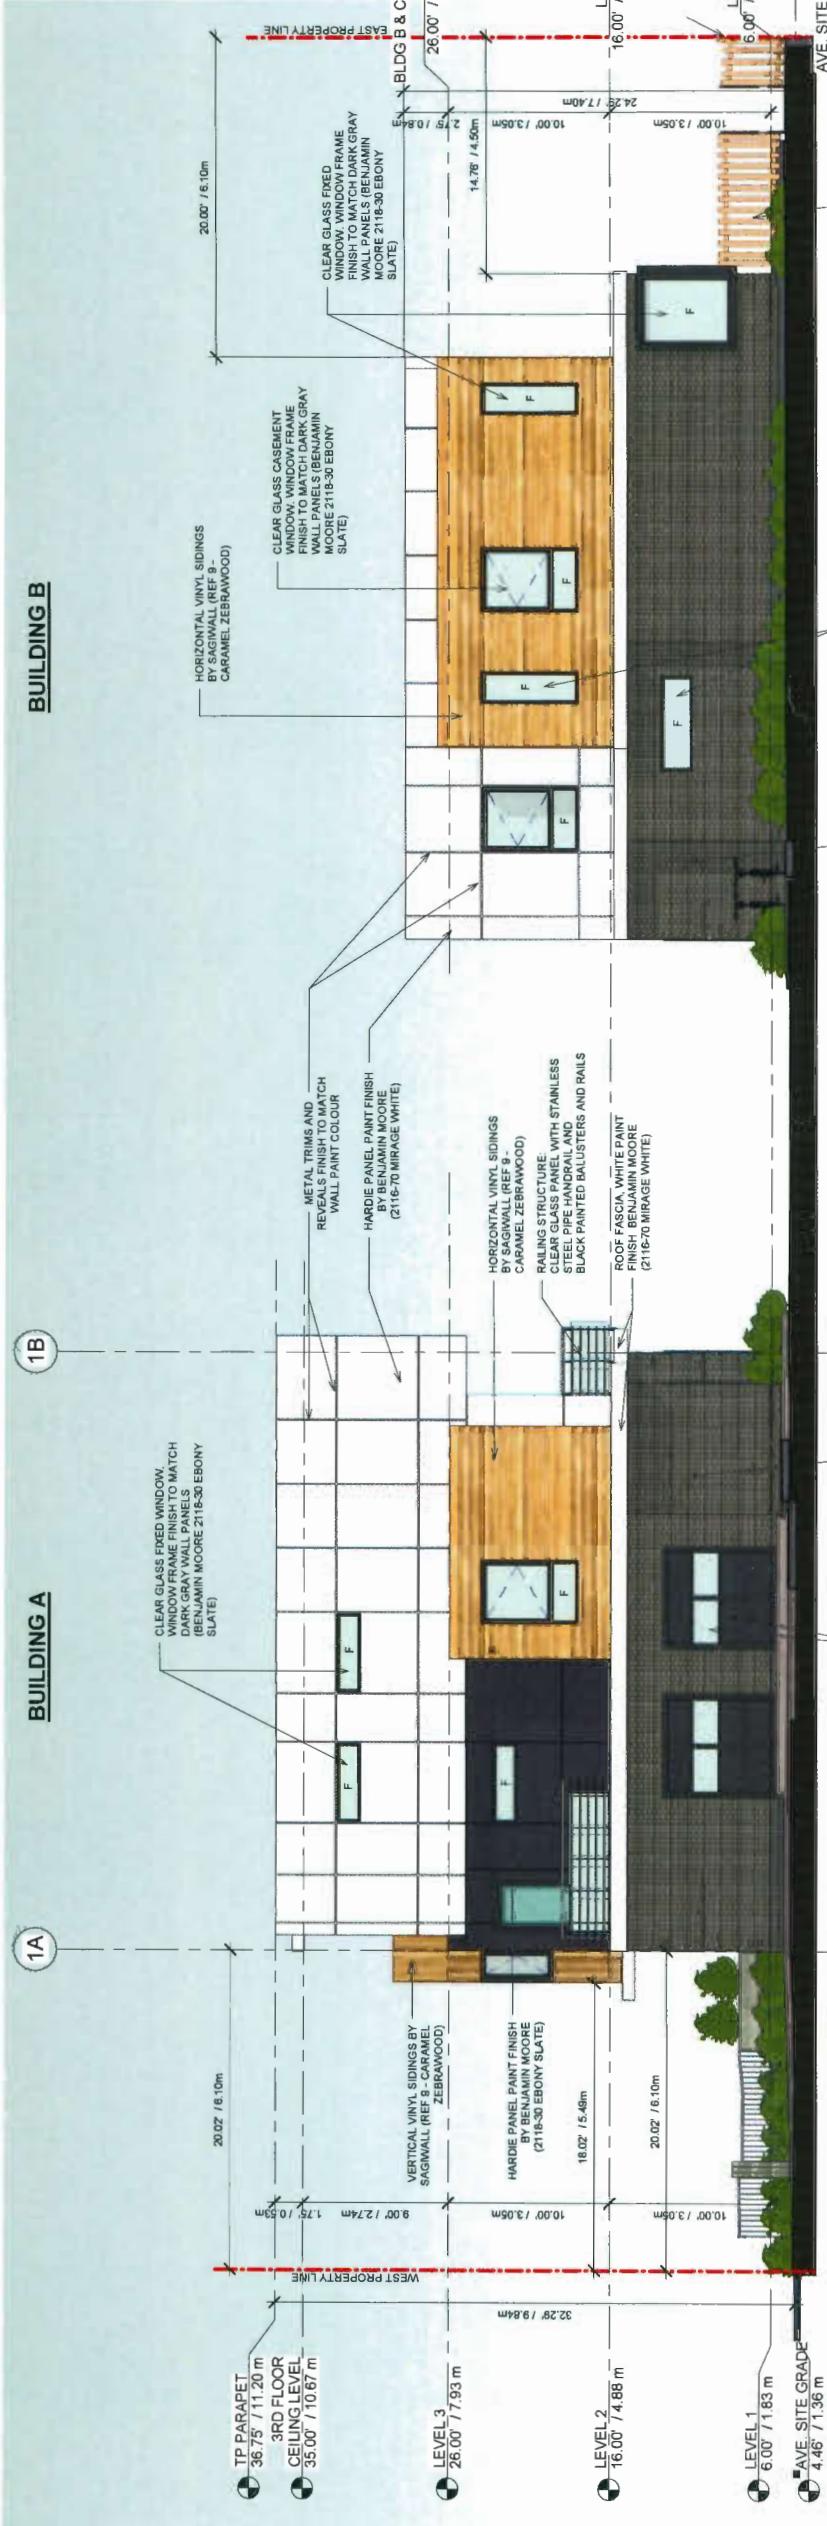

BUILDING A & B SOUTH ELEVATION

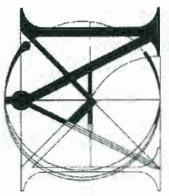


Matthew Cheng
Architect Inc.

Unit 202 - 670 EVANS AVENUE
VANCOUVER, BC V6A 2K9
Tel: (604) 731-3012; Fax: (604) 731-3908
Cell: (604) 649-0669 / Email: matthew@vancouver.ca

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2019-01-10
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2019-01-15
Re-issue for DPP Staff Review


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Project Number: 16RTH01
Revision: Dwg
Print Date: 2018/01/16

JAN 22 2019

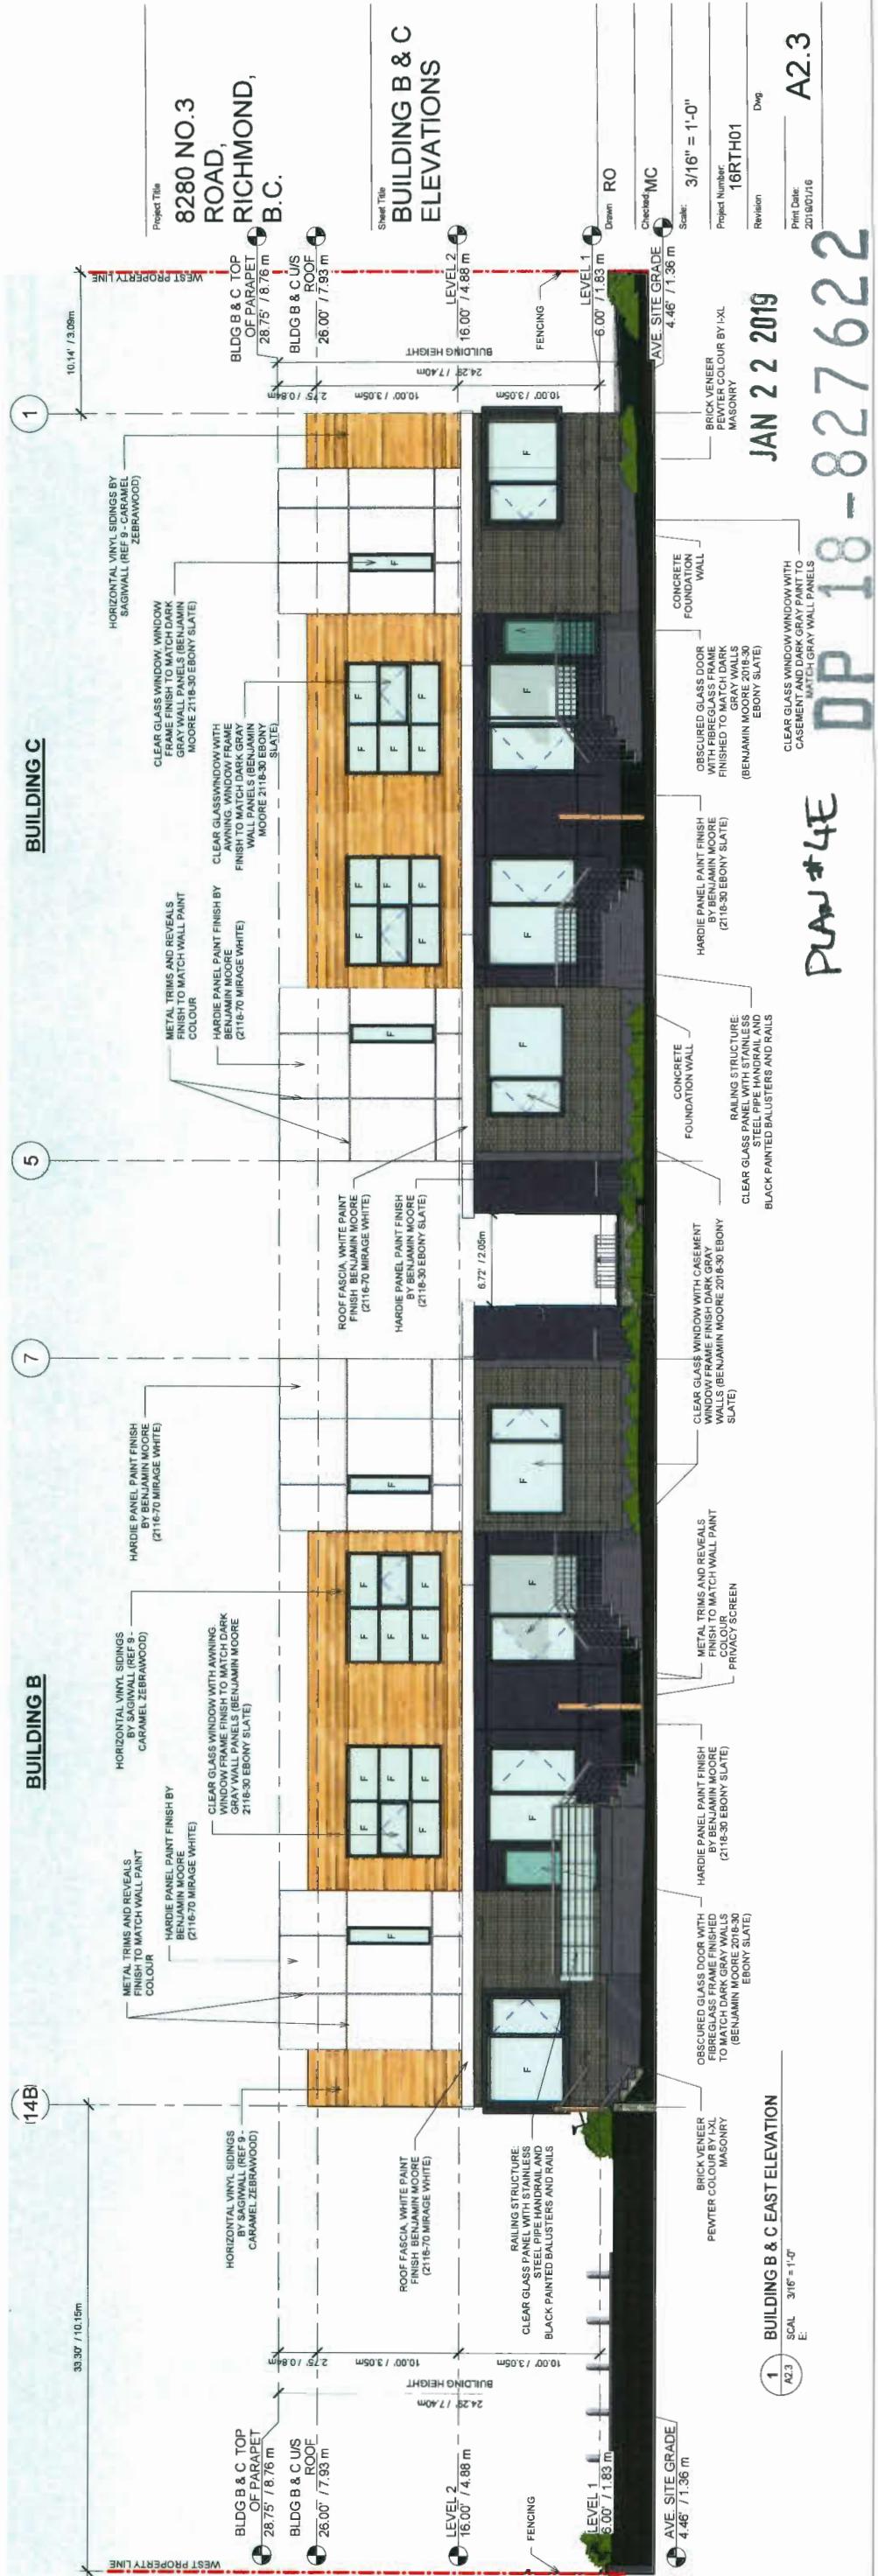PLAN #4E DP 18-827622



Matthew Cheng
Architect Inc.

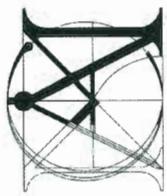Unit 202 - 670 EVANS AVENUE
VANCOUVER, BC V6A 2K9
Tel: (604) 731-3012 / Fax: (604) 731-3908
Cel: (604) 649-0669 / Email: matthew@mca.ca

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2018-12-19	ISSUE FOR DPP STAFF REVIEW
2019-01-15	RE-ISSUE FOR DPP STAFF REVIEW
2019-01-15	RE-ISSUE FOR DPP STAFF REVIEW



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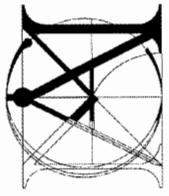
Project Title
**8280 NO.3
ROAD,
RICHMOND
B.C.**

Sheet Title
**BUILDING B & C
ELEVATIONS**

Drawn RNO

DP 18-827622
PLAN #4F JAN 22



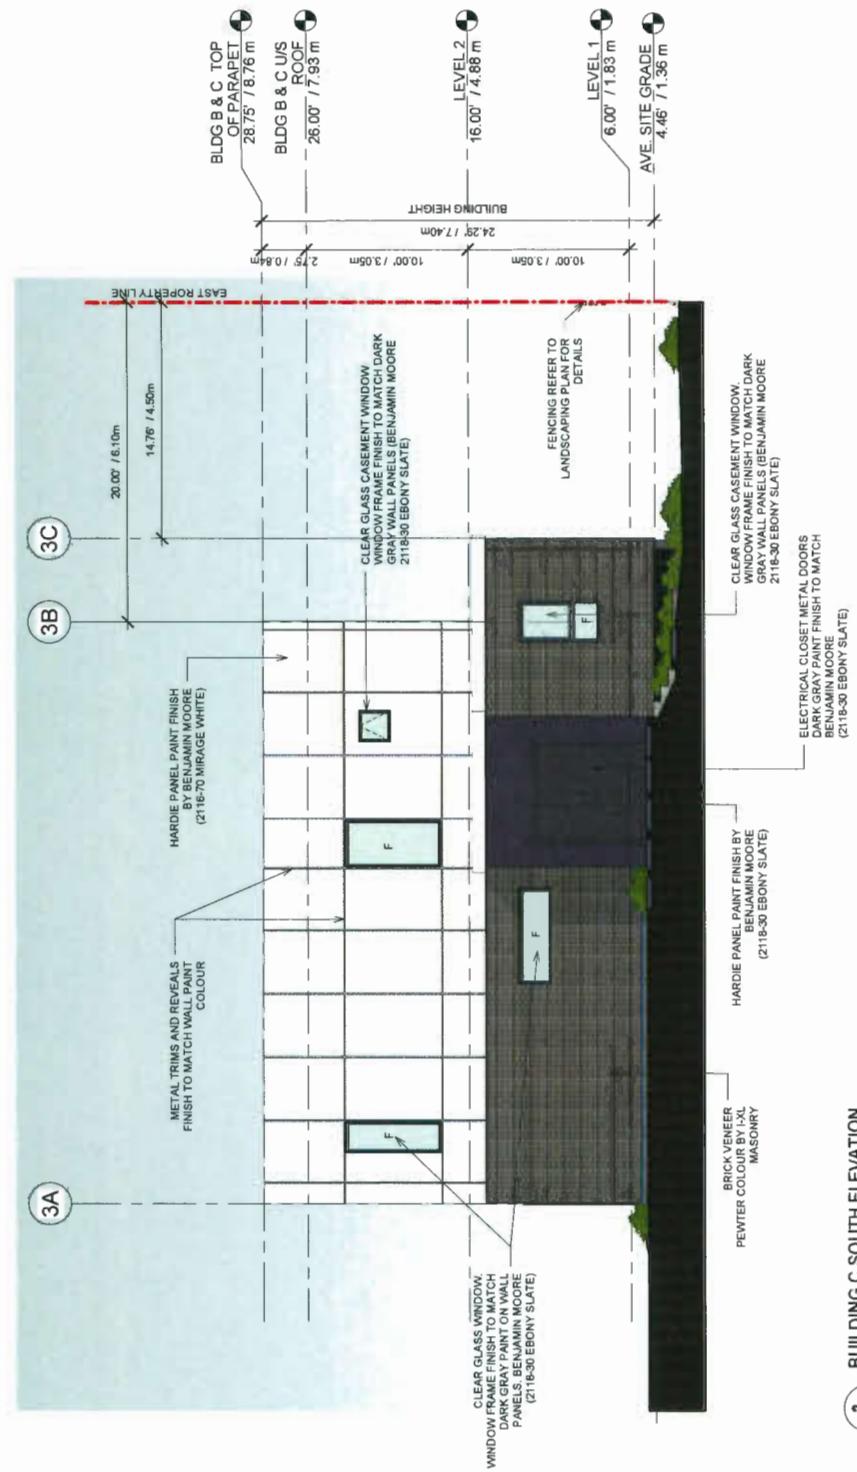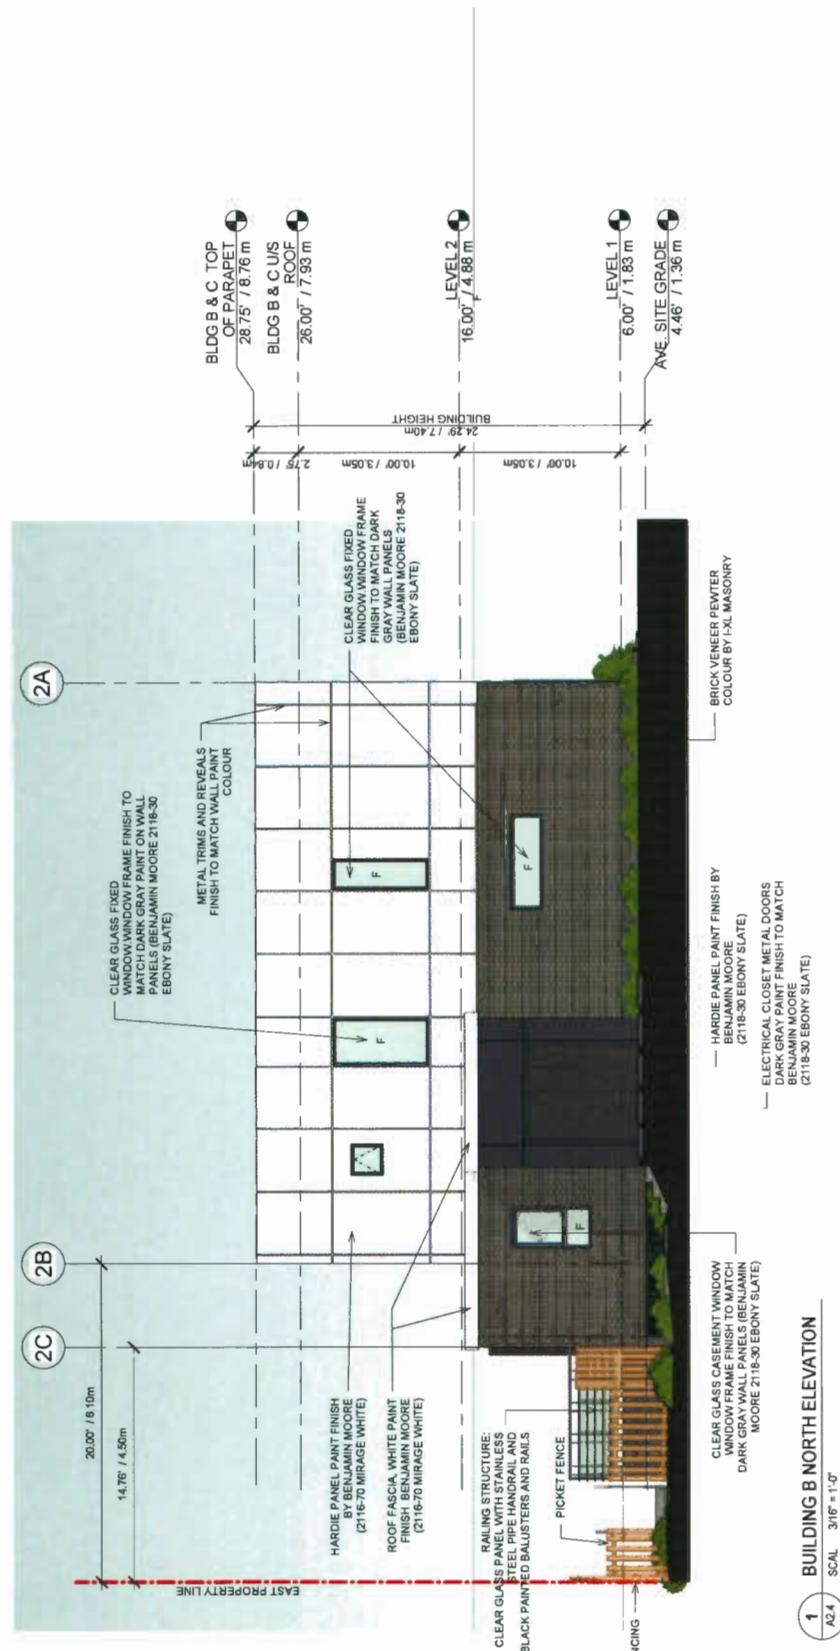

Matthew Cheng
Architect Inc.

Unit 202 - 670 EVANS AVENUE
VANCOUVER, BC V6A 2K9
Tel: (604) 731-3012 / Fax: (604) 731-3908
Cell: (604) 649-1669 / Email: matthew@enca.ca

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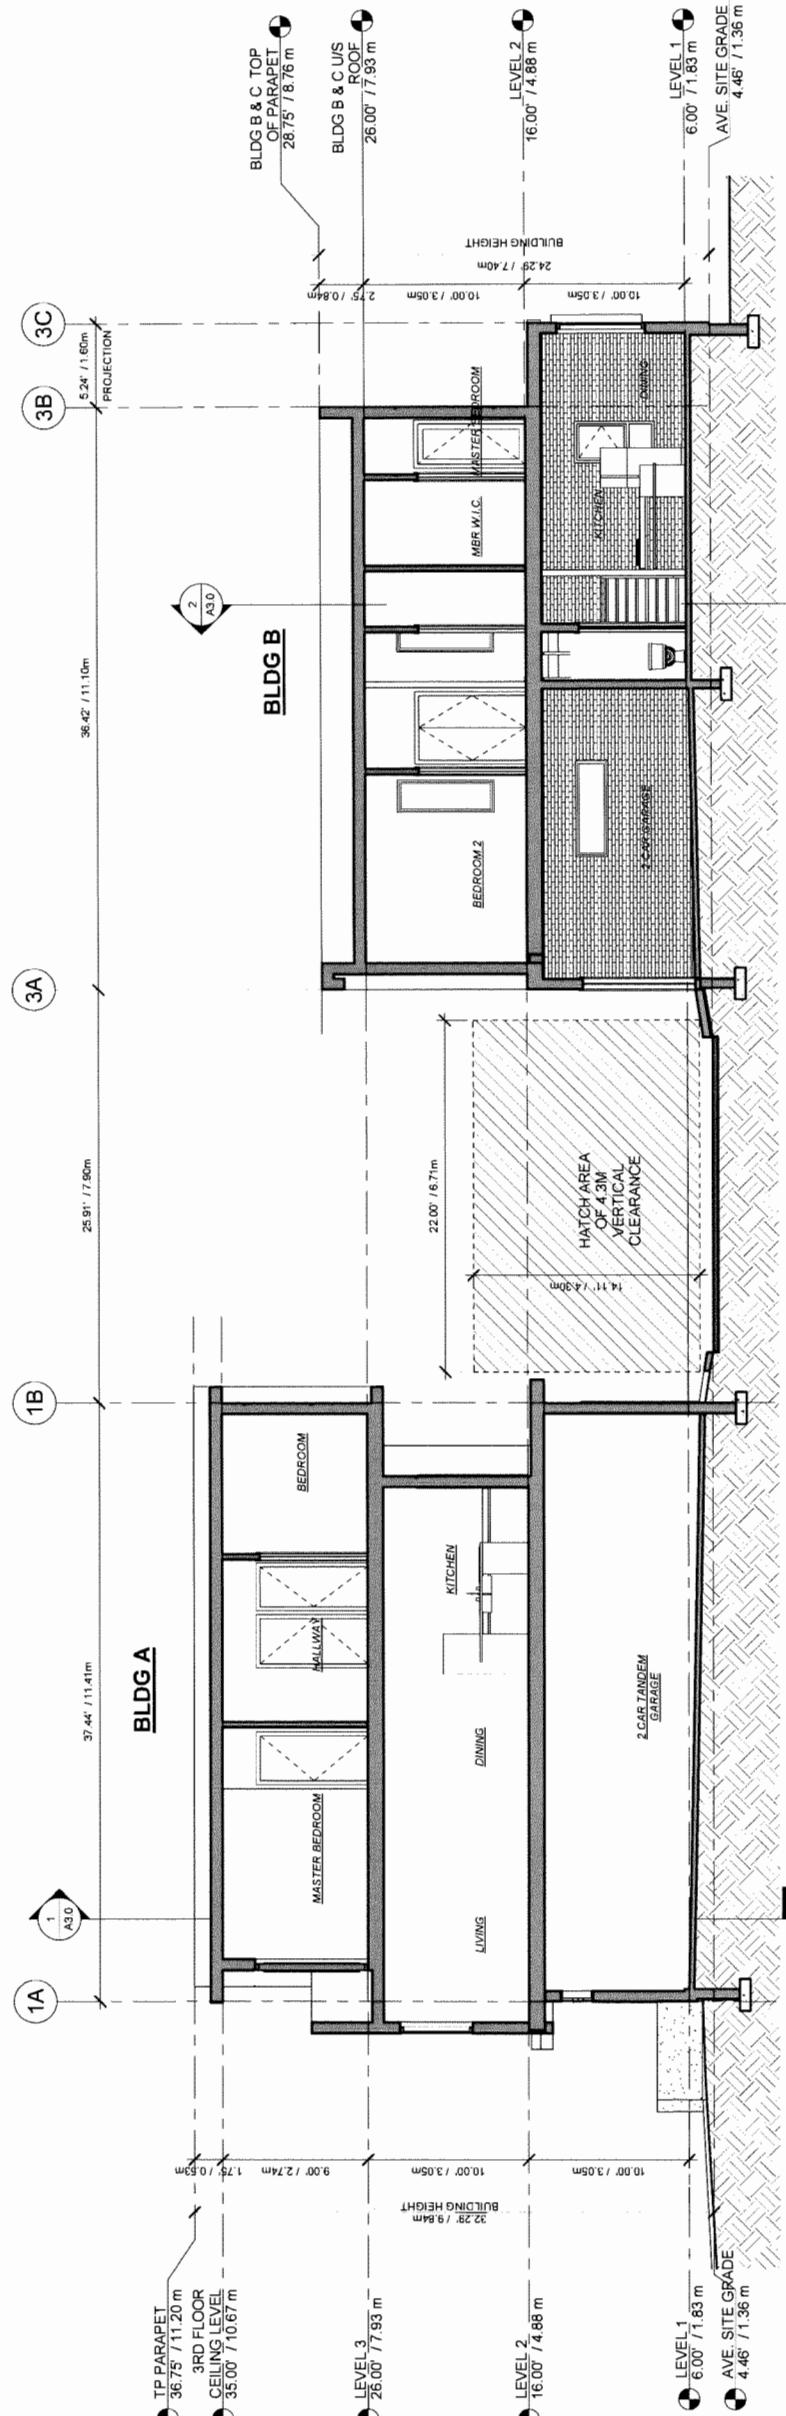
Revision: 2015-12-19
Issue for DPP Staff Review
2015-01-10
Re-issue for DPP Staff Review
2015-01-15


BLDG B & C TOP
OF PARAPET
28.75' / 8.76 m
BLDG B & C LUS
26.00' / 7.93 m
LEVEL 2
16.00' / 4.88 m
LEVEL 1
6.00' / 1.83 m
AVE. SITE GRADE
4.46' / 1.36 m

Project Title
8280 NO.3
ROAD,
RICHMOND,
B.C.

Sheet Title
BUILDING B & C
SECTIONS

Drawn: RO
Checked: MC
Scale: 3116' = 1'-0"
Project Number: 16RTH01
Revision: Dwg
Print Date: 2019/01/16



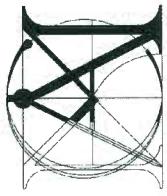

Matthew Cheng
Architect Inc.
Unit 202 - 670 EVANS AVENUE
VANCOUVER BC V6A 2K9
Tel: (604) 731-3012 Fax: (604) 731-6060 E-mail: matthecheng@vancouver.ca

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Revision:	2018-12-19	ISSUE FOR DPP STAFF REVIEW
	2019-01-10	RE-ISSUE FOR DPP STAFF REVIEW
	2019-01-15	RE-ISSUE FOR DPP STAFF REVIEW

Contents


Project Title
**8280 NO.3
ROAD,
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B.C.**


ROOF PLAN

Drawn RO

Scale: 1/8" = 1'-0"

A14

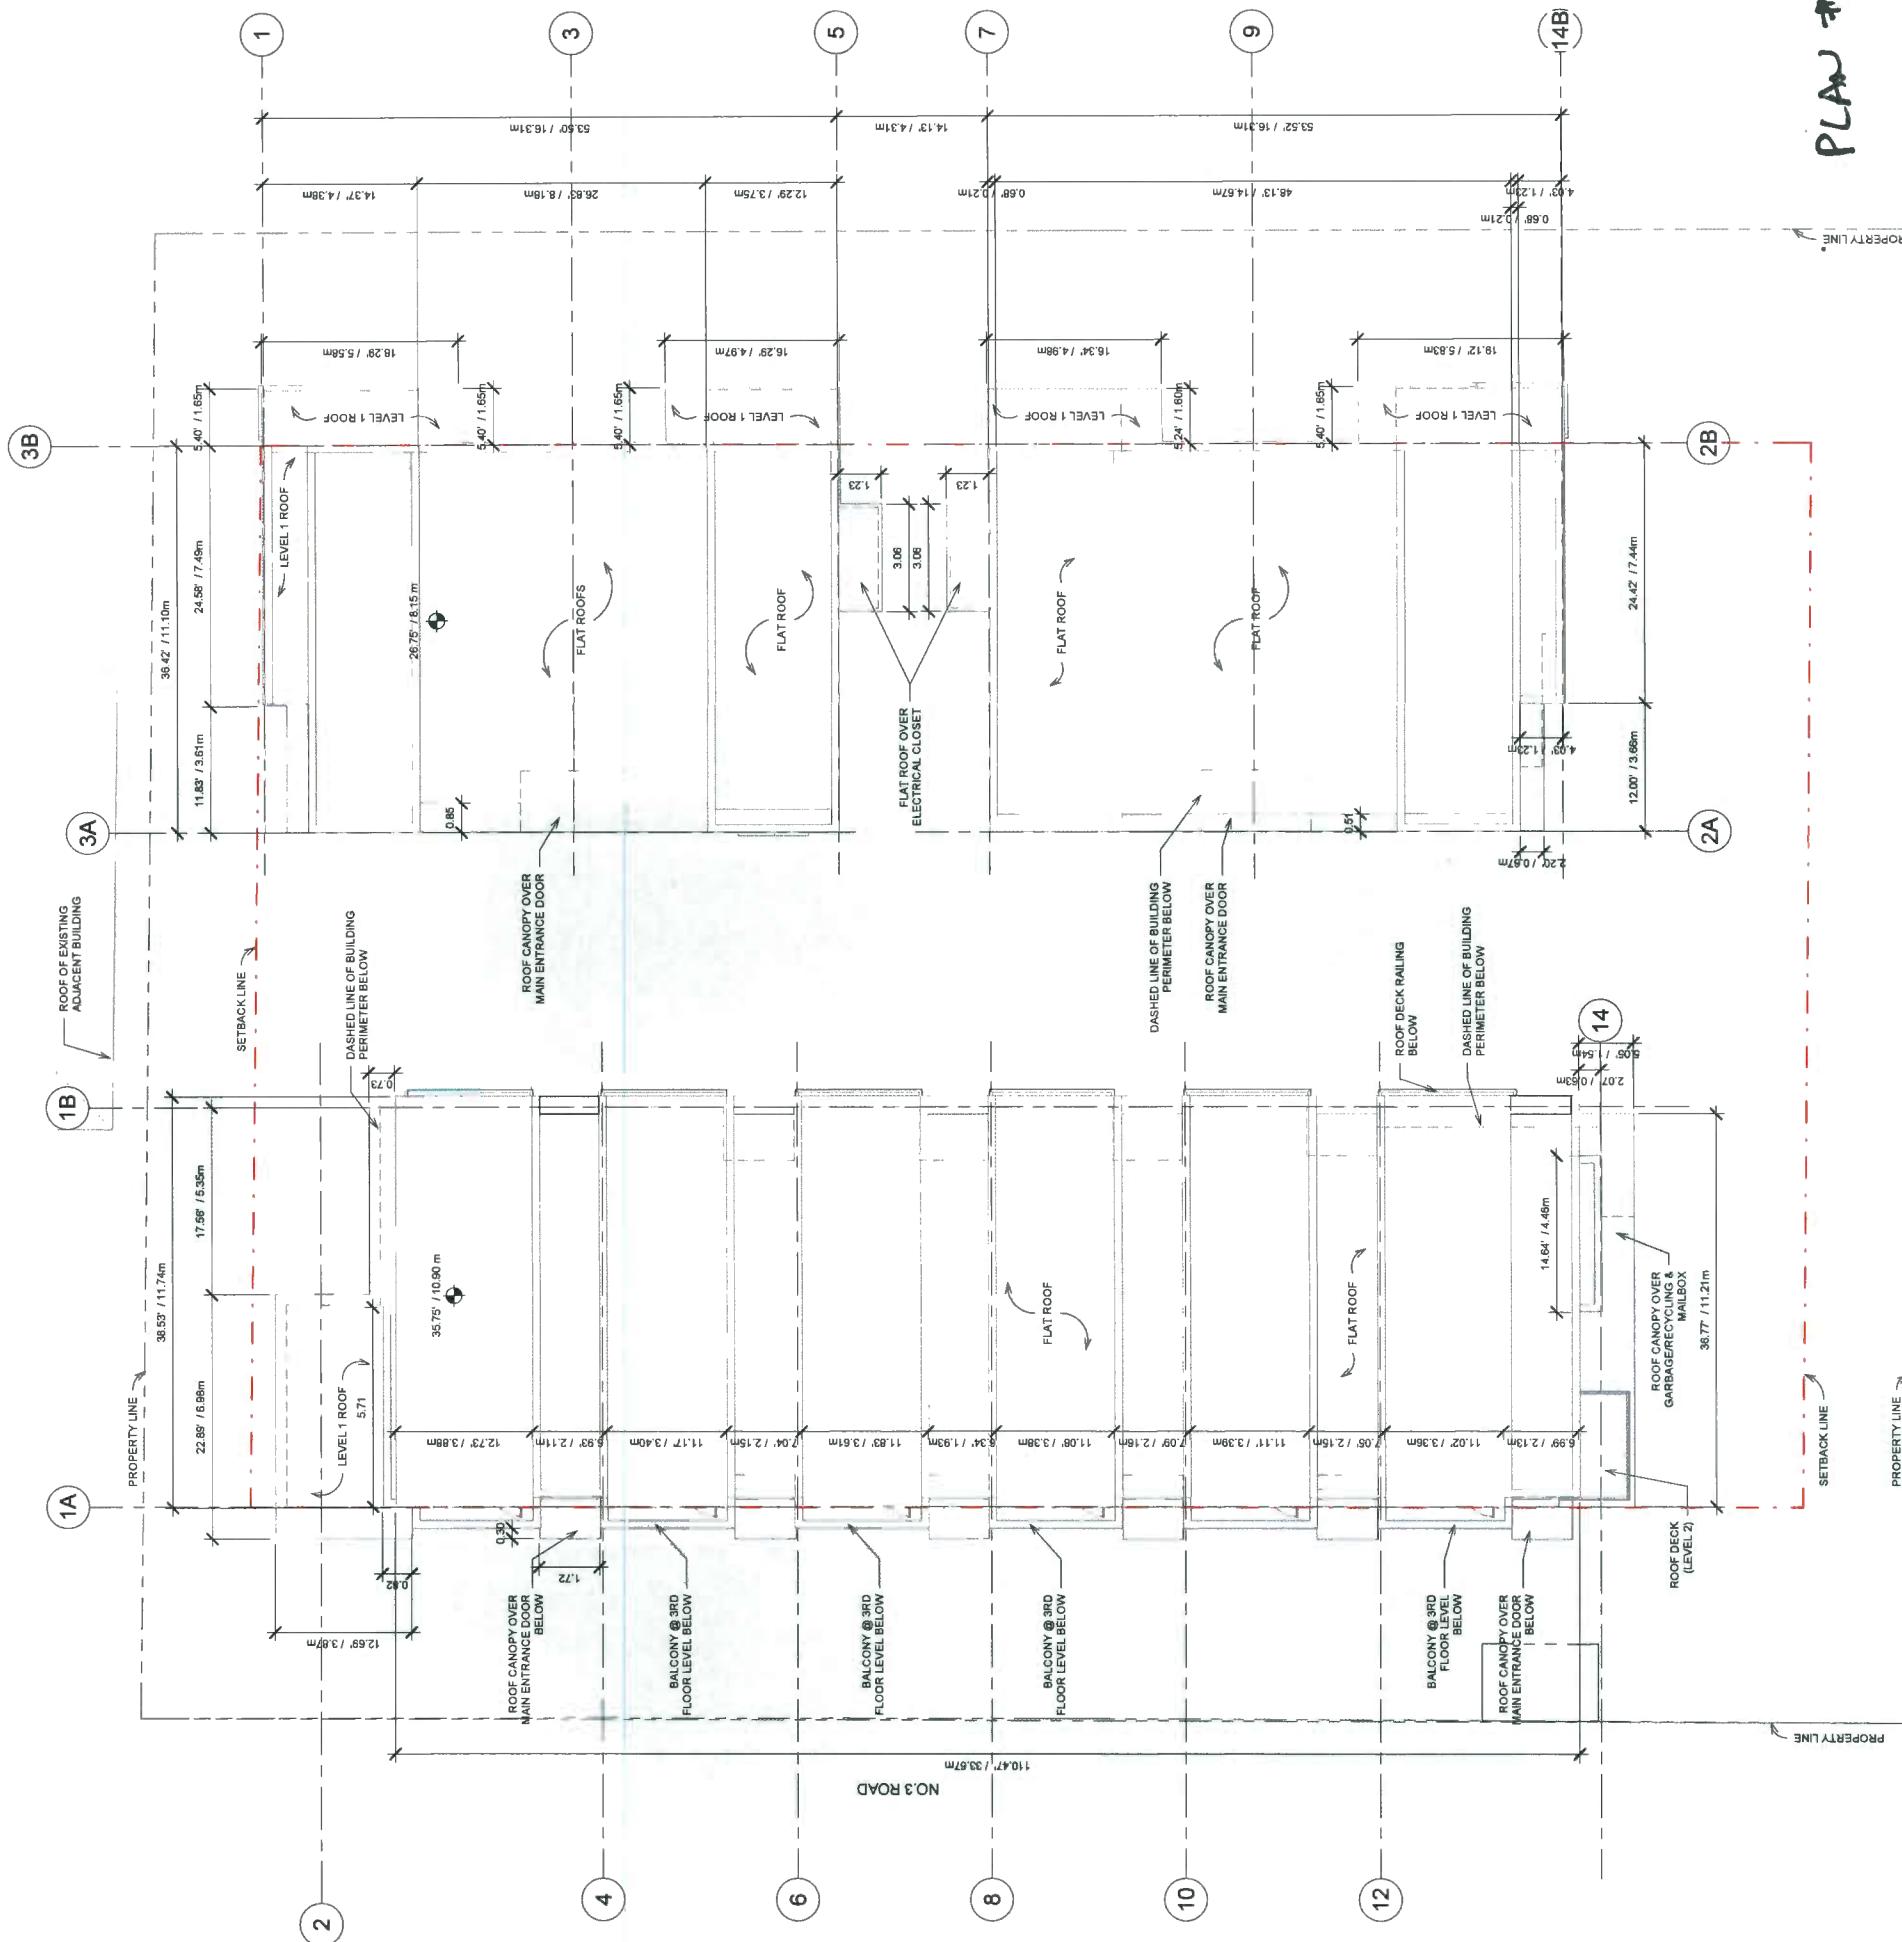

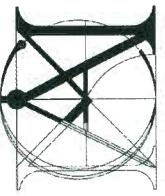**AGING-IN-PLACE FEATURES**

- PROVIDE AGING-IN-PLACE FEATURES ON ALL UNITS.
- FOR STAINLESS HANDRAILS:
AT THE TOP OF ALL STAIRWAYS, WALLS ARE REINFORCED WITH 2"X12 SOLID LUMBER AT 144 MM TO CENTRE.
- PROVIDE LEVER TYPE HANDLES FOR:
PLUMBING FIXTURES
ALL DOOR HANDLES
- PROVIDE SOLID BLOCKING IN WASHROOM WALLS FOR FUTURE GRAB BARS
BESIDE TOILET, BATHTUB AND SHOWER.

Matthew Cheng

Architect Inc.

Unit 202 - 67 EVANS AVENUE
VANCOUVER, BC V6A 2K9
Tel: (604) 731-3012 / Fax: (604) 731-3908
Cell: (604) 649-0669 / Email: matthew@mca.ca

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CERTIFIED ENERGY ADVISOR (CEA) RECOMMENDATIONS:

SPACE HEATING: AIR SOURCE HEAT PUMP (ASHP)
MECHANICAL ENGINEER TO PROVIDE A LETTER TO CITY OF
RICHMOND THAT SPECIFIES ALL EQUIPMENT COMPLIES WITH NOISE
REGULATIONS BY LAW BC 8656

INSULATION: R22 NOMINAL ABOVE GRADE WALLS

WINDOWS: USI 1.6 (DOUBLE LOW-E COATING WITH 12.7mm SPACER)

Revision: 2018-12-19
Issue for DPP Staff Review
2019-01-10
Re-issue for DPP Staff Review
2019-01-15

Consultants

Project Title: 8280 NO.3
ROAD,
RICHMOND,
B.C.

Sheet Title: COMPLEX
LEVEL 1

Drawn: RK


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Project Number: 16RTH01

Revision: 1

Date: 2019/01/16



NO.3 ROAD

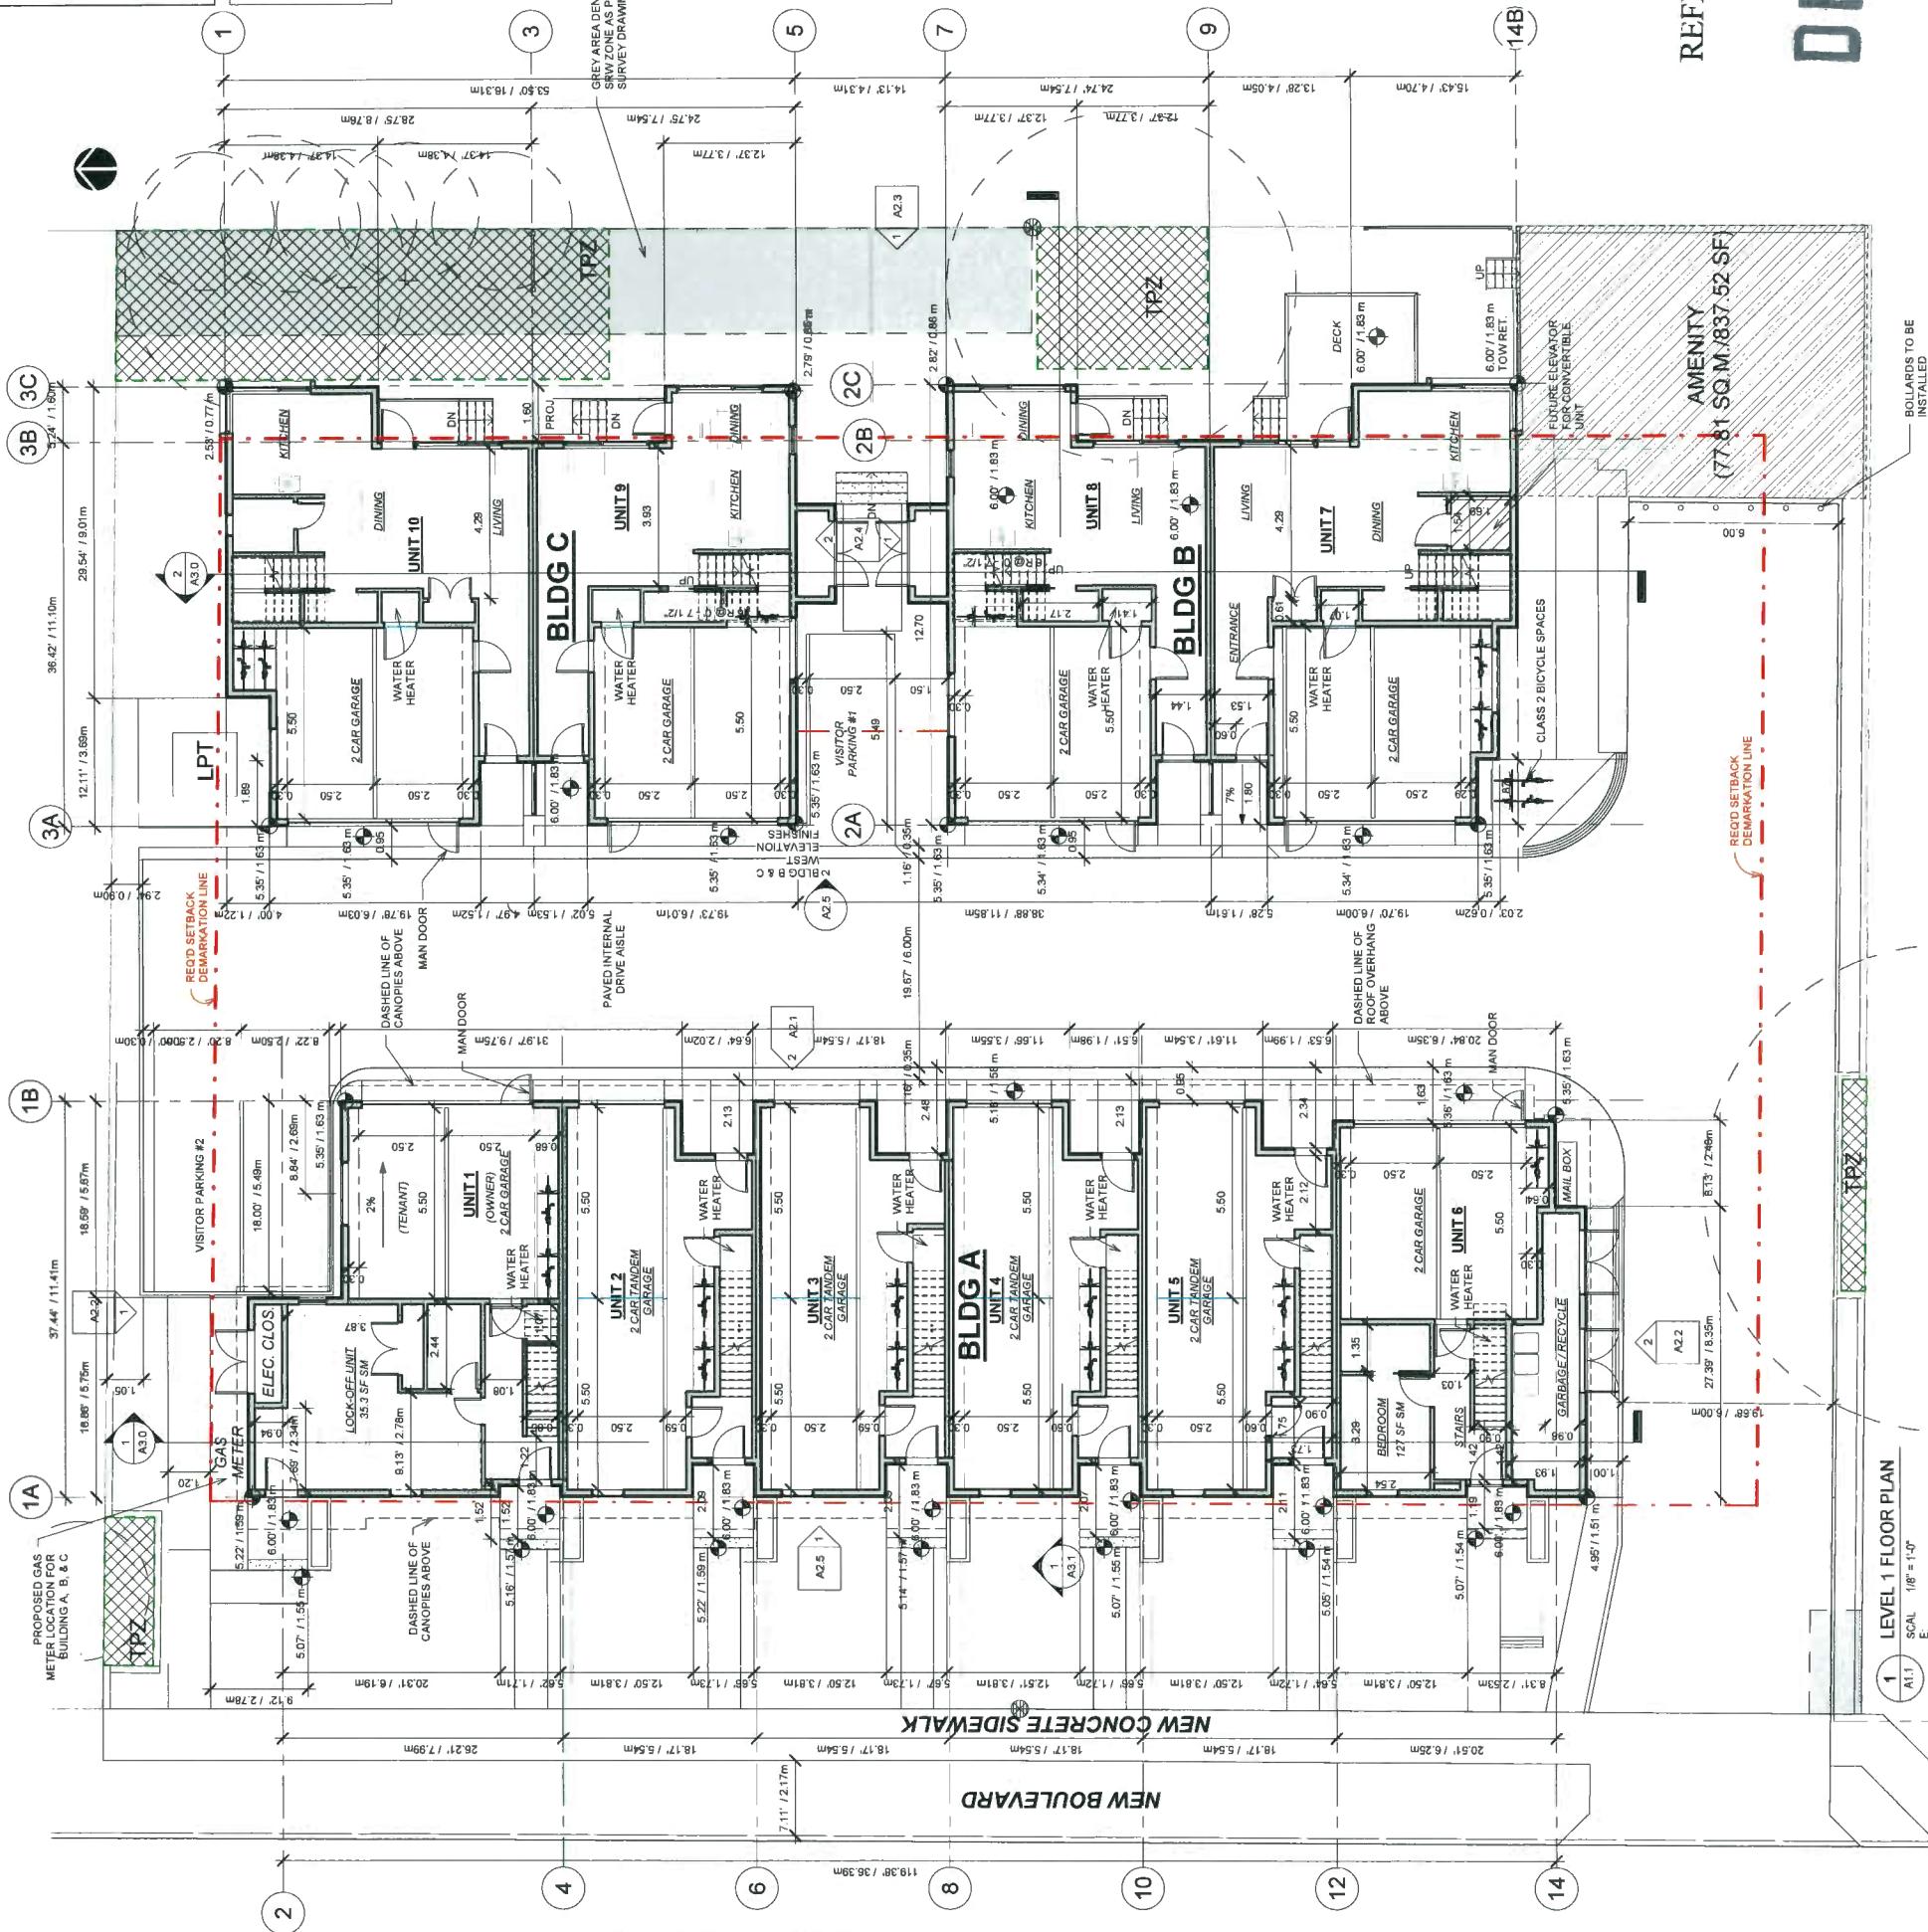
1 LEVEL 1 FLOOR PLAN
A.11 SCAL. 1/8" = 1'-0"
E.

DP 18-827622

REFERENCE PLAN

JAN 22 2019

A1.1

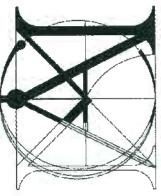

AGING-IN-PLACE FEATURES

PROVIDE AGING-IN-PLACE FEATURES ON ALL UNITS:

- PROVIDE LEVER TYPE HANDLES FOR:
PLUMBING FIXTURES
ALL DOOR HANDLES
 - PROVIDE SOLID BLOCKING IN WASHROOM WALLS FOR FUTURE GRAB BARS
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Matthew Cheng

Architect Inc.
Unit 202 - 670 EVANS AVENUE
VANCOUVER, BC V6A 2K9
Tel: (604) 731-3012 / Fax: (604) 731-6610 / Email: info@architectinc.ca

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Revision:	ISSUE FOR DPP STAFF REVIEW
2018-12-19	RE-ISSUE FOR DPP STAFF REVIEW
2019-01-10	RE-ISSUE FOR DPP STAFF REVIEW
2019-01-10	RE-ISSUE FOR DPP STAFF REVIEW

104

Project Title **8280 NO.3
ROAD,
RICHMOND
B.C.**

Sheet Title
COMPLEX
| EYE | 2

11


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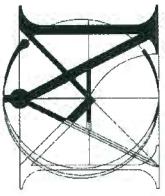
Dwg.

JAN 22 2019

REFERENCE PLAN



NO.3 ROAD

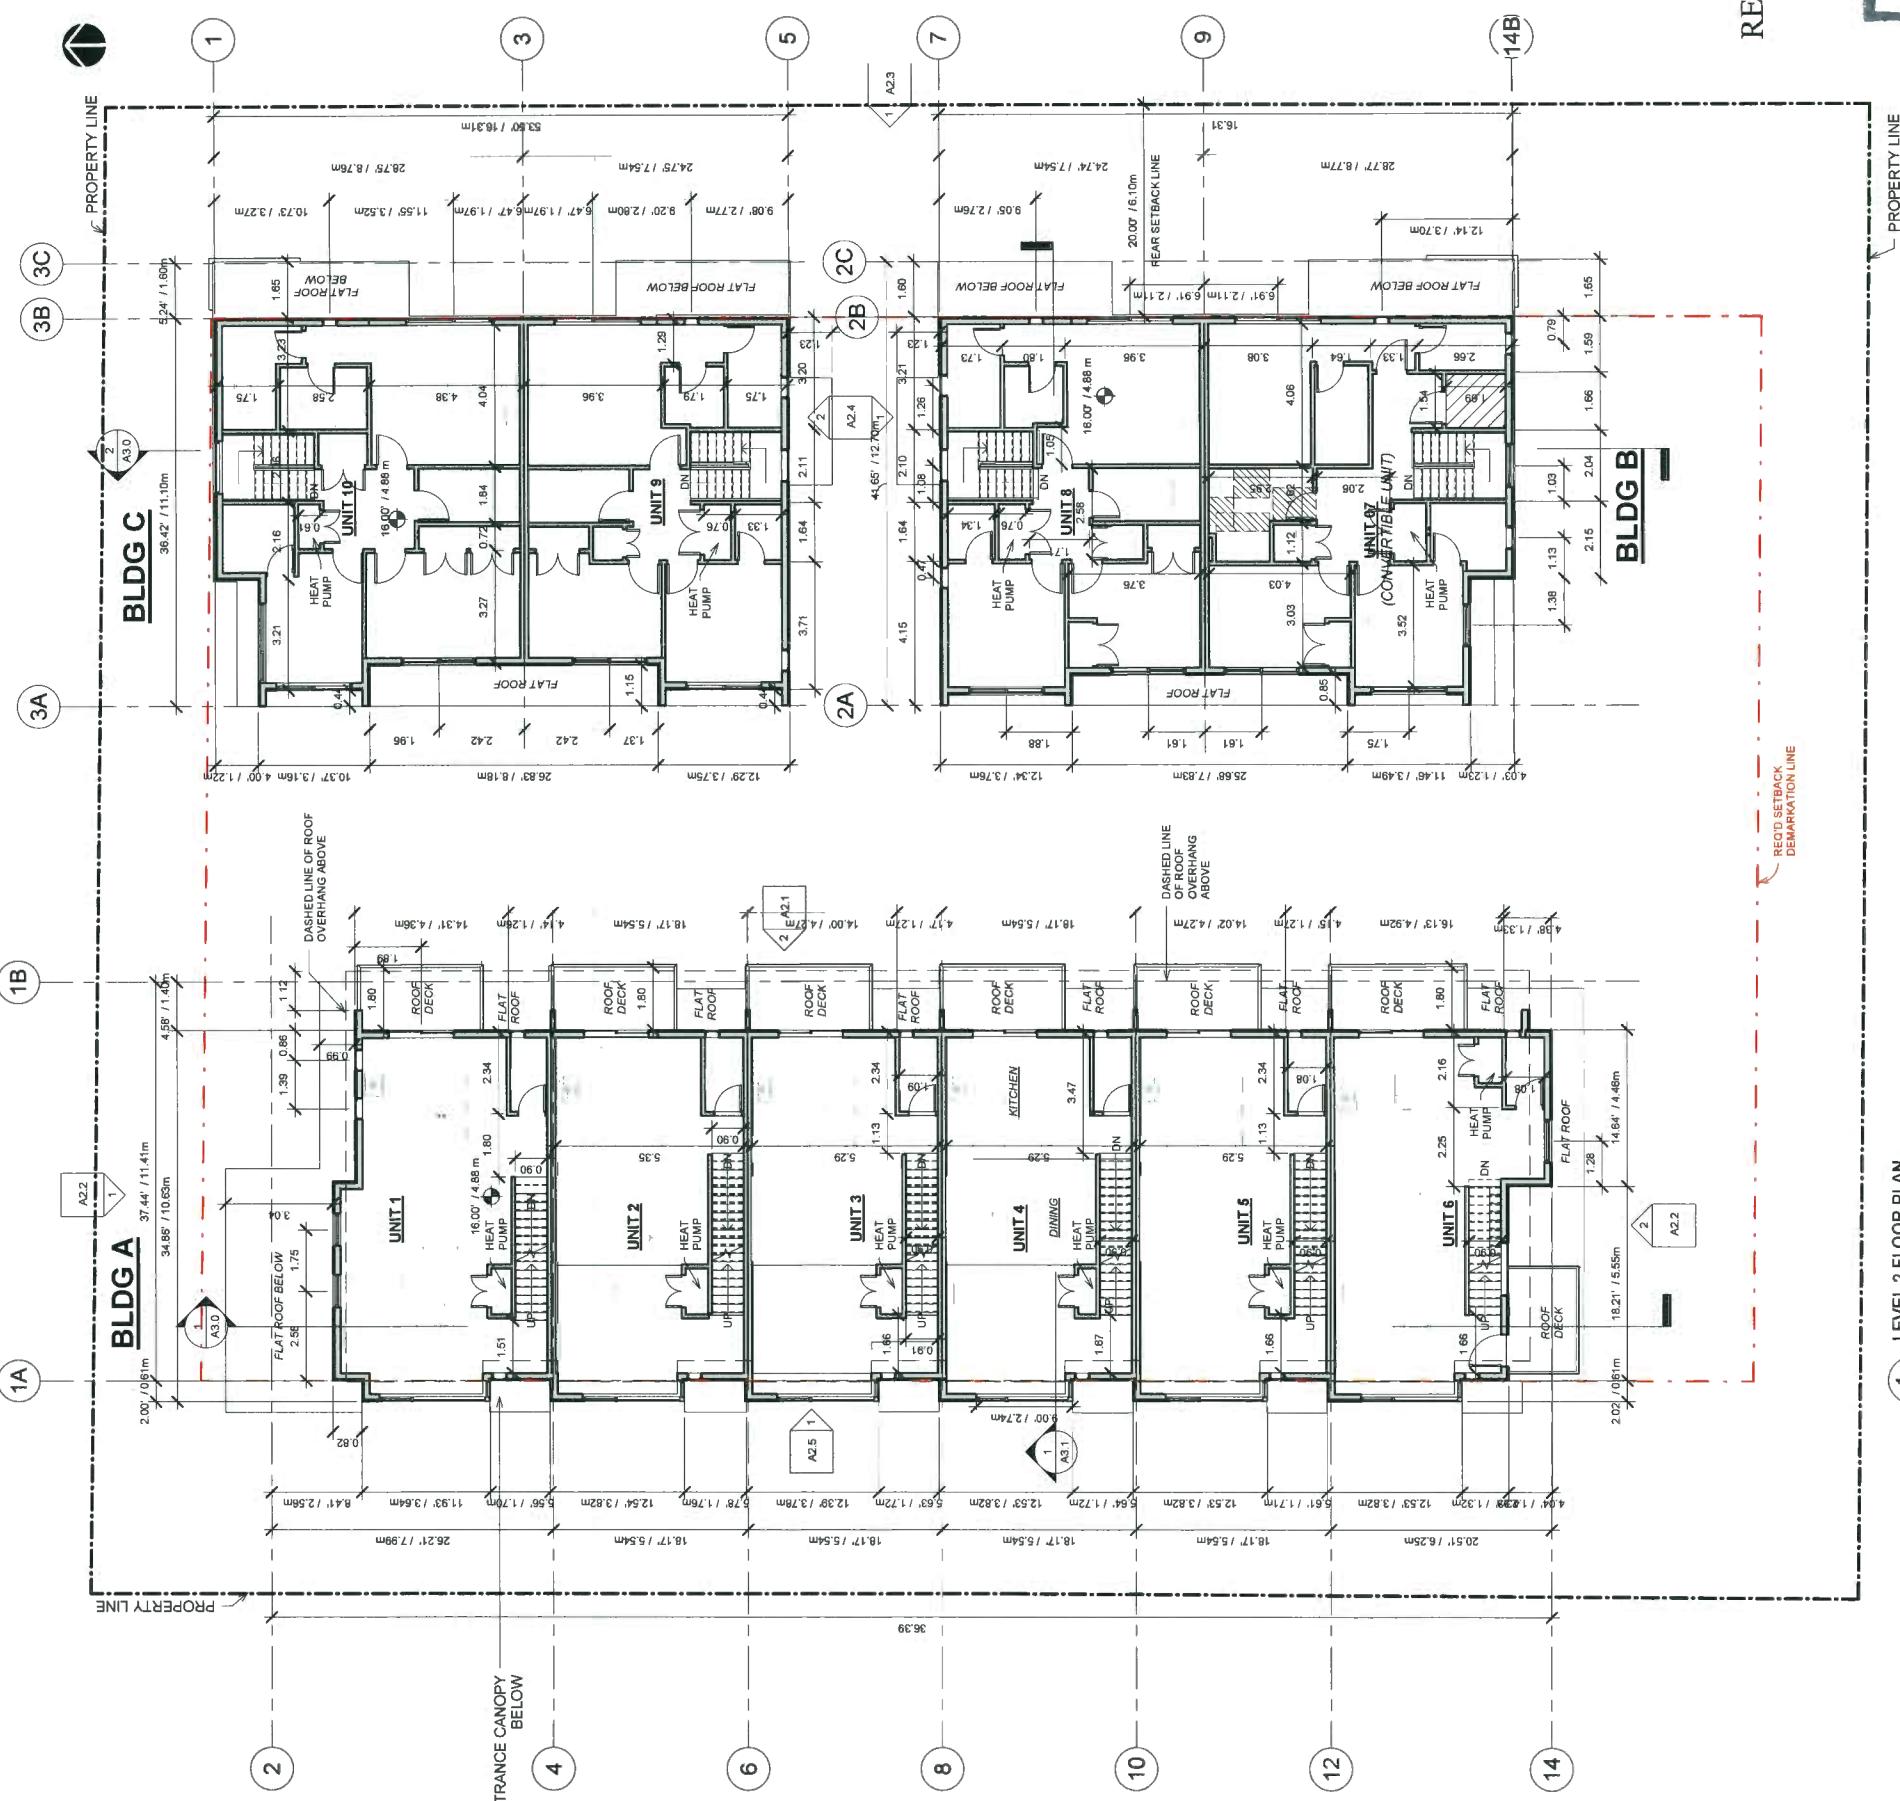**AGING-IN-PLACE FEATURES**

- PROVIDE AGING-IN-PLACE FEATURES ON ALL UNITS:
- FOR STARFISH HANDRAILS:
AT THE TOP OF ALL STAIRS VS. WALLS ARE REINFORCED WITH 2"X12 SOLID LUMBER AT 3MM TO CENTRE.
- PROVIDE LEVER TYPE HANDLES FOR:
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- ALL DOOR HANDLES
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REGULATIONS BY-LAW BC 8656

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WINDOWS: USI 1.6 (DOUBLE, LOW-E COATING WITH 12.7mm SPACER)

Revision: 2016-12-19
Issue for Opp Staff Review
Re-issue for Opp Staff Review
2016-01-10
2016-01-15

Consultants

Project Title
**8280 NO.3
ROAD,
RICHMOND,
B.C.**

Street Title
**COMPLEX
LEVEL 3**

Drawn RK

Checked MC


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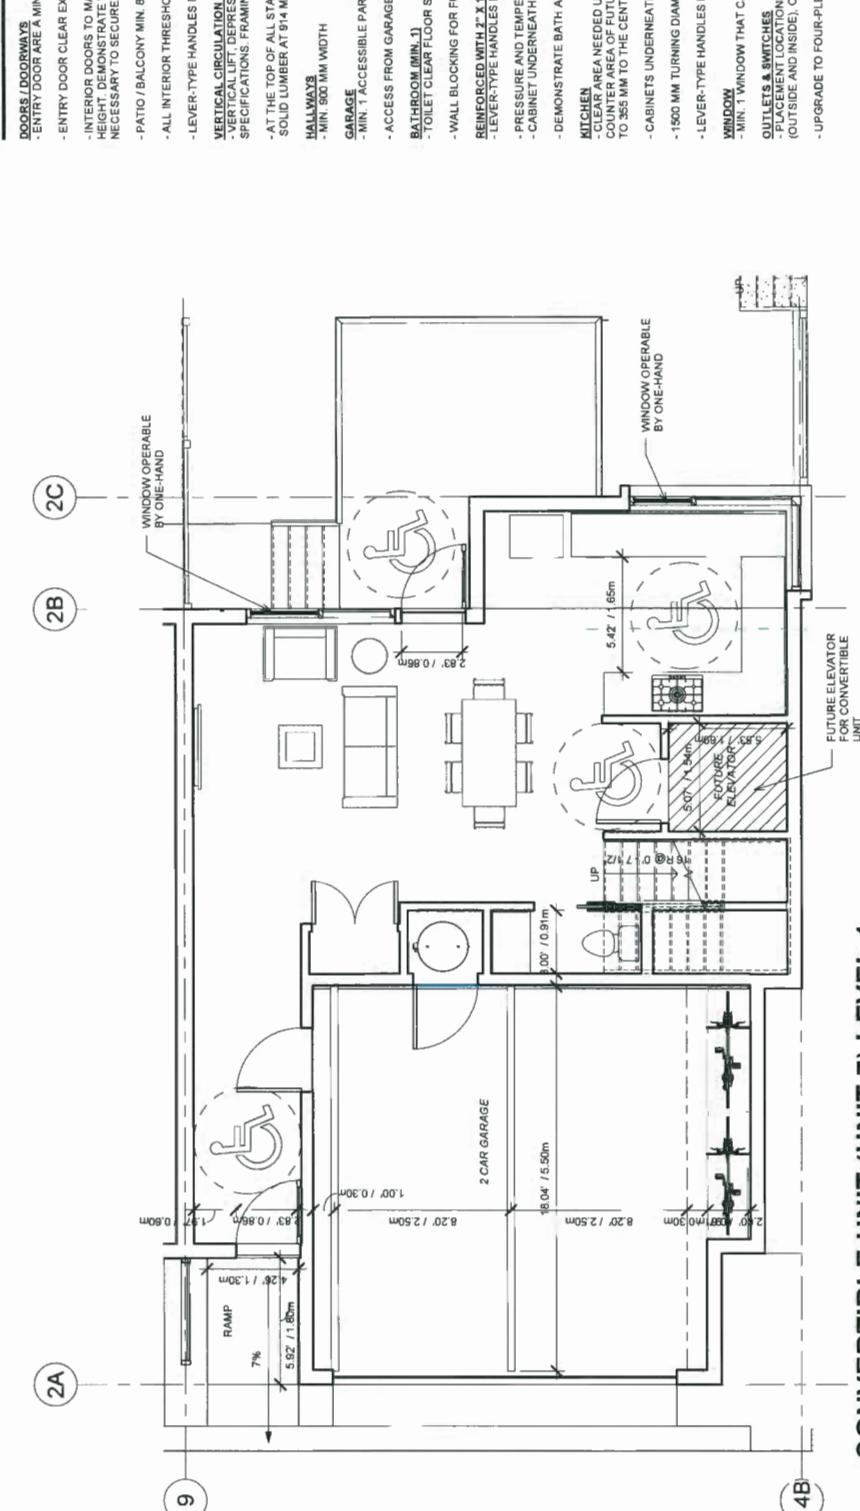
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Print Date: 2019/01/16


DP 18-827622

REFERENCE PLAN**JAN 22 2019**

CONVERTIBLE UNIT CHECKLIST

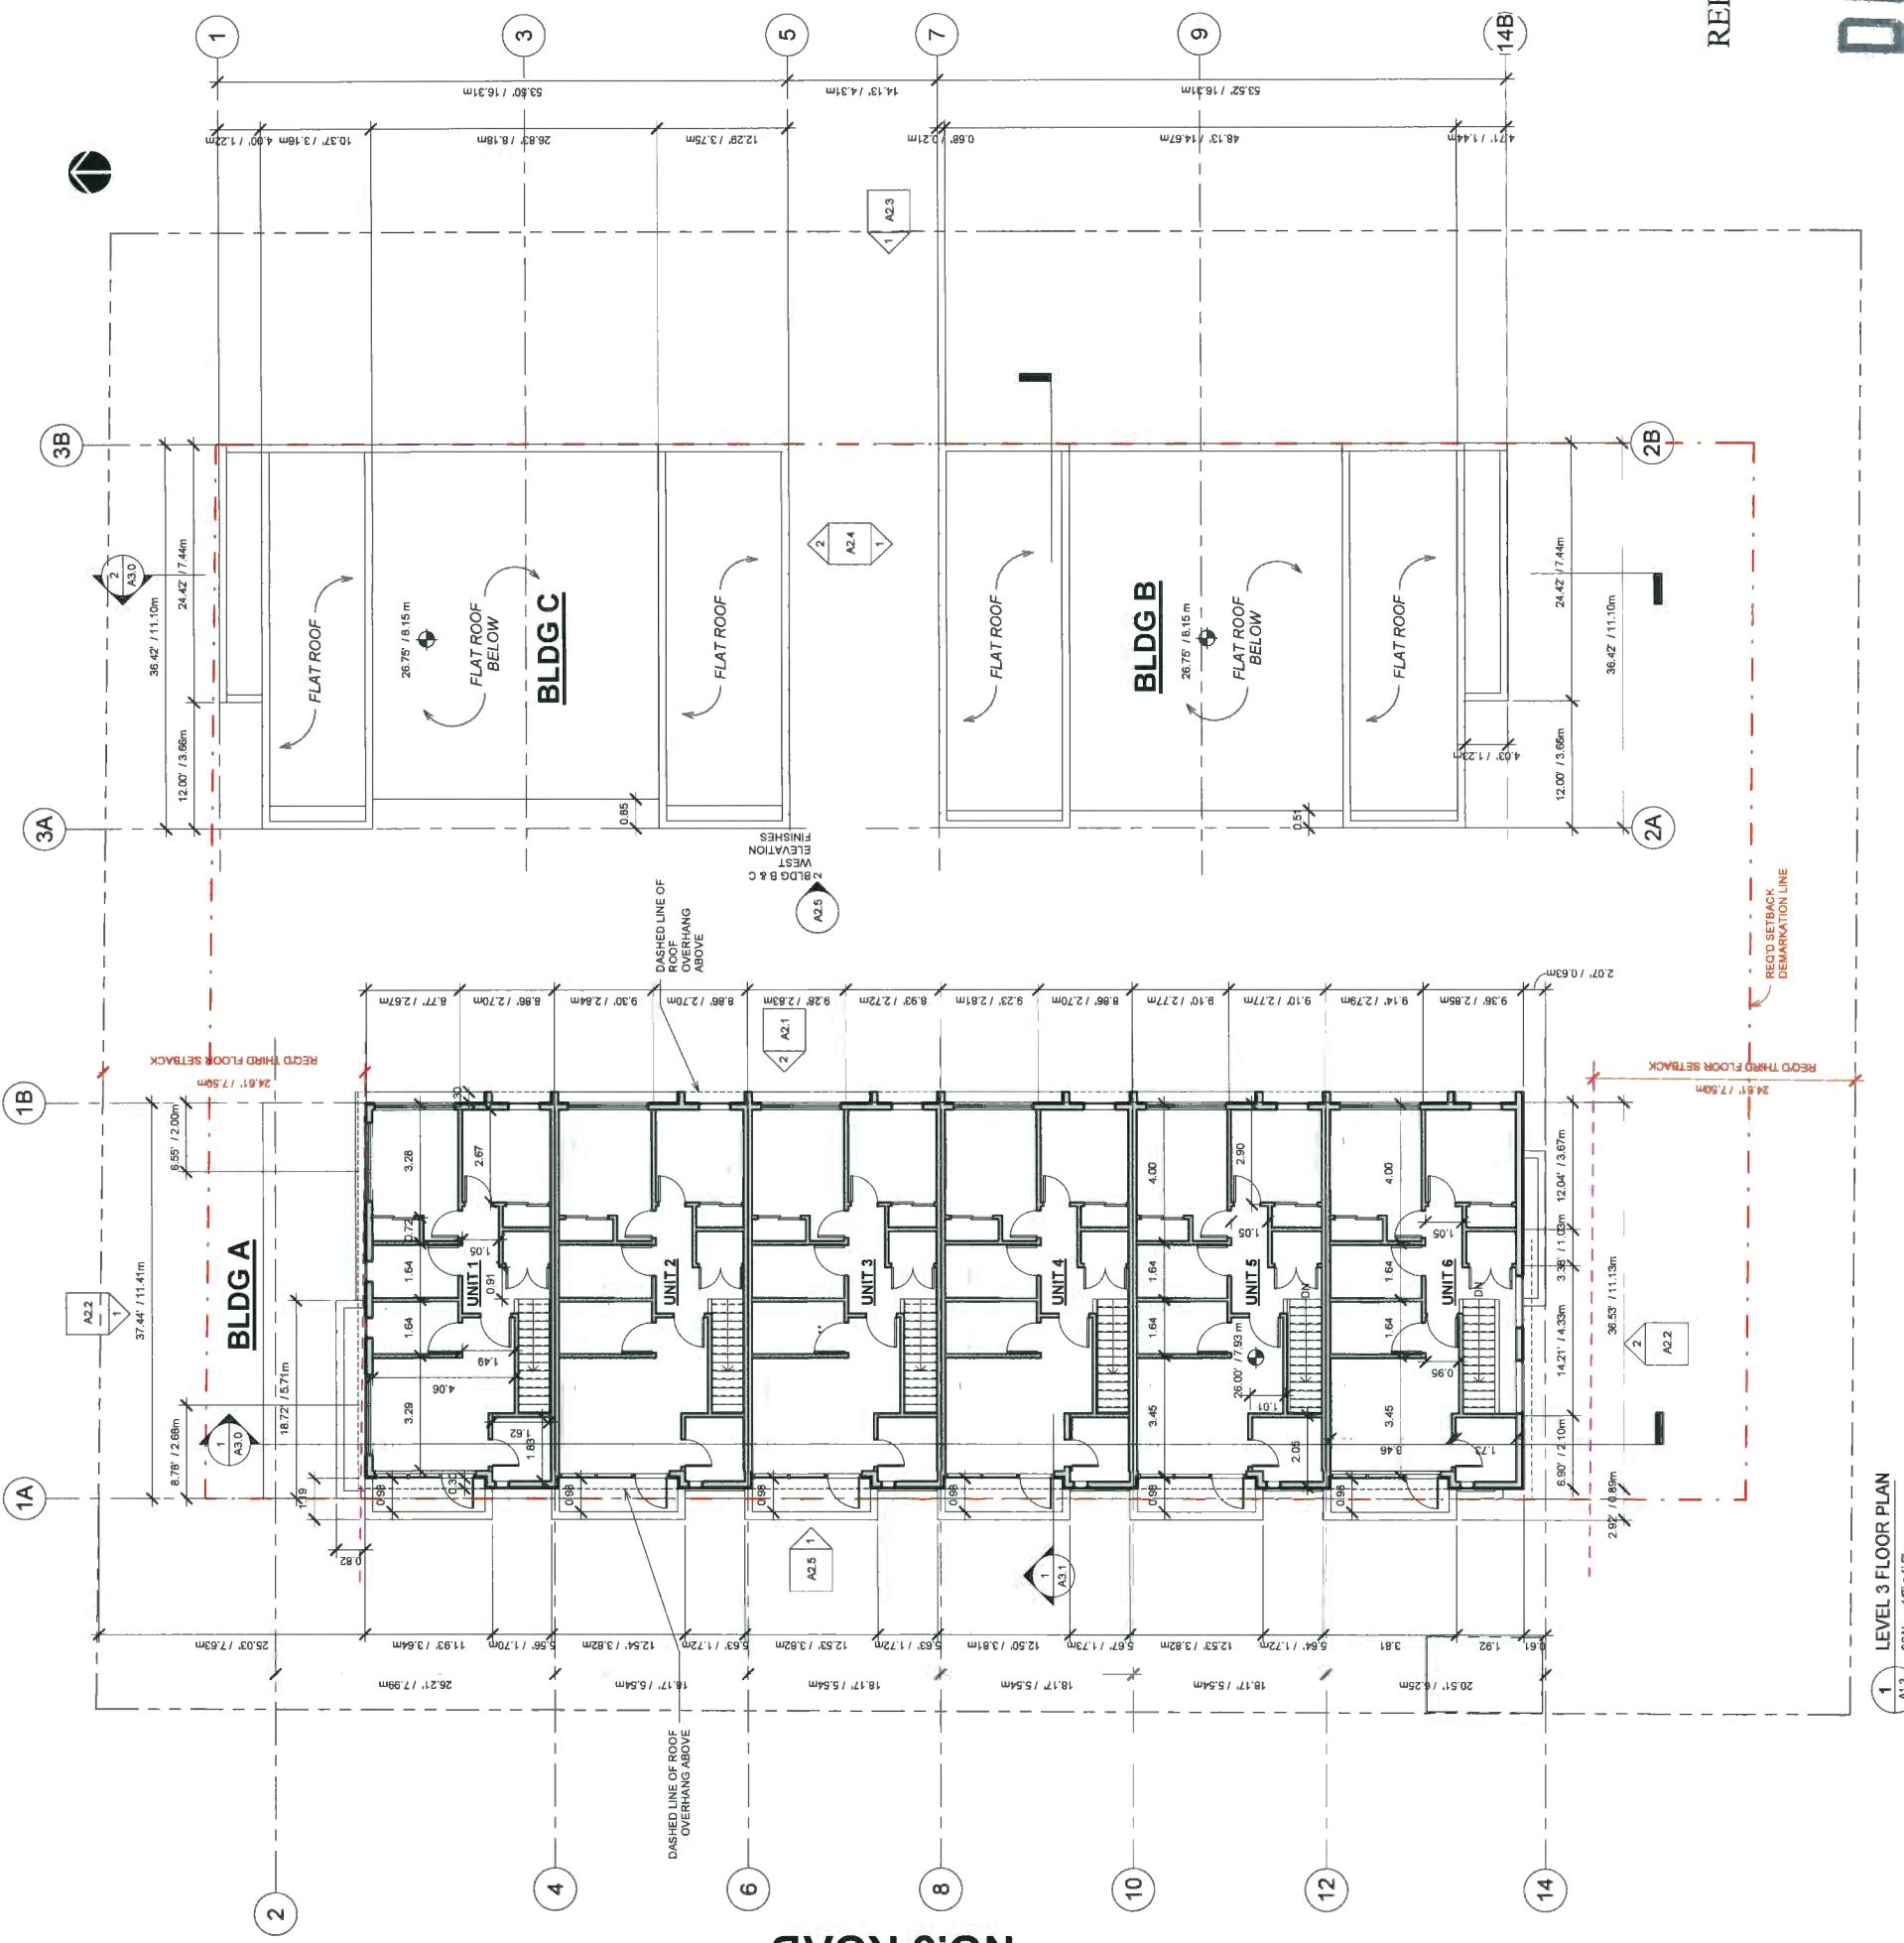

CONVERTIBLE UNIT (UNIT 7) LEVEL 1

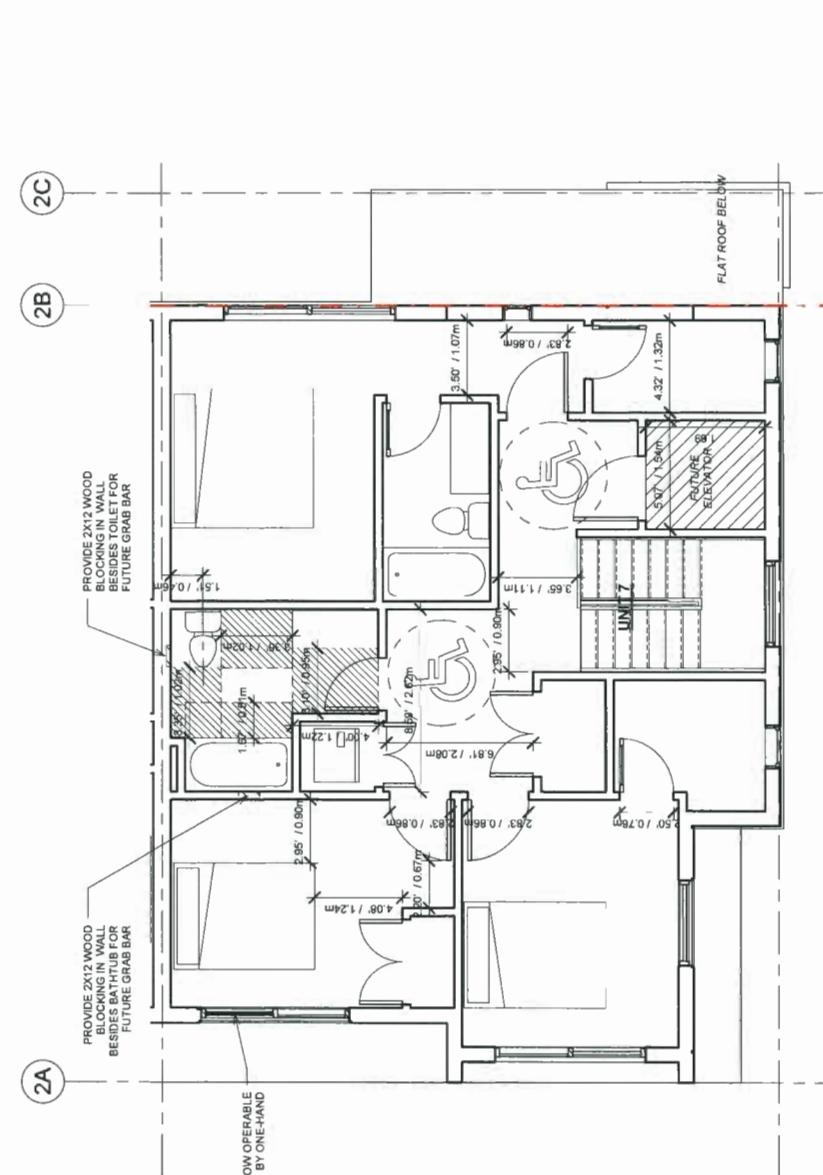

CONVERTIBLE UNIT (UNIT 7) LEVEL 2

REFERENCE PLAN

REF A - INITIAL RELEASE FOR ALL OTHERS SEE REVISION HISTORY (SHEET 6)		PROJECTION	DATE	DRAWN BY	CHECKED BY	SCALE: 1:50	REVISION
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REV B	1/10/2018	1:50	1:50				
REV A	1/10/2018	1:50	1:50				

DP 18-827622

JAN 22 2019

REF A - INITIAL RELEASE FOR ALL OTHERS SEE REVISION HISTORY (SHEET 6)		PROJECTION	DATE	DRAWN BY	CHECKED BY	SCALE: 1:4"	REVISION
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REV A	1/10/2018	1:4"	1:4"				

DP 18-827622

JAN 22 2019

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