



City of Richmond

Report to Development Permit Panel

To: Development Permit Panel

Date: November 14, 2019

From: Wayne Craig
Director, Development

File: DP 17-791045

Re: **Application by BOLD Properties (Cooney) Limited Partnership for a Development Permit at 6333 Cooney Road**

Staff Recommendation

That a Development Permit be issued which would permit the construction of a high-rise building containing approximately 83 dwelling units at 6333 Cooney Road on a site zoned "High Rise Apartment (ZHR8) Brighouse Village".


Wayne Craig
Director, Development
(604-247-4625)

WC:sb
Att. 5

Staff Report

Origin

BOLD Properties (Cooney) Limited Partnership has applied to the City of Richmond for permission to develop a high-rise residential development at 6333 Cooney Road on a site zoned “High Rise Apartment (ZHR8) Brighouse Village”. The developer’s proposal includes a total of 6,559 m² (70,597 ft²) floor area in a 14-storey tower development with approximately 83 dwelling units. The site is currently vacant.

The site is zoned “High Rise Apartment (ZHR8) – Brighouse Village (City Centre)”. Zoning Bylaw 8500, Amendment Bylaw 8738 (RZ 09-506908) and an associated Development Permit (DP 09-506909) were approved by Council on April 10, 2012 and Building Permits issued in 2013. In 2014, the Development Permit and Building Permits expired and the Servicing Agreement (SA 11-583906) was closed. The applicant is required to enter into a new Servicing Agreement and provide a new Letter of Credit security.

Like the original Development Permit, the subject Development Permit application proposes a tower and podium, although with a lower three-storey podium, increased separation of the tower from the west property line, more contemporary architectural design, and more generous residential lobby courtyard and lane sidewalk.

Development Information

Please refer to the attached Development Application Data Sheet (Attachment 1) for a comparison of the proposed development data with the relevant Bylaw requirements.

Background

Development surrounding the subject site is as follows:

To the north: A 14-storey residential tower that is designated under the City Centre Area Plan (CCAP) for high density high-rise mixed-use development (Urban Core T6 (45m)).

To the east: Across Cooney Road, a three-storey townhouse development that is designated under the CCAP for low density low-rise mixed-use development (General Urban T4 (15m)).

To the south: An older split-level house on an orphan lot designated under the CCAP for medium density mid-rise mixed use development (Urban Centre T5 (25m)). The City is reviewing a rezoning application (RZ 19-861646) from GUD GROUP to rezone 6371 Cooney Road from Low Density Townhouse (RTL1) to a Site Specific zone as per the CCAP in order to develop 14 apartment units.

To the west: Two older four-storey wood frame apartment buildings fronting Buswell Street in an area designated under the CCAP for medium density mid-rise mixed use development (Urban Centre T5 (25m)).

Staff Comments

The proposed scheme attached to this report has satisfactorily addressed the significant urban design issues and other staff comments identified as part of the review of the subject Development Permit application. In addition, it complies with the intent of the applicable sections of the Official Community Plan (OCP) and is in compliance with the “High Rise Apartment (ZHR8) Brighouse Village” zone.

Advisory Design Panel Comments

On February 21, 2019, the Advisory Design Panel (ADP) supported the subject Development Permit application moving forward to the Development Permit Panel, subject to the applicant giving consideration to the ADP’s comments. A copy of the relevant excerpt from the Advisory Design Panel Minutes is attached for reference (Attachment 2), together with the applicant’s design response in ‘***bold italics***’.

Analysis

Conditions of Adjacency

- The Cooney Road streetscape is enhanced with two residential unit entries, the residential tower lobby and entry courtyard. The residential tower and three-storey podium massing are provided along this frontage.
- The subject development will be accessed from a new interim City lane required to be constructed along the south edge of the subject site. The original rezoning secured public Rights-of-Way along the south edge of the site for a new City lane and along the Cooney Road frontage for future road widening. These Rights-of-Way areas will be designed and constructed via Servicing Agreement as secured by legal agreement registered on Title. Due to the passage of time, change in engineering requirements, change in ownership and additional lane widening for enhanced pedestrian passage, the applicant is required to enter into a new Servicing Agreement. The lane will be widened to ultimate width through the redevelopment of the site to the south.
- The development is setback along the north and west property lines, due to utility Right-of-Ways. The setback areas provide landscape buffers to the neighbouring residential developments. Shrubs, vines and low planting are proposed in front of the three-storey parking podium, and the walls treated with a relief pattern and inset panels to provide visual interest.
- The development is accommodated within a single tower, located at the southeast corner of the site facing the new lane and Cooney Road to maximize distance from existing neighbouring residential development, and minimize overlook.

Urban Design and Site Planning

- The proposed form of development takes advantage of the site’s proximity to the Canada Line and provision of a new City lane to create a high-density urban environment that is consistent with CCAP objectives.
- The distinctive tower is articulated with stepped roofline resulting from inset penthouse level, and stacked balconies.

- The three-storey podium includes a pedestrian-oriented residential frontage which could accommodate home based business uses, contributing towards local liveability. The podium also accommodates four levels of parking, including a level underground.
- Resident-shared amenity space is provided on the podium roof, including outdoor amenity space and an indoor amenity room pavilion at the north-west corner of the podium roof.
- Service uses, parking, loading and waste management are screened from public view.

Parking and Access

- The proposal includes 101 parking spaces within the parkade in compliance with Zoning Bylaw 8500.
- Parking, loading and waste management are accessed from the new City lane required to be constructed along the south edge of the subject development site. The proposed development will provide additional public Rights-of-Way (0.35 m width) along the north edge of the City lane Right-of-Way (ROW) to accommodate a wider sidewalk along the lane for enhanced pedestrian passage, ultimately to the future bus mall and Brighouse Canada Line Station when the properties to the west redevelop in the future. The interim 7.85 m lane width will be widened to ultimate 9.35 m lane width through the redevelopment of the site to the south.
- One medium (SU9) on-site loading space is provided adjacent to the new lane. The use of the loading space will be shared with the adjacent site to the south at 6371 Cooney Road and the applicant will provide a public Right-of-Way over the loading space for the shared use.
- Most of the utility Right-of-Way along the west property line is also covered by public Right-of-Way. The proposed development will provide Public Rights of Passage (PROP) over the remainder of the utility Right-of-Way along the west property line to accommodate potential future lane network construction.

Architectural Form and Character

- The proposed development contributes towards a modern architectural expression including:
 - Maximizing active transparent residential uses on the ground floor.
 - Three storey podium incorporates repeated vertical design treatment to break down the horizontal massing.
 - A distinct tower along the site's Cooney Road frontage, stepped back from the street-fronting podium and articulated with inset and projecting balconies, cladding incorporating strong graphic patterning in white, grey and black, together providing rhythm, variety and visual interest.
- Quality materials (e.g. cementitious panel, spandrel panels, aluminum frames, and glass guardrails) contribute towards a distinct identity and urban environment.
- A strong white-grey-black colour palette that, when used in combination with variations in massing and materials, helps break up the massing, reinforce the identity of the project and project a crisp, contemporary image.

Landscape Design and Open Space Design

- The CCAP encourages the provision of additional open space to enhance the urban environment. The subject development's public open space contributions are provided through public Rights-of-Way secured through the original rezoning and proposed additional public Right-of-Way to accommodate a wider sidewalk lane.

- 552 m² (5,942 ft²) of residential outdoor amenity space is provided, based on the OCP standard of 6 m² (65 ft²) per dwelling unit, comprising a consolidated, irrigated landscaped, multi-use, outdoor space at the podium roof level (co-located with required indoor residential amenity space), designed to provide for children's play, strolling, socializing, relaxing, and outdoor dining.
- Additional landscaping is provided at the residential lobby entrance, green roof on the indoor amenity pavilion, and landscape buffers along the north and west property lines.
- All landscaped areas will be irrigated and drought tolerant plants are incorporated in green roof and vegetated outdoor areas to reduce reliance on irrigation.
- Private outdoor patios and balconies are provided for all dwelling units in the tower.
- Prior to forwarding the subject application to Council, the applicant is required to provide to the City a Letter of Credit for landscaping in the amount of \$305,277.00, as estimated by the project Landscape Architect, to ensure that on-site landscape features are provided in accordance with the Development Permit.

Shared Indoor Amenity Space

- The OCP requires that multi-family development comprising 40 units or more provide at least 100 m² (1,076 ft²) of indoor amenity space. The subject development meets the OCP minimum and provides for attractive indoor amenity space located adjacent to the outdoor amenity space in the form of a 108 m² (1,161 ft²) enclosed pavilion at the podium roof level.

Crime Prevention Through Environmental Design

- CPTED measures enhance safety and personal security in and around the proposed building.

Casual surveillance is provided through minimizing blind corners, a prominent residential lobby entrance, locating visitor parking uses on the ground floor of the parkade, clear sightlines to exits within the parkade (mirrors where needed), glazed vestibules, street-oriented residential entries and lighting in all ***pedestrian*** areas.

- Territoriality is identified through landscape treatment.
- Target hardening security features are provided at all pedestrian and parking entrances.

Accessible Housing

- The proposed development includes 20 two-bedroom adaptable units that are designed with the potential to be easily renovated to accommodate a future resident in a wheelchair. These single-storey units are required to comply with the BC Building Code requirements for adaptable housing.
- All of the proposed units incorporate aging in place features to accommodate mobility constraints associated with aging. These features include:
 - Lever-type handles for plumbing fixtures and door handles.
 - Solid blocking in washroom walls to facilitate future grab bar installation beside toilets, bathtubs and showers.

Sustainability Measures

- The project will achieve the City standard of LEED "Silver" equivalent as per the attached LEED checklist (Attachment 3).
- District Energy Utility (DEU) compatible building and mechanical system designed to facilitate a future connection to a City utility. The applicant will be required to register a

legal agreement on Title securing the owner's commitment to connect to a District Energy Utility (DEU) that provides that no Building Permit will be issued unless the building is designed with the capability to connect to and be serviced by a DEU. The developer will also be required to provide mechanical drawings and energy modeling, which shall be reviewed by the City and LIEC for compliance with DEU requirements (i.e. capable of connecting to a future DEU system) prior to Building Permit issuance.

- Energized electric vehicle (EV) charging outlets for 100% of resident vehicle parking spaces (208V – 240V) and 10% of Class 1 secure bicycle storage spaces (120V).

Tree Management

- There are six trees (tag# 86, 87, 88, 89, 90, 91) located within the lane public Right-of-Way along the south edge of the subject development site as shown on the proposed tree management plan (DP Plan 40). These trees are in fair to poor condition and are in conflict with the required City lane construction.
- There are seven trees located on neighbouring property as follows:
 - Five trees (tag# OS2, OS3, OS4, OS5, and OS7) located on the neighbouring property to the south (6371 Cooney Road) will need to be removed to facilitate the required lane construction. The City has received a rezoning application for 6371 Cooney Road (RZ 19-861646) and the applicant has received written permission from the neighbouring property owner for the removal of these trees (Attachment 4). The applicant is required to obtain a tree removal permit for these trees.
 - Two trees (tag# OS1 and OS6) located on neighbouring property will not be impacted by the proposed development and are required to be protected. Installation of appropriate tree protection fencing is required as part of the development prior to any construction activities, including building demolition, occurring on-site. The applicant is also required to enter into a contract with a Certified Arborist for supervision of any on-site works conducted within the tree protection zone of the trees, monitor the trees and submit a post-construction assessment report to the City for review.
- There are a total of 19 new trees included in the Development Permit plans.

Affordable Housing

- The ZHR8 zone does not require the provision of built affordable housing units and voluntary cash contributions were provided through previous rezoning applications regarding the subject development site. In response to the need for affordable housing in the City, the applicant will be providing a voluntary contribution in the amount of \$100,000 towards the City's Affordable Housing Strategy (i.e. \$100,000 in addition previous contributions of \$30,545.00 via RZ 03-238768 and \$251,611.00 via RZ 09-506808).

City Centre Development

- The applicant will be providing a voluntary contribution in the amount of \$2,144.77 towards future City community planning studies, as set out in the City Centre Area Plan (i.e. \$19,779.77 at 2019 rate of \$0.28 per buildable square foot, less \$17,635 previously contributed via RZ 09-506808).
- Registration of a legal agreement on Title is required, ensuring that future owners are aware that the development is subject to potential impacts due to other development that may be approved within the City Centre.

Public Art

- The applicant will be providing a voluntary contribution in the amount of \$17,919.95 towards the City's Public Art Program (i.e. \$60,242.95 at 2019 rate of \$0.87 per residential square foot, less \$42,323 previously contributed via RZ 09-506808).

Servicing Agreement

- The applicant is generally required to design and construct the new City lane, Cooney Road frontage beatification, and sanitary sewer improvements. Further details are included in the attached Development Permit considerations (Attachment 5).

Discharges

The following legal agreements are obsolete and will be discharged from Title:

- SRW City utilities (1961 charge 300009C), which is now obsolete as all active City engineering utilities on/near the site are contained within other subsequent SRWs.
- Aircraft noise sensitive development covenant (2005 charge BX288986), which is now obsolete as a replacement covenant with SRW is also registered on Title (2012 charges BB4039857 and BB4039858).
- Servicing Agreement covenant (2012 charge BB4039865), which is now obsolete. Prior to discharge, the new Servicing Agreement and new Letter of Credit are required.
- Building Code equivalency covenant (2013 charge CA3162692), which is now obsolete as the proposed building design has changed.

Conclusions

The proposed development is consistent with Richmond's objectives for the subject property and Brighouse Village as set out in the Official Community Plan (OCP), City Centre Area Plan (CCAP), and Zoning Bylaw. The project will enhance the Brighouse Village urban community through its articulated form, pedestrian-oriented streetscape, adaptable housing, landscaping, widened lane public Right-of-Way, and sustainable development measures, including making provision for future connection to a City District Energy Utility system. The proposed development will also enhance the community through contributions towards Affordable Housing, community planning and Public Art, together with the developer's concurrent construction of off-site improvements secured through the original rezoning and updated through the subject Development Permit and Servicing Agreement applications. The applicant has agreed to complete DP considerations (Attachment 5). On this basis, staff recommend that the Development Permit be endorsed, and issuance by Council is recommended



Sara Badyal
Planner 2
(604-276-4282)

SB:blg

Attachment 1: Development Application Data Sheet

Attachment 2: Advisory Design Panel Meeting Minutes Annotated Excerpt (February 21, 2019)

Attachment 3: LEED Checklist

Attachment 4: Letter of permission for tree removal from owner of 6371 Cooney Road

Attachment 5: Development Permit Considerations



City of Richmond

Development Application Data Sheet

Development Applications Department

DP 17-791045

Attachment 1

Address:	6333 Cooney Road	BOLD Properties (Cooney) Limited	BOLD Properties (Cooney) Nominee Inc., Inc. No. BC1120735
Applicant:	Partnership	Owner:	
Planning Area(s):	City Centre (Brighouse Village)		

	Existing	Proposed
Site Area	2,458 m ²	No Change
Land Uses	Vacant	Multi-Family Residential
OCP Designation	Mixed-Use	Complies
Zoning	High Rise Apartment (ZHR8) - Brighouse Village	Complies
Number of Units	None	83 dwelling units, including: • 1 studio, 15 1-bedroom, 64 2-bedroom & 3 3-bedroom units • 81% family friendly units (2 & 3 bedroom) • 20 adaptable units

	Bylaw Requirement	Proposed	Variance
Floor Area Ratio	Max. 2.67	2.67	None permitted
Lot Coverage	Max. 70%	70%	None
Setback – Cooney Road	Min. 3 m	3 m	None
Setback – North Side Yard	Min. 2.7 m	2.7 m	None
Setback – South Side Yard	Min. 7.5 m	8.19 m	None
Setback – Rear Yard	Min. 1.5 m	1.5 m	None
Height	Max. 41 m	41 m	None
Lot Size	N/A	61 m lot width 39.6 Min. lot depth 2,458 m ² lot area	None
Parking Spaces	100 total spaces, including: 83 resident spaces 17 visitor spaces	101 total spaces, including: 84 resident spaces 17 visitor spaces	None
Parking – Accessible Spaces	2%	3.6% (3 spaces)	None
Parking – Small Car Spaces	Max. 50%	49% (49 spaces)	None
Parking – Tandem Spaces	Permitted	None	None
Off-Street Loading	1 medium truck (SU-9) space	1 medium truck (SU-9) space	None
Bicycle Storage	104 class 1 secure bike spaces 17 class 2 bike rack spaces	105 class 1 secure bike spaces 17 class 2 bike rack spaces	None
EV (Energized) Charging for Cars	100% Resident parking spaces	100% Resident parking spaces	None
Amenity Space – Indoor	Min. 100 m ² (1,076 ft ²)	108 m ² (1,161 ft ²)	None
Amenity Space – Outdoor	Min. 498 m ² (5,360 ft ²)	552 m ² (5,942 ft ²)	None

**Excerpt from the Minutes from
Advisory Design Panel Meeting
February 21, 2019**

DP 17-791045 – CITY CENTRE MIXED USE DEVELOPMENT

ARCHITECT:	Norr Architects Planners.
LANDSCAPE ARCHITECT:	Connect Landscape Architecture
PROPERTY LOCATION:	6333 Cooney Road

Applicant's Presentation

Simon Ho, Norr Architects Planners, and David Stoyko, Connect Landscape Architecture, presented the project and answered queries from the Panel on behalf of the applicant.

Panel Discussion

Comments from Panel members were as follows:

- extending the live-work units across the blank façade would be positive to energize the streetscape – **Improved. Additional dwelling unit added, increasing unit street frontage and reducing blank façade.**
- the tower design concept is strong; the podium is not as conceptually strong; language of the live-work units and the podium blank façade along Cooney Road need to be either unified or set these apart more from the rest of the development to provide a clear relationship; the roof form is an important component to achieve this – **Improved as noted above and design further refined, including podium and roof forms.**
- consider installing extensive green roof treatments for the lower roofs to improve views from the upper levels of the development and surrounding existing and future developments – **Improved. Extensive green roof treatment added to indoor amenity roof.**
- appreciate the proposed tower roofline treatment; support the angling of the roofline; however, the applicant could introduce a bolder approach subject to the height restrictions – **Improved and incorporated on all four elevations.**
- consider locating three-bedroom units close to the outdoor amenity area on Level 4 to provide a more direct adjacency for families with children to the amenity area – **Considered. Access for all units is provided through interior corridor from the elevator and stair lobby.**
- appreciate the proposed canopies on the indoor amenity space; consider providing weather protection from the indoor amenity space to the tower – **Considered. Maintaining an open outdoor amenity area is sought instead of visually splitting the amenity area into two separate areas.**
- appreciate the design of the bicycle racks – **Noted.**
- consider increasing the depth and area of balconies which have limited depths and sizes – **Considered.**
- appreciate the project's proposed mechanical systems and sustainability features – **Noted.**
- note that a vestibule is not provided at the main pedestrian entrance to the building – **Incorporated.**
- review the size of water entry room, which appears too small and may need to be increased – **Size of mechanical rooms on 1st and 2nd floors reviewed and confirmed by project Engineer.**
- the proposed location of the air cooled chiller plant at the southwest corner of the podium roof may not be appropriate due to potential noise issues to adjacent residential units in the subject development and neighbouring properties – **Reviewed by project Engineer, air-cooled chiller plant located on central spine area of tower roof, and equipment will be located on vibration isolators to mitigate any vibration and noise that could be produced.**
- a gas meter enclosure is not provided in the plans; location should be determined at this stage of the project as it affects the planning and design of other service rooms – **Incorporated.**
- review the location of the proposed generator room as it is under residential floor area and has potential noise, vibration and ceiling space plumbing issues; also look at the spacing requirement for louvers – **Reviewed. All**

adjacent residential units will incorporate acoustical enhancements to floor, wall and ceiling assemblies. Louvers spacing meets requirements.

- applicant needs to address parking ventilation at this stage of the project as there are no louvers provided in the plans; provision of shafts in the parkade may only be possible if one parking stall is removed – **Incorporated**.
- consider installing a canopy over the recessed entrances to the live-work unit along Cooney Road; will enhance the character and improve the weather protection for the live-work unit entries – **Incorporated**.
- appreciate the shift in the geometry of the paving near the tower entrance; also appreciate the lantern expression at the southeast corner of the building; all tower faces have a nice proportion to the articulation of the balconies except for the one corner at the tower entry; consider design development of the entry canopy to the tower, which could relate to the skewed geometry of the paving to provide a more dynamic character to the tower expression – **Incorporated**.

Entry canopy geometry mimics landscape paving geometry and corner glazing pattern improved to emphasize corner and entry expression.

- appreciate the model which expresses well the design intent of the building – **Noted**.
- appreciate the articulation on the podium – **Noted**.
- difficult to comment as the package provided by the applicant is incomplete – **Noted**.
- consider punctuating the landscaping on the north side of the building with higher shrubs or small trees – **Considered**.
The area is a PROP and utility SRW area, in which tree planting is not permitted.
- consider adding more soft landscaping on the outdoor amenity area on Level 4; the applicant could install planters on the edge with trailing plants to meet the vines that will be growing up from the ground level; additional shrub planting is also needed to better define and provide separation between various areas on the outdoor amenity area – **Improved**.
Design intent and functionality of the outdoor amenity area was reviewed and planting area was intensified adjacent to play lawn.
- appreciate the applicant contributing to the City's Public Art Fund; however, the applicant is encouraged to incorporate public art into the project as it improves the public realm – **Considered**.
- setbacks along the building façade on Cooney Road help break down the massing; however, consider pushing it more – **Considered**.
- consider using an intentional pattern for the accents on the residential podium façade along Cooney Road – **Improved**.
Design further refined.
- consider using different materials for the base and upper levels of the residential podium to provide a more pedestrian-oriented scale and character; will help articulate the base as a more public area due to the location of the live-work unit – **Considered**.
Design further refined, but additional materials were not incorporated as façade design and materiality is currently fairly complex.
- consider opening up the area near the entrance to the live-work unit to emphasize that it is a work area; consider introducing a different paving to differentiate the space as a work area rather than a sidewalk/pedestrian area – **Considered**.
- consider using a different language for the architecture of the live-work unit through the use of different materials on the front facade – **Improved**.
Design further refined, additional glazing and canopy provided.
- ensure that an appropriate space will be provided for installation of signage for the live-work unit – **Incorporated**.
- consider integrating more the District Energy Utility (DEU) room into the building façade; a different colour could be used to make these elements more of a feature – **Improved**.
Panel configuration and grille pattern revised for further integration.
- appreciate the random pattern on the north and west façades as it helps visually break down the massing and provides an appropriate interface with adjacent residential developments – **Noted**.
- consider a more prominent tower entry on the ground floor to emphasize it as an entrance – **Incorporated**.
Entry glazing expanded and canopy enlarged.
- appreciate the provision for bicycle storage; consider allocating a storage space for a hand bicycle – **Considered**.

- accessible parking spaces are proposed adjacent to the ramp; consider relocating or installing safety features – ***Improved by relocating spaces.***
- appreciate the provision of two-bedroom and three-bedroom accessible units; also consider providing one-bedroom accessible units – ***Considered. The one-bedroom unit compact size does not accommodate the required clearances.***
- appreciate the open kitchen concept; would be useful to a person using a mobility device – ***Noted.***
- clarify whether steps are proposed in the children's play area which could pose accessibility issues – ***Improved. A ramp provides access to the children's play structure area.***

Panel Decision

It was moved and seconded

That DP 17-791045 be supported to move forward to the Development Permit Panel subject to the applicant giving consideration to the comments of the Advisory Design Panel.

CARRIED

Opposed: Charan Sethi


KANE CONSULTING
Sustainability v4 for Building Design and Construction: Multifamily Midrise

Project Checklist
 Project Name: 6333 Cooney Road
 Date: Feb 19th, 2019




Y	?	N	Credit	Integrative Process	2
2	0	0	Credit	Location and Transportation	14
Y			Preq	Floodplain Avoidance	1
0	0	15	Credit	PERFORMANCE PATH	1
				LEED for Neighborhood Development Location	15
				PRESCRIPTIVE PATH	1
7	0	1	Credit	Site Selection	7
3	0	0	Credit	Compact Development	3
2	0	0	Credit	Community Resources	2
2	0	0	Credit	Access to Transit	2
0	2	5	Sustainable Sites	15	
Y			Preq	Construction Activity Pollution Prevention	1
Y			Preq	No Invasive Plants	1
0	1	1	Credit	Heat Island Reduction	1
0	0	3	Credit	Rainwater Management	3
0	1	1	Credit	Non-Toxic Pest Control	2
6	3	3	Water Efficiency	15	
Y			Preq	Water Metering	1
0	0	2	Credit	PERFORMANCE PATH	1
0	1	0	Credit	Total Water Use	12
				PRESCRIPTIVE PATH	1
3	2	1	Credit	Indoor Water Use	3
3	1	0	Credit	Outdoor Water Use	4
16	9	12	Energy and Atmosphere	37	
Y			Preq	Minimum Energy Performance	1
Y			Preq	Energy Metering	1
16	9	5	Credit	Education of the Homeowner, Tenant or Building Manager	30
0	0	5	Credit	Annual Energy Use	5
0	0	2	Credit	Efficient Hot Water Distribution	2
				Advanced Utility Tracking	2
4	1	4	Materials and Resources	9	
Y			Preq	Certified Tropical Wood	1
Y			Preq	Durability Management	1
1	0	0	Credit	Durability Management Verification	5
1	0.5	3.5	Credit	Environmentally Preferable Products	3
2	0.5	0.5	Credit	Construction Waste Management	2
TOTALS				56.5 23.5 30	Possible Points: 110
Certified: 40 to 49 points, Silver: 50 to 59 points, Gold: 60 to 79 points, Platinum: 80 to 110					

Attachment 4

Dear City of Richmond,

My name is Mao Wei Zhang and I am a director of the company (1111407 B.C. LTD.) that owns 6371 Cooney Road in Richmond. Following a conversation with Bold Properties in regards to their development at 6333 Cooney Road, I give permission for Bold Properties to remove the trees on 6371 Cooney Road at the time of construction as per the City's Staff Comments Letter dated November 9, 2018 stating "5 trees (tag# OS2, OS3, OS4, OS5, and OS7) located on neighbouring property will be severely impacted by the construction of the proposed access driveway on the development site. These trees are in poor condition but require written approval from the neighbouring property owner prior to removal."

Thanks for your cooperation and please contact me if you have more questions.

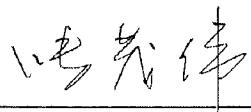

Mao Wei Zhang

1111407 B.C. LTD.

ycgimw@gmail.com

778 999 9516



**City of
Richmond**

Attachment 5

Development Permit Considerations

Development Applications Department
6911 No. 3 Road, Richmond, BC V6Y 2C1

Address: 6333 Cooney Road

File: DP 17-791045

Prior to forwarding this Development Permit application to Council for approval, the owner must complete the following requirements:

1. (*Voluntary Contributions*) City acceptance of the Owner's voluntarily contributions in the following amounts:
 - a) \$2,144.77 towards future City community planning studies, as set out in the City Centre Area Plan (i.e. \$19,779.77 at 2019 rate of \$0.28 per buildable square foot, less \$17,635 previously contributed via RZ 09-506808).
 - b) \$17,919.95 towards the City's Public Art Program (i.e. \$60,242.95 at 2019 rate of \$0.87 per residential square foot, less \$42,323 previously contributed via RZ 09-506808).
 - c) \$100,000 towards the City's Affordable Housing Strategy (Owner's offer in addition previous contributions of \$30,545.00 via RZ 03-238768 and \$251,611.00 via RZ 09-506808).
2. (*Landscape Security*) Submission of a Letter of Credit for landscaping in the amount of \$305,277 as specified on the landscape cost estimate provided and sealed by the project Landscape Architect (including materials, installation and 10% contingency).
3. (*Side Lane Enhanced Sidewalk Statutory Right of Way*) Granting approximately 15.4 m² (165.8 ft²) 0.35m wide statutory Right-of-Way for the purposes of Public Rights of Passage and utilities to accommodate an enhanced 1.85m wide sidewalk in the new lane along the south edge of the site and 2m x 2m corner cut at the southwest corner of the site. The works are to be built by the owner and maintained by the owner with the exception of City infrastructure, which is to be maintained by the City. Any works essential for public access within the required statutory Right-of-Way (SRW) are to be included in the Servicing Agreement (SA) and the maintenance & liability responsibility is to be clearly noted. The design must be prepared in accordance with City specifications and good engineering practice with the objective to optimize public safety.
4. (*Future Rear Lane Statutory Right of Way*) Granting approximately 17.5 m² (188.4 ft²) 1.5m wide statutory Right-of-Way for the purposes of Public Rights of Passage and utilities to accommodate future potential rear lane extension from north boundary of existing SRW plan BCP50328 to south boundary of existing SRW plan BCP20901 along the south edge of the site. The works are to be built by the owner and maintained by the owner with the exception of City infrastructure, which is to be maintained by the City. Any works essential for public access within the required statutory Right-of-Way (SRW) are to be included in the Servicing Agreement (SA) and the maintenance & liability responsibility is to be clearly noted. The design must be prepared in accordance with City specifications and good engineering practice with the objective to optimize public safety.
5. (*Shared Loading Bay Statutory Right of Way*) Granting of an approximately 56.1 m² (603.9 ft²) statutory Right-of-Way for the purposes of Public Rights of Passage for the shared use at all times of the loading bay with the proposed development and future development on the neighbouring property at 6371 Cooney Road. Any gates are to remain open from 7am to 7pm 7 days a week, and may only be secured if means are provided for the neighbouring property at 6371 Cooney Road to access the loading bay at all other times. The works are to be built by the owner and are to be maintained by the owner. Any works essential for public access within the required statutory Right-of-Way (SRW) are to be included in the Servicing Agreement (SA) and the maintenance & liability responsibility is to be clearly noted. The design must be prepared in accordance with good engineering practice with the objective to optimize public safety and after completion of the works, the owner is required to provide a certificate of inspection for the works, prepared and sealed by the owner's Engineer in a form and content acceptable to the City, certifying that the works have been constructed and completed in accordance with the accepted design.

6. (***Discharges***) Discharge the following obsolete charges from title:
 - a) SRW City utilities (1961 charge 300009C), which is now obsolete as all active City engineering utilities on/near the site are contained within other subsequent SRWs.
 - b) Aircraft noise sensitive development covenant (2005 charge BX288986), which is now obsolete as a replacement covenant with SRW is also registered on title (2012 charges BB4039857 and BB4039858).
 - c) Servicing agreement covenant (2012 charge BB4039865), which is now obsolete due to the passage of time. Prior to discharge, as noted below, a new servicing agreement and new letter of credit are required.
 - d) Building code equivalency covenant (2013 charge CA3162692), which is now obsolete as the proposed building design has changed.
7. (***City Centre Impacts***) Registration of a legal agreement on title stipulating that the development is subject to potential impacts due to other development that may be approved within the City Centre including without limitation, loss of views in any direction, increased shading, increased overlook and reduced privacy, increased ambient noise and increased levels of night-time ambient light, and requiring that the owner provide written notification of this through the disclosure statement to all initial purchasers, and erect signage in the initial sales centre advising purchasers of the potential for these impacts.
8. (***District Energy Utility***) Registration of a restrictive covenant and/or alternative legal agreement(s), to the satisfaction of the City, securing the owner's commitment to connect to District Energy Utility (DEU), which covenant and/or legal agreement(s) will include, at minimum, the following terms and conditions:
 - a) No building permit will be issued for a building on the subject site unless the building is designed with the capability to connect to and be serviced by a DEU and the owner has provided an energy modelling report satisfactory to the Director of Engineering;
 - b) If a DEU is available for connection, no final building inspection permitting occupancy of a building will be granted until:
 - i. the building is connected to the DEU, which may include the owner's supplied and installed central energy plant to provide heating and cooling to the building, at no cost to the City, or the City's DEU service provider, Lulu Island Energy Company, on the subject site satisfactory to the City;
 - ii. if the City so elects, the owner transfers ownership of the central energy plant on the site, if any, at no cost to the City, or City's DEU service provider, Lulu Island Energy Company, to the City and/or the City's DEU service provider, Lulu Island Energy Company, on terms and conditions satisfactory to the City;
 - iii. the owner enters into a Service Provider Agreement with the City and/or the City's DEU service provider, Lulu Island Energy Company, on terms and conditions satisfactory to the City; and
 - iv. the owner grants or acquires the Statutory Right-of-Way(s) and/or easements necessary for supplying the DEU services to the building and the operation of the central energy plant, if any, by the City and/or the City's DEU service provider, Lulu Island Energy Company.
 - c) If a DEU is not available for connection, no final building inspection permitting occupancy of a building will be granted until:
 - i. the City receives a professional engineer's certificate stating that the building has the capability to connect to and be serviced by a DEU;
 - ii. the owner enters into a covenant and/or other legal agreement to require that the building connect to a DEU when a DEU is in operation ;
 - iii. the owner grants or acquires the Statutory Right-of-Way(s) and/or easements necessary for supplying DEU services to the building; and
 - iv. the owner provides to the City a letter of credit, in an amount satisfactory to the City, for costs associated with acquiring any further Statutory Right of Way(s) and/or easement(s) and preparing and registering legal agreements and other documents required to facilitate the building connecting to a DEU when it is in operation.

9. (*Existing Tree Management*) The owner shall protect adjacent neighbouring trees, including:
 - a) (*Arborist Supervision*) Submission of a Contract entered into between the applicant and a Certified Arborist for supervision of any on-site works conducted within the tree protection zone of all trees to be protected. The Contract should include the scope of work to be undertaken, including: the proposed number of site monitoring inspections, and a provision for the Arborist to submit a post-construction assessment report to the City for review.
 - b) (*Tree Removal Permit*) 5 trees (tag# OS2, OS3, OS4, OS5, and OS7) located on neighbouring property will be severely impacted by the construction of the proposed access driveway on the development site. These trees are in poor condition. The neighbouring property owner has provided written approval and a tree removal permit is required to be obtained prior to removal.
 - c) (*Tree Protection*) 2 trees (tag# OS1 and OS6) located on neighbouring property to be protected require installation of appropriate tree protection fencing as part of the development prior to any construction activities, including building demolition, occurring on-site.
10. (*Servicing Agreement*) Enter into a Servicing Agreement* for the design and construction of Engineering and Transportation works in accordance with Transportation Association of Canada (TAC) Specifications, City Engineering Design Specifications and applicable Bylaws to the satisfaction of the City. A Letter of Credit or cash security for the value of the Service Agreement works, as determined by the City, will be required as part of entering into the Servicing Agreement. Works include, but may not be limited to, the following:
 - 10.I Road works:
 - a) Road Functional Design Works: Submission of a functional design (road works, interim and ultimate lane works), prepared to the satisfaction of the City, is required. Design to accommodate: Cooney Road frontage improvements and new lane. Works also include street lighting, traffic signage, boulevard landscaping, and street trees. The functional design is to indicate clearly all existing and proposed SRW PROPS, and include the frontage improvements listed below. Unless otherwise specified, all road works are to be designed as per bylaw, TAC Standards and the City's Engineering Design Specifications.
 - b) Cooney Road Frontage Improvements: Works to include, from east to west behind existing curb and gutter, grass boulevard (Min. 1.5 m) with street trees and new 2 m wide concrete sidewalk. The new sidewalk and boulevard are to transition to meet the existing frontage treatments to the north and south of the subject site. Sidewalk alignment with smooth transitions to north and south to be detailed on required road functional plan for City review in order to confirm interim frontage cross section. All existing driveways along the Cooney Road frontage are to be closed permanently. The Owner is responsible for the removal of the existing driveway let-downs and the replacement with sidewalk, boulevard and barrier curb and gutter to match frontage improvements. There are existing utility poles and junction boxes that will need to be relocated at the owner's cost.
 - c) New Lane: Interim lane to City Centre standard with additional sidewalk width. Works to include, from north to south, 1.85 m wide concrete sidewalk with street lighting located to maintain a 1.5 m width of sidewalk free and clear of obstruction, roll-over curb and remaining 6 m to be roadway driving surface approved by the City. Through the Servicing Agreement, decorative pavement treatment may be required to create a more pedestrian friendly environment in the lane.
 - 10.II Water Works:
 - a) Using the OCP Model, there is 659.0 L/s of water available at a 20 psi residual at Cooney Road. Based on the proposed development, site requires a minimum fire flow of 220 L/s.
 - b) At the Owner's cost, the Owner is required to:
 - i. Submit Fire Underwriter Survey (FUS) or International Organization for Standardization (ISO) fire flow calculations to confirm development has adequate fire flow for onsite fire protection. Calculations must be signed and sealed by a Professional Engineer and be based on Building Permit Stage building designs.
 - ii. Review hydrant spacing on all road frontages and install new fire hydrants as required to meet City spacing requirements for commercial land use.
 - iii. Obtain approval from Richmond Fire Rescue for all fire hydrant locations, relocations, and removals, as required.

- iv. Provide a Right-of-Way for water meter. Exact Right-of-Way dimensions to be finalized during the servicing agreement process.
 - c) At Owner's cost, the City is to:
 - i. Cut, cap, and remove the existing water service connections servicing 6333 Cooney Road.
 - ii. Install a new water service connection, complete with meter and meter box, to serve the proposed development.
- 10.III Storm Sewer Works:
- a) At the Owner's cost, the Owner is required to:
 - i. Provide an erosion and sediment control plan for all on-site and off-site works, to be reviewed as part of the servicing agreement design.
 - ii. Ensure trees are not placed on top of the storm sewer main and, follow offset and alignment similar to the existing trees at the Cooney frontage of the property to the north.
 - b) At Owner's cost, the City is to:
 - i. Cut, cap, and remove the existing storm service connections and inspection chambers servicing the subject site.
 - ii. Install a new storm service connection and type III inspection chamber. If required, the Owner shall provide a statutory Right-of-Way for the inspection chamber at their cost.
 - iii. Complete all tie-ins for the potential works to existing City infrastructure, to be determined by the pipe sizing calculations at the servicing agreement stage.
- 10.IV Sanitary Sewer Works:
- a) At the Owner's cost, the Owner is required to:
 - i. Install new sanitary sewer along Cook Road from existing manhole SMH58685 at the intersection of Cook Road and Buswell Street to a new manhole at the intersection of Cook Road and Cooney Road (approximately 165 m of 300 mm PVC sanitary sewer).
 - ii. Remove, or abandon and cut and cap, as per MMCD existing sanitary sewer between SMH57073 and SMH57072 in the SRW located along the south property line of 6333 Cooney Road (approximately 52 m of 300 mm PVC sanitary sewer).
 - iii. Remove existing and install new sanitary sewer from manhole SMH57091 to SMH57073 along the west property line of 6333 Cooney Road (approximately 53 m of 200 mm PVC sanitary sewer).
 - iv. Remove manhole SMH57093 located just south of the northwest corner of 6333 Cooney Road.
 - v. Ensure that the existing sanitary sewer along the west property line remains operational during any preload and/or construction phase. If the existing sanitary line is impacted during site preparation or construction of the proposed development then the owner shall be responsible to make the damaged sanitary system operational during the duration of the onsite works (i.e., temporary bypass via pumping, etc.). The damaged sanitary system shall be replaced at the same alignment through the servicing agreement, at the owner's costs, after completion of the site preparation and/or building construction works.
 - vi. Ensure no soil fill or building encroaches into the existing sanitary right of way along the west property line.
 - vii. Owner/Developer of the subject site has agreed to provide an engineering solution certified by a structural engineer stipulating that the footing and foundation design of the parkade will permit excavation to the bottom of the adjacent sanitary line without undermining the parkade structure. The purpose is to facilitate the removal of the existing sanitary sewer along west side and the installation of the new sanitary sewer.
 - b) Subject to available funding through the Development Coordinated Works budget, the city will provide funding for the construction of the following works. The owner is required to:
 - i. Install new sanitary sewer along Cooney Road from existing manhole SMH57072 to the new manhole (as noted above) at the intersection of Cook Road and Cooney Road (approximately 160 m of 300 mm PVC sanitary sewer). The developer is required to include the design of City funded sanitary main into the servicing agreement design.

- ii. Prior to commencing City funded sanitary main work on the Cooney Road frontage the developer must provide the City with a minimum 1 year notice of their intended start date, along with a cost estimate for the works to be reviewed by and approved by City staff.
- c) At Owner's cost, the City is to:
 - i. Complete all tie-ins for the proposed works to existing City infrastructure.
 - ii. Cut, cap, and remove the existing sanitary service connection and inspection chamber servicing the subject site.
 - iii. Install a new service connection off of the existing 300mm PVC sanitary sewer on Cooney Road, complete with inspection chamber. If required, the Owner shall provide a statutory Right-of-Way for the inspection chamber at their cost.

10.V Frontage Improvement Works:

- a) At the Owner's cost, the Owner is required to:
 - i. Coordinate with BC Hydro, Telus and other private communication service providers:
 1. To pre-duct for future hydro, telephone and cable utilities along all road frontages.
 2. Before relocating/modifying any of the existing power poles and/or guy wires within the property frontages.
 3. To underground overhead service lines.
 4. To locate/relocate all above ground utility cabinets and kiosks required to service the proposed development, and all above ground utility cabinets and kiosks located along the development's frontages, within the developments site (see list below for examples). A functional plan showing conceptual locations for such infrastructure shall be included in the development design review process. Please coordinate with the respective private utility companies and the project's lighting and traffic signal consultants to confirm the requirements (e.g., statutory Right-of-Way dimensions) and the locations for the aboveground structures. If a private utility company does not require an aboveground structure, that company shall confirm this via a letter to be submitted to the City. The following are examples of statutory Right-of-Ways that shall be shown on the architectural plans/functional plan, the servicing agreement drawings, and registered prior to SA design approval:

BC Hydro PMT	4.0 x 5.0 m
BC Hydro LPT	3.5 x 3.5 m
Street light kiosk	1.5 x 1.5 m
Traffic signal kiosk	2.0 x 1.5 m
Traffic signal UPS	1.0 x 1.0 m
Shaw cable kiosk	1.0 x 1.0 m
Telus FDH cabinet	1.1 x 1.0 m

- ii. Review street lighting levels along all road and lane frontages, and upgrade as required. Refer to drawings L12.3, complete with banner and without pedestrian light, flowerpot holder, and receptacle. The street light pole shall be painted RAL 5007 with a gloss, smooth-finish.

10.VI General Items:

- a) At the Owner's cost, the Owner is required to:
 - i. Provide, prior to start of site preparation works or within the first servicing agreement submission, whichever comes first, a preload plan and geotechnical assessment of preload, dewatering, and soil preparation impacts on the existing utilities fronting the entire development site and provide mitigation recommendations.
 - ii. Provide a video inspection report of the existing rear-yard sanitary sewers and storm sewer along the Cooney Road frontages prior to start of site preparation works or within the first servicing agreement submission, whichever comes first. A follow-up video inspection after site preparation works are complete (i.e. pre-load removal, completion of dewatering, etc.) to assess the condition of the existing utilities is required. Any utilities damaged by the pre-load, de-watering, or other ground preparation shall be replaced at the owner's cost.

- iii. Monitor the settlement at the adjacent utilities and structures during pre-loading, dewatering, and soil preparation works per a geotechnical engineer's recommendations, and report the settlement amounts to the City for review.
- iv. Submit a proposed strategy at the building permit stage for managing excavation de-watering. Note that the City's preference is to manage construction water onsite or by removing and disposing at an appropriate facility. If this is not feasible due to volume of de-watering, the owner will be required to apply to Metro Vancouver for a permit to discharge into the sanitary sewer system. If the sanitary sewer does not have adequate capacity to receive the volume of construction water, the owner will be required to enter into a de-watering agreement with the City to discharge treated construction water to the storm sewer system.
- v. Not encroach into City Rights-of-Way with any proposed trees, retaining walls, or other non-removable structures.
- vi. Coordinate the servicing agreement design for this development with the servicing agreement(s) for the adjacent development(s), both existing and in-stream. The owner's civil engineer shall submit a signed and sealed letter with each servicing agreement submission confirming that they have coordinated with civil engineer(s) of the adjacent project(s) and that the servicing agreement designs are consistent. The City will not accept the 1st submission if it is not coordinated with the adjacent developments. The coordination letter should cover, but not be limited to, the following:
 1. Corridors for City utilities (existing and proposed water, storm sewer, sanitary and DEU) and private utilities.
 2. Pipe sizes, material and slopes.
 3. Location of manholes and fire hydrants.
 4. Road grades, high points and low points.
 5. Alignment of ultimate and interim curbs.
 6. Proposed street lights design.
- vii. Enter into, if required, additional legal agreements, as determined via the subject development's Servicing Agreement(s) and/or Development Permit(s), and/or Building Permit(s) to the satisfaction of the Director of Engineering, including, but not limited to, site investigation, testing, monitoring, site preparation, de-watering, drilling, underpinning, anchoring, shoring, piling, pre-loading, ground densification or other activities that may result in settlement, displacement, subsidence, damage or nuisance to City and private utility infrastructure.

Prior to Building Permit* Issuance, the owner must complete the following requirements:

1. (*Legal Agreements*) Confirmation of compliance with existing and Development Permit legal agreements.
2. (*Accessibility and Sustainability*) Incorporation of special features in Building Permit (BP) plans as determined via the Development Permit process.
3. (*Aircraft Noise Sensitive Development*) Confirmation that the proposed development is designed in a manner that mitigates potential aircraft noise to the proposed dwelling units, including submission of:
 - a. Acoustic report prepared by a registered professional confirming design achieves the following CMHC interior noise level guidelines:

Portions of Dwelling Units	Noise Levels (decibels)
Bedrooms	35 decibels
Living, dining, recreation rooms	40 decibels
Kitchen, bathrooms, hallways, and utility rooms	45 decibels

- b. Mechanical report prepared by a registered professional confirming design achieves the ASHRAE 55-2004 "Thermal Environmental Conditions for Human Occupancy" standard for interior living spaces.

4. (**Construction Parking and Traffic Management Plan**) Submission of a Construction Parking and Traffic Management Plan* to the Transportation Department. Management Plan shall include location for parking for services, deliveries, workers, loading, application for any lane closures, and proper construction traffic controls as per Traffic Control Manual for works on Roadways (by Ministry of Transportation) and MMCD Traffic Regulation Section 01570. (<http://www.richmond.ca/services/ttp/special.htm>).
5. (**Latecomer works**) If applicable, payment of latecomer agreement charges, plus applicable interest associated with eligible latecomer works.
6. (**Construction Hoarding**) Obtain a Building Permit* (BP) for any construction hoarding associated with the proposed development. If construction hoarding is required to temporarily occupy a public street, the air space above a public street, or any part thereof, additional City approvals and associated fees may be required as part of the Building Permit. *For further information on the Building Permit, please contact the Building Approvals Department at 604-276-4285.*

Note:

- * This requires a separate application.
- Where the Director of Development deems appropriate, the preceding agreements are to be drawn not only as personal covenants of the property owner but also as covenants pursuant to Section 219 of the Land Title Act.
All agreements to be registered in the Land Title Office shall have priority over all such liens, charges and encumbrances as is considered advisable by the Director of Development. All agreements to be registered in the Land Title Office shall, unless the Director of Development determines otherwise, be fully registered in the Land Title Office prior to enactment of the appropriate bylaw.
The preceding agreements shall provide security to the City including indemnities, warranties, equitable/rent charges, letters of credit and withholding permits, as deemed necessary or advisable by the Director of Development. All agreements shall be in a form and content satisfactory to the Director of Development.
- Additional legal agreements, as determined via the subject development's Servicing Agreement(s) and/or Development Permit(s), and/or Building Permit(s) to the satisfaction of the Director of Engineering may be required including, but not limited to, site investigation, testing, monitoring, site preparation, de-watering, drilling, underpinning, anchoring, shoring, piling, pre-loading, ground densification or other activities that may result in settlement, displacement, subsidence, damage or nuisance to City and private utility infrastructure.
- Applicants for all City Permits are required to comply at all times with the conditions of the Provincial Wildlife Act and Federal Migratory Birds Convention Act, which contain prohibitions on the removal or disturbance of both birds and their nests. Issuance of Municipal permits does not give an individual authority to contravene these legislations. The City of Richmond recommends that where significant trees or vegetation exists on site, the services of a Qualified Environmental Professional (QEP) be secured to perform a survey and ensure that development activities are in compliance with all relevant legislation.

[signed copy on file]

Signed

Date

Initial:



City of Richmond

Development Permit

No. DP 17-791045

To the Holder: BOLD PROPERTIES (COONEY) LIMITED PARTNERSHIP

Property Address: 6333 COONEY ROAD

Address: C/O TOMMY HE, BOLD PROPERTIES
668 WEST HASTINGS STREET, UNIT 600
VANCOUVER, BC V6B 1P1

1. This Development Permit is issued subject to compliance with all of the Bylaws of the City applicable thereto, except as specifically varied or supplemented by this Permit.
2. This Development Permit applies to and only to those lands shown cross-hatched on the attached Schedule "A" and any and all buildings, structures and other development thereon.
3. Subject to Section 692 of the Local Government Act, R.S.B.C.: buildings and structures; off-street parking and loading facilities; roads and parking areas; and landscaping and screening shall be constructed generally in accordance with Plans #1 to #40 attached hereto.
4. Sanitary sewers, water, drainage, highways, street lighting, underground wiring, and sidewalks, shall be provided as required.
5. As a condition of the issuance of this Permit, the City is holding the security in the amount of \$305,277.00 to ensure that development is carried out in accordance with the terms and conditions of this Permit. Should any interest be earned upon the security, it shall accrue to the Holder if the security is returned. The condition of the posting of the security is that should the Holder fail to carry out the development hereby authorized, according to the terms and conditions of this Permit within the time provided, the City may use the security to carry out the work by its servants, agents or contractors, and any surplus shall be paid over to the Holder. Should the Holder carry out the development permitted by this permit within the time set out herein, the security shall be returned to the Holder. The City may retain the security for up to one year after inspection of the completed landscaping in order to ensure that plant material has survived.
6. If the Holder does not commence the construction permitted by this Permit within 24 months of the date of this Permit, this Permit shall lapse and the security shall be returned in full.

Development Permit
No. DP 17-791045

To the Holder: **BOLD PROPERTIES (COONEY) LIMITED PARTNERSHIP**

Property Address: **6333 COONEY ROAD**

Address: **C/O TOMMY HE, BOLD PROPERTIES
668 WEST HASTINGS STREET, UNIT 600
VANCOUVER, BC V6B 1P1**

7. The land described herein shall be developed generally in accordance with the terms and conditions and provisions of this Permit and any plans and specifications attached to this Permit which shall form a part hereof.

This Permit is not a Building Permit.

AUTHORIZING RESOLUTION NO.
DAY OF , .


ISSUED BY THE COUNCIL THE

DELIVERED THIS DAY OF , .

MAYOR



City of Richmond

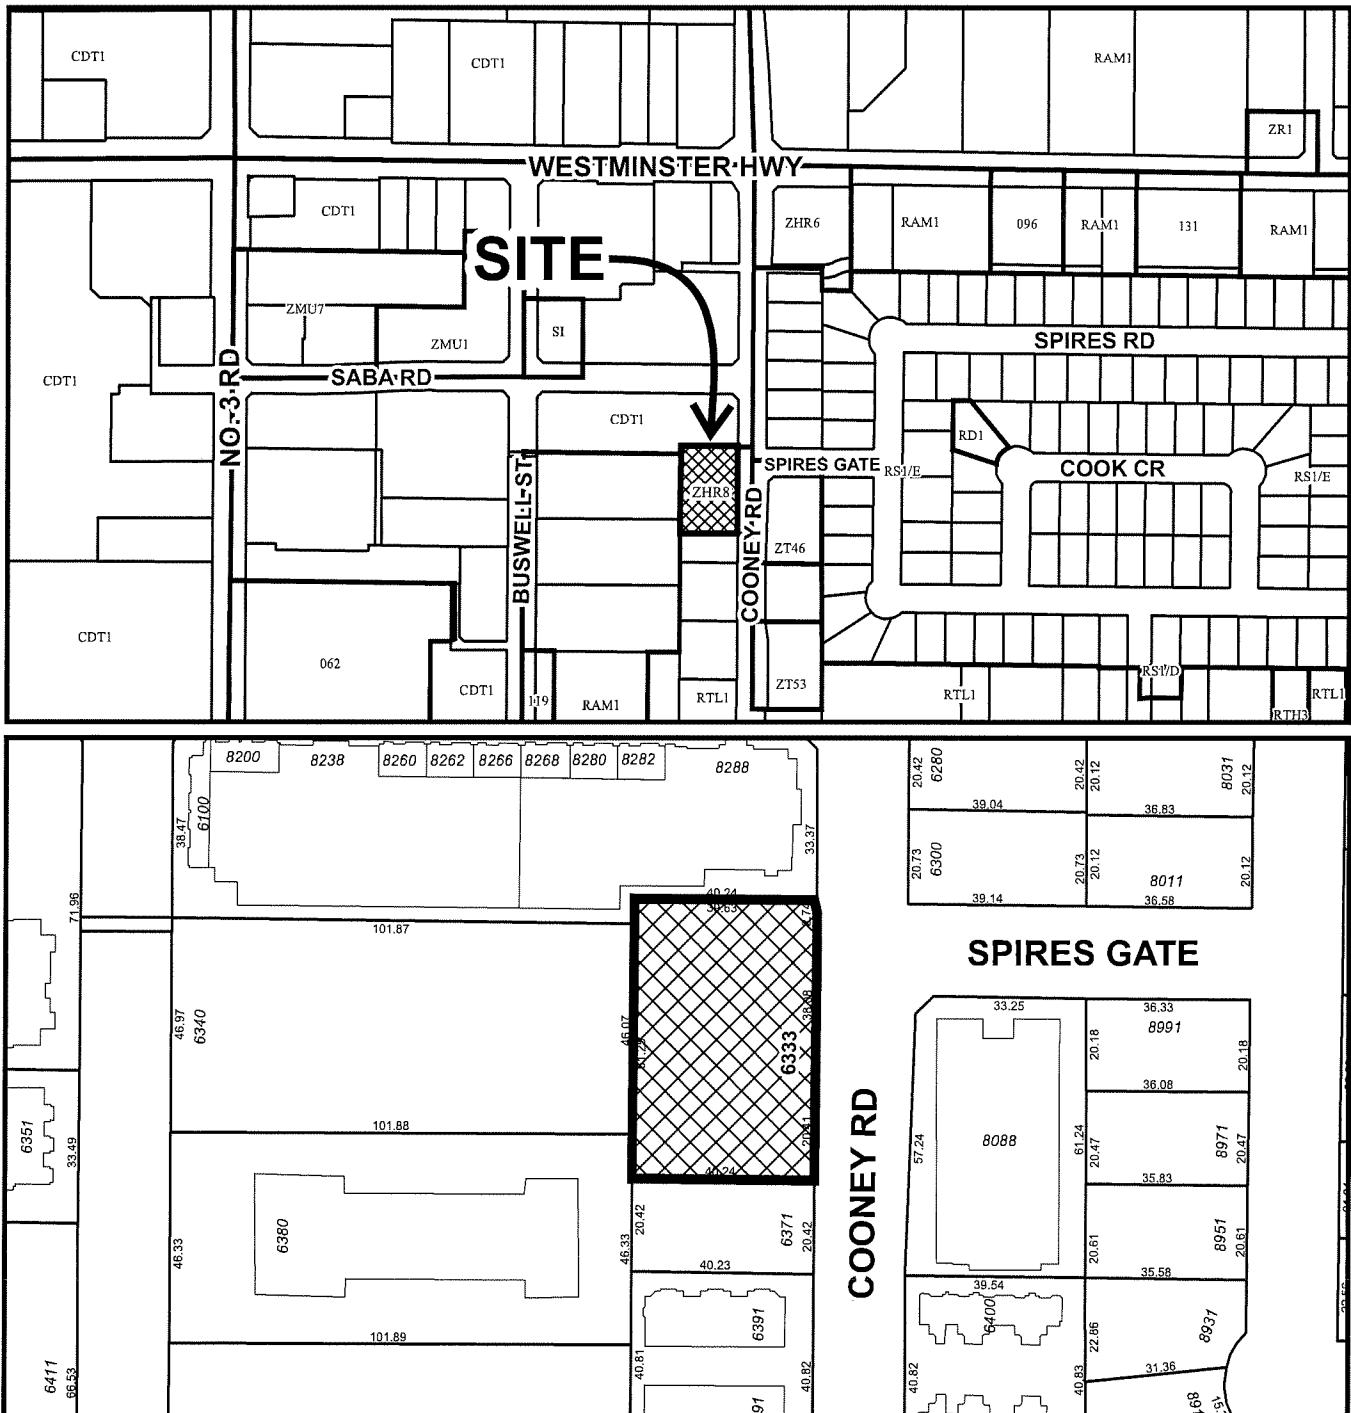

N

DP 17-791045
SCHEDULE "A"

Original Date: 11/16/17

Revision Date: 06/28/18

Note: Dimensions are in METRES



CONSULTANT INFORMATION

CHL: CONNECT LANDSCAPE ARCHITECTURE
Landscape Architectural Services
Structural Engineering Services
G TIANA DESIGN GROUP OF COMPANIES
Mechanical, HVAC & Associate Services
HATCH LTD. & ASSOCIATES LTD.
Interior Design Services

**NOT FOR
CONSTRUCTION**

PROJECT INFORMATION

**COONEY ROAD
TOWER**

6331 COONEY ROAD
RICHMOND, BC



PROJECT TEAM

OWNER	BOLD PROPERTIES (COONEY) LP
Project Site Address	600 - 6880 WEST HASTINGS STREET VANCOUVER, BC V6C 1P1
Project Name	TOMMY HERBANA MUSSATO
Project Lead	tommy@bold.ca
Project Manager	CONTACT: TOMMY HERBANA MUSSATO yoshi.tanaka@exp.com

MECHANICAL ENGINEER	NEMETZ (S/A) & ASSOCIATES LTD.
Project Lead	1100 - 808 W. HASTINGS ST., VANCOUVER, BC V6C 2X4
Project Manager	T: 604.684.5995 kevinhead@nemetz.ca
Project Lead	EXP
Project Manager	275 - 3001 WAYBURN DRIVE BURNABY, BC V5G 4W3 T: 604.874.1245 CONTACT: YOSHII TANAKA yoshi.tanaka@exp.com

GEOTECHNICAL ENGINEER

CONTACT: SIMON HO

s.ho@s2architecture.com

ELECTRICAL ENGINEER

CONTACT: MARK HERRON

markh@nemetz.com

BUILDING CODE CONSULTANT

CONTACT: DAVID GRAHAM
david@ghil.ca

ENVIRONMENTAL CONSULTANT

KANE CONSULTING PARTNERSHIP
408 - 535 THURLow ST.,
VANCOUVER, BC V6E 3L2
T: 604.924.0094
CONTACT: DANIEL ROBERTS
dam@kane-consulting.ca

STRUCTURAL ENGINEER

GLOTH SIMPSON GROUP OF COMPANIES
1661 WEST 5 AVENUE
VANCOUVER, BC V6J 1N3
T: 604.736.6562
CONTACT: MARK HERRON
gph@glotsimpson.com

LANDSCAPE ARCHITECT

CONNECT LANDSCAPE ARCHITECTURE
1661 HEMLOCK STREET
VANCOUVER, BC V6H 2V1
T: 604.581.3307
CONTACT: DAVID STOJKO
david@connectca.ca

LAND SURVEYOR

J.C. TAM AND ASSOCIATES
115 - 8833 ODIN CRESCENT
RICHMOND, BC V6X 3Z7
T: 604.214.8929

CIVIL

MPT ENGINEERING CO LTD.
320 - 1120 HORSESHOE WAY
RICHMOND, BC V7A 5H7
CONTACT: JEFF CRAWFORD
jeff.crawford@mpt.ca

DRAWING NO.

DP00-00-00

- Notes:**
- 20 Adaptable units provided and required to comply with BC Building Code adaptable unit standards.
 - Aging in place features provided in all units (level-style door handles and faucets, LED strip task lighting below washroom vanity mirrors, grab bar blocking at toilets, showers and bathtubs)
 - Indoor Amenity space to be provided for the shared use of all residents on level 4.
 - Building required to demonstrate LEED silver equivalent standard.
 - District Energy Utility requirements as per legal agreement.
 - Development is required to be designed and constructed to meet indoor acoustic and thermal criteria as per legal agreement.
 - Widened sidewalk SRW to be provided along north edge of lane SRW as per legal agreement.
 - Servicing Agreement required. Off-site and SRW works to be provided via separate required Servicing Agreement for City lane and frontage improvements as per legal agreement.
 - This Development Permit does not include signage. All signage required to comply with Sign Regulation bylaw 97/00, including submitting separate sign permit applications as needed.

PROJECT DEVELOPMENT STATISTICS											
Project Civic Address	6331 & 6351 Cooney Road, Richmond, BC	Area (SM)	Area (SF)								
Project Legal Description	LOT 2, PLAN 2000 AID LOT 132 EXCEPT PART SUBDIVIDED BY PLAN 366721, PLAN BCP 26662, BOTH OF SECTION 9, BLOCK 4 NORTH, BANC 5 WEST, NEW WESTMINSTER DISTRICT.	513.56 m ²	5,196.32 ft ²	246.50 m ²	2,654.37 ft ²	266.99 m ²	2,873.90 ft ²	266.99 m ²	2,873.90 ft ²	266.99 m ²	2,873.90 ft ²
City of Richmond Zoning District / Ordinance Designation	(19.8) 21HR8 High Rise Apartment - Frighton Village (City Centre) Ref: Adopted Bylaw 8738, Apr 10/12	575.68 m ²	6,198.81 ft ²	396.54 m ²	4,268.20 ft ²	625.83 m ²	6,791.14 m ²	327.11 m ²	3,521.08 m ²	327.11 m ²	3,521.08 m ²
Project Site Area	4.40 ha	26,460 sqft	41.00 m	134.61 ft	1.50 m	4.92 ft	2.70 m	6.98 ft	7.06 m	2.70 m	7.06 m
Allowed / Permitted Building Height (per 19.8.7.1)	1.50 m	4.92 ft	2.70 m	9.84 ft	2.70 m						
Road Setback (Cooney Road): per 19.8.6.1)	2.70 m	9.02 ft	2.70 m	9.02 ft	2.70 m	9.02 ft	2.70 m	9.02 ft	2.70 m	9.02 ft	2.70 m
North Setback (Adjacent Neighbouring Tower): per 19.8.6.2)	2.70 m	9.02 ft	2.70 m	9.02 ft	2.70 m	9.02 ft	2.70 m	9.02 ft	2.70 m	9.02 ft	2.70 m
South Setback (Adjacent Lane Definition): per 19.8.6.3)	2.70 m	9.02 ft	2.70 m	9.02 ft	2.70 m	9.02 ft	2.70 m	9.02 ft	2.70 m	9.02 ft	2.70 m
Floor Area Ratio / FAR (per 19.8.4)	2.67	6,563 sq.m	70,548 sqft	6,555 sq.m	70,597 sqft						
Lot Coverage Permitted (per 19.8.5)	70% Max	1,721 sq.m	18,522 sqft	1,711 sq.m	18,420 sqft						
PROJECT FLOOR AREA / FAR / FLOOR DEDUCTION											
FLOOR LEVEL											
	GROSS AREA	AREA (SM)	AREA (SF)	DEDUCTIONS	AREA (SM)	AREA (SF)	NET FAR	AREA (SM)	AREA (SF)	AREA (SM)	AREA (SF)
LEVEL 1	513.56 m ²	5,196.32 ft ²	246.50 m ²	2,654.37 ft ²	266.99 m ²	2,873.90 ft ²	266.99 m ²	2,873.90 ft ²	266.99 m ²	2,873.90 ft ²	266.99 m ²
LEVEL 2	575.68 m ²	6,198.81 ft ²	396.54 m ²	4,268.20 ft ²	625.83 m ²	6,791.14 m ²	327.11 m ²	3,521.08 m ²	327.11 m ²	3,521.08 m ²	327.11 m ²
LEVEL 3	390.83 m ²	4,208.81 ft ²	63.72 m ²	67.06 ft ²	63.72 m ²	67.06 ft ²	628.97 m ²	6,791.14 m ²	628.97 m ²	6,791.14 m ²	628.97 m ²
LEVEL 4	692.69 m ²	7,458.15 ft ²	745.81 m ²	8,114.00 ft ²	51.94 m ²	56.94 ft ²	529.06 m ²	5,694.72 ft ²	529.06 m ²	5,694.72 ft ²	529.06 m ²
LEVEL 5	576.62 m ²	6,205.66 ft ²	41.56 m ²	45.82 ft ²	51.94 m ²	56.94 ft ²	529.06 m ²	5,694.72 ft ²	529.06 m ²	5,694.72 ft ²	529.06 m ²
LEVEL 6	576.62 m ²	6,205.66 ft ²	41.56 m ²	45.82 ft ²	51.94 m ²	56.94 ft ²	529.06 m ²	5,694.72 ft ²	529.06 m ²	5,694.72 ft ²	529.06 m ²
LEVEL 7	576.62 m ²	6,205.66 ft ²	41.56 m ²	45.82 ft ²	51.94 m ²	56.94 ft ²	529.06 m ²	5,694.72 ft ²	529.06 m ²	5,694.72 ft ²	529.06 m ²
LEVEL 8	576.62 m ²	6,205.66 ft ²	41.56 m ²	45.82 ft ²	51.94 m ²	56.94 ft ²	529.06 m ²	5,694.72 ft ²	529.06 m ²	5,694.72 ft ²	529.06 m ²
LEVEL 9	576.62 m ²	6,205.66 ft ²	41.56 m ²	45.82 ft ²	51.94 m ²	56.94 ft ²	529.06 m ²	5,694.72 ft ²	529.06 m ²	5,694.72 ft ²	529.06 m ²
LEVEL 10	576.62 m ²	6,205.66 ft ²	41.56 m ²	45.82 ft ²	51.94 m ²	56.94 ft ²	529.06 m ²	5,694.72 ft ²	529.06 m ²	5,694.72 ft ²	529.06 m ²
LEVEL 11	576.62 m ²	6,205.66 ft ²	41.56 m ²	45.82 ft ²	51.94 m ²	56.94 ft ²	529.06 m ²	5,694.72 ft ²	529.06 m ²	5,694.72 ft ²	529.06 m ²
LEVEL 12	576.62 m ²	6,205.66 ft ²	41.56 m ²	45.82 ft ²	51.94						




CONSULTANT INFORMATION
CML
Project Lead & Architect
Architect: S2 ARCHITECTURE
Structural: GILCHRIST ENGINEERS OF CORPORALES
Mechanical: NELSON & ASSOCIATES LTD.
Electrical: HARRIS & ASSOCIATES LTD.
Interior: NELSON & ASSOCIATES LTD.

NOT FOR
CONSTRUCTION

PROJECT INFORMATION

COONEY ROAD
TOWER


6333 COONEY ROAD
RICHMOND, BC

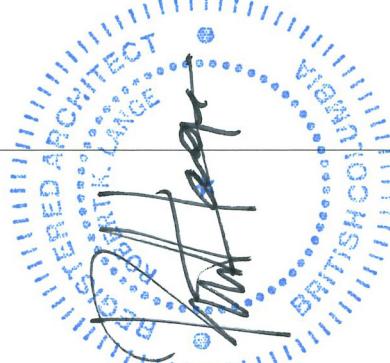

Plan 2

Nov 20, 2019
DP 17-791045

DP10-01-00

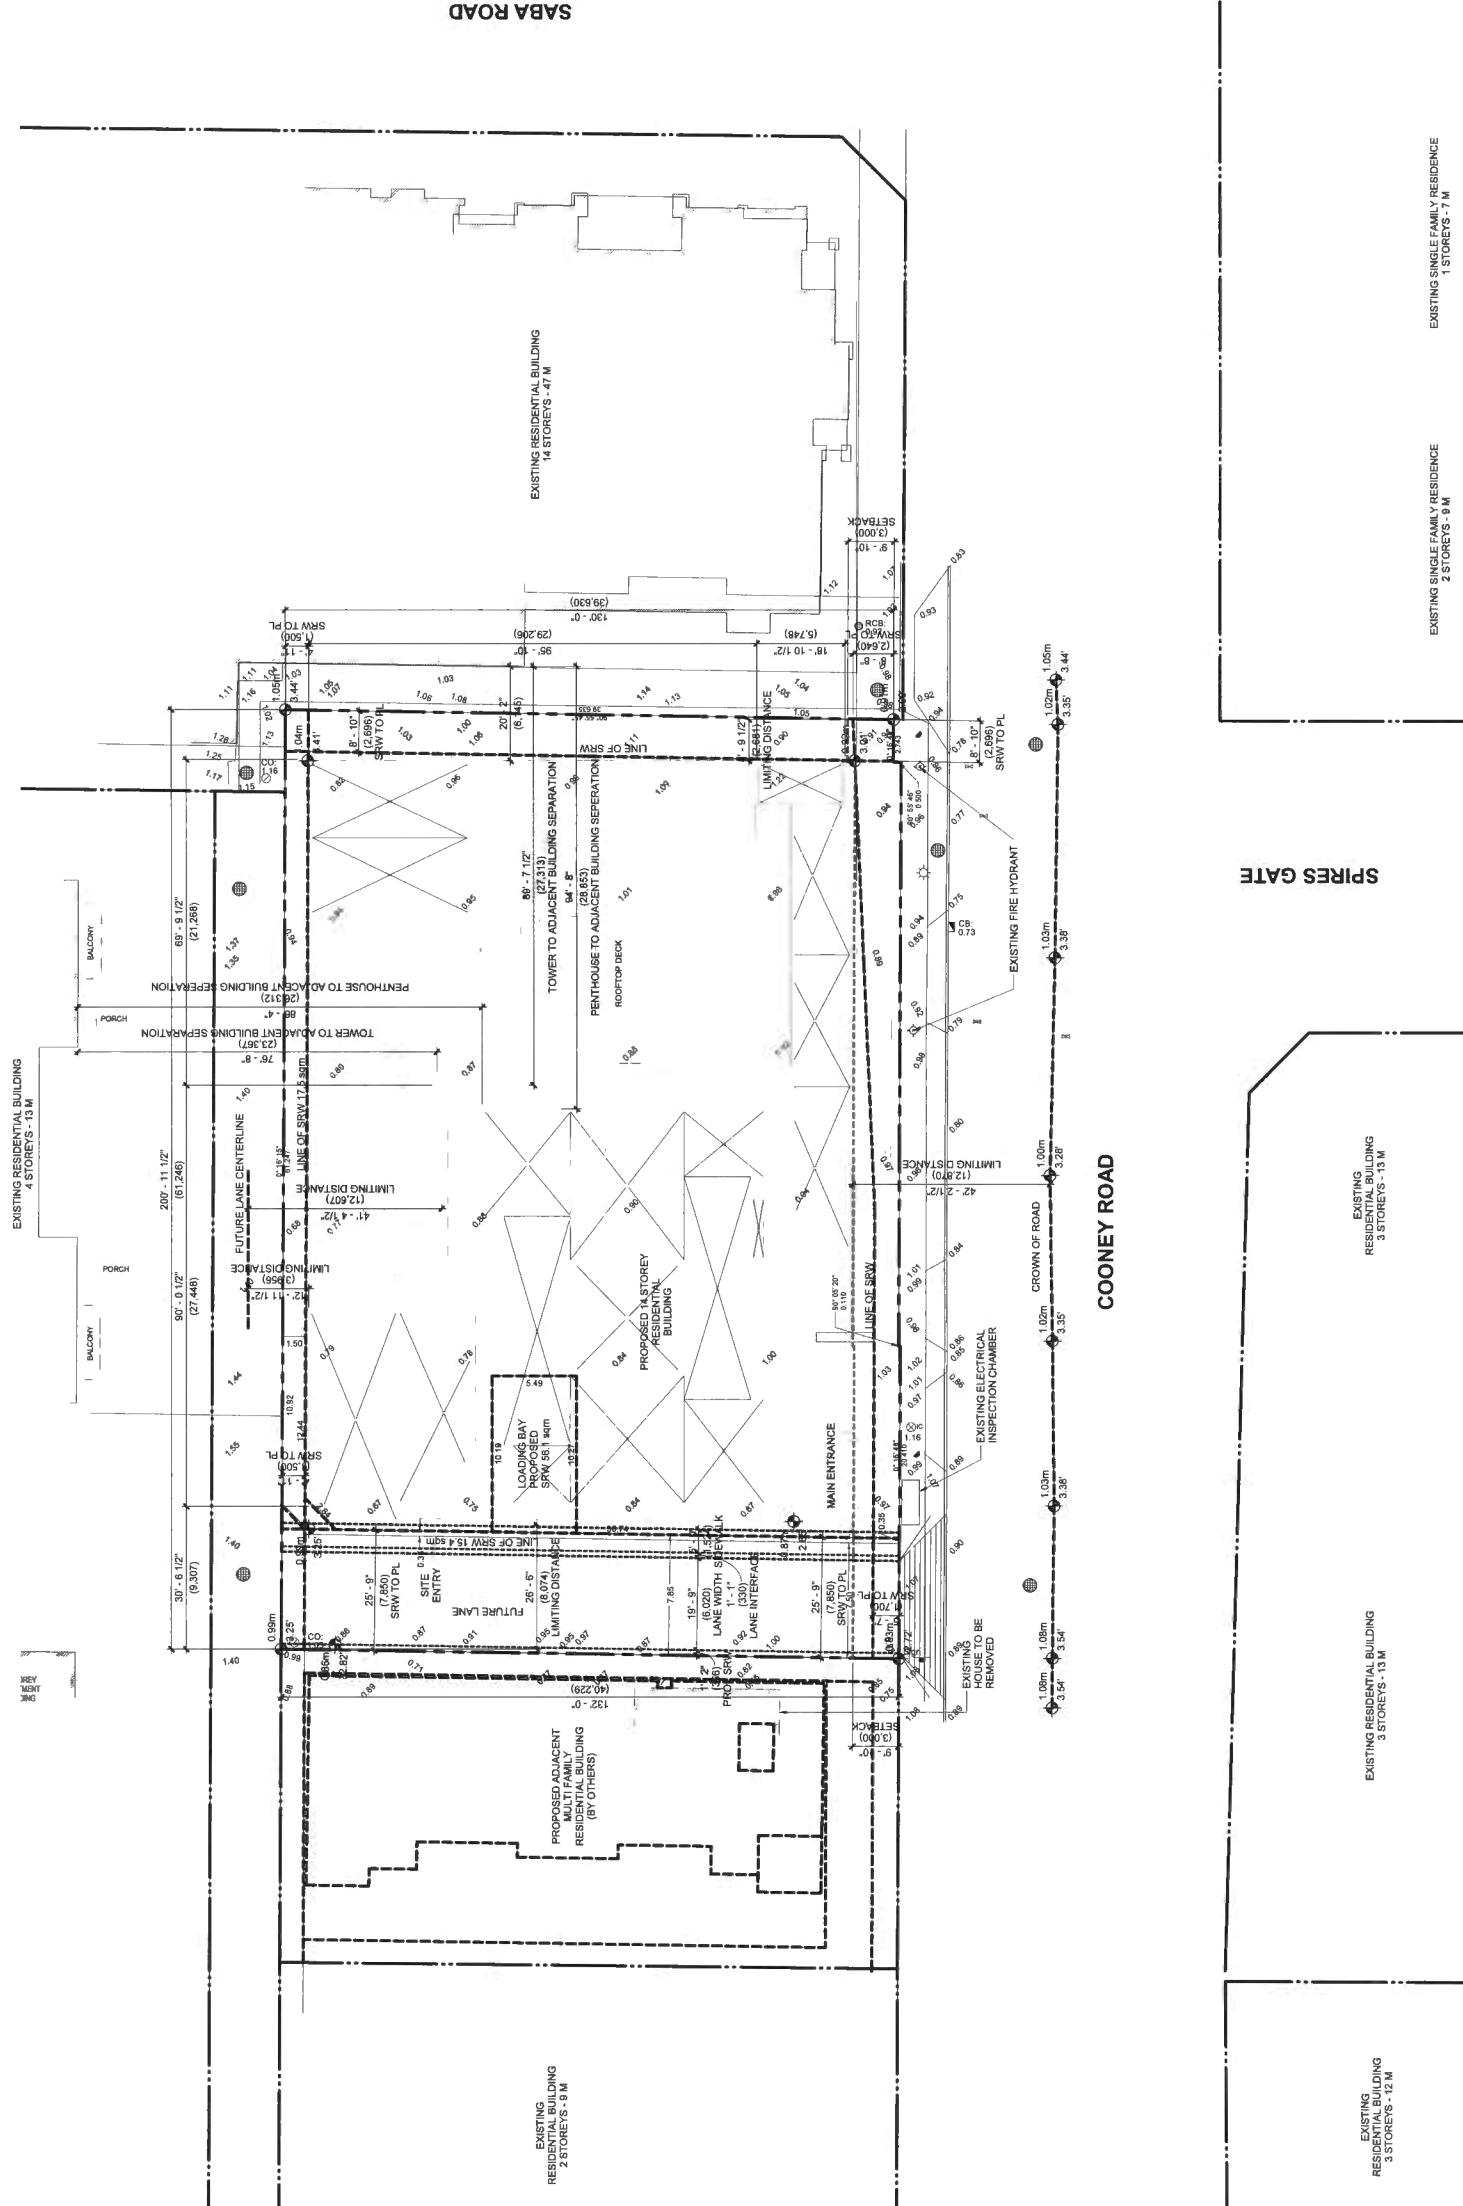

1 SITE PLAN
DP10-01-00 SCALE: 1/16 = 1'-0"

ISSUED DATE
DEVELOPMENT PERMIT 2017-11-03
UP APPLICATION 2018-09-28
RE-SUBMISSION 2019-02-01
UP RESUBMISSION 2019-10-31
UP PERMISSION 2019-11-08

SCALE 1/16 = 1'-0"
DATE 11/14/2019 4:27:50 PM
DRAWN BY JH
CHECKED BY SH
PROJECT NO. 219171
DRAWING TITLE SITE PLAN
DRAWING NO. DP10-01-00

EXISTING SINGLE FAMILY RESIDENCE
1 STOREYS - 7 M

EXISTING SINGLE FAMILY RESIDENCE
2 STOREYS - 9 M

EXISTING RESIDENTIAL BUILDING
3 STOREYS - 13 M




CONSULTANT INFORMATION
CNC: CONNECT LANDSCAPE ARCHITECTURE
Landscape Architect
Structural Engineer
Mechanical, HVAC, Fire Protection
Electrical, Electrical
Interior

NOT FOR CONSTRUCTION

PROJECT INFORMATION

COONEY ROAD TOWER


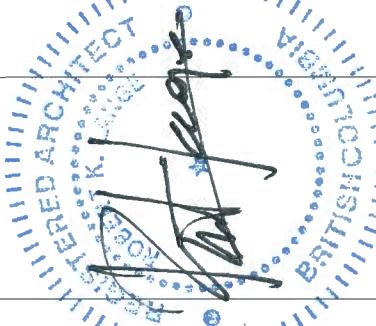
6338 COONEY ROAD
RICHMOND, BC

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DATE ISSUED: 11/11/2019 1:32:58 PM
DRAWN BY: JH
CHECKED BY: SH
PROJECT NO.: 21671

SCALE: As indicated
DATE: 11/11/2019 1:32:58 PM
DRAWN BY: JH
CHECKED BY: SH
PROJECT NO.: 21671


DRAWING TITLE: TRUCK ACCESS, BIKE STORAGE NOTES & PARKING NOTES
DRAWING NO.: DP10-02-00

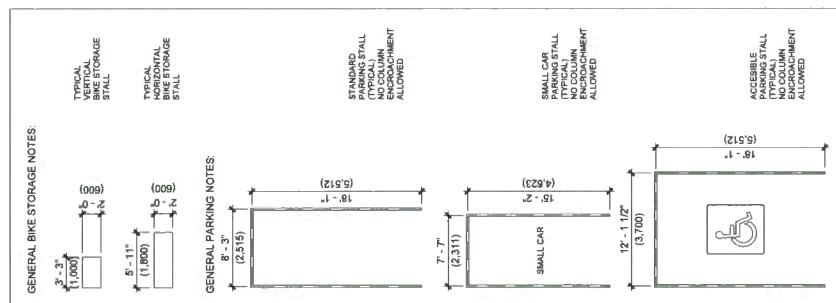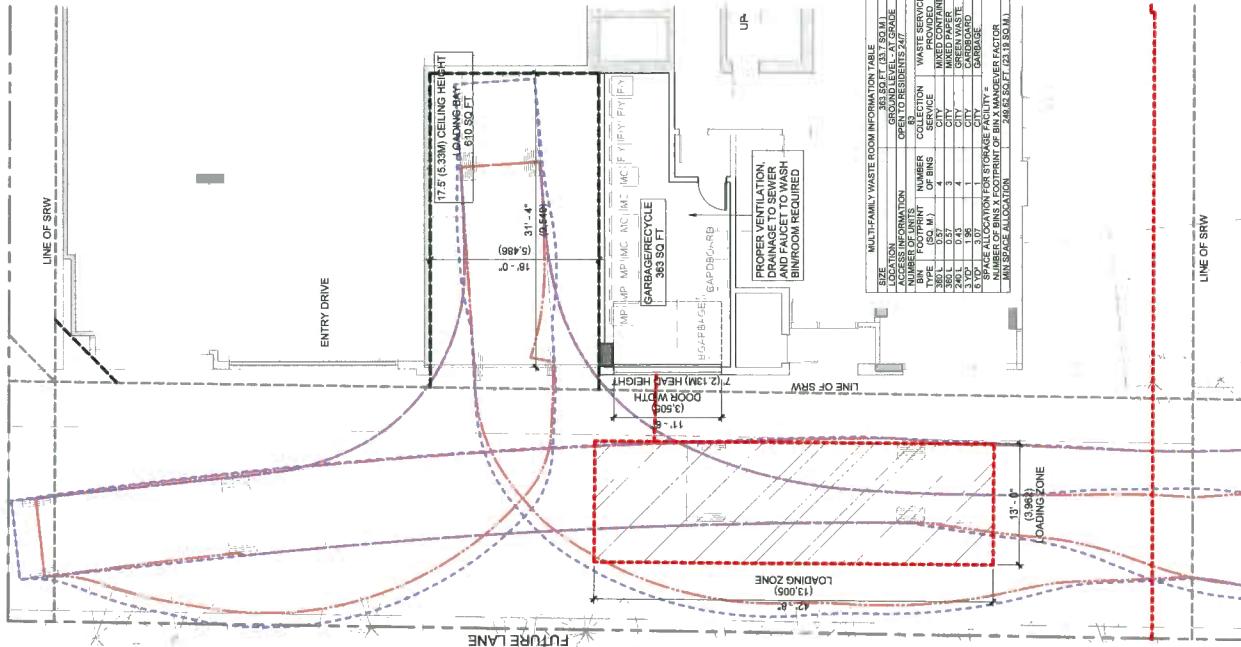

PARKING AND BIKE STORAGE NOTES

SCALE: 1/8 = 1'-0"

1 SU-9 INGRESS/EGRESS & WASTE MANAGEMENT PLAN
DP10-02-00 SCALE: 1/8 = 1'-0"

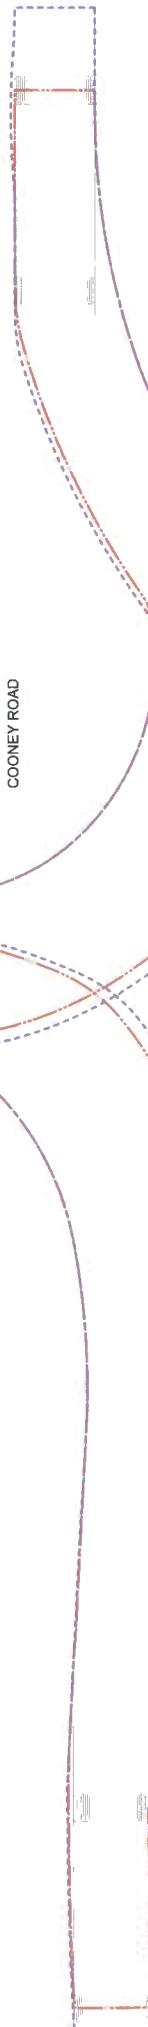

DATE ISSUED: 2019-09-28 2019-09-28
DRAWN BY: SH
CHECKED BY: SH
PROJECT NO.: 21671

SCALE: As indicated
DATE: 2019-09-28 2019-09-28
DRAWN BY: SH
CHECKED BY: SH
PROJECT NO.: 21671

DRAWING TITLE: TRUCK ACCESS, BIKE STORAGE NOTES & PARKING NOTES
DRAWING NO.: DP10-02-00



CONSULTANT INFORMATION
Cof. CONNECT LANDSCAPE ARCHITECTURE
Landscape ARCHITECTURE
Architectural DESIGN TEAM
Mechanical MECHANICAL
Electrical ELECTRICAL
Structural STRUCTURAL
Project Manager PROJECT MANAGER
Trevor M. BROWN
Trevor.M.Brown@connectlandscapes.com

CEPTED PRINCIPLES
- AVOID HIDDEN CORNERS AND INSTALL CONVEY MIRRORS TO PUBLICLY VISIBLE AREAS
- PROVIDE GLASS TO ELEVATOR LOBBIES
- ENSURE ADEQUATE LIGHTING THROUGHOUT PARKING AREA
- INSTALL HARDWIRES VIDEO SURVEILLANCE EQUIPMENT TO PARKING AREAS
- PROVIDE ROUGH SURFACE FINISH TO RAMPS TO DEFER SKATEBOARDERS

NOT FOR
CONSTRUCTION

PROJECT INFORMATION

COONEY ROAD
TOWER

6333 COONEY ROAD
RICHMOND, BC

APPROVED BY
BRIAN COONEY
OWNER & ARCHITECT
DATE: NOV 20, 2019

This drawing supersedes previous versions. Do not use this drawing.
Verify all dimensions, elevations and details, and project any drawings or documents prior to construction. Drawings are to be used for reference purposes only and must not be relied upon for construction work, unless noted otherwise by the drawing.


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ISSUED DATE: 2017-11-03
DEVELOPMENT PERMIT APPROVAL DATE: 2016-09-28
DRAWING NUMBER: DP20-01-00
RE SUBMISSION DATE: 2016-02-01
POST ADJ RESPONSE DATE: 2016-05-16
DP REIMBURSEMENT DATE: 2016-10-31
2016-11-28

SCALE: As indicated
DATE: 11/12/2019 9:54:40 AM
DRAWN BY: JH
CHECKED BY: SH
PROJECT NO: 29171
DRAWING TITLE: LEVEL 1 FLOOR PLAN
LEVEL: 1 FLOOR PLAN

DRAWING NO.: DP20-01-00



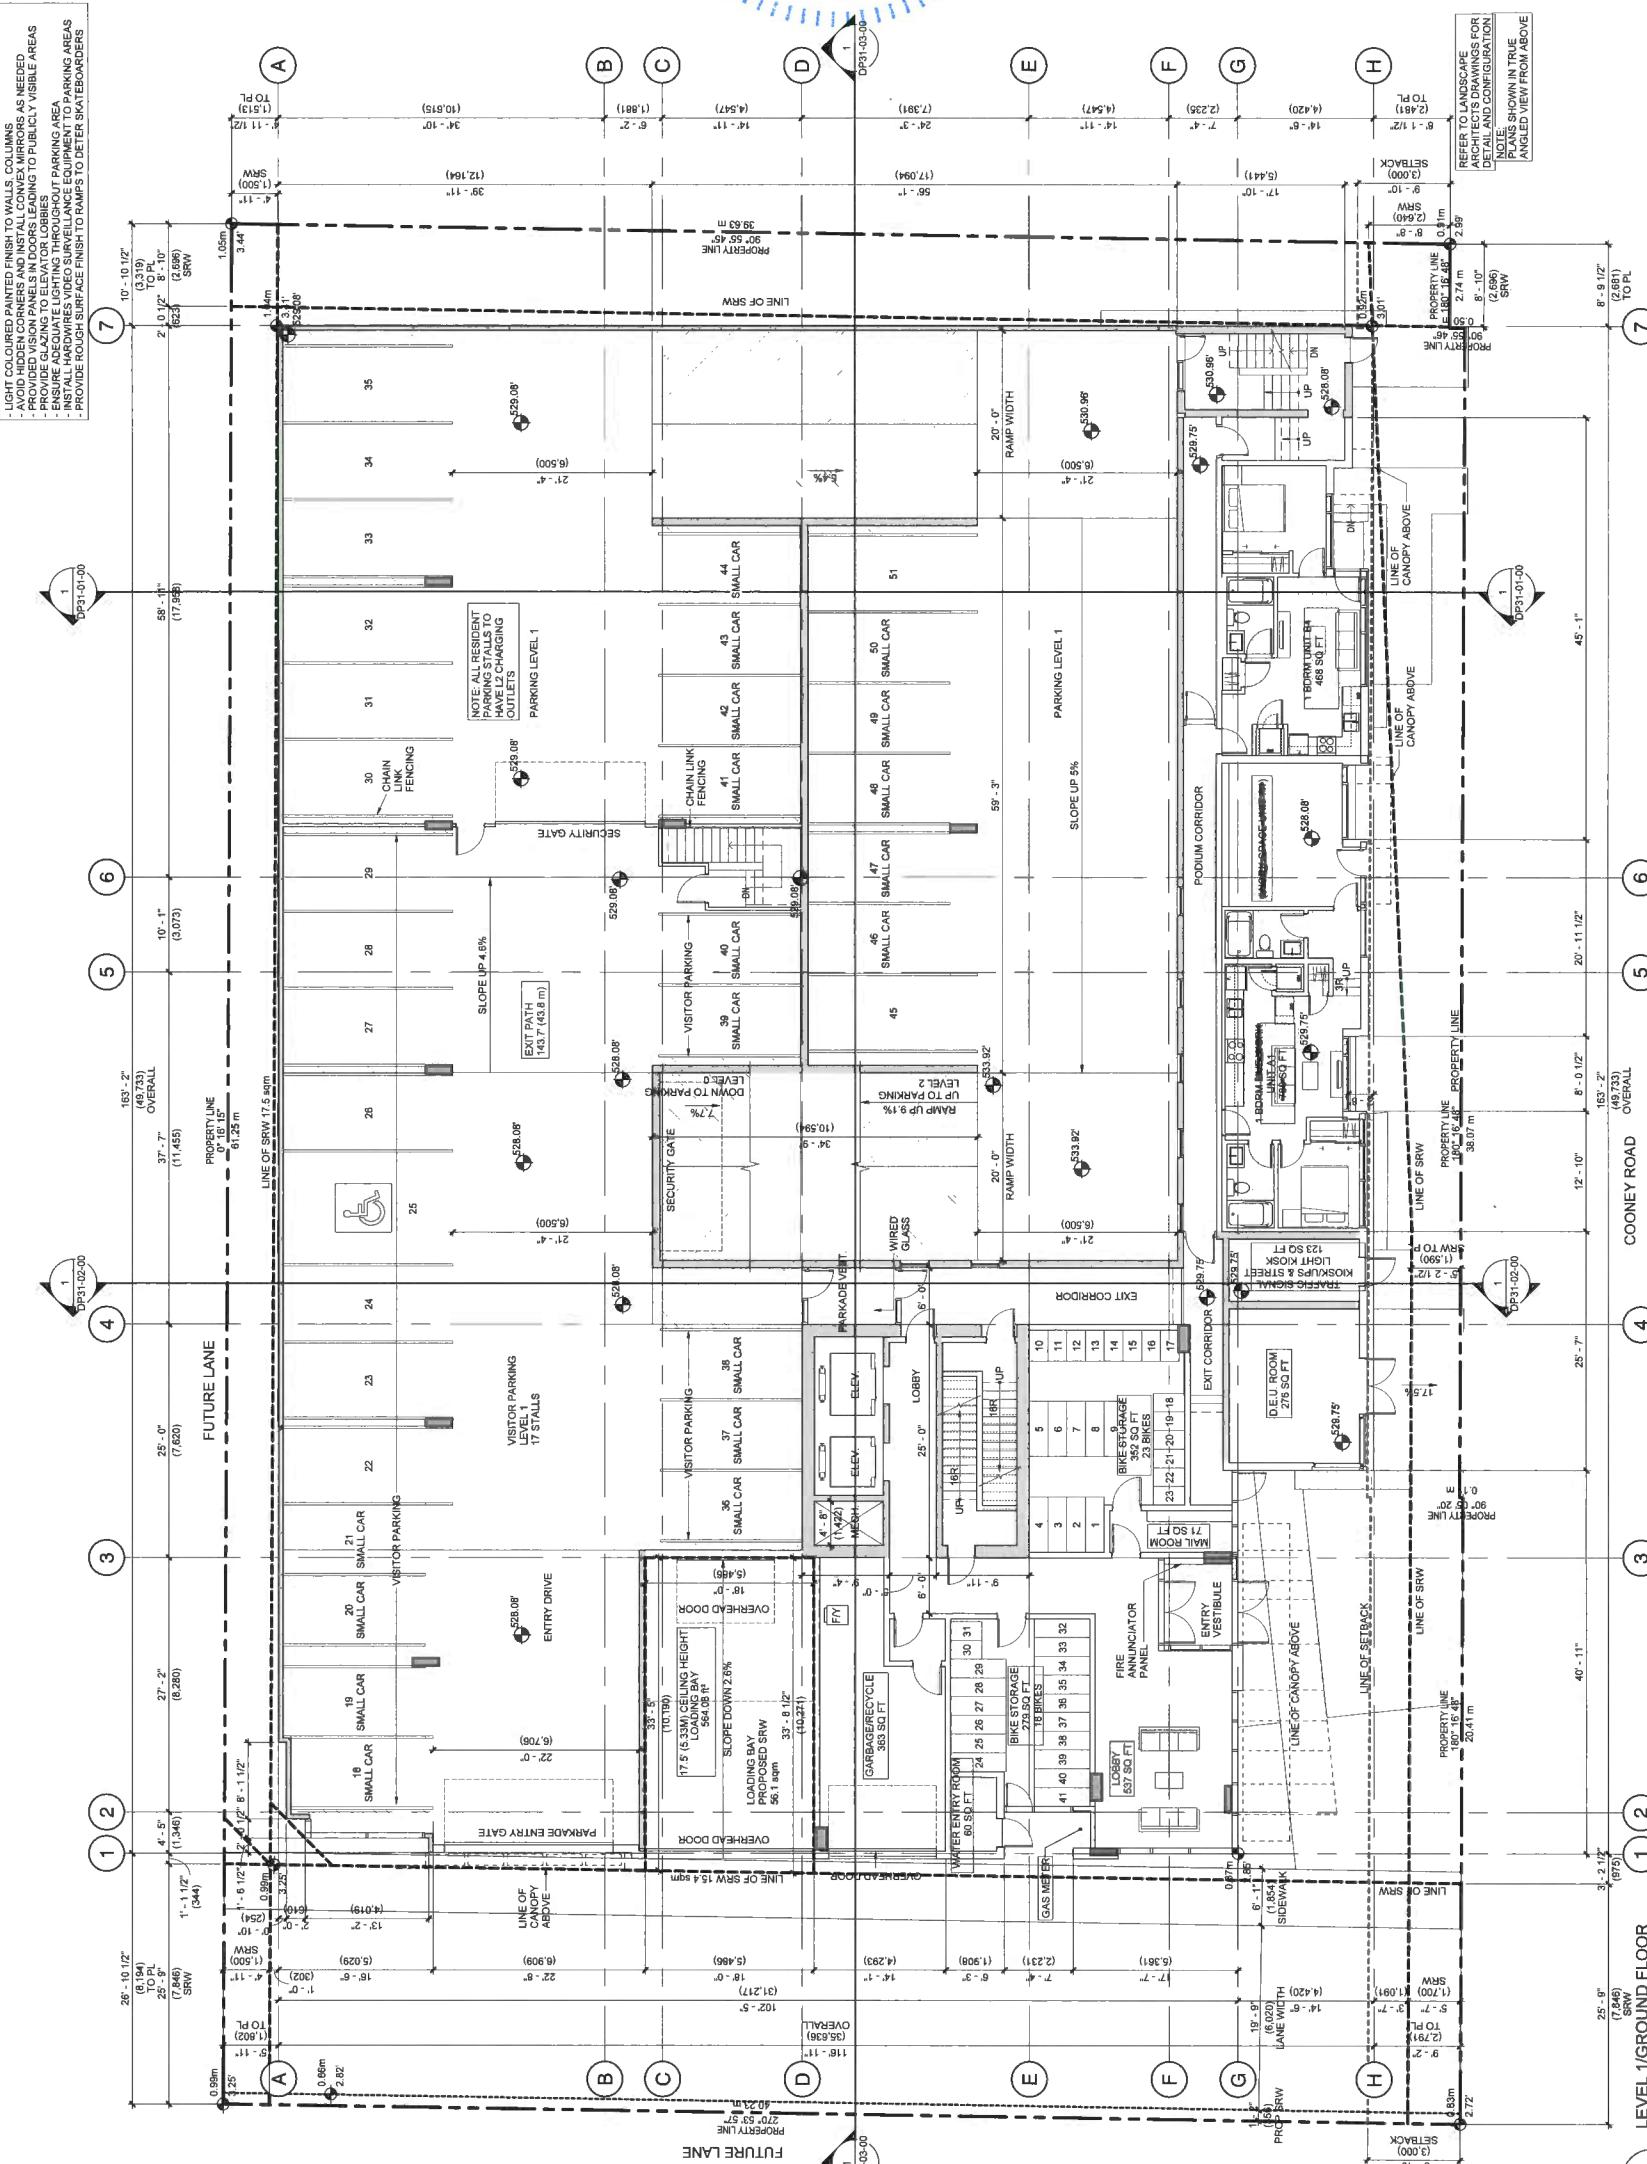

CONSULTANT INFORMATION
CINE
CHARTERED LANDSCAPE ARCHITECTURE
Architectural Services
GOLDMAN CONSULTING GROUP OF COMPANIES
Electrical
INTERIOR
NETT & ASSOCIATES LTD.

CPTED PRINCIPLES
- LIGHT COLOURED PAINTED FINISH TO WALLS, COLUMNS AS NEEDED
- PROVIDE SIGNIFICANT VISIBILITY AND ACCESS TO PUBLICLY VISIBLE AREAS
- PROVIDE GLAZING TO ELEVATOR CUBICLES
- ENSURE ADEQUATE LIGHTING THROUGHOUT PARKING AREA
- INSTALL HARDWARE VIDEO SURVEILLANCE EQUIPMENT TO PARKING AREAS
- PROVIDE ROUGH SURFACE FINISH TO RAMPS TO DETER SKATEBOARDERS

NOT FOR
CONSTRUCTION

PROJECT INFORMATION

COONEY ROAD
TOWER

6333 COONEY ROAD
RICHMOND, BC

CHARTERED ARCHITECT
S2 ARCHITECTURE

Plan 6

NOV 20, 2019

DP 17-791045

DATE
2011/11/03

APPL

RE-SUBMISSION

APPROVAL

RE-ASSIGN

SH

21871

PROJECT NO.

21871

DRAWING NO.

DP20-02-00

DRAWING INC.

DP20-02-00

DRAWING NO.

DP20-02-00

DRAWING INC.



Architecture

CONSULTANT INFORMATION

Civil: CHAN, KEE & PARTNERS 367, 369 West Cordova Street Vancouver, BC, Canada V6E 1H5	Architectural: COOK ARCHITECTURE 22 Argyle Street Vancouver, BC, Canada V6C 1G2	Structural: GUTTMAN GROUP OF COMPANIES ABE GROUP	Mechanical: HANNETT & ASSOCIATES LTD.
Electrical: BURKE CONSULTING			

HISTORICAL

CONSULTANT IN ENVIRONMENT
Chief Landscape Architect: CONNECT LANDSCAPE ARCHITECTURE
Associate: S2 ARCHITECTURE
Structural: GLUTMAN-SIMPSON GROUP OF COMPANIES
Mechanical: AME GROUP
Electrical: HEMETZ & ASSOCIATES LTD.

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CONSTRUCTION

10


COONEY ROAD
TOWER

6333 COONEY ROAD
BICHMOND BC

Plan 8

DP 17-791045
Nov 20, 2019

DP20-04-00

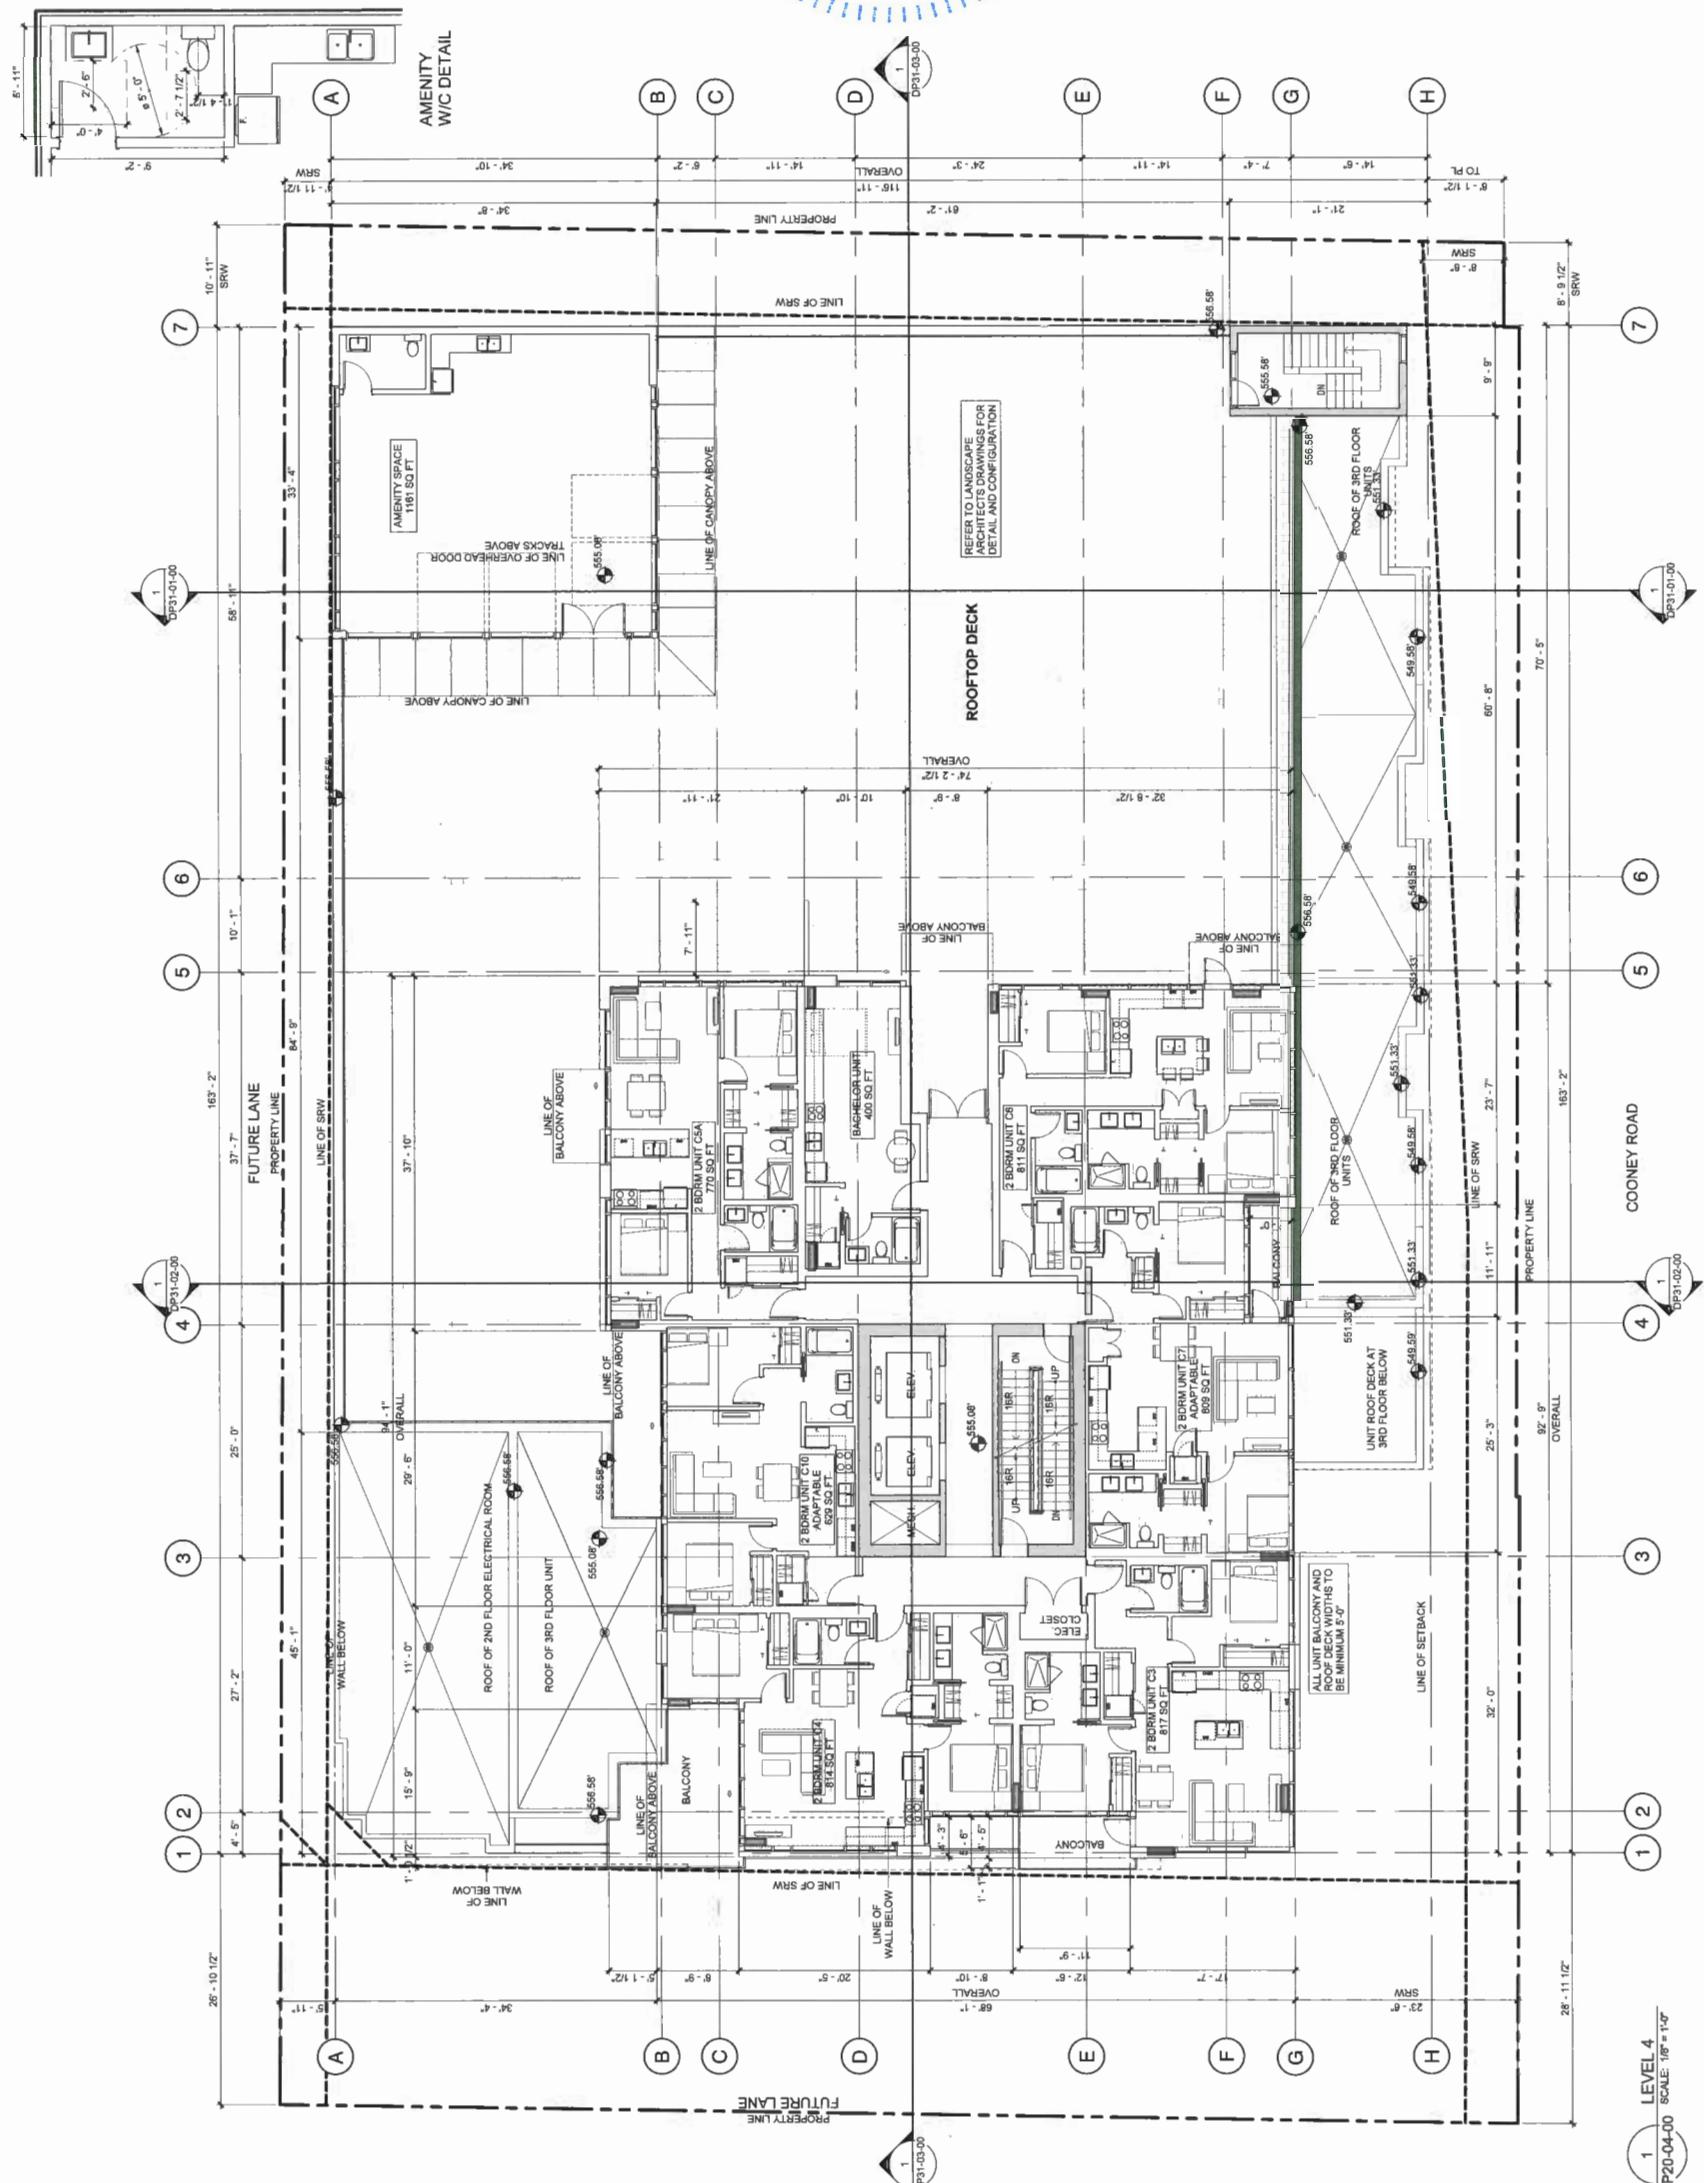



CONSULTANT INFORMATION

CONNECT LANDSCAPE
Architectural
Landscape
T Blakely Associates
www.blakelyassociates.com

CATHERINE HEMMETZ & ASSOCIATES
Architectural
GUTTMAN SHAPIRA GALT
Mechanical
Buchanan
Hemmetz & Associates

CONSULTANT INFORMATION

Arch:	CONNECTICUT
Landscape:	S2 ARCHITECTURE
Architectural:	GLODTHAM
Structural:	AME GROUP
Mechanical:	NEMETZ &
Electrical:	

NOT FOR
CONSTRUCTION

COONEY ROAD
TOWER

6333 COONEY ROAD
RICHMOND, BC

Plan 9

DP 17-791045
NOV 20, 2019

This architectural floor plan illustrates the layout of a residential building across multiple levels. The building features several units, each with its own unique configuration of rooms, including bedrooms, bathrooms, and living areas. Key dimensions for individual units include:

- Unit CS (Top Left):** Overall dimensions 37'-7" x 29'-6". Includes a balcony.
- Unit C6 (Top Right):** Overall dimensions 33'-4" x 23'-0". Includes a balcony.
- Unit C7 (Bottom Right):** Overall dimensions 25'-3" x 32'-9". Includes a balcony.
- Unit C8 (Bottom Center):** Overall dimensions 12'-6" x 20'-2". Includes a balcony.
- Unit C9 (Bottom Left):** Overall dimensions 11'-0" x 15'-9". Includes a balcony.
- Unit C10 (Center Left):** Overall dimensions 12'-6" x 20'-2". Includes a balcony.
- Unit C11 (Center Right):** Overall dimensions 11'-11" x 23'-7". Includes a balcony.
- Unit C12 (Bottom Center):** Overall dimensions 12'-6" x 20'-2". Includes a balcony.
- Unit C13 (Bottom Far Right):** Overall dimensions 11'-10" x 23'-7". Includes a balcony.

The plan also shows various shared spaces such as hallways, stairs, and common areas. Property lines are indicated by dashed lines, and specific points along these lines are marked with letters A through H. Key property line dimensions include:

- Level 1:** Overall width 68'-11", overall depth 92'-9".
- Level 2:** Overall width 68'-11", overall depth 92'-9".
- Level 3:** Overall width 27'-2", overall depth 25'-0".
- Level 4:** Overall width 25'-0", overall depth 29'-6".
- Level 5:** Overall width 10'-1", overall depth 37'-7".
- Level 6:** Overall width 10'-1", overall depth 37'-7".
- Level 7:** Overall width 58'-1", overall depth 37'-7".

Other notable features include a central staircase, multiple elevators (EVR), and various exterior access points. The plan is annotated with labels such as "PROPERTY LINE", "LINE OF SRW", "LINE OF FLOOR BELOW", and "LINE OF ROOF BELOW". Specific unit details like "2 BDRM & DEN UNIT BS 570 SQFT" and "2 BDRM UNIT C7 ADAPTABLE 869 SQFT" are also provided.



CONSULTANT INFORMATION

CMD: CONNECTLANDSCAPE
Landscape Architecture, San Francisco, CA
GLOTHMAN-SIMPSON GROUP: Architecture, San Francisco, CA
MEIER GROUP: Mechanical, San Francisco, CA
NEUBERZ & ASSOCIATES: Structural, San Francisco, CA
ITRADE: Interiors, San Francisco, CA

CONSULTANT INFORMATION

Cof:	CONNECT LANDSCAPE ARCHITECTURE
Landsc:	SE ARCHITECTURE
Architects	GLENDAHUNSON GROUP OF COMPANIES
Architect	AME GROUP
Mechanical	HOMETE & ASSOCIATES LTD.
Electrical	IMI

NOT FOR
CONSTRUCTION

MOLITOMI ET AL.

COONEY ROAD
TOWER

6333 COONEY ROAD
RICHMOND, BC

Plan 10

DP 17-791045
Nov 20, 2019

DRAWING NO.
DP20-06-00

DRAWING

This architectural floor plan illustrates the layout of DP2 LEVEL 6. The plan features several units, each with its own unique configuration of rooms, including bedrooms, bathrooms, and living areas. Units are labeled with letters and numbers, such as A1, B1, C1, D1, E1, F1, G1, H1, A2, B2, C2, D2, E2, F2, G2, H2, A3, B3, C3, D3, E3, F3, G3, H3, A4, B4, C4, D4, E4, F4, G4, H4, A5, B5, C5, D5, E5, F5, G5, H5, A6, B6, C6, D6, E6, F6, G6, H6, A7, B7, C7, D7, E7, F7, G7, and H7.

The plan includes various dimensions and labels:

- Overall Dimensions:** The overall width of the building is 94'-1".
- Unit Descriptions:**
 - UNIT C1:** 2 BDRM UNIT C1 ADAPTABLE 629 SQ FT
 - UNIT C2:** 2 BDRM UNIT C2 ADAPTABLE 629 SQ FT
 - UNIT C3:** 2 BDRM UNIT C3 ADAPTABLE 868 SQ FT
 - UNIT C4:** 2 BDRM UNIT C4 ADAPTABLE 868 SQ FT
 - UNIT C5:** 2 BDRM UNIT C5 675 SQ FT
 - UNIT C6:** 2 BDRM UNIT C6 675 SQ FT
 - UNIT C7:** 2 BDRM UNIT C7 675 SQ FT
- Balconies:** Numerous balconies are shown, including "BALCONY" labels and specific dimensions like 10'-0" and 11'-11".
- Property Lines:** The plan shows "PROPERTY LINE" and "FUTURE LANE" boundaries.
- Vertical Labels:** Labels such as "LINE OF SRW", "LINE OF SETBACK", "LINE OF COONEY ROAD", and "LINE OF STAIRCASE ROOF BELOW" are positioned along the perimeter.
- Horizontal Labels:** Labels like "OVERALL" and "ALL UNIT BALCONY AND ROOF DECK WIDTHS TO BE MINIMUM 6'0"" provide overall context and specific requirements.
- Orientation:** The plan includes orientation symbols and directional labels.



CONSULTANT INFORMATION
Dale Connect Landscape Architecture
Landscape Architectural Services Group / Cushman
Malouff, Nairn Group
Architects, Inc.
Interior Designers
Inventors

NOT FOR
CONSTRUCTION

PROJECT INFORMATION

COONEY ROAD
TOWER

6333 COONEY ROAD
RICHMOND, BC

SWEDDLED ARCHITECTURE
DESIGN & LARGEST
BRITISH COLUMBIA


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DATE
2011-09-20
APPROVAL
CD SUBMISSION
RE-SUBMISSION
POST APP RESPONSE
DP RESUBMISSION
DP RESUBMISSION

DATE
2011-09-20
DRAWN BY
JH
CHECKED BY
SH
PROJECT NO
219171
DR RESUBMISSION

Plan 11

DP 17-791045
Nov 20, 2019

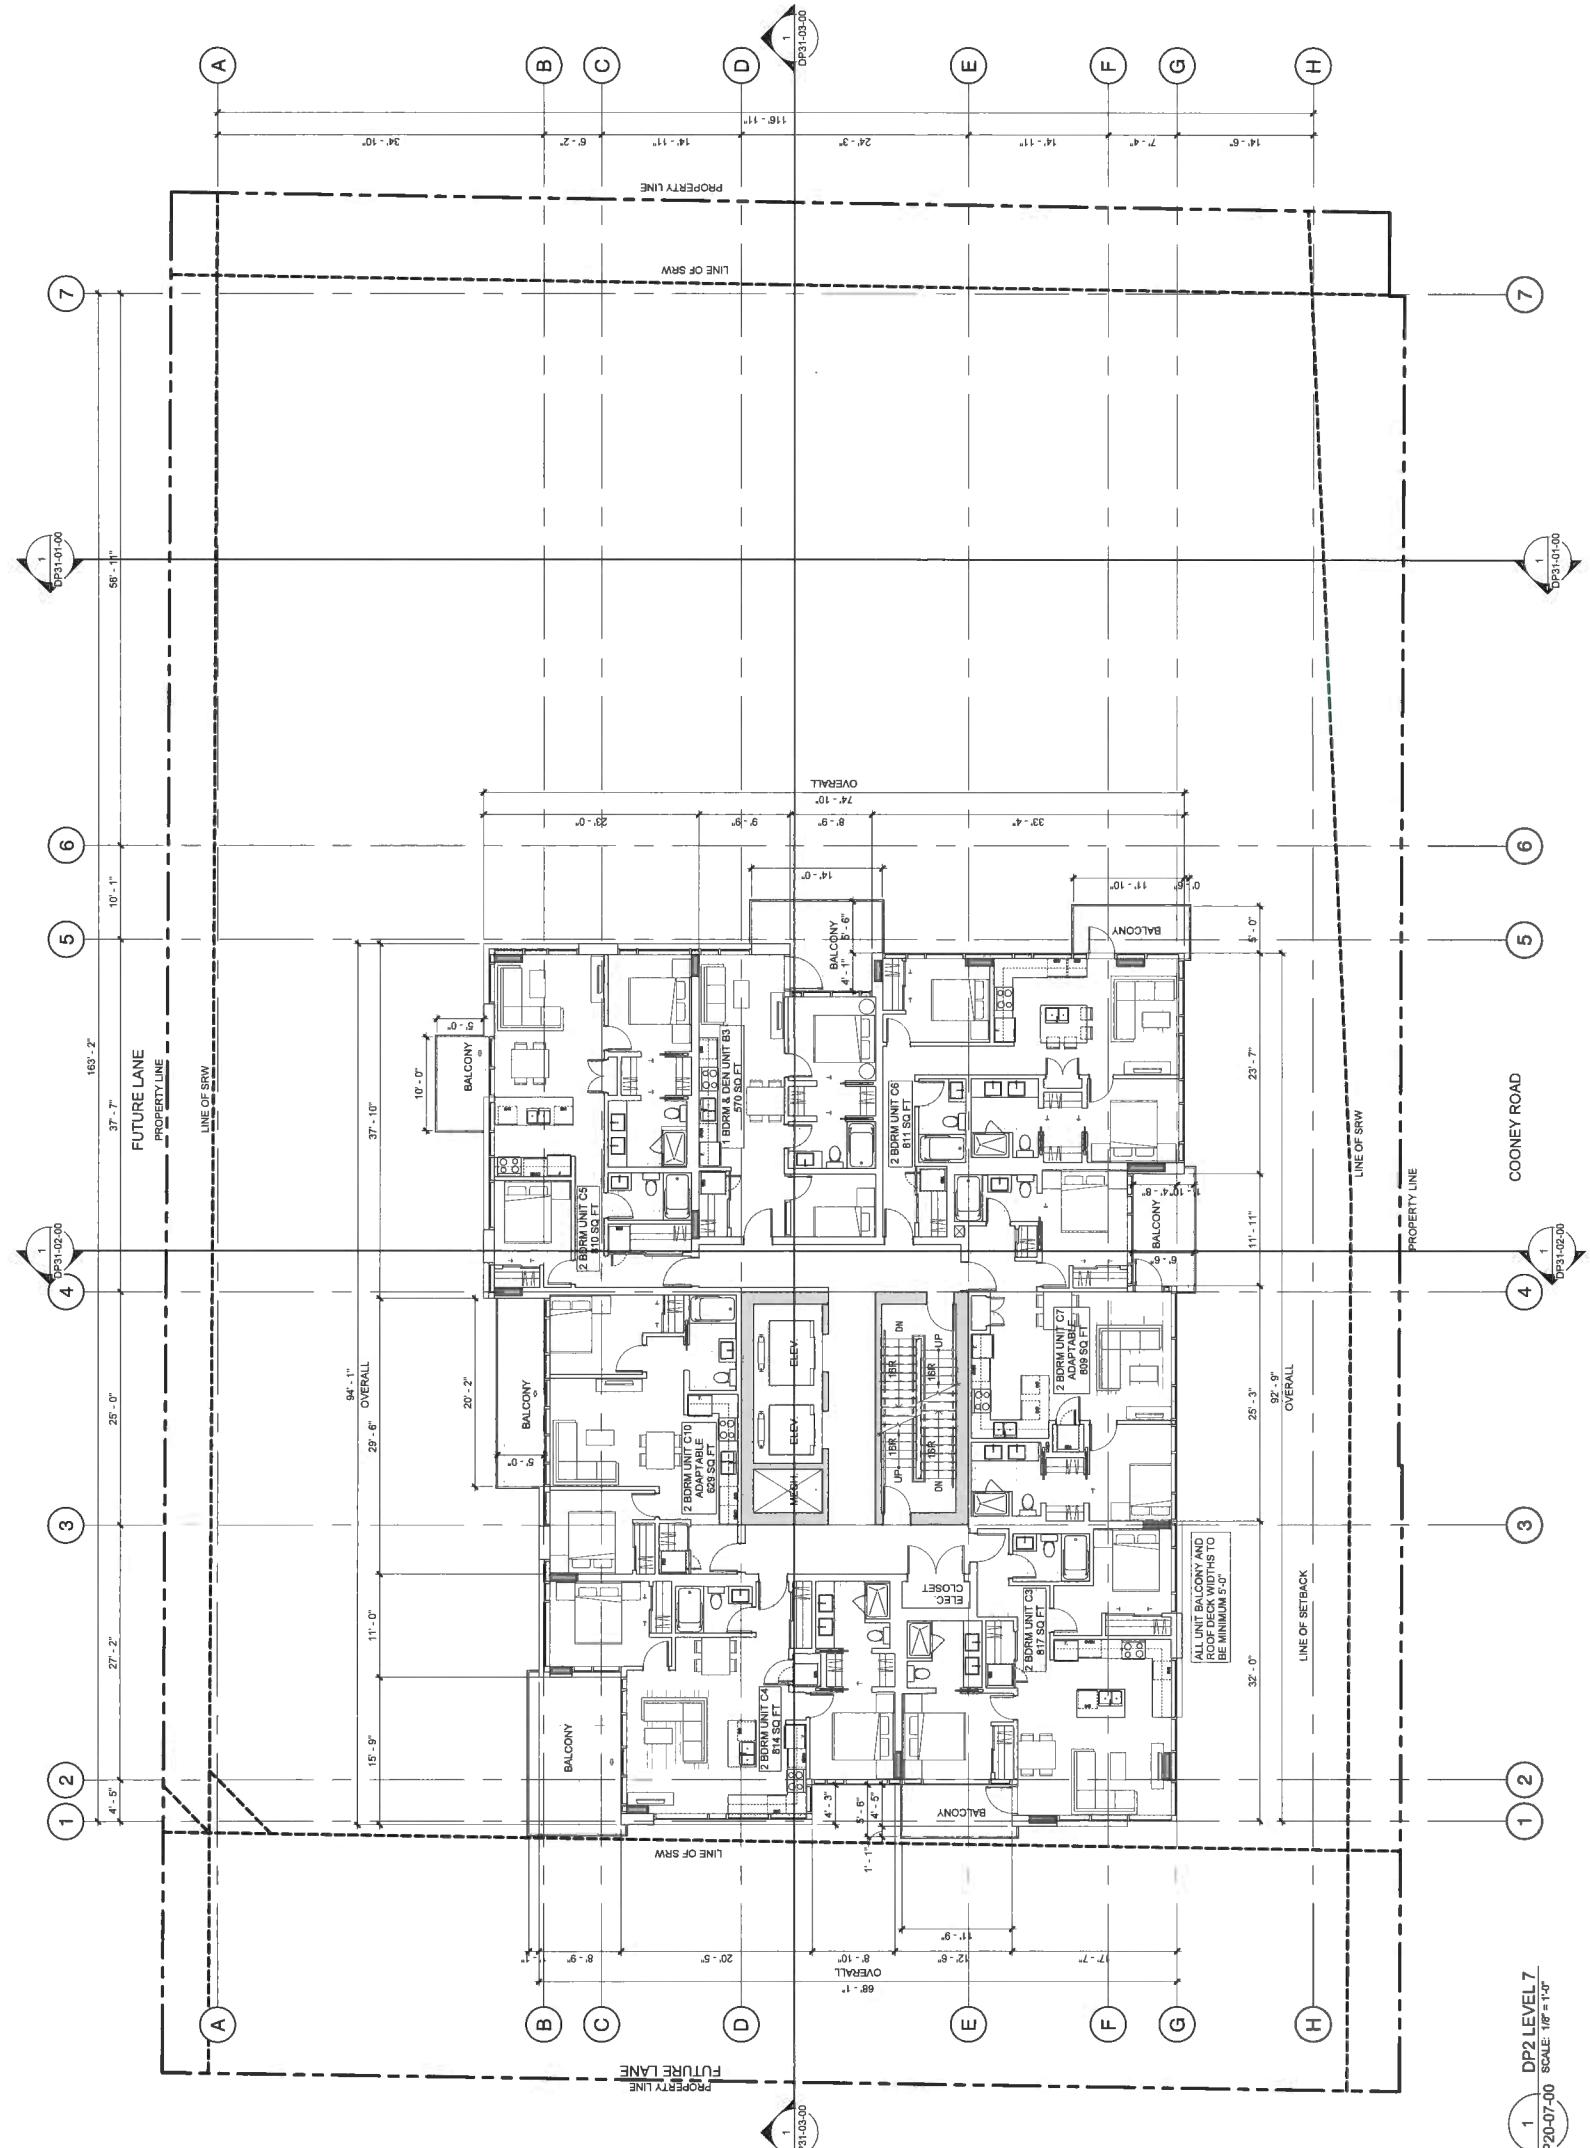

1 DP2 LEVEL 7
1 DP2-07-00 SCALE: 1'0" = 1'-0"

DP20-07-00
DRAWING NO.
DP2020-07-00
DRAWING DATE



architecture

CONSULTANT INFORMATION

CNL Landscape: CONNECTICUT LANDSCAPE ARCHITECTURE
Architecture: GLADWIN-SIMPSON GROUP OF COMPANIES
Structural: AME GROUP
Mechanical: NEMETZ & ASSOCIATES LTD.
Electrical: LARSONS
Landscape:

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CONSTRUCTION


COONEY ROAD
TOWER

6333 COONEY ROAD
RICHMOND, BC

REDACTED

Plan 12

DP 17-91043
NOV 20, 2019

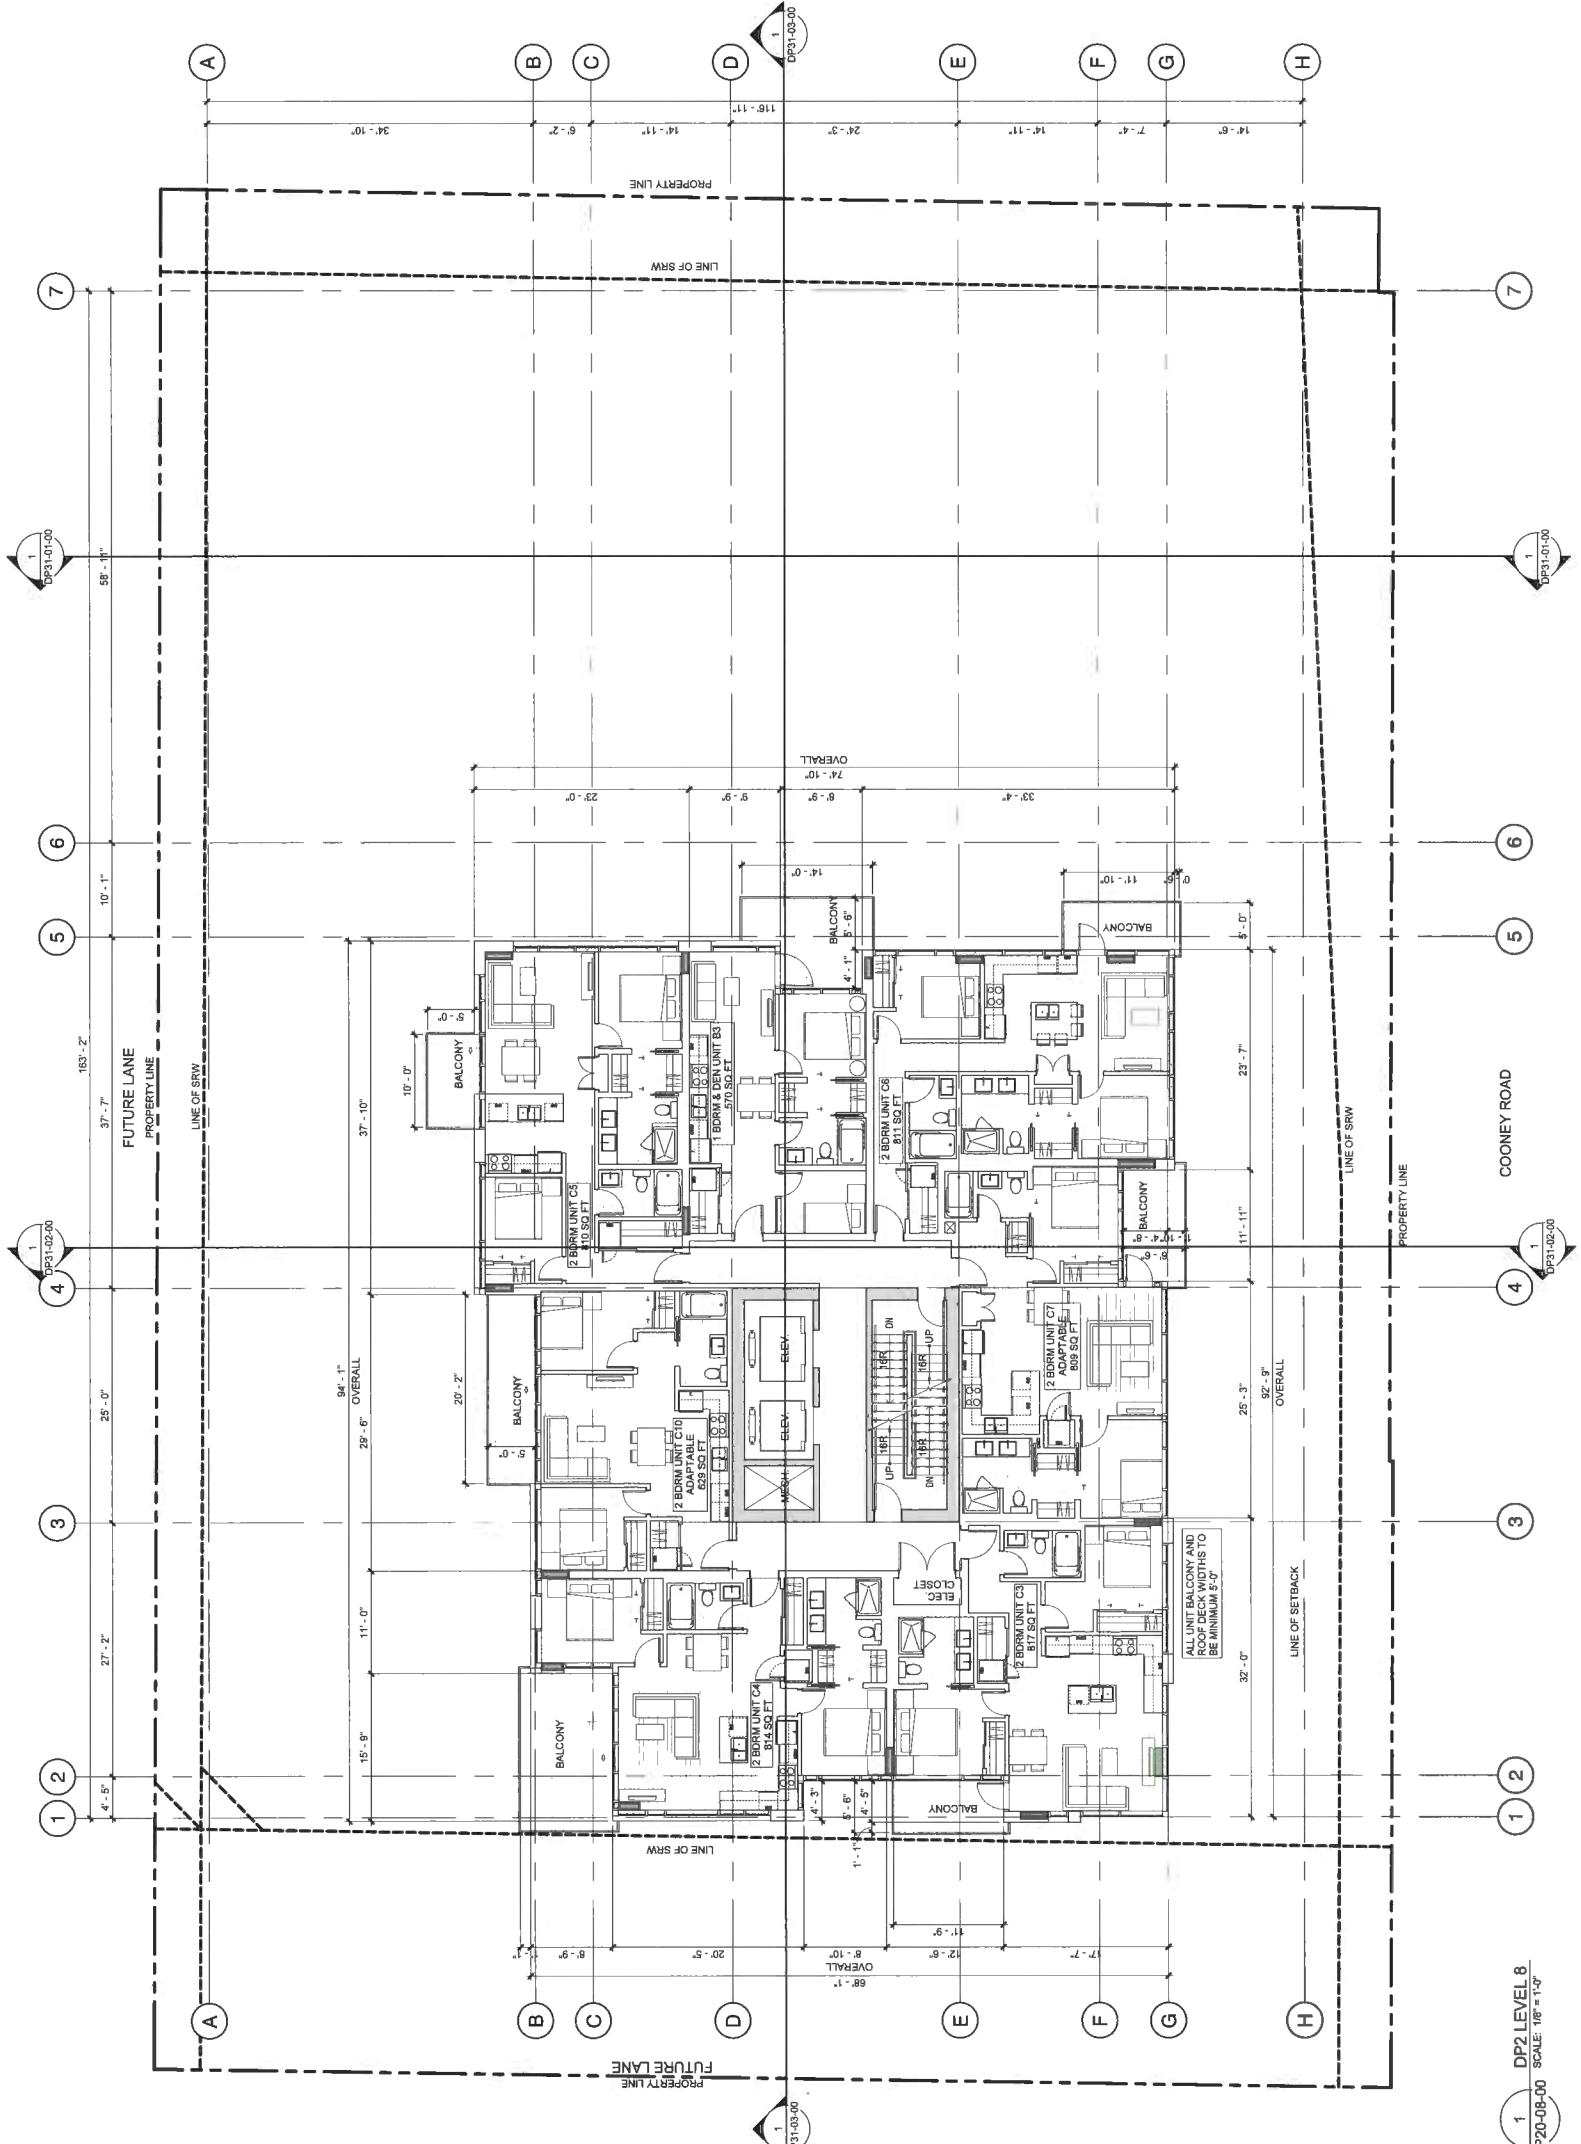



S2
architecture
200 28th Ave East
Vancouver, BC, Canada V6E
T: 604.541.0000
E: info@s2arch.com

CONSULTANT INFORMATION


CHE
Landscape Architect
Architectural Design & Companies
McDonald
McDonald
Hawthorne
Hawthorne
Hawthorne
Hawthorne

**NOT FOR
CONSTRUCTION**

PROJECT INFORMATION

**COONEY ROAD
TOWER**

6333 COONEY ROAD
RICHMOND, BC

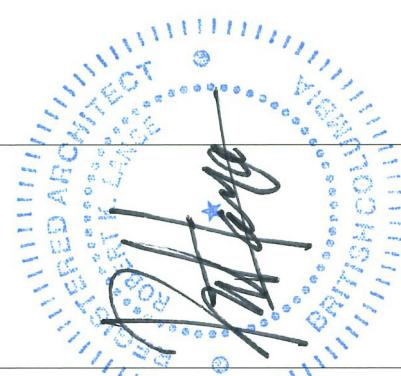

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not be accurate. The architect, project manager and designer
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This drawing is for planning purposes only and is not to be used
as a construction document. It is the responsibility of the architect,
developer and contractor to verify all dimensions and information
on this drawing prior to commencing work.


DATE: 2017-11-03
DEVELOPMENT PERMIT
APPROVAL
APPROVAL
RE-SUBMISSION
AP SUBMISSION
POST APP REVIEW
OP RESPONSE
OP RESUBMISSION
DP RESUBMISSION

DATE: 2019-09-26
DRAWN BY: JH
CHECKED BY: SH
PROJECT NO.: E9171
DRAWING NO.: LEVEL 9 FLOOR PLAN

DATE: 2019-02-01
2019-02-06
2019-02-11
2019-03-31
2019-11-06

SCALE: 1'0" = 1'-0"
DATE: 11/14/2019 4:23:14 PM
DRAWN BY: JH
CHECKED BY: SH
PROJECT NO.: E9171
DRAWING NO.: DP20-09-00

1 DP2 LEVEL 9
SCALE: 1'0" = 1'-0"

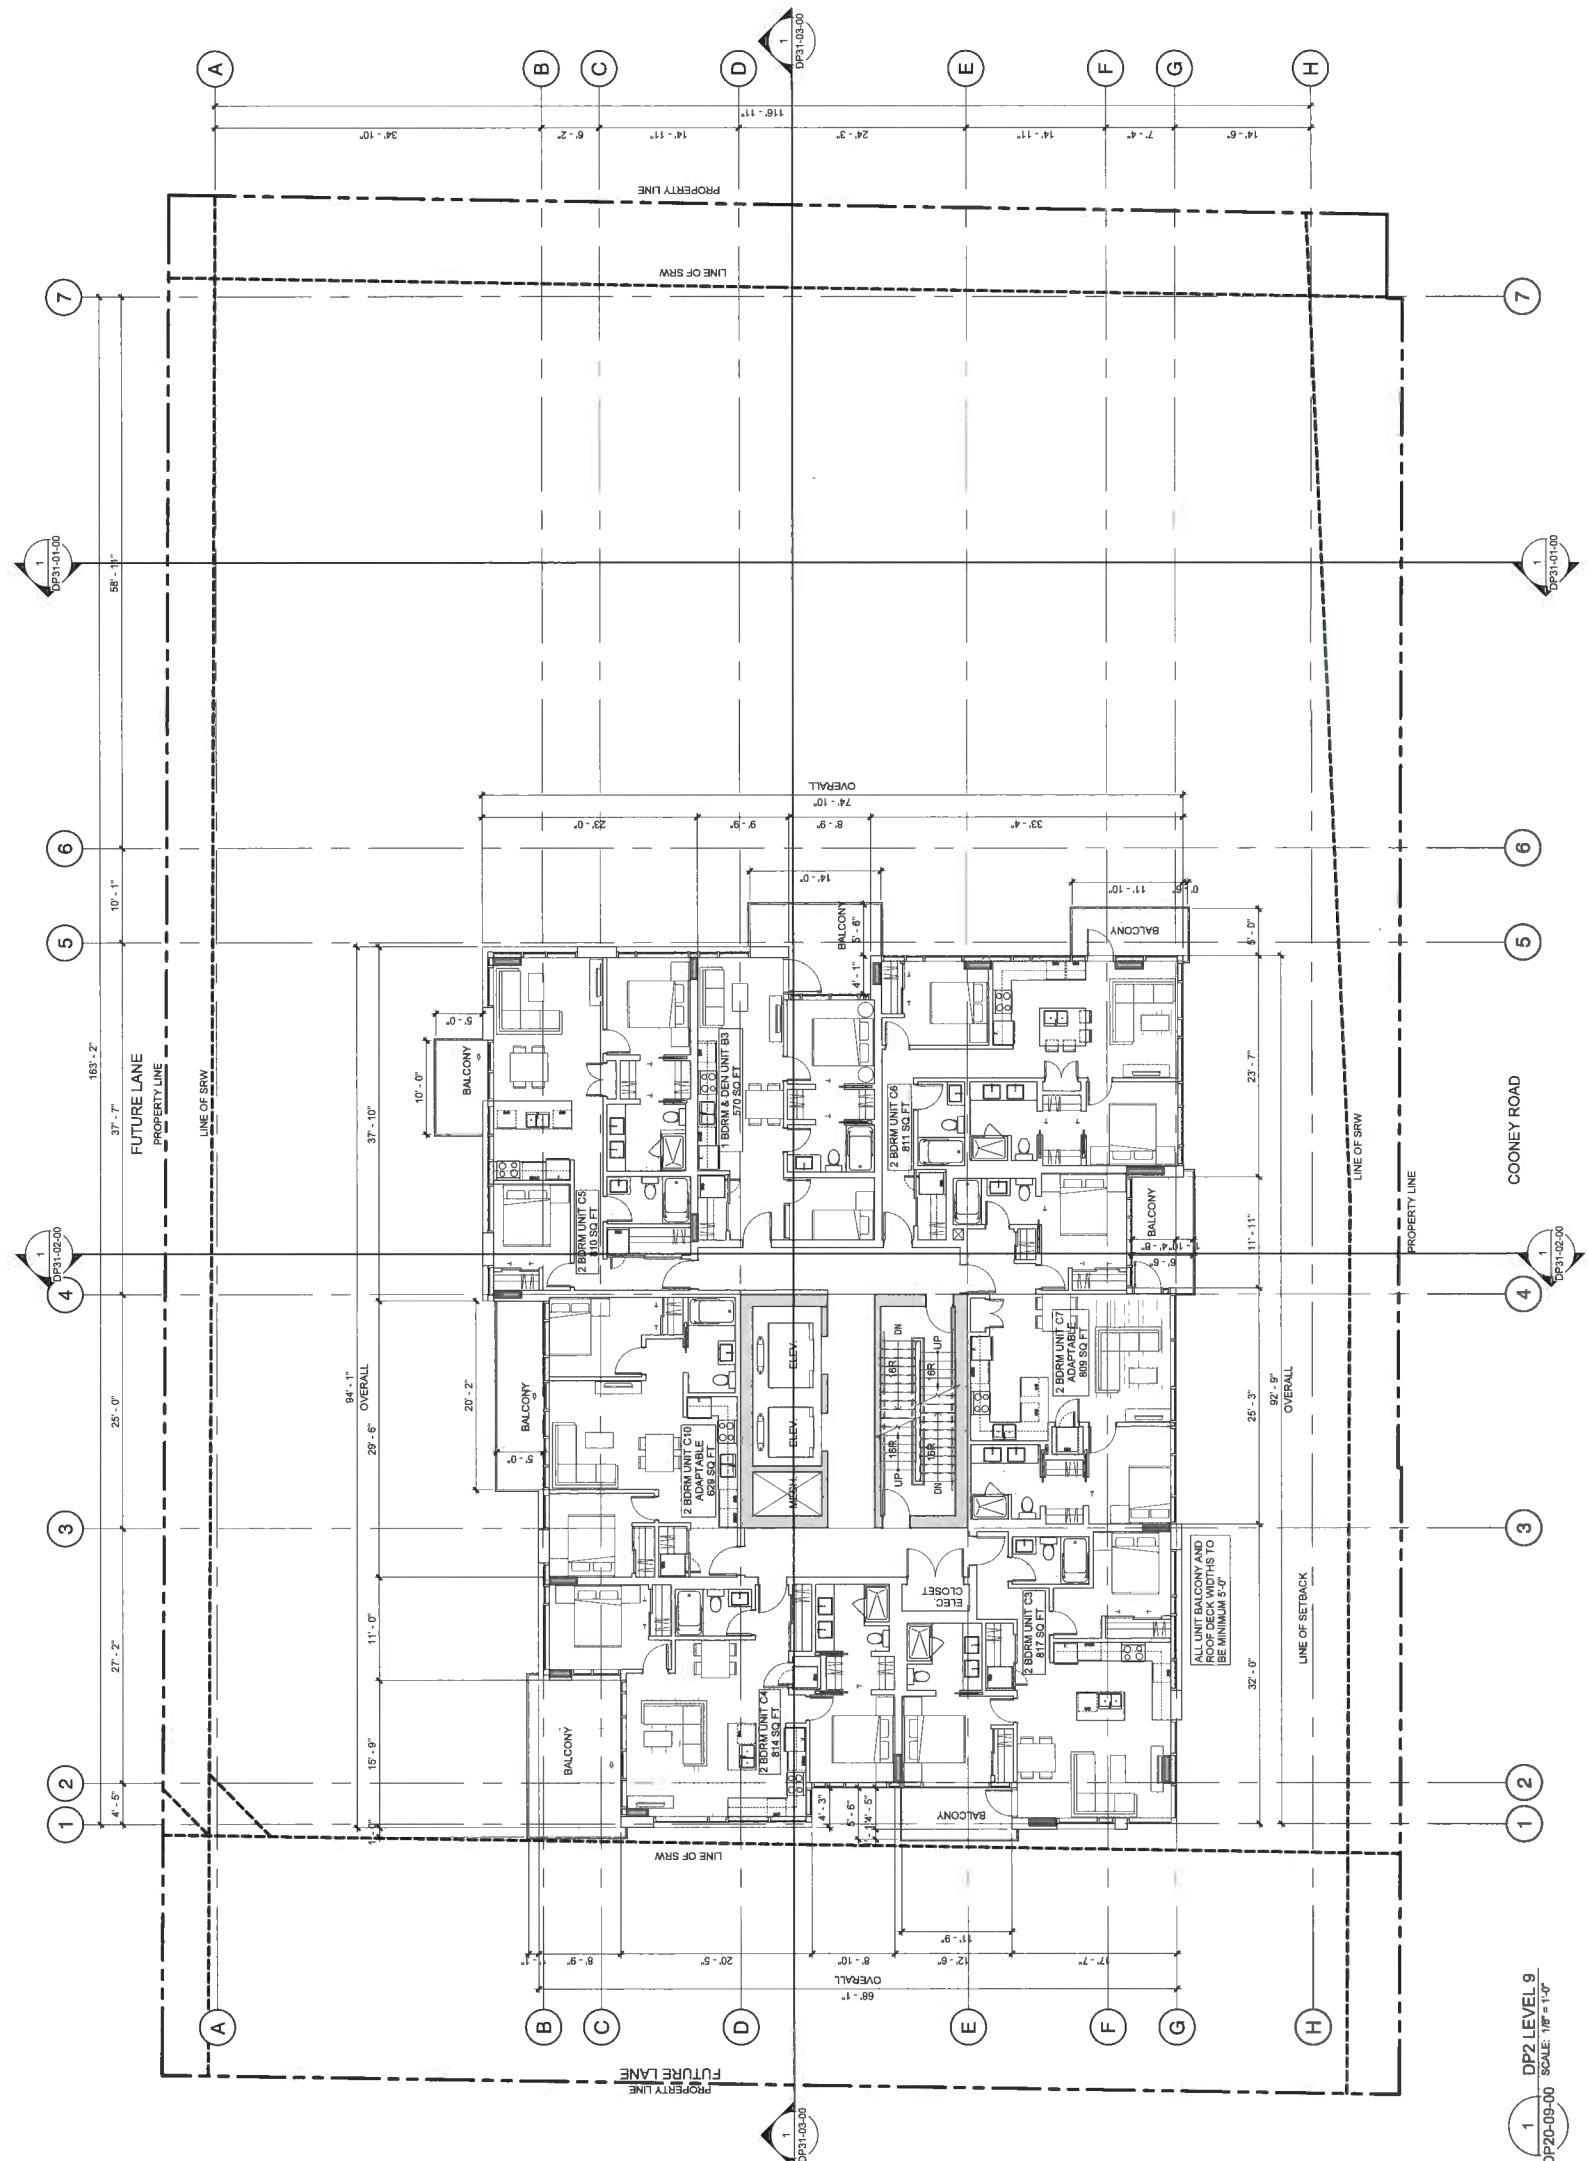



architecture
222-228 W. Gardner Street
Vancouver, BC, Canada V6B 1E9
† 604.541.3800

CONSULTANT INFORMATION

CML	CONNECT LANDSCAPE ARCHITECTURE
Landscape:	52 ARCHITECTURE LTD.
Architecture:	GLOTMAN-SIMPSON GROUP OF COMPANIES
Structure:	AME GROUP
Mechanical:	HEMNET & ASSOCIATES LTD.
Electrical:	BRUNTON

THEATRE WORKS

CONNECT LANDSCAPE ARCHITECTURE
BY: S2 ARCHITECTURE
ALAN SIMPSON GROUP OF COMPANIES
AMT GROUP
NEMETZ & ASSOCIATES LTD.

NOT FOR
CONSTRUCTION

110

COONEY ROAD
TOWER

6333 COONEY ROAD
RICHMOND BC


ROBERT KLAASSEN

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• Jan 14

DP 17-791045
NOV 20, 2019

DP20-10-00



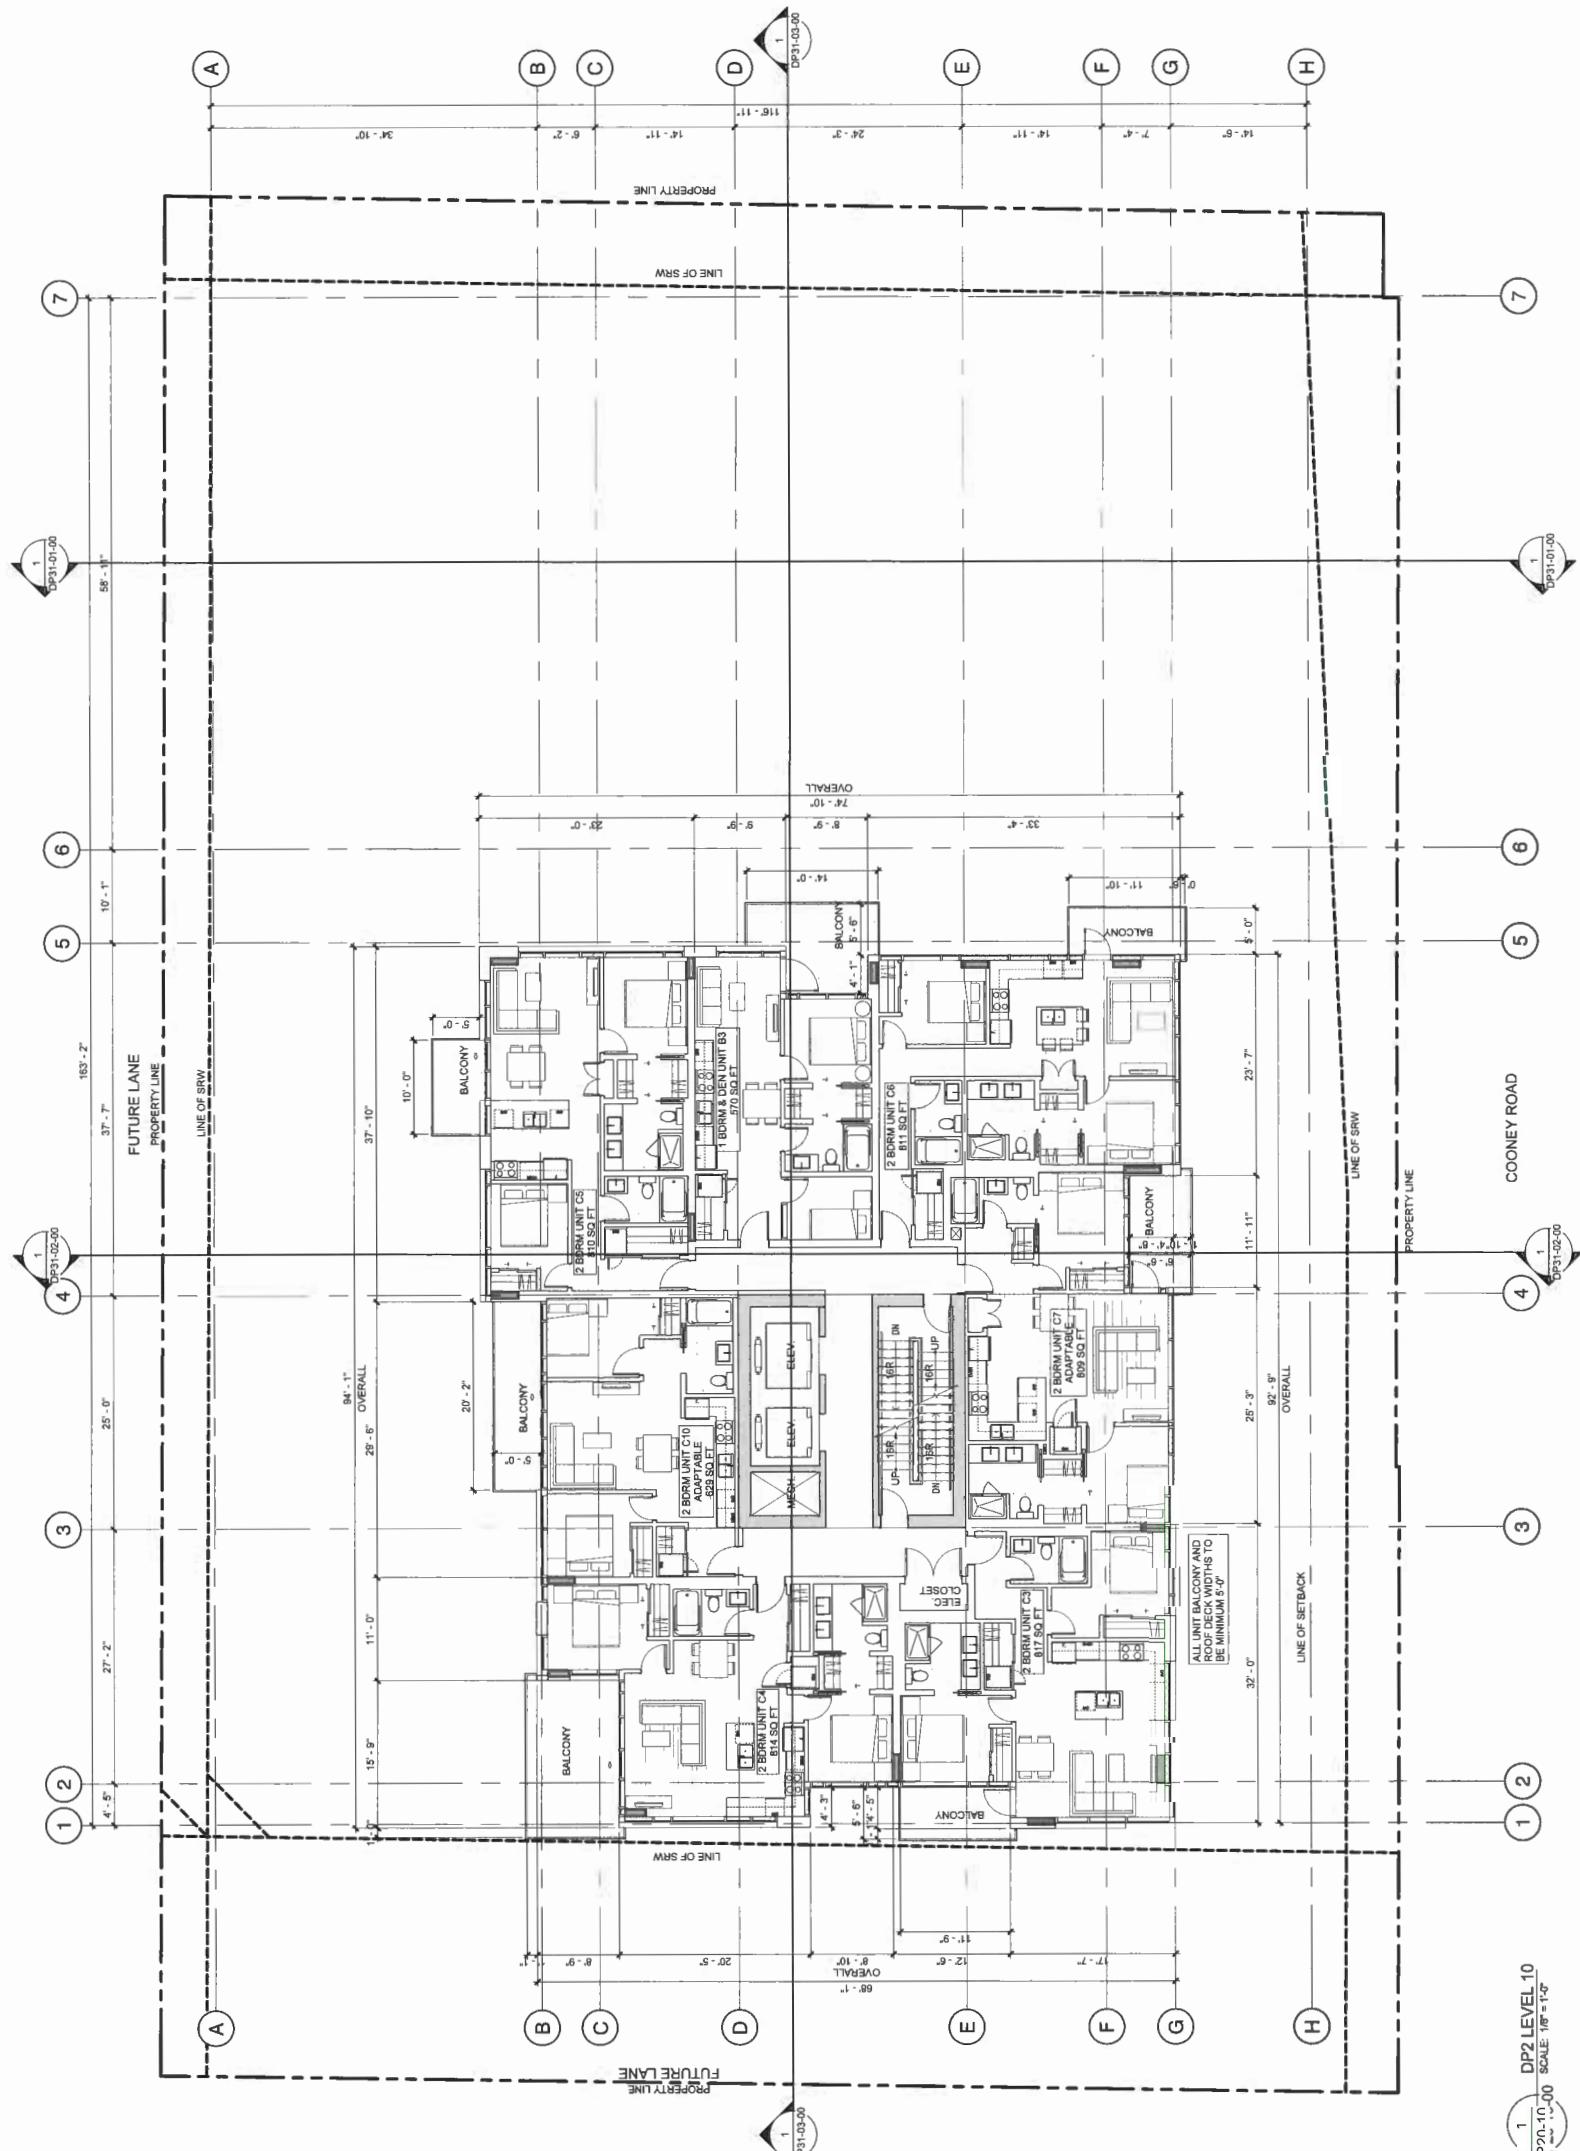

CONSULTANT INFORMATION

Civil:	CONNECT LANDSCAPE ARCHITECTURE
Landscape:	SZ ARCHITECTURE
Architectural:	GLOUTON-SIMPSON GROUP OF COMPANIES
Structural:	HME GROUP
Mechanical:	HEMNETT & ASSOCIATES LTD.
Electrical:	
Information:	

NOT FOR
CONSTRUCTION

PROJECT INFORMATION

OONEY ROAD
TOWER


6333 COONEY ROAD
RICHMOND, BC

A circular blue stamp with concentric dotted lines. The outer ring contains the text "BRITISH SOCIETY OF ARCHITECTS" and the inner ring contains "REGISTERED ARCHITECT".

Plan 15

DP 17-791045
Nov 20, 2019

DP20-11-00

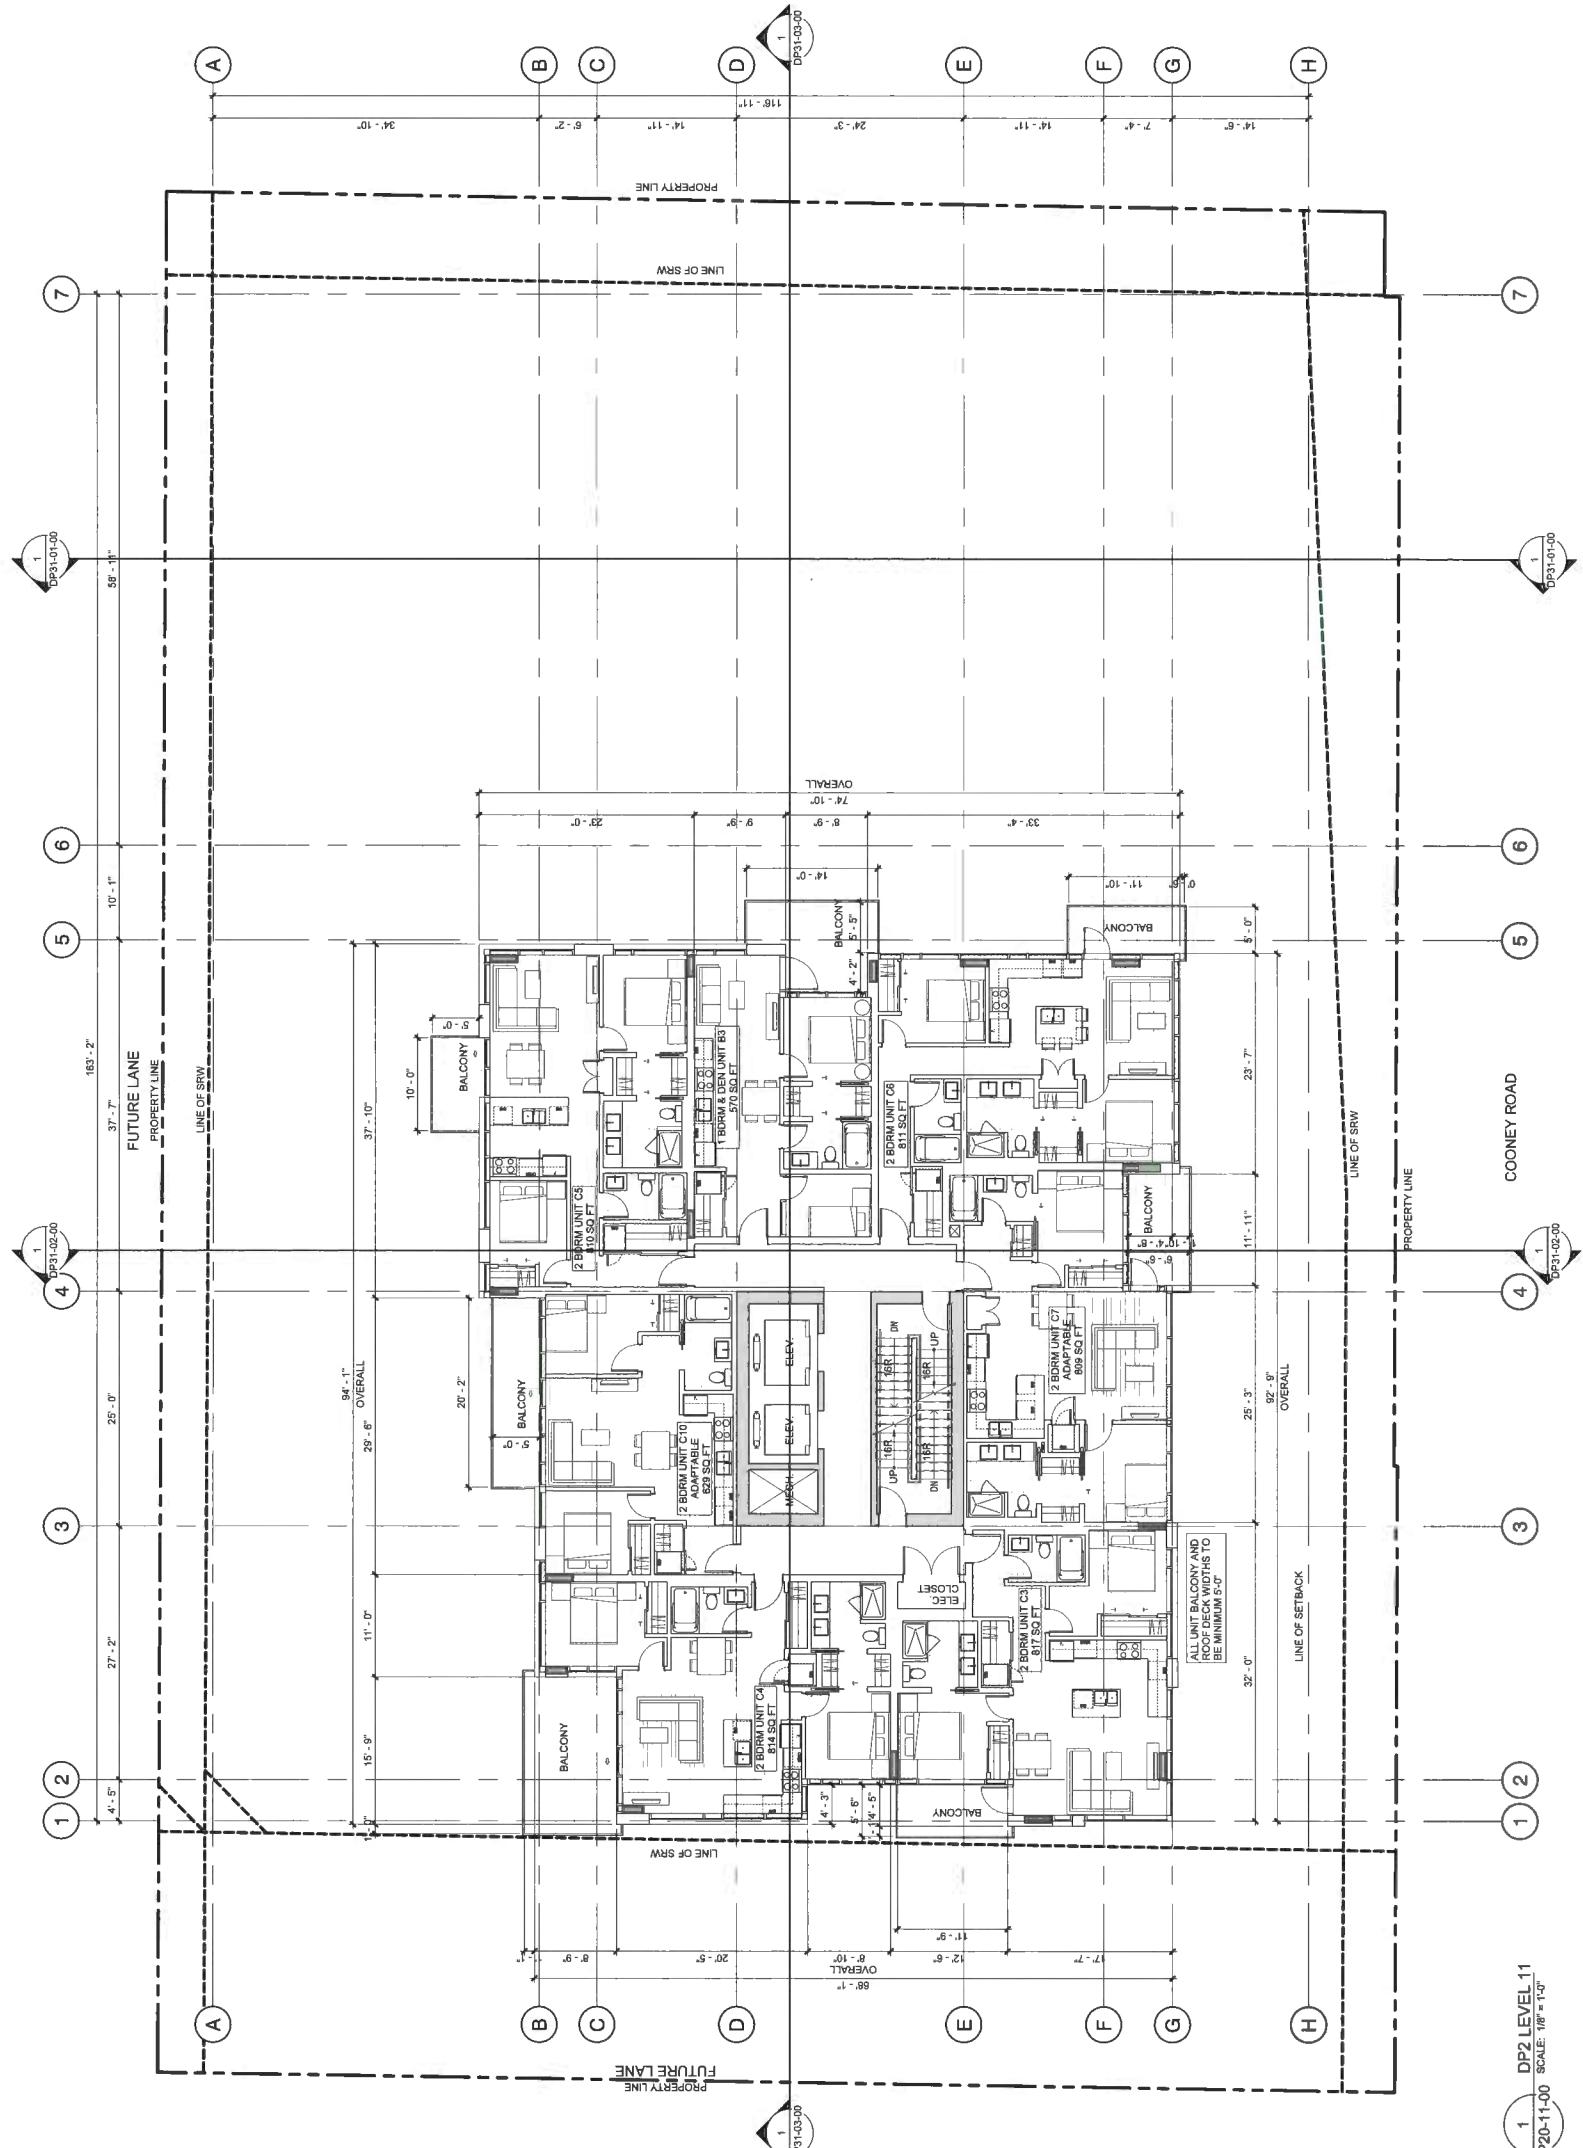



architecture

CONSULTANT INFORMATION

Chil. Landscape Architect	CONNECT LANDSCAPE ARCHITECTURE S2 ARCHITECTURE	Structural: GUTHMAN-SIMPSON GROUP OF COMPANIES	Mechanical: AME GROUP	Electrical: HEBEIT & ASSOCIATES LTD.
Civil Architect				

NOT FOR
CONSTRUCTION

CONTINUATION


COONEY ROAD
TOWER

6333 COONEY ROAD
RICHMOND, BC

A circular blue stamp from the British Museum Library. The outer ring contains the text "BRITISH MUSEUM LIBRARY" at the top and "LONDON" at the bottom. The inner circle contains "RED ARCHITECT" at the top and "ROBERT LINDSAY" at the bottom. A large, dark, handwritten signature is overlaid across the center of the stamp.

Plan 16

DP 17-791045
Nov 20, 2019

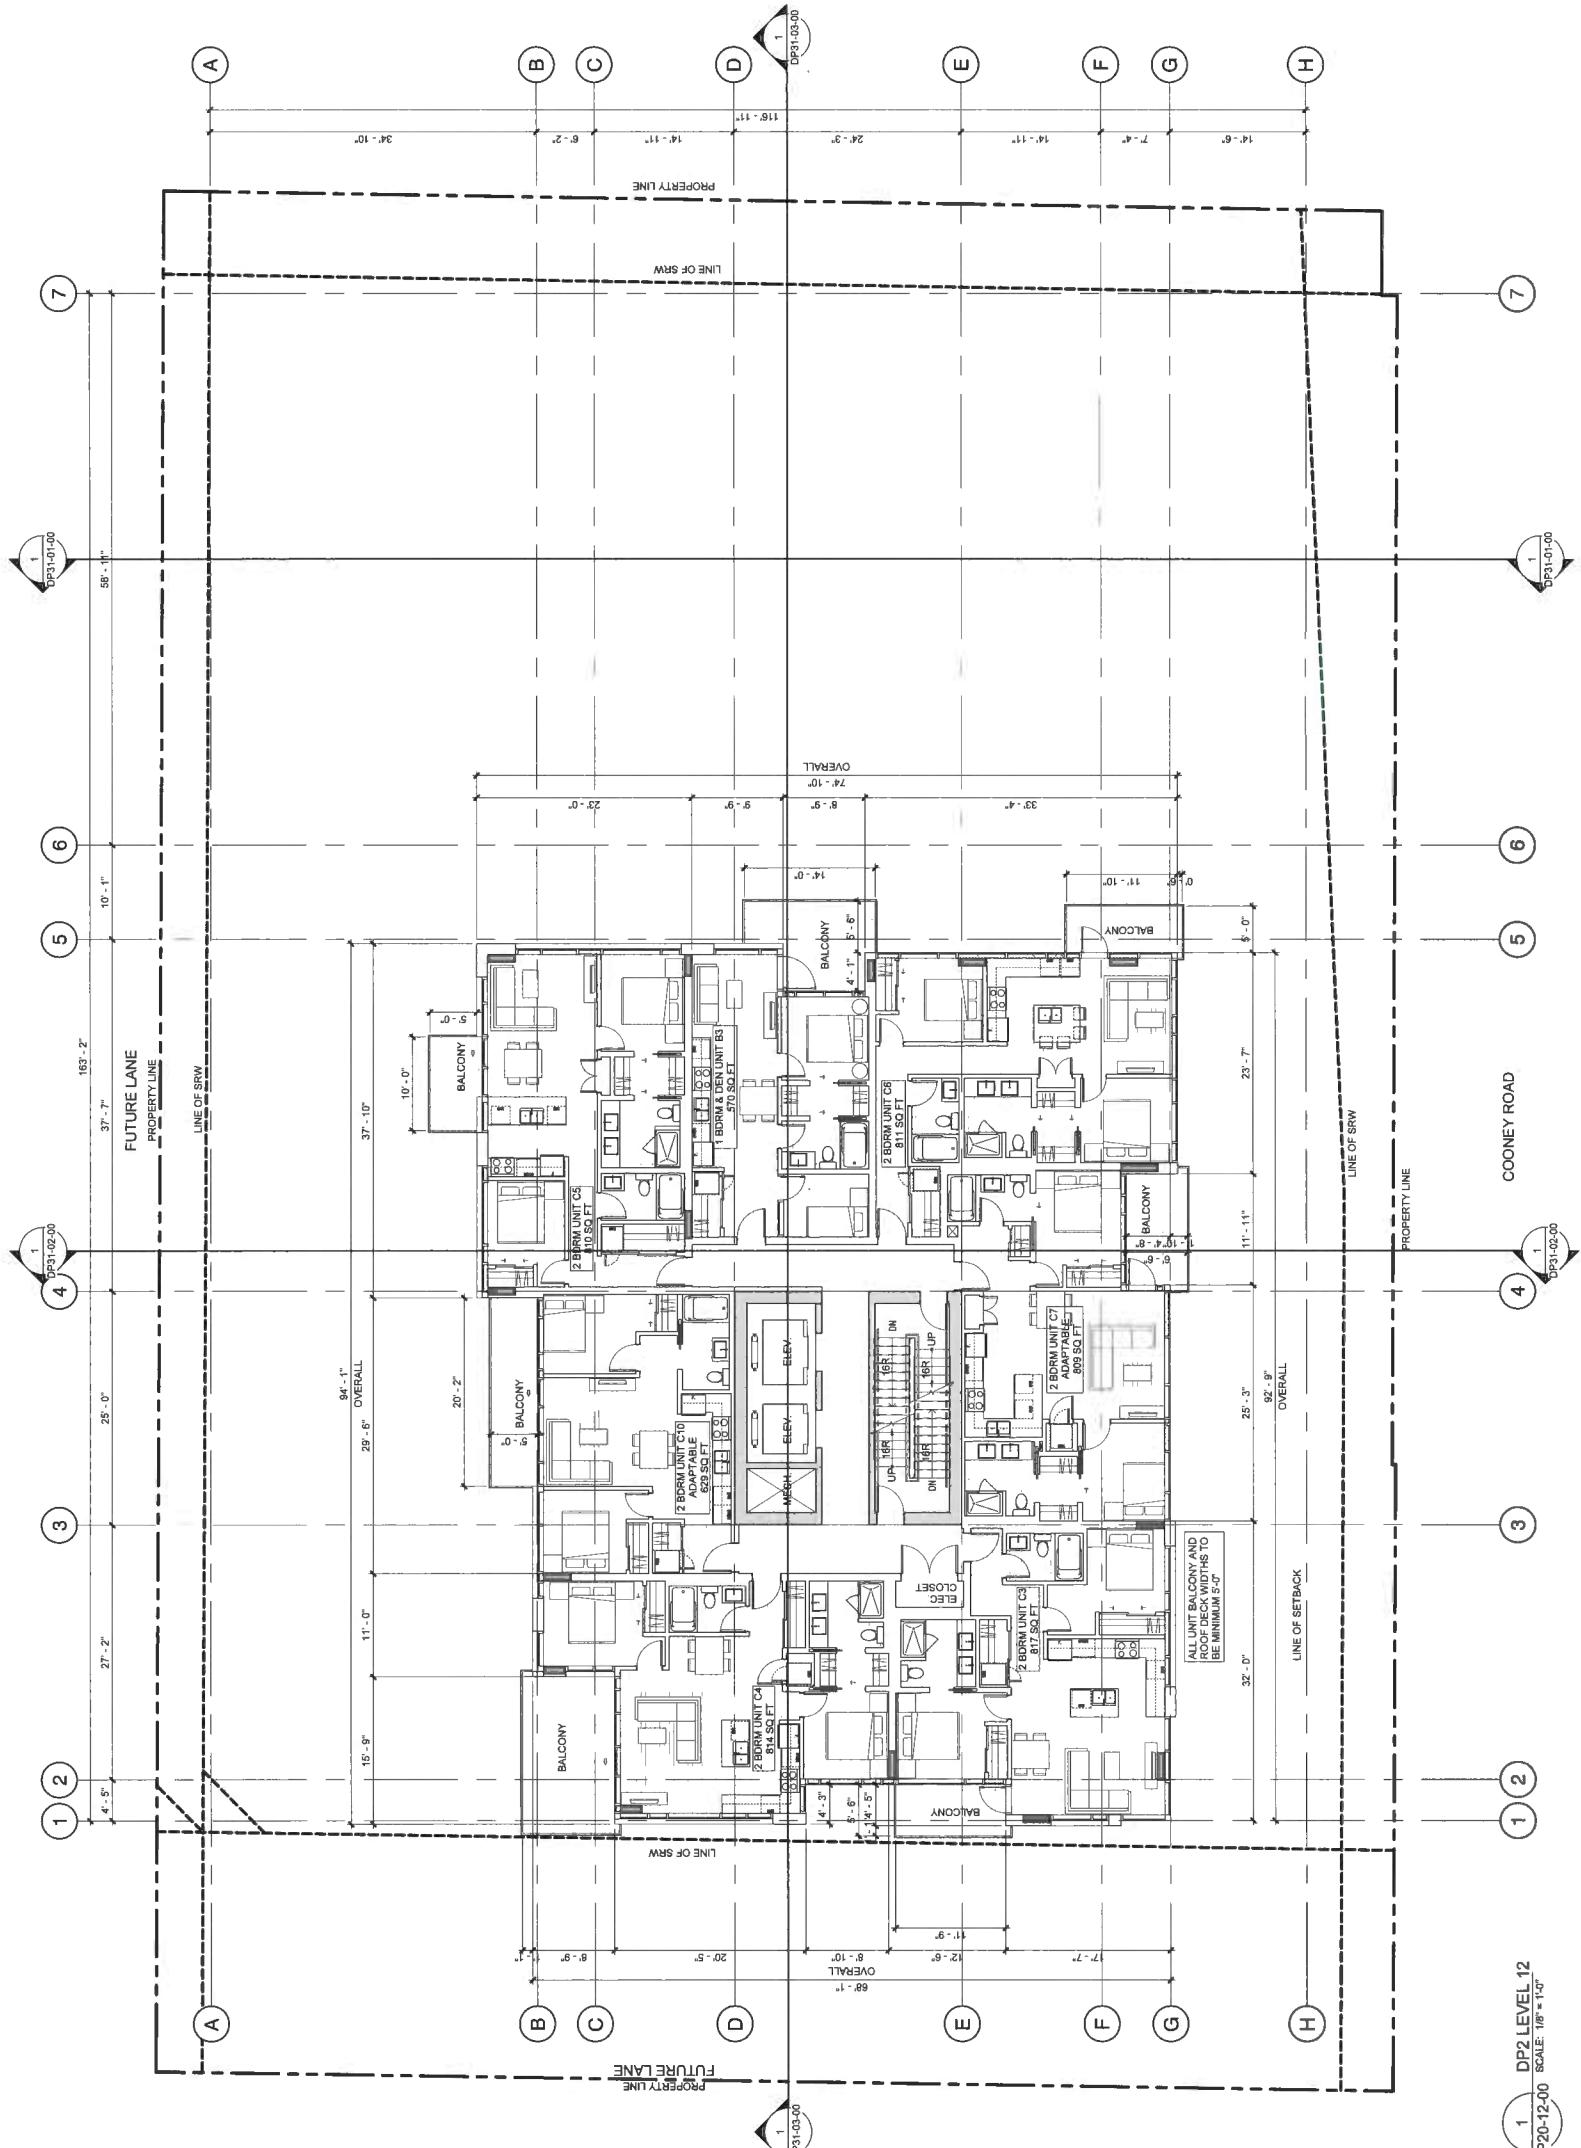



CONSULTANT INFORMATION

Client:	CONNECT LANDSCAPE ARCHITECTURE
Landscape:	SZ ANDERSON ARCHITECTURE
Architectural:	GLOTHAM-SIMPSON GROUP OF COMPANIES
Structural:	AME GROUP
Mechanical:	MEHMETZ & ASSOCIATES LTD.
Electrical:	WILHELM

NOT FOR
CONSTRUCTION


66333 COONEY ROAD
ELCHMONT, BC

A circular blue ink stamp. The outer ring contains the words "REGISTERED ARCHITECT" at the top and "LONDON" at the bottom, separated by dots. In the center, there is a handwritten signature that appears to read "J. H. Jeffs". A small five-pointed star is positioned to the right of the signature.

Plan 17

DP 17-791045
Nov 20, 2019

AB13

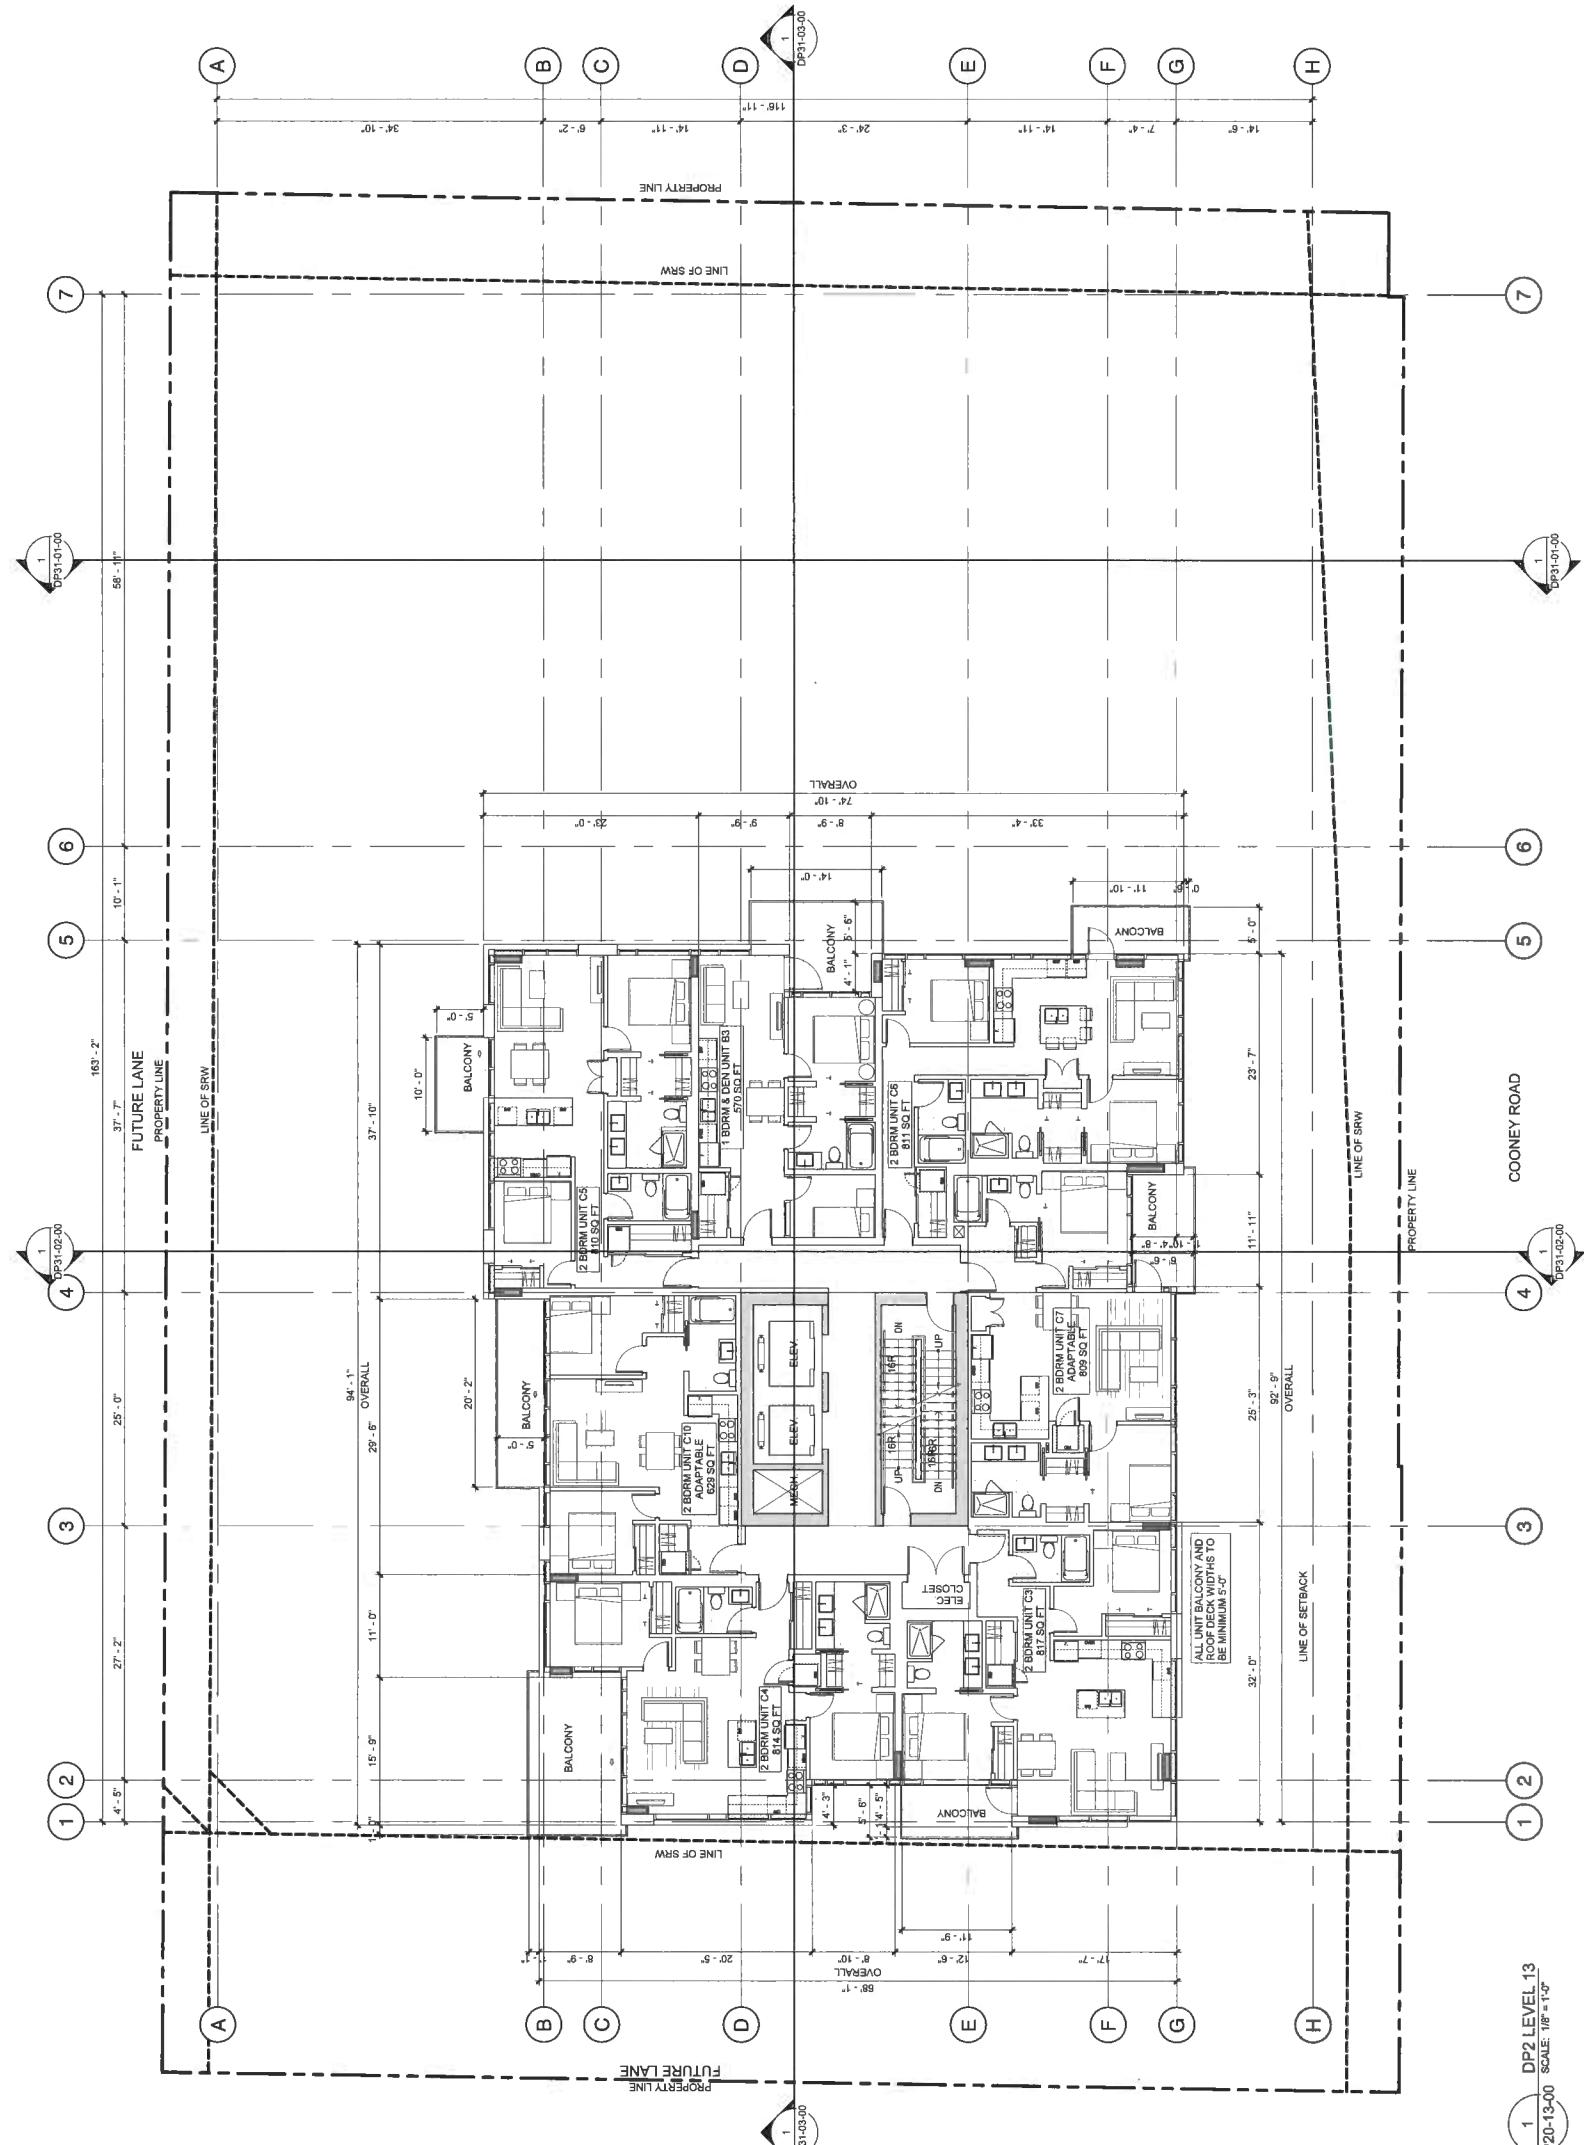



CONSULTANT INFORMATION

Civil:	Landscape: CONNECT LANDSCAPE ARCHITECTURE
Architectural:	sz ARCHITECTURE
Structural:	GUTHMAN-SAURON GROUP OF COMPANIES
Mechanical:	HASE GROUP
Electrical:	HEMETZ & ASSOCIATES LTD.
Infras:	

NOT FOR
CONSTRUCTION


66333 COONEY ROAD
RICHMOND BC

This drawing supersedes previous issues. Do not scale these drawings.

Plan 18

DP 17-791045
Nov 20, 2019

DP20-14-00

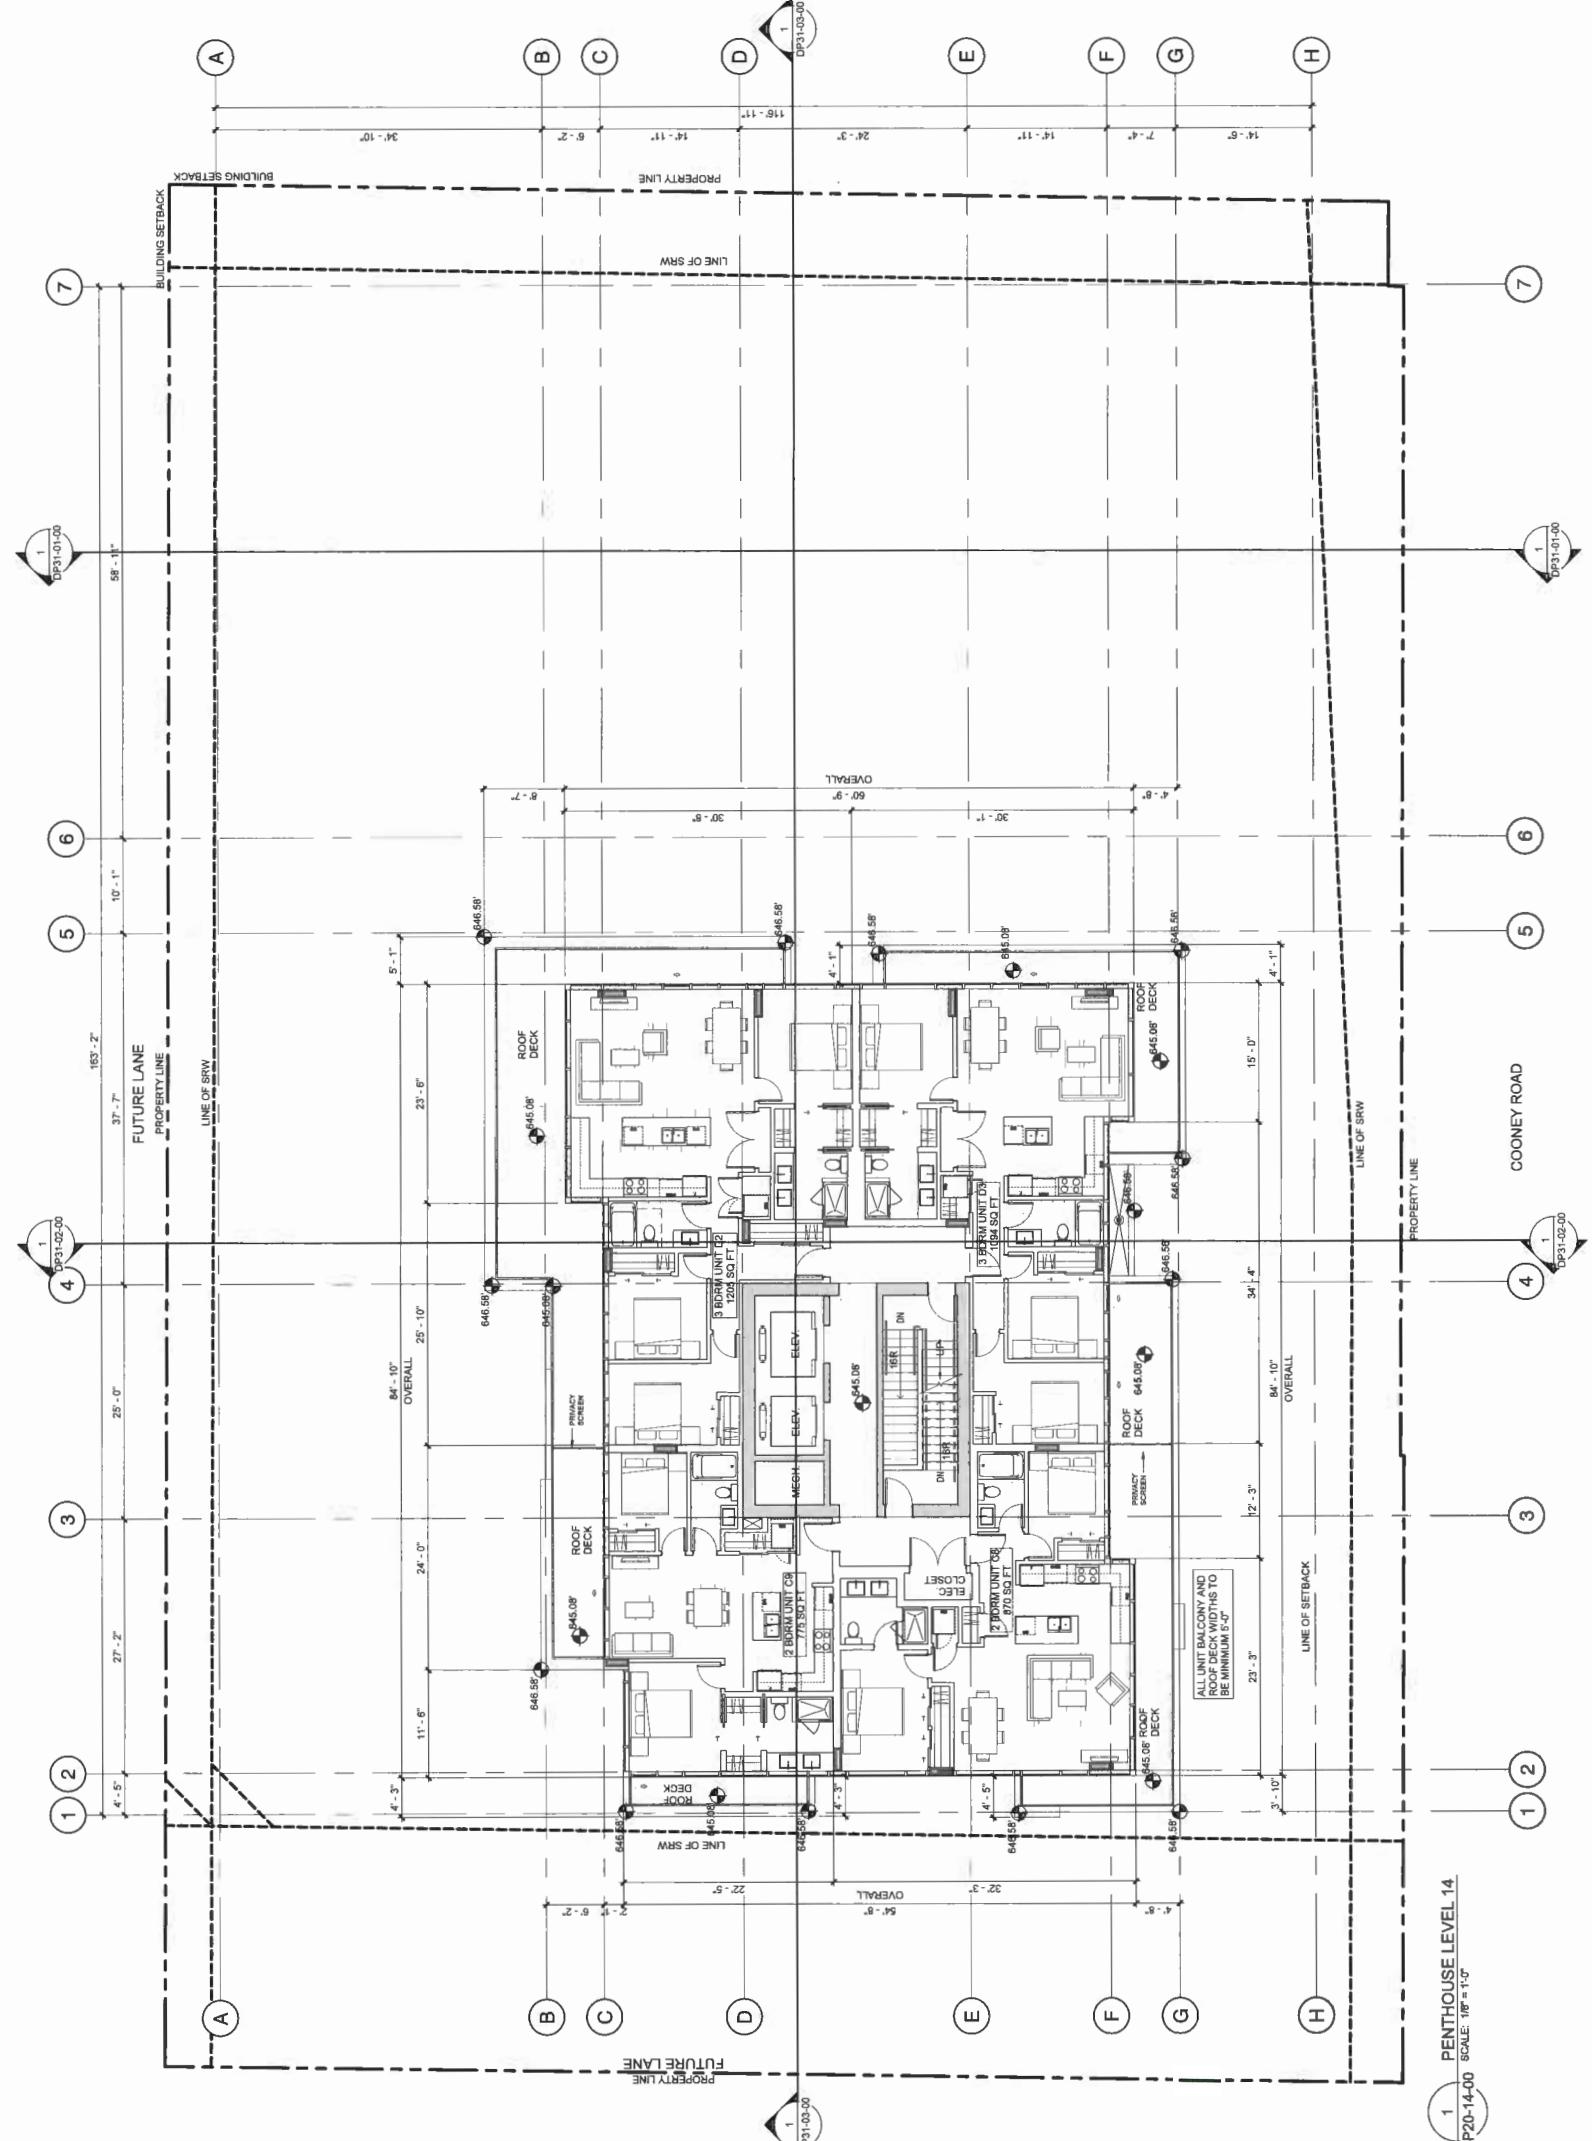

DP 17-791045

Plan 1A9

NOV 20, 2019



CONSULTANT INFORMATION

CHE
Landscape Architect
Architectural
Structural
Mechanical
Electrical
Interior

2010 Victoria Street
Victoria, BC, Canada V8T 1E5
Telephone: 250-412-1111

CH2M HILL CONSULTING GROUP LTD.
Mechanical, Electrical, Interior
KINNETZ & ASSOCIATES LTD.

**NOT FOR
CONSTRUCTION**

COONEY ROAD
TOWER


6333 COONEY ROAD
RICHMOND, BC

REGISTERED ARCHITECT
J. LANGE
BRITISH COLUMBIA

The drawings represent approximate areas. Do not scale them down. Verify dimensions, elevations and details, and report any discrepancies to the architect or engineer. This drawing is not to be used for construction purposes and is intended for reference purposes only. It is the responsibility of the user to verify all dimensions and details by calling the architect or engineer. The General Development Guidelines and Specifications are required by all. All drawings must be signed by a professional engineer. These drawings may be reproduced without the permission of the architect.

DATE: 2017-11-13
DEVELOPMENT PERMIT
APPLICATION NO.: 2016-09-26
RE-SUBMISSION
PAST APP RESPONSE
DP RESPONSE
DP RESUBMISSION
PROJECT NO.: 21971
DRAWING NO.: 21971
SCALE: 1" = 1'-0"
DATE: 11/13/2019 9:02:35 AM

DP20-15-00
DRAWING NO.: DP20-15-00
DRAFTING TITLE: ROOF PLAN

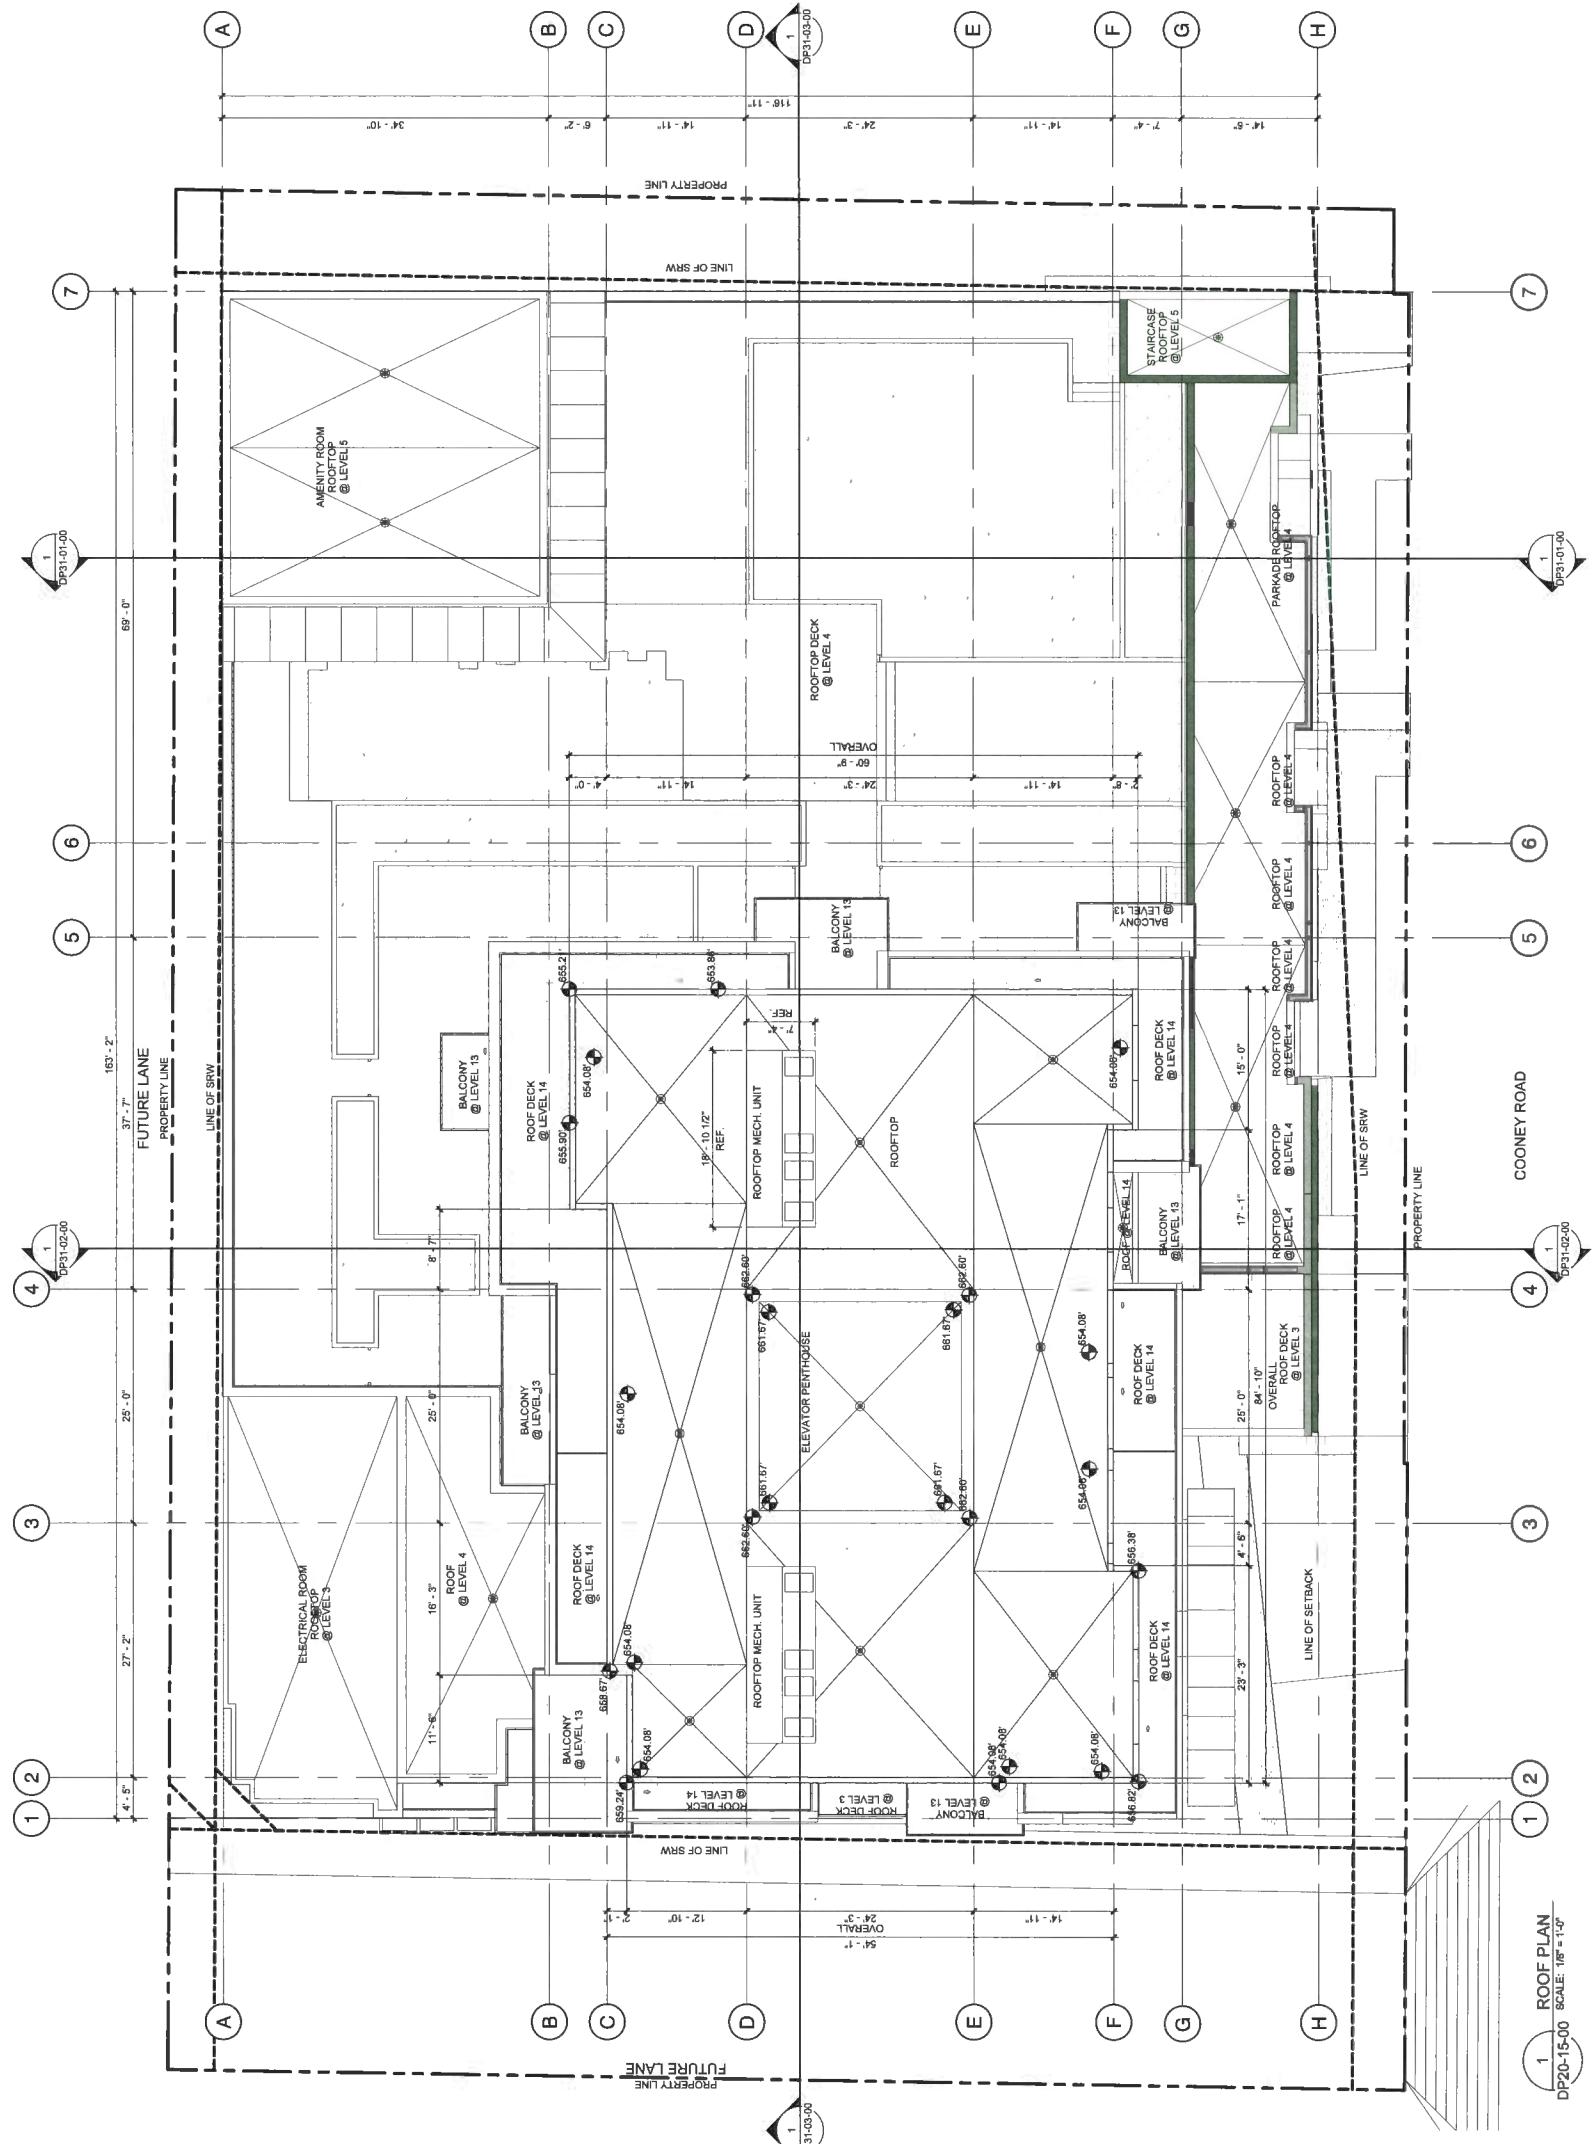



CONSULTANT INFORMATION

Civil:	Landscape: CONNECT LANDSCAPE ARCHITECTURE
Architectural:	S2 ARCHITECTURE
Structural:	GLODANSON+SIMPSON GROUP OF COMPANIES
Mechanical:	DAKIN GROUP
Electrical:	HENNETT & ASSOCIATES LTD.
Landscaping:	LANDSCAPE INC.

CONSULTANT INFORMATION

Civil:
Landscape: CONNECT LANDSCAPE ARCHITECTURE
Architecture: S2 ARCHITECTURE
Structural: GLOTMAN SAMSON GROUP OF COMPANIES LTD.
Mechanical:
Electrical: HEMET & ASSOCIATES LTD.
Environmental:

BUILDING FINISH SCHEDULE

- | BUILDING FINISH SCHEDULE | |
|--------------------------|-------------------------------------------------------------------------------------------------------|
| 1 | VISION GLASS WINDOW WALL 1 - CLEAR |
| 2 | INSULATED SPANDEL GLASS WINDOW
WALL 2 - BLACK |
| 3 | INSULATED SPANDEL GLASS WINDOW
WALL 3 - WHITE |
| 4 | INSULATED SPANDEL GLASS WINDOW
WALL 4 - GREY |
| 5 | PREFINISHED ALUMINUM MULLION 1 - BLA
ANDIZED |
| 6 | PREFINISHED ALUMINUM MULLION 2 - CLE
ANDIZED |
| 7 | GUARDRAIL - CLEAR GLAZED |
| 8 | ROOFTOP RTU SCREENING - TBD |
| 9 | LOUVRES - PREFINISHED EXTRUDED
ANODIZED ALUMINUM |
| 10 | GRILLES - PREFINISHED EXTRUDED
ANODIZED ALUMINUM |
| 11 | CEMENTITIOUS PANEL 1 - DARK GREY |
| 12 | CEMENTITIOUS PANEL 2 - GREY |
| 13 | CEMENTITIOUS PANEL 3 - WHITE |
| 14 | OVERHEAD DOOR - SECTIONAL GLAZED |
| 15 | PANTING SCREENS |
| 16 | GLASS AND STRUCTURAL STEEL CANOPY |
| 17 | PRIVACY SCREEN - OPAQUE GLAZED |
| 18 | STRUCTURAL STEEL FRAMING |
| 19 | CEMENTITIOUS PANEL 4 - ACCENT |
| 20 | CEMENTITIOUS PANEL 5 - LIGHT GREY |
| | NOTE: OPEN AND VENTED CAVITY PER
EFFECTIVE DATE, TYPICAL AT ALL PANEL EDGES
CLADDING LOCATIONS. |

NOT FOR
CONSTRUCTION

NOT FOR
CONSTRUCTION

6333 COONEY ROAD
COONEY ROAD
TOWER


6333 COONEY ROAD

A circular blue ink stamp. In the center is a five-pointed star. Around the perimeter, the words "REGISTERED ARCHITECT" are printed vertically along the left side and "BRITISH SCHOOL OF" are printed vertically along the right side. The entire stamp is surrounded by a decorative border of small blue dots.

Plan 20

DP 17-791045
NOV 20, 2019

DP30-01-00 C. Grevitt Pro

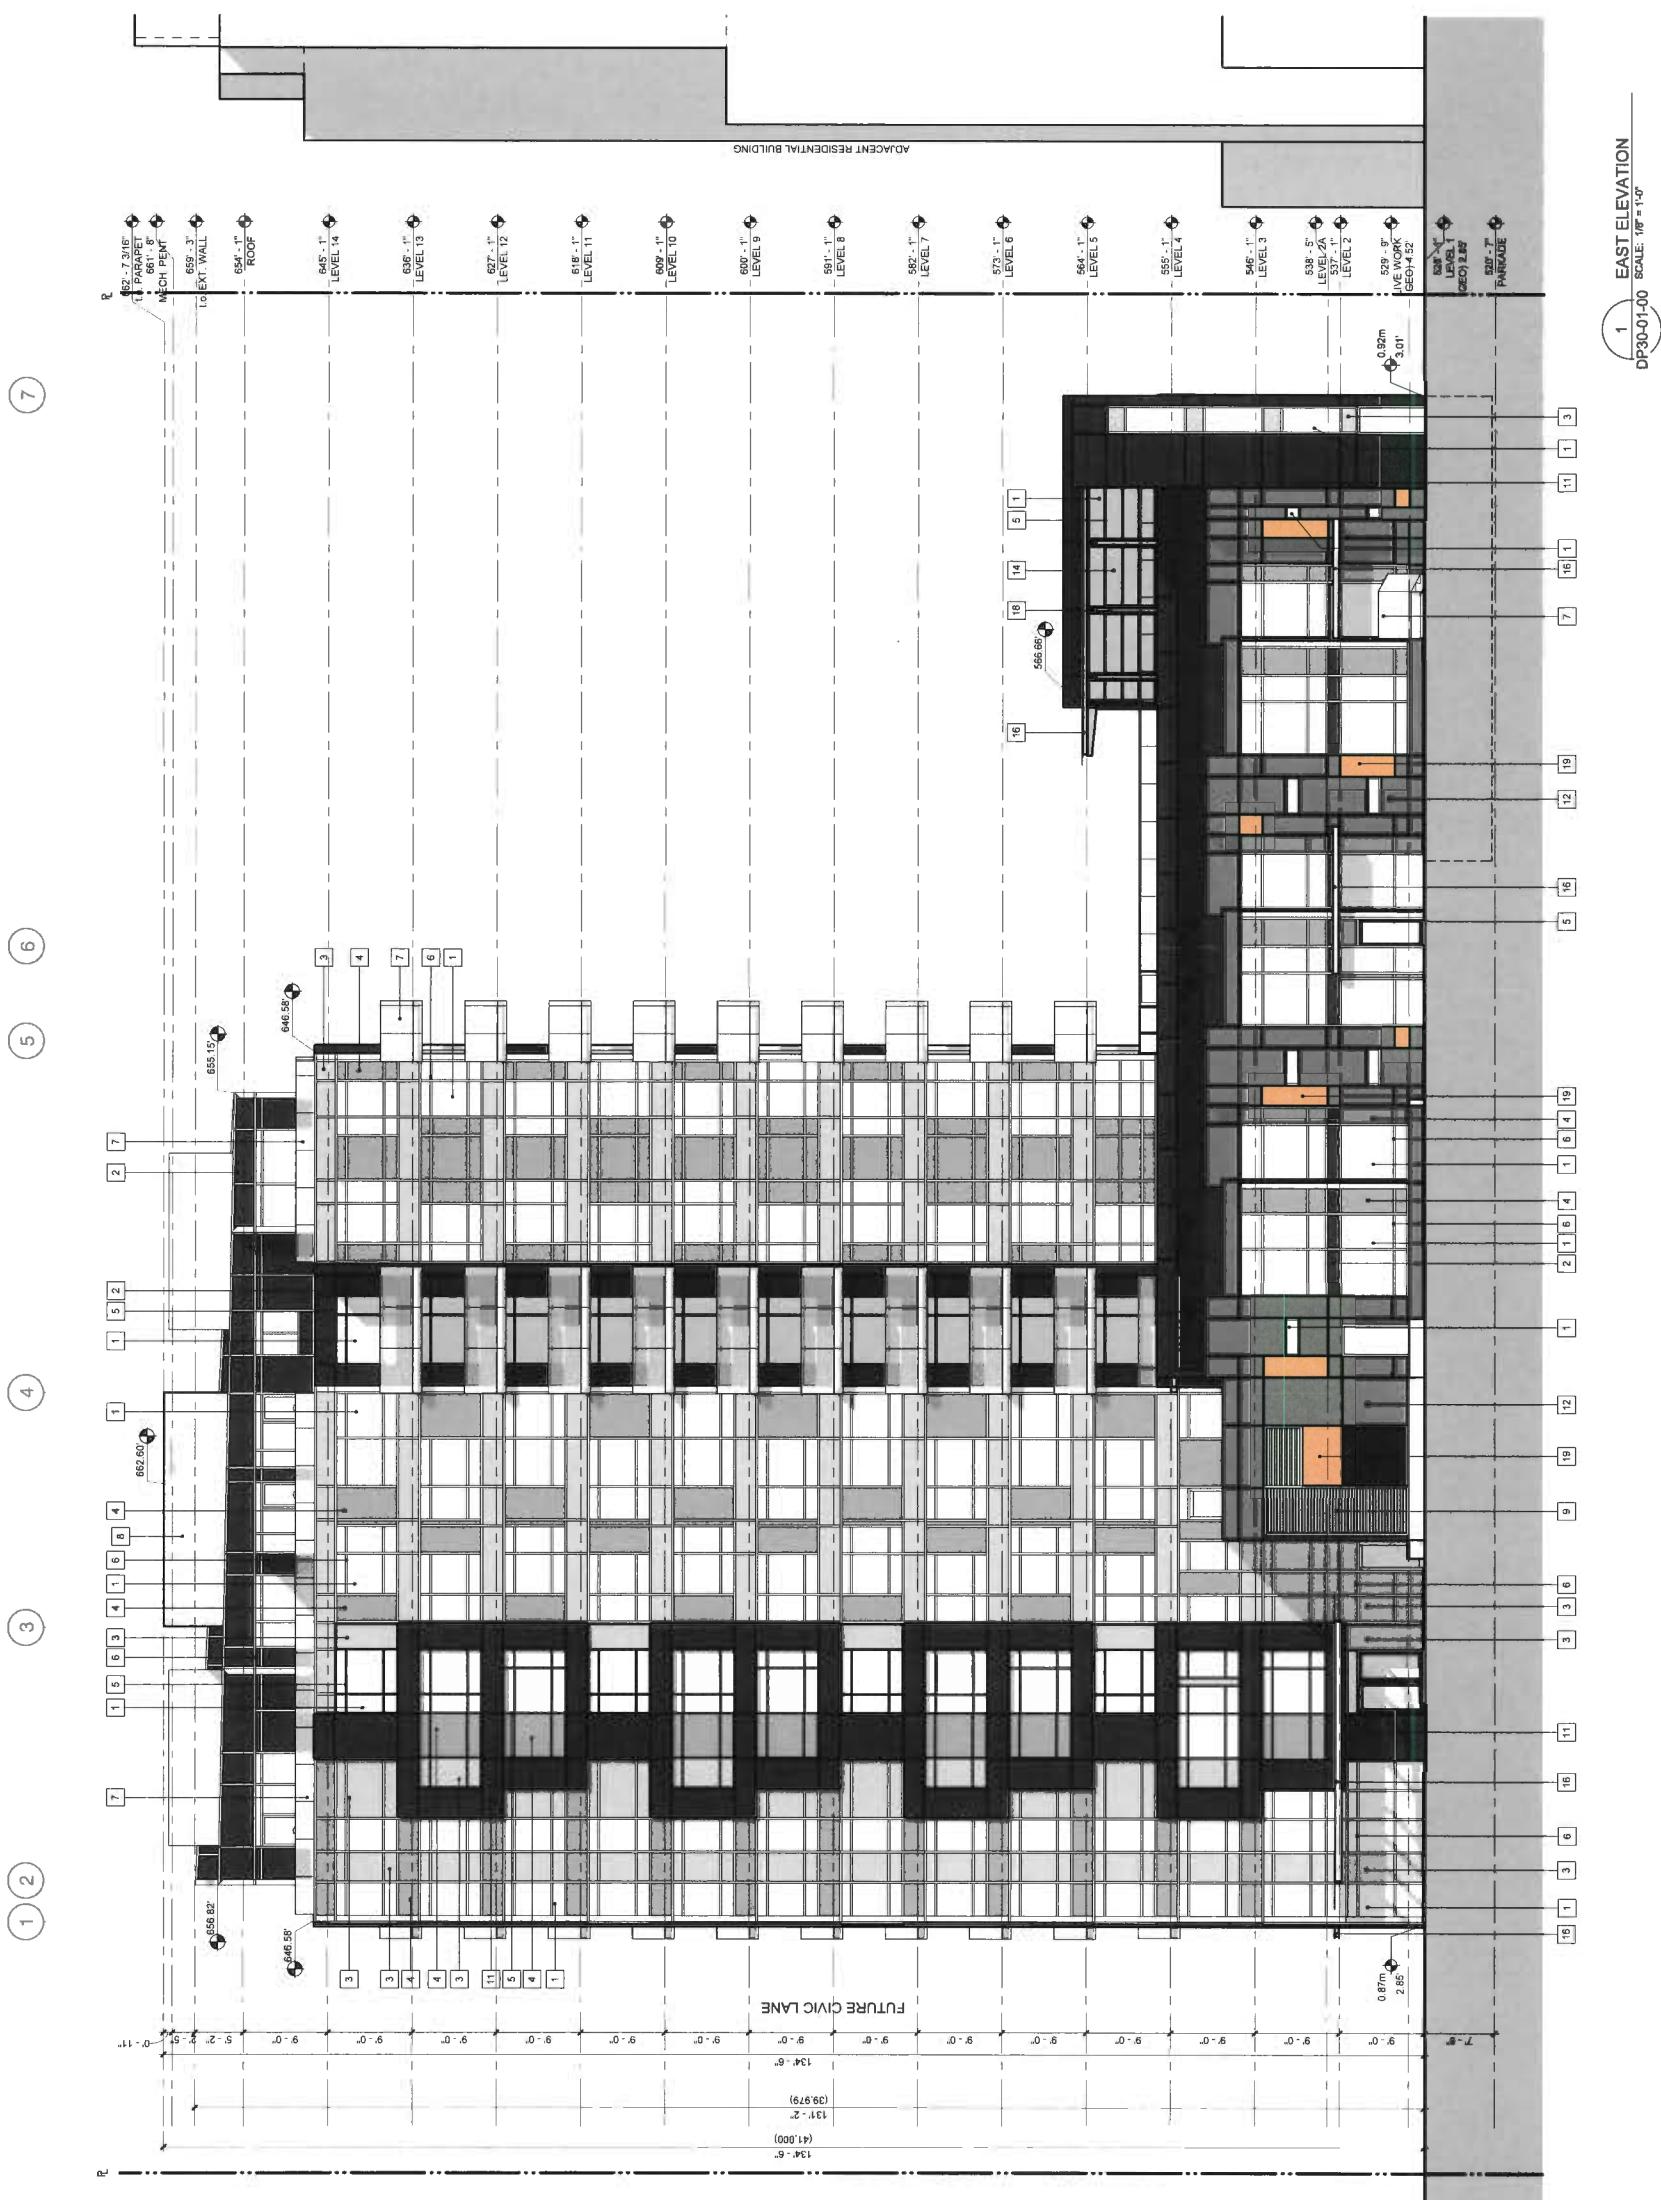



CONSULTANT INFORMATION
CHEC
CONNECT LANDSCAPE ARCHITECTURE
Landscape
Structural
Mechanical
Electrical
INTERIOR

BRUNNEN INC., Chemainus 985 139
Structural Engineers
Mechanical & Electrical Group
INTERIOR
INTERIOR

BUILDING FINISH SCHEDULE


1	VISION GLASS WINDOW/WALL 1 - CLEAR
2	INSULATED SPANDREL GLASS WINDOW WALL 2 - BLACK
3	INSULATED SPANDREL GLASS WINDOW WALL 3 - WHITE
4	INSULATED SPANDREL GLASS WINDOW WALL 4 - GREY
5	PREFINISHED ALUMINUM/MULLION 1 - BLACK ANODIZED
6	PREFINISHED ALUMINUM/MULLION 2 - CLEAR ANODIZED
7	Mech. Pent
8	ROOFTOP RIB SCREENING - TBD
9	LOUVERS - PREFINISHED EXTRUDED ANODIZED ALUMINUM
10	GRILLES - PREFINISHED EXTRUDED ANODIZED ALUMINUM
11	CEMENTITIOUS PANEL 1 - DARK GREY
12	CEMENTITIOUS PANEL 2 - GREY
13	CEMENTITIOUS PANEL 3 - WHITE
14	OVERHEAD DOOR - SECTIONAL GLAZED
15	PLANTING SCREENS
16	Glass and Structural Steel Canopy
17	Privacy Screen - OPAQUE GLAZED
18	STRUCTURAL STEEL FRAMING
19	CEMENTITIOUS PANEL 4 - ACCENT
20	CEMENTITIOUS PANEL 5 - LIGHT GREY NOTE: OPEN AIR VENTED CAVITY (PER EQUITE SPEC) TYPICAL AT ALL PANEL EDGE CLADDING LOCATIONS

NOT FOR
CONSTRUCTION

PROJECT INFORMATION


COONEY ROAD
TOWER
RICHMOND, BC
6333 COONEY ROAD

6333 COONEY ROAD

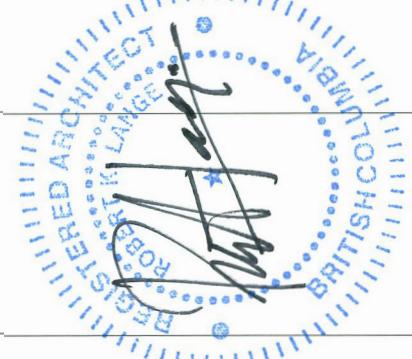

Plan 21

DP 17-791045 Nov 20, 2019

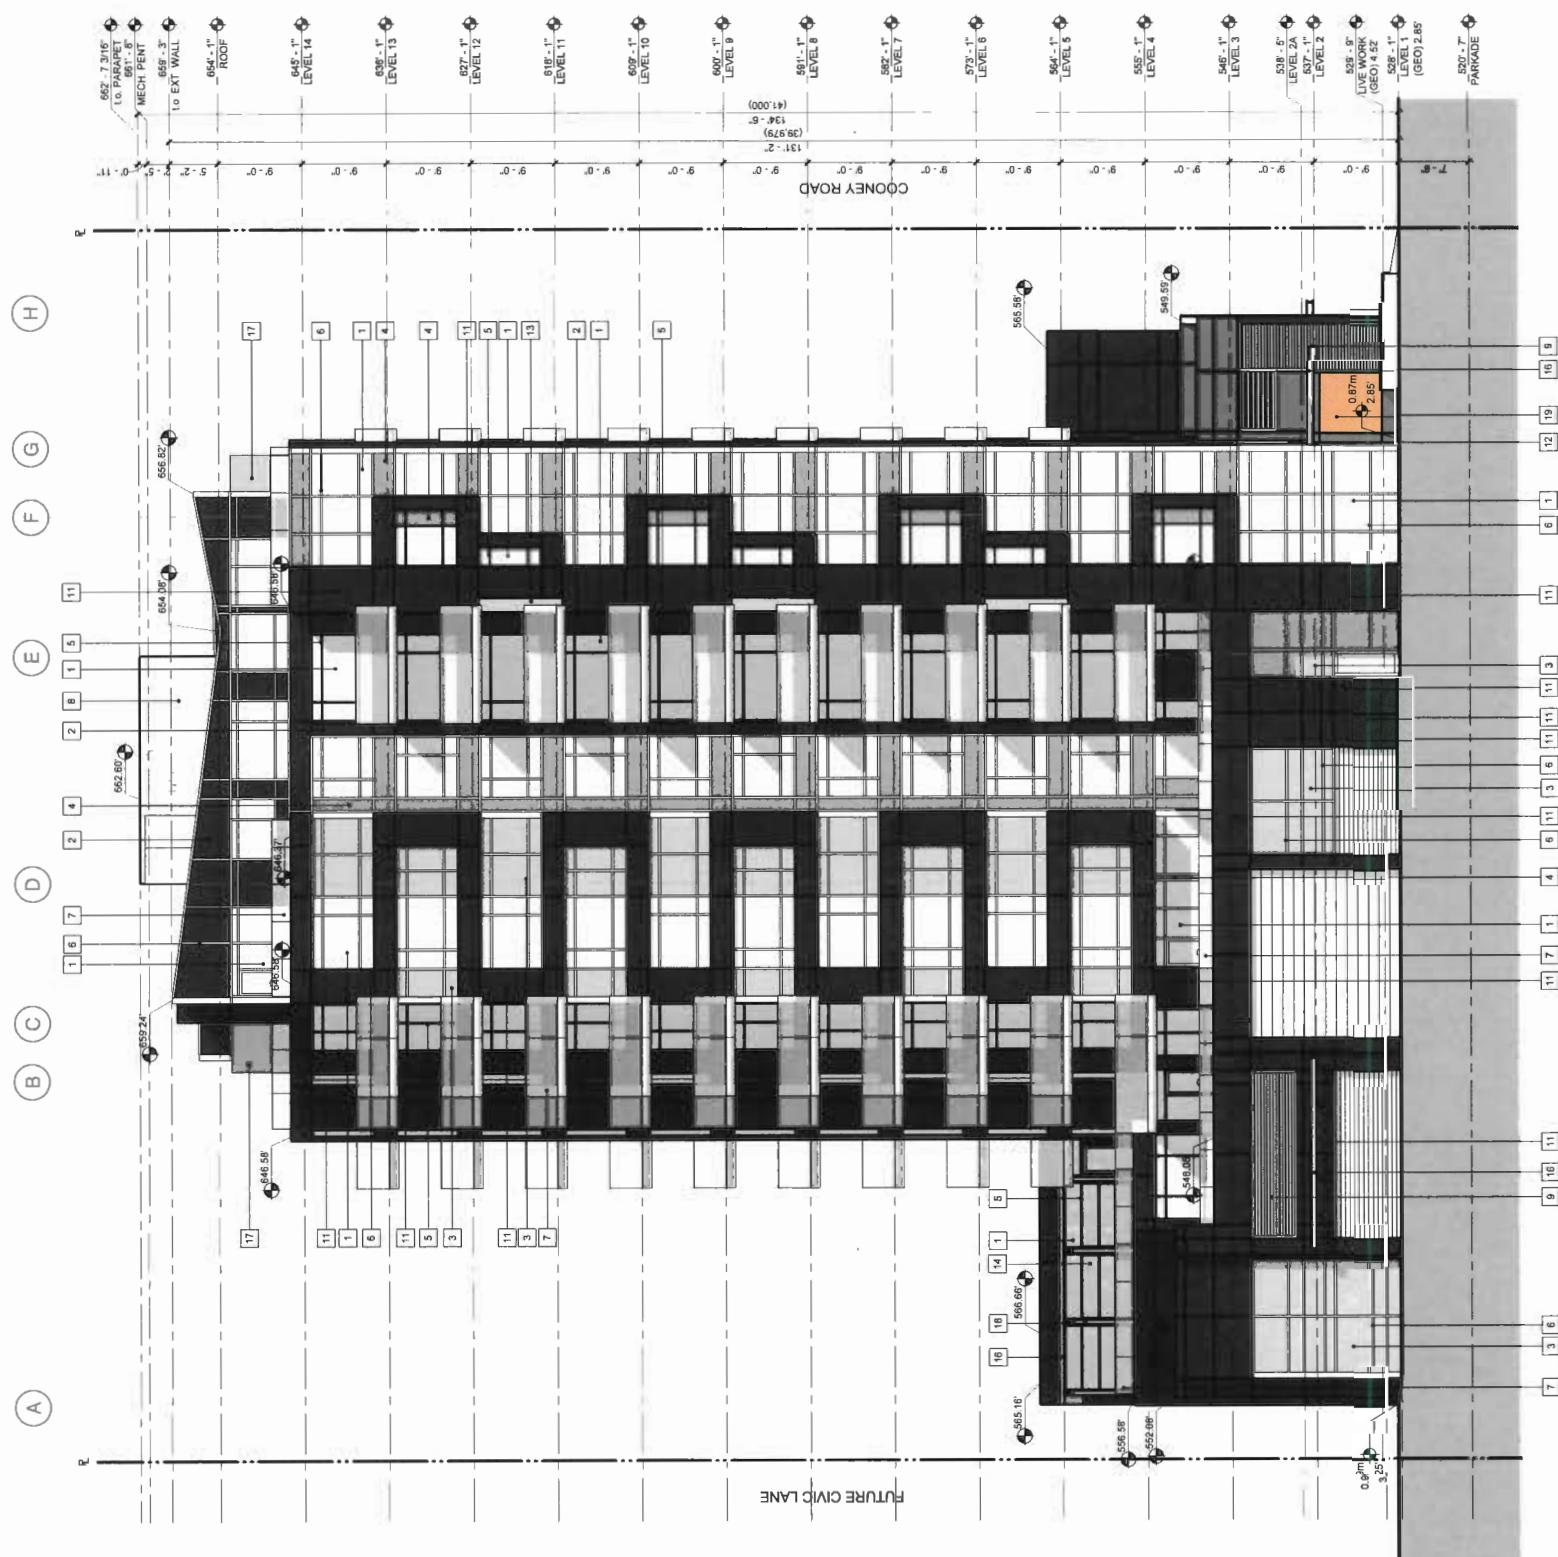

ISSUED
DATE
2011-11-23
APPLICATION
2011-09-28
RE-SUBMISSION
2011-05-16
POST APP RESPONSE
2011-10-31
DP RESUBMISSION
2011-11-08

SCALE
As indicated
DATE
11/11/2019 4:53:01 PM
DRAWN BY
JH
CHECKED BY
SH
PROJECT NO.
Z19771

DRAWING NO.
DP30-02-00
DRAFTER
SOUTH

1 SOUTH ELEVATION
DP30-02-00 SCALE: 1'-0"

DP30-02-00



Architecte
130 W Cordova Street
Vancouver, BC, V6B 5E6
604.681.3404
www.vancity.com

CONSULTANT INFORMATION

Chl. Landscape: CONNECT LANDSCAPE ARCHITECTURE
 Architect: R2 ARCHITECTURE
 Structural: GLUTMAN-SUPERNON GROUP OF COMPANIES
 AAE Group:
 Mechanical: JI
 Electrical: NEIMETT & ASSOCIATES LTD.
 Telephones: 416-241-1100

וְעַל־עֲדָמָה זֶבַח־יְהוָה

Architect: CONNECT LANDSCAPE ARCHITECTURE
Architect: SZ ARCHITECTURE
Architect: GLOTHMAN-SIMPSON GROUP OF COMPANIES
Architect: AME GROUP
Architect: NSMETZ & ASSOCIATES LTD.

NOT FOR
CONSTRUCTION

COONEY ROAD
TOWER

6333 COONEY ROAD
RICHMOND, BC

Plan 23

DP 17-791045 Nov 20, 2019



Architecture
W. Caudron & Sons
115
1980
www.caudron.com

CONSULTANT INFORMATION

CHE: Landscape: CONNECT LANDSCAPE ARCHITECTURE
Architecture: SZ ARCHITECTURE
Structure: GLUTMAN SIMPSON GROUP OF COMPANIES
Mechanical: HARRIS & ASSOCIATES LTD.
Electrical: ENGENIERS LTD.

www.harrisassociates.com

NOT FOR
CONSTRUCTION

LEADERSHIP


COONEY ROAD
TOWER

333 COONEY ROAD
RICHMOND BC

A handwritten signature "Frederick Lupton" is written over a circular blue ink stamp. The stamp contains the text "FREDERICK LUPTON ARCHITECT" around the top edge and "BRITISH COMMONWEALTH" around the bottom edge, separated by a decorative dotted border.

Plan 25

DP 17-191043
NOV 20, 2019

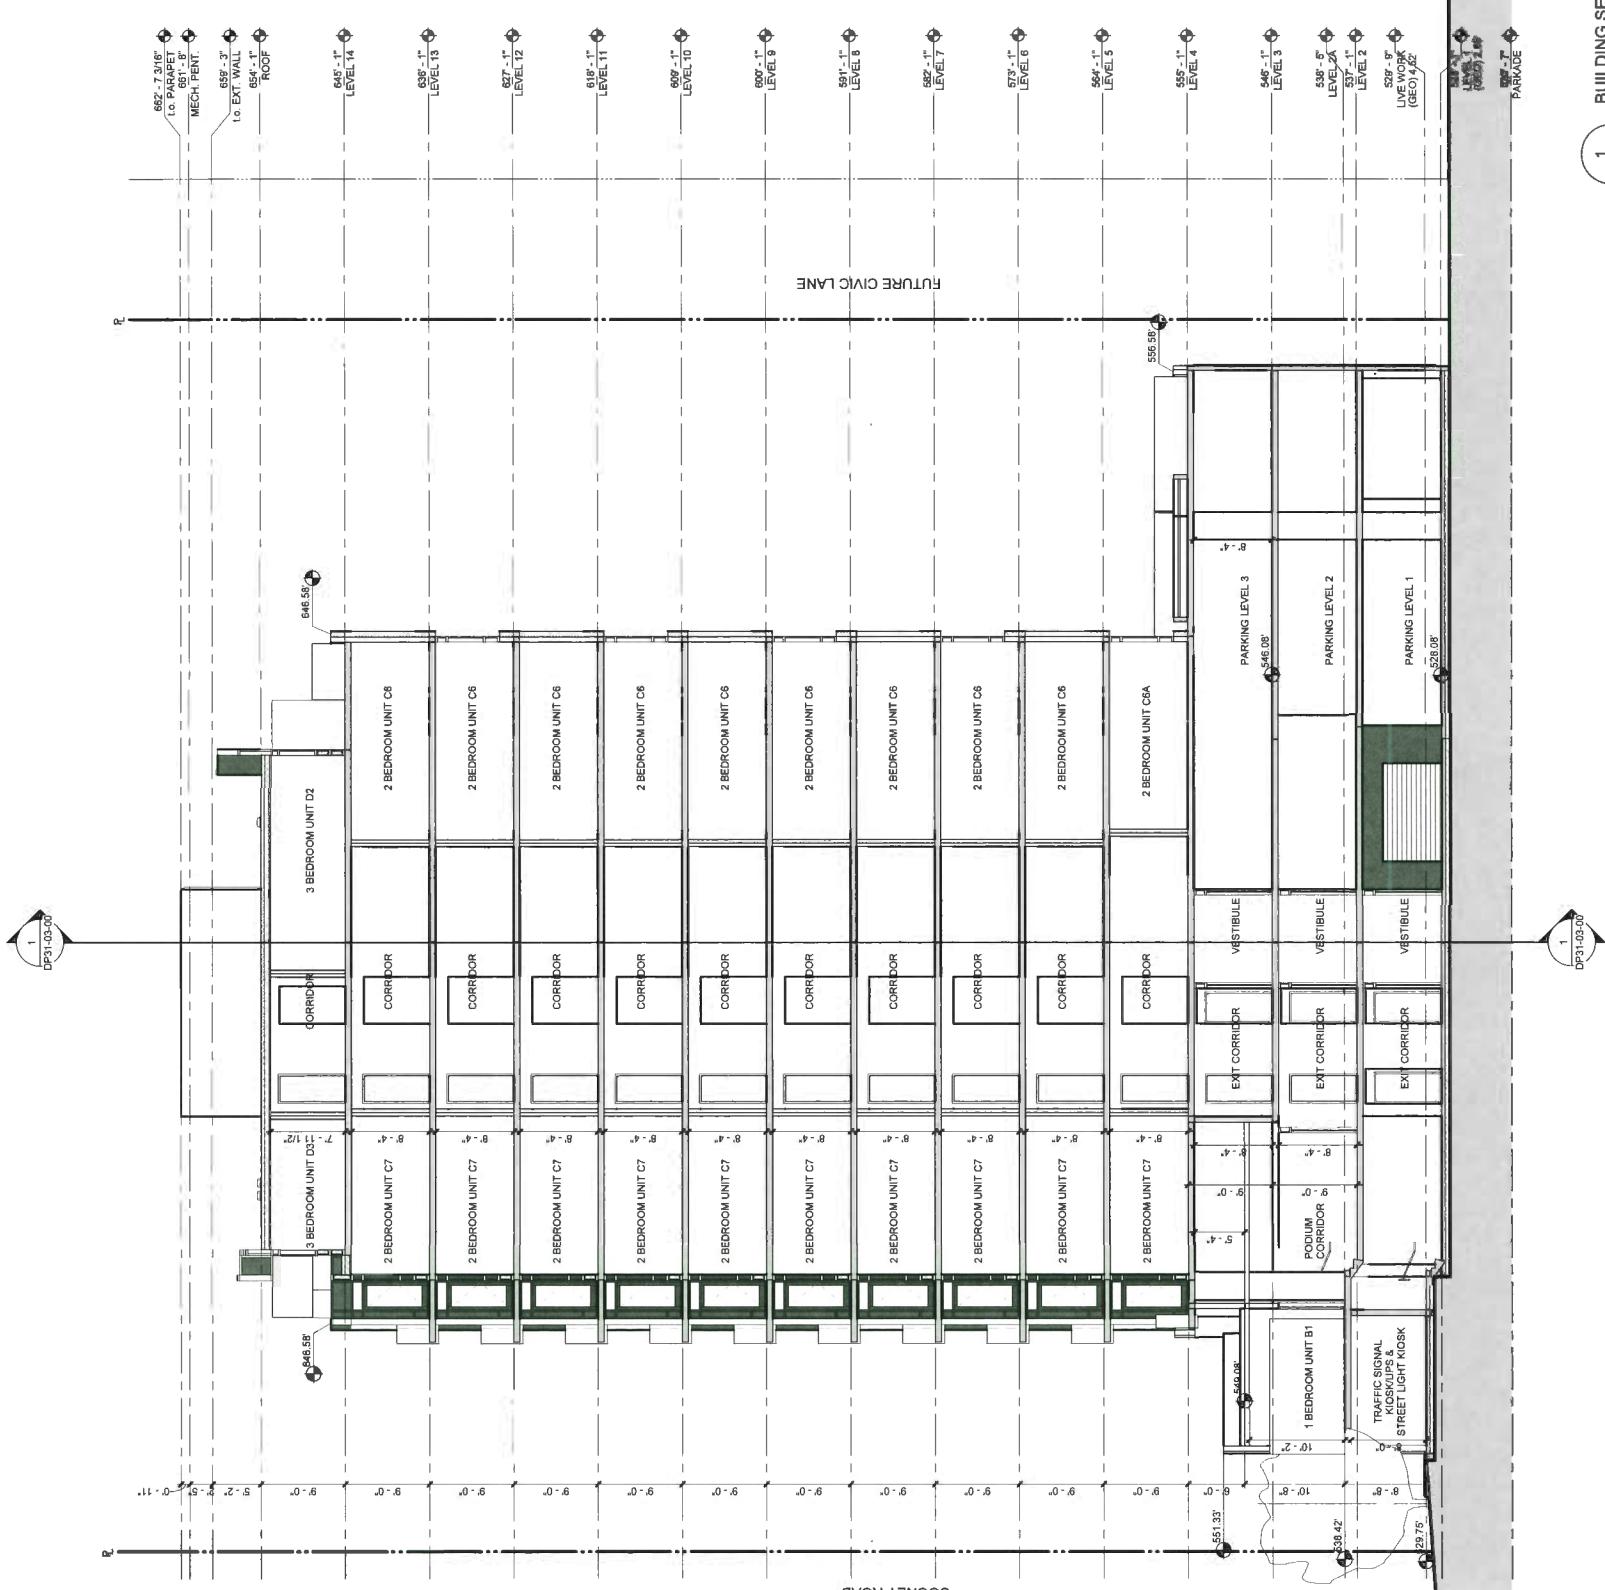



architecture
307 30th Street NW
Washington, DC 20007-1115
Telephone 202/347-1000

CONSULTANT INFORMATION

CHE:	CONNECT LANDSCAPE ARCHITECTURE
Landscape:	S2 ARCHITECTURE
Architectural:	GOTHAM-SEPPEN GROUP OF COMPANIES
Structural:	AME GROUP
Mechanical:	AME77 & ASSOCIATES LTD.
Electrical:	AME77

CONSULTANT INFORMATION

Chf.: CONNECT LANDSCAPE ARCHITECTURE
 Landscape: CONNECT LANDSCAPE ARCHITECTURE
 Architecture: SZ ARCHITECTURE
 Glotman-Simpson Group of Companies
 Structural: AME GROUP
 Mechanical: Nemeth & Associates Ltd.
 Electrical: Lengenbach

NOT FOR
CONSTRUCTION

PROJECT INFORMATION

COONEY ROAD
TOWER

6333 COONEY ROAD
BICHMOND BC

Plan 26

DP 17-791045 NOV 20, 2019

REV B Project
DP31-03-00

1 BUILDING SECTION - EAST
DP31-03-00 SCALE: 1/8" = 1'-0"

DP31-02-00
1

COONEY ROAD TOWER

6333 COONEY ROAD, RICHMOND, BRITISH COLUMBIA

RE-ISSUED FOR CITY COMMENTS

LANDSCAPE DRAWING INDEX

SHEET No.	SHEET NAME
L0.0	COVER SHEET & DRAWING LIST
L1.0	LANDSCAPE PLAN GROUND LEVEL
L1.1	LANDSCAPE PLAN FOURTH LEVEL
L1.2	LANDSCAPE PLAN ROOF LEVEL
L1.3	PRECEDENTS AND MATERIALS
L1.4	LANDSCAPE PERMEABILITY
L1.5	LANDSCAPE OPEN SPACE
L2.0	PLANT LIST AND PLANT MATERIALS
L2.1	GROUND LEVEL PLANTING PLAN
L2.2	FOURTH LEVEL PLANTING PLAN
L2.3	ROOF LEVEL PLANTING PLAN
L3.0	DETAILS - SOFTSCAPE
L3.1	DETAILS - HARDCAPE
L3.2	DETAILS - FURNISHINGS
L3.2	DETAILS - PLAY AREA

GENERAL NOTES

ALL LANDSCAPE ARCHITECTURAL DRAWINGS IN THIS PACKAGE SHALL BE READ IN CONJUNCTION WITH ALL OTHER DRAWINGS, DETAILS, SPECIFICATIONS, AND/OR OTHER CORRESPONDANCE THAT MAY BE ISSUED DURING THE COURSE OF THE CONTRACT.

IF A DISCREPANCY OCCURS BETWEEN THE DRAWINGS AND THE SPECIFICATIONS OR ANY OTHER DOCUMENT ASSOCIATED WITH THE PROJECT, THE CONFLICT SHALL BE REPORTED IN WRITING TO THE OWNER OR OWNERS REPRESENTATIVE TO OBTAIN CLARIFICATION AND APPROVAL BEFORE PROCEEDING WITH WORKS.

ALL EXISTING INFORMATION IS BASED ON AVAILABLE RECORDS AND SHALL NOT BE CONSTRUED TO BE COMPLETE OR ACCURATE. THE CONTRACTOR SHALL VISIT THE SITE TO VERIFY THE TRUE EXISTING CONDITIONS. ANY UNCLEAR ISSUES SHALL BE CLARIFIED WITH THE OWNER OR OWNERS REPRESENTATIVE. NO CLAIM SHALL BE ALLOWED FOR EXTRAS WHICH MAY ARISE THROUGH NEGLECT OF THIS ADVICE.

THE CONTRACTOR IS RESPONSIBLE FOR DETERMINING THE EXISTENCE, LOCATION, AND ELEVATION OF ALL UTILITIES AND CONCEALED STRUCTURES, AND IS RESPONSIBLE FOR NOTIFYING THE APPROPRIATE COMPANY, DEPARTMENT OR PERSON(S) OF ITS INTENTION TO CARRY OUT ITS OPERATIONS.

LAYOUT OF HARDCAPE, SITE FURNITURE, GROWING MEDIA, TREES, PLANTING, AND ALL OTHER MATERIALS IS TO BE STAKED OUT AND APPROVED BY OWNER OR OWNERS REPRESENTATIVE.

ALL PLANTING SHALL BE IN ACCORDANCE WITH THE CANADIAN LANDSCAPE STANDARD, LATEST EDITION.



DP 17-791045	Nov 20, 2019
Plan 27	
7 RE-ISSUED FOR CITY COMMENTS 19-11-06	
6 RE-ISSUED FOR DP APPLICATION 19-10-31	
5 ISSUED FOR PRIOR TO RESPONSE	
4 RE-ISSUED FOR DP APPLICATION	
3 RE-ISSUED FOR DP APPLICATION	
2 ISSUED FOR DP APPLICATION	
1 ISSUED FOR CLIENT REVIEW	
REVISIONS	

COONEY ROAD TOWER
6333 Cooney Road
Richmond, British Columbia
Scale: 1:200
Drawn: VGDS
Reviewed: DS
Project No. 06-561

COVER SHEET &
DRAWING LIST

LO.0

CONNECT LANDSCAPE ARCHITECTURE INC. DOES
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AND ELEVATION OF UTILITIES AND / OR
CONCEALED STRUCTURES AT THE PROJECT SITE.
THE CONTRACTOR IS RESPONSIBLE FOR
DETERMINING THE EXISTENCE, LOCATION, AND
ELEVATION OF ALL UTILITIES AND / OR
CONCEALED STRUCTURES, AND IS RESPONSIBLE
FOR NOTIFYING THE APPROPRIATE COMPANY,
DEPARTMENT OR PERSON(S) OF ITS INTENTION
TO CARRY OUT ITS OPERATIONS.

DP 17-791045
NOV 20, 2019
Plan 28

7 RE-ISSUED FOR CITY COMMENTS 19-11-06
6 RE-ISSUED FOR DP APPLICATION 19-10-31
5 ISSUED FOR PRIOR TO RESPON
4 RE-ISSUED FOR DP APPLICAT
3 RE-ISSUED FOR DP APPLICAT
2 ISSUED FOR DP APPLICATION
1 ISSUED FOR CLIENT REVIEW
REVISIONS

COONEY ROAD TOWER
6333 Cooney Road
Richmond, British Columbia
Scale: 1:100
Drawn: DS
Reviewed: DS
Project No. 06-581

LANDSCAPE PLAN
GROUND LEVEL

L1.0



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AND ELEVATION OF UTILITIES AND/OR
CONCEALED STRUCTURES AT THE PROJECT SITE.
THE CONTRACTOR IS RESPONSIBLE FOR
DETERMINING THE EXISTENCE, LOCATION, AND
ELEVATION OF ALL UTILITIES AND/OR
CONCEALED STRUCTURES, AND IS RESPONSIBLE
FOR NOTIFYING THE APPROPRIATE COMPANY,
DEPARTMENT OR PERSON(S) OF ITS INTENTION
TO CARRY OUT ITS OPERATIONS.

DP 17-791045 Plan 29
NOV 20, 2019

- 7 RE-ISSUED FOR CITY COMMENTS 19-11-06
6 RE-ISSUED FOR DP APPLICATION 19-10-31
5 ISSUED FOR PRIOR TO RESPONSE
4 RE-ISSUED FOR DP APPLICATION
3 RE-ISSUED FOR DP APPLICATION
2 ISSUED FOR DP APPLICATION
1 ISSUED FOR CLIENT REVIEW
REVISIONS

COONEY ROAD TOWER

6333 Cooney Road
Richmond, British Columbia

Scale: 1:100
Drawn: DS
Reviewed: DS
Project No. 06-581

LANDSCAPE PLAN
LEVEL 4

L1.1



CONNECT LANDSCAPE ARCHITECTURE INC. DOES NOT GUARANTEE THE EXISTENCE, LOCATION, AND ELEVATION OF UTILITIES AND / OR CONCEALED STRUCTURES AT THE PROJECT SITE.

THE CONTRACTOR IS RESPONSIBLE FOR DETERMINING THE EXISTENCE, LOCATION, AND ELEVATION OF ALL UTILITIES AND, OR CONCEALED STRUCTURES, AND IS RESPONSIBLE FOR NOTIFYING THE APPROPRIATE COMPANY, DEPARTMENT OR PERSON(S) OF ITS INTENTION TO CARRY OUT ITS OPERATIONS.

DP 17-791045 Plan 30 Nov 20, 2019

COONEY ROAD TOWER

6333 Cooney Road
Richmond, British Columbia

Drawn: _____ DS
Reviewed: _____ DS
Project No. _____ 06-581

LANDSCAPE PLAN
ROOF LEVEL

1

20 m

1

1

1

1

COONEY ROAD

LANDSCAPE INFLUENCES AND CONTEXT



"COURTYARD" SPACE VISIBLE FROM AMENITY ROOM



CONNECTED AMENITY ZONES



ANGLED LINES TO MATCH BUILDING GEOMETRY AND OVERLAPPING PAVING PATTERNS

LANDSCAPE FEATURES AND MATERIALS



STEPPING UP TO RAISED LAWN



TIMBER AND CONCRETE DETAILS



NATURAL 'STANDARD' PAVING



NATURAL LOOK PLAY STRUCTURES



SMALL BEACH PEBBLE



SAWCUT CONCRETE



NATURAL 'STANDARD' PAVING



CHARCOAL PATIO SLAB PAVING



CHARCOAL PATIO SLAB PRIVATE PATIOS

CONNECT LANDSCAPE ARCHITECTURE INC. DOES NOT GUARANTEE THE EXISTENCE, LOCATION, AND ELEVATION OF UTILITIES AND / OR CONCEALED STRUCTURES AT THE PROJECT SITE.
THE CONTRACTOR IS RESPONSIBLE FOR DETERMINING THE EXISTENCE, LOCATION, AND ELEVATION OF ALL UTILITIES AND / OR CONCEALED STRUCTURES, AND IS RESPONSIBLE FOR NOTIFYING THE APPROPRIATE COMPANY, DEPARTMENT OR PERSON(S) OF ITS INTENTION TO CARRY OUT ITS OPERATIONS.

DP 17-791045
Nov 20, 2019
Plan 31

7 RE-ISSUED FOR CITY COMMENTS	19-11-06
6 RE-ISSUED FOR DP APPLICATION	19-10-31
5 ISSUED FOR PRIOR TO RESPONSIBILITY	
4 RE-ISSUED FOR DP APPLICATION	
3 RE-ISSUED FOR DP APPLICATION	
2 ISSUED FOR DP APPLICATION	
1 ISSUED FOR CLIENT REVIEW	
REVISIONS	

COONEY ROAD TOWER
633 Cooney Road
Richmond, British Columbia
Scale: N/A
Drawn: DS
Reviewed: DS
Project No. 06-581

PRECEDENTS AND MATERIALS

CONNECT LANDSCAPE ARCHITECTURE, INC. DOES NOT GUARANTEE THE EXISTENCE, LOCATION, AND ELEVATION OF UTILITIES AND / OR CONCEALED STRUCTURES AT THE PROJECT SITE.
THE CONTRACTOR IS RESPONSIBLE FOR DETERMINING THE EXISTENCE, LOCATION, AND ELEVATION OF ALL UTILITIES AND / OR CONCEALED STRUCTURES, AND IS RESPONSIBLE FOR NOTIFYING THE APPROPRIATE COMPANY, DEPARTMENT OR PERSON(S) OF ITS INTENTION TO CARRY OUT ITS OPERATIONS.

NOV 20, 2019
DP 17-791045
Plan 31

7 RE-ISSUED FOR CITY COMMENTS 19-11-06
6 RE-ISSUED FOR DP APPLICATION 19-10-31
5 ISSUED FOR PRIOR-TO-RESPONSE
4 RE-ISSUED FOR DP APPLICATION
3 RE-ISSUED FOR DP APPLICATION
2 ISSUED FOR DP APPLICATION
1 ISSUED FOR CLIENT REVIEW


COONEY ROAD TOWER
6333 Cooney Road
Richmond, British Columbia
Scale: 1:200
Drawn: DS
Reviewed: DS
Project No. 06-581

LANDSCAPE
PERMEABILITY

0 10 15 20 m →

LEVEL 4 AND ROOF PERMEABILITY COONEY ROAD

GROUND LEVEL	LEVEL 4	ROOF
AREA	%	%
PERMEABLE GRAVEL AREA	25.1m ²	1.0%
LAWN, MINIMUM 12" SOIL ON SLAB OR ON GRADE	234.6m ²	9.5%
EXTENSIVE GREEN ROOF 15mm GROWING MEDIUM DEPTH PERMEABLE		1.7%
INTENSIVE GREEN ROOF OF PLANTER 450mm MIN GROWING MEDIUM DEPTH PERMEABLE	80m ²	3.3%
PLANTING ON GRADE 450mm 900mm GROWING MEDIUM DEPTH PERMEABLE	95m ²	3.9%
Hardscape Area	487.6m ²	19.8%
TOTAL	747.3m²	30.4%
NOTE: AREAS ARE DIRECT MEASUREMENTS. PERCENTAGES ARE BASED ON THE OVERALL SITE AREA of 2,458 SQ.M INSIDE THE PROPERTY LINES.	604m ²	28.2%
	80m ²	3.3%

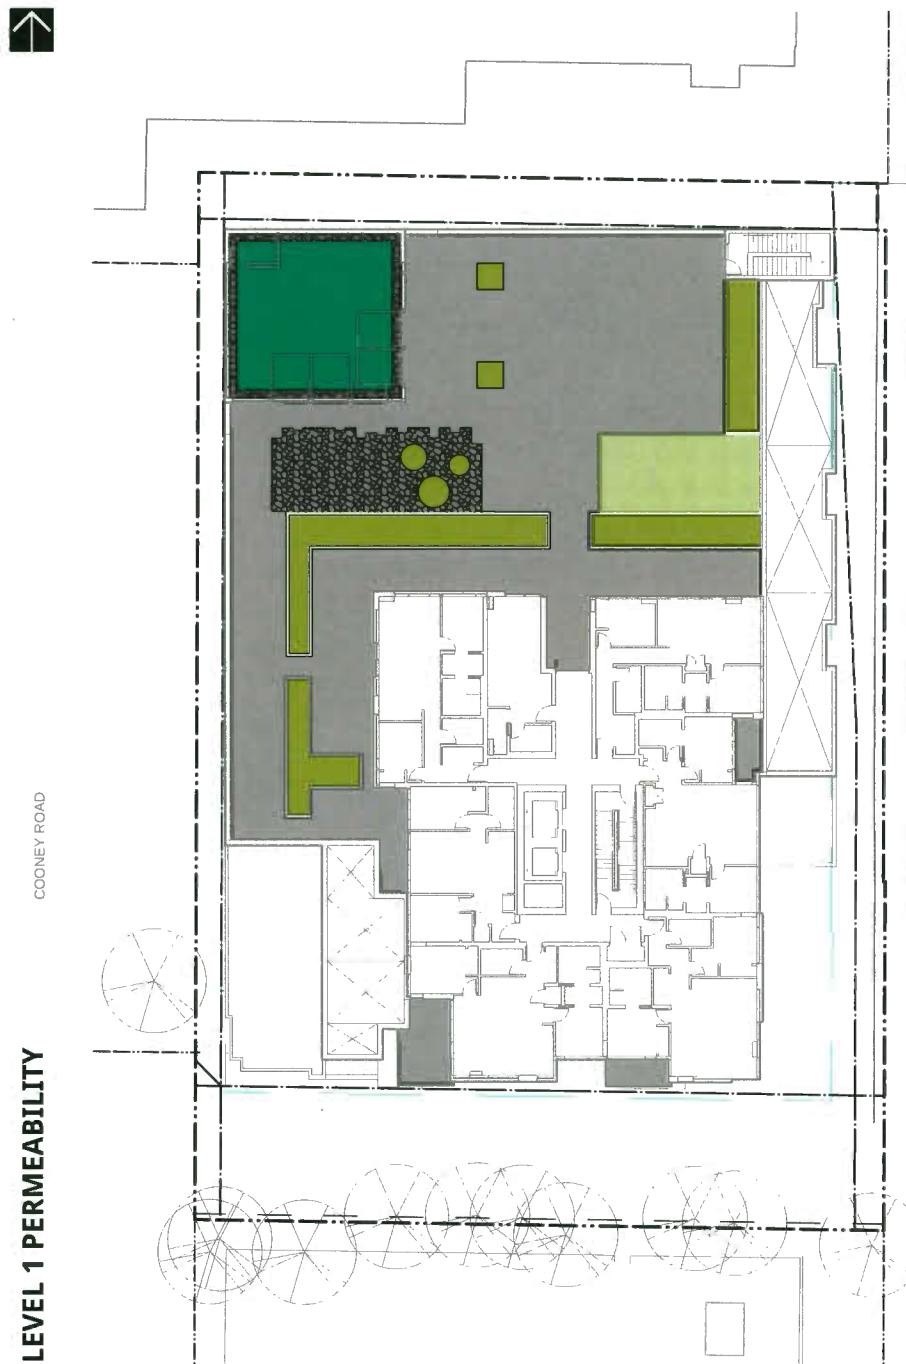

LEVEL 1 PERMEABILITY

COONEY ROAD



FUTURE LANE




L1.4

CONNECT LANDSCAPE ARCHITECTURE INC. DOES
NOT GUARANTEE THE EXISTENCE, LOCATION,
AND ELEVATION OF ALL UTILITIES AND / OR
CONCEALED STRUCTURES AT THE PROJECT SITE.
THE CONTRACTOR IS RESPONSIBLE FOR
DETERMINING THE EXISTENCE, LOCATION, AND
ELEVATION OF ALL UTILITIES AND / OR
CONCEALED STRUCTURES AND IS RESPONSIBLE
FOR NOTIFYING THE APPROPRIATE COMPANY,
DEPARTMENT OR PERSON(S) OF ITS INTENTION
TO CARRY OUT ITS OPERATIONS.

PLANT LIST

TREES

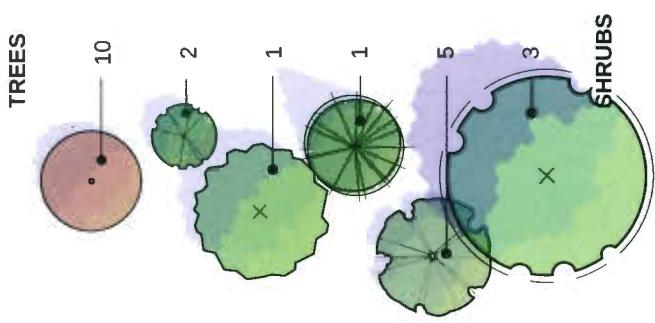

SHRUBS



COLOURS AND GRASSES

Cistus incanus
Rock Rose



EVERGREEN LAYERS



TREES

QTY.	BOTANICAL NAME	COMMON NAME	SIZE	SPACING
10	Acer Palmatum Aka kawa hime	Dwarf Japanese Maple	5cm cal., B&B	as shown
2	Liquidambar styraciflua 'Slender Silhouette'	Sweetgum	5cm cal., B&B	as shown
1	Malus x zumi 'Calocarpa'	Zumi Flowering Apple	6cm cal., B&B	as shown
1	Pinus engelmannii	Engelmann Spruce	3M height, B&B	as shown

5	Stevartia pseudocamellia	Street Tree - Species and final locations to City of Richmond specs.	7cm cal., B&B	as shown
3			3M height, B&B	as shown

1	Japanese Stewartia	Japanese Stewartia	3M height, B&B	as shown
---	--------------------	--------------------	----------------	----------

23	Cistus incanus	Rock Rose	#2 pot	18" o.c
23	Cotoneaster dammerii	Little-Leaf Cotoneaster	#2 pot	24" o.c
21	Forsythia x intermedia	Forsythia	#5 pot	36" o.c
10	Lavandula angustifolia 'Hidcote'	English Lavender	#2 pot	18" o.c
74	Prunus laurocerasus 'Otto Luyken'	Cherry Laurel	#5 pot	24" o.c
74	Polystichum munitum	Western Sword Fern	#2 pot	24" o.c
66	Rhododendron 'Crete'	Pink Rhododendron	#5 pot	36" o.c
48	Rhododendron 'Hotel'	Yellow Rhododendron	#5 pot	36" o.c
30	Spiraea bumuloides 'Goldflame'	Goldflame Spirea	#2 pot	24" o.c
36	Sarcococca hookerana humilis	Himalayan Sweet Box	#2 pot	24" o.c
78	Skimmia japonica	Japanese Skimmia	#3 pot	30" o.c
33	Taxus X Media 'Hicksii'	Hick's Yew - 1.5M height	#3 pot	20" o.c

168	TAXUS X MEDIA 'HICKSII'	Hick's Yew - 1.5M height	#3 pot	20" o.c
-----	-------------------------	--------------------------	--------	---------

GROUND COVERS AND VINES

44	Akebia quinata	Chocolate Vine	#2 pot	18" o.c
32	Arctostaphylos uva-ursi	Kinnikinnick	4'(10cm) pot	15" o.c
190	Ceanothus griseus horizontalis	Creeping California Lilac	4'(10cm) pot	15" o.c
392	Oxalis oreganum	Redwood Sorrel	4'(10cm) pot	15" o.c
36	Parthenocissus quinquefolia	Virginia Creeper	#2 pot	18" o.c
80	SQ.M. Eteria Colour Max Sedum Tile			

80	SQ.M. Eteria Colour Max Sedum Tile			
----	------------------------------------	--	--	--

GRASSES, PERENNIALS, BULBS, AND ANNUALS

12	Allium giganteum	Persian Onion	#1 pot	18" o.c
60	Carex eburnea	Bristleleaf Sedge	#1 pot	18" o.c
77	Hakonechloa macra	Japanese Forest Grass	#1 pot	18" o.c
17	Iris tenax	Oregon Iris	#1 pot	18" o.c
7	Liriope muscari	Lily Turf	#1 pot	18" o.c
12	Stipa tenuissima	Mexican Feather Grass	#1 pot	18" o.c

COONEY ROAD TOWER

6333 Cooney Road	6333 Cooney Road
Richmond, British Columbia	Richmond, British Columbia
Scale:	N/A
Drawn:	KDIDS
Reviewed:	DS
Project No.	06-581

PLANT LIST & MATERIALS

NOTES:

- 1) In case of discrepancy between plant numbers on this list and on the plan, the latter shall prevail.
- 2) All planting shall be in accordance with BC Landscape Standard, latest edition.
- 3) All planting beds to be mulched with 2" (50mm) of Answer Garden Products 'Humus builder' or approved equal.

CONNECT LANDSCAPE ARCHITECTURE INC. DOES
NOT GUARANTEE THE EXISTENCE, LOCATION,
AND ELEVATION OF ALL UTILITIES AND / OR
CONCEALED STRUCTURES AT THE PROJECT SITE.

THE CONTRACTOR IS RESPONSIBLE FOR
DETERMINING THE EXISTENCE, LOCATION, AND
ELEVATION OF ALL UTILITIES AND / OR
CONCEALED STRUCTURES AND IS RESPONSIBLE
FOR NOTIFYING THE APPROPRIATE COMPANY,
DEPARTMENT OR PERSON(S) OF ITS INTENTION
TO CARRY OUT ITS OPERATIONS.

DP 17-791045 Plan 33 Nov 20, 2019

- 7 RE-ISSUED FOR CITY COMMENTS 19-11-06
- 6 RE-ISSUED FOR DP APPLICATION 19-10-31
- 5 ISSUED FOR PRIOR TO RESPONSE
- 4 RE-ISSUED FOR DP APPLICATION
- 3 RE-ISSUED FOR DP APPLICATION
- 2 ISSUED FOR DP APPLICATION
- 1 ISSUED FOR CLIENT REVIEW
- REVISIONS

COONEY ROAD TOWER

6333 Cooney Road
Richmond, British Columbia

Scale: 1:100
Drawn: DS
Reviewed: DS
Project No. 06-581

LANDSCAPE PLANTING GROUND LEVEL

NOTE: SEE SHEET L2 FOR PLANT LIST



20 m


10 m

15 m

0 m

COONEY ROAD

FUTURE LANE

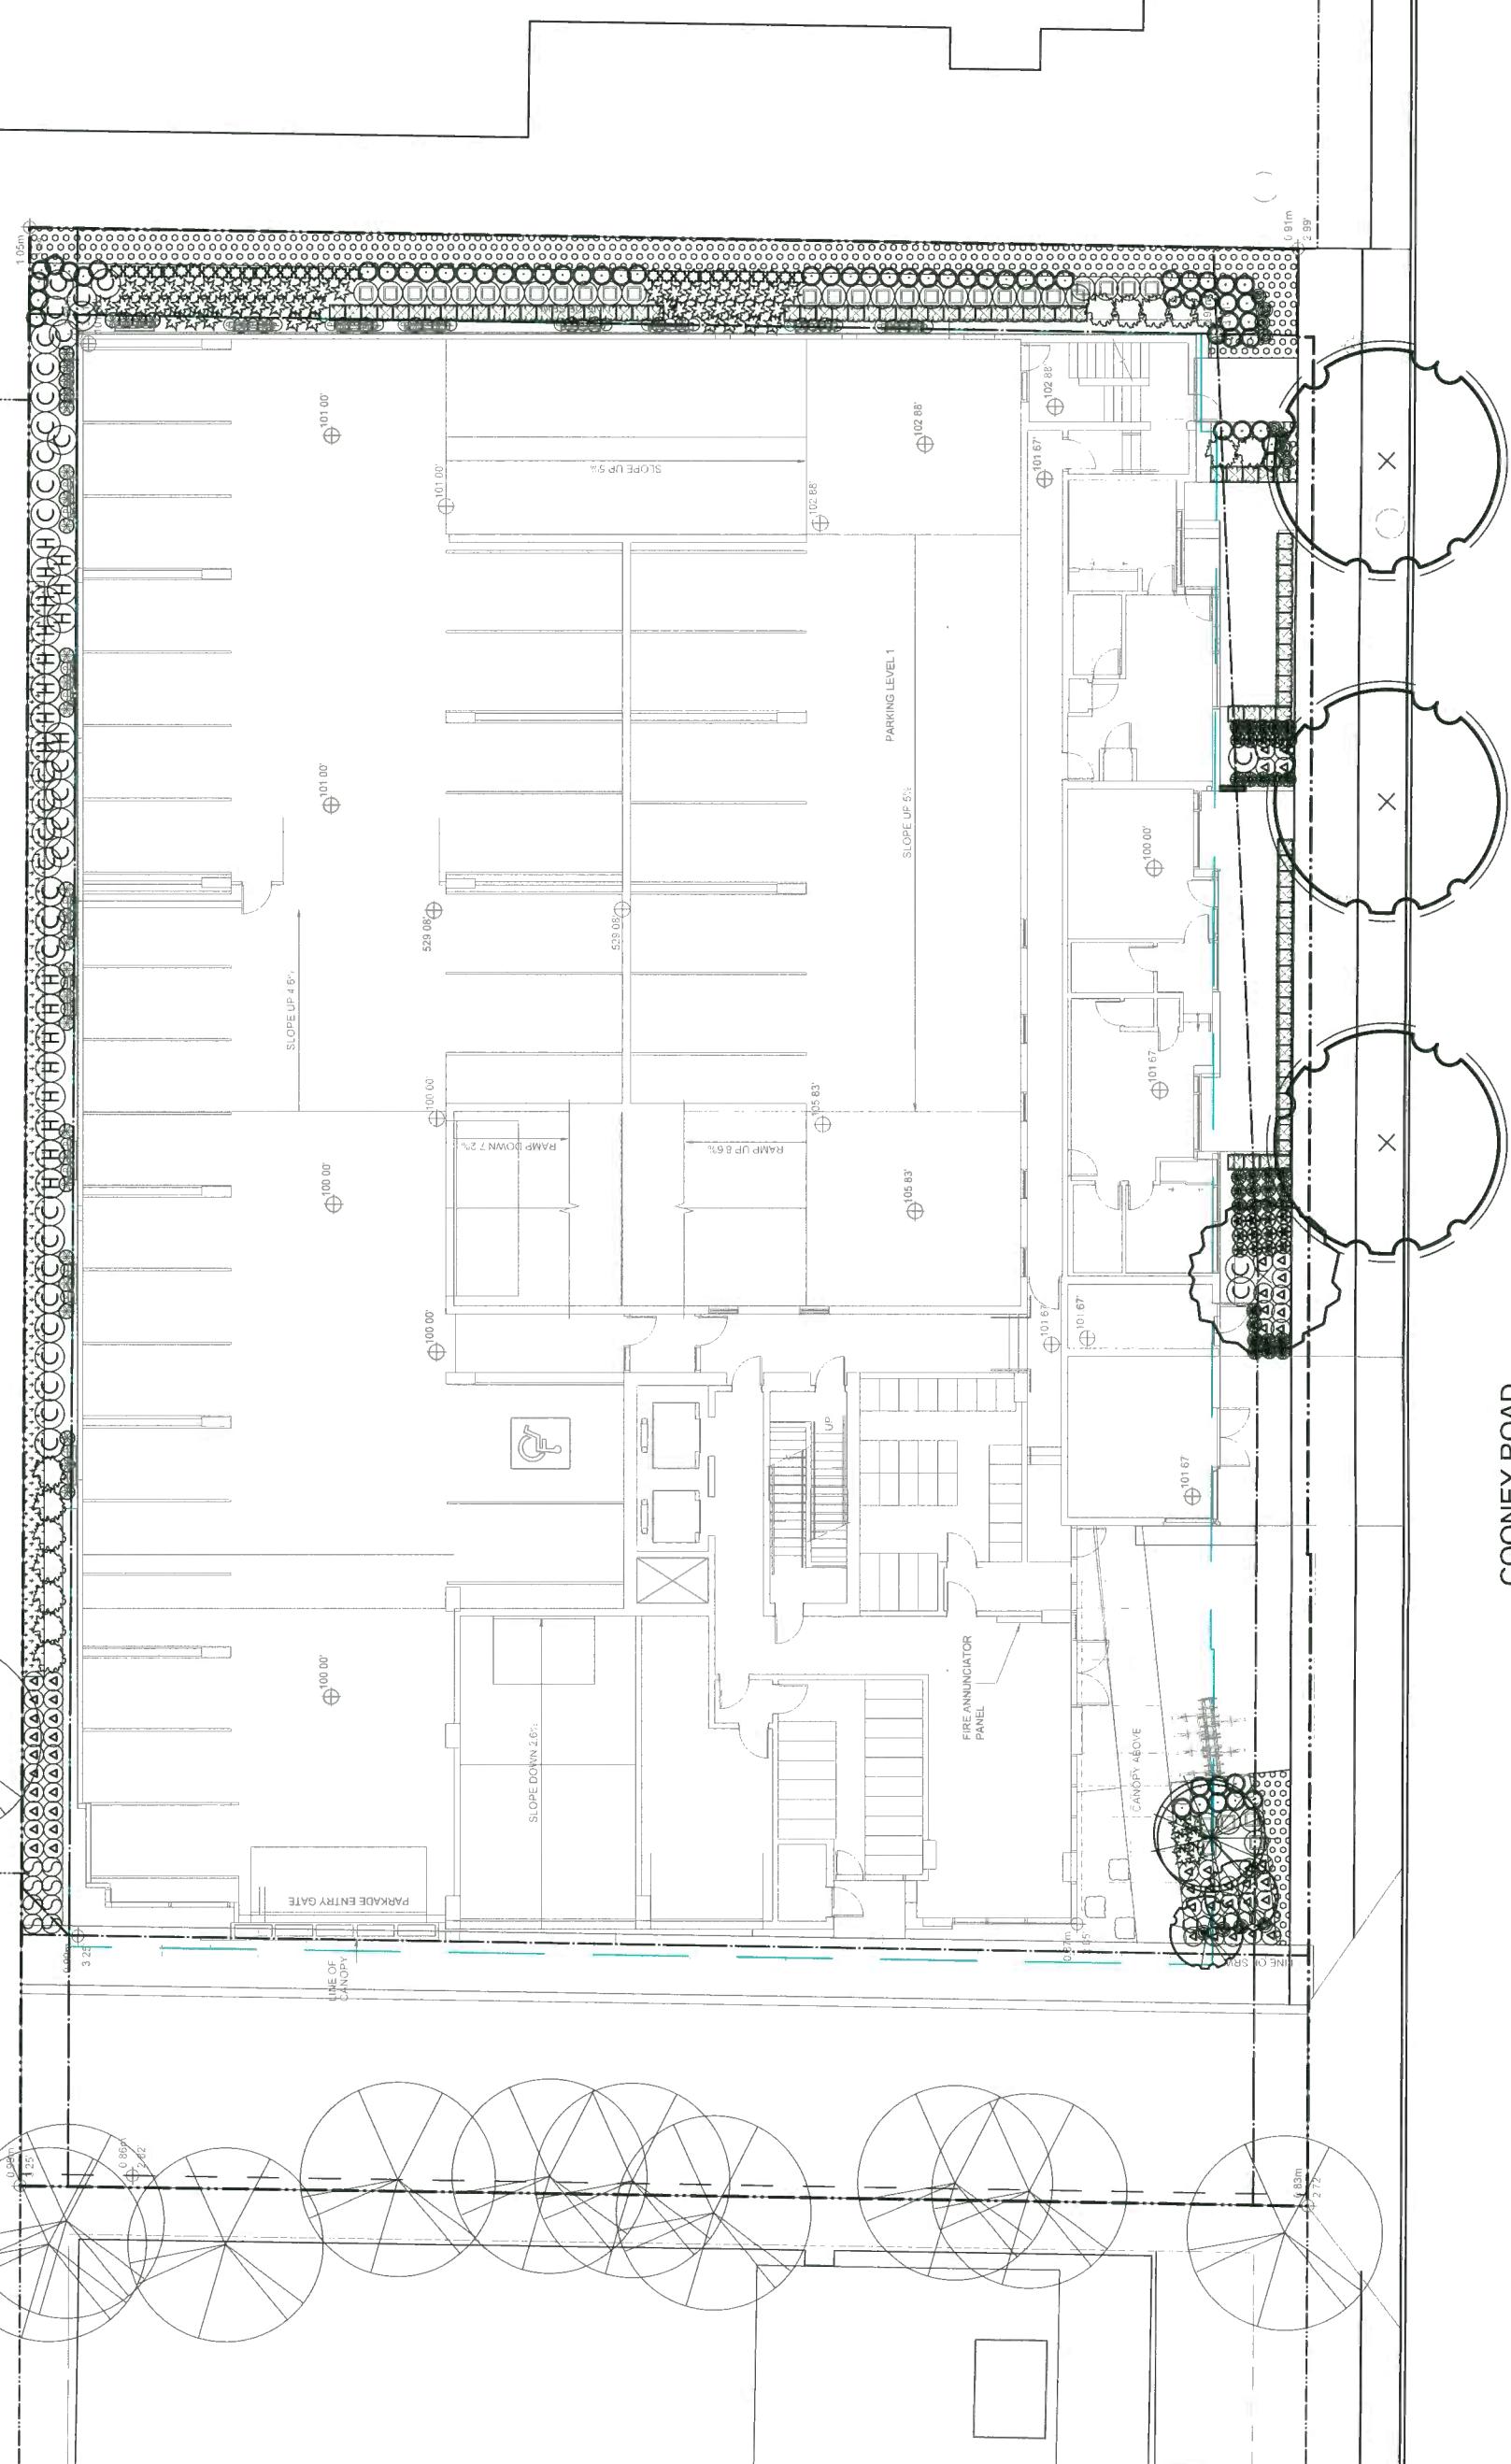

L2.1

CONNECT LANDSCAPE ARCHITECTURE INC. DOES NOT GUARANTEE THE EXISTENCE, LOCATION, AND ELEVATION OF UTILITIES AND / OR CONCEALED STRUCTURES AT THE PROJECT SITE.
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DP 17-791045 Plan 34 Nov 20, 2019
 7 RE-ISSUED FOR CITY COMMENTS 19-1106
 6 RE-ISSUED FOR DP APPLICATION 19-10-31
 5 ISSUED FOR PRIOR TO RESPONSE
 4 RE-ISSUED FOR DP APPLICATION
 3 RE-ISSUED FOR DP APPLICATION
 2 ISSUED FOR DP APPLICATION
 1 ISSUED FOR CLIENT REVIEW
 REVISIONS

COONEY ROAD TOWER

6333 Cooney Road
Richmond, British Columbia

Scale: 1:100
Drawn: DS
Reviewed: DS
Project No. 06-581

LANDSCAPE PLANTING LEVEL 4


NOTE: SEE SHEET L2.0 FOR PLANT LIST



15 20 m

0 10

COONEY ROAD

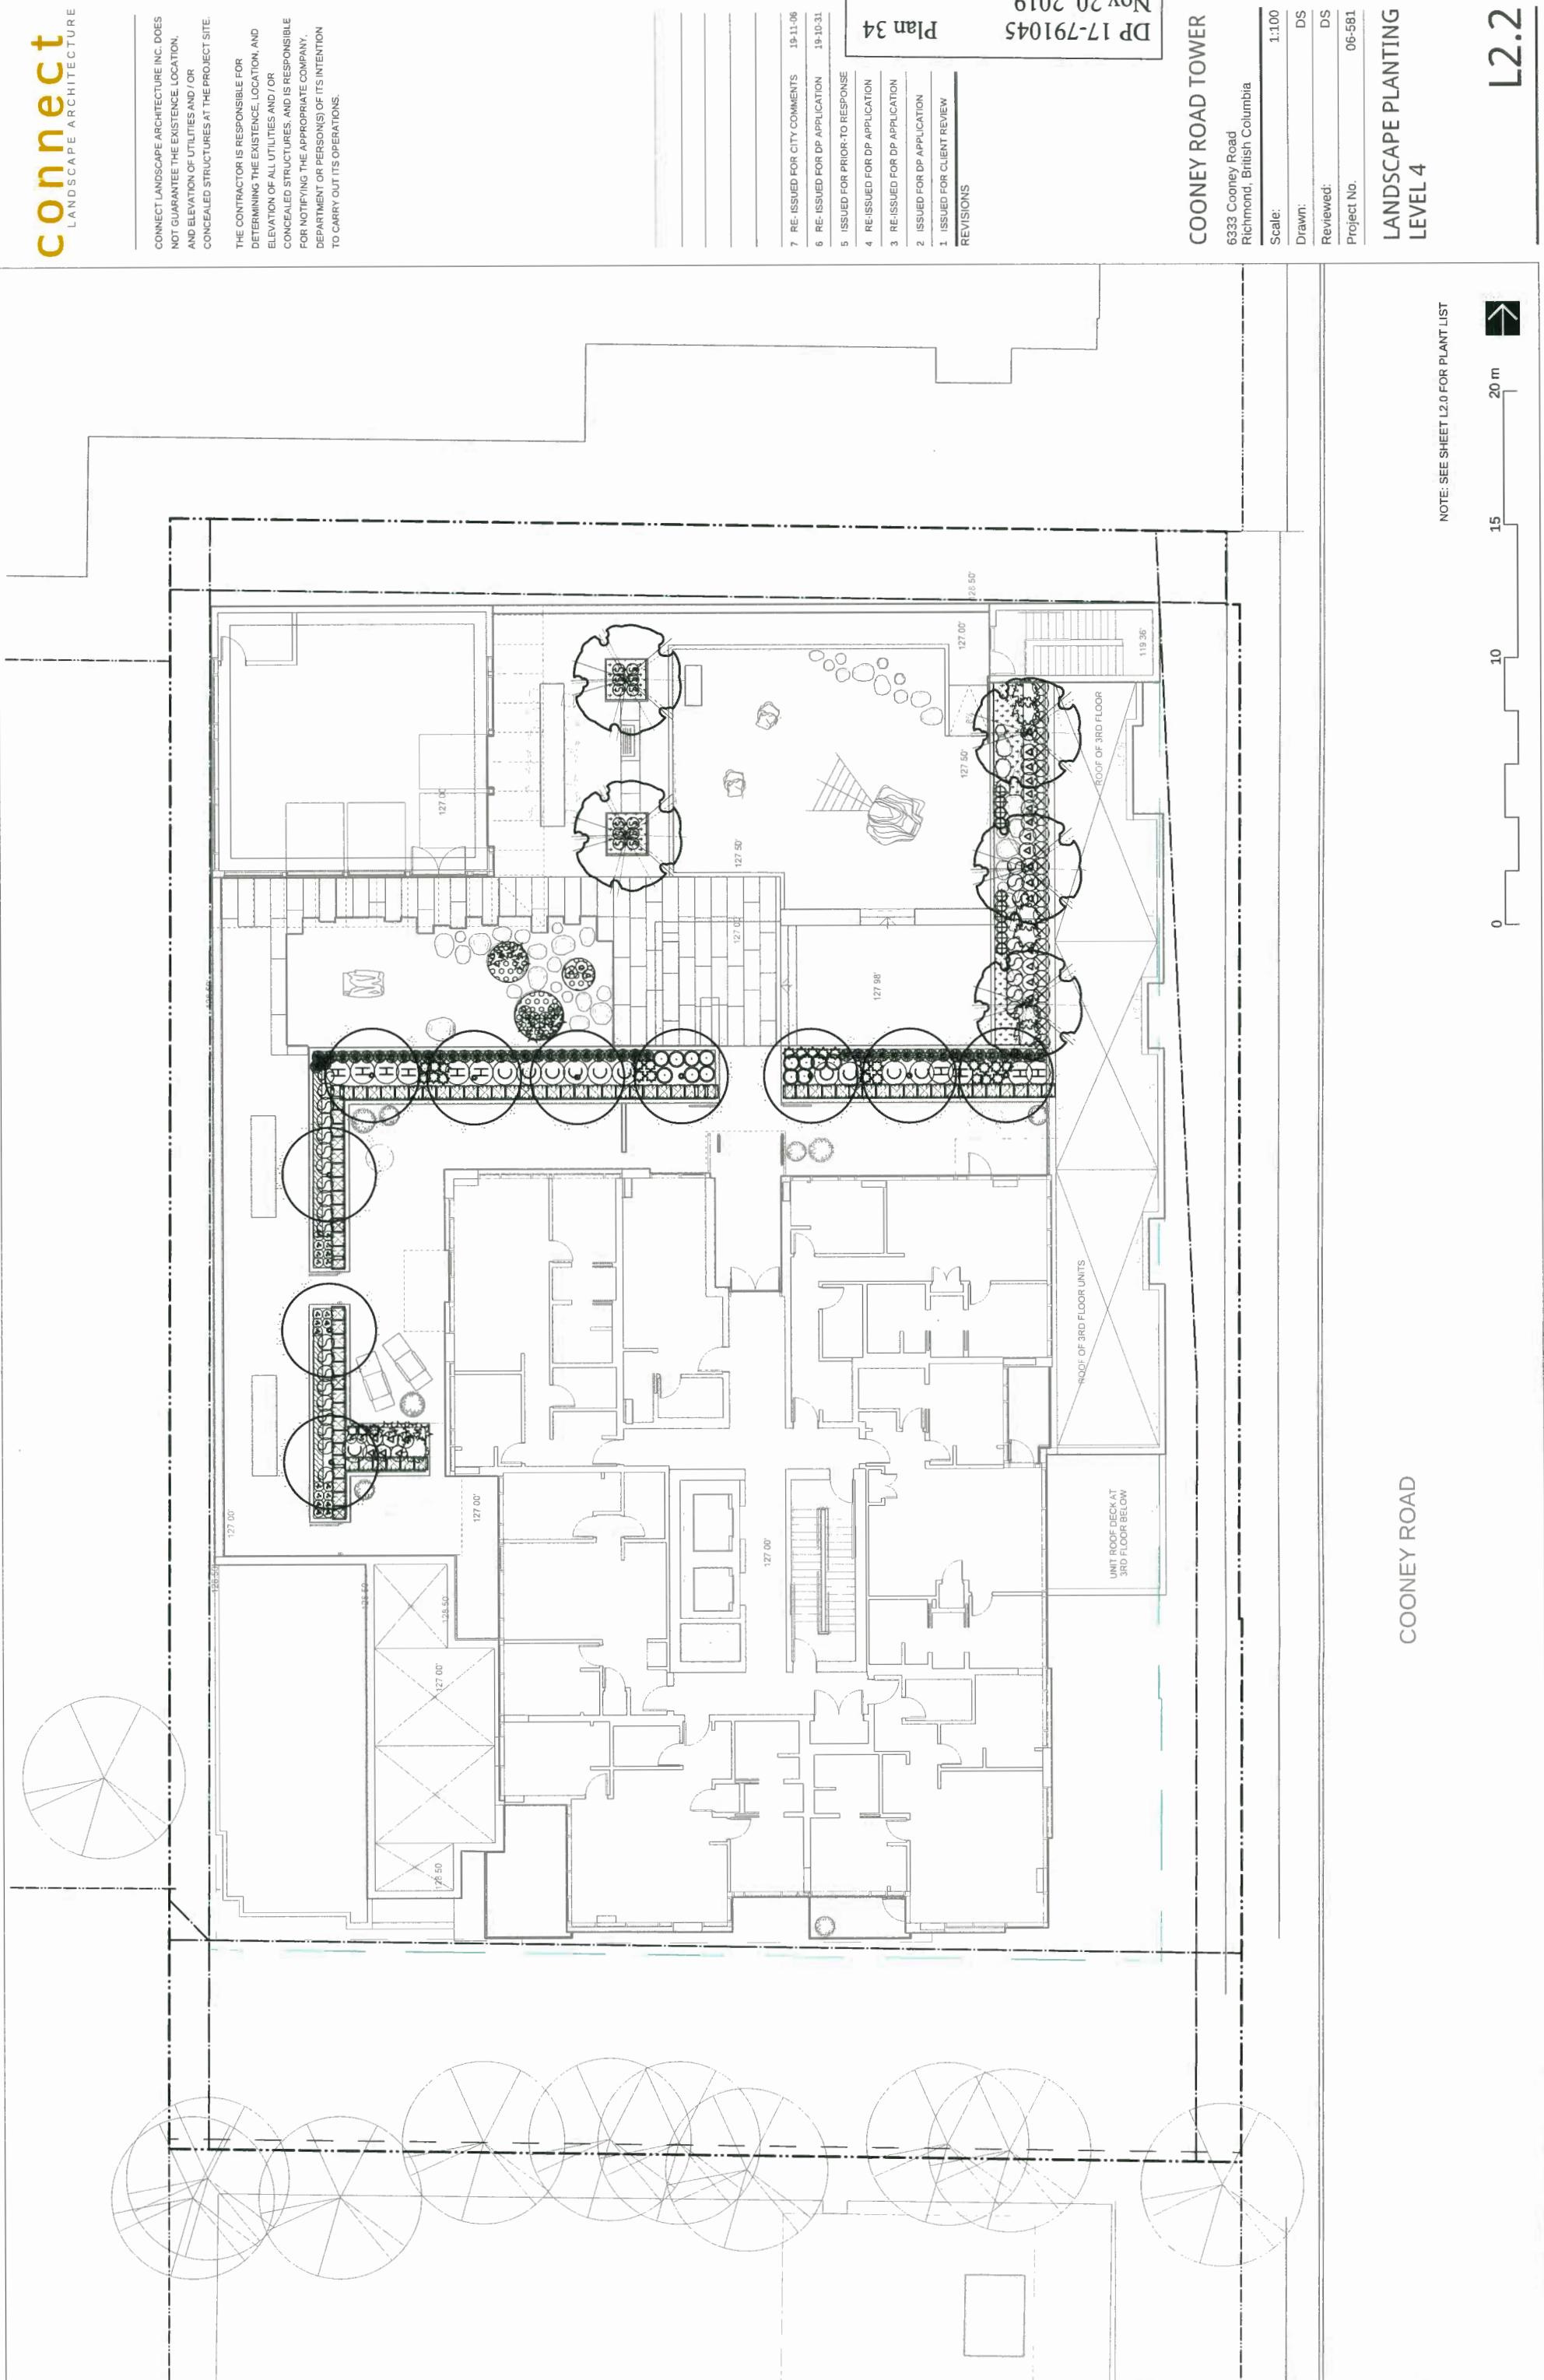

L2.2

CONNECT LANDSCAPE ARCHITECTURE INC. DOES
NOT GUARANTEE THE EXISTENCE, LOCATION,
AND ELEVATION OF UTILITIES AND / OR
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DEPARTMENT OR PERSON(S) OF ITS INTENTION
TO CARRY OUT ITS OPERATIONS.

DP 17-791045 Plan 35 Nov 20, 2019

- 7 RE-ISSUED FOR CITY COMMENTS 19-11-06
- 6 RE-ISSUED FOR DP APPLICATION 19-10-31
- 5 ISSUED FOR PRIOR TO RESPONSE
- 4 RE-ISSUED FOR DP APPLICATION
- 3 RE-ISSUED FOR DP APPLICATION
- 2 ISSUED FOR DP APPLICATION
- 1 ISSUED FOR CLIENT REVIEW
- REVISIONS

COONEY ROAD TOWER

6333 Cooney Road
Richmond, British Columbia

Scale: 1:100
Drawn: DS
Reviewed: DS
Project No. 06-581

LANDSCAPE PLANTING ROOF LEVEL

NOTE: SEE SHEET L2.0 FOR PLANT LIST



20 m

15


10

5

0


COONEY ROAD

L2.3

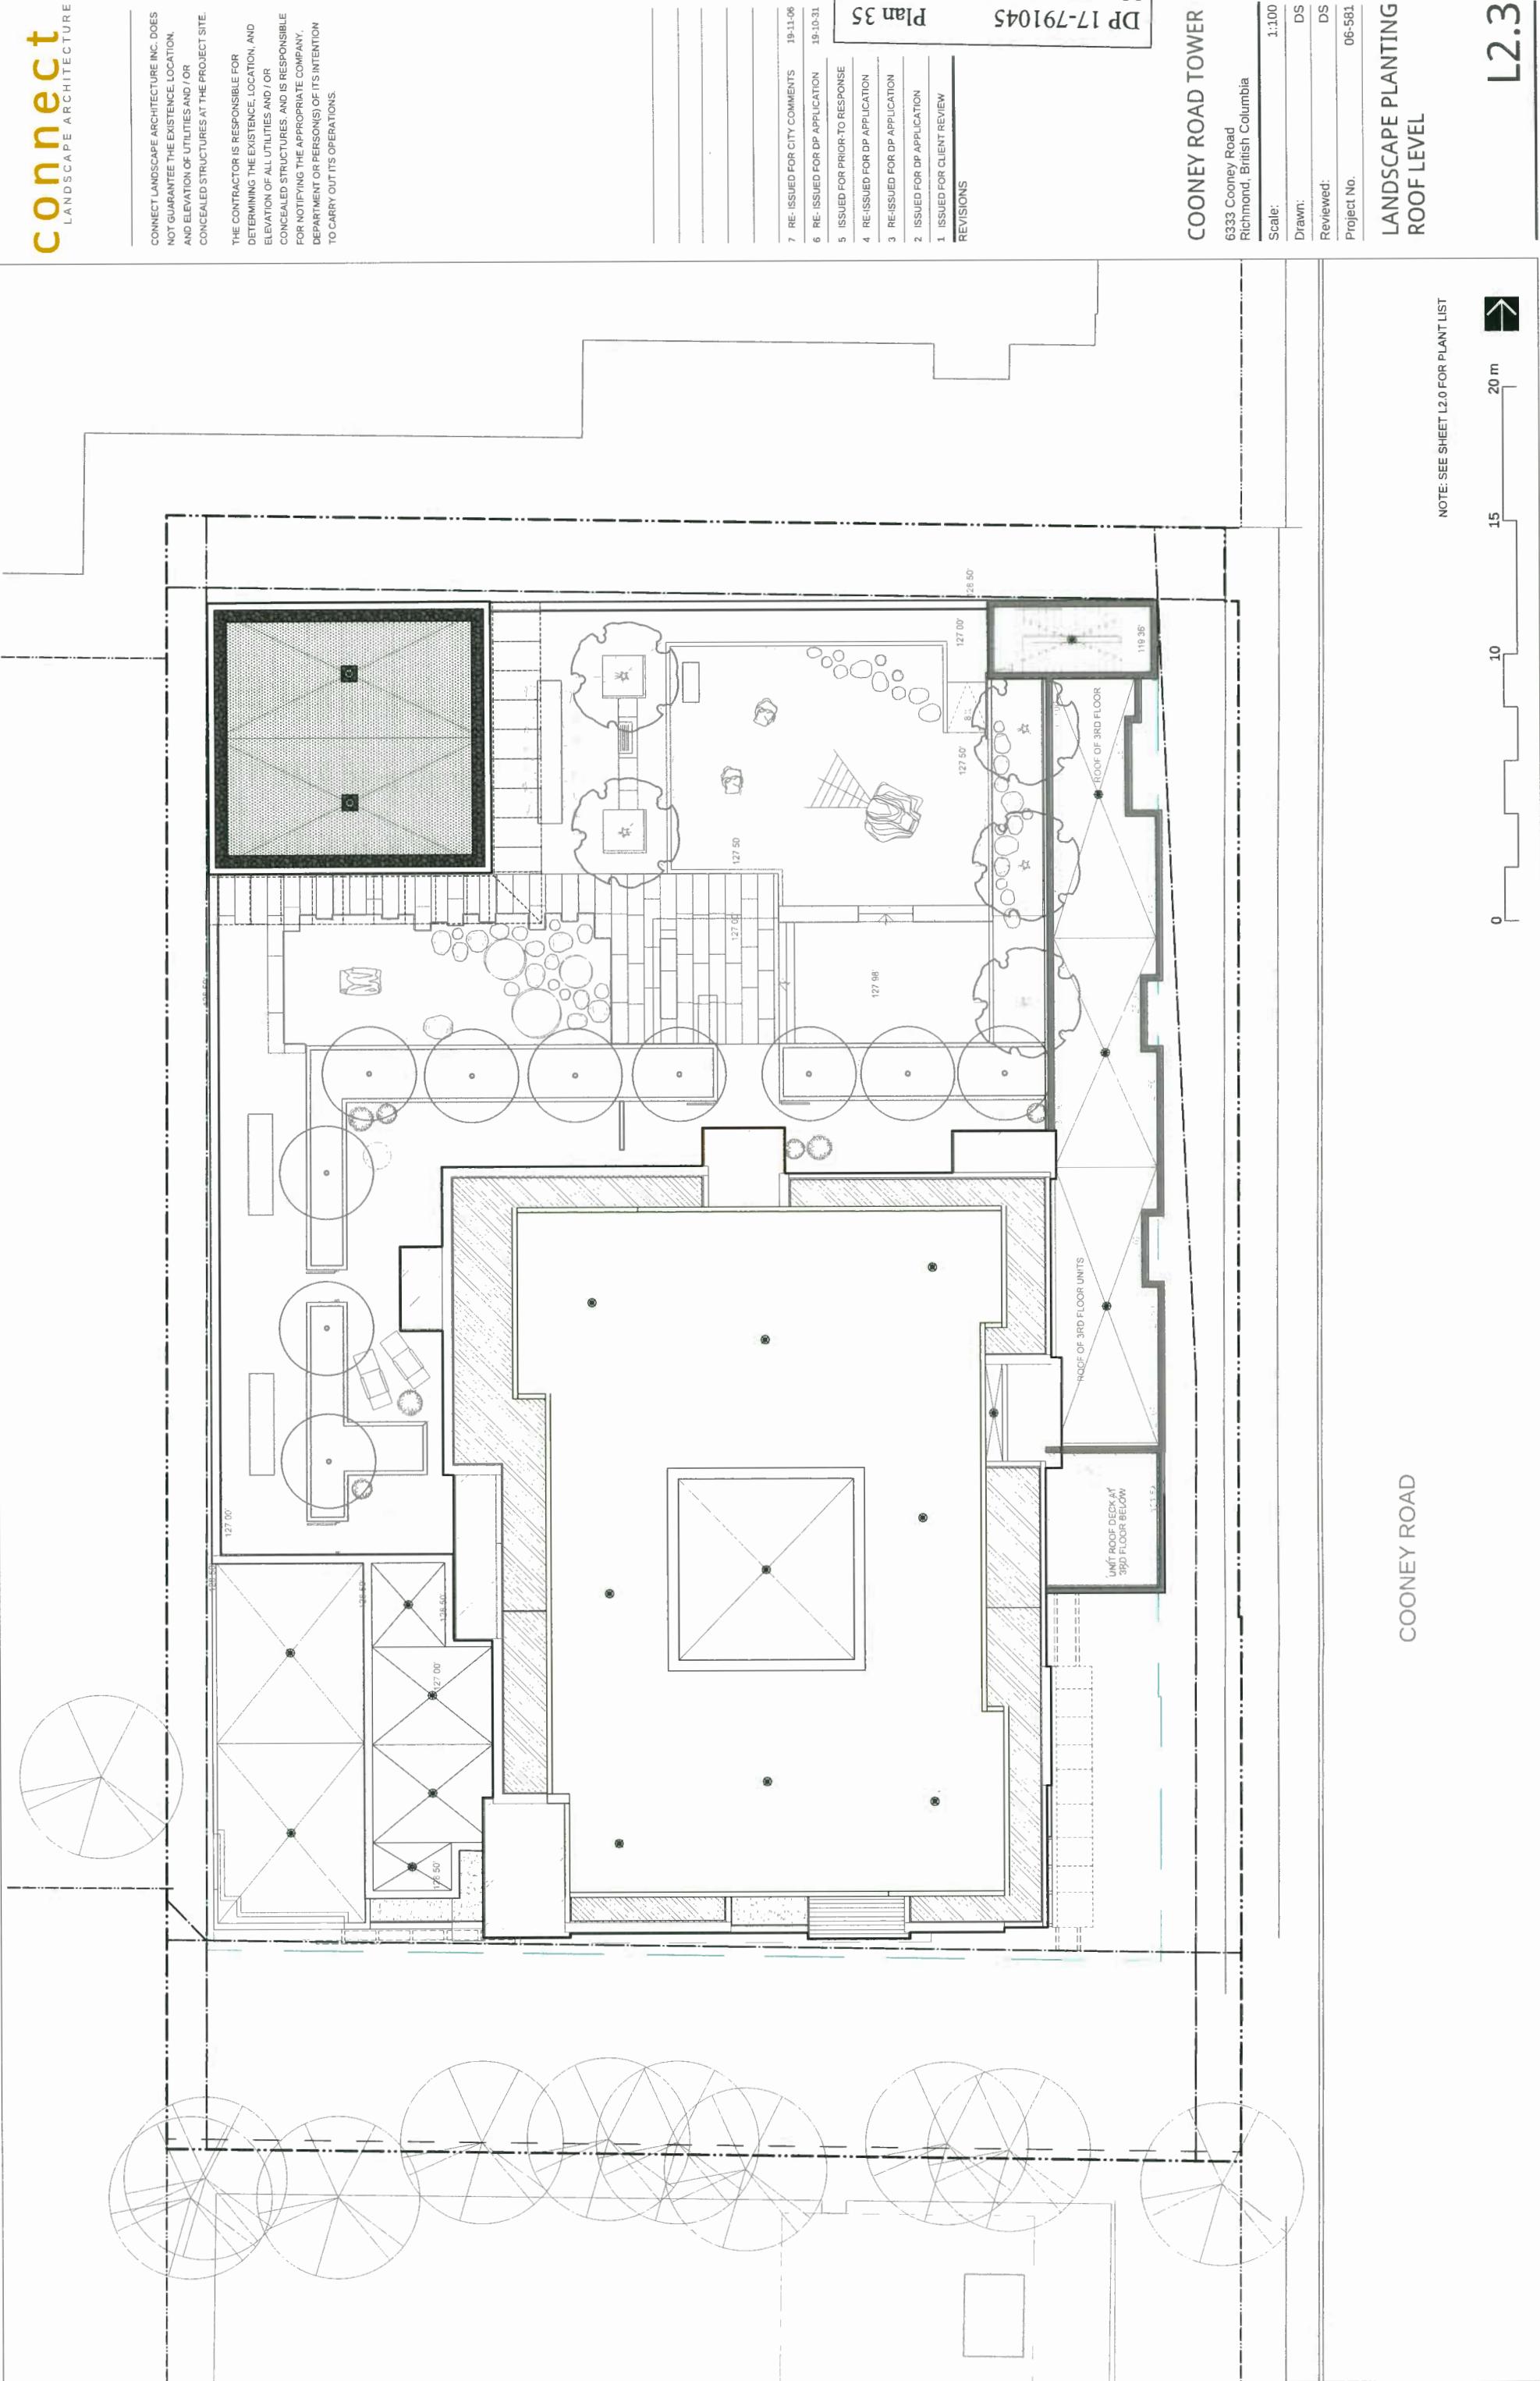


CONNECT LANDSCAPE ARCHITECTURE INC. DOES
NOT GUARANTEE THE EXISTENCE, LOCATION,
AND ELEVATION OF UTILITIES AND / OR
CONCEALED STRUCTURES AT THE PROJECT SITE.

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TO CARRY OUT ITS OPERATIONS.

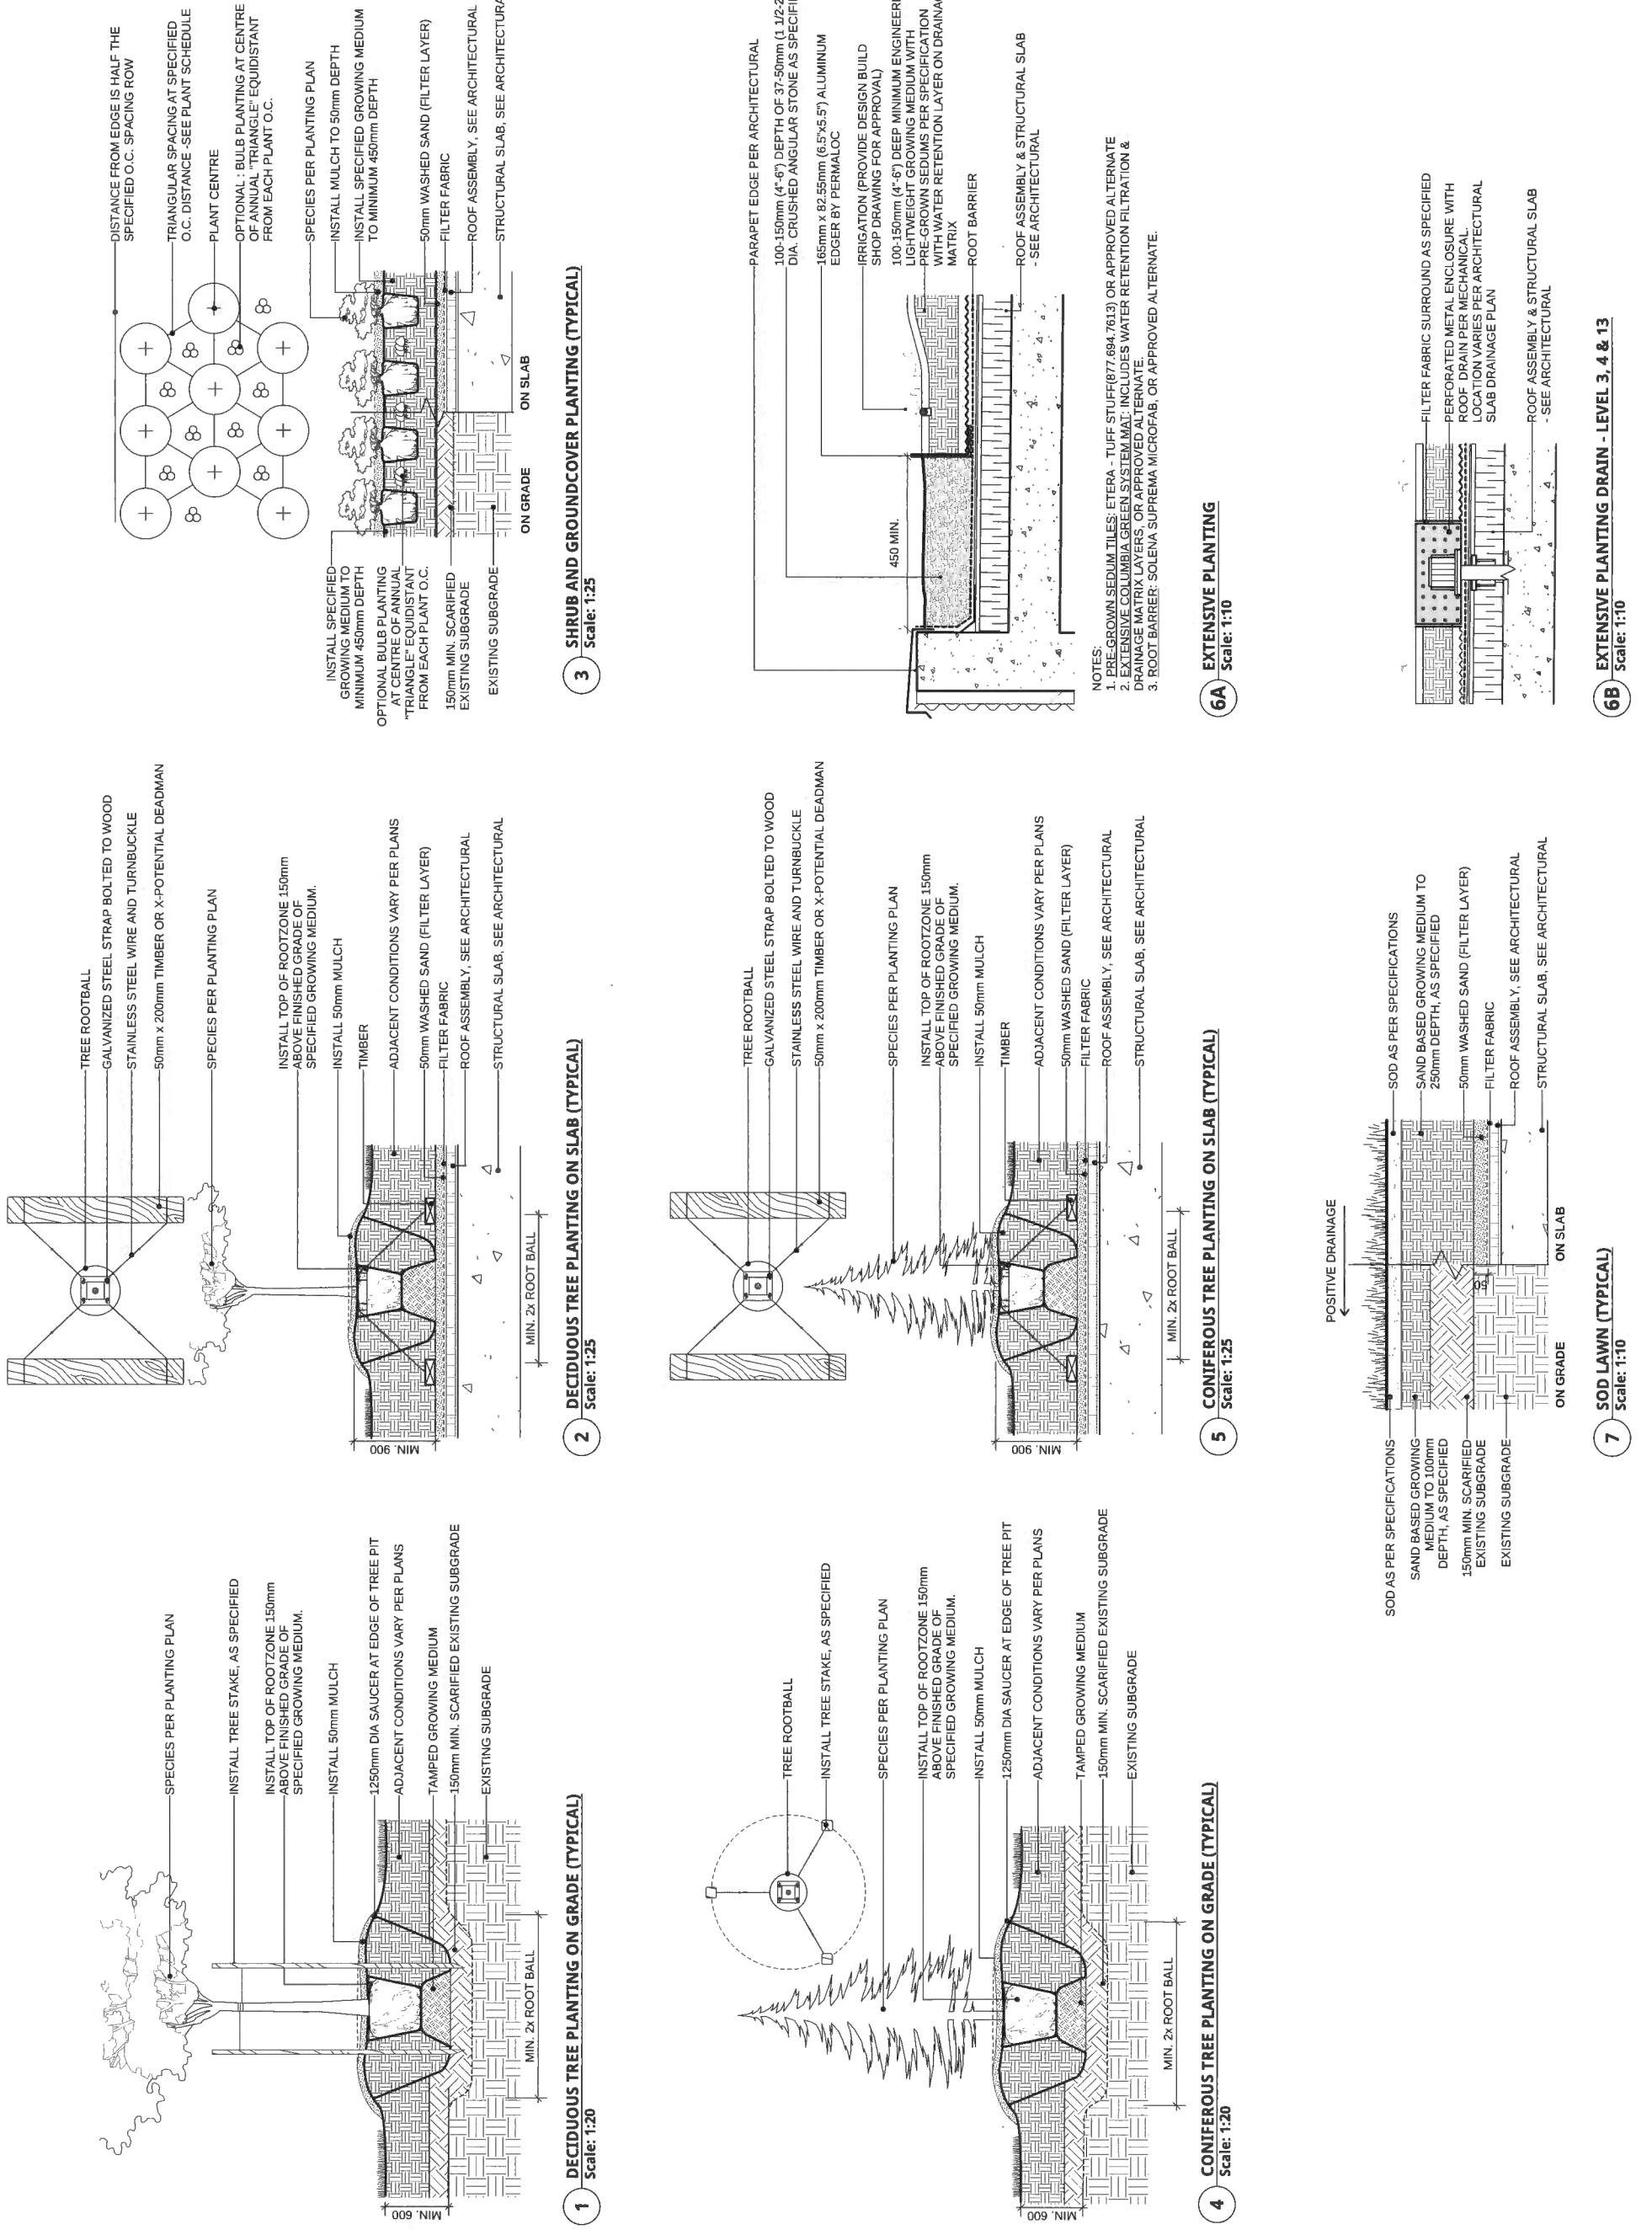


CIP CONCRETE PAVING NOTES:

1. SANDBLAST FINISH
2. SEE LAYOUT PLAN FOR SAWCUT JOINT PATTERN AND BAND WIDTH
3. EXP. JOINTS @ 6M O.C. MAX (PLUMB, STRAIGHT AND SQUARE)
- (AT CHANGES IN MATERIALS, FURNISHINGS, CURB EDGES - SPACING TO COINCIDE WITH PATTERN)
4. CONTROL JOINTS @ 1.5M O.C. (50°) O.C. MAX (PLUMB, STRAIGHT AND SQUARE)
5. FINAL LOCATION FOR JOINTS AND SAW CUTS TO BE CONFIRMED ON SITE WITH LANDSCAPE ARCHITECT
6. REFER TO CIVIL PLANS FOR VEHICULAR CONCRETE PAVING
7. FOR ALL HC ACCESSIBLE ROUTES ENSURE SAW CUT JOINTS RATHER THAN CONVEX TOOLED JOINTS
8. ALL OFF-SITE WORKS TO MEET CITY STANDARDS AND SPECIFICATIONS

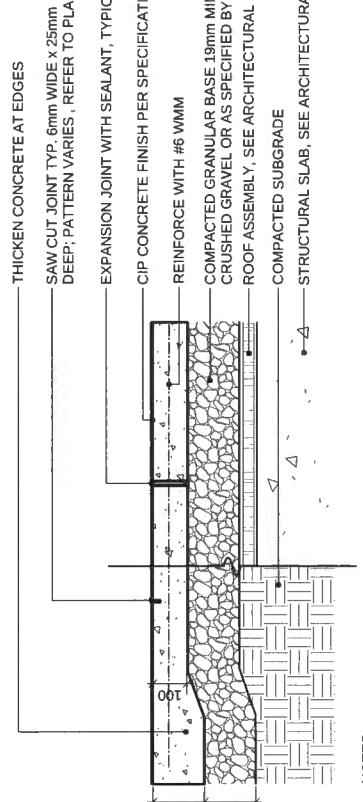


1 CIP CONCRETE ON GRADE / ON SLAB (TYPICAL)
Scale: 1:10

1. EXPANSION JOINTS 6m O.C. MAX CONTROL JOINTS @ 1.5m O.C. ADJUST TO SUIT SITE LAYOUT PLAN.
2. ALL SCORELINES TO BE APPROVED BY LANDSCAPE ARCHITECT ON-SITE PRIOR TO INSTALLATION.

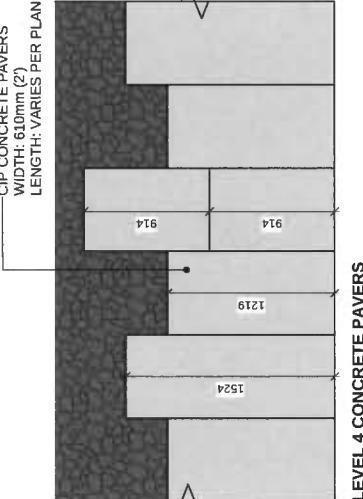


1 CIP CONCRETE ON GRADE / ON SLAB (TYPICAL)
Scale: 1:10

1. EXPANSION JOINTS 6m O.C. MAX CONTROL JOINTS @ 1.5m O.C. ADJUST TO SUIT SITE LAYOUT PLAN.
2. ALL SCORELINES TO BE APPROVED BY LANDSCAPE ARCHITECT ON-SITE PRIOR TO INSTALLATION.

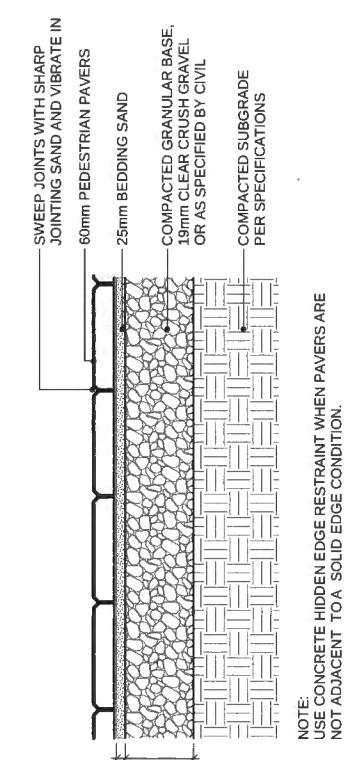


2 PEDESTRIAN UNIT PAVERS ON GRADE (TYPICAL)
Scale: 1:10

NOTE: USE CONCRETE HIDDEN EDGE RESTRAINT WHEN PAVERS ARE NOT ADJACENT TO A SOLID EDGE CONDITION.

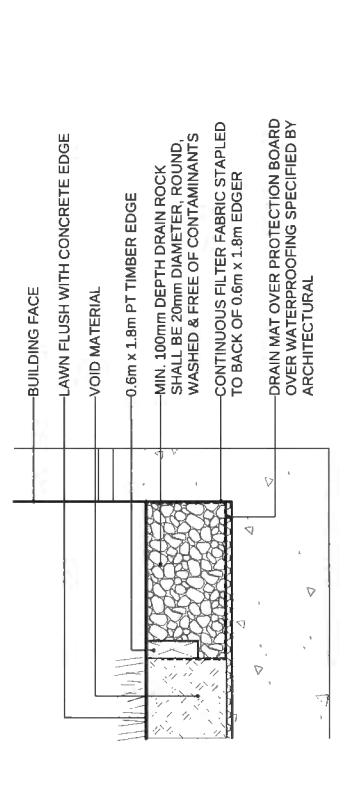


6 CIP CONCRETE STEPS
Scale: 1:10

NOTES: BOTTOM OF STAIR GRADES VARY, REFER TO GRADING PLAN FOR HEIGHTS.

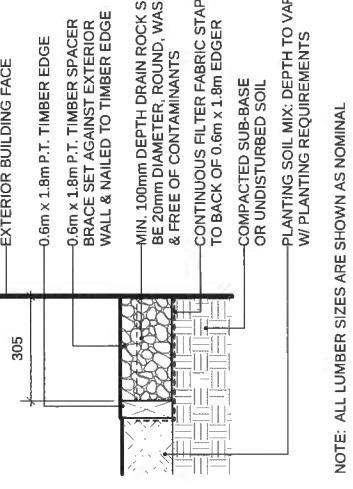

7 GRAVEL DRAIN STRIP - ON SLAB
Scale: 1:10

NOTES: ALL LUMBER SIZES ARE SHOWN AS NOMINAL.

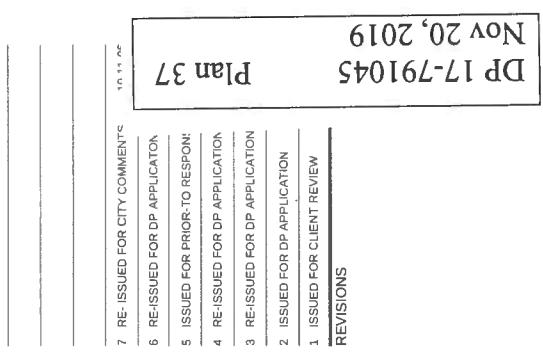


8 CIP CONCRETE RETAINING WALL (ON SLAB)
Scale: 1:120

NOTE: GUARDRAIL REQUIRED FOR ALL WALLS ABOVE 610mm (2'). USE CONCRETE HIDDEN EDGE RESTRAINT WHEN PAVERS ARE NOT ADJACENT TO A SOLID EDGE CONDITION.

PROPOSED RESIDENTIAL DEVELOPMENT

Port Moody, British Columbia
Scale: As Shown
Drawn: K/D/S
Reviewed: DS
Project No.: 06-581
LANDSCAPE DETAILS
HARDSCAPE

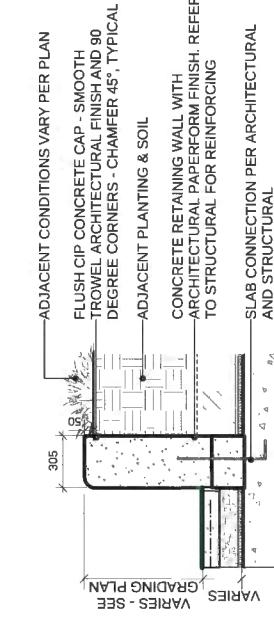

9 PROPOSED RESIDENTIAL DEVELOPMENT
Scale: 1:100

NOTE: GUARDRAIL REQUIRED FOR ALL WALLS ABOVE 610mm (2'). USE CONCRETE HIDDEN EDGE RESTRAINT WHEN PAVERS ARE NOT ADJACENT TO A SOLID EDGE CONDITION.





5 HYDRAULICALLY PRESSED CONCRETE PAVERS ON PEDESTALS
Scale: 1:10

NOTE: USE CONCRETE HIDDEN EDGE RESTRAINT WHEN PAVERS ARE NOT ADJACENT TO A SOLID EDGE CONDITION.

CONNECT LANDSCAPE ARCHITECTURE INC. DOES NOT GUARANTEE THE EXISTENCE, LOCATION, AND ELEVATION OF UTILITIES, AND / OR CONCEALED STRUCTURES AT THE PROJECT SITE.

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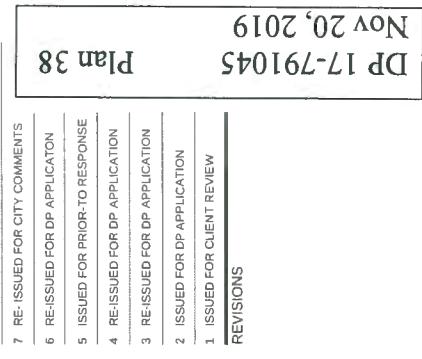
**MODEL: MBR350 - 5 BIKE RACK
FINISH: STANDARD POWDERCOATED SILVER 14
BY: MAGLIN SITE FURNISHINGS
(1.800.716.5506)**

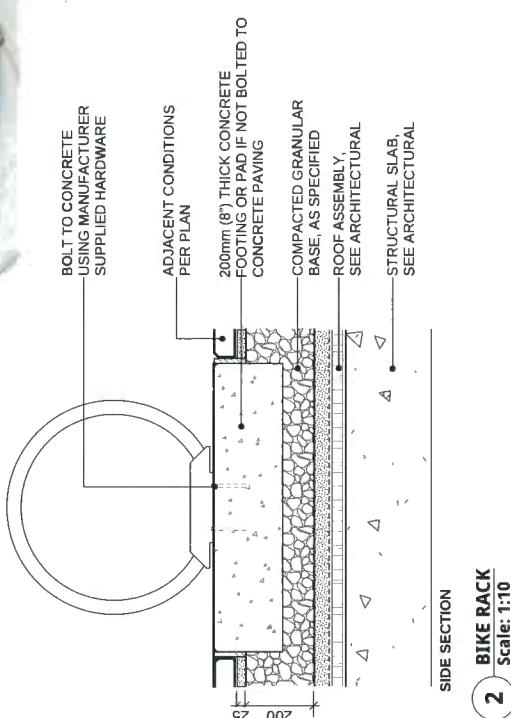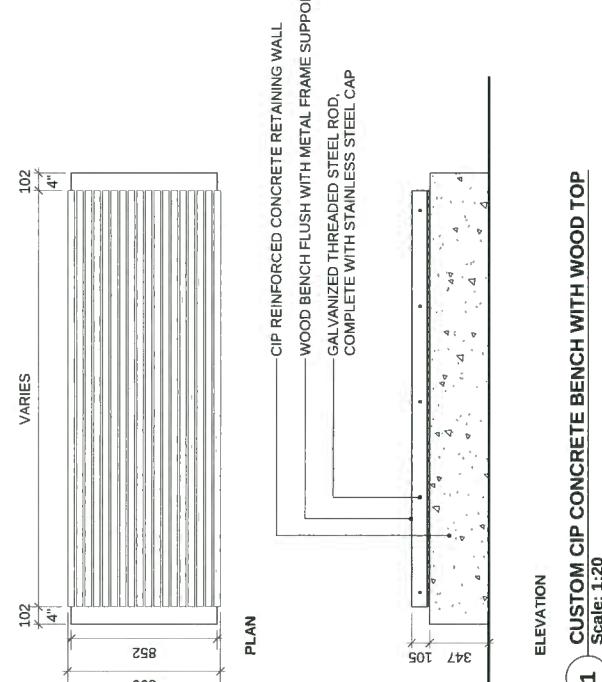

ILLIOTOM SEI ECTED BAWNT COLUMN BENCHES



**MODEL: HARVEST GROVE BBQ GRILL
AND COUNTER KIT**
**FINISH: CHARCOAL BLOCK AND
POLISHED GRANULAR COUNTER FINISH**
SB-33; SB-34; SB-35
GARDEN STATE CONCRETE



PROPOSED RESIDENTIAL DEVELOPMENT

Port Moody, British Columbia

Scale:	As Shown
Drawn:	KD/DS
Reviewed:	DS
Project No.	06-581

LANDSCAPE DETAILS

ELBNISHINGS

132

CONNECT LANDSCAPE ARCHITECTURE INC. DOES NOT GUARANTEE THE EXISTENCE, LOCATION, AND ELEVATION OF ALL UTILITIES AND/OR CONCEALED STRUCTURES AT THE PROJECT SITE.

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Plan 39

DP 17-791045
Nov 20, 2019

PROPOSED RESIDENTIAL DEVELOPMENT

Port Moody, British Columbia

Scale: As Shown


Drawn: K/D/S

Reviewed: D/S


Project No.: 06-581

LANDSCAPE DETAILS
PLAY AREA

L3.3

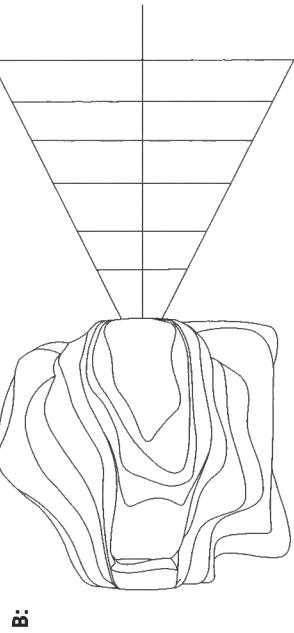

B:

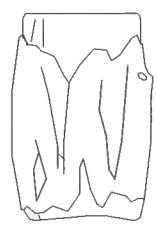


A:




ADVENTURESCAPE DESIGN #4 (168367)
A: LOG CRAWL TUNNEL (173594)
B: THE POINTE (166355) WITH OUTRIGGER
FINISH & COLOUR: TBD BY BOLD
BY: LANDSCAPE STRUCTURES
(1.800.328.0035)

PLAY EQUIPMENT


1
Scale: 1:25

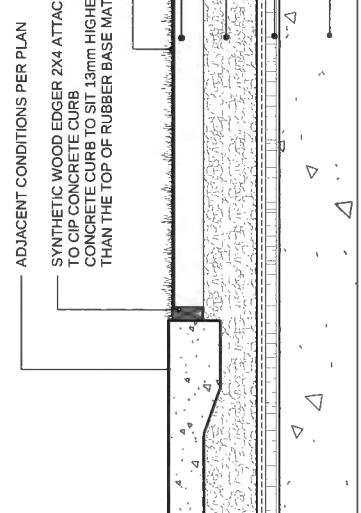

2 TURF SURFACING
Scale: 1:10

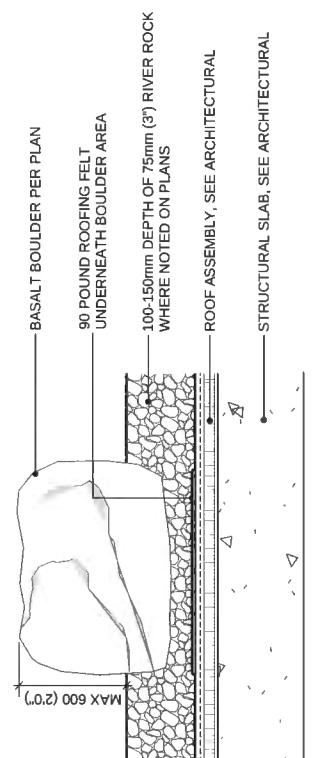

3 BASALT BOULDER
Scale: 1:10

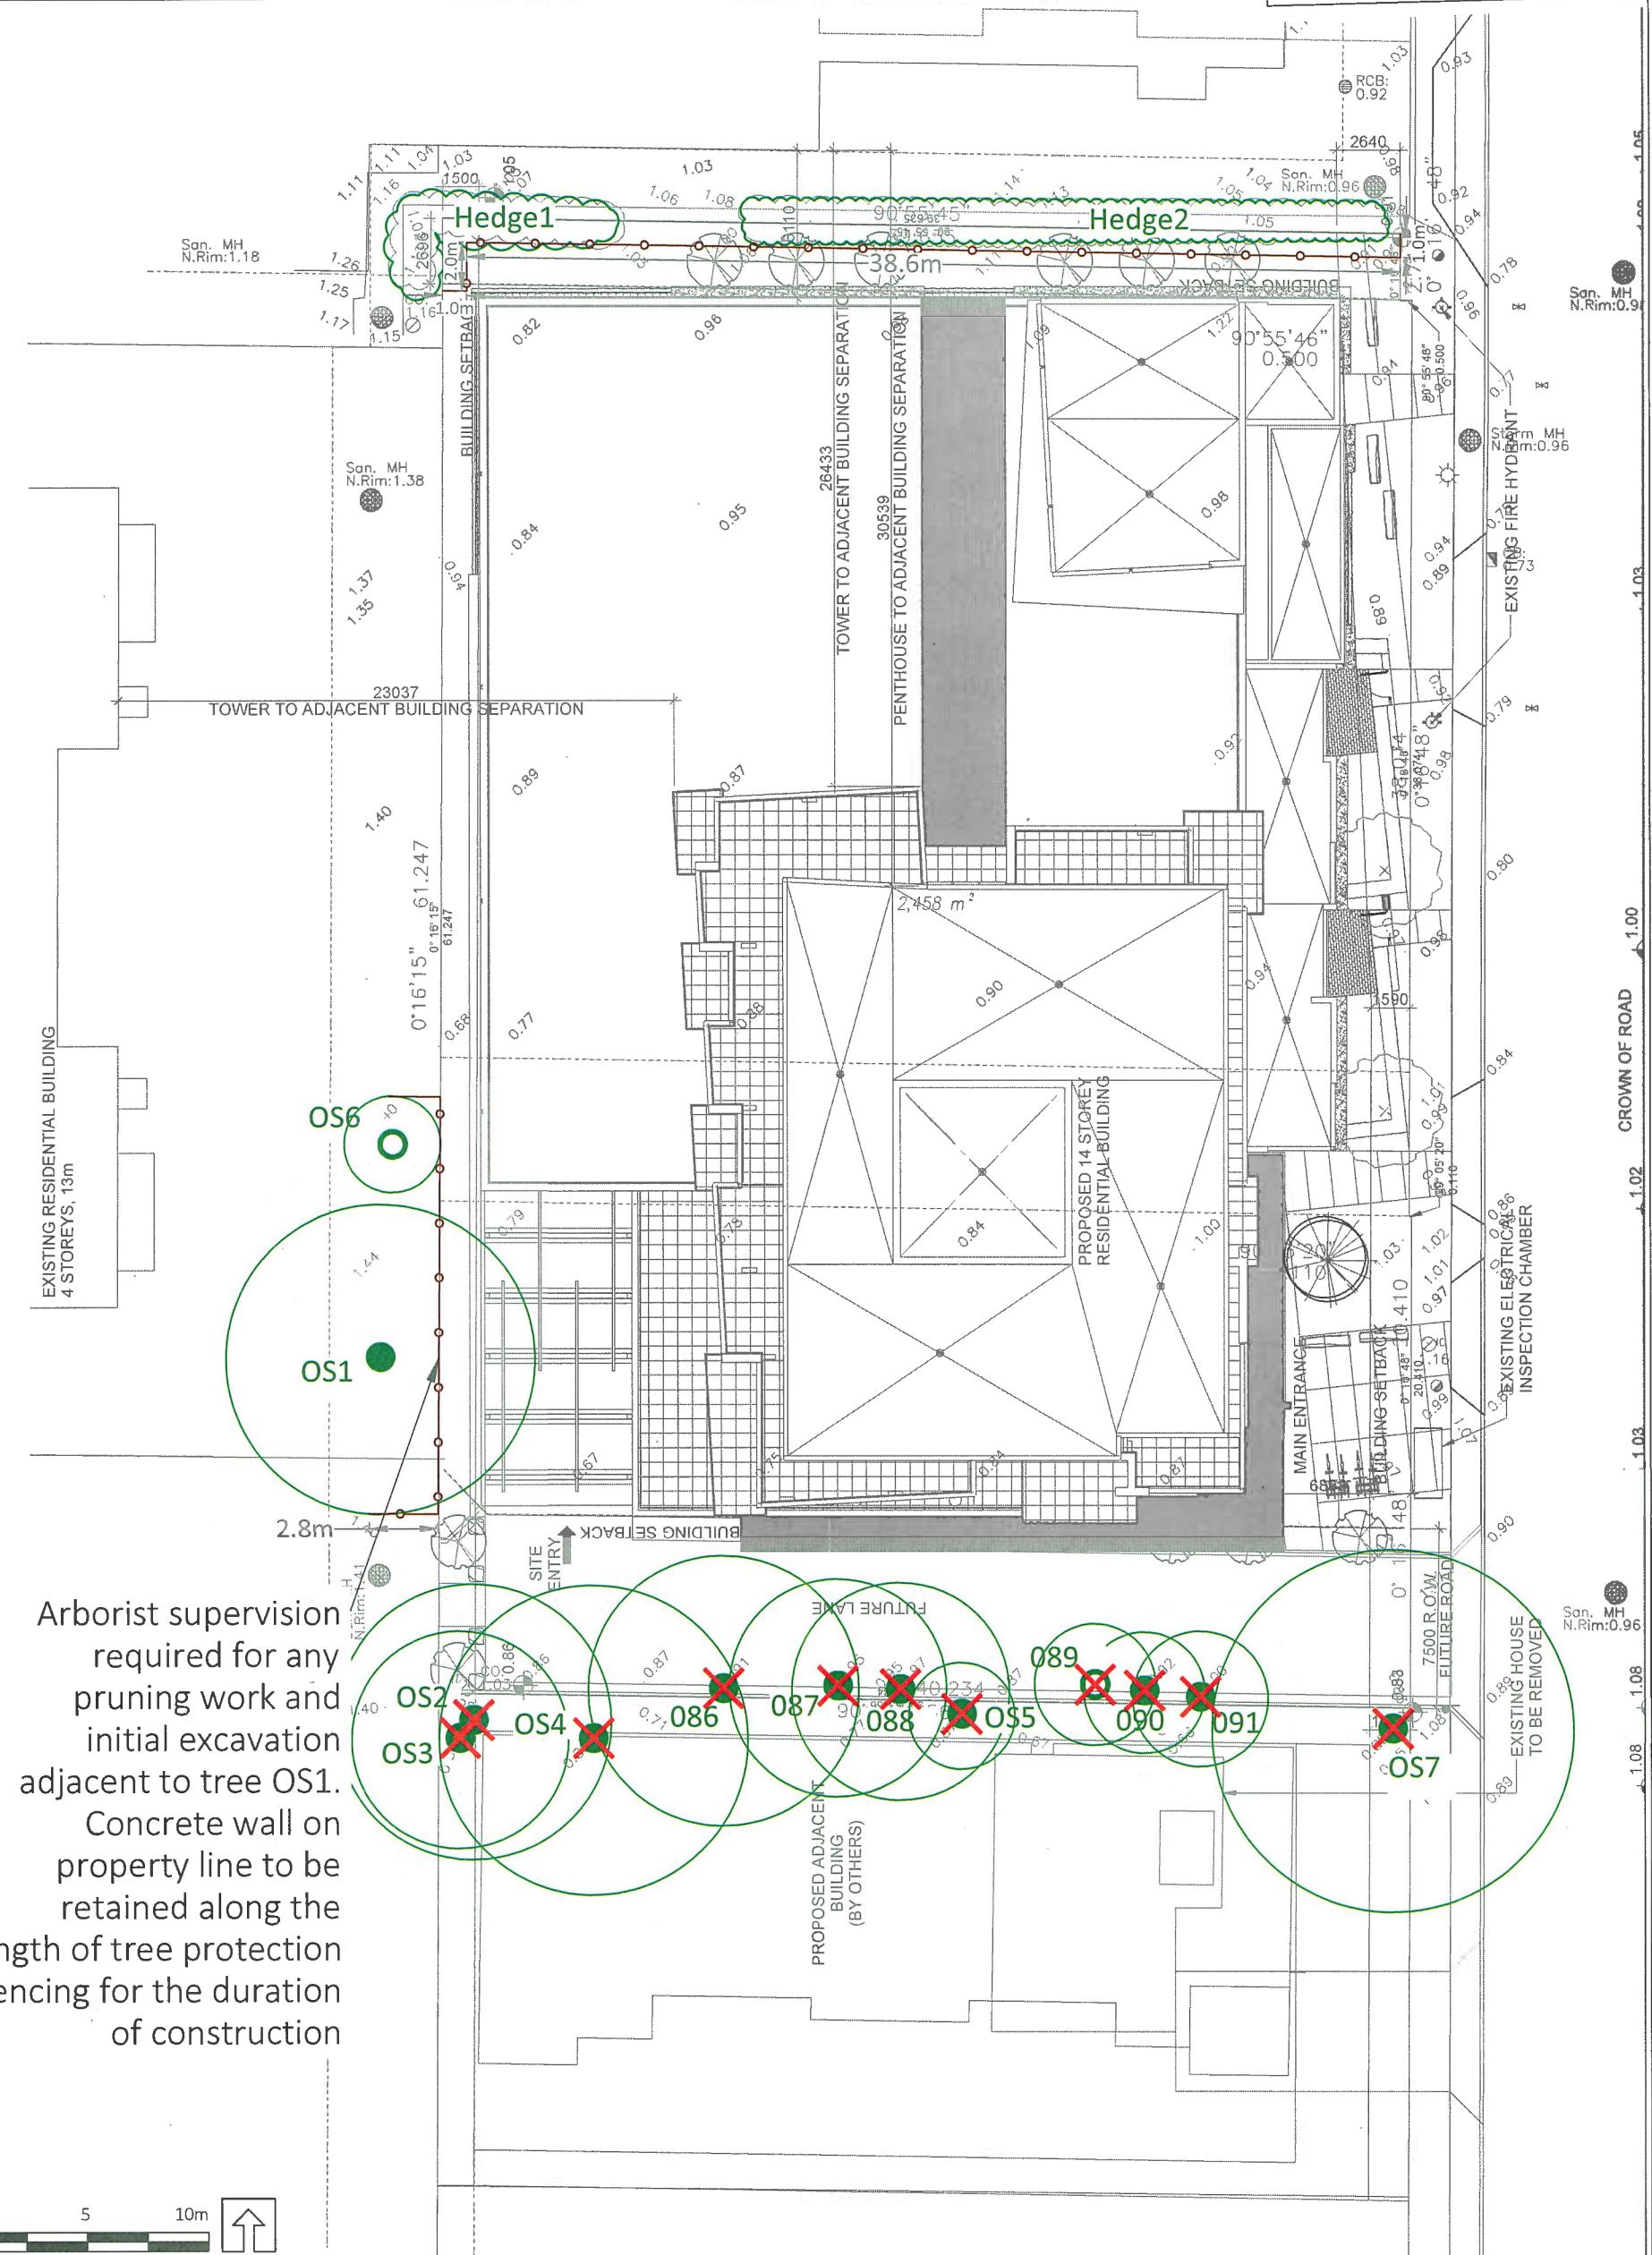




CONSULTANT INFORMATION
Cabi: DIRECT LANDSCAPE ARCHITECTURE
Landscape Architectural Services Group of Companies
Specialist: GUTHRIE-SIMPSON GROUP OF COMPANIES
Mechanical: KME GROUP
Electrical & Associates LTD.
Timber:

NOT FOR
CONSTRUCTION

PROJECT INFORMATION

COONEY ROAD
TOWER


6333 COONEY ROAD
RICHMOND, BC

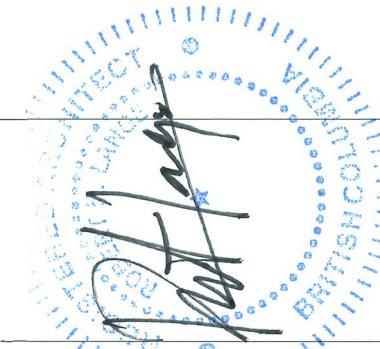


DP 17-791045 Reference Plan
Nov 20, 2019

CONSULTANT INFORMATION	NOT FOR CONSTRUCTION	PROJECT INFORMATION	COONEY ROAD TOWER	6333 COONEY ROAD RICHMOND, BC	MATT HAPGOOD BRITISH COLUMBIA	DATE ISSUED	SCALE
Cabi: DIRECT LANDSCAPE ARCHITECTURE Landscape Architectural Services Group of Companies Specialist: GUTHRIE-SIMPSON GROUP OF COMPANIES Mechanical: KME GROUP Electrical & Associates LTD. Timber:						2019-10-31 2019-11-06	1/4" = 1'-0"

C:\Pentel Project\19171A.dwg

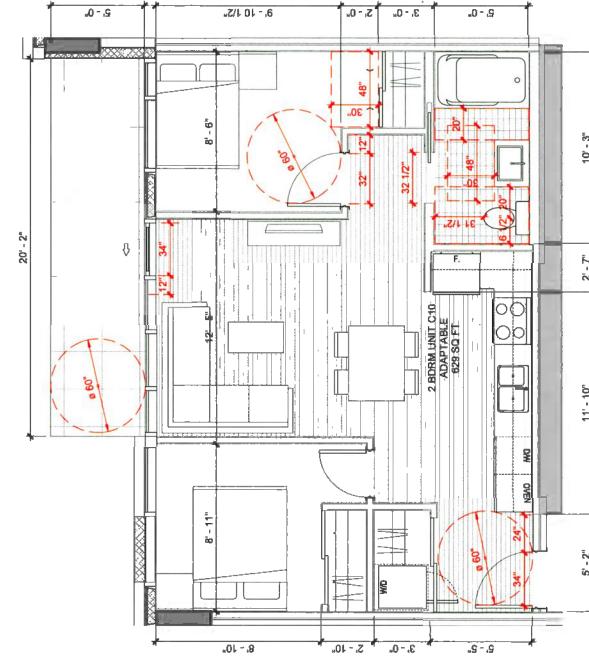

2 BDRM UNIT C10 ADAPTABLE - LEVEL 4-13
DP30-01-00 SCALE: 1/4" = 1'-0"

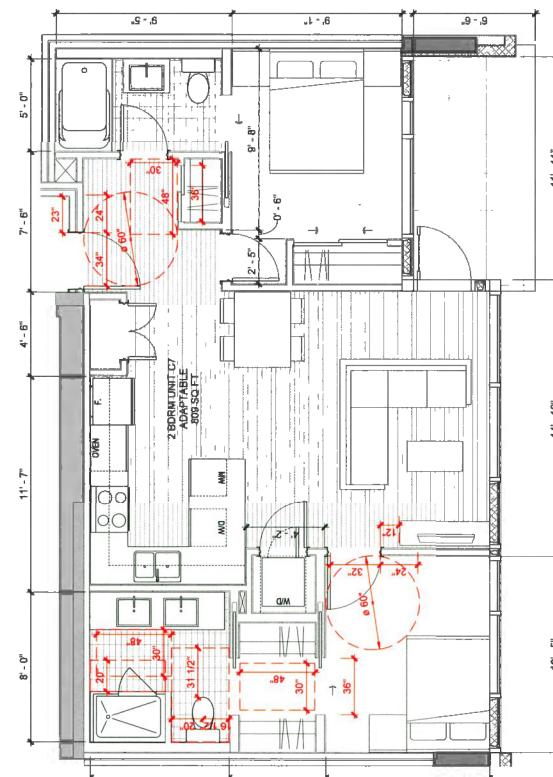


2 BDRM UNIT C7 ADAPTABLE - LEVEL 4-13
DP30-01-00 SCALE: 1/4" = 1'-0"

CONSULTANT INFORMATION	NOT FOR CONSTRUCTION	PROJECT INFORMATION	COONEY ROAD TOWER	6333 COONEY ROAD RICHMOND, BC	MATT HAPGOOD BRITISH COLUMBIA	DATE ISSUED	SCALE
Cabi: DIRECT LANDSCAPE ARCHITECTURE Landscape Architectural Services Group of Companies Specialist: GUTHRIE-SIMPSON GROUP OF COMPANIES Mechanical: KME GROUP Electrical & Associates LTD. Timber:						2019-10-31 2019-11-06	1/4" = 1'-0"


C:\Pentel Project\19171A.dwg

DP20-16-00

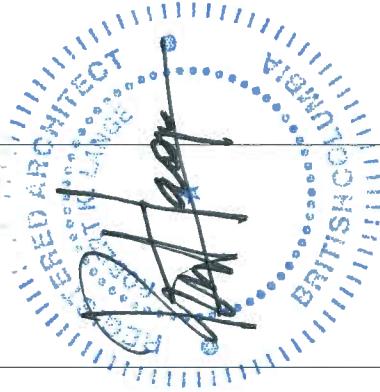

CONSULTANT INFORMATION


Cole: CONNECT LANDSCAPE ARCHITECTURE
Landscape Architectural Services Group of Companies
Specialist: GULATIAN SAMPSON GROUP LTD.
Reference: NAME: GULATIAN SAMPSON GROUP LTD.
Email: info@s2architecture.com
Phone:

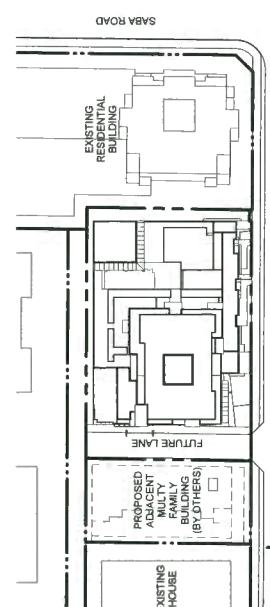

NOT FOR CONSTRUCTION

PROJECT INFORMATION

COONEY ROAD
TOWER
6333 COONEY ROAD
RICHMOND, BC

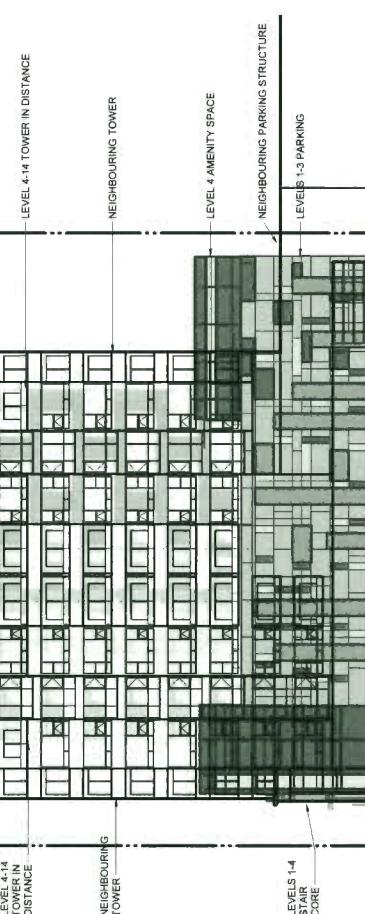

NORTH ELEVATION WITH MIRRORED ELEVATION OF NEIGHBOURING TOWER

SCALE: 1/16 = 1'-0"



ISSUED	DATE
DEVELOPMENT PERMIT APPLICATION	2017-11-20
RE-SUBMISSION	2018-05-28
DP SUBMISSION	2018-02-01
DP RESUBMISSION	2018-10-31
DP RESUBMISSION	2019-11-08

SCALE: As indicated

DATE: 11/14/2019 4:27:45 PM

DRAWN BY: JH

PROJECT NO: 21971

DRAWING TITLE: COONEY ROAD STREETSCAPE

1 COONEY ROAD STREETSCAPE
DP00-04-00 SCALE: 1/16 = 1'-0"

DRAWING NO.




CONSULTANT INFORMATION
CML CONNECT LANDSCAPE ARCHITECTURE
Landscape Architectural Services
GORDON & SONS GROUP OF COMPANIES
Metzler Associates Ltd.
Metzler & Associates Ltd.
Toronto

NOT FOR
CONSTRUCTION

PROJECT INFORMATION

COONEY ROAD
TOWER

6333 COONEY ROAD
RICHMOND, BC

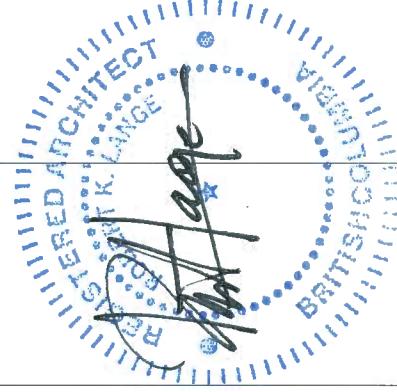

DP 17-791045 Reference Plan
Nov 20, 2019



DATE
11/14/2019 4:32:56 PM

DRAWN BY
JH

CHESTERBY SH

PROJECT NO.
21971

ISSUED
2017-11-03

DEVELOPMENT PERMIT
OP APPLICATION

2018-09-28

RE-SUBMISSION

2019-02-01

OP RESUBMISSION

2019-10-31

OP RESUBMISSION

2019-11-06

4

DP000-03-00
DRAWING NO.

DP 17-791045 Reference Plan
Nov 20, 2019