

Report to Development Permit Panel

To: Development Permit Panel

Date: April 21, 2023

From: Wayne Craig

Re:

File: DP 21-932383

Director of Development

Application by Flat Architecture Inc. for a Development Permit at 8951,

8971 Spires Road and 8991 Spires Gate

Staff Recommendation

That a Development Permit be issued which would:

- Permit the construction of 22 townhouse units and two secondary suites at 8951, 8971 Spires Road and 8991 Spires Gate and the surplus portion of Spires Road on a site zoned "Parking Structure Townhouses (RTP4)" zone; and
- 2. Vary the provisions of Richmond Zoning Bylaw 8500 to:
 - a) Reduce the minimum lot width from 40 m to 33.5 m; and
 - b) Reduce the minimum lot area from 2,400 m² to 2,000 m².

Wayne Craig

Director of Development

(604-247-4625)

WC:el

Att. 3

Staff Report

Origin

Flat Architecture Inc., on the behalf of 0924206 BC Ltd. (Incorporation number: BC0924206; Directors: Brian R. Purcell, John Young, Dexter Young, Michael Young and Eric Sen Hang Yung), has applied to the City of Richmond for permission to develop 22 residential units and two secondary suites at 8951, 8971 Spires Road and 8991 Spires Gate and the surplus portion of the Spires Road road allowance. The applicant has proposed to purchase the surplus road allowance and consolidate it into the development site. A total of 20 multi-level townhouse units and two ground-level flats fronting Spires Road will be included in the development. The unit sizes range between 71.27 m² (767 ft²) and 139.91 m² (1,505 ft²), providing a mix of two to five-bedroom units. Two of the 20 multi-level townhouse units are proposed to contain a two-bedroom secondary suite fronting Spires Gate. Parking will be provided within the parking structure at grade.

The site is being rezoned from "Single Detached (RS1/E)" zone to "Parking Structure Townhouses (RTP4)" zone for this project under Bylaw 10218 (RZ 18-818420), which received Third Reading following the Public Hearing on January 18, 2021. The site is currently vacant but previously contained three single-family dwellings.

Servicing Agreement

Frontage improvements, including beautification works along the site frontage (including ditch infill) and future back lane, road widening, new fire hydrants, public walkways on-site and upgrades to the storm sewer and sanitary sewer, were secured through the rezoning process and will be constructed through a separate Servicing Agreement (SA 21-930503). The Servicing Agreement must be entered into prior to final adoption of the rezoning bylaw.

Development Information

Please refer to the attached Development Application Data Sheet (Attachment 1) for a comparison of the proposed development data with the relevant Bylaw requirements.

Background

The Spires Road Neighbourhood is identified in the City Centre Area Plan as an area intended to transition from a predominately single-family neighbourhood toward a higher-density neighbourhood.

To the North: Across Spires Gate, Single-family homes on lots zoned "Single Detached (RS1/E)", which are designated as Park under the City Centre Area Plan.

To the South: A recently completed 64-unit high-density townhouse development (RZ 17-

766525 & DP 18-829140) on a lot zoned "Parking Structure Townhouses

(RTP4)".

To the East: Across Spires Road, single-family homes on lots zoned "Single Detached

(RS1/E)", which are designated for medium-density, mid-rise (4-8 storeys) housing with market rentals and affordable housing components, under the

recently updated City Centre Area Plan.

To the West: A 19-unit townhouse development (with a common parking structure), on a lot zoned "Town Housing (ZT46) – South McLennan and Brighouse Village (City Centre)".

Rezoning and Public Hearing Results

The Public Hearing for the rezoning of this site was held on January 18, 2021. No concern regarding the rezoning application was expressed at the Public Hearing.

Staff Comments

The proposed scheme attached to this report has satisfactorily addressed the significant urban design issues and other staff comments identified as part of the review of the subject Development Permit application. In addition, it complies with the intent of the applicable sections of the Official Community Plan and is generally in compliance with the "Parking Structure Townhouses (RTP4)" zone except for the zoning variances noted below.

Zoning Compliance/Variances (staff comments in bold)

The applicant requests to vary the provisions of Richmond Zoning Bylaw 8500 to:

- 1) Reduce the minimum lot width from 40 m to 33.5 m;
 - (Staff support this variance since the subject site is an orphaned site located between Spires Road and a future lane to the west. This corner lot is considered to have its front lot line along Spires Gate and a lot width of approximately 33.5 m. There is no opportunity for the developer to acquire additional property to meet the minimum lot width requirement. This corner site also has an approx. 61 m frontage along Spires Road. The variance was noted at time of rezoning, with no concerns identified at the Public Hearing.)
- 2) Reduce the minimum lot area from 2,400 m² to 2,000 m².

(Staff support this variance since the subject site is an orphaned site located between Spires Gate to the north and a recently approved townhouse development to the south. There is no opportunity for the developer to acquire additional property to meet the minimum lot size requirement. The variance was noted at time of rezoning, with no concerns identified at the Public Hearing.)

Advisory Design Panel Comments

The Advisory Design Panel (ADP) has reviewed the project and supports it. A copy of the relevant excerpt from the Advisory Design Panel Minutes from Wednesday, May 18, 2022 is attached for reference (Attachment 2). The design response from the applicant has been included immediately following the specific Design Panel comments and is identified in 'bold italics'.

Analysis

Conditions of Adjacency

- The proposed form of development on the subject site is the same as those on the surrounding properties to the south and west, which are grade-oriented housing in the form of high-density townhouses (i.e., low-rise, street wall buildings with common parking structures concealed from public view by non-parking uses).
- Location and orientation of windows are carefully considered to minimize the opportunity of looking into close-by windows of existing adjacent developments and units proposed on site.
 Planters are proposed on the roof deck to provide privacy screening between units facing each other across the internal courtyard.
- Lane dedication along the west side of the site for the provision of the future north-south lane parallel to Cooney Road has been secured at Rezoning. Since this future lane along the west property line of the site is not required for access for the proposed development, the lane is not required to be built at this time. The existing site grade along the west edge of the lane dedication area will be maintained to provide an appropriate transition to the adjacent townhouse development to the west. This lane dedication area will be maintained by the site's strata until the lane has become operational; and this arrangement has been secured through the rezoning process.
- To enhance pedestrian circulation within the Spires Road Neighbourhood, a 1.5 m wide SRW along the north side property line of the adjacent development site to the south has been secured for future pedestrian connection between Spires Road and the future back lane. A similar 1.5 m wide SRW along the south property line of the subject site has also been secured at rezoning stage in order to widen the walkway SRW to 3.0 m. Interim sod lawn within the 1.5 m wide SRW on the adjacent property has been provided as part of the adjacent development to the south. As part of this development, the developers are required to remove the sod lawn and construct within the 3.0 m wide SRW a 1.5 m wide concrete walkway and a 0.75 m wide swale for drainage along both edges of the walkway. These arrangements have been secured through the rezoning process and the design and construction of the walkway will be included in the Servicing Agreement.
- Perimeter drainage will be required as part of the Building Permit to ensure storm water is managed and addressed through the development and will not impact the neighbouring properties.

Urban Design and Site Planning

- The development will contain 22 units, including:
 - Two single-level Basic Universal Housing units at grade with direct access to Spires Road and direct access to the parking structure. The BUH units are two-bedroom units and are approximately 71 m² (767 ft²) in size.
 - Two four-storey units each with a secondary suite at grade. The secondary suites are two-bedroom units and are approximately 65 m² (700 ft²) in size. The secondary suites will have a direct, street-level entry from Spires Gate. The principal units will have direct access from the podium. These homes will also have direct access to the parking structure.

- o Two four-storey units each with a rec room and bathroom on the ground level. These homes will have a direct, street-level entry from Spires Gate, as well as direct access from the podium and the parking structure.
- o 16 three-storey townhouse units with main unit entry located on the podium level.
- Three townhouse blocks are proposed and are positioned to enclose a parking structure at grade. The townhouse blocks are connected by the outdoor courtyard space on the podium, above the parking structure.
- Pedestrian access to the podium (via exterior stairs) will be provided on both the Spires Road and the Spires Gate frontages.
- An enclosed lobby is also proposed along the Spires Road frontage to provide a secured space for the mailbox kiosk, elevator to the podium level and access to the enclosed parking area.
- Vehicular access to the parking structure will be from Spires Road.
- 31 residential parking spaces are proposed, which exceeds the minimum bylaw requirement.
- The proposal will feature 16 parking spaces in a tandem arrangement. This arrangement is consistent with the tandem parking provision of Richmond Zoning Bylaw 8500. A restrictive covenant to prohibit the conversion of the tandem garage area into habitable space, and to ensure that both parking spaces be assigned to the same dwelling unit where two parking spaces are provided in a tandem arrangement, has been secured at rezoning.
- A total of three accessible residential parking stalls are to be provided on site; two spaces will be assigned to the two Basic Universal Housing units proposed, and one space will be designated for visitor parking.
- A total of five visitor parking spaces (including one accessible parking stall) are to be provided throughout the site. The number of visitor parking spaces proposed is in compliance with the minimum bylaw requirement.
- Both internal and external bicycle parking spaces have been incorporated into the proposal and are in compliance with the Zoning Bylaw requirements.
- The enclosed garbage room housing garbage, recycling and organics storage bins is proposed to locate within the parking structure, by the security gate, and adjacent to the loading area.
- Indoor amenity space is not proposed on-site. A \$44,225.00 cash-in-lieu contribution has been secured as a condition of rezoning approval, consistent with the Official Community Plan (OCP).
- The overall size of the proposed outdoor amenity spaces comply with the Official Community Plan (OCP) requirements. The locations and sizes of the outdoor amenity spaces are appropriate for providing open landscape and amenity spaces convenient to all units.
- All of the units will have private outdoor areas at grade and/or on the elevated podium
 overtop the parking structure. All ground-level flats and secondary suites will have a private
 outdoor space consisting of a front yard on the street level; all townhouse units will have a
 private outdoor space consisting of a patio on the podium level and a roof top deck
 overlooking the internal courtyard.

• While the configurations of some the proposed yard/patio spaces at grade and/or on the podium level are slightly shallower than what is encouraged under the Development Permit Guidelines, the functionality of those yard spaces have not been compromised. Each of the proposed private outdoor space at grade includes a patio area that is large enough to accommodate a table with seating, a lawn area and/or a small garden of perennials, shrubs, with a tree to provide shade. Each of the proposed private outdoor space on the podium level is large enough to host a BBQ and seating area with a table.

Architectural Form and Character

- The proposed development embodies the Tudor style architecture with varying façade treatment at key points, steep roof pitches, proportionate windows set symmetrically into traditional massing forms and projecting bays with prominent gables.
- The building massing of the four-storey townhouse units along the road frontages are reduced by enclosing the top floor under the pitched roof.
- The top floor is also stepped back to increase sun penetration opportunity onto the internal courtyard on top of the parking podium.
- The proposal reinforces a pedestrian friendly streetscape along the road frontages with individual gates/walkways, street level entries and small gated front yards.
- All dwelling units have direct entrances either from the street or the internal courtyard on the
 podium. All entrances feature private yards and a lower entry roof to reflect a single-family
 character.
- The proposed building materials (brick veneer, high density fibre cement boards, stucco, wood trim, post, fascia and barge board, shingles and divided windows) are generally consistent with the Official Community Plan (OCP) Guidelines.
- Fibre cement boards and stucco are the two dominant materials used on the elevations. Façade details and trim contrast the background colours of the elevations. Asphalt shingles are used to accentuate a single family character. Brick veneer is used as accent material in the lower portions of the buildings. Board and batten with contrasting colours are used on the gable ends to reflect the Tudor style architecture.

Landscape Design and Open Space Design

- 19 bylaw-sized trees and one hedge row on the subject development site were assessed at the
 rezoning stage, and all of these trees and hedge row are identified for removal due to poor
 condition.
- Based on the 2:1 tree replacement ratio goal stated in the Official Community Plan (OCP), 38 replacement trees are required. The applicant is proposing to plant eleven replacement trees on-site, including six conifer and five deciduous trees at grade.
- The applicant has agreed to provide a voluntary contribution of \$20,250.00 to the City's Tree Compensation Fund in lieu of planting the remaining 27 replacement trees.
- A pedestrian-oriented streetscape along the road frontages is proposed with a defined edge with layered shrub planting, metal picket fence and slightly raised patios.
- Each ground-oriented unit will have a private front yard with a small lawn area and/or patio as well as a tree and landscape area to generate animation along the streetscape.

The front yards will be separated with a low metal fence with landscaping to provide privacy for individual units.

- At the intersection of Spire Road and Spires Gate, low-level ornamental shrubs will be provided to allow for clear visibility for vehicular movements.
- The area in front of the main lobby will be treated with permeable paving and highlighted with trees on either side to accentuate the entrance to the building.
- Decorative concrete paving is proposed at the vehicle entry of the site and permeable paving will be used to delineate the loading area by the vehicle entry.
- The west elevation will be screened by vigorous vines, supported by cable trellises.
- Circulation around the building is provided by a concrete pathway along the south and west property line.
- The courtyard on the podium level provides private patio spaces for residents.
 Low cast-in- place planters are proposed along the common walkway to establish an appealing and intimate residential character to encourage socialization and provide for casual surveillance of the common outdoor area.
- There are two outdoor spaces on the podium level:
 - O A children's play area is proposed at the northwest corner of the courtyard. Play equipment has been chosen to fit into the play area and to provide different play opportunities (i.e., climbing, social, imagination, balance and motor skills) that can be used by different age groups and for multiple purposes. A bench is also provided for caregivers.
 - Another outdoor amenity space is proposed at the southeast corner of the courtyard.
 This space is designed as a social area for more passive activities. Features proposed within this outdoor amenity space include a dining area with an outdoor kitchen and a community garden area with accessible planting pods.
- Planters are proposed at the roof decks to enhance privacy between units facing each other.
- A smart irrigation system fine-tunes its watering based on the amount of light, soil condition and local weather forecast is proposed to ensure continued maintenance of live landscaping.
- In order to ensure that the proposed landscaping works are completed, the applicant is required to provide a landscape security of \$187,615.31 in association with the Development.

Crime Prevention Through Environmental Design

- Site lighting and clear sight lines provide unobstructed views of the surrounding area. Walkways are direct and open.
- Wall-mounted lights are proposed on all sides of the parking podium. These lights are
 provided only where building-mounted lights are incapable of illuminating any external
 spaces. These lights are indirect and do not offer any unwanted glare with built-in anti-glare
 shading system.
- Plantings near residential entries are low to maximize views and casual surveillance opportunities of common areas.
- Expansive glazing for each unit increases the visual presence and surveillance along the road frontages, future back lane, outdoor amenity spaces and the courtyard on the podium level.

Sustainability

- The project will be designed to meet Step Code 3 requirements of the BC Energy Step Code, including energy modelling.
- No thermal breaks are required as no balconies are being proposed. The roof decks will be insulated from below with minimum R40 insulation to meet the minimum requirement.
- Sound transmission through the façade has been evaluated; conventional exterior construction, including windows and doors with standard thermal glazing satisfies the minimum requirements.
- Energy Star appliances, water sense toilets and energy efficient lighting (LED or CFL) will also be provided.

Accessible Housing

- The proposed development includes two BUH units that are designed to be easily renovated to accommodate a future resident in a wheelchair. These single-storey units are required to incorporate all of the accessibility provisions listed in the Basic Universal Housing Features section of the City's Zoning Bylaw, and are permitted a density exclusion of 1.86 m² (20 ft²) per unit.
- All of the proposed units incorporate aging-in-place features to accommodate mobility constraints associated with aging. These features include:
 - o Stairwell handrails;
 - o Lever-type handles for plumbing fixtures and door handles; and
 - o Solid blocking in washroom walls to facilitate future grab bar installation beside toilets, bathtubs and showers.

Conclusions

As the proposed development would meet applicable policies and Development Permit Guidelines, staff recommend that the Development Permit be endorsed, and issuance by Council be recommended.

Edwin Lee

Planner 2

(604-276-4121)

EL:is

Att. 1: Development Application Data Sheet

2: Excerpt from Advisory Design Panel Meeting Minutes (March 23, 2002)

3: Development Permit Considerations



Development Application Data Sheet

Development Applications Department

DP 21-932383 Attachment 1

Address: 8951, 8971 Spires Road and 8991 Spires Gate

Applicant: Flat Architecture Inc. Owner: 0924206 BC Ltd.

Planning Area(s): City Centre

Floor Area Gross: 2,660.75 m² Floor Area Net: 2,392.95 m²

	Existing	Proposed		
Site Area:	2,319.44 m²	2,068.0 m²		
Land Uses:	Single-Family Residential	Multiple-Family Residential		
OCP Designation:	Low-Density Residential	No Change		
	City Centre Area Plan Amended July 18, 2022:	Under the provisions for instream applications:		
Area Plan Designation:	Urban Centre T5	City Centre Area Plan: General Urban T4		
	Sub-Area B.2: Mixed Use – Mid-Rise Residential & Limited Commercial	Sub-Area B.1: Mixed Use – Low-Rise Residential & Limited Commercial		
Zoning:	Single Detached (RS1/E)	Parking Structure Townhouses (RTP4)		
Number of Units:	3	22		

	Bylaw Requirement	Proposed	Variance
Floor Area Ratio:	Max. 1.20	1.16	none permitted
Lot Coverage – Building:	Max. 50%	48.9%	none
Lot Coverage – Non-porous Max. 80% 66.8%		66.8%	none
Lot Coverage – Landscaping:	Min. 20%	20.0%	none
Setback – Front Yard - Spires Gate (m):	Min. 3.0 m	3.0 m	none
Setback – Exterior Side Yard – East – Spires Road (m):	Min. 3.0 m	3.0 m	none
Setback – Interior Side Yard - West (future lane) (m):	Min. 1.5 m	1.5 m	none
Setback - Rear - South (m):	Min. 1.5 m	1.5 m	none
Height (m):	Max. 15.0 m (4 storeys)	14.8 m (4 storeys)	none
Lot Depth:	Min. 30.0 m	61.22 m	none

Lot Width:	40 m	33.5 m	Variance Requested
Site Area:	Min. 2,400 m ²	2,068 m²	Variance Requested
Off-street Parking Spaces – Regular (R) / Visitor (V):	1.2 (R) and 0.2 (V) per unit	1.4 (R) and 0.2 (V) per unit	none
Off-street Parking Spaces - Total:	27 (R) and 5 (V)	31 (R) and 5 (V)	none
Tandem Parking Spaces:	Max. 50% of required residential spaces (27 x Max. 50% = 13)	12 + 4 extra small parking spaces	none
Small Car Parking Spaces	Max. 50% when 31 or more spaces are provided on-site (36 x Max. 50% = 18)	10	none
Handicap Parking Spaces:	Min. 2% when 11 or more spaces are required (36 x 2% = 1 spaces)	3	none
Bicycle Parking Spaces – Class 1 / Class 2:	1.25 (Class 1) and 0.20 (Class 2) per unit	Y Y NONA	
Off-street Parking Spaces – Total:	28 (Class 1) and 5 (Class 2)	36 (Class 1) and 5 (Class 2)	none
Amenity Space – Indoor:	Min. 100 m² or Cash-in- lieu	Cash-in-lieu	none

Excerpt from the Minutes from The Design Panel Meeting

Wednesday, May 18, 2022 – 4:00 p.m. Rm. M.1.003 Richmond City Hall

1. DP 21-932383 - 22 TOWNHOUSE UNITS OVER A PARKING PODIUM

ARCHITECT: FLAT Architecture

LANDSCAPE Architecture Panel Inc.

ARCHITECT:

PROPERTY 8951, 8971 Spires Road and 8991 Spires Gate

LOCATION:

Applicant's Presentation

Architect Rajinder Warraich, FLAT Architecture, Inc. and Landscape Architect Ruchir Dhall, Architecture Panel Inc., presented the project and answered queries from the Panel.

Panel Discussion

Comments from Panel members were as follows:

• the project was presented well by the applicant; the materials package is comprehensive and easy to understand;

Noted.

• the targeted insulation R-values for the proposed design look good; however, concerned on U- values for windows; the targeted 1.4 U-value for windows could be improved to a starting point of 0.39 which is seen in many existing buildings;

U value of windows to be based on energy modelling for Step code 3. It can vary from .39 to 1.4 as per energy model report.

• consider changing the language for solar heat gain coefficient (SHGC) from "0.32 or higher" to "0.32 or lower" as the latter values are better;

SHGC value to be .32 or lower as requested.

 consider a minimum HRV Sensible Recovery Efficiency (SRE) of 85% and not 65% due to improvements in products and technology;

Increased to 85 %.

the proposed gas or propane fire pit on the podium level outdoor amenity area is not consistent with the overall sustainability objective of the project; consider non fossil fuel-powered alternates such as an electric fire pit;

Fire pit Removed as suggested.

 appreciate the general landscape approach for the project and the hierarchy of outdoor spaces;

Noted.

 review the size and depth of planters proposed at the podium level to ensure they are adequate for planting and establishing trees; Planting depth and tree location;

Significant amendments have been done at the podium level despite having adequate soil volume for small trees (~750mm). They have been replaced with large shrubs like rhododendron vulcan, which assume similar height to the smaller trees creating a much thicker and colorful foliage presence. Also, significant sections of the hard patios have been substituted with water absorbent sod to increase the permeable areas.

appreciate the separation of the active from passive spaces in the outdoor amenity area; however, review the size of the play equipment and consider other alternatives considering the tightness of the outdoor amenity area; Outdoor;

Amenity area redesigned based on ADP discussion and comments. i.e., the consolidated dining and congregation area proposed towards the outdoor cooking areas to the N and the vegetable planters moved to the S so that both areas have consolidated sections with minimal breaks. Also, the outdoor firepit was taken out to achieve the above configuration per the ADP recommendations.

 ensure that picnic tables and planters at the community garden area are wheelchair accessible;

Yes, all outdoor amenity is accessible.

• look at fencing details to ensure appropriate distance between the pickets as the project moves forward to the next stages of the development process;

Distance between pickets is less than 4inch and meet BCB 2018.

there is too much landscaping on the limited open spaces in the project; consider simplifying the landscaping and not program every outdoor amenity space, e.g. a green space could be more appropriate for some areas than installing play areas and outdoor furniture;

The landscaping has been simplified by substituting the thick tree configuration with large shrubs on the podium level. Furthermore, simplification of landscape programming is what we feel an optimum solution to reducing the intense landscaping pointed above.

• overall, the project is well thought out and laid out considering the size of the subject site and the proposed number of housing units;

Noted.

- consider integrating a parcel delivery drop off area close to the mailbox in the main lobby of the building;
 - Parcel Delivery area is provided in the vestibule near main entrance. Vestibule with doors in 2 tiers (first door accessible to general public and second door accessible to authorized persons) are provided for security.
- consider adding more details to reflect a true Tudor style considering that the subject site is in a transition area from single-family to higher density residential developments;
 - The overall design of the buildings reflect a true Tudor style. More wood trims have been added in the elevations, window and door trims have been made more decorative, pitch of the roofs is steep and more masonry has been added on level 1 to give grounding effect.
- note that there is a difference between the renderings presented by the applicant and the landscape plans at the northeast corner of the site; the landscape plans indicate significant grass as opposed to the renderings which show thicker plantings; clarify the difference, including the proposed signage at the northeast corner;

Renderings updated and coordinated with landscape drawings.

- intensive planting at the northeast corner of the subject site could help soften the transition into the neighbourhood and create a gateway condition; Planting soften along northeast corner as suggested. Very distinct and low height perennials and grasses are proposed outside of the yard hedging to create a visually attractive but non-blocking vegetation arrangement.
- stairways that connect the ground level to the podium level look daunting; consider installing a landing halfway up the stairs to make them more accessible to people with mobility issues;
 - Provision of landing is not mandatory as per the code. Only the landing in main staircase has been removed because there isn't sufficient space to provide the requisite number of steps after the setback.
- ensure adequate wheelchair turnaround space for at-grade patios for Basic Universal Housing (BUH) units to enhance their accessibility;
 - Turnaround provided as 1.5 walkways are good for turnarounds.

consider toning down the differences in character, e.g. materials, colour and texture on the ground floor facades of the building to achieve more consistency; the stucco on the west ground floor façade appears out of character with the rest of the building facades; consider relating the stucco to the other building facades by either adding brick or fiber cement on the west ground floor façade; Noted,

The material is revised and brick added as per suggestion.

• the exterior treatment for the building base facing the street appears flat and is less successful than the treatment for the building base facing the podium; the in and out relationship with the bay windows facing the podium successfully breaks down the building mass;

The main entrance canopies to the units and entrance to the main lobby break the continuity of the material at grade level. The overall building is small and the introduction of brick cladding on the ground floor provides heavier base.

the metal and glass guardrails appear out of character with the rest of the detailing on the building; look at the metal picket fence on the landscape drawings and consider a greater relationship of the various fencing/guardrail materials;

Metal and glass guard changed to Picket fence style.

the metal and glass guardrails on the roof deck facing the podium are pushed forward a bit too much and appear more prominent than the traditional elements on the façade of the lower levels; consider pushing back the metal and glass guardrails to provide more prominence to the traditional elements;

We have converted all railings to picket style fence and have not pushed the railing inwards. Pushing the railing inwards will result in reduction of roof top patio areas.

• the second bedroom of BUH Unit 101 does not have a separate bathing space; the resident will have to go into the accessible bathroom to the master bedroom;

The entire design of BUH units and Level 1 has changed after the ADP meeting; separate bathing space added in the 2nd bathroom of both BUH units.

• in general, the kitchen space looks tight with respect to turning radii; ensure that there is a five-foot turning circle within the working area of the kitchen or clarify if that is being achieved;

The entire design of BUH units and Level 1 has changed after the ADP meeting and this concern has been addressed.

look at the proximity of the exit from the elevator to the top of the exit stairs on the podium level which could pose a safety concern for a person in wheelchair; review how those elements are related to one another; also look at the screening of exposed condensers in the area if they fit within the overall concept of the project;

In previous submissions the door of the elevator lobby was opening right in front of the top of the staircase. Now the position of this door has been changed to the side of the lobby and it opens on the podium pathway which does not pose any safety concern for a person on wheelchair. The condensers are well screened behind landscape planters.

 appreciate the provision of automated doors in certain locations of the building and not just at the main entrance; also appreciate the installation of wiring for automated door openers for entrances to units;

Noted.

 appreciate the accessibility of gathering places and common amenities such as garbage and recycling;

Noted.

• consider locating the two designated accessible parking stalls for BUH Units 101 and 102 to the northeast corner behind Unit 102 to make them more accessible to the two BUH units; also consider relocating the accessible visitor parking stall next to the accessible parking stall (i.e., stall number 20) to parking stall number 15; the proposal would eliminate the unnumbered stall on the northeast side but would enlarge the size of all accessible parking stalls in the proposed development;

The accessible parking for BUH Unit 1 and 2 are located right near there entrances in the new layout of level 1.

• consider installing doors swinging into the bedroom instead of into the washroom or installing pocket doors for the accessible washrooms of BUH units to enhance their accessibility to people in wheelchairs; updated,

The bathroom door opens towards the bedroom which addresses the concern in this comment.

- consider assigning mailboxes for BUH units which are between 57 cm to 110 cm from the ground level to make them accessible to people in wheelchairs;
 Noted.
- appreciate the applicant for identifying CPTED strategies for the project;

Noted.

the landscape design for the project will work well with the neighbourhood; Noted. agree with the Panel comment regarding the second bedroom of BUH unit 101 not having access to a bathing space without going to the ensuite washroom for the master bedroom;

Updated.

• the location of the stove and refrigerator for A3 units are very close to each other, which could potentially impact the working of these appliances;

Updated.

• look at the door swings not only of the BUH units but also of the refrigerators to ensure ease of opening;

The entire design of BUH units and Level 1 has changed after the ADP meeting. This concern has been addressed in the new design.

 support the Panel comment that the targeted U-values for windows should be pushed further;

U value to decrease based on the Energy modelling and step code requirements.

ensure accessibility of BUH units to adjacent open spaces;

The patio levels and the levels of the parkade have been kept at same levels as the BUH units for easy accessibility. Grade of all slopes/ramps leading up to the BUH units is less than 5%.

the aluminum and glass guardrails are very prominent and out of character, particularly in the courtyard as they are installed on the edge of the roof deck; support the Panel comment to recess the aluminum and glass guardrails if they will be retained or consider installing a picket style fence;

We have converted all railings to picket style fence and have not pushed the railing inwards. Pushing the railing inwards will result in reduction of roof top patio areas.

• the aluminum and glass guardrails on Level 2 appear too finicky and busy; a picket fence would be more appropriate or if the same materials for the guardrails are retained, consider recessing them back and not repeating them on the roof deck; and

All railings including guardrails converted to picket style railings.

support the Panel comment that the architectural expression on Level 1 on the south and west elevations are out of character with the rest of the development; the brick works well in other elevations; however, consider strategically using brick, e.g. in the corners and under the stairs due to cost considerations or if not using brick, consider using an alternate material and colour that blends better with the rest of the development considering that the west elevation will become prominent when the future lane and sidewalk will be constructed.

The material is revised and brick added as per suggestion.

Panel Decision

It was moved and seconded

That DP 21-932383 be supported to move forward to the Development Permit Panel subject to the applicant giving consideration to the comments of the Advisory Design Panel.

CARRIED

ATTACHMENT 3



Development Permit Considerations

Development Applications Department 6911 No. 3 Road, Richmond, BC V6Y 2C1

Address: 8951, 8971 Spires Road and 8991 Spires Gate

File No.: <u>DP 21-932383</u>

Prior to approval of the Development Permit, the developer is required to complete the following:

- 1. Receipt of a Letter of Credit for landscaping in the amount of \$187,615.31 (based on the costs estimate provided by a CSLA registered landscape Architect including 10% contingency).
- 2. City acceptance of the developer's offer to voluntarily contribute \$14,250 to the City's Tree Compensation Fund for the planting of replacement trees within the City.

Prior to Building Permit Issuance, the developer must complete the following requirements:

- Submission of a Construction Parking and Traffic Management Plan to the Transportation Department. Management Plan shall include location for parking for services, deliveries, workers, loading, application for any lane closures, and proper construction traffic controls as per Traffic Control Manual for works on Roadways (by Ministry of Transportation) and MMCD Traffic Regulation Section 01570.
- 2. Incorporation of accessibility measures in Building Permit (BP) plans as determined via the Rezoning and/or Development Permit processes.
- 3. If applicable, payment of latecomer agreement charges associated with eligible latecomer works.
- 4. Obtain a Building Permit (BP) for any construction hoarding. If construction hoarding is required to temporarily occupy a public street, the air space above a public street, or any part thereof, additional City approvals and associated fees may be required as part of the Building Permit. For additional information, contact the Building Approvals Department at 604-276-4285.

Note:

- * This requires a separate application.
- Where the Director of Development deems appropriate, the preceding agreements are to be drawn not only as personal covenants of the property owner but also as covenants pursuant to Section 219 of the Land Title Act.
 - All agreements to be registered in the Land Title Office shall have priority over all such liens, charges and encumbrances as is considered advisable by the Director of Development. All agreements to be registered in the Land Title Office shall, unless the Director of Development determines otherwise, be fully registered in the Land Title Office prior to enactment of the appropriate bylaw.
 - The preceding agreements shall provide security to the City including indemnities, warranties, equitable/rent charges, letters of credit and withholding permits, as deemed necessary or advisable by the Director of Development. All agreements shall be in a form and content satisfactory to the Director of Development.
- Additional legal agreements, as determined via the subject development's Servicing Agreement(s) and/or Development Permit(s), and/or Building Permit(s) to the satisfaction of the Director of Engineering may be required including, but not limited to, site investigation, testing, monitoring, site preparation, de-watering, drilling, underpinning, anchoring, shoring, piling, pre-loading, ground densification or other activities that may result in settlement, displacement, subsidence, damage or nuisance to City and private utility infrastructure.
- Applicants for all City Permits are required to comply at all times with the conditions of the Provincial Wildlife Act and Federal Migratory Birds Convention Act, which contains prohibitions on the removal or disturbance of both birds and their nests. Issuance of Municipal permits does not give an individual authority to contravene these legislations. The City of Richmond recommends that where significant trees or vegetation exists on site, the services of a Qualified Environmental Professional (QEP) be secured to perform a survey and ensure that development activities are in compliance with all relevant legislation.

Signed	Date



Development Permit

No. DP 21-932383

To the Holder: Flat Architecture Inc.

Property Address: 8951, 8971 Spires Road and 8991 Spires Gate

Address: 6321 King George Boulevard, Unit 209

Surrey, BC V3X 1G1


1. This Development Permit is issued subject to compliance with all of the Bylaws of the City applicable thereto, except as specifically varied or supplemented by this Permit.

- 2. This Development Permit applies to and only to those lands shown cross-hatched on the attached Schedule "A" and any and all buildings, structures and other development thereon.
- 3. The "Richmond Zoning Bylaw 8500" is hereby varied to:
 - a) Reduce the minimum lot width from 40 m to 33.5 m; and
 - b) Reduce the minimum lot area from 2,400 m² to 2,000 m².
- 4. Subject to Section 692 of the Local Government Act, R.S.B.C.: buildings and structures; off-street parking and loading facilities; roads and parking areas; and landscaping and screening shall be constructed generally in accordance with Plans #1 to #46 attached hereto.
- 5. Sanitary sewers, water, drainage, highways, street lighting, underground wiring, and sidewalks, shall be provided as required.
- 6. As a condition of the issuance of this Permit, the City is holding the security in the amount of \$187,615.31 to ensure that development is carried out in accordance with the terms and conditions of this Permit. Should any interest be earned upon the security, it shall accrue to the Holder if the security is returned. The condition of the posting of the security is that should the Holder fail to carry out the development hereby authorized, according to the terms and conditions of this Permit within the time provided, the City may use the security to carry out the work by its servants, agents or contractors, and any surplus shall be paid over to the Holder. Should the Holder carry out the development permitted by this permit within the time set out herein, the security shall be returned to the Holder. The City may retain the security for up to one year after inspection of the completed landscaping in order to ensure that plant material has survived.
- 7. If the Holder does not commence the construction permitted by this Permit within 24 months of the date of this Permit, this Permit shall lapse and the security shall be returned in full.

Development Permit No. DP 21-932383

To the Holder:	Flat Architecture Inc.		
Property Address:	8951, 8971 Spires Road and 8991 Spires Gate		
Address:	oulevard, Unit 209 1		
conditions and provision Permit which shall form	s of this Permit and an a part hereof.	enerally in accordance with the terms and y plans and specifications attached to this	
This Permit is not a Build	ding Permit.		
AUTHORIZING RESOLUT DAY OF ,	TION NO.	ISSUED BY THE COUNCIL THE	
DELIVERED THIS	DAY OF ,		
MAYOR			



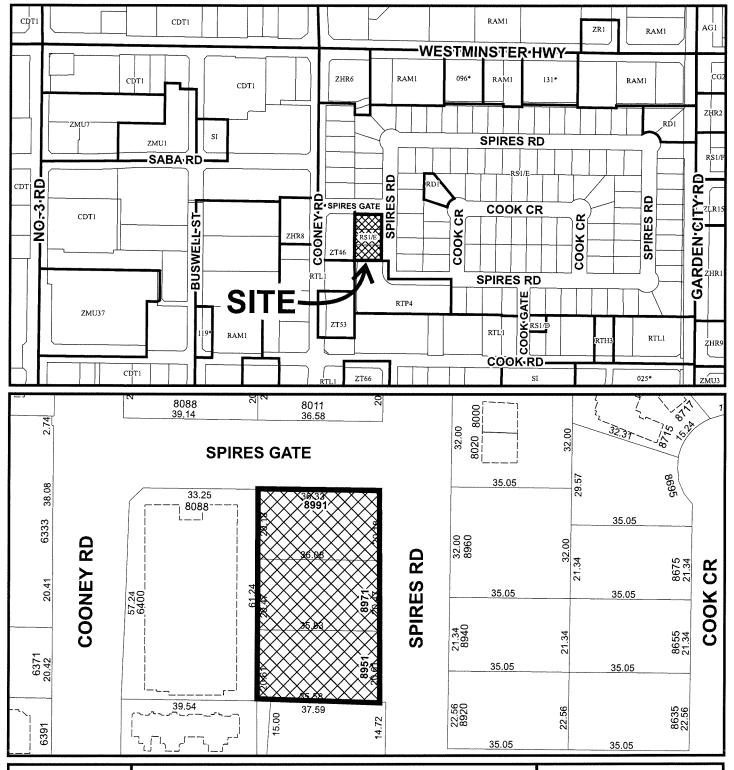



DP 21-932383 SCHEDULE "A"

Original Date: 05/19/21

Revision Date:

Note: Dimensions are in METRES

22 UNITS TOWNHOUSE DEVELOPMENT,

8951,8971 SPIRES ROAD,SPIRES GATE, RICHMOND,B.C

PROJECT RECONCILIATION		DP NO: 21-93			
CIVIC ADDRESS:		8951, 8971 Spires	RD & 8991 Spire	s Gate Richmond BC	
LOTAREA					
	TOTAL:	24,966.24		2319.44 m2	
	DEDICATIONS:	2,704.34		251.24 SQMT	
	NET AREA:	22,261.90	SQ.FT.	2068.2 SQMT	
ZONING					
	CURRENT	RS	-		
	PROPOSED	RTI	24		
	ATONO				
F.A.R CALCUL	Alions				
	FAR PROPOSED			1.17	on net
	FAR PROPOSED			1.17	orriet
EL OOP AREA	(EXCLUDING PARKING)				
LOOK AKEA	LEVELS			RESIDENTIAL	
	LLVLLO			NET	
				NET	
	PARKADE LEVEL- LVL 1			4,249.00 Sq.Ft.	394.75 M2.
	PODIUM LEVEL- LVL 2			9,835.00 Sq.Ft.	913.70 M2.
	THIRD FLOOR - LVL 3			9,868.00 Sq.Ft.	916.77 M2.
	FOURTH FLOOR- LVL4			4,688.00 Sq.Ft.	435.53 M2.
	GROSS TOTAL AREA			28,640.00 Sq.Ft.	2,660.75 M2.
	Deduction of 10m2 per stair per unit for 20 units	1"		2,655.46 Sq.Ft.	246.70 M2.
	(see table on right)				
	NET TOTAL AREA		1	25,984.54 Sq.Ft.	2,414.05 Sq.Ft.
				OUTDOOR AMENITY SPACE:	
				REQUIRED 6m2 per unit	1420 ft2 (132 m2)
				PLUS 10% OF NET SITE AREA	2227 ft2 (206.9 m2)
				TOTAL REQUIRED	3647 ft2 (338.9 m2)
				PROPOSED	4430 ft2 (411.56 m2
UNIT COUNT:					
	3 bed room Units	18			
	2 Bedroom H/C accessible Units (BUH units)	2			
	3 Bed TH units c/w Seconday Suite	2			
	Total No of Units	22			
OFF STREET	PARKING				
	RESIDENCES:				SAY
	REQUIRED	TOWNHOUSE	22 x 1.2	= 26.4 SPACES	27 SPACES
	PROVIDED			All Units to have Level 2 Charging Stations.	31 SPACES
	VISITORS				
	REQUIRED		22 X .2	= 4.4 SPACES	5 SPACES
	PROVIDED				5 SPACES
			TOTAL		36 SPACES
	TANDEM PARKING ASPACES				
	Max 50 % of required spaces (50 % of 32)		16		
	PROVIDED		16		
	SMALL CAR SPACES:				
	PROVIDED			2 Visitor and 8 Residential	
	ACCESSIBLE PARKING SPACES:				
	REQUIRED		2 % of 33 space:	s .66 spaces say 1 space	
	PROVIDED			3 Parking Spaces in total (2 for Accessible	
DIAWA: F.				units+ 1 for Visitor)	
BICYCLE PAR					
	CLASS 1		55 W : 55		00.00.000
	REQUIRED		22 X 1.25	27.5	28 SPACES
	PROVIDED				33 SPACES
	CLASS 2		00 V 0		5.0D4.050
	REQUIRED		22 X .2	4.4	5 SPACES
	PROVIDED				5 SPACES

				UN	IT TYPES & A	REAS	
		UNIT ARE	EAS (FT2)		TOTAL UNIT	TOTAL UNIT	
UNIT NO.	LEVEL1	LEVEL2	LEVEL3	LEVEL4	AREA IN FT2	AREA IN M2	UNIT TYPE
1	767.573	0	0	0	767.573	71.31	2 BEDROOM
2	767.149	0	0	0	767.149	71.27	2 BEDROOM
3	0	505.437	512	246.581	1264.018	117.43	3 BEDROOM
4	0	477.66	536.137	260	1273.797	118.34	3 BEDROOM
5	0	454.58	475.8	233.412	1163.792	108.12	3 BEDROOM
6	0	477.66	536.137	260	1273.797	118.34	3 BEDROOM
7	0	454.58	475.8	233.412	1163.792	108.12	3 BEDROOM
8	0	454.8	475.77	224	1154.57	107.26	3 BEDROOM
9		535.4	554	269.13	1358.53	126.21	3 BEDROOM
9A	697.48	0	0	0	697.48	64.80	2 BEDROOM SECONDARY SUITI
10	345.65	460.65	475.65	224	1505.95	139.91	3 BEDROOM
11	0	460.65	475.65	224	1160.3	107.80	3 BEDROOM
12	0	460.65	475.65	224	1160.3	107.80	3 BEDROOM
13	345.65	460.65	475.65	224	1505.95	139.91	3 BEDROOM
14		505	522	250	1277	118.64	3 BEDROOM
14A	740.49	0	0	0	740.49	68.79	2 BEDROOM SECONDARY SUIT
15	0	454	570	252.56	1276.56	118.60	3 BEDROOM
16	0	444	470.65	219	1133.65	105.32	3 BEDROOM
17	0	444	470.65	219	1133.65	105.32	3 BEDROOM
18	0	444	470.65	219	1133.65	105.32	3 BEDROOM
19	0	444	470.65	219	1133.65	105.32	3 BEDROOM
20	0	444	470.65	219	1133.65	105.32	3 BEDROOM
21	0	471.58	501.99	207.05	1180.62	109.68	3 BEDROOM
22	0	483.2	512	246	1241.2	115.31	3 BEDROOM

UNIT NO.	STAIRCASE DEDUCTION IN M2	STAIRCASE DEDUCTION ON HIGHES STOREY IN M2		
		0.00		
2	0.00	0.00		
	0.00	4.08		
3	7.43	4.08		
4	7.43	4.08		
5	7.43			
6	7.43	4.08		
7	7.43	4.08		
8	7.43	4.08		
9	10	4.08		
10	10	4.08		
11	8.18	4.08		
12	8.18	4.08		
13	10	4.08		
14	10	4.08		
15	7.53	3.90		
16	8.08	4.08		
17	8.08	4.08		
18	8.08	4.08		
19	8.08	4.08		
20	8.08	4.08		
21	8.08	4.08		
22	8.08	4.08		
TOTAL	165.05	81.42		
GF	RAND TOTAL	246.47		

FLAT TARE SARCHITECTURE SARCHI

Unit 209- 6321 King George Bl Surrey BC, V3X 1G1 www.flatarchitecture.ca contact@flatarchitecture.ca

604-503-4484


PROJECT INFO: 11 UNITS
Townhouse Development at 8951, 8971 Spires Rd., 8991 Spires Gate, Richmond, BC


31-Mar-23
PROJECT NO:
17-127
SCALE: DRAWI
AS Noted R.W

1. Issued For DP R.W 02/

DATA SHEET

40.1

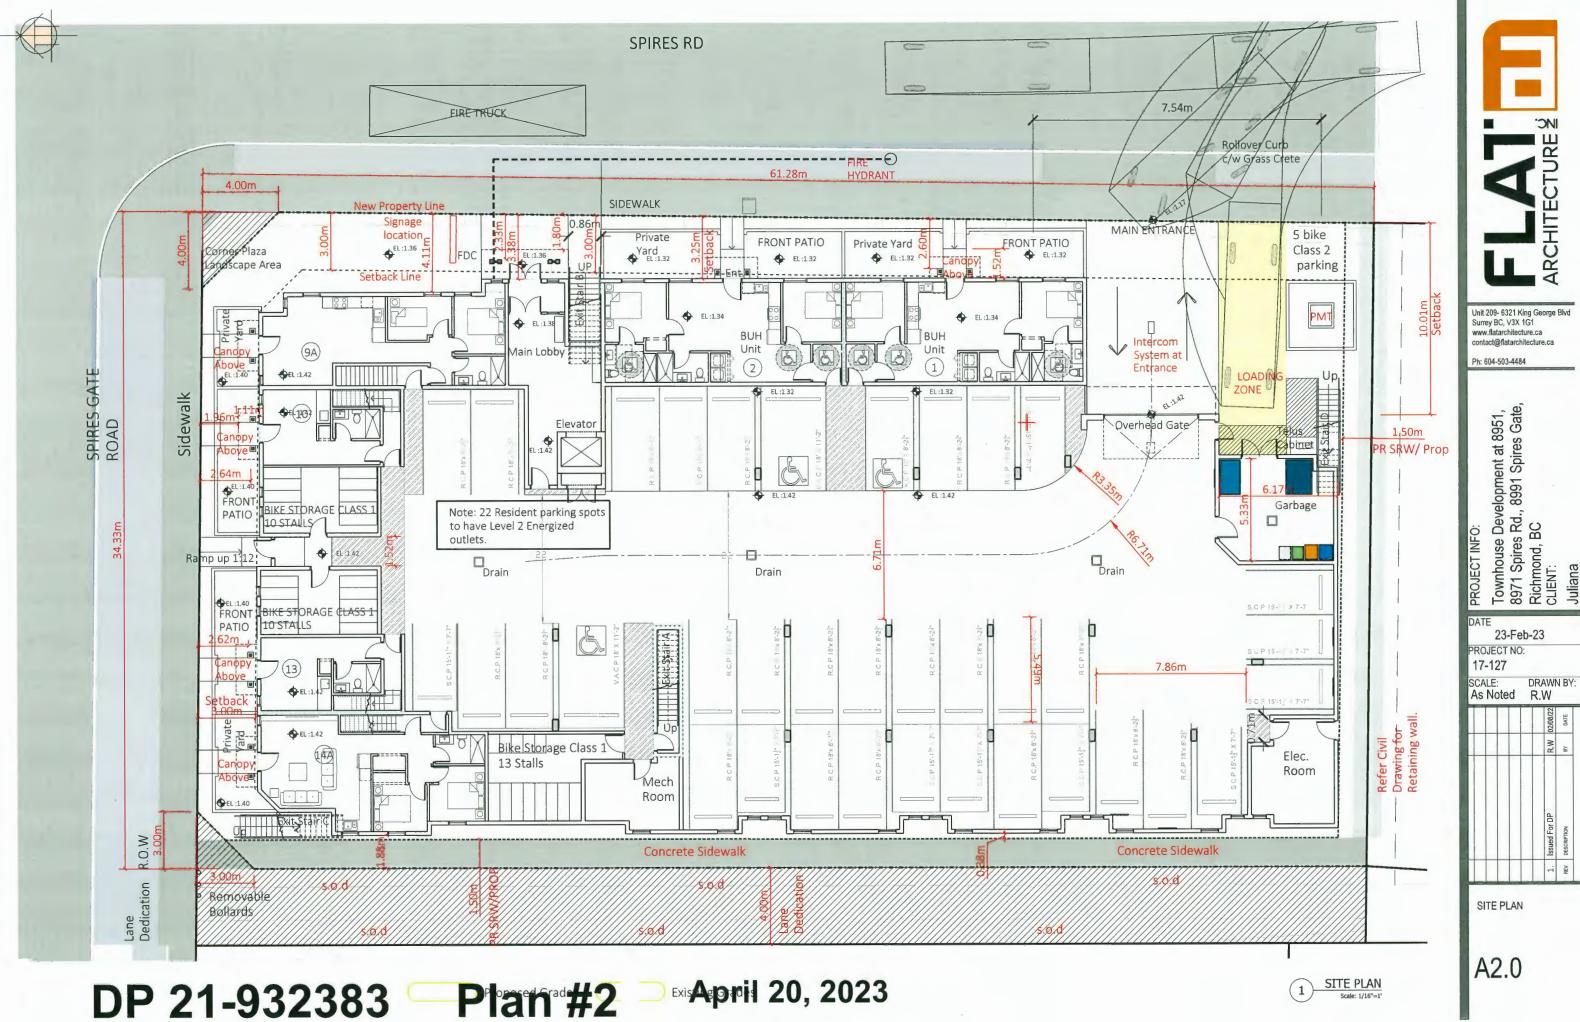

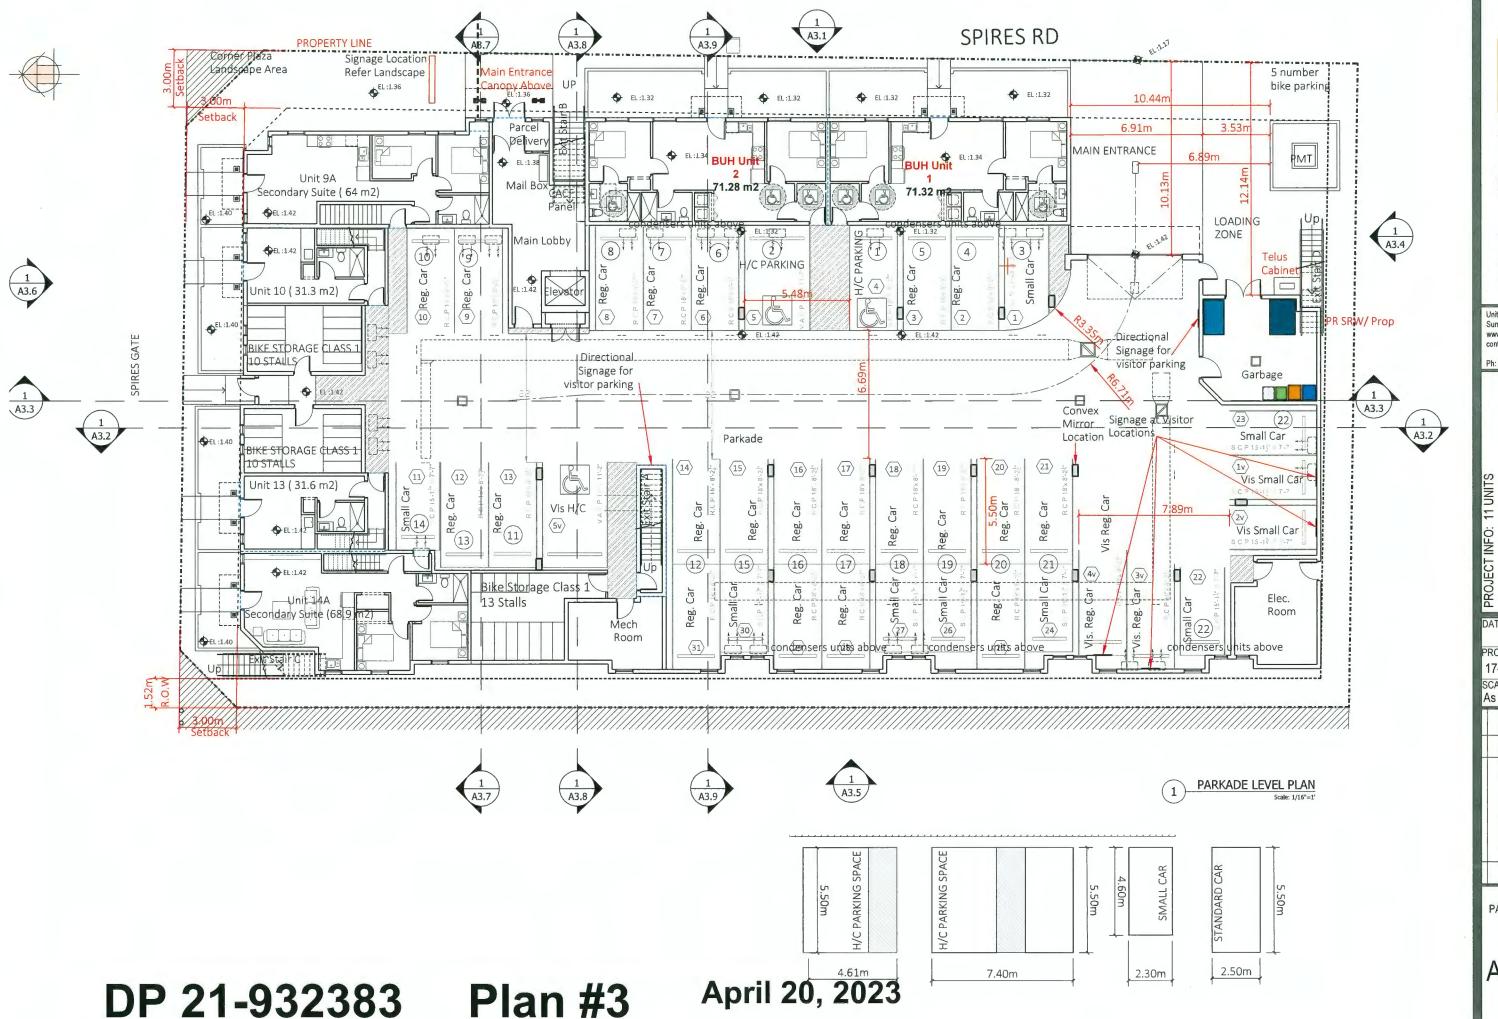


ARCHITECTURE ₹ Unit 209- 6321 King George Blvd Surrey BC, V3X 1G1 contact@flatarchitecture.ca Ph: 604-503-4484 Townhouse Development at 8951, 8971 Spires Rd., 8991 Spires Gate, Richmond, BC CLIENT: 31-Mar-23 ROJECT NO: 17-127 DRAWN BY: As Noted R.W

-i

PARKADE LVL PLAN



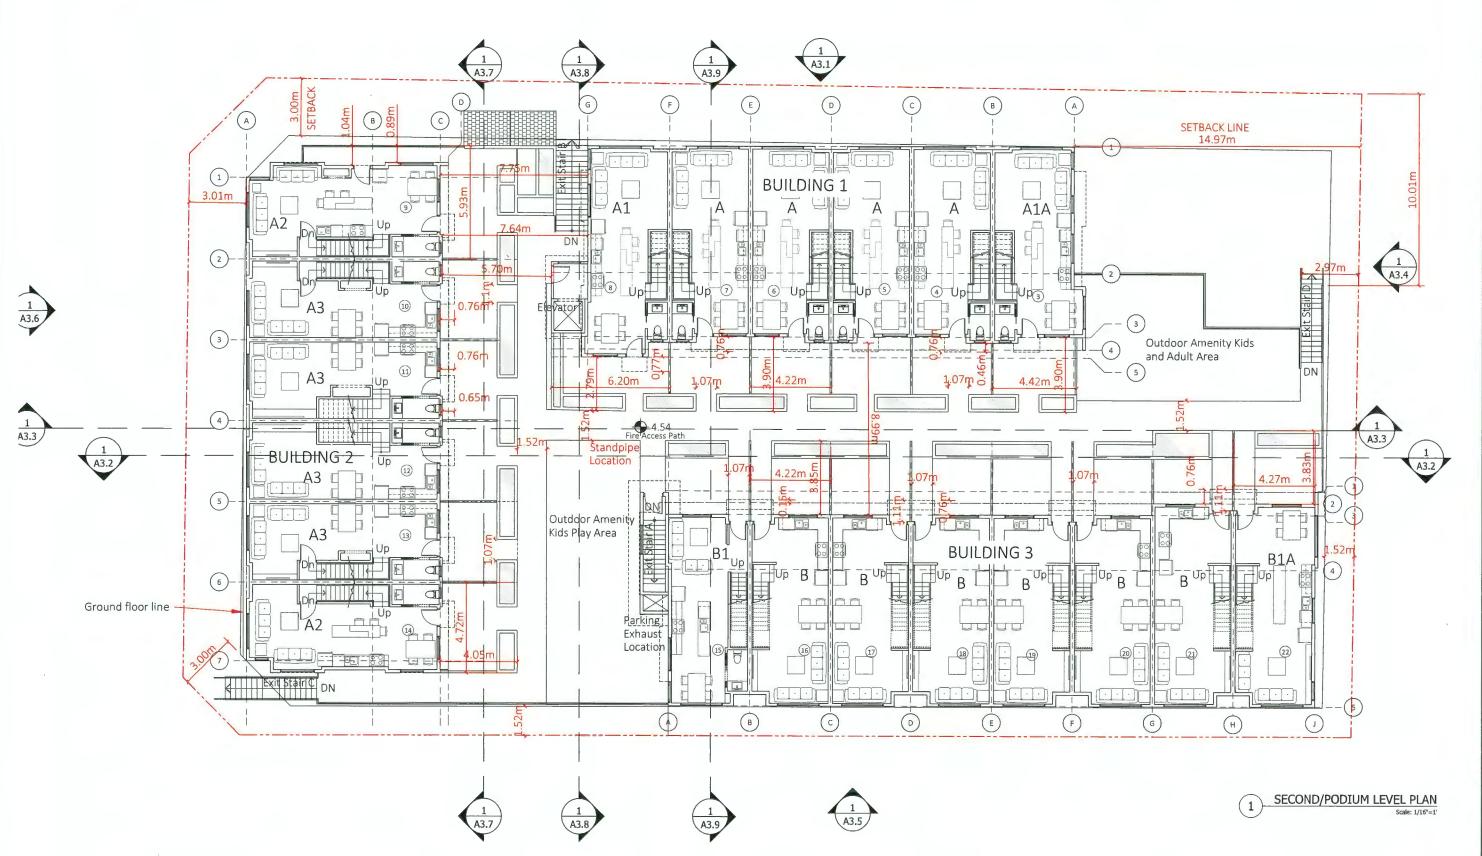




A2.2

PODIUM LEVEL PLAN




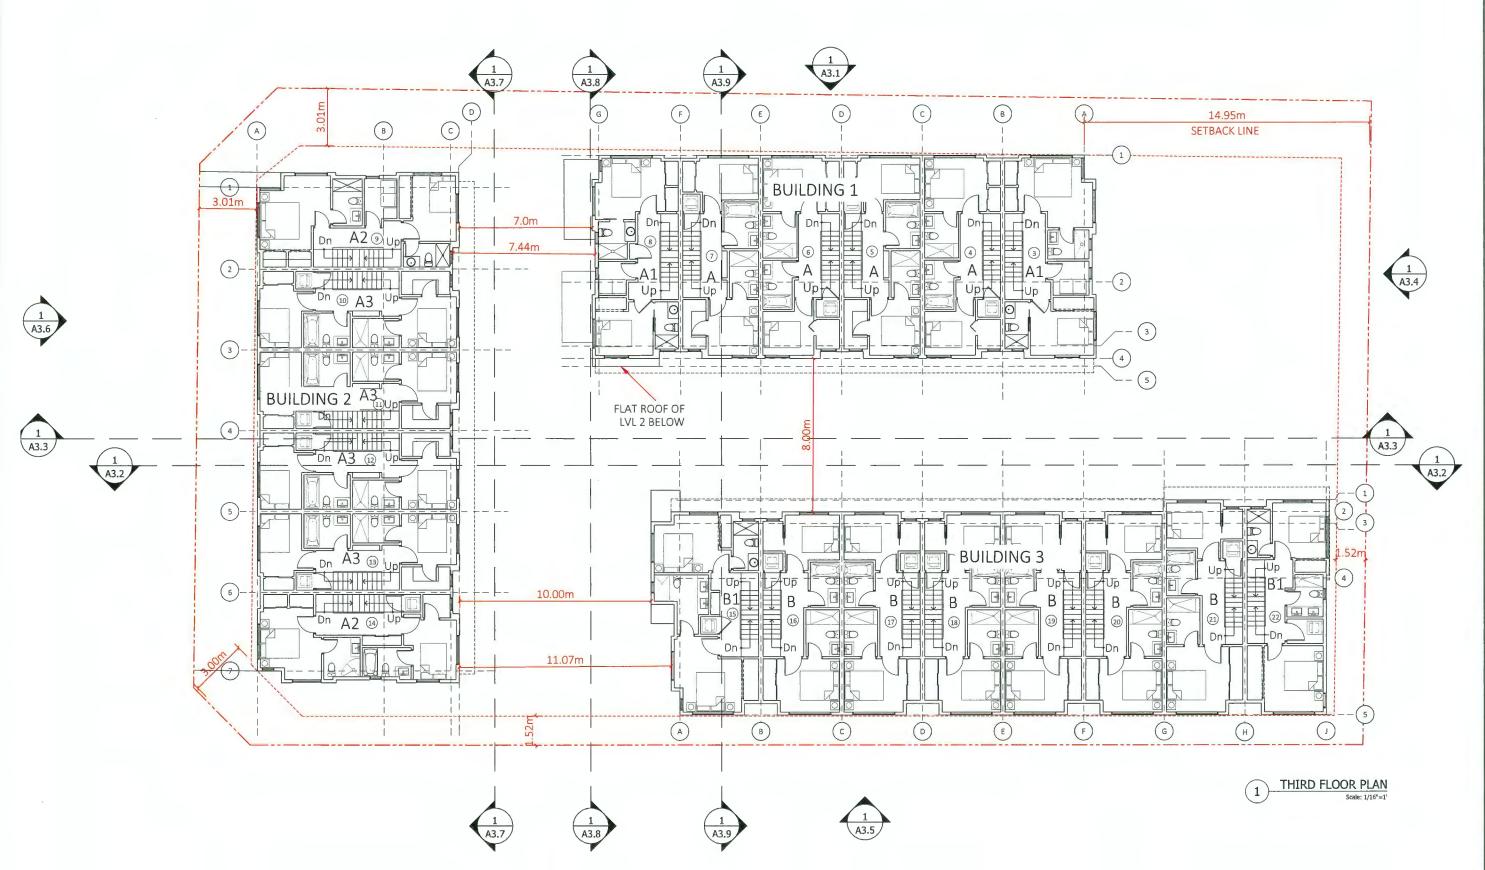

Unit 209-6321 King George Blvd Surrey BC, V3X 1G1 www.flatarchitecture.ca contact@flatarchitecture.ca PROJECT INFO: 11 UNITS
Townhouse Development at 8951,
8971 Spires Rd., 8991 Spires Gate,
Richmond, BC
CLIENT:
Juliana 31-Mar-23 PROJECT NO: 17-127 SCALE: DRAWN BY: As Noted R.W W.W

THIRD FLOOR PLAN



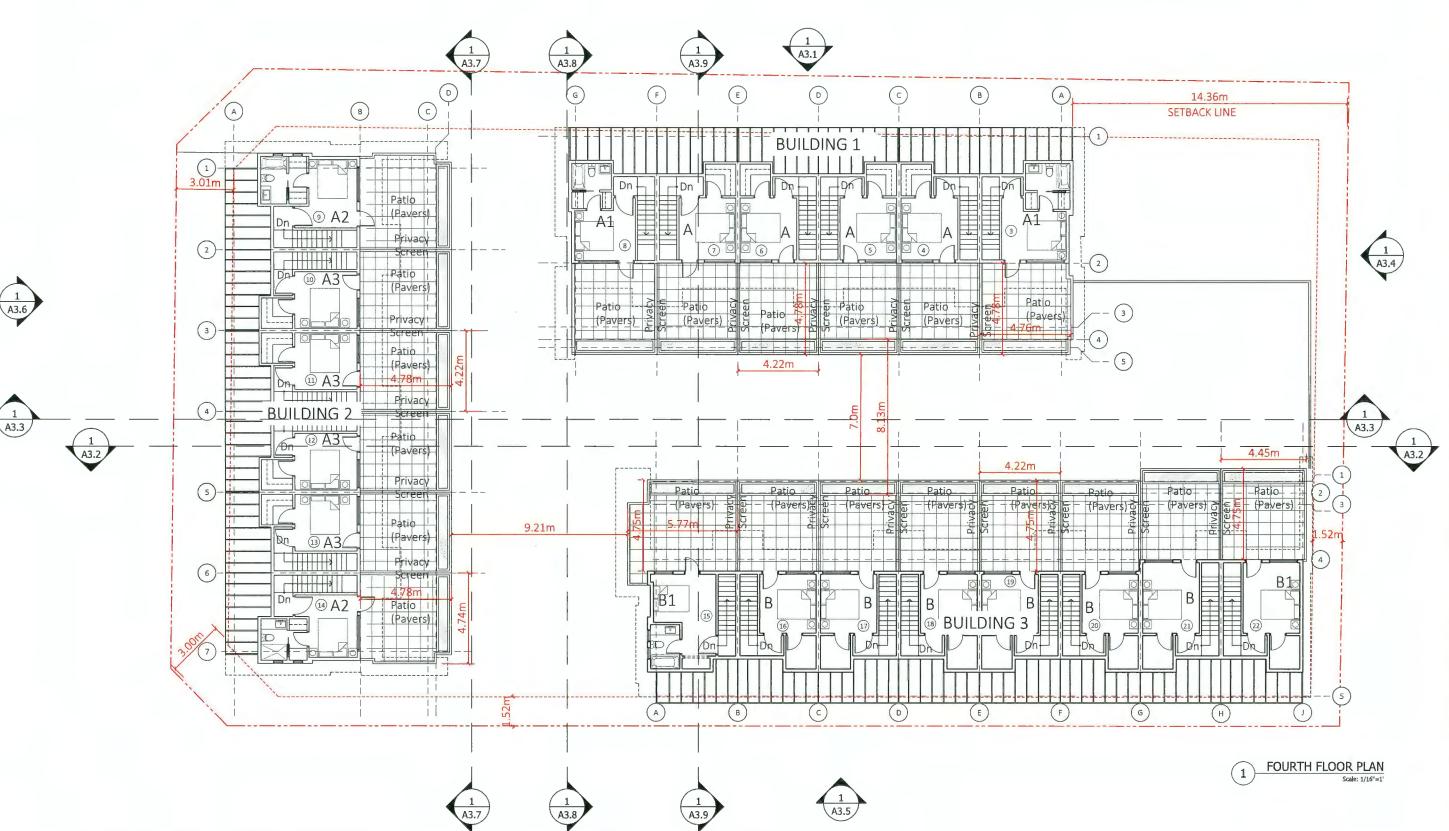

DP 21-932383 Plan #6 April 20, 2023



Unit 209- 6321 King George Blvd Surrey BC, V3X 1G1 www.flatarchitecture.ca contact@flatarchitecture.ca

Ph: 604-503-44

PROJECT INFO: 11 UNITS
Townhouse Development at 8951,
Townhouse Development at 8951,
Size Safe,
Size Safe,
Size Safe,
CLIENT:
Juliana


17-127
SCALE: DRAWN BY:
As Noted R.W


1. Issued For DP R.W 02/08/22

R.W 02/08/22

R.W 02/08/22

FOURTH FLOOR PLAN

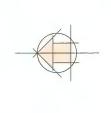

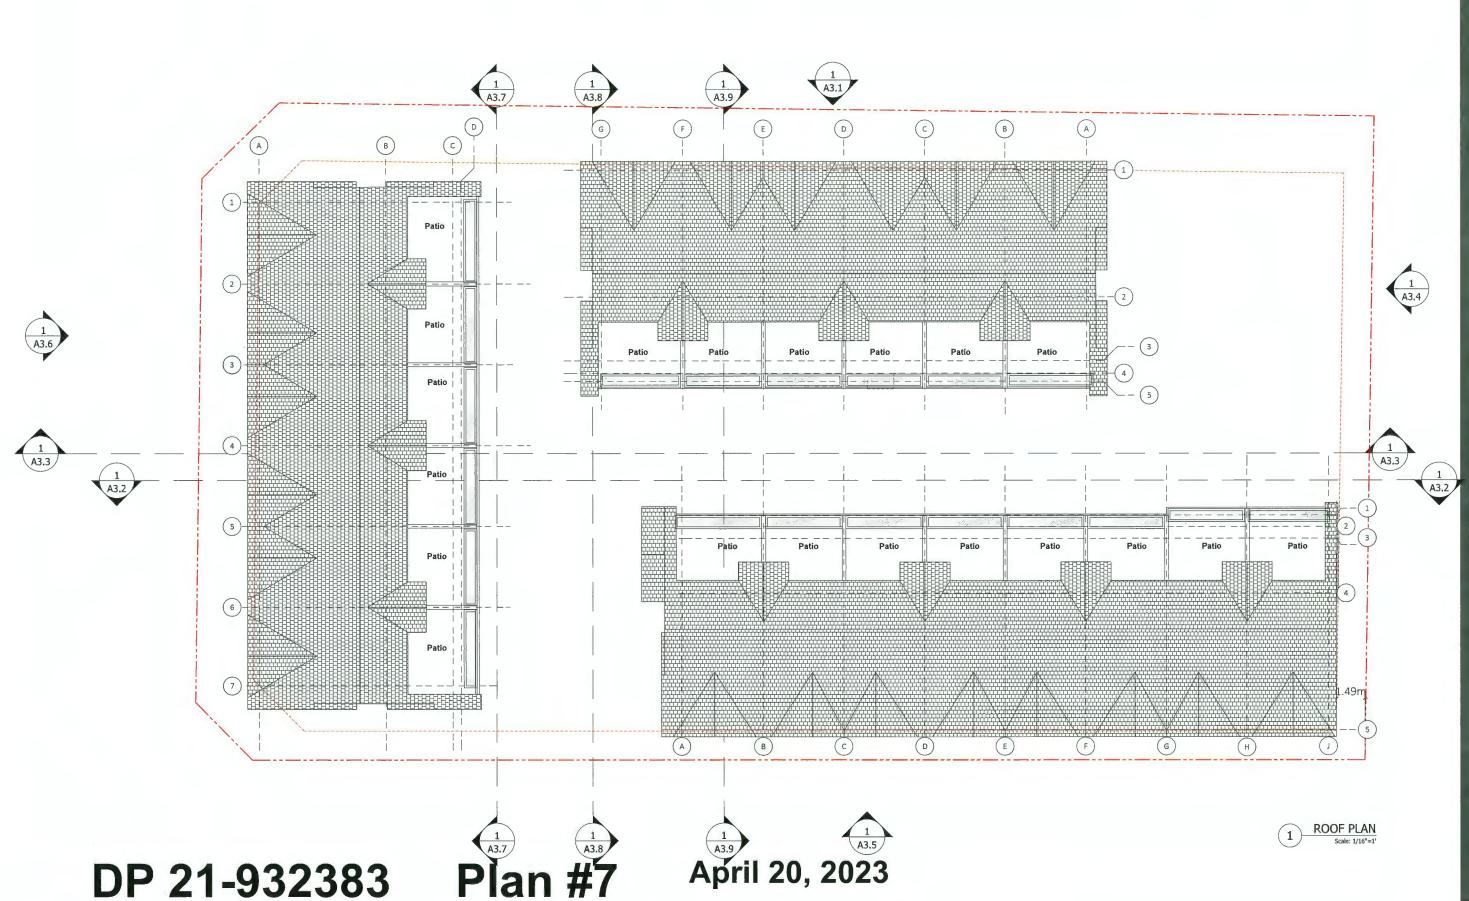

Surrey BC, V3X 1G1 www.flatarchitecture.ca contact@flatarchitecture.ca

Ph: 604-503-4484

Townhouse Development at 8951, 8971 Spires Rd., 8991 Spires Gate, Richmond, BC CLIENT: Juliana

23-Feb-23 PROJECT NO:

17-127 SCALE: DRAWN BY: As Noted R.W

ROOF PLAN

SPIRES GATE ROAD




23-Feb-23 PROJECT NO: 17-127

SCALE: DRAWN BY:
As Noted R.W ZZ7807Z7 M.W By Describe Income Inc

ACCESSIBILITY PLAN LEVEL 1

MAIN LEVEL PLAN

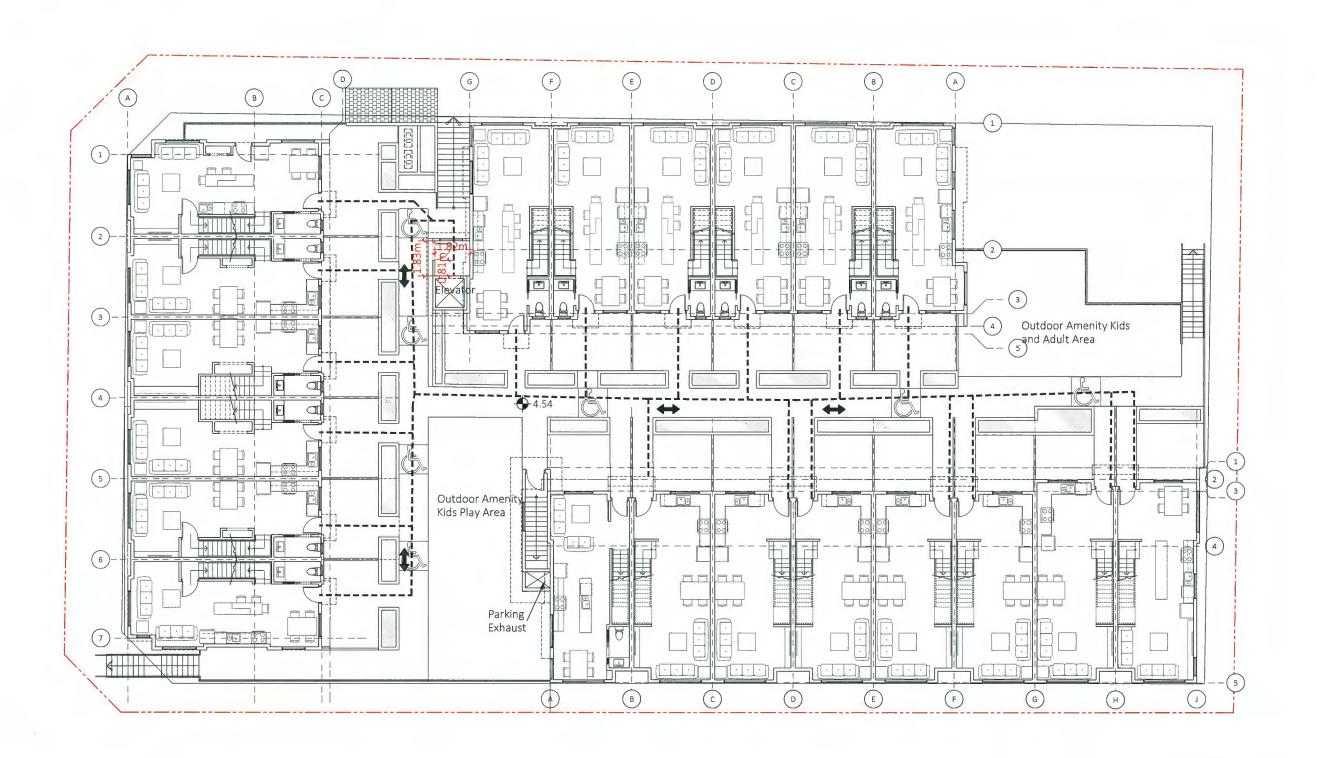



DATE

23-Feb-23
PROJECT NO:


17-127 SCALE: DRAWN BY:

As Noted R.W CARREL For DP R.W CARREL BY CARRE

ACCESSIBILITY PLAN PODIUM LVL

PODIUM LEVEL PLAN



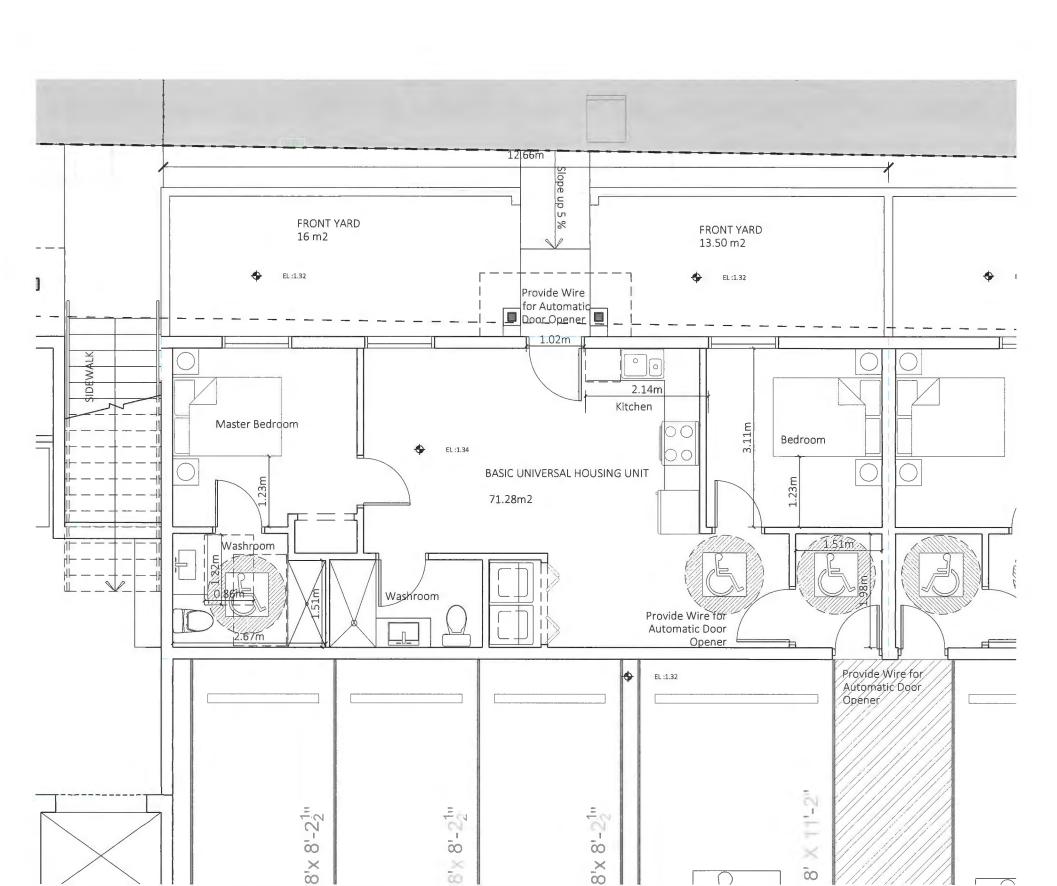

NOTE: THIS DESIGN **COMPLIES WITH THE BUH GUIDELINES OF** RICHMOND ZONING BY-LAWS.





- Floor finishes to be Slip Resistant DOORS AND DOORWAYS:
- All Exterior Doors to have flush threshold in **BUH** units
- All Doors to Accessible units to be min of
- Maneuvering space to meet BUH guidelines e.g 1220 on push side wih 600mm clearance on door handle side

one window is being provided to meet min sill height of 750mm in bedroom

OUTLETS AND SWITCHES

- Outlets, Thermostats and switches to meet **BUH** guidelines

BATHROOMS:

one bathroom is being provided to meet the BUH guidelines in bedroom.

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Ph: 604-503-4484

Townhouse Development at 8951, 8971 Spires Rd., 8991 Spires Gate, Richmond, BC CLIENT:

23-Feb-23 PROJECT NO:

17-127 DRAWN BY: As Noted R.W




A2.12

ACCESSIBLE UNIT

BUH- 2



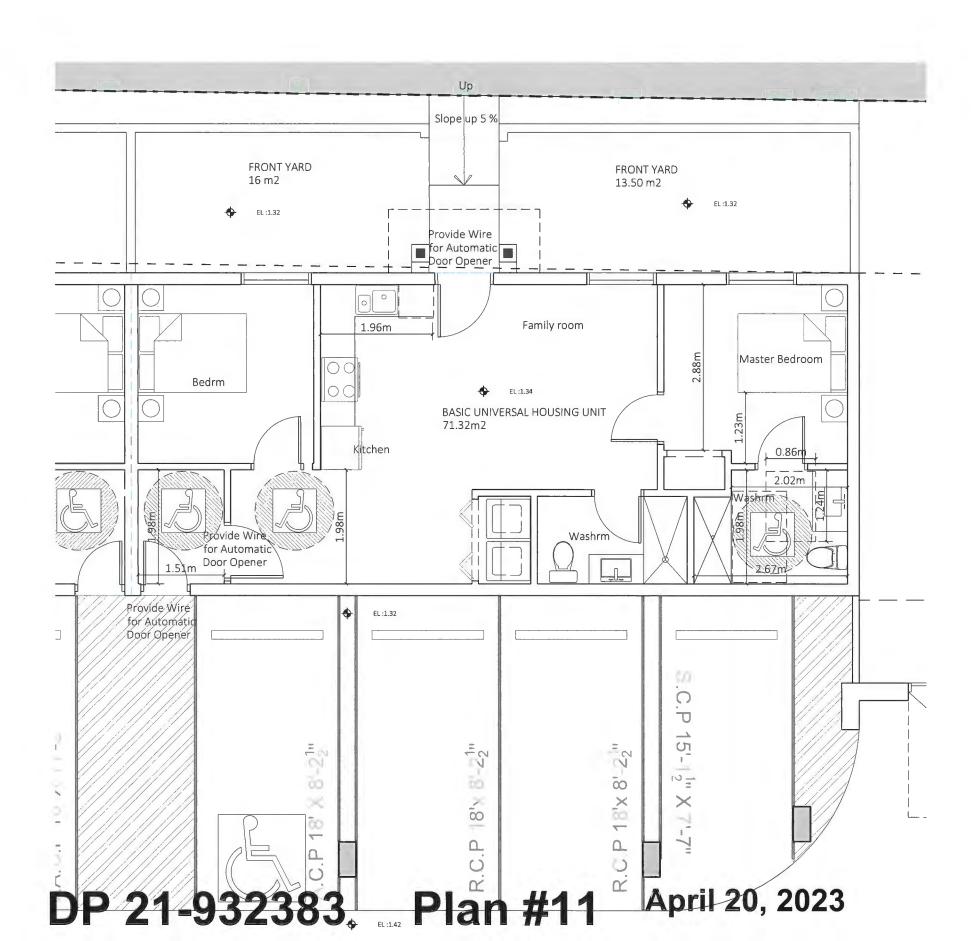

NOTE: THIS DESIGN COMPLIES WITH THE BUH GUIDELINES OF RICHMOND ZONING BY-LAWS.



FLOOR SURFACE:

- Floor finishes to be Slip Resistant DOORS AND DOORWAYS:
- All Exterior Doors to have flush threshold in BUH units
- All Doors to Accessible units to be min of 855mm
- Maneuvering space to meet BUH guidelines e.g 1220 on push side wih 600mm clearance on door handle side

WINDOWS:

 one window is being provided to meet min sill height of 750mm in bedroom

OUTLETS AND SWITCHES

 Outlets, Thermostats and switches to meet BUH guidelines

BATHROOMS:

- one bathroom is being provided to meet the BUH guidelines in bedroom.



Unit 209- 6321 King George Blvd Surrey BC, V3X 1G1 www.flatarchitecture.ca contact@flatarchitecture.ca

Ph: 604-503-4484

PROJECT INFO:
Townhouse Development at 8951,
Solution 121-12.


Richmond, BC
CLIENT:
Juliana


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A2.13


ACCESSIBLE UNIT

BUH- 1
Scale: 3/16"=1'



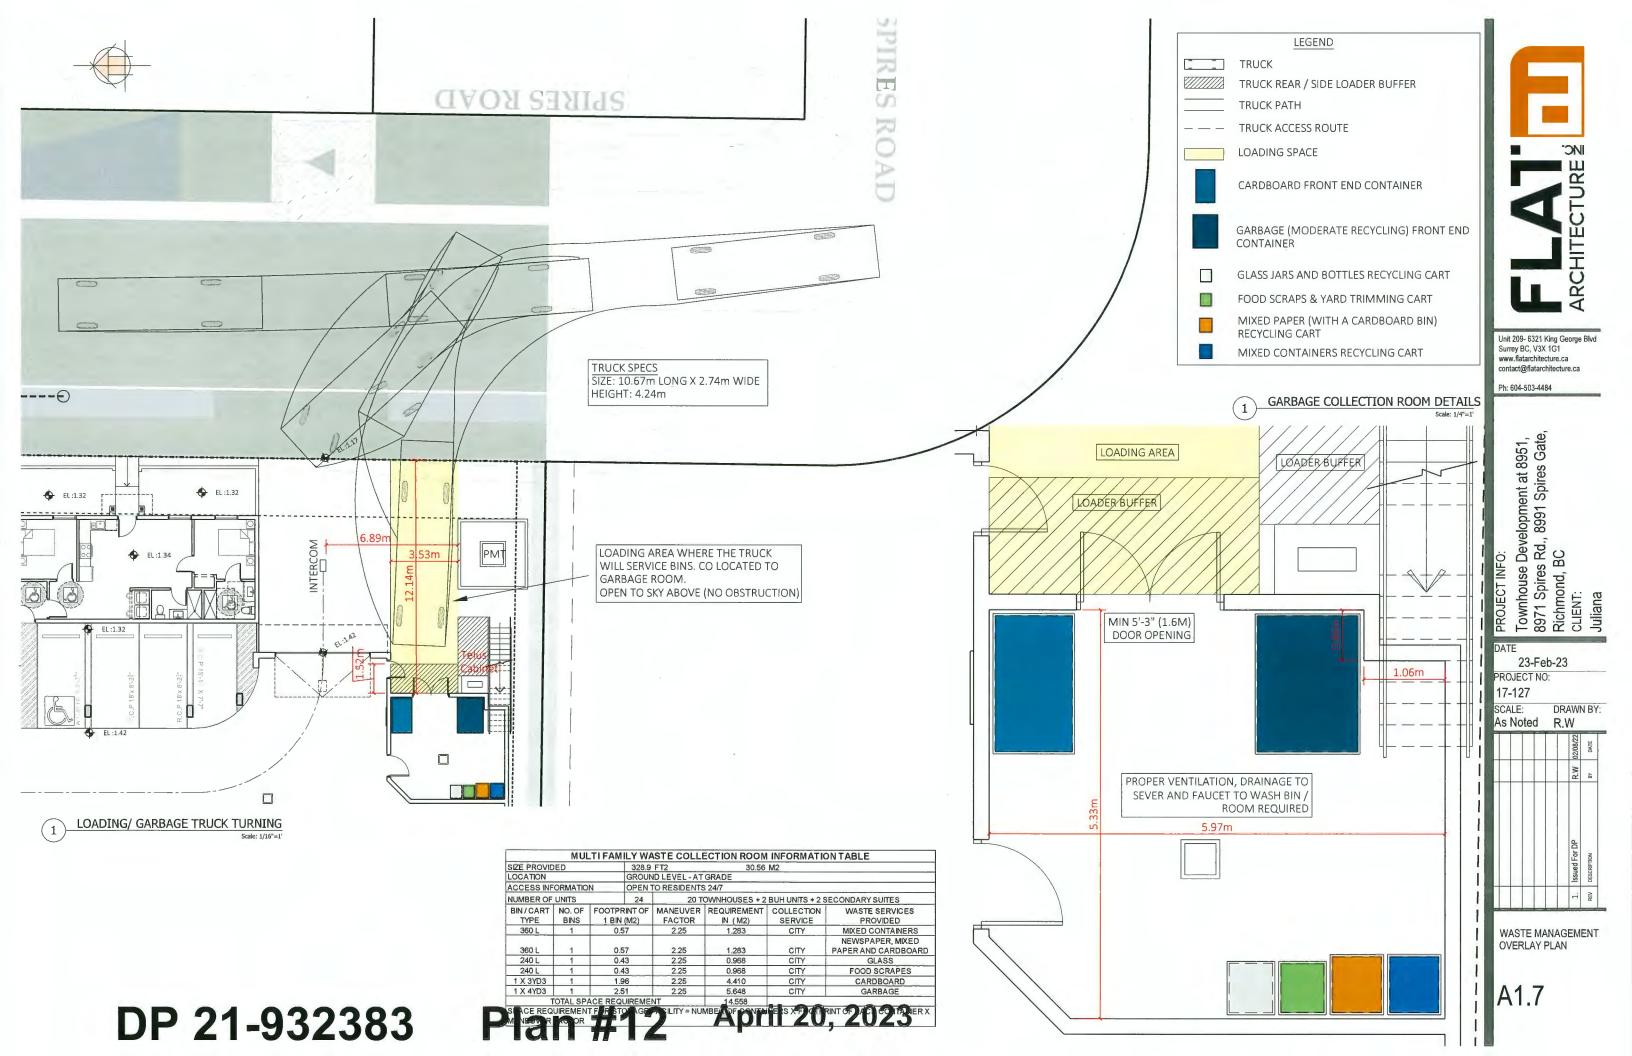

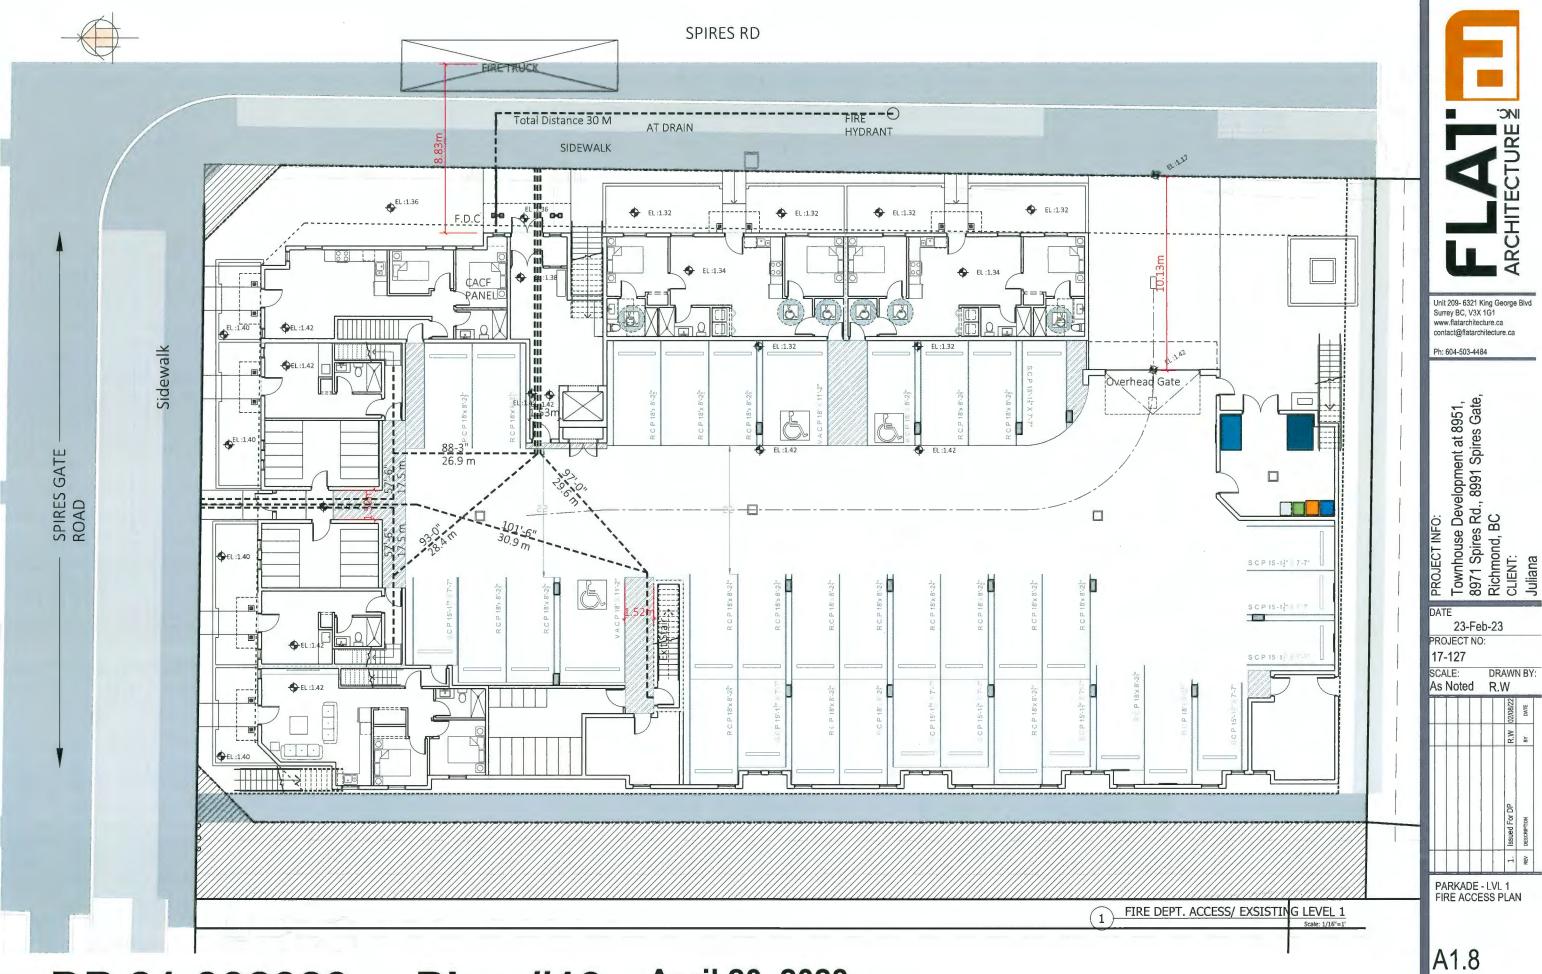
DP 21-932383 Plan #13 April 20, 2023

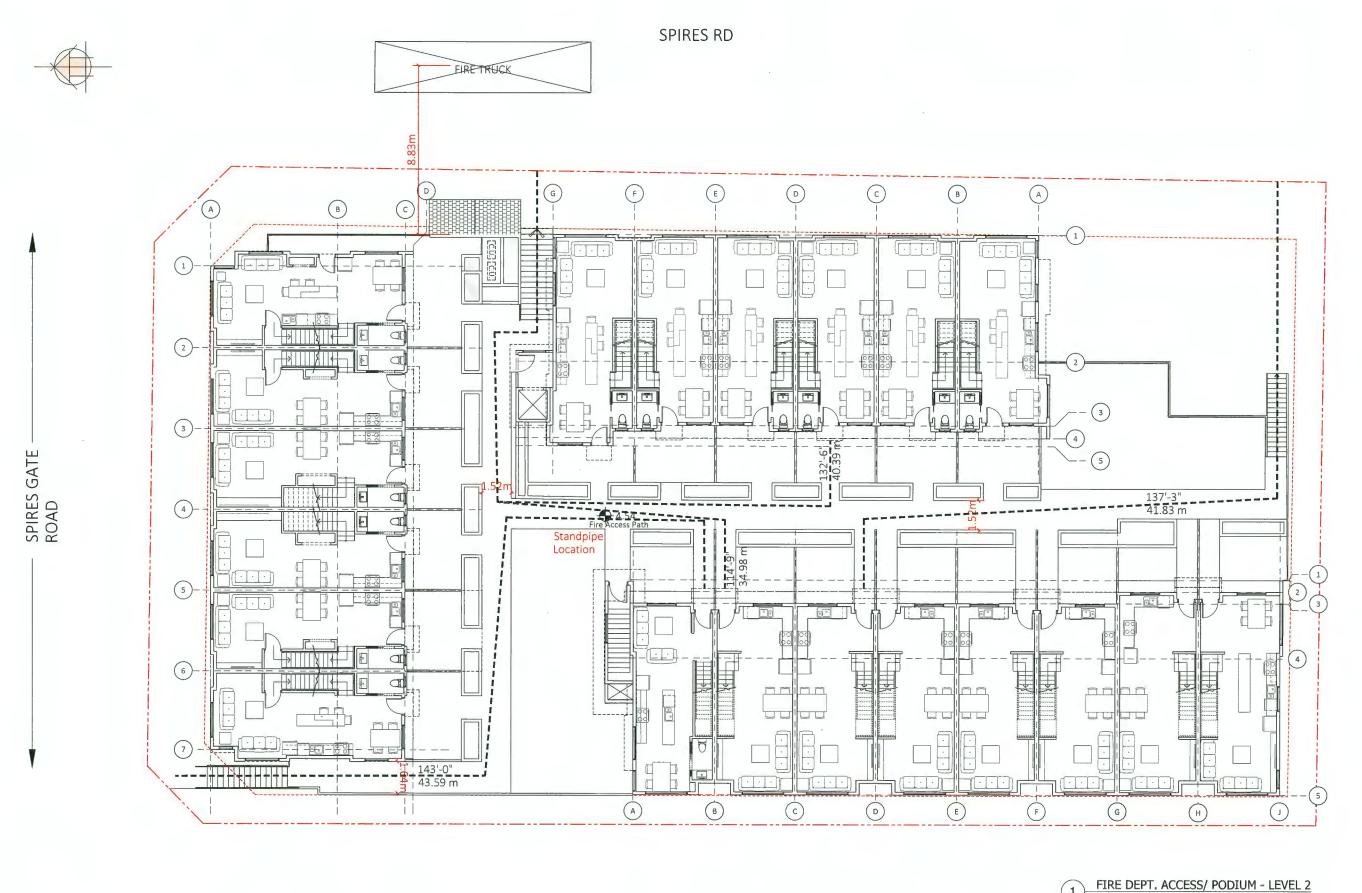


ARCHITECTURE ₹ Unit 209- 6321 King George Blvd Surrey BC, V3X 1G1 www.flatarchitecture.ca contact@ffatarchitecture.ca Ph: 604-503-4484 Townhouse Development at 8951, 8971 Spires Rd., 8991 Spires Gate, Richmond, BC CLIENT: 23-Feb-23 PROJECT NO: 17-127 SCALE: DRAWN BY: As Noted R.W

PODIUM - LVL 2 FIRE ACCESS PLAN

UM - LEVEL 2 Scale: 1/16"=1'

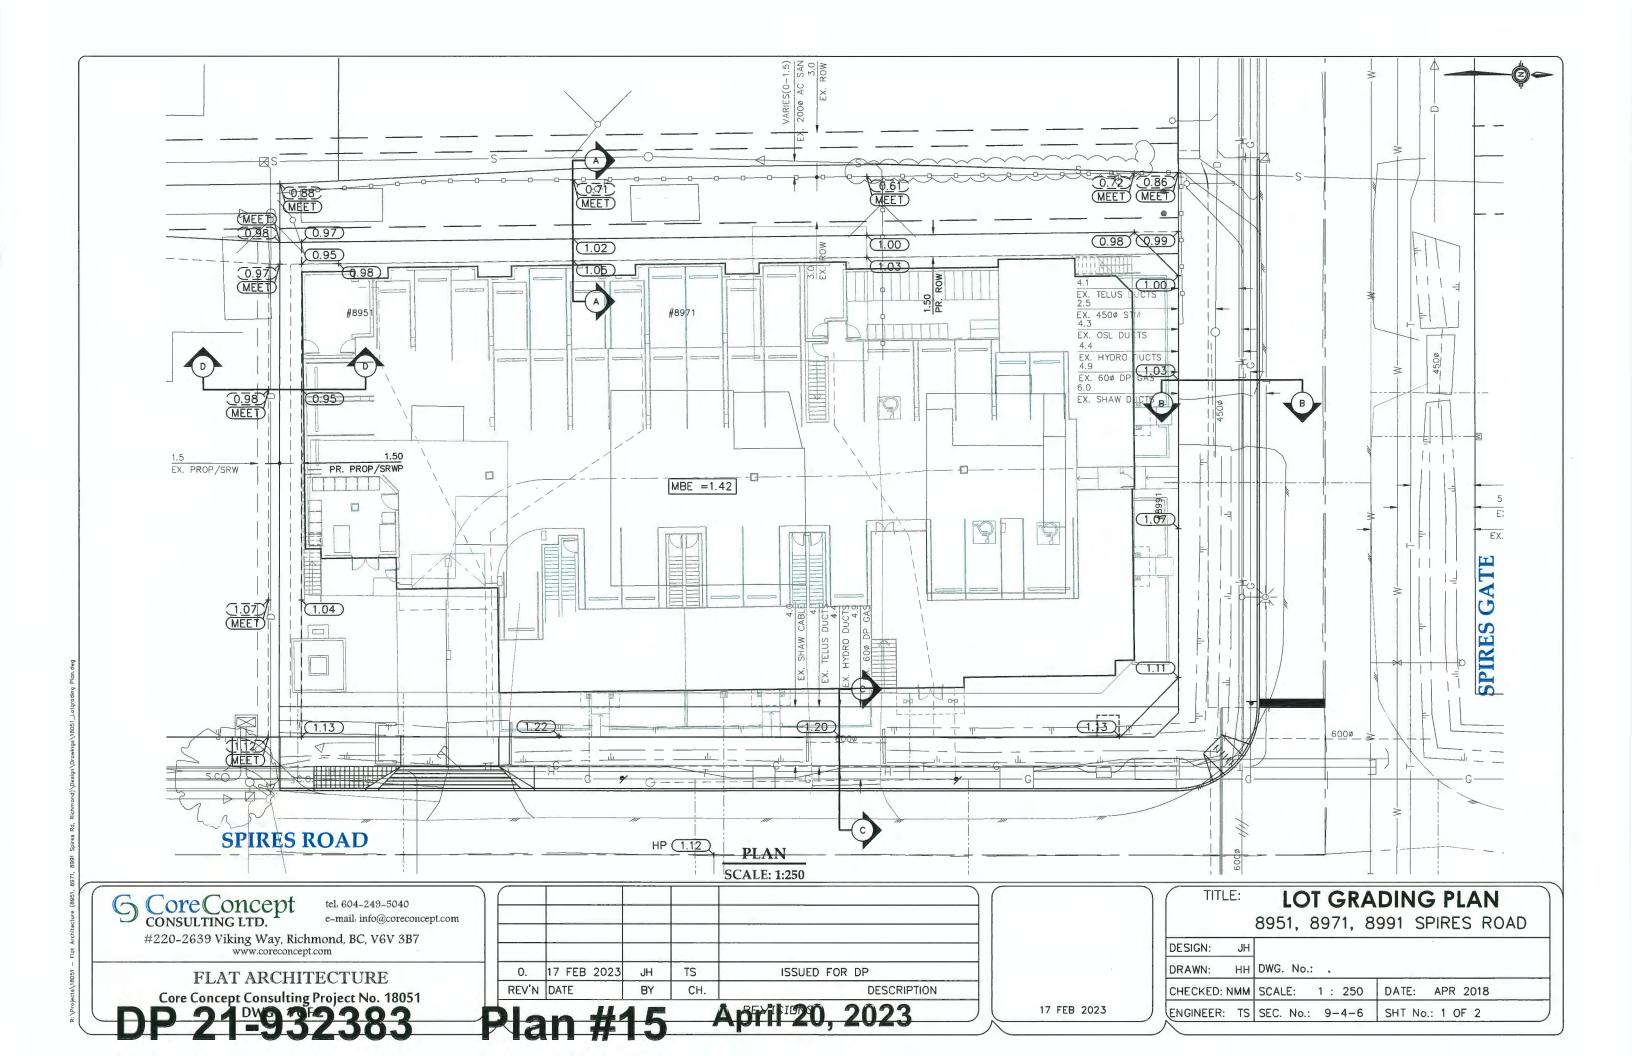

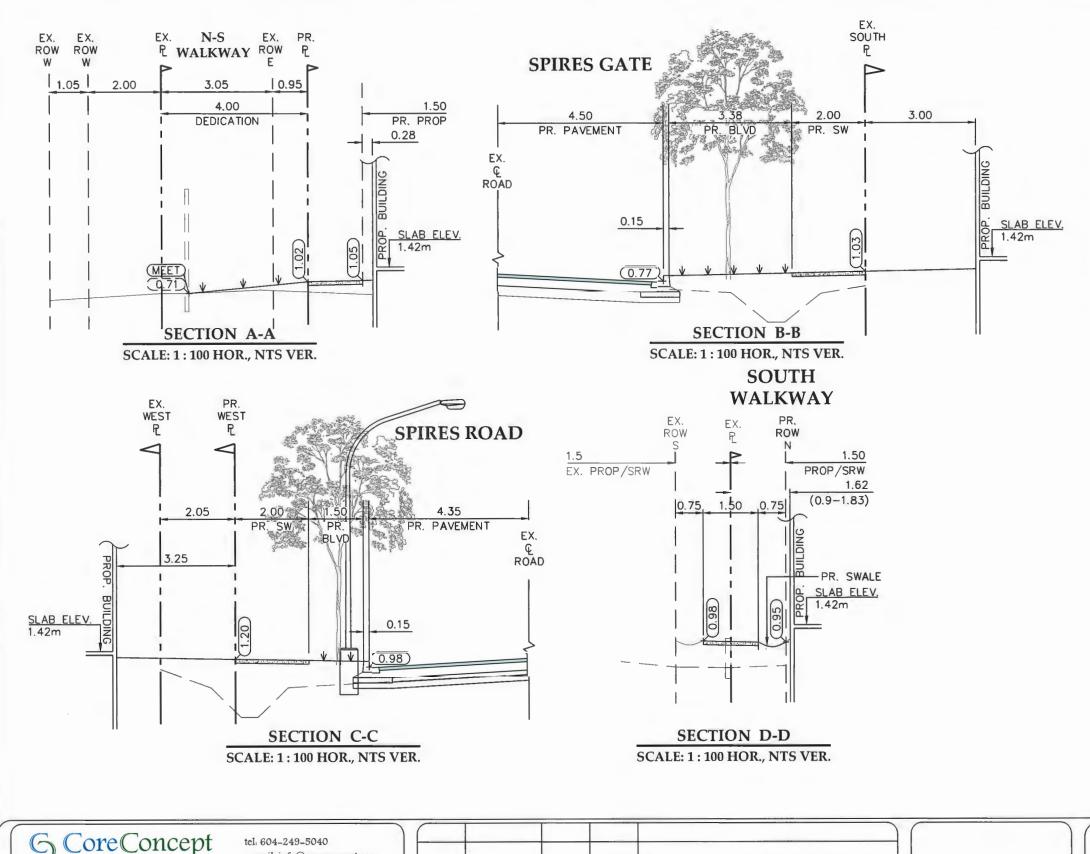

PROPOSED SITE GRADES: NW CORNER = 0.99m NE CORNER = 1.12m SW CORNER = 0.95m SE CORNER = 1.13m BUILDING 1 SLAB = 1.42m BUILDING 2 SLAB = 1.42m BUILDING 3 SLAB = 1.42m BUILDING 4 SLAB = 1.42m PARKADE SLAB AVERAGE = 1.42m PROPOSED AVERAGE SITE GRADE = 1.25m EXISTING SITE GRADES: NW CORNER = 0.56mNE CORNER = 0.52m SW CORNER = 0.48mSE CORNER = 0.34mEXISTING AVERAGE SITE GRADE = 0.48m MAX ROAD CENTERINE GRADE: MAX = 1.12m

PROPOSED SITE FILL VOLUME: SITE AREA = 1958m2 EXISTING AVERAGE SITE GRADE = 0.48m PROPOSED AVERAGE SITE GRADE = 1.25m FILL VOLUME = $(1.25m - 0.48m)*1985m^2 = 1528.5m^3$

CONSULTING LTD.

e-mail. info@coreconcept.com

#220-2639 Viking Way, Richmond, BC, V6V 3B7 www.coreconcept.com

FLAT ARCHITECTURE

Core Concept Consulting Project No. 18051

ISSUED FOR DP 17 FEB 2023 REV'N DATE DESCRIPTION


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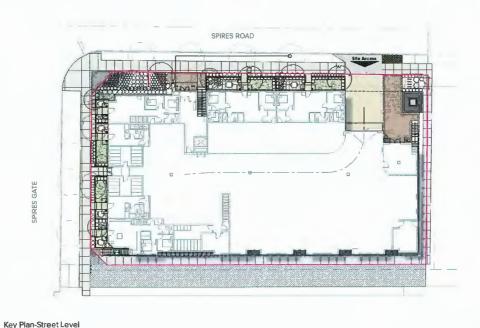
LOT GRADING PLAN

8951, 8971, 8991 SPIRES ROAD

DESIGN: JH HH DWG. No.: . DRAWN: CHECKED: NMM | SCALE: AS SHOWN DATE: APR 2018 ENGINEER: TS SEC. No.: 9-4-6 SHT No.: 2 OF 2

17 FEB 2023



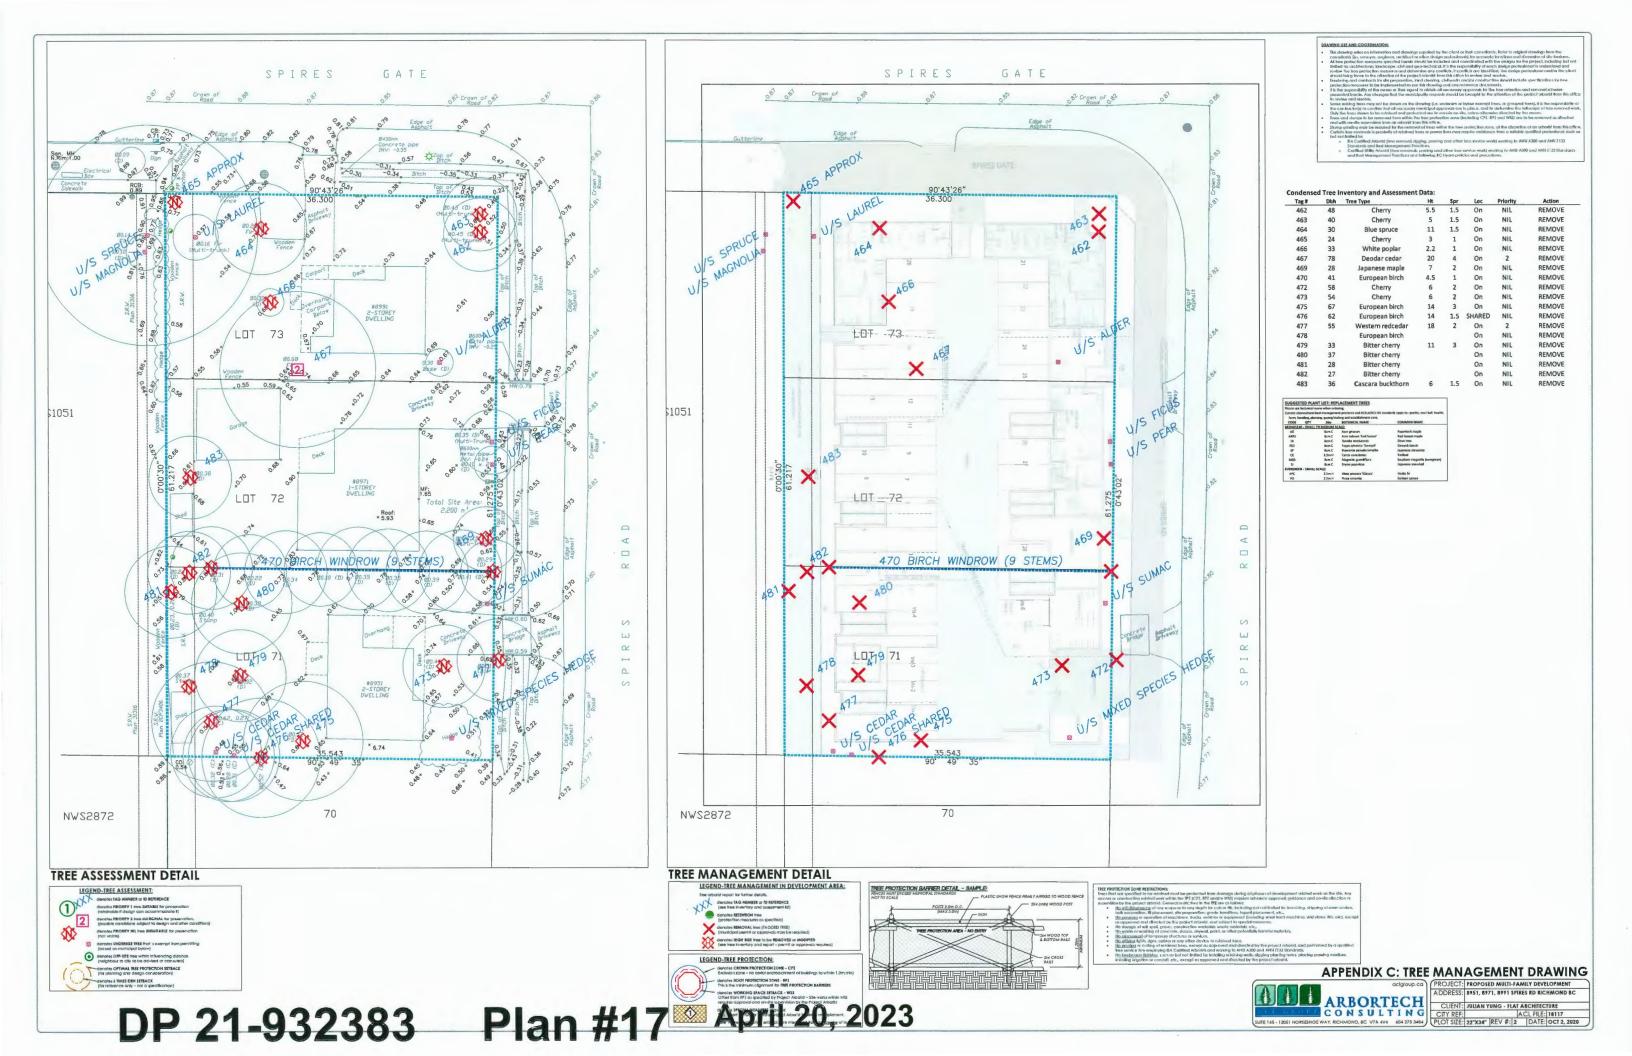

DESIGN RATIONALE AND SUMMARY

Scale: 1:300

Being an infill development among a mix of other townhouse complexes and rapidly evolving residential lots, the contextual treatment demands sensitivity and appropriate placement of elements.

We are proposing a relatively simple mix of surfaces and their configuration owing to a very small scale of such surfaces such as pathways to the units and the driveways. We have chosen to limit our selection to 2 or 3 chief finishes and reserved a more complex hierarchy of surfaces for the deck level.

The planting on the boulevard edges has been very carefully configured with some matching trees of the surrounding boulevardscape and what might be contextually appropriate with scale and available right of way. Similarly, being cognizant of the space requirements for the deck level planting, we have chosen to limit the trees and place the built up planters to the perimeter where possible for structural reasons. The trees selected for the internal layout are small and relatively less in number.

This development is amidst a rapidly changing area where a number of developments have sprung up in the past few years. Our design concept advocates a sensitive scheme that merges with the general transformation of the area.

The multi-user nature of the residential development demands privacy for the various units and their accessible spaces. The element used to define these spaces (private patios from one another) are emerald cedar (thuja occidentalls smaragd) and Taxus. These columnar hedge plants are used in tandem with smaller hedging material such as the Spirarea and the flowering perennials to allow for multiple layers of textural relief.


The north east corner of the site, and the area by main lobby are treated with multiple layers of ornamental grasses and flowering perennials which are placed in a way that emphasizes the project signee and create a welcoming landscape for those entering the site and building. Some of the proposed plants are PENNISETUM HAMELN, BLUE OAT GRASS and Hemerocallis illinoasphodelus, in addition to a Taxus buffer in the background to provide privacy for adjacent unit.

Vines and trellises are proposed along the west side of the building providing additional visually appealing green elements to the building to be enjoyed by pedestrians.


Outdoor Spaces

The outdoor amenity has been designed with a linear two zone concept. The main constituents are the Social recreational area and a playground. The social area has been augmented with an outdoor kitchen and sustainable elements like the garden plots. These are placed with raised planters c/w soout and work bench for the residents use at the deck level.

Further, we have proposed use of native plants requiring lower water intake and offering trees that encourage bird habitat such as the 'Bitter Chern' towards the lane.

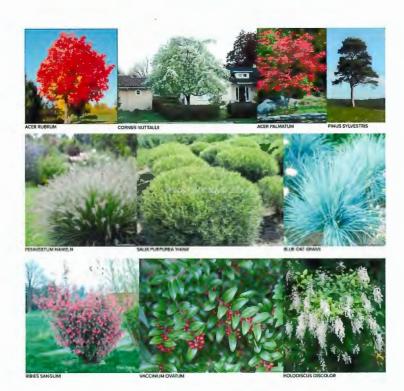

2 SOME PROPOSED PLANTS

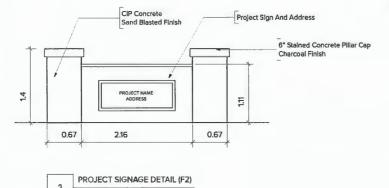

Scale: NTS

GENERAL NOTES

All materials and workmanship to CLS Standards, latest edition. Soil depths and subgrade preparation, soil quality and plant sizes to meet or exceed that standard.

Plant sizes in this list are specified according to the BC Landscape Standard's latest edition. Container sizes are specified as per "CNTA Standards'. Both plant size and container size are the minimum acceptable sizes. The installers are advised to search and review, make plant material available to the Landscape Architect for optional review at the source of supply. Area of search to include Lower Mainland and Fraser Valley. 'Substitutions' must obtain written approval from the Landscape Architect prior to making any substitutions to specified material. Unapproved substitutions will be rejected. Allow a minimum of five working days prior to delivery for request to substitute. Substitutions are sublect to the Landscape Standard.

All plant material must be provided from the certified 'Disease Free' nursery. All plant material must conform to the latest edition of the 'BC Landscape STandard'. Provide certification upon request. All landscaping and landscape materials to conform to the latest edition of the CLS standards.

Min, growing medium depths over prepared subgrade shall be:

 Lawn areas
 300mm

 Ground Cover Areas
 450mm

 Shrub Areas
 450mm

Tree Pits 300mm (around root balls)

Growing medium shall have physical and chemical properties as described in the standards for 'Ground'areas, except for the areas over structures where the medium shall conform to the requirements for level 1 applications. Processing and mixing of the growing medium shall be done off-site using a mechanized screening process. Proposed growing medium shall be tested by a recognized laboratory. The contractor shall guarantee that the soil submitted for testing is a sample representative of the soil to be used at the site.

On-Site or imported soils shall satisfy the requirements of the standards for growing medium. Soils shall be virtually free from subsoll, wood including woody plant parts, weed or reproducive parts of the weeds, plant pathogenic organisms, toxic material, stones over 30mm, and foreign objects.

All planting beds shall receive min, 50mm bark mulch.

The contractor shall maintain clean working conditions, remove all refuse and debris and present the site in a safe and clean condition upon completion of all works.

All the Planters are fixed not removable.

Plant species and varieties may not be substituted without the approval of the Landscape architect.

All plant material to be warranteed for one year from date of substantial completion.

All wood fences to be cedar, with one coat of clear penetrating preservative.

All planted areas to be equipped with automatic irrigation system.

Automatic zoned irrigation system to be provided with following primary zones,

- Street level boulevard areas including the ROW's, setbacks not part of private yards, driveway access etc. These include chiefly inground planting.
- Podium level public areas. This includes planting in planter beds and on slab.
- Individual yards on site level. Mainly inground planting.
- Individual yards on podium level. Mainly planter.
 All amenity areas on podium level. Mainly planter beds

These have been carefully chosen to address the varying volume of growing medium to be catered for and will employ suitable heads and discharge.

Landscape Plans are prepared based on latest architecture drawings Revision no. 3 on 30 March 2022.

SEE L8 FOR SOIL VOLUME CALCULATION OF PODIUM LEVEL DI ANTER SEE PAVING/SITE FURNISHING LEGENDS ON L4.

SEE L5 FOR PLANTER HEIGHT OF PODIUM LEVEL.

SEE L8 FOR SOIL VOLUME CALCULATION AND PLANTER HEIGHT OF ROOFTOP PLANTERS.



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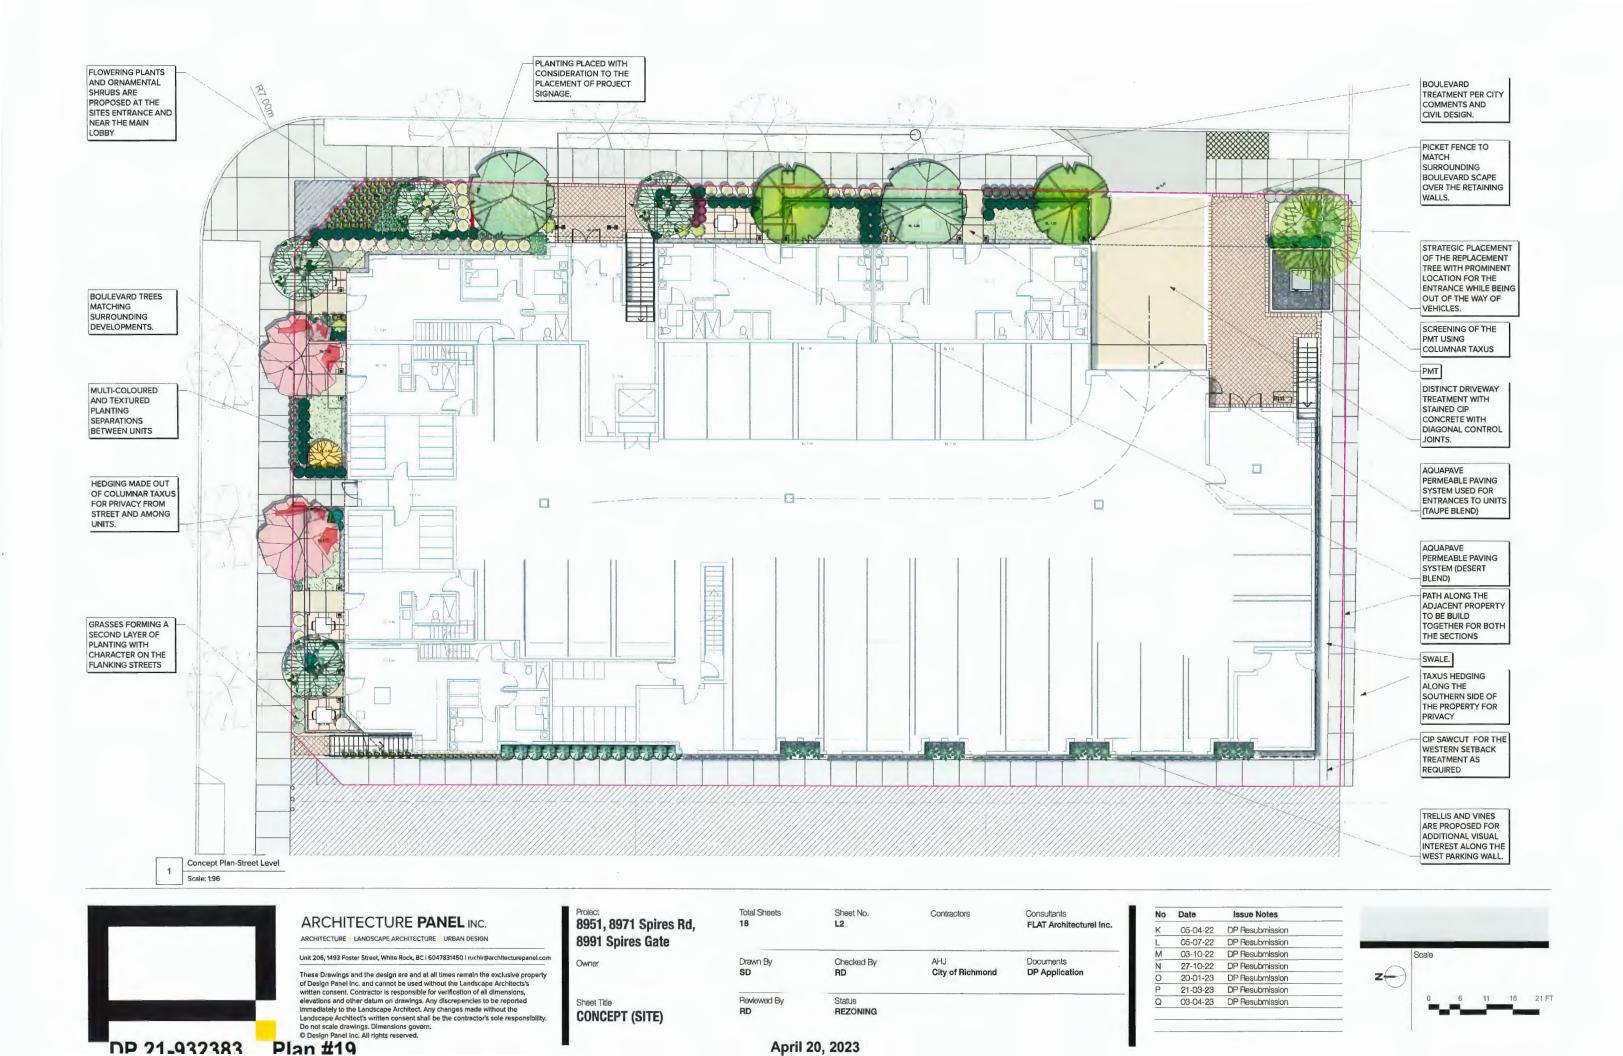
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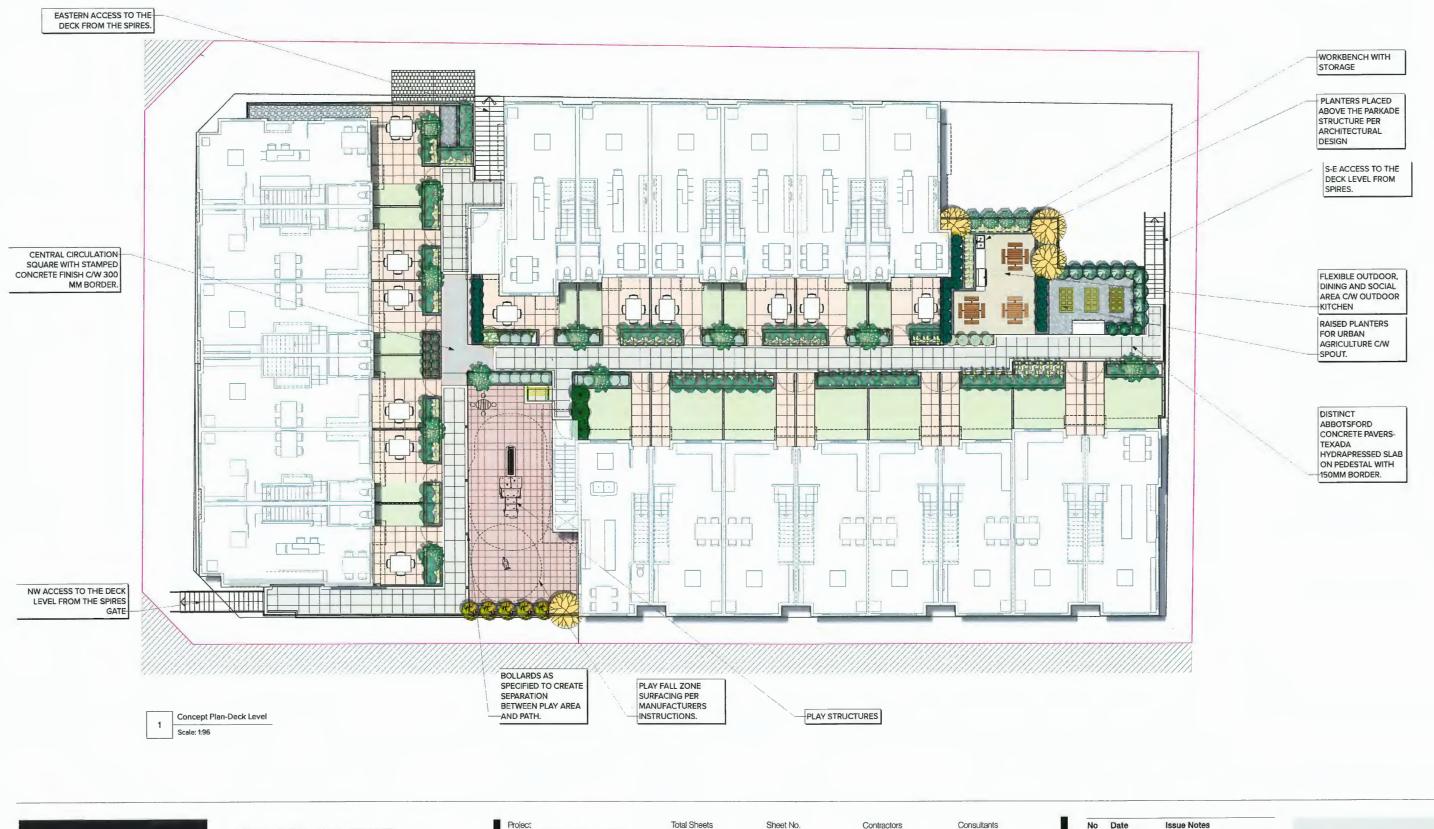
KEY PLAN

Total Sheets Sheet No. Contractors Consultants 18 L1 FLAT Architecture Documents Drawn By Checked By AH.J City of Richmond DP Application SD Reviewed By Status

No	Date	Issue Notes
K	05-04-22	DP Resubmission
L	05-07-22	DP Resubmission
М	03-10-22	DP Resubmission
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Plan #20


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Sheet Title


CONCEPT(DECK LEVEL)

18	L3		FLAT Architecturel Inc
Drawn By SD	Checked By RD	AHJ City of Richmond	Documents DP Application
Reviewed By	Status REZONING		

No	Date	Issue Notes	_
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М	03-10-22	DP Resubmission	
N	27-10-22	DP Resubmission	
0	20-01-23	DP Resubmission	
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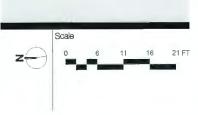
8951, 8971 Spires Rd, 8991 Spires Gate	
Owner	

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Owner	
Sheet Title HARDSCAPE/SITE	

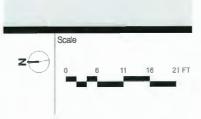
FURNISHINGS

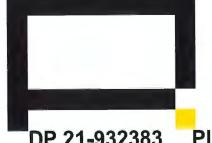18	L4	Contractors	FLAT Architecturel Inc.
Drawn By SD	Checked By RD	AHJ City of Richmond	Documents DP Application
Reviewed By	Status REZONING		

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M	03-10-22	DP Resubmission
N	27-10-22	DP Resubmission
0	20-01-23	DP Resubmission
Р	21-03-23	DP Resubmission
Q	03-04-23	DP Resubmission



Plan #21

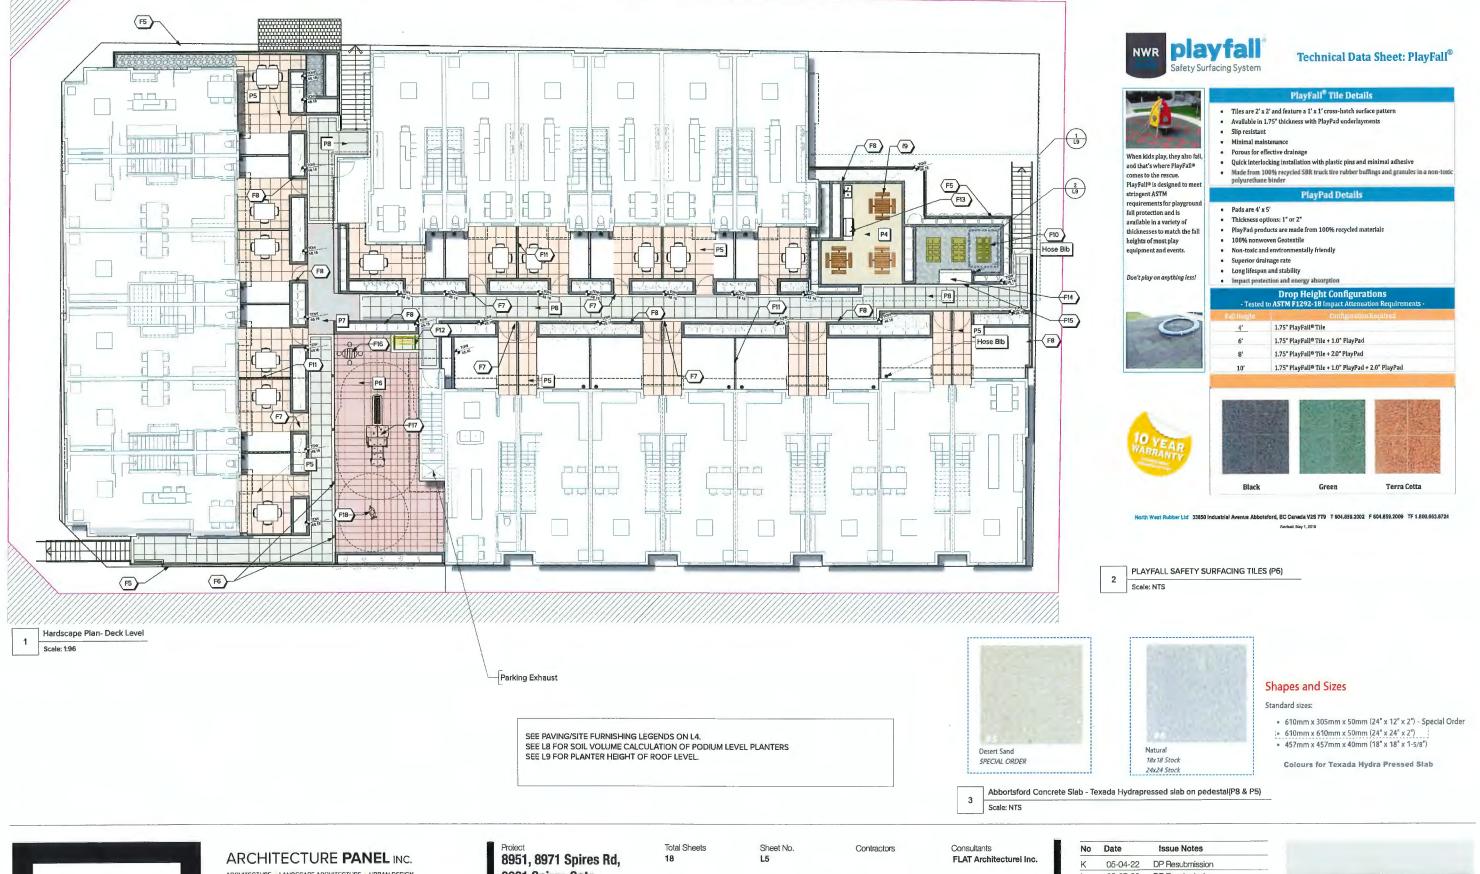




ARCHITECTURE LANDSCAPE ARCHITECTURE URBAN DESIGN


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Project 8951, 8971 Spires Rd, 8991 Spires Gate	Total Sheets 18	Sheet No. L5	Contractors	Consultants FLAT Architecturel Inc.
Owner	Drawn By SD	Checked By RD	AHJ City of Richmond	Documents DP Application
Sheet Title HARDSCAPE DECK LEVEL	Reviewed By RD	Status REZONING		

No	Date	Issue Notes	
K	05-04-22	DP Resubmission	
L	05-07-22	DP Resubmission	
М	03-10-22	DP Resubmission	
N	27-10-22	DP Resubmission	
0	20-01-23	DP Resubmission	
P	21-03-23	DP Resubmission	
Q	03-04-23	DP Resubmission	





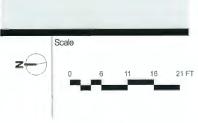

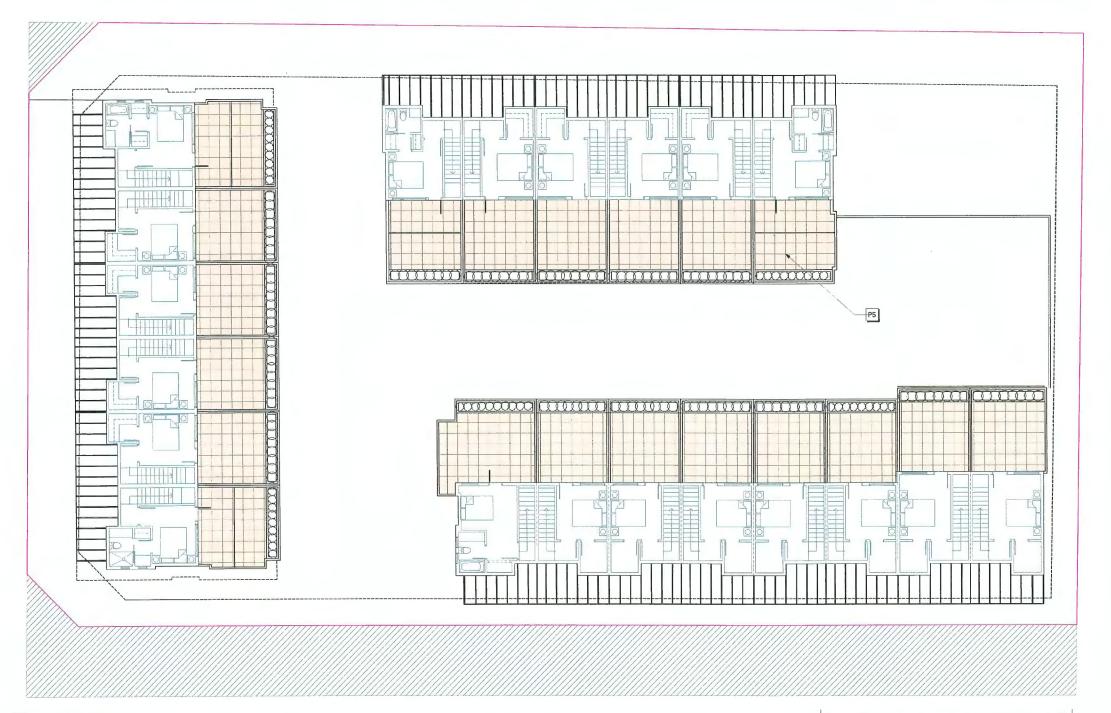

Natural 18x18 Stock 24x24 Stock

Shapes and Sizes

Standard sizes:


- 610mm x 305mm x 50mm (24" x 12" x 2") Special Order
- 610mm x 610mm x 50mm (24" x 24" x 2")
- 457mm x 457mm x 40mm (18" x 18" x 1-5/8")

Colours for Texada Hydra Pressed Slab

2 Abbortsford Concrete Slab - Texada Hydrapressed slab on pedestal(P8 & P5).

Scale: NTS

Planting Plan-Roof Level Scale: 1:96 A smart irrigation system will be provided to cover all common landscaping areas.

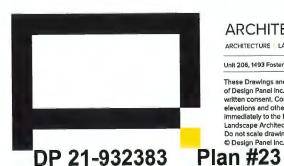

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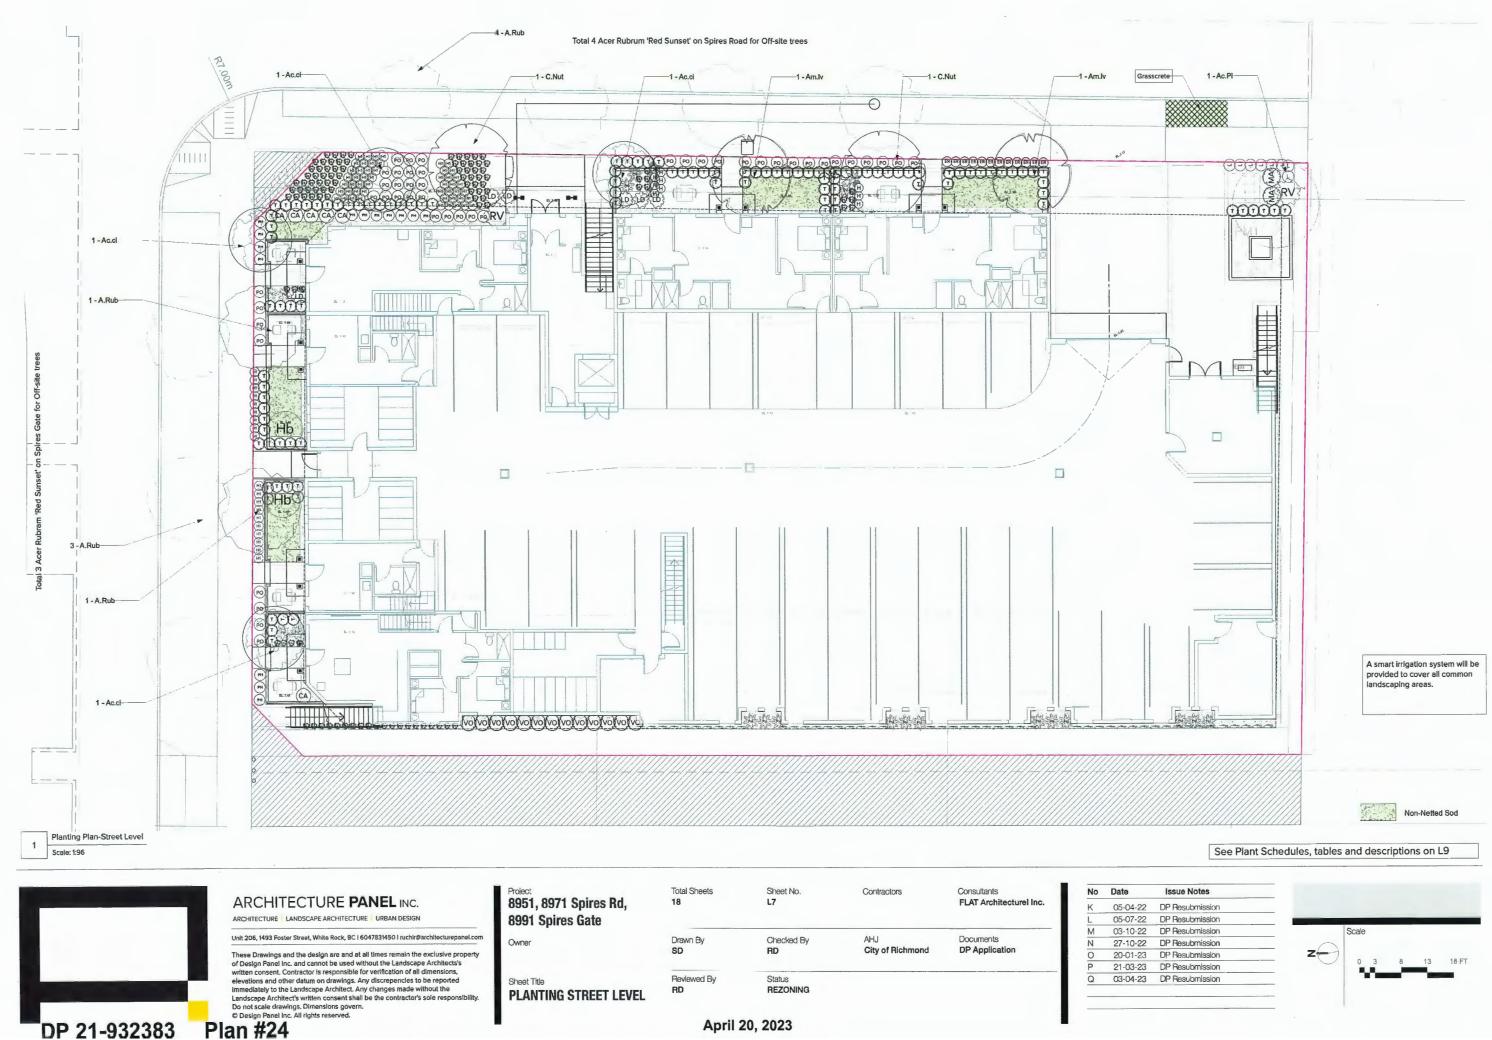
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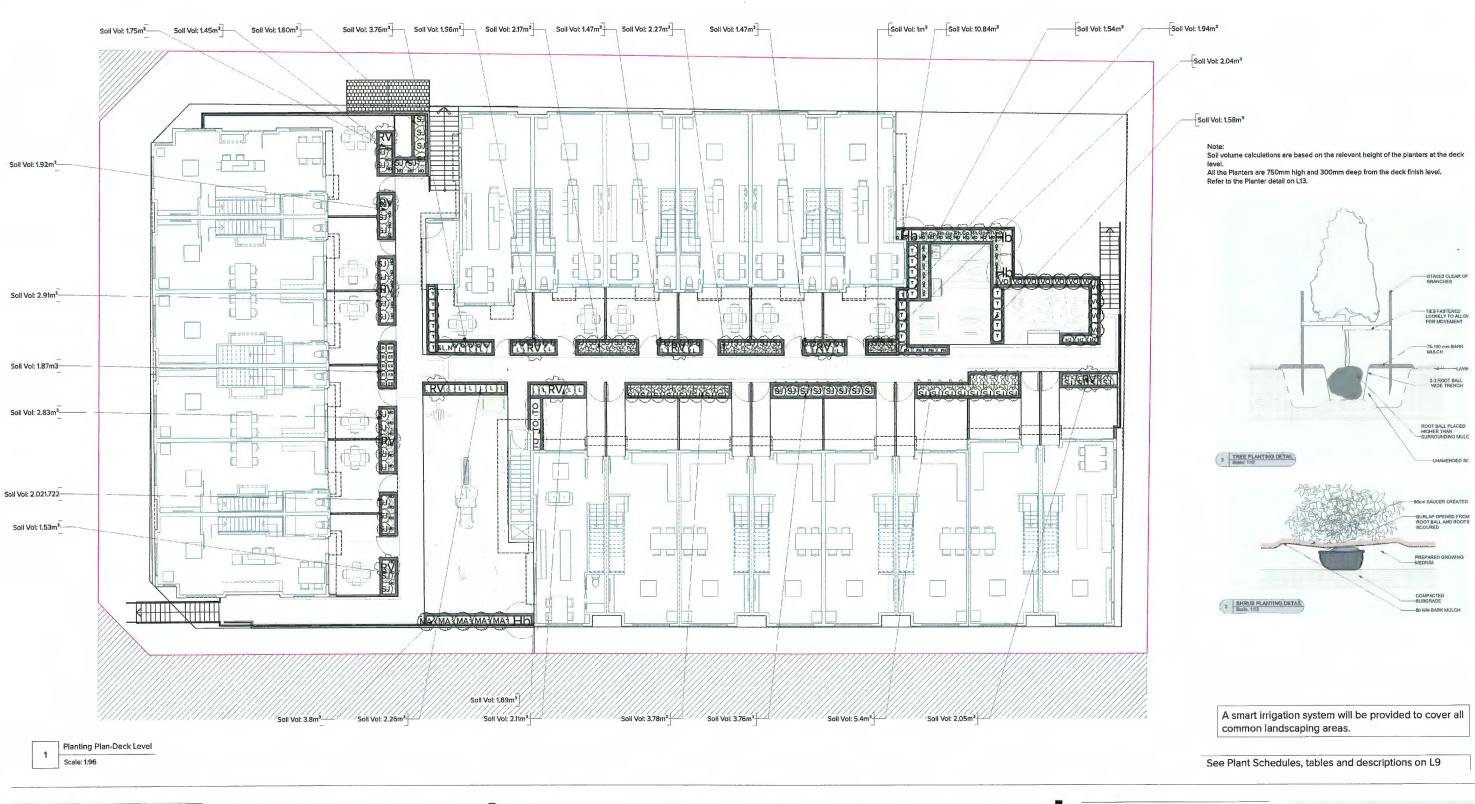
HARDSCAPE ROOF LEVEL

Total Sheets 18	Sheet No. L6	Contractors	Consultants FLAT Architecturel Inc.
Drawn By SD	Checked By RD	AHJ City of Richmond	Documents DP Application
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No	Date	Issue Notes	
K	05-04-22	DP Resubmission	
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M	03-10-22	DP Resubmission	
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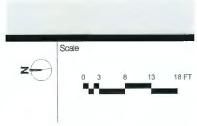
Plan #25


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8991 Spires Gate
Owner
Sheet Title
PLANTING DECK LEVEL

Total Sheets 18	Sheet No. L8	Contractors	Consultants FLAT Architecturel Inc.
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No	Date	Issue Notes
K	05-04-22	DP Resubmission
L	05-07-22	DP Resubmission
М	03-10-22	DP Resubmission
N	27-10-22	DP Resubmission
0	20-01-23	DP Resubmission
P	21-03-23	DP Resubmission
Q	03-04-23	DP Resubmission





List of Shrubs- Ground Level

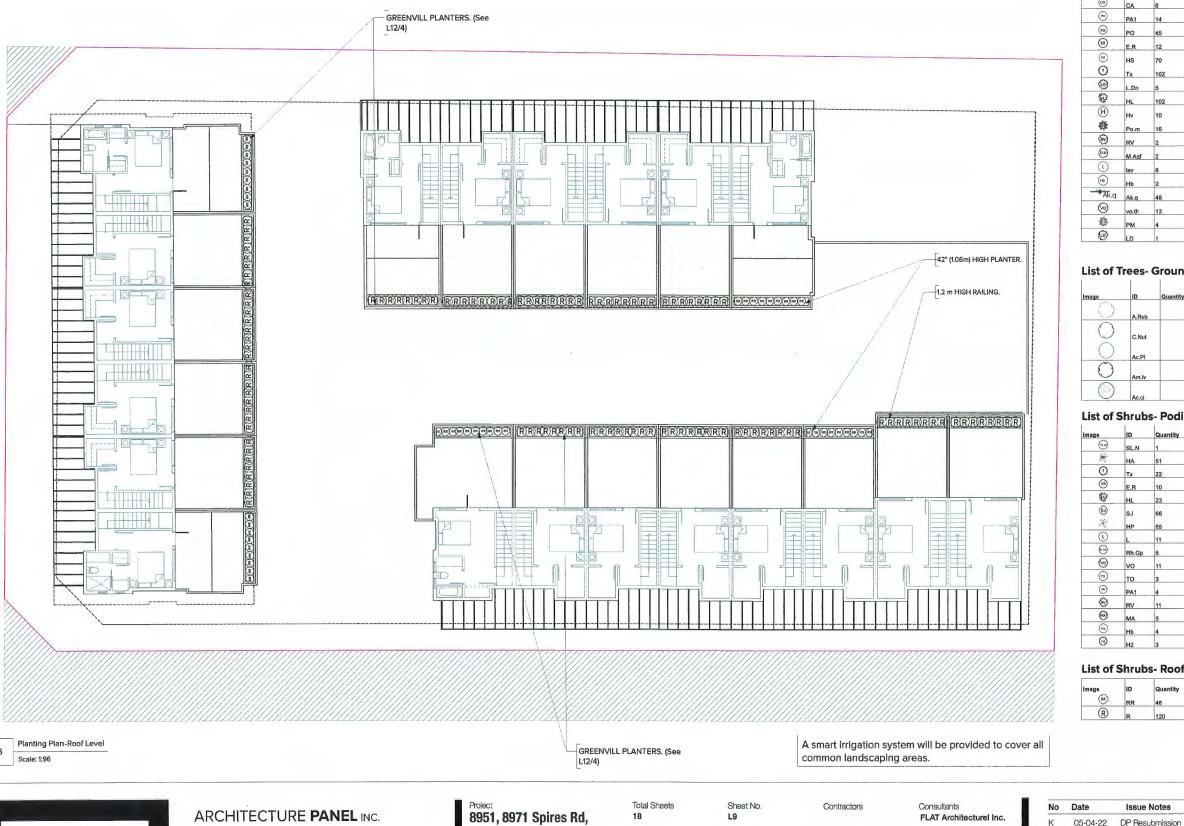Image	ID	Quantity	Latin Name	Common Name	Scheduled Size
(A)	CA	6	Calamagrostis x acutiflora 'Karl Foerster'	Foerster's Feather Reed Grass	#2 pat
(m)	PA1	14	Pennisetum alopecuroides 'Hamein'	Hamein Dward Fountain Grass	#2 pot
PO	PO	45	Pennisetum orientale	Oriental Fountain Grass	#3 pot
(ER)	E.R	12	Echinacea 'Rosita'	Purple coneflower Rosita (dwarf)	#1 pat
(HI)	нѕ	70	Helictotrichon sempervirens	Blue Oat Grass	#1 pot
0	Tx	102	Taxus sp	Yew, hedge variety	1.5 m. ht.
6	L.Dn	5	Ligularia dentata 'Brit Marie Crawford'	Brit Marie Crawford Ligularia	#1 pot
彩	HL	102	Hemerocallis x 'Lemon Yellow' or vars	Lemon Yellow Daylily	#1 pot
H	Hv	10	Heuchera vars	Coral bells	#1 pol
李	Po.m	16	Polystichum munitum	swordfern	#2 pot
€)	RV	2	Rhododendron Vulcan	Red Rhododendron	#7 pot
(MA)	M.Agf	2	Mahonia aquafolium	Oregon grapw	#3 pot
(L)	lav	8	Lavendula vars	Lavender	#1 pot
Нв	НЬ	2	Hibiscus syriacus 'Lucy'	Lucy Rose Of Sharon	1.5 m. ht
Ak.q	Ak.q	48	Akebia quinata	Chocolate vine	#3 pot staked
⊙	vo.th	13	Vaccinium ovatum 'Thunderbird'	evergreen huckleberry	#3 pat
爺	РМ	4	Polystichum munitum	swordfern	#3 pot
(ii)	LD	1	Ligularia dentata 'Brit Marie Crawford'	Brit Marie Crawford Ligularia	#1 pot

List of Trees- Ground Level

Image	ID	Quantity	Latin Name	Common Name	Scheduled Size
0	A.Rub	-	2 Acer rubrum 'Red Sunset'	Red Sunset Red Maple	8cm, cal.
\bigcirc	C.Nut	:	2 Corunus nuttallii 'National'	National Dogwood	4.0 m. ht. clump
0	Ac.Pl		1 Acer palmatum	Japanese Maple	8cm. cal.
0	Am.ly		2 Amelanchier laevis	Allegheny Serviceberry	8cm. cal.
	Ac.ci		4 Acer circinatum	Vine maple	4m ht.

List of Shrubs- Podium Level

lmage	ID	Quantity	Latin Name	Common Name	Scheduled Size
(I)	SL.N	1	Salix purpurea 'Nana'	Dwarf Arctic Blue Leaf Willow	#3 pot
PP'	HA	51	Hosta x 'Blue Angel'	Blue Angel Plantain Lily	#1 pot
0	Tx	22	Taxus sp	Yew, hedge variety	1.5 m. ht.
(ER)	E.R	10	Echinacea 'Rosita'	Purple coneflower Rosita (dwarf)	#1 pot
10	HL	23	Hemerocallis x 'Lemon Yellow' or vars	Lemon Yellow Daylily	#1 pot
(5)	SJ	66	Skimmia japonica	Japanese Skimmia	#2 pot
A.	HP	55	Hosta x 'Patriot'	Patriot Plantain Lily	#3 pot
L	L	11	Lavendula vars	Lavender	#1 pot
0	Rh.Gp	5	Rhododendron 'Gumpo Pink'	Pink Gumpo Azalea	#7 pot
(-)	vo	11	Vaccinium ovalum 'Thunderbird'	evergreen huckleberry	#3 pot
(TO)	то	3	Thuja occidentalis 'Smaragd'	Emerald Cedar	1.5 m. ht.
•	PA1	4	Pennisetum alopecuroides 'Hamein'	Hameln Dward Fountain Grass	#2 pot
(2)	RV	11	Rhododendron Vulcan	Red Rhododendron	#7 pot
(4)	MA	5	Mahonia aquafolium	Oregon grapw	#3 pot
(10)	НЬ	4	Hibiscus syriacus 'Lucy'	Lucy Rose Of Sharon	1.5 m. ht
(3)	H2	3	Bergenia cordifolia	Heartleaf Bergenia	#1 pot

List of Shrubs-Roof Level

Issue Notes

-	ID OI	Quantity	Latin Name	Common Name	Scheduled Size
(RR)	RR	46	Rosa rugosa 'Champlain'	Champlain Hardy Shrub Rose	#2 pot
R	R	120	Rosa Nutkana	Nootka Rose	#2 pol

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DP 21-932383

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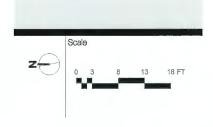
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Plan #26 Project **8951, 8971 Spires Rd,** 8991 Spires Gate Owner

Sheet Title **PLANTING ROOF LEVEL**

L9 Drawn By Checked By Documen City of Richmond SD RD DP Appli

L	05-07-22	DP Resubmission
 M	03-10-22	DP Resubmission
N	27-10-22	DP Resubmission
0	20-01-23	DP Resubmission
P	21-03-23	DP Resubmission
Q	03-04-23	DP Resubmission





April 20, 2023

Reviewed By

Status

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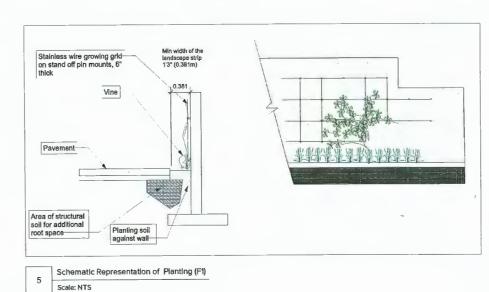


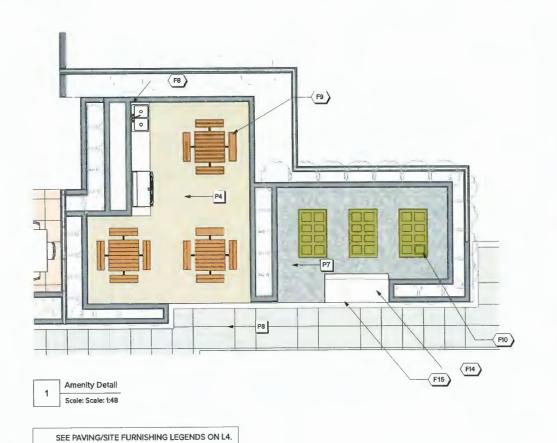


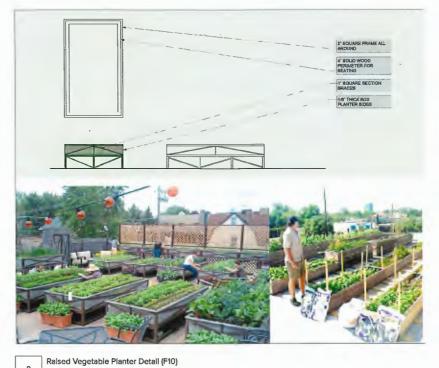Abbotsford AquaPave Taupe Blend (P3)

Scale: NTS

4 Abbotsford AquaPave Desert Sand Blend (P4)
Scale: NTS



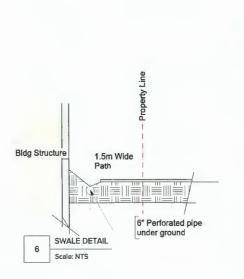

Scale: NTS





8 PROPOSED SQUARE BOLLARDS (F6)
Scale: NTS



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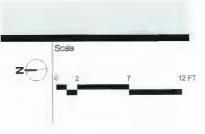
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Plan #27

Project 8951, 8971 Spires Rd 8991 Spires Gate
Owner
Sheet Title AMENITY/DETAILS-1


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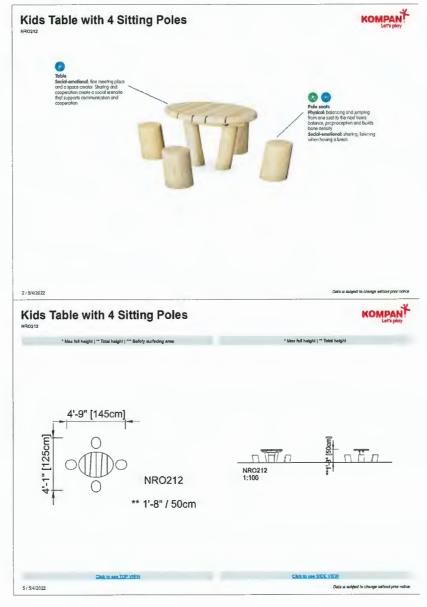
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М	03-10-22	DP Resubmission
N	27-10-22	DP Resubmission
0	20-01-23	DP Resubmission
Р	21-03-23	DP Resubmission
Q	03-04-23	DP Resubmission



Scale: NTS






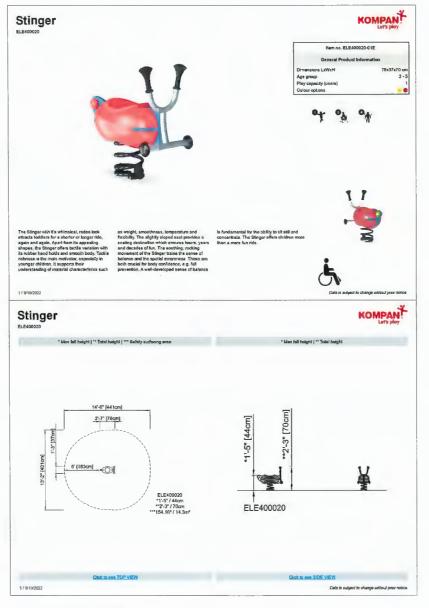

KOMPAN STINGER (F18) Scale: NTS

KIDS TABLE WITH SITTING (F16)

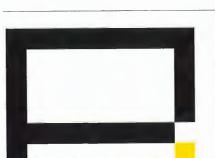

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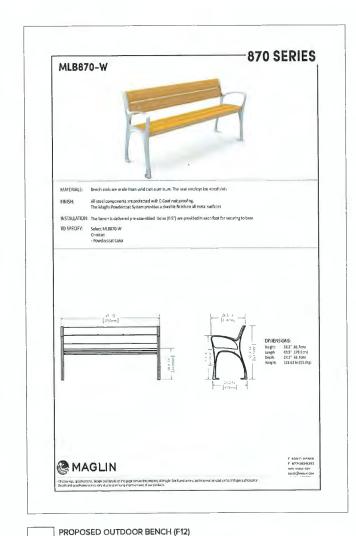
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Plan #28


Project 8951, 8971 Spires Rd, 8991 Spires Gate	Total Sheets 18	Sheet No. L11	Contractors	Consultants FLAT Architecturel Inc.
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Owner	Drawn By SD	Checked By RD	AHJ City of Richmond	Documents DP Application
Sheet Title	Reviewed By	Status		
DETAILS-2	RD	REZONING		

No	Date	Issue Notes
K	05-04-22	DP Resubmission
L	05-07-22	DP Resubmission
M	03-10-22	DP Resubmission
N	27-10-22	DP Resubmission
0	20-01-23	DP Resubmission
Р	21-03-23	DP Resubmission
Q	03-04-23	DP Resubmission





PROPOSED OUTDOOR DINING SET (F9) 2 Scale: NTS

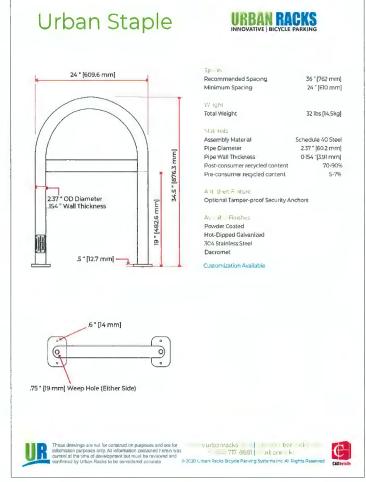

PROPOSED BIKE RACK (F4) 3 Scale: NTS

Perth



PROPOSED ROOF PLANTERS Scale: NTS

SEE PAVING/SITE FURNISHING LEGENDS ON L4.



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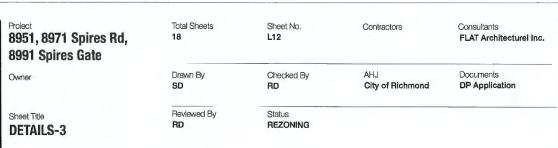
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WORKBENCH WITH STORAGE Global industrial

This sturdy workbench features an independently locking drawer and cabinet that secures supplies and tools. This allwelded drawer pedestals have full-width aluminum drawer handles and nylon drawer rollers for smooth opening. Secure supplies and tools with this sturdy workbench with independently locking drawer and cabinet. The drawers measure $13^{\text{\tiny{M}}}\text{W}~\text{x}$ 17-3/4"D and have weight capacity of 66 lbs per drawer. It includes four 5-1/2"H drawers and two 12"H drawers. The cabinet has a locking door and an adjustable shelf. The pedestals measure 15-3/4"W x 20"D x 32"H and can be arranged to suit your needs. It has a durable gray powder-coated finish. The workbench includes 1-3/4" thick maple butcher block top. It is easy to assemble.

@ ASSEMBLY

Product Details

Leg typ :	Fixed
And midy Wignie d	Yes
Edg - typ	Square
$\tau_{V_{L^1}}$.	Security Workbeitch
top fluterial	Migris Butch in Dinc":
Brand	Global Industrial
tog Siyla	Pude stall Leg
Siyle	6 Drawers, 2 Cabinst

Weights & Dimensions

Mondaction of Post House a

72 ld (132 88 cm) 32 IN (81-28 cm) Weight 4000 LBS (1018.13 kg) Wright Carally 365 LBS (136), 115()

Scale: NTS

Scale: NTS

DP 21-932383



Plan #30

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DETAILS-4

Total Sheets 18


Checked By Documents Drawn By City of Richmond SD RD

Sheet No.


L13 DP Application Reviewed By Status REZONING

Contractors Consultants FLAT Architecturel Inc.


Typical Residential Driveway/Sidewalk Construction

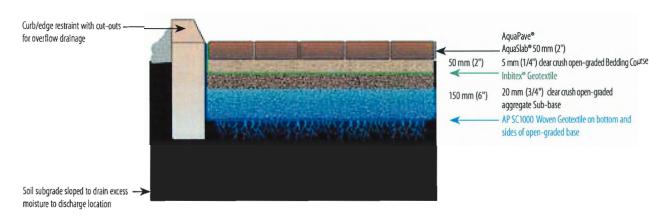

AquaPave Typical System Detail Scale: NTS

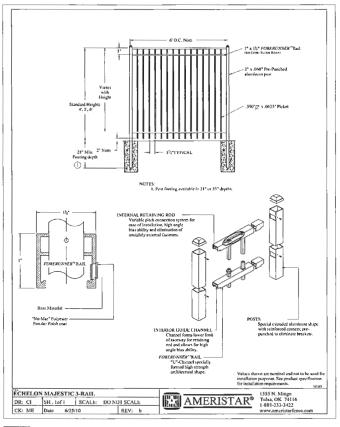


4' High Metal Fence detail (F5) Scale: Actual Size

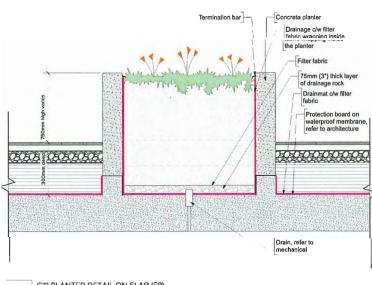

CIP PLANTER DETAIL ON SLAB (F8) Scale: 1:128

SEE PAVING/SITE FURNISHING LEGENDS ON L4.

No Date Issue Notes 05-04-22 DP Resubmission DP Resubmission 05-07-22 DP Resubmission 27-10-22 DP Resubmission DP Resubmission 21-03-23 DP Resubmission 03-04-23 DP Resubmission

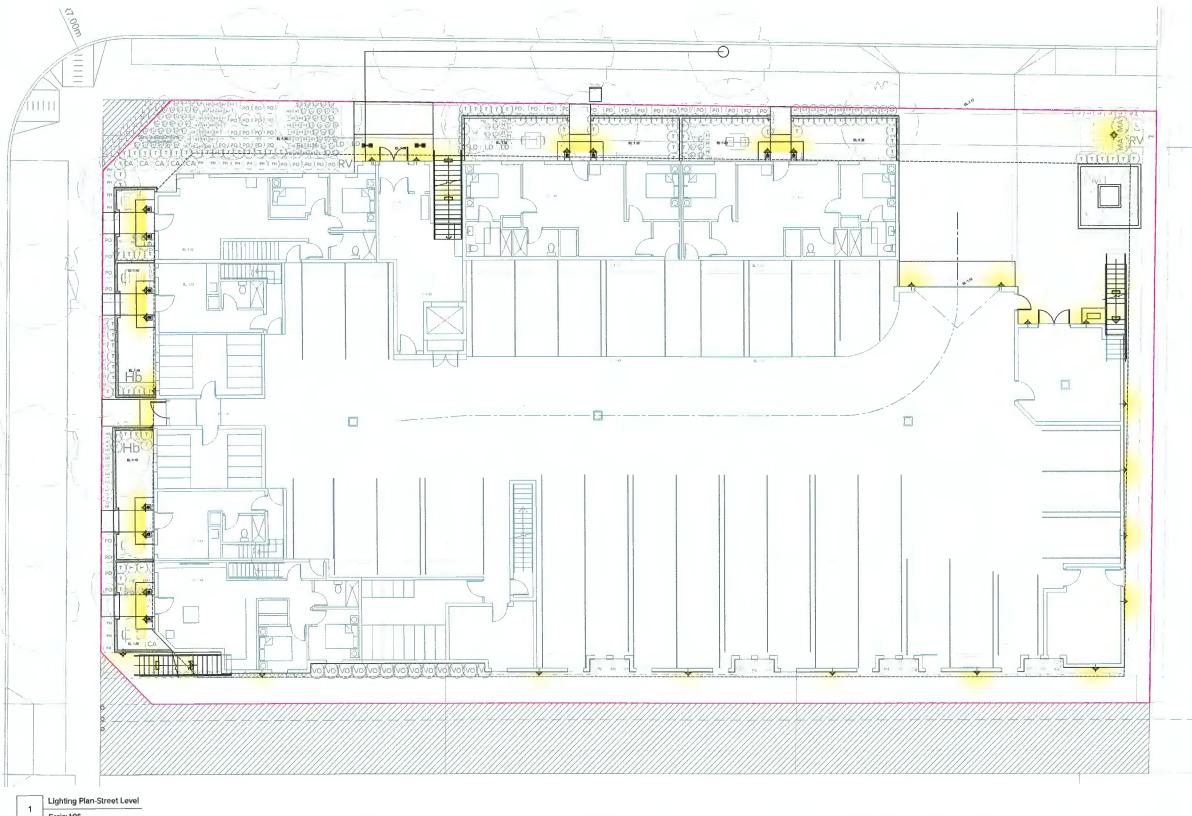

DESIGN RATIONALE OF SELECTED LIGHTING

On the entrance of the site from East, we want warm, inviting and calm appearance of the site and did not want too many distractions. So, there are wall light mounted at the entrance of the unit at planter wall to create inviting atmosphere for residents. These fixtures has potential for louvered shades to eliminate glare. At the corner of SE bicyle parking is screened from the street walkway and provided with bollard light for safe space and maneuver for cyclists as well as it can provide sufficent lighting to the wheelchair ramp. Rest of the illumination on the East of the site are provided by the building light and wall mounted lights at the exterior walls.

The same concept applied on the North side of the site and wall mounted lights are mounted on building walls.

Lane along the west and south property line with 1.5m walkway is illuminated with wall mounted lights on the building which provide smooth transition and ample lighting for pedestrain for crossing. The step lights are proposed at the stairs going to the deck level for smooth transition.

The main design criteria followed for lighting are as follows:

*Landscape lights are provided only where building mounted lights are incapable of

*Most landscape lights used are indirect and do not offer any unwanted glare with build in anti glare shading systems.

*No direct lighting fixtures are placed anywhere on the suite that offer security and reduce light





Wall Mounted Light 2 Scale: NTS

Scale: 1:96

DP 21-932383

ARCHITECTURE PANEL INC.

ARCHITECTURE | LANDSCAPE ARCHITECTURE | URBAN DESIGN

Unit 206, 1493 Foster Street, White Rock, BC I 6047831450 | ruchir@architecturepanel.com

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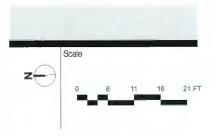
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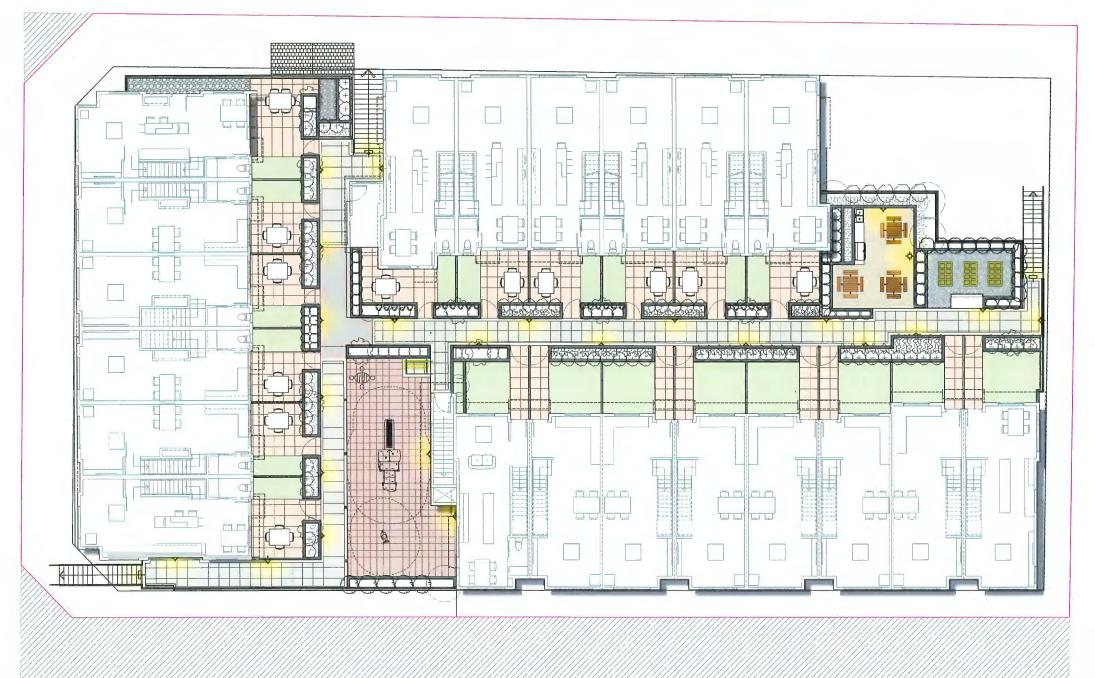
Plan #31 8951, 8971 Spires Rd, 8991 Spires Gate

LIGHTING PLAN (SITE)

Total Sheets	Sheet No.	Contractors	Consultants FLAT Architecturel Inc.
10	£14		PLAT Architecturer inc.
Drawn By	Checked By	AHJ	Documents
SD	RD	City of Richmond	DP Application
Reviewed By	Status		
RD	REZONING		

No	Date	Issue Notes	
K	05-04-22	DP Resubmission	
L	05-07-22	DP Resubmission	
М	03-10-22	DP Resubmission	
N	27-10-22	DP Resubmission	
0	20-01-23	DP Resubmission	
P	21-03-23	DP Resubmission	
Q	03-04-23	DP Resubmission	





DESIGN RATIONALE OF DECK LEVEL

At the podium level, there is enough light just beisde the stairs on $N\!W$ as well as SE corner. Which helps to provide illumination for movement and by the help of wall where lighting fixtures mounted will eventally helps to reduce the back spill in this case.

North facing units backyard at podium level are illuminated by the building lights and the path to access those units are illuminated with wall mounted lights at the center of the planter wall thorugh the east access of the stairs. At the pathway from NW to East stairs acess there would be minimum light spill because of the reflectance of the adjacent objects.

To aid the process of enhancing outdoor geathering area there are two bollards lights which can illuminate the fire pit as well as the entrance pathway. Moreover, wall mounted light has been selected for adorment of kitchen seating area.

The main design criteria followed for lighting are as follows:

*Landscape lights are provided only where building mounted lights are incapable of illuminating any external spaces.

*Most landscape lights used are indirect and do not offer any unwanted glare with build in anti glare shading systems.

*No direct lighting fixtures are placed anywhere on the suilte that offer security and reduce light pollution.





WALL MOUNTED LIGHT: CYPHER CY2- RADIUS CURVE



BOLLARD LIGHT: PROVIDENCE BOLLARD LIGHTING



STEP LIGHT:

Lighting Plan-Deck Level Scale: 1:96



ARCHITECTURE | LANDSCAPE ARCHITECTURE | URBAN DESIGN

Unit 206, 1493 Foster Street, White Rock, BC | 6047831450 | ruchir@architecturepanel.com

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Project 8951, 8971 Spires Rd, 8991 Spires Gate	
Owner	

Owner
Sheet Title LIGHITNG PLAN (DECK

LEVEL)


Total Sheets 18	Sheet No. L15	Contractors	Consultants FLAT Architecturel Inc.
Drawn By	Checked By	AHJ	Documents
SD	RD	City of Richmond	DP Application
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April 20, 2023

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K	05-04-22	DP Resubmission
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М	03-10-22	DP Resubmission
N	27-10-22	DP Resubmission
0	20-01-23	DP Resubmission
Р	21-03-23	DP Resubmission
Q	03-04-23	DP Resubmission

Issue Notes

No Date

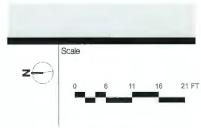

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Plan #32 DP 21-932383



FLAT ARCHITECTURE S

Unit 209- 6321 King George Blvd Surrey BC, V3X 1G1 www.flatarchitecture.ca contact@flatarchitecture.ca

Ph: 604-503-4484

PROJECT INFO:
Townhouse Development at 8951, 8971 Spires Rd., 8991 Spires Gate, Richmond, BC CLIENT:
Juliana

DATE
23-Feb-23
PROJECT NO:


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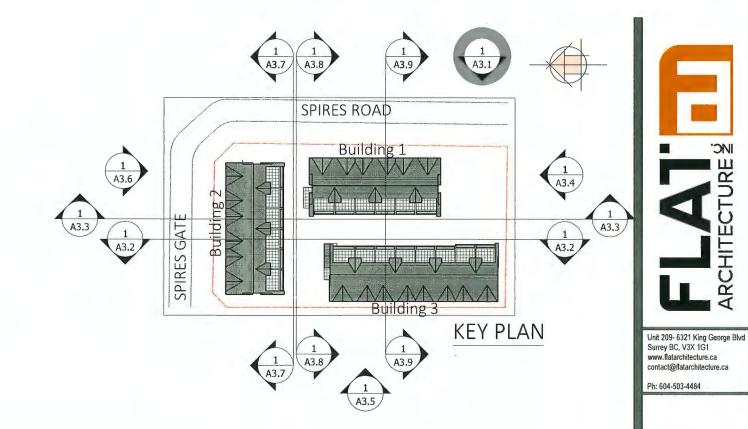
Issued For DP R.W 020822

MATERIAL BOARD

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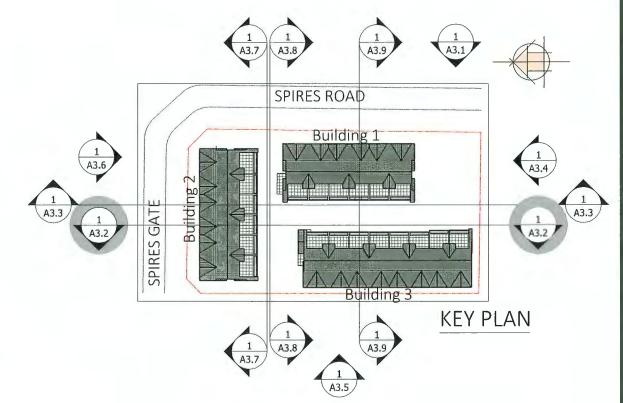


PAVERS: REFER LANDSCAPE DWGS



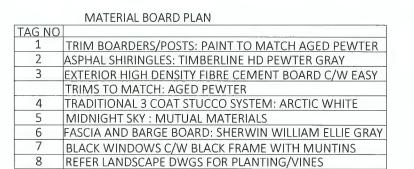

TAG NO 1 TRIM BOARDERS/POSTS: PAINT TO MATCH AGED PEWTER 2 ASPHAL SHIRINGLES: TIMBERLINE HD PEWTER GRAY 3 EXTERIOR HIGH DENSITY FIBRE CEMENT BOARD C/W EASY TRIMS TO MATCH: AGED PEWTER 4 TRADITIONAL 3 COAT STUCCO SYSTEM: ARCTIC WHITE 5 MIDNIGHT SKY: MUTUAL MATERIALS 6 FASCIA AND BARGE BOARD: SHERWIN WILLIAM ELLIE GRAY 7 BLACK WINDOWS C/W BLACK FRAME WITH MUNTINS 8 REFER LANDSCAPE DWGS 9 PAVERS: REFER LANDSCAPE DWGS





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29-Mar-23

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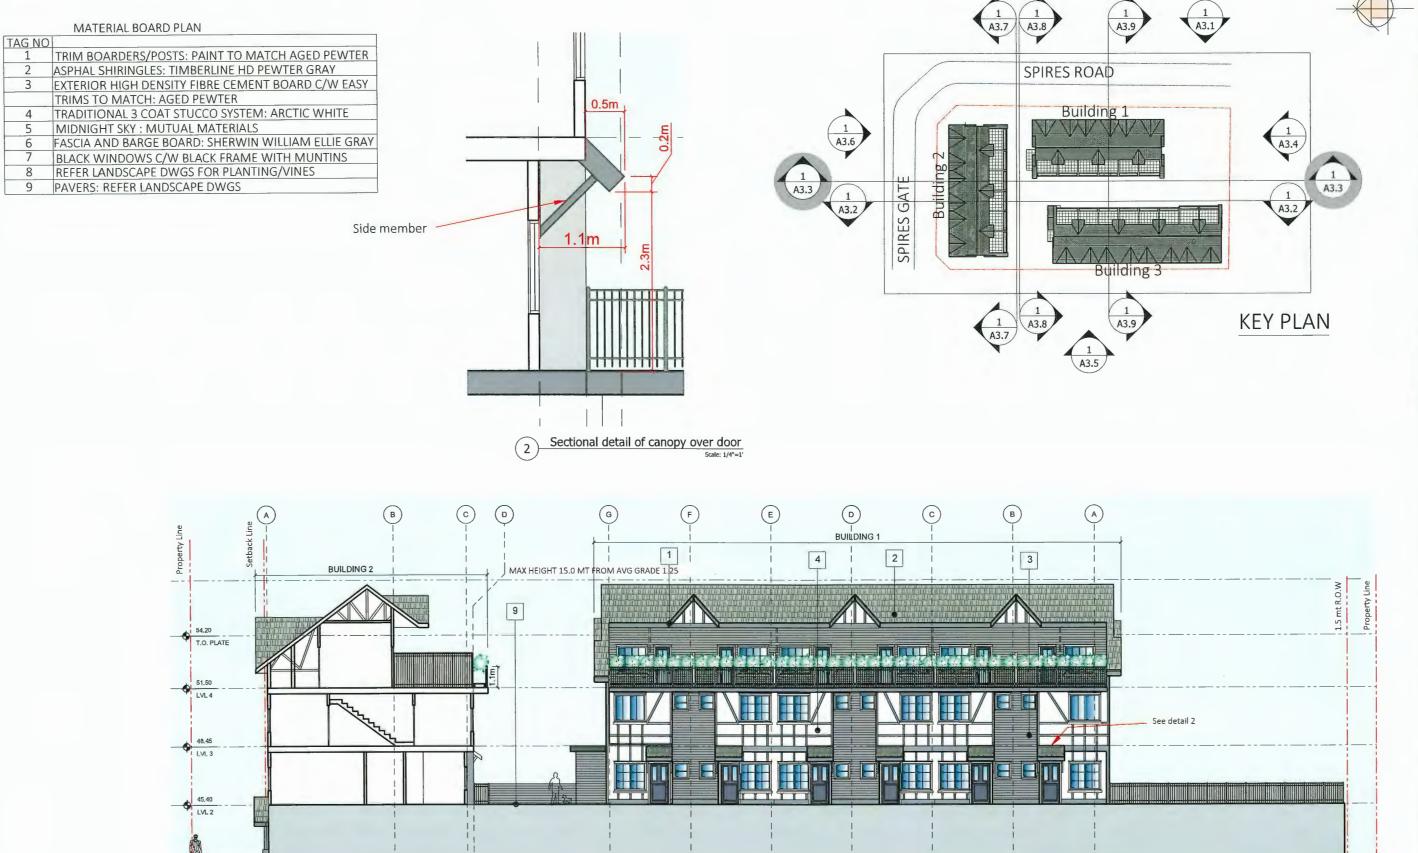
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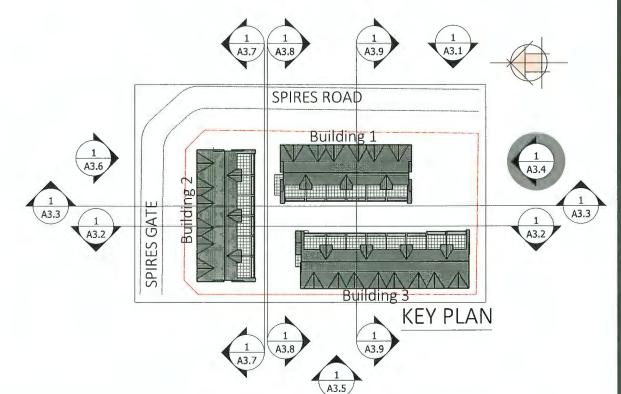
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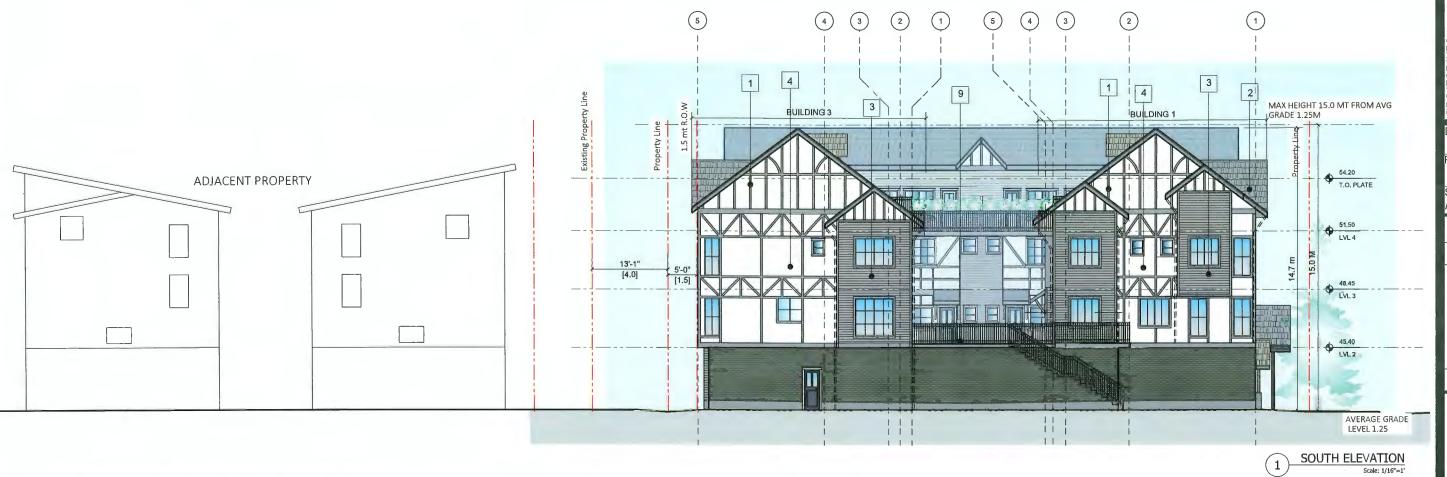
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Podium Level Elevations / WEST ELEVATION

MATERIAL BOARD PLAN

	MATERIAL BOARD FEAN
TAG NO	
1	TRIM BOARDERS/POSTS: PAINT TO MATCH AGED PEWTER
2	ASPHAL SHIRINGLES: TIMBERLINE HD PEWTER GRAY
3	EXTERIOR HIGH DENSITY FIBRE CEMENT BOARD C/W EASY
	TRIMS TO MATCH: AGED PEWTER
4	TRADITIONAL 3 COAT STUCCO SYSTEM: ARCTIC WHITE
5	MIDNIGHT SKY : MUTUAL MATERIALS
6	FASCIA AND BARGE BOARD: SHERWIN WILLIAM ELLIE GRAY
7	BLACK WINDOWS C/W BLACK FRAME WITH MUNTINS
8	REFER LANDSCAPE DWGS FOR PLANTING/VINES
9	PAVERS: REFER LANDSCAPE DWGS






Unit 209-6321 King George Blvd www.flatarchitecture.ca contact@flatarchitecture.ca PROJECT INFO:
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8971 Spires Rd., 8991 Spires Gate,
Richmond, BC
CLIENT:
Juliana


29-Mar-23 PROJECT NO:

17-127 SCALE:

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ELEVATION



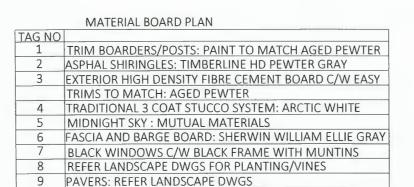

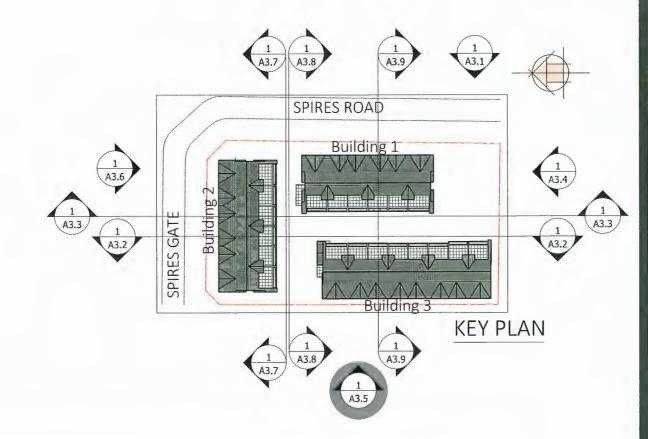


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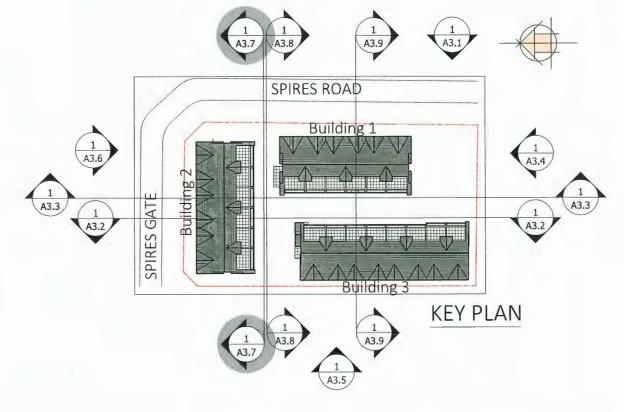
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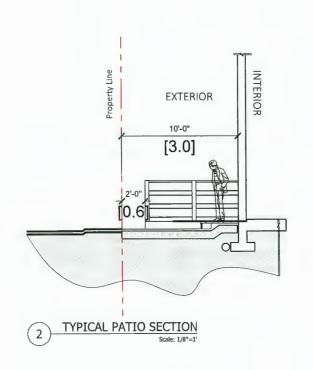


DP 21-932383 Plan #39

MATERIAL BOARD PLAN

MATERIAL BOARD FLAN
TRIM BOARDERS/POSTS: PAINT TO MATCH AGED PEWTER
ASPHAL SHIRINGLES: TIMBERLINE HD PEWTER GRAY
EXTERIOR HIGH DENSITY FIBRE CEMENT BOARD C/W EASY
TRIMS TO MATCH: AGED PEWTER
TRADITIONAL 3 COAT STUCCO SYSTEM: ARCTIC WHITE
MIDNIGHT SKY : MUTUAL MATERIALS
FASCIA AND BARGE BOARD: SHERWIN WILLIAM ELLIE GRAY
BLACK WINDOWS C/W BLACK FRAME WITH MUNTINS
REFER LANDSCAPE DWGS FOR PLANTING/VINES
PAVERS: REFER LANDSCAPE DWGS

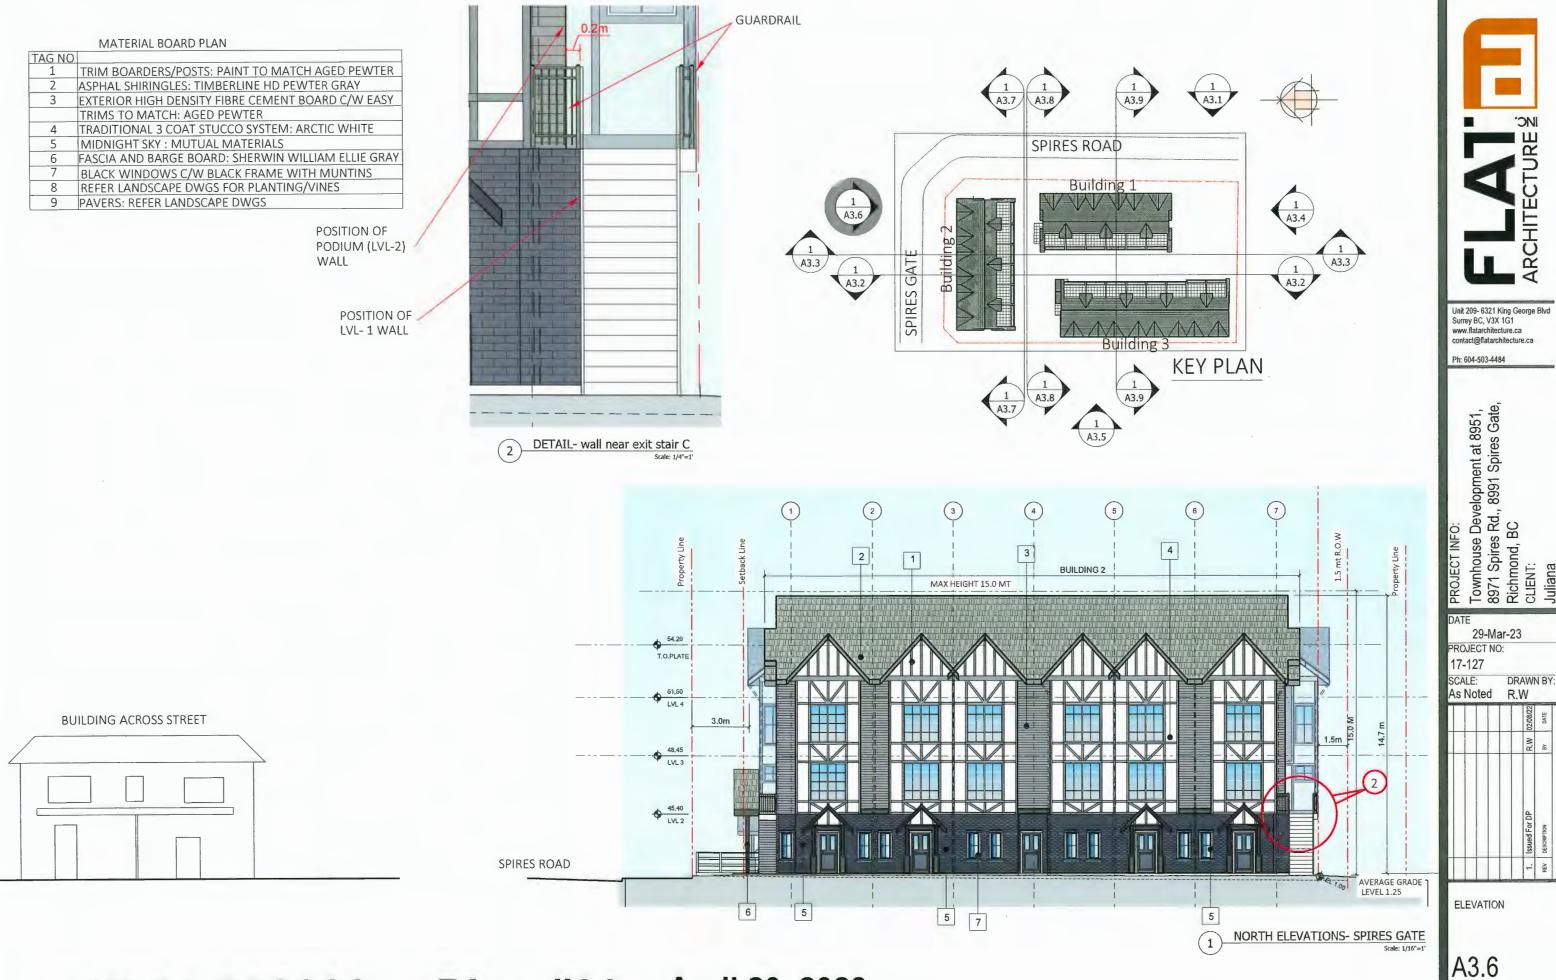





Podium Level Elevations Building 2 (South Side)

Scale: 1/16"=1"

Unit 209- 6321 King George Blvd Surrey BC, V3X 1G1

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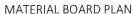
h: 604-503-4484

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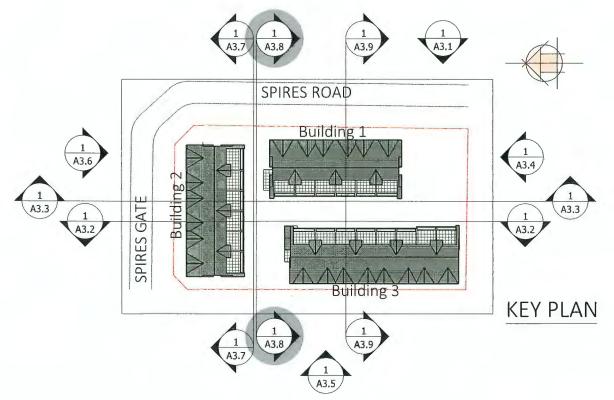
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SOUTH ELEVATIONS



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2	ASPHAL SHIRINGLES: TIMBERLINE HD PEWTER GRAY
3	EXTERIOR HIGH DENSITY FIBRE CEMENT BOARD C/W EASY
	TRIMS TO MATCH: AGED PEWTER
4	TRADITIONAL 3 COAT STUCCO SYSTEM: ARCTIC WHITE
5	MIDNIGHT SKY : MUTUAL MATERIALS
6	FASCIA AND BARGE BOARD: SHERWIN WILLIAM ELLIE GRAY
7	BLACK WINDOWS C/W BLACK FRAME WITH MUNTINS
8	REFER LANDSCAPE DWGS FOR PLANTING/VINES
9	PAVERS: REFER LANDSCAPE DWGS





North Elevation
Scale: 1/16"=1"

FLAT TARE S

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CLIENT:
Juliana


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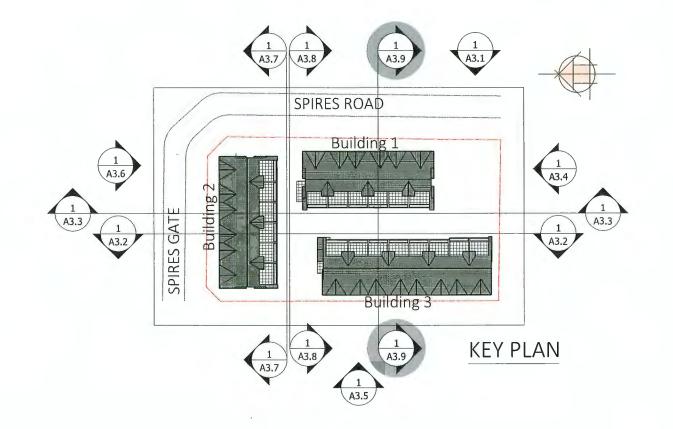
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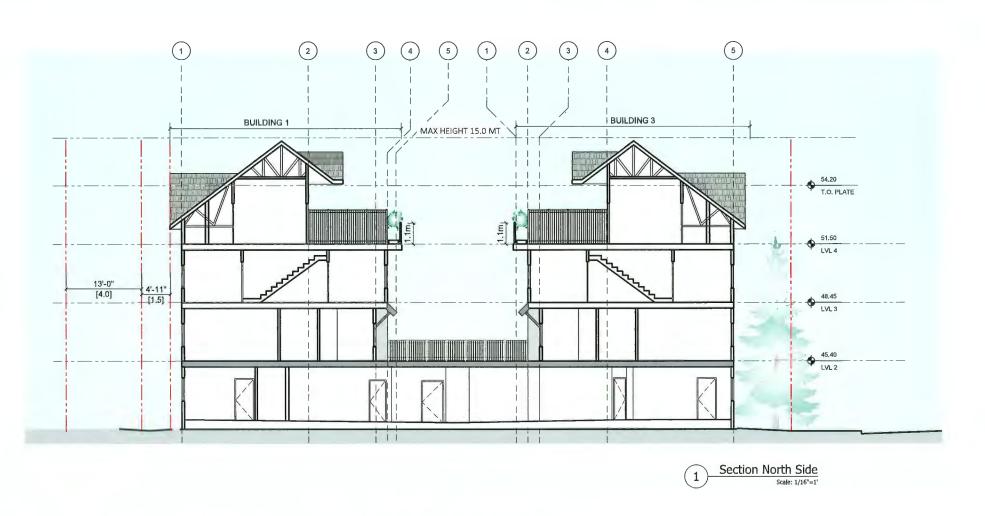
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NORTH ELEVATIONS







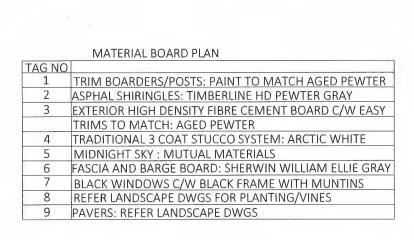

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Townhouse Development at 8951, 8971 Spires Rd., 8991 Spires Gate, Richmond, BC

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SECTION (NORTH)







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23-Feb-23 PROJECT NO:

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3D VIEW



1 VIEW FROM CORNER OF SPIRES GATE AND SPIRES RD
Scale: N.T.5



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23-Feb-23
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3D VIEW





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3D VIEW



VIEW FROM NORTHWEST CORNER
Scale: N.T.S.



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