

# **Report to Development Permit Panel**

To: Development Permit Panel

**Date:** July 4, 2022

From: Wayne Craig

Re:

File: DF

DP 20-921387

Director, Development

Application by Westmark Development Ltd. for a Development Permit at

7117 Lindsay Road

#### Staff Recommendation

That a Development Permit be issued which would:

- 1. Permit the construction of 10 townhouse dwellings at 7117 Lindsay Road on a site zoned "Town Housing (ZT23) Laurelwood"; and
- 2. Vary the provisions of Richmond Zoning Bylaw 8500 to reduce the minimum setback from a public road from 6.0 m to 3.8 m (measured from the boundary of the public rights-of- passage (PROP) statutory right-of-way (SRW) along the eastern edge of the subject site).

Wayne Craig Director, Development (604-247-4625)

WC/SB:blg

Att. 3

#### **Staff Report**

#### Origin

Westmark Development Ltd. has applied to the City of Richmond for permission to develop 10 townhouse dwellings at 7117 Lindsay Road on a site zoned "Town Housing (ZT23) - Laurelwood". The site is currently vacant.

Westmark Development Ltd. has applied on behalf of the property owner, numbered company 1276425 B.C. Ltd. Directors of the numbered company are Raman Bains and Suneil Bains.

There is no associated rezoning application.

A Servicing Agreement is required as a condition of Development Permit issuance and includes, but is not limited to, public walkway, lane and service infrastructure improvements.

### **Development Information**

Please refer to attached Development Application Data Sheet (Attachment 1) for a comparison of the proposed development data with the relevant Bylaw requirements.

#### **Background**

Development surrounding the subject site is as follows:

To the North: A townhouse development on a property also zoned "Town Housing (ZT23) -

Laurelwood" with vehicle access from the Lynnwood Drive cul-de-sac.

To the South: Semi-detached dwellings on properties zoned "Single Family Zero Lot Line

(ZS24)" with vehicle access from Lindsay Road.

To the East: Semi-detached dwellings on properties zoned "Single Family Zero Lot Line

(ZS24)" with vehicle access from the Lindsay Road cul-de-sac.

To the West: A townhouse development on a property also zoned "Town Housing (ZT23) -

Laurelwood" with vehicle access from the rear lane.

### **Public Input**

Public correspondence was received regarding the subject application (Attachment 2), expressing the following:

 Concern regarding pedestrian safety for students in the road and lane, and request for speed bumps along Lindsay Road and in the lane to slow traffic and address pedestrian safety.

To accommodate pedestrians, this development would provide a new public walkway along the subject site's south frontage that connects to the existing walkways along the east and west sides of the subject site. In addition, as part of the required frontage improvements, speed bumps would be constructed in the east-west lane and north-south lane located to the south and east of the subject site. Should there be concerns after residents move into the proposed development, Transportation staff would review and confirm any traffic-related concerns raised by area residents. A public process would be conducted before decisions on the implementation of any such measures were made.

 Concern regarding existing parking along Lindsay Road and in the lane and a request for the development to provide sufficient on-site parking for residents and guests of the proposed development.

The development proposal meets all parking requirements of Zoning Bylaw 8500 for on-site resident and visitor parking. Any available on-street parking is not taken into account to meet development requirements. Traffic Bylaw 5870 restricts on-street parking to no more than three hours between 8:00 am and 6:00 pm (residents parking in front of their home excluded). Should there be an issue, residents may contact Community Bylaws with concerns for enforcement of the bylaw.

 Request for visual cues to discourage illegal parking such as signage and road marking, and concern regarding existing parking blocking road visibility at the corner of Lindsay Road and Linfield Gate.

Cars should be parked no less than 6 m away from a property line at a corner in compliance with Traffic Bylaw 5870. Should there be an issue, residents may contact Community Bylaws with concerns for enforcement of the bylaw.

• Request for a resident parking permit system.

Traffic Bylaw 5870 has no provisions for a resident parking permit system. Should there be any violations of on-street parking regulations, residents may contact Community Bylaws with concerns for enforcement of the bylaw.

#### **Staff Comments**

The proposed scheme attached to this report has satisfactorily addressed the significant urban design issues and other staff comments identified as part of the review of the subject Development Permit application. In addition, it complies with the intent of the applicable sections of the Official Community Plan (OCP) and is generally in compliance with the "Town Housing (ZT23) - Laurelwood" zone except for the zoning variance noted below.

# Zoning Compliance/Variances (staff comments in bold italics)

The applicant requests to vary the provisions of Richmond Zoning Bylaw 8500 to reduce the minimum setback from a public road from 6.0 m to 3.8 m (measured from the boundary of the public rights-of-passage (PROP) statutory right-of-way (SRW) along the eastern edge of the subject site).

(Staff supports the proposed variance as an attractive pedestrian-oriented frontage is provided along the east lane frontage, and the variance improves both tree retention and public pedestrian improvements accommodated along the south lane frontage. A 5.5 m wide statutory right-of-way (SRW) along the west edge of the site accommodates a public sidewalk, grass boulevard with street trees and public parking. Due to the combined width of the statutory right-of-way (SRW) and City lane, a public road setback is required from the boundary of the statutory right-of-way (SRW). The proposed setback will not impact pedestrian or vehicle circulation, and is consistent with setbacks provided in the existing development north of the site which also has frontage on this lane).

#### **Analysis**

#### Conditions of Adjacency

- The site grade is proposed to meet the existing grade of adjacent properties. Perimeter retaining walls are not proposed.
- The subject site abuts a three-storey townhouse development to the north. The proposed development would also provide three-storey massing adjacent to the existing development.
- The subject site abuts a public walkway in a statutory right-of-way (SRW) along the east edge of the adjacent three-storey townhouse development to the west of the subject site. The proposed western units would have a 3 m setback, pedestrian-oriented front entries, and gated front yards, providing connections to and animating the walkway consistent with CPTED principles. The proposed public walkway along the south edge of the subject site would also provide a connection between the existing walkway and the Lindsay Road sidewalk.

#### Urban Design and Site Planning

- The proposed development consists of 10 townhouse dwellings arranged on a central drive aisle. A public walkway is provided along the south edge of the subject site adjacent to the side City lane and three existing Douglas Fir trees, which are proposed to be retained. Retention of these trees along the south property line strongly informed the proposed layout. The public walkway and outdoor amenity area would be constructed with supervision by the project arborist within the tree protection zone.
- The two front buildings (along the east property line) contain a total of five dwellings and would have direct access to the sidewalk along the east public road extension of Lindsay Road. Front yards are landscaped and include a covered patio for weather protection. Two of the dwellings would have some interior living space at grade.
- The two rear buildings (along the west property line) contain a total of five dwellings with covered entries and gated yards accessed directly from the public walkway along the west edge of the subject site. Three of the dwellings would have some interior living space at grade. Two of the dwellings also have direct access from the drive aisle. Front doors along the drive aisle are set back to allow space for a roof overhang providing weather protection.
- Each dwelling has a garage containing two vehicle parking spaces and one to two Class 1 bicycle parking spaces. Two visitor vehicle parking spaces are proposed at the north end of the drive aisle, and two Class 2 bicycle parking spaces are proposed between the two rear buildings beside the drive aisle.
- Garbage, recycling and organics container storage is accommodated in each garage and truck turning is accommodated on-site for collection from in front of each garage.

#### Architectural Form and Character

- The proposed architectural form and character draws from the two neighbouring townhouse development designs. The material palette consists of Hardie Board horizontal, board and batten and shingle siding in off-white, painted wood trim, cultured stone, and black asphalt shingles.
- A band of cultured stone is provided along the base of the elevations. Black and off-white Hardie Board siding is used. Articulation is used to visually distinguish individual dwelling units
- Gable roof character reinforce the low-rise residential character of the development.

### Landscape Design and Open Space Design

- There are five existing trees located on the subject site, two additional existing trees located in the lane south of the subject site, one additional tree that straddles the shared property line (located both in the lane and on-site), and four additional trees located on the adjacent site to the north of the subject site and close to the shared property line. Four of the trees are proposed to be removed. Please refer to the tree management plan included in the Development Permit (DP) plans.
- Four existing trees are proposed to be retained along the site's east and south frontages. One existing Linden tree is located in the grass boulevard in an SRW along the site's east property line. Three existing Douglas Fir trees are located at the interface between the site's south property line and the City lane. On-site building layout, public walkway, landscaping, and off-site lane cross-section have been designed to retain these trees. The applicant is required to enter into a contract with a registered arborist and provide a \$30,000.00 tree survival security prior to Development Permit issuance.
- Four existing trees on-site are proposed to be removed and replaced. Two of the trees conflict with the City lane upgrade required for lane functionality and safety, one tree conflicts with the requirement for on-site truck turning and townhouse garage access, and the condition of one tree is not good enough to withstand the impacts of required City lane upgrades and site redevelopment. The removal of the four trees would require the planting of eight replacement trees based on the 2:1 replacement ratio contained in the Official Community Plan (OCP). A total of 13 trees are proposed in the development, which includes nine deciduous and four coniferous.
- Four existing trees located on the neighbouring property to the north and adjacent to the subject site are required to be protected under the supervision of the project arborist, including construction of the visitor parking spaces along the north property line.
- Each dwelling unit has a private outdoor space at grade that includes a small lawn, patio, tree, and planted area.
- A 1.5 m wide public walkway is proposed in a new SRW along the south edge of the subject site, providing a connection between the west public walkway out to Granville Avenue and the Lindsay Road sidewalk to the east. The walkway curves around three existing trees being retained and within the tree protection area, Western Sword Fern planting is incorporated and the walkway material changes from concrete to crushed gravel.
- A shared outdoor amenity area is provided at the south end of the drive aisle with bench seating, lawn and a low play structure over fiber wood chip surfacing, allowing for active play in close proximity to the trees to be retained. Low fencing and a gate would mark the entry and low fencing provides a separation from the public walkway.
- For this small development, indoor amenity space is not proposed on-site. In compliance with the OCP, the applicant has agreed to provide a cash-in-lieu contribution in the amount of \$18,050.00 (e.g. \$1,805.00 per dwelling unit) to the City's Leisure Facilities Reserve prior to Development Permit issuance.
- The drive aisle is predominantly asphalt with concrete curbs. Interlocking pavers are proposed at the driveway entrance and north and south ends of the drive aisle.
- All soft landscaped areas would be provided with automatic irrigation.
- A landscape security in the amount of \$86,815.00 is required prior to Development Permit issuance to ensure that the agreed upon landscaping works are installed.

## Crime Prevention Through Environmental Design

- The proposed development would enhance passive surveillance for the pedestrian routes along the frontages of the subject site. Fencing proposed within the front yards and amenity area will be 0.9 m (3 ft.) tall to provide clear sightlines from the units to the public walkway west of the subject site, the proposed public walkway along the south edge of the subject site adjacent to the lane, and the lane sidewalk along the east edge of the subject site while maintaining separation of the public and private realms.
- Front yards are landscaped with low shrubs and to maintain clear sightlines.
- Pedestrian site access is controlled via gates at each of the walkways to the unit entries.
- The mailbox is proposed beside the driveway with clear visibility.
- Lighting is proposed for all pedestrian routes and unit entrances and designed to limit any light spillover onto adjacent properties.

### Accessible Housing

- The proposed development includes one convertible unit that is designed with the potential to be easily renovated to accommodate a future resident in a wheelchair. The potential conversion of this three-storey unit will require installation of chair lifts at both stair wells.
- All of the proposed units incorporate aging in place features to accommodate mobility constraints associated with aging. These features include:
  - o Stairwell hand rails.
  - Lever-type handles for plumbing fixtures and door handles.
  - O Solid blocking in washroom walls to facilitate future grab bar installation beside toilets, bathtubs and showers.

### Sustainability

- The applicant has provided a letter from the Coordinating Registered Professional confirming that the buildings are being designed to achieve Step 4 of the BC Energy Step Code and a Certified Energy Advisor has been engaged to ensure the requirement is met.
- Each dwelling would have an air source heat pump for heating and cooling. Heat pumps have been located in the private yard of each unit. The proposed locations of the heat pumps are shown on the site plan. The applicant has confirmed that the noise generated by the heat pumps will comply with Richmond Noise Regulation Bylaw 8856.
- 100% of the residential parking spaces are provided with Class 2 EV charging in the garage, as per Richmond Zoning Bylaw 8500.

#### Public Art

• The applicant has agreed to participate in the City's Public Art Program through a contribution in the amount of \$12,176.49 (e.g. \$0.93 per buildable square foot of residential floor area) to the City's Public Art Reserve for City-wide projects prior to Development Permit issuance.

#### **Conclusions**

As the proposed development would meet applicable policies and Development Permit Guidelines, staff recommend that the Development Permit be endorsed, and issuance by Council be recommended.

Sara Badyal Planner 3

(604-276-4282)

Sara Badyal

SB:blg

# Attachments:

Attachment 1: Development Application Data Sheet

Attachment 2: Public Correspondence Attachment 3: DP Considerations



# **Development Application Data Sheet**

Development Applications Department

**Proposed** 

DP 20-921387 Attachment 1

**Existing** 

Address: 7117 Lindsay Road

Applicant: Westmark Development Ltd. Owner: 1276425 B.C. Ltd.

Planning Area(s): Laurelwood Sub-Area (Blundell)

Site Area	1,843 m²		1,843 m²	
Land Uses	Vacant		Multi-family	
OCP Designation	Neighbourhood Residential		Complies	
Sub-Area Plan Designation	Residential (Townhouses)		Complies	
Zoning	Town Housing (ZT23) – Laure	elwood	Variance noted below	
Number of Units	None		10	0
	Bylaw Requirement	ľ	Proposed	Variance
Floor Area Ratio	Max. 0.66 FAR		0.66 FAR	None permitted
Lot Coverage	Max. 40%		35%	None
Setback – (East) Public Road (from SRW edge) Front Yard (from property line)	Min. 6 m 3.8 m Min. 6 m 9.4 m			2.2 m reduction to Public Road setback
Setback – Side Yard (South)	Min. 3 m		3 m	None
Setback – Side Yard (North)	Min. 3 m		3.2 m	None
Setback – Rear Yard (West)	Min. 3 m		3.1 m	None
Height	Max. 11 m and 3 storeys 11 m and 3		n and 3 storeys	None
Lot Size	Min. 1,830 m <sup>2</sup>		1,843 m <sup>2</sup>	None
Off-street Parking Spaces: Resident Visitor	22 20 2		22 20 2	None
Accessible Parking Spaces	Not required		None	None
Small Car Parking Spaces	Not permitted		None	None
Tandem Parking Spaces	Max. 50%		50%	None
Bicycle class 1 secure spaces	13		15	None
Bicycle class 2 rack spaces	2		2	None
Loading Spaces	i Niono		e manoeuvring for collections	None
Amenity Space – Indoor	Min. 50 m <sup>2</sup>		Cash-in-lieu None	
Amenity Space – Outdoor	Min. 60 m <sup>2</sup>		61 m <sup>2</sup>	None

From: Jennifer Tsoi

**Sent:** May 14, 2021 10:51 AM

To: DevApps

Subject: 7117 Lindsay neighbourhood

Dear Sir

We notice there will be a new townhouse built in our neighborhood.

We hope you can aware the serious problem for parking, and we lack of small park for our area's kids play around. Our kids always play around the cul de sac, and the traffic of cars are around the area, it creates the risk and dangerous for our kids.

Please consider this seriously for us.

Thanks Jennifer Tsoi From: Sharon Krowchuk

7171 Lindsay Rd V7C 2P5 s\_krow@telus.net 604 376 9300 To: Planning and Development Department

City of Richmond Richmond City Hall 6911 No. 3 Rd Richmond, BC

Date: June 21, 2021

Re: Development Permit Application No. DP20-921387 - 7117 Lindsay Rd

Planning and Development Staff,

I am writing to you regarding the **impact** of further neighbourhood densification at the north end of Lindsay Rd, along with **recommendations** to address these concerns.

Parking Congestion: Street parking on Lindsay Rd. is extremely limited or not available in late afternoon through to morning. There is a spillage of cars onto Lindsay Rd from the nearby multi-family complexes. I have also observed vehicles parked in the laneway in the vicinity of the coach houses. Apparently, these past developments did not provide sufficient on-site parking. Vehicles have partially blocked my front driveway and fully blocked my laneway access on numerous occasions. The parking congestion limits road visibility at the corner of Lindsay Rd and Linfield Gate, and at the foot of driveways.

**Increased traffic**: There are "rush hour" flows of traffic down Lindsay Rd, including vehicles with revved up engines and loud music. I have had to place orange cones on my driveway to prevent it from being used repeatedly as a turnaround point.

**Safety:** Lindsay Rd is a walking route for students of the two nearby schools. Pedestrian safety is a key priority as many pedestrians walk on the road and in the laneway - a laneway that is the proposed access to the development. A speeding problem already exists in the laneway, which necessitated the posting of speed signs at both entrances.

**Recommendations**: I am sure that the City of Richmond recognizes that densification in this area has reached a point where proactive traffic control measures must be implemented. May I suggest the following be considered along with any other measures already under contemplation by your staff:

- Sufficient on-site parking at 7117 Lindsay Rd for its residents and guests
- Visual cues to drivers to discourage illegal parking (signage, road markings)
- A resident parking permit system
- Speed bumps on Lindsay Rd and in the laneway to slow traffic and address pedestrian safety

The proposed 10 townhouses will bring at least 20 additional vehicles (2 per unit) along with visitor vehicles. The complaint-driven bylaw process handles parking violations on an individual basis and will not solve the ongoing problem of parking, safety and road visibility issues resulting from neighbourhood densification.

As a homeowner and long-time resident of this neighbourhood, I am personally not in favour of this development; however, should it go forward, might I please ask the City of Richmond to address the impact before the project is fully underway?

I hope that my comments help the planning process. I am happy to engage in further discussions.

Thank you for your consideration.



# **Development Permit Considerations**

Development Applications Department 6911 No. 3 Road, Richmond, BC V6Y 2C1

Address: 7117 Lindsay Road File No.: DP 20-921387

# Prior to forwarding the Development Permit to Council for approval, the developer is required to complete the following:

- 1. (Cash-in-lieu of Indoor Amenity Space) Contribution of \$18,050 (e.g. \$1,805 per dwelling unit) in-lieu of on-site indoor amenity space to go towards the City's Leisure Facilities Reserve in accordance with the OCP.
- 2. (Public Art) Contribution of \$12,176.49 (e.g. \$0.93 per buildable square foot of residential floor area) to the City's Public Art Reserve for City-wide projects on City lands.
- 3. (Tree Protection Fencing) Installation of appropriate tree protection fencing around all trees to be retained as part of the development prior to any construction activities, including building demolition, occurring on-site.
- 4. (Arborist Contract) Submission of a Contract entered into between the applicant and a Certified Arborist for supervision of any works conducted within the tree protection zone of the trees to be retained. The Contract should include the scope of work to be undertaken, including: the proposed number of site monitoring inspections, and a provision for the Arborist to submit a post-construction assessment report to the City for review.
- 5. (Tree Survival Security) Enter into a legal agreement and submission of a Tree Survival Security to the City in the amount of \$30,000 for the three existing trees along the south property line and one existing tree along the west property line to be retained. The security is to be released 90% upon project completion inspection confirming tree survival and 10% after one year maintenance period inspection confirming tree survival.
- 6. (Landscape Security) Enter into a legal agreement and submission of a Landscape Security in the amount identified in the cost estimate prepared by the Landscape Architect (including materials, labour and 10% contingency).
- 7. (Public Walkway SRW) Granting of a statutory right-of-way for the purposes of public rights of passage to accommodate a 1.5m wide walkway along the south property line, widening to meander around the three existing trees being retained, and connections with corner cuts to adjacent public walkways east and west of the subject site. The exact dimensions of the SRW is to be confirmed via functional plan and legal survey. The works are to be built by the Owner and are to be maintained by the Owner. Any works essential for public access within the required statutory right-of-way (SRW) are to be included in the Servicing Agreement (SA) and the maintenance & liability responsibility is to be clearly noted. The design must be prepared in accordance with good engineering practice with the objective to optimize public safety and after completion of the works, the Owner is required to provide a certificate of inspection for the works, prepared and sealed by the Owner's Engineer in a form and content acceptable to the City, certifying that the works have been constructed and completed in accordance with the accepted design. Works to be secured via SA.
- 8. (Flood Indemnity) Registration of a flood indemnity covenant on title.
- 9. (No Rental or Age Restrictions) Registration of a restrictive covenant prohibiting (a) the imposition of any strata bylaw that would prohibit any residential dwelling unit from being rented; and (b) the imposition of any strata bylaw that would place age-based restrictions on occupants of any residential dwelling unit.
- 10. (Tandem Parking) Registration of a legal agreement on title prohibiting the conversion of the tandem parking area into habitable space.
- 11. (Servicing Agreement) Enter into a Servicing Agreement\* for the design and construction of transportation and engineering infrastructure works. A Letter of Credit for the value of the Service Agreement works, as determined by the City, will be required as part of entering into the Servicing Agreement. Works include, but may not be limited to the following:
  - 1) Transportation Works:
    - a) Functional Plan: SA detailed design for frontage improvement works are to be based on approved functional plan.

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- b) Public walkway: 1.5m wide concrete walkway to be provided (SRW required) along south property line, meandering around trees to be retained and tying into existing walkways east and west of the site. Gravel surfacing to be used instead of concrete where required for tree protection only.
- c) East frontage (north-south lane):
  - i) The existing as-built frontage improvements (per SA 96-154 Road Works) are to be kept, i.e. measuring from west to east:
    - 1.5 m wide concrete sidewalk.
    - 0.15 m wide barrier curb.
    - 2.3 m wide street parking.
    - 0.15 m wide rollover curb.
    - 6.1 m wide pavement.
    - 0.15 m wide barrier curb.
    - Grass strip over the remaining space to the east property line of the road.

(Note 1: The above frontage improvements are supported by a 6.1 m wide existing lane dedication and 5.55 m wide existing SRW/PROP).

(Note 2: The existing frontage improvements must be restored if damaged by any construction works related to the subject development including pavement, curb, decorative paver treatments, etc.).

- ii) Traffic safety requirements: Speed bump installation, with location to be determined through road functional plan.
- d) South frontage (east-west lane): There are mature trees at the western section of the lane that have been identified for protection. As a result, the frontage improvements along this frontage involve two different lane upgrade cross-sections, i.e. full lane standards at the eastern end of the lane and narrower pavement along the tree protection zone section.
  - i) Full lane upgrade section: Along the eastern section of the lane (beyond the tree protection zone), the frontage improvements are to include (south to north):
    - 0.7 m wide setback (lighting/drainage strip). (Note: The existing street lighting is to be retained).
    - 0.15 m wide rollover curb.
    - 5.1 m wide pavement.
    - 0.15 m wide rollover curb.
    - 1.5 m wide concrete walkway (on SRW).
  - ii) Tree Protection Zone section: Along the western section of the lane (tree protection zone area), the frontage improvements are to include (south to north):
    - 0.7 m wide setback (lighting/drainage strip).
    - 0.15 m wide rollover curb.
    - Widen existing pavement as much as possible without encroaching into the tree protection zone (or keep existing pavement width).
    - No rollover curb along the edge of pavement across the north side of driving surface.
    - 1.5 m wide concrete walkway (on SRW). (Gravel walking surface for irrigation if it is determined by Tree Bylaw/Parks that a concrete walkway over the tree protection area would not be supported).
  - iii) Pavement transition section: A transition section is required to connect the wider and narrower sections of the lane. (The taper ratio used is to reflect traffic speed, available tangent sections and TAC standards, e.g. transition ratio from 3:1 to 5:1).
  - iv) Grade differential: There is a difference in elevations along the subject site's south property line. The frontage improvements are to take this grade differential into account.
  - v) Traffic safety requirements: Speed bumps are required at the eastern section of the lane in advance of the narrower pavement next to the protected trees.

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#### vi) Traffic signage:

- Install WA-23 (road arrow sign) for northbound traffic at the west end of the lane.
- Install WA-23T supplementary sign (LANEWAY NARROWS) for westbound traffic in advance of the narrower section of the lane.
- vii) Accessibility requirements: Wheelchair ramps are required at the eastern and western ends of the above noted new sidewalk.
- viii) Walkway connections: The development fronting walkway is to connect to the existing walkways at the east and west ends of the lane (R-15-SD).
- e) Southeast frontage (intersection of lane, Lindsay Road and Lindsay Road cul-de-sac): The intersection located at the southeast corner of the site, is to be redesigned and rebuilt as necessary to include the following. (Note: Any required works are to be confined to the area behind the existing curb line at the junction connection to the Lindsay Road cul-de-sac)
  - i) A crossing to accommodate pedestrian movements from the intersection to the sidewalks along the site's south and east frontages.
  - ii) Reconstruct the existing curb at the junction to a lane let-down. Design details: per City Engineering Design Specifications (R-7-SD); 6.0 m wide; and minimum 1.0 m separation (measured at the flare) from the property line of each of the two adjacent properties. (Note: The existing letdown at Lynwood Drive (to the west of the subject site) where it meets Lindsay Road can be used as a design guide. Refer to SA 96-154 for typical design).
  - iii) Review and modify as necessary intersection geometry (e.g. 5.5 m curb return per City Engineering Design Specifications).
  - iv) Completion of curb and pavement works.

#### 2) Water Works:

- a) Using the OCP Model with the upgrades identified below, there will be 373 L/s of water available at a 20 psi residual at the Lindsay Road frontage. Based on your proposed development, your site requires a minimum fire flow of 220 L/s.
- b) At Developer's cost, the Developer is required to:
  - i) Submit Fire Underwriter Survey (FUS) or International Organization for Standardization (ISO) fire flow calculations to confirm development has adequate fire flow for onsite fire protection. Calculations must be signed and sealed by a Professional Engineer and be based on Building Permit Stage building designs.
  - ii) Install approximately 90 m of 200 mm diameter water main from the existing water main on Lindsay Road to the existing water main on Lynnwood Drive, complete with a new hydrant along the frontage of the development site.
  - iii) Install a water service connection for the development site off of the proposed water main, complete with water meter and meter chamber.
  - iv) Provide a right-of-way for the water meter. Minimum right-of-way dimensions to be the size of the meter box (from the City of Richmond supplementary specifications) + any appurtenances (for example, the bypass on W2o-SD) + 0.5 m on all sides. Exact right-of-way dimensions to be finalized via the servicing agreement process.
- c) At Developer's cost, the City will:
  - i) Complete all tie-ins for the proposed works to existing City infrastructure.

### 3) Storm Sewer Works:

- a) At Developer's cost, the Developer is required to:
  - i) Install approximately 70 m of storm sewer from the existing storm sewer on Lindsay Road to the existing storm sewer on Lynnwood Drive, sized via a capacity analysis (minimum 600 mm diameter). The capacity analysis shall be reviewed as part of the servicing agreement. Tie-in to the storm sewer on Lindsay Road is to be via a new manhole.
  - ii) Install a storm service connection for the development site off of the proposed storm sewer, complete with inspection chamber.

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- iii) Review the existing perforated drain pipes in the lane and remove, retain, or reconfigure as appropriate.
- iv) Provide an erosion and sediment control plan for all on-site and off-site works, to be reviewed as part of the servicing agreement design.
- b) At Developer's cost, the City will:
  - i) Cap and remove all existing storm service connections to the development site.
  - ii) Complete all tie-ins for the proposed works to existing City infrastructure.
- 4) Sanitary Sewer Works:
  - a) At Developer's cost, the City will:
    - i) Install a new sanitary connection complete with inspection chamber, utilizing the existing stub at the south property line if feasible.
- 5) Frontage Improvements:
  - a) At Developer's cost, the Developer is required to:
    - i) Locate/relocate all above ground utility cabinets and kiosks required to service the proposed development, and all above ground utility cabinets and kiosks located along the development's frontages, within the developments site (see list below for examples). A functional plan showing conceptual locations for such infrastructure shall be included in the development design review process. Please coordinate with the respective private utility companies and the project's lighting and traffic signal consultants to confirm the requirements (e.g., statutory right-of-way dimensions) and the locations for the aboveground structures. If a private utility company does not require an aboveground structure, that company shall confirm this via a letter to be submitted to the City. The following are examples of statutory right-of-ways that shall be shown on the architectural plans/functional plan, the servicing agreement drawings, and registered prior to SA design approval:
      - BC Hydro PMT  $-4.0 \times 5.0 \text{ m}$
      - BC Hydro LPT 3.5 x 3.5 m
      - Street light  $kiosk 1.5 \times 1.5 \text{ m}$
      - Traffic signal kiosk 2.0 x 1.5 m
      - Traffic signal UPS 1.0 x 1.0 m
      - Shaw cable  $kiosk 1.0 \times 1.0 \text{ m}$
      - Telus FDH cabinet 1.1 x 1.0 m
    - ii) Review street lighting levels along all road and lane frontages, and upgrade as required.
    - iii) Complete other frontage improvements as per Transportation requirements.
- 6) General Items:
  - a) At Developer's cost, the Developer is required to:
    - i) Provide, prior to start of site preparation works or within the first servicing agreement submission, whichever comes first, a preload plan and geotechnical assessment of preload, dewatering, and soil preparation impacts on the existing utilities fronting the development site and provide mitigation recommendations.
    - ii) Provide a video inspection report of the existing utilities along the development frontages prior to start of site preparation works or within the first servicing agreement submission, whichever comes first. A follow-up video inspection, complete with a civil engineer's signed and sealed recommendation letter, is required after site preparation works are complete (i.e. pre-load removal, completion of dewatering, etc.) to assess the condition of the existing utilities and provide recommendations to retain, replace, or repair. Any utilities damaged by the pre-load, de-watering, or other ground preparation shall be replaced or repaired at the Developer's cost.
    - iii) Conduct pre- and post-preload elevation surveys of all surrounding roads, utilities, and structures. Any damage, nuisance, or other impact to be repaired at the developer's cost. The post-preload elevation survey shall be incorporated within the servicing agreement design.

Initial:	

- iv) Monitor the settlement at the adjacent utilities and structures during pre-loading, dewatering, and soil preparation works per a geotechnical engineer's recommendations, and report the settlement amounts to the City for approval.
- v) Not encroach into City rights-of-ways with any proposed trees, retaining walls, or other non-removable structures. Retaining walls proposed to encroach into rights-of-ways must be reviewed by the City's Engineering Department.
- vi) Enter into, if required, additional legal agreements, as determined via the subject development's Servicing Agreement(s) and/or Development Permit(s), and/or Building Permit(s) to the satisfaction of the Director of Engineering, including, but not limited to, site investigation, testing, monitoring, site preparation, dewatering, drilling, underpinning, anchoring, shoring, piling, pre-loading, ground densification or other activities that may result in settlement, displacement, subsidence, damage or nuisance to City and private utility infrastructure.

# Prior to Building Permit Issuance, the developer must complete the following requirements:

- 12. Incorporation of accessibility measures in Building Permit (BP) plans as determined via the Rezoning and/or Development Permit processes.
- 13. Submission of a Construction Parking and Traffic Management Plan to the Transportation Department. Management Plan shall include location for parking for services, deliveries, workers, loading, application for any lane closures, and proper construction traffic controls as per Traffic Control Manual for works on Roadways (by Ministry of Transportation) and MMCD Traffic Regulation Section 01570. In addition to the general Plan requirements, the Developer is also to meet the following site-specific requirements:
  - a) Consult with Traffic Operations to identify the access route for construction-related vehicles that would present the least traffic impact on nearby residential neighbourhoods.
  - b) Construction related parking is not permitted in nearby residential areas. Other off-site parking arrangements are to be made. The City is to be provided with written evidence of such arrangements.
- 14. If applicable, payment of latecomer agreement charges, plus applicable interest associated with eligible latecomer works.
- 15. Obtain a Building Permit (BP) for any construction hoarding. If construction hoarding is required to temporarily occupy a public street, the air space above a public street, or any part thereof, additional City approvals and associated fees may be required as part of the Building Permit. For additional information, contact the Building Approvals Department at 604-276-4285.

#### Note:

- \* This requires a separate application.
- Where the Director of Development deems appropriate, the preceding agreements are to be drawn not only as personal covenants
  of the property owner but also as covenants pursuant to Section 219 of the Land Title Act.
  - All agreements to be registered in the Land Title Office shall have priority over all such liens, charges and encumbrances as is considered advisable by the Director of Development. All agreements to be registered in the Land Title Office shall, unless the Director of Development determines otherwise, be fully registered in the Land Title Office prior to enactment of the appropriate bylaw.
  - The preceding agreements shall provide security to the City including indemnities, warranties, equitable/rent charges, letters of credit and withholding permits, as deemed necessary or advisable by the Director of Development. All agreements shall be in a form and content satisfactory to the Director of Development.
- Additional legal agreements, as determined via the subject development's Servicing Agreement(s) and/or Development Permit(s), and/or Building Permit(s) to the satisfaction of the Director of Engineering may be required including, but not limited to, site investigation, testing, monitoring, site preparation, de-watering, drilling, underpinning, anchoring, shoring, piling, pre-loading, ground densification or other activities that may result in settlement, displacement, subsidence, damage or nuisance to City and private utility infrastructure.

Initial:	
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• Applicants for all City Permits are required to comply at all times with the conditions of the Provincial Wildlife Act and Federal Migratory Birds Convention Act, which contain prohibitions on the removal or disturbance of both birds and their nests. Issuance of Municipal permits does not give an individual authority to contravene these legislations. The City of Richmond recommends that where significant trees or vegetation exists on site, the services of a Qualified Environmental Professional (QEP) be secured to perform a survey and ensure that development activities are in compliance with all relevant legislation.

[signed copy on file]		
Signed	Date	



# **Development Permit**

No. DP 20-921387

To the Holder: WESTMARK DEVELOPMENT LTD.

Property Address: 7117 LINDSAY ROAD

Address: C/O SUNNY BAINS

2631 VIKING WAY, UNIT 203 Richmond, BC V6V 3B5


1. This Development Permit is issued subject to compliance with all of the Bylaws of the City applicable thereto, except as specifically varied or supplemented by this Permit.

- 2. This Development Permit applies to and only to those lands shown cross-hatched on the attached Schedule "A" and any and all buildings, structures and other development thereon.
- 3. The "Richmond Zoning Bylaw 8500" is hereby varied to reduce the minimum setback from a public road from 6.0 m to 3.8 m (measured from the boundary of the public rights of passage statutory right of way along the eastern edge of the subject site).
- 4. Subject to Section 692 of the Local Government Act, R.S.B.C.: buildings and structures; off-street parking and loading facilities; roads and parking areas; and landscaping and screening shall be constructed generally in accordance with Plans #1 to #17 attached hereto.
- 5. Sanitary sewers, water, drainage, highways, street lighting, underground wiring, and sidewalks, shall be provided as required.
- 6. As a condition of the issuance of this Permit, the City is holding the security in the amount of \$86,815.00 to ensure that development is carried out in accordance with the terms and conditions of this Permit. Should any interest be earned upon the security, it shall accrue to the Holder if the security is returned. The condition of the posting of the security is that should the Holder fail to carry out the development hereby authorized, according to the terms and conditions of this Permit within the time provided, the City may use the security to carry out the work by its servants, agents or contractors, and any surplus shall be paid over to the Holder. Should the Holder carry out the development permitted by this permit within the time set out herein, the security shall be returned to the Holder. The City may retain the security for up to one year after inspection of the completed landscaping in order to ensure that plant material has survived.
- 7. If the Holder does not commence the construction permitted by this Permit within 24 months of the date of this Permit, this Permit shall lapse and the security shall be returned in full.

# **Development Permit** No. DP 20-921387

To the Holder:	WESTMARK DEVELOPMENT LTD.	
Property Address:	7117 LINDSAY ROAD	
Address:	C/O SUNNY BAINS 2631 VIKING WAY, UNIT 203 RICHMOND, BC V6V 3B5	
	of this Permit and any part hereof.	nerally in accordance with the terms and plans and specifications attached to this
AUTHORIZING RESOLUT DAY OF ,	ION NO.	ISSUED BY THE COUNCIL THE
DELIVERED THIS D	AY OF ,	·
MAYOR		



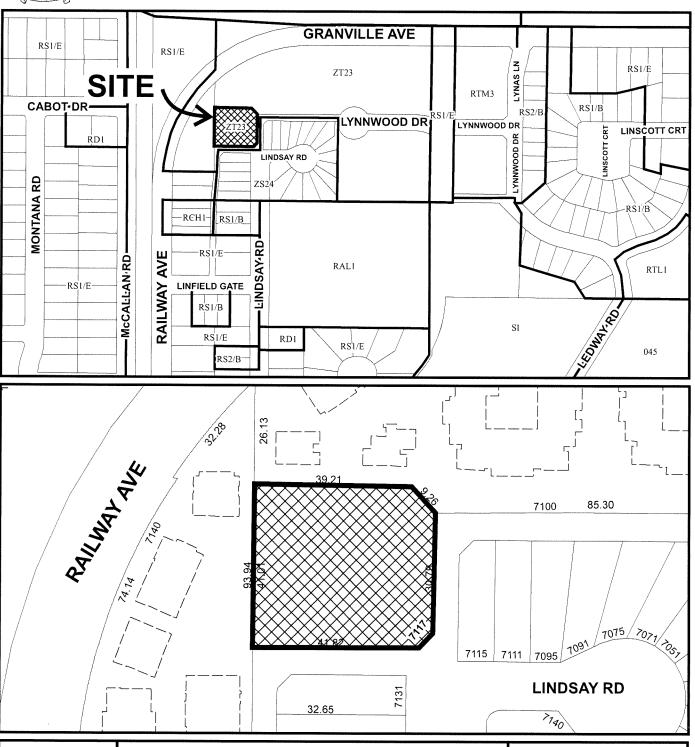




DP 20-921387 SCHEDULE "A"

Original Date: 01/29/21

Revision Date: 06/28/22

Note: Dimensions are in METRES



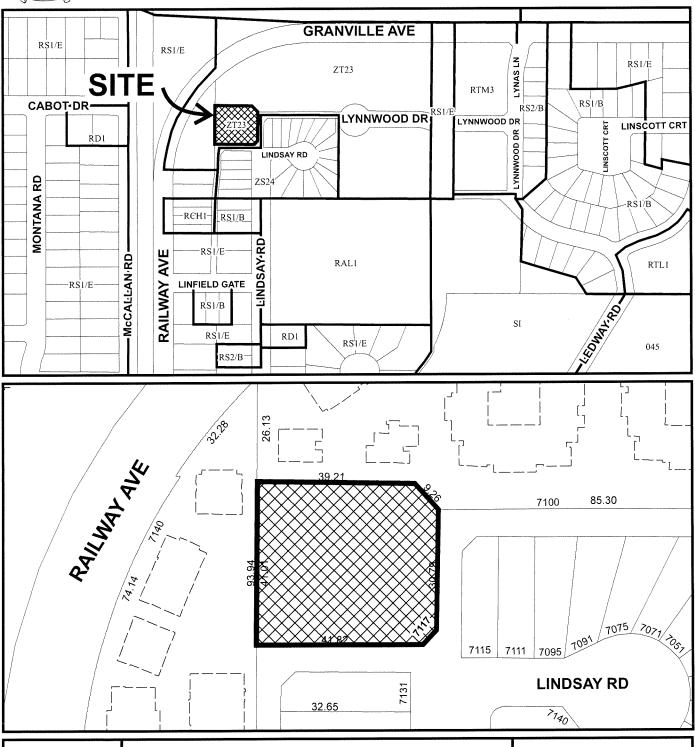





DP 20-921387


Original Date: 01/29/21


Revision Date: 06/28/22


Note: Dimensions are in METRES

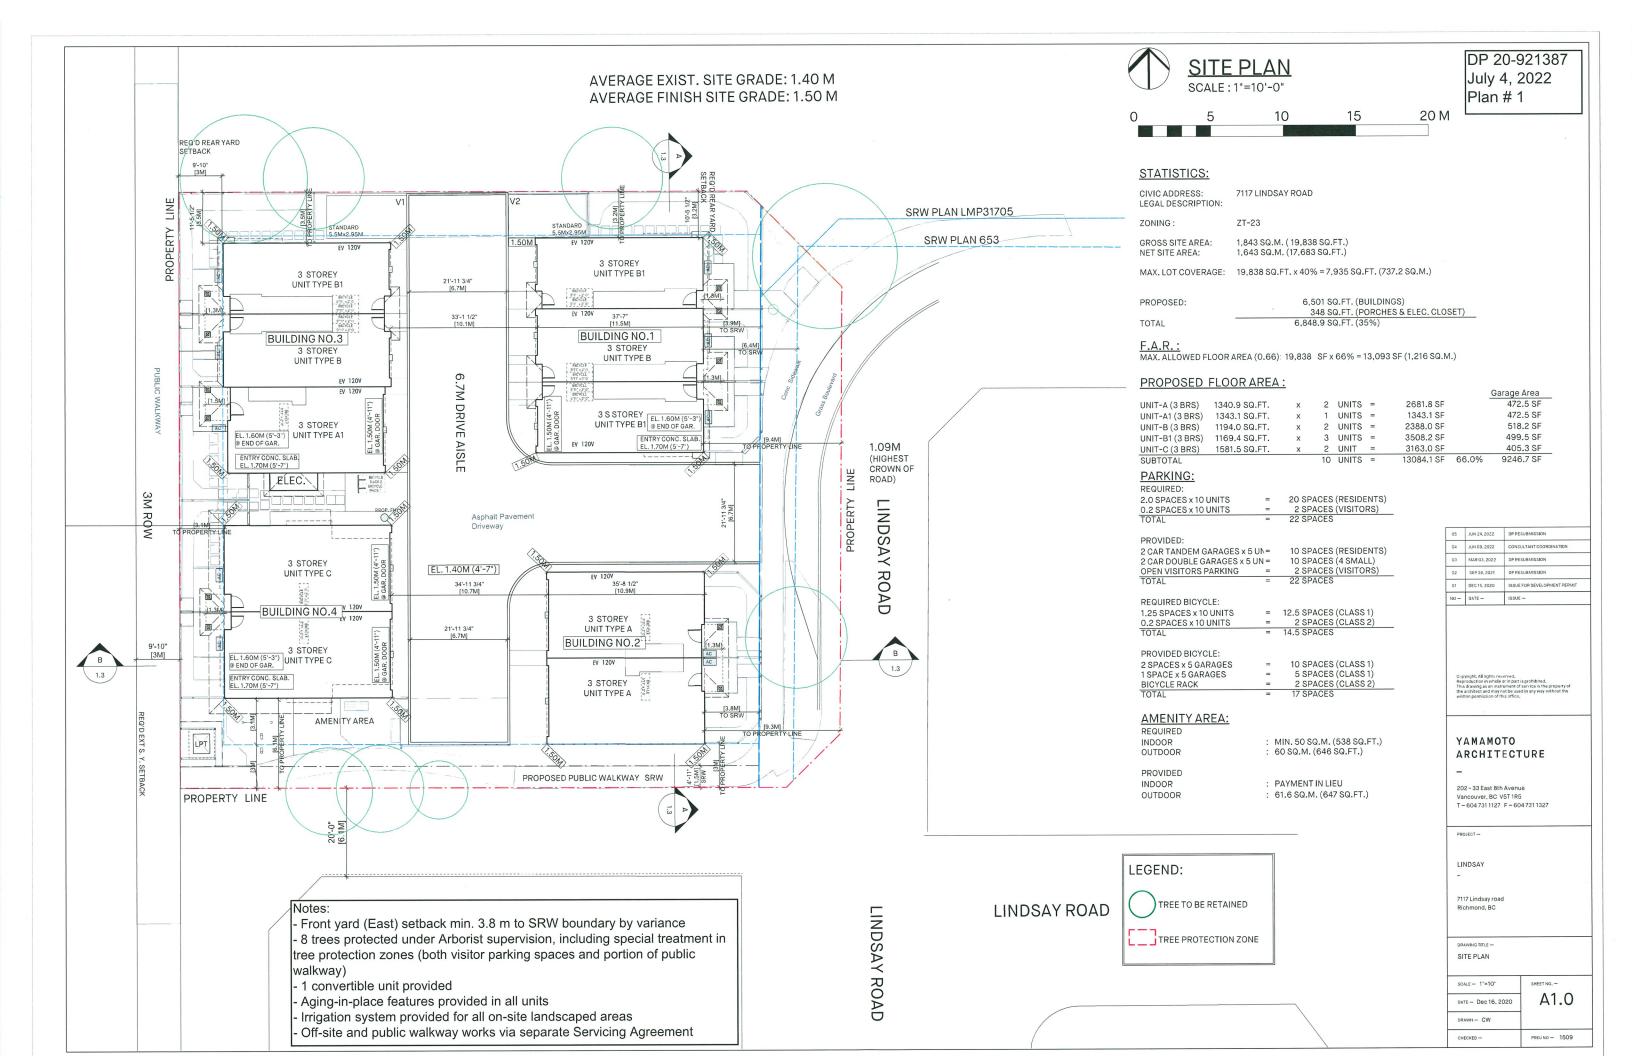

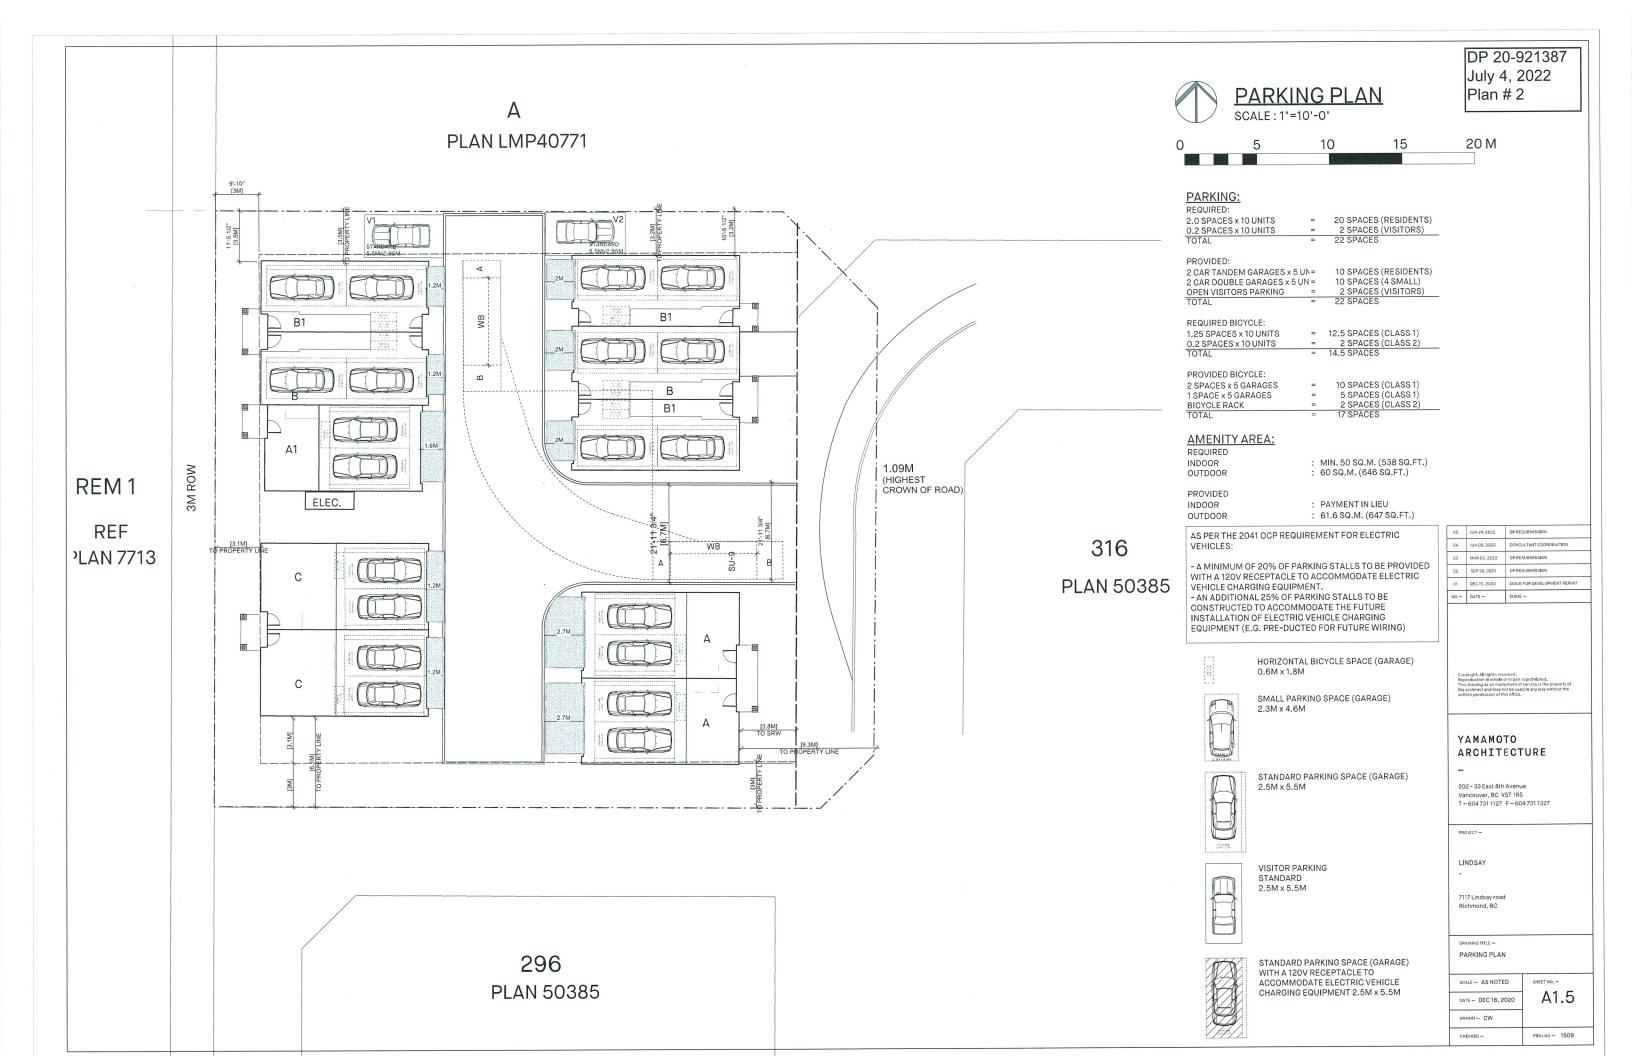

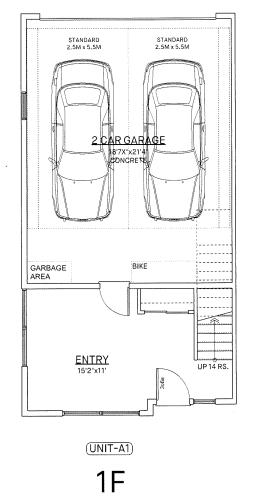

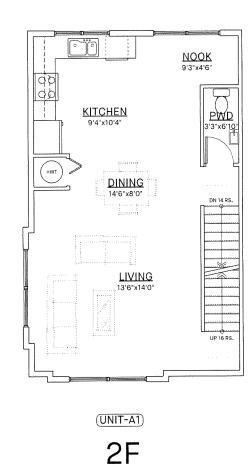

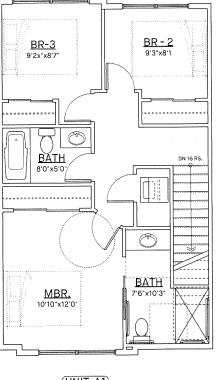

(UNIT-A1)

3F

DP 20-921387 July 4, 2022 Plan # 3

Doors & Doorways	Entry door min, 863 mm but ideally 914 mm and have clear access.	COMPLIES
	Entry door clear exterior floor space min. 1220 mm depth by door width plus 600 mm on latch side (not needed if rough in wiring provided for future automatic door opener)	COMPLIES
	Interior doors to main living areas, 1 bathroom and 1 bedroom, min. 800 mm clean opening with flush mm clean opening with flush Demonstrate wheelchair access between the hallway and rooms and widen hallway and rooms if necessary to secure access.	COMPLIES
	Patio/balcony min. 860 mm clear opening. Note how accessed. All interior thresholds within units	COMPLIES
	comply with BC Building Code Lever-type handles for all doors.	COMPLIES
Vertical Circulation	Stair lift, staircase width, framing support, and landings, as noted on floor plans in compliance with manufacturer specifications. OR	COMPLIES
	Vertical lift, depressed slab area, and landings, as noted on floor plans in compliance with manufacturer specifications. Framing to accommodate shaft constluction without impact to surrounding structre	NOT APPLICABLE
	At the top of all stairways, walls are reinforced with 2" x 12" solid lumber at 914mm to centre.	COMPLIES
Hallways	Min. 900 mm width	COMPLIES
Garages	Min. 1 accessible parking space with min. 4 m garage width	COMPLIES
	Access from garage to living area with min, 800 mm clear door opening.	COMPLIES
Bathrooms (Min. 1)	At least 510.0 mm from any obstruction on the non-grab bar side and at least 800.0 mm from any obstruction in front of the toilet	COMPLIES
	Lever-type handles for plumbing fixtures.	COMPLIES
	Pressure and temperature control valves are installed on all shower faucets	COMPLIES
	Cabinets underneath sink(s) are easily removed.	COMPLIES
	Demonstrate bath and shower controls are accessible (layout or fixture placement)	COMPLIES
Kitchen	Clear area needed under future work space, Plumbing and gas pipes (in-wall and in-floor) located clear of under counter area of future work space (stove, sink & min, 810 mm wide counter)	COMPLIES
	Cabinets underneath sink are easily removed.	COMPLIES
	1500 mm turning diameter or turning path diagram	COMPLIES
	Lever-type handles for plumbing fixtures.	COMPLIES
Windows	Min, 1 window that can be opened with a single hand (bathroom, kitchen, living room)	COMPLIES
Outlets & Switches	Placement locations of electrical outlets: beside window, bottom of statinways, beside toilet, above external doors (outside and inside), on front face of kichen counter, within proximity of control centre for smart home options.	TO BE LOOKED AT DURING THE BP STAGE
	Upgrade to four-plex outlets in master bedroom, home office, garage, and recreation.	COMPLIES

CONVERTIBLE UNIT CHECKLIST:

Convertible Housing is housing that is designed and built to look like traditional housing but has

04	JUN 09, 2022	CONSULTANT COORDINATION
03	MAR 03, 2022	DP RESUBMISSION
02	SEP 28, 2021	OP RESUBMISSION
01	DEC 15, 2020	ISSUE FOR DEVELOPMENT PERIMI
NO	DATE -	ISSUE -

05 JUN 24, 2022 DP RESUBMISSION

YAMAMOTO ARCHITECTURE

202 - 33 East 8th Avenue Vancouver, BC V5T 1R5 T - 604 731 1127 F - 604 731 1327

PROJECT --

LINDSAY

7117 Lindsay road Richmond, BC


DRAWING TITLE —

CONVERTIBLE UNIT
FLOOR PLANS


SCALE - 1/4"=1"-0" SHEET NO. 
DATE - DEC 16, 2020 A2.2

ORAWIN - CW

CHECKED - PROJ NO - 1509

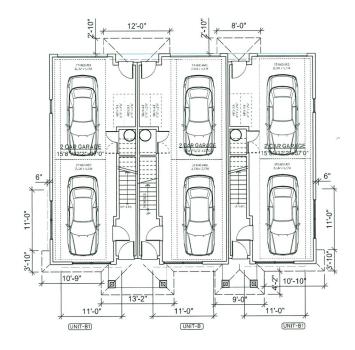


GROUND FLOOR PLAN

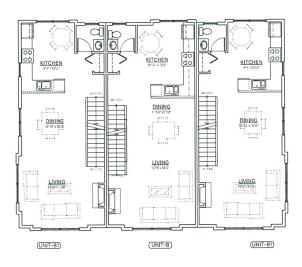

SECOND FLOOR PLAN

1/8" = 1'-0"

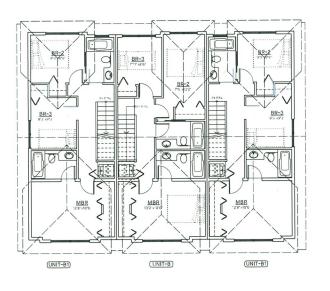

THIRD FLOOR PLAN

NO -	DATE -	ISSUE -
01	DEC 15, 2020	ISSUE FOR DEVELOPMENT PERMIT
02	SEP 28, 2021	DP RESUBMISSION
03	MAR 03, 2022	DP RESUBMISSION
04	JUN 09, 2022	CONSULTANT COORDINATION
05	JUN 24, 2022	DP RESUBMISSION

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#### YAMAMOTO ARCHITECTURE

202 - 33 East 8th Avenue Vancouver, BC V5T 1R5 T - 604 731 1127 F - 604 731 1327

PROJECT —

LINDSAY

7117 Lindsay road Richmond, BC

DRAWING TITLE —
BUILDING NO.1
PLANS & ELEVATIONS

SCALE - 1/8'=1'-0'
DATE - DEC 16, 2020

A3.1


KEY PLAN

В


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CHECKED - PROJ NO - 1509


DP 20-921387 July 4, 2022 Plan # 5

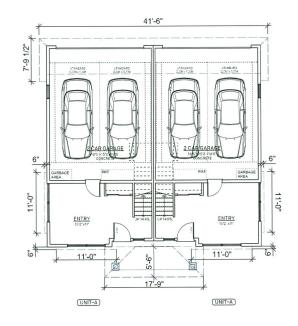

GROUND FLOOR PLAN
1/8" = 1'-0"

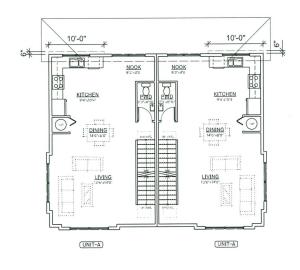

SECOND FLOOR PLAN
1/8" = 1'-0"

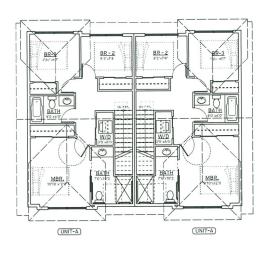

THIRD FLOOR PLAN

05	JUN 24, 2022	DP RESUBMISSION
04	JUN 09, 2022	CONSULTANT COORDINATION
03	MAR 03, 2022	DP RESUBMISSION
02	SEP 28, 2021	DP RESUBMISSION
01	DEC 15, 2020	ISSUE FOR DEVELOPMENT PERMIT
NO -	DATE -	ISSUE -

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#### YAMAMOTO ARCHITECTURE

202 - 33 East 8th Avenue Vancouver, BC V5T1R5 T - 6047311127 F - 6047311327

PROJECT -

LINDSAY

7117 Lindsay road Richmond, BC


DRAWING TITLE —
BUILDING NO.2
PLANS & ELEVATIONS

SCALE - 1/8"=1"-0"


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DRAWN - CW

PROJ NO - 1509




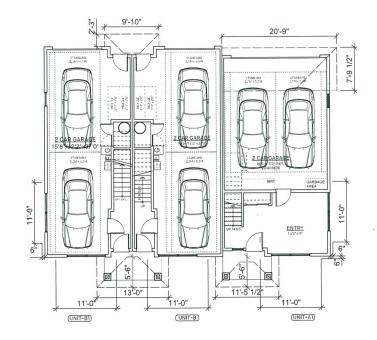

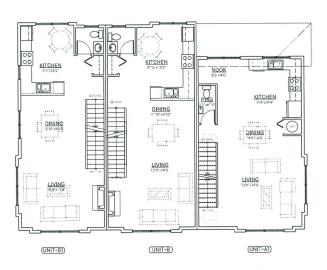

SECOND FLOOR PLAN

1/8" = 1'-0"

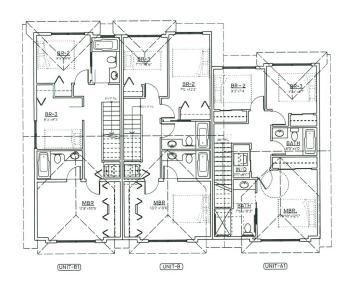

THIRD FLOOR PLAN

01	DEC 15, 2020	ISSUE FOR DEVELOPMENT PERMIT	
02	SEP 28, 2021	DP RESUBMISSION	
03	MAR 03, 2022	DP RESUBMISSION	
04	JUN 09, 2022	CONSULTANT COORDINATION	
05	JUN 24, 2022	DP RESUBMISSION	

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#### YAMAMOTO ARCHITECTURE

202 - 33 East 8th Avenue Vancouver, BC V5T 1R5 T - 604 731 1127 F - 604 731 1327

LINDSAY

7117 Lindsay road Richmond, BC

DRAWING TITLE —
BUILDING NO.3
PLANS & ELEVATIONS

SCALE - 1/8"=1"-0"

DATE - DEC16, 2020

DRAWN - CW

PROJ NO - 1509


BUILDING NO.2

C

A


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KEY PLAN

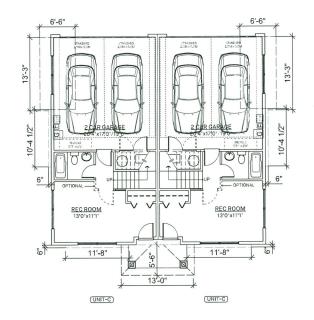


GROUND FLOOR PLAN

1/8" = 1'-0"

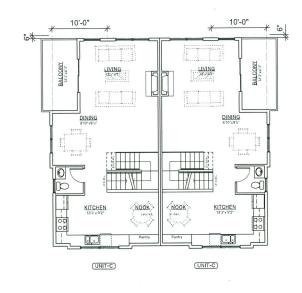

SECOND FLOOR PLAN
1/8" = 1'-0"

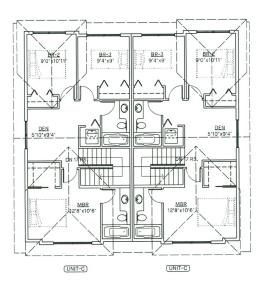

THIRD FLOOR PLAN

NO -	DATE -	ISSUE -
01	DEC 15, 2020	ISSUE FOR DEVELOPMENT PERMIT
02	SEP 28, 2021	DP RESUBMISSION
03	MAR 03, 2022	DP RESUBMISSION
04	JUN 09, 2022	CONSULTANT COORDINATION
05	JUN 24, 2022	DP RESUBMISSION

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#### YAMAMOTO ARCHITECTURE

202 - 33 East 8th Avenue Vancouver, BC V5T 1R5 T - 604 731 1127 F - 604 731 1327


LINDSAY

7117 Lindsay road
Richmond, BC

DRAWING TITLE —
BUILDING NO.4
PLANS & ELEVATIONS

SCALE - 1/8"=1"-0" SHEET NO. 
DATE - DEC 16, 2020 A3.4

DRAWN - CW

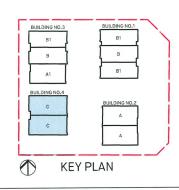









#### **MATERIAL IMAGES:**





MATTE BLACK



PORTICO WHITE

#### MATERIAL LEGEND:

CHARCOAL GRAY





- 1 ASPHALT SHINGLE ROOF CHARCOAL
  - (2) METAL GUTTER AND DOWNSPOUT MAKIN METALS MATTE BLACK
  - (3) P.T. WOOD WIN./DOOR TRIM, FASCIA, HORIZ. BAND PAINTED MATTE BLACK
  - (4) DOUBLE GLAZED VINYL FRAMED WINDOW / PATIO
  - (5) BOARD & BATTEN SIDING JM DREAM COLLECTION "PORTICO WHITE"
  - 6 SHINGLE SIDING JM DREAM COLLECTION 'PORTICO WHITE'
  - HORIZONTAL SIDING JM DREAM COLLECTION "PORTICO WHITE"
  - 8 FLAGSTONE UPTO WINDOW SILL
  - 9 METAL GARAGE DOOR W/ FROSTED GLASS
  - ENTRY # STEEL PLAQUE
     UNIT NUMBER

DP 20-921387 July 4, 2022 Plan #8

05	JUN 24, 2022	DP RESUBMISSION
04	JUN 09, 2022	CONSULTANT COORDINATION
03	MAR 03, 2022	DP RESUBMISSION
02	SEP 28, 2021	DP RESUBMISSION
01	DEC 15, 2020	ISSUE FOR DEVELOPMENT PERMIT
NO -	DATE -	ISSUE -

#### OTOMAMAY ARCHITECTURE

202 - 33 East 8th Avenue Vancouver, BC V5T1R5 T = 6047311127 F = 6047311327

PROJECT -

LINDSAY

7117 Lindsay road Richmond, BC

DRAWING TITLE -

ELEVATIONS - BUILDING NO.1 PLANS & ELEVATIONS

SCALE - 1/8"=1'-0"	SHEET NO. —
DATE - DEC 16, 2020	A4.1
DRAWN- CW	



В

В



#### **WEST ELEVATION** 1/8" = 1'-0"



#### **SOUTH ELEVATION** 1/8" = 1'-0"



# **EAST ELEVATION**



NORTH ELEVATION 1/8" = 1'-0"

#### **MATERIAL IMAGES:**





MATTE BLACK



#### **MATERIAL LEGEND:**

- CHARCOAL GRAY



PORTICO WHITE

- 1 ASPHALT SHINGLE ROOF CHARCOAL (2) METAL GUTTER AND DOWNSPOUT - MAKIN METALS - MATTE BLACK
- P.T. WOOD WIN./DOOR TRIM, FASCIA, HORIZ, BAND
   PAINTED MATTE BLACK
- DOUBLE GLAZED VINYL FRAMED WINDOW / PATIO
- 5 BOARD & BATTEN SIDING JM DREAM COLLECTION "PORTICO WHITE"
- 6 SHINGLE SIDING JM DREAM COLLECTION "PORTICO WHITE"
- (7) HORIZONTAL SIDING JM DREAM COLLECTION "PORTICO WHITE" 8 FLAGSTONE UPTO WINDOW SILL
- 9 METAL GARAGE DOOR W/ FROSTED GLASS
- ENTRY # STEEL PLAQUE
   UNIT NUMBER

DP 20-921387 July 4, 2022 Plan # 9

05	JUN 24, 2022	DP RESUBMISSION
04	JUN 09, 2022	CONSULTANT COORDINATION
03	MAR 03, 2022	DP RESUBMISSION
02	SEP 28, 2021	DP RESUBMISSION
01	DEC 15, 2020	ISSUE FOR DEVELOPMENT PERMIT
NO -	DATE -	ISSUE -

#### YAMAMOTO ARCHITECTURE

202 - 33 East 8th Avenue Vancouver, BC V5T 1R5 T-6047311127 F-6047311327

LINDSAY

7117 Lindsay road

DRAWING TITLE -

ELEVATIONS - BUILDING NO.2 PLANS & ELEVATIONS

SCALE - 1/8"=1'-0" SHEET NO. -A4.2 DATE - DEC 16, 2020

DRAWN- CW

В

**KEY PLAN** 



#### **WEST ELEVATION** 1/8" = 1'-0"



#### SOUTH ELEVATION 1/8" = 1'-0"



#### **EAST ELEVATION** 1/8" = 1'-0"



#### NORTH ELEVATION 1/8" = 1'-0"

#### **MATERIAL IMAGES:**





MATTE BLACK



PORTICO WHITE

#### MATERIAL LEGEND:



CHARCOAL GRAY



- 1 ASPHALT SHINGLE ROOF CHARCOAL
- (2) METAL GUTTER AND DOWNSPOUT MAKIN METALS MATTE BLACK
- P.T. WOOD WIN./DOOR TRIM, FASCIA,
  HORIZ, BAND
   PAINTED MATTE BLACK
- DOUBLE GLAZED VINYL FRAMED WINDOW / PATIO
- 5 BOARD & BATTEN SIDING JM DREAM COLLECTION "PORTICO WHITE"
- 6 SHINGLE SIDING JM DREAM COLLECTION "PORTICO WHITE"
- (7) HORIZONTAL SIDING JM DREAM COLLECTION "PORTICO WHITE"
- 8 FLAGSTONE UPTO WINDOW SILL
- (9) METAL GARAGE DOOR W/ FROSTED GLASS
- ENTRY # STEEL PLAQUE
   UNIT NUMBER

DP 20-921387 July 4, 2022 Plan # 10

03 02 01	MAR 03, 2022 SEP 28, 2021 DEC 15, 2020	DP RESUBMISSION  DP RESUBMISSION  ISSUE FOR DEVELOPMENT PERMI
03	MAR 03, 2022	DP RESUBMISSION
04	JUN 09, 2022	CONSULTANT COORDINATION
05	JUN 24, 2022	DP RESUBMISSION

#### YAMAMOTO ARCHITECTURE

202 - 33 East 8th Avenue Vancouver, BC V5T 1R5 T-6047311127 F-6047311327

LINDSAY

В1

В

**KEY PLAN** 

В

7117 Lindsay road Richmond, BC

DRAWING TITLE -ELEVATIONS - BUILDING NO.3

PLANS & ELEVATIONS SCALE - 1/8"=1'-0" SHEET NO. -

A4.3 DATE - DEC 16, 2020 DRAWN - CW CHECKED -PROJ NO - 1509



#### WEST ELEVATION 1/8" = 1'-0"



## **SOUTH ELEVATION**



### **EAST ELEVATION**



#### NORTH ELEVATION 1/8" = 1'-0"

#### **MATERIAL IMAGES:**



CHARCOAL GRAY



MATTE BLACK



PORTICO WHITE





#### **MATERIAL LEGEND:**

- 1 ASPHALT SHINGLE ROOF CHARCOAL
  - 2 METAL GUTTER AND DOWNSPOUT MAKIN METALS MATTE BLACK
  - P.T. WOOD WIN./DOOR TRIM, FASCIA, HORIZ, BAND
     PAINTED MATTE BLACK
  - DOUBLE GLAZED VINYL FRAMED WINDOW / PATIO
  - (5) BOARD & BATTEN SIDING JM DREAM COLLECTION "PORTICO WHITE"
  - 6 SHINGLE SIDING JM DREAM COLLECTION "PORTICO WHITE"
  - (7) HORIZONTAL SIDING JM DREAM COLLECTION 'PORTICO WHITE'
  - 8 FLAGSTONE UPTO WINDOW SILL
  - 9 METAL GARAGE DOOR W/ FROSTED GLASS
  - ENTRY # STEEL PLAQUE
     UNIT NUMBER

DP 20-921387 July 4, 2022 Plan # 11

05	JUN 24, 2022	DP RESUBMISSION
04	JUN 09, 2022	CONSULTANT COORDINATION
03	MAR 03, 2022	DP RESUBMISSION
02	SEP 28, 2021	DP RESUBMISSION
01	DEC 15, 2020	ISSUE FOR DEVELOPMENT PERMIT
NO -	DATE -	ISSUE -

#### YAMAMOTO ARCHITECTURE

202 - 33 East 8th Avenue Vancouver, BC V5T1R5 T-6047311127 F-6047311327

PROJECT -


LINDSAY


7117 Lindsay road Richmond, BC

DRAWING TITLE -


ELEVATIONS - BUILDING NO.4 PLANS & ELEVATIONS SCALE - 1/8"=1'-0"

A4.4 DATE - DEC 16, 2020 PROJ NO - 1509

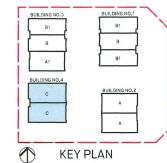

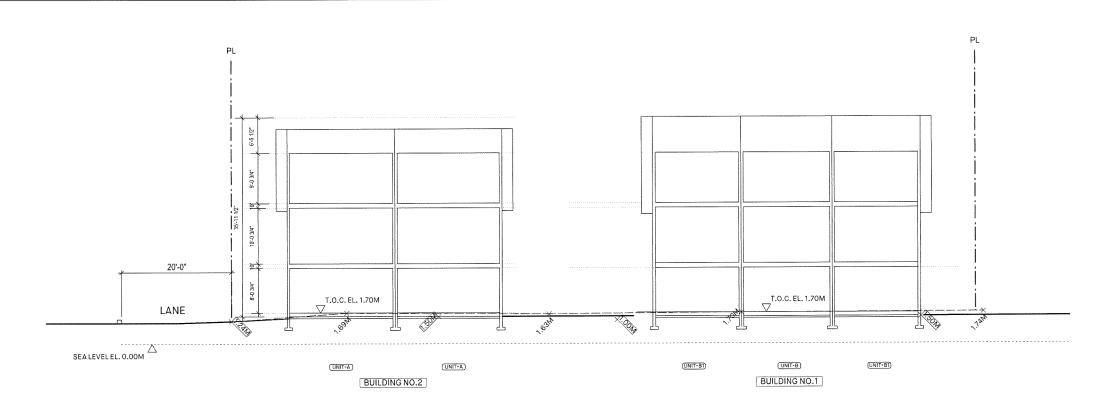

SITE SECTION - A

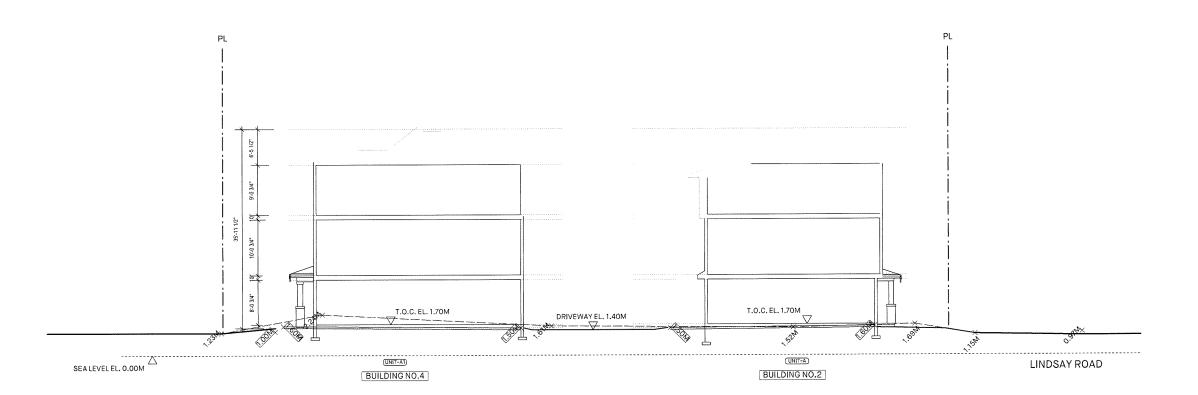

SITE SECTION - B SCALE: 1/8"=1'-0" DP 20-921387 July 4, 2022 Plan # 12

05	JUN 24, 2022	OP RESUBMISSION
04	JUN 09, 2022	CONSULTANT COORDINATION
03	MAR 03, 2022	DP RESUBMISSION
02	SEP 28, 2021	DP RESUBMISSION
01	DEC 15, 2020	ISSUE FOR DEVELOPMENT PERMIT
мо —	DATE -	ISSUE -

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#### YAMAMOTO ARCHITECTURE

202 - 33 East 8th Avenue Vancouver, BC V5T 1R5 T - 604 731 1127 F - 604 731 1327

PROJECT -

LINDSAY


7117 Lindsay road Richmond, BC


DRAWING TITLE — SITE SECTIONS


CHECKED --

SCALE - 1/8'=1'-0' SMEET NO. 
DATE - DEC 16, 2020

DRAWII - CW

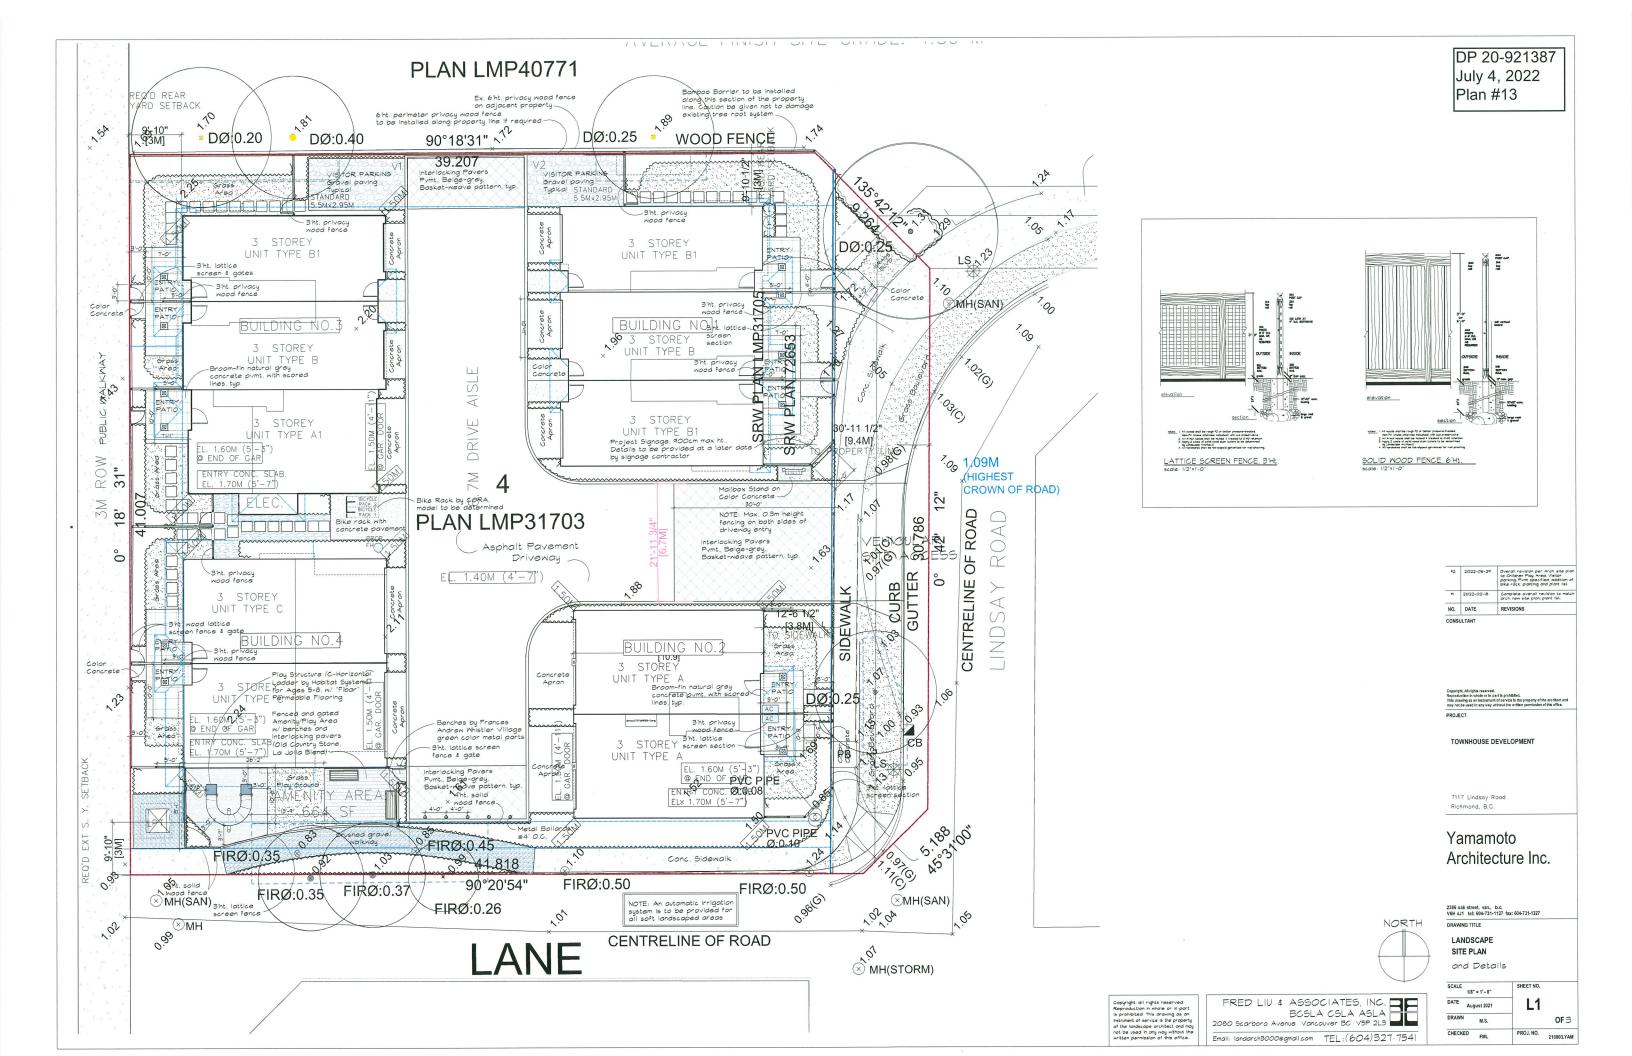

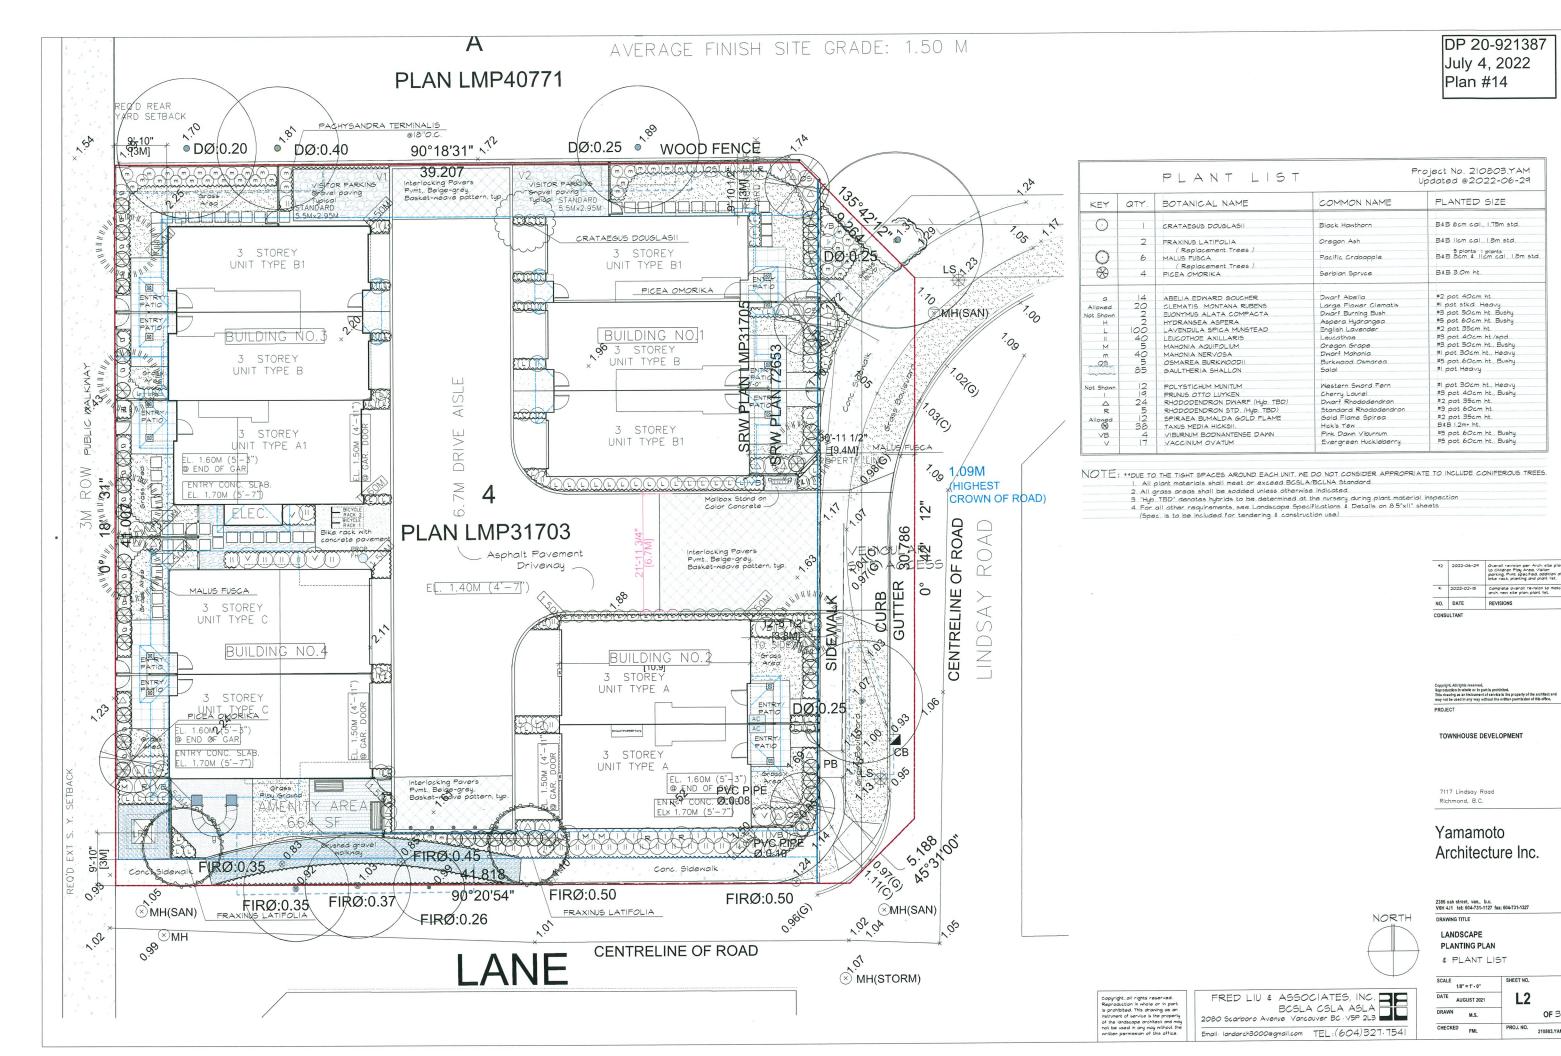

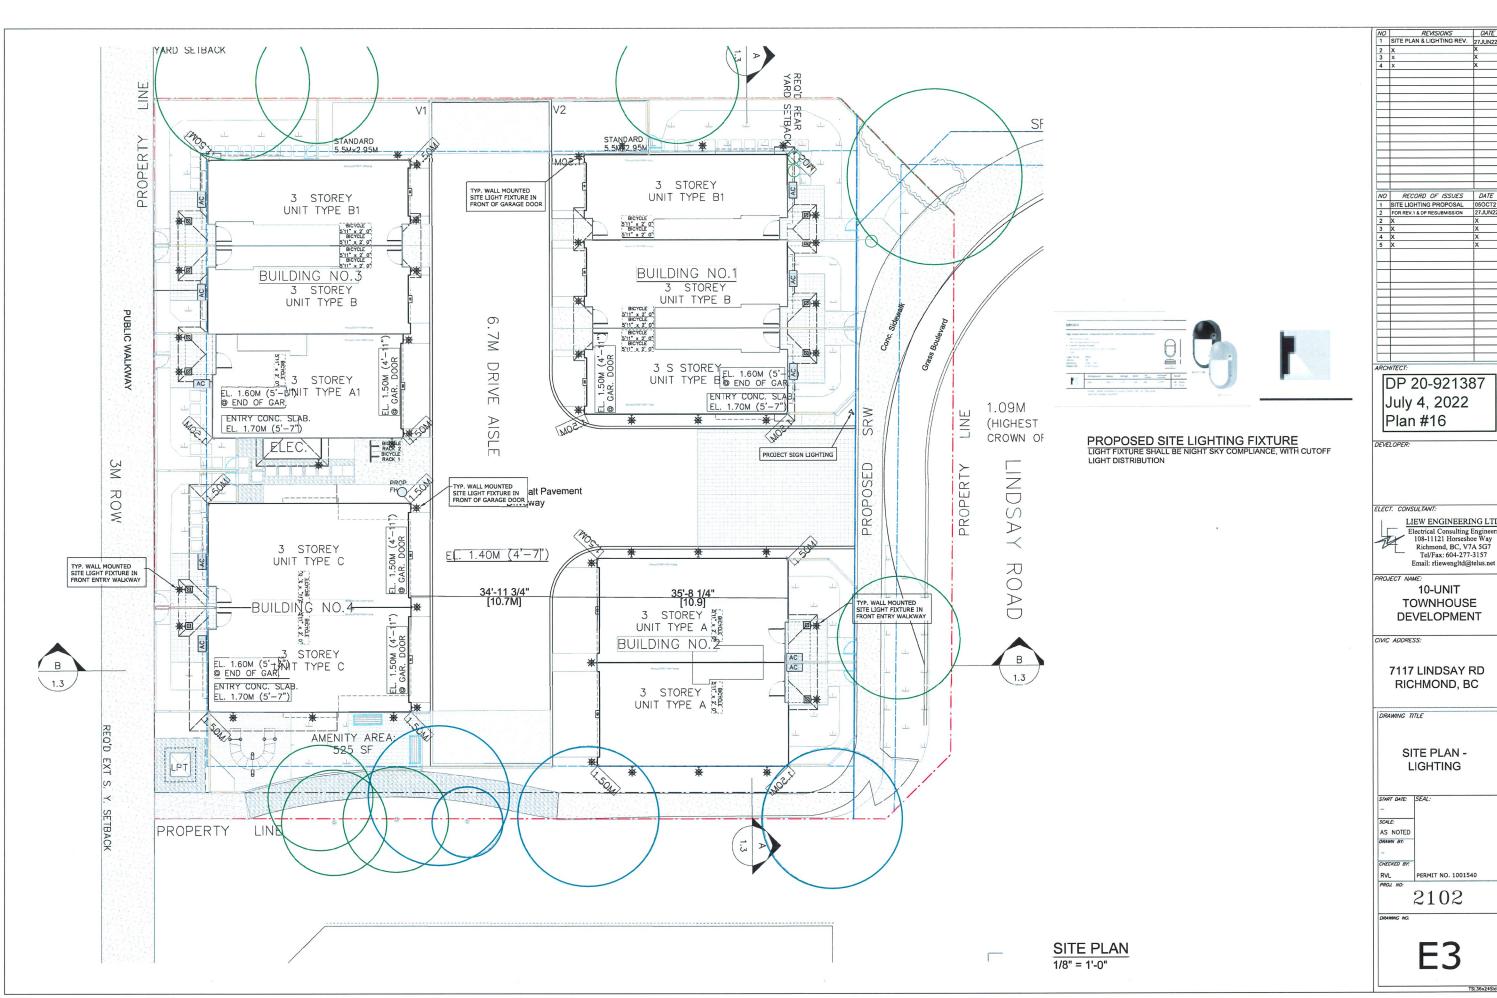

1 SITE LIGHTING PROPOSAL 05OCT21 2 FOR REV.1 & DP RESUBMISSION 27JUN22

July 4, 2022



10-UNIT **TOWNHOUSE** DEVELOPMENT

7117 LINDSAY RD RICHMOND, BC

> SITE PLAN -LIGHTING

2102

# PER LETTER OF ASSURANCE FOR ARBORIST SUPERVISION ARBORIST SUPERVISION IS RECOMMENDED FOR, BUT NOT LIMITED TO:

- Prior to the start of construction, after tree protection fencing & mulch has been installed;
- Prior to and/or at tree pruning for construction clearance of tree canopies. This should be prior to construction.
- Prior to and/or at prep & installation of root aeration pipes (removal of debris, installation of aeration pipes, granular backfill, etc.) in TPZ for retained trees #5, 7 & 199;
- 4. At excavation of new foundation for Building 4:
- Prior to any preparation for any paving (walkways or driveway) in the vicinity of TPZ for Trees #1, 5, 7, 10, 11 & 199;
- Prior to landscaping portion of construction (this includes: installation of bamboo barrier along north propertyline, grading, installation of Amenity Area components if in or adjacent to TPZ);
- Prior to any work, not currently identified, that is in ANY Tree Protection Zone (TPZ);
- Post construction to document condition of trees and construction impacts;
- 9. Or whenever requested by Owner, Contractor, or City Staff.

#### TREE PROTECTION NOTES:


- Verify elevations and dimensions prior to construction. Report discrepancies for clarification. Clarify requirements before construction as needed, and well in advance of site work.
- Refer to written Arborist's Report and consult Project Arborist (Catherine Grey DBA Quercus Consulting) as required. Parks Dept Arborist must approve any changes to protection areas and work plans in or adjacent to tree protection areas.
- 3. All landscape work to conform to the Canadian Landscape Standard as a minimum.
- All tree work to meet or exceed standards of the International Society of Arboriculture (ISA).
- 5. Dimension protection barriers as shown and follow technical guidelines as per City of Richmond. Tree protection barriers to be at least 1.2m in height and constructed of either snow fencing securely fastened to metal or wood stakes spaced no further than 1m apart, or plywood nailed to to wooden stakes, or other form of barrier satisfactory to the City Inspector.
- 6. Do not remove trees without City Permit. Do not prune City trees without permission. Do not prune any trees without prior approval and supervision of Project Arborist.
- Mulch Tree Protection Zones as indicated on Plan with 3" Nutra-Mulch or 3" arborist chips (tree service) with no green or diseased matter.
- Water retained trees in protection zones June 1 September 30, every two weeks (twice a month) to a depth of 2", unless equal rainfall has occurred. Use soaker hoses or oscillating sprinkler. Avoid watering after 10am.
- No storage of any kind and no dumping or clean out of stucco, paint or any other materials in any Tree Protection Zone (TDZ)
- No work to be performed in any Tree Protection Zone (TPZ) without authorization and supervision by Project Arborist.
- No utility trenching through any TPZ. Utility connections to be coordinated with Engineering Department and private utility companies. Report proposed conflicts, in advance of any work, to Project Arborist.
- 12. No irrigation trenching through any TPZ.
- 13. PROPERTY OWNER & CONTRACTORS MAY BE HELD FINANCIALLY & LEGALLY LIABLE FOR ANY DAMAGE TO TREES

TREES: #1, 10, 11 & 12 are owned by 7088 Lynnwood (all to be retained).

TREES: #2, 5 & 200 are CoR owned (all to be retained).

TREES: #3, 198 & 7 are on propertyline, co-owned by CoR & 7117 Lindsay (#7 to be retained).

TREES: #199 & 9 are on 7117 Lindsay (both to be removed).

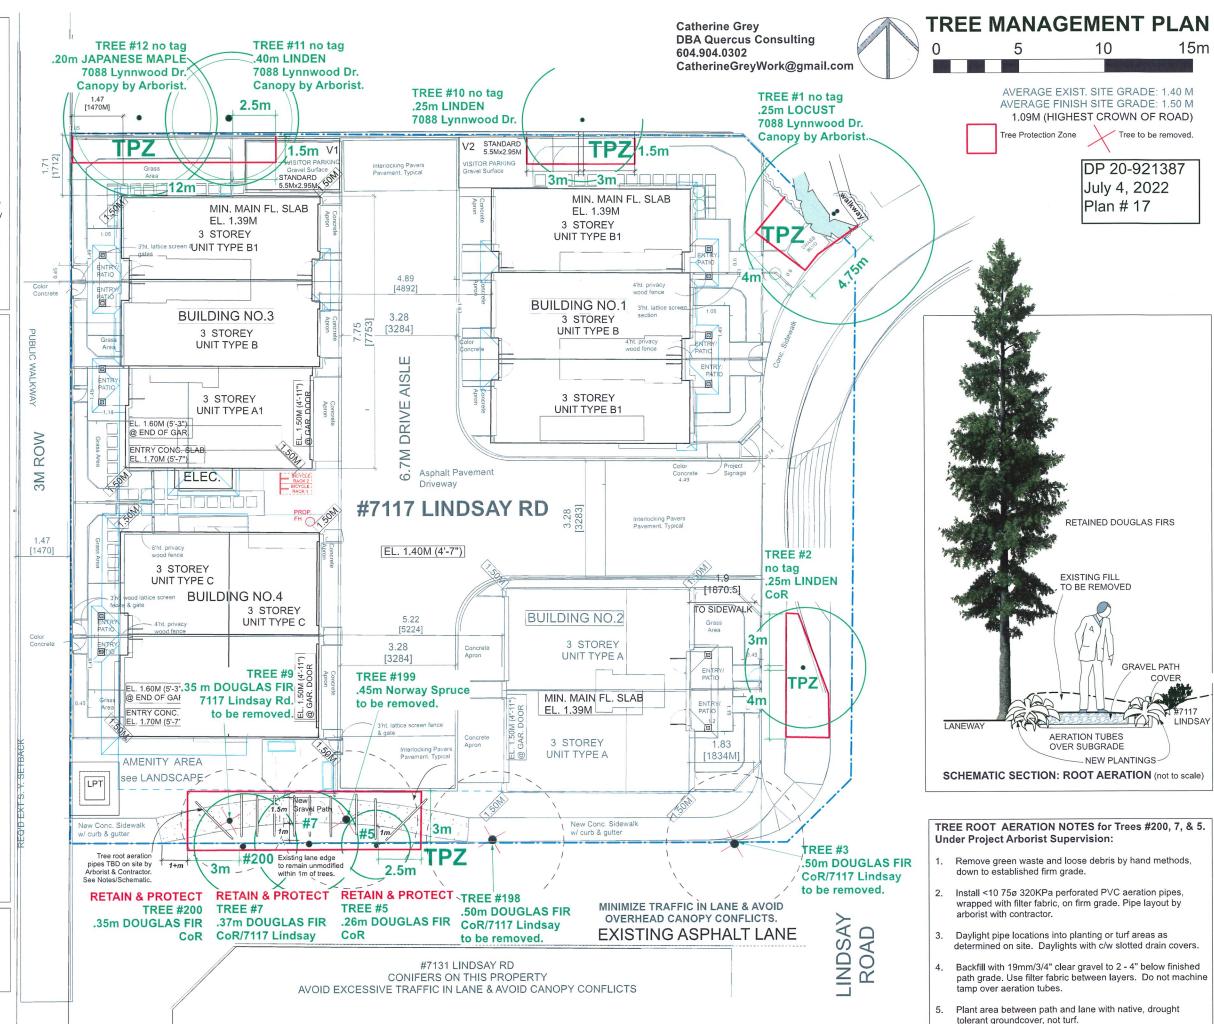









7151 Lindsay Rd



7115 Lindsay Rd



 $\begin{array}{|c|c|c|c|}\hline 7 & 7140 \\ \hline & Lindsay \ Rd \\ \hline \end{array}$ 



7135&7131 Lindsay Rd



4 7088 Lindsay Rd



7131 Lindsay Rd

05	JUN 24, 2022	DP RESUBMISSION
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NO -	DATE -	ISSUE -

DP 20-921387 July 4, 2022 Reference Plan

# YAMAMOTO ARCHITECTURE

202 - 33 East 8th Avenue Vancouver, BC V5T 1R5 T - 604 731 1127 F - 604 731 1327

LINDSAY

7117 Lindsay road Richmond, BC

DRAWING TITLE -CONTEXT PLAN & PHOTOGRAPHS

SCALE - AS NOTED A1.2 DATE - DEC 16, 2020 DRAWN - CW


PROJ NO - 1509

CONTEXT PLAN - PHOTOGRAPHS


WE A.	7	3 10 10
5 7088 Lindsay F	₹d	




9 7115&7111 Lindsay Rd

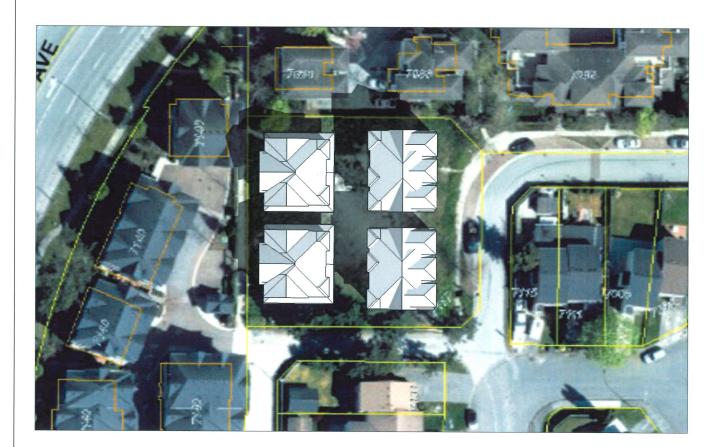


March 21 - 10am

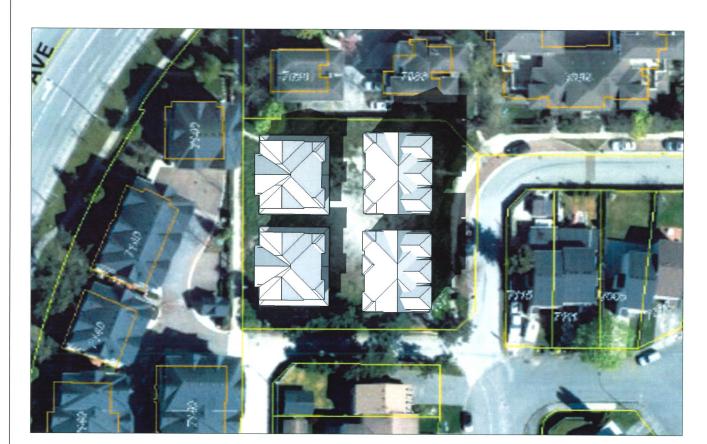

<u>March 21 - 2pm</u>

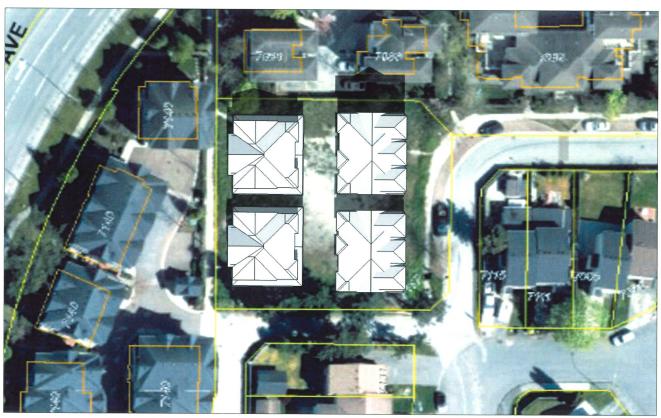

March 21 - 12pm

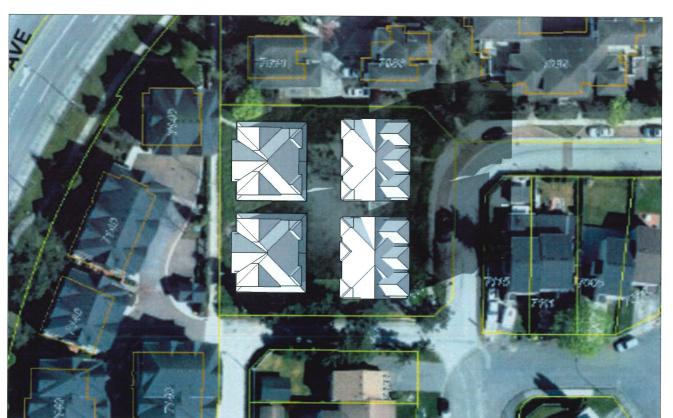

<u>March 21 - 4pm</u>



DP 20-921387 July 4, 2022 Reference Plan

NO —	DATE -	ISSUE -
01	DEC 15, 2020	ISSUE FOR DEVELOPMENT PERMIT
02	SEP 28, 2021	DP RESUBMISSION
03	MAR 03, 2022	DP RESUBMISSION
04	JUN 09, 2022	CONSULTANT COORDINATION
05	JUN 24, 2022	DP RESUBMISSION

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#### YAMAMOTO ARCHITECTURE

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PROJECT -

LINDSAY

7117 Lindsay road Richmond, BC


DRAWING TITLE -

SCALE - AS NOTED


DATE - DEC 16, 2020

SHADOW ANALYSIS


DEC 16, 2020 A1.3

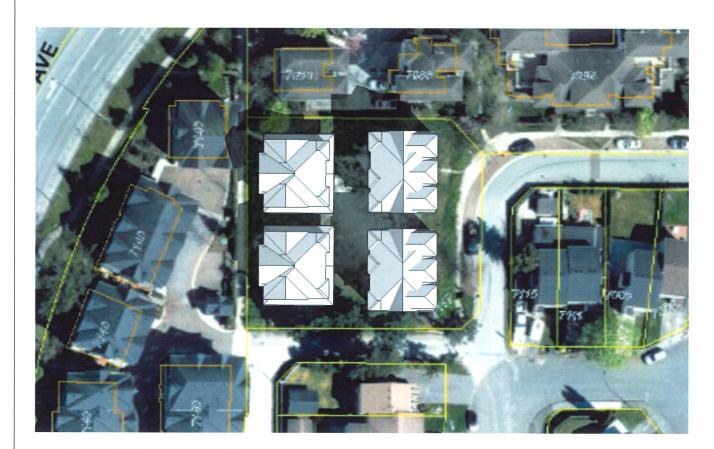


<u>September 21 - 10am</u>

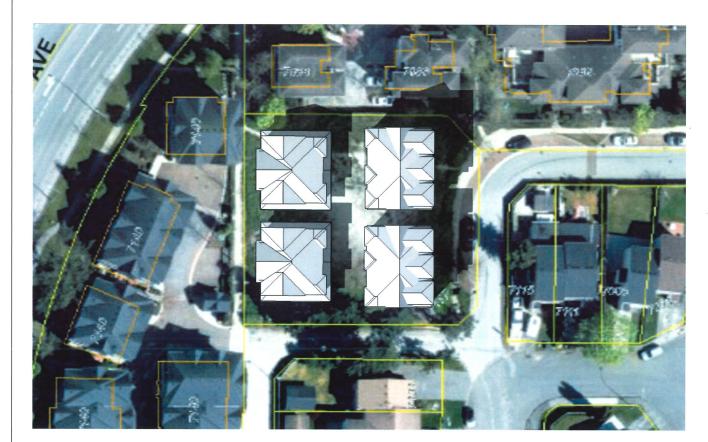

September 21 - 2pm

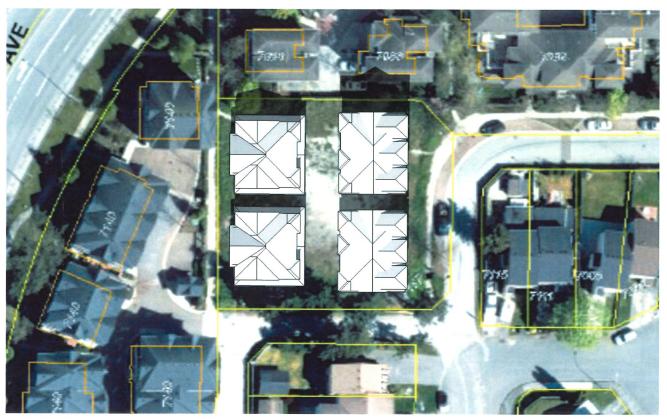

September 21 - 12pm

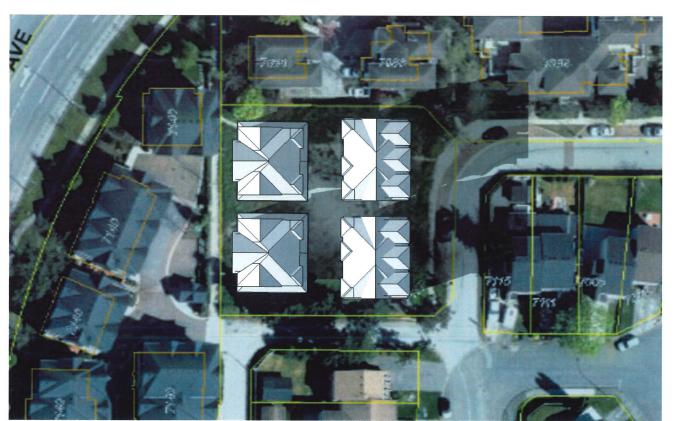

September 21 - 4pm



July 4, 2022 Reference Plan

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LINDSAY

7117 Lindsay road Richmond, BC

SHADOW ANALYSIS

SCALE - AS NOTED DATE - DEC 16, 2020

A1.4